


DRAWING TO BE USED FOR PLANNING PURPOSES ONLY


- GENERAL NOTES
- DO NOT SCALE THIS DRAWING.
 - CONTRACTOR TO CHECK ALL DIMENSIONS AND REPORT ALL ERRORS AND OMISSIONS TO THE ENGINEER.
 - ANY DISCREPANCY TO BE REPORTED IMMEDIATELY TO THE ENGINEER.
 - THIS DRAWING TO BE READ IN CONJUNCTION WITH ALL RELEVANT ARCHITECTS, SUBCONTRACTORS AND SPECIALISTS DRAWINGS AND SPECIFICATIONS.

RD1 - LONGSECTION
SCALE: H 1:500,V 1:100. DATUM: 25.000

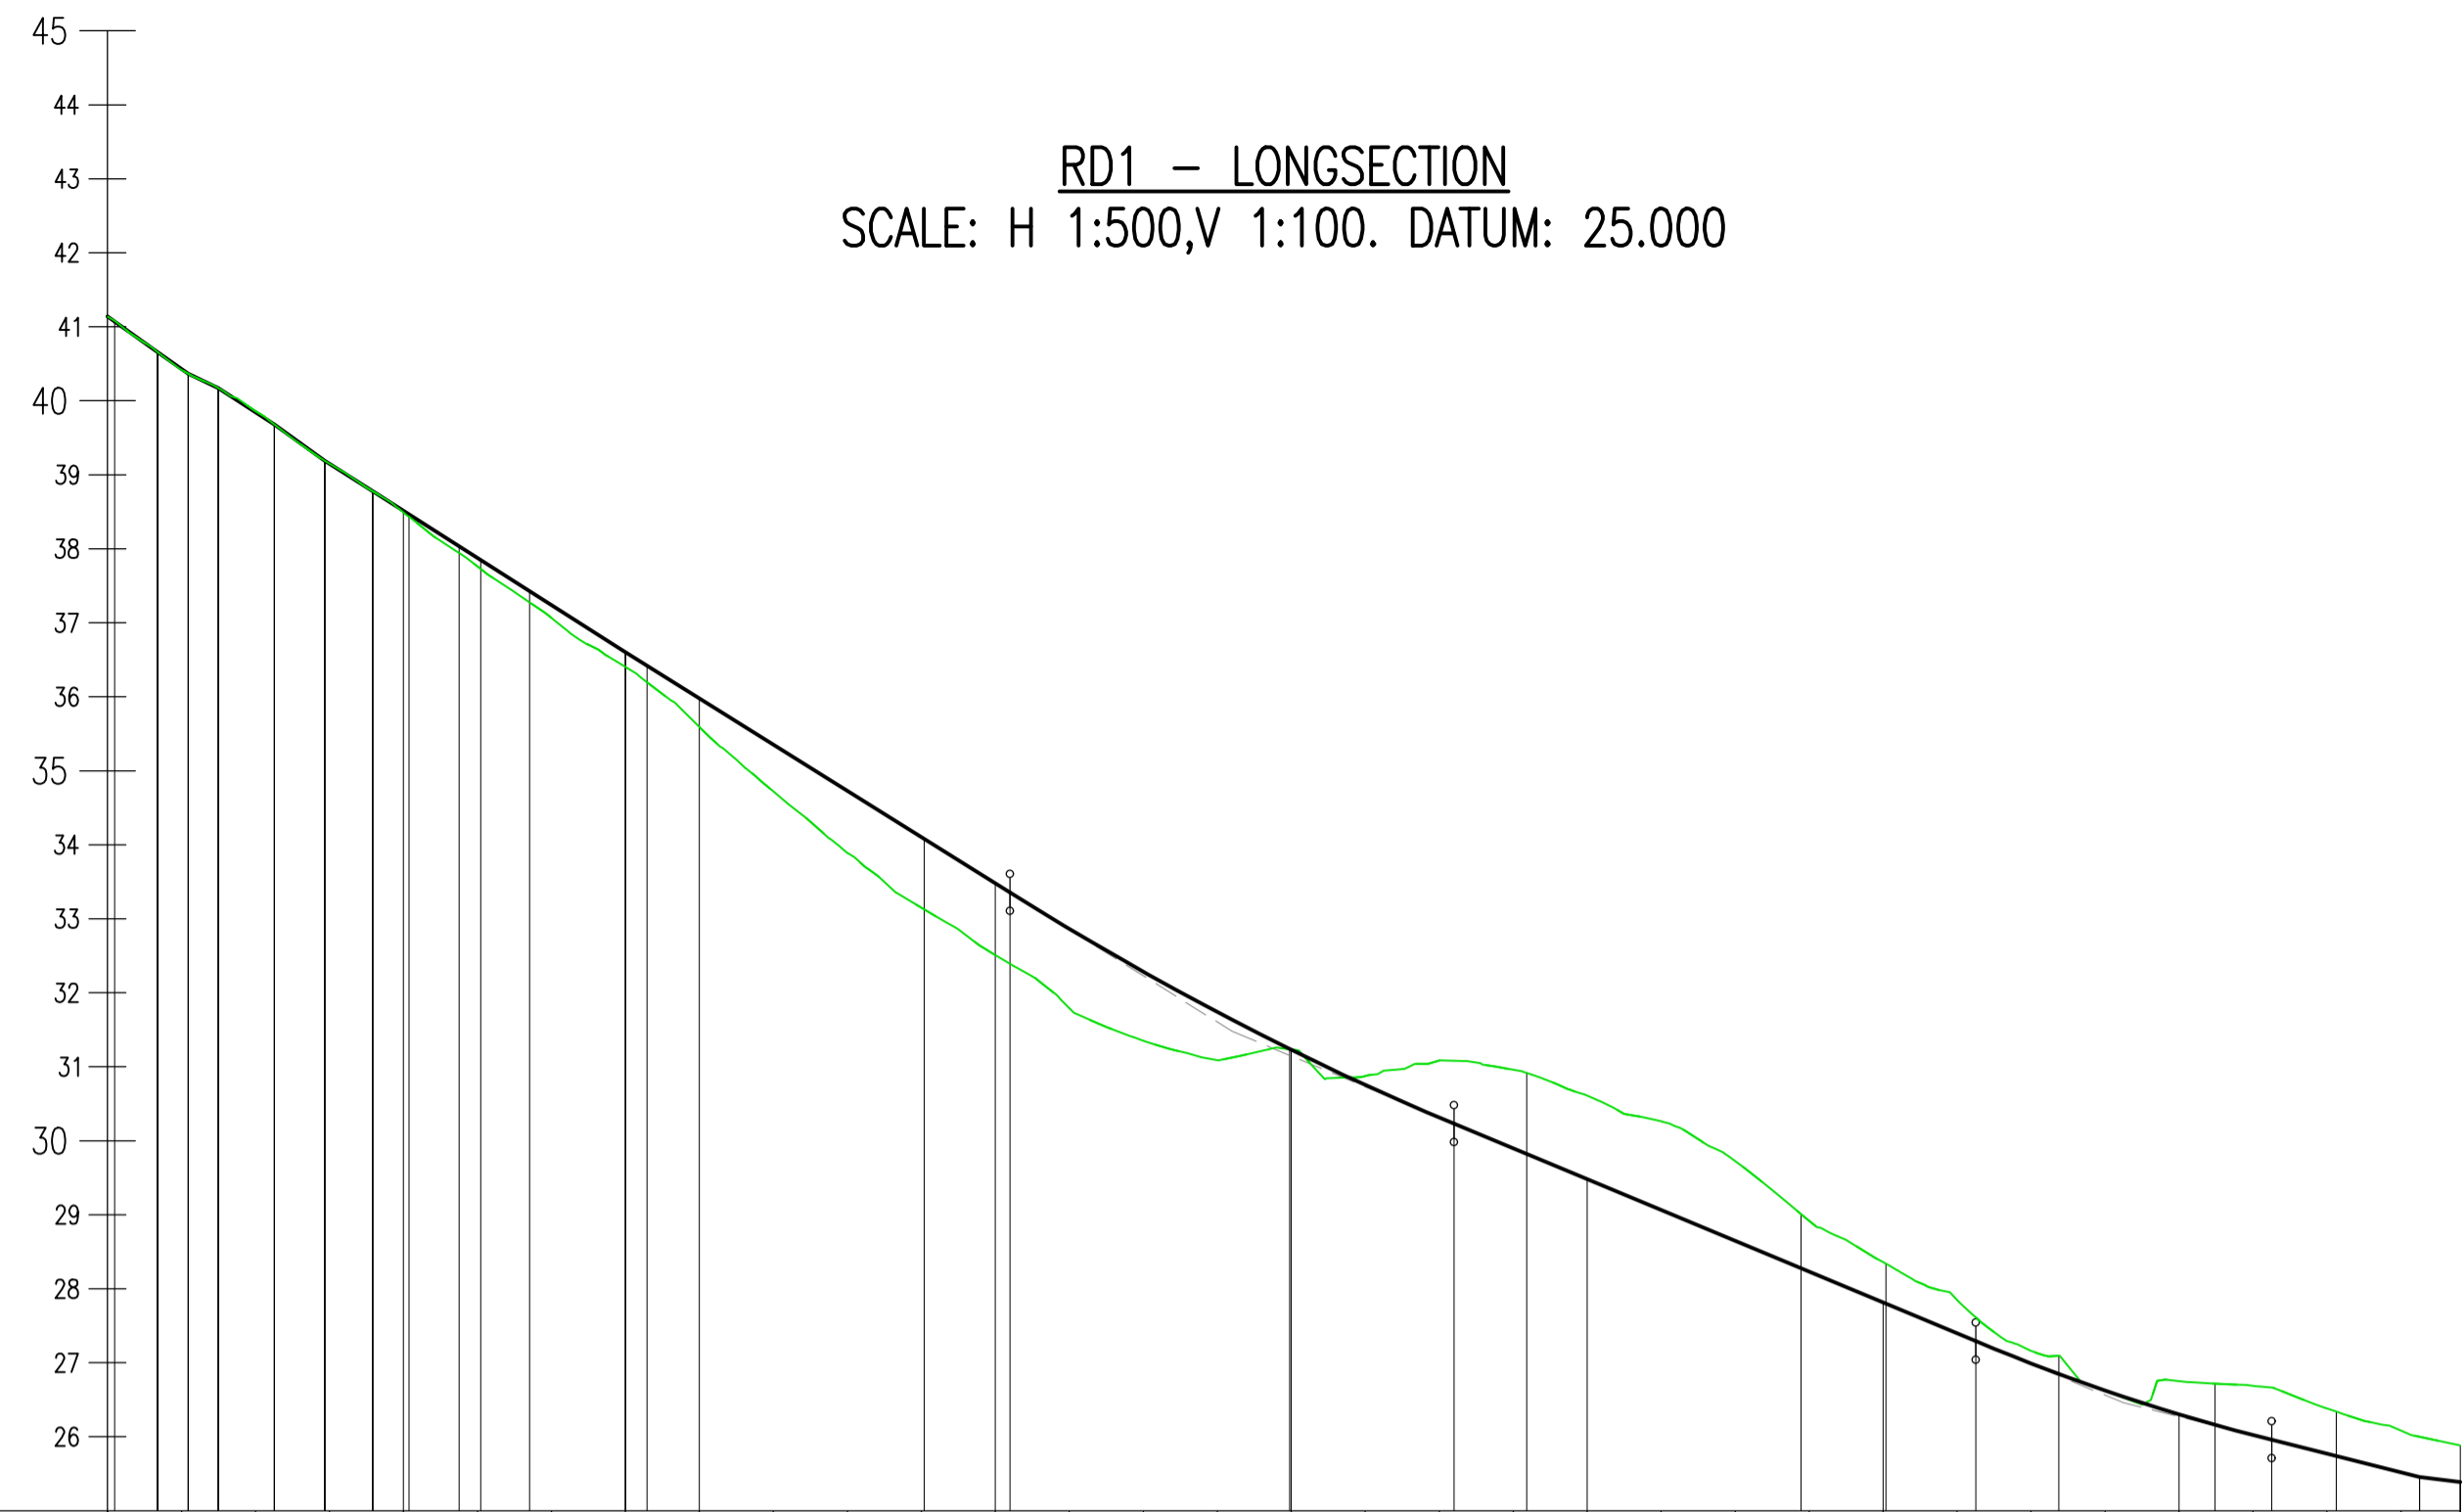


CHAINAGE	00.000	05.000	10.000	15.000	20.000	25.000	30.000	35.000	40.000	45.000	50.000	55.000	60.000	65.000	70.000	75.000	80.000	85.000	90.000	95.000	100.000	105.000	110.000	115.000	120.000	125.000	130.000	135.000	140.000	145.000	150.000	155.000	159.009		
EXISTING LEVELS	41.140	40.418	39.861	39.152	38.492	37.781	37.065	36.402	35.592	34.720	33.881	33.149	32.509	31.793	31.351	31.090	31.232	30.875	30.822	30.959	30.608	30.263	29.725	28.917	28.360	27.813	27.848	27.162	26.623	26.753	26.689	26.383	26.081	25.681	
PROPOSED LEVELS	41.140	40.430	39.846	39.150	38.513	37.877	37.240	36.604	35.979	35.354	34.729	34.104	33.479	32.855	32.285	31.740	31.230	30.754	30.313	29.896	29.479	29.063	28.646	28.229	27.813	27.396	26.981	26.566	26.303	26.022	25.771	25.521	25.389		
HORIZONTAL GEOMETRY																																			
VERTICAL GEOMETRY																																			

RD2 - LONGSECTION
SCALE: H 1:500,V 1:100. DATUM: 25.000

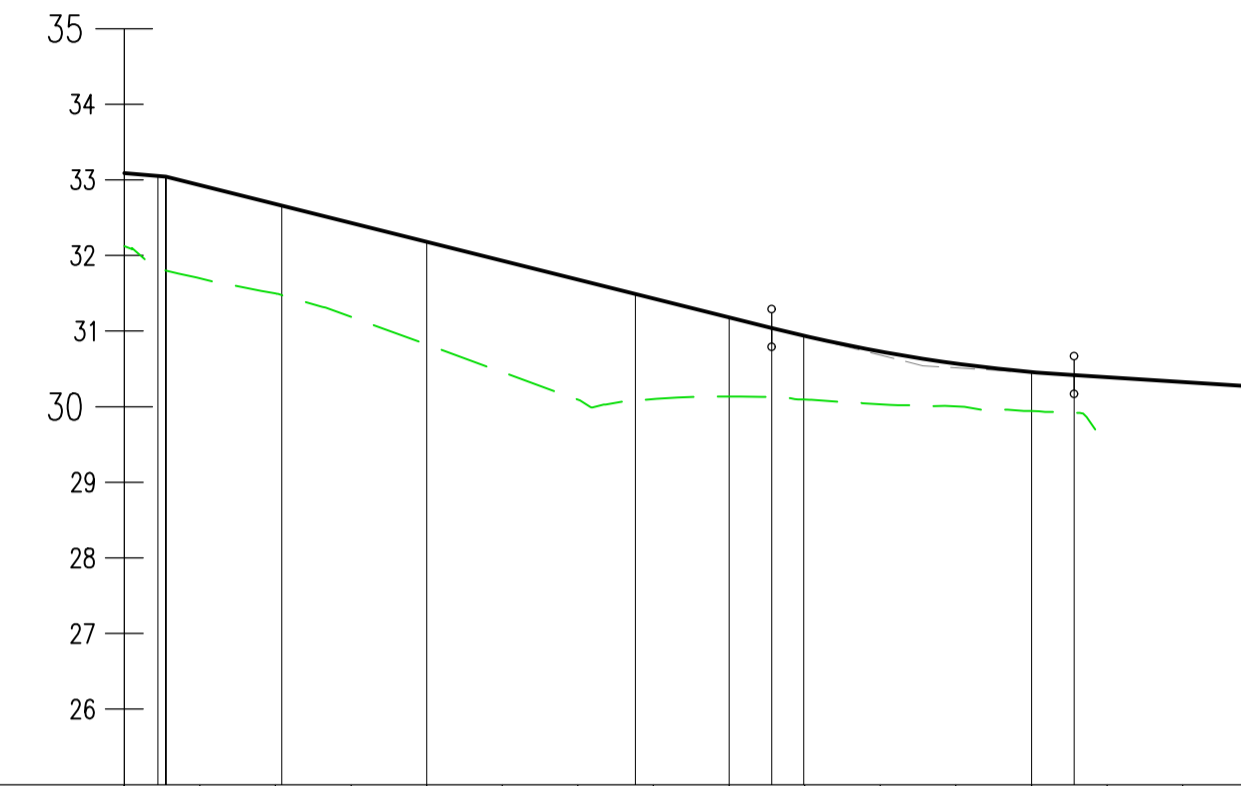


CHAINAGE	00.000	05.000	10.000	15.000	20.000	25.000	30.000	35.000	40.000	45.000	50.000	55.000	60.000	65.000	70.000	75.000
EXISTING LEVELS	32.124	31.687	31.497	31.188	30.823	30.457	30.092	30.101	30.136	30.095	30.033	30.004	29.942	29.881	29.819	29.757
PROPOSED LEVELS	33.087	32.932	32.682	32.432	32.182	31.932	31.682	31.432	31.182	30.937	30.730	30.571	30.459	30.389	30.326	30.263
HORIZONTAL GEOMETRY																
VERTICAL GEOMETRY																

PATH - LONGSECTION
SCALE: H 1:500,V 1:100. DATUM: 20.000

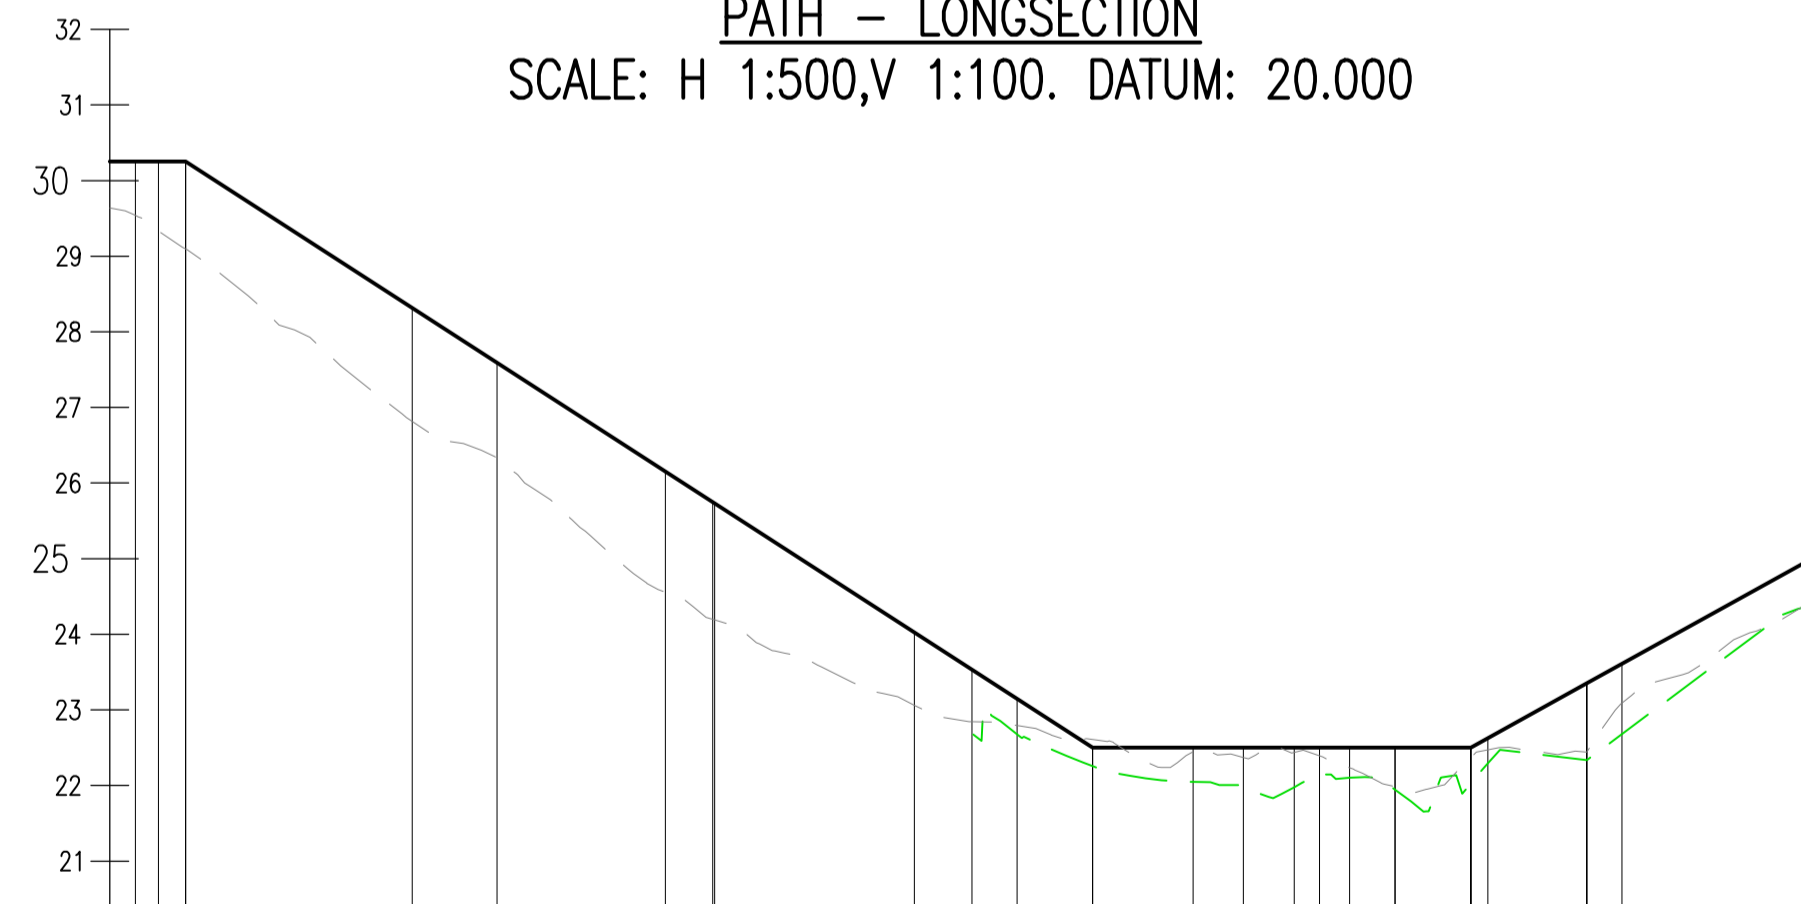

CHAINAGE	00.000	05.000	10.000	15.000	20.000	25.000	30.000	35.000	40.000	45.000	50.000	55.000	60.000	65.000	70.000	75.000	80.000	85.000	90.000	95.000	100.000	105.000	110.000	115.000	119.594	
EXISTING LEVELS (TOPO)																										
EXISTING LEVELS (LIDAR)	29.638	29.097	28.322	27.599	26.817	26.393	25.618	24.747	24.189	23.738	23.263	22.804	22.792	22.608	22.239	21.972	22.145	21.943	22.031	22.399	22.680	23.422	24.385	24.425		
PROPOSED LEVELS	30.250	30.250	29.604	28.958	28.312	27.667	27.021	26.375	25.729	25.083	24.438	23.792	23.146	22.500	22.500	22.500	22.500	22.500	22.500	22.500	22.500	22.500	23.164	24.164		
HORIZONTAL GEOMETRY																										
VERTICAL GEOMETRY																										

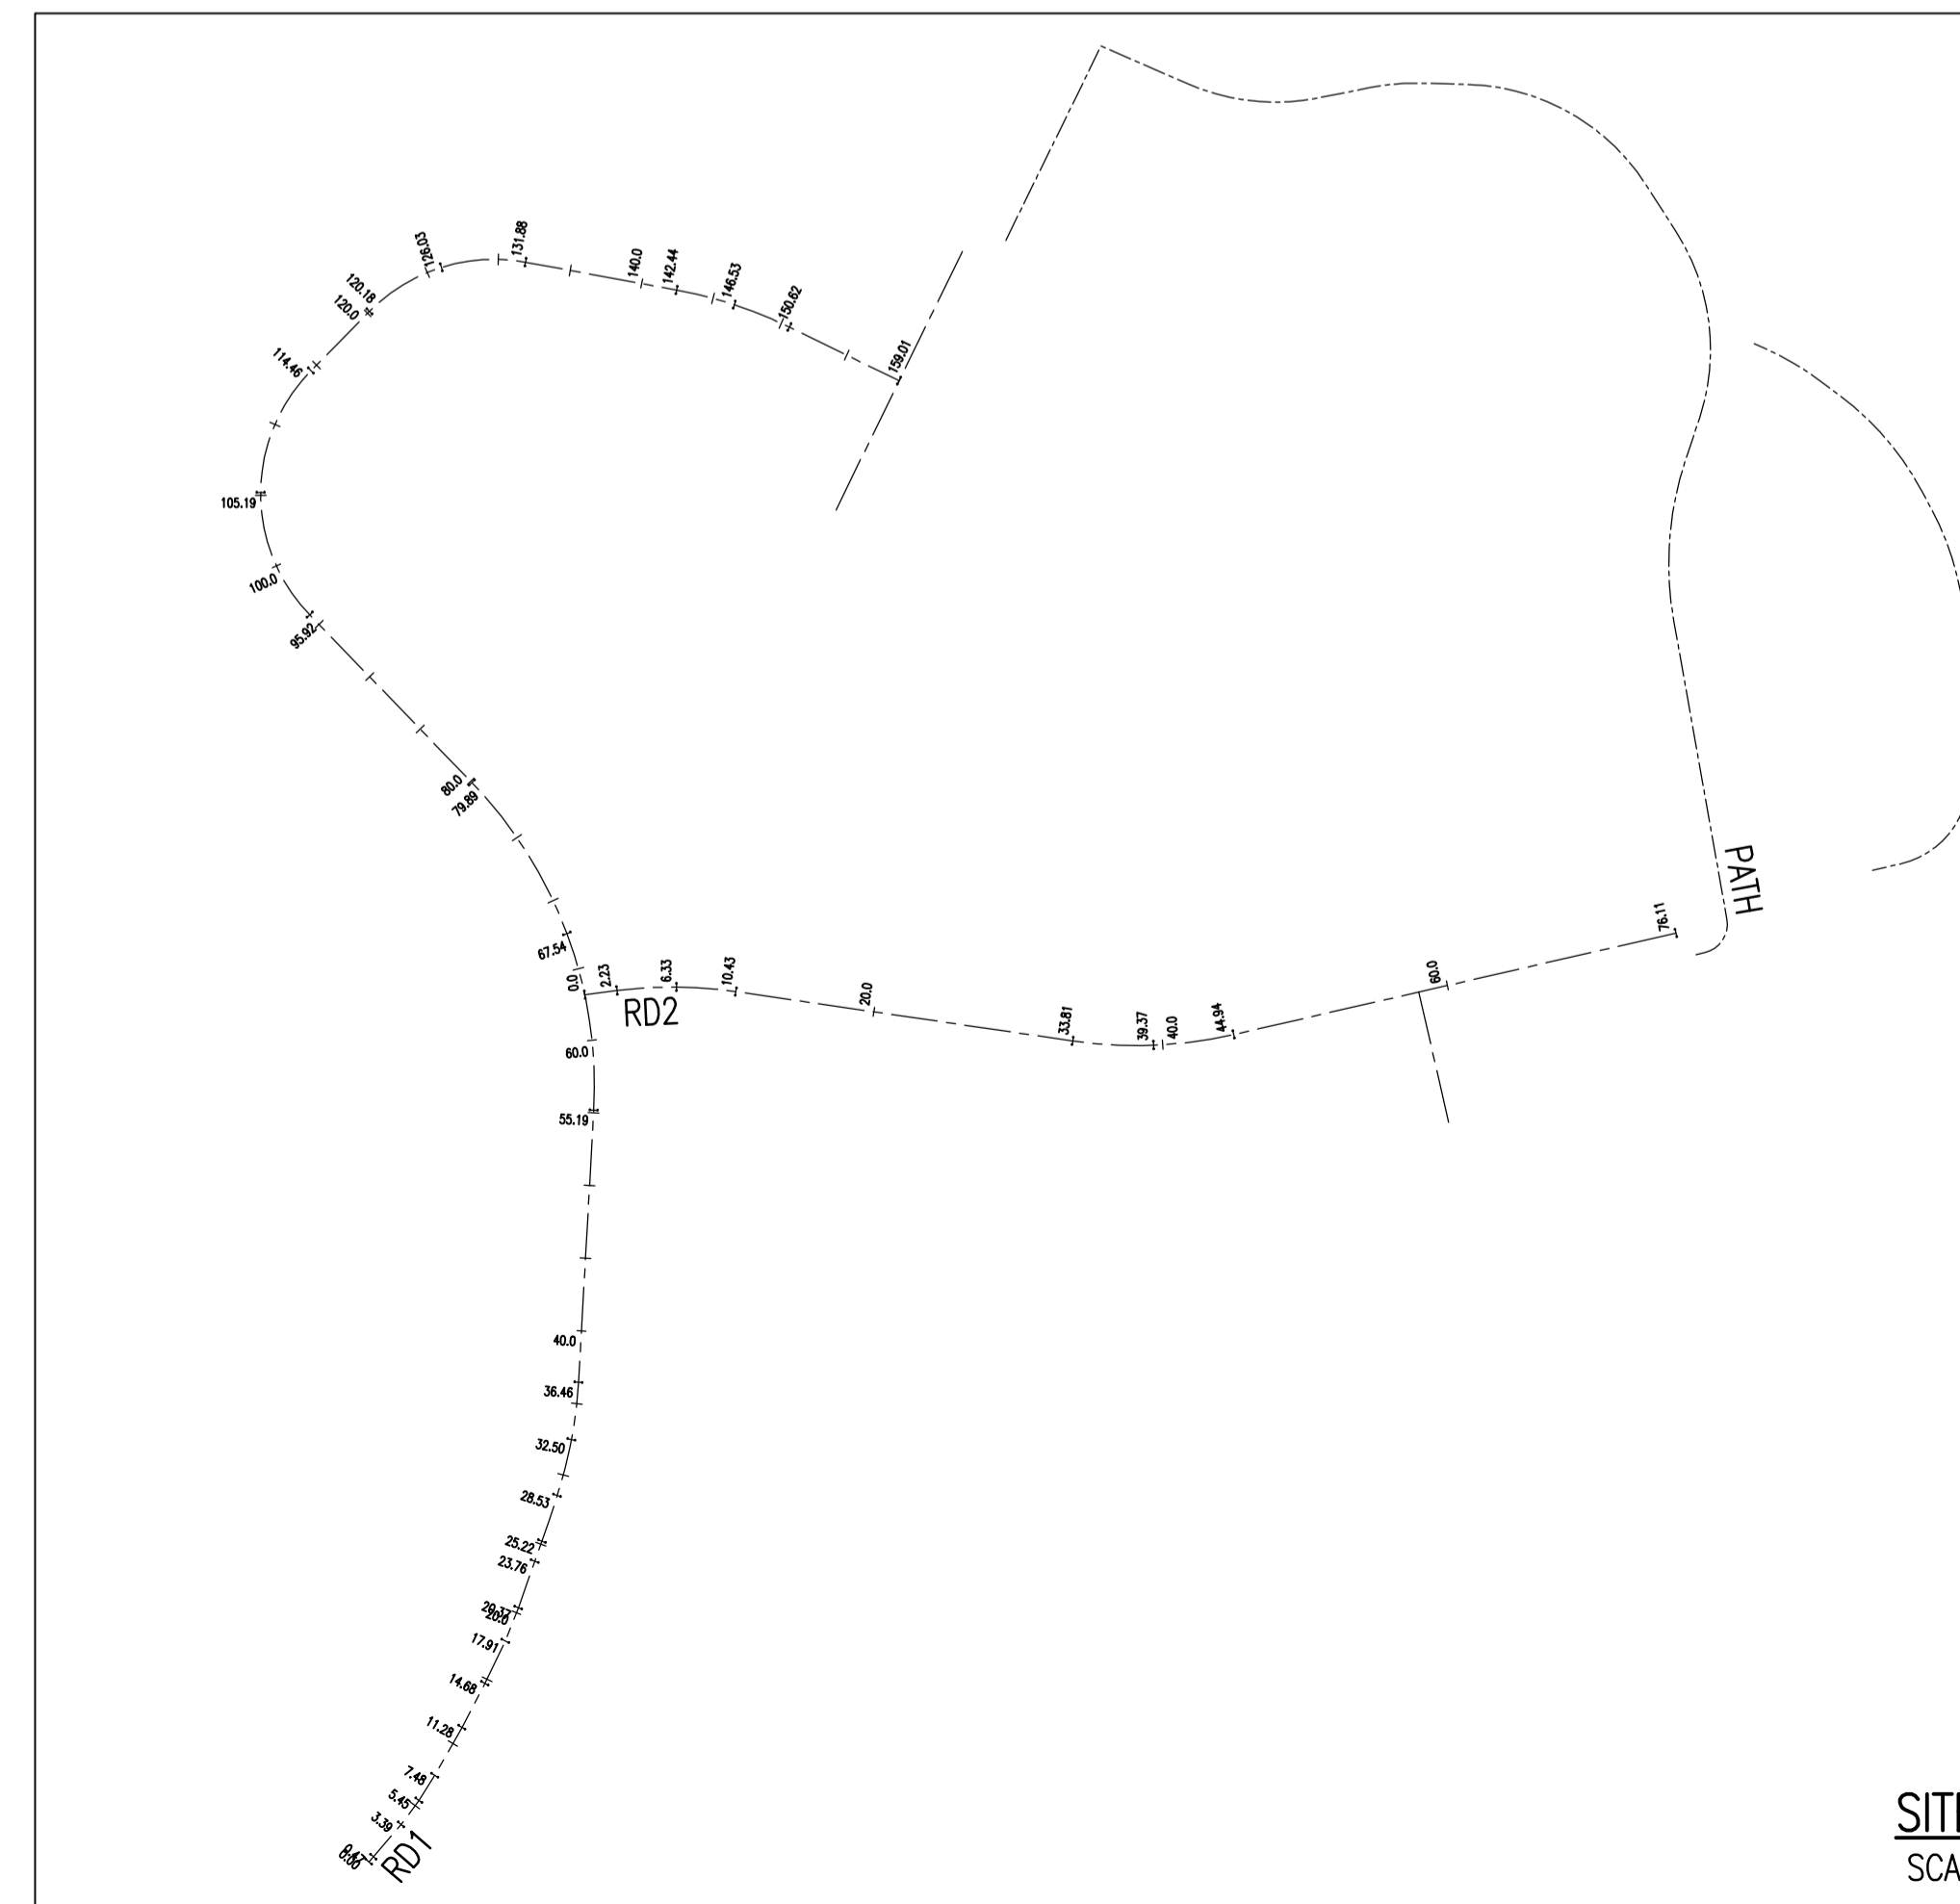

Rev.	Detail	By	Date
B	DRAWING REVISED TO SUIT CURRENT ARCHITECT LAYOUT.	DH	28.06.23
A	RD1 LONGSECTION REVISED, RD2 & 3 LONGSECTIONS SHOWN.	DH	29.03.23

Reinforcement schedules nos.



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Client
OBSIDIAN DEVELOPMENT

Project
**HOUSING DEVELOPMENT
AWEL Y MOR
ST DOGMAELLS
PEMBROKESHIRE**

Drawing Title
**HIGHWAY
LONGSECTION**

PLANNING

Project No. C1825	Drawing No. C-SK04
Scales AS SHOWN	Date 21.03.23
Drawn DH	Checked DF
Sheet Size A1	Revision B

SITE PLAN
SCALE 1:500

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