
AUBURN MUNICIPAL STATE OF THE PROPERTY OF THE

BRANNAN PARK
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ST AV

AERIAL PHOTO

VICINITY MAP

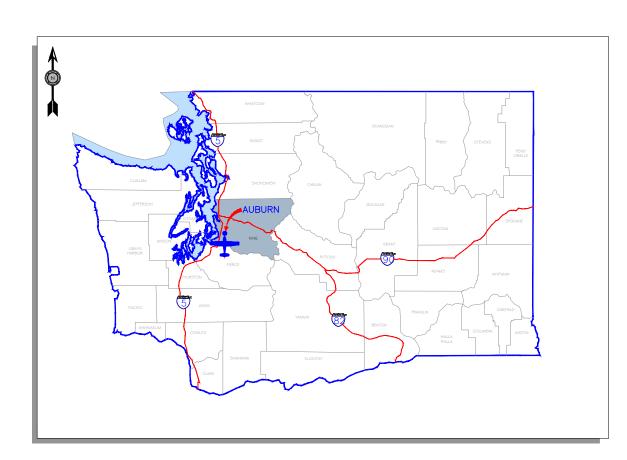

LOCATION MAP

AUBURN MUNICIPAL AIRPORT (S50) AIRPORT MASTER PLAN

CITY OF AUBURN, WASHINGTON AIP NO. 3-53-0003-018-2012 AIRPORT LAYOUT PLAN MAY 2015

SHEET INDEX

NUMBER	CONTENTS
1	COVER SHEET
2	AIRPORT DATA SHEET
3	AIRPORT LAYOUT PLAN
4	NORTH TERMINAL AREA PLAN
5	SOUTH TERMINAL AREA PLAN
6	AIRPORT AIRSPACE PLAN (FAR PART 77)
7	RUNWAY 16 RPZ AND INNER APPROACH PLAN AND PROFILE
8	RUNWAY 34 RPZ AND INNER APPROACH PLAN AND PROFILE
9	RUNWAY 16 APPROACH PLAN AND PROFILE
10	RUNWAY 34 APPROACH PLAN AND PROFILE
11	AIRPORT LAND USE PLAN W/2032 NOISE CONTOURS
12	EXHIBIT "A" AIRPORT PROPERTY PLAN



NO.	DATE	BY	APPR	REVISIONS
1	3/21	REN	GJR	AS-BUILT DRAWING AIP #3-53-0003-025
				RUNWAY 16-34 EXTENSION, 2018-ANM-2528-NRA


AIRPORT DATA TABLE						
DESCRIPTION		EXISTING	FUTURE			
AIRPORT ELEVATION (MSL)		62.8'	63.4' EST.			
AIRPORT ACREAGE		110	123.83			
ARP COORDINATES	LAT. LONG.	N 47° 19' 39.44" 1 W 122° 13' 35.95"	N 47° 19' 40.79" W 122° 13' 35.96"			
MAGNETIC DECLINATION		16°8'25"Ê (3/2014) ANNUAL RATE OF CHANGE 0°10.6'W	ANNUAL RATE OF CHANGE 0°10.6'W			
MEAN MAX. DAILY TEMPERATURE		78.8°	SAME			
FAA IDENTIFIER		S50	SAME			
DATUM		NAD 83/NGVD 88	SAME			

RUNWAY DATA TABLE					
	EXISTING CONDITIONS RUNWAY 16 - 34	FUTURE CONDITIONS RUNWAY 16 - 34			
RUNWAY LENGTH AND WIDTH	3841' X 75' 1	4118' X 75' (SEE NOTE 1)			
RUNWAY LIGHTING	MIRL	SAME			
RUNWAY PAVEMENT STRENGTH (LBS)	12,500 SW	SAME			
RUNWAY PAVEMENT TYPE	ASPHALT	SAME			
RUNWAY PERCENT WIND COVERAGE (12 MPH)	98.9%	SAME			
RUNWAY PERCENT GRADIENT / MAXIMUM GRADE	0.192%	SAME			
AIRPORT REFERENCE CODE (ARC)	B-I (SMALL)	SAME / (A-II RESERVE)			
FAR PART 77 DESIGNATION	UTILITY (VISUAL)	SAME			
NPIAS ROLE / SERVICE LEVEL	RELIEVER	SAME			
TERMINAL NAVAIDS	NONE	SAME			
TAXIWAY LIGHTING	MITL	SAME			
TAXIWAY MARKING	CENTERLINE	SAME			

RUNWAY DATA TABLE						
	À	EXISTING CONDITIONS	EXISTING STANDARD	FUTURE CONDITIONS	FUTURE STANDARD	
RUNWAY SAFETY AREA LENGTH AND WIDTH LENGTH BEYOND RUNWAY END (SEE NOTE 2)		4129' X 120' 240'	4129' X 120' } 240' }	4598' X 120' 240' (SEE NOTE 2)	4598' X 120' 240' (SEE NOTE 2)	
OBJECT FREE AREA LENGTH AND WIDTH LENGTH BEYOND RUNWAY END (SEE NOTE 2)		4129' X 250' 240'	4129' X 250' { 240'	4598' X 250' 240' (SEE NOTE 2)	4598' X 250' 240' (SEE NOTE 2)	
OBSTACLE FREE ZONE LENGTH AND WIDTH LENGTH BEYOND RUNWAY END (SEE NOTE 2)		4089' X 500' 200'	4089' X 500' } 200' }	4518' X 500' 200' (SEE NOTE 2)	4518' X 500' 200' (SEE NOTE 2)	
OFZ PENETRATION (YES/NO) (SEE NOTE 2)		NO	NO	NO	NO	


	EXISTING C	EXISTING CONDITIONS		FUTURE CONDITIONS	
RUNWAY END		16	34	16	34
RUNWAY APPROACH CATEGORY		VISUAL	VISUAL	SAME	SAME
RUNWAY APPROACH SLOPE P	ART 77 REQUIRED	20:1	20:1	20:1	20:1
	ACTUAL	20:1 (SEE NOTE 3)	20:1 (SEE NOTE 3)	20:1 (SEE NOTE 3)	20:1 (SEE NOTE 3)
APPROACH VISIBILITY MINIMUMS		1 MILE	1 MILE	SAME	SAME
RUNWAY MARKINGS		VISUAL	VISUAL	NON-PRECISION	NON-PRECISION
RUNWAY END COORDINATES	LAT. LONG.	N 47° 19' 58.40" W 122° 13' 36.15"	N 47° 19' 20.49" ⁽ W 122° 13' 35.74"	SAME	SAME
INSTRUMENTATION AND APPROACH A	AIDS	GPS	GPS	GPS / NEXTGEN	GPS / NEXTGEN
VISUAL AIDS		VASI4; REIL	VASI4; REIL	PAPI4; REIL	PAPI4; REIL
CRITICAL AIRCRAFT (ARC)		CESSNA	A 340A	SAME / PILATUS F	C-12 (RESERVE)
WINGSPAN		<4	9'	SAME (RES	ERVE <79')
WEIGHT (LBS)		<12,	500	SAM	ИE
APPROACH SPEED		<91 KNOTS SAME		ИЕ	
LENGTH OF HAUL		<500 MILES SAME		ИE	

	NON STANDARD CONDITIONS						
NO.	ITEM	DESCRIPTION	DISPOSITION				
1	TAXILANE OFA	CLEARANCE TO PARKED AIRCRAFT LESS THAN STANDARD	RECONFIGURE APRON				
2	TAXILANE OFA	CLEARANCE TO ADJACENT HANGAR LESS THAN STANDARD	USE FAA ALTERNATIVE TAXILANE OFA CLEARANCE STANDARD BASED ON MAX AC WINGSPAN				
3	OFA / OFZ / RSA	AREA PROVIDED BEYOND RUNWAY ENDS LESS THAN ADG I STANDARD	DISPLACED THRESHOLDS AND DECLARED DISTANCES USED TO PROVIDE STANDARD DIMENSIONS BEYOND RUNWAY ENDS FOR SPECIFIC OPERATIONS				

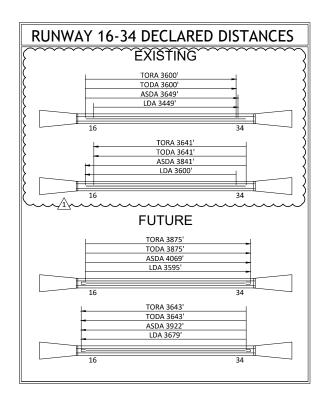

NOTES:

- 1. RUNWAY HAS EXISTING DISPLACED THRESHOLDS (RWY 16 200'; RWY 34 241') WITH A FUTURE RWY 16 DISPLACED OF 477'.
- 2. THE ENDS OF THE FUTURE OFZ, RSA, AND OFA BASED ON THE LIMITS OF AIRPORT PROPERTY (FENCE). RUNWAY LENGTHS AVAILABLE FOR TAKEOFF AND LANDING DEFINED BY DECLARED DISTANCES (PER FAA AC 150/5300-13A).
- 3. UNOBSTRUCTED 20:1 APPROACH OBTAINED WITH THRESHOLD SITING SURFACES ESTABLISHED AT EACH RUNWAY THRESHOLD.

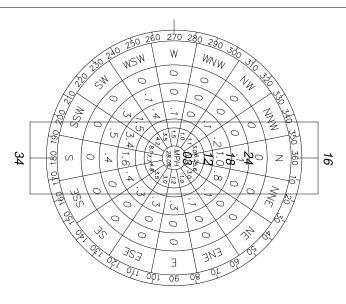

ALL WEATHER WIND ROSE

SOURCE: ESTIMATED BY CH2MHILL, JULY 1977 12 MPH 98.9%

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NO.	DATE	BY	APPR	REVISIONS	
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				RUNWAY 16-34 EXTENSION, 2018-ANM-2528-NRA	
				REVISED RUNWAY LENGTH, ARP, OFA, RSA, AND	
				OFZ DIMENSIONS; REVISED DECLARED DISTANCES	
				TABLE. REVISED FUTURE RUNWAY STRIPING TO	
				NON-PRECISION.	

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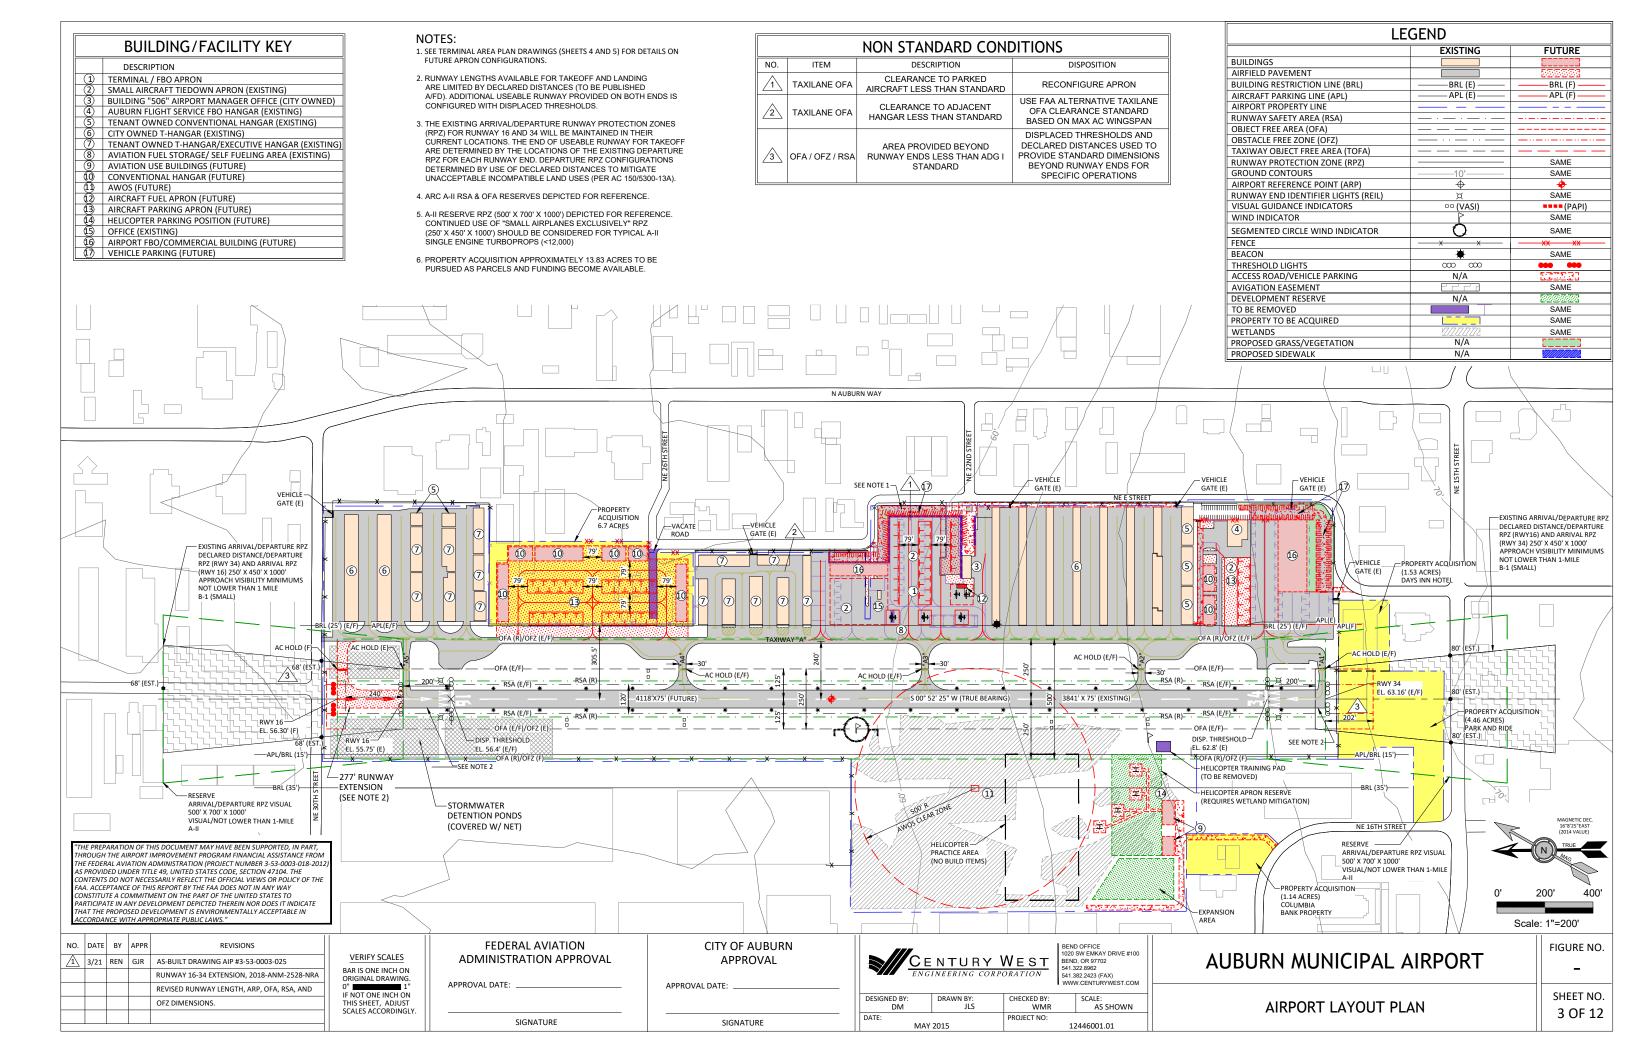
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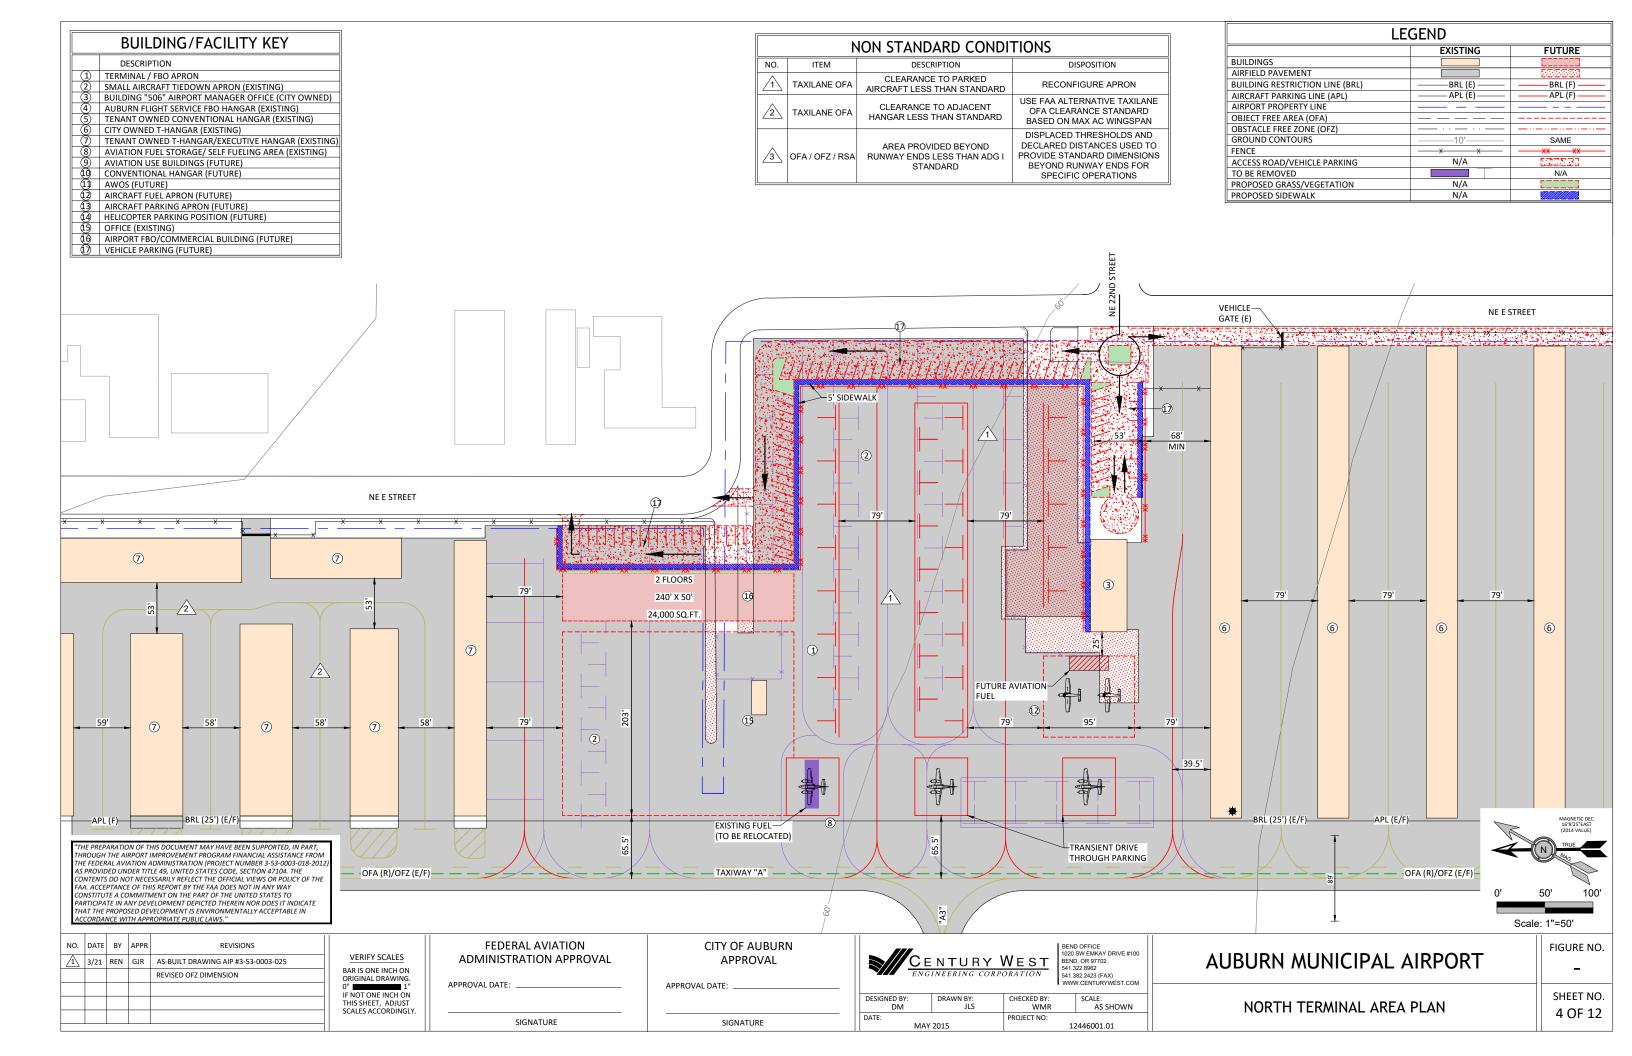
>///	CENTURY WEST
7333	ENGINEERING CORPORATION


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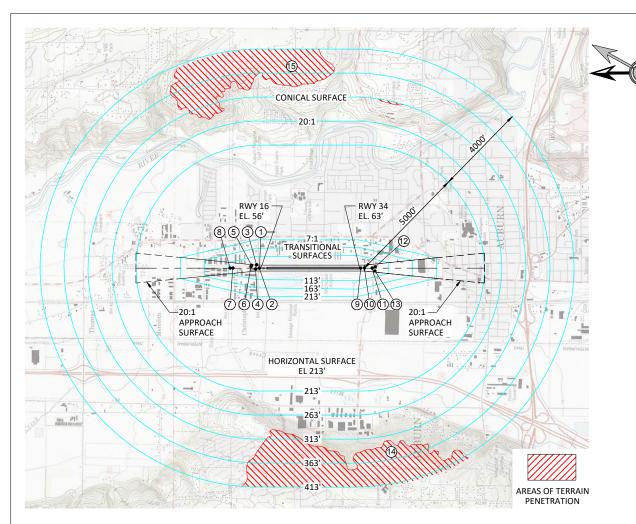
		Lw	WW.CENTURYWEST.COM	lŀ
ESIGNED BY: DM	DRAWN BY: JLS	CHECKED BY: WMR	SCALE: AS SHOWN	
ATE:		PROJECT NO:]
	2015		12446001 01	

AUBURN MUNICIPAL AIRPORT	FIGURE NO.
AIRPORT DATA SHEET	SHEET NO. 2 OF 12







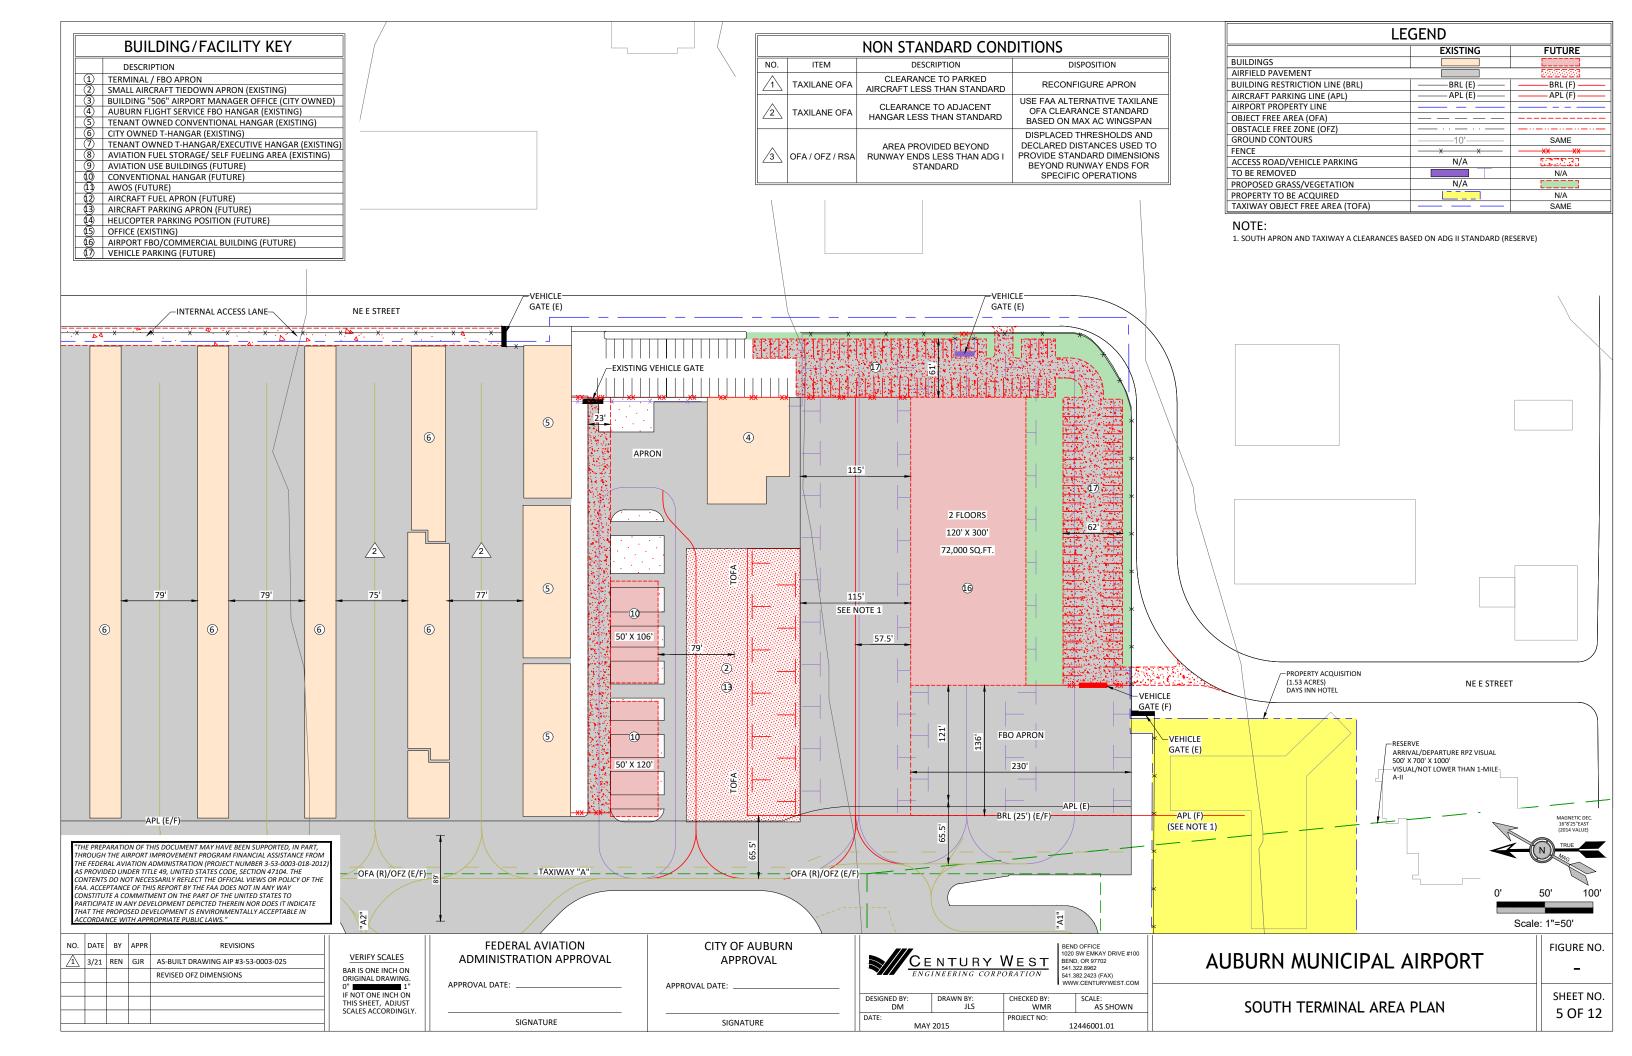

FAR PART 77 PLAN VIEW

Scale: 1"=2000'

RUNWAY 16/34

FAR PART 77 DIMENSIONAL STANDARDS

RUNWAY ULTIMATE LENGTH = 4,118' RUNWAY TYPE = B-I (SMALL) PRIMARY SURFACE WIDTH = 500' (EXISTING/FUTURE) APPROACH SURFACE INNER WIDTH = 250' / FUTURE (500') APPROACH SURFACE OUTER WIDTH = 1,250' / FUTURE (2,000') APPROACH SURFACE LENGTH = 5.000' RADIUS OF HORIZONTAL SURFACE = 5,000' APPROACH SLOPE = 20:1

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				REVISED OFZ DIMENSION; RUNWAY 16-34
				RUNWAY LENGTH IN PLAN AND PROFILE VIEWPORTS

VERIFY SCALES BAR IS ONE INCH ON ORIGINAL DRAWING 0" 1"
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CITY OF AUBURN

CENTURY WEST ENGINEERING CORPORATION

MAY 2015

DESIGNED BY

3 BUILDING
4 BUILDING
5 BUILDING
6 POWER POLE

7 POWER LINE 8 POWER LINE

10 PARKING LO

14 TERRAIN 15 TERRAIN

(1) NE 15TH STREET (12) BUILDING (13) BUILDING

9 FENCE

1.2

EXISTING/FUTURE

20:1 TSS

FUTURE

SURFACE

20:1 APPROACH

-EXISTING

SURFACE

20:1 APPROACH

(E) 20:1 APPROACH

SURFACE (FAR PART 77)

EXISTING/FUTURE

250' X 450' X 1000'

B-I (SMALL)

200'

ARRIVAL/DEPARTURE RPZ VISUAL

EL. 56.3'

(E) RWY 16 EL. 55.75'

3841' X 75

(EXISTING)

4118' X 75

(FUTURE)

RUNWAY 16-34 PLAN VIEW

--200

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AUBURN MUNICIPAL AIRPORT

AIRPORT AIRSPACE PLAN (FAR PART 77)

453

490'

661' 688'

1164' 1279'

45'

520

635'

-498

EXISTING/FUTURE

250' X 450' X 1000'

B-I (SMALL)

00

-200'

-200'

(E/F) RWY 34—\ 9 11 13 \

ARRIVAL/DEPARTURE RPZ VISUAL

EXISTING/FUTURE

1000'

Scale: 1"=1000"

(E) 20:1 APPROACH -

SURFACE (FAR PART 77)

(E) 20:1 APPROACH

20:1 TSS

- FUTURE

SURFACE

EXISTING -

SURFACE


2000'

20:1 APPROACH

20:1 APPROACH

FIGURE NO. SHEET NO. 6 OF 12

OCS/TSS W/ DISPLACED THRESHOLD

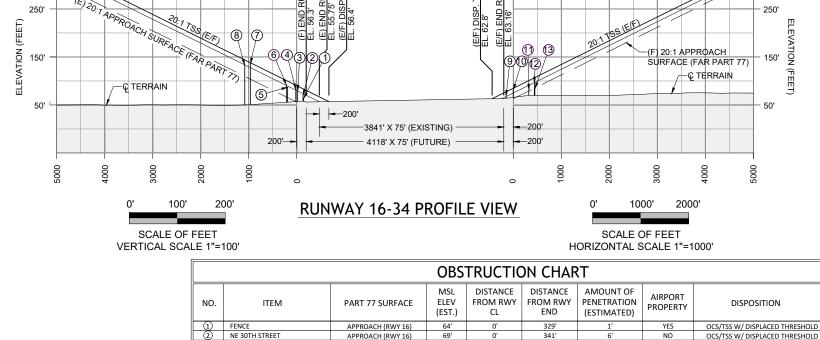

APPROACH (RWY 16)

APPROACH (RWY 16)

APPROACH (RWY 16)

APPROACH (RWY 16

APPROACH (RWY 16)

APPROACH (RWY 34)

APPROACH (RWY 34)

APPROACH (RWY 34)

APPROACH (RWY 34)

CONICAL

135.6'

68'

6730'


NOTES:

1. DISTANCES FOR NOTED OBSTRUCTIONS ARE BASED ON THE ULTIMATE RUNWAY CONFIGURATION. DIMENSIONS INCLUDE 200' DISTANCE FROM RUNWAY END TO BEGINNING OF APPROACH.

250

2. RUNWAY CONFIGURED WITH DISPLACED THRESHOLDS AT BOTH ENDS TO MAINTAIN EXISTING APPROACH OBSTRUCTION CLEARANCE. THRESHOLD SITING SURFACES (20:1) IDENTIFIED FOR BOTH RUNWAY ENDS.

			OB	STRUC	TION C	HART		
NO.	ITEM	PART 77 SURFACE	MSL ELEV (EST.)	DISTANCE FROM RWY CL	DISTANCE FROM RWY END	AMOUNT OF PENETRATION (ESTIMATED)	AIRPORT PROPERTY	DISPOSITION
1	FENCE	APPROACH (RWY 16)	64'	0'	329'	1'	YES	OCS/TSS W/ DISPLACED THRESHOLD
2	NE 30TH STREET	APPROACH (RWY 16)	69'	0'	341'	6'	NO	OCS/TSS W/ DISPLACED THRESHOLD
3	BUILDING	APPROACH (RWY 16)	79'	138'	453'	10'	NO	OCS/TSS W/ DISPLACED THRESHOLD
4	BUILDING	APPROACH (RWY 16)	83'	34'	490'	11'	NO	OCS/TSS W/ DISPLACED THRESHOLD
(5)	BUILDING	APPROACH (RWY 16)	87'	117'	661'	8'	NO	OCS/TSS W/ DISPLACED THRESHOLD
(6)	POWER POLE	APPROACH (RWY 16)	92'	69'	688'	11'	NO	OCS/TSS W/ DISPLACED THRESHOLD

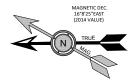

- 1. RPZ LOCATION DETERMINED BY DECLARED DISTANCES TO MITIGATE ROAD AND OTHER OFF-AIRPORT LAND USES WITHIN RPZ (NO CHANGE IN EXISTING CONDITIONS WITHIN RPZ, PER FAA GUIDANCE ON LAND USES IN RPZ'S).
- 2. END OF RSA, OFA, AND OFZ AT RUNWAY 16 END LIMITED BY FIXED OBJECT FENCE. DECLARED DISTANCES AND DISPLACED THRESHOLD USE TO PROVIDE REQUIRED PROTECTED/CLEAR AREAS, FOR TAKEOFF AND LANDING OPERATIONS.
- 3. A-II RESERVE RPZ (500' X 700' X 1000') DEPICTED FOR REFERENCE. CONTINUED USE OF "SMALL AIRPLANES EXCLUSIVELY" RPZ (250' X 450' X 1000') SHOULD BE CONSIDERED FOR TYPICAL A-II SINGLE ENGINE TURBOPROPS (<12,000)
- 4. SEE SHEET (3 OF 12) FOR FULL LEGEND.
- 5. RUNWAY LENGTHS AVAILABLE FOR TAKEOFF AND LANDING ARE LIMITED BY DECLARED DISTANCES (TO BE PUBLISHED A/FD). ADDITIONAL USEABLE RUNWAY PROVIDED ON BOTH ENDS IS CONFIGURED WITH DISPLACED THRESHOLDS.

THROUGH THE AIRPORT IMPROVEMENT PROGRAM FINANCIAL ASSISTANCE FROM THE FEDERAL AVIATION ADMINISTRATION (PROJECT NUMBER 3-53-0003-018-2012 AS PROVIDED LINDER TITLE 49 LINITED STATES CODE SECTION 47104. THE AS PROVIDED UNDER TITLE 49, ONTIFED STAIRS CODE, SECTION 47104. THE CONTENTS OD NOT NECESSARILY REFLECT THE OFFICIAL VIEWS OR POLICY OF THE FAA. ACCEPTANCE OF THIS REPORT BY THE FAA DOES NOT IN ANY WAY CONSTITUTE A COMMITMENT ON THE PART OF THE UNITED STATES TO PARTICIPATE IN ANY DEVELOPMENT DEPICTED THEREIN NOR DOES IT INDICATE THAT THE PROPOSED DEVELOPMENT IS ENVIRONMENTALLY ACCEPTABLE IN ACCORDANCE WITH APPROPRIATE PUBLIC LAWS."

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Γ					REVISED OFZ DIMENSIION; RUNWAY 16-34
					RUNWAY LENGTH IN PLAN AND PROFILE VIEWPORTS

VERIFY SCALES BAR IS ONE INCH ON ORIGINAL DRAWING 0" 1"
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SIGNATURE

CITY OF AUBURN APPROVAL APPROVAL DATE: DESIGNED BY DM SIGNATURE

Vertical Scale: 1"=10"

EXISTING/FUTURE

FUTURE 20:1

(FAR PART 77)

APPROACH SURFACE

ARRIVAL/DEPARTURE RPZ VISUAL

S 85TH AVENUE

B-I (SMALL) (SEE NOTE 1)



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FIGURE NO. AUBURN MUNICIPAL AIRPORT SHEET NO. **RUNWAY 16 RPZ AND INNER APPROACH**

PLAN AND PROFILE

Horizontal Scale: 1"=100'

BRL (25') (E/F) APL (E/F)

AC HOLD (I

OFA (E/F)

RSA (E/F)

RSA (E/F)

277' RUNWA'

(SEE NOTE 5)

EXTENSION

ÔFÂ (E/F)

AC HOLD (E)

EL. 55.75' (E)

OFA (R)/OFZ (E/F)

RSA (R)

7 OF 12

END OF RWY 34

OFA (R)/OFZ (E/F

TOFA/TODA

EL. 56.4' (E/F)

SÉE NÔTE S

EXISTING/FUTURE 20:1 THRESHOLD

SITING SURFACE

79' MSL

83' MSL

BLAST

(SEE NOTE 2

RWY 16-


APL/BRL (15')

EL. 56.30' (F)

FENCE (F

87' MSL


STORMWATER -**DETENTION PONDS** ARRIVAL/DEPARTURE RPZ VISUAL (COVERED) FXISTING 20:1 -500' X 700' X 1000' APPROACH SURFACE BRL (35')-VISUAL/NOT LOWER THAN 1-MILE (FAR PART 77) A-II (SEE NOTE 3) 100' **RUNWAY 16 PLAN VIEW** Scale: 1"=100' 110' FUTURE 20,1 APPROACH SURFACE 100' 90' 80' NOTE: 1. BUILDING PROPORTIONS EXAGGERATED DUE TO 70' VERT. SCALE 60' Ç TERRAIN (E/F) 0.192 % 3841' X 75' (EXISTING) 200'--4118' X 75' (FUTURE) 20' 100' 200' **RUNWAY 16 PROFILE VIEW**

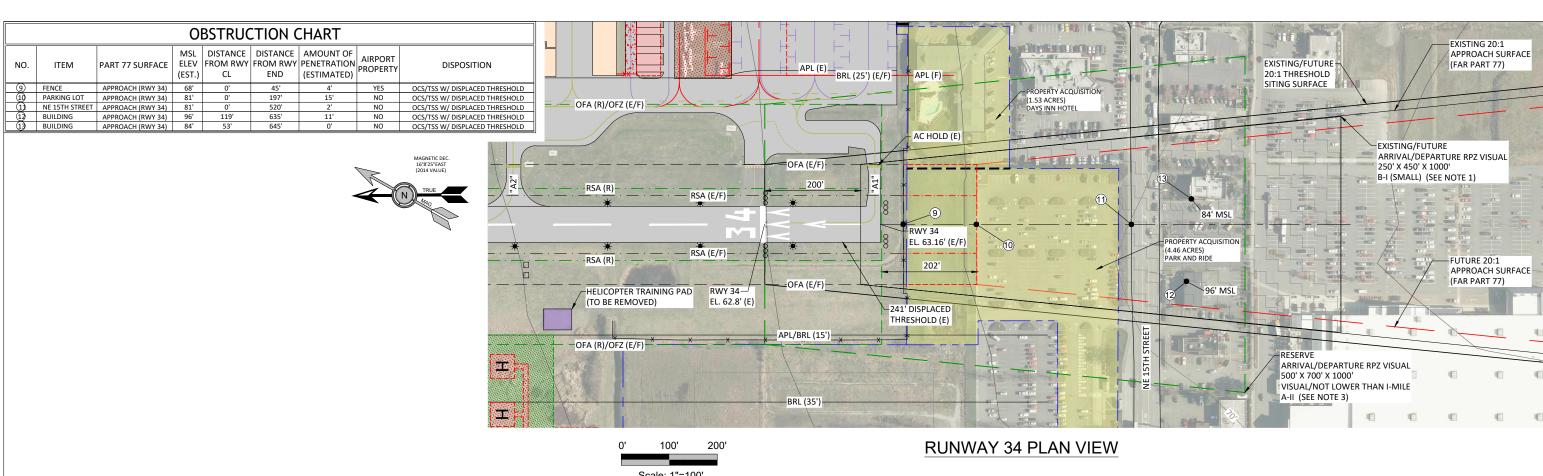

NOTES

- 1. RPZ LOCATION DETERMINED BY DECLARED DISTANCES TO MITIGATE ROAD AND OTHER OFF-AIRPORT LAND USES WITHIN RPZ (NO CHANGE IN EXISTING CONDITIONS WITHIN RPZ, PER FAA GUIDANCE ON LAND USES IN RPZ'S).
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ĺ					REVISED OFZ DIMENSION; RUNWAY 16-34
					RUNWAY LENGTH IN PLAN AND PROFILE VIEWPORTS
ĺ					
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VERIFY SCALES

BAR IS ONE INCH ON ORIGINAL DRAWING.
0" 1" 1"
IF NOT ONE INCH ON THIS SHEET, ADJUST SCALES ACCORDINGLY.
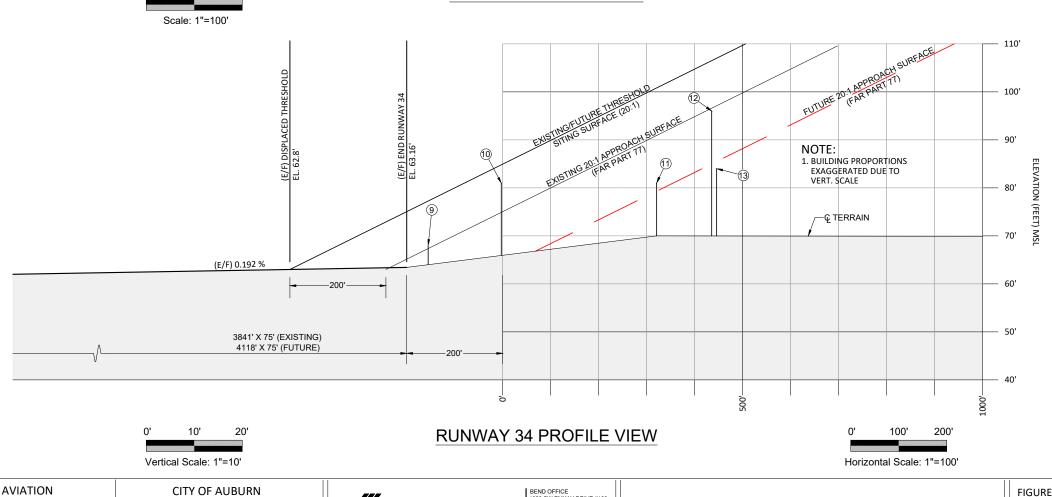
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SIGNATURE

APPROVAL

APPROVAL DATE: _______

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7///	ENGINEERING CORPORATION	5

DRAWN BY: JLS

MAY 2015

DESIGNED BY

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AUBURN MUNICIPAL AIRPORT
RUNWAY 34 RPZ AND INNER APPROACH
PLAN AND PROFILE

SHEET NO. 8 OF 12

