


GUS ENGELING WMA

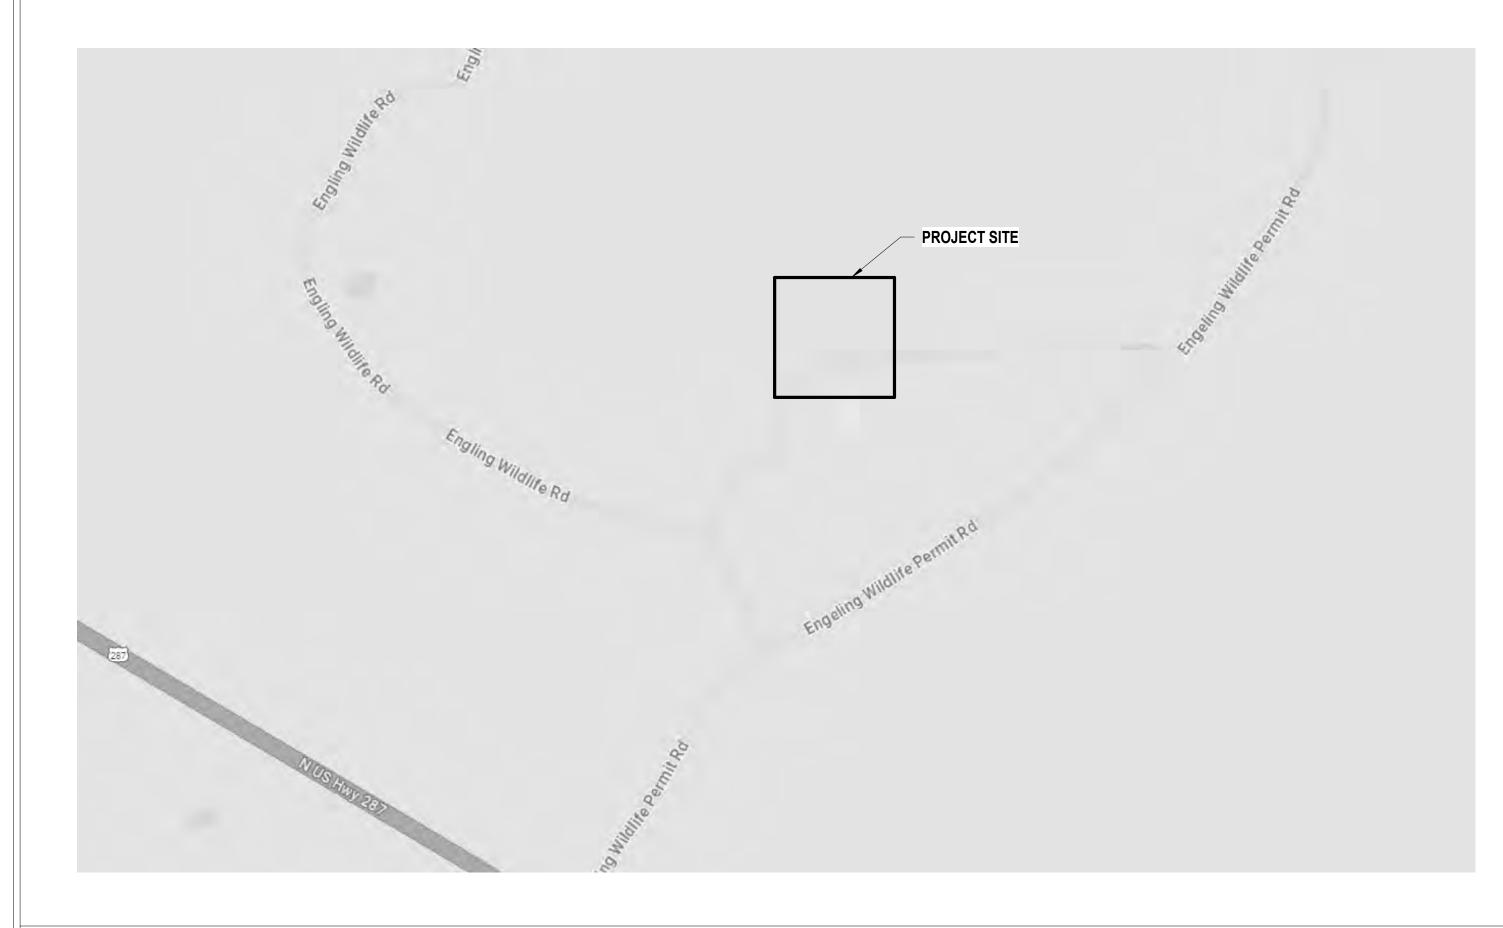

SITE LOCATION MAP NOT TO SCALE

SITE ADDRESS:

16419 N US Hwy 287, Tennessee Colony, TX 75861

DESIGN TEAM

PROJECT ARCHITECT:

Contact: Megan Weinzierl Office: 512.453.0767 megan.weinzierl@mwmdg.com

MEP: DBR INC.

Contact : Mark Stringer Office: 214.217.9500 mark.stringer@dbrinc.com

CIVIL ENGINEER: CLICK ENGINEERING INC

Contact: Matt Cain Office: 214.871.2302 mcain@clickeng.com

PROJECT MANAGER:

Contact: Megan Weinzierl Office: 512.453.0767 megan.weinzierl@mwmdg.com

STRUCTURAL: CLICK ENGINEERING, INC

Contact: Jacob Click Office: 214.871.2302 jclick@clickeng.com

PROJECT

GUS ENGELING WMA

GATHERING LODGE AND BUNKHOUSES

DATE: 04/03/2024 PROJECT NO: 1211534

BUILDING CODE SUMMARY

v. GAS CODE

INTERNATIONAL BUILDING CODE 202: i. BUILDING CODE iii. PLUMBING CODE iv. MECHANICAL CODE

vi. RESIDENTIAL CODE vii. EXISTING BUILDINGS INTERNATIONAL EXISTING BUILDINGS CODE 202

*International Fire Code omitted in lieu of TPWD's implementation of National Fire Protection Association code: I. NATIONAL FIRE PROTECTION ASSOCIATION

NATIONAL ELECTRICAL CODE NFPA-70 2023 i. ELECTRICAL CODE ii. FIRE CODE

iii. LIFE SAFETY CODE NFPA - 101 2021 III. ENERGY CONSERVATION

i. ENERGY* INTERNATIONAL ENERGY CONSERVATION CODE 2021

*Energy Standard for State-Funded Buildings, ASHRAE/IESNA Standard 90.1 (2013) omitted in lieu of INTERNATIONAL ENERGY CONSERVATION CODE 2021.

i. WATER SUPPLY ii. LANDSCAPE IRRIGATION TEXAS ADMIN CODE - TITLE 30 PART 1 CHAPTER 344

iii. ON-SITE SEWAGE V. ACCESSIBILITY CODES

ii. ARCHITECTURAL BARRIERS ACT ACCESSIBILITY GUIDELINES: OUTDOOR DEVELOPED AREAS 2015

iii. 2012 TEXAS ACCESSIBILITY STANDARDS, ELIMINATION OF ARCHITECTURAL BARRIERS, TEXAS GOVERNMENT CODE, CHAPTER 469

i. ASTM F1487-17, STANDARD CONSUMER SAFETY PERFORMANCE SPECIFICATIONS FOR PLAYGROUND EQUIPMENT FOR PUBLIC USE ii. ASTM F2223-15, STANDARD GUIDE FOR ASTM STANDARDS ON PLAYGROUND SURFACING

SCOPE OF WORK

BASE BID: CONSTRUCTION OF GATHERING LODGE AND WEST BUNKHOUSE INCLUDING SITEWORK AND SITE UTILITIES.

ADD ALTERNATE 1: CONSTRUCTION OF EAST BUNKHOUSE INCLUDING UTILITIES FROM EXTERIOR BUILDING CONNECTION POINTS.

REFERENCE BID FORM FOR OWNER'S CONTINGENCY ALLOWANCE FOR FURNITURE, FIXTURES AND EQUIPMENT (FFE)

INDEX OF DRAWING

G000 COVER

G001 SYMBOLS, GENERAL NOTES, AND ABBREVIATIONS

G002 ADA DIAGRAMS G003 CODE PLANS

C1.01 DIMENSION CONTROL AND PAVING PLAN C2.01 GRADING PLAN

C3.01 DRAINAGE PLAN

C4.01 UTILITY PLAN

C5.01 EROSION CONTROL PLAN C6.01 DETAILS

C6.02 DETAILS

A001 ARCHITECTURAL SITE PLAN

A101 FLOOR PLAN - GATHERING LODGE

A102 FLOOR PLAN - BUNKHOUSES A111 ENLARGED FLOOR PLANS

A131 ROOF PLAN - GATHERING LODGE

A132 ROOF PLAN - BUNKHOUSE

A151 RCP - GATHERING LODGE

A152 RCP - BUNKHOUSE

A201 BUILDING ELEVATIONS - GATHERING LODGE

A202 BUILDING ELEVATIONS - BUNKHOUSE

A301 BUILDING SECTIONS - GATHERING LODGE

A302 BUILDING SECTIONS - GATHERING LODGE A311 WALL SECTIONS

A312 WALL SECTIONS

A401 SECTION DETAILS A402 MILLWORK DETAILS

A501 INTERIOR ELEVATIONS - GATHERING LODGE

A502 INTERIOR ELEVATIONS - GATHERING LODGE

A503 INTERIOR ELEVATIONS - BUNKHOUSE A601 SCHEDULES

S1.1 GENERAL NOTES

S1.2 GENERAL NOTES (CONTD.)

S1.3 SPECIAL INSTRUCTION CRITERIA AND SCHEDULES S2.1 GATHERING LODGE FOUNDATION AND SLAB PLAN

S2.2 BUNKHOUSE FOUNDATION AND SLAB PLAN S3.1 FOUNDATION DETAILS

S3.2 FOUNDATION DETAILS

S4.1 GATHERING LODGE ROOF FRAMING PLAN S4.2 BUNKHOUSE ROOF FRAMING PLAN

S5.1 TYPICAL FRAMING DETAILS AND SCHEDULES

S5.2 TYPICAL FRAMING SECTIONS AND DETAILS

S5.3 TYPICAL FRAMING SECTIONS AND DETAILS S5.4 FRAMING SECTIONS AND DETAILS

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M2.01A GATHERING LODGE FLOOR PLAN MECHANICAL M2.01B EAST AND WEST BUNKHOUSE FLOOR PLANS MECHANICAL

M7.01 SYMBOLS, LEGEND AND GENERAL NOTES MECHANICAL

M7.02 SCHEDULES MECHANICAL

M8.01 DETAILS MECHANICAL M8.02 DETAILS MECHANICAL

E2.01A GATHERING LODGE FLOOR PLAN POWER

E2.01B EAST AND WEST BUNKHOUSE FLOOR PLANS POWER

E3.01A GATHERING LODGE FLOOR PLAN LIGHTING E3.01B EAST AND WEST BUNKHOUSE FLOOR PLANS LIGHTING

E3.01D RISER DIAGRAMS

E7.01 ELECTRICAL SYMBOLS AND LIGHT FIXTURE SCHEDULES

E8.01 DETAILS ELECTRICAL

P2.01A GATHERING LODGE FLOOR PLAN PLUMBING

P2.01AU GATHERING LODGE UNDERFLOOR PLUMBING

P2.01B EAST & WEST BUNKHOUSE FLOOR PLANS PLUMBING

P2.01BU EAST & WEST BUNKHOUSE FLOOR PLANS UNDERFLOOR PLUMBING P2.02A GATHERING LODGE ROOF PLAN PLUMBING

P2.02B SCHEDULES AND DETAILS PLUMBING P7.01 SCHEDULES & DETAILS PLUMBING

P7.02 PLUMBING RISER SYMBOLS AND LEGENDS PLUMBING

TEXAS PARKS 8

WILDLIFE

TEXAS PARKS AND WILDLIFE

INFRASTRUCTURE DIVISION

4200 SMITH SCHOOL ROAD AUSTIN, TEXAS 78744-3292



Christy Seals 4/16/2024 4:55:16 PM RELEASED TEXAS SOLICITATION PARKS & INFRASTRUCTURE WILDLIFE

2. CONTRACTOR SHALL BE RESPONSIBLE FOR PROTECTING ALL EXISTING CONDITIONS NOT INDICATED TO BE DEMOLISHED, AND FOR REPAIRING ANY DAMAGE CAUSED BY CONSTRUCTION ACTIVITIES TO SUCH CONDITIONS AT NO EXTRA COST

3. CONTRACTOR SHALL IMMEDIATELY NOTIFY THE DESIGN TEAM OF ANY UNREPORTED OBSTACLES OR DISCREPANCIES THAT MAY IMPEDE OR PREVENT THE PROPER CONSTRUCTION OF THIS PROJECT.

4. CONTRACTOR SHALL MAINTAIN THE JOB SITE IN A SAFE, NEAT AND WORKMANLIKE MANNER AT ALL TIMES. JOB SITE SAFETY SHALL NOT BE COMPROMISED. 5. ALL HOLES, TRENCHES, AND OTHER HAZARDOUS AREAS SHALL BE ADEQUATELY

PROTECTED BY BARRICADES, FENCING, LIGHTS, AND/OR OTHER PROTECTIVE DEVICES AT ALL TIMES.

6. REMOVAL OF EXCAVATED MATERIALS AND DAILY CLEANUP OPERATIONS SHALL BE PERFORMED TO THE SPECIFICATIONS AND TO THE SATISFACTION OF THE OWNER AND ARCHITECT/ENGINEER.

7. PERMISSIBLE STAGING AND SPOILS AREA TO BE LOCATED ON SITE, AFTER COORDINATION WITH OWNER, FOR SPECIFIC LOCATION TO MINIMIZE DISRUPTION OF DRIVEWAY AND BUILDING OPERATIONS.

8. UNLESS OTHERWISE NOTED, ANY SIDEWALK CLOSURES REQUIRED FOR PROJECT CONSTRUCTION SHALL REQUIRE A TRAFFIC CONTROL PLAN AND PERMIT TO OPERATE IN THE ROW. PERMIT AND PLAN SHALL BE APPROVED BY RIGHT OF WAY MANAGEMENT AND SHALL BE THE RESPONSIBILITY OF THE CONTRACTOR.

9. CONTRACTOR IS RESPONSIBLE TO COORDINATE ALL TRADES PRIOR TO BEGINNING WORK.

GENERAL NOTES

- A. THE WORK DESCRIBED HEREIN SHALL COMPLY WITH TEXAS CIVIL STATUES -ARTICLE 9102-ARCHITECTURAL BARRIERS ACT - TAS 2012 (TEXAS ACCESSIBILITY STANDARDS) AND I.E.C.C.
- B. DIMENSIONS NOTED "CLEAR" OR "CLR" MUST BE ACCURATELY MAINTAINED. ALLOW FOR THICKNESS OF ALL WALL FINISHES. THE MEASUREMENTS SHALL NOT VERY MORE THAN 1/8" WITHOUT WRITTEN CONSENT FORM THE
- C. "ALIGN" MEANS TO ACCURATELY LOCATE FINISHES IN THE SAME PLANE. "TYPICAL" OR "TYP" MEANS IDENTICAL FOR ALL SIMILAR CONDITIONS, U.N.O. "VERIFY" OR "VER" MEANS TO ASCERTAIN AND CONFIRM APPLICATION WITH
- D. PROVIDE BLOCKING PER MANUFACTURER REQUIREMENTS FOR ALL WALL MOUNTED EQUIPMENT.
- E. CONTRACTOR IS NOT TO SCALE DRAWINGS.
- F. ALL INTERIOR WALLS TO BE J3 UNO.
- CONTRACTOR SHALL PROVIDE HARD TROWELED CONCRETE FINISH FOR ALL SEALED CONCRETE FLOORS.

ABBREVIATIONS ACOUSTICAL CEILING TILE AL, ALUM ALUMINUM ANOD ANNODIZED BCS BABY CHANGING STATION COLOR ANODIZED FINISH CLOSET CLEAR ANODIZED FINISH CLA CEILING COL(S) COLUMN(S) CONCRETÉ MASONRY UNIT CONCRETE DOWNSPOUT

GLAZING (WINDOW, GLASS)

INSULATED (REFER TO GLAZING SPECIFICATIONS)

OPEN TO UNDERSIDE OF DECK (NO CEILING)

CONCRETE WITH PENETRATING SEALER

THERMOSET POLYESTER FINISH AAMA 60.8

TONGUE AND GROVE WOOD PLANKS

WATER RESISTANT GYPSUM BOARD and

NOT APPLIED FINISH / NOT APPLICABLE

GYPSUM BOARD

HOLLOW METAL

MANUFACTURER

NOT IN CONTRACT

OVERHEAD OBJECT/LINE

LAVATORY

HOSE BIBB

INTERIOR

MIRROR

MOP SINK

ON CENTER

PLYWOOD

PAINTED

STEEL

STAINED

SIMILAR

REFURBISHED

RUBBER BASE ROUGH OPENING

SOLID CORE WOOD

TEMPERED GLASS

TOWEL DISPENSER

TOP OF STRUCTURE

TRANSOM WINDOW

VERIFY IN FIELD

WOOD SEALER

VINYL COMPOSITION TILE

WHERE APPLICABLE) WOOD

MEDIUM DENSITY OVERLAP

METAL

NEW

MIR MS

MTL

O.C.

O/USD

PLWD

STN

T.O.S.

T & G

TRAN

UR

VYL

VCT

MDO

DB DRESSING BENCH EXISTING EXTERIOR FLOOR DRAIN

GAUGE GRAB BAR GENERAL CONTRACTOR

PLYWOOD

CONCRETE

CMU

BRICK

MATERIALS LEGEND

SPRAY FOAM INSULATION

RIGID INSULATION

GYPSUM BOARD

BATT INSULATION

WALL LEGEND

NEW PARTITION/WALL CONSTRUCTION

FLOOR FINISH LEGEND STAINED CONCRETE

> SEALED CONCRETE CARPET TILE

CEILING LEGEND

GYPSUM BOARD CEILING

WOOD SLAT SOFFIT

24" X 48 LIGHT FIXTURE

SURFACE MOUNTED LIGHT FIXTURE RECESSED LIGHT FIXTURE R

RECESSED CAN LIGHT S ROUND SURFACE MOUNT FIXTURE (WATERPROOF FIXTURE) DOWNLIGHT PENDANT DOWNLIGHT PENDANT SUPPLY GRILL

EXHAUST FAN WALL SCONCE (EXTERIOR)


WALL SCONCE (READING LIGHT) WALL SCONCE (VANITY LIGHT) TRACK LIGHTING

CEILING FAN

CEILING FAN WITH LIGHT KIT

24X24 CEILING ACCESS PANEL NON-RATED --(ACUDOR UF-5500-24-24) RATED -- (ACUDOR FW-5050-24-24) CONTRACTOR FV FIT W/STRUCT

SYMBOLS LEGEND

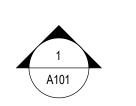

1i

BUILDING ELEVATIONS

INTERIOR ELEVATIONS

BUILDING SECTION

WALL SECTION

COLUMN GRIDS

LEVEL ELEVATION

EQUIPMENT TAG

PLAN, SECTION OR ELEVATION

DETAIL OR ENLARGEMENT



ROOM IDENTIFICATION



CEILING HEIGHT




DOOR TAG

WALL TAG




SPOT ELEVATION

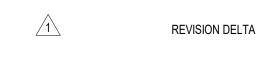

VIEW TITLE & SCALE SCALE: 1/8" = 1'-0"


LIMITS OF CONSTRUCTION


KEYNOTE ANNOTATION

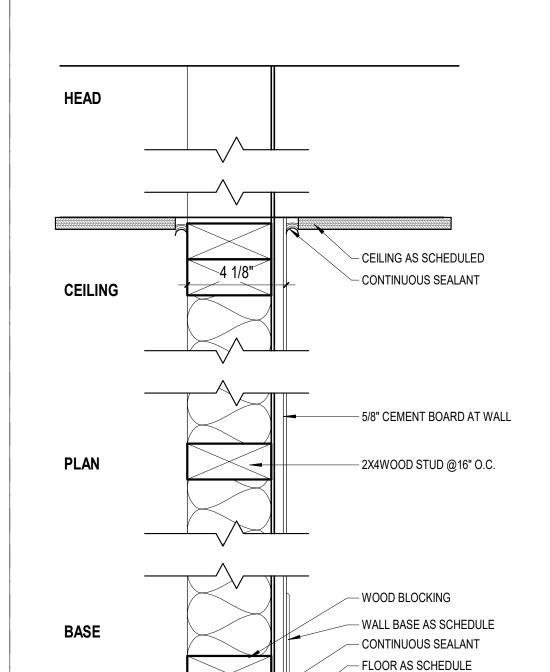



PARTITION TYPE 'P6'

PARTITION TYPES SCALE: 3" = 1'-0"

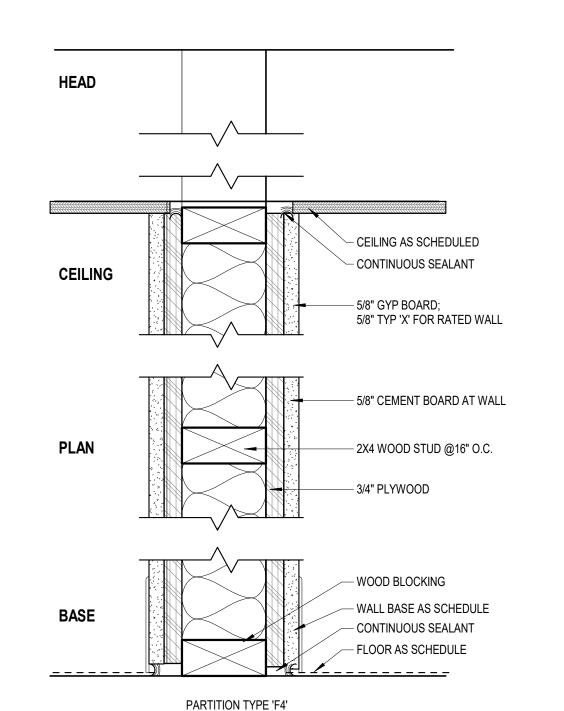


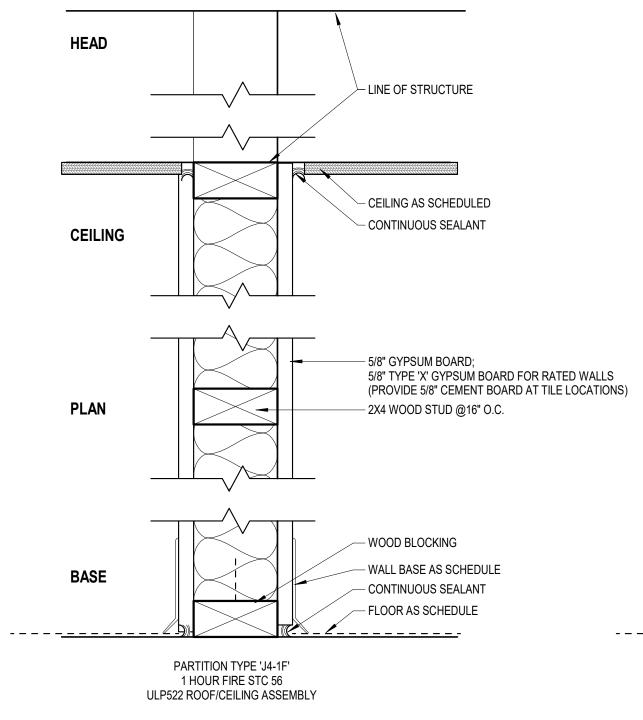

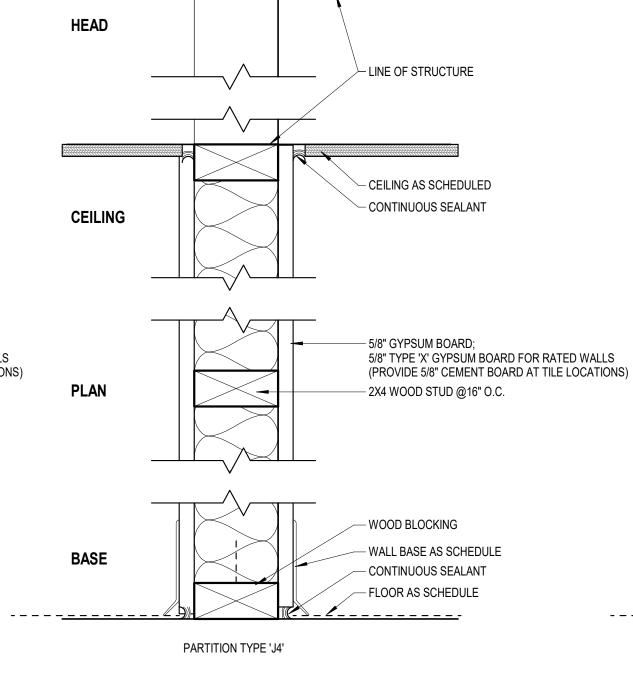

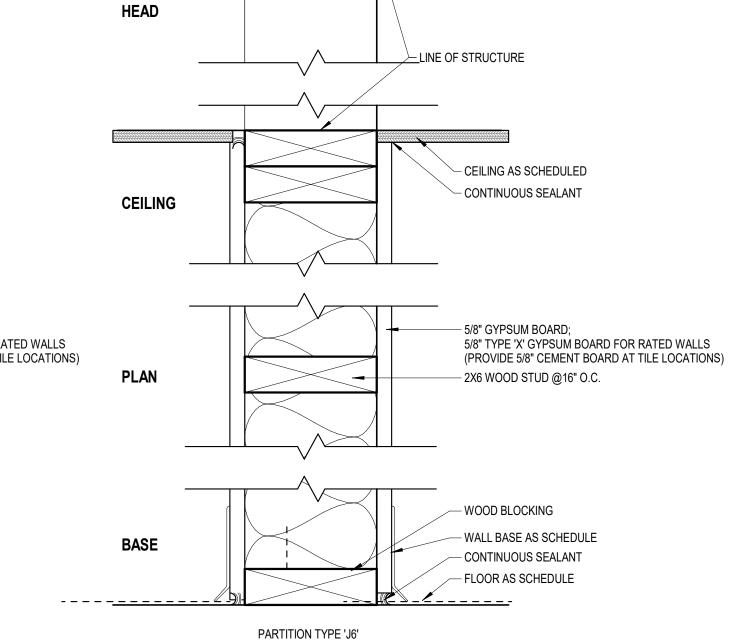



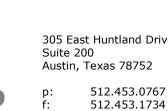

SHEET TITLE

SYMBOLS, GENERAL NOTES, AND ABBREVIATIONS

DATE: April 3, 2024

DESIGNED BY: MW

DRAWN BY: EB REVIEWED BY: OH

ΓEXAS

PARKS 8

WILDLIFE

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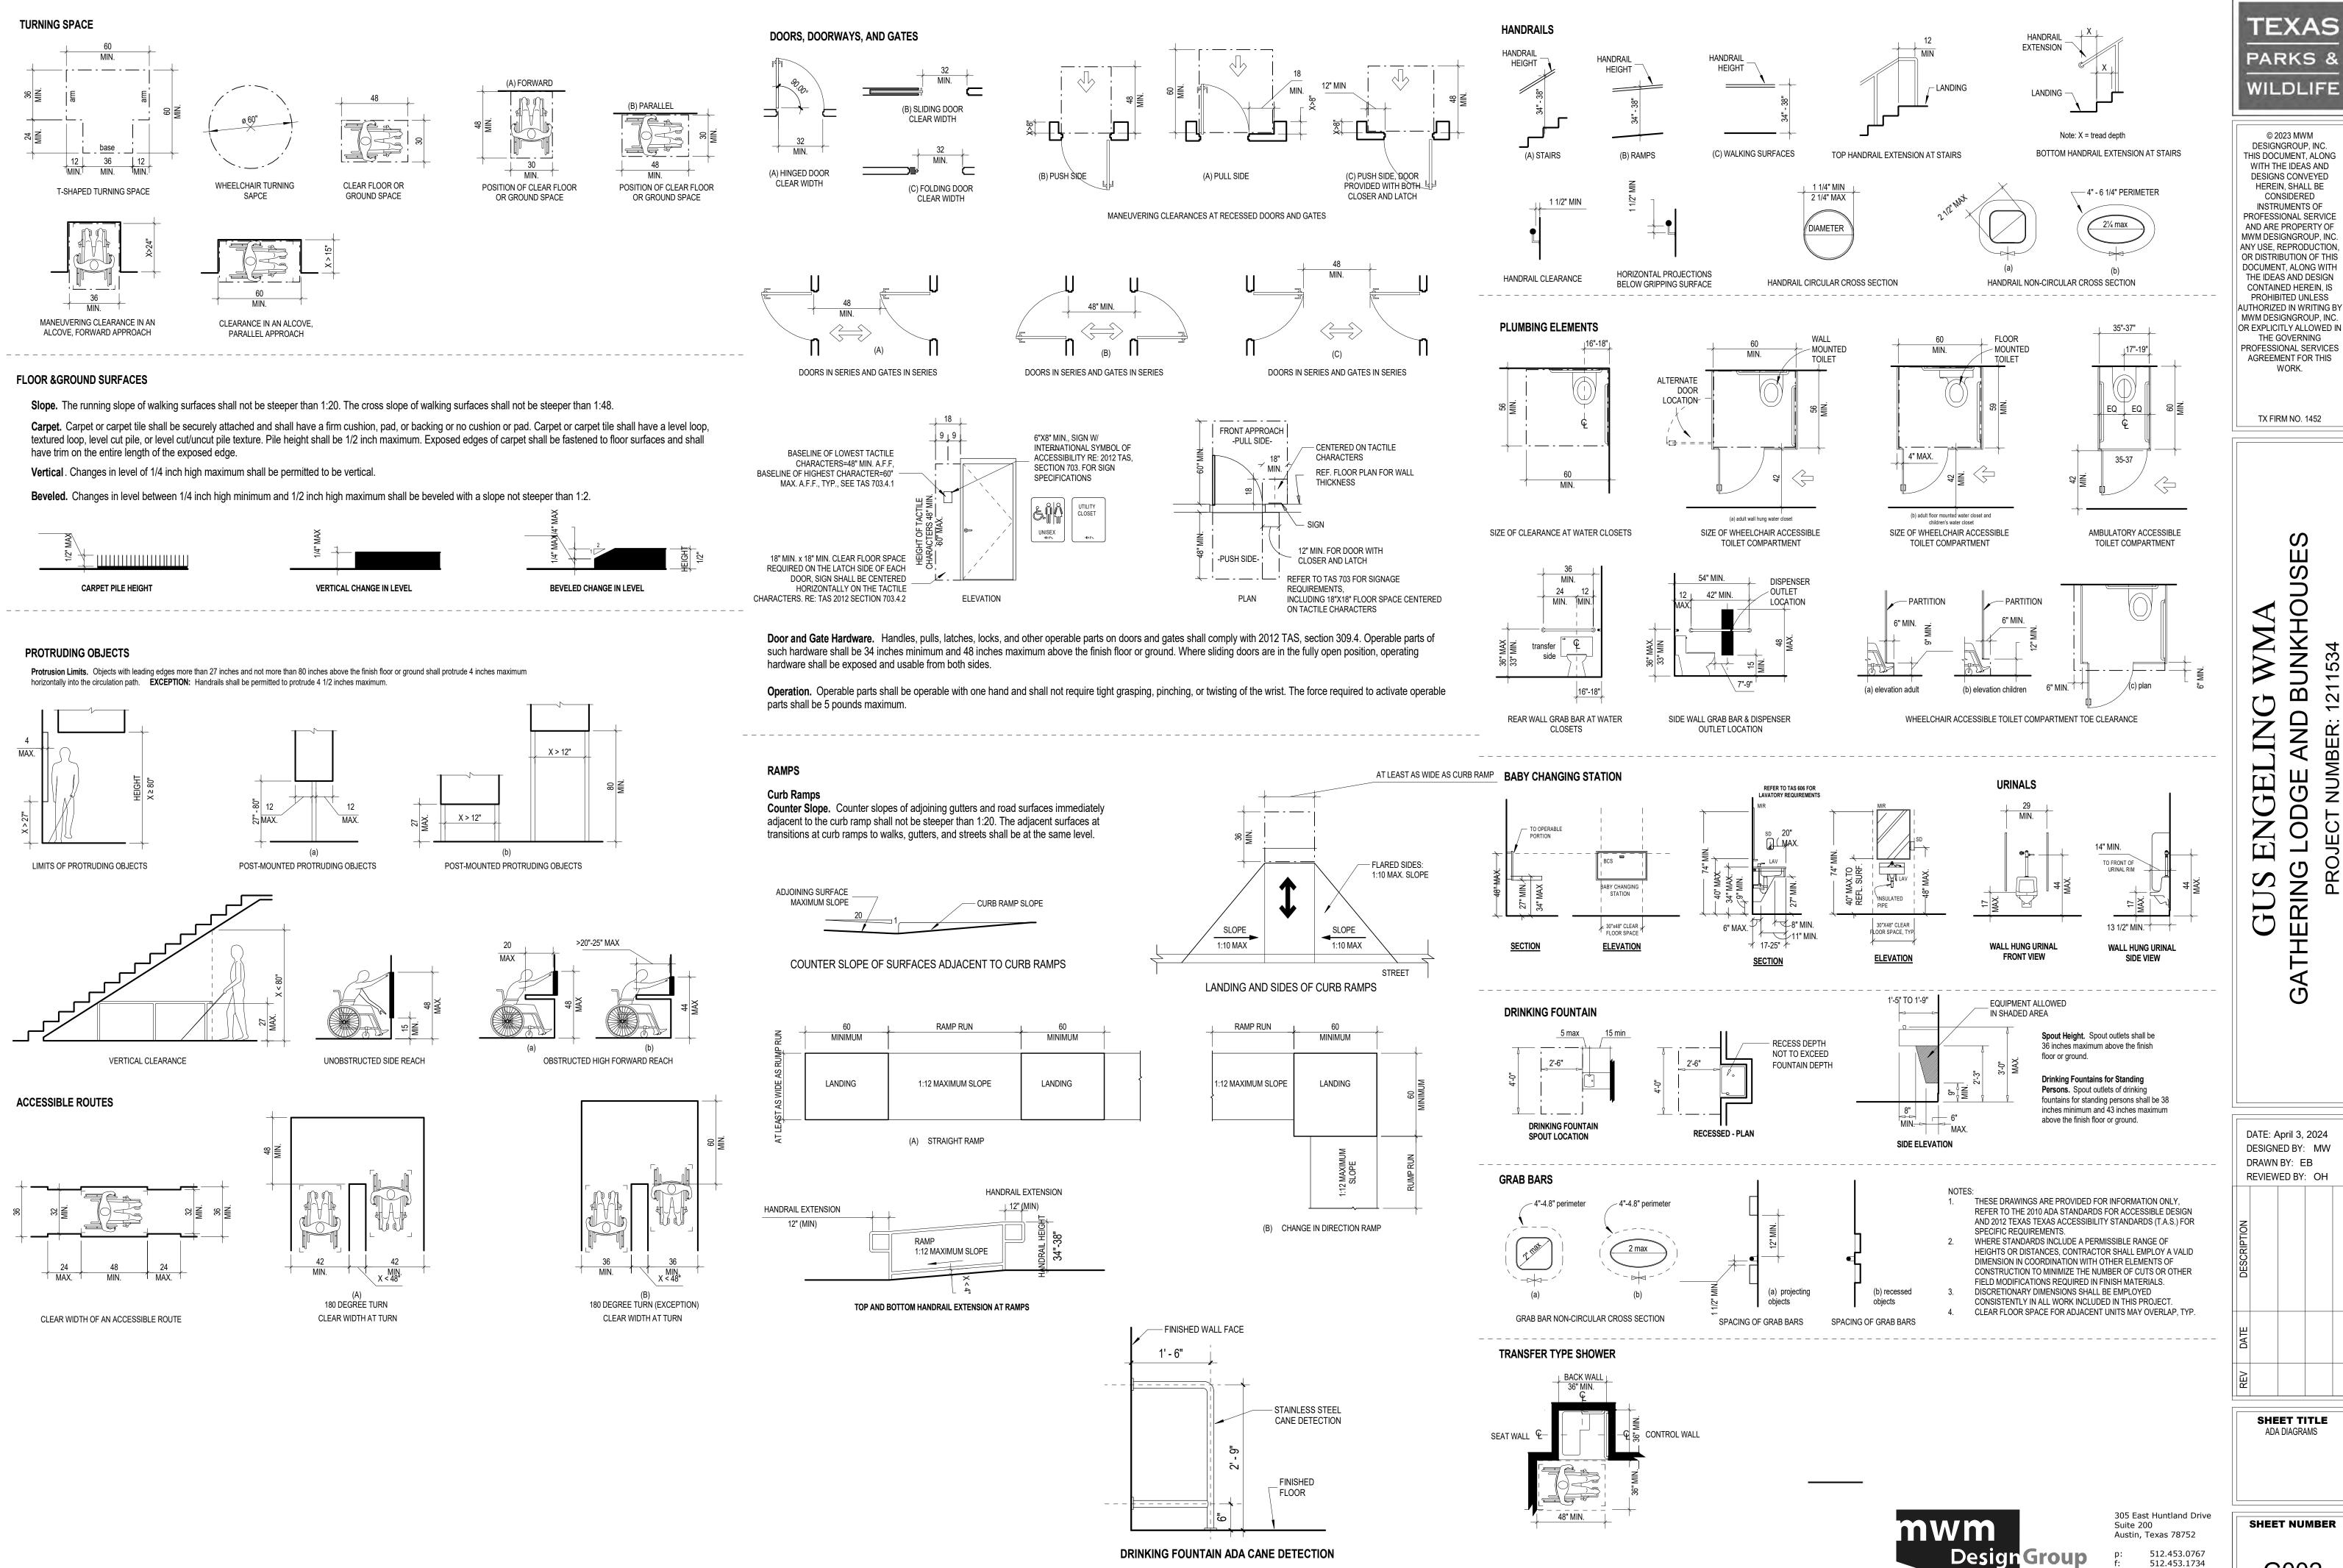
TX FIRM NO. 1452

UNKHO

GELING

305 East Huntland Drive SHEET NUMBER

TBAE FIRM REGISTRATION NO.: 1452 TBPE FIRM REGISTRATION NO.: F-1416 TBPLS FIRM REGISTRATION NO.: 10065600



SHEET TITLE SHEET NUMBER

TBPE FIRM REGISTRATION NO.: F-1416

TBAE FIRM REGISTRATION NO.: 1452

TBPLS FIRM REGISTRATION NO.: 10065600

ADA DIAGRAMS

ΓEXAS

WILDLIFE

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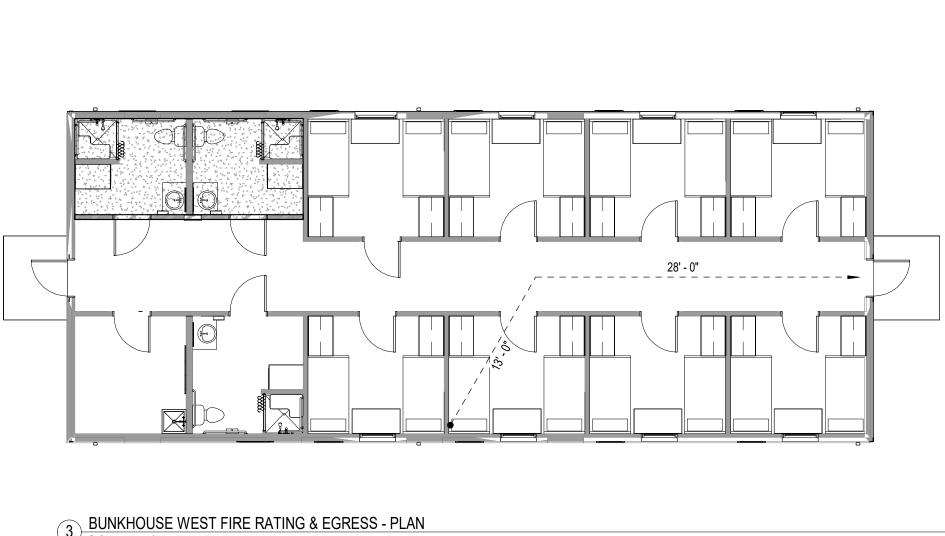
THE GOVERNING


WORK.


TX FIRM NO. 1452

ERING






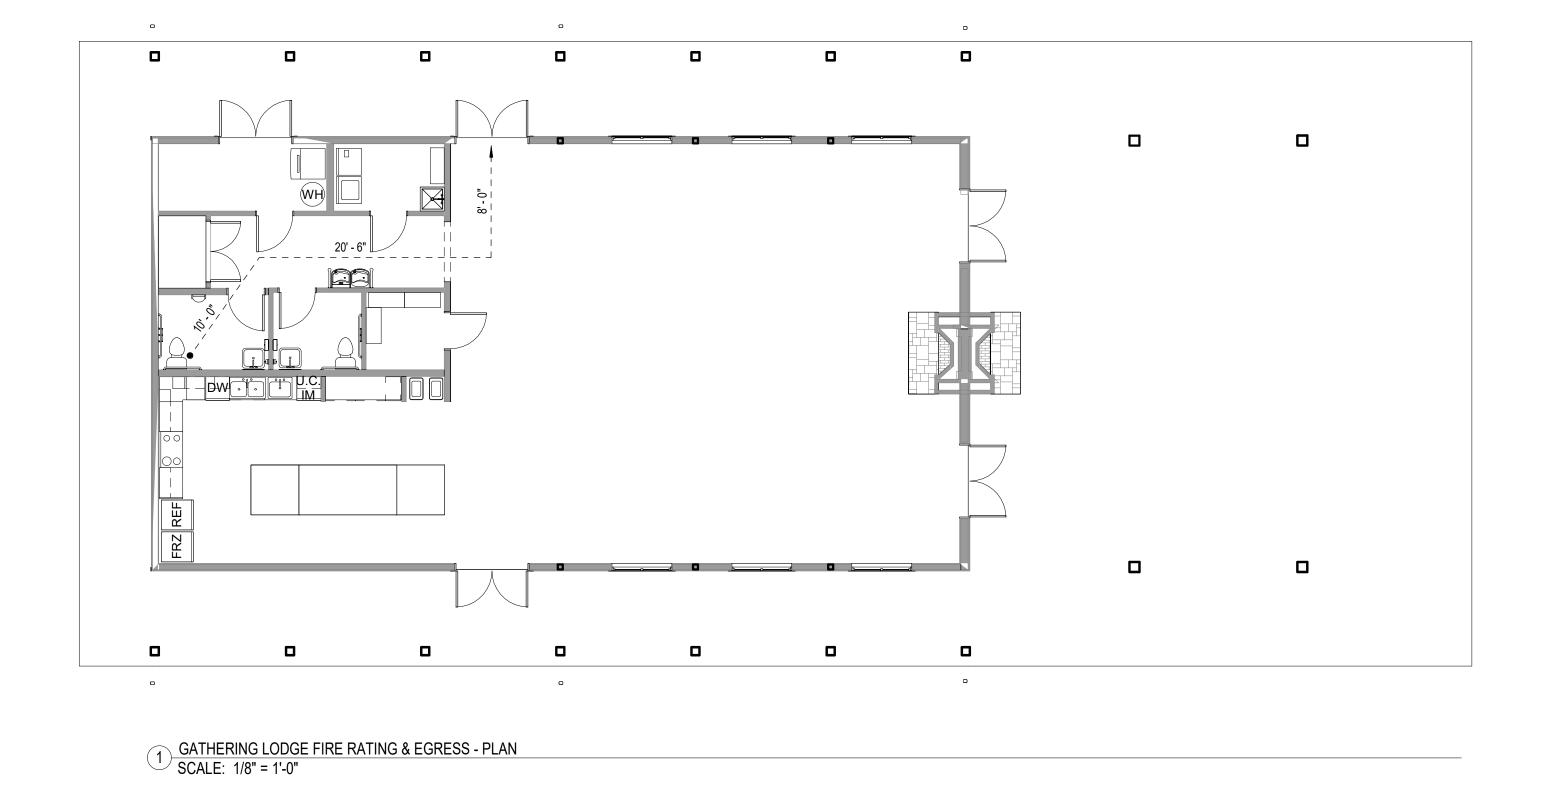

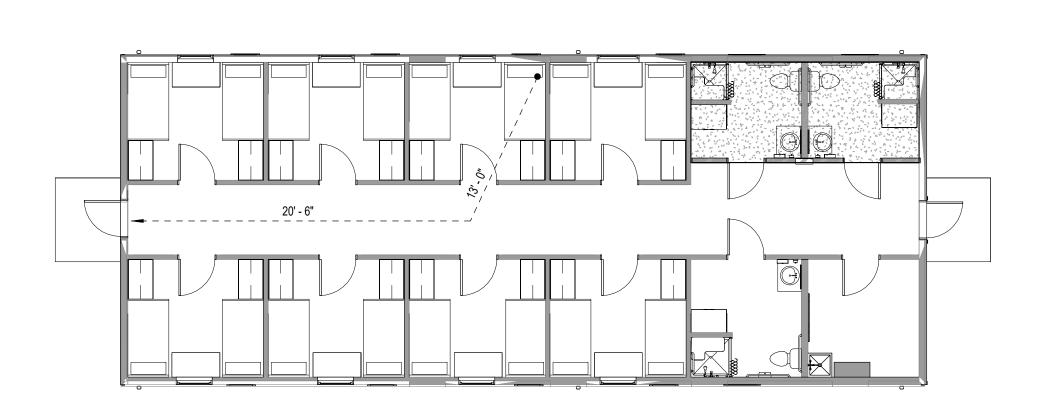

BUNKHOUSE EAST FIRE RATING & EGRESS - PLAN SCALE: 1/8" = 1'-0"

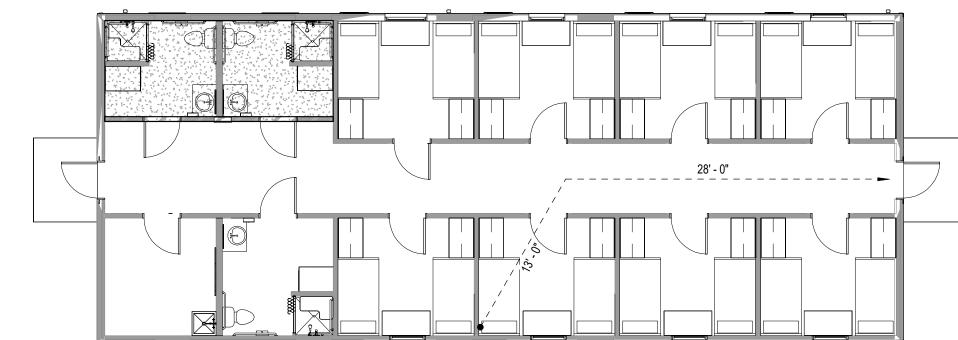

3 BUNKHOUSE WEST FIRE RATING & EGRESS - PLAN SCALE: 1/8" = 1'-0"

CODE SUMMARY

INTERNATIONAL CODE COUNCIL ADOPTIONS BUILDING CODE: INTERNATIONAL BUILDING CODE 2021 STRUCTURAL CODE: INTERNATIONAL BUILDING CODE 2021 PLUMBING CODE: INTERNATIONAL PLUMBING CODE 2021

 MECHANICAL CODE: INTERNATIONAL MECHANICAL CODE 2021 GAS CODE: INTERNATIONAL FUEL GAS CODE 2021 RESIDENTIAL CODE: INTERNATIONAL RESIDENTIAL CODE 2021 EXISTING BUILDINGS: INTERNATIONAL EXISTING BUILDINGS CODE 2021

NATIONAL FIRE PROTECTION CODE ELECTRICAL CODE: NATIONAL ELECTRICAL CODE NFPA-70 2023 FIRE CODE: NFPA-1 2015 LIFE SAFETY CODE: NFPA-101 2015

ENERGY CONSERVATION

 ENERGY: INTERNATIONAL ENERGY CONSERVATION CODE 2021 **ACCESSIBILITY CODES**

 US DEPT. OF JUSTICE, 2010 ADA STANDARDS FOR ACCESSIBLE DESIGN ARCHITECTURAL BARRIERS ACT ACCESSIBILITY GUIDELINES; OUTDOOR DEVELOPED AREAS 2015 2012 TEXAS ACCESSIBILITY STANDARDS, ELIMINATION OF ARCHITECTURAL BARRIERS,

TEXAS GOVERNMENT CODE, CHAPTER 469 **BUILDING CODE GATHERING LODGE**

OCCUPANCY GROUP: NFPA 101 CHAPTER 12, NEW ASSEMBLY

SPRINKLER SYSTEM PRESENT : NOT REQUIRED

CONSTRUCTION TYPE: VB

AREA (SF): 2,476 SF 4,820 SF WITH EXTERIOR CANOPY

REQUIRED NUMBER OF EXITS = 2

OCCUPANT LOAD: 53

BUILDING CODE BUNKHOUSE (2 TOTAL)

OCCUPANCY GROUP: NFPA 101 CHAPTER 26, LODGING OR ROOMING HOUSE

SPRINKLER SYSTEM PRESENT : YES

CONSTRUCTION TYPE: VB

AREA (SF): 1,845 SF (EA)

REQUIRED NUMBER OF EXITS = 2

OCCUPANT LOAD: 16 EACH BUNKHOUSE

LIFE SAFETY KEY

1 HOUR FIRE RATED

EGRESS TRAVEL DISTANCE



1 HOUR RATED IN HORIZONTAL PLANE (CEILINGS)

NOTE: REFER MEP FOR SMOKE DETECTOR LOCATIONS

S BUNKHO GUS ENGELING THERING LODGE AND E

TEXAS

PARKS 8

WILDLIFE

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AGREEMENT FOR THIS

WORK.

TX FIRM NO. 1452

DATE: April 3, 2024 DESIGNED BY: MW DRAWN BY: EB REVIEWED BY: OH

SHEET TITLE

SHEET NUMBER

G003

TBAE FIRM REGISTRATION NO.: 1452 TBPE FIRM REGISTRATION NO.: F-1416


305 East Huntland Drive

512.453.0767 512.453.1734


Suite 200 Austin, Texas 78752

Design Group

TBPLS FIRM REGISTRATION NO.: 10065600

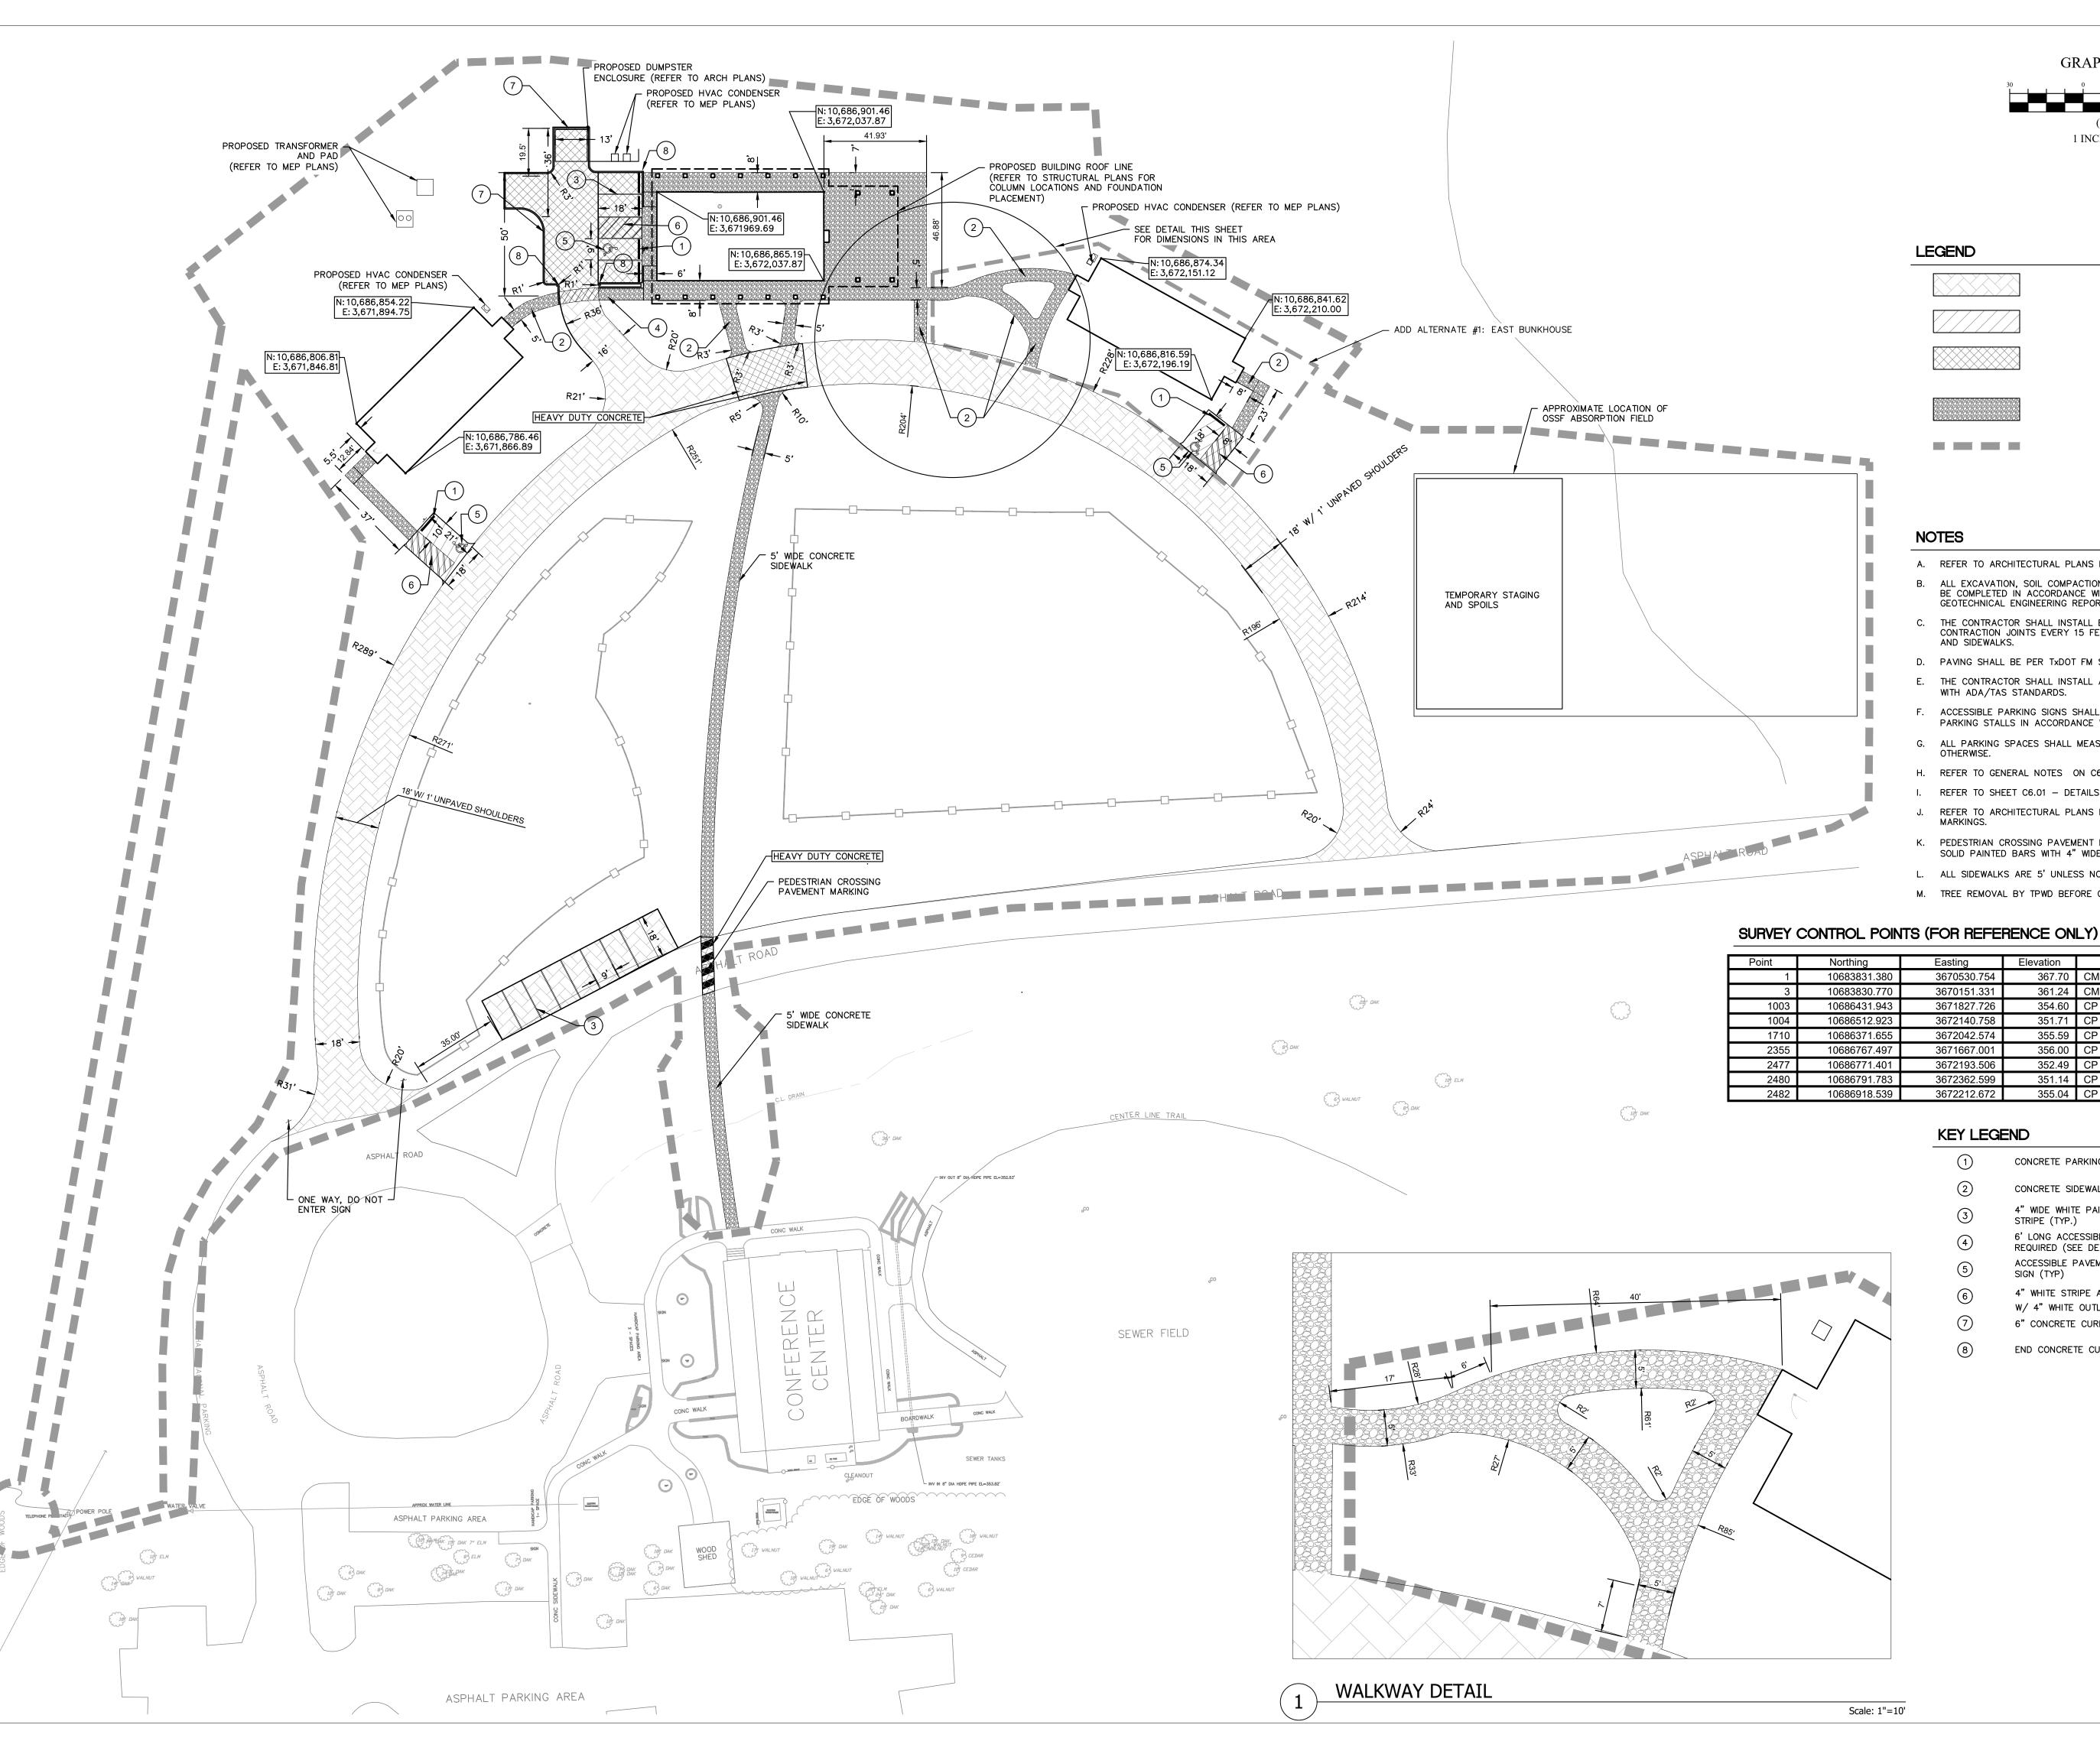



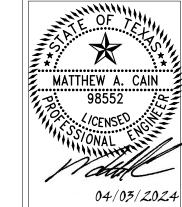

S

WMA

GUS EN

DATE: APRIL 3,2024

DESIGNED BY: MAC

DRAWN BY: JG

REVIEWED BY: MAC

- A. REFER TO ARCHITECTURAL PLANS FOR EXACT BUILDING DIMENSIONS.
- B. ALL EXCAVATION, SOIL COMPACTION, SUBGRADE PREPARATION AND PAVING SHALL BE COMPLETED IN ACCORDANCE WITH THE RECOMMENDATIONS OF THE GEOTECHNICAL ENGINEERING REPORT.

GRAPHIC SCALE

(IN FEET)

1 INCH = 30 FEET

ASPHALT PAVEMENT

CONCRETE SIDEWALK

LIMITS OF DISTURBANCE

REGULAR DUTY CONCRETE PAVEMENT

HEAVY DUTY CONCRETE PAVEMENT

- THE CONTRACTOR SHALL INSTALL EXPANSION JOINTS EVERY 200 FEET, AND CONTRACTION JOINTS EVERY 15 FEET MINIMUM FOR ALL CONCRETE PAVING, CURBS AND SIDEWALKS.
- D. PAVING SHALL BE PER TXDOT FM STANDARDS.
- E. THE CONTRACTOR SHALL INSTALL ACCESSIBLE PARKING SIGNAGE IN ACCORDANCE WITH ADA/TAS STANDARDS.
- ACCESSIBLE PARKING SIGNS SHALL BE PLACED AT THE HEAD OF ALL ACCESSIBLE PARKING STALLS IN ACCORDANCE WITH TAS/ADA STANDARDS.
- G. ALL PARKING SPACES SHALL MEASURE 9' WIDE BY 18' DEEP, UNLESS NOTED
- H. REFER TO GENERAL NOTES ON C6.01 DETAILS.
- I. REFER TO SHEET C6.01 DETAILS FOR PAVING CONSTRUCTION DETAILS.
- REFER TO ARCHITECTURAL PLANS FOR ACCESSIBLE SIGNAGE AND PAVEMENT
- K. PEDESTRIAN CROSSING PAVEMENT MARKING SHALL CONSIST OF 24" WIDE WHITE SOLID PAINTED BARS WITH 4" WIDE WHITE PAINTED OUTLINE.
- L. ALL SIDEWALKS ARE 5' UNLESS NOTED OTHERWISE.
- M. TREE REMOVAL BY TPWD BEFORE CONSTRUCTION BEGINS.


Point	Northing	Easting	Elevation	Description
1	10683831.380	3670530.754	367.70	CM ALUMINUM CAP "FOUND"
3	10683830.770	3670151.331	361.24	CM ALUMINUM CAP "FOUND"
1003	10686431.943	3671827.726	354.60	CP 1/2" IRW/CAP SET
1004	10686512.923	3672140.758	351.71	CP 1/2" IRW/CAP SET
1710	10686371.655	3672042.574	355.59	CP 60D NAIL SET
2355	10686767.497	3671667.001	356.00	CP B/SPIKE SET
2477	10686771.401	3672193.506	352.49	CP B/SPIKE SET
2480	10686791.783	3672362.599	351.14	CP 1/2" IRS W/TPWD ALUM CAP
2482	10686918.539	3672212.672	355.04	CP 1/2" IRS W/ TPWD ALUM CAP

- CONCRETE PARKING BUMPER (TYP.)
- CONCRETE SIDEWALK
- 4" WIDE WHITE PAINTED TRAFFIC STRIPE (TYP.)
- 6' LONG ACCESSIBLE CURB RAMP AS
- REQUIRED (SEE DETAIL, SHEET C6.01) ACCESSIBLE PAVEMENT MARKING AND
- 4" WHITE STRIPE AT 2' O.C. AT 45 DEGREE ANGLE W/ 4" WHITE OUTLINE
- 6" CONCRETE CURB
- END CONCRETE CURB



mwm **Design** Group SHEET TITLE DIMENSION CONTROL AND PAVING PLAN

SHEET NUMBER

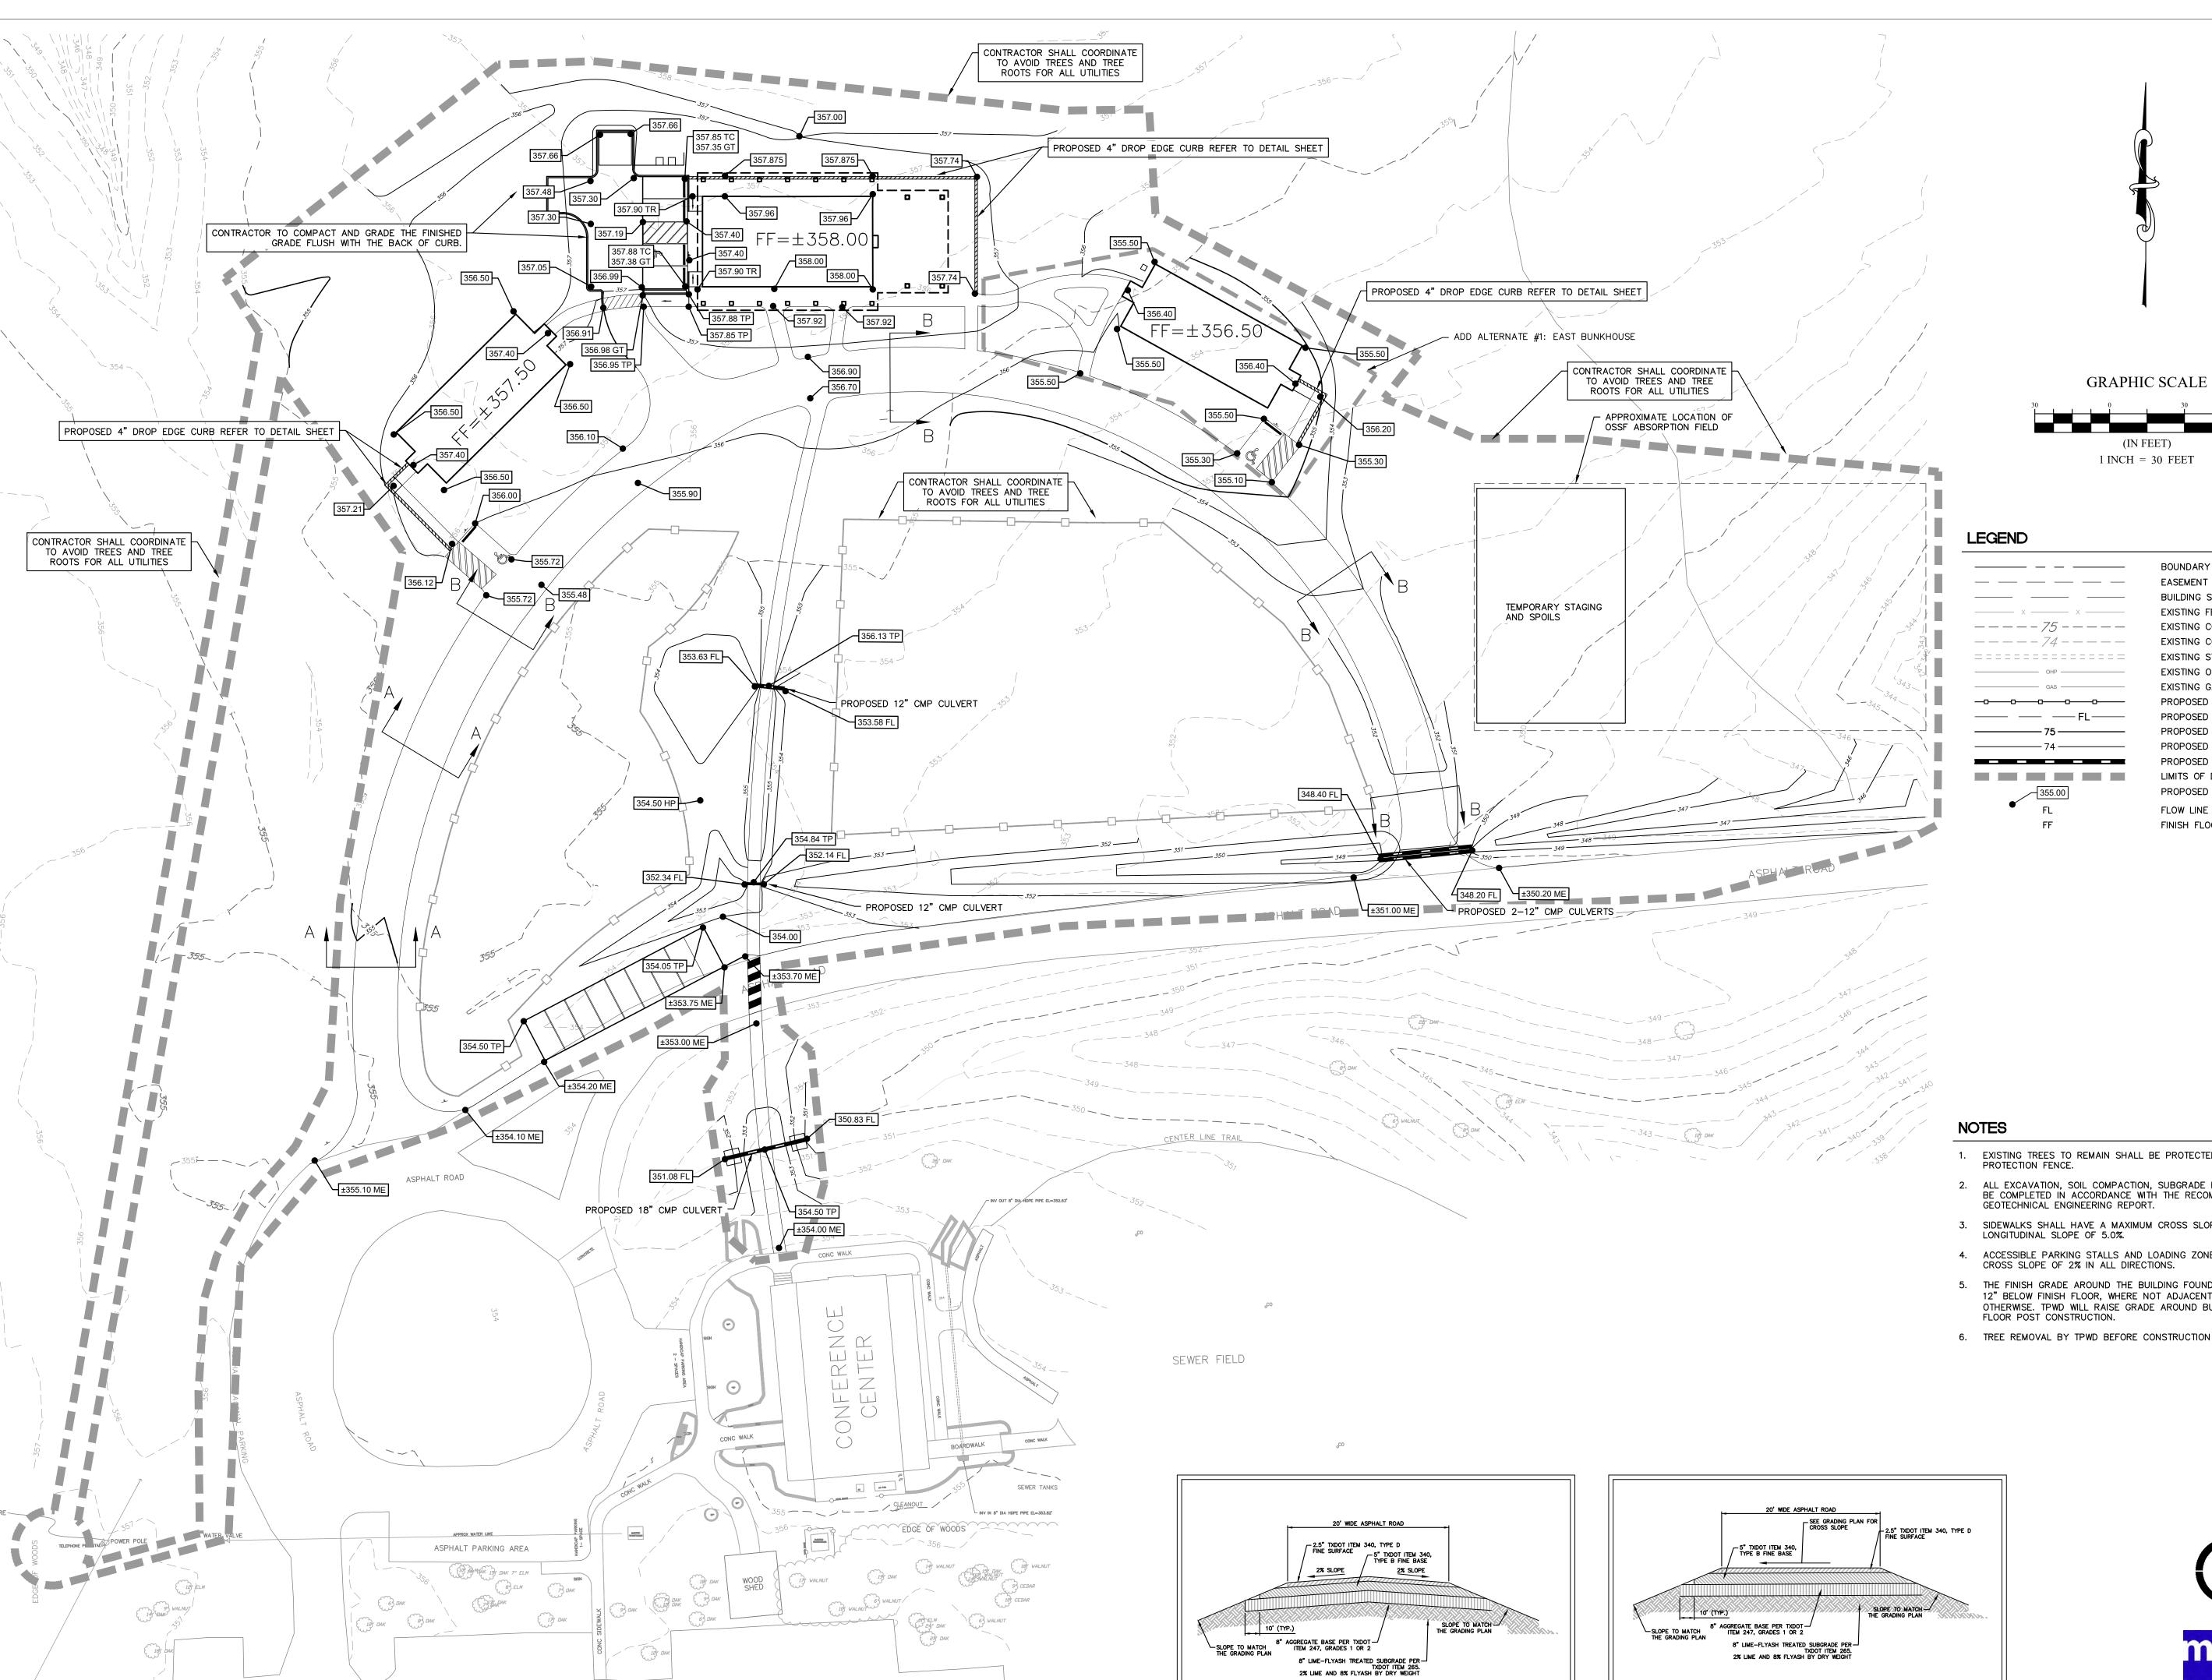



ASPHALT PARKING AREA

ASPHALT ROADWAY DETAIL - A

Scale: Not to Scale




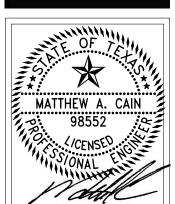

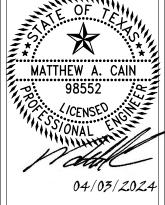

S

UNKHOU

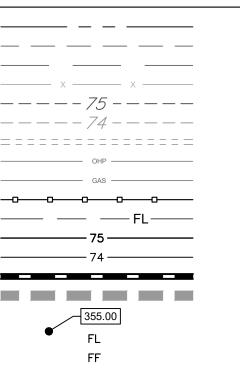

BOUNDARY / PROPERTY LINE EASEMENT LINE BUILDING SETBACK EXISTING FENCE LINE EXISTING CONTOUR (MAJOR INTERVAL) EXISTING CONTOUR (MINOR INTERVAL) EXISTING STORM SEWER EXISTING OVERHEAD POWER LINE EXISTING GAS MAIN PROPOSED FENCE LINE PROPOSED FIRE LANE PROPOSED CONTOUR (MAJOR INTERVAL) PROPOSED CONTOUR (MINOR INTERVAL) PROPOSED STORM SEWER LINE LIMITS OF DISTURBANCE PROPOSED SPOT ELEVATION FLOW LINE FINISH FLOOR

- 1. EXISTING TREES TO REMAIN SHALL BE PROTECTED IN PLACE REFER TO C5.01 FOR
- ALL EXCAVATION, SOIL COMPACTION, SUBGRADE PREPARATION AND PAVING SHALL BE COMPLETED IN ACCORDANCE WITH THE RECOMMENDATIONS OF THE GEOTECHNICAL ENGINEERING REPORT.
- 3. SIDEWALKS SHALL HAVE A MAXIMUM CROSS SLOPE OF 2.0%, AND A MAXIMUM LONGITUDINAL SLOPE OF 5.0%.
- 4. ACCESSIBLE PARKING STALLS AND LOADING ZONES SHALL HAVE A MAXIMUM CROSS SLOPE OF 2% IN ALL DIRECTIONS.
- 5. THE FINISH GRADE AROUND THE BUILDING FOUNDATION SHALL BE A MINIMUM OF 12" BELOW FINISH FLOOR, WHERE NOT ADJACENT TO CONCRETE, UNLESS NOTED OTHERWISE. TPWD WILL RAISE GRADE AROUND BUILDING TO BE 6" BELOW FINISH
- 6. TREE REMOVAL BY TPWD BEFORE CONSTRUCTION BEGINS.

ASPHALT ROADWAY DETAIL - B

Scale: Not to Scale



GRADING PLAN

SHEET TITLE

DATE: APRIL 3,2024 DESIGNED BY: MAC


DRAWN BY: JG REVIEWED BY: MAC

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Design Group







G WMA BUNKHOUSES

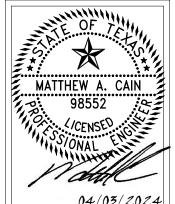GUS ENGELING

GRAPHIC SCALE

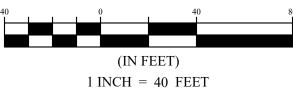

LEGEND

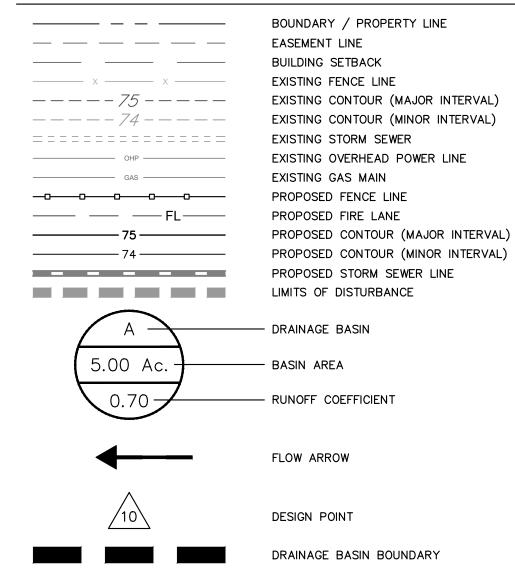

NOTES

- 1. PEAK RUNOFF CALCULATED BY RATIONAL METHOD.
- 2. INTENSITIES BASED OFF OF ISWM MANUAL.
- PROPOSED CULVERTS SIZED TO FLOW 10 YEAR STORM EVENT, WITHIN THE CULVERT BARREL.

PEAK RUNOFF CALCULATIONS

				Time of			
Design	Drainage	Total	Cumulative	Concentration	Intensity	Run-off	COMMENTS
Point	Basin	Area C-Value	C-Value	T _c	I ₁₀	Q ₁₀	
		(Acres)		(Min.)	(in/hr)	(cfs)	
Proposed C	onditions						
	A	0.57	0.49	15.00	5.74	1.60	TO MOST NORTHERLY 12" CMP CULVERT
	В	0.42	0.41	15.00	5.74	0.99	TO 12" CMP CULVERT TO THE SOUTH
	С	1.32	0.47	15.00	5.74	3.56	TO EASTERN 2-12" CMP CULVERT
	D	1.53	0.78	15.00	5.74	6.85	TO MOST SOUTHERN 18" CMP CULVERT






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DRAWN BY: JG
REVIEWED BY: MAC

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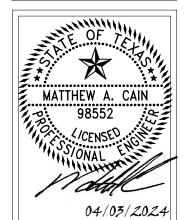
SHEET TITLE

DRAINAGE PLAN

sheet number C3.01



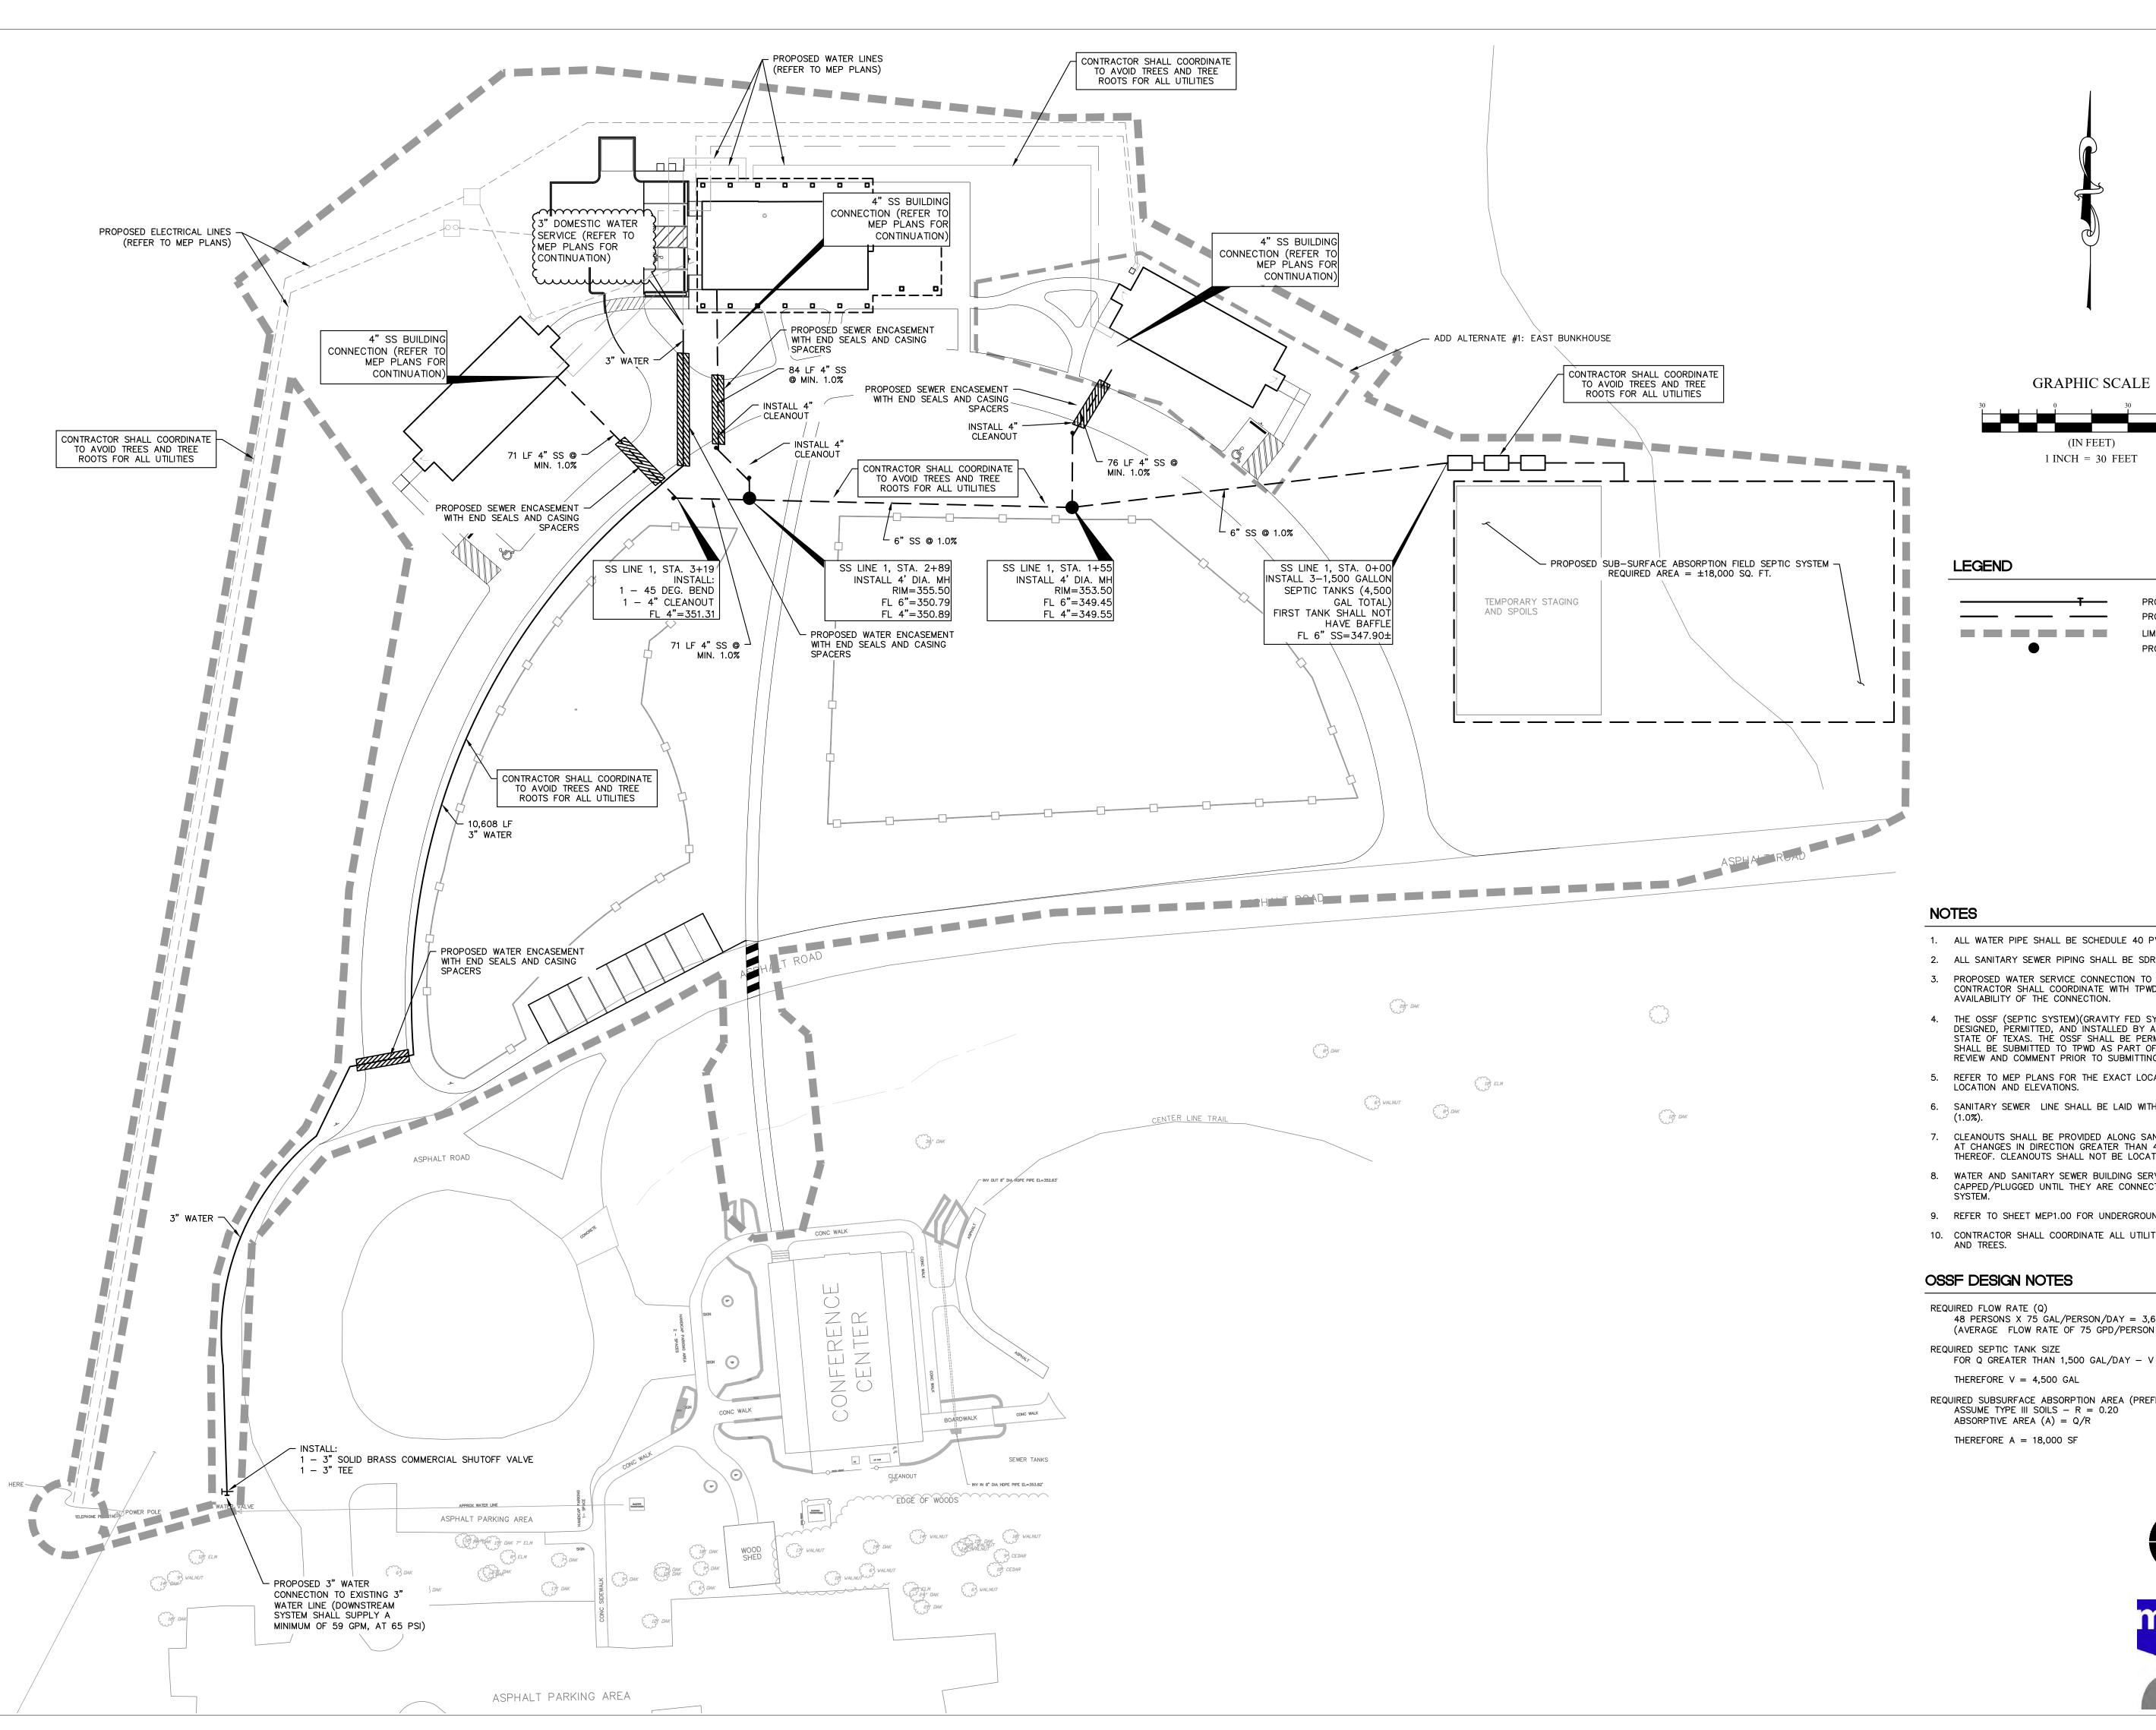



S

WMA SUNKHOUS

GUS

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DATE: APRIL 3,2024

DESIGNED BY: MAC DRAWN BY: JG

REVIEWED BY: MAC

PROPOSED WATER LINE AND VALVE PROPOSED SANITARY SEWER LINE LIMITS OF DISTURBANCE PROPOSED MANHOLE

- 1. ALL WATER PIPE SHALL BE SCHEDULE 40 PVC.
- 2. ALL SANITARY SEWER PIPING SHALL BE SDR 26 PVC.
- 3. PROPOSED WATER SERVICE CONNECTION TO BE PROVIDED BY TPWD. THE CONTRACTOR SHALL COORDINATE WITH TPWD TO VERIFY LOCATION AND TIME OF AVAILABILITY OF THE CONNECTION.
- 4. THE OSSF (SEPTIC SYSTEM)(GRAVITY FED SYSTEM PREFERRED) SHALL BE DESIGNED, PERMITTED, AND INSTALLED BY A INSTALLER LICENSED BY TCEQ IN THE STATE OF TEXAS. THE OSSF SHALL BE PERMITTED THROUGH THE COUNTY. DESIGN SHALL BE SUBMITTED TO TPWD AS PART OF SHOP SUBMITTAL PROCESS FOR REVIEW AND COMMENT PRIOR TO SUBMITTING TO THE COUNTY DR.
- 5. REFER TO MEP PLANS FOR THE EXACT LOCATION OF UTILITY BUILDING ENTRANCE
- 6. SANITARY SEWER LINE SHALL BE LAID WITH A MINIMUM SLOPE OF ONE PERCENT
- 7. CLEANOUTS SHALL BE PROVIDED ALONG SANITARY SEWER EVERY 100 FEET, AND AT CHANGES IN DIRECTION GREATER THAN 45 DEGREES, OR COMBINATION THEREOF. CLEANOUTS SHALL NOT BE LOCATED WITHIN SIDEWALKS OR PAVING.
- 8. WATER AND SANITARY SEWER BUILDING SERVICE CONNECTIONS SHALL BE CAPPED/PLUGGED UNTIL THEY ARE CONNECTED TO THE BUILDING PLUMBING
- 9. REFER TO SHEET MEP1.00 FOR UNDERGROUND ELECTRICAL COORDINATION.
- 10. CONTRACTOR SHALL COORDINATE ALL UTILITY LINES IN FIELD TO AVOID ROOTS

48 PERSONS X 75 GAL/PERSON/DAY = 3,600 GAL/DAY (AVERAGE FLOW RATE OF 75 GPD/PERSON BASED ON HOTELS/MOTELS PER BED)

FOR Q GREATER THAN 1,500 GAL/DAY - V = 1,750+0.75Q

REQUIRED SUBSURFACE ABSORPTION AREA (PREFERRED GRAVITY FED SYSTEM) ASSUME TYPE III SOILS -R = 0.20ABSORPTIVE AREA (A) = Q/R

THEREFORE A = 18,000 SF







SHEET TITLE

UTILITY PLAN

SHEET NUMBER C4.01

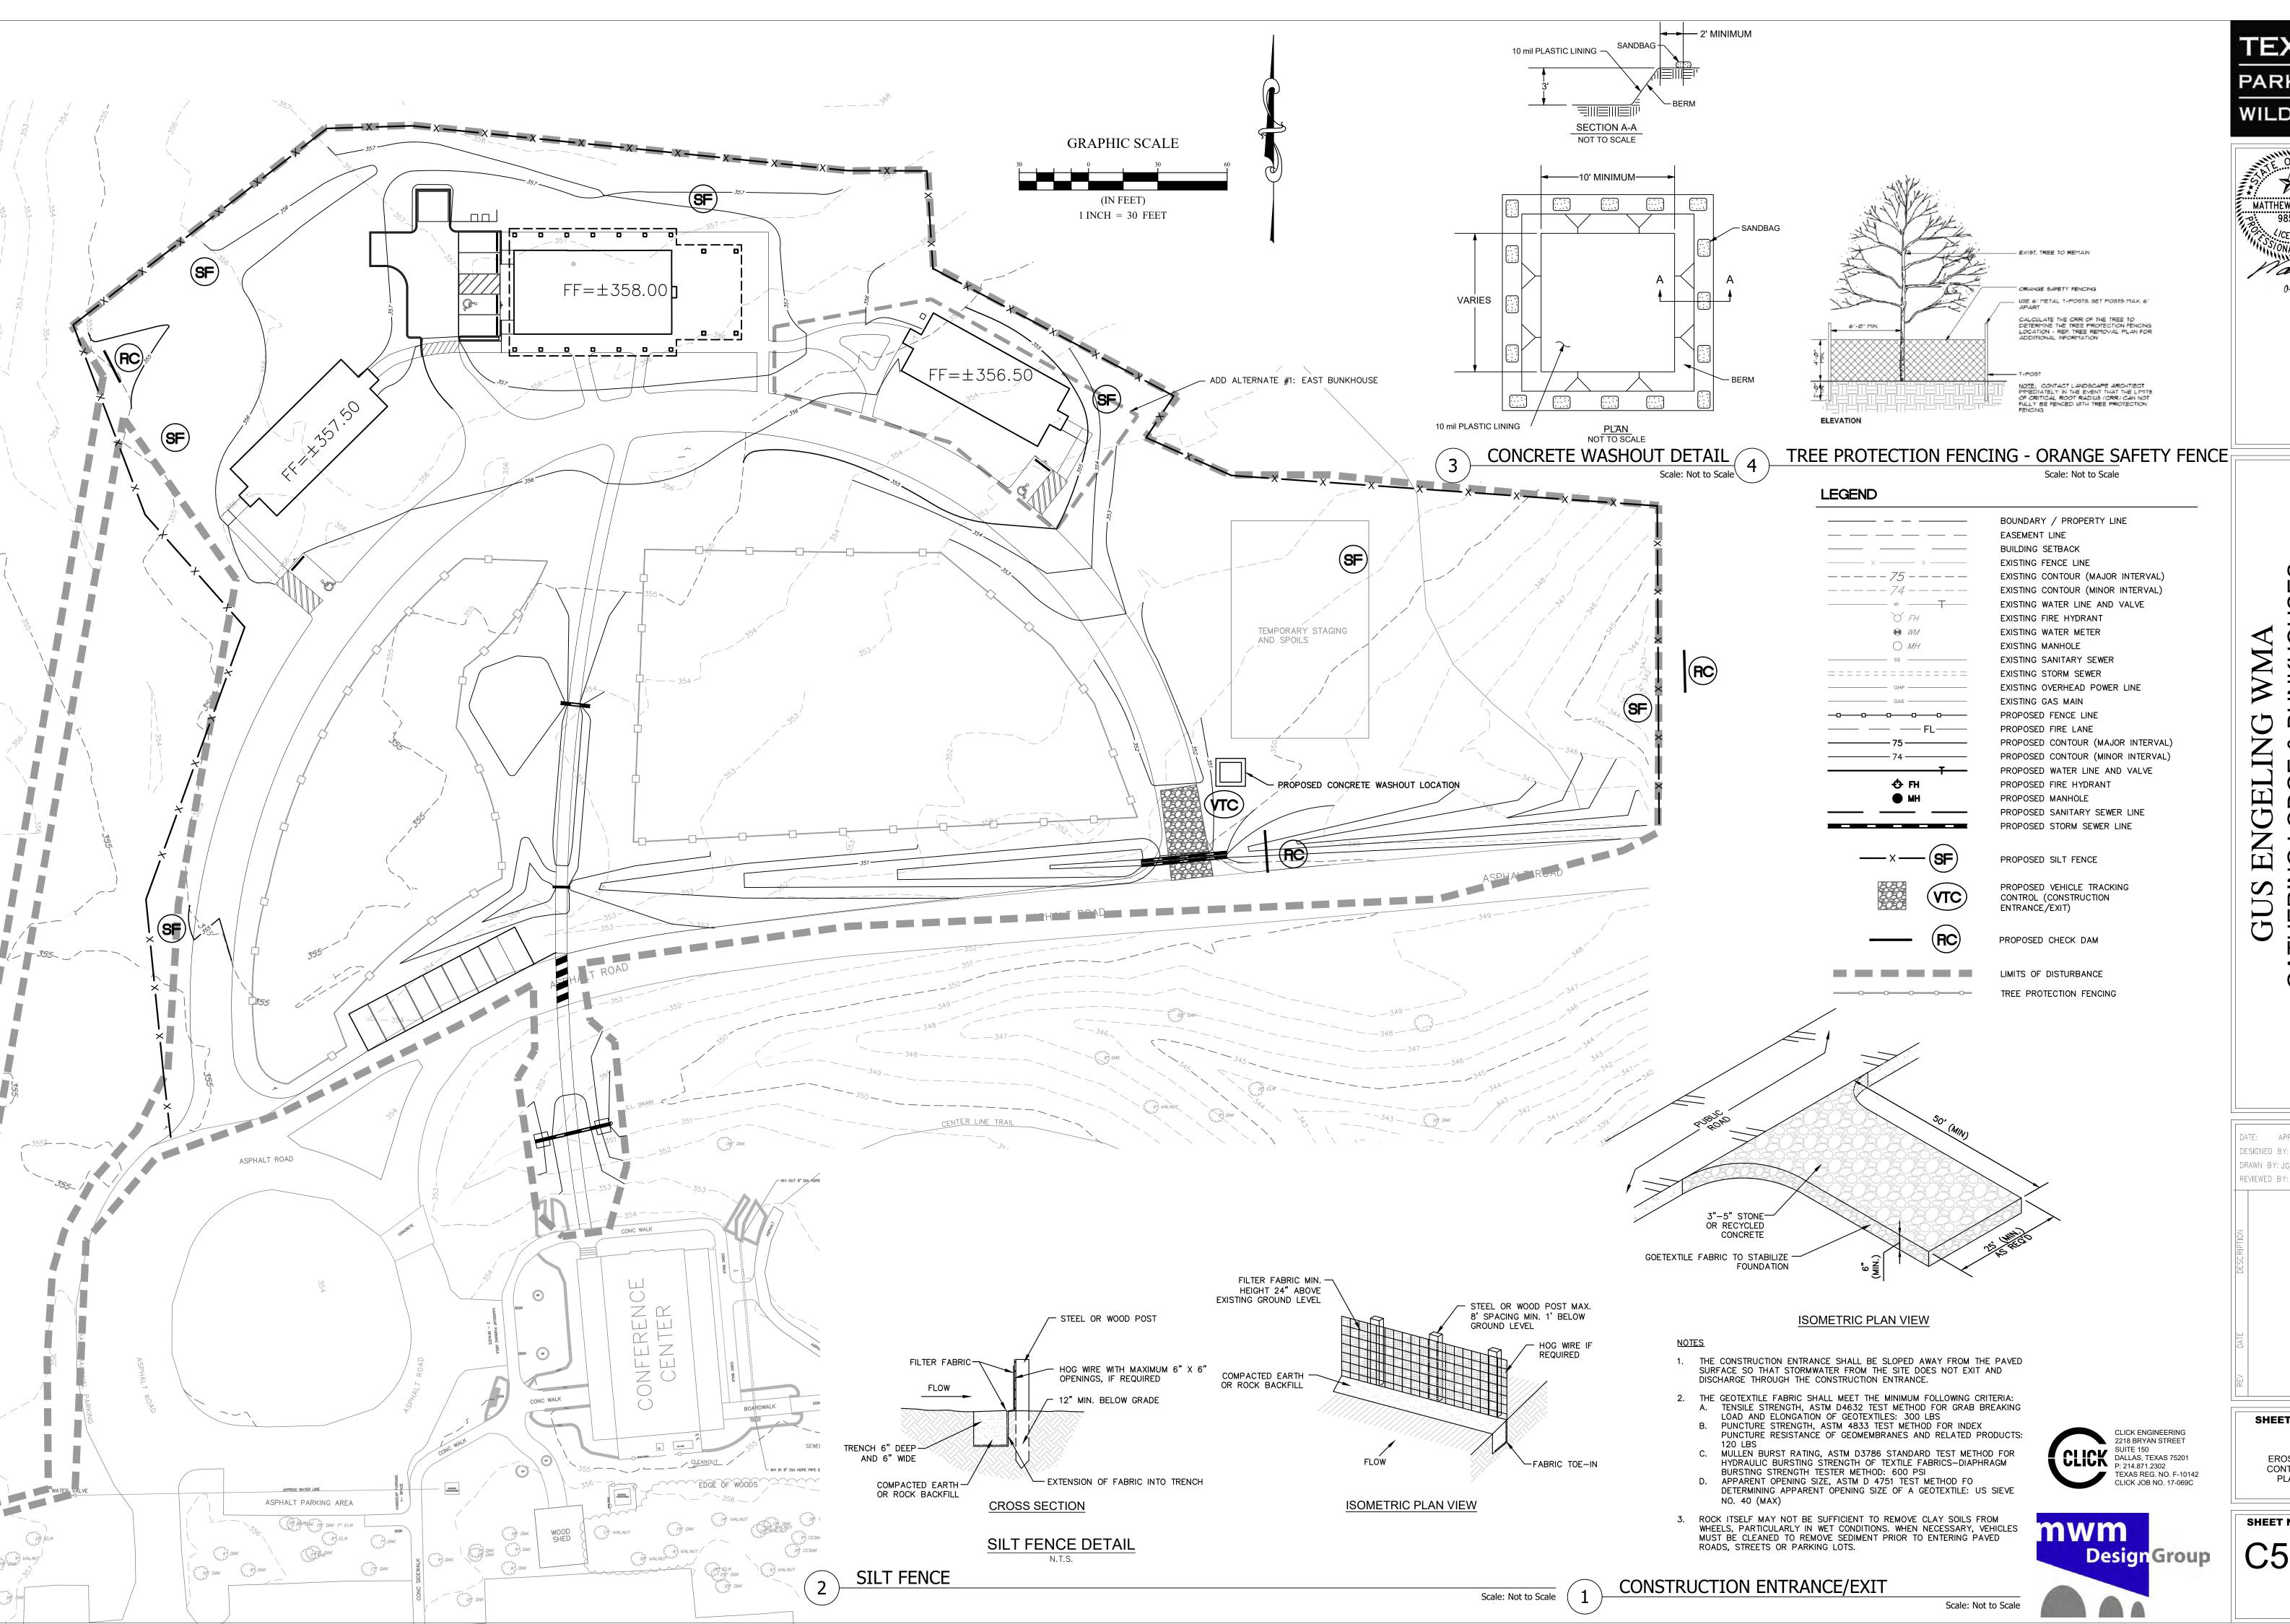

TEXAS PARKS & WILDLIFE

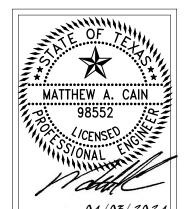

BUNKHOUS 5

DATE: APRIL 3,2024 DESIGNED BY: MAC DRAWN BY: JG REVIEWED BY: MAC

SHEET TITLE

EROSION CONTROL

LION

SHEET NUMBER

DATE: APRIL 3,2024 DESIGNED BY: MAC DRAWN BY: JG REVIEWED BY: MAC

C


SHEET TITLE

UMENT

LION

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SHEET NUMBER




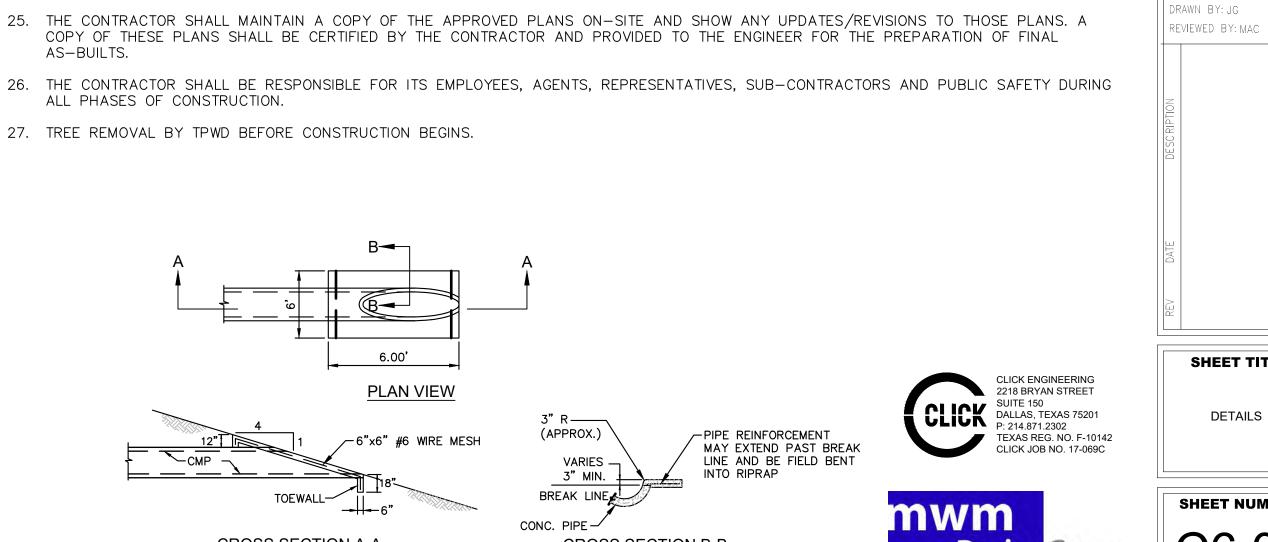

CROSS SECTION A-A CROSS SECTION B-B CONCRETE SLOPED END SECTION

6.00'

PLAN VIEW

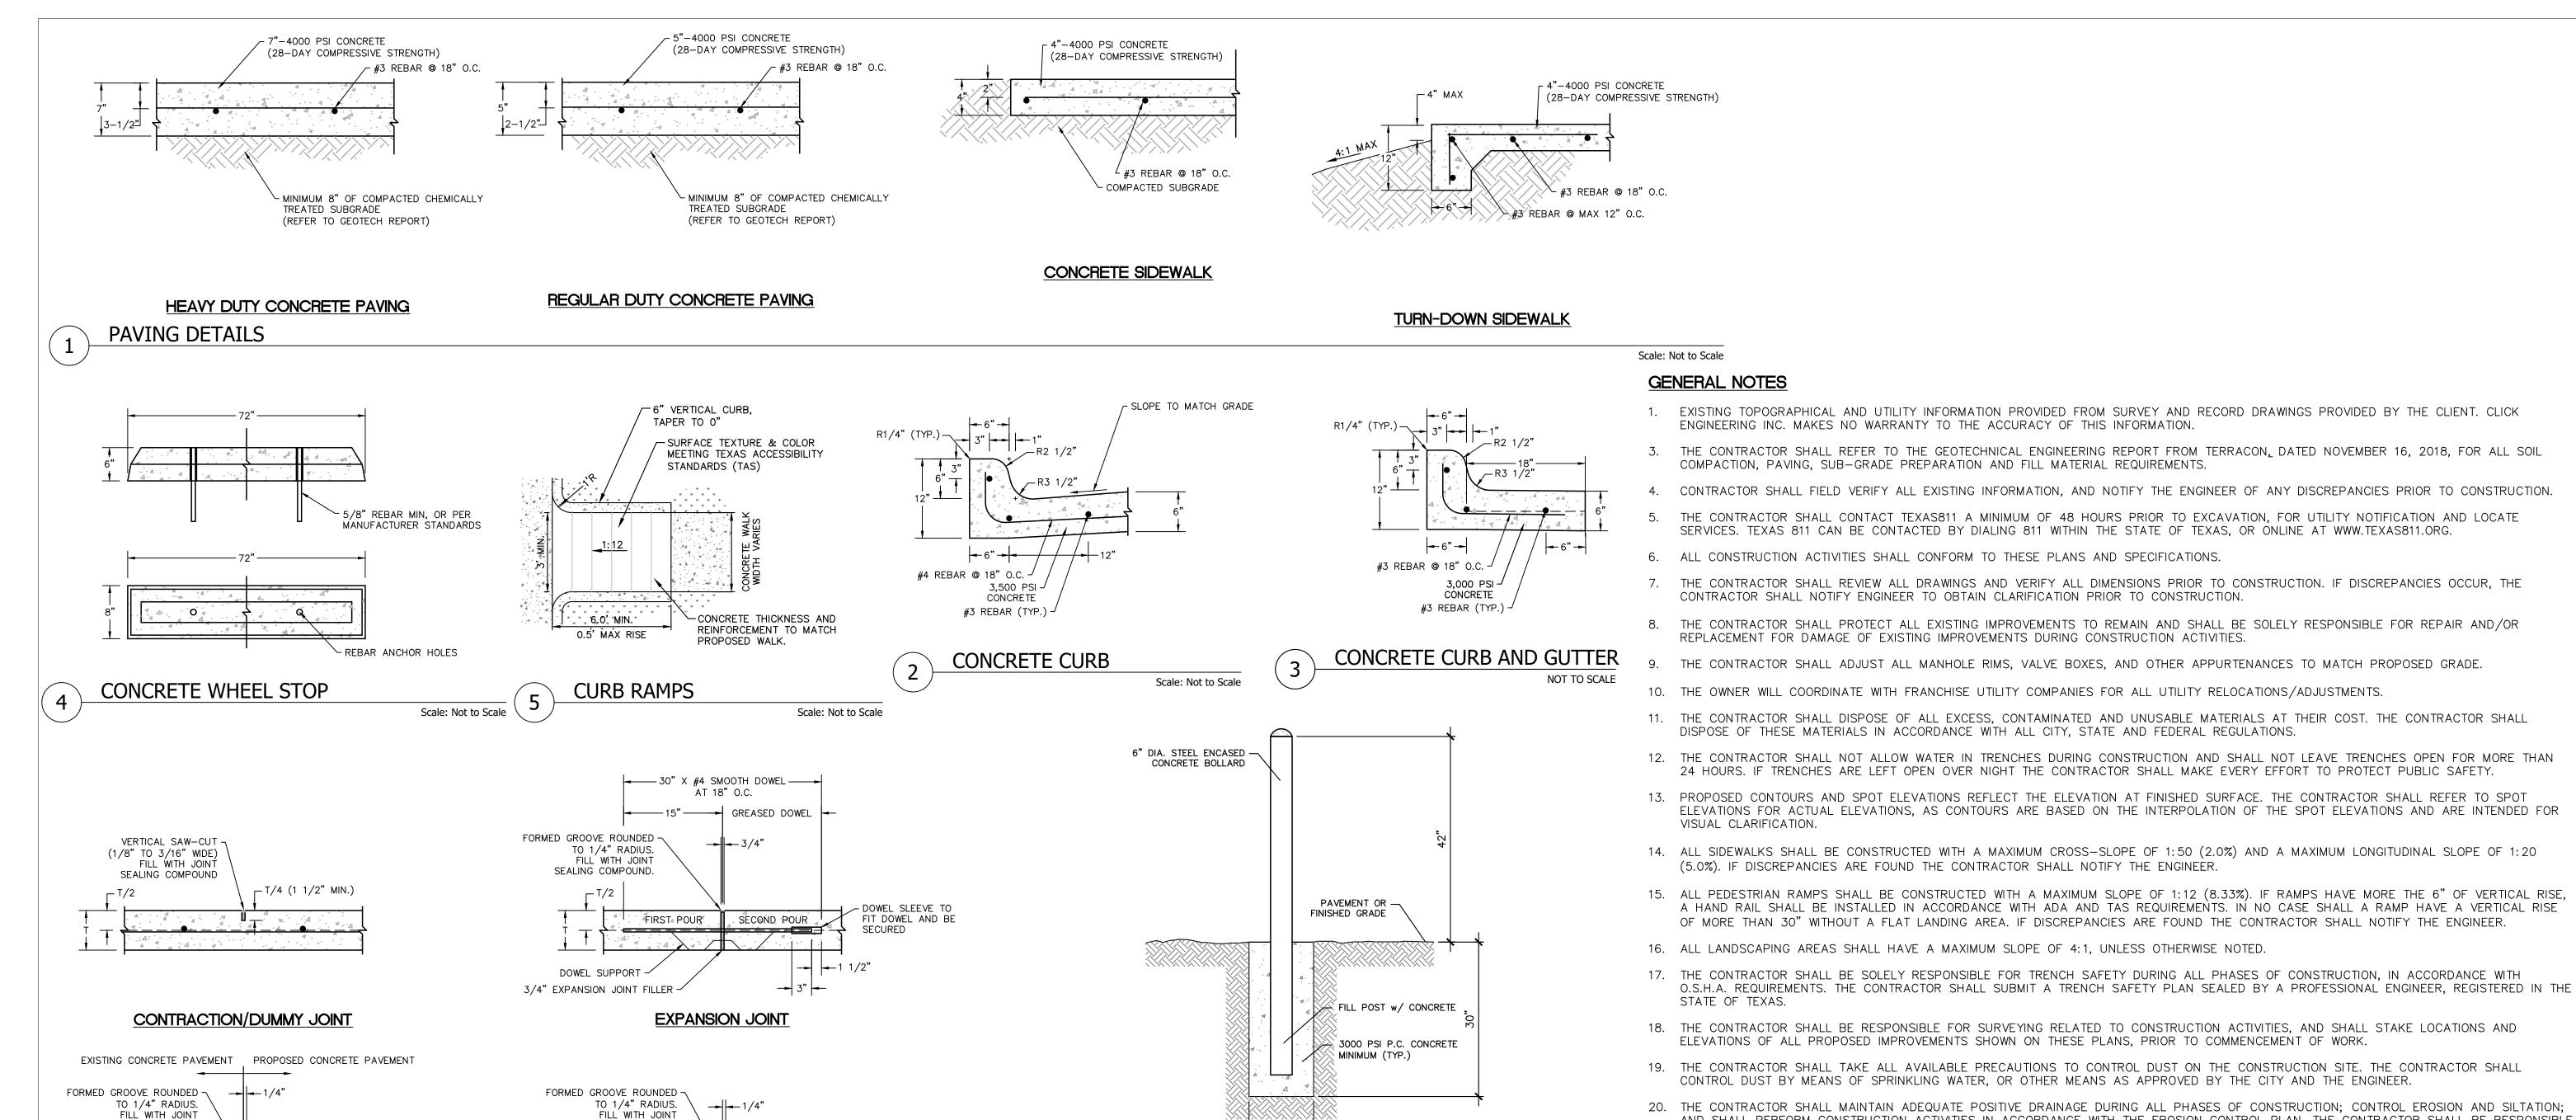

SEALING COMPOUND.

1/2" EXPANSION -JOINT FILLER

SECTION B-B

EXPANSION JOINTS 25' O.C. MAX.

DOWEL WITH #4 BARS AT 18" C-C WHEN CONNECTING TO EXISTING SIDEWALKS, DRIVEWAYS,

. INSTALL 1/2" Ø X 18" SMOOTH DOWELS @ 18" (GREASE ONE END) THROUGH EXPANSION JOINTS. . TOOLED CONTRACTION JOING JOINTS SHALL BE AT INTERVALS MATCHING THE SIDEWALK WIDTH.

FIRST POUR

— T/4 (1 1/2" MIN.)

SECOND POUR

- LAP BARS 40 DIA.

AND TIE.

COMPOUND

#4 ø X 18" @ 18"

<u>SECTION C—C</u> N.T.S

SMOOOTH DOWEL (GREASE ONE END)

CONSTRUCTION JOINT

SEALING COMPOUND.

DRILL AND EPOXY

- T/4 (1 1/2" MIN.)

SAWED CONSTRUCTION/BUTT JOINT

CONCRETE PAVEMENT JOINTS

SIDEWALK PAVEMENT JOINTS


30" X #3 REBAR @ 18" O.C.

CENTERED ON JOINT

1/2" RAD. TYP.

EXPANSION JOINT (TYP.)

. REINFORCEMENT TO BE #3 BARS AT 18" C-C

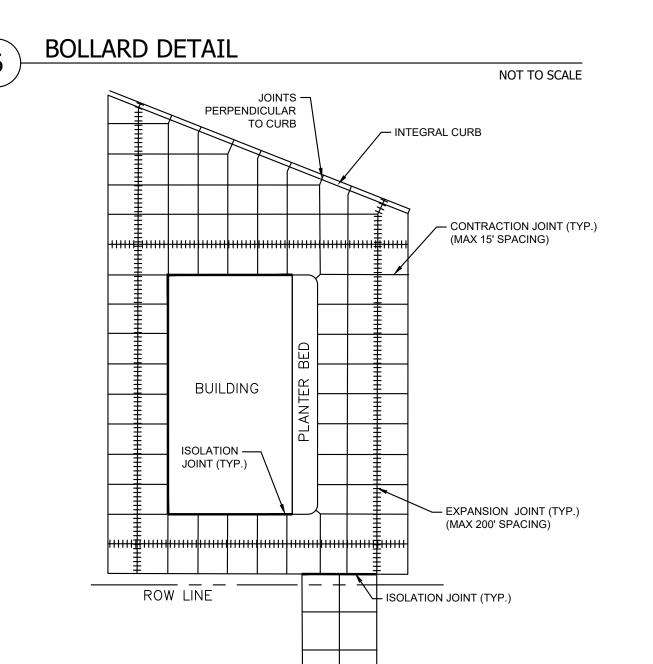

BOLLARD SHALL BE HOT DIPPED GALVANIZED

10" MIN.

TYPICAL CONCRETE JOINT PLAN

Scale: Not to Scale

Scale: Not to Scale

Scale: Not to Scale

Scale: Not to Scale

-PIPE REINFORCEMENT

INTO RIPRAP

MAY EXTEND PAST BREAK

LINE AND BE FIELD BENT

AND SHALL PERFORM CONSTRUCTION ACTIVITIES IN ACCORDANCE WITH THE EROSION CONTROL PLAN. THE CONTRACTOR SHALL BE RESPONSIBLE

21. ALL SIGNS, PAVEMENT MARKINGS AND OTHER TRAFFIC CONTROL DEVICES SHALL CONFORM TO THE "MANUAL FOR UNIFORM TRAFFIC CONTROL

24. ALL MATERIALS TESTING RESULTS MUST CONFORM TO THE SPECIFICATIONS/RECOMMENDATIONS DESCRIBED IN THE PLANS, AND GEOTECHNICAL

COPY OF THESE PLANS SHALL BE CERTIFIED BY THE CONTRACTOR AND PROVIDED TO THE ENGINEER FOR THE PREPARATION OF FINAL

3" R— (APPROX.)

CONC. PIPE

VARIES -

3" MIN. BREAK LINE

REPORT. IF THE MATERIALS TESTING RESULTS DO NOT CONFORM TO THE SPECIFICATIONS/ RECOMMENDATIONS, THE MATERIALS MUST BE

22. THE CONTRACTOR SHALL SUBMIT A PAVEMENT JOINT LAYOUT PLAN TO THE ENGINEER, FOR APPROVAL, PRIOR TO PAVING CONSTRUCTION

23. THE CONTRACTOR SHALL PLACE ALL CONDUIT SLEEVES, INCLUDING ELECTRICAL AND IRRIGATION, UNDER PAVING PRIOR TO PAVING

FOR MEETING ALL FEDERAL, STATE AND LOCAL REGULATIONS FOR EROSION CONTROL AND PROTECTION.

ACTIVITIES. ALL PAVING JOINTS SHALL EXTEND THROUGH THE CURB.

REMOVED AND REPLACED AT THE CONTRACTORS EXPENSE.

27. TREE REMOVAL BY TPWD BEFORE CONSTRUCTION BEGINS.


CONSTRUCTION ACTIVITIES.

ALL PHASES OF CONSTRUCTION.

CMP

AS-BUILTS.



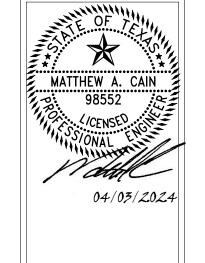

S UNKHOU WM

ENGELIN

GUS

C

CAST IRON, PVC, OR HDPE CLEANOUT

NOT TO SCALE

CLICK ENGINEERING 2218 BRYAN STREET

TEXAS REG. NO. F-10142

CLICK JOB NO. 17-069C

Design Group

SUITE 150
DALLAS, TEXAS 75201
P: 214.871.2302

CONCRETE RING

└6"X4" REDUCER

— 4"ø PVC/HDPE PIPE

- 45° BEND

Scale: Not to Scale

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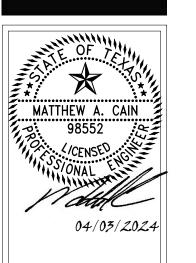
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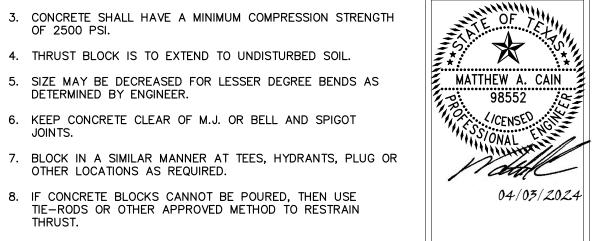
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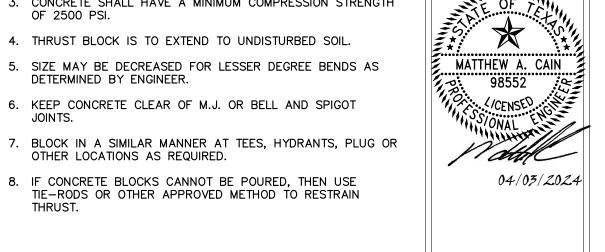
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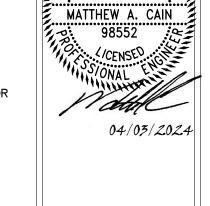
DETAILS


SHEET NUMBER C6.02









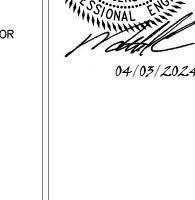

CONSTRUCTION KEY NOTES: A. LENGTH "Y & W" AS REQUIRED TO OBTAIN BEARING AREA AGAINST UNDISTURBED SOIL. B. ADDITIONAL EXCAVATION IF NECESSARY TO OBTAIN

SHALL BE INCREASED ACCORDINGLY.

OF 2500 PSI.

DETERMINED BY ENGINEER.

OTHER LOCATIONS AS REQUIRED.

2. AREAS FOR PIPE LARGER THAN 18" SHALL BE CALCULATED.

4. THRUST BLOCK IS TO EXTEND TO UNDISTURBED SOIL.

6. KEEP CONCRETE CLEAR OF M.J. OR BELL AND SPIGOT

8. IF CONCRETE BLOCKS CANNOT BE POURED, THEN USE

TIE-RODS OR OTHER APPROVED METHOD TO RESTRAIN

REQUIRED BEARING AREA. C. MINIMUM THRUST BLOCK AREA REQUIREMENTS FOR (Y &

W) AS FOLLOWS:

FINISHED GRADE

SEWER CLEANOUT

TOTAL AREA EQUALS

AREA REQUIRED FOR

	PIPE SIZE	WATER PIPE			
		TEE, DEAD END 90° BEND	45° AND 22 1/2° BENDS		
	4" & 1FSS	3 SO FEET	3 SO FEET		

PIPE	WATER PIPE				
SIZE	TEE, DEAD END 90° BEND	45° AND 22 1/2° BENDS			
4" & LESS	3 SQ. FEET	3 SQ. FEET			
6"	4 SQ. FEET	3 SQ. FEET			
8"	6 SQ. FEET	3 SQ. FEET			
10"	9 SQ. FEET	5 SQ. FEET			
12"	13 SQ. FEET	7 SQ. FEET			
16"	23 SQ. FEET	12 SQ. FEET			
18"	29 SQ. FEET	15 SQ. FEET			

BENDS THRUST BLOCK DETAILS

CROSSES

- 1/2 AREA REQUIRED FOR

TEES

AREA FOR TE

DÍAMETER

SECTION "A-A"

12." MIN.	BACKFILL — COMPACTED TO A MIN. OF 95% PROCTOR DENSITY
DETECTION TAPE	INITIAL BACKFILL – GRANULAR MATERIAL COMPACTED TO A MIN. OF 90% PROCTOR DENSITY
	COMPACTED CRUSHED STONE, STD. GRADATION
EARTH 3" MIN. ROCK 6" MIN.	X/X/X/X/X/X/X/X/X/,

SANITARY SEWER TRENCH AND EMBEDMENT

CARRIER PIPE -

STEEL CASING -

-BACKFILL - COMPACTED TO

- INSTALL DETECTABLE MARKING TAPE

Scale: Not to Scale

-NATURAL GROUND OR ROCK

NOT TO SCALE

1' FROM

BELL END

CROSS SECTION

ONE SPACER PLACED AT

EACH END OF CASING

_SEAL WITH APPROVED

NON-SHRINK GROUT

A MIN. OF 95% PROCTOR

- COMPACTED CRUSHED

STONE, STD. GRADATION

DENSITY

OUTSIDE DIAMETER OF PIPE PLUS 16" MINIMUM TRENCH WIDTH 24"

-FINAL BACKFILL -

ČFÍNÁL BACKFÍLL

OUTSIDE DIAMETER OF

PIPE PLUS 16" MINIMUM WIDTH 24"

WATER LINE EMBEDMENT

MANHOLE RING AND COVER DETAIL

ASSEMBLY PLAN VIEW

WATER VALVE DETAIL

VALVE BOX WITH -

BY BRASS & HAYS

OR EQUIVALENT

NECESSARY **EXTENSIONS**

COVER BY BRASS & HAYS OR EQUIVALENT

— SEE NOTE #2

-FINISH GRADE

CONCRETE PAD 24" SQUARE SHALL BE

1. RESILIENT SEAT VALVES SHALL BE

2. A PERMANENTLY ATTACHED VALVE

STANDARDS.

OF VALVE BOX LID.

INSTALLED IN ACCORDANCE WITH AWWA

EXTENSION STEM SHALL BE REQUIRED FOR

THE TOP OF VALVE BOX. THIS EXTENSION

ANY VALVE THATS OPERATING NUT IS LOCATED IN EXCESS OF 4 FEET BELOW

SHALL BE OF SUFFICIENT LENGTH TO

3. DUCTILE IRON OR C-900 PVC PIPE SHALL

BE USED FOR VALVE STACKS WITH

4. CUT A "V" SHAPED SYMBOL ON THE

ADJUSTABLE VALVE BOXES.

THE VALVE LOCATION.

INSURE THAT ITS TOP IS WITHIN 4 FEET

NEAREST CURB FACE WITH THE POINT OF

Scale: Not to Scale

1. MANHOLE LID SHALL BE SOLID AND PROVIDED

2. 24" HEAVY DUTY MANHOLE FRAME AND COVER IS TO BE AS MANUFACTURED BY THE NEENAH

FOUNDARY CO. TYPE R-1687 OR EQUAL. THE

MANUFACTURE'S STANDARD LETTERING SHOWING

Scale: Not to Scale

TOTAL WEIGHT OF THE MANHOLE AND RING

3. THE HORIZONTAL BEARING SURFACES ARE TO

SHALL BE APPROXIMATELY 410 LBS.

4. THE SOLID LID WILL BE PROVIDED WITH

WITH PICK SLOTS ONLY.

BE MACHINE FINISHED.

"SANITARY SEWER".

THE "V" SYMBOL POINTING TOWARDS

POURED AROUND ALL VALVE BOXES NOT PLACED WITHIN CONCRETE

PAVEMENT. 3000 P.S.I. CONCRETE.

SOLID BRASS 3" SHUTOFF


-CONCRETE BASE BLOCK

MIN. WIDTH: NORMAL

(POURED) LENGTH: 2'-0"

LID SECTION VIEW

VALVE BY MUELLER OR

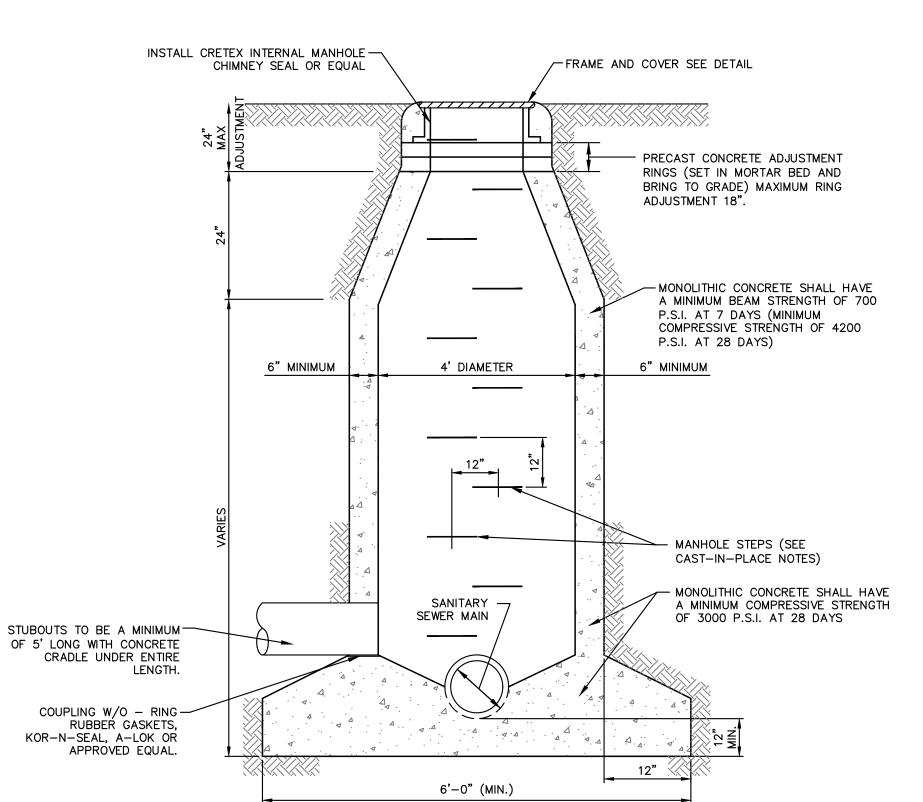

1. CONCRETE SHALL BE A MONOLITHIC POUR.

2. MANHOLE STEPS SHALL BE COPOLYMER POLYPROPYLENE PLASTIC COATED, GRADE 60, STEEL REINFORCED STEP MODEL PS2-PF AS MANUFACTURED BY M.A. INDUSTRIES INC. OF PEACHTREE CITY, GEORGIA

MANHOLE DETAIL

OR EQUAL.

CASING SCHEDULE 2,000 PSI NON-SHRINK-MIN. CASING WALL CONCRETE GROUT CASING THICKNESS (IN.) _STEEL CASING 0.200 14" 0.375 - CASING SPACER 16" 0.375 18**"** 0.375 1. SPACERS SHALL BE RACI HIGH DENSITY POLYETHYLENE AS —UNDISTURBED EARTH MANUFACTURED BY RECON PIPE CORP., OR APPROVED EQUAL. CARRIER PIPE

- SPACERS

6' SPACING

TYPICAL

2. MAINTAIN 10' SPACING (TYPICAL) BETWEEN SPACERS.

SEE THE PLAN/PROFILE FOR BEGINNING AND ENDING STATIONS.

4. PRESSURE 2,000 PSI CONCRETE GROUT BETWEEN CASING AND SURROUNDING EARTH.

STEEL PIPE ENCASEMENT DETAIL


CARRIER PIPE

12"

mwm

NOT TO SCALE

Scale: Not to Scale

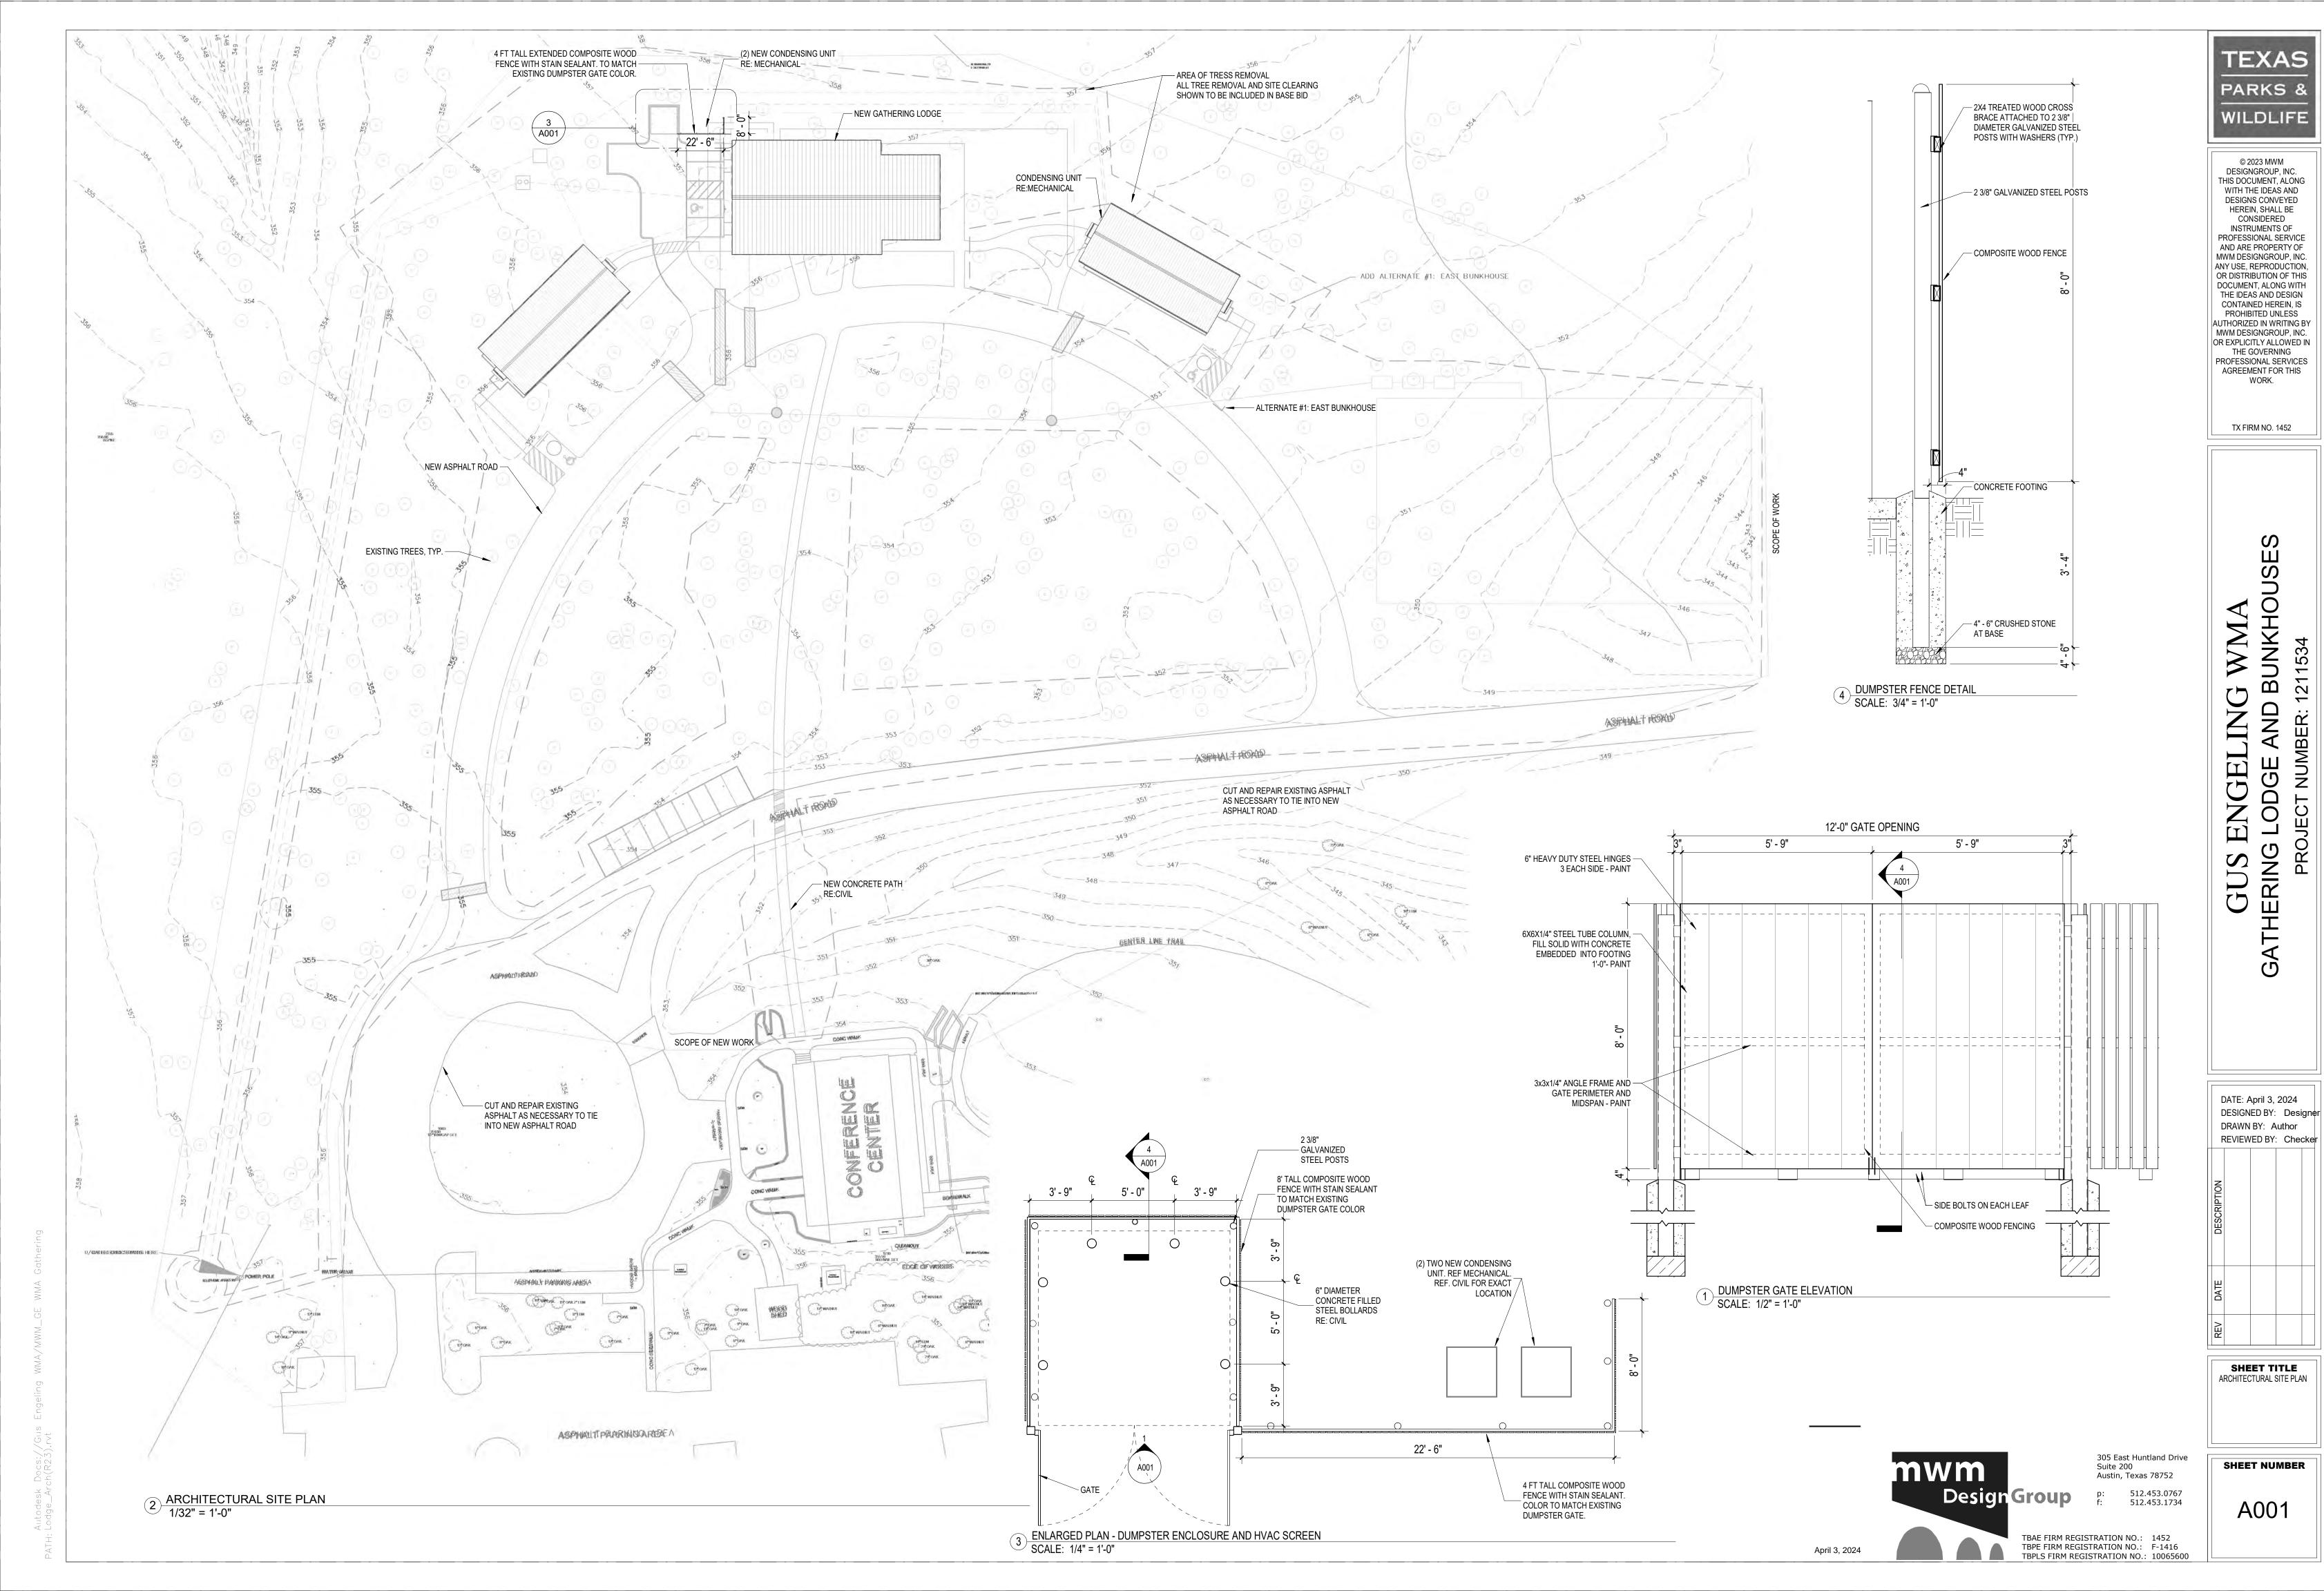

00% CONSTRUCTION DOCUMENTS

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TEXAS

PARKS 8

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TX FIRM NO. 1452

ENGELING 3 LODGE AND BI

DATE: April 3, 2024 DESIGNED BY: MW DRAWN BY: EB REVIEWED BY: OH

SHEET TITLE FLOOR PLAN - GATHERING

SHEET NUMBER

TBAE FIRM REGISTRATION NO.: 1452 TBPE FIRM REGISTRATION NO.: F-1416

A101

THE ARCHITECT.

MOUNTED EQUIPMENT.

F. ALL INTERIOR WALLS TO BE J3 UNO.

SEALED CONCRETE FLOORS.

FLOOR PLAN NOTES

ABBREVIATIONS.

OTHERWISE, TYP.

MOUNTED EQUIPMENT.

1 STANDING SEAM METAL ROOF, TYP. 2 PREFINISHED MTL DOWNSPOUT

4 PREFINISHED MTL GUTTER 5 WOOD BEAM STAIN, ST-1

7 CASED OPENING

16 MOP SINK

23 1X4 TRIM

17 STAIN CEDAR POST

20 THROUGH WALL FLASHING

22 WOOD COLUMN STAIN (ST-1)

24 MOUNTED AT 12' AFF, TYP

26 BUILT-IN TWIN XL BED RE:1/A402

27 BUILT-IN CLOSET RE:10/A402

28 BUILT-IN DESK RE: 4/A402

29 46" CEILING FAN

8 ADA COMPLIANT SINK

OTHERWISE.

E. CONTRACTOR IS NOT TO SCALE DRAWINGS.

ARTICLE 9102-ARCHITECTURAL BARRIERS ACT - TAS 2012 (TEXAS

B. DIMENSIONS NOTED "CLEAR" OR "CLR" MUST BE ACCURATELY MAINTAINED. ALLOW FOR THICKNESS OF ALL WALL FINISHES. THE MEASUREMENTS SHALL

NOT VERY MORE THAN 1/8" WITHOUT WRITTEN CONSENT FORM THE

"TYPICAL" OR "TYP" MEANS IDENTICAL FOR ALL SIMILAR CONDITIONS. U.N.O.

"VERIFY" OR "VER" MEANS TO ASCERTAIN AND CONFIRM APPLICATION WITH

CONTRACTOR SHALL PROVIDE HARD TROWELED CONCRETE FINISH FOR ALL

C. "ALIGN" MEANS TO ACCURATELY LOCATE FINISHES IN THE SAME PLANE.

D. PROVIDE BLOCKING PER MANUFACTURER REQUIREMENTS FOR ALL WALL

A. REFER TO G001 SERIES SHEETS FOR ADDITIONAL NOTES AND

WATERPROOFING MEMBRANE OR APPROVED EQUAL.

DESIGNATION TAG INFORMATION.

B. CONTROL JOINTS (CJ) TO BE ALIGNED WITH CENTER OF EXTERIOR COLUMN

C. ALL NEW WALLS SCHEDULED TO RECEIVE CERAMIC TILE SHALL BE FINISHED WITH 5/8" CEMENT BACKER BOARD PROTECTED WITH SCHLUTER

WHERE PAINT WORK OCCURS AT WET SPACES, CONTRACTOR IS

CONTRACTOR IS RESPONSIBLE FOR INSTALLING BLOCKING WHERE REQUIRED TO MOUNT TELEVISIONS, BOARDS, AND ACCESSORIES.

DOOR LOCATIONS TO BE 6" OFF ADJACENT WALL UNLESS NOTED

H. ALL DIMENSIONS FROM FINISHED FACE OF WALL UNLESS NOTED

K. FOR ALL FLOOR DRAIN LOCATIONS REFER TO PLUMBING DRAWINGS.

KEYNOTES

3 FIBER CEMENT FACIA W/SEMI-TRANSPARENT STAIN TO MATCH TRIM

STANDING SEAM METAL ROOF CANOPY OVER EXTERIOR DOOR,

11 IRONSTONE HEARTH COURSING TO MATCH EXISTING CONFERENCE

9 SINK W/ COMPACT GARBAGE DISPOSAL. REF. PLUMBING

10 RUMFORD R4848 BACK TO BACK FIREPLACE

18 HARDIE TRIM TYP AT EA ELEVATION CORNER 19 TRIM, PAINTED TO MATCH HARDIE SIDING

25 STEEL COLUMN WITH CEDAR CLADDING, STAINED ST-1

21 1X6 STAINED T&G CEDAR SLATS, ST-2

12 4X8 MOUNTED PLYWOOD BOARD 13 (3) 36" WIRE SHELVING UNITS, 60"H, 15"D. 14 36" WIRE SHELVING UNITS, 60"H, 14"D.

15 WATER HEATR, REF, PLUMBING

THE CONTRACTOR SHALL NOT SCALE THE DRAWINGS.

REFER TO SHEET G0.01 FOR SYMBOL LEGENDS & DESCRIPTIONS, AND PLAN

RESPONSIBLE FOR PROTECTING MISC. FIXTURES, INCLUDING BUT NOT LIMITED TO: PAPER TOWEL DISPENSER, HAND DRYER, SOAP DISPENSERS.

PROVIDE BLOCKING PER MANUFACTURER REQUIREMENTS FOR ALL WALL

ACCESSIBILITY STANDARDS) AND I.E.C.C.

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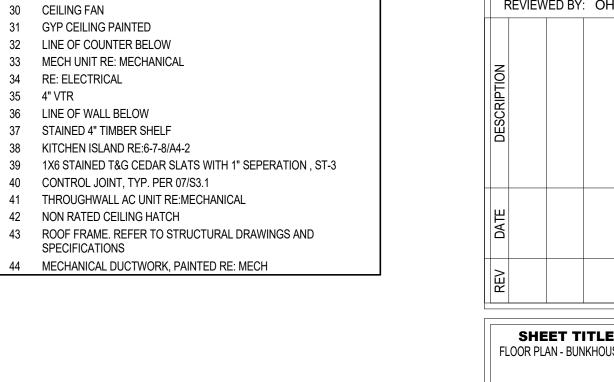
SHEET TITLE FLOOR PLAN - BUNKHOUSES


SHEET NUMBER

A102

TBAE FIRM REGISTRATION NO.: 1452 TBPE FIRM REGISTRATION NO.: F-1416





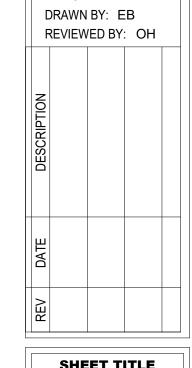


512.453.1734

512.453.0767

305 East Huntland Drive Suite 200 Austin, Texas 78752



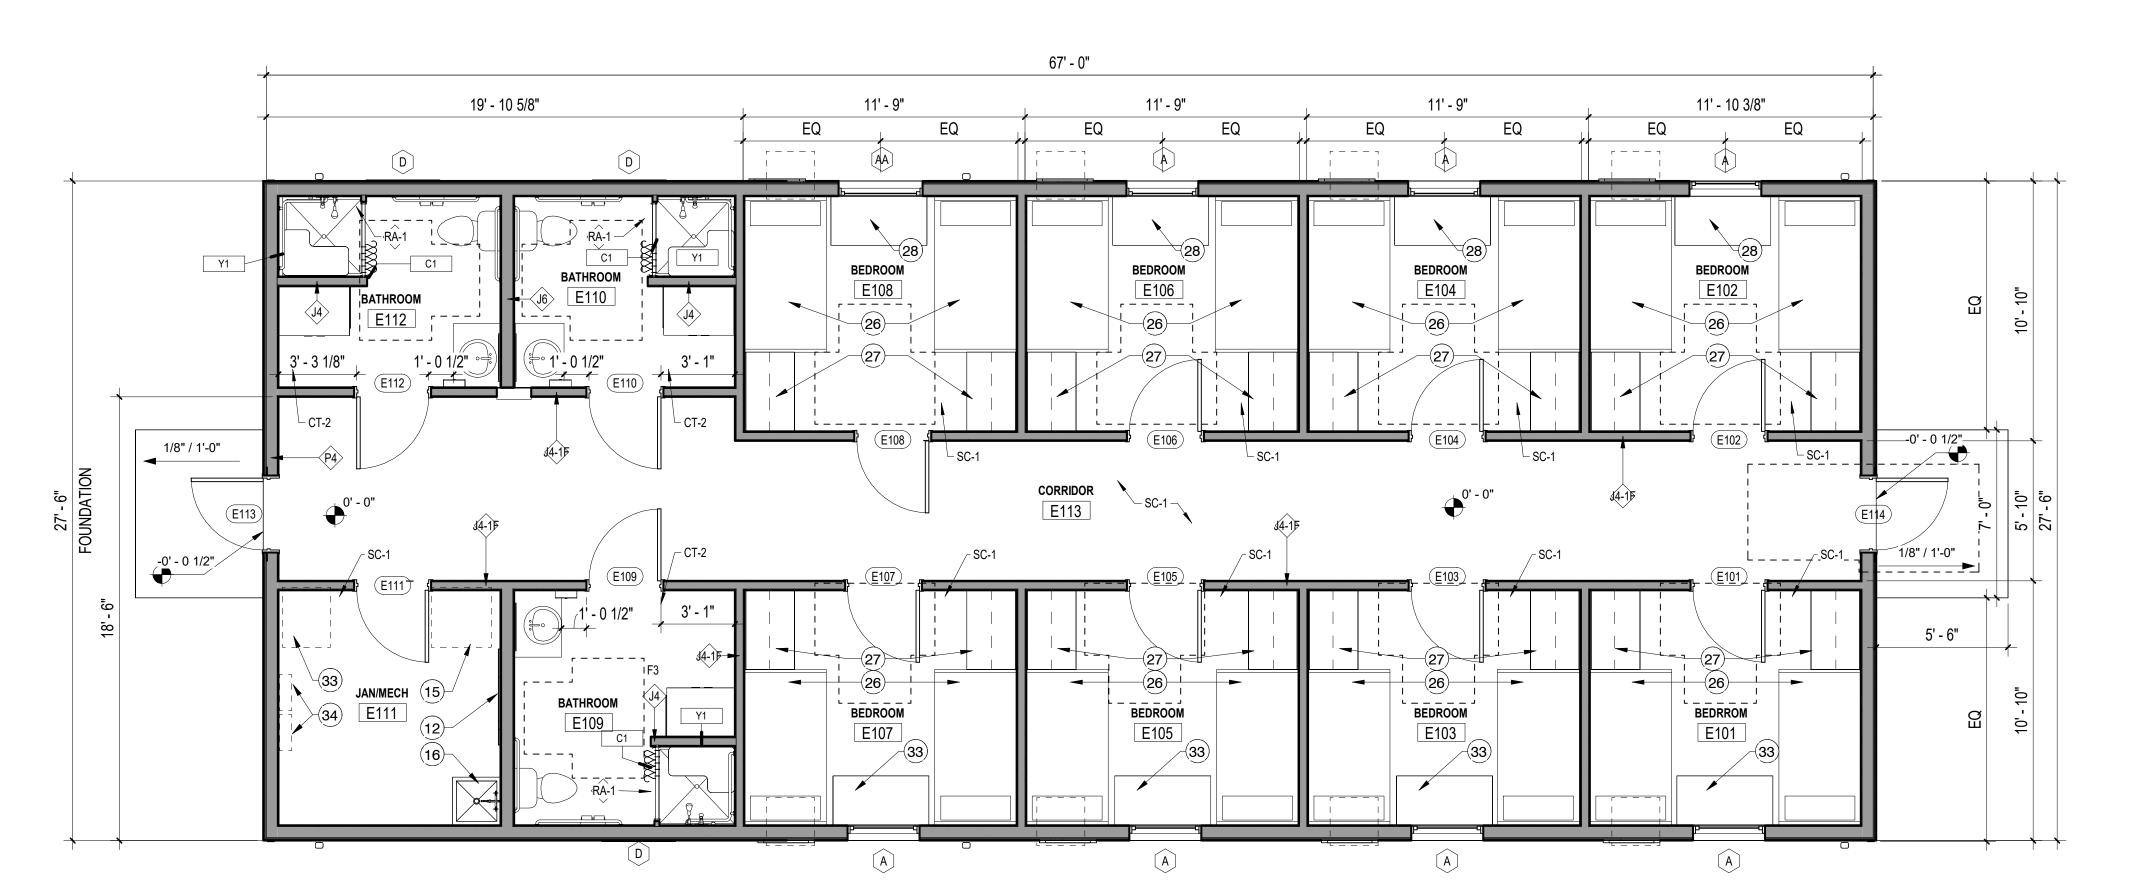

2 FLOOR PLAN - BUNKHOUSE EAST (ADD ALTERNATE)
SCALE: 1/4" = 1'-0"

11' - 10 3/8" 11' - 9" 11' - 9" 11' - 9" EQ EQ A202 _____ ______ · - - - - - - - - - - |- - - - - - \-A31+ 🗲 √ A311 -/ _ADA UNIT BEDROOM BEDROOM\5 BEDROOM **BATHROOM BATHROOM** W106 5' - 4" [∟] CT-2 -----CORRIDOR F - - - - - - - -**BATHROOM BEDRROM BEDROOM** BEDROOM BEDROOM W105 $-\left(\frac{2}{A111}\right)$ EQ 11' - 9" 9' - 7 1/4" 11' - 10 3/8" 11' - 9" 11' - 9" 10' - 3 3/8" 67' - 0"

1 FLOOR PLAN - BUNKHOUSE WEST SCALE: 1/4" = 1'-0"

_1' - 5 1/2"___

RESTROOM

M1 S1

18" MIN

9' - 3"

1 GATHERING ENLARGED RESTROOM PLAN SCALE: 1/2" = 1'-0"

2' - 11 1/4"

RESTROOM

104

7' - 9"

S1 U.C.

G36

2 BUNKHOUSE LARGE BATHROOM W109 SCALE: 1/2" = 1'-0"

512.453.0767 512.453.1734

305 East Huntland Drive Suite 200 Austin, Texas 78752

SHEET NUMBER

TBAE FIRM REGISTRATION NO.: 1452
TBPE FIRM REGISTRATION NO.: F-1416
TBPLS FIRM REGISTRATION NO.: 10065600

A111

SHEET TITLE ENLARGED FLOOR PLANS

DRAWN BY: EB REVIEWED BY: OH

DATE: April 3, 2024 DESIGNED BY: MW

GUS ENGELING WMA
THERING LODGE AND BUNKHOUSE PROJECT NUMBER:

TEXAS

PARKS 8

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TX FIRM NO. 1452

3 PLAN DETAIL AT FIREPLACE - GATHERING LODGE SCALE: 1/2" = 1'-0"

2' - 6"

5' - 0" 9' - 4"

S1 M1 11 A402 BATHROOM — STORAGE RE: 1/A402 & 2/A402 W109 <u>J6</u> G42 CLR DIM G24/36 G36 SHOWER STALL RE:
PLUMBING SCHEDULE 9' - 7 1/4"

PROVIDE SMOOTH STONE – EDGE AT TRIM WITH CONTINUOUS SEALANT, TYP.

2 A312

FLUID APPLIED

MEMBRANE AIR BARRIER

OVER BRICK AND CMU

2' - 2"

- BRICK GROUT SOLID

— FIRE BRICK W/HEATSTOP II REFRACTORY MORTAR

- 8" CMU REF. STRUCTURE

ROOF PLAN NOTES

CONTRACTOR SHALL COORDINATE ROOF PENETRATIONS IN BETWEEN STANDING SEAM RIBS.

KEYNOTES

3 FIBER CEMENT FACIA W/SEMI-TRANSPARENT STAIN TO MATCH TRIM

6 STANDING SEAM METAL ROOF CANOPY OVER EXTERIOR DOOR,

11 IRONSTONE HEARTH COURSING TO MATCH EXISTING CONFERENCE

9 SINK W/ COMPACT GARBAGE DISPOSAL. REF. PLUMBING

10 RUMFORD R4848 BACK TO BACK FIREPLACE

18 HARDIE TRIM TYP AT EA ELEVATION CORNER 19 TRIM, PAINTED TO MATCH HARDIE SIDING

25 STEEL COLUMN WITH CEDAR CLADDING, STAINED ST-1

39 1X6 STAINED T&G CEDAR SLATS WITH 1" SEPERATION, ST-3

43 ROOF FRAME. REFER TO STRUCTURAL DRAWINGS AND

44 MECHANICAL DUCTWORK, PAINTED RE: MECH

21 1X6 STAINED T&G CEDAR SLATS, ST-2

12 4X8 MOUNTED PLYWOOD BOARD 13 (3) 36" WIRE SHELVING UNITS, 60"H, 15"D. 14 36" WIRE SHELVING UNITS, 60"H, 14"D.

15 WATER HEATR. REF. PLUMBING

1 STANDING SEAM METAL ROOF, TYP.

2 PREFINISHED MTL DOWNSPOUT

4 PREFINISHED MTL GUTTER 5 WOOD BEAM STAIN, ST-1

7 CASED OPENING 8 ADA COMPLIANT SINK

16 MOP SINK

23 1X4 TRIM

29 46" CEILING FAN 30 CEILING FAN

34 RE: ELECTRICAL

35 4" VTR

31 GYP CEILING PAINTED 32 LINE OF COUNTER BELOW 33 MECH UNIT RE: MECHANICAL

36 LINE OF WALL BELOW 37 STAINED 4" TIMBER SHELF 38 KITCHEN ISLAND RE:6-7-8/A4-2

40 CONTROL JOINT, TYP. PER 07/S3.1 41 THROUGHWALL AC UNIT RE:MECHANICAL

42 NON RATED CEILING HATCH

SPECIFICATIONS

17 STAIN CEDAR POST

20 THROUGH WALL FLASHING

22 WOOD COLUMN STAIN (ST-1)

26 BUILT-IN TWIN XL BED RE:1/A402 27 BUILT-IN CLOSET RE:10/A402 28 BUILT-IN DESK RE: 4/A402

24 MOUNTED AT 12' AFF, TYP




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TX FIRM NO. 1452

AND BUNKHOUS WMA GUS ENGELING ERING LODGE AND B

DATE: April 3, 2024 DESIGNED BY: MW DRAWN BY: EB REVIEWED BY: OH

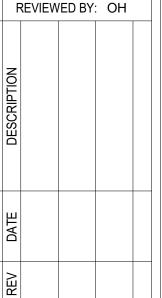

SHEET TITLE ROOF PLAN - GATHERING

SHEET NUMBER

TBAE FIRM REGISTRATION NO.: 1452 TBPE FIRM REGISTRATION NO.: F-1416

305 East Huntland Drive

512.453.0767 512.453.1734

Suite 200 Austin, Texas 78752

Design Group

TBPLS FIRM REGISTRATION NO.: 10065600

3

TYP

2' - 3 5/8"___

TYP

CONTRACTOR SHALL COORDINATE ROOF PENETRATIONS IN BETWEEN STANDING SEAM RIBS.



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TX FIRM NO. 1452

AND BUNKHOUS

GUS ENGELING ERING LODGE AND B

3 FIBER CEMENT FACIA W/SEMI-TRANSPARENT STAIN TO MATCH TRIM

6 STANDING SEAM METAL ROOF CANOPY OVER EXTERIOR DOOR,

8 ADA COMPLIANT SINK

12 4X8 MOUNTED PLYWOOD BOARD

15 WATER HEATR. REF. PLUMBING 16 MOP SINK

20 THROUGH WALL FLASHING

26 BUILT-IN TWIN XL BED RE:1/A402 27 BUILT-IN CLOSET RE:10/A402

34 RE: ELECTRICAL 35 4" VTR 36 LINE OF WALL BELOW

39 1X6 STAINED T&G CEDAR SLATS WITH 1" SEPERATION, ST-3 40 CONTROL JOINT, TYP. PER 07/S3.1

41 THROUGHWALL AC UNIT RE:MECHANICAL

KEYNOTES

1 STANDING SEAM METAL ROOF, TYP. 2 PREFINISHED MTL DOWNSPOUT

4 PREFINISHED MTL GUTTER 5 WOOD BEAM STAIN, ST-1

7 CASED OPENING 9 SINK W/ COMPACT GARBAGE DISPOSAL. REF. PLUMBING

10 RUMFORD R4848 BACK TO BACK FIREPLACE 11 IRONSTONE HEARTH COURSING TO MATCH EXISTING CONFERENCE CENTER

13 (3) 36" WIRE SHELVING UNITS, 60"H, 15"D. 14 36" WIRE SHELVING UNITS, 60"H, 14"D.

17 STAIN CEDAR POST 18 HARDIE TRIM TYP AT EA ELEVATION CORNER 19 TRIM, PAINTED TO MATCH HARDIE SIDING 21 1X6 STAINED T&G CEDAR SLATS, ST-2

22 WOOD COLUMN STAIN (ST-1) 24 MOUNTED AT 12' AFF, TYP 25 STEEL COLUMN WITH CEDAR CLADDING, STAINED ST-1

28 BUILT-IN DESK RE: 4/A402 29 46" CEILING FAN 30 CEILING FAN 31 GYP CEILING PAINTED

32 LINE OF COUNTER BELOW 33 MECH UNIT RE: MECHANICAL

37 STAINED 4" TIMBER SHELF 38 KITCHEN ISLAND RE:6-7-8/A4-2

42 NON RATED CEILING HATCH 43 ROOF FRAME. REFER TO STRUCTURAL DRAWINGS AND SPECIFICATIONS 44 MECHANICAL DUCTWORK, PAINTED RE: MECH

> DATE: April 3, 2024 DESIGNED BY: MW DRAWN BY: EB REVIEWED BY: OH

SHEET TITLE ROOF PLAN - BUNKHOUSE

SHEET NUMBER

512.453.0767 512.453.1734 A132

Design Group

305 East Huntland Drive Suite 200 Austin, Texas 78752

TBAE FIRM REGISTRATION NO.: 1452 TBPE FIRM REGISTRATION NO.: F-1416

D.S.


TYP

2 ROOF PLAN - BUNKHOUSE EAST (ALT)
SCALE: 1/4" = 1'-0"

D.S.

1 ROOF PLAN - BUNKHOUSE WEST SCALE: 1/4" = 1'-0"

TBPLS FIRM REGISTRATION NO.: 10065600

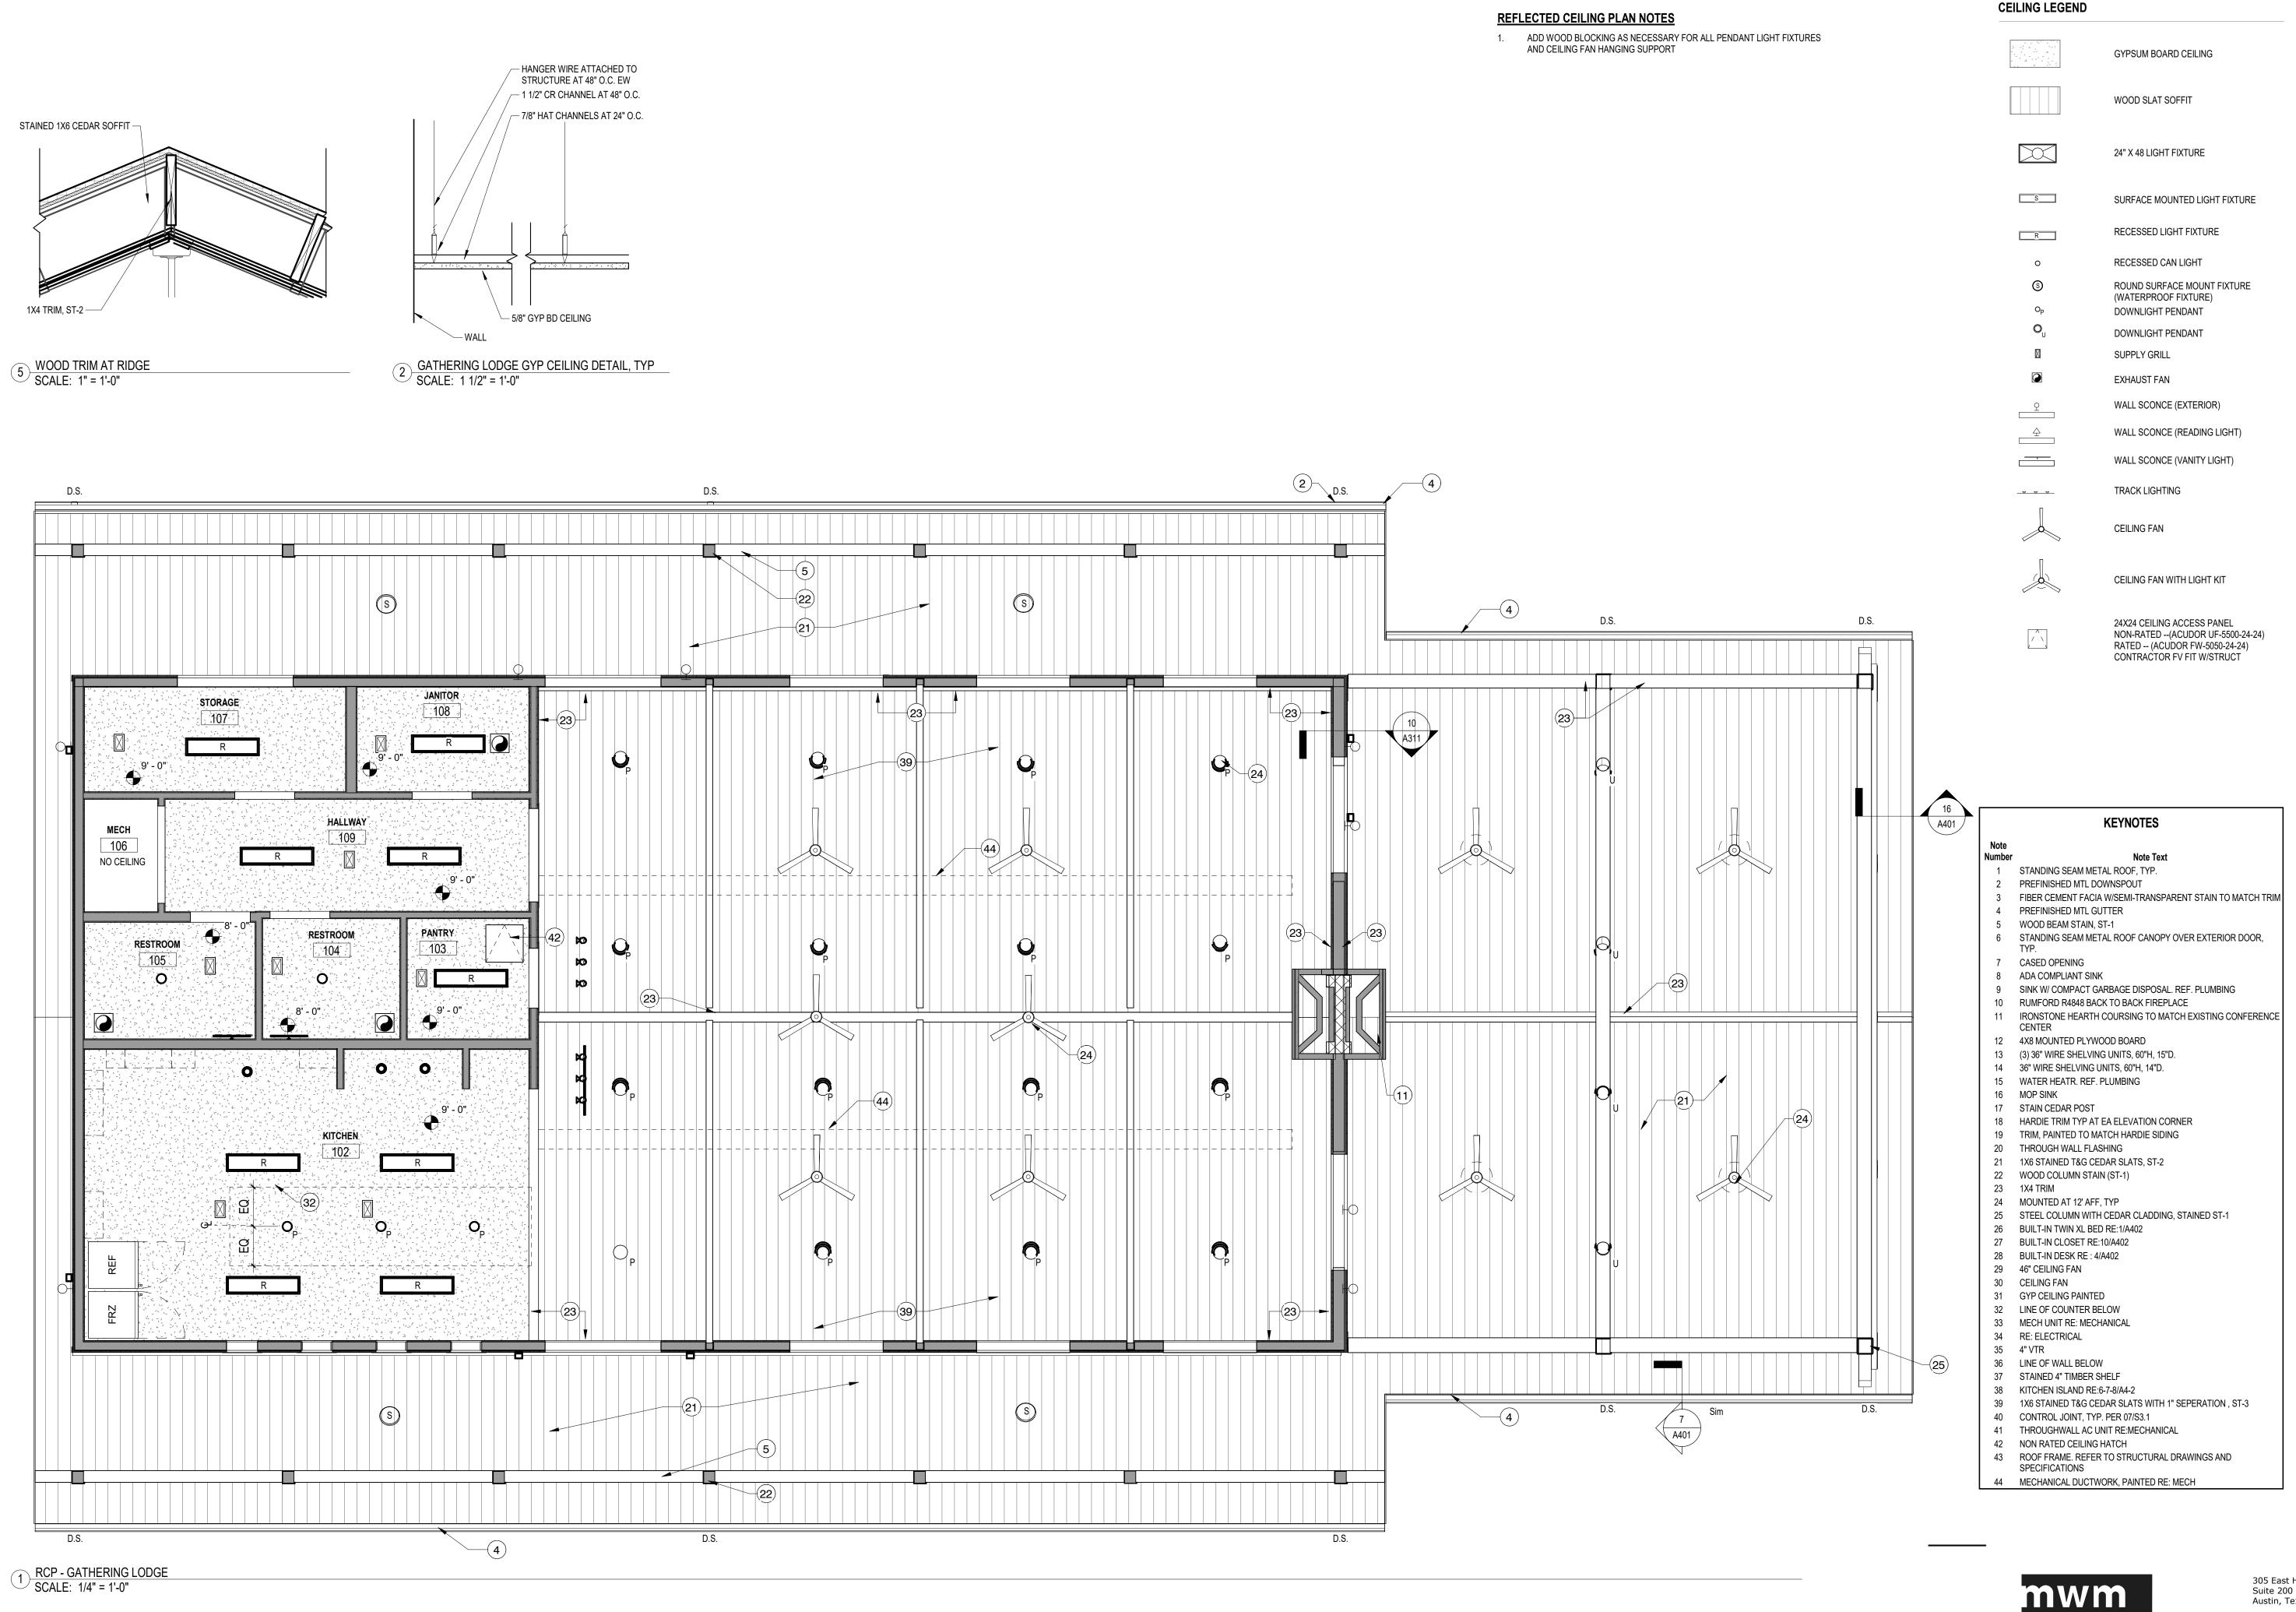

TEXAS PARKS 8 WILDLIFE

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TX FIRM NO. 1452

GUS ENGELING THERING LODGE AND E

DATE: April 3, 2024

DESIGNED BY: MW

REVIEWED BY: OH

DRAWN BY: EB

305 East Huntland Drive Suite 200 Austin, Texas 78752 512.453.0767 512.453.1734

SHEET NUMBER

SHEET TITLE

RCP - GATHERING LODGE

TBPE FIRM REGISTRATION NO.: F-1416 TBPLS FIRM REGISTRATION NO.: 10065600

TBAE FIRM REGISTRATION NO.: 1452

Design Group

A151

GYPSUM BOARD CEILING

WOOD SLAT SOFFIT



(21)

BEDROOM (29)

24" X 48 LIGHT FIXTURE



SURFACE MOUNTED LIGHT FIXTURE




RECESSED LIGHT FIXTURE

RECESSED CAN LIGHT




ROUND SURFACE MOUNT FIXTURE (WATERPROOF FIXTURE) DOWNLIGHT PENDANT

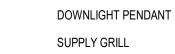




WALL SCONCE (EXTERIOR) WALL SCONCE (READING LIGHT)

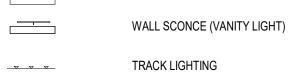

TRACK LIGHTING

CEILING FAN

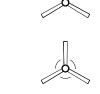

CEILING FAN WITH LIGHT KIT

24X24 CEILING ACCESS PANEL NON-RATED --(ACUDOR UF-5500-24-24) RATED -- (ACUDOR FW-5050-24-24) CONTRACTOR FV FIT W/STRUCT

KEYNOTES

Number

STANDING SEAM METAL ROOF, TYP.

2 PREFINISHED MTL DOWNSPOUT 3 FIBER CEMENT FACIA W/SEMI-TRANSPARENT STAIN TO MATCH TRIM 4 PREFINISHED MTL GUTTER

5 WOOD BEAM STAIN, ST-1

6 STANDING SEAM METAL ROOF CANOPY OVER EXTERIOR DOOR,

7 CASED OPENING

8 ADA COMPLIANT SINK 9 SINK W/ COMPACT GARBAGE DISPOSAL. REF. PLUMBING 10 RUMFORD R4848 BACK TO BACK FIREPLACE

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44 MECHANICAL DUCTWORK, PAINTED RE: MECH

42 NON RATED CEILING HATCH 43 ROOF FRAME. REFER TO STRUCTURAL DRAWINGS AND SPECIFICATIONS

305 East Huntland Drive Suite 200 Austin, Texas 78752 512.453.0767 512.453.1734

TBAE FIRM REGISTRATION NO.: 1452 TBPE FIRM REGISTRATION NO.: F-1416 TBPLS FIRM REGISTRATION NO.: 10065600

Design Group

1 RCP - BUNKHOUSE EAST (ALT)
SCALE: 1/4" = 1'-0"

2 RCP - BUNKHOUSE WEST SCALE: 1/4" = 1'-0"

BATHROOM

BEDROOM (29)

BEDROOM

2' - 4 3/8"2' - 3 5/8"

BATHROOM

SHEET TITLE RCP - BUNKHOUSE

SHEET NUMBER

TEXAS

PARKS 8

WILDLIFE

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WORK.

TX FIRM NO. 1452

S

BUNKHO

NUMBER:

GUS ENGELING THERING LODGE AND B

DATE: April 3, 2024

DESIGNED BY: MW

REVIEWED BY: OH

DRAWN BY: EB



GATHERING LODGE BUILDING ELEVATION - SOUTH SCALE: 1/4" = 1'-0"

TBAE FIRM REGISTRATION NO.: 1452 TBPE FIRM REGISTRATION NO.: F-1416 TBPLS FIRM REGISTRATION NO.: 10065600

April 3, 2024