

**1 STAGING PLAN**  
SCALE: 1" = 30'

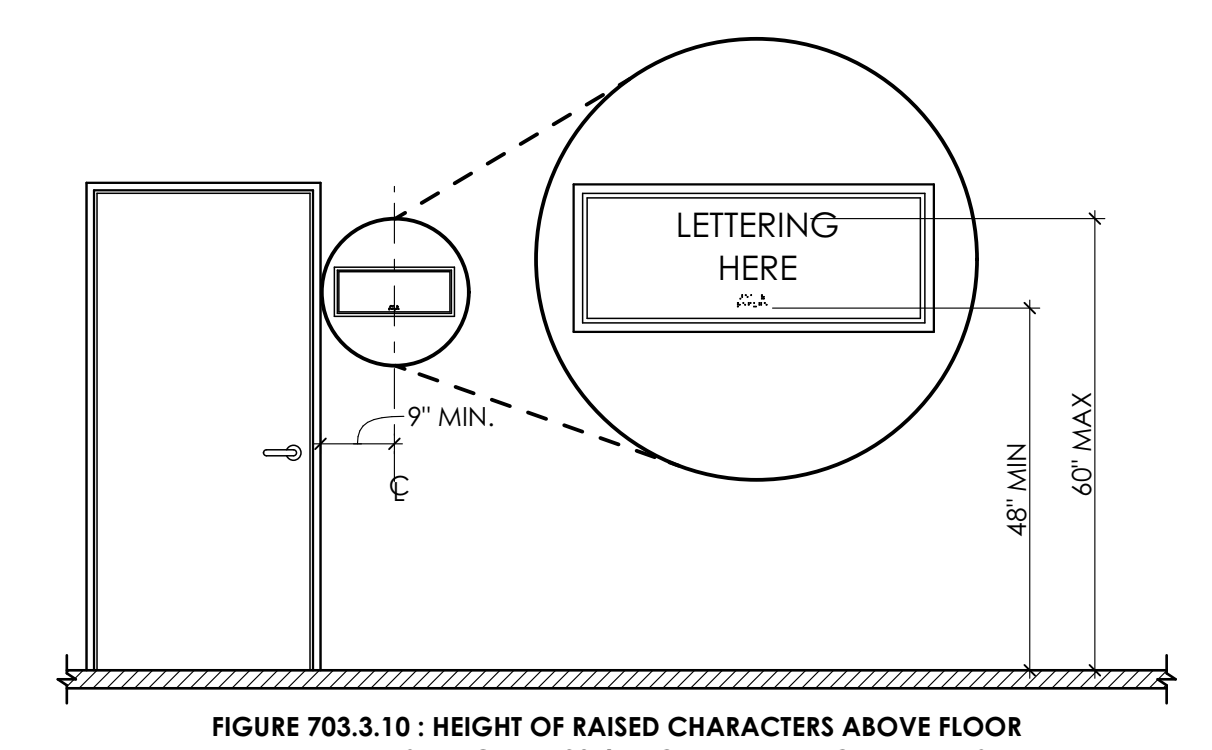


FIGURE 703.3.10 : HEIGHT OF RAISED CHARACTERS ABOVE FLOOR  
SEE FIGURE 703.4.5 FOR BRAILLE REQUIREMENTS

**3 MOUNTING HEIGHT DETAIL**  
SCALE: 1/2" = 1'-0"


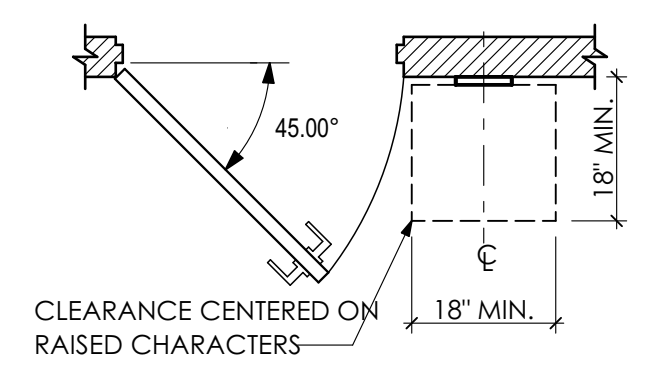


FIGURE 703.3.11 : LOCATION OF SIGNS AT DOORS

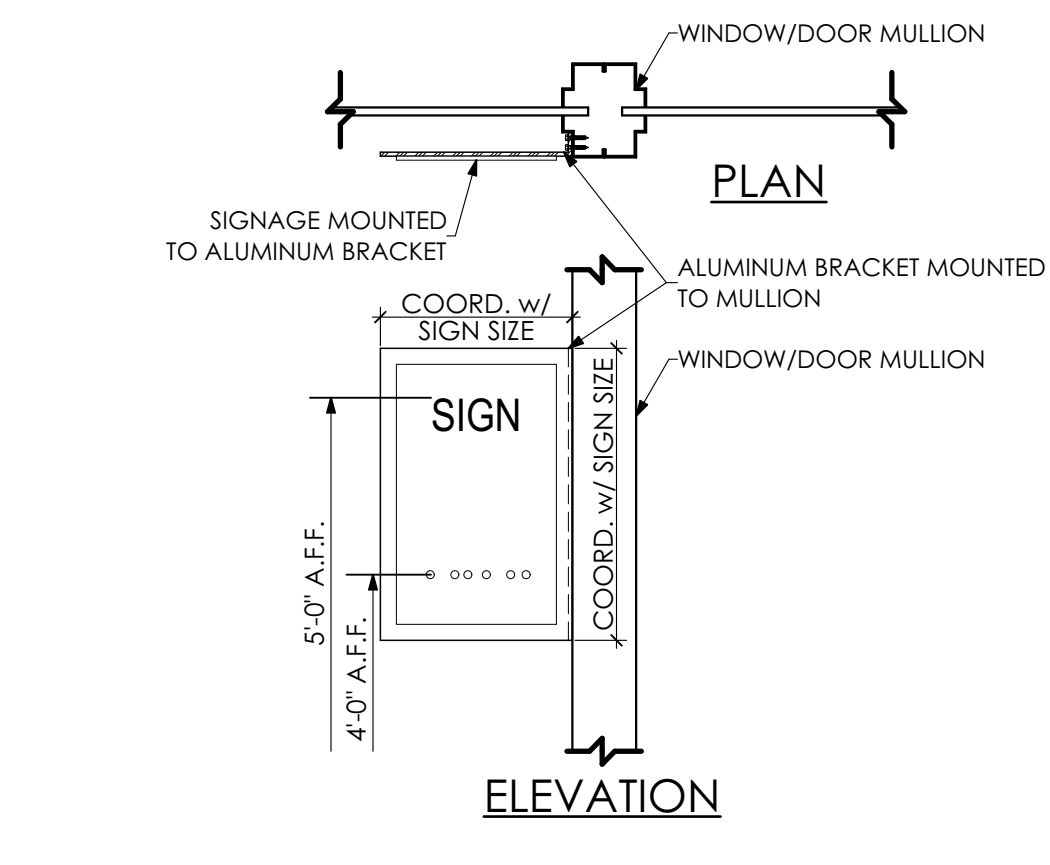

**2 SIGN MOUNTING - STOREFRONT**  
SCALE: 1" = 1'-0"

**KEY NOTES**

- 01 GENERAL CONSTRUCTION**
- 1.50 GENERAL CONSTRUCTION NOTE
- 1.50.01 G.C. TO PROVIDE TEMPORARY 8'-0" HIGH CHAIN-LINK FENCE AS SHOWN.
- 1.50.02 G.C. TO PROVIDE TWO (2) 8'-0" WIDE CHAIN LINK FENCE GATES WITH PADLOCK.
- 32 EXTERIOR IMPROVEMENTS**
- 32.20 SITEMARK
- 32.20.01 EXCAVATE FOR CONSTRUCTION STAGING AREA. PROVIDE MINIMUM 8" OF AASHTO #2A STONE.
- 32.92 TURF AND GRASSES | SPEC 329200**
- 32.92.05 AT THE COMPLETION OF THE WORK, REMOVE STONE AND BACKFILL WITH CLEAN FILL AND SEED ENTIRE AREA, BY G.C.

BUILDING CODE SUMMARY	APPLICABLE CODES AND ORDINANCES
	2018 IBC: ALL APPLICABLE CHAPTERS 2018 IEBC: ALL APPLICABLE CHAPTERS ANSI 117.1, 2017 EDITION: ALL APPLICABLE CHAPTERS ALL APPLICABLE SUB-CODES AND STANDARDS

PROJECT SCOPE:	PARTIAL RENOVATION RENOVATION OF EXISTING PREFABRICATED METAL WAREHOUSE INTO OFFICE SPACE.
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BUILDING AND PROJECT DATA		
BUILDING DESCRIPTION AND USE	OFFICE w/ PARTIAL MEZZANINE	
<b>IEBC 2018</b>		
CLASSIFICATION OF WORK	CHAPTER 5, SECTION 507	LEVEL 3 RENOVATION

USE AND OCCUPANCY	IBC 2018	REQUIRED	PROVIDED
CHAPTER 3			B/S2 (NON SEPARATED / MIXED USE)
CONSTRUCTION TYPE	SECTION 602 AND TABLE 601		TYPE II-B
AUTOMATIC SPRINKLER SYSTEM	SECTION 903		NO
BUILDING HEIGHT	TABLE 504.4	75' MAX.	APPX. 31'-6"
BUILDING STORIES	TABLE 504.4	3 MAX.	2
FLOOR AREA / STORY	TABLE 506.2		
TOTAL FLOOR AREA PER STORY		42,991 SQ. FT. MAX. (B)	
THE BUILDING IS SEPARATED INTO TWO DISTINCT BUILDINGS BY AN EXISTING 2-HR FIRE WALL.			
BUILDING 1	LIMITED WORK IN THIS BUILDING.		
BUILDING 2			
BASEMENT			11,071 SQ. FT.
FIRST FLOOR			12,757 SQ. FT.
SECOND FLOOR			12,757 SQ. FT.
FIRST FLOOR			30,199 SQ. FT.
MEZZANINE AREA			3,415 SQ. FT.
TOTAL AREA (ENTIRE BUILDING / EXCLUDING MEZZANINES)			66,784 SQ. FT.

TABLE 1004.1.2   MAXIMUM FLOOR AREA ALLOWANCES PER OCCUPANT - BUILDING 2			
BUSINESS AREAS (MAIN USE)	21,979 SQ. FT. (GROSS)	150 SQ. FT. / PERSON (GROSS)	146.5 (147)
ACCESSORY USES TO THE MAIN USE			
ASSEMBLY (UNCONCENTRATED)	1,774 SQ. FT. (NET)	15 SQ. FT. / PERSON (NET)	118.3 (119)
STORAGE / MECHANICAL AREAS	6,446 SQ. FT. (GROSS)	300 SQ. FT. / PERSON (GROSS)	21.5 (22)
TOTAL OCCUPANCY - BUILDING 2			288

MEANS OF EGRESS	IBC 2018	REQUIRED	PROVIDED
MEANS OF EGRESS SIZING	SECTION 1005		
STAIRWAYS	SECTION 1005.3.1	0.3 INCHES PER OCCUPANT	SEE LIFE SAFETY PLANS
OTHER EGRESS COMPONENTS	SECTION 1005.3.2	0.2 INCHES PER OCCUPANT	SEE LIFE SAFETY PLANS
STAIRWAYS	SECTION 1009 & 1011		
STAIRWAY WIDTH	SECTION 1011.2	44" (36" IF OCC. < 50)	38" (MEZZ. OCC. < 50)
ACCESSIBLE STAIRWAY WIDTH	SECTION 1009.3	48"	N/A - NON-ACC. MEZZANINE
AREA OF REFUGE	SECTION 1009.6	NO	N/A
EXTERIOR AREA FOR ASSISTED RESCUE	SECTION 1009.7	NO	N/A
MAXIMUM PATH OF COMMON EGRESS TRAVEL	SECTION 1006.2.1	75'	SEE LIFE SAFETY PLANS
MAXIMUM EXIT ACCESS TRAVEL DISTANCE	SECTION 1017 & TABLE 1017.2	250'	SEE LIFE SAFETY PLANS
MINIMUM CORRIDOR WIDTH	SECTION 1020.2	44"	SEE LIFE SAFETY PLAN
MAXIMUM DEAD END	SECTION 1020.4	50'	N/A
MINIMUM NUMBER OF EXITS	SECT. 1006 & TABLE 1006.3.1	2	SEE LIFE SAFETY PLANS

PLUMBING SYSTEMS	IBC 2018	REQUIRED	PROVIDED
TABLE 2902.1 MINIMUM NUMBER OF REQUIRED PLUMBING FIXTURES   BUILDING 2 - OCCUPANCY CLASSIFICATION: B (BUSINESS)			
WATER CLOSETS - MALE	1 PER 40	8	16
WATER CLOSETS - FEMALE	1 PER 40	8	16
LAVATORIES - MALE	1 PER 200	2	12
LAVATORIES - FEMALE	1 PER 200	2	12
BATHTUBS / SHOWERS	-	-	-
DRINKING FOUNTAINS	1 PER 500	2	2
OTHER	SERVICE SINK	1	1

ENERGY CONSERVATION	IECC 2018	REQUIRED	PROVIDED
CLIMATE ZONE			
SECT. C301 AND TAB. 301.1		PENNSYLVANIA - BERKS COUNTY - 5A	
TABLES C402.1.3 & C402.1.4   OPAQUE THERMAL ENVELOPE INSULATION COMPONENT MINIMUM REQUIREMENTS			
ROOFS	R-VALUE	U-FACTOR	PROVIDED
INSULATION ABOVE ROOF DECK (EXISTING ROOF TO REMAIN   PATCHING ONLY)	R-30ci	U-0.032	R-30 ci (EXISTING)
WALLS, ABOVE GRADE			
METAL FRAMED	R-13 + R-7.5ci	U-0.064	R-19 + R-7.5 ci
SLAB-ON-GRADE FLOORS			
UNHEATED SLABS	R-10   2" BELOW	F-0.54	R-10   2" BELOW
DOORS			
OPAQUE, NON-SWINGING	R-4.75	U-0.21	U-0.136 *
OPAQUE, SWINGING	-	U-0.37	U-0.16 0"
TABLE C402.4   BUILDING ENVELOPE FENESTRATION MAXIMUM U-FACTOR AND SHGC REQUIREMENTS			
FENESTRATION	U-FACTOR	SHGC	ORIENTATION
FIXED FENESTRATION	0.38		PF < 0.2
OPERABLE FENESTRATION	0.45		0.2 ≤ PF < 0.5
ENTRANCE DOORS (GLAZED)	0.77		PF ≤ 0.5

CODE REQUIRED SIGNAGE - IBC 2018						
ID OR POSTED OCCUPANT LOAD						
ID	SIGNAGE TEXT		SIZE	DUPLICATE BRAILLE TEXT	TACTILE TEXT	ISA
CS-1	EXIT/EXIT ACCESS (IN ADDITION TO ILLUMINATED SIGN)	IBC SECTION 1013	4'x6'	YES	YES	YES
CS-4	TOILET ROOM (MENS/WOMENS/UNSEX)	IBC SECTION 2902.4	6'x9'	YES	YES	NO
CS-5	FIRE EXTINGUISHER	IFC SECTION 906.6	3'x6'	YES	YES	NO

**GENERAL SIGNAGE NOTES**

- ALL REQUIRED ACCESSIBILITY SIGNAGE SHALL FOLLOW THE INTERNATIONAL SYMBOL OF ACCESSIBILITY IN SIZE, COLOR, PROPORTIONS, AND TEXT (TACTILE AND BRAILLE TEXT REQUIREMENTS).
- ALL SIGNAGE SHALL FOLLOW IBC 2018, ICC A117.1 - 2009, AND 2010 ADA STANDARDS/REQUIREMENTS.
- GENERAL CONTRACTOR SHALL VERIFY SIGNAGE QUANTITIES.
- REFER TO LIFE SAFETY PLANS ON SHEETS A-003 AND A-004 FOR SIGNAGE LOCATIONS. GENERAL CONTRACTOR SHALL VERIFY/CONFIRM FINAL LOCATIONS OF ALL SIGNS WITH AUTHORITY HAVING JURISDICTION.
- REFER TO SHEET A-005 FOR TYPICAL ACCESSIBILITY DETAILS.
- SIGNAGE FOR RATED BARRIERS SHALL BE LOCATED WITHIN 15 FEET OF THE END OF EACH WALL OR PARTITION AND SPACED AT INTERVALS NOT EXCEEDING 30 FEET ALONG THE WALL OR PARTITION. THE LETTERING SHALL NOT BE LESS THAN 3 INCHES IN HEIGHT WITH A MINIMUM 3/8" STROKE IN A CONTRASTING COLOR.

**MG ARCHITECTS**  
ESTABLISHED 1920

ARCHITECTURAL DESIGN  
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PROJECT #:  
**22-0012**

PROFESSIONAL SEAL

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FACILITY UPGRADES  
1238 COUNTY WELFARE ROAD LEESPORT, PA 19533

ISSUED		
ID	DESCRIPTION	DATE

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P.M. e-MAIL: JIMS@MG-Architects.com  
DRAWN BY: DK, SG, BB, JS  
CLIENT PROJ #:

SHEET TITLE:  
**CONTRACTOR LAYDOWN AREA AND CODE SUMMARY**

**A-002**

SEE SHEET A-003 & 005 FOR SIGNAGE REQUIREMENTS













# BERKS AGRICULTURAL CENTER BUILDING EXPANSION

## CONSTRUCTION DOCUMENTS BERN TOWNSHIP, BERKS COUNTY, PENNSYLVANIA



PENNSYLVANIA ACT 287 OF 1974 AS AMENDED BY PA ACT 121 OF OCTOBER 5, 2008 73 P.S. 176.106 REQUIRES NOTIFICATION OF EXCAVATORS, DESIGNERS, OR ANY PERSON PREPARING TO DISTURB THE EARTH'S SURFACE ANYWHERE IN THE COMMONWEALTH.

**SERIAL NUMBER: 20181550064**

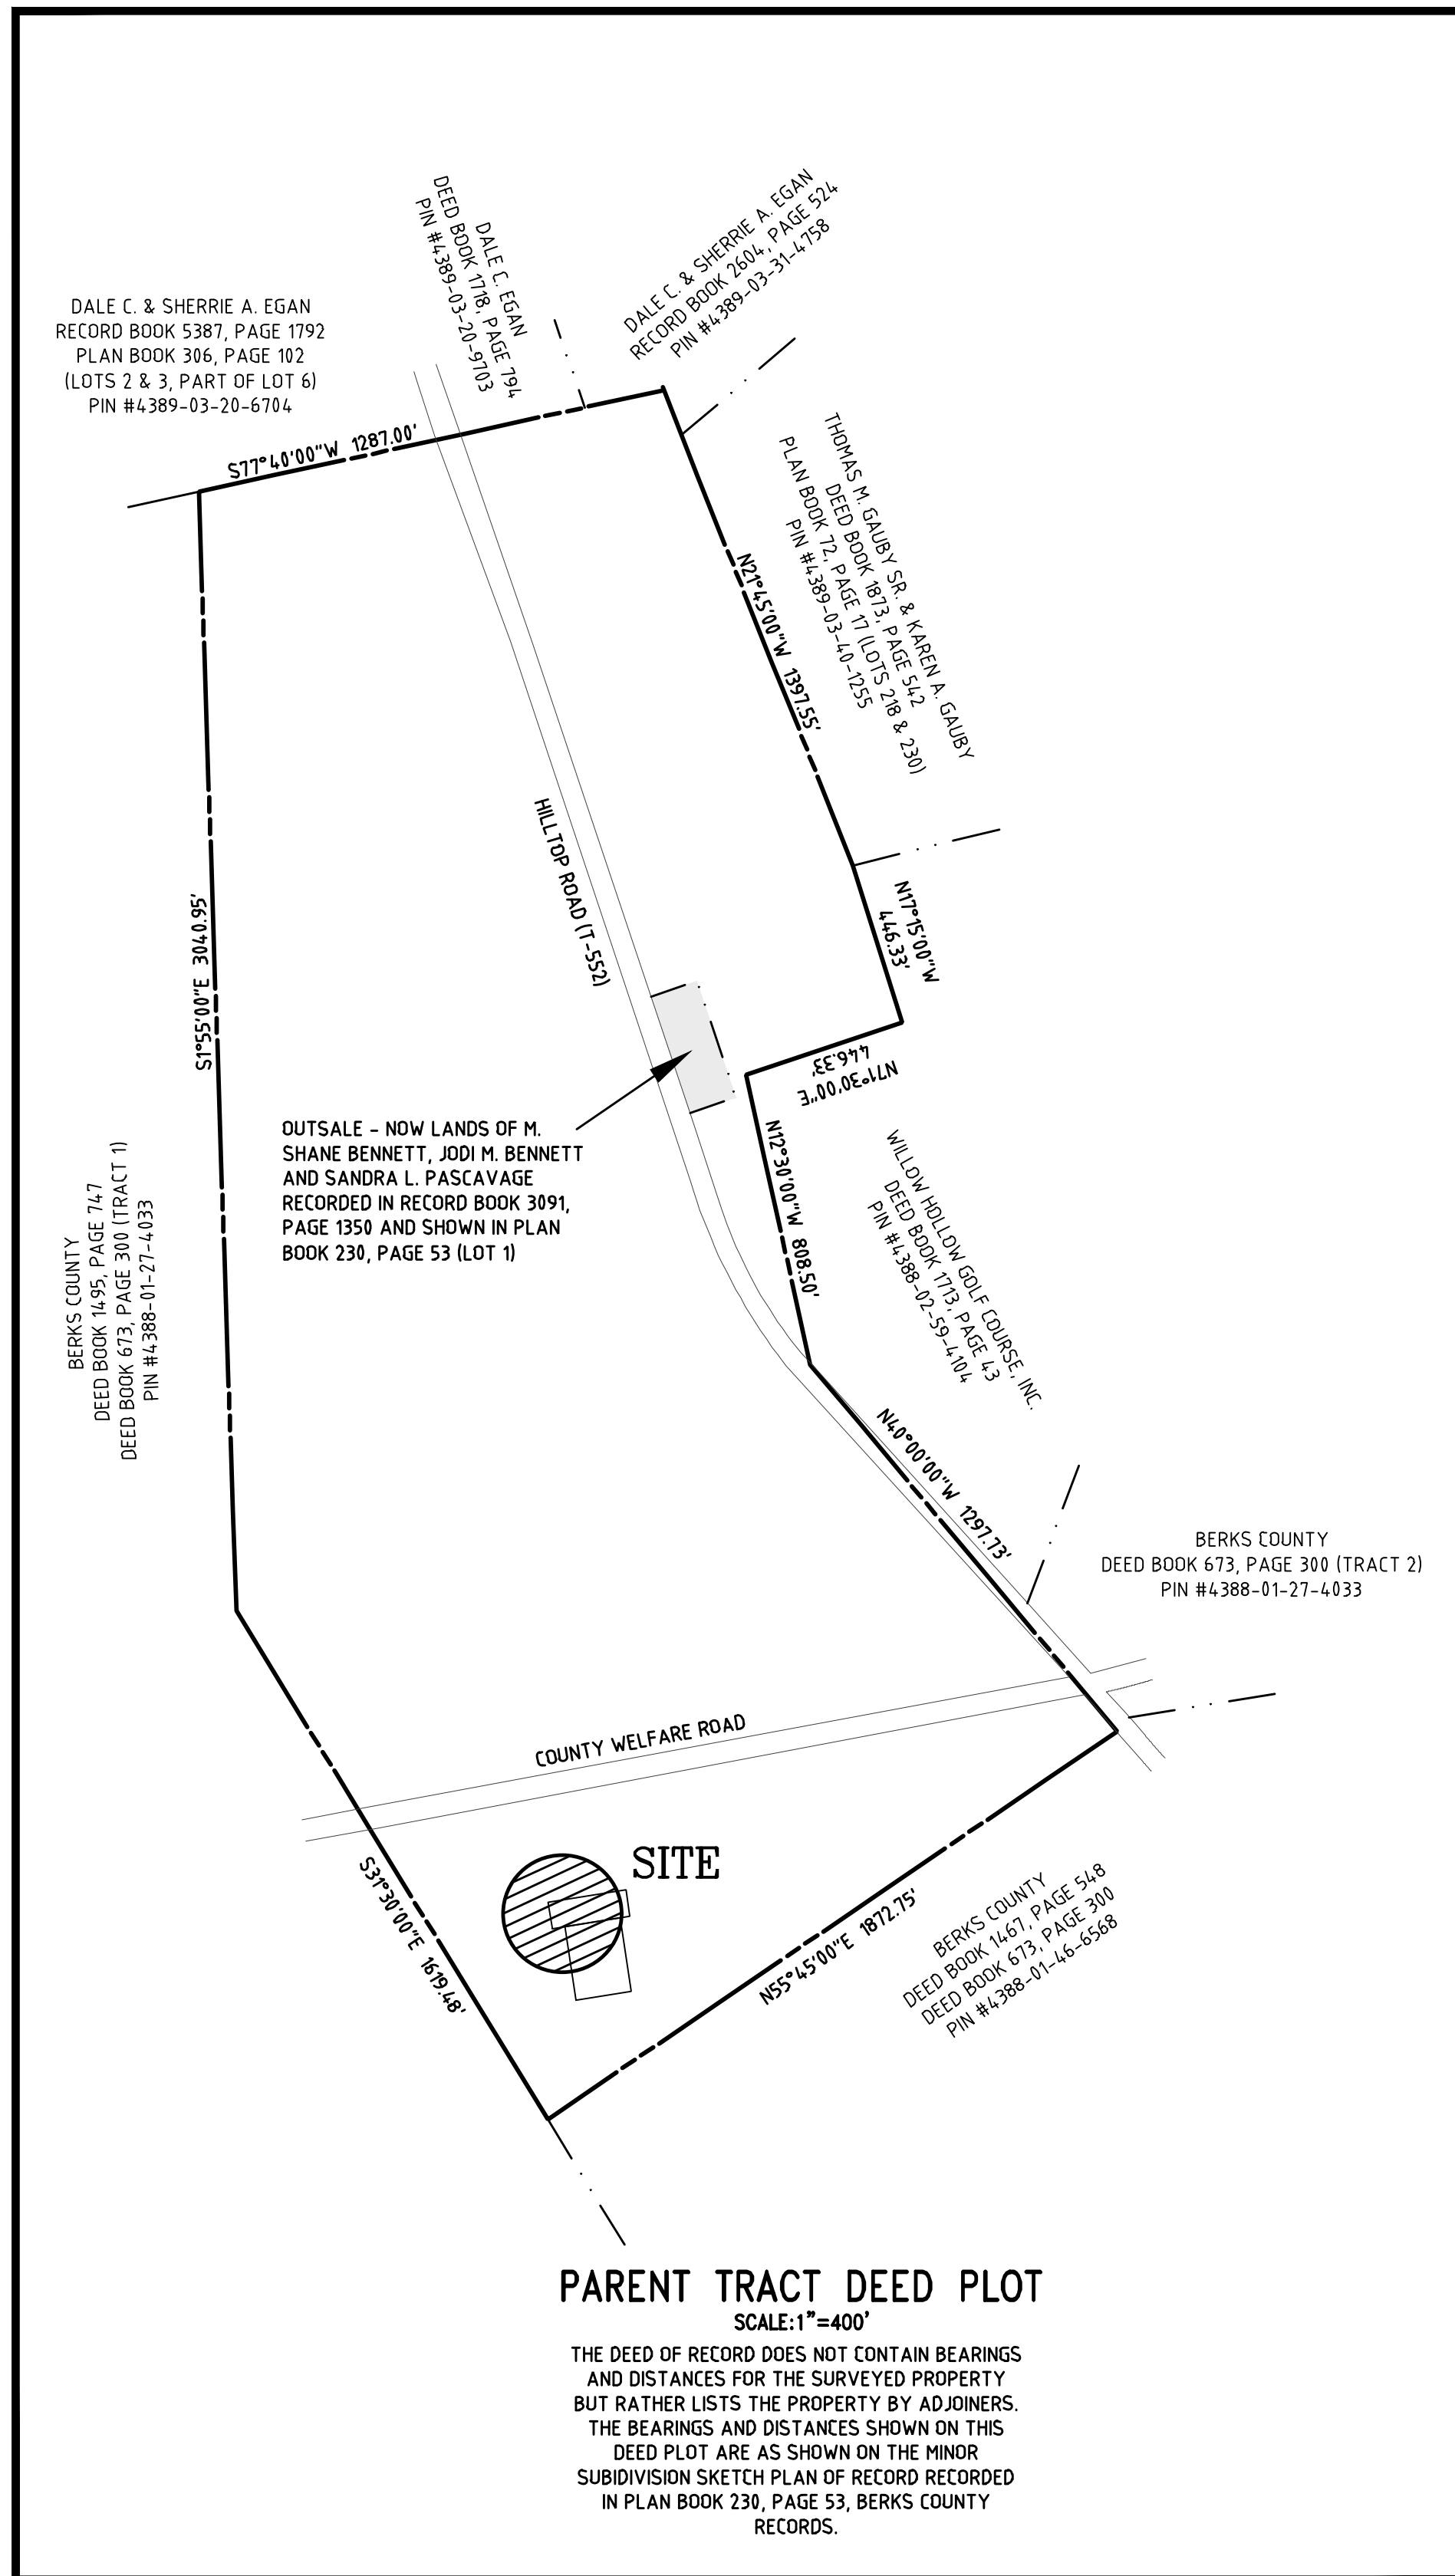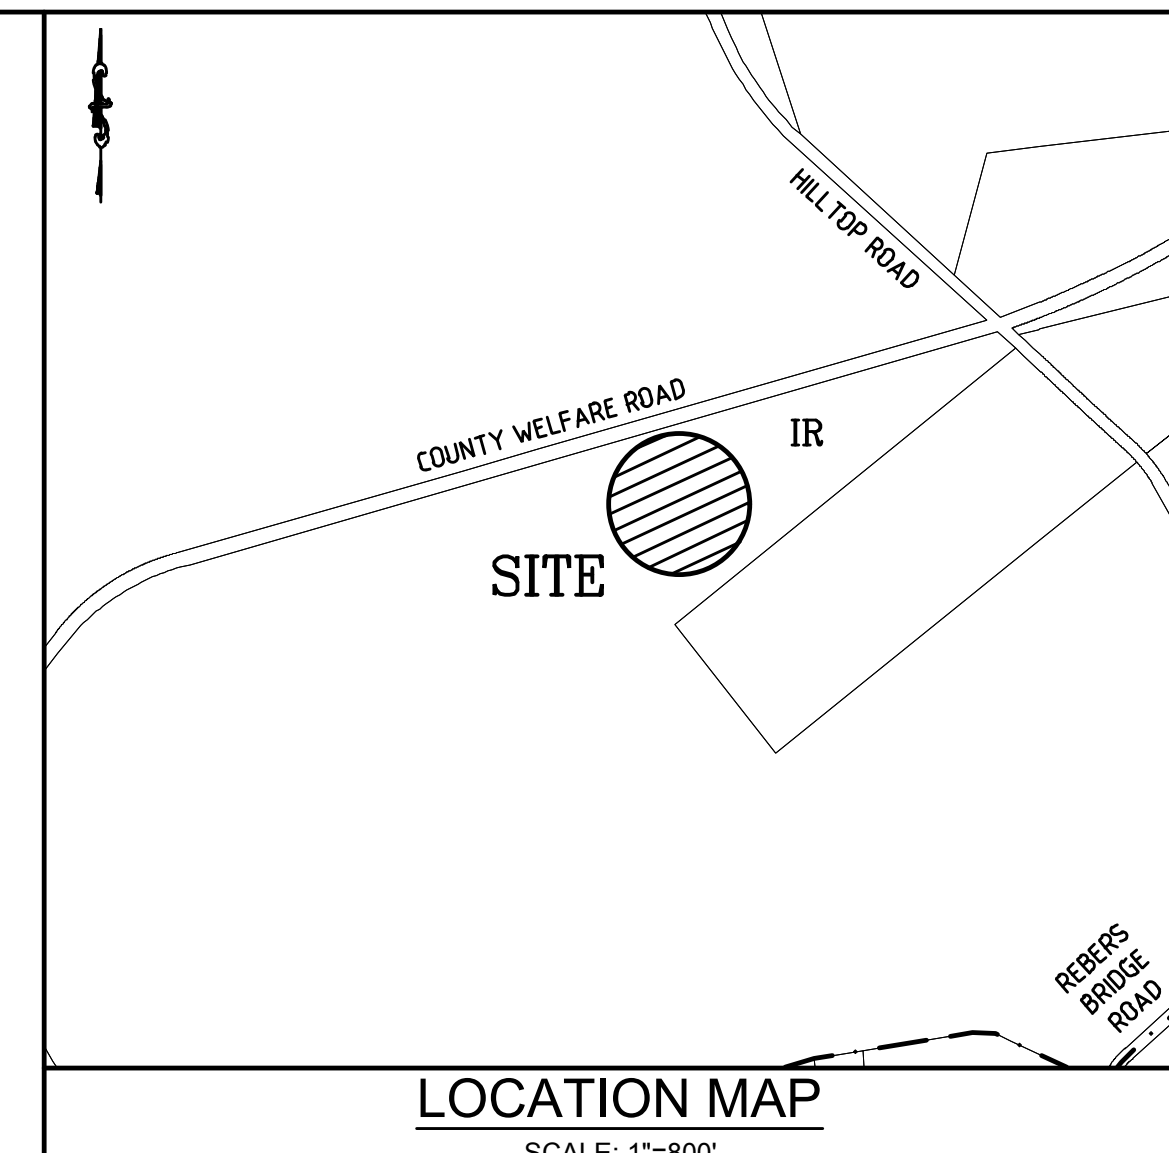

### NOTES:

- THESE PLANS HAVE BEEN PREPARED FOR LAND DEVELOPMENT PURPOSES ONLY. ADDITIONAL DATA MAY BE NECESSARY FOR CONSTRUCTION.
- REFER TO THE LATEST ARCHITECTURAL DRAWINGS FOR COMPLETE DIMENSIONS AND CONSTRUCTION DETAILS FOR THE PROPOSED BUILDING AND ASSOCIATED EXTERIOR FEATURES.
- PURSUANT TO PA ACT 121 (2008), NOTIFICATION TO THE "ONE-CALL SYSTEM" IS REQUIRED AT LEAST THREE (3) WORKING DAYS PRIOR TO DISTURBING EARTH WITH ANY TYPE OF POWERED EQUIPMENT. CALL 1-800-242-1776.
- THE CONTOURS AND TOPOGRAPHICAL INFORMATION SHOWN IS BASED ON A FIELD SURVEY PERFORMED BY STACKHOUSE BENSINGER INC. (SBI) IN JUNE OF 2018.
- THE LOCATIONS OF UNDERGROUND UTILITIES HAVE BEEN SHOWN BASED ON FIELD SURVEY AND SURFACE OBSERVATION AND EXISTING DATA PROVIDED BY UTILITIES. STACKHOUSE BENSINGER INC. (SBI) MAKES NO GUARANTEES THAT THE UNDERGROUND UTILITIES SHOWN COMPRISE ALL SUCH UTILITIES IN THE AREA, EITHER IN SERVICE OR ABANDONED. SBI DOES NOT WARRANT THAT THE UNDERGROUND UTILITIES SHOWN ARE IN THEIR EXACT LOCATION; THEREFORE, SBI SHALL NOT BE RESPONSIBLE OR HELD LIABLE FOR ANY UTILITY NOT SHOWN OR SHOWN ON THE DRAWINGS IN A LOCATION OTHER THAN WHERE IT IS ACTUALLY DISCOVERED UPON EXCAVATION. SBI HAS NOT PHYSICALLY EXCAVATED AND LOCATED ANY UNDERGROUND LINES.
- THERE ARE NO APPARENT SINKHOLES IN THE PROJECT AREA.
- WHEREVER POSSIBLE, NATURAL FEATURES OF THE SITE SUCH AS LARGE TREES, WOODED AREAS AND NATURAL WATERCOURSES AND BODIES OF WATER SHALL BE PRESERVED DURING CONSTRUCTION.
- ALL CONSTRUCTION SHALL BE SUBJECT TO THE REQUIREMENTS OF THE PENNSYLVANIA UNIFORM CONSTRUCTION CODE, AS ADOPTED BY THE MUNICIPALITY.
- ALL CONSTRUCTION IMPROVEMENTS SHALL BE LOCATED, DESIGNED, INSTALLED AND/OR CONSTRUCTED IN ACCORDANCE WITH ALL CURRENT STANDARDS SPECIFIED BY THE TOWNSHIP OF BERN. IF NOT COVERED, THEN PENNDOT PUBLICATION 408-SPECIFICATIONS, PENNDOT STANDARDS FOR ROADWAY CONSTRUCTION RC SERIES SHALL APPLY, UNLESS OTHERWISE NOTED ON THE PLANS.
- AS IT RELATES TO CONSTRUCTION ACTIVITY, AND AS NEEDED TO CONSTRUCT IMPROVEMENTS AS INDICATED ON THE PLAN(S), THE CONTRACTOR SHALL REMOVE AND/OR DISPOSE OF ANY BY-PRODUCTS, UNUSED STOCK, DEMOLITION DEBRIS, ETC. IN ACCORDANCE WITH ALL LOCAL, STATE, AND/OR FEDERAL REGULATIONS GOVERNING SUCH DISPOSAL.
- THE CONTRACTOR SHALL PROVIDE EASO CONTROL MEASURES AS NECESSARY.
- STACKHOUSE BENSINGER INC. HAS NOT PROVIDED THE DESIGN OF SHORING, TRENCHING, EXCAVATION, SUPPORT, SHIELDING OR BENCHING ASSOCIATED WITH THE INSTALLATION OF UTILITIES, GRADING, ETC. ON THE PLAN(S). IT SHALL BE THE RESPONSIBILITY OF THE CONTRACTOR TO DETERMINE THE LOCATION OF UTILITIES AND TO COMPLY WITH OSHA TRENCHING REQUIREMENTS.
- IF UNFORESEEN SUBSURFACE OR GEOLOGIC CONDITIONS ARE ENCOUNTERED, INCLUDING BUT NOT LIMITED TO DUMPS, FOUNDATIONS, ARCHAEOLOGICAL ARTIFACTS OR FEATURES, SPRINGS, ROCK, SINKHOLES, ETC., THE CONTRACTOR SHALL STOP WORK IMMEDIATELY AND NOTIFY STACKHOUSE BENSINGER INC. AND THE OWNER.
- ALL EQUIPMENT OPERATED ON NEWLY PAVED SURFACES SHALL HAVE RUBBER WHEELS OR RUNNERS AND SHALL HAVE RUBBER, WOOD, OR SIMILAR PROTECTIVE PADS BETWEEN OUTRIGGERS AND THE ROADWAY SURFACE. IN THE EVENT THAT OTHER THAN RUBBER EQUIPPED MACHINERY IS AUTHORIZED FOR USE, THE PAVED SURFACE SHALL BE PROTECTED BY THE USE OF MATTING, WOOD, OR OTHER SUITABLE PROTECTIVE MATERIAL HAVING A MINIMUM THICKNESS OF (4) FOUR INCHES.
- NO OPENINGS WITHIN THE CLEAR ZONE OF AN OPEN ROAD, ACCESS DRIVE OR PARKING AREA SHALL BE ALLOWED AT THE END OF EACH WORKDAY. IF A TRENCH NEEDS TO BE LEFT OPEN AT THE END OF A WORKDAY, REFER TO PENNDOT SPECIFICATIONS FOR ACCEPTABLE PROTECTION GUIDELINES FOR ALL OPENINGS.
- WORK ZONE TRAFFIC CONTROL SHALL COMPLY WITH PUBLICATION 23 (MAINTENANCE MANUAL) AND PUBLICATION 213 (TEMPORARY TRAFFIC CONTROL GUIDELINES).
- FINAL SEWER, WATER, GAS, ELECTRIC, TELEPHONE AND DATA SERVICE LOCATIONS AT THE BUILDING SHALL BE VERIFIED BY THE ARCHITECT OR MECHANICAL/ELECTRICAL ENGINEER PRIOR TO ANY SUCH CONSTRUCTION.
- ALL SANITARY SEWER CONSTRUCTION SHALL BE IN ACCORDANCE WITH THE BERN TOWNSHIP MUNICIPAL AUTHORITY OF THE TOWNSHIP OF BERN, BERKS COUNTY, CURRENT RULES AND REGULATIONS AND DEP REGULATIONS. IT IS RECOMMENDED THAT THE PERMIT(S) BE OBTAINED PRIOR TO ORDERING OF MATERIALS IN THE EVENT THE MUNICIPAL SPECIFICATIONS DIFFER FROM INFORMATION SHOWN ON THE DRAWINGS. THE CONTRACTOR MUST MEET THE MUNICIPALITY'S SPECIFICATIONS.
- ALL LATERALS/BUILDING SEWERS SHALL HAVE A MINIMUM COVER OF FOUR (4) FEET AND A MINIMUM SLOPE OF 1/4" PER FOOT.
- ALL WATER LINE CONSTRUCTION SHALL BE IN ACCORDANCE WITH THE READING AREA WATER AUTHORITY CURRENT SPECIFICATIONS OR THE TOWNSHIP OF BERN MUNICIPAL AUTHORITY RULES AND SPECIFICATIONS AND CURRENT DEP REGULATIONS.
- FIRE HYDRANTS AND THEIR LOCATIONS WILL BE SUBJECT TO APPROVAL BY THE FIRE MARSHAL.
- ALL FIRE HYDRANT LATERALS SHALL INCLUDE A 6" GATE VALVE.
- A MINIMUM 10' HORIZONTAL CLEARANCE SHALL BE PROVIDED BETWEEN WATER MAINS AND SANITARY SEWER MAINS, WHERE PRACTICAL.
- A MINIMUM 5' HORIZONTAL CLEARANCE BETWEEN WATER MAINS AND STORM SEWERS SHALL BE PROVIDED, WHERE PRACTICAL.

- A MINIMUM 18" VERTICAL CLEARANCE BETWEEN WATER MAINS AND STORM SEWERS SHALL BE PROVIDED.
- A MINIMUM 18" VERTICAL CLEARANCE BETWEEN WATER MAINS AND SANITARY SEWER MAINS SHALL BE PROVIDED.
- GAS, WATER AND SANITARY LATERALS TO HAVE A 10' HORIZONTAL DISTANCE FROM EACH OTHER.
- ROOF DRAINS SHALL BE DIRECTED AWAY FROM STRUCTURES TO PREVENT INFILTRATION NEAR THE STRUCTURE FOUNDATION. THE OUTLETS SHALL HAVE POSITIVE DRAINAGE AWAY FROM THE STRUCTURE.
- IT SHALL BE THE RESPONSIBILITY OF THE CONTRACTOR TO COORDINATE WITH THE APPROPRIATE UTILITY COMPANY THE REMOVAL, RELOCATION, ABANDONMENT OR INSTALLATION OF ANY PUBLIC UTILITY LINES, POLES, VAULTS, ETC. (GAS, ELECTRIC, TELEPHONE, CABLE TV AND FIBER OPTIC COMMUNICATIONS).
- THE CONTRACTOR(S) IS(ARE) RESPONSIBLE TO CONTACT EACH UTILITY COMPANY OR AUTHORITY AT LEAST 3 DAYS BEFORE ANY EXCAVATION OF EXISTING UTILITIES. PRIOR TO BEGINNING CONSTRUCTION THE CONTRACTOR SHALL INVESTIGATE EXISTING UNDERGROUND UTILITY LOCATIONS, RESEARCH PUBLIC AND SITE UTILITY RECORDS, AND DIG TEST PITS IN AREAS TO THE EXTENT NECESSARY TO VERIFY EXISTING UTILITY DEPTHS AND LOCATIONS AND TO VERIFY THAT STORM DRAINAGE AND UTILITY SYSTEMS PIPE, EXCAVATION, FILLING AND GRADING MAY BE INSTALLED IN COMPLIANCE WITH ORIGINAL DESIGN AND REFERENCED STANDARDS.
- IF THE CONTRACTOR DETERMINES THAT THE LOCATION OF EXISTING UTILITY LINES ARE NOT AS DEPICTED ON THE DRAWINGS (HORIZONTALLY OR VERTICALLY) OR THE ORIGINAL DESIGN IS IN CONFLICT WITH THE EXISTING UTILITIES, HE SHALL IMMEDIATELY NOTIFY THE DESIGN PROFESSIONAL OF SUCH CONFLICT. THE CONTRACTOR IS CAUTIONED NOT TO ORDER ANY MATERIALS OR PERFORM ANY FURTHER WORK UNTIL SUCH VERIFICATION AND/OR DESIGN PROFESSIONAL CLARIFICATION HAS BEEN PROVIDED. THE CONTRACTOR WILL BE REQUIRED TO REPAIR ALL DAMAGED UTILITY LINES AT HIS EXPENSE.
- THE CONTRACTOR IS RESPONSIBLE TO OBTAIN ALL REQUIRED MUNICIPAL PERMITS.
- IF THE CONTRACTOR DETERMINES THAT STRUCTURES OR IMPROVEMENTS CANNOT BE MANUFACTURED OR CONSTRUCTED AS INDICATED ON THE DRAWINGS, OR IF THE DESIGN DRAWINGS INDICATE CONFLICTING INFORMATION, THE CONTRACTOR SHALL IMMEDIATELY NOTIFY THE DESIGN PROFESSIONAL. THE CONTRACTOR IS CAUTIONED NOT TO ORDER ANY MATERIALS OR PERFORM ANY FURTHER WORK UNTIL SUCH VERIFICATION AND/OR DESIGN PROFESSIONAL CLARIFICATION HAS BEEN PROVIDED.
- CONTRACTOR SHALL HAVE ALL PROPERTY LINES LOCATED BEFORE CONSTRUCTION COMMENCES. THE CONTRACTOR SHALL MAKE SURE NO CONSTRUCTION ACTIVITY OCCURS OUTSIDE PROPERTY LIMITS, UNLESS WITH DESIGNATED CONSTRUCTION EASEMENTS.
- CONTRACTOR MUST CONFIRM BUILDING DIMENSIONS PRIOR TO ANY SUCH CONSTRUCTION. BUILDING DIMENSIONS AND DETAILS FOR EXTERIOR STEPS, RAILINGS, ETC. SHOULD BE TAKEN FROM THE ARCHITECTURAL PLANS. DO NOT USE THESE PLANS FOR BUILDING-RELATED CONSTRUCTION.
- THE CONTRACTOR SHALL BE RESPONSIBLE FOR THE INSTALLATION AND MAINTENANCE OF TEMPORARY EROSION AND SEDIMENT CONTROL MEASURES TO CONTROL SEDIMENT RUNOFF FROM THE AREA OF CONSTRUCTION TO INCLUDE COMPOST FILTER SOCK OR ROCK FILTERS, AS NECESSARY. ADDITIONAL E & S MEASURES ARE TO BE PROVIDED IF DIRECTED BY THE OWNER, DESIGN ENGINEER OR THE TOWNSHIP PER THE PA DEP EROSION & SEDIMENT POLLUTION CONTROL PROGRAM MANUAL.
- ALL PARKING STALLS SHALL BE DELINEATED BY 4" PAINTED WHITE LINES. ALL HANDICAP PARKING SYMBOLS, AISLE HATCHING AND SIGNS SHALL COMPLY WITH CURRENT ADA CONTRASTING COLOR VISIBILITY, DIMENSIONAL AND SIZE REQUIREMENTS AND SPECIFICATIONS.
- ALL PAVING THICKNESSES SHOWN ARE THE COMPACTED THICKNESS.
- ALL SIDEWALK DIMENSIONS ARE TAKEN FROM THE BACK OF THE CURB, UNLESS OTHERWISE NOTED.
- ADJUSTMENT OF EXISTING WATER VALVES, CLEANOUTS, UTILITY BOXES AND COVERS, ETC. WITHIN NEW SIDEWALK IS INCIDENTAL TO THE SIDEWALK CONSTRUCTION.
- ALL ADA ACCESS ROUTES, RAMPS AND PARKING AREAS SHALL BE CONSTRUCTED IN ACCORDANCE TO THE DIMENSIONS INDICATED ON THE PLANS AND DETAILS. THEY SHALL COMPLY WITH THE FOLLOWING GUIDELINES AS WELL AS ALL APPLICABLE BUILDING CODES FOR THIS PROJECT:
  - CROSS-SLOPES FOR RAMPS AND ACCESS ROUTES SHALL NOT EXCEED 2 PERCENT.
  - ALL CONCRETE SURFACES SHALL HAVE A SLIP-RESISTANT FINISH.
  - RAMPS SHALL NOT EXCEED 1:12 SLOPE (8.3 PERCENT) AND SHALL NOT EXCEED A VERTICAL RISE OF 30 INCHES.
  - ACCESS ROUTES SHALL NOT EXCEED 1:20 SLOPE (5 PERCENT) AND SHALL NOT EXCEED A LONGITUDINAL LENGTH OF 200 FEET.
  - PASSENGER LOADING ZONES SHALL PROVIDE AN ACCESS AISLE AT LEAST 60 INCHES WIDE AND 20 FEET LONG ADJACENT AND PARALLEL TO THE VEHICLE PULL-UP SPACE AND SHALL NOT EXCEED 2 PERCENT IN ALL DIRECTIONS.
  - HANDRAILS SHALL BE INSTALLED ON BOTH SIDES OF RAMPS IF THE RAMP LENGTH EXCEEDS 6 FEET OR THE VERTICAL RISE EXCEEDS 6 INCHES. THE TOP HEIGHT OF HANDRAILS SHALL BE A MINIMUM OF

- 34 INCHES AND A MAXIMUM OF 38 INCHES. HANDRAILS ARE NOT REQUIRED ON CURB RAMPS.
- WHERE PROVIDED, THE MINIMUM INSIDE CLEARANCE BETWEEN HANDRAILS SHALL BE AS SPECIFIED ON THE DRAWINGS, EXCEPT IN NO CASE SHALL THE CLEARANCE BE LESS THAN 36 INCHES FOR RAMPS. LANDINGS THAT CHANGE DIRECTION SHALL MAINTAIN A CLEARANCE OF AT LEAST 60 INCHES BETWEEN HANDRAILS. GUARDS SHALL BE PROVIDED ALONG OPEN-SIDED WALKING SURFACES, INDUSTRIAL EQUIPMENT PLATFORMS, STEPS, RAMPS AND LANDINGS THAT ARE LOCATED MORE THAN 30 INCHES ABOVE THE FLOOR OR GRADE BELOW. GUARDS SHALL FORM A PROTECTIVE BARRIER NOT LESS THAN 42 INCHES IN HEIGHT. REFER TO THE SECTION "GUARDS" IN THE BUILDING CODE FOR ADDITIONAL CONSTRUCTION REQUIREMENTS.

- ALL GRADING SHALL PROMOTE POSITIVE DRAINAGE AWAY FROM THE BUILDING.
- LOCATION OF LANDSCAPING WILL BE SUCH AS TO ENSURE NO INTERFERENCE WITH EXISTING OR PROPOSED SEWER LINES, WATER LINES, UTILITY LINES AND STORM DRAINAGE FACILITIES.

### SITE DATA

**RECORD OWNER:** COUNTY OF BERKS  
633 COURT STREET  
READING PA 19601

**SITE ADDRESS:** 1261 COUNTY WELFARE ROAD  
LEESPORT, PA 19533

**DEED BOOK VOLUME:** 837, PAGE 546

**SOURCE OF TITLE:** BEING PART OF THE SAME PREMISES WHICH WILLIAM W. ESSIACK, BY DEED DATED NOVEMBER 13, 1940 AND RECORDED IN THE OFFICE FOR THE RECORDER OF DEEDS, IN DEED BOOK VOLUME 837 PAGE 546, BERKS COUNTY RECORDS, GRANTED AND CONVEYED INTO THE COUNTY OF BERKS.

**TAX MAP:** 4388-01-27-4033

**SOURCE OF DATUM:** SITE PLAN PREPARED BY BOYD C. WAGNER, ORDER NO. 1681, DRAWING NO. A-1, DATED MARCH 15, 1973, ISSUED JULY 16, 1973

**NOTES:**

- THE LOCATIONS OF UNDERGROUND UTILITIES HAVE BEEN SHOWN BASED ON FIELD SURVEY AND SURFACE OBSERVATION AND EXISTING DATA PROVIDED BY UTILITIES. STACKHOUSE BENSINGER INC. (SBI) MAKES NO GUARANTEES THAT THE UNDERGROUND UTILITIES SHOWN COMPRISE ALL SUCH UTILITIES IN THE AREA, EITHER IN SERVICE OR ABANDONED. SBI DOES NOT WARRANT THAT THE UNDERGROUND UTILITIES SHOWN ARE IN THE EXACT LOCATION, THEREFORE, SBI SHALL NOT BE RESPONSIBLE OR HELD LIABLE FOR ANY UTILITY NOT SHOWN OR SHOWN ON THE DRAWINGS IN A LOCATION OTHER THAN WHERE IT IS ACTUALLY DISCOVERED UPON EXCAVATION. SBI HAS NOT PHYSICALLY EXCAVATED AND LOCATED ANY UNDERGROUND LINES.
- THE PROPERTY SHOWN HERE IS LOCATED WITHIN A ZONE X, AREA DETERMINED TO BE OUTSIDE THE 0.2% ANNUAL CHANCE FLOODPLAIN, PER FLOOD INSURANCE RATE MAP PANEL NO. 42011C03344G, WITH AN EFFECTIVE DATE OF JULY 3, 2012.

**TOTAL TRACT AREA:** 160.7 +/- ACRES  
**DEVELOPMENT AREA:** 0.078 ACRES (3400 S.F.)

### ZONING DATA

IR (INSTITUTIONAL / RECREATIONAL DISTRICT)	<b>REQUIRED</b>
MINIMUM LOT AREA:	5 ACRES
MINIMUM LOT WIDTH AT STREET LINE:	200 FEET
BUILDING LINE:	200 FEET
MINIMUM FRONT YARD:	100 FEET
MINIMUM SIDE YARD:	50 FEET
MINIMUM REAR YARD:	50 FEET
MINIMUM OPEN SPACE:	60 PERCENT
MAXIMUM BUILDING HEIGHT:	35 FEET

**INTENDED USE:** BUILDING ADDITION  
**WATER SUPPLY:** EXISTING, PUBLIC - NO NEW CONNECTIONS  
**SANITARY SEWER DISPOSAL:** EXISTING, PUBLIC - NO NEW CONNECTIONS

**PARKING**  
EXISTING ADA SPACES: 6  
PROPOSED ADA SPACES: 1  
TOTAL ADA PARKING SPACES: 7

**WAIVER NOTE:**  
AT A MEETING ON SEPTEMBER 4, 2018, THE BERN TOWNSHIP BOARD OF SUPERVISORS APPROVED A WAIVER OF THE REGULAR LAND DEVELOPMENT PROCEDURES TO PERMIT THE PLAN TO PROCEED AS A SKETCH PLAN FOR RECORD.

PLAN LIST INDEX		
PLAN TITLE	PLAN NO.	SHEET NO.
COVER SHEET	C-1.1	SHEET 1 OF 4
EXISTING CONDITIONS AND SITE DEMOLITION	C-2.1	SHEET 2 OF 4
SITE LAYOUT, GRADING AND UTILITY	C-3.1	SHEET 3 OF 4
SITE CONSTRUCTION DETAILS	C-4.1	SHEET 4 OF 4

ALL PLANS LISTED IN THE PLAN LIST INDEX WILL BE RECORDED IN THE BERKS COUNTY RECORDER OF DEEDS OFFICE.

SEAL		
NO.	DATE	REVISION

### REVISIONS CONSULTANT

**STACKHOUSE BENSINGER INC.**  
LANDSCAPE ARCHITECTURE  
CIVIL ENGINEERING  
LAND PLANNING  
MUNICIPAL CONSULTING  
SURVEYING  
330 REVERE BOULEVARD  
SINKING SPRING, PA 19608  
VOICE: (610) 777-8000 FAX: (610) 796-2983  
www.sbsinc.com  
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### PROJECT INFORMATION

**CLIENT:** Muhlenberg Green Architects  
955 Berkshire Boulevard, Suite 101  
Wyomissing PA 19610-1278

**PROJECT:** Berks Agricultural Center Building Expansion  
Bern Township Berks County Pennsylvania

**PLAN TITLE:** COVER SHEET

**PLAN STATUS:** CONSTRUCTION DOCUMENTS

**ISSUE DATE:** 2-22-2023

**PROPERTY P.I.N.:** 4388-01-27-4033

**FILE NAME:** 2018-035\_cdoccs

**DRAWN BY:** ESD

**CHECKED BY:** AIO

**PLAN SCALE:** 1"=10'

**PROJECT NUMBER:** 2018-035

**PLAN NO.:** C-1

**SHEET 1 OF 4**














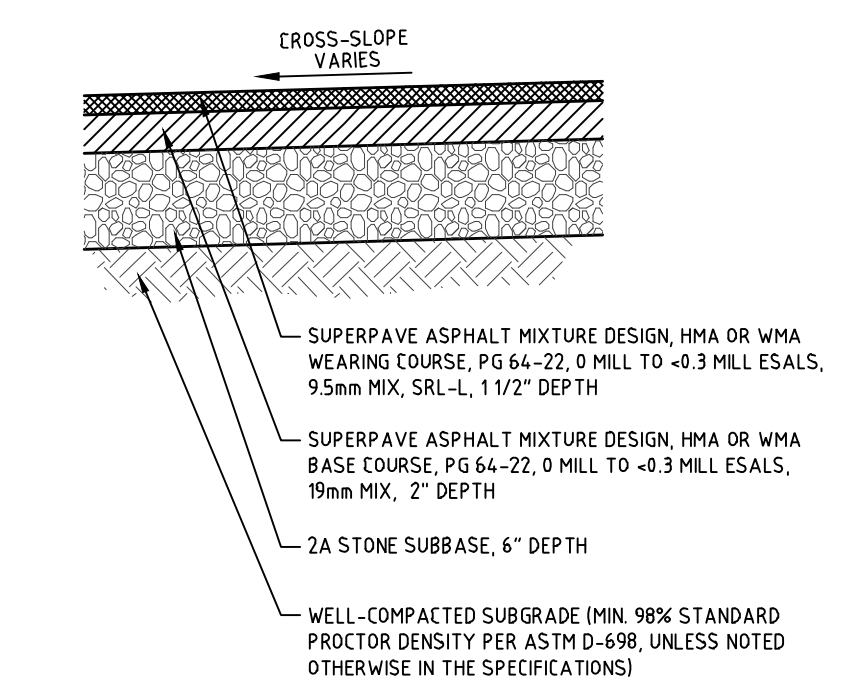


**NOTE:**  
USE THIS DETAIL FOR ALL PROPOSED PAVING AND ANY PAVING THAT MAY REQUIRE REMOVAL AND REPLACEMENT.

**PAVING CROSS-SECTION**

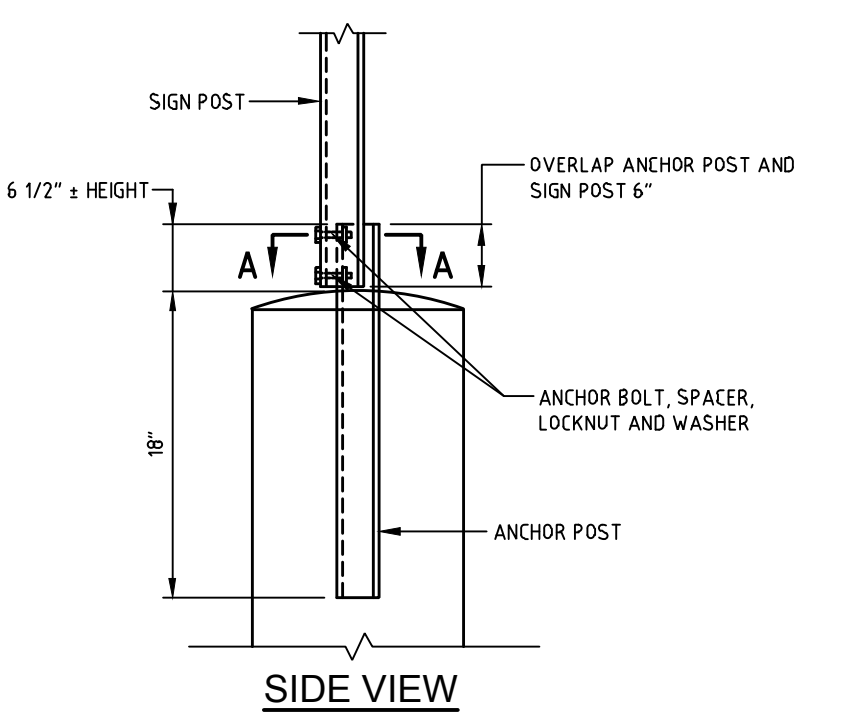
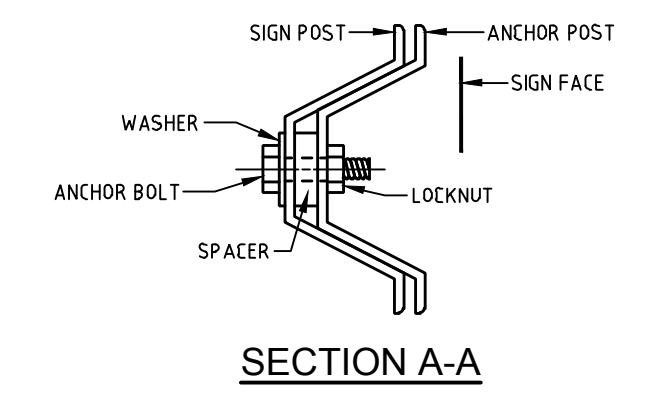


**CHANNEL BAR POST ANCHOR**


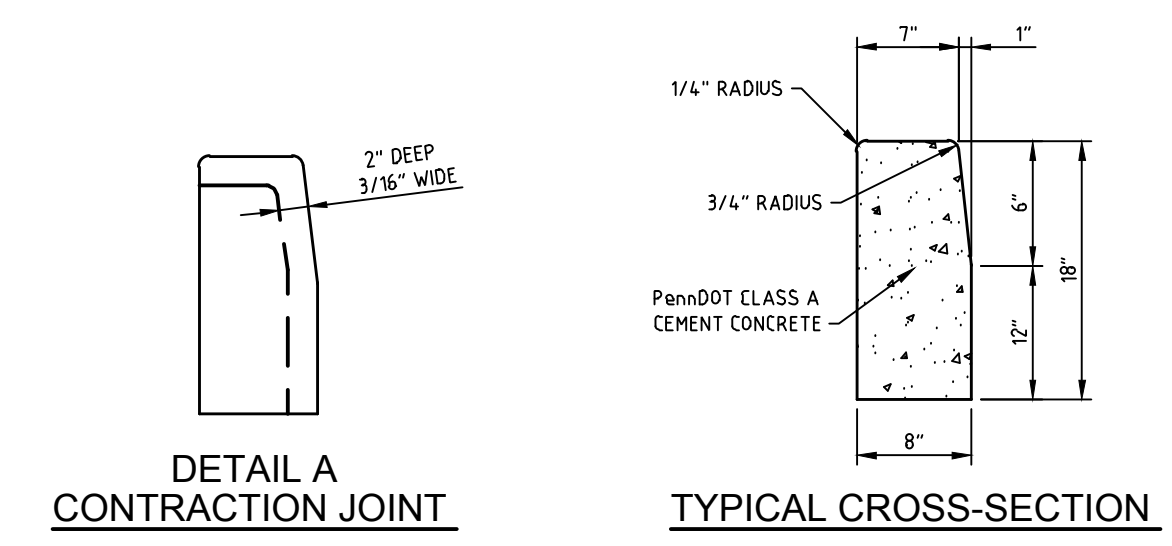


**NOTES:**  
1. MATERIALS AND CONSTRUCTION SHALL MEET THE REQUIREMENTS OF PUBLICATION 449, SECTION 430.  
2. SPACE CONTRACTION JOINTS IN UNIFORM LENGTHS OR SECTIONS.  
3. PLACE 3/4\"/>

**CONCRETE CURB AT PLANTER**

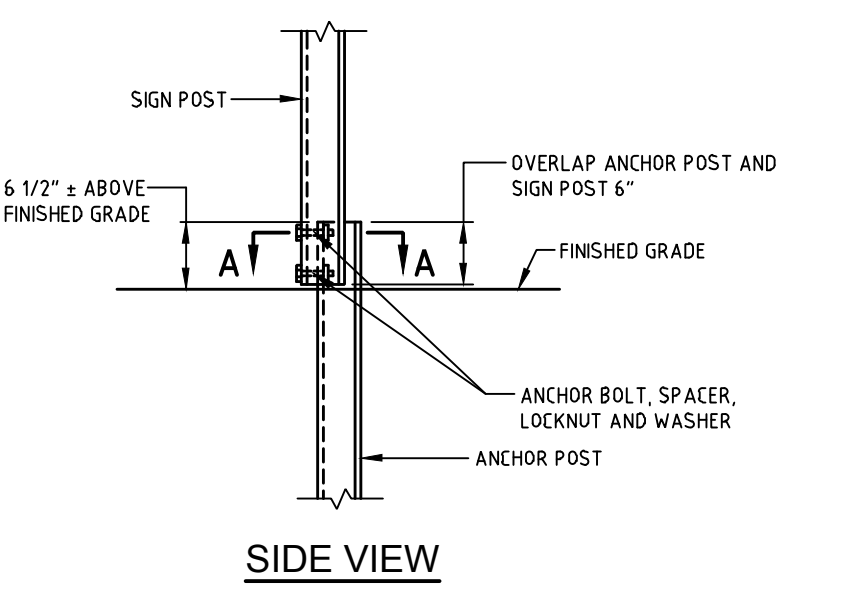
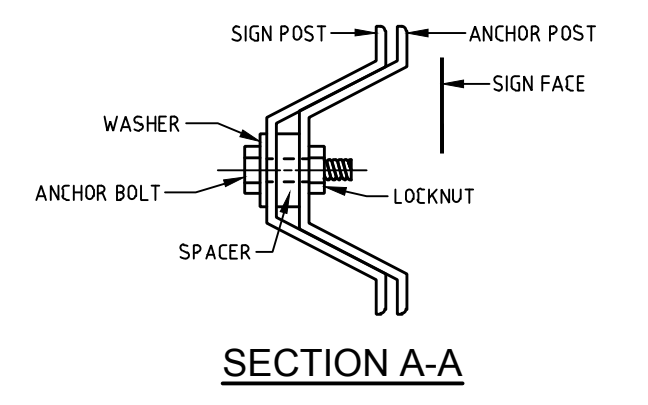


**CHANNEL BAR POST INSTALLATION**

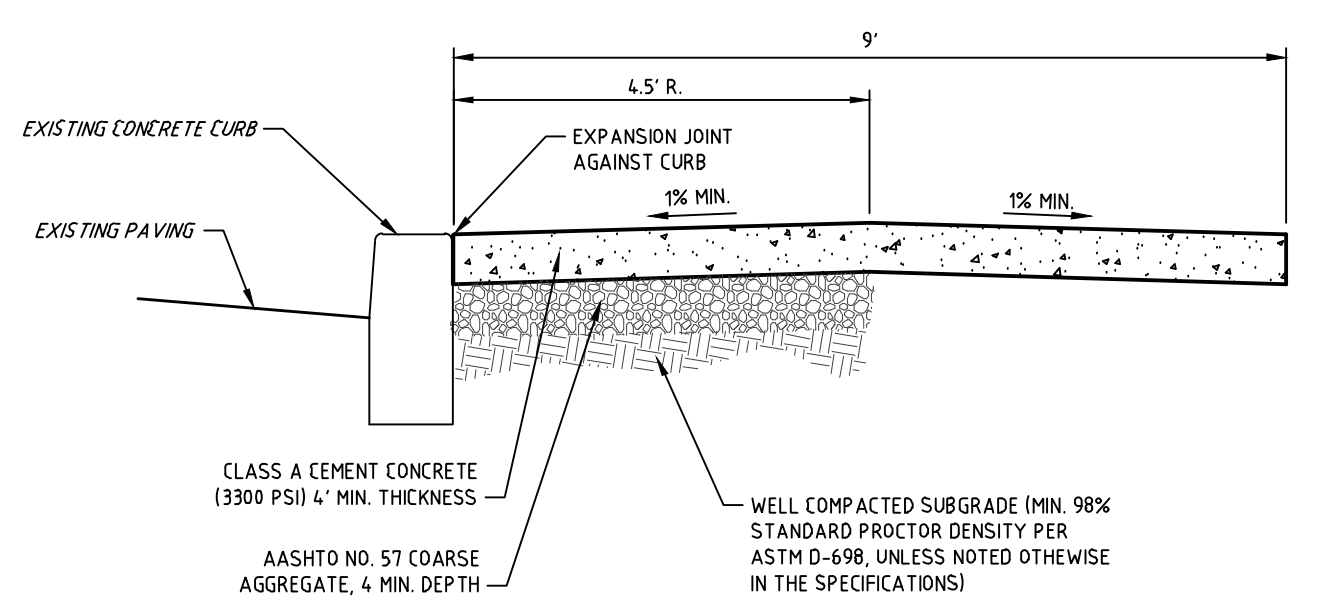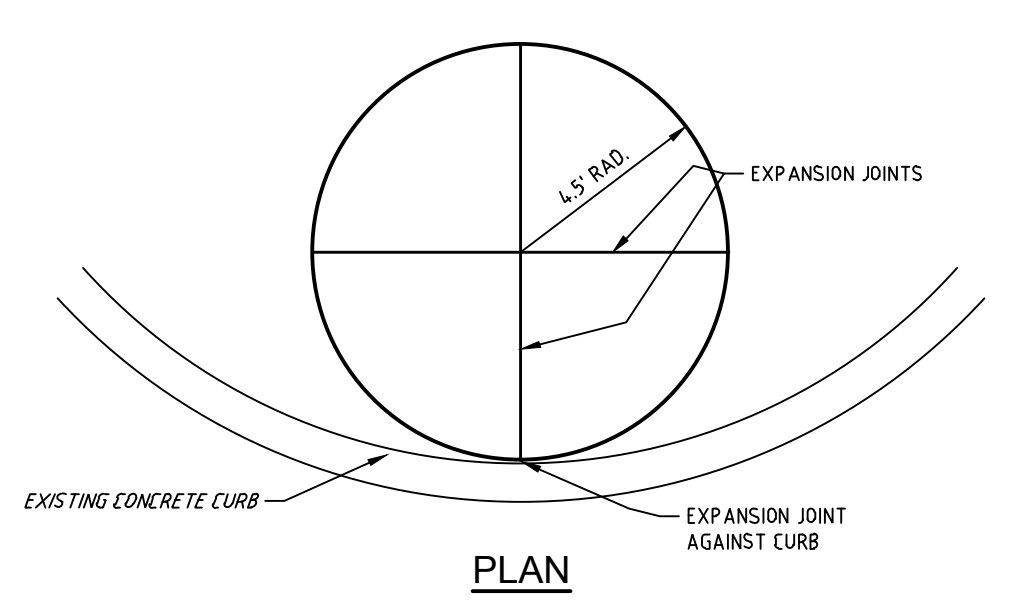


**NOTES:**  
1. 3/4\"/>

**CONCRETE FLAG POLE BASE**

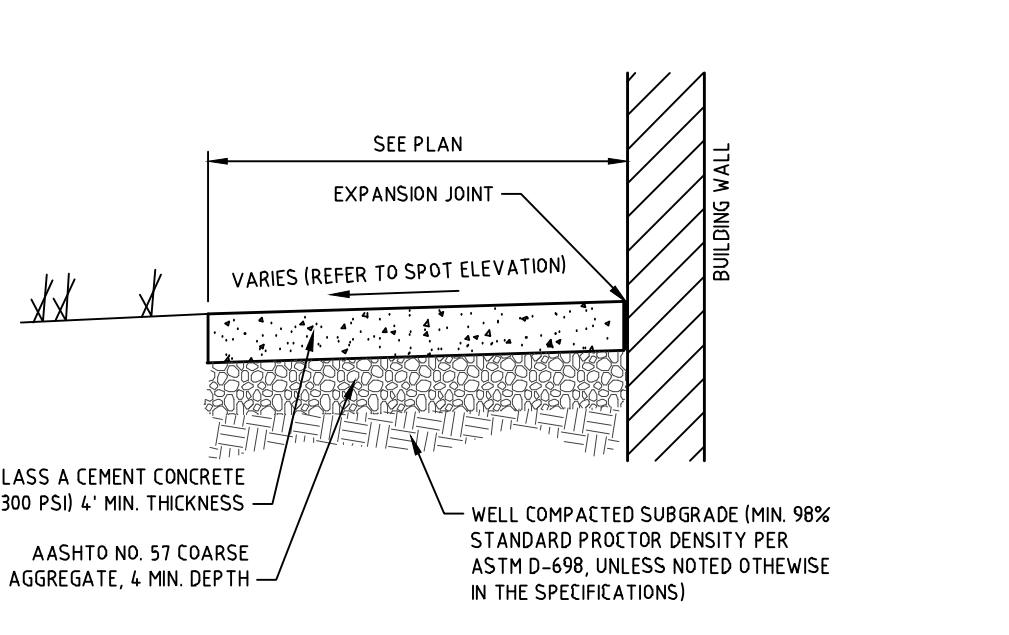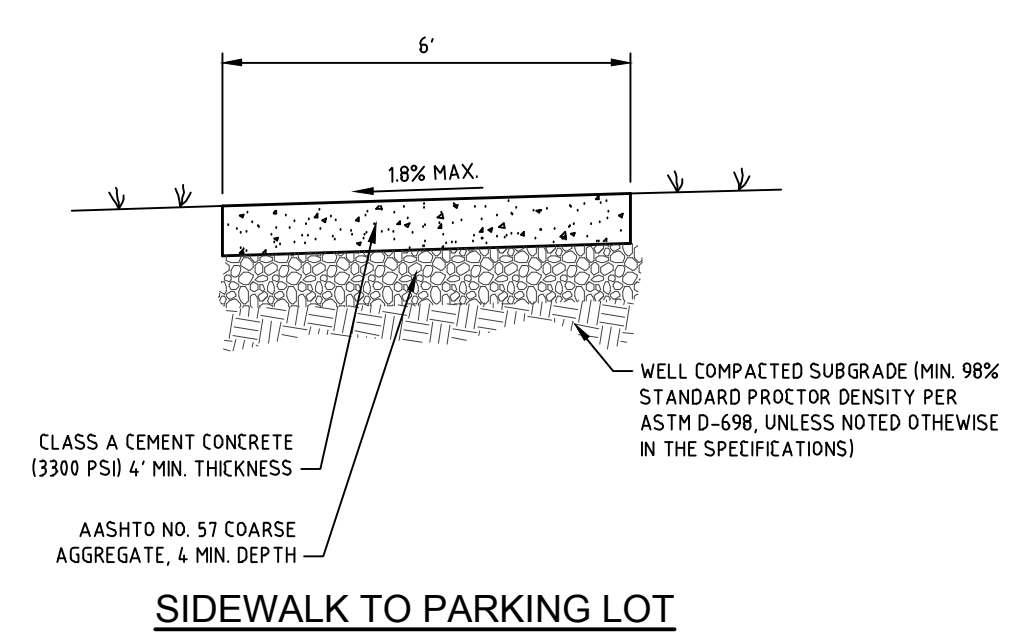

**NOTES:**  
1. 3/4\"/>

**CONCRETE SIDEWALK**

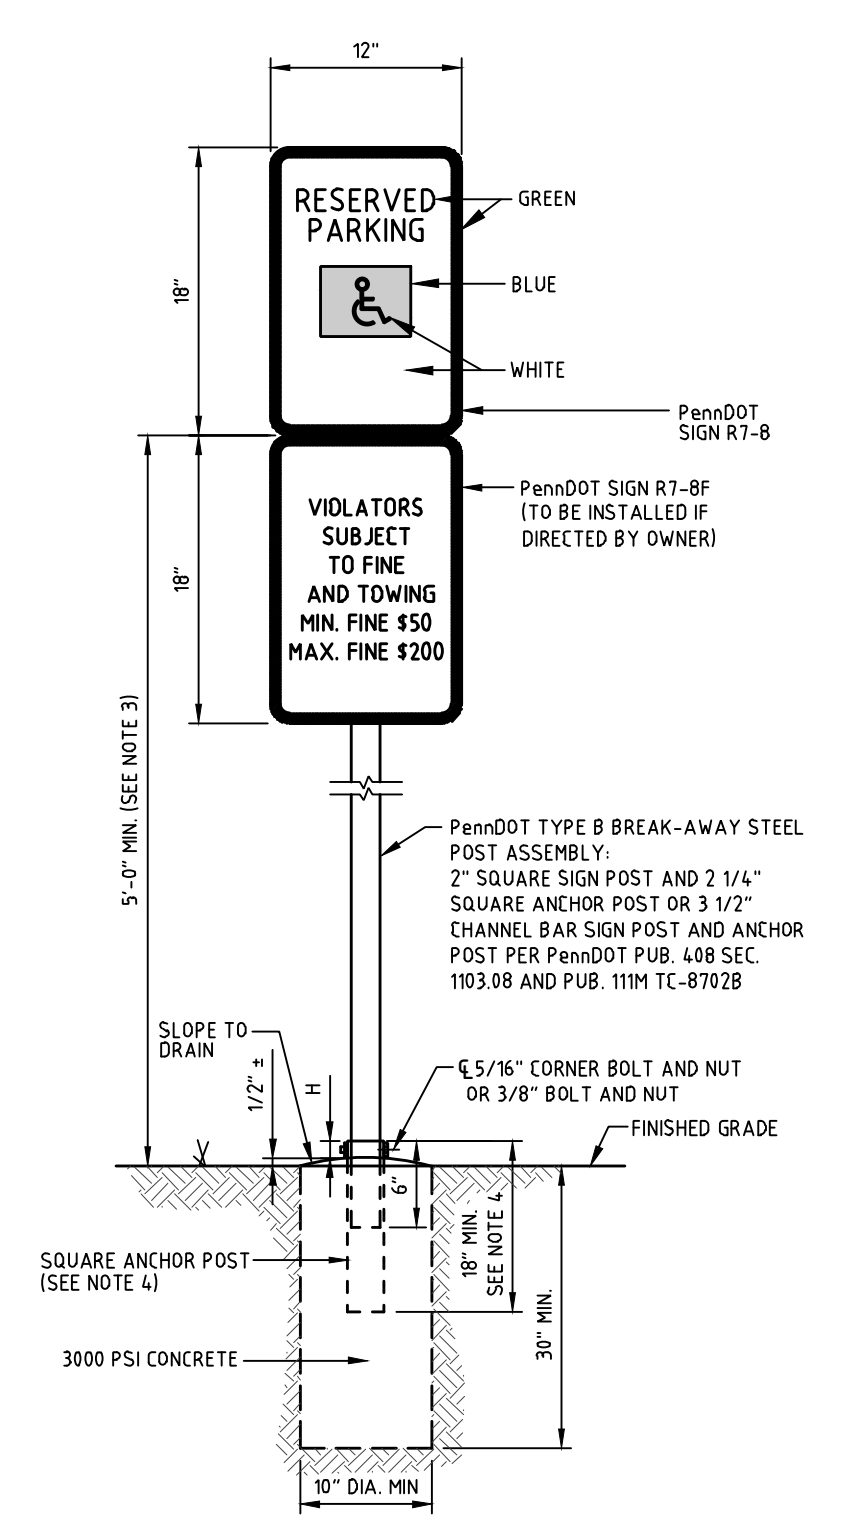

**NOTES:**  
1. ALL SIGN PAINT TO BE REFLECTORIZED.  
2. SIGN MOUNTING HEIGHT IS SUBJECT TO APPROVAL BY STATE AND LOCAL INSPECTORS.  
3. TOP OF CONCRETE BASE MAY BE BURIED 3\"/>

**SIGN IDENTIFICATION AND SIGN POST INSTALLATION**

NO.	DATE	REVISION

**REVISIONS CONSULTANT**

**STACKHOUSE BENSINGER INC.**  
LANDSCAPE ARCHITECTURE  
CIVIL ENGINEERING  
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EMAIL: ssainc@sbinc.com

**PROJECT INFORMATION**

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Wyomissing PA 19610-1278  
**PROJECT:** Berks Agricultural Center Building Expansion  
Bern Township Berks County Pennsylvania


**SITE CONSTRUCTION DETAILS**

PLAN STATUS:	CONSTRUCTION DOCUMENTS
ISSUE DATE:	2-22-2023
PROPERTY P.I.N.	4388-01-27-4033
FILE NAME:	2018-035_CD005
DRAWN BY:	ESD
CHECKED BY:	AIO
PLAN SCALE:	NO SCALE
PROJECT NUMBER:	2018-035
PLAN NO.:	C-4







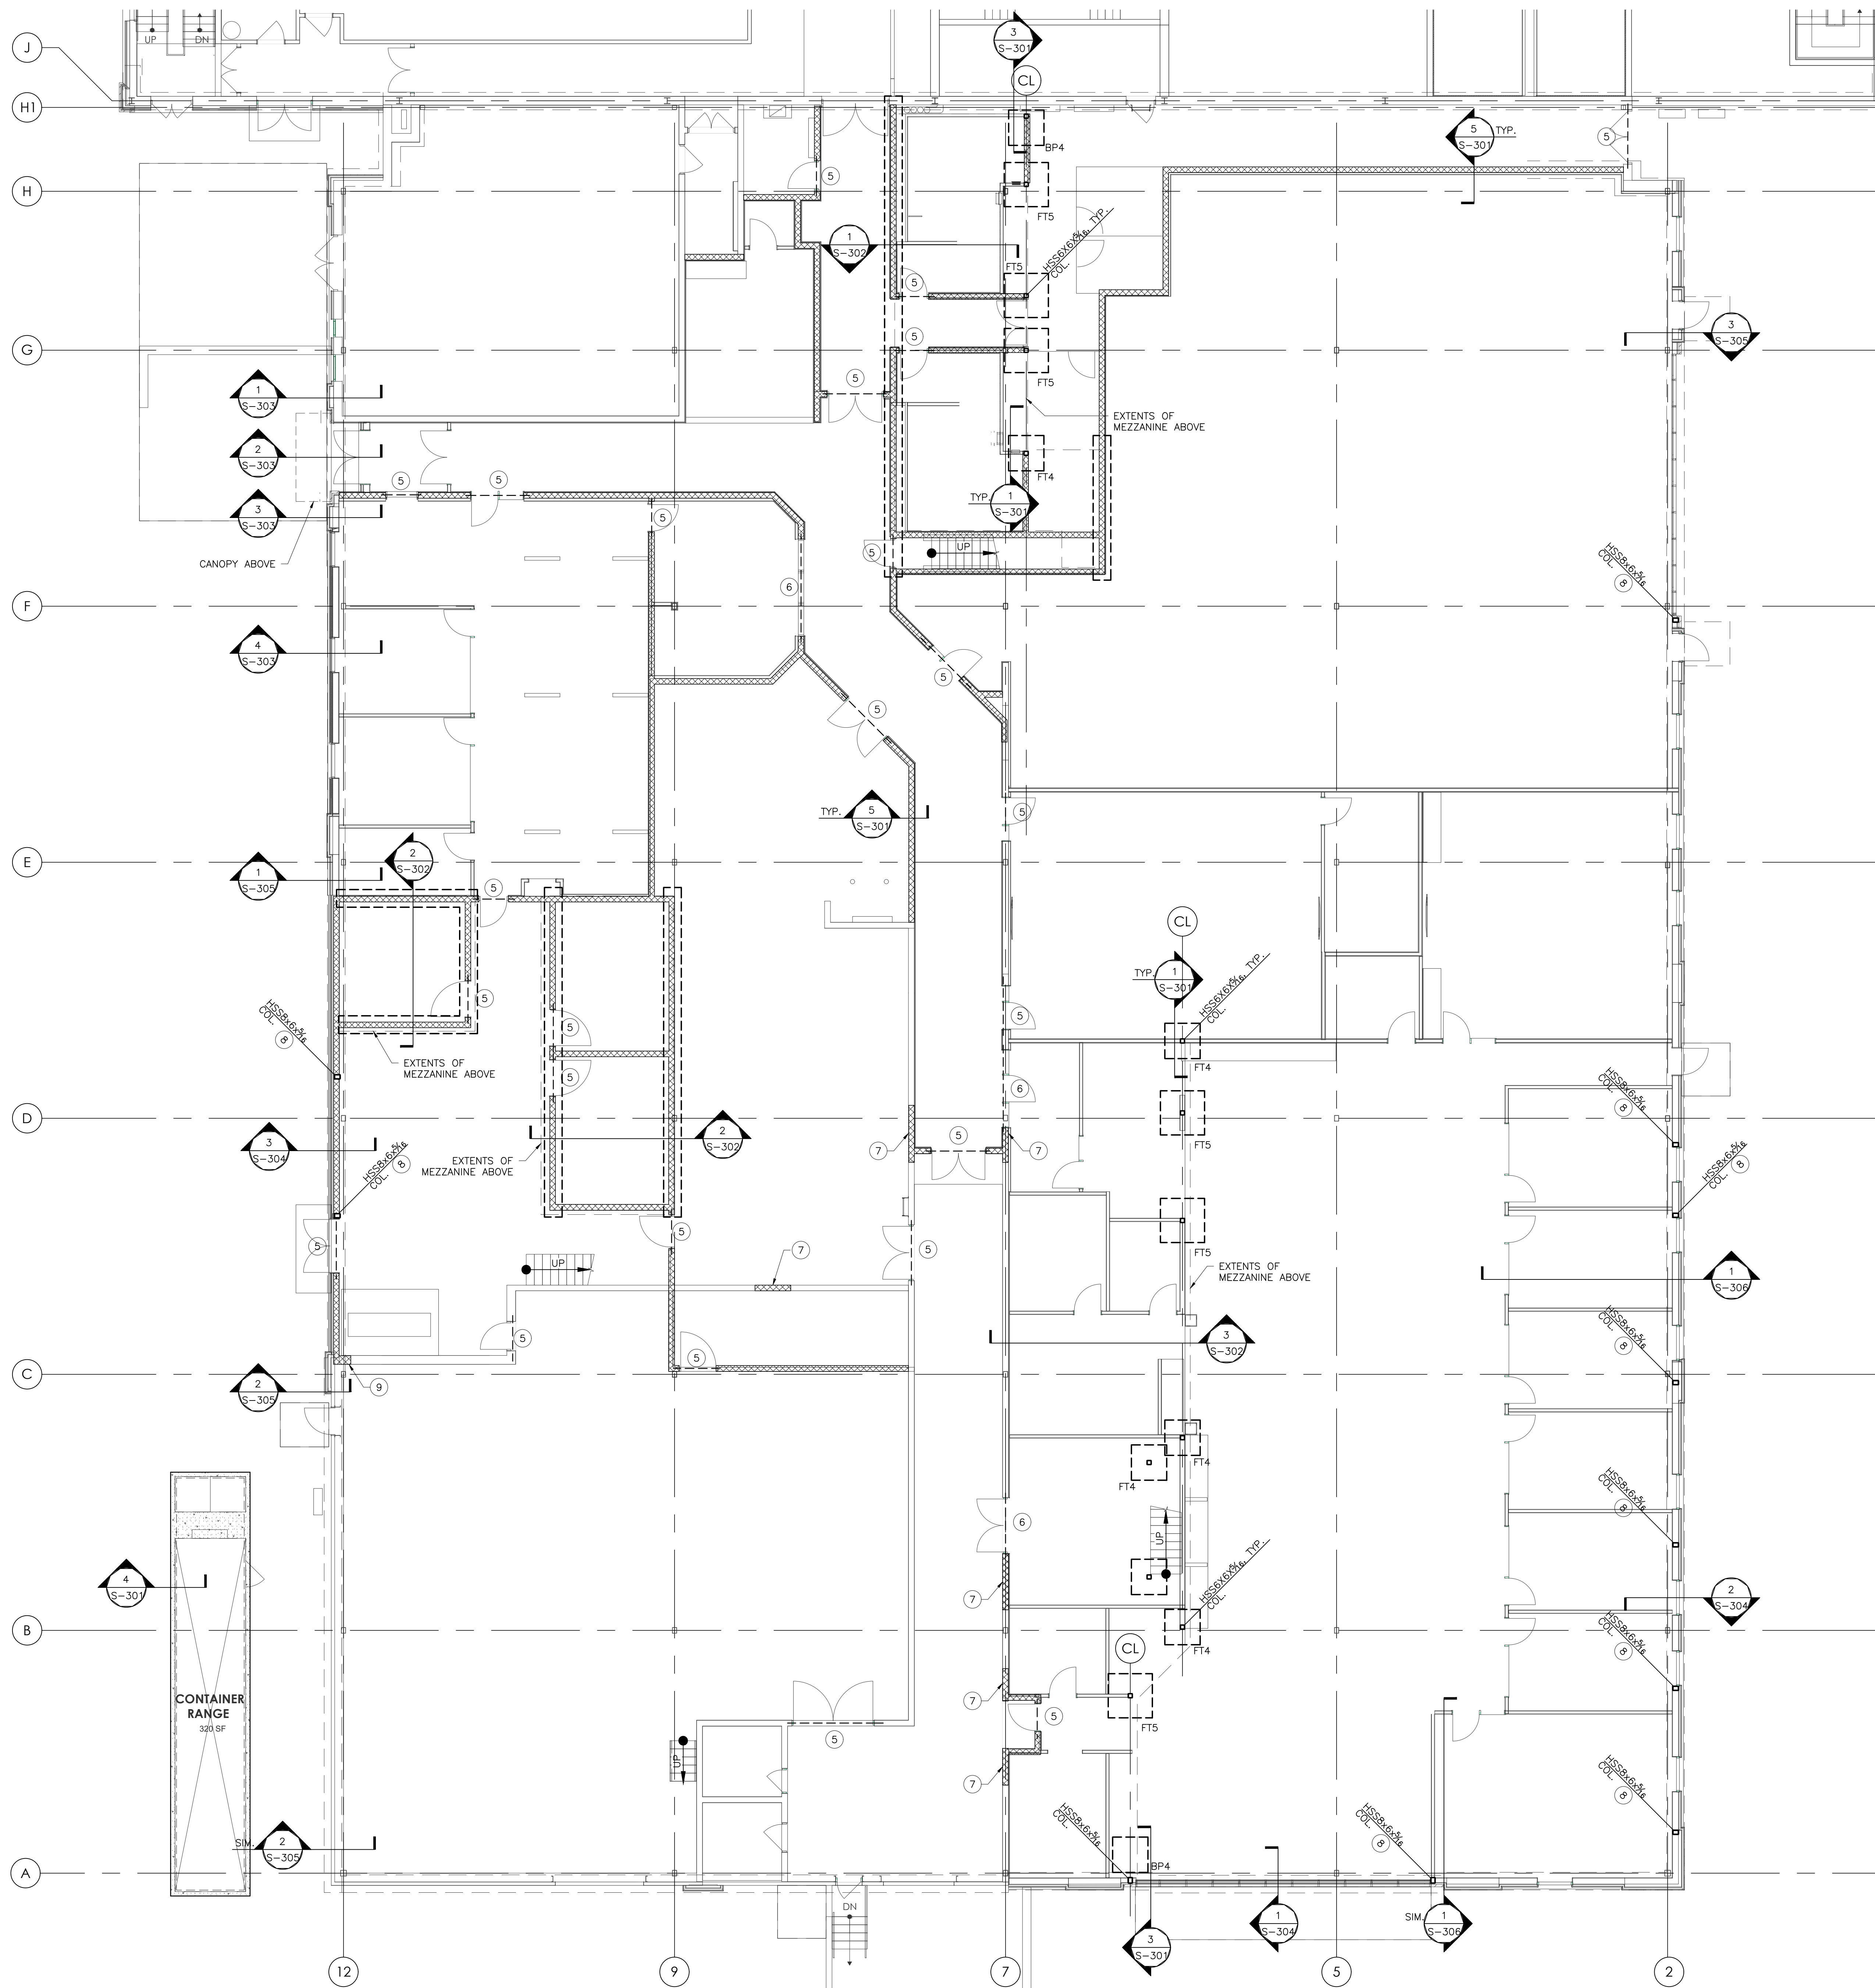

1 FLOOR PLAN  
SCALE: 1/8" = 1'-0"



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WYOMISSING, PA 19610  
610.376.4927  
www.MG-Architects.com

PROJECT #:  
22-0012

CONSULTANT  
**DIGENOVA**  
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1017 Commonwealth Pike, Suite 1000 610.270.8110 Phone  
700 South Mountain Pike, P.O. Box 1000 610.270.8657 Fax

SALVATORE DIGENOVA  
ENGINEER  
REGISTRATION NO. 042432-E  
DATE: \_\_\_\_\_ SIGNED: \_\_\_\_\_

COUNTY OF BERKS  
REX LEVINGOOD, DIR. OF FAC. & OPS  
1238 COUNTY WELFARE ROAD #260  
LEESPORT, PA 19533  
610.478.6201 X6220  
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BERKS COUNTY AGRICULTURAL CENTER  
**FACILITY UPGRADES**  
1238 COUNTY WELFARE ROAD  
LEESPORT, PA 19533

ISSUED  
DATE: 03/30/23

REVISED	DESCRIPTION	DATE

PROJ. MGR.: S.DI GENOVA  
P.M. @-MAIL: <consultant@pm email>  
DRAWN BY: JF  
CLIENT PROJ #: 2022-010.00  
SHEET SCALE  
1 1  
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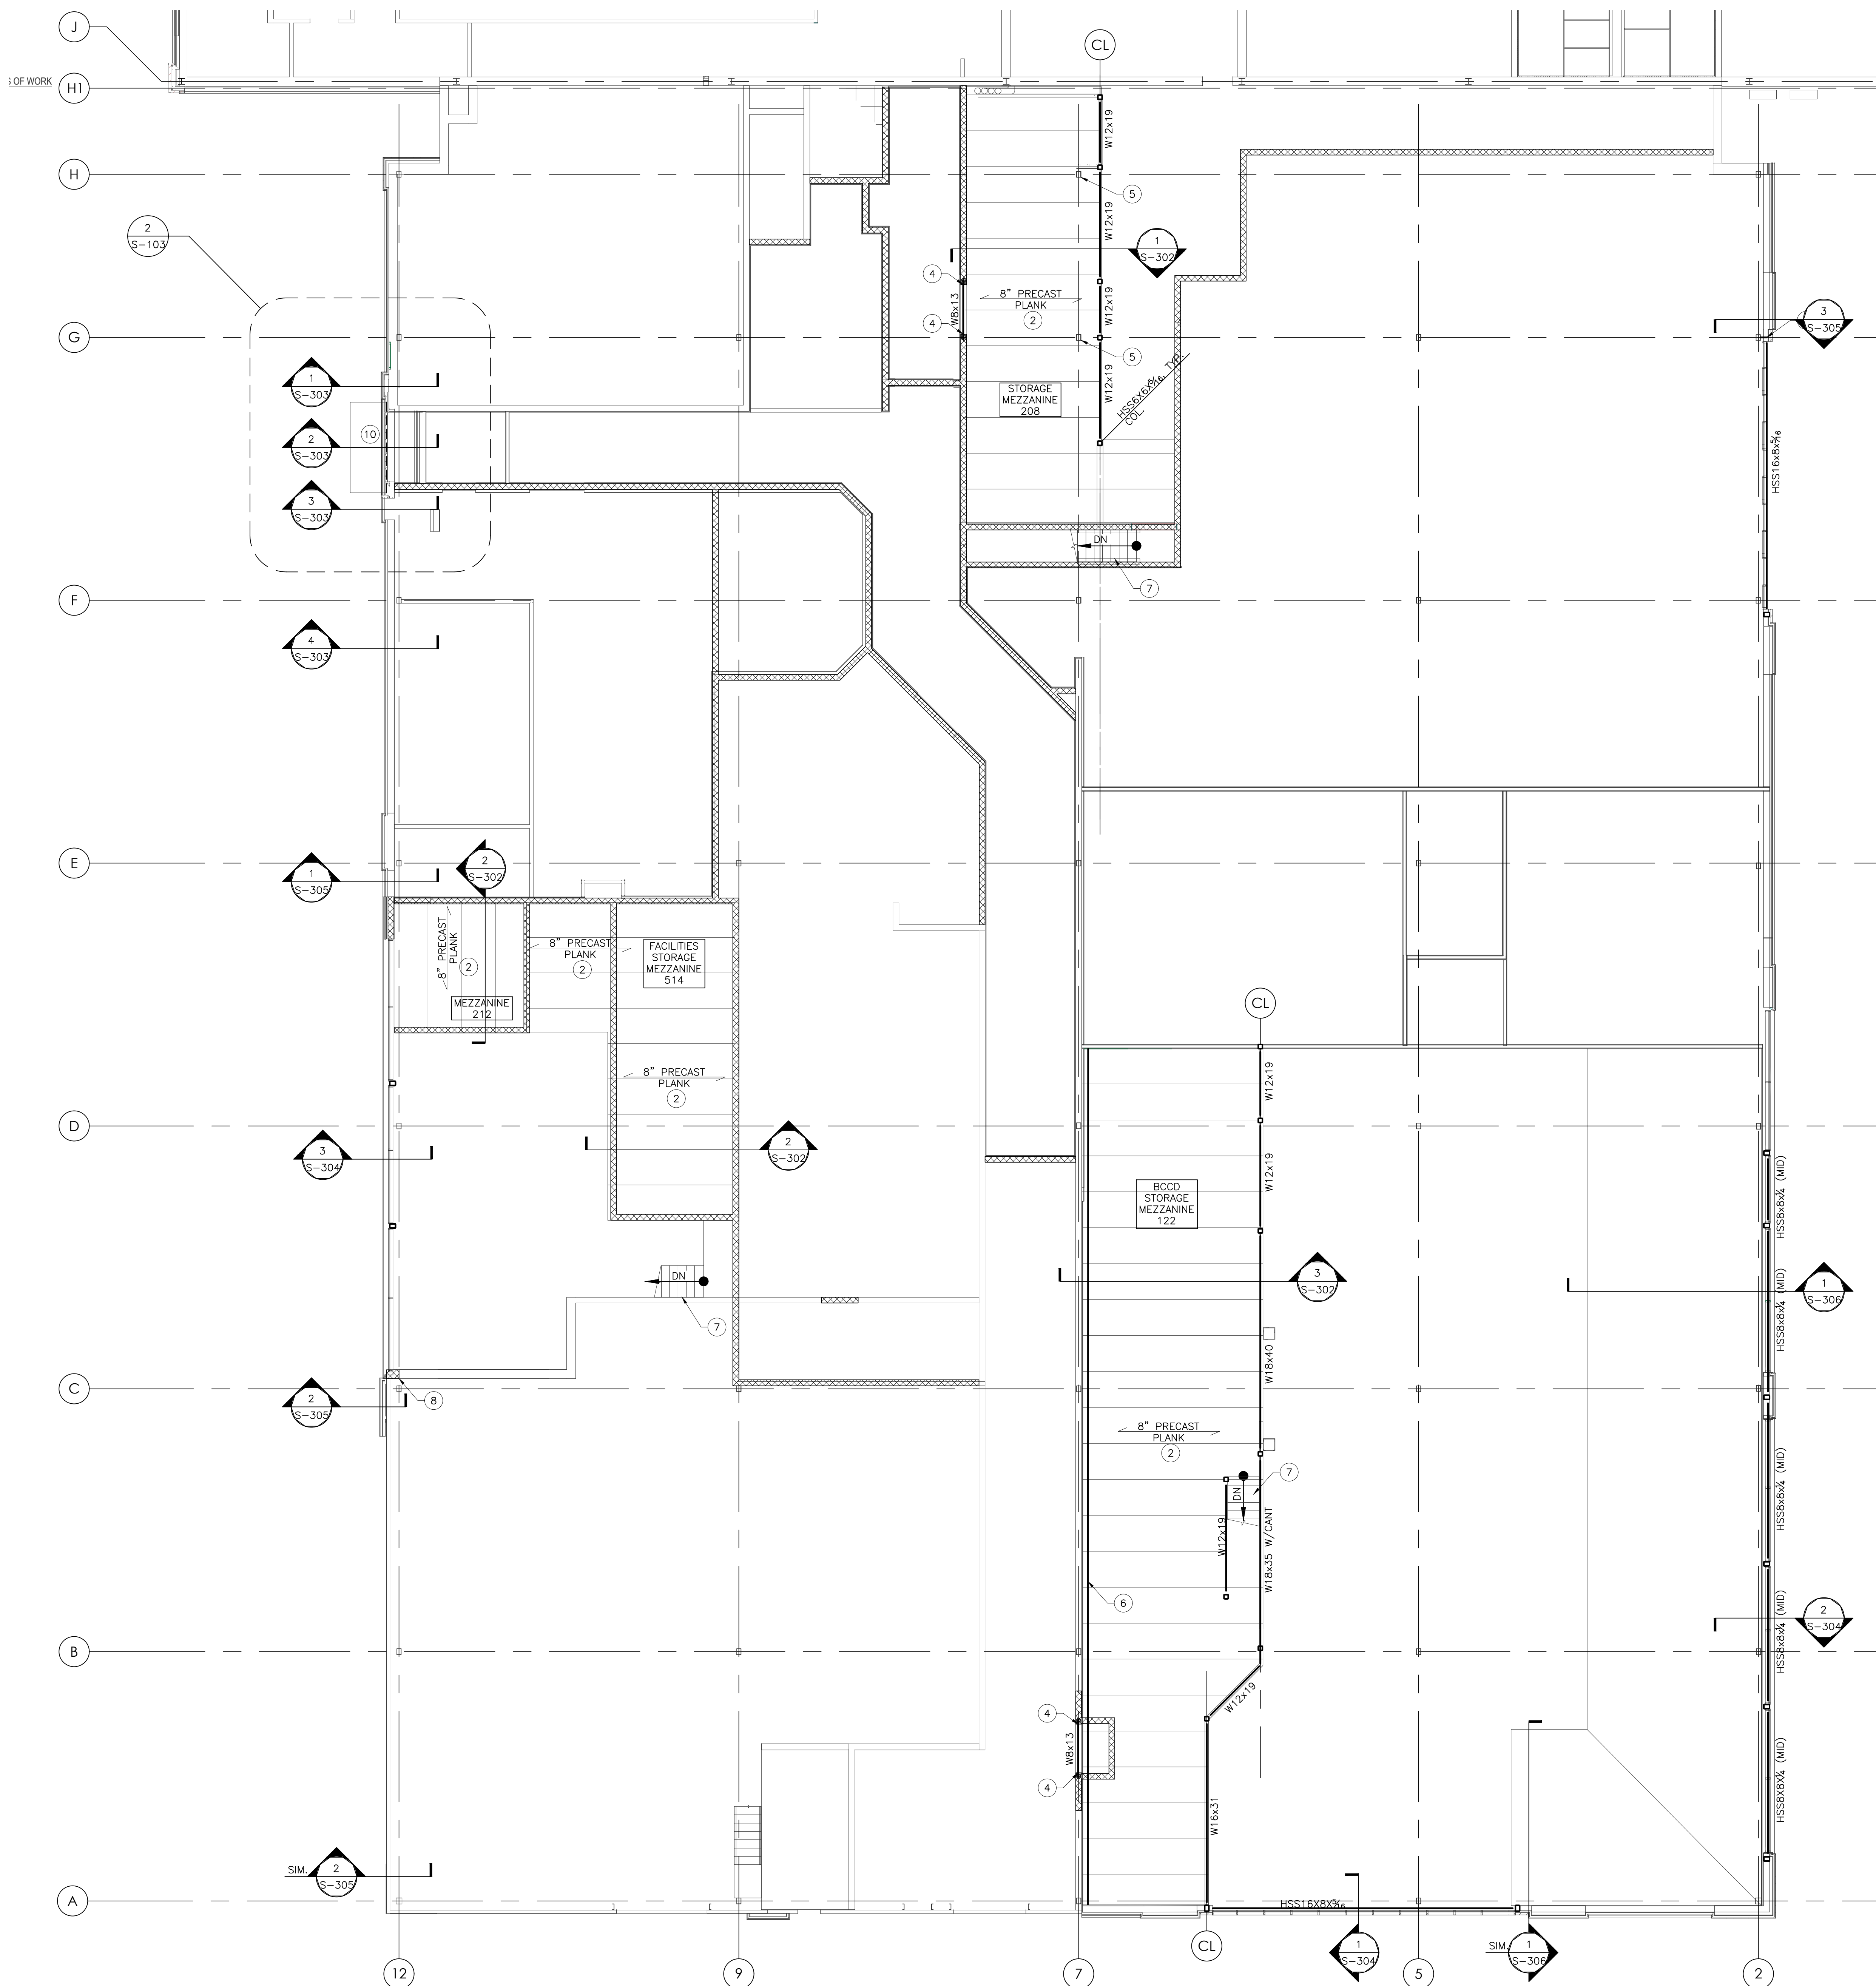
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FOUNDATION PLAN


S-101

- NOTES:
- COORDINATE EXTENT AND LOCATION OF SIDE WALKS AND EXIT STEP-OFF PADS WITH ARCH DRAWINGS.
  - TYP. TOP OF LEVELING PLATE ELEVATION TO BE (-7") BELOW FINISH FLOOR FOR ALL COLUMNS. U.N.O.
  - REFER TO ARCHITECTURAL FLOOR PLANS FOR ADDITIONAL DIMENSIONS AND FOR COORDINATING LOCATIONS OF COLUMNS, BEARING WALLS AND SHEAR WALLS.
  - SEE ARCH. DWG'S FOR EXTENT AND LOCATION OF PERIMETER UNDER-SLAB RIGID INSULATION.
  - PROVIDE (N) PRE-CAST/CONC. HEADER, SEE DETAIL 7/S-301.
  - PROVIDE (N) STL BEAM HEADER, SEE DETAIL 8/S-301.
  - INFILL (E) OPENING W/ CMU TO MATCH EXISTING.
  - (N) HSS COLUMN TO FIT WITHIN WALL CAVITY. ATTACH (N) HSS COLUMN TO CMU FOUNDATION WALL W/ 3/4" THK, RECTANGULAR BASE PLATE & (4) 3/4" DIA. EXPANSION BOLTS.
  - ATTACH (N) CMU WALL TO (E) CMU WALL W/ #5 HORIZ. BARS @ 24" O.C. (VERT.). DRILL & GROUT INTO (E) CMU WALL, 6" MIN. EMBED.
  - 8"-16ga MTL STUD BOX, TYP @ ALL EXTERIOR DOOR/WINDOW OPENINGS, U.N.O.





**1 MEZZANINE FRAMING PLAN**  
 S-103 SCALE: 1/8"=1'-0"

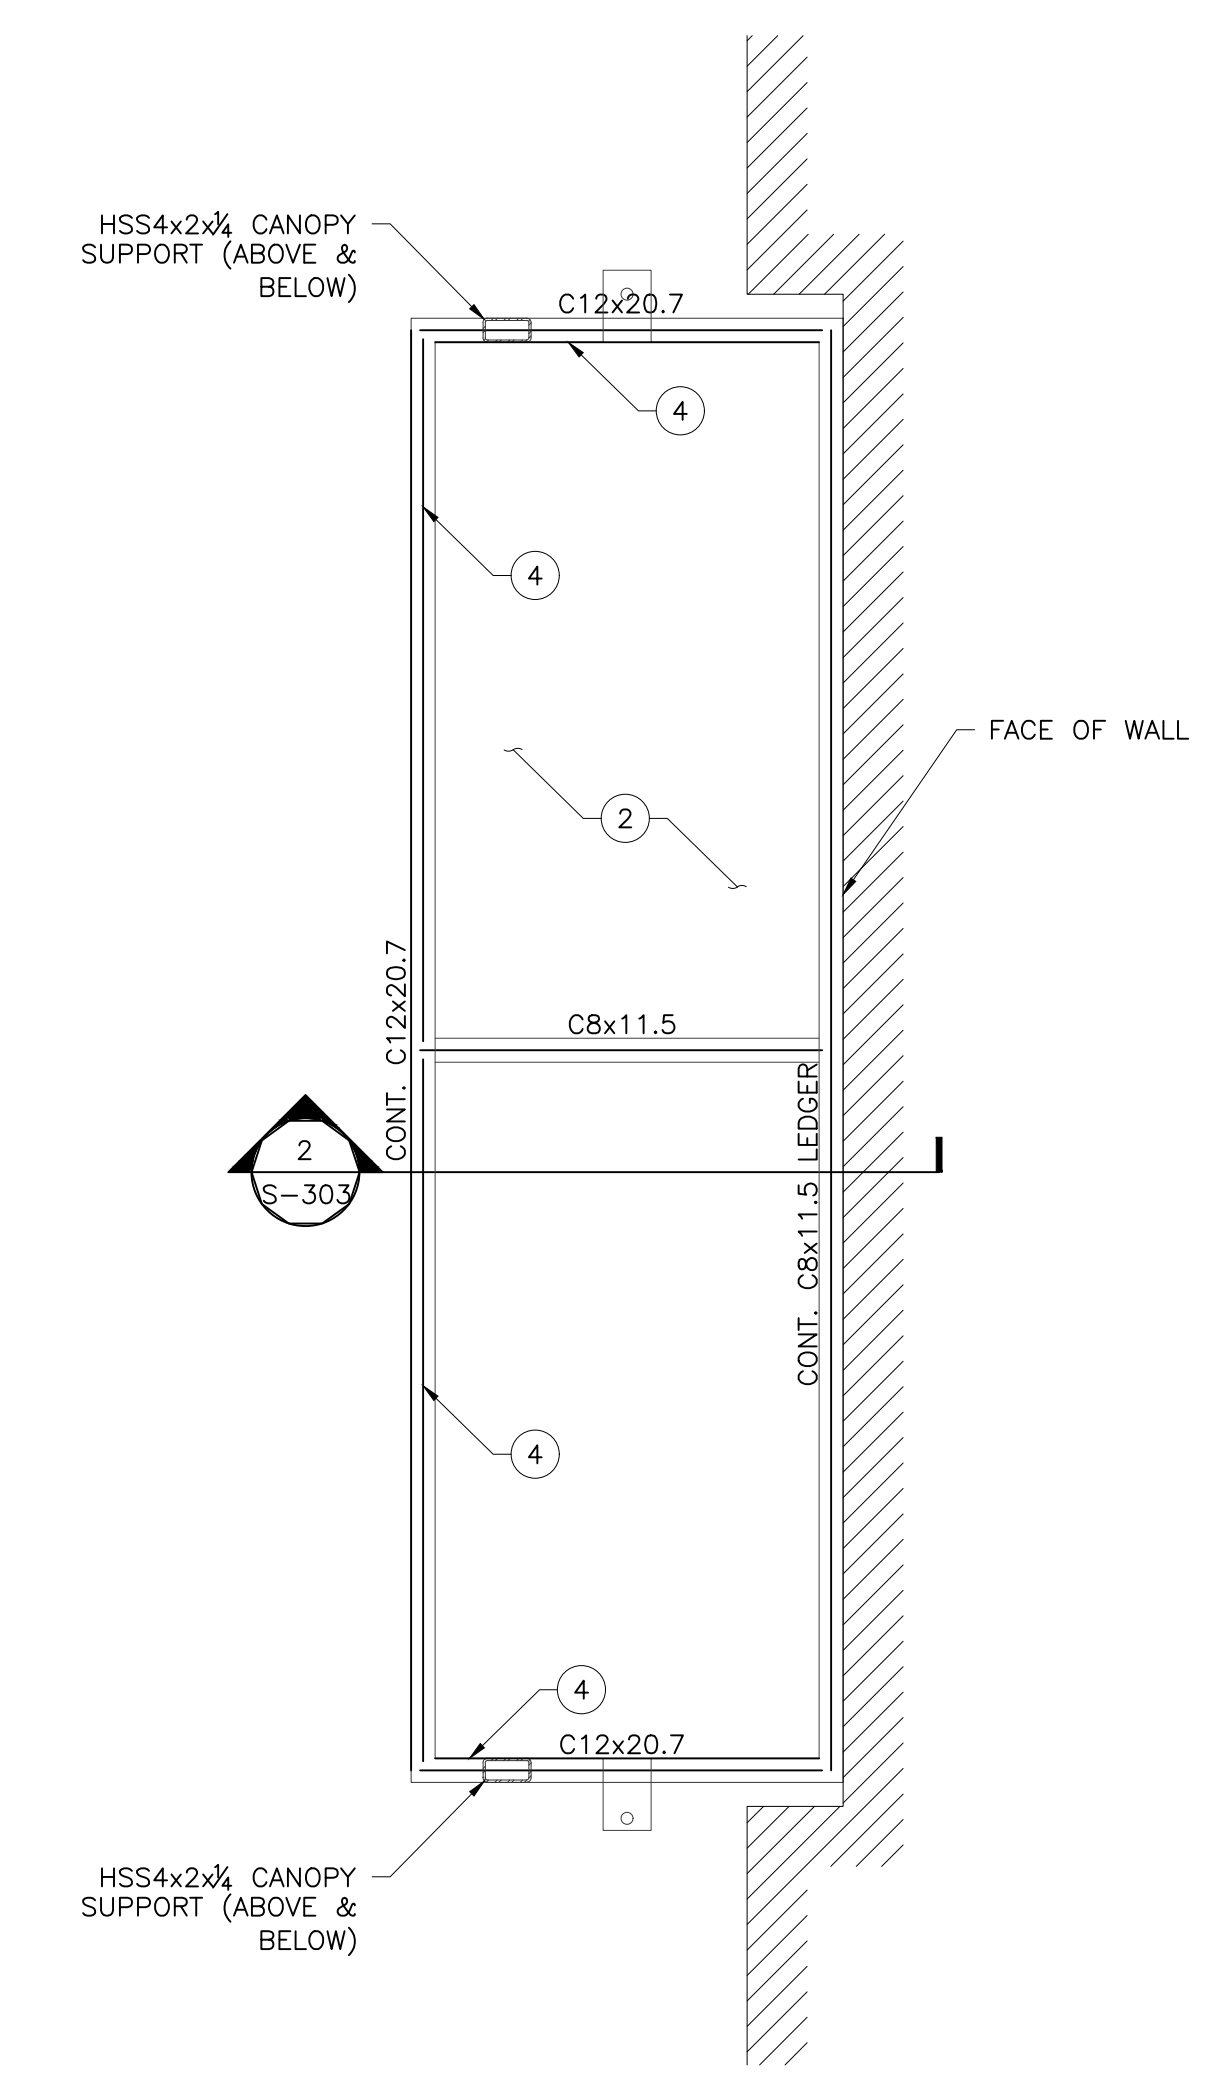

**2 CANOPY ROOF PLAN**  
 S-103 SCALE: 3/4"=1'-0"

- NOTES:
1. B.O.S. = 9'-8" (COORD. W/ ARCH'L)
  2. 1½-20GA GALV. MTL ROOF DECK.
  3. ALL CANOPY STL. TO BE GALVANIZED.
  4. CONT. ∠3x3x¼ DECK SUPPORT ANGLE.

- NOTES:
1. T.O. MEZZ ELEV. = 9'-8" (COORD. W/ ARCH'L)
  2. 8" PRECAST CONC. HOLLOW CORE PLANK, PROVIDED BY OTHERS (LIVE LOAD = 125 PSF MIN.)
  3. PROVIDE HSS OUTRIGGER (TO MATCH SIZE OF HSS COLUMN) FULLY WELDED TO HSS COLUMN.
  4. PROVIDE BM BRG POCKET, SEE DETAIL 9/S-301
  5. PROVIDE OPENING/BLOCK OUT OF (N) PLANK AROUND (E) COLUMN.
  6. PROVIDE (N) CONT. ∠8x8x¼ LEDGER.
  7. PRE-FABRICATED STEEL STAIRS, COOR. W/ARCH'L
  8. ATTACH (N) CMU WALL TO (E) CMU WALL W/ #5 HORIZ. BARS @ 24" O.C. (VERT.). DRILL & GROUT INTO (E) CMU WALL, 6" MIN. EMBED.
  9. 8"-16ga MTL STUD BOX, TYP. @ ALL EXTERIOR DOOR/WINDOW OPENINGS, U.N.O.
  10. 12"-14ga MTL STUD BOX HEADER.

ISSUED  
 DATE: 03/30/23

REVISION	DESCRIPTION	DATE

PROJ. MGR.: S.DI GENOVA  
 P.M. @-MAIL: <consultant@pm email>  
 DRAWN BY: JF  
 CLIENT PROJ #: 2022-010.00  
 SHEET TITLE


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SHEET TITLE:  
**MEZZANINE/  
 HI-WINDOW PLAN**

**S-103**





1 ROOF FRAMING PLAN  
S202 SCALE: 1/8"=1'-0"

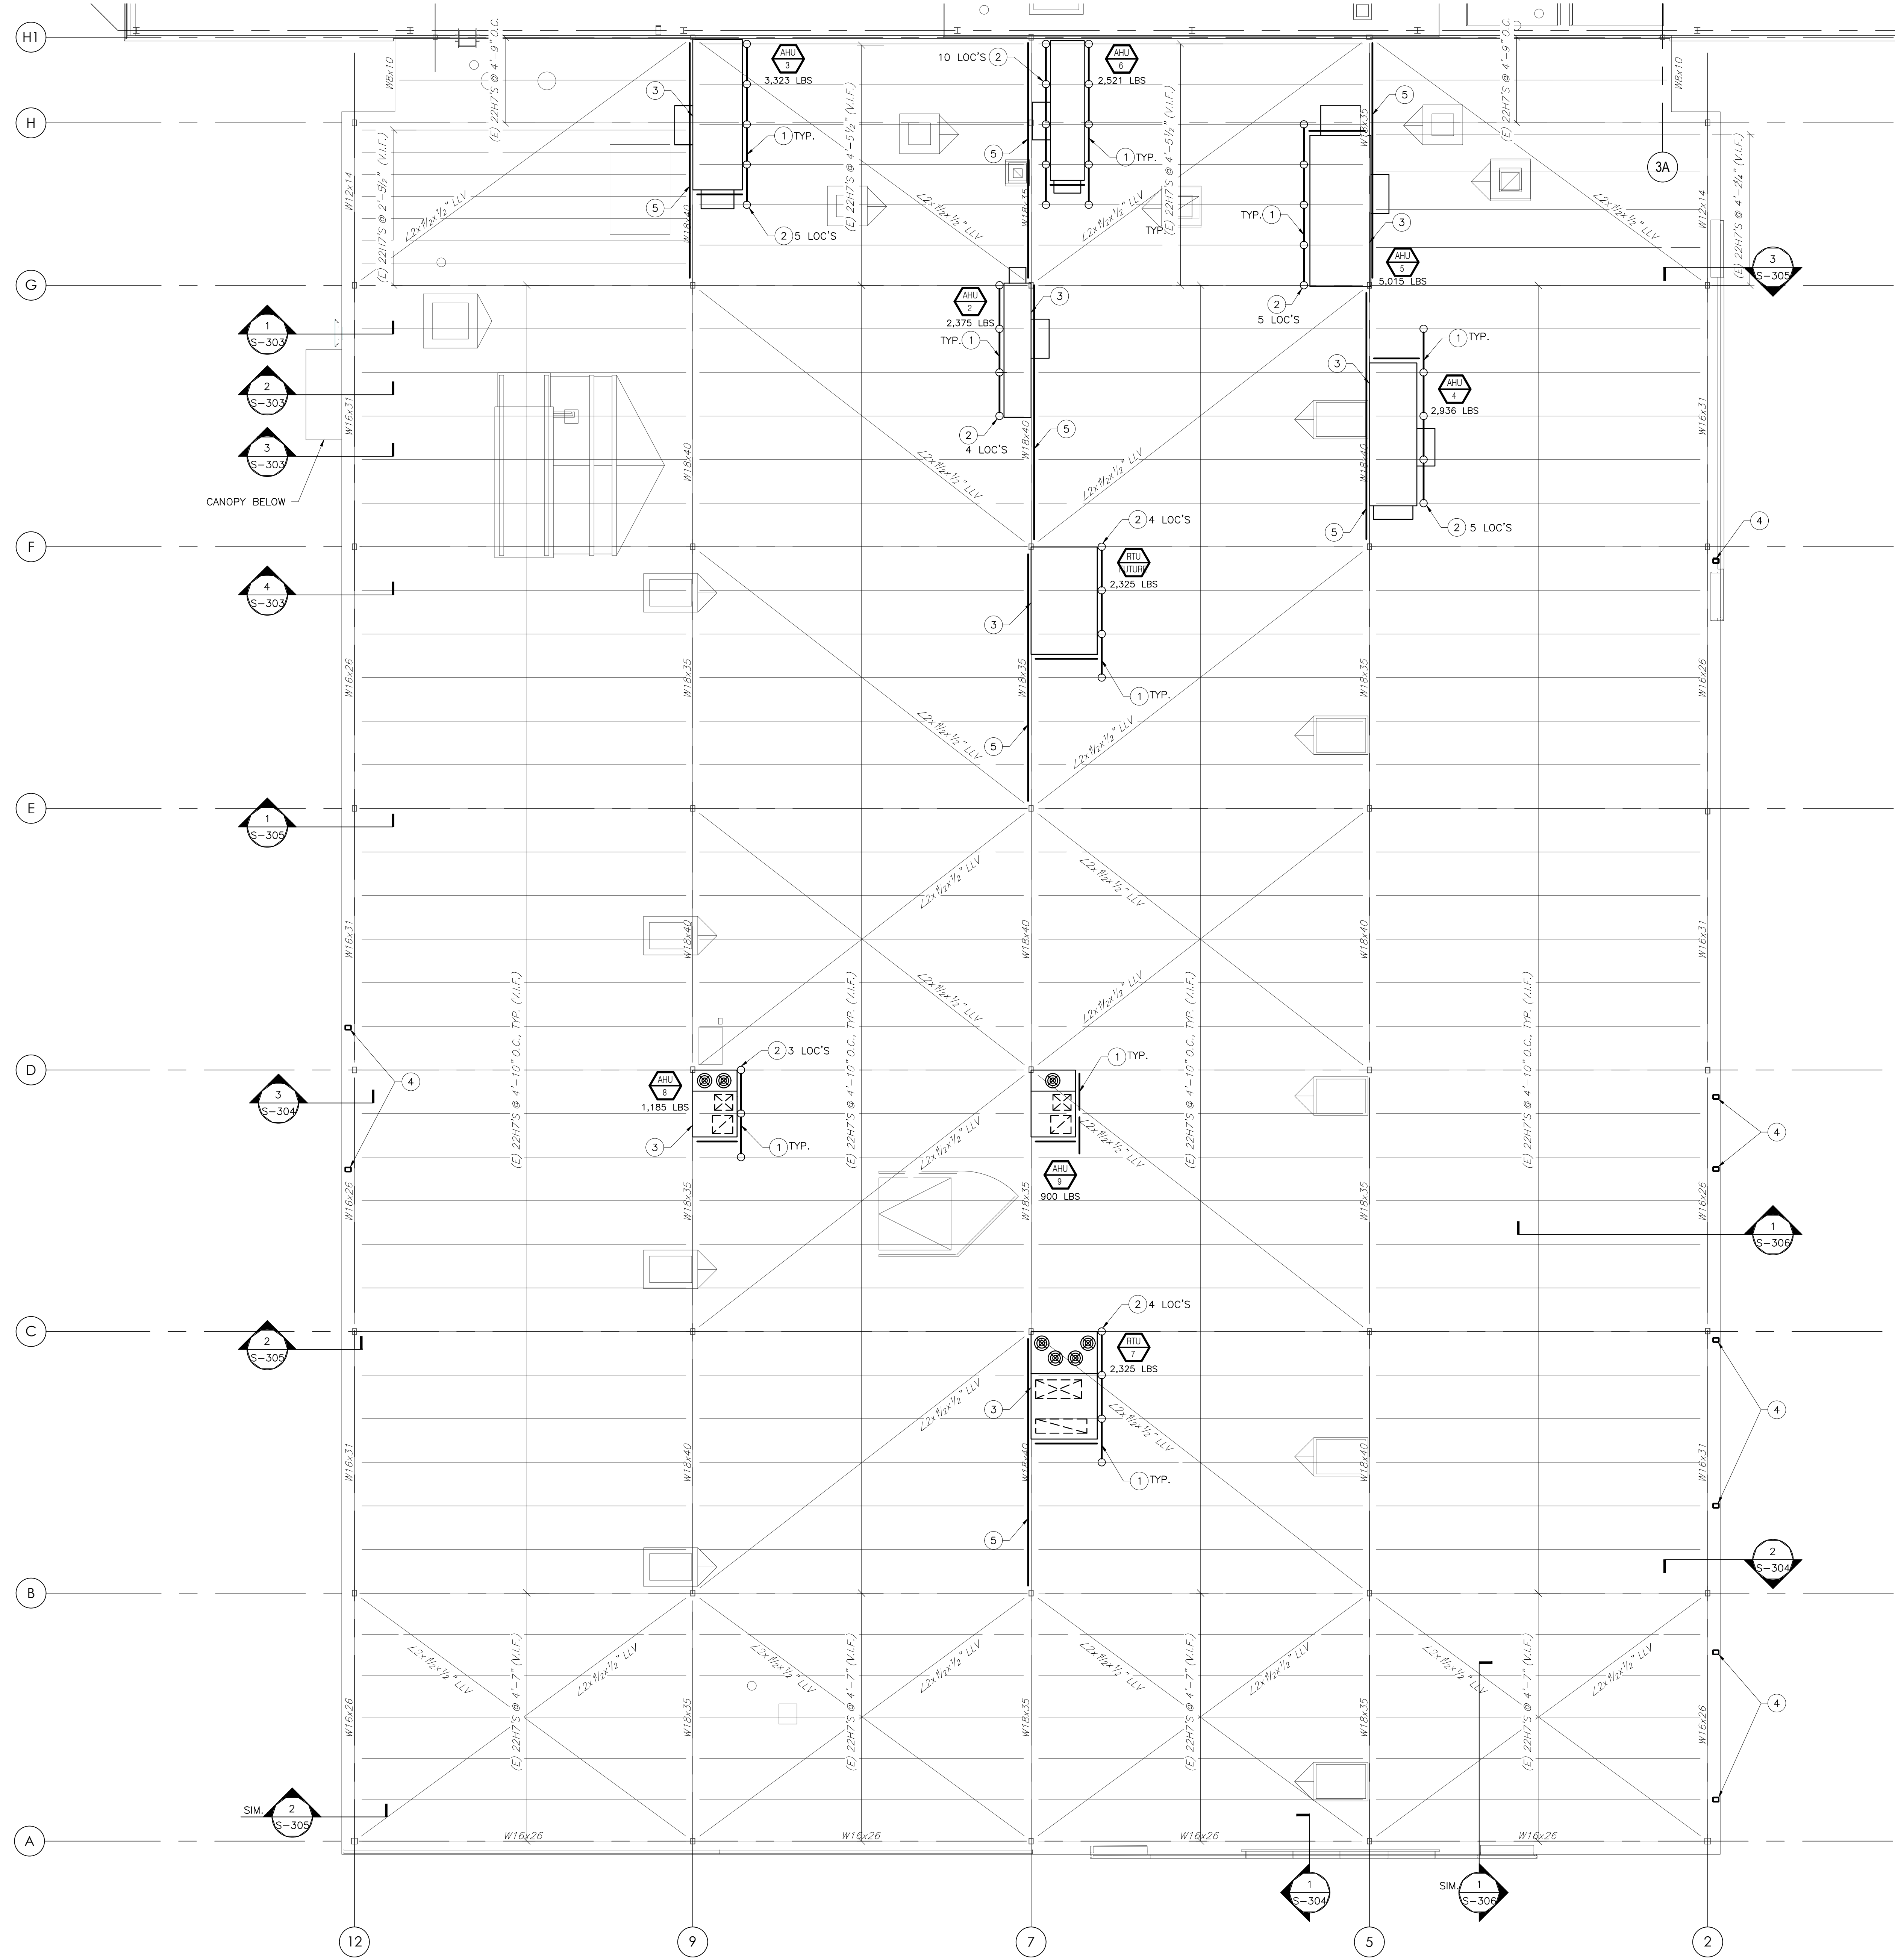- NOTES:
- 1 PROVIDE FRAMED ROOF OPENING FOR ALL RTU LOC'S AND PENETRATIONS, SEE DETAIL 4/S-302.
  - 2 PROVIDE JOIST REINF. FOR ALL RTU LOCATION, SEE DETAIL 5/S-302.
  - 3 LINE UP ONE SIDE OF UNIT OVER JOIST/BEAM.
  - 4 ATTACH (N) HSS COL., LOCATED WITHIN WALL CAVITY, TO (E) ROOF BEAM W/ 3/8" THK BENT PLATE, FULLY WELDED TO BOTTOM FLANGE OF (E) ROOF BM & FACE OF (N) HSS COL.
  - 5 REINFORCE (E) ROOF BEAM, SEE DETAIL 10/S-301
  - 6 ADJUST OVERALL UNIT, AS REQ'D, TO ENSURE SUPPLY & DUCT RETURN FALL BETWEEN EXISTING JOISTS.



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www.MG-Architects.com

PROJECT #:  
22-0012

CONSULTANT  
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1022 Commonwealth Park Blvd. #100 610.276.8100  
7700 South Main Street, P.O. Box 100 610.276.8657 Fax

SALVATORE DIGENOVA  
ENGINEER  
REGISTRATION NO. 042432-E  
DATE: SKINNED

COUNTY OF BERKS  
REX LEVENGOOD, DIR. OF FAC. & OPS  
1238 COUNTY WELFARE ROAD #260  
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610.478.6201 X6220  
RLevengood@CountyOfBerks.gov

BERKS COUNTY AGRICULTURAL CENTER  
**FACILITY UPGRADES**  
1238 COUNTY WELFARE ROAD  
LEESPORT, PA 19533

ISSUED  
DATE: 03/30/23

REV#	DESCRIPTION	DATE

PROJ. MGR.: S.DI GENOVA  
P.M. @-MAIL: <consultant.pm email>  
DRAWN BY: JF  
CLIENT PROJ #: 2022-010.00  
DATE: 03/30/23

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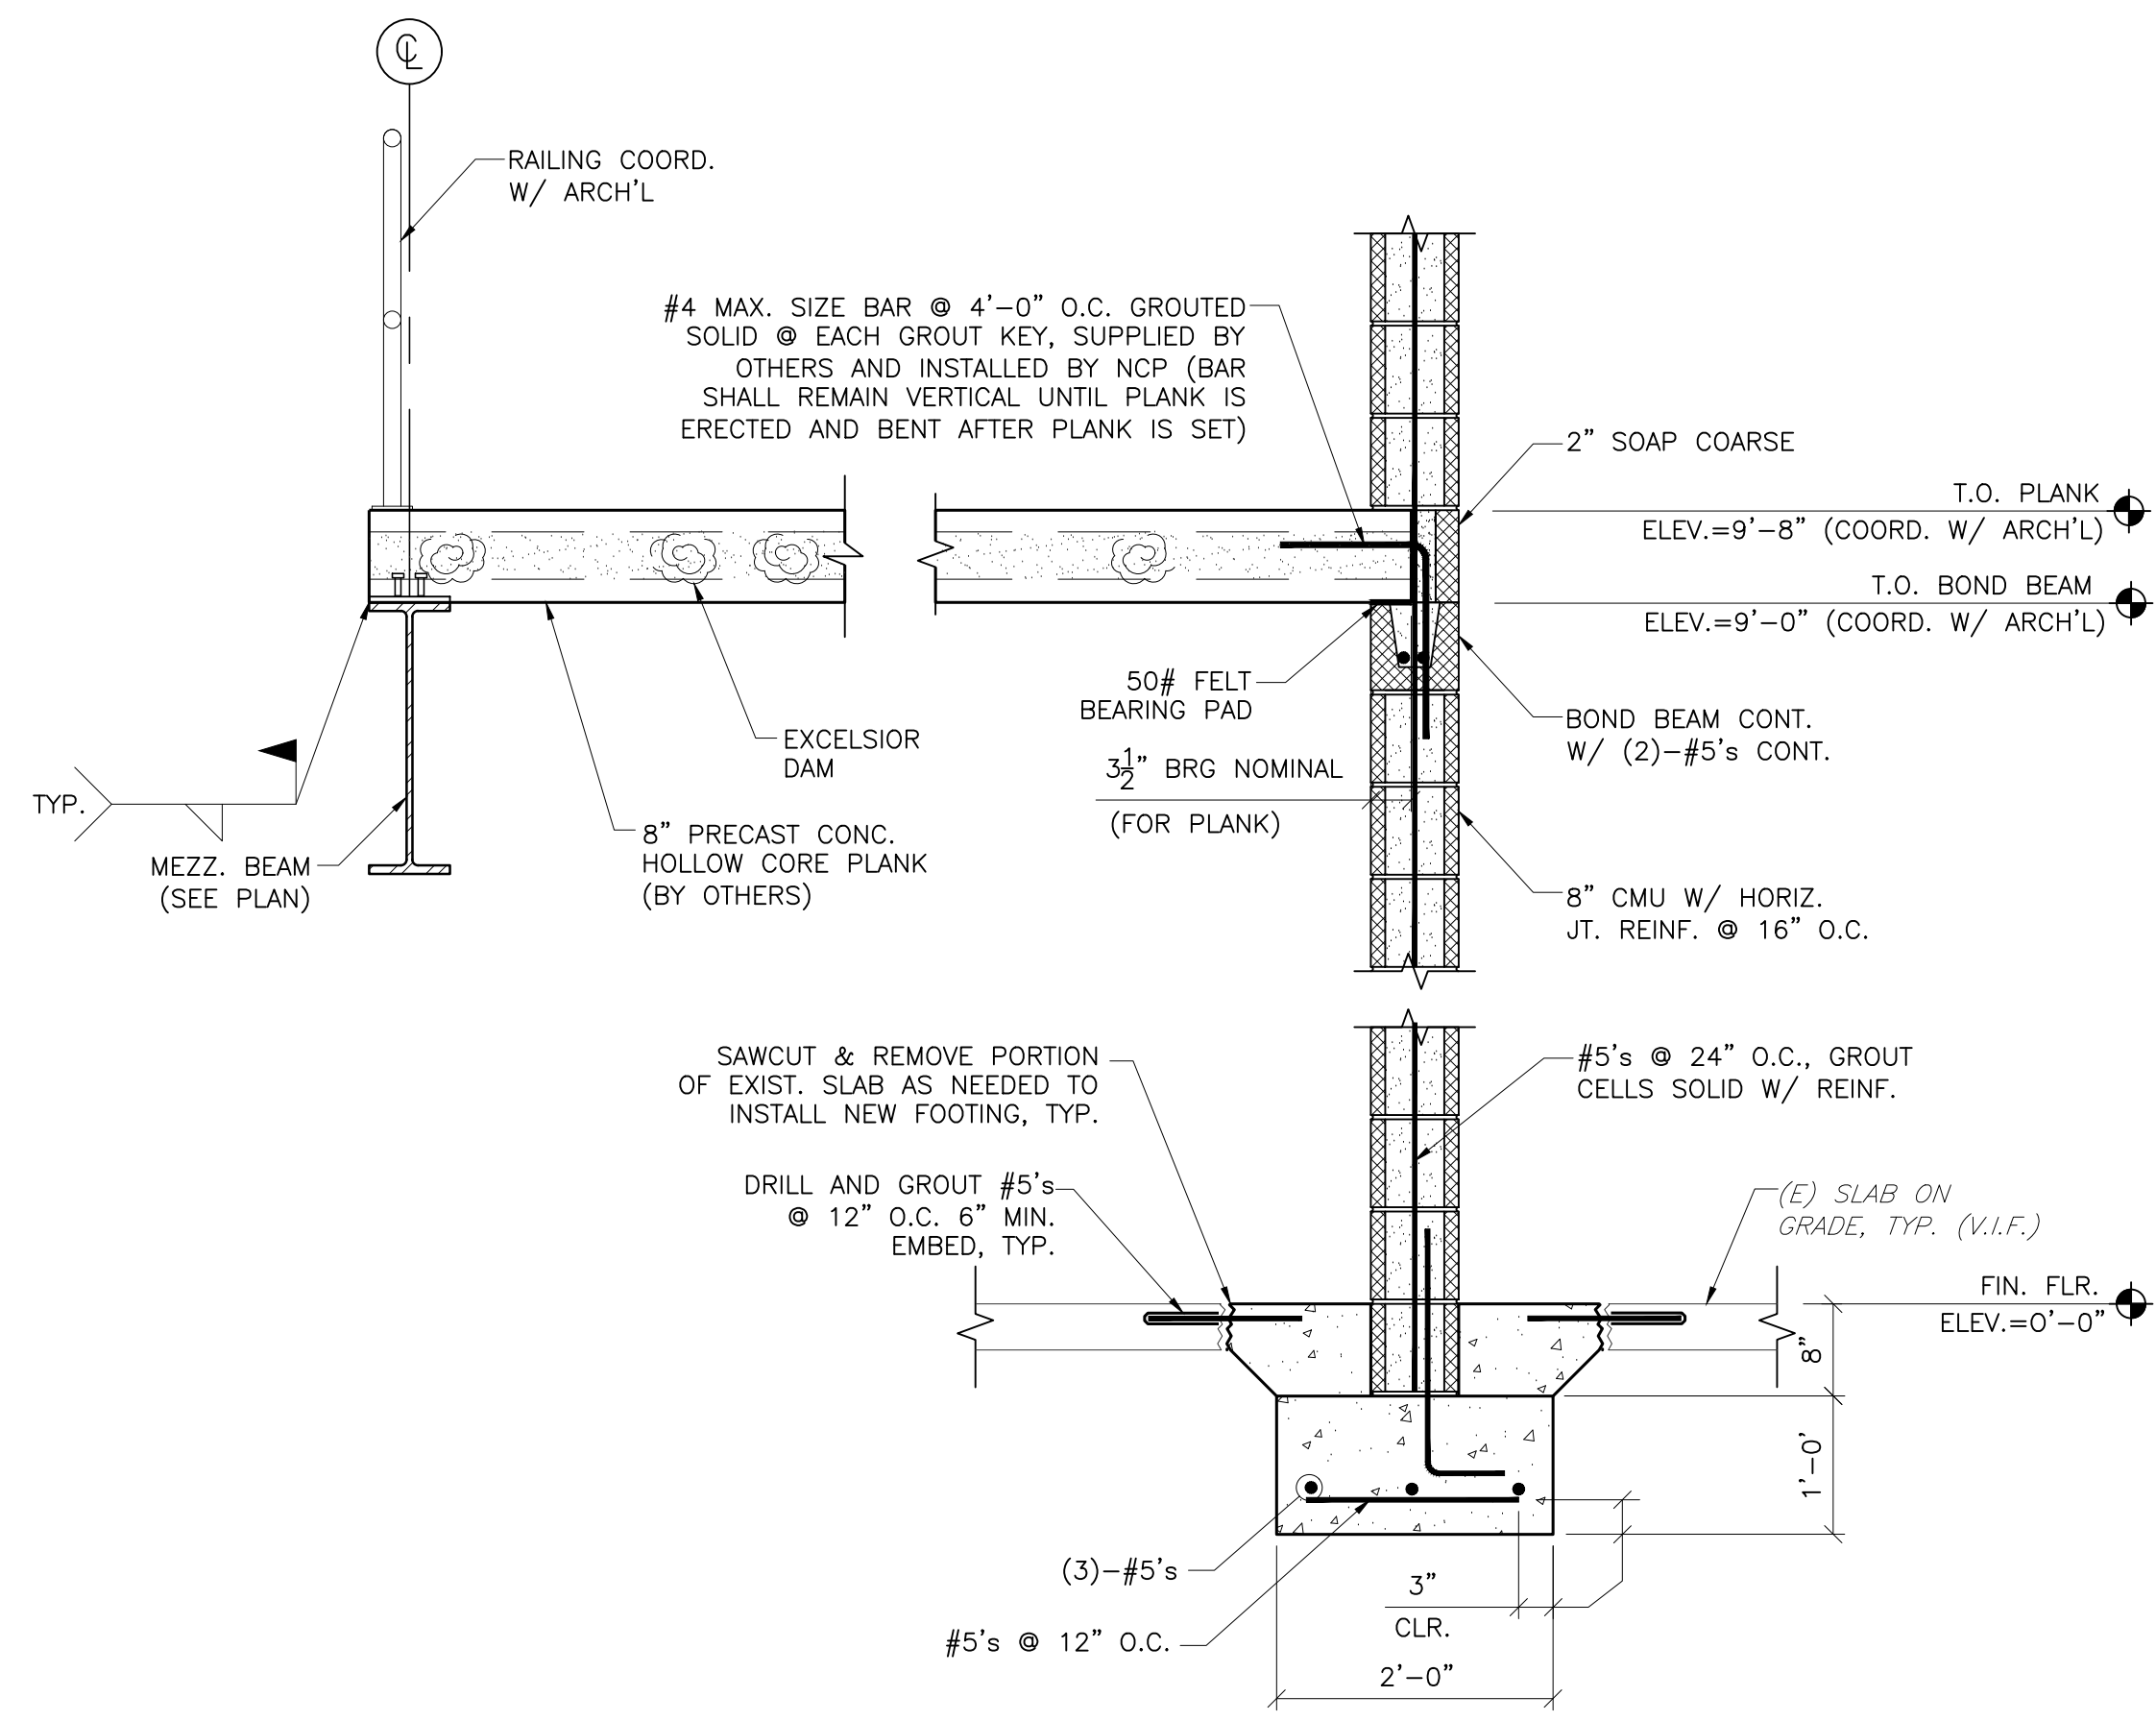
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**ROOF FRAMING PLAN**

**S-202**












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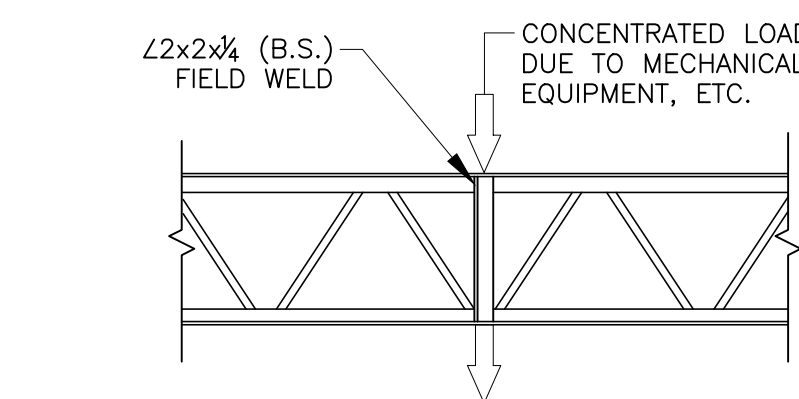
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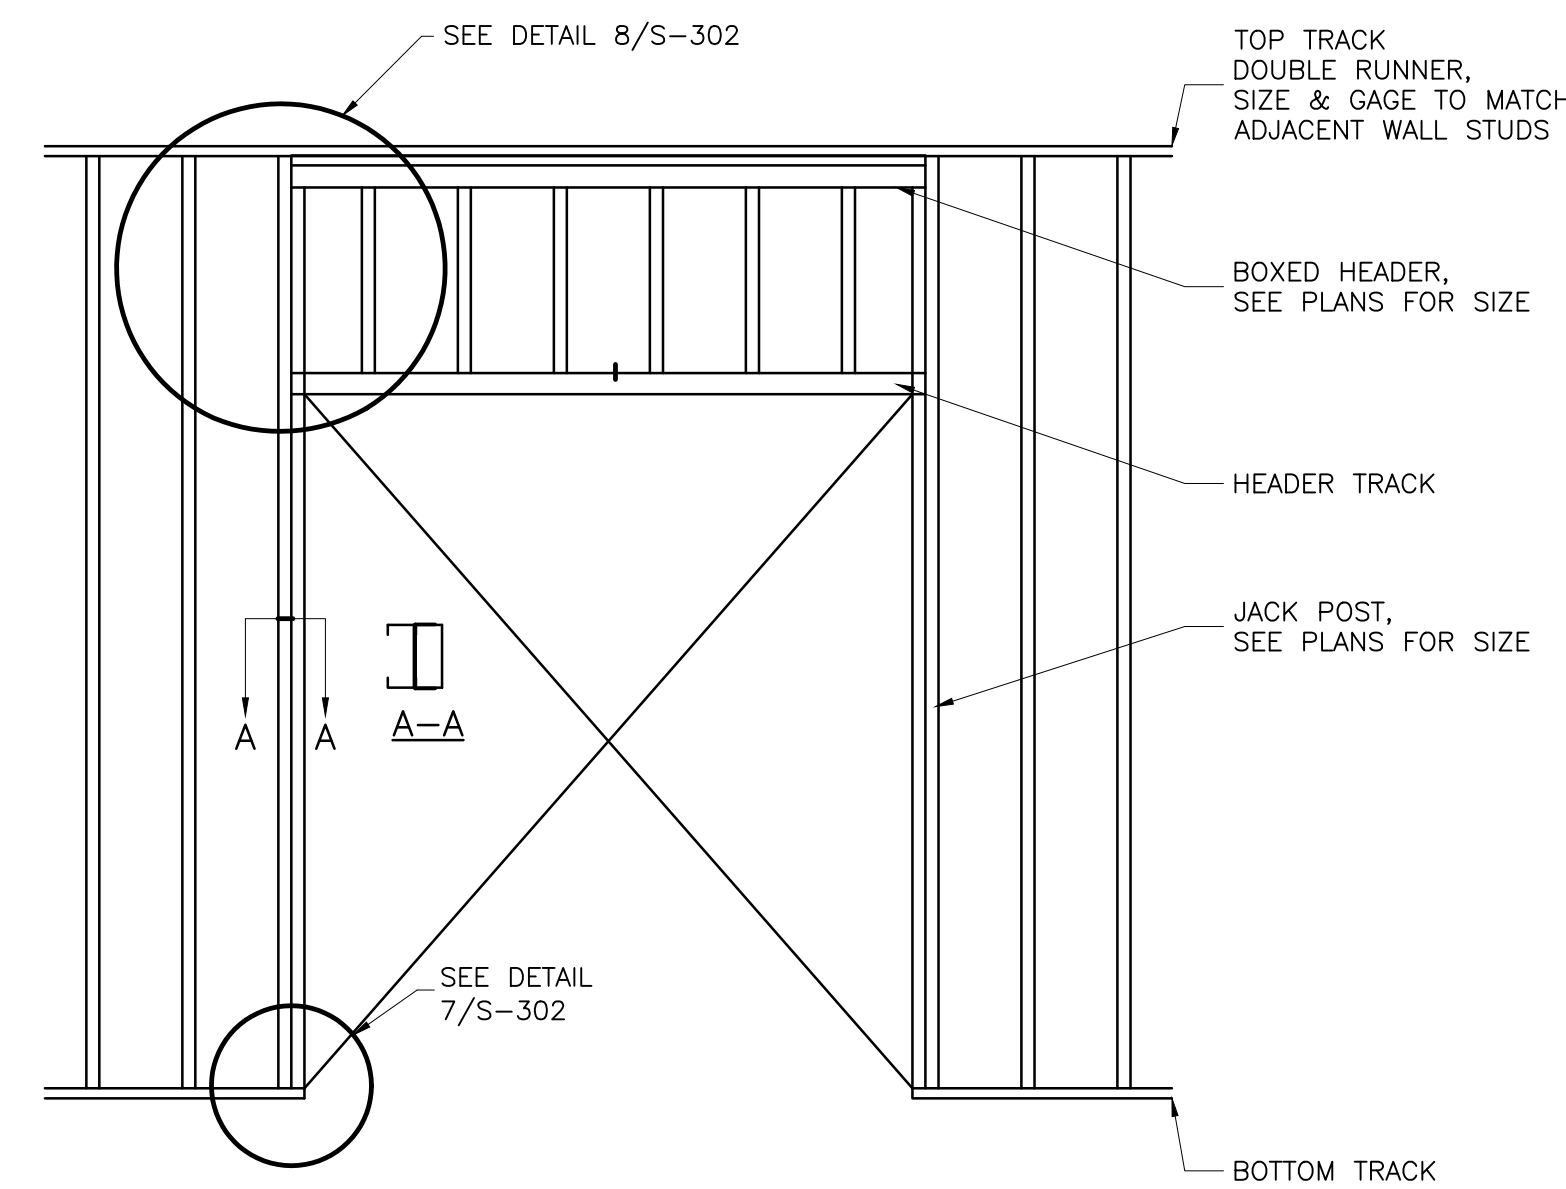
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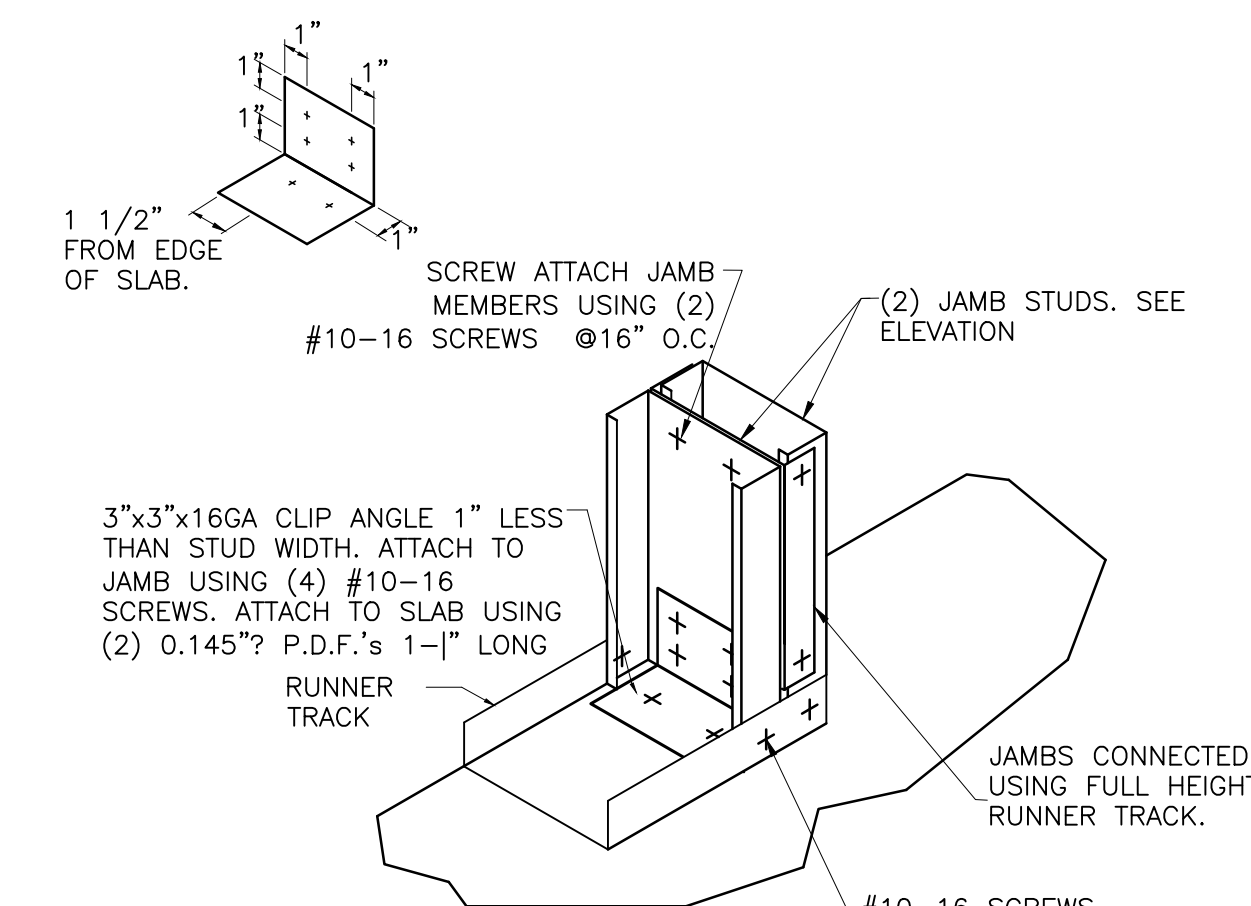
4 FRAMED ROOF OPENING DETAIL  
S-302 SCALE: 3/4" = 1'-0"

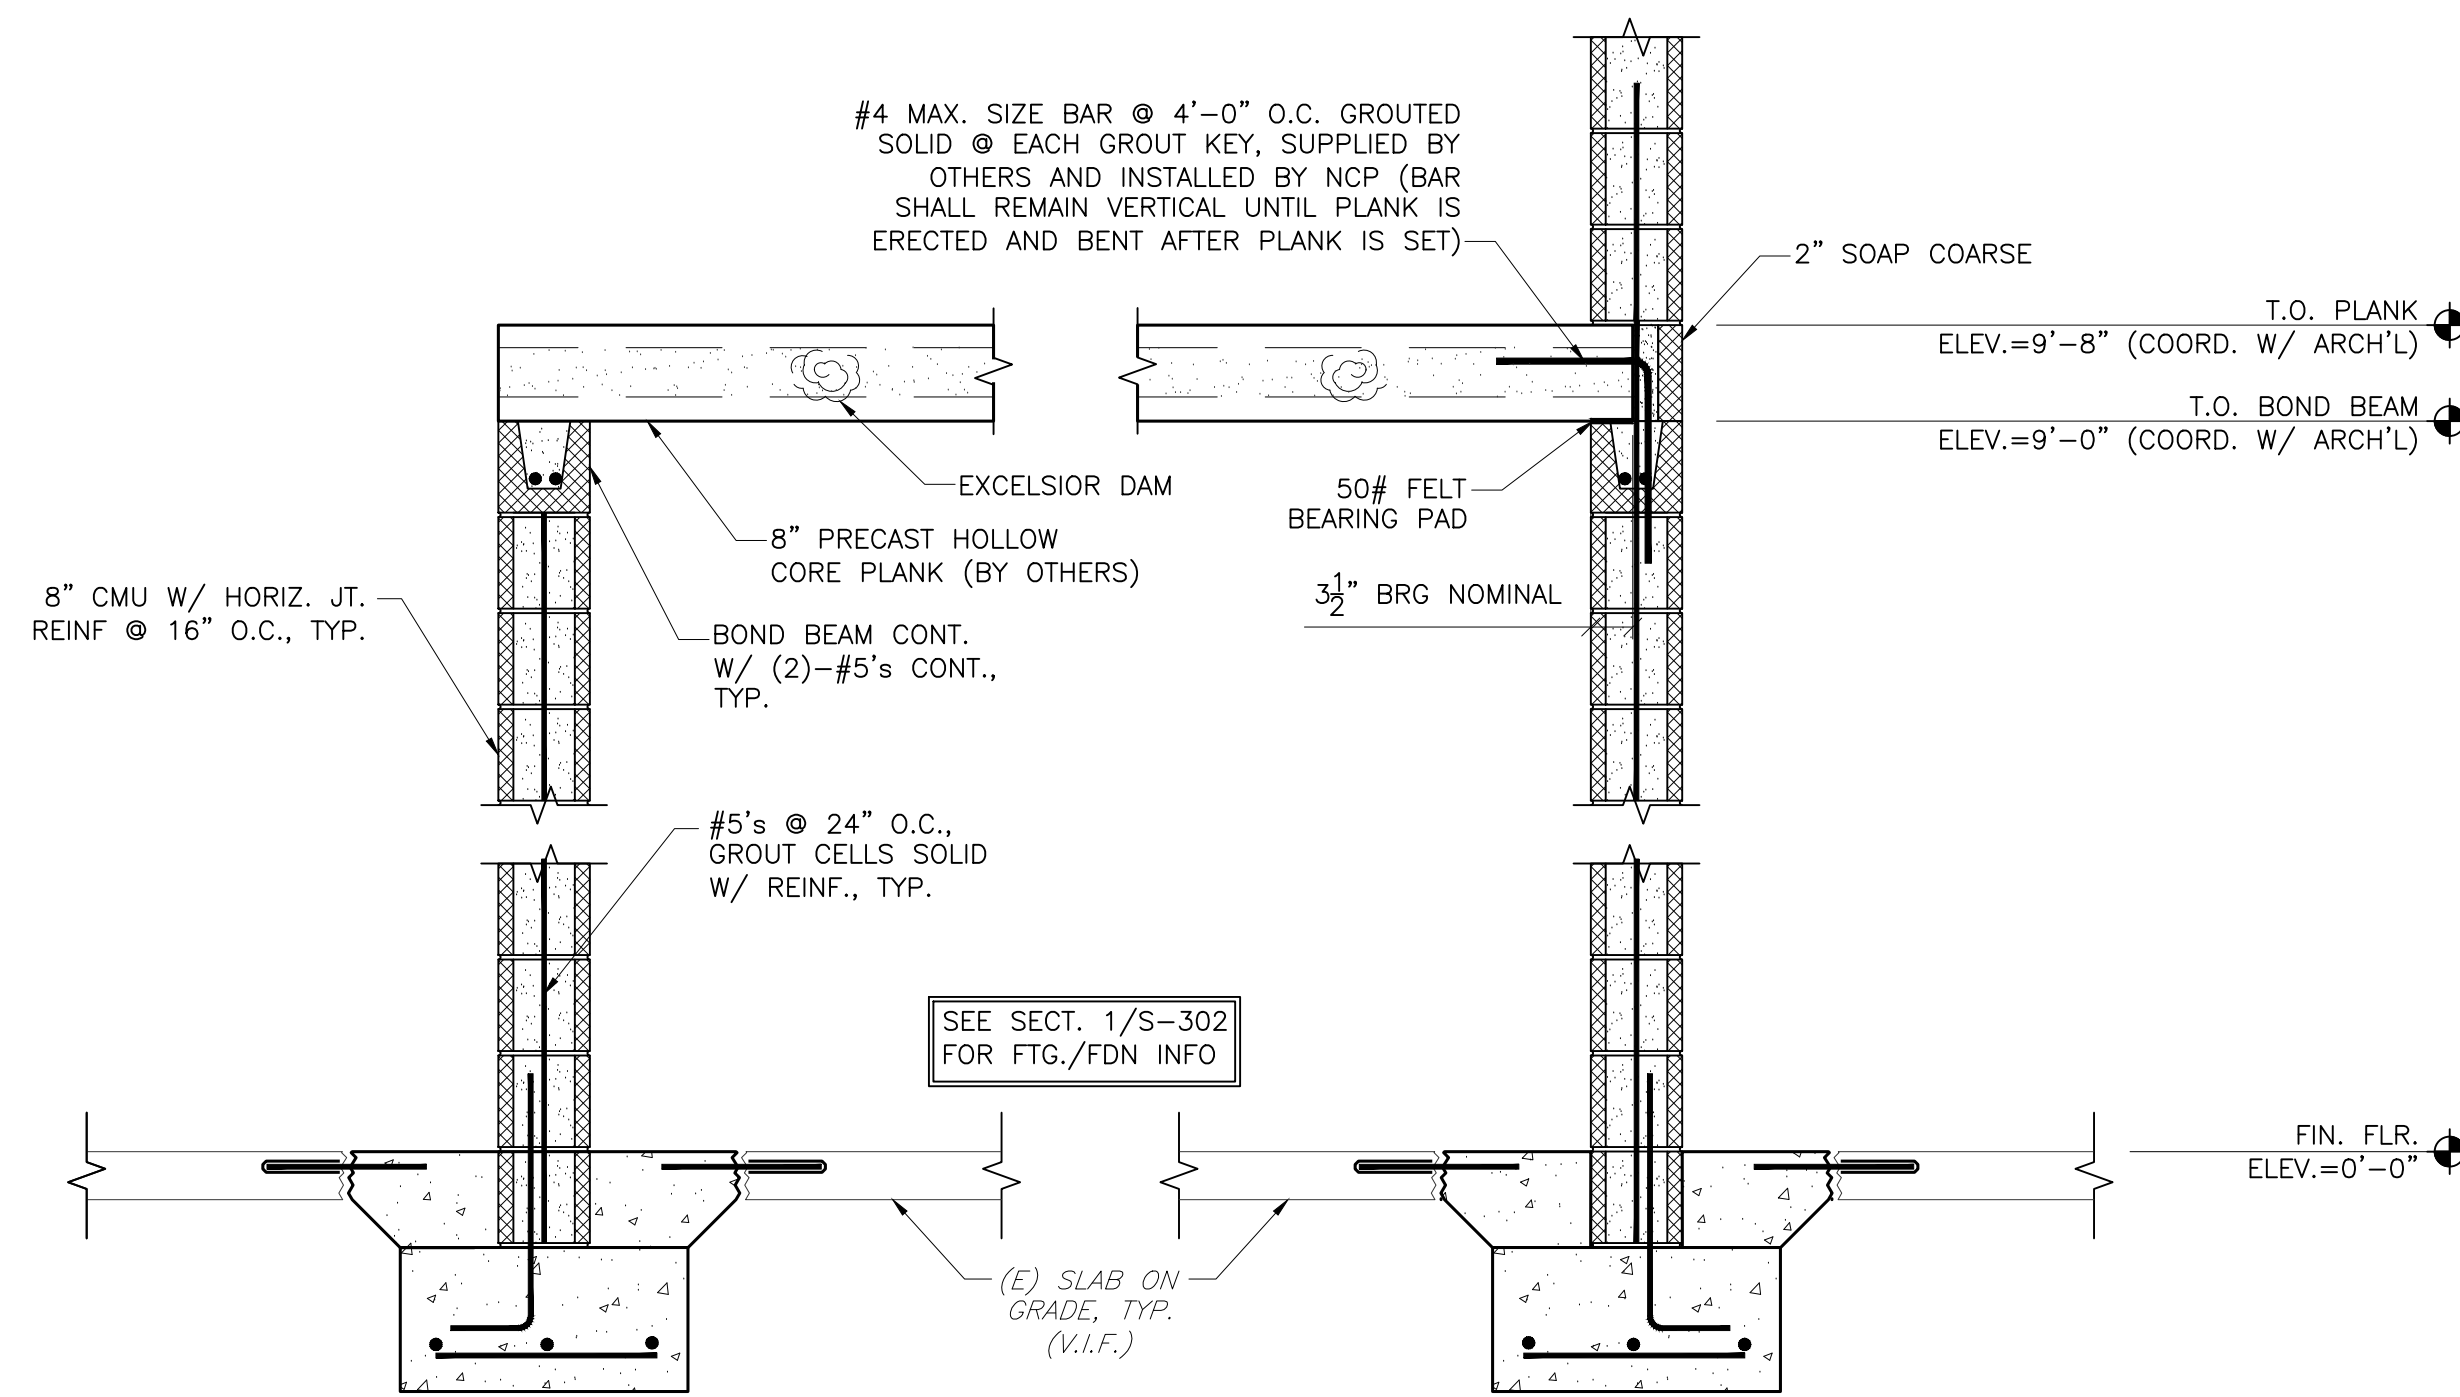


5 PANEL POINT REINF. DETAIL  
S-302 SCALE: 3/4" = 1'-0"

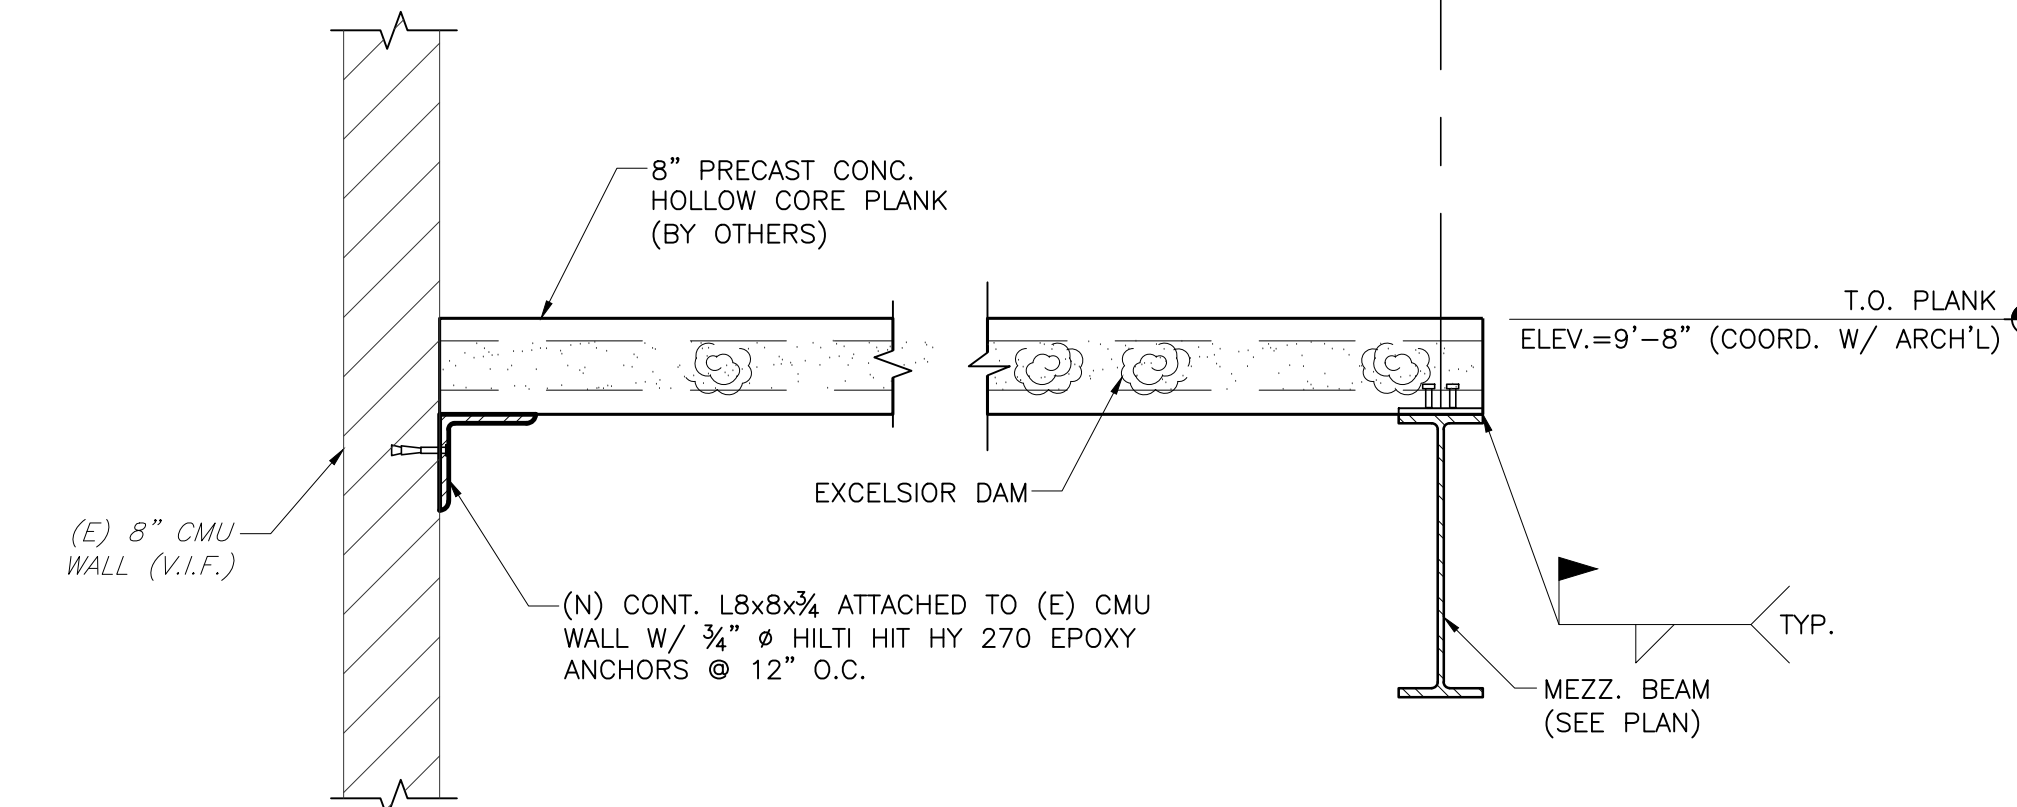


6 TYP. WALL OPENING  
S-302 SCALE: 1/2" = 1'-0"

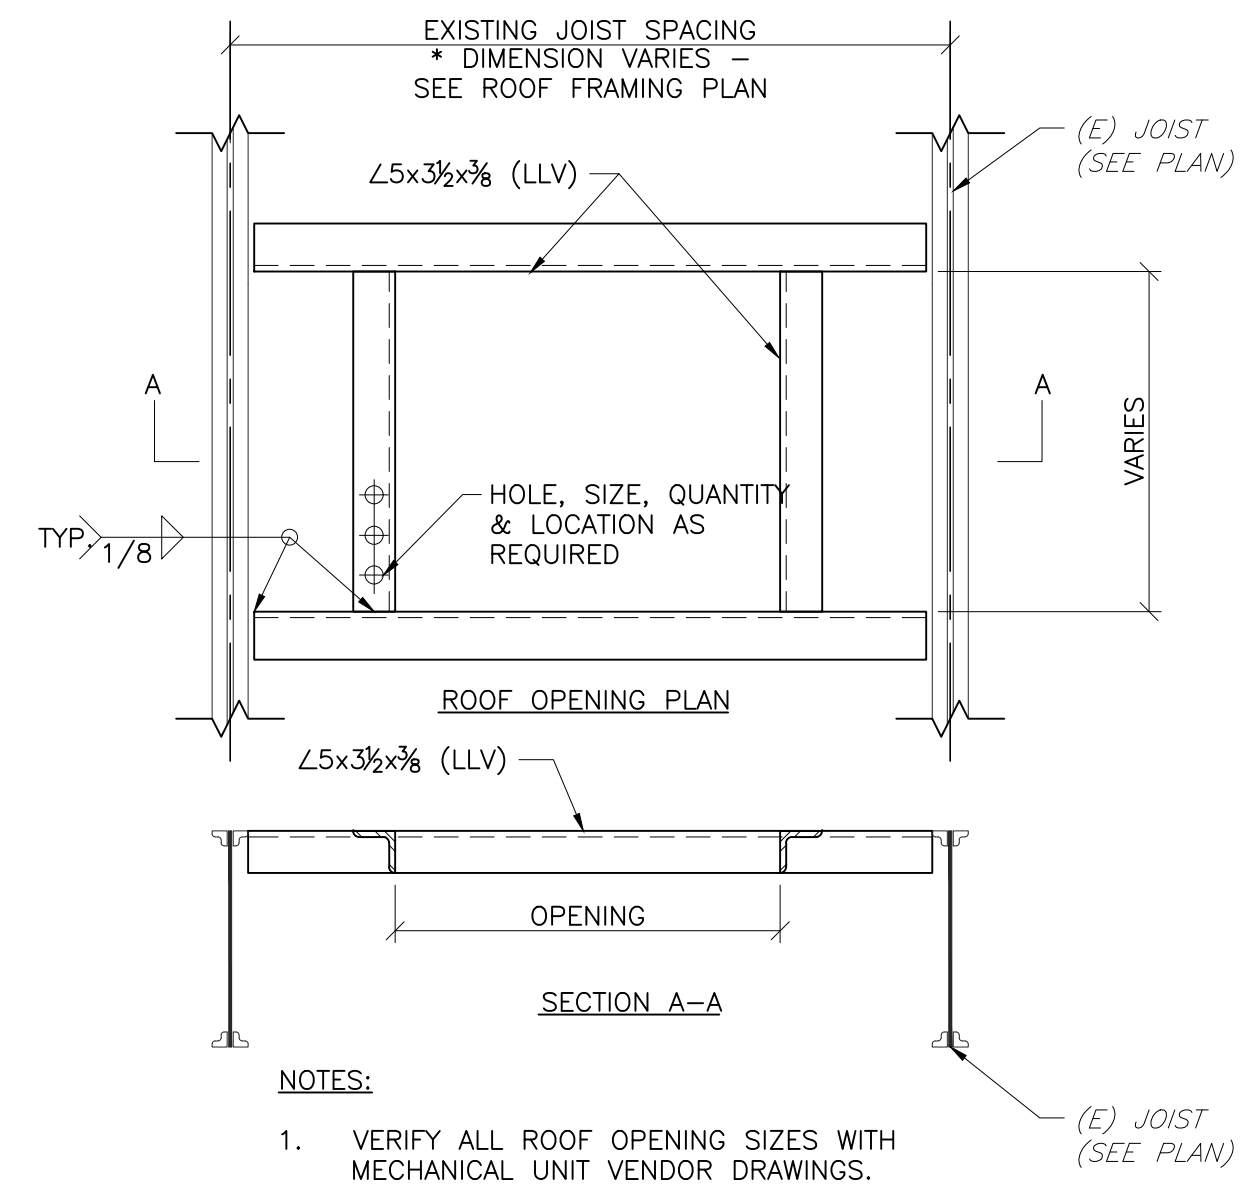


7 JAMB ANCHORAGE  
S-302 SCALE: 1/2" = 1'-0"

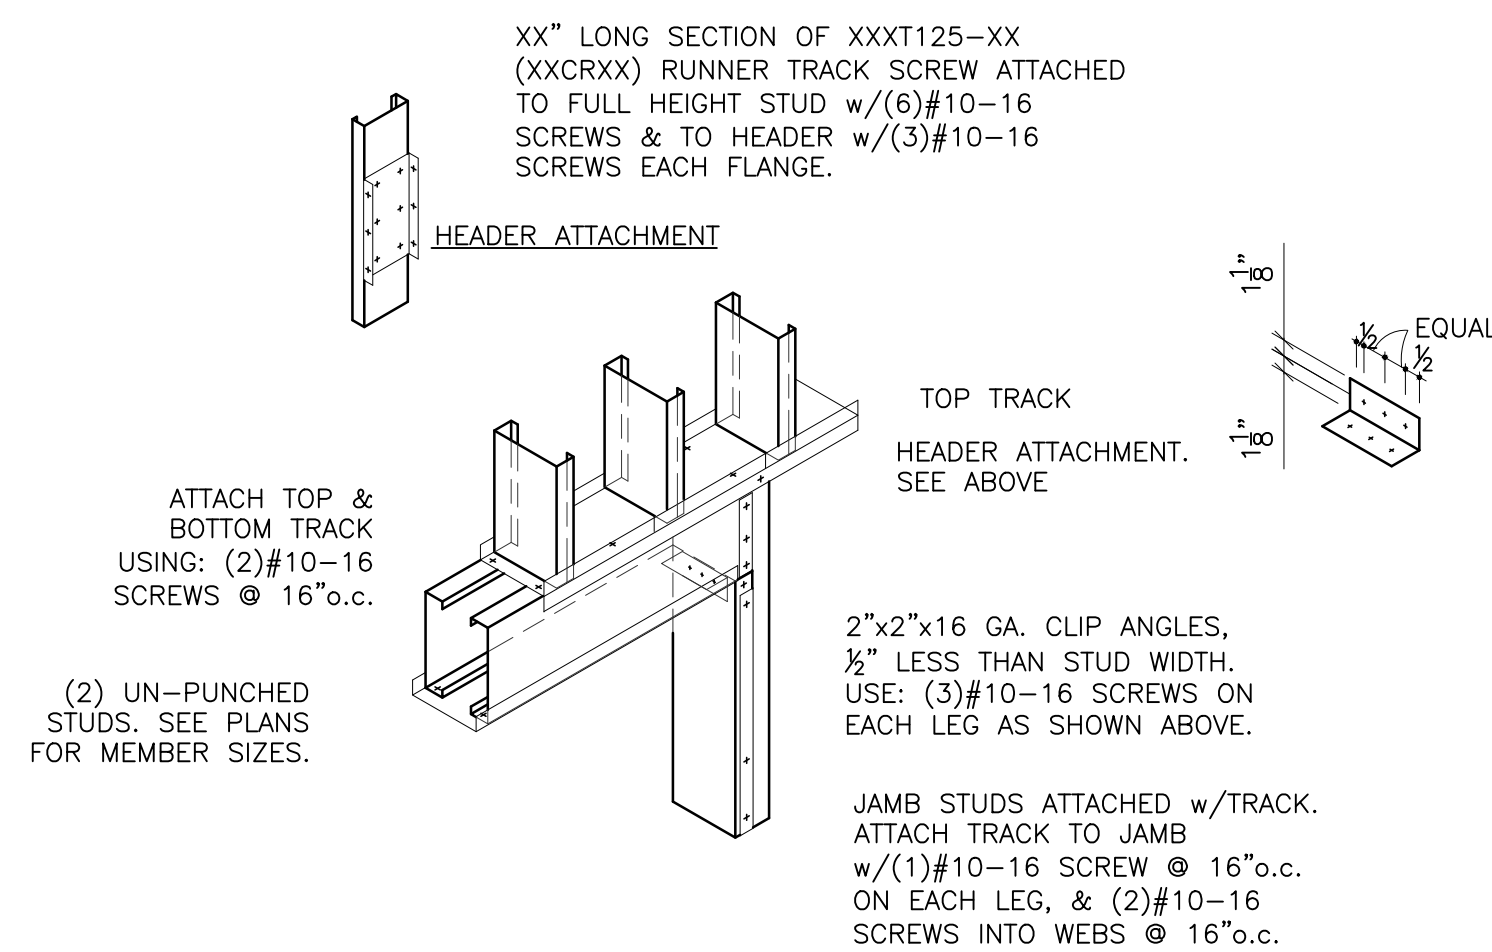


8 BOXED HEADER CONNECTION  
S-302 SCALE: 1/2" = 1'-0"

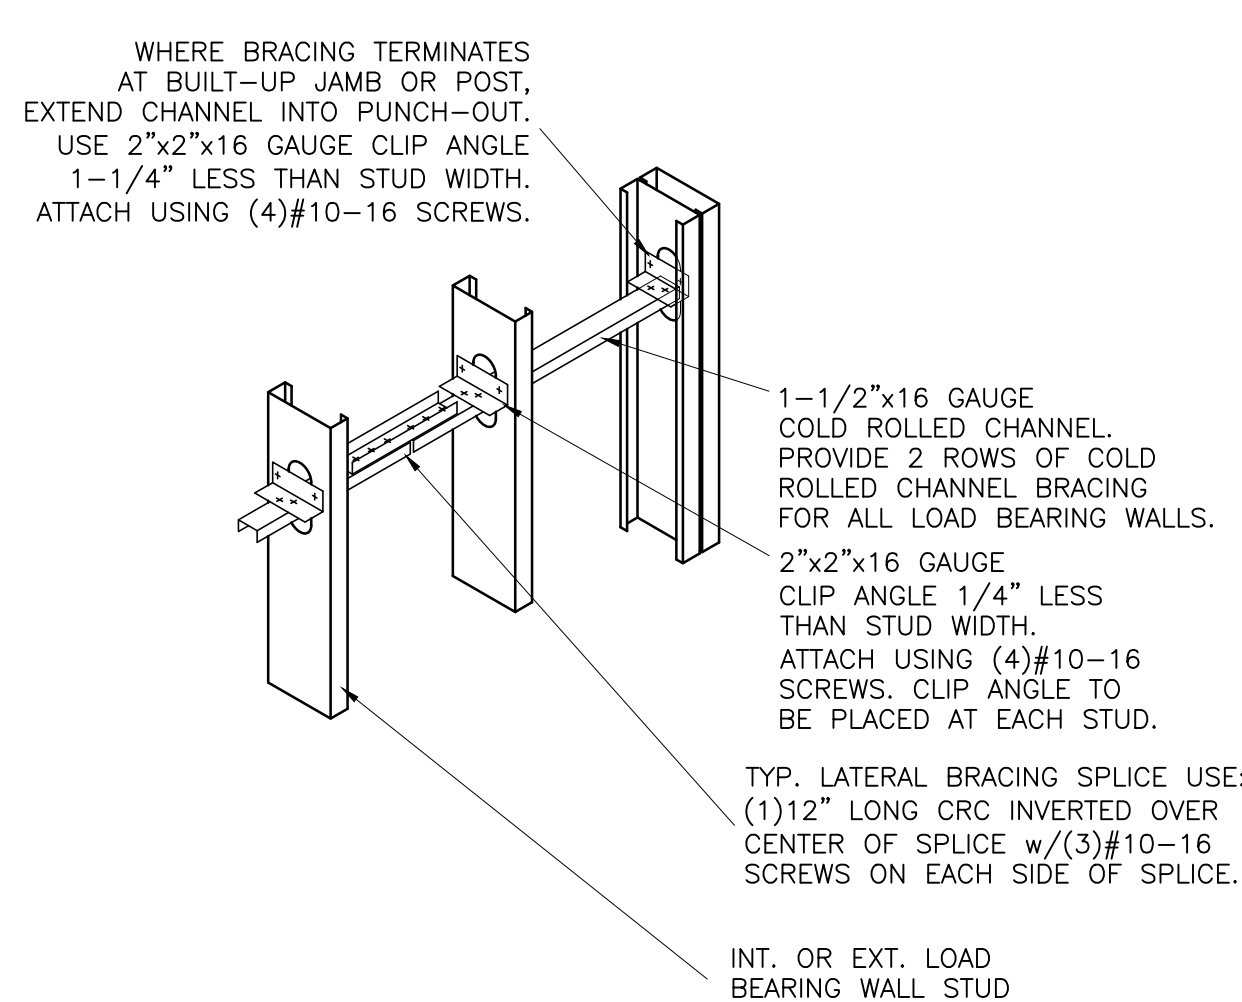

9 LATERAL BRACING  
S-302 SCALE: 1/2" = 1'-0"

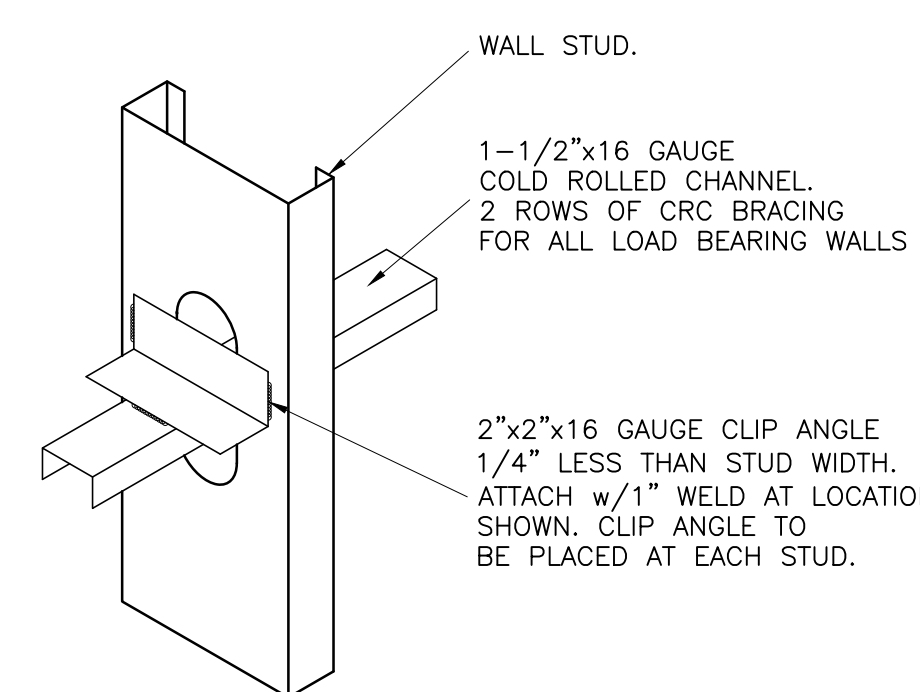

10 LATERAL BRACING  
S-302 SCALE: 1/2" = 1'-0"

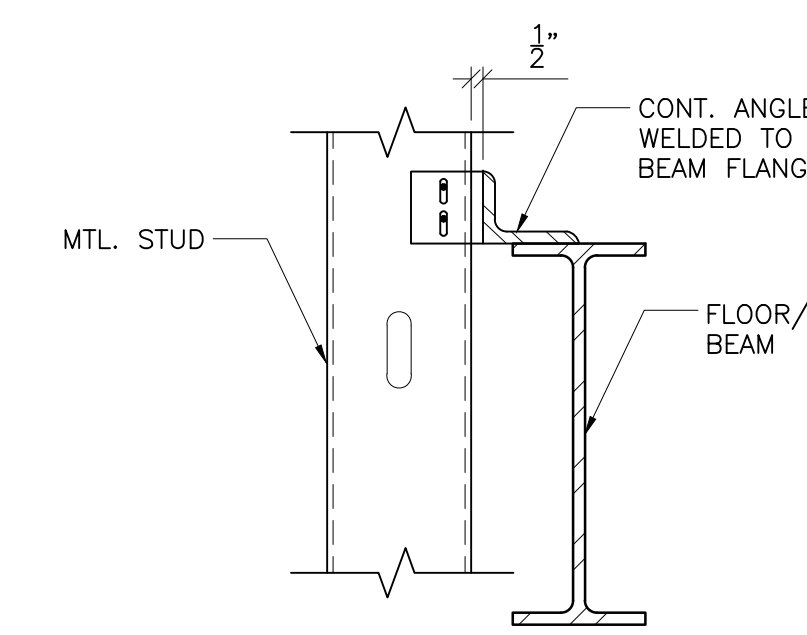

11 TYP. MTL. STUD CONNECTION  
S-302 SCALE: N.T.S.

REV#	DESCRIPTION	DATE

PROJ. MGR.: S.DI GENOVA
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CLIENT PROJ #: 2022-010.00
DATE: 03/30/23
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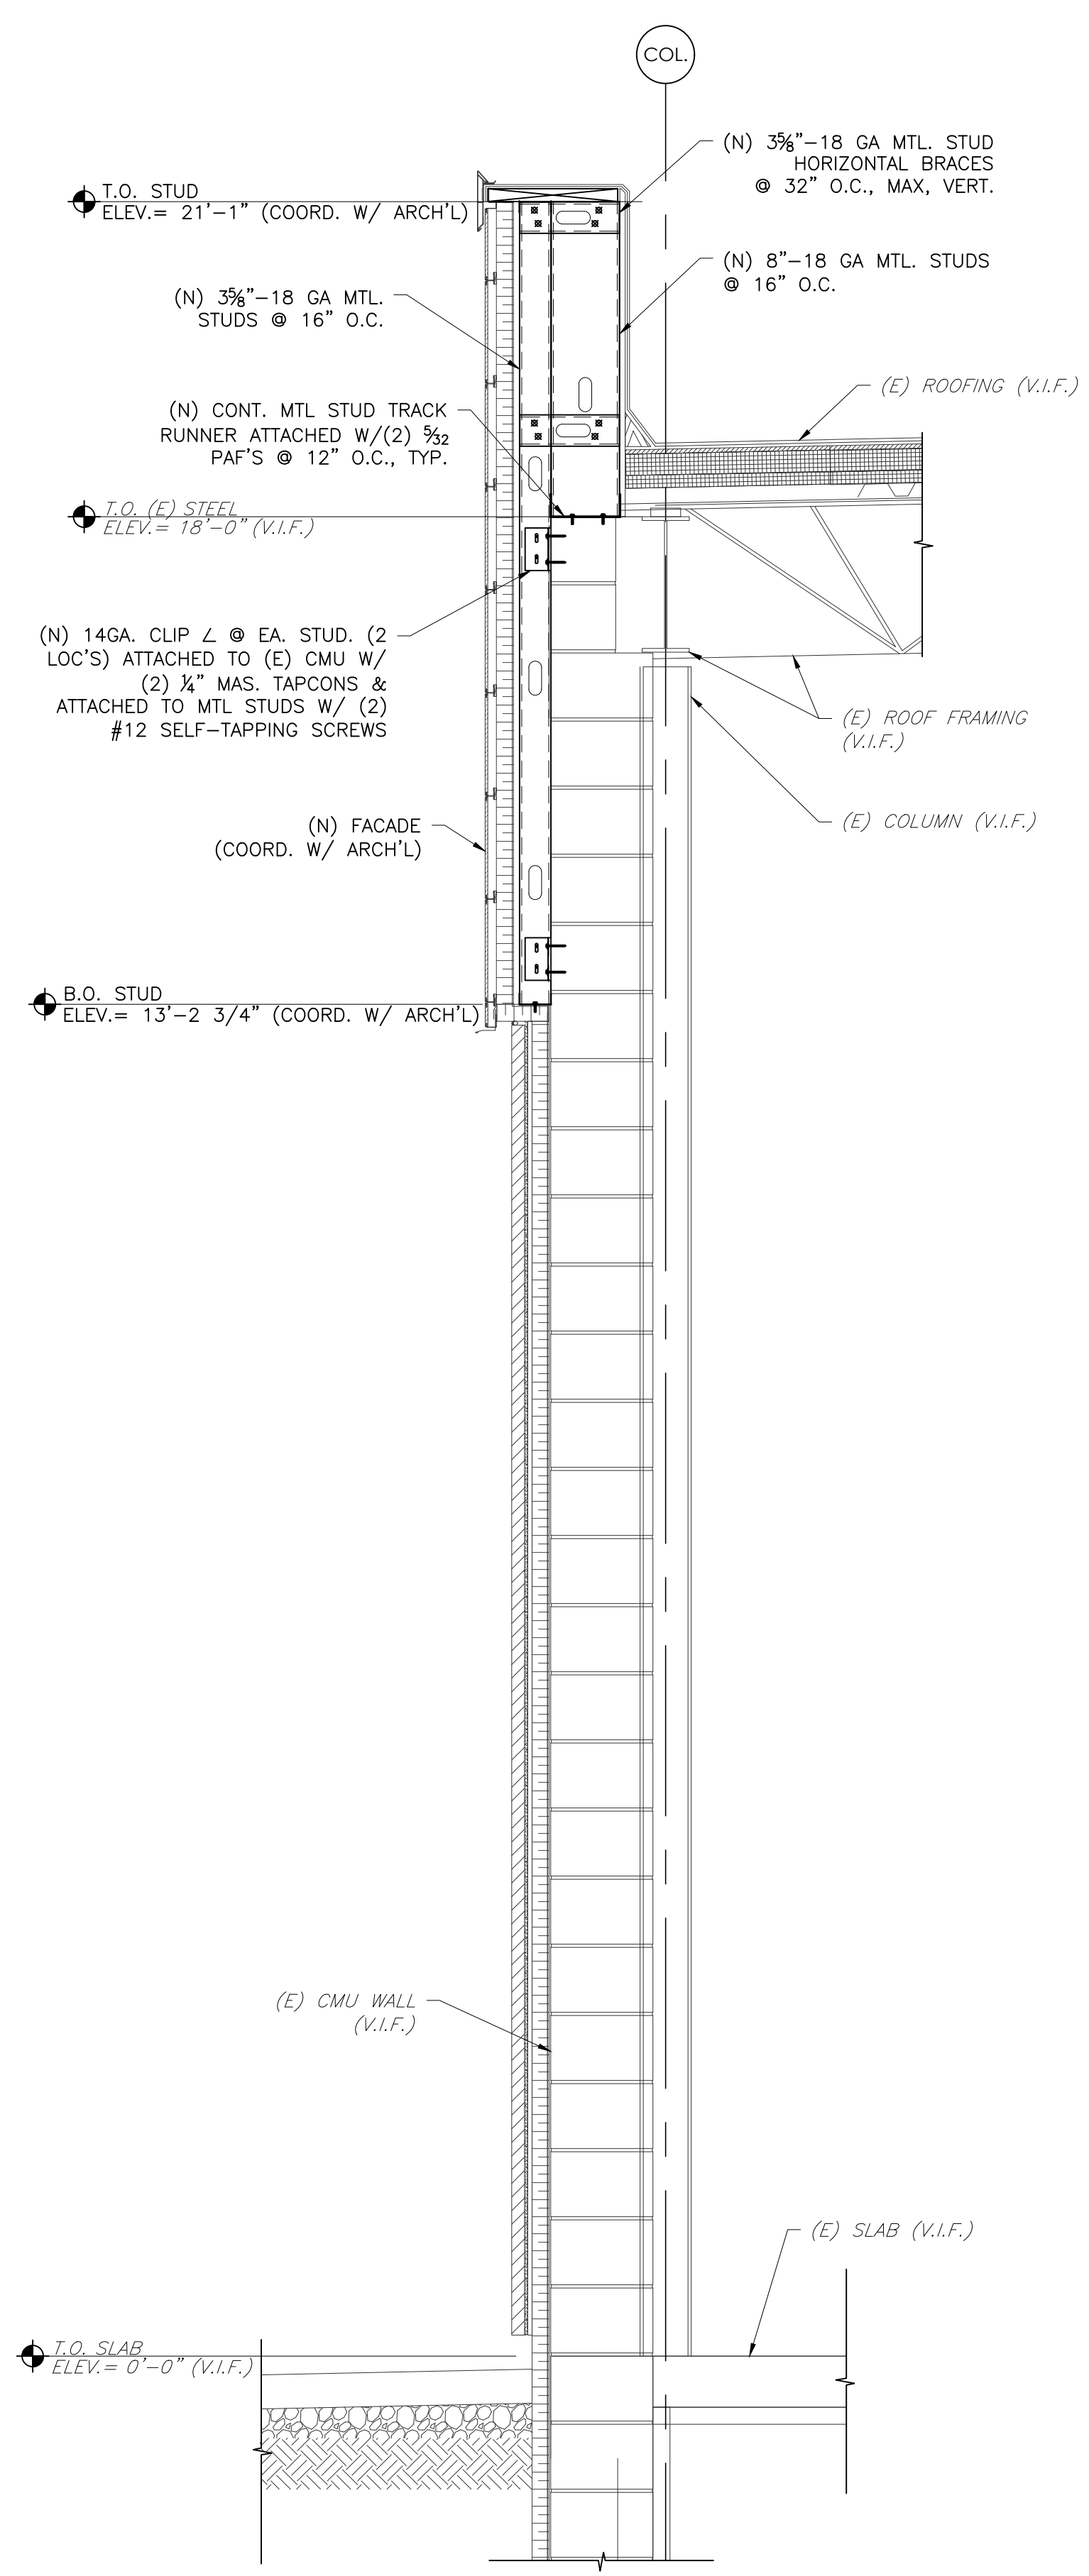
REVISION	DESCRIPTION	DATE

PROJ. MGR.: S.DI GENOVA  
P.M. @-MAIL: <consultant/pm\_email>  
DRAWN BY: JF  
CLIENT PROJ #: 2022-010.00  
SHEET SCALE: 1/8" = 1'-0"  
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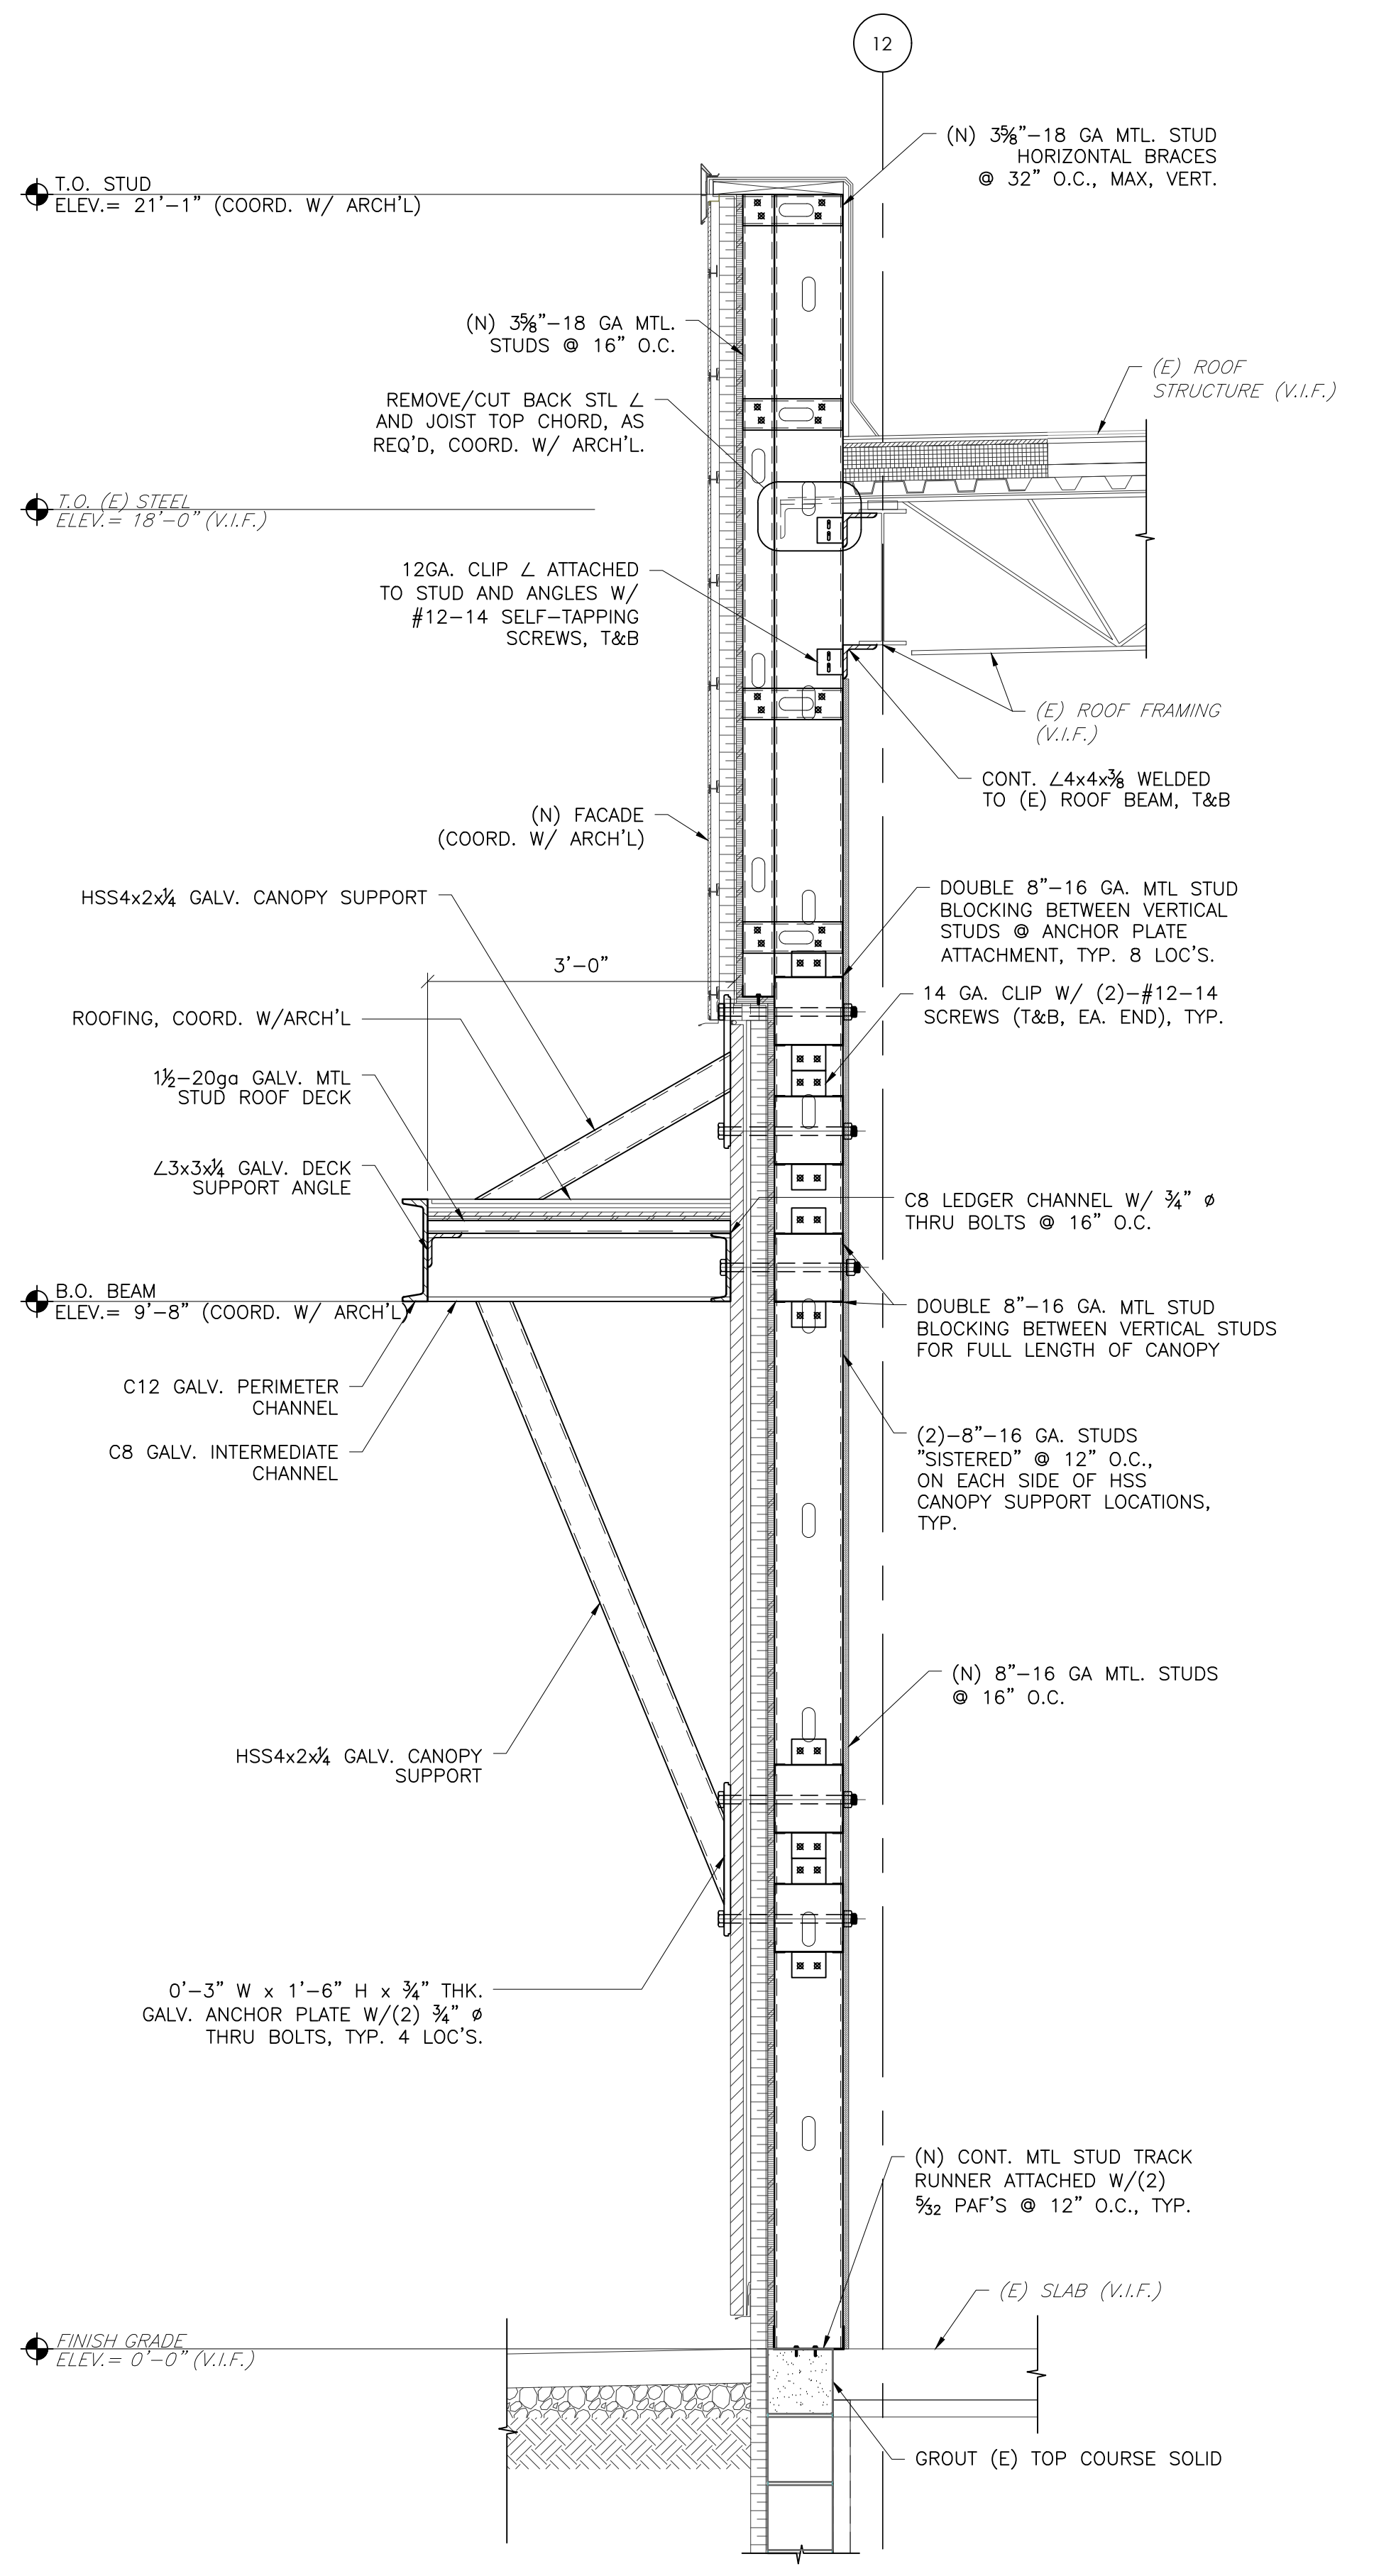
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SHEET TITLE:  
**SECTIONS AND DETAILS**


**S-303**




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S-303 SCALE: 3/4" = 1'-0"  
REF: 2/A-301



**2 WALL SECTION**  
S-303 SCALE: 3/4" = 1'-0"  
REF: 3/A-301

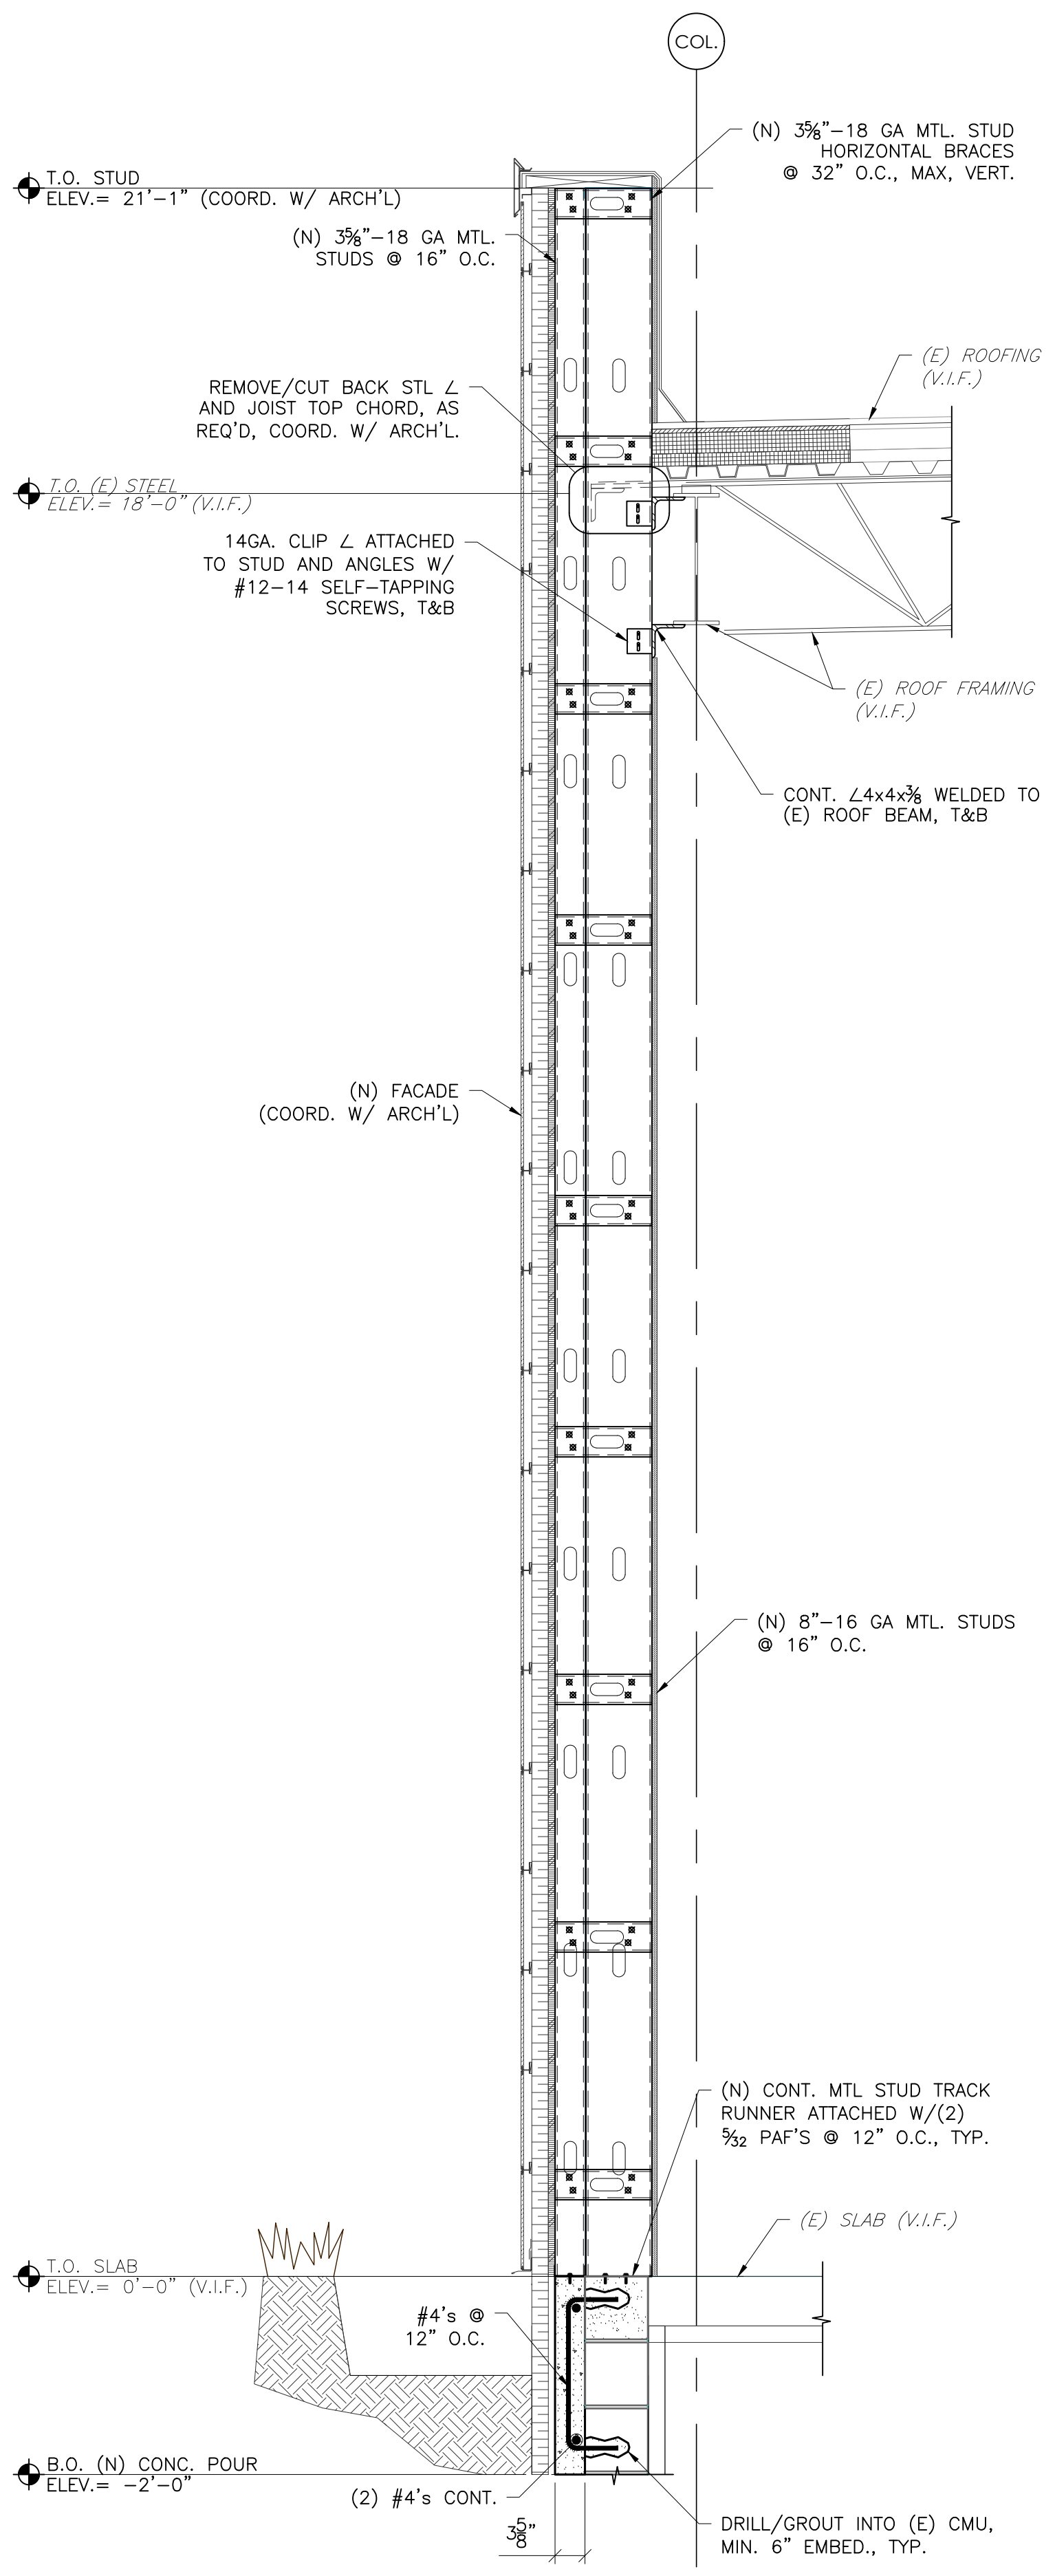

**3 WALL SECTION**  
S-303 SCALE: 3/4" = 1'-0"  
REF: 4/A-301

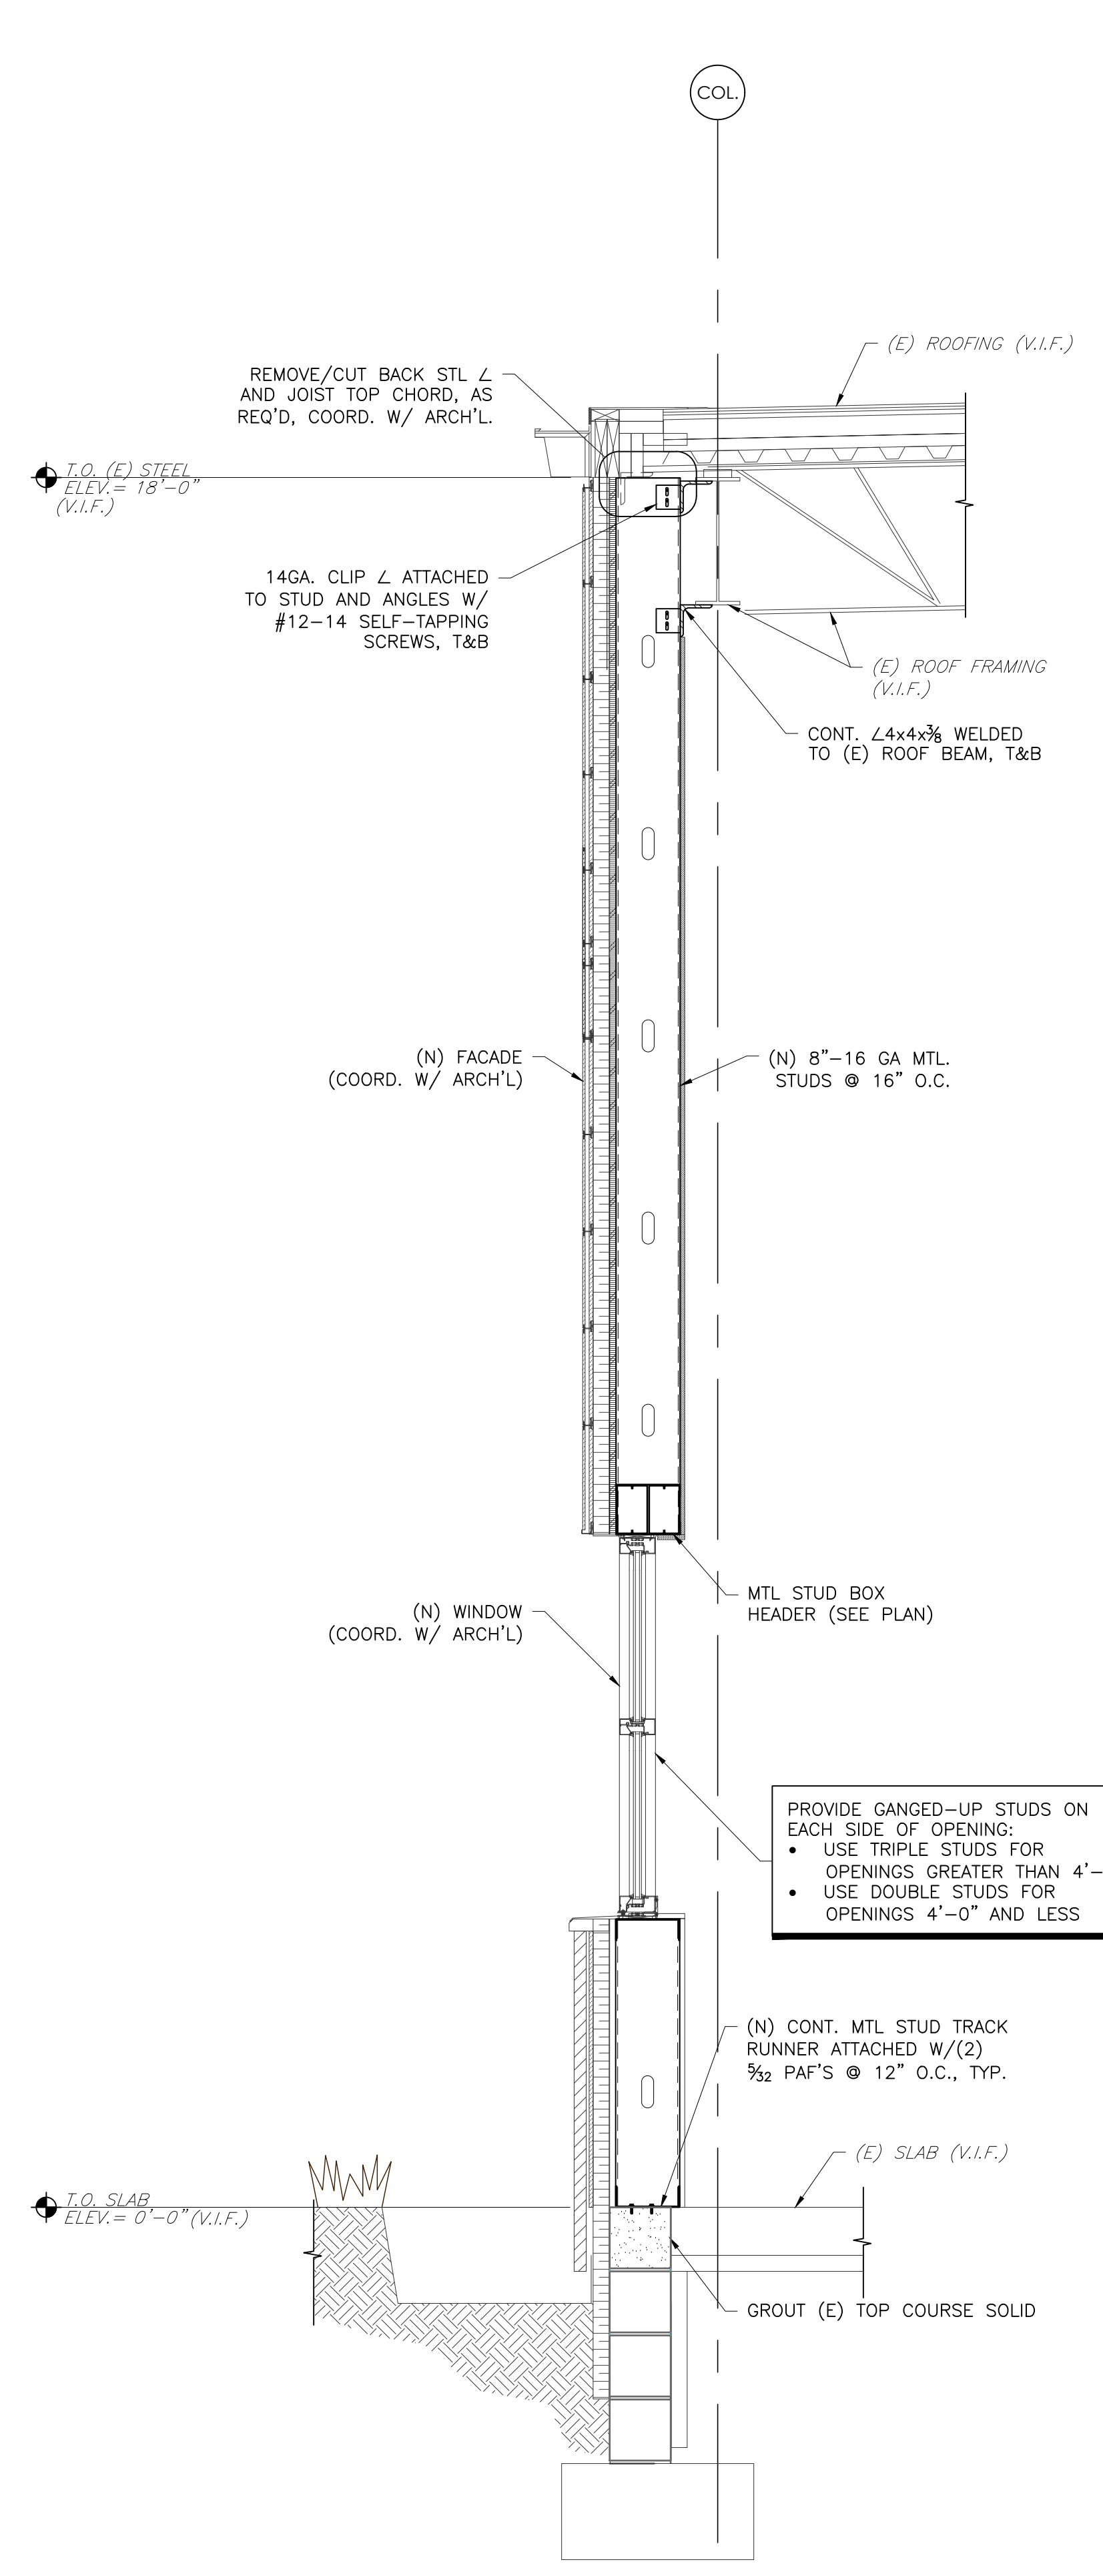

**4 WALL SECTION**  
S-303 SCALE: 3/4" = 1'-0"  
REF: 2/A-302

**METAL STUD FRAMING NOTE:**  
CONTRACTOR TO COORDINATE ALL DIMENSIONS, ELEVATIONS, LAYOUTS, AND ETC. OF ALL METAL STUD CONSTRUCTION SUCH AS PARAPETS AND CANOPIES WITH ARCH'L DRAWINGS.







ISSUED  
DATE: 03/30/23


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BAR IS ONE (1) INCH LONG ON ORIGINAL DRAWING


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SHEET TITLE:  
**SECTIONS AND DETAILS**


**S-305**



**3 WALL SECTION**  
S-305 SCALE: 3/4" = 1'-0"  
REF: 4/A-303

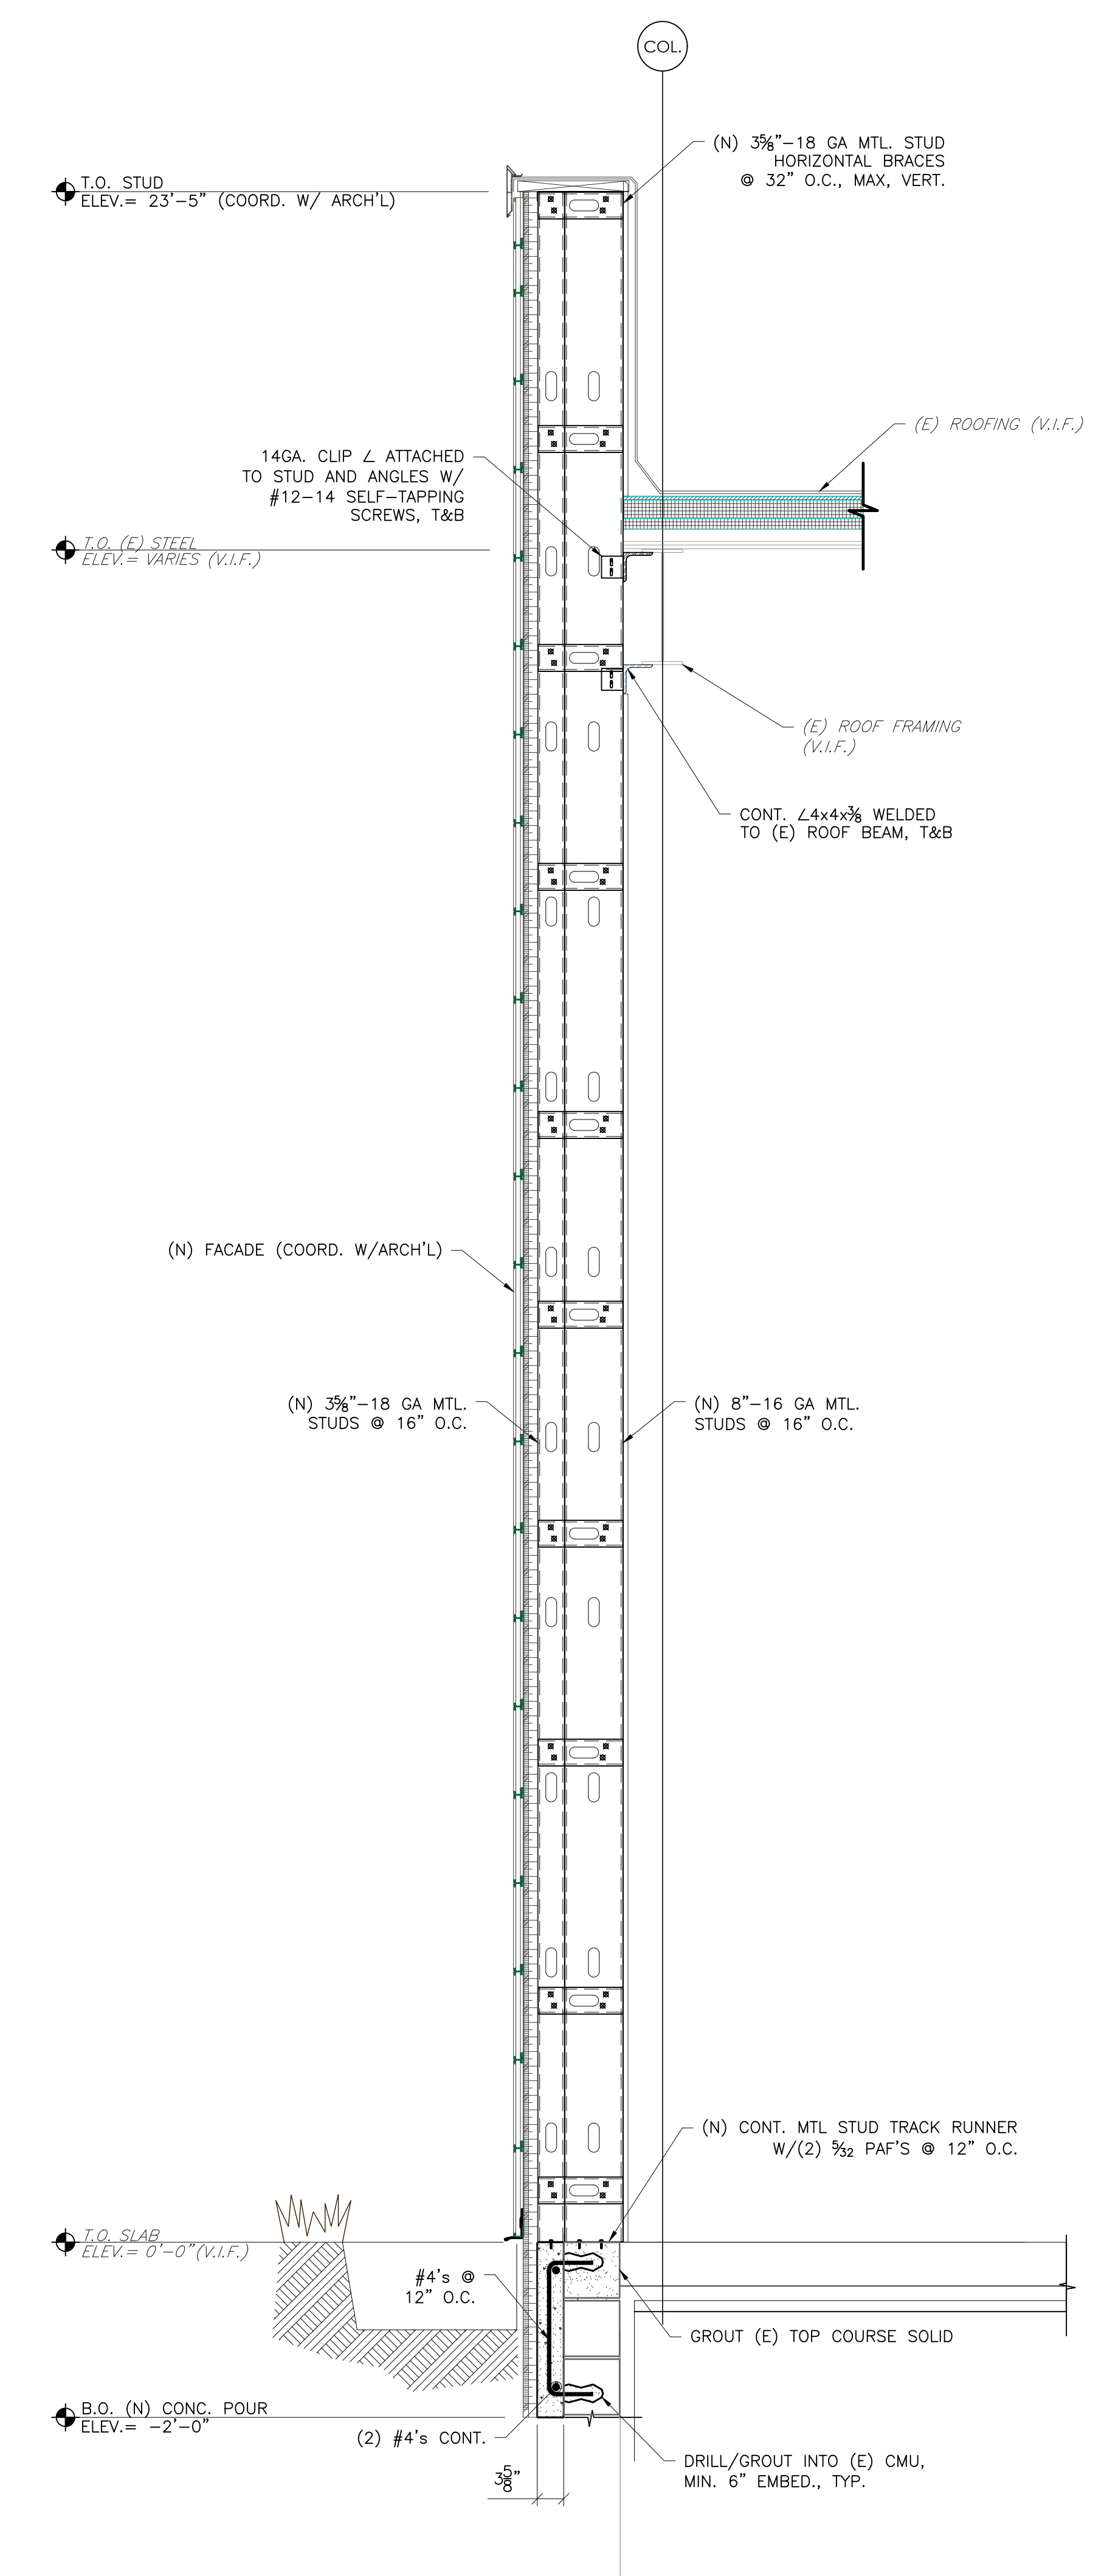

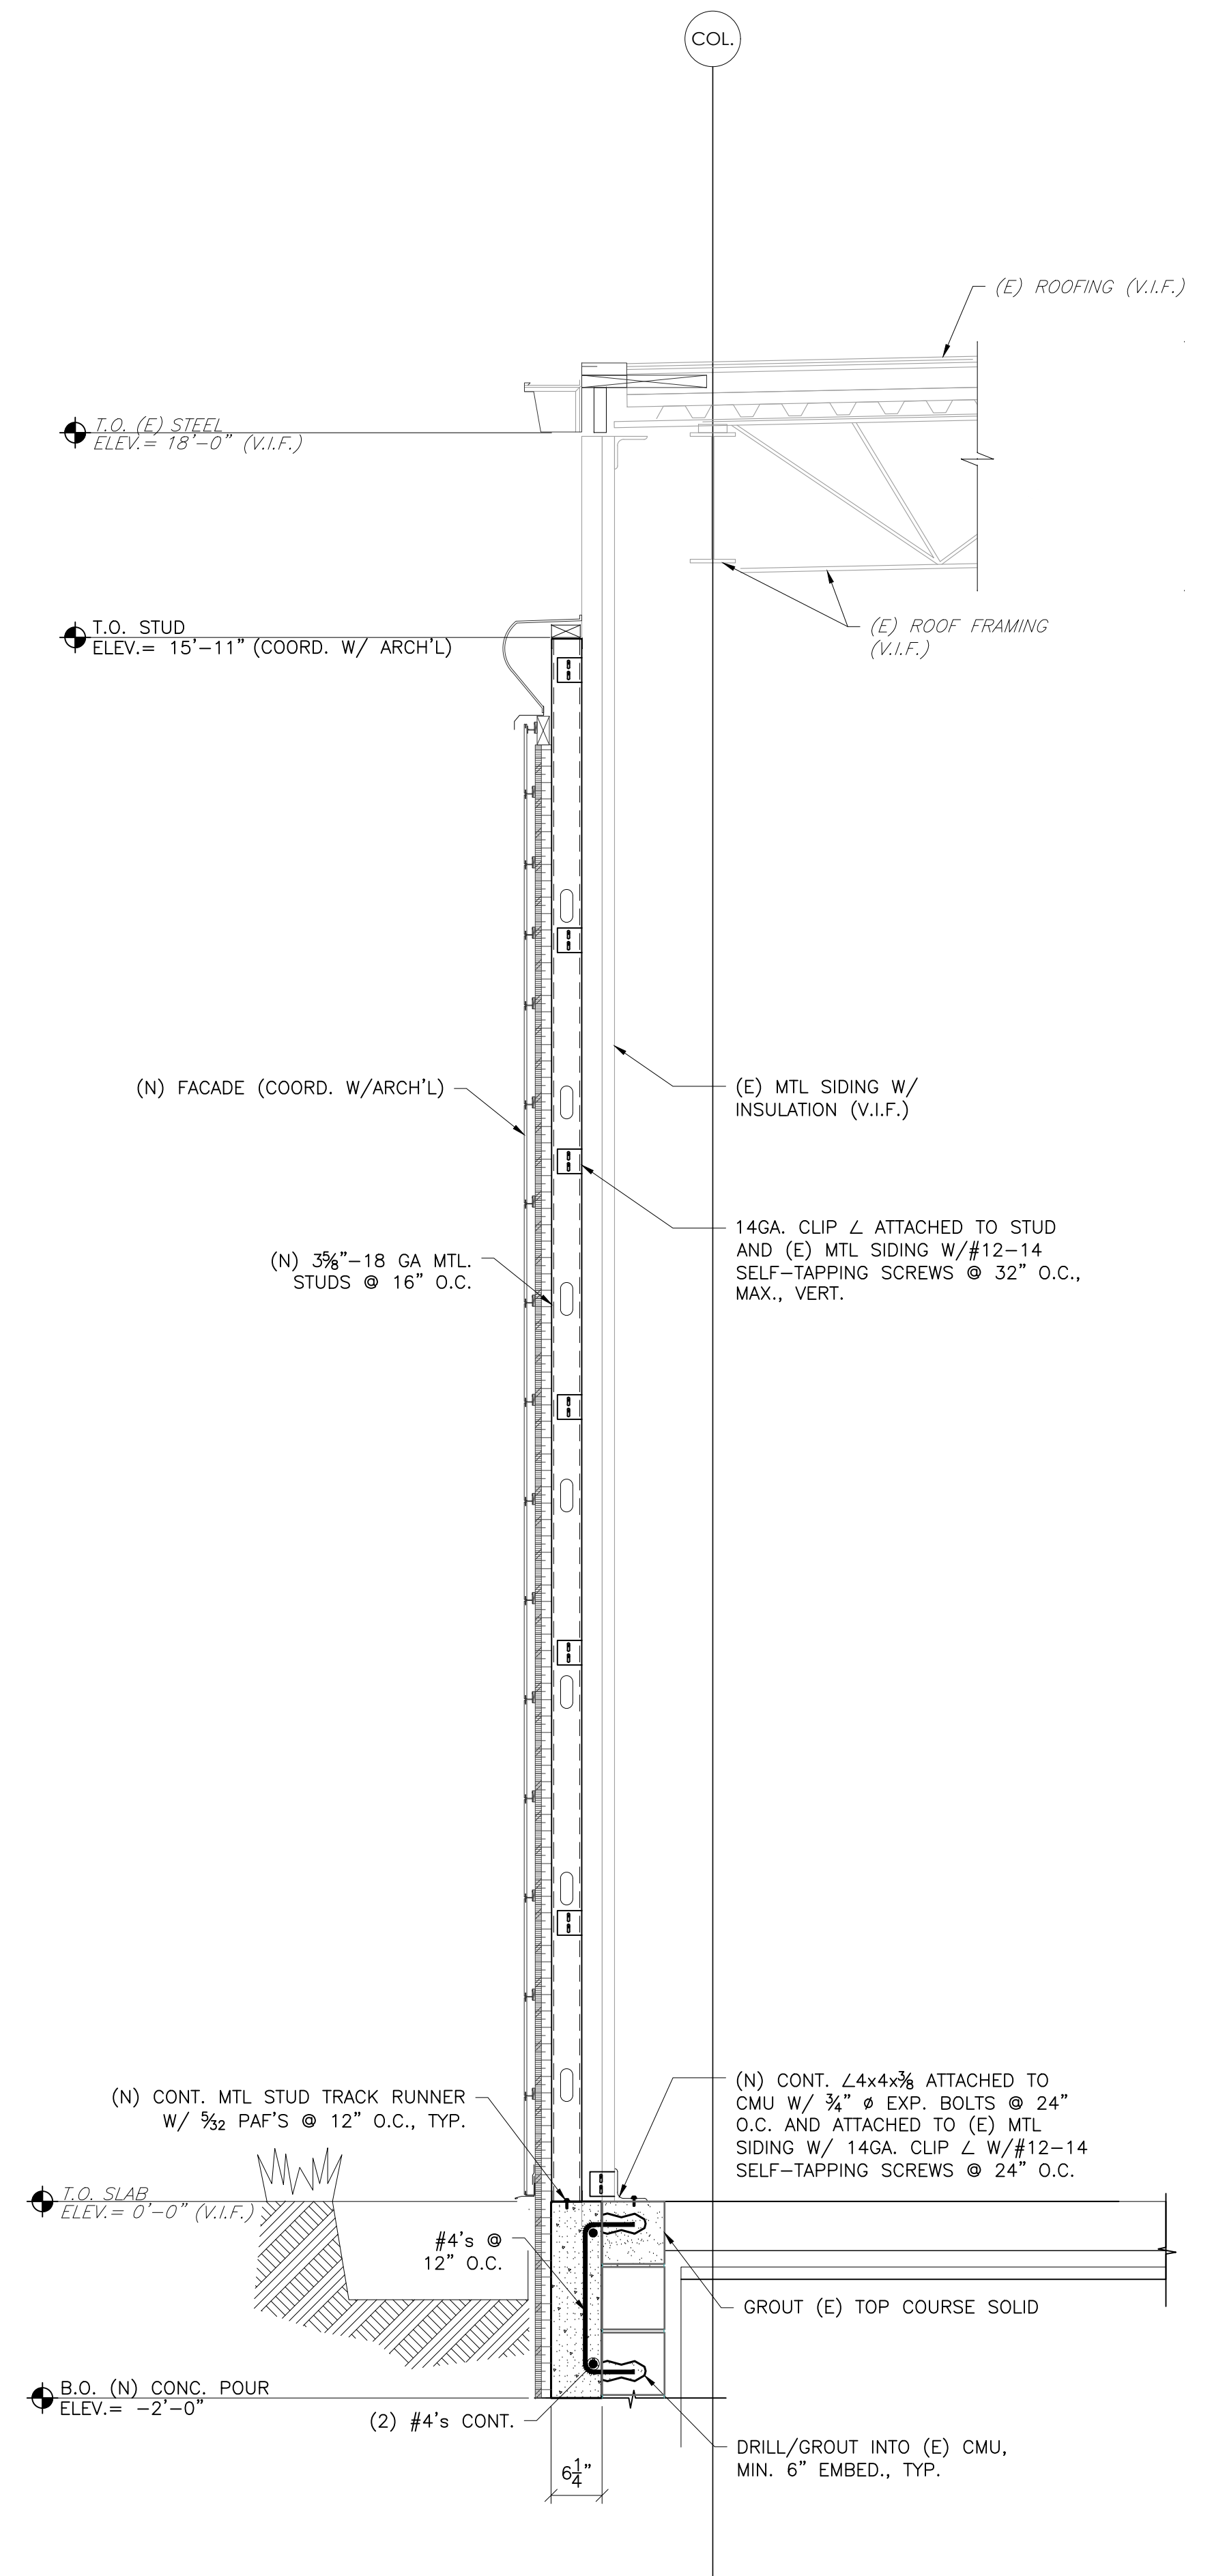
**2 WALL SECTION**  
S-305 SCALE: 3/4" = 1'-0"  
REF: 2/A-303

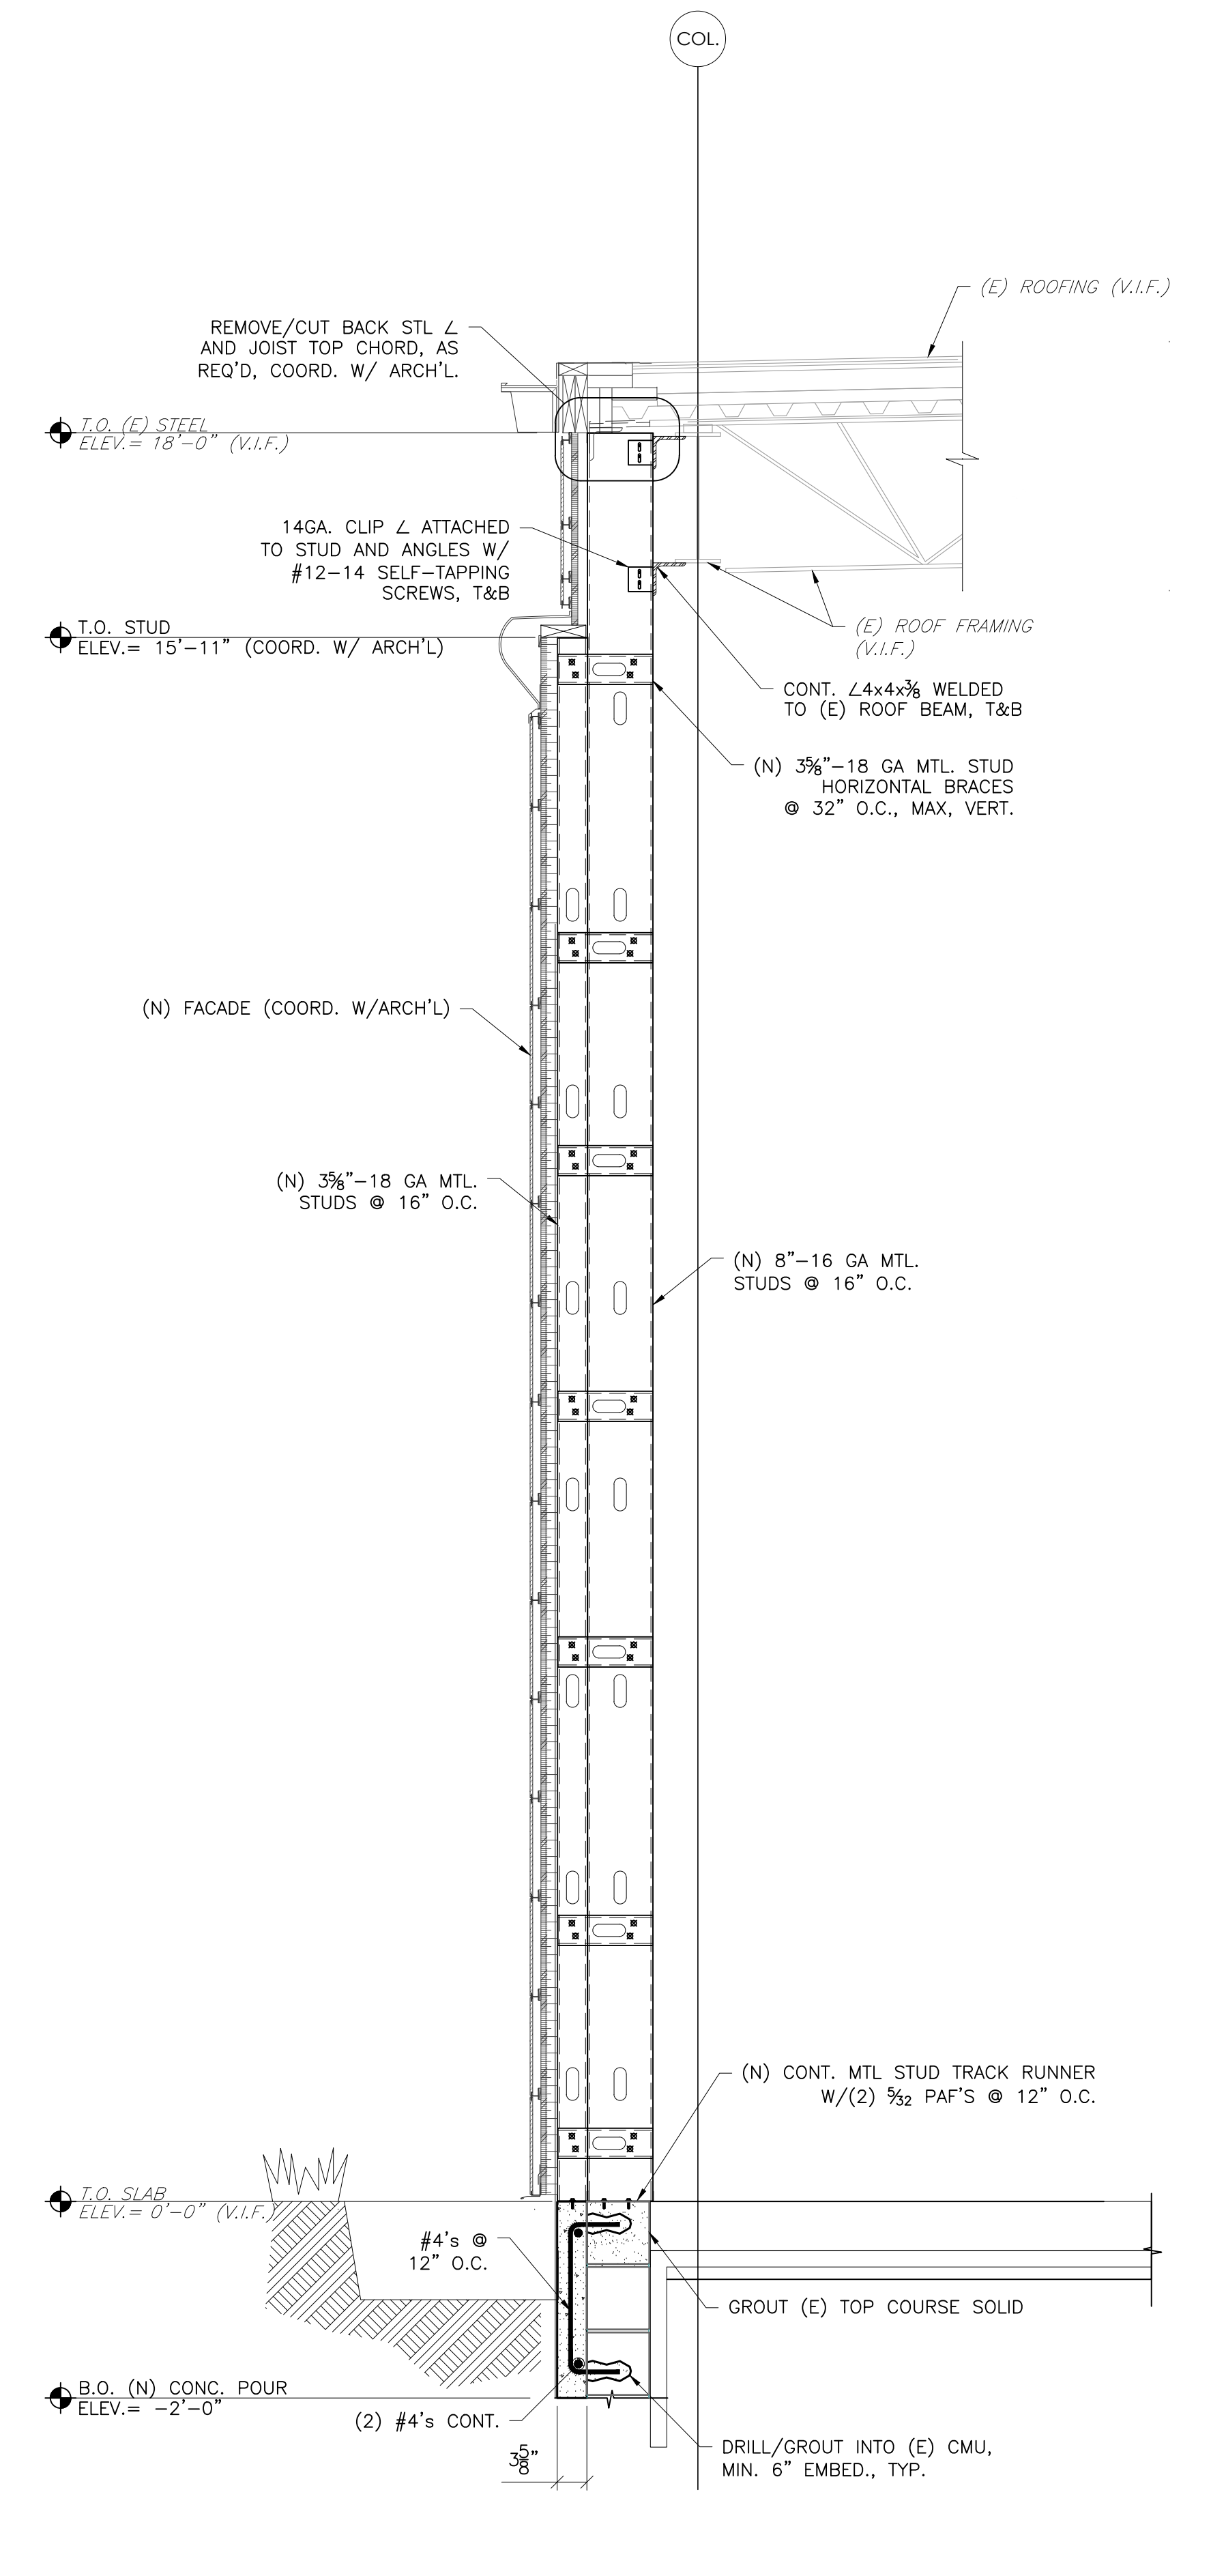

**1 WALL SECTION**  
S-305 SCALE: 3/4" = 1'-0"  
REF: 3/A-302

**METAL STUD FRAMING NOTE:**  
CONTRACTOR TO COORDINATE ALL DIMENSIONS, ELEVATIONS, LAYOUTS, AND ETC. OF ALL METAL STUD CONSTRUCTION SUCH AS PARAPETS AND CANOPIES WITH ARCH'L DRAWINGS.



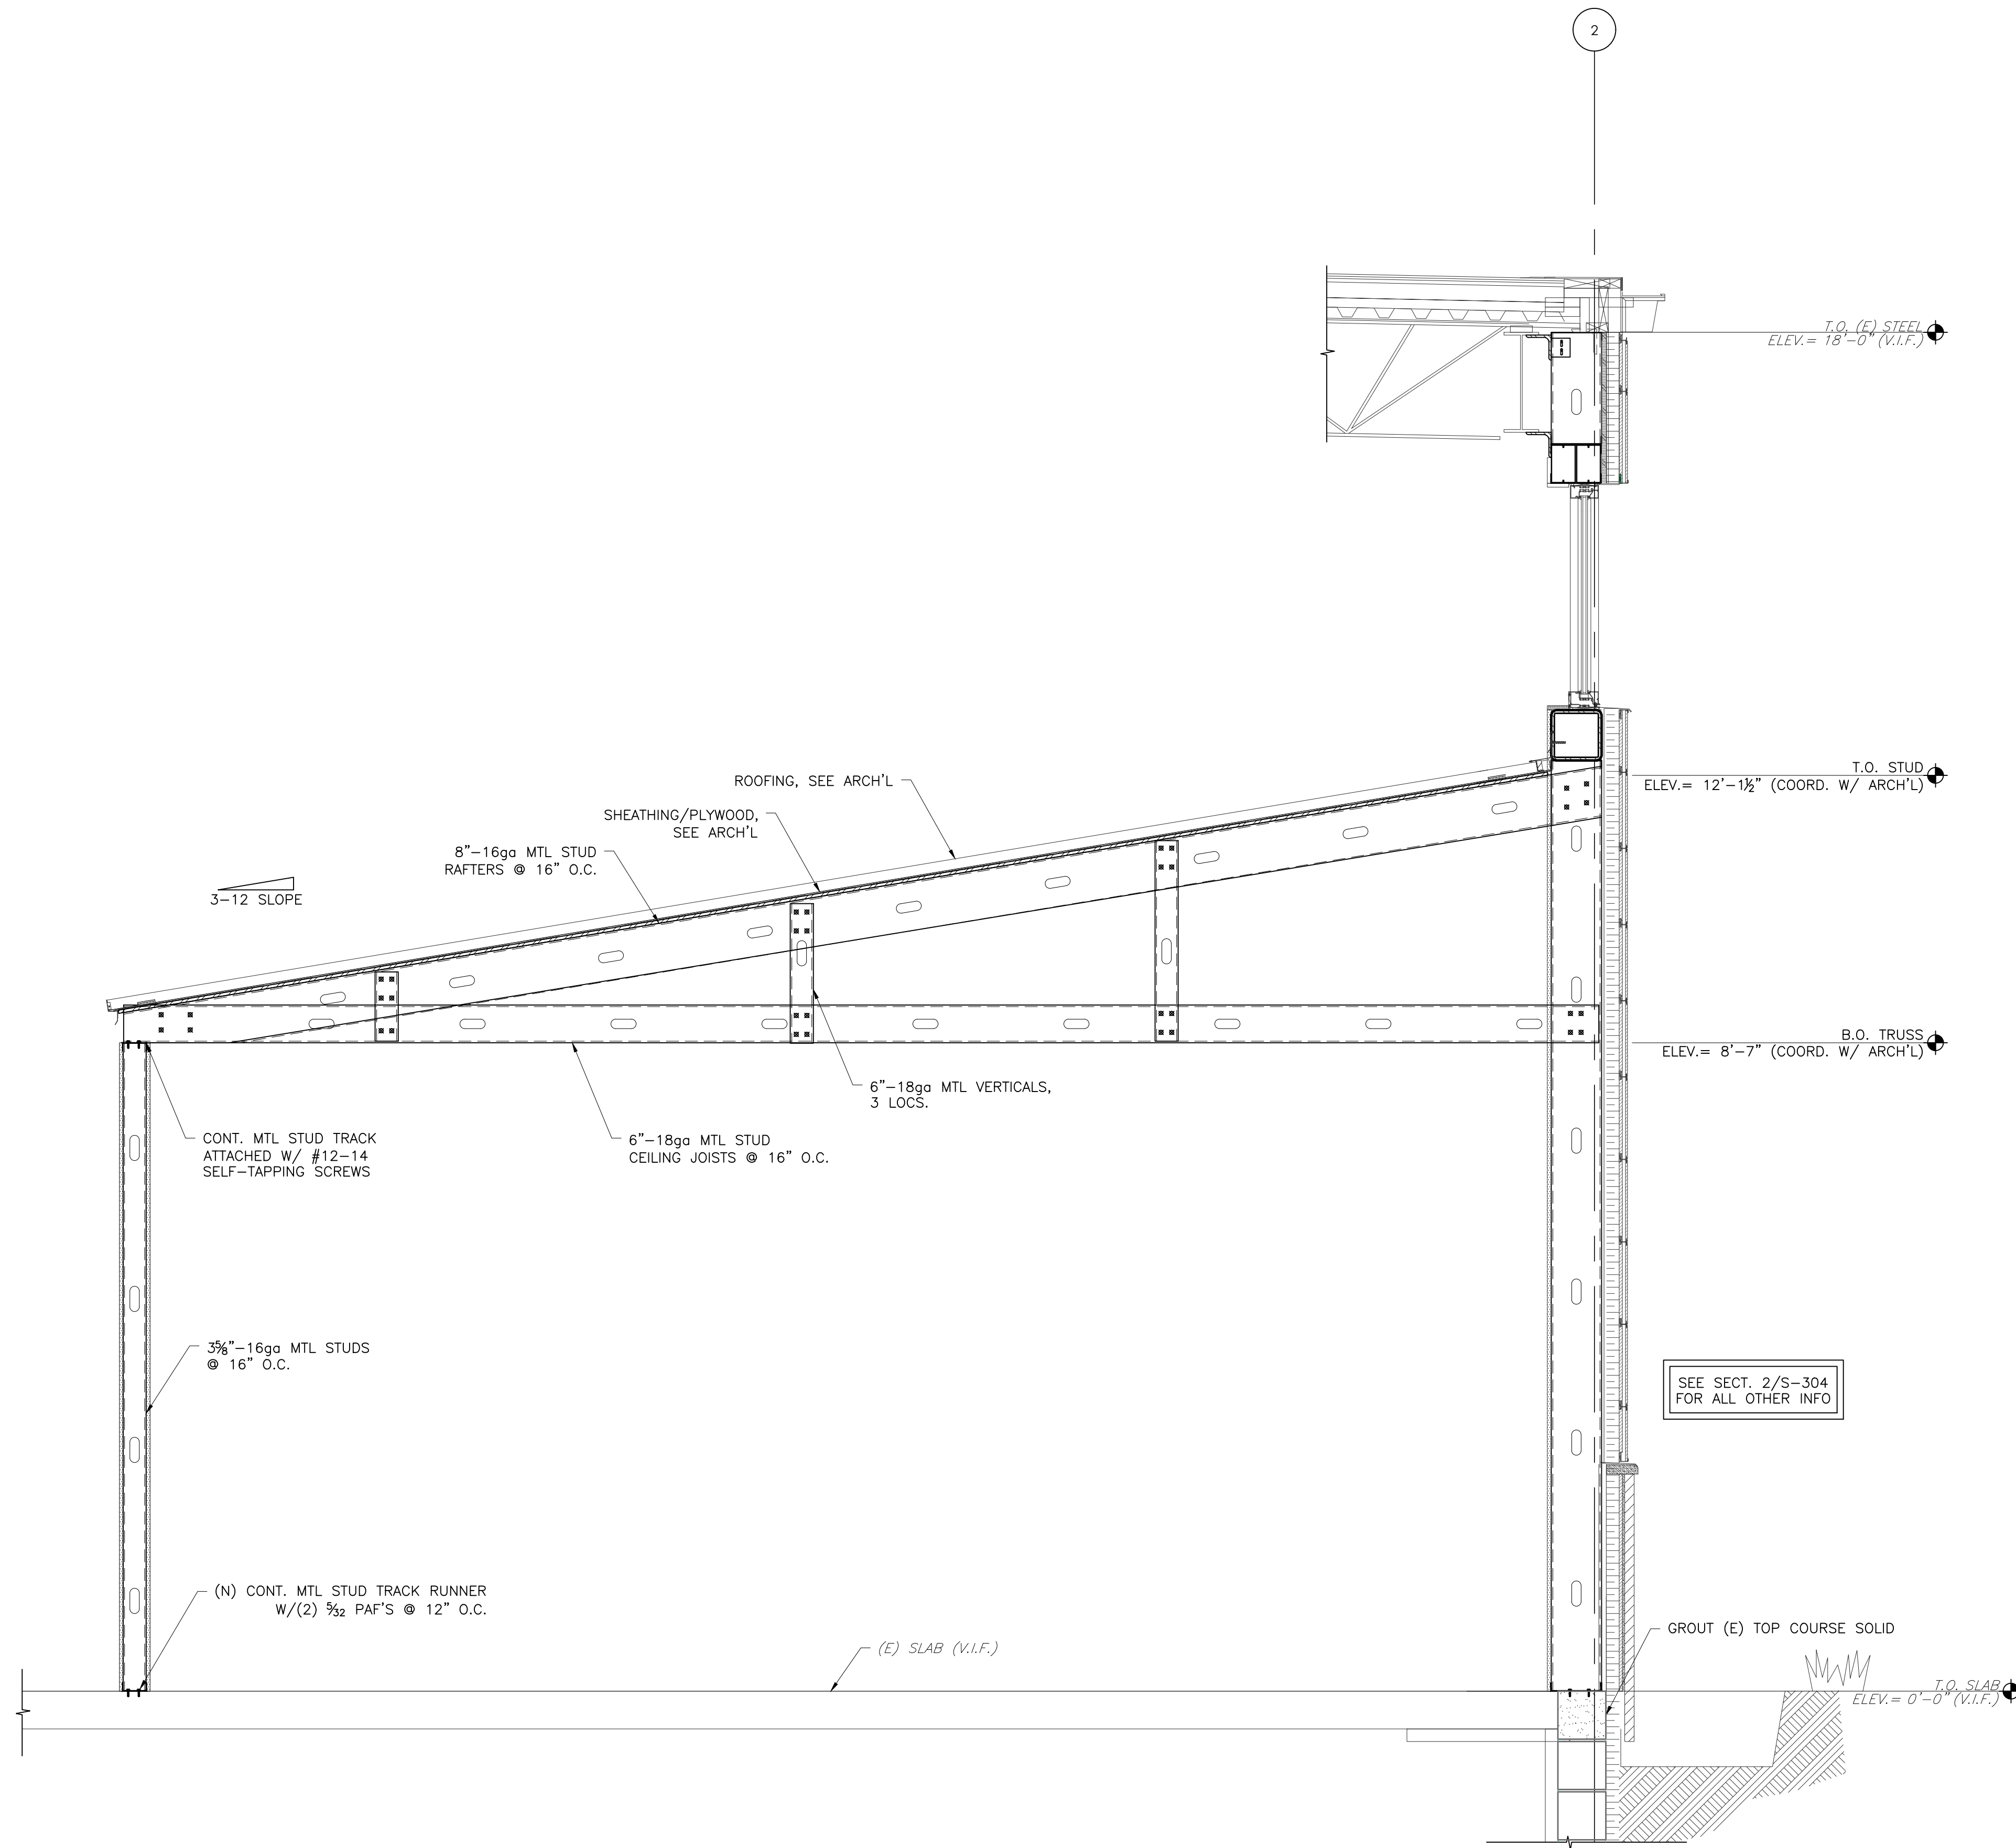

**1 WALL SECTION**  
S-306 SCALE: 3/4" = 1'-0"

REF: 1/A-305

**NOTES:**

- PROVIDE 8"-16ga MTL STUD BOX HEADERS AT ALL OPENINGS WITHIN OFFICE PARTITION WALLS. PROVIDE TRIPLE GANGED-UP STUDS ON EACH SIDE OF OPENING. COORD. ALL LOCATIONS, SIZES, ETC. OF ALL OPENINGS W/ARCH'L

**METAL STUD FRAMING NOTE:**  
CONTRACTOR TO COORDINATE ALL DIMENSIONS, ELEVATIONS, LAYOUTS, AND ETC. OF ALL METAL STUD CONSTRUCTION SUCH AS PARAPETS AND CANOPIES WITH ARCH'L DRAWINGS.



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CONSULTANT  
**DIGENOVA**  
**ASSOCIATES, INC.**  
STRUCTURAL ENGINEERING + DESIGN  
1212 Conestoga Pike, Suite 100 610.276.9110 Phone  
700 South Mountain Pike, P.O. Box 12402 610.276.9657 Fax

SALVATORE DIGENOVA  
ENGINEER  
REGISTRATION NO. 042432-E  
DATE: \_\_\_\_\_ SIGNED: \_\_\_\_\_

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**FACILITY UPGRADES**  
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LEESPORT, PA 19533

ISSUED  
DATE: 03/30/23

REV#	DESCRIPTION	DATE

PROJ. MGR.: S.DI GENOVA  
P.M. @-MAIL: <consultant.pm email>  
DRAWN BY: JF  
CLIENT PROJ #: 2022-010.00  
1 1/8" = 1'-0" SCALE  
1 1/8" = 1'-0" SCALE  
BAR IS ONE (1) INCH LONG ON ORIGINAL DRAWING

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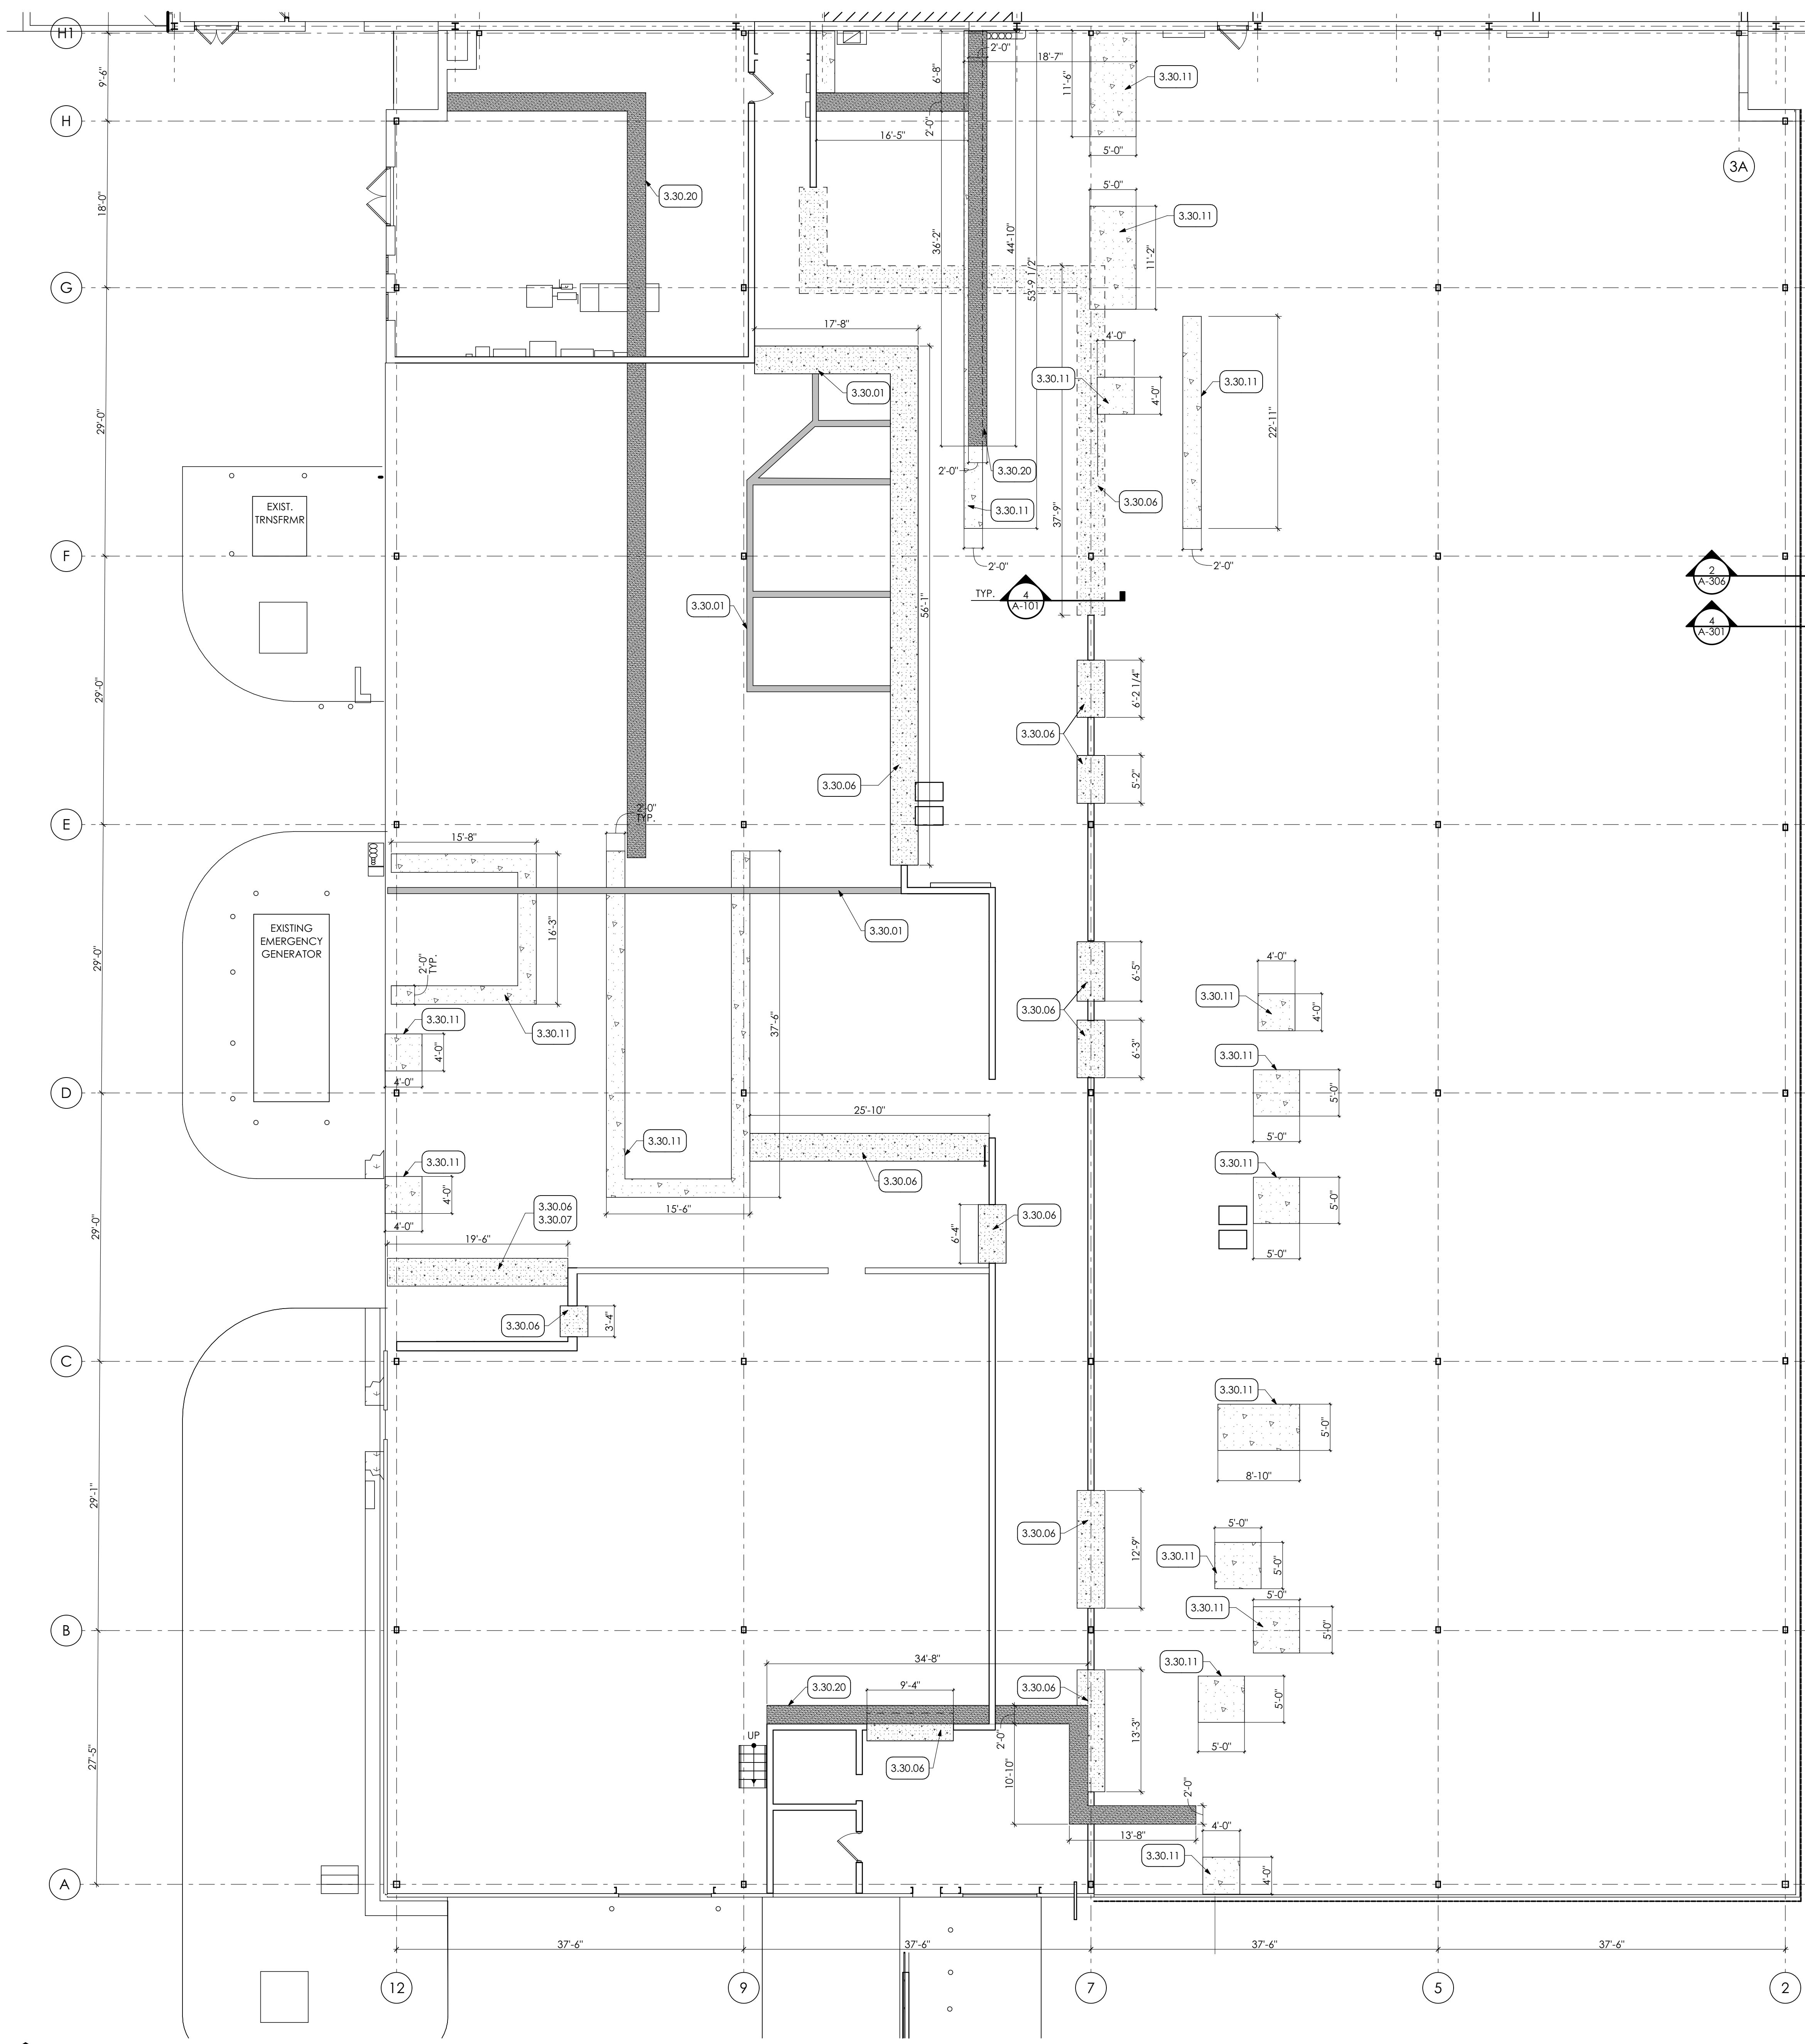
SHEET TITLE:  
**SECTIONS AND DETAILS**

**S-306**











**1 SLAB DEMOLITION PLAN**  
SCALE: 1/8" = 1'-0"


- KEY NOTES**
- 02 DEMOLITION**
- 2.01.29 EXISTING CONCRETE SLAB TO REMAIN.
  - 2.01.36 EXISTING CONCRETE FOOTING TO REMAIN.
  - 2.41 SELECTIVE DEMOLITION | SPEC 024119
  - 2.41.50 REMOVE COURSE OF EXISTING CMU BELOW CONCRETE SLAB.
  - 2.41.51 NEATLY CUT AND REMOVE EXISTING SLAB.
- 03 CONCRETE**
- 3.30 CAST-IN-PLACE CONCRETE | SPEC 033000 | 032000**
- 3.30.01 GRIND AND PATCH CONCRETE SLAB AT SECTION OF REMOVED CMU PARTITION.
  - 3.30.06 FILL OPENING WITH CONCRETE TO FINISH FLUSH WITH EXISTING CONCRETE SLAB.
  - 3.30.07 FOUNDATION STEPS IN THIS AREA, REMOVE ONE ROW OF CMU BELOW SLAB TO ALLOW FOR PATCHING.
  - 3.30.10 #5 REBAR SET INTO EXISTING SLAB W/ EPOXY.
  - 3.30.11 NEATLY CUT AND REMOVE CONCRETE SLAB, AND EXCAVATE FOR NEW FOOTING. BACKFILL AND PATCH CONCRETE. COORDINATE WITH STRUCTURAL DRAWINGS. LOCATION OF SLAB REMOVAL OF PROPOSED SANITARY LINE, P.C. TO PROVIDE EXACT LOCATION. G.C. TO CUT SLAB AND EXCAVATE TO DEPTH REQUIRED BY P.C. P.C. PROVIDE BACKFILL, G.C. TO PROVIDE STONE BASE AND CONCRETE PATCH. COORDINATE WITH PLUMBING DRAWINGS.
  - 3.30.22 PATCH GRIND CONCRETE AT AREAS OF REMOVED TERRAZZO.

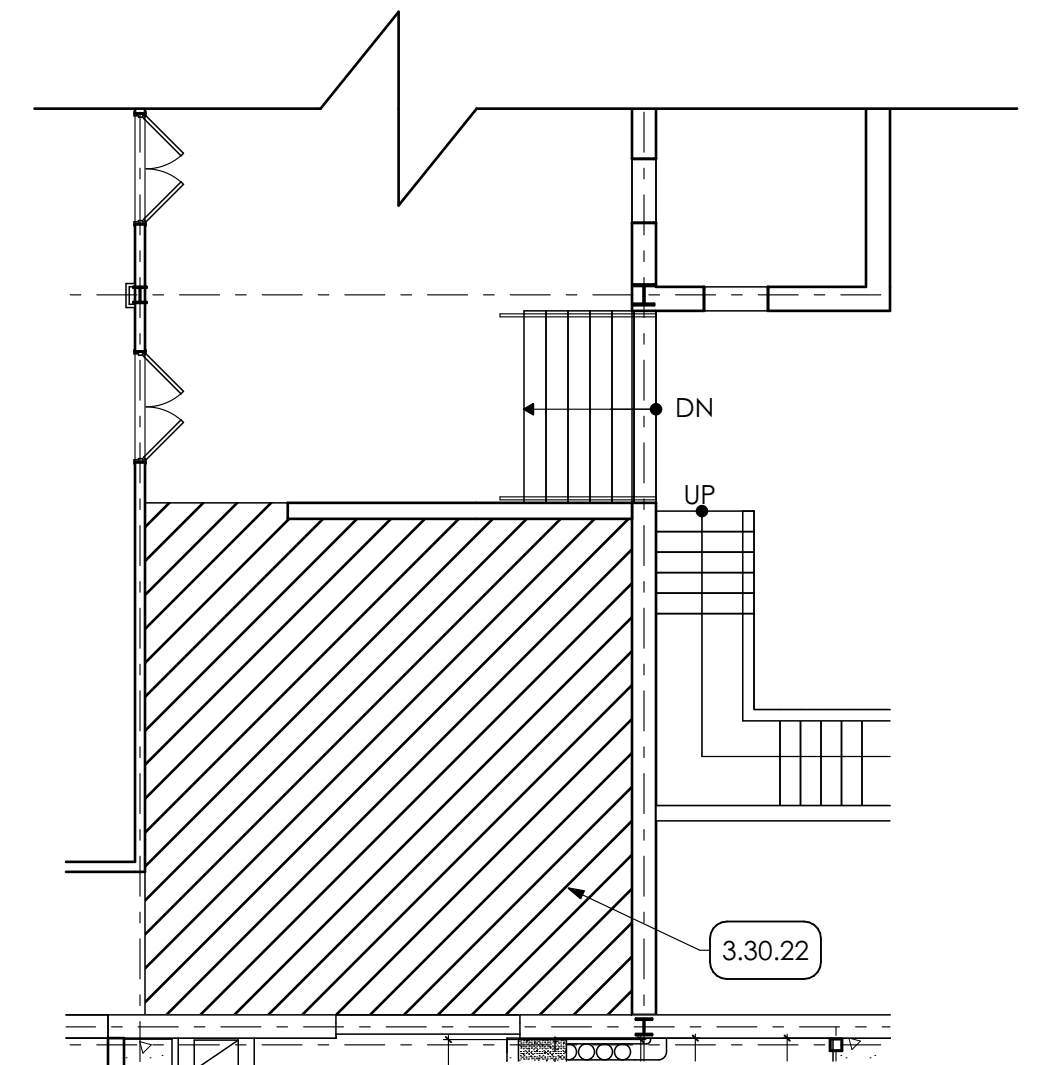

**2 SLAB REPAIR PLAN**  
SCALE: 1/8" = 1'-0"

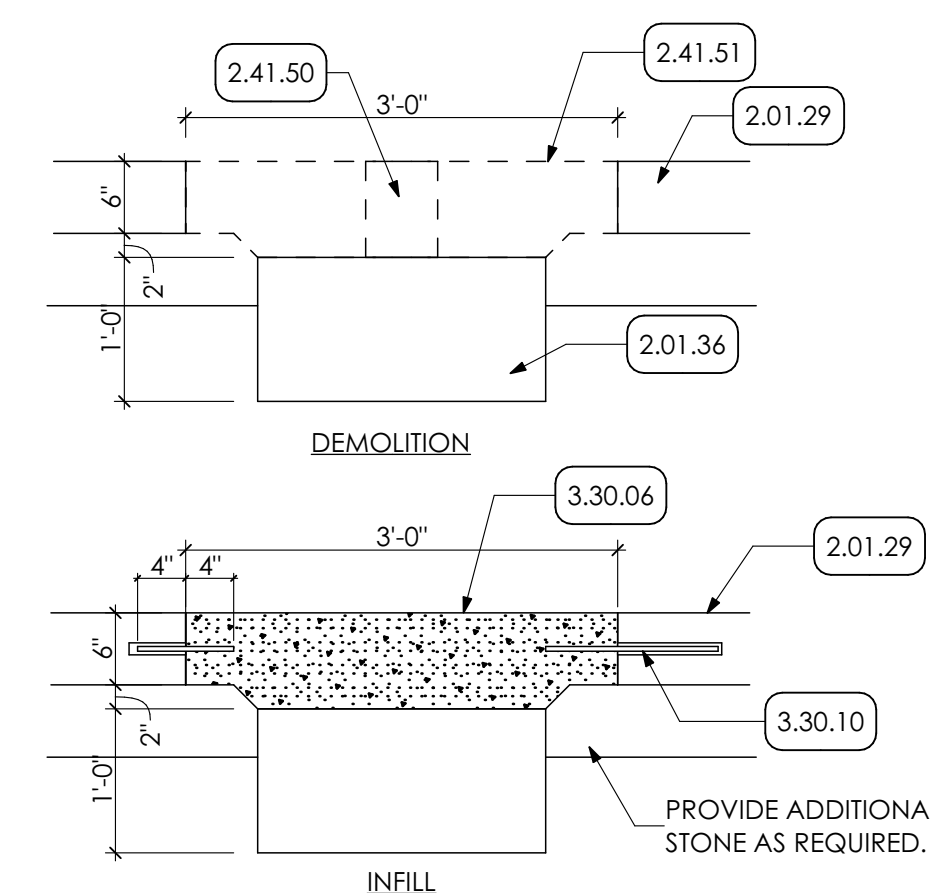

**4 SLAB REPAIR DETAIL**  
SCALE: 3/4" = 1'-0"

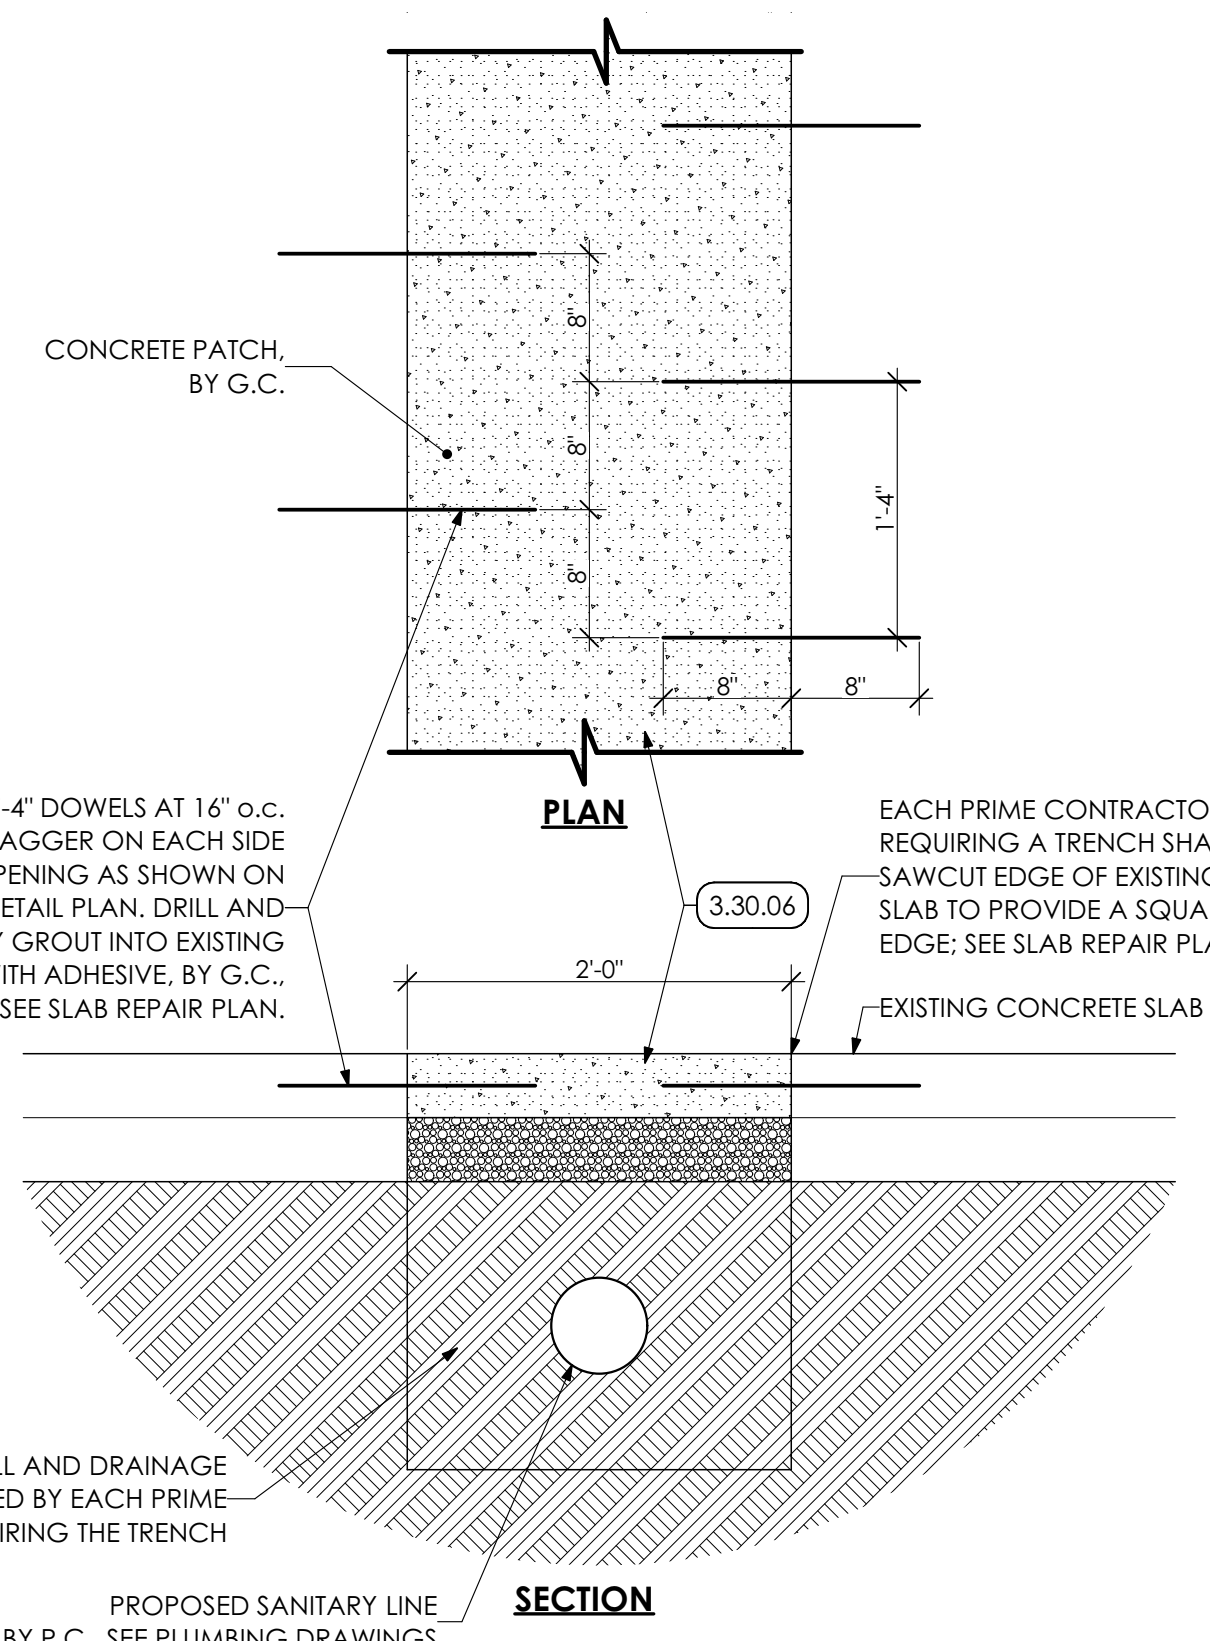

**3 SLAB REPAIR DETAIL-TRENCH**  
SCALE: 1" = 1'-0"

**GENERAL SHEET NOTES:**


1. ALL LOCATIONS WHERE AN ADJACENT CMU PARTITION IS ADJACENT TO A DOOR BEING REMOVED, GRIND AND PATCH AROUND DOOR AND ALONG REMOVED CMU PARTITION.



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ID	DESCRIPTION	DATE


PROJ. MGR.: JIM SARRO  
P.M. e-MAIL: JMS@MG-Architects.com  
DRAWN BY: DK, SG, BB, JS  
CLIENT PROJ #:  
SHEET SCALE: 1" = 1'-0"  
BAR IS ONE (1) INCH LONG ON ORIGINAL DRAWING

SHEET TITLE:  
**SLAB REPAIR PLAN**  
**A-101**

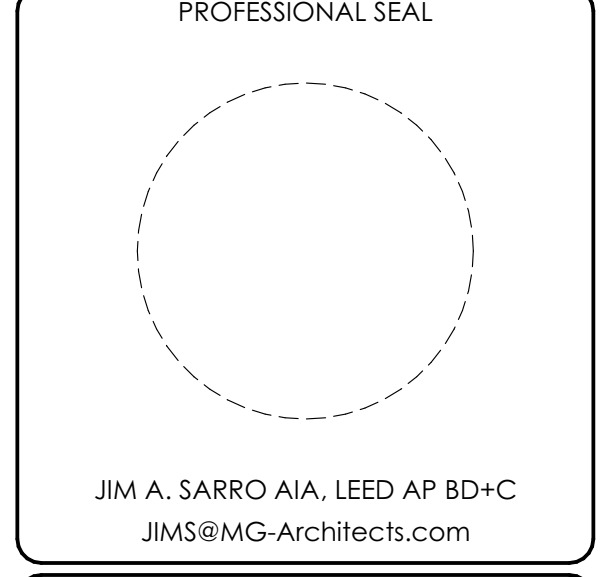





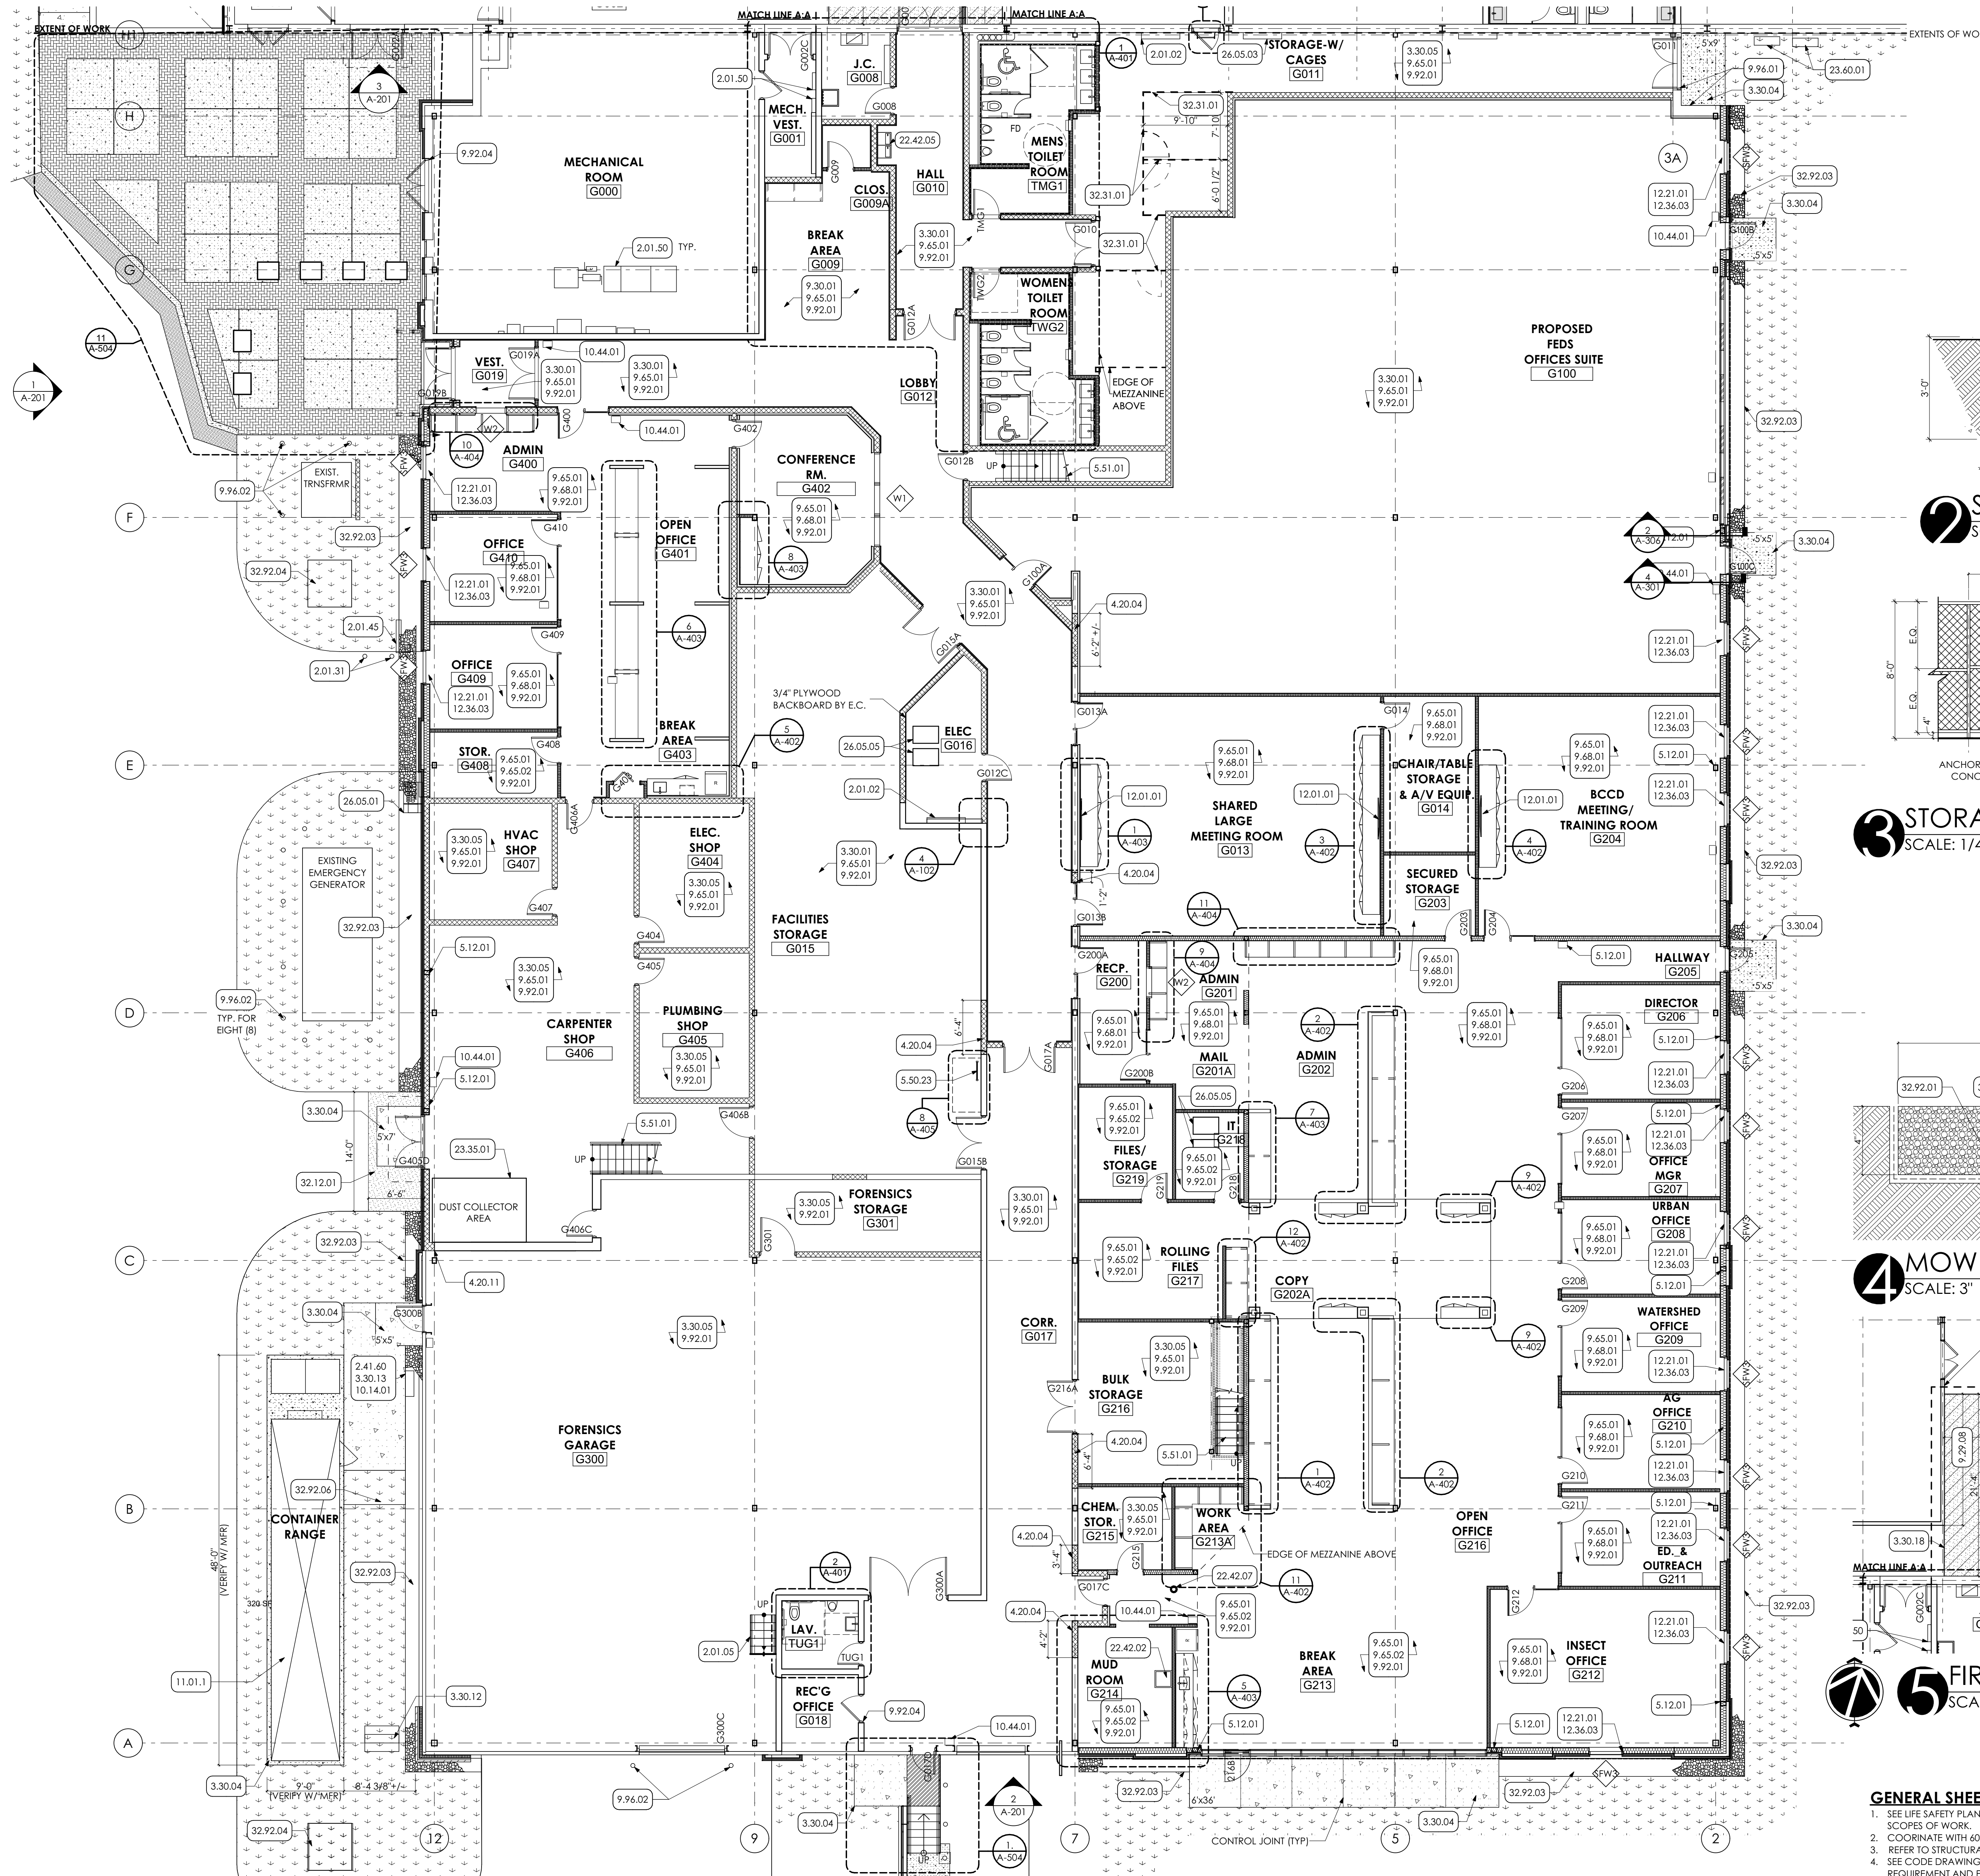

**FIRST FLOOR PLAN**  
SCALE: 1/8" = 1'-0"

**SIGN BASE DETAIL**  
SCALE: 1/2" = 1'-0"

**STORAGE CAGE DETAIL**  
SCALE: 1/4" = 1'-0"

**MOW STRIP**  
SCALE: 3" = 1'-0"

**FIRST FLOOR PLAN**  
SCALE: 1/8" = 1'-0"

**GENERAL SHEET NOTES**

- SEE LIFE SAFETY PLANS, SHEET A-002, A-003 FOR ADDITIONAL SCOPES OF WORK.
- COORDINATE WITH 600-SERIES SHEETS FOR SCHEDULES.
- REFER TO STRUCTURAL DRAWINGS FOR CONCRETE PAD DETAILS.
- SEE CODE DRAWINGS A-003, A-004, A-005 FOR SIGNAGE REQUIREMENT AND FIRE EXTINGUISHER LOCATIONS.
- COORDINATE WITH 700-SERIES SHEETS FOR FINISHES.

**LEGEND**

32.92.04 SEEDING BY G.C. (APPROX. 4000 SQ. FT.)

- KEY NOTES**
- 02 DEMOLITION**
    - 2.01 EXISTING CONDITIONS
    - 2.01.02 EXISTING ELECTRICAL PANELS TO REMAIN.
    - 2.01.05 EXISTING STAIR TO REMAIN.
    - 2.01.31 EXISTING BOLLARDS TO REMAIN.
    - 2.01.45 EXISTING GAS METER TO REMAIN.
    - 2.01.50 EXISTING ELECTRICAL EQUIPMENT
    - 2.41 **SELECTIVE DEMOLITION | SPEC 024119**
    - 2.41.60 CAREFULLY REMOVE SIGN. STORE FOR REINSTALL.
  - 03 CONCRETE**
    - 3.30 **CAST-IN-PLACE CONCRETE | SPEC 033000 | 032000**
    - 3.30.01 GRIND AND PATCH CONCRETE SLAB AT SECTION OF REMOVED CMU PARTITION.
    - 3.30.04 CAST-IN-PLACE CONCRETE PAD WITH DRAINAGE FILL. COORDINATE WITH STRUCTURAL DRAWING.
    - 3.30.05 PREP AND SEAL ENTIRE SURFACE OF EXISTING CONCRETE SLAB.
    - 3.30.12 REINSTALL SIGN ON NEW CONCRETE FOUNDATION.
    - 3.30.13 EXCAVATE FOR NEW SIGN BASE. PROVIDE CONCRETE SIGN BASE PER DETAIL AND BACKFILL.
    - 3.30.18 TRANSITION STRIPE.
  - 04 MASONRY**
    - 4.22 **CMU MASONRY | SPEC 042000**
    - 4.20.04 INFILL EXISTING OPENING WITH CMU TO MATCH EXISTING WALL THICKNESS (ASSUMED TO BE 8") FINISH FLUSH WITH ADJACENT SURFACE. TOOTH NEW CMU INTO EXISTING. EXTEND EXISTING CMU WALL TO NEW. TOOTH NEW CMU INTO EXISTING CMU.
    - 4.20.11
  - 05 METALS**
    - 5.12 **STRUCTURAL STEEL FRAMING | SPEC 051200**
    - 5.12.01 STEEL COLUMN. COORDINATE WITH STRUCTURAL DRAWINGS.
    - 5.50 **METAL FABRICATIONS | SPEC 055000 | SPEC 055213**
    - 5.50.23 WALL MOUNTED METAL LADDER WITH INTERMEDIATE LANDING PLATFORM.
    - 5.51 **METAL STAIRS | SPEC 055100**
    - 5.51.01 CONCRETE FILLED METAL PAN STAIRS.
  - 06 WOODS, PLASTICS AND COMPOSITES**
    - 6.10 **ROUGH CARPENTRY | SPEC 061000**
    - 6.10.03 WOOD SHELVING FOR WIDTH OF CLOSET. PROVIDE A 36" LENGTH OF SHELVING AT ADA HEIGHT.
  - 09 FINISHES**
    - 9.29 **GYPSUM BOARD | SPEC 092900**
    - 9.29.08 EXTEND EXISTING PLASTER WALL FLUSH TO UNDERSIDE OF NEW PLASTER CEILING. FINISH FLUSH WITH ADJACENT EXISTING SURFACES.
    - 9.30 **CERAMIC TILING | SPEC 093013**
    - 9.30.01 CERAMIC COVE BASE PROFILE FOR PERIMETER OF ROOM. COORDINATE WITH FINISH SCHEDULE.
    - 9.65 **RESILIENT BASE | SPEC 096513**
    - 9.65.01 4" HIGH RUBBER COVE BASE CONTINUOUS FOR PERIMETER OF ROOM OR CORRIDOR.
    - 9.65.02 PROVIDE LVT OVER HYDRAULIC CEMENT UNDERLAYMENT THROUGHOUT ENTIRE ROOM OR CORRIDOR. PREP SUBSTRATE AS REQUIRED PER MANUFACTURER'S RECOMMENDATIONS.
    - 9.66 **TERRAZZO FLOORING | SPEC 096600**
    - 9.66.01 PATCH TERRAZZO FLOORING TO FINISH FLUSH WITH ADJACENT SURFACE. COLOR TO MATCH EXISTING.
    - 9.68 **CARPETING | SPEC 096800 | 035416**
    - 9.68.01 PROVIDE CARPET TILE OVER HYDRAULIC CEMENT UNDERLAYMENT THROUGHOUT ROOM OR CORRIDOR. PREP SUBSTRATE AS REQUIRED PER MANUFACTURER RECOMMENDATIONS.
    - 9.92 **INTERIOR PAINTING | SPEC 099213**
    - 9.92.01 PREP. PRIME PAINT (TWO (2) COATS) ALL WALLS IN ROOM. UNLESS SPECIFIC WALLS NOTED OTHERWISE. PAINT ENTIRE WALL INCLUDING EXPOSED CONDUIT. FROM FLOOR TO 4" ABOVE NEW CEILING GRID OR TO ROOF DECK IN AREAS OF OPEN CEILINGS.
    - 9.92.04 PREP. PRIME PAINT (TWO (2) COATS) ENTIRE EXISTING DOOR FRAME
    - 9.92.05 DO NOT PAINT MURALS.
    - 9.96 **HIGH-PERFORMANCE COATING | SPEC 099600**
    - 9.96.01 PREP. PRIME PAINT (2 COATS) ENTIRE SURFACE WITH HIGH PERFORMANCE COATING.
    - 9.96.02 PREP AND PAINT (TWO (2) COATS) EXISTING PIPE BOLLARDS.
  - 10 SPECIALTIES**
    - 10.14 **SIGNAGE**
    - 10.14.01 REINSTALL EXISTING SIGN ON NEW CONCRETE FOUNDATION. UTILIZING EXISTING MOUNTING HOLES.
    - 10.44 **FIRE PROTECTION SPECIALTIES | SPEC 104400**
    - 10.44.01 FIRE EXTINGUISHER WITH FIRE PROTECTION CABINET
  - 11 EQUIPMENT**
    - 11.01 **EQUIPMENT | BY OWNER**
    - 11.01.1 CONTAINER RANGE PROVIDED AND INSTALLED BY OWNER.
  - 12 FURNISHINGS**
    - 12.01 **AV EQUIPMENT**
    - 12.01.01 WALL MOUNTED TELEVISION AND BRACKET PROVIDED BY AND INSTALLED BY OWNER.
    - 12.21 **HORIZONTAL LOUVER BLINDS | SPEC 122413**
    - 12.21.01 MANUALLY OPERATED HORIZONTAL BLINDS FOR FULL LENGTH OF WINDOW OPENING.
    - 12.36.1 **SOLID SURFACE COUNTERTOP | SPEC 123661.16**
    - 12.36.03 SOLID SURFACE WINDOW SILL FOR WIDTH OF OPENING.
  - 22 PLUMBING | BY P.C.**
    - 22 WORK DESCRIBED IN THESE KEYNOTES IS THE RESPONSIBILITY OF THE P.C. UNLESS NOTED OTHERWISE. COORDINATE WITH PLUMBING DRAWING.
    - 22.42 **COMMERCIAL PLUMBING FIXTURES**
    - 22.42.02 NEW UTILITY SINK.
    - 22.42.05 ADA COMPLIANT HI-LOW DRINKING FOUNTAINS.
    - 22.42.07 FLOOR DRAIN; COORDINATE w/ PLUMBING DRAWINGS.
  - 23 HVAC | BY H.C.**
    - 23 WORK DESCRIBED IN THESE KEYNOTES IS THE RESPONSIBILITY OF THE H.C. UNLESS NOTED OTHERWISE. COORDINATE WITH MECHANICAL DRAWING.
    - 23.35 **SPECIAL EXHAUST SYSTEMS**
    - 23.35.01 REINSTALL STORED DUST COLLECTOR.
    - 23.60 **CENTRAL COOLING EQUIPMENT**
    - 23.60.01 REINSTALL EXISTING CONDENSOR UNITS AND PADS.
  - 26 ELECTRICAL | BY E.C.**
    - 26 WORK DESCRIBED IN THESE KEYNOTES IS THE RESPONSIBILITY OF THE E.C. UNLESS NOTED OTHERWISE. COORDINATE WITH ELECTRICAL DRAWING.
    - 26.05 **COMMON WORK RESULTS FOR ELECTRICAL**
    - 26.05.01 EXISTING ELECTRICAL CONDUIT.
    - 26.05.03 REINSTALL STORED ELECTRICAL PANELS.
    - 26.05.05 RACKS BY E.C.
  - 32 EXTERIOR IMPROVEMENTS**
    - 32.12 **ASPHALT PAVING | SPEC 321216**
    - 32.12.01 NEATLY CUT EXISTING ASPHALT AND EXCAVATE FOR NEW CONCRETE SLAB. BACKFILL AND PATCH EXISTING ASPHALT AS REQUIRED TO FINISH FLUSH WITH ADJACENT SURFACE.
    - 32.31 **CHAIN LINK FENCES AND GATES | SPEC 323113**
    - 32.31.01 NEW METAL MESH STORAGE FENCING WITH SWING DOOR.
    - 32.32 **TURF AND GRASSES | SPEC 329200**
    - 32.32.01 WEED BARRIER
    - 32.32.02 #4 WASHED RIVER STONE
    - 32.32.03 24" WIDE GRAVEL MOW STRIPE. SEE DETAIL.
    - 32.32.04 BACKFILL TO FINISH FLUSH WITH ADJACENT GRADE AND PROVIDE SEED. BY G.C. BACKFILL FOR ELECTRIC CONDUIT AND PLUMBING LINES BY G.C. E.C. AND P.C. TO RUN THEIR OWN LINES. COORDINATE WITH ELECTRICAL AND PLUMBING DRAWINGS.
    - 32.92.06

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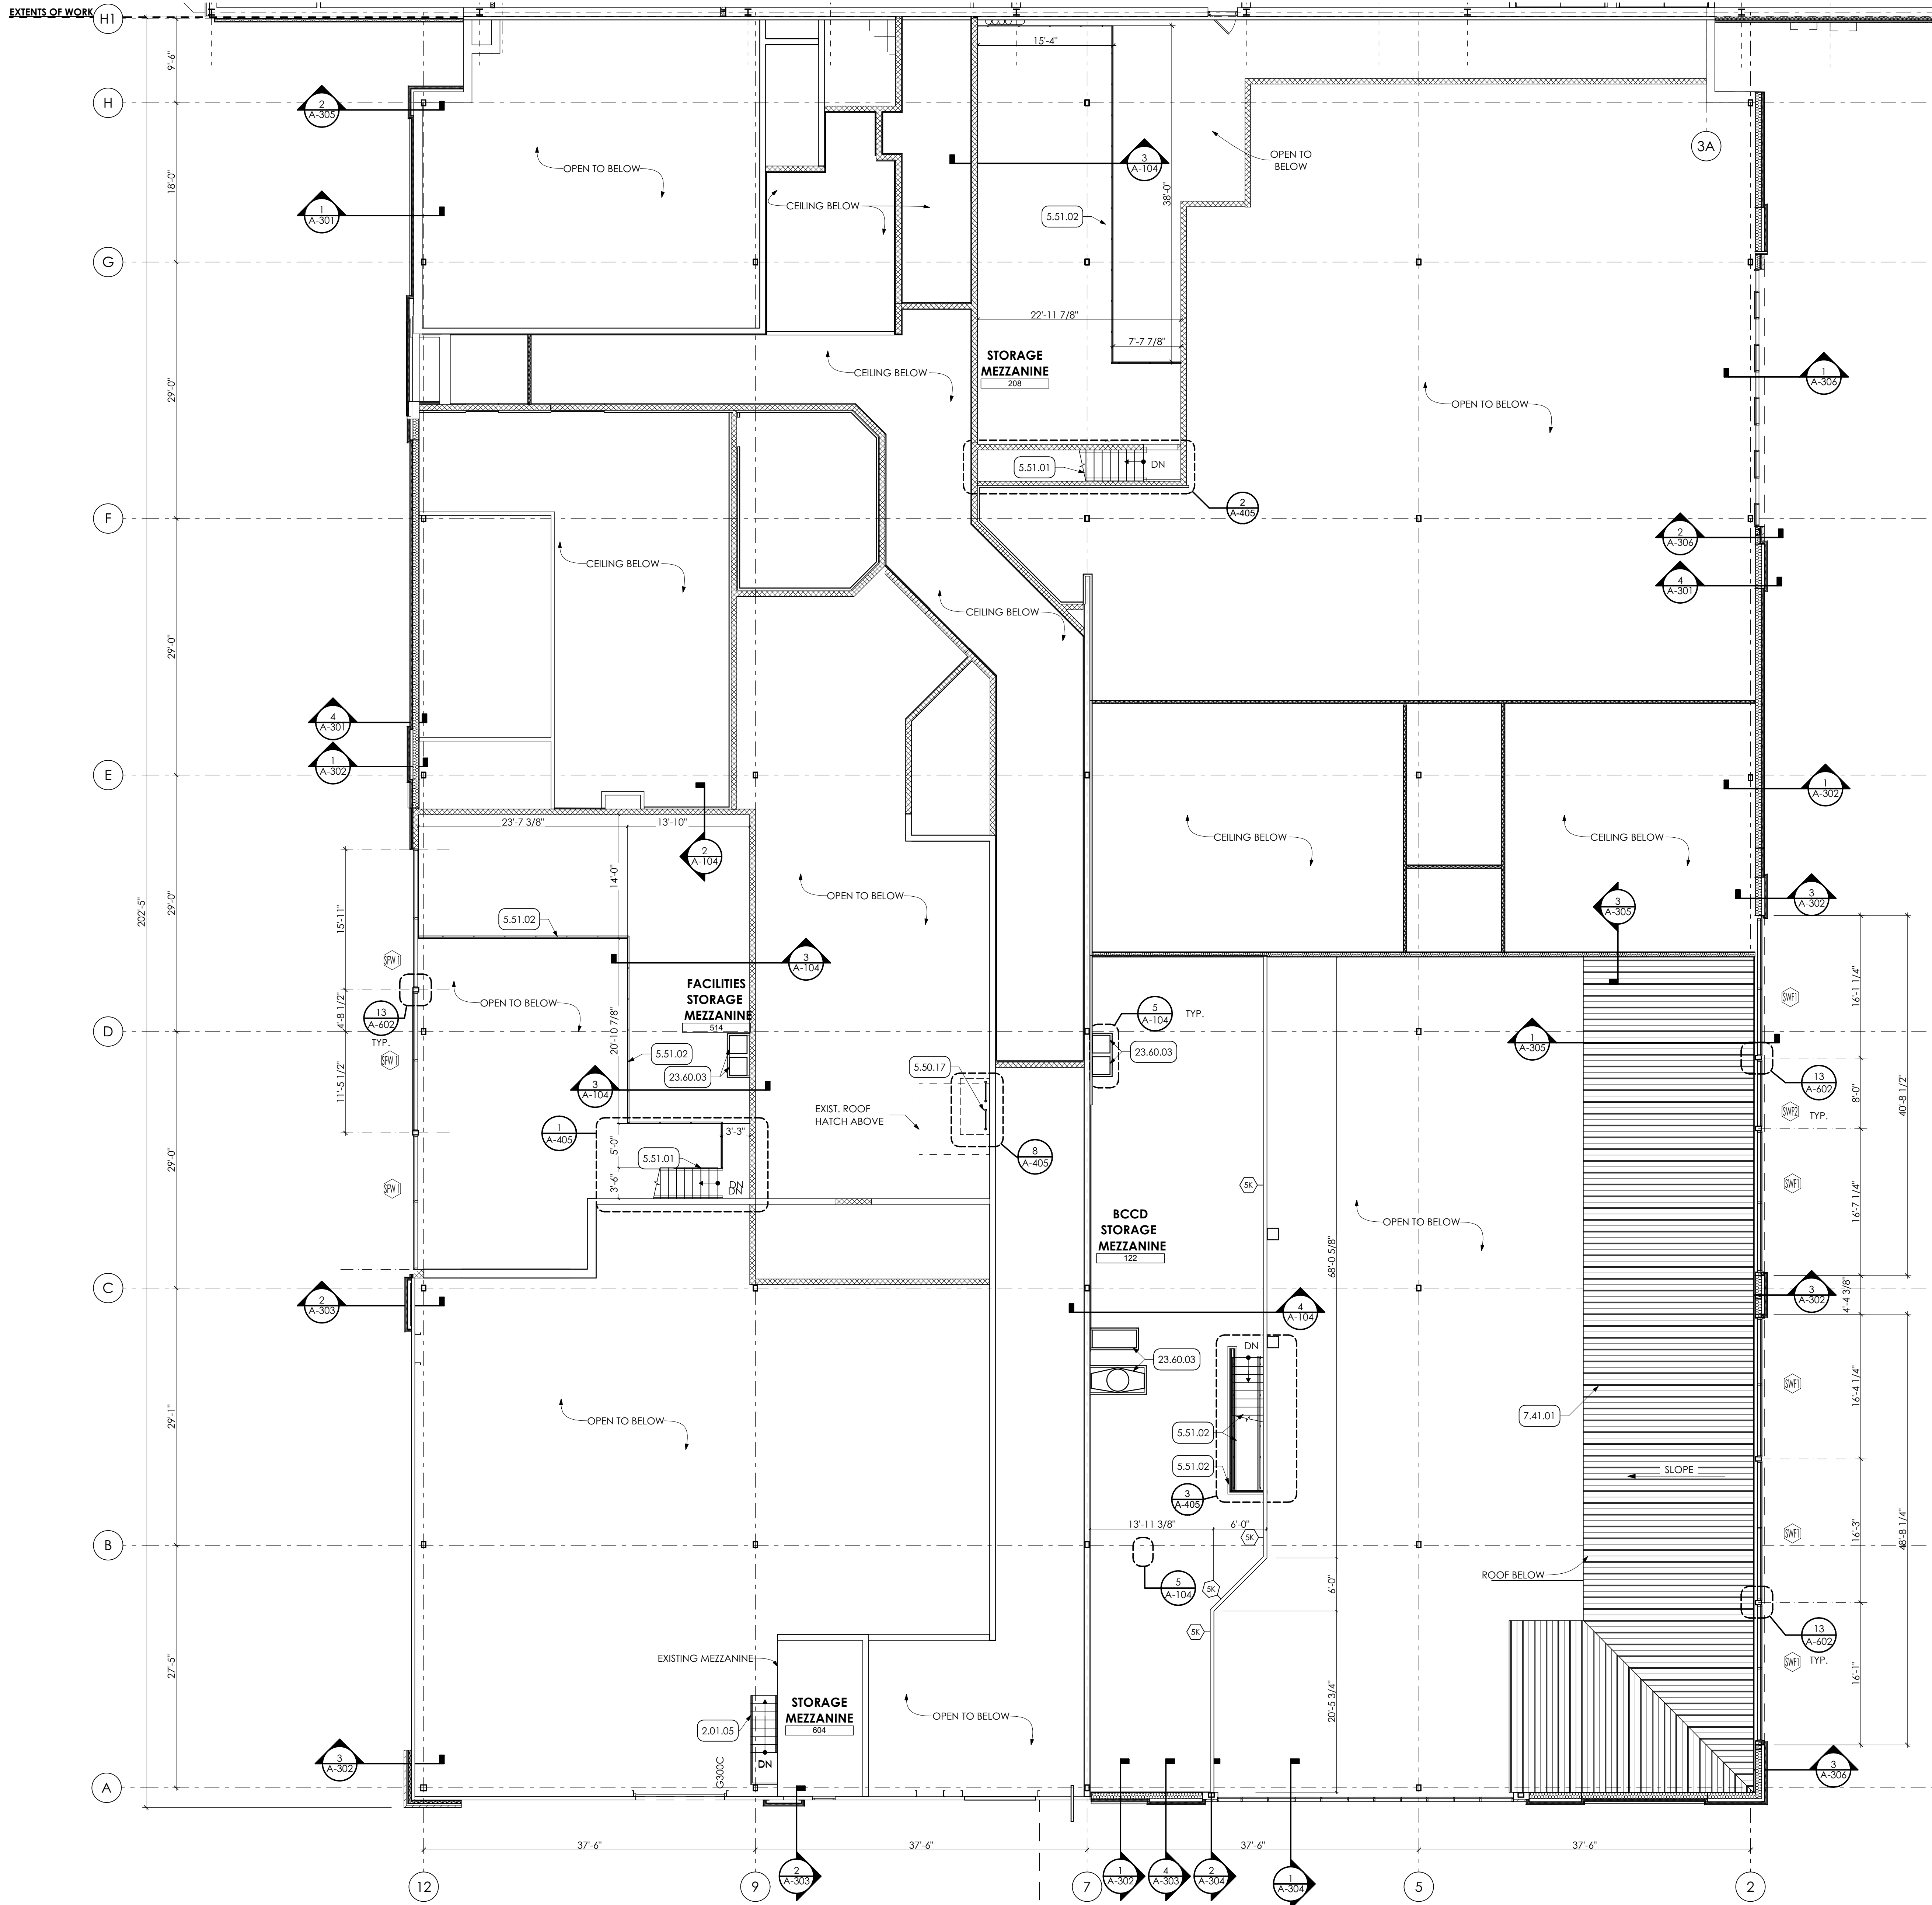
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P.M. e-MAIL: JMS@MG-Architects.com  
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SHEET TITLE:  
**KEYNOTE PLAN**

**A-103**





- KEY NOTES**
- 01 GENERAL CONSTRUCTION**
    - 1.50.02 G.C. TO PROVIDE TWO (2) 8'-0" WIDE CHAIN LINK FENCE GATES WITH PADLOCK.
  - 02 DEMOLITION**
    - 2.01 EXISTING CONDITIONS
    - 2.01.05 EXISTING STAIR TO REMAIN.
  - 03 CONCRETE**
    - 3.45 PRECAST ARCHITECTURAL CONCRETE COORDINATE WITH STRUCTURAL DRAWINGS
    - 3.45.02 8" PRECAST CONCRETE PLANK
  - 04 MASONRY**
    - 4.22 CMU MASONRY | SPEC 042000
    - 4.20.05 8" CMU GROUTED SOLID, COORDINATE WITH STRUCTURAL DRAWINGS.
  - 05 METALS**
    - 5.12 STRUCTURAL STEEL FRAMING | SPEC 051200
    - 5.12.09 STEEL ANGLE, COORDINATE W/ STRUCTURAL DRAWINGS.
    - 5.12.11 SCHEDULED BEAM, COORDINATE W/ STRUCTURAL DRAWINGS.
    - 5.50 METAL FABRICATIONS | SPEC 055000 | SPEC 055213
    - 5.50.14 1 1/2" DIA. STEEL PIPE GUARDRAIL, 42" HIGH, PREP AND PAINTED.
    - 5.50.15 1/4" x 4" H. STEEL KICK PLATE, PREP AND PAINTED.
    - 5.50.16 1/4"x4"x6" STEEL ANGLE WELDED TO STEEL POST WITH TWO (2) 3/4" MOUNTING HOLES, PREP AND PAINTED.
    - 5.50.17 WALL MOUNTED METAL LADDER WITH CAGE TO ROOF HATCH ABOVE
    - 5.50.22 12ga. CONTINUOUS ALUMINUM J-CANNEL.
    - 5.51 METAL STAIRS | SPEC 055100
    - 5.51.01 CONCRETE FILLED METAL PAN STAIRS.
    - 5.51.02 1 1/2" DIA. METAL PIPE GUARDRAIL AT 42" HT. AND HANDRAIL AT 36" HT., PREP AND PAINT.
  - 07 THERMAL AND MOISTURE PROTECTION**
    - 7.41 METAL ROOF PANELS | SPEC 074113
    - 7.41.01 STANDING SEAM METAL ROOF PANEL.
  - 09 FINISHES**
    - 9.22 NON-STRUCTURAL METAL FRAMING | SPEC 092216
    - 9.22.04 3 5/8" METAL STUD FRAMING AT 16" O.C.
    - 9.29 GYPSUM BOARD | SPEC 092900
    - 9.29.01 5/8" GYPSUM BOARD
  - 12 FURNISHINGS**
    - 12.36 QUARTZ AGGLOMERATE COUNTERTOPS | SPEC 123661.19
    - 12.36.04 QUARTZ WALL CAP FOR LENGTH OF WALL.
  - 23 HVAC | BY H.C.**
    - 23 WORK DESCRIBED IN THESE KEYNOTES IS THE RESPONSIBILITY OF THE H.C. UNLESS NOTED OTHERWISE. COORDINATE WITH MECHANICAL DRAWING.
  - 23.60 CENTRAL COOLING EQUIPMENT**
    - 23.60.03 HOT WATER COIL BY H.C.
  - 32 EXTERIOR IMPROVEMENTS**
    - 32.20 SIEWORK
    - 32.20.01 EXCAVATE FOR CONSTRUCTION STAGING AREA. PROVIDE MINIMUM 8" OF AASHTO #2A STONE.
    - 32.92 TURF AND GRASSES | SPEC 329200
    - 32.92.05 AT THE COMPLETION OF THE WORK, REMOVE STONE AND BACKFILL WITH CLEAN FILL AND SEED ENTIRE AREA, BY G.C.

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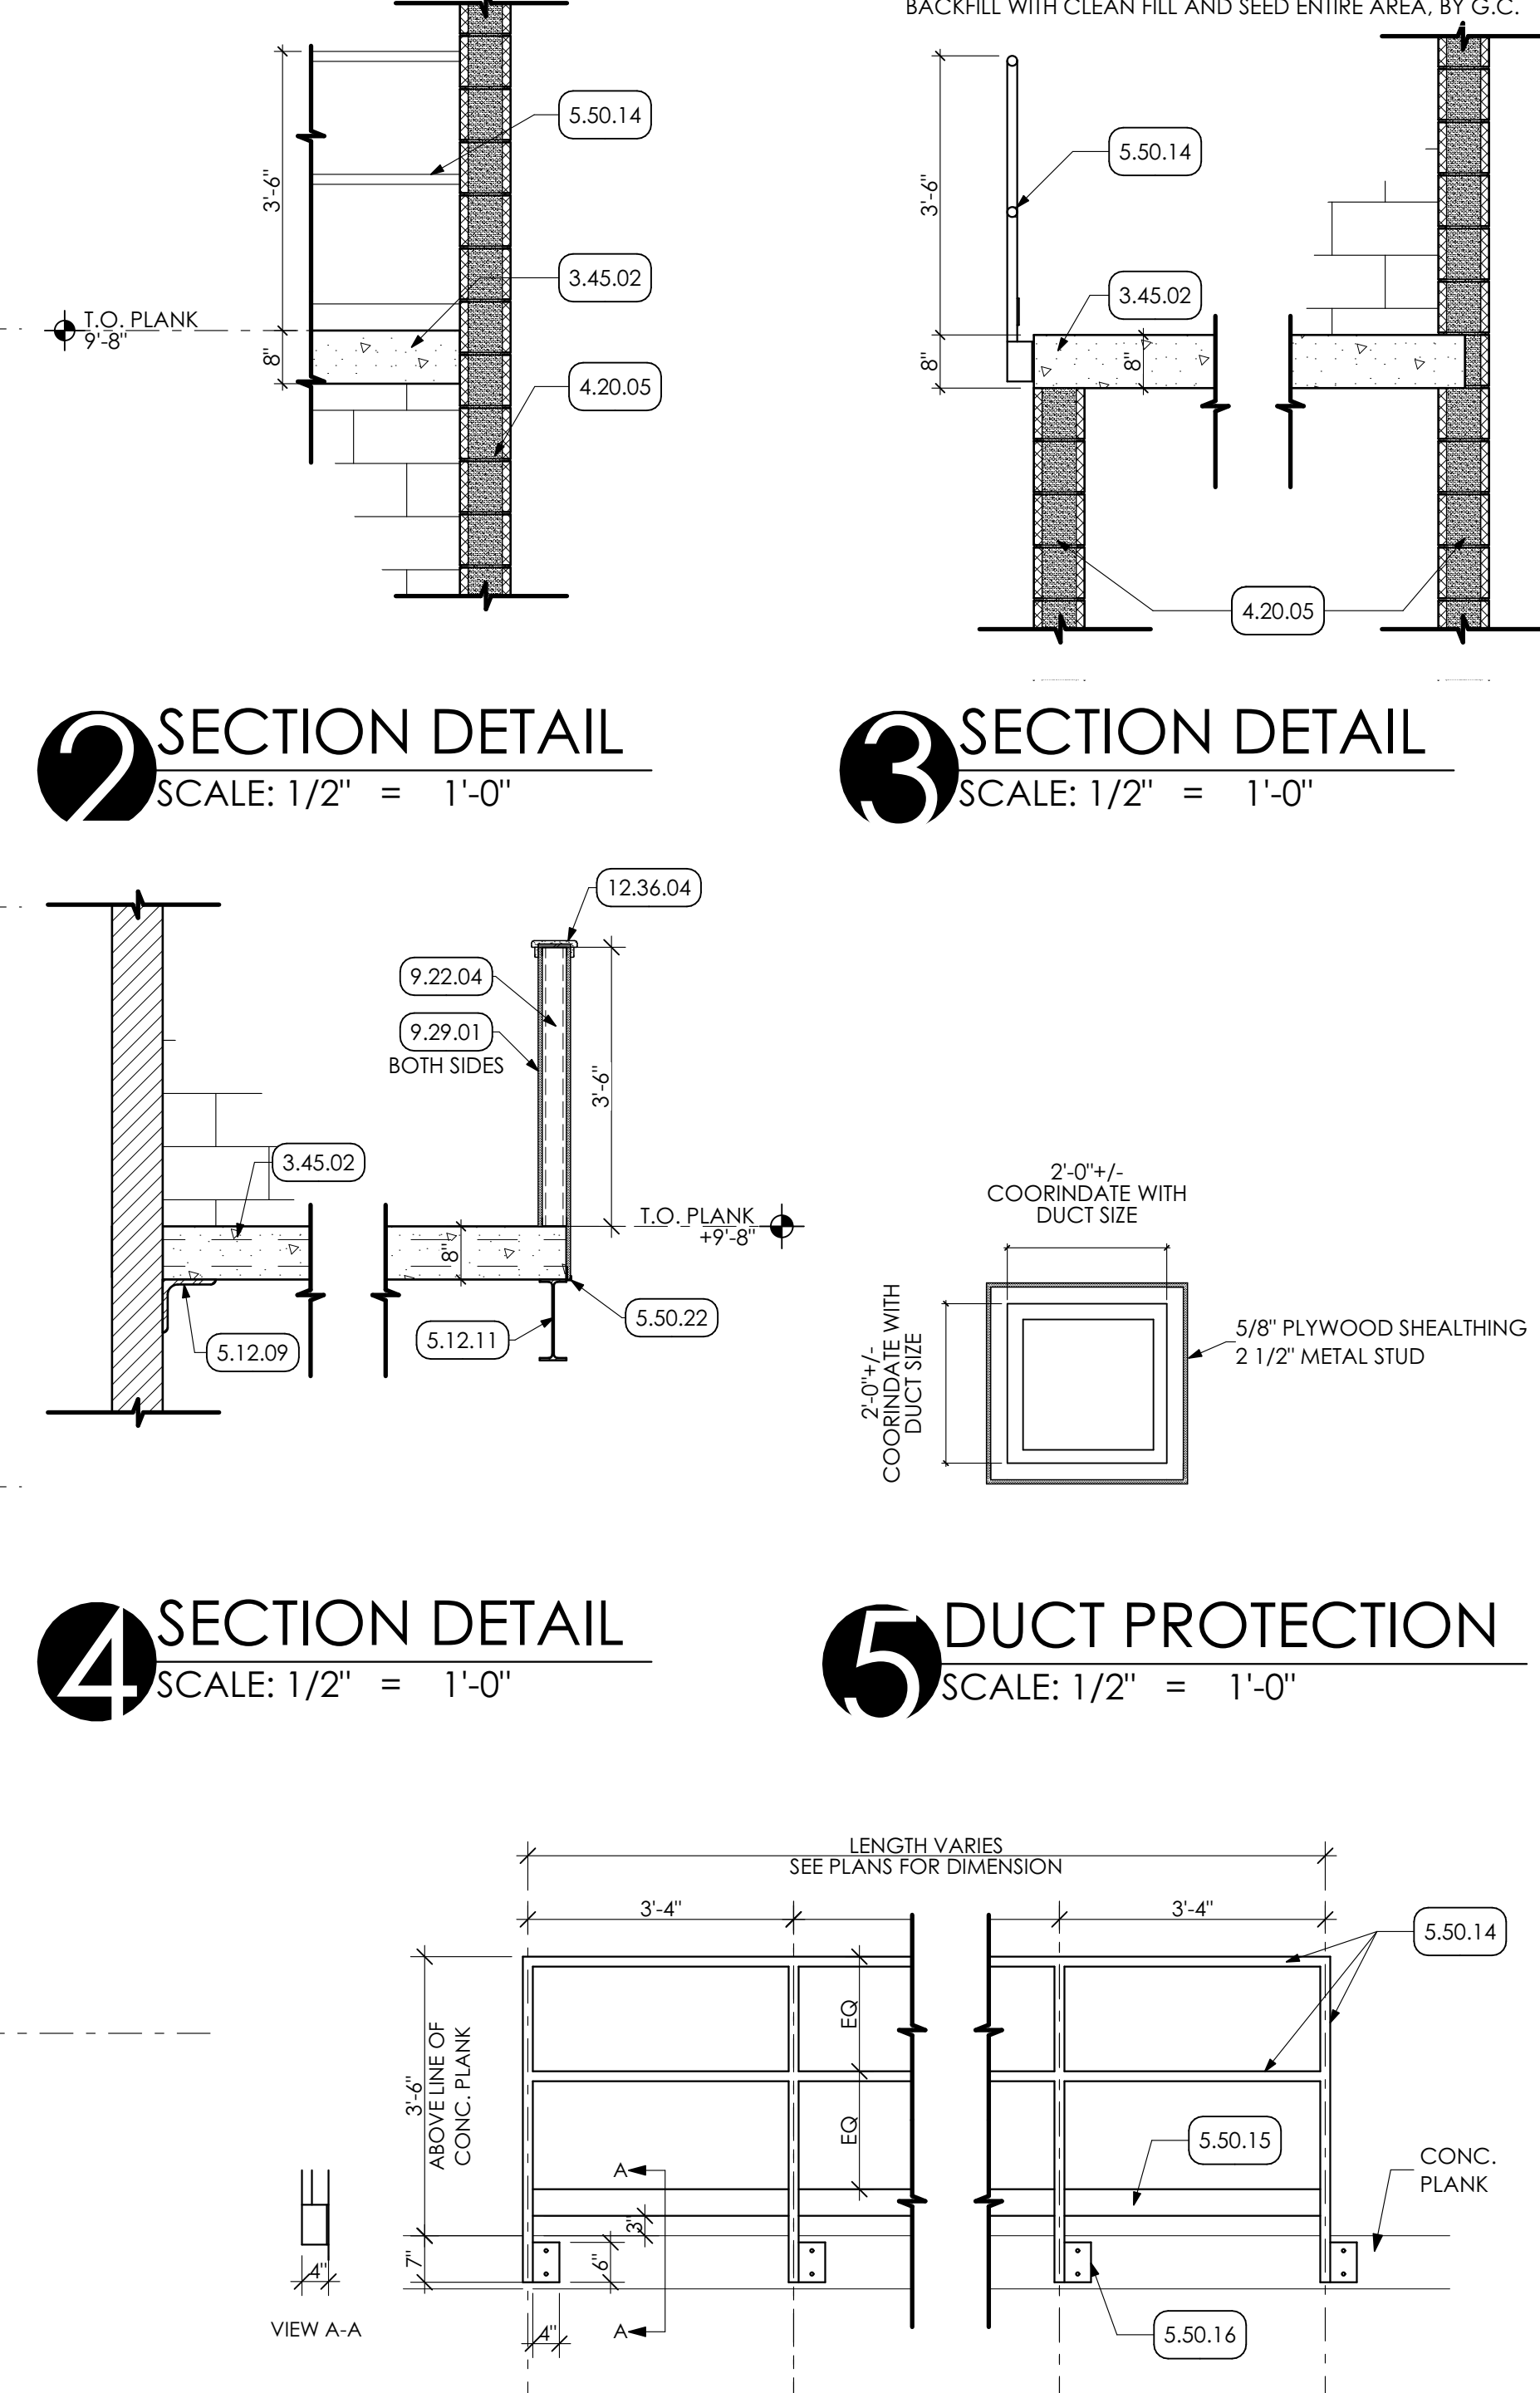
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**1 MEZZANINE / HIGH WINDOW PLAN**  
 SCALE: 1/8" = 1'-0"

**GENERAL SHEET NOTES**  
 1. REFER TO 600 SERIES SHEETS FOR SCHEDULES.

**6 TYPICAL RAILING DETAIL**  
 SCALE: 1/2" = 1'-0"

ISSUED

DATE: ISSUED 3/30/23


ID	DESCRIPTION	DATE

PROJ. MGR.: JIM SARRO  
 P.M. e-MAIL: JIMS@MG-Architects.com  
 DRAWN BY: DK, SG, BB, JS  
 CLIENT PROJ #:

SHEET TITLE:  
**MEZZANINE PLAN AND DETAILS**

**A-104**



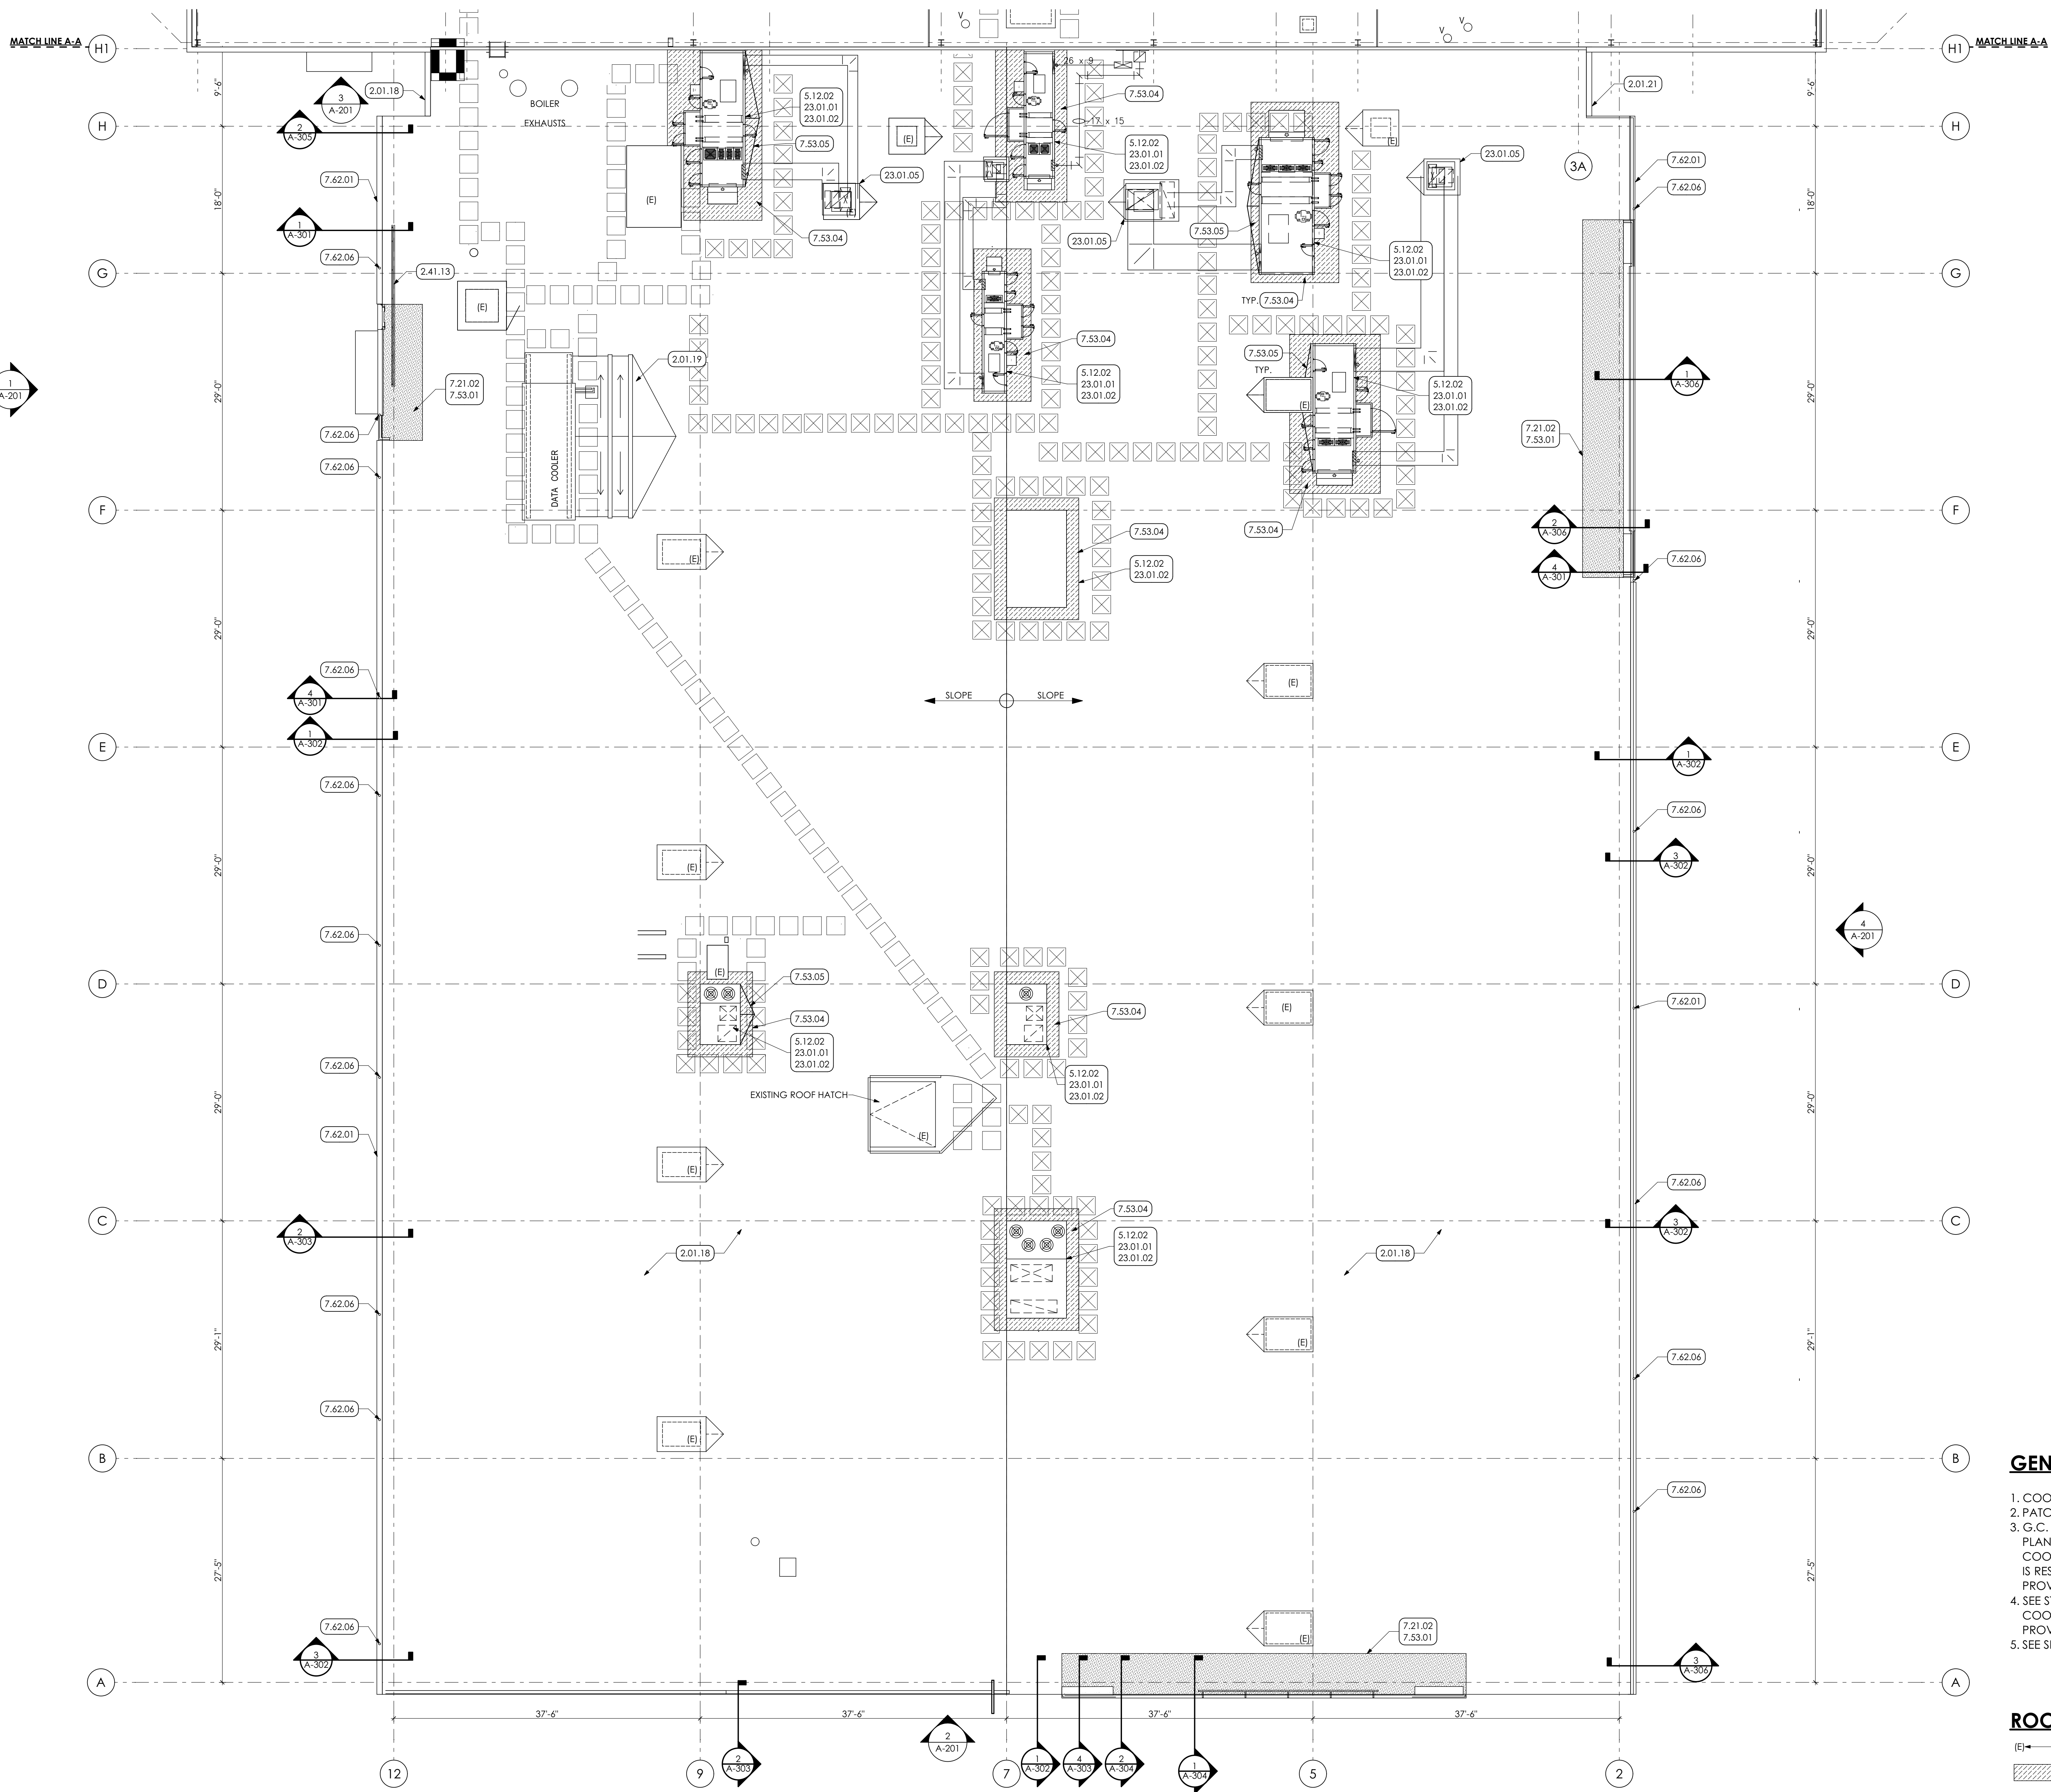

- KEY NOTES**
- 01 GENERAL CONSTRUCTION**
  - 1.50 GENERAL CONSTRUCTION NOTE**
  - 1.50.02 G.C. TO PROVIDE TWO (2) 8'-0" WIDE CHAIN LINK FENCE GATES WITH PADLOCK.
  - 02 DEMOLITION**
  - 2.01 EXISTING CONDITIONS**
  - 2.01.18 EXISTING EPDM MEMBRANE ROOF MEMBRANE, G.C. TO PROTECT AS REQUIRED IN AREAS OF WORK.
  - 2.01.19 EXISTING DATA COOLER TO REMAIN.
  - 2.01.21 EXISTING GUTTER TO REMAIN.
  - 2.01.49 EXISTING WALKPADS TO REMAIN.
  - 2.41 SELECTIVE DEMOLITION | SPEC 024119**
  - 2.41.13 REMOVE EXISTING RAILING.
  - 05 METALS**
  - 5.12 STRUCTURAL STEEL FRAMING | SPEC 051200**
  - 5.12.02 ROOF TOP SUPPORT FRAMING BY G.C. COORDINATE LOCATION OF UNIT WITH H.C. AND COORDINATE WITH STRUCTURAL DRAWINGS.
  - 07 THERMAL AND MOISTURE PROTECTION**
  - 7.21 THERMAL INSULATION | SPEC 072100**
  - 7.21.02 PATCH AREA SHOWN WITH NEW POLY-ISO INSULATION, TO MATCH EXISTING INSULATION THICKNESS, BY G.C.
  - 7.53 ELASTOMERIC ROOFING | SPEC 075323**
  - 7.53.01 PATCH AREA SHOWN WITH NEW EPDM MEMBRANE TO MATCH EXISTING MEMBRANE THICKNESS.
  - 7.53.04 PATCH AREA SHOWN AROUND NEW ROOF TOP UNITS WITH EPDM MEMBRANE TO MATCH EXISTING MEMBRANE THICKNESS AND TO MAINTAIN EXISTING WARRANTY. EPDM TO EXTEND UP FACE OF ROOF TOP CURB.
  - 7.53.05 TAPERED INSULATION SLOPED AT 1/4 INCH PER FOOT.
  - 7.53.10 NEW EPDM WALKWAY PADS, MATCH EXISTING ROOF PADS.
  - 7.62 SHEET METAL FLASHING/TRIM | SPEC 076200**
  - 7.62.01 PREFINISHED 8"x8" METAL BOX GUTTER COMPLETE WITH END PIECES, OUTLET TUBES AND OTHER ACCESSORIES AS REQUIRED. FURNISH FLAT STOCK GUTTER BRACKETS AND FLAT STOCK GUTTER BRACKETS AND SPACERS FABRICATED FROM SAME METAL AS GUTTER WITH THICKNESS NOT LESS THAN TWICE THE GUTTER THICKNESS.
  - 7.62.06 PREFINISHED 3" DOWNSPOUT WITH MITERED ELBOWS FURNISH WITH METAL HANGERS FROM SAME MATERIAL AS DOWNSPOUT AND ANCHORS. CONNECT TO UNDERGROUND STORM WATER SYSTEM.
  - 23 HVAC | BY H.C.**
  - 23 WORK DESCRIBED IN THESE KEYNOTES IS THE RESPONSIBILITY OF THE H.C. UNLESS NOTED OTHERWISE. COORDINATE WITH MECHANICAL DRAWING.
  - 23.01 ROOF TOP UNITS**
  - 23.01.01 ROOF TOP UNITS.
  - 23.01.02 NEW ROOF TOP CURBS PROVIDED BY H.C. AND INSTALLED BY G.C. H.C. TO LOCATE CURBS ON ROOF PRIOR TO INSTALLATION OF STEEL JOIST REINFORCING.
  - 23.01.05 METAL CAP OVER OPENING BY H.C.
  - 32 EXTERIOR IMPROVEMENTS**
  - 32.20 SITEWORK**
  - 32.20.01 EXCAVATE FOR CONSTRUCTION STAGING AREA. PROVIDE MINIMUM 8" OF AASHTO #2A STONE.
  - 32.92 TURF AND GRASSES | SPEC 329200**
  - 32.92.05 AT THE COMPLETION OF THE WORK, REMOVE STONE AND BACKFILL WITH CLEAN FILL AND SEED ENTIRE AREA, BY G.C.

- GENERAL SHEET NOTE**
1. COORDINATE RTU LOCATIONS WITH MECHANICAL PLANS
  2. PATCHING AREAS NOTED ARE APPROXIMATE. G.C. TO V.I.F.
  3. G.C. TO REVIEW ELECTRICAL, PLUMBING, AND MECHANICAL PLANS FOR ROOF PENETRATIONS. ALL PRIMES TO COORDINATE WITH G.C. FOR ANY ROOF PENETRATIONS. G.C. IS RESPONSIBLE TO PREPARE ROOF PENETRATIONS AND PROVIDE PATCHING OF EPDM.
  4. SEE STRUCTURAL DRAWINGS FOR NEW RTU SUPPORT. G.C. TO COORDINATE LOCATIONS OF SUPPORTS WITH H.C. H.C. TO PROVIDE G.C. WITH CUT SHEETS OF UNITS.
  5. SEE SHEET A-502 FOR TYPICAL ROOF DETAILS

- ROOF PLAN LEGEND**
- (E) — EXISTING TO REMAIN
  - 7.53.04
  - 2.01.49
  - 7.53.10

ESTABLISHED 1920

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PROJECT #:  
**22-0012**

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DRAWN BY: DK, SG, BB, JS  
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SCALE: 1" = 1'-0"

BAR IS ONE (1) INCH LONG ON ORIGINAL DRAWING

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SHEET TITLE:  
**ROOF PLAN**

**A-105**








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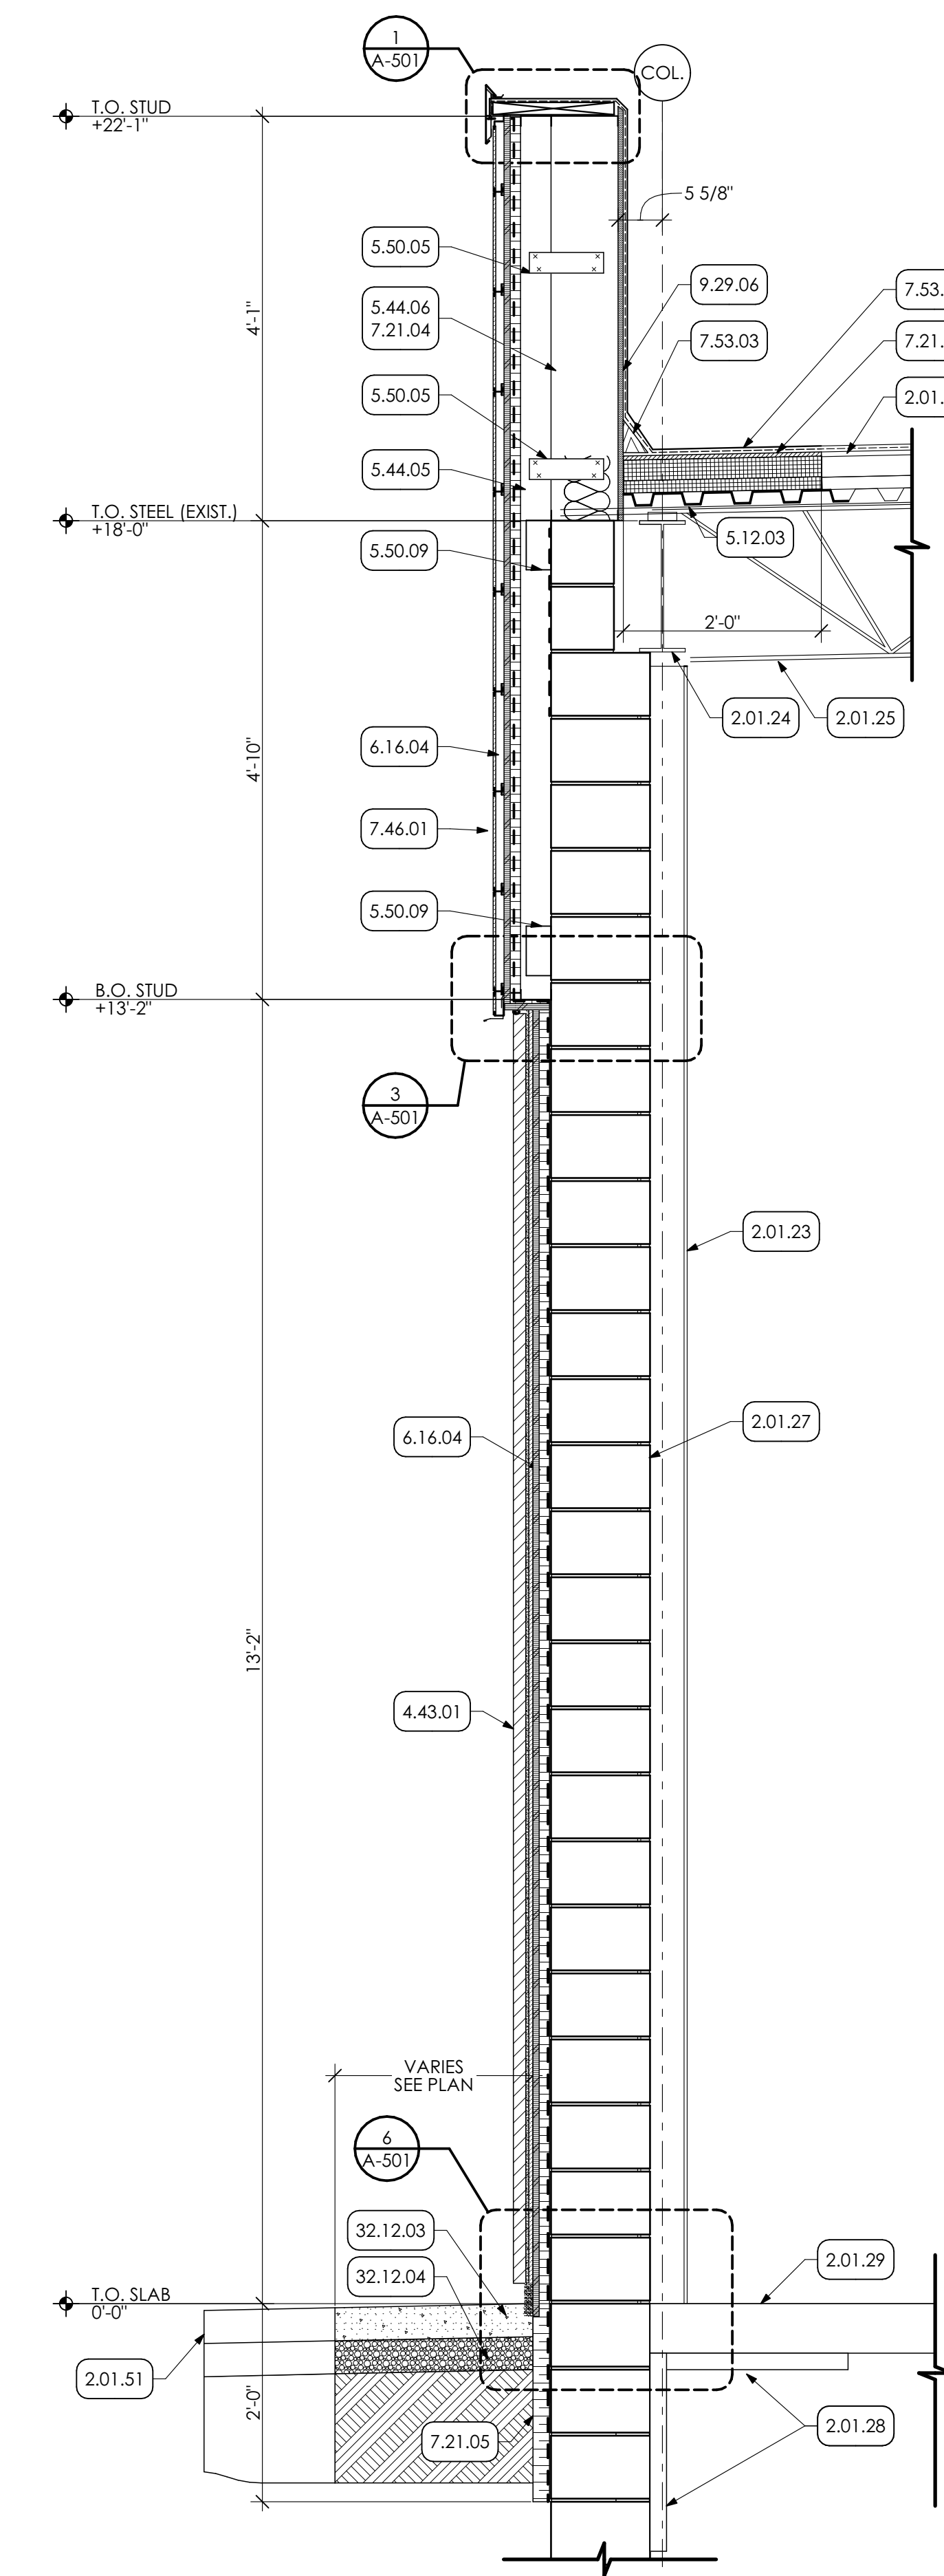
SHEET TITLE:  
**WALL SECTIONS**

**A-301**


- KEY NOTES**
- 02 DEMOLITION**
  - 02.01 EXISTING CONDITIONS**
  - 2.01.23 EXISTING COLUMN TO REMAIN.
  - 2.01.24 EXISTING BEAM TO REMAIN.
  - 2.01.25 EXISTING JOIST TO REMAIN.
  - 2.01.26 EXISTING ROOF ASSEMBLY TO REMAIN.
  - 2.01.27 EXISTING CHAU WALL TO REMAIN.
  - 2.01.28 EXISTING RIGID INSULATION TO REMAIN.
  - 2.01.29 EXISTING CONCRETE SLAB TO REMAIN.
  - 2.01.51 EXISTING ASPHALT TO REMAIN.
  - 04 MASONRY**
  - 4.43 MANUFACTURED MASONRY VENEER | SPEC 047300**
  - 4.43.01 MANUFACTURED MASONRY VENEER
  - 05 METALS**
  - 5.12 STRUCTURAL STEEL FRAMING | SPEC 051200**
  - 5.12.03 INFILL AREA SHOWN WITH NEW METAL DECKING. TO MATCH EXISTING METAL DECKINGS. BY G.C.
  - 5.44 COLD FRAMED METAL FRAMING | SPEC 054000**
  - 5.44.05 3/8" STRUCTURAL METAL STUDS @ 16 O.C. COORDINATE WITH STRUCTURAL DRAWINGS.
  - 5.44.06 8" STRUCTURAL METAL STUDS @ 16 O.C. COORDINATE WITH STRUCTURAL DRAWINGS.
  - 5.50 METAL FABRICATIONS | SPEC 055000 | SPEC 055213**
  - 5.50.05 METAL UTILITY ANGLE. COORDINATE WITH STRUCTURAL DRAWINGS.
  - 5.50.07 METAL ANGLE COORDINATE WITH STRUCTURAL DRAWINGS.
  - 5.50.09 14 GAUGE METAL CLIP COORDINATE WITH STRUCTURAL DRAWINGS.
  - 5.50.11 12 GAUGE METAL CLIP COORDINATE WITH STRUCTURAL DRAWINGS.
  - 06 WOODS, PLASTICS AND COMPOSITES**
  - 6.16 SHEATHING | SPEC 061600**
  - 6.16.04 2" STRUCTURAL INSULATED WALL SHEATHING
  - 07 THERMAL AND MOISTURE PROTECTION**
  - 7.21 THERMAL INSULATION | SPEC 072100**
  - 7.21.02 PATCH AREA SHOWN WITH NEW POLY-ISO INSULATION. TO MATCH EXISTING INSULATION THICKNESS. BY G.C.
  - 7.21.04 R-19 BATT INSULATION
  - 7.21.05 2" RIGID INSULATION
  - 7.44 SIDING | SPEC 074444**
  - 7.46.01 SOLID PHENOLIC PANELS WOOD LOOK WITH CLIP SYSTEM. COLOR 1.
  - 7.46.02 SOLID PHENOLIC PANELS WITH EXPOSED FASTENERS. COLOR 2
  - 7.53 ELASTOMERIC ROOFING | SPEC 075323**
  - 7.53.01 PATCH AREA SHOWN WITH NEW EPDM MEMBRANE TO MATCH EXISTING MEMBRANE THICKNESS.
  - 7.53.03 CANT STRIP
  - 09 FINISHES**
  - 9.29 GYPSUM BOARD | SPEC 092900**
  - 9.29.01 5/8" GYPSUM BOARD
  - 9.29.05 1/2" CEMENT BOARD
  - 9.29.06 1/2" COVERBOARD EXTEND FROM TOP OF DECKING TO TOP OF PARAPET.
  - 32 EXTERIOR IMPROVEMENTS**
  - 32.12 ASPHALT PAVING | SPEC 321216**
  - 32.12.03 ASPHALT PAVING
  - 32.12.04 CRUSHED STONE
  - 32.92 TURF AND GRASSES | SPEC 329200**
  - 32.92.03 24" WIDE GRAVEL MOW STRIPE. SEE DETAIL.




**1 WALL SECTION**  
 SCALE: 3/4" = 1'-0"

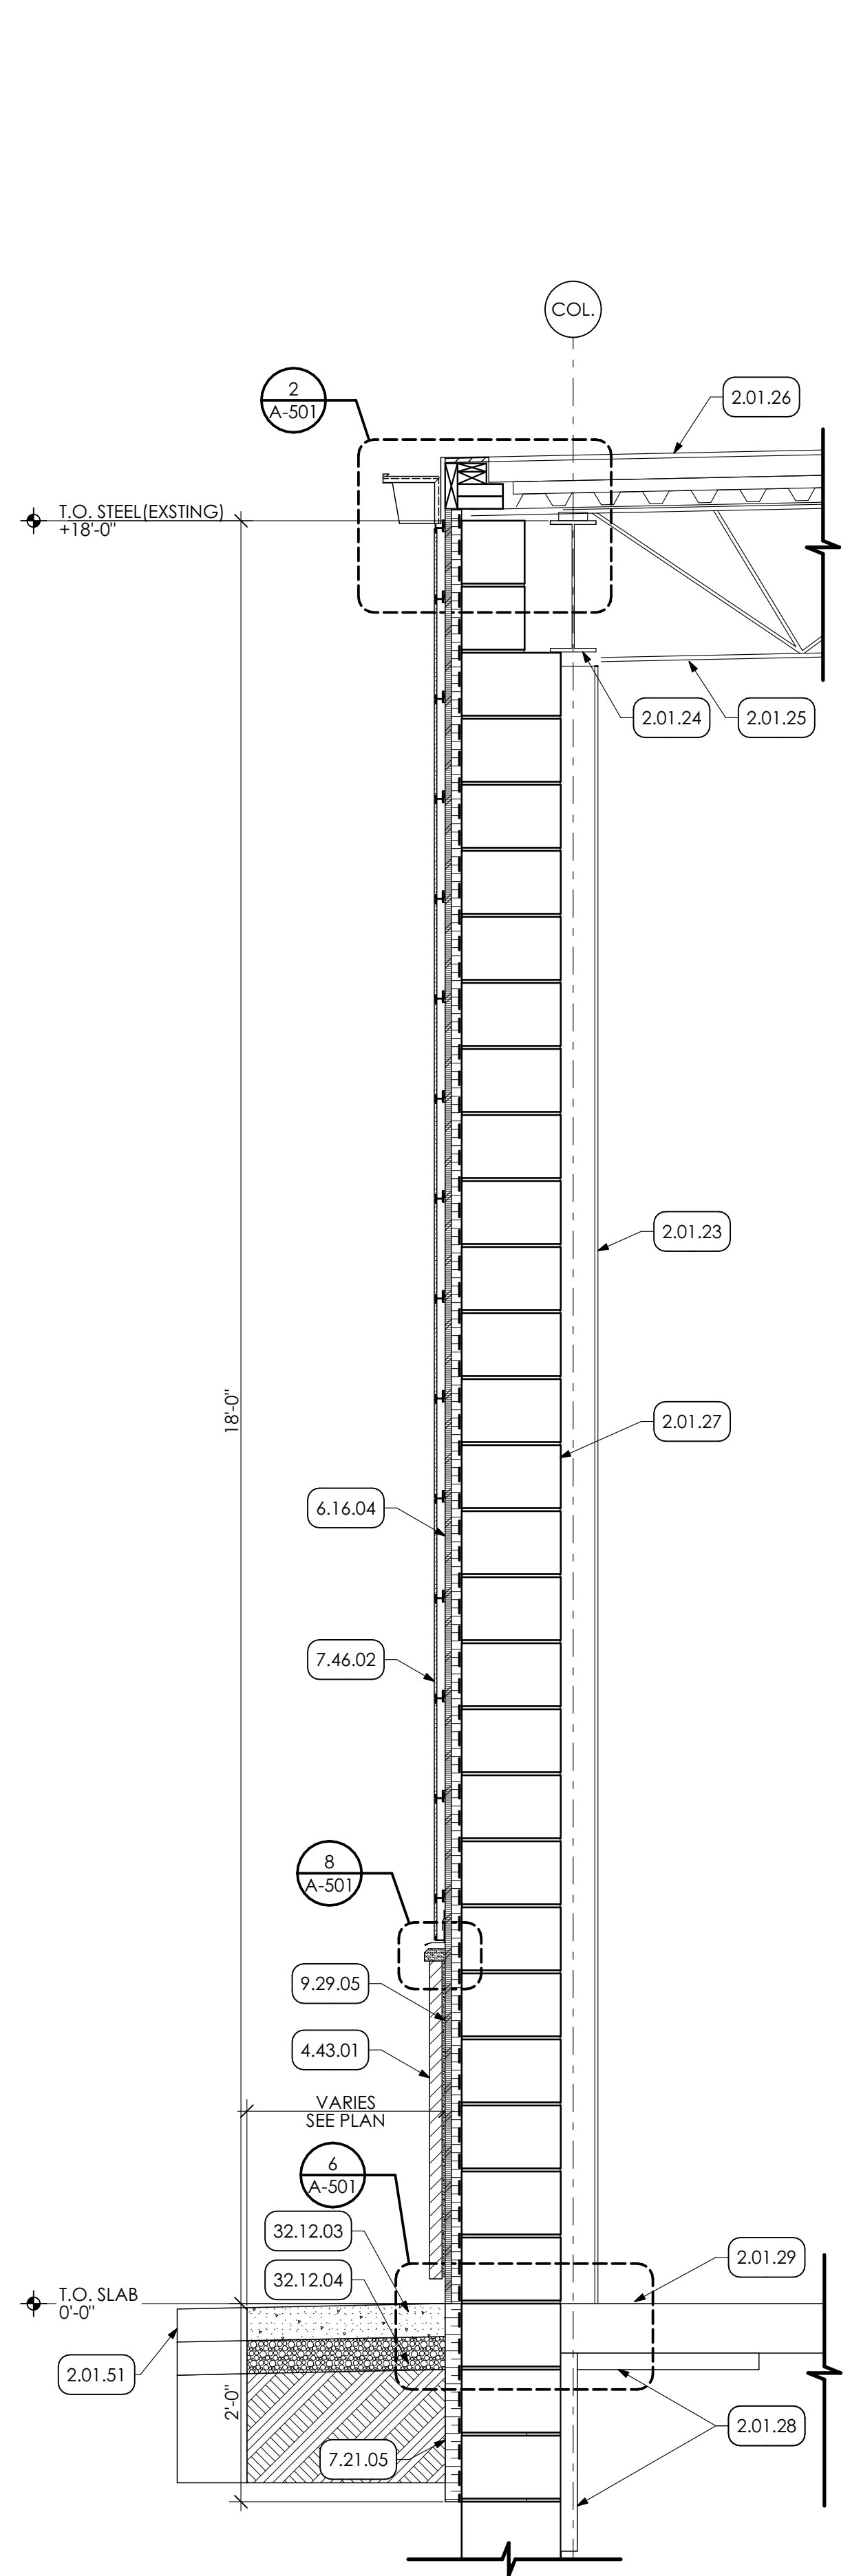

**2 WALL SECTION**  
 SCALE: 3/4" = 1'-0"

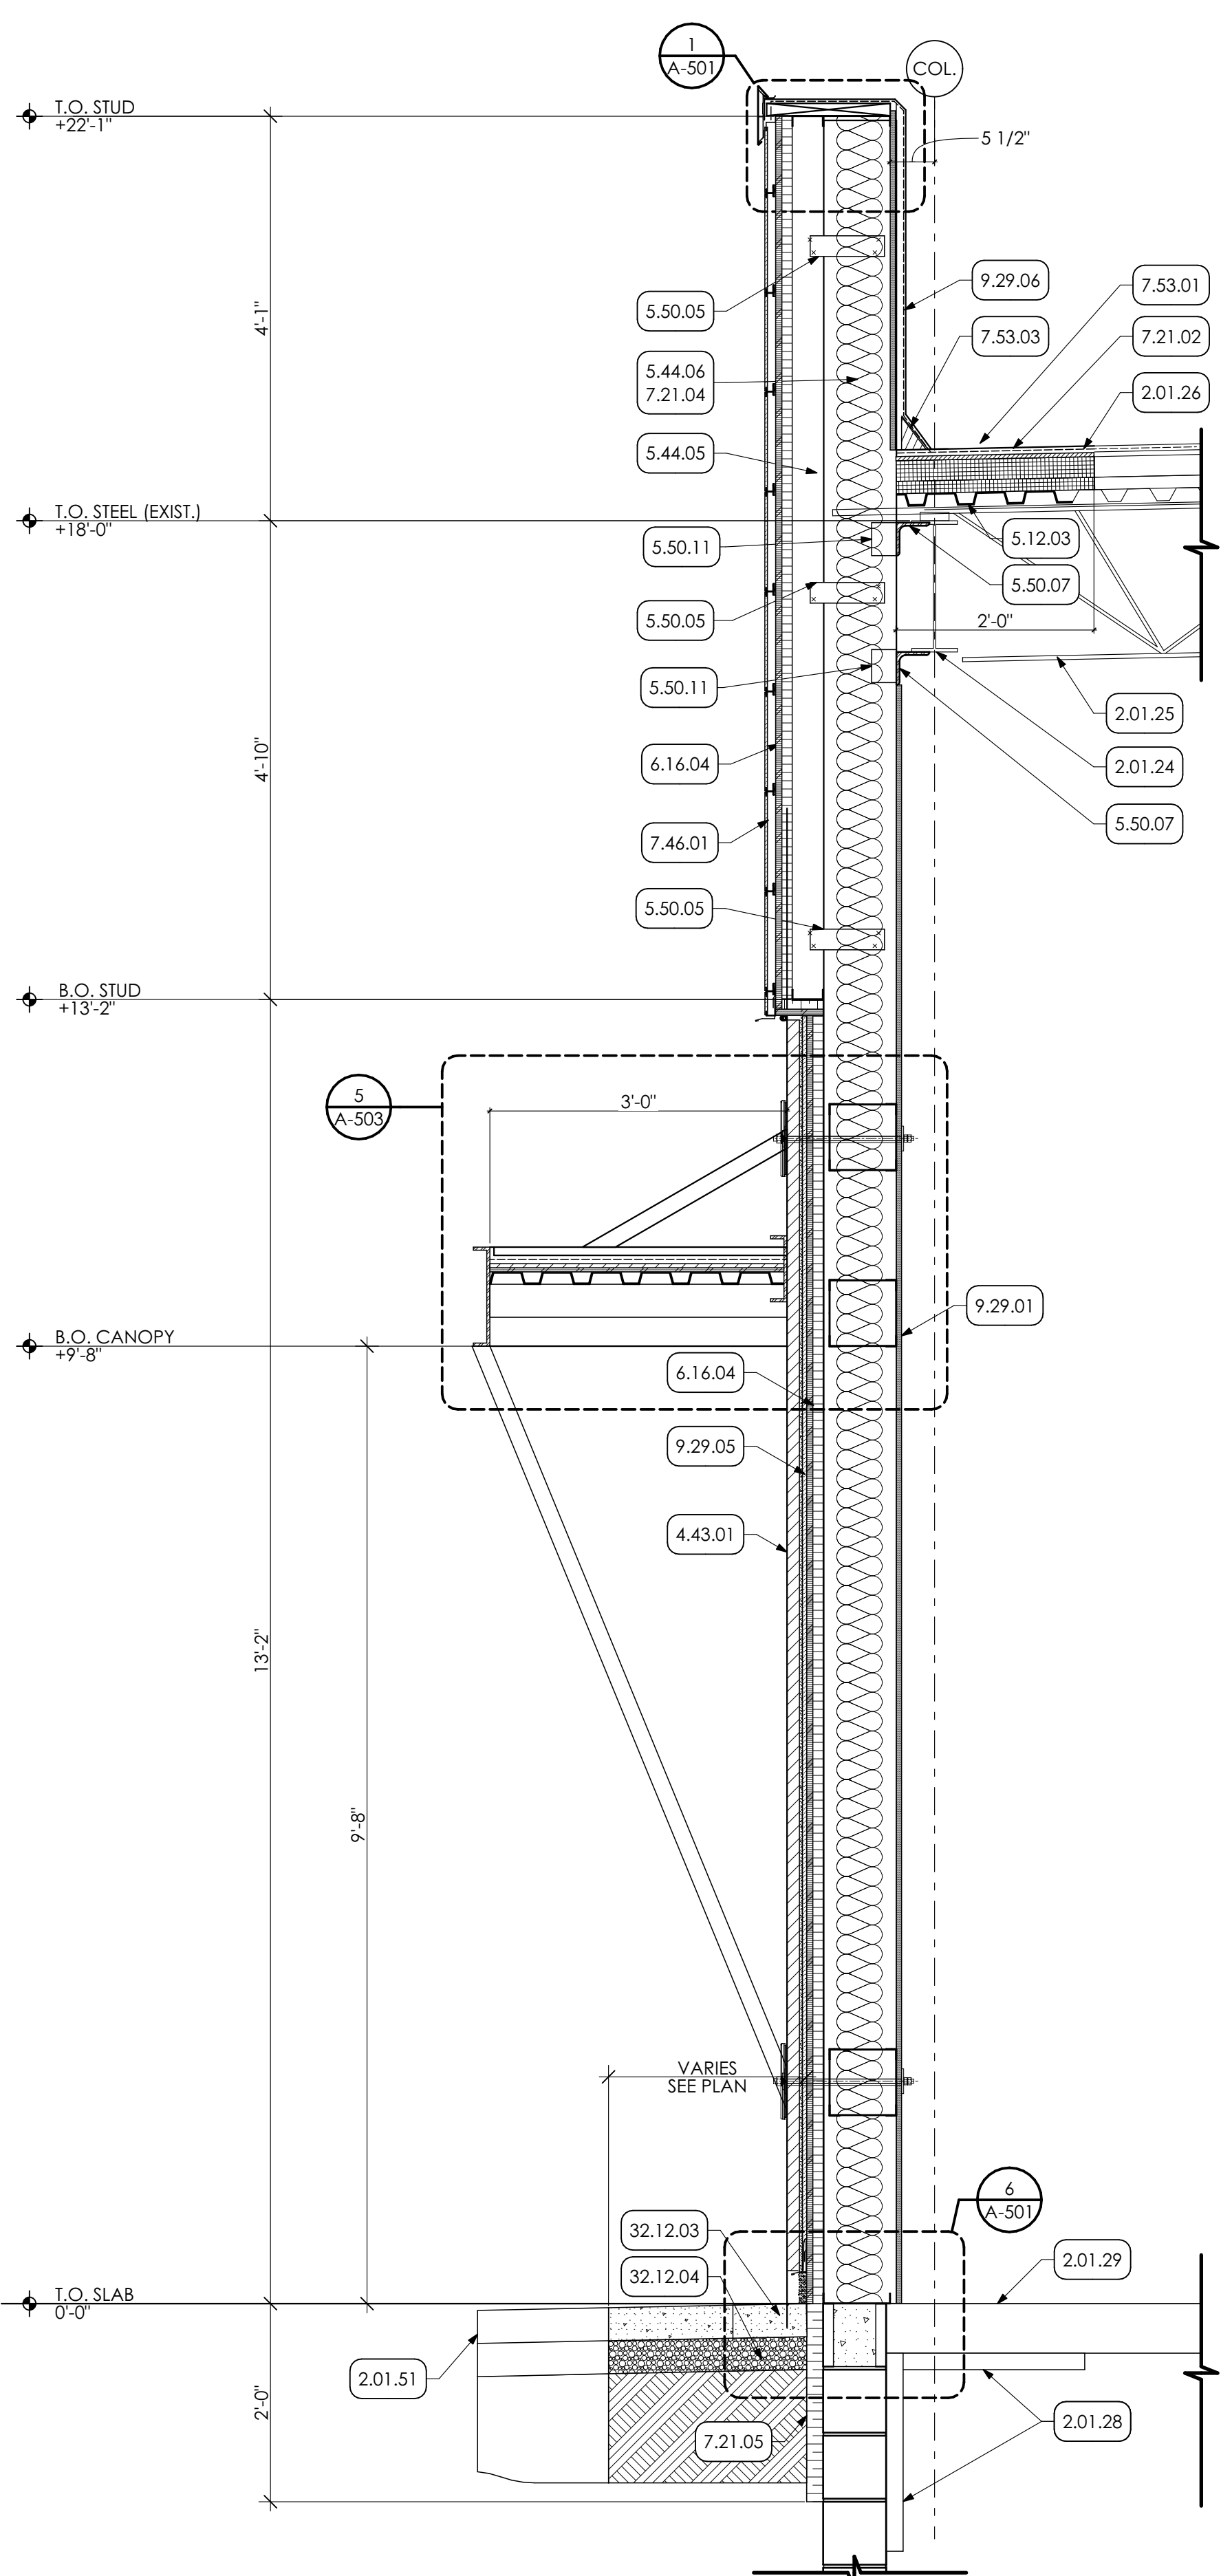

**3 WALL SECTION**  
 SCALE: 3/4" = 1'-0"

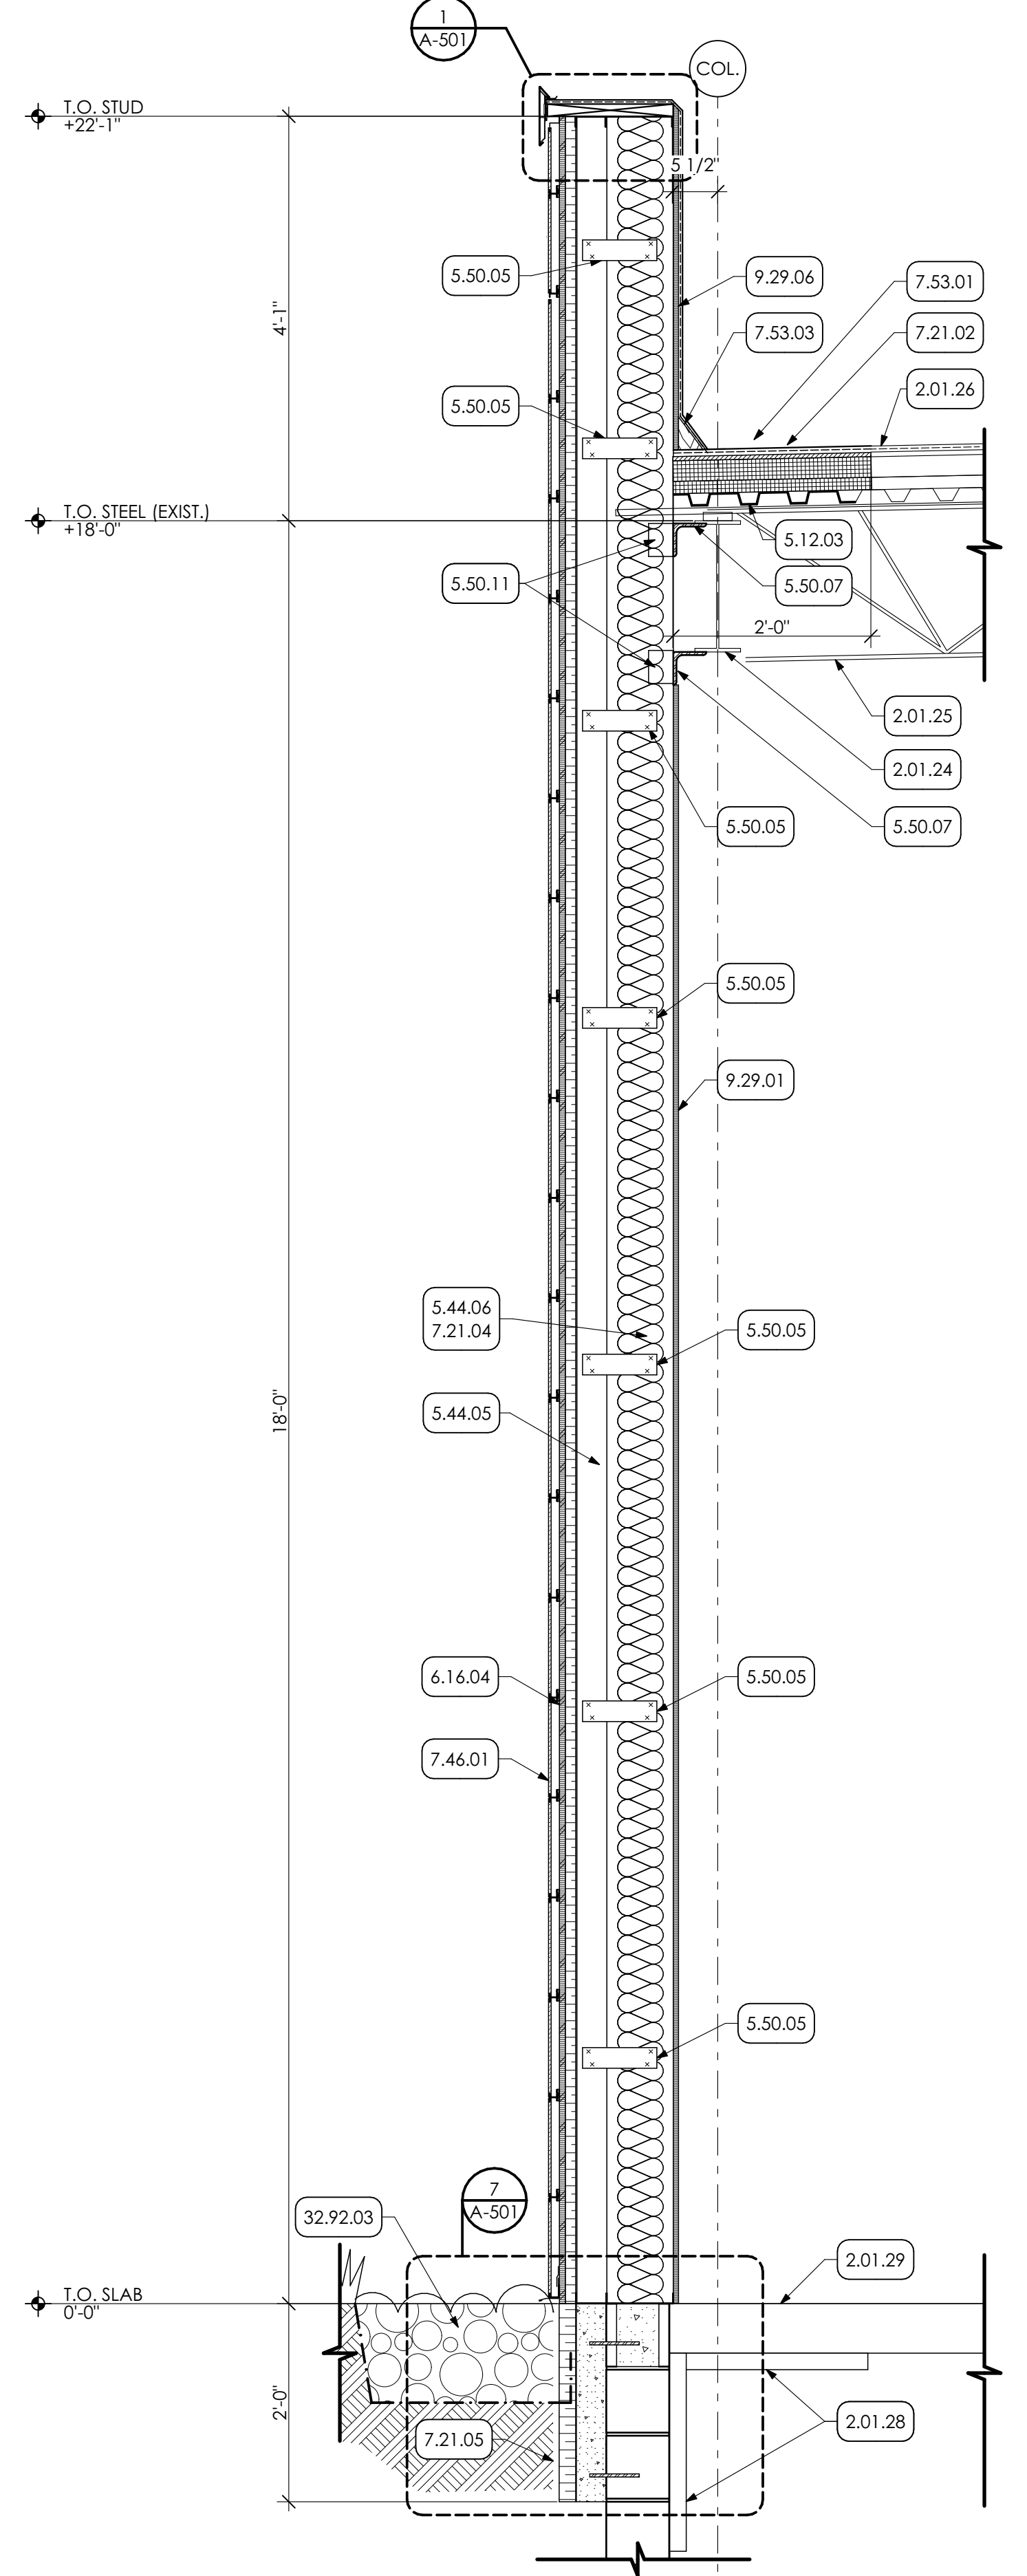

**4 WALL SECTION**  
 SCALE: 3/4" = 1'-0"

























