



REQUEST FOR CHANGE ORDER PROPOSAL

Ag Center Facility Upgrades	Date: 8/18/2023
County of Berks	MGA Proj. #: 22-0012
County Services Center-16th Floor 633 Court Street Reading, PA 19601	Contract For: GC/EC
FROM: Muhlenberg Greene Architects, Ltd. 955 Berkshire Boulevard, Suite 101 Wyomissing, PA 19610-1278	TO: GC/EC
Attn: James A. Sarro, AIA	Attn: All PM's
<p>Please submit an itemized proposal for changes in the <input checked="" type="checkbox"/> Contract Sum <input checked="" type="checkbox"/> Contract Time, and a proposed scope of work breakdown, for proposed modifications to the Contract Documents described herein. Within seven (7) days the Contractor must submit this proposal or notify the Architect, in writing, of the date on which proposal submission is anticipated.</p> <p>THIS IS NOT A CHANGE ORDER, A CONSTRUCTION CHANGE DIRECTIVE, OR A DIRECTION TO PROCEED WITH THE WORK DESCRIBED IN THE PROPOSED MODIFICATIONS.</p> <p>Description of Request: Revised drawings including revisions to the door and hardware schedules as well as additional door replacements.</p>	
AUTHORIZATION	
Requested By: James A. Sarro, AIA Principal	8/18/2023 Date
DISTRIBUTION	
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Copied to: File	
Attachments: A-003, AD-101, A-101, A-102, A-103, A-601, A-701, A-704, A-705, E-101, E-201, E-301	

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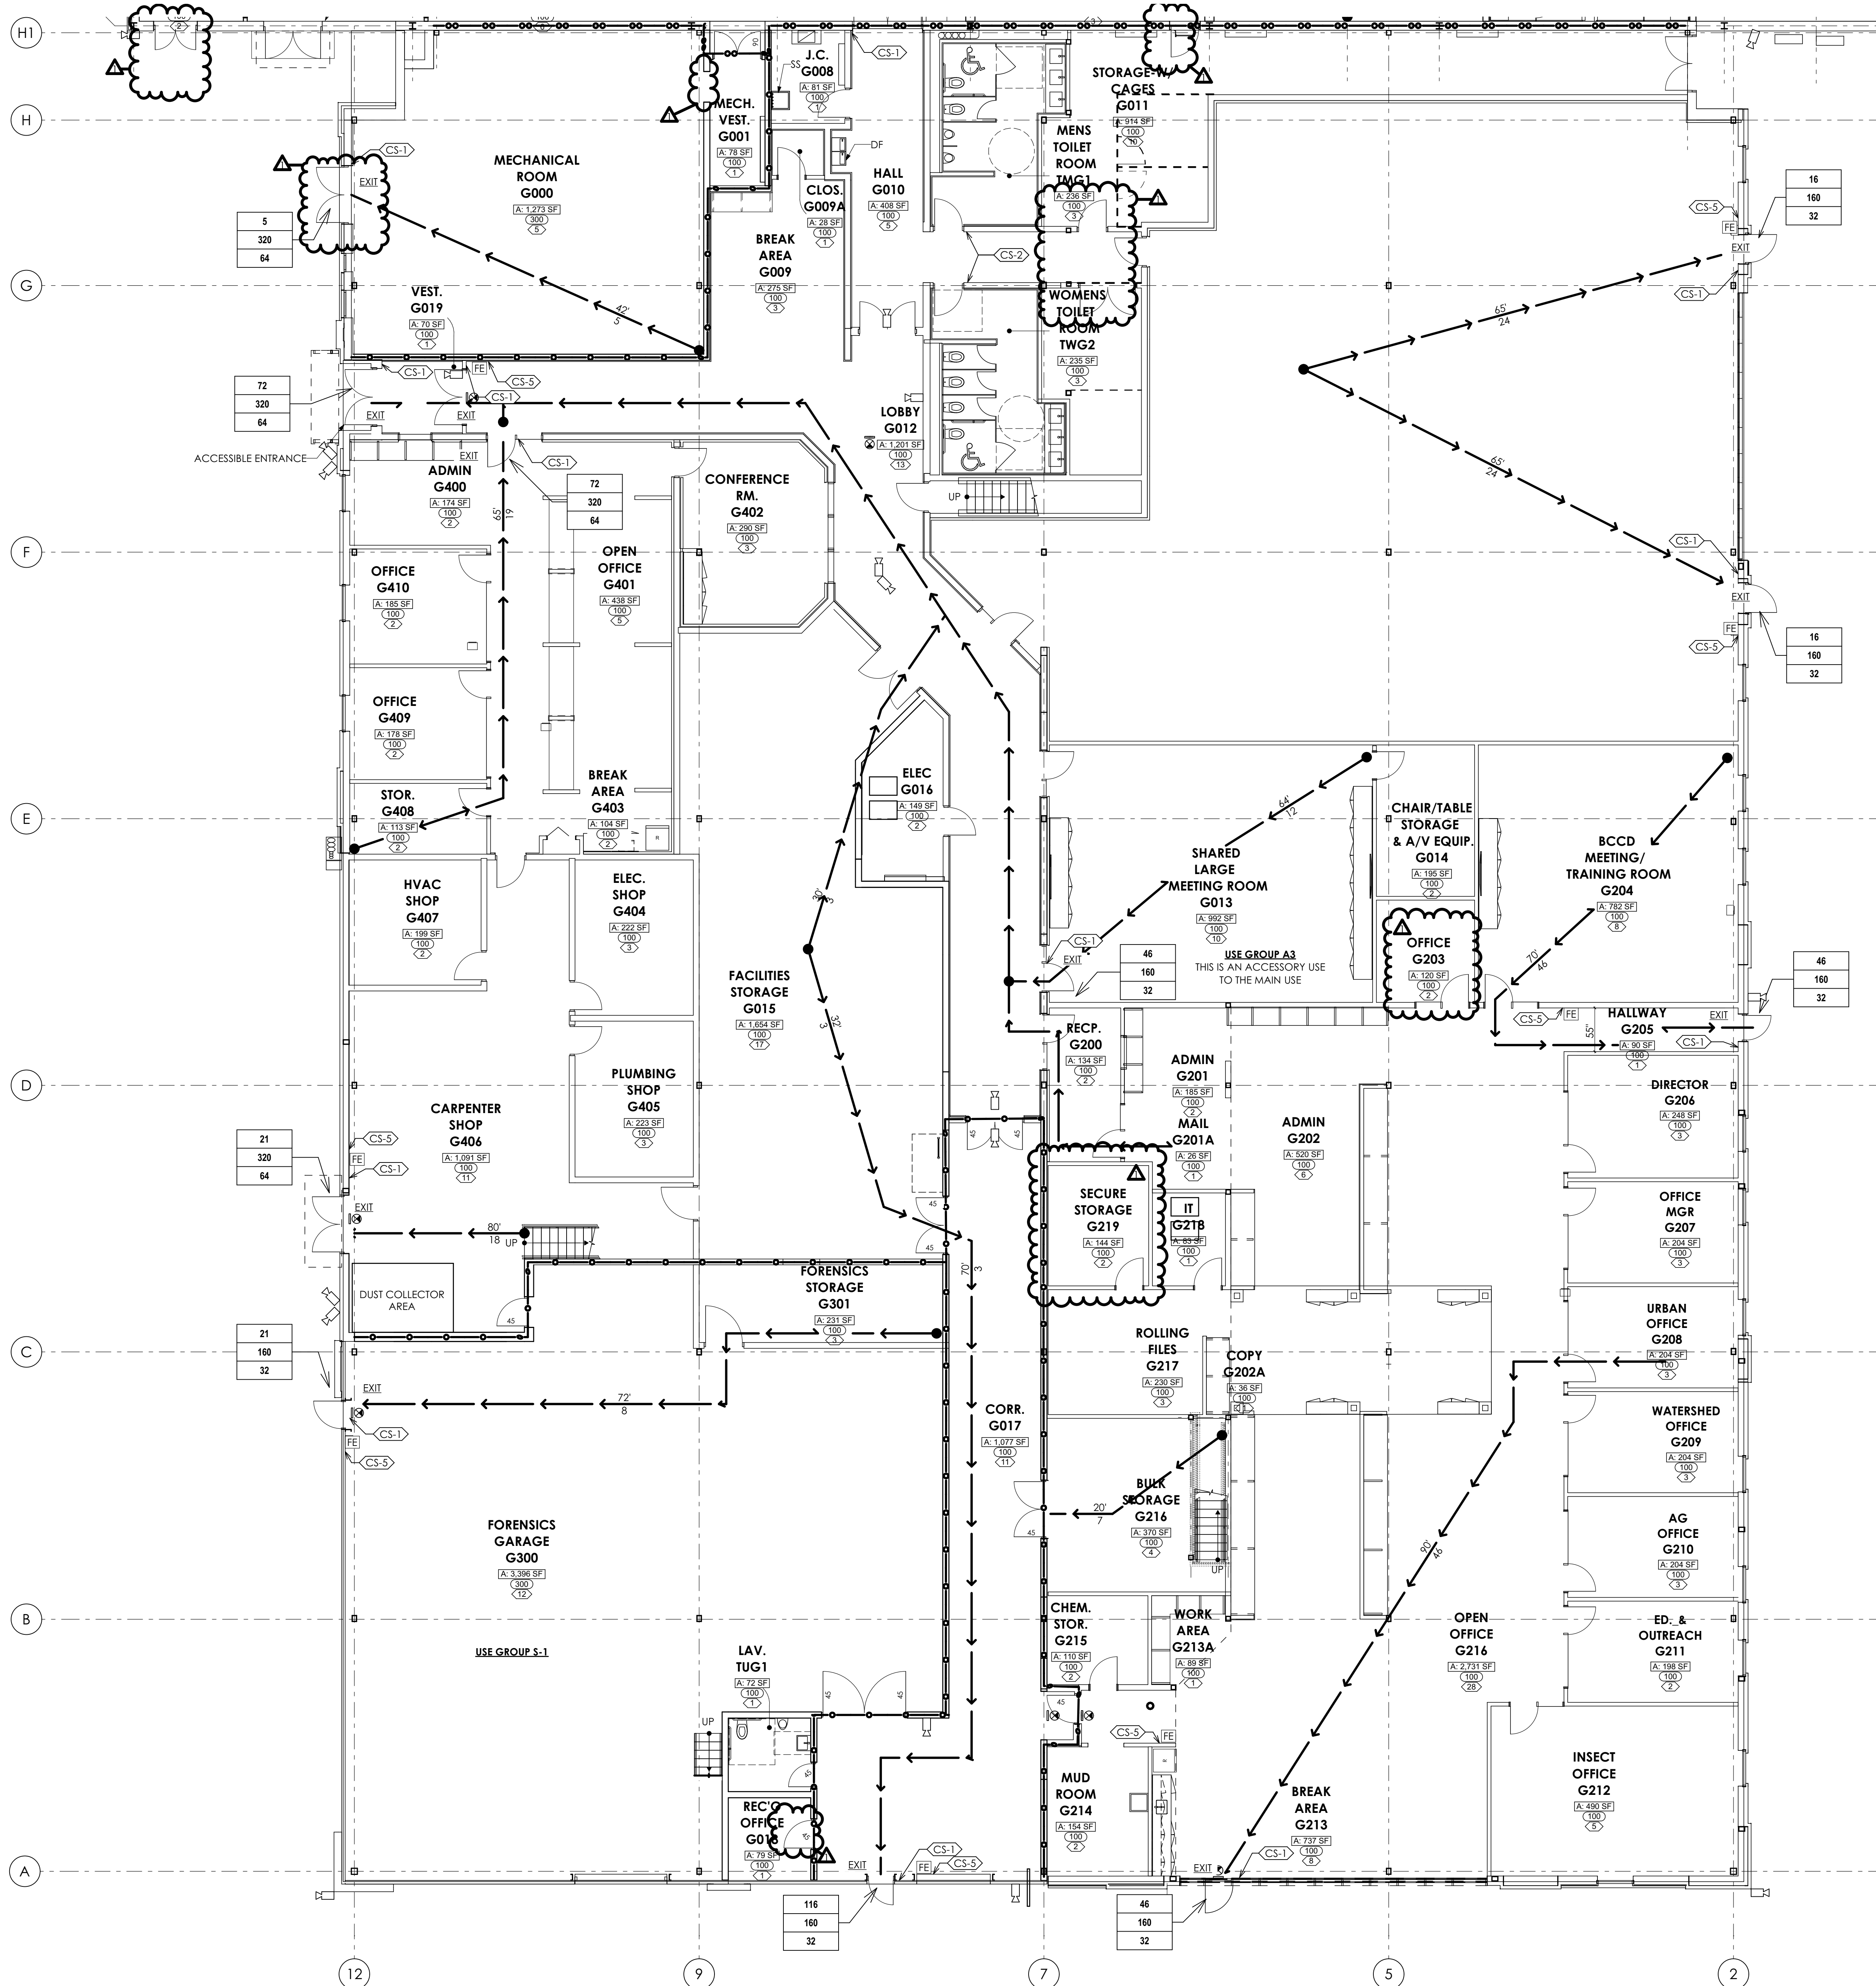
MG Architects, Ltd.

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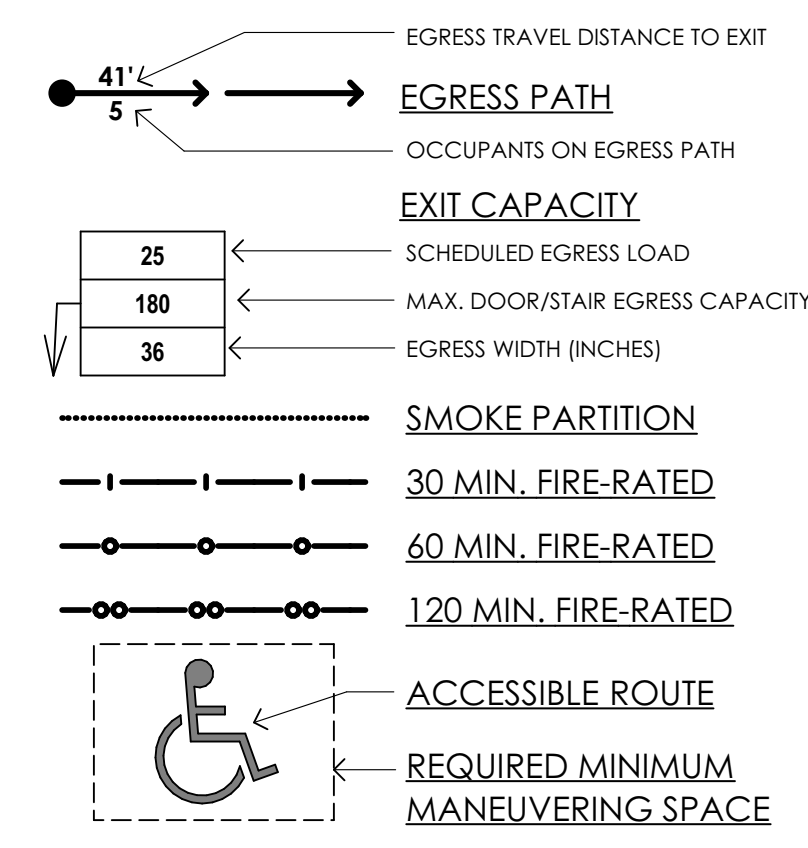
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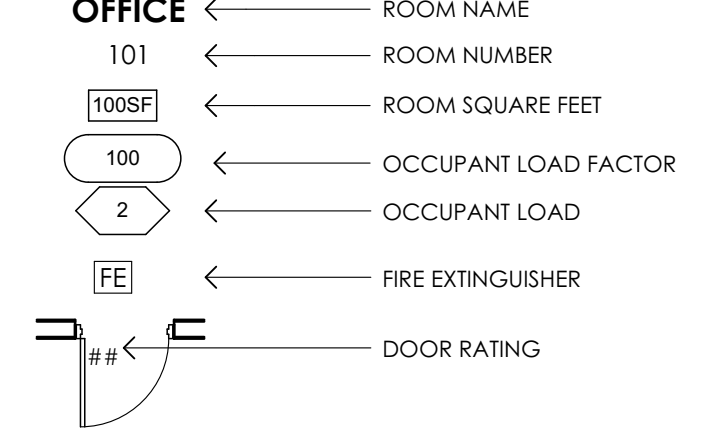
ROBERT B. CONKLIN, AIA, CSI | SCOTT O. GRAHAM, AIA, LEED AP BD+C | JAMES A. SARRO, AIA, LEED AP BD+C



LIFE SAFETY LEGEND



ROOM TAG



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PROJECT #:
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 RLEVENGOOD@CountyOfBerks.gov

**BERKS COUNTY AGRICULTURAL CENTER
 FACILITY UPGRADES**
 1238 COUNTY WELFARE ROAD LEESPORT, PA 19533

ISSUED		
ID	DESCRIPTION	DATE
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	CONSTRUCTION	6/29/23
	REVISION #1	8/18/23

PROJ. MGR.: JIM SARRO
 P.M. e-MAIL: JIMS@MG-Architects.com
 DRAWN BY: DK, SG, BB, JS
 CLIENT PROJ #:

SCALE: 1" = 1'-0"
 BAR IS ONE (1) INCH LONG ON ORIGINAL DRAWING

SHEET TITLE:
FIRST FLOOR LIFE SAFETY PLAN


A-003



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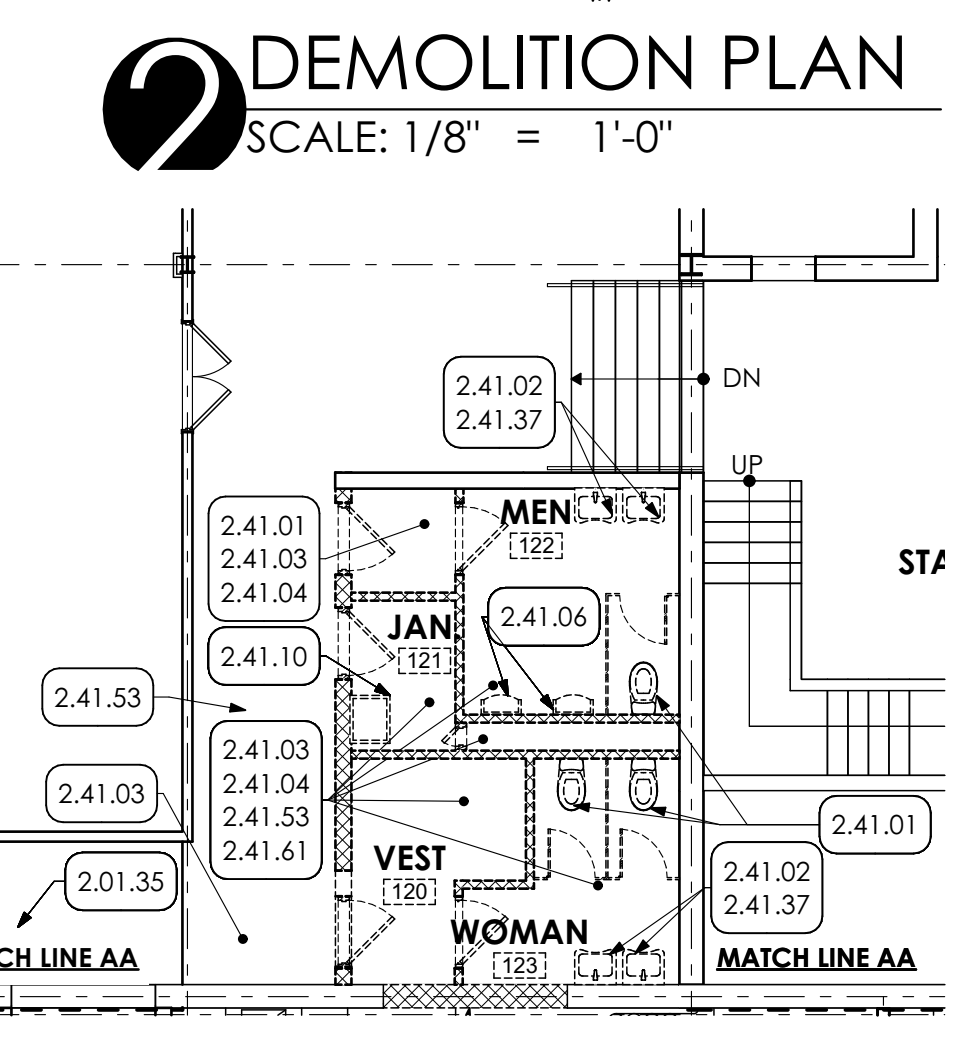
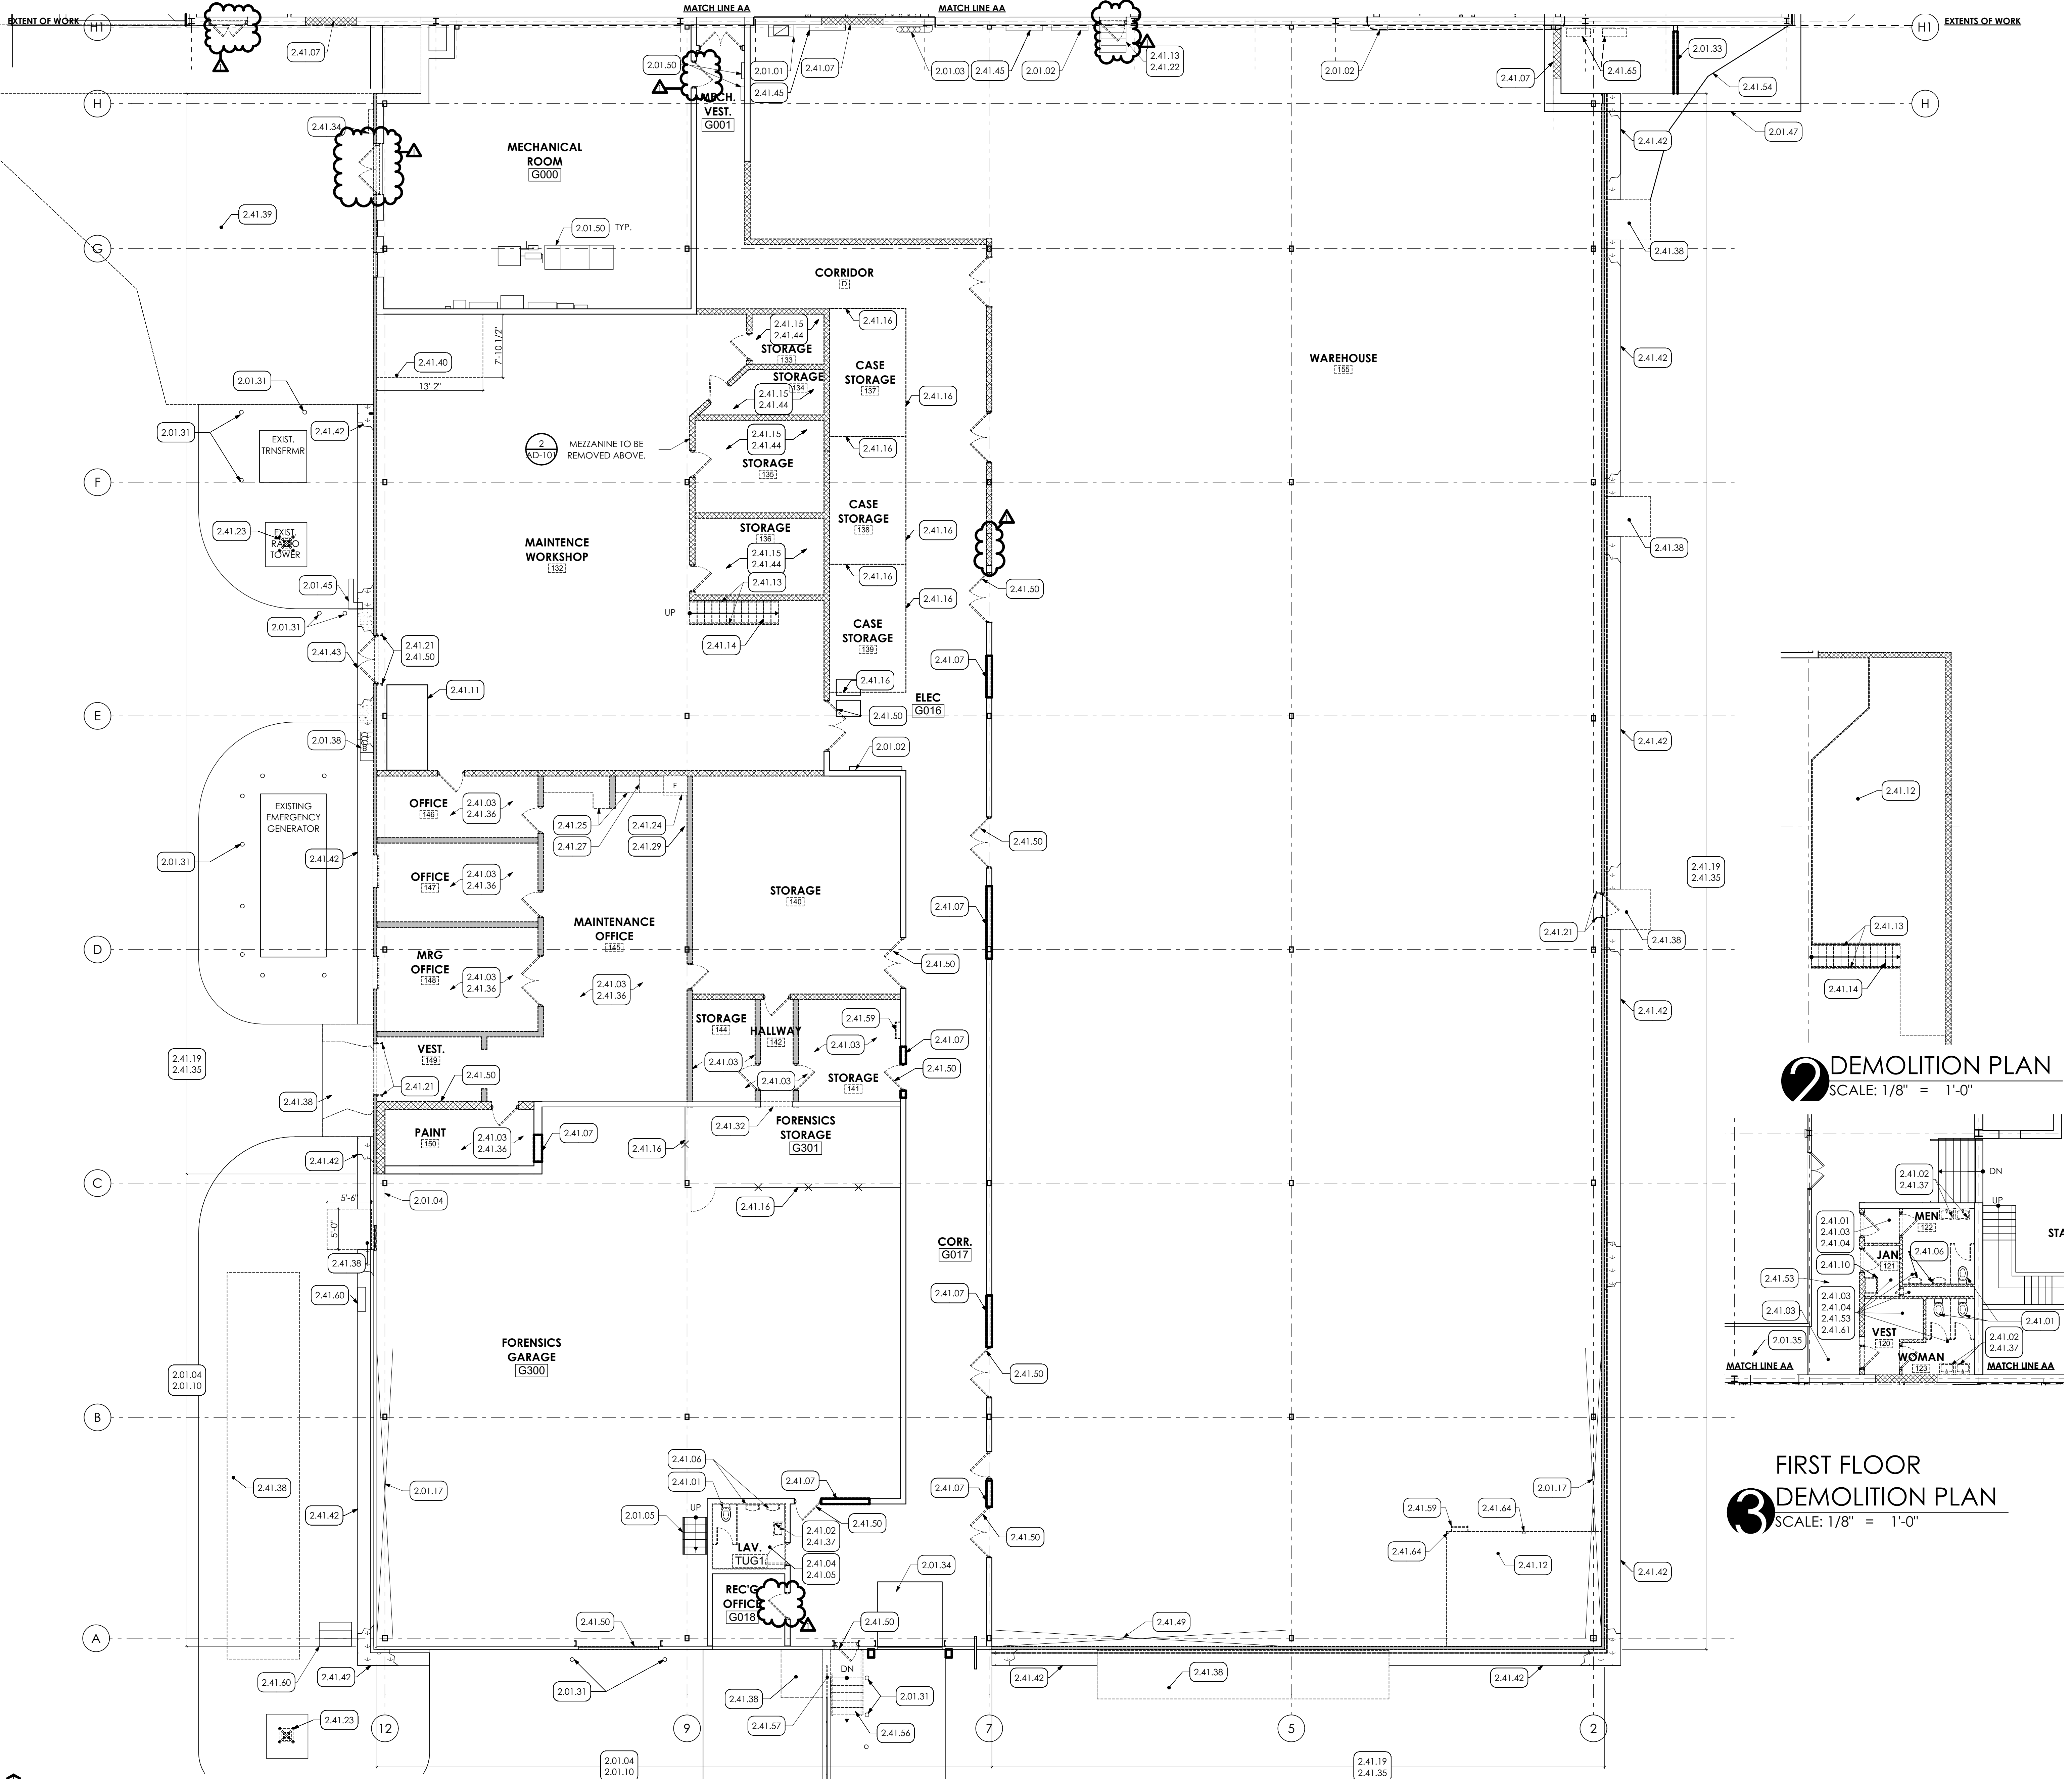
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SHEET TITLE:
DEMOLITION PLANS

AD-101

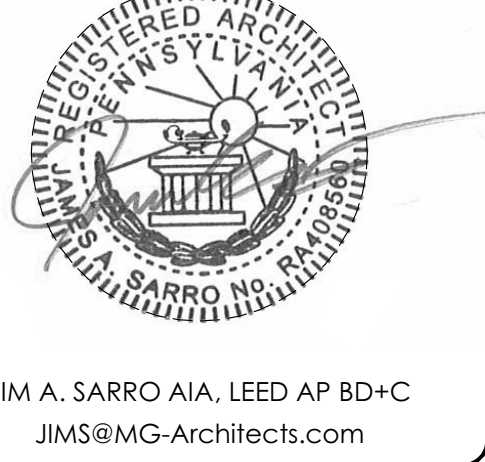

- ### KEY NOTES
- 02 EXISTING CONDITIONS**
 2.01.01 EXISTING DUCT RISER TO REMAIN.
 2.01.02 EXISTING ELECTRICAL PANELS TO REMAIN.
 2.01.03 EXISTING GLYCOL LINES TO REMAIN.
 2.01.04 EXISTING GIRT TO REMAIN.
- 2.01.05 EXISTING STAIR TO REMAIN.
 2.01.10 EXISTING INSULATED METAL PANEL TO REMAIN.
 2.01.17 EXISTING X-BRACING TO REMAIN.
 2.01.31 EXISTING BOLLARD TO REMAIN.
 2.01.33 EXISTING DOWNSPOUT AND EXTENSION TO BE RELOCATED.
 2.01.34 EXISTING DOCK LEVELER TO REMAIN.
 2.01.35 EXISTING ACOUSTIC PANEL CEILING TO REMAIN.
 2.01.38 EXISTING CONDUIT TO REMAIN IN PLACE. E.C. TO PROVIDE TEMPORARY SUPPORT.
 2.01.45 EXISTING GAS METER TO REMAIN.
 2.01.47 UNDERGROUND EXISTING FIBER OPTIC LINES ARE LOCATED IN THIS AREA. USE CAUTION DURING EXCAVATION.
 2.01.50 EXISTING ELECTRICAL EQUIPMENT
- 2.41 SELECTIVE DEMOLITION - SPEC 024119**
 2.41.01 REMOVE EXISTING TOILET AND CAP SANITARY LINE BELOW SLAB. BY P.C. PROVIDE CONCRETE TO FINISH FLUSH WITH TOP OF EXISTING SLAB. PROVIDE A MINIMUM OF 2" CLEARANCE ABOVE CAP. BY P.C.
 2.41.02 REMOVE EXISTING WALL MOUNTED SINK AND CAP SANITARY LINE BELOW SLAB. BY P.C. PROVIDE CONCRETE TO FINISH FLUSH WITH TOP OF EXISTING SLAB. PROVIDE A MINIMUM OF 2" CLEARANCE ABOVE CAP. BY P.C.
 2.41.03 REMOVE EXISTING SUSPENDED CEILING PANELS, GRID, SUSPENSION WIRES, AND ACCESSORIES IN ITS ENTIRETY FROM ENTIRE ROOM.
 2.41.04 REMOVE EXISTING FLOOR TILE AND MORTAR IN ITS ENTIRETY DOWN TO EXISTING CONCRETE SLAB THROUGHOUT ROOM.
 2.41.05 REMOVE EXISTING CERAMIC TILE, MORTAR AND GYPSUM BOARD FROM THE PERIMETER OF ROOM OR CORRIDOR.
 2.41.06 REMOVE EXISTING URINAL AND CAP SANITARY LINE BELOW SLAB. BY P.C. PROVIDE CONCRETE TO FINISH FLUSH WITH TOP OF EXISTING SLAB. PROVIDE A MINIMUM OF 2" CLEARANCE ABOVE CAP. BY P.C.
 2.41.07 REMOVE PORTION OF EXISTING MASONRY WALL TO CREATE NEW OPENING. COORDINATE WITH FLOOR PLAN.
 2.41.10 REMOVE EXISTING UTILITY SINK AND CAP SANITARY LINE BELOW SLAB. BY P.C. PROVIDE CONCRETE TO FINISH FLUSH WITH TOP OF EXISTING SLAB. PROVIDE A MINIMUM OF 2" CLEARANCE ABOVE CAP. BY P.C.
 2.41.11 CAREFULLY REMOVE EXISTING DUST COLLECTOR AND STORE FOR REINSTALLATION. BY H.C.
 2.41.12 REMOVE EXISTING MEZZANINE PLATFORM IN ITS ENTIRETY.
 2.41.13 REMOVE EXISTING RAILING.
 2.41.14 REMOVE EXISTING WOOD STAIRCASE.
 2.41.15 REMOVE EXISTING MEZZANINE ATTACHMENTS, BEAMS, COLUMNS.
 2.41.16 REMOVE EXISTING WOOD STORAGE CAGES IN THEIR ENTIRETY.
 2.41.19 REMOVE EXISTING METAL GIRT AND SAG RODS.
 2.41.21 REMOVE EXISTING DOOR FRAMING
 2.41.22 REMOVE EXISTING STAIRCASE
 2.41.23 REMOVE RADIO ANTENNA AND FOUNDATION, INCLUDING UNDERGROUND CONDUIT AND WIRES IN THEIR ENTIRETY, BY E.C.
 2.41.24 REMOVE REFRIGERATOR.
 2.41.25 REMOVE COUNTER TOP.
 2.41.27 REMOVE WALL CABINET
 2.41.29 REMOVE BASEBOARD HEAT BY H.C.
 2.41.32 REMOVE OPENING HARDWARE.
 2.41.34 REMOVE EXISTING CMU ENCLOSURE AND PIPING.
 2.41.35 REMOVE EXISTING INSULATED METAL PANEL. INCLUDING WINDOWS AND DOORS LOCATED WITHIN THE PANEL.
 2.41.36 REMOVE EXISTING CARPET IN ITS ENTIRETY DOWN TO EXISTING CONCRETE SLAB THROUGHOUT ROOM.
 2.41.37 REMOVE EXISTING WALL MOUNTED MIRROR.
 2.41.38 EXCAVATE FOR NEW CONCRETE SLAB. COORDINATE WITH FLOOR PLANS.
 2.41.39 NEATLY CUT AND REMOVE EXISTING ASPHALT AND EXCAVATE FOR NEW HARDSCAPING. COORDINATE WITH FLOOR PLANS.
 2.41.40 REMOVE PORTION OF EXISTING CONCRETE SLAB FOR NEW ENTRANCE VESTIBULE. COORDINATE WITH FLOOR PLANS. EXCAVATE FOR NEW MOW STRIP. COORDINATE WITH DETAIL.
 2.41.42 NEATLY CUT AND REMOVE EXISTING ASPHALT AND EXCAVATE FOR NEW RIGID INSULATION. COORDINATE WITH WALL SECTIONS.
 2.41.44 REMOVE EXISTING MEZZANINE LIGHT FIXTURES. BY E.C.
 2.41.45 REMOVE AND STORE FOR REINSTALLATION EXISTING ELECTRICAL PANEL. BY E.C. COORDINATE WITH ELECTRICAL DRAWINGS.
 2.41.49 EXISTING X-BRACING TO BE REMOVED.
 2.41.50 REMOVE COURSE OF EXISTING CMU BELOW CONCRETE SLAB.
 2.41.53 REMOVE EXISTING TERRAZZO FLOORING.
 2.41.54 EXCAVATE LOWER EXISTING GRADE FOR NEW DOOR. COORDINATE W/ FLOOR PLANS.
 2.41.56 REMOVE EXISTING CONCRETE STAIR.
 2.41.57 CUTBACK EXISTING RAILING AS SHOWN. COORDINATE WITH FLOOR PLAN.
 2.41.59 REMOVE EXISTING WALL HUNG LADDERS, INCLUDING LADDER ABOVE MEZZANINE.
 2.41.60 CAREFULLY REMOVE SIGN. STORE FOR REINSTALL.
 2.41.61 CAREFULLY REMOVE EXISTING ACCESSORIES AND STORE FOR EVALUATION AND POSSIBLE REINSTALLATION IN NEW TOILET ROOMS.
 2.41.64 REMOVE COLUMN AND ALL ATTACHMENTS IN THEIR ENTIRETY.
 2.41.65 CAREFULLY REMOVE EXISTING CONDENSING UNITS AND PADS AND STORE FOR REINSTALLATION. BY H.C.





2 DEMOLITION PLAN
SCALE: 1/8" = 1'-0"

3 FIRST FLOOR DEMOLITION PLAN
SCALE: 1/8" = 1'-0"

- ### DEMOLITION LEGEND
- EXISTING PARTITION TO REMAIN
 - DOOR TO REMAIN
 - EXISTING GYPSUM BOARD PARTITION TO BE DEMOLISHED
 - DOOR AND FRAME TO BE DEMOLISHED
 - EXISTING MASONRY PARTITION TO BE DEMOLISHED
 - DOOR AND FRAME TO BE DEMOLISHED

1 FIRST FLOOR DEMOLITION PLAN
SCALE: 1/8" = 1'-0"

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- KEY NOTES**
- 02 DEMOLITION**
- 2.01.29 EXISTING CONCRETE SLAB TO REMAIN.
 - 2.01.36 EXISTING CONCRETE FOOTING TO REMAIN.
 - 2.41 SELECTIVE DEMOLITION | SPEC 024119
 - 2.41.50 REMOVE COURSE OF EXISTING CMU BELOW CONCRETE SLAB.
 - 2.41.51 NEATLY CUT AND REMOVE EXISTING SLAB.
- 03 CONCRETE**
- 3.30 CAST-IN-PLACE CONCRETE | SPEC 033000 | 032000**
- 3.30.01 GRIND AND PATCH CONCRETE SLAB AT SECTION OF REMOVED CMU PARTITION.
 - 3.30.06 FILL OPENING WITH CONCRETE TO FINISH FLUSH WITH EXISTING CONCRETE SLAB.
 - 3.30.07 FOUNDATION STEPS IN THIS AREA. REMOVE ONE ROW OF CMU BELOW SLAB TO ALLOW FOR PATCHING.
 - 3.30.10 #5 REBAR SET INTO EXISTING SLAB W/ EPOXY.
 - 3.30.11 NEATLY CUT AND REMOVE CONCRETE SLAB, AND EXCAVATE FOR NEW FOOTING. BACKFILL AND PATCH CONCRETE. COORDINATE WITH STRUCTURAL DRAWINGS. LOCATION OF SLAB REMOVAL OF PROPOSED SANITARY LINE. P.C. TO PROVIDE EXACT LOCATION. G.C. TO CUT SLAB AND EXCAVATE TO DEPTH REQUIRED BY P.C. P.C. PROVIDE BACKFILL. G.C. TO PROVIDE STONE BASE AND CONCRETE PATCH. COORDINATE WITH PLUMBING DRAWINGS.
 - 3.30.20 PATCH GRIND CONCRETE AT AREAS OF REMOVED TERRAZZO.
 - 3.30.23 LOCATION OF SLAB REMOVAL OF PROPOSED CONDUIT E.C. TO PROVIDE EXACT LOCATION. G.C. TO CUT SLAB AND EXCAVATE TO DEPTH REQUIRED BY E.C. E.C. PROVIDE BACKFILL. G.C. TO PROVIDE STONE BASE AND CONCRETE PATCH. COORDINATE WITH ELECTRICAL DRAWINGS.
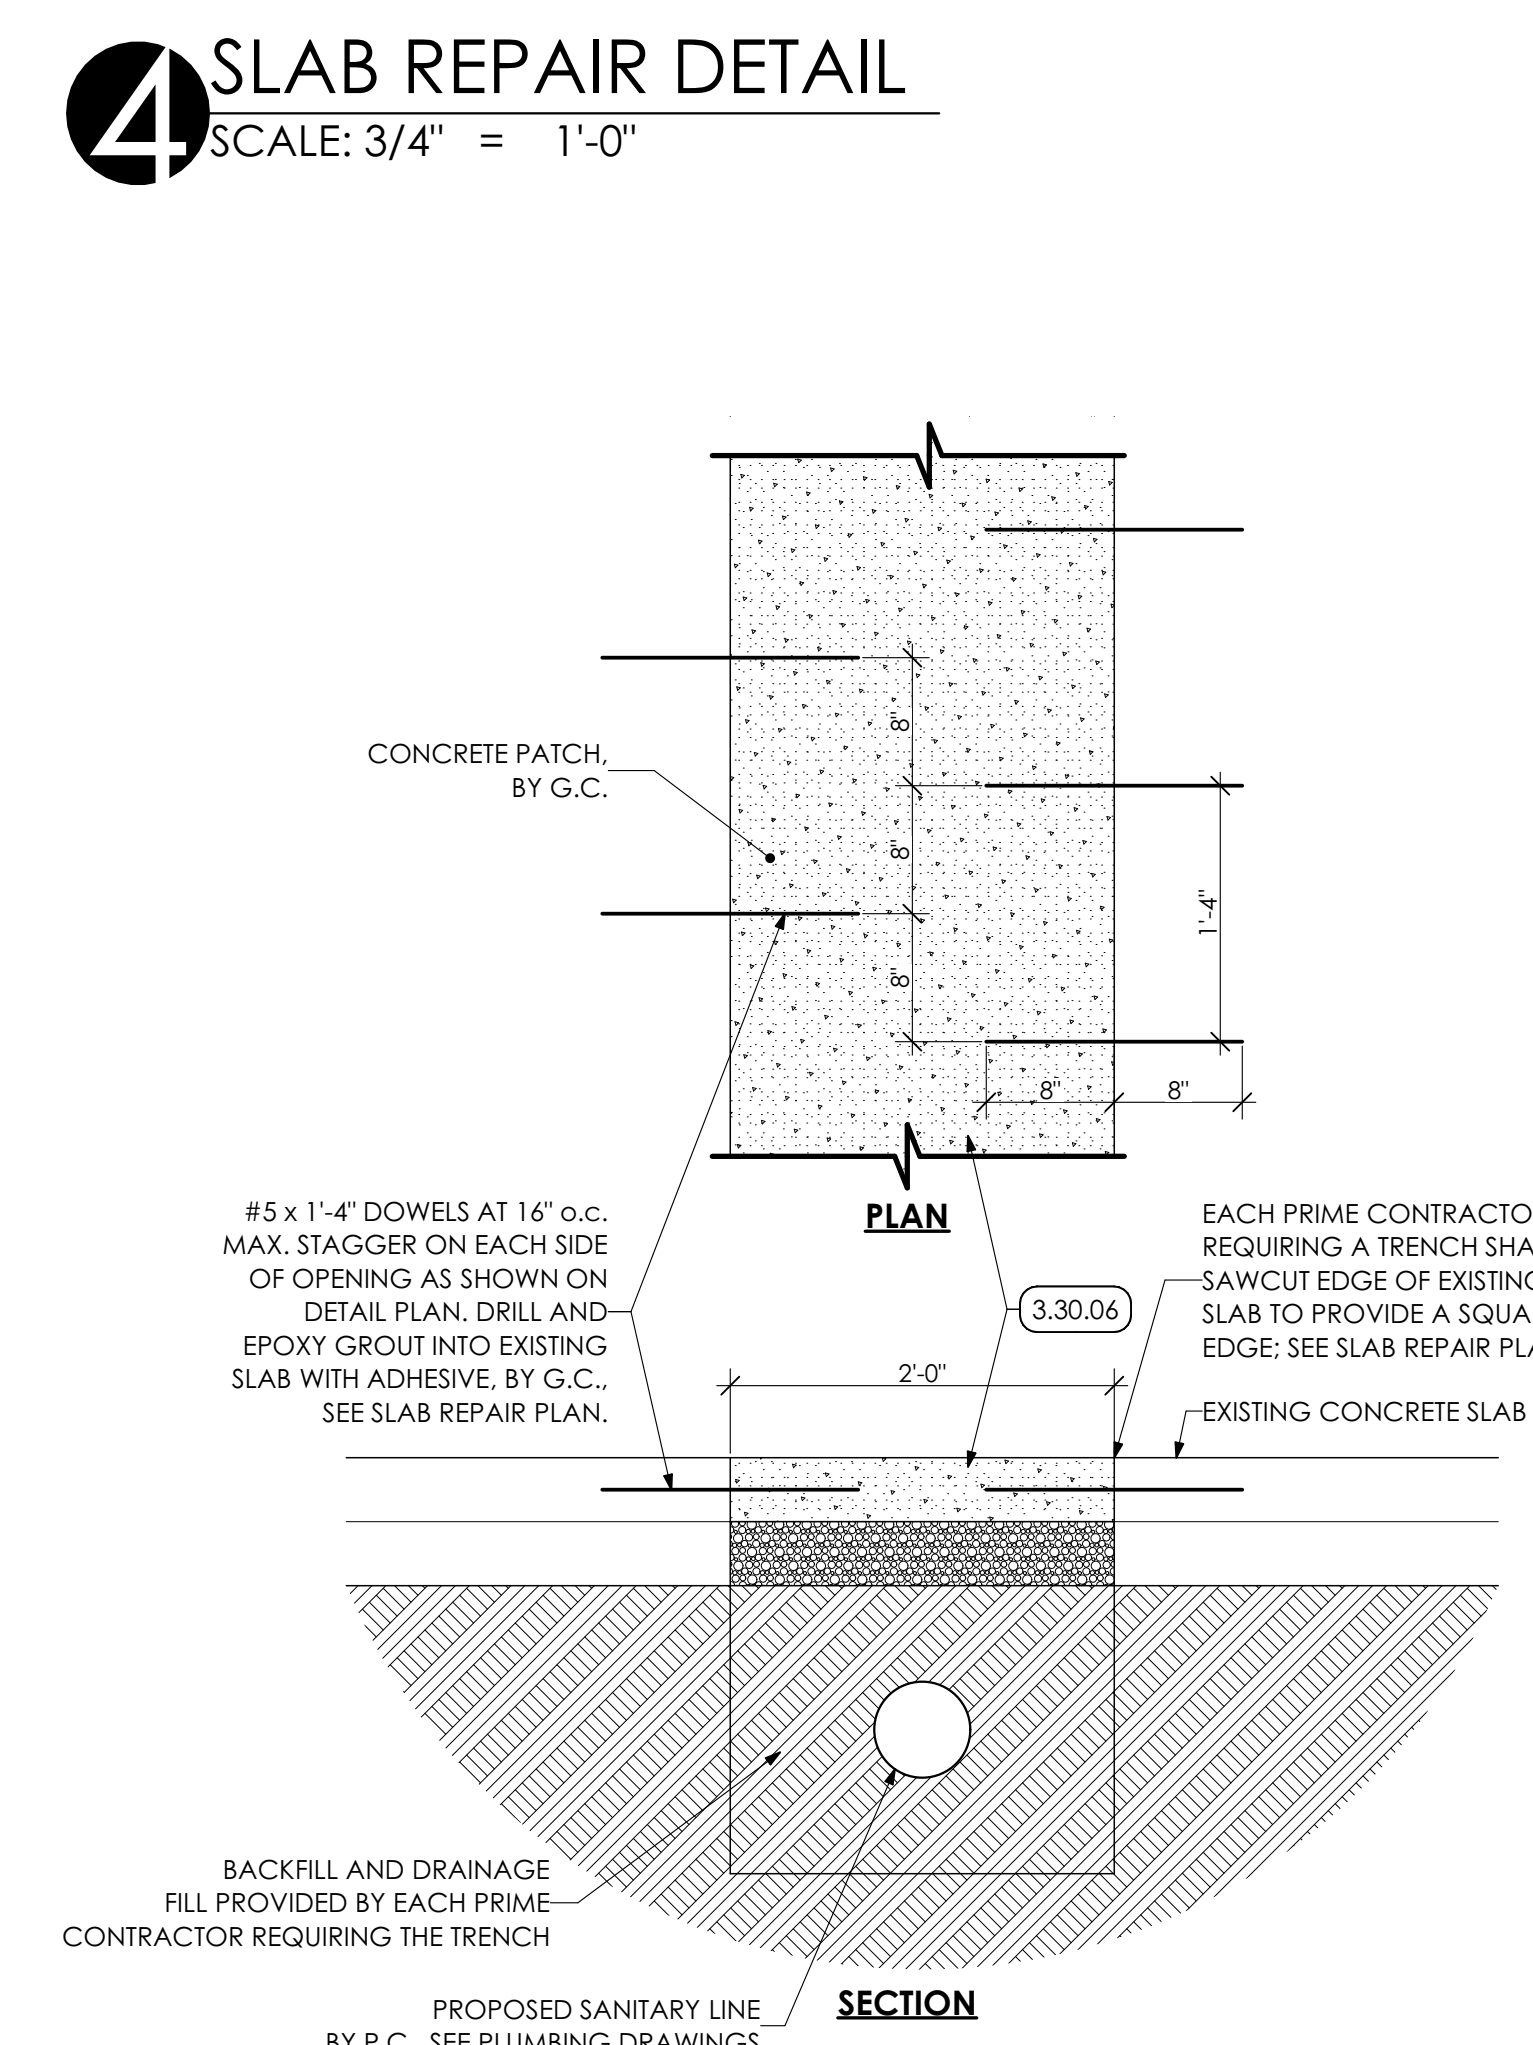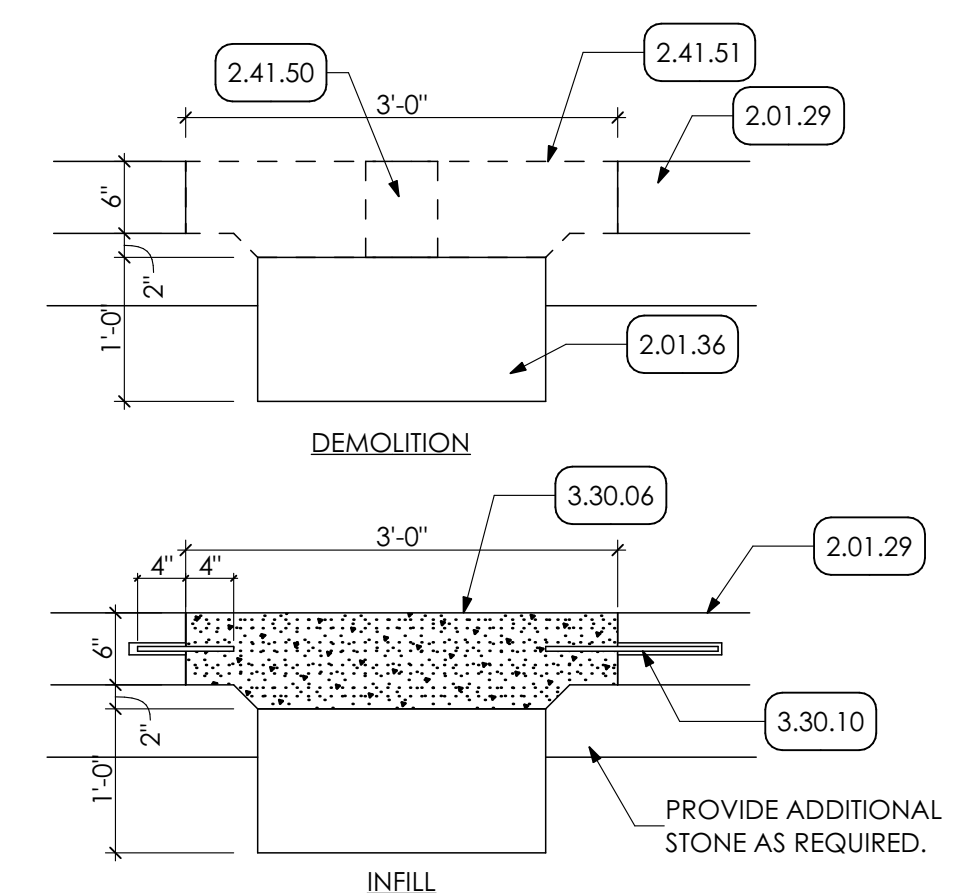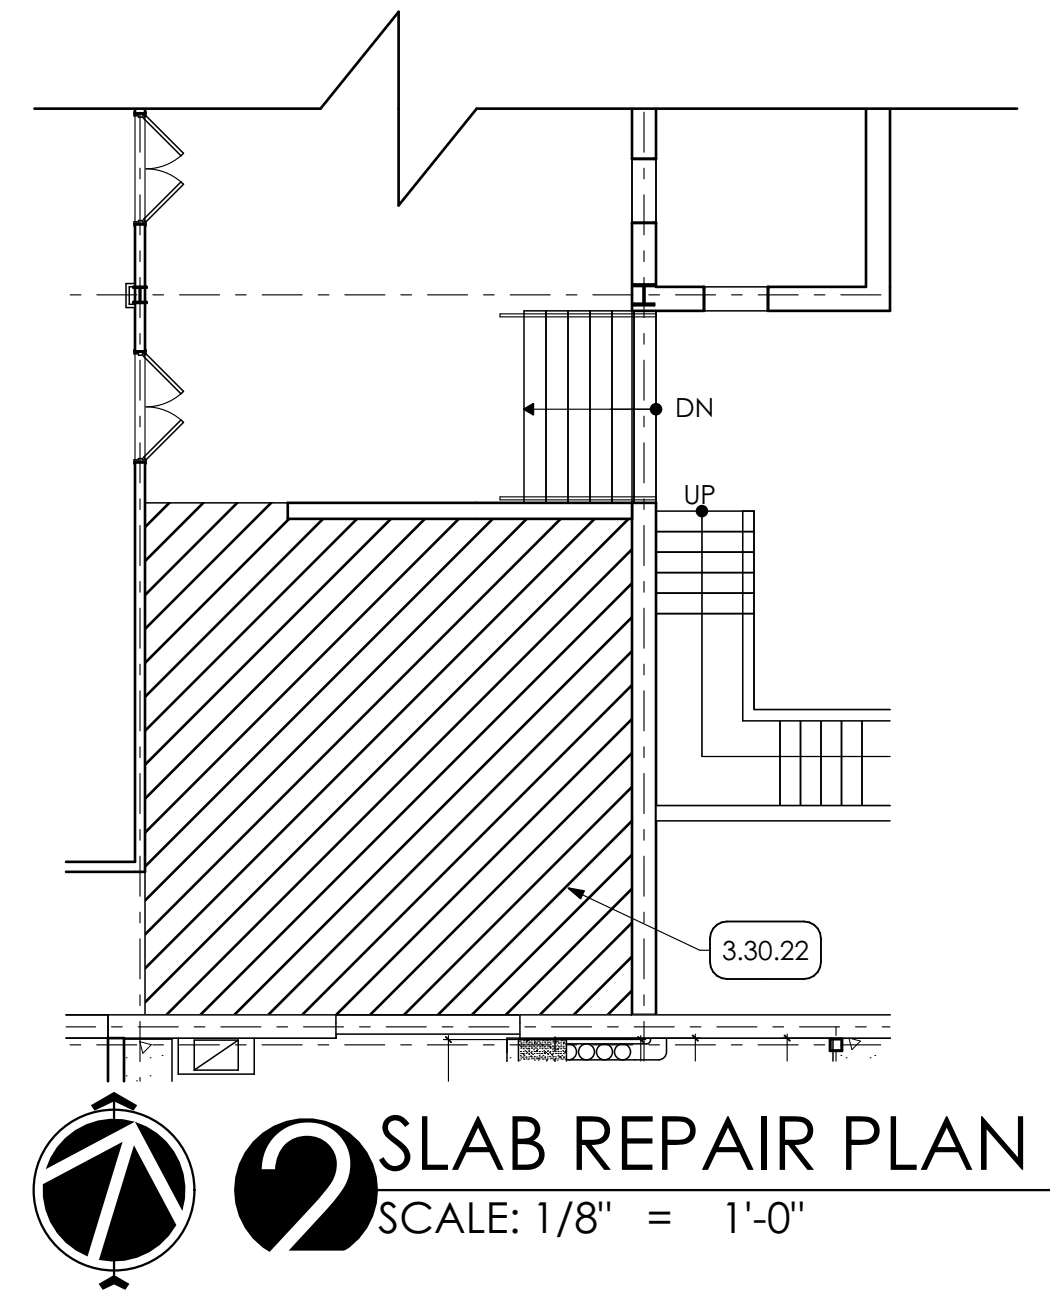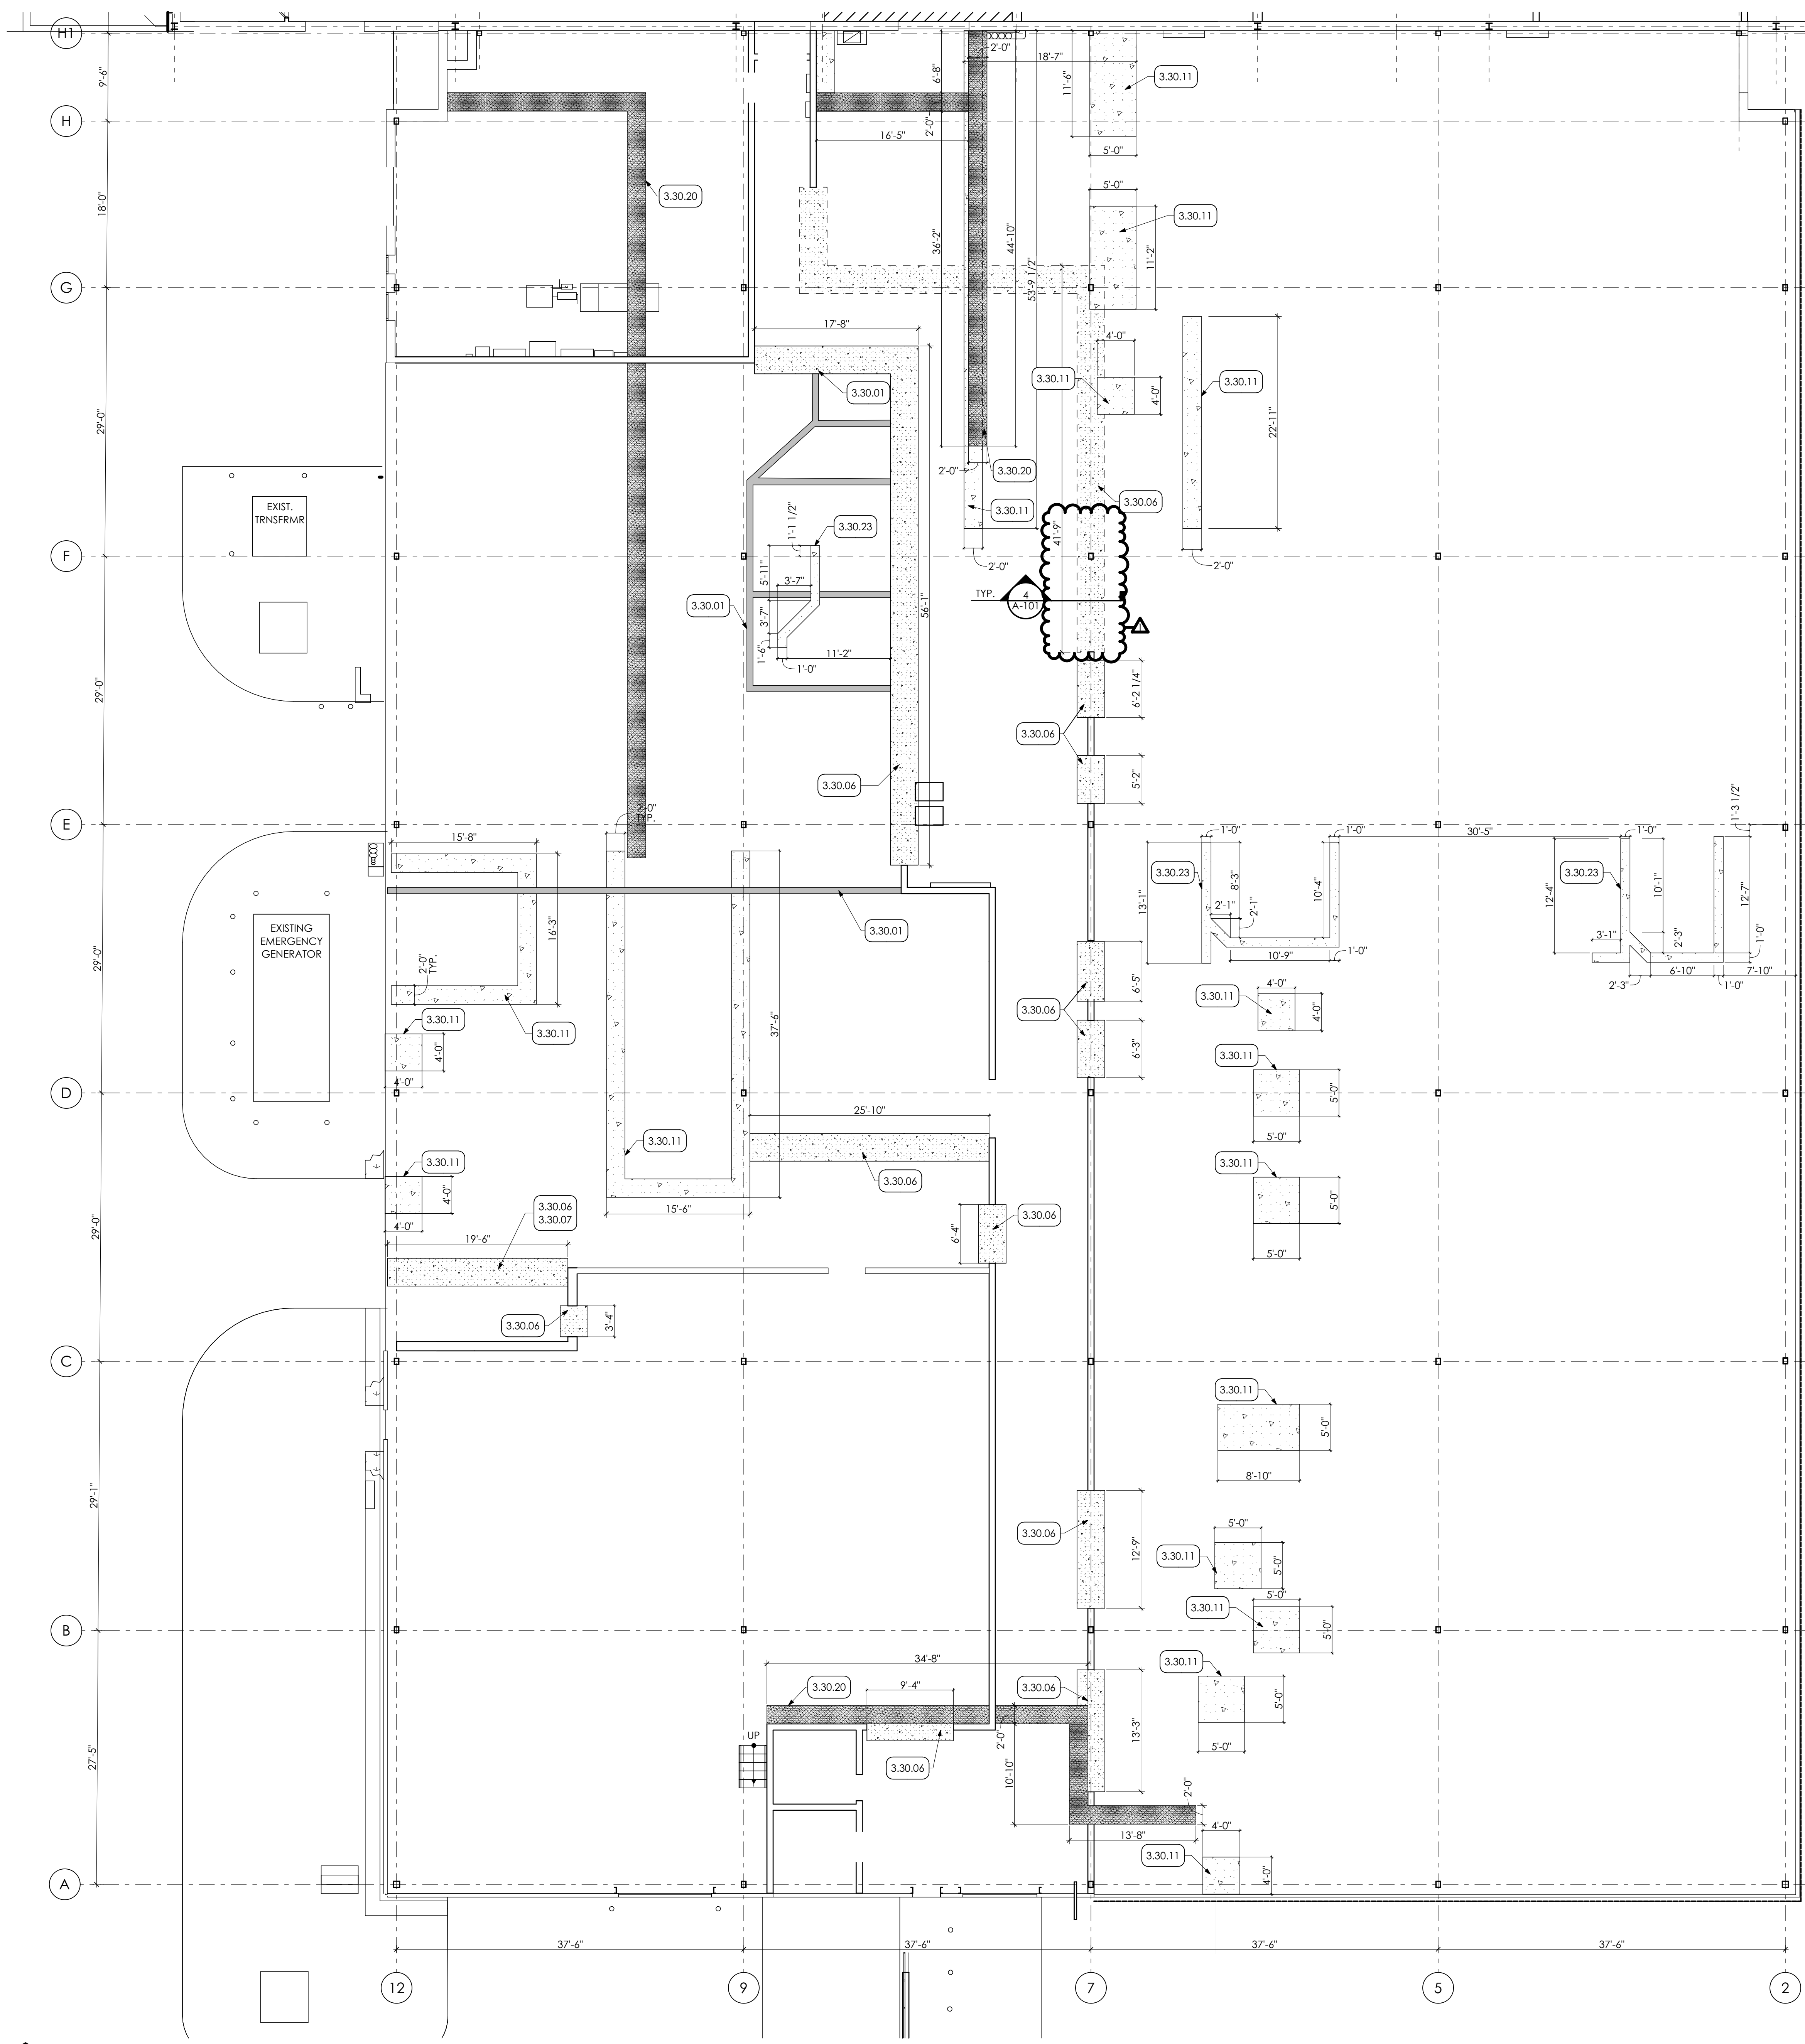
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PROFESSIONAL SEAL

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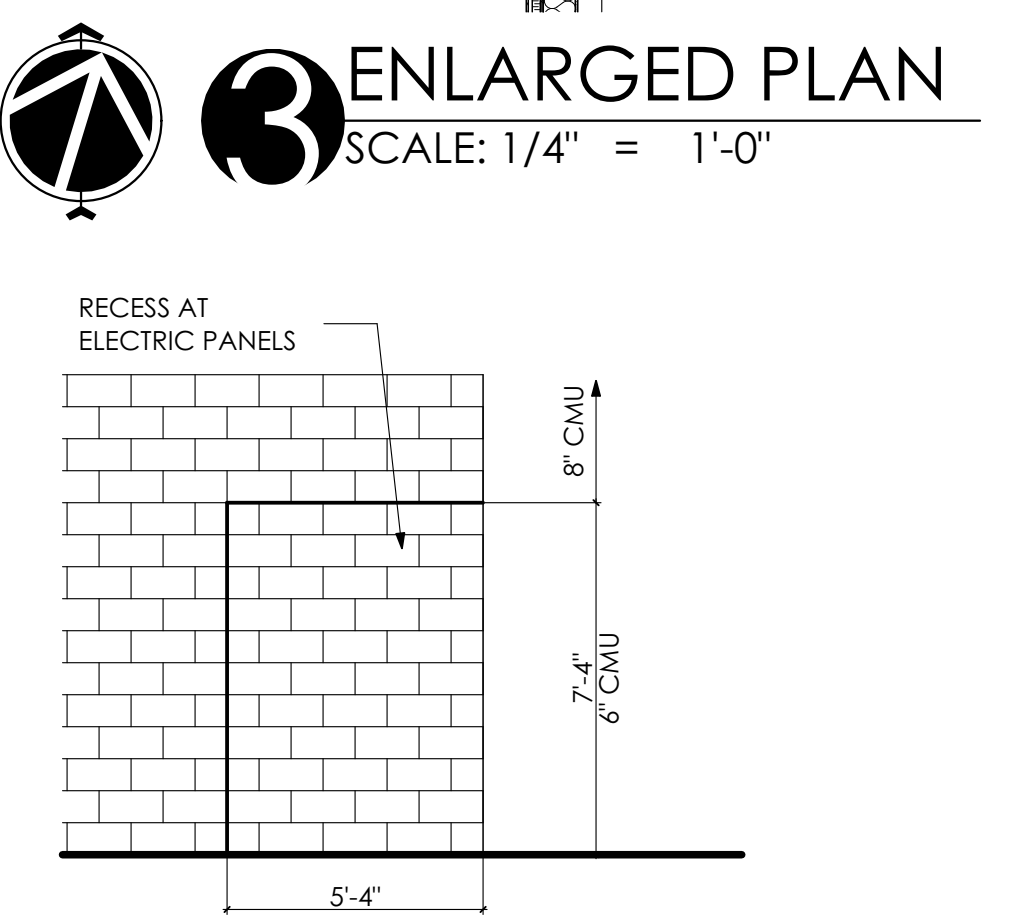
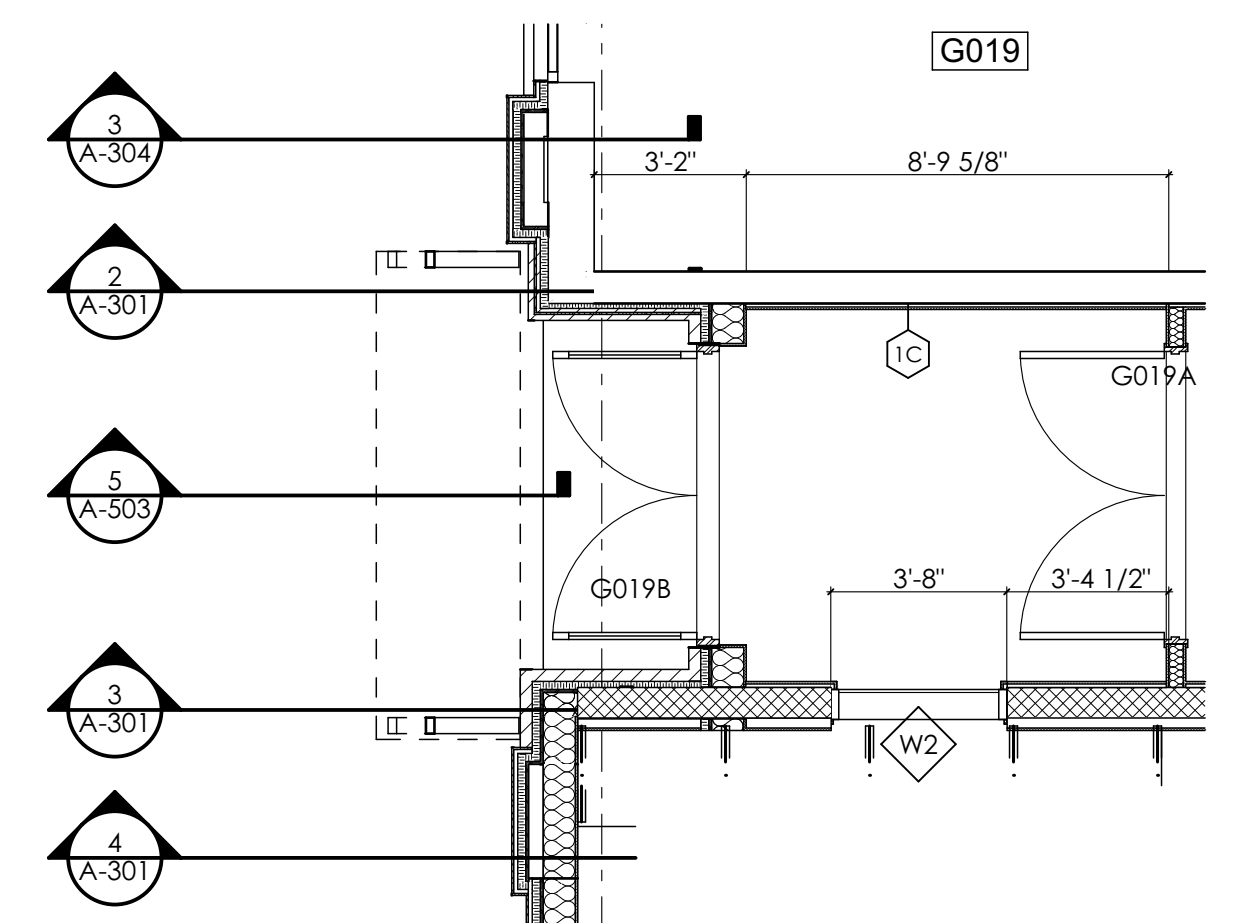
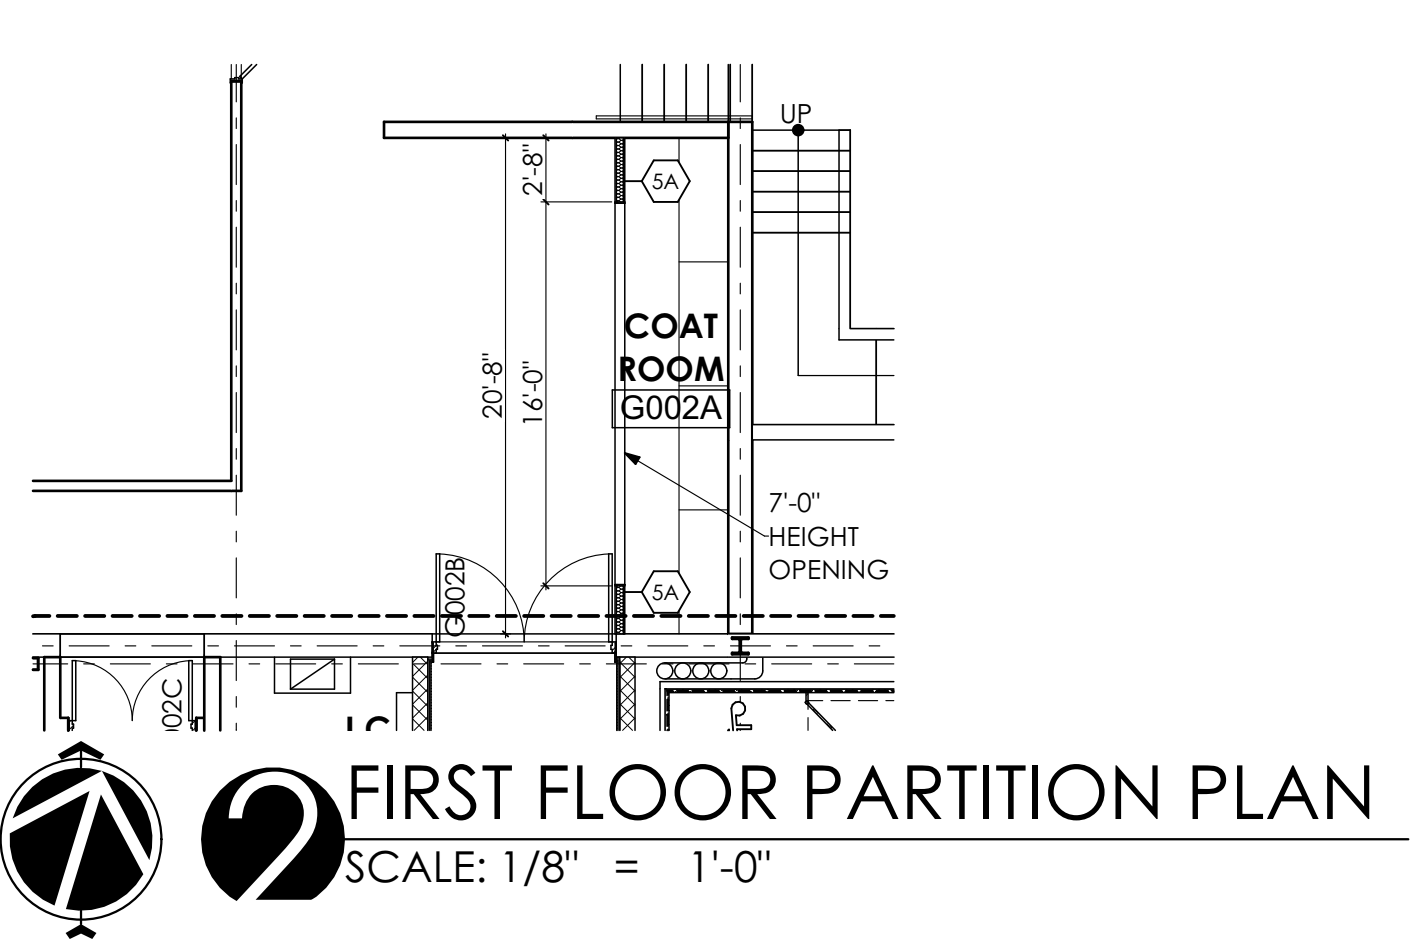
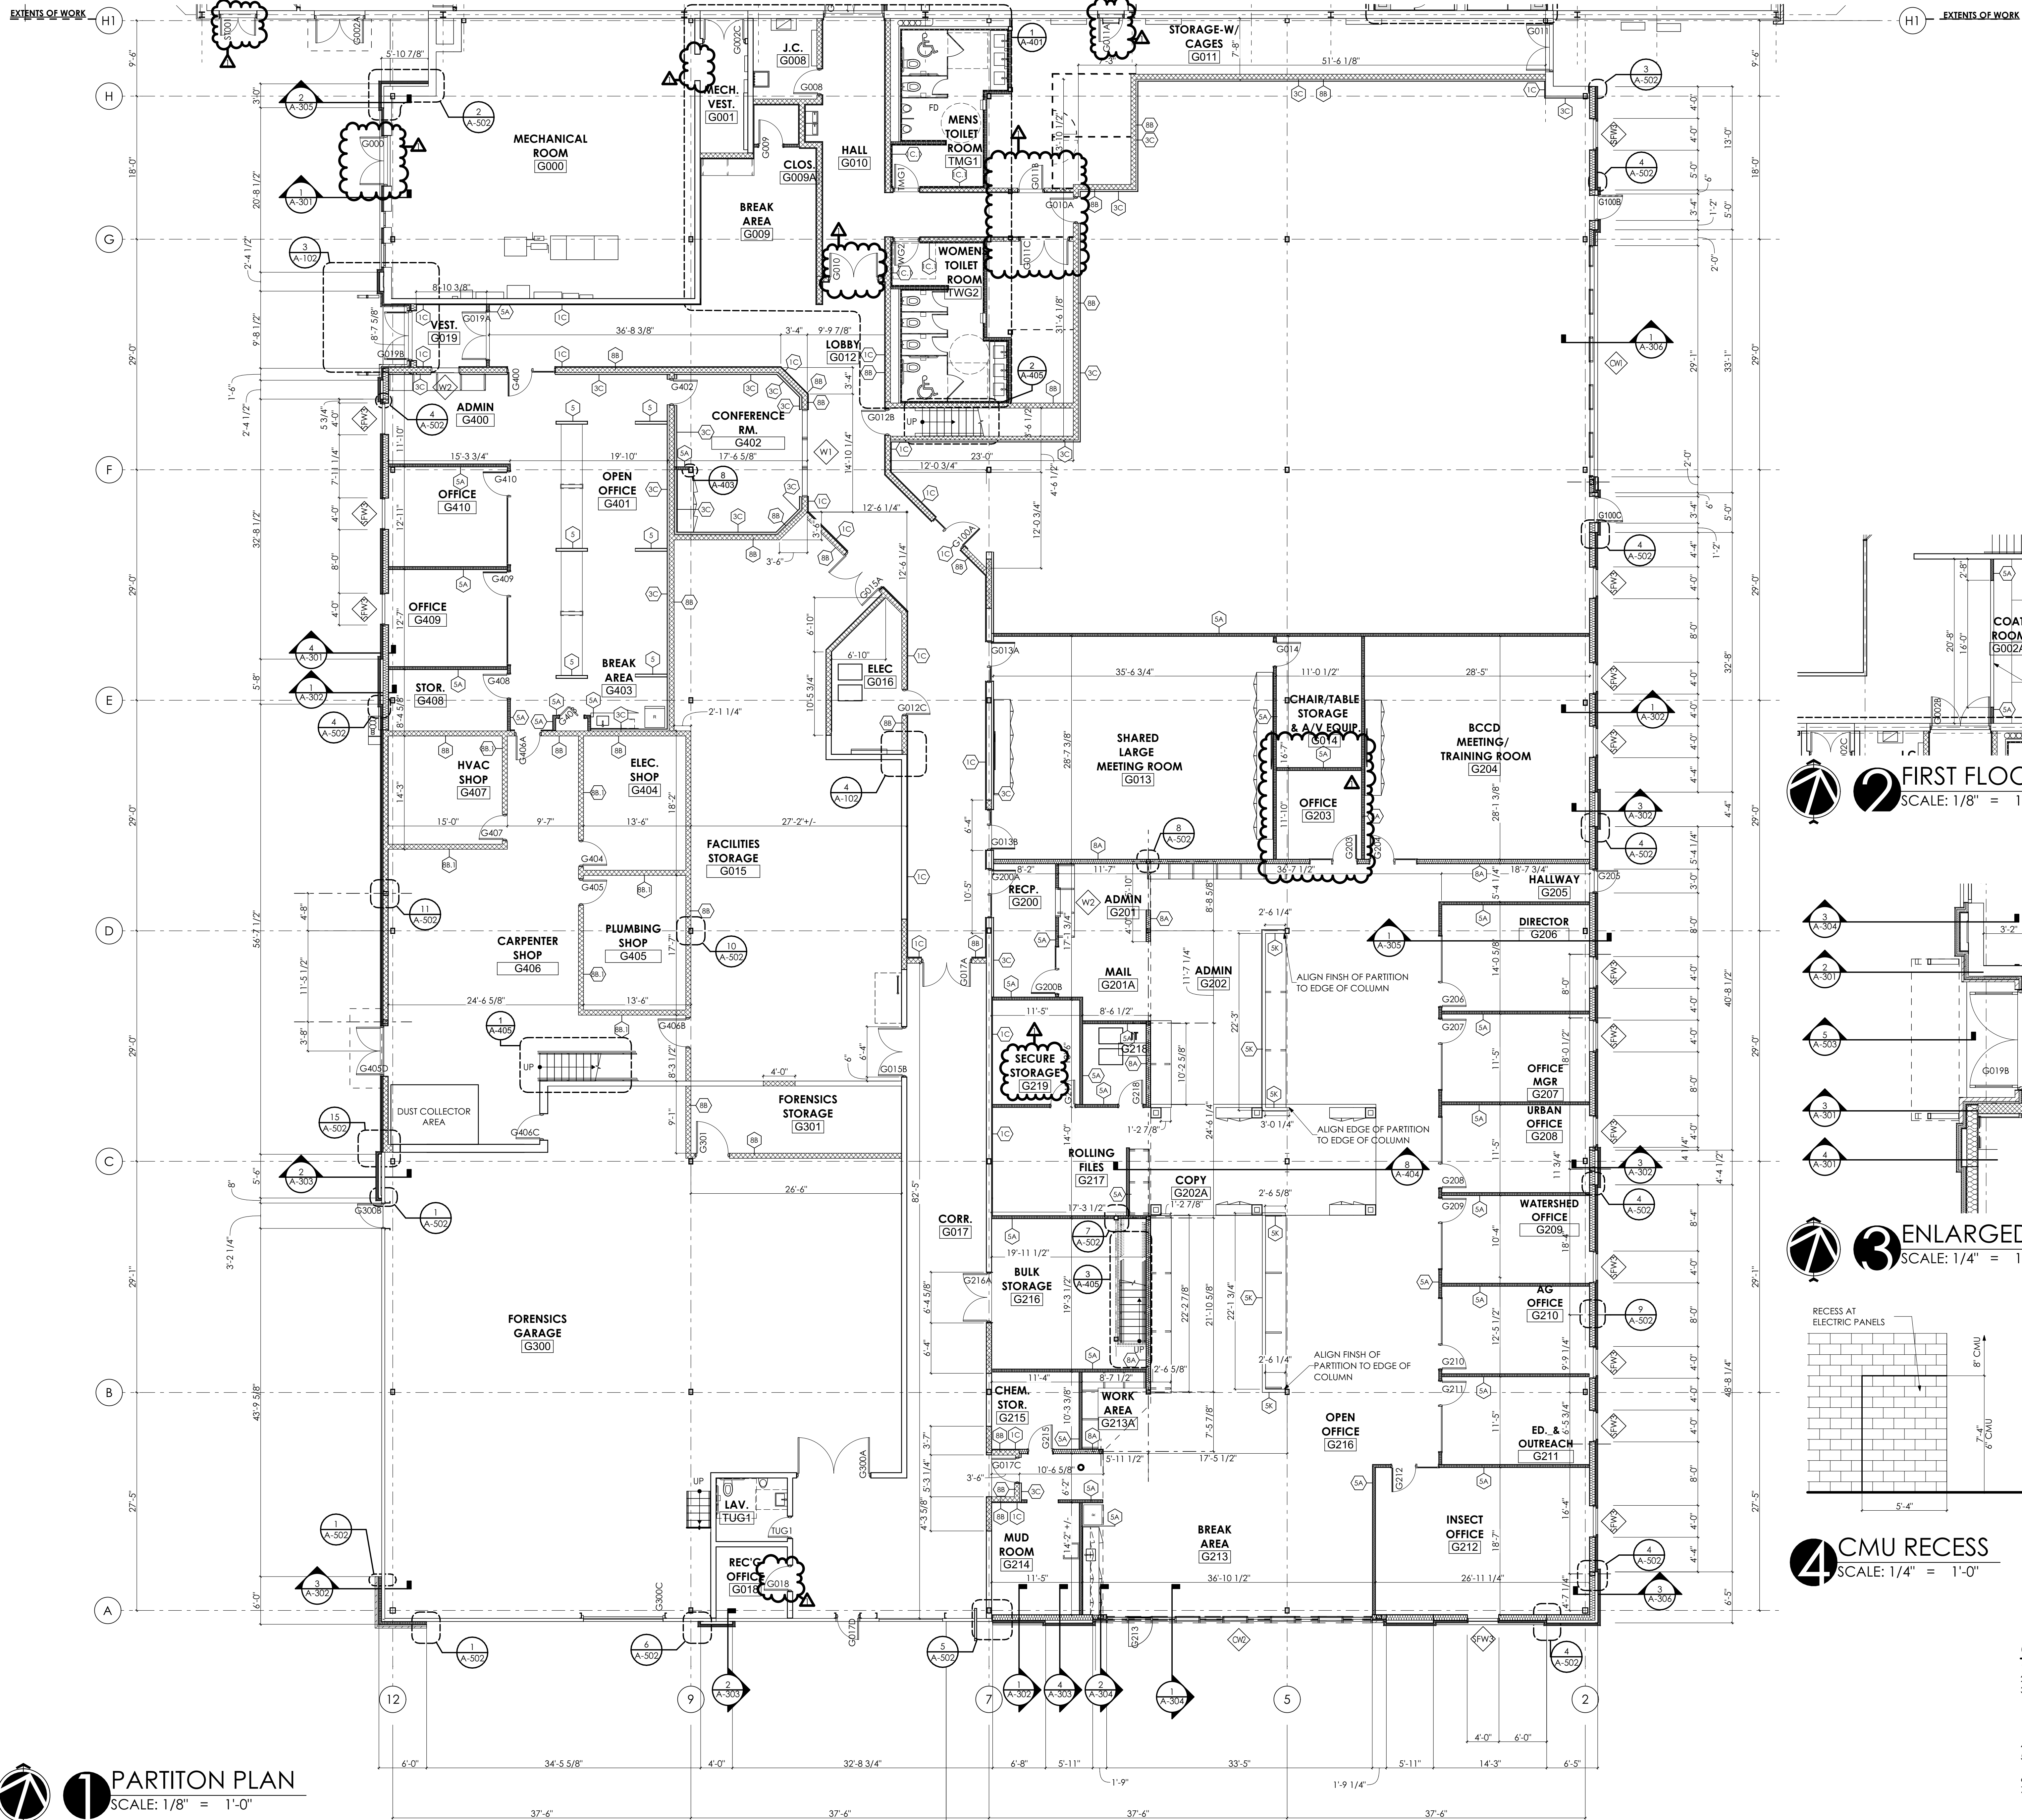
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SHEET TITLE:
SLAB REPAIR PLAN

A-101

GENERAL SHEET NOTES:

- ALL LOCATIONS WHERE AN ADJACENT CMU PARTITION IS ADJACENT TO A DOOR BEING REMOVED. GRIND AND PATCH AROUND DOOR AND ALONG REMOVED CMU PARTITION.



- GENERAL SHEET NOTES**
- REFER TO 600 SERIES FOR SCHEDULES.
 - REFER TO SHEET A-702 FOR FINISH SCHEDULE INFORMATION.
 - ABANDONED PENETRATIONS OF EXISTING CMU PARTITIONS GREATER THAN 9 SQUARE INCHES ARE TO RECEIVE A SOAP BLOCK INFILL. SEE DETAIL 2/A-603. CONTRACTOR RESPONSIBLE FOR DEMOLITION THAT CREATED ABANDONED OPENING IS RESPONSIBLE TO PROVIDE THE SOAP BLOCK INFILL.
 - EXTERIOR PLAN DIMENSIONS ARE TO OUTSIDE FACE OF ELEMENTS.
 - PARTITION DIMENSIONS ARE TO ONE FACE OF STUD OR MASONRY FROM A COLUMN CENTER LINE OR ANOTHER PARTITION.
 - SEE SHEET A-201 FOR EXTERIOR BUILDING ELEVATIONS.
 - REFER TO STRUCTURAL DRAWINGS FOR STEEL COLUMN SIZES, COORDINATE WITH FINISH COLUMN ENCLOSURE.

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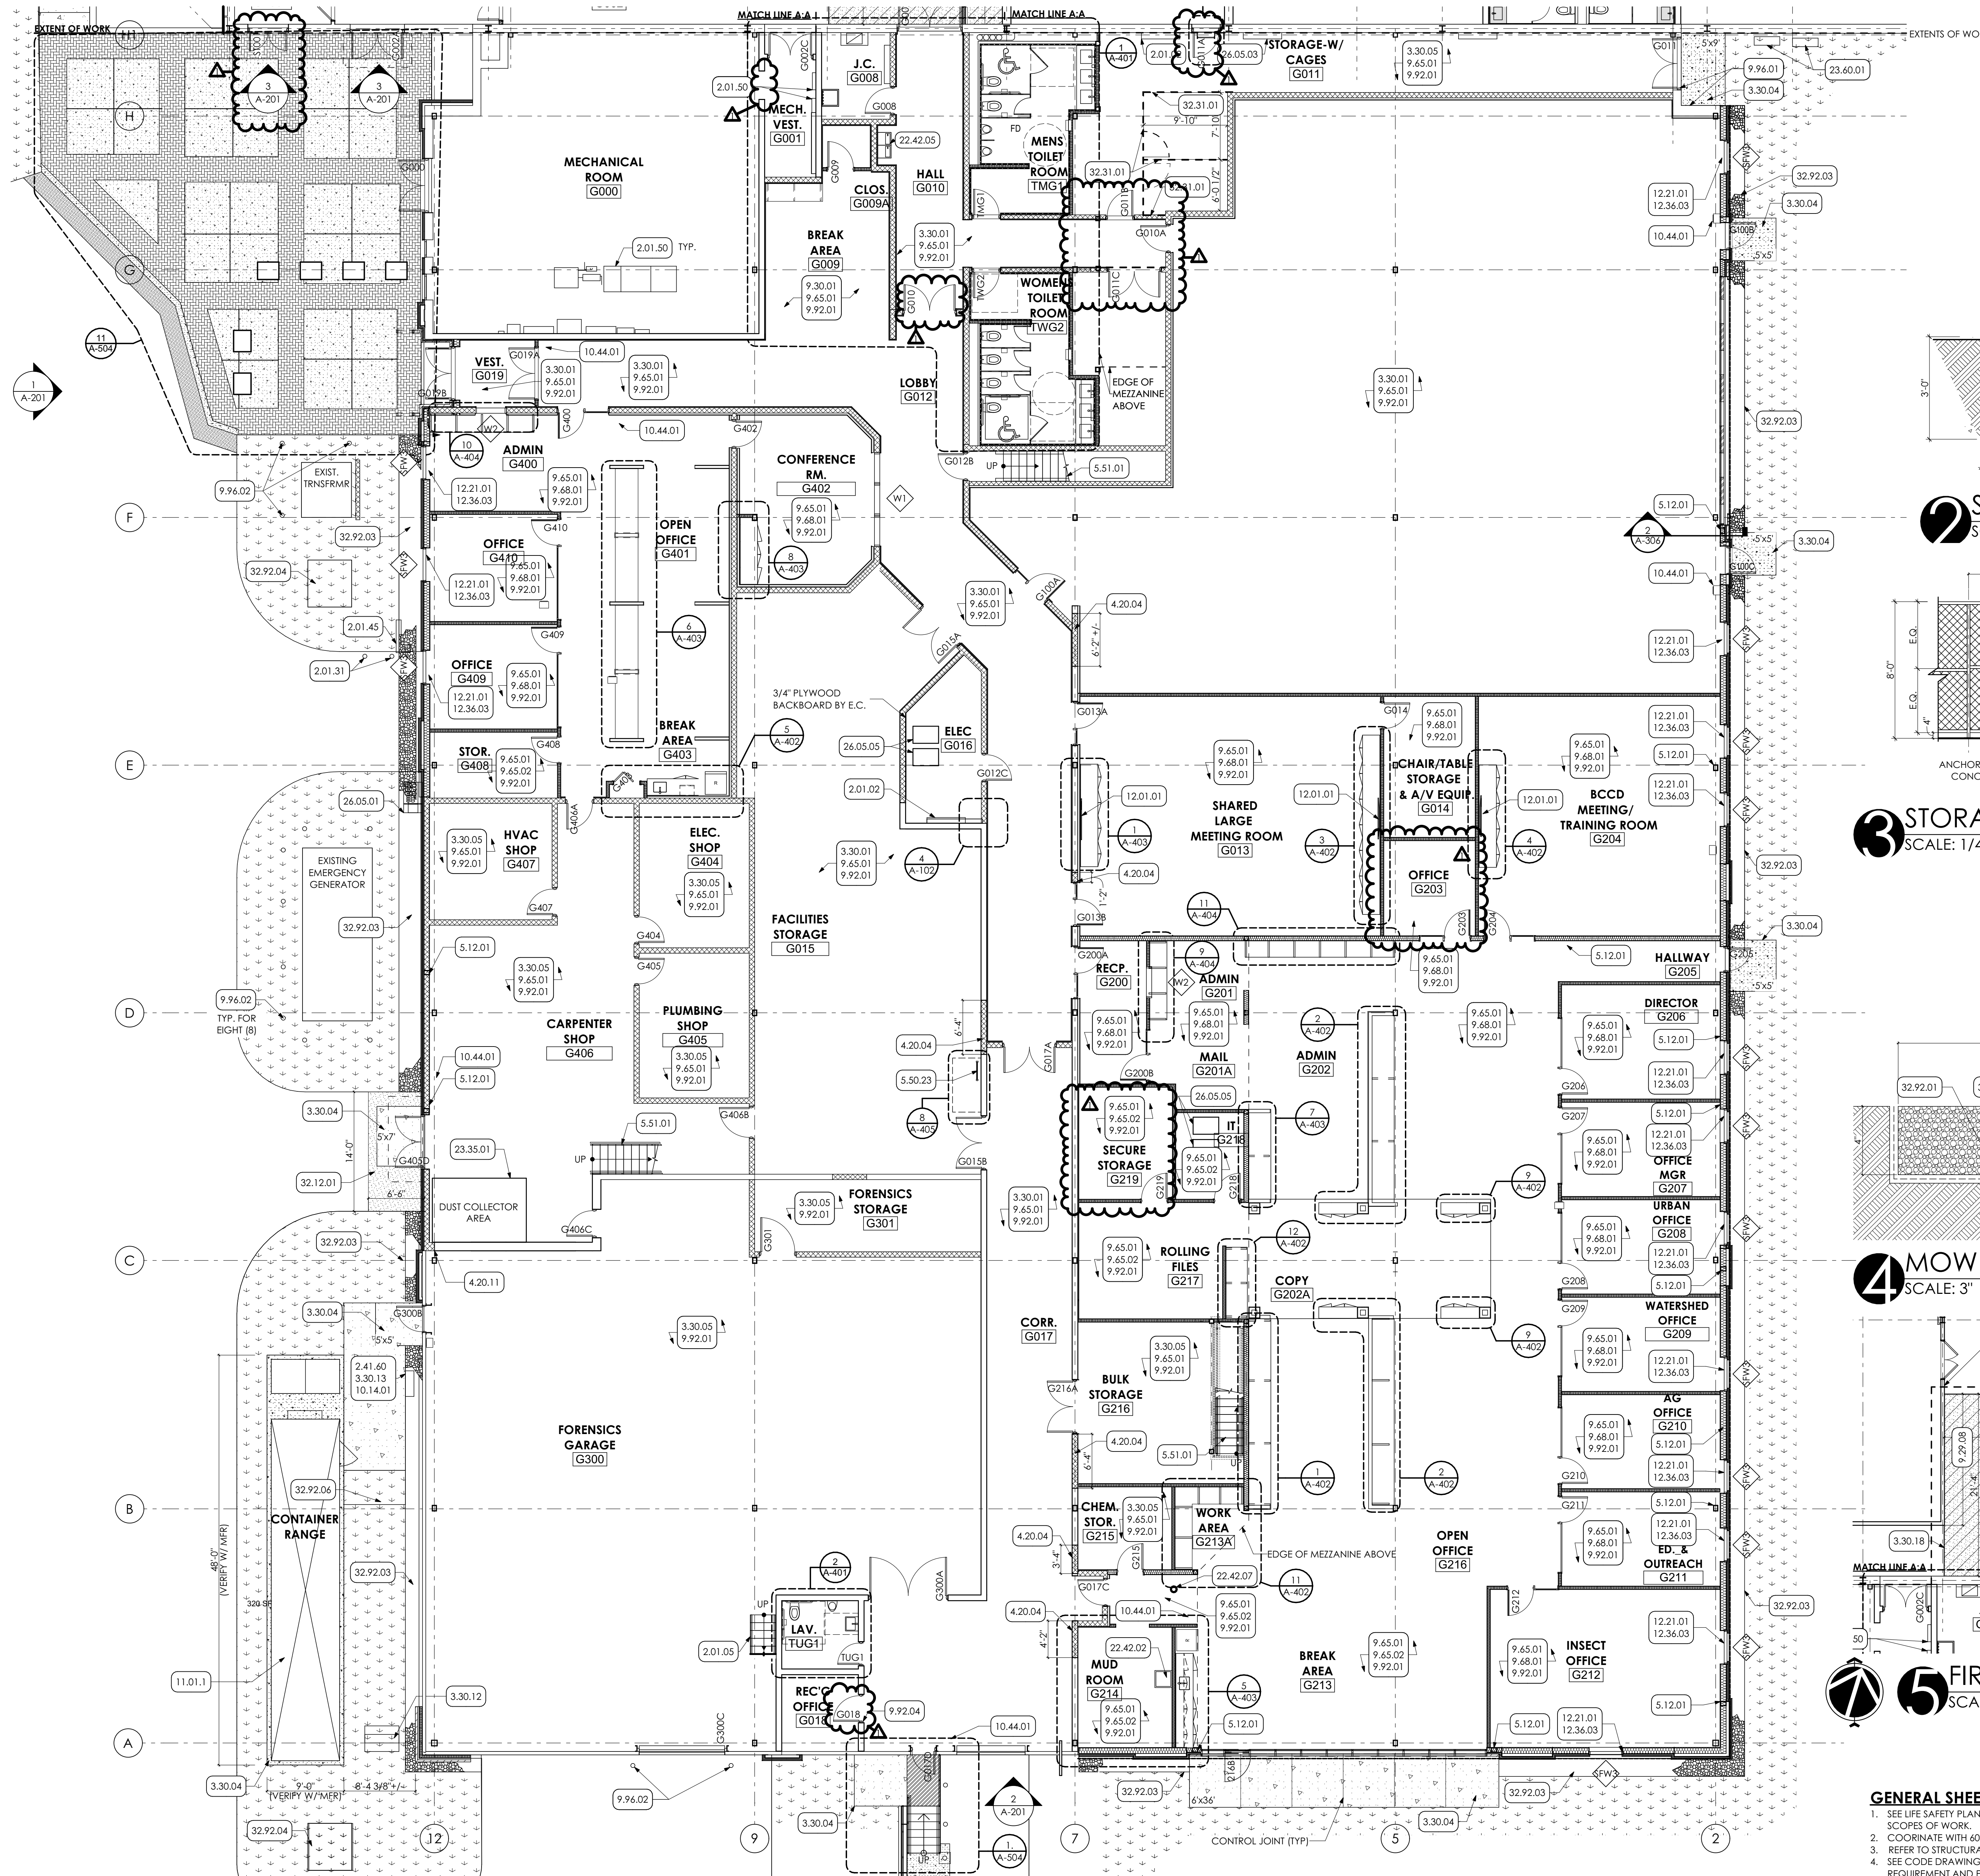
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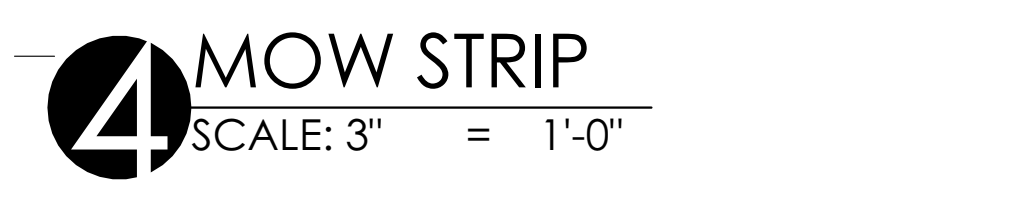
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SHEET TITLE:
PARTITION PLAN
A-102



FIRST FLOOR PLAN
SCALE: 1/8" = 1'-0"



GENERAL SHEET NOTES

- SEE LIFE SAFETY PLANS, SHEET A-002, A-003 FOR ADDITIONAL SCOPES OF WORK.
- COORDINATE WITH 600-SERIES SHEETS FOR SCHEDULES.
- REFER TO STRUCTURAL DRAWINGS FOR CONCRETE PAD DETAILS.
- SEE CODE DRAWINGS A-003, A-004, A-005 FOR SIGNAGE REQUIREMENT AND FIRE EXTINGUISHER LOCATIONS.
- COORDINATE WITH 700-SERIES SHEETS FOR FINISHES.

LEGEND

32.92.04 SEEDING BY G.C. (APPROX. 4000 SQ. FT.)

- KEY NOTES**
- 02 DEMOLITION**
 - 2.01 EXISTING CONDITIONS
 - 2.01.02 EXISTING ELECTRICAL PANELS TO REMAIN.
 - 2.01.05 EXISTING STAIR TO REMAIN.
 - 2.01.31 EXISTING BOLLARDS TO REMAIN.
 - 2.01.45 EXISTING GAS METER TO REMAIN.
 - 2.01.50 EXISTING ELECTRICAL EQUIPMENT
 - 2.41 SELECTIVE DEMOLITION | SPEC 024119
 - 2.41.60 CAREFULLY REMOVE SIGN. STORE FOR REINSTALL.
 - 03 CONCRETE**
 - 3.30 CAST-IN-PLACE CONCRETE | SPEC 033000 | 032000
 - 3.30.01 GRIND AND PATCH CONCRETE SLAB AT SECTION OF REMOVED CMU PARTITION.
 - 3.30.04 CAST-IN-PLACE CONCRETE PAD WITH DRAINAGE FILL. COORDINATE WITH STRUCTURAL DRAWING.
 - 3.30.05 PREP AND SEAL ENTIRE SURFACE OF EXISTING CONCRETE SLAB.
 - 3.30.12 REINSTALL SIGN ON NEW CONCRETE FOUNDATION.
 - 3.30.13 EXCAVATE FOR NEW SIGN BASE. PROVIDE CONCRETE SIGN BASE PER DETAIL AND BACKFILL.
 - 3.30.18 TRANSITION STRIPE.
 - 04 MASONRY**
 - 4.22 CMU MASONRY | SPEC 042000
 - 4.20.04 INFILL EXISTING OPENING WITH CMU TO MATCH EXISTING WALL THICKNESS (ASSUMED TO BE 8") FINISH FLUSH WITH ADJACENT SURFACE. TOOTH NEW CMU INTO EXISTING. EXTEND EXISTING CMU WALL TO NEW. TOOTH NEW CMU INTO EXISTING CMU.
 - 4.20.11
 - 05 METALS**
 - 5.12 STRUCTURAL STEEL FRAMING | SPEC 051200
 - 5.12.01 STEEL COLUMN. COORDINATE WITH STRUCTURAL DRAWINGS.
 - 5.50 METAL FABRICATIONS | SPEC 055000 | SPEC 055213
 - 5.50.23 METAL MOUNTED METAL LADDER WITH INTERMEDIATE LANDING PLATFORM.
 - 5.51 METAL STAIRS | SPEC 055100
 - 5.51.01 CONCRETE FILLED METAL PAN STAIRS.
 - 06 WOODS, PLASTICS AND COMPOSITES**
 - 6.10 ROUGH CARPENTRY | SPEC 061000
 - 6.10.03 WOOD SHELVING FOR WIDTH OF CLOSET. PROVIDE A 36" LENGTH OF SHELVING AT ADA HEIGHT.
 - 09 FINISHES**
 - 9.29 GYPSUM BOARD | SPEC 092900
 - 9.29.08 EXTEND EXISTING PLASTER WALL FLUSH TO UNDERSIDE OF NEW PLASTER CEILING. FINISH FLUSH WITH ADJACENT EXISTING SURFACES.
 - 9.30 CERAMIC TILING | SPEC 093013
 - 9.30.01 CERAMIC COVE BASE PROFILE FOR PERIMETER OF ROOM. COORDINATE WITH FINISH SCHEDULE.
 - 9.65 RESILIENT BASE | SPEC 096513
 - 9.65.01 4" HIGH RUBBER COVE BASE CONTINUOUS FOR PERIMETER OF ROOM OR CORRIDOR.
 - 9.65.02 PROVIDE LVT OVER HYDRAULIC CEMENT UNDERLAYMENT THROUGHOUT ENTIRE ROOM OR CORRIDOR. PREP SUBSTRATE AS REQUIRED PER MANUFACTURER'S RECOMMENDATIONS.
 - 9.66 TERRAZZO FLOORING | SPEC 096600
 - 9.66.01 PATCH TERRAZZO FLOORING TO FINISH FLUSH WITH ADJACENT SURFACE. COLOR TO MATCH EXISTING.
 - 9.68 CARPETING | SPEC 096800 | 035416
 - 9.68.01 PROVIDE CARPET TILE OVER HYDRAULIC CEMENT UNDERLAYMENT THROUGHOUT ROOM OR CORRIDOR. PREP SUBSTRATE AS REQUIRED PER MANUFACTURER'S RECOMMENDATIONS.
 - 9.92 INTERIOR PAINTING | SPEC 099213
 - 9.92.01 PREP. PRIME PAINT (TWO (2) COATS) ALL WALLS IN ROOM. UNLESS SPECIFIC WALLS NOTED OTHERWISE. PAINT ENTIRE WALL INCLUDING EXPOSED CONDUIT. FROM FLOOR TO 4" ABOVE NEW CEILING GRID OR TO ROOF DECK IN AREAS OF OPEN CEILINGS.
 - 9.92.04 PREP. PRIME PAINT (TWO (2) COATS) ENTIRE EXISTING DOOR FRAME
 - 9.92.05 DO NOT PAINT MURALS.
 - 9.96 HIGH-PERFORMANCE COATING | SPEC 099600
 - 9.96.01 PREP. PRIME PAINT (2 COATS) ENTIRE SURFACE WITH HIGH PERFORMANCE COATING.
 - 9.96.02 PREP AND PAINT (TWO (2) COATS) EXISTING PIPE BOLLARDS.
 - 10 SPECIALTIES**
 - 10.14 SIGNAGE
 - 10.14.01 REINSTALL EXISTING SIGN ON NEW CONCRETE FOUNDATION. UTILIZING EXISTING MOUNTING HOLES.
 - 10.44 FIRE PROTECTION SPECIALTIES | SPEC 104400
 - 10.44.01 FIRE EXTINGUISHER WITH FIRE PROTECTION CABINET
 - 11 EQUIPMENT**
 - 11.01 EQUIPMENT | BY OWNER
 - 11.01.1 CONTAINER RANGE PROVIDED AND INSTALLED BY OWNER.
 - 12 FURNISHINGS**
 - 12.01 AV EQUIPMENT
 - 12.01.01 WALL MOUNTED TELEVISION AND BRACKET PROVIDED BY AND INSTALLED BY OWNER.
 - 12.21 HORIZONTAL LOUVER BLINDS | SPEC 122413
 - 12.21.01 MANUALLY OPERATED HORIZONTAL BLINDS FOR FULL LENGTH OF WINDOW OPENING.
 - 12.36.1 SOLID SURFACE COUNTERTOP | SPEC 12361.16
 - 12.36.03 SOLID SURFACE WINDOW SILL FOR WIDTH OF OPENING.
 - 22 PLUMBING | BY P.C.**
 - 22 WORK DESCRIBED IN THESE KEYNOTES IS THE RESPONSIBILITY OF THE P.C. UNLESS NOTED OTHERWISE. COORDINATE WITH PLUMBING DRAWING.
 - 22.42 COMMERCIAL PLUMBING FIXTURES
 - 22.42.02 NEW UTILITY SINK.
 - 22.42.05 ADA COMPLIANT HI-LOW DRINKING FOUNTAINS.
 - 22.42.07 FLOOR DRAIN: COORDINATE W/ PLUMBING DRAWINGS.
 - 23 HVAC | BY H.C.**
 - 23 WORK DESCRIBED IN THESE KEYNOTES IS THE RESPONSIBILITY OF THE H.C. UNLESS NOTED OTHERWISE. COORDINATE WITH MECHANICAL DRAWING.
 - 23.35 SPECIAL EXHAUST SYSTEMS
 - 23.35.01 REINSTALL STORED DUST COLLECTOR.
 - 23.60 CENTRAL COOLING EQUIPMENT
 - 23.60.01 REINSTALL EXISTING CONDENSOR UNITS AND PADS.
 - 26 ELECTRICAL | BY E.C.**
 - 26 WORK DESCRIBED IN THESE KEYNOTES IS THE RESPONSIBILITY OF THE E.C. UNLESS NOTED OTHERWISE. COORDINATE WITH ELECTRICAL DRAWING.
 - 26.05 COMMON WORK RESULTS FOR ELECTRICAL
 - 26.05.01 EXISTING ELECTRICAL CONDUIT.
 - 26.05.03 REINSTALL STORED ELECTRICAL PANELS.
 - 26.05.05 RACKS BY E.C.
 - 32 EXTERIOR IMPROVEMENTS**
 - 32.12 ASPHALT PAVING | SPEC 321216
 - 32.12.01 NEATLY CUT EXISTING ASPHALT AND EXCAVATE FOR NEW CONCRETE SLAB. BACKFILL AND PATCH EXISTING ASPHALT AS REQUIRED TO FINISH FLUSH WITH ADJACENT SURFACE.
 - 32.31 CHAIN LINK FENCES AND GATES | SPEC 323113
 - 32.31.01 NEW METAL MESH STORAGE FENCING WITH SWING DOOR.
 - 32.32 TURF AND GRASSES | SPEC 323200
 - 32.32.01 WEED BARRIER
 - 32.32.02 #4 WASHED RIVER STONE
 - 32.32.03 24" WIDE GRAVEL MOW STRIPE. SEE DETAIL.
 - 32.32.04 BACKFILL TO FINISH FLUSH WITH ADJACENT GRADE AND PROVIDE SEED. BY G.C. BACKFILL FOR ELECTRIC CONDUIT AND PLUMBING LINES BY G.C., E.C., AND P.C. TO RUN THEIR OWN LINES. COORDINATE WITH ELECTRICAL AND PLUMBING DRAWINGS.
 - 32.92.06

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PROJECT #:
22-0012

PROFESSIONAL SEAL

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FACILITY UPGRADES

1238 COUNTY WELFARE ROAD LEESPORT, PA 19533

ISSUED
DATE: ISSUED 6/29/23



ID	DESCRIPTION	DATE
	CONSTRUCTION	6/29/23
	REVISION #1	8/18/23

PROJ. MGR.: JIM SARRO
P.M. e-MAIL: JIMS@MG-Architects.com
DRAWN BY: DK, SG, BB, JS
CLIENT PROJ #:
SHEET SCALE
1" = 1'-0"
BAR IS ONE (1) INCH LONG ON ORIGINAL DRAWING

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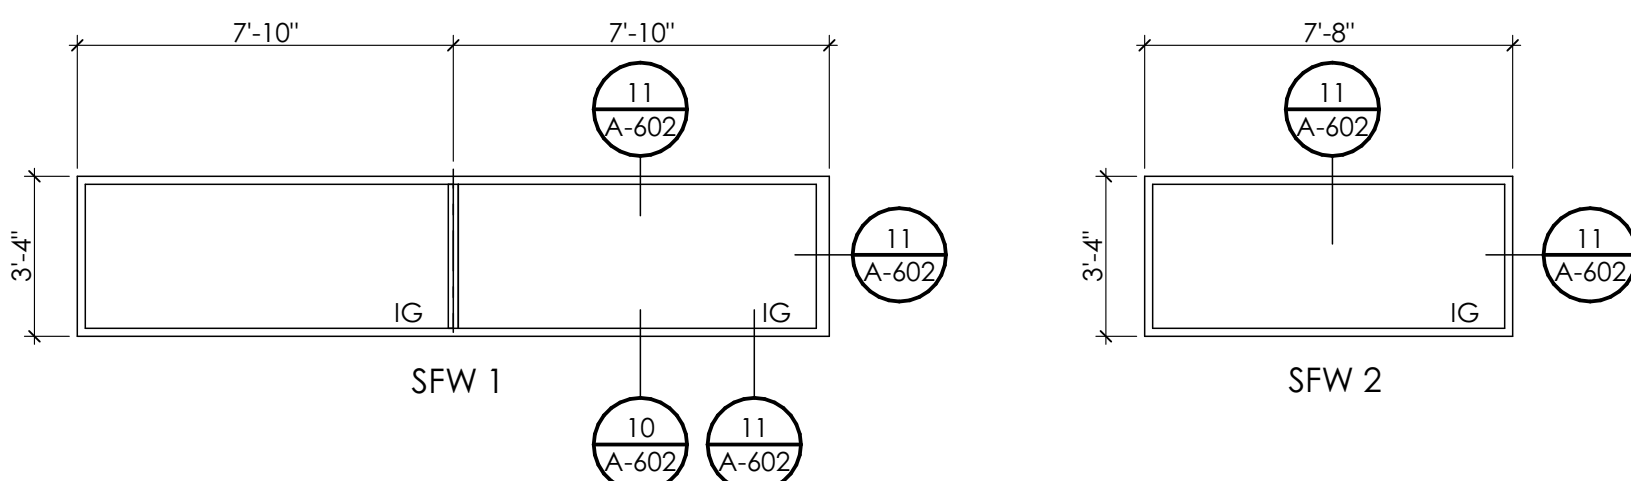
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KEYNOTE PLAN

A-103

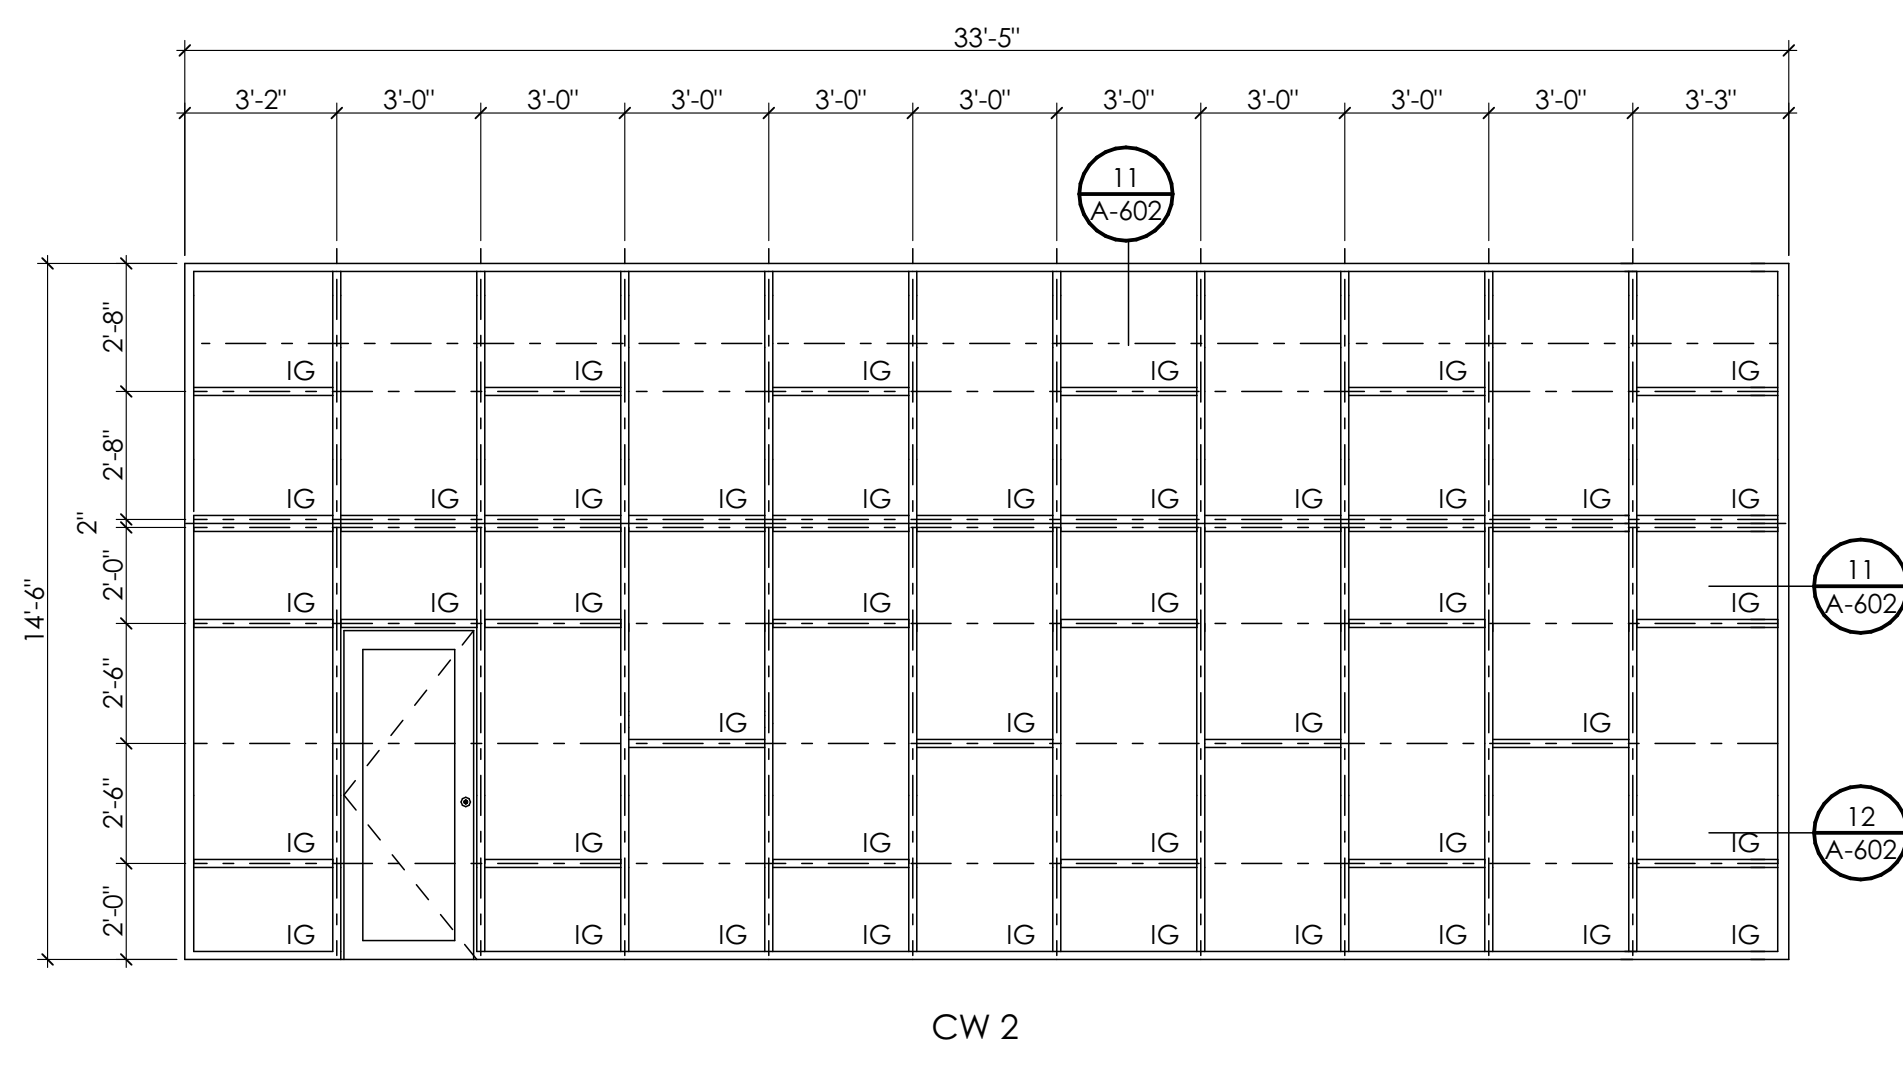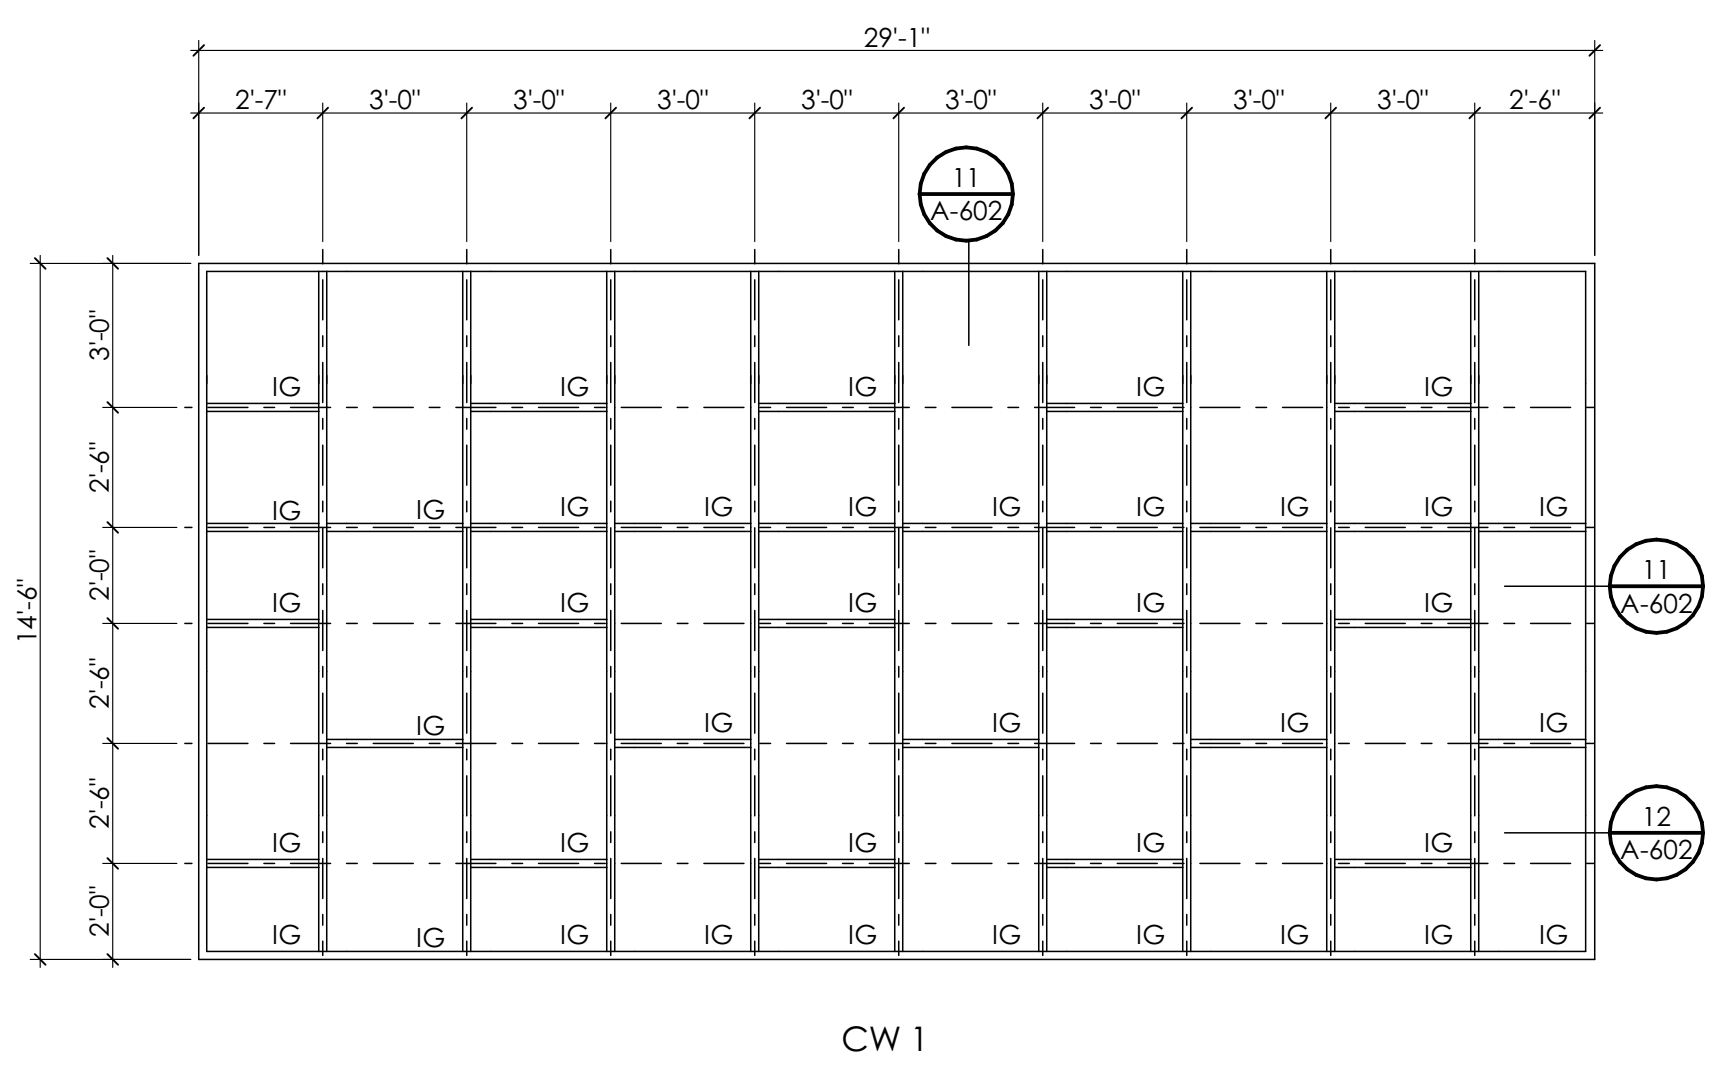


1 CURTAINWALL TYPES | SPEC: 084413

SCALE: 1/4" = 1'-0"




5 STOREFRONT TYPES | SPEC: 084113

SCALE: 1/4" = 1'-0"

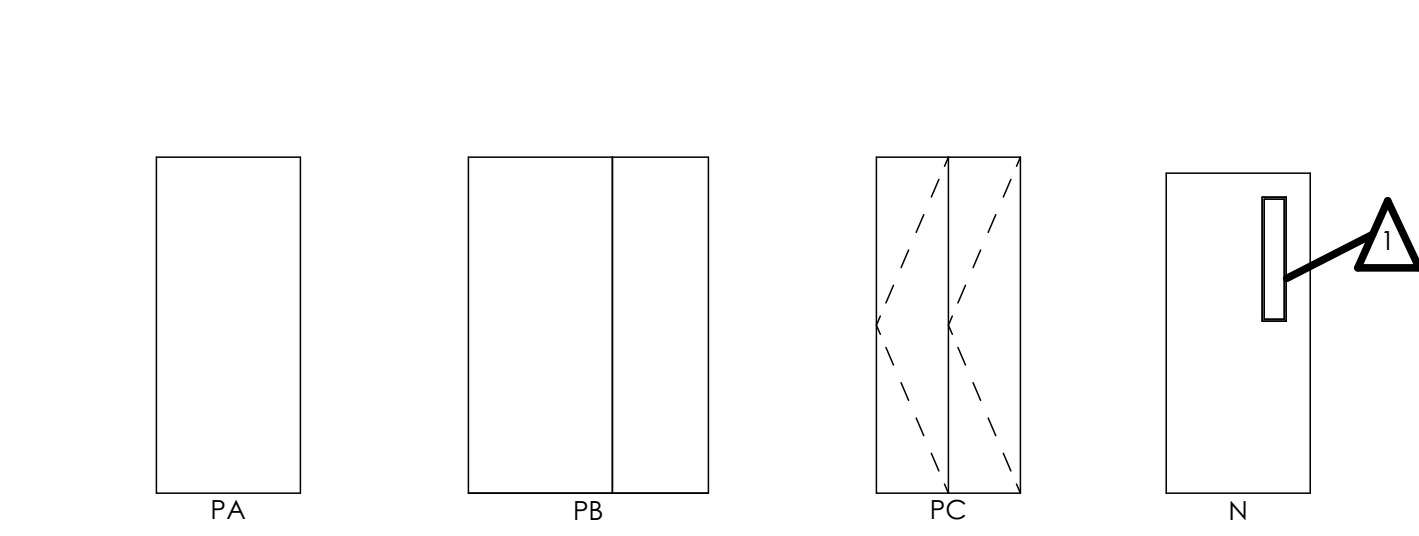


7 DOOR PANELS | SPEC: 081113/081416

SCALE: 1/4" = 1'-0"

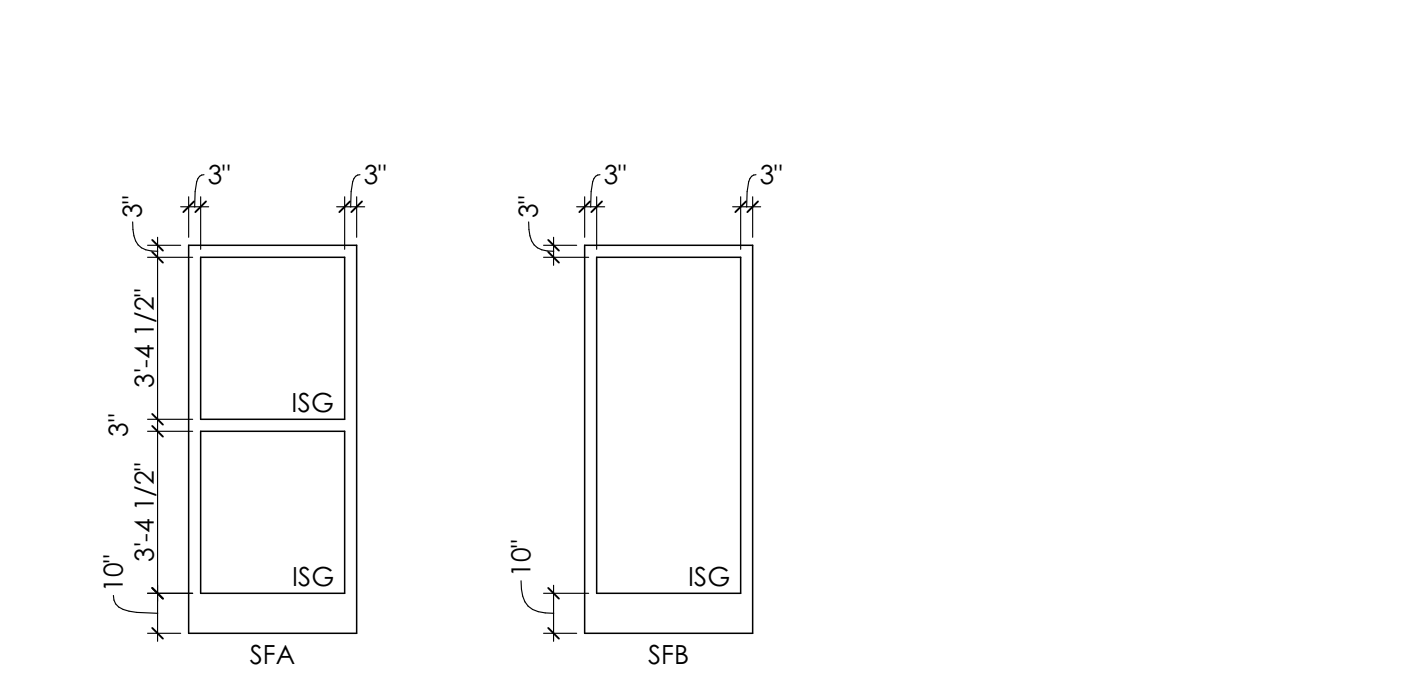


9 STOREFRONT DOOR PANEL | SPEC: 084113

SCALE: 1/4" = 1'-0"

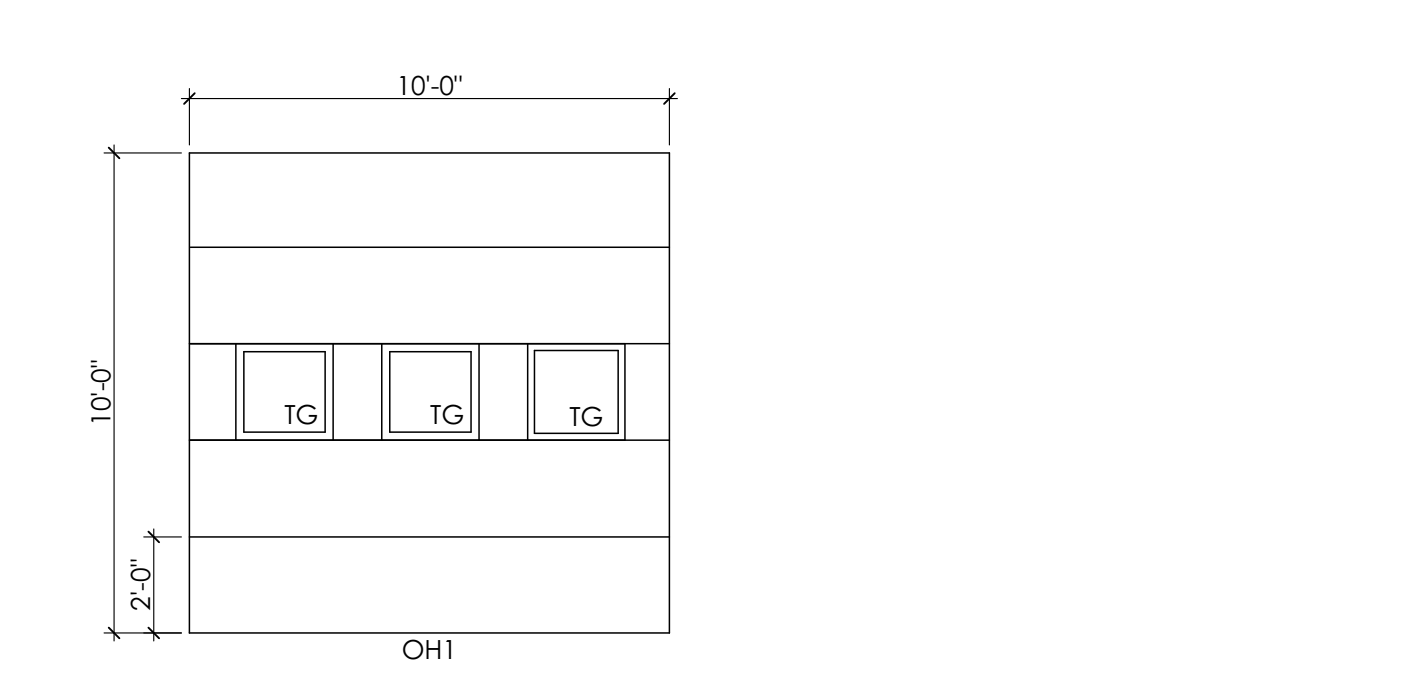


11 SECTIONAL DOOR | SPEC: 083613

SCALE: 1/4" = 1'-0"

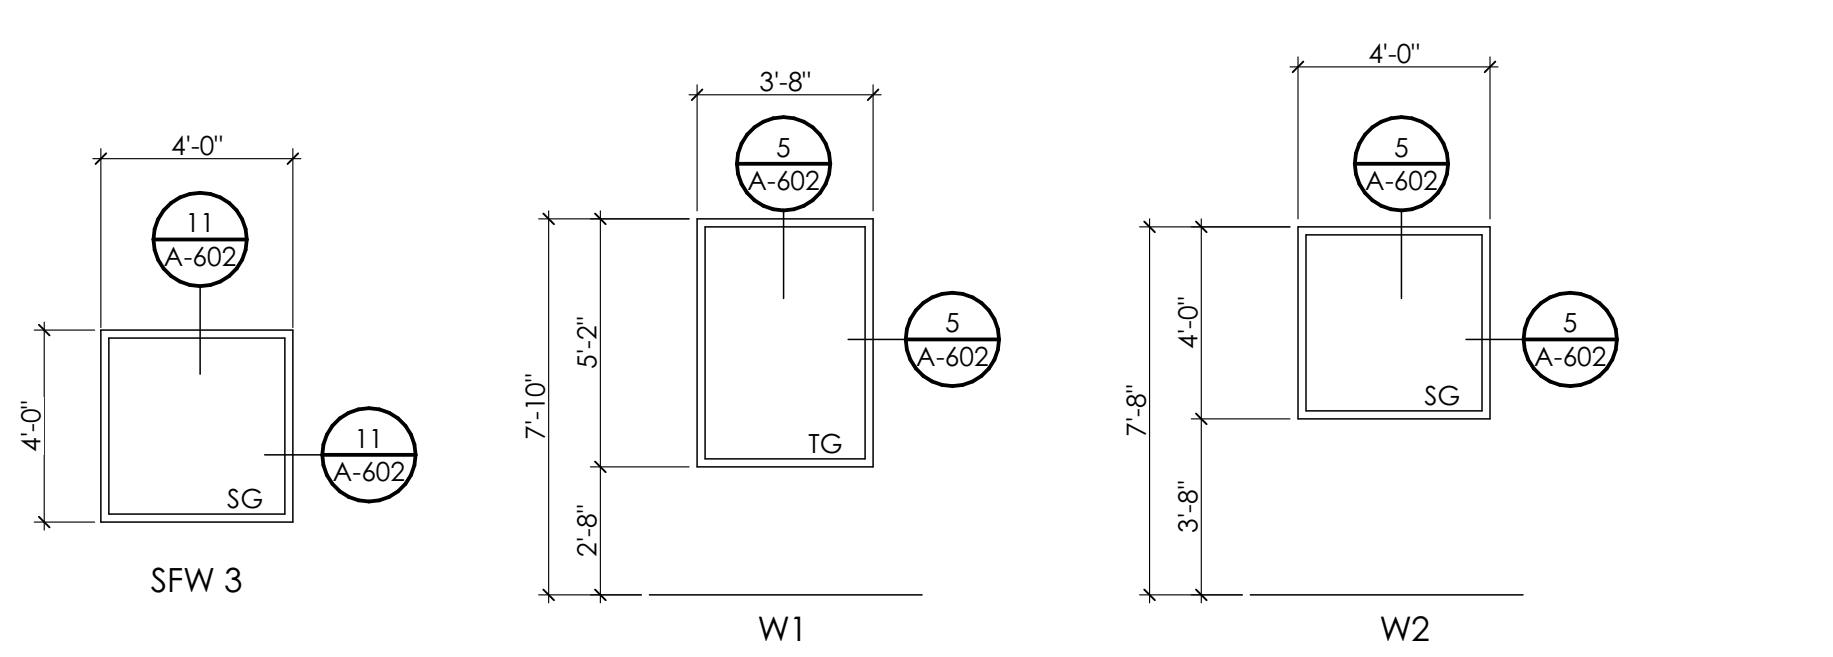


6 HM WINDOW TYPES | SPEC: 081113

SCALE: 1/4" = 1'-0"

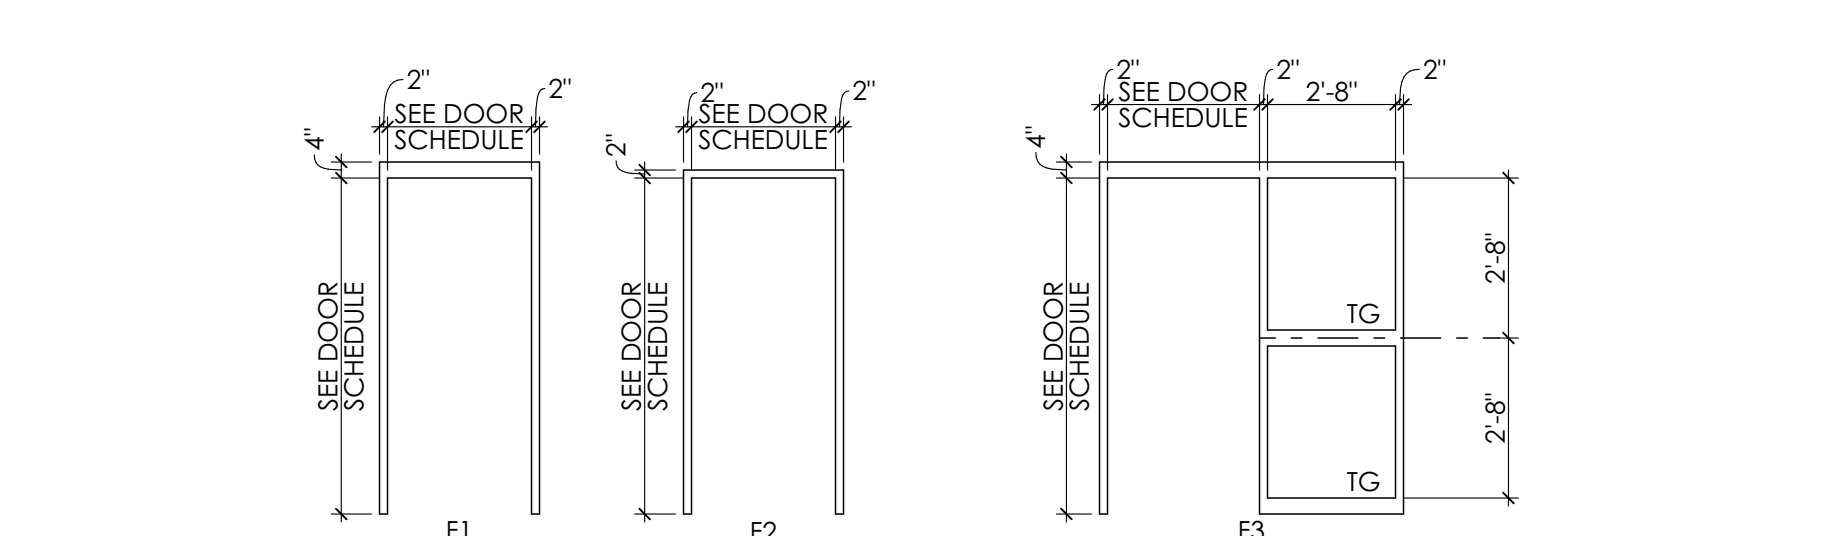


8 HM FRAME TYPE | SPEC: 081113

SCALE: 1/4" = 1'-0"

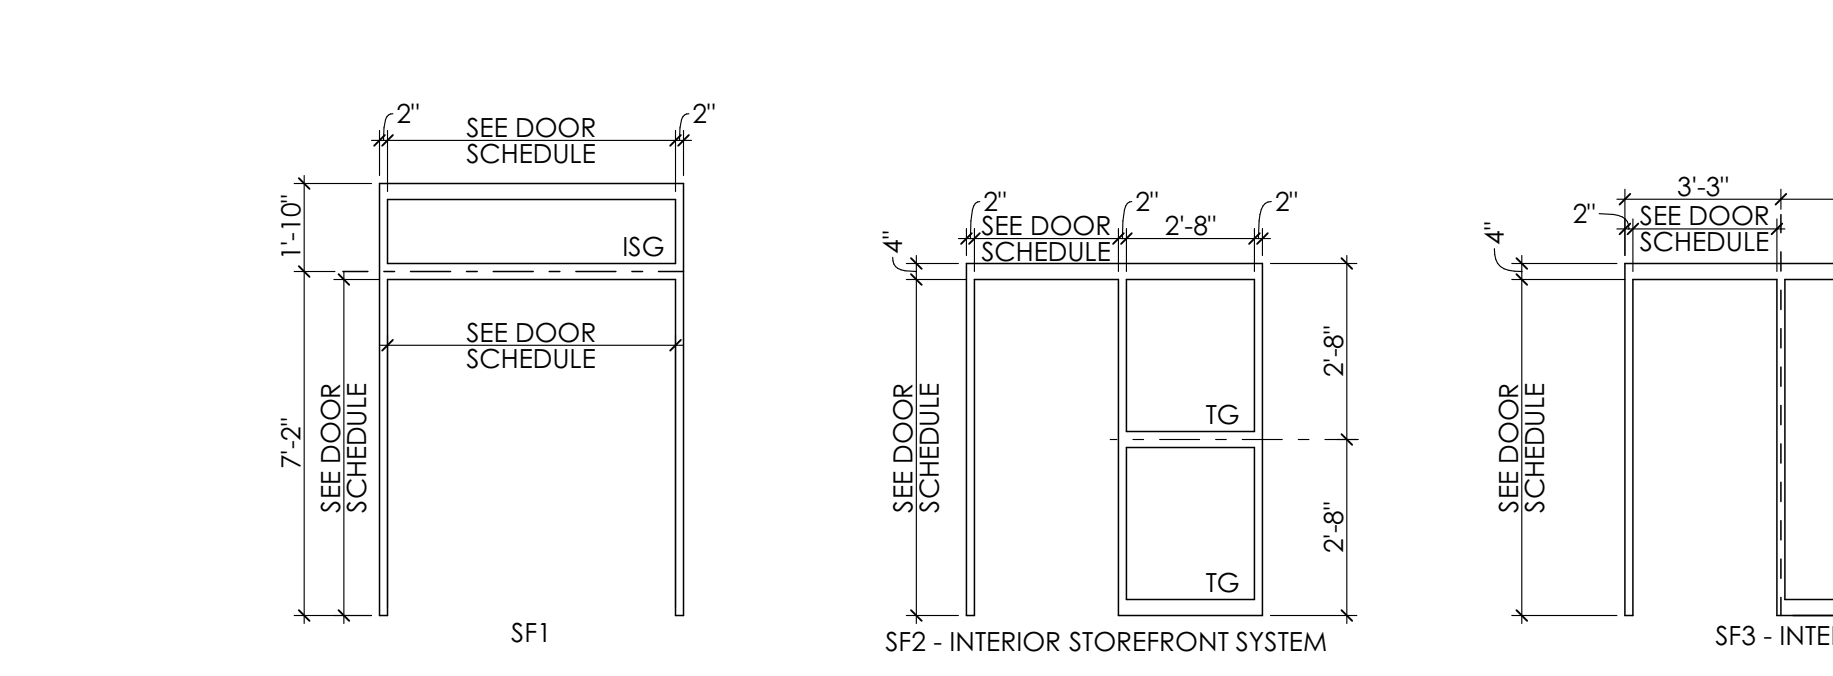

10 STOREFRONT FRAME TYPE | SPEC: 084113

SCALE: 1/4" = 1'-0"

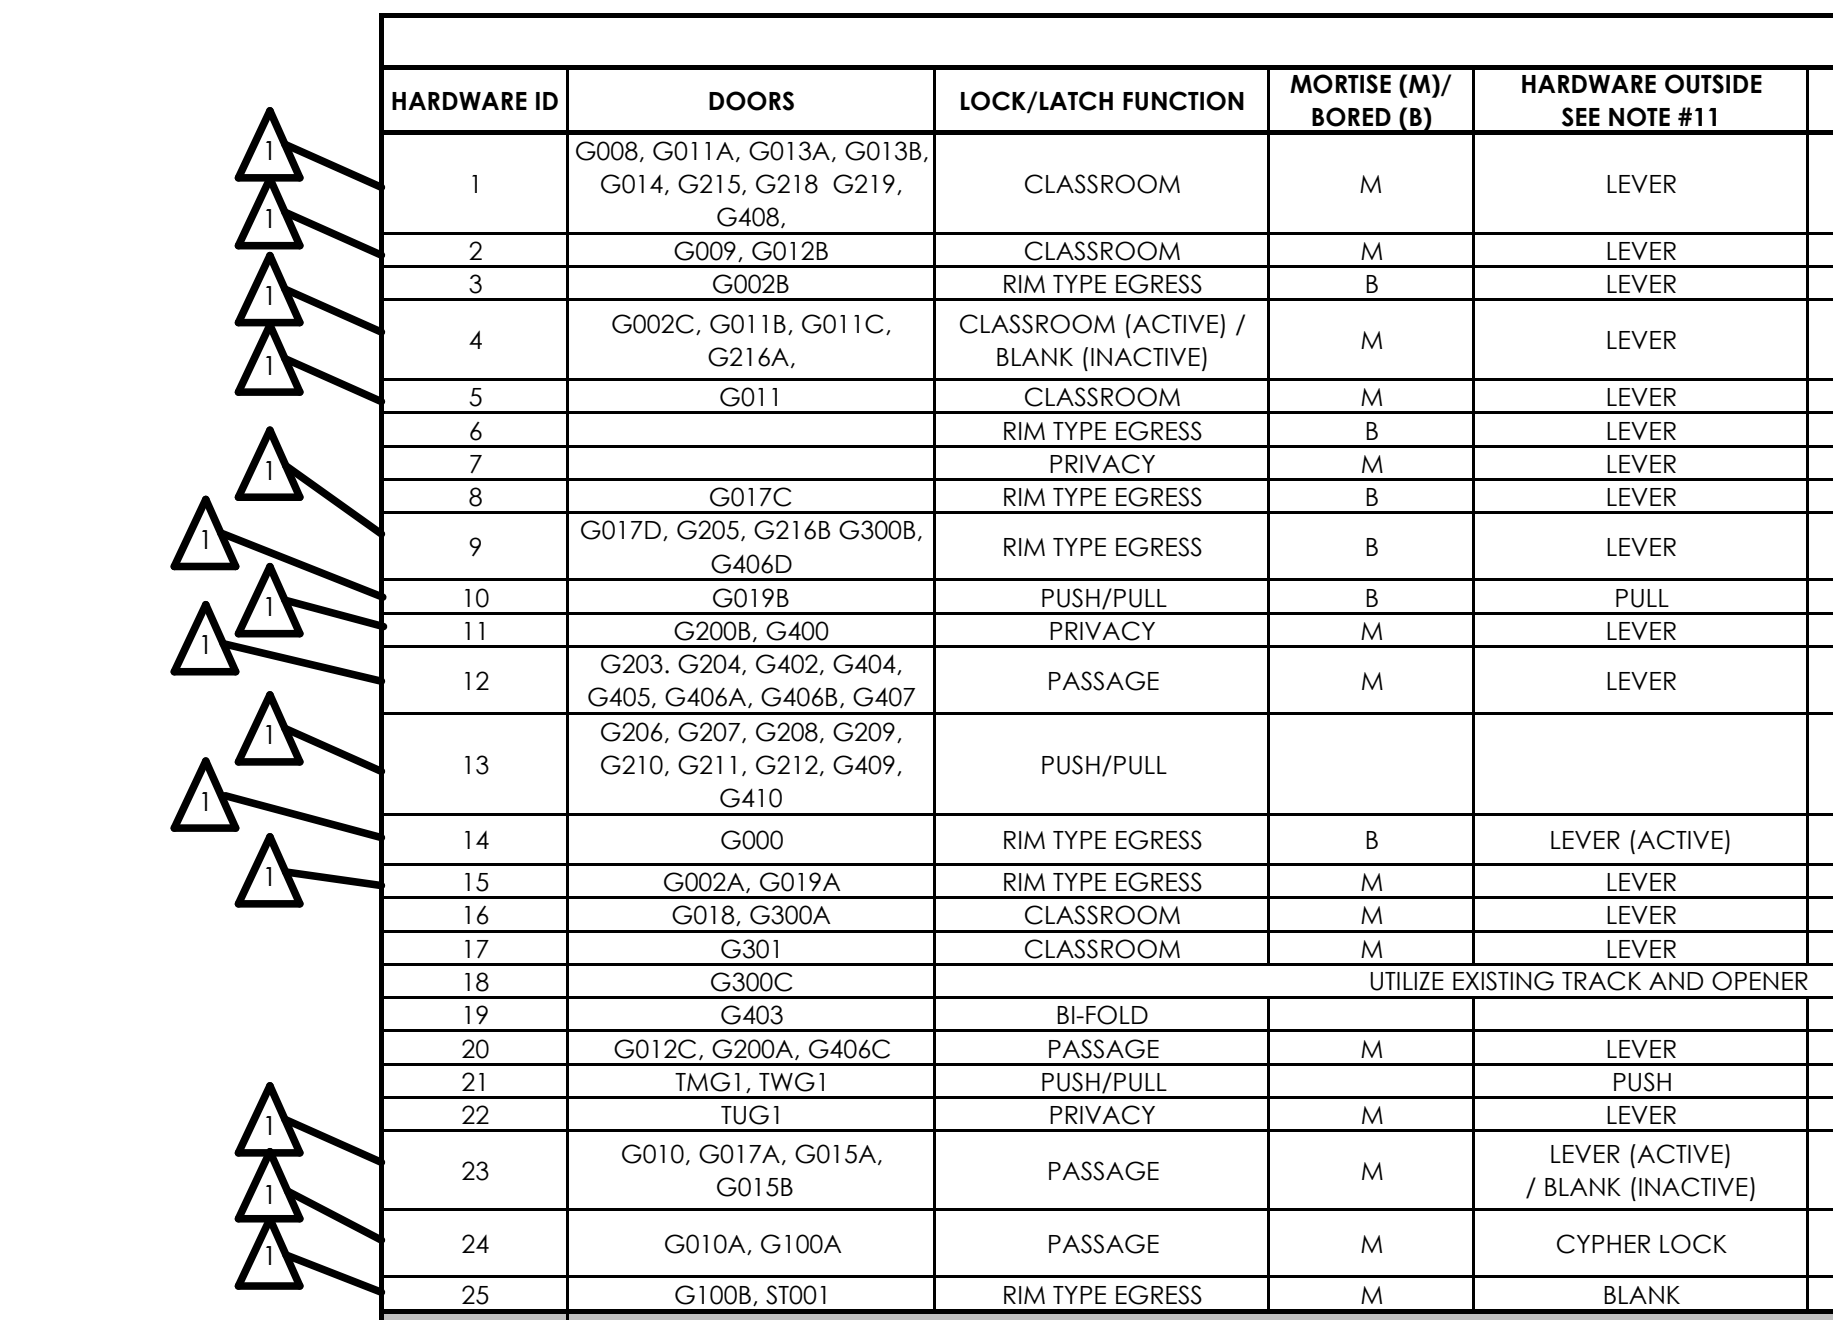

ID	ROOM NAME	PANEL				FRAME				HARDWARE		NOTES
		EL	MATL	W	H	THK	EL	MATL	HEAD	TAIL	SET NO	
G000	MECHANICAL ROOM	PA	HM	3'-0"	7'-0"	1 3/4"	F1	HM	A601/3	A601/3	14	CARD ACCESS
G002A	CORR.	PA	HM	3'-0"	7'-0"	1 3/4"	F1	HM	A601/3	A601/3	15	CARD ACCESS
G002B	CORR.	PA	SC/WD	[23'-0"	7'-0"	1 3/4"	F1	HM	A601/1	A601/1	3	90 MINS
G002C	CORR.	PA	SC/WD	[23'-0"	7'-0"	1 3/4"	F1	HM	A601/1	A601/1	4	90 MINS
G009	BREAK AREA	PA	SC/WD	3'-0"	7'-0"	1 3/4"	F2	HM	A601/2	A601/2	2	
G010	HALL	PA	SC/WD	[23'-0"	7'-0"	1 3/4"	F1	HM	A601/1	A601/1	23	CARD ACCESS
G010A	HALL	PA	SC/WD	3'-0"	7'-0"	1 3/4"	F1	HM	A601/1	A601/1	24	
G010	HALL	PA	SC/WD	2'-0"	7'-0"	1 3/4"	F1	HM	A601/1	A601/1	4	CARD ACCESS
G011	STORAGE W/ CAGES	PA	HM	[23'-0"	7'-0"	1 3/4"	F1	HM	A601/1	A601/1	5	CARD ACCESS
G011A	STORAGE W/ CAGES	PA	HM	3'-0"	7'-0"	1 3/4"	F1	HM	A601/3	A601/3	1	PROVIDE DEADBOLT
G011B	STORAGE W/ CAGES	PA	HM	3'-0"	7'-0"	1 3/4"	F1	HM	A601/3	A601/3	4	CARD ACCESS
G011C	STORAGE W/ CAGES	PA	HM	[23'-0"	7'-0"	1 3/4"	F1	HM	A601/3	A601/3	4	CARD ACCESS
G012B	LOBBY	PA	SC/WD	3'-0"	7'-0"	1 3/4"	F1	HM	A601/1	A601/1	2	CARD ACCESS
G012C	LOBBY	PA	SC/WD	3'-0"	7'-0"	2 3/4"	F2	HM	A601/3	A601/3	20	
G013A	SHARED LARGE MEETING ROOM	PA	SC/WD	3'-0"	7'-0"	1 3/4"	F3	HM	A601/9	A601/9	1	
G013B	SHARED LARGE MEETING ROOM	PA	SC/WD	3'-0"	7'-0"	1 3/4"	F3	HM	A601/9	A601/9	1	
G014	CHAIR/TABLE STOR. AV EQUIP	PA	SC/WD	3'-0"	7'-0"	1 3/4"	F2	HM	A601/2	A601/2	1	
G015A	FACILITIES STORAGE	PA	SC/WD	[23'-0"	7'-0"	1 3/4"	F1	HM	A601/1	A601/1	23	CARD ACCESS
G015B	FACILITIES STORAGE	PA	SC/WD	[23'-0"	7'-0"	1 3/4"	F1	HM	A601/3	A601/3	23	45MINS
G017A	CORR.	PA	SC/WD	[23'-0"	7'-0"	1 3/4"	F1	HM	A601/1	A601/1	23	45MINS
G017B	CORR.	PA	SC/WD	[23'-0"	7'-0"	1 3/4"	F1	HM	A601/3	A601/3	14	45MINS
G017C	CORR.	PA	SC/WD	3'-0"	7'-0"	1 3/4"	F1	HM	A601/1	A601/1	8	45MINS
G017D	CORR.	PA	HM	3'-0"	7'-0"	1 3/4"	F2	HM	A601/4	A601/4	9	CARD ACCESS REVERSE DOOR SWING IN EXISTING OPENING
G018	REC'G OFFICE	PA	HM	3'-0"	7'-0"	1 3/4"	F1	HM	A601/3	A601/3	16	CARD ACCESS
G019A	VEST.	SFA	AL/GL	[23'-0"	7'-0"	1 3/4"	SF1	AL/GL	A601/5	A601/5	10	CARD ACCESS
G019B	VEST.	SFA	AL/GL	[23'-0"	7'-0"	1 3/4"	SF1	AL/GL	A601/6	A601/6	15	CARD ACCESS
G100A	PROPOSED FED OFFICE SUITE	PA	SC/WD	3'-0"	7'-0"	1 3/4"	F3	HM	A601/1	A601/1	24	
G100B	PROPOSED FED OFFICE SUITE	PA	HM	3'-0"	7'-0"	1 3/4"	F2	HM	A601/1	A601/1	THI	25
G100C	PROPOSED FED OFFICE SUITE	PA	HM	3'-0"	7'-0"	1 3/4"	F2	HM	A601/1	A601/1	THI	25
G200A	REC'D.	PA	SC/WD	3'-0"	7'-0"	1 3/4"	F3	HM	A601/2	A601/2	20	CARD ACCESS
G200B	REC'D.	PA	SC/WD	3'-0"	7'-0"	1 3/4"	F3	HM	A601/2	A601/2	11	CARD ACCESS
G203	OFFICE	PA	SC/WD	3'-0"	7'-0"	1 3/4"	F3	HM	A601/2	A601/2	12	
G204	CONF. MEETINGS/ TRAINING ROOM	PA	SC/WD	3'-0"	7'-0"	1 3/4"	F2	HM	A601/4	A601/4	12	
G205	HALLWAY	PA	HM	3'-0"	7'-0"	1 3/4"	F2	HM	A601/1	A601/1	THI	9
G206	DIRECTOR	SFB	AL/GL	3'-0"	7'-0"	1 3/4"	SF3	AL/GL	A601/5	A601/5	13	
G207	OFFICE MGR.	SFB	AL/GL	3'-0"	7'-0"	1 3/4"	SF3	AL/GL	A601/5	A601/5	13	
G208	URBAN OFFICE	SFB	AL/GL	3'-0"	7'-0"	1 3/4"	SF3	AL/GL	A601/5	A601/5	13	
G209	WATERSHED	SFB	AL/GL	3'-0"	7'-0"	1 3/4"	SF3	AL/GL	A601/5	A601/5	13	
G210	OFFICE	SFB	AL/GL	3'-0"	7'-0"	1 3/4"	SF3	AL/GL	A601/5	A601/5	13	
G211	ED. & OUT REACH	SFB	AL/GL	3'-0"	7'-0"	1 3/4"	SF3	AL/GL	A601/5	A601/5	13	
G212	INSECT OFFICE	SFA	AL/GL	3'-0"	7'-0"	1 3/4"	SF2	AL/GL	A601/5	A601/5	13	
G213	CHEM. STOR.	PA	SC/WD	3'-0"	7'-0"	1 3/4"	F2	HM	A601/2	A601/2	1	
G214A	BULK STORAGE	PA	SC/WD	[23'-0"	7'-0"	1 3/4"	F1	HM	A601/3	A601/3	4	45MINS
G214B	BULK STORAGE	PA	SFB	3'-0"	7'-0"	1 3/4"	CW2	AL/GL	MANUF. STD.	THI	9	CARD ACCESS
G218	IT	M	SC/WD	3'-0"	7'-0"	1 3/4"	F2	HM	A601/2	A601/2	2	
G219	SECURED STORAGE	PA	SC/WD	3'-0"	7'-0"	1 3/4"	F2	HM	A601/2	A601/2	2	
G300A	FORENSICS GARAGE	PA	HM	[23'-0"	7'-0"	1 3/4"	F1	HM	A601/3	A601/3	16	45MINS
G300B	FORENSICS GARAGE	PA	HM	3'-0"	7'-0"	1 3/4"	F1	HM	A601/4	A601/4	THI	9
G300C	FORENSICS GARAGE	OH1	SL	12'-0"	14'-0"	2"	EXISTING				18	INSTALL DOOR ON EXISTING FRAME/TRACK, CARD READER
G301	FORENSICS STORAGE	PA	HM	3'-0"	7'-0"	1 3/4"	F1	HM	A601/1	A601/1	17	CARD ACCESS
G400	ADMIN	PA	SC/WD	3'-0"	7'-0"	1 3/4"	F3	HM	A601/9	A601/9	11	
G402	CONFERENCE RM.	PA	SC/WD	3'-0"	7'-0"	1 3/4"	F1	HM	A601/1	A601/1	12	
G403	BREAK AREA	PC	SC/WD	3'-0"	7'-0"	1 3/4"	F2	HM	A601/13	A601/13	19	
G404	ELEC. SHOP	PA	HM	3'-0"	7'-0"	1 3/4"	F1	HM	A601/3	A601/3	12	
G405	PLUMBING SHOP	PA	HM	3'-0"	7'-0"	1 3/4"	F1	HM	A601/3	A601/3	12	
G406A	CARPENTER SHOP	PA	HM	3'-0"	7'-0"	1 3/4"	F1	HM	A601/1	A601/1	12	
G406B	CARPENTER SHOP	PA	HM	3'-0"	7'-0"	1 3/4"	F1	HM	A601/3	A601/3	12	
G406C	CARPENTER SHOP	PA	HM	3'-0"	7'-0"	1 3/4"	F1	HM	A601/3	A601/3	20	CARD ACCESS
G406D	CARPENTER SHOP	PA	HM	[23'-0"	7'-0"	1 3/4"	F1	HM	A601/8	A601/8	THI	9
G407	HVAC SHOP	PA	HM	3'-0"	7'-0"	1 3/4"	F1	HM	A601/3	A601/3	12	
G408	STOR.	PA	SC/WD	3'-0"	7'-0"	1 3/4"	F2	HM	A601/2	A601/2	1	
G409	OFFICE	SF	AL/GL	3'-0"	7'-0"	1 3/4"	SF3	AL/GL	A601/5	A601/5	13	
G410	OFFICE	SF	AL/GL	3'-0"	7'-0"	1 3/4"	SF3	AL/GL	A601/5	A601/5	13	
1M0	1 MEN'S TOILET ROOM	PA	SC/WD	3'-0"	7'-0"	1 3/4"	F1	HM	A601/1	A601/1	THI	21
1W0	1 WOMAN'S TOILET ROOM	PA	SC/WD	3'-0"	7'-0"	1 3/4"	F1	HM	A601/1	A601/1	THI	21
TUG	1 LAV.	PA	HM	3'-0"	7'-0"	1 3/4"	F1	HM	A601/3	A601/3	THI	22
ST01	STAIRWELL	PA	HM	3'-0"	7'-0"	1 3/4"	F1	HM	A601/3	A601/3	THI	25

GENERAL DOOR NOTES



1. ALL HOLLOW METAL DOORS AND FRAMES IN EXTERIOR WALLS SHALL BE GALVANIZED AND INSULATED. REFER TO SPECIFICATIONS
2. ALL METAL THRESHOLDS SHALL BE SET IN A BED OF SEALANT.
3. PROVIDE CONTINUOUS SEALANT AT PERIMETER OF DOOR FRAMES, BOTH SIDES.
4. AT EXTERIOR WALLS ALL STEEL LINTELS SHALL BE GALVANIZED AND PAINTED.
5. UNLESS OTHERWISE NOTED ALL WOOD DOORS SHALL BE PREFINISHED. REFER TO SPECIFICATIONS. ALL HOLLOW METAL DOORS AND FRAMES TO BE PRIMED AND PAINTED.
6. UNLESS NOTED "R.O." (ROUGH OPENING), DIMENSIONS REPRESENT UNIT SIZES. SEE SCHEDULE FOR DOOR TYPES & HEIGHTS.
7. SEE SCHEDULE FOR GLASS TYPES

GLAZING TYPES | SPEC: 088000/088853


- IG - INSULATED GLAZING
- G - MONOLITHIC GLAZING
- TG - TEMPERED GLAZING
- SG - SECURITY GLAZING

DOOR HARDWARE SCHEDULE | SPEC: 087111


HARDWARE ID	DOORS	LOCK/LATCH FUNCTION	MORTISE (M)/ BORED (B)	HARDWARE OUTSIDE SEE NOTE #11	HARDWARE INSIDE SEE NOTE #11	HINGE	ELECTRIC LOCK & POWER TRANSFER	CONTACT POSITION SWITCH	CARD/KEY FOB READER	CLOSER / HOLD-OPEN	STOP/BUMPER	KEYED REMOVABLE MULLION	KICK PLATE	GASKET	FLOOR SWEEP	THRESHOLD	ACCESSORIES	NOTES
1	G008, G011A, G013A, G013B, G014, G215, G218, G219, G40B.	CLASSROOM	M	LEVER	LEVER	1.5 PAIR			YES	CLOSER	WALL STOP							
2	G009, G012B	CLASSROOM	M	LEVER	LEVER	1.5 PAIR	YES	YES	YES		WALL STOP							
3	G002B	RIM TYPE EGRESS	B	LEVER	PANIC BAR	1.5 PAIR				CLOSER	WALL STOP			YES				
4	G002C, G011B, G011C, G214A.	CLASSROOM (ACTIVE) / BLANK (INACTIVE)	M	LEVER	LEVER	1.5 PAIR	YES	YES	YES		WALL STOP							TOP/BOTTOM LATCH ON INACTIVE LEAF
5	G011	CLASSROOM	M	LEVER	LEVER	1.5 PAIR			YES					YES	YES	ALUM		
6	G012B	RIM TYPE EGRESS	B	LEVER	PANIC BAR	1.5 PAIR	YES	YES	YES									
7	G012C	PRIVACY	M	LEVER	LEVER	1.5 PAIR			YES									
8	G017D, G205, G214B, G300B, G406D	RIM TYPE EGRESS	B	LEVER	PANIC BAR	1.5 PAIR	YES	YES	YES					YES				
9	G017B	PUSH/PULL	B	PULL	PUSH	CONT.	YES	YES	YES	CLOSER				YES		ALUM	ASTRAGAL	
10	G203, G204, G402, G404, G405, G406A, G406B, G407	PRIVACY	M	LEVER	LEVER	1.5 PAIR	YES	YES	YES					YES				
12	G206, G207, G208, G209, G210, G211, G212, G409, G410	PASSAGE	M	LEVER	LEVER	1.5 PAIR			YES									
13	G000	PUSH/PULL																
14	G000	RIM TYPE EGRESS	B	LEVER (ACTIVE)	PANIC BAR	1.5 PAIR	YES	YES	YES			X		YES	YES	ALUM		TOP/BOTTOM LATCH ON INACTIVE SIDE
15	G002A, G019A	RIM TYPE EGRESS	M	LEVER	PANIC BAR	1.5 PAIR	YES	YES	YES			X		YES	YES	ALUM		
16	G018, G300A	CLASSROOM	M	LEVER	LEVER	1.5 PAIR	YES	YES	YES					YES				
17	G301	CLASSROOM	M	LEVER	LEVER	1.5 PAIR	YES	YES	YES									
18	G300C																	
19	G403	BI-FOLD																OVERHEAD DOOR MFG. STD STANDARD BI-FOLD
20	G012C, G004, G406C	PASSAGE	M	LEVER	LEVER	1.5 PAIR	YES	YES	YES									
21	1M0, 1W0, 1W1	PUSH/PULL	M	PUSH	PULL	1.5 PAIR												
22	G011	PRIVACY	M	LEVER	LEVER	1.5 PAIR												MARBLE
23	G010, G017A, G015A, G015B	PASSAGE	M	LEVER (ACTIVE) / BLANK (INACTIVE)	LEVER (ACTIVE) / BLANK (INACTIVE)	1.5 PAIR	YES	YES	YES	CLOSER (ACTIVE)		X		YES				TOP/BOT. LATCH ON INACTIVE SIDE
24	G010A, G100A	PASSAGE	M	CYPHER LOCK	LEVER	1.5 PAIR									SEE NOTE 10#	SEE NOTE 10#	SEE NOTE 10#	SEE NOTE 10#
25	G100B, ST01	RIM TYPE EGRESS	M															

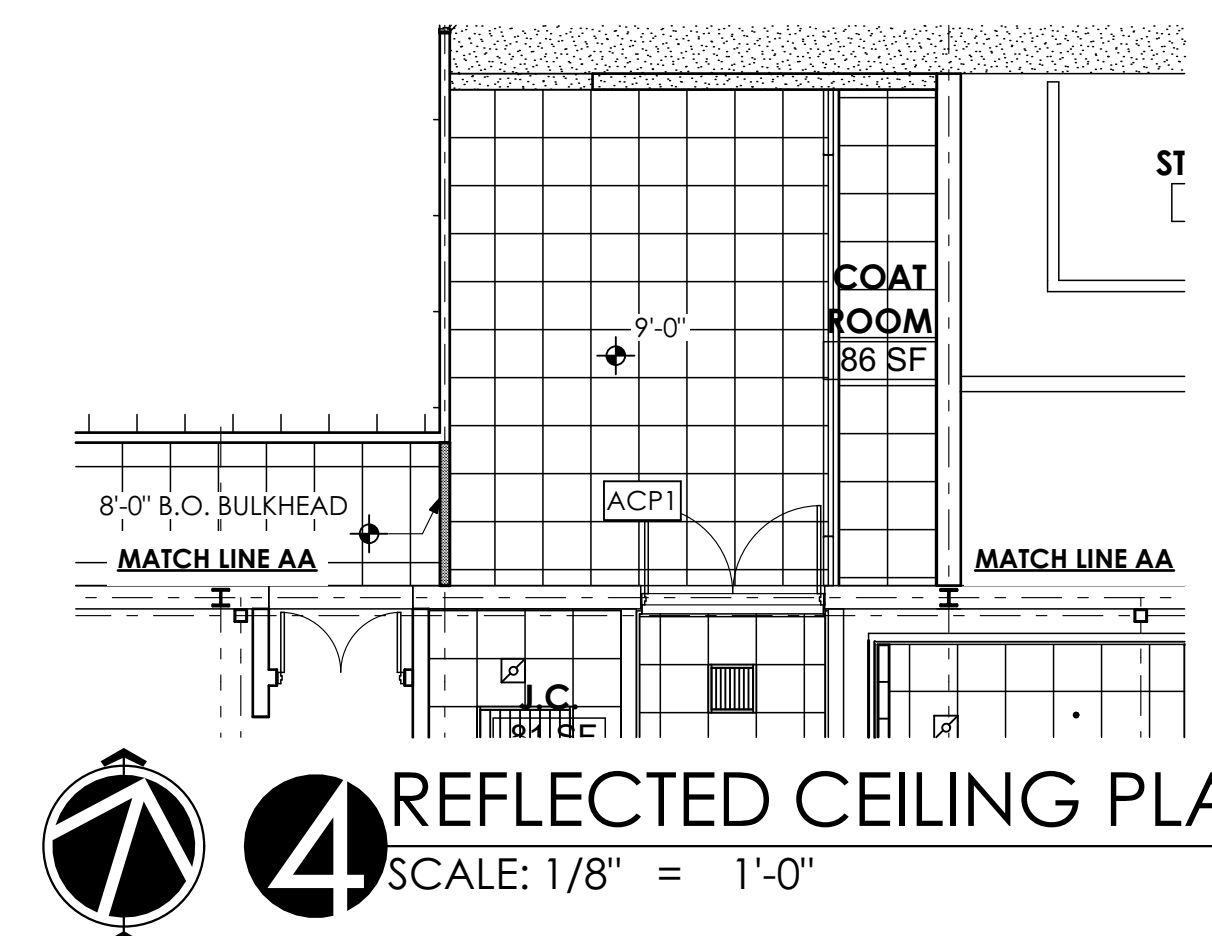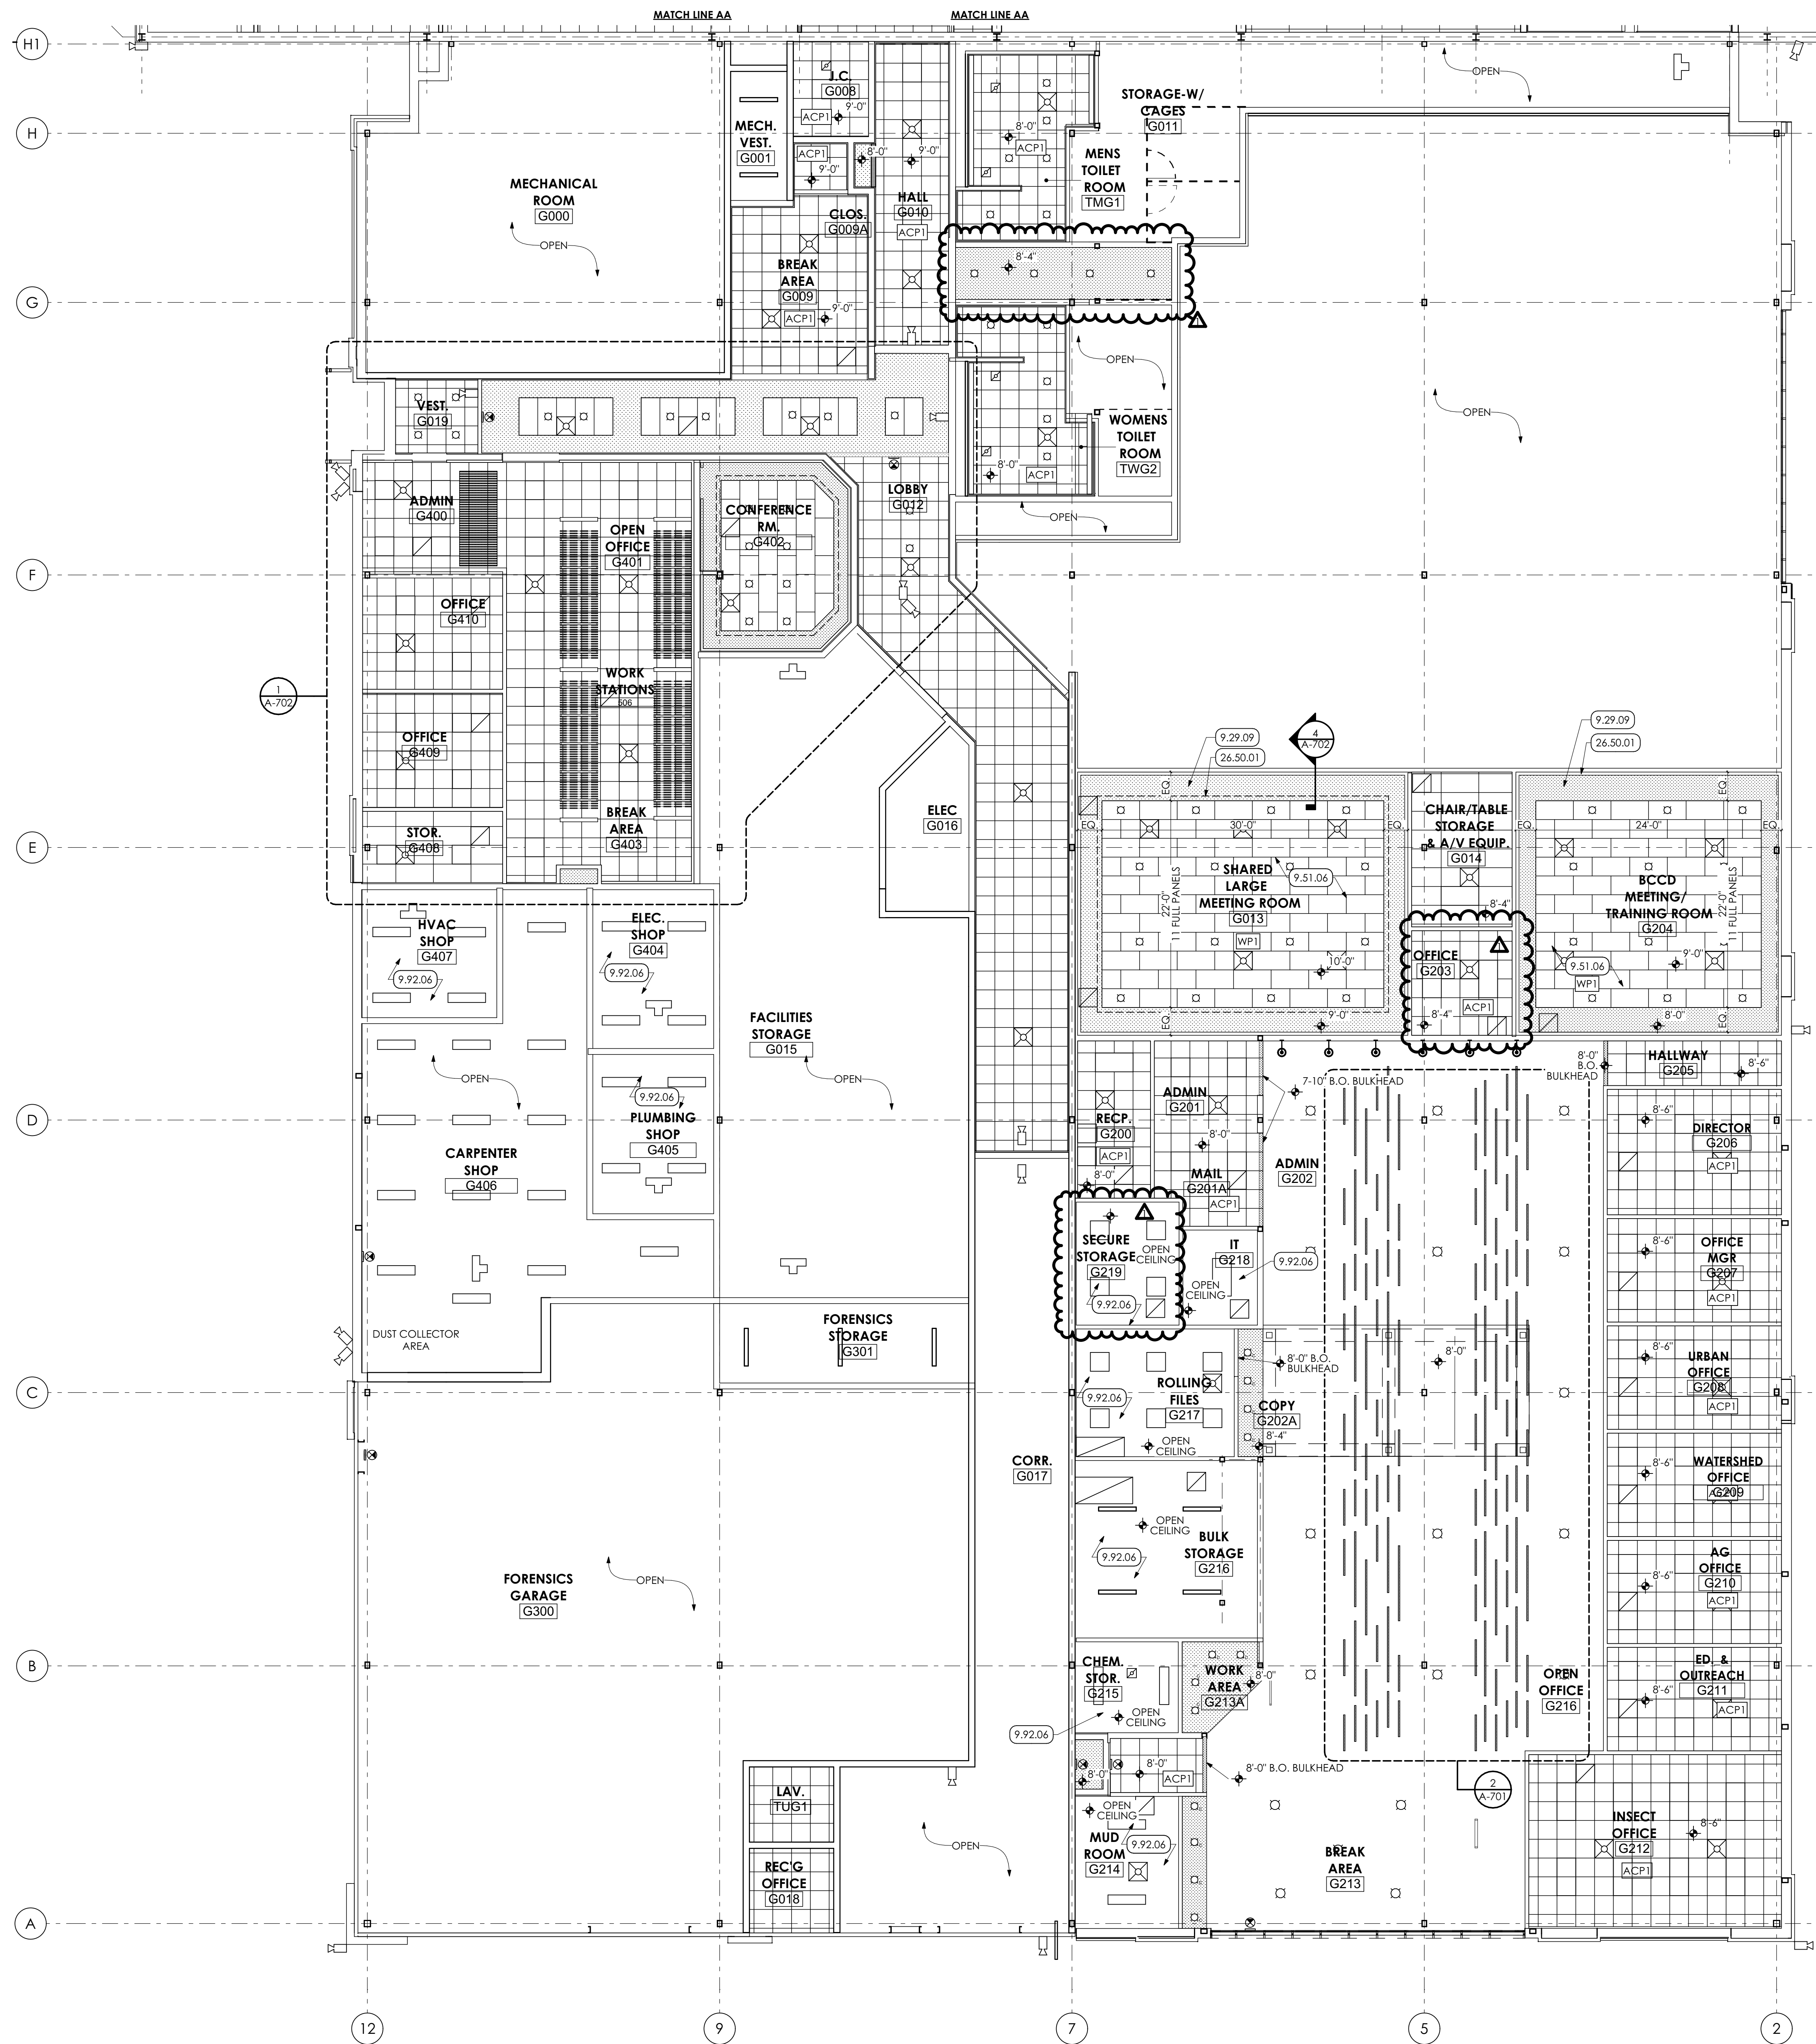

4 REFLECTED CEILING PLAN
SCALE: 1/8" = 1'-0"

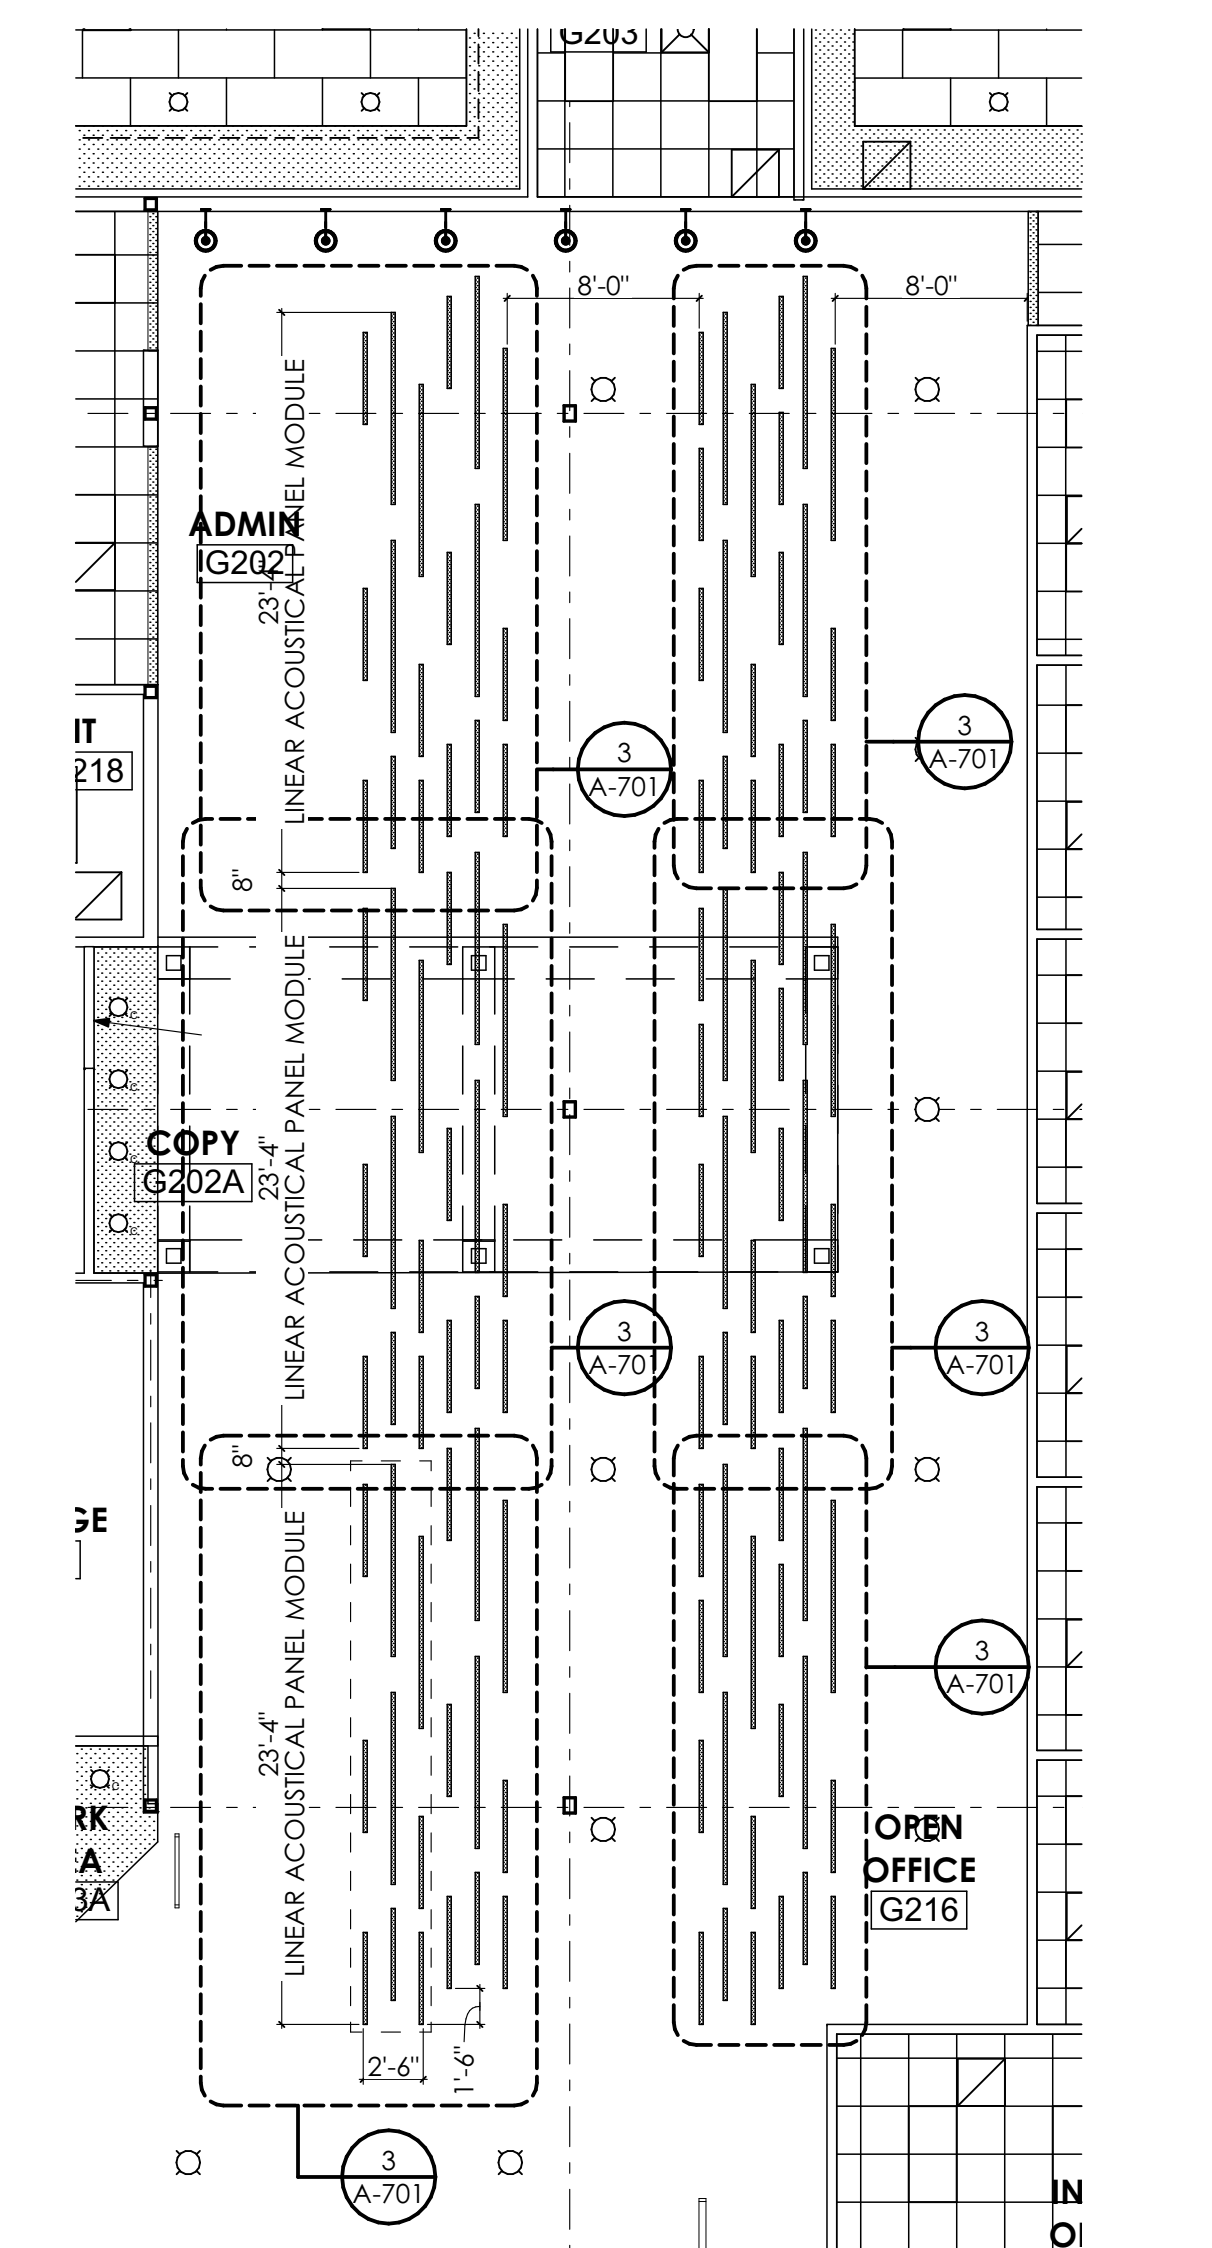

2 OPEN OFFICE REFLECTED CEILING PLAN
SCALE: 1/8" = 1'-0"

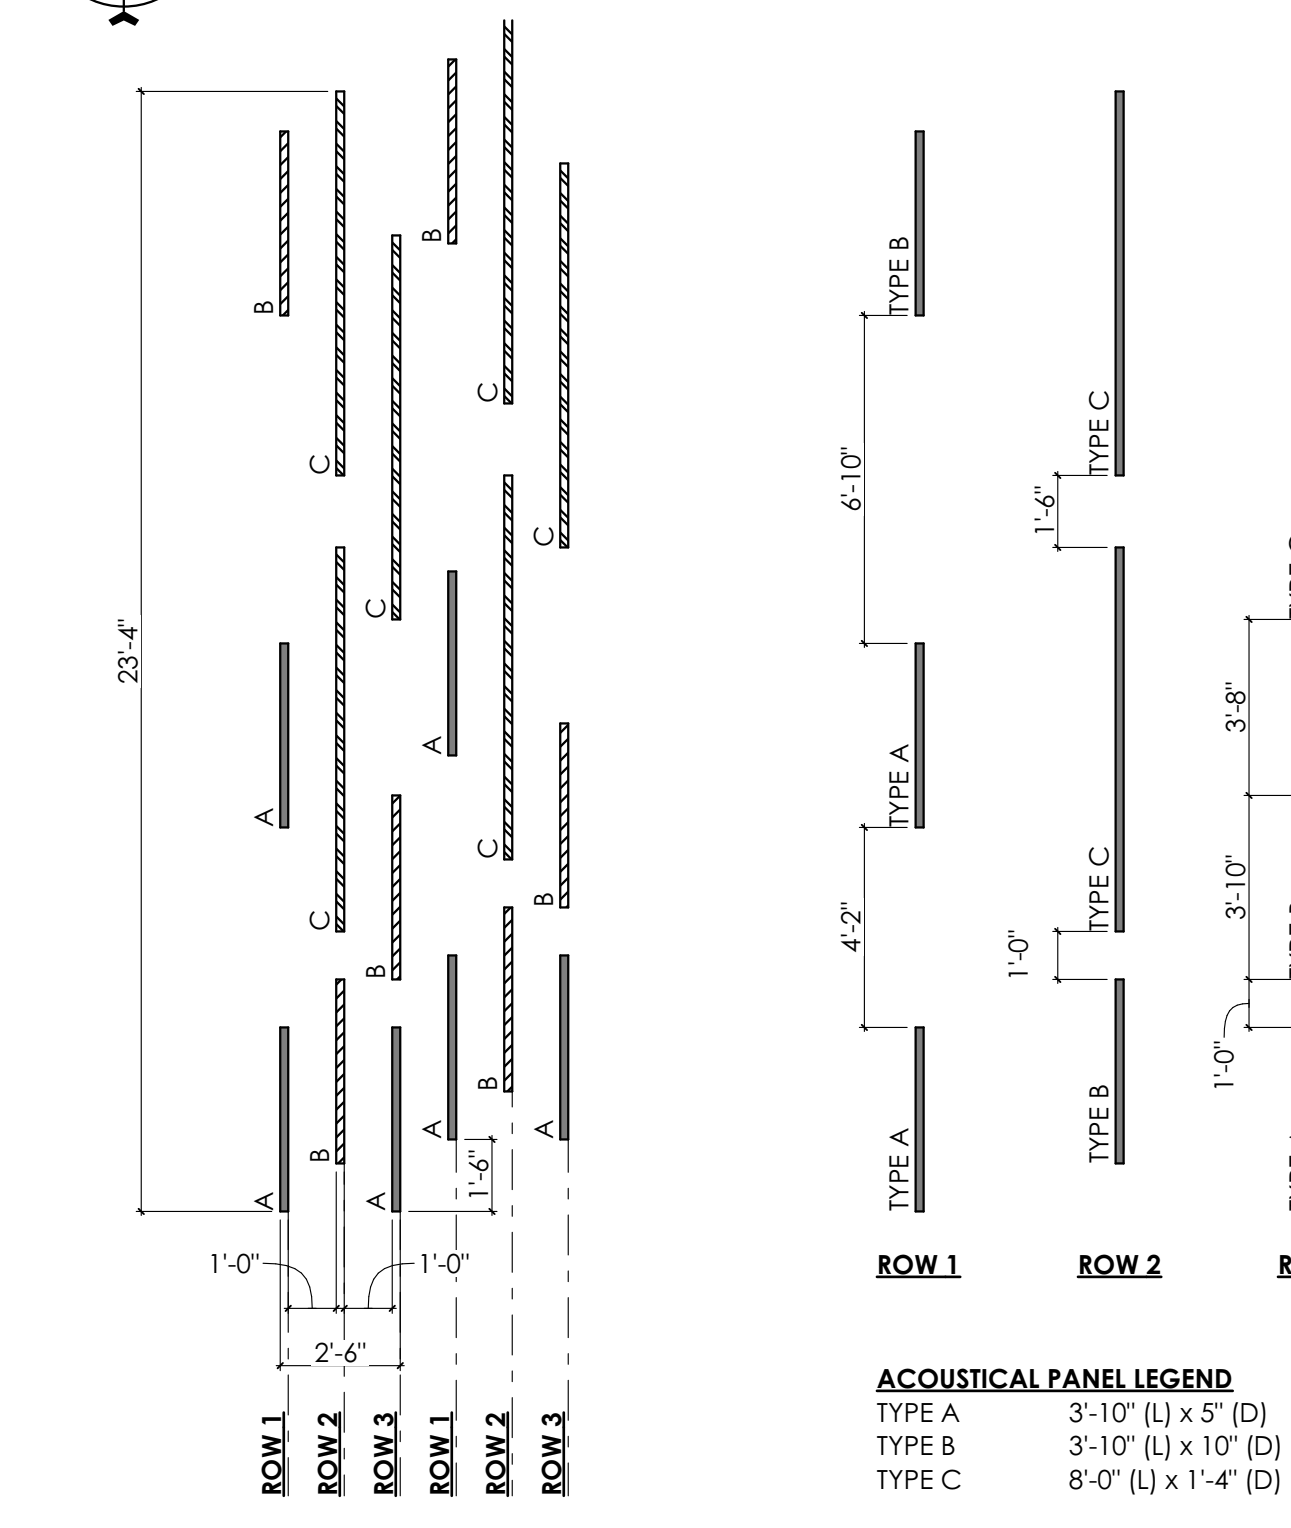

3 LINEAR ACOUSTICAL CEILING LAYOUT
SCALE: 1/4" = 1'-0"

- KEY NOTES**
- 01 GENERAL CONSTRUCTION**
1.50.02 GENERAL CONSTRUCTION NOTE
G.C. TO PROVIDE TWO (2) 8'-0" WIDE CHAIN LINK FENCE GATES WITH PADLOCK.
 - 09 FINISHES**
9.29.09 GYPSUM BOARD | SPEC 092900
9.29.09 5/8" GYPSUM BOARD SOFFIT, PAINTED
9.51 ACOUSTIC CEILINGS | SPEC 095100
9.51.02 ACP-1 24" x 48" ACOUSTICAL CEILING PANEL AND METAL SUSPENSION GRID SYSTEM.
9.51.03 ACP-2 24" x 24" ACOUSTICAL CEILING PANEL AND METAL SUSPENSION GRID SYSTEM.
9.51.05 WP-2 SUSPENDED WOOD SLAT CEILING.
9.51.06 WP-1 SUSPENDED WOOD PANEL CEILING.
9.92 INTERIOR PAINTING | SPEC 099123
9.92.06 PREP, PRIME, AND PAINT (TWO (2) COATS) UNDERSIDE OF CONCRETE PLANK MEZZANINE.
 - 26 ELECTRICAL | BY E.C.**
26 WORK DESCRIBED IN THESE KEYNOTES IS THE RESPONSIBILITY OF THE E.C. UNLESS NOTED OTHERWISE. COORDINATE WITH ELECTRICAL DRAWINGS.
26.50 LIGHTING
26.50.01 LINEAR SOFFIT COVE LIGHTING.
 - 32 EXTERIOR IMPROVEMENTS**
32.20 SITEWORK
32.20.01 EXCAVATE FOR CONSTRUCTION STAGING AREA. PROVIDE MINIMUM 8" OF AASHTO #2A STONE.
32.92 TURF AND GRASSES | SPEC 329200
32.92.05 AT THE COMPLETION OF THE WORK, REMOVE STONE AND BACKFILL WITH CLEAN FILL AND SEED ENTIRE AREA. BY G.C.

- REFLECTED CEILING PLAN GENERAL NOTES:**
1. UNLESS NOTED OTHERWISE, ALL DIMENSIONS ARE FROM FACE OF FINISH SURFACE.
 2. FIXTURES SHALL BE CENTERED WITHIN SOFFITS AND CEILING GRIDS UNLESS NOTED OTHERWISE.
 3. CEILING PANELS TO BE CENTERED IN ROOM UNLESS NOTED OR SHOWN OTHERWISE.
 4. SEE ELECTRICAL DRAWINGS FOR LIGHT TYPES AND SWITCHING.
 5. WHERE THERE IS A DISCREPANCY BETWEEN THE REFLECTED CEILING PLANS AND FIRE PROTECTION, MECHANICAL, FIRE ALARM, AND/OR LIGHTING PLANS THE ENGINEER'S DRAWINGS TAKE PRECEDENT. EXCEPT IF LIGHTING LAYOUTS ARE IMPACTED. IN THAT CASE CONSULT WITH THE ARCHITECT.

- REFLECTED CEILING PLAN LEGEND**
- 2x2 ACOUSTICAL PANEL
[ACP1] 9.51.03
 - 2x4 ACOUSTICAL PANEL
[ACP2] 9.51.02
 - REGULAR CEILING
[WP1] 9.51.06
 - WOODWORKS GRILLE
[WP2] 9.51.05
 - GYPSUM BOARD CEILING / SOFFIT
PREP AND PAINT (TWO (2) COATS)
 - SECURITY CAMERA LOCATION:
COORDINATE W/ ELECTRICAL DWGS.
 - DIFFUSER, REGISTERS, AND GRILLES.
- BY H.C. COORDINATE W/
MECHANICAL DRAWINGS
 - HEATERS. COORDINATE W/
MECHANICAL DRAWINGS


- ACOUSTICAL PANEL LEGEND**
- TYPE A 3'-10" (L) x 5' (D)
 - TYPE B 3'-10" (L) x 10' (D)
 - TYPE C 8'-0" (L) x 1'-4" (D)
 - COLOR 01
 - COLOR 02
 - COLOR 03



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	REVISION #1	8/18/23



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DRAWN BY: DK, SG, BB, JS
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SCALE: 1" = 1'-0"
BAR IS ONE (1) INCH LONG ON ORIGINAL DRAWING



REFLECTED CEILING PLAN

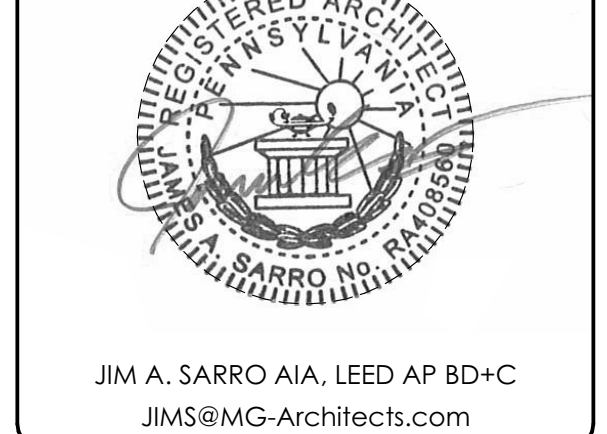A-701

1 REFLECTED CEILING PLAN
SCALE: 1/8" = 1'-0"

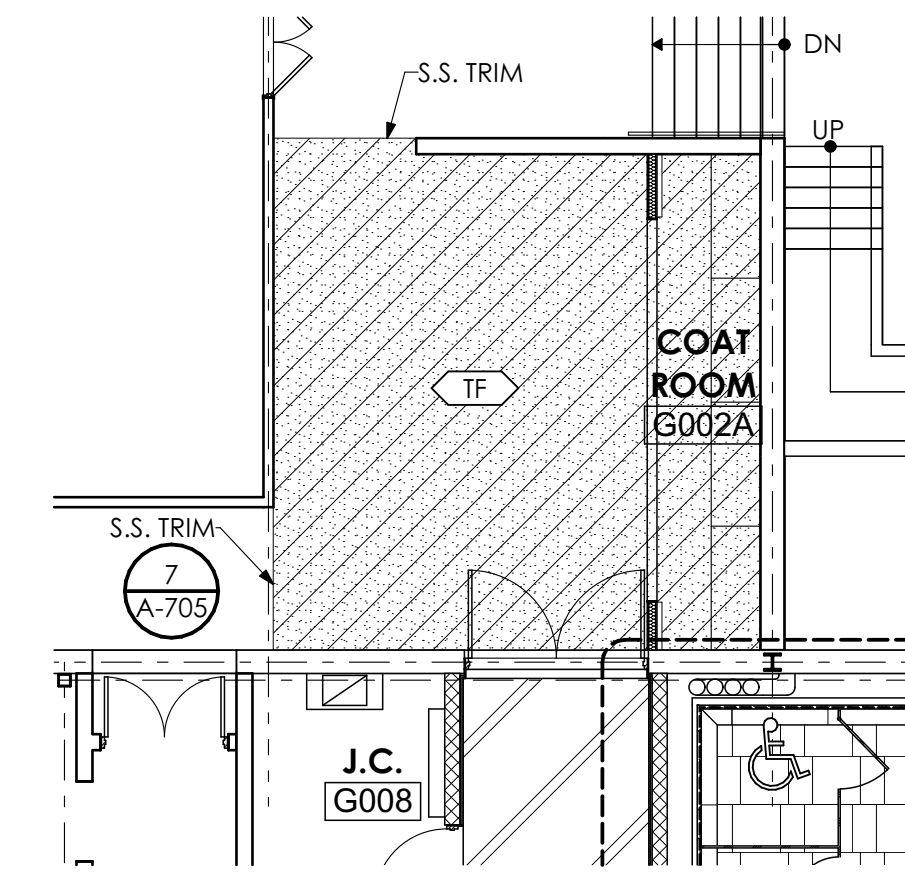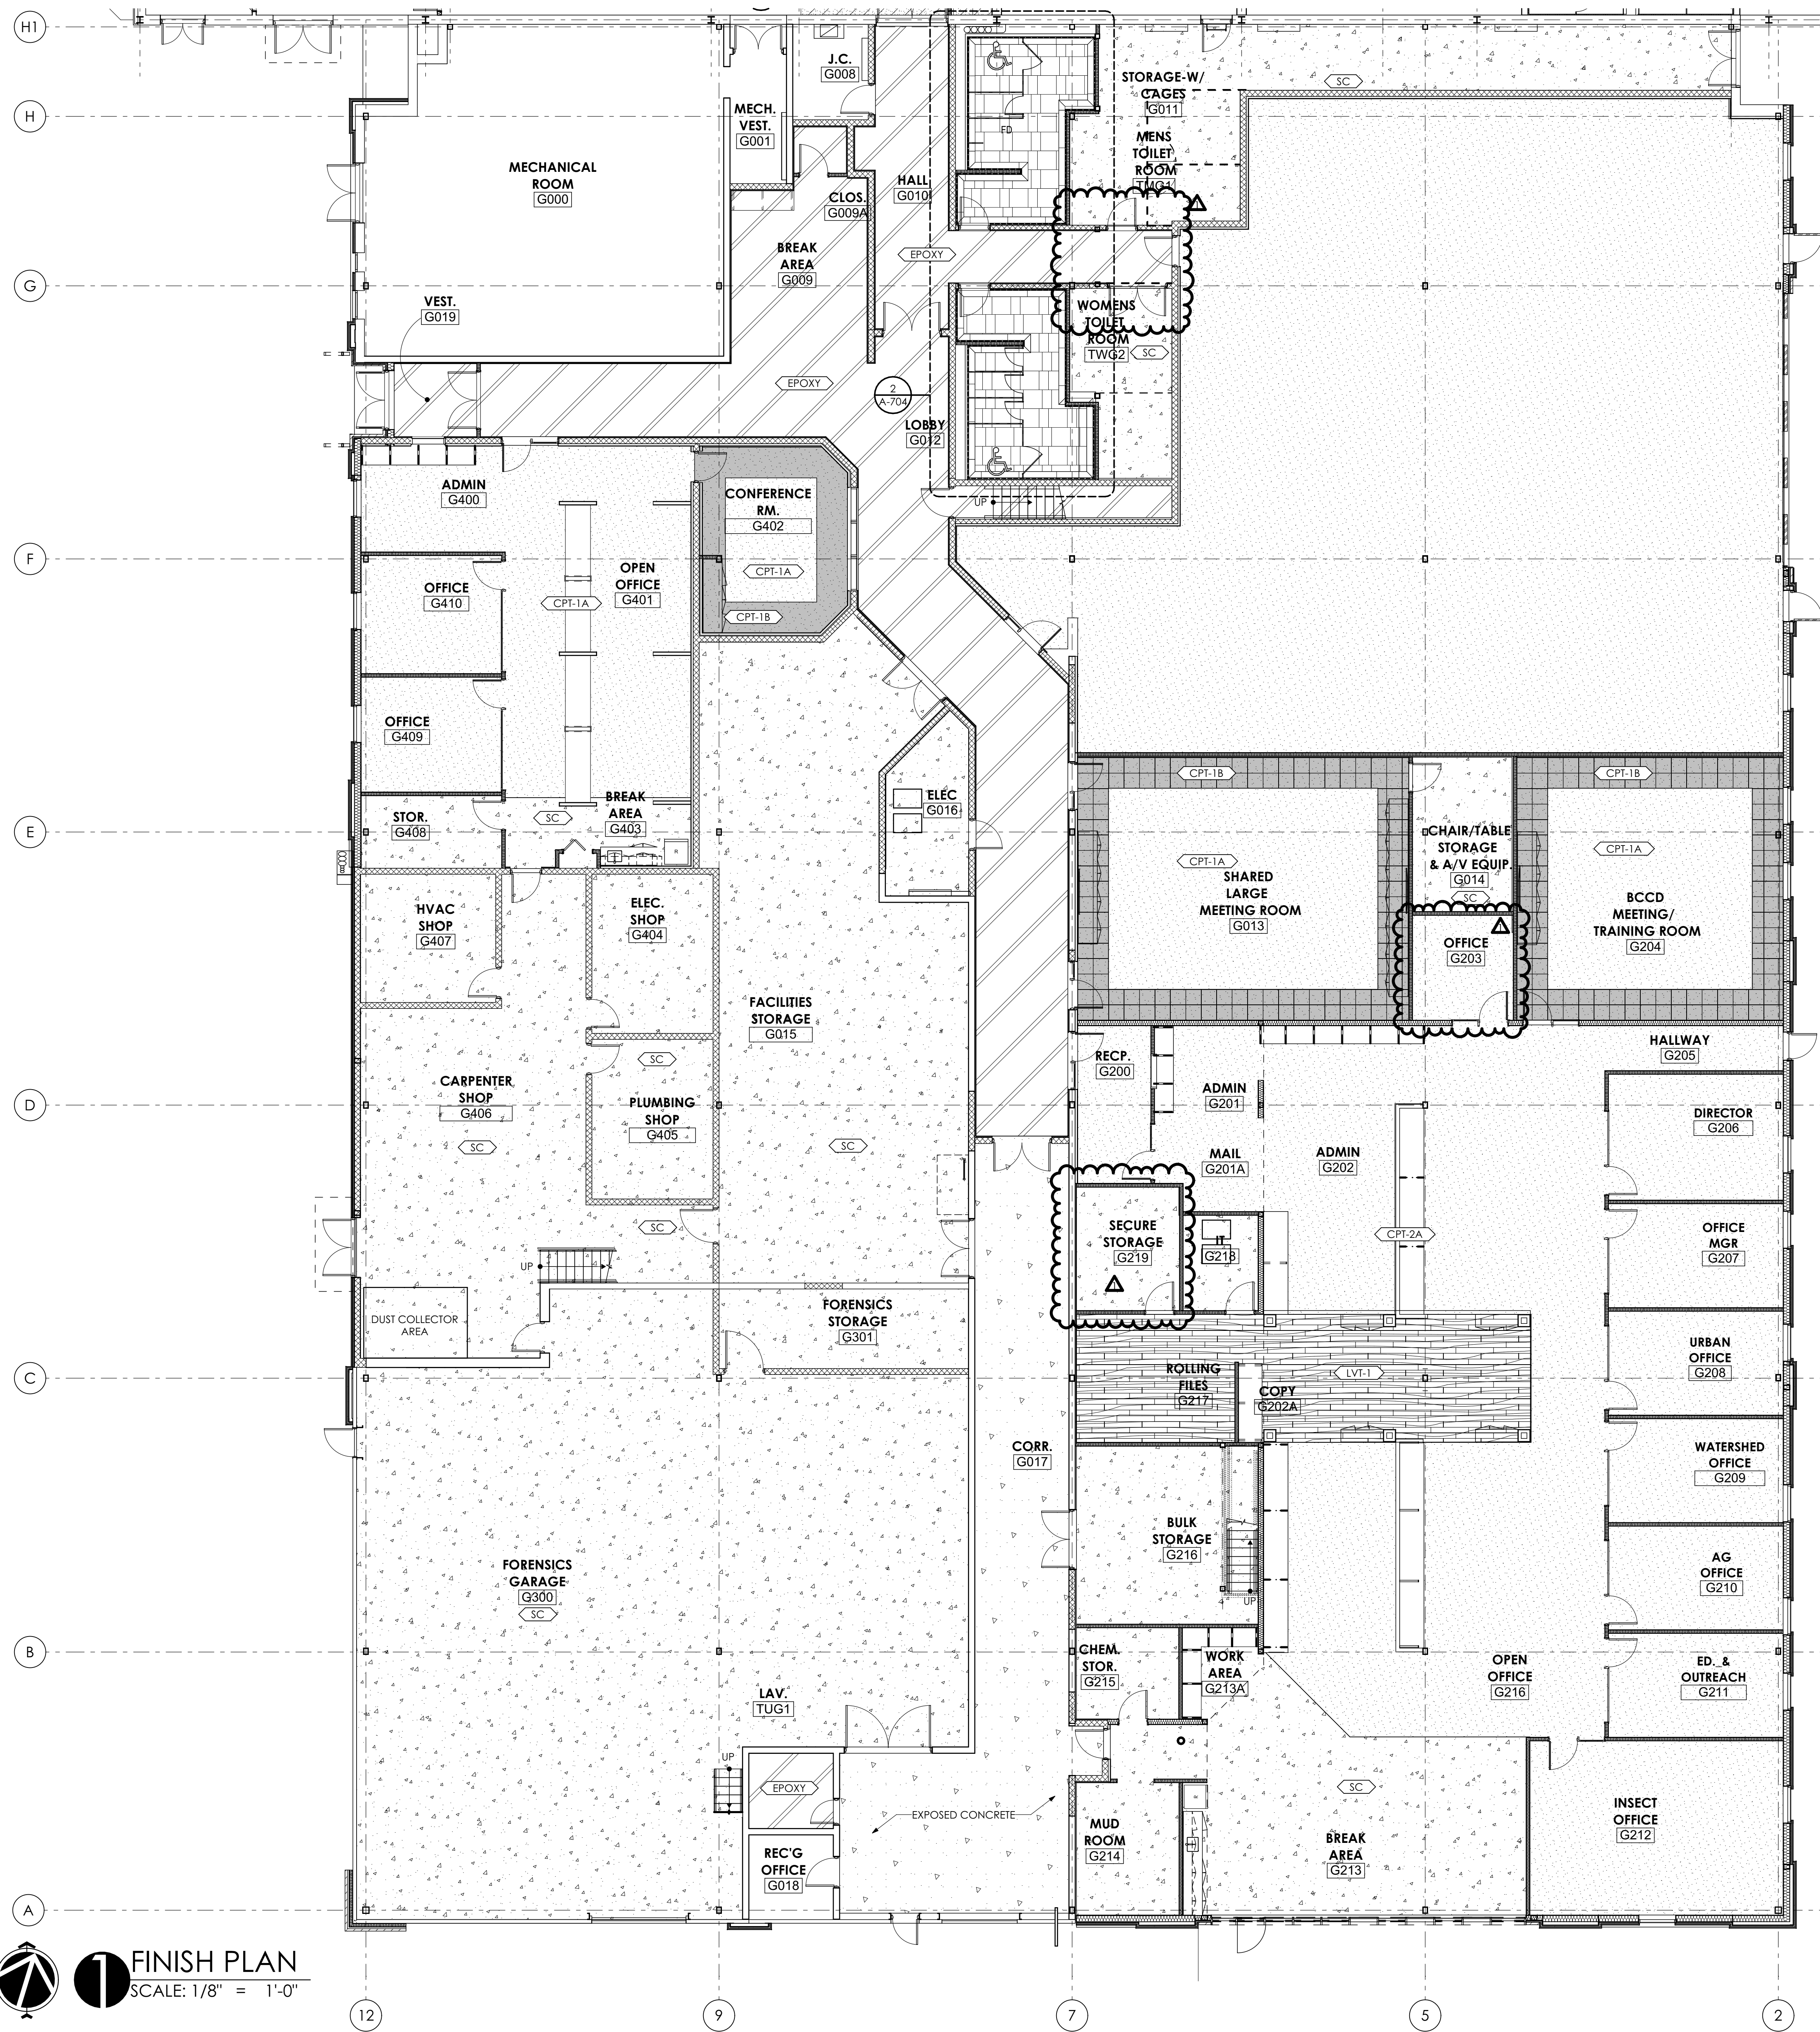

3 LOBBY FINISH PLAN
SCALE: 1/8" = 1'-0"

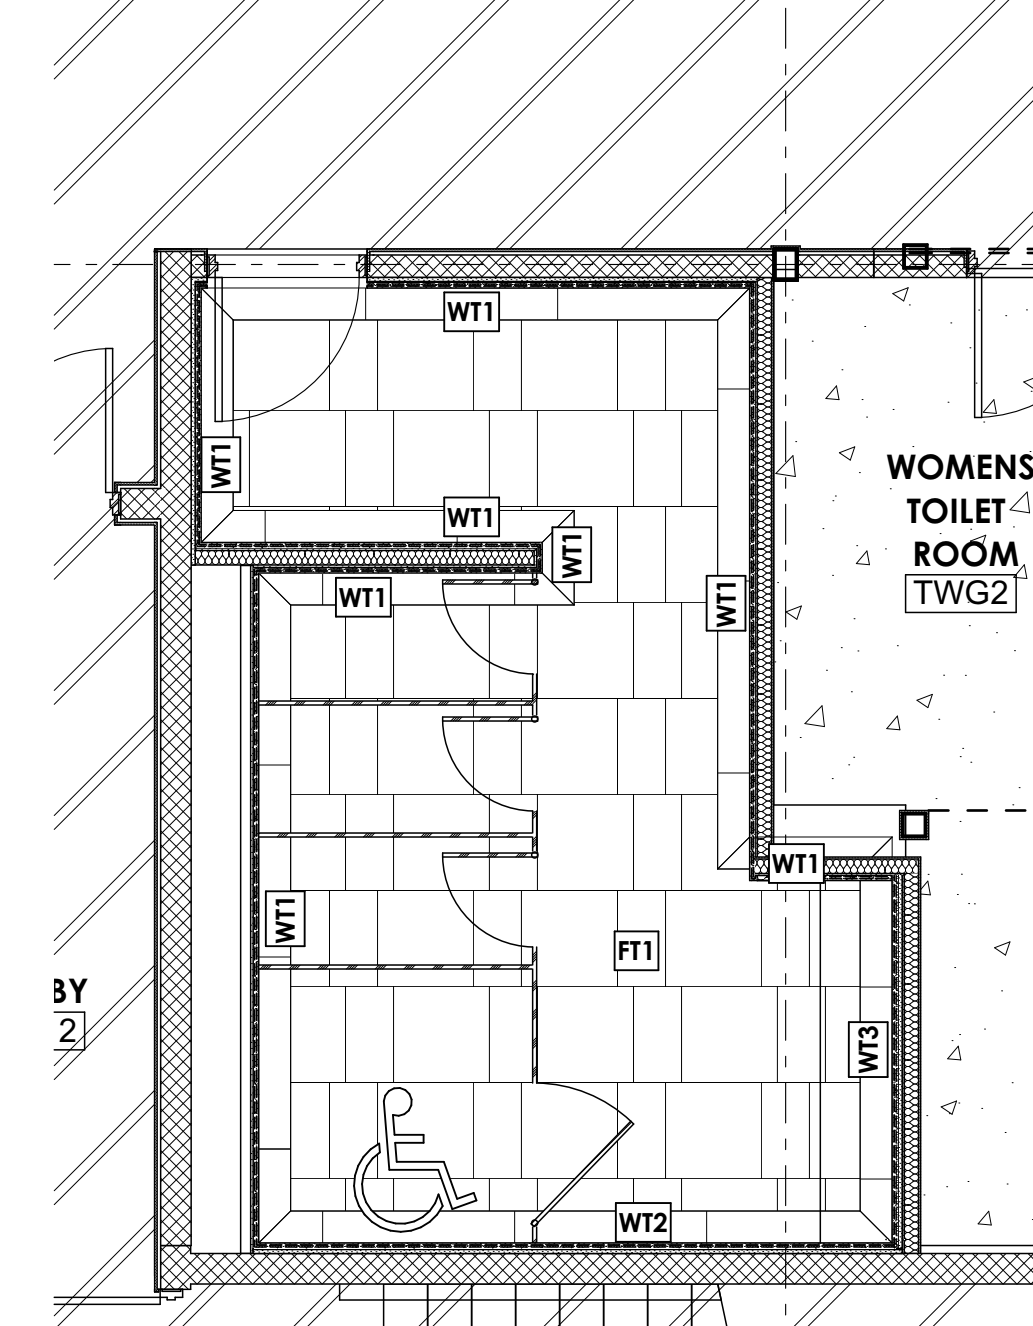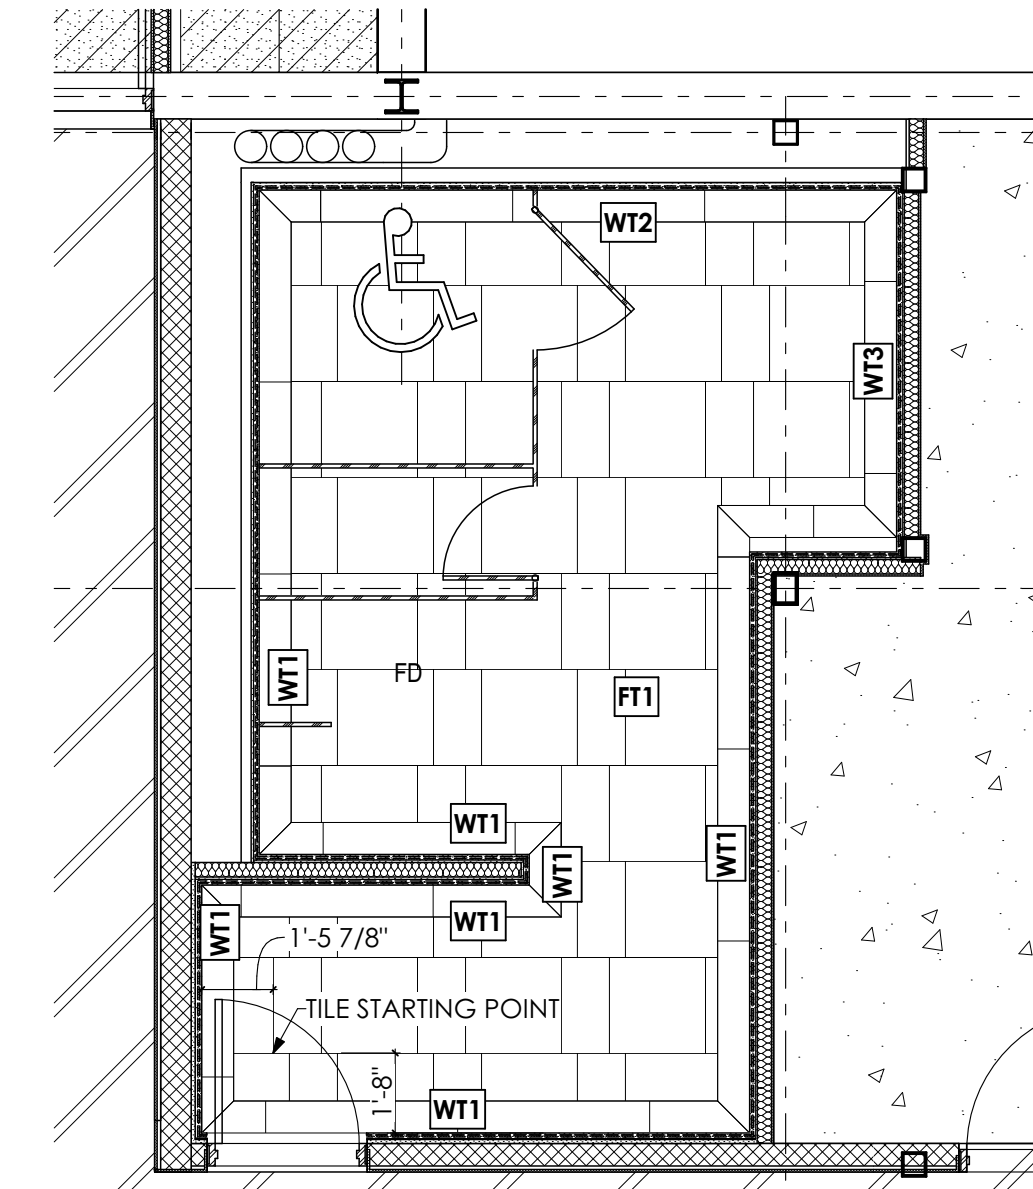

ENLARGED TOILET RM. FINISH PLAN
SCALE: 1/4" = 1'-0"

FINISH PLAN LEGEND

- CARPET
- CARPET ACCENT / BORDER
- EPOXY FLOOR FINISH
- SEAL CONCRETE
- LVT FLOORING
- TERRAZZO FLOORING
- WT1 WALL TILE PATTERN ID
- FT1 FLOOR TILE PATTERN ID

GENERAL SHEET NOTES

1. REFER TO SHEET A-705 FOR SCHEDULES AND DETAILS.

FINISH PLAN
SCALE: 1/8" = 1'-0"

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SHEET TITLE:
FINISH PLAN

A-704



KEYED DRAWING NOTES

- 1 UP TO ROOM CONTROLLER ON MEZZANINE LEVEL. REFER TO DRAWING E102 FOR CONTINUATION.
- 2 UP TO UL 424 EMERGENCY ROOM CONTROLLER ON MEZZANINE LEVEL. REFER TO DRAWING E102 FOR CONTINUATION.
- 3 CONNECT DOWNLIGHT DRIVER TO UL 424 EMERGENCY ROOM CONTROLLER.
- 4 MOUNT APPROXIMATELY 8'-6" A.F.F. TO BOTTOM OF LUMINAIRE.
- 5 MOUNT APPROXIMATELY 8'-0" A.F.F. TO CENTER OF LUMINAIRE.
- 6 CENTER LUMINAIRE VERTICALLY IN UPPERMOST WALL PANEL, APPROXIMATELY 11'-0" A.F.F.
- 7 CENTER LUMINAIRE APPROXIMATELY 11'-0" A.F.F.
- 8 EXTEND 344V, 2W, 0/NO GND. TO NORMALLY ENERGIZED BUS OF EXISTING PANEL. NET, PROVIDE NEW 20 AMP, SINGLE POLE CIRCUIT BREAKER.
- 9 LOW VOLTAGE SWITCH FOR MANUAL CONTROL OF MEZZANINE LIGHTING.
- 10 CONNECT TO UNSWITCHED LEG OF EXISTING BRANCH CIRCUIT SERVING LIGHTING REMOVED FROM THIS AREA.
- 11 EXISTING LUMINAIRE RELOCATED AND USED AS TEMPORARY LIGHTING FOR THE FUTURE FEDERAL SUITE.



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ISSUED FOR REVIEW	3/22/23


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SCALE: 1/8" = 1'-0"
0 1 2 3 4 5 6 7 8 9 10
BAR & ONE (1) INCH LONG ON ORIGINAL DRAWINGS

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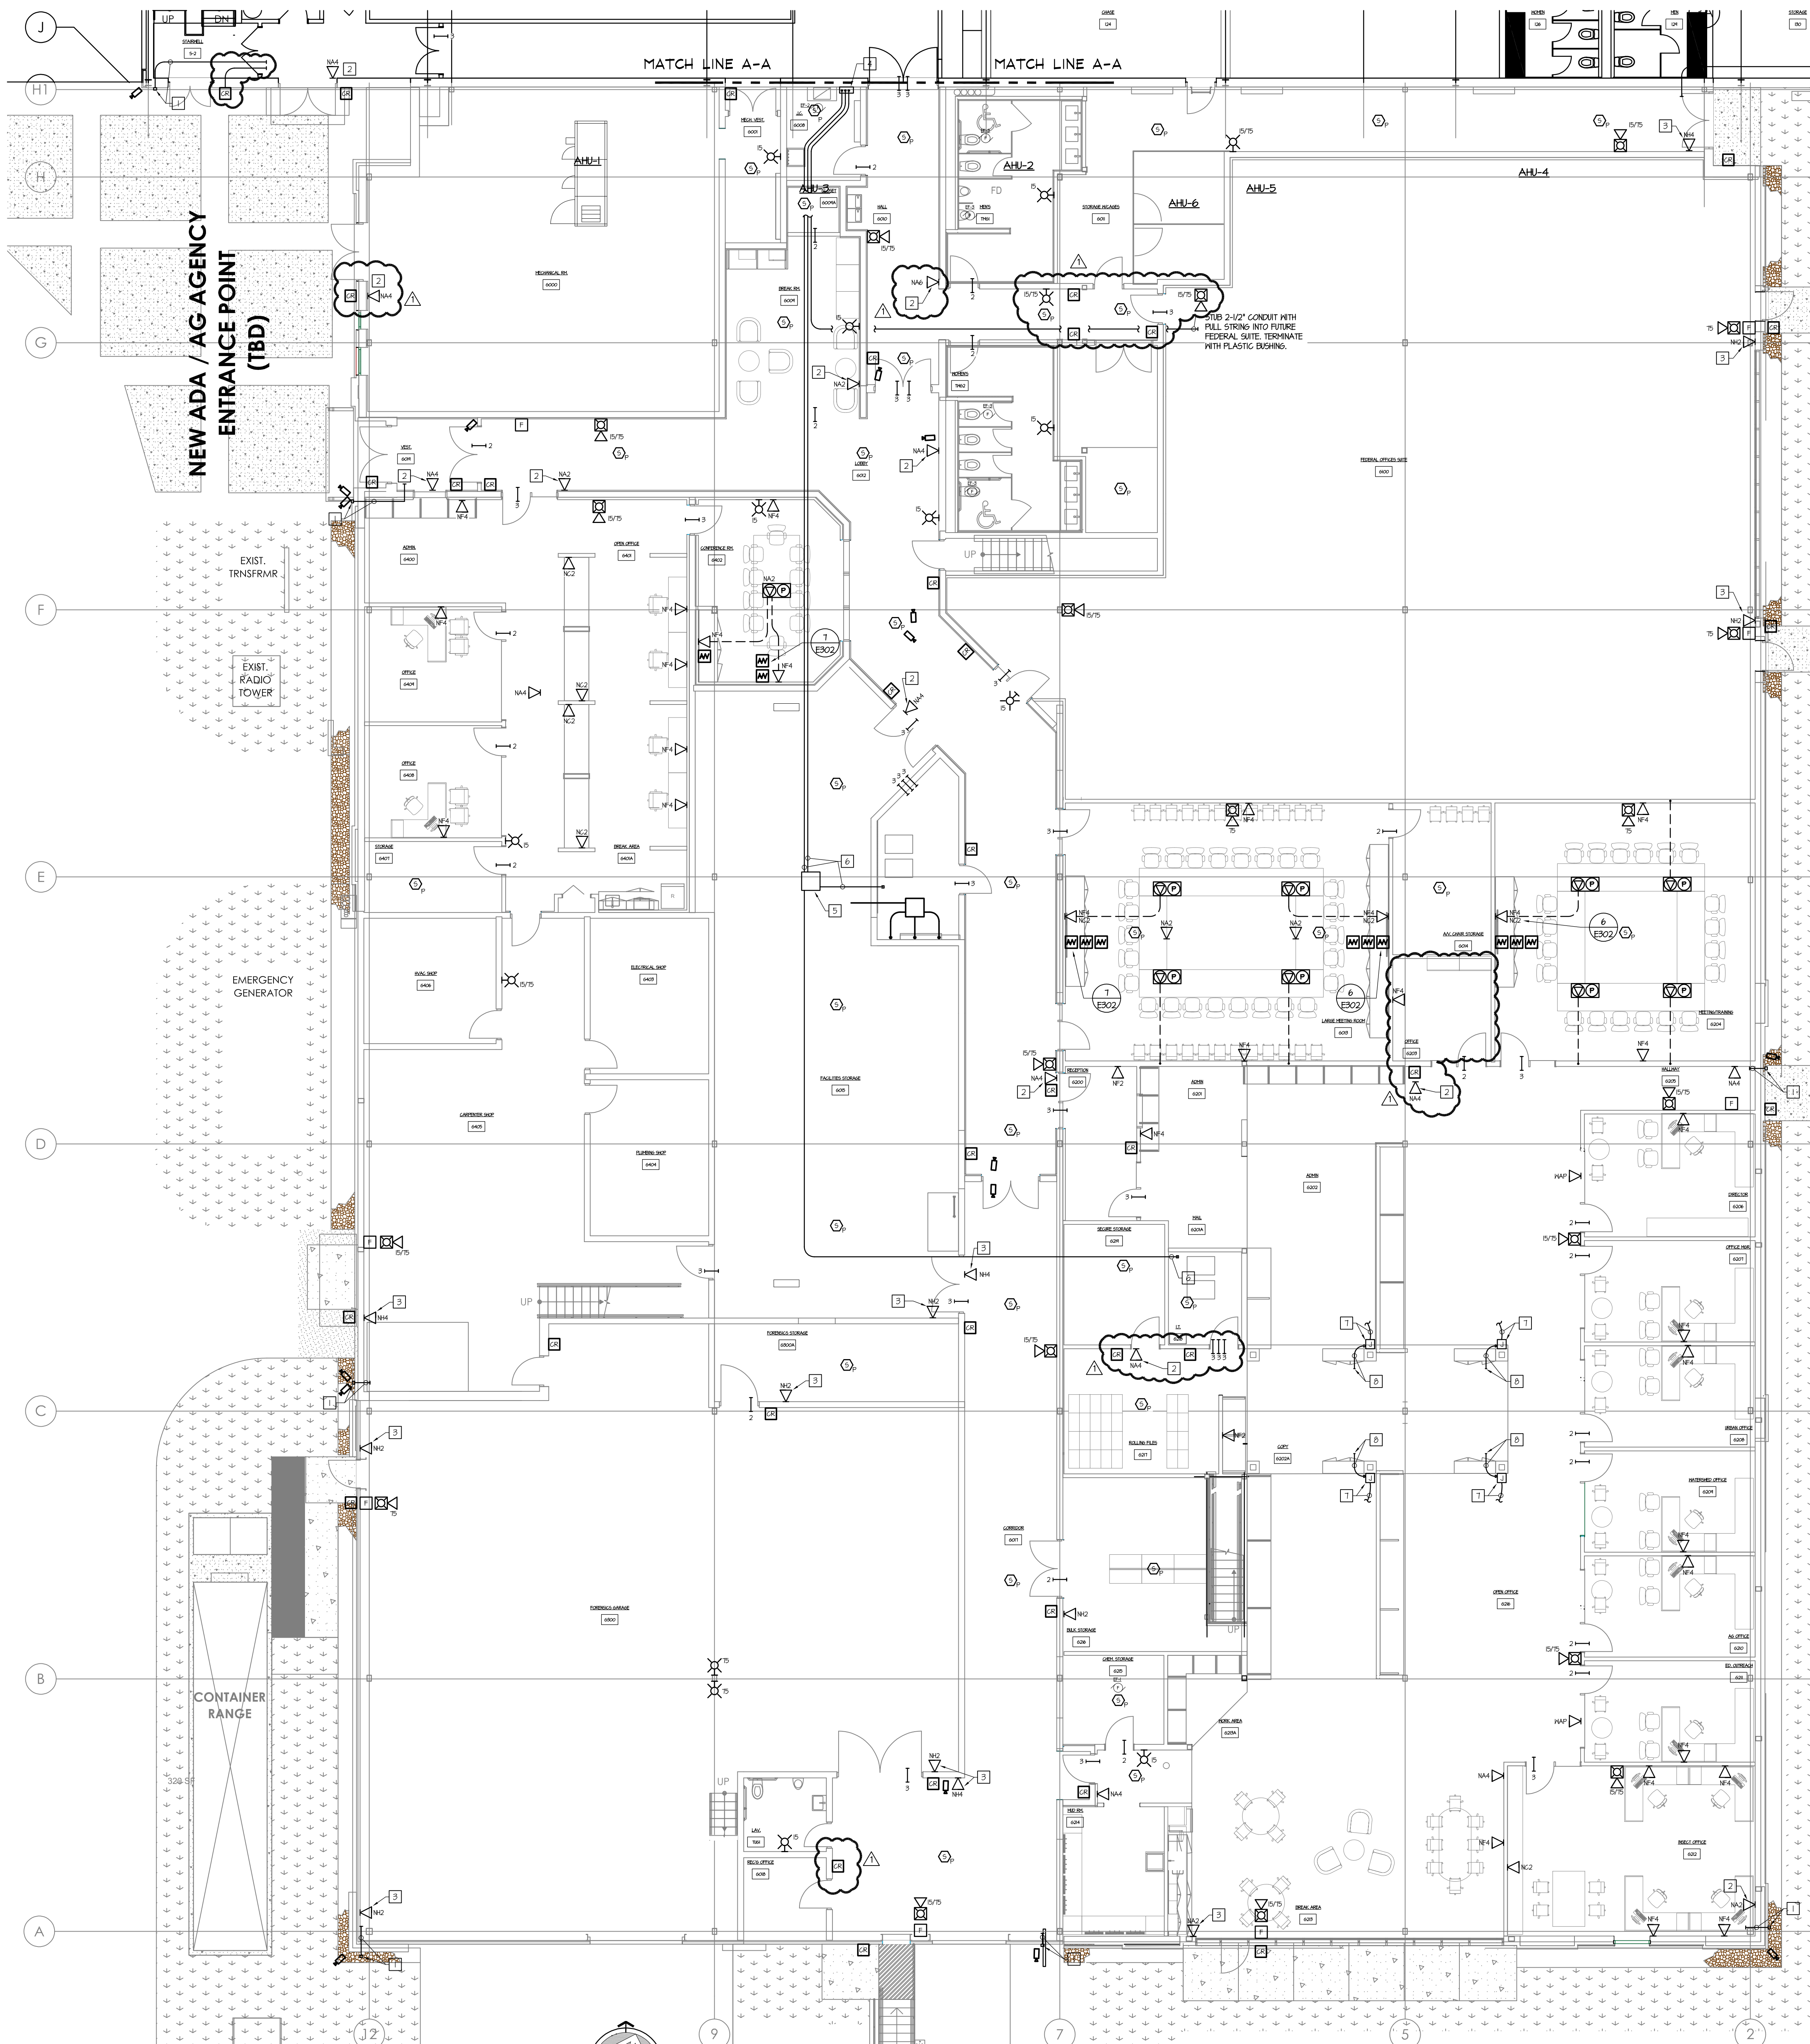
SHEET TITLE:
FIRST FLOOR LIGHTING PLAN

E101



FIRST FLOOR LIGHTING PLAN
SCALE: 1/8" = 1'-0"

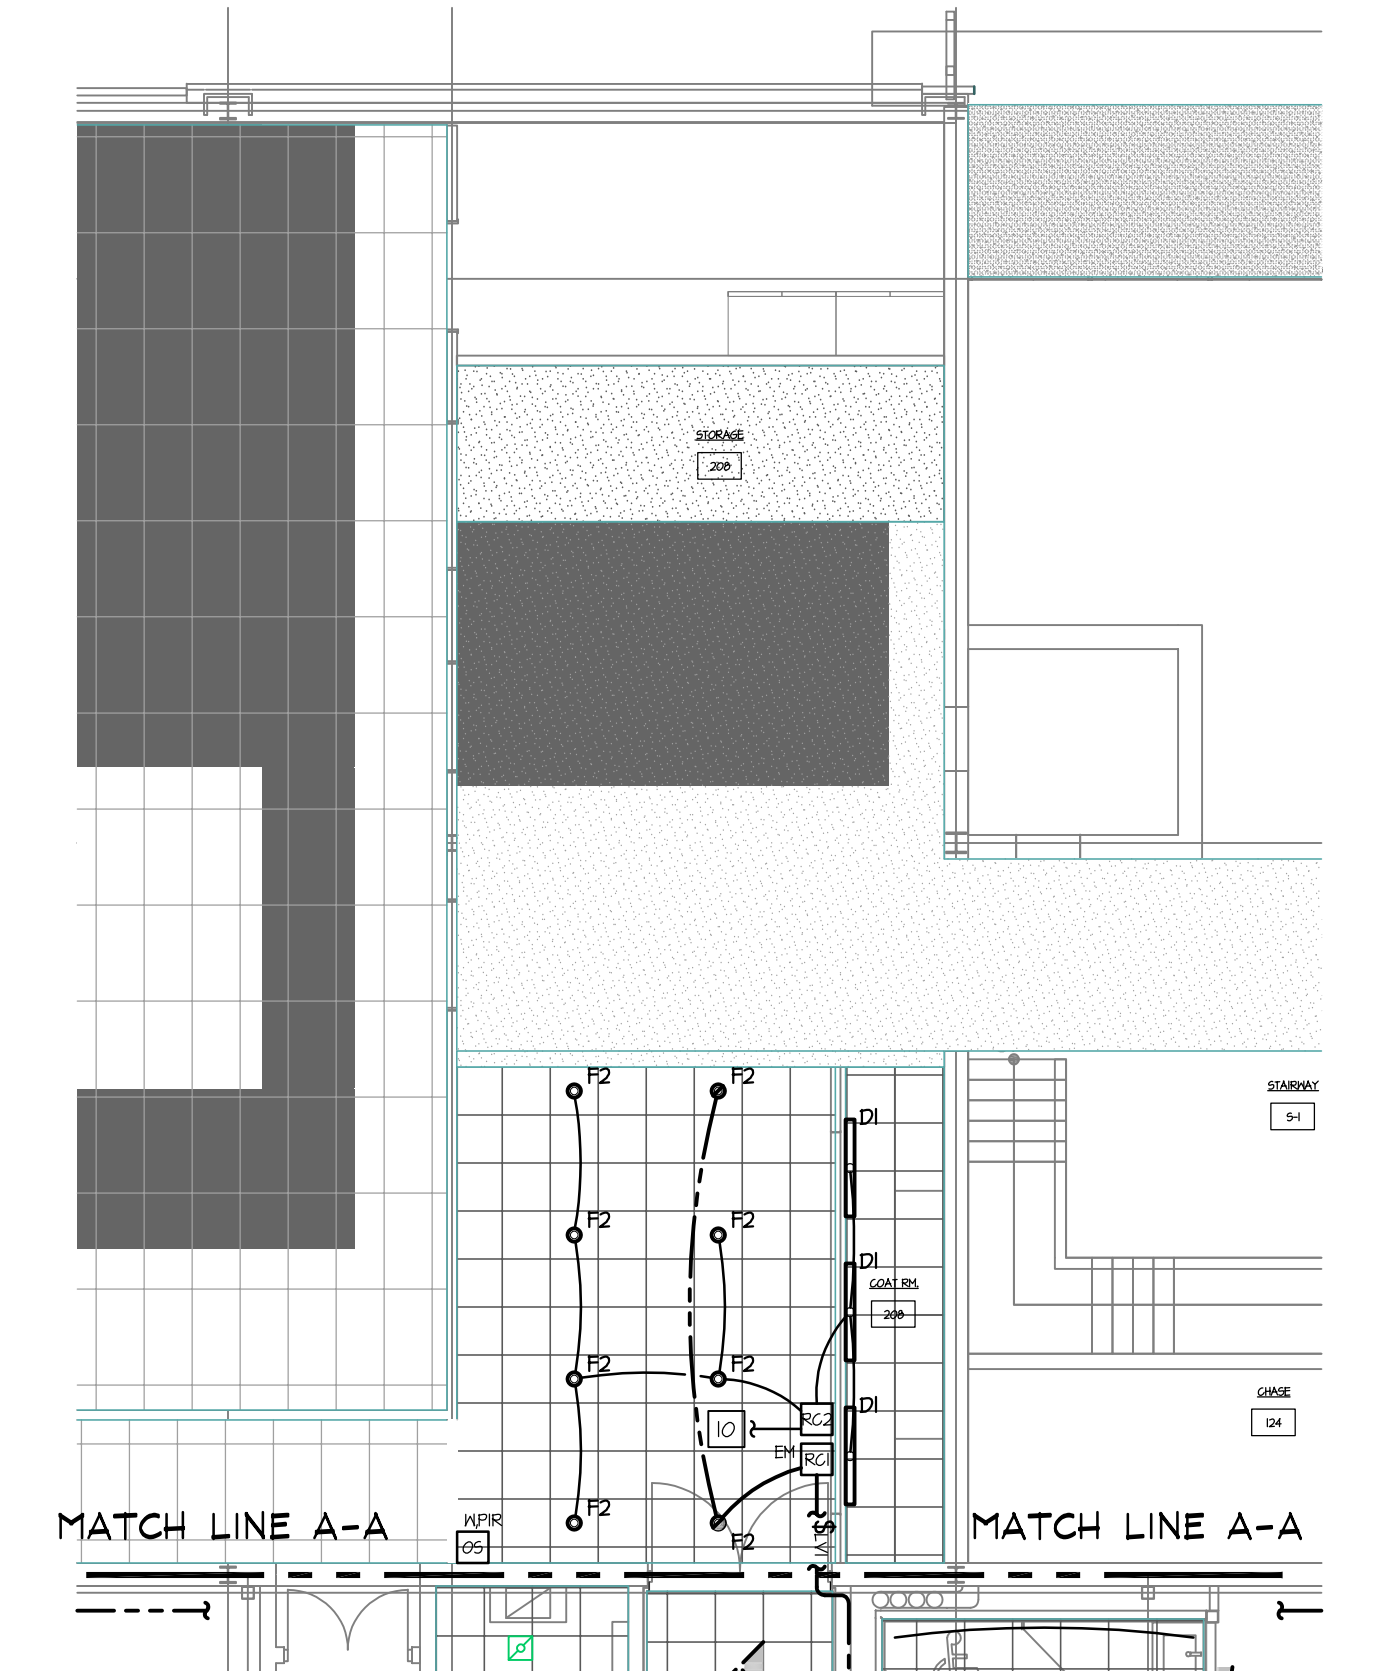0 1 2 3 4 5 6 7 8 9 10
SCALE: 1/8" = 1'-0"




1 FIRST FLOOR SYSTEMS PLAN
SCALE: 1/8" = 1'-0"

KEYED DRAWING NOTES


- 1 FINISH AND INSTALL 3/4" CONDUIT SLEEVE THROUGH WALL BETWEEN CEILING CAVITY AND EXTERIOR CAMERA LOCATION. INSTALL OWNER FURNISHED DUCK BOX AT CAMERA LOCATION AND TERMINATE CONDUIT SLEEVE. TERMINATE CONDUIT IN CEILING SPACE WITH PLASTIC BUSHING.
- 2 LOCATE DATA OUTLET ABOVE CEILING. COORDINATE FINAL LOCATION TO BE ACCESSIBLE FROM A REMOVED CEILING PANEL.
- 3 LOCATE DATA OUTLET ON WALL, APPROXIMATELY 4" ABOVE FINISHED FLOOR.
- 4 1/2" SQ. x 6" DEEP NEMA 1 PULL BOX WITH HINGED COVER FOR DATA CABLES. WALL MOUNT APPROXIMATELY 4" ABOVE FINISHED FLOOR TO CENTER.
- 5 2 1/2" SQ. x 6" DEEP NEMA 1 PULL BOX WITH HINGED COVER FOR DATA CABLES. MOUNT TO UNDERSIDE OF ROOF STRUCTURE.
- 6 2" CONDUIT WITH (3) 12 STRAND, MULTI-MODE FIBER OPTIC CABLE AND (4) 4 PAIR UTP CAT 6 CABLES.
- 7 PROVIDE FLUSH WALL BOX FOR FURNITURE DATA IN-FEED. PROVIDE 2" LIQUID TIGHT FLEXIBLE METAL CONDUIT PIPE TO FURNITURE SYSTEM BACKRAY CONNECTION POINT. VERIFY REQUIREMENTS WITH SPECIFIC FURNITURE SUPPLIER PRIOR TO ROUGH-IN.
- 8 EXTEND 2" CONDUIT FROM BOX TO ABOVE CEILING CONCEAL CONDUIT WITHIN COLUMN. PROVIDE (4) CAT 6 DATA CABLES PER REPRESENTATION TO DATA RACK IN I.T. 625. VERIFY EXACT QUANTITY OF REPRESENTATION WITH ARCHITECT AND OWNER.

DATA NETWORK SYMBOL KEY


- | | |
|------|--|
| ▽ 2 | PHONE/DATA OUTLET - FLUSH MOUNTED, 4" SQUARE BOX WITH SINGLE GANG TRIM, 1/8" AFF WITH 1" CONDUIT TO ABOVE ACCESSIBLE CEILING PLenum - NUMBER INDICATES QUANTITY OF PORTS - HUBBELL #5626 STAINLESS STEEL DECORATOR COVER PLATE WITH HUBBELL #5626 DECORATOR OUTLET FRAME |
| F | 18" ABOVE FINISHED FLOOR |
| C | 12" ABOVE FINISHED CEILING |
| K | 48" ABOVE FINISHED FLOOR |
| H | 80" ABOVE FINISHED FLOOR |
| A | ABOVE CEILING - PROVIDE SINGLE GANG OUTLET BOX WITH GROMMET IN KICKOUT. MOUNT BOX TO STRUCTURE ABOVE CEILING. |
| B | BOX WITH BLANK COVER AND 3/4" CONDUIT TO ABOVE CEILING |
| E | EXISTING |
| (HG) | HARD CEILING LOCATION |
| ▽ 2 | 5/11 EZ PATH SERIES 22 - BY ELECTRICAL CONTRACTOR |
| ▽ 3 | 5/11 EZ PATH SERIES 33 - BY ELECTRICAL CONTRACTOR |
| ▽ 4 | 5/11 EZ PATH SERIES 33 WITH CONDUIT ATTACHMENT PLATE AND LENGTH OF 4" CONDUIT AS REQUIRED TO REACH ACCESSIBLE CEILING - BY ELECTRICAL CONTRACTOR SUPPORT CONDUIT FROM STRUCTURE AND PROVIDE PLASTIC BUSHING IN MASONRY CONSTRUCTION. THE ABOVE HEIGHTS SHALL BE USED FOR REFERENCE TO NEAREST BLOCK OR BRICK CORNER. |

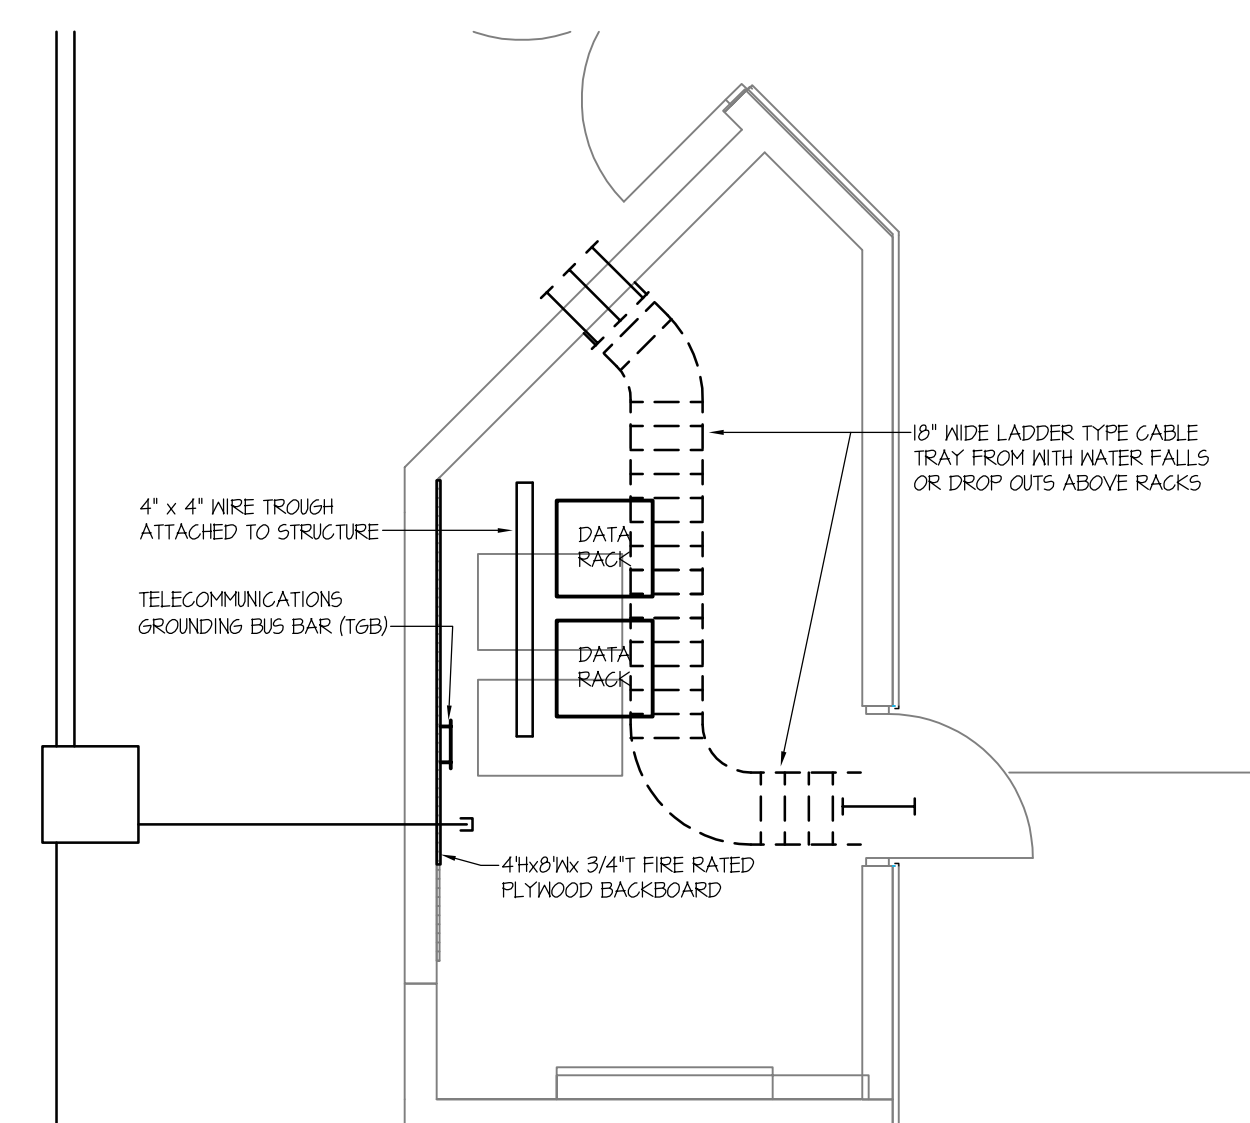

3 ELECTRICAL G016 ENLARGED PLAN
SCALE: 1/2" = 1'-0"

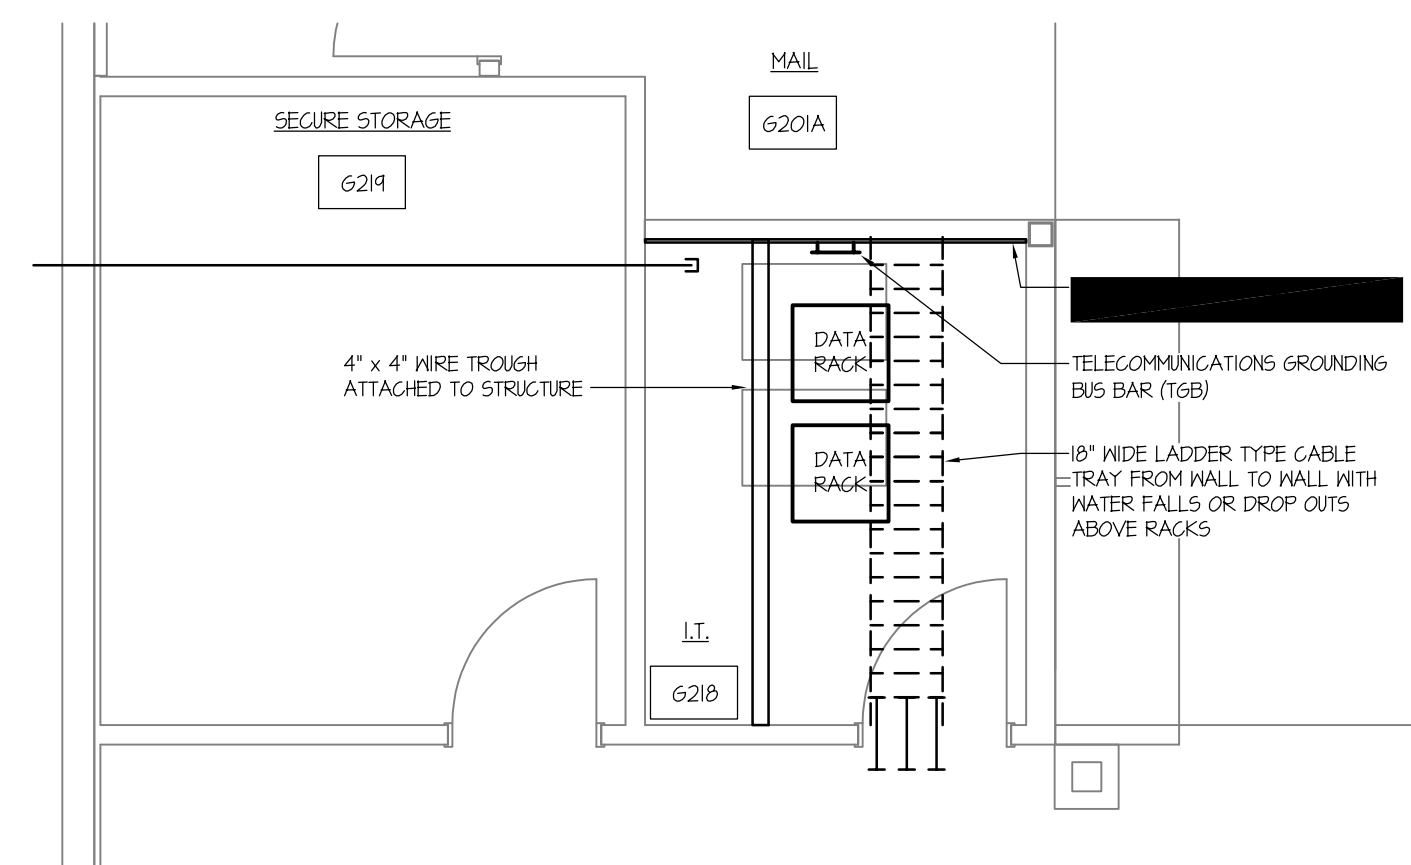

2 I.T. G215 ENLARGED PLAN
SCALE: 1/2" = 1'-0"

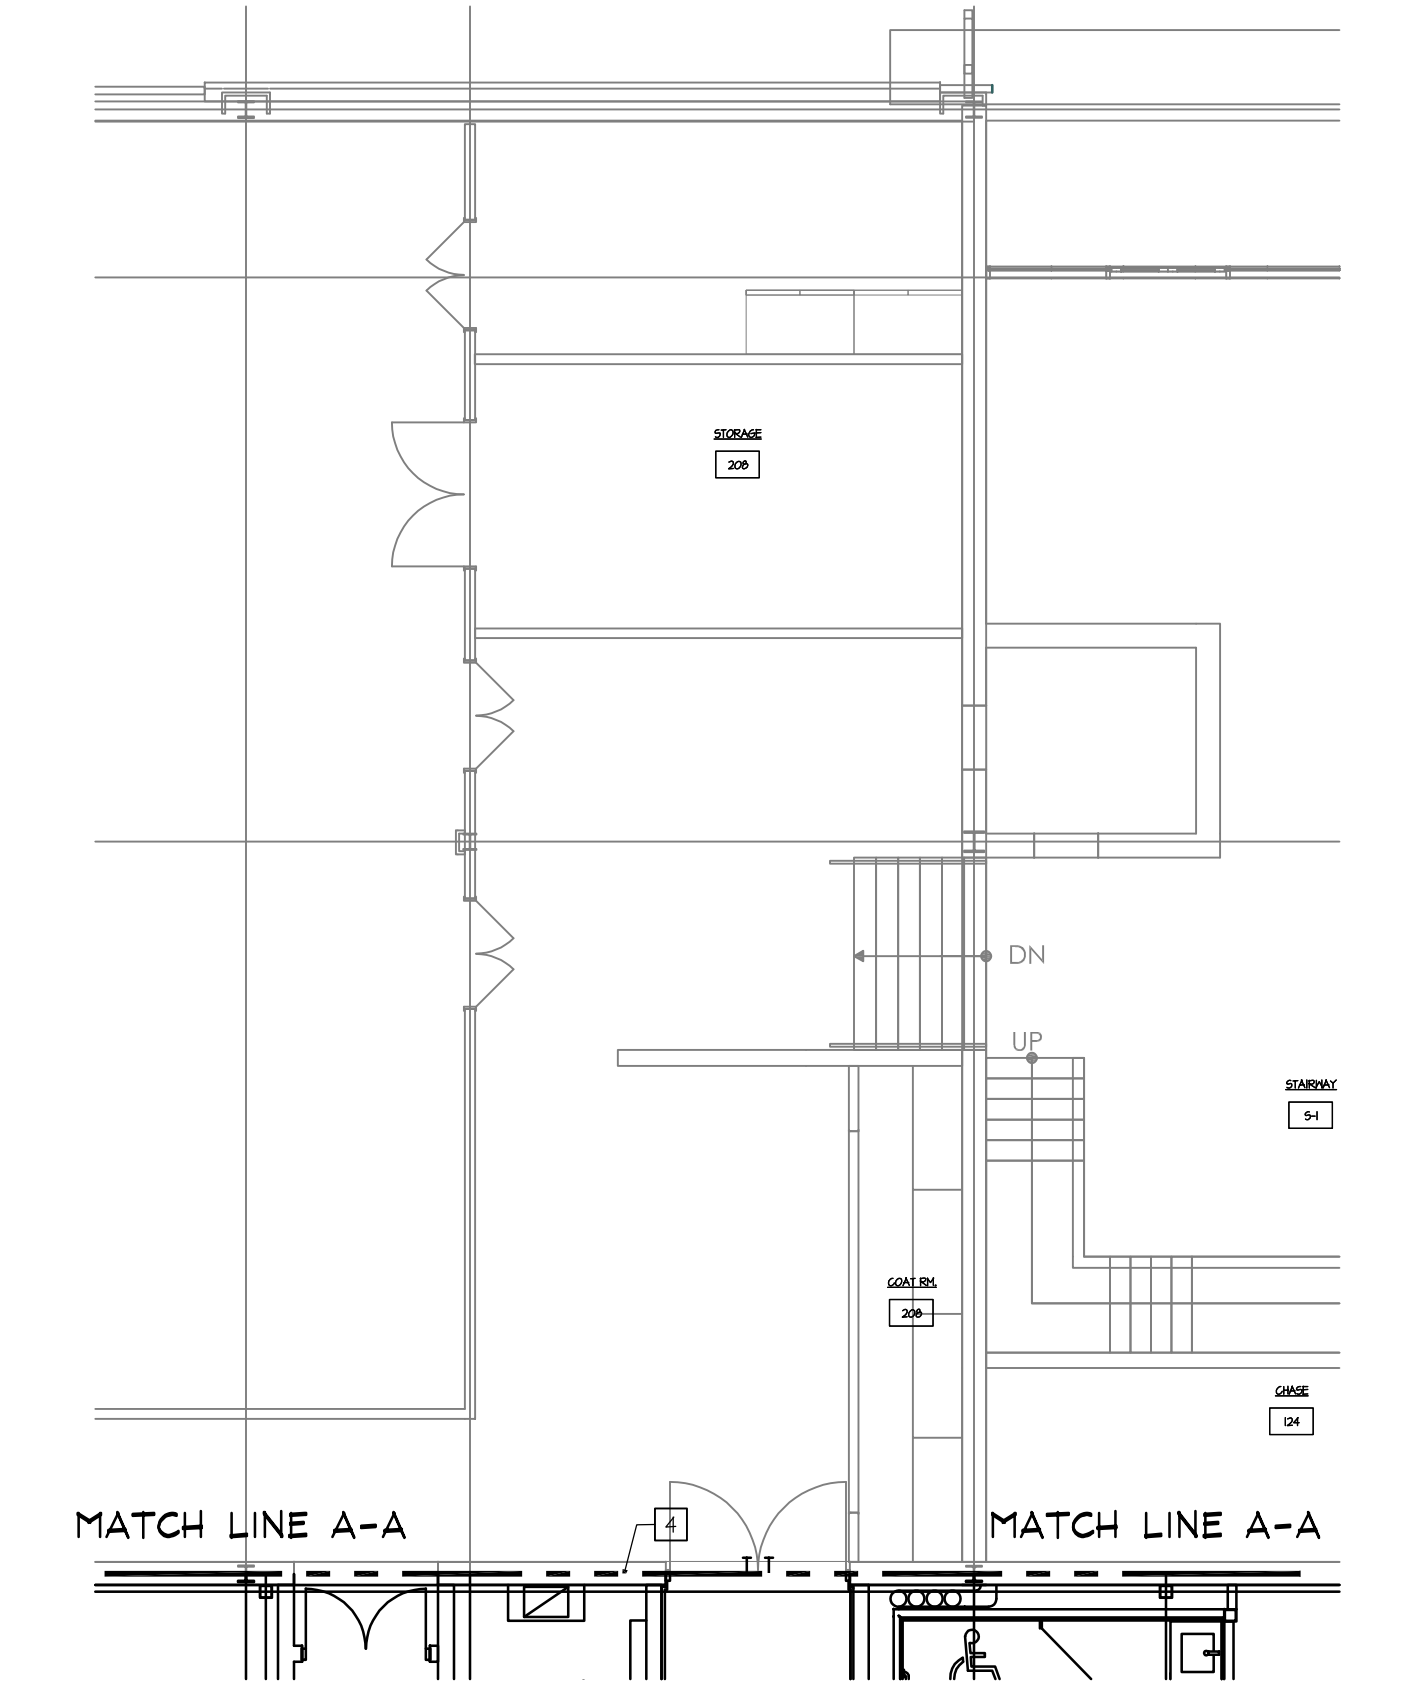

FIRST FLOOR SYSTEMS PLAN
SCALE: 1/8" = 1'-0"

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BAR & ONE (1) INCH LONG ON ORIGINAL DRAWINGS

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FIRST FLOOR SPECIAL SYSTEMS PLAN

E301