
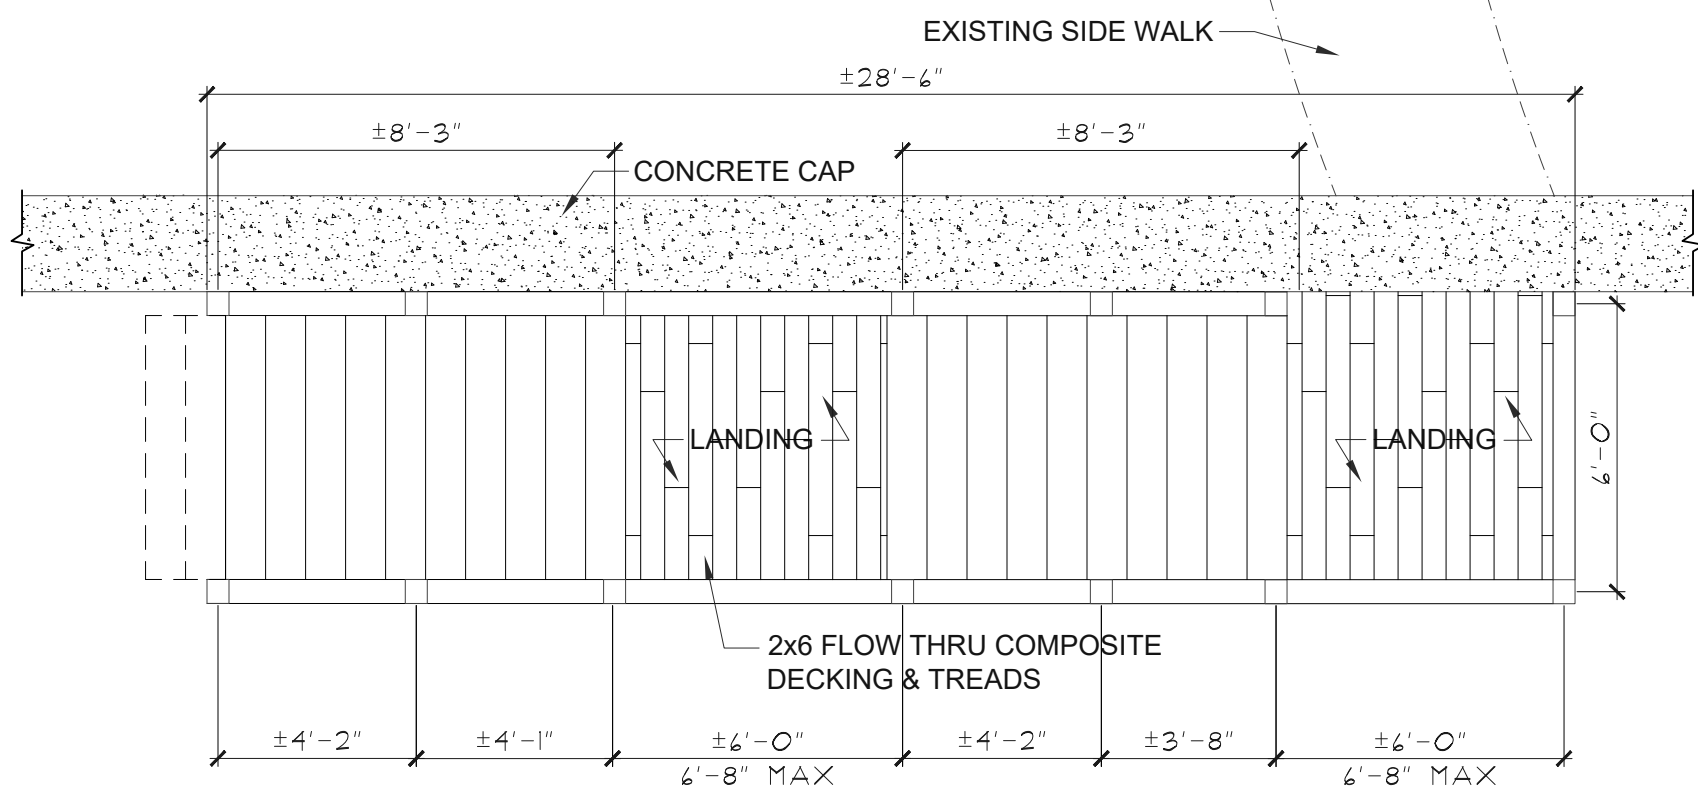


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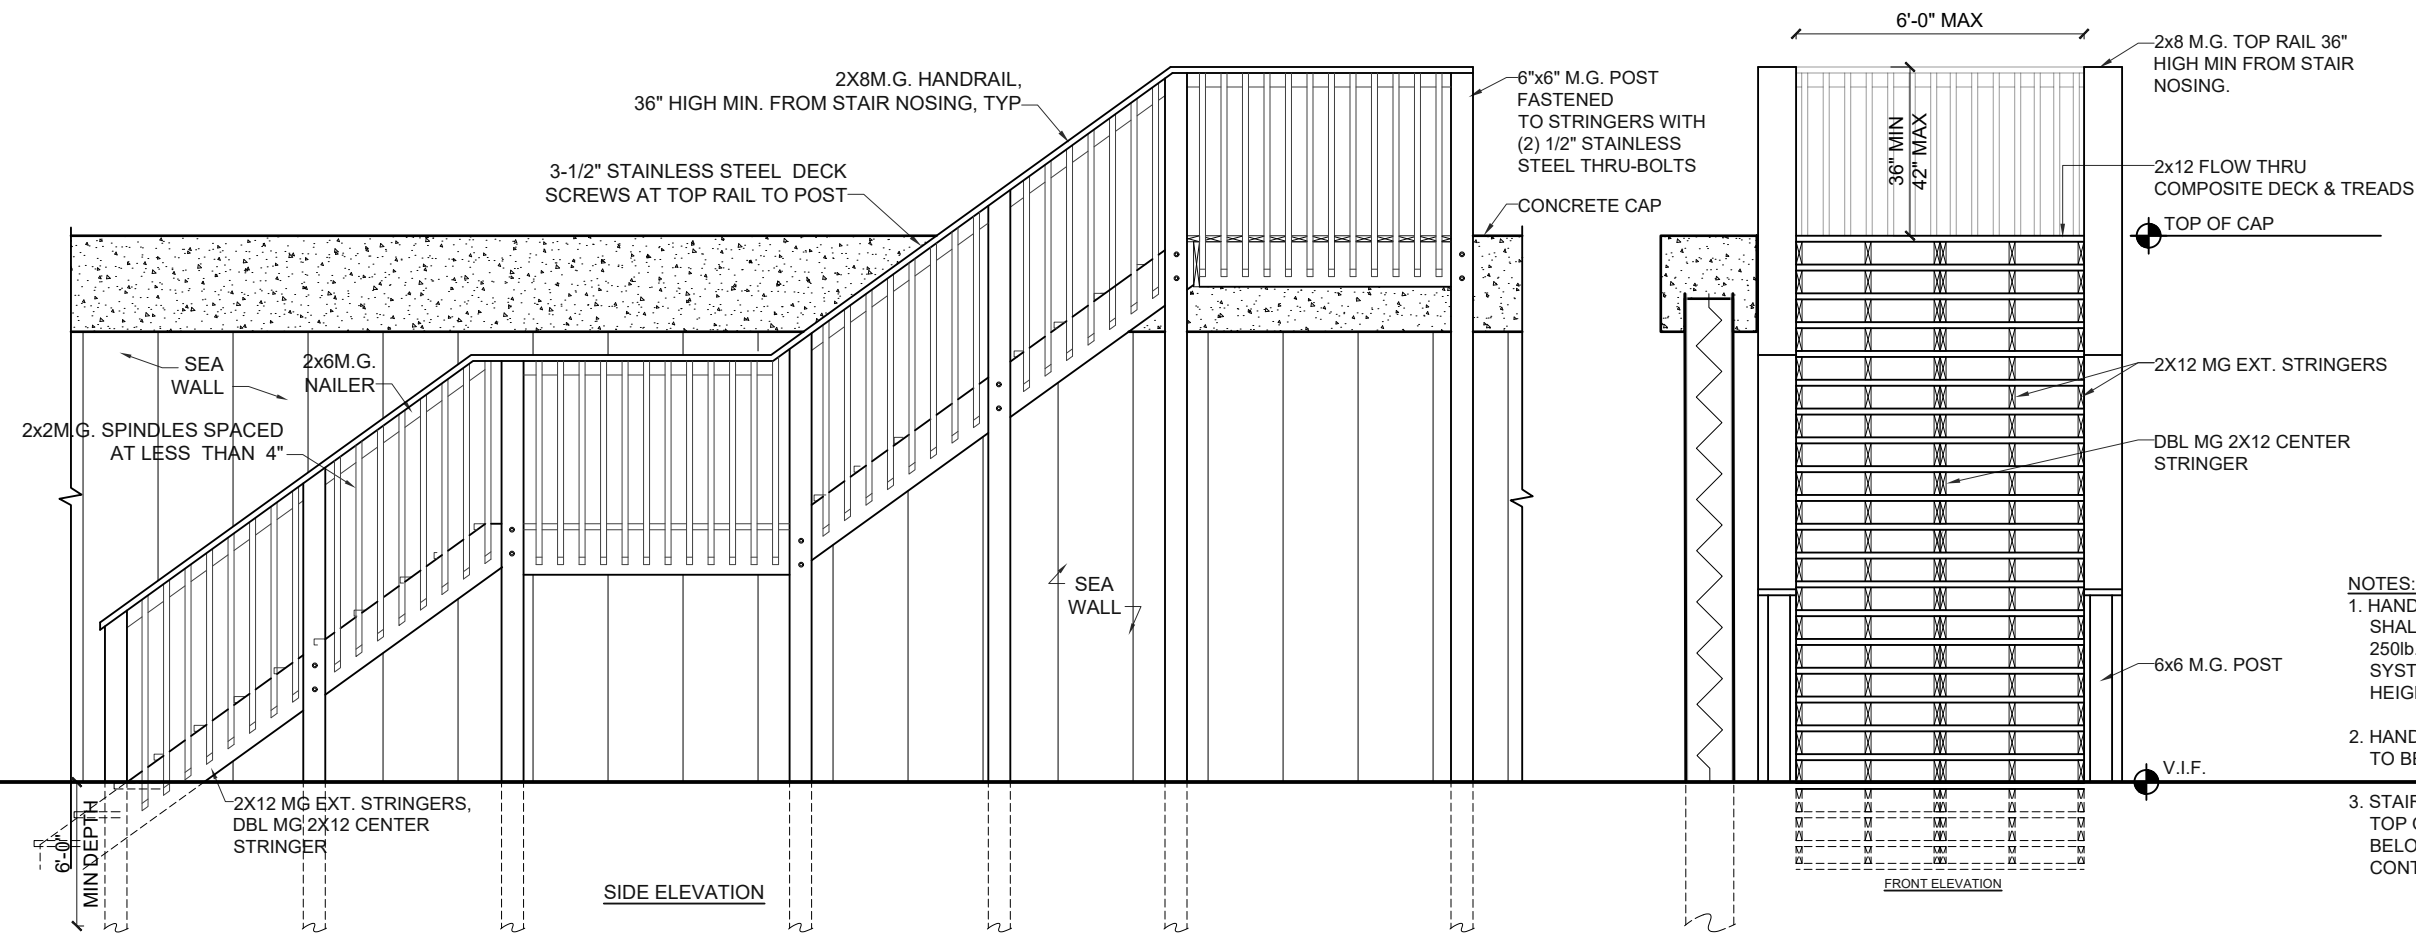
**1** STAIR FLOOR PLAN  
 S5.0 SCALE: 1/4"=1'-0"

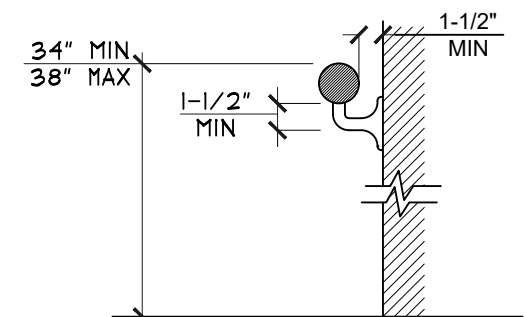

HANDRAIL GRIPPING SURFACES WITH A CIRCULAR CROSS SECTION SHALL HAVE AN OUTSIDE DIAMETER OF 1-1/4" MINIMUM AND 2" MAXIMUM.

HANDRAIL GRIPPING SURFACES WITH A NON-CIRCULAR CROSS SECTION SHALL HAVE A PERIMETER DIMENSION OF 4" MINIMUM AND 6-1/4" MAXIMUM, AND A CROSS-SECTION DIMENSION OF 2-1/4" MAXIMUM.

**2** RAIL DETAILS  
 S5.0 SCALE: 1"=1'-0"



**3** STAIR DETAILS  
 S5.0 SCALE: 1/4"=1'-0"

**NOTES:**


- HANDRAIL, SUPPORTS, & FASTENERS SHALL BE CAPABLE OF SUPPORTING A 250lb. POINT LOAD @ ANY POINT ON SYSTEM. TOP RAIL SHALL BE A MIN. HEIGHT OF 36".
- HANDRAIL STYLE, SPINDLES OR RAILS, TO BE DETERMINED BY OWNER.
- STAIRS TO BE SAME ELEVATION AS TOP OF CAP & EXTEND 3 STEPS BELOW THE BEACH ELEVATION, CONTRACTOR TO DETERMINE

STRUCTURAL PLANS FOR SEAWALL REPAIR AT THE

# SHERWIN CONDOMINIUM

2555 SOUTH ATLANTIC AVENUE  
 DAYTONA BEACH SHORES, FL 32118


NO	REMARKS	DATE
1	FOR CONSTRUCTION	3/5/24

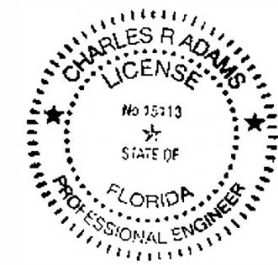


BEACH APPROACH STAIRS

DRAWN BY EAA	SHEET 8 OF 11
CHECKED BY JAA	S5.0
SCALE AS NOTED	
DATE 6 MAR 2024	


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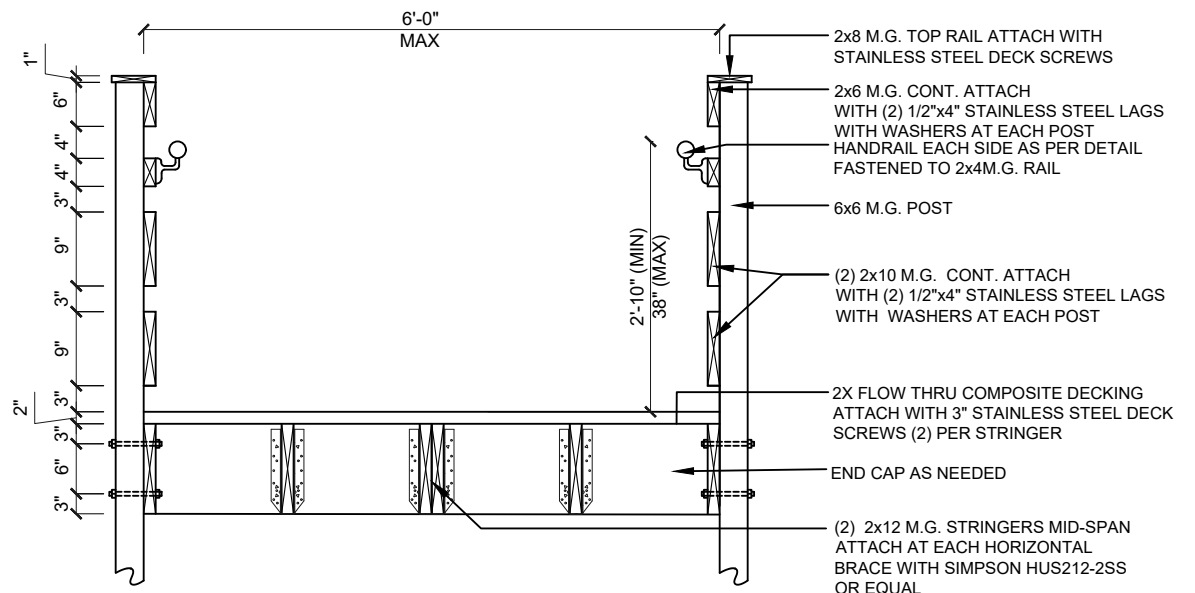
2 RAIL DETAILS - SPINDLES  
S5.1 SCALE: 1/2"=1'-0"

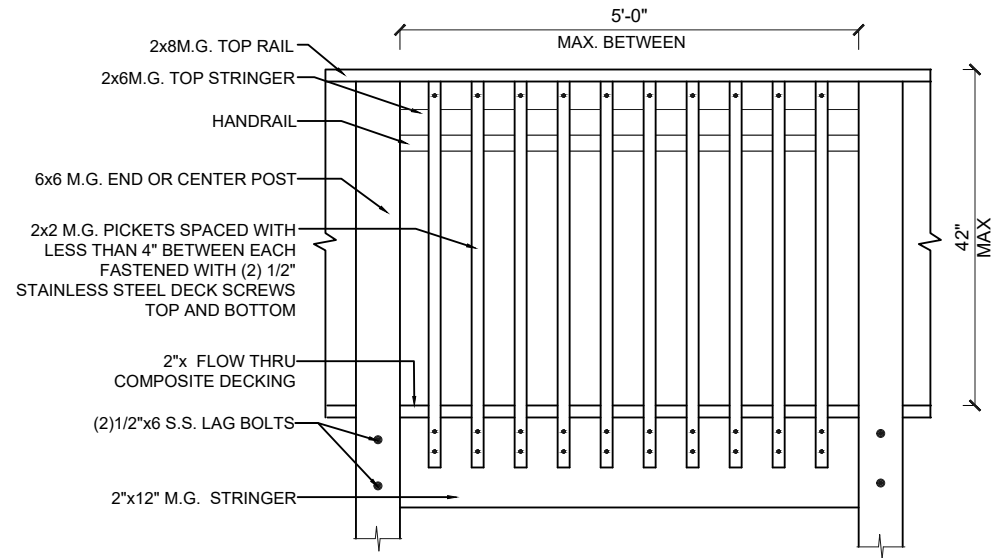

1 RAIL DETAILS - SPINDLES  
S5.1 SCALE: 1/2"=1'-0"

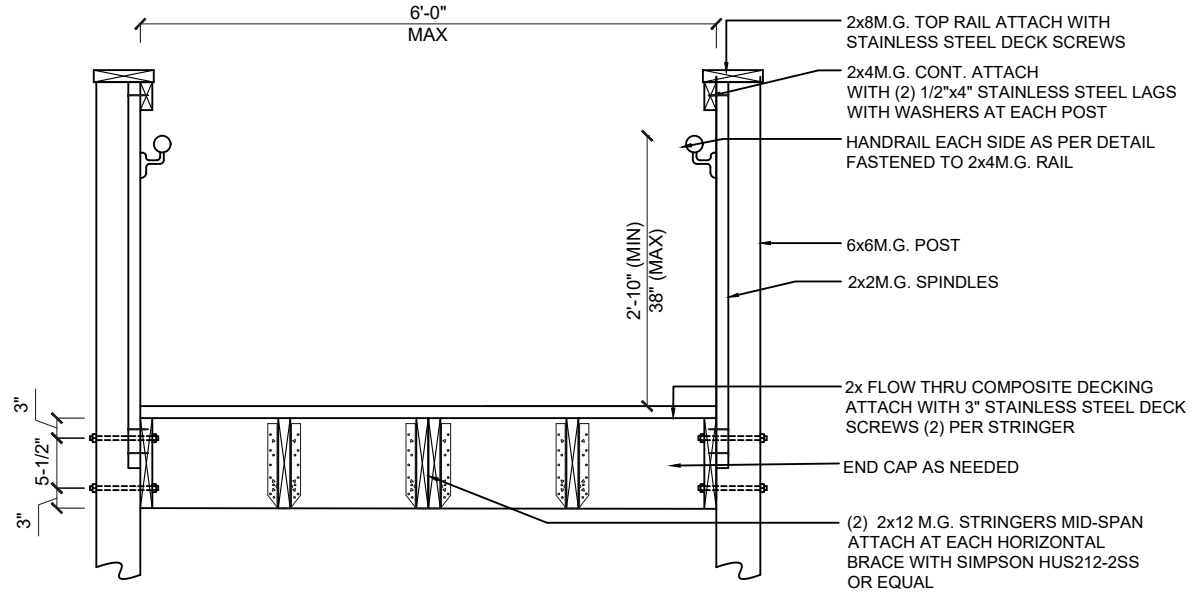


4 RAIL DETAILS - HORIZONTAL 2X  
S5.1 SCALE: 1/2"=1'-0"

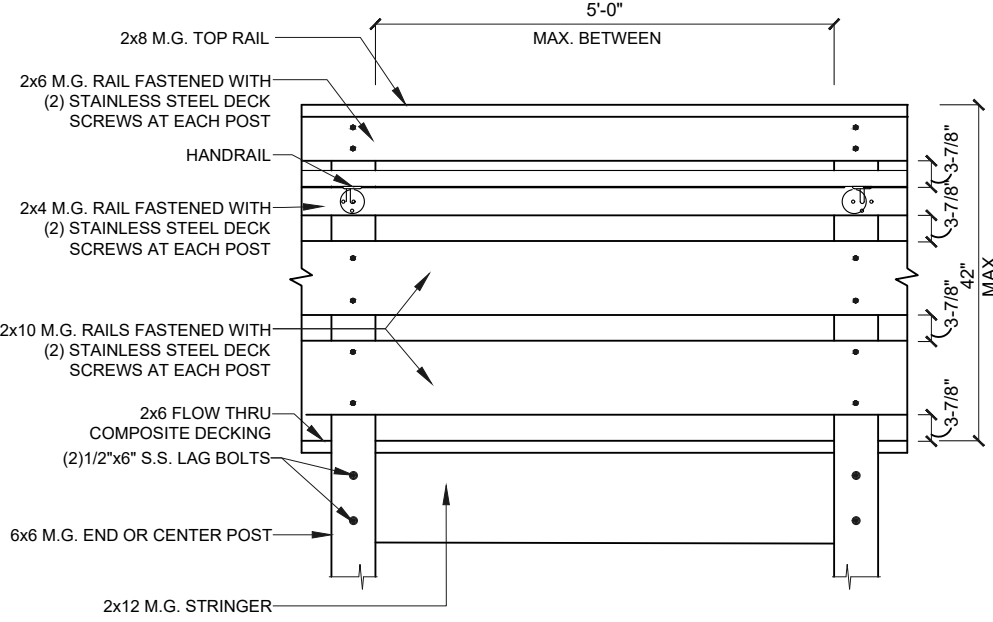

3 RAIL DETAILS - HORIZONTAL 2X  
S5.1 SCALE: 1/2"=1'-0"

STRUCTURAL PLANS FOR SEAWALL REPAIR AT THE  
**SHERWIN CONDOMINIUM**  
2555 SOUTH ATLANTIC AVENUE  
DAYTONA BEACH SHORES, FL 32118

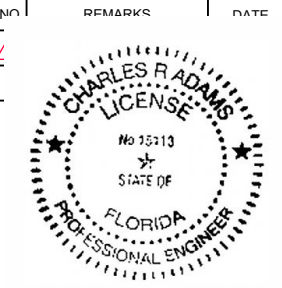

RAIL DETAILS	
DRAWN BY EAA	SHEET 9 OF 11
CHECKED BY JAA	<b>S5.1</b>
SCALE AS NOTED	
DATE 6 MAR 2024	

24-1002 - SHERWIN - 2555 S ATLANTIC AVE - SEAWALL REPAIR