New Bus Parking / Exterior Plaza & Curtain Wall Replacement

Absegami High School 201 South Wrangleboro Road, Galloway, NJ 08205

Greater Egg Harbor Regional High School District

1824 Dr. Dennis Foreman Drive, Mays Landing, NJ 08330



French & Parrello Associates, P.A. Consulting Engineers | Wall, New Jersey

Gillan & Hartmann, Inc. Consulting Engineers | Mont Clare, Pennsylvania

> COORDINATION NOTES - ABSEGAMI HIGH SCHOOL 1. CONTRACTOR IS ADVISED THAT ADDITIONAL WORK WILL BE PERFORMED AT THE SCHOOL UNDER SEPARATE CONTRACTS AT THE SAME TIME AS WORK SHOWN ON THESE DRAWINGS. 2. OTHER WORK WILL INCLUDE, BUT IS NOT LIMITED TO, THE FOLLOWING:

SOCCER FIELD RECONSTRUCTION AND IRRIGATION 2.3. RENOVATIONS AT EXISTING FIELD HOUSE 3. THE RESPECTIVE CONTRACTORS SHALL COORDINATE OPERATIONS WITH THEIR COUNTERPARTS AS REQUIRED TO FACILITATE AND

ACCOMMODATE EACH OTHERS' WORK AND MAINTAIN BUILDING SECURITY AND WEATHERTIGHTNESS.

2.1. TENNIS COURT RECONSTRUCTION, MILLING / RE-PAVING AND WALKWAYS

DRAWING INDEX GENERAL General Notes, Typical Details, Legends and Abbreviations Site Layout Plan Grading Plan Construction Details ARCHITECTURAL Demolition & Floor Plans & Elevations at Bus Parking / Exterior Plaza

New Bus Parking / Exterior Plaza & Curtain Wall Replacement at Absegami High School

Project Owner Name Greater Egg Harbor Regional High School District

Absegami High School 201 South Wrangleboro Rd Galloway, NJ 08205


5369-5 Drawn By

Title Sheet and

Drawing Index

No. Date Description

Drawing Number

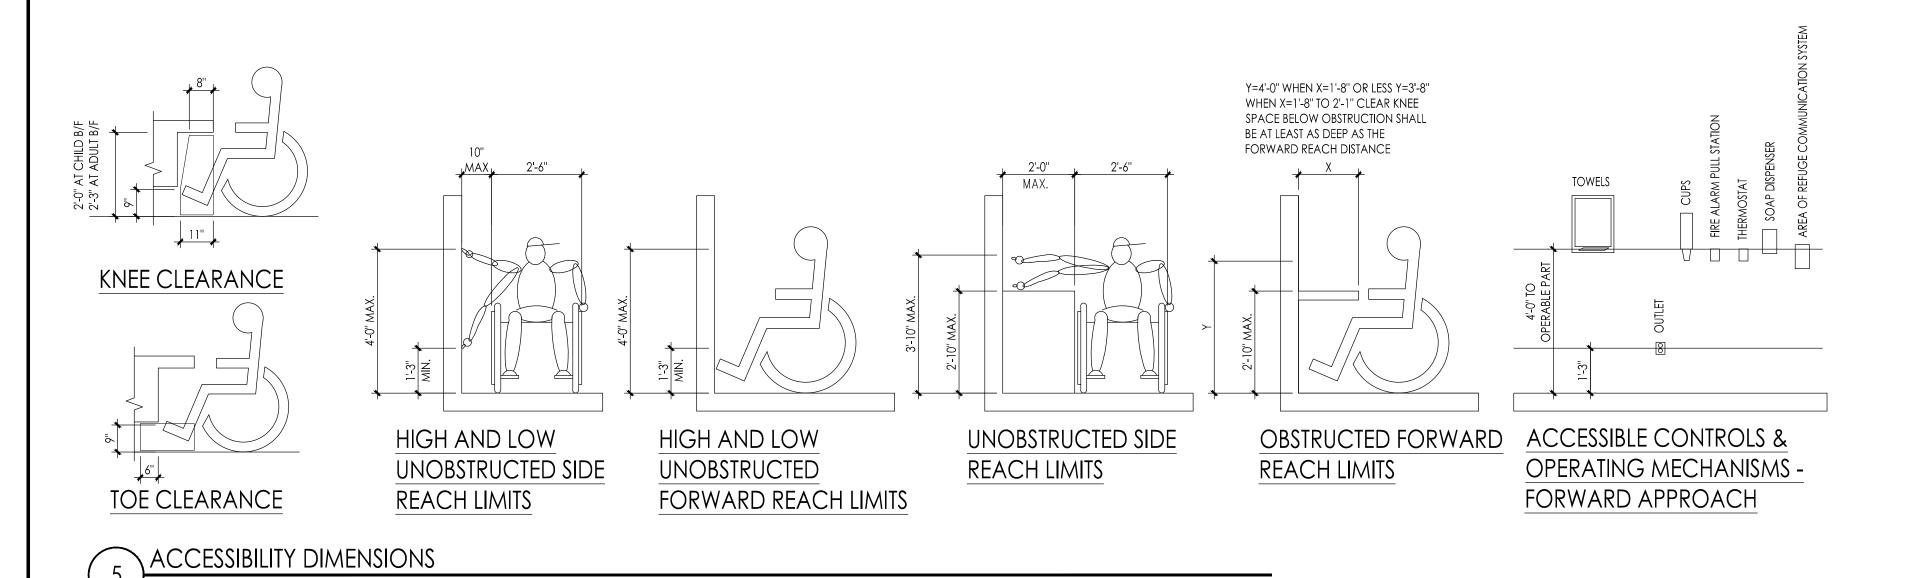

GENERAL NOTES

- ALL CONTRACTORS SHALL VISIT THE SITE AND VERIFY ALL EXISTING CONDITIONS BEFORE SUBMITTING A BID. DISCREPANCIES OR OMISSIONS MUST BE REPORTED TO THE ARCHITECT IN WRITING (10) DAYS PRIOR TO BID OPENING. IF HE OR SHE DOES NOT, CONTRACTOR SHALL CORRECT SAME AT NO CHANGE IN CONTRACT PRICE.
- CONTRACTOR SHALL PROVIDE ALL REQUIRED SAFETY PROTECTION DURING CONSTRUCTION. 3. IT SHALL BE THE CONTRACTOR'S RESPONSIBILITY TO PROVIDE A SUFFICIENT WORK
- FORCE TO MEET COMPLETION DATES AS OUTLINED IN THE SPECIFICATIONS. NO EXCEPTIONS WILL BE ALLOWED.
- 4. DO NOT SCALE THE DRAWINGS.
- 5. DETAILS NOTED "TYPICAL" IMPLY ALL SUCH CONDITIONS BE TREATED SIMILARLY.
- AND CEILING OF ROOMS SCHEDULED. REFER TO PLANS, DETAILS, INTERIOR ELEVATION, CEILING PLANS, AND NOTES FOR THOSE MATERIALS NOT INDICATED ON THE SCHEDULE BUT ARE STILL REQUIRED IN THE ROOM. UNLESS OTHERWISE NOTED AND UNLESS FACTORY FINISHED, ALL EXPOSED SURFACES

6. MATERIALS LISTED ON THE FINISH SCHEDULE REFER TO THE MAJORITY OF WALLS, FLOOR

- OF CMU, CONCRETE, PLASTER, WOOD, GYPSUM BOARD, HOLLOW METAL, HARDWOODS, MISC. METALS ETC., ARE TO RECEIVE PRIME AND FINISH COATS OF PAINT OR CLEAR FINISH AS SPECIFIED AND IN COLORS AS SELECTED BY ARCHITECT. EXCLUDED FROM THIS IS BRICK.
- 8. ALL OUTSIDE CORNERS OF INTERIOR CONCRETE MASONRY UNITS (CMU) ARE TO BE BULLNOSED UNLESS NOTED OTHERWISE.
- 9. CALL BEFORE YOU DIG. BEFORE DIGGING CONTRACTOR SHALL CALL 1-800-242-1776 TO HAVE UTILITIES IDENTIFY UNDERGROUND LOCATION OF ALL SERVICE LINES.
- 10. ALL WORK PERTAINING TO THESE DRAWINGS SHALL BE PERFORMED IN ACCORDANCE WITH ALL APPLICABLE STATE AND LOCAL CODES AND IN AGREEMENT WITH ALL AGENCIES HAVING JURISDICTION.
- 11. THE CONTRACTOR IS RESPONSIBLE TO SECURE ALL PERMITS, TO OBTAIN APPROVALS AS REQUIRED AND COORDINATE INSPECTION WITH LOCAL BUILDING INSPECTOR. ALL PERMIT AND APPLICATION FEES WILL BE PAID BY THE OWNER AND DELIVERED BY THE CONTRACTOR.
- 12. DRAWINGS AND SPECIFICATIONS COMPLEMENT EACH OTHER. WORK NOT SHOWN ON DRAWING BUT CALLED FOR IN THE SPECIFICATIONS IS STILL REQUIRED, AND ALL WORK NOT CALLED FOR IN SPECIFICATIONS, BUT CALLED OUT OR SHOWN IN DRAWINGS IS STILL REQUIRED. 13. THE OWNER WILL REMOVE AND RE-INSTALL ALL MOVEABLE EQUIPMENT. EACH
- Contractor is responsible to remove, store and re-install existing built-in EQUIPMENT REQUIRED TO PERFORM THEIR WORK UNLESS NOTED OTHERWISE. 14. IN ACCORDANCE WITH NJAC 5:23-6.6(i), ALL MATERIALS AND METHODS USED SHALL
- 15. WHERE THERE IS AN ACCESSIBLE CONCEALED FLOOR, FLOOR-CEILING OR ATTIC SPACE, FIRE WALLS, FIRE BARRIERS, FIRE PARTITIONS, SMOKE BARRIERS AND SMOKE PARTITIONS OR ANY OTHER WALL REQUIRED TO HAVE PROTECTED OPENINGS OR PENETRATIONS SHALL BE EFFECTIVELY AND PERMANENTLY IDENTIFIED IN ACCORDANCE WITH THE FIRE AND/OR SMOKE PROTECTED ASSEMBLY MARKING DETAIL - SEE DETAIL 8 /


COMPLY WITH THE REQUIREMENTS SPECIFIED IN N.J.A.C. 5:23-6.8, MATERIALS AND

SYMBOL LIST

XX AXXX	section number WALL SECTION drawing number
XX AXXX	detail number DETAIL INFORMATION drawing number
<u> </u>	DEMOLITION NOTE REFERENCE T SEE DEMOLITION NOTES
<u>x</u>	WINDOW OR CURTAINWALL TYP SEE WINDOW/CURTAINWALL SCHEDULE
(XX)	DOOR NUMBER SEE DOOR SCHEDULE
	BORROWED LIGHT NUMBER SEE DOOR SCHEDULE
XXXX 000	ROOM NAME/NUMBER
_	

X > ————— EQUIPMENT NUMBER OR LETTER

MATERIAL LEGEND

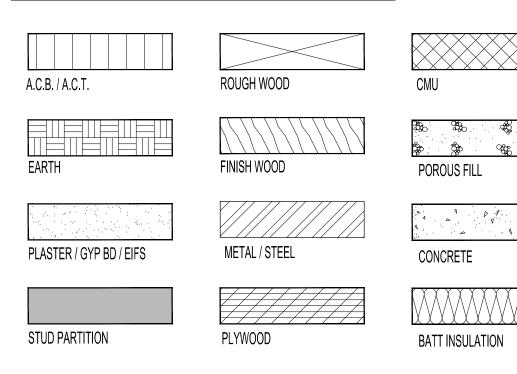

RIGID INSULATION

3 NOT USED

4 NOT USED Scale: N.T.S.

ARREVIATIONS

ABBRE	VIATIONS						
AACB	Acrylic acoustical ceiling board	FA	Fire alarm	N	North	Ţ	<u>Tread</u>
A/C AB	Air conditioning Anchor bolt	FB FBRK	Face brick Fire brick	NIC NO	Not in contract Number	TB. TC	Top of bank Terra cotta
ACB	Acoustical ceiling board	FD	Floor drain	NOM	Nominal	TEL	Telephone
AD	Area drain	FE	Fire extinguisher	NRC	Noise reduction coefficient	T&G	Tongue and groove
ADJ	Adjacent	FEC	Fire extinguisher cabinet	NTS	Not to scale	TG.	Top of grate
ADJT AFF	Adjustable Above finished floor	FES FF	Flared end section Finish floor			TGR THK	Top of grade Thick
AGG	Aggregate	FFE	Finished floor elevation	OA	Overall	THR	Threshold
AL	Aluminum	FGL	Fiberglass	OC	On center	TKS	Tackstrip
ALT PID	Alternating	FIN FIX	Finish	OD	Outside diameter	TLT, TOIL	Toilet
ALT. BID ANC	Alternate bid Anchor, Anchorage	FLG	Fixture Flashing	OH OP	Overhead Opaque	TOC TOM	Top of curb Top of masonry
ANOD	Anodized	FLR	Floor	OPG	Opening	TOP	Top of plank
AP	Access panel	FND	<u>F</u> oundation	OPP	Opposite	TOS	Top of steel
APX ARCH	Approximate Architect	FR FRP	Frame Fiberglass reinforced polyester			TPD TPG	Toilet paper dispenser
ARCH	Alchiilect	FP	Fire proof	PAR	Parallel	TPTN	Tempered plate glass Toilet partition
		FRT	Fire retardant	PBD	Particleboard	TV	Television
BB.	Bottom of bank	FS	Floor sink	PC	Plumbing contractor	TYP	<u>Typical</u>
BD BIT	Board Bituminous	FT FTG	Feet	PCC PERI	Precast concrete Perimeter	TZ	Terrazzo
BF	Barrier Free	FUR	Footing Furring	PG	Plate glass		
BLDG	Building	TOR	1 311119	PK	Parking	UC	Undercut
BLK	Block		_	PL	Plate	UL	Underwriter's laborator
BLKG	Blocking Bench mark	GA GB	Gauge Grab bar	P LAM PLAS	Plastic laminate	UNO UR	Unless Noted Otherwis
BM BOT	Bottom	GC GC	Grab bar General contractor	PNL	Plaster Panel	UK	Urinal
BRG	Bearing	GCMU	Glazed concrete masonry unit	PNT	Paint (ed)		
BRK	Brick	GD	Grade, grading	PR	Pair	VAT	Vinyl Asbestos Tile
BRZ	Bronze Both sides	GEP GF	Gypsum wall board epoxy painted Ground face	PTT PRTT	Precast Terrazzo Tile Precast Resilient Terrazzo Tile	VB VCT	Vapor Barrier
BS BUR	Built up roof	GL	Glass, Glazing	PSF	Pounds per square foot	VERT	Vinyl Composition Tile Vertical
5 510	2011 06 1001	GLB	Glass block	PSI	Pounds per square inch	VEST	Vestibule
		GP	Gypsum wall board painted	PTD	Paper towel dispenser	VET	Vinyl Enhanced Tile
CAB	Cabinet	GPDW	Gypsum drywall	PTN	Partition	VIF	Verify In Field
CB CEM	Catch basin Carpet Entry Mat	GR GRD.F.BLK	Grade Ground face block	PTR PVC	Paper towel receptor Polyvinyl chloride	VIN VNR	Vinyl Veneer
CEM PLAS	Cement plaster	GSFT	Glazed structural facing tile	PVMT	Pavement	VTR	Vent Thru Roof
CEP	CMU epoxy painted	GST	Glazed structural tile	PWD	Plywood		
CFL	Counter flashing	GT	Grout			147	\\\1
CFMF CHT	Cold-Formed Metal Framing Ceiling height	GV GVL	Galvanized Gravel	QT	Quarry tile	W W/	West With
CI	Cast iron	GWB	Gypsum Wall Board	QTY	Quantity	W/O	Without
CJ	Control joint	3,12	Cypsell Hall beard	α	Q o d i i i i i	WB	Wood base
CL	Centerline / closet	HB	Hose bib	_		WC	Water Closet
CLG CLR	Ceiling Clear	HD HDW	Head Hardware	R RA	Riser Return air	WD WDW	Wood Window
CMU	Concrete masonry unit	HM	Hollow metal	RAD	Radius	WG	Wire Glass
COL	Column	HOR	Horizontal	RBT	Rubber tile	WH	Wall hung
CONC	Concrete	HP	Highpoint	RCP	Reinforced concrete pipe	WIN	Window
COND CONST	Condition Construction	HR HTR	Hour Heater	RD RE	Roof drain	WM WP	Wire mesh
CONT	Continuous	HVC	Heating & ventilation contractor	REF	Reinforce (d), (ing) Reference (s)	WPT	Waterproofing / Work Work point
CONTR	Contractor	1110	ricaning a vermianeri cermacion	REFL	Reflected	WR	Water repellent
COOL	Cooling			REG	Register	WS	Waterstop
CPP CPP	CMU Painted	ID INL	Inside diameter Inlet	REM REQ	Remove	WSCT WTW	Wainscot Wall to wall
CPR CPT	Copper Carpet	INL INS	Insulate (d), (ion)	RES	Required Resilient	WWF	Wall 10 Wall Welded Wire Fabric
CRS	Course	INT	Interior	RET	Return	, , , , , ,	Troided Trie Labile
CSMU	Calcium silicate masonry unit	INV	Invert	RFG	Roofing		
CST CT	Cast stone Ceramic tile			RFH RH	Roof hatch		
CTP	Clear tempered plate glass	JC	Janitor's closet	RM	Right hand Room		
CTR	Counter	JT	Joint	RO	Rough opening		
CWP	Clear wire plate			ROW	Right of way		
		V ⊂ DI	Kaana's aamant plaster	RRT	Radial rubber tile		
D	Drain (s)	KCPL KIT	Keene's cement plaster Kitchen	RUB RV	Rubber, base Radon vent		
DBL	Double	KPL	Kickplate	RWC	Rain water conductor		
DF	Drinking fountain		•				
DIM	Dimension	1	l o o otho	C	Cauth		
DIAM DK	Diameter Deck	l LAB	Length Laboratory	S SBS	South Styrene butadiene styrene		
DMB	Dry marker board	LAM	Laminate (d)	SEC	Security		
DN	Down	LAV	Lavitory	SC	Solid core		
DR DS	Door Downspout	LDR LF	Leader Lineal foot/Linear feet	SCH SCT	Schedule Structural clay tile		
DM D2	Downspout Dumbwaiter	Lr LH	Left-hand	SD	Structural clay tile Storm drain		
		LL	Liveload	SFGL	Safety glass		
F	Fort	LOC	Location	SHM	Security hollow metal		
E EA	East Each	LPT LTL	Low point Lintel	SHTH SIM	Sheathing Similar		
EB	Exibition Board	LW	Lightweight	SKL	Skylight		
EC	Electrical contractor	LWC	Lightweight concrete	SL	Sleeve		
EF	Exhaust fan			SNT	Sealant		
EIFS EJ, EXP JT	Exterior insulated finish system Expansion joint	MAS	Masonry	SOG SP	Slab on grade Soundproof		
EJ, EXP JI EL	Elevation	MAT	Material	SPAC'G	Spacing		
ELEC	Electrical	MAX	Maximum	SPEC	Specification		
ELEV	Elevator	MC MECH	Mechanical contractor	SPF, BLK	Split face block		
EMER ENC	Emergency Enclosure	MECH MED	Mechanical Medium	SPK SQ	Speaker Square		
ENTR	Entrance	MET	Mediom	SQ. FT.	Square foot / feet		
EOP	Edge of paving	MFR	Manufacturer	SST	Stainless steel		
EP	Epoxy paint	MH	Manhole	STD	Standard Souting		
EPDM EQ	Ethylene propylene diene monomer Equal	s MIN MISC	Minimum Miscellaneous	STG STR	Seating Structural		
EQP	Equal Equipment	MMB	Membrane	SUS	Suspended		
ERF	Epoxy Resinous Flooring	MO	Masonry opening	SWF	Security Window Film		
ETR	Existing To Remain	MOV	Movable	SYN	Synthetic		
ETR-R ETZ	Existing To Remain - Refinished Epoxy Terrazzo	MR MT	Mop receptor Marble threshold	SYS	System		
EWC	Electric water cooler	MTD	Mounted				
EXB	Expansion bolt	MTFR	Metal furring				
EXG	Existing	MULL	Mullion				
EXP EXT	Exposed Exterior						
_/\\	2						

Project Name

New Bus Parking / Exterior Plaza & Curtain Wall Replacement at Absegami High School

Project Owner Name Regional High School District

Project Location Absegami High School 201 South Wrangleboro Rd Galloway, NJ 08205

Project Number Project Date 01.23.2024


W.D.H. Drawn By Scale

AS NOTED Drawing Name

General Notes,

No. Date Description

Drawing Number

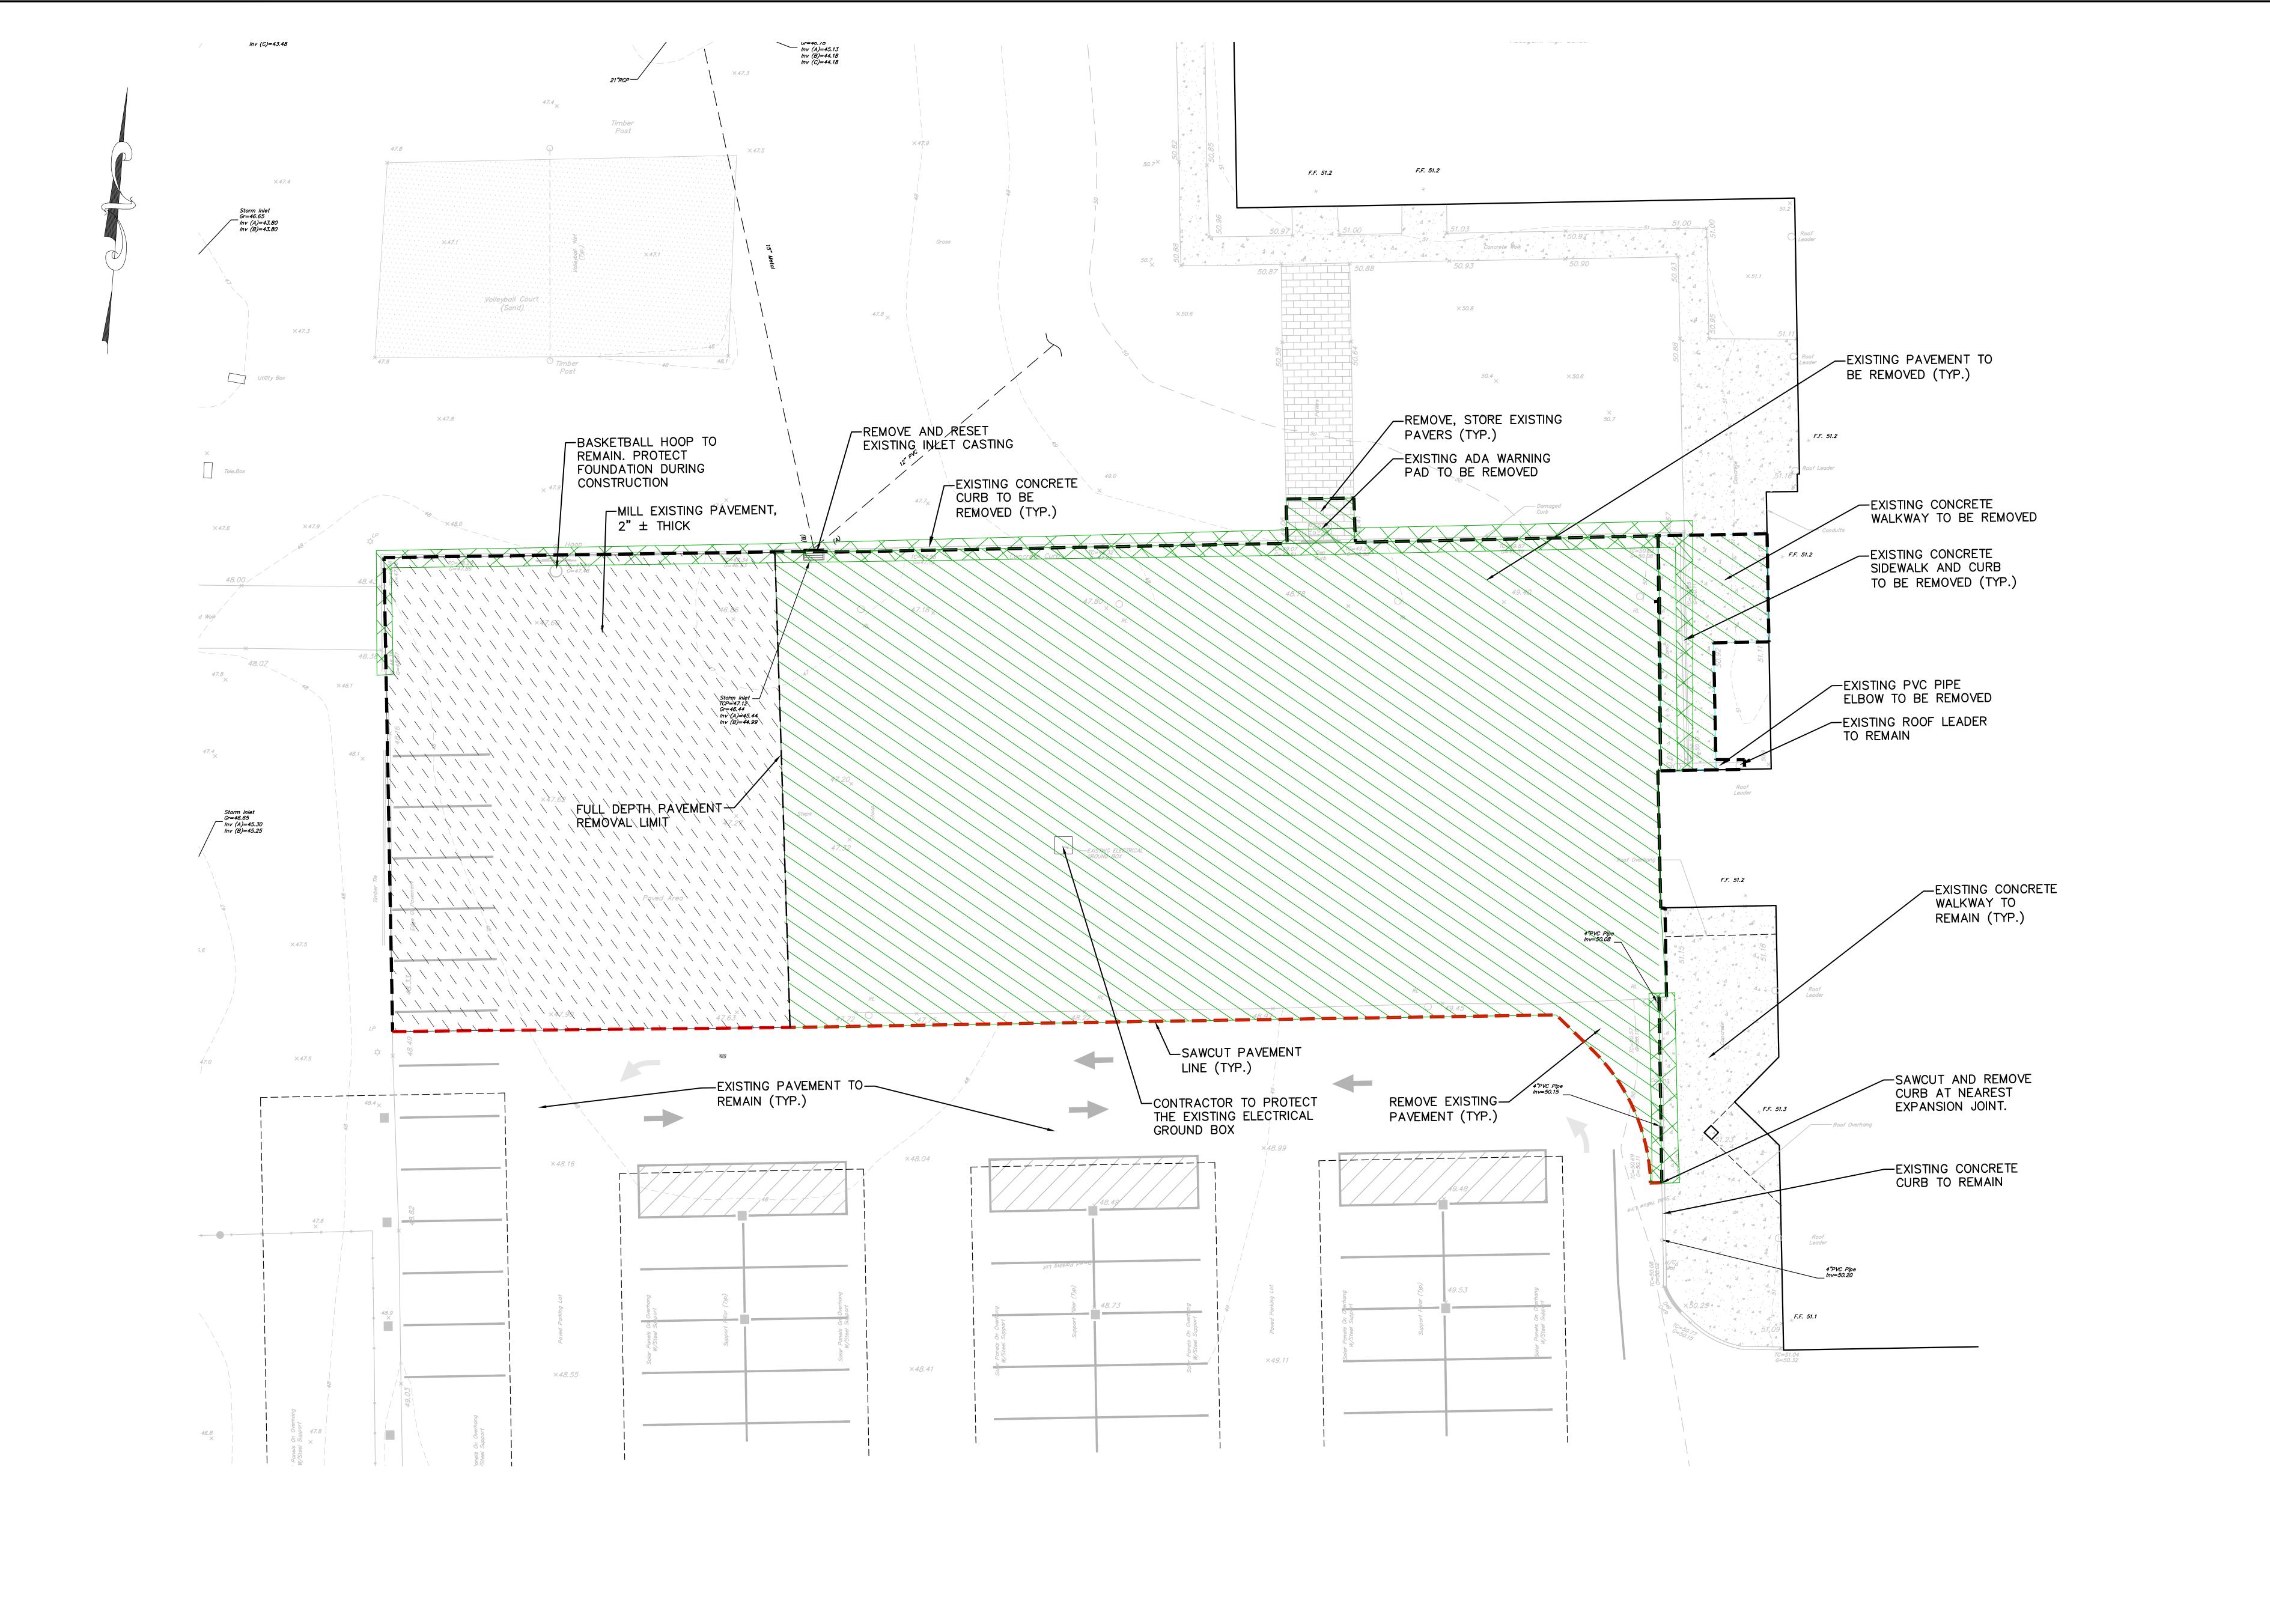

DEMOLITION NOTES:

- THE CONTRACTOR SHALL BE RESPONSIBLE FOR THE DEMOLITION AND REMOVAL OF ALL EXISTING STRUCTURES, FOUNDATIONS, VEGETATION, ABOVE AND BELOW GRADE UTILITIES, MISCELLANEOUS DEBRIS AND ALL OTHER MATERIALS AND ITEMS LOCATED WITHIN THE DEMOLITION LIMITS AS INDICATED ABOVE. EXISTING IMPROVEMENTS, LOCATED WITHIN THE PROJECT SITE SHALL BE PROTECTED
- BY THE CONTRACTOR AND ALL EXISTING IMPROVEMENTS OR OTHER AMENITIES DISTURBED BY THEIR OPERATIONS MUST BE RESTORED AND/OR REPLACED BY THE CONTRACTOR TO THE SATISFACTION OF THE OWNER. ALL EXISTING STRUCTURES SHALL BE DEMOLISHED IN SUCH A MANNER SO AS TO
- MINIMIZE DISTURBANCE TO THE SURROUNDING PROPERTIES, NO DUST, PARTICLES OF DEBRIS OR WATER FROM THE DUST CONTROL SHALL BE PERMITTED OUTSIDE OF THE DESIGNATED WORK AREAS.
- 4. AT THE END OF DEMOLITION OPERATIONS INDICATED, THE CONTRACTOR SHALL INSTALL A SILT FENCE AND HAY BALE SEDIMENT BARRIERS AROUND THE PERIMETERS OF THE DEMOLITION AREAS TO MAINTAIN ADEQUATE SILT AND SOIL EROSION CONTROL AND ADEQUATE WATER DRAINAGE AROUND DEMOLITION AREA PERIMETERS, UNTIL BACKFILLING AND REGRADING OPERATIONS ARE COMPLETED AND THE AREA IS
- THE CONTRACTOR SHALL BE RESPONSIBLE FOR STRIPPING THE PROPERTY TO REMOVE ALL IMPERVIOUS AND DELETERIOUS MATERIALS FROM THE SURFACE OF THE DEMOLITION AREA, INCLUDING ALL CONSTRUCTION DEBRIS AND VEGETATION. PRIOR TO COMMENCING ANY EARTHWORK AND REGRADING THE CONTRACTOR SHALL PERFORM EXPLORATORY TEST PITS WITHIN THE DEMOLITION LIMITS TO IDENTIFY ANY BURIED DEMOLITION DEBRIS, FOUNDATION ELEMENTS AND ABANDON UTILITIES. THE CONTRACTOR SHALL REMOVE ALL DEBRIS, INCLUDING BUT NOT LIMITED TO, FOUNDATIONS, BRICK, WOOD, CONCRETE, METAL AND ASPHALT FRAGMENTS FROM THE SITE TO AN APPROVED NJDEP LANDFILL.
- 6. THE CONTRACTOR SHALL BE RESPONSIBLE FOR THE REMOVAL AND DISPOSAL OF ALL EXCESS FILL GENERATED DURING THE DEMOLITION AND CONSTRUCTION ACTIVITIES.

- 1. BY SUBMITTING A BID, THE BIDDER WARRANTS THAT THEY HAVE CAREFULLY EXAMINED THE SITE AND HAS FAMILIARIZED THEMSELVES WITH ALL PROVISIONS OF THE CONTRACT DOCUMENTS AND THAT WHERE THE DRAWINGS AND SPECIFICATIONS REQUIRE A GIVEN RESULT, SUCH RESULT CAN BE PRODUCED UNDER THE TERMS OF THE CONTRACT DOCUMENTS.
- 2. THE CONTRACTOR SHALL PROCURE AND PAY FOR ALL NECESSARY PERMITS AND LICENSES REQUIRED TO CARRY OUT THEIR WORK IN FULL ACCORDANCE WITH REQUIREMENTS OF ALL REGULATIONS AND AUTHORITIES HAVING JURISDICTION. THE CONTRACTOR SHALL COMPLY WITH ALL FEDERAL, STATE AND LOCAL LAWS AND ALL CODES, RULES AND REGULATIONS OF HEALTH, PUBLIC OR OTHER AUTHORITY CONTROLLING OR LIMITING THE METHODS, MATERIAL TO BE USED, OR THE ACTIONS OF OF THOSE EMPLOYED IN WORK OF THIS KIND. ALL WORK, LABOR OR MATERIAL NECESSARY TO COMPLY WITH THESE LAWS, CODES, RULES AND REGULATIONS SHALL BE PERFORMED AND FURNISHED BY THE CONTRACTOR.
- 3. THE CONTRACTOR SHALL PROVIDE AND MAINTAIN ALL NECESSARY EQUIPMENT AND METHODS TO KEEP EXCAVATIONS FREE OF WATER AND PROTECT WORK AND ADJACENT STRUCTURES FROM DAMAGE BY WATER DURING ALL STAGES OF THEIR ACTIVITIES. NO SEPARATE PAYMENT WILL BE MADE FOR DEWATERING OPERATIONS AND/OR SUBSURFACE SOILS THAT HAVE BEEN AFFECTED BY WEATHER AND ALL COSTS THEREOF SHALL BE INCLUDED IN THE PRICE BID FOR THIS
- 4. THE CONTRACTOR SHALL FURNISH, PLACE AND MAINTAIN SHEETING, BRACING, SHORING, AND OTHER SUPPORTS REQUIRED BY THEIR WORK AND TO PROTECT ADJACENT STRUCTURES. NO SEPARATE PAYMENT WILL BE MADE FOR THIS WORK AND ALL COSTS THEREOF SHALL BE INCLUDED IN THE PRICE BID FOR THIS PROJECT.

UTILITY NOTES:

AND/OR CONSTRUCTION ACTIVITIES.

- 1. THE CONTRACTOR SHALL BE RESPONSIBLE FOR CONTACTING THE RESPECTIVE UTILITY COMPANIES PRIOR TO DEMOLITION OR CONSTRUCTION ACTIVITIES TO DETERMINE THE EXACT LOCATIONS AS NECESSARY AND IN ACCORDANCE WITH THE REQUIREMENTS OF THE CONTRACT DOCUMENTS. UTILITY LOCATIONS SHOWN ON THESE PLANS ARE FROM ABOVE-GROUND OBSERVATIONS AND FROM RECORD INFORMATION PROVIDED BY THE UTILITY COMPANIES. IN ADDITION, THE LOCATION AND TYPE OF THE EXISTING UTILITIES SHOWN ON THESE PLANS IS NOT GUARANTEED TO BE ACCURATE NOR ALL INCLUSIVE. THE CONTRACTOR SHALL USE THE EXISTING UTILITY LOCATIONS SHOWN AS AN AID IN DETERMINING EXACT LOCATIONS. THE CONTRACTOR MUST CONTACT THE "ONE CALL SYSTEM" AT 1-800-272-1000 AT LEAST 72 HOURS PRIOR TO ANY EXCAVATION, DEMOLITION
- 2. THE CONTRACTOR IS RESPONSIBLE FOR THE COORDINATION, SCHEDULING AND ALL COSTS REQUIRED FOR NEW SERVICE CONNECTIONS, CAP, DISCONNECT AND REMOVE THE EXCESS UTILITIES IN ACCORDANCE WITH THE REQUIREMENTS OF THE UTILITY AGENCY OR THE AUTHORITY HAVING JURISDICTION. IN ADDITION, IF THE EXISTING IMPROVEMENTS LOCATED WITHIN THE PROJECT ARE DISTURBED BY THE CONTRACTOR OR THE UTILITY COMPANIES, THE CONTRACTOR SHALL BE RESPONSIBLE FOR THE RESTORATION OF THE IMPROVEMENTS IN ACCORDANCE WITH THE REQUIREMENTS OF THE OWNER.
- 3. IF ANY UTILITY FACILITIES, INCLUDING DISTRIBUTION MAINS OR SERVICES FOR ADJACENT STRUCTURES OR PROPERTIES, ARE DISRUPTED OR DAMAGED DURING THE CONSTRUCTION WORK ASSOCIATED WITH THIS PROJECT, THE CONTRACTOR IS RESPONSIBLE FOR RESTORING THE UTILITY FACILITIES BY THE END OF THE

WORKING DAY AT NO ADDITIONAL EXPENSE TO THE OWNER.

4. THE CONTRACTOR SHALL BE RESPONSIBLE FOR THE COORDINATION, INSTALLATION AND SUPPLY OF ANY UTILITY SERVICE REQUIRED FOR THIS PROJECT, INCLUDING TEMPORARY POWER AND TELEPHONE SERVICES. ALL COSTS FOR THIS WORK SHALL BE INCLUDED IN THE PRICE BID FOR THIS PROJECT.


LEGEND



FULL DEPTH PAVEMENT/CONCRETE SIDEWALK TO BE REMOVED



PAVEMENT SURFACE COURSE MILLING, 2" \pm THICK

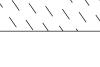

EXISTING CONCRETE CURB TO BE



REMOVED



Wall, New Jersey 07719 732.312.9800 FPAengineers.com FRENCH & PARRELLO ASSOCIATES New Jersey ▲ New York ▲ Pennsylvania ▲ Georgia

BRIAN R. DECINA, PE

PROFESSIONAL ENGINEER, NJ LIC. No. GE45149

Drawing Number

Regional High School District Project Location Absegami High School 201 South Wrangleboro Rd Galloway, NJ 08205

Project Name

New Bus Parking / Exterior

Absegami High School

Greater Egg Harbor

Plaza & Curtain Wall

Replacement at

Project Owner Name


Project Number 5369-5 Project Date 01.23.2024 Checked By

> B.R.D. Drawn By

Scale

Drawing Name **EXISTING CONDITION** AND DEMOLITION

No. Date Description

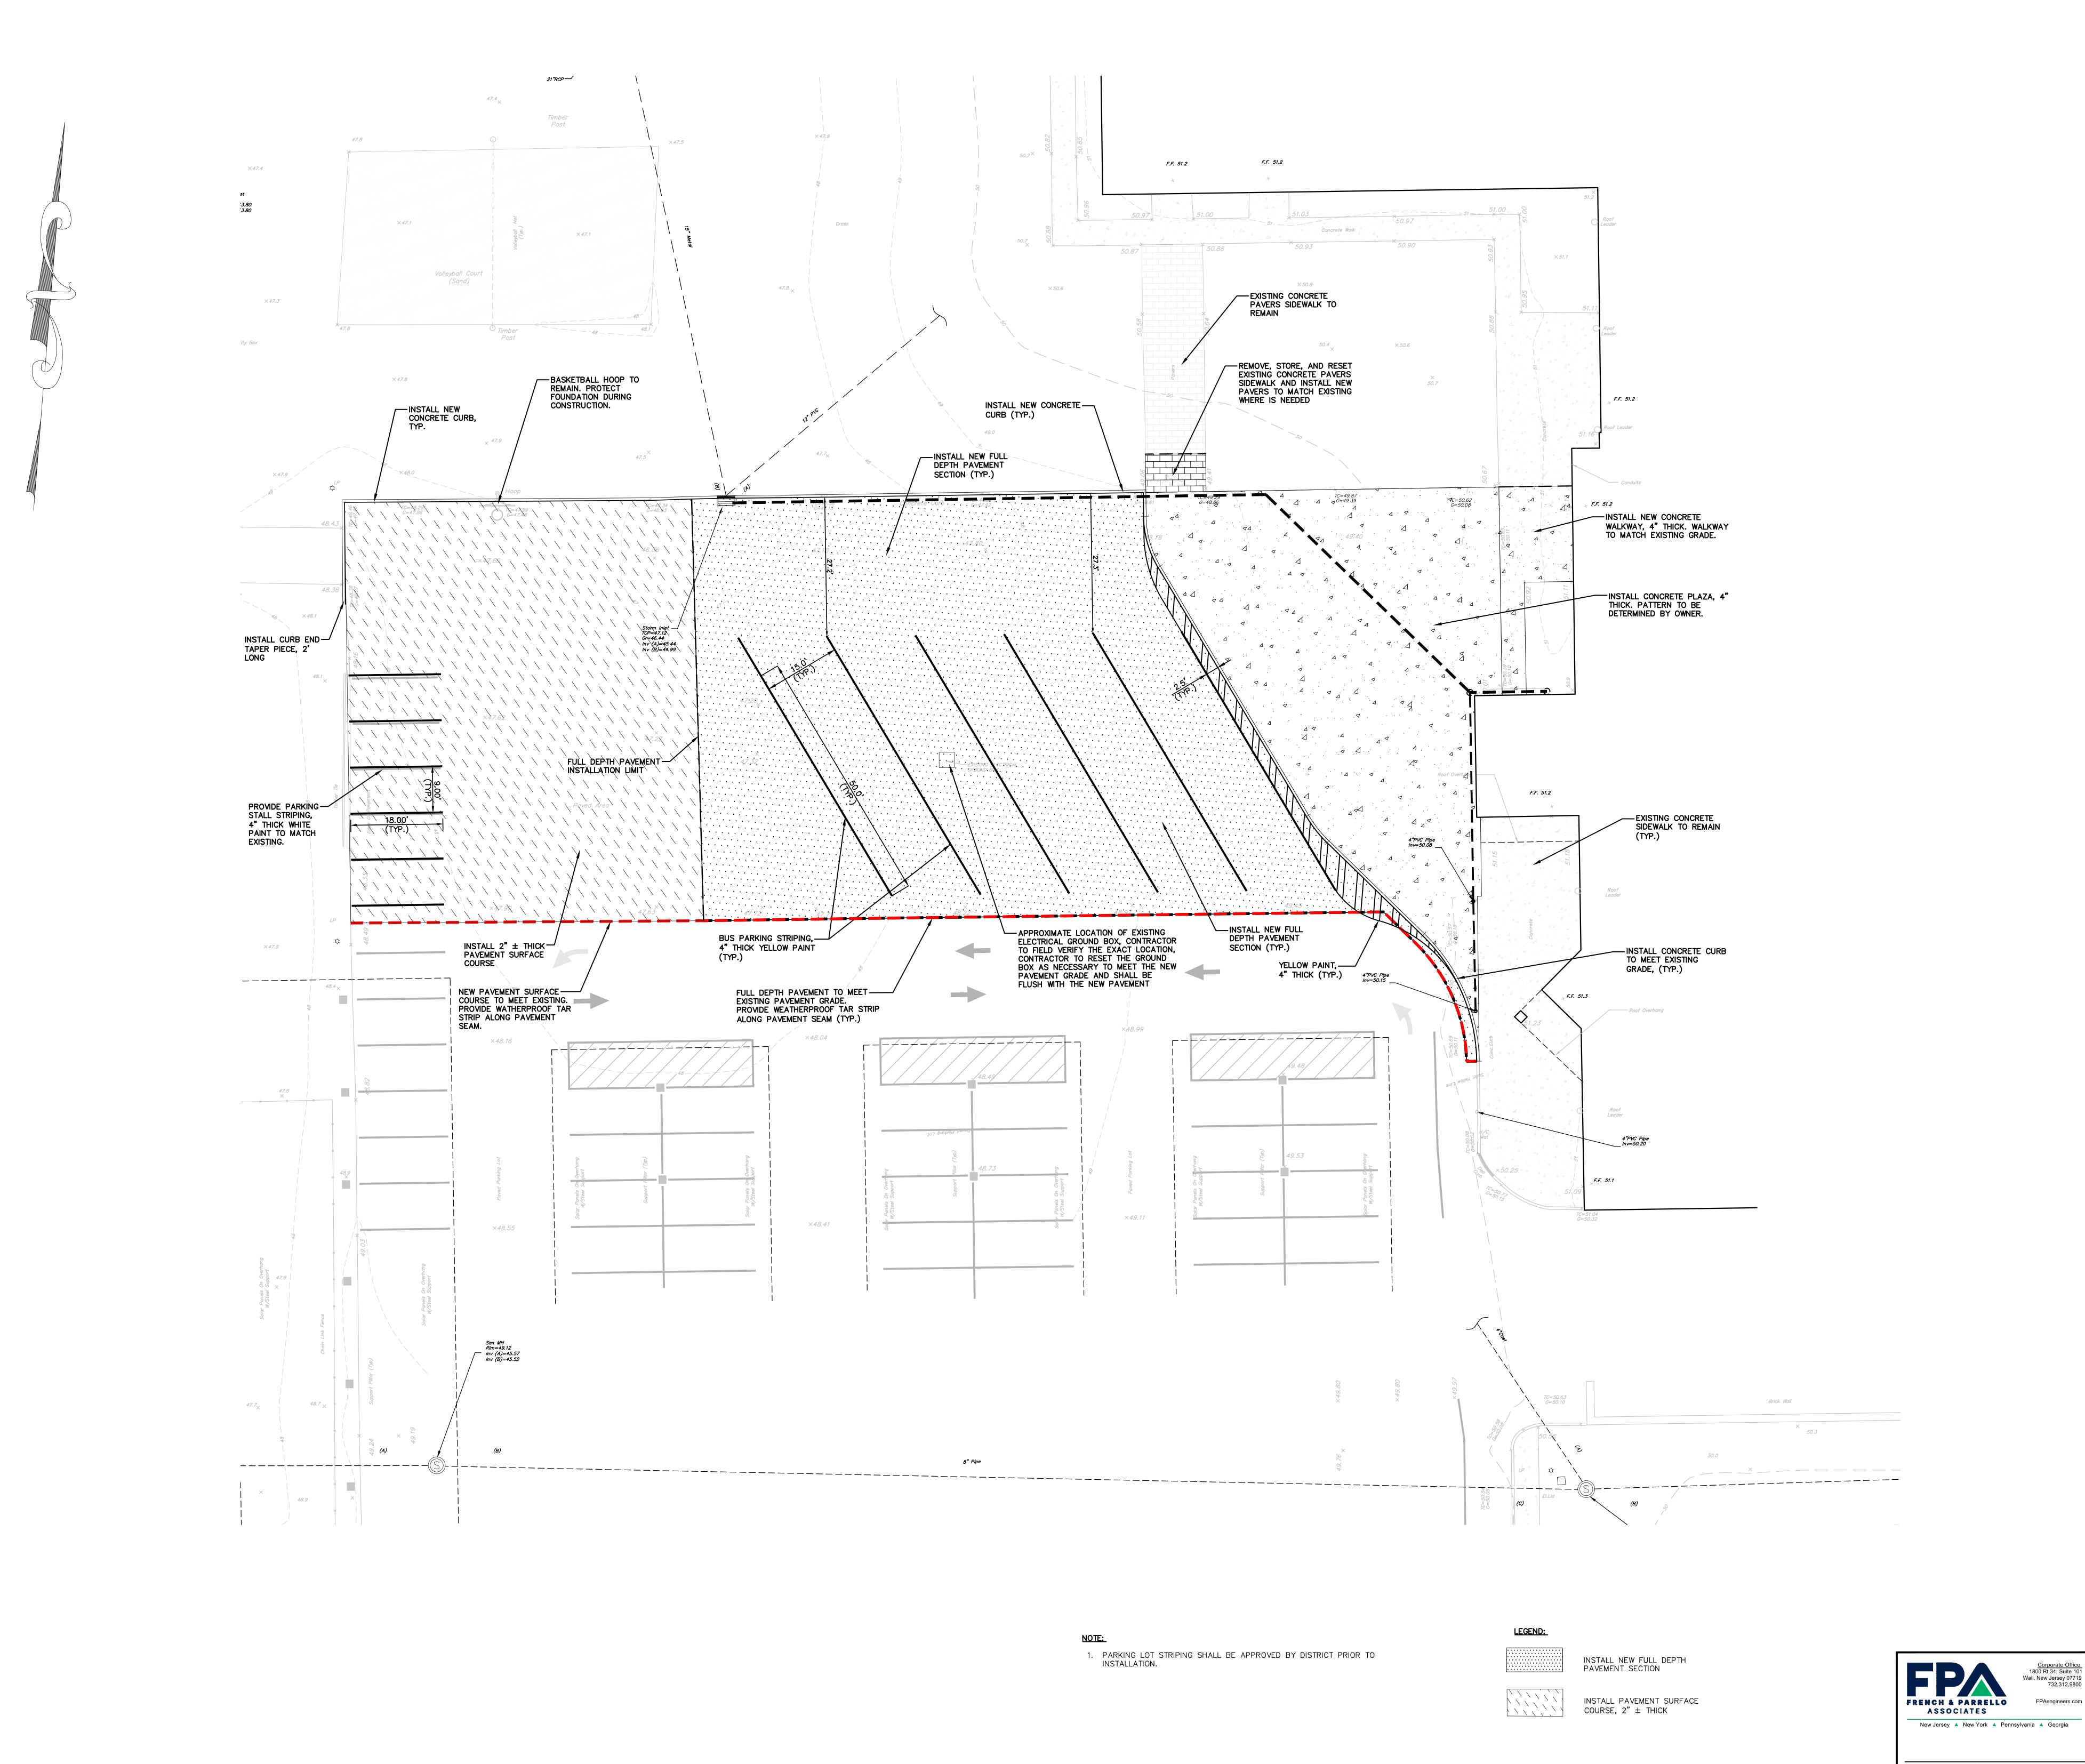

GEORGE R. DUTHIE JR., AIA, PP
NJ-21AI01299200
JASON J. DUBOWITCH, AIA
NJ-21AI01979800 | PA-RA406009

Estigns

Fraytak Veisz Hopkins Duthie P C

Corporate: 1515 Lower Ferry Road - Trenton - New Jersey 08618
Pennsylvania: 140 Whitaker Ave - Mont Clare - Pennsylvania 19453

New Bus Parking / Exterior
Plaza & Curtain Wall
Replacement at
Absegami High School

Greater Egg Harbor Regional High School District

Absegami High School 201 South Wrangleboro Rd Galloway, NJ 08205

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5369-5

Project Date

01.23.2024

Checked By

B.R.D.

T.L.V.
Scale

1" = 10'

SITE LAYOUT PLAN


Drawing Name

Revisions

No. Date Description

Drawing Number

BRIAN R. DECINA, PE
PROFESSIONAL ENGINEER, NJ LIC. No. GE45149

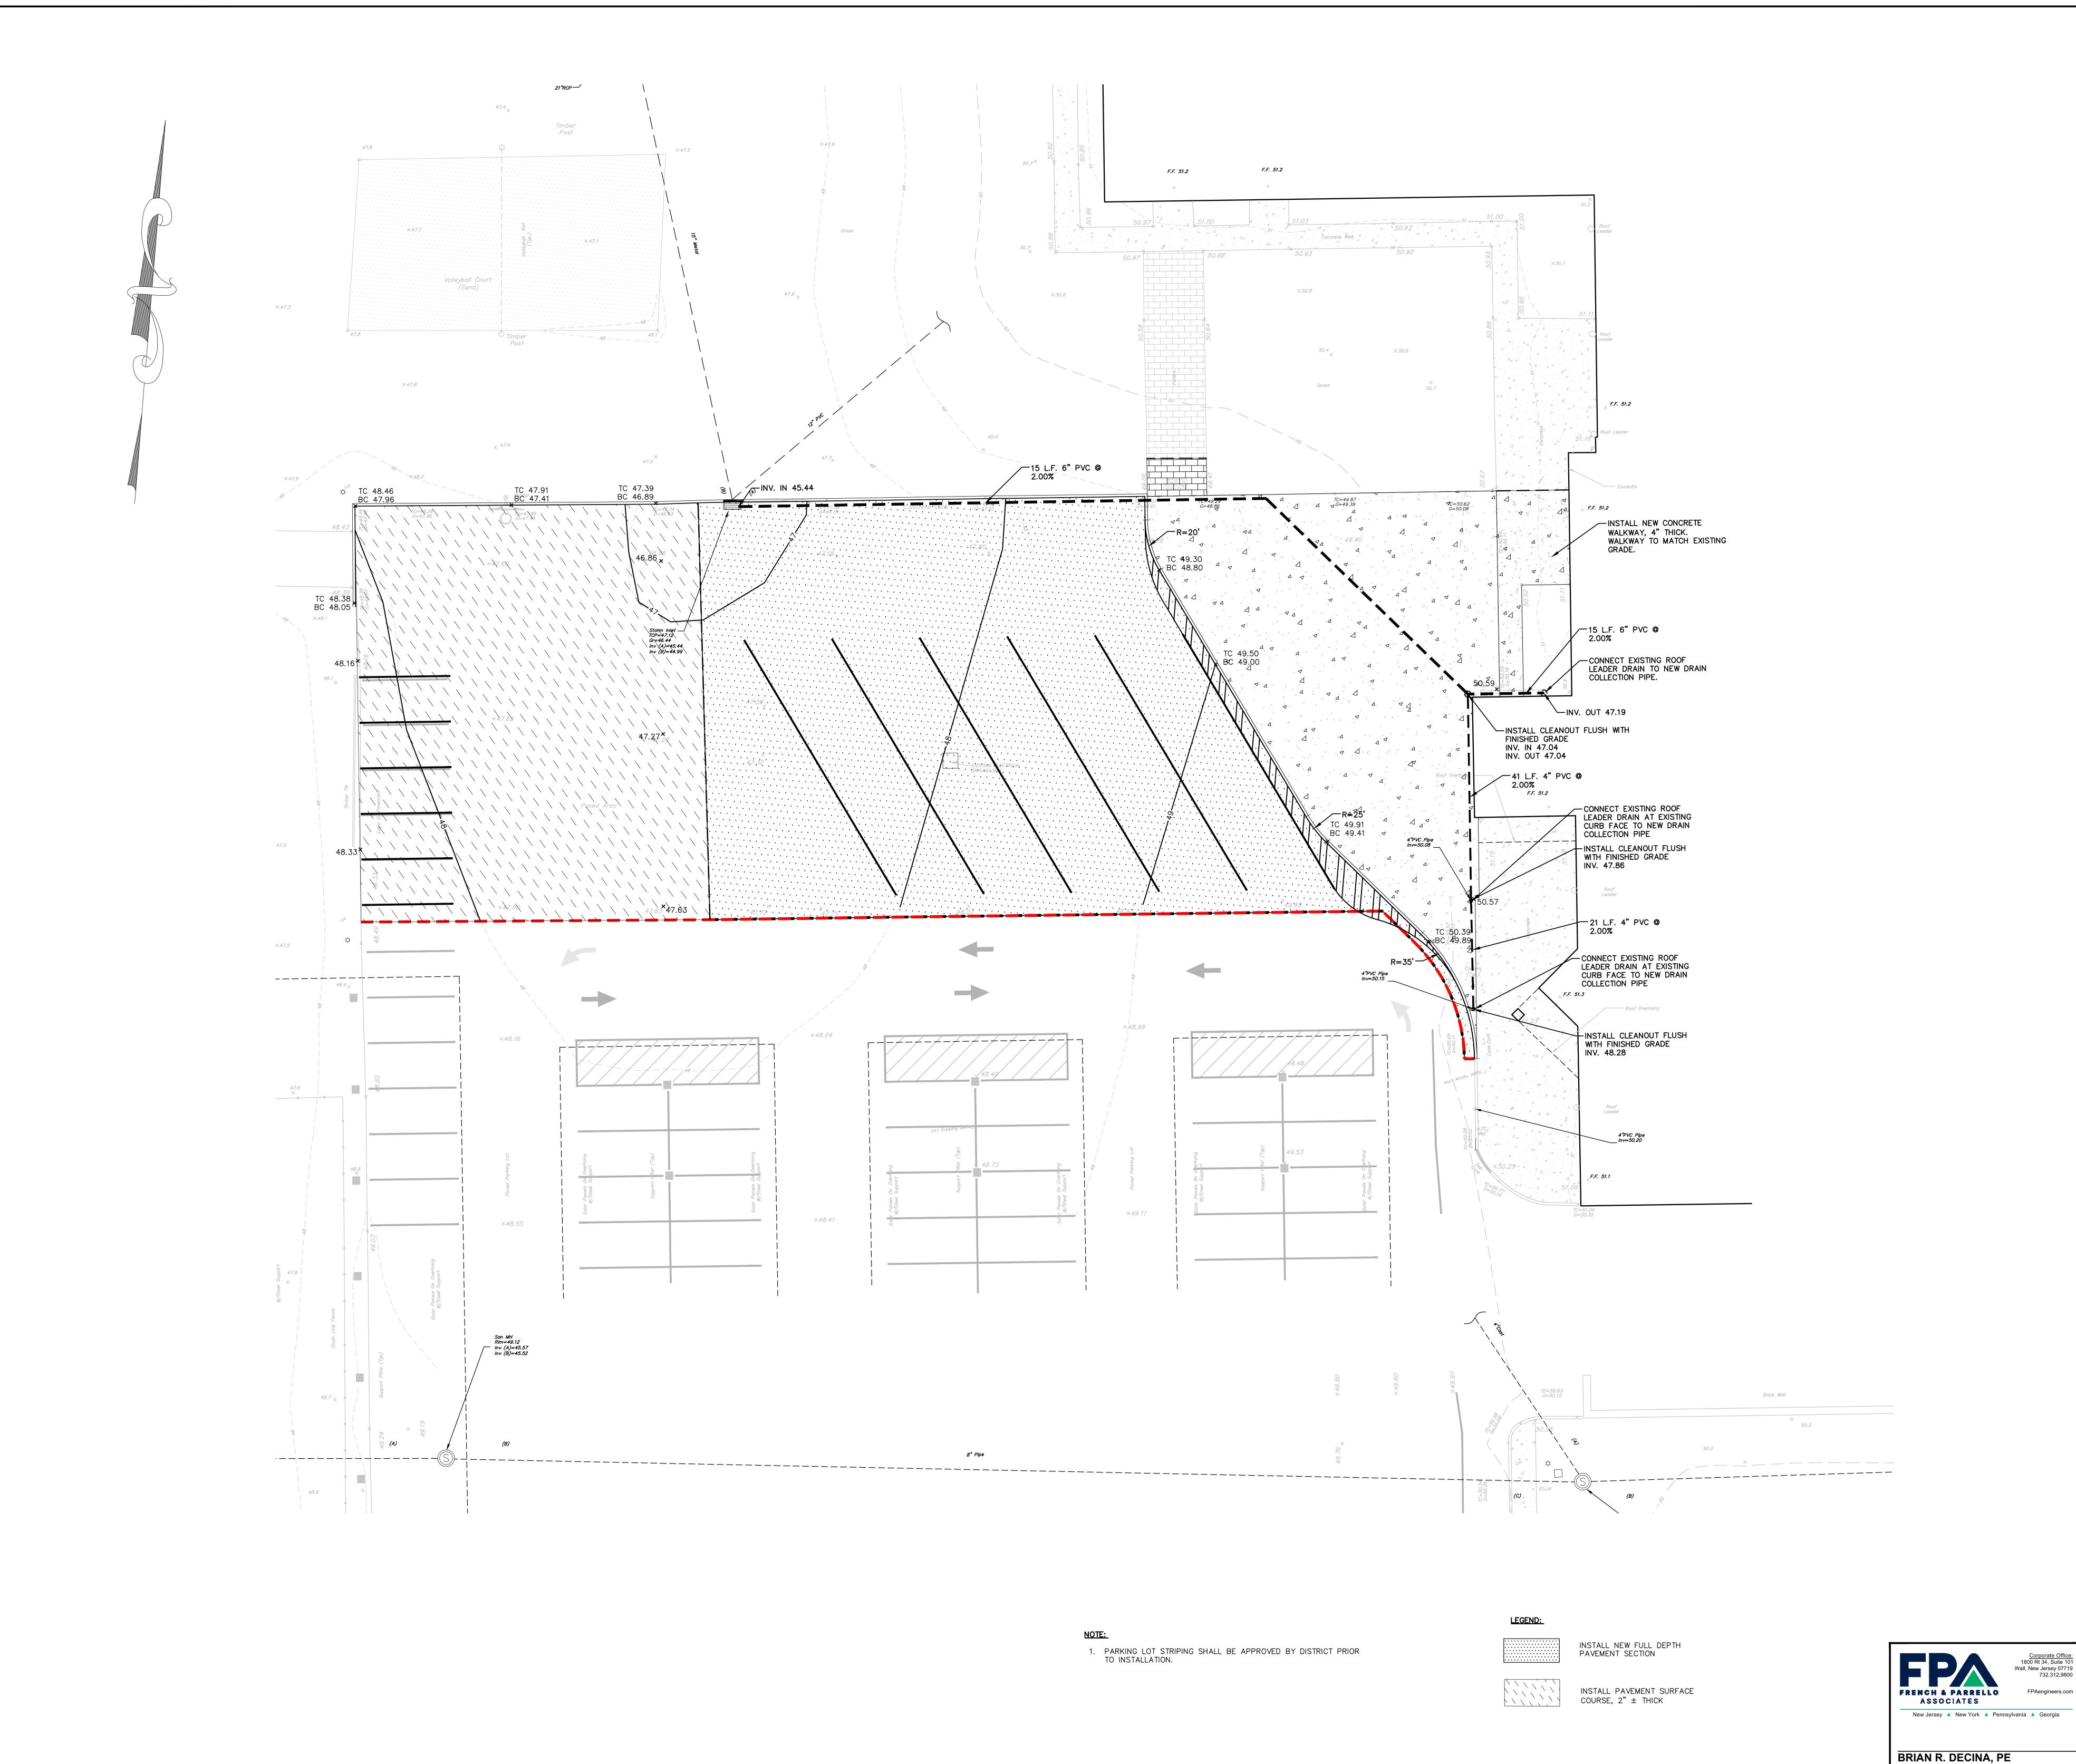

WILLIAM D. HOPKINS III, AIA, NJ - 21AI01706000 | PA - RA012520X

GEORGE R. DUTHIE JR., AIA, NJ - 21AI01299200

JASON J. DUBOWITCH, AIA NJ - 21AI01979800 | PA - RA406009

F V H D P C . C O M Architect

Estible
Fraytak Veisz Hopkins Duthie PC
Corporate: 1515 Lower Ferry Road - Trenton - New Jersey 08618
Pennsylvania: 140 Whitaker Ave - Mont Clare - Pennsylvania 19453

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Checked By

B.R.D.

Drawn By

Drawing Name

GRADING PLAN


Revisions


No. Date Description

Drawing Number

PROFESSIONAL ENGINEER, NJ LIC. No. GE45149

C-102

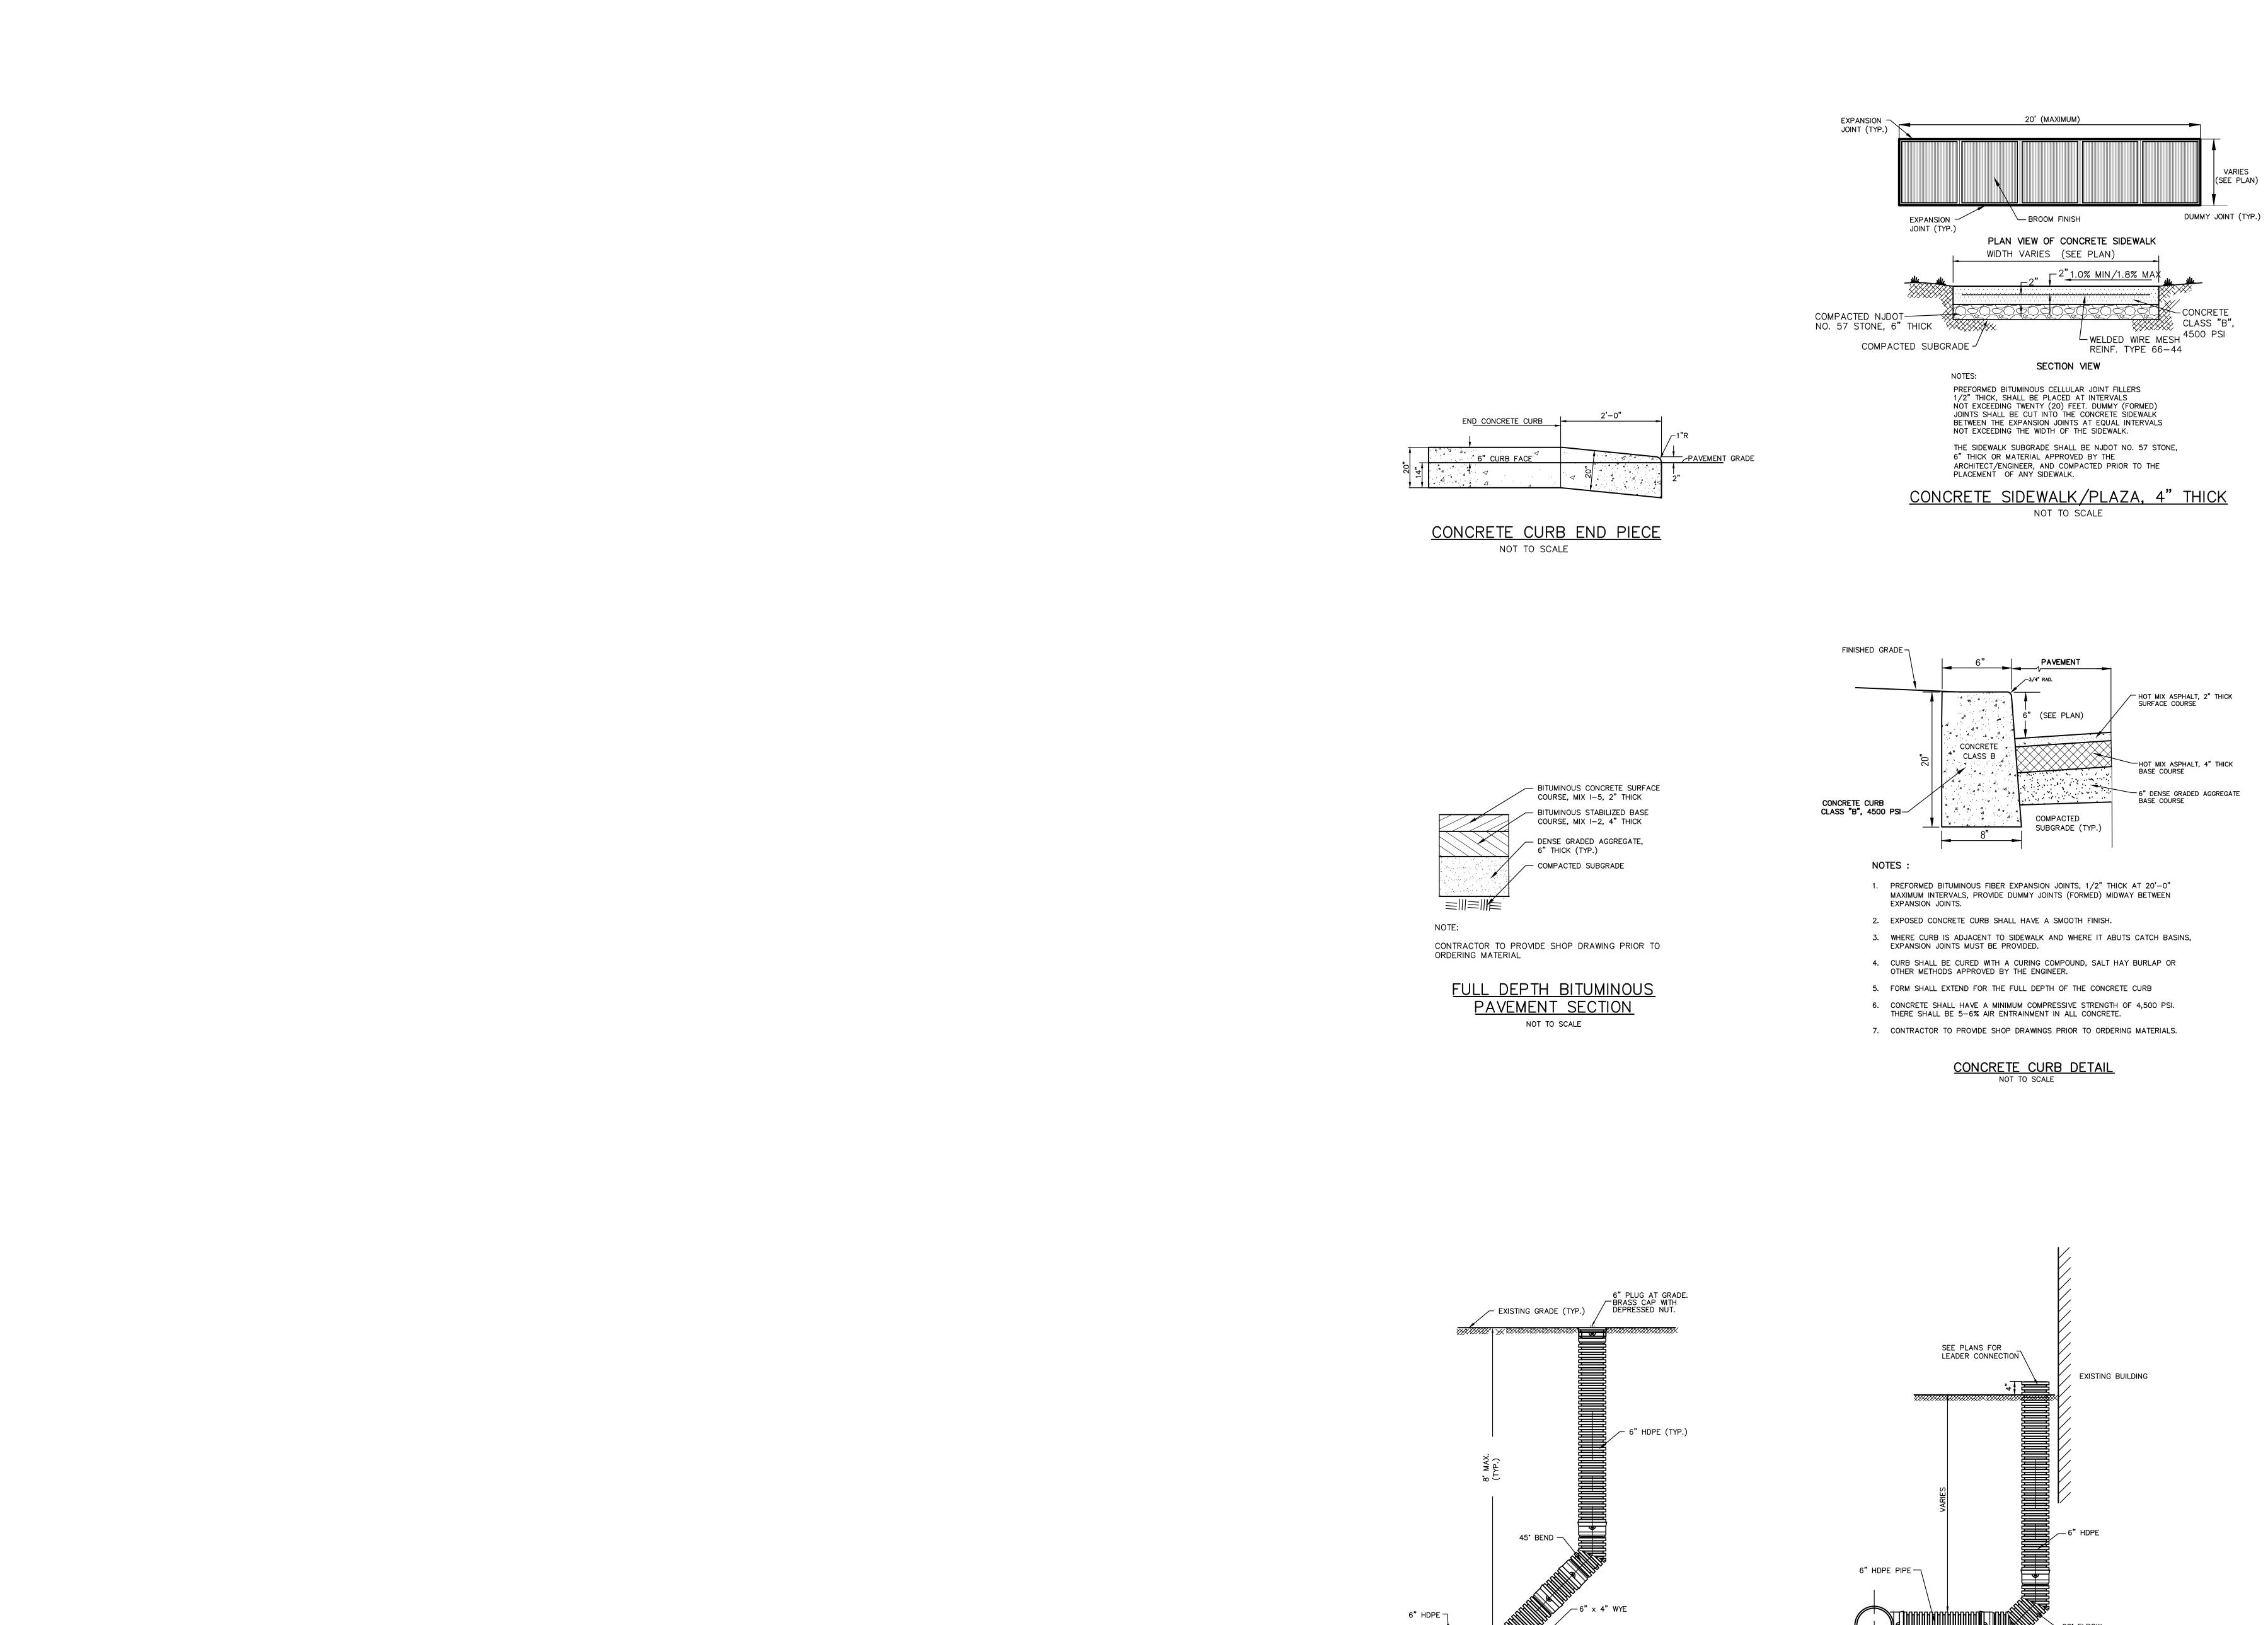

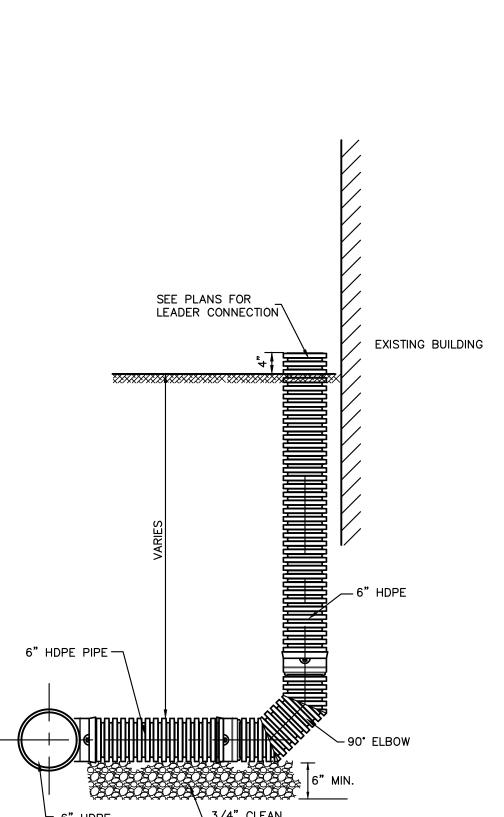

6" HDPE PIPE FOR ROOF LEADER TIE-IN

NOT TO SCALE

6" HDPE PIPE PROFILE CLEANOUT

NOT TO SCALE



VARIES (SEE PLAN)

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Drawing Name CONSTRUCTION

AS SHOWN

DETAILS

No. Date Description

<u>Corporate Office:</u> 1800 Rt 34, Suite 101 Wall, New Jersey 07719 732.312.9800 Drawing Number

FRENCH & PARRELLO ASSOCIATES


BRIAN R. DECINA, PE

New Jersey ▲ New York ▲ Pennsylvania ▲ Georgia

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C-103



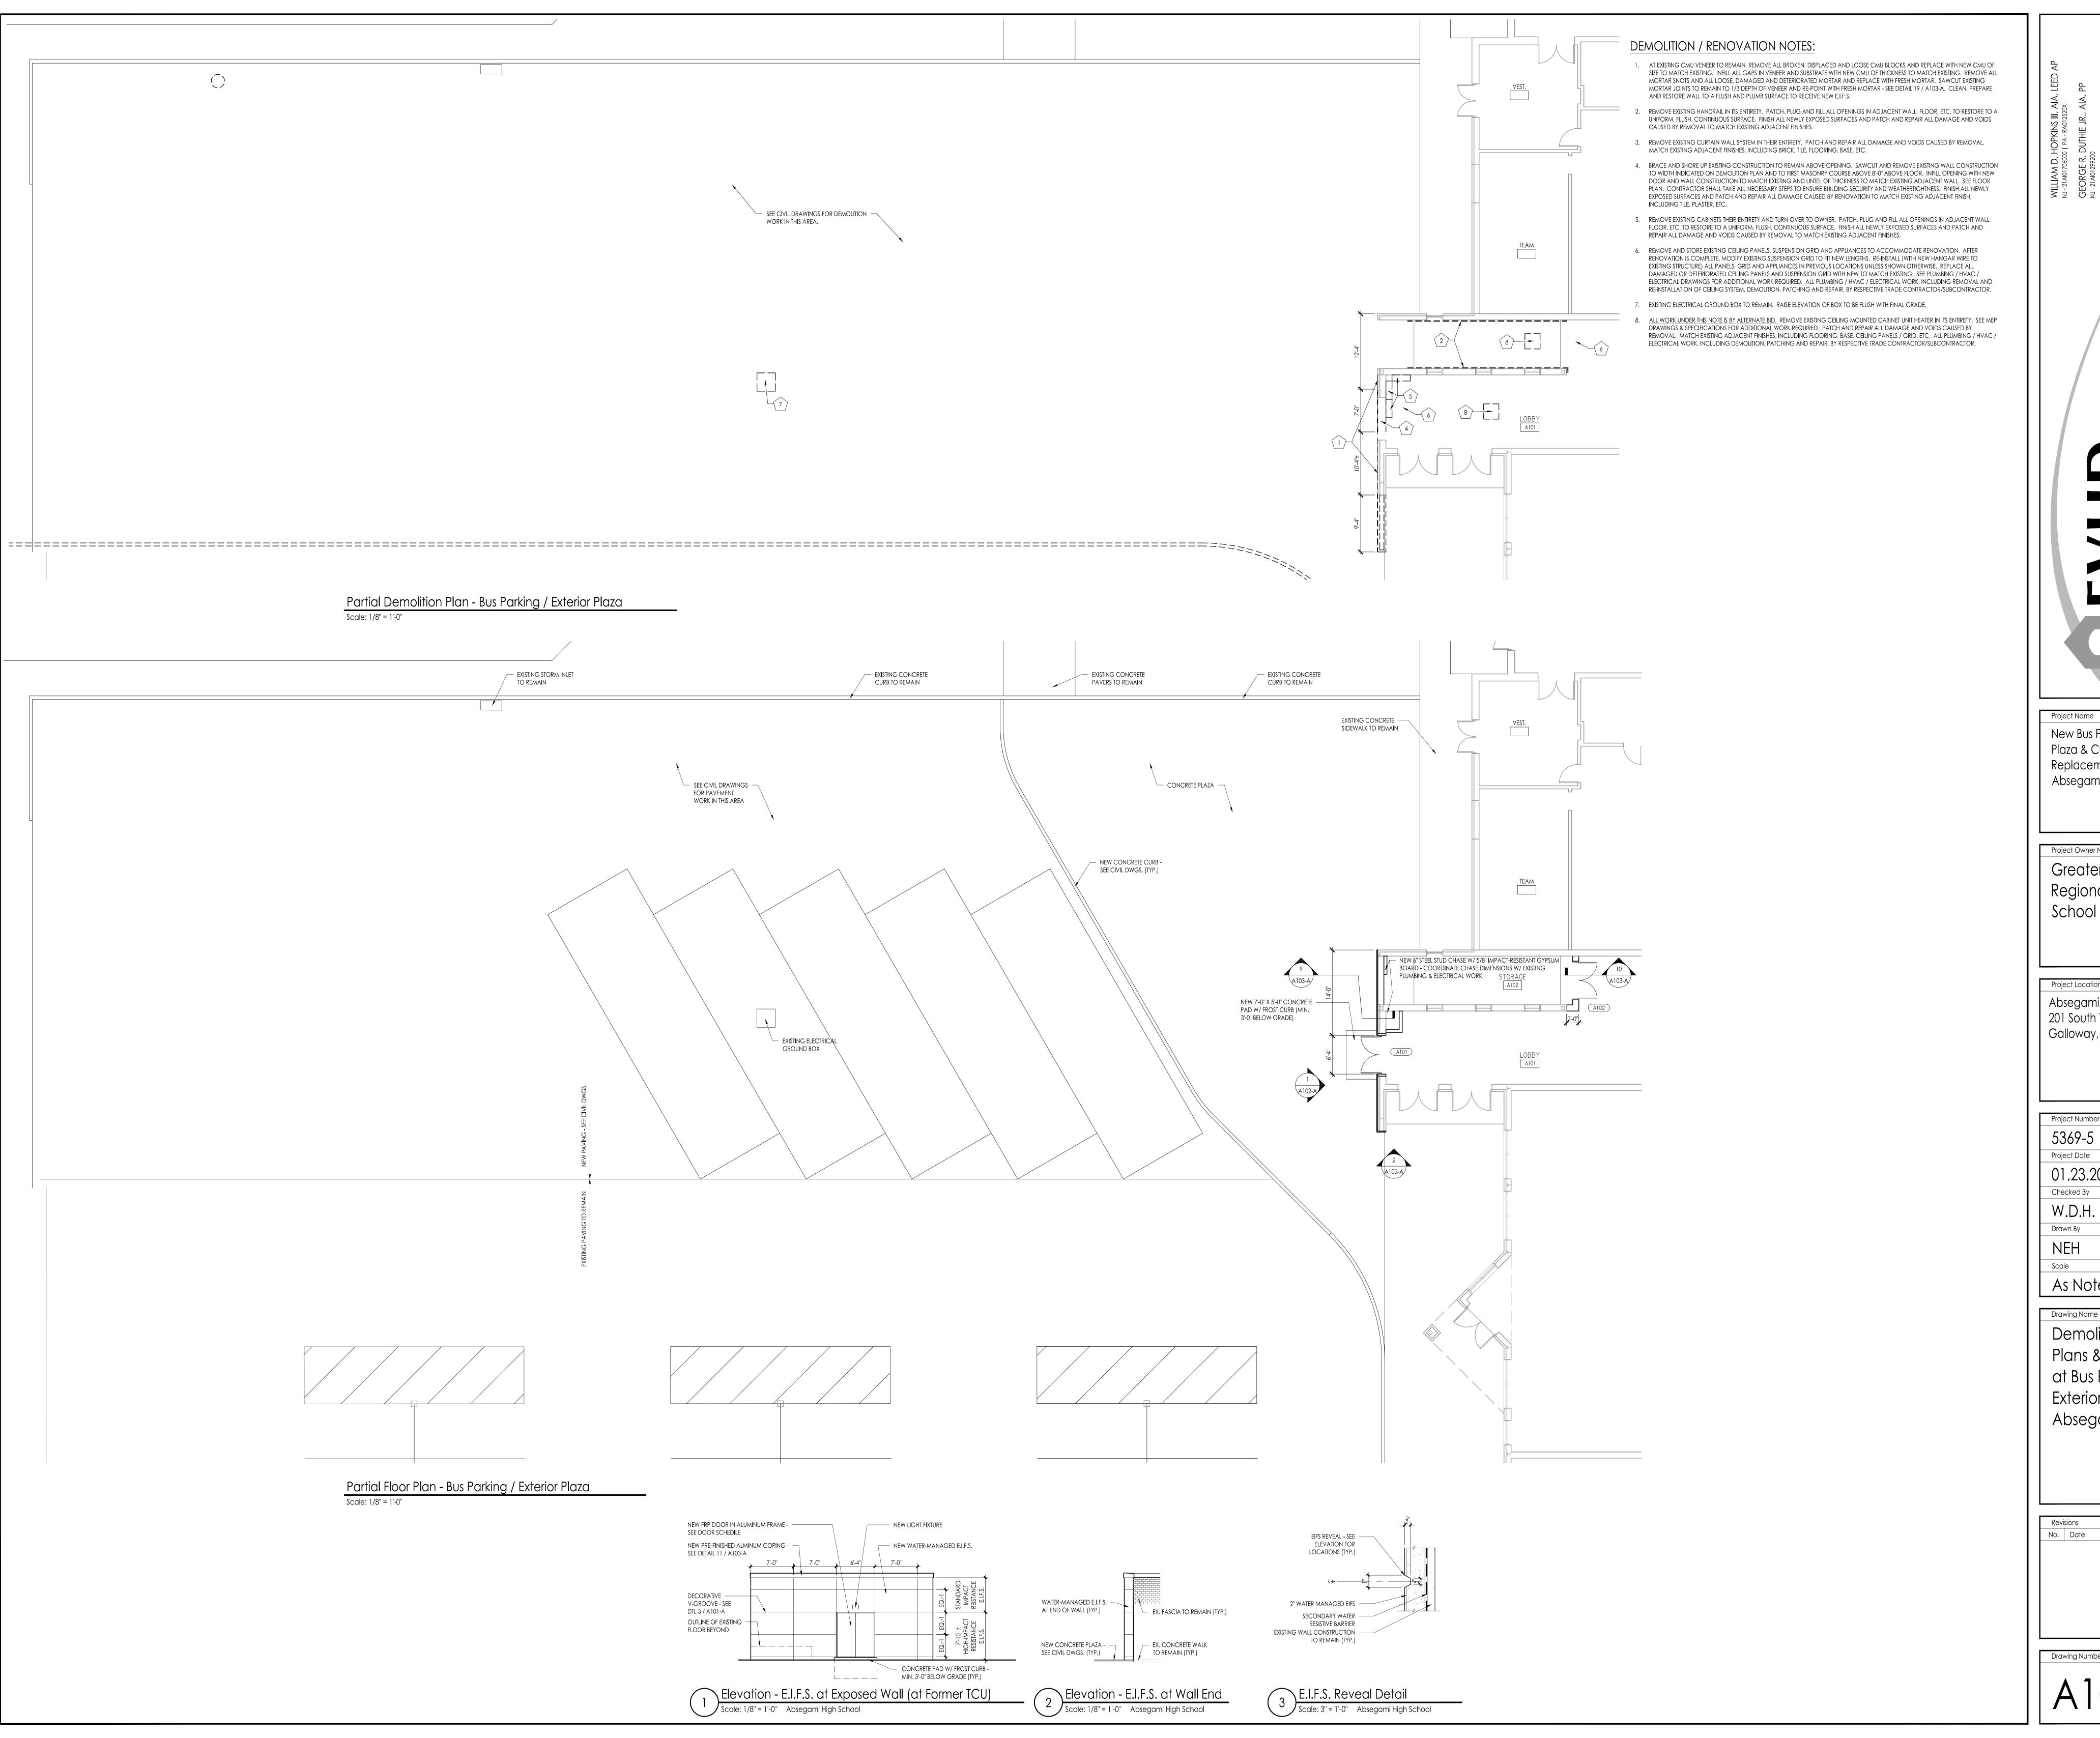

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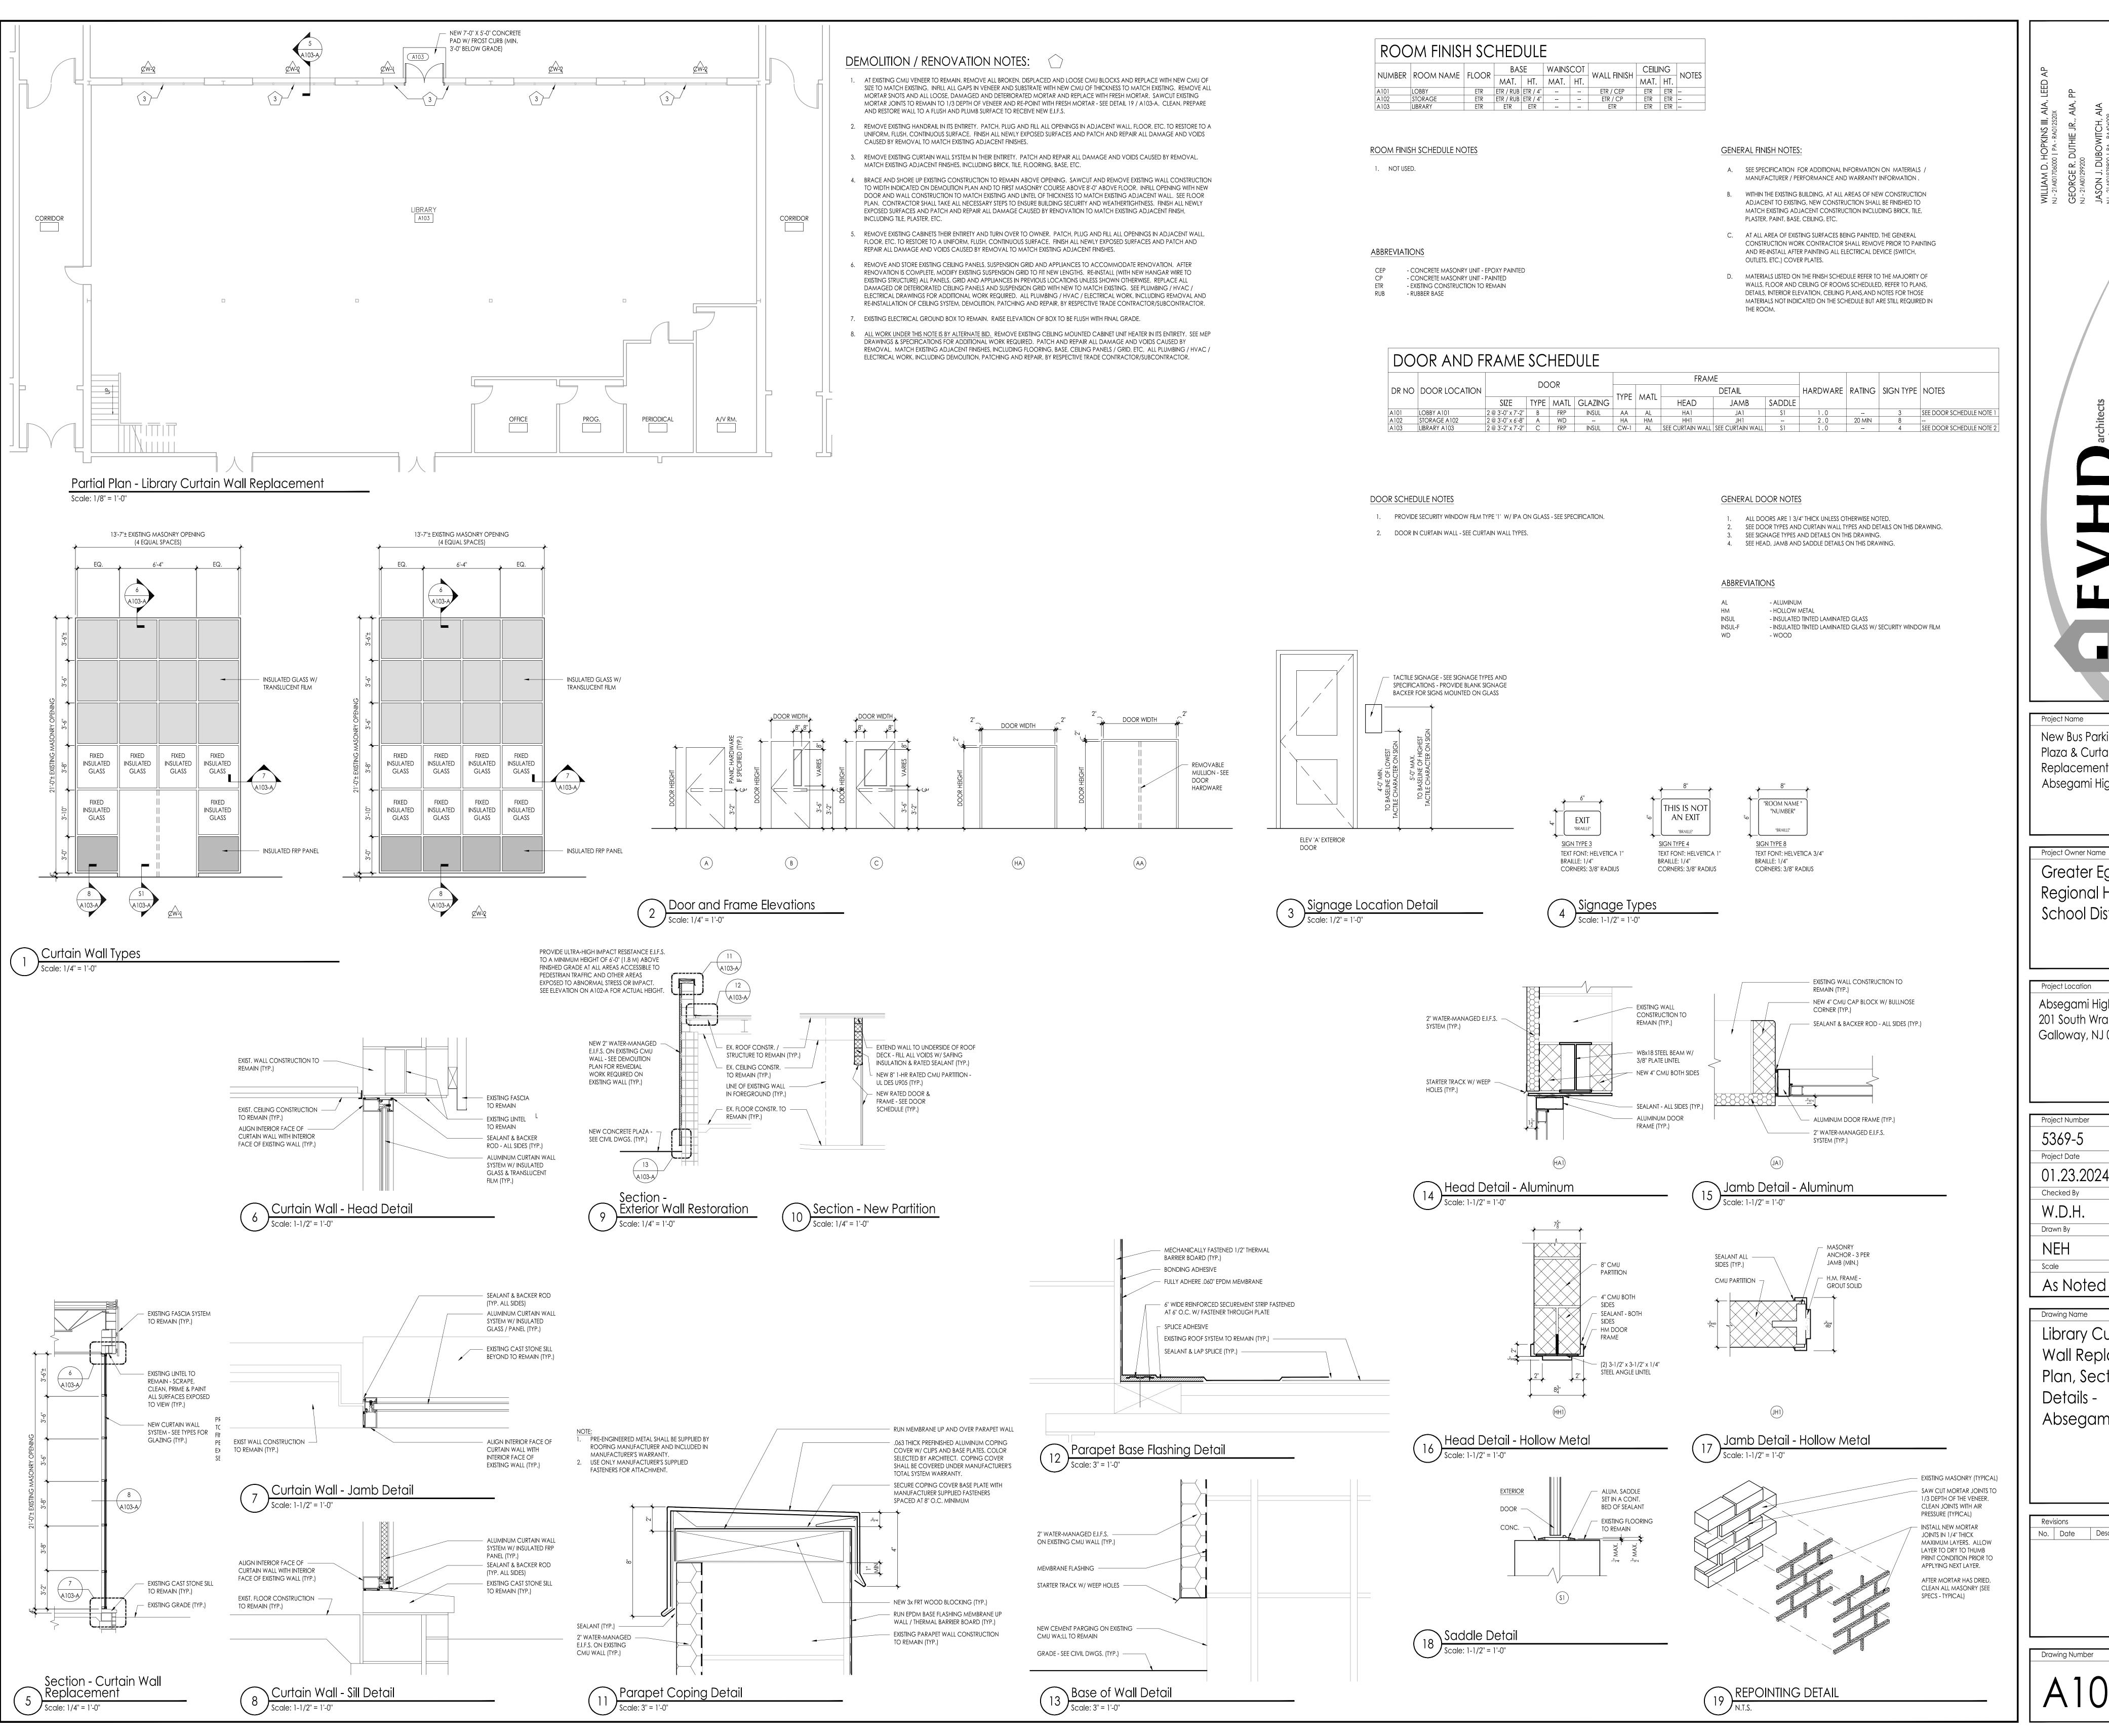
Project Number 5369-5 Project Date

01.23.2024 W.D.H.

As Noted

Demolition & Floor Plans & Elevations at Bus Parking / Exterior Plaza -Absegami HS

No. Date Description



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Drawing Name Library Curtain Wall Replacement Plan, Sections & Details -Absegami HS

No. Date Description

Drawing Number