#### REPORT OF THE PLANNING AND DEVELOPMENT DEPARTMENT FOR

#### **APPLICATION FOR REZONING ORDINANCE 2024-415 TO**

#### PLANNED UNIT DEVELOPMENT

#### **JUNE 20, 2024**

The Planning and Development Department hereby forwards to the Planning Commission, Land Use and Zoning Committee, and City Council its comments and recommendation regarding Application for Rezoning Ordinance 2024-415 to Planned Unit Development.

Location: South side of Valley Ridge Boulevard between

Coconut Palm Parkway and Joellyn Court

**Real Estate Number(s):** 168149-9900

Current Zoning District(s): Planned Unit Development (PUD 2015-282-E)

**Proposed Zoning District:** Planned Unit Development (PUD)

Current Land Use Category: Mixed Use (MU)

**Planning District:** Southeast, District 3

Council District: District 11

Applicant/Agent: Steve Diebenow, Esq.

DMH & D, PLLC

One Independent Drive, suite 1200

Jacksonville Florida 32202

Owner: SONOC Company, LLC

P.O. Box 19366

Jacksonville Florida 32245

Staff Recommendation: DENY

#### **GENERAL INFORMATION**

Application for Planned Unit Development 2024-415 seeks to rezone approximately 0.17 acres of land from PUD to PUD. The rezoning to PUD is being sought to allow a 170 foot high Track III wireless communication tower in Nocatee PUD adjacent to the St. Johns County line. The Nocatee PUD lists cell towers as permitted uses. The purpose of the PUD is to seek relief from the setback

requirements for single family dwellings, right of ways and wetlands and remove the requirement that a Track III tower be outside the urban boundary.

A balloon test will be conducted the week of July 8, 2024 pursuant to Section 656.1507 (c) of the Zoning Code. The balloon shall be red and a minimum of four feet in diameter, anchored to the ground so that it flies at the same height and location as the proposed tower. The balloon shall be flown continuously from 7:00 a.m. until sunset for two separate days within the same week.

#### **CRITERIA FOR REVIEW**

Pursuant to the provisions of Section 656.125 of the Zoning Code, the Planning and Development Department, Planning Commission and City Council (including the appropriate committee) shall evaluate and consider the following criteria of an application for rezoning to Planned Unit Development.

#### (A) Is the proposed zoning district consistent with the 2045 Comprehensive Plan?

Yes. The Planning and Development Department finds that the subject property is located in the Mixed Use (MU) functional land use category as defined by the Future Land Use Map series (FLUMs) contained within the Future Land Use Element (FLUE) adopted as part of the 2045 Comprehensive Plan. [The proposed PUD is requesting to construct a 170 foot high wireless communication tower. Therefore, the proposed rezoning is consistent with the FLUMs adopted as part of the 2045 Comprehensive Plan pursuant to Chapter 650 Comprehensive Planning for Future Development of the Ordinance Code.

## (B) Does the proposed rezoning further the goals, objectives and policies of the <u>2045</u> Comprehensive Plan?

Yes. This proposed rezoning to Planned Unit Development is consistent with the <u>2045</u> <u>Comprehensive Plan</u>, and furthers the following goals, objectives and policies contained herein, including:

#### **Future Land Use Element:**

Goal 1 To ensure that the character and location of land uses optimize the combined potentials of economic benefit and enjoyment, wellness and protection of natural resources, while minimizing the threat to health, safety and welfare posed by hazards, nuisances, incompatible land uses and environmental degradation.

**Objective 1.1** Ensure that the type, rate, and distribution of growth in the City results in compact and compatible land use patterns, an increasingly efficient urban service delivery system and discourages proliferation of urban sprawl through implementation of regulatory programs, intergovernmental coordination mechanisms, and public/private coordination.

**Policy 1.1.9** Promote the use of Planned Unit Developments (PUD) zoning districts, cluster developments, and other innovative site planning and smart growth techniques in order to allow for appropriate combinations of complementary land uses, densities and intensities consistent with

the underlying land use category or site specific policy, and innovation in site planning and design, subject to the standards of this element and all applicable local, regional, State and federal regulations. These techniques should consider the following criteria in determining uses, densities, intensities, and site design:

- Potential for the development of blighting or other negative influences on abutting properties
- Site Access
- Transition of densities and comparison of percentage increase in density above average density of abutting developed properties
- Natural or man-made buffers and boundaries
- Height of development
- Bulk and scale of development

#### (C) Does the proposed rezoning conflict with any portion of the City's land use Regulations?

The written description and the site plan of the intended plan of development, meets all portions of the City's land use regulations and furthers their intent by providing specific development standards.

Pursuant to the provisions of Section 656.341(d) of the Zoning Code, the Planning and Development Department, Planning Commission and City Council (including the appropriate committee) shall evaluate and consider the following criteria for rezoning to Planned Unit Development district:

#### (1) Consistency with the 2045 Comprehensive Plan

In accordance with Section 656.129 Advisory recommendation on amendment of Zoning Code or rezoning of land of the Zoning Code, the subject property is within the following functional land use category as identified in the Future Land Use Map series (FLUMs): Mixed Use (MU). The Planning and Development Department finds that the proposed PUD is consistent with the 2045 Comprehensive Plan, as evaluated in Criteria (B).

#### (2) Consistency with the Concurrency Mobility and Management System

Pursuant to the provisions of Chapter 655 Concurrency and Mobility Management System of the Ordinance Code, the development will be required to comply with all appropriate requirements of the Concurrency and Mobility Management System (CMMSO) prior to development approvals.

#### (3) Allocation of residential land use

This proposed Planned Unit Development intends to utilize lands for a 170 foot high wireless communication tower. This proposed development will not exceed the projected holding capacity reflected in Table L-20, Land Use Acreage Allocation Analysis for <u>2045 Comprehensive Plan</u>'s Future Land Use Element, contained within the Future Land Use Element (FLUE) of the <u>2045 Comprehensive Plan</u>.

#### (4) Internal compatibility

This proposed PUD is consistent with the internal compatibility factors. An evaluation of the internal compatibility of a proposed Planned Unit Development shall be based on the following factors:

- o The use of topography, physical environment and other natural features: The site plan indicates the tower will not disturb any existing wetlands on the site.
- o Compatible relationship between land uses in a mixed use project: The PUD is for a single use wireless communication tower.

#### (5) External Compatibility

Based on the written description of the intended plan of development and site plan, the Planning and Development Department finds that external compatibility is **not** achieved by the following:

- The type, number and location of surrounding external uses: The Department finds the tower is of an incompatible design, considering the size of the site, placement of the tower and residential uses in the area. The area can be characterized as single family subdivisions and a church surrounded by wetland areas. The photo simulations in the application show the upper portion of the tower is visible from several neighborhoods. The staff finds the location and existing trees have the ability to reduce the visual impact of the tower. The site has a stand of large mature pine trees that screen the view of the tower compound. Staff has concerns if these trees were removed, the tower would be considerably more visible to the residents. Staff has concerns if the parcel was cleared of trees for the construction of the tower. A solution could be allowing removal of only the trees necessary for construction of the access road and 75 x 75 foot tower compound. There is an above ground JEA electrical transmission line directly east of the subject property.
- The Comprehensive Plan and existing zoning on surrounding lands: The adjacent uses, zoning and land use categories are as follows:

Adjacent	Land Use	Zoning	Current Use
Property	Category	District	
North	MU	PUD (15-282)	Single family dwellings, wetlands
South	MU	PUD (15-282)	Single family dwellings, wetlands
East			Elec. power lines / St. Johns County
West	MU	PUD (15-282)	Single family dwellings, wetlands

O Any other factor deemed relevant to the privacy, safety, preservation, protection or welfare of lands surrounding the proposed PUD which includes any existing or planned use of such lands: Part 15 of the Zoning Code requires Track II towers to be 100% of the tower height (170 feet) from a public right of way. The site plan shows the tower 100 feet from the right

of way of Valley Ridge Boulevard. The tower does not meet the setback requirements from a transportation view corridor in the Zoning Code. Moving the tower farther from the road will create wetland impacts.

Track III towers shall be set back a distance of at least: 250 feet or 200 percent of the tower height, (340 feet) whichever distance is greater, from the nearest residentially zoned parcel. There are no residential dwellings within the 340 foot radius on the City of Jacksonville side. However, there are two dwellings in St. Johns County that fall inside the 340 foot radius. The proposed tower does not meet the setback requirements from residential dwellings in the Zoning Code. The application states the tower is designed to collapse within a 50 foot radius.

#### (6) Intensity of Development

The proposed development is consistent with the Mixed Use (MU) functional land use category. The PUD is appropriate at this location because [the tower is a utility with little traffic impact.

#### (7) Usable open spaces plazas, recreation areas.

Open spaces or recreation areas are not required.

#### (8) Impact on wetlands

The site plan indicates the tower will be setback 54 feet from the delineated wetlands. According to Part 15 of the Zoning Code, a Track III tower must be set back a minimum distance of 250 feet or 200 percent of the tower height, (340 feet) whichever distance is greater, from the nearest boundary of environmentally sensitive lands. **The proposed tower does not meet the setback requirement from wetlands.** Any development impacting wetlands will be permitted pursuant to local, state and federal permitting requirements.

#### (9) Listed species regulations

No wildlife survey was required as the project is less than the 50-acre threshold.

#### (10) Off-street parking including loading and unloading areas.

The site will have an access road for maintenance vehicles. No parking area is required.

#### (11) Sidewalks, trails, and bikeways

There is an existing sidewalk along Valley Ridge Boulevard.

#### **SUPPLEMENTAL INFORMATION**

Upon visual inspection of the subject property on June 6, 2024, the required Notice of Public Hearing sign was posted.



#### **RECOMMENDATION**

Based on the foregoing, it is the recommendation of the Planning and Development Department that Application for Rezoning 2024-415 be DENIED with the following exhibits:

- 1. The original legal description dated August 28, 2023.
- 2. The original written description dated February 15, 2024.
- 3. The original site plan dated June 23, 2023.




Aerial view of subject property.



View along Valley Ridge Blvd



View of subject property and power line easement on Valley Ridge Blvd

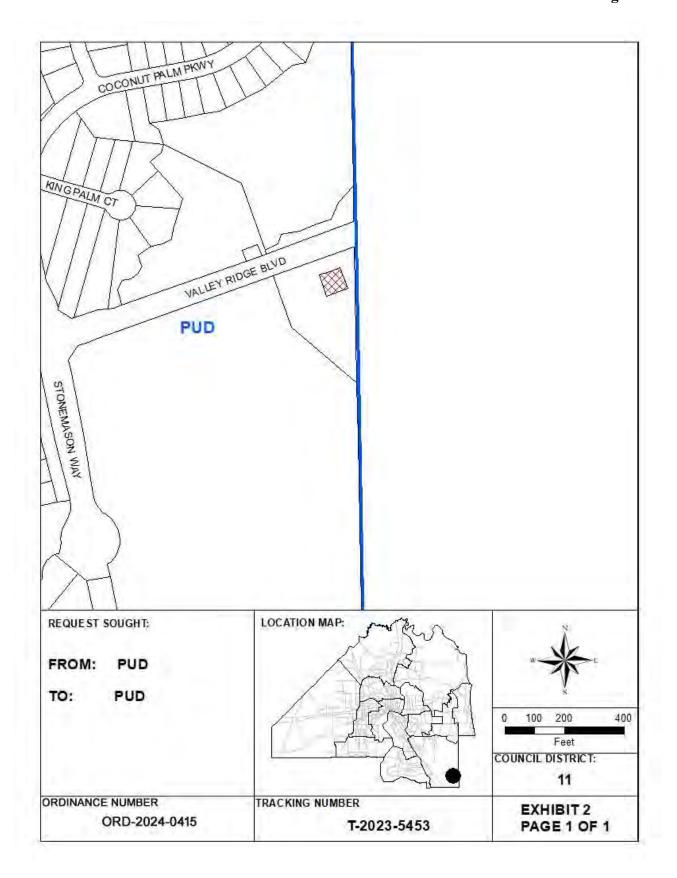

#### **Application For Rezoning To PUD**

#### Planning and Development Department Info

Ordinance # 2024-0415 Staff Sign-Off/Date BEL / N/A

**Filing Date** 05/29/2024 **Number of Signs to Post** 1

**Hearing Dates:** 

**1st City Council** 06/25/2024 **Planning Commission** 06/20/2024

Land Use & Zoning 07/16/2024 2nd City Council N/A

**Neighborhood Association NONE** 

Neighborhood Action Plan/Corridor Study NONE

9043011279

#### **Application Info**

9043011269

Tracking #5453Application StatusPENDINGDate Started02/15/2024Date Submitted02/15/2024

#### **General Information On Applicant-First Name Middle Name Last Name DIEBENOW** STEVE **Company Name** DRIVER, MCAFEE, HAWTHORNE AND DIEBENOW, PLLC **Mailing Address** ONE INDEPENDENT DRIVE, STE. 1200 City State **Zip Code** 32202 **JACKSONVILLE** FL Phone **Email** Fax

SDIEBENOW@DRIVERMCAFEE.COM

Last Name		First Name	Middle Name
N/A		N/A	Midule Name
,	rust Name	.4	
Company/T			
SONOC COM	IPANY, LLC		
<b>Mailing Add</b>	ress		
P.O BOX 193	866		
City		State	Zip Code
JACKSONVIL	LE	FL	32245
	Fax	Email	

revious Zoning Ap f Yes, State Applic	•		te?	
lap RE#	Council District	-	From Zoning District(s)	To Zoning District
ap 168149 9900	11	3	PUD	PUD
1ap 168149 9900	11 10 digit nu	3		PUD

Land Use Category Prop If Yes, State Land Use		
Total Land Area	a (Nearest 1/100th of an Acr	<b>e)</b> 0.17
	Development Numb	oer
Proposed PUD Name	COASTAL RIDGE PUD	

#### •Justification For Rezoning Application =

THIS PUD IS FILED TO CLARIFY THAT THE NOCATEE JACKSONVILLE PUD PERMITS A "TRACK III" CONVENTIONAL WIRELESS TOWER AS DEFINED IN PART 15 OF THE ZONING CODE WITHIN THE SUBURBAN DEVELOPMENT AREA ON THE PROPERTY AND TO PERMIT THE PROPOSED CONVENTIONAL WIRELESS TOWER AS CONCEPTUALLY DEPICTED IN THE ATTACHED SITE PLAN.

EV DID CE DOUI EVADO AN			
LEY RIDGE BOULEVARD AN	D WEST (	OF ST. JOHNS COUNT	Y LINE
Street Name, Type and D	Direction		Zip Code
VALLEY RIDGE BLVD			32081
•	Street Name, Type and D	Street Name, Type and Direction VALLEY RIDGE BLVD	Street Name, Type and Direction VALLEY RIDGE BLVD

#### Required Attachments For Formal, Complete application

The following items must be labeled as exhibits and attached to application in the order prescribed below. All pages of the application must be on  $8\frac{1}{2}$ " X 11" paper with provision for page numbering by the staff as prescribed in the application instructions manual. Please check each item below and the PUD Check List for inclusion of information required.

**Exhibit 1** A very clear, accurate and legible legal description of the property that must be only and entirely placed on the JP&DD formatted forms provided with the application package. The legal description may be either lot and block or metes and bounds.

**Exhibit A** Property Ownership Affidavit – Notarized Letter(s).

**Exhibit B** Agent Authorization - Notarized letter(s) designating the agent.

**Exhibit C** Binding Letter.

**Exhibit D** Written description in accordance with the PUD Checklist and with provision for dual page numbering by the JP&DD staff.

Exhibit E Scalable site plan with provision for dual page numbering by the JP&DD staff drawn at a scale large enough to clearly indicate the following: (a) North arrow and scale; (b) Property lines and dimensions of the site; (c) Building locations and building lot coverage; (d) Parking area; (e) Required Landscaped Areas; (f) All ingress and egress locations (driveways, alleys and easements) within 660 feet; (g) Adjacent streets and rights-of-way; (h) jurisdictional wetlands; and (i) existing site conditions and improvements that will be undisturbed.

Exhibit F Land Use Table

**Exhibit G** Copy of the deed to indicate proof of property ownership.

#### Supplemental Information =

Supplemental Information items are submitted separately and not part of the formal application

Exhibit H Aerial Photograph.

Exhibit I	Listed Species Survey (If the proposed site is greater than fifty acres).
Exhibit J	Other Information as required by the Department (i.e*building elevations, *signage details, traffic analysis, etc.).
Exhibit K	Site Location Map.


#### Public Hearings And Posting Of Signs =

No application will be accepted until all the requested information has been supplied and the required fee has been paid. Acceptance of a completed application does not guarantee its approval by the City Council. The applicant will be notified of public hearing dates on this application upon the filing of the application. The applicant or authorized agent MUST BE PRESENT at the public hearings. The required SIGN(S) must be POSTED on the property BY THE APPLICANT within 5 days after the filing of an application. The sign(s) may be removed only after final action of the Council and must be removed within 10 days of such action.

The applicant must also pay for the required public notice stating the nature of the proposed request which is required to be published in an approved newspaper AT LEAST 14 DAYS IN ADVANCE OF THE PUBLIC HEARING. (The Daily Record - 10 North Newnan Street, Jacksonville, FL 32202 • (904) 356-2466 • Fax (904) 353-2628) Advertising costs are payable by the applicant directly to the newspaper and the applicant must furnish PROOF OF PUBLICATION to the Planning and Development Department, 214 North Hogan Street, Ed Ball Building, Suite 300, Jacksonville, Florida, 32202, prior to the public hearing.

#### **Application Certification –**

I, hereby, certify that I am the owner or the authorized agent of the owner(s) of the property described herein, that all answers to the questions in this application and all information contained in the material attached to and made a part of this application, are accurate and true to the best of my knowledge and belief. I also attest that all required information for this rezoning application is completed and duly attached in the prescribed order. Furthermore, if the package is found to be lacking the above requirements, I understand that the application will be returned for correct information.

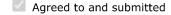

#### Filing Fee Information

1) Rezoning Application's General Base Fee: \$2,269.00

2) Plus Cost Per Acre or Portion Thereof

**0.17 Acres @ \$10.00 /acre:** \$10.00

3) Plus Notification Costs Per Addressee

**3 Notifications @ \$7.00 /each:** \$21.00

4) Total Rezoning Application Cost (Not to Exceed \$15,000.00): \$2,300.00

NOTE: Advertising Costs To Be Billed to Owner/Agent

#### **EXHIBIT 1**

#### **LEGAL DESCRIPTION**

August 28, 2023

#### PARENT TRACT DESCRIPTION (PREPARED BY SURVEYOR)

A PORTION OF SECTION 25, TOWNSHIP 4 SOUTH, RANGE 28 EAST, DUVAL COUNTY, FLORIDA, ALSO BEING A PORTION OF THOSE LANDS DESCRIBED IN OFFICIAL RECORDS BOOK 9494, PAGE 905 OF THE CURRENT PUBLIC RECORDS OF DUVAL COUNTY, FLORIDA, BEING MORE PARTICULARLY DESCRIBED AS FOLLOWS:

THAT PART OF SECTION 25, TOWNSHIP 4 SOUTH, RANGE 28 EAST, DUVAL COUNTY, FLORIDA LYING SOUTH OF VALLEY RIDGE BOULEVARD, A VARIABLE WIDTH RIGHT-OF-WAY AS RECORDED IN PLAT BOOK 65, PAGES 50 THROUGH 53 OF THE PUBLIC RECORDS OF SAID DUVAL COUNTY AND LYING NORTHERLY OF THOSE LANDS DESCRIBED IN OFFICIAL RECORDS BOOK 15469, PAGE 919 OF SAID PUBLIC RECORDS.

#### NEXTOWER LEASE PARCEL DESCRIPTION

A PARCEL OF LAND LYING IN SECTION 25, TOWNSHIP 4 SOUTH, RANGE 28 EAST, DUVAL COUNTY, FLORIDA; SAID PARCEL OF LAND BEING MORE PARTICULARLY DESCRIBED AS FOLLOWS:

COMMENCE AT THE INTERSECTION OF THE EAST LINE OF SECTION 25, TOWNSHIP 4 SOUTH, RANGE 28 EAST, DUVAL COUNTY, FLORIDA AND THE SOUTH RIGHT-OF-WAY LINE OF VALLEY RIDGE BOULEVARD (A VARIABLE WIDTH RIGHT-OF-WAY PER PLAT BOOK 65, PAGES 50-53 OF THE PUBLIC RECORDS OF SAID DUVAL COUNTY); THENCE S70° 30' 10"W ALONG SAID SOUTH RIGHT-OF-WAY LINE FOR 105.29 FEET; THENCE S19° 29' 50"E FOR 50.00 FEET; THENCE N70° 30' 10"E FOR 37.50 FEET TO THE POINT OF BEGINNING OF THE HEREIN DESCRIBED PARCEL OF LAND; THENCE S19° 29' 50"E FOR 75.00 FEET; THENCE S70° 30' 10"W FOR 75.00 FEET; THENCE N19° 29' 50"W FOR 75.00 FEET; THENCE N70° 30' 10"E FOR 75.00 FEET TO THE POINT OF BEGINNING. SAID PARCEL OF LAND SITUATE, LYING AND BEING IN DUVAL COUNTY, FLORIDA, CONTAINING 5,625 SQUARE FEET OF LAND MORE OR LESS.


#### NEXTOWER INGRESS/EGRESS & UTILITIES EASEMENT DESCRIPTION

A 30-FEET WIDE EASEMENT STRIP OF LAND FOR THE PURPOSES OF INGRESS/EGRESS AND UTILITIES LYING IN SECTION 25, TOWNSHIP 4 SOUTH,

Exhibit 1 Page 1 of 2

RANGE 28 EAST, DUVAL COUNTY, FLORIDA; SAID EASEMENT STRIP LYING 15.00 FEET BOTH SIDES OF THE FOLLOWING DESCRIBED EASEMENT CENTERLINE:

COMMENCE AT THE INTERSECTION OF THE EAST LINE OF SECTION 25, TOWNSHIP 4 SOUTH, RANGE 28 EAST, DUVAL COUNTY, FLORIDA AND THE SOUTH RIGHT-OF-WAY LINE OF VALLEY RIDGE BOULEVARD (A VARIABLE WIDTH RIGHT-OF-WAY PER PLAT BOOK 65, PAGES 50-53 OF THE PUBLIC RECORDS OF SAID DUVAL COUNTY); THENCE S70° 30' 10"W ALONG SAID SOUTH RIGHT-OF-WAY LINE FOR 105.29 FEET TO THE POINT OF BEGINNING OF THE HEREIN DESCRIBED EASEMENT CENTERLINE; THENCE S19° 29' 50"E FOR 50.00 FEET TO THE POINT OF TERMINUS. THE SIDELINES OF SAID EASEMENT TO BE SHORTENED AND PROLONGED TO MEET AT RIGHT-OF-WAY LINES AND LEASE PARCEL LINES.

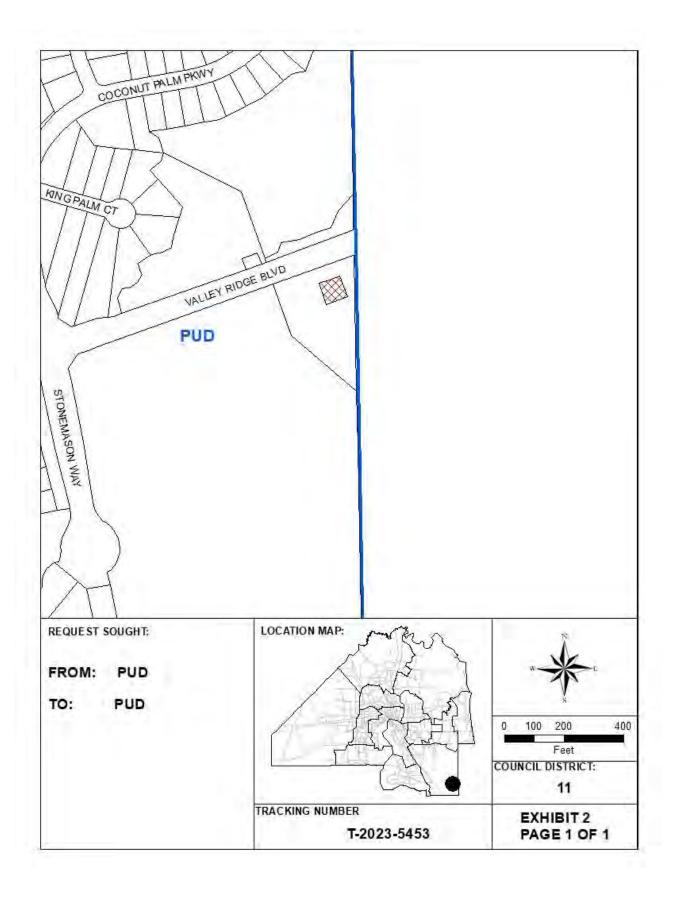

## EXHIBIT A Property Ownership Affidavit

City of Jacksonville Planning and Development Department 214 North Hogan Street, Suite 300 Jacksonville, Florida 32202

Re: Property Ownership Affidavit for 0 Coastal Ridge Boulevard, Jacksonville, FL 32081 (RE# 168149 9900)

Ladies and Gentlemen: I, Harry D. Francis, as J.T. of SONOC COMPANY, LLC, a Delaware limited liability company, hereby certify that said entity is the Owner of the property described in Exhibit 1, in connection with filing an application for land use amendment, rezoning, waiver, variance, and/or general approval of cell towers and such other entitlements as may be required for the above referenced property, submitted to the Jacksonville Planning and Development Department. SONOC COMPANY, LLC, a Delaware limited liability company Title STATE OF Florida COUNTY OF DAVA The foregoing instrument was acknowledged before me by means of physical presence or \( \square\$ online notarization, this 5 day of Johnson 2025 by, Lagray D. Warre as of SONOC COMPANY LLC, a Delaware limited liability company, on behalf of the company, who is personally known to me or \( \Bar\) has produced as identification. [Notary Seal] TINA E. MILLER

> Commission # HH 092371 Expires May 9, 2025

Bonded Thru Troy Fain Insurance 800-385-7019



Department of State / Division of Corporations / Search Records / Search by Entity Name /

#### **Detail by Entity Name**

Foreign Limited Liability Company SONOC COMPANY, LLC

**Filing Information** 

 Document Number
 M00000000509

 FEI/EIN Number
 59-3609703

 Date Filed
 03/16/2000

State DE

Status ACTIVE

**Principal Address** 

4310 PABLO OAKS COURT JACKSONVILLE, FL 32224-9631

Changed: 04/30/2002

Mailing Address
P.O. BOX 19366

JACKSONVILLE, FL 32245-9366

Changed: 04/30/2002

**Registered Agent Name & Address** 

D.D.I., INC.

4310 PABLO OAKS COURT JACKSONVILLE, FL 32224-9631

Address Changed: 04/30/2002 <u>Authorized Person(s) Detail</u>

Name & Address

Title Manager, President

Pritchard, Robert H. 4310 PABLO OAKS COURT JACKSONVILLE, FL 32224-9631

Title VP, Treasurer, Asst. Secretary

FRANCIS, HARRY D.
4310 PABLO OAKS COURT
JACKSONVILLE, FL 32224-9631

Title VP

OKO, SCOTT A.
4310 PABLO OAKS COURT
JACKSONVILLE, FL 32224-9631

Title Secretary

MORGAN, JUDY B. 4310 PABLO OAKS COURT JACKSONVILLE, FL 32224-9631

Title MEMBER

D.D.I., INC. 4310 PABLO OAKS COURT JACKSONVILLE, FL 32224-9631

#### **Annual Reports**

Report Year	Filed Date
2021	04/28/2021
2022	03/31/2022
2023	04/06/2023

#### **Document Images**

04/06/2023 ANNUAL REPORT	View image in PDF format
03/31/2022 ANNUAL REPORT	View image in PDF format
04/28/2021 ANNUAL REPORT	View image in PDF format
02/25/2020 ANNUAL REPORT	View image in PDF format
03/29/2019 ANNUAL REPORT	View image in PDF format
04/27/2018 ANNUAL REPORT	View image in PDF format
02/09/2017 ANNUAL REPORT	View image in PDF format
02/26/2016 ANNUAL REPORT	View image in PDF format
02/13/2015 ANNUAL REPORT	View image in PDF format
02/07/2014 ANNUAL REPORT	View image in PDF format
02/07/2013 ANNUAL REPORT	View image in PDF format
01/27/2012 ANNUAL REPORT	View image in PDF format
01/28/2011 ANNUAL REPORT	View image in PDF format
01/21/2010 ANNUAL REPORT	View image in PDF format
01/15/2009 ANNUAL REPORT	View image in PDF format
01/31/2008 ANNUAL REPORT	View image in PDF format
02/12/2007 ANNUAL REPORT	View image in PDF format
02/15/2006 ANNUAL REPORT	View image in PDF format
03/24/2005 ANNUAL REPORT	View image in PDF format

04/13/2004 ANNUAL REPORT	View image in PDF format
04/25/2003 ANNUAL REPORT	View image in PDF format
04/30/2002 ANNUAL REPORT	View image in PDF format
04/23/2001 ANNUAL REPORT	View image in PDF format
03/16/2000 Foreign Limited	View image in PDF format

Florida Department of State, Division of Corporations

## EXHIBIT B Agent Authorization

City of Jacksonville Planning and Development Department 214 North Hogan Street, Suite 300 Jacksonville, Florida 32202

Re: Agent Authorization for 0 Coastal Ridge Boulevard, Jacksonville, FL 32081 (RE# 168149 9900)

(RE# 100147 7700)	
Ladies and Gentlemen:	• •
McAfee, Hawthorne & Diebenow, PLLC, to amendment, rezoning, waiver, variance, and/e entitlements as may be required for the above authorization to file such applications, papers	of SONOC company, hereby authorizes and empowers Driver, a act as agent to file an application for land use or general approval of cell towers and such other e referenced property and in connection with such documents, requests and other matters necessary acksonville Planning and Development Department.
	SONOC COMPANY, LLC, a Delaware limited liability company
	Au 1 Francis
	Signed HARRY D. FRANCIS
	Printed
	VICE PRESIDENT
	Title
STATE OF Haida COUNTY OF Dunal	
online notarization, this 5 day of 4	LC, a Delaware limited liability company, on behalf
of the company, who is personally known to as identification.	o me or □ has produced
as identification.	1 000
[Notary Seal] Commission # HH 0923 Expires May 9, 2025 Bonded Thru Troy Fain Insura	Ottom Signatura

## EXHIBIT C Binding Letter

City of Jacksonville Planning and Development Department 214 North Hogan Street, Suite 300 Jacksonville, Florida 32202

Re: Binding Letter for 0 Coastal Ridge Boulevard, Jacksonville, FL 32081 (RE# 168149 9900)

Ladies and Gentlemen:

SONOC COMPANY, LLC, a Delaware limited liability company

Harry A FRANCIS

Printed

Vice Printed

Title

STATE OF Havida

The foregoing instrument was acknowledged before me by means of physical presence or online notarization, this day of have to be as of SONOC COMPANY, LLC, a Delaware limited liability company, on behalf of the company, who is personally known to me or has produced as identification.

as identification

[Notary Seal]

TINA E. MILLER
Commission # HH 092371
Expires May 9, 2025
Bonded Thru Troy Fain Insurance 800-385-7019

(Notary Signature)

#### PUD WRITTEN DESCRIPTION COASTAL RIDGE PUD February 15, 2024

#### I. PROJECT DESCRIPTION

A. Number of acres, location of site, existing use, surrounding uses, types of businesses, and proposed uses: Applicant proposes to rezone approximately 0.17 acres of property on the property located at 0 Coastal Ridge Boulevard, Jacksonville, Florida 32081 (RE# 168149 9900) as more particularly described in Exhibit 1 (the "Property") and conceptually depicted in the Site Plan filed herewith. The land subject to this PUD is the NexTower lease parcel description, including the ingress/egress and utilities easement description, as specified in Exhibit 1. The Property is located within the Nocatee DRI, the MU land use category, and the Suburban Development Area. The Property is zoned PUD pursuant to Ordinance 2015-282-E (the "Nocatee Jacksonville PUD").

Map H of the Nocatee DRI and the Nocatee Jacksonville PUD designate the Property for Town Center uses, which includes a wide range of uses from residential, office/commercial (including cellular telephone antenna facilities), and intensive commercial uses. This PUD is filed to clarify that the Nocatee Jacksonville PUD permits a "Track III" conventional wireless tower as defined in Part 15 of the Zoning Code ("Conventional Wireless Tower") within the Suburban Development Area on the Property and to permit the proposed Conventional Wireless Tower as conceptually depicted in the attached site plan. The documents typically required for a Conventional Wireless Tower application are filed herewith as Exhibit J. All uses other than Conventional Wireless Towers shall comply with the Nocatee Jacksonville PUD.

The surrounding land use and zoning designations are as follows:

Direction	Land Use	Zoning	Existing Use
North	MU	PUD (2015-282)	Undeveloped
East	New Town	PUD (2016-24)	Single-family
	(St. Johns County)	(St. Johns County)	
South	MU	PUD (2015-282)	Church
West	MU	PUD (2015-282)	Church

B. Project name: Coastal Ridge PUD.

C. Project engineer: Towersource.

D. Project developer: NexTower Development Group II, LLC.

E. Project agent: Driver, McAfee, Hawthorne & Diebenow, PLLC.

F. Current land use designation: MU.

G. Current zoning district: PUD (2015-282)

H. Requested zoning district: PUD.

I. Real estate number: 168149 9900.

#### II. QUANTITATIVE DATA

A. Total acreage: 0.17 acres.

B. Maximum height for a wireless communication tower: One hundred seventy (170) feet.

#### III. STATEMENTS

A. How does the proposed PUD differ from the usual application of the Zoning Code?

This PUD adopts the Nocatee Jacksonville PUD in full but clarifies that Conventional Wireless Towers are permitted. This PUD sets a maximum limit on the height of the proposed Conventional Wireless Tower, requires a two hundred forty (240) foot setback from developed single-family boundary lot lines, fifty (50) feet from environmentally sensitive lands, one hundred (100) feet from a transportation view corridor, and permits the tower facility to be screened by PVC fencing.

B. Describe the intent for the continued operation and maintenance of those areas and functions described herein and facilities which are not to be provided, operated or maintained by the City.

Owner and/or tenant will be responsible for the operation and maintenance of the areas and functions described herein and any facilities that are not provided, operated or maintained by the City.

#### IV. USES AND RESTRICTIONS

- A. Permitted Uses:
  - 1. As permitted in the Nocatee Jacksonville PUD.
  - 2. Wireless communication towers, including Conventional Wireless Towers located within the Suburban Development Area.
- B. Permissible Uses by Exception:
  - 1. As permitted in the Nocatee Jacksonville PUD.
- C. Permitted Accessory Uses and Structures:

1. As permitted in the Nocatee Jacksonville PUD and Section 656.403.

#### V. DESIGN GUIDELINES

- A. All uses except for Conventional Wireless Towers shall comply with the design guidelines within the Nocatee Jacksonville PUD.
- B. Conventional Wireless Towers:
  - 1. Height: The maximum height of a Conventional Wireless Tower is one hundred seventy (170) feet.
  - 2. Design: Any Conventional Wireless Tower must be a monopole design.
  - 3. Minimum Setbacks for Conventional Wireless Towers (as measured from the base of the monopole):
    - a. Two hundred forty (240) feet from the nearest developed single-family boundary lot line.
    - b. Two hundred fifty (250) feet or two hundred percent (200%) of the tower height, whichever distance is greater, from the nearest boundary of a public park, historic district, historic landmark, or Neighborhood Conservation District.
    - c. Fifty (50) feet from the nearest environmentally sensitive lands.
    - d. One hundred (100) feet from any transportation view corridor.
- C. Separation: No Conventional Wireless Tower shall be permitted to be constructed within two thousand six hundred forty (2,640) feet of another Conventional Wireless Tower.
- D. Collocation: Conventional Wireless Towers shall be designed to accommodate collocation of antennas for multiple wireless communication service providers, as follows:

Conventional Tower Height	Minimum Number of Spaces for Providers
< 110 feet	2
110 feet – 130 feet	3
131 feet – 170 feet	4

E. Balloon Test: A balloon test for the proposed Conventional Wireless Tower shall be conducted as follows, unless otherwise prohibited by law:

- 1. The balloon shall be red and a minimum of four (4) feet in diameter, anchored to the ground so that it flies at the same height and location as the proposed tower.
- 2. The balloon shall be flown continuously from 7:00 AM until sunset for two (2) separate days within the same week.
- 3. The balloon test shall be conducted during the week prior to the first scheduled public hearing for this PUD rezoning before the City Council committee of reference. Notice of the scheduled week of the balloon test shall be given along with the notice of the public hearing in accordance with Section 656.124, Ordinance Code.

#### F. Performance Standards:

- 1. *No advertising*. The proposed Conventional Wireless Tower shall not be used for any advertising purpose, including signage, designs or logos.
- 2. Security wall or fence. A minimum eight (8) foot high finished masonry wall or PVC or wooden fence shall be required around all portions of the Conventional Wireless Tower visible from the public view. For purposes of this Section, a finished masonry wall includes, but is not limited to, stucco, brick or any other decorative cover or finish.
- 3. Landscaping. The visual impacts of Conventional Wireless Tower site shall be mitigated through the use of a landscaping buffer outside the perimeter of the security fence or wall. The landscape buffer shall be a minimum of ten (10) feet on all sides subject to and consisting of the following:
  - a. A row of evergreen shade trees a minimum of fifteen (15) feet tall (at the time of planting) with a four-inch caliper, spaced a maximum of fifteen (15) feet apart; and
  - b. A row of evergreen shrubs such as viburnum, ligustrum, holly or juniper, a minimum of four-feet tall (at the time of planting) and potted in seven-gallon containers, planted four feet on center, in order to maintain 80 percent opacity within one (1) year of planting.
  - c. The landscaping buffer shall be properly maintained through an irrigation system.
- 4. *Illumination*. No signals, lights or illumination shall be permitted on the Conventional Wireless Tower, unless otherwise required by the Federal Aviation Administration.
- 5. *Color*. The Conventional Wireless Tower shall either have a dull gray or galvanized finish or have a noncontrasting finish that minimizes the visibility of the tower from

- public view, except where contrasting color is required by federal or state regulation.
- 6. Required signs. The security fence or wall surrounding the tower site shall contain a sign, measuring no more than thirty (30) inches wide by twenty-four (24) inches high, identifying the primary party responsible for the operation and maintenance of the facility, the address and telephone number of that party, the FCC registration and site identification numbers of the tower and the street address of the tower site, where applicable.

#### G. Registration and Reporting Requirements:

- 1. Annual registration. On or before June 1 of each calendar year, the owner of the Conventional Wireless Tower shall file with the City's Wireless Communications Coordinator (the "Coordinator") a declaration as to the continuing operation of the facility, as well as the name and address of the tower owner, the service provider's tower identification number, the address of the tower (if no numerical address then general site location), and the real estate number for the subject parcel, including identification of all wireless communication service providers located on the tower, complete with names, addresses, and phone numbers of the respective contact persons and the service provider's tower identification number.
- 2. Transfer of wireless communication tower ownership; declaration. Should there be a transfer of tower ownership or lease, within thirty (30) days of the transfer, the new wireless communication tower owner shall file with the Coordinator a declaration with the updated name and address of the tower owner, the service provider's tower identification number, the address of the tower (if no numerical address then general site location), and the real estate number for the subject parcel.
- 3. Certification of structural integrity. Every five (5) years after issuance of the initial permit, or as otherwise requested by the City, the owner of the Conventional Wireless Tower within the City shall file with the Coordinator a "Certification of Structural Integrity." This certification shall be prepared by a licensed professional engineer, who shall attest that a thorough and complete inspection of the tower was conducted and that the tower and accessory structures are continuing to perform as originally designed.
- 4. *Noncompliance*. Failure to timely file the annual declaration, transfer declaration, or Certification of Structural Integrity shall result in a presumption that the tower is either unused or unsafe, thereby subjecting the tower to removal under the abandonment provisions of Part 15.
- 5. Signage for public contact information on the base of ground mounted wireless communication towers. Each ground mounted wireless communication tower owner shall place on the tower compound fence, facing a public right of way or private road, a permanent sign, no higher than five (5) feet and no lower than four

(4) feet in height from the base of the ground, which provides for the name and address of the wireless communication tower owner, the name and phone number of a point of contact for the wireless communication tower owner, and the service provider's tower identification number. The sign area for the sign must be at least twenty-four (24) inches wide and at least eighteen (18) inches tall, or be clearly visible and legible to an individual standing no more than fifteen (15) feet from the sign, but no greater in sign area than six (6) square feet. The purpose of this signage is to provide the public with contact information for the wireless communication tower owner and a point of contact who can assist the public with questions regarding the wireless communication tower.

#### H. Ingress, Egress and Circulation:

- 1. *Parking Requirements*. Parking for any use other than Conventional Wireless Towers shall be as required in the Nocatee Jacksonville PUD. No parking spaces shall be required for a Conventional Wireless Tower.
- 2. Vehicular Access. Vehicular access to the Property shall be by way of Valley Ridge Boulevard, substantially as shown on the Site Plan. The Property shall be sufficiently accessible to permit entry onto the Property by fire, police, and rescue.
- 3. *Pedestrian Access*. As required by the Nocatee Jacksonville PUD.
- I. Signs: Signs for uses other than wireless communication towers shall be consistent with the requirements for the Nocatee Jacksonville PUD.
- J. Landscaping: Landscaping for uses other than wireless communication towers shall be consistent with the requirements for the Nocatee Jacksonville PUD.
- K. Recreation and Open Space: Recreation and open space shall be provided as required by the 2045 Comprehensive Plan.
- L. Utilities: Essential services, including water, sewer, and gas, as required to serve the project shall be permitted on the site.
- M. Wetlands: Development which would impact wetlands will be permitted in accordance with local, state and federal requirements.

## VI. JUSTIFICATION FOR PLANNED UNIT DEVELOPMENT CLASSIFICATION FOR THIS PROJECT

In accordance with Section 656.341(d) of the Code the PUD meets the applicable Criteria for review as follows:

A. Consistency with the Comprehensive Plan. The proposed PUD is consistent with the general purpose and intent of the City's 2045 Comprehensive Plan and Land Use

Regulations, will promote the purposes of the City's 2045 Comprehensive Plan and specifically contributes to:

#### Future Land Use Element

- 1. Goal 1 To ensure that the character and location of land uses optimize the combined potentials for economic benefit, enjoyment, wellness and protection of natural resources, while minimizing the threat to health, safety and welfare posed by hazards, nuisances, incompatible land uses and environmental degradation.
- 2. Objective 1.1 Ensure that the type, rate, and distribution of growth in the City results in compact and compatible land use patterns, an increasingly efficient urban service delivery system and discourages proliferation of urban sprawl through implementation of regulatory programs, intergovernmental coordination mechanisms, and public/private coordination.
- 3. Policy 1.1.9 Promote the use of Planned Unit Development (PUD) zoning districts, cluster developments, and other innovative site planning and smart growth techniques in order to allow for appropriate combinations of complementary land uses, densities and intensities consistent with the underlying land use category or site specific policy, and innovation in site planning and design, subject to the standards of this element and all applicable local, regional, State and federal regulations. These techniques should consider the following criteria in determining uses, densities, intensities, and site design:
  - a. Potential for the development of blighting or other negative influences on abutting properties
  - b. Traffic Impacts
  - c. Site Access
  - d. Transition of densities and comparison of percentage increase in density above average density of abutting developed properties
  - e. Configuration and orientation of the property
  - f. Natural or man-made buffers and boundaries
  - g. Height of development
  - h. Bulk and scale of development
  - i. Building orientation
  - j. Site layout
  - k. Parking layout
  - 1. Opportunities for physical activity, active living, social connection, and access to healthy food
- 4. Policy 1.1.13 Require mitigation of adverse land use impacts on adjacent uses during development and redevelopment through:
  - a. Creation of complementary uses;
  - b. Enhancement of transportation connections;

- c. Use of noise, odor, vibration and visual/ aesthetic controls; and/or
- d. Other appropriate mitigation measures such as requirements for buffer zones and landscaping between uses.
- 5. Policy 1.1.22 Future development orders, development permits and plan amendments shall maintain compact and compatible land use patterns, maintain an increasingly efficient urban service delivery system and discourage urban sprawl as described in the Development Areas and the Plan Category Descriptions of the Operative Provisions.
- 6. Goal 3 To achieve a well balanced and organized combination of residential, non-residential, recreational and public uses served by a convenient and efficient transportation network, while protecting and preserving the fabric and character of the City's neighborhoods and enhancing the viability of non-residential areas.
- B. Consistency with the Concurrency Management System. All development will secure necessary approvals from the CMMSO and pay all required fees in accordance with Chapter 655 of the Code.
- C. Allocation of residential land use.

This PUD permits the Conventional Wireless Tower and development already approved in the Nocatee Jacksonville PUD.

- D. Internal compatibility. The Site Plan attached as Exhibit E addresses access and circulation within the site. Access to the site is available from Valley Ridge Boulevard. Location of the access points shown on the Site Plan as well as final design of the access points is subject to the review and approval of the City Traffic Engineer and the Planning and Development Department.
- E. **External compatibility** / **Intensity of development.** The proposed development is consistent with and complimentary to existing uses in the area and will provide much needed communication infrastructure to the Nocatee community.
- F. Usable open spaces, plazas, recreation areas. Development which requires open space shall be provided according to the Nocatee Jacksonville PUD
- G. **Impact on wetlands.** Development which would impact wetlands will be permitted in accordance with local, state and federal requirements.
- H. **Listed species regulations.** The Property is less than fifty (50) acres and therefore a listed species survey is not required.
- I. **Off-Street parking including loading and unloading areas.** Parking is not required for the Conventional Wireless Tower. All other uses shall comply with the Nocatee Jacksonville PUD.

J.	Sidewalks, trails and bikeways. with the City regulations.	Pedestrian	circulation	will be	addressed	consistent

## **EXHIBIT J Conventional Wireless Tower Application Documents**

#### Answers to Standards and Criteria Set Forth in Sec. 656.1507(d)

An application for a conventional wireless tower permit shall be granted only if the Council finds, from a preponderance of the record evidence, that the proposed tower meets the following standards and criteria:

(1) The proposed tower shall be consistent with the Comprehensive Plan, including any subsequent plan adopted by the Council pursuant thereto;

The proposed tower is a one hundred seventy (170) foot conventional wireless tower (the "Conventional Wireless Tower") located at 0 Coastal Ridge Boulevard, Jacksonville, Florida 32081 (RE# 168149 9900) as more particularly described in Exhibit 1 (the "Property") and conceptually depicted in the Site Plan filed as Exhibit E with the PUD rezoning application assigned tracking number Z-5453 (the "PUD Application"). The land subject to the PUD Application is the NexTower lease parcel description, including the ingress/egress and utilities easement description, as specified in Exhibit 1. As further demonstrated in Exhibit D of the PUD Application (the "Written Description"), the Conventional Wireless Tower is consistent with the 2045 Comprehensive Plan, including the following goals, objectives and policies of the 2045 Future Land Use Element:

Goal 1, Objective 1.1, Policy 1.1.9, Policy 1.1.13, Policy 1.1.22, and Goal 3.

(2) The proposed tower shall comply with both the siting and design standards for conventional wireless towers and the performance standards for all wireless communication towers;

The Conventional Wireless Tower is located within the Suburban Development Area. Map H of the Nocatee DRI and the Nocatee Jacksonville PUD approved pursuant to Ordinance 2015-282-E designate the Property for Town Center uses, which includes a wide range of uses from residential, office/commercial (including cellular telephone antenna facilities), and intensive commercial uses. These two (2) locational requirements are accounted for in the Written Description and are intended to facilitate consistent tower development with the established wireless communication towers that have already been developed in Nocatee in St. Johns County. The Conventional Wireless Tower design, e.g., a monopole, is the same design utilized by other towers within Nocatee that are located within St. Johns County.

The height of the Conventional Wireless Tower is limited to one hundred seventy (170) feet as specified in the Written Description. The maximum permitted height under the zoning code is one hundred ninety-nine (199) feet.

The design of the Conventional Wireless Tower is a monopole design, meeting the design requirement set forth in Section 656.1507(a).

The minimum setback required in the Written Description is two hundred forty (240) feet from the nearest developed single-family boundary lot line. This request is accounted for in the Written Description and is a decrease from the required two hundred fifty (250) feet or two hundred percent (200%) of the height tower minimum setback from a residential use set forth

in Section 656.1507(a). Between the Conventional Wireless Tower and the closest single-family dwelling is a tree buffer, a utility powerline easement, and additional tree buffering on the east side of the powerlines. The Conventional Wireless Tower meets and exceeds the minimum setbacks from the nearest public park, historic district, historic landmark, or Neighborhood Conservation district. The minimum setback from environmentally sensitive lands is fifty (50) feet, which matches the certified fall radius of the Conventional Wireless Tower and will not affect the surrounding wetlands. The Conventional Wireless Tower is located one hundred (100) feet from the Valley Ridge Boulevard transportation view corridor, which exceeds the certified fall radius of the Conventional Wireless Tower.

There are no conventional wireless towers within two thousand six hundred forty (2,640) feet of the Conventional Wireless Tower.

The Conventional Wireless Tower provides colocation for a minimum of four (4) service providers.

(3) The proposed tower site shall be sufficiently accessible to permit entry onto the property by fire, police, rescue and other services;

The Property will be sufficiently accessible to permit entry by fire, police, rescue and other services.

(4) The height of the proposed tower shall be deemed necessary to provide the wireless provider's designed service;

The height of the Conventional Wireless Tower is necessary to provide sufficient colocation space to the carriers and to meet the needs of the emerging wireless communication and data needs of the Nocatee community as demonstrated in the propagation map.

(5) The absence of any existing or proposed towers, buildings or other structures that could provide technologically and structurally suitable space for collocation on commercially reasonable terms;

There are no towers, existing or proposed, buildings or other structures that could provide technologically and structurally suitable space for collocation on commercially reasonable terms. As demonstrated in the submitted RF Package, there are no wireless communication towers within one (1) mile of the Conventional Wireless Tower. The minimum tower separation is one half (1/2) mile, meaning that the closest cell tower is over twice the required distance under the Zoning Code.

- (6) The proposed tower shall be compatible with the existing contiguous uses or zoning and compatible with the general character and aesthetics of the surrounding neighborhood or the area, considering:
  - (i) The design and height of the communication tower;

The existing towers in and around Nocatee are two hundred fifty-five (255) feet, two hundred seventeen (217) feet, one hundred eighty-four (184) feet, one hundred thirty-six (136) feet, and one hundred twenty-five (125) feet as depicted in the submitted RF Package. The Conventional Wireless Tower is one hundred seventy (170) feet, including a ten (10) foot lightning rod at the top of the tower. The surrounding area features large mature trees and powerlines to the east of the Property.

(ii)The potential adverse impact upon any environmentally sensitive lands, historic districts or historic landmarks, public parks or transportation view corridors; and

There are no potential adverse impacts upon any environmentally sensitive lands, historic districts or historic landmarks, public parks or transportation view corridors. The Conventional Wireless Tower is located fifty (50) feet from the nearest environmentally sensitive land and one hundred (100) feet from Valley Ridge Boulevard. The certified fall radius is fifty (50) feet, such that the Conventional Wireless Tower will not affect either. There are no historic districts, historic landmarks or public parks within proximity of the Conventional Wireless Tower.

(iii)The mitigating effect of any existing or proposed landscaping, fencing or other structures in the area, as well as the proximity of the communications tower to existing or proposed buildings or structures.

The Conventional Wireless Tower facility will provide landscaping as required under Part 15 and will be screened with a PVC fence. There are mature trees in the vicinity, as well as power poles running north and south between the Conventional Wireless Tower and the nearest single-family dwelling.

## -N70° 30' 10"E 26.56' POINT OF COMMENCEMENT **NEXTOWER LEASE PARCEL & EASEMENT** INTERSECTION OF SOUTH R/W LINE OF VALLEY RIDGE BLVD. & EAST LINE OF SECTION 25-4-28 POINT OF BEGINNING NEXTOWER 30' WIDE INGRESS/EGRESS & UTILITY EASEMENT CENTERLINE POINT OF BEGINNING NEXTOWER LEASE PARCEL & UTILITY EASEMENT CENTERLINE ST. JOHNS COUNTY PARCEL ID: 0696300220 **KELLY POINTE AT NOCATEE PHASE 1** OWNER: TOLOMATO CDD PLAT BOOK 65, PAGES 100-105 O.R. 4483, PAGE 819 PROPOSED 170' **MONOPOLE TOWER PARENT TRACT** RE#: 168149-9900 SONOC COMPANY O.R. 9494, PAGES 905 & 909 125.0' ELECTRIC EASEMENT PER O.R. 569, PAGE 242 **NORTHERLY LINES OF LANDS**-DESCRIBED IN O.R. 15469, PAGE 919 RE# 168149-9850 OWNER: GALEONE VICTOR, AS BISHOP OF DIOCESE OF ST AUGUSTINE O.R. 15469, PAGE 919 ● INDICATES 5/8" REBAR & CAP SET STAMPED LB 7810 INDICATES 5/8" REBAR & CAP FOUND STAMPED LB 3624 INDICATES 4"x4" CONCRETE MONUMENT STAMPED LB 3624 R/W INDICATES RIGHT-OF-WAY O.R. INDICATES OFFICIAL RECORDS BOOK ID INDICATES IDENTIFICATION NAVD INDICATES NORTH AMERICAN VERTICAL DATUM FLOOD ZONE NOTE THE HEREON DESCRIBED LEASE PARCEL AND EASEMENT APPEAR TO LIE IN FLOOD ZONE X BASED ON THE FEDERAL EMERGENCY MANAGEMENT ACT FIRM, COMMUNITY PANEL MAP NUMBERS 12031C0595H & 12031C0675H DATED JUNE 3, 2013. **TOWER DATA** (PROPOSED 170' MONOPOLE) LATITUDE: 30° 07' 29.49" NORTH LONGITUDE: 81° 26' 03.38" WEST SCALE: 1"=30' GROUND ELEVATION: 25.5' NAVD 1988

# BOUNDARY & TOPOGRAPHIC SURVEY OF NEXTOWER LEASE PARCEL

IN SECTION 25, TOWNSHIP 4 SOUTH, RANGE 28 EAST DUVAL COUNTY, FLORIDA

#### PARENT TRACT DESCRIPTION (PREPARED BY SURVEYOR)

A PORTION OF SECTION 25, TOWNSHIP 4 SOUTH, RANGE 28 EAST, DUVAL COUNTY, FLORIDA, ALSO BEING A PORTION OF THOSE LANDS DESCRIBED IN OFFICIAL RECORDS BOOK 9494, PAGE 905 OF THE CURRENT PUBLIC RECORDS OF DUVAL COUNTY, FLORIDA, BEING MORE PARTICULARLY DESCRIBED AS FOLLOWS:

THAT PART OF SECTION 25, TOWNSHIP 4 SOUTH, RANGE 28 EAST, DUVAL COUNTY, FLORIDA LYING SOUTH OF VALLEY RIDGE BOULEVARD, A VARIABLE WIDTH RIGHT-OF-WAY AS RECORDED IN PLAT BOOK 65, PAGES 50 THROUGH 53 OF THE PUBLIC RECORDS OF SAID DUVAL COUNTY AND LYING NORTHERLY OF THOSE LANDS DESCRIBED IN OFFICIAL RECORDS BOOK 15469, PAGE 919 OF SAID PUBLIC RECORDS.

#### **NEXTOWER LEASE PARCEL DESCRIPTION**

A PARCEL OF LAND LYING IN SECTION 25, TOWNSHIP 4 SOUTH, RANGE 28 EAST, DUVAL COUNTY, FLORIDA; SAID PARCEL OF LAND BEING MORE PARTICULARLY DESCRIBED AS FOLLOWS:

COMMENCE AT THE INTERSECTION OF THE EAST LINE OF SECTION 25, TOWNSHIP 4 SOUTH, RANGE 28 EAST, DUVAL COUNTY, FLORIDA AND THE SOUTH RIGHT-OF-WAY LINE OF VALLEY RIDGE BOULEVARD (A VARIABLE WIDTH RIGHT-OF-WAY PER PLAT BOOK 65, PAGES 50-53 OF THE PUBLIC RECORDS OF SAID DUVAL COUNTY); THENCE S70° 30' 10"W ALONG SAID SOUTH RIGHT-OF-WAY LINE FOR 105.29 FEET; THENCE S19° 29' 50"E FOR 50.00 FEET; THENCE N70° 30' 10"E FOR 37.50 FEET TO THE POINT OF BEGINNING OF THE HEREIN DESCRIBED PARCEL OF LAND; THENCE S19° 29' 50"E FOR 75.00 FEET; THENCE S70° 30' 10"W FOR 75.00 FEET; THENCE N19° 29' 50"W FOR 75.00 FEET; THENCE N70° 30' 10"E FOR 75.00 FEET TO THE POINT OF BEGINNING. SAID PARCEL OF LAND SITUATE, LYING AND BEING IN DUVAL COUNTY, FLORIDA, CONTAINING 5,625 SQUARE FEET OF LAND MORE OR LESS.

#### **NEXTOWER INGRESS/EGRESS & UTILITIES EASEMENT DESCRIPTION**

A 30-FEET WIDE EASEMENT STRIP OF LAND FOR THE PURPOSES OF INGRESS/EGRESS AND UTILITIES LYING IN SECTION 25, TOWNSHIP 4 SOUTH, RANGE 28 EAST, DUVAL COUNTY, FLORIDA; SAID EASEMENT STRIP LYING 15.00 FEET BOTH SIDES OF THE FOLLOWING DESCRIBED EASEMENT CENTERLINE:

COMMENCE AT THE INTERSECTION OF THE EAST LINE OF SECTION 25, TOWNSHIP 4 SOUTH, RANGE 28 EAST, DUVAL COUNTY, FLORIDA AND THE SOUTH RIGHT-OF-WAY LINE OF VALLEY RIDGE BOULEVARD (A VARIABLE WIDTH RIGHT-OF-WAY PER PLAT BOOK 65, PAGES 50-53 OF THE PUBLIC RECORDS OF SAID DUVAL COUNTY); THENCE S70° 30' 10"W ALONG SAID SOUTH RIGHT-OF-WAY LINE FOR 105.29 FEET TO THE POINT OF BEGINNING OF THE HEREIN DESCRIBED EASEMENT CENTERLINE; THENCE S19° 29' 50"E FOR 50.00 FEET TO THE POINT OF TERMINUS. THE SIDELINES OF SAID EASEMENT TO BE SHORTENED AND PROLONGED TO MEET AT RIGHT-OF-WAY LINES AND LEASE PARCEL LINES.

#### **SURVEYOR'S NOTES**

1. BEARINGS SHOWN HEREON ARE ASSUMED AND REFERENCED TO THE SOUTH RIGHT-OF-WAY LINE OF VALLEY RIDGE BOULEVARD AS BEARING S70° 30' 10"W.

- 2. THE BOUNDARY SURVEY SHOWN HEREON IS BASED ON ACTUAL FIELD MEASUREMENTS AND OBSERVATIONS DATED APRIL 17, 2023.
- 3. THIS SURVEY MAP OR THE COPIES THEREOF ARE NOT VALID WITHOUT THE SIGNATURE AND THE ORIGINAL RAISED SEAL OF A FLORIDA LICENSED SURVEYOR AND MAPPER.

4. CENTER OF PROPOSED TOWER LATITUDE, LONGITUDE AND ELEVATIONS SHOWN HEREON WERE ESTABLISHED FROM RTK GPS OBSERVATIONS REFERENCED TO THE STATE OF FLORIDA PERMANENT REFERENCE NETWORK. THE VALUES FOR THE PROPOSED TOWER LATITUDE, LONGITUDE AND ELEVATION SHOWN HEREON EXCEED FAA "1-A" ACCURACY REQUIREMENTS. ELEVATIONS ARE NORTH AMERICAN VERTICAL DATUM OF 1988 (NAVD 88) AND ARE REFERENCED TO THE STATE OF FLORIDA PERMANENT REFERENCE NETWORK.

5. THE PURPOSE OF THIS SURVEY IS TO SHOW IMPROVEMENTS ASSOCIATED WITH A PROPOSED TELECOMMUNICATIONS FACILITY AND PROVIDE LEGAL DESCRIPTIONS FOR SAID FACILITY AND ASSOCIATED EASEMENTS. THIS IS NOT A BOUNDARY SURVEY OF THE PARENT TRACT.

- 6. MEASURED BEARINGS AND DISTANCES WERE IN SUBSTANTIAL AGREEMENT WITH RECORD DATA UNLESS OTHERWISE NOTED.
- 7. PROPERTY TIES ARE PERPENDICULAR MEASURE UNLESS OTHERWISE NOTED.
- 8. THIS SURVEY CONSISTS OF 2 SHEETS.



	-				
	BOOK/PAGE	49/45	This map prepared by:	SCALE	1"=30'
TONECYPHER	DRAWN	DWS	DAVID W. STONECYPHER	DATE	APRIL 17, 2023
URVEYING INC.	CHECKED	DWS	PROFESSIONAL SURVEYOR & MAPPER FLA. LICENSE NO. 6391	PROJECT #	22-0132

1225 NW 16TH AVENUE GAINESVILLE, FLORIDA 32601
Tel.: (352) 379-0948
Email: dws@stone-survey.com
WWW.STONE-SURVEY.COM
Professional Surveying & Mapping Certificate of Authorization
No.: LB 7810

COMMUNICATION TOWER SITE
COASTAL RIDGE NXFL-352

NEXTOWER DEVELOPMENT GROUP II, LLC

## **BOUNDARY & TOPOGRAPHIC SURVEY OF NEXTOWER LEASE PARCEL** IN SECTION 25, TOWNSHIP 4 SOUTH, RANGE 28 EAST DUVAL COUNTY, FLORIDA POINT OF COMMENCEMENT NEXTOWER LEASE PARCEL & EASEMENT INTERSECTION OF SOUTH R/W LINE OF VALLEY RIDGE BLVD. & EAST LINE OF SECTION 25-4-28 BOTTOM OF BANK & LIMITS OF TREES TREE LEGEND **LEGEND** POINT OF BEGINNING ● INDICATES 5/8" REBAR & CAP SET STAMPED LB 7810 **PINE TREE** NEXTOWER 30' WIDE INGRESS/EGRESS & UTILITY EASEMENT CENTERLINE INDICATES 5/8" REBAR & CAP FOUND STAMPED LB 3624 BAY TREE INDICATES 4"x4" CONCRETE MONUMENT STAMPED LB 3624 R/W INDICATES RIGHT-OF-WAY INDICATES DIAMETER OF TREE TRUNK AS MEASURED AT 4'± ABOVE GROUND O.R. INDICATES OFFICIAL RECORDS BOOK ID INDICATES IDENTIFICATION INDICATES TREE CLUSTER SIZES NAVD INDICATES NORTH AMERICAN VERTICAL DATUM INDICATES LIGHT POLE INDICATES ELECTRIC JUNCTION BOX INDICATES FIBEROPTIC MARKER SCALE: 1"=10' INDICATES COMMUNICATIONS PEDESTAL POINT OF BEGINNING INDICATES ELECTRIC MANHOLE NEXTOWER LEASE PARCEL POINT OF TERMINUS— NEXTOWER 30' WIDE INGRESS/EGRESS & UTILITY EASEMENT CENTERLINE INDICATES WATER METER +15.2' INDICATES SPOT ELEVATION LELECTRIC TRANSFORMERS 25.1' **SURVEYOR'S NOTES** 1. BEARINGS SHOWN HEREON ARE ASSUMED AND REFERENCED TO THE SOUTH RIGHT-OF-WAY LINE OF VALLEY RIDGE BOULEVARD AS BEARING S70° 30' 10"W. 2. ELEVATIONS ARE NORTH AMERICAN VERTICAL DATUM OF 1988 (NAVD 88) AND ARE REFERENCED TO ELEVATIONS SHOWN HEREON WERE ESTABLISHED FROM RTK GPS OBSERVATIONS REFERENCED TO THE STATE OF FLORIDA PERMANENT REFERENCE NETWORK. 3. PROPERTY TIES ARE PERPENDICULAR MEASURE UNLESS OTHERWISE NOTED. 4. THIS SURVEY CONSISTS OF 2 SHEETS. STONECYPHER APRIL 17, 2023 **PARENT TRACT** SURVEYING INC. RE#: 168149-9900 SONOC COMPANY O.R. 9494, PAGES 905 & 909 22-0132 1225 NW 16TH AVENUE GAINESVILLE, FLORIDA 32601 Tel.: (352) 379-0948 Email: dws@stone-survey.com WWW.STONE-SURVEY.COM **COMMUNICATION TOWER SITE COASTAL RIDGE NXFL-352** NEXTOWER DEVELOPMENT GROUP II, LLC | SHEET # Professional Surveying & Mapping Certificate of Authorization No.: LB 7810



## **NXFL-342 COASTAL RIDGE**

#### **PROPOSED 170' MONOPOLE TOWER**

(160' STEEL TOWER W/ 10' APPURTENANCE)

0 COASTAL RIDGE BLVD, JACKSONVILLE FL 32224

## **HEIGHT RESTRICTION ZONE MAP**

Land Development Review



\*PROPOSED PROJECT NOT LOCATED IN HIEGHT RESTRICTION ZONE



## **NXFL-342 COASTAL RIDGE**

#### **PROPOSED 170' MONOPOLE TOWER**

(160' STEEL TOWER W/ 10' APPURTENANCE)

0 COASTAL RIDGE BLVD, JACKSONVILLE FL 32224

## **LAND USE MAP**

#### **Duval Map**



\*PROPOSED PROJECT LOCATED WITHIN THE MU LAND USE DISTRICT




# NXFL-342 COASTAL RIDGE PROPOSED 170' MONOPOLE TOWER

(160' STEEL TOWER W/ 10' APPURTENANCE)
0 COASTAL RIDGE BLVD, JACKSONVILLE FL 32224

## **PARKS MAP**

Land Development Review

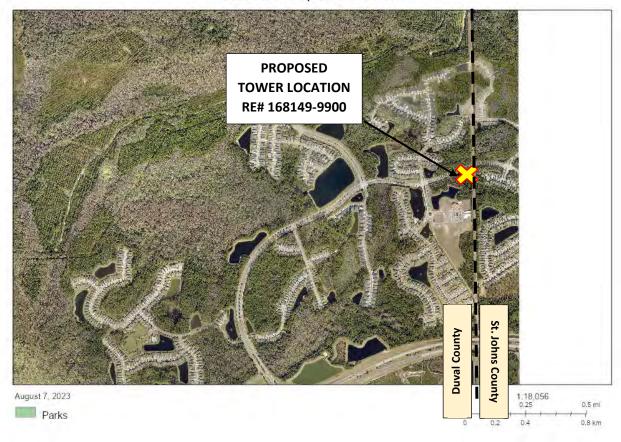




# NXFL-342 COASTAL RIDGE PROPOSED 170' MONOPOLE TOWER


(160' STEEL TOWER W/ 10' APPURTENANCE)
0 COASTAL RIDGE BLVD, JACKSONVILLE, FL 32224

# **ZONING MAP**

#### **Duval Map**



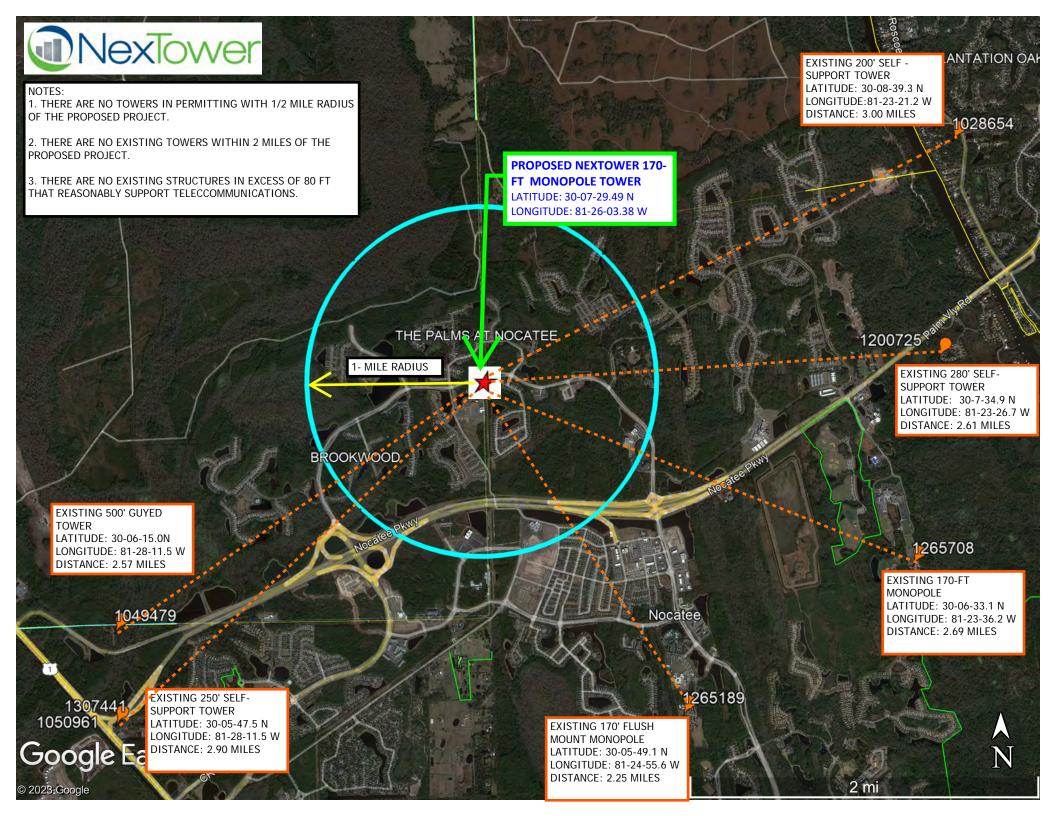

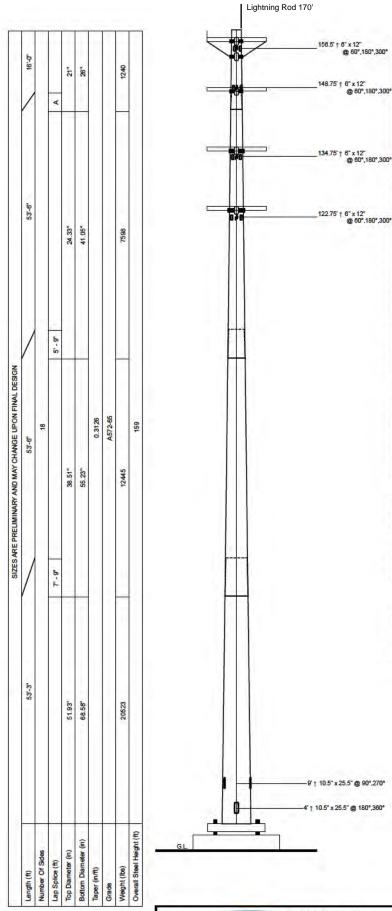

#### **Designed Appurtenance Loading**

Elev	Description	Tx-Line
160	(1) 30,000 Sq. Inches 8,000# (at top)	(12) 1 5/8*
158	Platform - 12' w/ Enhanced Support Rail	
148	Platform - 12' w/ Enhanced Support Rail	
148	(1) 30,000 Sq. Inches 8,000# (below top)	(12) 1 5/8*
136	Platform - 12' w/ Enhanced Support Rail	
136	(1) 30,000 Sq. Inches 8,000# (below top)	(12) 1 5/8"
124	Platform - 12' w/ Enhanced Support Rail	
124	(1) 25,000 sq. in. (8000 lbs) (below top)	(12) 1 5/8"

#### Design Criteria - ANSI/TIA-222-H

Wind Speed (No Ice)	129 mph			
Wind Speed (Ice)	30 mph			
Design Ice Thickness	0.25 in			
Risk Category	II.			
Exposure Category	C			
Topographic Factor Procedure	Method 1 (Simplified)			
Topographic Category	1			
Ground Elevation	26 ft			
Seismic Importance Factor, le	1.00			
0.2-sec Spectral Response, Ss	0.097 g			
1-sec Spectral Response, S1	0.051 g			
Site Class	D (DEFAULT)			
Seismic Design Category	В			
Basic Seismic Force-Resisting System	Telecommunication Tower (Pole: Steel)			

#### **Limit State Load Combination Reactions**

Load Combination	Axial (kips)	Shear (kips)	Moment (ft-k)	Deflection (ft)	Sway (deg)
1.2 D + 1.0 Wo	100.87	66.67	8742.4	12.04	8.89
0.9 D + 1.0 Wo	75.69	66.63	8567.87	11.71	8.62
1.2 D + 1.0 Ev + 1.0 Eh	102.5	2.51	372	0.54	0.4
0.9 D - 1.0 Ev + 1.0 Eh	73.85	2.52	363.78	0.53	0.39
1.0 D + 1.0 Wo (Service @ 80 mph)	84.08	12.9	1682.2	2.35	1.72

#### **Base Plate Dimensions**

Shape	Diameter	Thickness	<b>Bolt Circle</b>	Bolt Qty	Bolt Diameter
Round	81.75"	2.5"	76*	24	2.25"

#### **Material List**

Display	Value	
A	3, - 8.	

#### Notes

- 1) Antenna Feed Lines Run Inside Pole
- 2) All dimensions are above ground level, unless otherwise specified.
- 3) Weights shown are estimates. Final weights may vary.
- 4) Full Height Step Bolts
- 5) This tower design and, if applicable, the foundation design(s) shown on the following page(s) also meet or exceed the requirements of the 2020 Florida Building Code.



**Sabre Industries** 7101 Southbridge Drive P.O. Box 658 Sioux City, IA 51102-0658 Phone (712) 259-6690 Fax (712) 279-0814

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Quote:	24-0536-JDS		
Customer:	NEXTOWER		
Site Name:	Coastal Ridge, F	L NXFL-342	
Description:	160' Monopole		
Date:	EIGIONOO	By: RM	Page: 4



#### PROPOSAL

Prepared for: **NEXTOWER**  Proposal No.: 24-0536-JDS

13577 NW 2nd Lane, Suite 20 Newberry, FL 32669

6/8/2023 Page 1 Reference: 160' Monopole/Coastal Ridge, FL NXFL-342

Attn: Joel Rousseau

Freight: Origin

#### SABRE MONOPOLE

Quantity of one (1) Sabre Monopole. The monopole has an overall height of 160'. The overall height of this monopole includes the foundation projection.

Date:

The monopole will be eighteen-sided and tapered in design with a top diameter of 21" and a base diameter of 68.58".

See the tower profile included in this proposal for the design parameters.

The monopole will be designed to support the following equipment:

	ANTENNA MODEL NUMBER (QTY)	RADO YES		ELEVATION	TX. LINE SIZE & TYPE	FREQUENCY	AZIMUTH TO NORTH	ANTENNA MOUNT	MOV PROV YES	UNT IDED NO
1	(1) 30,000 Sq. Inches 8,000# (at top)		X	160'	(12) 1 5/8"	N/A	Unknown	12' H.D. Platform with Enhanced Support Rail with Collar Mount		X
2	(1) 30,000 Sq. Inches 8,000# (below top)		X	148'	(12) 1 5/8"	N/A	Unknown	12' H.C. Platform with Enhanced Support Rail with Collar Mount		X
3	(1) 30,000 Sq. Inches 8,000# (below top)		X	136'	(12) 1 5/8"	N/A	Unknown	12' H.C. Platform with Enhanced Support Rail with Collar Mount		X
4	(1) 25,000 sq. in. (8000 lbs) (below top)		X	124'	(12) 1 5/8"	N/A	Unknown	12' H.C. Platform with Enhanced Support Rail with Collar Mount		X

Note: This monopole has been designed for a fall radius less than 50 feet.

#### ITEM I **MONOPOLE MATERIALS**.

Materials to be provided include:

Complete monopole steel and hardware

Anchor bolts and templates, (24) bolts 84" long

Step Bolts

Twelve (12) 6" x 12" access ports with J hooks (see notes)

Four (4) 10.5" x 25.5" access ports (see notes)

200' Safety Climb without harness

10' x 3/4" lightning rod copper clad and stiffener

P.E. certified profile drawings (see notes)

P.E. certified foundation design (see notes)

Final erection drawings

#### MONOPOLE FREIGHT TO DUVAL COUNTY, FL

#### ANCHOR BOLT FREIGHT TO DUVAL COUNTY, FL

#### **NOTES:** Terms will be reviewed upon receipt of order.

Wind induced vibrations, such as vortex shedding and harmonic oscillation/resonance, of structures of all types due to unpredictable interaction with wind and surrounding structures, exposure and terrain rarely occur. The owner's maintenance program should include observations for vibration and any resulting loosening of connecting hardware or damage to the structure. The Sabre warranty specifically excludes failure due to fatigue or similar phenomena as a result of the aforementioned behavior.



# Coastal Ridge NXFL-342

# PHOTOGRAPHIC SIMULATIONS OF PROPOSED 160' MONOPOLE TOWER WITH 10' APPURTENANCE

(170' total height above ground level)

## FOR PROPOSED WIRELESS TELECOMMUNICATIONS FACILITY

April 26, 2023



TOGRAPHIC SIMULATIONS \* BALLOON TESTS \* LAND SURVEYING \* CAD SERVICES




(352) 363-5560

# SHEET TITLE Photographic Simulations

Photographic Simulations 160' Monopole Tower with 10' appurtenance

#### **COVER SHEET**

SHEET#

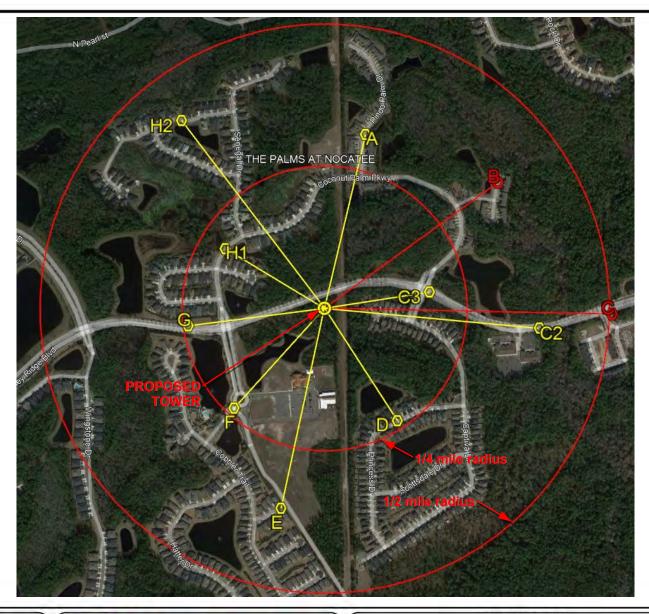



#### Ehrke Enterprises, LLC

3441 NW 103rd Drive Gainesville, Florida 32606 Phone: (352) 215-8539 Email. jamesehrke@eellc.org 13577 NW 2nd Lane, Suite 20 Newberry Florida 32669 (352) 363-5560

#### SHEET TITLE

Photographic Simulations 160' Monopole Tower with 10' appurtenance

**Photo Location Map** 

SHEET#





Photo Simulation of Proposed Tower from 1653' looking South.



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Gainesville, Florida 32606
Phone: (352) 215-8539
Email: jamesehrke@eellc.org




13577 NW 2nd Lane, Suite 20 Newberry Florida 32669 (352) 363-5560


#### SHEET TITLE

Photographic Simulations 160' Monopole Tower with 10' appurtenance

#### View A

SHEET#

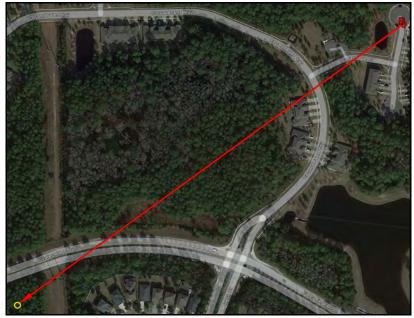

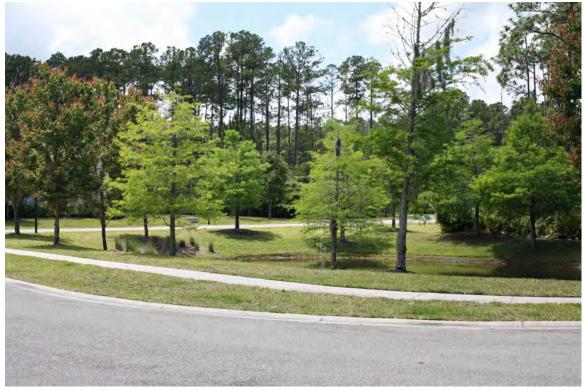

Existing view from 1988' looking SW. Proposed tower not visible.



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#### SHEET TITLE

Photographic Simulations 160' Monopole Tower with 10' appurtenance

View B

SHEET#







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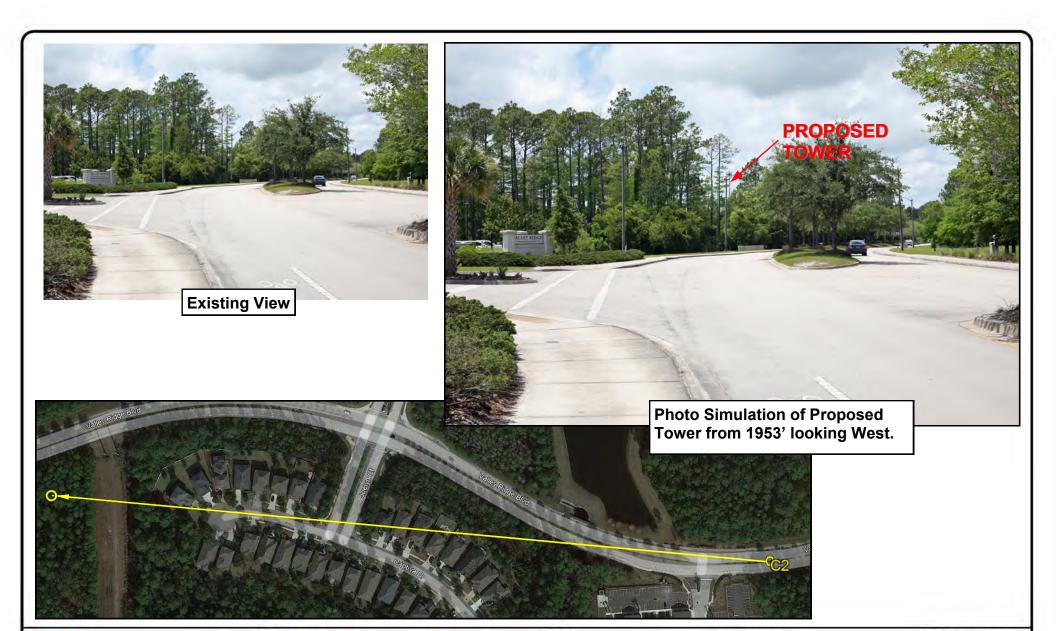
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#### SHEET TITLE

Photographic Simulations 160' Monopole Tower with 10' appurtenance

**View C** 

SHEET#





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#### SHEET TITLE

Photographic Simulations 160' Monopole Tower with 10' appurtenance

View C2

SHEET#



**Existing View** 



Proposed Tower from 994' looking West.



Email. jamesehrke@eellc.org PHOTOGRAPHIC SIMULATIONS \* BALLOON TESTS \* LAND SURVEYING \* CAD SERVICES



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#### SHEET TITLE

Photographic Simulations 160' Monopole Tower with 10' appurtenance

View C3

SHEET#

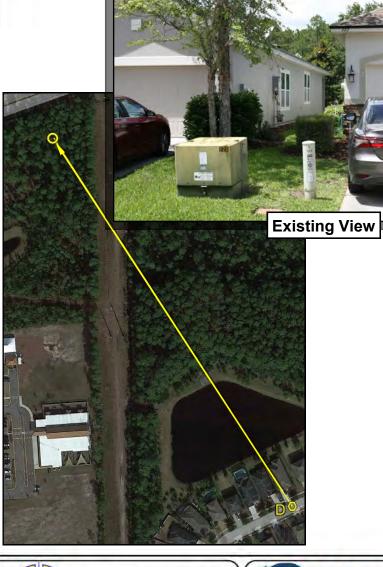


Photo Simulation of Proposed Tower from 1238' looking NW.





## Ehrke Enterprises, LLC

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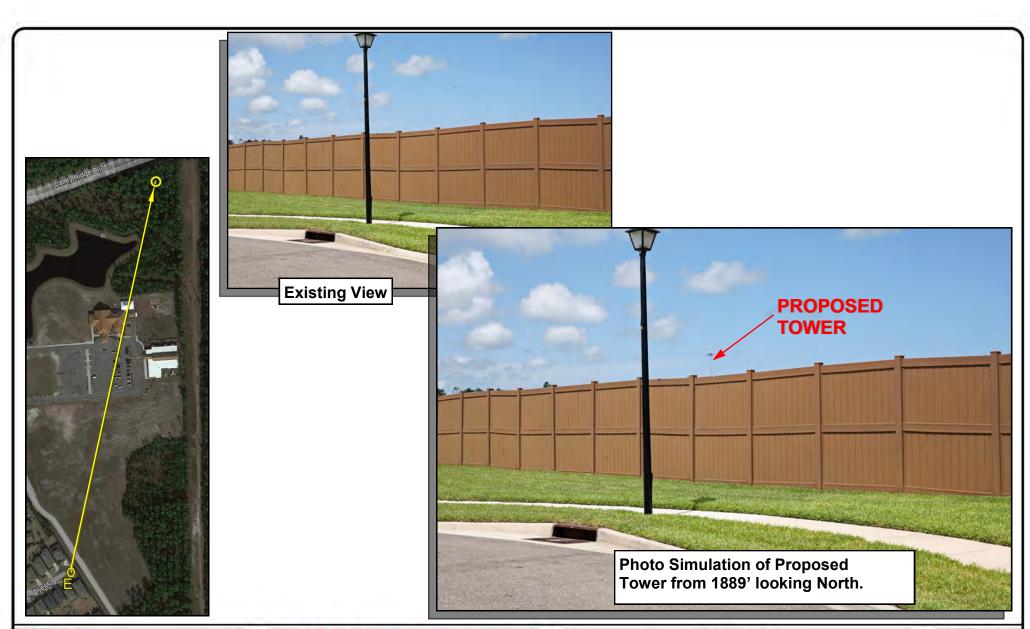
13577 NW 2nd Lane, Suite 20 Newberry Florida 32669 (352) 363-5560

#### SHEET TITLE

Photographic Simulations 160' Monopole Tower with 10' appurtenance

**View D** 

SHEET#





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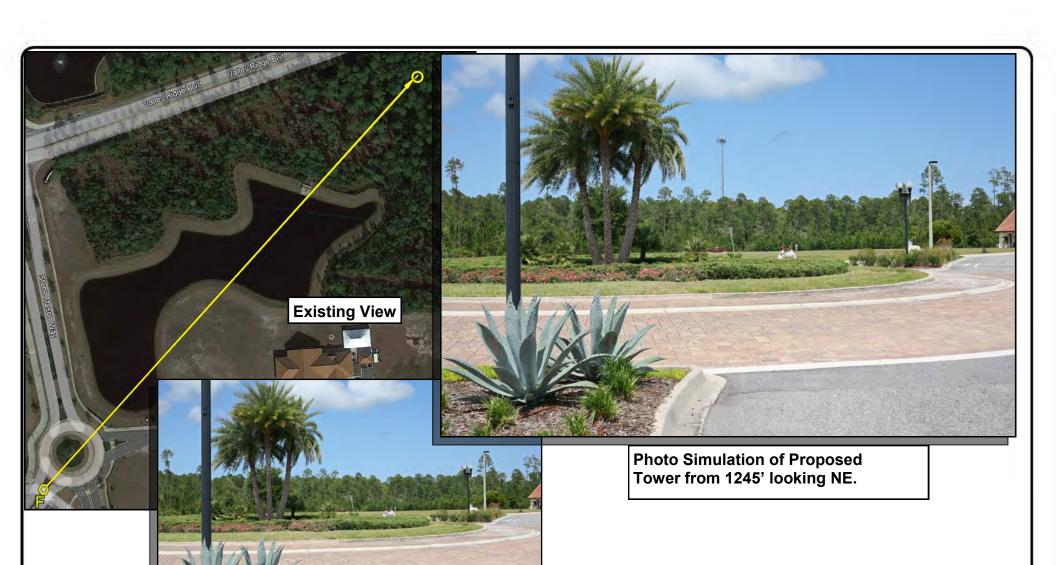
13577 NW 2nd Lane, Suite 20 Newberry Florida 32669 (352) 363-5560

#### SHEET TITLE

Photographic Simulations 160' Monopole Tower with 10' appurtenance

**View E** 

SHEET#





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#### SHEET TITLE

Photographic Simulations 160' Monopole Tower with 10' appurtenance

**View F** 

SHEET#









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Email: jamesehrke@eellc.org



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#### SHEET TITLE

Photographic Simulations 160' Monopole Tower with 10' appurtenance

**View G** 


SHEET#







Photo Simulation of Proposed Tower from 1073' looking SE.

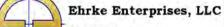

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#### SHEET TITLE

Photographic Simulations 160' Monopole Tower with 10' appurtenance

View H<sub>1</sub>







Photo Simulation of Proposed Tower from 2185' looking SE.



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#### SHEET TITLE

Photographic Simulations 160' Monopole Tower with 10' appurtenance

View H2

The process used to generate the enclosed photo simulation is a quantitative approach, which precisely creates the effect or anticipated visual impact of proposed tall structures.

The computations utilized to prepare the simulation are based on the theory of photogrammetry, which is the science of measurement by means of photographs. The scale and position of objects in photographs vary according to the distance and position of the corresponding actual objects relative to the camera. The photogrammetric relationship between height and distance is an inverse proportionate relationship.

When necessary, both horizontal and oblique photographs are utilized to control the accurate placement of the simulated tall structure within the target photograph. The height of the proposed tall structure in the target photograph is based on data obtained from a certified balloon test performed at the proposed site.

Both reference photographs and target photographs are produced in digital format utilizing a fixed 50 mm camera lens and full frame digital camera.(35mm camera equivalent) A 50 mm camera lens is used because when combined with a 35 mm film format, it is considered to best approximate the viewpoint of the human eye.

The procedure utilized to produce our photo simulations is listed below:

- Reference photographs are taken of existing similar tall structures with known or measured heights, at a known distance from the tall structure.
- Target photographs are taken of the proposed tall structure location during a certified balloon test from various points of interest. Mapping Grade Hand Held GPS is used to determine the distance from the camera lens to the proposed tall structure location.
- Digital photographs are up-loaded into an image-editing program, which is utilized to generate the photo simulation.
- Based on reference photograph and target photograph intelligence, the pictorial height and placement of the simulated tall structure is calculated and placed within the target photograph.





SHEET TITLE
Photographic Simulations
160' Monopole Tower with 10' appurtenance

PHOTO SIMULATION METHODOLOGY

To Whom It May Concern:

We hereby certify that on April 23, 2023 between the time of 1:00 pm and 3:15 pm, we positioned a Five foot +/- diameter weather balloon at approximately 170 feet above ground level tethered at Latitude 30° 07' 29.49" North and Longitude 81° 26' 03.38" West.

Please contact at me at (352) 215-8539 if I can provide additional information.

Ehrke Enterprises, LLC

James A. Ehrke

James A. Ehrke Florida Registered Surveyor and Mapper Certificate of Registration No. 6053







# SHEET TITLE Photographic Simulations 160' Monopole Tower with 10' appurtenance

**Balloon Test Certification** 


SHEET#




# **Objective**

- Provide In-Building coverage to our customers in the Palms At Nocatee and surrounding areas.
- location: 30.124858,-81.434272
- Issue:
  - Customers in Palms At Nocatee community have no or very poor indoor coverage.
- In order to provide Ultra Capacity 5G to our customers in the Palms At Nocatee areas, we are proposing the following:
  - Request to build a new tower within the search ring for 9JK2870.
  - Proposed site will allow us to deploy a full array that will include L21,L25,L6,L7,N6,N25.
  - Full array will allow deployment of our entire Mid-Band, Low-Band and 5G spectrum portfolio and provide Ultra Capacity 5G to this area.

# Mid-Band 5G Coverage Analysis

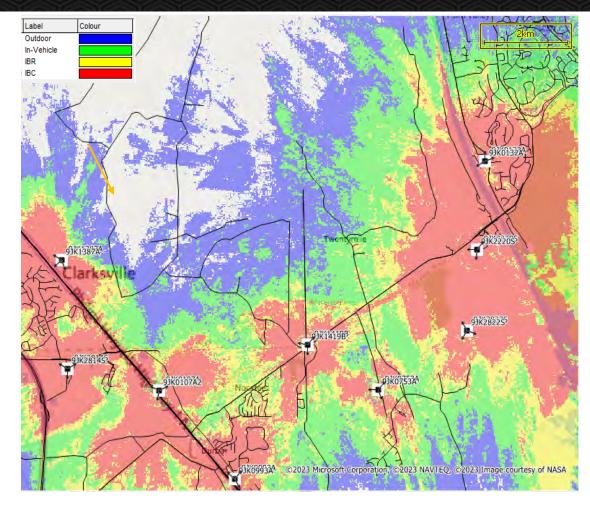

• Existing and planned Mid-Band Coverage.

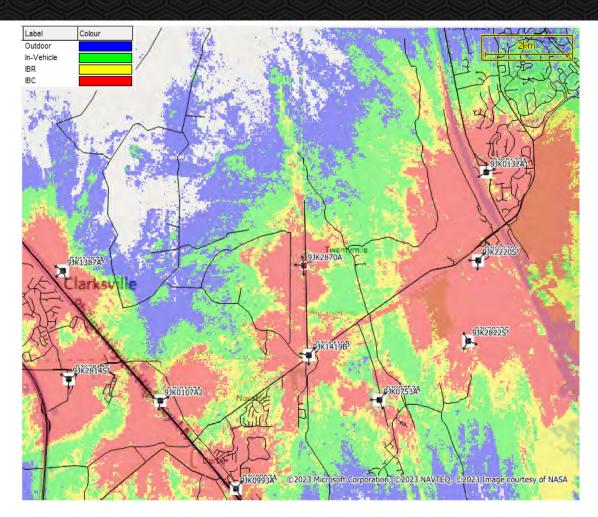

Existing and planned Mid-Band Coverage with proposed site.

T-Mobile Confidential T-Mobile\*


# Starling User Data



Slide indicates number of users with poor coverage in this area.

T-Mobile Confidential  $\mathbf{T} \cdot \mathbf{Mobile}$ 


# Satellite View

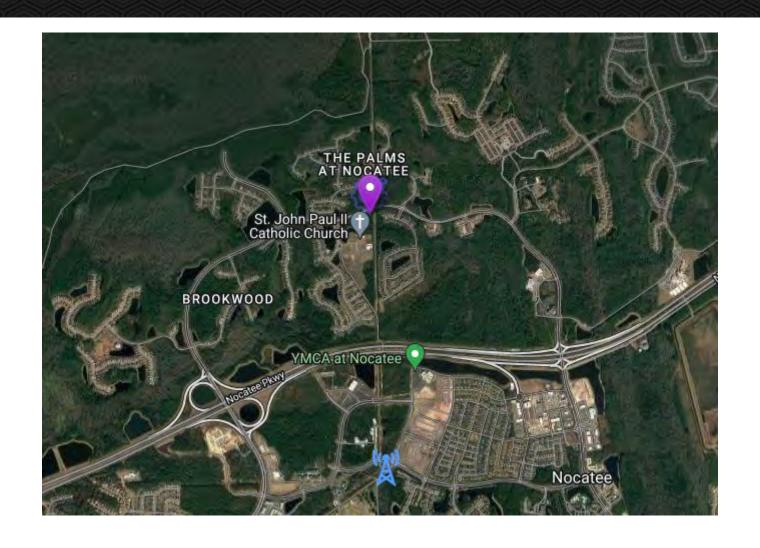

T-Mobile Confidential  $\mathbf{T} \cdot \mathbf{Mobile}$ 

# Neighbor Data

S:Site Code	S:Site Latitude	S:Site Longitude	Antenna Height
9JK0107A	30.096590	-81.469689	217'
9JK0132A	30.144290	-81.389213	184'
9JK1387A	30.123519	-81.493978	125'
9JK1419B	30.106122	-81.432889	136'
9JK2220S	30.126000	-81.391000	255'

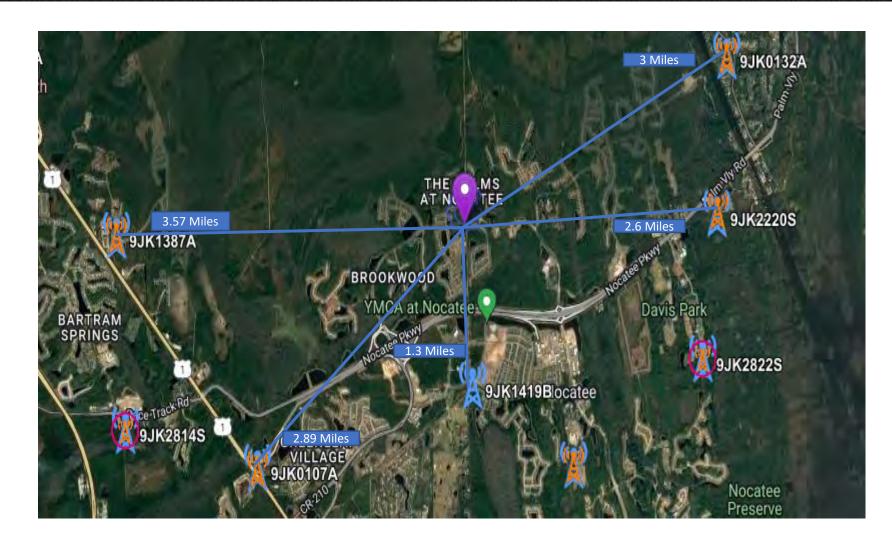

T-Mobile Confidential  $\mathbf{T} \cdot \mathbf{Mobile}^{\cdot}$ 

# STONECYPHER SURVEYING INC.

1225 NW 16<sup>TH</sup> AVENUE, GAINESVILLE, FLORIDA 32601

PHONE: 352-379-0948

## **FAA "1-A CERTIFICATION**

April 18, 2023

NexTower Development Group II, LLC 13577 NW 2<sup>nd</sup> Lane, Suite 20 Newberry, FL 32669

**Site Name:** 

COASTAL RIDGE

**Site Number:** 

NXFL-352

Site Data:

Proposed 170' Monopole

**Tower Information** 

**Geographic Coordinates:** 

Latitude - 30° 07' 29.49" North

Longitude - 81° 26' 03.38" West

**Ground Elevation:** 

Base of Proposed Tower - 25.5'

#### Certification

I hereby certify that the latitude of **30° 07′ 29.49″ North** and the longitude of **81° 26′ 03.38″ West** are within 20-feet horizontally, and that the ground elevation at the base of the tower of **25.5** feet is accurate to within 3-feet vertically. The horizontal datum (coordinates) are in terms of North American Datum of 1983/2011 (NAD 83/2011) and is expressed as degrees, minutes, and seconds, to the nearest hundredth of a second. The vertical datum (elevation) is in terms of the North American Vertical Datum of 1988 (NAVD 88) and is determined to the nearest foot.


David W. Stonecypher

**Professional Surveyor and Mapper No. LS 6391** 

Stonecypher Surveying Inc. – Business No. LB 7810

State of Florida



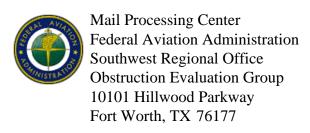

Issued Date: 08/07/2023

David Boeff NexTower Development Group II, LLC 4210 NW 37th Place Suite 600 Gainesville, FL 32606

#### \*\* DETERMINATION OF NO HAZARD TO AIR NAVIGATION \*\*

The Federal Aviation Administration has conducted an aeronautical study under the provisions of 49 U.S.C., Section 44718 and if applicable Title 14 of the Code of Federal Regulations, part 77, concerning:

Structure: Antenna Tower NXFL-342 Coastal Ridge

Location: Jacksonville, FL

Latitude: 30-07-29.49N NAD 83

Longitude: 81-26-03.38W

Heights: 26 feet site elevation (SE)

170 feet above ground level (AGL) 196 feet above mean sea level (AMSL)

This aeronautical study revealed that the structure does not exceed obstruction standards and would not be a hazard to air navigation provided the following condition(s), if any, is(are) met:

It is required that FAA Form 7460-2, Notice of Actual Construction or Alteration, be e-filed any time the project is abandoned or:

	At least 10 days prior to start of construction (7460-2, Part 1)	
X	Within 5 days after the construction reaches its greatest height (7460-2, P	art 2

Based on this evaluation, marking and lighting are not necessary for aviation safety. However, if marking/lighting are accomplished on a voluntary basis, we recommend it be installed in accordance with FAA Advisory circular 70/7460-1 M.

This determination expires on 02/07/2025 unless:

- (a) the construction is started (not necessarily completed) and FAA Form 7460-2, Notice of Actual Construction or Alteration, is received by this office.
- (b) extended, revised, or terminated by the issuing office.
- (c) the construction is subject to the licensing authority of the Federal Communications Commission (FCC) and an application for a construction permit has been filed, as required by the FCC, within

6 months of the date of this determination. In such case, the determination expires on the date prescribed by the FCC for completion of construction, or the date the FCC denies the application.

NOTE: REQUEST FOR EXTENSION OF THE EFFECTIVE PERIOD OF THIS DETERMINATION MUST BE E-FILED AT LEAST 15 DAYS PRIOR TO THE EXPIRATION DATE. AFTER RE-EVALUATION OF CURRENT OPERATIONS IN THE AREA OF THE STRUCTURE TO DETERMINE THAT NO SIGNIFICANT AERONAUTICAL CHANGES HAVE OCCURRED, YOUR DETERMINATION MAY BE ELIGIBLE FOR ONE EXTENSION OF THE EFFECTIVE PERIOD.

This determination is based, in part, on the foregoing description which includes specific coordinates, heights, frequency(ies) and power. Any changes in coordinates, heights, and frequencies or use of greater power, except those frequencies specified in the Colo Void Clause Coalition; Antenna System Co-Location; Voluntary Best Practices, will void this determination. Any future construction or alteration, including increase to heights, power, or the addition of other transmitters, requires separate notice to the FAA. This determination includes all previously filed frequencies and power for this structure.

If construction or alteration is dismantled or destroyed, you must submit notice to the FAA within 5 days after the construction or alteration is dismantled or destroyed.

This determination does include temporary construction equipment such as cranes, derricks, etc., which may be used during actual construction of the structure. However, this equipment shall not exceed the overall heights as indicated above. Equipment which has a height greater than the studied structure requires separate notice to the FAA.

This determination concerns the effect of this structure on the safe and efficient use of navigable airspace by aircraft and does not relieve the sponsor of compliance responsibilities relating to any law, ordinance, or regulation of any Federal, State, or local government body.

A copy of this determination will be forwarded to the Federal Communications Commission (FCC) because the structure is subject to their licensing authority.

If we can be of further assistance, please contact our office at (404) 305-6462, or mike.blaich@faa.gov. On any future correspondence concerning this matter, please refer to Aeronautical Study Number 2023-ASO-16540-OE.

Signature Control No: 584736710-595666403

(DNE)

Michael Blaich Specialist


Attachment(s) Frequency Data Map(s)


cc: FCC

# Frequency Data for ASN 2023-ASO-16540-OE

LOW FREQUENCY	HIGH FREQUENCY	FREQUENCY UNIT	ERP	ERP UNIT
				-
6	7	GHz	55	dBW
6	7	GHz	42	dBW
10	11.7	GHz	55	dBW
10	11.7	GHz	42	dBW
17.7	19.7	GHz	55	dBW
17.7	19.7	GHz	42	dBW
21.2	23.6	GHz	55	dBW
21.2	23.6	GHz	42	dBW
614	698	MHz	1000	W
614	698	MHz	2000	W
698	806	MHz	1000	W
806	901	MHz	500	W
806	824	MHz	500	W
824	849	MHz	500	W
851	866	MHz	500	W
869	894	MHz	500	W
896	901	MHz	500	W
901	902	MHz	7	W
929	932	MHz	3500	W
930	931	MHz	3500	W
931	932	MHz	3500	W
932	932.5	MHz	17	dBW
935	940	MHz	1000	W
940	941	MHz	3500	W
1670	1675	MHz	500	W
1710	1755	MHz	500	W
1850	1910	MHz	1640	W
1850	1990	MHz	1640	W
1930	1990	MHz	1640	W
1990	2025	MHz	500	W
2110	2200	MHz	500	W
2305	2360	MHz	2000	W
2305	2310	MHz	2000	W
2345	2360	MHz	2000	W
2496	2690	MHz	500	W

## TOPO Map for ASN 2023-ASO-16540-OE

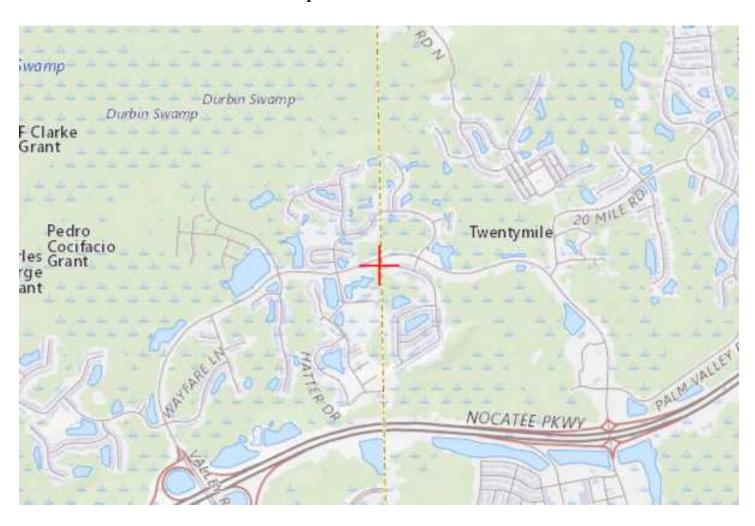

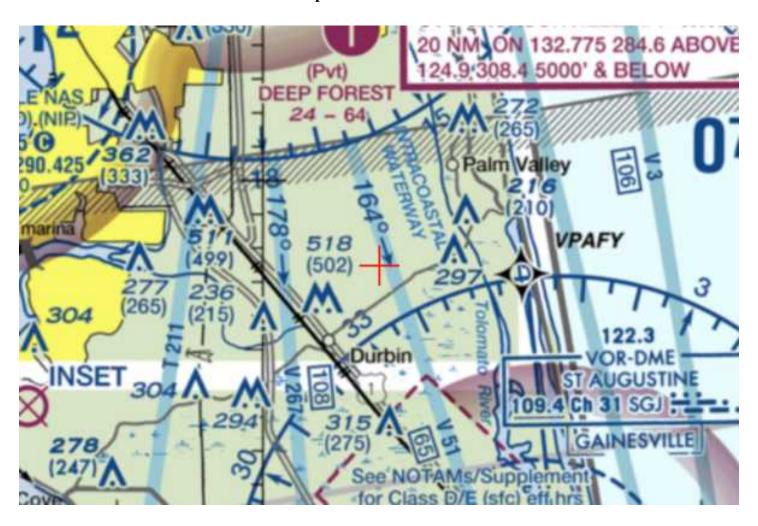



#### **Circle Search for Cases Results**

Records 1 to 1 of 1 Page 1 of 1

Case Number	City	State	Latitude	Longitude	Site Elevation	Structure Height	Total Height
2023-ASO-16540-OI	Jacksonville	FL	30° 07' 29.49" N	81° 26' 03.38" W	26	170	196

Rows per Page: 20 🗸

Records 1 to 1 of 1 Page: 1 Page 1 of 1

2023-ASO-16540-OE NexTower Site, NXFL342 Coastal Ridge

There are no additional FAA filings within 1- mile of the proposed tower location.



## UNITED STATES OF AMERICA FEDERAL COMMUNICATIONS COMMISSION ANTENNA STRUCTURE REGISTRATION



OWNER: NexTower Development Group II, LLC

FCC Registration Number (F	RN): 0023566987		
ATTN: Joel Rousseau			Antenna Structure Registration Number
NexTower Development (	Proup II I I C		1325411
13577 NW 2nd Lane	Broup II, LLC		
Suite 20			Issue Date
			08/09/2023
Location of Antenna Struct	ure		Ground Elevation (AMSL)
Valley Ridge Boulevard			7.7 meters
Jacksonville, FL 32081			Overall Height Above Ground (AGL)
County: DUVAL			51.8 meters
Latitude	Longitude		Overall Height Above Mean Sea Level (AMSL)
30- 07- 29.4 N	081- 26- 03.3 W	NAD83	
Cont	or of Arroy Coordinates		59.5 meters
Cent	er of Array Coordinates N/A	A 0	Type of Structure MTOWER
	N/A		Monopole
			Мопоров
Painting and Lighting Requ	irements:		Δ.
FAA Chapters NONE			
Conditions:			

This registration is effective upon completion of the described antenna structure and notification to the Commission. YOU MUST NOTIFY THE COMMISSION WITHIN 5 DAYS OF COMPLETION OF CONSTRUCTION OR CANCELLATION OF YOUR PROJECT, please file FCC Form 854. To file electronically, connect to the antenna structure registration system by pointing your web browser to <a href="https://www.fcc.gov/antenna-structure-registration">https://www.fcc.gov/antenna-structure-registration</a>. Electronic filing is required. Use purpose code "NT" for notification of completion of construction; use purpose code "CA" to cancel your registration.

The Antenna Structure Registration is not an authorization to construct radio facilities or transmit radio signals. It is necessary that all radio equipment on this structure be covered by a valid FCC license or construction permit.

You must immediately provide a copy of this Registration to all tenant licensees and permittees sited on the structure described on this Registration (although not required, you may want to use Certified Mail to obtain proof of receipt), and *display* your Registration Number at the site. See reverse for important information about the Commission's Antenna Structure Registration rules.

You must comply with all applicable FCC obstruction marking and lighting requirements, as set forth in Part 17 of the Commission's Rules (47 C.F.R. Part 17). These rules include, but are not limited to:

- **Posting the Registration Number:** The Antenna Structure Registration Number must be displayed in a conspicuous place so that it is readily visible near the base of the antenna structure. Materials used to display the Registration Number must be weather-resistant and of sufficient size to be easily seen at the base of the antenna structure. Exceptions exist for certain historic structures. See 47 C.F.R. 17.4(g)-(h).
- *Inspecting lights and equipment:* The obstruction lighting must be observed at least every 24 hours in order to detect any outages or malfunctions. Lighting equipment, indicators, and associated devices must be inspected at least once every three months.
- Reporting outages and malfunctions: When any top steady-burning light or a flashing light (in any position) burns out or malfunctions, the outage must be reported to the nearest FAA Flight Service Station, unless corrected within 30 minutes. The FAA must again be notified when the light is restored. The owner must also maintain a log of these outages and malfunctions.
- Maintaining assigned painting: The antenna structure must be repainted as often as necessary to maintain good visibility.
- **Complying with environmental rules:** If you certified that grant of this registration would not have a significant environmental impact, you must nevertheless maintain all pertinent records and be ready to provide documentation supporting this certification and compliance with the rules, in the event that such information is requested by the Commission pursuant to 47 C.F.R. 1.1307(d).
- **Updating information:** The owner must notify the FCC of proposed modifications to this structure; of any change in ownership; or, within 30 days of dismantlement of the structure.

Copies of the Code of Federal Regulations (which contain the FCC's antenna structure registration rules, 47 C.F.R Part 17) are available from the Government Printing Office (GPO). To purchase CFR volumes, call (202) 512-1800. For GPO Customer Service, call (202) 512-1803. For additional FCC information, consult the Antenna Homepage on the internet at <a href="https://www.fcc.gov/antenna-structure-registration">https://www.fcc.gov/antenna-structure-registration</a> or call (877) 480-3201 (TTY 717-338-2824).

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# **NXFL-342 COASTAL RIDGE**

## **PROPOSED 170' MONOPOLE TOWER**

(160' STEEL TOWER W/ 10' APPURTENANCE)
0 COASTAL RIDGE BLVD, JACKSONVILLE FL 32224

# **HISTORIC STUCTURES -DISTRICTS MAP**

## Land Development Review



\* NO HISTORICAL FEATURE FOUND



# **NXFL-342 COASTAL RIDGE**

## **PROPOSED 170' MONOPOLE TOWER**

(160' STEEL TOWER W/ 10' APPURTENANCE)
0 COASTAL RIDGE BLVD, JACKSONVILLE FL 32224

# **WETLANDS MAP**

## Land Development Review



## Notes:

- 1. Wetland Delineation provided by Terracon Environmental Inc.
- 2. Proposed Center of Tower is

**RAN Template:**4Sec-67E5D998E 6160 (no GSM) 4S

A&L Template: 4Sec-67E5998E\_1xAIR+1OP

 $9 J K 2870 A\_Market \ Swap\_1\_preliminary$ 

**Print Name:** Standard **PORs:** Coverage Strategy\_Regional Coverage

Section 1 - Site Information

Site ID: 9JK2870A Status: Preliminary

Version: 1

Project Type: Market Swap
Approved: Not approved
Approved By: Not approved

Last Modified By: Ernest.Shuman@T-Mobile.com

RAN Template: 4Sec-67E5D998E 6160 (no GSM)

Approved By: Not approved
Last Modified: 05/03/2023 12:52:43 PM

Site Name: 9JK2870 Site Class: Monopole

Site Type: Structure Non Building Plan Year:

Market: JACKSONVILLE FL

Vendor: Nokia
Landlord: Vertical Bridge

Latitude: 30.124522 Longitude: -81.434385

Address: Unassigned Address; Closest Avail: 12428

Valley Ridge Blvd

City, State: Ponte Vedra Beach, FL

Region: SOUTH

AL Template: 4Sec-67E5998E\_1xAIR+1OP

Sector Count: 4 Antenna Count: 8 Coax Line Count: 0 TMA Count: 0 RRU Count: 8


Section 2 - Existing Template Images

---- This section is intentionally blank. ----



## Section 3 - Proposed Template Images

4 Sec 67E5A998E.JPG

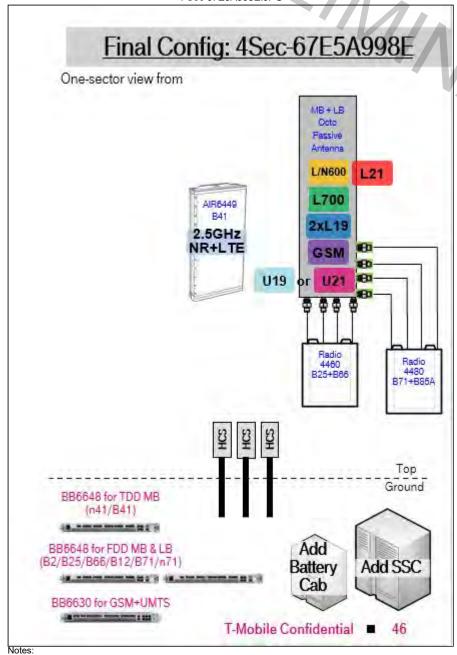



## Section 4 - Siteplan Images

----- This section is intentionally blank. -----



**RAN Template:** 4Sec-67E5D998E 6160 (no GSM) **A&L Template:** 4Sec-67E5998E\_1xAIR+1OP

9JK2870A\_Market Swap\_1\_preliminary

Print Name: Standard PORs: Coverage Strategy\_Regional Coverage

# **Existing RAN Equipment** ---- This section is intentionally blank. ----

	Propos	ed RAN Equipment
	Template: 45	Sec-67E5D998E 6160 (no GSM)
Enclosure	1	2
Enclosure Type	(Enclosure 6160 AC V1)	B160
Baseband	RP 6651 N600 L600 L700 RP 6651 N2500 L2500 RP 6651 L1900 L2100	
Transport System	(CSR IXRe V2 (Gen2))	
Hybrid Cable System	(Hybrid Trunk 6/24 4AWG 60m (x 3)	
RAN Scope of Wor	k:	

**RAN Template:** 4Sec-67E5D998E 6160 (no GSM)

**A&L Template:** 4Sec-67E5998E\_1xAIR+1OP

9JK2870A\_Market Swap\_1\_preliminary

Print Name: Standard PORs: Coverage Strategy\_Regional Coverage

## Section 6 - A&L Equipment

Existing Template: Custom
Proposed Template: 4Sec-67E5998E\_1xAIR+1OP

	Sect	tor 1 (Proposed	d) view from fr	ont (Note: the i	mages show view from behi	nd)			
Coverage Type	A - Outdoor Macro	A - Outdoor Macro							
Antenna	1					2			
Antenna Model	Commscope - FF	VV-65C-R3-V1 (Octo	D))		AIR 6419 B41 (Active Antenna - Mass	sive MIMO)			
Azimuth	(350)								
M. Tilt	0				0				
Height (ft)	(160)				(160)				
Ports	P1	P2	P3	P4	P5	P6			
Active Tech	L700 L600 N600	L700 L600 N600	(L2100) (L1900) (N1900)	L2100 L1900 N1900	(L2500) (N2500)	(L2500) (N2500)			
Dark Tech									
Restricted Tech									
Decomm. Tech									
E. Tilt									
Cables	Coax Jumper (x2)	Coax Jumper (x2)	Coax Jumper (x2)	Coax Jumper (x2)					
TMAs									
Diplexer / Combiners									
Radio	Radio 4480 B71+B85 (At Antenna)	Radio 4480 B71+B85 (At Antenna)	Radio 4460 B25+B66 (At Antenna)	Radio 4460 B25+B66 (At Antenna)					
Sector Equipment									
Unconnected Equip	oment:								
Scope of Work:									
*A dashed border in	dicates shared conn	cates shared connected equipment. Any shared equipment, besides the first, is denoted with the SHARED keyword.							

**RAN Template:** 4Sec-67E5D998E 6160 (no GSM) A&L Template: 4Sec-67E5998E\_1xAIR+1OP

9JK2870A\_Market Swap\_1\_preliminary

Print Name: Standard PORs: Coverage Strategy\_Regional Coverage

	Sact	tor 2 (Proposer	1) view from fr	ont (Note: the i	mages show view from behir	ad)		
Cavarana Tura	Sector 2 (Proposed) view from front (Note: the images show view from behind)							
Coverage Type	A - Outdoor Macro	9						
Antenna	1					2		
Antenna Model	(Commscope - FFVV-65C-R3-V1 (Octo))				(AIR 6419 B41 (Active Antenna - Mass	sive MIMO)		
Azimuth	55							
M. Tilt	0				0			
Height (ft)	160				160			
Ports	P1	P2	P3	P4	P5	P6		
Active Tech	L700 L600 N600	L700 L600 N600	(L2100) (L1900) (N1900)	L2100 L1900 N1900	(L2500) (N2500)	L2500 N2500		
Dark Tech								
Restricted Tech								
Decomm. Tech								
E. Tilt								
Cables	Coax Jumper (x2)	Coax Jumper (x2)	Coax Jumper (x2)	Coax Jumper (x2)				
TMAs								
Diplexer / Combiners								
Radio	Radio 4480 B71+B85 (At Antenna)	Radio 4480 B71+B85 (At Antenna)	Radio 4460 B25+B66 (At Antenna)	Radio 4460 B25+B66 (At Antenna)				
Sector Equipment								
Unconnected Equip	ment:							
Scope of Work:								
*A dashed border in	dicates shared connected equipment. Any shared equipment, besides the first, is denoted with the SHARED keyword.							

**RAN Template:** 4Sec-67E5D998E 6160 (no GSM) A&L Template: 4Sec-67E5998E\_1xAIR+1OP

9JK2870A\_Market Swap\_1\_preliminary

Print Name: Standard PORs: Coverage Strategy\_Regional Coverage

	Sector 3 (Proposed) view from front (Note: the images show view from behind)							
Coverage Type	A - Outdoor Macro	A - Outdoor Macro						
Antenna		,	1		2	2		
Antenna Model	Commscope - FF	VV-65C-R3-V1 (Oct	0)		(AIR 6419 B41 (Active Antenna - Mass	sive MIMO)		
Azimuth	180							
M. Tilt	0				0			
Height (ft)	160				160			
Ports	P1	P2	P3	P4	P5	P6		
Active Tech	L700 L600 N600	L700 L600 N600	L2100 L1900 N1900	L2100 L1900 N1900	(L2500) (N2500)	(L2500) (N2500)		
Dark Tech								
Restricted Tech								
Decomm. Tech								
E. Tilt								
Cables	Coax Jumper (x2)	Coax Jumper (x2)	Coax Jumper (x2)	Coax Jumper (x2)				
TMAs								
Diplexer / Combiners								
Radio	Radio 4480 B71+B85 (At Antenna)	Radio 4480 B71+B85 (At Antenna)	Radio 4460 B25+B66 (At Antenna)	Radio 4460 B25+B66 (At Antenna)				
Sector Equipment								
Unconnected Equip Scope of Work:	Unconnected Equipment:  Scope of Work:							
*A dashed border in	*A dashed border indicates shared connected equipment. Any shared equipment, besides the first, is denoted with the SHARED keyword.							

**RAN Template:** 4Sec-67E5D998E 6160 (no GSM) A&L Template: 4Sec-67E5998E\_1xAIR+1OP

9JK2870A\_Market Swap\_1\_preliminary

Print Name: Standard PORs: Coverage Strategy\_Regional Coverage

	Sector 4 (Proposed) view from front (Note: the images show view from behind)						
Coverage Type	A - Outdoor Macro	A - Outdoor Macro					
Antenna		•	I		:	2	
Antenna Model	Commscope - FF	VV-65C-R3-V1 (Oct	0)		AIR 6419 B41 (Active Antenna - Mass	sive MIMO)	
Azimuth	275						
M. Tilt	0				0		
Height (ft)	160				160		
Ports	P1	P2	P3	P4	P5	P6	
Active Tech	L700 L600 N600	L700 L600 N600	L2100 L1900 N1900	L2100 L1900 N1900	L2500 (N2500)	L2500 (N2500)	
Dark Tech							
Restricted Tech							
Decomm. Tech							
E. Tilt							
Cables	Coax Jumper (x2)	Coax Jumper (x2)	Coax Jumper (x2)	Coax Jumper (x2)			
TMAs							
Diplexer / Combiners							
Radio	Radio 4480 B71+B85 (At Antenna)	Radio 4480 B71+B85 (At Antenna)	Radio 4460 B25+B66 (At Antenna)	Radio 4460 B25+B66 (At Antenna)			
Sector Equipment							
Unconnected Equip	Unconnected Equipment:  Scope of Work:						
*A dashed border in	dicates shared conn	ected equipment. Ar	ny shared equipmen	t. besides the first. is	s denoted with the SHARED keyword.		

# CITY OF JACKSONVILLE NOTES

All construction shall be performed in accordance with the approved plans and comply with all standard city policies and practices. City approval is contingent upon any required state or federal permit approvals such as those from the Department of Environmental Protection or the St. Johns River Water Management District (SJRWMD).

## **UTILITY WORK**

Plan approval through Development Services does not include utilities. Proposed water, sewer or electric construction must be approved separately through the respective utility company. In most cases, this will be:

JEA JEA Tower - 4th Floor 21 W. Church Street

iacksonville, PL 32202 http://www.jea.com/business/services/devandbuild/developers.asp

## WORK WITHIN THE RIGHT-OF-WAY

CITY: Except for new subdivision infrastructure construction, all work performed within a City of Jacksonville right-of-way or easement requires a Right-of-way Permit. The contractor performing the proposed work must have a current Right-of-way Bond on file with Development Services. Right-of-way Permit applications are processed at:

evelopment Services Custom dward Ball Building, 2nd Floo 14 N. Hogan St. acksonville. FL 32202

STATE: All work performed within a state right-of-way requires a permit from the Florida Department of Transportation (FDDT), it is the developer's responsibility to obtain required FDDT permits or maintenance-of-traffic approvals for work within FDDT right-of-ways. The FDDT regional office can be contacted at (904) 360-5200 Any changes to the approved plans needed for FDDT approval must be submitted to Development Services as

Adjacent State Roads: NA

RAILROAD: Railroad companies may require special approvals or permits to work within their right-of-ways. It is the developer's responsibility to obtain permission from any railroad right-of-way owner before performing any work within their right-of-way.

## **STORMWATER**

Annual reports in compliance with the SJRWMD stormwater permits are required from the maintenance entity of all stormwater management facilities. Send copies of the reports to:

stormwater management racintit

Edward Ball Building, 10th Flor 214 N. Hogan St.

Jacksonville, FL 32202 http://www.coj.net/Departments/Public+Works/Engineering+and+Construction+Managemi

The owner of any project one (1) acre or larger is required to provide a Notice of Intent (NOI) in accordance with criteria set forth in the city's NPDES permit within 48 hours of beginning construction. Send NOI and NOI fee to:

Florida Department of Environmental Protection NPDES Stormwater Notices Center, Mail Station #2

2600 Blair Stone Road

(866) 336-6312

The contractor shall contact the Environmental Quality Division, Erosion and Sedimentation Control Section (ESC) to provide verification that applicable stormwater permits have been obtained and to schedule a pre-construction

ESC site inspection:
Environmental Quality Division
407 North Laura Street Third Fla

FIRE MARSHALL

## Plan review and approval does not relieve the contractor of complying with all applicable State Fire Codes.

Underground mains and hydrants shall be installed, completed, and in service prior to construction work.

Underground contractor shall submit to the Fire Marshall for approval complete specs for all underground pipe and fittings relating to fire protection PRIOR to installation and inspection. Contractor shall include manufacturer's name and pipe ID along with contractor's state license number.


## LANDSCAPE

ſ	A Site Work Permit is required for this project.			_
l	Tree Fund payment is due:	inches at \$	= \$	
l	Article 25 funds are due:	inches at \$	= \$	

TRAFFIC E	ENGINEERING
TRAFFIC SIGN	S
Metro Name (each)	
Standard (each)	
Stop/Yield (each)	
Design (per plat)	1 per plat
Installation (per hour)	1 per 2 signs (rounded up)
Streetlights Req	uired
	s change from time to time. Consult Attachment 8 of the Land Development Procedures lev.com/) for the current rates before paying for any sign installations.
No lane closures allowed	d from 7 a.m. till 9 a.m. and from 4 p.m. till 6 p.m.

## SITE NAME:

# COASTAL RIDGE NXFL-342

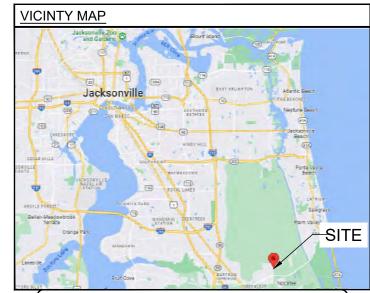

	SHEET INDEX
NO.	DESCRIPTION
T-1	CITY OF JACKSONVILLE TITLE SHEET
T-2	COVER SHEET
	SURVEY
GN-1	GENERAL NOTES
C-1	PARCEL MAP
C-1A	OVERALL SITE PLAN
C-1B	DETAILED SITE PLAN
C-2	FENCE, GATE, AND COMPOUND DETAILS
C-3	GRADING AND EROSION CONTROL PLAN
C-3A	GRADING AND EROSION CONTROL DETAILS
C-3B	GRADING AND EROSION CONTROL NOTES
C-4	ACCESS ROAD DETAILS
C-5	TOWER ELEVATION
E-1	BASIC SERVICE AND POWER COORDINATION ROUTING PLAN
E-1A	POWER FIBER ROUTE
E-2	GROUNDING PLAN
E-3	SINGLE-LINE DIAGRAM
E-4	ELECTRICAL NOTES
E-5	ELECTRICAL DETAILS
E-6	H-FRAME DETAILS
L-1	TREE REMOVAL PLAN
L-2	LANDSCAPE DETAILS

# PLAN APPROVAL

Date	Development Services Division (Chief)
Date	Review Group (Reviewer)

Plan approval is valid for five years after the initial approval date. Revisions made after the initial approval date do not extend this five-year time frame.

# PLAN APPROVAL IS SUBJECT TO THE FOLLOWING NOTES AND CONDITIONS:

-	

# **GENERAL PROJECT INFORMATION**

GENERAL	
City Development Number	
Concurrency Application Number	168149-9900
Property Appraiser Number (RE #)	
Zoning Designation	PUD
Zoning Application(s) (if any)	
PUD Ordinance Number	
FIRM - Community - Panel 12031C0	595H & 12031C0675H DATED JUNE 3, 201
Flood Zones (Show in Plans)	X
Base Flood Elev. (Show in Plans)	
Vertical Datum Used for Project	NAVD88
JEA Availability Number	
SUBDIVISION	
PSD Number	
City or Private Inspection	
Public or Private Roads	
Subdivision ("911") Disk Provided?	
odbarrision ( 511 ) bisk i fortaca:	
NON-SUBDIVISION	
North American Industry	
Classification System (NAICS)	
Impervious Area (Sg. Ft.)	1115 SOFT



A&E FIRM:

towersource

A NextEdge Company

1355 WINDWARD CONCOURSE SUITE 410 ALPHARETTA, GA 30005 678-990-2338

THE INFORMATIN CONTAINED IN THIS SET OF DOCUMENTS IS PROPRIETARY BY NATURE. ANY USE OR DISCLOSURE OTHER THAN THAT WHICH RELATES TO THE CLIENT IS STRICTLY PROHIBITED.

A&E PROJECT #:	NXFL-342
DRAWN BY:	JCR
CHECKED BY:	BAA

REVISIONS			
NO.	DATE	DESCRIPTION	
Α	05/01/23	ISSUED FOR REVIEW	
В	06/13/23	UPDATED PER COMMENTS	
0	06/23/23	ISSUED FOR CONSTRUCTION	



THIS ITEM HAS BEEN DIGITALLY SIGNED AND SEALED BY JAVAD K. PARSA, P.E ON THE DATE ADJACENT TO THE SEAL.

PRINTED COPIES OF THIS DOCUMENT ARE NOT CONSIDERED SIGNED AND SEALED AND THE SIGNATURE MUST BE VERIFIED ON ANY ELECTRONIC COPIES.

NEXTOWER SITE NAME:

COASTAL RIDGE NXFL-342

TOWER OWNE

NEXTOWER

DESIGN TYPE:

RAWLAND

SHEET TITLE

**COVER SHEET** 

DRAWING NO

T1

## PREPARED FOR:



SITE NAME:

# **COASTAL RIDGE** NXFL-342

PROJECT DESCRIPTION

# **GREENFIELD** PROPOSED 160' MONOPOLE TOWER & TELECOMMUNICATIONS FACILITY

(TOTAL HEIGHT 170' INCLUDING APPURTENANCE)

# VICINTY MAP



## DRIVING DIRECTIONS FROM 214 N HOGAN ST IACKSONVILLE EL

USE THE RIGHT 2 LANES TO TAKE THE NOCATEE PARKWAY EXIT

JACKSONVILLE, FL.	
HEAD NORTH ON HOGAN ST TOWARD W MONROE ST	0.1 MI
TURN RIGHT AT THE 1ST CROSS STREET ONTO W MONROE ST	0.2 MI
TURN RIGHT AT THE 2ND CROSS STREET ONTO FL-10 E/N MAIN ST	1.2 MI
USE THE LEFT LANE TO MERGE ONTO FL-10 E	0.5 MI
USE THE LEFT LANE TO KEEP LEFT	0.2 MI
MERGE ONTO I-95 S	10.9 MI
USE THE RIGHT 2 LANES TO TAKE EXIT 337 TO MERGE ONTO I-295 N	TOWARD JAX
BEACHES	1.7 MI
TAKE EXIT 60 FOR US-1 S/GREENLAND RD	0.2 MI
USE THE LEFT 2 LANES TO TURN LEFT ONTO US-1 S	2.3 MI
KEEP RIGHT TO STAY ON US-1 S	3.6 MI

CONTINUE ONTO NOCATEE PKWY TAKE THE VALLEY RIDGE BLVD N EXIT 0.3 MI MERGE ONTO VALLEY RIDGE BLVD AND THE SITE WILL BE ON THE RIGHT 1.8 MI

## PROJECT SUMMARY

SITE ADDRESS: 0 COASTAL RIDGE BOULEVARD

JACKSONVILLE, FL 32081

LATITUDE: LONGITUDE: 30° 07' 29.49" -81° 26' 03.38" PARCEL ID: 168149-9900

COUNTY: DUVAL ZONING CLASSIFICATION: PUD

CITY OF JACKSONVILLE ZONING JURISDICTION: DISTURBED AREA: 7,125± SQ. FT. (0.163 ACRES) SONOC COMPANY LAND OWNER:

APPLICANT: NEXTOWER DEVELOPEMENT

GROUP II, LLC.

13577 NW 2ND LANE, SUITE 20 NEWBERRY, FL 32669

PH: 352-363-5560

JOEL ROUSSEAU PH: 352-283-0001

ENGINEER: TOWERSOURCE 1355 WINDWARD CONCOURSE

SUITE 410 ALPHARETTA, GA 30005 678-990-2338 JAVAD K. PARSA, P.E.

TELEPHONE COMPANY: CONSULT CM

POWER COMPANY:

CONTACT:

FLORIDA BUILDING CODE, 7TH EDITION (2020). NATIONAL FIRE PROTECTION ASSOCIATION (NFPA) 70 FLORIDA FIRE PREVENTION CODE 7TH EDITION 2020 NATIONAL ELECTRICAL CODE, 2017 EDITION. TIA-222-G WITH ADDENDUM 1 AND 2 APPLICABLE STANDARDS. LIFE SAFETY COPE NFPA-101-10

AMERICAN INSTITUTE OF STEEL CONSTRUCTION (AISC) 360-10 AND 341-10. UNDERWRITERS LABORITORIES (U.L.) APPROVED ELECTIRCAL PRODUCTS. LOCAL JURISDICTIONAL REQUIREMENTS.

CITY/COUNTY ORDINANCES.

_					
		SHEET INDEX			
	NO.	DESCRIPTION			
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	C-2	FENCE, GATE, AND COMPOUND DETAILS			
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		POWER FIBER ROUTE			
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	E-6 H-FRAME DETAILS				
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	L-2	LANDSCAPE PLAN			
	L-2	LANDOOAT L I LAN			



678-990-2338

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1		A&E PROJECT #:	NXFL-342
┨		DRAWN BY:	JCR
1	$\prod$	CHECKED BY:	BAA

	REVISIONS		
NO.	DATE	DESCRIPTION	
Α	05/01/23	ISSUED FOR REVIEW	
В	06/13/23	UPDATED PER COMMENTS	
0	06/23/23	ISSUED FOR CONSTRUCTION	



JAVAD K. PARSA, P.E ON THE DATE ADJACENT TO THE

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MUST BE VERIFIED ON ANY ELECTRONIC COPIES.

**COASTAL RIDGE** NXFL-342

**NEXTOWER** 

**RAWLAND** 

**COVER SHEET** 



Call before you dig.

# -N70° 30' 10"E 26.56' POINT OF COMMENCEMENT **NEXTOWER LEASE PARCEL & EASEMENT** INTERSECTION OF SOUTH R/W LINE OF VALLEY RIDGE BLVD. & EAST LINE OF SECTION 25-4-28 POINT OF BEGINNING NEXTOWER 30' WIDE INGRESS/EGRESS & UTILITY EASEMENT CENTERLINE POINT OF BEGINNING NEXTOWER LEASE PARCEL & UTILITY EASEMENT CENTERLINE ST. JOHNS COUNTY PARCEL ID: 0696300220 **KELLY POINTE AT NOCATEE PHASE 1** OWNER: TOLOMATO CDD PLAT BOOK 65, PAGES 100-105 O.R. 4483, PAGE 819 PROPOSED 170' **MONOPOLE TOWER PARENT TRACT** RE#: 168149-9900 SONOC COMPANY O.R. 9494, PAGES 905 & 909 125.0' ELECTRIC EASEMENT PER O.R. 569, PAGE 242 **NORTHERLY LINES OF LANDS**-DESCRIBED IN O.R. 15469, PAGE 919 RE# 168149-9850 OWNER: GALEONE VICTOR, AS BISHOP OF DIOCESE OF ST AUGUSTINE O.R. 15469, PAGE 919 ● INDICATES 5/8" REBAR & CAP SET STAMPED LB 7810 INDICATES 5/8" REBAR & CAP FOUND STAMPED LB 3624 INDICATES 4"x4" CONCRETE MONUMENT STAMPED LB 3624 R/W INDICATES RIGHT-OF-WAY O.R. INDICATES OFFICIAL RECORDS BOOK ID INDICATES IDENTIFICATION NAVD INDICATES NORTH AMERICAN VERTICAL DATUM FLOOD ZONE NOTE THE HEREON DESCRIBED LEASE PARCEL AND EASEMENT APPEAR TO LIE IN FLOOD ZONE X BASED ON THE FEDERAL EMERGENCY MANAGEMENT ACT FIRM, COMMUNITY PANEL MAP NUMBERS 12031C0595H & 12031C0675H DATED JUNE 3, 2013. **TOWER DATA** (PROPOSED 170' MONOPOLE) LATITUDE: 30° 07' 29.49" NORTH LONGITUDE: 81° 26' 03.38" WEST SCALE: 1"=30' GROUND ELEVATION: 25.5' NAVD 1988

# BOUNDARY & TOPOGRAPHIC SURVEY OF NEXTOWER LEASE PARCEL

IN SECTION 25, TOWNSHIP 4 SOUTH, RANGE 28 EAST DUVAL COUNTY, FLORIDA

# PARENT TRACT DESCRIPTION (PREPARED BY SURVEYOR)

A PORTION OF SECTION 25, TOWNSHIP 4 SOUTH, RANGE 28 EAST, DUVAL COUNTY, FLORIDA, ALSO BEING A PORTION OF THOSE LANDS DESCRIBED IN OFFICIAL RECORDS BOOK 9494, PAGE 905 OF THE CURRENT PUBLIC RECORDS OF DUVAL COUNTY, FLORIDA, BEING MORE PARTICULARLY DESCRIBED AS FOLLOWS:

THAT PART OF SECTION 25, TOWNSHIP 4 SOUTH, RANGE 28 EAST, DUVAL COUNTY, FLORIDA LYING SOUTH OF VALLEY RIDGE BOULEVARD, A VARIABLE WIDTH RIGHT-OF-WAY AS RECORDED IN PLAT BOOK 65, PAGES 50 THROUGH 53 OF THE PUBLIC RECORDS OF SAID DUVAL COUNTY AND LYING NORTHERLY OF THOSE LANDS DESCRIBED IN OFFICIAL RECORDS BOOK 15469, PAGE 919 OF SAID PUBLIC RECORDS.

## **NEXTOWER LEASE PARCEL DESCRIPTION**

A PARCEL OF LAND LYING IN SECTION 25, TOWNSHIP 4 SOUTH, RANGE 28 EAST, DUVAL COUNTY, FLORIDA; SAID PARCEL OF LAND BEING MORE PARTICULARLY DESCRIBED AS FOLLOWS:

COMMENCE AT THE INTERSECTION OF THE EAST LINE OF SECTION 25, TOWNSHIP 4 SOUTH, RANGE 28 EAST, DUVAL COUNTY, FLORIDA AND THE SOUTH RIGHT-OF-WAY LINE OF VALLEY RIDGE BOULEVARD (A VARIABLE WIDTH RIGHT-OF-WAY PER PLAT BOOK 65, PAGES 50-53 OF THE PUBLIC RECORDS OF SAID DUVAL COUNTY); THENCE S70° 30' 10"W ALONG SAID SOUTH RIGHT-OF-WAY LINE FOR 105.29 FEET; THENCE S19° 29' 50"E FOR 50.00 FEET; THENCE N70° 30' 10"E FOR 37.50 FEET TO THE POINT OF BEGINNING OF THE HEREIN DESCRIBED PARCEL OF LAND; THENCE S19° 29' 50"E FOR 75.00 FEET; THENCE S70° 30' 10"W FOR 75.00 FEET; THENCE N19° 29' 50"W FOR 75.00 FEET; THENCE N70° 30' 10"E FOR 75.00 FEET TO THE POINT OF BEGINNING. SAID PARCEL OF LAND SITUATE, LYING AND BEING IN DUVAL COUNTY, FLORIDA, CONTAINING 5,625 SQUARE FEET OF LAND MORE OR LESS.

## **NEXTOWER INGRESS/EGRESS & UTILITIES EASEMENT DESCRIPTION**

A 30-FEET WIDE EASEMENT STRIP OF LAND FOR THE PURPOSES OF INGRESS/EGRESS AND UTILITIES LYING IN SECTION 25, TOWNSHIP 4 SOUTH, RANGE 28 EAST, DUVAL COUNTY, FLORIDA; SAID EASEMENT STRIP LYING 15.00 FEET BOTH SIDES OF THE FOLLOWING DESCRIBED EASEMENT CENTERLINE:

COMMENCE AT THE INTERSECTION OF THE EAST LINE OF SECTION 25, TOWNSHIP 4 SOUTH, RANGE 28 EAST, DUVAL COUNTY, FLORIDA AND THE SOUTH RIGHT-OF-WAY LINE OF VALLEY RIDGE BOULEVARD (A VARIABLE WIDTH RIGHT-OF-WAY PER PLAT BOOK 65, PAGES 50-53 OF THE PUBLIC RECORDS OF SAID DUVAL COUNTY); THENCE S70° 30' 10"W ALONG SAID SOUTH RIGHT-OF-WAY LINE FOR 105.29 FEET TO THE POINT OF BEGINNING OF THE HEREIN DESCRIBED EASEMENT CENTERLINE; THENCE S19° 29' 50"E FOR 50.00 FEET TO THE POINT OF TERMINUS. THE SIDELINES OF SAID EASEMENT TO BE SHORTENED AND PROLONGED TO MEET AT RIGHT-OF-WAY LINES AND LEASE PARCEL LINES.

# **SURVEYOR'S NOTES**

1. BEARINGS SHOWN HEREON ARE ASSUMED AND REFERENCED TO THE SOUTH RIGHT-OF-WAY LINE OF VALLEY RIDGE BOULEVARD AS BEARING S70° 30' 10"W.

- 2. THE BOUNDARY SURVEY SHOWN HEREON IS BASED ON ACTUAL FIELD MEASUREMENTS AND OBSERVATIONS DATED APRIL 17, 2023.
- 3. THIS SURVEY MAP OR THE COPIES THEREOF ARE NOT VALID WITHOUT THE SIGNATURE AND THE ORIGINAL RAISED SEAL OF A FLORIDA LICENSED SURVEYOR AND MAPPER.

4. CENTER OF PROPOSED TOWER LATITUDE, LONGITUDE AND ELEVATIONS SHOWN HEREON WERE ESTABLISHED FROM RTK GPS OBSERVATIONS REFERENCED TO THE STATE OF FLORIDA PERMANENT REFERENCE NETWORK. THE VALUES FOR THE PROPOSED TOWER LATITUDE, LONGITUDE AND ELEVATION SHOWN HEREON EXCEED FAA "1-A" ACCURACY REQUIREMENTS. ELEVATIONS ARE NORTH AMERICAN VERTICAL DATUM OF 1988 (NAVD 88) AND ARE REFERENCED TO THE STATE OF FLORIDA PERMANENT REFERENCE NETWORK.

5. THE PURPOSE OF THIS SURVEY IS TO SHOW IMPROVEMENTS ASSOCIATED WITH A PROPOSED TELECOMMUNICATIONS FACILITY AND PROVIDE LEGAL DESCRIPTIONS FOR SAID FACILITY AND ASSOCIATED EASEMENTS. THIS IS NOT A BOUNDARY SURVEY OF THE PARENT TRACT.

- 6. MEASURED BEARINGS AND DISTANCES WERE IN SUBSTANTIAL AGREEMENT WITH RECORD DATA UNLESS OTHERWISE NOTED.
- 7. PROPERTY TIES ARE PERPENDICULAR MEASURE UNLESS OTHERWISE NOTED.
- 8. THIS SURVEY CONSISTS OF 2 SHEETS.



	-				
	BOOK/PAGE	49/45	This map prepared by:	SCALE	1"=30'
TONECYPHER	DRAWN	DWS	DAVID W. STONECYPHER	DATE	APRIL 17, 2023
URVEYING INC.	CHECKED	DWS	PROFESSIONAL SURVEYOR & MAPPER FLA. LICENSE NO. 6391	PROJECT #	22-0132

1225 NW 16TH AVENUE GAINESVILLE, FLORIDA 32601
Tel.: (352) 379-0948
Email: dws@stone-survey.com
WWW.STONE-SURVEY.COM
Professional Surveying & Mapping Certificate of Authorization
No.: LB 7810

COMMUNICATION TOWER SITE
COASTAL RIDGE NXFL-352

NEXTOWER DEVELOPMENT GROUP II, LLC

# **BOUNDARY & TOPOGRAPHIC SURVEY OF NEXTOWER LEASE PARCEL** IN SECTION 25, TOWNSHIP 4 SOUTH, RANGE 28 EAST DUVAL COUNTY, FLORIDA POINT OF COMMENCEMENT NEXTOWER LEASE PARCEL & EASEMENT INTERSECTION OF SOUTH R/W LINE OF VALLEY RIDGE BLVD. & EAST LINE OF SECTION 25-4-28 BOTTOM OF BANK & LIMITS OF TREES TREE LEGEND **LEGEND** POINT OF BEGINNING ● INDICATES 5/8" REBAR & CAP SET STAMPED LB 7810 **PINE TREE** NEXTOWER 30' WIDE INGRESS/EGRESS & UTILITY EASEMENT CENTERLINE INDICATES 5/8" REBAR & CAP FOUND STAMPED LB 3624 BAY TREE INDICATES 4"x4" CONCRETE MONUMENT STAMPED LB 3624 R/W INDICATES RIGHT-OF-WAY INDICATES DIAMETER OF TREE TRUNK AS MEASURED AT 4'± ABOVE GROUND O.R. INDICATES OFFICIAL RECORDS BOOK ID INDICATES IDENTIFICATION INDICATES TREE CLUSTER SIZES NAVD INDICATES NORTH AMERICAN VERTICAL DATUM INDICATES LIGHT POLE INDICATES ELECTRIC JUNCTION BOX INDICATES FIBEROPTIC MARKER SCALE: 1"=10' INDICATES COMMUNICATIONS PEDESTAL POINT OF BEGINNING INDICATES ELECTRIC MANHOLE NEXTOWER LEASE PARCEL POINT OF TERMINUS— NEXTOWER 30' WIDE INGRESS/EGRESS & UTILITY EASEMENT CENTERLINE INDICATES WATER METER +15.2' INDICATES SPOT ELEVATION LELECTRIC TRANSFORMERS 25.1' **SURVEYOR'S NOTES** 1. BEARINGS SHOWN HEREON ARE ASSUMED AND REFERENCED TO THE SOUTH RIGHT-OF-WAY LINE OF VALLEY RIDGE BOULEVARD AS BEARING S70° 30' 10"W. 2. ELEVATIONS ARE NORTH AMERICAN VERTICAL DATUM OF 1988 (NAVD 88) AND ARE REFERENCED TO ELEVATIONS SHOWN HEREON WERE ESTABLISHED FROM RTK GPS OBSERVATIONS REFERENCED TO THE STATE OF FLORIDA PERMANENT REFERENCE NETWORK. 3. PROPERTY TIES ARE PERPENDICULAR MEASURE UNLESS OTHERWISE NOTED. 4. THIS SURVEY CONSISTS OF 2 SHEETS. STONECYPHER APRIL 17, 2023 **PARENT TRACT** SURVEYING INC. RE#: 168149-9900 SONOC COMPANY O.R. 9494, PAGES 905 & 909 22-0132 1225 NW 16TH AVENUE GAINESVILLE, FLORIDA 32601 Tel.: (352) 379-0948 Email: dws@stone-survey.com WWW.STONE-SURVEY.COM **COMMUNICATION TOWER SITE COASTAL RIDGE NXFL-352** NEXTOWER DEVELOPMENT GROUP II, LLC | SHEET # Professional Surveying & Mapping Certificate of Authorization No.: LB 7810

## GENERAL NOTES:

- ALL CONSTRUCTION TO COMPLY WITH THE FOLLOWING CODES PLUS LATEST STATE AMENDMENTS: - 6TH (2017) EDITION FLORIDA BUILDING CODE
- CONTRACTOR IS TO COMPLY WITH THE REQUEST FOR QUOTATION (RFQ) AND CONSTRUCTION SPECIFICATIONS (LATEST REVISION) & BUILDING MANUFACTURER'S DRAWINGS, ALL PREVIOUSLY PROVIDED BY NEXTOWER.
- DIMENSIONS TO ALL EXISTING SITE FEATURES SHALL BE FIELD VERIFIED BY THE CONTRACTOR & ANY DISCREPANCIES SHALL BE REPORTED TO THE OWNER'S REPRESENTATIVE
- THE CONTRACTOR SHALL DETERMINE THE EXACT LOCATION OF EXISTING UTILITIES, PIPES, OR ANY OTHER SUBSURFACE STRUCTURES PRIOR TO COMMENCING WORK. THE CONTRACTOR SHALL CONTACT THE LOCAL UTILITY LOCATING SERVICE 48 HRS PRIOR TO DIGGING, DRILLING, OR BLASTING.
- NEXTOWER'S CONSTRUCTION PROJECT MANAGER OR NEXTOWER'S REPRESENTATIVE SHALL BE NOTIFIED IN WRITING OF ANY CONDITIONS THAT VARY FROM THE PLANS. THE CONTRACTOR'S WORK SHALL NOT VARY FROM THE PLANS WITHOUT THE EXPRESSED WRITTEN APPROVAL OF NEXTOWER'S CONSTRUCTION PROJECT MANAGER OR NEXTOWER'S REPRESENTATIVE
- IT SHALL BE THE CONTRACTOR'S RESPONSIBILITY TO EXAMINE ALL DRAWINGS & SPECIFICATIONS AND TO COORDINATE HIS WORK WITH THE WORK OF ALL OTHERS TO ENSURE THAT WORK PROGRESSION IS NOT INTERRUPTED
- CONTRACTOR SHALL COORDINATE THE CONSTRUCTION SCHEDULE WITH THE PROPERTY OWNER AS TO AVOID ANY INTERRUPTIONS WITH THE PROPERTY OWNER'S OPERATIONS.
- CONTRACTOR SHALL KEEP THE PROJECT SITE FREE FROM ACCUMULATION OF WASTE MATERIALS & RUBBISH AT ALL TIMES DURING THE CONSTRUCTION PERIOD, & SHALL REMOVE ALL WASTE MATERIALS & RUBBISH FROM THE PROJECT SITE AT THE COMPLETION OF WORK, EXCEPT THOSE SPECIFICALLY REQUIRED BY THE CONTRACT DOCUMENTS TO BE LEFT FOR THE OWNER'S MAINTENANCE.
- THE CONTRACTOR SHALL RESTORE ALL PROPERTY TO IT'S PRE-CONSTRUCTION CONDITION TO THE OWNER'S SATISFACTION
- ID. THE CONTRACTOR SHALL PROTECT EXISTING PROPERTY LINE MONUMENTATION. ANY DISTURBED, DAMAGED, OR REMOVAL OF MONUMENTATION SHALL BE REPLACED AT THE CONTRACTOR'S EXPENSE UNDER THE SUPERVISION OF A
- DAMAGE TO EXISTING STRUCTURES & UTILITIES SHALL BE REPAIRED OR REPLACED TO OWNER'S SATISFACTION AT THE CONTRACTOR'S EXPENSE. MAINTAIN FLOW FOR ALL UTILITIES.
- 12. ALL UTILITY CONNECTIONS TO EXISTING SYSTEMS SHALL BE COORDINATED WITH THE OWNER OR OWNER'S REPRESENTATIVE AND THE UTILITY COMPANY PRIOR TO EACH CONNECTION.
- 13. UNLESS OTHERWISE INDICATED, NEXTOWER SHALL OBTAIN & PROVIDE CONSTRUCTION PERMITS. THE CONTRACTOR SHALL OBTAIN, AT HIS OWN EXPENSE, ALL REQUIRED LOCAL, CITY, STATE AND/OR COUNTY CONSTRUCTION LICENSES. UPON COMPLETION OF THE WORK, THE CONTRACTOR SHALL APPLY FOR & PROVIDE A CERTIFICATE OF OCCUPANCY.
- 14. THE CONTRACTOR SHALL BE RESPONSIBLE FOR DEWATERING AND THE MAINTENANCE OF SURFACE FOR CONSTRUCTION.
- 15 CONTRACTOR SHALL COMPLY WITH ALL LOCAL STATE & FEDERAL REGULATIONS
- 16.  $\,$  CONSTRUCTION WASTE MAY NEITHER BE BURNED NOR BURIED AND MUST BE TAKEN TO AN APPROVED LANDFILL.
- 17. SECURITY TO THE SITE SHALL BE MAINTAINED AT ALL TIMES.
- 18. CONTRACTOR IS RESPONSIBLE FOR THE CONDITION OF THE EQUIPMENT DURING AND AFTER CONSTRUCTION. THE EQUIPMENT SHALL NOT BE USED FOR STORAGE OF TOOLS, CONSTRUCTION MATERIALS OR EQUIPMENT. CONTRACTOR SHALL ENSURE THE SHELTER IS CLEANED AT CONCLUSION OF CONSTRUCTION.
- 19. FOR GREENFIELD/NEW TOWERS SITES, CONTRACTOR IS RESPONSIBLE FOR ENSURING THE TOWER LIGHTS ARE MONITORED MORNING AND NIGHT EACH 24 HRS FROM THE TIME THE TOWER IS TOPPED OUT UNTIL SITE HAS ALARMS CONNECTED TO THE OPERATIONS SWITCH OR NOC. CONTRACTOR TO NOTIFY PROJECT MANAGER AT THE TIME THE TOWER IS TOPPED OUT TO FORWARD NOTIFICATION TO NEXTOWER REGULATORY AND FCC/FAA
- 20. THIS PROJECT MEETS ALL REQUIREMENTS FOR 10/2 SELF-CERTIFICATION: CERTIFICATION OF QUALIFICATION TO USE A GENERAL PERMIT FOR A STORMWATER MANAGEMENT SYSTEM SERVING LESS THAN 10 ACRES TOTAL PROJECT AREA AND LESS THAN TWO ACRES IMPERVIOUS SURFACE

## **GENERAL NOTES CONTINUED:**

FOR THE PURPOSE OF CONSTRUCTION DRAWINGS, THE FOLLOWING DEFINITIONS SHALL APPLY:

CONTRACTOR GENERAL CONTRACTOR

SUBCONTRACTOR HIRED BY GENERAL CONTRACTOR. SUBCONTRACTOR-OWNER NEXTOWER ORIGINAL EQUIPMENT MANUFACTURER

PRIOR TO THE SUBMISSION OF BIDS, THE CONTRACTOR SHALL VISIT THE CELL SITE TO FAMILIARIZE WITH THE EXISTING CONDITIONS AND TO CONFIRM THAT THE WORK CAN BE ACCOMPLISHED AS SHOWN ON THE CONSTRUCTION DRAWINGS. ANY

DISCREPANCY FOUND SHALL BE BROUGHT TO THE ATTENTION OF OWNER

- ALL MATERIALS FURNISHED AND INSTALLED SHALL BE IN STRICT ACCORDANCE WITH ALL APPLICABLE CODES, REGULATIONS AND ORDINANCES. CONTRACTOR SHALL ISSUE ALL APPROPRIATE NOTICES AND COMPLY WITH ALL LAWS, ORDINANCES, RULES, REGULATIONS AND LAWFUL ORDERS OF ANY PUBLIC AUTHORITY REGARDING THE PERFORMANCE OF THE WORK. ALL WORK CARRIED OUT SHALL COMPLY WITH ALL APPLICABLE MUNICIPAL AN UTILITY COMPANY SPECIFICATIONS AND LOCAL JURISDICTIONS CODES, ORDINANCES AND APPLICABLE REGULATIONS.
- DRAWING PROVIDED WERE DESIGN AND SCALED TO 11x17 FORMAT.
- UNLESS NOTED OTHERWISE, THE WORK SHALL INCLUDE FURNISHING MATERIALS, EQUIPMENT, APPURTENANCES AND LABOR NECESSARY TO COMPLETE ALL INSTALLATIONS AS INDICATED ON THE DRAWINGS.
- THE CONTRACTOR SHALL INSTALL ALL EQUIPMENT AND MATERIALS IN ACCORDANCE WITH MANUFACTURER RECOMMENDATIONS UNLESS SPECIFICALLY STATED OTHERWISE
- IF THE SPECIFIED FOUIPMENT CAN NOT BE INSTALLED AS SHOWN ON THESE DRAWINGS THE CONTRACTOR SHALL PROPOSE AN ALTERNATIVE INSTALLATION FOR APPROVAL BY THE OWNER.
- CONTRACTOR SHALL DETERMINE ACTUAL ROUTING OF CONDUIT, POWER AND T1 CABLES, GROUNDING CABLES AS SHOWN ON THE POWER, GROUNDING AND TELCO PLAN DRAWINGS.
- CONTRACTOR SHALL PROTECT EXISTING IMPROVEMENTS, PAVEMENTS, CURBS, LANDSCAPING AND STRUCTURES. ANY DAMAGED PART SHALL BE REPAIRED AT CONTRACTOR'S EXPENSE TO THE SATISFACTION OF OWNER
- CONTRACTORS SHALL LEGALLY AN PROPERLY DISPOSE OF ALL SCRAP MATERIAL


## SITE WORK GENERAL NOTES:

- THE CONTRACTOR SHALL CONTACT UTILITY LOCATING SERVICES PRIOR TO THE START OF CONSTRUCTION. CONTRACTOR IS TO POT HOLE UTILITY LOCATES POST MARKING TO VERIFY UTILITY LOCATES ARE CORRECT
- ALL EXISTING ACTIVE SEWER, WATER, GAS, ELECTRIC AND OTHER UTILITIES WHERE ENCOUNTERED IN THE WORK, SHALL BE PROTECTED AT ALL TIMES AND WHERE REQUIRED FOR THE PROPER EXECUTION OF THE WORK, SHALL BE RELOCATED AS DIRECTED BY CONTRACTOR EXTREME CAUTION SHOULD BE USED BY THE CONTRACTOR/SUBCONTRACTOR WHEN EXCAVATION OR DRILLING PIERS AROUND OR NEAR UTILITIES.
- ALL SITE WORK SHALL BE AS INDICATED ON THE DRAWINGS AND PROJECT SPECIFICATIONS.
- IF NECESSARY, RUBBISH, STUMPS, DEBRIS, STICKS, STONES AND OTHER REFUSE SHALL BE REMOVED FROM THE SITE AND DISPOSED OF LEGALLY.
- ALL EXISTING INACTIVE SEWER, WATER, GAS, ELECTRIC AND OTHER UTILIZES WHICH INTERFERE WITH THE EXECUTION OF THE WORK, SHALL BE REMOVED AND/OR CAPPED. PLUGGED OR OTHERWISE DISCONTINUED AT POINTS WHICH WILL NOT INTERFERE WITH THE EXECUTION OF THE WORK, SUBJECT TO THE APPROVAL OF CONTRACTOR, OWNER AND/OR LOCAL UTILITIES.
- THE OWNER SHALL PROVIDE SITE SIGNAGE IN ACCORDANCE WITH THE TECHNICAL SPECIFICATION FOR SITE SIGNAGE (TO BE INSTALLED BY CONTRACTOR).
- THE SITE SHALL BE GRADED TO CAUSE SURFACE WATER TO FLOW AWAY FROM THE BTS EQUIPMENT AND TOWER AREAS.
- NO FILL OR EMBANKMENT MATERIAL SHALL BE PLACED ON FROZEN GROUND FROZEN MATERIALS, SNOW OR ICE SHALL NOT BE PLACED IN ANY FILL OR
- THE SUB GRADE SHALL BE COMPACTED AND BROUGHT TO A SMOOTH UNIFORM GRADE PRIOR TO FINISHED SURFACE APPLICATION.
- 10. THE AREAS OF THE OWNERS PROPERTY DISTURBED BY THE WORK AND NOT COVERED BY THE TOWER FOLIPMENT OR DRIVEWAY SHALL BE GRADED TO A UNIFORM SLOPE, AND STABILIZED TO PREVENT EROSION AS SPECIFIED ON THE PROJECT SPECIFICATIONS.
- 11. CONTRACTOR SHALL MINIMIZE DISTURBANCE TO EXISTING SITE DURING CONSTRUCTION. EROSION CONTROL MEASURES, IF REQUIRED DURING CONSTRUCTION, SHALL BE IN CONFORMANCE WITH THE LOCAL GUIDELINES FOR EROSION AND SEDIMENT CONTROL.
- 12. CONTRACTOR SHALL NOT INSTALL EQUIPMENT THAT WILL IMPEDE DOOR OR ACCESS PANELS

- HOLLOW CONCRETE MASONRY UNITS SHALL MEET A.S.T.M. SPECIFICATION C90, GRADE N. TYPE 1. THE SPECIFIED DESIGN COMPRESSIVE STRENGTH OF CONCRETE MASONRY (F'm) SHALL BE 1500 PSI
- MORTAR SHALL MEET THE PROPERTY SPECIFICATION OF A.S.T.M. C270 TYP, "S' MORTAR AND SHALL HAVE A MINIMUM COMPRESSIVE STRENGTH OF 2000 PSI.
- GROUT SHALL MEET A.S.T.M. SPECIFICATION C475 AND HAVE A MINIMUM 28 DAY COMPRESSIVE STRENGTH OF 2000 PSI
- CONCRETE MASONRY SHALL BE LAID IN RUNNING (COMMON) BOND.
- WALL SHALL RECEIVE TEMPORARY BRACING, TEMPORARY BRACING SHALL NOT BE REMOVED UNTIL GROUT IS FULL CURED.

## STRUCTURAL STEEL NOTES:

- ALL STEEL WORK SHALL BE PAINTED IN ACCORDANCE WITH THE PROJECT SPECIFICATIONS AND IN ACCORDANCE WITH ASTM A36 UNLESS OTHERWISE
- STRUCTURAL STEEL SHALL CONFORM TO THE LATEST EDITION OF THE AISC. "SPECIFICATION FOR THE DESIGN. FABRICATION & ERECTION OF STRUCTURAL STEEL FOR BUILDINGS"
- ALL INTERIOR STRUCTURAL STEEL SHALL BE FINISHED WITH ONE COAT FABRICATOR'S NON-LEAD, RED OXIDE PRIMER. PRIMING SHALL BE PERFORMED AFTER SHOP FABRICATION TO THE GREATEST EXTENT POSSIBLE. ALL DINGS SCRAPES, MARS, & WELDS IN THE PRIMED AREAS SHALL BE REPAIRED BY FIELD TOUCH-UP PRIOR TO COMPLETION OF THE WORK.
- ALL EXTERIOR STRUCTURAL STEEL SHALL BE GALVANIZED IN ACCORDANCE WITH THE SPECIFICATION ASTM A123 UNI ESS OTHERWISE NOTED. GAI VANIZING SHALL BE PERFORMED AFTER SHOP FABRICATION TO THE GREATEST EXTENT POSSIBLE ALL DINGS, SCRAPES, MARS, & WELDS SHALL BE REPAIRED BY FIELD TOUCH-UP PRIOR TO COMPLETION OF THE WORK.
- INSTALLATION OF CONCRETE EXPANSION/WEDGE ANCHOR, SHALL BE PER MANUFACTURER'S RECOMMENDED PROCEDURE, THE ANCHOR BOLT, DOWEL OR ROD SHALL CONFORM TO MANUFACTURER'S RECOMMENDATION FOR EMBEDMENT DEPTH OR AS SHOWN ON THE DRAWINGS. NO REBAR SHALL BE CUT WITHOUT PRIOR CONTRACTOR APPROVAL WHEN DRILLING HOLES IN CONCRETE SPECIAL INSPECTIONS, REQUIRED BY GOVERNING CODES SHALL BE PERFORMED IN ORDER TO MAINTAIN MANUFACTURERS MAXIMUM ALLOWABLE LOADS.
- HOLES SHALL NOT BE PLACED THROUGH STRUCTURAL STEEL MEMBERS EXCEPT AS SHOWN AND DETAILED ON THE DRAWINGS.
- CONNECTIONS:
  - ALL WELDING SHALL BE DONE USING E70XX ELECTRODES AND SHALL CONFORM TO AISC AND AWS D1.1. WHERE FILLET WELD SIZES ARE NOT SHOWN, PROVIDE THE MINIMUM SIZE PER TABLE J.2.4 IN THE AISC "MANUAL OF STEEL CONSTRUCTION". 13th EDITION. AT THE COMPLETION OF WELDING, ALL DAMAGE TO GALVANIZED COATING SHALL BE REPAIRED.
- BOLTED CONNECTIONS SHALL USE BEARING TYPE GALVANIZED ASTM A325 BOLTS (3/4") AND SHALL HAVE A MINIMUM OF TWO BOLTS UNLESS NOTED OTHERWISE.
- NON-STRUCTURAL CONNECTIONS FOR STEEL GRATING MAY USE 5/8" DIA GALVANIZED ASTM A307 BOLTS UNLESS NOTED OTHERWISE.
- 7.4. CONNECTION DESIGN BY FABRICATOR WILL BE SUBJECT TO REVIEW AND APPROVAL BY ENGINEER.
- STEEL SHAPE
- W SHAPES ASTM A992, GR 50 8.1.
- 8.2. PLATES, ANGLES, CHANNELS - ASTM A36

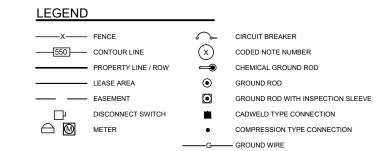

## ABBREVIATIONS:

ADDITE	IATIONO.	SYMBOL	<u>-S:</u>
AGL	ABOVE GRADE LEVEL	S/G	SOLID GROUND BUSS BAR
BTS	BASE TRANSCEIVER STATION	S/N	SOLID NEUTRAL BUSS BAR
(E)	EXISTING		SUPPLEMENTAL GROUND CONDUCTOR
MIN. N.T.S.	MINIMUM NOT TO SCALE	· _ ·	2-POLE THERMAL-MAGNETIC CIRCUIT
REF	REFERENCE	0	BREAKER
RF	RADIO FREQUENCY	<u>о</u>	SINGLE-POLE THERMAL-MAGNETIC
T.B.D.	TO BE DETERMINED		CIRCUIT BREAKER
T.B.R.	TO BE RESOLVED	•	CHEMICAL GROUND ROD
TYP	TYPICAL REQUIRED		DISCONNECT SWITCH
REQ EGR	EQUIRED EQUIPMENT GROUND RING		
AWG	AMERICAN WIRE GAUGE	$\bigcirc$	METER
MGB	MASTER GROUND BUSS	_	EXOTHERMIC WELD (CADWELD)
EG	EQUIPMENT GROUND	•	(UNLESS OTHERWISE NOTED)
BCW	BARE COPPER WIRE	_	MEQUALIDAL MELD
SIAD	SMART INTEGRATED ACCESS DEVICE		MECHANICAL WELD
GEN	GENERATOR	•	3/4" x 10'-0" COPPER CLAD STEEL
IGR RBS	INTERIOR GROUND RING (HALO) RADIO BASE STATION	•	GROUND ROD
U.N.O.	UNLESS NOTED OTHERWISE		3/4" x 10'-0" COPPER CLAD STEEL

ledot

GROUNDING WIRE

GROUND ROD WITH INSPECTION SLEEVE

# 13577 NW 2ND LANE, SUITE 20



1355 WINDWARD CONCOURSE SUITE 410 ALPHARETTA, GA 30005 678-990-2338

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REVISIONS		
NO.	DATE	DESCRIPTION
Α	05/01/23	ISSUED FOR REVIEW
В	06/13/23	UPDATED PER COMMENTS
0	06/23/23	ISSUED FOR CONSTRUCTION



JAVAD K. PARSA, P.E ON THE DATE ADJACENT TO THE

PRINTED COPIES OF THIS DOCUMENT ARE NOT CONSIDERED SIGNED AND SEALED AND THE SIGNATURE MUST BE VERIFIED ON ANY ELECTRONIC COPIES.

COASTAL RIDGE NXFL-342


**NEXTOWER** 

RAWLAND

**GENERAL NOTES** 

DRAWING NO

GN<sub>1</sub>

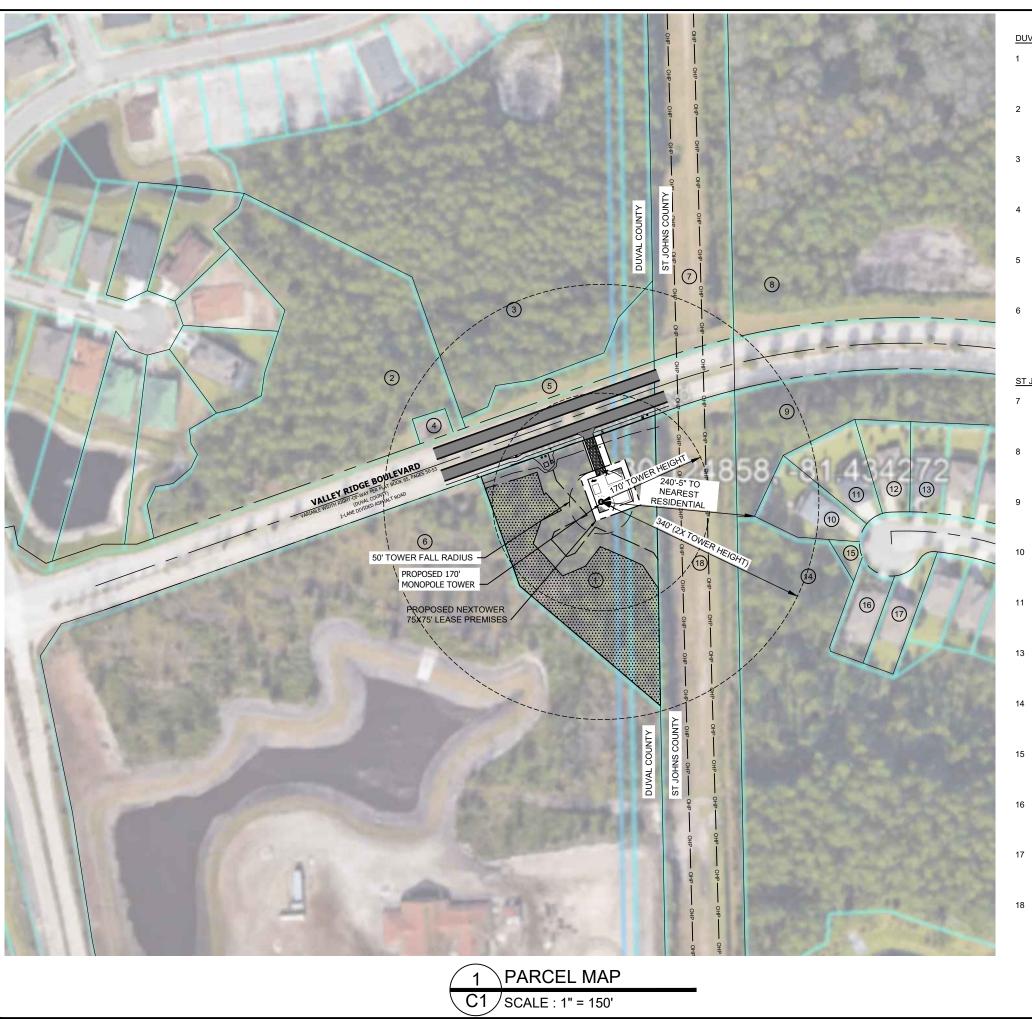

## **DUVAL COUNTY PARCELS**

- 1 RE# 168149 9900 0 COASTAL RIDGE BLVD SONOC COMPANY ZONED - PUD
- 2 RE# 168150 2025 0 COCONUT PALM PKWY PALMS AT NOCATEE HOMEOWNERS ASSOCIATION INC ZONED - PLID
- 3 RE# 168150 2400 0 COCONUT PALM PKWY PALMS AT NOCATEE HOMEOWNERS ASSOCIATION INC ZONED - PUD
- RE# 168150 2030
  0 COCONUT PALM PKWY
  PALMS AT NOCATEE HOMEOWNERS ASSOCIATION INC
  ZONED PUD
- 5 RE# 168150 2440 0 COCONUT PALM PKWY PALMS AT NOCATEE HOMEOWNERS ASSOCIATION INC ZONED - PUD
- 6 RE# 168149 9850 127 STONEMASON WAY GALEONE VICTOR BISHOP OF DIOCESE OF ST AUGUSTINE ZONED - PLID

## ST JOHNS COUNTY PARCELS

- 7 STRAP# 0680580002 773 COCONUT PALM PKWY PALMS AT NOCATEE HOMEOWNERS ASSOC ZONED - PUDVVVV
- 8 STRAP# 0680520002 222 CAPTIVA DR KELLY POINTE HOMEOWNERS ASSOCIATION INC ZONED - PUD
- STRAP# 0680520010 17 CAPTIVA DR WETTSCHURACK JEFFREY D,HEATHER ZONED - PUD
- 10 STRAP# 0680520020 21 CAPTIVA DR WEBER RYAN,NICOLE ZONED - PUD
- 1 STRAP# 0680520030 25 CAPTIVA DR MOATZ STEPHEN C ZONED - PUD
- 13 STRAP# 0680520040 .29 CAPTIVA DR SPECIALE MARK,BLAIR ZONED - PUD
- 4 STRAP# 0680520002 222 CAPTIVA DR KELLY POINTE HOMEOWNERS ASSOCIATION INC ZONED - PUD
- 15 STRAP# 0680520002 222 CAPTIVA DR KELLY POINTE HOMEOWNERS ASSOCIATION INC ZONED - PUD
- 6 STRAP# 0680520170 24 CAPTIVA DR TRIANA JOHN,NANCY ZONED - PUD
- 17 STRAP# 0680520180 28 CAPTIVA DR MC QUAIG ERIN DOYLE ZONED - PUD
- STRAP# 0696300220 4254 VALLEY RIDGE BLVD TOLOMATO CDD ZONED - PUD

GRAPHIC SCALE

150 0 150

SCALE: 1" = 150'-0"








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NEXTOWER SITE NAME:

COASTAL RIDGE NXFL-342

TOWER OWNE

NEXTOWER

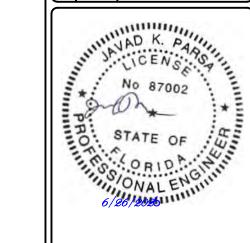DESIGN TYPE


**RAWLAND** 

SHEET TITLE:

PARCEL MAP

DRAWING NO.

C1

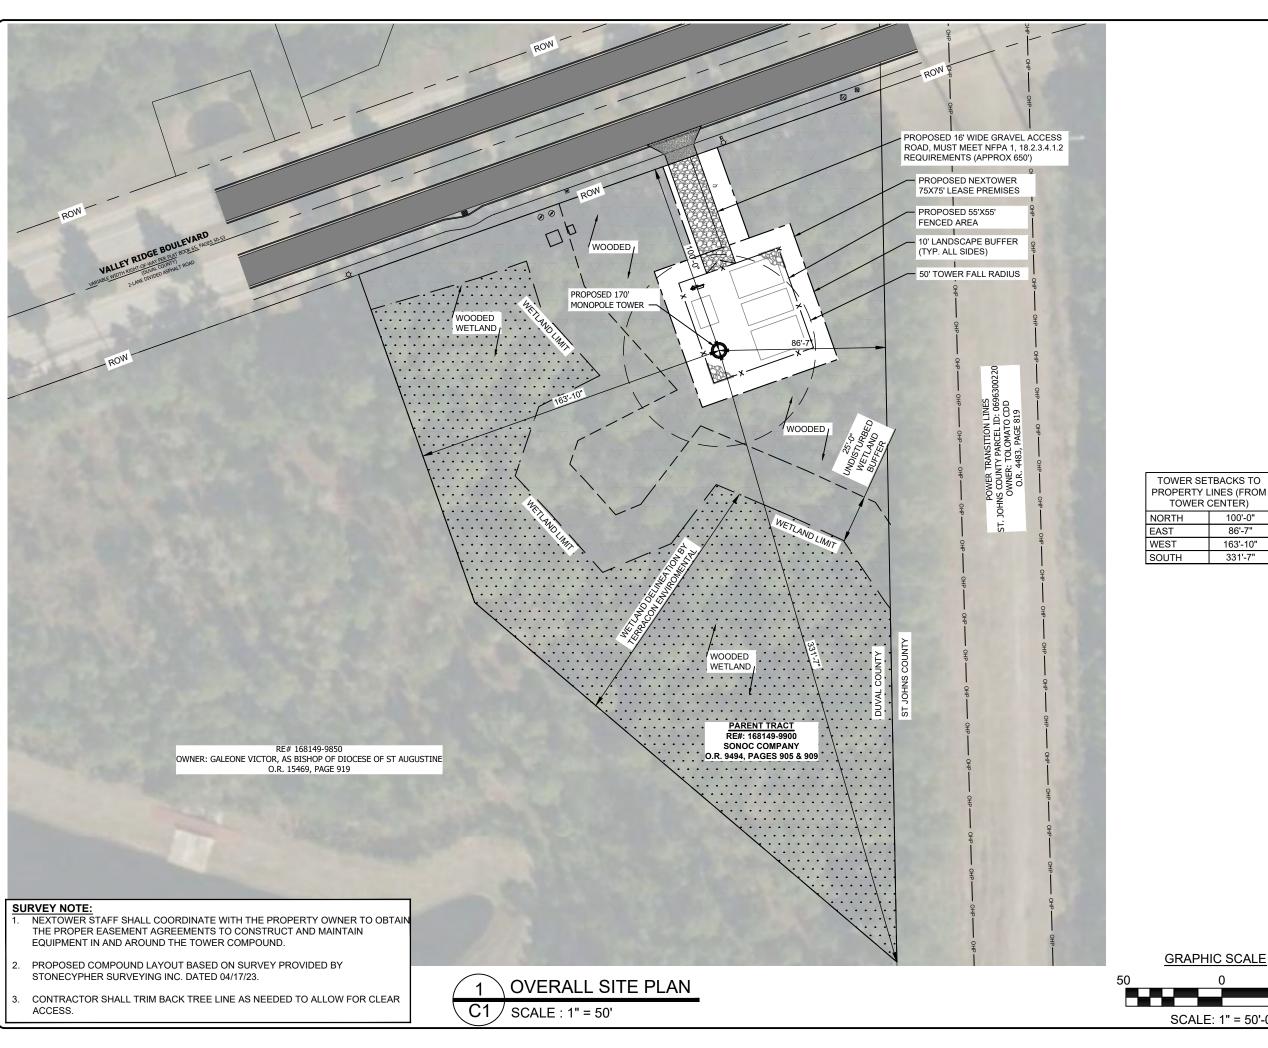





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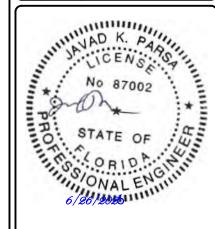
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**COASTAL RIDGE** NXFL-342

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RAWLAND

**OVERALL SITE PLAN** 

C<sub>1</sub>A


**GRAPHIC SCALE** SCALE: 1" = 50'-0"

TOWER CENTÈR)

100'-0"

86'-7" 163'-10"

331'-7"

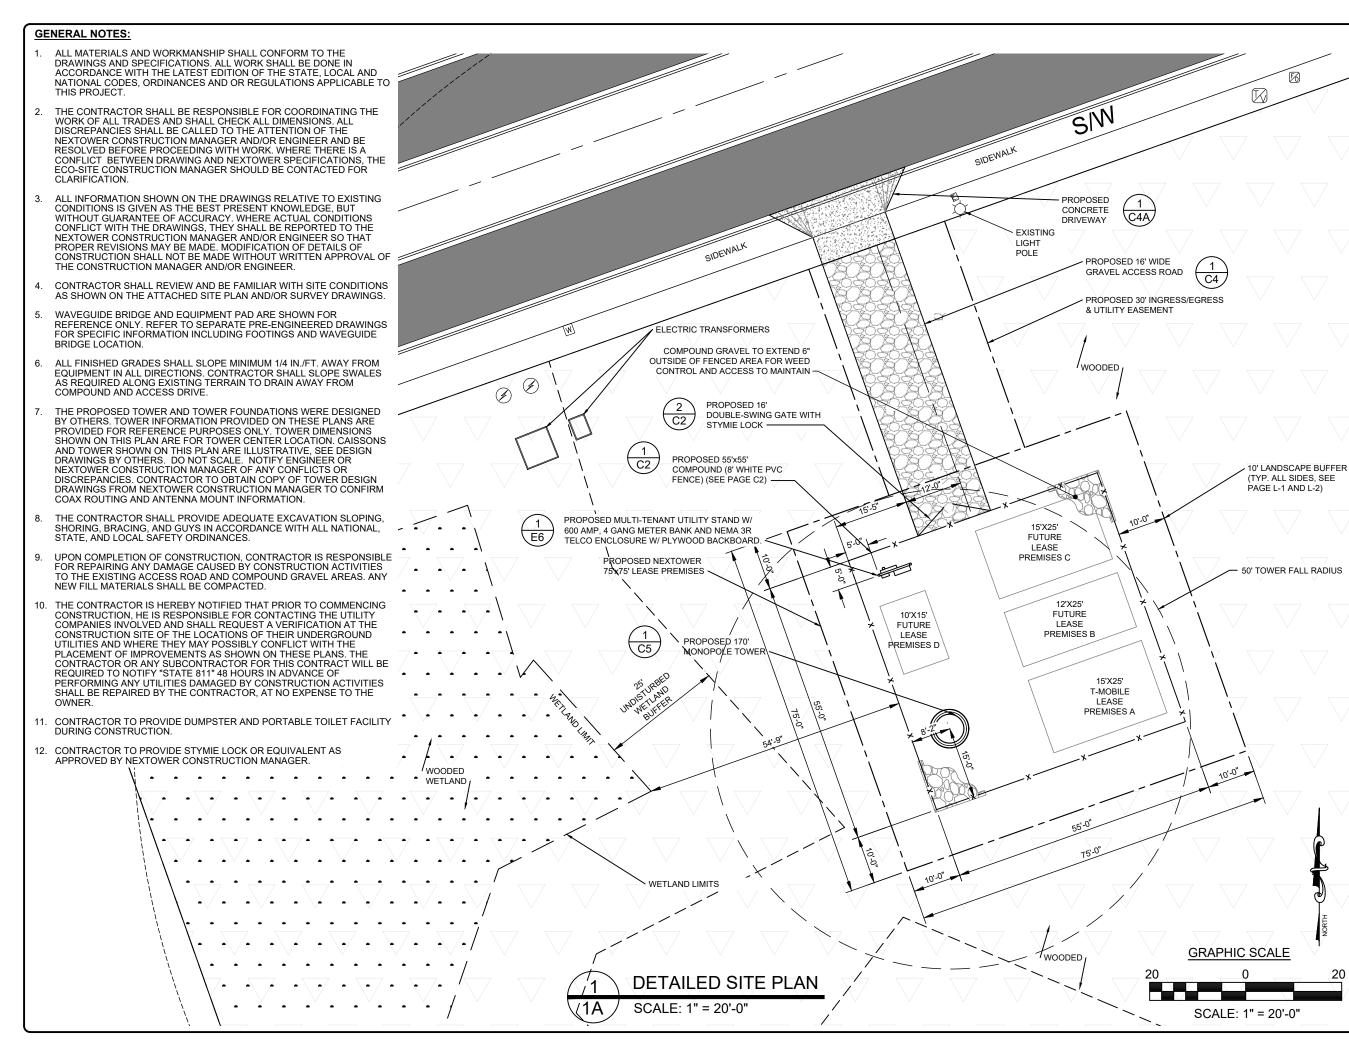





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NEXTOWER SITE NAME:

COASTAL RIDGE NXFL-342

OWER OWNER

**NEXTOWER** 

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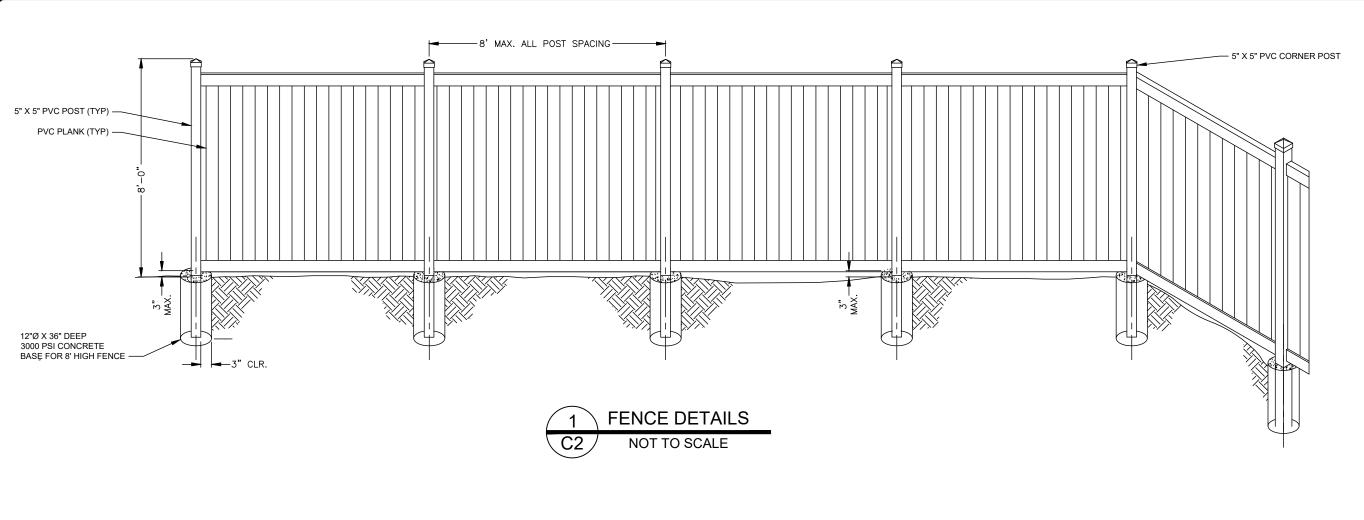
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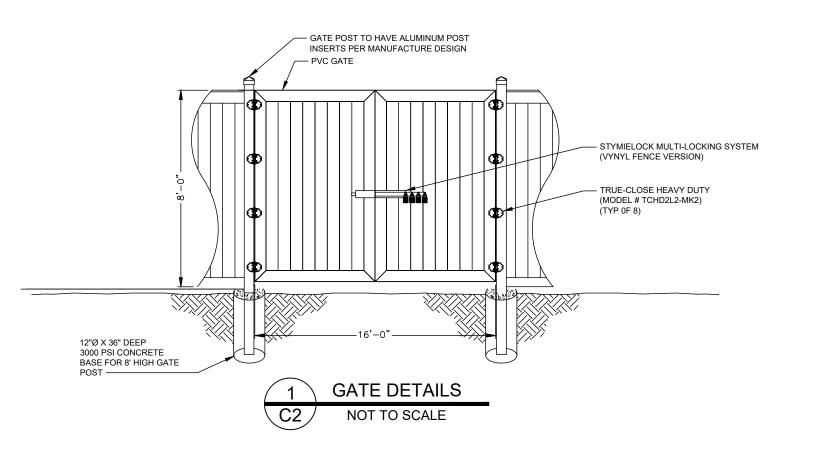
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DETAILED SITE PLAN

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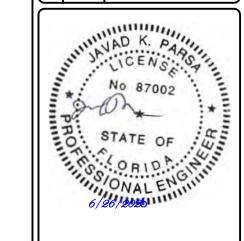


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COASTAL RIDGE NXFL-342

TOWER OWNE

NEXTOWER

DESIGN TYPE


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SHEET TITI

FENCE, GATE, AND COMPOUND DETAILS

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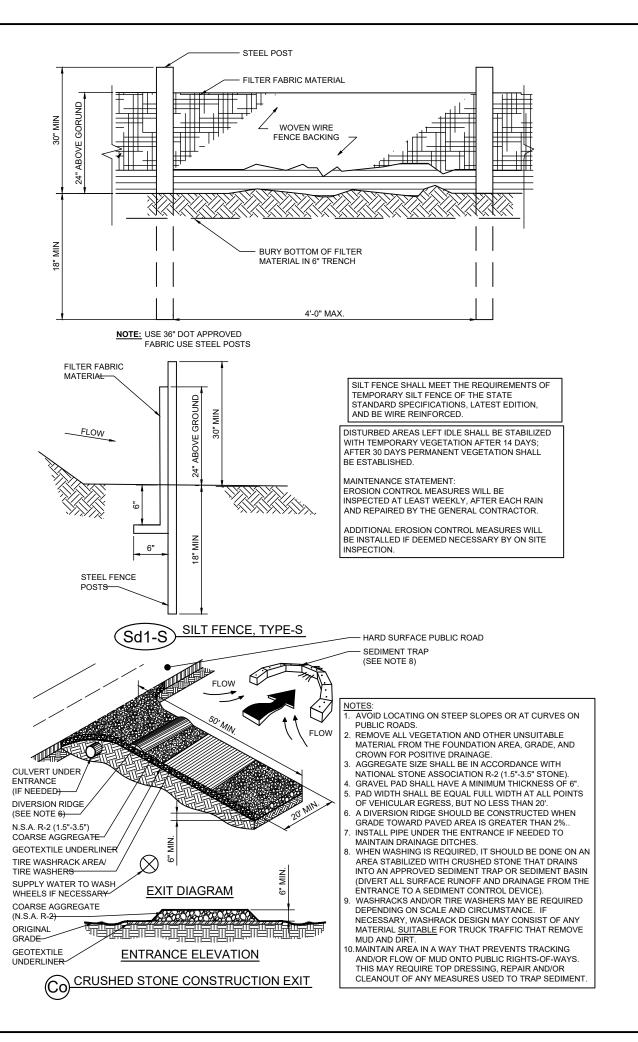


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**COASTAL RIDGE** 

**GRADING AND EROSION CONTROL PLAN** 

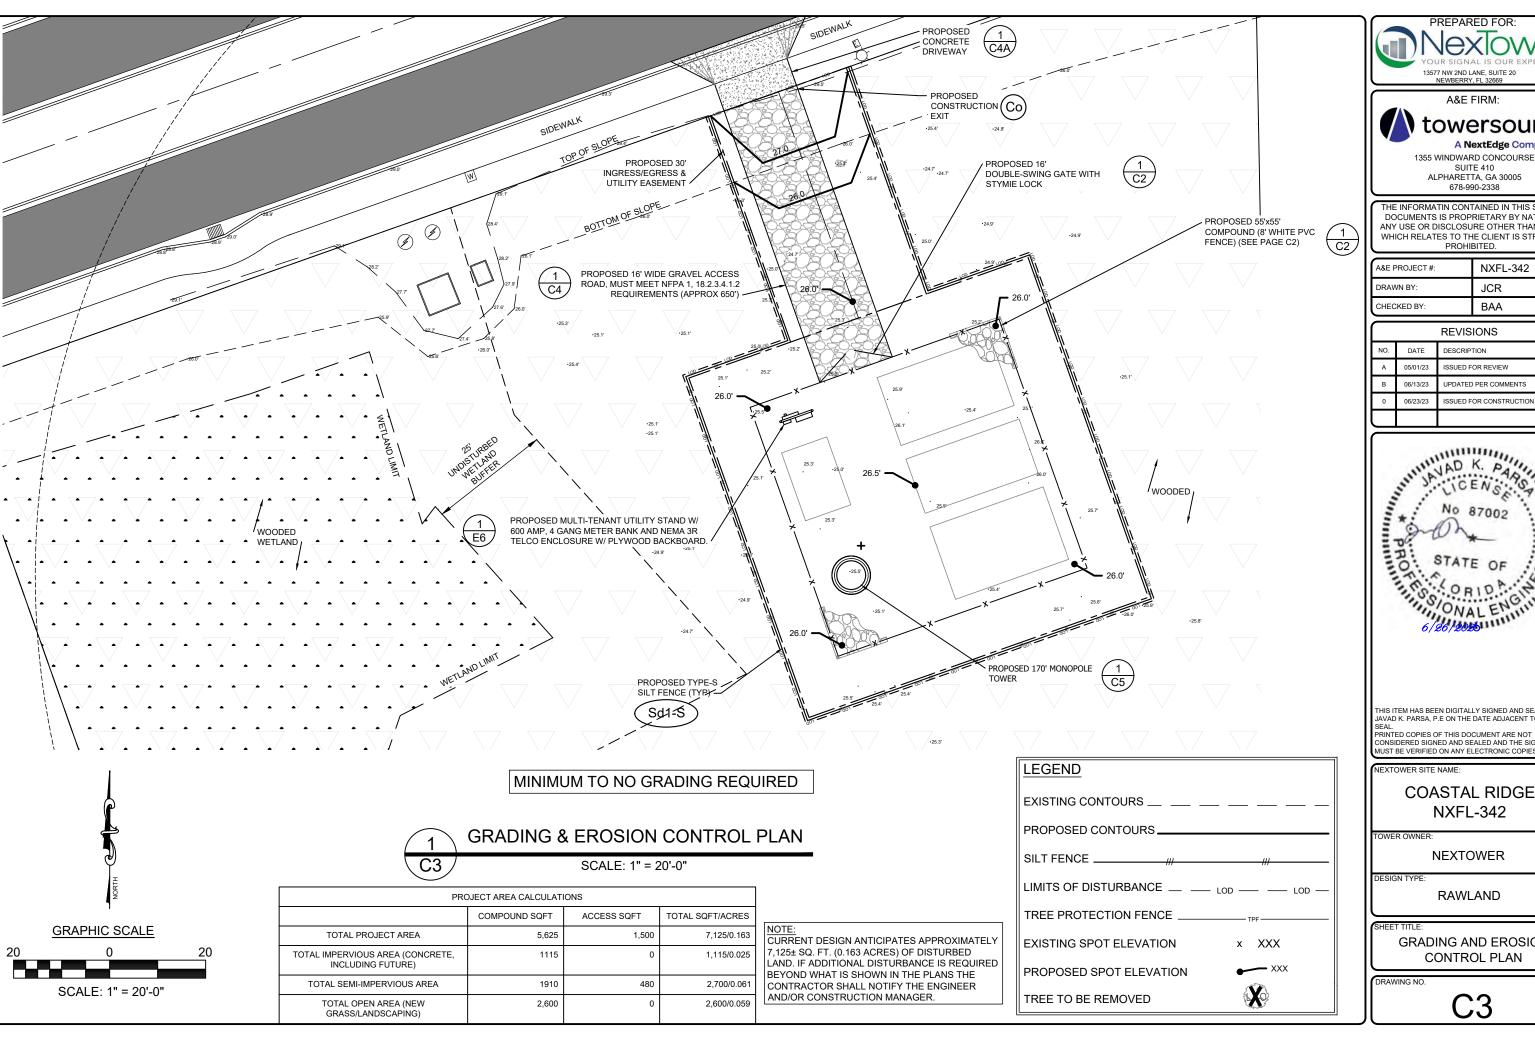







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NEXTOWER SITE NAME

COASTAL RIDGE NXFL-342

TOWER OWN

**NEXTOWER** 

DESIGN TYPE:

RAWLAND

SHEET TITLE

GRADING AND EROSION CONTROL DETAILS

DRAWING NO

C3A

#### EXCAVATION & GRADING NOTES:

- ALL EXCAVATIONS ON WHICH CONCRETE IS TO BE PLACED SHALL BE SUBSTANTIALLY HORIZONTAL ON UNDISTURBED AND UNFROZEN SOIL AND BE FREE FROM LOOSE MATERIAL AND EXCESS GROUNDWATER. DEWATERING FOR EXCESS GROUNDWATER SHALL BE PROVIDED IF REQUIRED.
- CONCRETE FOUNDATIONS SHALL NOT BE PLACED ON ORGANIC MATERIAL. IF SOUND SOIL IS NOT REACHED AT THE DESIGNATED EXCAVATION DEPTH, THE UNSATISFACTORY SOIL SHALL BE EXCAVATED TO ITS FULL DEPTH AND EITHER BE REPLACED WITH MECHANICALLY COMPACTED GRANULAR MATERIAL OR THE EXCAVATION BE FILLED WITH CONCRETE OF THE SAME QUALITY SPECIFIED FOR THE FOLINDATION
- 3. CRUSHED STONE MAY BE USED TO STABILIZE THE BOTTOM OF THE EXCAVATION. STONE, IF USED, SHALL NOT BE USED AS COMPILING CONCRETE THICKNESS.
- ALL EXCAVATIONS SHALL BE CLEAN OF UNSUITABLE MATERIAL SUCH AS VEGETATION, TRASH
  DEBRIS AND SO FORTH BEFORE AND AFTER COMPLETION OF THE FOUNDATION AND OTHER
  CONSTRUCTION BELOW GRADE, AND BEFORE BACKFILLING.
- 5. BACKFILLING SHALL
  - -USE APPROVED MATERIALS CONSISTING OF EARTH, LOAM, SANDY CLAY, SAND AND GRAVEL, OR SOFT SHALE:
  - BE FREE FROM CLODS OR STONES OVER 2-1/2" MAXIMUM DIMENSIONS
    BE PLACED IN 6" LAYERS AND COMPACTED TO 95% STANDARD PROCTOR
    EXCEPT IN GRASSED/LANDSCAPED AREAS, WHERE 90% STANDARD PROCTOR
    IS REQUIRED.
- 6. FILL PREPARATION
  - REMOVE ALL VEGETATION, TOPSOIL, DEBRIS, WET AND UNSATISFACTORY SOIL MATERIALS, OBSTRUCTIONS, AND DELETERIOUS MATERIALS FROM GROUND SURFACE PRIOR TO PLACING FILLS. PLOW, STRIP, OR BREAK UP SLOPED SURFACES STEEPER THAN 1 VERTICAL TO 4 HORIZONTAL SO FILL MATERIAL WILL BOND WITH EXISTING SURFACE. WHEN SUBGRADE OR EXISTING GROUND SURFACE TO RECEIVE FILL HAS A DENSITY LESS THAN THAT REQUIRED FOR FILL, BREAK UP GROUND SURFACE TO DEPTH REQUIRED, PULVERIZE, MOISTURE-CONDITION OR AERATE SOIL AND RECOMPACT TO REQUIRED DENSITY.
- 7. PROTECT EXISTING GRAVEL SURFACING AND SUBGRADE IN AREAS WHERE EQUIPMENT LOADS WILL OPERATE. USE PLANKING OR OTHER SUITABLE MATERIALS DESIGNED TO SPREAD EQUIPMENT LOADS. REPAIR DAMAGE TO EXISTING GRAVEL SURFACING OR SUBGRADE WHERE SUCH DAMAGE IS DUE TO THE CONTRACTOR'S OPERATIONS. DAMAGED GRAVEL SURFACING SHALL BE RESTORED TO MATCH THE ADJACENT UNDAMAGED GRAVEL SURFACING AND SHALL BE OF THE SAME THICKNESS.
- 8. REPLACE EXISTING GRAVEL SURFACING ON AREAS FROM WHICH GRAVEL SURFACING IS REMOVED DURING CONSTRUCTION OPERATIONS. GRAVEL SURFACING SHALL BE REPLACED TO MATCH EXISTING ADJACENT GRAVEL SURFACING AND SHALL BE OF THE SAME THICKNESS. SURFACES OF GRAVEL SURFACING SHALL BE FREE FROM CORRUGATIONS AND WAVES. EXISTING GRAVEL SURFACING MAY BE EXCAVATED SEPARATELY AND REUSED IF INJURIOUS AMOUNTS OF EARTH, ORGANIC MATTER, OR OTHER DELETERIOUS MATERIALS ARE REMOVED PRIOR TO REUSE. FURNISH ALL ADDITIONAL GRAVEL RESURFACING MATERIAL AS REQUIRED. BEFORE GRAVEL SURFACING IS REPLACED, SUBGRADE SHALL BE GRADED TO CONFORM TO REQUIRED SUBGRADE ELEVATIONS, AND LOOSE OR DISTURBED MATERIALS SHALL BE THOROUGHLY COMPACTED. DEPRESSIONS IN THE SUBGRADE SHALL BE FILLED AND COMPACTED WITH APPROVED SELECTED MATERIAL. GRAVEL SURFACING MATERIAL MAY BE USED FOR FILLING DEPRESSIONS IN THE SUBGRADE. SUBJECT TO ENGINEER'S APPROVAL.
- 9. DAMAGE TO EXISTING STRUCTURES AND UTILITIES RESULTING FROM CONTRACTOR'S NEGLIGENCE SHALL BE REPAIRED / REPLACED TO OWNER'S SATISFACTION AT CONTRACTOR'S EXPENSE
- 10. CONTRACTOR SHALL COORDINATE THE CONSTRUCTION SCHEDULE WITH PROPERTY OWNER SO AS TO AVOID INTERRUPTIONS TO PROPERTY OWNER'S OPERATIONS.
- 11. ENSURE POSITIVE DRAINAGE DURING AND AFTER COMPLETION OF CONSTRUCTION.
- 12. ALL CUT AND FILL SLOPES SHALL BE 2 HORIZONTAL TO 1 VERTICAL MAXIMUM
- 13. REMOVE ALL ORGANICS, ROCKS GREATER THAN 3", UNUSED FILL AND OTHER DEBRIS TO AN AREA OFF SITE IN A LEGAL MANNER.
- CONTRACTOR SHALL ENSURE THAT SOILS ARE SUITABLE TO PREVENT SETTLING OF PLATFORM AND EQUIPMENT.

ACTIVITY SCHEDULE	
WORK DESCRIPTION	WORKING DAYS
INSTALLATION OF EROSION CONTROL MEASURES	1-2
CLEARING, GRUBBING, AND GRADING	3-5
MAINTAINING EROSION CONTROL MEASURES	6-8
TEMPORARY GRASSING	9-12
BUILDING CONSTRUCTION	13-19
FINAL LANDSCAPING, GRASSING	20-23
REMOVING EROSION CONTROL MEASURES	24-26

THE INSTALLATION OF EROSION CONTROL MEASURES AND PRACTICES SHALL TAKE PLACE PRIOR TO OR CONCURRENT WITH LAND DISTURBING ACTIVITIES.

#### GENERAL NOTES:

- ALL MATERIALS AND WORKMANSHIP SHALL CONFORM TO THE DRAWINGS AND SPECIFICATIONS. ALL WORK SHALL BE DONE IN ACCORDANCE WITH THE LATEST EDITION OF THE STATE, LOCAL AND NATIONAL CODES, ORDINANCES AND OR REGULATIONS APPLICABLE TO THE PROJECT.
- THE CONTRACTOR SHALL BE RESPONSIBLE FOR COORDINATING THE WORK OF ALL TRADES AND SHALL CHECK ALL DIMENSIONS. ALL DISCREPANCIES SHALL BE CALLED TO THE ATTENTION OF THE NEXTOWER CONSTRUCTION MANAGER AND/OR ENGINEER AND BE RESOLVED BEFORE PROCEEDING WITH WORK. WHERE THERE IS A CONFLICT BETWEEN DRAWING AND NEXTOWER SPECIFICATIONS, THE NEXTOWER CONSTRUCTION MANAGER SHOULD BE CONTACTED FOR CLARIFICATION
- 3. ALL INFORMATION SHOWN ON THE DRAWINGS RELATIVE TO EXISTING CONDITIONS IS GIVEN AS THE BEST PRESENT KNOWLEDGE, BUT WITHOUT GUARANTEE OF ACCURACY. WHERE ACTUAL CONDITIONS CONFLICT WITH THE DRAWINGS, THEY SHALL BE REPORTED TO THE NEXTOWER CONSTRUCTION MANAGER AND /OR ENGINEER SO THAT PROPER REVISIONS MAY BE MADE. MODIFICATION OF DETAILS OF CONSTRUCTION SHALL NOT BE MADE WITHOUT WRITTEN APPROVAL OF THE CONSTRUCTION MANAGER AND/OR ENGINEER.
- 4. CONTRACTOR SHALL REVIEW AND BE FAMILIAR WITH SITE CONDITIONS AS SHOWN ON THE ATTACHED SITE PLAN AND/OR SURVEY DRAWINGS.
- ALL FINISHED GRADE3S SHALL SLOPE MINIMUM 1/4 IN./FR. AWAY FROM EQUIPMENT IN ALL DIRECTIONS. CONTRACTOR SHALL SLOPE SWALES AS REQUIRED ALONG EXISTING TERRAIN TO DRAIN AWAY FROM COMPOLIND AND ACCESS DRIVE
- 6. THE PROPOSED TOWER AND TOWER FOUNDATIONS WERE DESIGNED BY OTHERS. TOWER INFORMATION PROVIDED ON THESE PLANS ARE PROVIDED FOR REFERENCE PURPOSES ONLY. TOWER DIMENSIONS SHOWN THIS PLAN ARE FOR TOWER CENTER LOCATION. CAISSONS AND TOWER SHOWN ON THIS PLAN ARE ILLUSTRATIVE, SEE DESIGN DRAWINGS BY OTHERS. DO NOT SCALE. NOTIFY ENGINEER OR NEXTOWER CONSTRUCTION MANAGER OF ANY CONFLICTS OR DISCREPANCIES. CONTRACTOR TO OBTAIN COPY OF TOWER DESIGN DRAWINGS FROM NEXTOWER CONSTRUCTION MANAGER TO CONFIRM COAX ROUTING AND ANTENNA MOUNT INFORMATION.
- 7. THE CONTRACTOR SHALL PROVIDE ADEQUATE EXCAVATION SLOPING SHORING, BRAVING, AND GUYS IN ACCORDANCE WITH ALL NATIONAL, STATE, AND LOCAL SAFETY ORDINATES.
- UPON COMPLETION OF CONSTRUCTION, CONTRACTOR IS RESPONSIBLE FOR REPAIRING ANY DAMAGE CAUSED BY CONSTRUCTION ACTIVITIES TO THE EXISTING ACCESS ROAD AND COMPOUND GRAVEL AREAS. ANY NEW FILL MATERIAL SHALL BE COMPACTED.
- 9. THE CONTRACTOR IS HEREBY NOTIFIED THAT PRIOR COMMENCING CONSTRUCTION, HE/SHE IS RESPONSIBLE FOR CONTACTING THE UTILITY COMPANIES INVOLVED AND SHALL REQUEST A VERIFICATIONS AT THE CONSTRUCTION SITE OF THE LOCATIONS OF THEIR UNDERGROUND UTILITIES AND WHERE THEY MAY POSSIBLY CONFLICT WITH THE PLACEMENT OF IMPROVEMENTS AS SHOWN ON THESE PLANS. THE CONTRACTOR OR ANY SUBCONTRACTOR FOR THEIR CONTRACT WILL BE REQUIRED TO NOTIFY "STATE 811" IN ADVANCE OF PERFORMING ANY WORK. ANY UTILITIES DAMAGED BY CONSTRUCTION ACTIVITIES SHALL BE REPAIRED BY THE CONTRACTOR, AT NO EXPENSE TO THE OWNER.
- CONTRACTOR TO PROVIDE DUMPSTER AND PORTABLE TOILET FACILITY DURING CONSTRUCTION.
- CONTRACTOR TO PROVIDE STYMIE LOCK OR EQUIVALENT AS APPROVED BY NEXTOWER CONSTRUCTION MANAGER.









#### GENERAL EROSION & SEDIMENT CONTROL NOTES:

- ADDITIONAL EROSION CONTROL MEASURES WILL BE EMPLOYED WHERE DETERMINED NECESSARY BY ACTUAL SITE CONDITIONS.
- PRIOR TO COMMENCING LAND DISTURBANCE ACTIVITY, THE LIMITS OF LAND DISTURBANCE SHALL
  BE CLEARLY AND ACCURATELY DEMARCATED WITH STAKES, RIBBONS, OR OTHER APPROPRIATE
  AND ACCURATELY DEMARCATED WITH STAKES, RIBBONS, OR OTHER APPROPRIATE
- 3. THE CONSTRUCTION OF THE SITE WILL INITIATE WITH THE INSTALLATION OF EROSION CONTROL MEASURES SUFFICIENT TO CONTROL SEDIMENT DEPOSITS AND EROSION. CONTRACTOR SHALL CALL APPROPRIATE COUNTY FOR AN INSPECTION OF SOIL EROSION CONTROL MEASURES PRIOR TO BEGINNING GRADING ACTIVITY. ALL SEDIMENT CONTROL WILL BE MAINTAINED UNTIL ALL UPSTREAM GROUND WITHIN THE CONSTRUCTION AREA HAS BEEN COMPLETELY STABILIZED.
- 4. THE LOCATION OF SOME OF THE EROSION CONTROL DEVICES MAY HAVE TO BE ALTERED FROM THAT SHOWN ON THE PLANS IF DRAINAGE PATTERNS DURING CONSTRUCTION ARE DIFFERENT FROM THE FINAL PROPOSED DRAINAGE PATTERNS. ANY DIFFICULTY IN CONTROLLING EROSION DURING ANY PHASE OF CONSTRUCTION SHALL BE REPORTED TO THE ENGINEER IMMEDIATELY.
- EROSION CONTROL MEASURES WILL BE MAINTAINED AT ALL TIMES. IF FULL IMPLEMENTATION OF THE APPROVED PLAN DOES NOT PROVIDE FOR ELECTIVE EROSION CONTROL, ADDITIONAL EROSION AND SEDIMENT CONTROL MEASURES SHALL BE IMPLEMENTED TO CONTROL OR TREAT THE SEDIMENT SOURCE.
- 6. THE CONTRACTOR SHALL REMOVE ACCUMULATED SILT WHEN THE SILT IS WITHIN 12" OF THE TOP OF THE SILT FENCE.
- FAILURE TO INSTALL, OPERATE OR MAINTAIN ALL EROSION CONTROL MEASURES WILL RESULT IN ALL CONSTRUCTION BEING STOPPED ON THE JOB SITE UNTIL SUCH MEASURES ARE CORRECTED.
- 8. SILT BARRIERS TO BE PLACED AT DOWNSTREAM TOE OF ALL CUT AND FILL SLOPES.
- ANY DISTURBED AREA LEFT EXPOSED FOR A PERIOD GREATER THAN 7 DAYS SHALL BE STABILIZED WITH SEEDING.
- 10. SEEDING

AGRICULTURAL LIMESTONE

FERTILIZER. 5-10-15

A. SEEDING WITH MULCH (CONVENTIONAL SEEDING ON SLOPES LESS THAN 3:1) (HYDRAULIC SEEDING EQUIPMENT ON SLOPES 3:1 AND STEEPER)

4000 LBS./acre

1500 lbs./acre

800 lbs./acre

MULCH STRAW OR HAY 5000 lbs./arce APPLICATION PLANNING SEED SPECIES RATE/ACRE DATES **HULLED COMMON BERMUDA GRASS** 3/1 - 6/15 FESCUE 9/1 - 10/31 50lbs FESCUE 11/1 -2/28 RYE GRASS 50lbs

HAY MULCH FOR TEMPORARY COVER 5000lbs. 6/15 -8/31

B. TOPDRESSING: APPLY WHEN PLANTS ARE 2 TO 4 INCHES TALL FERTILIZER (AMMONIUM NITRATE 33.5%) 300 lbs./acre

C. <u>SECOND-YEAR-FERTILIZER:</u> (5-10-15 OR EQUIVALENT)

HYDRAULIC SEEDING EQUIPMENT WHEN HYDRAULIC SEEDING AND FERTILIZING EQUIPMENT IS USED, NO GRADING AND SHAPING OR SEEDBED PREPARATION WILL BE REQUIRED. THE FERTILIZER, SEED AND WOOD CELLULOSE FIBER MULCH WILL BE MIXED WITH WATER AND APPLIED IN A SLURRY. ALL SLURRY INGREDIENTS MUST BE COMBINED TO FORM A HOMOGENEOUS MIXTURE, AND SPREAD UNIFORMLY OVER THE AREA WITHIN ONE HOUR AFTER MIXTURE IS MADE. STRAW OR HAY MULCH AND ASPHALT EMULSION WILL BE APPLIED WITH BLOWER-TYPE MULCH SPREADING EQUIPMENT WITHIN 24 HOURS AFTER SEEDING, THE MULCH WILL BE SPREAD UNIFORMLY OVER THE AREA, LEAVING ABOUT 25 PERCENT OF THE GROUND SURFACE EXPOSED.

CONVENTIONAL SEEDING EQUIPMENT GRADE, SHAPE AND SMOOTH WHERE NEEDED TO PROVIDE FOR SAFE EQUIPMENT OPERATION AT SEEDING TIME AND FOR MAINTENANCE PURPOSES. THE LIME AND FERTILIZER IN DRY FORM WILL BE SPREAD UNIFORMLY OVER THE AREA IMMEDIATELY BEFORE SEEDBED PREPARATION. A SEEDBED WILL BE PREPARED BY SCARIFYING TO A DEPTH OF 1 TO 4 INCHES AS DETERMINED ON SITE. THE SEEDBED MUST BE WELL PULVERIZED, SMOOTHED AND FIRMED. SEEDING WILL BE DONE WITH CULTIPACKER-SEEDER, DRILL, ROTARY SEEDER OR OTHER MECHANICAL OR HAND SEEDER. SEED WILL BE DISTRIBUTED UNIFORMLY OVER A FRESHLY PREPARED SEEDBED AND COVERED LIGHTLY. WITHIN 24 HOURS AFTER SEEDING, STRAW OR HAY MULCH WILL BE SPREAD UNIFORMLY OVER THE AREA, LEAVING ABOUT 25 PERCENT OF THE GROUND SURFACE EXPOSED. MULCH WILL BE SPREAD WITH BLOWER-TYPE MULCH EQUIPMENT OR BY HAND AND ANCHORED IMMEDIATELY AFTER IT IS SPREAD. A DISK HARROW WITH THE DISK SET STRAIGHT OR A SPECIAL PACKER DISK MAY BE USED TO PRESS THE MULCH INTO THE SOIL.

- 11. CONTRACTOR SHALL REMOVE ALL EROSION & SEDIMENT CONTROL MEASURES AFTER COMPLETION OF CONSTRUCTION AND ESTABLISHMENT OF PERMANENT GROUND COVER.
- 12. THE ESCAPE OF SEDIMENT FROM THE SITE SHALL BE PREVENTED BY THE INSTALLATION OF EROSION CONTROL MEASURES AND PRACTICES PRIOR TO, OR CONCURRENT WITH, LAND-DISTURBING ACTIVITIES
- 13. ALL CUT AND FILL SLOPES MUST BE SURFACED ROUGHENED AND VEGETATED WITHIN SEVEN (7) DAYS OF THEIR CONSTRUCTION.
- 14. ALL FILL SLOPES WILL HAVE SILT FENCE AT TOE OF SLOPES.
- 15. ALL SEDIMENT AND EROSION CONTROL MEASURES WILL BE CHECKED DAILY AND ANY DEFICIENCIES NOTED WILL BE CORRECTED BY THE END OF EACH DAY. ADDITIONAL EROSION AND SEDIMENT CONTROL MEASURES WILL BE INSTALLED IF DEEMED NECESSARY AFTER ON-SITE INSPECTION BY THE ISSUING AUTHORITY.
- 16. THE ONLY MATERIAL TO BE BURIED ON-SITE IS VEGETATIVE MATERIAL. CONSTRUCTION WASTE MAY NEITHER BE BURNED NOR BURIED AND MUST BE TAKEN TO A STATE APPROVED LANDFILL.
- 17. A 25' MIN UNDISTURBED VEGETATIVE BUFFER ADJACENT TO ALL RUNNING STREAMS AND CREEKS WILL BE LEFT AND MAINTAINED.



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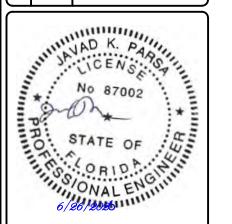
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NEXTOWER SITE NAME

COASTAL RIDGE NXFL-342

TOWER OWN

NEXTOWER

DESIGN TYPE:


RAWLAND

GUEET TITLE

GRADING AND EROSION CONTROL NOTES

DRAWING NO

C<sub>3</sub>B

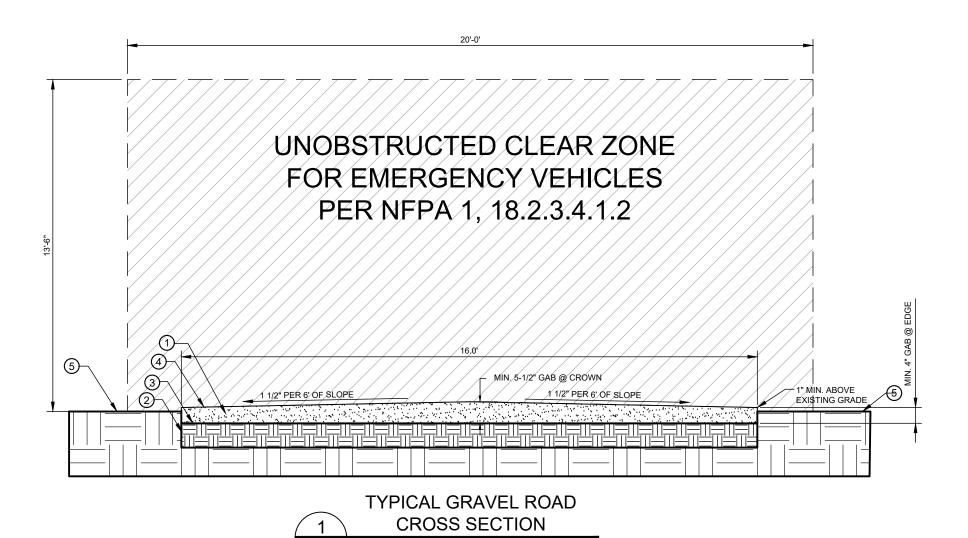

\*\* CONTRACTOR SHALL BE RESPONSIBLE FOR CLEARING & GRUBBING THE CONSTRUCTION SITE AND ROADWAY AREAS. THE CONTRACTOR SHALL COMPLY, WHEN NECESSARY, WITH THE RECOMMENDATIONS CONTAINED WITHIN THE GEOTECHNICAL REPORT PREPARED FOR THIS SITE FOR SITE WORK PREPARATION & FOUNDATION WORK. \*\*

NOT TO SCALE

- 1. REMOVE ALL ORGANIC MATERIAL. (STUMPS, ROOTS, LEAVES, ETC.) A MIN 3" OF SOIL TO BE REMOVED.
- 2. LEVEL AND COMPACT SUBGRADE TO A 95% COMPACTION.
- 3. INSTALL GEOTEXTILE FABRIC (AND/OR OTHER STABILIZATION METHOD) OVER SUBGRADE ON ALL ROADS.
- 4. INSTALL MIN. 4" OF GRADED AGGREGATE BASE (GAB/CRUSHER RUN) WITH 5-1/2" AT CROWN. GAB SHALL HAVE A 1-1/2" TO 6' SLOPE FROM CROWN. ALL GAB SHALL BE COMPACTED TO A 95% COMPACTION AT A MAXIMUM DRY DENSITY AS DETERMINED BY ASTM D-1557 OR WITHIN PLUS OR MINUS 3% OF OPTIMUM MOISTURE CONTENT.
- EXISTING GRADE.

## ROAD MUST COMPLY WITH THESE FIRE DEPARTMENT REQUIREMENTS:

- WIDTH OF FIRE DEPARTMENT ACCESS ROAD (S): NFPA 1, 18.2.3.4.1.1 FIRE DEPARTMENT ACCESS ROADS SHALL
  HAVE AN UNOBSTRUCTED WIDTH OF NOT LESS THAN 20FT (6.1M) /CAPT GROFF ONE DIRECTION 15FT WIDTH.
  VERTICAL CLEARANCE: NFPA 1, 18.2.3.4.1.2 FIRE DEPARTMENT ACCESS ROADS SHALL HAVE AN UNOBSTRUCTED
  VERTICAL CLEARANCE OF NOT LESS THAN 13FT 6 IN. (4.1M).
- DRIVING SURFACE: NFPA 1, 18.2.3.4.2 SURFACE. FIRE DEPARTMENT ACCESS ROADS SHALL BE DESIGNED AND MAINTAINED TO SUPPORT THE IMPOSED LOADS OF FIRE APPARATUS AND SHALL BE PROVIDED WITH AN ALL-WEATHER DRIVING SURFACE.(JFRD APPARATUS HEAVIEST WEIGHT IS 42.5 TONS).








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A&E PROJECT #:	NXFL-342
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CHECKED BY:	BAA

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NEXTOWER SITE NAME:

COASTAL RIDGE NXFL-342

TOWER OWNE

**NEXTOWER** 

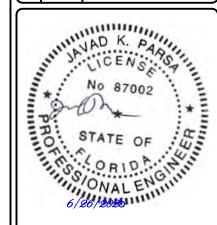DESIGN TYP


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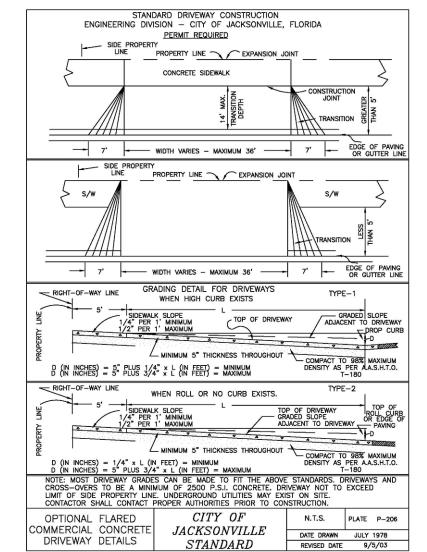
SHEET TITLE

ACCESS ROAD DETAILS

DRAWING NO

C4



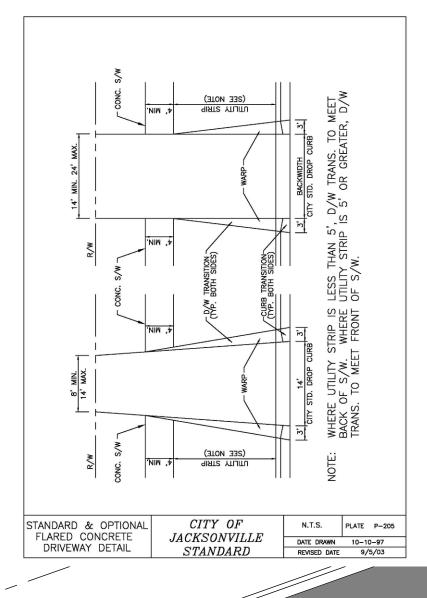

SIW

EXISTING LIGHT POLE

**DRIVEWAY DETAIL** 

NOT TO SCALE








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WER OWNER:

**NEXTOWER** 

DESIGN TYP


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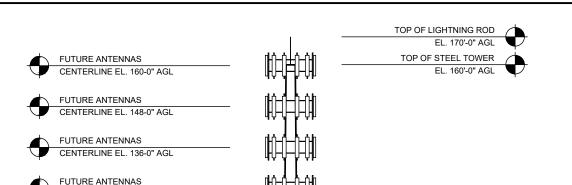
SHEET TITLE

DRIVEWAY DETAILS

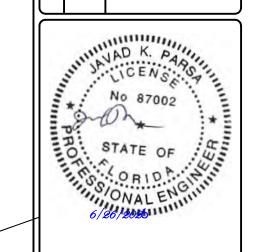DRAWING NO

C4A



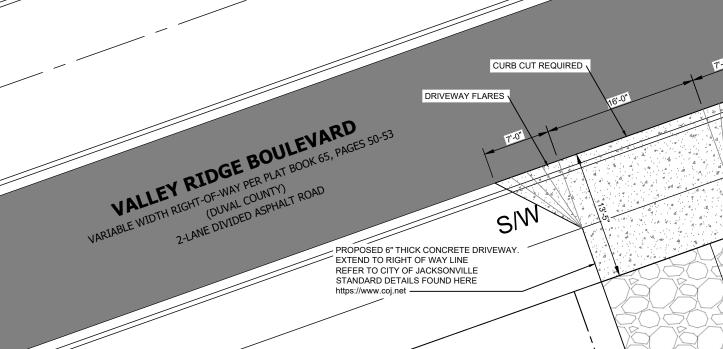



1" BORDER - 3" RADII COLOR: BACKGROUND/ WHITE LEGEND AND BORDER/ BLACK

ALL LETTERS 1 1/2" SERIES C PER FDOT INDEX NUMBER 17355

1" SPACING BETWEEN LINES OF TEXT

## NOTE:

CONTRACTOR TO COORDINATE SITE SIGNAGE WITH NEXTOWER CM. NEXTOWER TO PROVIDE RF AND IDENTIFICATION SIGNS AT TIME OF CONSTRUCTION.



# TELECOMMUNICATIONS SIGN DETAIL

/ NOT TO SCALE




PROPOSED FENCE

CENTERLINE EL. 124-0" AGL

FINISHED FLOOR ELEVATION MIN. 6' ABOVE FINAL GRADE

## NOTE:

ELEVATION DRAWING SHOWN FOR GENERAL REFERENCE ONLY AND NOT USED FOR THE PURPOSE OF CONSTRUCTION. REFER TO TOWER MANUFACTURER DRAWING FOR DETAIL & SPECIFICATIONS.

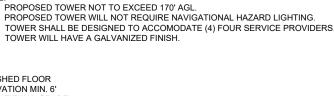

PREPARED FOR:

VOUR SIGNAL IS OUR EXPERIENCE

13677 NW 2ND LANE, SUITE 20

NEWBERRY, FL 32669

A&E FIRM:




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COASTAL RIDGE NXFL-342

TOWER OWN

**NEXTOWER** 

DESIGN TYP

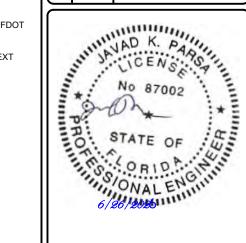
RAWLAND

SHEET TITLE

**TOWER ELEVATION** 

DRAWING NO

C5

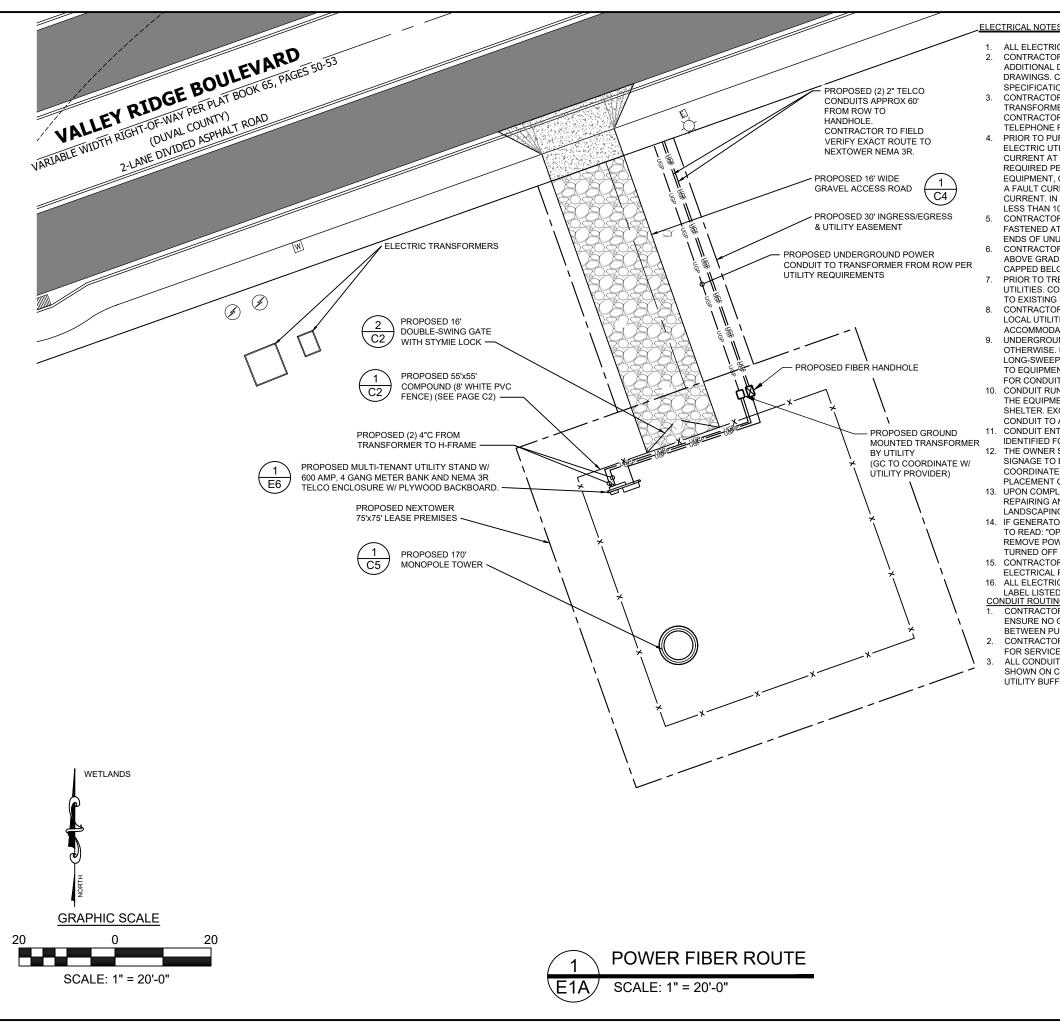

## ELECTRICAL NOTES AND SPECIFICATIONS:

- . ALL ELECTRICAL WORK SHALL COMPLY WITH NEC, STATE, AND LOCAL CODES.
- CONTRACTOR SHALL OBTAIN OWNER/TENANT SPECIFICATIONS AND REVIEW FOR ADDITIONAL DETAILS AND REQUIREMENTS THAT MAY NOT BE SHOWN IN THESE DRAWINGS. CONTRACTOR SHALL COMPLY WITH ANY ADDITIONAL OWNER/TENANT SPECIFICATIONS AND REQUIREMENTS.
- CONTRACTOR SHALL COORDINATE WITH THE ELECTRICAL UTILITY FOR THE EXACT TRANSFORMER LOCATION, METERING REQUIREMENTS, AND SERVICE ROUTING. CONTRACTOR SHALL COORDINATE WITH THE TELEPHONE UTILITY FOR THE EXACT TELEPHONE REQUIREMENTS AND SERVICE ROUTING.
- PRIOR TO PURCHASING EQUIPMENT, THE CONTRACTOR SHALL CONTACT THE ELECTRIC UTILITY AND OBTAIN IN WRITING THE MAXIMUM AVAILABLE FAULT CURRENT AT THE UTILITY SERVICE POINT. PROVIDE MAX AFC SIGNAGE AS REQUIRED PER NEC 110.24. THE CONTRACTOR SHALL ENSURE ALL ELECTRICAL EQUIPMENT, CIRCUIT BREAKERS, DISCONNECTS, FUSES, AND PANEL BOARDS HAVE A FAULT CURRENT INTERRUPTING RATING GREATER THAN THE AVAILABLE FAULT CURRENT. IN NO CASE SHALL THE FAULT CURRENT INTERRUPTING RATING BE LESS THAN 10.000 AMPS.
- CONTRACTOR TO PROVIDE 2-200 LB TEST POLYETHYLENE PULL CORDS SECURELY FASTENED AT EACH END OF POWER AND TELCO CONDUIT. PROVIDE CAPS ON ENDS OF UNUSED CONDUIT.
- CONTRACTOR TO PROVIDE A REBAR MARKER WITH AT LEAST 2 FEET EXPOSED ABOVE GRADE AND PAINTED BRIGHT ORANGE TO INDICATE LOCATION OF CONDUIT CAPPED BELOW GRADE.
- PRIOR TO TRENCHING, CONTRACTOR SHALL LOCATE ALL EXISTING UNDERGROUND UTILITIES. CONTRACTOR SHALL REPAIR AT CONTRACTOR'S EXPENSE ANY DAMAGE TO EXISTING UTILITIES.
- B. CONTRACTOR TO VERIFY EXACT ROUTING OF POWER AND TELCO CONDUIT WITH LOCAL UTILITIES AND OWENR/TENANT. ENSURE ALL CONDUIT STUB-UPS ACCOMMODATE EQUIPMENT REQUIREMENTS.
- UNDERGROUND CONDUITS SHALL BE SCHEDULE 40 PVC UNLESS NOTED
  OTHERWISE. USE RIGID GALVANIZED STEEL CONDUIT UNDER ROADS. USE
  LONG-SWEEP RIGID GALVANIZED STEEL (RGS) FOR ELBOWS. USE RGS FOR RISERS
  TO EQUIPMENT. MANUFACTURED BENDS SHALL HAVE A MINIMUM RADIUS OF 24"
  FOR CONDUIT.
- 10. CONDUIT RUNS SHALL HAVE A CONTINUOUS SLOPE DOWNWARD AND AWAY FROM THE EQUIPMENT TO ALLOW WATER TO FLOW AWAY FROM THE EQUIPMENT AND SHELTER. EXCAVATE TRENCHES ALONG STRAIGHT LINES PRIOR TO INSTALLING CONDUIT TO ACCOMMODATE ADJUSTING THE ELEVATION, AS NEEDED.
- 11. CONDUIT ENTERING EQUIPMENT SHALL BE SEALED WITH A SEALANT THAT IS IDENTIFIED FOR USE WITH THE CABLE. CONDUCTOR INSULATION, SHIELDING, ETC.
- 12. THE OWNER SHALL FURNISH AND THE CONTRACTOR SHALL INSTALL ADDITIONAL SIGNAGE TO BE LOCATED AT THE COMPOUND FENCE. CONTRACTOR SHALL COORDINATE WITH OWNER/TENANT NEXTOWER CONSTRUCTION MANAGER FOR PLACEMENT OF SIGNAGE.
- UPON COMPLETION OF CONSTRUCTION, CONTRACTOR IS RESPONSIBLE FOR REPAIRING ANY DAMAGE CAUSED BY CONSTRUCTION ACTIVITIES TO THE LANDSCAPING AREA.
- 14. IF GENERATOR/FUEL CELL IS INSTALLED, CONTRACTOR SHALL PROVIDE A LABEL TO READ: "OPENING THE DISCONNECT WILL CAUSE THE GENERATOR TO START. TO REMOVE POWER ENTIRELY FROM THE EQUIPMENT, THE GENERATOR MUST BE TURNED OFF AND THE GENERATOR BREAKER MUST BE OPENED."
- 15. CONTRACTORS SHALL ENSURE A MINIMUM 3' CLEARANCE IN FRONT OF ELECTRICAL PANELS PER NEC.
- 16. ALL ELECTRICAL MATERIALS, DEVISES, APPLIANCES AND EQUIPMENT SHALL BE LABEL LISTED BY AN APPROVED THIRD PARTY TESTING AGENCY. CONDUIT ROUTING NOTE:
- CONTRACTOR TO PROVIDE PULL BOXES AS NEEDED TO ENSURE NO GREATER THAN 360 DEGREES OF BENDS BETWEEN PULL POINTS IN CONDUIT RUNS
- 2. CONTRACTOR COORDINATE WITH LOCAL UTILITY COMPANY FOR SERVICE TO THIS POINT.
- ALL CONDUIT TO BE RUN WITHIN 2' UTILITY BUFFER AS SHOWN ON CIVIL PLANS. CONDUIT SHOWN OUTSIDE OF 2' UTILITY BUFFER FOR CLARITY PURPOSES ONLY.





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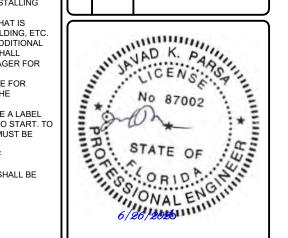
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NEXTOWER SITE NAME:

COASTAL RIDGE NXFL-342

WER OWNER

**NEXTOWER** 


DESIGN TYPE

**RAWLAND** 

SHEET TITLE

POWER FIBER ROUTE

DRAWING NO

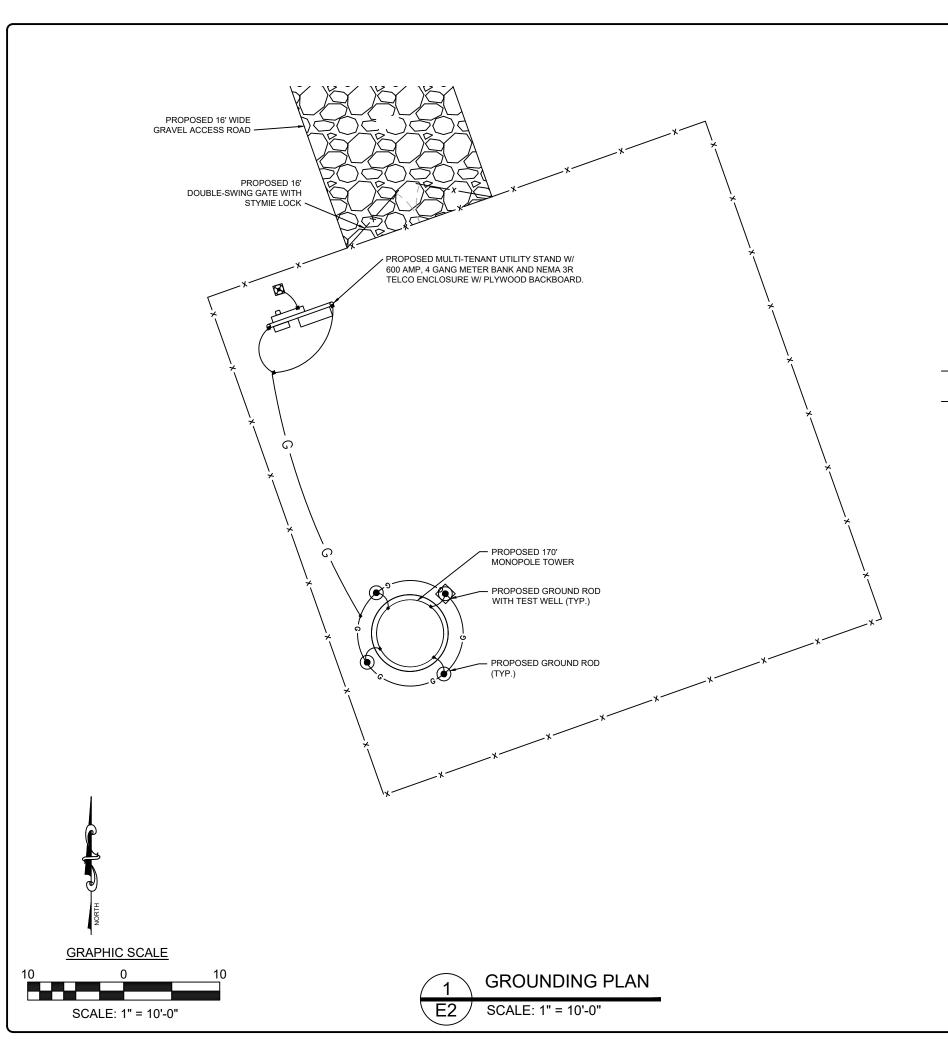

## **GROUNDING NOTES AND SPECIFICATIONS:**

- THE GROUND RING SHALL CONSIST OF 2 AWG TINNED SOLID BARE COPPER CONDUCTOR, UNLESS NOTED OTHERWISE, BURIED AT 30" BELOW FINISHED GRADE (OR BELOW FROSTLINE). ALL CONNECTIONS SHALL BE MADE USING AN EXOTHERMIC WELD, UNLESS NOTED OTHERWISE
- 2. GROUND CONDUCTOR BEND RADIUS SHALL NOT BE LESS THAN 12"
- GROUND RODS SHOULD BE SPACED 2X HEIGHT APART AROUND COMPOUND GROUND RING. (EX. 10' ROD SHOULD BE SPACED 20' APART). MINIMUM SPACING BETWEEN GROUND RODS IS 10' UNLESS NOTED OTHERWISE.
- 4. CONTRACTOR SHALL BOND THE TOWER GROUND BAR (TOGB) TO THE GROUND RING USING A 2 AWG TINNED SOLID BARE COPPER CONDUCTOR AND AN EXOTHERMIC WELD.
- CONTRACTOR SHALL BOND THE MAIN GROUND BAR (MGB) & EXTERNAL GROUND BAR (GB2)
  TO THE GROUND RING USING 2 AWG TINNED SOLID BARE COPPER CONDUCTORS AND
  EXOTHERMIC WELDS.
- 6. ALL GROUNDING/BONDING CONDUCTORS LOCATED ABOVE FINISHED GRADE SHALL BE RUN IN 1/2" FLEX CONDUIT
- 7. CONTRACTOR SHALL NOTIFY THE OWNER/TENANT ECO-SITE CONSTRUCTION MANAGER TO INSPECT THE GROUNDING SYSTEM PRIOR TO BACKFILLING.

## LEGEND:

- GROUND ROD EXOTHERMICALLY WELDED TO GROUND RING

G — GROUND RING

ledow

GROUND ROD TEST WELL

EXOTHERMIC WELD TYPE CONNECTION

PA

PARALLEL CADWELD

MECHANICAL CONNECTION

## GROUNDING NOTES:

- TOWER GROUNDING: EXTEND #2 SOLID TINNED CU WIRE FROM EQUIPMENT GROUND RING TO TOWER GROUND RING AND MAKE EXOTHERMIC CONNECTION.
- 2. GROUND ROD: COPPER CLAD STEEL , 5/8"Ø TEN (10) FEET LONG
- 3. <u>ICE BRIDGE SUPPORT POST GROUNDING:</u> EXTEND #2 TINNED CU WIRE FROM BURIED GROUND RING TO ALL ICE BRIDGE SUPPORT POST AND EXOTHERMICALLY WELD.
- FENCE GROUNDING: IF FENCE IS WITHIN 6' OF GROUNDING RING, EXTEND #2 TINNED CU WIRE FROM BURIED GROUND RING TO FENCE CORNER POSTS AND EXOTHERMICALLY WELDED. BOND INTERMEDIATE POST IF REQUIRED TO MAINTAIN 25' MAX. SPACING.
- 5. TOWER GROUNDING BAR: EXTEND #2 TINNED CU WIRE FROM BURIED GROUND RING UP TO THE TOWER GROUND BAR AND MAKE A MECHANICAL CONNECTION SECURE GROUND BAR DIRECTLY TO TOWER WITH ISOLATOR KIT USING STAINLESS STEEL MOUNTING MATERIAL.
- 6. <u>CABINET GROUNDING:</u> BOND EACH CABINET TO EQUIPMENT GROUND RING WITH A MECHANICAL CONNECTION AT CABINET AND EXOTHERMIC WELD AT GROUND RING.
- 7. MULTI TENANT UTILITY FRAME:BOND TELCO BOX AND FRAME POST TO COMPOUND GROUND RING WITH MECHANICAL CONNECTION AT CABINET AND EXOTHERMIC WELD AT GROUND RING. BOND METER TO ISOLATED GROUND ROD.
- 8. ANTENNA GROUND BAR: MOUNT GROUND BAR DIRECTLY TO THE TOWER AT TOP OF COAX RUNS. SECURE TO TOWER WITH ISOLATOR KIT USING STAINLESS STEEL MOUNTING MATERIAL.
- 9.  $\frac{\text{FENCE/GATE:BOND ALL FENCEPOSTS AND GATES TO COMPOUND GROUND RING WITH EXOTHERMIC WELDS.}$
- 10. EXTERIOR GFCI RECEPTACLE GROUNDING: EXTEND #2 TINNED CU WIRE FROM BURIED GROUND RING TO THE EXTERIOR GFCI RECEPTACLE AND MAKE A MECHANICAL CONNECTION.
- 11. SSC AND FLEXI STAND, SHALL BE MECHANICALLY LUGGED WITH EXOTHERMIC WELD TO THE GROUND RING (OR MECHANICALLY LUGGED TO A BUS BAR PLACED BETWEEN THEM ON THE PAD, WHICH IS THEN WELDED TO THE GROUND RING. UTILITY H-FRAME POSTS AND ICEBRIDGE SHALL BE WELDED.



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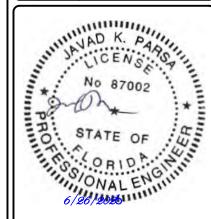


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NEXTOWER SITE NAME:

COASTAL RIDGE NXFL-342

OWER OWNER:

NEXTOWER

DESIGN TYPE

RAWLAND

SHEET TITLE:

GROUNDING PLAN

DRAWING NO

## CONTRACTOR INSTALLATION NOTES

- SCOPE
- PROVIDE LABOR, EQUIPMENT, MATERIALS, ETC., REQUIRED TO COMPLETE THE INSTALLATION SHOWN.
- CODES AND STANDARDS: INSTALLATION SHALL COMPLY WITH APPLICABLE LAWS AND ORDINANCES, UTILITY COMPANY REGULATIONS,
- & APPLICABLE REQUIREMENTS OF LATEST EDITIONS OF CODES LIST ON GN-1.
  - OBTAIN & PAY FOR REQUIRED PERMITS, LICENSES, FEES, INSPECTIONS, ETC..
- COORDINATION:
- COORDINATE ELECTRICAL WORK WITH OTHER TRADES.
- SUBMITTALS:
- SUBMIT BROCHURES FOR APPROVAL ON DISCONNECT SWITCH & OTHER MAJOR SYSTEM COMPONENTS.
- DO NOT INTERRUPT EXISTING SERVICES WITHOUT WRITTEN PERMISSION OF THE OWNER
- EQUIPMENT: CONNECT ELECTRICALLY OPERATED EQUIPMENT.
- RECORD DRAWINGS:

MAINTAIN A RECORD OF ALL CHANGES, SUBSTITUTIONS BETWEEN WORK AS SPECIFIED AND INSTALLED. RECORD CHANGES ON A CLEAN SET OF CONTRACT DOCUMENTS WHICH SHALL BE TURNED OVER TO THE OWNER UPON COMPLETION OF THE PROJECT.

- IDENTIFY DISCONNECT SWITCH WITH PERMANENT ENGRAVED NAMEPLATE.
- 10. GUARANTEE/WARRANTY:

GUARANTEE INSTALLATION TO BE FREE OF DEFECTS, SHORTS, GROUNDS. ETC., FOR A PERIOD OF ONE YEAR. FURNISH WARRANTY SO THE DEFECTIVE MATERIALS AND/OR WORKMANSHIP WILL BE REPAIRED/REPLACED. IMMEDIATELY UPON NOTIFICATION AT NO COST TO THE OWNER FOR PERIOD OF WARRANTY.


- **CUTTING & PATCHING:**
- PROVIDE CUTTING REQUIRED TO DO THE WORK. DO NOT CUT STRUCTURAL ELEMENTS WITHOUT APPROVAL. PATCHING SHALL BE OF QUALITY EQUAL TO & OF MATCHING APPEARANCE OF EXISTING CONSTRUCTION.
- 12. TRENCHING & BACKFILL:
- PROVIDE FOR ALL UNDERGROUND INSTALLED CONDUIT AND/OR CABLES.

UNDERGROUND CONDUIT SHALL BE SCHEDULE 40 PVC CONDUIT (MEETING NEMA TC2-1990). UNDERGROUND PVC CONDUIT SHALL TRANSITION TO RIGID GALVANIZED STEEL CONDUIT BEFORE RISING ABOVE GRADE OR WHEN SUBJECTED TO VEHICLE TRAFFIC LOADS. ALL CONDUIT BENDS SHALL BE A MINIMUM OF 24" RADIUS. EXPOSED CONDUIT SHALL BE RIGID GALVANIZED STEEL. RGS CONDUIT, WHEN SPECIFIED, SHALL MEET UL-6 FOR GALVANIZED STEEL. ALL FITTINGS SHALL BE SUITABLE FOR USE WITH THREADED RIGID CONDUIT.

- INTERIOR CONDUIT SHALL BE ELECTRICAL METALLIC TUBING WITH COMPRESSION TYPE FITTINGS.
- 14 SUPPORTS:
- AS REQUIRED BY THE NEC.
- 15 CONDUCTORS:

USE 98% CONDUCTIVITY COPPER WITH TYPE THHN/THWN INSULATION, 600 VOLT, COLOR CODED. USE SOLID CONDUCTORS FOR WIRE UP TO #8 AWG. USE STRANDED CONDUCTORS FOR WIRE #8 AWG AND ABOVE.

- 16. CONNECTORS FOR POWER CONDUCTORS:
- USE PRESSURE TYPE INSULATED TWIST CONNECTORS FOR #10 AWG AND SMALLER. USE SOLDERLESS MECHANICAL TERMINAL LUGS FOR #8 AWG AND LARGER.
- 17. GROUNDING
- A. ALL MATERIALS SHALL BE INSTALLED PER MANUFACTURER'S RECOMMENDATIONS & INSTRUCTIONS.
- B. ALL CONNECTIONS SHALL BE 2- HOLE LUG UNLESS UNDERGROUND.
- C. LUGS SHALL BE ATTACHED TO GROUND BARS USING STAINLESS STEEL OR HOT-DIPPED GALVANIZED STEEL BOLTS, NUTS, & LOCKWASHERS.
- D. PROVIDE TESTING OF GROUNDING SYSTEM AS DIRECTED BY CONSTRUCTION MANAGER.

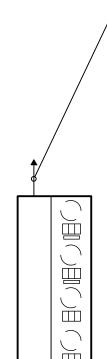

(2) 4"C POWER SERVICE FROM TRANSFORMER TO MULTI TENANT FRAME: COORDINATE W/ LOCAL UTILITY FOR DETAILS

ELECTRICAL CONTRACTOR SHALL SIZE, FURNISH AND INSTALL SECONDARY WIRE BASED ON UTILITY PROVIDERS FINAL DEMARCATION POINT AS REQUIRED TO SUPPLY THE PROPOSED 600 AMP SERVICE. WIRE SIZE SHALL BE IN ACCORDANCE WITH SECTION C405.7.3.1 OF THE FLORIDA ENERGY CONSERVATION CODE SO THAT THE MAXIMUM VOLTAGE DROP IS 2% OR





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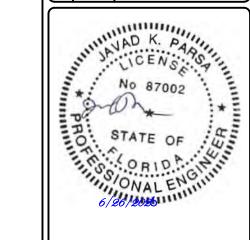


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COASTAL RIDGE NXFL-342

**NEXTOWER** 

**RAWLAND** 

SINGLE-LINE DIAGRAM

DRAWING NO

## **GREENFIELD GROUNDING NOTES:**

- ALL GROUND ELECTRODE SYSTEMS (INCLUDING TELECOMMUNICATION, RADIO, LIGHTNING PROTECTION AND AC POWER GES'S) SHALL BE BONDED TOGETHER AT OR BELOW GRADE, BY TWO OR MORE COPPER BONDING CONDUCTORS IN ACCORDANCE WITH THE NEC.
- THE SUBCONTRACTOR SHALL PERFORM IEEE FALL-OF-POTENTION RESISTANCE TO EARTH TESTING (PER IEEE 1100 ABD 81) FOR GROUNDING ELECTRODE SYSTEMS THE SUBCONTRACTOR SHALL FURNISH AND INSTALL SUPPLEMENTAL GROUND ELECTRODES AS NEEDED TO ACHIEVE A TEST RESULT OF 5 OHMS OR LESS
- THE SUBCONTRACTOR IS RESPONSIBLE FOR PROPERLY SEQUENCING GROUNDING AND UNDERGROUND CONDUIT INSTALLATION AS TO THE PREVENT ANY LOSS OF CONTINUITY IN THE GROUND SYSTEM OR DAMAGE TO THE CONDUIT AND PROVIDE TESTING RESULTS.
- 4. METAL CONDUIT AND TRAY SHALL BE GROUNDED AND MADE ELECTRICALLY CONTINUOUS WIT LISTED BONDING FITTINGS OR BY BONDING ACROSS THE DISCONTINUITY WITH #6 AWG COPPER WIRE UL APPROVED GROUNDING TYPE CONDUIT CLAMPS
- METAL RACEWAY SHALL NOT BE USED AS THE NEC REQUIRED EQUIPMENT GROUND CONDUCTOR. STRANDED COPPER CONDUCTORS WITH GREEN INSULATION, SIZED IN ACCORDANCE WITH THE NEC, SHALL BE FURNISHED AND INSTALLED WITH THE POWER CIRCUITS TO BTS EQUIPMENT.
- EACH BTS CABINET FRAME SHALL BE DIRECTLY CONNECTED TO THE MASTER GROUND BAR WITH GREEN INSULATED SUPPLEMENTAL EQUIPMENT GROUND WIRES, 6 AWG STRANDED COPPER OR LARGER FOR INDOOR BTS; #2 AWG SOLID TINNED COPPER FOR OUTDOOR BTS.
- ALL EXTERIOR GROUND CONDUCTORS BETWEEN EQUIPMENT/GROUND BARS AND THE GROUND RING SHALL BE #2 AWG SOLID TINNED COPPER UNLESS OTHERWISE INDICATED
- 8. ALUMINUM CONDUCTOR OR COPPER CLAD STEEL CONDUCTOR SHALL NOT BE USED FOR GROUNDING CONNECTIONS.
- USE OF 90° BENDS IN THE PROTECTION GROUNDING CONDUCTORS SHALL BE AVOIDED WHEN 45° BENDS CAN BE ADEQUATELY SUPPORTED.
- 10. EXOTHERMIC WELDS SHALL BE USED FOR ALL GROUNDING CONNECTIONS BELOW GRADE.
- ALL GROUND CONNECTIONS ABOVE GRADE (INTERIOR AND EXTERIOR) SHALL BE FORMED USING HIGH PRESS CRIMPS.
- COMPRESSION GROUND CONNECTIONS MAY BE REPLACED BY EXOTHERMIC WELD CONNECTIONS.
- 13. ICE BRIDGE BONDING CONDUCTORS SHALL BE EXOTHERMICALLY BONDED OR BOLTED TO THE BRIDGE AND THE TOWER GROUND BAR.
- APPROVED ANTIOXIDANT COATINGS (IE CONDUCTIVE GEL OR PASTE) SHALL BE USED ON ALL COMPRESSION AND BOLTED GROUND CONNECTIONS.
- 15. ALL EXTERIOR GROUND CONNECTIONS SHALL BE COATED WITH A CORROSION RESISTANT MATERIAL.
- 16. MISCELLANEOUS ELECTRICAL AND NON-ELECTRICAL METAL BOXES, FRAMES AND SUPPORTS SHALL BE BONDED TO THE GROUND RING, IN ACCORDANCE WITH THE NEC.
- 17. BOND ALL METALLIC OBJECTS WITHIN 6 FT. OF MAIN GROUND WIRES WITH 1-#2 AWG TIN-PLATED COPPER GROUND CONDUCTOR.
- 18. GROUND CONDUCTORS USED IN THE FACILITY GROUND AND LIGHTING PROTECTION SYSTEMS SHALL NOT BE ROUTED THROUGH METALLIC OBJECTS THAT FORM A RING AROUND THE CONDUCTOR SUCH AS METALLIC CONDUITS METAL SUPPORT CLIPS OR SLEEVES THROUGH WALLS OR FLOORS, WHEN IT IS REQUIRED TO BE HOUSED IN CONDUIT TO MEET CODE REQUIREMENTS OR LOCAL CONDITIONS, NON-METALLIC MATERIAL SUCH AS PVC PLASTIC CONDUIT SHALL BE USED. WHERE USE OF METAL CONDUIT IS UNAVOIDABLE (EG NON-METALLIC CONDUIT PROHIBITED BY LOCAL CODE) THE GROUND CONDUCTOR SHALL BE BONDED TO EACH END OF THE METAL CONDUIT.

## **GENERAL ELECTRICAL NOTES:**

- ALL ELECTRICAL WORK SHALL BE IN ACCORDANCE WITH THE LATEST VERSION OF THE NATIONAL ELECTRICAL CODE AND ALL LOCAL AND STATE CODES, LAWS, AND ORDINANCES.
- ALL UNDERGROUND CONDUIT SHALL BE PVC SCHEDULE 40 UNLESS OTHERWISE INDICATED. CONDUITS EXPOSED ABOVE GROUND OR ROUTED UNDER GRAVEL ROAD SHALL BE RIGID GALVANIZED STEEL. ALL UNDERGROUND CONDUIT SHALL TRANSITION FROM PVC TO RIGID AT THE 90° BEND BELOW GRADE. SUPPLY UTILITY MARKING TAPE BURIED 12" BELOW GRADE ALONG ENTIRE LENGTH OF UNDERGROUND CONDUITS.

- ALL CONDUCTORS SHALL BE COPPER WITH THHN/THWN INSULATION. CONTROL CONDUCTORS SHALL BE STRANDED. POWER & LIGHTING CONDUCTORS SHALL BE SOLID FOR #10 & #12 CONDUCTORS AND STRANDED FOR ALL OTHER SIZES.
- ELECTRICAL DRAWINGS ARE IN PART DIAGRAMMATIC. COORDINATE ELECTRICAL WORK WITH BUILDING STRUCTURE AND MECHANICAL EQUIPMENT. PROVIDE ADDITIONAL SUPPORTS FOR ELECTRICAL EQUIPMENT WHERE THE BUILDING STRUCTURE IS NOT ADAPTED TO MOUNTING EQUIPMENT THEREON.
- LOCATE ALL UNDERGROUND UTILITIES BEFORE TRENCHING. IF CONFLICTS ARISE, CONTACT UTILITY COMPANY AND ENGINEER IMMEDIATELY.
- PROVIDE 200 LB TEST PULL WIRES IN EACH EMPTY TELEPHONE AND POWER CONDUIT
- 7. COORDINATE ALL CONDUIT STUB-UP LOCATIONS WITH UTILITY COMPANY
- 8. PROVIDE WEATHERPROOF SEALS FOR ALL CONDUIT STUB-UPS. ALL EXPOSED CONDUITS SHALL HAVE WEATHERPROOF CAPS NOT DUCT TAPE.
- CONDUIT TO BE INSTALLED PER NEC REQUIREMENTS. MAX OF (4) 90'S ALLOWED IN SINGLE RUN OF CONDUIT. IF MORE BENDS ARE REQUIRED INSTALL PULL BOX EVERY (4) 90'S, (4) BENDS, OR 150' IN LENGTH
- 10. FIBER CONDUITS: CONDUITS TO BE INSTALLED FROM ROW OF PUBLIC ROAD TO COMPOUND. HAND HOLES TO BE INSTALLED IN ROW, AT COMPOUND AND EVERY 400' BETWEEN (OR AS DIRECTED BY UTILITY OR REQUIRED BY NEC). USE HIGHLINE PHA173030 12,000LB HAND HOLE OR APPROVED EQUIVALENT.
  - 11.1. CONDUIT 1 (, WHEN PROVIDER IS TOWERCLOUD, SOUTHERNLIGHT, COX OR ZAYO):

RUN  $\stackrel{(1)}{}$  4"C WITH  $\stackrel{(3)}{}$  1-1/4" INNER DUCTS WITH PULL STRING FROM HAND HOLE AT ROW OF STREET STRAIGHT TO NEMA BOX ON UTILITY FRAME.

11.2. CONDUIT 2\* (WHEN PROVIDER IS AT&T OR WINDSTREAM):
11.2.1. GREENFIELDS AND COLOS WHERE PROVIDER DOES NOT HAVE
NEMA BOX IN COMPOUND:
RUN (1) 4"C FROM FIBER PROVIDERS HAND HOLE AT ROW TO NEMA
CABINET MOUNTED ON MULTI TENANT FRAME. AND ALSO FROM MULTI
TENANT NEMA CABINET TO NEMA BOX ON UTILITY FRAME.
(STUB UP CONDUIT IF FIBER PROVIDER IS NOT YET AT ROW)
11.2.2. COLOS WHERE PROVIDER HAS EXISTING MULTI TENANT NEMA BOX
IN COMPOUND: ONLY RUN (1) 4" C FROM EXISTING MULTI TENANT NEMA
TO NEMA BOX ON UTILITY FRAME.

\*CONSULT CM FOR CORRECT FIBER PROVIDER OPTION.
\*CONTRACTOR RESPONSIBLE FOR ENSURING EASEMENT IS CORRECTLY MARKED IN FIELD BEFORE INSTALLING FIBER.

## **GENERAL GROUNDING NOTES:**

- 1. TO ENSURE PROPER BONDING, ALL CONNECTIONS SHALL BE AS FOLLOWS:
- 1.1. #2 TINNED SOLID COPPER WIRE: EXOTHERMICALLY WELDED TO RODS OR GROUND RING
- 1.2. LUGS AND BUS BAR (UNLESS NOTED OTHERWISE): SANDED CLEAN, COATED WITH OXIDE INHIBITOR AND BOLTED FOR MAXIMUM SURFACE CONTACT. ALL LUGS SHALL BE COPPER (NO ALUMINUM SHALL BE PERMITTED). PROVIDE LOCK WASHERS FOR ALL MECHANICAL CONNECTIONS FOR GROUND CONDUCTORS. USE STAINLESS STEEL HARDWARE THROUGHOUT.
- 2. ALL GROUNDING CABLE IN CONCRETE OR THROUGH WALLS SHALL BE IN 3/4" PVC CONDUIT. SEAL AROUND CONDUIT THROUGH WALLS. NO METALLIC CONDUIT SHALL BE USED FOR GROUNDING CONDUCTORS.
- 3. GROUND RODS SHOULD BE SPACED 2X HEIGHT APART AROUND COMPOUND GROUND RING. (EX. 10' ROD SHOULD BE SPACED 20' APART).
- 4. CONSTRUCTION PROJECT MANAGER OR REPRESENTATIVE WILL BE PRESENT TO INSPECT EXOTHERMICALLY WELDS AND MEGGER TEST DURING BURIAL. MAXIMUM 5 OHMS RESISTANCE IS REQUIRED. IF COMPOUND GROUND RING AND RODS DON'T MEET REQUIREMENTS THEN CONTINUE GROUND RING DOWN EASEMENT WITH GROUND RODS SPACED AT 2X HEIGHT APART.
- 5. DO NOT INSTALL GROUND RING OUTSIDE OF LEASED AREA.
- MAKE ALL GROUND CONNECTIONS AS SHORT AND DIRECT AS POSSIBLE. AVOID SHARP BENDS. ALL BENDS SHALL BE A MINIMUM 12" RADIUS AND NO GREATER THAN 90 DEGREES.
- 7. ALL EXOTHERMIC WELDS TO BURIED GROUND RING SHALL BE THE PARALLEL TYPE, EXCEPT FOR THE GROUND RODS WHICH SHALL BE THE TEE TYPE.
- 8. BOND DOOR FRAMES, HANDRAILS, UNUSED HATCH PLATES AND MISCELLANEOUS LIFTING EYE/PLATES TO GROUND RING. BOND METAL AWNING TO DOOR FRAME.
- 9. BOND SERVICE CONDUITS TO GROUND RING AS THEY CROSS. DO NOT EXOTHERMICALLY WELD TO CONDUITS.
- 10. ALL BUS BAR SHALL BE GALVANIZED. ALL CONNECTIONS TO BUS BAR ARE TO BE 2 HOLE LUGS.

## **ELECTRICAL INSTALLATION NOTES:**

- ALL ELECTRICAL WORK SHALL BE PERFORMED IN ACCORDANCE WITH THE PROJECT SPECIFICATIONS, NEC AND ALL APPLICABLE LOCAL CODES.
- CONDUIT ROUTINGS ARE SCHEMATIC SUBCONTRACTOR SHALL INSTALL CONDUITS SO THAT ACCESS TO EQUIPMENT IS NOT BLOCKED.
- WIRING, RACEWAY AND SUPPORT METHODS AND MATERIALS SHALL COMPLY WITH THE REQUIREMENTS OF THE NEC.
- 4. ALL CIRCUITS SHALL BE SEGREGATED AND MAINTAIN MINIMUM CABLE SEPARATION AS REQUIRED BY THE NEC.
- 5. CABLE SHALL NOT BE ROUTED THROUGH LADDER-STYLE CABLE TRAY RUNGS.
- EACH END OF EVERY POWER, POWER PHASE CONDUCTOR (I.E., HOTS), GROUNDING AND T1 CONDUCTOR AND CABLE SHALL BE LABELED WITH COLOR-CODED INSULATION OR ELECTRICAL TAPE (3M BRAND, 1/2" PLASTIC ELECTRICAL TAPE WITH UV PROTECTION, OR EQUAL). THE IDENTIFICATION METHOD SHALL CONFORM WITH NEC AND OSHA.
- ALL ELECTRICAL COMPONENTS SHALL BE CLEARLY LABELED WITH PLASTIC TAPE PER COLOR SCHEDULE ALL EQUIPMENT SHALL BE LABELED WITH THEIR VOLTAGE RATING, PHASE CONFIGURATION, WIRE CONFIGURATION, POWER OR CAPACITY RATING AND BRANCH CIRCUIT ID NUMBERS (IE PANEL BOARD AND CIRCUIT ID'S)
- PANEL BOARDS (ID NUMBERS ) AND INTERNAL CIRCUIT BREAKERS (CIRCUIT ID NUMBERS) SHALL BE CLEARLY LABELED WITH PLASTIC LABELS.
- ALL TIE WRAPS SHALL BE CUT FLUSH WITH APPROVED CUTTING TOOL TO REMOVE SHARP EDGES.
- 10. POWER, CONTROL AND EQUIPMENT GROUND WIRING IN TUBING OR CONDUIT SHALL BE SINGLE CONDUCTOR (#14 AWG OR LARGER), 600 V, OIL RESISTANT THHN OR THWN-2 CLASS B STRANDED COPPER CABLE RATED FOR 90° C (WET & DRY) OPERATION LISTED OR LABELED FOR THE LOCATION AND RACEWAY SYSTEM USED UNLESS OTHERWISE SPECIFIED.
- 11. SUPPLEMENTAL EQUIPMENT GROUND WIRING LOCATED INDOORS SHALL BE SINGLE CONDUCTOR (#6 AWG OR LARGER), 600V, OIL RESISTANT THHN OR THWN-2, CLASS B STRANDED COPPER CABLE RATED FOR 90° C (WET AND DRY) OPERATION LISTED OR LABELED FOR THE LOCATION AND RACEWAY SYSTEM USED UNLESS OTHERWISE SPECIFIED.
- 12. POWER AND CONTROL WIRING, NOT IN TUBING OR CONDUIT, SHALL BE MULTI-CONDUCTOR, TYPE TC CABLE (#14 AWG OR LARGER), 600 V, OIL RESISTANT THHN OR THWN-2, CLASS B STRANDED COPPER CABLE RATED FOR 90°C (WET AND DRY) OPERATION WITH OUTER JACKET LISTED OR LABELED FOR THE LOCATION USED UNLESS OTHERWISE SPECIFIED.
- 13. ALL POWER AND GROUNDING CONNECTIONS SHALL BE CRIMP-STYLE, COMPRESSION WIRE LUGS AND WIRE NUTS BY THOMAS AND BETTS (OR EQUAL). LUGS AND WIRE NUTS SHALL BE RATED FOR OPERATION AT NO LESS THAN 75° C 190° C IF AVAILABLE).
- 14. RACEWAY AND CABLE TRAY SHALL BE LISTED OR LABELED FOR ELECTRICAL USE IN ACCORDANCE WITH NEMA, UL, ANSI/IEEE AND NEC.
- ELECTRICAL METALLIC TUBING (EMT) OR RIGID NONMETALLIC CONDUIT (IE RIGID PVC SCHEDULE 40 OR RIGID PVC SCHEDULE 80 FOR LOCATION SUBJECT TO PHYSICAL DAMAGE SHALL BE USED FOR EXPOSED INDOOR LOCATIONS.
- ELECTRICAL METALLIC TUBING (EMT), ELECTRICAL NONMETALLIC TUBING (ENT)
  OR RIGID NONMETALLIC CONDUIT (RIGID PVC, SCHEDULE 40) SHALL BE USED
  FOR CONCEALED INDOOR LOCATIONS.
- 17. GALVANIZED STEEL INTERMEDIATE METALLIC CONDUIT (IMC) SHALL BE USED FOR OUTDOOR LOCATIONS ABOVE GRADE.
- 18. RIGID NONMETALLIC CONDUIT (IE RIGID PVC SCHEDULE 40 OR RIGID PVC SCHEDULE 80) SHALL BE USED UNDERGROUND; DIRECT BURIED, IN AREAS OF OCCASIONAL LIGHT VEHICLE TRAFFIC OR ENCASED IN REINFORCED CONCRETE IN AREAS OF HEAVY VEHICLE TRAFFIC.
- LIQUID-TIGHT FLEXIBLE METALLIC CONDUIT (LIQUID-TITE FLEX) SHALL BE USED INDOORS AND OUTDOORS WHERE VIBRATION OCCURS OR FLEXIBILITY IS NEEDED.
- CONDUIT AND TUBING FITTINGS SHALL BE THREADED OR COMPRESSION-TYPE AND APPROVED FOR THE LOCATION USED. SET SCREW FITTINGS ARE NOT ACCEPTABLE.
- 21. CABINETS, BOXES AND WIRE WAYS SHALL BE LABELED FOR ELECTRICAL USE IN ACCORDANCE WITH NEMA, UL, ANSI/IEEE AND NEC.
- WIREWAYS SHALL BE EPOXY-COATED (GRAY) AND INCLUDE A HINGED COVER, DESIGNED TO SWING OPEN DOWNWARDS; SHALL BE PANDUIT TYPE E (OR EQUAL); AND RATED NEMA 1 (OR BETTER).
- 23. EQUIPMENT CABINETS, TERMÌNAL BOXES, JUNCTION BOXES AND PULL BOXES SHALL BE GALVANIZED OR EPOXY-COATED SHEET STEEL, SHALL MEET OR EXCEED UL 50 AND RATED NEMA 1 (OR BETTER) INDOORS OR NEMA 3R (OR BETTER) OUTDOORS.
- 24. METAL RECEPTACLE SWITCH AND DEVICE BOXED SHALL BE GALVANIZED, EPOXY-COATED OR NOT CORRODING SHALL MEET OR EXCEED UL 514A AND NEMA OS 1; AND RATED NEMA 1 (OR BETTER INDOORS OR WEATHER PROTECTED (WP OR BETTER OUTDOORS.
- 25. NONMETALLIÒ RECEPTACLE, SWITCH AND DEVICE BOXES SHALL MEET OR EXCEED NEMA OS 2; AND RATED NEMA 1 (OR BETTER) INDOORS OR WEATHER PROTECTED (WP OR BETTER) OUTDOORS.
- 26. THE SUBCONTRACTOR SHALL NOTIFY AND OBTAIN NECESSARY AUTHORIZATION FROM THE CONTRACTOR BEFORE COMMENCING WORK ON THE AV POWER DISTRIBUTION PANELS.
- 27. THE SUBCONTRACTOR SHALL PROVIDE NECESSARY TAGGING ON THE BREAKERS, CABLES AND DISTRIBUTION PANELS IN ACCORDANCE WITH THE APPLICABLE CODES AND STANDARDS TO SAFEGUARD AGAINST LIFE AND PROPERTY.
- 28. INSTALL PLASTIC LABEL ON THE METER CENTER IDENTIFYING SPECIFIC CARRIER.
- 29. FLEX CONDUIT RUNS NOT TO EXCEED 36" WITHOUT PRIOR TMO APPROVAL.



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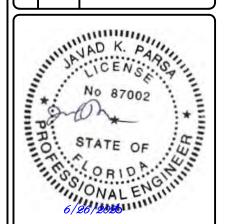
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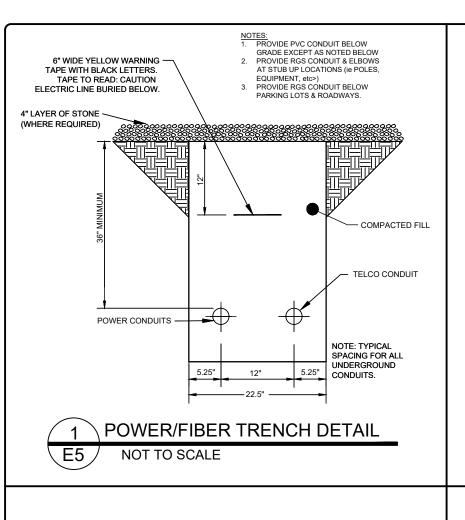
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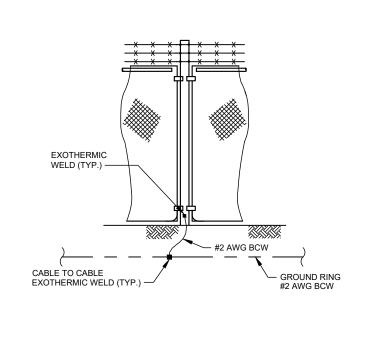
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SHEET TITLE

**ELECTRICAL NOTES** 


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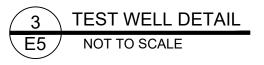





**FENCE GROUNDING** 

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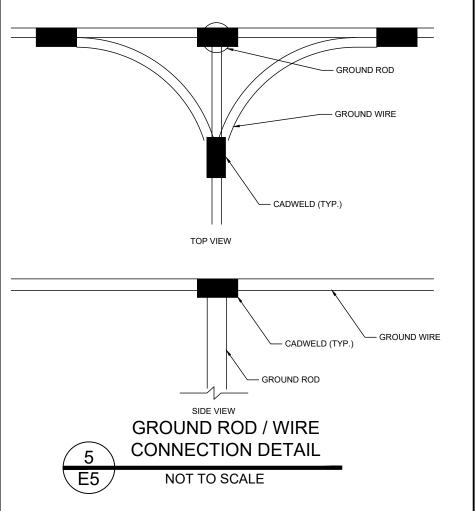





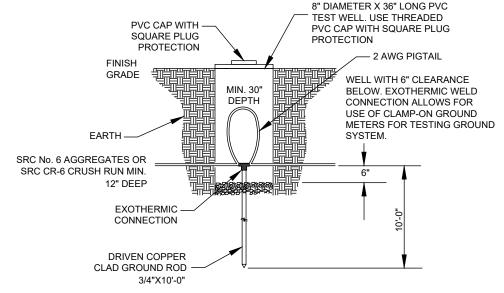

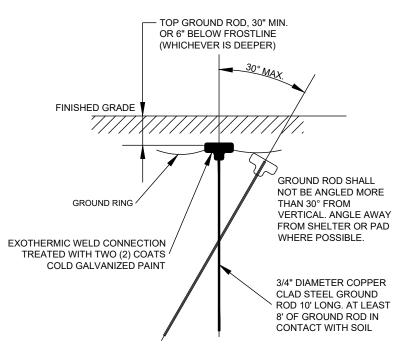
**GROUND ROD DETAIL** 

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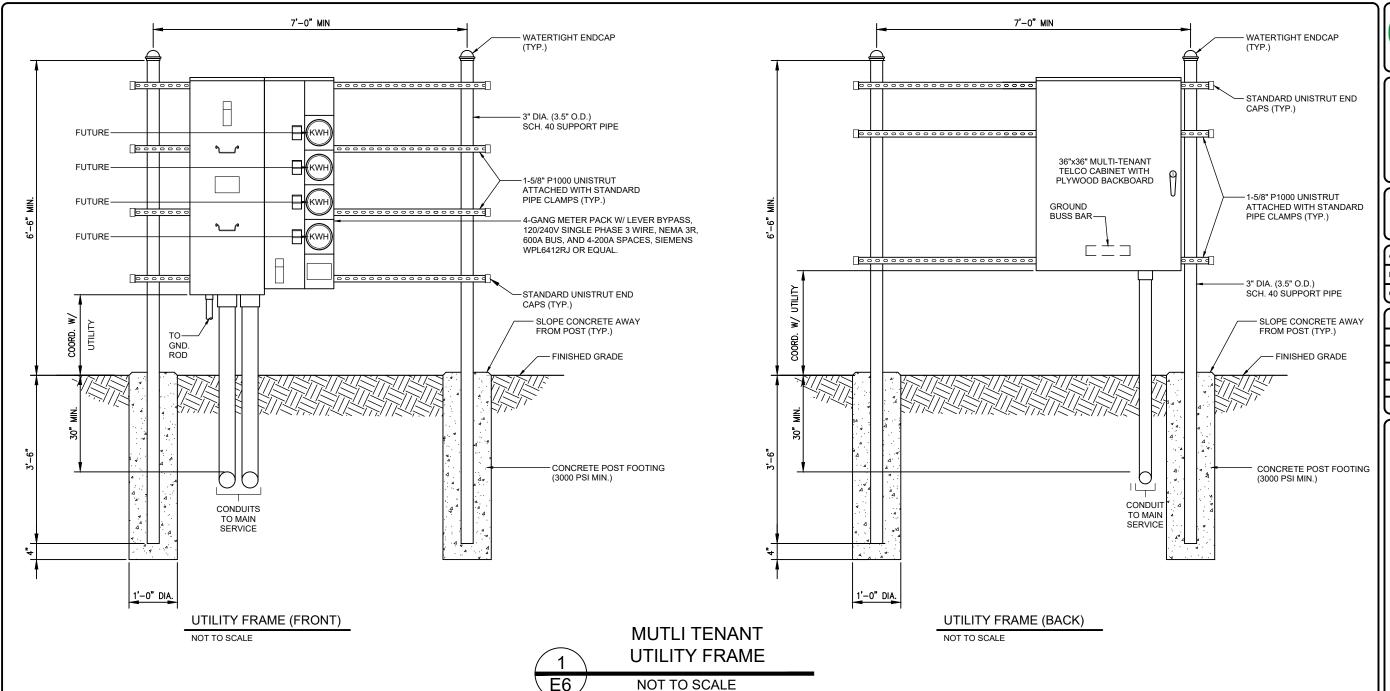
DESIGN TYPE:

RAWLAND

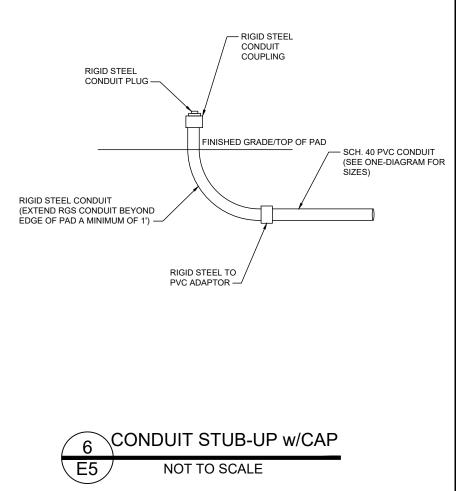SHEET TITLE

**ELECTRICAL DETAILS** 
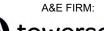
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## NOTES:

- ALL UNDERGROUND CONDUIT SHALL BE PVC SCHEDULE 40 UNLESS OTHERWISE INDICATED. ALL CONDUITS EXPOSED ABOVE GROUND SHALL BE RIGID GALVANIZED STEEL. ALL UNDERGROUND CONDUIT SHALL TRANSITION FROM PVC TO RIGID AT THE 90° BEND BELOW GRADE.
- CONTRACTOR SHALL FIELD LOCATE THE METER PEDESTAL AS SHOWN ON SITE PLAN.
   INSTALL THE METER PEDESTAL NEAR THE PERIMETER OF THE FENCED COMPOUND WITH
   THE METERS FACING AS SHOWN.
- 3. THE CONTRACTOR SHALL COORDINATE WITH THE LOCAL UTILITY COMPANY FOR THE CONDUIT RUN TO THE MAIN SERVICE CONNECTION OR TRANSFORMER.
- THE CONTRACTOR SHALL COORDINATE WITH THE LOCAL UTILITY COMPANY FOR GROUND ROD REQUIREMENTS. IF REQUIRED, THE CONTRACTOR SHALL ORDER AND PAY FOR NECESSARY GROUND TESTS.
- 5. SUPPORT POST AND UNISTRUT SHALL BE GALVANIZED. PIPE CLAMPS AND HARDWARE SHALL BE GALVANIZED OR STAINLESS STEEL.
- TELCO CABINET SHALL BE 36"x48"x10" HOFFMAN OR EQUIVALENT. PROVIDE 3/4" PLYWOOD BACKBOARD INSIDE THE MULTI-TENANT TELCO CABINET.
- ADJUSTMENTS TO THE METER PEDESTAL DESIGN MAY BE REQUIRED DEPENDING ON THE EXACT METER PANEL INSTALLED. CONTRACTOR SHALL FIELD COORDINATE ADJUSTMENTS AND INFORM THE ENGINEER IF ANY UNUSUAL CONDITIONS ARE FOUND TO EXIST



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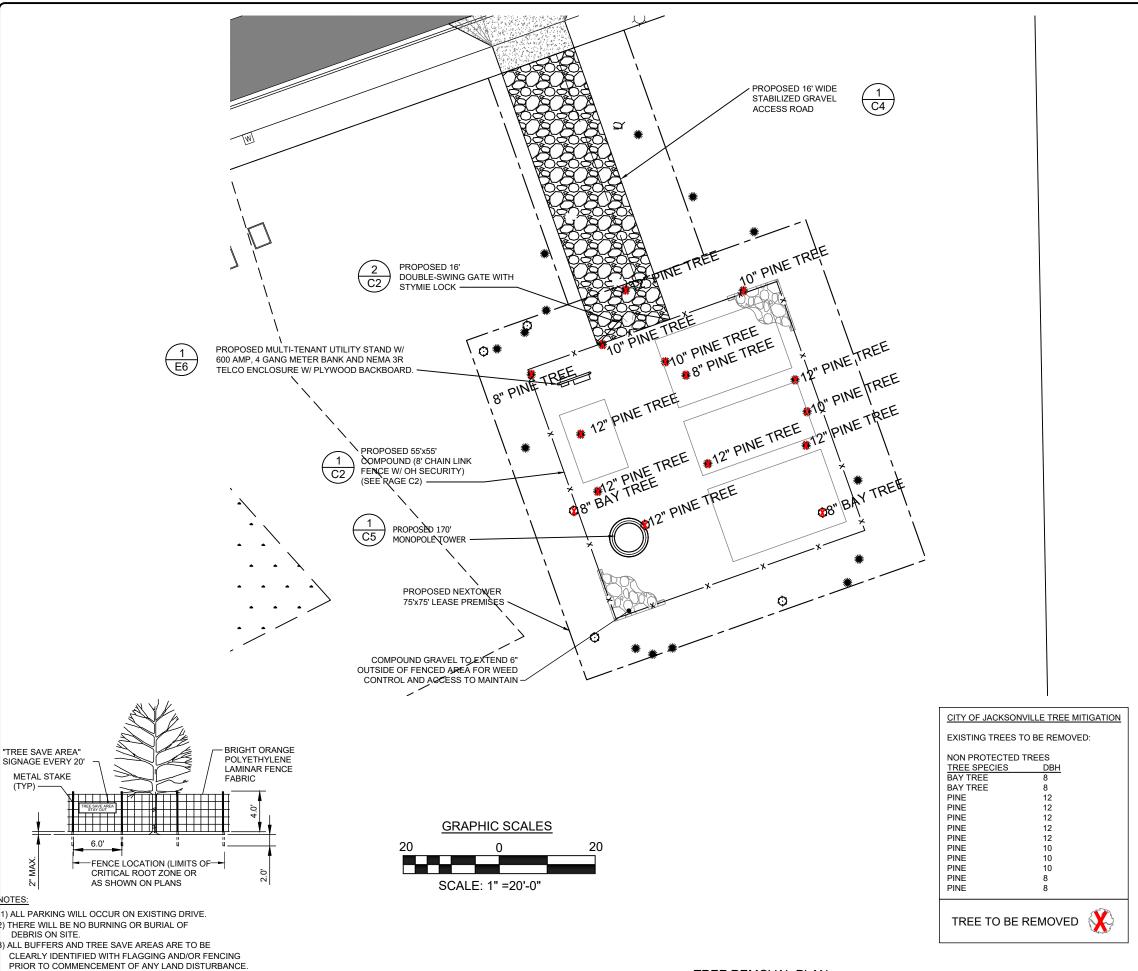
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TREE PROTECTION DETAIL

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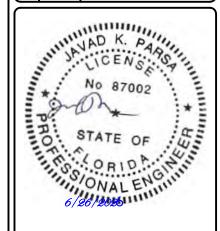
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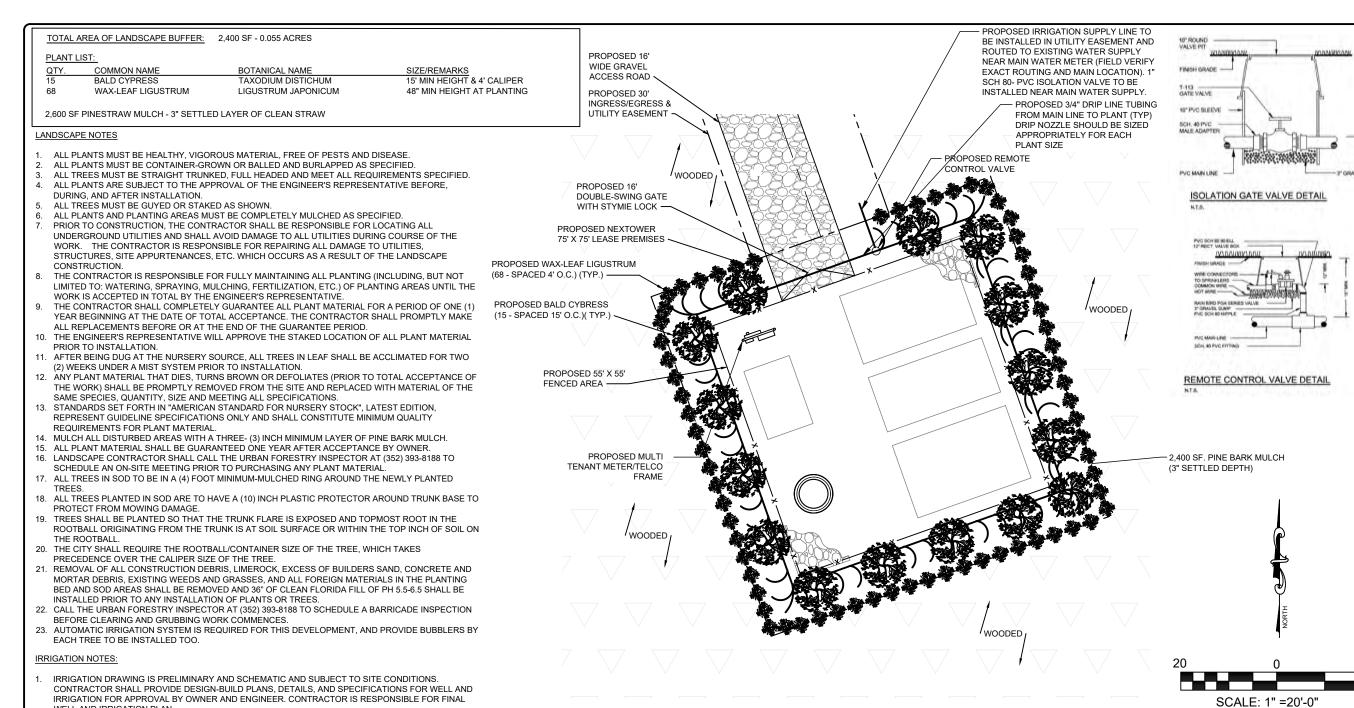
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TREE REMOVAL PLAN

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WELL AND IRRIGATION PLAN

INSTALLATION

DETERMINING LOCATION.

GPM AND ADJUST THE DESIGN ACCORDINGLY.

REGULATORY CODES, WHICHEVER IS MORE STRINGENT.

12. IRRIGATION MAIN LINE SHALL BE MINIMUM 1" SCHEDULE 80 PVC.

13. DRIP LINES SHALL BE MINIMUM 3/4" "BROWN" DRIP LINE TUBING

DESIGN IS BASED ON ASSUMED 10 GPM AT A MINIMUM 60 PSI. CONTRACTOR SHALL VERIFY PSI AND

CONTRACTOR IS RESPONSIBLE TO VERIFY THAT THE PLAN COMPLIES WITH APPLICABLE LOCAL

COUNTY, AND STATE REGULATIONS AND SHALL FOLLOW REGULATIONS DURING INSTALLATION. CONTRACTOR SHALL OBTAIN ALL PERMITS FOR WELL(IF REQUIRED) AND IRRIGATION INSTALLATION.

CONTRACTOR SHALL NOTIFY UTILITY LOCATOR COMPANY AT LEAST 2 BUSINESS DAYS PRIOR TO ALL FOLJIPMENT, INCLUDING BUT NOT LIMITED TO WELL BACKELOW, AND IRRIGATION COMPONENTS

PROPERLY GROUND CONTROLLER TO PROPOSED GROUND RING WITH AWG #6 BARE SOLID COPPER

MANUFACTURER'S RECOMMENDATIONS. COORDINATE WITH OWNER'S REPRESENTATIVE FOR


SHALL BE INSTALLED PER MANUFACTURER'S SPECIFICATIONS OR IN ACCORDANCE WITH

WELL AND EQUIPMENT SHALL BE AS GENERALLY LOCATED AS SHOWN ON THE PLAN. FINAL LOCATIONS OF ALL EQUIPMENT SHALL BE APPROVED BY OWNER'S REPRESENTATIVE PRIOR TO

10. SYSTEM SHALL INCLUDE RAIN SENSOR/RAIN SHUT-OFF DEVICE PER LOCAL CODES AND

LOCATION. CONSIDER EASE OF MAINTENANCE, VANDALISM, AND OBSTRUCTIONS WHEN

. IRRIGATION DESIGN SHALL BE BASED ON DRIP IRRIGATION WITH MAXIJET SYSTEM, UNLESS OTHERWISE APPROVED BY OWNER'S REPRESENTATIVE.

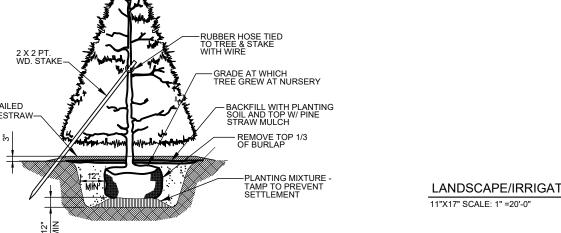

TREE PLANTING DETAIL



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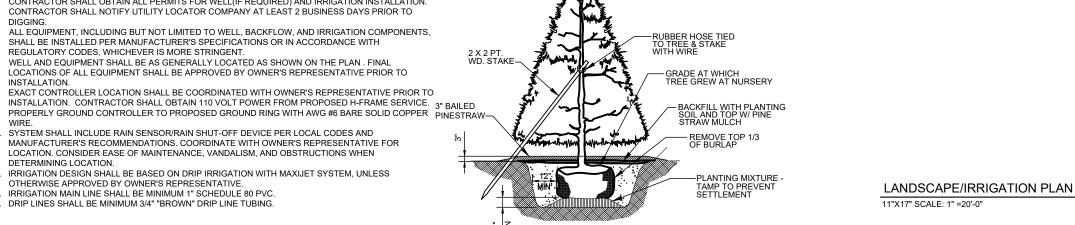
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COASTAL RIDGE NXFL-342

**NEXTOWER** 

RAWLAND

LANDSCAPE DETAILS



## **EXHIBIT F**

## **Land Use Table**

Total gross acreage	<u>0.17</u> Acres	100%
Amount of each different land use by acreage		
Single family	Acres	%
Total number of dwelling units	D.U.	
Multiple family	Acres	%
Total number of dwelling units	D.U.	
Commercial	Acres	%
Industrial	Acres	%
Other land use (cell tower use)	<u>0.17</u> Acres	100 %
Active recreation and/or open space	Acres	%
Passive open space	Acres	%
Public and private right-of-way	Acres	%

The land use estimates in this table are subject to change within the allowable densities and intensities of use, as set forth in the PUD Written Description. The maximum coverage by buildings and structures is subject to the PUD Written Description.



THIS DOCUMENT PREPARED BY AND RETURN TO:

ROBERT A. LEAPLEY, ESQUIRE PAPPAS METCALF JENKS MILLER & REINSCH, P.A. 200 WEST FORSYTH STREET, SUITE 1400 JACKSONVILLE, FLORIDA 32202-4327 

#### **SPECIAL WARRANTY DEED**

THIS SPECIAL WARRANTY DEED is made and executed the 23<sup>rd</sup> day of November, 1999, by **D.D.I., INC.**, a Florida corporation (hereinafter called "Grantor"), to **DDI TRUST I**, a Delaware business trust, whose address is One Rodney Square, 1<sup>st</sup> Floor, 920 King Street, Wilmington, Delaware 19801 (hereinafter called "Grantee").

#### WITNESSETH:

That in consideration of the sum of Ten and No/100 Dollars (\$10.00) and other valuable considerations, the receipt and sufficiency of which are hereby acknowledged, Grantor hereby grants, bargains, sells, conveys and confirms to Grantee, its successors and assigns, all of the real property in Duval County, Florida, more particularly described on Exhibit "A" attached hereto and made a part of this Special Warranty Deed (the "Property"), together with all tenements, hereditaments and appurtenances pertaining to the Property, subject to the restrictions, easements, agreements, reservations and other matters set forth on Exhibit "B" attached hereto and made a part hereof (the "Permitted Exceptions").

#### TO HAVE AND TO HOLD the same in fee simple forever.

Grantor hereby covenants with Grantee that the Property is free from all encumbrances placed on the Property by Grantor (except for the Permitted Exceptions as set forth on Exhibit "B") and that Grantor will warrant and defend Grantee's title against lawful claims of all persons claiming by, through or under Grantor (except claims made pursuant to matters set forth on Exhibit "B") but against none other.



IN WITNESS WHEREOF, Grantor has	set its hand and seal as of the day and year first
above written.	,, , <u>,</u>
Signed, sealed and delivered	"GRANTOR"
in the presence of:	
	D.D.I., INC., a Florida corporation
1 1	
//_///	$\sim 1/\sim 1$
- July -	By: Hay I haves
Print Name: Rober # A. Leapley	Harry D. Francis
	Its Vice President
Mar D. Savery	ns vice i resident
Print Name: ANN D. SAVERY	
	[CORPORATE SEAL]
	[COID OIGHTE SEAL]
	· · ·
STATE OF FLORIDA }	
}SS	Comment
COUNTY OF DUVAL }	
,	
The foregoing instrument was acknowledge	d before me this 232 day of November, 1999, by
Harry D. Francis, as Vice President of D.D.I., I	NC. a Florida cornoration on behalf of the
corporation.	rves, a Florida corporation, on benan of the
1	
	Kan W Ameri
	Print Name: ANN D. SAVERY
Ann D. Savery	NOTARY PUBLIC
MY COMMISSION # CC546473 EXPIRES	State of Florida at Large
April 9, 2000  BONDED THRU TROY FAIN INSURANCE, INC.	Commission #
	My Commission Expires:
	wy Commission Expires.
	Personally Known
	Or Produced I.D.
	[check one of the above]
	[one of the above]
	Type of Identification Produced

EXHIBIT "A"

May 14, 1999 ("Property")

Work Order No. S98-354

Page 1 of 1

#### **Legal Description**

#### **DUVAL COUNTY, FLORIDA**

TRACT "A"

All of Sections 36, 46, and 53 and portions of Sections 25, 34, 35, 47, 48, 49, and 55, Township 4 South, Range 28 East, Duval County, Florida, being more particularly described as follows:

For Point of Beginning, commence at the point of intersection of the Southerly boundary of Section 34, Township 4 South, Range 28 East, with the Northeasterly right of way line of U.S. Highway 1, State Road No. 5, and run North 41°50'26" West along said right of way line, a distance of 925.00 feet to a point; run thence North 76°59'37" East, a distance of 4,715.0 feet to a point; run thence North 00°37'22" West, a distance of 3625.0 feet to a point; run thence North 89°34'10" East, a distance of 1,965.0 feet; run thence North 34°06'08" East, a distance of 3,495.66 feet to a point on the Northerly boundary of Section 49; run thence North 75°13'42" East along the Northerly boundary of Section 49 and 53, the same being Southerly boundary of Section 45 and along the Southerly boundary of Section 52, Township and Range aforementioned, and it's Northeasterly projection, a distance of 6,620.70 feet to a point on the East line of Section 25, said Township and Range, run thence South 00°54'07" East along last said Section line and along the East line of Section 36, a distance of 9,798.05 feet to its point of intersection with the Northwesterly right of way line of Palm Valley Road, County Road No. 210; run thence South 55°21'50" West along said right of way line, a distance of 146.60 feet to a point on the South line of said Section 36; run thence South 89°37'49" West along the South line of Sections 34, 35 and 36, a distance of 14,298.23 feet to the Point of Beginning.

#### **EXHIBIT "B"**

#### [Permitted Exceptions]

- 1. All easements, covenants, restrictions and other matters affecting the Property and recorded in the public records of Duval County, Florida, as of the date hereof, none of which shall be reimposed by this Exhibit "B".
- 2. Lien of taxes for the year 1999 and subsequent years.

page

9494

Book

#### State of Delaware

PAGE

### Office of the Secretary of State

I, EDWARD J. FREEL, SECRETARY OF STATE OF THE STATE OF DELAWARE, DO HEREBY CERTIFY THE ATTACHED IS A TRUE AND CORRECT COPY OF THE CERTIFICATE OF MERGER, WHICH MERGES:

"DDI TRUST I", A DELAWARE BUSINESS TRUST,

WITH AND INTO "SONOC COMPANY, LLC" UNDER THE NAME OF "SONOC COMPANY, LLC", A LIMITED LIABILITY COMPANY ORGANIZED AND EXISTING UNDER THE LAWS OF THE STATE OF DELAWARE, AS RECEIVED AND FILED IN THIS OFFICE THE TWENTY-FOURTH DAY OF NOVEMBER, A.D. 1999, AT 9 O'CLOCK A.M.

AND I DO HEREBY FURTHER CERTIFY THAT THE EFFECTIVE DATE OF THE AFORESAID CERTIFICATE OF MERGER IS THE THIRTIETH DAY OF NOVEMBER, A.D. 1999.

> Doc# 99303632 Book: 9494 Pages: 909 -Filed & Recorded 12/16/99 09:56:56 AM HENRY W COOK CLERK CIRCUIT COURT DUVAL COUNTY TRUST FUND RECORDING 2.00 13.00

Edward J. Freel, Secretary of State

AUTHENTICATION:

0102756

11-24-99 DATE:

3127974 8100M

991504017

Book 9494 Page 910

# CERTIFICATE OF MERGER OF DDI TRUST I, a Delaware business trust INTO SONOC COMPANY, LLC, a Delaware limited liability company

To the Secretary of State State of Delaware

SONOC Company, LLC, a limited liability company ("Surviving LLC") organized under the Delaware Limited Liability Company Act, pursuant to a Plan and Agreement of Merger and for the purpose of merging with a Delaware business trust pursuant to Title 6, Section 18-209 of the Delaware Code and Title 12, Section 3815 of the Delaware Code, hereby certifies that:

1. The name and jurisdiction of organization of each constituent entity are:

#### NAME


#### **JURISDICTION**

DDI Trust I SONOC Company, LLC Delaware Delaware


- 2. A Plan and Agreement of Merger has been approved and executed by each of the Surviving LLC and DDI Trust I (the "Merging Trust"), which are all of the constituent entities.
- 3. The name of the Surviving LLC is SONOC Company, LLC, a Delaware limited liability corporation.
  - 4. The merger shall be effective on November 30, 1999.
- 5. The agreement of merger is on file at the following place of business of the Surviving LLC: 4310 Pablo Oaks Court, Jacksonville, Florida 32224.

or any person holding an interest in the Merging Signed on Market 23. 1999	r will be furnished by the Surviving LLC, on Surviving LLC and to any beneficial owner of Trust.
	SONOC COMPANY, LLC, a Delaware
·	limited liability company
Print or Type Name]  [Print or Type Name]  [Print or Type Name]	By: A. D. Reguer  Name: H. D. Francis  Title: Vice President
STATE OF FLORIDA)	
COUNTY OF DUVAL)ss.	12120 ANIFMREIZ
The foregoing instrument was acknowled 1999, by H. D. Francis, the Vice President of	edged before me this $\frac{33^{12}}{120}$ day of NOVEMBER, of SONOC Company, LLC, a Delaware limited me or has produced
liability company, who is personally known to	The dr. Law passes
as identification.	Vi O Caddald -
OFFICIAL SEAL LON A. Goddard My Commission Expires 4/27/2002	NOTARY PUBLIC, State of Florida Print Name: U21 A. GODDALD
Commission #CC 729887	My Commission Expires: 4 37 3003

# EXHIBIT H Aerial Photograph

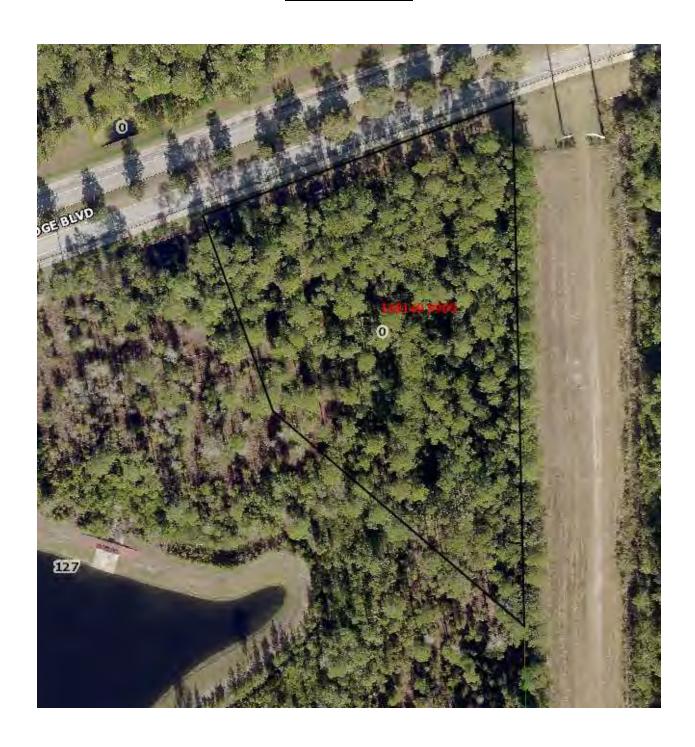

## EXHIBIT K Site Location Map

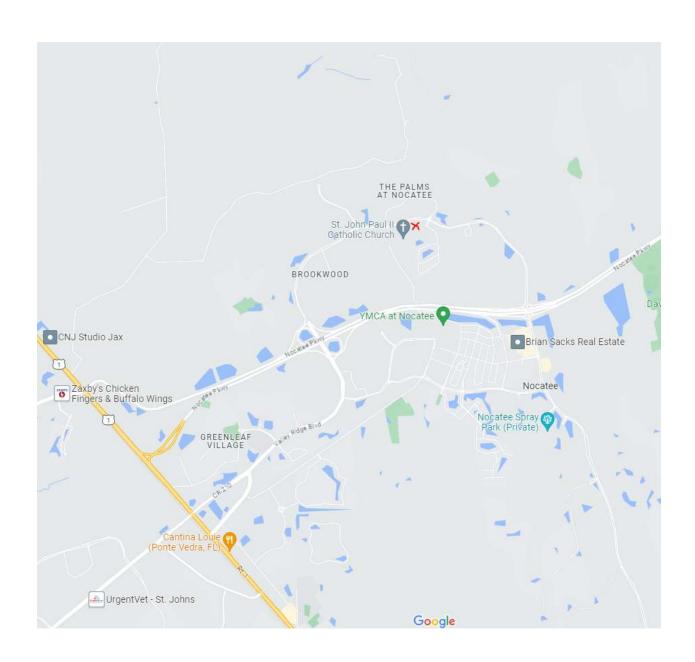



June 8, 2023

Joel Rousseau Nextower 4210 NW 37th Place, Suite 600 Gainesville, FL 32606

RE: Proposed 160' Monopole for Coastal Ridge, FL

Dear Mr. Rousseau,

Upon receipt of order, we propose to design and supply the above referenced Sabre monopole for an Ultimate Wind Speed of 129 mph, Risk Category II, Exposure Category C, and Topographic Category 1, in accordance with the Telecommunications Industry Association Standard ANSI/TIA-222-H, "Structural Standard for Antenna Supporting Structures and Antennas".

When designed according to this standard, the wind pressures and steel strength capacities include several safety factors, resulting in an overall minimum safety factor of 25%. Therefore, it is highly unlikely that the monopole will fail structurally in a wind event where the design wind speed is exceeded within the range of the built-in safety factors.


Should the wind speed increase beyond the capacity of the built-in safety factors, to the point of failure of one or more structural elements, the most likely location of the failure would be within the monopole shaft, above the base plate. Assuming that the wind pressure profile is similar to that used to design the monopole, the monopole will buckle at the location of the highest combined stress ratio within the monopole shaft. This is likely to result in the portion of the monopole above leaning over and remaining in a permanently deformed condition. *Please note that this letter only applies to the above referenced monopole designed and manufactured by Sabre Towers & Poles*. This would effectively result in a fall radius equal to 50' at ground level.

Sincerely,

Robert E. Beacom, P.E., S.E. Engineering Manager

RE	LNAME	LNAME2	MAIL_ADDR1	MAIL_CITY MAIL_STATE MAIL_ZIP	MAIL_STATE	MAIL_ZIP
168149 9850	168149 9850 GALEONE VICTOR BISHOP OF DIOCESE OF ST AUGUSTINE		11625 OLD ST AUGUSTINE RD	JACKSONVILLE FL		32258-2061
168150 2025	168150 2025 PALMS AT NOCATEE HOMEOWNERS ASSOCIATION INC		10175 FORTUNE PKWY SUITE 906 JACKSONVILLE FL	JACKSONVILLE		32256
168149 9900	168149 9900 SONOC COMPANY		4310 PABLO OAKS CT	JACKSONVILLE FL	FL	32224
	SOUTHEAST	JOANNE PARKER GRIFFIN 4222 LALOSA DR	4222 LALOSA DR	JACKSONVILLE FL		32217

## Land Development Review

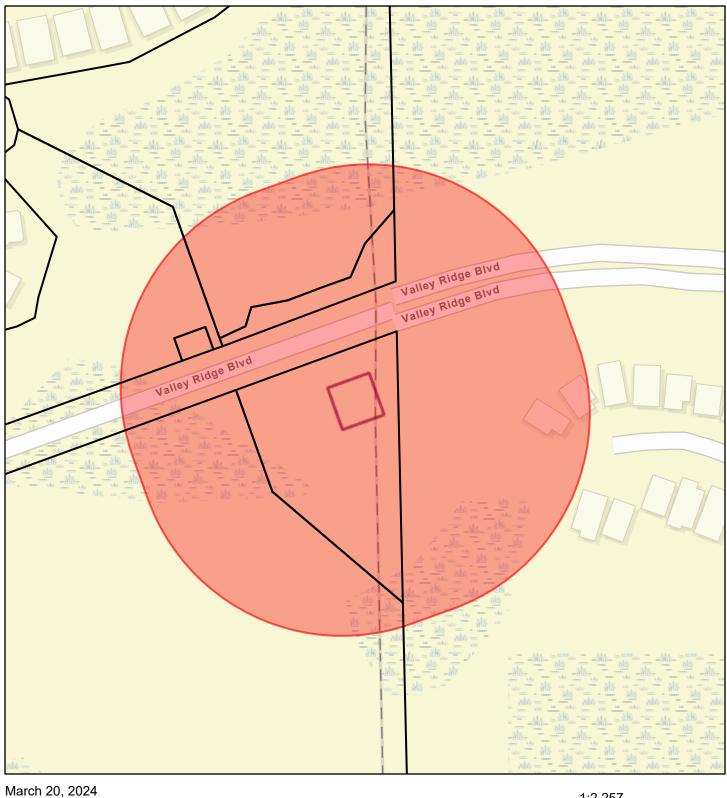

Esri Community Maps Contributors, City of Jacksonville, FDEP, © OpenStreetMap, Microsoft, Esri, TomTom, Garmin, SafeGraph, GeoTechnologies, Inc, METI/NASA, USGS, EPA, NPS, US Census Bureau, USDA, USFWS

#### Jim Overton Duval County

Date Time, 04/19/2024 02/510M Dujwer: P00 Clark: JMB

Praisection, 61540ac.

OR Processing \$2,000.00 CR 7 Year

Driver McAfne Havilliante &#38, Dichenow, PLLC One Independent Privo, Same 1200 Indownwille PL 32202

Lord-

17400

Receipt 272 23 06/12/2462

Table Conference \$ 2,000.00
Check \$2,800.00
Chk#21802
Bulance \$0.00

\$2,500.00

PART BY: FREE PROMOTE FORWASTERN AND DEBENOW, P. L.

#### al County, City Of Jacksonville Jim Overton, Tax Collector

231 E. Forsyth Street Jacksonville, FL 32202

#### **General Collection Receipt**

Date: 4/16/2024 Email: BLewis@coj.net

/er McAfee Hawthorne & Diebenow, PLLC ne Independent Drive, Suite 1200 Jacksonville FL 32202 1: Coastal Ridge PUD application

Activity	Interfund	Future	Debit Amount	Credit Amount
00000000	00000	0000000	2300.00	0.00
0000000	00000	0000000	0.00	2300.00

Total Due: \$2,300.00

#### Jim Overton , Tax Collector General Collections Receipt City of Jacksonville, Duval County

Account No: CR728484
REZONING/VARIANCE/EXCEPTION

Name: Driver McAfee Hawthome & Diebenow, PLLC Address: One Independent Drive, Suite 1200 Jacksonville FL 32202 Description: Coastal Ridge PUD application

Total Due: \$2,300.00

Date: 4/16/2024