### FOWLER RESIDENCE

### 68 Adel Ln, Wenatchee, WA 98801

PHASE: DD set

**ABBREVIATIONS** 

DN

DWG

ELEC

ELEV

EQUIP

EXH

DOOR

DOWNSPOUT

**EXPANSION BOLT** 

**EXPANSION JOINT** 

ELECTRICAL

**ELEVATION** 

**EQUIPMENT** 

**EXPANSION** 

**FIBERGLASS** FLOOR DRAIN

**EXTERIOR** 

**EXHAUST** 

EQUAL

**ANCHOR BOLT** FLOORING FACE OF CONCRETE FACE OF FINISH FACE OF STUD APPROXIMATE FTG FOOTING ASPH **ASPHALT** B1/2 BOTTOM OF **FURN** FURNISH(ED) BY OWNER GAUGE BOARD GALV GALVANIZED BLDG BUILDING GALVANIZED IRON BLK(G) BLOCK(ING) GLB GLUE LAMINATED BEAM BM BEAM or BENCH MARK GSM GALVANIZED SHEET METAL BOT GYP GYP. BD. **BUILT UP ROOF** GYPSUM BOARD CATCH BASIN НВ CAST IRON HDR CONTROL JOINT **HDWR HARDWARE** CENTERLINE HM HOLLOW METAL CAB'T CABINET HORIZ HORIZONTAL HT CEM CEMENT CER CERAMIC INSIDE FACE OF FRAMING CUBIC FEET/MINUTE IF.O.F. INSUL CIRC CIRCUMFERENCE INSULATION INT CM CENTIMETERS CONCRETE MASONRY UNIT LAM LAMINATE COLUMN COL CONC MAX MAXIMUM CONSTRUCTION **MEMBRANE** MECH **MECHANICAL** CERAMIC TILE MANUFACTURER DRINKING FOUNTAIN MIN MINIMUM MISCELLANEOUS MTD NAT DIMENSION NOT IN CONTRACT

NTS

OA

OD

OPG

OPP

PERIM

PLAM

PLAS

POL

PR

PLYWD

NOT TO SCALE

ON CENTER (S)

PERIMETER

PLYWOOD

POLISHED

**QUARRY TILE** 

OUTSIDE DIAMETER

PLATE/PROPERTY LINE

PLASTIC LAMINATE

OUTSIDE FACE OF FRAMING

POWER ACTUATED FASTENERS

QUANTITY RISER/RADIUS **ROOF DRAIN** REFRIGERATOR REINFORCED REVERSED **ROUGH OPENING** ROUND HEAD MACHINE BOLT ROOM **ROUGH OPENING** REDWOOD SOLID CORE SCHED SCHEDULE SOAP DISPENSER SECT SECTION SHT SHEET SHTG SHEATHING SIMILAR SQUARE STAINLESS STEEL STD STANDARD STL STEEL STOR STORAGE STRUC STRUCTURAL SUSP SUSPENDED SYM SYMETRICAL TONGUE AND GROOVE TOP AND BOTTOM TO BE CONFIRMED TOP OFBLOCK TOP OF MASONRY TOP TOP OF PLATE TOP OF SLAB TOP OF WALL TUBULAR STEEL TYPICAL UNLESS OTHERWISE NOTED VINYL TILE VERTICAL GRAIN WATER RESISTANT WAINSCOT WB **WOOD BASE** WATER CLOSET WOOD WATER HEATER

WIN


WATERPROOF(ING)

WELDED WIRE FABRIC

SHEET INDEX

### SHEET NO. DESCRIPTION Lower Level - General Plan Main Level - General Plan Garage Upper Level - General Plan Exterior Elevations **Exterior Elevations** A-500 Doors Schedule Windows Schedule Building Sections Building Sections **Building Sections** Garage Sections A-700 Assemblies Details- Windows Lower Level - Reflected Ceiling Plan Main Level - Reflected Ceiling Plan Upper Garage Level - Reflected Ceiling Plan Enlarged Areas - Stairs Enlarged Areas - Stairs Structural General Notes Foundation Plan - Lower Level Foundation Plan - Garage Main Level - Framing Plan Upper Garage Level - Framing Plan Roof - Framing Plan Lower Level - Shear Walls Plan Main Level - Shear Walls Plan

### VICINITY MAP

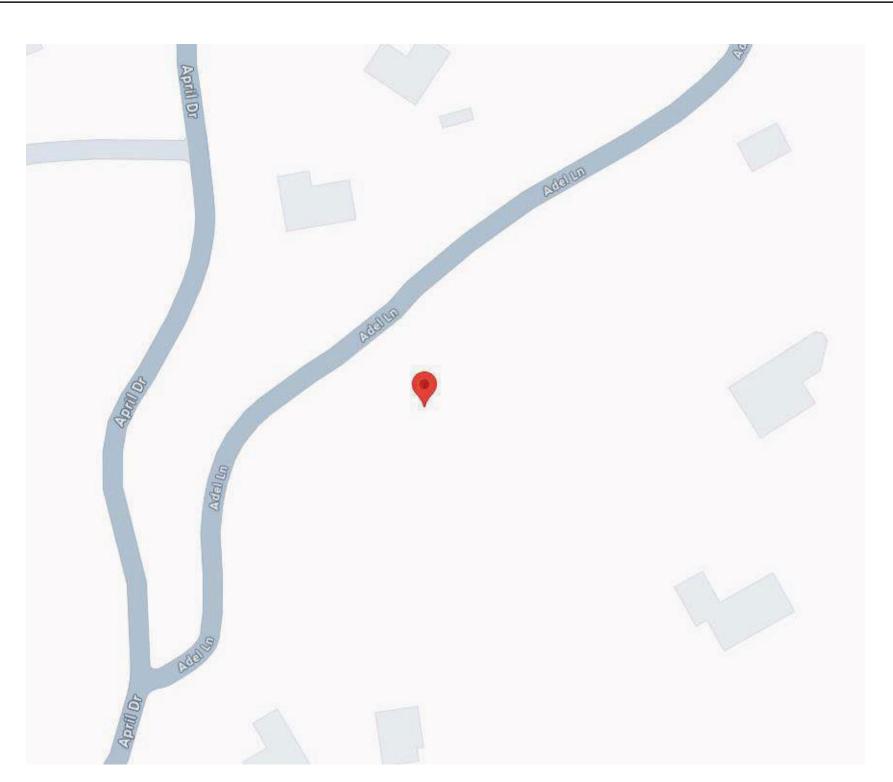


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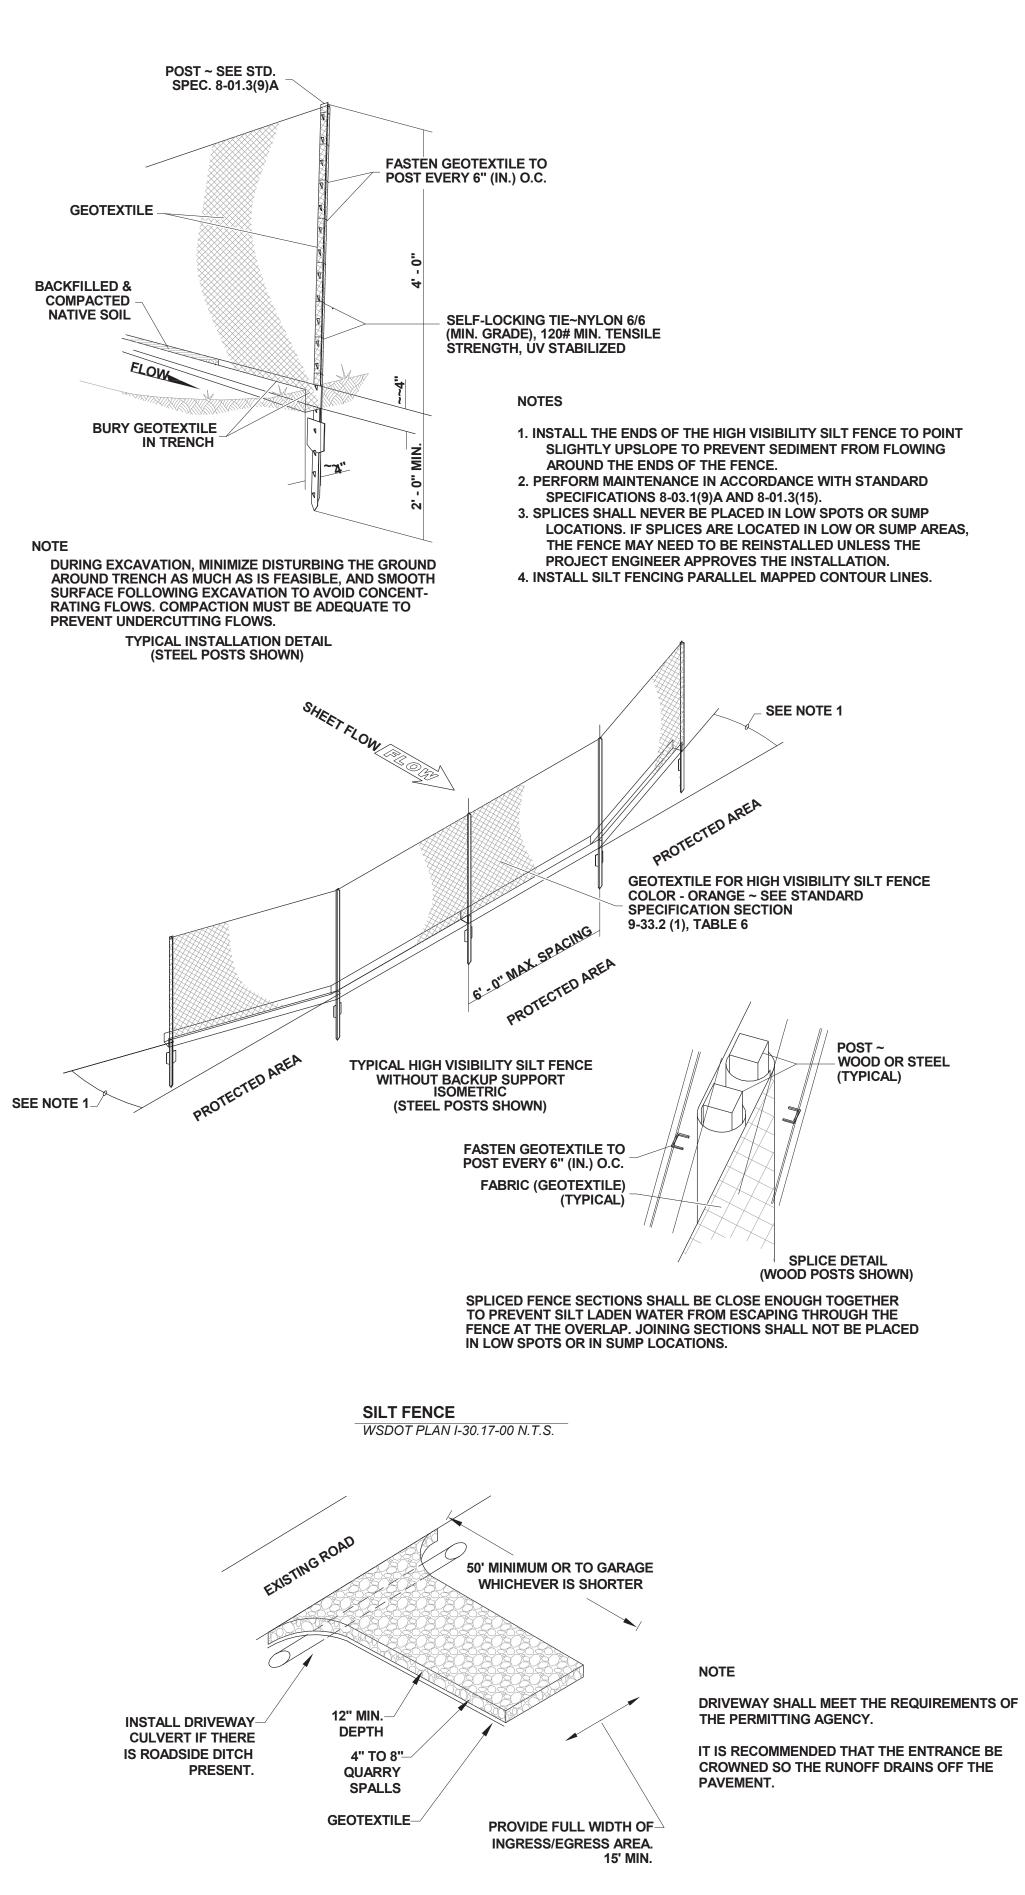
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G-001

**Cover Sheet** 





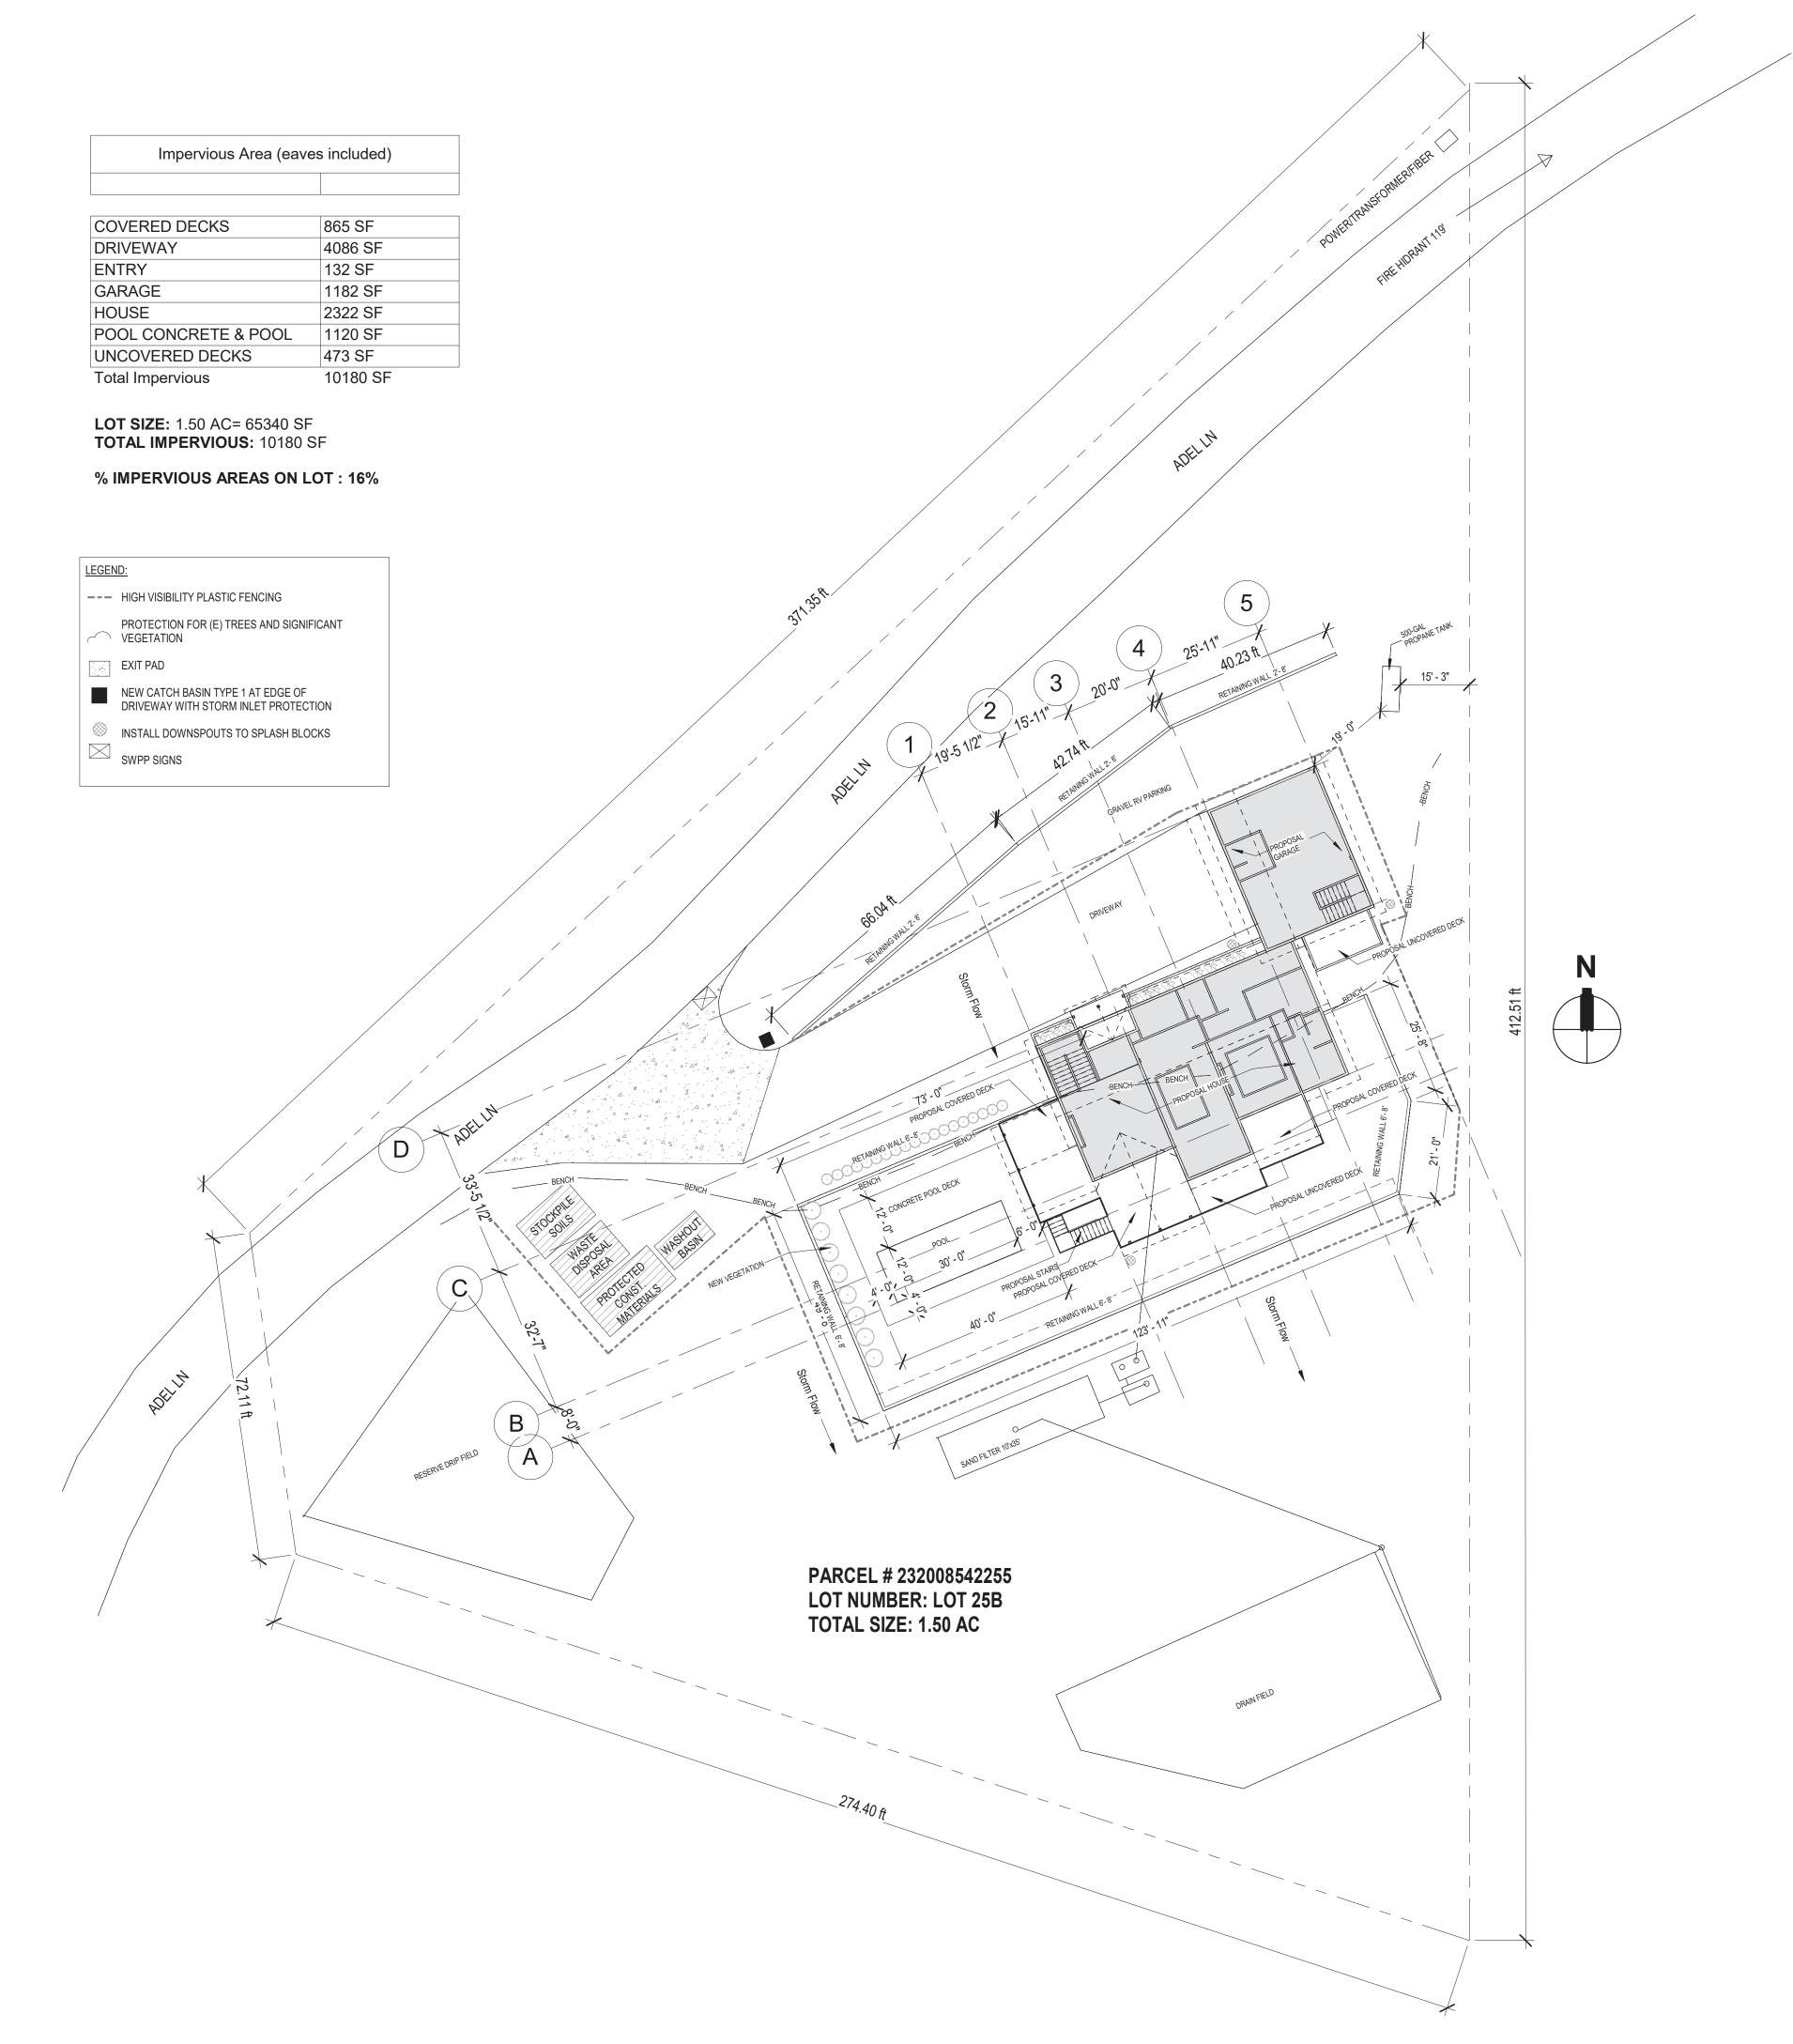

STABILIZED CONSTRUCTION ENTRANCE/EXIT

DOE MANUAL BMP C105

2 SWPPP DETAILS 1/8" = 1'-0"



No.	Description	Date	
	Revision 1	Date 1	

OWLER RESIDE Adel Ln, Wenatchee, WA 98801

Date: 24 03 04

68


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A-000

Site Plan



### **GENERAL PLAN NOTES:**

1. ALL DIMENSIONS & SITE CONDITIONS TO BE VERIFIED BY CONTRACTOR PRIOR TO CONSTRUCTION. 2. ALL FINISHES (INTERIOR & EXTERIOR) TO BE VERIFIED WITH OWNER PRIOR TO CONSTRUCTION.

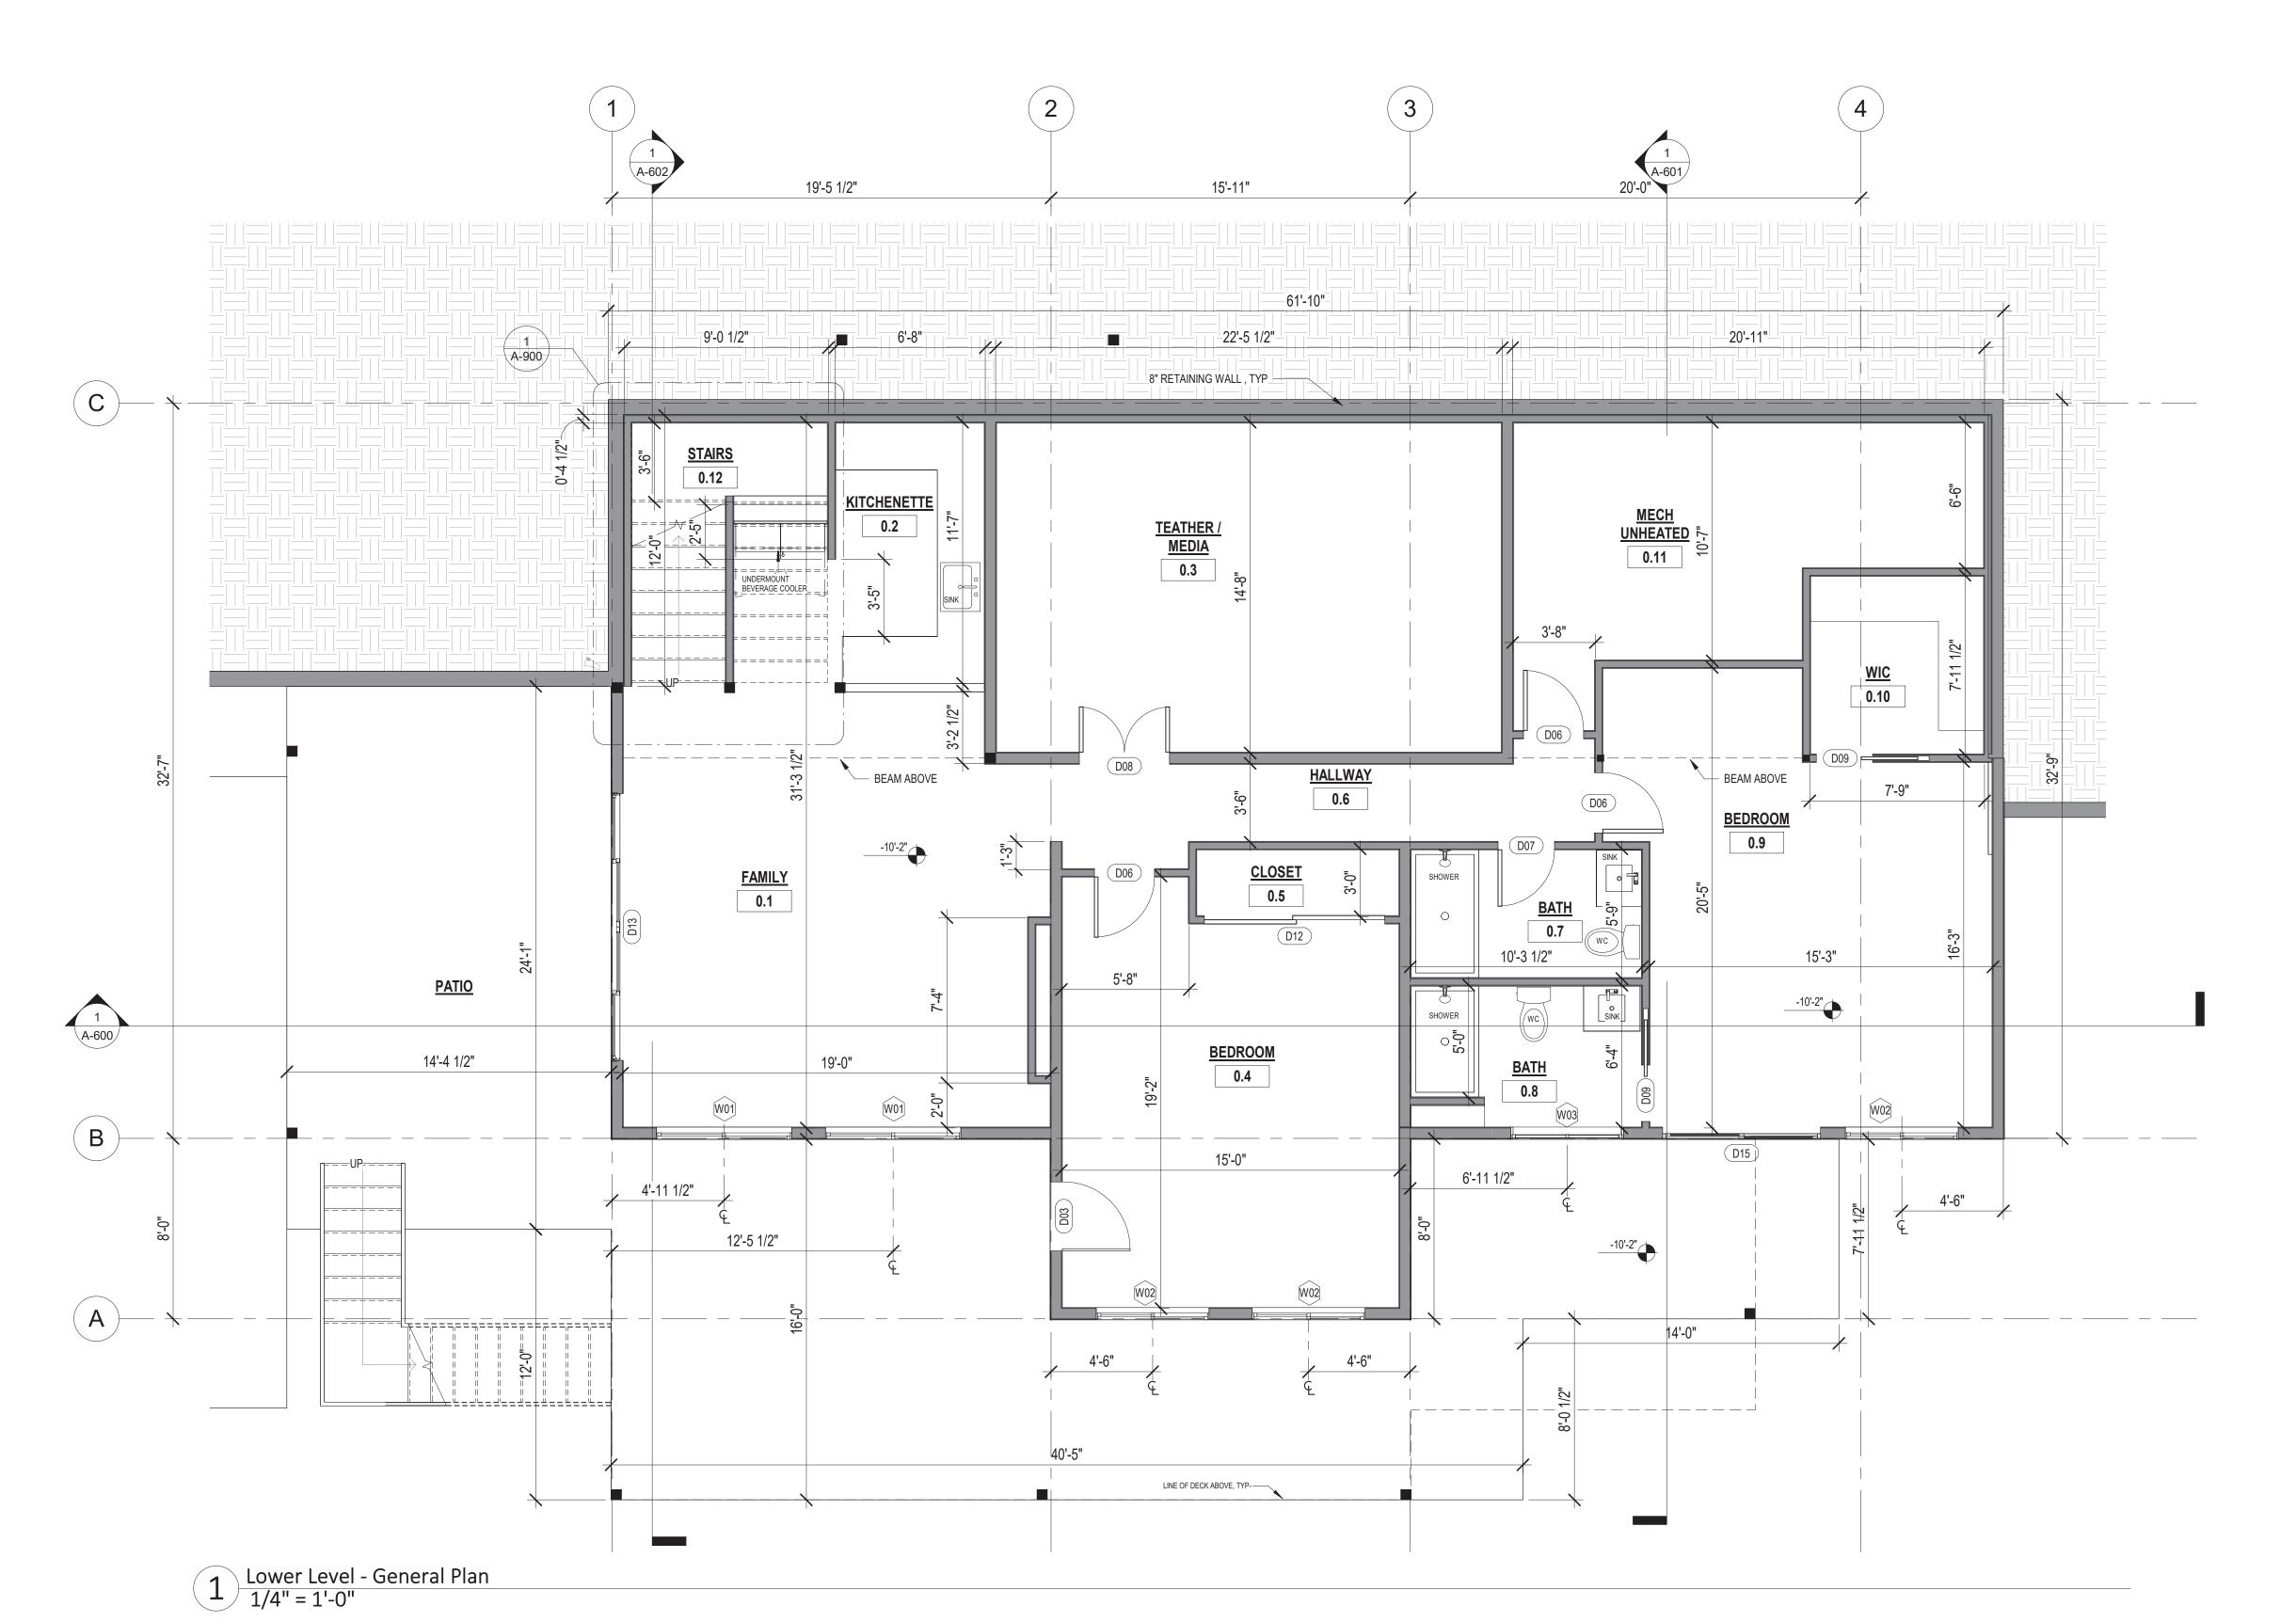3. VERIFY ALL DOOR AND WINDOW STYLES AND SIZES WITH OWNER PRIOR TO CONSTRUCTION. MANUFACTURER

TO SUPPLY ALL ROUGH OPENING SIZES. 4. CONTRACTOR TO VERIFY ALL CLEARANCES OF ALL DOORS, WINDOWS AND OTHER ITEMS THAT ARE CRITICAL,

PRIOR TO CONSTRUCTION. 5. CONTRACTOR TO ADAPT PLANS AS REQUIRED TO MEET ALL APPLICABLE CODES AT SITE.

**6.** ALL BEAMS TO BE SIZED BY A LICENSED STRUCTURAL ENGINEER. 7. PORCHES, BALCONIES OR RAISED FLOOR SURFACES LOCATED MORE THAN 30 INCHES ABOVE THE FLOOR OR GRADE BELOW AT ANY POINT WITHIN 36 INCHES HORIZONTALLY SHALL HAVE GUARDS NOT LESS THAN 36 INCHES IN HEIGHT. OPEN SIDES OF STAIRS WITH A TOTAL RISE OF MORE THAN 30 INCHES ABOVE THE FLOOR OR GRADE BELOW SHALL HAVE GUARDS NOT LESS THAN 34 INCHES IN HEIGHT MEASURED VERTICALLY FROM THE NOSING OF THE TREADS. INSECT SCREENING SHALL NOT BE CONSIDERED AS A GUARD. IRC 2018, R312.1.1 & R312.1.2 8. M1305.1.2 APPLIANCES IN ATTICS. ATTICS CONTAINING APPLIANCES SHALL BE PROVIDED WITH AN OPENING AND A CLEAR AND UNOBSTRUCTED PASSAGEWAY LARGE ENOUGH TO ALLOW REMOVAL OF THE LARGEST APPLIANCE, BUT NOT LESS THAN 30 INCHES HIGH AND 22 INCHES WIDE AND NOT MORE THAN 20 FEET LONG MEASURED ALONG THE CENTERLINE OF THE PASSAGEWAY FROM THE OPENING TO THE APPLIANCE. THE PASSAGEWAY SHALL HAVE CONTINUOUS SOLID FLOORING IN ACCORDANCE WITH CHAPTER 5 NOT LESS THAN 24 INCHES WIDE. A LEVEL SERVICE SPACE AT LEAST 30 INCHES DEEP AND 30 INCHES WIDE SHALL BE PRESENT ALONG ALL SIDES OF THE APPLIANCE WHERE ACCESS IS REQUIRED. THE CLEAR ACCESS OPENING DIMENSIONS SHALL BE A MINIMUM OF

20 INCHES BY 30 INCHES, AND LARGE ENOUGH TO ALLOW REMOVAL OF THE LARGEST APPLIANCE. EXCEPTIONS: a. THE PASSAGEWAY AND LEVEL SERVICE SPACE ARE NOT REQUIRED WHERE THE APPLIANCE CAN BE SERVICED AND REMOVED THROUGH THE REQUIRED OPENING.

b. WHERE THE PASSAGEWAY IS UNOBSTRUCTED AND NOT LESS THAN 6 FEET HIGH AND 22 INCHES WIDE FOR ITS ENTIRE LENGTH, THE PASSAGEWAY SHALL BE NOT MORE THAN 50 FEET LONG.

9. APPLIANCE ACCESS FOR INSPECTION SERVICE, REPAIR AND REPLACEMENT. APPLIANCES SHALL BE ACCESSIBLE FOR INSPECTION, SERVICE, REPAIR AND REPLACEMENT WITHOUT REMOVING PERMANENT CONSTRUCTION, OTHER APPLIANCES, OR ANY OTHER PIPING OR DUCTS NOT CONNECTED TO THE APPLIANCE BEING INSPECTED, SERVICED, REPAIRED OR REPLACED. A LEVEL WORKING SPACE AT LEAST 30 INCHES DEEP AND 30 INCHES WIDE SHALL BE PROVIDED IN FRONT OF THE CONTROL SIDE TO SERVICE AN APPLIANCE. M1305.1.1

10. EMERGENCY ESCAPE AND RESCUE OPENINGS SHALL BE OPERATIONAL FROM THE INSIDE OF THE ROOM WITHOUT THE USE OF KEYS, TOOLS OR SPECIAL KNOWLEDGE. WINDOW OPENING CONTROL DEVICES COMPLYING WITH ASTM F 2090 SHALL BE PERMITTED FOR USE ON WINDOWS SERVING AS A REQUIRED EMERGENCY ESCAPE AND RESCUE OPENING. ALL SLEEPING ROOMS TO HAVE AN EXTERIOR ACCESS THROUGH A DOOR OR WINDOW WITH A MINIMUM OF 5.7 SQUARE FEET NET CLEAR OPENING AS PER IRC 2018 R310.2.1. EXCEPTION: GRADE FLOOR OR BELOW GRADE OPENINGS SHALL HAVE A MINIMUM NET CLEAR OPENING OF 5 SQUARE FEET. MAXIMUM SILL HEIGHT TO BE 44 INCHES. MINIMUM NET CLEAR OPENING HEIGHT TO BE 24 INCHES. MINIMUM NET CLEAR OPENING WIDTH TO BE 20 INCHES.

11. ALL RETURN AIR GRILLS ARE TO BE LOCATED TO COMPLY WITH SECTION M1602 OF THE IRC 2018. 12. ALL SQUARE FOOTAGE MEASUREMENTS ARE APPROXIMATE AND MAY DIFFER FROM ACTUAL CONSTRUCTED RESIDENCE OR BUILDING.

13. FIRE SPRINKLER SYSTEM TO BE DESIGNED AND INSTALLED (IF REQUIRED BY LOCAL CODES) AS PER THE IRC 2018 AND BY A LICENSED PROFESSIONAL IN THE AREA OF CONSTRUCTION. 14. ALL BATHROOM EXHAUST VENTS SHALL BE VENTED DIRECTLY TO THE EXTERIOR OF THE HOME AND NOT INTO

THE ATTIC. IRC 2018, M1505.2 BUILT-INS CLG. JSTS. AS PER EXISTING WALLS

NEW WALLS

	Lower Level Rooms	
Number	Name	Area

HEATED	)	
0.1	FAMILY	351 SF
0.2	KITCHENETTE	78 SF
0.3	TEATHER / MEDIA	326 SF
0.4	BEDROOM	265 SF
0.5	CLOSET	26 SF
0.6	HALLWAY	93 SF

0.3	TEATHER / MEDIA	326 SF
0.4	BEDROOM	265 SF
0.5	CLOSET	26 SF
0.6	HALLWAY	93 SF
0.7	BATH	58 SF
0.8	BATH	64 SF
0.9	BEDROOM	289 SF
0.10	WIC	60 SF
0.12	STAIRS	98 SF
		1709 SF

		1709 SF
UNHEA	TED	
0.11	MECH UNHEATED	197 SF
	·	197 SF
Grand to	otal	1906 SF



Description

**L** 89


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Lower Level - General Plan





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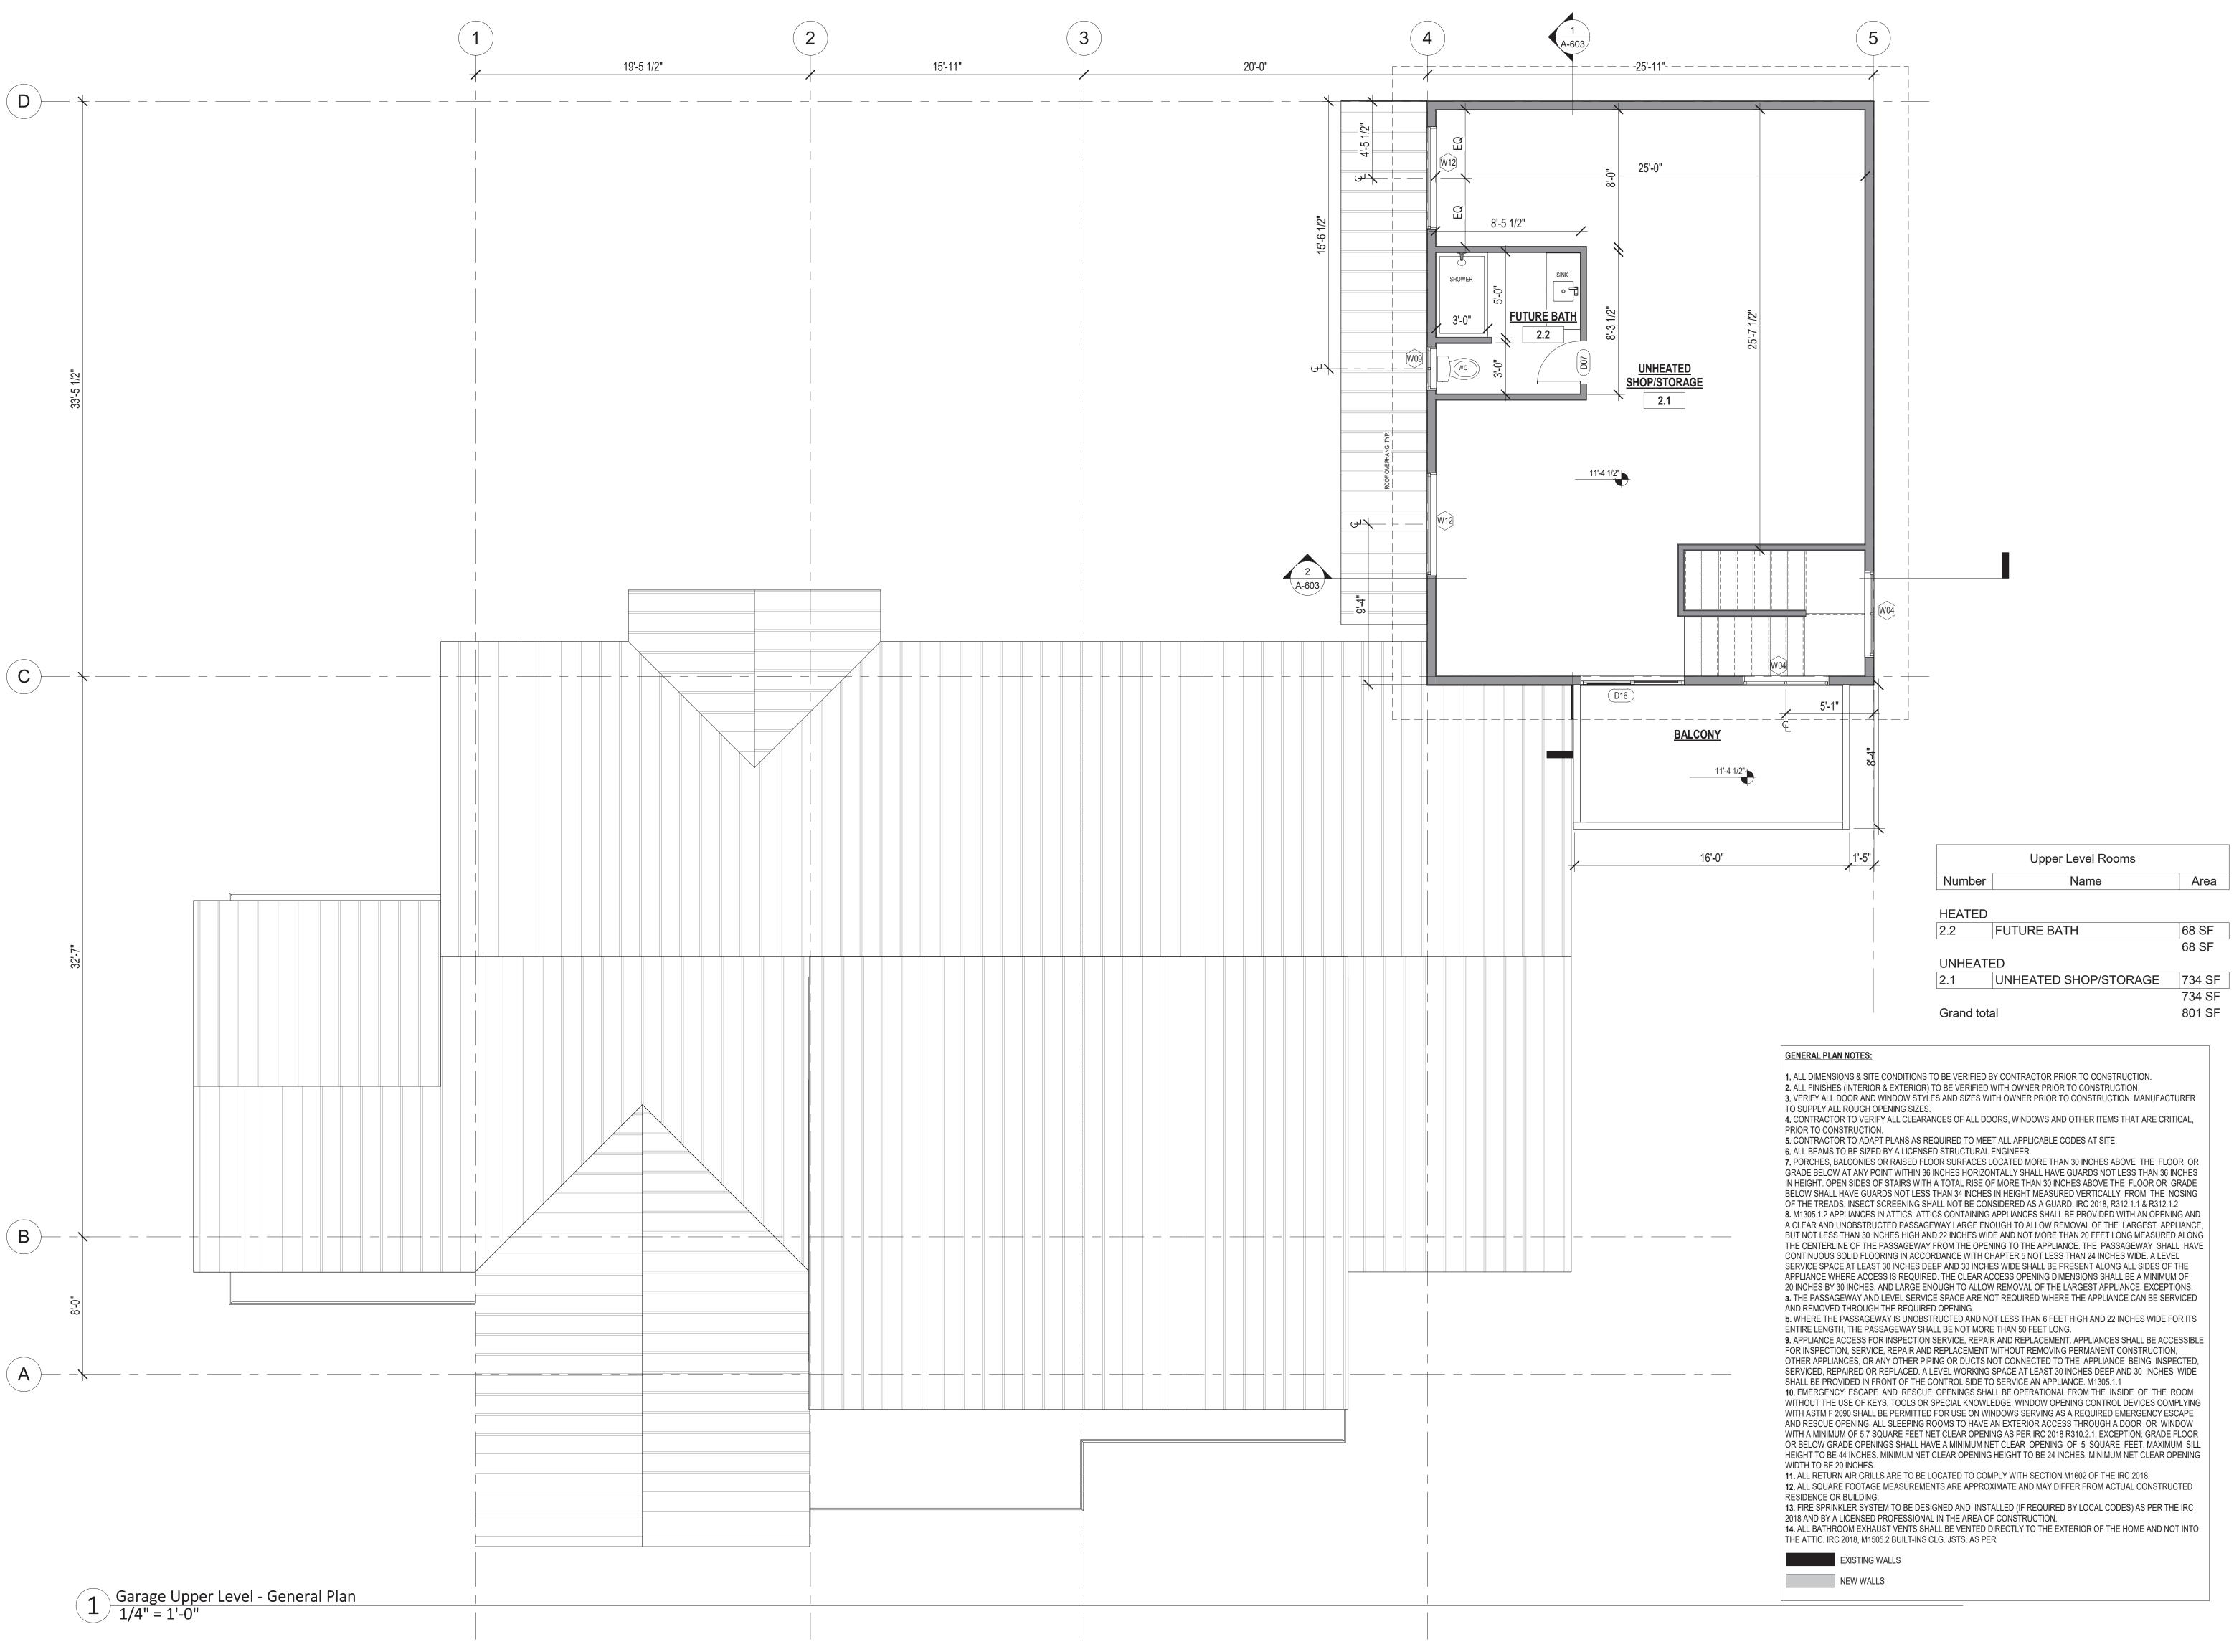
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Main Level - General Plan



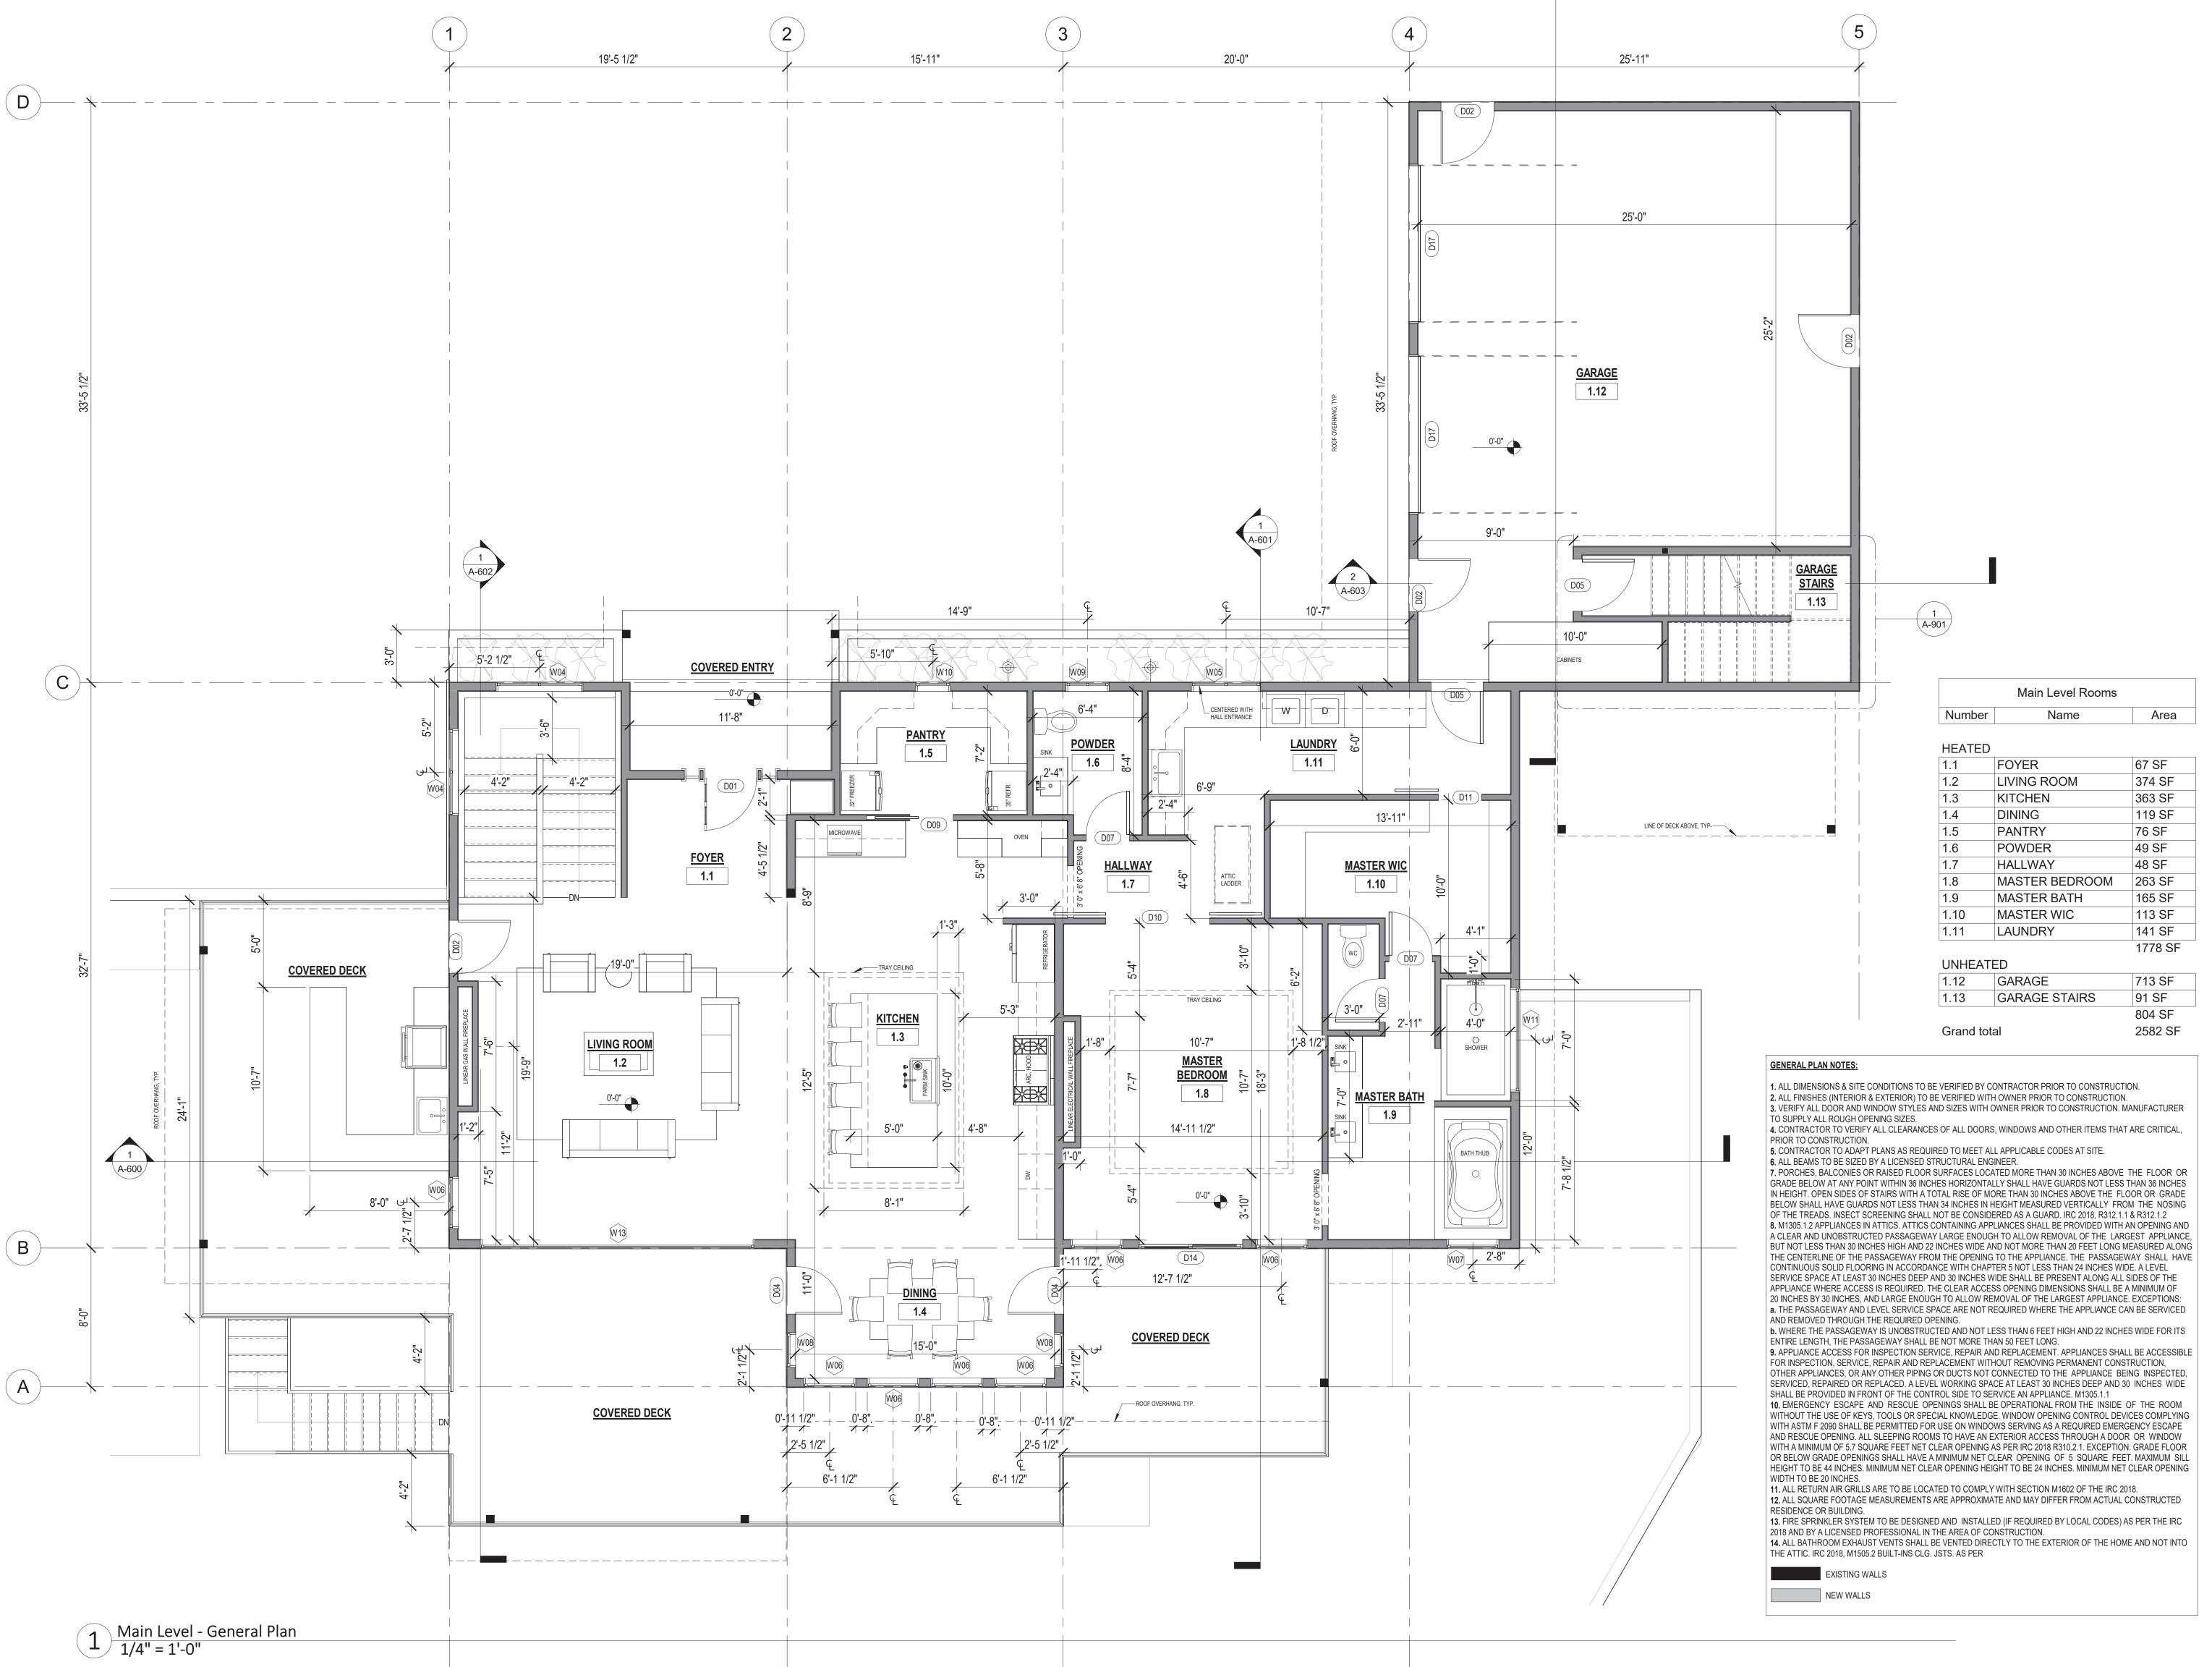

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Garage Upper Level -General Plan

ONTRACTOR TO VERIEV ALL WINDOW AND DO


1. CONTRACTOR TO VERIFY ALL WINDOW AND DOOR STYLES AND SIZES WITH OWNER PRIOR TO CONSTRUCTION.

2. PROVIDE STEPS AND GUARD RAILS AS PER CODE BASED ON SITE CONDITIONS


PROVIDE STEPS AND GUARD RAILS AS PER CODE BASED ON SITE CONDITIONS.
 GROUND LINES SHOWN FOR REFERENCE ONLY AND VARY DEPENDING ON SITE CONDITIONS.
 ALL FINISH MATERIALS TO BE VERIFIED WITH OWNER PRIOR TO CONSTRUCTION.
 REFER TO TYPICAL WALL DETAIL FOR FRAMING METHODS AND OTHER MISC. INFORMATION.
 CONTRACTOR TO PROVIDE ADEQUATE ROOF VENTILATION AS REQ'D BY CURRENT CODES.



No.	Description	Date
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1 Entry Elevation 1/4" = 1'-0"

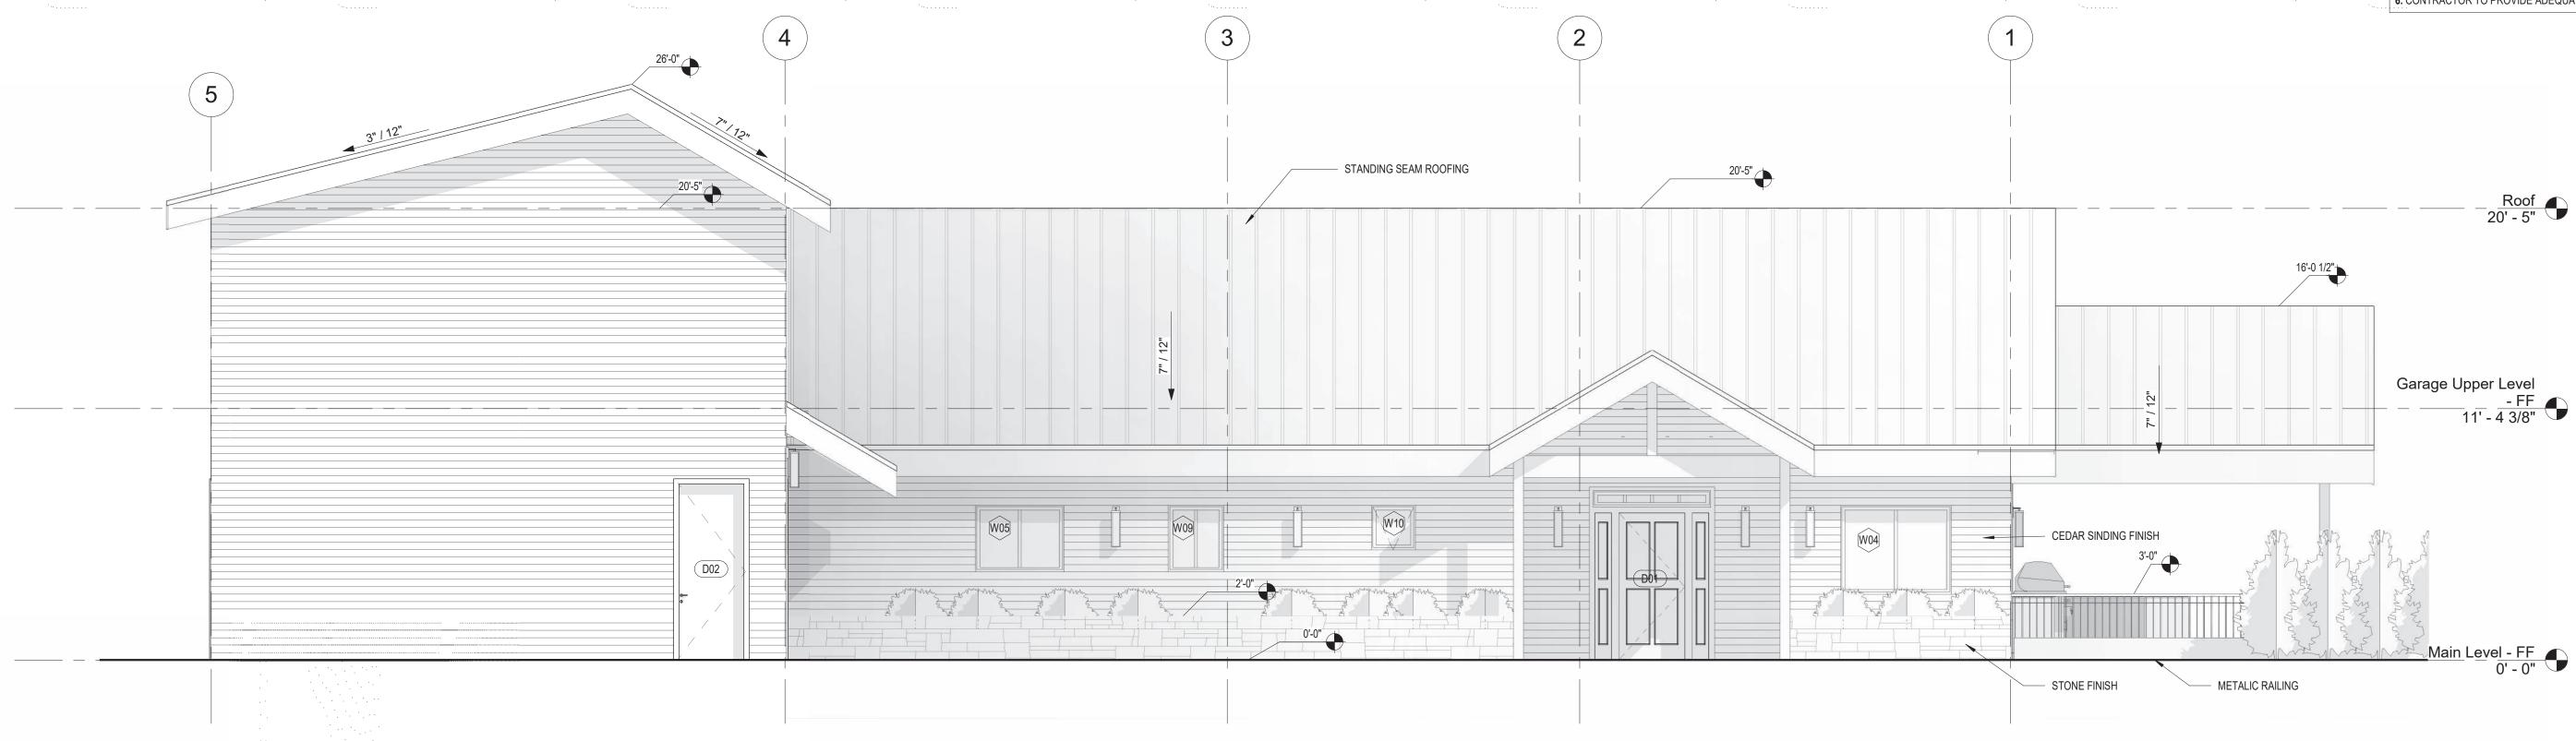

Job No: Project Number
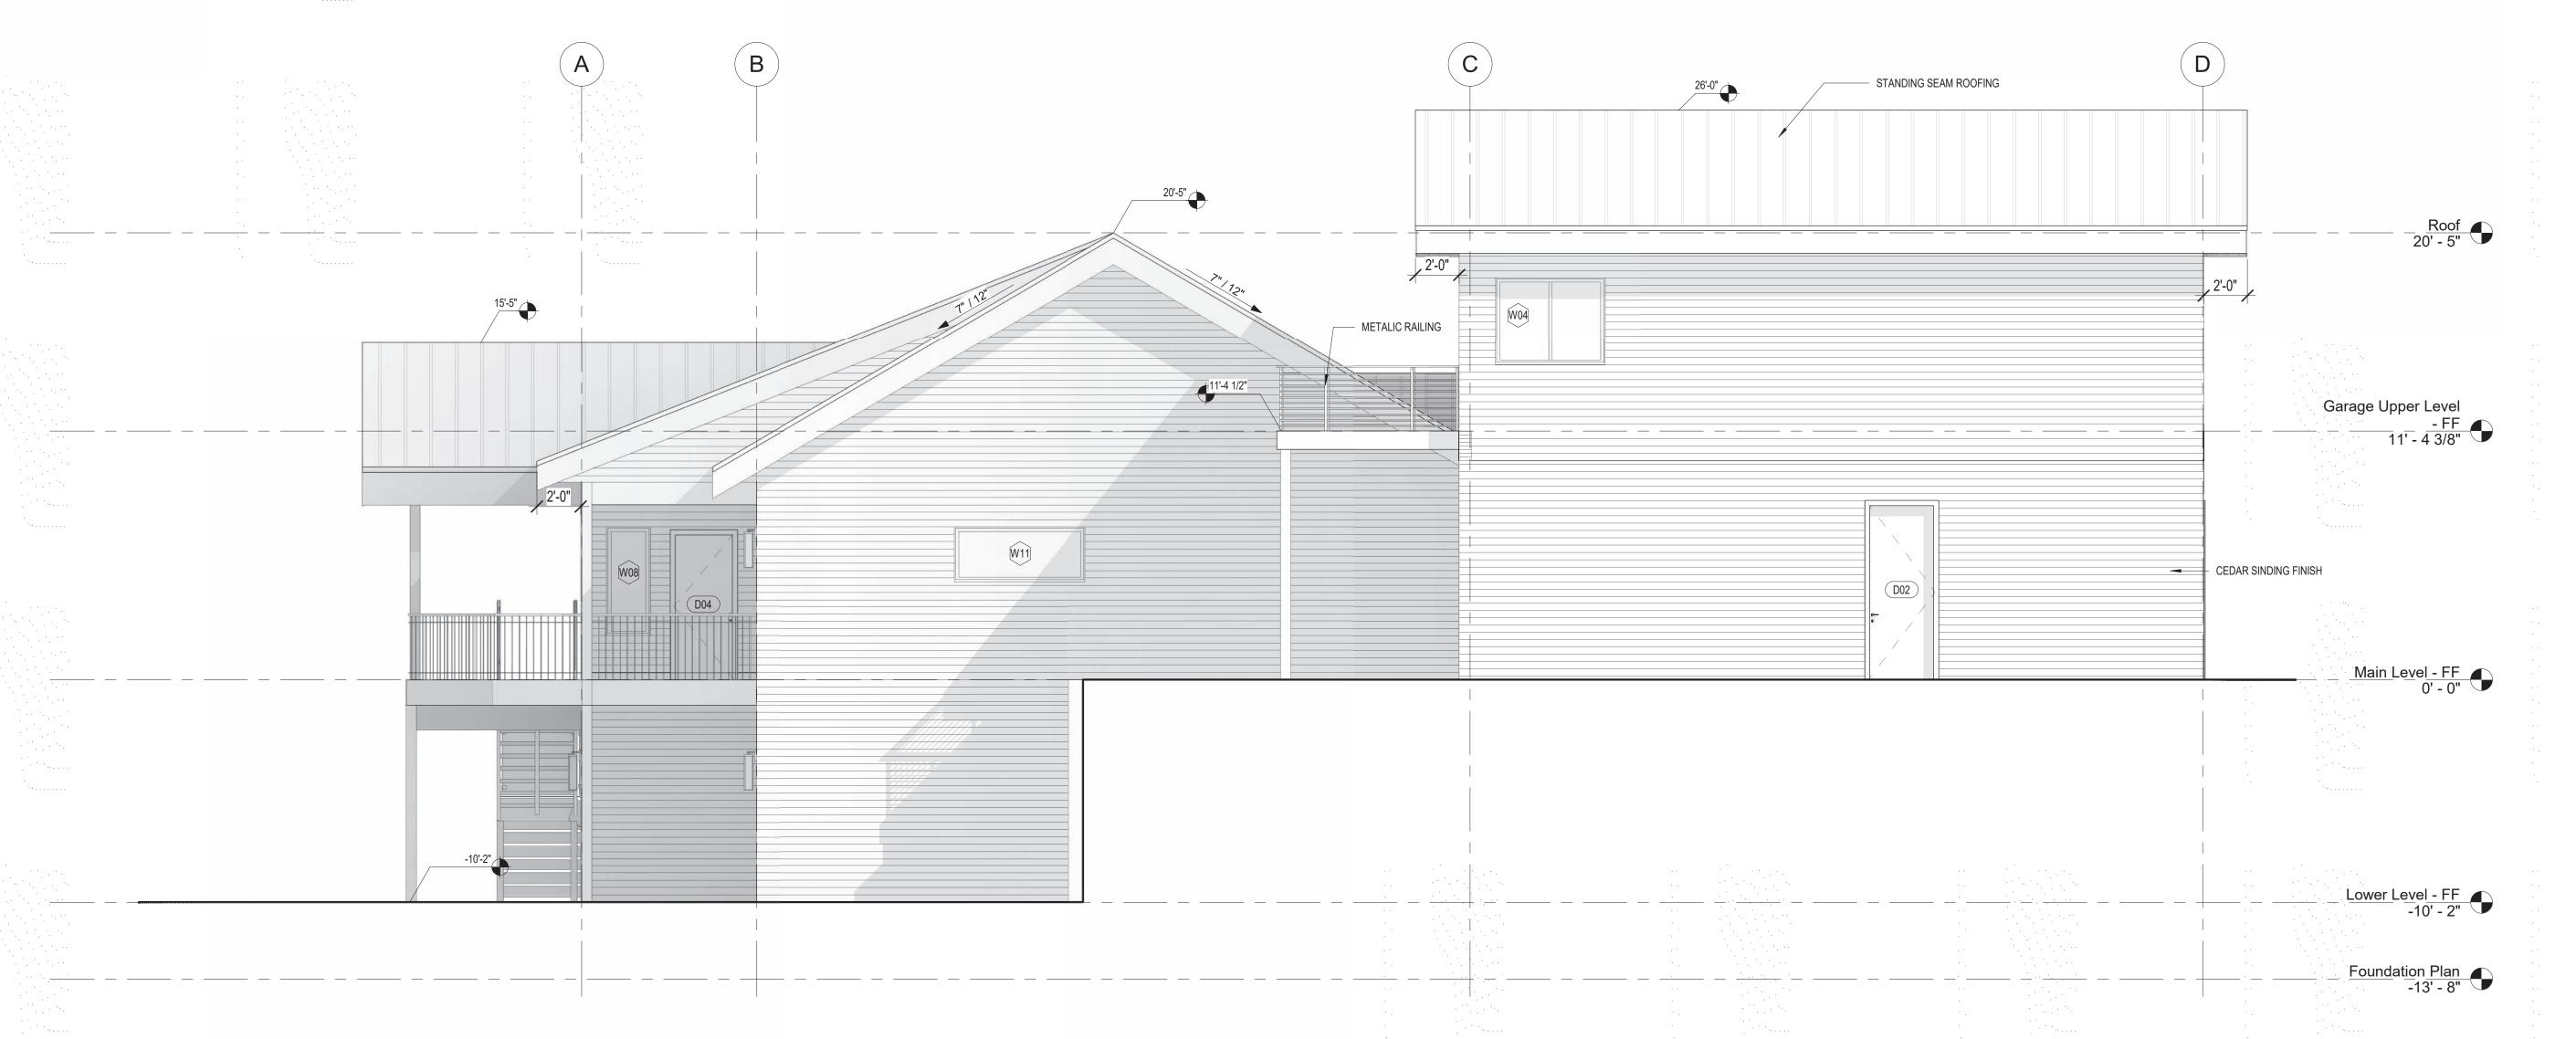
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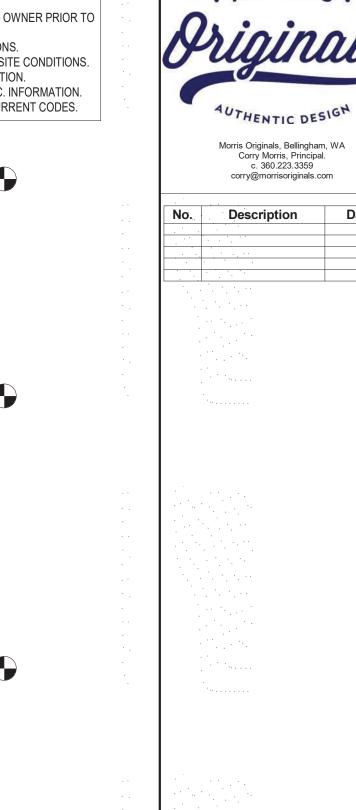
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A-200
Exterior Elevations





Date: 24 03 04

Job No: Project Number


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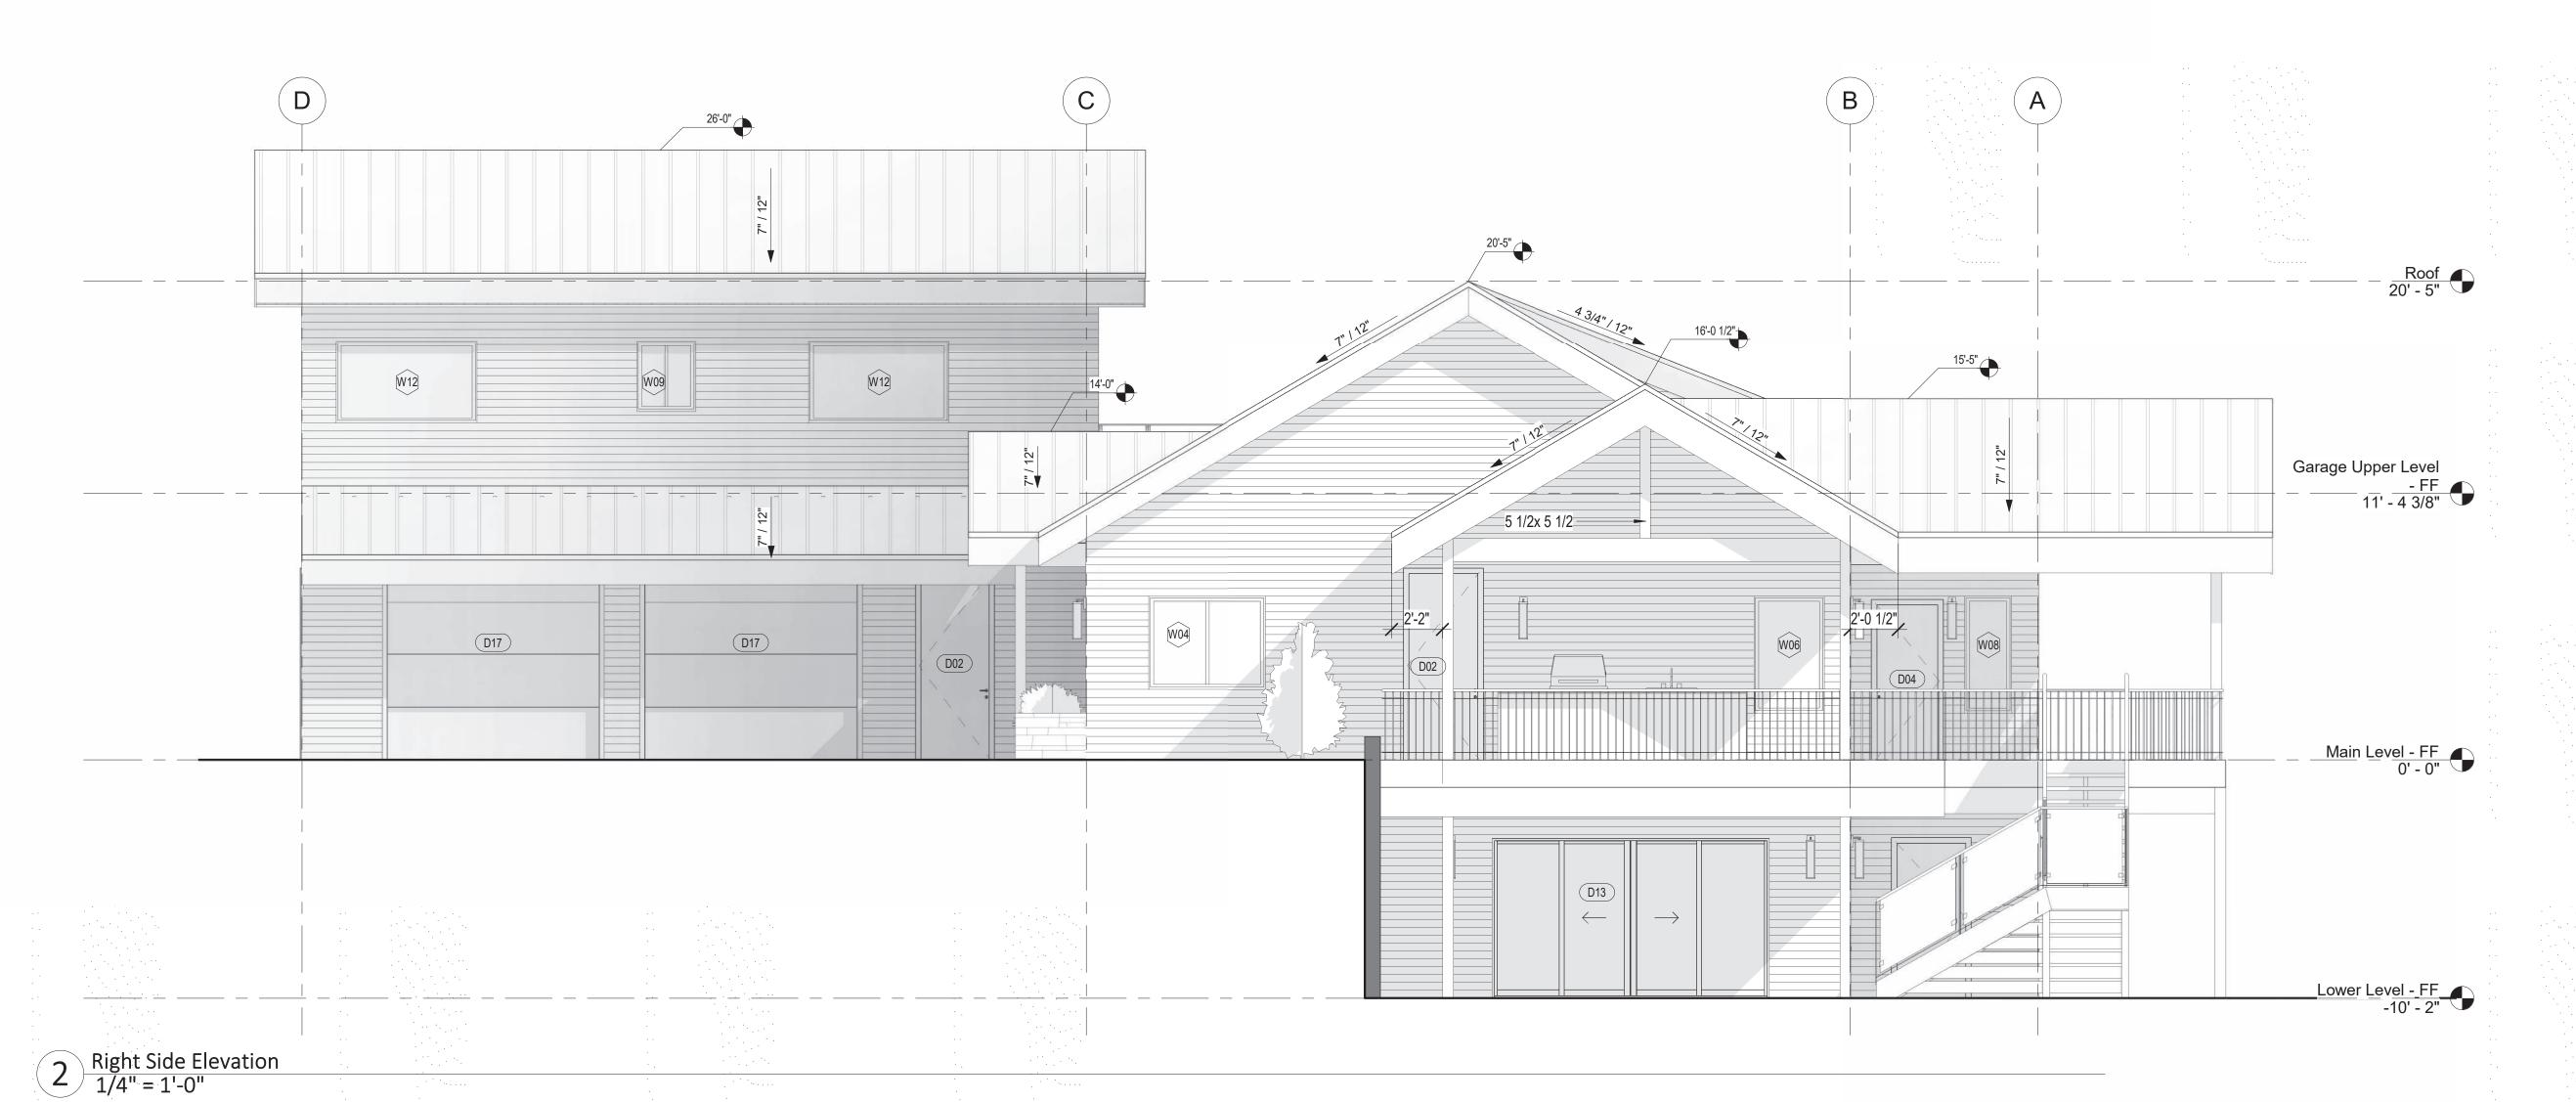
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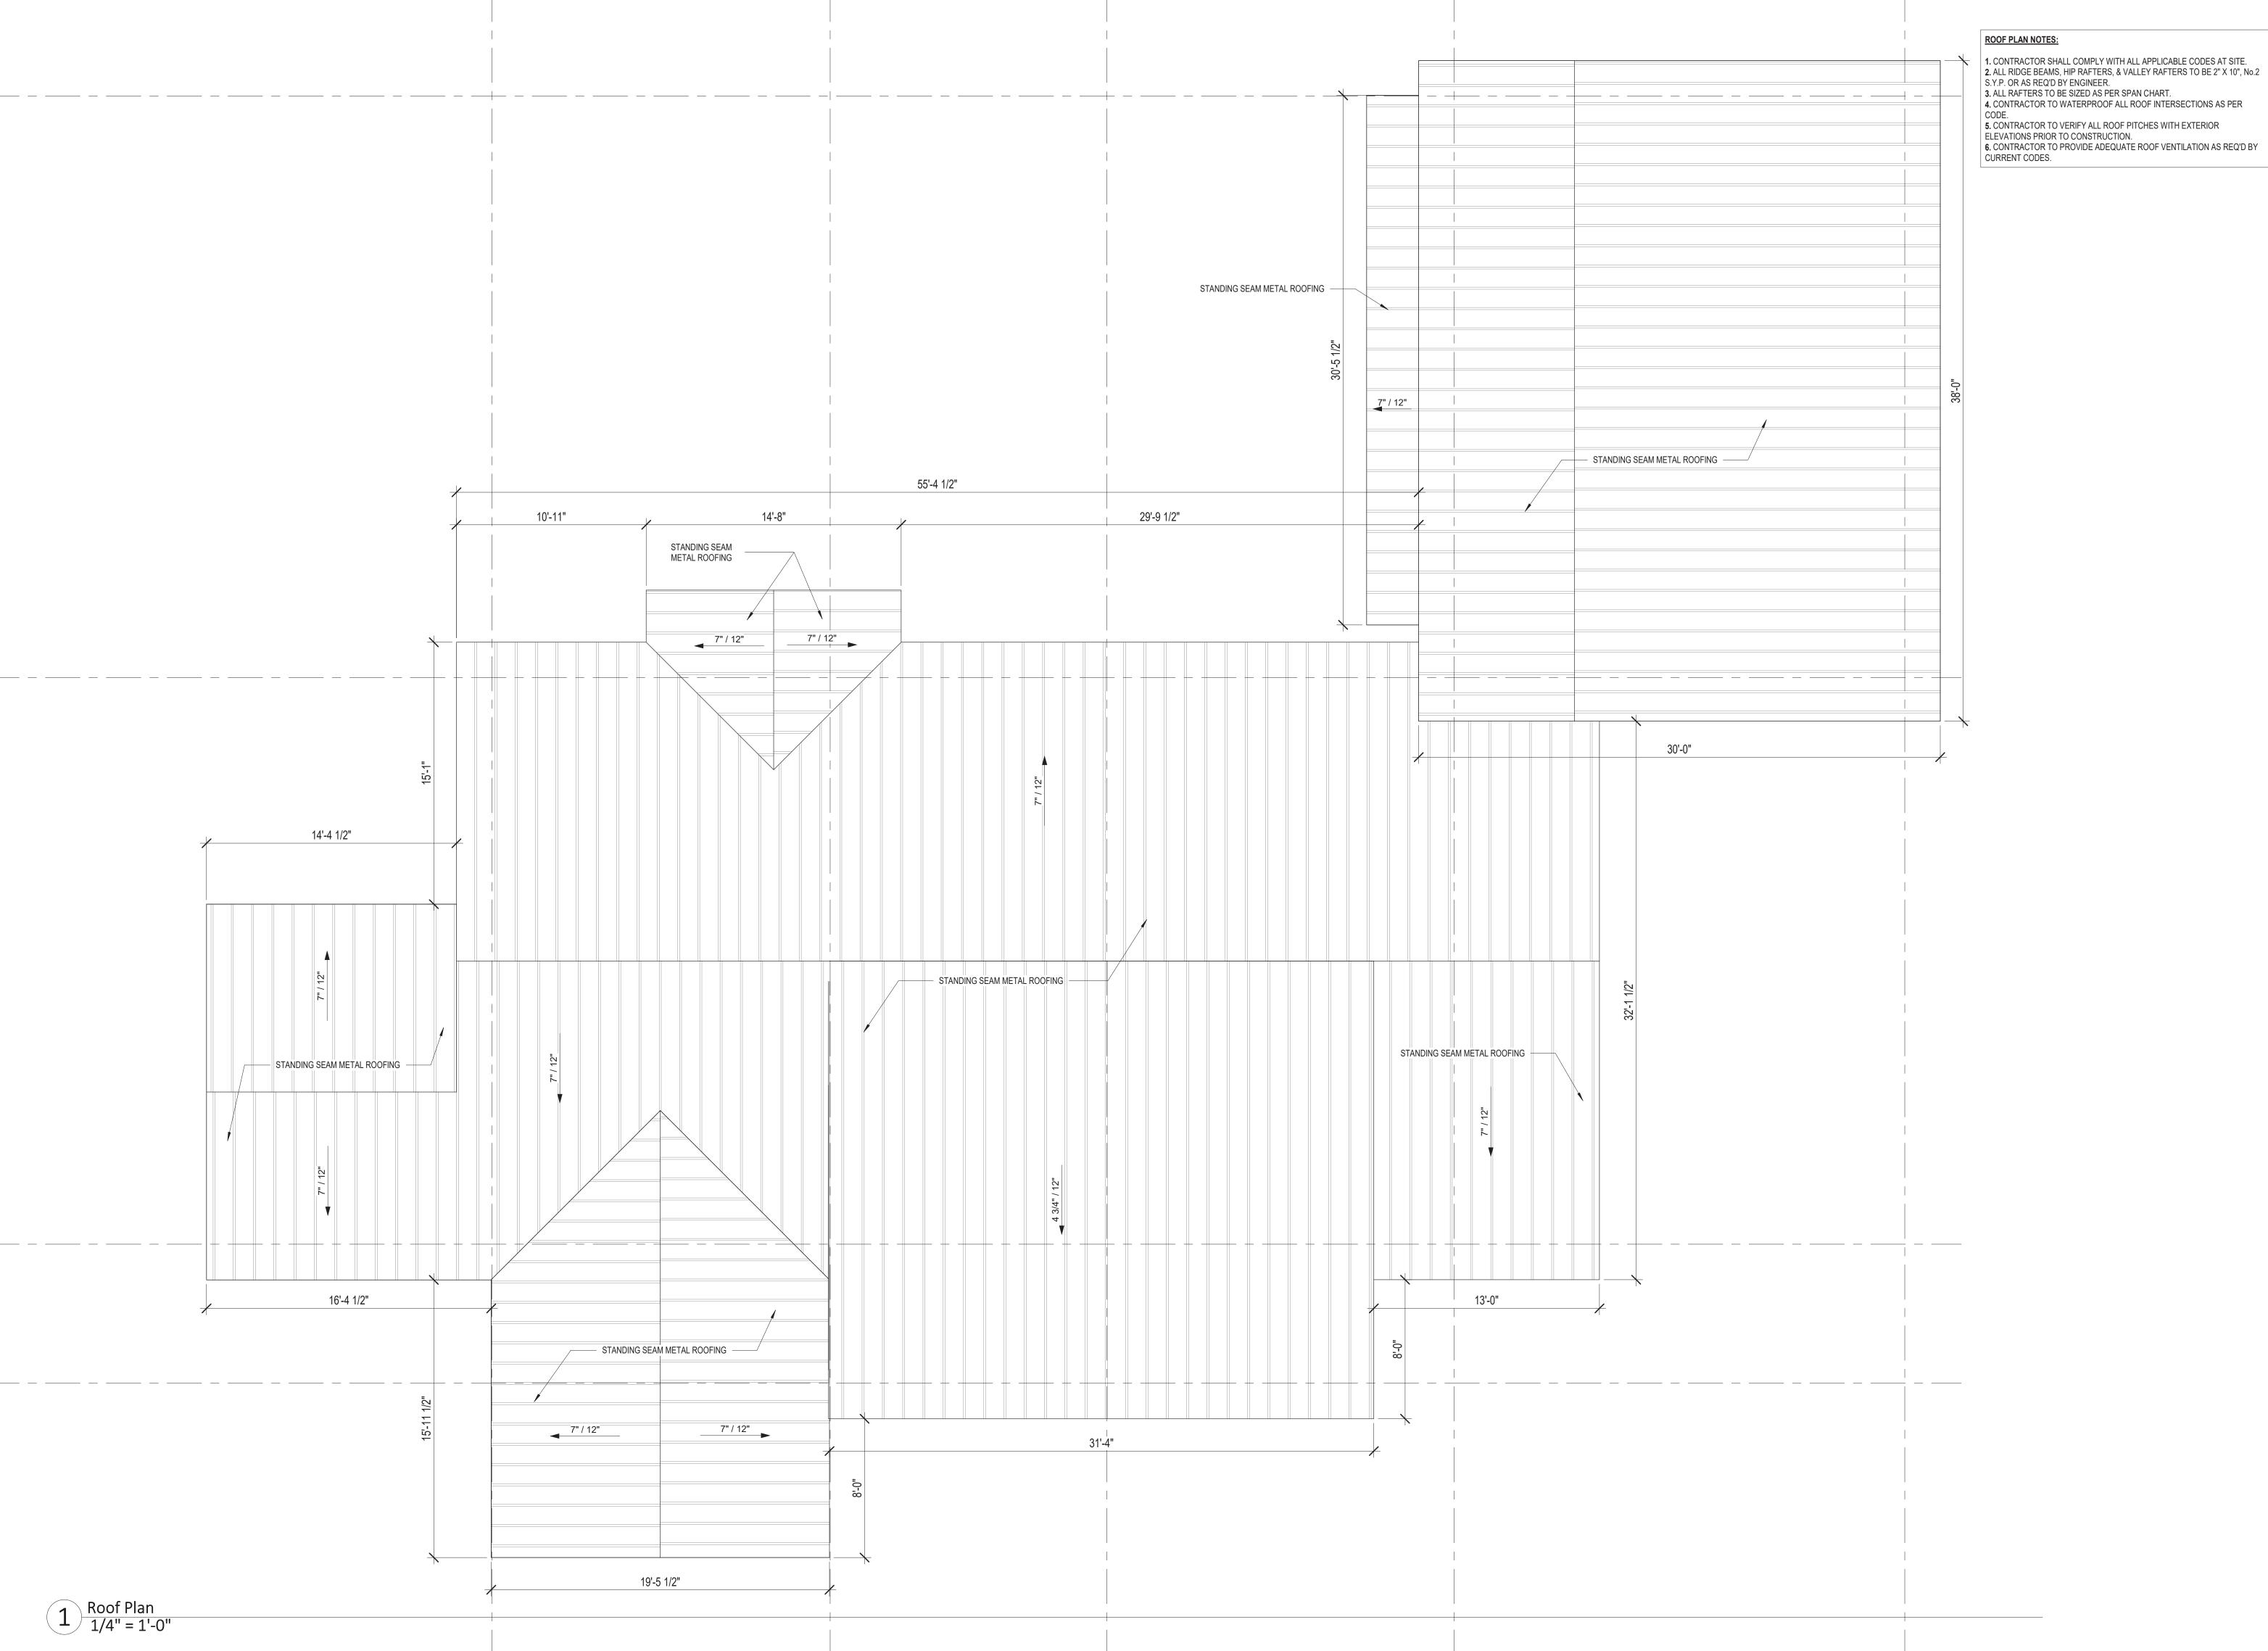
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A-201

Exterior Elevations





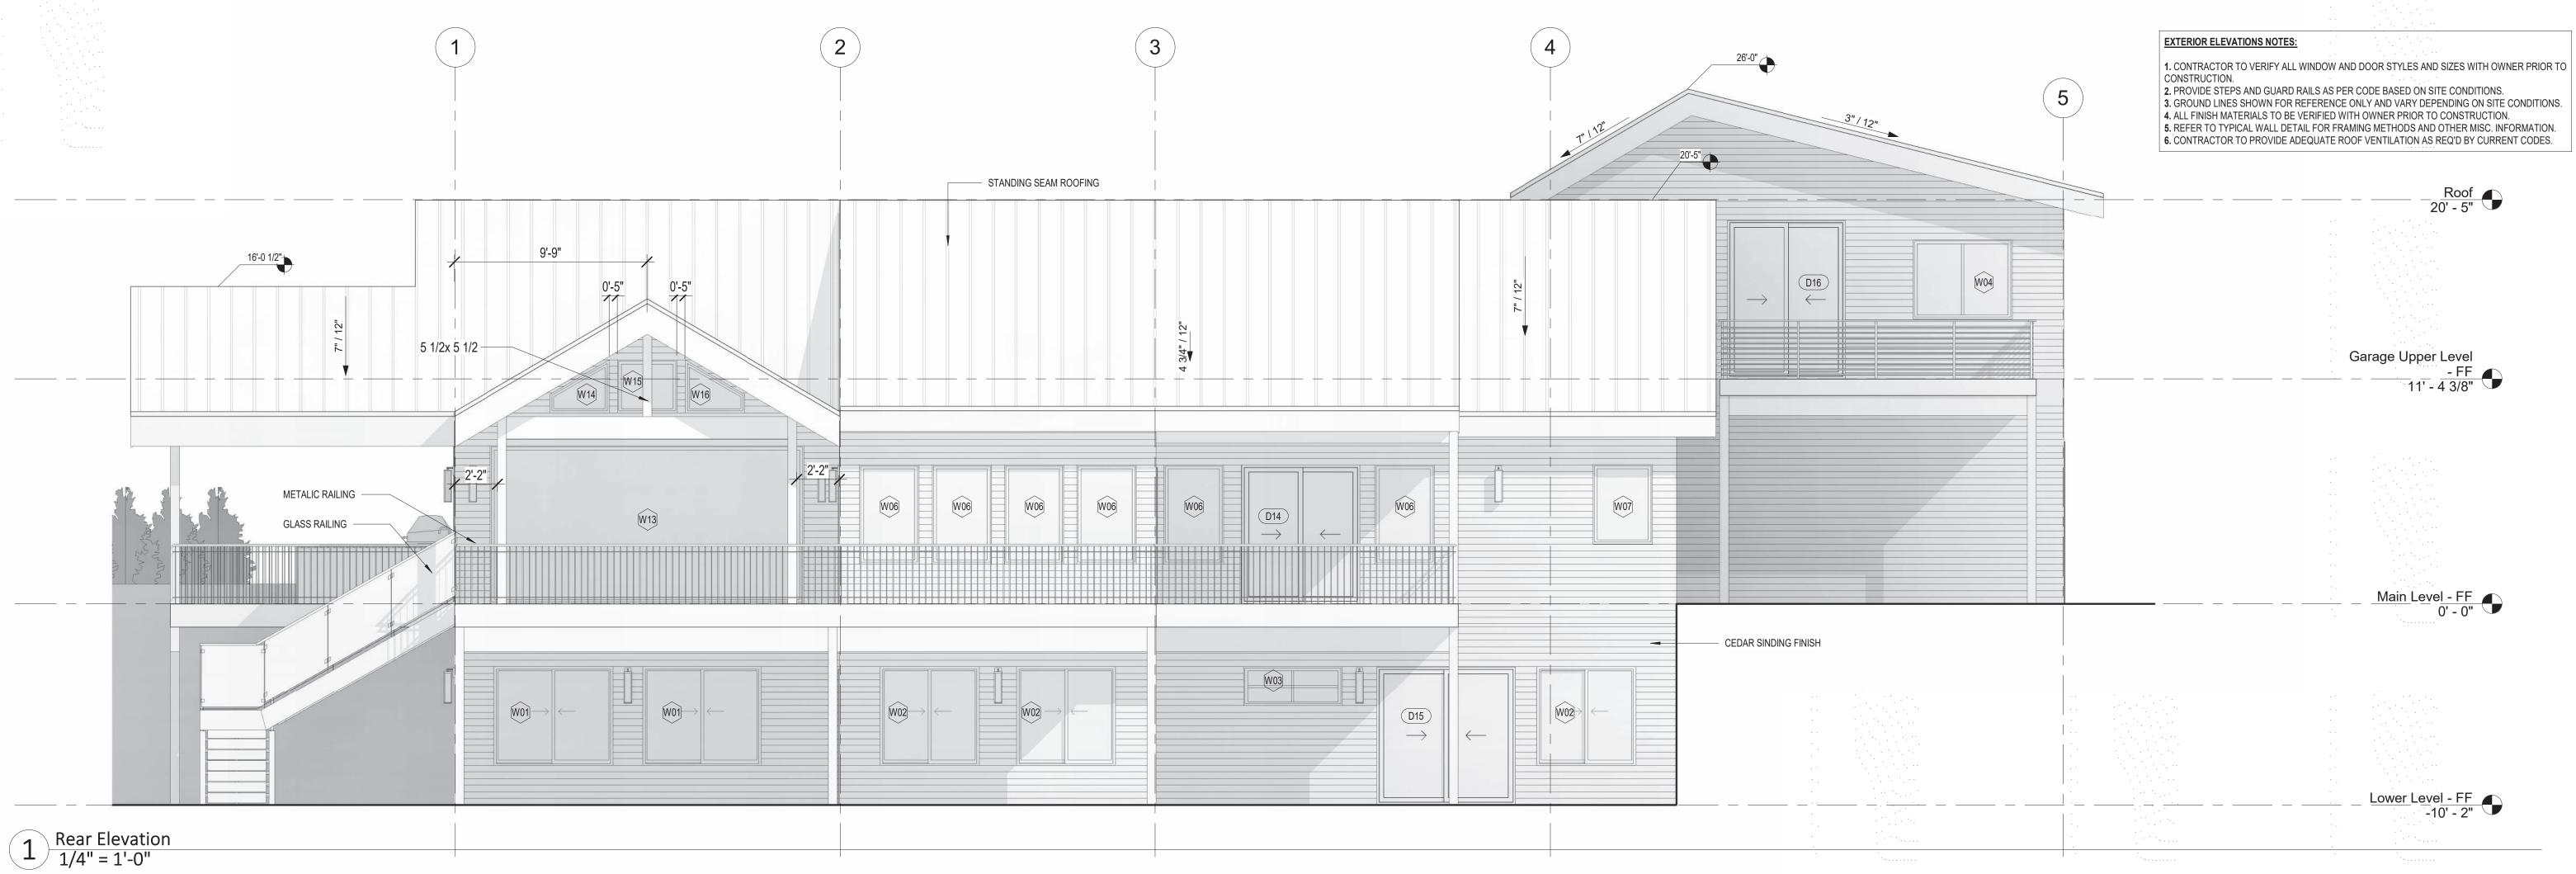

3. ALL RAFTERS TO BE SIZED AS PER SPAN CHART.
4. CONTRACTOR TO WATERPROOF ALL ROOF INTERSECTIONS AS PER

AUTHENTIC DESIGH Morris Originals, Bellingham, WA Corry Morris, Principal. c. 360.223.3359 corry@morrisoriginals.com

Description

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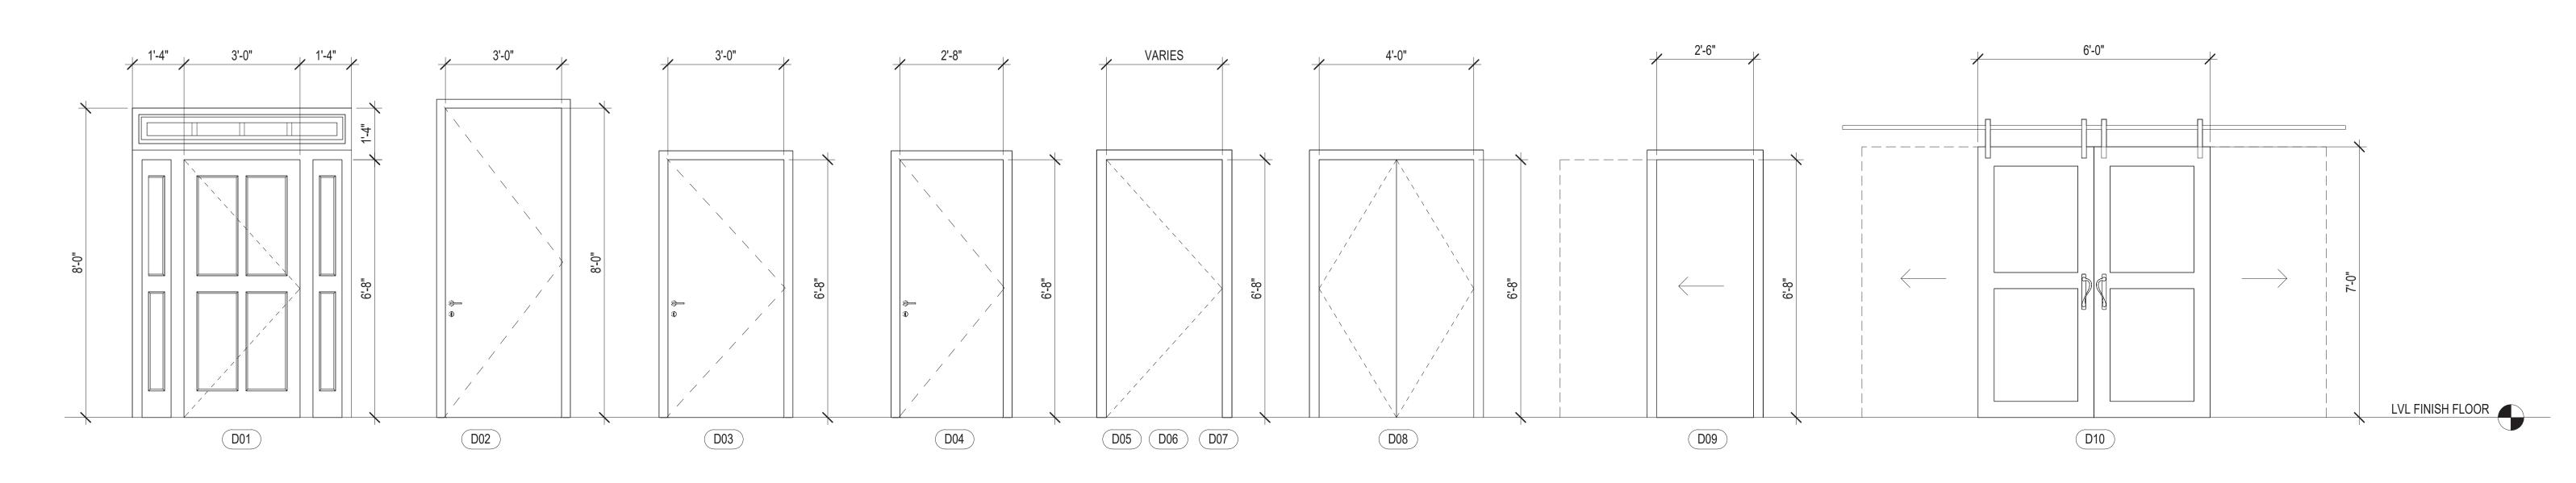
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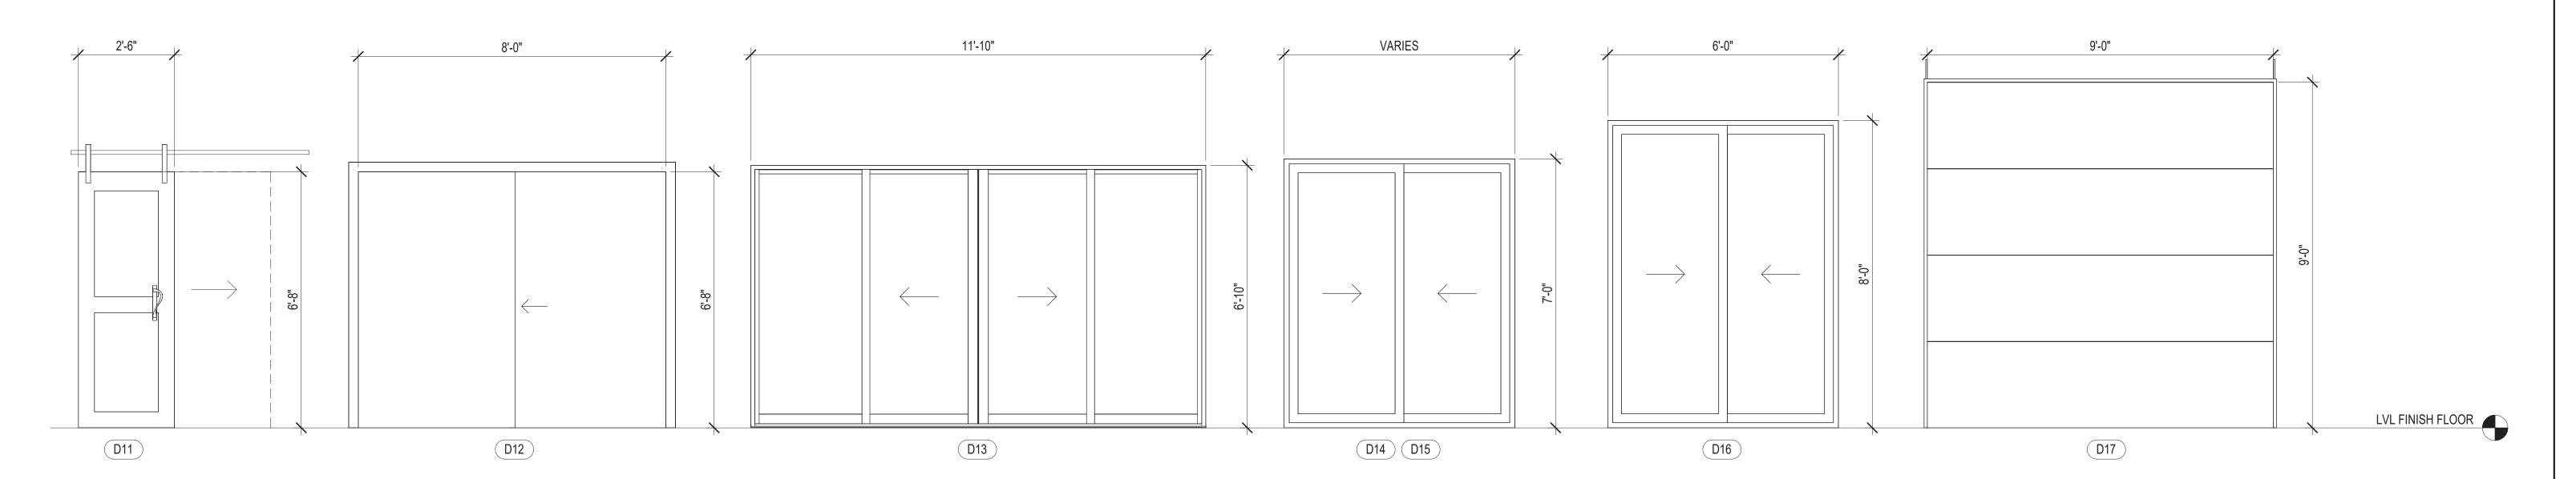
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**A-440** 

**Roof Plan** 

No.	Description	Date





### DOOR SCHEDULE 1/2" = 1'-0"

	DOORS SCHEDULE						
DOORS	DESCRIPTION	WIDTH	HEIGHT	TOTAL			
D01	Entry Door - Single Flush - Wood panel and frame - Tramson and fixed both sides	3' - 0"	6' - 8"	1			
D02	Exterior Door - Single Flush - Wood panel and frame	3' - 0"	8' - 0"	4			
D03	Exterior Door - Single Flush - Wood panel and frame	3' - 0"	6' - 8"	1			
D04	Exterior Door - Single Flush - Wood panel and frame	2' - 8"	6' - 8"	2			
D05	Interior Door - Single Flush - Wood panel and frame	3' - 0"	6' - 8"	2			
D06	Interior Door - Single Flush - Wood panel and frame	2' - 8"	6' - 8"	3			
D07	Interior Door - Single Flush - Wood panel and frame	2' - 6"	6' - 8"	5			
D08	Interior Door - Double Flush - Wood panel and frame	4' - 0"	6' - 8"	1			
D09	Interior Door - Single Pocket - Wood panel and aluminum frame	2' - 6"	6' - 8"	3			
D10	Interior Door - Double Barn - Wood panel and aluminum frame	6' - 0"	7' - 0"	2			
D11	Interior Door - Single Barn - Wood panel and aluminum frame	2' - 6"	6' - 8"	1			
D12	Interior Door - Closet Sliding- Wood panels and aluminum frame	8' - 0"	6' - 8"	1			
D13	Exterior Door - 2 Sliding panels and 2 fixed - Glazed panels and aluminum frame	11' - 10"	6' - 10"	1			
D14	Exterior Door - Sliding - Glazed panels and aluminum frame	6' - 0"	7' - 0"	1			
D15	Exterior Door - Sliding - Glazed panels and aluminum frame	7' - 0"	7' - 0"	1			
D16	Exterior Door - Sliding - Glazed panels and aluminum frame	6' - 0"	8' - 0"	1			
D17	Garage Door - OHD	9' - 0"	9' - 0"	2			

NOTE: FOR OPENING SIDE, SEE FLOOR PLANS

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Date: 24 03 04


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A-500

**Doors Schedule** 



WINDOW SCHEDULE
1/2" = 1'-0"

		WINDOW SCH	EDULE		
WINDO W	TYPE	WIDTH	HEIGHT	FRAME MATERIAL	ТОТА
W01	Sliding - 2 Glazed Panels	6' - 0"	5' - 0"	Aluminum	2
W02	Sliding - 2 Glazed Panels	5' - 0"	5' - 0"	Aluminum	3
W03	Fixed - 2+2 Glazed Panels	5' - 0"	2' - 0"	Aluminum	1
W04	Fixed - 2 Glazed Panels	5' - 0"	4' - 0"	Aluminum	4
W05	Fixed - 2 Glazed Panels	4' - 0"	3' - 0"	Aluminum	1
W06	Fixed - 1 Glazed Panel	3' - 0"	5' - 0"	Aluminum	7
W07	Fixed - 1 Glazed Panel	3' - 0"	4' - 0"	Aluminum	1
W08	Fixed - 1 Glazed Panel	2' - 0"	5' - 0"	Aluminum	2
W09	Fixed - 2 Glazed Panels	2' - 6"	3' - 0"	Aluminum	2
W10	Awning - 1 Glazed Panel	2' - 0"	2' - 0"	Aluminum	1
W11	Fixed - 1 Glazed Panel	6' - 0"	2' - 6"	Aluminum	1
W12	Fixed - 1 Glazed Panel	6' - 0"	3' - 6"	Aluminum	2
W13	Fixed - 1 Glazed Panel	15' - 10"	8' - 0"	Aluminum	1
W14	Fixed - 1 Glazed Panel	3' - 0"	see drawing	Aluminum	1
W15	Fixed - 1 Glazed Panel	3' - 0"	2' - 8"	Aluminum	1
W16	Fixed - 1 Glazed Panel	3' - 0"	see drawing	Aluminum	1

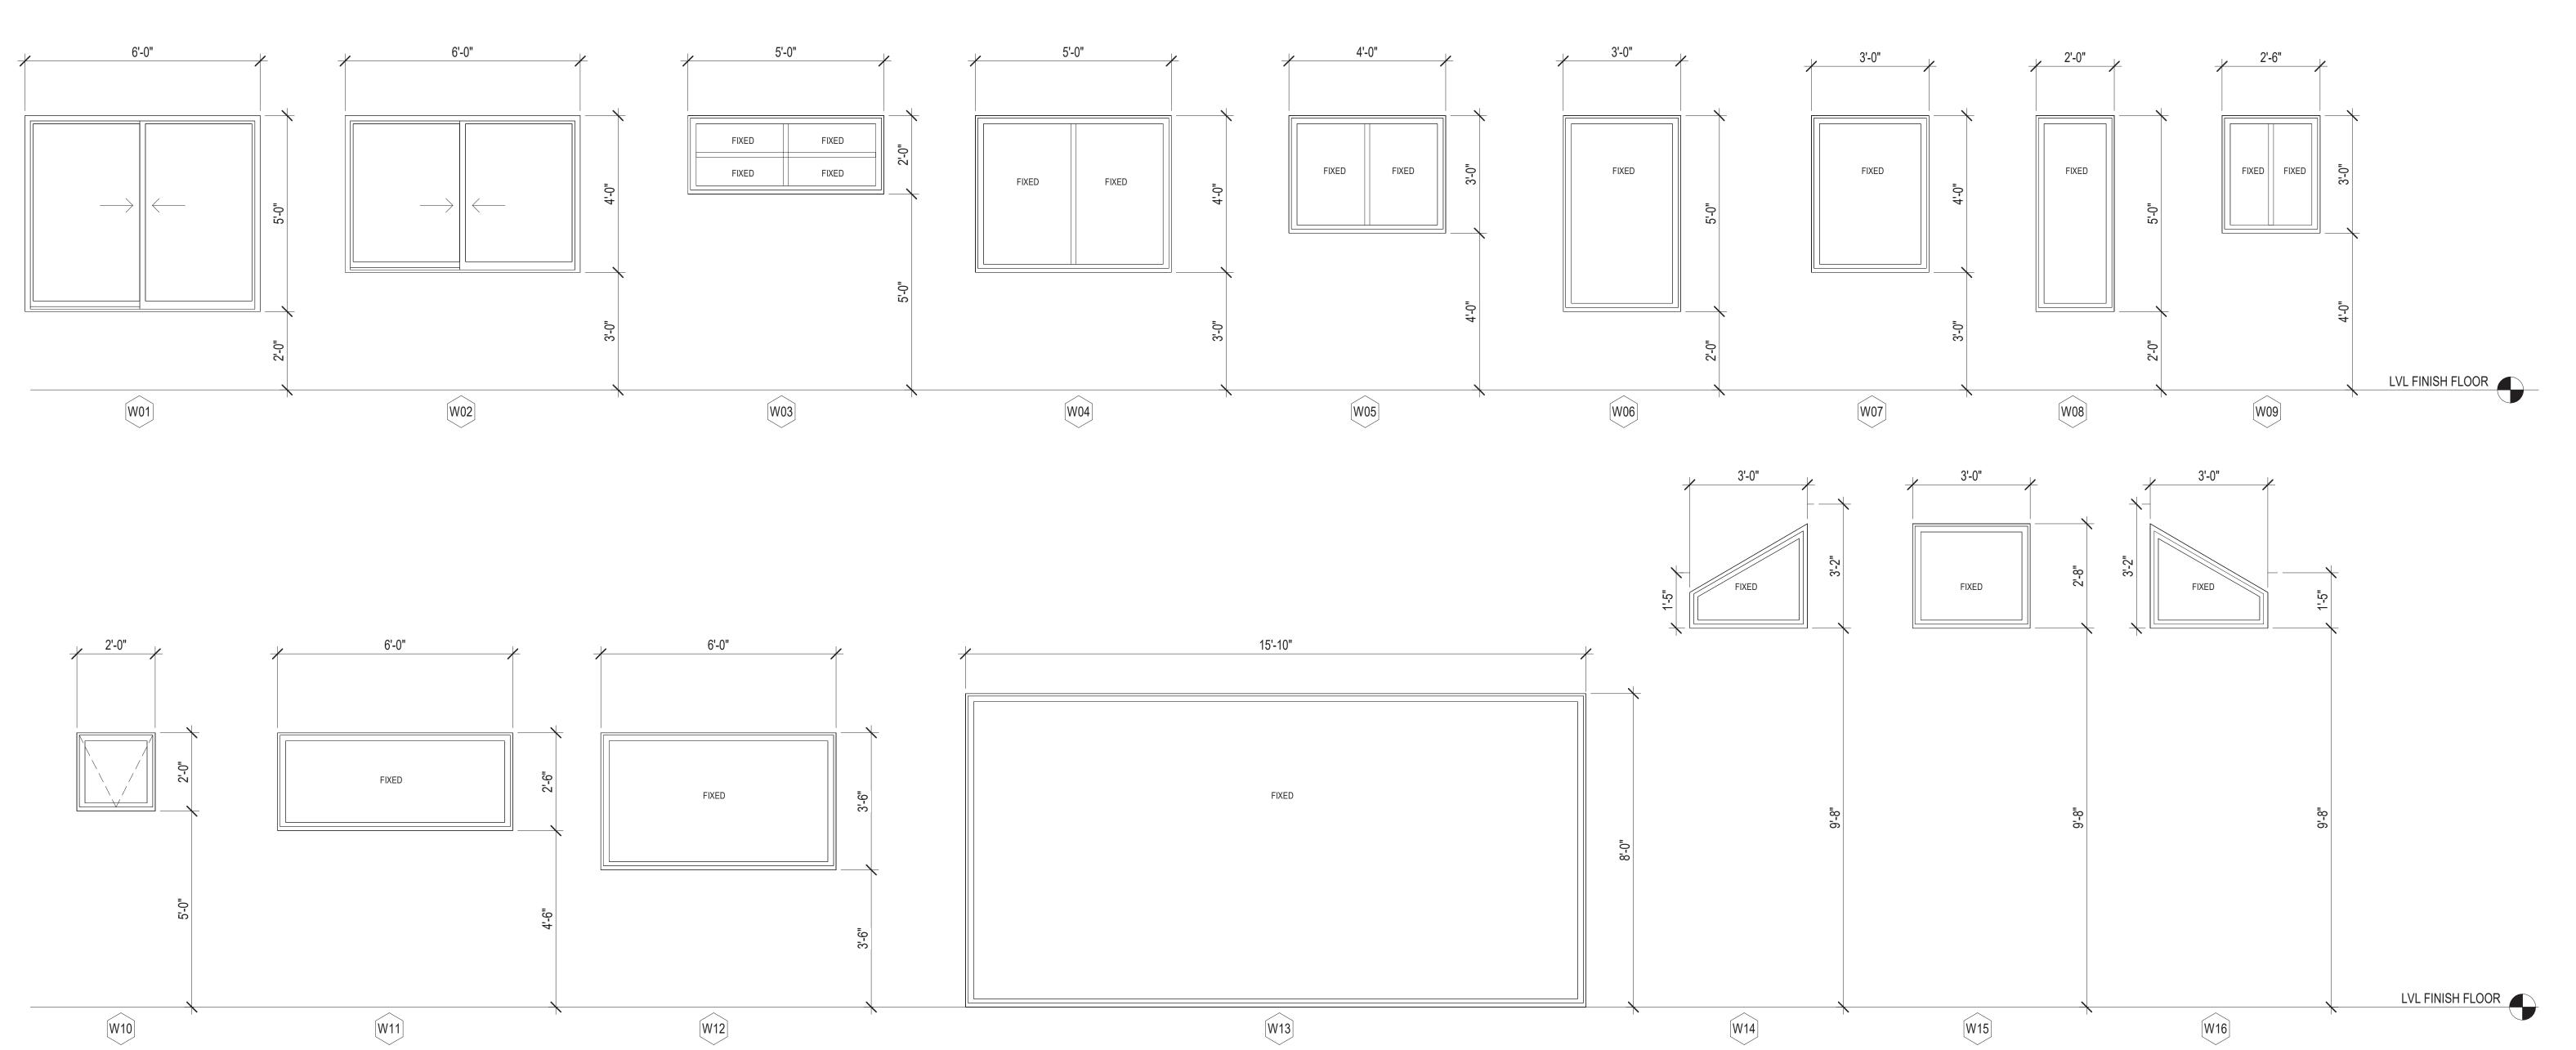

No. Description Date

# FOWLER RESIDENCE 68 Adel Ln, Wenatchee, WA 98801

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A-501

Windows Schedule

1. CONTRACTOR SHALL COMPLY WITH ALL APPLICABLE CODES AT SITE.


2. ALL RIDGE BEAMS, HIP RAFTERS, & VALLEY RAFTERS TO BE 2" x 10", OR AS REQ'D BY ENGINEER.

3. CONTRACTOR TO PROVIDE RAFTER BRACING TO MEET APPLICABLE CODES.

**4.** CONTRACTOR TO THOROUGHLY WATERPROOF ALL EXTERIOR INTERSECTIONS AS PER CODE AND TYPICAL BUILDING PRACTICES.

5. ALL BEAMS TO BE SIZED BY A LICENSED STRUCTURAL ENGINEER.

6. ALL LUMBER SIZES AND SPACING TO BE VERIFIED BY CONTRACTOR PRIOR TO CONSTRUCTION.
7. CONTRACTOR TO PROVIDE ADEQUATE ROOF VENTILATION AS REQ'D. BY CURRENT CODES.

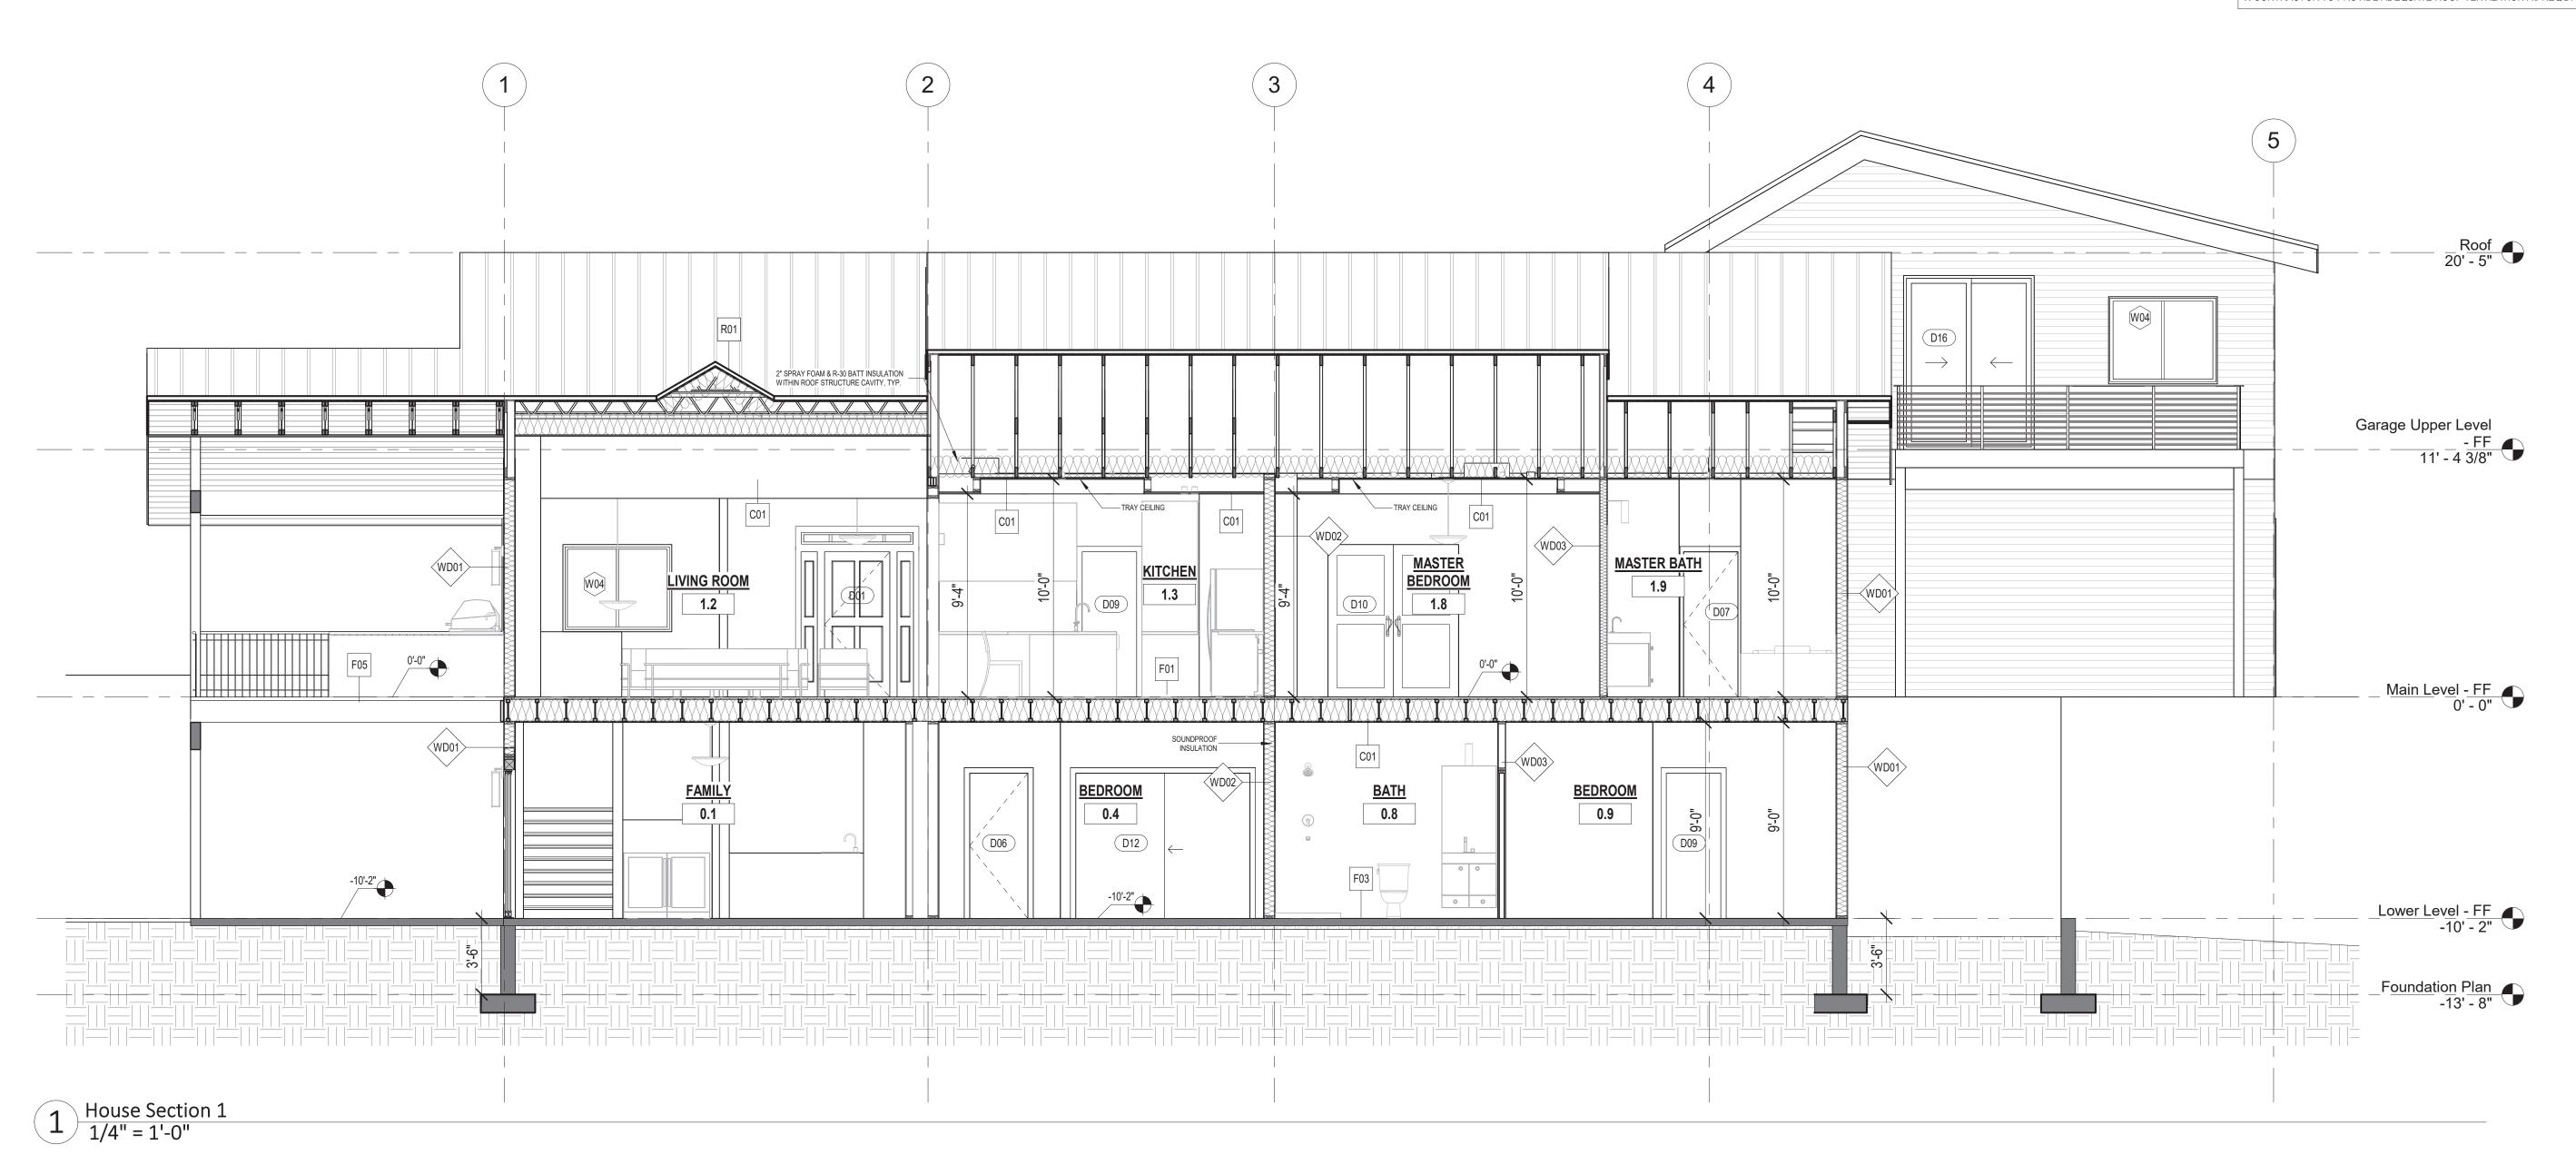

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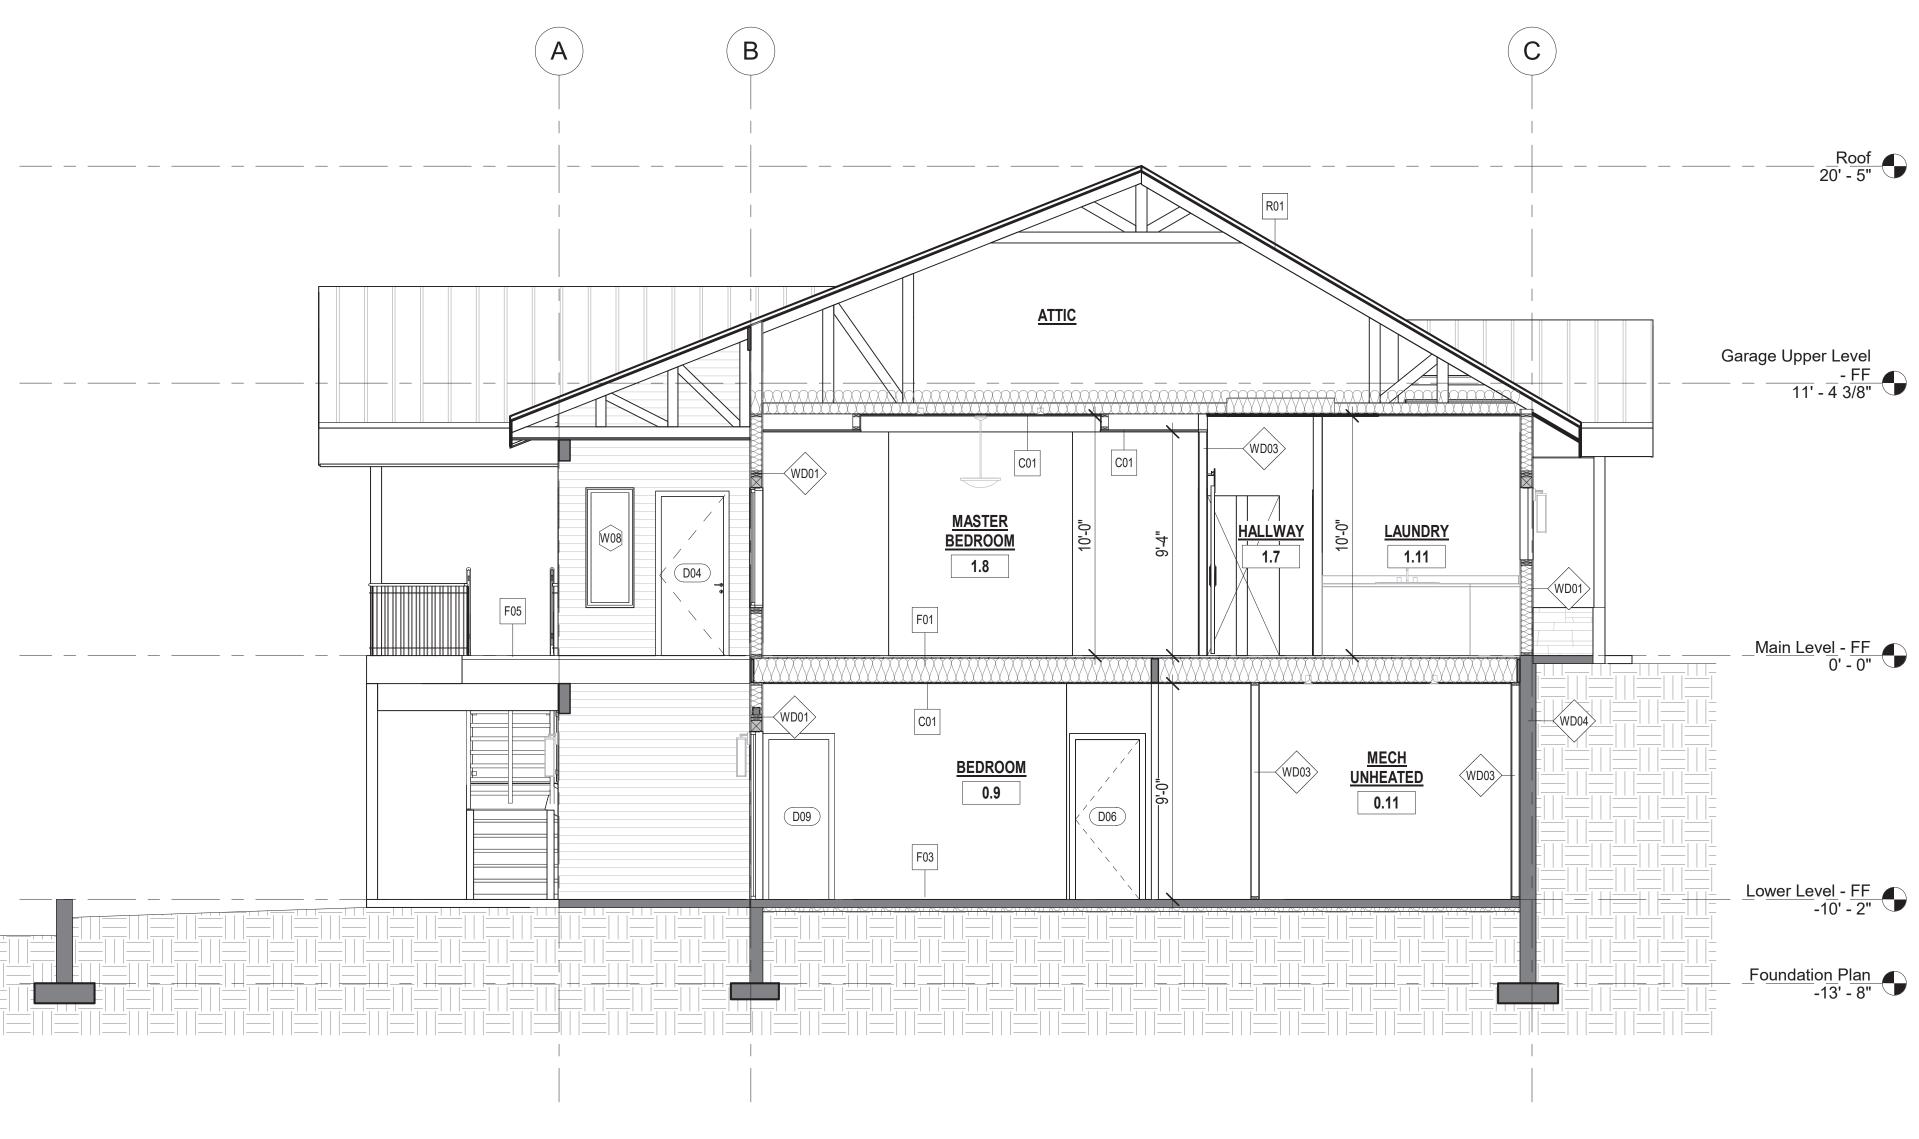
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A-600

**Building Sections** 



1 House Section 2 1/4" = 1'-0"

### **BUILDING SECTIONS NOTES:**

1. CONTRACTOR SHALL COMPLY WITH ALL APPLICABLE CODES AT SITE.

ALL RIDGE BEAMS, HIP RAFTERS, & VALLEY RAFTERS TO BE 2" x 10", OR AS REQ'D BY ENGINEER.
 CONTRACTOR TO PROVIDE RAFTER BRACING TO MEET APPLICABLE CODES.

4. CONTRACTOR TO THOROUGHLY WATERPROOF ALL EXTERIOR INTERSECTIONS AS PER CODE AND

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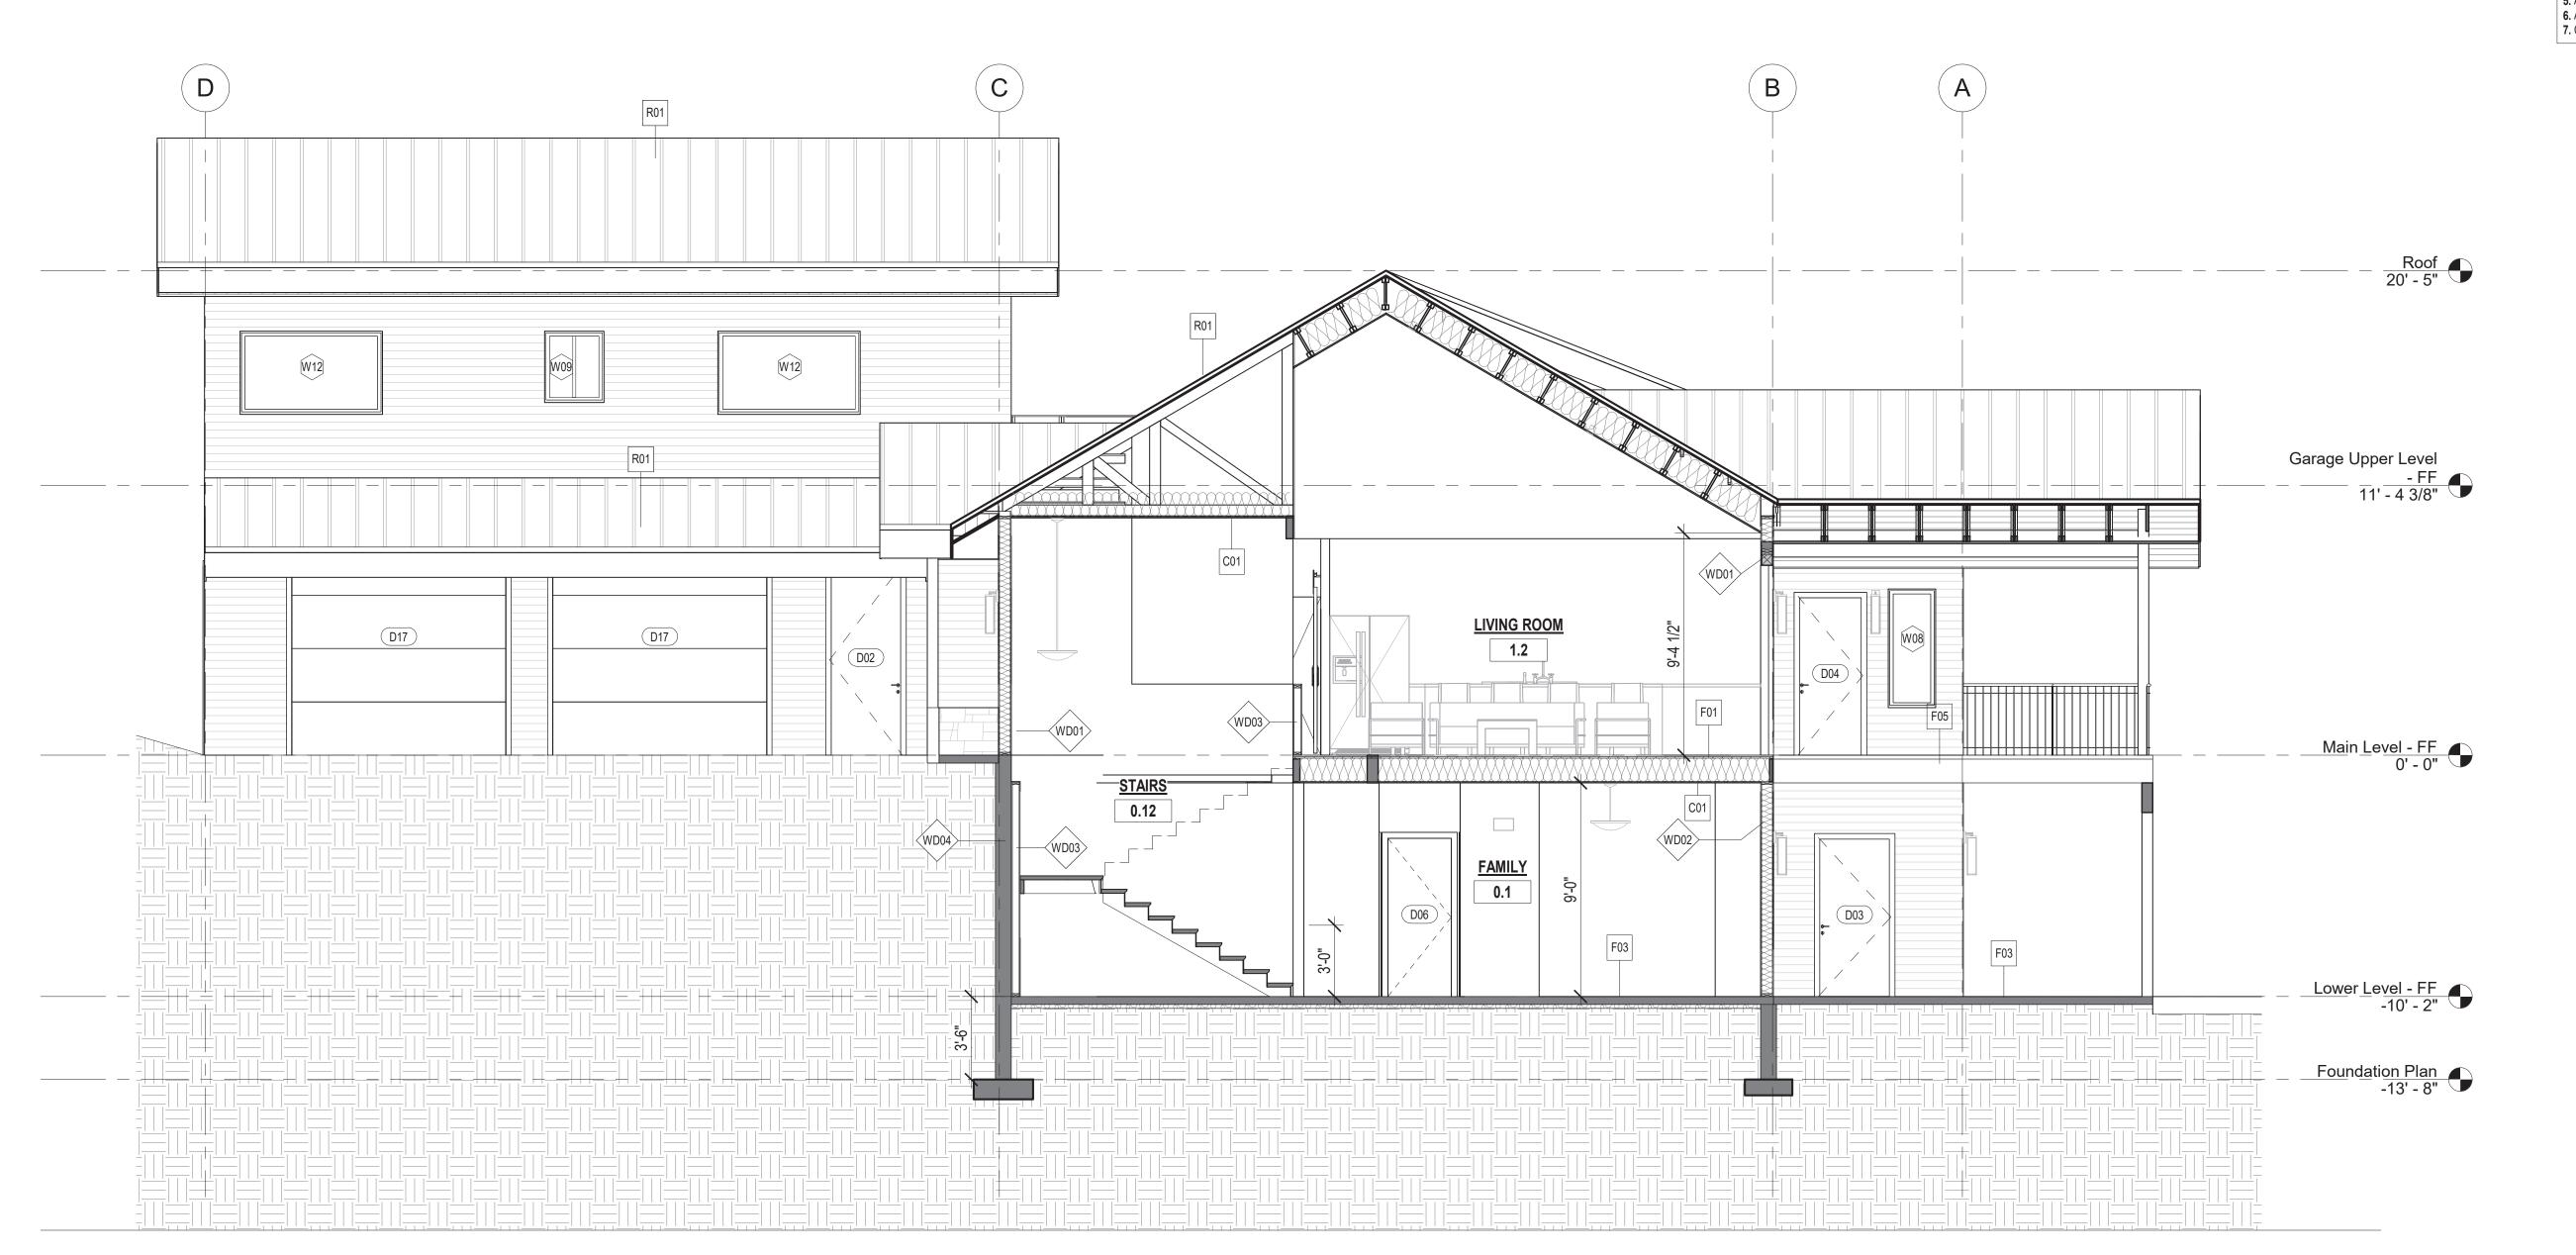
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**A-601** 

**Building Sections** 



### **BUILDING SECTIONS NOTES:**

1. CONTRACTOR SHALL COMPLY WITH ALL APPLICABLE CODES AT SITE.

2. ALL RIDGE BEAMS, HIP RAFTERS, & VALLEY RAFTERS TO BE 2" x 10", OR AS REQ'D BY ENGINEER. 3. CONTRACTOR TO PROVIDE RAFTER BRACING TO MEET APPLICABLE CODES.

4. CONTRACTOR TO THOROUGHLY WATERPROOF ALL EXTERIOR INTERSECTIONS AS PER CODE AND

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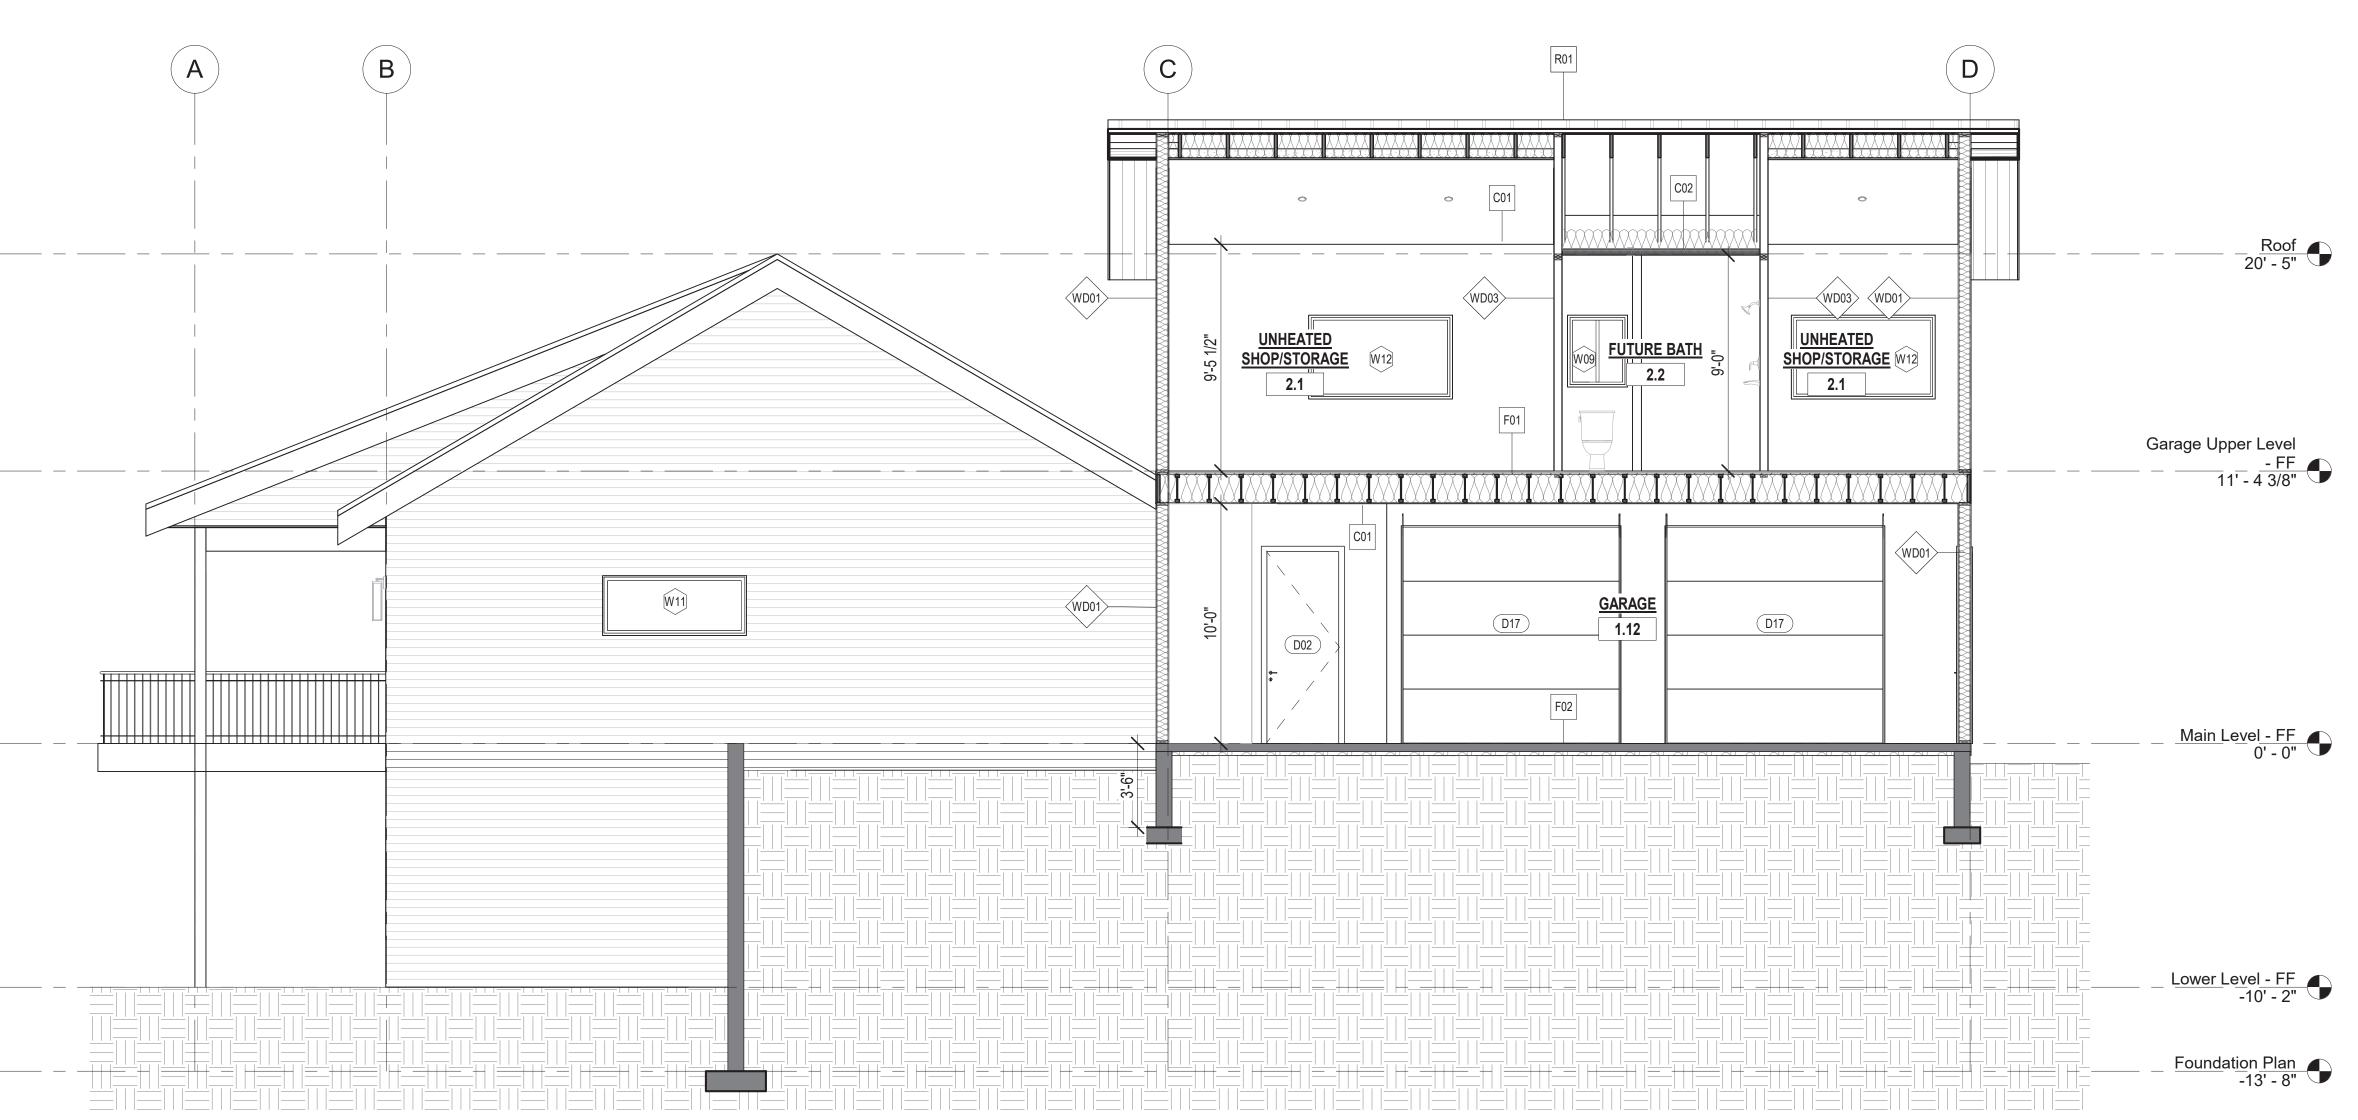
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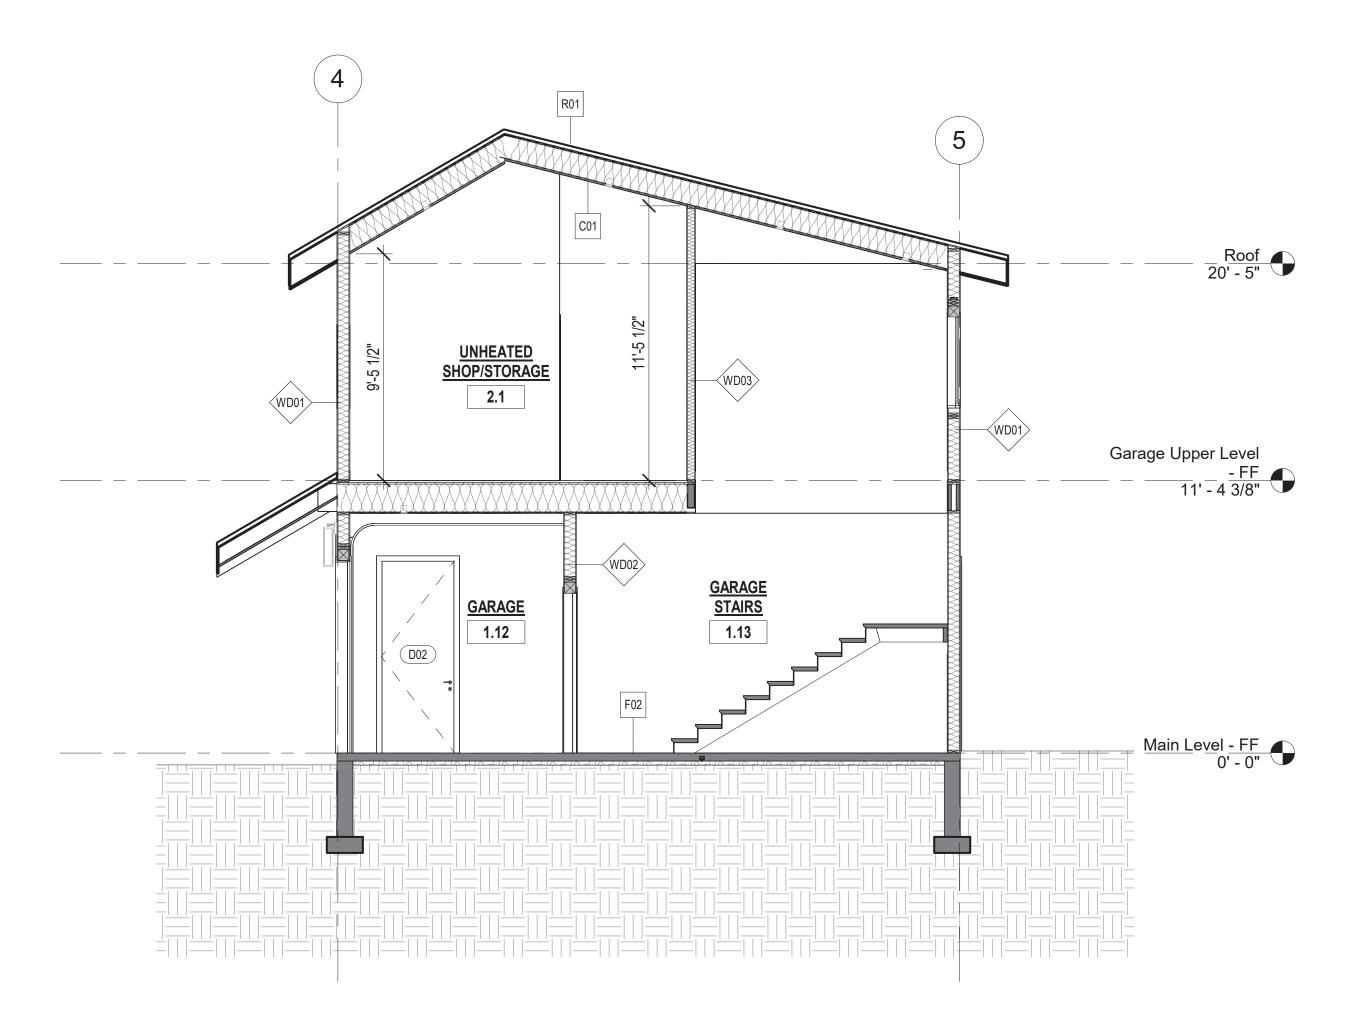
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A-602

**Building Sections** 



1 Garage Section 1 1/4" = 1'-0"



**BUILDING SECTIONS NOTES:** 

1. CONTRACTOR SHALL COMPLY WITH ALL APPLICABLE CODES AT SITE.

CONTRACTOR SHALL COMPLET WITH ALL AFFEIGABLE CODES AT SHE.
 ALL RIDGE BEAMS, HIP RAFTERS, & VALLEY RAFTERS TO BE 2" x 10", OR AS REQ'D BY ENGINEER.
 CONTRACTOR TO PROVIDE RAFTER BRACING TO MEET APPLICABLE CODES.

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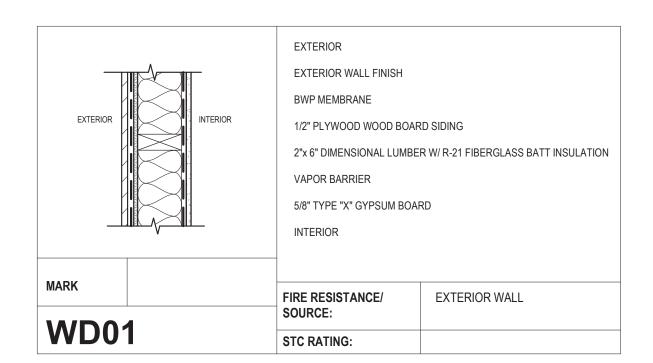
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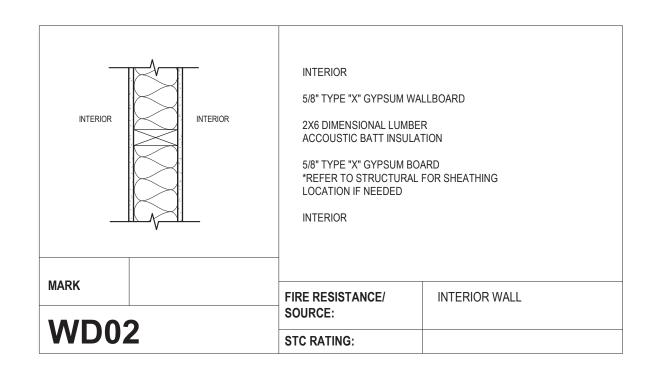
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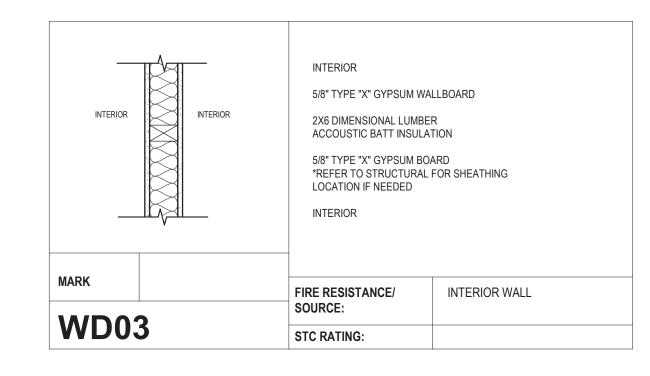
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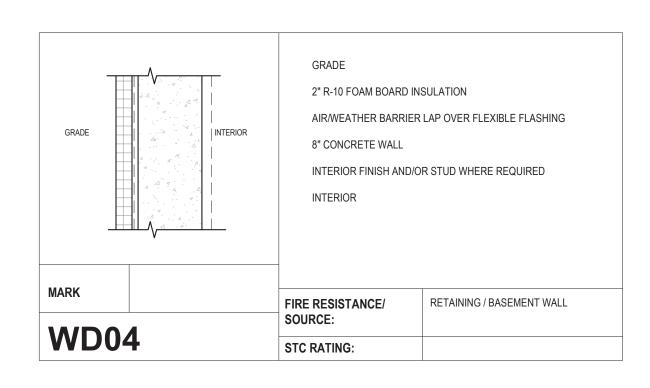
**Garage Sections** 















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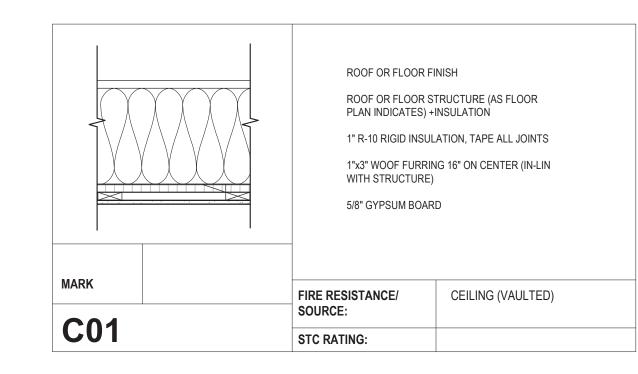


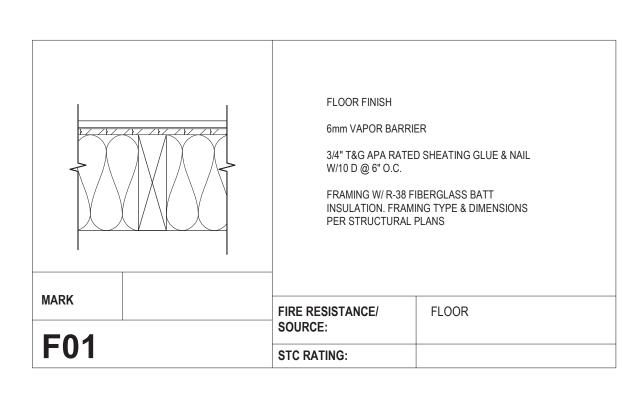


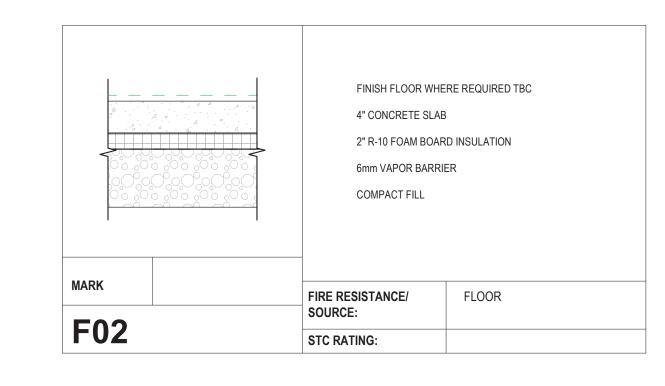
### ROOFS

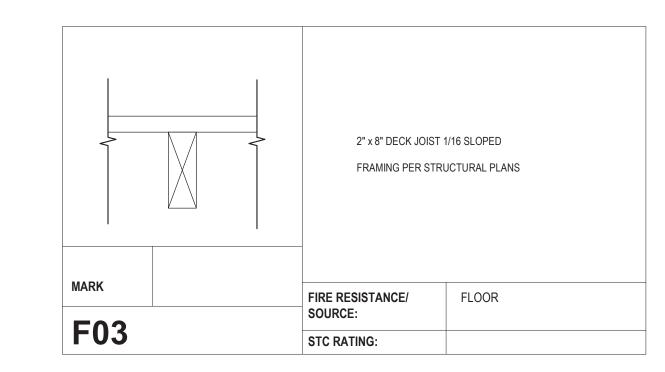




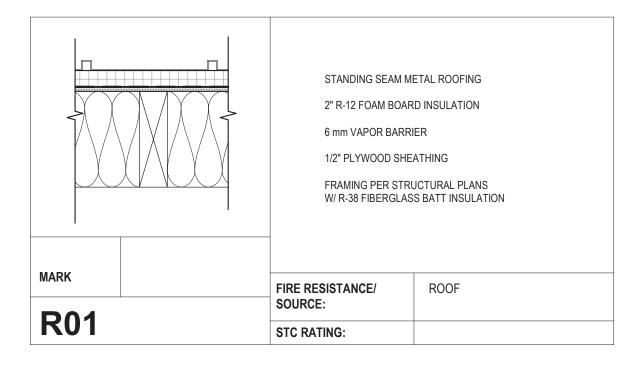

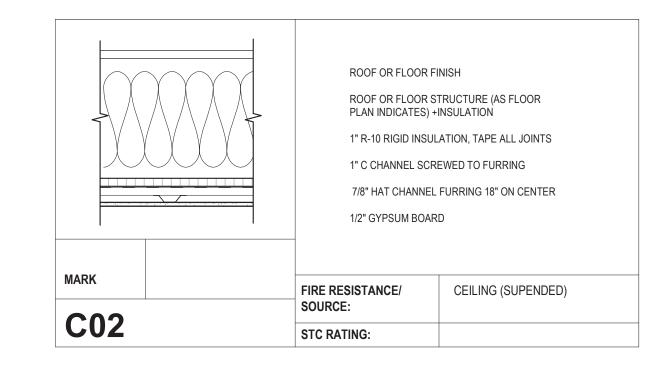

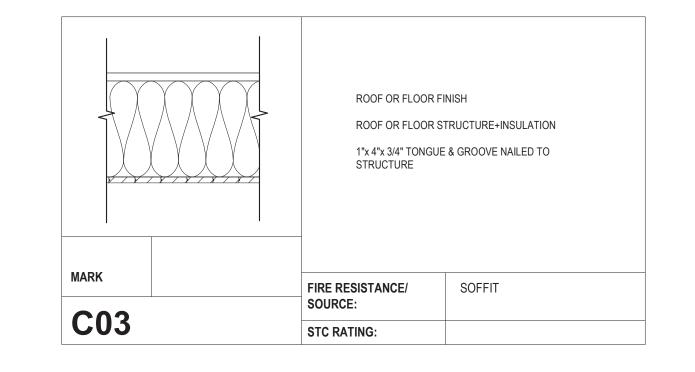

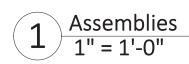

AUTHENTIC DESIGN

Morris Originals, Bellingham, WA Corry Morris, Principal. c. 360.223.3359 corry@morrisoriginals.com

Description

Date: 24 03 04


Drawn By (initials): Autor

Job No: Project Number

Check By (initials): CM

A-700

Assemblies

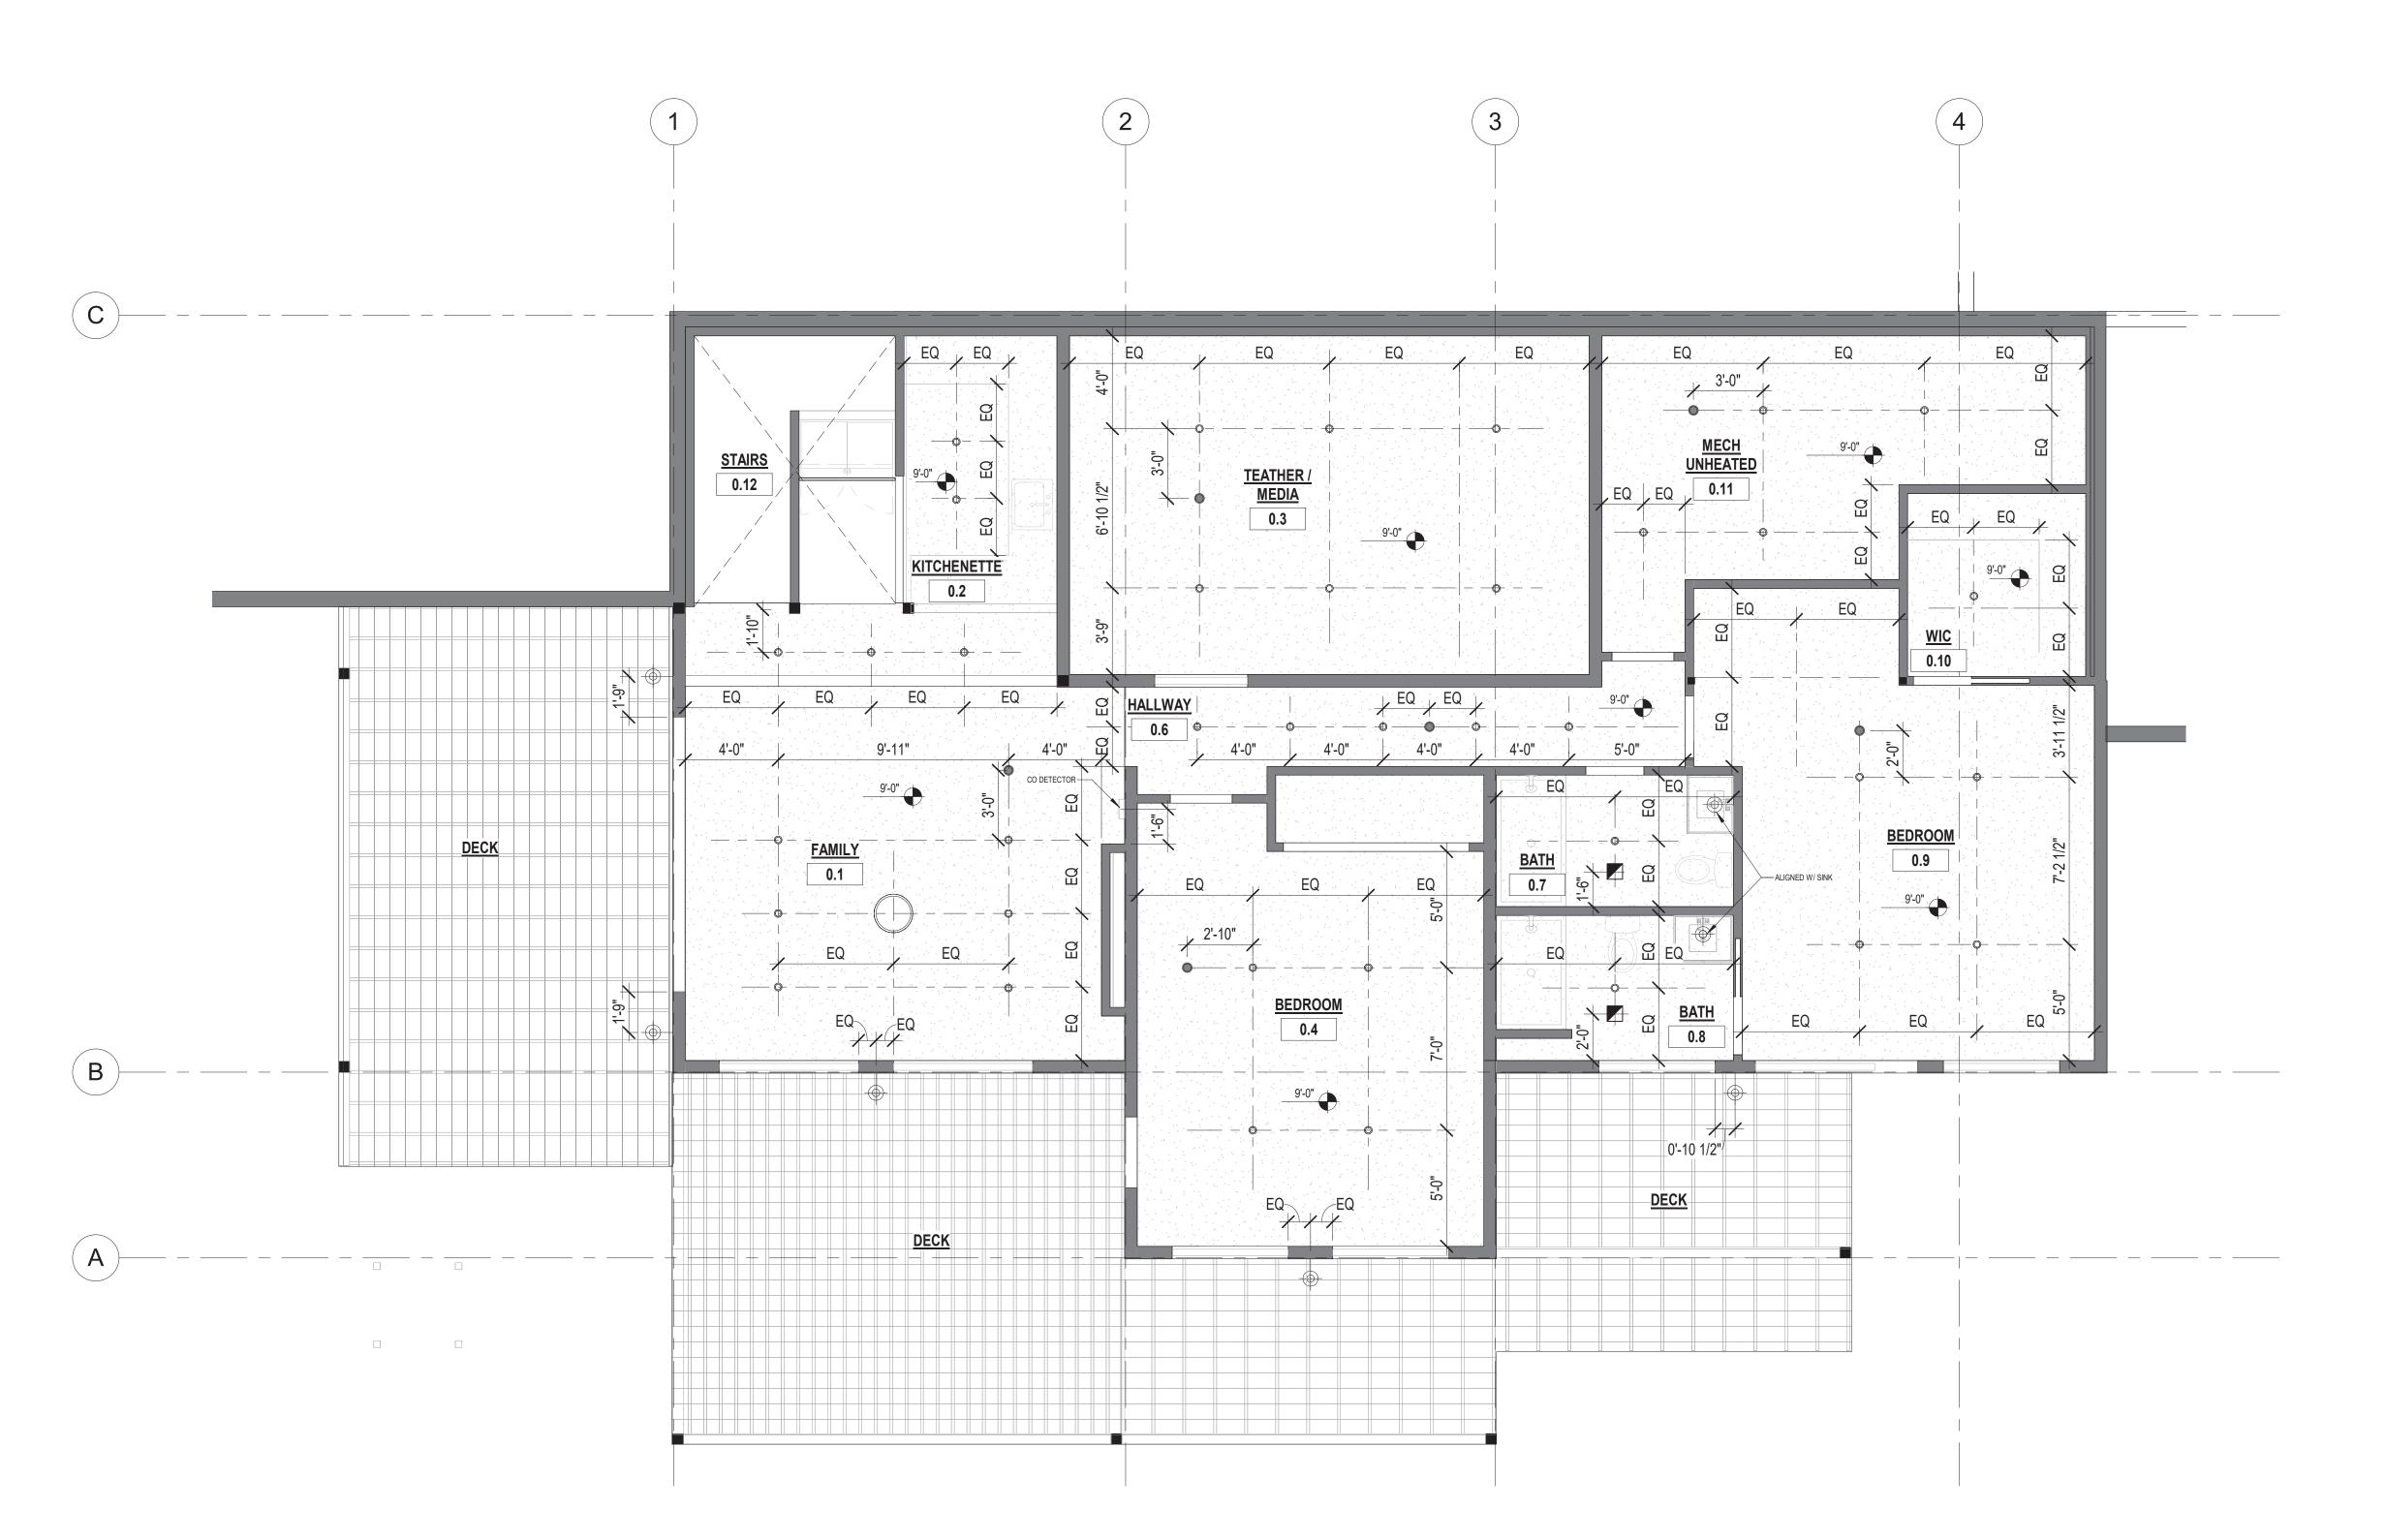

1 Lower Level - Reflected Ceiling Plan 1/4" = 1'-0"

REFLECTED CEILING PLAN NOTES:

1. ALL WORK SHALL COMPLY WITH ALL CODES APPLICABLE AT SITE.

2. SMOKE ALARMS SHALL BE INSTALLED IN THE FOLLOWING LOCATIONS: EACH SLEEPING ROOM, OUTSIDE EACH SEPARATE SLEEPING AREA IN THE IMMEDIATE VICINITY OF THE BEDROOMS, ON EACH ADDITIONAL STORY OF THE DWELLING, INCLUDING BASEMENTS AND HABITABLE ATTICS. WHEN MORE THAN ONE SMOKE ALARM IS REQUIRED TO BE INSTALLED WITHIN A DWELLING THE ALARM DEVICES SHALL BE INTERCONNECTED IS SUCH A MANNER THAT THE ACTUATION OF ONE ALARM WILL ACTIVATE ALL OF THE ALARMS IN THE UNIT. SMOKE ALARMS SHALL BE HARD WIRED WITH A BATTERY BACK UP.

3. CARBON MONOXIDE ALARMS SHALL BE INSTALLED OUTSIDE OF EACH SEPARATE SLEEPING AREA IN THE IMMEDIATE

VICINITY OF THE BEDROOMS IN DWELLING UNITS WITHIN WHICH FUEL-FIRED APPLIANCES ARE INSTALLED AND IN DWELLING UNITS WITH ATTACHED GARAGES.

**4.** A 125 VOLT, SINGLE PHASE, 15-20 AMPERE RATED RECEPTACLE OUTLET SHALL BE INSTALLED AT AN ACCESSIBLE LOCATION FOR THE SERVICING OF HEATING, AIR CONDITIONING AND REFRIGERATION EQUIPMENT. THE RECEPTACLE SHALL BE LOCATED ON THE SAME LEVEL AND WITHIN 25 FEET OF THE EQUIPMENT. THE RECEPTACLE OUTLET SHALL NOT BE CONNECTED TO THE LOAD SIDE OF THE HVAC EQUIPMENT DISCONNECTING MEANS.

SYMBOL	DESCRIPTION	SYMBOL	DESCRIPTION
	SUSPENDED CEILING.		EXHAUST FAN
	VAULTED CEILING	•	SMOKE DETECTOR
	T&G VAULTED CEILING/ SOFFIT		
0	4" RECESSED CAN LIGHT FIXTURE		
	WALL MOUNTED-LIGHT FIXTURE		
	PENDANT LIGHT FIXTURE		
	CO DETECTOR		



No. Description Date

### FOWLER RESIDENC 68 Adel Ln, Wenatchee, WA 98801

Date: 24 03 04

Job No: Project Number


Drawn By (initials): Autor

Check By (initials): CM

A-800

Lower Level - Reflected Ceiling Plan



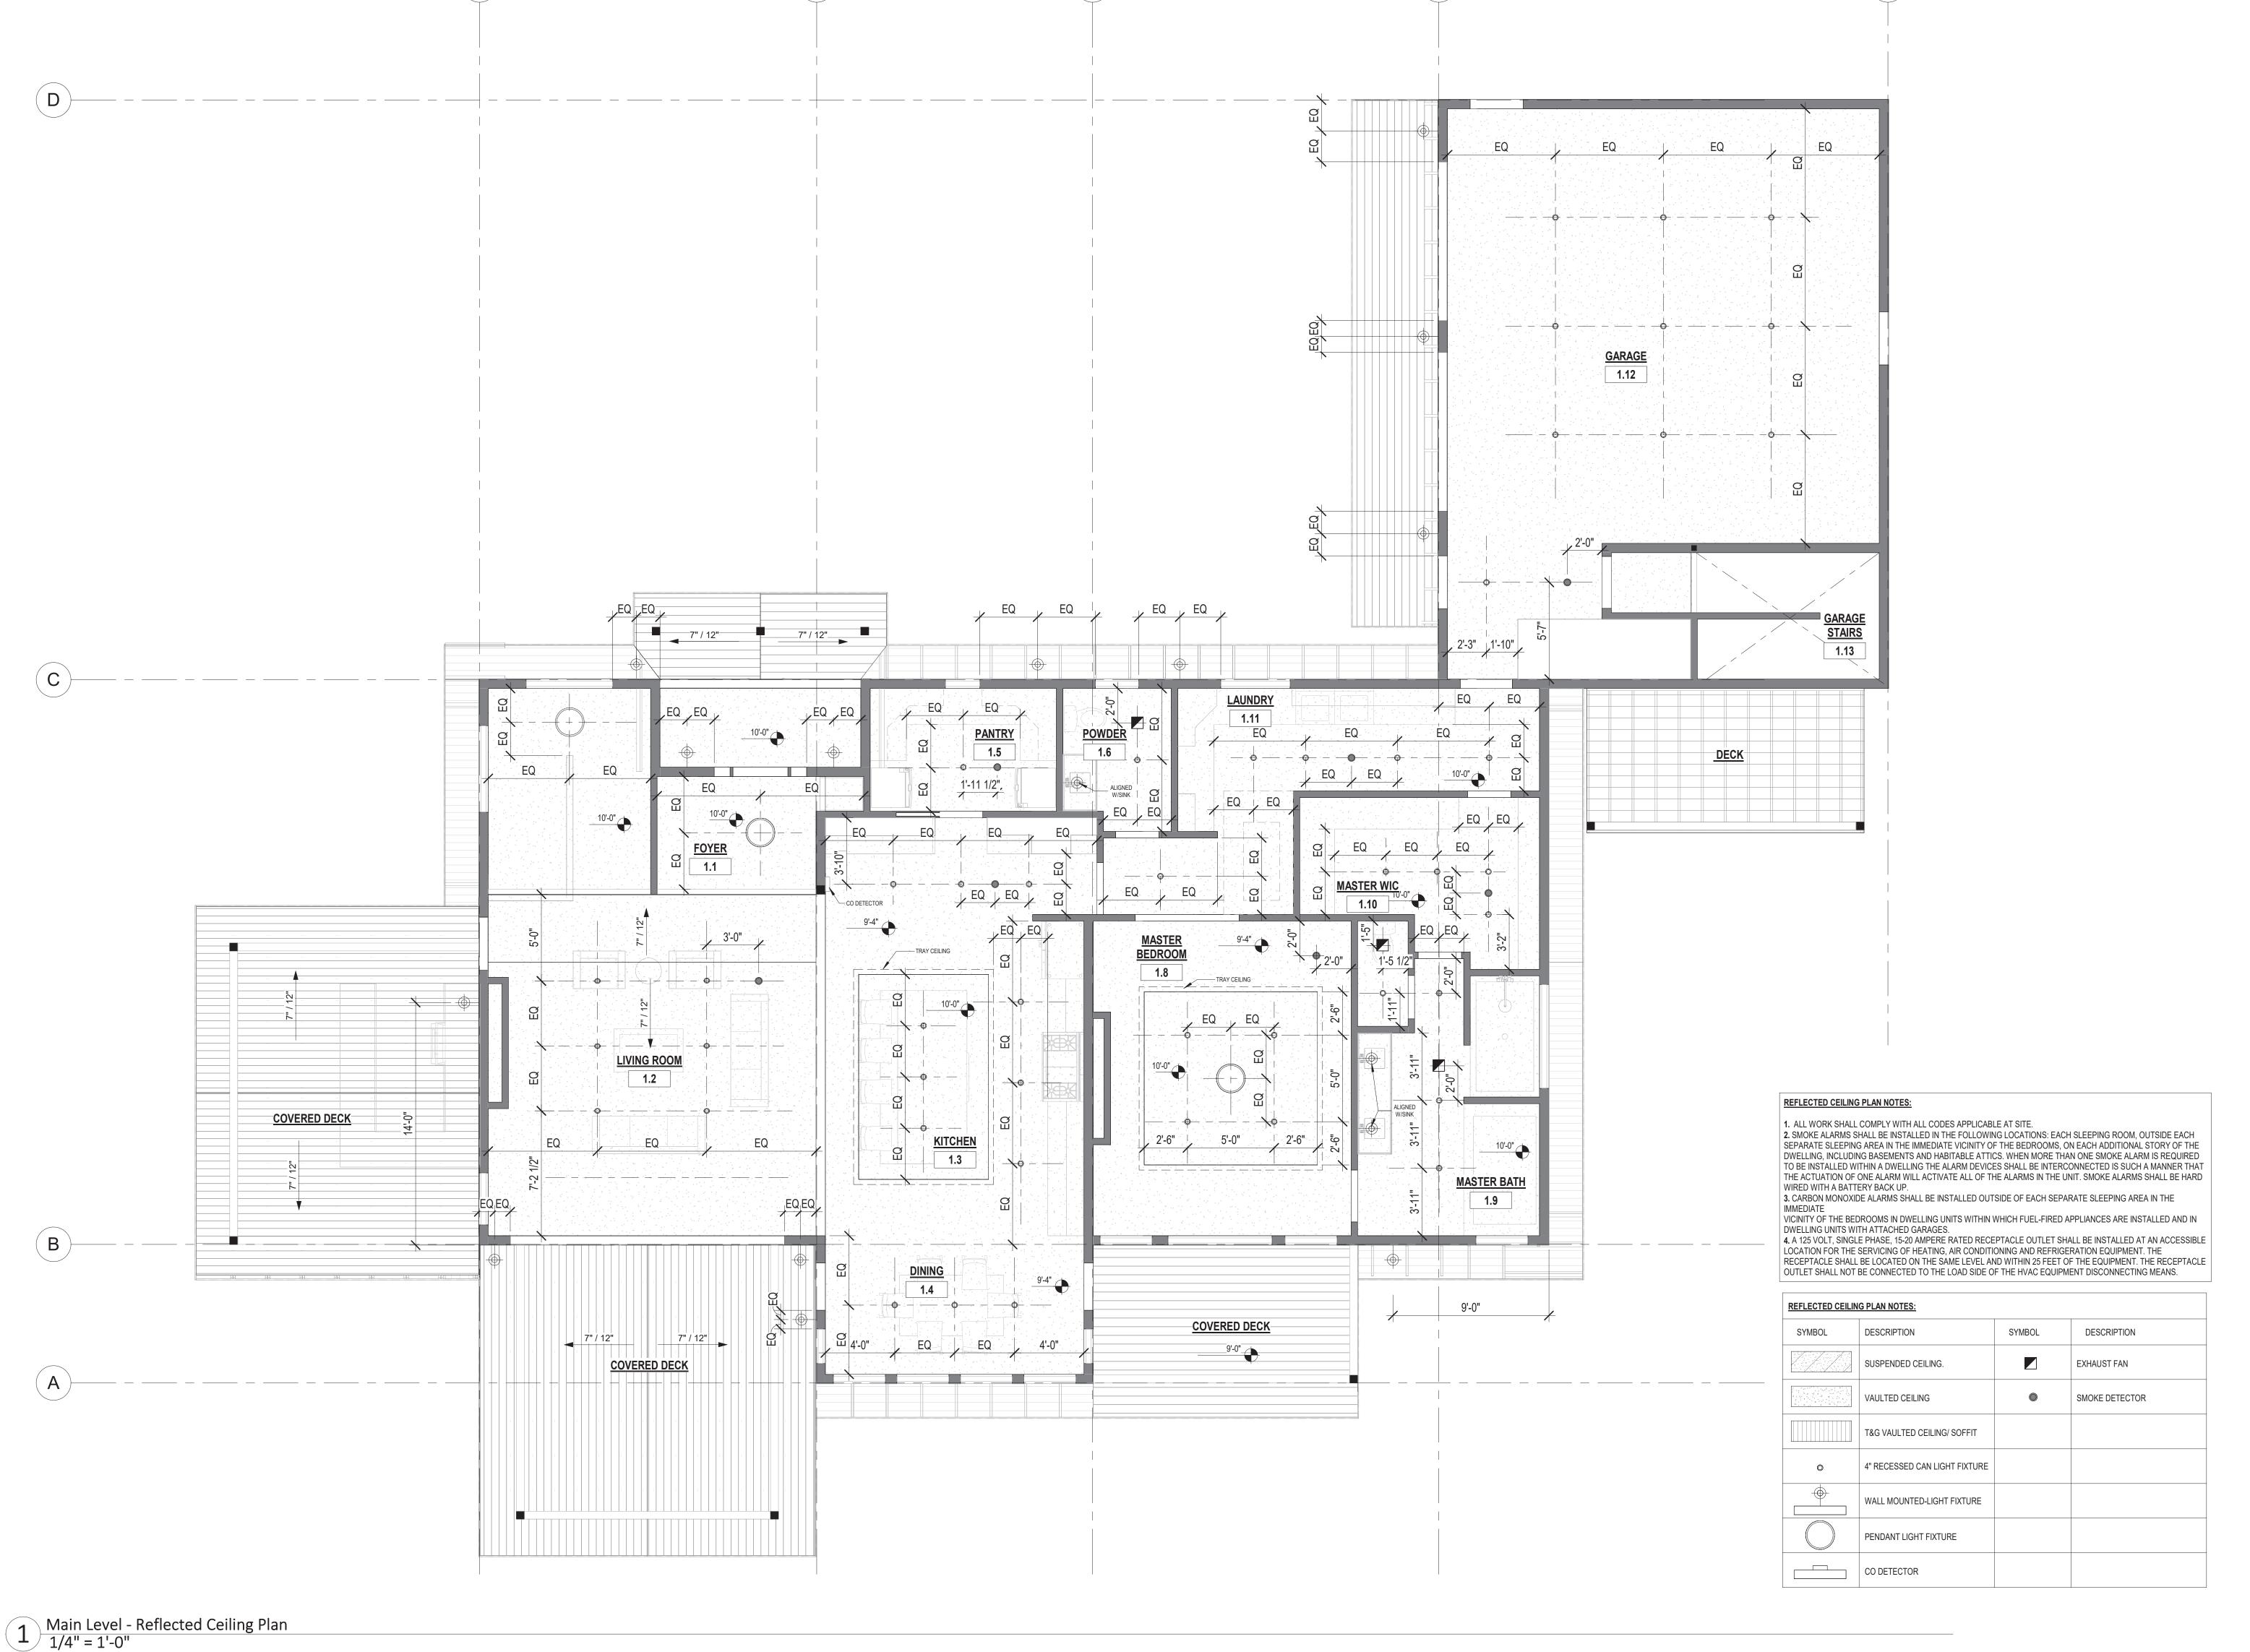

MORRIS.

Principal

AUTHENTIC DESIGN

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Corry Morris, Principal.
c. 360.223.3359
corry@morrisoriginals.com

Date: 24 03 04


Job No: Project Number

Drawn By (initials): Autor

Check By (initials): CM

A-801

Main Level - Reflected Ceiling Plan

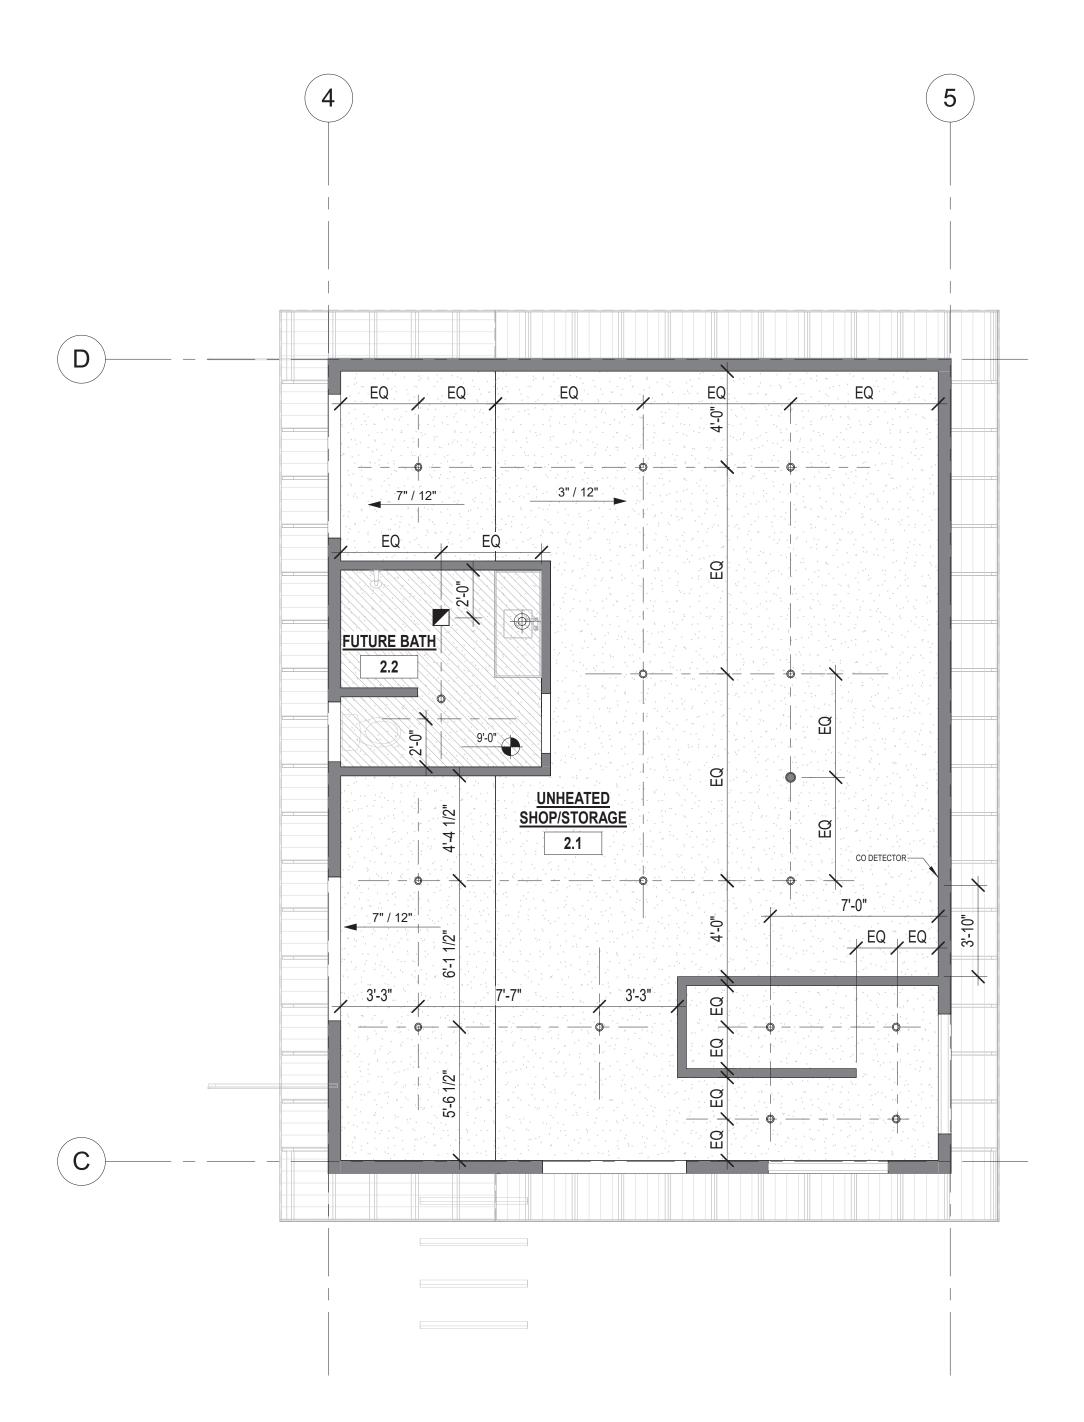

Garage Upper Level - Reflected Ceiling Plan 1/4" = 1'-0"

### REFLECTED CEILING PLAN NOTES:

1. ALL WORK SHALL COMPLY WITH ALL CODES APPLICABLE AT SITE.

2. SMOKE ALARMS SHALL BE INSTALLED IN THE FOLLOWING LOCATIONS: EACH SLEEPING ROOM, OUTSIDE EACH SEPARATE SLEEPING AREA IN THE IMMEDIATE VICINITY OF THE BEDROOMS, ON EACH ADDITIONAL STORY OF THE DWELLING, INCLUDING BASEMENTS AND HABITABLE ATTICS. WHEN MORE THAN ONE SMOKE ALARM IS REQUIRED TO BE INSTALLED WITHIN A DWELLING THE ALARM DEVICES SHALL BE INTERCONNECTED IS SUCH A MANNER THAT THE ACTUATION OF ONE ALARM WILL ACTIVATE ALL OF THE ALARMS IN THE UNIT. SMOKE ALARMS SHALL BE HARD WIRED WITH A BATTERY BACK UP.

3. CARBON MONOXIDE ALARMS SHALL BE INSTALLED OUTSIDE OF EACH SEPARATE SLEEPING AREA IN THE

IMMEDIATE
VICINITY OF THE BEDROOMS IN DWELLING UNITS WITHIN WHICH FUEL-FIRED APPLIANCES ARE INSTALLED AND IN DWELLING UNITS WITH ATTACHED GARAGES.

4. A 125 VOLT, SINGLE PHASE, 15-20 AMPERE RATED RECEPTACLE OUTLET SHALL BE INSTALLED AT AN ACCESSIBLE LOCATION FOR THE SERVICING OF HEATING, AIR CONDITIONING AND REFRIGERATION EQUIPMENT. THE RECEPTACLE SHALL BE LOCATED ON THE SAME LEVEL AND WITHIN 25 FEET OF THE EQUIPMENT. THE RECEPTACLE OUTLET SHALL NOT BE CONNECTED TO THE LOAD SIDE OF THE HVAC EQUIPMENT DISCONNECTING MEANS.

REFLECTED CEILIN	IG PLAN NOTES:		
SYMBOL	DESCRIPTION	SYMBOL	DESCRIPTION
	SUSPENDED CEILING.		EXHAUST FAN
	VAULTED CEILING	•	SMOKE DETECTOR
	T&G VAULTED CEILING/ SOFFIT		
•	4" RECESSED CAN LIGHT FIXTURE		
	WALL MOUNTED-LIGHT FIXTURE		
	PENDANT LIGHT FIXTURE		
	CO DETECTOR		



No. Description Date

## FOWLER RESIDENC 68 Adel Ln, Wenatchee, WA 98801

Date: 24 03 04


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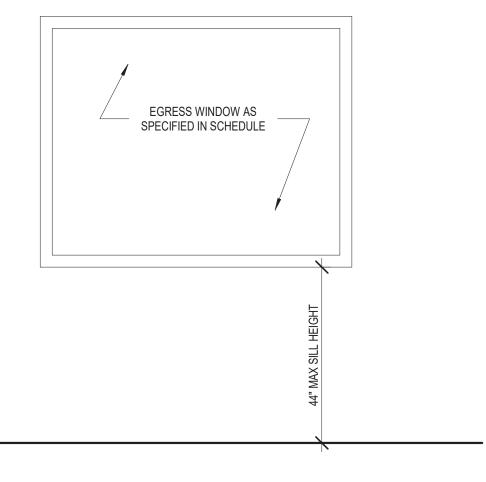
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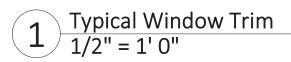
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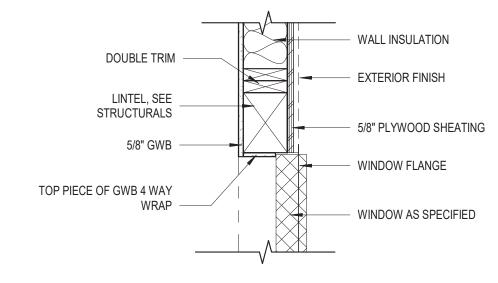
A-802

Upper Garage Level -Reflected Ceiling Plan










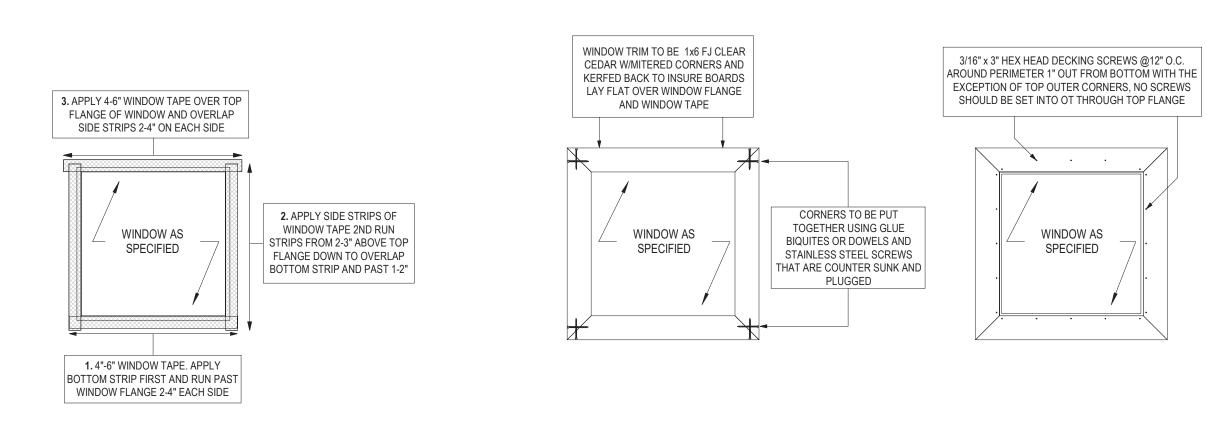

### 3 Head Jamb 1" = 1' 0"

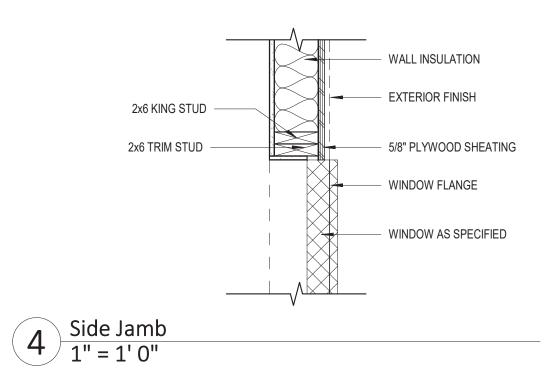

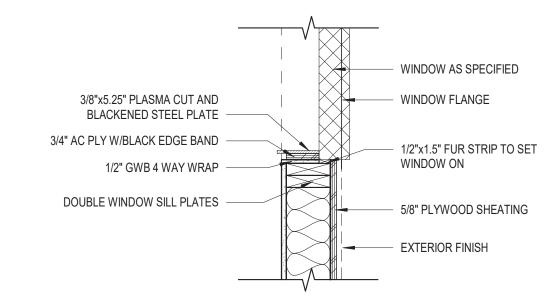

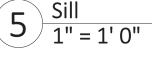

Typical Egress Window
1/2" = 1' 0"

MORRIS.

Proposition of the state of the sta

No. Description Date

FOWLER RESIDENCE 68 Adel Ln, Wenatchee, WA 98801

Date: 24 03 04

Job No: Project Number

Drawn By (initials): Author

Check By (initials): CM

A-701


Details- Windows


Stairs - Landing Attachment
1" = 1' 0"


House Stair - Section 1
1/2" = 1'-0"


Stairs - Hight End Attachment
1" = 1' 0"

House Stair - Section 2 1/2" = 1'-0"

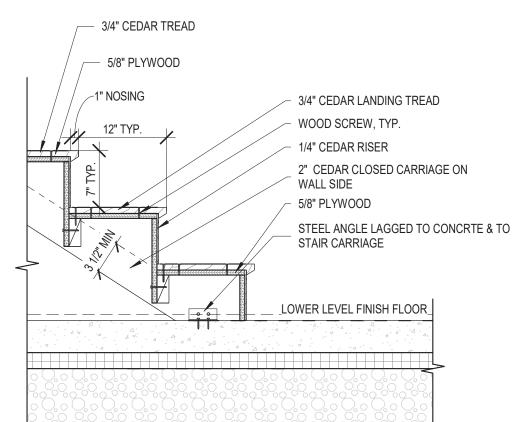


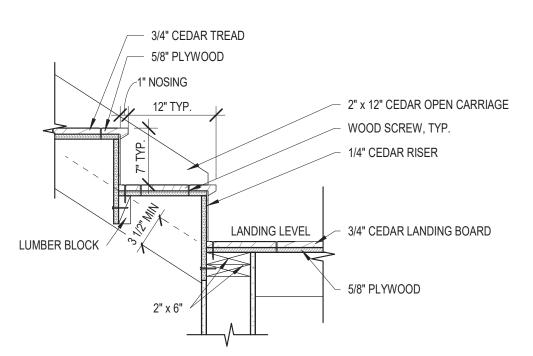


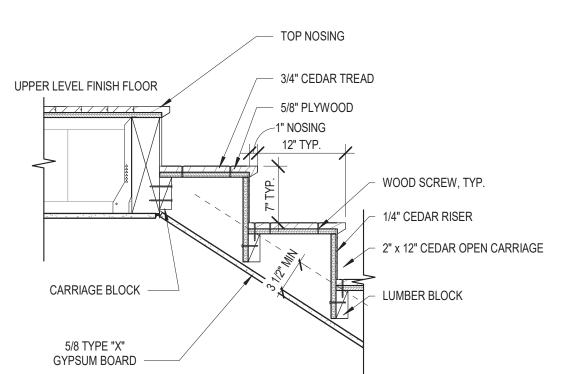


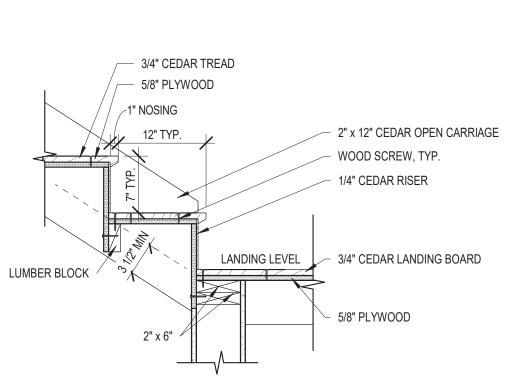



A-900

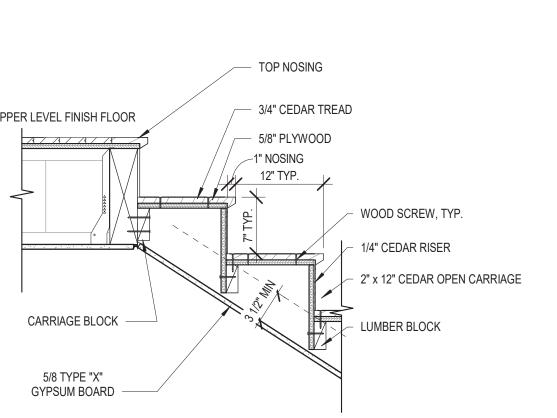


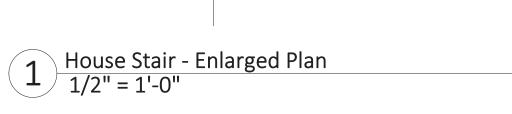

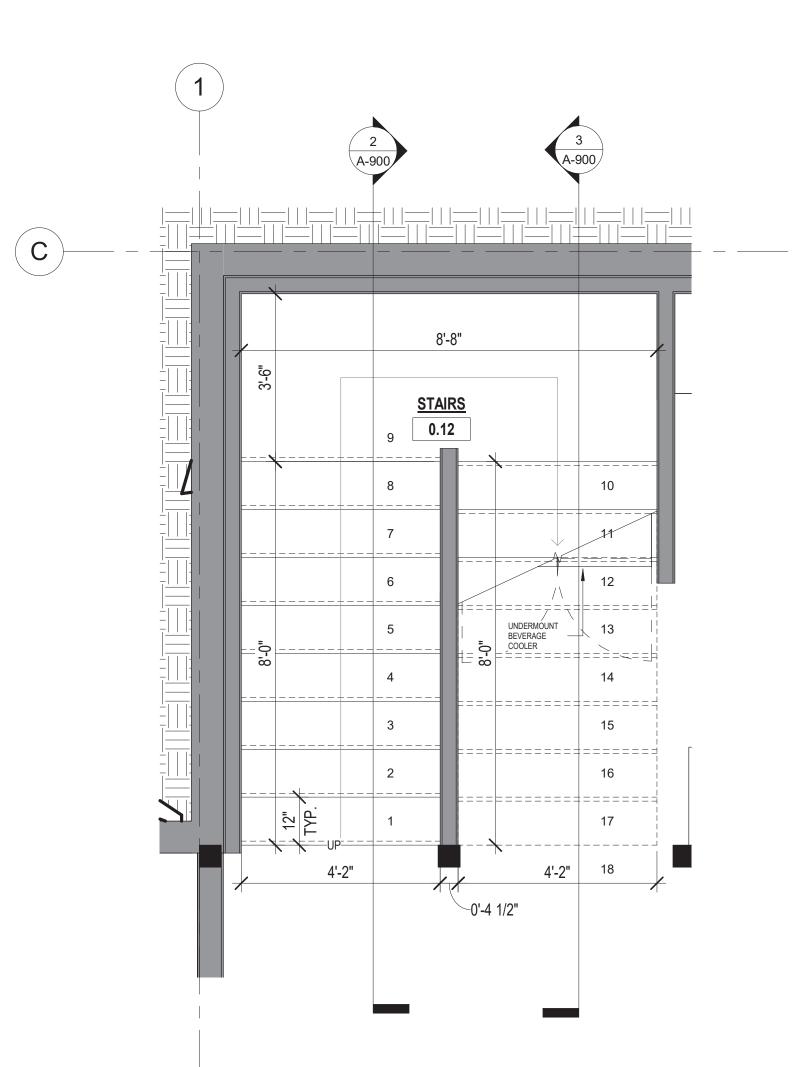

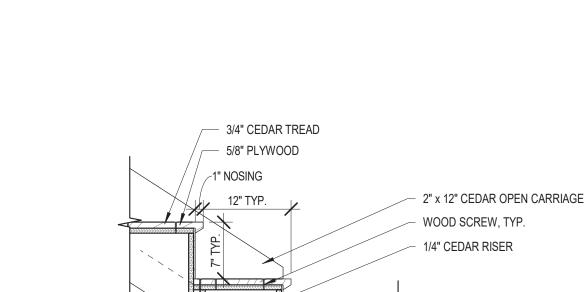

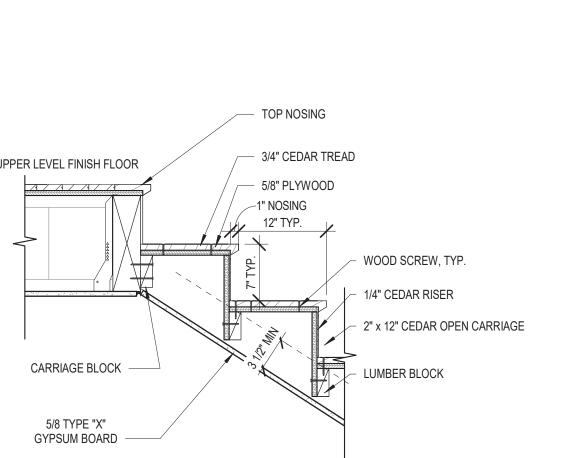

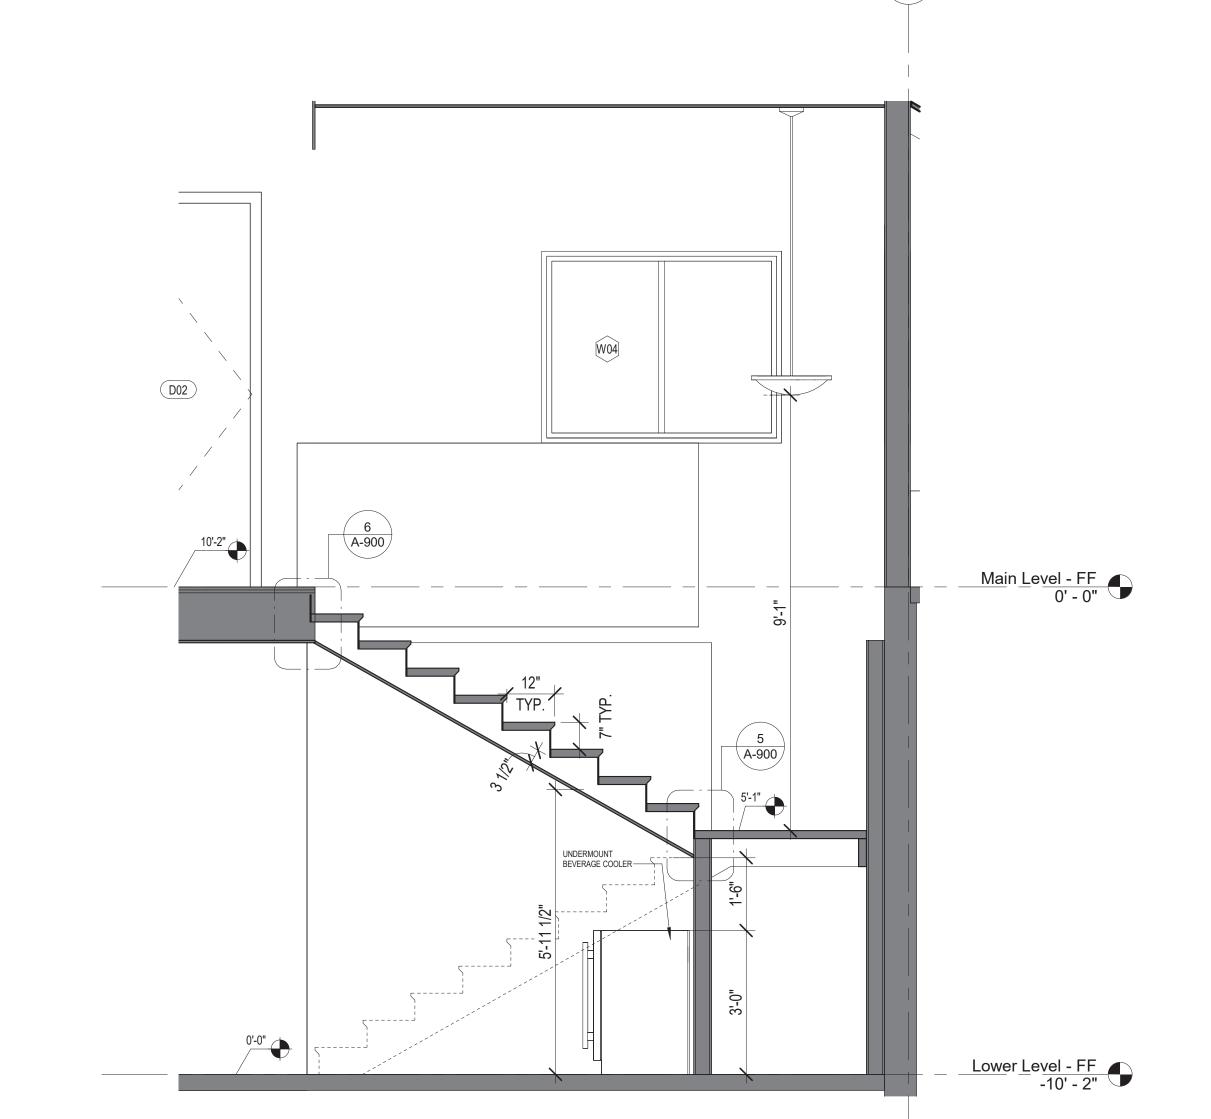



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AUTHENTIC DESIGH

Date: 24 03 04 Job No: Project Number

Drawn By (initials): Autor

Check By (initials): CM

A-900

Enlarged Areas - Stairs



FOV 68 Adel

Date: 24 03 04


Job No: Project Number

Drawn By (initials): Author

A-901

Enlarged Areas - Stairs


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TOP NOSING

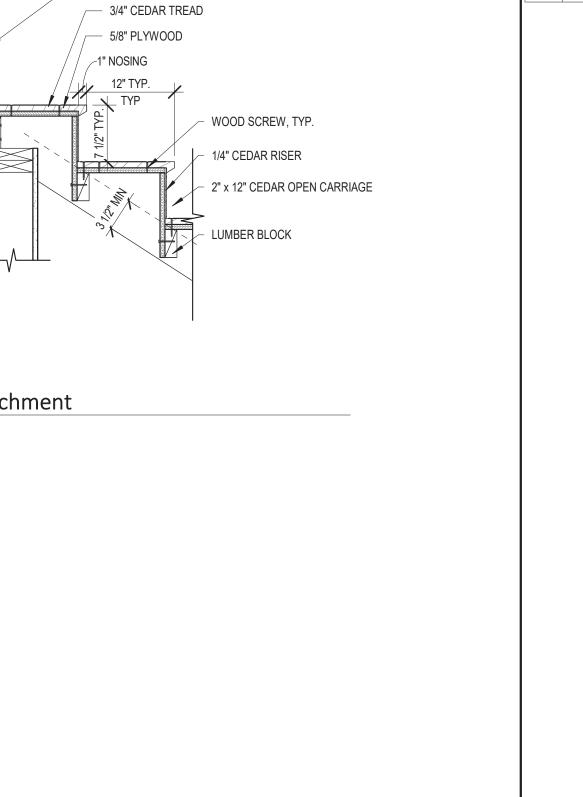UPPER LEVEL FINISH FLOOR

CARRIAGE BLOCK ----



/ 3/4" CEDAR TREAD

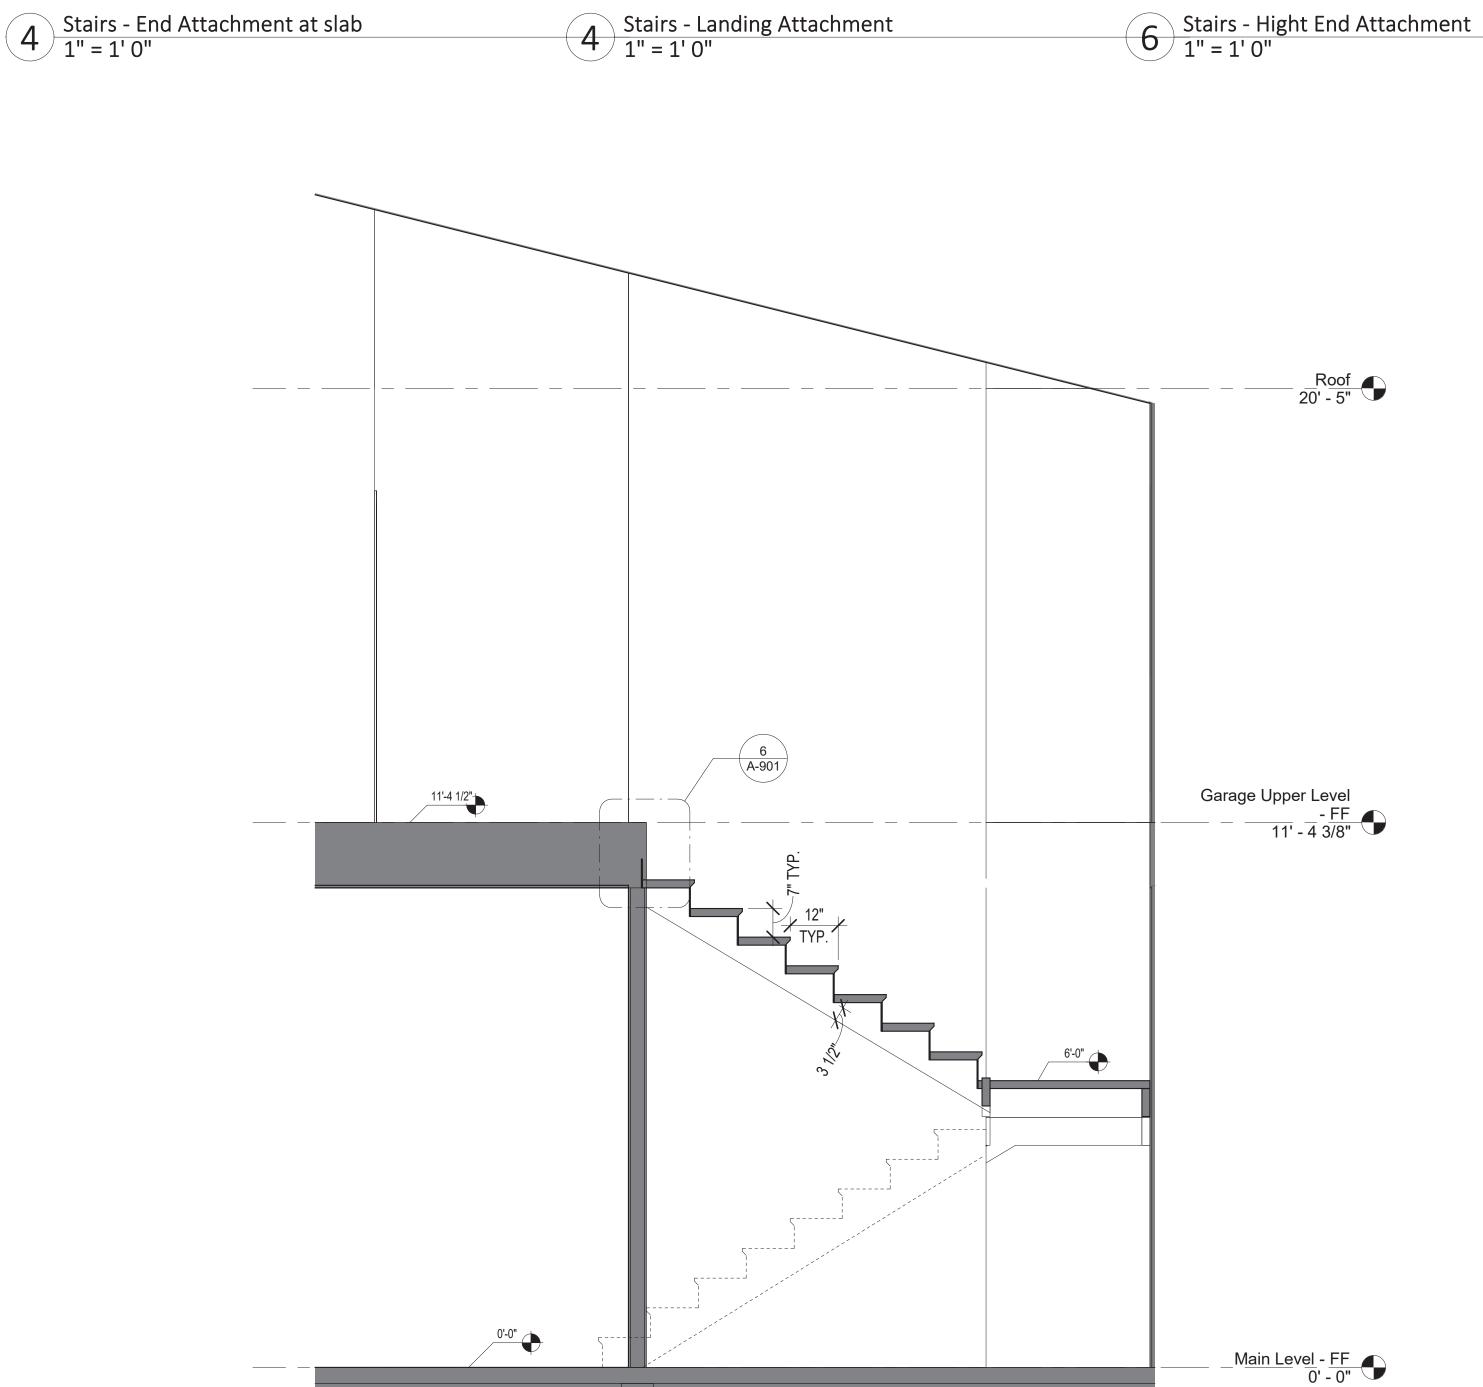5/8" PLYWOOD

LANDING LEVEL

- 2" x 12" CEDAR OPEN CARRIAGE

- 3/4" CEDAR LANDING BOARD

WOOD SCREW, TYP.

1/4" CEDAR RISER

5/8" PLYWOOD

-1" NOSING

2" x 6" BEAMS

CONCEALED FLANGE JOIST HANGER

Garage Stair - Section 2
1/2" = 1'-0"

— 3/4" CEDAR TREAD

- 5/8" PLYWOOD

3/4" CEDAR LANDING TREAD

2" CEDAR CLOSED CARRIAGE ON

STEEL ANGLE LAGGED TO CONCRTE & TO

WOOD SCREW, TYP.

1/4" CEDAR RISER


WALL SIDE


5/8" PLYWOOD

STAIR CARRIAGE

LOWER LEVEL FINISH FLOOR

-1" NOSING

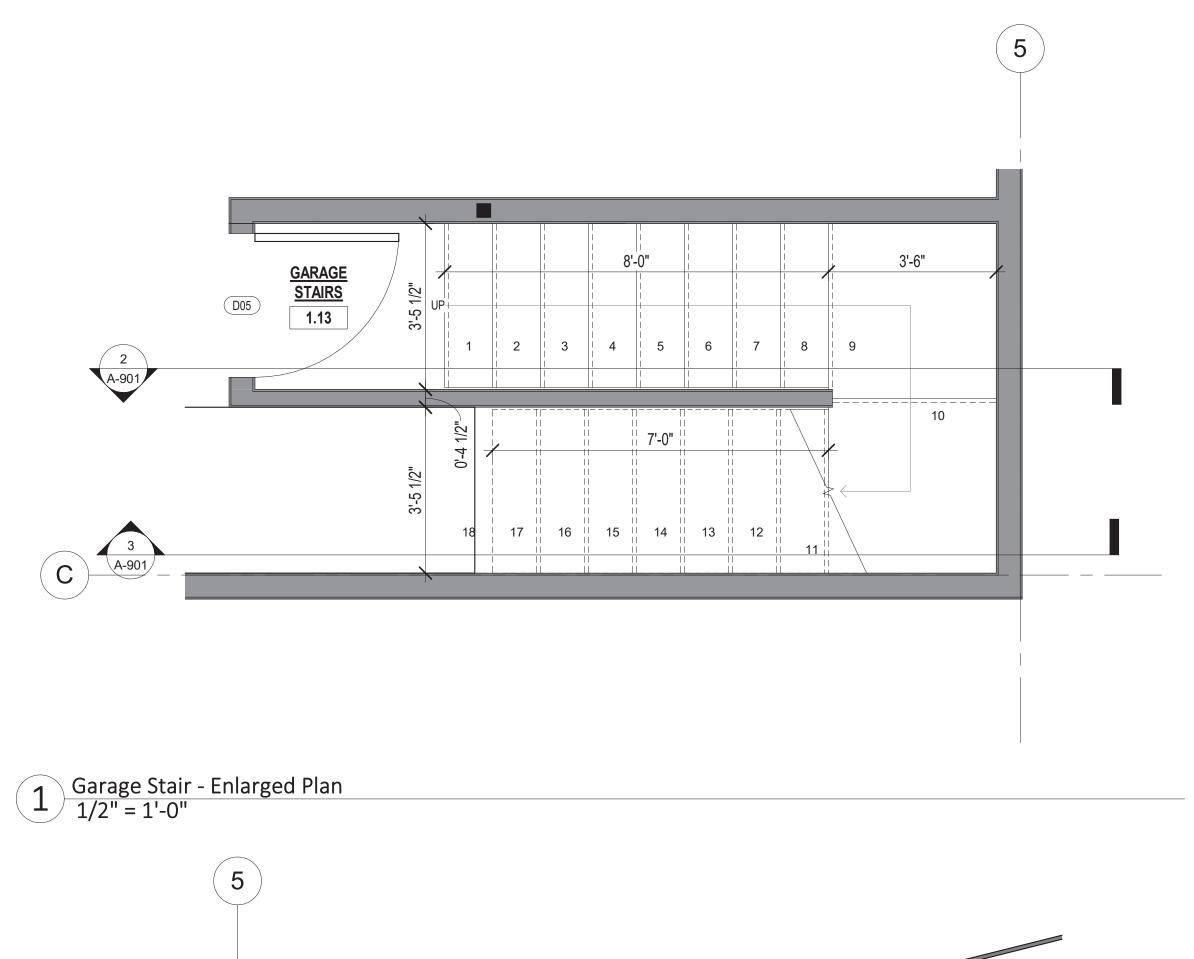

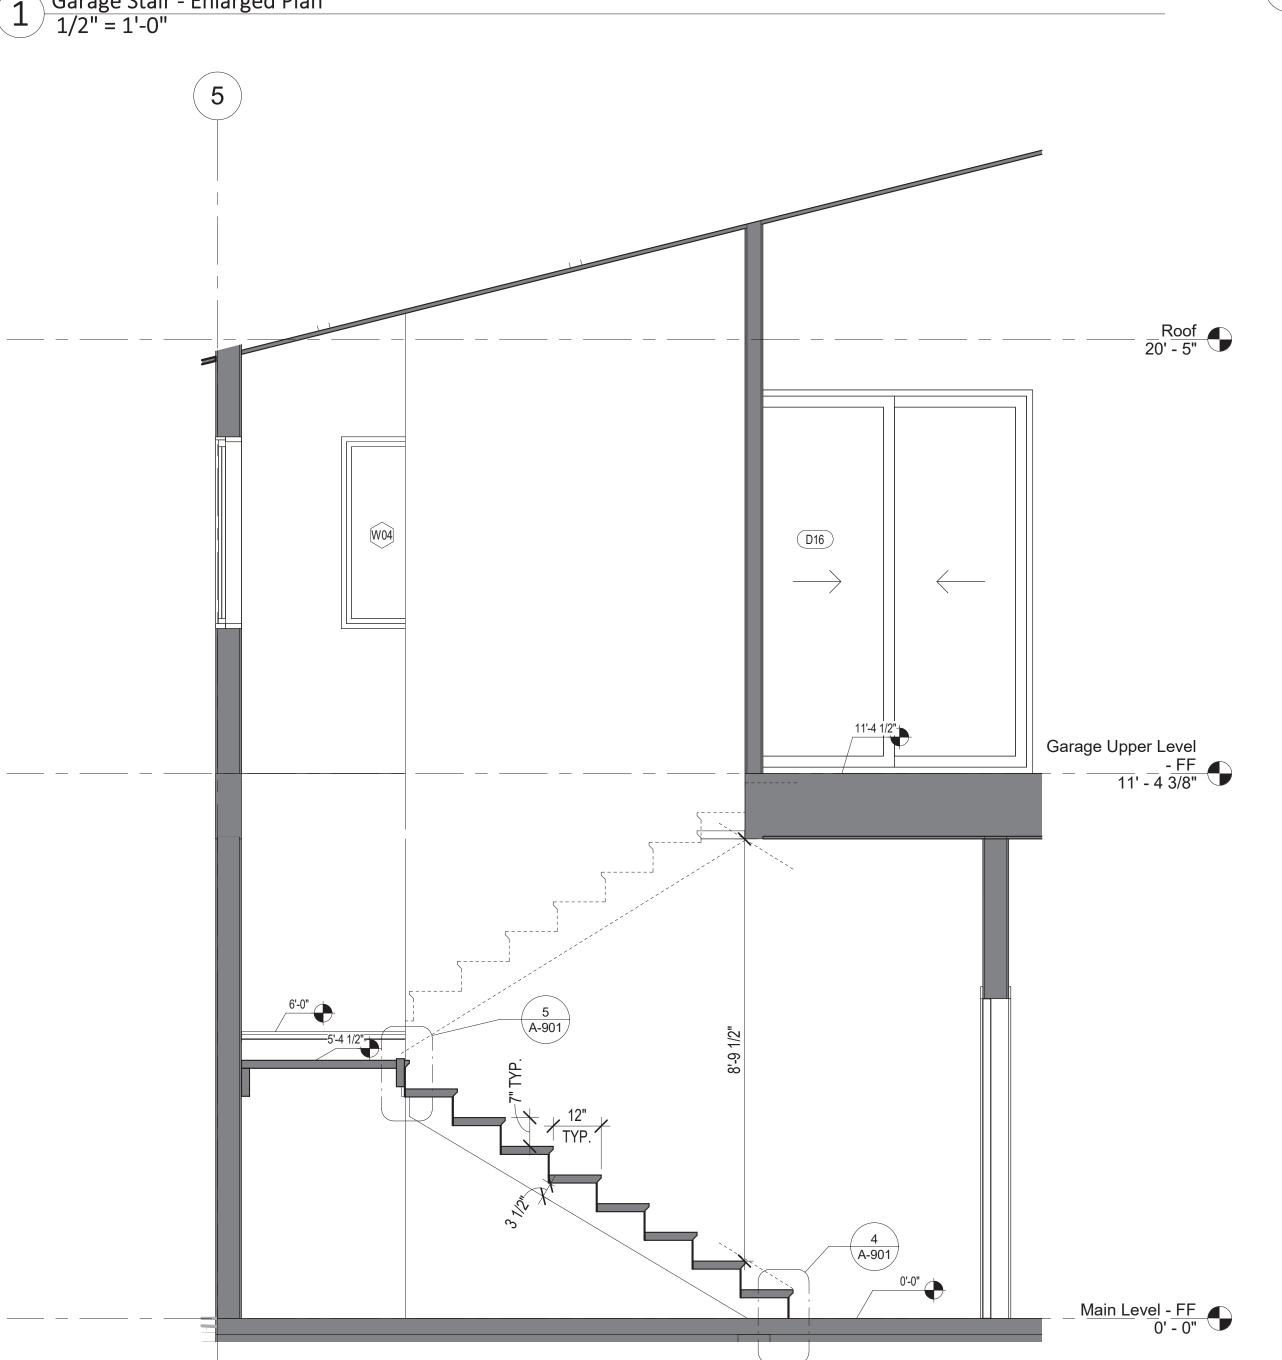

Garage Stair - Section 1
1/2" = 1'-0"

### STRUCTURAL NOTES:

- ALL CONSTRUCTION SHALL CONFORM TO THE 2018 IBC & OTHER APPLICABLE BUILDING CODES & TO ALL REQUIREMENTS & REGULATIONS OF THE CITY, COUNTY, STATE AND/OR OTHER GOVERNING AGENCY HAVING JURISDICTION
- VERIFY ALL DIMENSIONS, MATERIALS USED AND CONDITION BEFORE CONSTRUCTION. - CONTRACTOR SHALL PROVIDE ALL TEMPORARY BRACING, SHORING, GUYING, OR OTHER MEANS TO AVOID EXCESSIVE STRESS & TO HOLD STRUCTURAL ELEMENTS IN PLACE DURING CONSTRUCTION
- DO NOT SCALE DRAWINGS. USE DIMENSIONS.
   IT IS THE RESPONSIBILITY OF THE CONTRACTORS TO NOTIFY THE OWNER, ARCHITECT OR ENGINEER OF ANY PLYWOOD: - DO NOT SCALE DRAWINGS. USE DIMENSIONS.
- ALL MANUFACTURED MATERIALS, COMPONENTS, FASTENERS, ASSEMBLIES, ETC, SHALL BE
- HANDLED AND INSTALLED IN ACCORDANCE WITH MANUFACTURERS INSTRUCTIONS AND PROVISIONS OF APPLICABLE IRC RECOMMENDATIONS WHERE SPECIFIC MANUFACTURED PRODUCTS
- ARE CALLED FOR, GENERIC EQUALS WHICH MEET APPLICABLE STANDARDS AND SPECIFICATIONS

### REINFORCEMENT:

- REINFORCEMENT BARS TO BE DEFORMED BARS CONFORMING TO CURRENT ASTM A615 GRADE 60. - ALL REINFORCEMENT STEEL SHALL BE DETAILED, FABRICATED AND PLACED IN ACCORDANCE WITH ACI DETAILING FLOOR SHEATHING MUST BE TONGUE AND GROOVE (T&G) MANUAL 315-80
- ALL WELDED WIRE FABRIC SHALL CONFORM TO CURRENT ACTM A 185 SPECS
- REINFORCEMENT SHALL BE ACCURATELY PLACED AND ADEQUATELY SUPPORTED BY CONCRETE,
- METAL, OR OTHER APPROVED CHAIRS,
- SPACERS OR TIES AND SECURED AGAINST DISPLACEMENT DURING CONCRETE OR GROUT PLACEMENT. TACK WELDING NOT ALLOWED.

### STEEL ACCESSORIES:

- FOUNDATION BOLTS TO BE 5/8 DIA. X 10 WITH NOT LESS THAN 7 EMBEDMENT INTO CONCRETE. - HOLD DOWN AT FOUNDATION AND STEEL CONNECTORS TO BE SIMPSON MFG. OR APPROVED EQUAL.

### **FOUNDATION NOTES:**

- -ASSUMED ALLOWABLE SOIL BEARING VALUE 1,500 PSF. FOUNDATION FOOTING SHALL BE PLACED UPON FIRM, UNDISTURBED SOIL. FOOTINGS PLACED UPON FILL SHALL BE SUBJECT TO THE REQUIREMENTS OF CHAPTER 17 OF THE IBC.
- EXTERIOR WALL, BOTTOM SILL PLATES, SHALL BE PRESSURE TREATED OR EQUAL, & SHALL BEAR/ EXTEND MINIMUM 7" ABOVE FINISH GRADE
- FOUNDATION THICKNESS INDICATED ARE MINIMUM.
- ALL CONCRETE SHALL DEVELOPED A MIN 28 DAY STRENGTH

LOCATION	F'C @ 28 DAY
FOOTINGS	3000 PSI
SLAB ON GRADE	3000 PSI

### **FRAMING:**

- GENERAL FRAMING REQUIREMENT
- INTERIOR BEARING WALLS OVER 10'-0" IN HEIGHT TO BE MINIMUM 2x6'S AT 12" O.C.
- ALL GLU-LAM BEAMS SHALL BE 24 F- V4
- PROVIDE SOLID BLOCKING AT 8'-0" O.C. MAXIMUM AT RAFTERS AND ROOF JOISTS - PROVIDE SOLID BLOCKING AT +10'-0" O.C. ABOVE FINISHED FLOOR AND AT ALL **FURR-DOWNS**
- COORDINATE FRAMING LAYOUTS WITH MECHANICAL TRADES. CUT AND BLOCK FOR ALL MECHANICAL INSTALLATIONS. ROOF VENTS, ETC.
- USE DOUBLE STUDS UNDER BEARING POINTS OF GIRDERS AND BEAMS- U.N.O.
- PREFAB METAL HANGERS AND OTHER MISC. FRAMING ANCHORS SHALL BE MANUFACTURED BY SIMPSON STRONG-TIE CO. INC. OR APPROVED EQUAL

### HEADER SCHEDULE (NON-BEARING)

SPAN UP TO 5'-0'	USE (2) 2x6 HEADER
SPAN UP TO 7'-0'	USE (2) 2x8 HEADER
SPAN UP TO 9'-0'	USE (2) 2x10 HEADER

ALL BEARING HEADERS ARE SPECIFIED ON THE PLANS.

- PLYWOOD SHALL BE AMERICAN PLYWOOD ASSOCIATION (APA) GROUP 1
- ALL PLYWOOD TO BE STANDARD INT-APA (WITH EXTERIOR GLUE)
- THE FOLLOWING SHALL BE THE MINIMUM PLYWOOD THICKNESS U.N.O.:
- ROOF 15/32" (I.B.C. ID INDEX 32/16)
- FLOOR 3/4" (I.B.C. ID INDEX 48/24) WALL SHEATHING - 1/2" (I.B.C. ID INDEX 32/16)
- USE PLYWOOD "H" CLIPS AT ALL UNBLOCKED ROOF SHEATHING EDGES
- MIDWAY BETWEEN SUPPORTS AT EACH EDGE.

### **NAILING NOTES:**

USE THE FOLLOWING NAILING U.N.O.:

WITH STAGGERED PANEL EDGES.

- FRAMING NAILING PER I.B.C..
- ROOF SHEATHING NAIL WITH 10d COMMON NAILS AT 6" O.C. ALONG ALL PANEL EDGES AND BOUNDARIES PERIMETER OF ROOF AND AT 12" O.C. ALONG ALL INTERMEDIATE FRAMING MEMBERS. UNBLOCKED

- SHEATHING SHALL BE INSTALLED PERPENDICULAR TO FRAMING MEMBERS

- DIAPHRAGM U.N.O. ON THE PLANS.
- FLOOR SHEATHING NAIL WITH 10d COMMON NAILS AT 6" O.C. ALONG ALL PANEL EDGES AND DIAPHRAGM BOUNDARIES AND AT 10" O.C.
- ALONG ALL INTERMEDIATE FRAMING MEMBERS. UNLOCKED DIAPHRAGM
- EXCEPT AS NOTED ON THE PLANS.
- WALL SHEATHING NAIL WITH 8d COMMON NAILS AT 6" O.C. ALONG ALL PANEL EDGES AND AT 10" O.C. ALONG ALL INTERMEDIATE
- FRAMING MEMBERS U.N.O. BLOCKED ALL PANEL EDGES AT THE SHEAR WALLS.
- SEE SHEAR WALL SCHEDULE FOR ADDITIONAL REQUIREMENTS.
- ALL NAILING TO COMPLY WITH I.B.C

### **WOOD FRAMING LUMBER:**

- ALL SAWN LUMBER SHALL BE DOUGLAS FIR-LARCH
- GRADING SHALL BE IN ACCORDANCE WITH CURRENT WWPA STANDARD GRADING RULES.
- GRADE NO. 2 POST AND BEAMS FLOOR AND CEILING JOIST RAFTERS. - GRADE NO. 2 SILLS, PLATES, BLOCKING AND STUDS
- ALL MEMBERS 2X AND LESS IN LEAST DIMENSION SHALL BE KILN DRIED.
- ALL GLUE LAMINATED MEMBERS SHALL BE FABRICATED WITH WATERPROOF GLUE.
- PRESSURE TREATED LUMBER:
- ALL WOOD IN PERMANENT CONTACT WITH CONCRETE TO BE PRESSURE TREATED OR DECAY
- LUMBER SHALL BEAR AN APPROVED GRADING STAMP

### **WOOD TRUSS NOTES:**

- TRUSS STRESS ENGINEERING AND DETAILED DRAWINGS SHALL BE STAMPED BY AN LICENSED ENGINEER REGISTERED IN WASHINGTON STATE. (DRAWINGS DETAILS SHALL BE ON JOB SITE FOR FRAMING INSPECTION.)
- PRE-MANUFACTURED TRUSSES SHALL BE IDENTIFIED BY MANUFACTURER'S
- FIELD ASSEMBLED TRUSS ANALYSIS AND DETAILS SHALL BE SUBMITTED TO THE BUILDING DEPARTMENT FOR APPROVAL.
- CONTRACTOR SHALL APPLY AND INSTALL ALL ROOF VENTS REQUIRED BY CODE

### **DESIGN CRITERIA**

**SOIL BEARING:** 1500 PSF FROST LINE: 24" MINIMUM

**SNOW LOAD:** 40 PSF ROOF SNOW LOAD

SEISMIC DESIGN: SEISMIC DESIGN CATEGORY "D0"

110 MPH EXPOSURE "C"

### **ABBREVIATIONS:**

WIND SPEED:

Α		G		R	
ΔR	Anchor Bolt		Gauge Galvanized	R RAD RCP REBAR REINF REQD RH RM	Riser
ADJ AFF AGG	Adjustable/ Adjacent Above Finished Floor	GA GALV GC GD GFI	General Contractor	RCP REBAR	Radius Reflected Ceiling Plan Reinforcing Bar Reinforced
ALT	Aggregate Alternate/ Alteration	GFI CI	Garbage Disposal Ground Fault Interrupter Glass/ Glazing/ Glazed Glue Laminated Wood	REINF	Reinforced Required
_		ĞL GLAM	Glue Laminated Wood	RH	Robe Hook/Right Hand Room
3		GND GWB	Ground Gypsum Wall Board	RO	Rough Opening
BD BLDG	Board Building			S	
BLKG BM_	Blocking Beam	Н			0 5 1
SÖT BTWN	Bottom	HB	Hose Bib	SF SHT	Square Feet Sheet
	Between	HDR HM	Header Hollow Metal	SHT SHTG SHV SIM SPEC	Sheathing Sheet Vinyl Similar
)		HÖRIZ HR	Horizontal Hour/ Handrail Height_	SIM SPEC	Specification
CAB CARP	Çabinet	HT HTB	Hand Towel Bar	STEC SQ STD STL STOR STRUCT	Square Standard
;ARP ;J	Carpet Control Joint	HWT	Hot Water Tank	STL STOR	Steel Storage
)L )LG	Center Line Ceiling			STRUCT SYM	Structure/ Structural Symmetrical
XLR XOL	Clear Column	INSUL	Insulation	O 1111	Cymmet red.
CL CLG CLR COL CONC	Concrete Continuous	INT	Interior	Τ	
COORD	Coordinate	J		T&B T&G	Top & Bottom
		JST JT	Joist Joint	T&G TB TOC	Tongue & Groove Towel Bar/ Tack Board
1	penny (nails)	JI	JOINT	TEL	Top of Cúrb/ Top of Concrete Telephone Thick
BL	Clothes` Dryér Double	L		THK TOW	Top of Wall
BL ET IA IM	Detail Diameter	LH LHR	Left Hand	TOW TPD TV_	Toilet Paper Dispenser Television
DIM DL	Dimension Dead Load	LHR LL	Left Hand Reverse Live Load	TYP	Typical
OL ON OR	Down Door/ Drain			U	
OS OW	Door/ Drain Downspout Dishwasher	М			
		MAX MB MECH	Maximum Machine Bolt/Marker Board Mechanical	UNO	Unless Noted Otherwise
	Each	MECH MTL	Metal	W	
3	Expansion Bolt	MFR MIN	Manufacturer/Manufacturing Minimum/Minute Miscellaneous		
	Expansion Joint Elevation	MTL MFR MIN MISC MTD	Miscellanéous Mounted	W/O W/	Without
A B J L LEC	Electrical Equal			WD	With Wood
QUIP XP	Equipment Expansion	N N	North	WDW WWF	Window Welded Wire Fabric
QUIP XP XIST XT	Existing Exterior	NA NO./#	Not Applicable		
-		NO./# NOM NTS	Not Applicable Number Nominal	Υ	
)	Floor Drain	NIS	Not To Scale	YD	Yard Drain/ Yard
DN IC	Foundation Furnished and Installed	0	0 "		
īN	by Contractor Finish	OA OC OD OPNG OPP	Overall On Center	SYMBC	DLS USED BREVIATIONS
iò	Furnished and Installed by Owner	OD OPNG	Outside Diameter Opening	72 YD	BILL VIA HONS
L L	Floor	OPP	Opposite	&	And
LOOR M	Fluorescent From	Р		L @	Angle At
ÖC OF OIC	Face Of Concrete Face Of Finish	PL	Plate Plastic Laminate	<u>C</u>	Centerline
	Furnished by Owner Installed by Contractor	PL PLAM PLYWD PR PSL	Plastic Laminate Plywood Pair	d PL	Penny Property Line/ Plate
<u>-</u> 0S	Face of Studs Foot or Feet	PSL	Pair Parallel Strand Lumber (Paralla		Plus or Minus
TG URN	Footing Furnace/ Furnish				
51111	Tarridooy Turriion				

THENTIC DESIGN Morris Originals, Bellingham, WA c. 360.223.3359


corry@morrisoriginals.com

Date: 24 03 04 Job No: Project Number

Drawn By (initials): Author

Check By (initials): CM

Structural General Notes

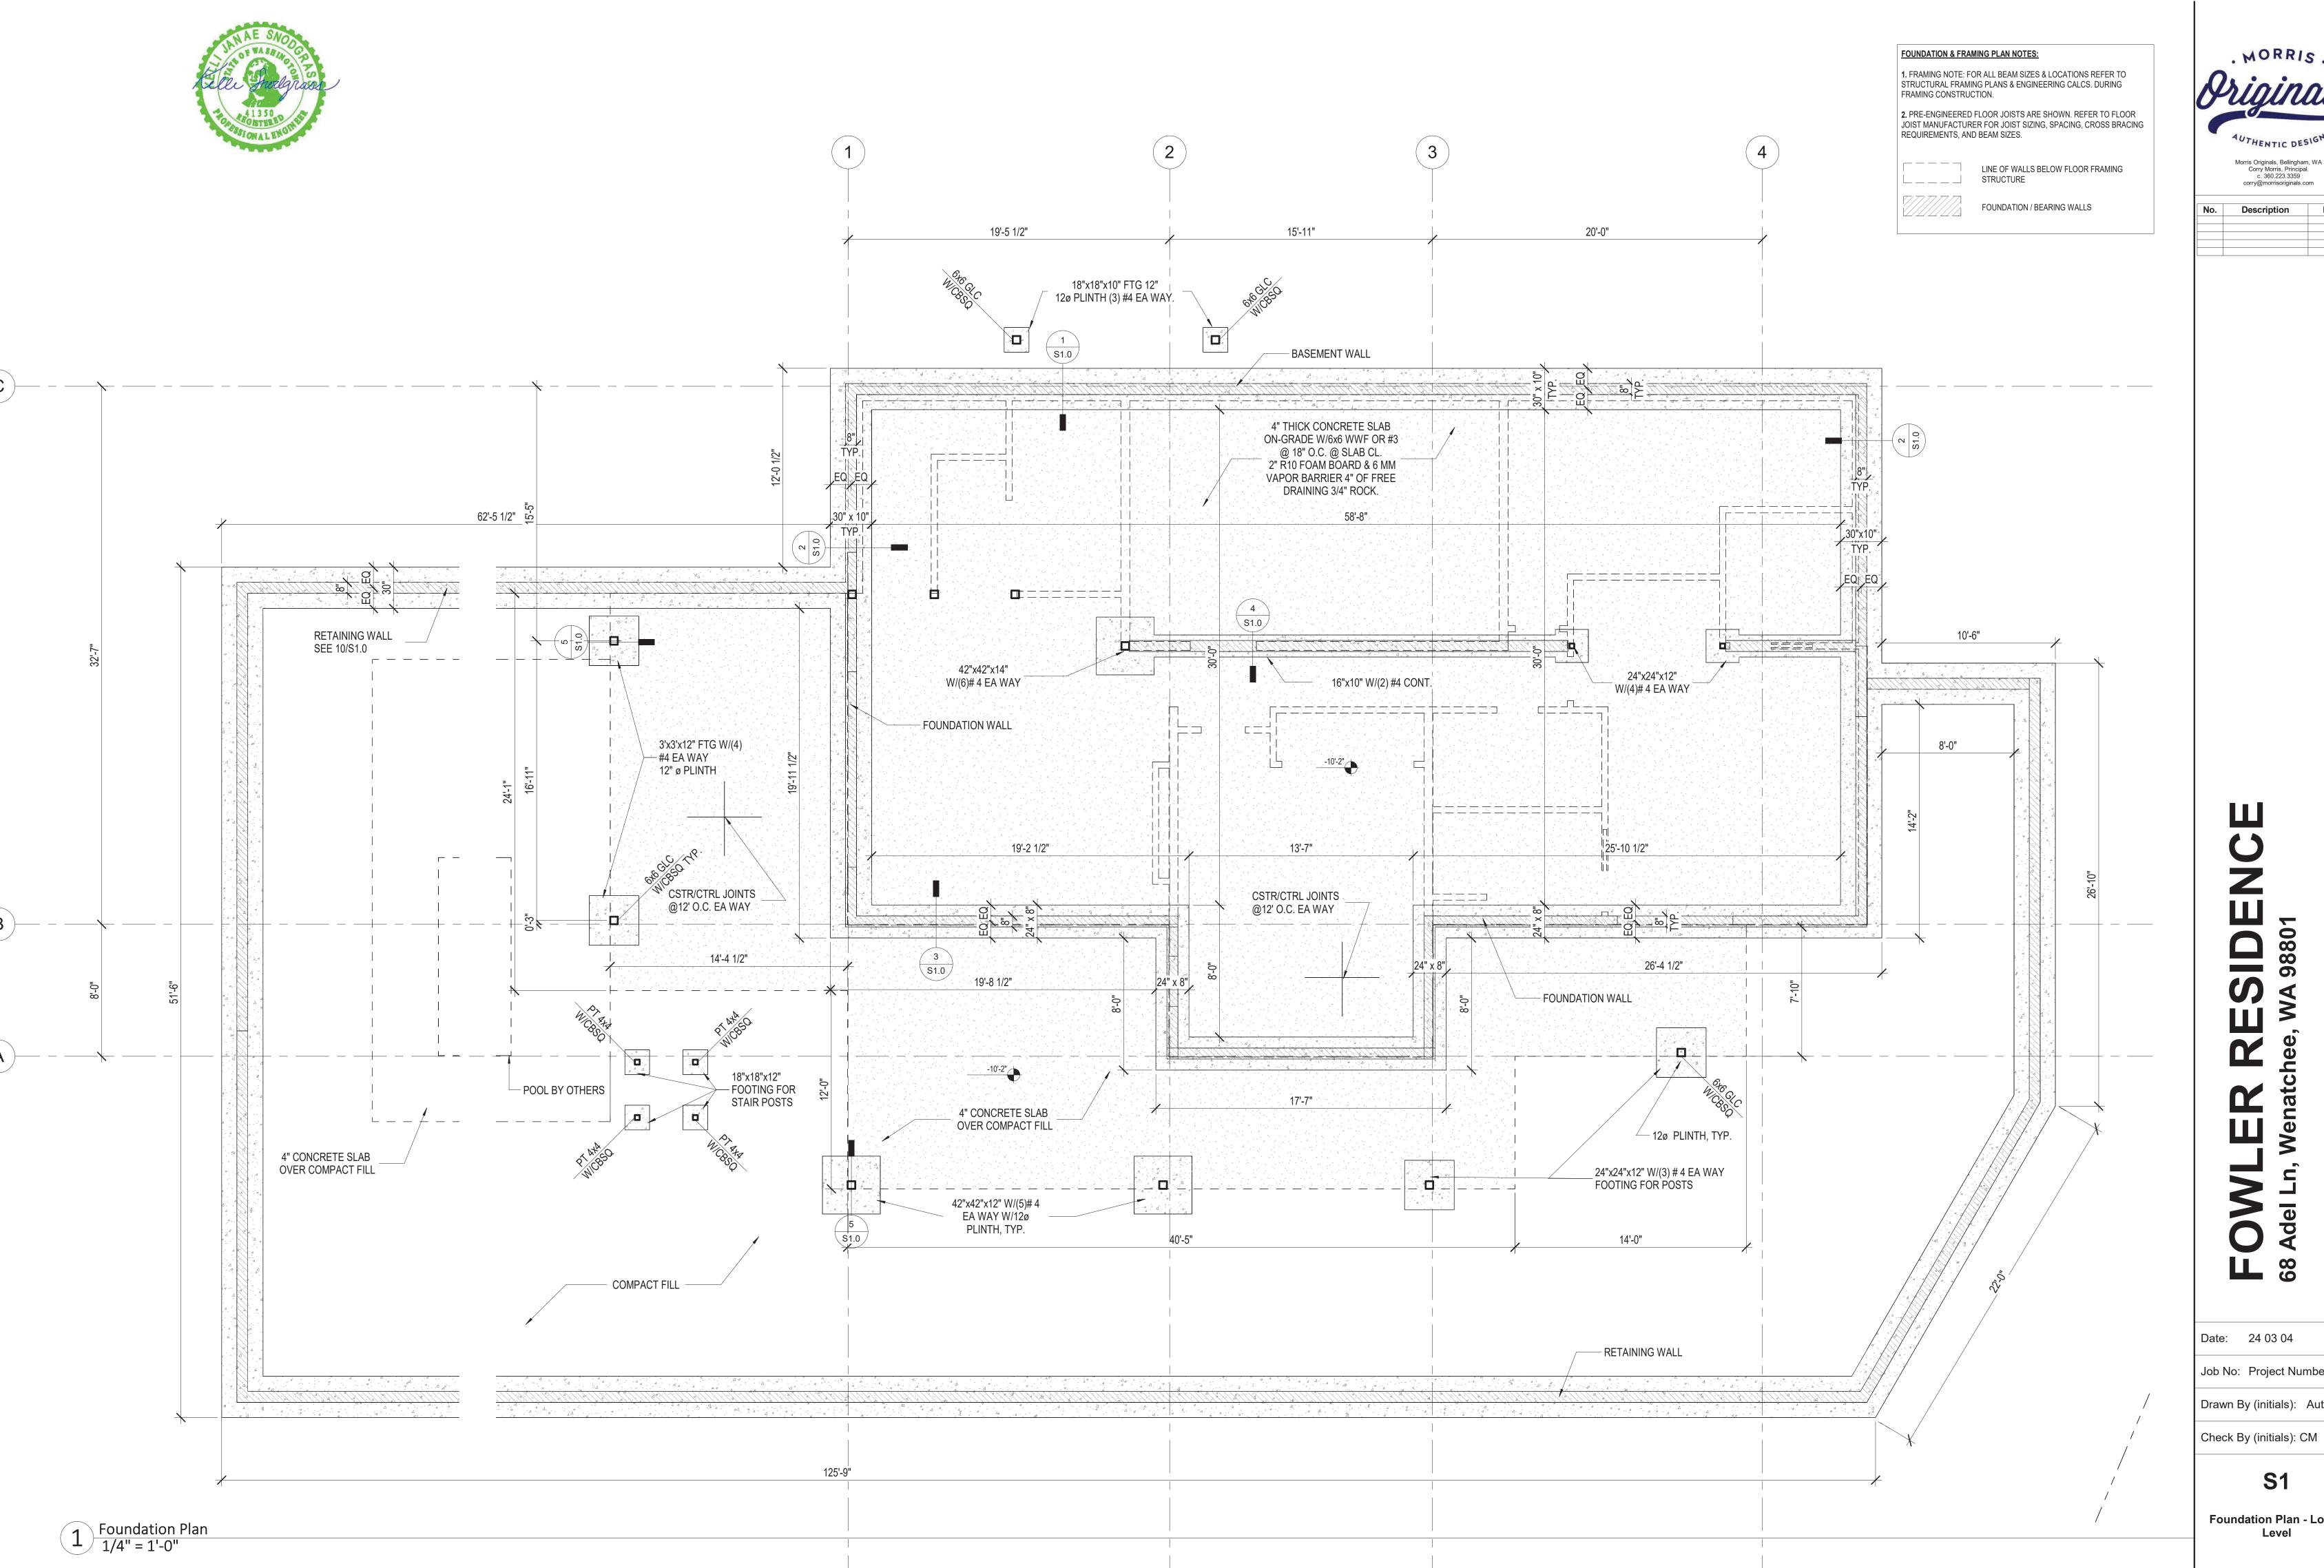

AUTHENTIC DESIGN Morris Originals, Bellingham, WA Corry Morris, Principal. c. 360.223.3359


Description

Date: 24 03 04

Job No: Project Number

Drawn By (initials): Autor

Foundation Plan - Lower

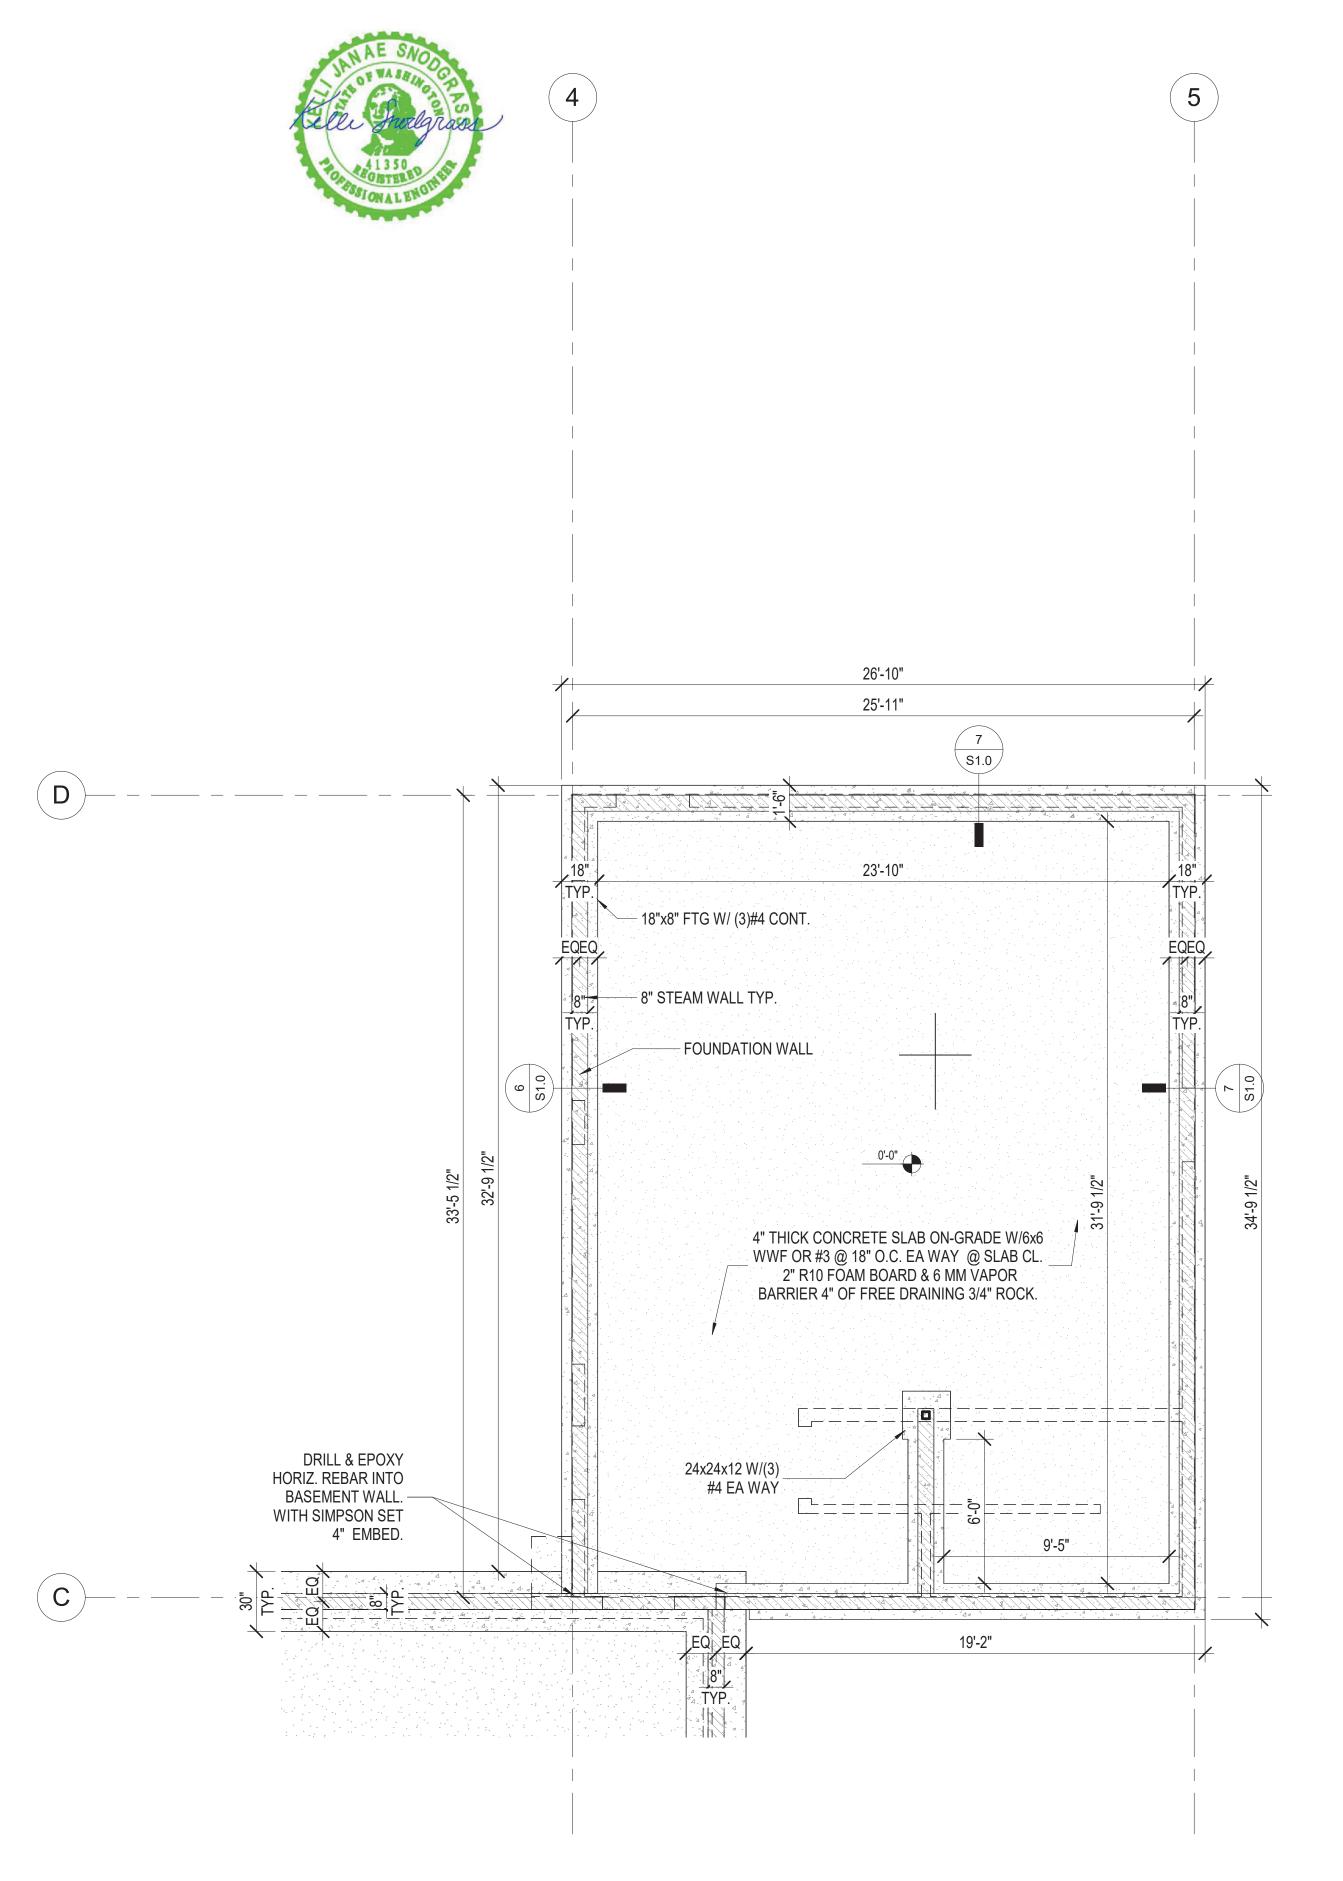

Foundation Plan - Garage 1/4" = 1'-0"

### **FOUNDATION & FRAMING PLAN NOTES:**

1. FRAMING NOTE: FOR ALL BEAM SIZES & LOCATIONS REFER TO STRUCTURAL FRAMING PLANS & ENGINEERING CALCS. DURING FRAMING CONSTRUCTION.

2. PRE-ENGINEERED FLOOR JOISTS ARE SHOWN. REFER TO FLOOR JOIST MANUFACTURER FOR JOIST SIZING, SPACING, CROSS BRACING REQUIREMENTS, AND BEAM SIZES.

LINE OF WALLS BELOW FLOOR FRAMING
STRUCTURE

FOUNDATION / BEARING WALLS

MORRIS

AUTHENTIC DESIGN

Morris Originals, Bellingham, WA
Corry Morris, Principal.
c. 360.223.3359
corry@morrisoriginals.com

Description

# FOWLER RESIDENCI

Date: 24 03 04


Job No: Project Number

Drawn By (initials): Author

Check By (initials): CM

**S2** 

Foundation Plan - Garage

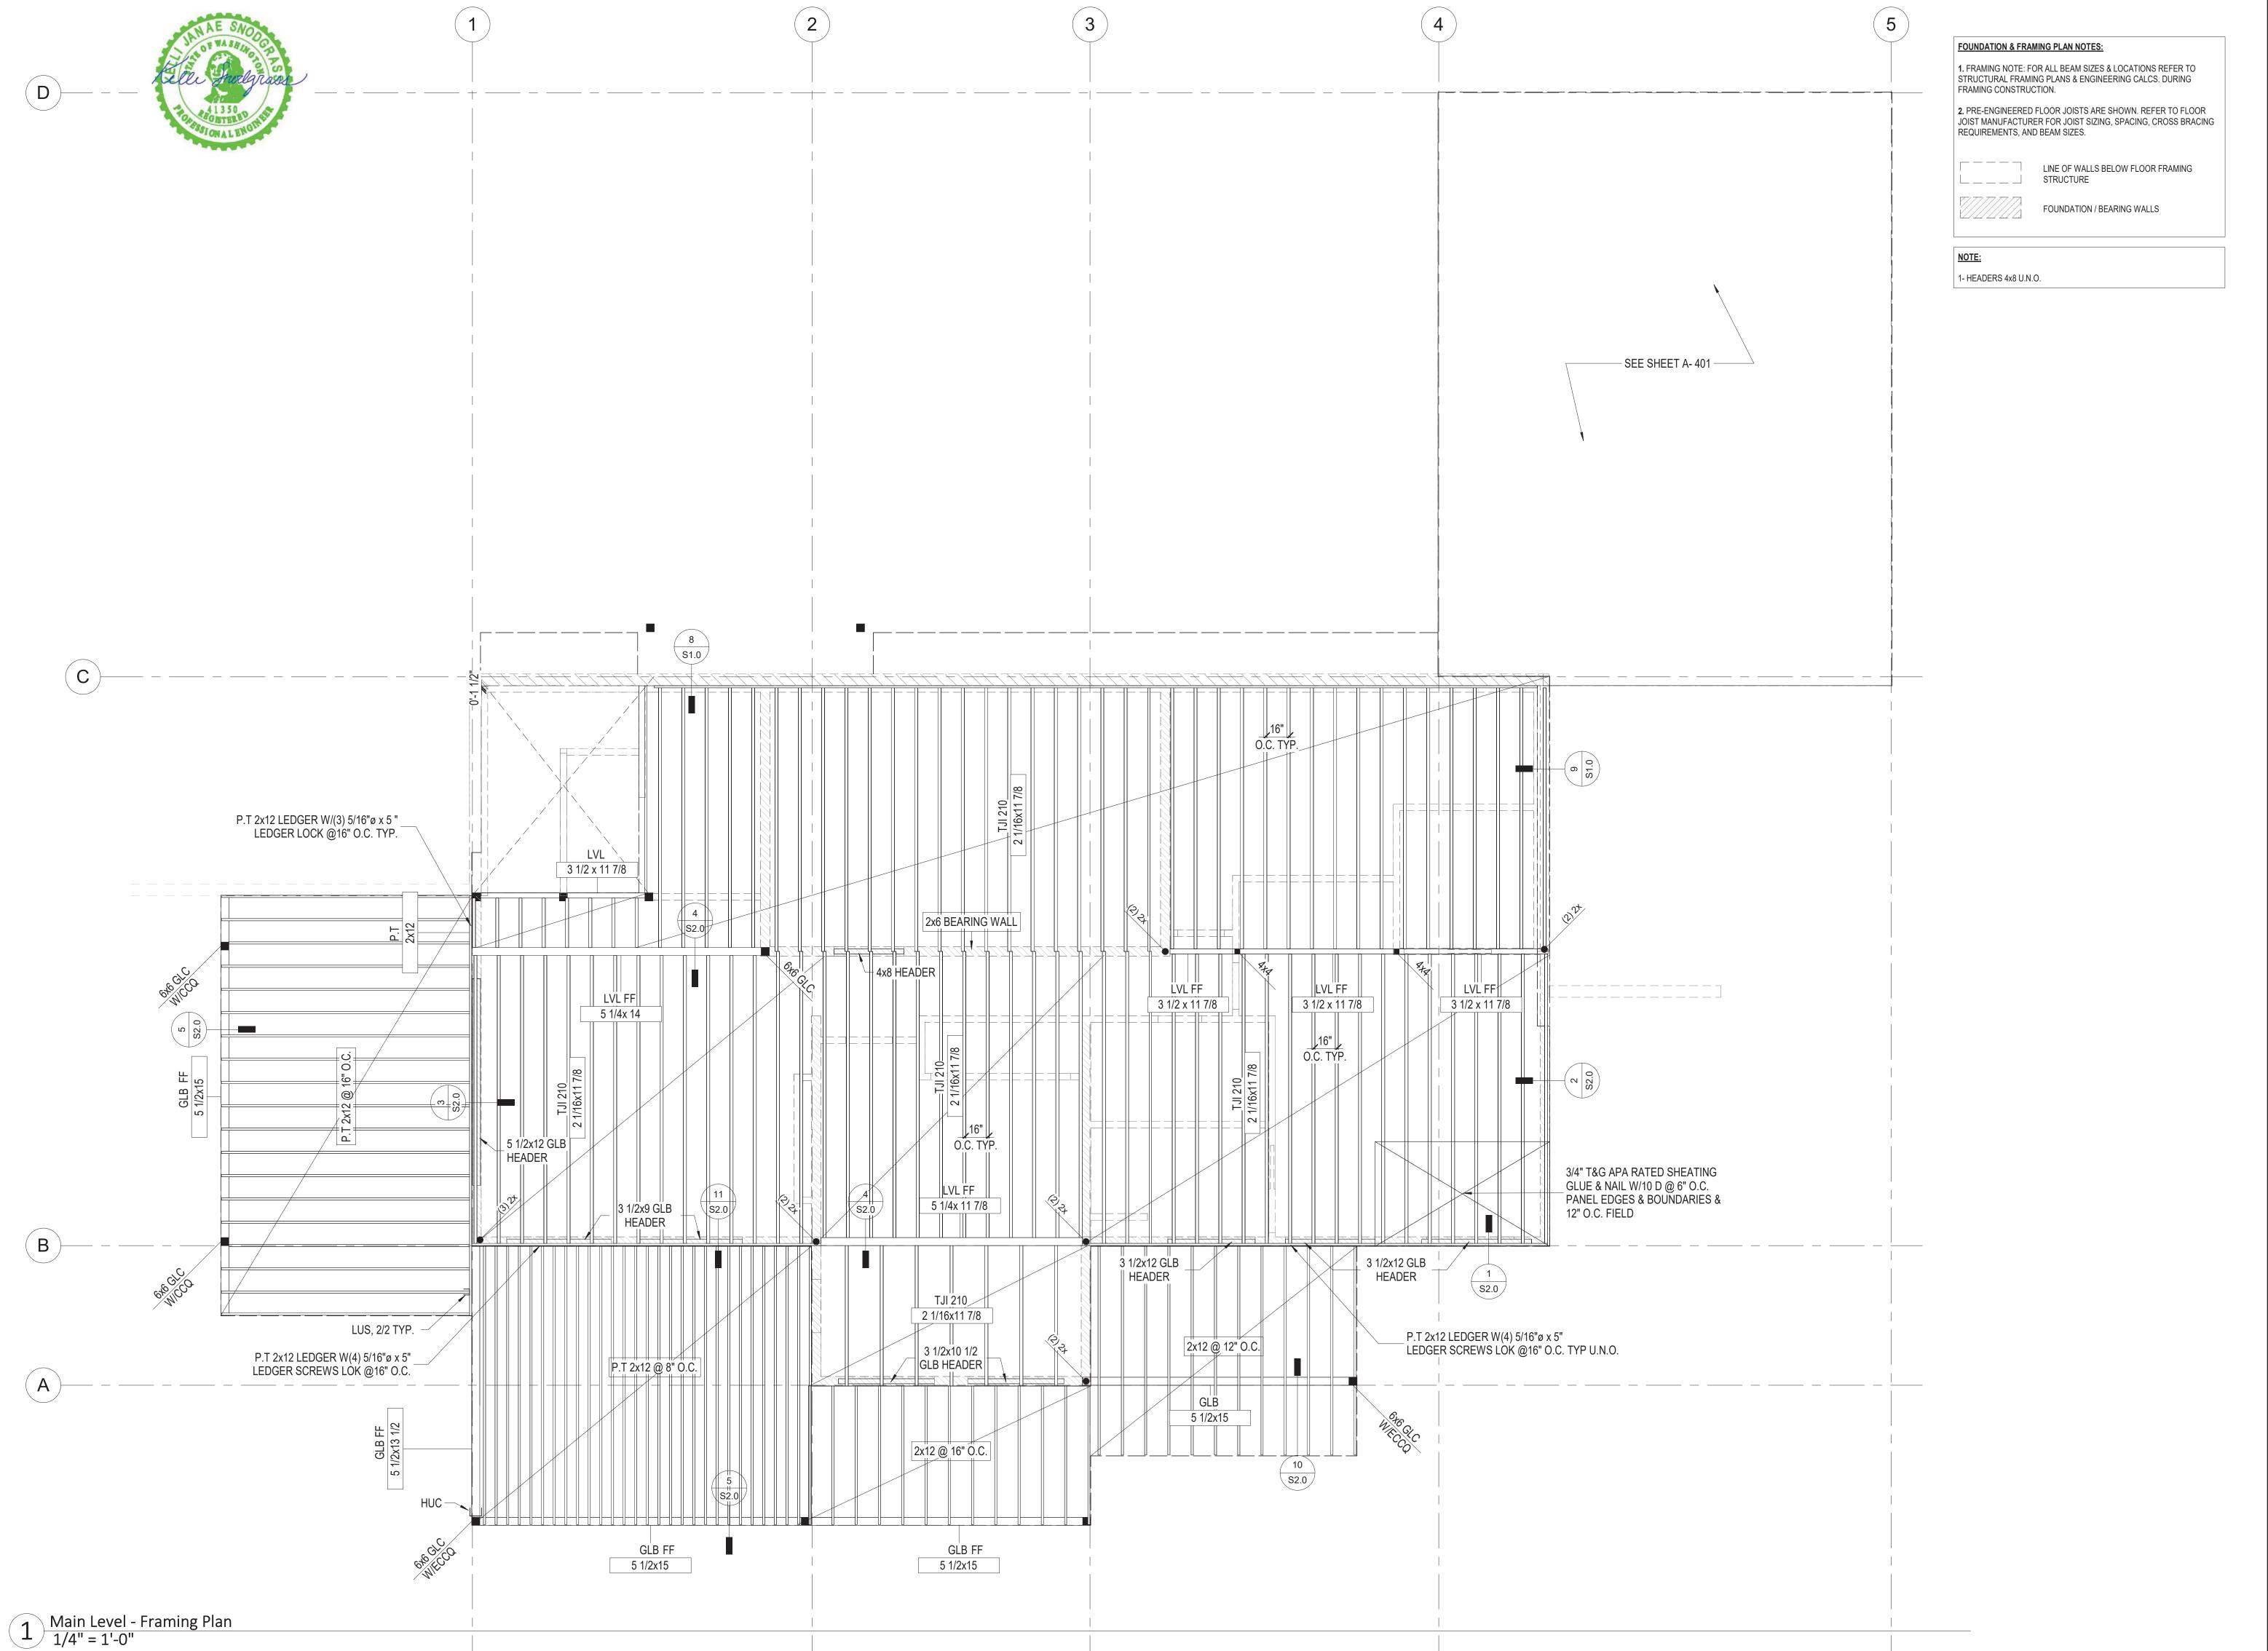



o. Description Date

FOWLER RESIDE 68 Adel Ln, Wenatchee, WA 98801

Date: 24 03 04

Job No: Project Number


Drawn By (initials): Author

Check By (initials): CM

**S**3

Main Level - Framing Plan



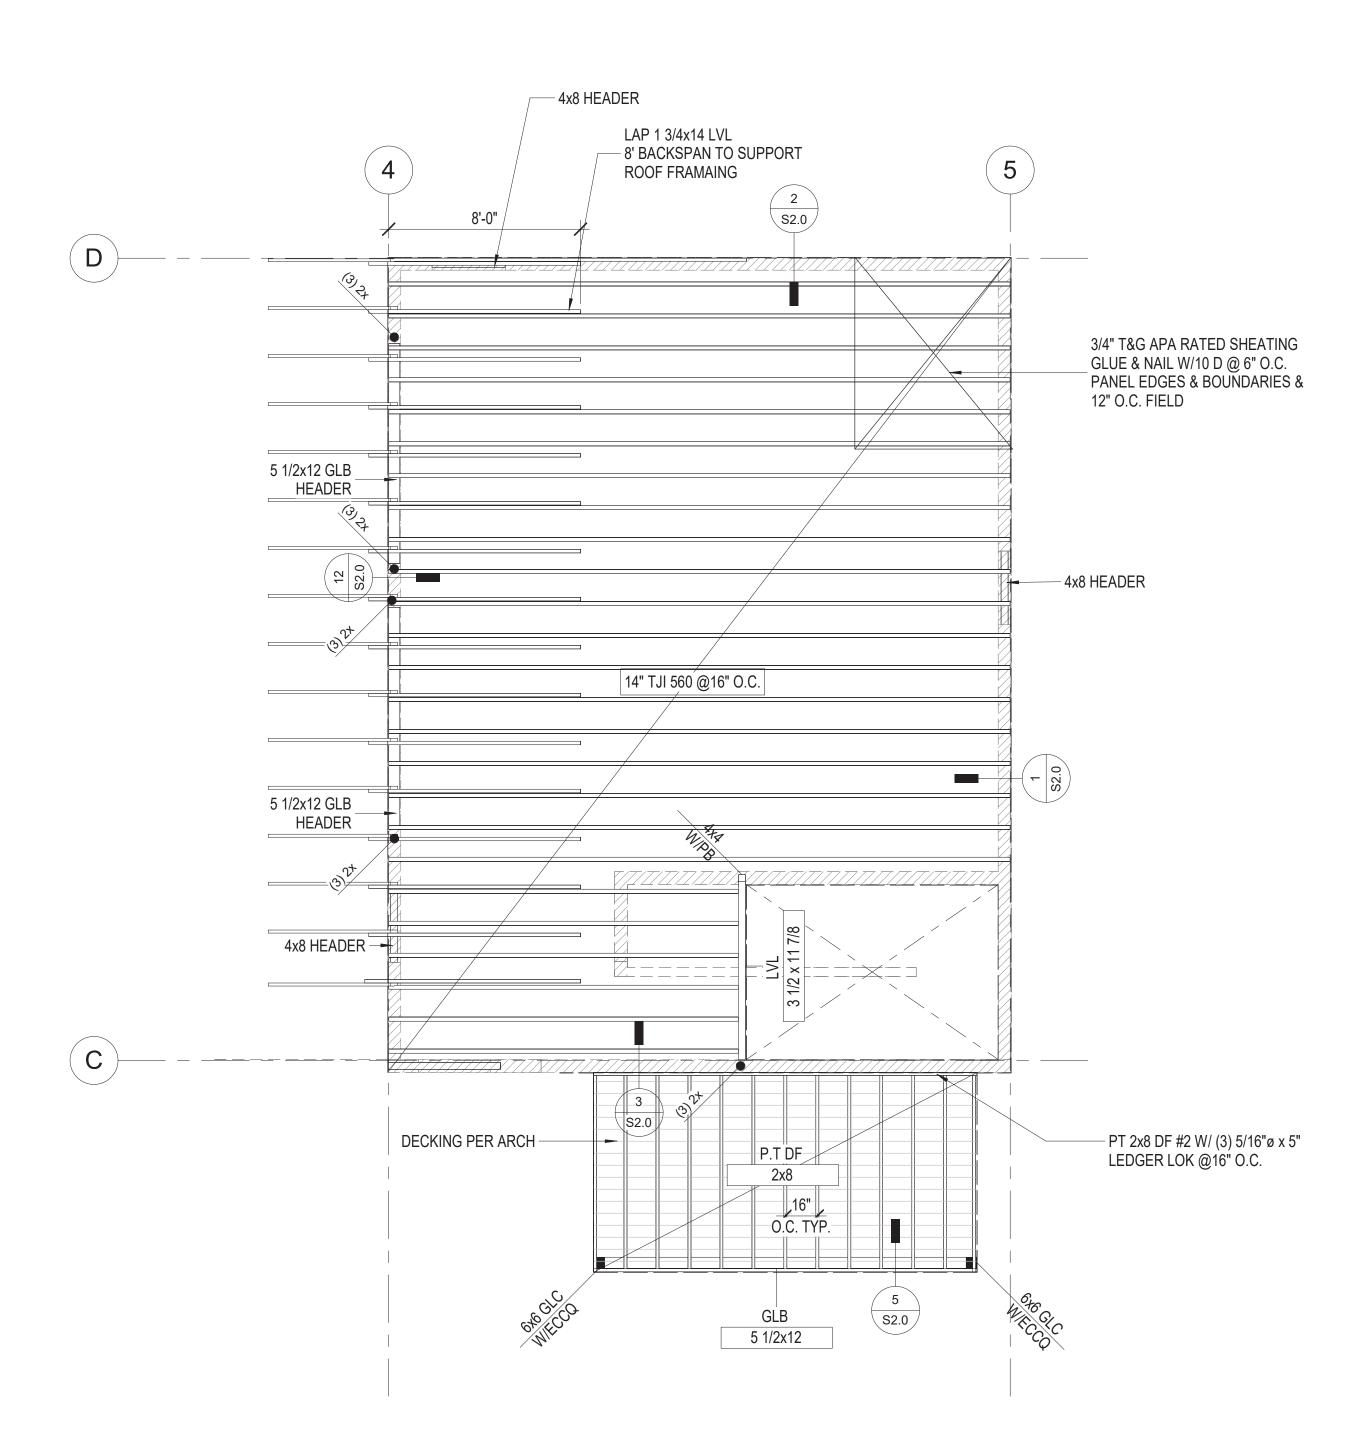

Garage Upper Level - Framing Plan
1/4" = 1'-0"

**FOUNDATION & FRAMING PLAN NOTES:** 

1. FRAMING NOTE: FOR ALL BEAM SIZES & LOCATIONS REFER TO STRUCTURAL FRAMING PLANS & ENGINEERING CALCS. DURING FRAMING CONSTRUCTION.

2. PRE-ENGINEERED FLOOR JOISTS ARE SHOWN. REFER TO FLOOR JOIST MANUFACTURER FOR JOIST SIZING, SPACING, CROSS BRACING REQUIREMENTS, AND BEAM SIZES.

LINE OF WALLS BELOW FLOOR FRAMING STRUCTURE

FOUNDATION / BEARING WALLS

NOTE:

1- HEADERS 4x8 U.N.O.

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FOWLER RESIDENCE 68 Adel Ln, Wenatchee, WA 98801

Date: 24 03 04


Job No: Project Number

Drawn By (initials): Autor

**S4** 

Upper Garage Level -Framing Plan

Check By (initials): CM

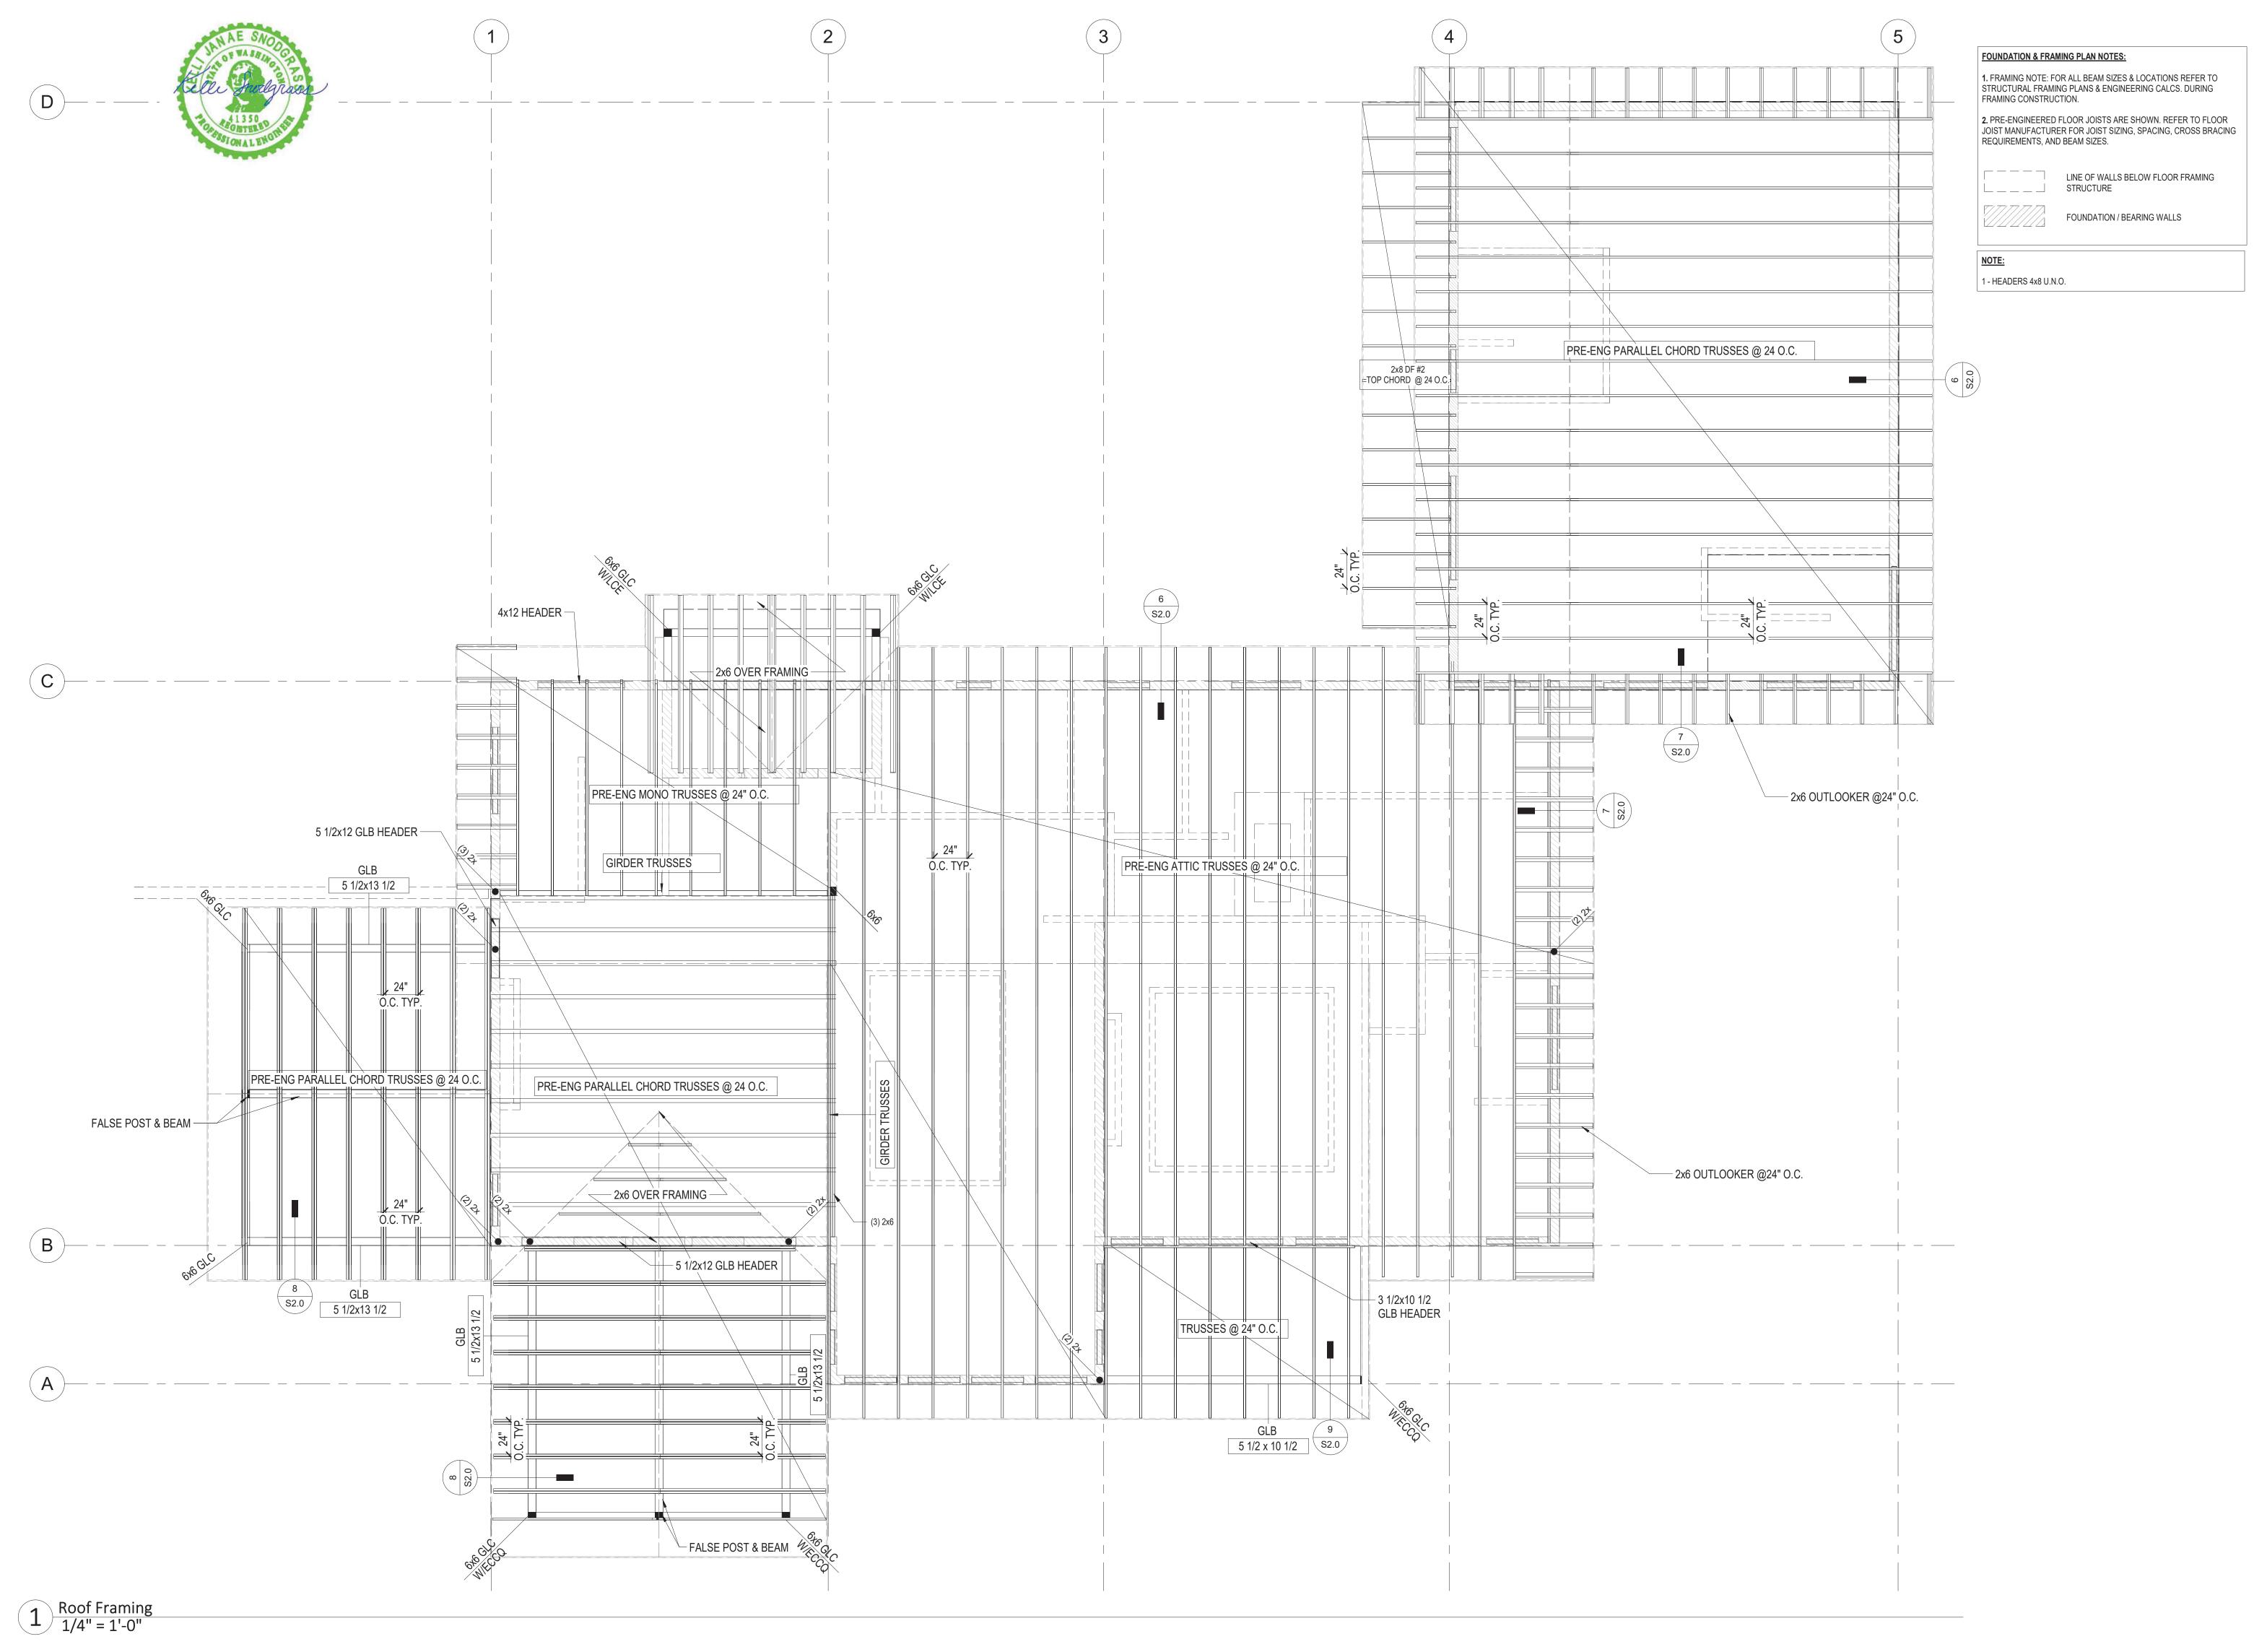



corry@morrisoriginals.com

O. Description Date

FOWLER RI 68 Adel Ln, Wenatchee,

Date: 24 03 04

Job No: Project Number


Drawn By (initials): Autor

Check By (initials): CM


**S5** 

Roof - Framing Plan



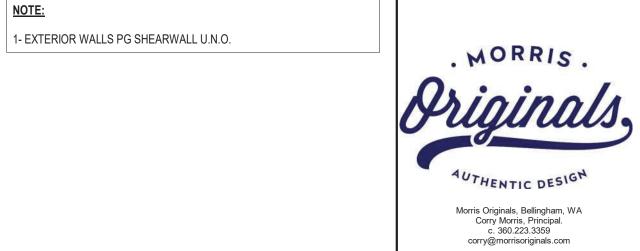

No.	Description	Date					

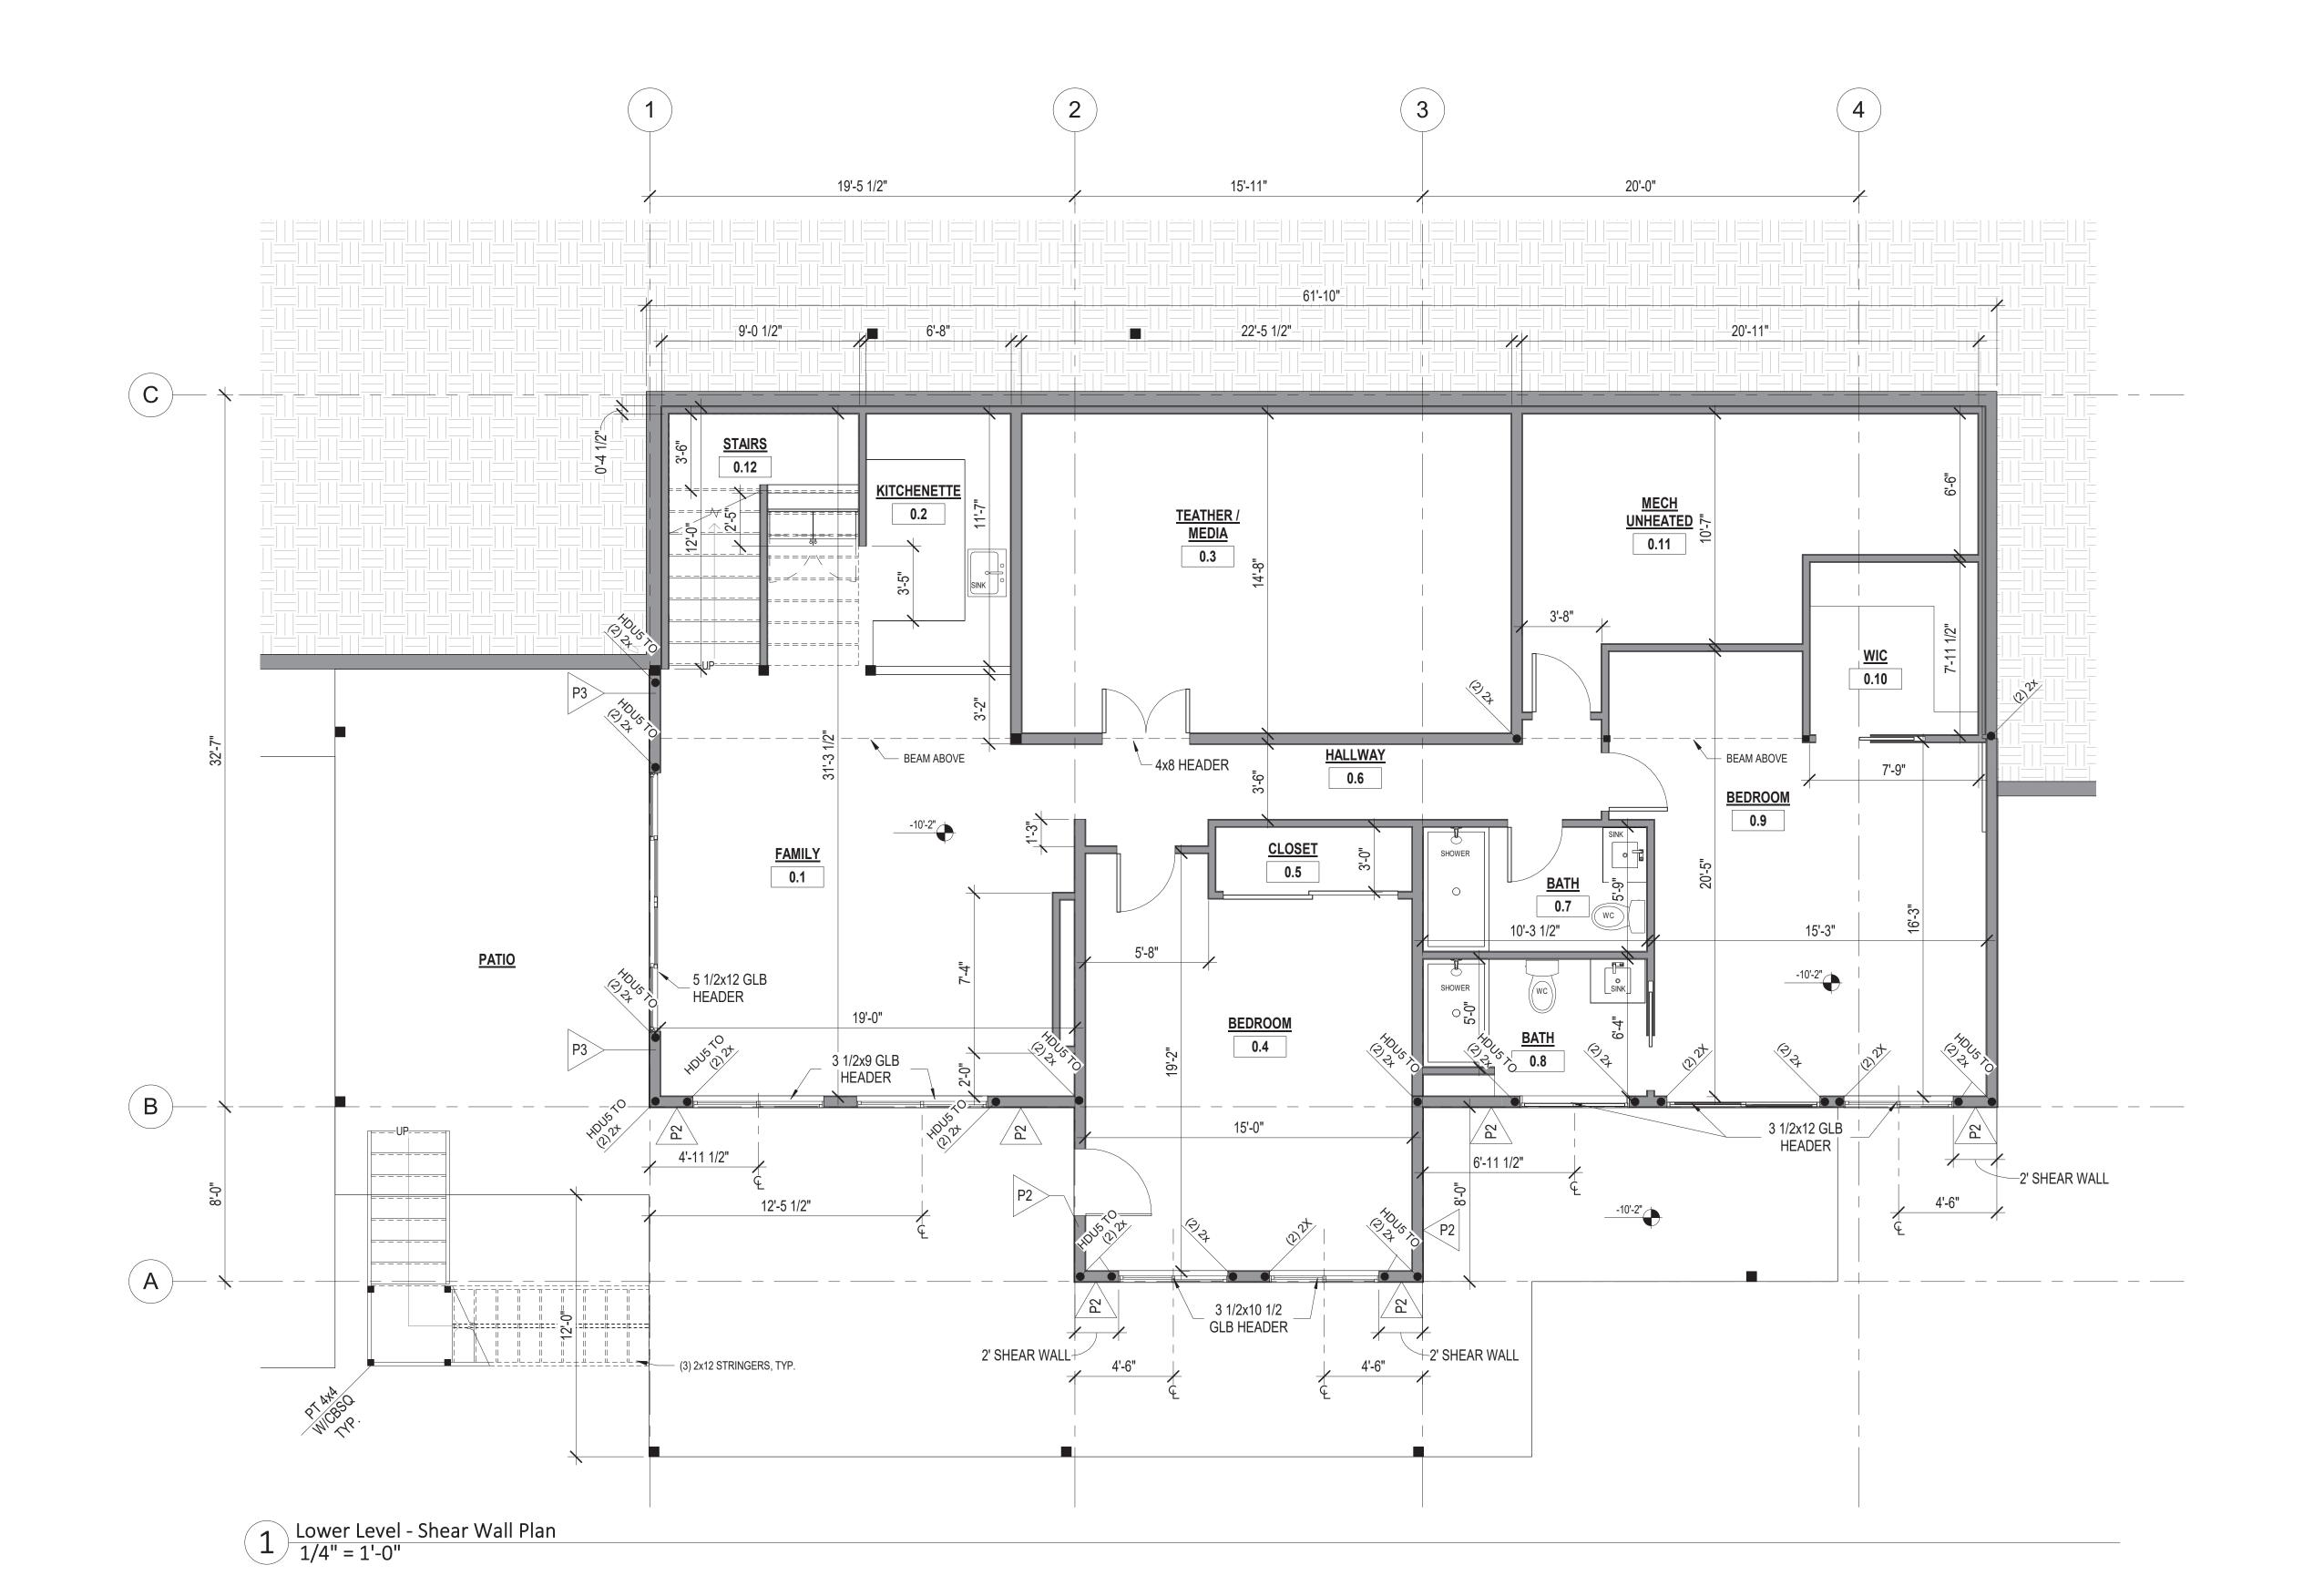

Date: 24 03 04

Job No: Project Number

FOV 68 Adel


Drawn By (initials): Autor

Check By (initials): CM

**S6** 

98801

Lower Level - Shear Walls

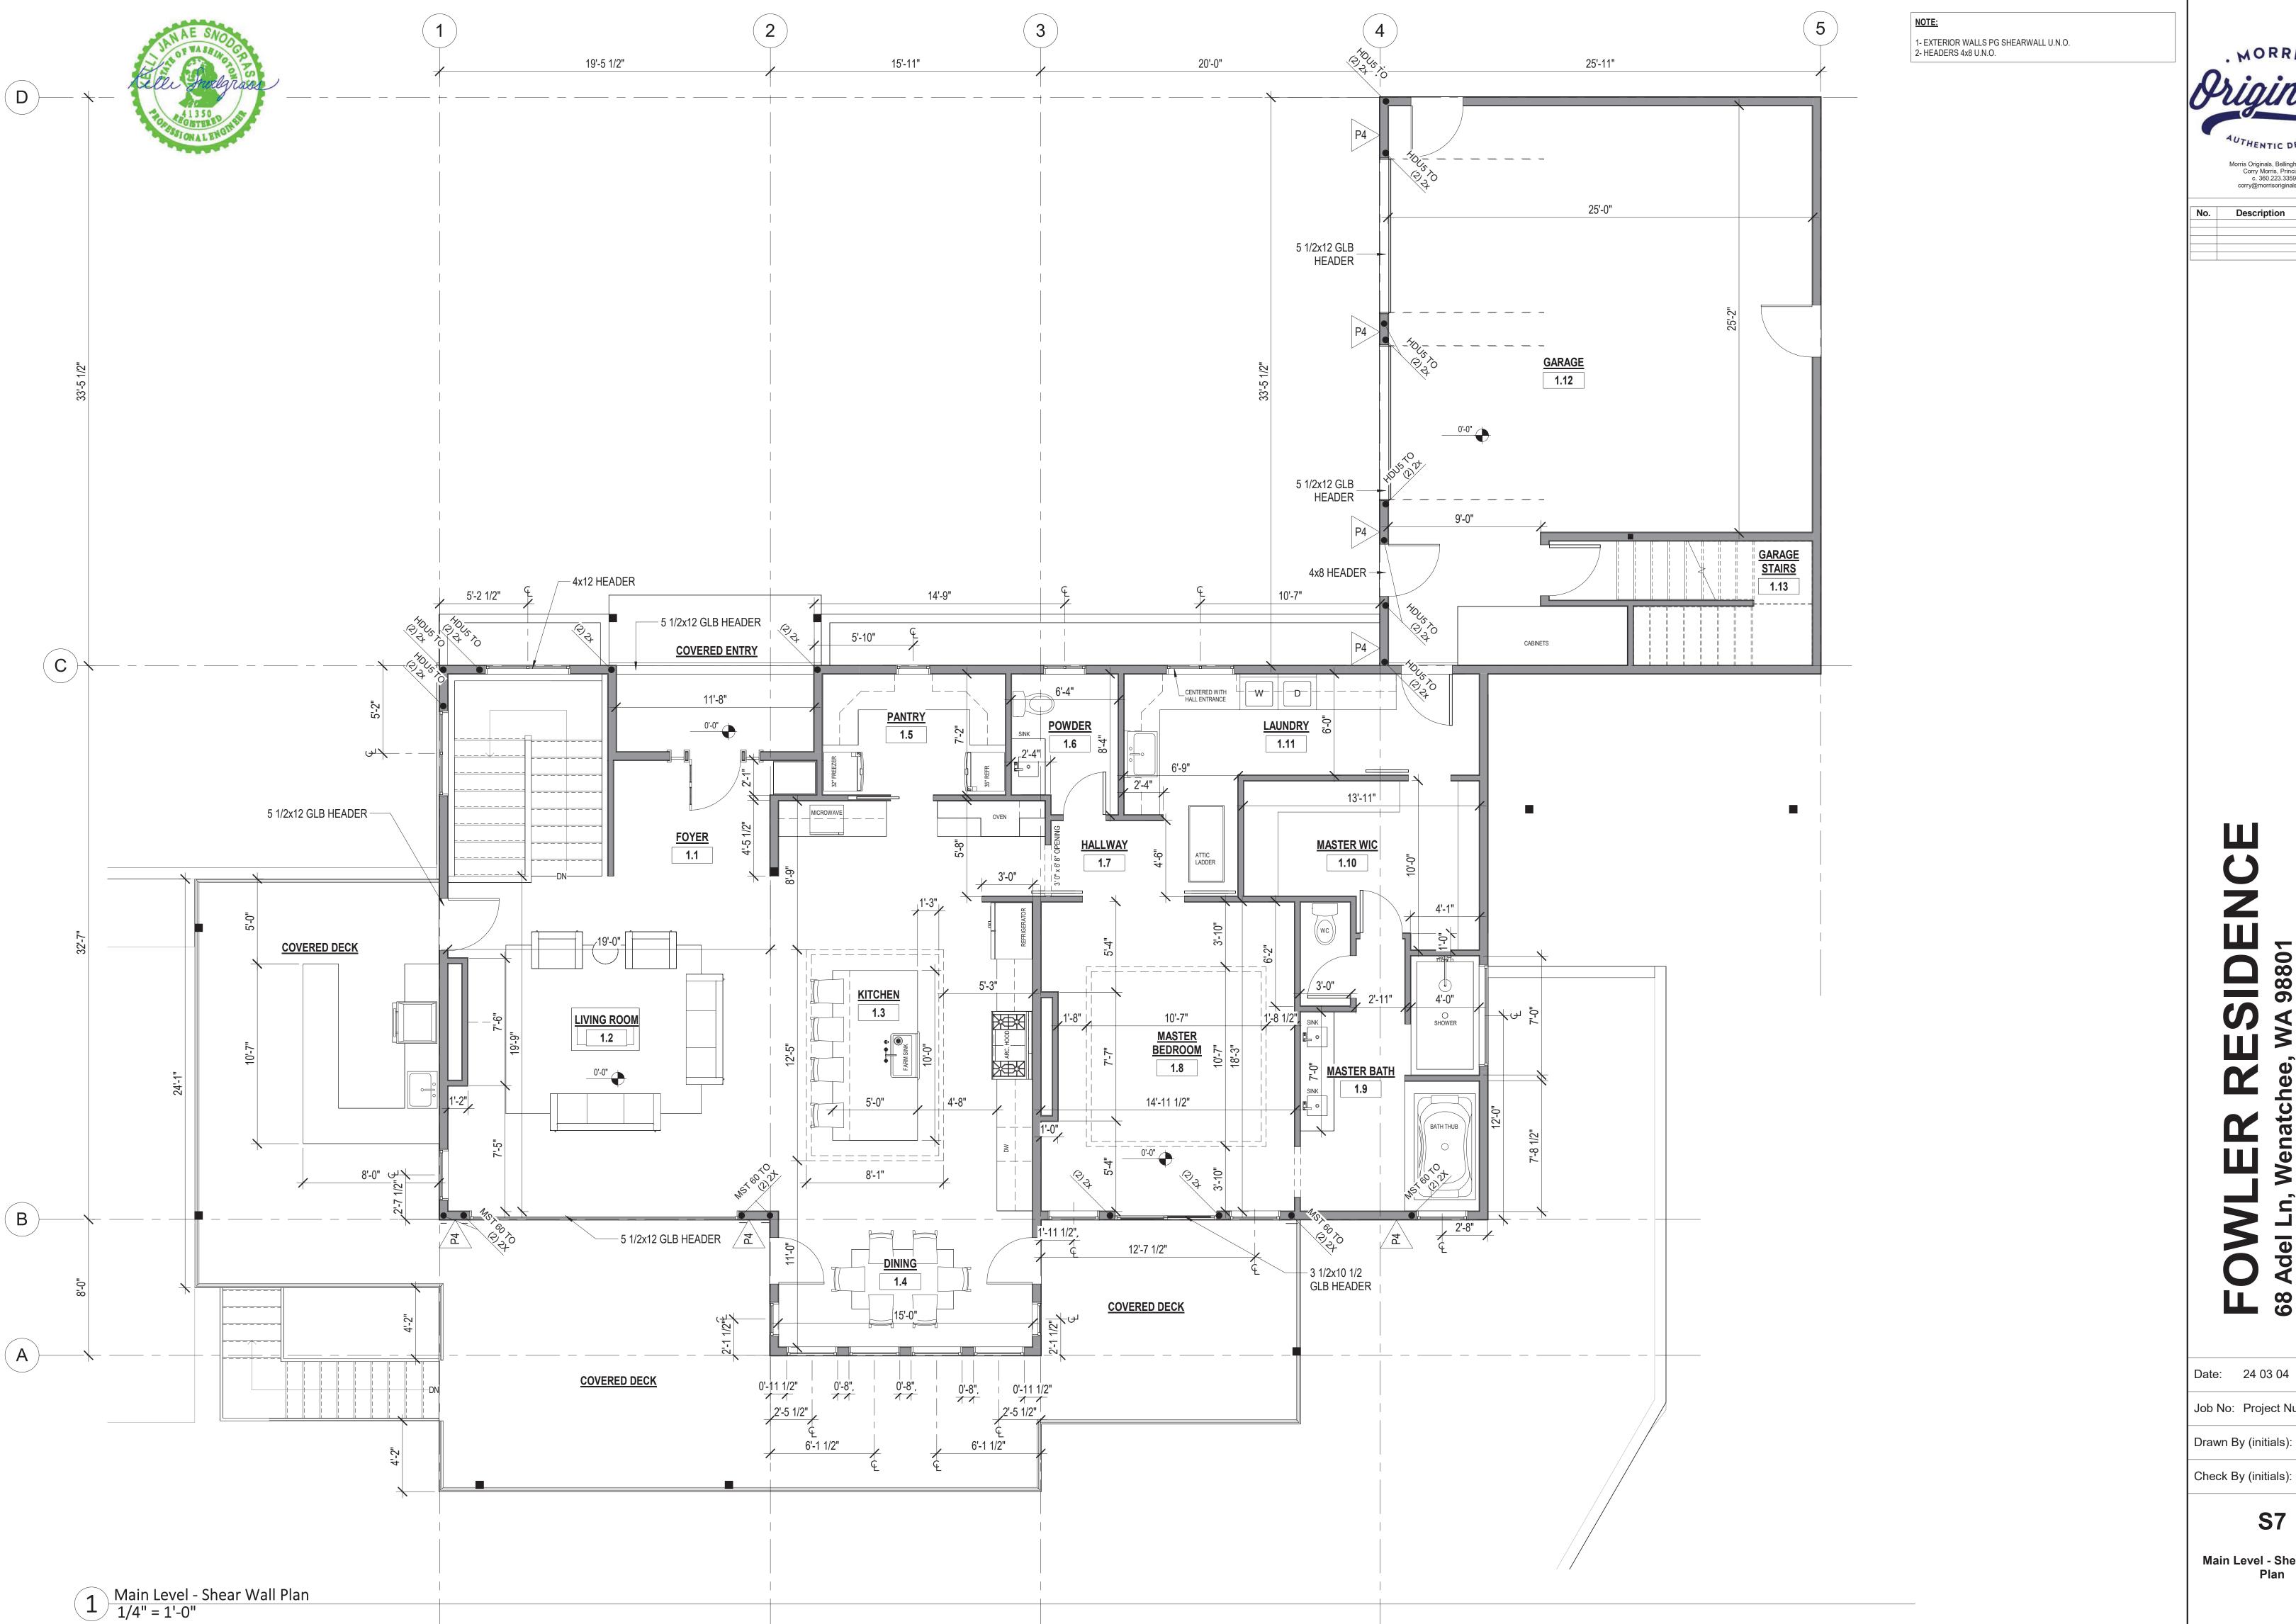

AUTHENTIC DESIGH Morris Originals, Bellingham, WA Corry Morris, Principal. c. 360.223.3359 corry@morrisoriginals.com

Job No: Project Number


Drawn By (initials): Autor

FOV 68 Adel

Check By (initials): CM

**S7** Main Level - Shear Walls



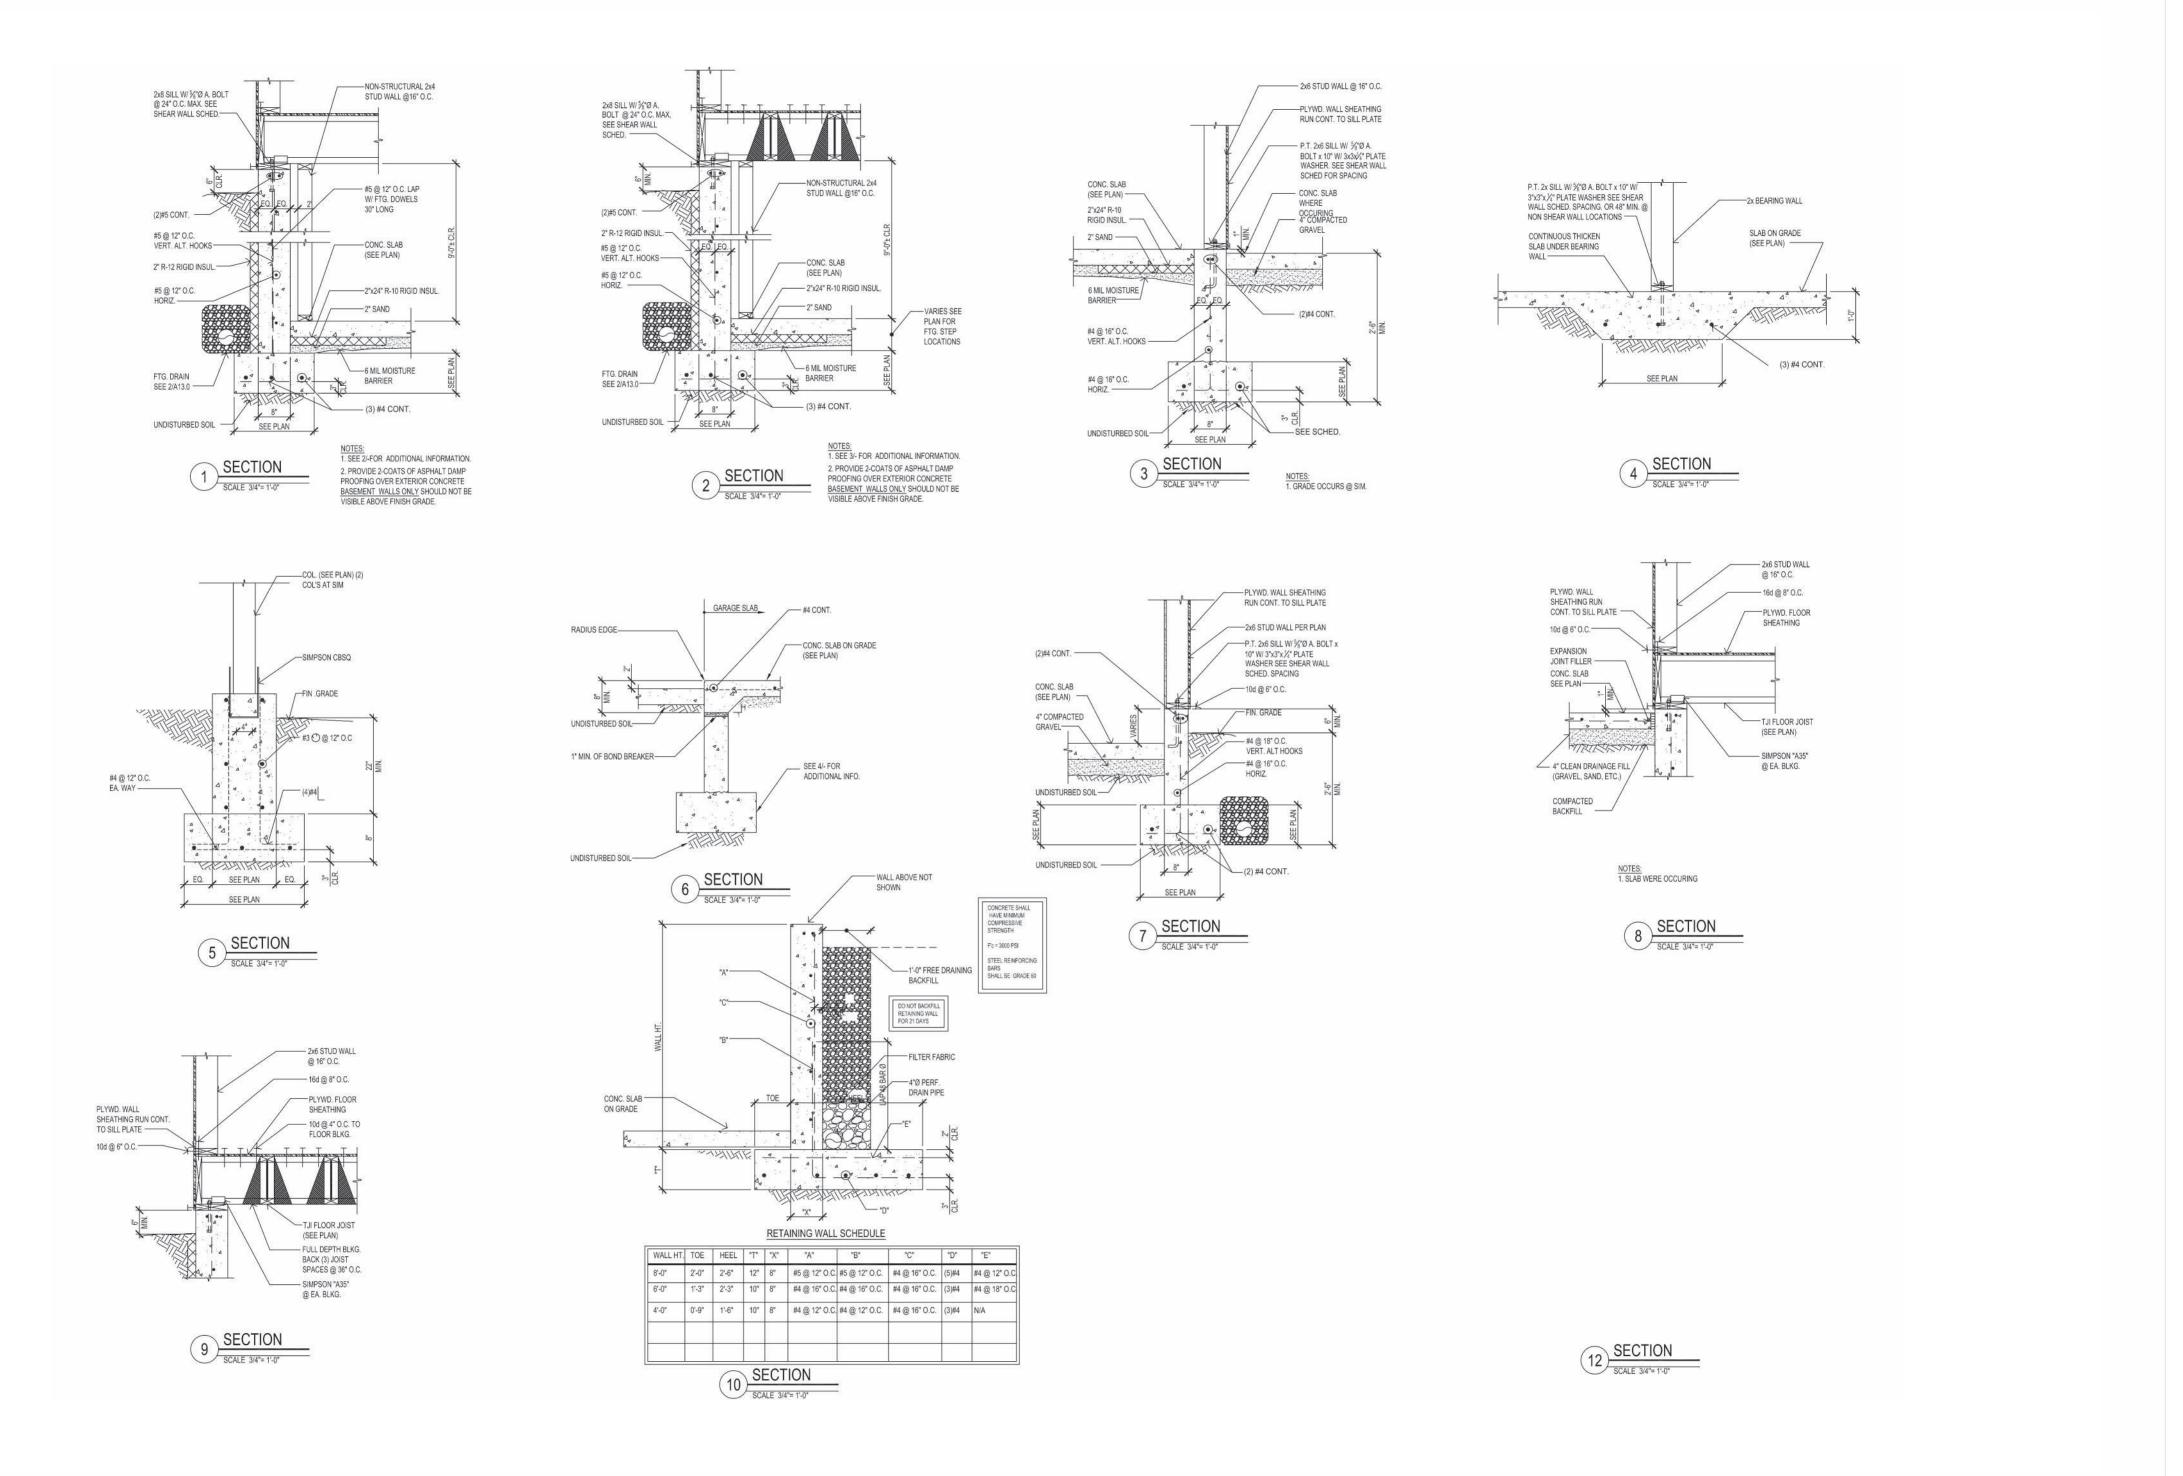

FOWLER RES

Date: 24 03 04


Job No: Project Number

Drawn By (initials): Author

Check By (initials): CM

**S1.0** 

Details

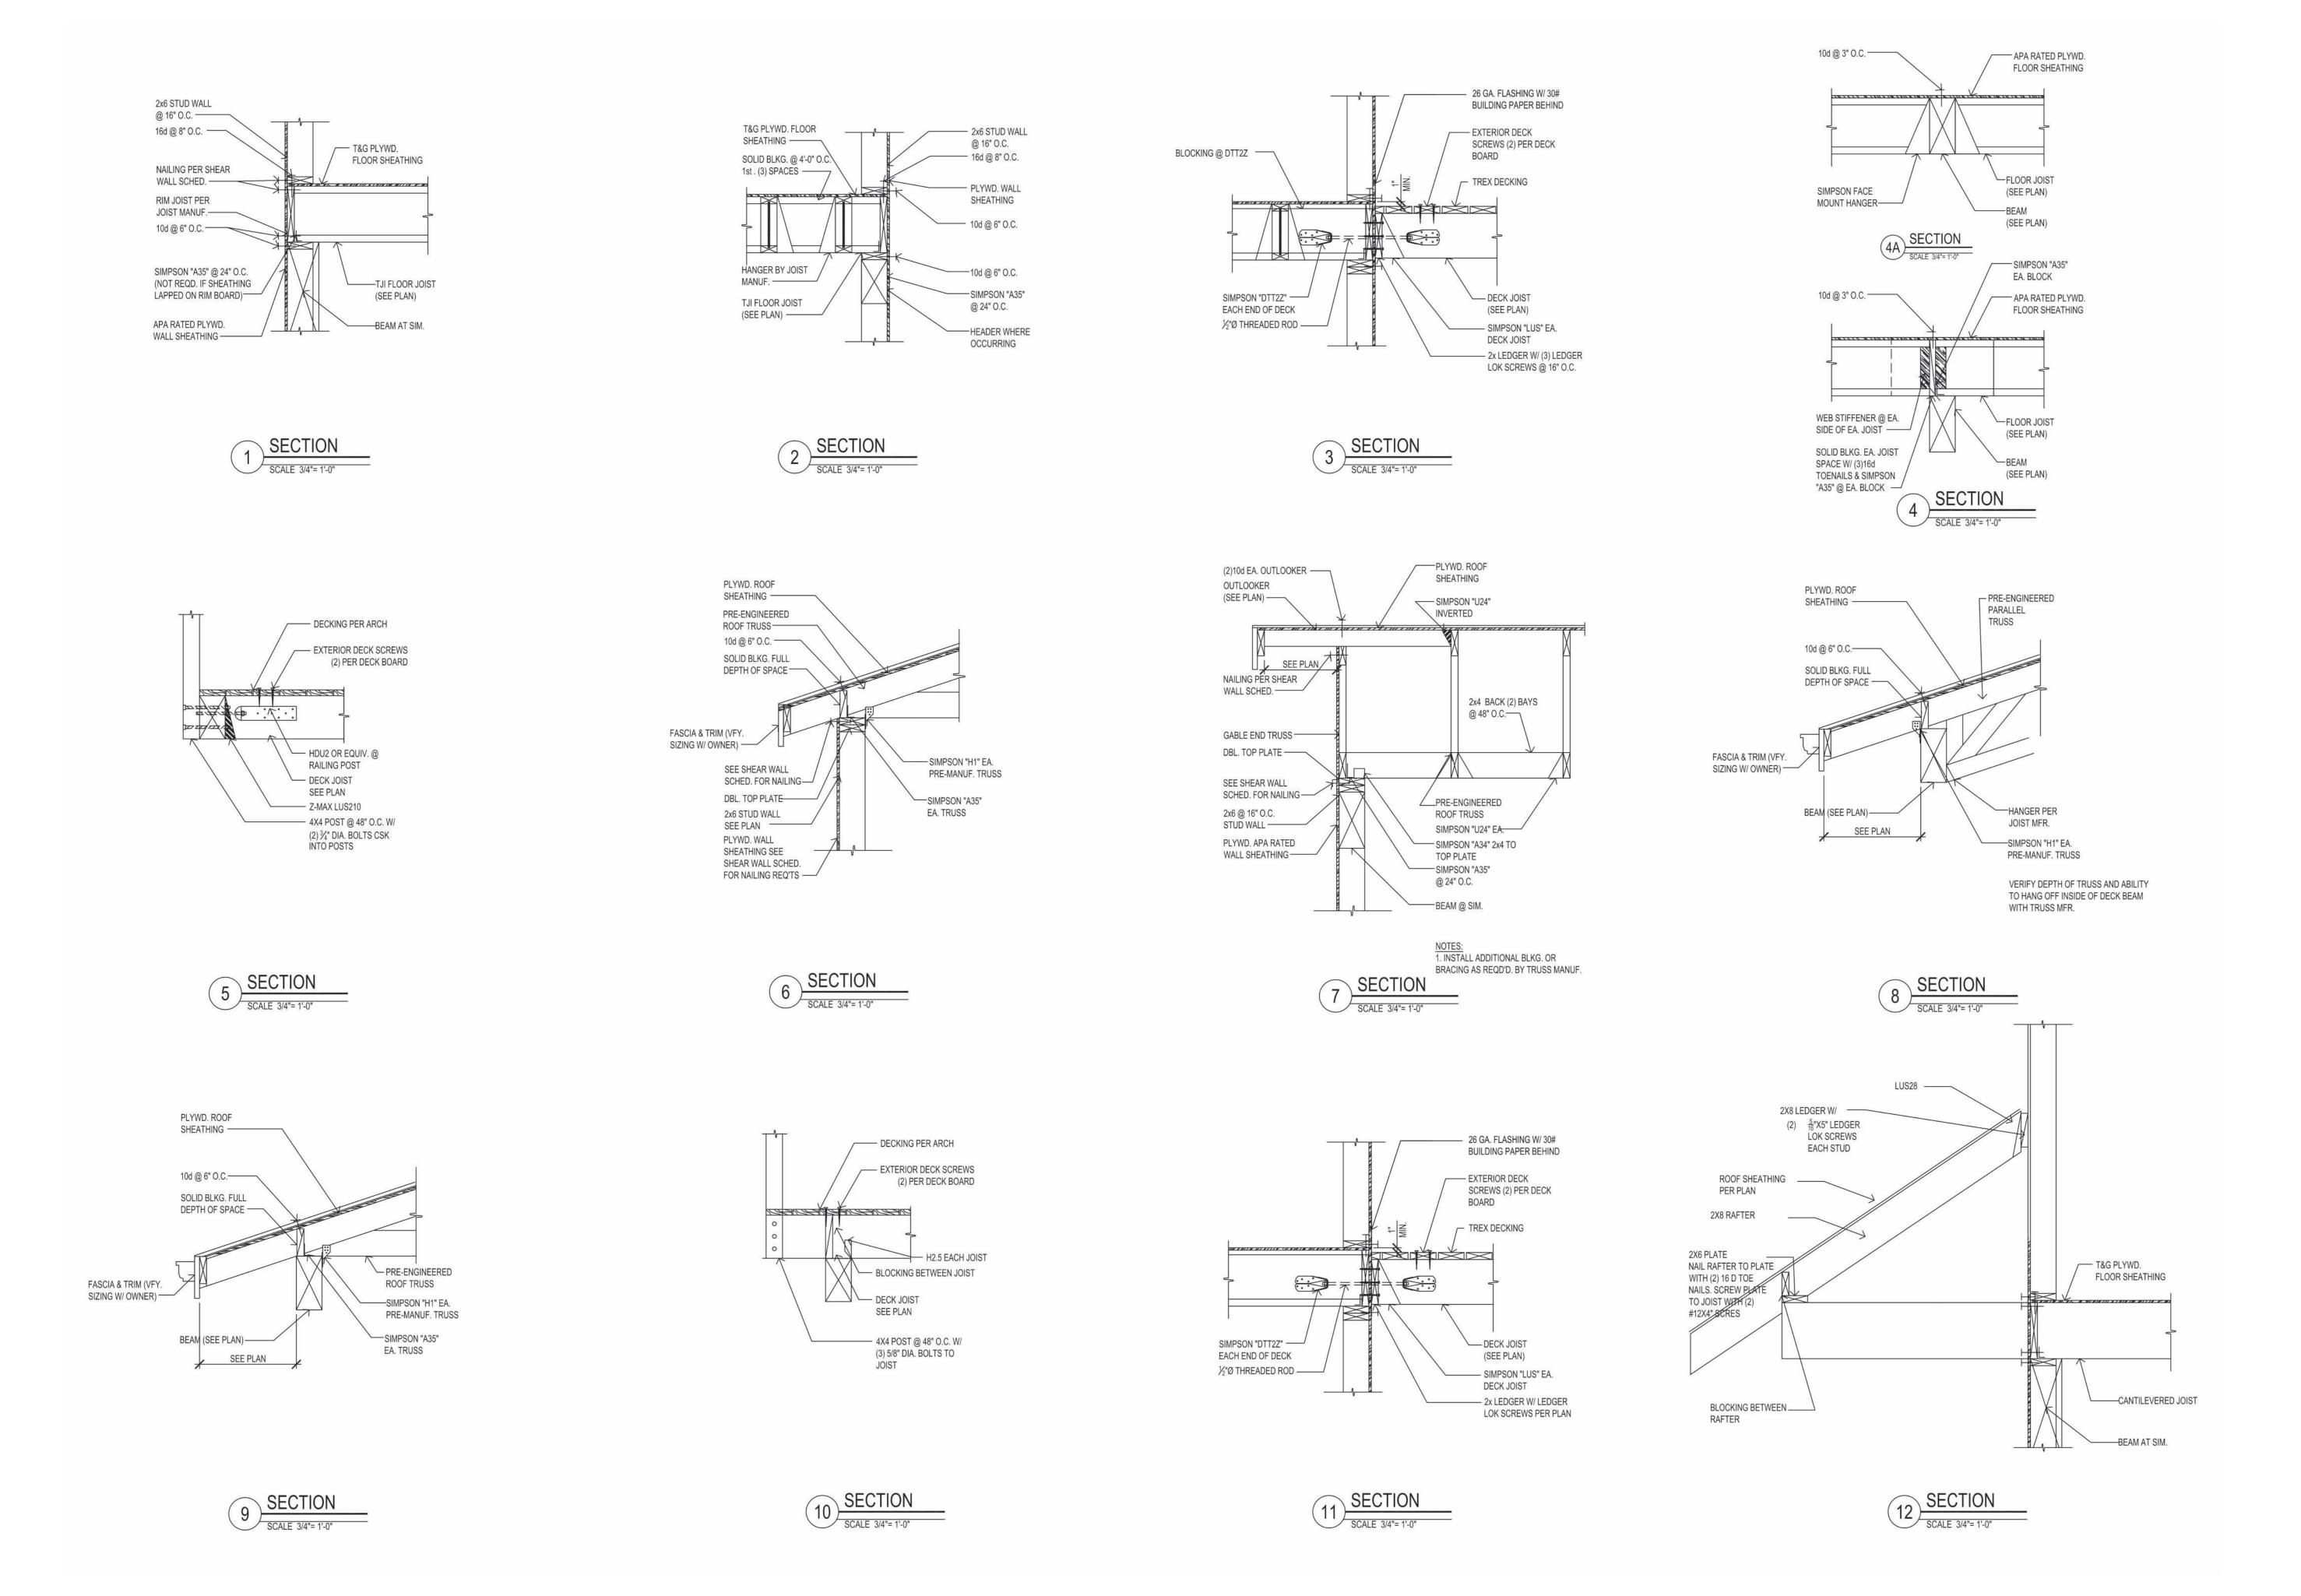



No. Description Date

LER RESIDENCI Wenatchee, WA 98801

Date: 24 03 04

Job No: Project Number

Drawn By (initials): Author

**L** 89

Check By (initials): CM

**S2.0** 

Details