

PROPOSED FLOOR PLAN ACCESSORY DWELLING UNIT SCALE: 1/4" = 1'-0" WALL LEGEND / FOR THIS FLOOR PLAN ONLY

NEW 2X4 STUD WALLS

WINDOW & DOOR SCHEDULE	U-FACTOR	SHGC
1) 2'-8" x 6'-8" POCKET DOOR		
2 5'-0" x 4'-0" VINYL SLIDING WINDOW	0.30	0.23
3 3'-0" x 1'-0" VINYL SLIDING WINDOW	0.30	0.23
4) 3'-0" x 6'-8" WOOD DOOR		
5) 2'-8" x 6'-8" WOOD DOOR		
6 6'-0" x 6'-8" SLIDING CLOSET DOOR		
7 5'-0" x 6'-8" SLIDING CLOSET DOOR		
8 2'-6" x 6'-8" METAL DOOR WITH MIN. OPENING OF 100 SQ. FT. FOR MAKE UP AIR		
9 PAIR OF 2'-6" x 6'-8" BI-FOLD LOUVERED WOOD DOOR (ROUGH OPENING 5'-1" x 6'-8") WITH MIN. OPENING OF 100 SQ. FT FOR MAKE UP AIR		
2'-0" x 6'-8" WOOD DOOR WITH MINIMUM OPENING OF 100 SQ. IN FOR MAKE UP AIR (ROUGH OPENING 2'-3" x 6'-10")		
(1) 3'-0" x 2'-0" VINYL SLIDING WINDOW WITH TEMPERED GLASS	0.30	0.23
(12) 5'-0" x 5'-0" SLIDING VINYL SLIDING WINDOW	0.30	0.23
(13) SHOWER SWING DOOR ENCLOSURE WITH TEMPERED GLASS		
(14) SHOWER SLIDING DOOR ENCLOSURE WITH TEMPERED GLASS		

FLOOR PLAN NOTES

- I) FAMILY ROOM ATTIC AREA SHALL BE ACCESSIBLE FROM ATTIC ACCESS AT HALLWAY, PROVIDE ACCESS BETWEEN BEDROOM-3 ATTIC AND KITCHEN / FAMILY ATTIC THROUGH CALIFORNIA FRAMING AREA.
- 2)+1+SHOWER HEAD & SHOWER CONTROL LOCATION
- 3) SHOWER COMPARTMENTS AND WALLS ABOVE BATHTUB WITH SHOWER HEADS SHALL BE FINISHED WITH A SMOOTH, NONABSORBENT SURFACE TO A HEIGHT NOT LESS THAN 6 FEET ABOVE FLOOR (R307.2)
- 4) NONASBESTOS FIBER-CEMENT BACKER BOARD, NONASBESTOS FIBER MAT REINFORECED CEMENTATIOUS BACKER UNITS, GLASS MAT GYPSUM BACKING PANELS OR FIBER-REINFORCED GYPSUM PANELS SHALL BE USED AS A BACKER FOR WALL TILE IN TUB AND SHOWER AREAS AND WALL PANELS IN SHOWER AREA. (R702.4.2)

•	REVISIONS	DATE

BASIL AMMARI P.E.

202 AMBLING DRIVE BREA, CA 92821 TEL: 949-279-7410

BEDROOMS THREE

PROPOSED FLOOR PLAN

Documents prepared by the Designer are instruments of service for use solely with the respect to this project. The Designer shall retain all common law, statutory and other reserved rights, including copyright. The owner shall not reuse or permit the reuse of the Designer's documents except by mutual agreement in writing.


> DRAWN BY D.R.

CONSULTANT / DESIGNER SIGNATURE

DATE 06/15/2022

SCALE 1/4" = 1'-0"

JOB NO.

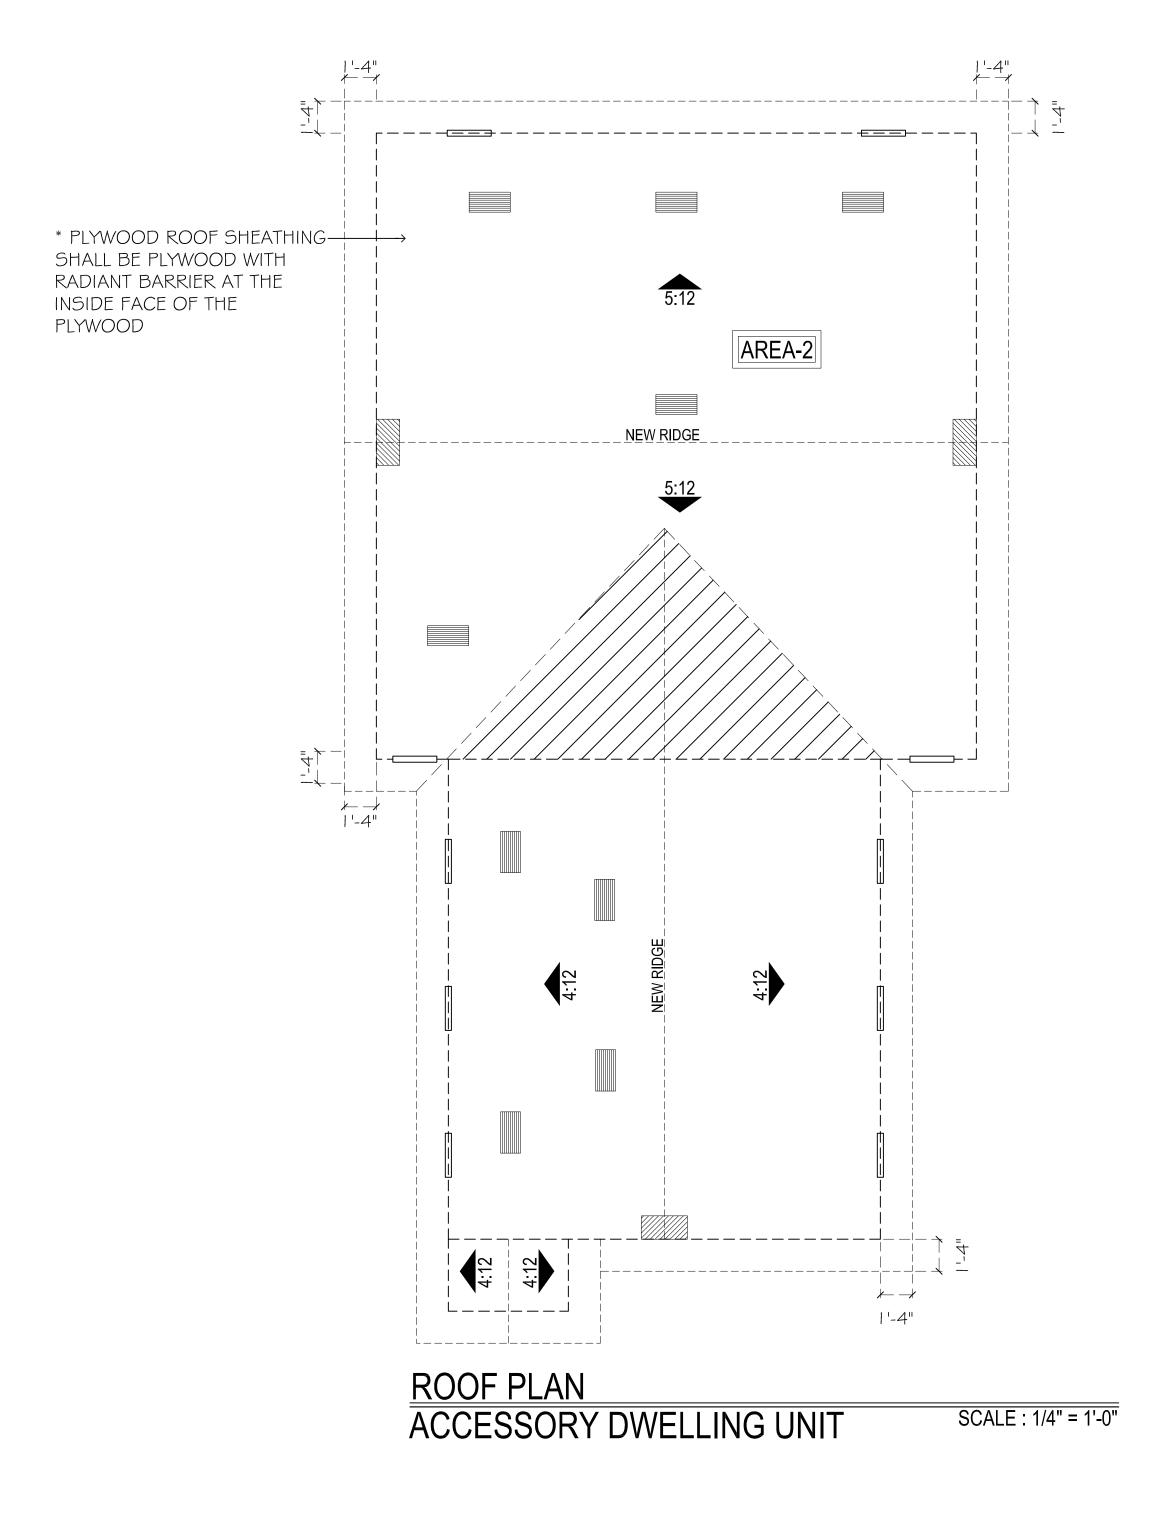

ROOF VENTILATION LEGEND

O, HAGIN LOW PROFILE FLAT SHINGLE ROOF VENT 72 SQ IN NET FREE AREA

14"x24" Galvanized Steel Gable End Vent 147 Sq. IN net free area.

14 1/2" Eave Vent 12 Sq. IN Net Free area.

VENTILATION CALCULATION

* AREA-1

- * TOTAL ROOF AREA = 360 SQ. FT. * REQUIRED VENTILATION = 360 / 150 = 2.4 SQ. FT. = 345.6 SQ. IN
- * 345 / 2 = 173 SQ. IN. (HIGH & LOW)
- * PROVIDE (2) O,HAGIN VENT & (6) EAVE VENT (LOW)
- PROVIDED VENTILATION = $(2x72) + (6 \times 12) = 216 \text{ SQ. IN (LOW)}$ * PROVIDE (2) O, HANGIN VENTS AND (1) GABLE VENT (HIGH) VENTILATION PROVIDED = (2 x 72) + 147 = 291 SQ. IN. (HIGH)

* AREA-2

- * TOTAL ROOF AREA = 640 SQ. FT. * REQUIRED VENTILATION = 640 / 150 = 4.27 SQ. FT. = 414.4 SQ. IN.
- * 615 / 2 = 308 SQ. IN (HIGH & LOW)
- * PROVIDE (4) 0,HAGIN VENTS & (4) EAVE VENTS (LOW)

 * PROVIDE (4)* 72 + (4)*12 = 336 SQ. IN (LOW)
 PROVIDED (2) GABLE VENTS & (1) O, HAGAN VENT
- * PROVIDE (2)* 147 + (1) *72 = 336 SQ. IN (LOW)

* ROOFING MATERIAL SHALL BE CLASS A ROOFING, GAF TIMBERLINE HDZ ASPHALT SHINGLES, ICC-ESR-1475, ASTMD3161, ASPHALT SHINGLES SHALL MEET THE CLASSIFICATION REQUIREMENTS OF CRC TABLES, ASPHALT SHINGLES SHALL MEET THE CLASSIFICATION REQUIREMENTS OF TABLE R905.2.4.1 FOR THE APPROPRIATE ULTIMATE DESIGN WIND SPEED

REVISIONS DATE

BASIL AMMARI P.E.

202 AMBLING DRIVE BREA, CA 92821 TEL: 949-279-7410

BEDROOMS THREE

PROPOSED ROOF PLAN

Documents prepared by the Designer are instruments of service for use solely with the respect to this project. The Designer shall retain all common law, statutory and other reserved rights, including copyright. The owner shall not reuse or permit the reuse of the Designer's documents except by mutual agreement in writing.

> DRAWN BY D.R.

CONSULTANT / DESIGNER SIGNATURE

DATE 06/15/2022

SCALE 1/4" = 1'-0"

JOB NO.

ELEVATIONS LEGEND (1) 3-COATS 7/8" STUCCO FINISH WITH TWO LAYERS OF GRADE D PAPER OVER ALL WOOD BASE SHEATHING ELEVATIONS NOTES: (2) COMPOSITE ROOF ASPHALT SHINGLES NOTES: I) A MINIMUM 26 ga. CORROSION RESISTANT OR PLASTIC WEEP SCREED WITH A MINIMUM VERTICAL I) PAINT OF ADU SHALL MATCH EXISTING DWELLING UNIT. (3) AN ADDRESS FOR THE ADU SHALL BE PLACED FLANGE OF 3 1/2" SHALL BE PROVIDED AT OR BELOW AT THIS LOCATION, NUMBERS SHALL BE FOUNDATION PLATE LINE ON EXTERIOR STUD WALLS. 2) STUCCO FINISH AT ADU SHALL MATCH EXISTING CONTRAST WITH BACK GROUND, BE ARABIC SCREED SHALL BE A MINIMUM OF 4" ABOVE EARTH 2" DWELLING UNIT IN COLOR, STYLE AND MATERIAL LETTERS AND MIN. 4" HIGH \$ MIN. 1/2" ABOVE PAVED AREAS. (R703.7.2.1) STROKE ROOF ROOF HDR <u>---</u>25'-7 1/2"-J-0"— -20'-0" -20'-0"-RIGHT SIDE ELEVATION LEFT SIDE ELEVATION SCALE: 1/4" = 1'-0" SCALE : 1/4" = 1'-0" ROOF HDR, HDR <u>~</u> -4'-0"- → —25'-O"— FRONT ELEVATION REAR ELEVATION SCALE: 1/4" = 1'-0" SCALE: 1/4" = 1'-0"

	REVISIONS	DATE	
H			

BASIL AMMARI P.E.

202 AMBLING DRIVE BREA, CA 9282 I TEL: 949-279-74 I O

DETACHED ADU 1 000 SQ FT THREE BEDROOMS ONE STORY

PROPOSED ELEVATIONS

Documents prepared by the Designer are instruments of service for use solely with the respect to this project. The Designer shall retain all common law, statutory and other reserved rights, including copyright. The owner shall not reuse or permit the reuse of the Designer's documents except by mutual agreement in writing.

DRAWN BY
D.R.

CONSULTANT / DESIGNER SIGNATURE

DATE 06/15/2022 SCALE

SCALE 1/4" = 1'-0" JOB NO.

A-5