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PROPOSED NEW
TENANT SPACE RENOVATION
THE CHICKEN COOP
8116 CLIFFDALE RD SUITE 116
FAYETTEVILLE, NC

ADA AND LEGAL DISCLAIMER

THIS DOCUMENT IS NOT REPRESENTED TO COMPLY WITH ALL REQUIREMENTS CONTAINED IN THE AMERICANS WITH DISABILITIES ACT (ADA) OR LAWS ARCHITECTS AND ENGINEERS ARE NOT LICENSED TO INTERPRET LAWS OR GIVE ADVICE CONCERNING LAWS. THE OWNER SHOULD HAVE THIS DOCUMENT REVIEWED BY HIS ATTORNEY TO DETERMINE IF IT COMPLIES WITH ADA AND OTHER LAWS.

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Revisions:

Drawing Title:
COVERSHEET

Project:

Project No. 116120

Drawing No.

Scale:

A-0

Date: 08/20/21

Drawn by: TPJr Checked by: GAO

PROPOSED NEW
TENANT SPACE UPFIT
THE CHICKEN COOP
8116 CLIFFDALE RD SUITE 116
FAYETTEVILLE, NC 28314



1 Kitchen



2 Dining Area

SHEET NUMBERING SYSTEM

- A-0 COVER
- A-1.0 APPENDIX B
- A-1.1 FLOOR PLAN
- P-1.0 PLUMBING PLANS
- M/E-1.0 MECHANICAL PLAN/ELECTRICAL PLAN

GENERAL

CIVIL
N/A

LANDSCAPE
N/A

ARCHITECTURAL




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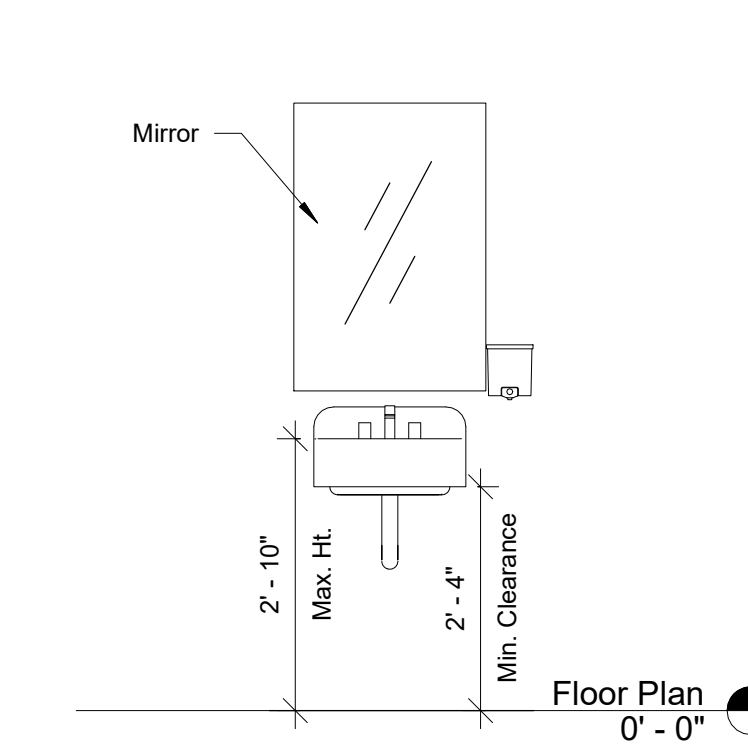
Mark	Description
1	48" Sandwich Station
2	Reach-in Refrigerator
3	72" Stainless Steel Worktable
4	Reach-in Freezer
5	8x8 Walk-in Cooler
6	Drink Fountain
7	Stainless Steel 3 Compartment Sink
8	Stainless Steel 1 Compartment Sink
9	Register/POS
10	Refrigerated Drink Machine
11	Combo Griddle/Oven/Range
12	Charbroiler
13	Basket Fryer Gas (1)
14	Gas Pressure Fryer




1 Floor Plan
 1/4" = 1'-0"

Floor Plan Notes:

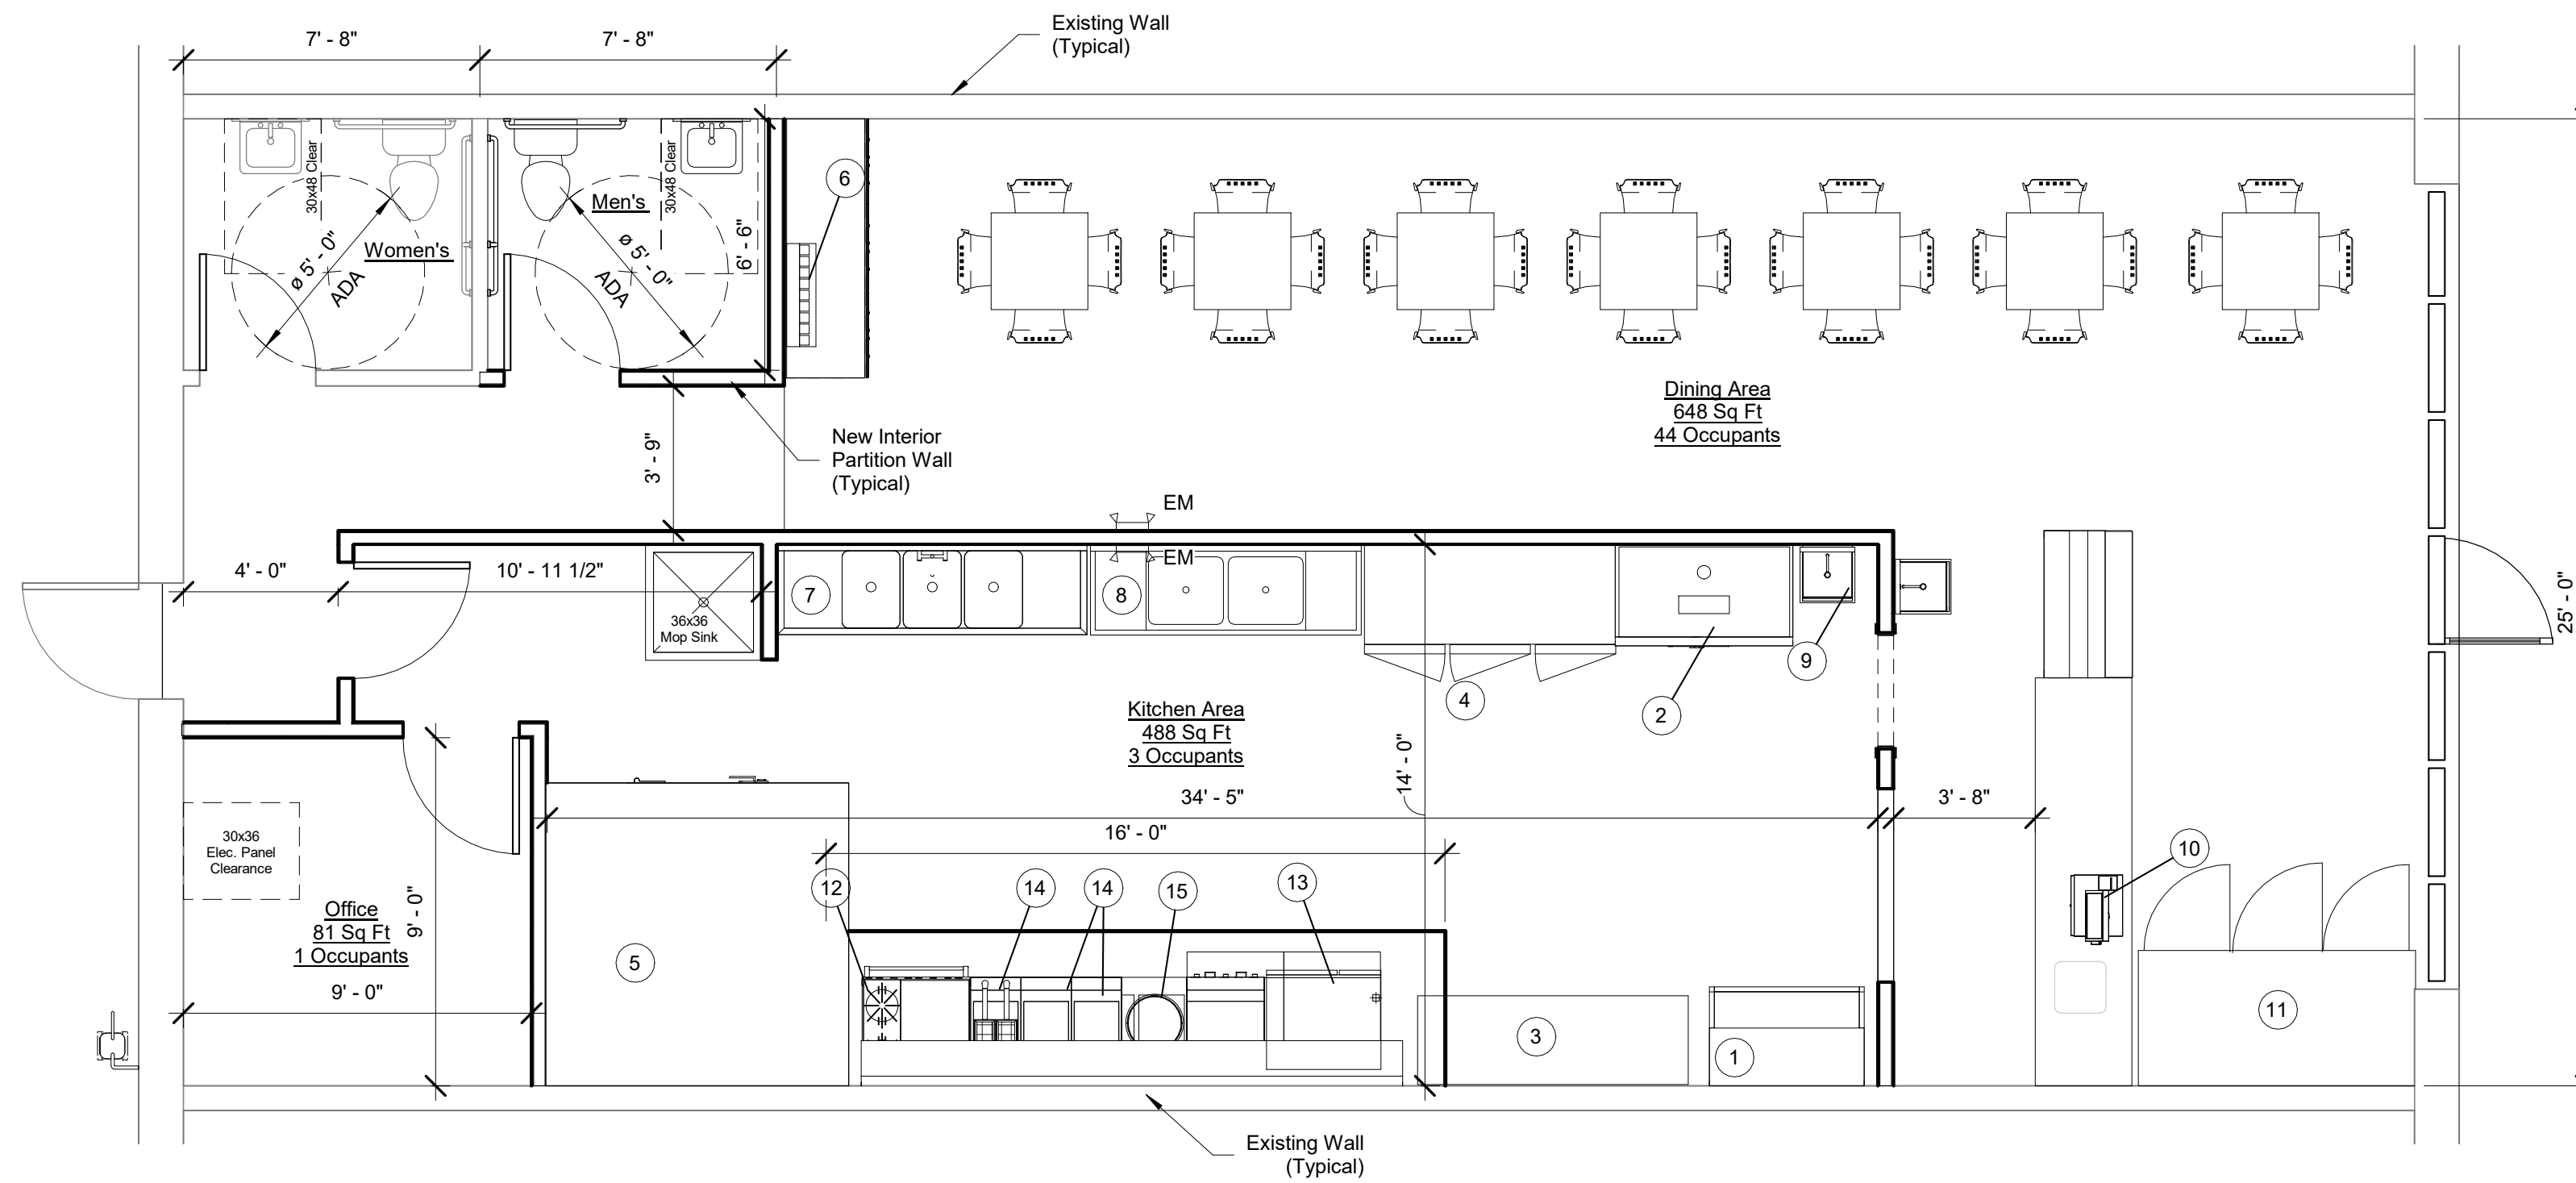
- All structural information shown for reference purposes only. Contractor shall have licensed structural engineer review and design all structural elements such as all framing walls, beams, connections, headers, joists and rafters.
- All dimensions are from center line of stud to face of exterior stud unless noted otherwise.
- Window sizes indicated on plans are noted by approximate rough opening size. Refer to plans and exterior elevations for window types.
- Coordinate location of utility meters with site plan and locate away from public view visual impact shall be minimized, i.e. mount as low as possible.
- Do not scale drawings. Follow dimensions only.
- Contractor shall field verify all cabinet dimensions before fabrication.
- All glass located within 18" of floor, 12" of a door located within 60" of floor at bathtubs, whirlpools, showers, saunas, steam rooms or hot tubs shall be tempered.
- All exposed insulation shall have a foam e spread rating of less than 25 and a smoke density rating of less than 450.
- Provide combustion air vents, with screen and back damper, for fireplaces, wood stoves and any appliance with an open flame.
- Bathrooms and utility rooms shall be vented to the outside with a minimum of a 90 cfm fan. Range hoods shall also be vented to outside.
- Attic HVAC units shall be located within 20'-0" of its service opening. Return air grilles shall not be located within 10'-0" of a gas fired appliance.
- All walls and ceilings in storage areas to have 5/8" Type-X gyp. brd. with 1-Hour fire rating.
- All interior walls shall be covered with 1/2" gyp. brd., with metal corner reinforcing, tape float and sand. (3 coats) use 5/8" gyp. brd. on ceilings when supporting members are 24" O.C. or greater. Use 1/2" gyp. brd. on ceiling members less than 24" O.C.
- All bath and toilet area walls and ceiling shall have water resistant gyp. brd. or FRP




2 Elevation - ADA Lavatory Front
 1/2" = 1'-0"

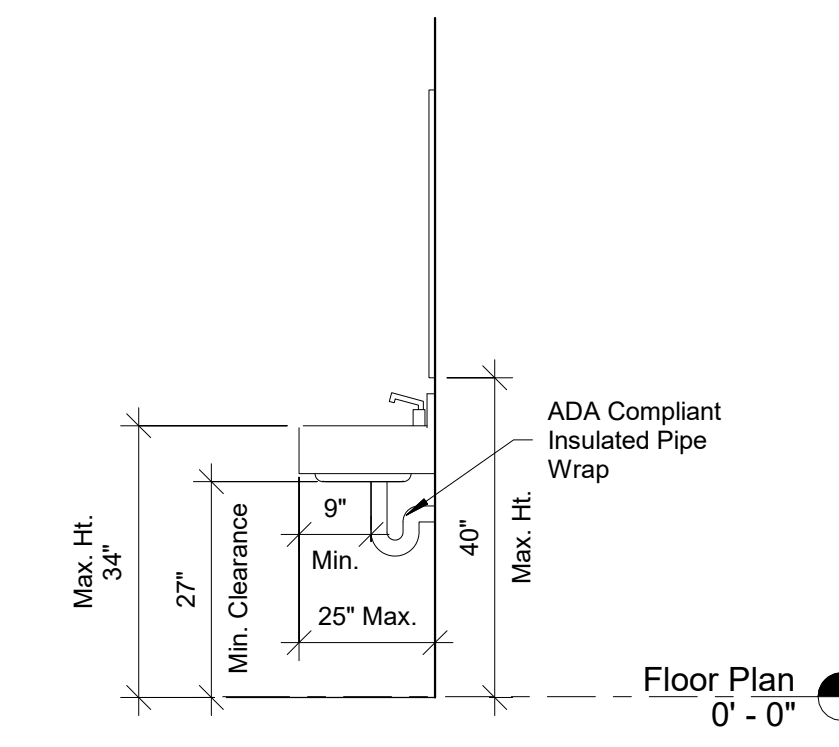


3 Elevation - ADA Lavatory Side
 1/2" = 1'-0"

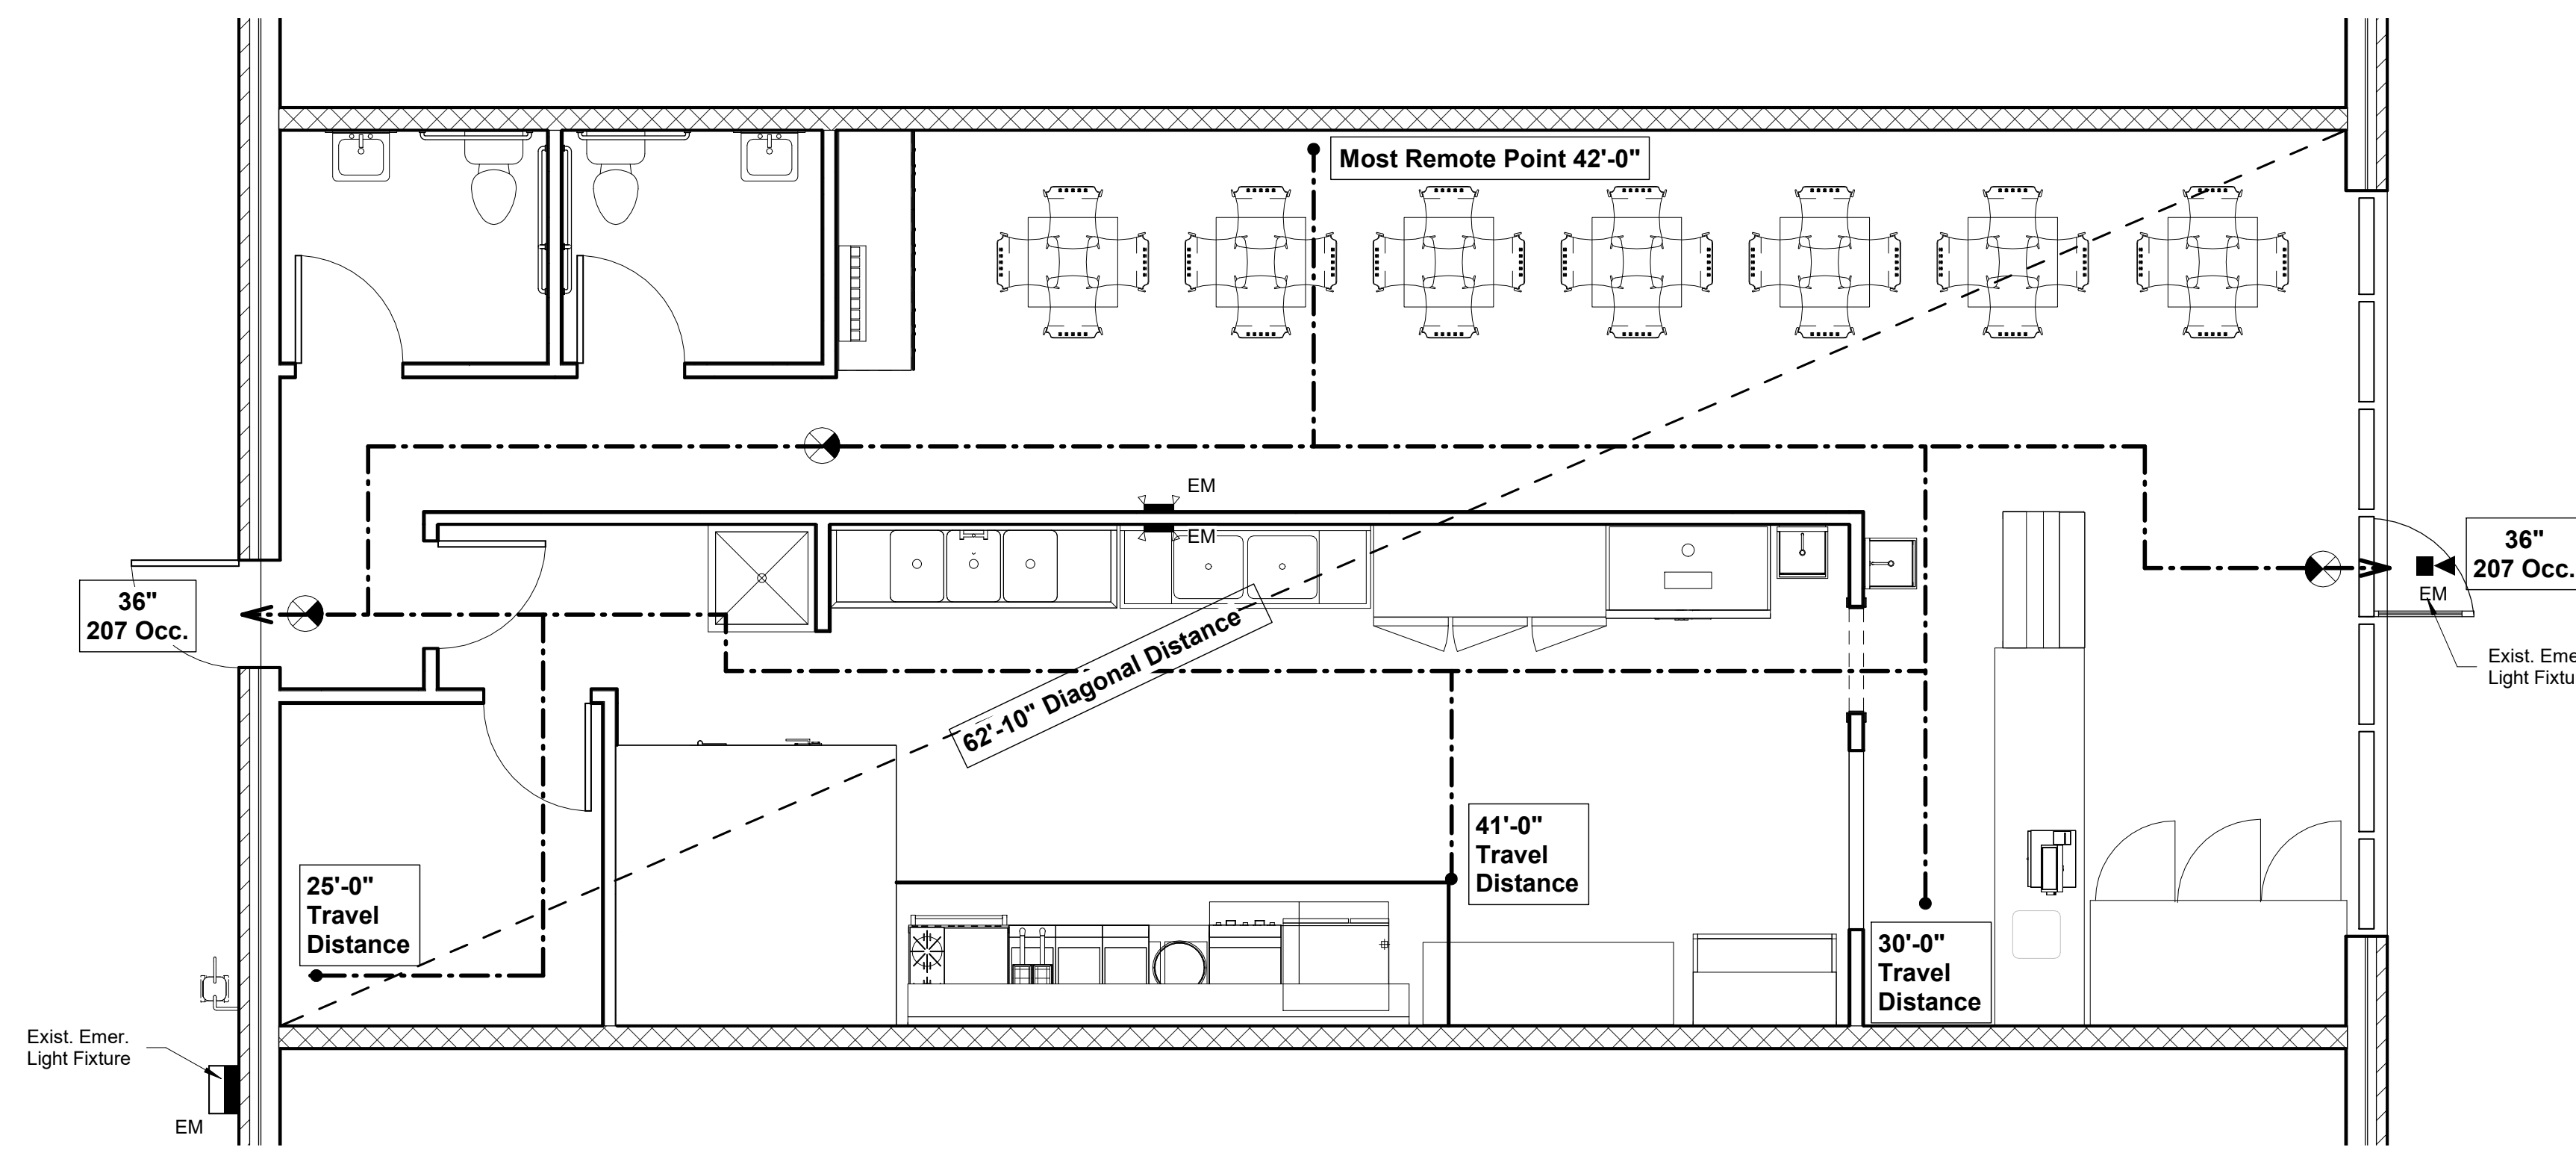

6 Life Safety Plan
 1/4" = 1'-0"

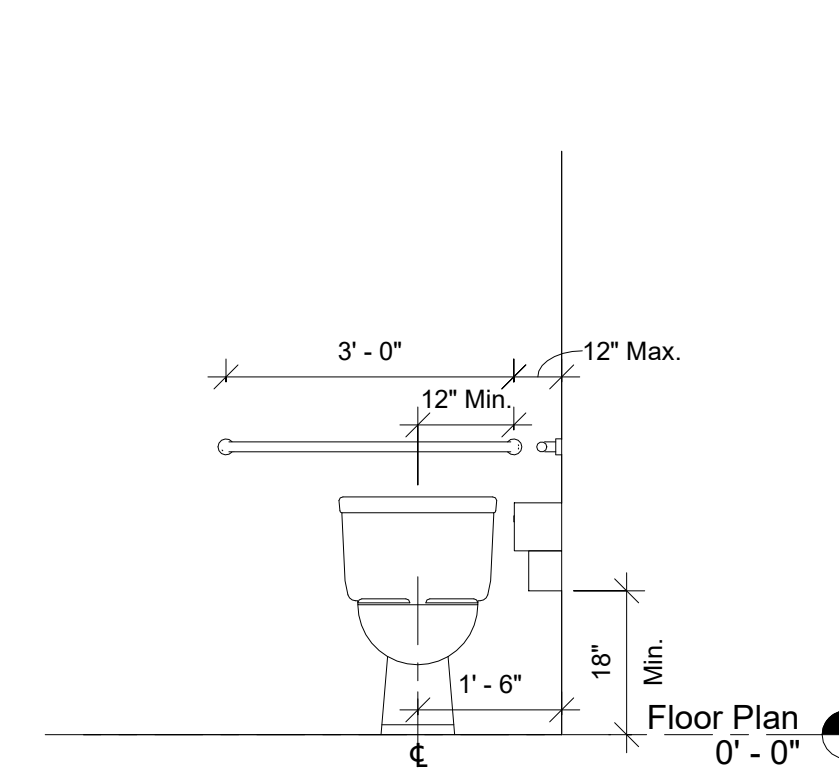

4 Elevation - ADA Toilet Front
 1/2" = 1'-0"

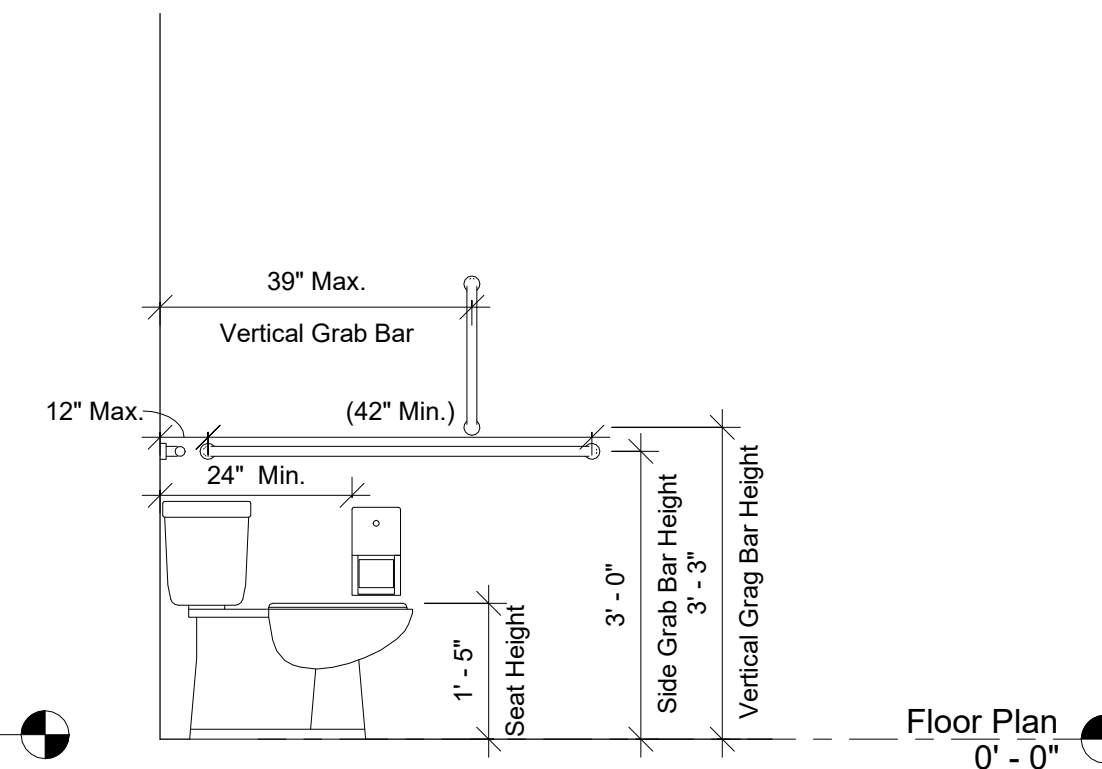

5 Elevation - ADA Toilet Side
 1/2" = 1'-0"

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Revisions:

Drawing Title:
Floor Plan

Project:

Project No: 116120

Drawing No:

Scale: As Indicated

A-1.2

Date: 08/20/21

Drawn by: TPJr Checked by: GAO




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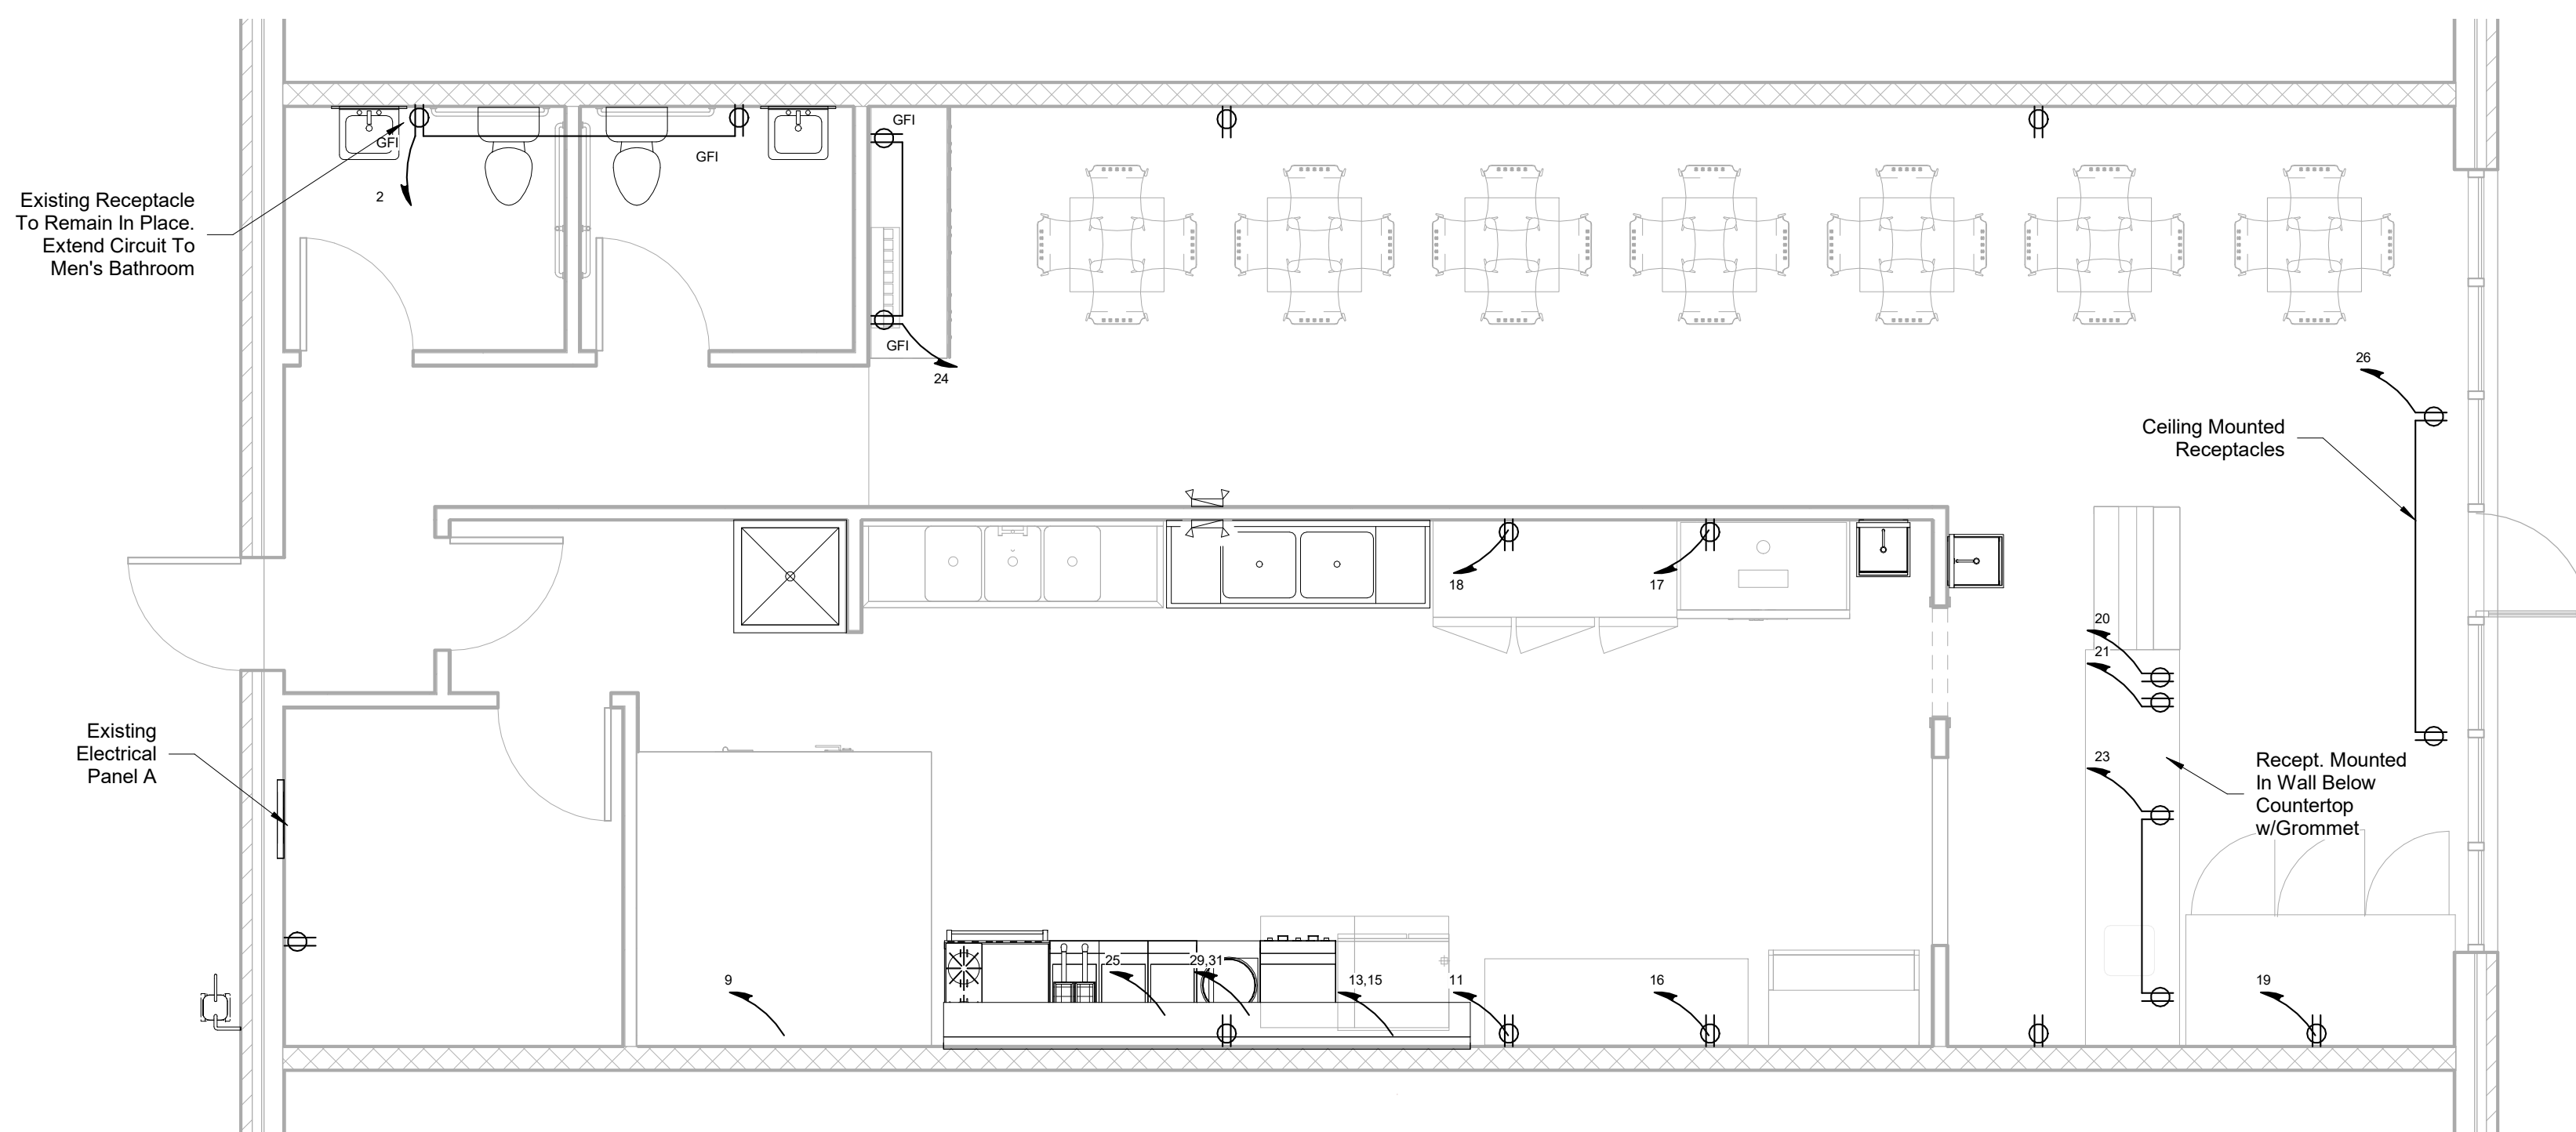
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OUTSIDE AIR CALCULATION	
OCCUPANCY TYPE:	ASSEMBLY A-2
ACTUAL NUMBER OF OCCUPANTS (P2)	48 PEOPLE
NET SQUARE FOOTAGE OF HEATED BUILDING: (Az)	1500 SQ/FT
BUILDING EXHAUST REQUIREMENTS	
EXHAUST REQUIRED (1500 * 0.06)	90 CFM
TOILET EXHAUST REQUIRED (2 FLUSHING FIXTURES * 75 CFM EACH))	150 CFM
TOTAL BUILDING EXHAUST AIR REQUIRED	240 CFM
BUILDING VENTILATION REQUIREMENTS	
PEOPLE * 7.5 CFM TABLE 4.3: 2018 NC MECH CODE	
48 PEOPLE * 7.5 CFM/PERSON	360 CFM
OUTSIDE AIR SUB-TOTAL	600 CFM
OUTSIDE AIR REQUIRED = 480 / 0.80 (EFFECTIVENESS)	750 CFM
BUILDING EXHAUST PROVIDED	
EXIST. NEW	
75 CFM 75 CFM	150 CFM
OUTSIDE AIR PROVIDED	
EXIST. SPLIT 5 TONS	
900	900 CFM



1 Lighting & Mechanical Plan
1/4" = 1'-0"

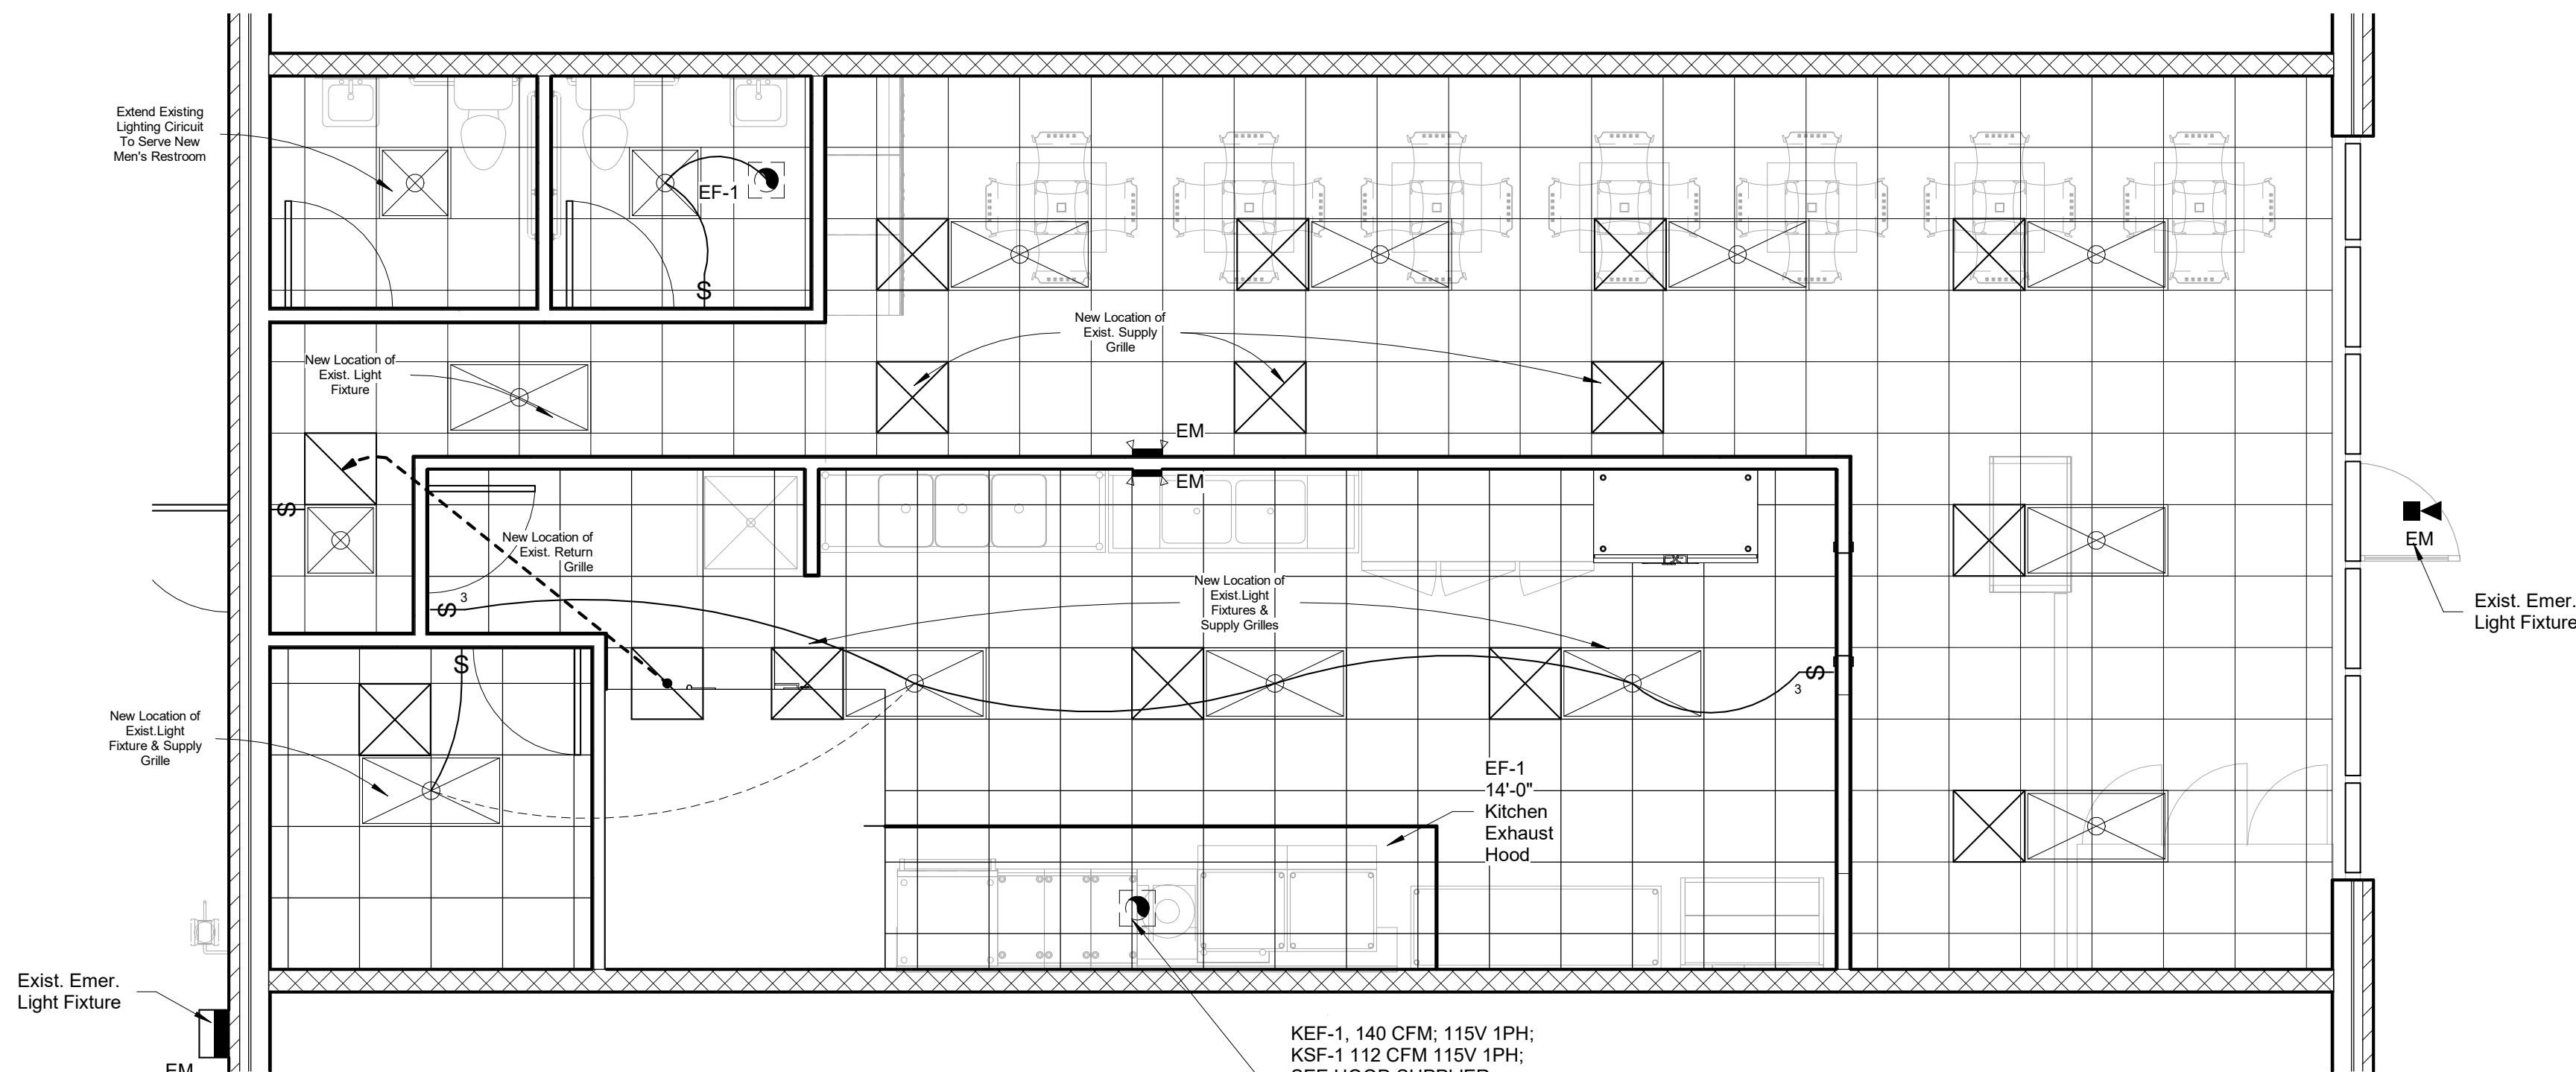

2 Power Plan
1/4" = 1'-0"

PANEL "A" EXISTING PANEL		PHASE 3 WIRE 4 VOLTS 208/1 MAIN 200A									
TYPE NEMA MOUNTING FLUS ENCLOSUR		SHORT CKT. RATING 22.00 RMS SYM.									
<input checked="" type="checkbox"/> GROUND TERMINAL BAR		<input checked="" type="checkbox"/> NEUTRAL TERMINAL BAR									
PHAS LOADIN	DESCRIPTION	CKT TYPE	WIRE SIZE	CKT BKR TRIP	CKT NO	A	B	C	DESCRIPTION	PHAS LOADIN	
0.1	Outdoor Lightin	EX	1 20	1	2				BATHROOM SIGN	0.3	
0.3	Exist.	EX	1 20	3	4				WATER HEATER	1.0	
0.5	Exist.	EX	1 20	7	8				AIR CONDENSING	1.0	
4.9	WALK-IN POWER APPLIANCE RECEPTACLE STEAMER	K	1 20	9	1					3.5	
0.6	REACH-IN REFRIGERATOR DRINK APPLIANCE RECEPTACLE KITCHEN HOOD	K	1 20	1	1				APPLIANCE RECEPTACLE FREEZER ICE CREAM SANDWICH DRINK STATION RECEPTABLE SIGN	0.3	
0.6	REACH-IN REFRIGERATOR DRINK APPLIANCE RECEPTACLE KITCHEN HOOD	K	1 20	1	1					3.5	
0.8	REACH-IN REFRIGERATOR DRINK APPLIANCE RECEPTACLE KITCHEN HOOD	K	1 20	1	1					0.3	
0.4	REACH-IN REFRIGERATOR DRINK APPLIANCE RECEPTACLE KITCHEN HOOD	K	1 20	2	2					0.5	
0.3	REACH-IN REFRIGERATOR DRINK APPLIANCE RECEPTACLE KITCHEN HOOD	E	1 20	2	2					0.3	
1.0	REACH-IN REFRIGERATOR DRINK APPLIANCE RECEPTACLE KITCHEN HOOD	H	1 20	2	2					0.3	
5.2	PRESSURE FRYER	K	6 50	2	3						
	SPAC			3	3						
	SPAC			3	3						
	SPAC			3	3						
	SPAC			3	3						
	SPAC			3	3						
7.4				4	4					5.6	
6.2										5.3	
6.0										5.3	
SUB-TOTAL									SUB-TOTAL		
C CONTINUOUS						E ESTIMATED			TOTAL CONNECTED LOAD = 37.0 KVA AMPS = 77.1		
H HVAC						EX EXIST			TOTAL OF SPACES 4		
N NON-CONTINUOUS											
R RECEPTACLE											
K KITCHEN											

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Revisions:

Drawing Title:

Electrical & Mechanical Plan

Project:

Project No: 116120 Drawing No:

Scale: As indicated **M/E-1.0**

Date: 08/20/21 Drawn by: TPJr Checked by: GAO

ELECTRICAL LEGEND	
	DUPLEX RECEPTACLE; MOUNT AT 18" A.F.F.
	DUPLEX RECEPTACLE; GROUND FAULT INTERRUPTER
	DUPLEX RECEPTACLE; WEATHERPROOF/GROUND FAULT INTERRUPTER
	SINGLE POLE POWER/LIGHTING HOMERUN (SINGLE PHASE)
	2-POLE POWER HOMERUN (SINGLE PHASE)
	DISCONNECT
	JUNCTION BOX
	POWER PANEL
	SWITCH, OCCUPANCY SENSOR
	3-WAY SWITCH
	3-WAY DIMMER SWITCH
	LAY-IN/SURFACE MOUNTED LED
	EMERGENCY LIGHT
	EXIT/EMERGENCY COMBO

Scope of Work: Mechanical & Electrical


Mechanical: Mechanical work will require the relocation of existing return and supply grilles to coordinate with new partition wall layout, installation of toilet exhaust fan, and installation of kitchen hood. Existing 3 Ton Air Conditioning Unit to remain in place to serve new occupancy. No other mechanical work will be required.

Lighting: Electrical Lighting work will require the relocation of existing light fixtures to coordinate with new partition wall layout. One light fixture and switch to be added.

Power: Electrical Power work will require addition of new circuits to serve kitchen and dining room equipment. Verify all power requirements and location of outlets with owner and equipment specifications.

EXHAUST FAN SCHEDULE											
MARK	LOCATION	SERVICE	CFM	S.P.	WATTS	RPM	VOLT	PHASE	DRIVE	COMMENTS	NOTES
EF-1	CEILING	EXHAUST	75	0.125"	80	1050	120	1	DIRECT	FAN/LIGHT COMBO	(1)(2)(3)(4)

- (1) ROOF CAP WITH BIRDSCREEN
- (2) MESH FILTER
- (3) BACKDRAFT DAMPER
- (4) WIRED FOR CONTINUOUS OPERATION DURING NORMAL HOURS

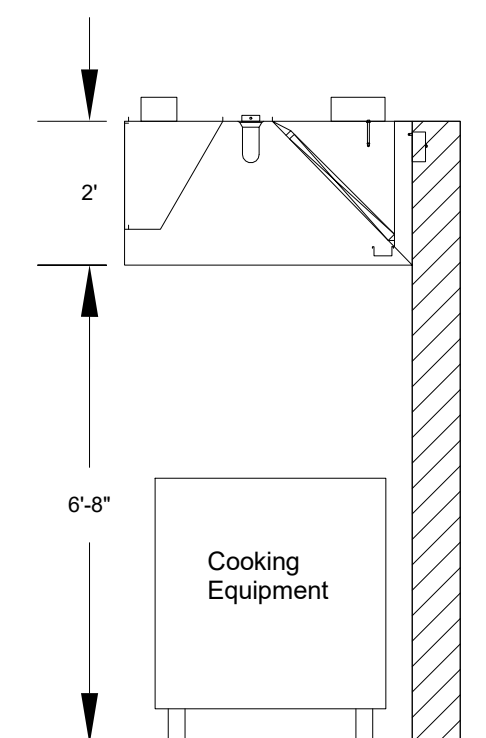

HOOD DETAIL
N.T.S.

HOOD INFORMATION											
HOOD NO.	MOUNTING	MODEL	HOOD DIMENSIONS	HOOD CONSTR.	TEMP RATING	EXHAUST	SUPPLY	TOTAL	SECTION	LIGHTING DETAILS	GREASE FILTRATION
NO.			LENGTH WIDTH HEIGHT		600 DEG F	CFM COLLAR DIM S.P.	MUA	WEIGHT	LOCATION	LAMP QTY FOOT CANDLES TYPE QTY SIZE	SS BAFFLE 4 16X24X3
EH-1	WALL MOUNTED	GHW-72-S	72 48 24	SS EXPOSED	600 DEG F	1000 9Wx12L 0.42	700 CFM	264 LBS	SINGLE	100W A19 2 39.21	

INTEGRAL SUPPLY PLENUM INFORMATION											
HOOD NO.	MOUNTING	POS.	TYPE	CFM	COLLARS						
NO.					TYPE MOUNT QTY W L CFM S.P. VEL						
EH-1	WALL MOUNTED	FRONT	FRONT	700	MUA FACTORY 1 1 6 700 0.03 700						

FIRE SUPPRESSION											
HO NO.	MOUNTING	MODEL	LOCATION	FLOWPOINTS	SUPPLY						
NO.				HOODS PCU	LINE						
EH-1	WALL MOUNTED	ANSUL R-102	REMOTE MOUNTED	2 USED 5 AVAIL	CONT. CONT.						

EXHAUST FAN											
HOOD NO.	MOUNTING	MODEL	DRIVE TYPE	FAN SPEED	ACT VOLUME	S.P. EXTERNAL	HP	BASE WT			
NO.				RPM	CFM	IN. WG		LBS			
EH-1	WALL MOUNTED		DIRECT	1553	1000	0.629 in. wg	1/4	55			

PLUMBING NOTES:
 PLUMBING WORK SHALL BE IN ACCORDANCE WITH THE NORTH CAROLINA PLUMBING CODE 2012 EDITION AND LOCAL CODES.

ALL WORK SHALL BE COORDINATED AND PERFORMED WITH PRIOR APPROVAL FROM THE GENERAL CONTRACTOR AND OWNER TO SUIT THE OWNER'S OPERATING CONDITIONS.

PLUMBING CONTRACTOR SHALL FIELD VERIFY ALL EXISTING CONDITIONS AND NOTIFY THE GENERAL CONTRACTOR OF ANY DEVIANCES FROM THE CONTRACT DRAWINGS PRIOR TO STARTING ANY WORK.

THE PLUMBING CONTRACTOR SHALL COORDINATE WITH OTHER TRADES INVOLVED IN THIS PROJECT PRIOR TO INSTALLATION OF HIS EQUIPMENT, SO AS TO AVOID CONFLICTS DURING CONSTRUCTION AND ALLOW FOR OPTIMUM WORKING SPACE AND MAINTENANCE. THINK OF OTHER CONTRACTORS AND THEIR REQUIREMENTS IN VERTICAL CHASES AND WALL MOUNT SPACE. ALL CONTRACTORS TO FOLLOW THIS ORDER OF PRIORITY:

1. STORM AND SANITARY SEWER LINES
2. DUCTWORK AND HVAC SYSTEMS
3. HOT AND COLD WATER LINES
4. RIGID CONDUIT
5. CABLE

THE PLUMBING CONTRACTOR TO ORGANIZE HIS PIPING IN ATTIC SPACES, CRAWL SPACES, AND ABOVE CEILINGS. MAKE RUNS PARALLEL, PERPENDICULAR, AND GROUPED TOGETHER WHERE POSSIBLE. LOCATE MAJOR GROUPINGS OVER HALLWAYS AND AREAS OF PUBLIC ACCESS IF POSSIBLE. FREE RUNS OF PIPING IS NOT ACCEPTABLE.

THE PLUMBING CONTRACTOR SHALL LAY OUT AND INSTALL HIS WORK IN ADVANCE OF POURING CONCRETE FLOORS OR WALLS. HE SHALL FURNISH ALL SLEEVES TO THE GENERAL CONTRACTOR FOR OPENINGS THROUGH POURED MASONRY FLOORS, OR WALLS, ABOVE GRADE REQUIRED FOR PASSAGE OF ALL PIPES TO SUPPORT HIS EQUIPMENT.

HORIZONTAL DRAINAGE AND WASTE PIPE SHALL HAVE A MINIMUM SLOPE OR FALL OF 1/8 INCH PER FOOT. ALL CHANGE OF HORIZONTAL DIRECTIONS IN SOIL WASTE PIPE SHALL BE MADE WITH LONG RADIUS FITTINGS WITH "Y" BRANCHES AND 1/8 OR 1/16 BENDS.

COLD AND HOT WATER PIPING ABOVE GRADE SHALL BE TYPE "L" HARD DRAWN COPPER TUBING CONFORMING TO ASTM B-88 WITH SWEAT JOINTS AND WROUGHT OR CAST VALVES AND FITTINGS (UNIONS, STRAINERS, ETC.). JOINT SHALL BE MADE WITH LEAD FREE SOLDER.

ALL HOT WATER PIPING SHALL BE INSULATED WITH 1 INCH THICK SECTIONAL INSULATION OR FIBROUS GLASS MATERIALS WITH FACTORY APPLIED COVER. COVER SHALL BE EMBOSSED VAPOR BARRIER, LAMINATED WITH PRESSURE SEALING CAP ADHESIVE.

ALL COLD WATER PIPING SHALL BE INSULATED WITH 1/2 INCH THICK SECTIONAL INSULATION OR FIBROUS GLASS MATERIALS WITH FACTORY APPLIED COVER. COVER SHALL BE EMBOSSED VAPOR BARRIER, LAMINATED WITH PRESSURE SEALING CAP ADHESIVE.

SANITARY HORIZONTAL WASTE, VENT PIPING, AND FITTINGS ABOVE GRADE SHALL BE SCHEDULE 40 PVC-DWV PIPE-CELLULAR CORE FROM CHARLOTTE PIPE AND FOUNDRY COMPANY OR APPROVED EQUAL, AND MUST MEET OR EXCEED THE REQUIREMENTS OF ASTM F-891, NSF STANDARD NO. 14, AND IAPMO UPC.

ALL WASTE STACK PIPING SHALL BE CAST IRON AND INSULATED FOR SOUND IN WALLS.

ALL WASTE AND STORM PIPING ABOVE CEILING, VERTICAL CHASES, WALLS SHALL BE INSULATED WITH 1/2 INCH THICK SECTIONAL INSULATION OR FIBROUS GLASS MATERIALS WITH FACTORY APPLIED COVER. COVER SHALL BE EMBOSSED VAPOR BARRIER, LAMINATED WITH PRESSURE SEALING CAP ADHESIVE. NO INSULATION REQUIRED IN CRAWL SPACE OR BELOW FLOOR SLAB OF ANY WASTE AND STORM PIPING.

IN LIEU OF FIBERGLASS INSULATION, THE PLUMBING CONTRACTOR IS ALLOWED TO USE CLOSED CELL INSULATION, 1/2 INCH THICK ARMSTRONG/ARMAFLEX II ON ALL COLD WATER PIPES, RIGID URETHANE FOAM INSULATION, 1 INCH THICK ARMSTRONG/ARMALOK II ON ALL HOT WATER PIPING.

ALL PLUMBING EQUIPMENT SHALL BE INSTALLED PER MANUFACTURER'S RECOMMENDATIONS.

ALL FIXTURES, DRAINS, TRAPS, ETC. SHALL BE SET PLUMB AND LEVEL.

ALL HANDICAPPED FIXTURES AND TRIM SHALL BE INSTALLED IN ACCORDANCE WITH THE NORTH CAROLINA PLUMBING CODE 2018 EDITION.

CHROME PLATED ESCUTCHEONS SHALL BE PROVIDED AT EACH WALL PENETRATION.

ESCUTCHEONS SHALL BE CHROME PLATED, SPRING TYPE, ON ALL PIPES PASSING THROUGH WALLS AND CEILINGS IN FINISHED AREAS. FLOOR ESCUTCHEONS SHALL BE CAST BRASS, CHROME PLATED, WITH SET SCREW.

ESCUTCHEONS SHALL BE OF SUFFICIENT SIZE TO COVER OUTSIDE DIAMETER OF THE PIPE OR THE INSULATION OF THE PIPE.

FLASHING FOR VENTS THROUGH THE ROOF SHALL BE TWO-PIECE TYPE, 16 OUNCE COPPER COUNTER FLASHING AND BASE FLASHING, OR A TWO-PIECE TYPE, 4 POUND LEAD COUNTER FLASHING AND BASE FLASHING. THE BASE FLASHING SHALL BE INSTALLED BY THE GENERAL CONTRACTOR WITH THE ROOF SYSTEM.

VENT FLASHING SHALL EXTEND DOWN AT LEAST 4 INCHES FROM THE TOP OF THE PIPE. FLASHING SHALL EXTEND AT LEAST 12 INCHES IN ALL DIRECTIONS FROM THE PIPE AND SHALL BE PARALLEL TO THE ROOF LINE.

ALL EQUIPMENT AND INSTALLED MATERIALS SHALL BE THOROUGHLY CLEAN AND FREE OF ALL DIRT, OIL, GRIT, GREASE, AND ETC.

ALL PLUMBING SYSTEMS AND EQUIPMENT SHALL BE GUARANTEED FOR A PERIOD OF ONE YEAR AFTER FINAL ACCEPTANCE OF THE BUILDING FROM THE OWNER.

PLUMBING FIXTURE SCHEDULE						
SYMBOL	FIXTURE DESCRIPTION	FIXTURE MOUNTING	SUPPLY	WASTE	VENT	REMARKS
P1	2 COMPARTMENT SINK	FLOOR MOUNTED	1/2" C.W. /H.W.	2"	2"	(8)
P2	3 COMPARTMENT SINK	FLOOR MOUNTED	1/2" C.W. /H.W.	2"	2"	(8)
P3	HANDWASH SINK	WALL MOUNTED	1/2" C.W. /H.W.	2"	2"	(8)
P4	MOP SINK	FLOOR MOUNTED	1/2" C.W. /H.W.	2"	2"	
P5	WATER HEATER	RACK MOUNTED	3/4" C.W. /H.W.			(11)
P6	LAVATORY	WALL MOUNTED	1/2" C.W. /H.W.	2"	1-1/2"	(1)(2)(3)(4)(5)(8)(10)
P7	ELONGATED BOWL; FLUSH TANK TOILET	FLOOR MOUNTED	3/4" C.W.	3"	2"	(1)(2)(6)(7)(12)(14)
P8	BAR SINK	WALL MOUNTED	1/2" C.W. /H.W.	2"	2"	(8)
P9	STEAMER	COUNTERTOP	1/2" C.W.	1 1/2"	2"	

- (1) HANDICAPPED
- (2) VITREOUS CHINA
- (3) 4 INCH CENTER
- (4) SINGLE LIFT MIXING FAUCET
- (5) VINYL COVERED INSULATION FOR WASTE/WATER PIPING
- (6) 16-1/2" HIGH BOWL
- (7) 1.6 GALLONS PER FLUSH
- (8) STAINLESS STEEL
- (9) MOUNT BOTTOM OF APRON @ 29" A.F.F.
- (10) CHROME FAUCET FINISH
- (11) 2 GALLON EXPANSION TANK
- (12) Accessible Fixture
- (13) RH Flush
- (14) LH Flush


Scope Of Work: Plumbing

This proposed project includes the installation of a new kitchen area to an existing tenant space. Demolition requires the saw cutting of existing concrete slab to access existing sanitary sewer. Existing toilet room fixtures to be in place in new construction. Existing plumbing water supply and sewer lines to be re-routed to serve proposed sinks and hand sink.

WATER CALCULATIONS				
QTY.	ITEM	C.W. FIXTURE UNITS	WATER SUPPLY FIXTURE UNITS EACH	WATER SUPPLY FIXTURE UNITS TOTAL
2	WATER CLOSET	5.0	5.0	10.0
3	HAND SINK (LAVATORY)	1.5	2.0	6.0
2	SINK	1.5	2.0	4.0
1	MOP SINK	1.5	2.0	2.0
1	BAR SINK	1.5	2.0	1.5
1	STEAMER	1.5	2.0	1.5
TOTAL WATER SUPPLY FIXTURE UNITS				25.0


DRAINAGE CALCULATIONS			
QTY.	ITEM	DRAINAGE FIXTURE UNITS	DRAINAGE FIXTURE UNITS TOTAL
2	WATER CLOSET	4.0	8.0
3	LAVATORY	2.0	12.0
2	SINK	2.0	4.0
1	MOP SINK	2.0	2.0
1	BAR SINK	2.0	2.0
1	STEAMER	2.0	2.0
TOTAL DRAINAGE FIXTURE UNITS			30.0

GREASE INTERCEPTOR SIZING CALCULATIONS									
QTY.	ITEM	SIZE (INCHES)			NUMBER OF COMPARTMENTS	CUBIC INCHES = a*b*c*d	CAPACITY/GALS = e/231	DRAINAGE LOAD = f/0.75	PEAK FLOW = g/2
		LENGTH (a)	WIDTH (b)	DEPTH (c)					
1	CAN WASH EXIST	36	36	4	1	5184	22.44	16.83	8.4 GPM
1	PREP SINK	18	16	14	2	4032	17.45	13.09	6.5 GPM
1	POT SINK	24	24	14	3	24192	104.7	78.5	39.3 GPM
3	HAND SINK	9	9	5	1	1215	5.26	3.95	1.98 GPM
1	BAR SINK	8	8	6	4	1536	6.65	4.99	2.5 GPM
1	FLOOR DRAIN	N/A	N/A	N/A	1	28.28	0.12	0.09	0.05 GPM
1	STEAMER	N/A	N/A	N/A	1	28.28	0.12	0.09	0.05 GPM
TOTAL GPM									58.78 GPM
57.45 X 24 MINS=									1411 GALS

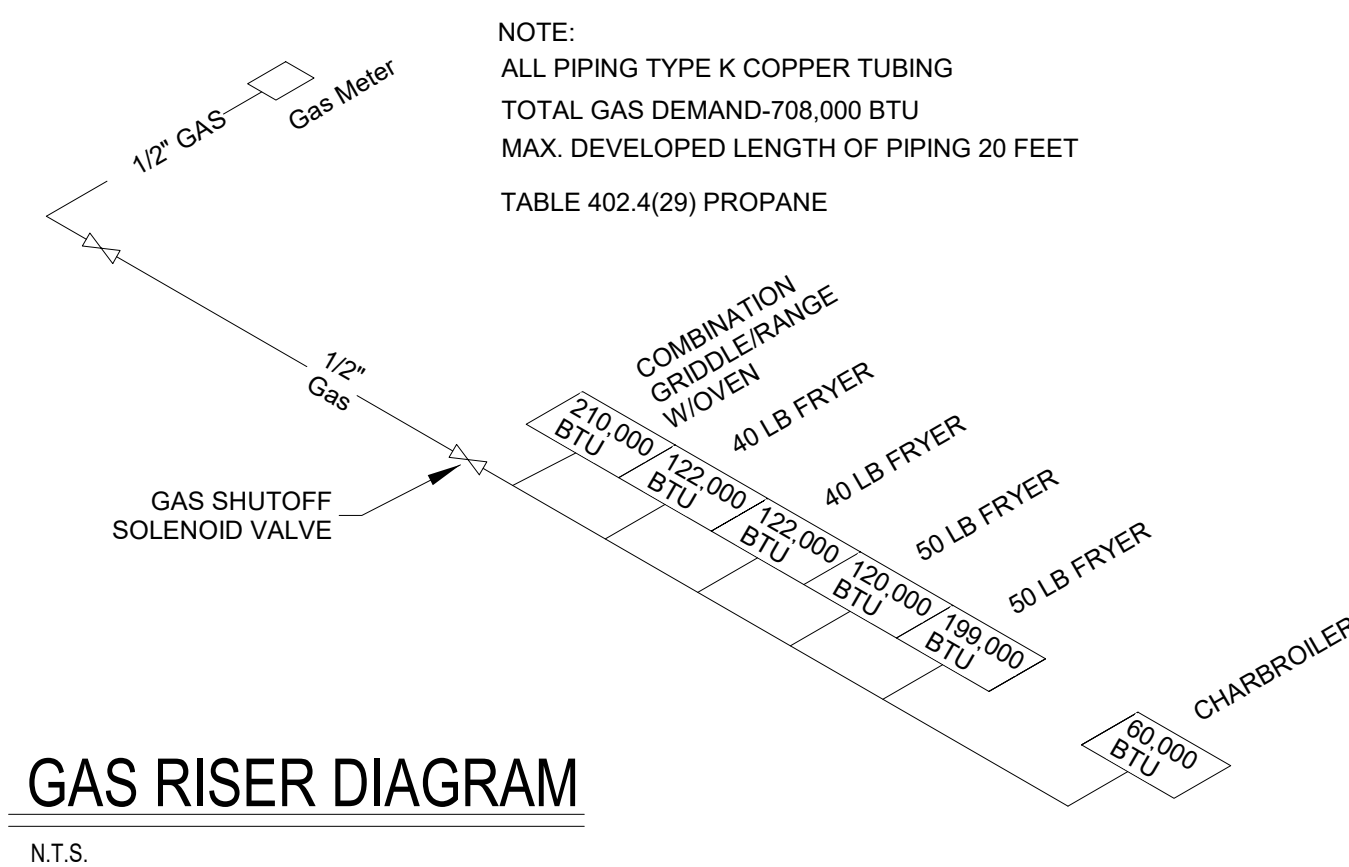


GAS RISER DIAGRAM
 N.T.S.

Hot & Cold Water Plan
 1/4" = 1'-0"

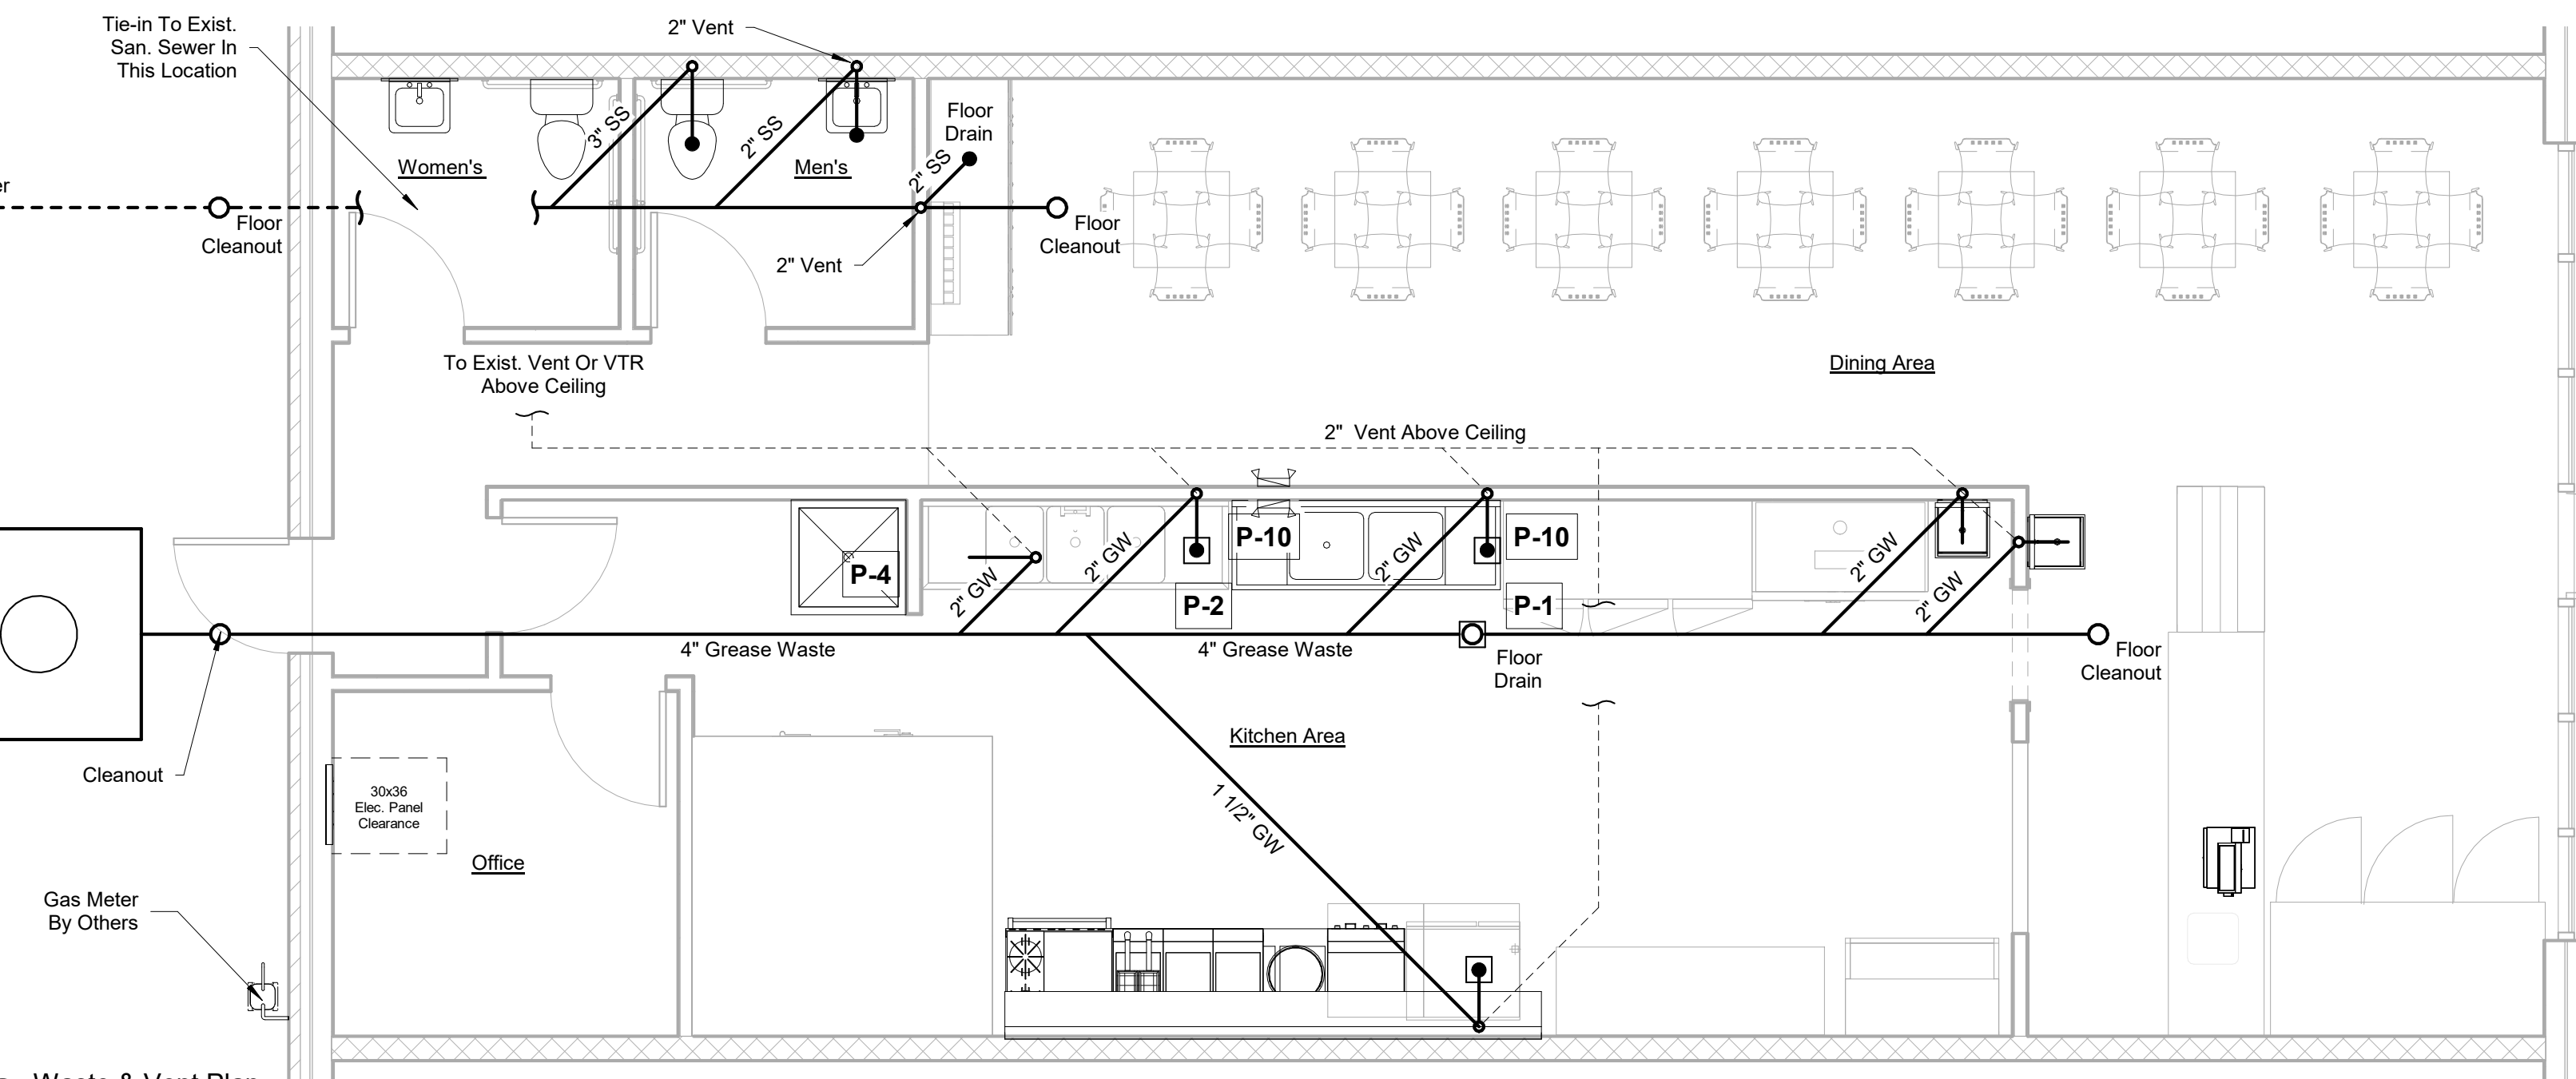

Waste & Vent Plan
 1/4" = 1'-0"

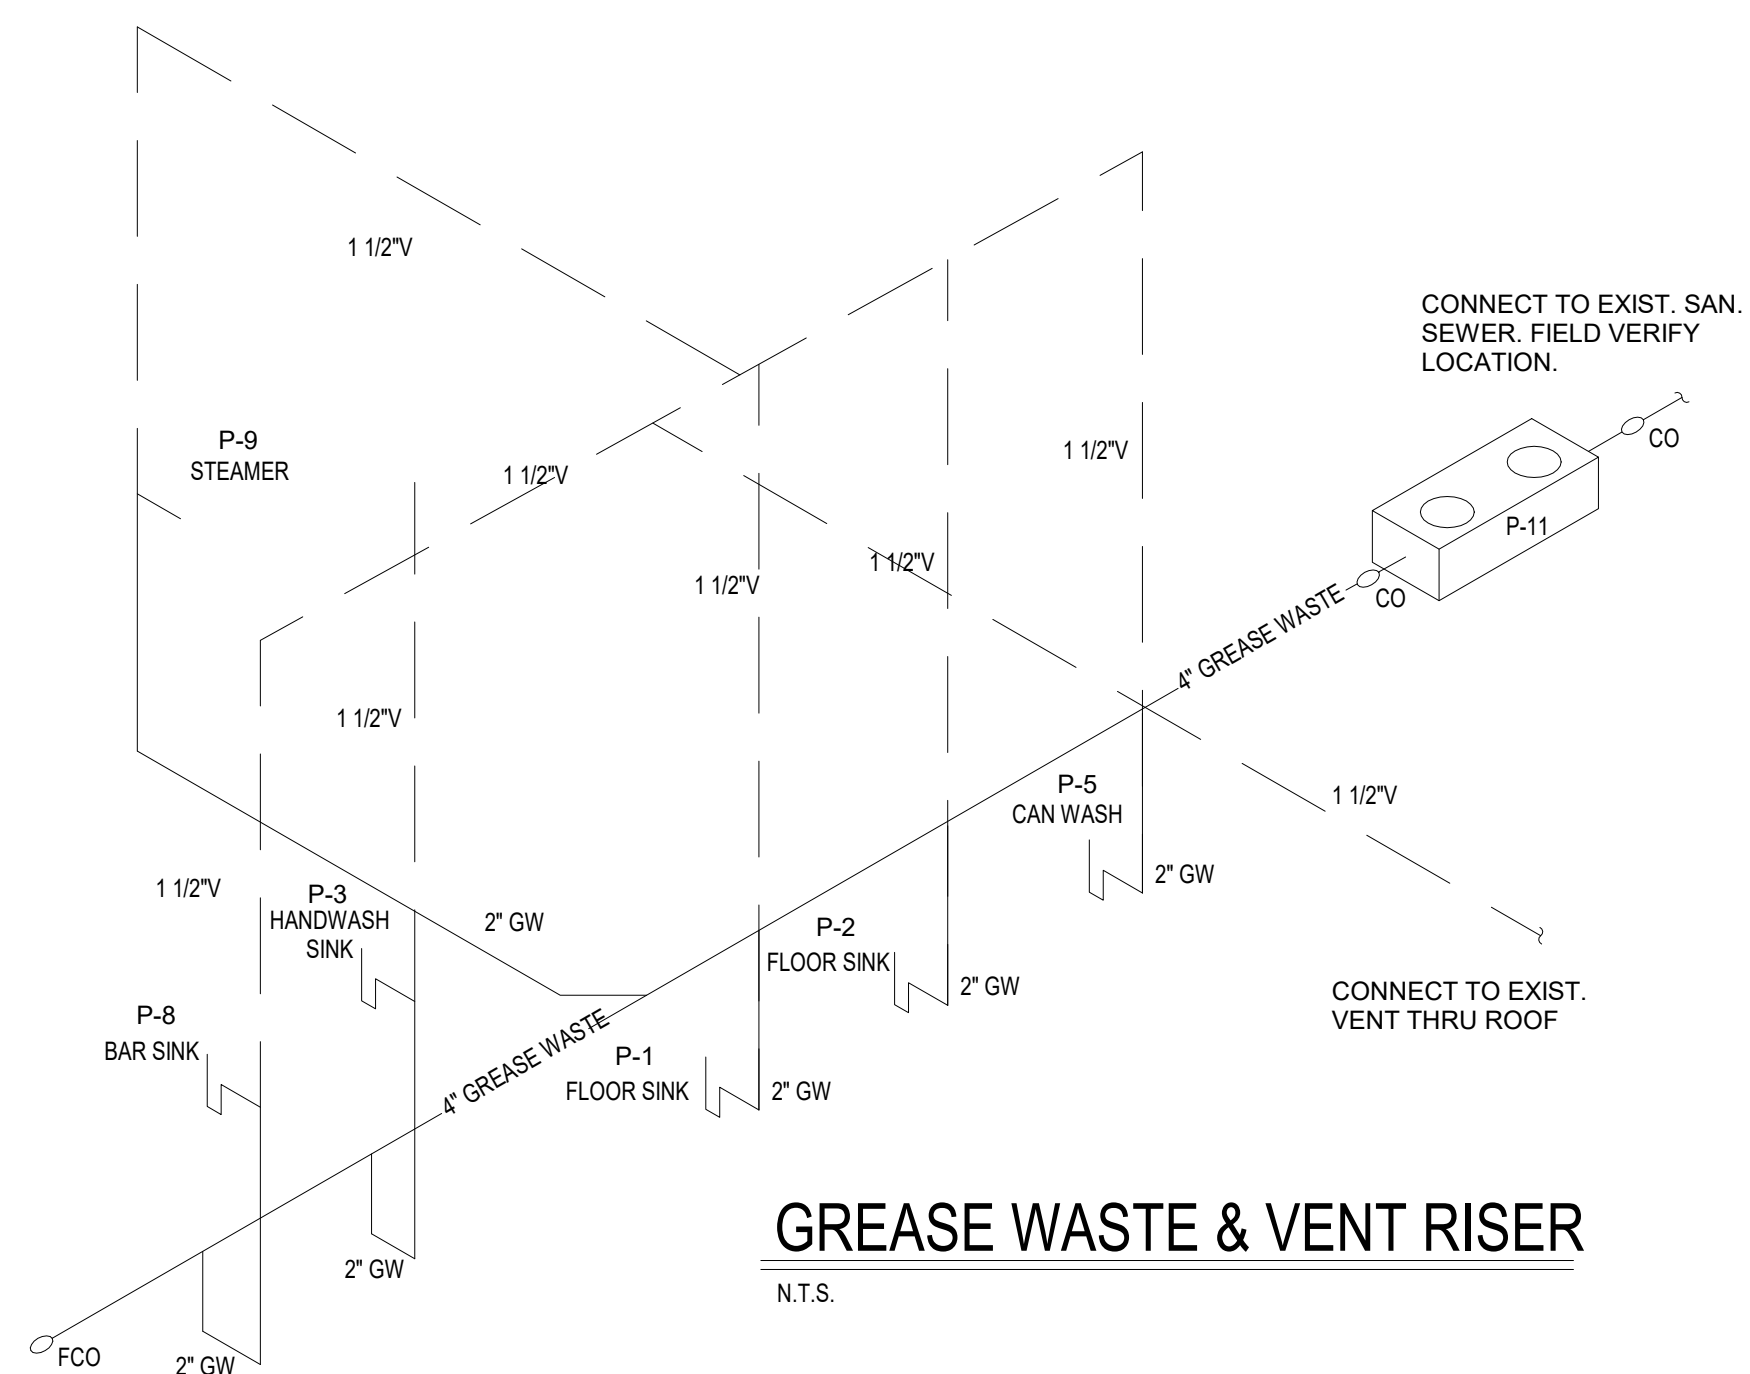

GREASE WASTE & VENT RISER
 N.T.S.



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Revisions:

Drawing Title:
**Plumbing
 Plan**

Project:

Project No: 116120

Scale: As Indicated

Date: 08/20/21

Drawing No:
P-1.0

Drawn by: TPJr Checked by: GAO