




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DEMOLITION PLAN 1/4" = 1'-0"

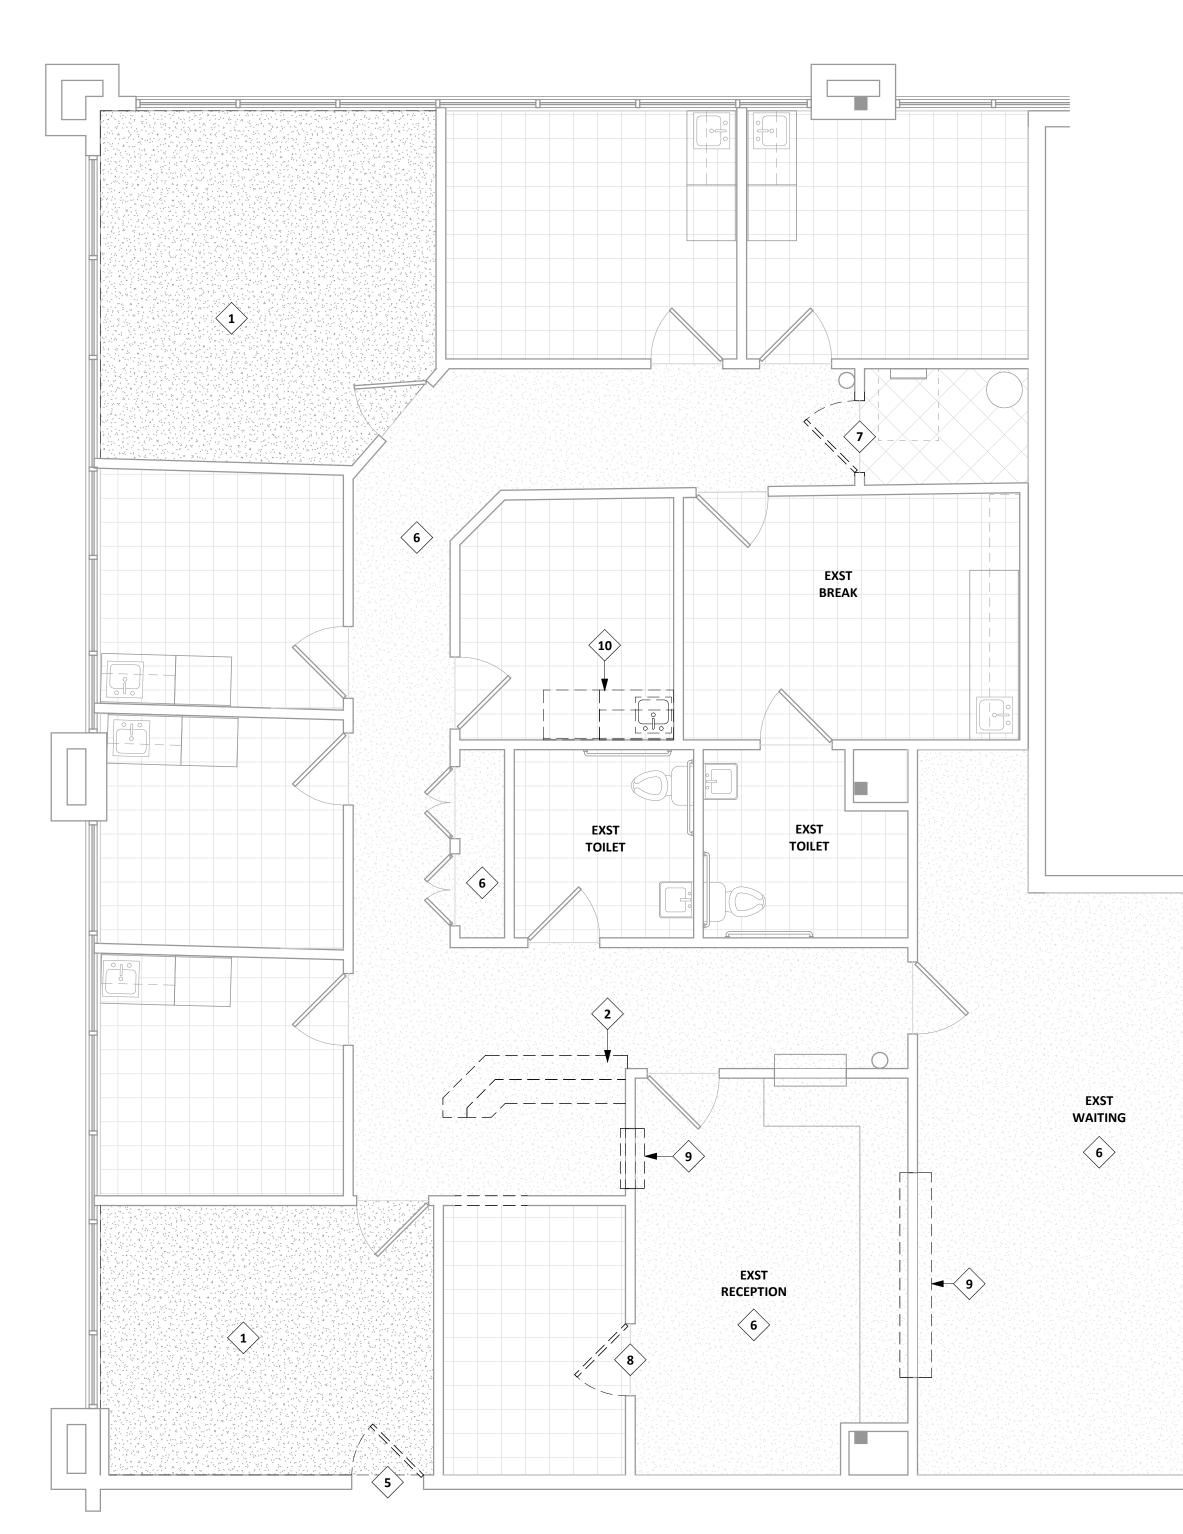

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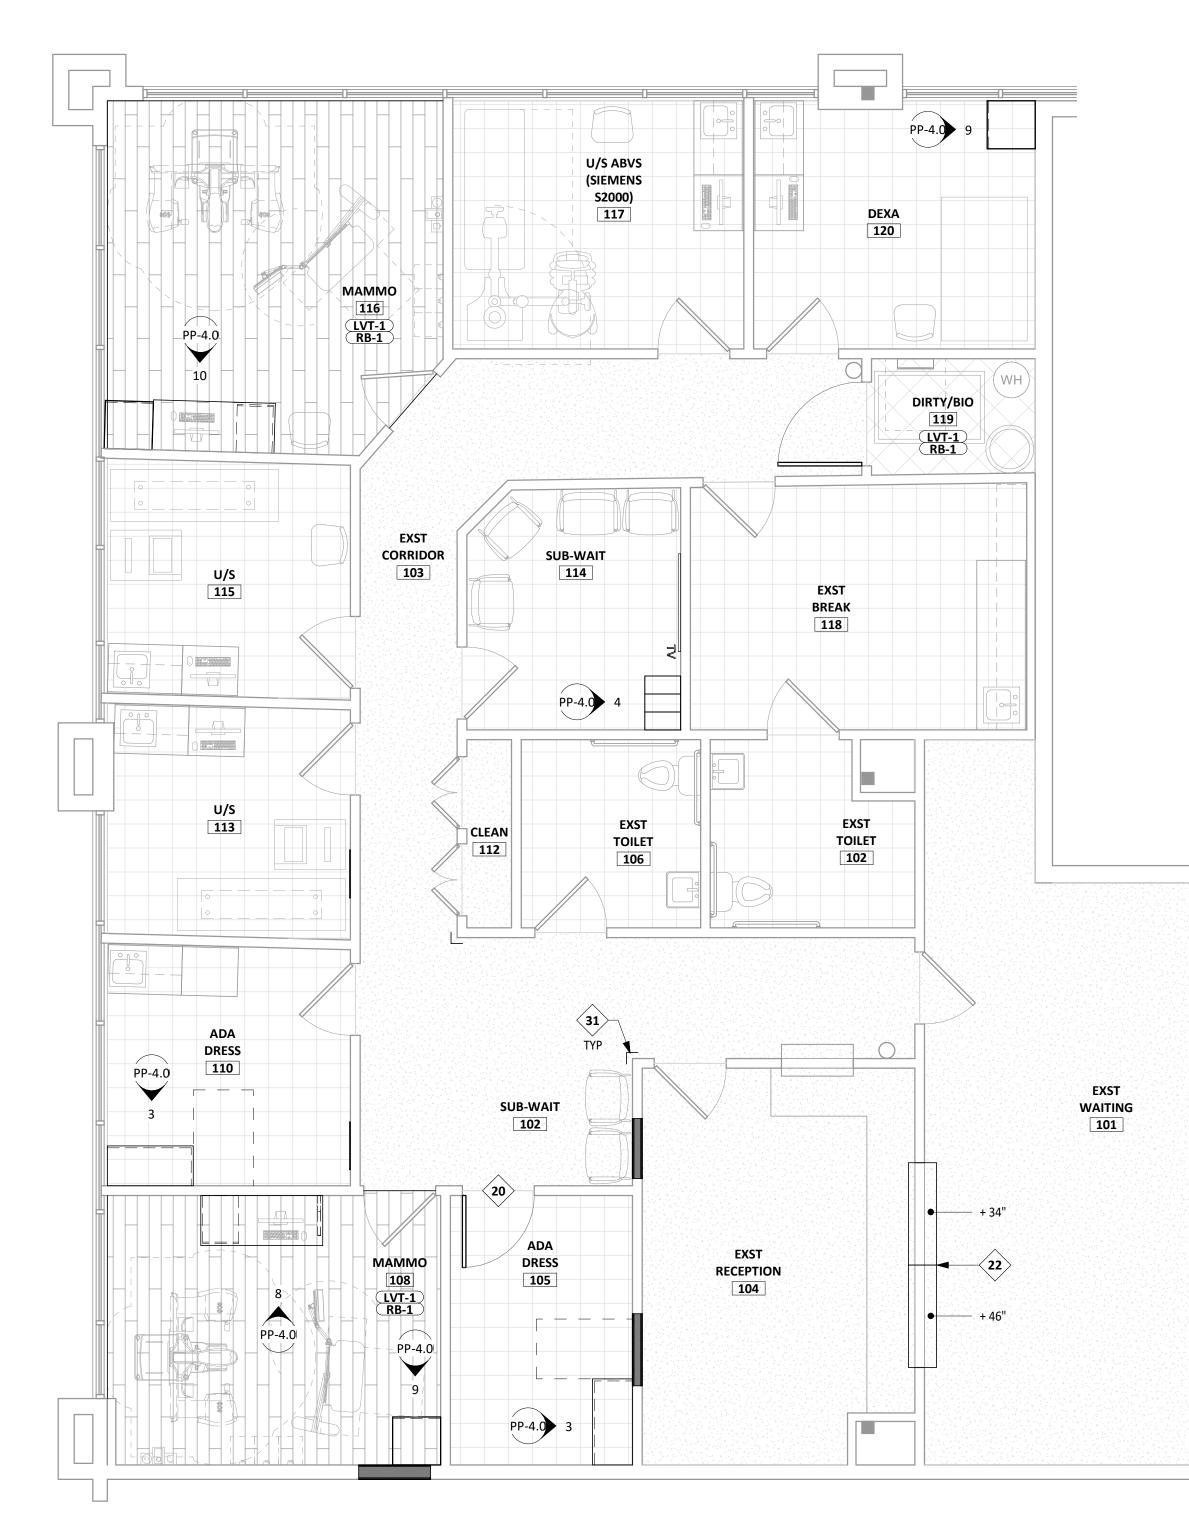


	STRUCTURAL, ELECTRICAL, M	OUT AS SHOWN AND NOTIFY ARCHITECT ECHANICAL, PIPE WORK, FIRE PROTECT		
	INDICATED IN ASTM C 63 2. WIRE HANGERS, BRACES,	AL CEILING GRID WHERE SHOWN. SYSTEM; ATTACHMENT DEVICES; SIZED 5, TABLE 1, DIRECT HUNG AND TIES: ZINC-COATED CARBON-STEE	L WIRE. SIZE: PROVIDE YIELD	Soaring Eight
	WIRE. C. ACOUSTIC PANELS: INSTALL A	MES THE HANGER DESIGN LOAD BUT N COUSTIC PANELS WITH UNDAMAGED I RS AND EDGE MOLDINGS. SCRIBE AND	EDGES AND FIT ACCURATELY INTO	
	PENETRATIONS TO PROVIDE	A NEAT, PRECISE FIT.		
		2'X2'X5/8" TILES	IITE FINISH. (NOTE: IN MRI ROOM ONLY	
	E. INSTALL NEW CEILINGS TO CO ALL LOCAL BUILDING CODES.	DMPLY WITH ALL SEISMIC RESTRAINT R SEE DETAILS 19&20/A-901 .	EQUIREMENTS IN ACCORDANCE WITH	
	F. REFER TO ELECTRICAL ENGIN INFORMATION.	EERING DOCUMENTS FOR LIGHT FIXTUR	RES SPECIFICATION AND ADDITIONAL	
	G. UNLESS NOTED OTHERWISE I WHERE SPECIFIED IN PLANS.	DOWN LIGHTS AND PENDANTS SHALL E	BE CENTERED IN ACT OR INSTALLED	
	H. UNLESS NOTED OTHERWISE A AND SPECIFICATIONS.	ALL GWB CEILINGS TO BE PAINTED. REF	ER TO FINISH LEGEND FOR LOCATIONS	
	MECHANICAL DIFFUSERS, RE AUDIOVISUAL EQUIPMENT, S	NATE LOCATIONS OF ALL CEILING ELEN FURN AIR GRILLES, FIRE PROTECTION DE ECURITY DEVICES, ETC. FOR CONFLICTS LATION OF ANY SUCH ELEMENTS.	VICES, ACCESS PANELS, EXIT SIGNS,	
	J. GC TO NOTIFY ARCHITECT OF BEFORE PROCEEDING WITH C	ANY REQUIREMENTS FOR ACCESS PAN CONSTRUCTION.	ELS NOT SHOWN ON DOCUMENTS	
		ATION AS REQUIRED BY PERMITTED SHI		
	COLOR AND LOCATIONS.	I THE MRI ROOM SHALL BE NON FERRO	MAGNETIC	
		ROOM UNLESS NOTED OTHERWISE.	IMAGNETIC.	
	KEYED NOTES	#		
	RCP SYMBOLS			
	(SEE ELECTRICAL & MECHANICAL	SHEETS FOR MORE INFO)		
	NEW ACT CEILING	EXISTING CEILING	12'-10'' CEILING HEIGHT TAG	
	NEW GWB CEILING AND/OR SOFFIT	EXISTING GWB CEILING AND/OR SOFFIT	NEW / EXISTING EXIT SIGN	
			Ø Ø	
	NEW FLUORESCENT FIXTURE - 2'x4' / 2'x2'	EXISTING FIXTURE TO REMAIN	NEW / EXISTING DOWNLIGHT	
6			9	
	NEW HVAC RETURN / EXHAUST / SUPPLY	EXISTING HVAC TO REMAIN	NEW / EXISTING WALL WASHER LIGHT	
				REV DATE DESCRIPTION
1	NEW / EXISTING HVAC SIDEWALL DIFFUSER	NEW / EXISTING X-RAY IN USE SIGN	NEW / EXISTING LINEAR LIGHT FIXTURE	
		AL NOTES AND L		
	THE GENERAL CONTRACTOR SHA ALL DEVICES PER THE FOLLOWIN	LL BE RESPONSIBLE TO COORDINATE AL G:	L TRADES AND THE LOCATION OF	
◆		ECTURAL PLANS, SECTIONS AND ELEVA		PROJECT NUMBER:
No.	DRAWING, DEVICES SHALL BI	CHANICAL AND ELECTRICAL DRAWINGS E UNIFORMLY AND SYMMETRICALLY M	OUNTED. VERTICALLY ALIGN	23-031.2
	D. DEVICES INSTALLED IN MASC	HTS INDICATED UNLESS SEPARATED HO		
	BY THE ARCHITECT AT TIME (E. DEVIATIONS FROM THESE PR	DF ROUGH-IN. INCIPLES WITHOUT PRIOR APPROVAL V	VILL BE CORRECTED BY THE	02/06/2024 Sheet Title:
	CONTRACTOR AT NO COST TO F. AVOID DEVICE PLACEMENT II	O THE OWNER. N THE CENTER OF WALLS AS PRACTICAL	LY FEASIBLE.	
		EMERGENCY ST		REFLECTED
	- DIM: 80" OR TOW CEILING	LIGHT SWITCH	ніснест	CEILING PLAN
	6" BELOW CEILING 48" TYP. 48" TYP.	THERMOSTAT, CONTROLLER DUPLEX RECEPT		SHEET NUMBER:
	LEAST 6" BEI 48" T 18" T 18" T 18" T			PP-3.0

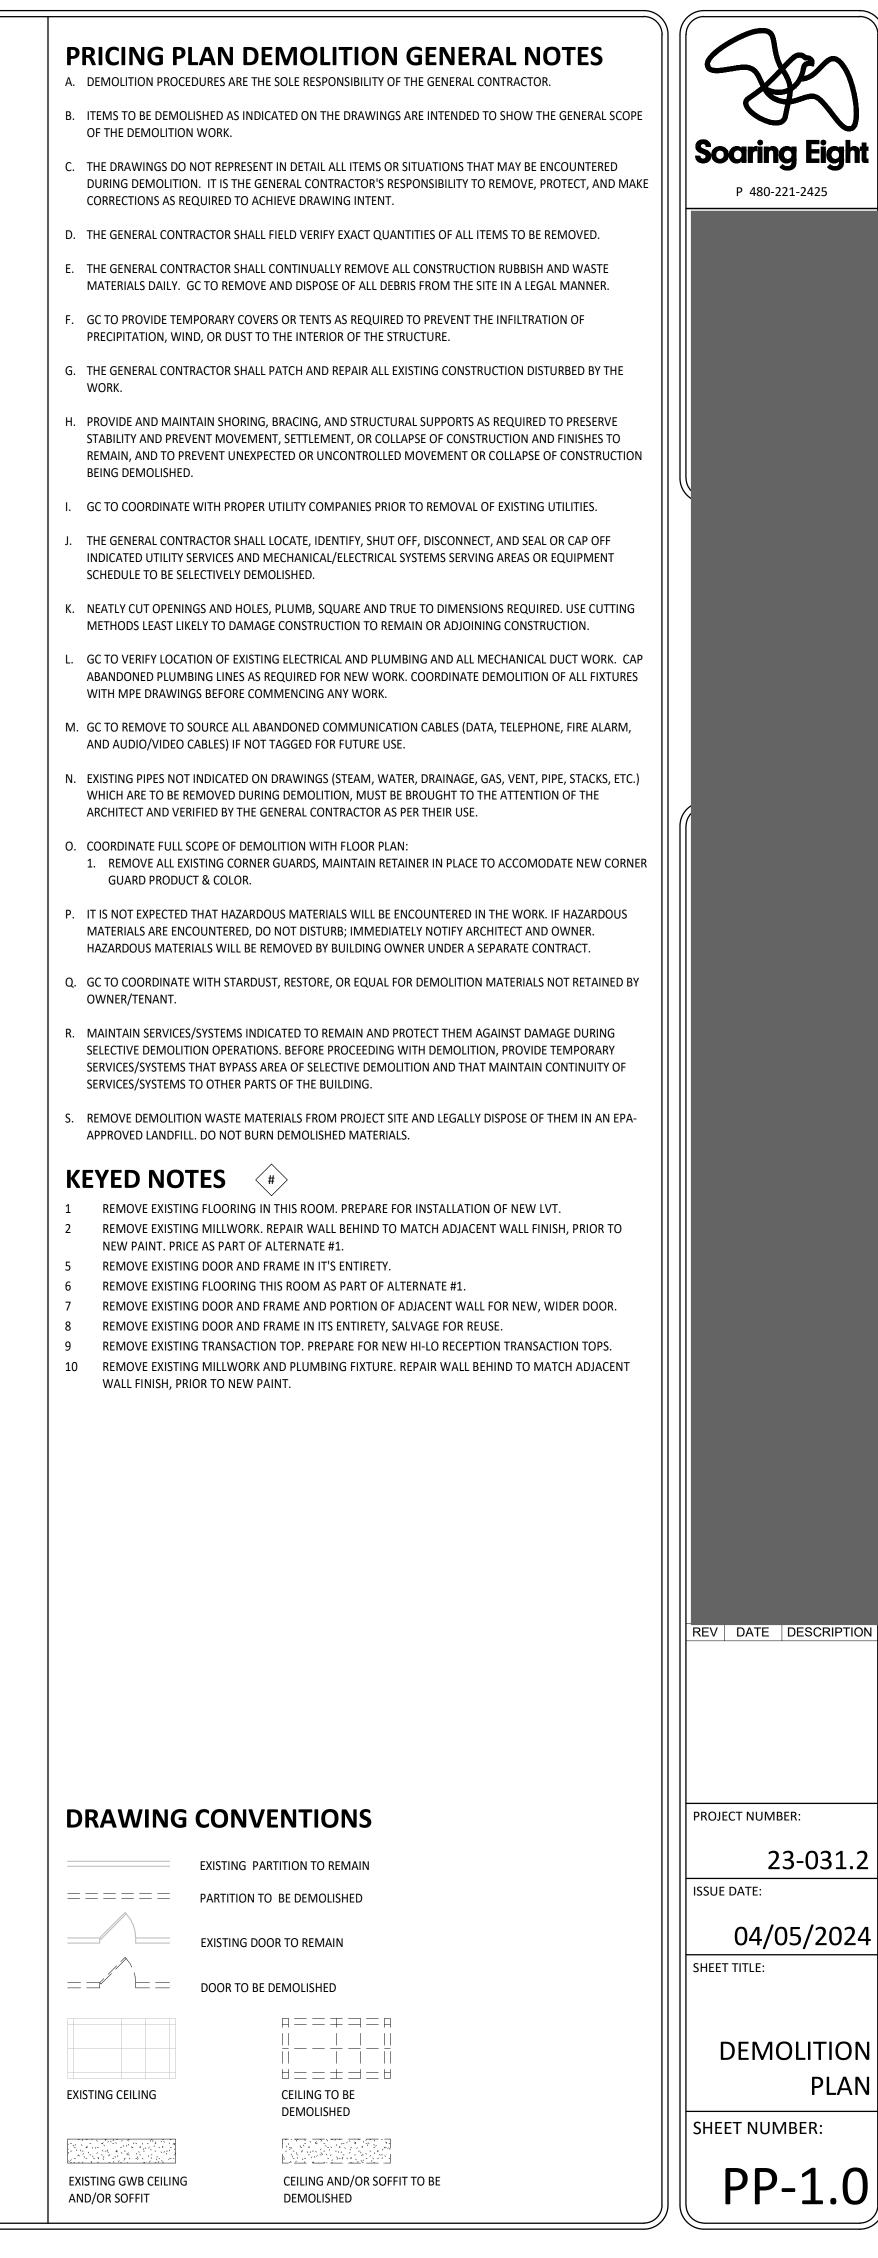

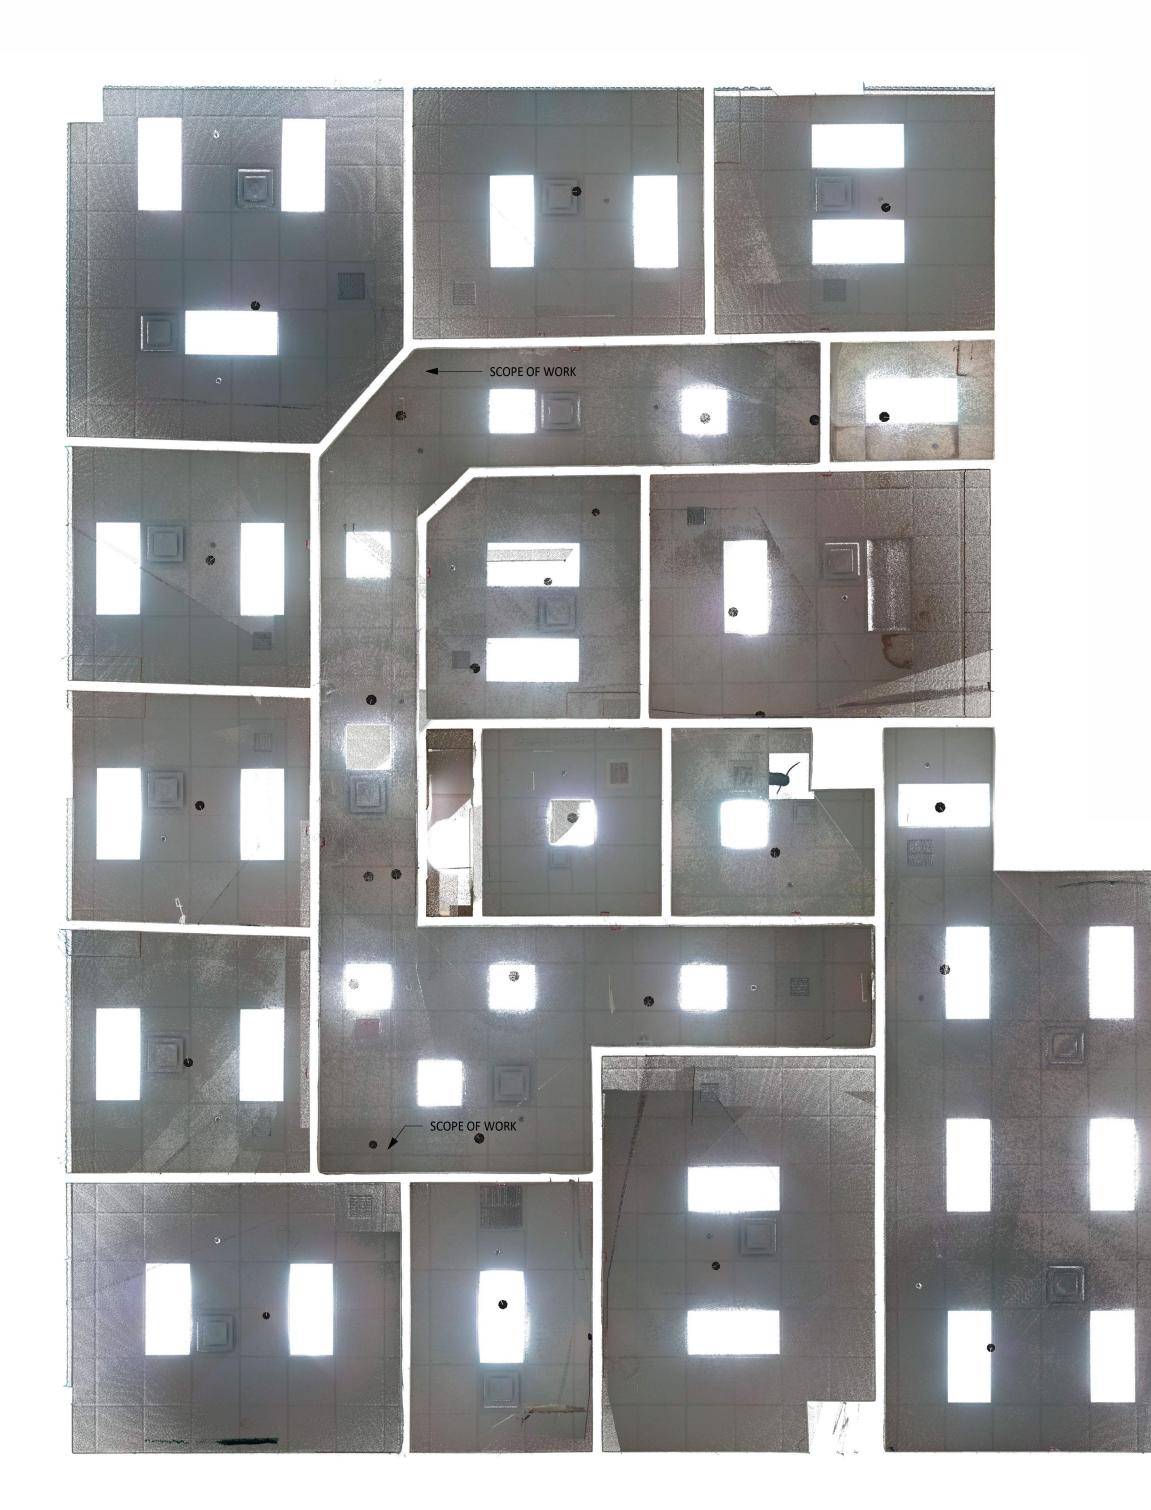A. GC TO REVIEW CEILING			
STRUCTURAL, ELECTRICA PROCEEDING WITH CON	LAYOUT AS SHOWN AND NOTIFY ARCHIT		
 PROVIDE: DIRECT-H INDICATED IN ASTM WIRE HANGERS, BRA 	STICAL CEILING GRID WHERE SHOWN. UNG SYSTEM; ATTACHMENT DEVICES; SIZ C 635, TABLE 1, DIRECT HUNG ACES, AND TIES: ZINC-COATED CARBON-S ^T 3 TIMES THE HANGER DESIGN LOAD BUT	TEEL WIRE. SIZE: PROVIDE YIELD	Soaring Eight
SUSPENSION SYSTEM RU	ALL ACOUSTIC PANELS WITH UNDAMAGE INNERS AND EDGE MOLDINGS. SCRIBE AN /IDE A NEAT, PRECISE FIT.		
	JLAR 2'X2'X5/8" TILES	WHITE FINISH. (NOTE: IN MRI ROOM ONLY	
E. INSTALL NEW CEILINGS T	TO COMPLY WITH ALL SEISMIC RESTRAIN DES. SEE DETAILS 19&20/A-901 .	REQUIREMENTS IN ACCORDANCE WITH	
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	T OF ANY REQUIREMENTS FOR ACCESS P.	ANELS NOT SHOWN ON DOCUMENTS	
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L. REFER TO THIS SHEET FO COLOR AND LOCATIONS.	OR TYPICAL ELECTRICAL, SWITCHING, AND	COMMUNICATIONS DEVICE MOUNTING	
M. ALL MATERIALS USED W	ITHIN THE MRI ROOM SHALL BE NON FER	ROMAGNETIC.	
N. CEILING HEIGHTS NOTED	PER ROOM UNLESS NOTED OTHERWISE.		
RCP SYMBOL			
		[12'-10''] CEILING HEIGHT TAG	
(SEE ELECTRICAL & MECHANI NEW ACT CEILING NEW GWB CEILING	ICAL SHEETS FOR MORE INFO)	CEILING HEIGHT TAG	
(SEE ELECTRICAL & MECHANI	ICAL SHEETS FOR MORE INFO)	CEILING HEIGHT TAG	
(SEE ELECTRICAL & MECHANI NEW ACT CEILING NEW GWB CEILING	ICAL SHEETS FOR MORE INFO)	CEILING HEIGHT TAG	
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FINIS	SH SCHEDU	LE				
NAME	DESCRIPTION	MANUFACTURER	STYLE / COLOR / ETC.	SIZE	INSTALLATION NOTES	NOTES
LVT-1*	LUXURY VINYL TILE	SHAW CONTRACT	VY252 QUIET COVER / 00250 NATURAL	6"X48"	SEE FINISH PLAN FOR DIRECTION	
RB-1	RUBBER BASE	TARKETT	TRADITIONAL VINYL 1/8" - TYPE TV COVED PROFILE /COLOR: CHARCOAL	4" H	PREFORMED OUTSIDE AND INSIDE CORNERS	
TS-1	FLOOR TRANSITION	SCHLUTER	RENO-U / SATIN ANODIZED ALUMINUM		OPTIONAL, SEE TRANSITION DETAILS	
TS-3	FLOOR TRANSITION	SCHLUTER	DILEX-AHK / SATIN ANODIZED ALUMINUM		FLOOR TILE TO WALL TILE TRANISTION	
CG-1	CORNER GUARDS	INPRO CORP	160 SURFACE MOUNT / 0258 CHINO	2" WING, 48" TALL	MOUNTED RIGHT ABOVE BASE	
PT-1	PAINT	SHERWIN WILLIAMS	SW 7567 NATURAL TAN / SHEEN: VELVET			THROUGHOUT (WALLS & CEILI
PT-2	PAINT	SHERWIN WILLIAMS	SW 7567 NATURAL TAN / SHEEN: SEMI-GLOSS			TOILET ROOM WALLS/ CEILING
PT-3	PAINT	SHERWIN WILLIAMS	SW 6992 INKWELL / SHEEN: GLOSS			HM DOOR FRAMES
PLM-1	PLASTIC LAMINATE	NEVAMAR	VA7002T TEXTURED FINISH, AEON SCRATCH RESISTANCE / COOL CHIC			ALL COUNTERTOPS & BENCHTC
PLM-2	PLASTIC LAMINATE	WILSONART	7965K-12 SOFT GRAIN FNISH, AEON SCRATCH RESISTANCE / WALNUT HEIGHTS		VERTICAL GRAIN	ALL CABINET FACES, U.N.O.



NOTES
ALLS & CEILINGS), U.N.O.
ALLS/ CEILINGS
S
S & BENCHTOPS, U.N.O.

PRICING PLAN SCOPE OF WORK NOTES

A. PRIOR TO NEW PRIMER AND PAINT, PATCH ALL SURFACES AS REQUIRED TO RECEIVE NEW FINISH PER FINISH MANUFACTURER'S RECOMMENDATIONS.

B. GC TO PROVIDE CORNER GUARDS AT ALL EXPOSED CORNERS WHERE SHOWN ON PLAN. (SEE KEYNOTE 31). REFER TO FINISH SCHEDULE FOR SPECIFICATION.

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REV DATE DESCRIPTION

PROJECT NUMBER:

ISSUE DATE:

SHEET TITLE:

23-031.2

04/05/2024

FLOOR PLAN

PP-2.0

SHEET NUMBER:

- C. REPLACE ALL DAMAGED CEILING TILES THROUHGOUT SUITE.
- D. PROVIDE NEW MINI-SPLIT IN EACH OF (2) MAMMO ROOMS.

SOW ALTERNATES:

#1. PAINT ENTIRE SUITE, ALL ROOMS (WALLS, GWB CEILINGS & BULKHEADS) PT-1 AND TOILET ROOMS PT-2; PAINT ALL EXISTING HOLLOW METAL DOORS FRAMES, PT-3; PROVIDE NEW LVT-1 AND RB-1 THROUGHOUT ENTIRE SUITE.

#2. PROVIDE NEW LVT-1 AND RB-1 IN ALL AREAS SHOWN IN KEYNOTE 6.

#3 PROVIDE AN ALLOWANCE FOR NEW DIMMABLE DOWNLIGHTS IN EACH OF (3) ULTRASOUND ROOMS, EACH OF (2) MAMMO ROOMS AND THE DEXA ROOM.

PRICING PLAN FINISHES GENERAL NOTES

A. ALL PARTITIONS RECEIVING PAINT TO RECEIVE COMPLETE PRIMER COAT PRIOR TO FINISH PAINT COATS. REMOVE HARDWARE, LIGHTING FIXTURES, AND SIMILAR ITEMS THAT ARE NOT TO BE PAINTED. MASK ITEMS THAT CANNOT BE REMOVED. REINSTALL ITEMS IN EACH AREA AFTER PAINTING IS COMPLETE. PATCH CLEAN AND PREPARE SURFACES IN AN AREA BEFORE BEGINNING PAINTING IN THAT AREA. SCHEDULE PAINTING SO CLEANING OPERATIONS WILL NOT DAMAGE NEWLY PAINTED SURFACES.

APPLICATION SCHEDULE: A. GYPSUM BOARD:


- 1. GLOSS LEVEL 3 LATEX: TWO COATS OVER LATEX PRIMER/SEALER
- B. STEEL:
 1. GLOSS LEVEL 4 LATEX: TWO COATS OVER ALKYD ANTICORROSIVE PRIMER
- C. WOOD: INCLUDING WOOD TRIM ARCHITECTURAL WOODWORK:1. SEMIGLOSS LATEX: TWO COATS OVER LATEX PRIMER FOR WOOD
- B. ALL FLOORING TRANSITIONS TO OCCUR AT CENTERLINE OF DOOR (UNO).
- C. GENERAL CONTRACTOR TO PROVIDE AND INSTALL SCHEDULED FLOORING FROM PARTITION TO PARTITION
- D. GC TO PROVIDE NOT LESS THAN 10% EXTRA STOCK OF ALL FINISH MATERIALS TO OWNER.

KEYED NOTES

20 NEW LOCATION OF EXISTING DOOR.

AND UNDER MILLWORK, WHERE ACCESSIBLE.

- 22 NEW HI-LO COUNTERTOP.
- 31 CORNER GUARD, TYPICAL AS SHOWN. SEE FINISH SCHEDULE AND SPECIFICATION.

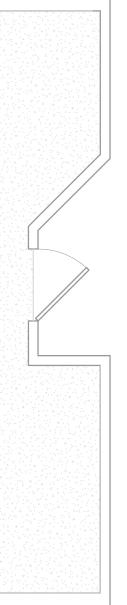

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DRAWING CONVENTIONS



NEW STANDARD PARTITION OR WALL INFILL EXISTING PARTITION

EXISTING DOOR

NEW DOOR

CORNER GUARD