
PETTIGREW STATE PARK CAMPGROUND AND OFFICE IMPROVEMENTS

CRESWELL, NORTH CAROLINA

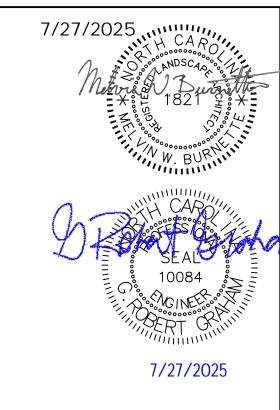



REVISIONS

SCO ID#: 20-22411-02A

DEPARTMENT OF NATURAL AND CULTURAL RESOURCES DIVISION OF PARKS & RECREATION

SCHEDULE OF THE OF THE

SITE/CIVIL

FINCH & ASSOCIATES, PLLC

309 NORTH BOYLAN AVENUE, RALEIGH, NC 27603-1402 TEL. (919) 833-1212

ENVIRONMENTAL

SOIL & ENVIRONMENTAL CONSULTANTS, P.A.

NORTH QUARTER OFFICE PARK 8412 FALLS OF THE NEUSE RD, STE 104, RALEIGH, NC 27615 TEL. (919) 846-5900

ARCHITECTURAL

SKINNER FARLOW KIRWAN ARCHITECTURE

301 GLENWOOD AVE, STE 270, RALEIGH, NC 27603 TEL. (984) 222-0572

STRUCTURAL

LYNCH MYKINS

301 N. MAIN ST, STE 105, RALEIGH, NC 27603 TEL. (919) 809-8942

PLUMBING, MECHANICAL, ELECTRICAL ENGINEERED DESIGNS PLLC

1151 SE CARY PKWY, STE 200, CARY, NC 27518 TEL. (919) 851-8481

PETTIGREW STATE PARK | Comment of the comment of t

VICINITY MAP NOT TO SCALE

SCHEDULE OF DRAWINGS

·U	COVER SHEET
0.1	SPECIAL INSPECTIONS NOTES

SITE/CIVIL

• · · - / •		
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L1.2 DEMOLITION PLAN

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L4.0 PLANTING PLAN

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G-03 APPENDIX B - SHOWER HOUSE

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AO102 OFFICE ROOF PLANS - BASE BID

AO103 OFFICE EXTERIOR ELEVATIONS - BASE BID AO104 OFFICE WALL SECTIONS - BASE BID

AO105 OFFICE FLOOR PLANS - ALTERNATE #1

AO106 OFFICE FLOOR PLANS - ALTERNATE #2
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SS102 SLAB-ON-GRADE PLAN - SHOWER HOUSE SS103 LOW ROOF FRAMING PLAN - SHOWER HOUSE SS104 HIGH ROOF FRAMING PLAN - SHOWER HOUSE

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MECHANICAL

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001 MECHANICAL LEGEND, ABBREVIATIONS, SCHEDULES

MC101 FLOOR PLAN
MO101 MECHANICAL PLAN

MS101 MECHANICAL FLOOR PLAN
MS102 MECH ISOMETRIC SECTIONS

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E002 OVERALL ELECTRICAL SITE PLAN

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E004D ELECTRICAL SITE PLAN - EAST DEMOLITION

E004 PARTIAL ELECTRICAL SITE PLAN - EAST EC101 CABIN FLOOR PLANS - LIGHTING AND POWER PLANS

EC101 CABIN FLOOR PLANS - LIGHTING AND POWER PLA EO101D OFFICE LIGHTING PLAN - DEMO

EO101D OFFICE LIGHTING PLAN - DEMO EO201D OFFICE POWER PLAN - DEMO EO101 OFFICE LIGHTING PLAN - NEW

EO101 OFFICE LIGHTING PLAN - NEV EO201 OFFICE POWER PLAN - NEW

ES101 SHOWER HOUSE FLOOR PLAN - LIGHTING ES201 SHOWER HOUSE FLOOR PLAN - POWER

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7#. 20-22411-02A Construction Documents

CAMPGROUND AND OFFIC 2252 LAKE SHOR

DRAWN BY MWB
CHECKED BY GMF
PROJ. NO. 20061
DATE 7/27/2025

	SPEN STSTEWITHEAT FOWIF SCHEDOLE																						
	INDOOR UNIT													OUTDOOR UNIT (95 °F ENT AMBIENT)									
MARK	NOMINAL	BASIS OF DESIGN	MODEL	CFM	MINIMUM	SUPPLY FAN	HEATING			COOLING	CAP. (MBH	1)			ELECTRICAL	-	MARK	MODEL	EER/SEER	E	LECTRICAL		REMARKS
	TONS	MANUFACTURER			OUTSIDE	FAN HP	AUX. KW/			ENT AIR	ENT AIR	LVG AIR	LVG AIR	VOLTAGE/						VOLTS/PH	MCA	МОСР	
					AIR		STAGES	TOTAL	SENSIBLE	DB °F	WB∘F	DB °F	WB∘F	PHASE	MCA	MOCP				VOLIS/FII	WICA	WIOCF	
AHU-1	2	TRANE	TEM6A0N24H21	715	47	1/3	3.84/1	23.10	18.3	77.5	63.7	53.5	52.2	230/1	24	25	HP-1	4TWR7024A1	12.5/17	230/1	15	25	1,2,3,4,5
AHU-2	3.5	TRANE	TEM6A0C42H41	1,245	206	1/2	7.68/1	40.20	30.7	79.4	66.0	56.2	55.1	230/1	45.0	45	HP-2	4TWR4042G1	12/14.5	230/1	25	40	1,2,3,4,5
DEMADICO	TALA DIZO																						

1. R-454B REFRIGERANT.

2. VARIABLE SPEED ECM MOTOR. 3. NEC RATED DISCONNECTS.

4. TWO STAGE COMPRESSOR.

5. PROGRAMMABLE THERMOSTAT.

GAS-FIRED UNIT HEATER SCHEDULE																		
				FAN DA	TA	ELECTRICA	\L			GAS HEA	ΓING							
MARK	LOCATION / SERVES	MANUFACTURER	MODEL	CFM	HP	VOLTAGE	PHASE	MCA	MOCP	INTAKE VENT DIA	EXH VENT DIA	INPUT	ОИТРИТ	MOUNTING HEIGHT	GAS	AFUE	WEIGHT	REMARKS
		(BASIS OF DESIGN)										MBH	МВН	BOTTOM	TYPE		LBS	
GUH-1	SHOWER BLDG	STERLING	GG-030-A1P	370	1/20	120	1	3.7	15	4	4	30.0	24.9	10'-0''	PROPANE	83	60	1,2,3,4,5
GUH-2	SHOWER BLDG	STERLING	GG-030-A1P	370	1/20	120	1	3.7	15	4	4	30.0	24.9	10'-0"	PROPANE	83	60	1,2,3,4,5
GUH-3	SHOWER BLDG	STERLING	GG-030-A1P	370	1/20	120	1	3.7	15	4	4	30.0	24.9	10'-0"	PROPANE	83	60	1,2,3,4,5
GUH-4	SHOWER BLDG	STERLING	GG-030-A1P	370	1/20	120	1	3.7	15	4	4	30.0	24.9	10'-0''	PROPANE	83	60	1,2,3,4,5

1. PROVIDE WITH INTEGRAL CIRCUIT BREAKER AND THERMOSTAT.

2. PROVIDE LOCKING THERMOSTAT COVER. POWER VENTED.

4. PROVIDE 4" COMBUSTION AIR INLET KIT.

5. MIN. CLEARANCE TO COMBUSTIBLES: 1" TOP, BACK AND SIDES.

						FAN S	CHEDUL	E							
MARK	BASIS OF DESIGN	LOCATION	MODEL NO.	TYPE	DRIVE	SERVICE	CFM	S.P.	SONES	RPM	BHP	MHP	VOLTAGE/	CONTROL	REMARKS
	MANUF							("W.C.)				OR WATTS	PHASE		
F-1	GREENHECK	SHOWER BLDG	SE1-18-429-VG	PROP	DIRECT	EXHAUST	1,000	0.10	1.4	358	0.01	3/4	120/1	TSTAT	1 THROUGH 4,7
F-2	GREENHECK	SHOWER BLDG	SE1-18-429-VG	PROP	DIRECT	EXHAUST	1,000	0.10	1.4	358	0.01	3/4	120/1	TSTAT	1 THROUGH 4,7
F-1	GREENHECK	TOILET(OFFICE BLDG)	SP-AP0511W	CEIL	DIRECT	EXHAUST	110	0.26	0.8	861		11 WATTS	120/1	OCC SENSOR	1,2,3,5,6
F-2	GREENHECK	TOILET(OFFICE BLDG)	SP-AP0511W	CEIL	DIRECT	EXHAUST	110	0.26	0.8	861		11 WATTS	120/1	OCC SENSOR	1,2,3,5,6
F-3	GREENHECK	TOILET(OFFICE BLDG)	SP-AP0511W	CEIL	DIRECT	EXHAUST	110	0.26	0.8	861		11 WATTS	120/1	OCC SENSOR	1,2,3,5,6
F-4	BIG ASS FANS	CABINS	HAIKU L 44	CEIL	ECM	CIRCULATION	4,660	N/A	N/A	260		20.3 W	120/1	WALL CONTROL	9,10
F-5	BIG ASS FANS	FAMILY TOIL/SHOWER	HAIKU 52	CEIL	ECM	CIRCULATION	1425-6595	N/A	N/A	200		52 W	120/1	WALL CONTROL	8,10
F-3	GREENHECK	SHOWER BLDG	G-097-VG	ROOF	ECM	JAN EXHAUST	100	0.50	4.5	1120		0.25	120/1	ALWAYS ON	1.11

1. N.E.C. RATED DISCONNECT SWITCH BY MC.

2. SPEED CONTROLLER ON MOTOR. 3. CUSTOMIZABLE HIGH SPEED (5--80-110 CFM).

4. FAN TO BE CONTROLLED BY OUTSIDE AIR TEMPERATURE SENSOR. WHEN OUTSIDE AIR IS 75dF OR ABOVE, FAN SHALL OPERATE. PROVIDE OA TEMP SENSOR.

5. PROVIDE FAN WITH OCCUPANCY SENSOR, ADJUSTABLE TIME. 6. INTEGRAL BACKDRAFT DAMPER.

7. ALUMINUM BLADE PROPELLER, CORROSION RESISTANT FASTENERS, EC MOTOR, WEATHERHOOD WITH BIRD SCREEN.

8. AIRFOIL FINISH: CARAMEL BAMBOO, HARDWARE FINISH: OIL RUBBED BRONZE. DOWNROD EXTENTION. MOUNT 8'-0" AFF TO BOT OF FAN.

9. BLACK FINISH, DOWNROD EXTENSION. MOUNT 8'-0" AFF TO BOT OF FAN.

10. PROVIDE HARD-WIRED WALL CONTROL.

11, BACKDRAFT DAMPER, BIRD SCREE, SLOPED ROOF CURB.

	PACKAGED TERMINAL HEAT PUMP SCHEDULE (PTAC)													
MARK	TYPE	BASIS OF DESIGN	CFM	REFRIG	MINIMUM		TING	POWER CORD	COOLING CAP. (BTUH)	EL	ECTRICAL	•	EER	REMARKS
IVIARA	ITPE	MANUFACTURER	CFIVI	KEFKIG	AIR	₹	KW		TOTAL	VOLTAGE/ PHASE	MCA	МОСР	EER	
PTAC-1	HEAT PUMP	AMANA PTH	310	R32	40	8.5	2.5	YES	9,000	208/1	4.2	15	12.0	1,2,3,4,5

1. WASHABLE FILTERS. WALL SLEEVE.

3. ANTI-SHORT CYCLE TIMER.

4. ALUMINUM OUTDOOR GRILLE.

EXTERNAL DISCONNECT.

			AIR DISTRI	BUTION SCHI	EDULE				
MARK	BASIS OF DESIGN MANUFACTURER	MODEL	TYPE	PANEL SIZE IN X IN	NECK SIZE IN X IN	CFM RANGE	MAX. PD (IN. H₂O)	MAX. NC	REMARKS
Α	PRICE	ASCDA	CEILING SUPPLY	12X12	6	TO 95	0.05	<20	
В	PRICE	ASCDA	CEILING SUPPLY	12X12	8	100-175	0.05	<20	
С	PRICE	620D	SIDEWALL SUPPLY	16X10	14X8	300-345	0.05	<20	
D	PRICE	620D	SIDEWALL SUPPLY	12X8	10X6	155-170	0.05	<20	
E	PRICE	620D	SIDEWALL SUPPLY	10X8	8X6	130-145	0.05	<20	
F	PRICE	PDDR	CEILING RETURN	16X16	8X8	105-175	0.05	<20	
G	PRICE	630D	SIDEWALL RETURN	12X6	10X4	75-85	0.05	<20	

1. REFER TO ARCHITECTURAL PLANS FOR COORDINATION OF CEILING TYPES AND RATINGS. 2. ALL SIDEWALL DIFFUSERS SHALL HAVE AN OPPOSED BLADE DAMPER FOR BALANCING.

3. ALL WALL & CEILING DIFFUSERS AND GRILLES TO BE WHITE FINISH EXCEPT AS SPECIFICALLY NOTED OTHERWISE.

	ELECTRIC HEATER SCHEDULE									
DESIGNATION	MANUFACTURER	MODEL NO.	CFM	HP	KW	VOLTAGE/	MOUNTING	LOCATION	REMARKS	
						PHASE	HEIGHT			
EH-1	MARKEL	E3055T2DWB	100	12.5	1.5	120/1	3' AFF TO TOP	FAM TOILET 102	1,2,3,4	
EH-2	MARKEL	E3055T2DWB	100	12.5	1.5	120/1	3' AFF TO TOP	JAN 104	1,2,3	

1. PROVIDE WITH INTEGRAL CIRCUIT BREAKER AND THERMOSTAT.

RECESSED MOUNTING. 3. PROVIDE GFCI PROTECTION.

4. RATED FOR DAMP LOCATION.

		DESIGNATION	
(.	REMARKS		
	KEWAKKO	AHU-1	
		AHU-2	
)		HP-1	
)		HP-2	-
)		GUH-1	-
)		GUH-2	-
)		GUH-3	_
)		GUH-4	-
)		F-1	-

ABBREVIATIONS: EC: ELECTRICAL CONTRACTOR FWE: FURNISHED WITH EQUIPMENT MC: MECHANICAL CONTRACTOR

EQUIPMENT DESCRIPTION

AIR HANDLING UNIT

AIR HANDLING UNIT

HEAT PUMP

HEAT PUMP

GAS-FIRED UNIT HEAT

GAS-FIRED UNIT HEAT

GAS-FIRED UNIT HEAT

GAS-FIRED UNIT HEAT

FAN SHOWER BLDG

FAN SHOWER BLDG

FAN OFFICE BLDG

FAN OFFICE BLDG

FAN OFFICE BLDG

CEILING FAN

CEILING FAN

PACKAGED TERMINAL A/C UNIT

ELECTRIC HEATER

ELECTRIC HEATER

REMARKS 1. ONE PER CABIN. 2. ALT #1.

F-2

F-1

F-2

F-3

F-4

F-5

PTAC-1

EH-1

EH-2

3. ALT #2. 4. CORD & PLUG CONNECTED.

NOTE: MANUFACTURES SHOWN ON SCHEDULES ARE BASIS OF DESIGN. REFER TO SPECIFICATIONS FOR OTHER ALLOWED MANUFACTURERS.

EQUIPMENT | VOLTAGE/

FURN. BY

MC

MC

MC

MC

PHASE

230/1

230/1

230/1

120/1

120/1

208/1

120/1

MECHANICAL / ELECTRICAL EQUIPMENT COORDINATION SCHEDULE

3/4

3/4

11 WATTS

11 WATTS

11 WATTS

20.3 WATTS

52 WATTS

1/3

1/20 3.7

1/20 3.7

1/20 3.7

1/20 3.7

1/2

0.1

0.1

HEATER KW | WATTS/MHP |

7.68

1.5

1.5

	ABOVE FINISHED FLOOR
	AIR HANDLING UNIT AND NUMBER
	ANALOG INPUT
	ANALOG OUTPUT
	APPROXIMATELY
	ARCHITECTURAL
	BRAKE HORSEPOWER
BI	BINARY INPUT
ВО	BINARY OUTPUT
BOD	BOTTOM OF DUCT
BOP	BOTTOM OF PIPE
BTU	BRITISH THERMAL UNIT
BTUH	BRITISH THERMAL UNIT PER HOUR
CFM	CUBIC FEET PER MINUTE
CONTR	CONTRACTOR
DB	DRY BULB
DN	DOWN
DWG	DRAWING
EAT	ENTERING AIR TEMPERATURE
EC	ELECTRICAL CONTRACTOR
EF-1	EXHAUST FAN AND NUMBER
EFF	EFFICIENCY
EQUIP	EQUIPMENT
ESP	EXTERNAL STATIC PRESSURE
EXST	
GC	GENERAL CONTRACTOR
HP	HORSEPOWER
HVAC	HEATING, VENTILATING AND AIR CONDITIONING
IN	INCH
KW	KILOWATT
LAT	LEAVING AIR TEMPERATURE
LBS	POUNDS
MAX	MAXIMUM
MBH	1,000 BTU PER HOUR
MC	MECHANICAL CONTRACTOR
MFR	MANUFACTURER
MIN	MINIMUM
MTD	MOUNTED
N/A	NOT APPLICABLE
NO	NUMBER
NTS	NOT TO SCALE
	OUTSIDE AIR
OA	
OBD	OPPOSED BLADE DAMPER
OD	OUTSIDE DIAMETER
PC	PLUMBING CONTRACTOR
PSI	
QTY	QUANTITY
RA	RETURN AIR
	REQUIRED
	REVISION
RH	RELATIVE HUMIDITY
	REVOLUTIONS PER MINUTE
SA	SUPPLY AIR
SMACNA	SHEET METAL AND AIR CONDITIONING
	CONTRACTORS NATIONAL ASSOCIATION
SP	STATIC PRESSURE
SPEC	SPECIFICATION
SQ	SQUARE
STD	STANDARD
TEMP	TEMPERATURE
TSP	TOTAL STATIC PRESSURE
T'STAT	THERMOSTAT
TYP	TYPICAL
UON	UNLESS OTHERWISE NOTED
VAV	VARIABLE AIR VOLUME
VEL	VELOCITY
	VARIABLE SPEED DRIVE
VFD	
VFD WB	WET BULB
	WET BULB WATER GUAGE

DISCONNECT | STARTER |

FURN. BY FURN. BY

MC

MC

MC

MC

MC

MC

15

4.2 15

N/A

N/A

NA

NA

NA

NA

N/A

N/A

N/A

N/A

N/A

FWE

FWE

CONTROLS

TSTAT

OCC SEN

OCC SEN

OCC SEN

TSTAT

TSTAT

TSTAT

N/A WALL CONTROL

N/A WALL CONTROL

REMARKS


MECHANICAL ABBREVIATIONS

ABOVE FINISHED FLOOR

IDITIONING	
NG ITION	

	MECHAI	NICAL LEGEND
		SUPPLY AIR DUCT SECTION
		RETURN AIR DUCT SECTION
		EXHAUST AIR DUCT SECTION
	14x10	SQUARE SHEETMETAL DUCTWORK (DIMENSIONS ARE IN INCHES)
	14"ø	ROUND SHEETMETAL DUCTWORK (DIMENSIONS ARE IN INCHES)
		INTERNAL DUCT LINING
		TRANSITION
		SQUARE-TO-ROUND TRANSITION
	D or R	CHANGE IN ELEVATION OF DUCTWORK — D=DROP, R=RISE
		DUCT TURNING UP
		DUCT TURNING DOWN
		ELBOW WITH TURNING VANES (ALL ELBOWS SHALL HAVE TURNING VANES
	D + R	ROUND ELBOW (R = 1.5*D)
		SPIN-IN FITTING WITH SCOOP EXTRACTOR AND BALANCING DAMPER WITH LOCKING QUADRANT
	//////////////////////////////////////	FLEXIBLE DUCT
	\boxtimes	SUPPLY AIR DIFFUSER
		RETURN AIR GRILLE OR REGISTER
		EXHAUST AIR GRILLE OR REGISTER
		LINEAR SLOT DIFFUSER
	<u> </u>	SUPPLY DIFFUSER (SIDEWALL OR DUCT MOUNTED)
	+	RETURN GRILLE OR REGISTER (SIDEWALL OR DUCT MOUNTED)
	(B 220) ▼ FD	DIFFUSER SYMBOL — LETTER=TYPE, NUMBER=CFM
	- MD	FIRE DAMPER
		MANUAL OPERATED DAMPER
	□ MOD □ SD	MOTOR OPERATED DAMPER
		DUCT MOUNTED SMOKE DETECTOR
	Ū	THERMOSTAT (INSTALL 48" AFF)
	\oplus	HUMIDISTAT (INSTALL 48" AFF)
	(1)	KEYED NOTE NUMBER
	—— R ——	REFRIGERANT PIPING
	—— D ——	CONDENSATE DRAIN PIPING

North Carolina License # P-3001 1151 SE Cary Parkway, Suite 200 Cary, North Carolina 27518 P 919.851.8481 F 919.851.9703 www.engineereddesigns.com CORPORATE

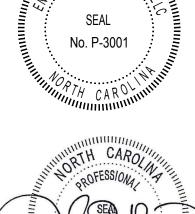

REVISIONS


DOCUMENTS

16-14421-01A

DRAWN BY **DNF** CHECKED BY JRQ PROJ. NO. 1381-20 **DATE** 7/27/2025 SHEET NAME MECHANICAL LEGEND,

ABBREVIATIONS, SCHEDULES

SHEET M-001

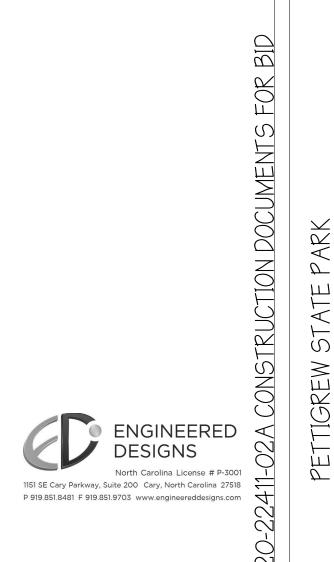

PETTIGREW STATE PARK CAMPGROUND AND OFFICE IMPROVEMENTS 2252 LAKE SHORE ROAD CRESWELL, NORTH CAROLINA

PROJECT STATUS
CONSTRUCTION
DOCUMENTS

20-22411-02A

Finch & Associates 309 North Boylan Avenue Raleigh, NC 27603-1402 T 919 | 833-1212 F 919 | 834-3203 NCBELS Lic. No. P-1845 NCBOL1 Lic. No. C-656


SHEET NAME FLOOR PLAN

DRAWN DNF

CHECKED JRQ

PROJECT NO. 1381-20

DATE 7/27/2025 MC-101

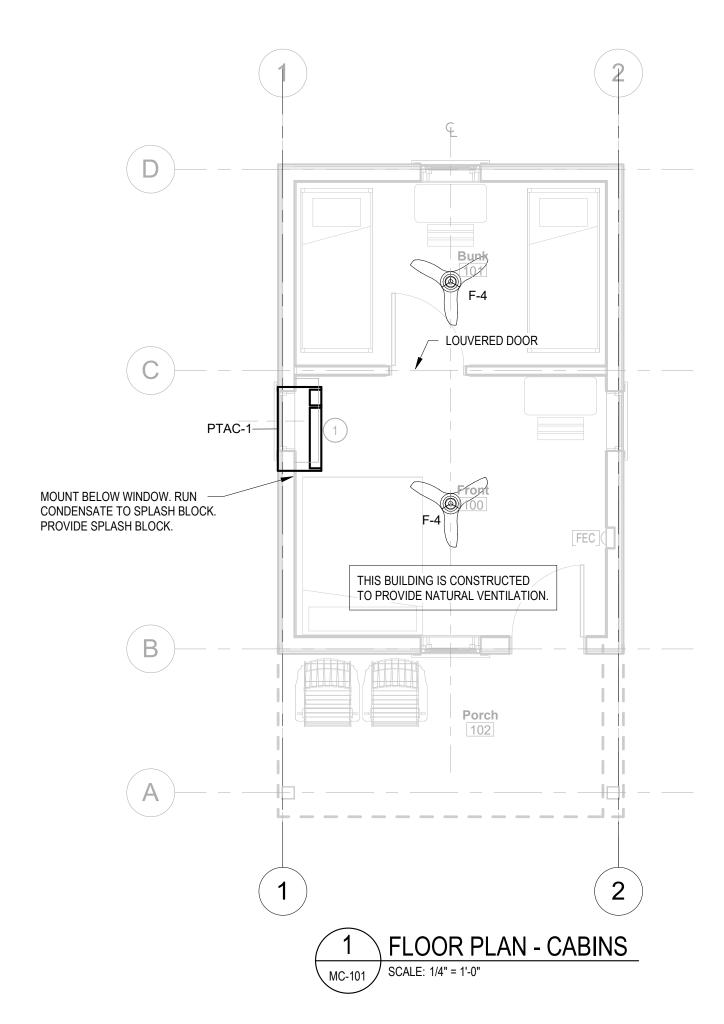



NOTES KEYED TO PLAN

- 1 FAN IN BASE BID. EXTEND DUCT TO ROOF JACK. PROVIDE ROOF JACK.
- 2 FAN IN BASE BID. EXTEND DUCT TO ROOF JACK. PROVIDE ROOF JACK.
- (3) EXTEND CONDENSATE DRAIN LINE FULL SIZE TO EXISTING FLOOR DRAIN. LEAVE AIR GAP.
- EXTEND CONDENSATE DRAIN LINE FULL SIZE TO SPLASH BLOCK. PROVIDE SPLASH BLOCK.
- 5 PROVIDE FAN-COIL SUPPORT PLENUM. SEE DETAIL 2/M601.
- EXTEND 8X8 OA DUCT TO WALL LOUVER. 10X10 LOUVER BY GC, 50% FREE AREA. TRANSITION TO 14X4 DUCT, EXTEND DOWN AND CONNECT TO RA PLENUM. PROVIDE BALANCING DAMPER.
- 7 EXTEND 4X4 OA DUCT TO WALL LOUVER. 6X6 LOUVER BY GC, 50% FREE AREA.
- 8 CONNECT 4X4 OA DUCT TO RA PLENUM. PROVIDE BALANCING DAMPER.
- 9 PROVIDE 14X14 RA OPENING IN RETURN DUCT.

PROJECT STATUS
CONSTRUCTION
DOCUMENTS 20-22411-02A

Finch & Associates 309 North Boylan Avenue Raleigh, NC 27603-1402 T 919 | 833-1212 F 919 | 834-3203 NCBELS Lic. No. P-1845 NCBOL1 Lic. No. C-656

CONSTRUCTION DOCUMENTS FOR BID

PROJECT NO. 1381-20 7/27/2025 MECHANICAL PLANS


MO-101

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North Carolina License # P-3001

1151 SE Cary Parkway, Suite 200 Cary, North Carolina 27518

P 919.851.8481 F 919.851.9703 www.engineereddesigns.com

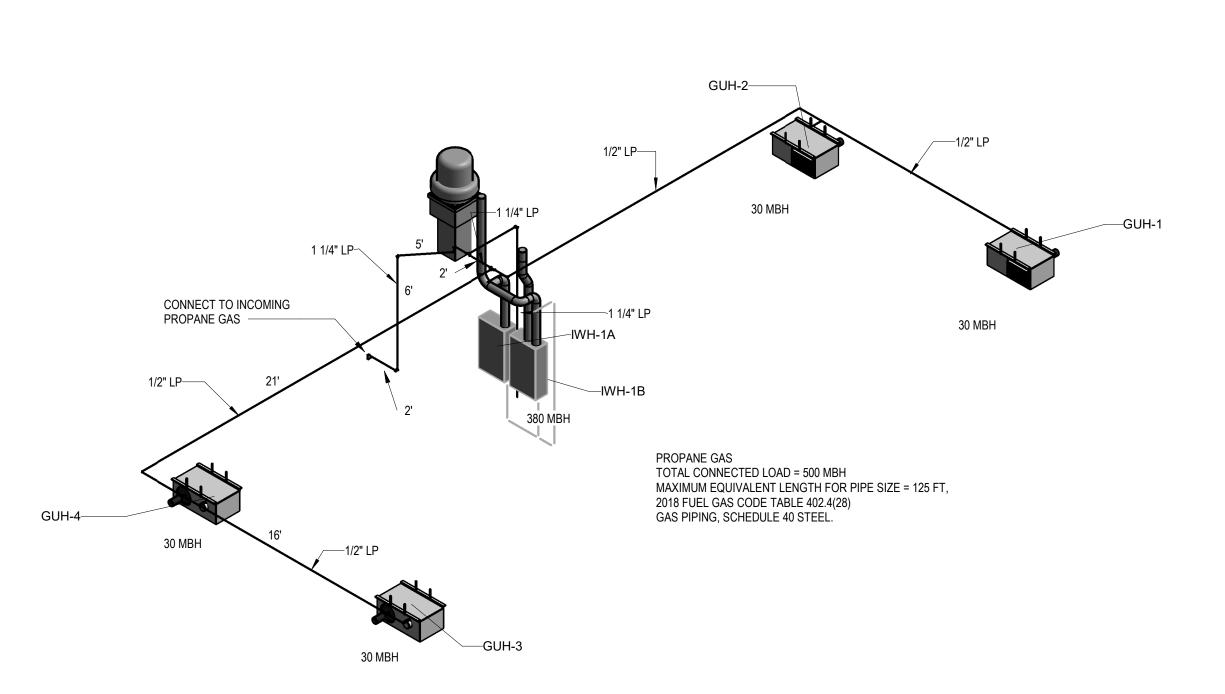

GAS PIPING RISER

NOTES KEYED TO PLANS

1 MAKE-UP AIR THROUGH LOW LOUVERS PROVIDED BY GC (TYPICAL).

2 2 12X12 DUCT DOWN TO 8'-10" AFF.

ELECTRICAL COMPONENTS OF THE FAN TO BE LOCATED NO LESS THAN 3'-0" FROM THE THRESHOLD OF THE SHOWER STALL PER CODE.

PROJECT STATUS
CONSTRUCTION
DOCUMENTS 20-22411-02A


Finch & Associates 309 North Boylan Avenue Raleigh, NC 27603-1402 T 919 | 833-1212 F 919 | 834-3203 NCBELS Lic. No. P-1845 NCBOL1 Lic. No. C-656


CONSTRUCTION DOCUMENTS FOR BID


TE PARK E IMPROVEMENTS RE ROAD CAROLINA

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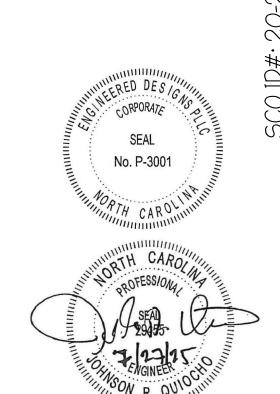
DNF CHECKED JRQ PROJECT NO. 1381-20 7/27/2025 SHEET NAME MECHANICAL PLAN, GAS PIPING RISER MS-101



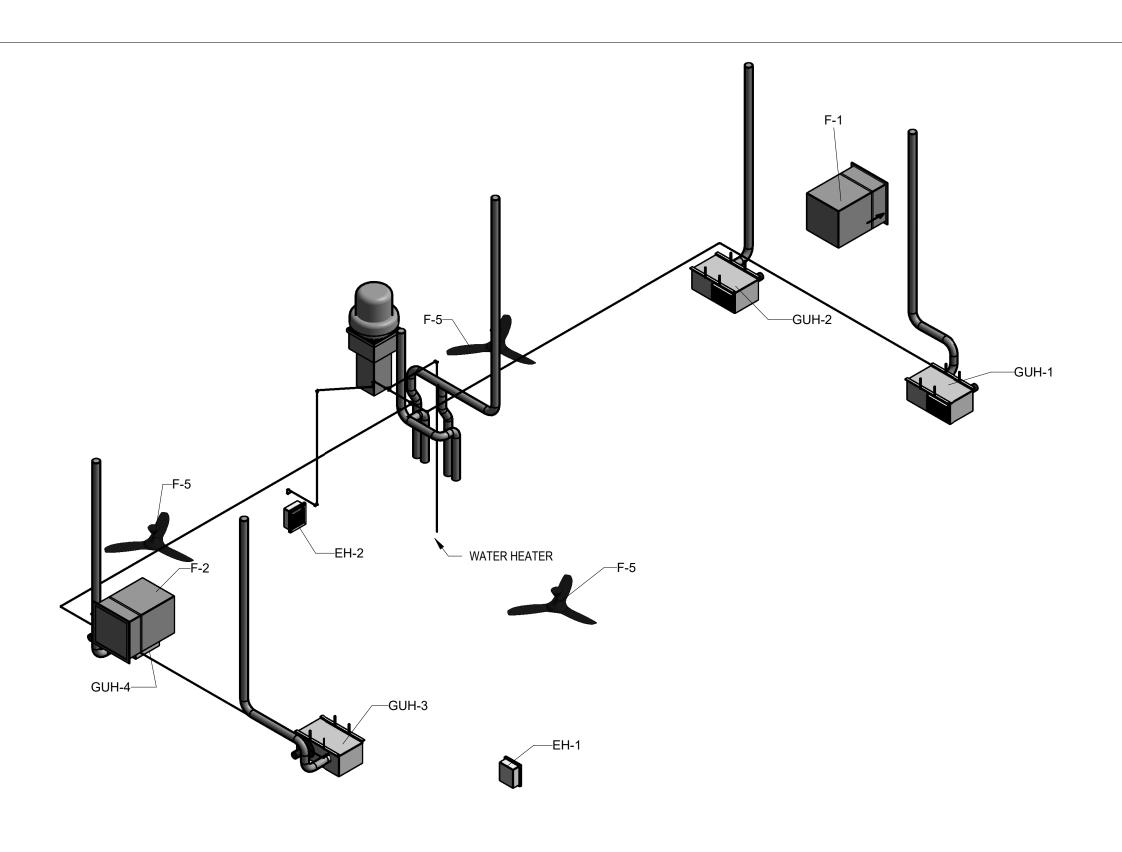

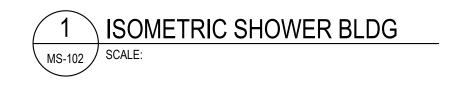

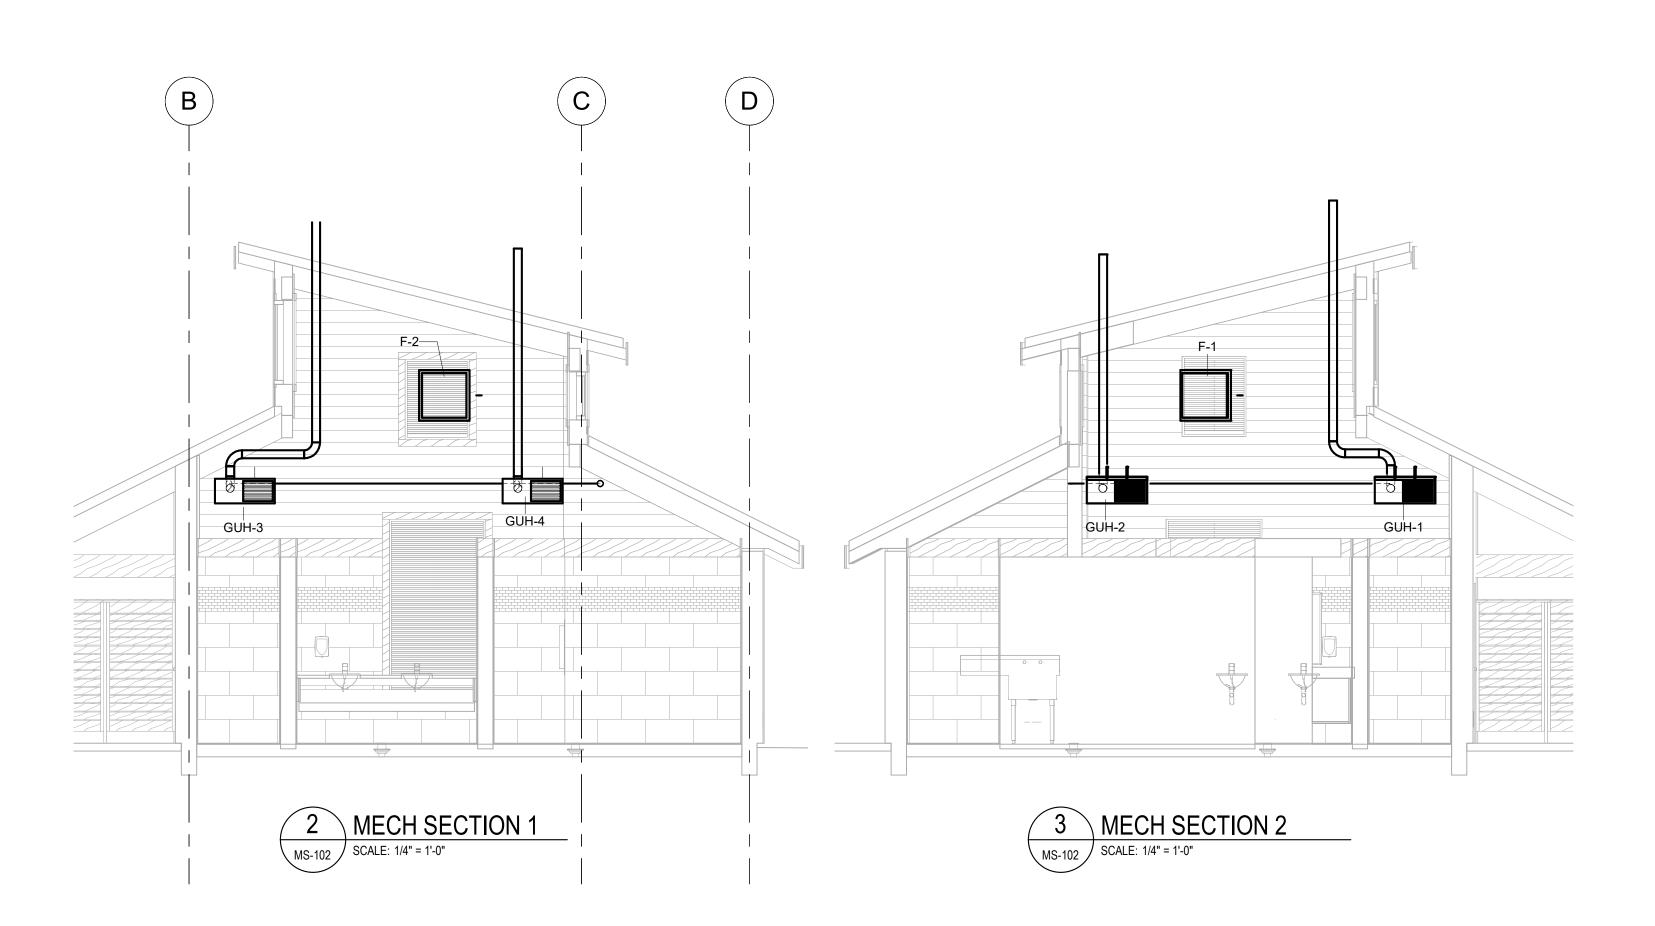



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1151 SE Cary Parkway, Suite 200 Cary, North Carolina 27518
P 919.851.8481 F 919.851.9703 www.engineereddesigns.com PETTIGREW STATE PARK
CAMPGROUND AND OFFICE IMPROVEMENTS
2252 LAKE SHORE ROAD
CRESWELL, NORTH CAROLINA

PROJECT STATUS
CONSTRUCTION
DOCUMENTS

20-22411-02A

Finch & Associates 309 North Boylan Avenue Raleigh, NC 27603-1402 T 919 | 833-1212 F 919 | 834-3203 NCBELS Lic. No. P-1845 NCBOL1 Lic. No. C-656

OWNER ID

DRAWN DNF
CHECKED JRQ
PROJECT NO. 1381-20 06/27/22 SHEET NAME

MECH ISOMETRIC,


SECTIONS


SHEET NO.


MS-102 1 GAS FLUE VENT INSTALLATION DETAIL
M-601 SCALE: NOT TO SCALE

PAN-COIL SUPPORT DETAIL

SCALE: NOT TO SCALE

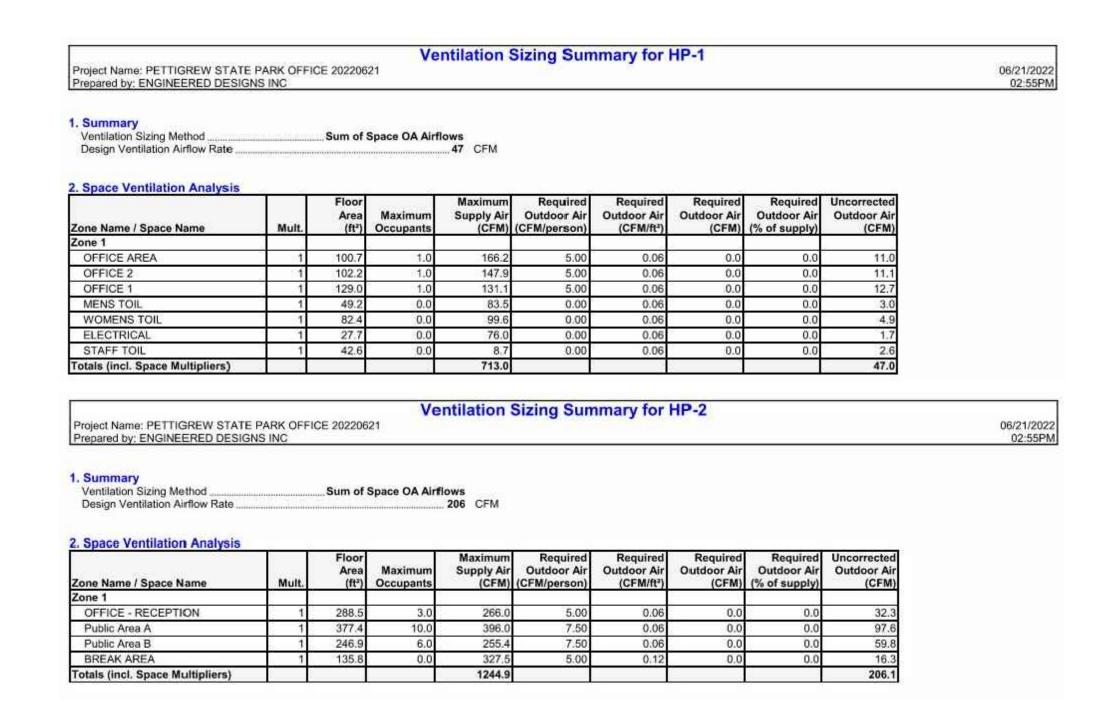

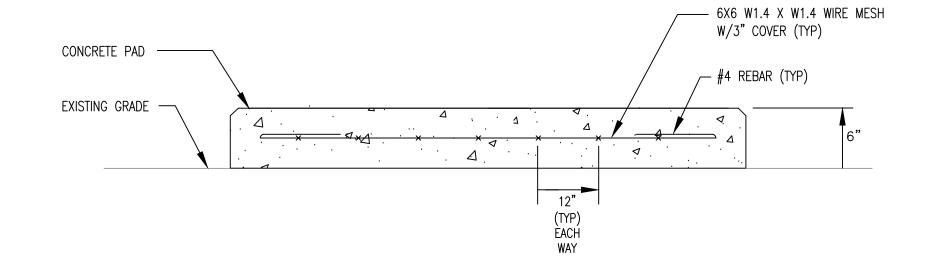


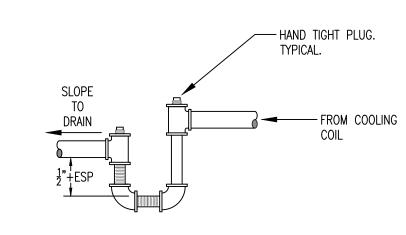

4 CONDENSATE TRAP DETAIL
M-601 SCALE: NONE

3 EXTERIOR CONCRETE PAD DETAIL


M-601 SCALE: NONE

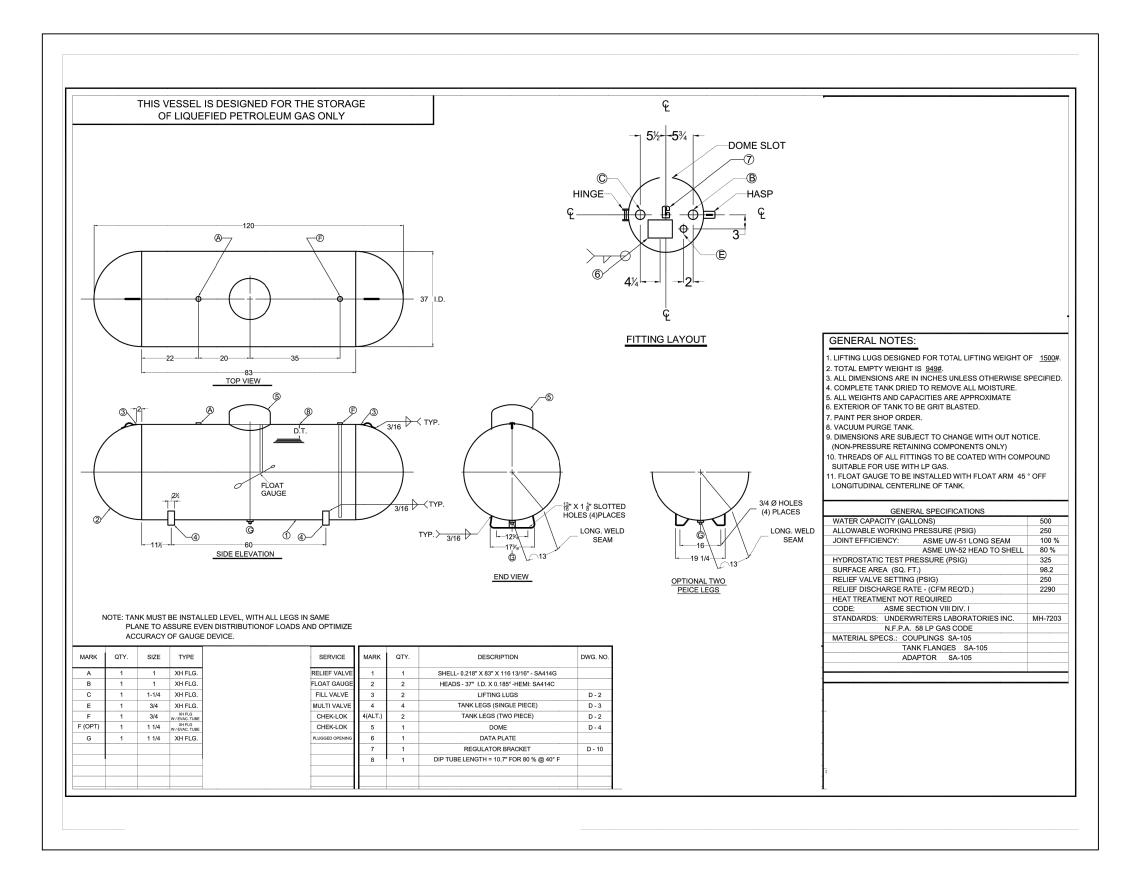

5 PROPANE TANK DETAIL

M-601 SCALE: NONE



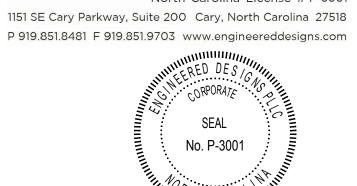



SK OVEMENTS

10

REVISIONS

PROJECT STATUS

OWNER ID

DOCUMENTS

16-14421-01A

CONSTRUCTION

CAMPGROUND AND OFFICE IMPROVI 2252 LAKE SHORE ROAD

DRAWN BY **DNF**CHECKED BY **JRQ**PROJ. NO. 1381-20
DATE 7/27/2025
SHEET NAME
MECHANICAL DETAILS

SHEET M-601

GENERAL PROJECT NOTES

. VERIFY ALL MECHANICAL EQUIPMENT FOR VOLTAGE, LOAD, BREAKER SIZE, WIRING, FUSING, RECEPTACLE TYPE, LOCATIONS, AND MOUNTING HEIGHTS WITH THE MECHANICAL CONTRACTOR PRIOR TO ROUGH-IN OF ANY ELECTRICAL WORK. PROVIDE ALL RECEPTACLES AND DISCONNECTS AS REQUIRED.

2. THE ELECTRICAL CONTRACTOR SHALL MAKE ALL FINAL EQUIPMENT CONNECTIONS FOR MECHANICAL, AND PLUMBING EQUIPMENT.

3. REFERENCE ALL ARCHITECTURAL, STRUCTURAL, PLUMBING, & HVAC DRAWINGS PRIOR TO CONSTRUCTION.

TYP	ICAL DEVICE MOUNTIN	IG HEIGHT
RECEPTACLES LIGHT SWITCHES DATA OUTLETS EXIT LIGHTS NOTE: DIMENSIONS	ARE TO DEVICE CENTERLINE UNLESS NOTED OTHER	18" AFF 48" AFF 18" AFF CEILING

COORDINATION NOTE TO **ELECTRICAL CONTRACTOR**

THE ELECTRICAL CONTRACTOR SHALL COORDINATE ALL POWER REQUIREMENT NEEDS FOR DOOR HARDWARE WITH DOOR HARDWARE VENDOR PRIOR TO ROUGH-IN. THE ELECTRICAL CONTRACTOR SHALL COORDINATE ALL ROUTING OF CONDUIT, WIRING AND TERMINATION POINTS WITH THE ARCHITECT AND DOOR HARDWARE VENDOR PRIOR TO ROUGH-IN. THE ELECTRICAL CONTRACTOR SHALL PROVIDE ALL JUNCTION BOXES, PUSH-PADS, LOW-VOLTAGE TRANSFORMERS, RELAYS, AND ALL OTHER COMPONENTS AS REQUIRED FOR DOOR HARDWARE TO PROVIDE A COMPLETE AND OPERATIONAL SYSTEM, IT IS THE RESPONSIBILITY OF THE ELECTRICAL CONTRACTOR TO COORDINATE ALL INFORMATION IN ORDER TO CORRECTLY PREP THE DOOR INDICATED ON THIS PLAN.

LED LIGHT FIXTURE POWER CIRCUITRY NOTE TO E.C.

CONTRACTOR SHALL NOT EXCEED THE LED MANUFACTURERS RECOMMENDED MAXIMUM LOAD RATINGS FOR LED LIGHT FIXTURE CIRCUITS THAT ARE PROVIDED AND INSTALLED FOR THIS PROJECT. CONTRACTOR SHALL VERIFY ALL LOAD INFORMATION REQUIREMENTS WITH THE LED LIGHT FIXTURE MANUFACTURER (FOR THE ACTUAL LED LIGHT FIXTURES THAT ARE PURCHASED FOR THIS PROJECT) AND INSTALL POWER CIRCUITS TO THESE FIXTURES AS REQUIRED BY THE MANUFACTURER'S RECOMMENDATIONS. ANY CHANGES TO THE CIRCUITRY AND/OR FIXTURE SWITCHING ARRANGEMENTS FOR THIS PROJECT SHALL BE DOCUMENTED AND SHOWN ON THE AS-BUILT DOCUMENTS.

ENERGY CODE SUMMARY

METHOD OF COMPLIANCE: ENERGY CODE - PRESCRIPTIVE

ADDITIONAL PRESCRIPTIVE COMPLIANCE: ☐ C406.2 MORE EFFICIENT HVAC EQUIPMENT PERFORMANCE ☑ C406.3 REDUCED LIGHTING POWER DENSITY ☐ C406.4 ENHANCED DIGITAL LIGHTING CONTROLS ☐ C406.5 ON-SITE RENEWABLE ENERGY ☐ C406.6 DEDICATED OUTDOOR AIR SYSTEM ☐ C406.7 REDUCED ENERGY USE IN SERVICE WATER HEATING

LIGHTING SCHEDULE LAMP TYPE REQUIRED IN FIXTURE NUMBER OF LAMPS IN FIXTURE SEE LIGHT FIXTURE SCHEDULE BALLAST TYPE USED IN THE FIXTURE NUMBER OF BALLASTS IN FIXTURE

TOTAL WATTAGE PER FIXTURE 112W VS. 130W TOTAL INTERIOR WATTAGE SPECIFIED VS. ALLOWED (CABIN) TOTAL INTERIOR WATTAGE SPECIFIED VS. ALLOWED (SHOWER HOUSE) 978W VS. 1,044W 1,041W VS. 1,515W TOTAL INTERIOR WATTAGE SPECIFIED VS. ALLOWED (OFFICE RENO)

EXTERIOR EFFICIENCY EQUIPMENT SCHEDULES WITH MOTORS (NOT USED FOR MECHANICAL SYSTEMS)

MOTOR HORSEPOWER NUMBER OF PHASES MINIMUM EFFICIENCY MOTOR TYPE NUMBER OF POLES

ELECTRICAL DESIGNER STATEMENT

TO THE BEST OF MY KNOWLEDGE AND BELIEF, THE DESIGN OF THIS BUILDING COMPLIES WITH THE ELECTRICAL SYSTEM AND EQUIPMENT REQUIREMENTS OF THE NORTH CAROLINA ENERGY CODE 2018 EDITION

EQUAL LIGHTING MANUFACTURER NOTE

THE LIGHTING FIXTURES INDICATED WITHIN THIS FIXTURE SCHEDULE ONLY INDICATE THE MINIMAL QUALITY STANDARDS THAT ARE REQUIRED FOR THE FIXTURES THAT ARE TO BE INSTALLED WITHIN THIS FACILITY. SEE INTERIOR LIGHTING SPECIFICATION SECTION 265100.2. FOR ALL ACCEPTABLE MANUFACTURERS PER NORTH CAROLINA GENERAL STATURE GS-133.

				LIC	GHT F	IXTURE S	SCHEDULE	
FIXTURE TYPE	DESCRIPTION	MOUNTING	VOLTS/WATTS	LAI TYPE	MPS LUMENS	MANUFACTURER	SERIES NO.	REMARKS
Α	4' LINEAR LED PENDANT LIGHT FIXTURE	PENDANT	120/28	LED	3700	COOPER HUBBELL LITHONIA MOBERN	METALUX: 4SNLED-LD5-37SL-LN-UNV-L835-CD1-U-AYC CHAIN SET	PENDANT MOUNT FIXTURES AT 8'-0" A.F.F. UNLESS NOTED OTHERWISE
С	6" PENDANT LED CYLINDER LIGHT FIXTURE	PENDANT	120/22.7	LED	2000	HUBBELL COOPER LITHONIA MOBERN	PRESCOLITE: LTC-6RD-PCC-20L35K8WD-DM1-SS-BL	PENDANT MOUNT FIXTURES AT 10'-0" A.F.F. UNLESS NOTED OTHERWISE
D	2' LINEAR WALL MOUNT LED WET LOCATION FIXTURE	WALL	120/36	LED	5200	JADEMAR COOPER LITHONIA MOBERN	JVTHB-SL-2-36W-40K-D-SAC-SS-SMB	FIXTURE SHALL BE WET LOCATION RATED PROVIDE MOUNTING HARDWARE FOR WALL MOUNTING
F	6" PENDANT LED CYLINDER LIGHT FIXTURE	PENDANT	120/12	LED	1000	HUBBELL COOPER LITHONIA MOBERN	PRESCOLITE: LTC-6RD-PCC-10L35K8WD-DM1-SS-BL	PENDANT MOUNT FIXTURES AT 10'-0" A.F.F. UNLESS NOTED OTHERWISE
L2	2' LINEAR WALL MOUNT LED FIXTURE	WALL	120/33	LED	4000	HE WILLIAMS COOPER LITHONIA MOBERN	WMAUD-2-L20-840U-L20-840D-A-F-DIMU-DIMD-UNV	FIXTURE SHALL BE DAMP LOCATION RATED. WALL MOUNT FIXTURES AT 8'-0" A.F.F. UNLESS NOTED OTHERWISE
L4	4' LINEAR WALL MOUNT LED FIXTURE	WALL	120/64	LED	6000	HE WILLIAMS COOPER LITHONIA MOBERN	WMAUD-4-L40-840U-L40-840D-A-F-DIMU-DIMD-UNV	FIXTURE SHALL BE DAMP LOCATION RATED WALL MOUNT FIXTURES AT 8'-0" A.F.F. UNLESS NOTED OTHERWISE
P4	4' LINEAR LED PENDANT LIGHT FIXTURE	PENDANT	120/39	LED	5000	CURRENT COOPER LITHONIA MOBERN	LITE-CONTROL: SAE101-P-ID-STD-4-SOF-CX-40K-I050-D075	
\$4	4' LINEAR LED SURFACE LIGHT FIXTURE	SURFACE	120/11.3	LED	1500	HE WILLIAMS COOPER LITHONIA MOBERN	39-4-L30-840-A-(L15)-DIM-UNV	
WP	EXTERIOR WALL PACK	WALL	120/13	LED	1450	MOBERN KENALL HUBBELL	SAYLITE: DBEL-ACEM-BR-SDT-PC XXX XXX	PROVIDE WITH INTEGRAL PHOTOCELL PROVIDE WITH 90 MINUTE BATTERY BACKUP
EM	EMERGENCY LIGHT FIXTURE	WALL	120/6.6	LED	NA	MOBERN SURE LITES HUBBELL	SAYLITE: RMR-16-LED XXX XXX	PROVIDE WITH 90 MINUTE BATTERY BACKUP PROVIDE WITH SELF-DIAGNOSTIC FEATURE
EX/EM	EXIT LIGHT FIXTURE WITH EMERGENCY HEADS	WALL OR CEILING AS	120/2	LED	N/A	MOBERN SURE LITES HUBBELL	SAYLITE: CKXTEU-#-R-W-W-EM XXX XXX	PROVIDE WITH 90 MINUTE BATTERY BACKUP PROVIDE WITH SELF-DIAGNOSTIC FEATURE

LIGHT FIXTURE SCHEDULE NOTES

- ALL LIGHTING FIXTURES SHALL BE U.L. LISTED. ALL LED FIXTURE SHALL HAVE MINIMUM CRI OF 80 UNLESS SPECIFICALLY NOTED OTHERWISE.
- LUMEN OUTPUT NOTED FOR LED FIXTURES IS THE MINIMUM THAT MUST BE PROVIDED FOR THE FIXTURE SPECIFIED.
- VERIFY ALL MOUNTING HEIGHTS WITH ARCHITECT PRIOR TO ROUGH-IN.
- COORDINATE ALL COLORS/FINISH OPTIONS OF LIGHT FIXTURES WITH THE ARCHITECT PRIOR TO PURCHASING.
- ALL LIGHTING FIXTURES INDICATED WITHIN THE LIGHTING FIXTURE SCHEDULE SHALL BE PROVIDED WITH ALL REQUIRED MOUNTING HARDWARE, CONNECTORS AND ANY OTHER NEEDED FIXTURE OPTIONS FOR A COMPLETE AND OPERATIONAL INSTALLATION AS INTENDED ON THE DRAWINGS. CONTRACTOR SHALL BE RESPONSIBLE FOR PROVIDING ALL REQUIRED COMPONENTS AT NO ADDITIONAL

INDICATED

COST TO THE OWNER. PROVIDE 20'-0", SQUARE STEEL POLE AND MOUNTING ARMS IN CONFIGURATIONS AS INDICATED ON THE PLANS FOR MOUNTING FIXTURES AT THE TOP OF THE DECK. COORDINATE INSTALLATION OF POLE ON TOP OF CONCRETE PARAPET / COLUMNS WITH STRUCTURAL PLANS AS REQUIRED. CONFIRM POLE AND FIXTURE FINISH WITH ARCHITECT PRIOR TO PURCHASE.

LIGHT FIXTURE SCHEDULE NOTES (CONTINUED):

- 8. THE FIXTURE SHALL BE CONFIGURED TO DIM TO 50% OF LIGHT OUTPUT IF MOTION IS NOT DETECTED FOR 30 MINUTES. WHEN MOTION IS DETECTED, THE FIXTURE SHALL AUTOMATICALLY RETURN TO 100% LIGHT OUTPUT.
- THE FIXTURE SHALL BE CONFIGURED TO DIM TO 50% OF LIGHT OUTPUT IF MOTION IS NOT DETECTED FOR 30 MINUTES. WHEN MOTION IS DETECTED. THE FIXTURE SHALL AUTOMATICALLY RETURN TO 100% LIGHT OUTPUT, ADDITIONALLY, WHEN ADEQUATE DAY-LIGHT LEVELS ARE DETECTED, THE FIXTURE SHALL SHUT-OFF. THE FIXTURE SHALL TURN ON AGAIN ONCE DAY-LIGHT LEVELS DROP BELOW ACCEPTABLE FOOTCANDLE LEVELS WITHIN THE DECK. THE CONTRACTOR SHALL CONFIRM MINIMUM, ACCEPTABLE DAY-LIGHT FOOTCANDLE LEVEL AT WHICH POINT THE FIXTURE SHUTS OFF WITH THE OWNER AS PART OF THE FIXTURE CONFIGURATION / START-UP
- SERVICES. 10. CONTRACTOR SHALL PROVIDE OWNER WITH (2) NEW CONFIGURATION TOOLS AT THE COMPLETION OF THE PROJECT AND TRAINING
- ACCORDINGLY, REFER TO SPECIFICATIONS FOR ADDITIONAL REQUIREMENTS. 11. PROVIDE SWIVEL PENDANT MOUNT FITTING FOR SECURING FIXTURES TO JUNCTION BOX AT DECK STRUCTURE.

POWER/DATA SYMBOLS

WALL MOUNTED DUPLEX RECEPTACLE. "T" INDICATES MOUNTED LINEAR LED LIGHT FIXTURE, LETTER INDICATES FIXTURE TYPE. SEE ABOVE COUNTER-TOP LIGHT FIXTURE SCHEDULE FOR DESCRIPTION. HALF-SHADING INDICATES FIXTURE TO BE PROVIDED WITH 90 MINUTE BATTERY SPECIAL PURPOSE RECEPTACLE. COORDINATE RECEPTACLE TYPE BACK-UP DRIVER. WITH ASSOCIATED EQUIPMENT. WALL MOUNTED LINEAR LED FIXTURE, LETTER INDICATES FIXTURE ELECTRICAL EQUIPMENT CONNECTION (HARD-WIRED OR CONNECTED TYPE. SEE LIGHT FIXTURE SCHEDULE FOR DESCRIPTION. TO SWITCH MOUNTED ON EQUIPMENT HALF-SHADING INDICATES FIXTURE TO BE PROVIDED WITH 90 MINUTE BATTERY BACK-UP DRIVER PANELBOARD 4'-0" LED STRIP LIGHT FIXTURE **EXTERIOR EMERGENCY WALLPACK**

LIGHT FIXTURE SYMBOLS

PENDANT MOUNTED LIGHT FIXTURE

INDICATED. SHADING INDICATES FACE

INDICATED. SHADING INDICATES FACE

DESCRIPTION

EGRESS LIGHT FIXTURE

LIGHTING CONTROLS SYMBOLS

SINGLE POLE SWITCH

TIME OF NO MOTION.

FIRE ALARM SYMBOLS

NORTHERNLY DIRECTION

INTERIOR WALL MOUNTED EMERGENCY BATTERY BACK-UP

EXIT LIGHT, CEILING MOUNTED, DIRECTIONAL ARROW AS

EXIT LIGHT, WALL MOUNTED, DIRECTIONAL ARROW AS

PHOTOCELL, ROOF MOUNTED WITH THE SENSOR POINTED IN A

VACANCY SENSOR TO TURN OFF LIGHTS AFTER A PRE-PROGRAMMED

PHOTOELECTRIC SMOKE DETECTOR WITH AUDIBLE SOUNDER BASE

COMBINATION PHOTOELECTRIC CARBON-MONOXIDE/SMOKE

JUNCTION BOX. SIZE PER N.E.C. "A" X ELECTRICAL UTILITY METER POWER PULLBOX

DUAL PORT ELECTRIC VEHICLE CHARGING STATION


NEC APPROVED FAN RATED BOX UTILITY POWER TRANSFORMER

HEAVY DUTY DISCONNECT. SIZE AS INDICATED IN DRAWINGS. 30 FRAME SIZE NF FUSE SIZE -'NF' INDICATES NON-FUSED

MOTOR RATED TOGGLE SWITCH, SQ'D TYPE K OR EQUAL

GROUND LOOP CONDUCTOR

10' X 3/4" COPPER CLAD STEEL GROUND ROD

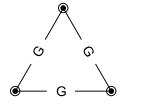

10' X 10' X 10' SERVICE GROUNDING GRID


RACEWAY SYMBOLS



CONDUIT CONCEALED IN WALLS OR ABOVE CEILINGS

DESCRIPTION

UNSWITCHED LIGHTING CIRCUIT

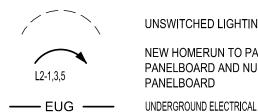

NEW HOMERUN TO PANELBOARD. LETTERS INDICATE PANELBOARD AND NUMBERS INDICATE CIRCUITS IN PANELBOARD

SPECIALTY EQUIPMENT SYMBOLS

<u>SYMBOL</u>

EV2: PEDESTAL-MOUNTED DUAL-PORT EV CHARGING STATION SPECIFICATION: MFG: CHARGEPOINT CT-4021, 23FT CORD X2. ADJUSTABLE AMPERAGE-12/32 AMPS X2, INPUT CURRENT-30AMPS, VOLTAGE 208V/1PH, BREAKER SIZE-40AMP X2, ENCLOSURE NEMA TYPE 3R, TEMP RANGE-(-40 DEG TO +122 DEG F). OTHER MANUFACTURER'S ARE BOSCH AND LEGRAND.

DETECTOR WITH AUDIBLE SOUNDER BASE

ABBREVIATIONS

SYMBOL DESCRIPTION EQUIPMENT GROUND CONDUCTOR EMERGENCY ELECTRIC WATER COOLER ELECTRIC WATER HEATER G, GND GROUND GROUNDING ELECTRODE CONDUCTOR

GROUND FAULT INTERUPTER ONE THOUSAND CIRCULAR MILS KILO-VOLT AMPERES KILOWATTS KILOWATT-HOURS MAIN CIRCUIT BREAKER

MAIN LUG ONLY NATIONAL ELECTRICAL CODE NOT TO SCALE PH. Ø PHASE UNLESS OTHERWISE NOTED

VOLTS WEATHERPROOF TRANSFORMER

GENERAL SYMBOLS LEGEND NOTES:

- A. NOT ALL SYMBOLS SHOWN ON THIS SHEET ARE NECESSARILY USED ON THE DRAWINGS AND WHEN NOT USED THEY SHOULD BE ASSUMED NOT TO APPLY TO THIS PROJECT. ADDITIONAL SYMBOLS MAY BE INCLUDED ON DRAWINGS THAT ARE NOT SHOWN HERE AND ARE IDENTIFIED ON THE
- DRAWINGS PERTAINING TO THAT PARTICULAR SYSTEM. B. REFER TO SPECIFICATIONS, ARCHITECTURAL DRAWINGS, APPLICABLE SCHEDULES AND DETAILS FOR ADDITIONAL INFORMATION REGARDING EACH DEVICE IDENTIFIED ON THIS LEGEND.
- C. SUBSCRIPTS SHOWN ON THE LEGEND ON A DEVICE MAY BE APPLIED TO ANY DEVICE IN THE SAME GROUP. I.E. "C" INDICATES COUNTER HEIGHT.
- D. ABBREVIATIONS MAY BE APPLIED TO ANY SYMBOL. E. REFER TO OTHER TRADE DRAWINGS FOR THOSE TRADES EQUIPMENT SYMBOLS AND ABBREVIATIONS.
- F. VERIFY LOCATIONS AND DIMENSIONS OF ALL EQUIPMENT AND COORDINATE WITH OTHER TRADES PRIOR TO THE START OF
- G. CONTRACTOR SHALL BE RESPONSIBLE TO VERIFY LOCATIONS AND ELEVATIONS OF CASEWORK PRIOR TO ROUGH-IN.
- H. ALL BRANCH CIRCUITS SHALL CONSIST OF 2#12 + #12G IN 1/2"C.
- THHN/THWN IN EMT UNLESS OTHERWISE NOTED. I. MINIMUM RACEWAY SIZE IS 1/2" FOR ALL CIRCUITS UNLESS OTHERWISE
- J. ALL FIRE ALARM RACEWAY AND JUNCTION BOXES SHALL BE PAINTED OR
- DYED RED. K. ALL SECURITY AND COMMUNICATIONS CONDUIT SHALL BE PROVIDED

WITH A THERMOPLASTIC (NYLON) INSULATED BUSHINGS AT BOTH THE DEVICE OUTLET AND THE END OF THE CONDUIT, PRIOR TO CABLING LEAVING RACEWAY.

MECHANICAL/ELECTRICAL WIRING COORDINATION NOTE

THE MECHANICAL AND ELECTRICAL CONTRACTORS SHALL FULLY COORDINATE ALL WORK PRIOR TO ROUGH-IN OF ANY MECHANICAL OR ELECTRICAL EQUIPMENT. REFER TO MECHANICAL SCHEDULES FOR DESIGNATIONS OF ALL EQUIPMENT REQUIRING CONTROL WIRING.

THE MECHANICAL CONTRACTOR SHALL PROVIDE ALL CONTROL WIRING AND HARDWARE RELATED TO CONTROL WORK (I.E. TRANSFORMERS, CONTROL MODULES, CONNECTORS, ETC..). ALL CONTROL WIRING SHALL BE PLENUM RATED AND INSTALLED IN CONDUIT

THE ELECTRICAL CONTRACTOR SHALL BE RESPONSIBLE FOR THE PROVIDING ALL MATERIALS AND LABOR TO PROVIDE THE 120V POWER SOURCES REQUIRED TO OPERATE ALL LOW VOLTAGE MECHANICAL EQUIPMENT AND MAKE FINAL 120 VOLT CONNECTIONS TO CONTROL EQUIPMENT. ELECTRICAL CONTRACTOR SHALL PROVIDE ALL JUNCTION BOXES AND/OR RECEPTACLES, 120 VOLT WIRING AND SHALL INSTALL ALL WIRING IN CONDUIT

WIRE/CONDUIT FOR MECHANICAL EQUIPMENT IS SIZED USING THE 75°C COLUMN FROM NEC TABLE 310-16. CONFIRM MECHANICAL EQUIPMENT TERMINATIONS ARE RATED FOR 75°C OR HIGHER.

ROUGH-IN NOTES

RECEPTACLES:
MOUNT AT 18" A.F.F. TO CENTERLINE UNLESS OTHERWISE NOTED. ADJUST TO MATCH MASONRY COURSES IF APPLICABLE. MOUNT ALL BOXES TRUE AND PLUMB.

MOUNT AT 4" ABOVE COUNTERTOP OR BACKSPLASH AS APPLICABLE TO CENTERLINE. WHERE COUNTERTOP IS NOT SHOWN ON ARCHITECTURAL PLANS, MOUNT AT 48" A.F.F. TO CENTERLINE. ADJUST TO MATCH MASONRY COURSES IF APPLICABLE. MOUNT ALL BOXES TRUE AND PLUMB. BOXES FOR DEVICES ON OPPOSITE SIDES OF A COMMON WALL MUST BE OFFSET 12".

PROVIDE DOUBLE-GANG BOX WITH SINGLE GANG PLASTER RING. MOUNT OUTLET BOXES AT 18" A.F.F. TO CENTERLINE UNLESS OTHERWISE NOTED. ADJUST ALL MOUNTING HEIGHTS TO MATCH MASONRY COURSES AS APPLICABLE, MOUNT ALL BOXES TRUE AND PLUMB.

MOUNT AT 48" A.F.F. TO TOP. ADJUST TO MATCH MASONRY COURSES AS APPLICABLE. MOUNT ALL BOXES TRUE AND PLUMB.

MOUNT ALL PULL STATIONS AT 48" A.F.F. TO CENTERLINE, MOUNT ALL SPEAKER/STROBES, STROBES AND REMOTE ALARM INDICATORS 80" A.F.F. TO BOTTOM OF DEVICE UNLESS OTHERWISE NOTED, COORDINATE LOCATION OF FAN CONTROL RELAY WITH DIVISION 23 CONTRACTOR, PROVIDE DUCT DETECTORS TO DIVISION 23 CONTRACTOR FOR MOUNTING, ALL WIRING BY DIVISION 26 CONTRACTOR, WIRE DUCT DETECTORS TO REMOTE ALARM INDICATORS IN CORRIDORS. COORDINATE LOCATIONS OF MAGNETIC DOOR HOLDERS PRIOR TO INSTALLATION. ADJUST ALL MOUNTING HEIGHTS TO MATCH MASONRY COURSES AS APPLICABLE. ALL DEVICES TO BE MOUNTED TRUE AND PLUMB.

EXPOSED ELECTRICAL INSTALLATION NOTES

- A. INSTALLATION OF THE ELECTRICAL BOXES AND SYSTEMS SHALL BE CONCEALED WITHIN WALLS, CEILINGS, AND SURFACES THROUGHOUT. ALL DEVICES SHALL BE FLUSH MOUNT OR RECESS MOUNT AS NOTED ON CONTRACT DOCUMENTS, LOCATIONS WHERE CONCEALED FLUSH MOUNT IS NOT POSSIBLE DUE TO OBSTRUCTIONS IN THE CAVITY, OR SIMILAR CONDITION, SHALL BE IDENTIFIED BY CONTRACTOR TO THE PROJECT ARCHITECT/ENGINEER IN WRITING. SURFACE MOUNT OF DEVICES AND EXPOSED RACEWAY SHALL ONLY BE PERMITTED IN AREAS NOTED OR WHERE WRITTEN APPROVAL OF THE PROJECT ARCHITECT/ENGINEER
- B. EXPOSED DEVICES AND RACEWAY IN THE PARKING DECK AREA AND WITHIN ELECTRICAL/MECHANICAL/TELECOM ROOMS (I.E. UTILITY SPACES) SHALL BE NEATLY RUN PLUMB AND LEVEL WITH BUILDING ELEMENTS, PARALLEL AND PERPENDICULAR TO WALLS/FLOORS AND CEILINGS, RACEWAYS SHALL BE NEATLY GROUPED AND RUN TOGETHER WHERE POSSIBLE. THE USE OF STANDOFF (MINERALLAC) TYPE STRAPS SHALL NOT BE PERMITTED WHERE CONDUIT IS LOCATED WITHIN 10'-0" OF THE FLOOR. ALL EXPOSED CONDUIT INSTALLED WITHIN UTILITY SPACES SHALL UTILIZE OFFSETS AND BE SECURED WITH ONE (1) HOLE OR TWO (2) HOLE STRAPS. DEVICE BOXES INSTALLED WITHIN UTILITY SPACES SHALL BE LISTED FOR SURFACE MOUNT APPLICATIONS AND CONTAIN NO SHARP EDGES I.E. SHALL BE HANDY BOX TYPE.


VOLTAGE DROP WIRING NOTE

THE CONTRACTOR SHALL BE RESPONSIBLE FOR ENSURING VOLTAGE DROP CONDITIONS OF FINAL CONDUIT / CONDUCTOR ROUTINGS DO NOT EXCEED THE FOLLOWING MAXIMUM VALUES AND UPSIZE CONDUCTORS AND CONDUIT AS REQUIRED:

- A. FEEDER CIRCUITS: MAX 3% VOLTAGE DROP (PER NEC ARTICLE 215.2(A)(4) INFORMATIONAL NOTE NO. 2)
- B. BRANCH CIRCUITS: MAX 3% VOLTAGE DROP (PER NEC ARTICLE 210.19(A)(1) INFORMATIONAL NOTE NO. 4) C. COMBINED VOLTAGE DROP ON FEEDER AND BRANCH CIRCUIT TO THE FURTHEST DEVICE OUTLET / UTILIZATION EQUIPMENT SHALL NOT EXCEED 5%.
- D. EQUIPMENT GROUND CONDUCTORS SHALL BE UPSIZED AS REQUIRED PER NEC ARTICLE 250.122.(B).

WHERE THE CONDUCTOR LENGTH FROM THE PANEL TO THE LAST OUTLET ON A 120 VOLT CIRCUIT EXCEEDS 75 FEET, THE BRANCH CIRCUIT CONDUCTORS SHALL NOT BE SMALLER THAN #10 AWG. WHERE CONDUCTOR LENGTH FROM THE PANEL TO THE LAST OUTLET EXCEEDS 125 FEET CONDUCTORS SHALL NOT BE SMALLER THAN #8 AWG.



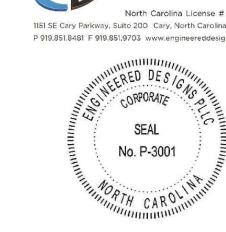

ENGINEER 07-27-25 /EMENT

DJH 07/27/2025

CHECKED JRQ 'ROJECT NO. 20061 ELECTRICALLEGEND AND NOTES


CONSTRUCTION

DOCUMENTS 20-22411-02A

8 8 8

919 919 BELS


18 - L 22

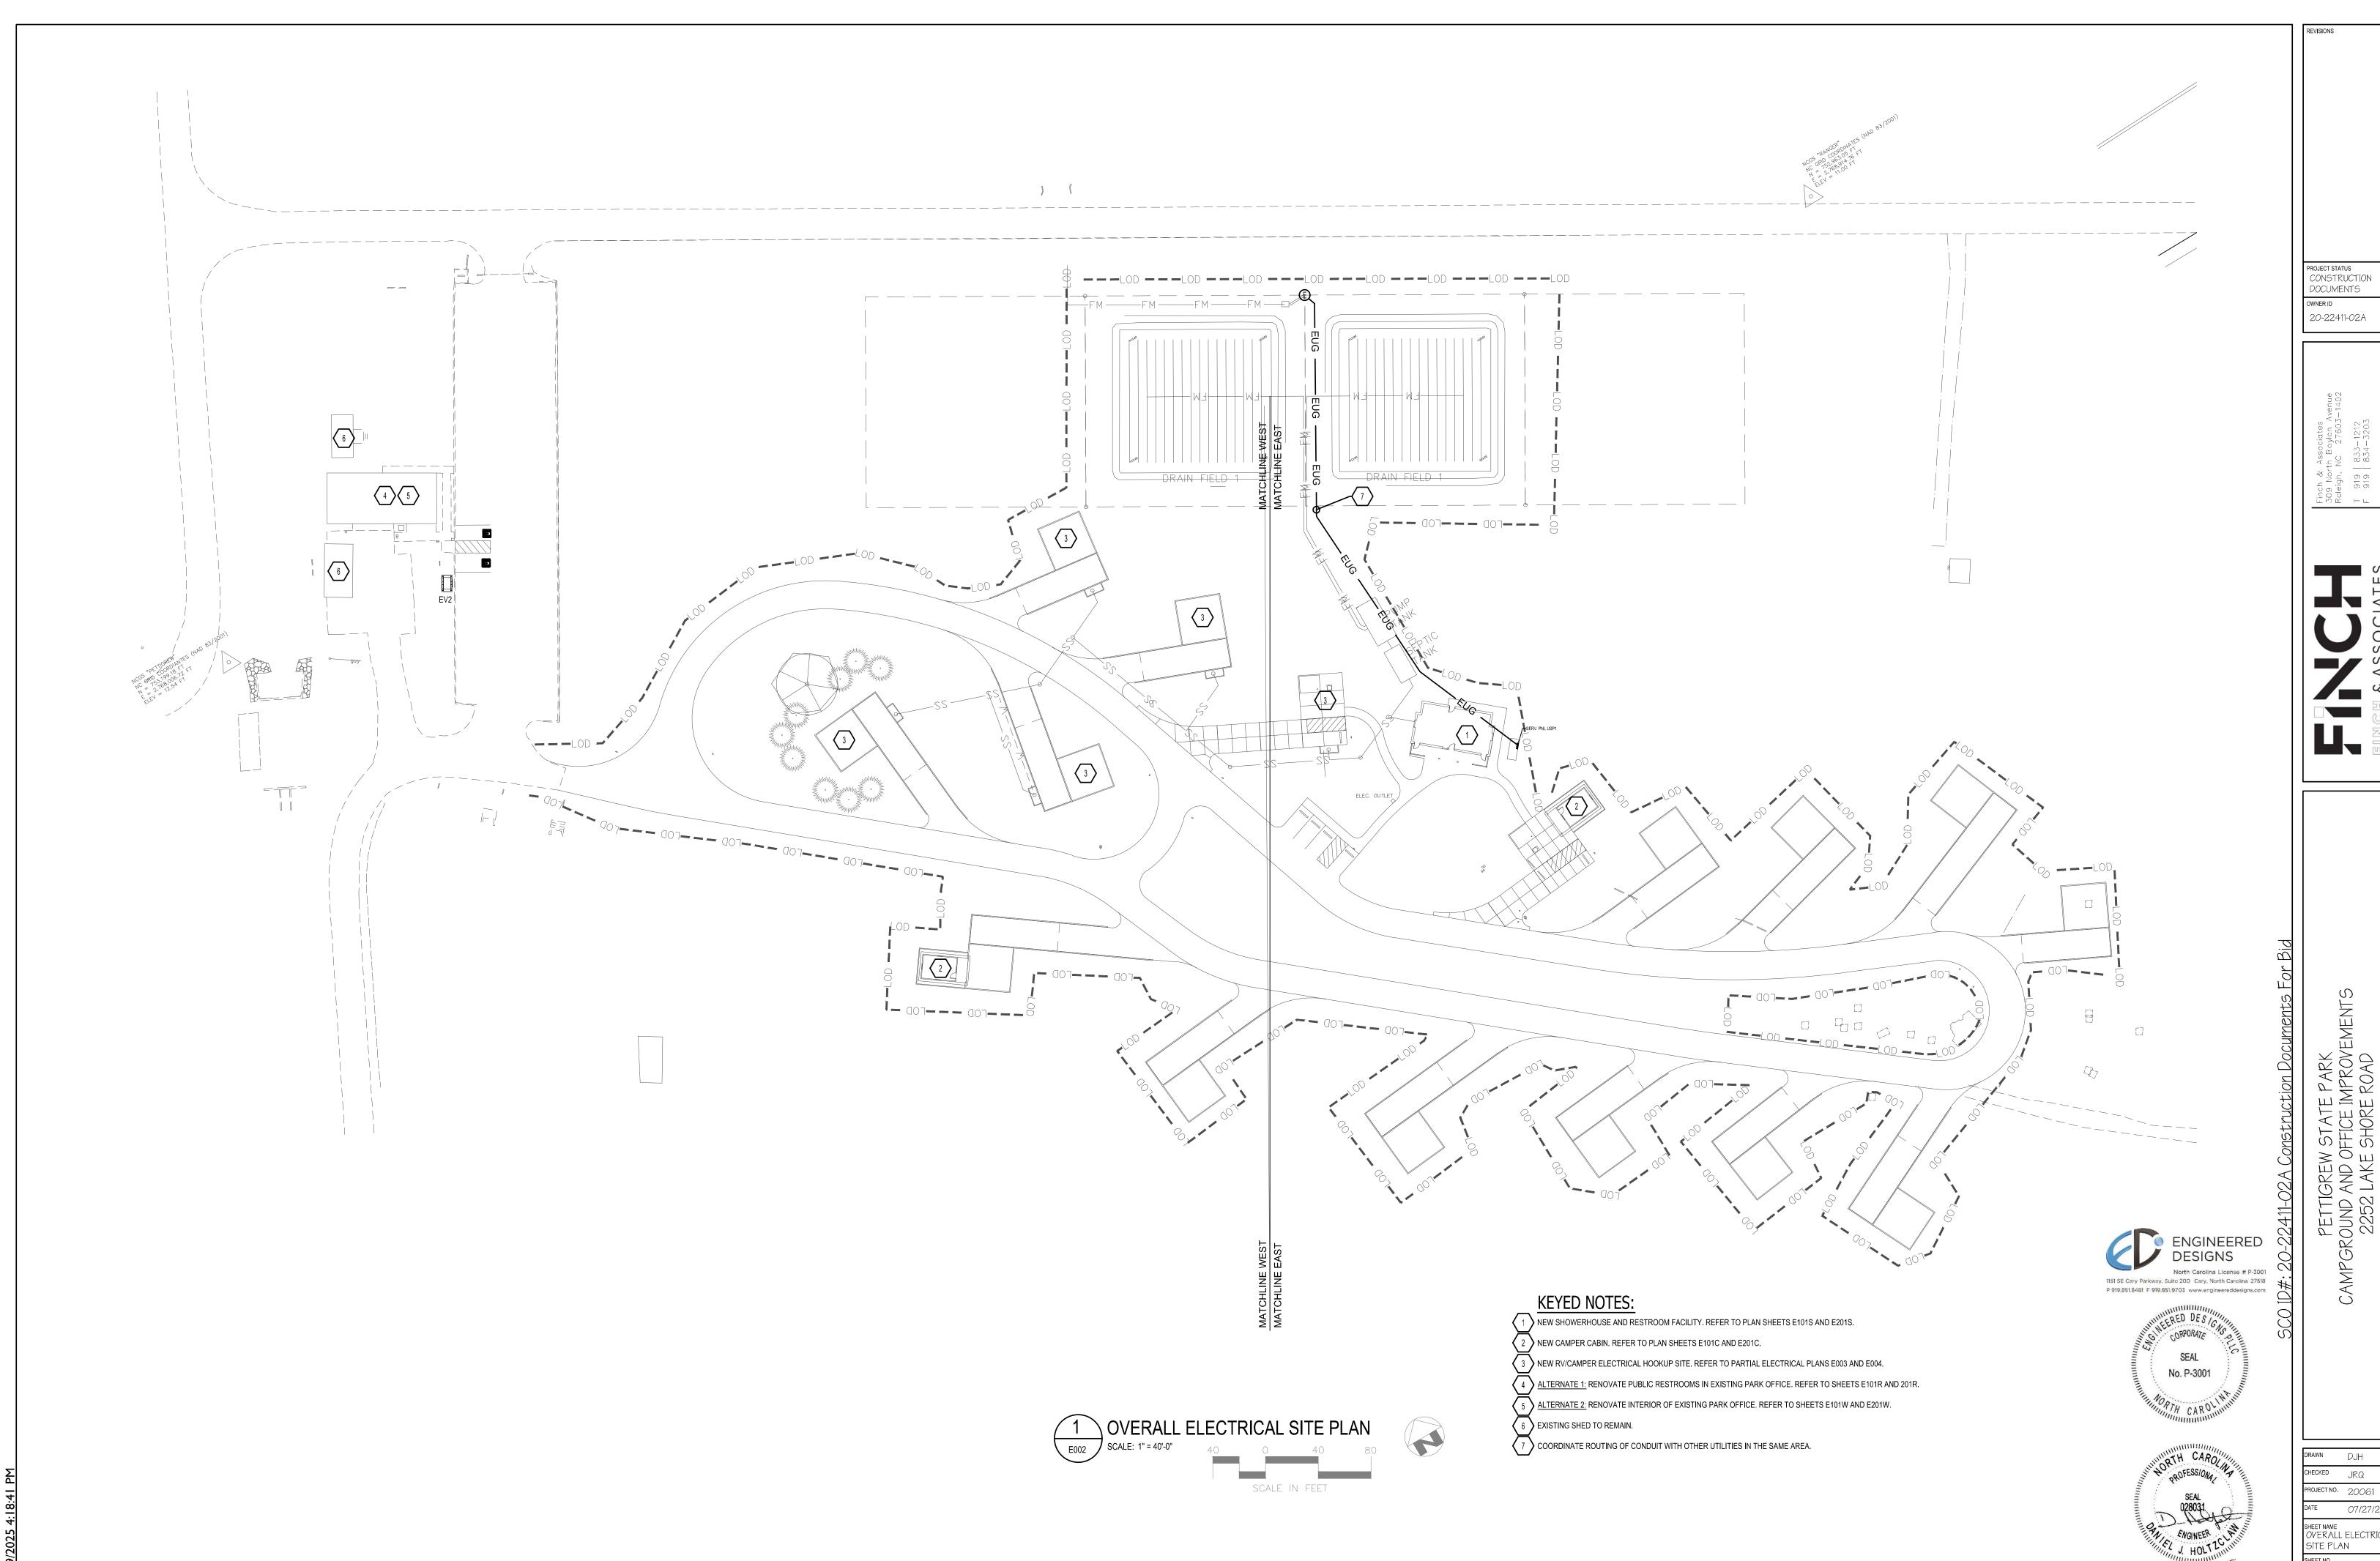

STATE PARK FICE IMPROVEMENTS SHORE ROAD STH CAROLINA

DRAWN DJH CHECKED JRQ PROJECT NO. 20061 DATE 07/27/2025

SHEET NAME
OVERALL ELECTRICAL
SITE PLAN
SHEET NO. E-002

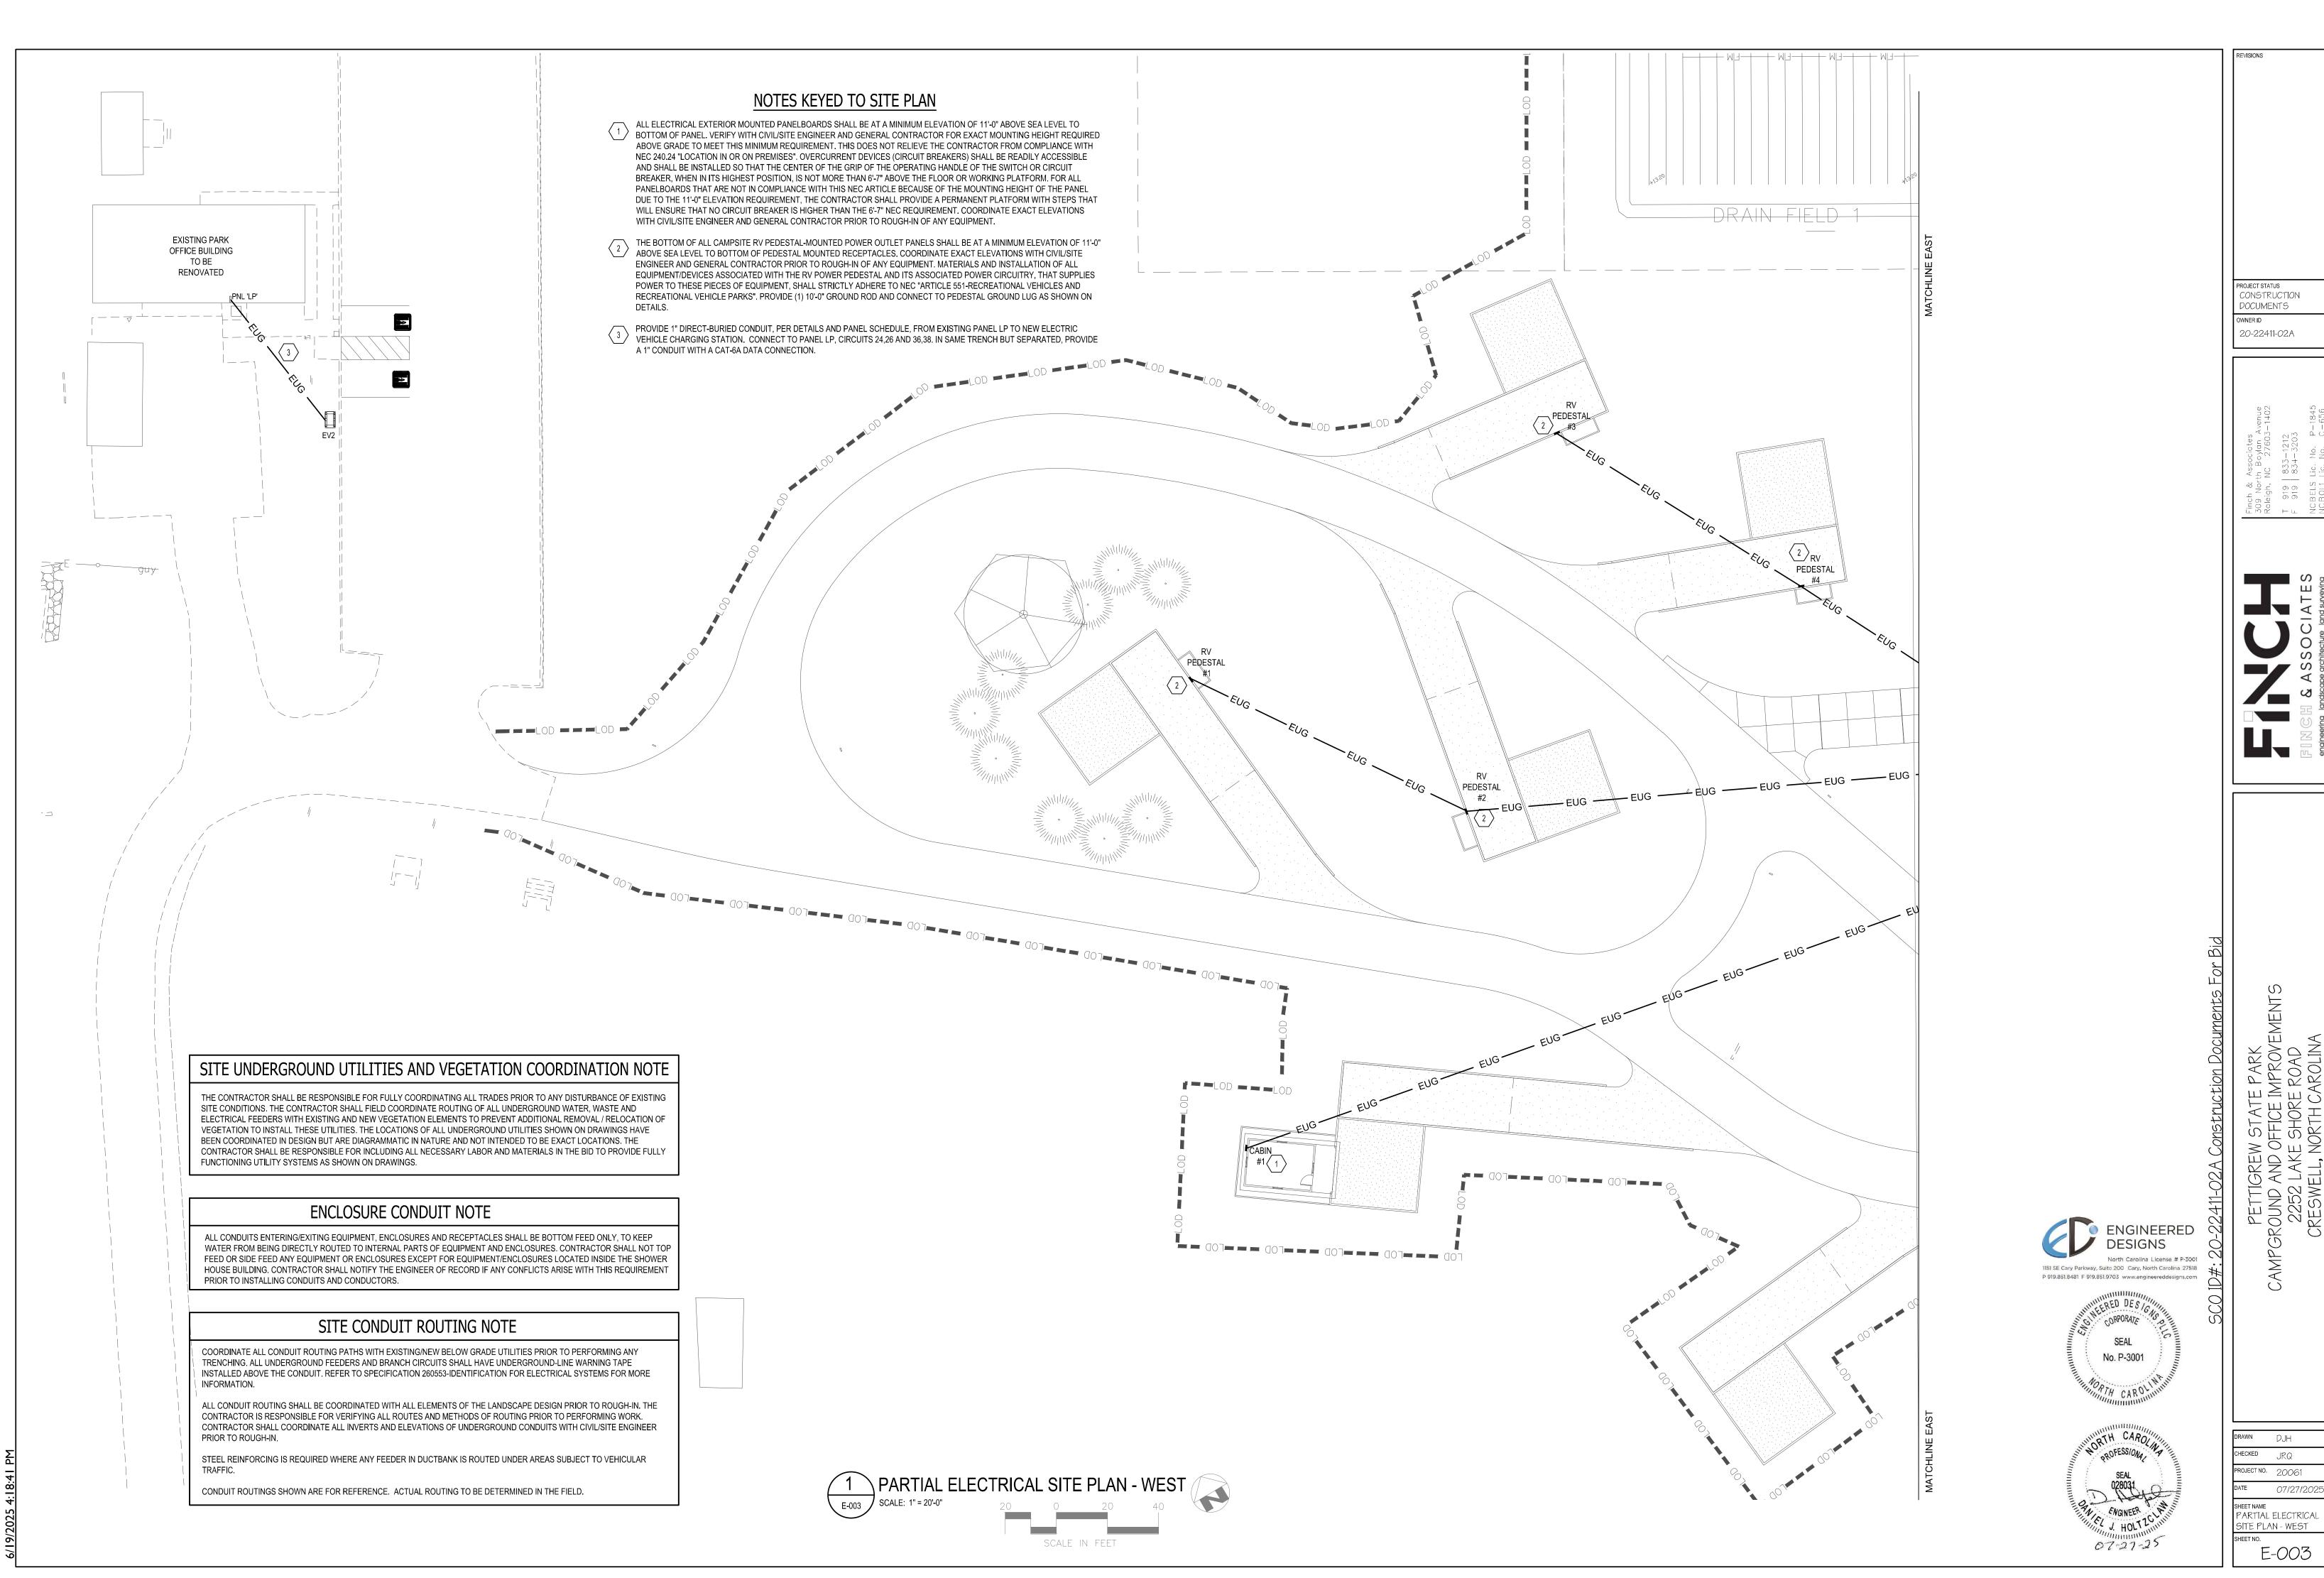

CONSTRUCTION

DRAWN DJH CHECKED JRQ PROJECT NO. 20061 DATE 07/27/2025


CONSTRUCTION DOCUMENTS

20-22411-02A

DJH

PROJECT NO. 20061 07/27/2025 SHEET NAME ELECTRICAL SITE PLAN EAST DEMOLITION

E-004D

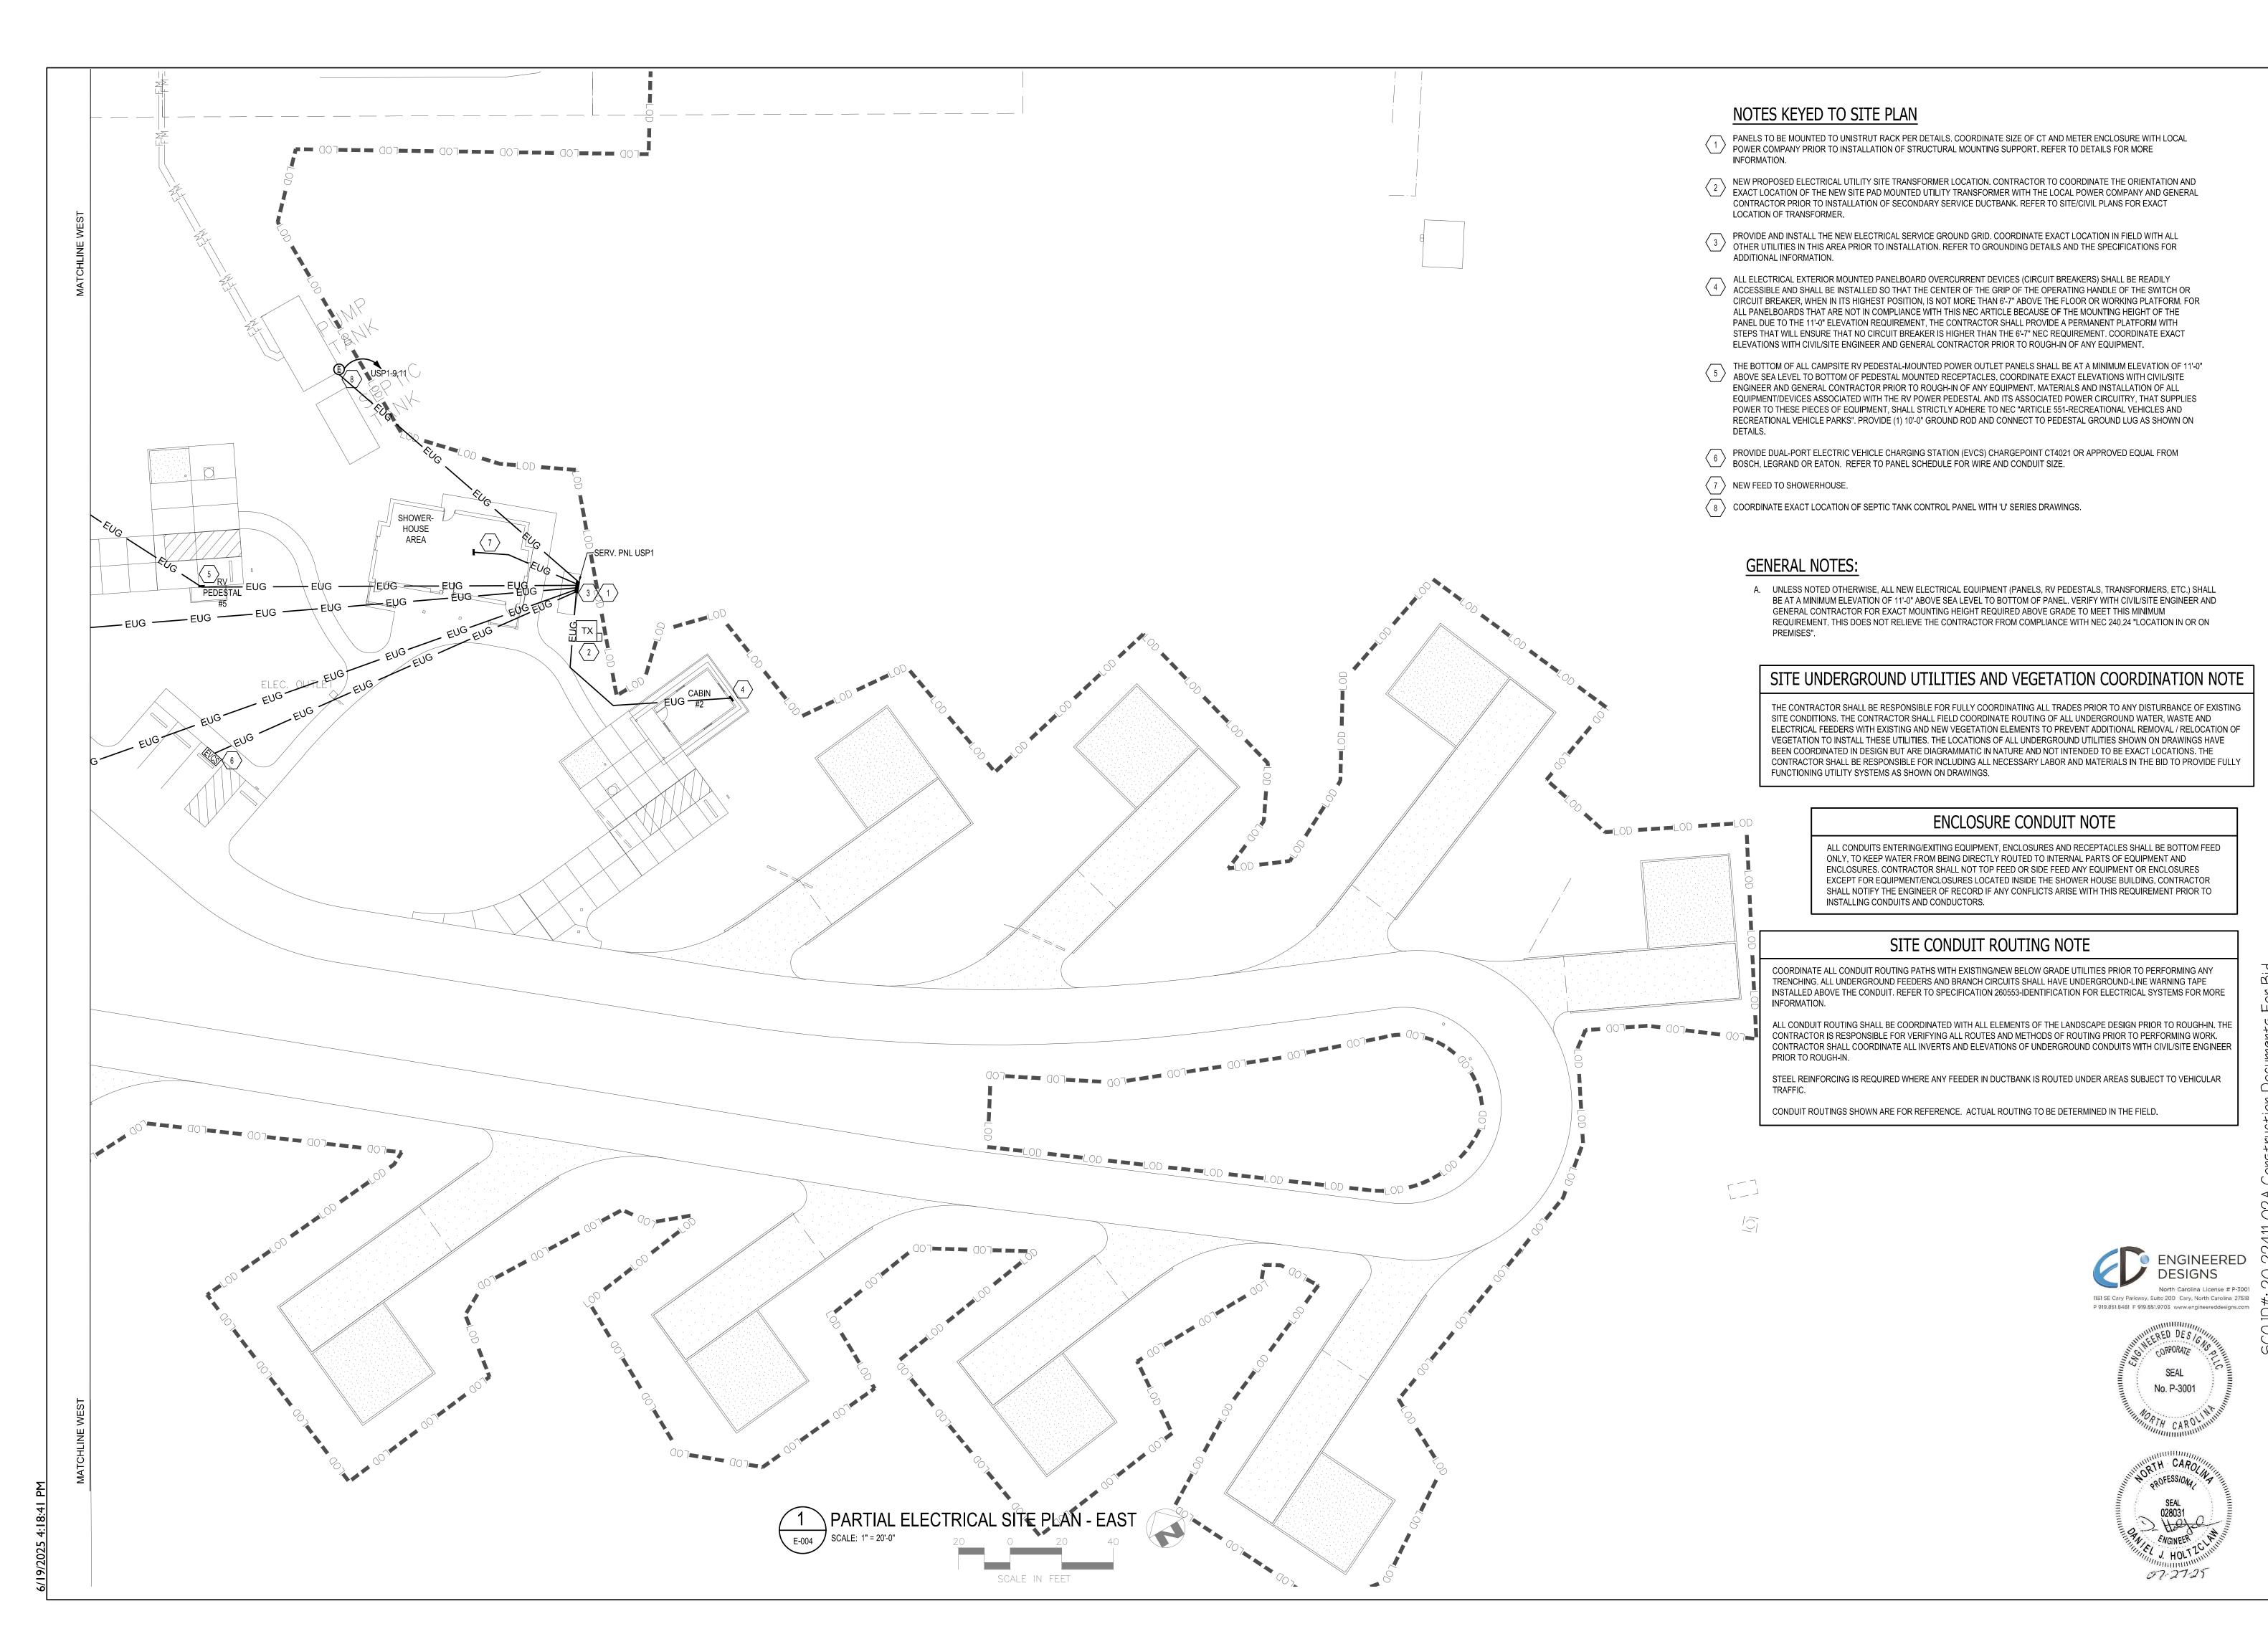

CONSTRUCTION DOCUMENTS

20-22411-02A

MA HL XX

EMENT

DJH 07/27/2025

CHECKED JRQ PROJECT NO. 20061 SHEET NAME PARTIAL ELECTRICAL SITE PLAN - WEST SHEET NO.


E-004

DJH

CABIN LIGHTING & POWER PLANS


07/27/2025


CHECKED JRQ PROJECT NO. 20061

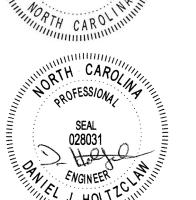

SEAL

No. P-3001

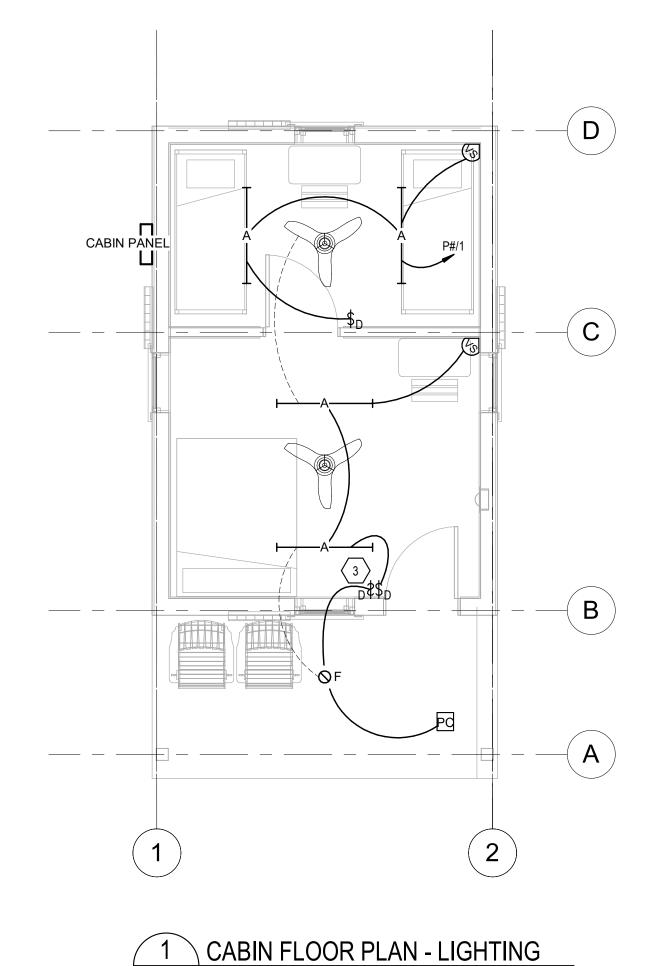

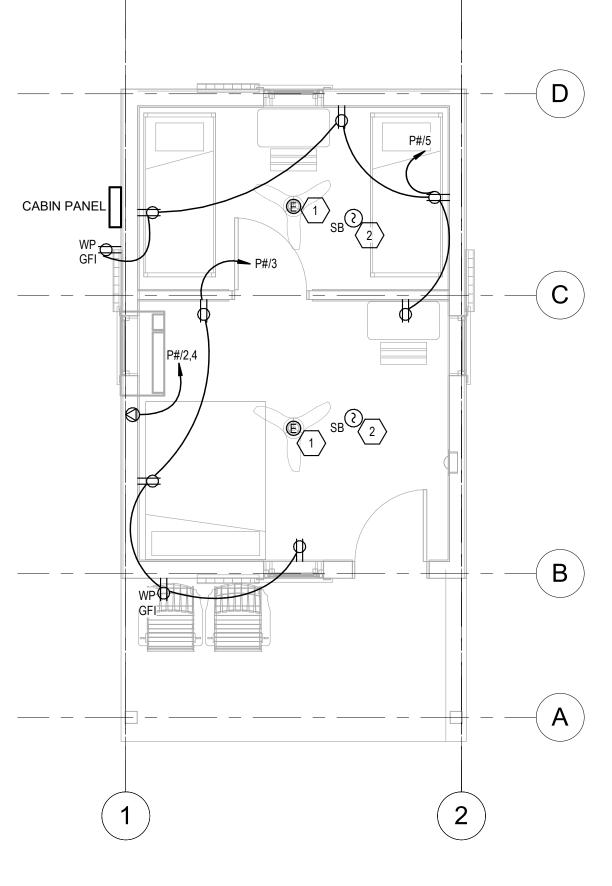

2 CABIN FLOOR PLAN - POWER

CONDUIT ROUTING NOTE

NO CONDUIT SHALL BE EXPOSED WITHIN THIS BUILDING WITH THE EXCEPTION THAT EXPOSED CONDUIT IS ALLOWED ON BOTTOM OF BEAMS TO CONNECT TO LIGHT FIXTURES.

NOTES KEYED TO PLANS

- TO PROVIDE NEC APPROVED CEILING FAN BOX. MOUNT ROOF LEVEL ON ROOF RIDGE BEAM. MECHANICAL TO PROVIDE WALL SWITCH TO CONTROL FAN. COORDINATE WITH MECHANICAL FOR LOCATION OF SWITCH. PROVIDE POWER FOR FAN FROM UNSWITCHED ROOM LIGHTING CIRCUIT. PROVIDE CONDUIT AND WIRE TO MAKE CONNECTION.
- NEW SMOKE ALARM TO BE HARD WIRED FROM NEW PANEL (CIRCUIT #6) AND SHALL ALSO HAVE BACK-UP BATTERIES. LOCATE SMOKE DETECTOR 36" (IN THE HORIZONTAL PATH) FROM THE TIP OF THE ROOM CEILING FAN. THE SMOKE ALARM MUST ALSO BE WITHIN 36" HORIZONTALLY OF THE CEILING PEAK AND NOT CLOSER THAN 4" VERTICALLY FROM THE CEILING PEAK.
- $\sqrt{3}$ CONNECT LIGHT SWITCH IN SERIES WITH THE PHOTOCELL SO PHOTOCELL TURNS LIGHT OFF REGARDLESS OF SWITCH POSITION.

ARC-FAULT INTERRUPTER NOTE TO CONTRACTOR

PROVIDE ARC FAULT CIRCUIT INTERRUPTER (AFCI) PROTECTION AT FIRST RECEPTACLE IN THE CIRCUIT AS REQUIRED PER NEC (2014) 210.12(A)(5).

EQUIPMENT/FIXTURE/DEVICE COORDINATION NOTE

ALL LOCATIONS AND MOUNTING HEIGHTS OF WALL MOUNTED DEVICES, LIGHT SWITCHES, LIGHT FIXTURES (INTERIOR & EXTERIOR), DISCONNECT SAFETY SWITCHES, MOTOR RATED SWITCHES, PANELBOARDS, ETC... SHALL BE CLOSELY COORDINATED WITH THE ARCHITECTURAL PLANS AND SHALL ALSO BE APPROVED BY THE OWNERS REPRESENTATIVE AND/OR ARCHITECT PRIOR TO ROUGH-IN. MOUNTING HEIGHTS OF LIGHT FIXTURES, RECEPTACLES, LIGHT SWITCHES, DISCONNECT SAFETY SWITCHES, PANELBOARDS, MOTOR RATED SWITCHES, ETC... MAY VARY DEPENDING ON THE CASEWORK, DOOR, WINDOW, CEILING, ETC... INFORMATION. CONTRACTOR WILL BE RESPONSIBLE FOR REVIEWING ALL OTHER PROJECT PLANS (PARTICULARLY THE ARCHITECTURAL AND STRUCTURAL PLANS), PROPERLY COORDINATING ALL EQUIPMENT LOCATIONS/MOUNTING HEIGHTS AND HAVING THE OWNERS REPRESENTATIVE AND/OR ARCHITECT VERIFY THE LOCATIONS SO THAT THE POWER/LIGHTING CONDUITS, DEVICE BACK BOXES, JUNCTION BOXES, PULL BOXES, ETC... ARE PROPERLY ROUGHED-IN TO AVOID ANY POTENTIAL CONFLICT OF OTHER TRADES.

**ANY DEVICES THAT ARE NOT LOCATED IN THE CORRECT LOCATIONS WILL BE REMOVED AND RELOCATED AT THE CONTRACTORS EXPENSE. ANY WALLS OR CEILINGS THAT ARE REQUIRED TO BE PATCHED DUE TO THE INCORRECT LOCATION OF DEVICES WILL ALSO BE PATCHED AND REFINISHED AT THE CONTRACTORS EXPENSE IF COORDINATION OF EQUIPMENT/DEVICES IS NOT PERFORMED WITH THE OWNERS REPRESENTATIVE AND/OR ARCHITECT PRIOR TO ROUGH-IN.

20-22411-02A

Finch & Associates 309 North Boylan Avenue Raleigh, NC 27603-1402 T 919 | 833-1212 F 919 | 834-3203 NCBELS Lic. No. P-1845 NCBOL1 Lic. No. C-656

A. EXTERIOR LIGHTING SHOWN IS TO BE REMOVED (INCLUDING CONDUIT, WIRE AND SWITCHING) BACK TO PANEL IN THE BASE BID.

KEYED NOTES:

ALTERNATE 1: REMOVE EXISTING LIGHTS AND SWITCHING IN TOILET ROOM. PRESERVE CIRCUITING FOR REUSE IN NEW WORK PHASE.

1 PARK OFFICE FLOOR PLAN - LIGHTING DEMO

SCALE: 1/4" = 1'-0"

 \oslash

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SCO ID#: 20-22411-02A Construction Documents For PETTIGREW STATE PARK
CAMPGROUND AND OFFICE IMPROVEMENTS
2252 LAKE SHORE ROAD
CRESWELL, NORTH CAROLINA

20-22411-02A

Finch & Associates 309 North Boylan Avenue Raleigh, NC 27603-1402 T 919 | 833-1212 F 919 | 834-3203 NCBELS Lic. No. P-1845 NCBOL1 Lic. No. C-656

KEYED NOTES:

ALTERNATE 1: REMOVE EXISTING RECEPTACLES AND POWER CONNECTIONS (CONDUIT AND WIRE) IN TOILET ROOM. PRESERVE CIRCUITING FOR REUSE IN NEW WORK PHASE.

ALTERNATE 2: REMOVE EXISTING RECEPTACLES AND POWER CONNECTIONS (CONDUIT AND WIRE) INCLUDING SURFACE CONDUIT IN THIS AREA BACK TO SOURCE PANEL 'LP'.
REMOVE SWITCH AND CIRCUIT FOR HVAC EQUIPMENT SHOWN TO BE REMOVED ON SHEET MO-101 BACK TO SOURCE PANEL.


3 ALTERNATE 1: DISCONNECT EXISTING WATER HEATER AND RECONNECT AS INDICATED ON NEW WORK PLANS. REFER TO SHEET E0-201.


4 REMOVE DISCONNECT SWITCH AND CIRCUIT ASSOCIATED WITH DEMO'ED HP-1.

ALTERNATE 2 E EX. ICE CHEST EX. EXH FAN ALTERNATE 1 (E) EX. HAND DRYER EX. DATA SERVICE -EX. TOWER

> PARK OFFICE FLOOR PLAN - POWER DEMO EO-201D | SCALE: 1/4" = 1'-0"

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PETTIGREW STATE PARK
CAMPGROUND AND OFFICE IMPROVEMENTS
2252 LAKE SHORE ROAD
CRESWELL, NORTH CAROLINA

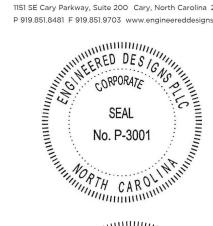CHECKED JRQ PROJECT NO. 20061 07/27/2025

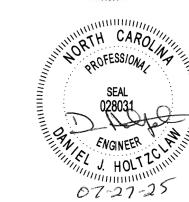SHEET NAME
OFFICE POWER PLAN DEMO

20-22411-02A

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KEYED NOTES:

CONNECT NEW LIGHTS AND SWITCHING TO EXISTING CIRCUIT FROM DEMOLITION PHASE.

GENERAL NOTES:

A. CONNECT NEW EXTERIOR LIGHTS TO EXISTING EXTERIOR LIGHT CIRCUIT, LP/4.

PARK OFFICE FLOOR PLAN - LIGHTING ALTERNATE 1 & 2

SCALE: 1/4" = 1'-0"





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FAGINEER CAMILLIAN

FOR INC. T. C. M. T.

PETTIGREW STATE PARK
CAMPGROUND AND OFFICE IMPROVEMENTS
2252 LAKE SHORE ROAD
CRESWELL, NORTH CAROLINA

KEYED NOTES:

20-22411-02A

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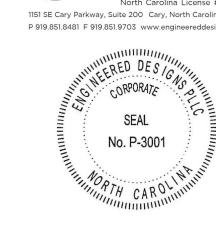
PETTIGREW STATE PARK
CAMPGROUND AND OFFICE IMPROVEMENTS
2252 LAKE SHORE ROAD
CRESWELL, NORTH CAROLINA


DRAWN DJH


CHECKED JRQ

PROJECT NO. 20061 SHEET NAME
OFFICE POWER PLAN - |
NEW

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A. LIGHTS IN TOILET AND SHOWER AREAS ARE CONTROLLED BY A PROGRAMMABLE TIME CLOCK
B. EXTERIOR LIGHTS ARE CONTROLLED THROUGH THE TIME CLOCK AND PHOTOCELL WITH AN UNSWITCHED HOT LEG RUN TO THE BATTERY BACKUP.

KEYED NOTES:

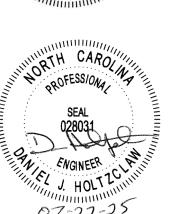(1) WEATHERPROOF PHOTOCELL MOUNTED AT PEAK OF ROOF FOR EXTERIOR LIGHTING.

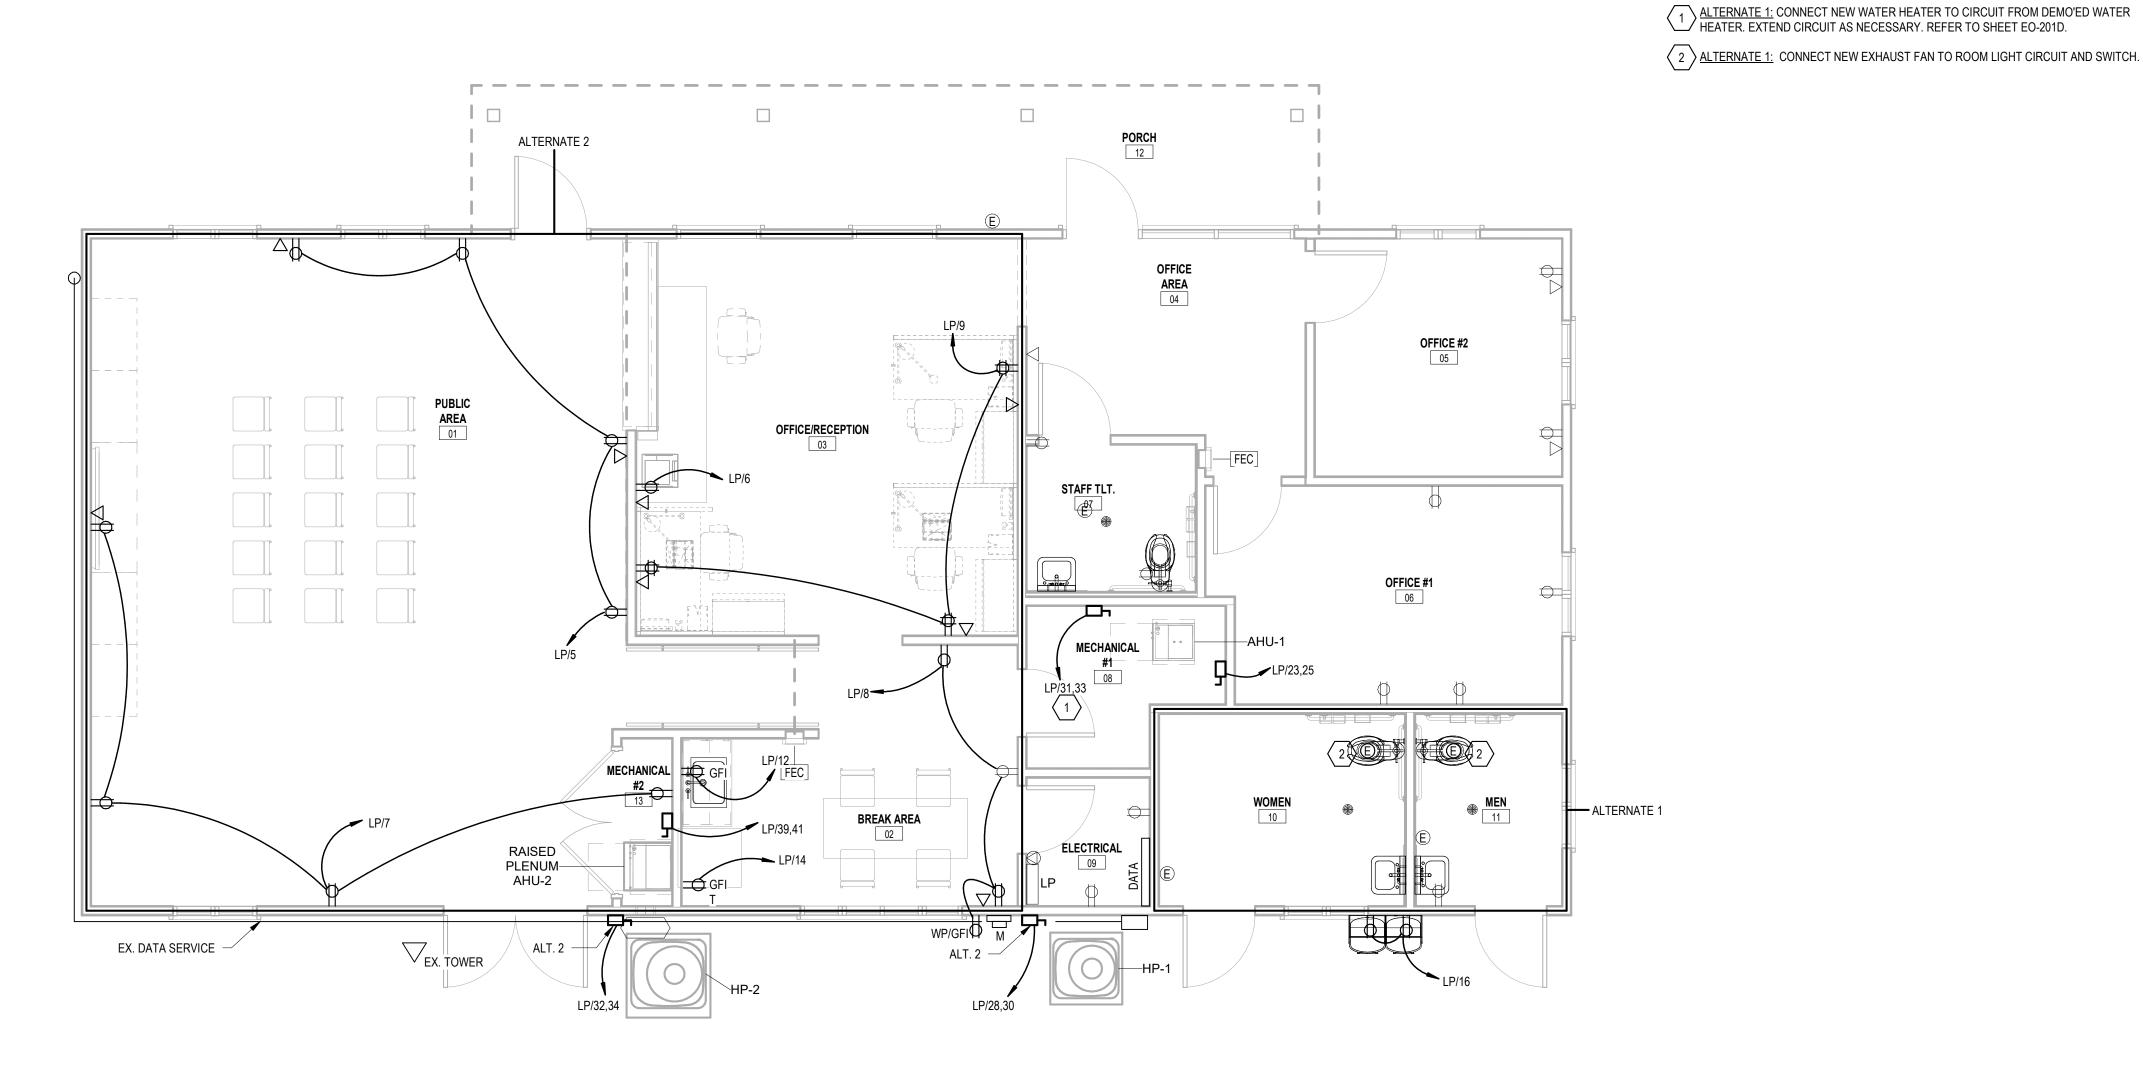JAN./STORAGE CHASE 106 WOMEN 101 FAMILY 1 Pg Pg WP [WP] 8

3

1 2

SHOWER HOUSE FLOOR PLAN - LIGHTING SCALE: 1/4" = 1'-0"

6

9

5



struction Documents For Bid

PETTIGREW STATE PARK
CAMPGROUND AND OFFICE IMPROVEMENTS
2252 LAKE SHORE ROAD
CRESWELL, NORTH CAROLINA

DJH

SHEET NAME
SHOWER HOUSE
LIGHTING PLAN

07/27/2025

CHECKED JRQ PROJECT NO. 20061



GENERAL NOTES:

A. GAS PIPING MUST BE BONDED PER THE NORTH CAROLINA PLUMBING CODE SECTION 310.1
 TO A CONNECTION POINT MENTIONED IN NEC 250.104(B).
 B. ALL DISCONNECTS/CONTROLLERS SHOWN FOR HVAC EQUIPMENT ARE PROVIDE BY MECHANICAL.
 COORDINATE WITH MECHANICAL FOR LOCATION AND CONNECTION REQUIREMENTS.


PROJECT STATUS
CONSTRUCTION
DOCUMENTS

20-22411-02A

CHECKED JRQ PROJECT NO. 20061 07/27/2025 SHEET NAME
SHOWER HOUSE
POWER PLAN

ES-201

SEAL No. P-3001

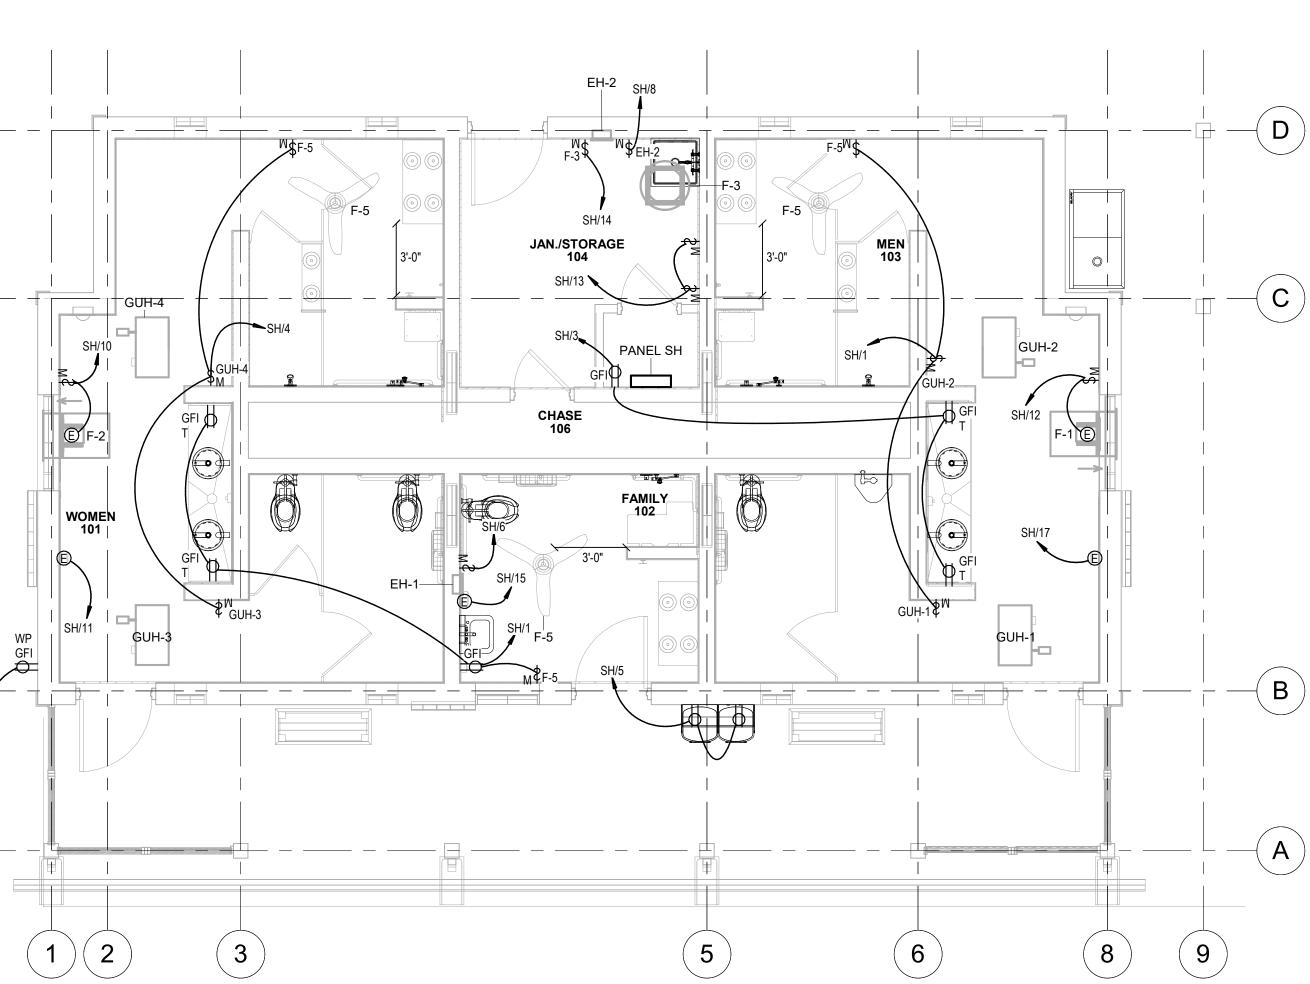

SHOWER HOUSE FLOOR PLAN - POWER

SCALE: 1/4" = 1'-0"

					D.	ANEI	"D#" /	TVDIC	- AI C	ADIN	PANE	\ DE	CCD 1		ANEI N	IOTE	#4						
CT DESCRIPTION	LIGHT	RECP	Імоток	HEAT	OTHER	C	F# (l N	l w	CB	PHASE		W	I N	T EGC		OTHER	HEAT	MOTOR	RECP	LIGHT	DESCRIPTION	Тст
1 LIGHTS	145					3/4"	12	12	12	20	A	15	12	12	12	3/4"			1368	TALOF		AC UNIT	2
3 RECEPTACLES		900				3/4"	12	12	12	20	В	2P	12	'-	'-	0, -			1368			PTAC-1	4
5 RECEPTACLES		720				3/4"	12	12	12	20	A	20	12	12	12	3/4"	150					SMOKE ALARMS	6
7 SPARE										20	В											SPACEONLY	8
9 SPARE										20	Α											SPACEONLY	10
11 SPARE										20	В											SPACEONLY	12
VOLTAGE	240/120			PANEL	LOAD	ΩИΩ	VECTED	DEM	AND	NE	KVA	TOTA	LS:	KVA	AMPS	LOAD	NOTES:						
PHA SE/WIRE	1 PHA SE	3 WRE		SUM	MARY	K	VA	FAC	TOR	TC	DTAL	PHAS	EA:	2.4	19.9	1. LAF	RGEST OF	NEC TAI	BLE 220-1	2 OR CO	NNECTE	DLOAD.	
MAIN SIZE	30 AMPS	3		LIGHTING	NOTE 1	(). 1	12	5%		0.2	PHAS	EB:	2.3	18.9	2. <10	KVA - 100)% +>10	KVA - 50%	6			
MAIN TY PE	M.C.B.			RECP. NO	DTE 2	•	1.6	N	EC		1.6					3. INCI	LUDES 12	5% OF LA	ARGEST M	OTOR			
ENCLOSURE	NEMA 3F	R		MOTOR I	NOTE 3	2	2.7	N	EC		2.7	TOTA	L:	4.7	19.4	4							
TYPE	PANELB	OARD		HEAT			0.0	10	0%		0.0	PANE	L NOTE	S:									
BUSSING	COPPER			OTHER			0.2	10	0%		0.2	1.	LABE	EACH	CABIN	PANEL	"P#" (PLA	CE NUME	BER OF CA	BIN WHE	RE THE	"#" IS INDICATED.	
BREAKER TYPE	BOLT Of	N										1	THERE	SHAL	L BE PA	NELS "	P1" AND"	P2"					
MOUNTING	SURFAC	Æ		TOTAL K	VA	4	1.7				4.7	2.											
MINIMUM AIC RATING	10,000			KVA X 1	1000 / VOI	_TS =	TOTAL A	AMPS		,	19.5	3.											

											P/	NEL "S	H"											
СТ	DESCRIPTION	LIGHT	RECP	MOTOR	HEAT	OTHER	С	EGC	N	W	СВ	PHASE	СВ	W	N	EGC	С	OTHER	HEAT	MOTOR	RECP	LIGHT	DESCRIPTION	СТ
1	MENS RR RCPT.		775				3/4"	12	12	12	20	Α	15	12	12	12	3/4"		888				GUH-1,2	2
3	WOMENS RR RCPT.		540				3/4"	12	12	12	20	В	15	12	12	12	3/4"		888				GUH-3,4	4
5	EWC NOTE 1		-			800	3/4"	12	12	12	20	Α	20	12	12	12	3/4"		1500		-		⊟ +1	6
7	LIGHTS	862	ı				3/4"	12	12	12	20	В	20	12	12	12	3/4"		1500			-	D1- 2	8
9	EXTERIOR ROPT.		180				3/4"	12	12	12	20	Α	20	12	12	12	3/4"			1600			FAN F-2	10
11	HAND DRYER 101		-	500	500		3/4"	12	12	12	20	В	20	12	12	12	3/4"			1600			FAN F-1	12
13	INST. WTR. HTR.		-		200		3/4"	12	12	12	20	Α	15	12	12	12	3/4"			650			FAN F-3	14
15	HAND DRYER 102		-	500	500		3/4"	12	12	12	20	В	20										SPARE	16
17	HAND DRYER 103			500	500		3/4"	12	12	12	20	Α	20										SPARE	18
19	SPARE		-								20	В	20										SPARE	20
21	SPARE		-								20	Α	20										SPARE	22
23	SPARE		1						-		20	В	20	1								-	SPARE	24 26 28
25	SPARE		1						-		20	Α	20	-		-							SPARE	26
27	SPARE		ı						-		20	В	20	-									SPARE	28
29	SPARE		1						-		20	Α	20	1								-	SPARE	30
VO	LTAGE	240/120			PANEL	LOAD	∞N/	1ECTED	DEM	AND	NE	CKVA	TOTA	LS:	KVA	AMPS	LOAD	NOTES:						
PH/	ASE/WIRE	1 PHASE	3 WRE		SUM	W ARY	K	VA	FAC	TOR	TO	OTAL	PHASE A:		7.6	63.3	1. LAF	RGEST OF:	NEC TAI	BLE 220-1	2 OR 00	NNECTE	LOAD.	
MA	IN SIZE	125 AMF	S		LIGHTING	NOTE 1	C).9	12:	5%		1.1	PHAS	EB:	7.4	61.6	2. <10	KVA - 100)% +>10	KVA - 509	%			
MA	IN TY PE	M.C.B.			RECP. NO	DTE 2	1	.5	N	EC		1.5					3. INC	LUDES 125	5% OF LA	ARGEST M	10TOR			
ENC	CLOSURE	NEMA 1			MOTOR I	VOTE3	5	5.4	NE	EC		5.4	TOTA	L:	15.0	62.4	4							
TYF	PE	PA NELBO	OARD		HEAT		6	3.5	10	0%		6.5	PANE	L NOTE	ES:									
BU	SSING	OPPER .					C	8.0	10)%		0.8	1.	PROV	IDE BR	EAKER (MTH G	FCI PROTE	CTION.					
BR	REAKER TYPE BOLT ON												2.											
МО	UNTING		TOTAL KVA 15.0		5.0				15.2	3.														
MIN	MINIMUM AIC RATING 14,000				KVA X 1	000 / VOI	_TS =	TOTAL A	MPS			63.3	4.											

				P	LUMBING/ELECTRI	CAL EQUIPMENT SCH	EDULE		
EQUIPMENT DESIGNATION	EQUIPMENT DESCRIPTION	EQUIPMENT FURNISHED BY	VOLTAGE/ PHASE	KW	HP	DISCONNECT FURNISHED BY	STARTER FURNISHED BY	CONTROLS	REMARKS
EDF-1	ELECTRIC DRINKING FOUNTAIN	PC	120 / 1	-	-	PC	N/A	W/EQUIP	
EWH-1	ELECTRIC WATER HEATER	PC	120 / 1	4.5	-	EC	N/A	W/EQUIP	A.O. SMITH MODEL ENT-50; ALTERNATE #1
IWH-1A	TANKLESS WATER HEATER, PROPANE	PC	120 / 1	0.2	-	EC	N/A	W/EQUIP	A.O. SMITH MODEL CT-199I-P; BASE BID
IWH-1B	TANKLESS WATER HEATER, PROPANE	PC	120 / 1	0.2	-	EC	N/A	W/EQUIP	A.O. SMITH MODEL CT-199I-P; BASE BID

		MECH	ANICAL /	ELECTRIC	AL EQUIPM	ENTC	ORDIN	IATION	CHEDULE			
EQUIPMENT DESIGNATION	EQUIPMENT DESCRIPTION	EQUIPMENT FURN. BY	VOLTAGE/ PHA SE	HEATER KW	WATTS/MHP	НР	MCA	MOCP		STARTER FURN. BY	CONTROLS	REMARKS
AHU-1	AIR HANDLING UNIT	MC	230/1	3.84		1/3	24	25	MC	N/A	TSTAT	
AHU-2	AIR HANDLING UNIT	MC	230/1	7.68		1/2	45	45	MC	N/A	TSTAT	
HP-1	HEAT PUMP	MC	230/1				15	25	MC	N/A	TSTAT	
HP-2	HEAT PUMP	MC	230/1				25	40	MC	N/A	TSTAT	
GUH-1	GAS-FIRED UNIT HEAT	MC	120/1			1/20	3.7	15	MC	NA	TSTAT	
GUH-2	GAS-FIRED UNIT HEAT	MC	120/1			1/20	3.7	15	MC	NA	TSTAT	
GUH-3	GAS-FIRED UNIT HEAT	MC	120/1			1/20	3.7	15	MC	NA	TSTAT	
GUH-4	GAS-FIRED UNIT HEAT	MC	120/1			1/20	3.7	15	MC	NA	TSTAT	
F-1	FAN SHOWER BLDG	MC	120/1		3/4	0.1			MC	N/A	TSTAT	
F-2	FAN SHOWER BLDG	MC	120/1		3/4	0.1		×	MC	N/A	TSTAT	
F-1	FAN OFFICE BLDG	MC	120/1		11 WATTS				MC	N/A	OCC SEN	
F-2	FAN OFFICE BLDG	MC	120/1		11 WATTS				MC	N/A	OCC SEN	
F-3	FAN OFFICE BLDG	MC	120/1		11 WATTS				MC	N/A	OCC SEN	
F-4	CEILING FAN	MC	120/1		20.3 WATTS				MC	N/A	WALL CONTROL	
F-5	CEILING FAN	MC	120/1		52 WATTS				MC	N/A	WALL CONTROL	
PTAC-1	PACKAGED TERMINAL A/C UNIT	MC	208/1	2.5			4.2	15	MC	N/A	TSTAT	
EH-1	ELECTRIC HEATER	MC	120/1	1.5						FWE	TSTAT	
EH-2	ELECTRIC HEATER	MC		1.5	, , , , , , , , , , , , , , , , , , ,					FWE	TSTAT	

ABBREVIATIONS:

EC: ELECTRICAL CONTRACTOR FWE: FURNISHED WITH EQUIPMENT


MC: MECHANICAL CONTRACTOR

REMARKS ONE PER CABIN.

2. ALT #1. 3. ALT #2.

CORD & PLUG CONNECTED.

										0	FFIC	E PANE	EL "LI	D "											
СТ	DESCRIPTION	LIGHT	RECP	MOTOR	HEAT	OTHER	С	EGC	N	W	СВ	PHASE	СВ	W	N	EGC	С	OTHER	HEAT	MOTOR	RECP	LIGHT	DESCRIPTION	СТ	
1	OFFICE LTG.		775			-	3/4"	12	12	12	20	Α	20	12	12	12	3/4"			722			OFFICE LTG.	2	
3	OFFICE LTG.		720	-		-	3/4"	12	12	12	20	В	20	12							-		EXTERIOR LTG.	4	
5	PUBLIC AREA RCP.		720				3/4"	12	12	12	20	Α	20	12	12	12	3/4"	1000					OFF./REC. COPIER	6	
7	PUBLIC AREA RCP.	862					3/4"	12	12	12	20	В	20								720		RCPT. 02 & EXT.	8	
9	OFF./REC. RCPT.		1080				3/4"	12	12	12	20	Α	20								-		OFFICE/RR RCPT.	10	
11	OFFICE/RR RCPT.										20	В	20	12	12	12	3/4"	1000					BREAKAREA REF.	12	
13	HAND DRY ER							-			20	Α	20	12	12	12	3/4"	1000					BREAKAREARCP.	14	
15	DOCK LTG.				-		-	-			20	В	20	12	12	12	3/4"	1000					EWC (NOTE 2)	16	
17	HAND DRY ER										20	Α	20										SPARE	18	
19	TOILET LTS, FANS	120	-	600	1		3/4"	12	12	12	15	В	60		1								SPARE	20	
	SPACE			-			-	- [20	Α] "								-		JOFAIL	22	
	AIR HANDLER			432	1920		3/4"	10	10	10	25	В	40	8	8	10	1"	3600					EVCS	24	
25	AHU-1 (NOTE 1)			432	1920		-	-	-	10	25	Α	ן יי	8				3600						26	
27	SPARE						-	-	-		30	В	25	10	10	12	3/4"		1440				HEAT PUMP HP-1	28	
29	SPAIL										30	Α	23	10					1440				(NOTE 1)	30	
31	WATER HEATER				2250		3/4"	12	-	10	30	В	40	8	8	12	3/4"		2400				HEAT PUMP HP-2	32	
33	WATERTIESTER.				2250		-	-	-	10	30	Α] 40	8					2400				(NOTE 1)	34	
35	SHOP HVAC		-	-	-			-	-	-	30	В	40	8	8	10	1"	3600					EVCS	36	
37			I	I	I					I	00	Α]	8	1			3600						38	
	AIR HANDLER		-	588	3840		3/4"	10	8	8	45	В	50	8	8	10	3/4"						HP-2	40	
41	AHU-2			588	3840					8	٦٥	Α		8										42	
VO	_TAGE	240/120			PANEL	LOAD	CONV	ECTED	DEM	AND	NB	CKVA	TOTA		KVA	AMPS	LOAD	NOTES:							
PHA	SEMIRE	1 PHASE	3 WIRE		SUMN	MARY	K	/A	FAC	TOR	TO	OTAL	PHAS	EA:	25.4	211.4	1. LAF	RGEST OF:	: NEC TAI	BLE 220-1	2 OR 00	NNECTE	D LOAD.		
MAI	NSIZE	400 AMF	rs		LIGHTING	NOTE 1	1	.0	12	5%		1.2	PHAS	EB:	25.1	209.1	2. <10	KVA - 100)% +>10	KVA - 50%	6				
MAI	NTYPE	M.C.B.			RECP. NO	DTE 2	4	.0	NE	EC		4.0					3. INC	LUDES 128	5% OF LA	ARGEST M	IOTOR				
	LOSURE	NEMA 1			MOTOR N	VOTE 3		.4	NE			3.4	TOTA	L:	50.5	210.2	4								
TYF		PA NELBO	OARD		HEAT		23	3.7	100	0%	:	23.7	PANE	L NOTE	ES:										
BUS	USSING COPPER				OTHER		18	3.4	100	0%		18.4	1.	PROV	IDE NEV	N aral	JIT BRE	AKER AS	SHOWNI	N EXISTIN	G SQUA	RE-D NQ	OB PANEL. NEW		
BRE	REAKER TYPE BOLT ON													BREAL	KERS S	SHALL B	ECOM	PATIBLEV	VITH EXIS	TING PAN	EL RATE	D FOR M	INIMUM 14KAIC.		
MO	JNTING	SURFAC	Æ		TOTAL K	VA	50	0.5			;	50.7	2.	PROV	IDE NEV	N GFI PF	ROTEC	TED 120V/	20A CIRC	JUIT BREA	KER COI	MPATIBLE	E WITH PANEL.		
MINIMUM AIC RATING EXISTING					KVA X 1	000 / VOL	TS =	TOTAL A	MPS		2	11.3	3.	PROV	IDE NEV	N 15A B	REAKE	ER IN POSI	TION 19,	COMPATIE	3. PROVIDE NEW 15A BREAKER IN POSITION 19, COMPATIBLE WITH PANEL.				

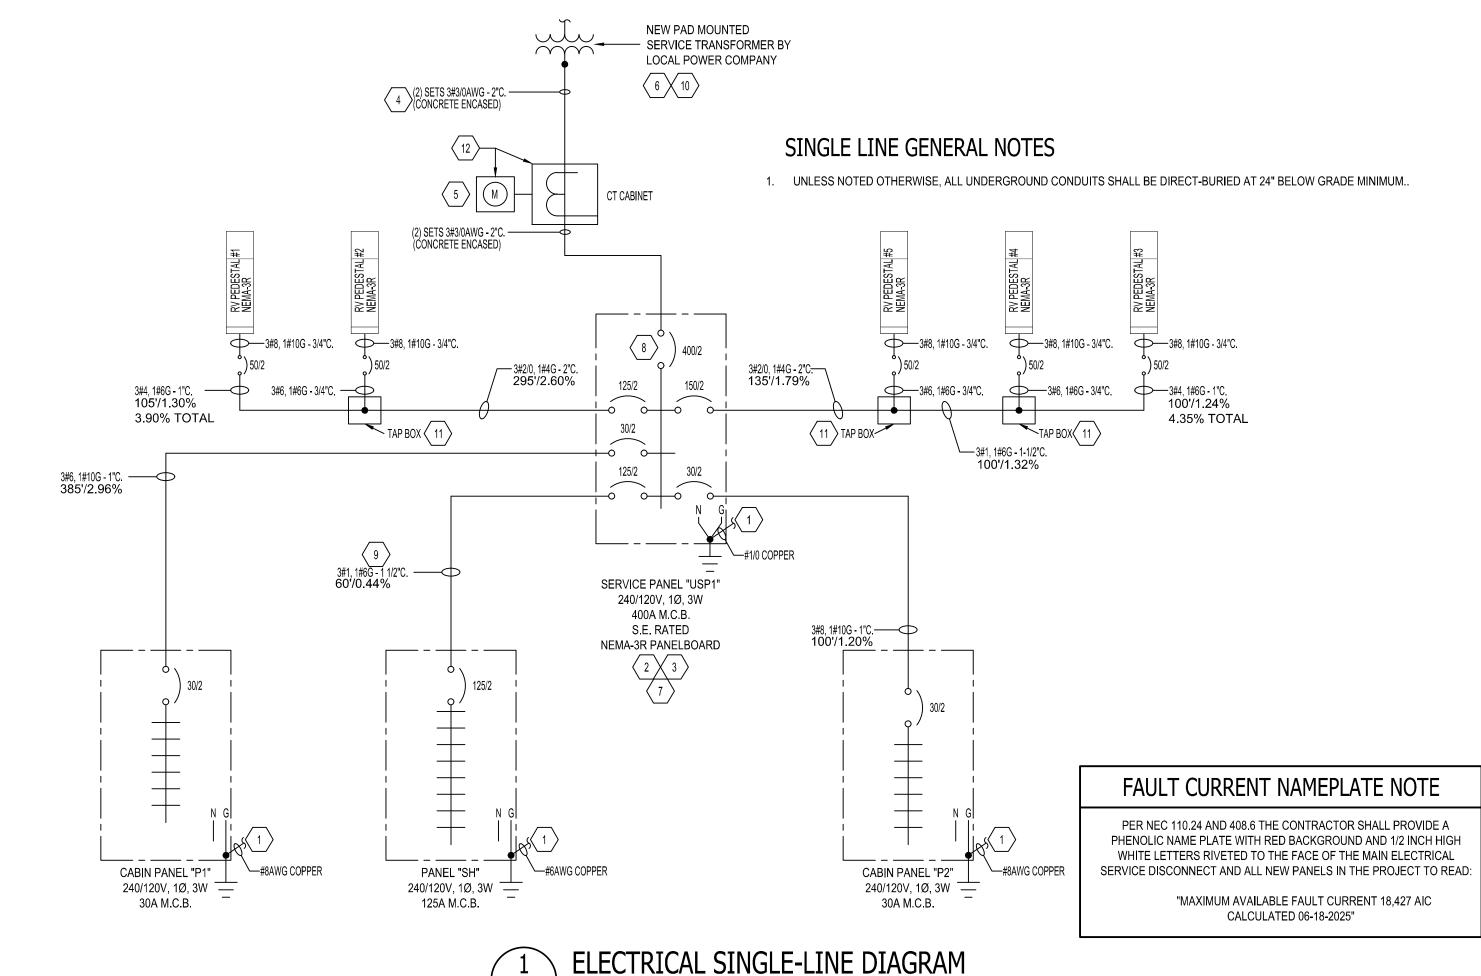

SCALE: NTS

NOTES KEYED TO SINGLE-LINE DIAGRAM

- $\langle 1 \rangle$ CONNECT 1#1/0 SERVICE GROUND TO GROUND RODS PER NEC 250. REFER TO GROUNDING DETAILS.
- PROVIDE PHENOLIC FAULT CURRENT NAMEPLATE FOR THIS NEW SERVICE PANELBOARD. REFER TO THE FAULT CURRENT NAMEPLATE NOTE ON THIS SHEET FOR MORE INFORMATION.
- \langle 3 \rangle ALL SERVICE EQUIPMENT SHALL BE S.E. RATED.
- NEW ELECTRICAL SERVICE FROM NEW PAD MOUNTED TRANSFORMER TO BE PROVIDED AND INSTALLED BY THE ELECTRICAL CONTRACTOR. ELECTRICAL CONTRACTOR SHALL PROVIDE 10'-0" OF ADDITIONAL CONDUCTORS (SLACK) WITHIN NEW SITE TRANSFORMER FOR CONNECTION BY THE LOCAL POWER COMPANY. THE UNDERGROUND CONDUIT FROM THE NEW EXTERIOR MOUNTED ELECTRICAL SERVICE WIREWAY SHALL BE SLOPED AT A MINIMUM OF 2% BACK TOWARDS THE NEW SITE TRANSFORMER PIT PAD. COORDINATE ALL WORK WITH LOCAL POWER COMPANY AND ALL OTHER TRADES PRIOR TO BEGINNING ANY WORK ASSOCIATED WITH THIS NEW ELECTRICAL SERVICE FEEDER. SERVICE FEEDERS TO BE CONCRETED ENCASED (3-INCHES OF CONCRETE ON ALL SIDES OF DUCTBANK). REFER TO SPECIFICATIONS AND DETAIL 4a ON THIS SHEET FOR ADDITIONAL INFORMATION.
- METER ENCLOSURE & CT CABINET ENCLOSURE FURNISHED & INSTALLED BT EC. WILTERS & CTST OF MICHES & MICHAELES & MICHAEL METER ENCLOSURE & CT CABINET ENCLOSURE FURNISHED & INSTALLED BY EC. METERS & CTs FURNISHED & INSTALLED BY LOCAL POWER COMPANY. COORDINATE EXACT REQUIREMENTS WITH LOCAL POWER COMPANY.
- REFER TO CIVIL/SITE PLANS FOR LOCATION OF ELECTRICAL UTILITY SITE TRANSFORMER.
- PROVIDE PHENOLIC FAULT CURRENT NAMEPLATE FOR THIS NEW SERVICE PANEL. AVAILABLE FAULT CURRENT AT THE SECONDARY OF THE UTILITY TRANSFORMER TO BE OBTAINED FROM DUKE ENERGY ONCE THE TRANSFORMER PROVIDE PHENOLIC FAULT CURRENT NAMEPLATE FOR THIS NEW SERVICE PANEL. AVAILABLE FAULT CORRENT AT THE SECONDARY OF THE OTHER TOWNS OF THE ALL THE SECONDARY OF THE STEEL TOWNS OF THIS LABEL WILL BE PROVIDED TO THE E.C..
- (8) IN ADDITION TO THE NAMEPLATE INFORMATION REQUIRED FOR THIS SERVICE PANELBOARD, THE CONTRACTOR SHALL INCLUDE THE FOLLOWING ON THE NAMEPLATE "MAIN SERVICE DISCONNECT".
- $\Big\langle$ 9 $\Big\rangle$ FEEDER SHALL BE ENCASED IN CONCRETE PER DETAILS.
- NEW SITE ELECTRICAL TRANSFORMER PAD INSTALLATION PROVIDED BY ELECTRICAL CONTRACTOR. SITE TRANSFORMER AND FINAL TERMINATIONS PROVIDED BY LOCAL POWER COMPANY. VERIFY EXACT MATERIALS NEEDED AND 10 INSTALLATION REQUIREMENTS OF NEW SITE ELECTRICAL TRANSFORMER CONCRETE PAD WITH LOCAL POWER COMPANY. IT IS THE RESPONSIBILITY OF THE CONTRACTOR TO INSTALL ALL POWER COMPANY INFRASTRUCTURE REQUIRED FOR THIS NEW ELECTRICAL SITE TRANSFORMER PAD EXACTLY PER THE LOCAL POWER COMPANIES STANDARDS.
- PROVIDE U.L. WET LOCATION LISTED TAP BOX IN NEMA 3R ENCLOSURE. TAP BOX TO BE SIZED PER NEC. COORDINATE EXACT LOCATION OF TAP BOX WITH ARCHITECT AND GENERAL CONTRACTOR PRIOR TO ROUGH-IN OF NEW PANEL FEEDERS.
- COORDINATE DEMARCATION POINT OF LOCAL POWER COMPANY WORK/MATERIALS PRIO MOUNTED ON EXTERIOR UNISTRUT RACK. REFER TO DETAILS FOR MORE INFORMATION. COORDINATE DEMARCATION POINT OF LOCAL POWER COMPANY WORK/MATERIALS PRIOR TO INSTALLING THE C.T. CABINET ENCLOSURE AND THE METER BASE ENCLOSURE. ELECTRICAL SERVICE METER AND C.T. CABINET TO BE

WATH CAROLIN 028031 SWGINEER 07-27-25

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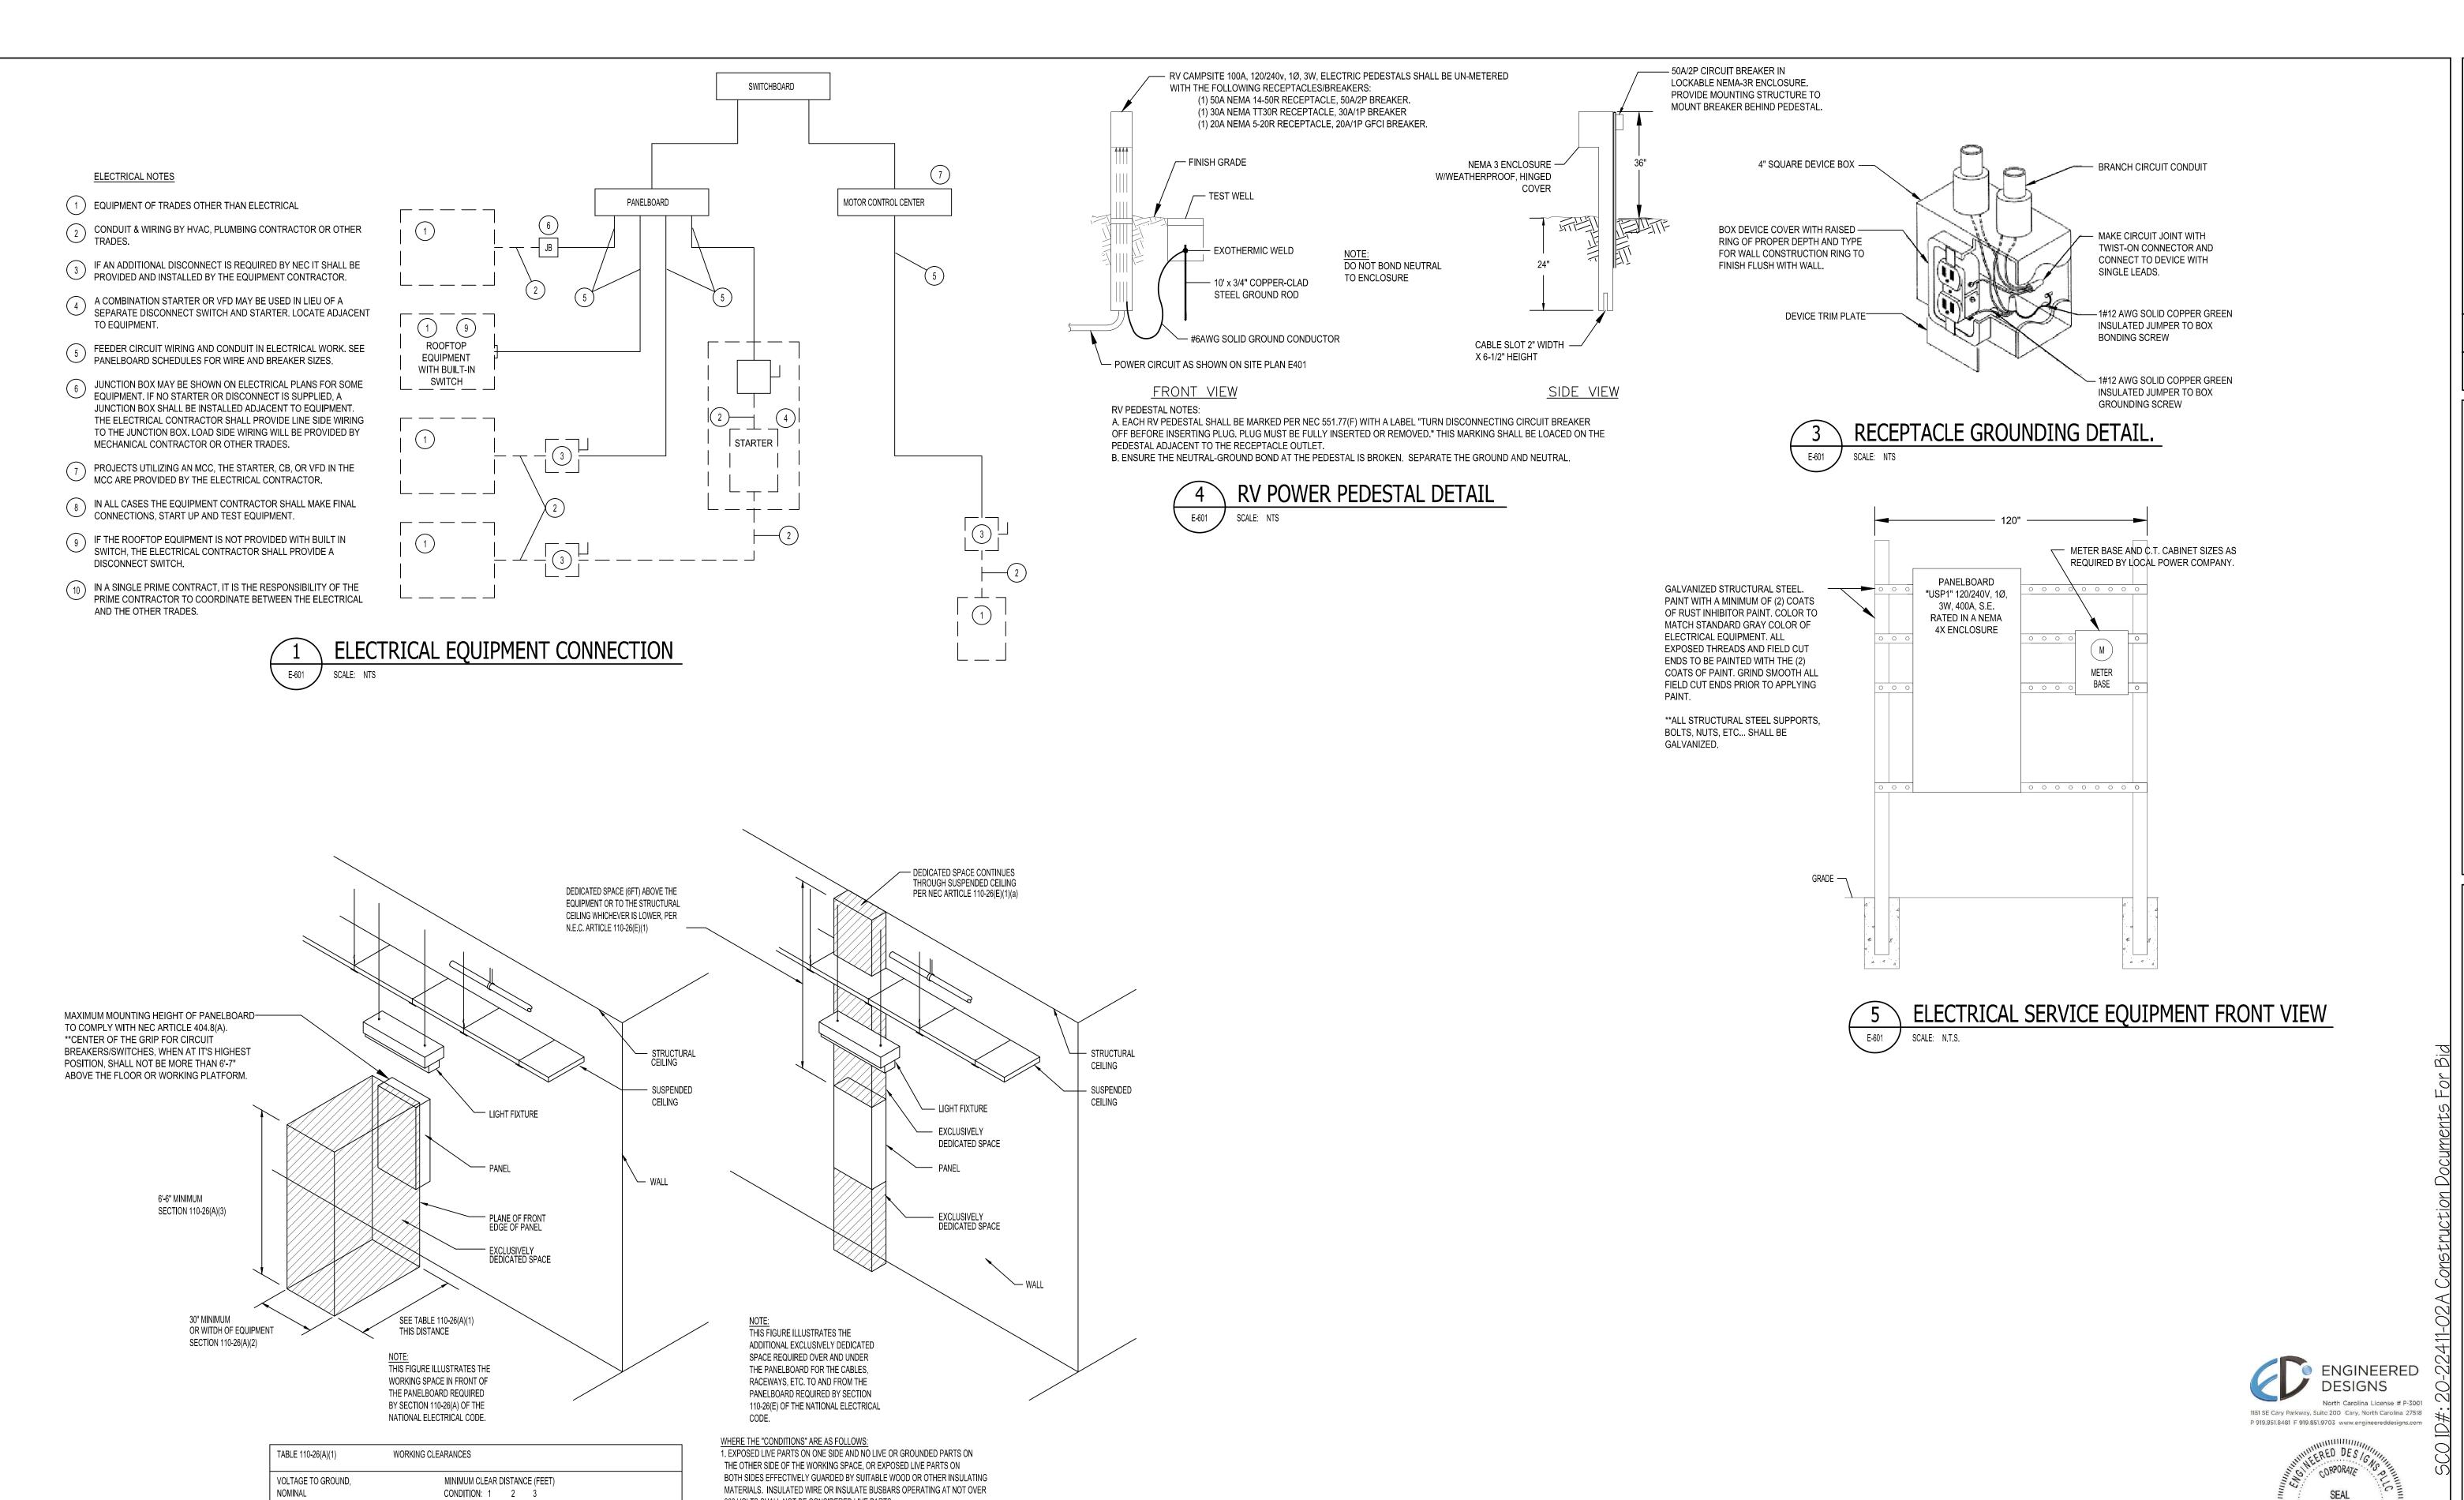
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STATE PARK FICE IMPROVEMENTS SHORE ROAD STH CAROLINA

DJH

CHECKED JRQ PROJECT NO. 20061 07/27/2025 SHEET NAME ELECTRICAL RISERS AND SCHEDULES

E-401



300 VOLTS SHALL NOT BE CONSIDERED LIVE PARTS.

PROVIDED IN CONDITION 1) WITH THE OPERATOR BETWEEN.

2. EXPOSED LIVE PARTS ON ONE SIDE AND GROUNDED PARTS ON THE OTHER SIDE.
3. EXPOSED LIVE PARTS ON BOTH SIDES OF THE WORK SPACE (NOT GUARDED AS

0-150 151-600 3 3 3 3 3 1/2 4

SCALE: NTS

E-601

NOTES:
NO PIPING, DUCTS OR EQUIPMENT FOREIGN TO THE ELECTRICAL EQUIPMENT OR ARCHITECTURAL APPURTENANCES
SHALL BE PERMITTED TO BE INSTALLED IN, ENTER OR PASS THROUGH THE DEDICATED SPACES SHOWN ABOVE.

DEDICATED SPACE REQUIREMENTS FOR PANELBOARDS

PETTIGREW STATE PARK CAMPGROUND AND OFFICE IMPROVEMENTS 2252 LAKE SHORE ROAD CRESWELL, NORTH CAROLINA

CONSTRUCTION

DOCUMENTS

20-22411-02A

833-12 834-32 Lic. No.

DRAWN DJH

CHECKED JRQ

PROJECT NO. 20061

DATE 07/27/2025

SHEET NAME
ELECTRICAL DETAILS


SEAL 028031


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ENGINEER CLAUMING

HOLT TOMAN

SHEET NO. E-601



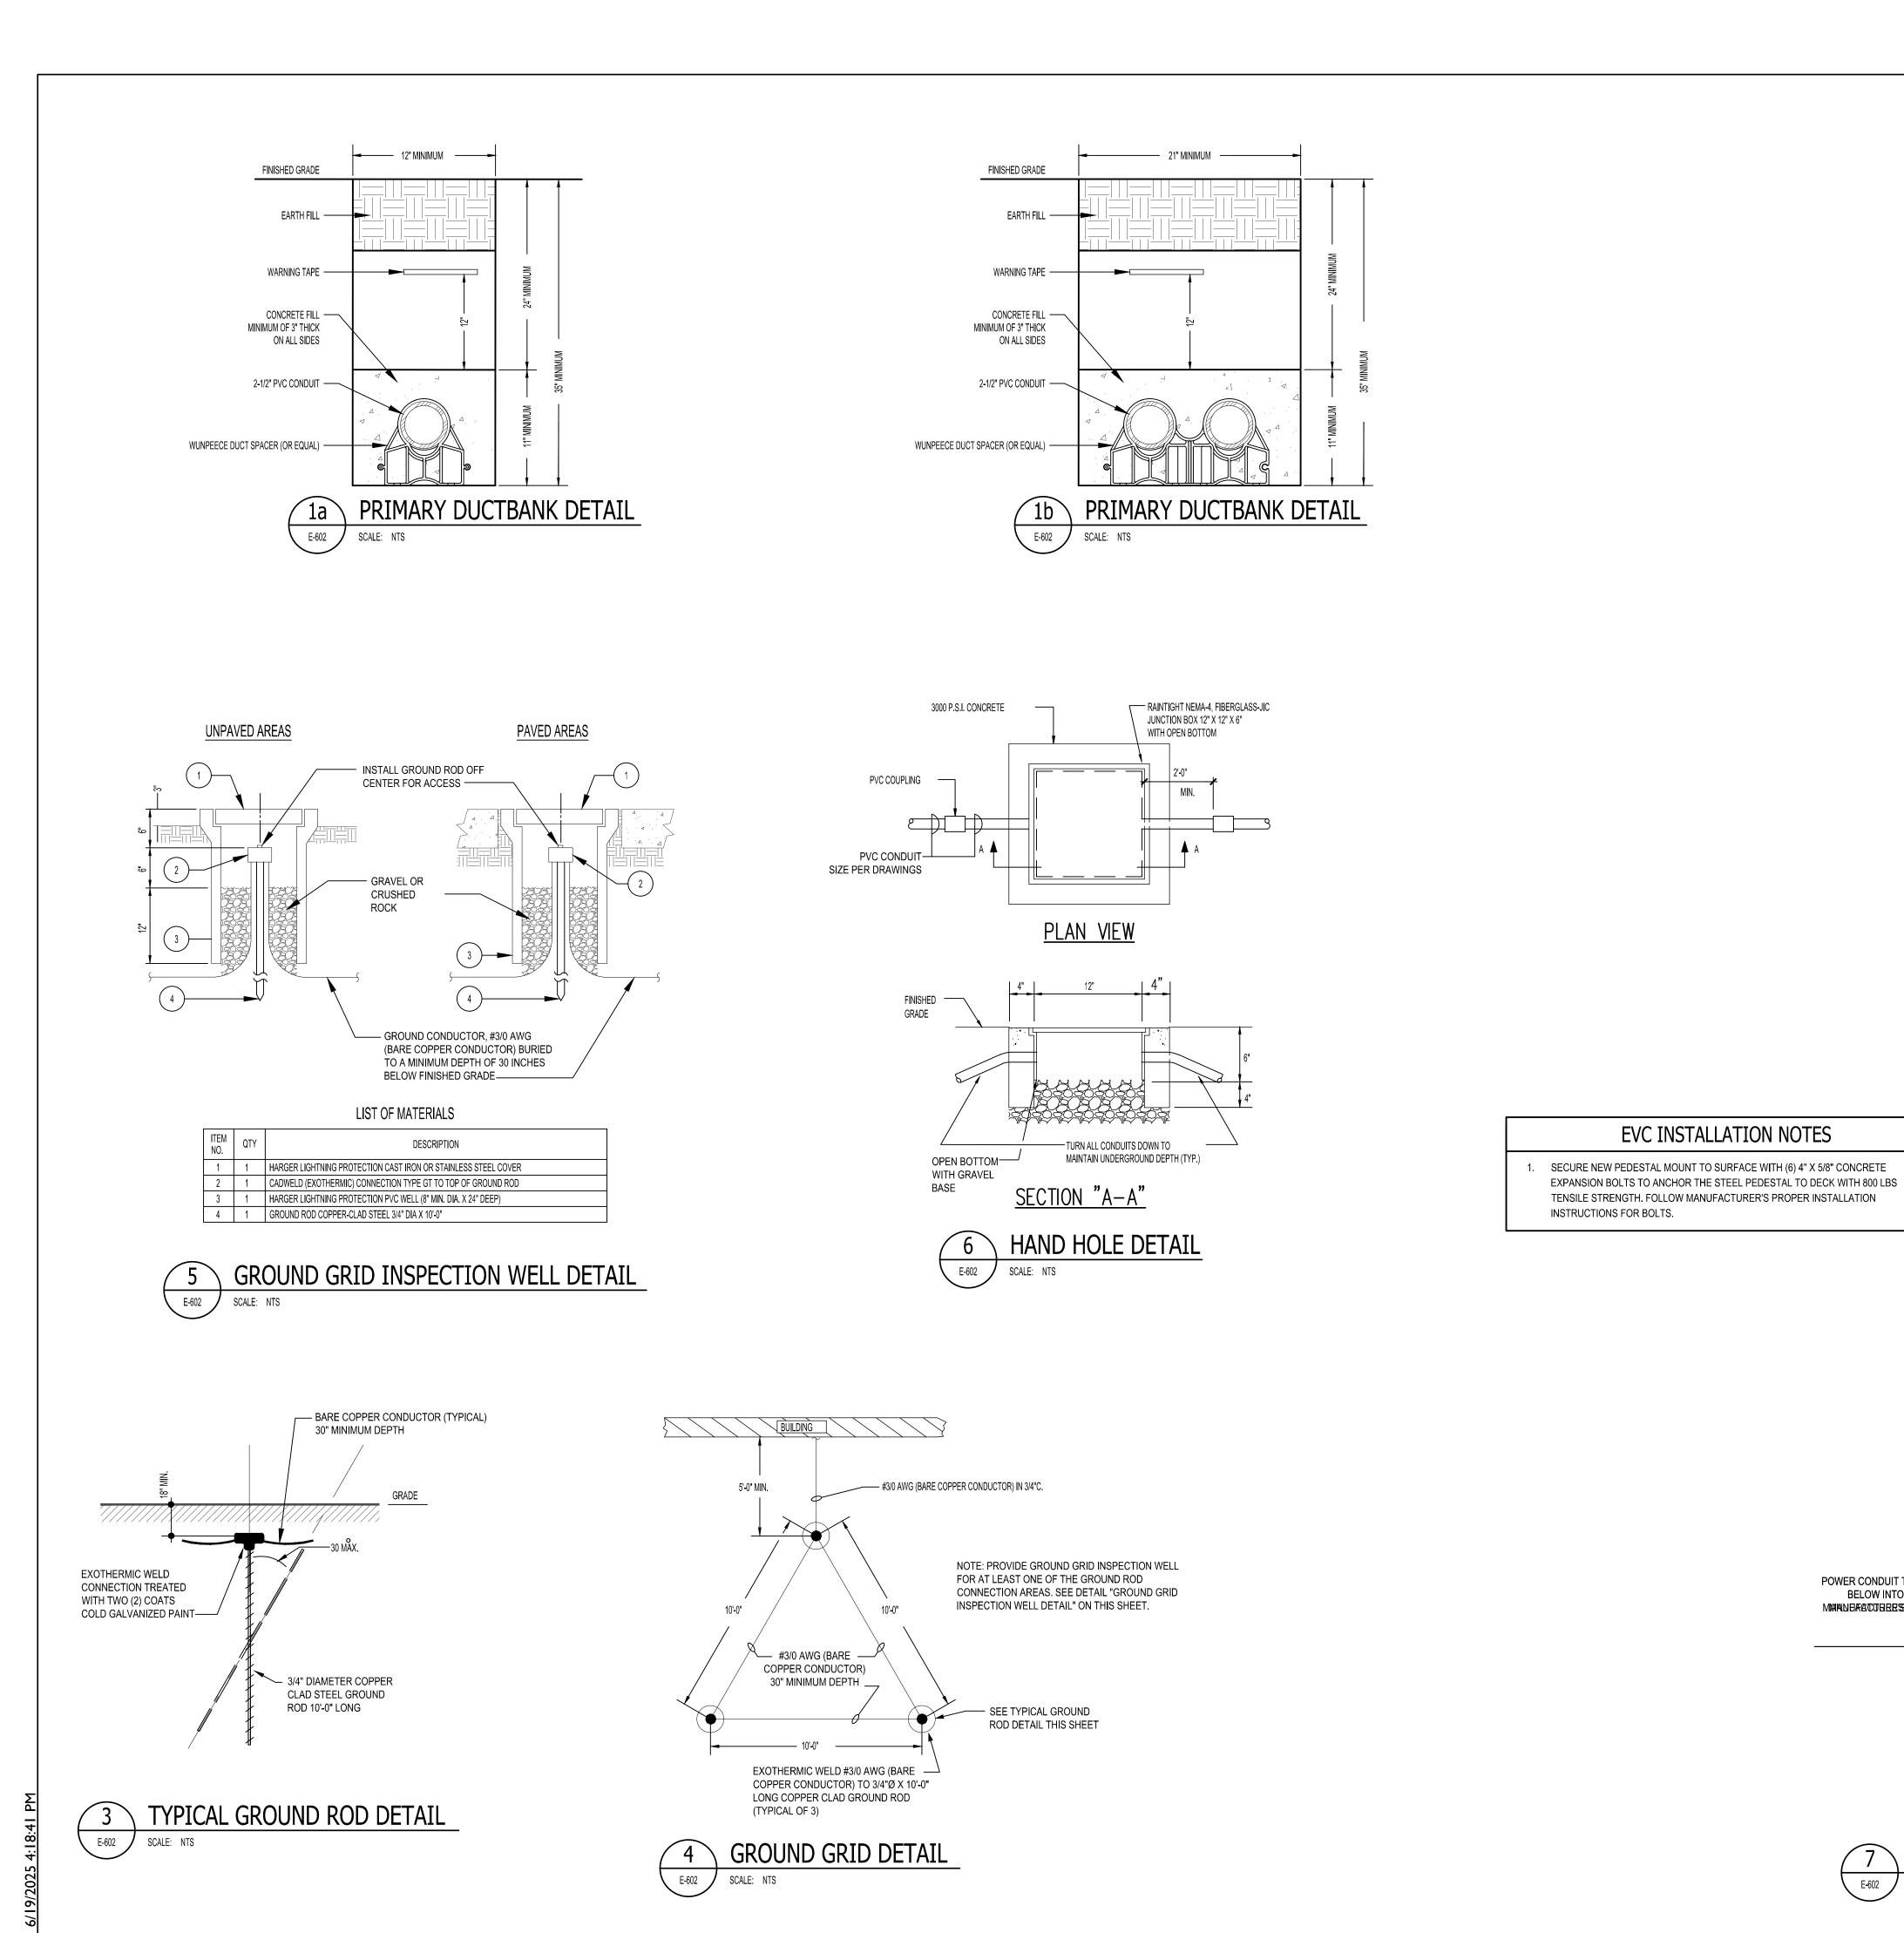

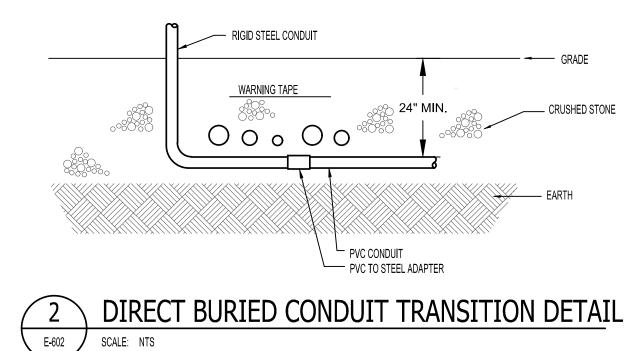EVC INSTALLATION NOTES

EVCS DUAL CHARGING STATION

POWER CONDUIT TO ENTER FROM THE BELOW INTO EVCS UNIT PER

MMANDACTURES INSTRUCTIONS

NOTE 1 (TYPICAL) -

EV CHARGING STATION DETAIL

MAXIMUM ADA REACH HEIGHT 48"AFF TO HEIGHT OF HIGHEST

CONTROL DEVICE

CONCRETE

PROJECT STATUS

CONSTRUCTION DOCUMENTS 20-22411-02A

PETTIGREW STATE PARK
CAMPGROUND AND OFFICE IMPROVEMENTS
2252 LAKE SHORE ROAD
CRESWELL, NORTH CAROLINA

(DRAWN DJH CHECKED JRQ PROJECT NO. 20061 07/27/2025 SHEET NAME ELECTRICAL DETAILS E-602

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1151 SE Cary Parkway, Suito 200 Cary, North Carolina 27518

P 919.851.8481 F 919.851.9703 www.engineereddesigns.com

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