2157 LAKESHORE BLVD WEST

ISSUED FOR ZBA SUBMISSION FEB 7TH, 2020

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1	ISSUE FOR REZONING SUBMISSION	2020-02-07

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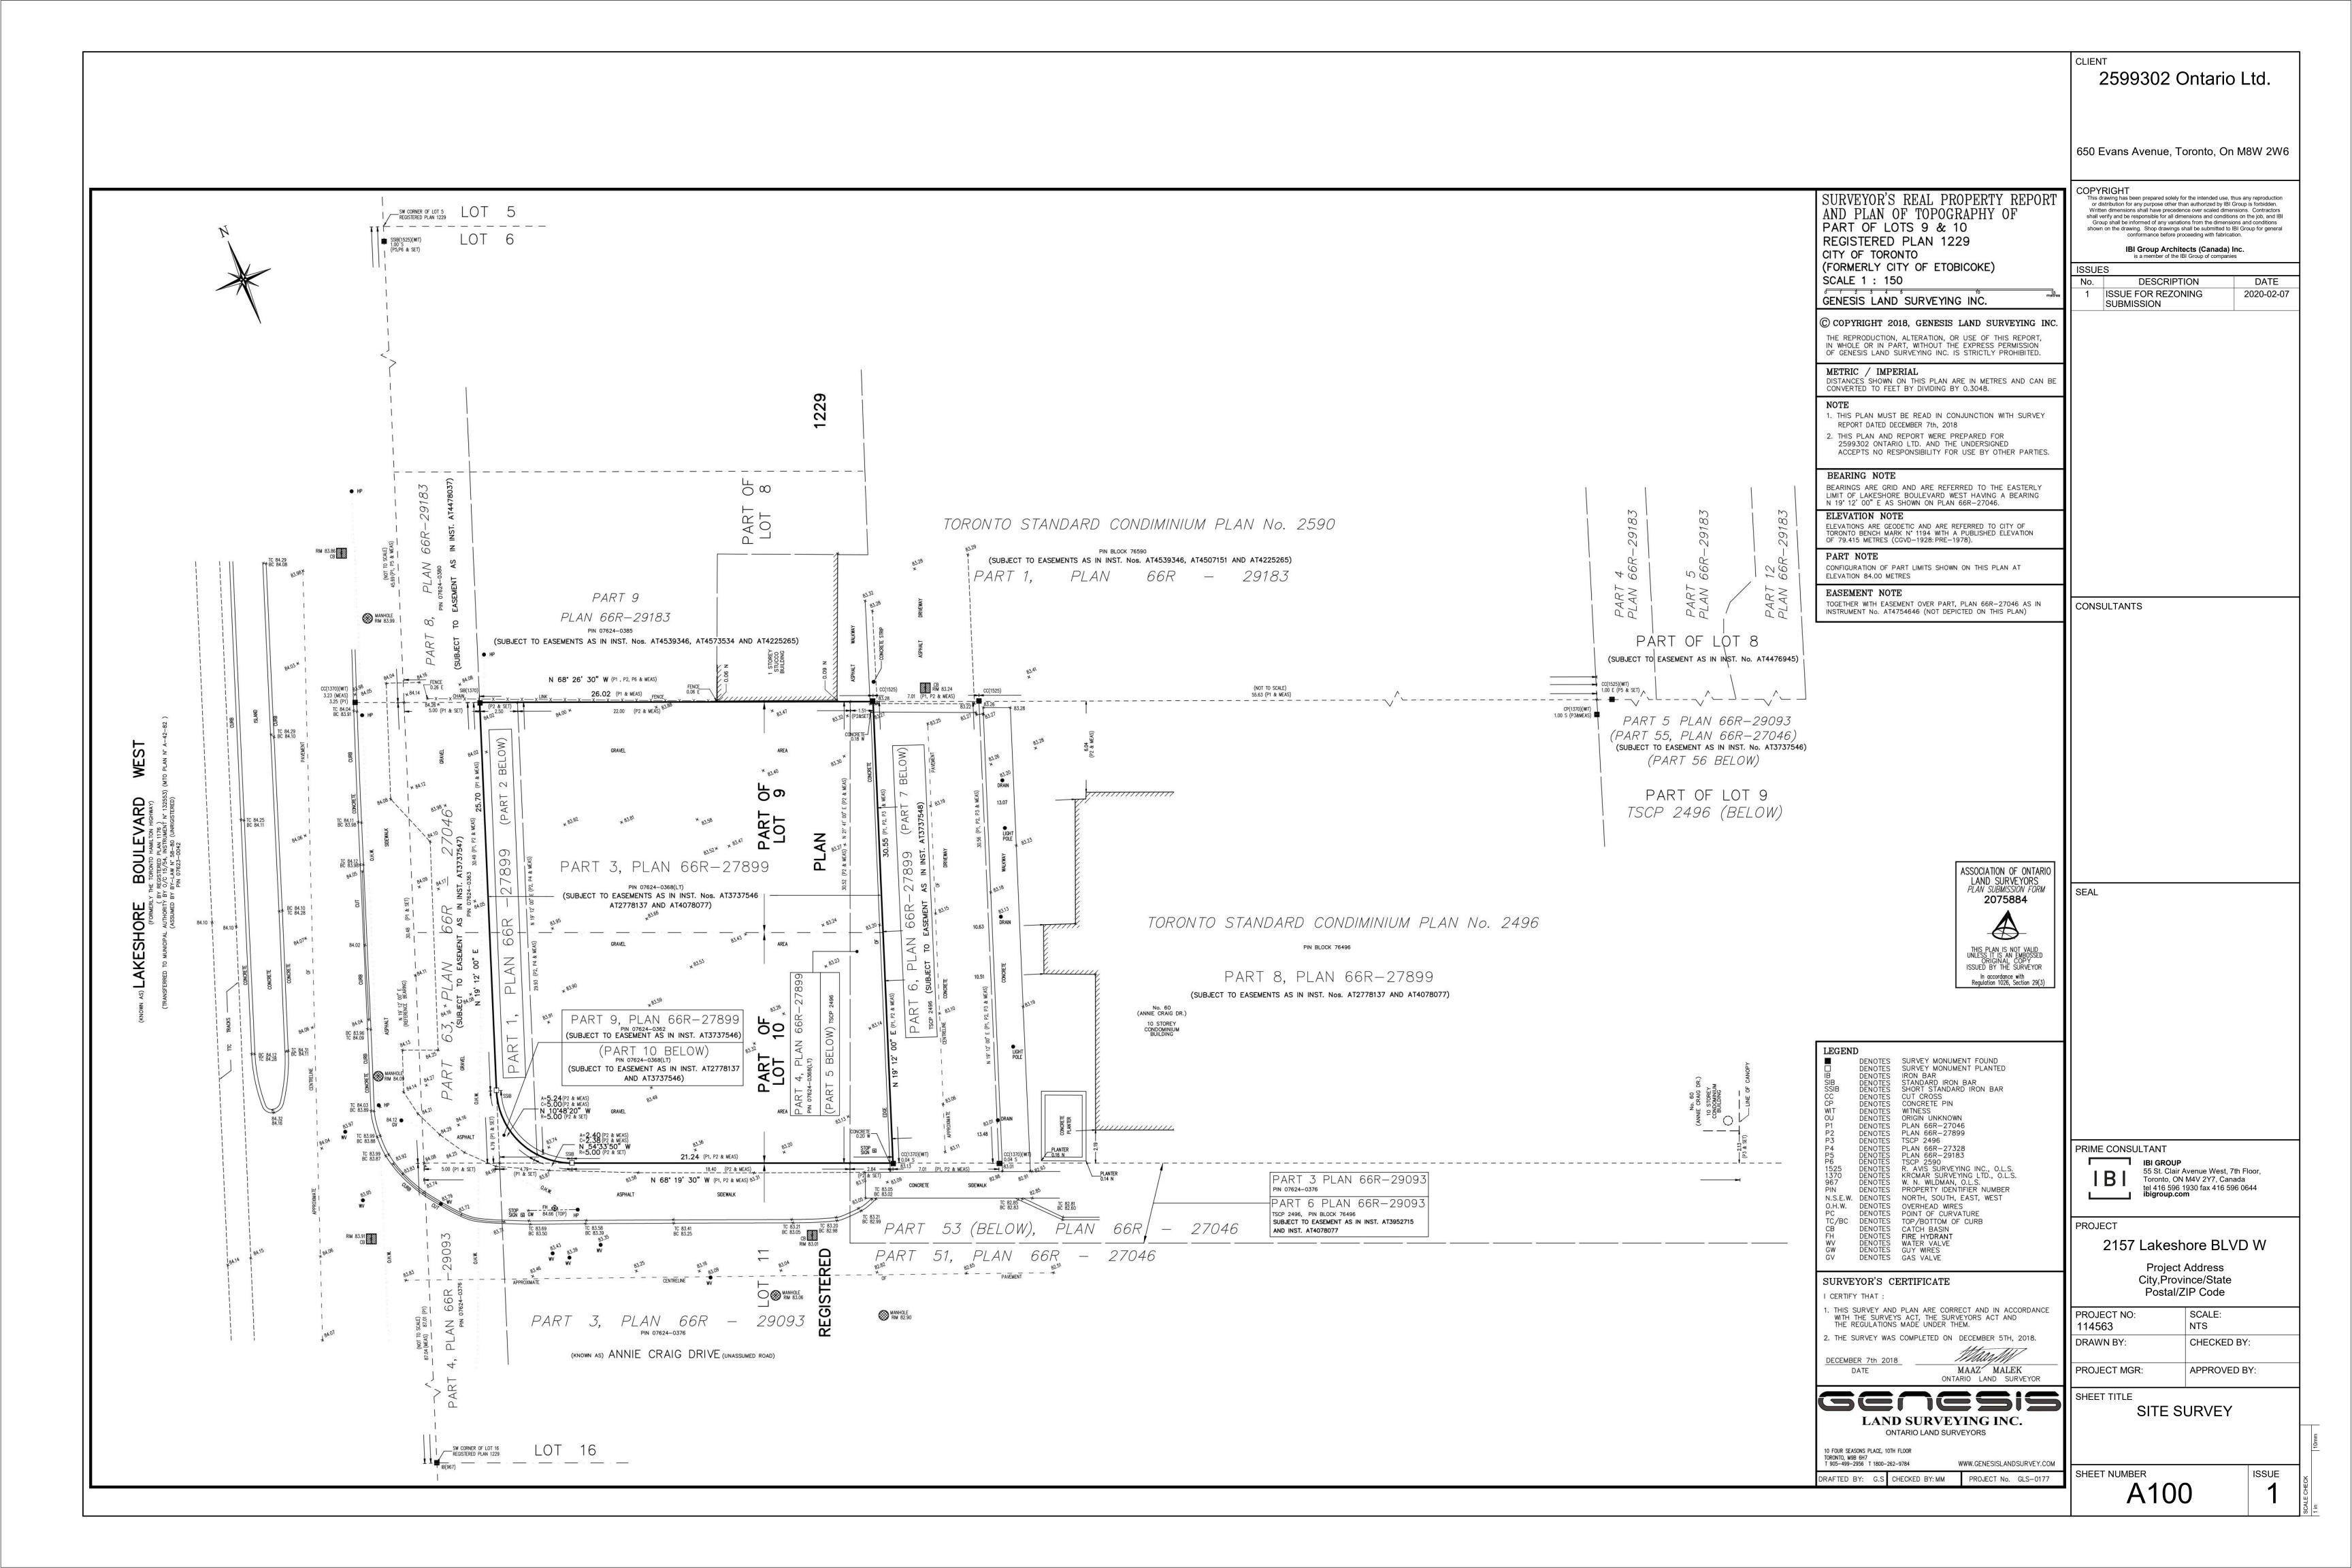
2157 Lakeshore BLVD W

Project Address City,Province/State Postal/ZIP Code

PROJECT NO: 114563	SCALE: NTS
DRAWN BY:	CHECKED BY:
PROJECT MGR:	APPROVED BY:

DRAWING LIST AND ARCHITECTURAL VISUALIZATION

SHEET NUMBER A000



Floor	GCA per floor		GFA (569-13)		GFA (Etobicoke Zoning By- Law)	
	m²	fl²	m²	fl²	m²	ft²
Mechanical Penthouse	486.2	5,233.4	0.0	0.0	486.2	5,233.4
Level 13	668.6	7,196.8	616.5	6,636.0	668.6	7,196.8
Level 12	668.6	7,196.8	616.5	6,636.0	668.6	7,196.8
Level 11	668.6	7,196.8	616.5	6,636.0	668.6	7,196.8
Level 10	668.6	7,196.8	616.5	6,636.0	668.6	7,196.8
Level 9	668.6	7,196.8	616.5	6,636.0	668.6	7,196.8
Level 8	668.6	7,196.8	616.5	6,636.0	668.6	7,196.8
Level 7	668.6	7,196.8	616.5	6,636.0	668.6	7,196.8
Level 6	668.6	7,196.8	616.5	6,636.0	668.6	7,196.8
Level 5	668.6	7,196.8	616.5	6,636.0	668.6	7,196.8
Level 4	668.6	7,196.8	616.5	6,636.0	668.6	7,196.8
Level 3	668.6	7,196.8	616.5	6,636.0	668.6	7,196.8
Level 2	660.0	7,104.2	578.2	6,223.7	660.0	7,104.2
Ground Floor	492.0	5,295.8	450.8	4,852.4	492.0	5,295.8
P1	737.5	7,938.4	0.0	0.0	0.0	0.0
Total (Above Grade)	8,992.8	96,797.7	7,810.5	84,071.5	8,992.8	96,797.7
Total (Below Grade)	737.5	7,938.4				

	9,730.3	104,736.1	GFA (569-13)		(Etobicoke Zoning By- Law)	
TOTAL		4	m²	fl²	m²	ft²
			7,810.5	84,071.5	8,992.8	96,797.7

DENSITY	Site Area (sm)*	Site Area (sm)**	
	788.0	1,158.0	
FSI (569-13)	9.91	6.74	
FSI (Etobicoke Zoning By- Law)	11.41	7.77	

*the actual site area **commercial development site area that is found in the site-specific by-law (By-Law 338-2010)

UNITS			
Floor	DOUBLE QUEEN	KING	Total
_evel 13	8	7	15
_evel 12	8	7	15
_evel 11	8	7	15
_evel 10	8	7	15
_evel 9	8	7	15
_evel 8	8	7	15
_evel 7	8	7	15
_evel 6	8	7	15
_evel 5	8	7	15
_evel 4	8	7	15
_evel 3	8	7	15
Totals	88	77	165

AMENITY						
	Indoor	Outdoor				
Floors	m²	m²				
Total Indoor amenity Provided (@2ND	246.0					

BUILDING HEIGHT					
	Height (m)	Geodedic Elevation (m)			
Height (Top of Mechanical Penthouse)	50.600	134.600			
Height (Top of the 13th Floor)	44.600	128.600			

Building height measured from established grade: 84.0m

VEHICULAR PARKING REQUIRED

Use	No.Units/GFA	Required Parking Rate	Required Parking Supply	
Hotel	165	0.32 spaces per unit	53	Spaces
Restaurant	158 sq.m.	0 if GFA <200 sq.m.	0	Spaces
	Total Required		53	Spaces
Electric Vehicle Infrastructure		20% of the parking spaces	11	Spaces

Accessible Parking Spaces

From By-law:

"The number of required parking spaces is 13 to 100, a minimum of 1 parking space for every 25 parking spaces or part thereof must comply with all regulations for an accessible parking space in Section 200.15"

Two (2) accessible parking spaces required.

An accessible parking space must have the following minimum dimensions:

(A) Length of 5.6 metres;

(B) Width of 3.4 metres; and

(C) Vertical clearance of 2.1 metres

(D) The entire length of an accessible parking space must be adjacent to a 1.5 metre wide barrier free aisle. In this case, the two accessible parking spaces can share the barrier free aisle.

VEHICULAR PARKING PROVIDED

Parking Types		Parking Provided
	Parking Provided in the Site	44
Vehicular Parking	Parking Provided from the Adjacent Site	10
Total Provided		54
Accessible Parking		
Electric Vehicle Infrastructure		1

BICYCLE PARKING SPACES

Use	No.Units/GFA		Required Parking Rate	Required Parking Short-Term	Required Parking Long-Term
Hotel		165	N/A		0
Restaurant	158 sq.m.		Short Term: 3 plus 0.25 bicycle parking spaces for each 100 square metres Long Term: 0.13 bicycle parking spaces for each 100 square metres		4
Total Required		4 short-term and 1 long-term			
Total Provided				4 short-term and 1 long-term	
% of Net Floor Area Occupie	d for each Bicycle Parking Floor				1

Statistics Template - Toronto Green Standard Version 3.0 Mid to High Rise Residential and all New Non-Residential Development

The Toronto Green Standard Version 3.0 Statistics Template is submitted with Site Plan Control Applications and stand alone Zoning Bylaw Amendment applications. Complete the table and copy it directly onto the Site Plan submitted as part of the application.

For Zoning Bylaw Amendment applications: complete General Project Description and Section 1. For Site Plan Control applications: complete General Project Description, Section 1 and Section 2.

For further information, please visit www.toronto.ca/greendevelopment

General Project Description	Proposed
Total Gross Floor Area	7810.5
Breakdown of project components (m²)	
Residential	
Retail	
Commercial	6781.5 (Hotel Units)
Industrial	
Institutional/Other	1029 (Hotel Amenity)
Total number of residential units	165

Section 1: For Stand Alone Zoning Bylaw Amendment Applications and **Site Plan Control Applications**

Automobile Infrastructure	Required	Proposed	Proposed %
Number of Parking Spaces	53	54	100%
Number of parking spaces dedicated for priority LEV parking	0	0	
Number of parking spaces with EVSE	11	11	20%

Cycling Infrastructure	Required	Proposed	Proposed %
Number of long-term bicycle parking spaces (residential)			
Number of long-term bicycle parking spaces (all other uses)	1	1	100%
Number of long-term bicycle parking (all uses) located on:			
a) first storey of building			
b) second storey of building			
c) first level below-ground	1	1	100%
d) second level below-ground			
e) other levels below-ground			





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Statistics Template - Toronto Green Standard Version 3.0 Mid to High Rise Residential and all New Non-Residential Development

Required	Proposed	Proposed %
4	4	100%
0	0	
0	0	
	Required 4 0 0	Required Proposed 4 4 0 0 0 0

Tree Planting & Soil Volume Required Proposed Proposed % 143.32Cu.mt 143.33Cu.mt Total Soil Volume (40% of the site area \div 66 m² x 30 m³).

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PROJECT

2157 Lakeshore BLVD W

Project Address City,Province/State Postal/ZIP Code

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PROJECT MGR:	APPROVED BY:


TEMPLATE

SHEET TITLE SITE STATISTICS AND TGS


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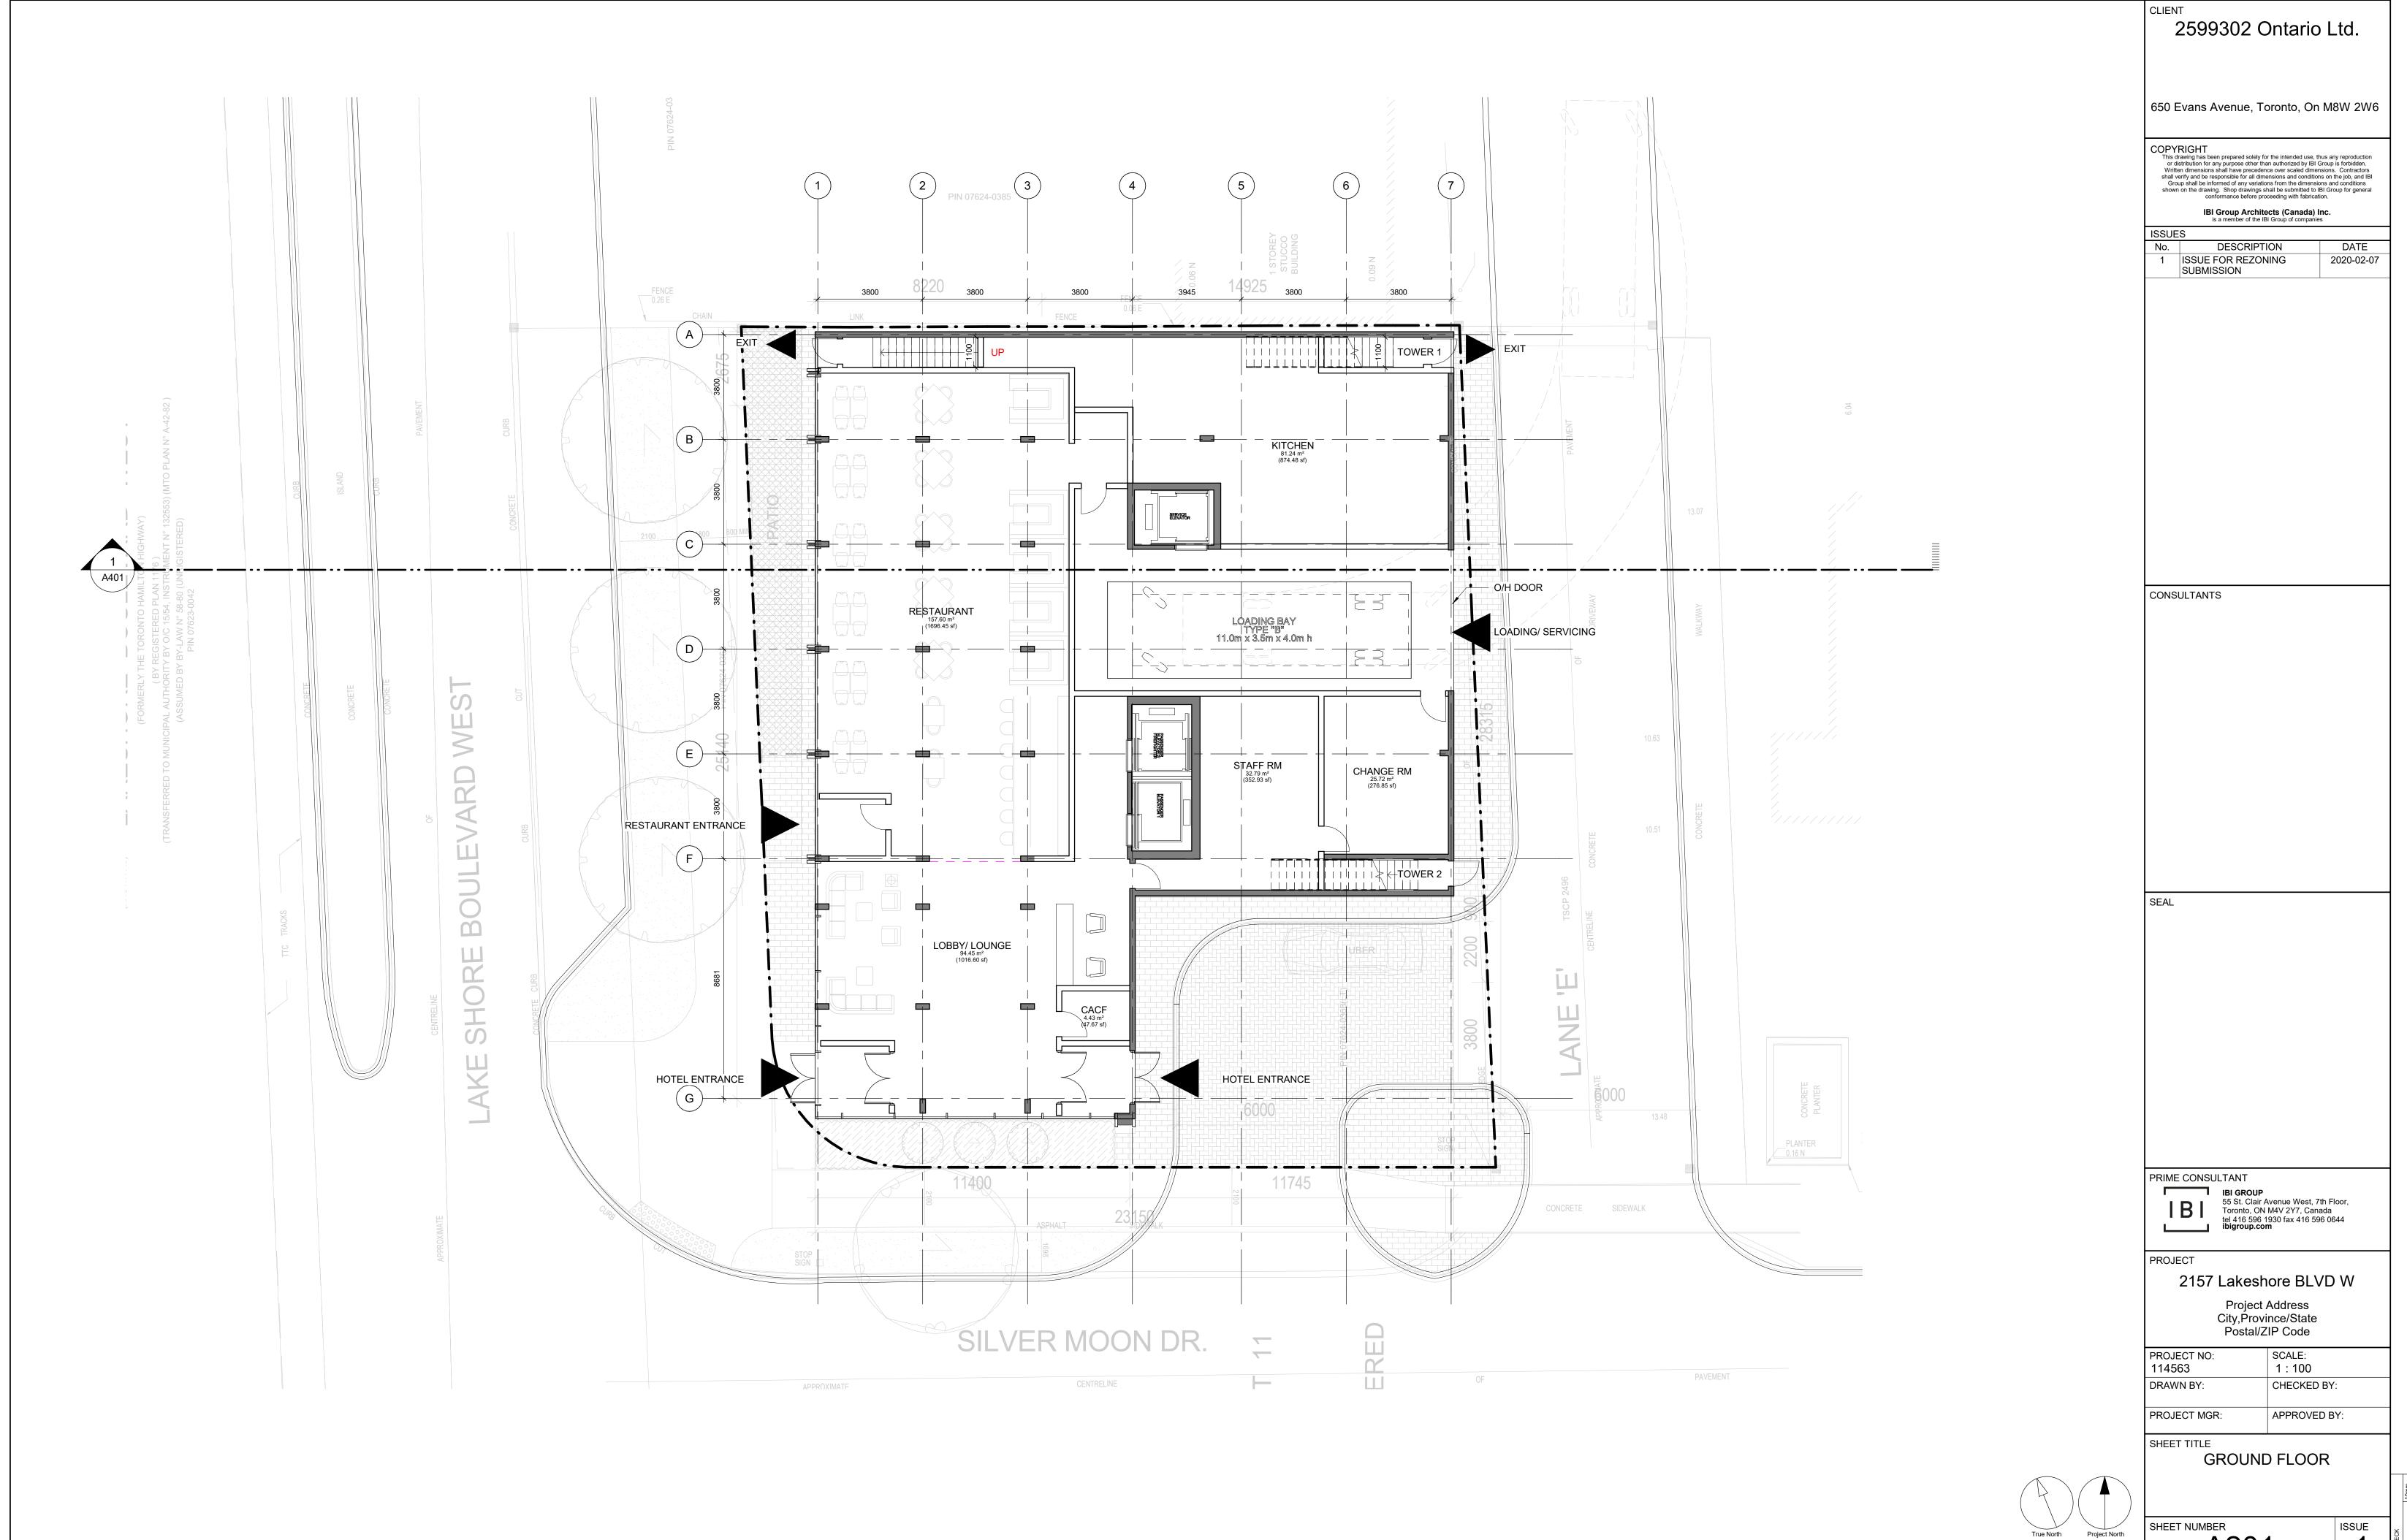
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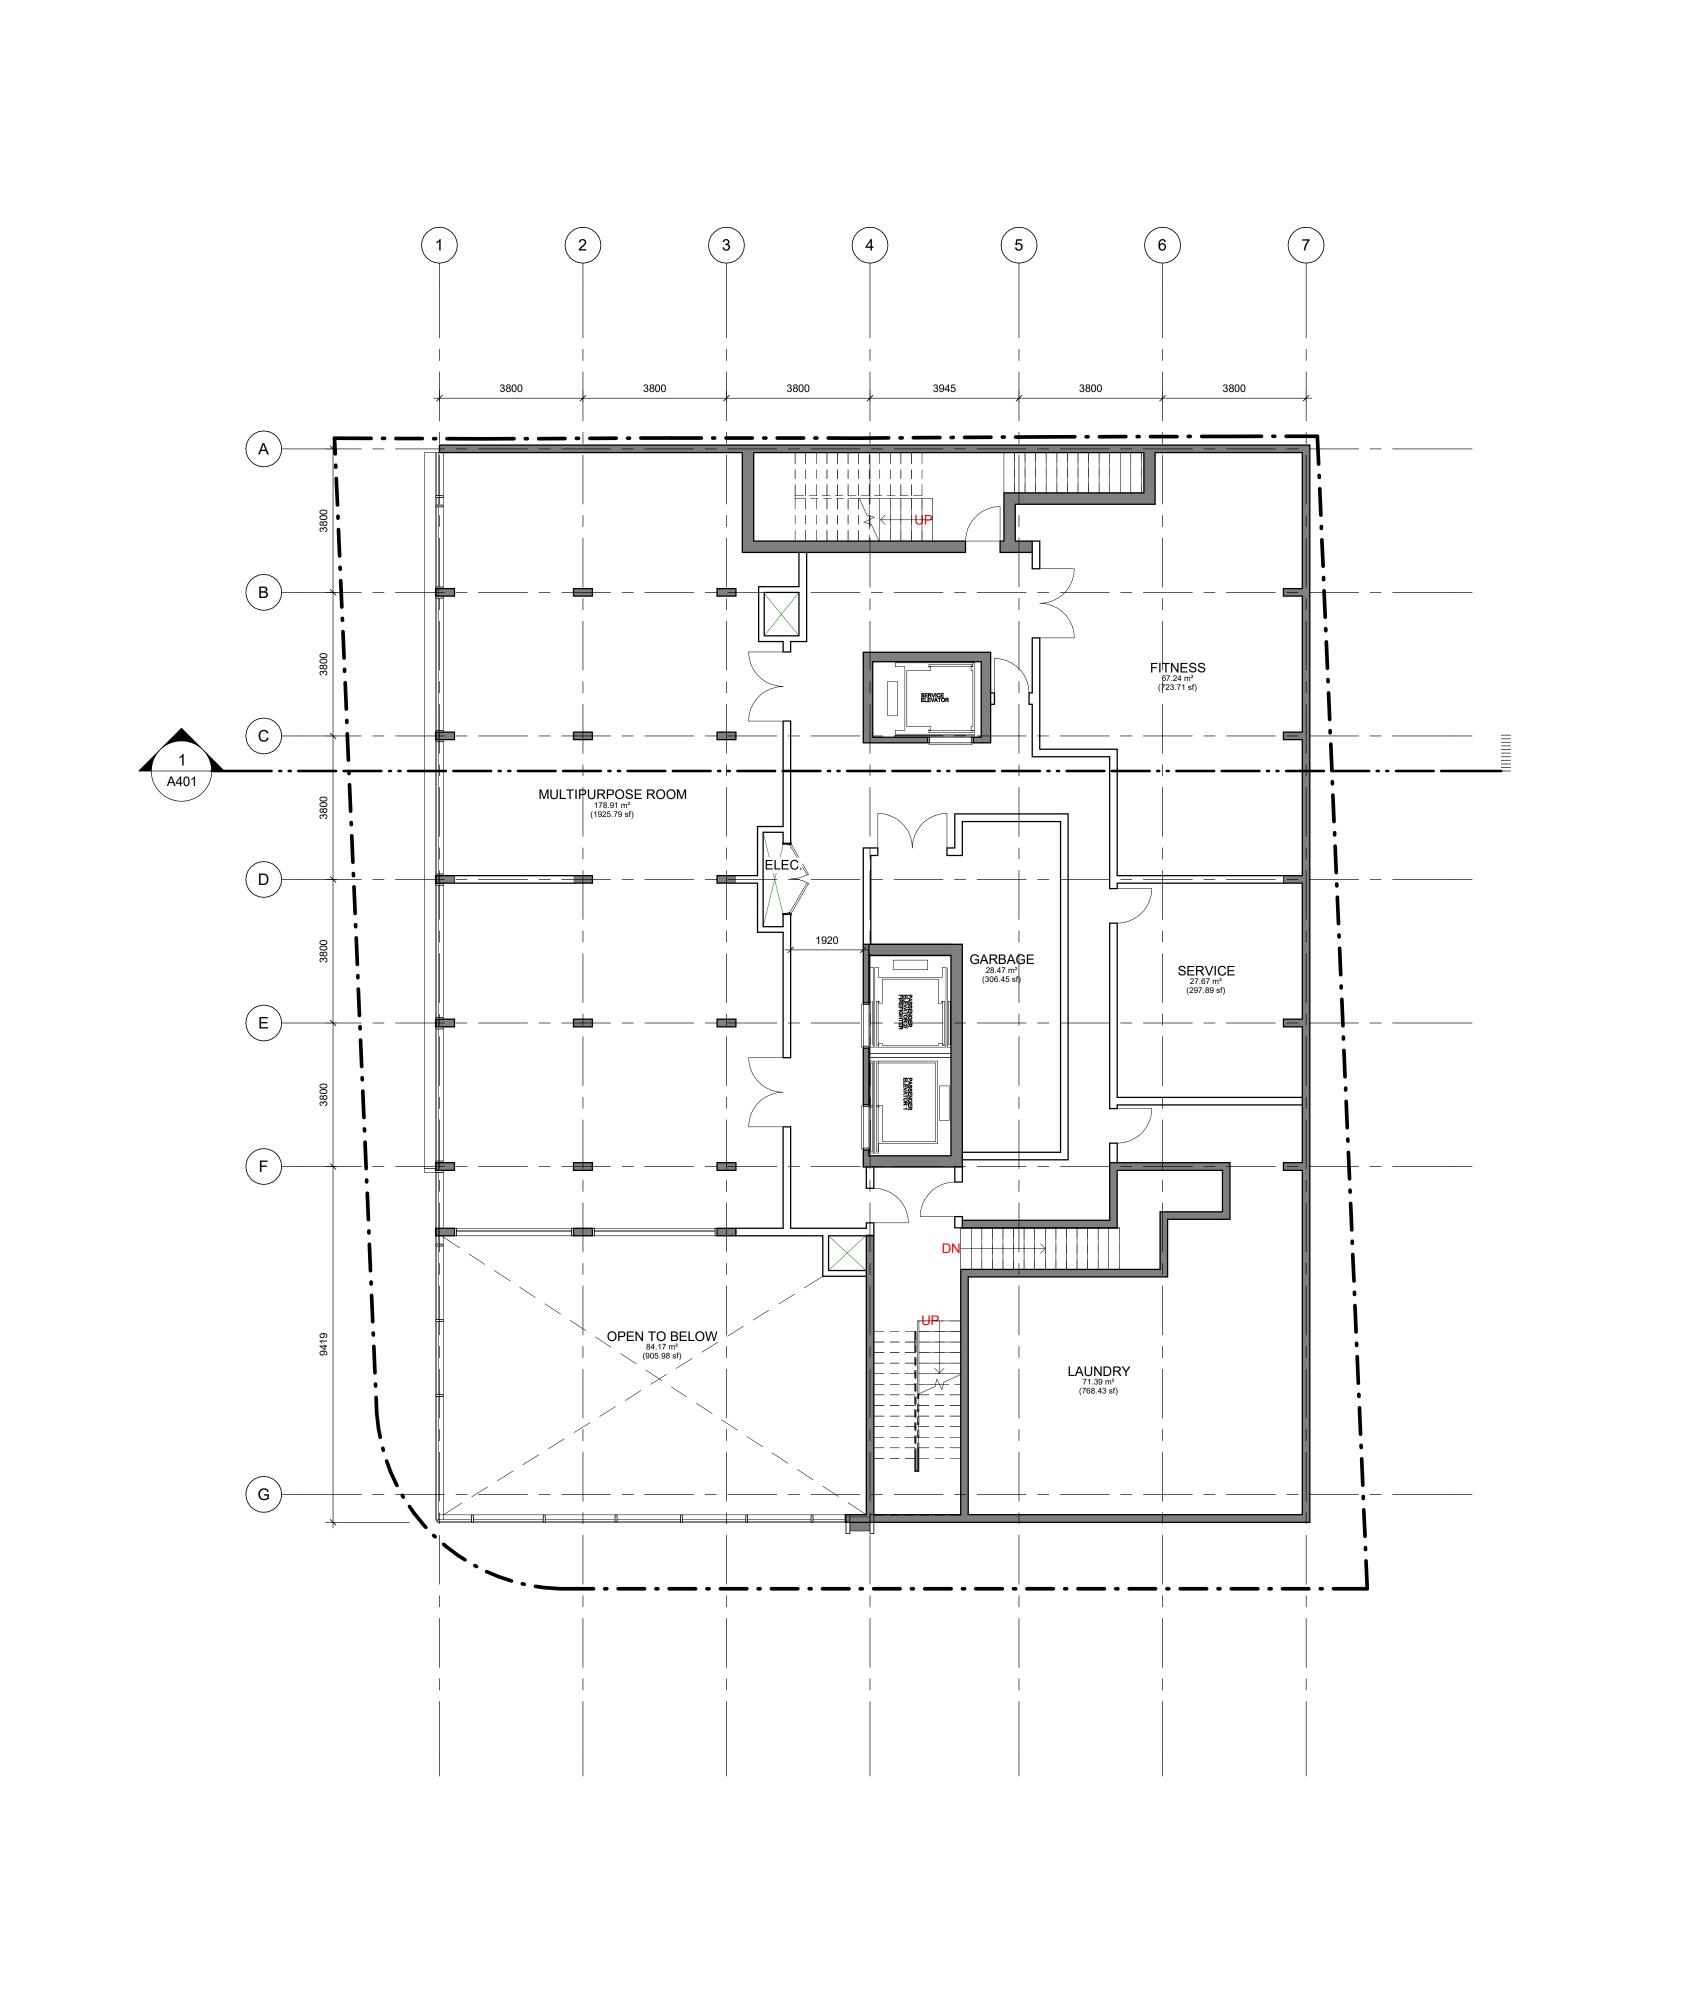


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A201

ISSUE

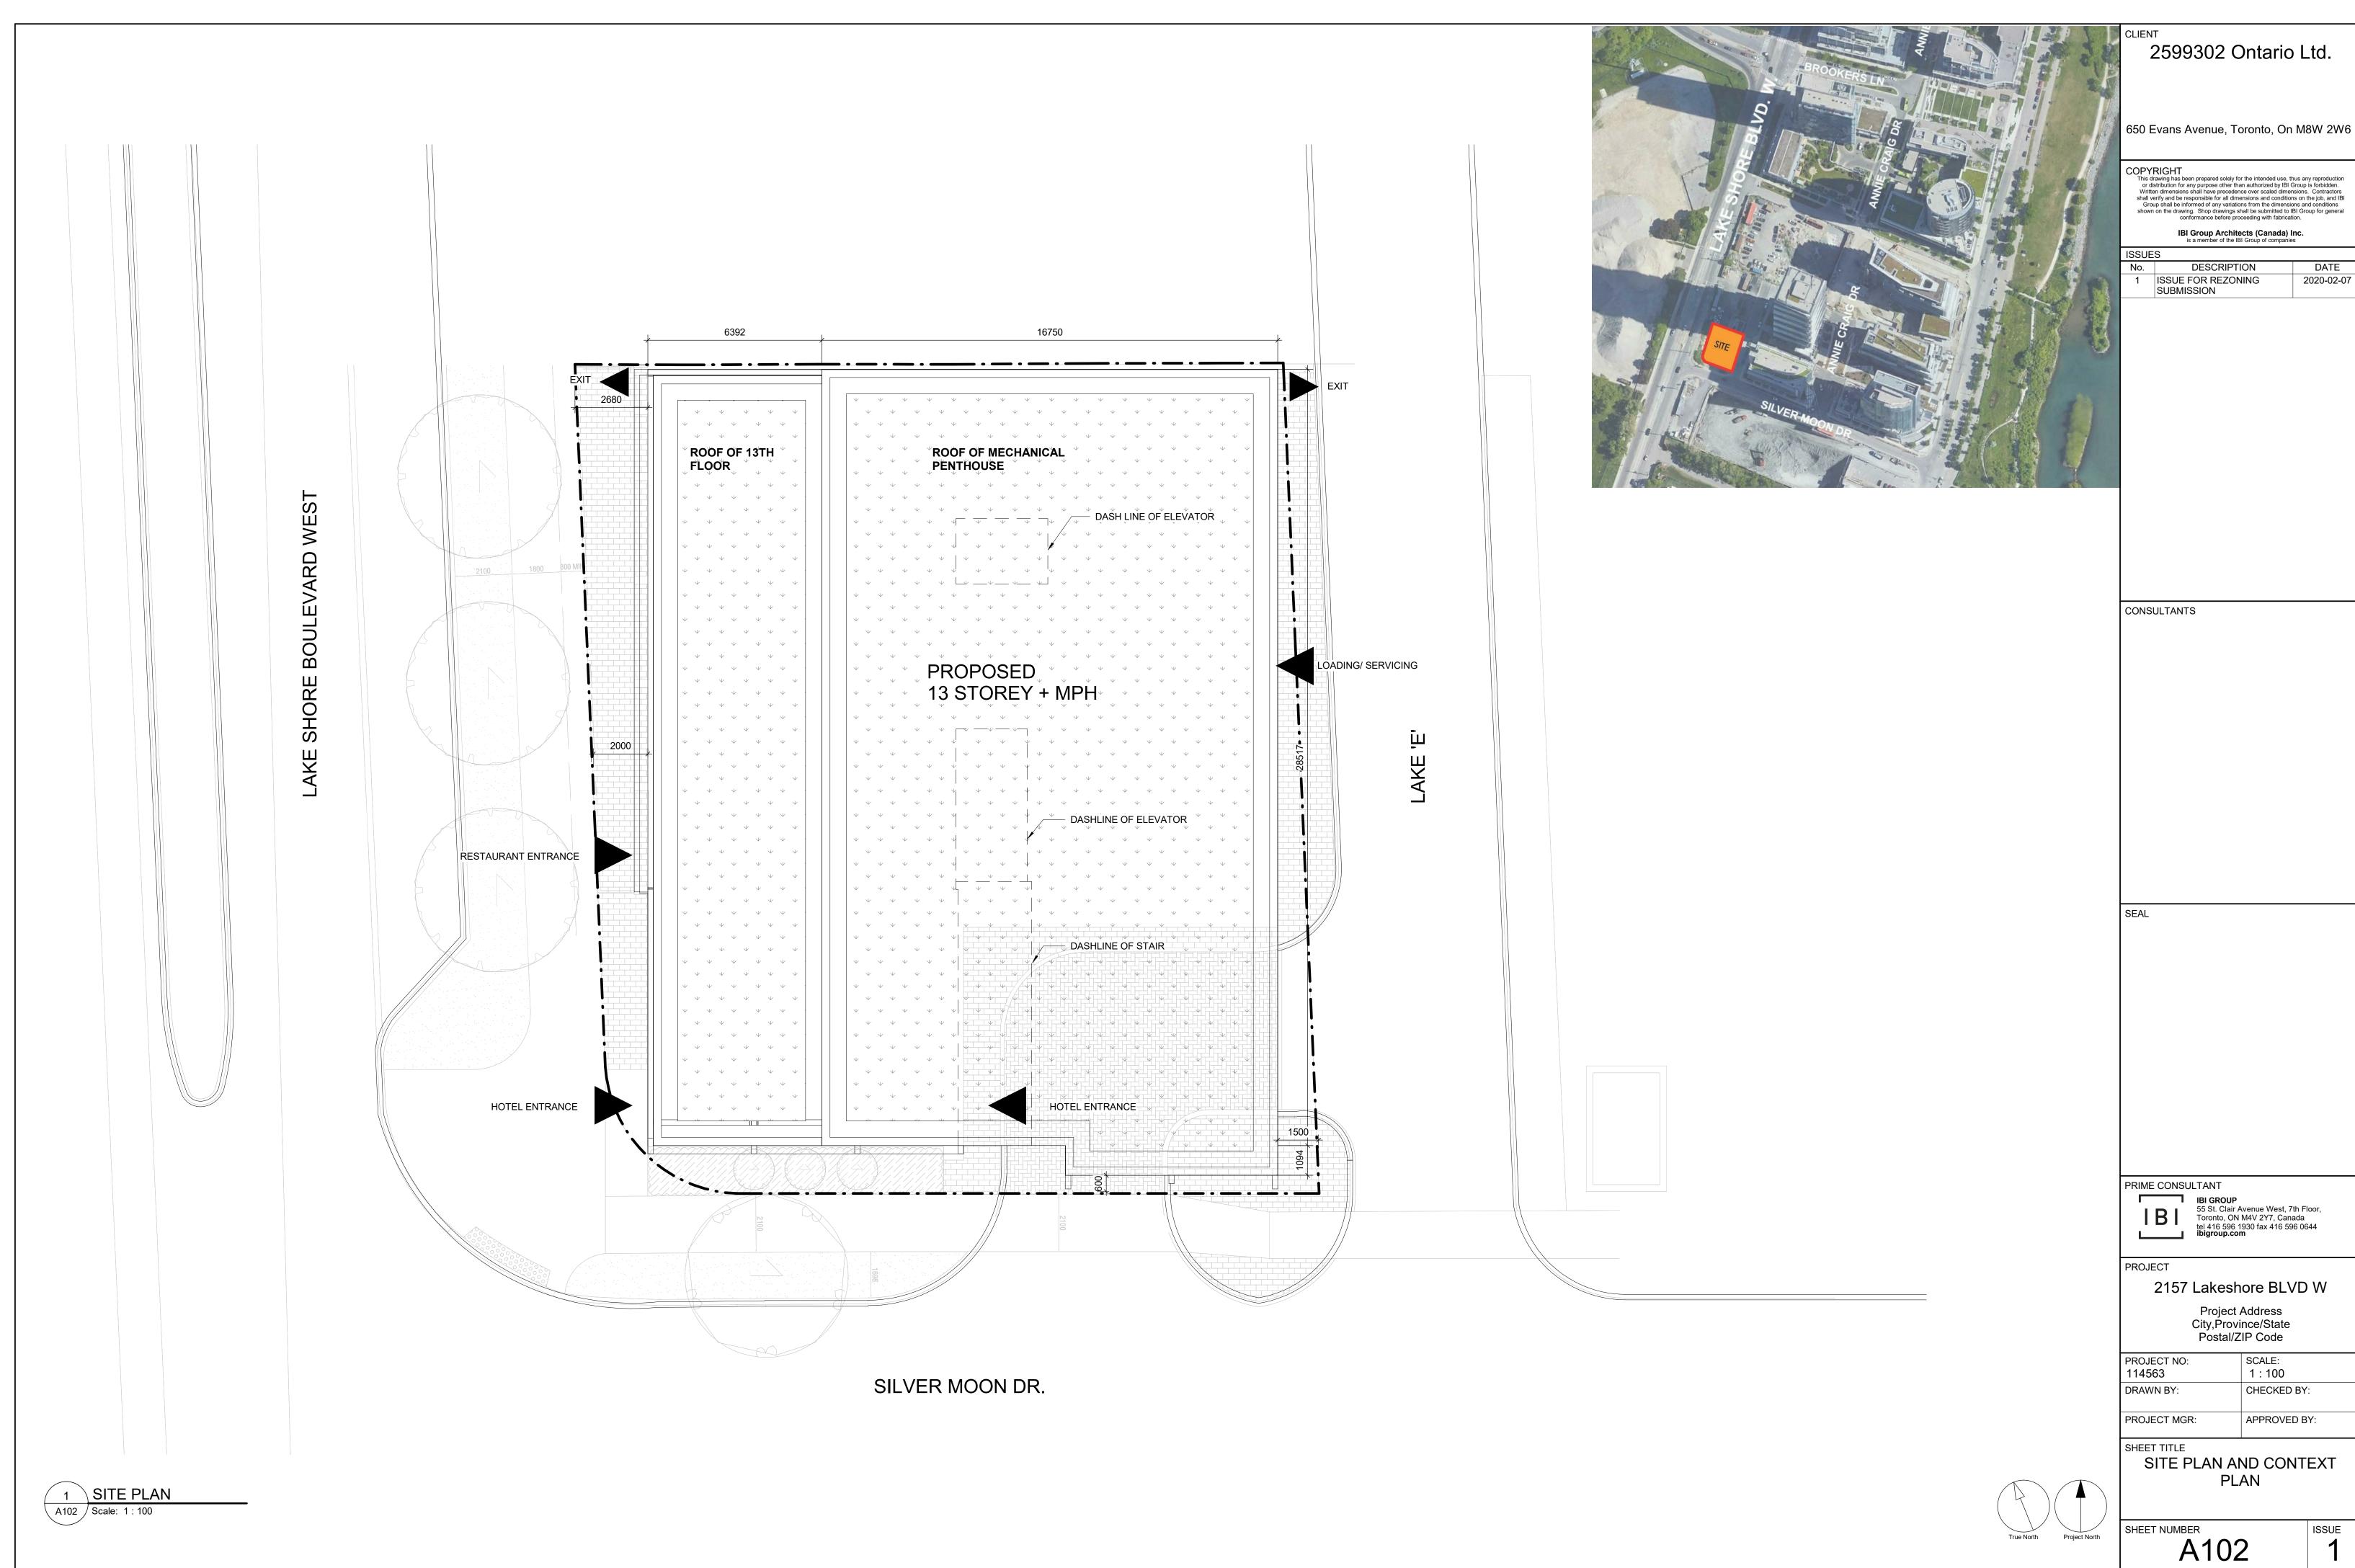

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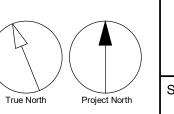
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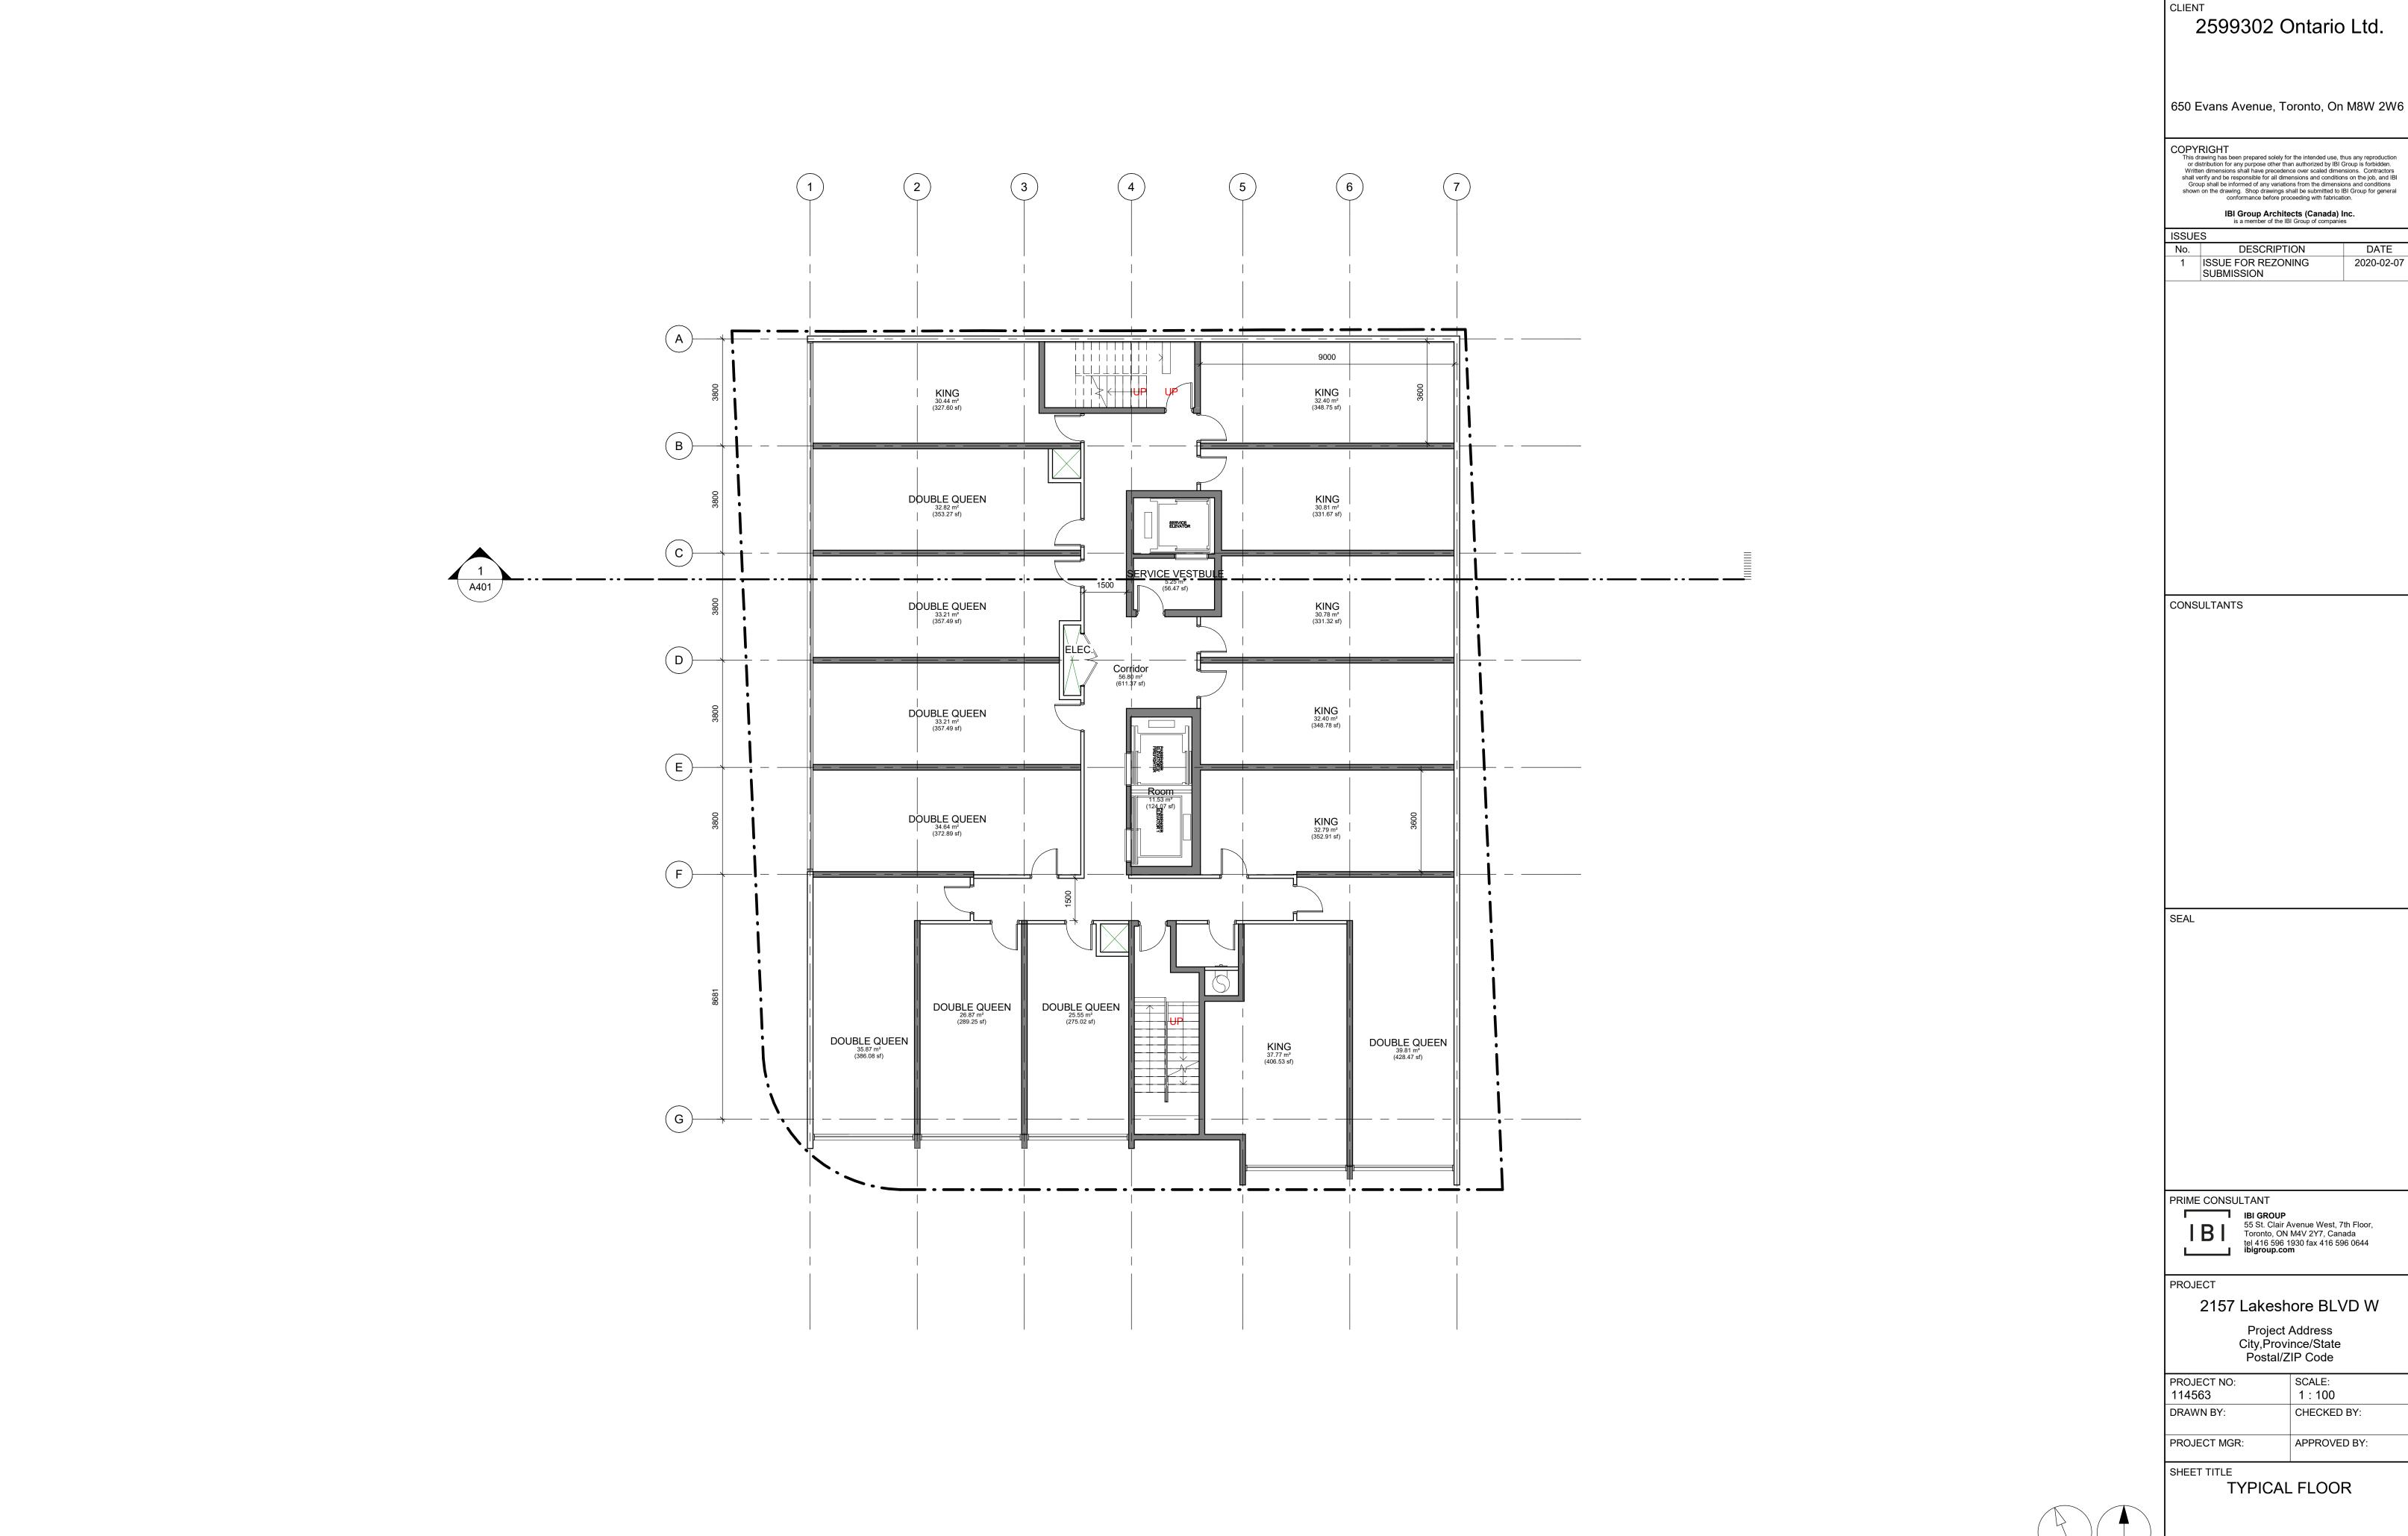
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SHEET TITLE LEVEL 2

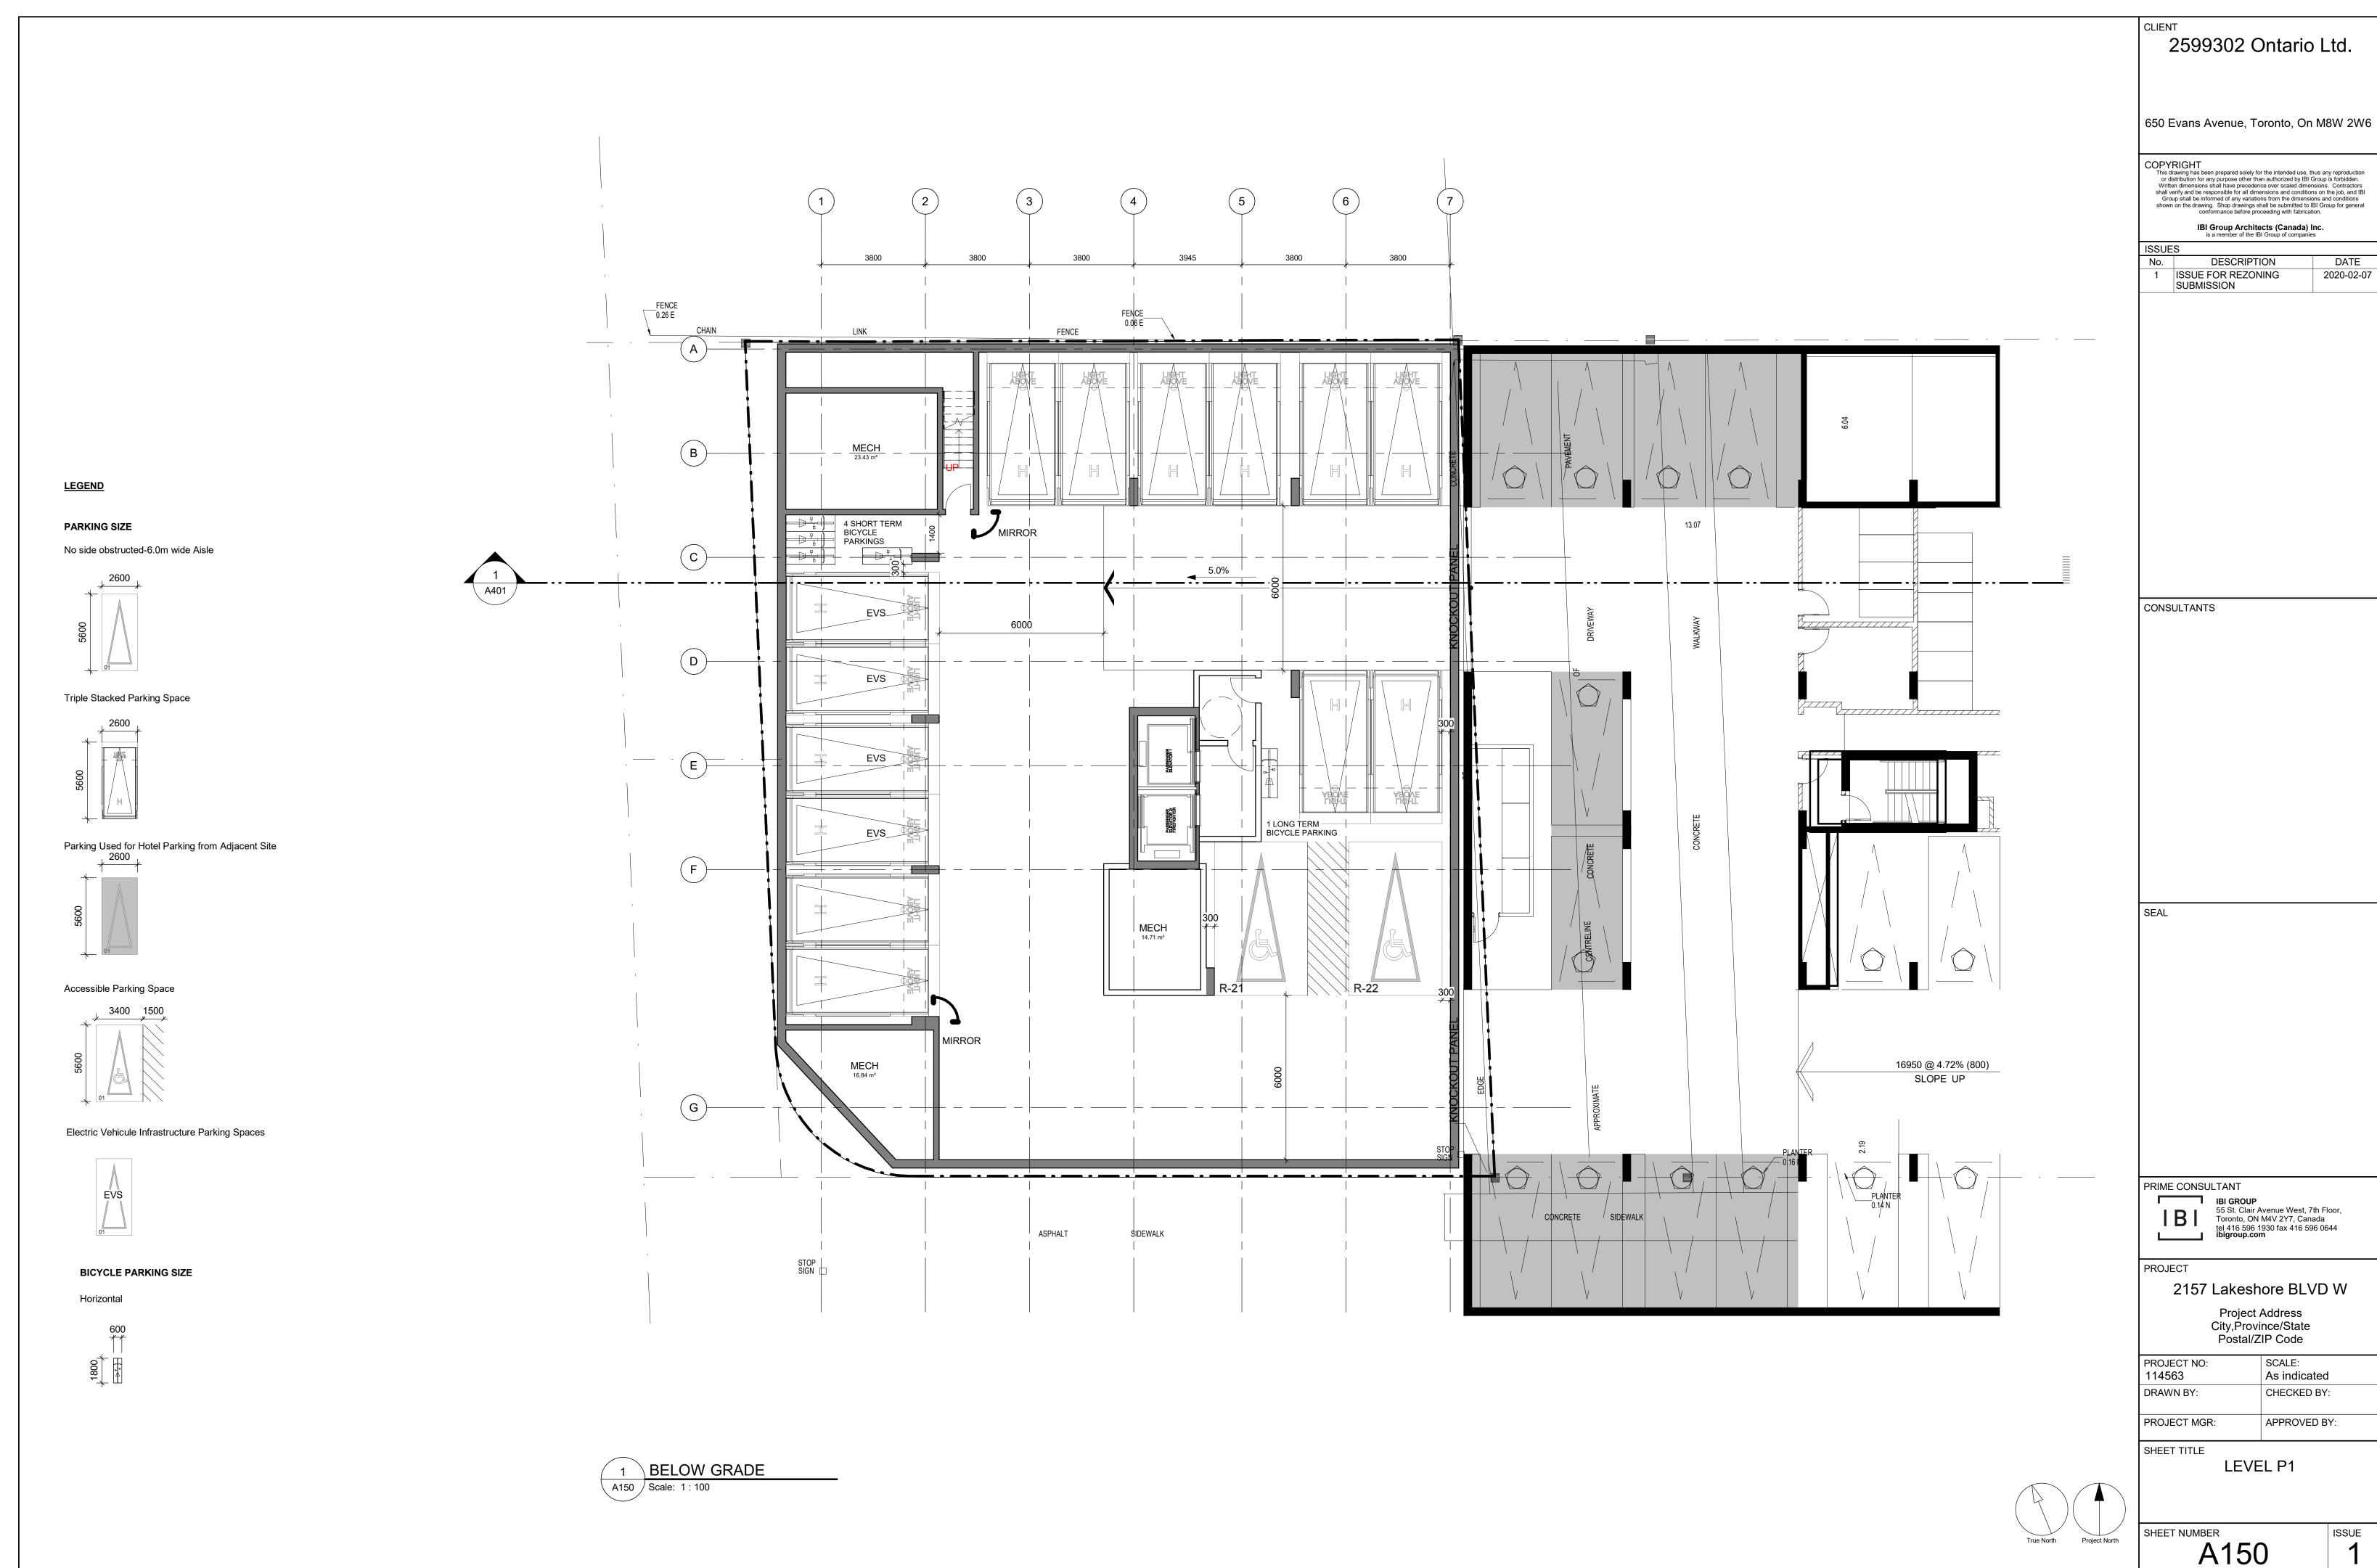


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A203 Issue

SHEET NUMBER



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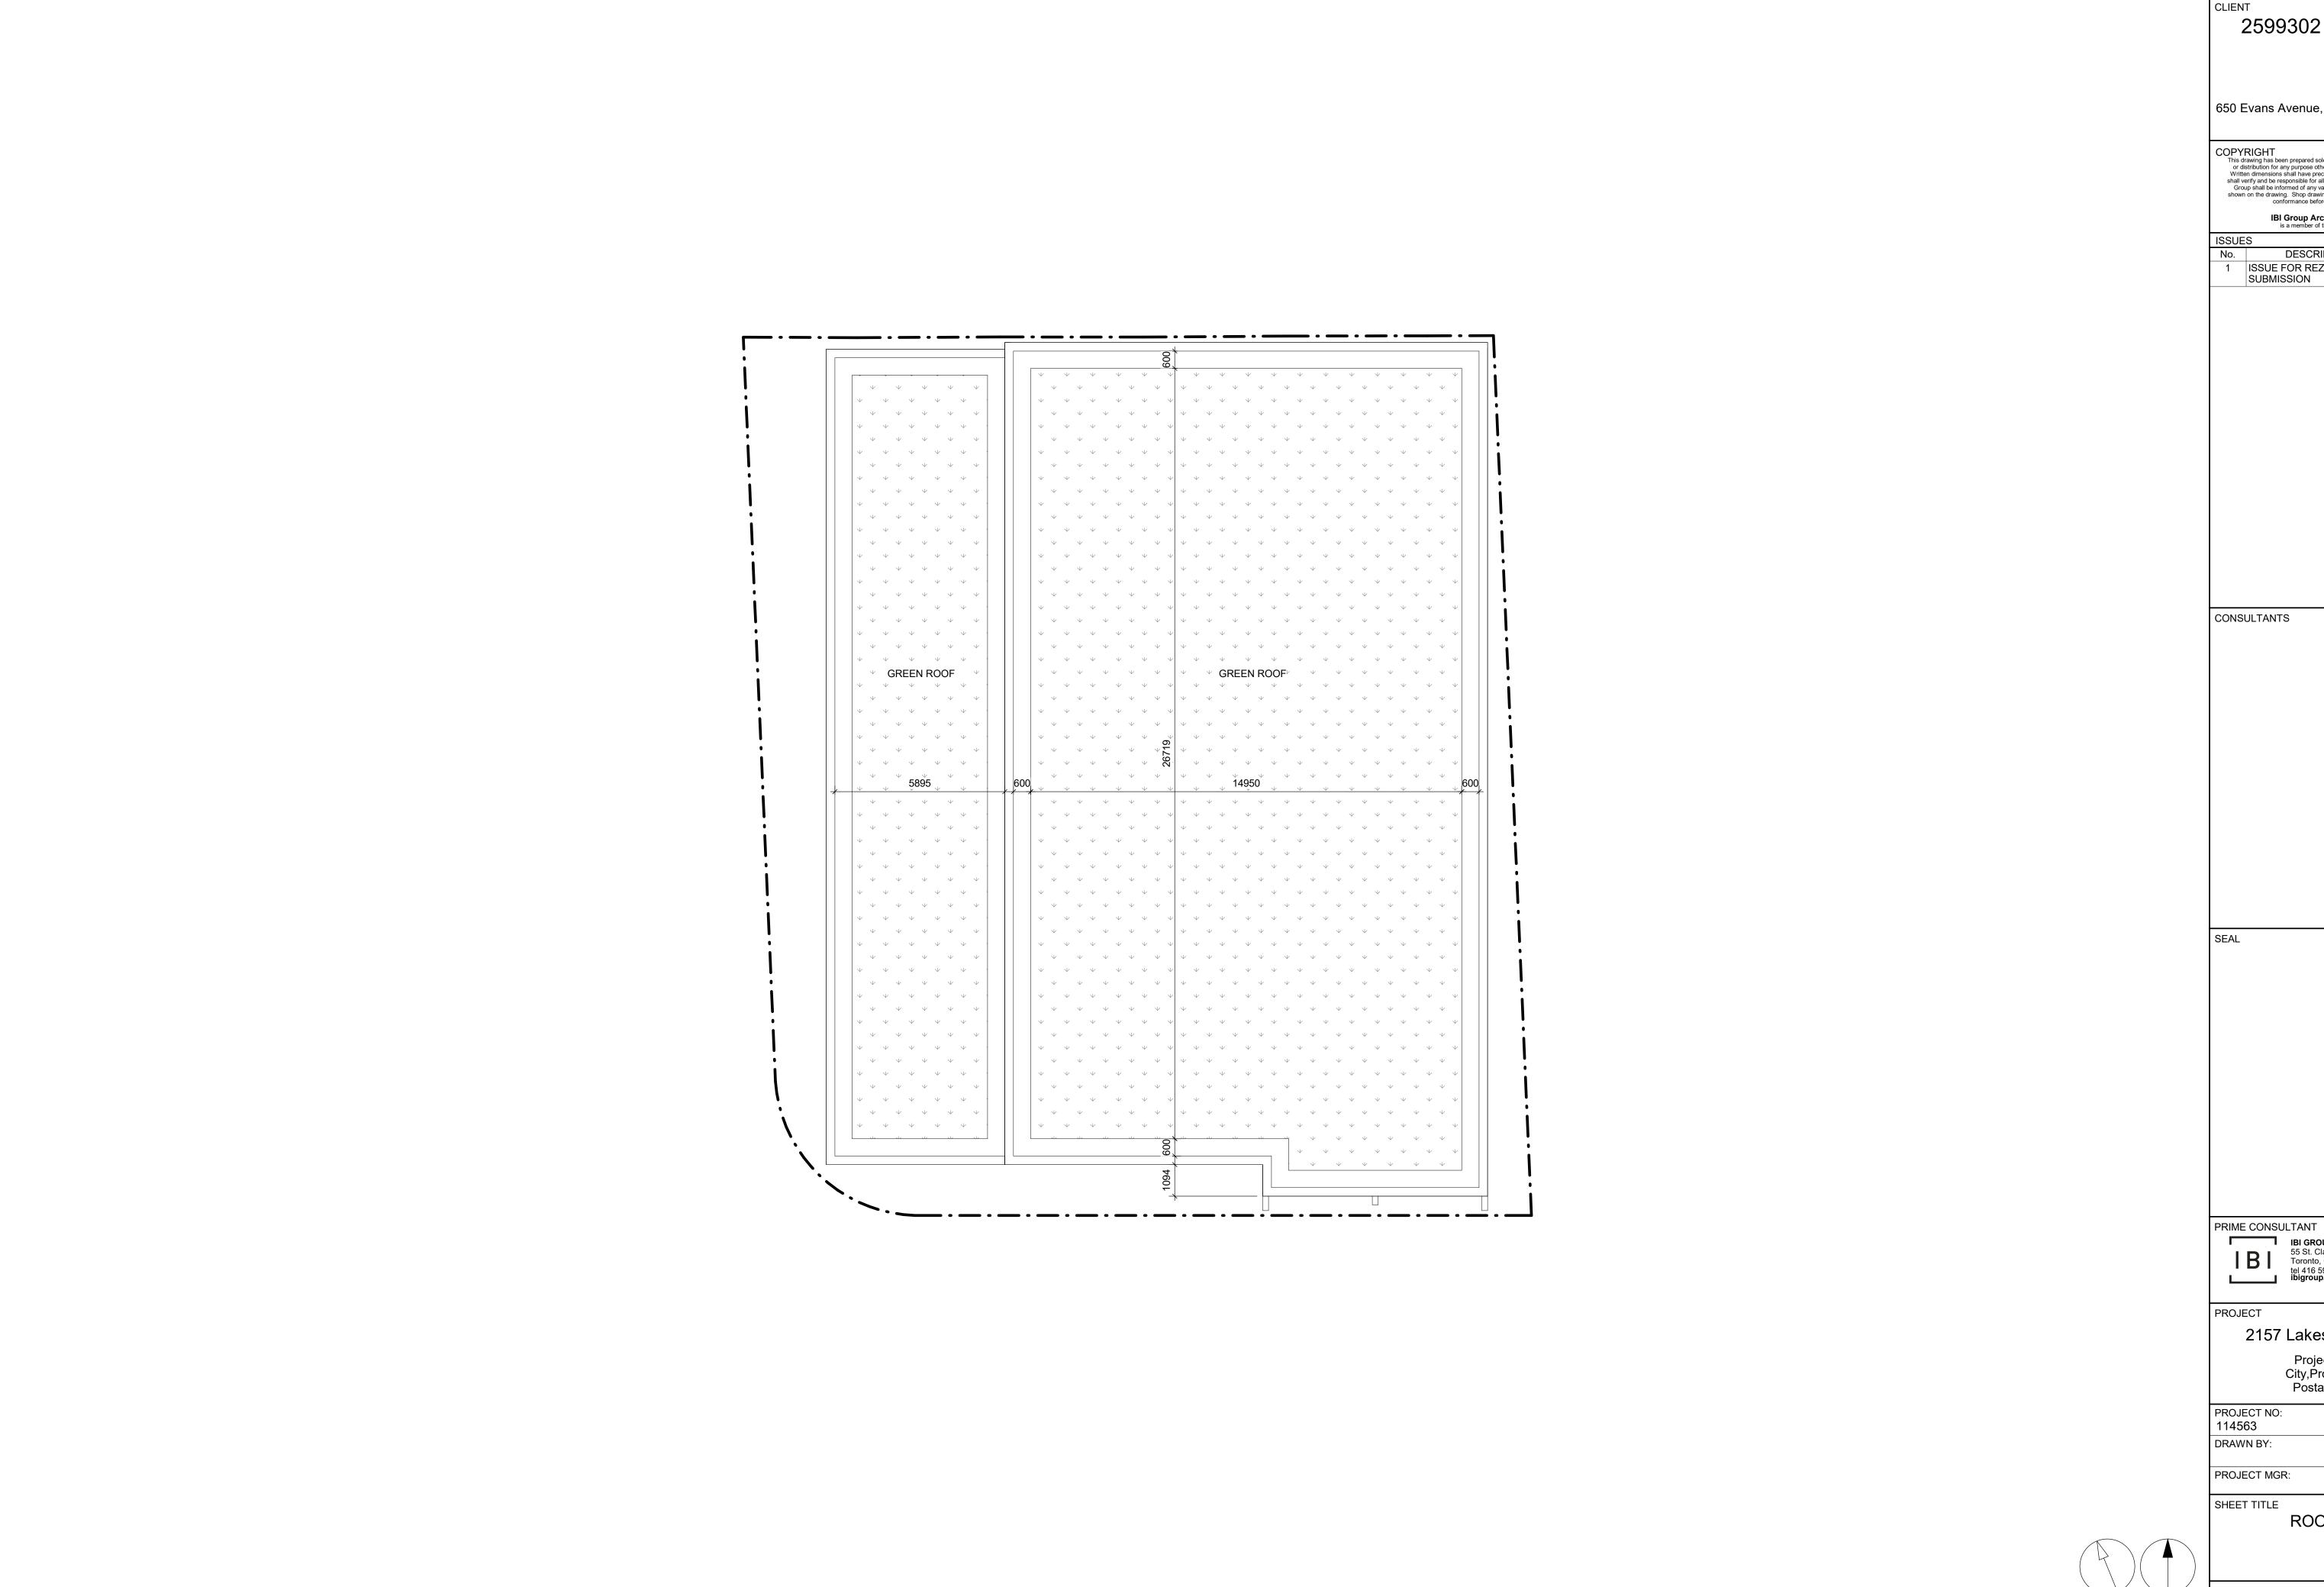
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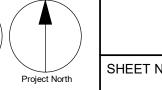
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ROOF PLAN

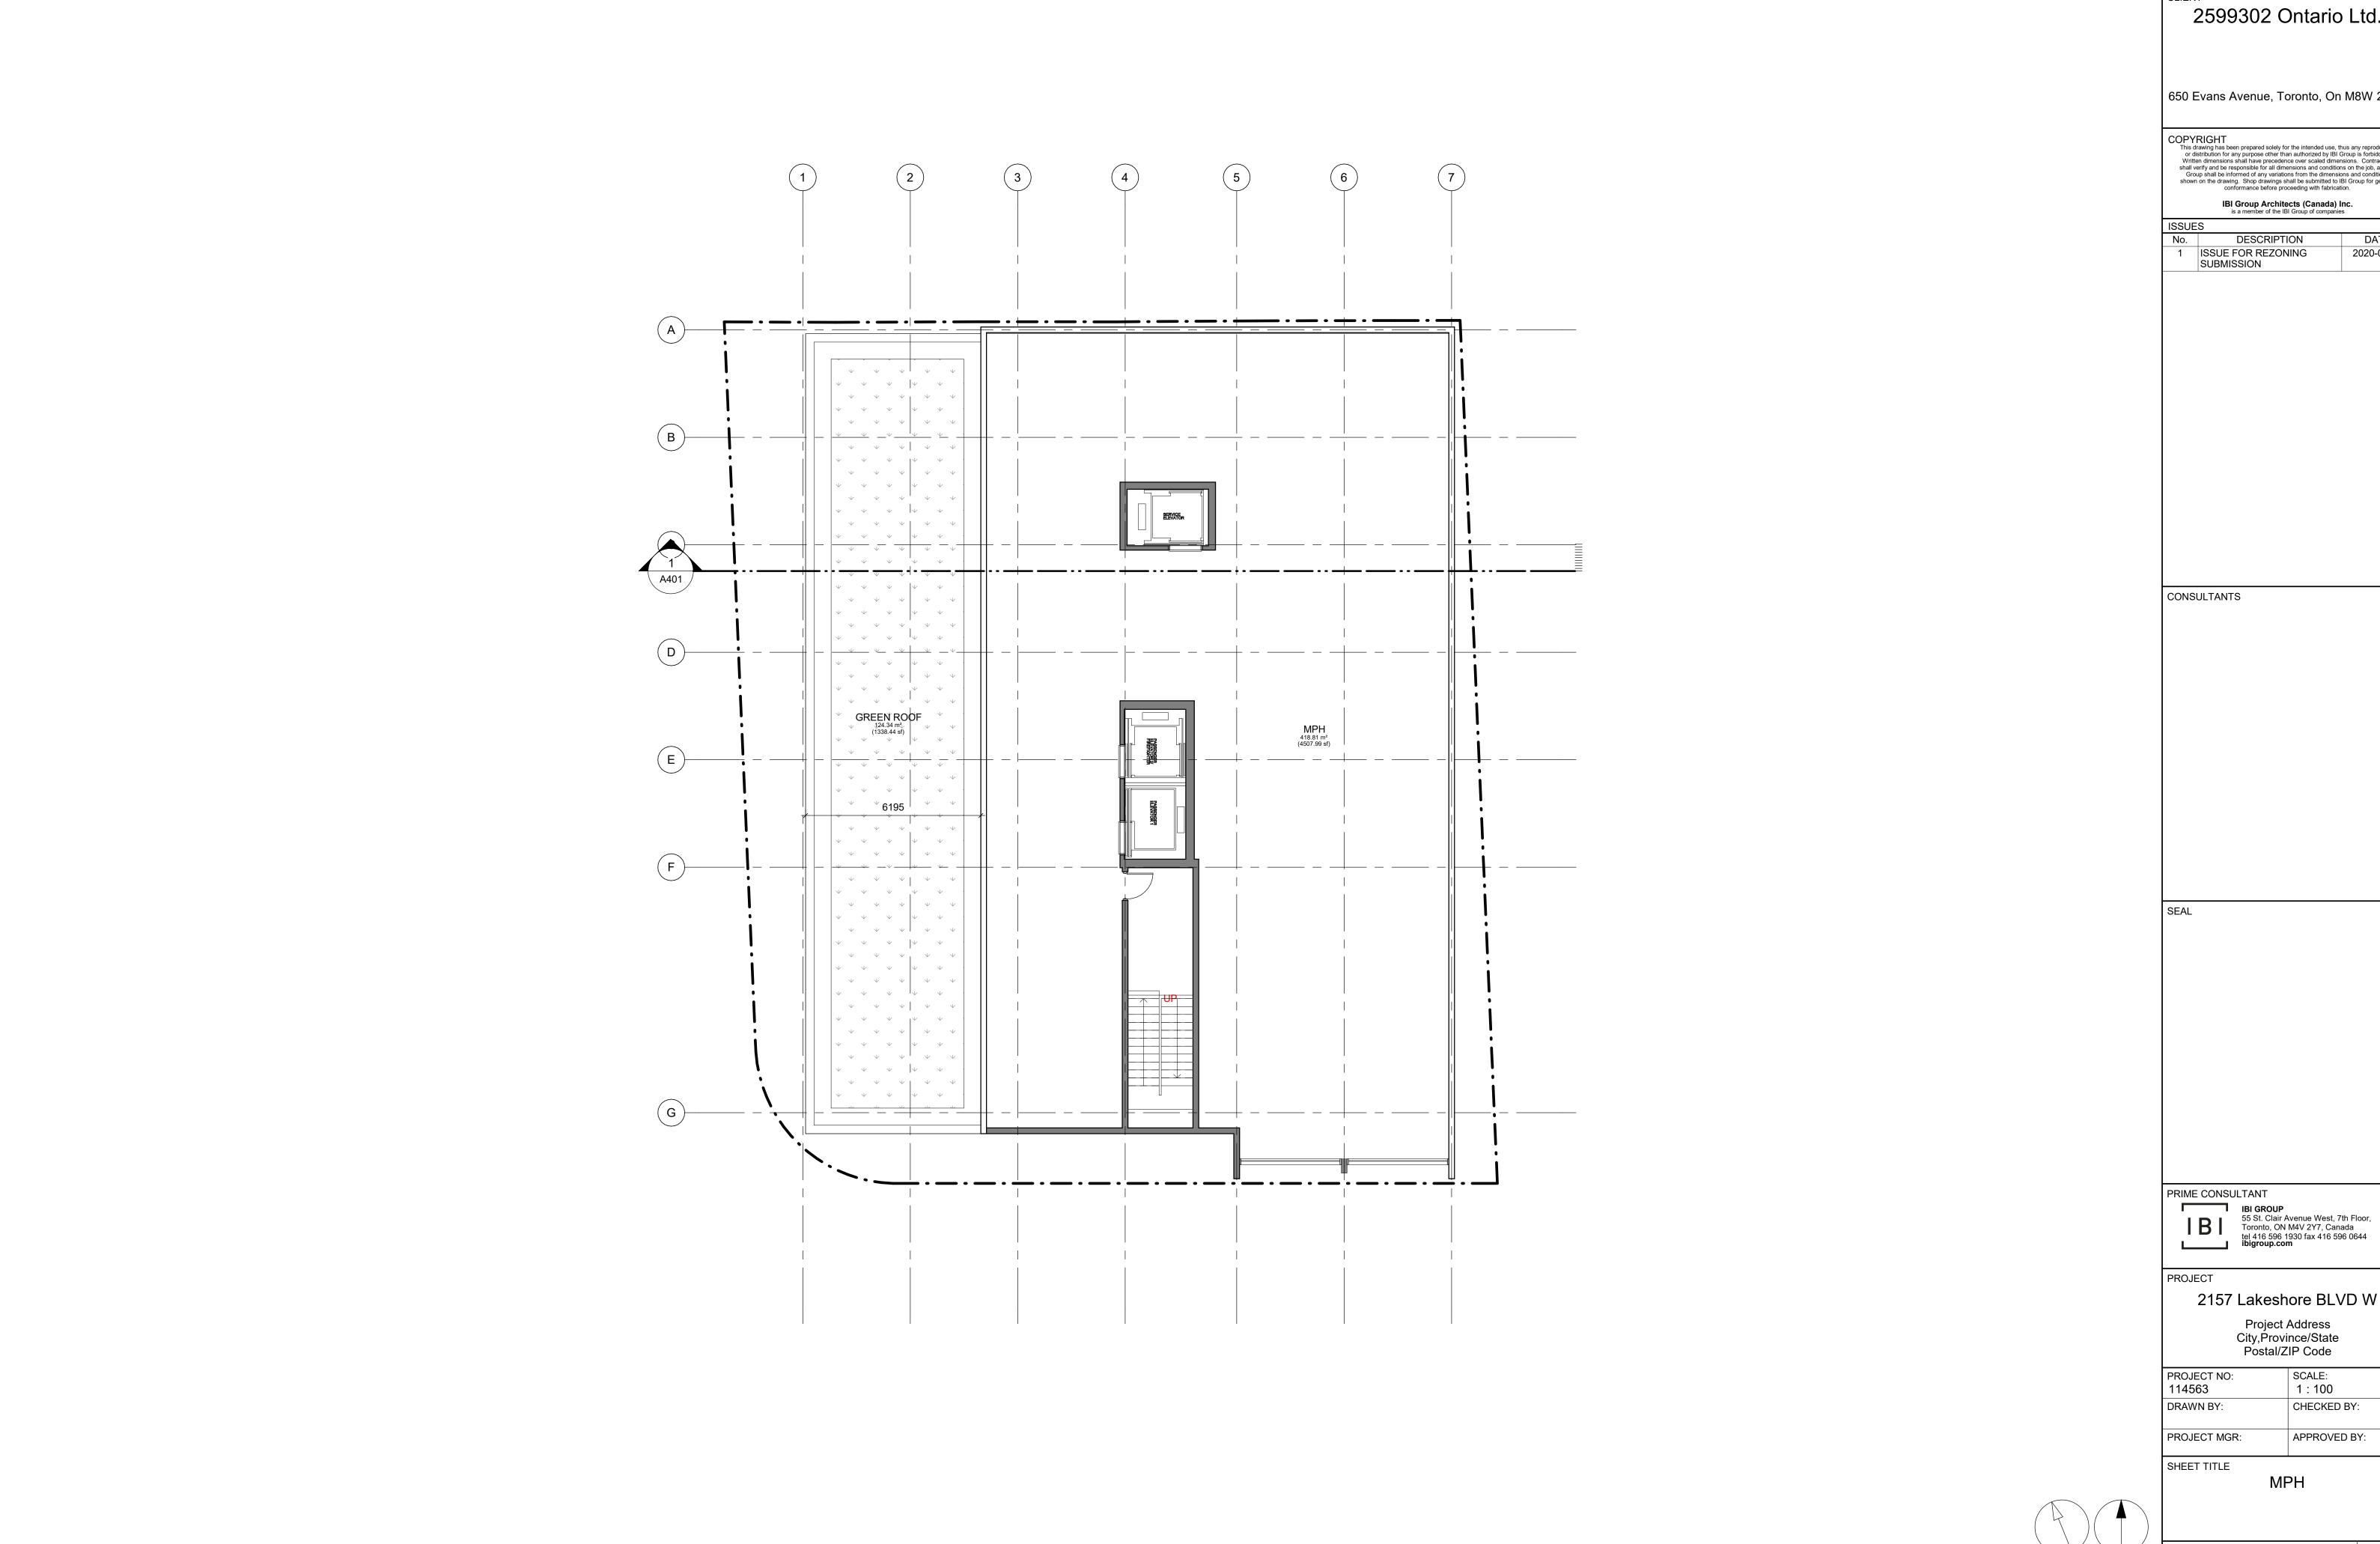

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A205 ISSUE 1

