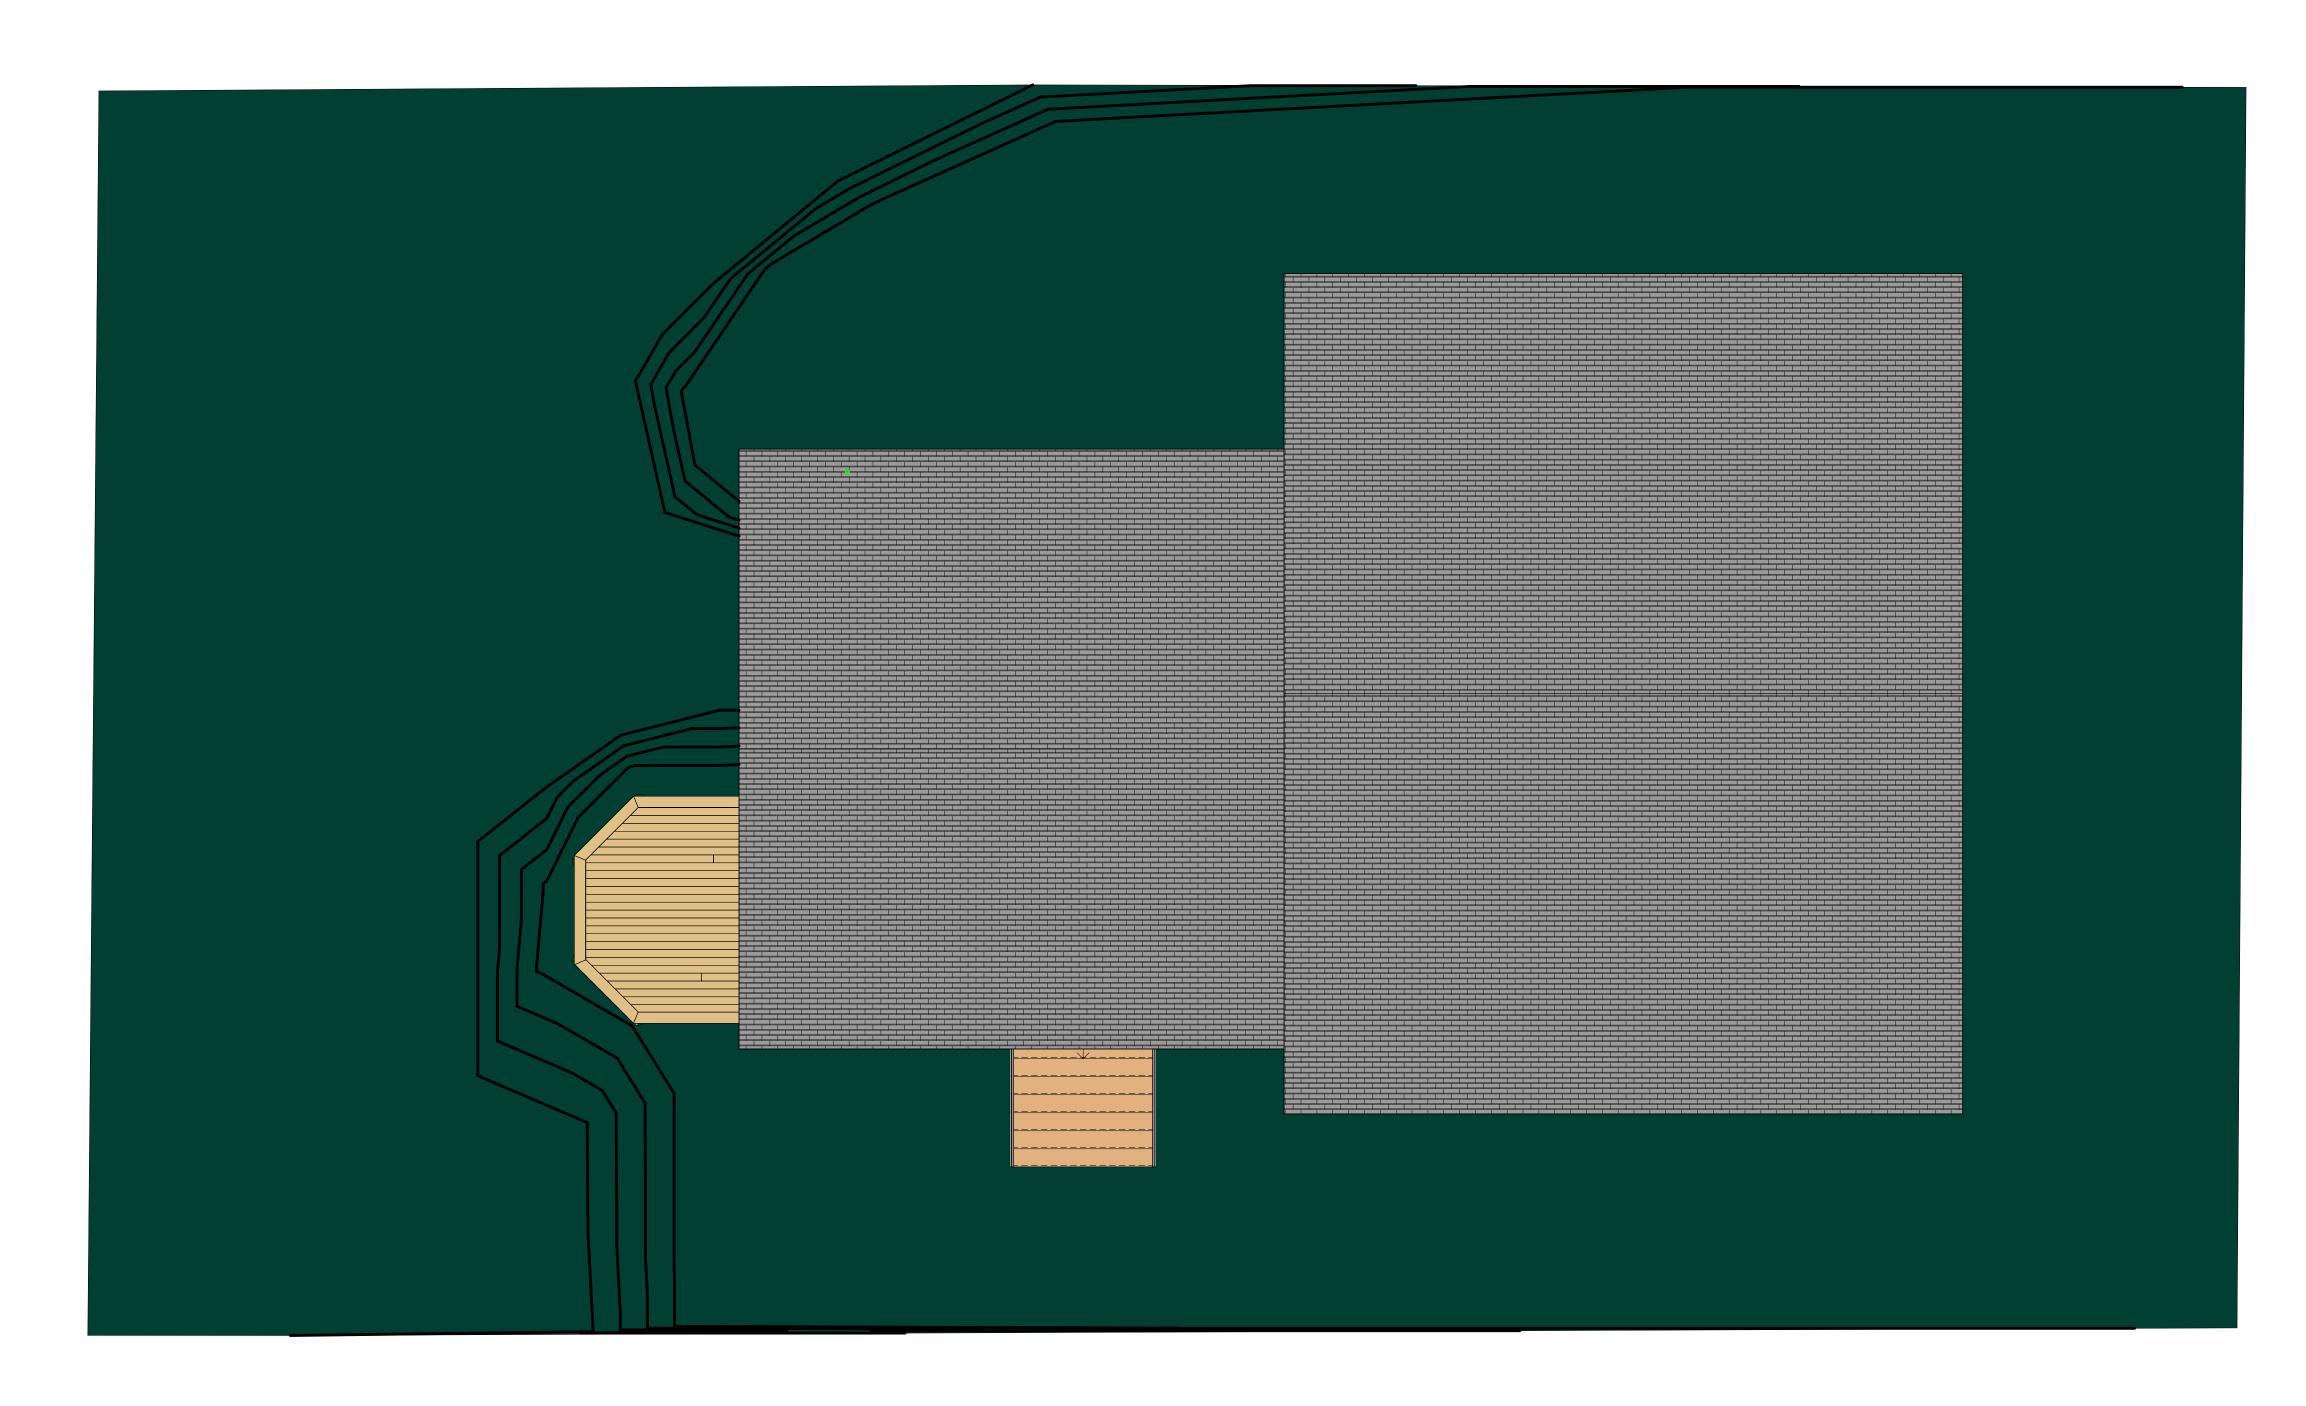
# COTTAGE RENOVATION & EXTENSION PLANS

ALPHA ENGINEERING LIMITED

> 11 JONES ROAD BISHOP'S COVE, NL A0A 3X1

709-589-5258 www.alphaengineeringltd.com CLIENT
AEL Web Development
Bishop's Cove, NL



Site Plan
3/16" = 1'-0"

Project Dtrawing List			
Sheet Number	Sheet Name		
0	Cover		
A1	Site Plan & Project Drawing List		
A2	Room Schedules		
A3	Northeast 3D View		
A4	Southwest 3D View		
A5	Northwest 3D View		
A6	Southeast 3D View		
A7	Building North & South Elevations		
A8	Building East & West Elevations		
A9	Footing & Foundation Dims		
A10	Garage Floor Dimensions		
A11	First Floor Dimensions		
A12	Windows & Doors Plans & Schedules		
A13	Framing Details & Specification		
A14	Stair Sections		

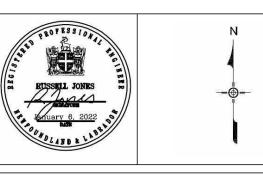
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A0A 3X1
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**Revision Schedule** Description Jan 6, 2022

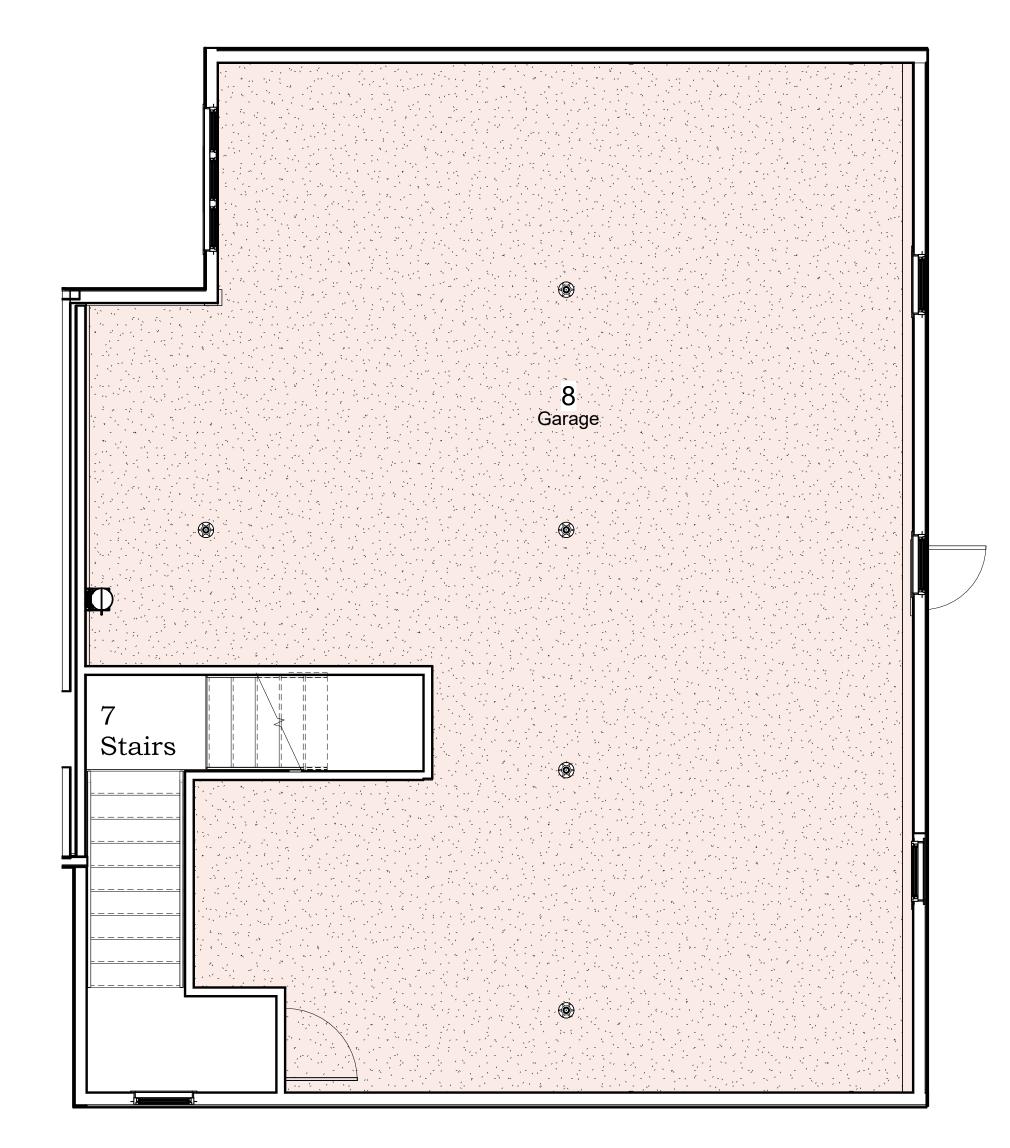
Cottage Reno 1 Site Plan & Project Drawing List

2021-07 Project number 06/01/22 Drawn by Checked by

**A1** 

Scale

3/16" = 1'-0"



1) Garage Room Schedule 1/4" = 1'-0"

Room Schedule	
Number	Name

Master Bedroom
Ensuite
Walk-in Closet
Closet
Bedroom
Closet
Bedroom
Closet
Laundry
Storage
Hall
Stairs
Garage

Pirst Room Schedule
1/4" = 1'-0"

Master Bedroom

Bedroom

Bedroom

Walk-in Closet

1C Closet

Stairs

Ensuite

Storage

Laundry

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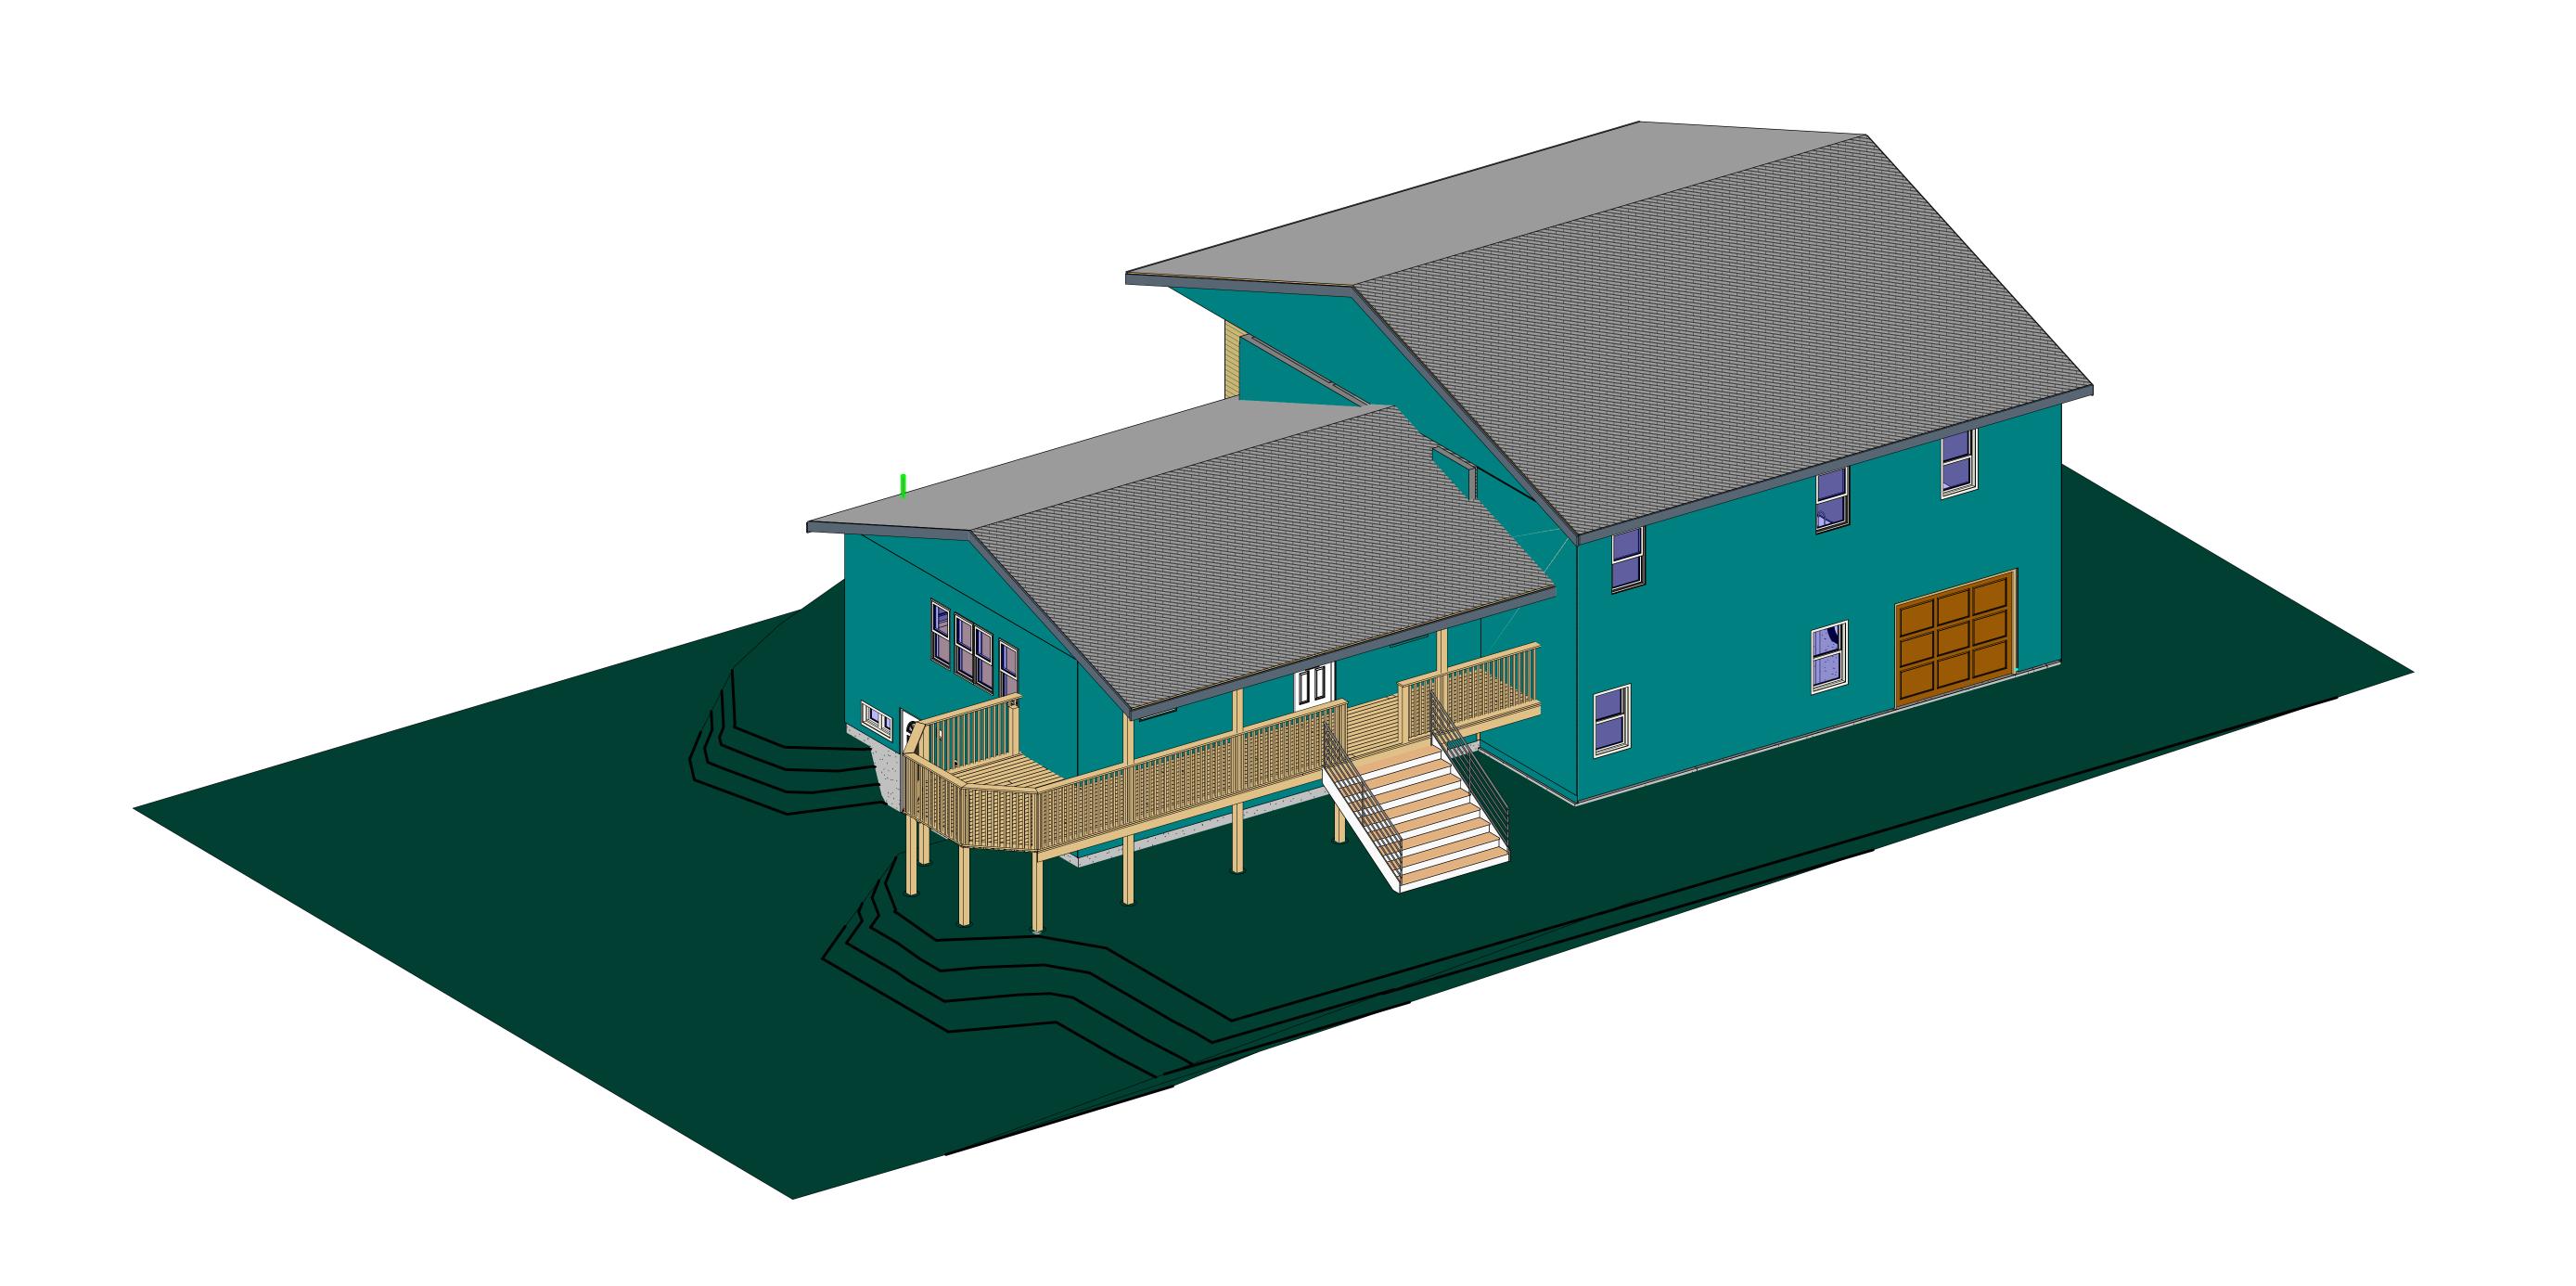
No.	Description	Date
1	IFC	Jan 6, 2022

Cottage Reno 1 Room Schedules

2021-07 Project number 06/01/22 Date Drawn by Checked by

A2

1/4" = 1'-0"



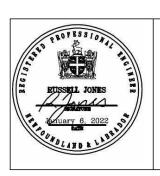
1 Northeast 3D View

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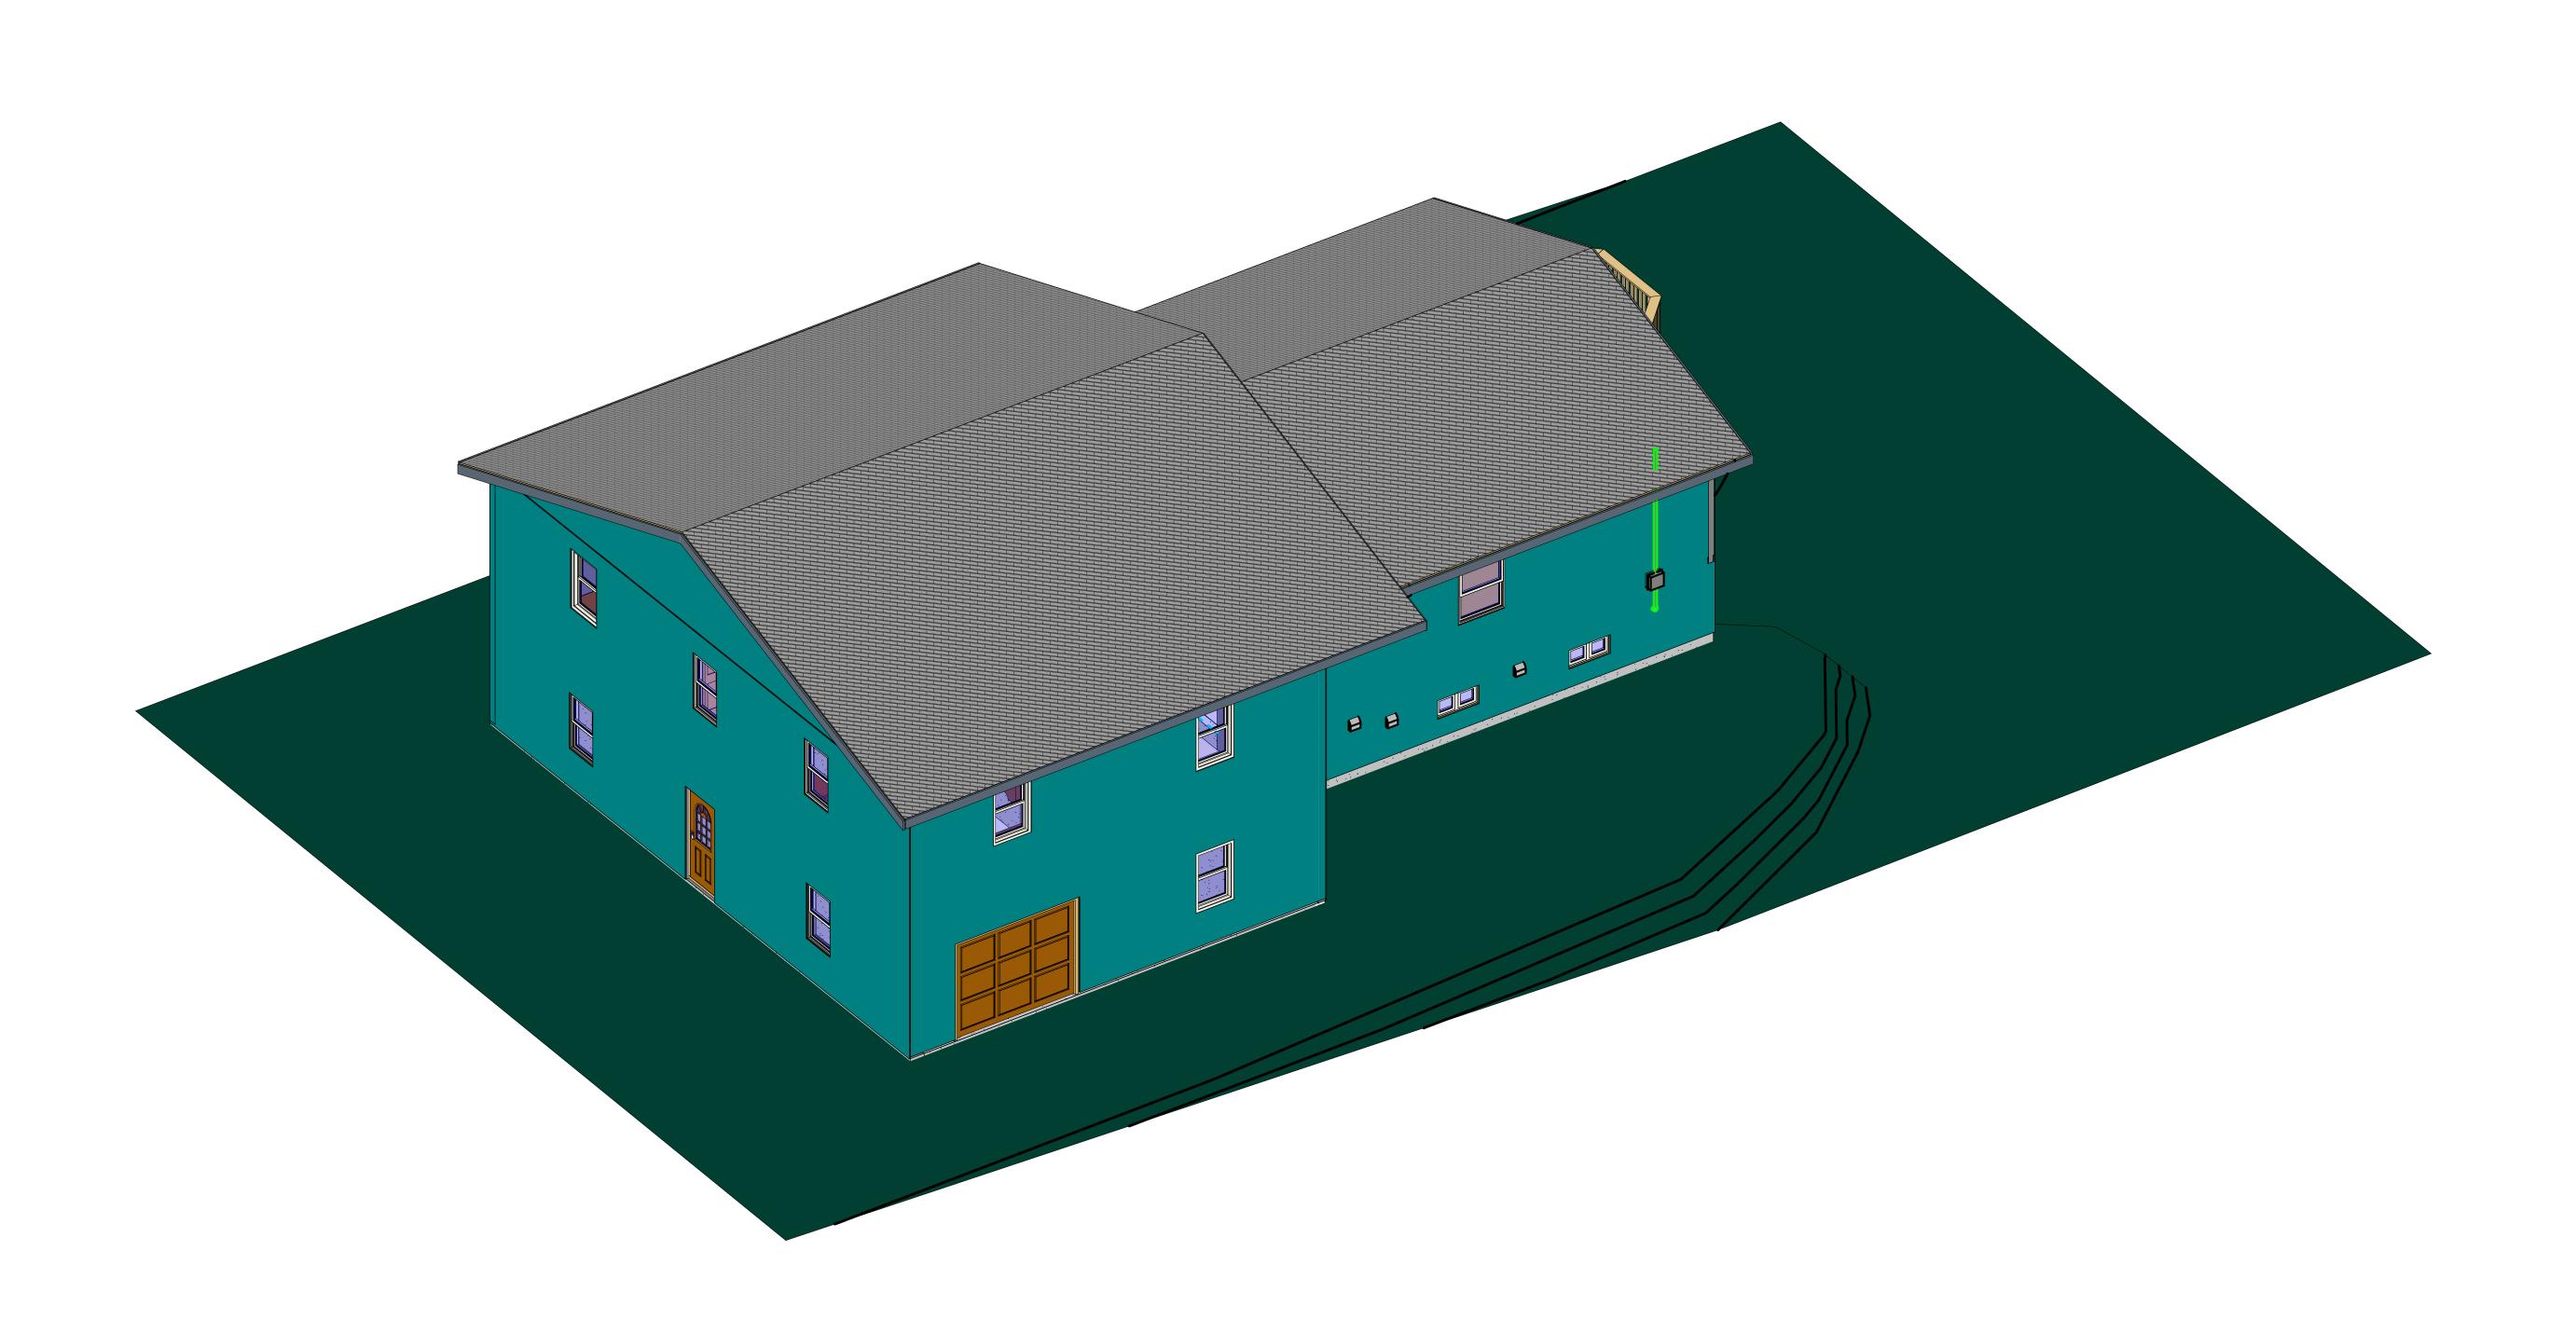
**Revision Schedule** Description Jan 6, 2022

Cottage Reno 1 Northeast 3D View

Project number 2021-07 06/01/22 Date Drawn by Checked by

**A**3

Scale



1 Southwest 3D View

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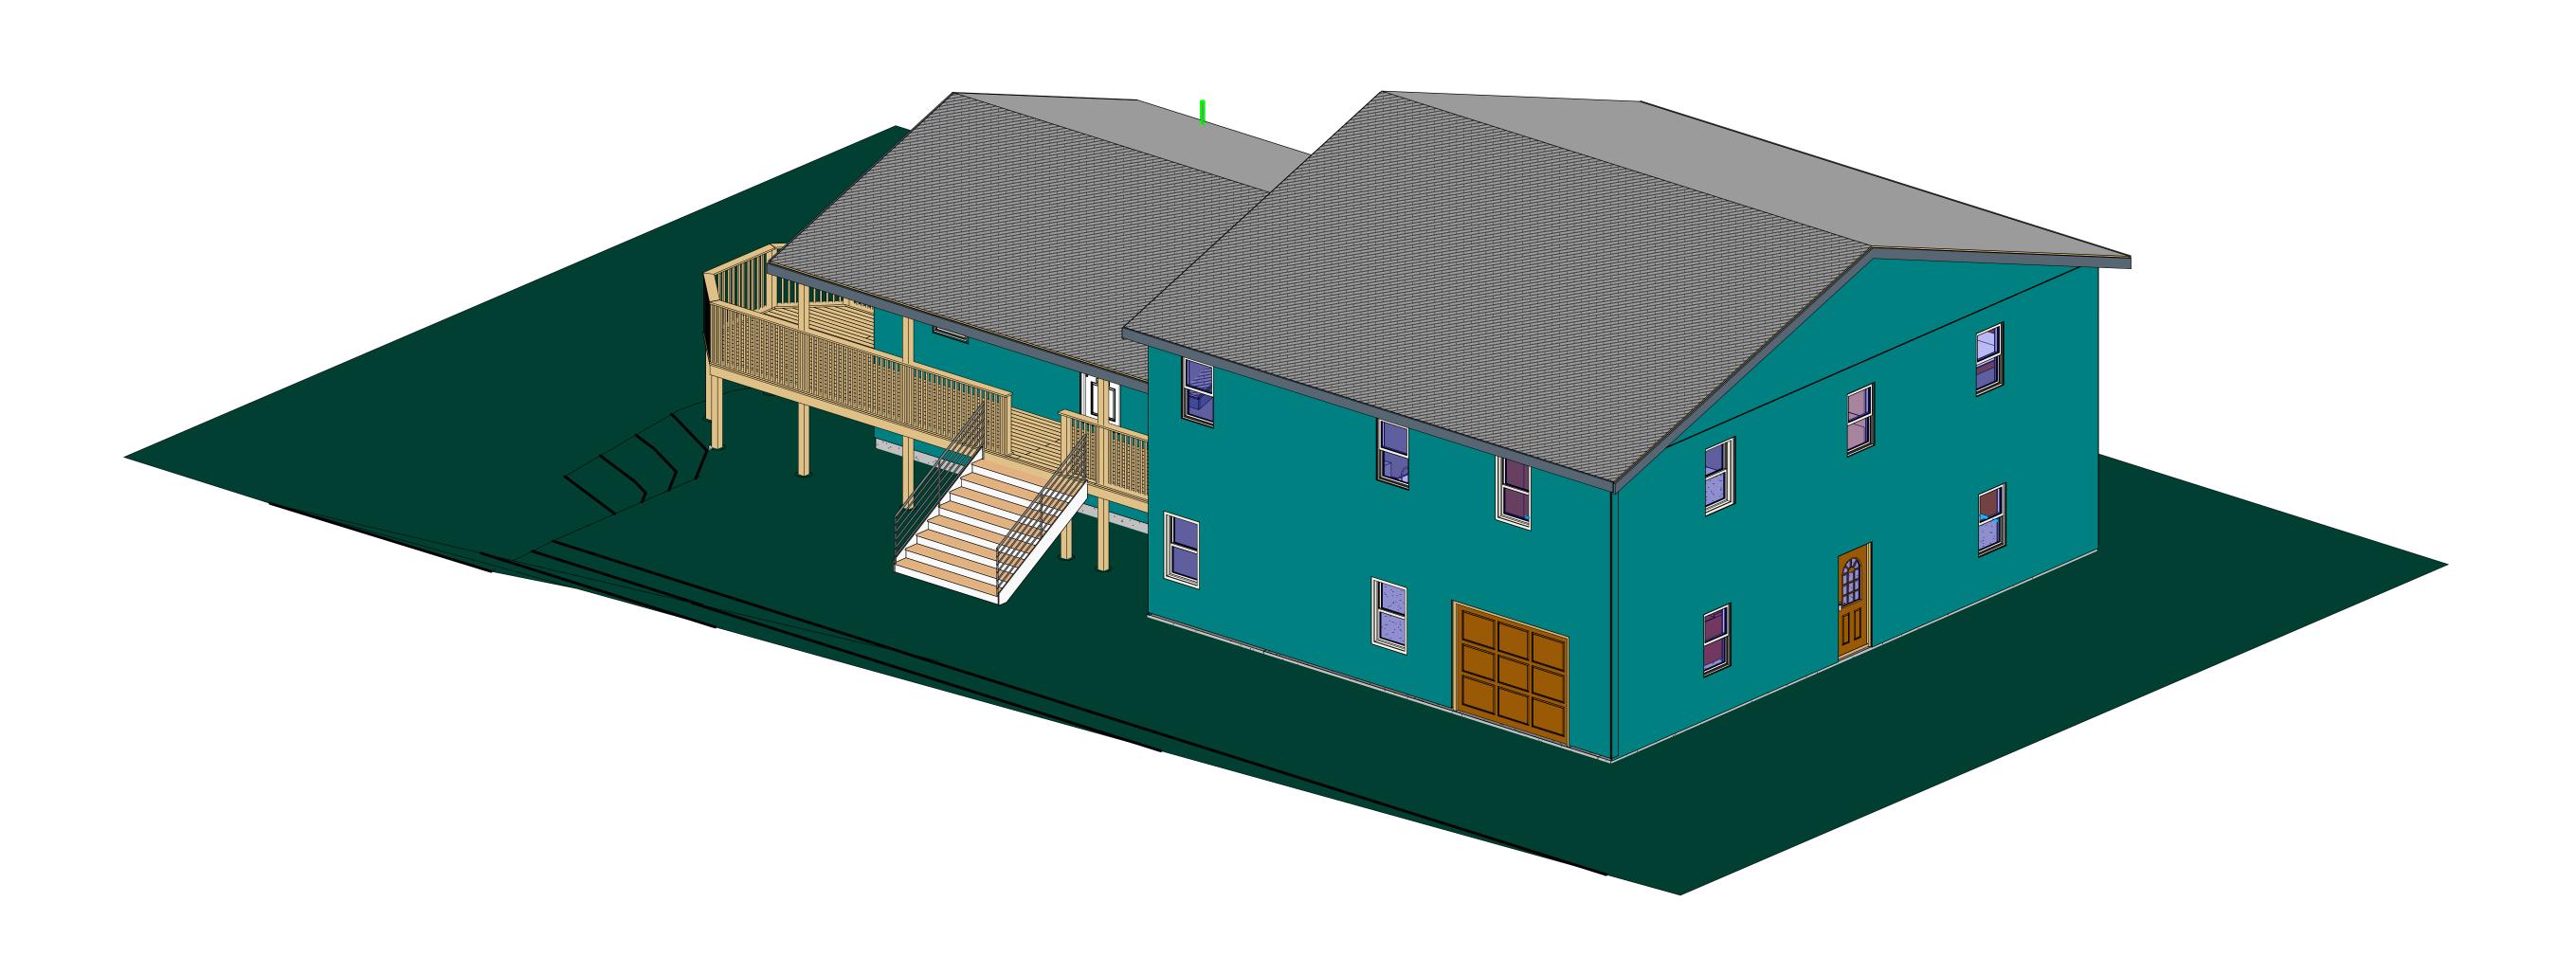
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Revision Schedule		
Revisi on	Description	Date
1	IFC	Jan 6, 2022

Cottage Reno 1 Southwest 3D View

2021-07 Project number 06/01/22 Date Drawn by Checked by



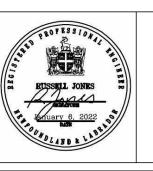
1 Northwest 3D View

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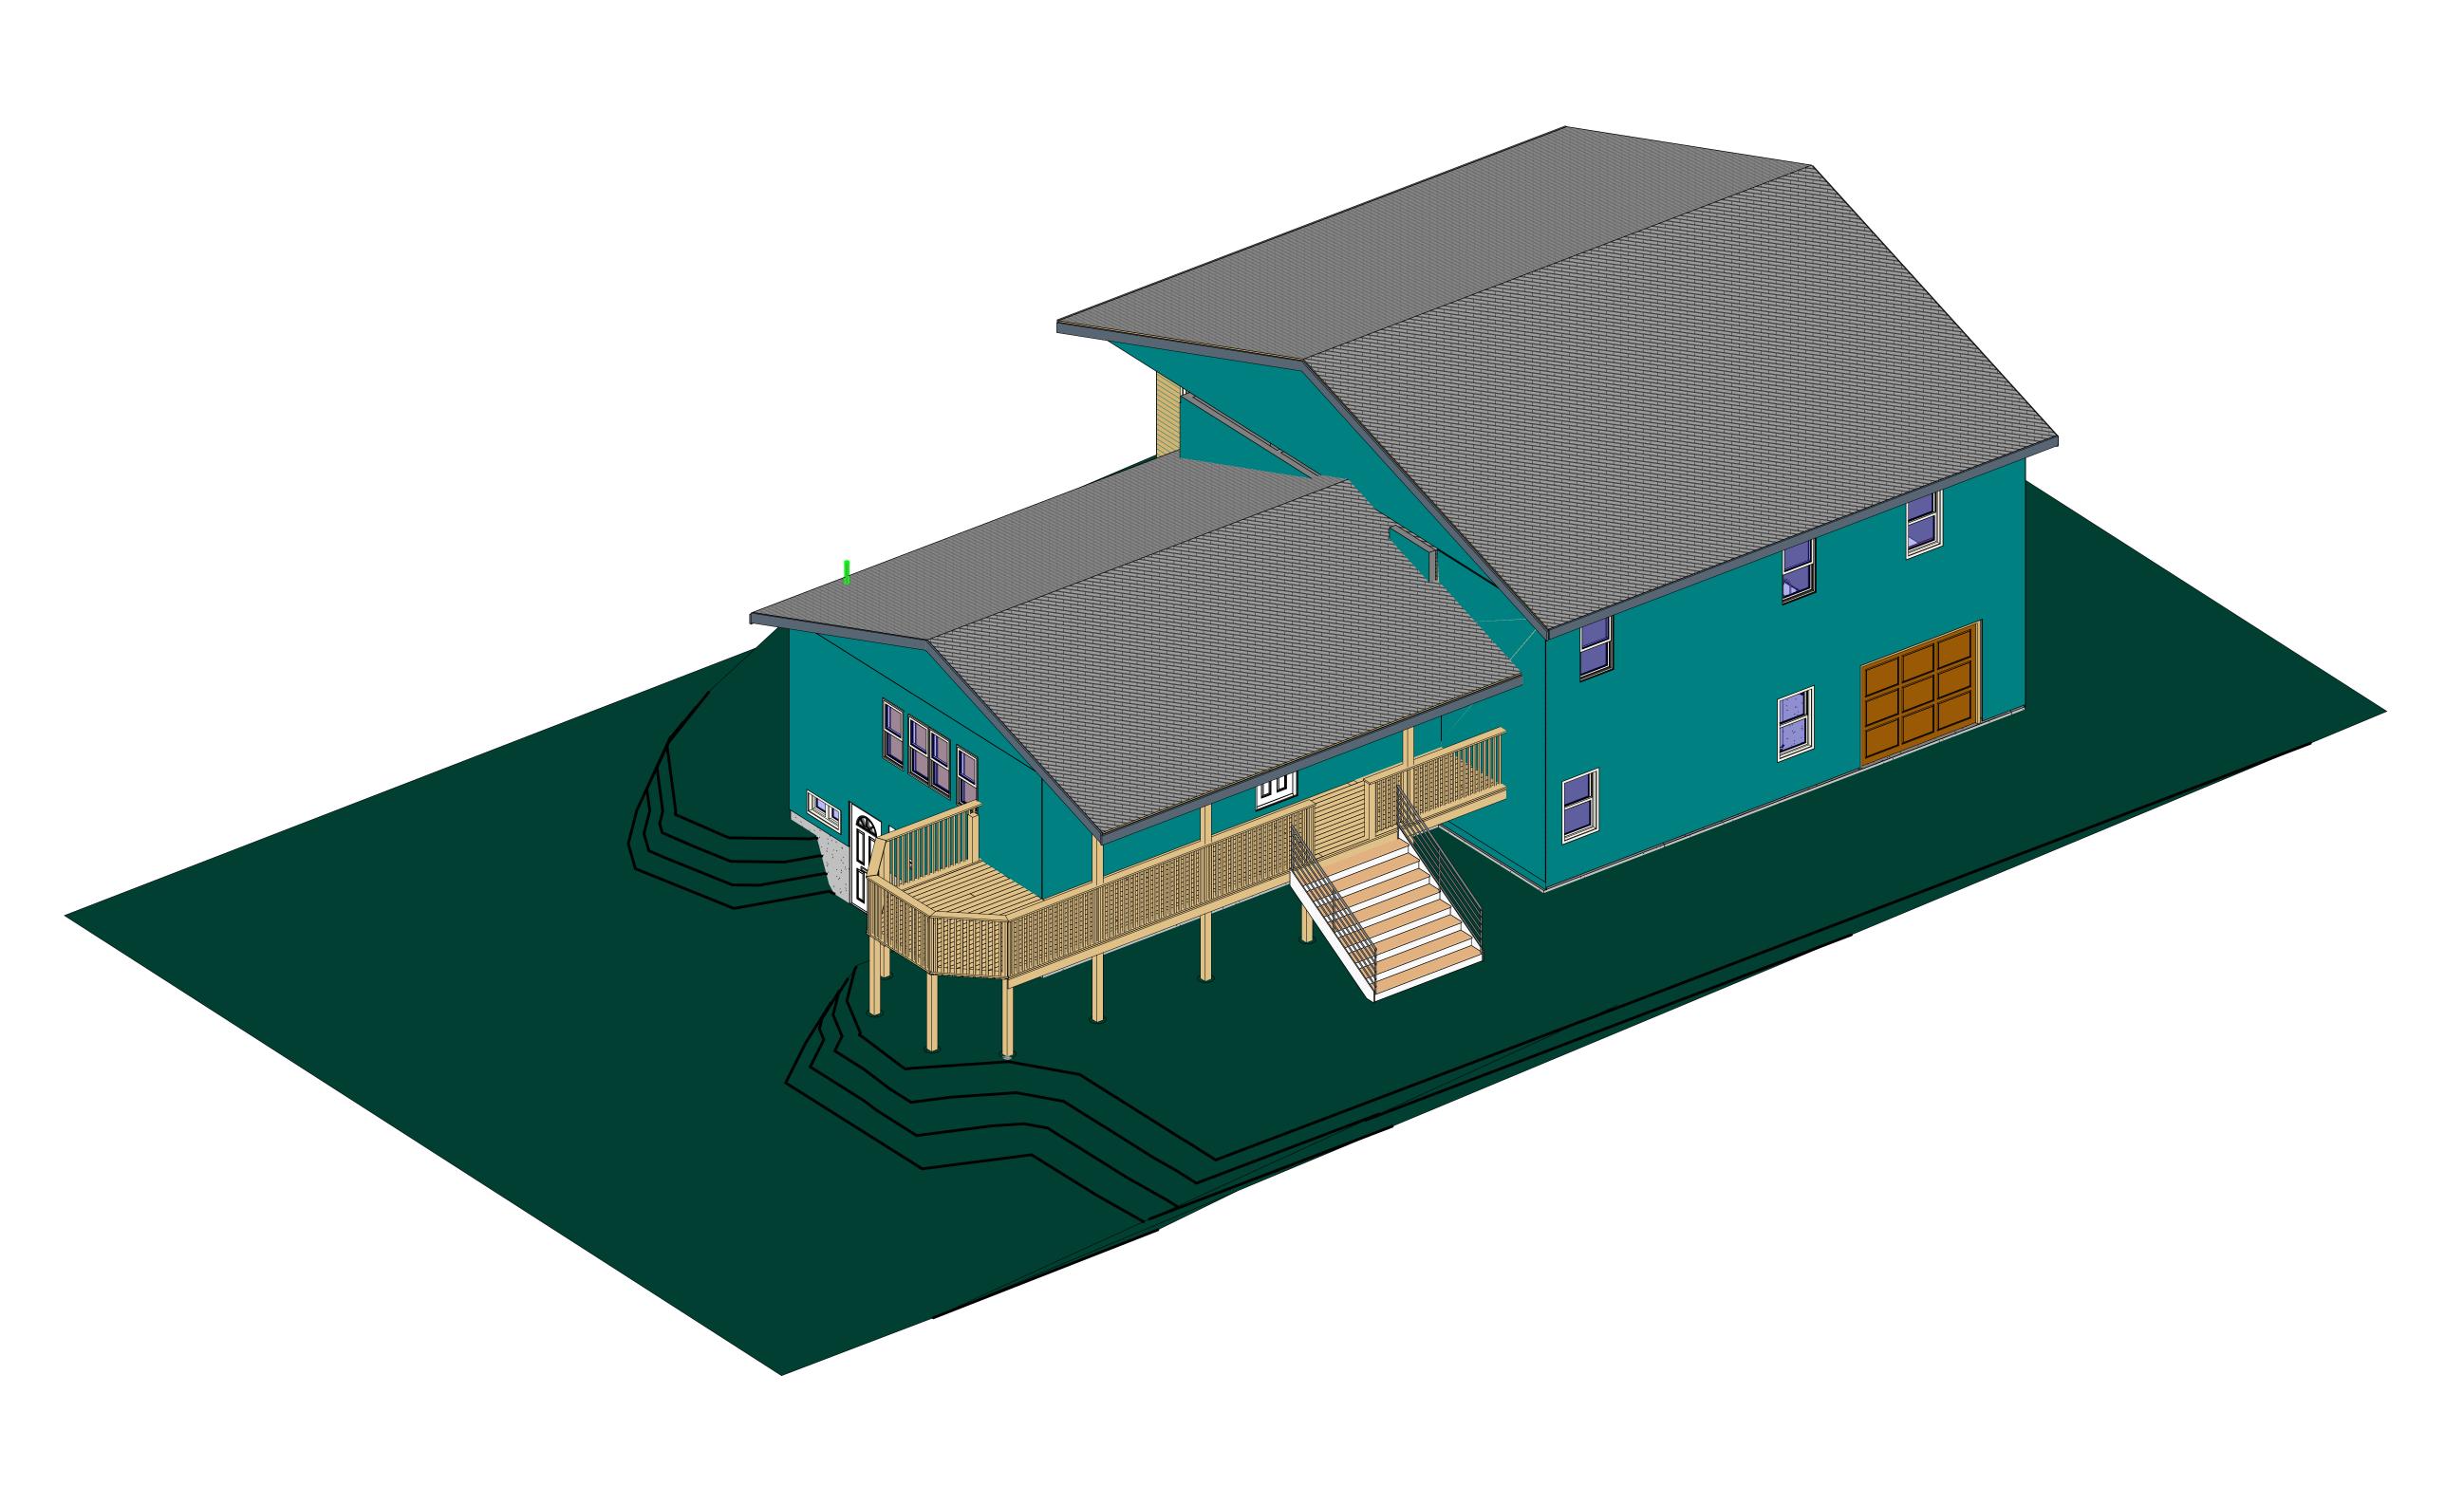
Cottage Reno 1 Northwest 3D View

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Scale



Southeast 3D View

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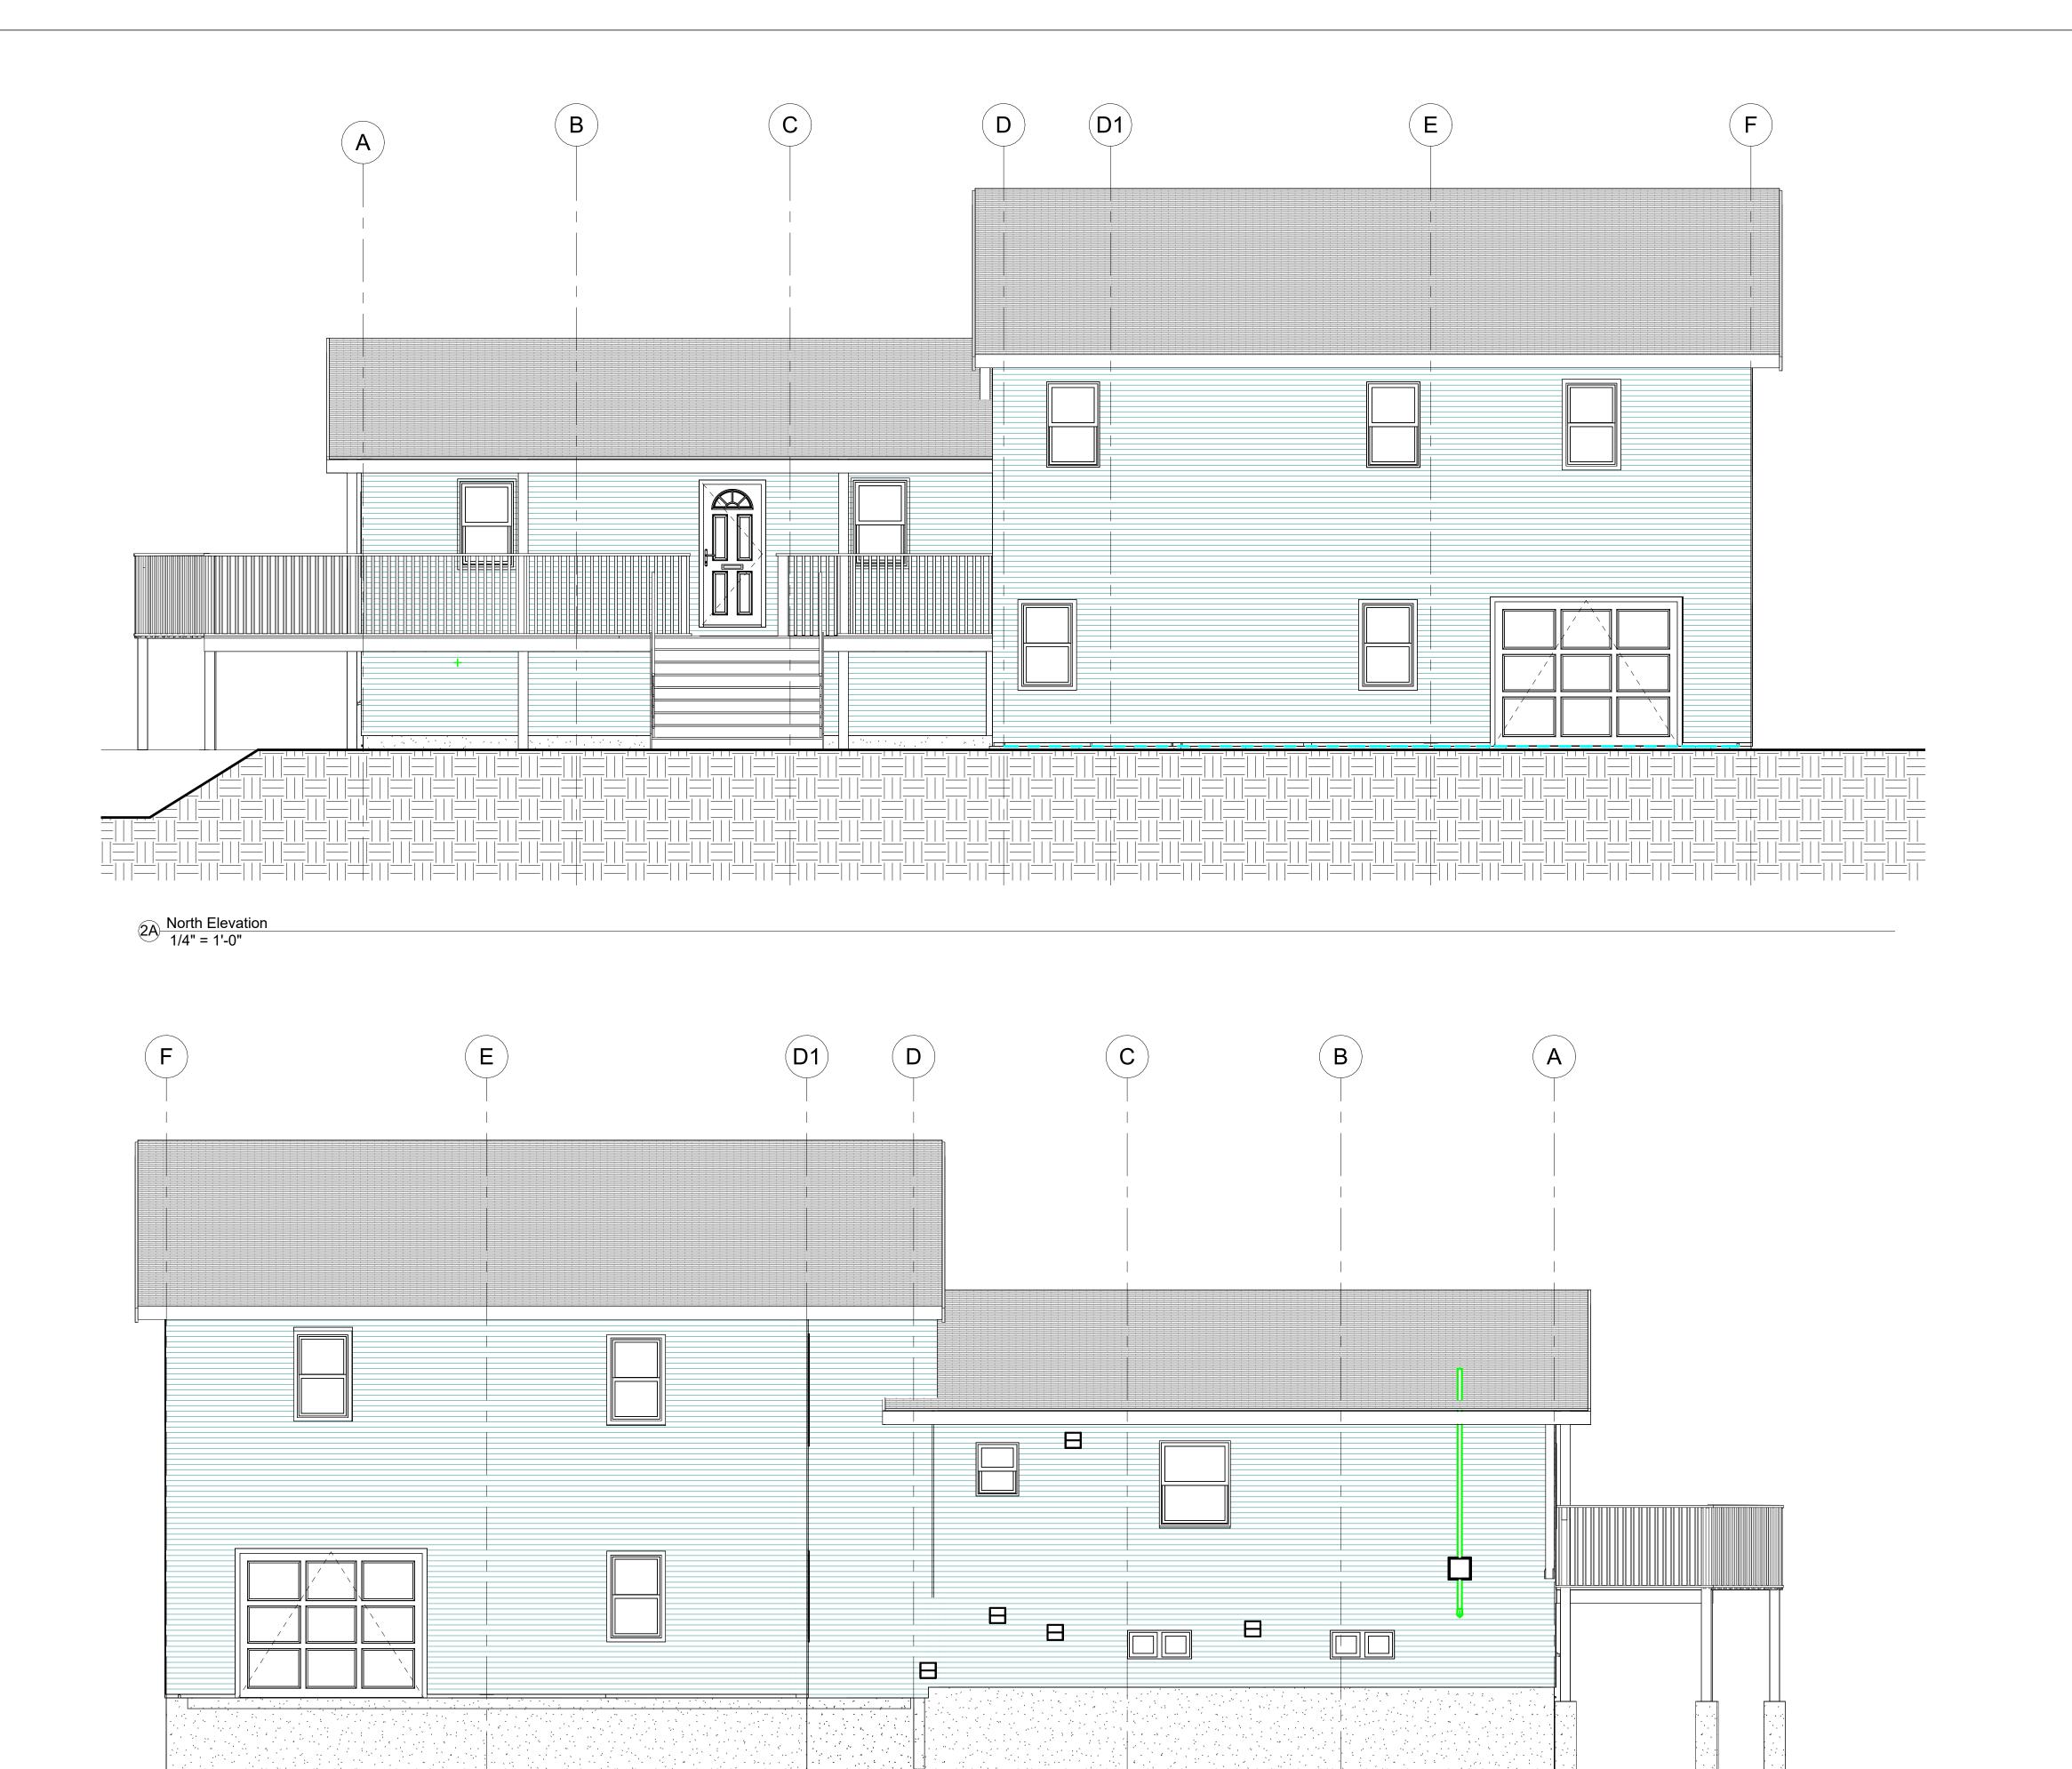
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	Revision Schedule		
Revisi on	Description	Date	
1	IFC	Jan 6, 2	

Cottage Reno 1 Southeast 3D View

2021-07 Project number 06/01/22 Date Drawn by Checked by

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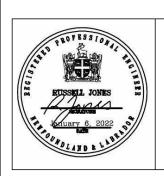


2 South Elevation 1/4" = 1'-0"

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Cottage Reno 1 Building North & South Elevations

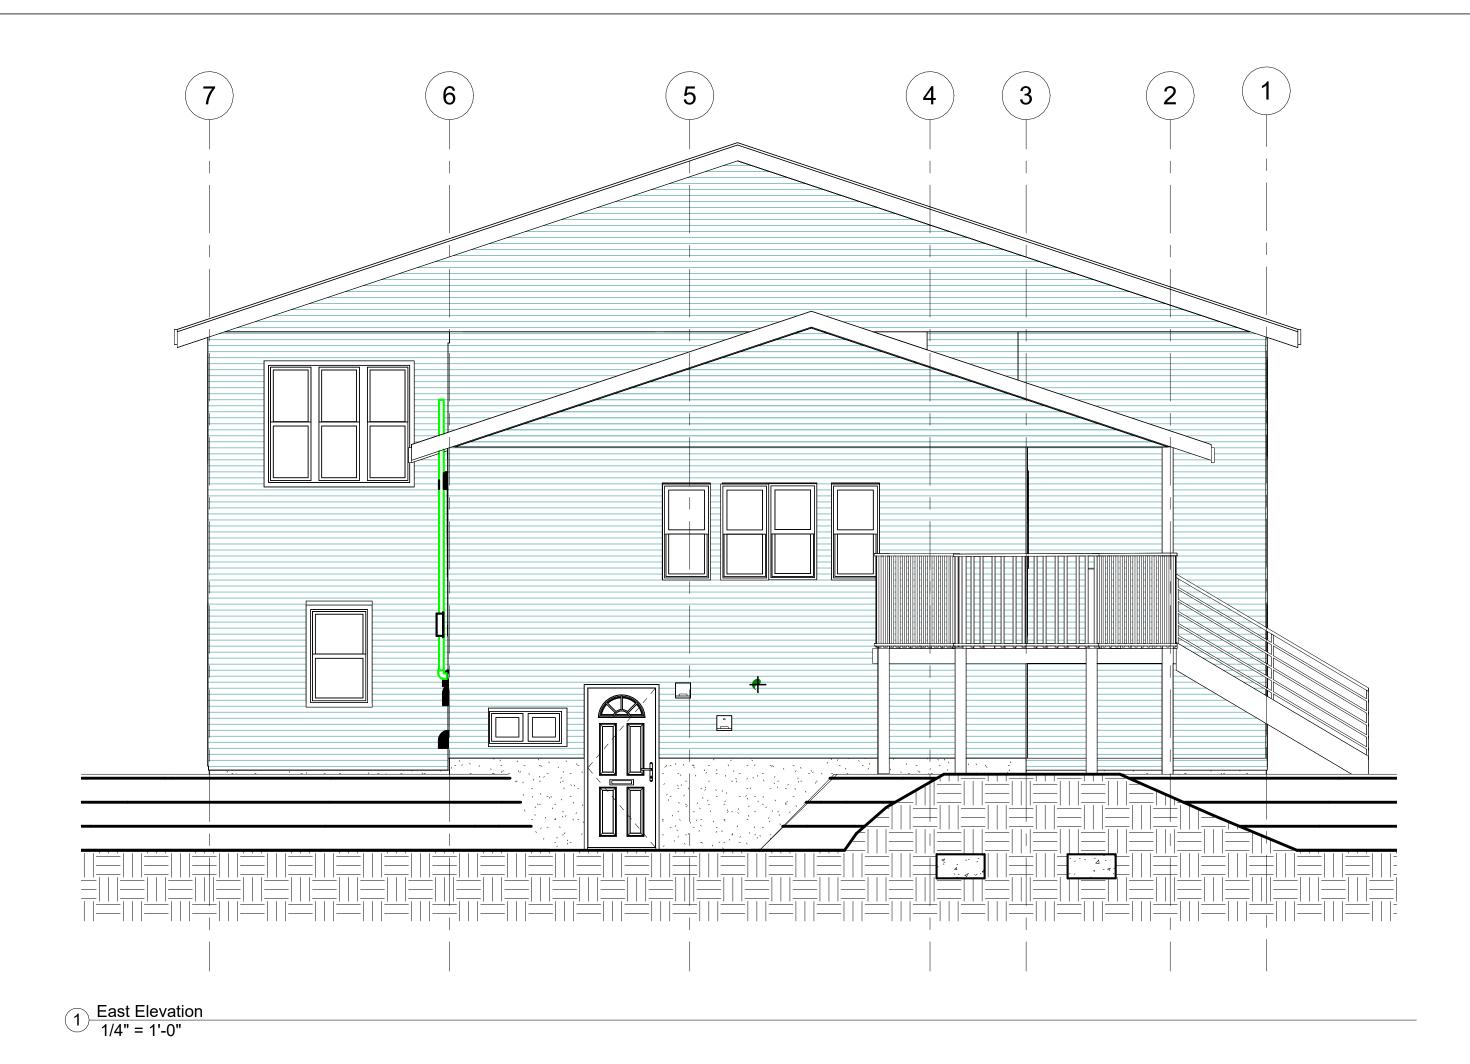
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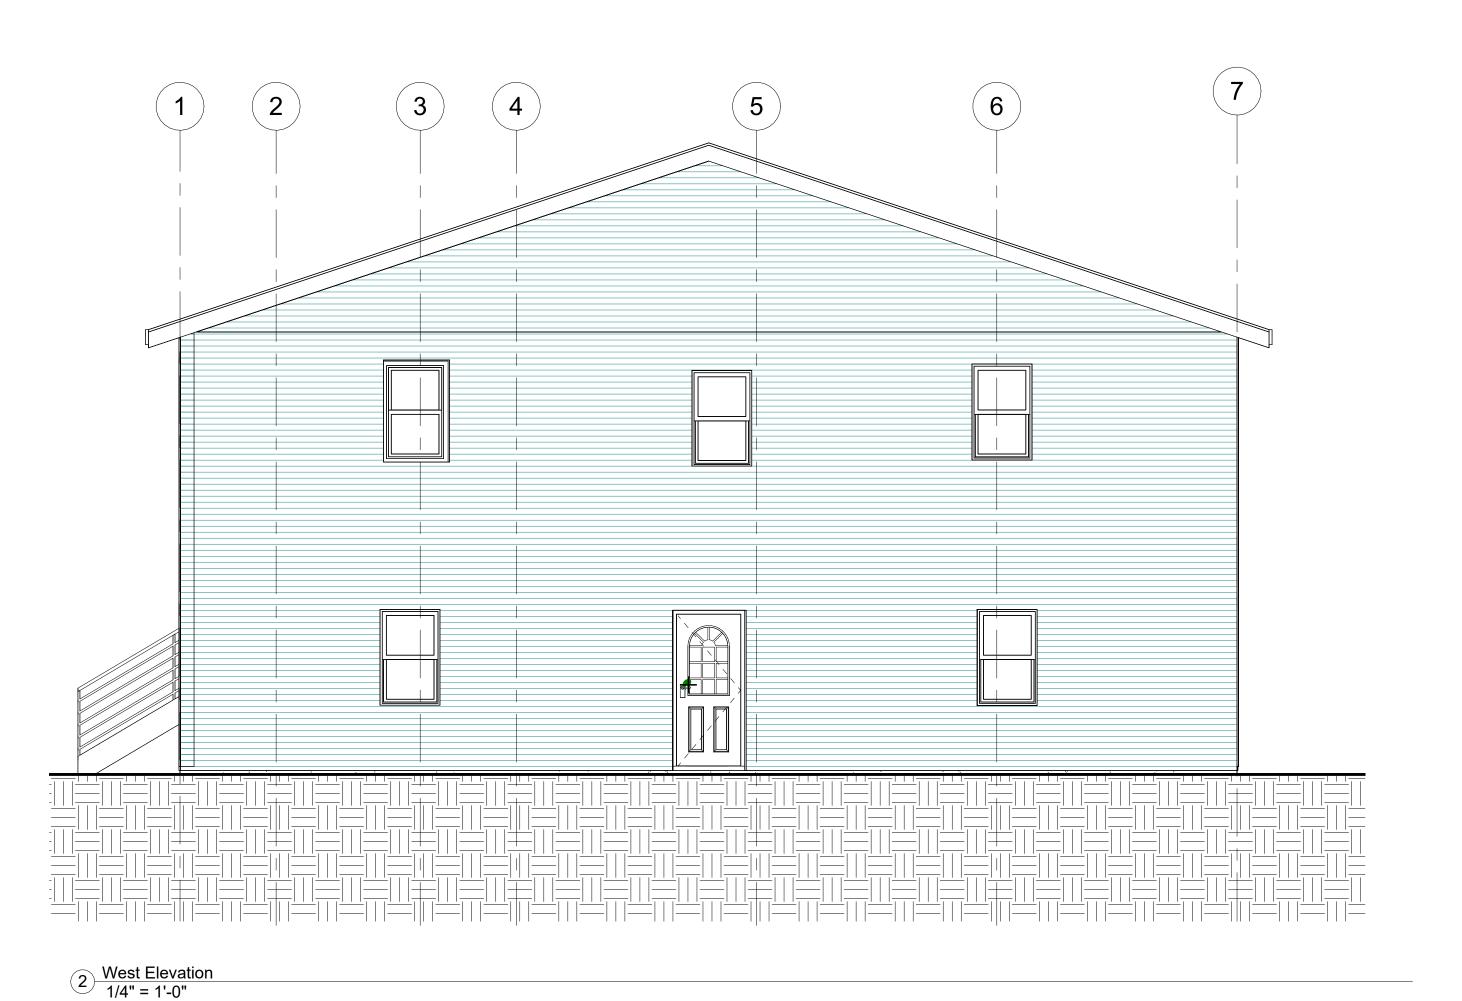
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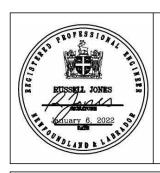




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1	IFC	Jan 6, 2022

Cottage Reno 1 Building East & West Elevations

2021-07 Project number 06/01/22 Drawn by Checked by

**A8** 

Scale

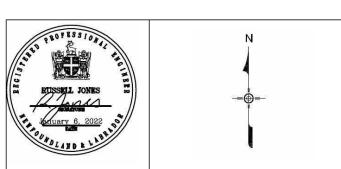
Footing & Foundation Dimensions
1/4" = 1'-0"

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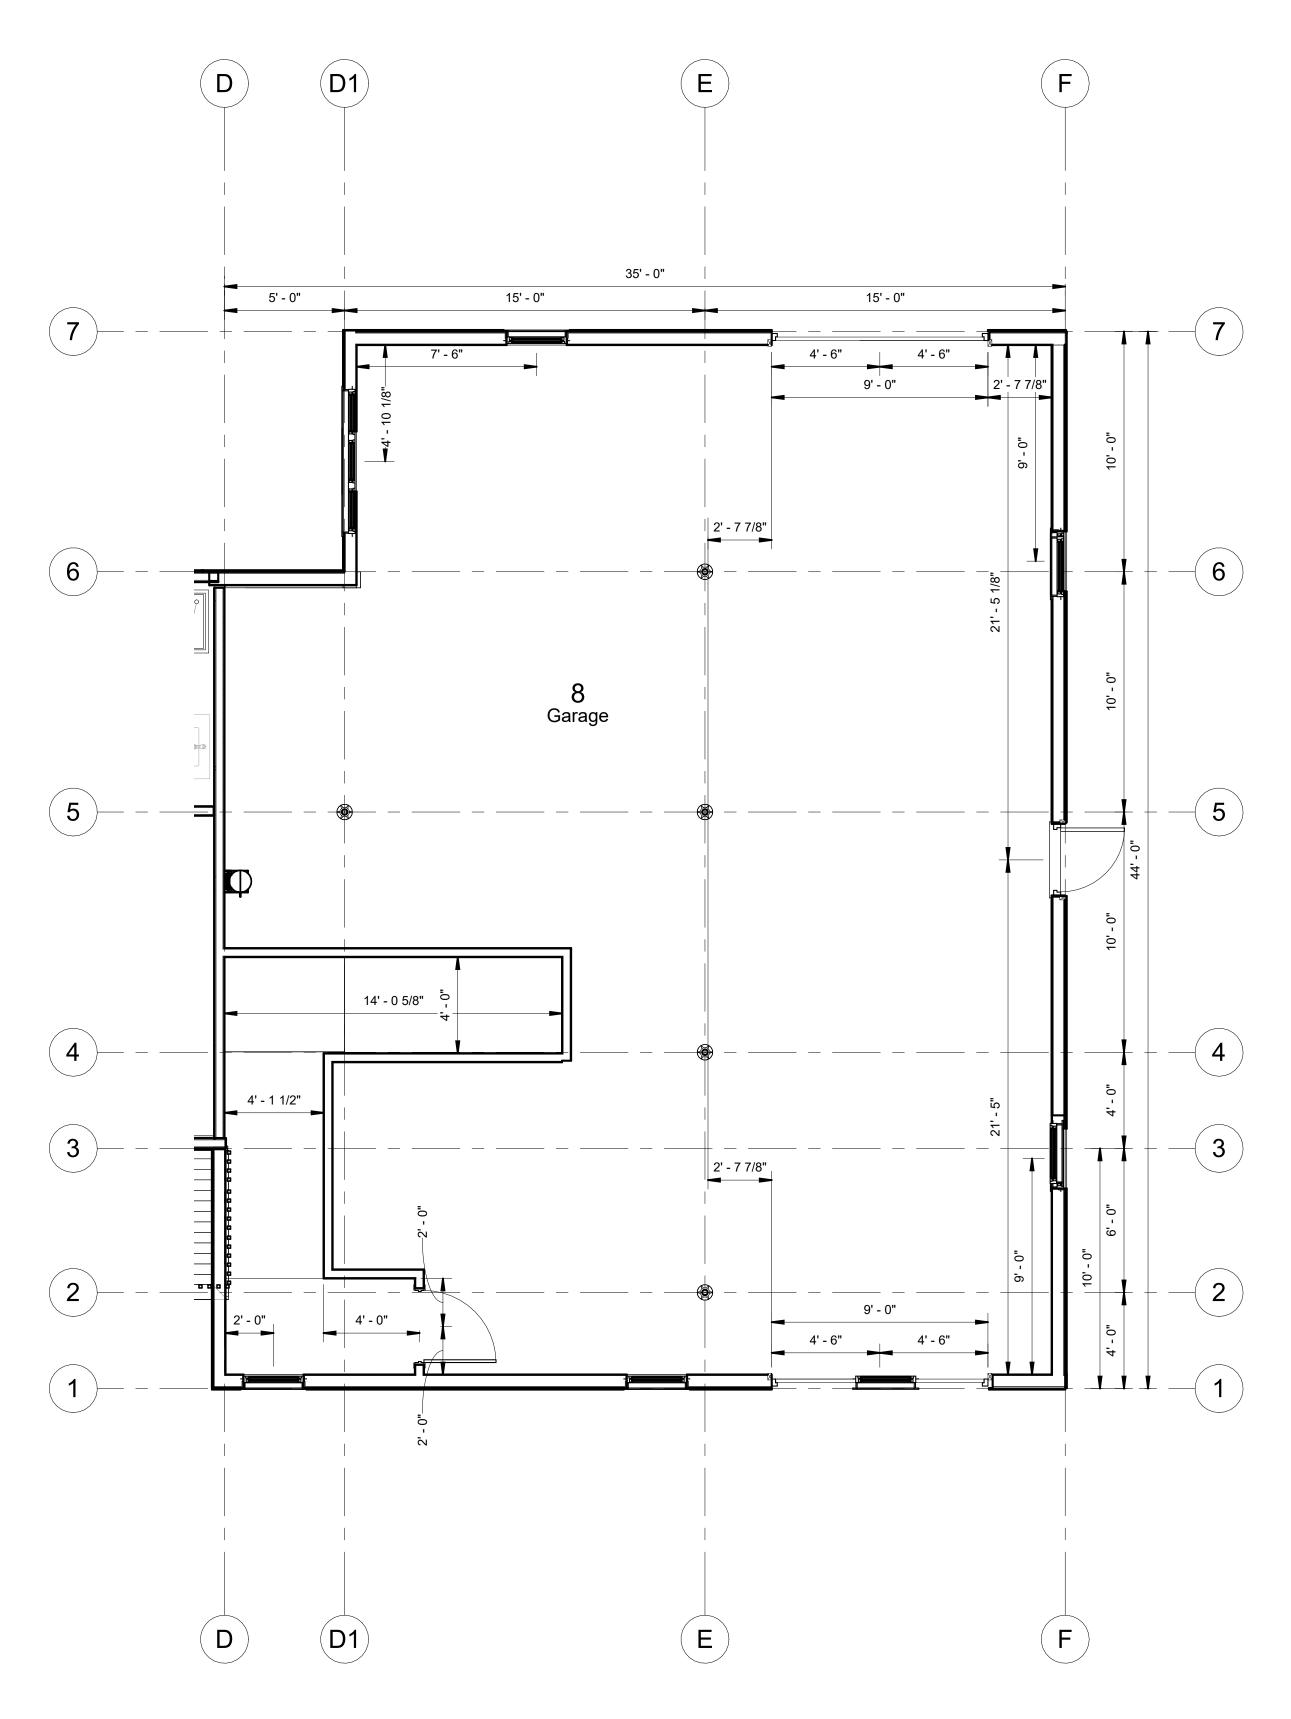
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Issued For JDR Review Jan 6, 2022

#### Cottage Reno 1 Footing & Foundation Dims

<b>A O</b>	
Checked by	RLJ
Drawn by	RLJ
Date	06/01/22
Project number	2021-07

A9

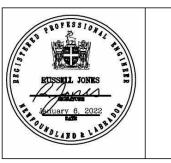


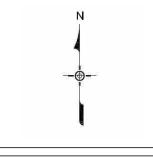
1 Garage Floor Dimensions 1/4" = 1'-0"

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Description Jan 6, 2022

**Revision Schedule** 

Cottage Reno 1 Garage Floor Dimensions

2021-07 Project number 06/01/22 Drawn by Checked by

A10

Scale

#### $\bigcirc$ (D1) (B)65' - 0" 35' - 0" 30' - 0" 7' - 6 3/4" 10' - 0" 10' - 0" 10' - 0" 15' - 0 3/4" - 13' - 6" <del>-</del> 5 5 **EXISTING** 18' - 2 1/8" COTTAGE 13' - 5 1/2" BASEMENT 13' - 9 3/4" 3 9' - 6 5/8" 10' - 0" 10' - 0" 5' - 9 7/8" 7' - 10 5/8" 6' - 10 7/8" 5' - 0" 15' - 0" 15' - 0" 30' - 0" 35' - 0" 65' - 0" $\bigcirc$ D

First Floor Dimensions
1/4" = 1'-0"

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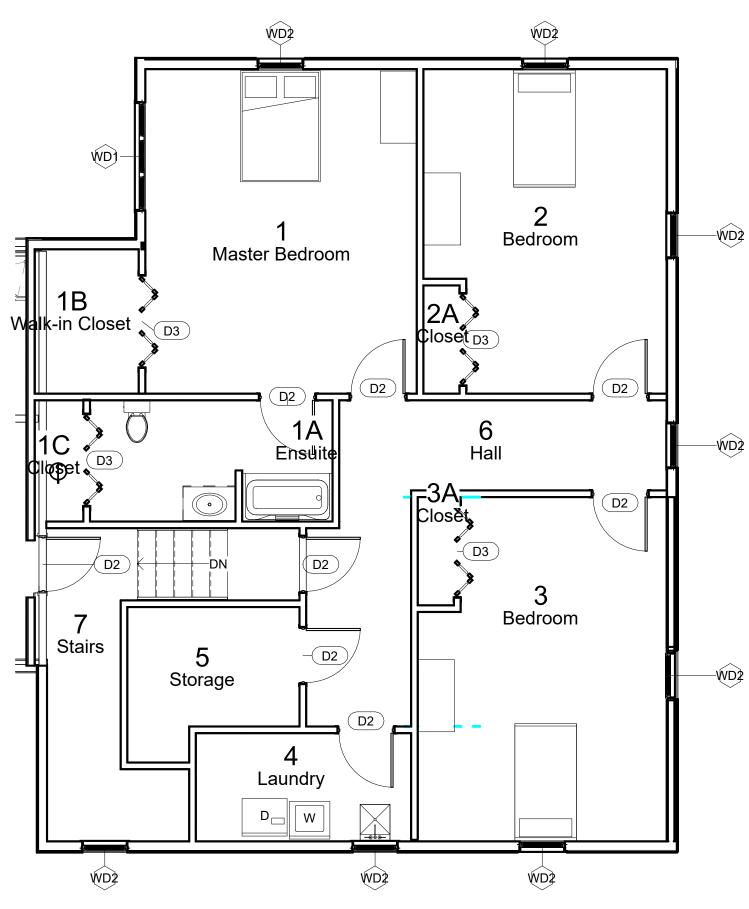
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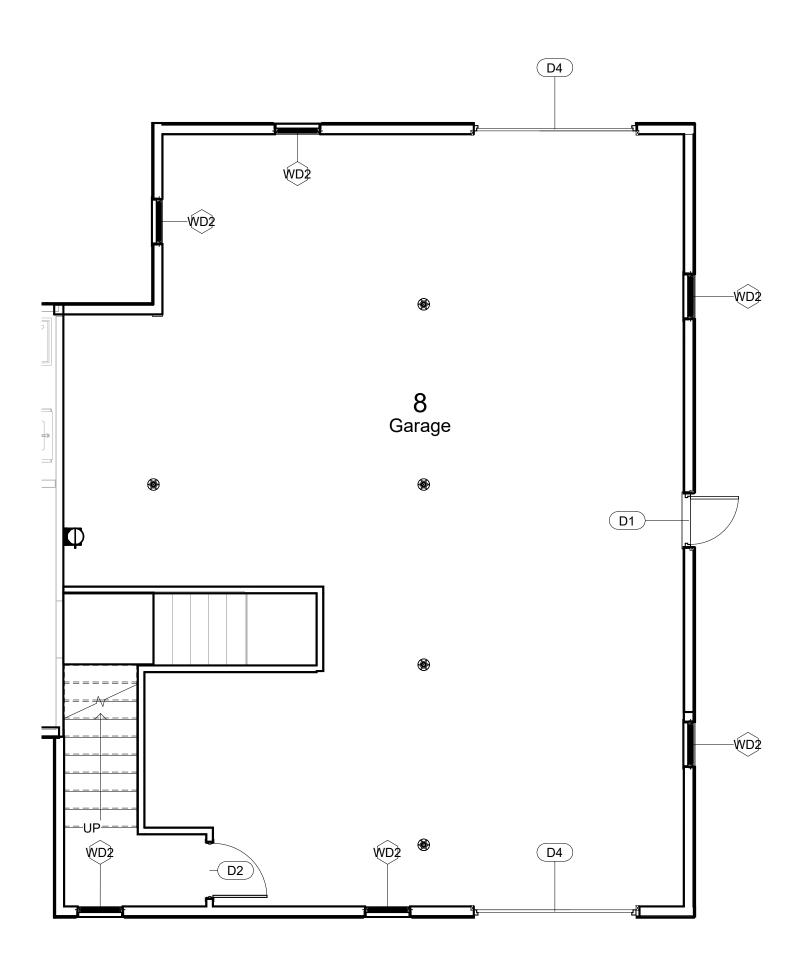
Revision Schedule			
Revisi on	Description	Date	
1	IFC	Jan 6, 2022	

#### Cottage Reno 1 First Floor Dimensions

oject number	2021-07	
ate	06/01/22	
awn by	RLJ	
necked by	RLJ	4:20 AM
		1 5



First Windows & Doora
3/16" = 1'-0"



Garage Windows & Doors
3/16" = 1'-0"

	Door Schedule				
Door Number	Room Name & Number	Width	Height	Comments	
D1	8 Garage	3' - 0"	6' - 8"	Steel Exterior Door With Vented Sliding Glass Window	
D2	1 Master Bedroom	3' - 0"	6' - 8"	Interior Wood Panel Door	
D2	1A Ensuite	3' - 0"	6' - 8"	Interior Wood Panel Door	
D2	2 Living Room	3' - 0"	6' - 8"	Interior Wood Panel Door	
D2	7 Stairs	3' - 0"	6' - 8"	Interior Wood Panel Door	
D2	7 Stairs	3' - 0"	6' - 8"	Interior Wood Panel Door	
D2	8 Garage	3' - 0"	6' - 8"	Interior Wood Panel Door	
D2	4 Laundry	3' - 0"	6' - 8"	Interior Wood Panel Door	
D2	3 Bedroom	3' - 0"	6' - 8"	Interior Wood Panel Door	
D2	5 Storage	3' - 0"	6' - 8"	Interior Wood Panel Door	
D3	7 Stairs	5' - 0"	6' - 8"	Inrerior Bi-Fold Wood Panel Door	
D3	1B Walk-in Closet	5' - 0"	6' - 8"	Inrerior Bi-Fold Wood Panel Door	
D3	2A Closet	5' - 0"	6' - 8"	Inrerior Bi-Fold Wood Panel Door	
D3	3A Closet	5' - 0"	6' - 8"	Inrerior Bi-Fold Wood Panel Door	
D4	8 Garage	9' - 0"	7' - 0"	Insulated Garage Door With Windows	
D4	8 Garage	9' - 0"	7' - 0"	Insulated Garage Door With Windows	
ED1	Cottage Main WR Door	2' - 8"	6' - 8"	Existing Cottage Door	
ED2	Cottage Basement WR Door	2' - 8"	6' - 8"	Existing Cottage Door	
ED3	Main Cottage Entrance	0' - 0"	0' - 0"	Existing Cottage Door	
ED4	Cottage Basement Entrance Door	0' - 0"	0' - 0"	Existing Cottage Door	

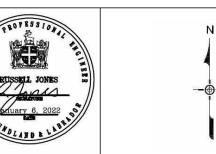
Window Schedule							
Type Mark	Roon Name & Number	Width	Height	Comments			
EWD-1	Existing Cottage	2' - 6"	4' - 0"	Existing Cottage Window			
EWD-1	Existing Cottage	2' - 6"	4' - 0"	Existing Cottage Window			
EWD-2	Existing Cottage	2' - 0"	4' - 0"	Existing Cottage Window			
EWD-2	Existing Cottage	2' - 0"	4' - 0"	Existing Cottage Window			
EWD-2	Existing Cottage	2' - 0"	4' - 0"	Existing Cottage Window			
EWD-2	Existing Cottage	2' - 0"	4' - 0"	Existing Cottage Window			
EWD-3	Existing Cottage	3' - 0"	1' - 4"	Existing Cottage Window			
EWD-3	Existing Cottage	3' - 0"	1' - 4"	Existing Cottage Window			
EWD-3	Existing Cottage	3' - 0"	1' - 4"	Existing Cottage Window			
EWD-5	Existing Cottage	3' - 4"	4' - 0"	Existing Cottage Window			
EWD-6	Existing Cottage	2' - 0"	2' - 6"	Existing Cottage Window			
WD1	1 Master Bedroom	6' - 0"	5' - 0"	Existing Cottage Window			
WD2	1 Master Bedroom	2' - 6"	4' - 0"	Triple Glazed, Low-E & Argon Filled Solid Vinyl Casement Window			
WD2	4 Laundry	2' - 6"	4' - 0"	Triple Glazed, Low-E & Argon Filled Solid Vinyl Casement Window			
WD2	3 Bedroom	2' - 6"	4' - 0"	Triple Glazed, Low-E & Argon Filled Solid Vinyl Casement Window			
WD2	8 Garage	2' - 6"	4' - 0"	Insulated Garage Door with Windows			
WD2	8 Garage	2' - 6"	4' - 0"	Insulated Garage Door with Windows			
WD2	2 Bedroom	2' - 6"	4' - 0"	Triple Glazed, Low-E & Argon Filled Solid Vinyl Casement Window			
WD2	8 Garage	2' - 6"	4' - 0"	Triple Glazed, Low-E & Argon Filled Solid Vinyl Casement Window			
WD2	3 Bedroom	2' - 6"	4' - 0"	Triple Glazed, Low-E & Argon Filled Solid Vinyl Casement Window			
WD2	2 Bedroom	2' - 6"	4' - 0"	Triple Glazed, Low-E & Argon Filled Solid Vinyl Casement Window			
WD2	8 Garage	2' - 6"	4' - 0"	Triple Glazed, Low-E & Argon Filled Solid Vinyl Casement Window			
WD2	8 Garage	2' - 6"	4' - 0"	Triple Glazed, Low-E & Argon Filled Solid Vinyl Casement Window			
WD2	8 Garage	2' - 6"	4' - 0"	Triple Glazed, Low-E & Argon Filled Solid Vinyl Casement Window			
WD2	4 Laundry	2' - 6"	4' - 0"	Triple Glazed, Low-E & Argon Filled Solid Vinyl Casement Window			
WD2	2 Bedroom	2' - 6"	4' - 0"	Triple Glazed, Low-E & Argon Filled Solid Vinyl Casement Window			

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**Revision Schedule** Description Jan 6, 2022

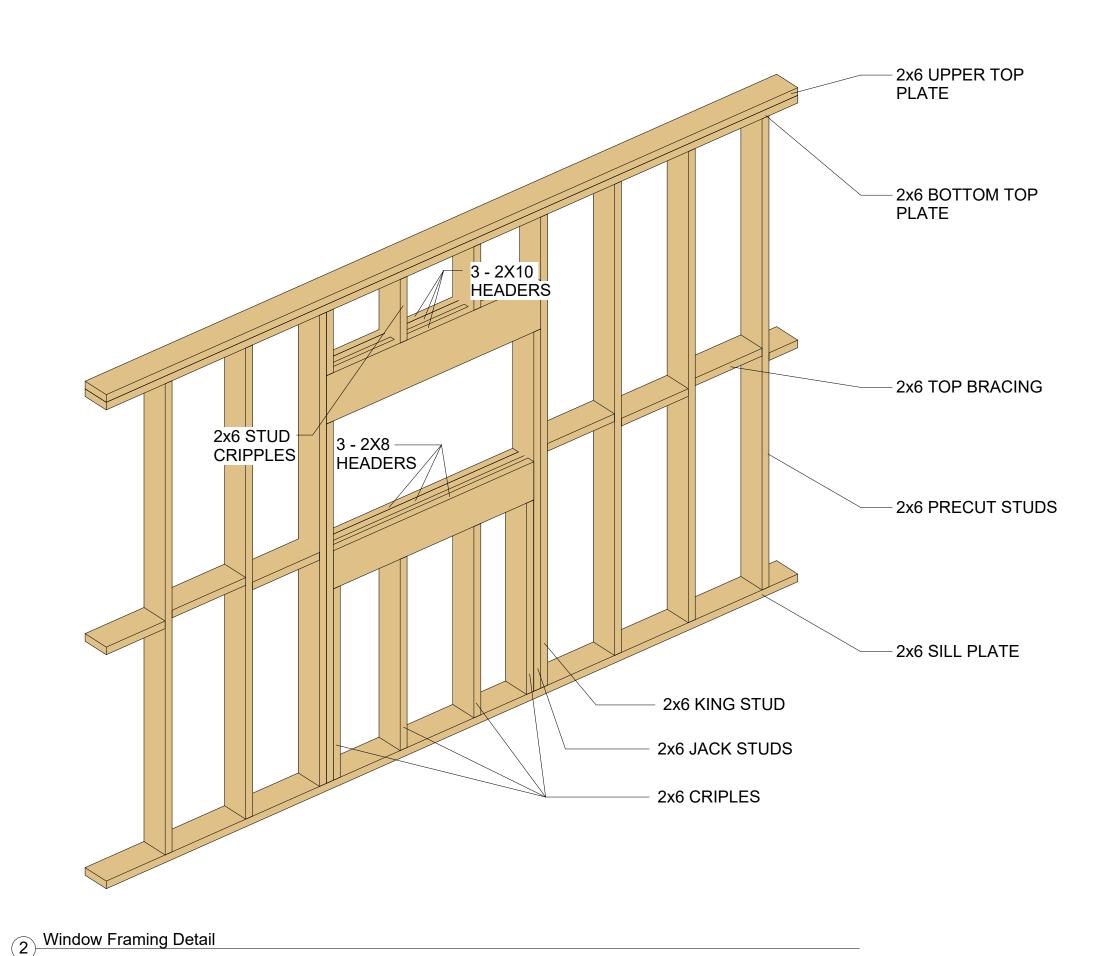
Cottage Reno 1 Windows & Doors Plans & Schedules

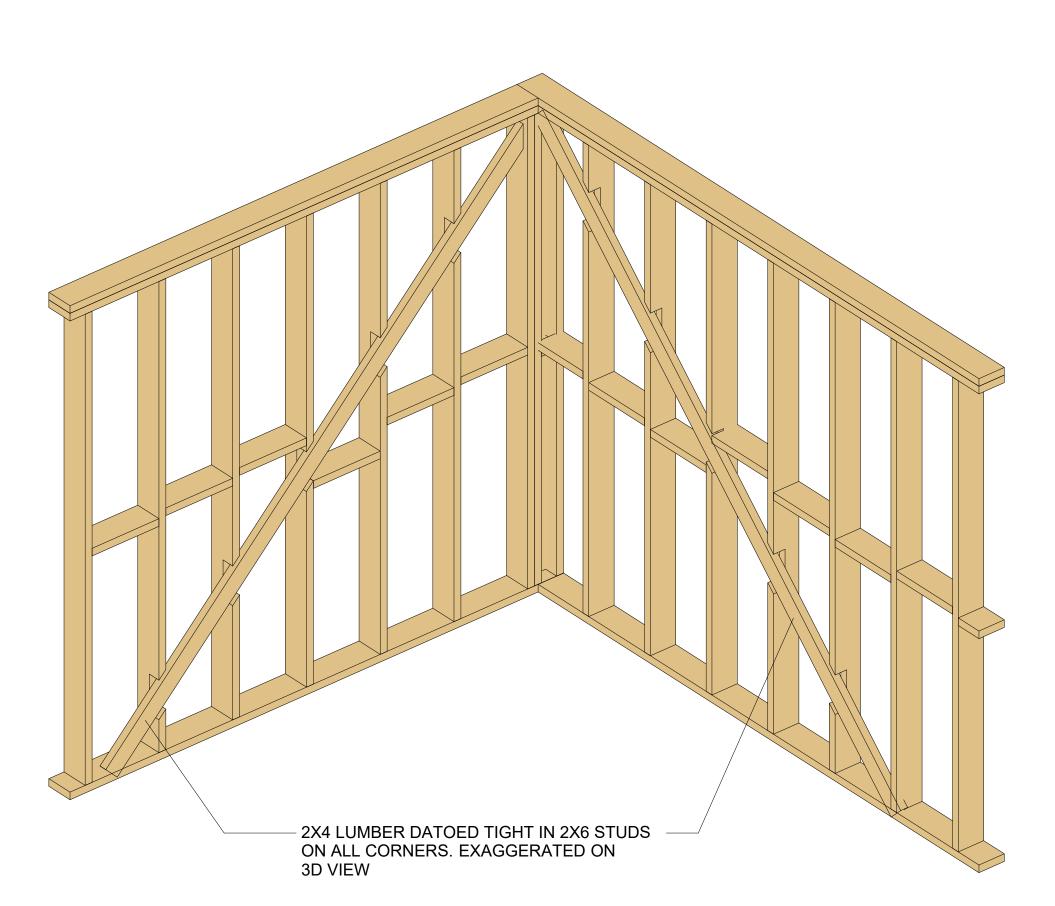
Project number 06/01/22 Drawn by Checked by

A12

Scale

3/16" = 1'-0"





#### Bracing Corner Wal

#### **GENERAL**

- 1. THE CONTRACTOR SHALL VISIT AND INSPECT THE SITE AND SHALL ALSO CAREFULLY EXAMINE THE DRAWINGS AND SPECIFICATIONS IN ORDER THAT HE MAY BE THOROUGHLY FAMILIAR WITH THE SITE AND LOCAL CONDITIONS, AND ALL MATTERS WHICH CAN IN ANYWAY AFFECT THE WORK COVERED BY THESE DRAWINGS
- 2. OBTAIN AND PAY FOR ALL PERMITS REQUIRED BY AUTHORITIES HAVING JURISDICTION. COORDINATE THE PAYMENT OF THE SAME WITH THE OWNER.
- 3. ALL WORK SHALL TO BE IN DONE IN STRICT ACCORDANCE WITH THE LATEST EDITION OFTHE NBC, NPC, CEC, NFC, ASHRAE, SMACNA AND ALL AUTHORITIES HAVING JURISDICTION.
- 4. ALL WORK SHALL BE PERFORMED IN A NEAT AND WORKMANLIKE MANNER AND INACCORDANCE WITH GENERALLY ACCEPTED STANDARDS OF GOOD PRACTICE. ALL WORK SHALL BE COMPLETED BY QUALIFIED TRADE PERSONS. ALL WORK SHALL COMPLY INACCORDANCE WITH NBC AND ALL OTHER APPLICABLE CODES AND REGULATIONS GOVERNING.
- 5. CONDUCT HEALTH AND SAFETY OPERATIONS IN STRICT ACCORDANCE WITH LATEST EDITION OF THE NL'S OCCUPATIONAL HEALTH AND SAFETY (OH&S) ACT AND REGULATIONS-NL REGULATION 5/12 OCCUPATIONAL HEALTH AND SAFETY REGULATIONS.
- 6. ALL PRODUCTS USED ON THIS PROJECT SHALL HAVE A MINIMUM FLAME SPREAD RATING OF 25 AND MAXIMUM SMOKE DEVELOPED RATING OF 50 IN
- ACCORDANCE WITH CAN4-S102.7. ALL MATERIALS AND EQUIPMENT USED ON THIS PROJECT ARE TO BE NEW AND CSA APPROVED.
- 7. COORDINATE WITH THE OWNER, ALL EQUIPMENT THE OWNER IS PROVIDING. 8. FLASH AND SEAL ALL BUILDING OPENINGS TO PROVIDE A WEATHER TIGHT CONSTRUCTIONS.
- 9. CONCRETE DESIGN STRENGTH: 30MPA AT 28 DAYS.

WOOD FRAME BUILDING CONSTRUCTION

- 1. GENERAL REQUIREMENTS FOR REQUIREMENTS FOR WOOD FRAME BUILDING CONSTRUCTION:
- .1 FOLLOW NBC 2015 REQUIREMENTS PART 9 AND THE COMPANION DOCUMENTS TO THE NBC: STRUCTURAL COMMENTARIES (USER S GUIDE NBC 2015: PART 4 OF.DIVISION B) AND THE ILLUSTRATED USER S GUIDE NBC 2015: PART 9 OF DIVISION B, HOUSING AND SMALL BUILDINGS.
- 2. LUMBER:
- .1 MANUFACTURED IN ACCORDANCE WITH CSA O141-2005 (R2019). SOFTWOOD LUMBER AND CONFORMING TO THE REQUIREMENTS OF THE CANADIAN AND US LUMBER GRADING RULES, INCLUDING BUT NOT LIMITED TO: (A) CLASSIFICATION; (B) MEASUREMENT; (C) STANDARD SIZES; (D) GRADING RULES; (E) IDENTIFICATION (GRADE STAMPS AND CERTIFICATES); AND (F) REQUIREMENTS AND RESPONSIBILITIES OF ACCREDITATION BOARD AND GRADING AGENCY RESPONSIBILITIES.
- .2 DIMENSION LUMBER WITH GRADE STAMPED ON ONE FACE AT A DISTANCE OF APPROXIMATELY 2 FT (600 MM) FROM ONE END OF EACH PIECE. .3 QUALITY ENSURED BY: (A) GRADING AGENCIES ACCREDITED BY THE CANADIAN LUMBER STANDARDS ACCREDITATION BOARD (CLSAB); (B)
- NATIONAL LUMBER GRADES AUTHORITY (NLGA) STANDARD GRADING RULES FOR CANADIAN LUMBER (2017). .3 SELECTION FOR INDIVIDUAL ELEMENTS OF CONSTRUCTION, FLOOR ASSEMBLE INCLUDING JOISTS, SILLS AND GIRDERS, STUDS, STRAPPING, ROOF TRUSSES, ETC. BASED ON CANADIAN WOOD COUNCIL (CWC), TO THE FOLLOWING TABLE:

DIMENSIONAL LUMBER-GRADES AND USE						
GRADE CATEGORY	SIZE	ACCEPTABLE GRADES	PRINCIPAL USE			
STRUCTURAL LIGHT FRAMING	2" TO 4" NOMINAL THICK AND WIDE	NO 2 AND BETTER	TRUSSES, LINTELS, RAFTERS AND JOISTS IN SMALLER DIMENSIONS			
STRUCTURAL JOISTS AND PLANKS	2" TO 4" NOMINAL THICK AND 5" OR MORE WIDE	NO 1 AND BETTER	TRUSSES, LINTELS, RAFTERS AND JOISTS IN DIMENSIONS GREATER THAN 5" NOMINAL			
LIGHT FRAMING	2" TO 4" NOMINALTHICK AND WIDE	STANDARD AND BETTER	GENERAL FRAMING WHERE HIGH STRENGTH VALUES ARE NOT REQUIRED SUCH AS PLATES AND BLOCKING			
STUDS	2" TO 4" NOMINAL THICK AND 2" WIDE AND LESS THAN 10"-0" LONG	STUD, ECONOMY STUD	PRINCIPALLY USED IN WALLS, STUD GRADE SUITABLE FOR BEARING WALL APPLICATIONS. ECONOMY GRADE SUITABLE FOR TEMPORARYAPPLICATIONS.			

#### NOTES:

- 1. GRADES MAY BE BUNDLED INDIVIDUALLY OR THEY MAY BE INDIVIDUALLY STAMPED BUT THEY MUST BE GROUPED TOGETHER WITH THE ENGINEERING PROPERTIES DICTATED BY THE LOWEST STRENGTH GRADE IN THE BUNDLE.
- LOWEST STRENGTH GRADE IN THE BUNDLE.
- 2. THE COMMON GRADE MIX SHOWN IS THE MOST ECONOMICAL BLENDING OF STRENGTH FOR MOST APPLICATIONS WHERE APPEARANCE IS NOT A
- FACTOR AND AVERAGE STRENGTH IS ACCEPTABLE.
- 3. EXCEPT FOR ECONOMY GRADE, ALL GRADES ARE STRESS GRADED WHICH MEANS SPECIFIED STRENGTHS HAVE BEEN ASSIGNED AND SPAN TABLES CALCULATED. ECONOMY AND UTILITY GRADES ARE SUITED FOR TEMPORARY CONSTRUCTION OR FOR APPLICATIONS WHERE STRENGTH AND APPEARANCE ARE NOT IMPORTANT.
- 4. CONSTRUCTION, STANDARD, STUD, AND NO. 3 GRADES SHOULD BE USED IN DESIGNS THAT ARE COMPOSED OF 3 OR MORE ESSENTIALLY PARALLEL
- MEMBERS (LOAD SHARING) SPACED AT 610MM (24") CENTRES OR LESS.
- 5. STRENGTH PROPERTIES AND APPEARANCE ARE BEST IN THE PREMIUM GRADES SUCH AS SELECT STRUCTURAL.
- 6. ECONOMY AND UTILITY GRADES ARE ONLY SUITABLE FOR TEMPORARY CONSTRUCTION OR APPLICATIONS WHERE STRENGTH AND APPEARANCE ARE NOT IMPORTANT.
- \* REFERENCE CANADIAN WOOD COUNCIL (CWC), WEB SITE HTTPS://CWC.CA/ HOW-TO-BUILD-WITH-WOOD/WOOD-PRODUCTS/LUMBER/GRADES/

#### ALPHA Engineering Ltd

SITE 4, BOX 95 BISHOP'S COVE, NL A0A 3X1 CELL: 709-589-5258 WWW.ALPHAENGINEEERINGLTD.COM

NOTES:
1. DO NOT SCALE FROM DRAWINGS.
2. UNLESS OTHERWISE NOTED, ALL
DIMENSIONS ARE IN FEET AND INCHES.
3. CONTRACTOR SHALL VERIFY ALL
EXISTING CONDITIONS ON SITE PRIOR TO
PROCEEDING WITH ANY PORTION OF
THIS WORK.

Revision Schedule					
Revisi on	Description	Date			
В	Issued For Client Review	Dec 20,2021			

Wrice Cottage Framing Details & Specification

Project number	2021-07
Date	2021/12/20
Drawn by	RLJ
Checked by	RLJ

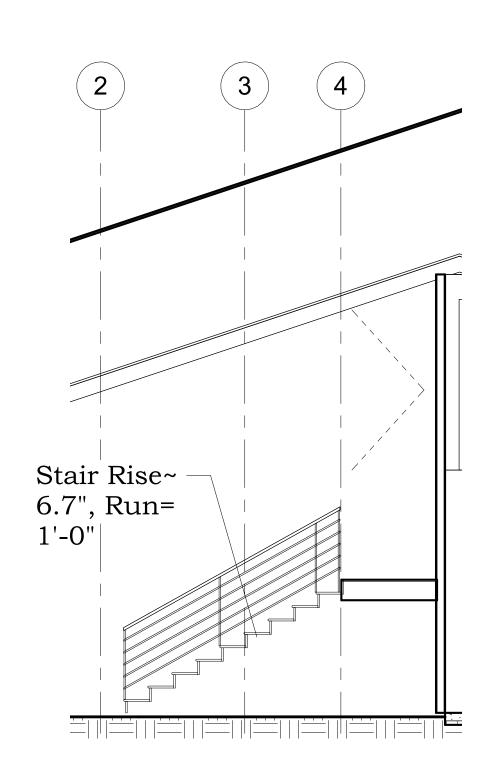
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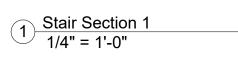
Scale

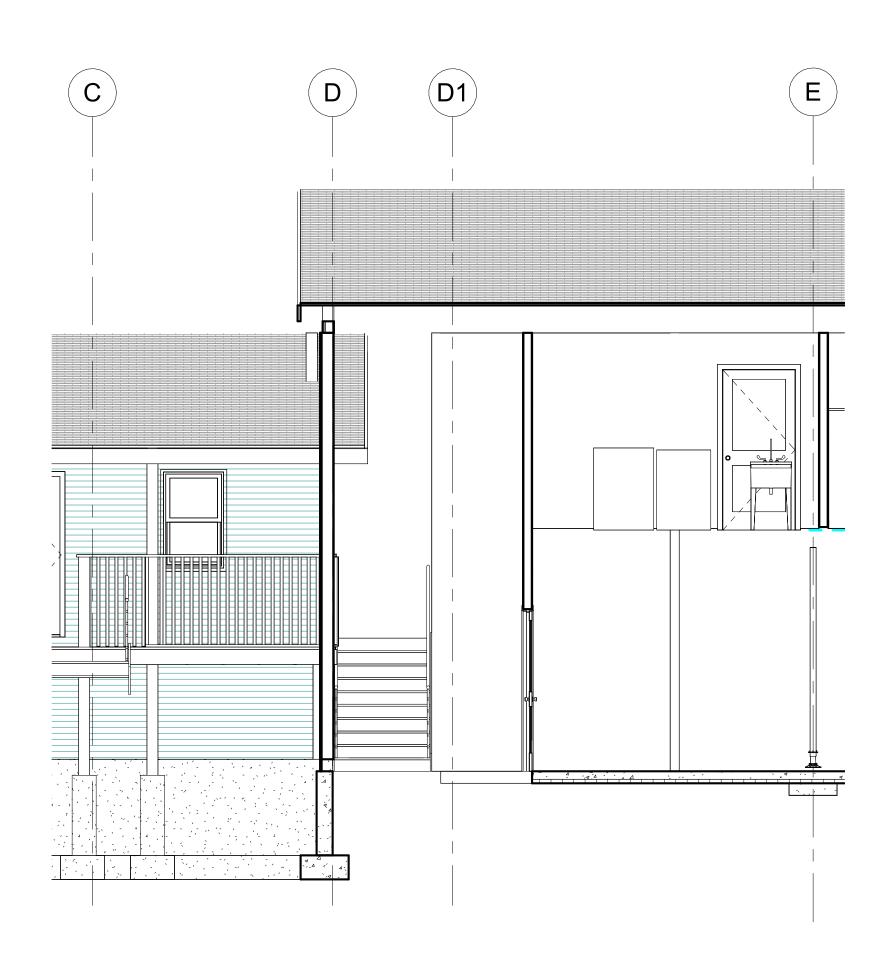
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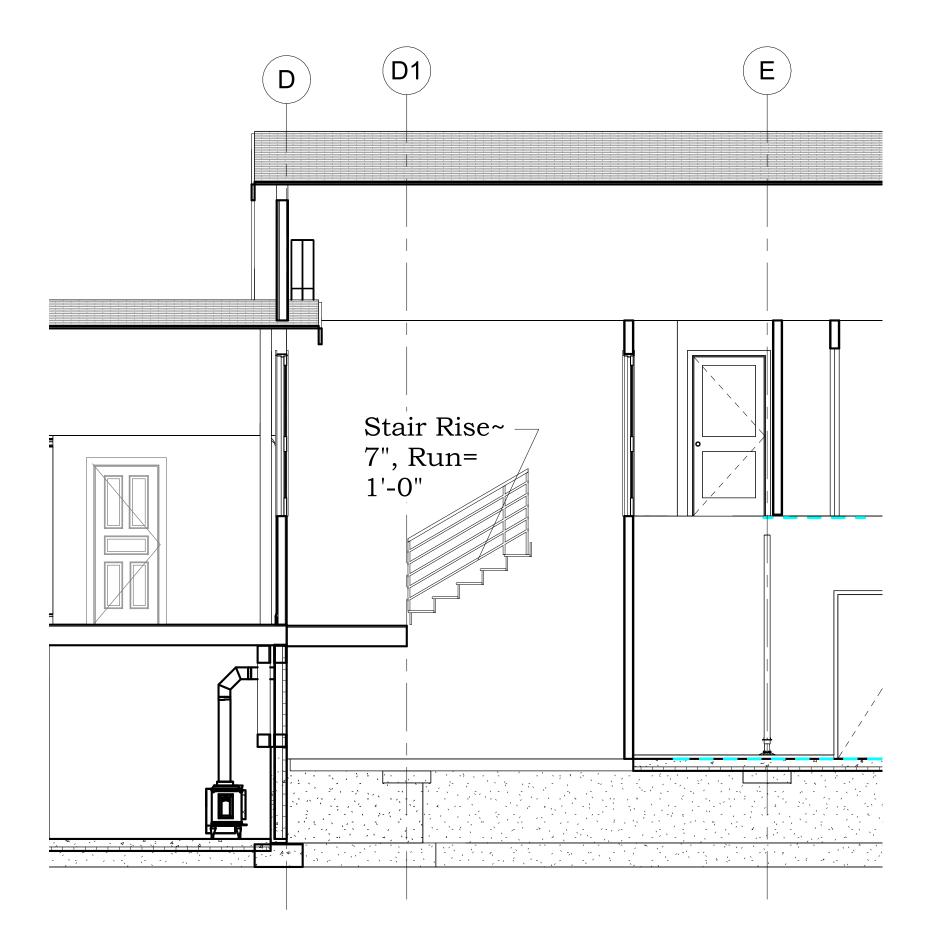
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3 Stair Section 2 1/4" = 1'-0"

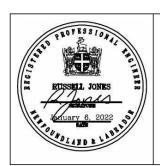


2 Stair Section 3
1/4" = 1'-0"

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PROVINCE OF NEWFOUNDLAND AND LABRADOR PERMIT HOLDER This Permit Allows

ALPHA ENGINEERING LTD

TO PRACTICE PROFESSIONAL ENGINEERING IN NEWFOUNDLAND AND LABRADOR.
PERMIT NO. AS ISSUED BY PEGNL N0900 WHICH IS VALID FOR THE YEAR 2022

**Revision Schedule** Description

Cottage Reno 1 Stair Sections

2021-07 Project number 06/01/22 Date Drawn by Checked by

A14

Scale