
COTTAGE RENOVATION & EXTENSION PLANS

ALPHA ENGINEERING LIMITED

> 11 JONES ROAD BISHOP'S COVE, NL A0A 3X1

709-589-5258 www.alphaengineeringltd.com CLIENT
AEL WEB SITE
DEVELOPMENT
BISHOP'S COVE, NL
A0A 3X1

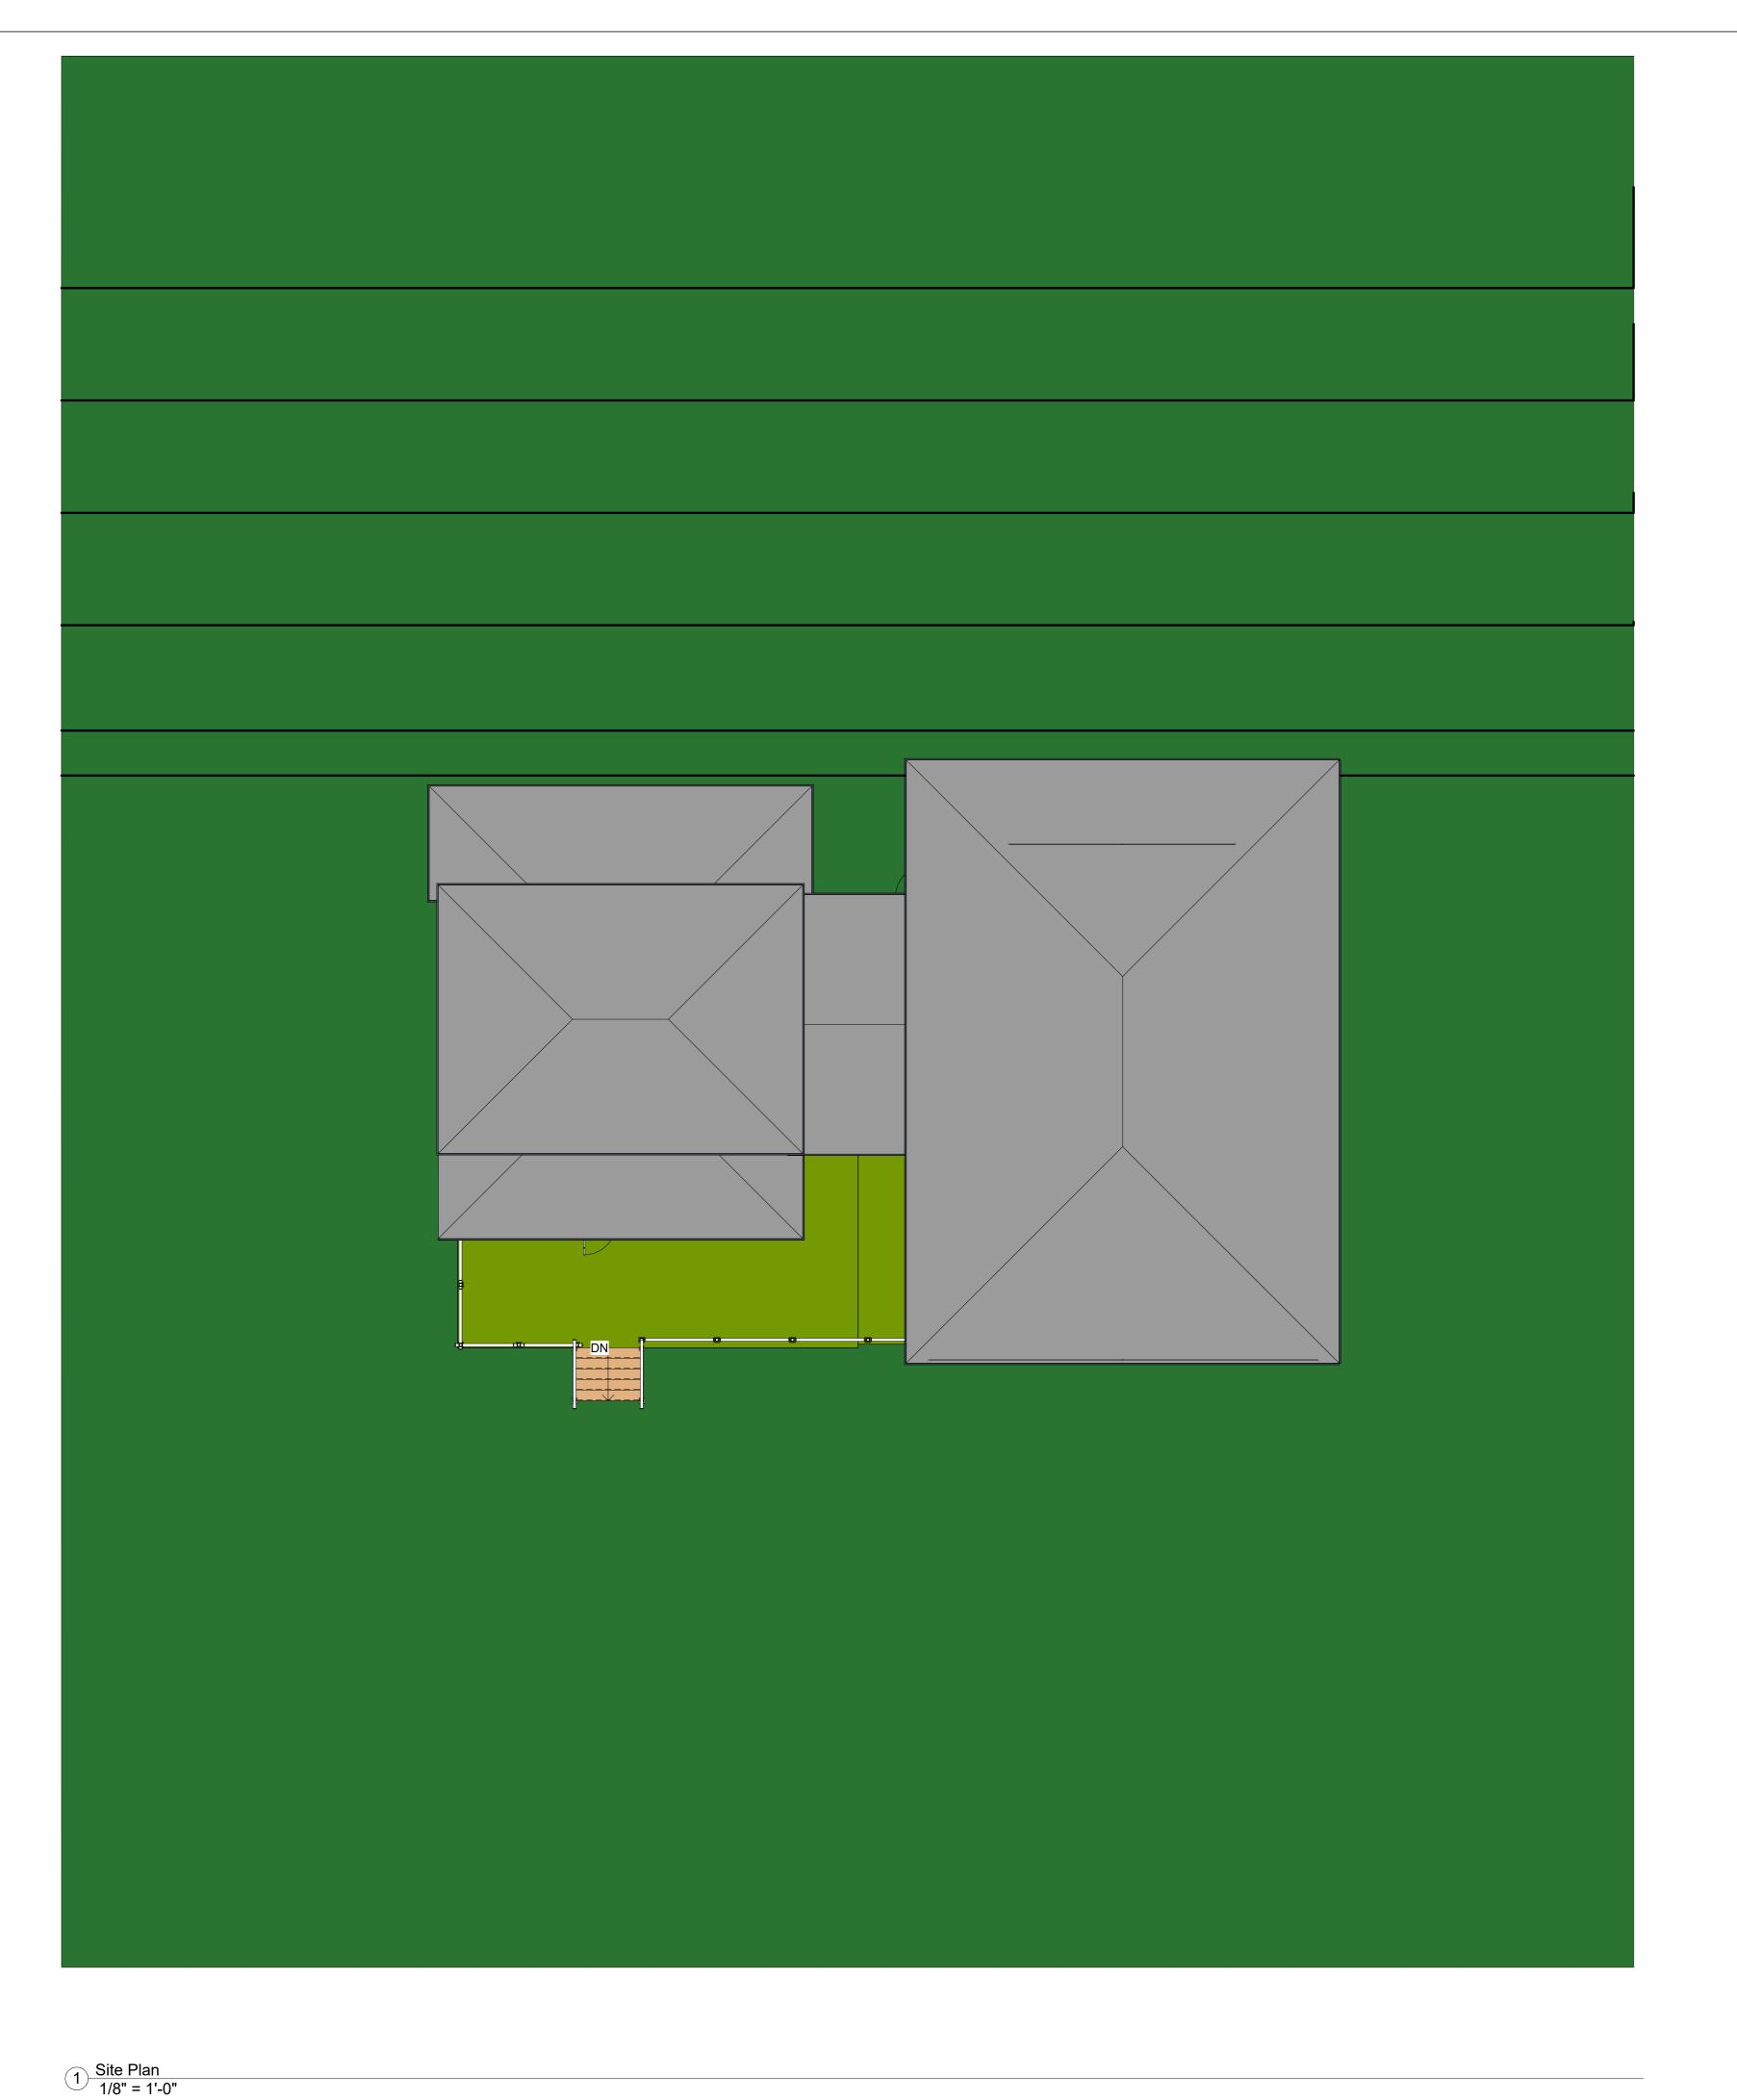

Project Sheet List		
Sheet		
Number	Sheet Name	

0	Cover
A1	Site Plan & Project Drawing List
A2	Room Legend & Room Schedule
A3	North East 3D View
A4	North West 3D View
A5	South East 3D View
A6	South West 3D View
A7	Building North & South Elevations
A8	Building East & West Elevations
A9	Footing & Foundation Plan
A10	Floor Plan Dimensions
A11	Framing Details & Specification
A12	Ensuite 2A Room Elevations

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BISHOP'S COVE, NL
A0A 3X1
CELL: 709-589-5258
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NOTES:

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PROJECT COTTAGE RENOVATION 2


Site Plan & Project Drawing List

2022-024 Sept 13, 2022 Project number Drawn by

A1

Scale

Checked by

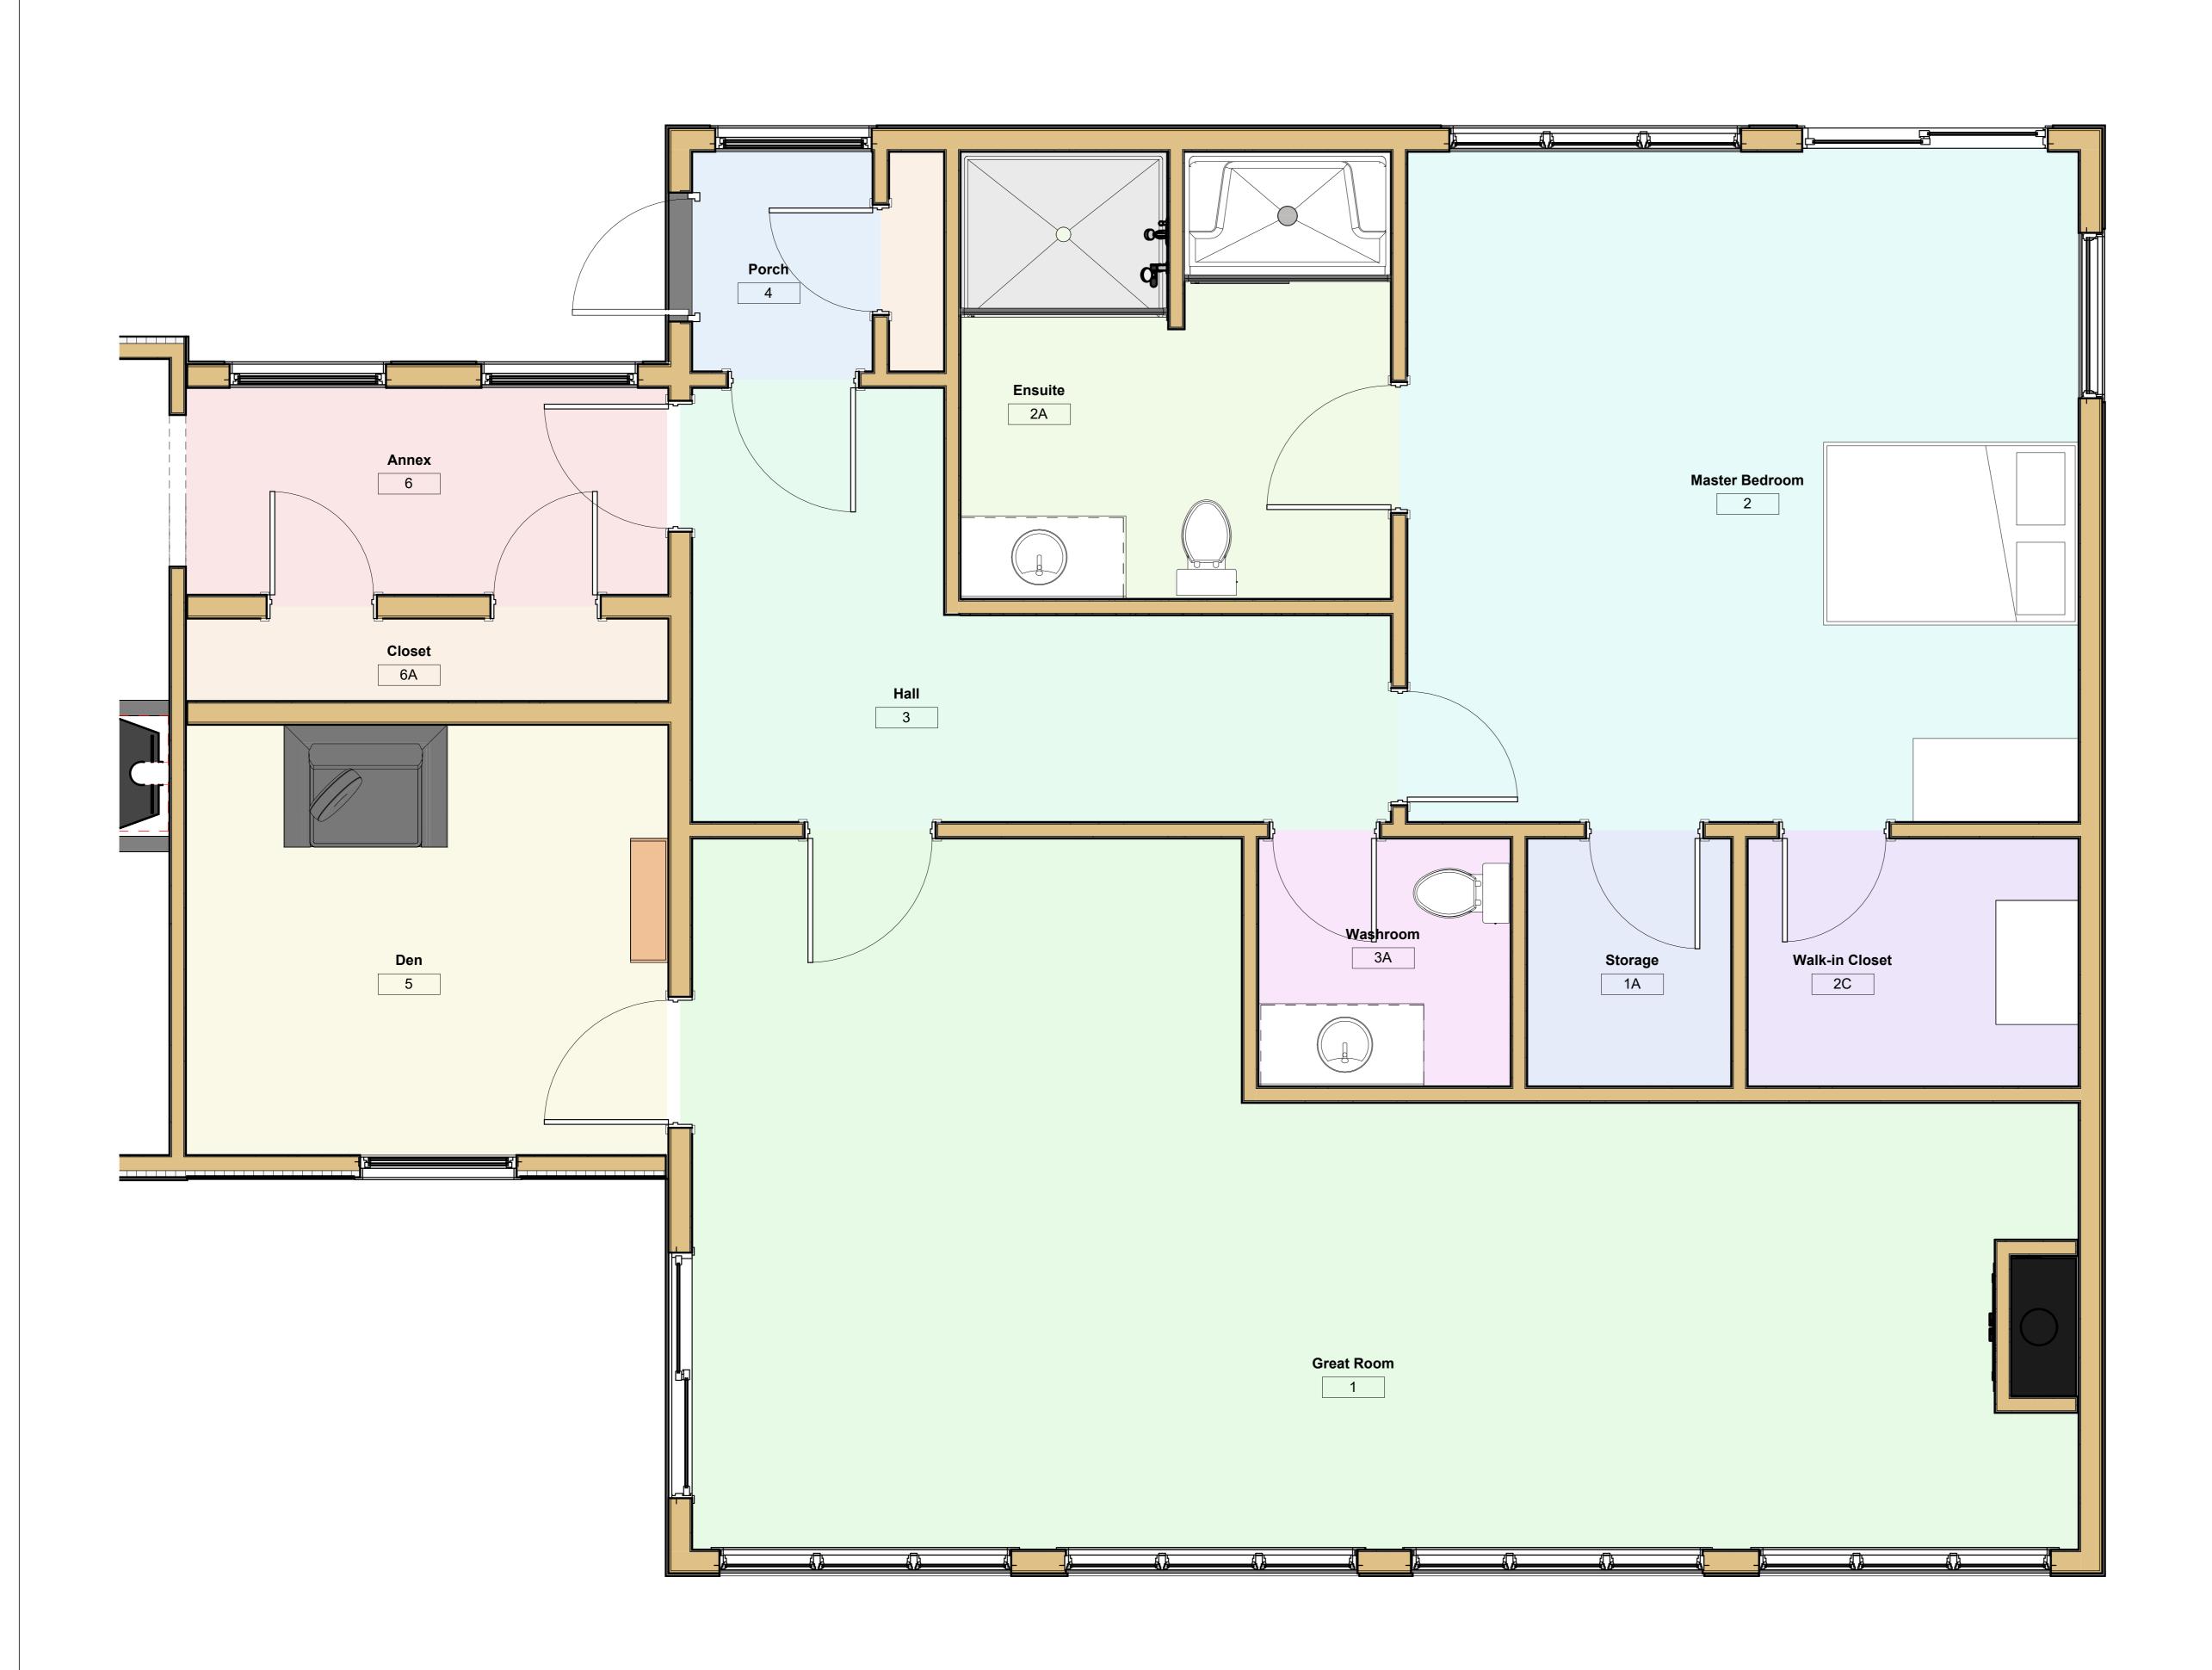

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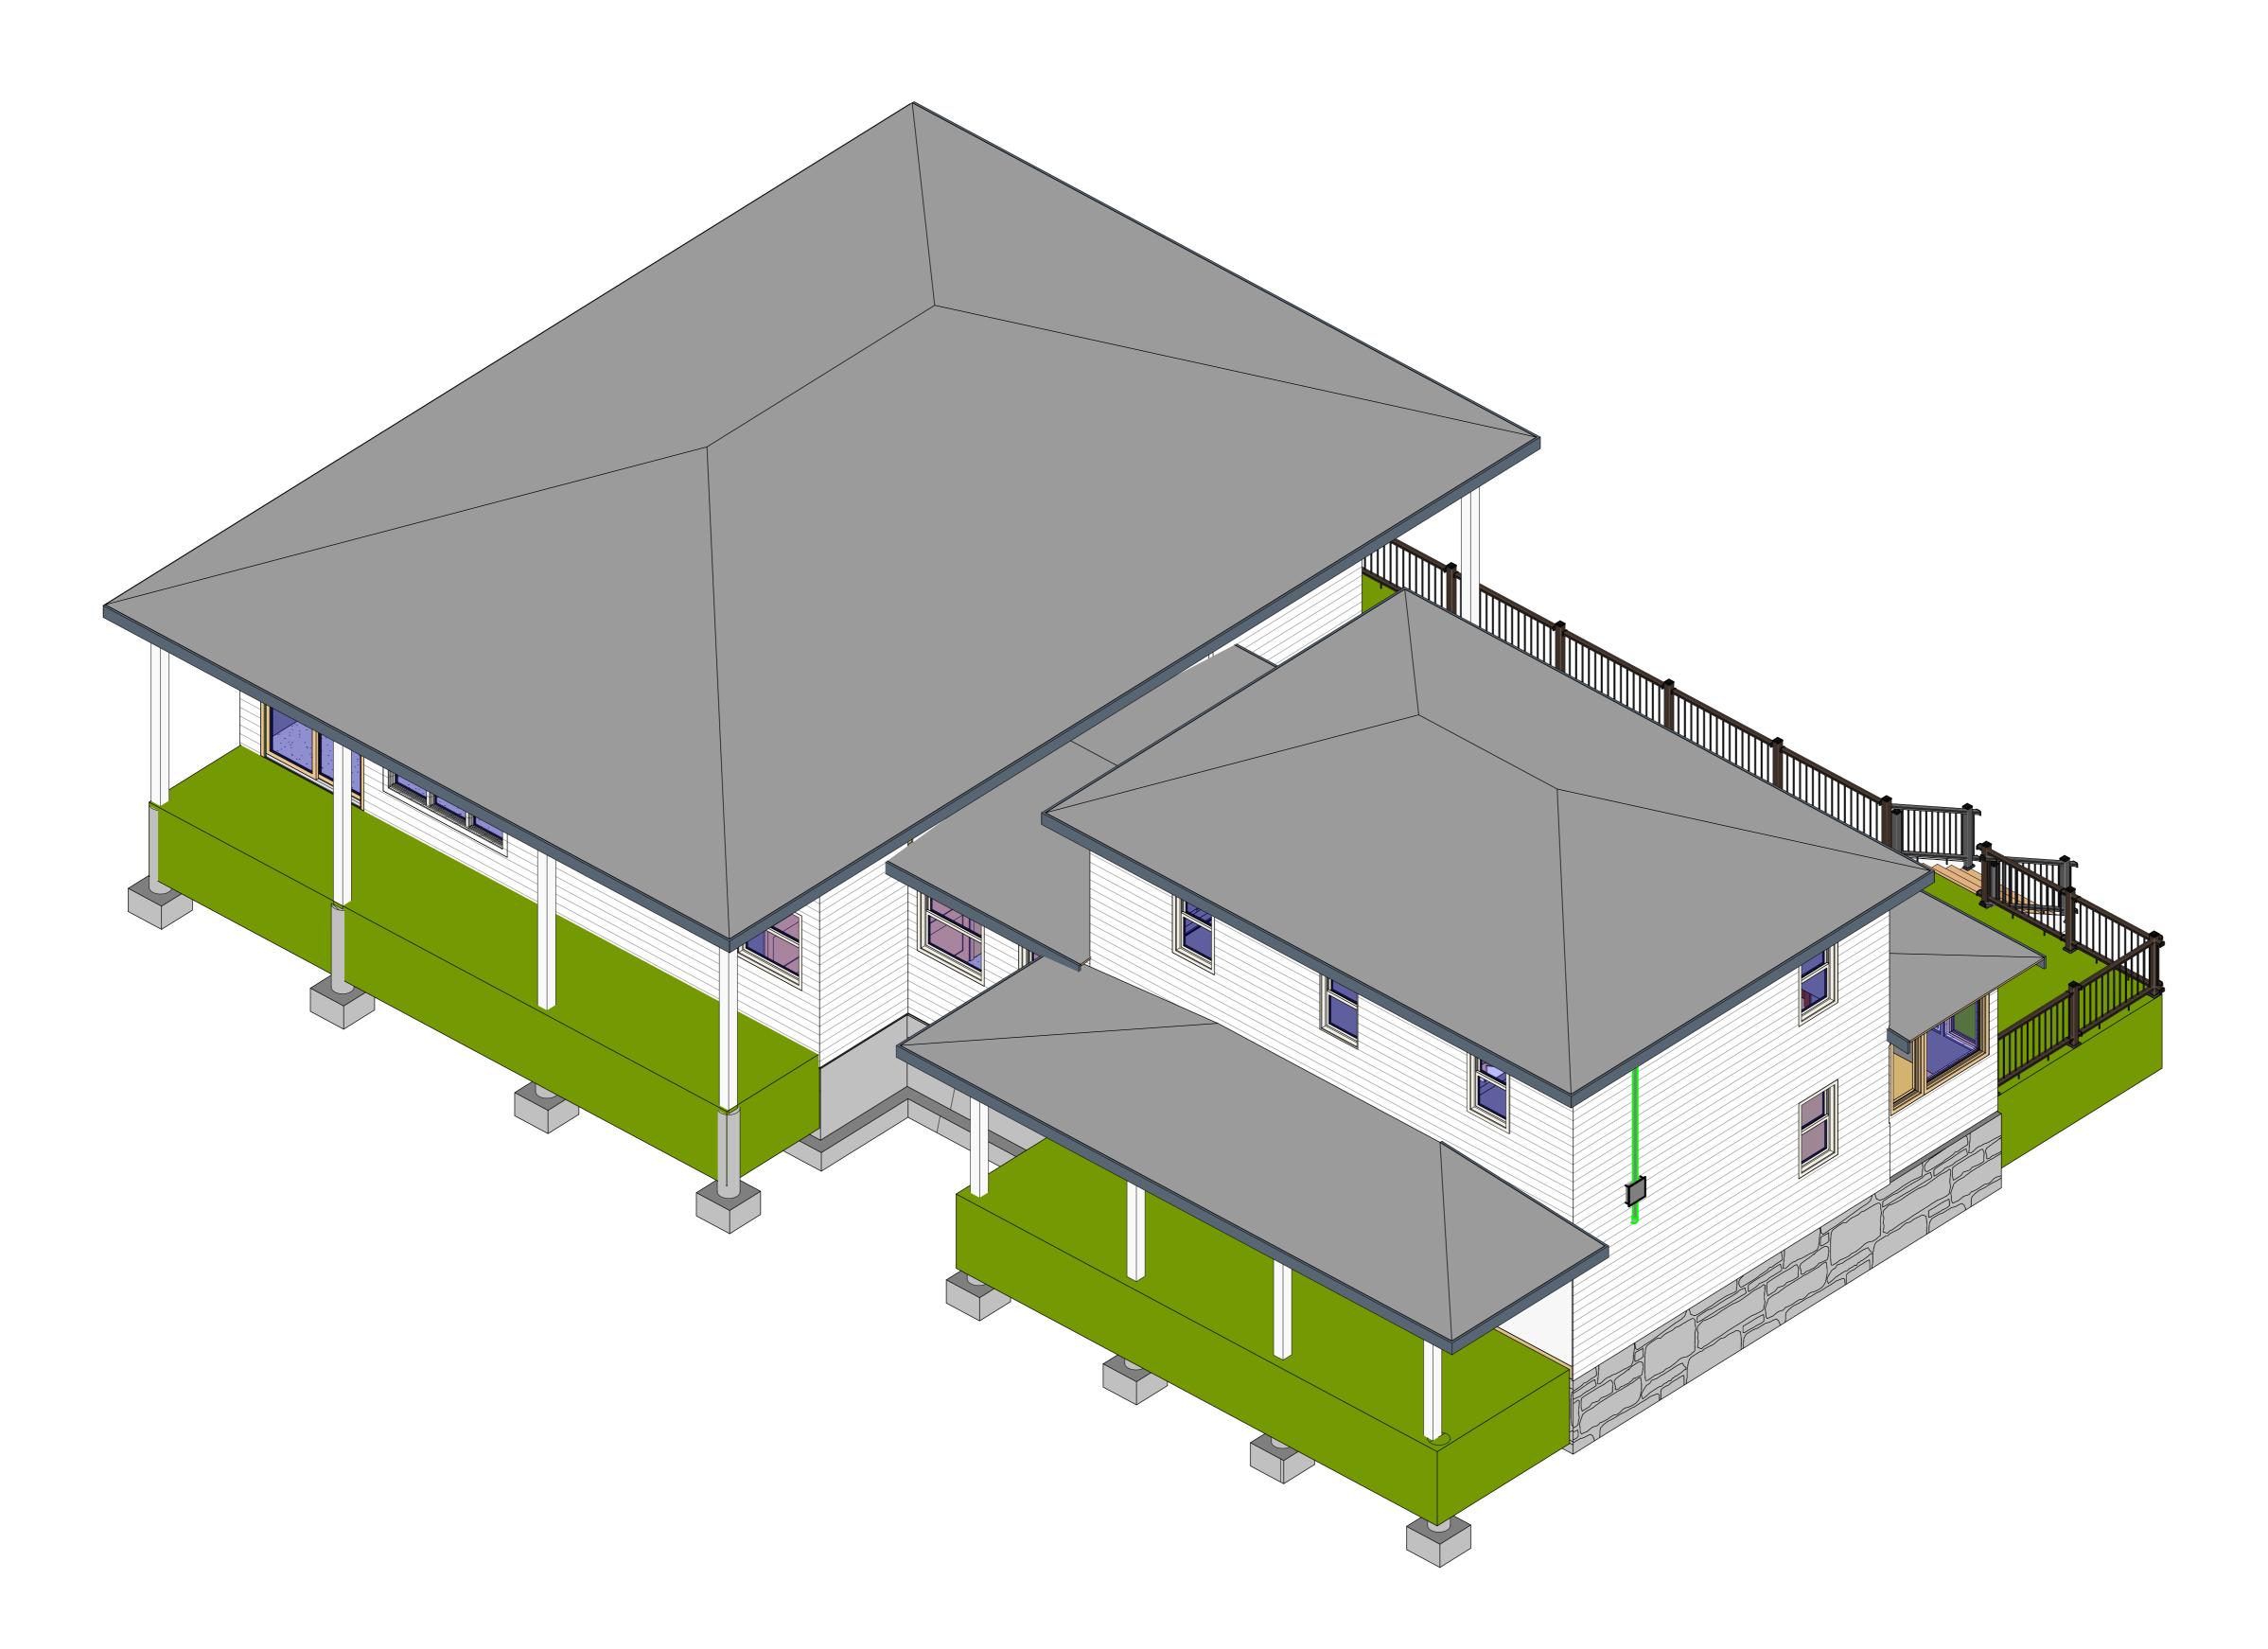
Date Jan 13, 2023 IF Client Use

PROJECT COTTAGE **RENOVATION 2**

Room Legend & Room Schedule

2022-024 Project number Sept 13, 2022 Drawn by Checked by

A2




North East 3D View

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PROJECT COTTAGE RENOVATION 2 North East 3D View


2022-024 Project number Sept 13, 2022 RLJ Drawn by Checked by

North West 3D View
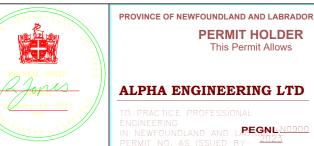
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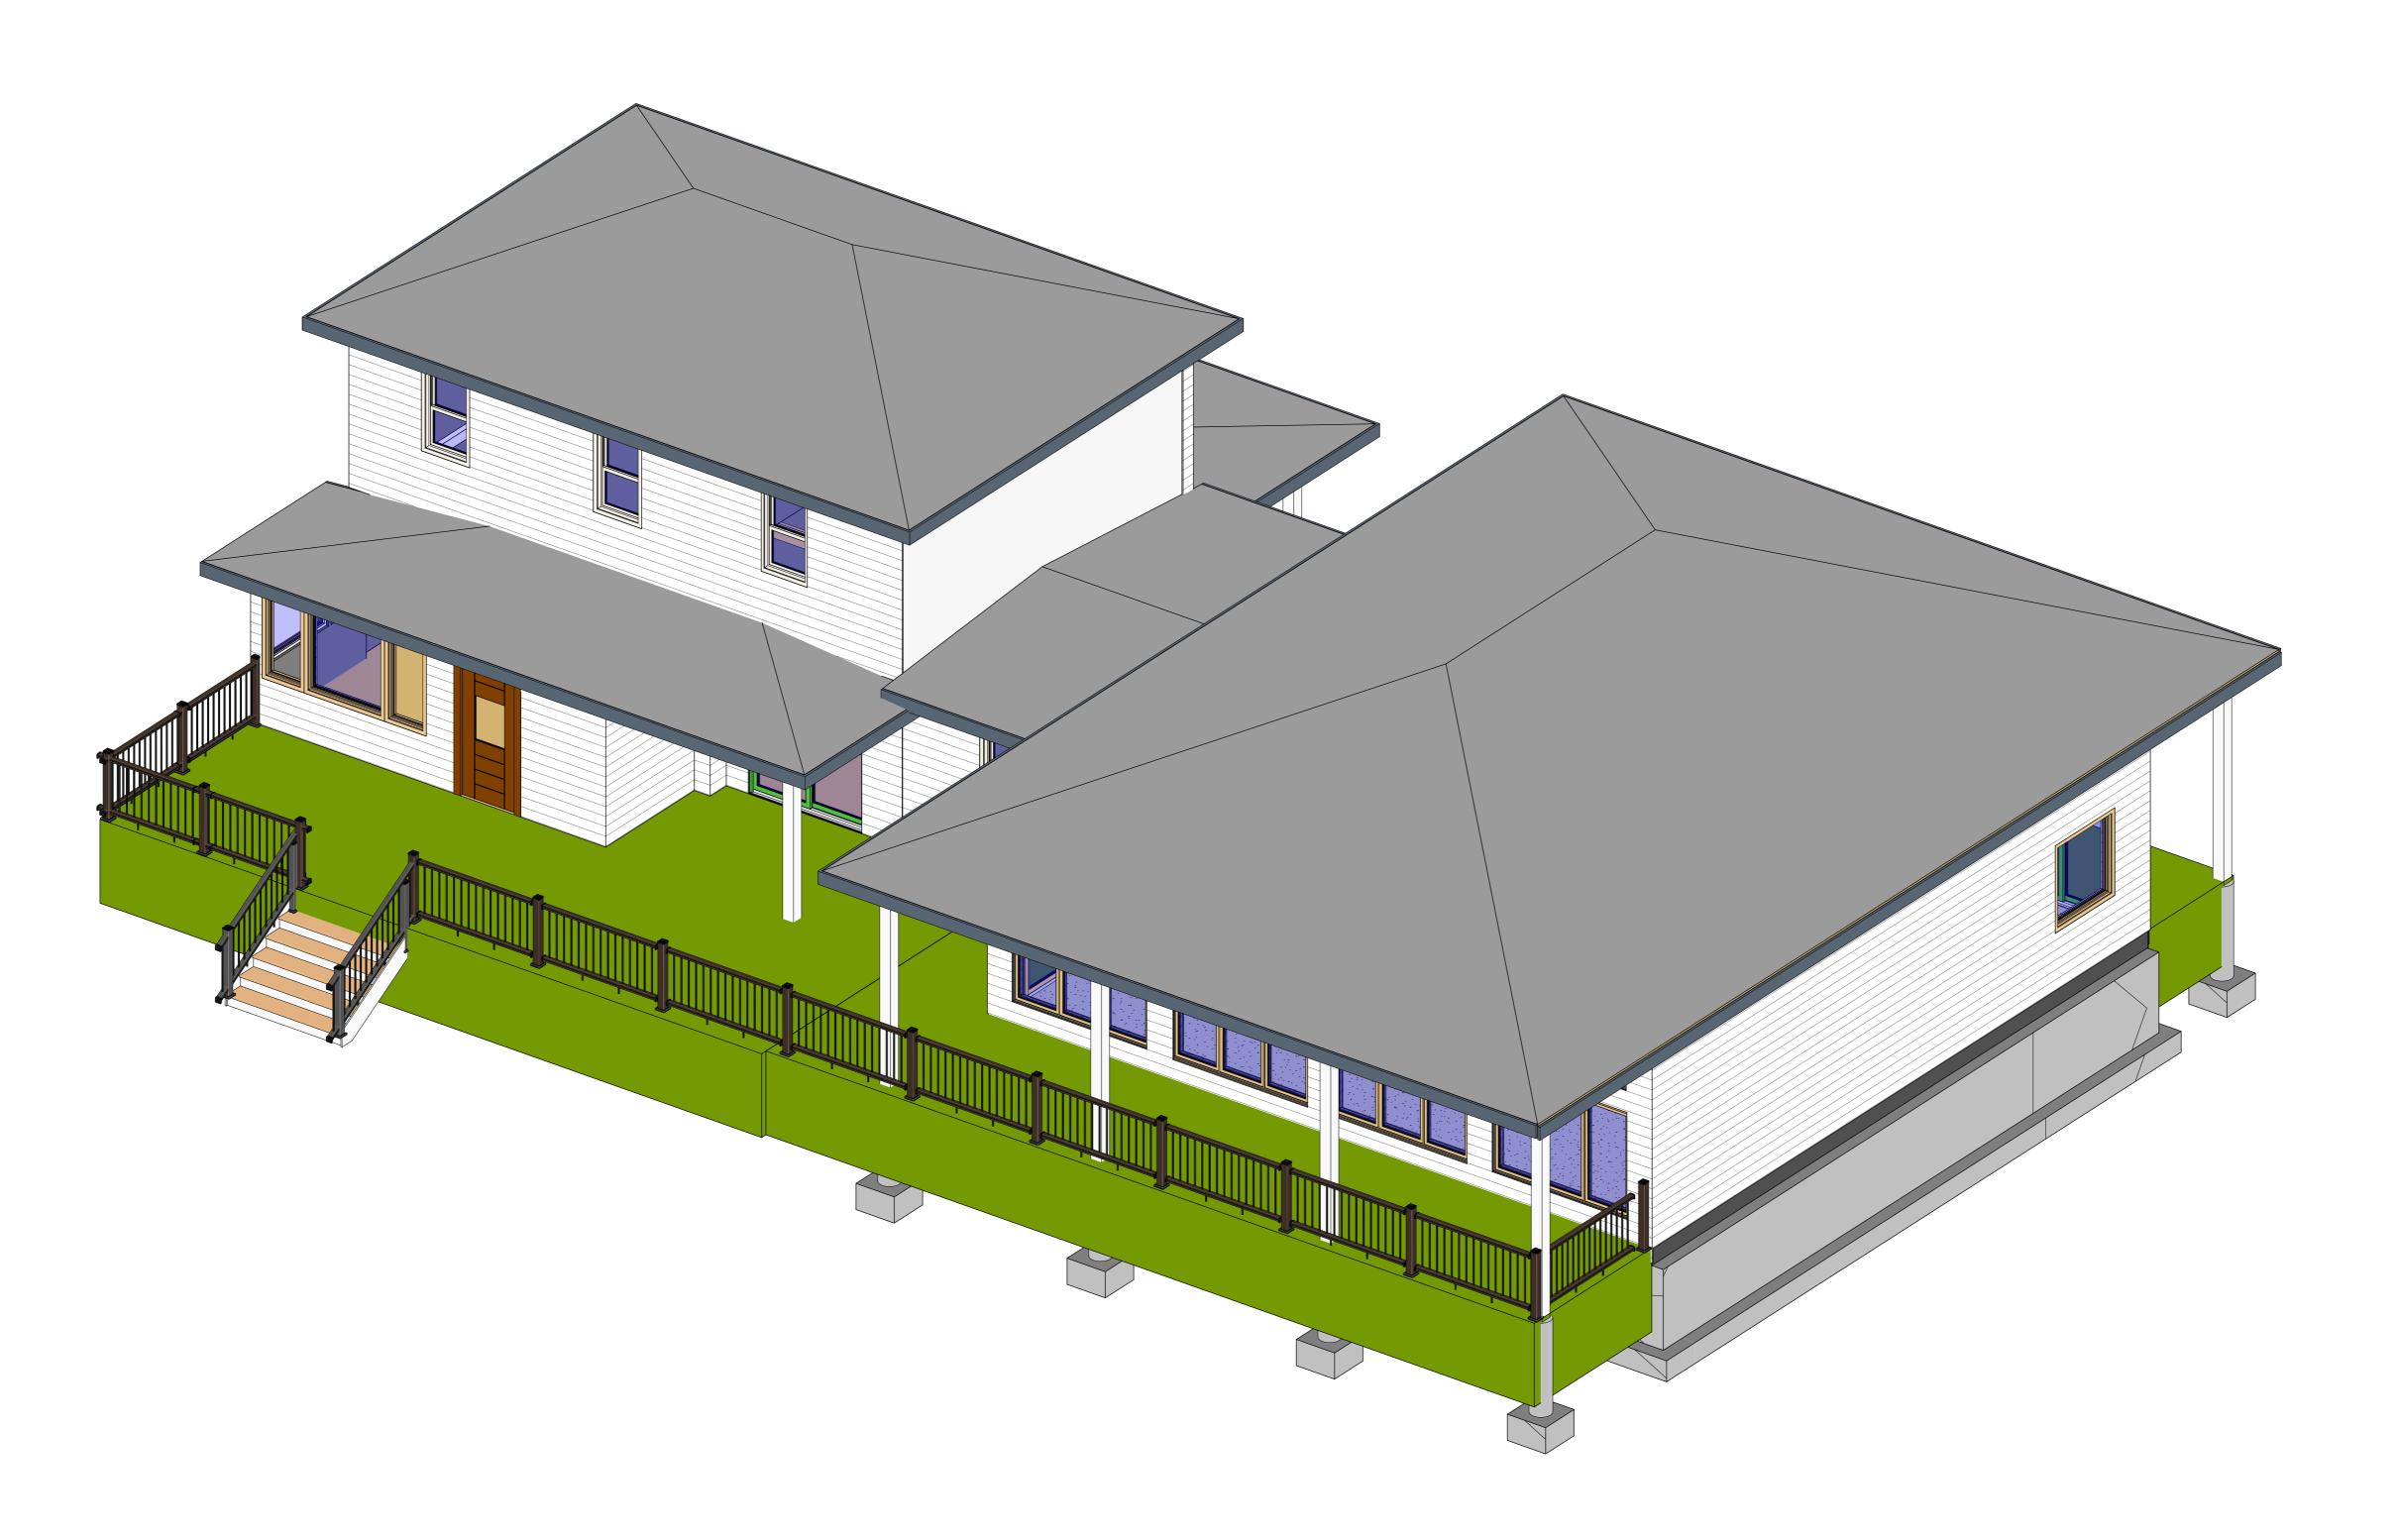
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PROJECT COTTAGE **RENOVATION 2** North West 3D View

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South East 3D View

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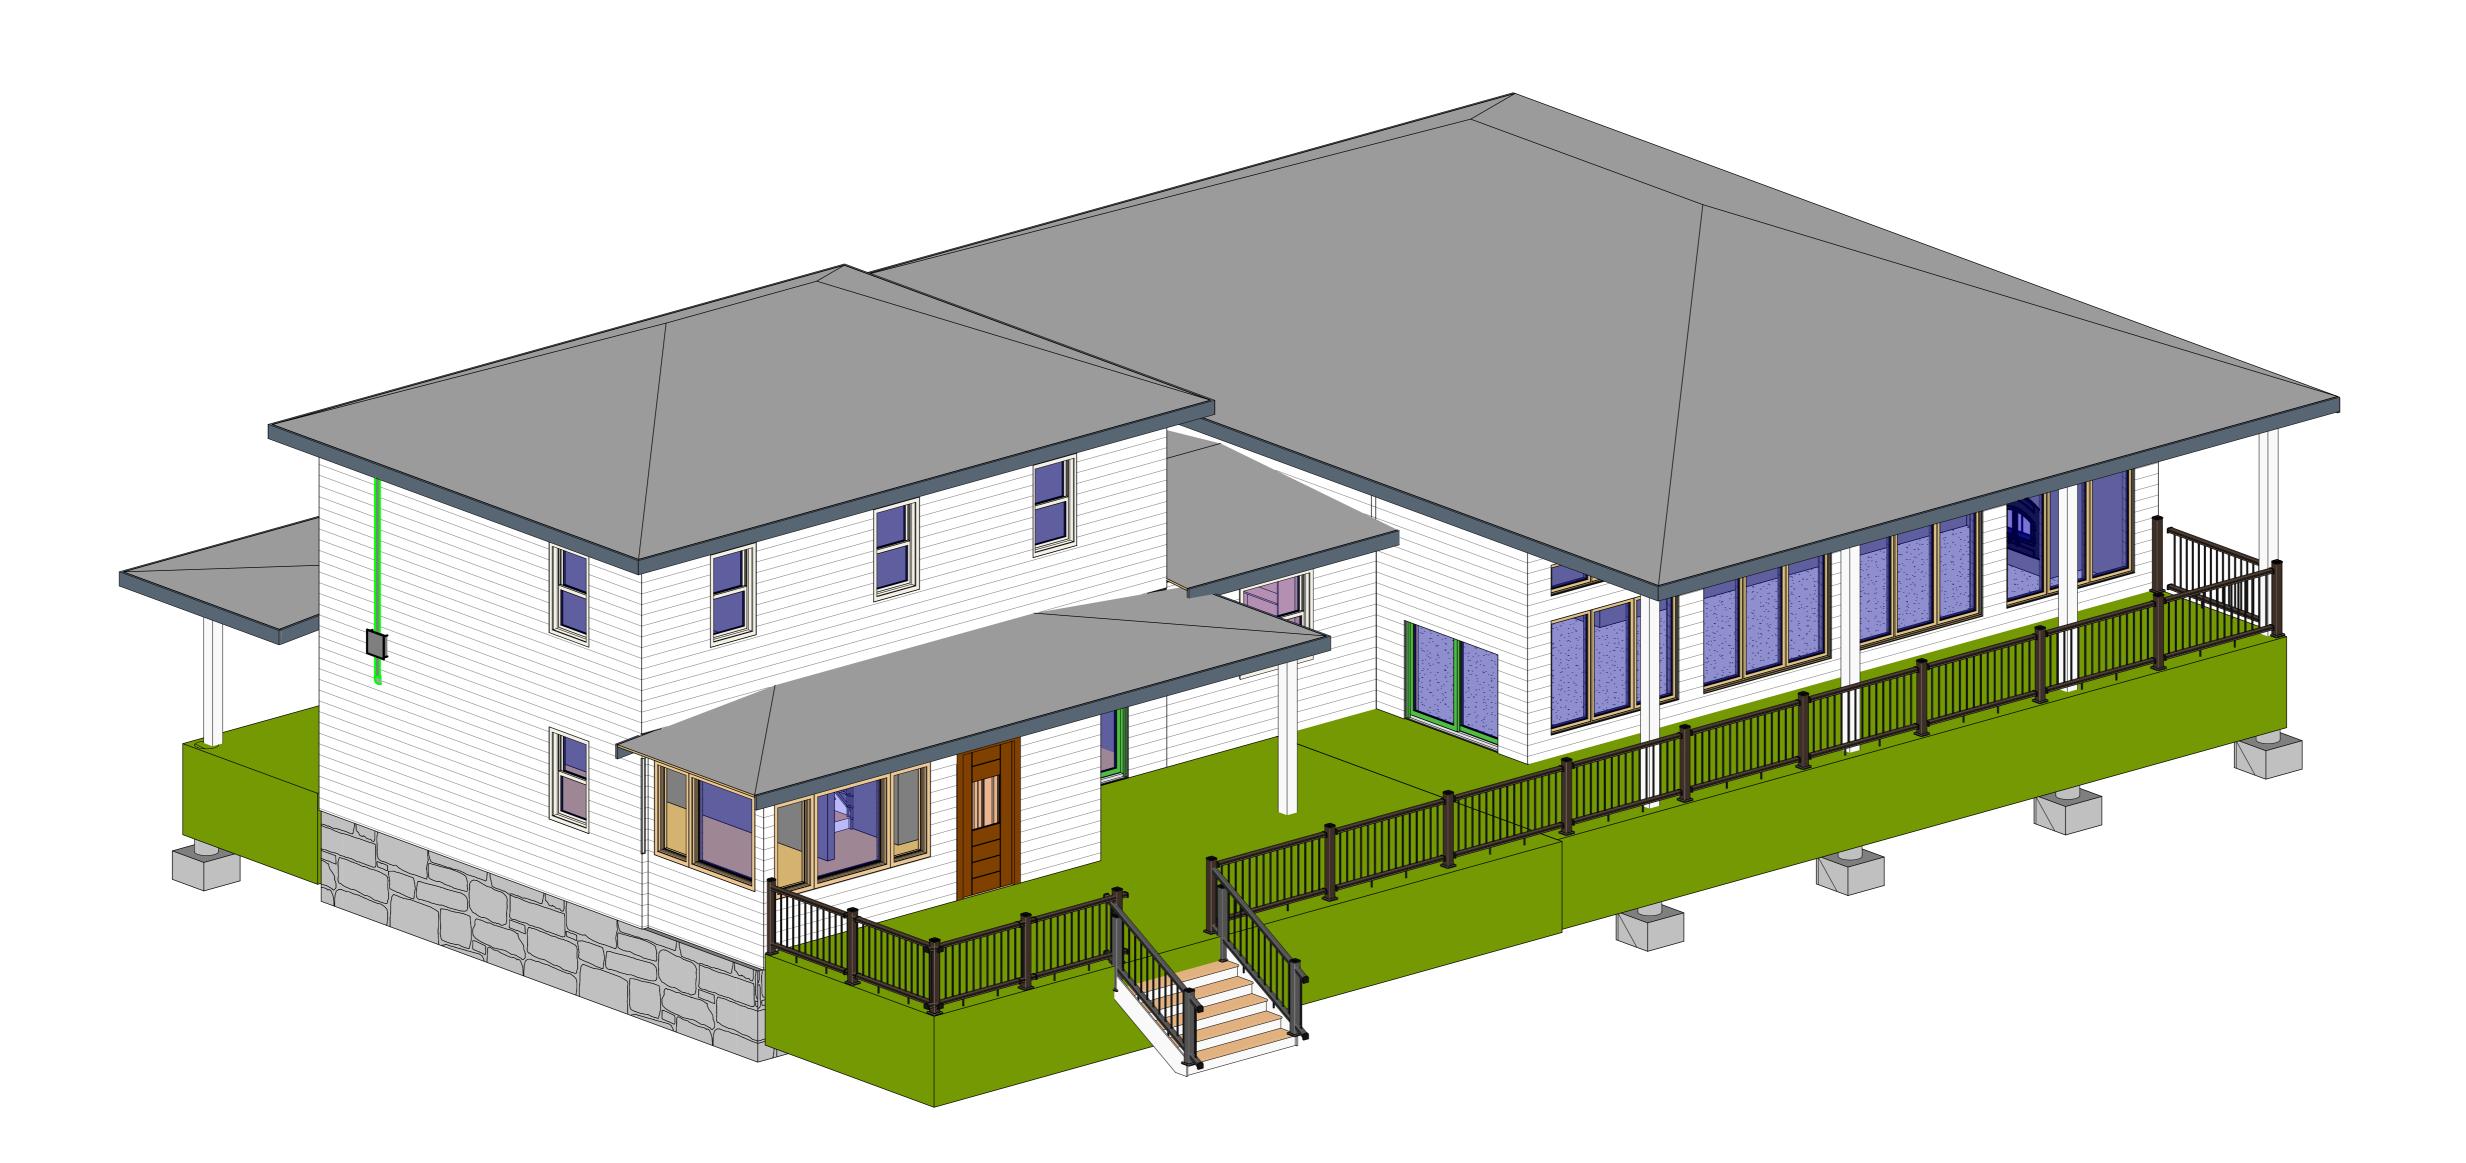
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No.	Description	Date
1	IF Client Use	Jan 13, 2023

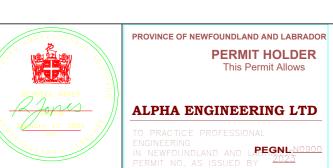PROJECT COTTAGE **RENOVATION 2** South East 3D View

2022-024 Project number Sept 13, 2022 RLJ Drawn by Checked by




South West 3D View

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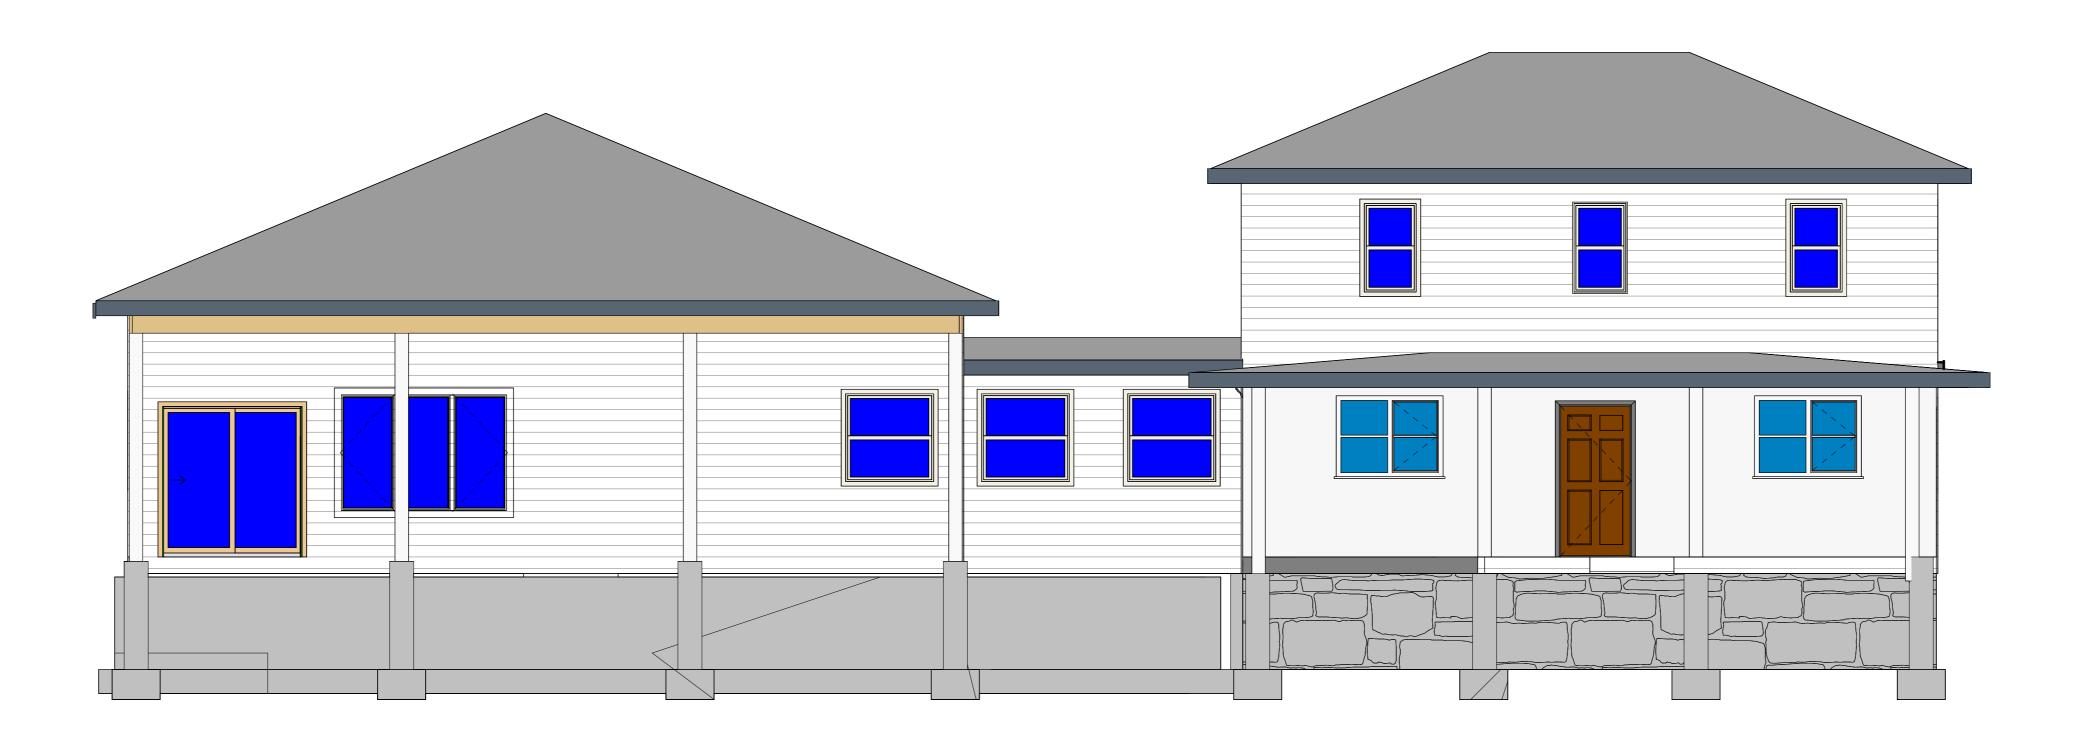
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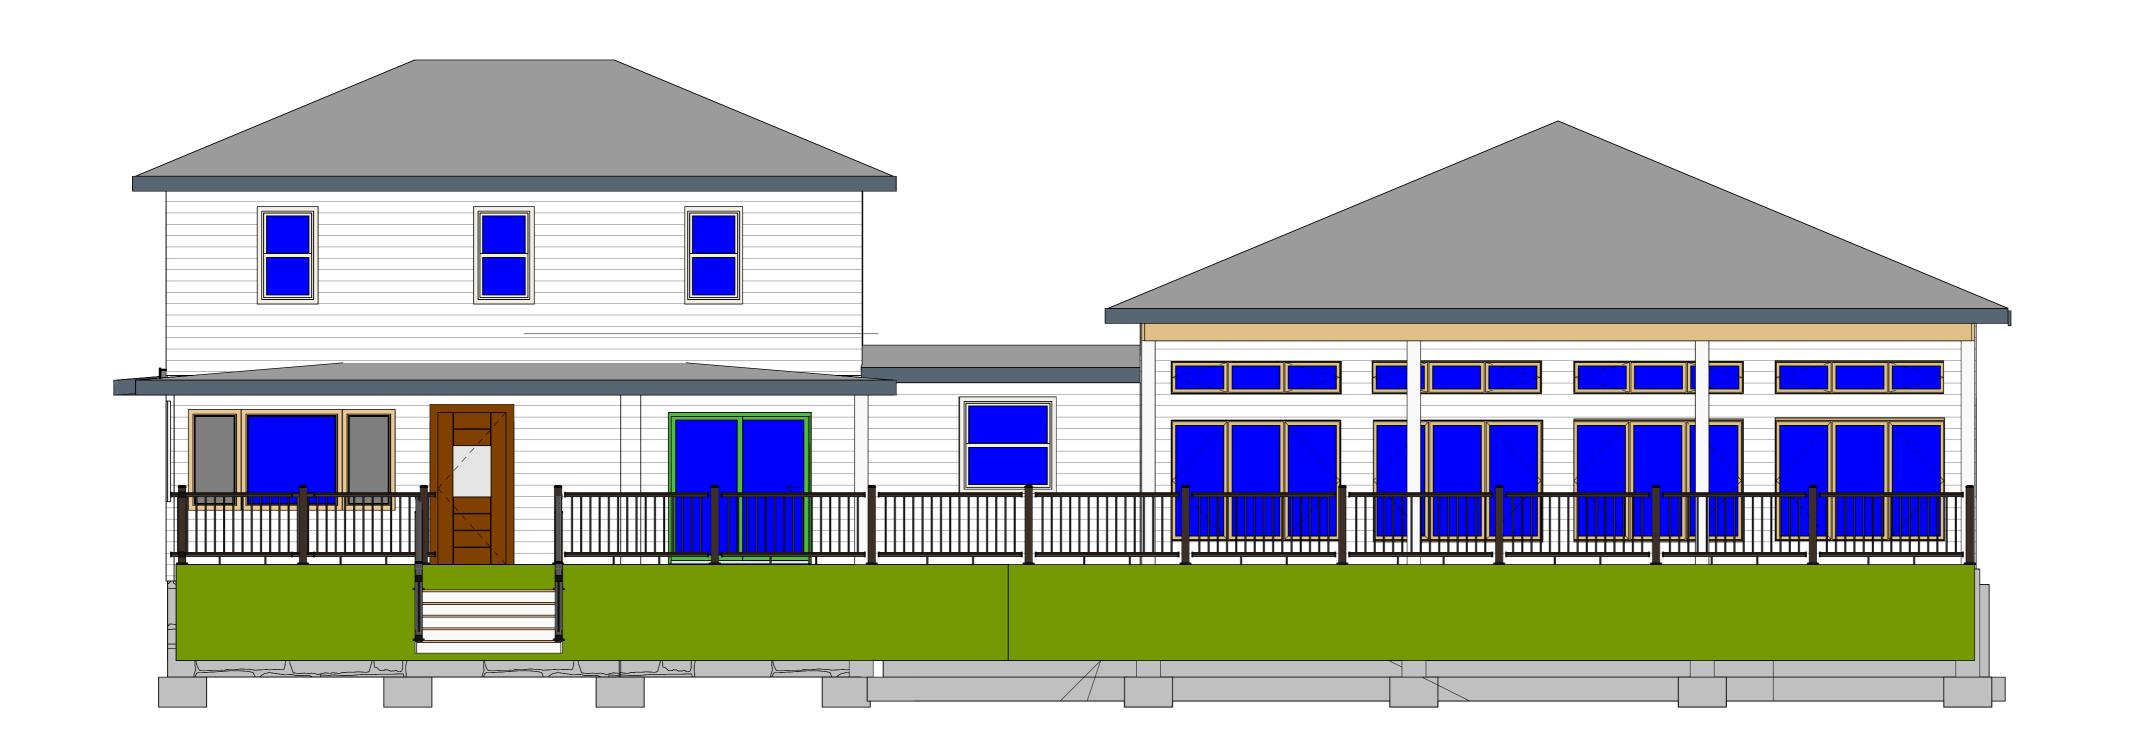
No.	Description	Date
1	IF Client Use	Jan 13, 2023

PROJECT COTTAGE RENOVATION 2 South West 3D View

	Project number	2022-024
	Date	Sept 13, 2022
Di	Drawn by	RLJ
	Checked by	RI.I

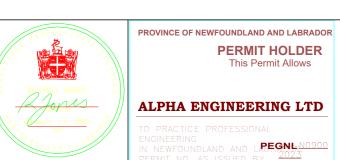

1 North Elevation 1/4" = 1'-0"



2 South Elevation 1/4" = 1'-0"

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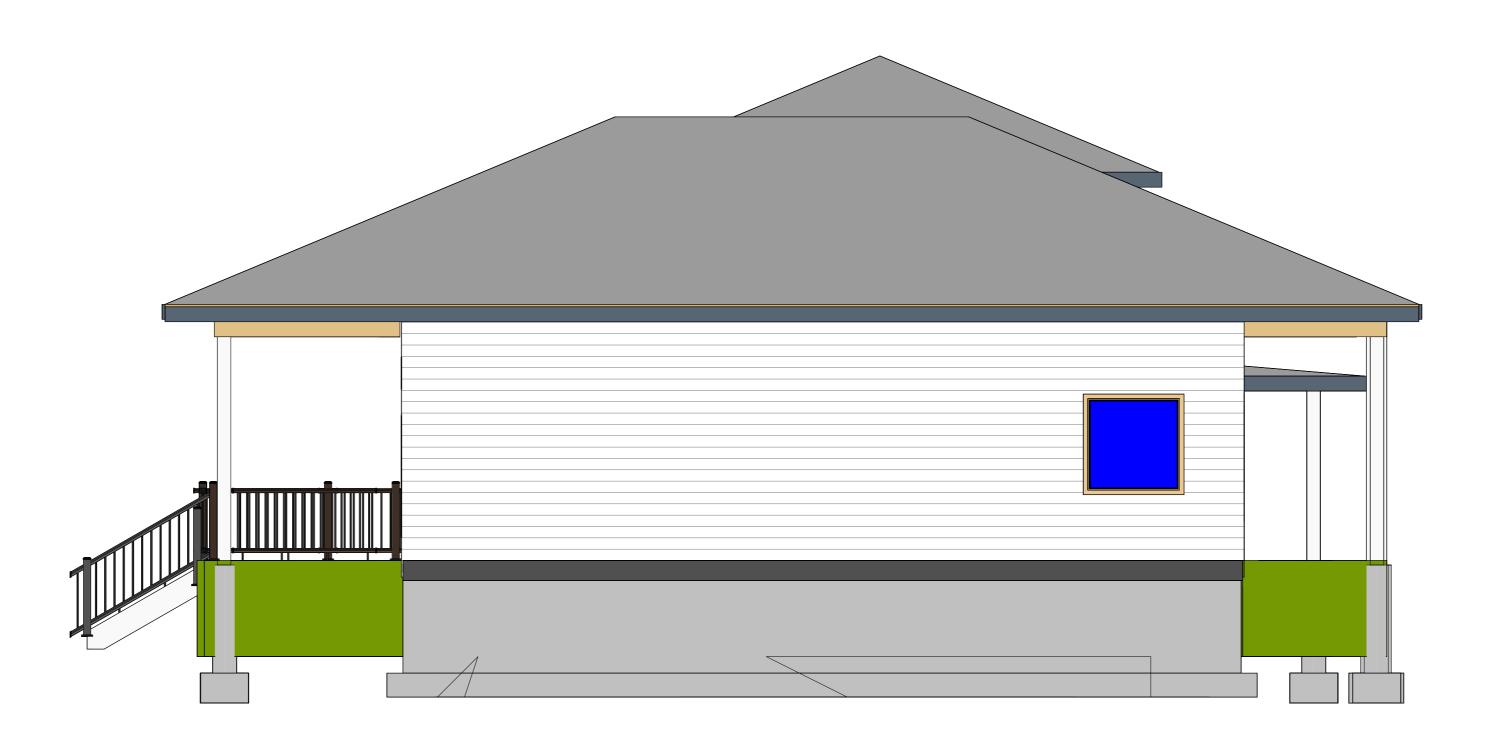
PROJECT COTTAGE **RENOVATION 2**

Building North & South Elevations

2022-024 Project number Sept 13, 2022 Drawn by Checked by

A7

Scale



1 East Elevation 1/4" = 1'-0"



West Elevation
1/4" = 1'-0"

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PERMIT HOLDER
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Date Jan 13, 2023 IF Client Use


PROJECT COTTAGE RENOVATION 2

Building East & West Elevations 2022-024 Project number

Sept 13, 2022 Drawn by Checked by

A8

Scale

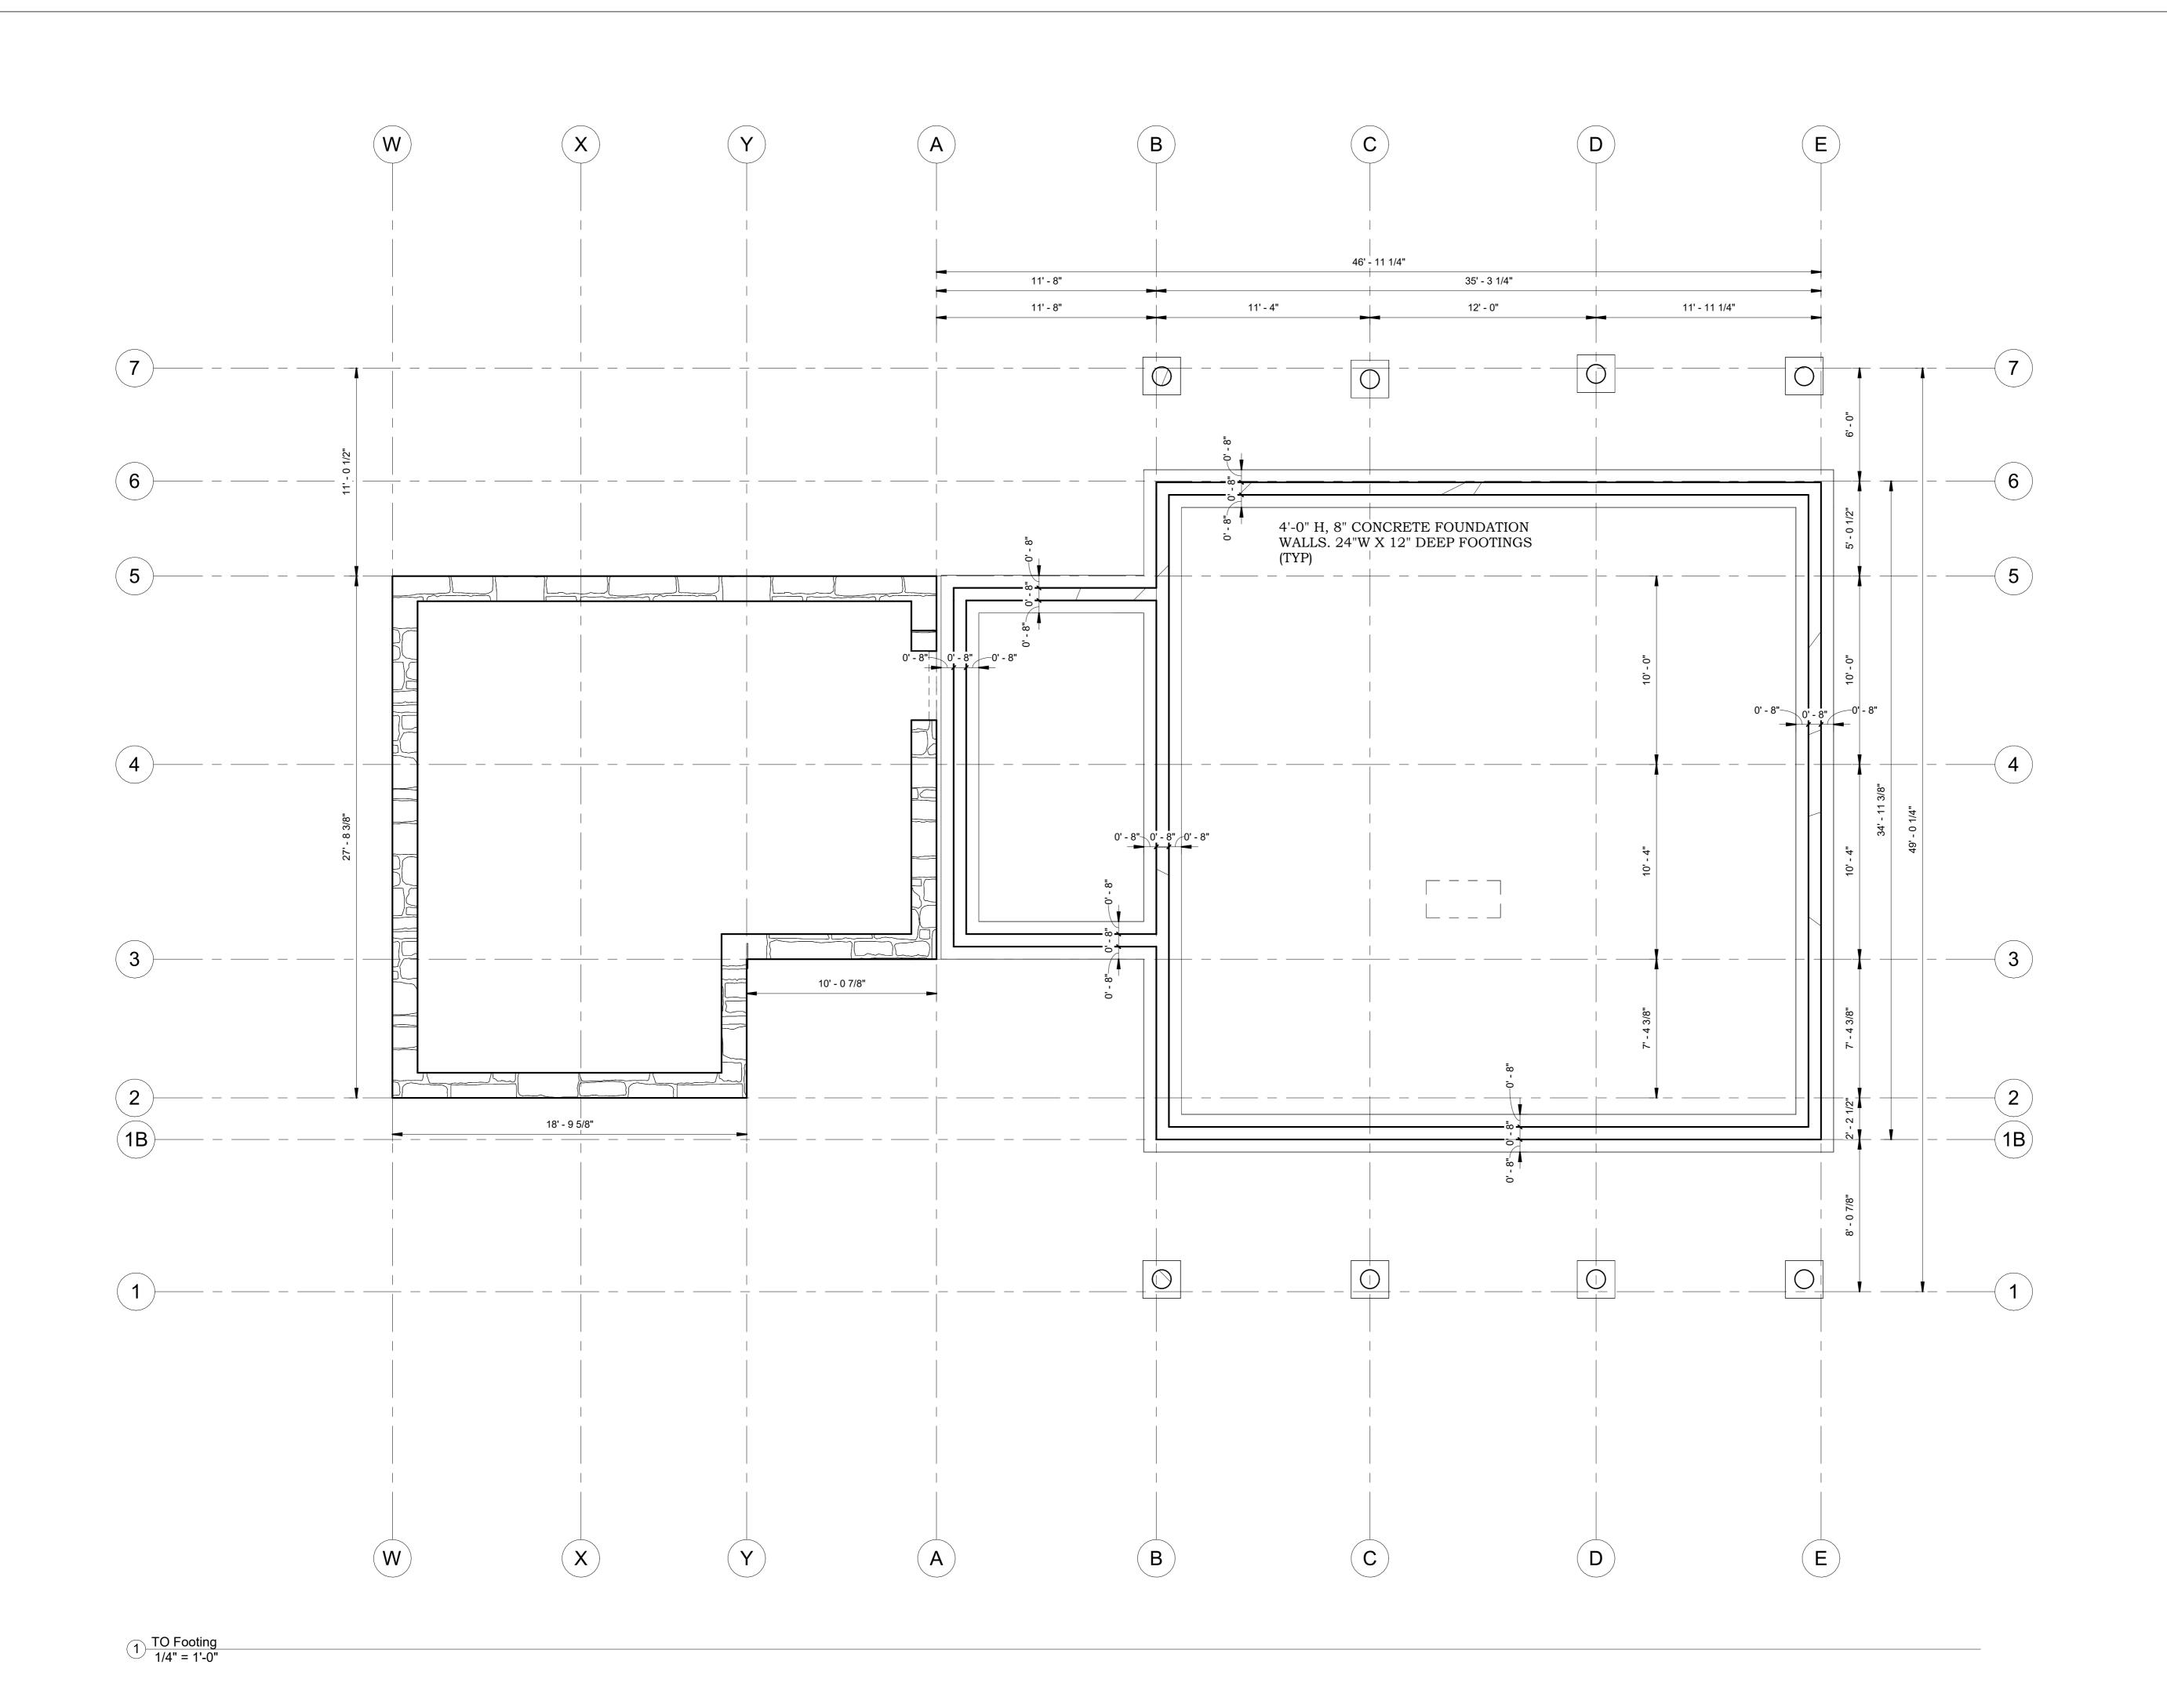

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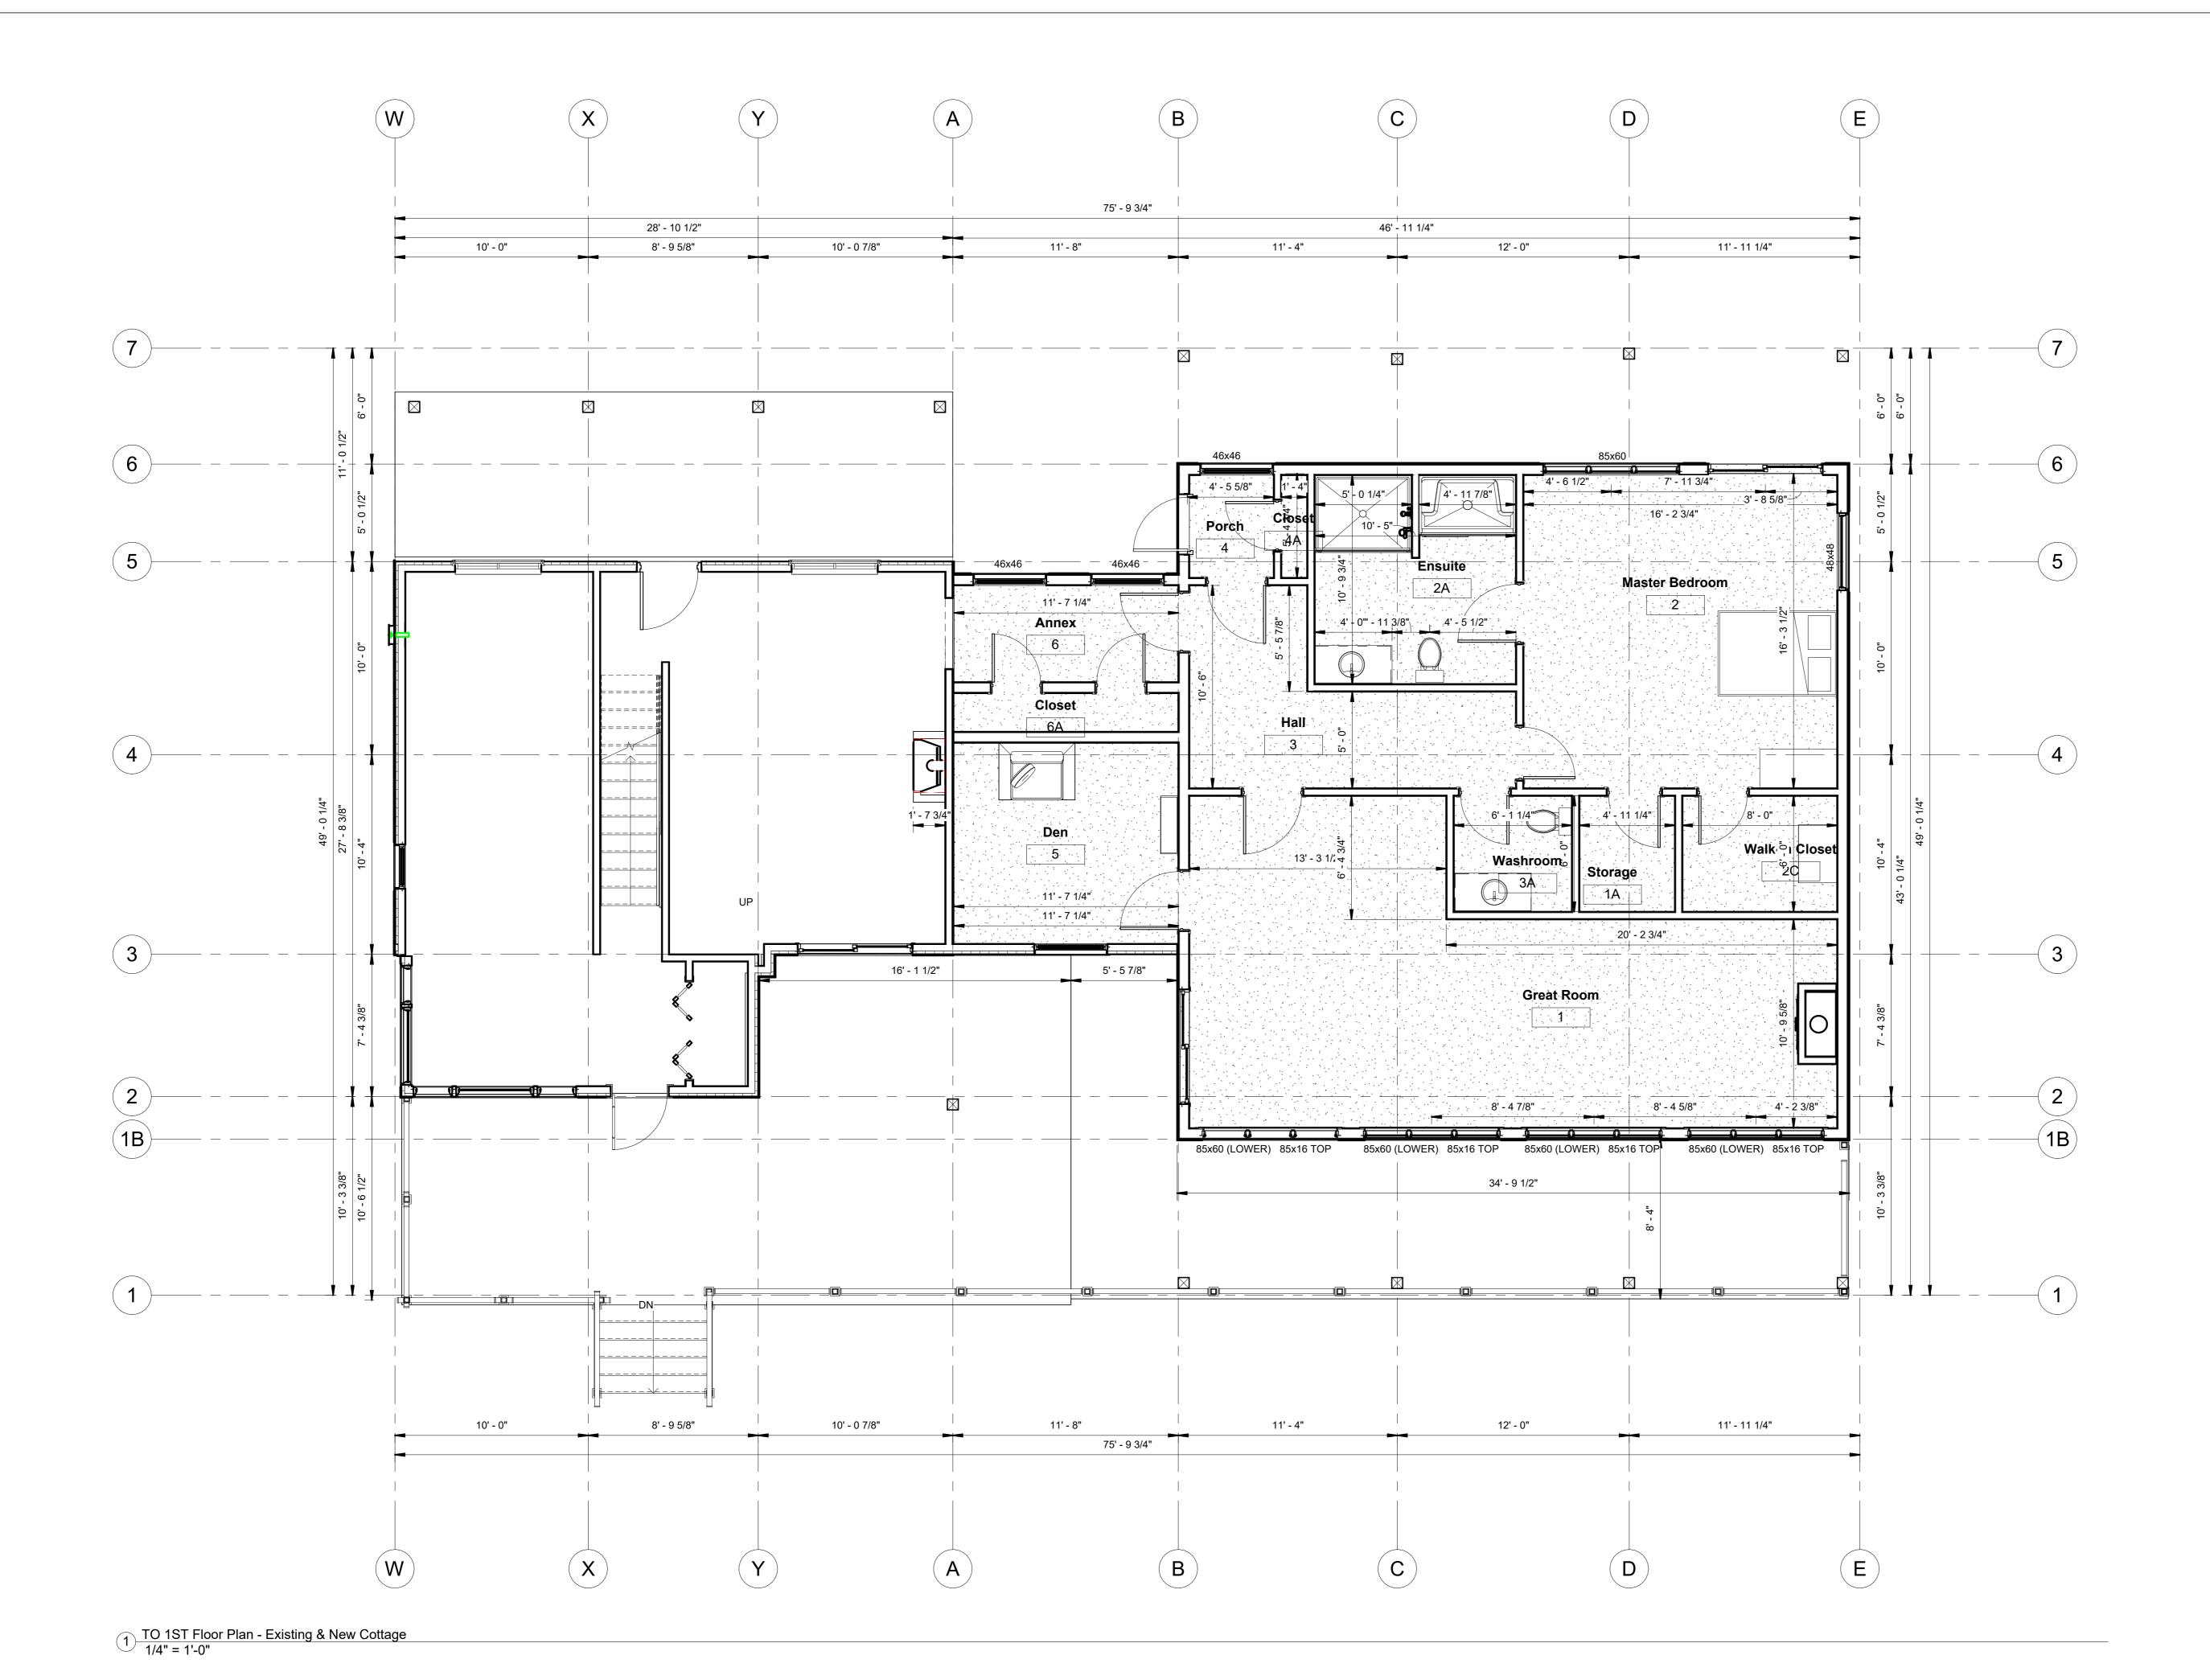


Date Jan 13, 2023 IF Client Use

PROJECT COTTAGE **RENOVATION 2** Footing & Foundation Plan

2022-024 Project number Sept 13, 2022 Drawn by Checked by

A9



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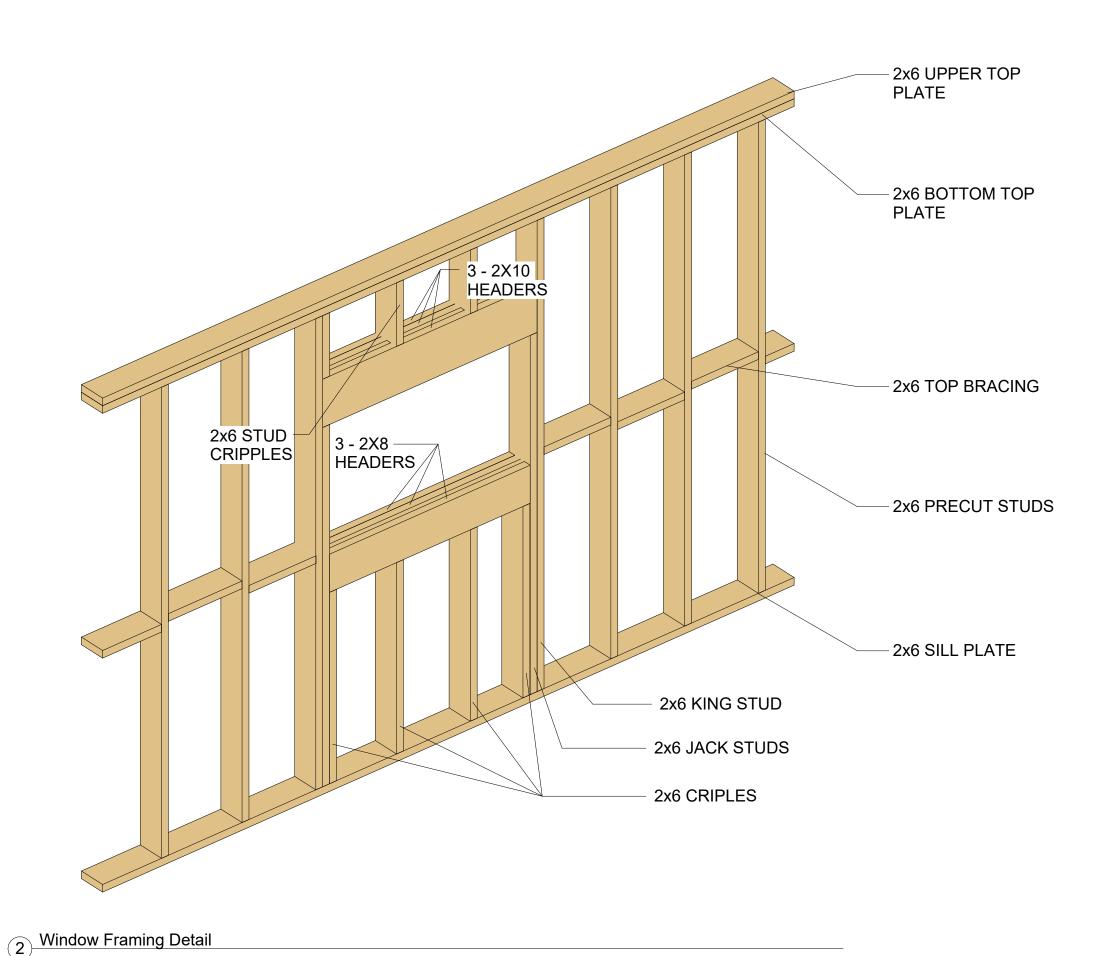
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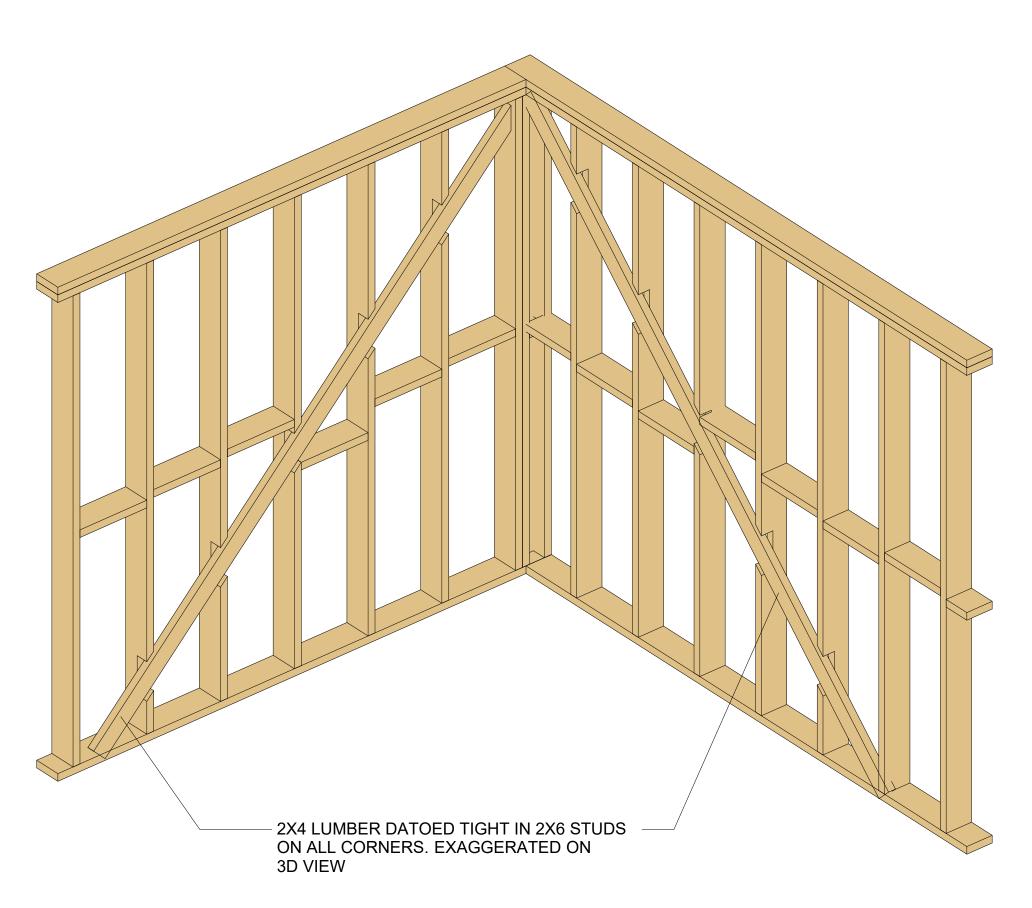
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PROJECT COTTAGE **RENOVATION 2** Floor Plan Dimensions

2022-024 Project number Sept 13, 2022 Drawn by Checked by

A10





Bracing Corner Wall

GENERAL

- 1. THE CONTRACTOR SHALL VISIT AND INSPECT THE SITE AND SHALL ALSO CAREFULLY EXAMINE THE DRAWINGS AND SPECIFICATIONS IN ORDER THAT HE MAY BE THOROUGHLY FAMILIAR WITH THE SITE AND LOCAL CONDITIONS, AND ALL MATTERS WHICH CAN IN ANYWAY AFFECT THE WORK COVERED BY THESE DRAWINGS AND SPECIFICATION.
- 2. OBTAIN AND PAY FOR ALL PERMITS REQUIRED BY AUTHORITIES HAVING JURISDICTION. COORDINATE THE PAYMENT OF THE SAME WITH THE OWNER.
- 3. ALL WORK SHALL TO BE IN DONE IN STRICT ACCORDANCE WITH THE LATEST EDITION OFTHE NBC, NPC, CEC, NFC, ASHRAE, SMACNA AND ALL AUTHORITIES HAVING JURISDICTION.
- 4. ALL WORK SHALL BE PERFORMED IN A NEAT AND WORKMANLIKE MANNER AND INACCORDANCE WITH GENERALLY ACCEPTED STANDARDS OF GOOD PRACTICE. ALL WORK SHALL BE COMPLETED BY QUALIFIED TRADE PERSONS. ALL WORK SHALL COMPLY INACCORDANCE WITH NBC AND ALL OTHER APPLICABLE CODES AND REGULATIONS GOVERNING.
- 5. CONDUCT HEALTH AND SAFETY OPERATIONS IN STRICT ACCORDANCE WITH LATEST EDITION OF THE NL'S OCCUPATIONAL HEALTH AND SAFETY (OH&S) ACT AND REGULATIONS-NL REGULATION 5/12 OCCUPATIONAL HEALTH AND SAFETY REGULATIONS.
- 6. ALL PRODUCTS USED ON THIS PROJECT SHALL HAVE A MINIMUM FLAME SPREAD RATING OF 25 AND MAXIMUM SMOKE DEVELOPED RATING OF 50 IN ACCORDANCE WITH CAN4-S102.7. ALL MATERIALS AND EQUIPMENT USED ON THIS PROJECT ARE TO BE NEW AND CSA APPROVED.
- 7. COORDINATE WITH THE OWNER, ALL EQUIPMENT THE OWNER IS PROVIDING. 8. FLASH AND SEAL ALL BUILDING OPENINGS TO PROVIDE A WEATHER TIGHT CONSTRUCTIONS.
- 9. CONCRETE DESIGN STRENGTH: 30MPA AT 28 DAYS.

WOOD FRAME BUILDING CONSTRUCTION

- 1. GENERAL REQUIREMENTS FOR REQUIREMENTS FOR WOOD FRAME BUILDING CONSTRUCTION:
- .1 FOLLOW NBC 2015 REQUIREMENTS PART 9 AND THE COMPANION DOCUMENTS TO THE NBC; STRUCTURAL COMMENTARIES (USER S GUIDE NBC 2015: PART 4 OF.DIVISION B) AND THE ILLUSTRATED USER S GUIDE NBC 2015: PART 9 OF DIVISION B, HOUSING AND SMALL BUILDINGS. 2. LUMBER:
- .1 MANUFACTURED IN ACCORDANCE WITH CSA O141-2005 (R2019). SOFTWOOD LUMBER AND CONFORMING TO THE REQUIREMENTS OF THE CANADIAN AND US LUMBER GRADING RULES, INCLUDING BUT NOT LIMITED TO: (A) CLASSIFICATION; (B) MEASUREMENT; (C) STANDARD SIZES; (D) GRADING RULES; (E) IDENTIFICATION (GRADE STAMPS AND CERTIFICATES); AND (F) REQUIREMENTS AND RESPONSIBILITIES OF ACCREDITATION BOARD AND GRADING AGENCY RESPONSIBILITIES.
- .2 DIMENSION LUMBER WITH GRADE STAMPED ON ONE FACE AT A DISTANCE OF APPROXIMATELY 2 FT (600 MM) FROM ONE END OF EACH PIECE.
- .3 QUALITY ENSURED BY: (A) GRADING AGENCIES ACCREDITED BY THE CANADIAN LUMBER STANDARDS ACCREDITATION BOARD (CLSAB); (B) NATIONAL LUMBER GRADES AUTHORITY (NLGA) STANDARD GRADING RULES FOR CANADIAN LUMBER (2017).
- .3 SELECTION FOR INDIVIDUAL ELEMENTS OF CONSTRUCTION, FLOOR ASSEMBLE INCLUDING JOISTS, SILLS AND GIRDERS, STUDS, STRAPPING, ROOF TRUSSES, ETC. BASED ON CANADIAN WOOD COUNCIL (CWC), TO THE FOLLOWING TABLE:

DIMENSIONAL LUMBER-GRADES AND USE			
GRADE CATEGORY	SIZE	ACCEPTABLE GRADES	PRINCIPAL USE
STRUCTURAL LIGHT FRAMING	2" TO 4" NOMINAL THICK AND WIDE	NO 2 AND BETTER	TRUSSES, LINTELS, RAFTERS AND JOISTS IN SMALLER DIMENSIONS
STRUCTURAL JOISTS AND PLANKS	2" TO 4" NOMINAL THICK AND 5" OR MORE WIDE	NO 1 AND BETTER	TRUSSES, LINTELS, RAFTERS AND JOISTS IN DIMENSIONS GREATER THAN 5" NOMINAL
LIGHT FRAMING	2" TO 4" NOMINALTHICK AND WIDE	STANDARD AND BETTER	GENERAL FRAMING WHERE HIGH STRENGTH VALUES ARE NOT REQUIRED SUCH AS PLATES AND BLOCKING
STUDS	2" TO 4" NOMINAL THICK AND 2" WIDE AND LESS THAN 10"-0" LONG	STUD, ECONOMY STUD	PRINCIPALLY USED IN WALLS, STUD GRADE SUITABLE FOR BEARING WALL APPLICATIONS. ECONOMY GRADE SUITABLE FOR TEMPORARYAPPLICATIONS.

NOTES:

- 1. GRADES MAY BE BUNDLED INDIVIDUALLY OR THEY MAY BE INDIVIDUALLY STAMPED BUT THEY MUST BE GROUPED TOGETHER WITH THE ENGINEERING PROPERTIES DICTATED BY THE LOWEST STRENGTH GRADE IN THE BUNDLE
- LOWEST STRENGTH GRADE IN THE BUNDLE.
- 2. THE COMMON GRADE MIX SHOWN IS THE MOST ECONOMICAL BLENDING OF STRENGTH FOR MOST APPLICATIONS WHERE APPEARANCE IS NOT A FACTOR AND AVERAGE STRENGTH IS ACCEPTABLE
- 3. EXCEPT FOR ECONOMY GRADE, ALL GRADES ARE STRESS GRADED WHICH MEANS SPECIFIED STRENGTHS HAVE BEEN ASSIGNED AND SPAN TABLES CALCULATED. ECONOMY AND UTILITY GRADES ARE SUITED FOR TEMPORARY CONSTRUCTION OR FOR APPLICATIONS WHERE STRENGTH AND APPEARANCE ARE NOT IMPORTANT.
- 4. CONSTRUCTION, STANDARD, STUD, AND NO. 3 GRADES SHOULD BE USED IN DESIGNS THAT ARE COMPOSED OF 3 OR MORE ESSENTIALLY PARALLEL MEMBERS (LOAD SHARING) SPACED AT 610MM (24") CENTRES OR LESS.
- 5. STRENGTH PROPERTIES AND APPEARANCE ARE BEST IN THE PREMIUM GRADES SUCH AS SELECT STRUCTURAL.
- 6. ECONOMY AND UTILITY GRADES ARE ONLY SUITABLE FOR TEMPORARY CONSTRUCTION OR APPLICATIONS WHERE STRENGTH AND APPEARANCE ARE NOT IMPORTANT.
- * REFERENCE CANADIAN WOOD COUNCIL (CWC), WEB SITE HTTPS://CWC.CA/ HOW-TO-BUILD-WITH-WOOD/WOOD-PRODUCTS/LUMBER/GRADES/

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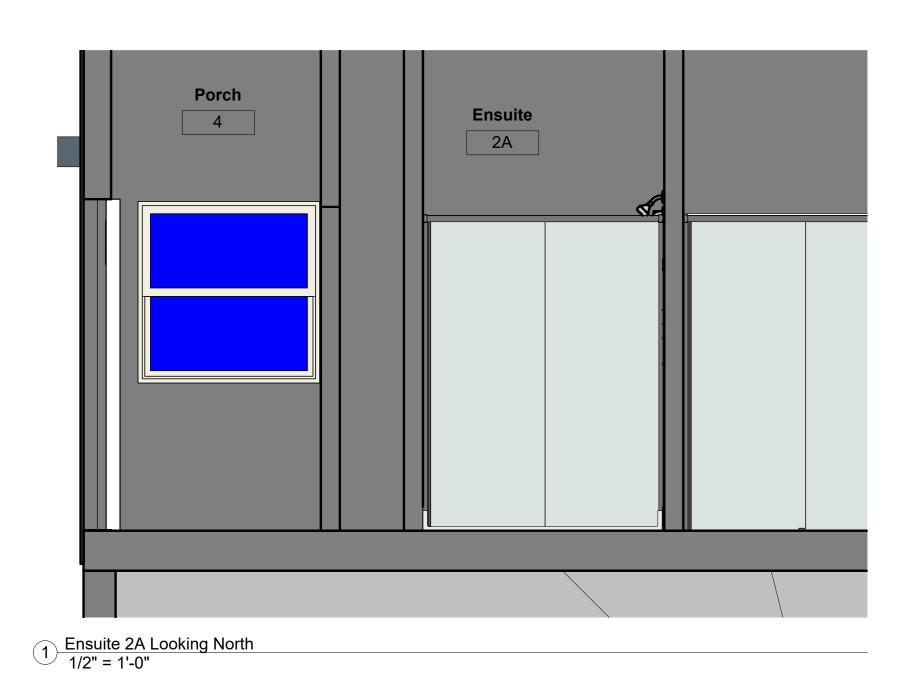
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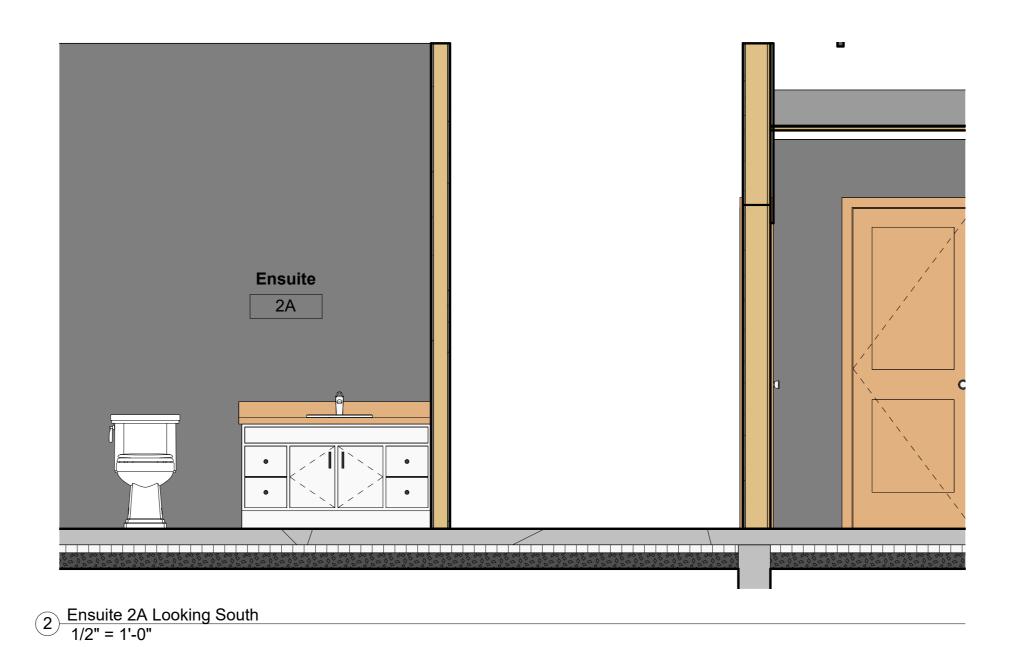
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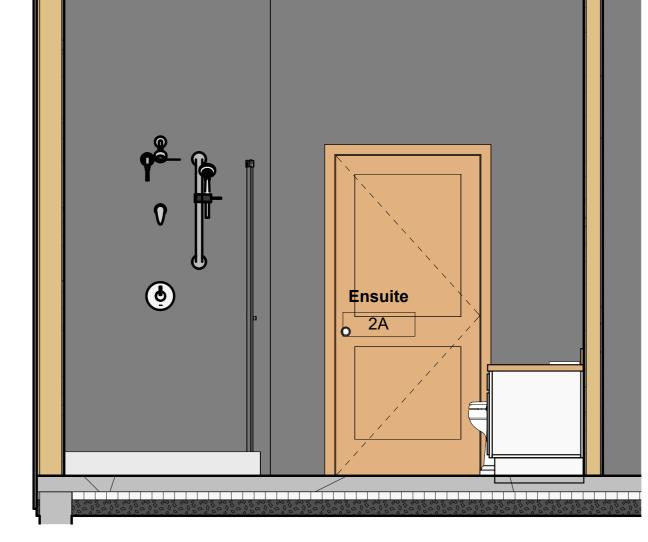
> Project Galway Cottage Renovation

Framing Details & Specification


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3 Ensuite 2A Looking East 1/2" = 1'-0"



Ensuite 2A Looking West
1/2" = 1'-0"

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No.	Description	Date
	IF Client Use	Jan 13, 2023
	+	

PROJECT COTTAGE RENOVATION 2

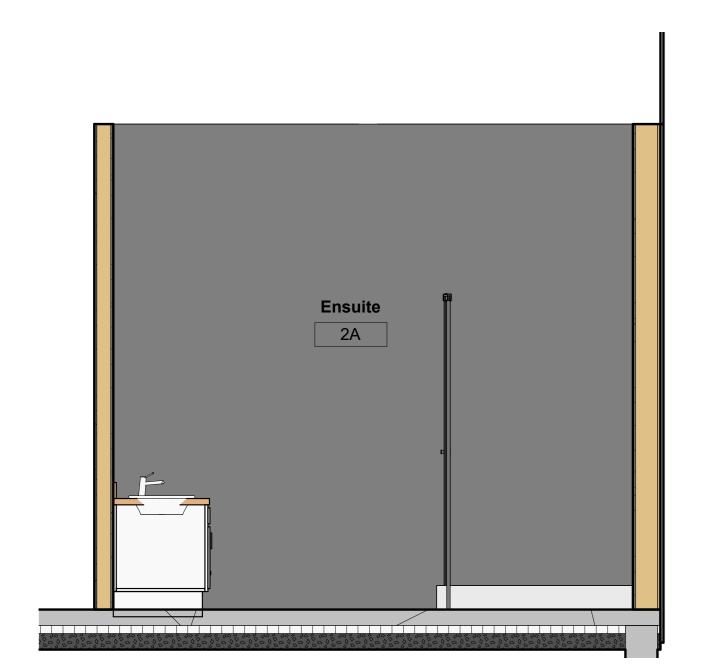Ensuite 2A Room Elevations

Project number	2022-024
Date	Sept 13, 2022
Drawn by	RLJ
Checked by	RLJ

A12

Scale