



1/8" = 1'-0"

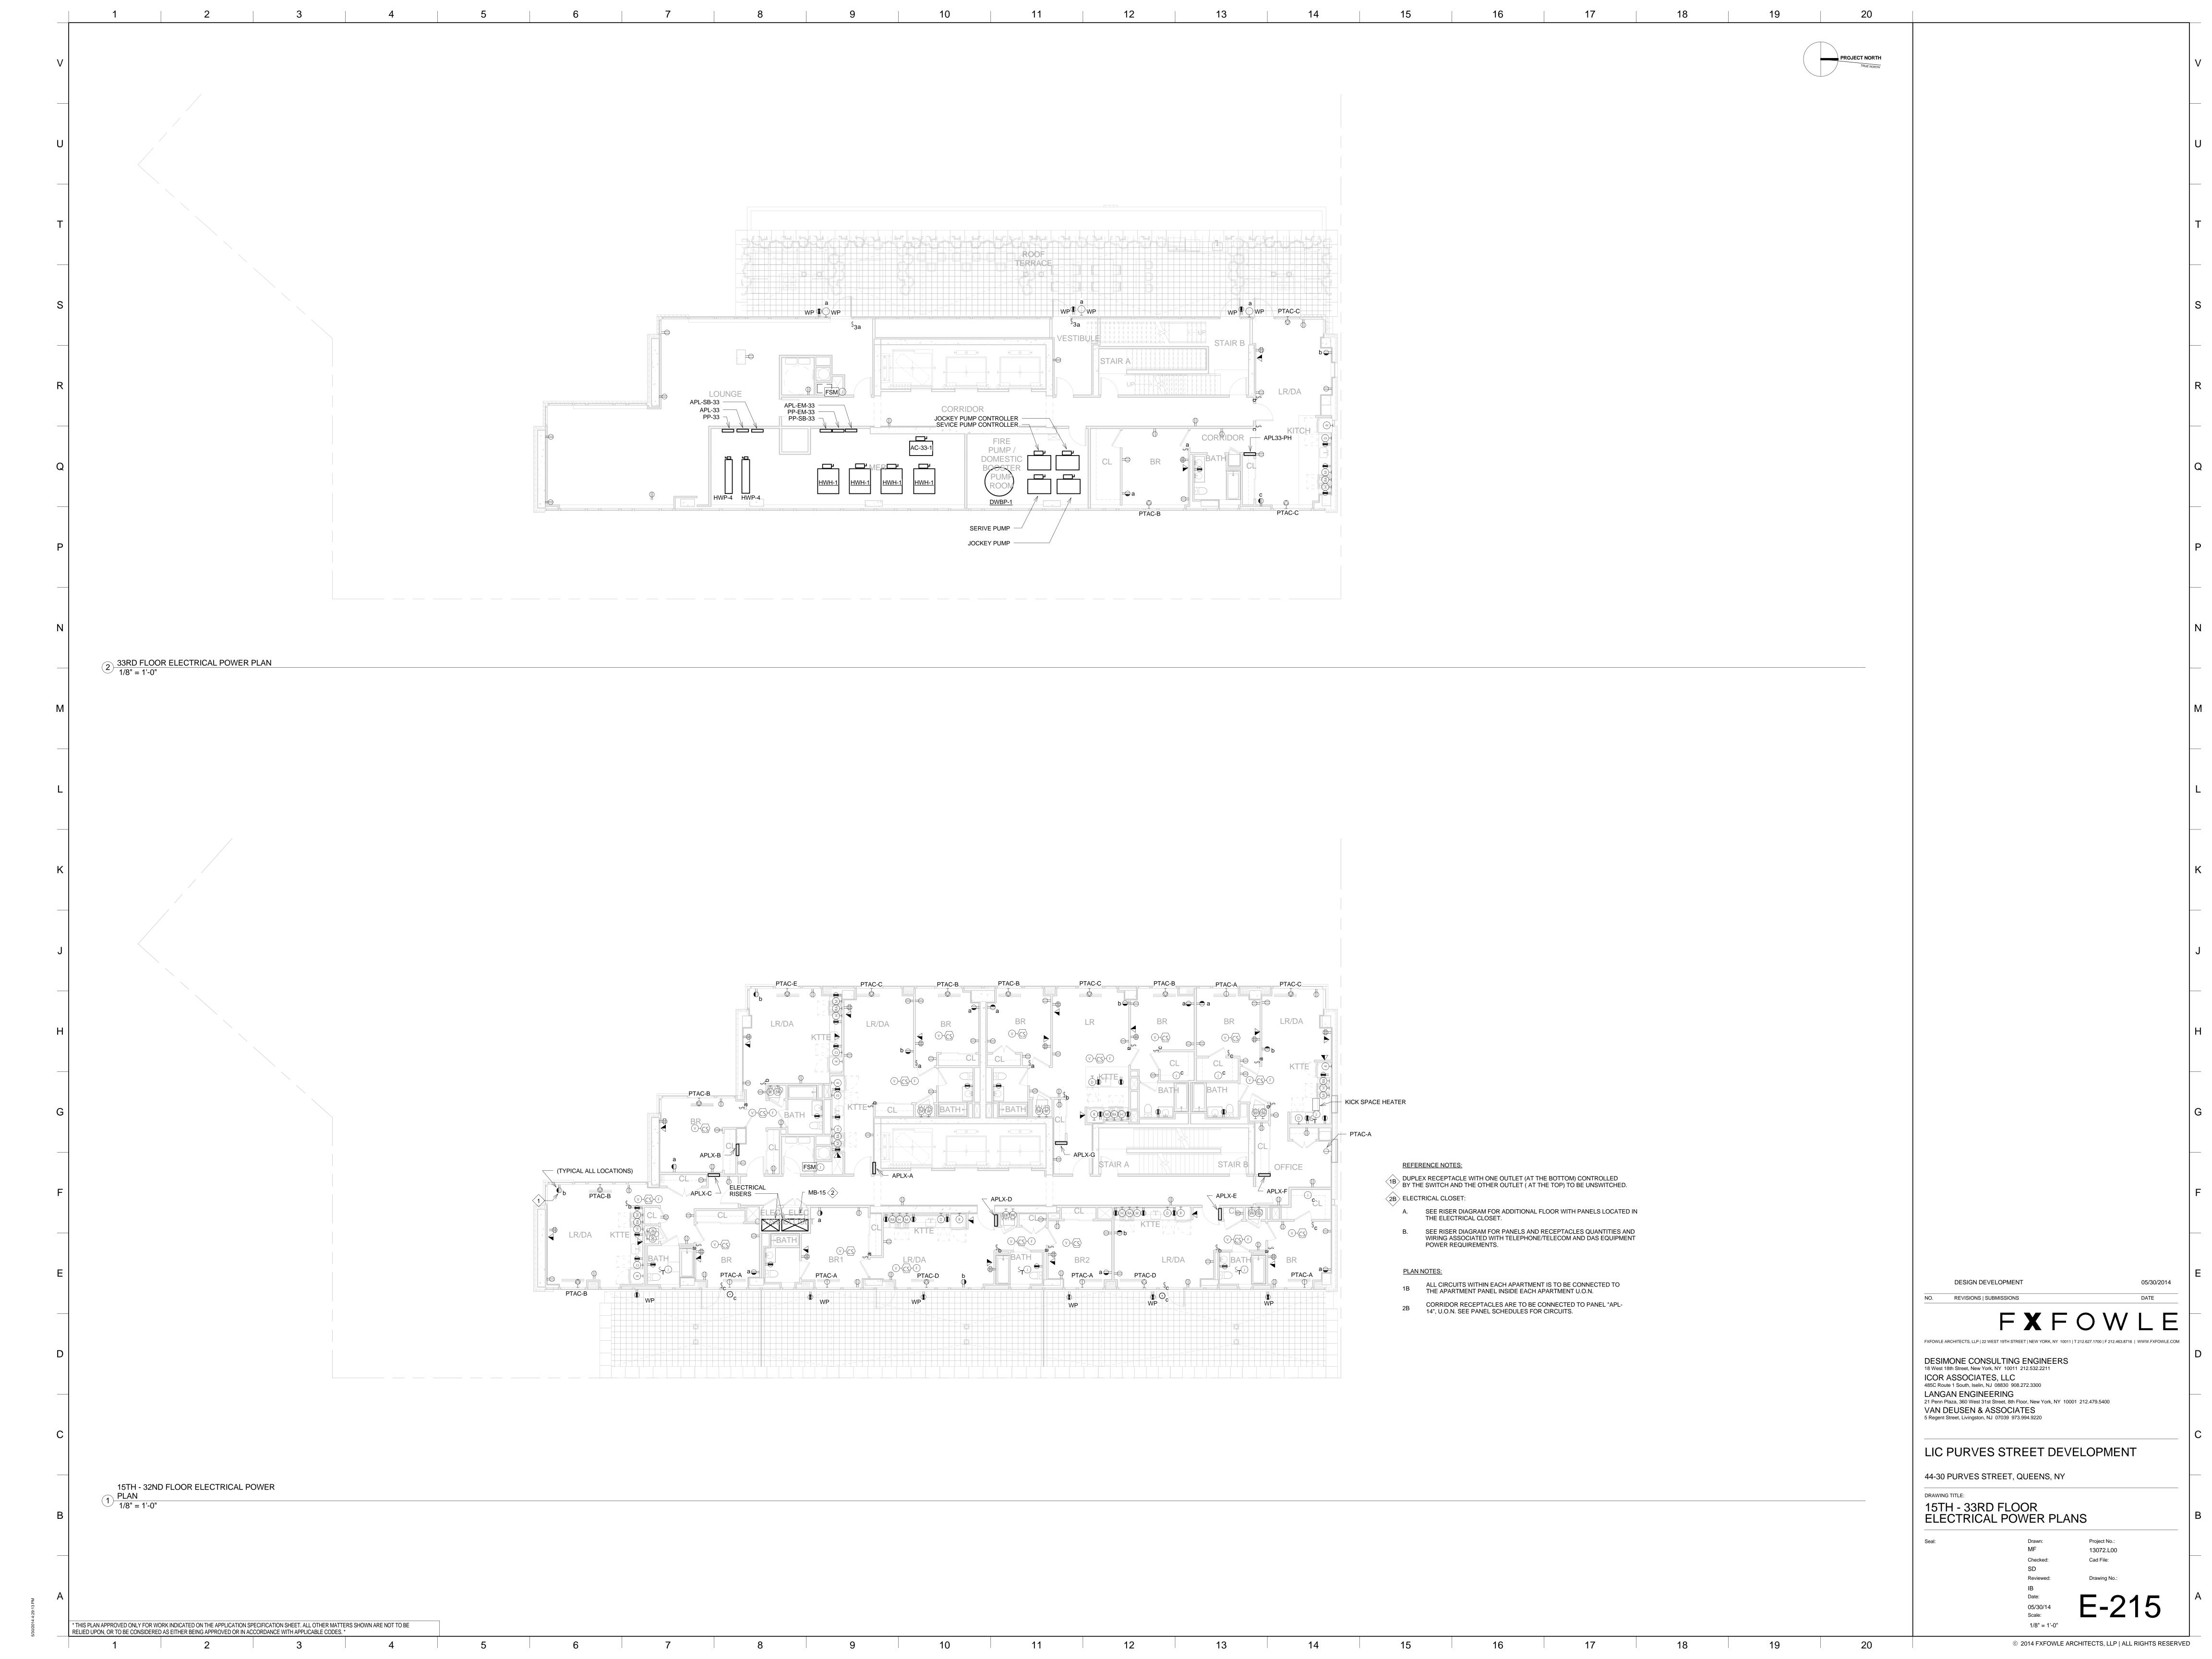

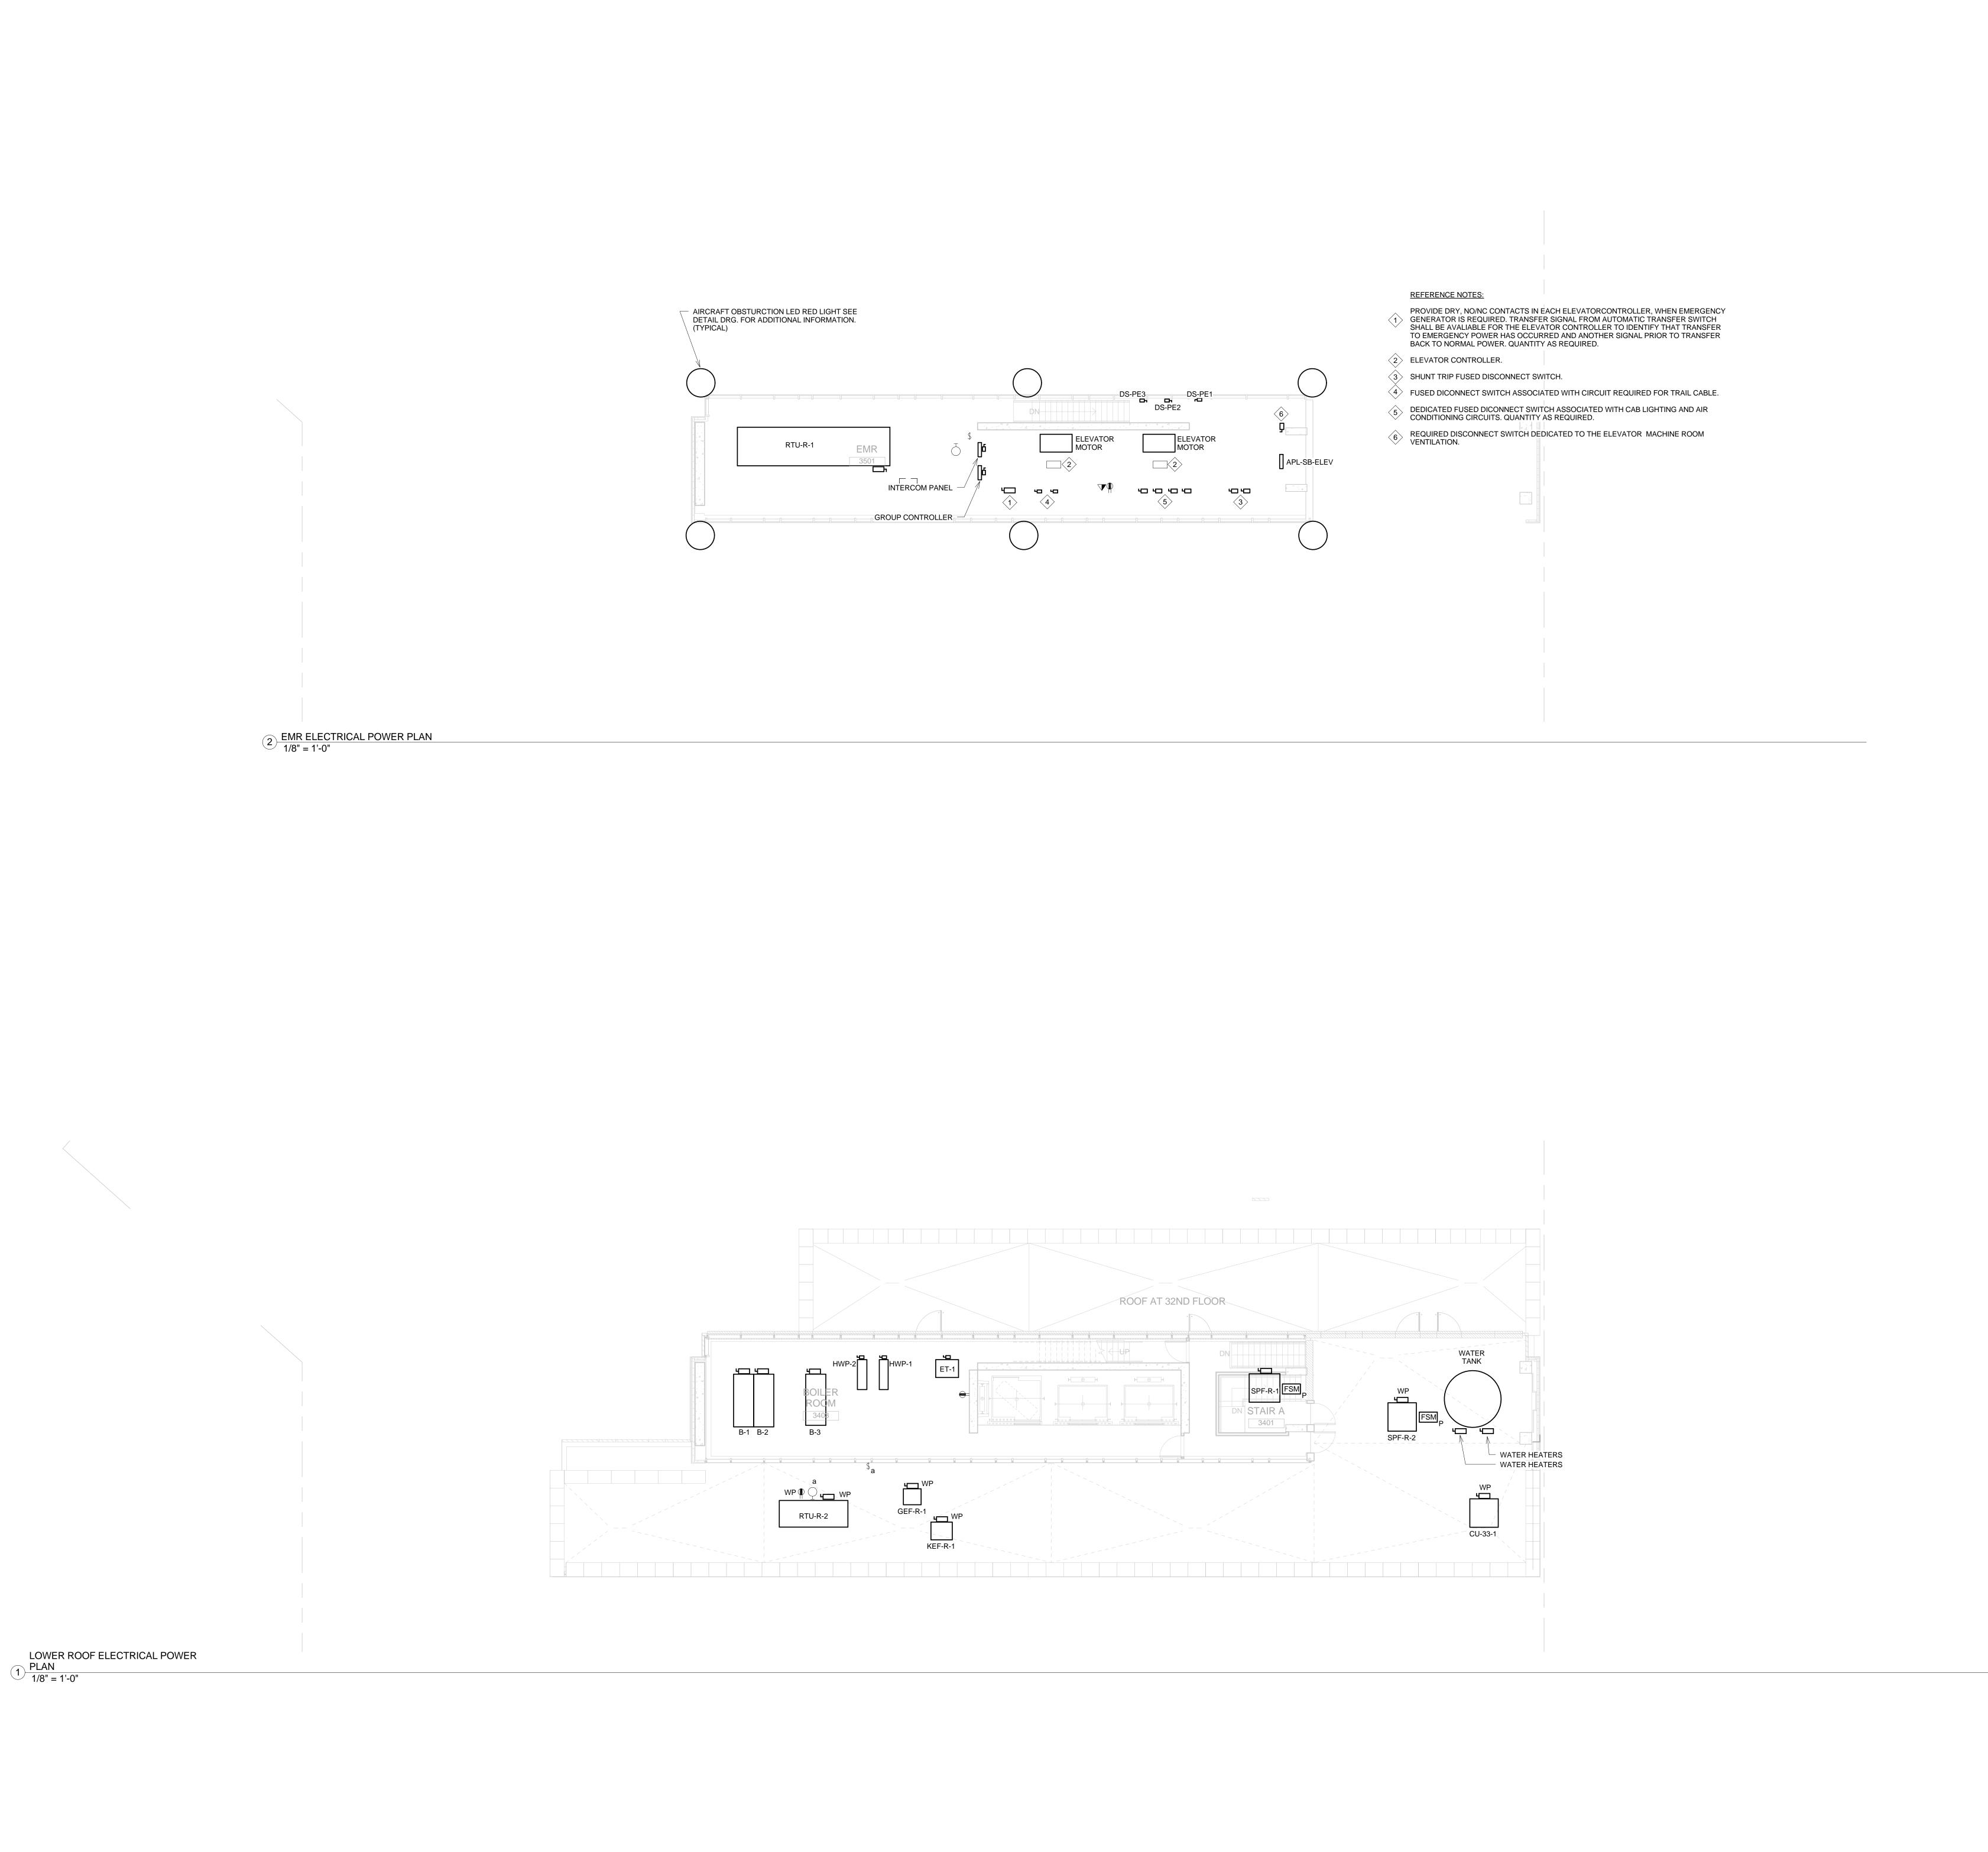

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18 West 18th Street, New York, NY 10011 212.532.2211

ICOR ASSOCIATES, LLC
485C Route 1 South, Iselin, NJ 08830 908.272.3300

LANGAN ENGINEERING
21 Penn Plaza, 360 West 31st Street, 8th Floor, New York, NY 10001 212.479.5400

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LIC PURVES STREET DEVELOPMENT

44-30 PURVES STREET, QUEENS, NY

PROJECT NORTH

TRUE NORTH


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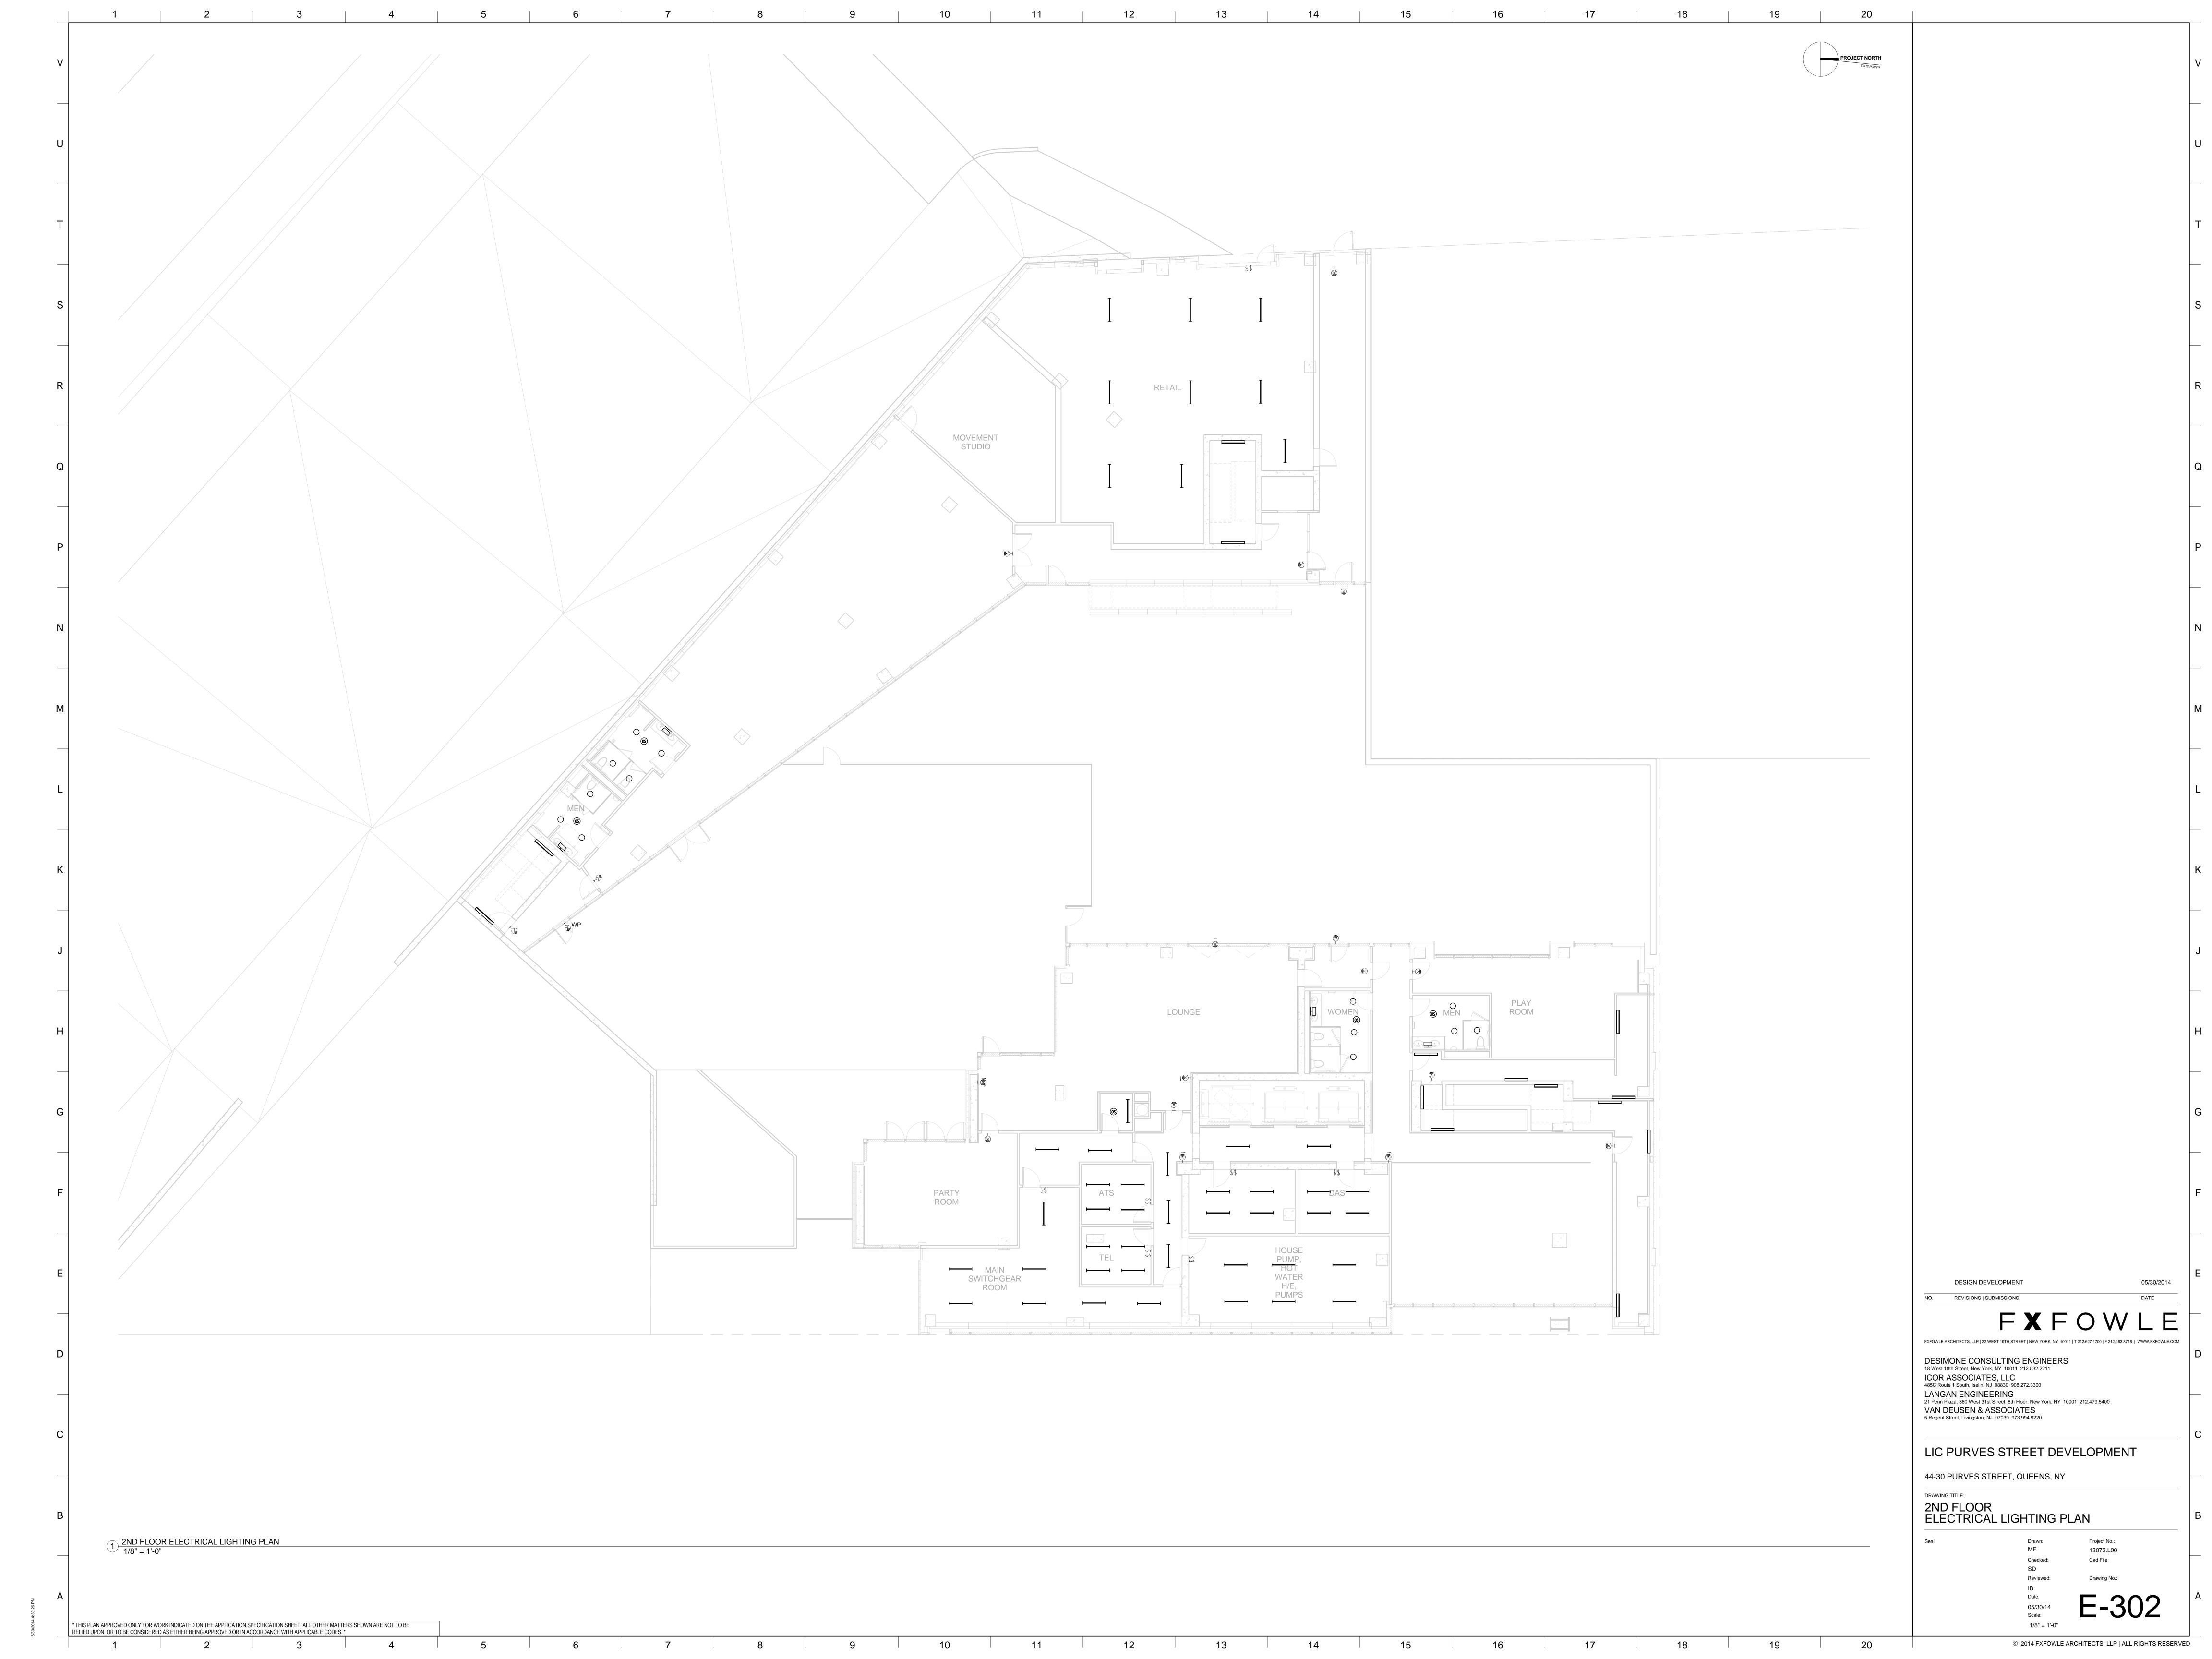
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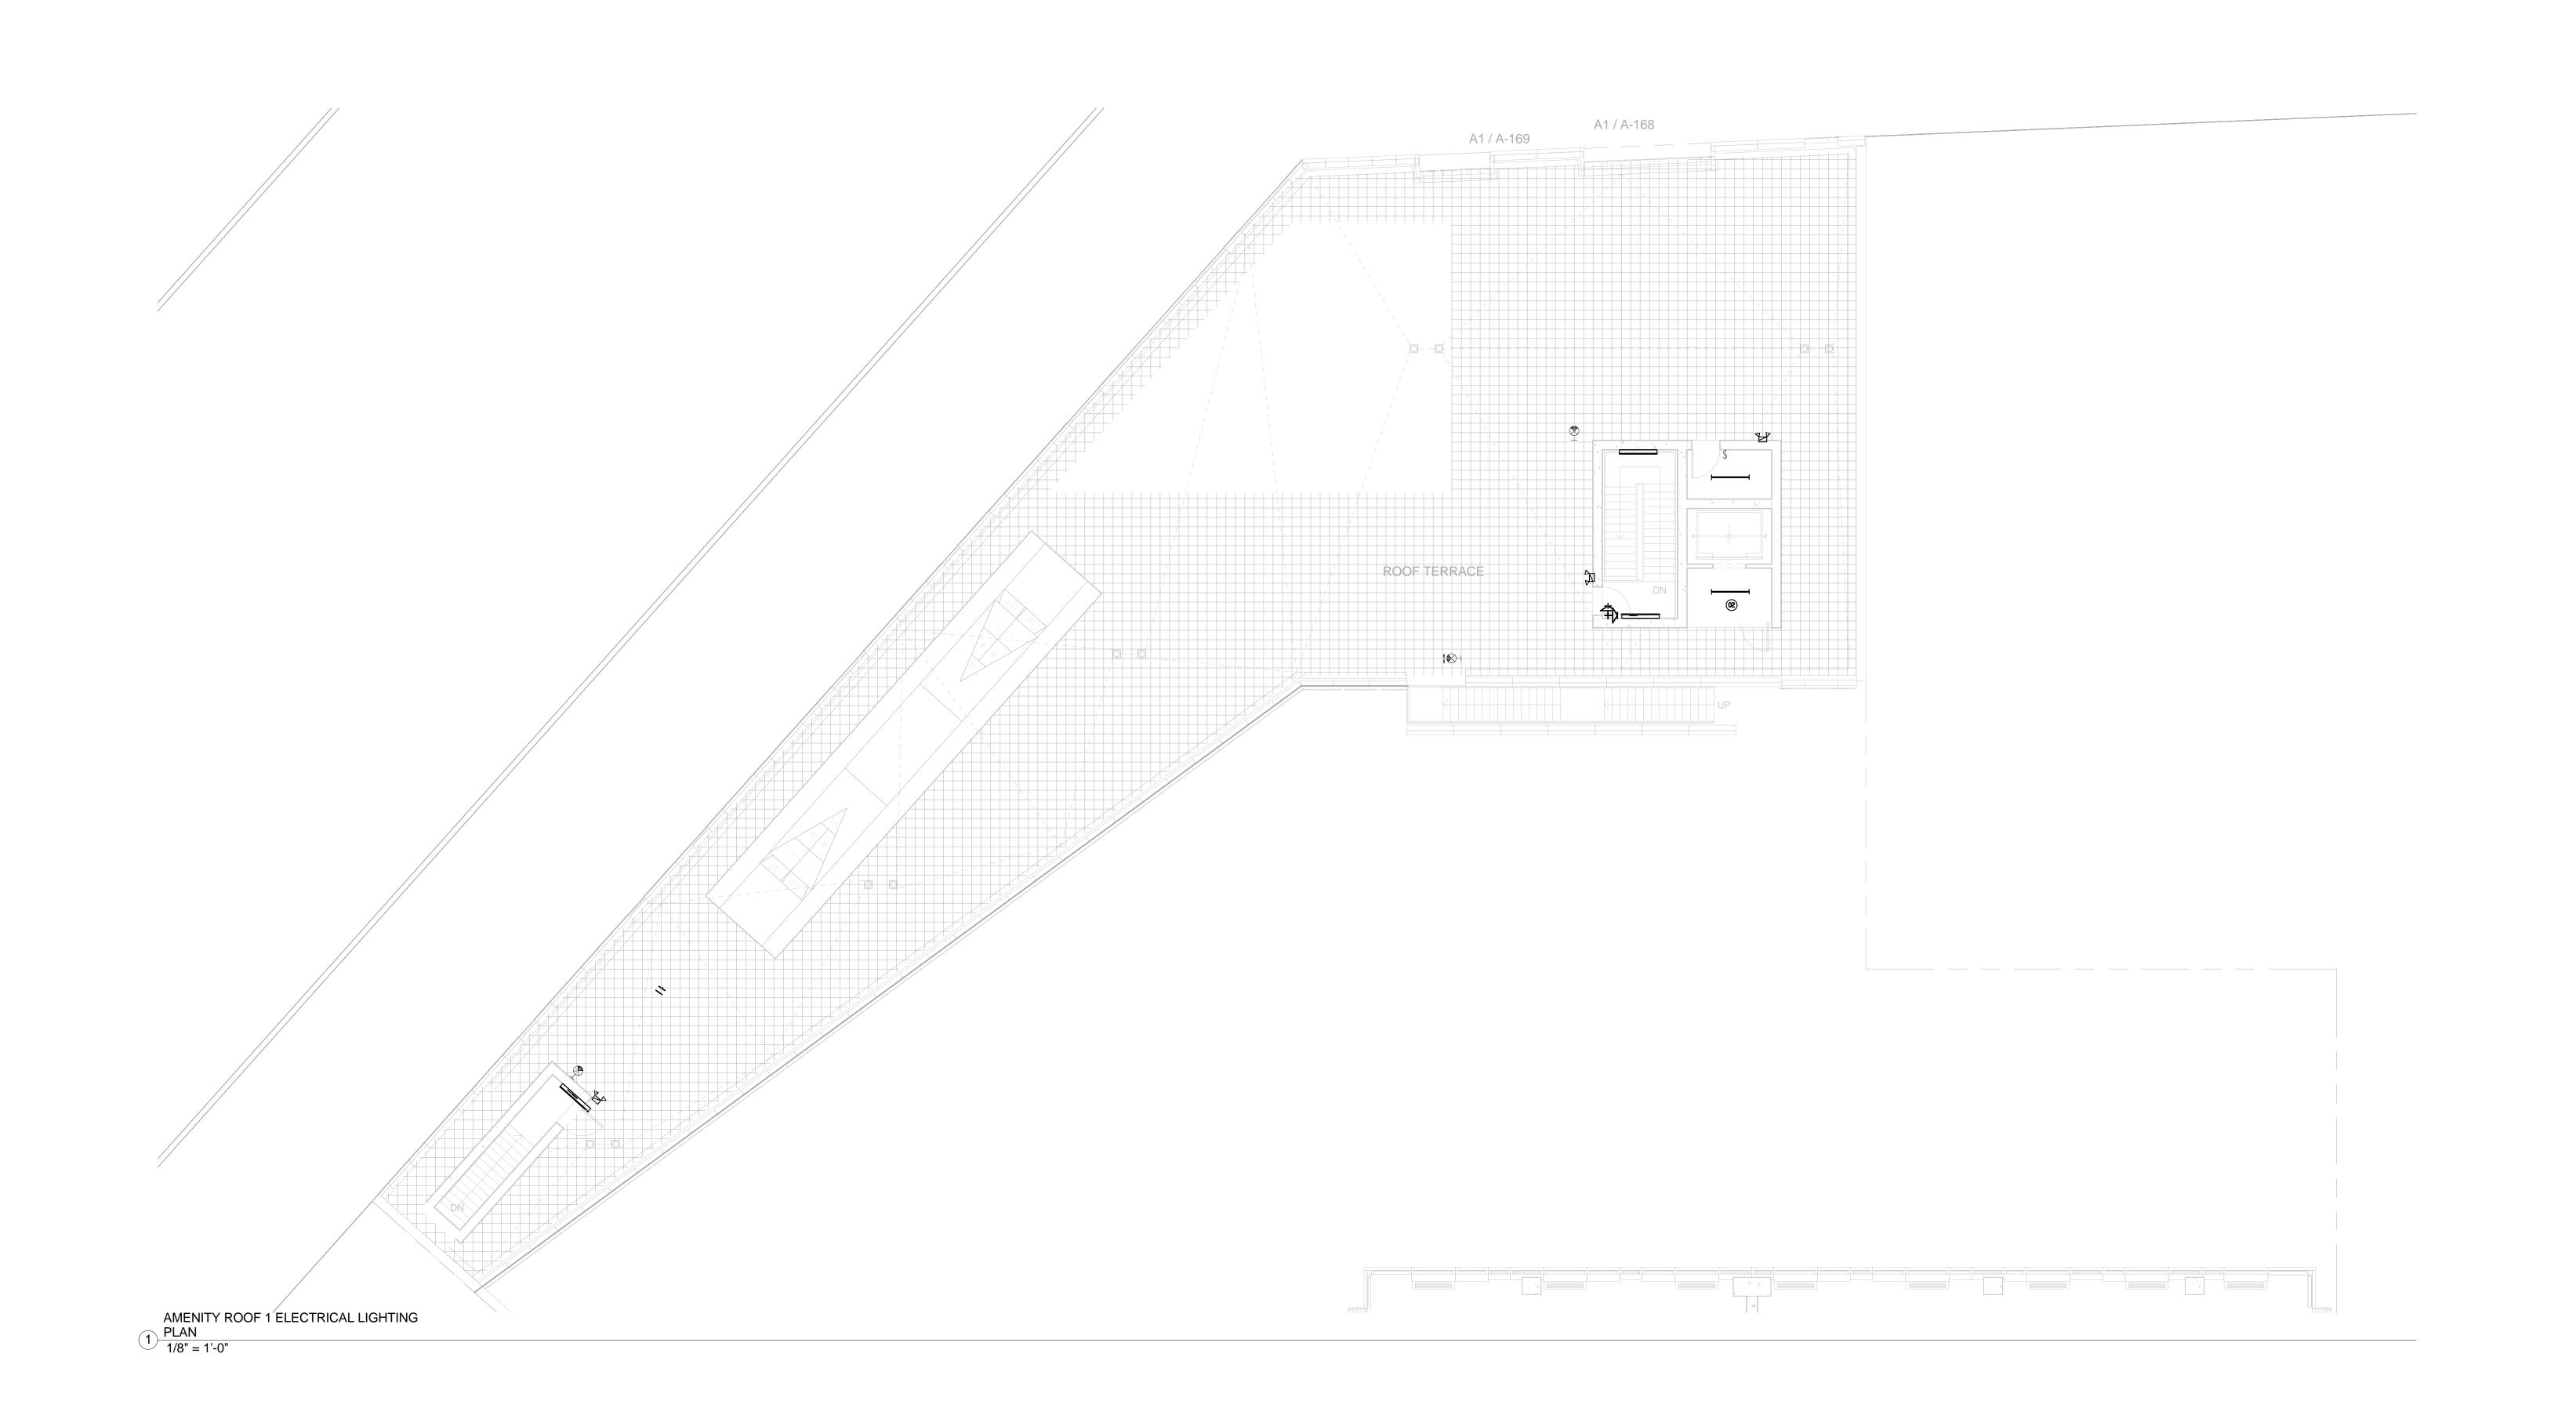
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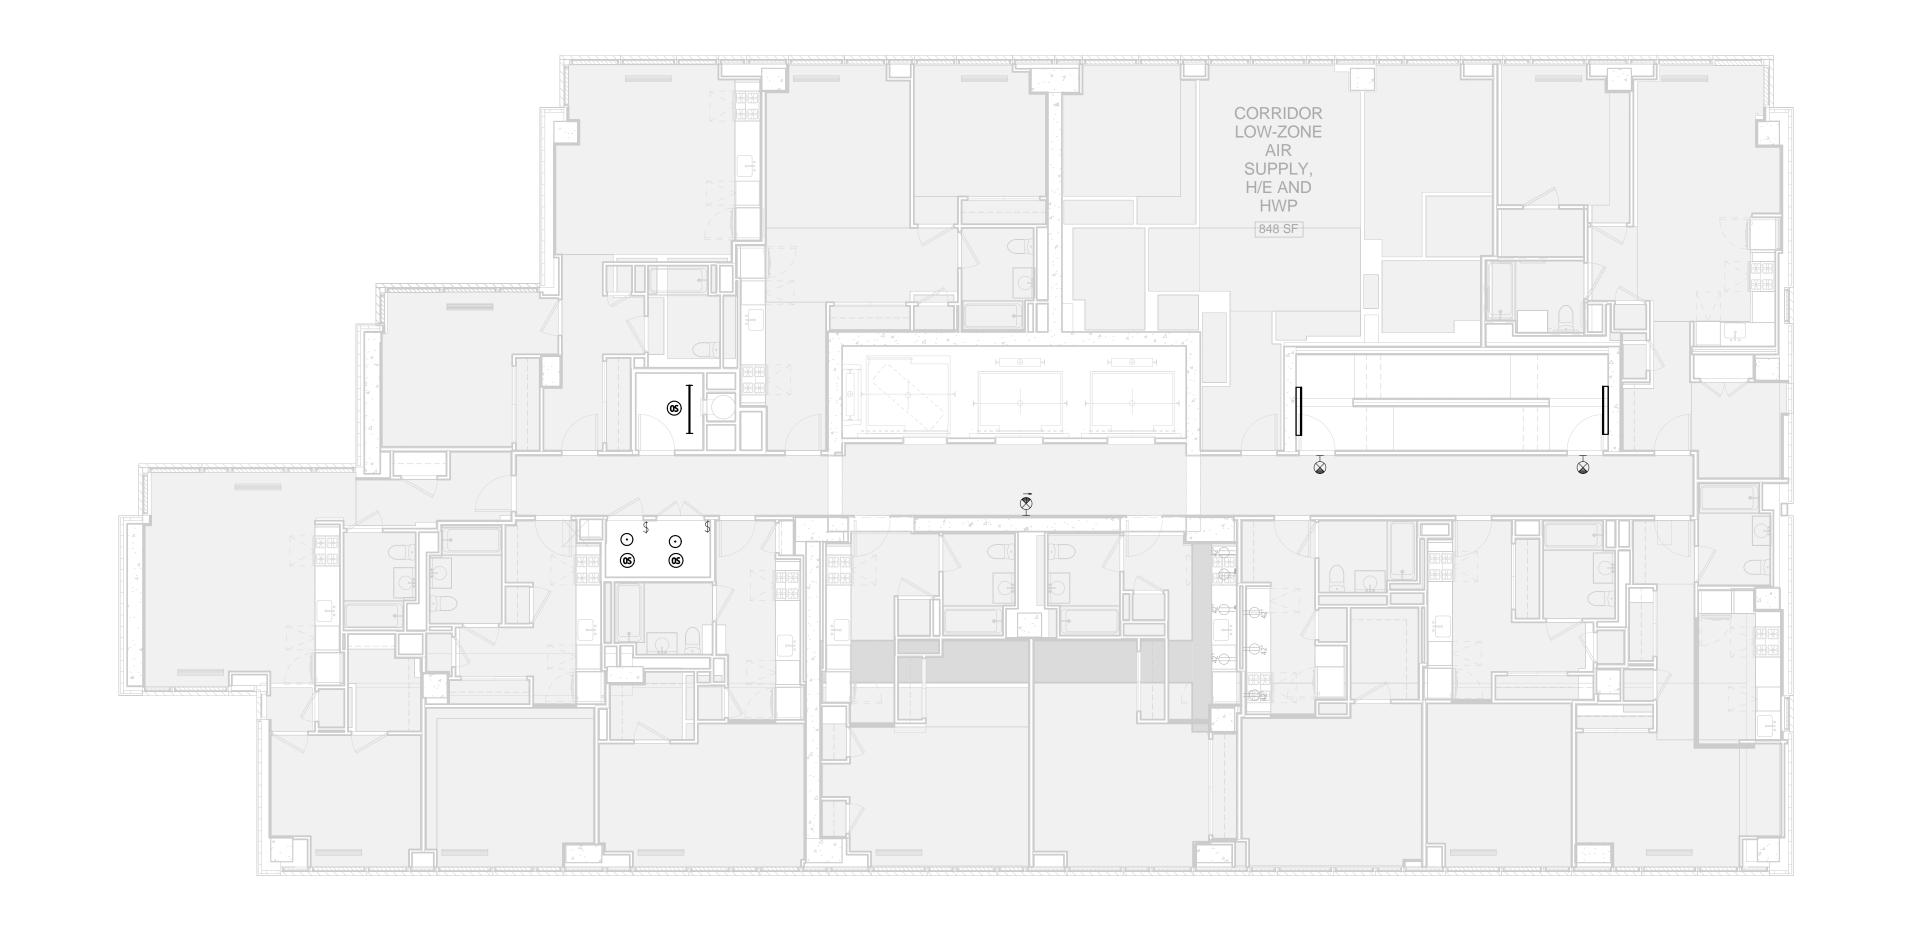
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AMENITY BUILDING ROOF ELECTRICAL LIGHTING PLAN

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14TH FLOOR ELECTRICAL LIGHTING

3RD - 13TH FLOOR ELECTRICAL

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1 LIGHTING PLAN
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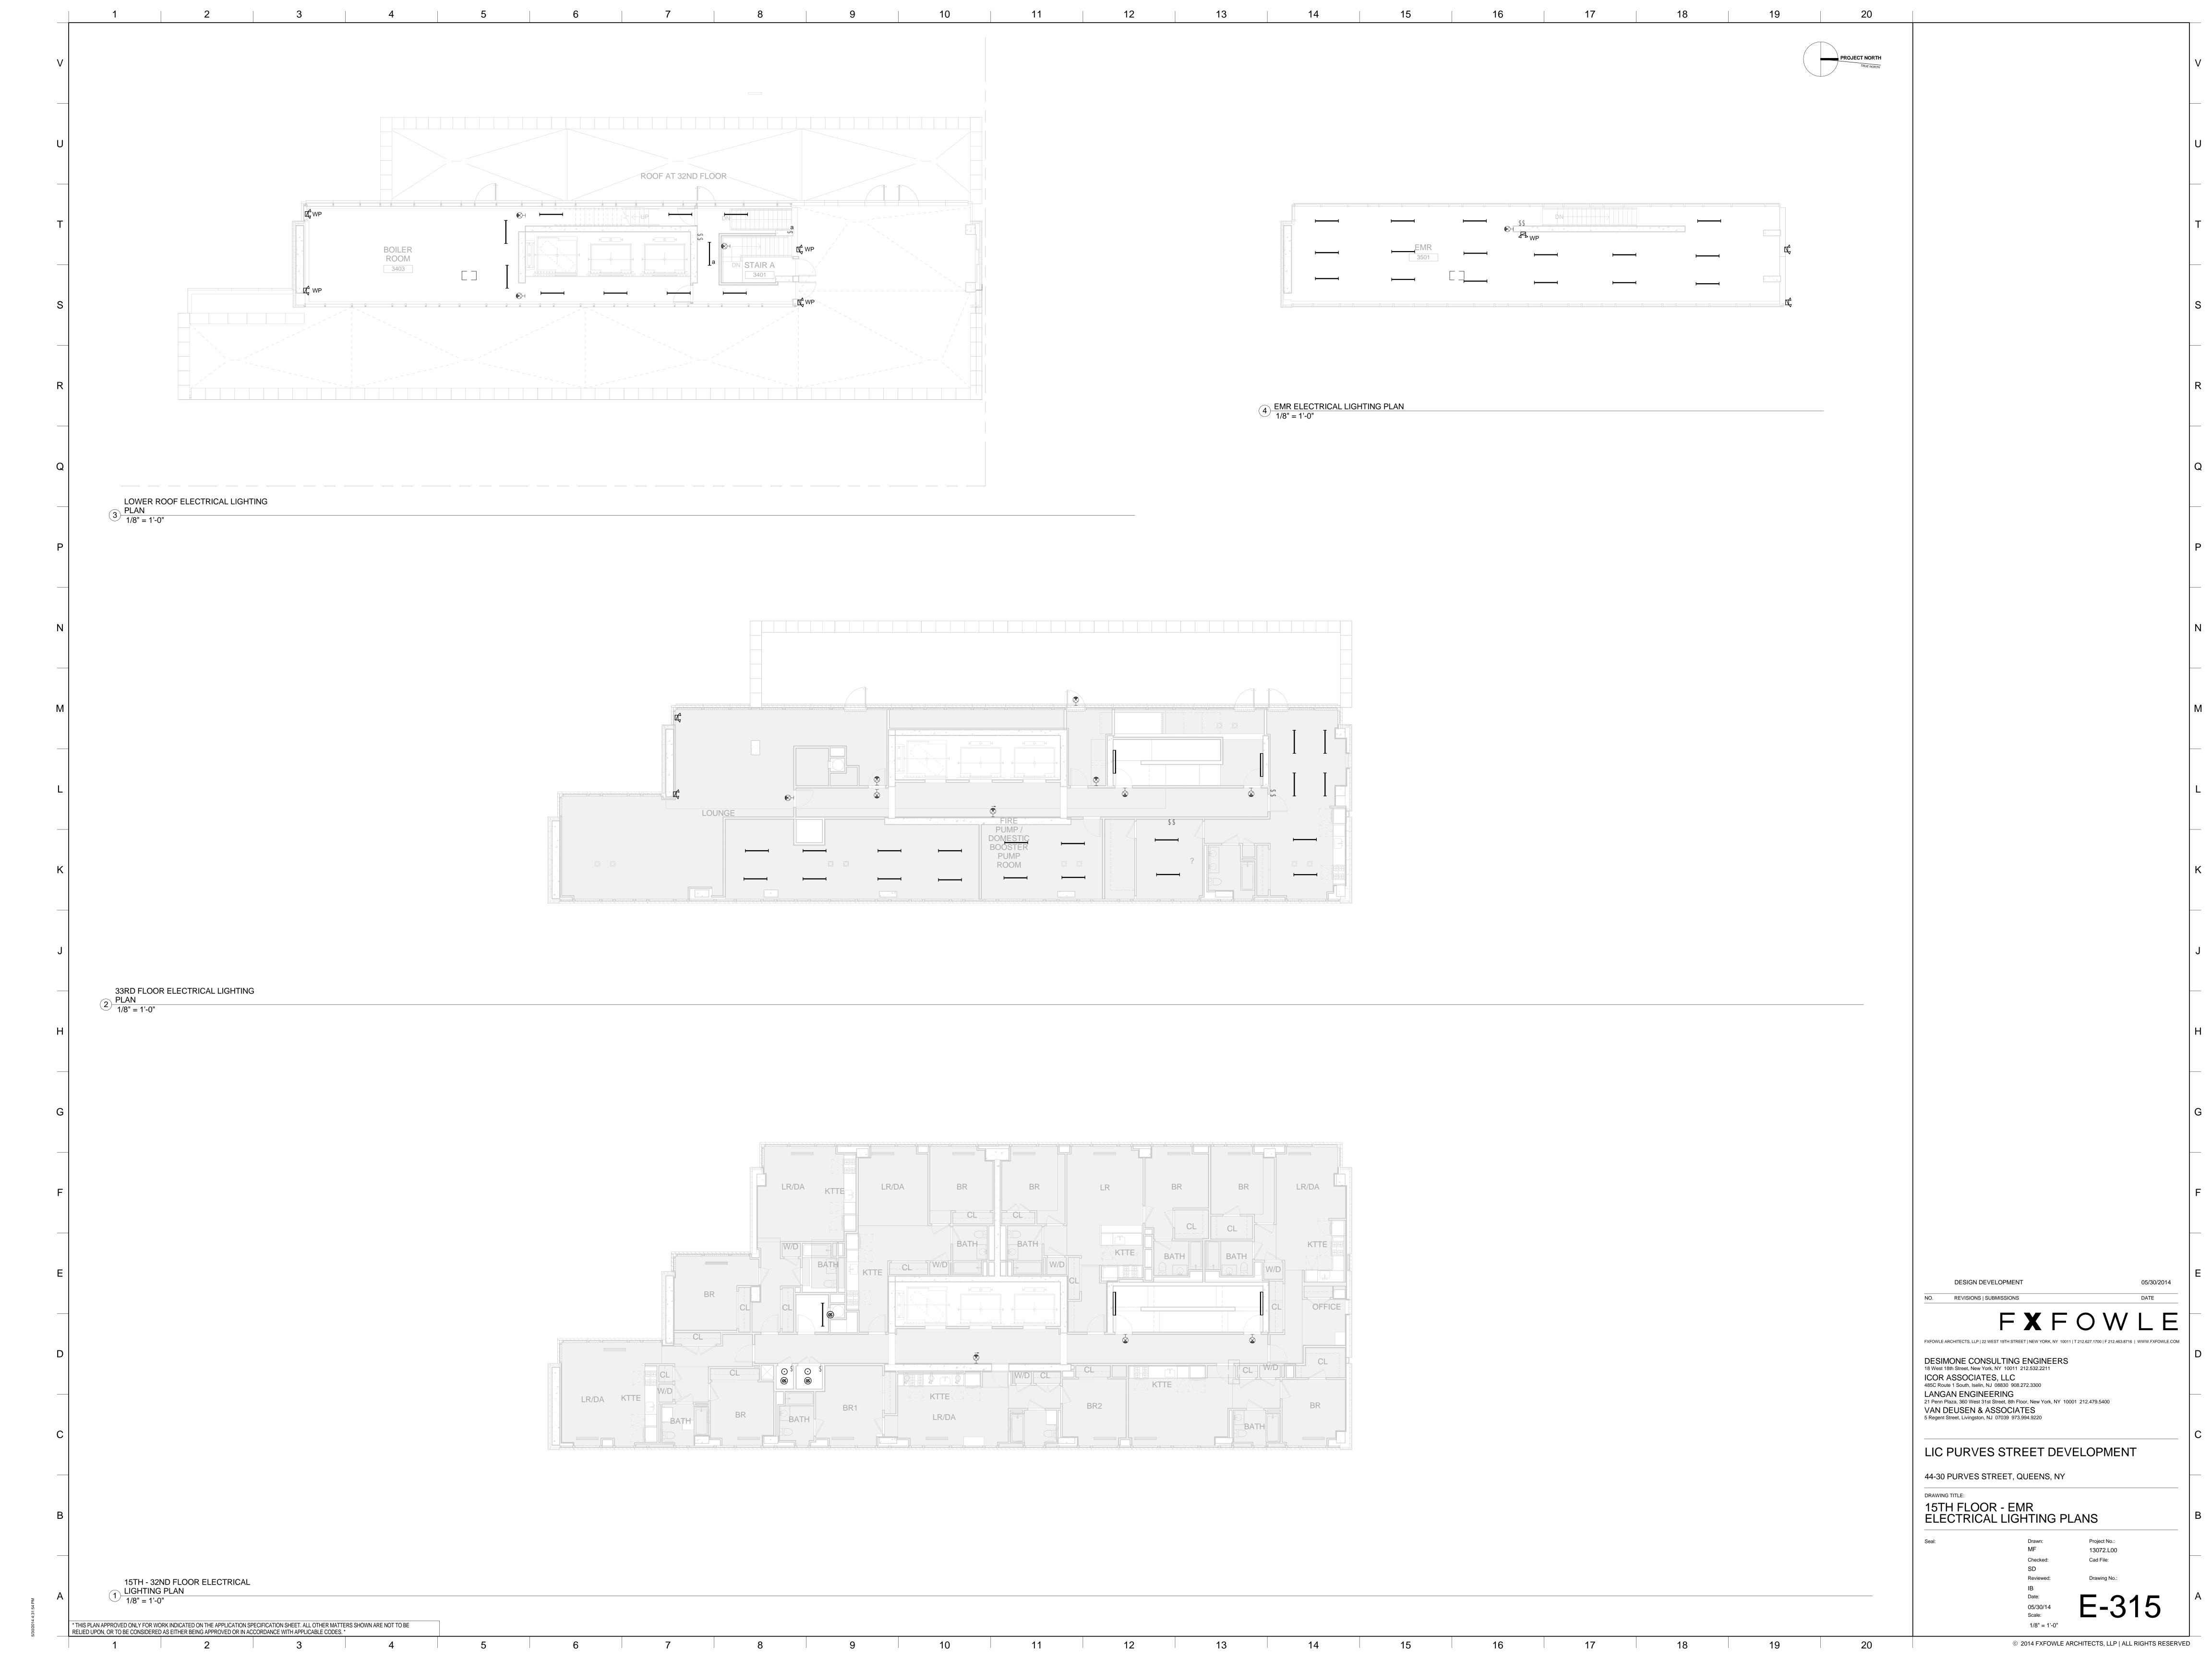
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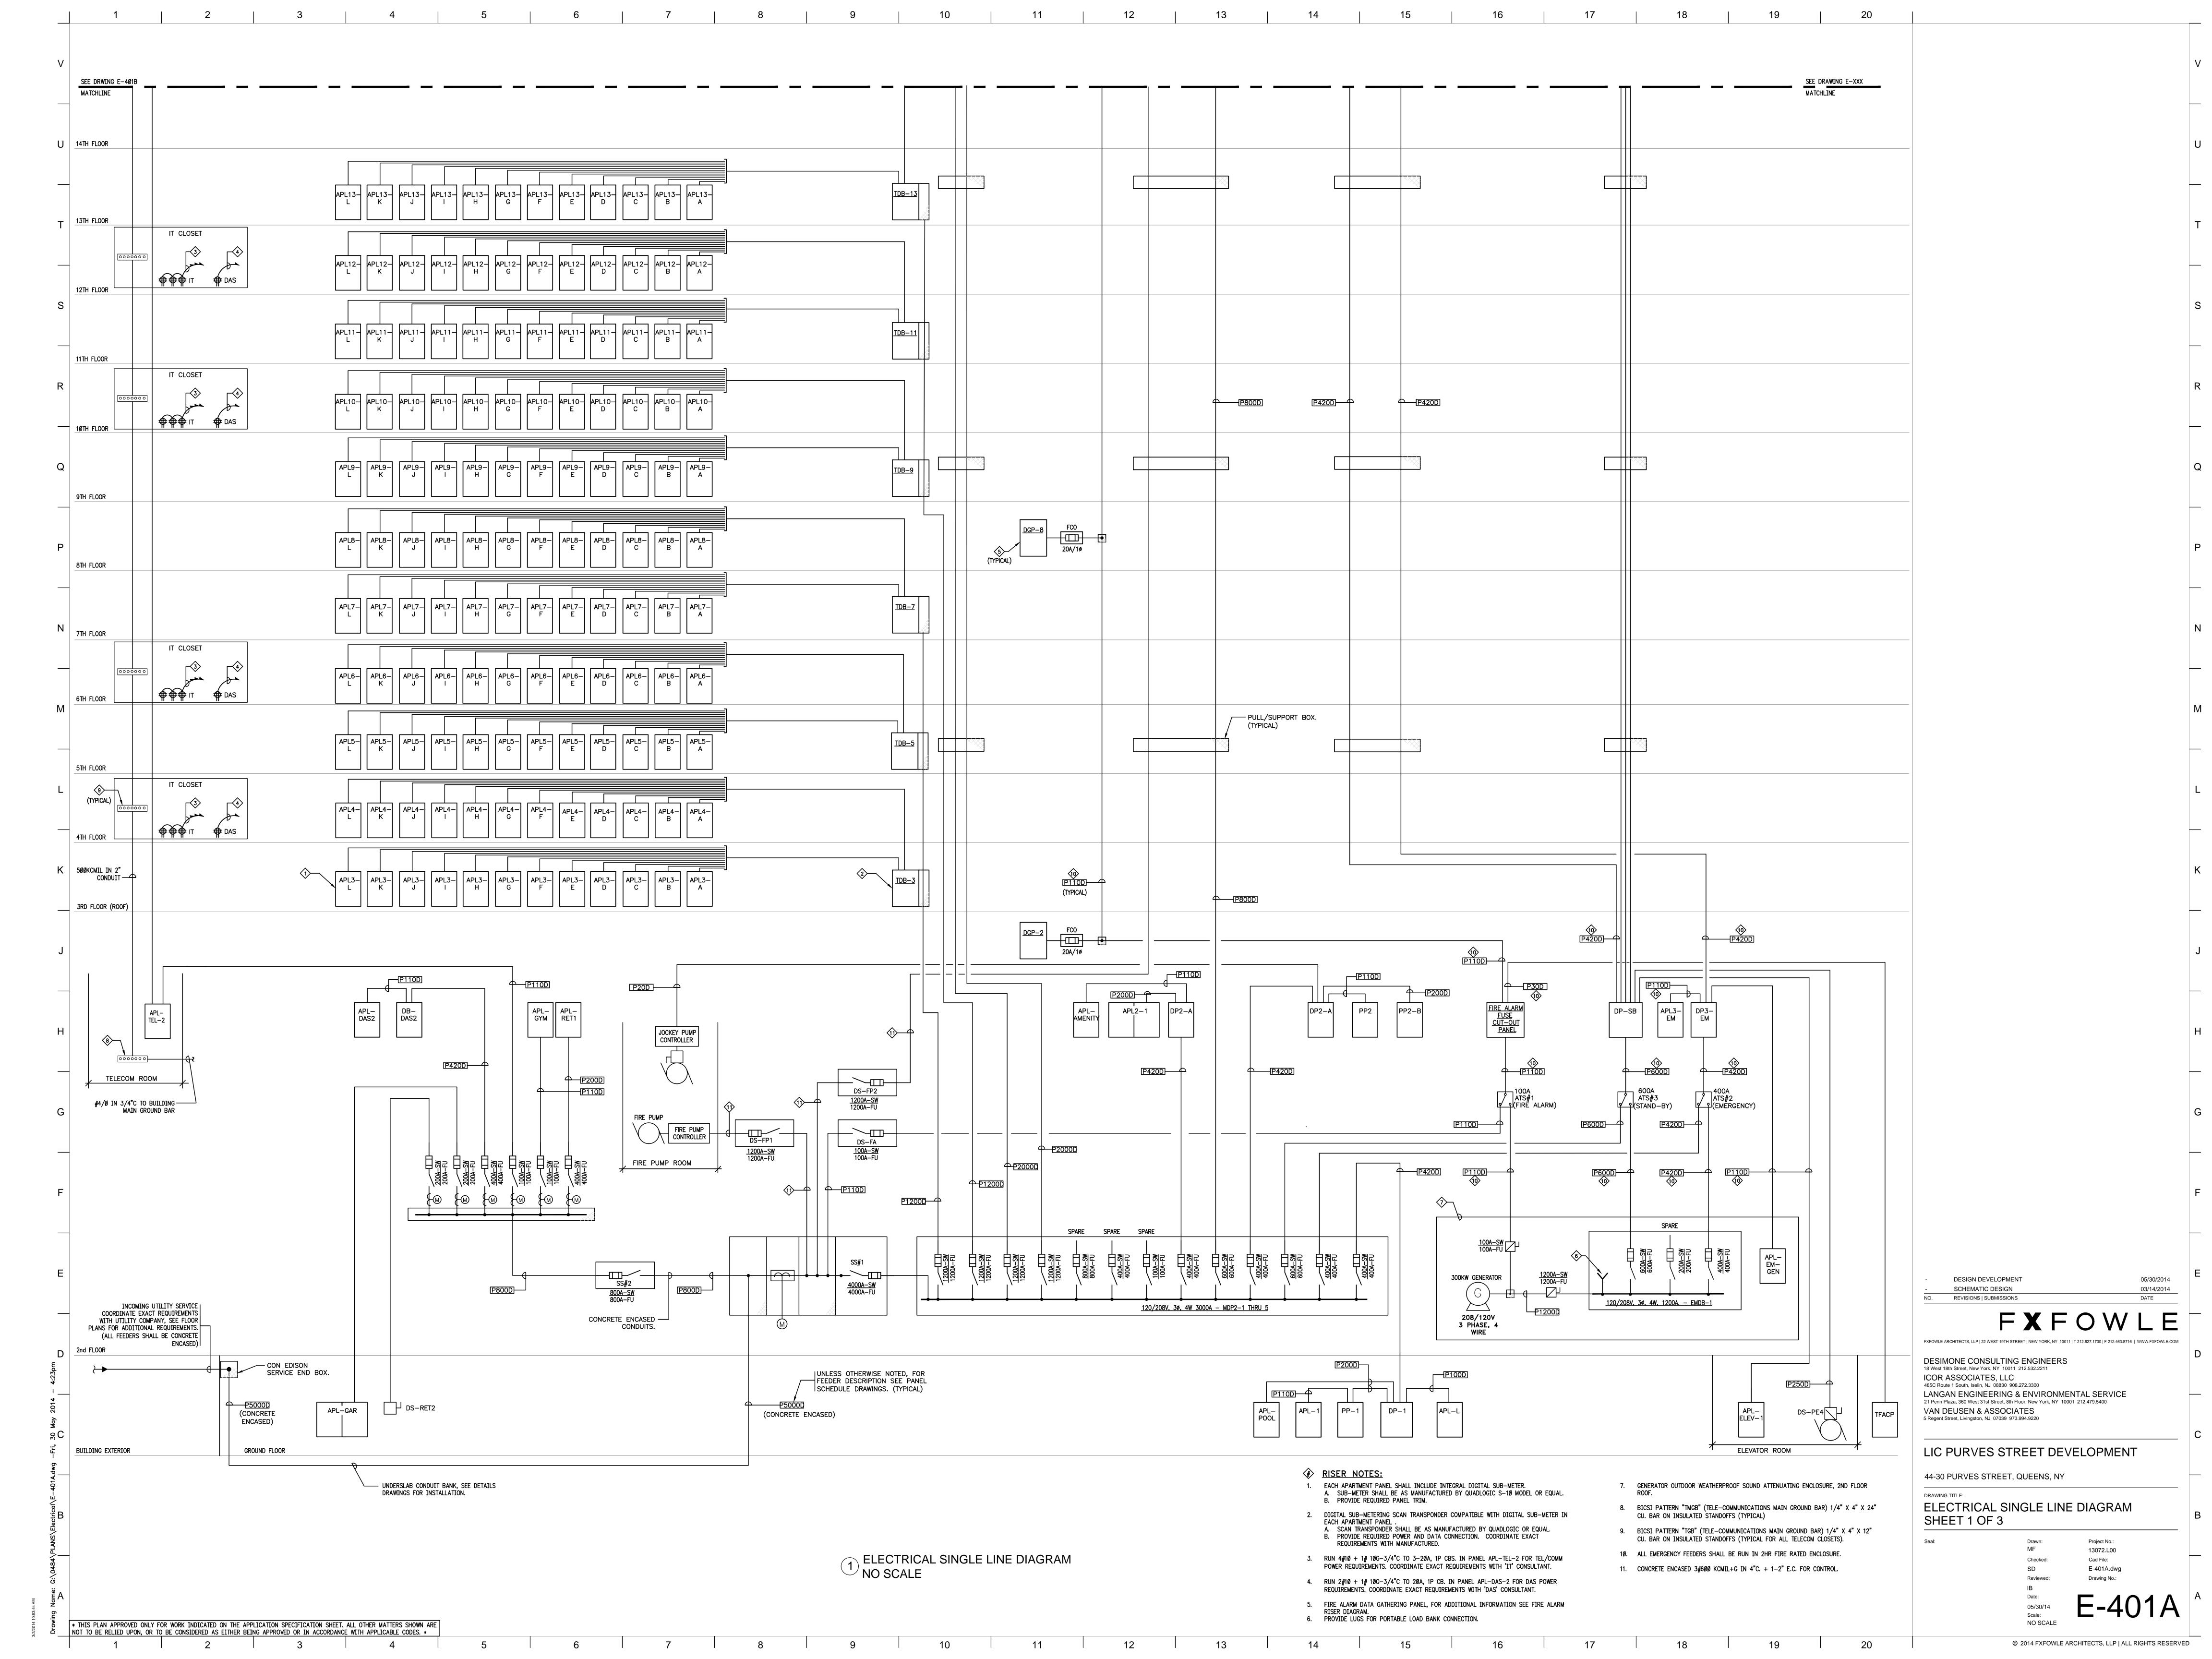
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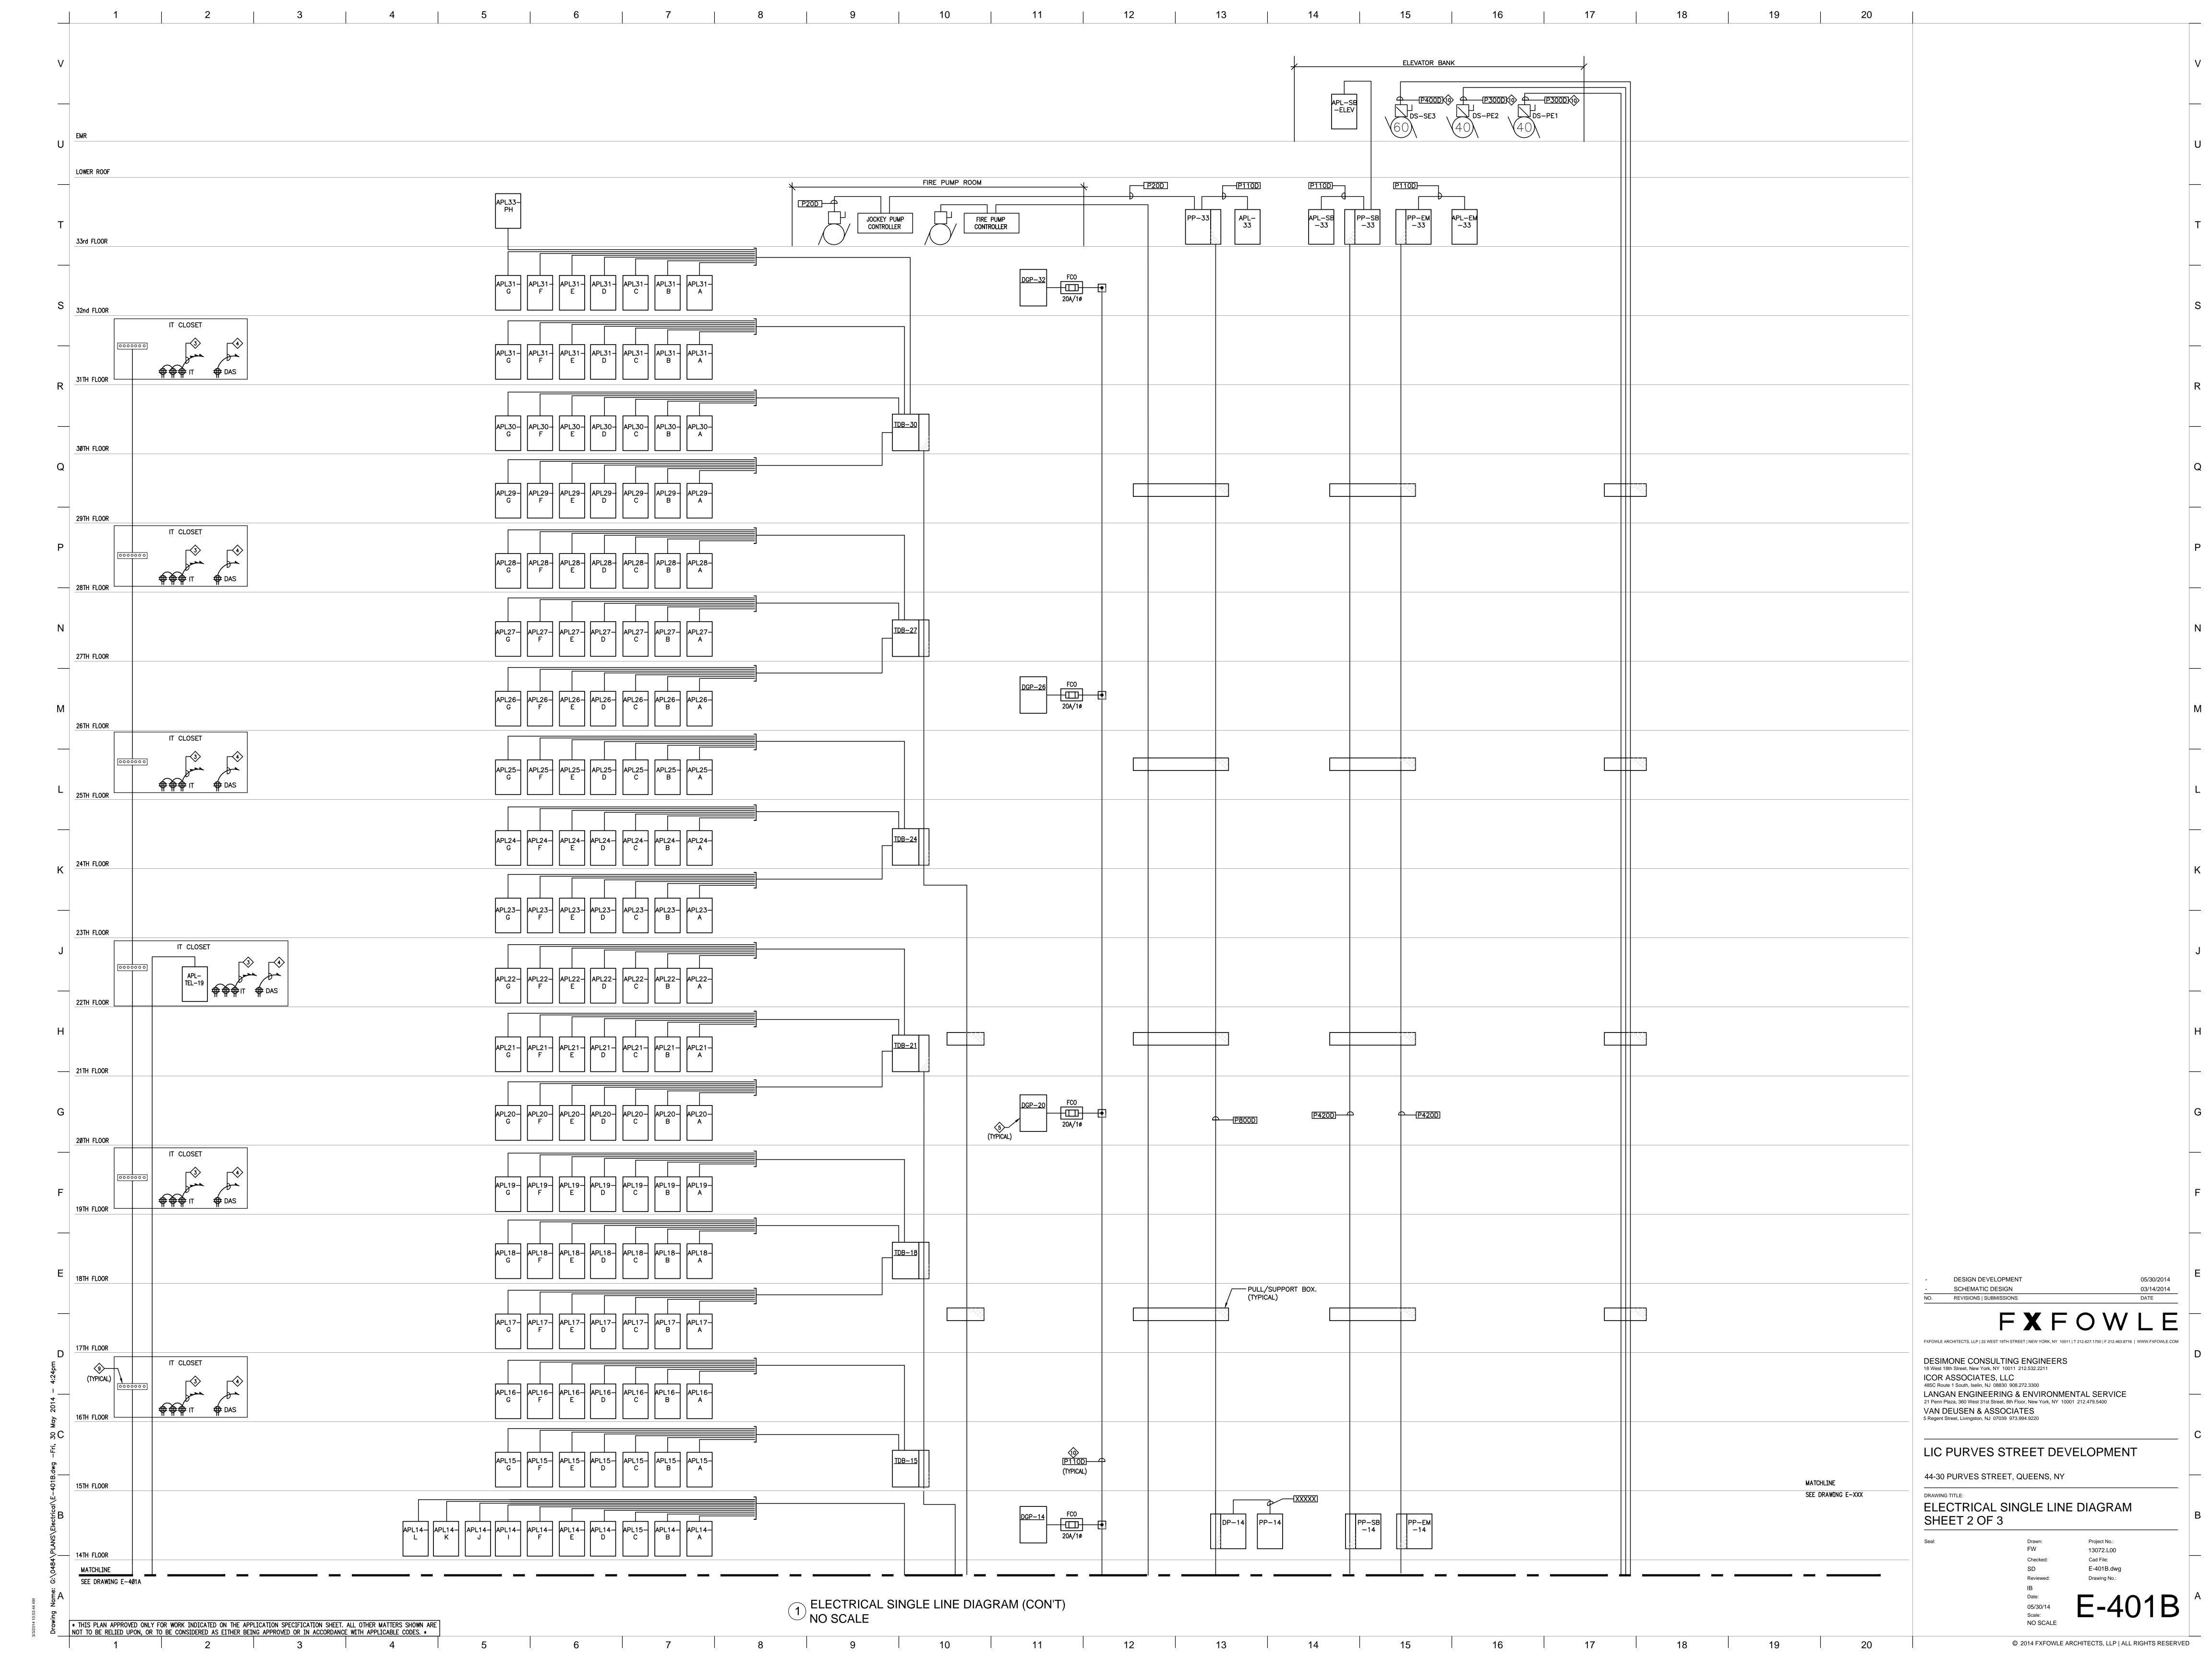
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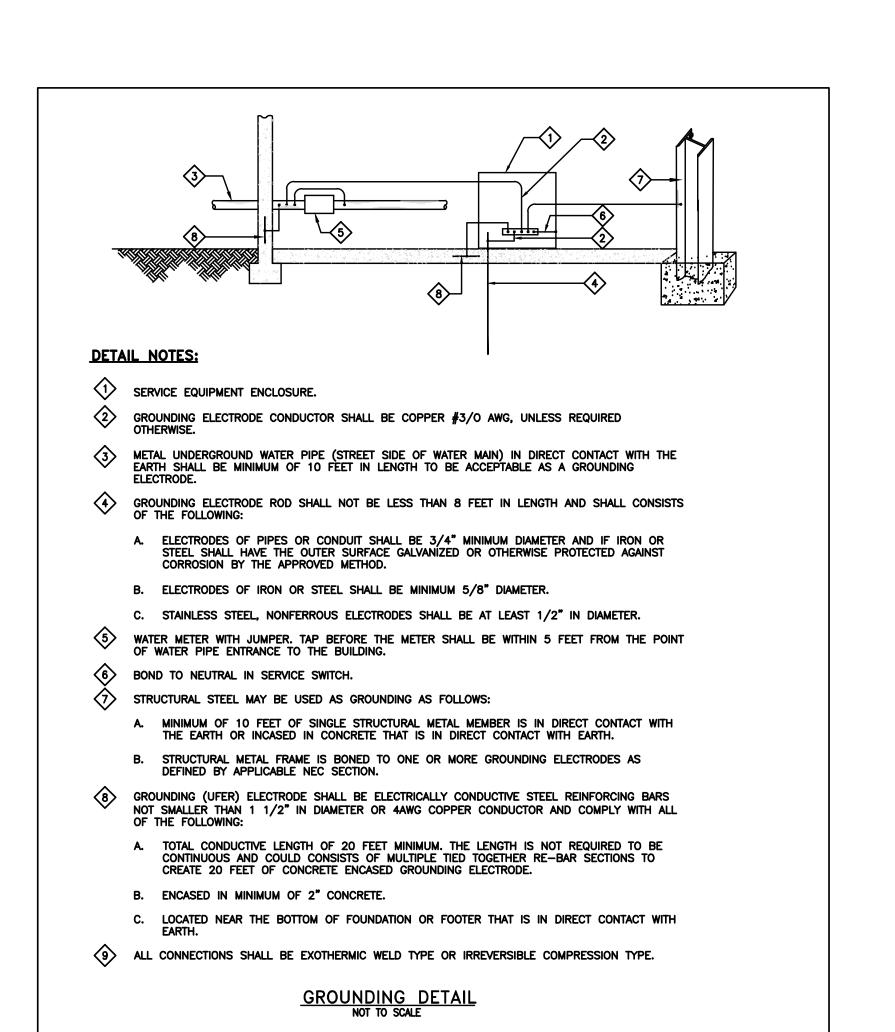
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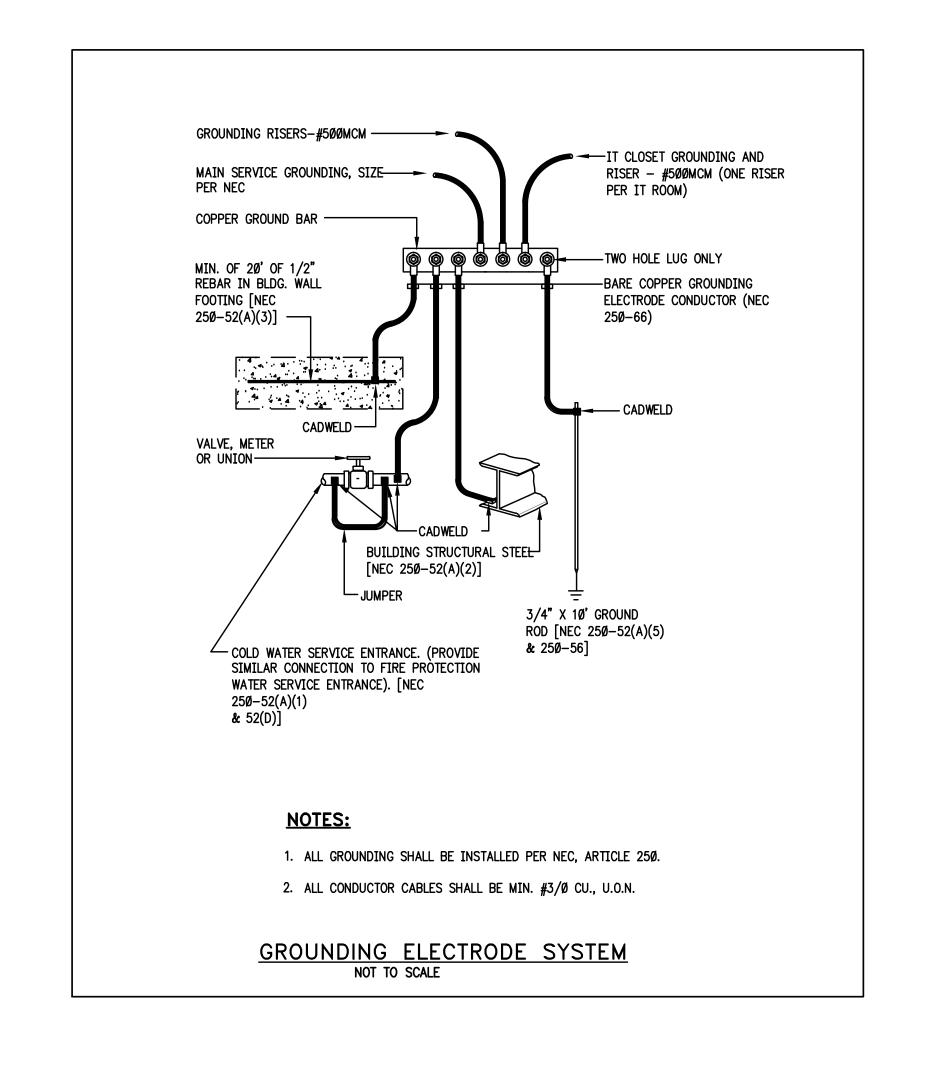
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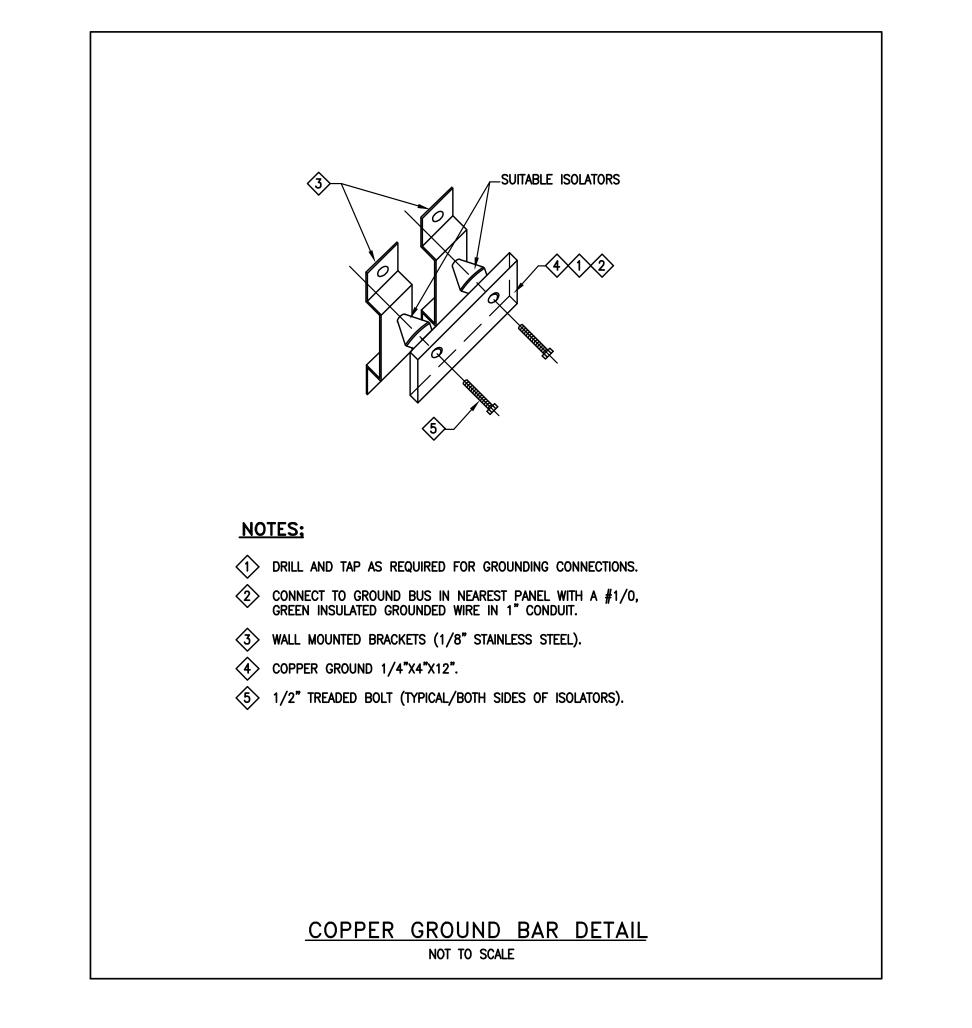





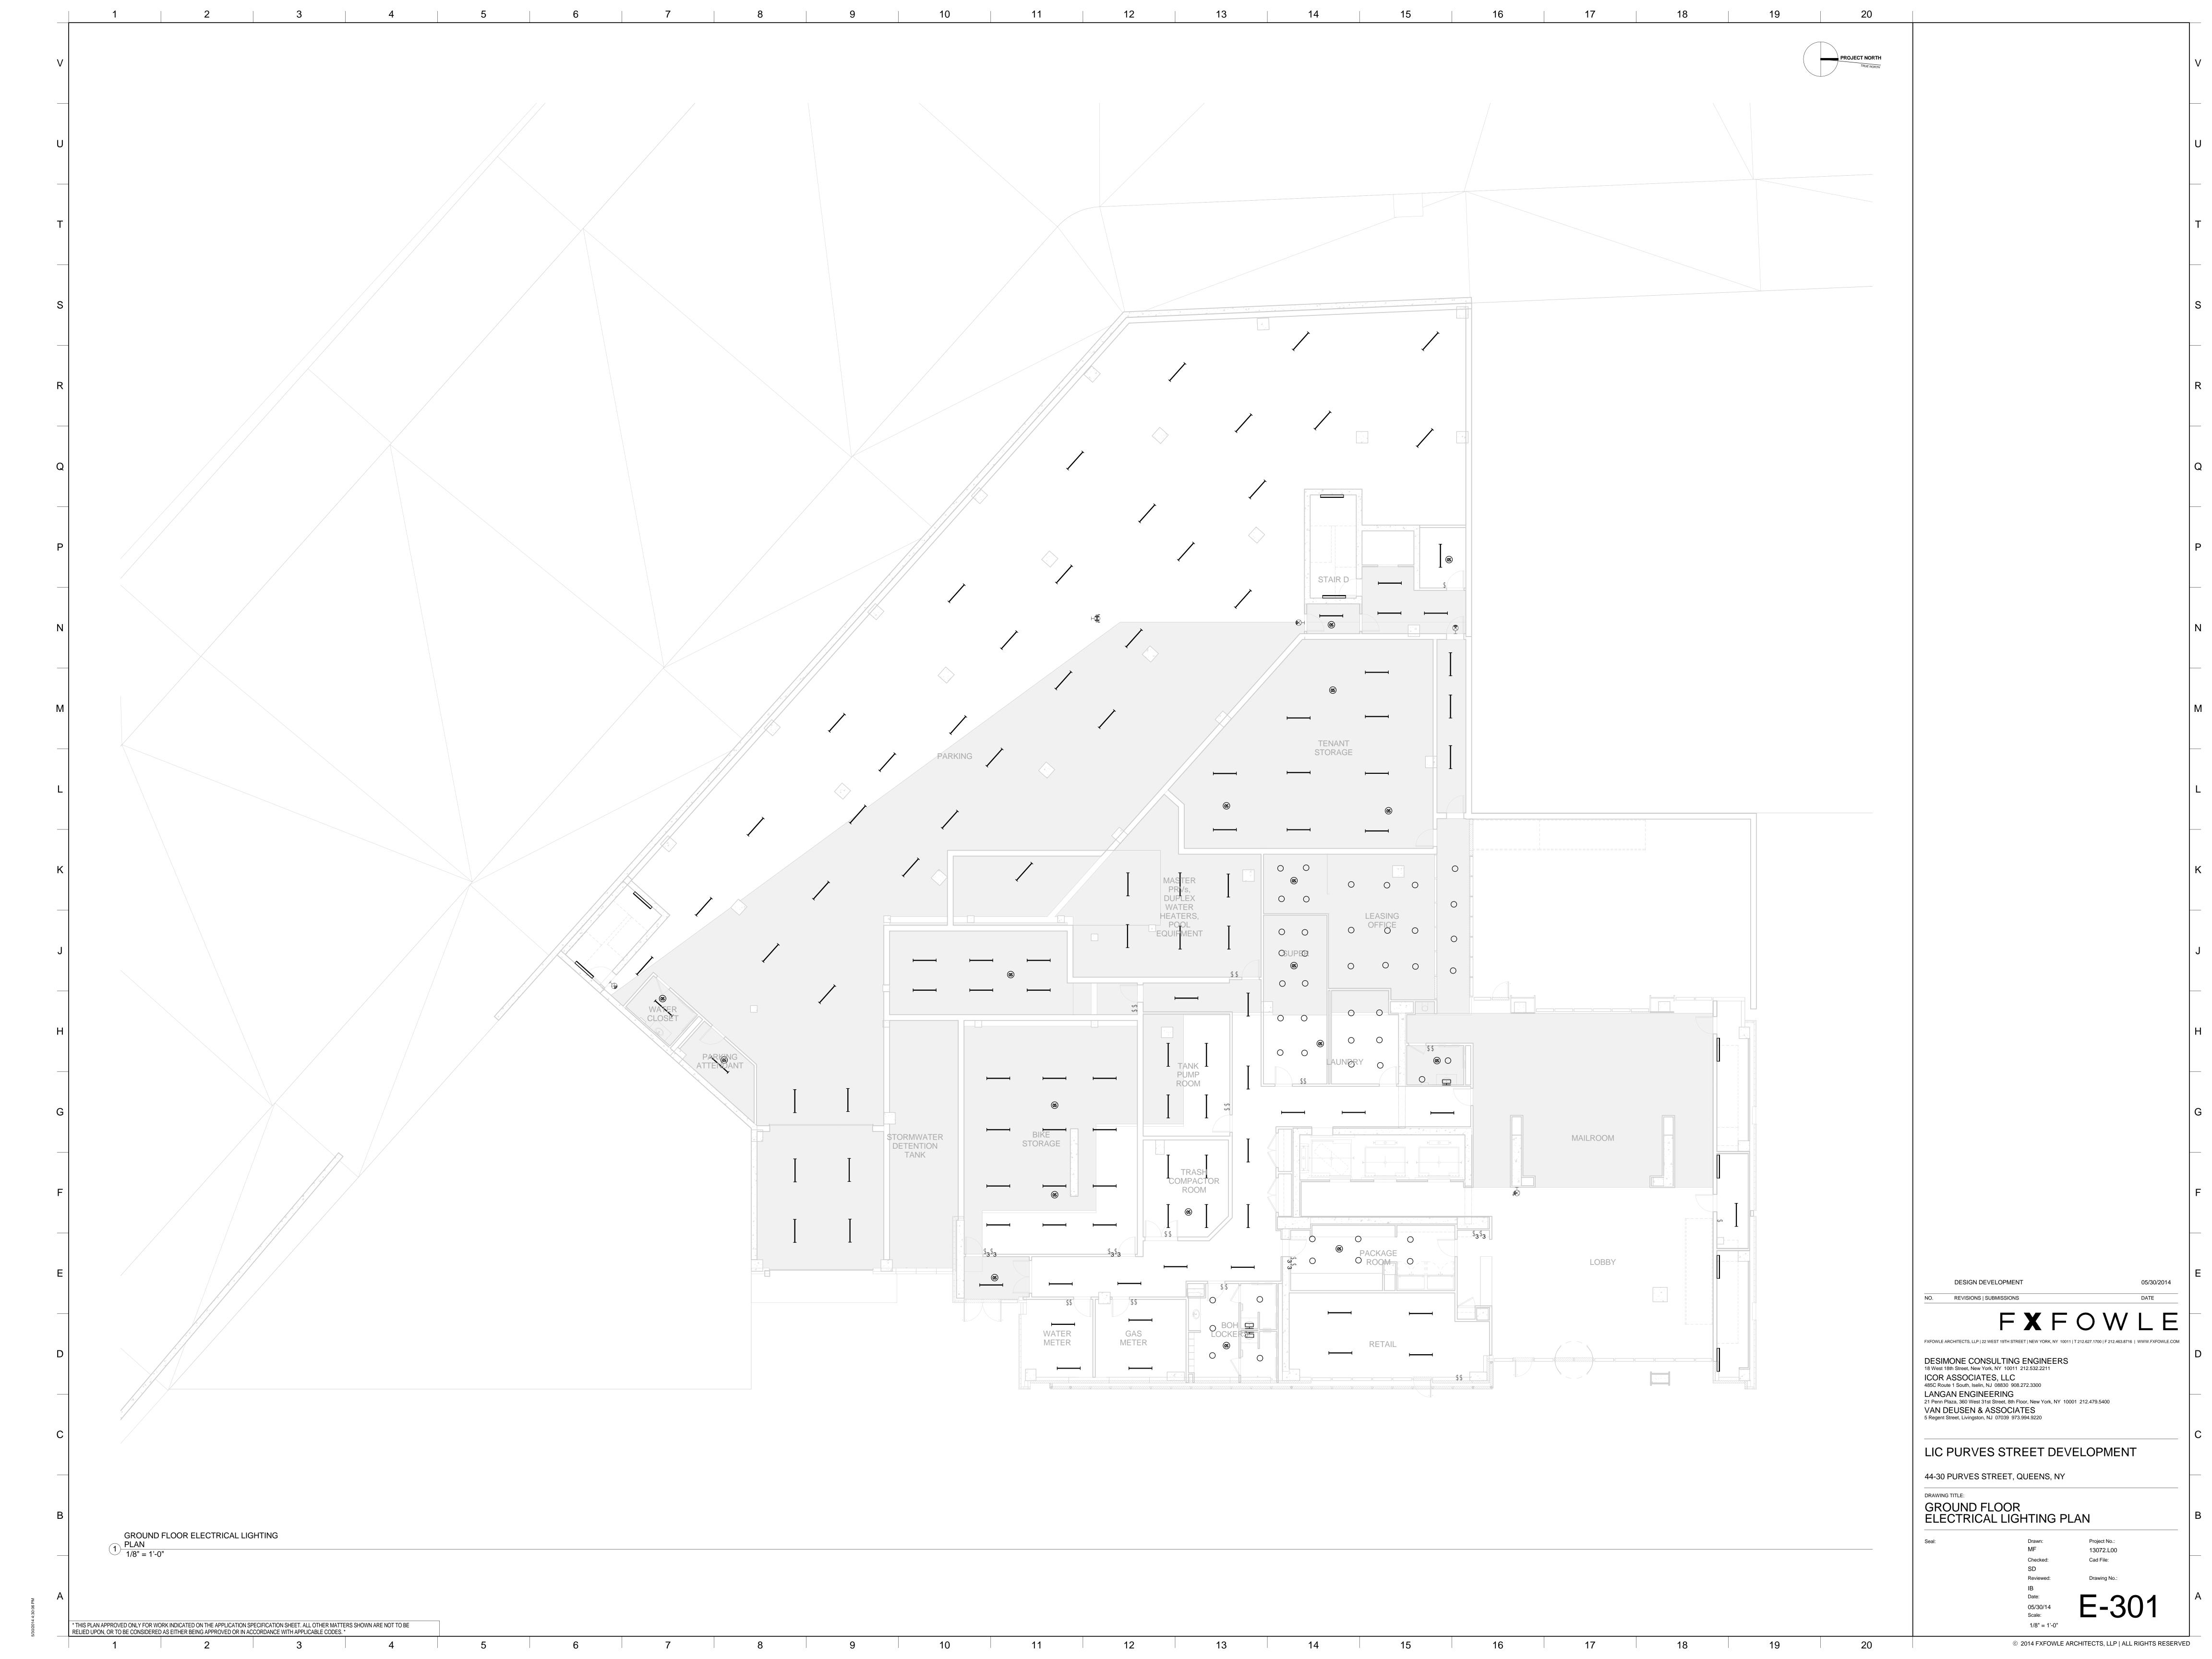










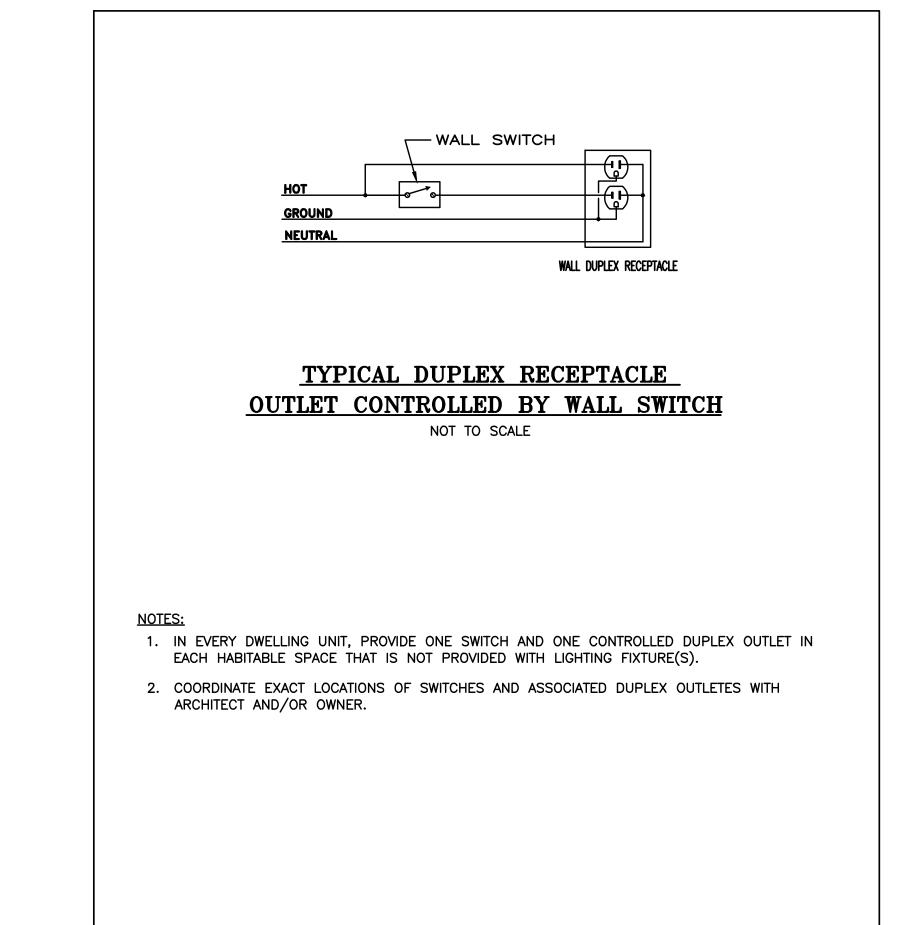


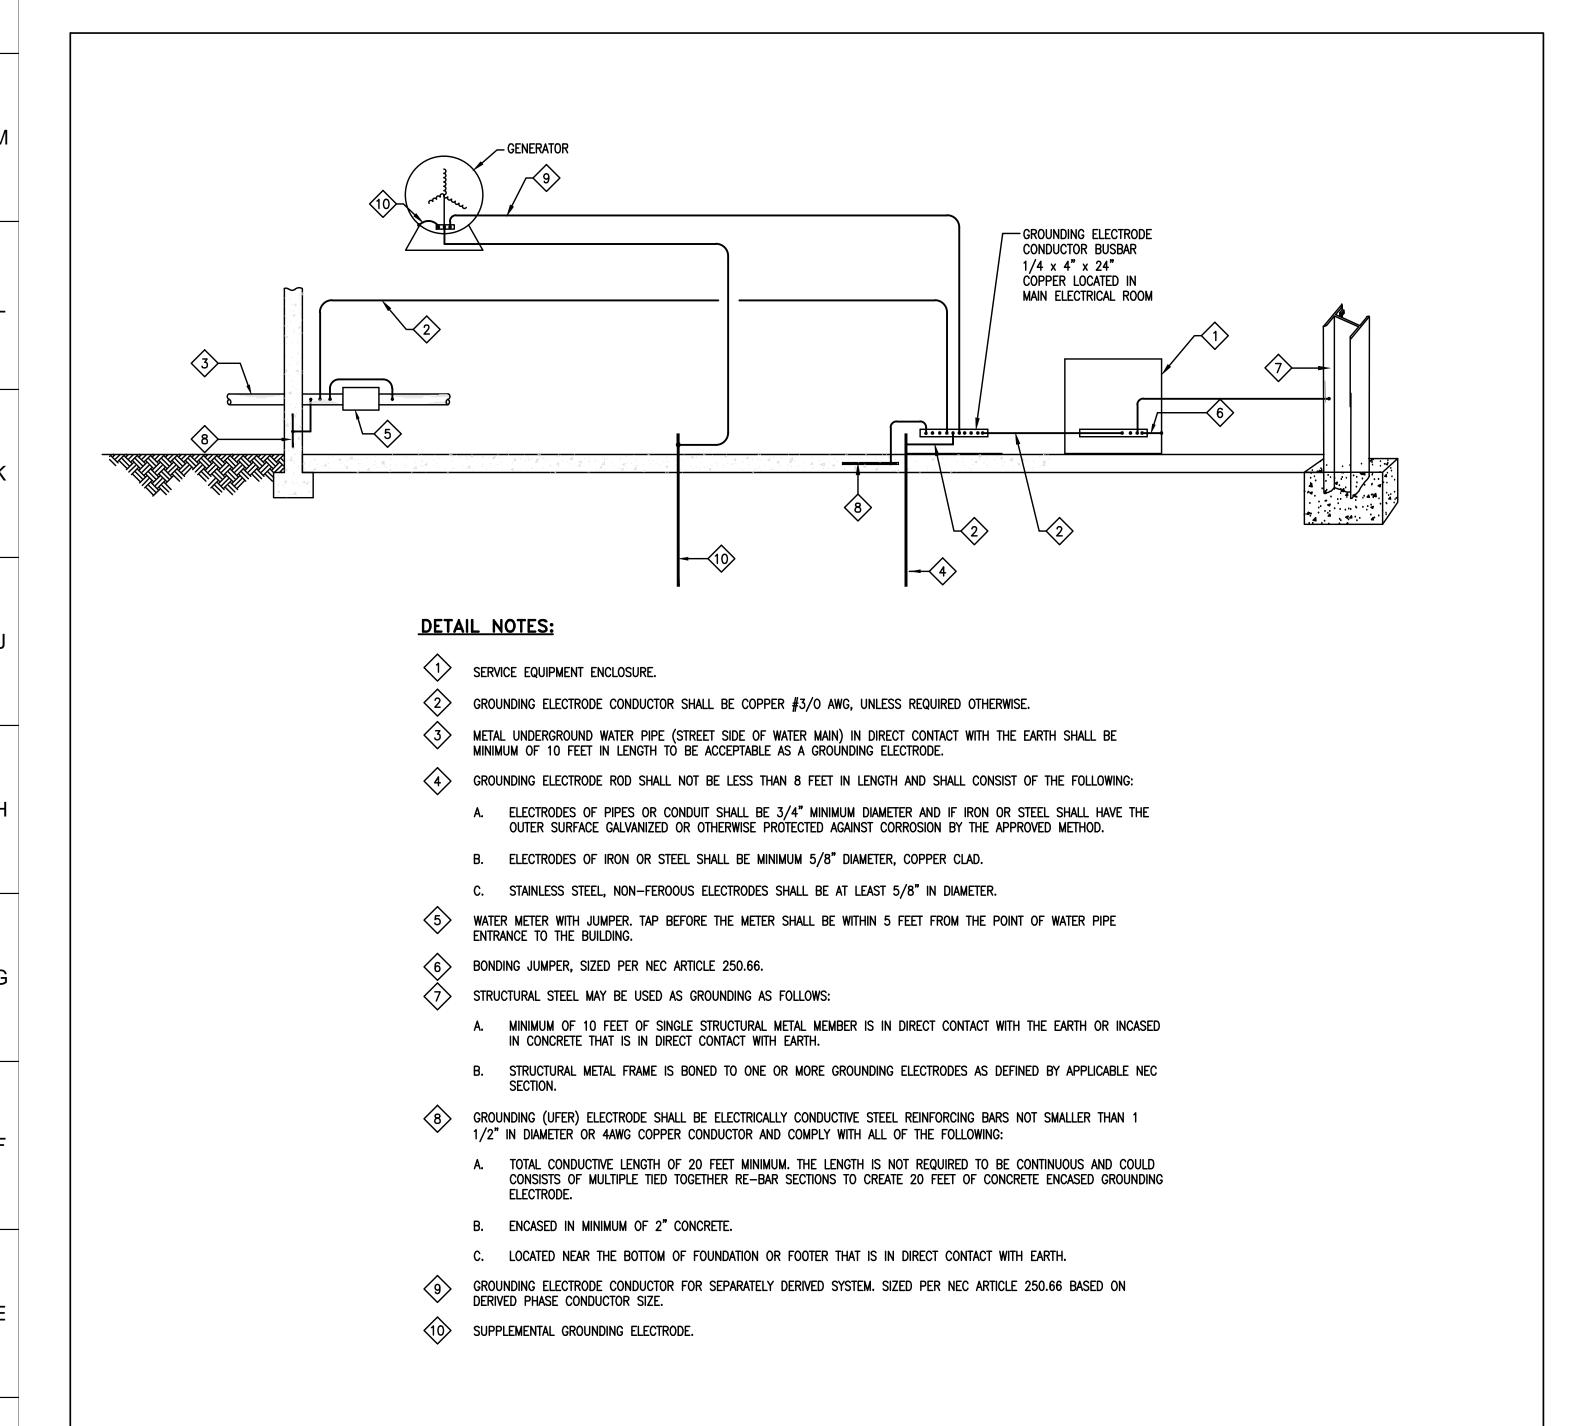

**GROUNDING DETAIL** 

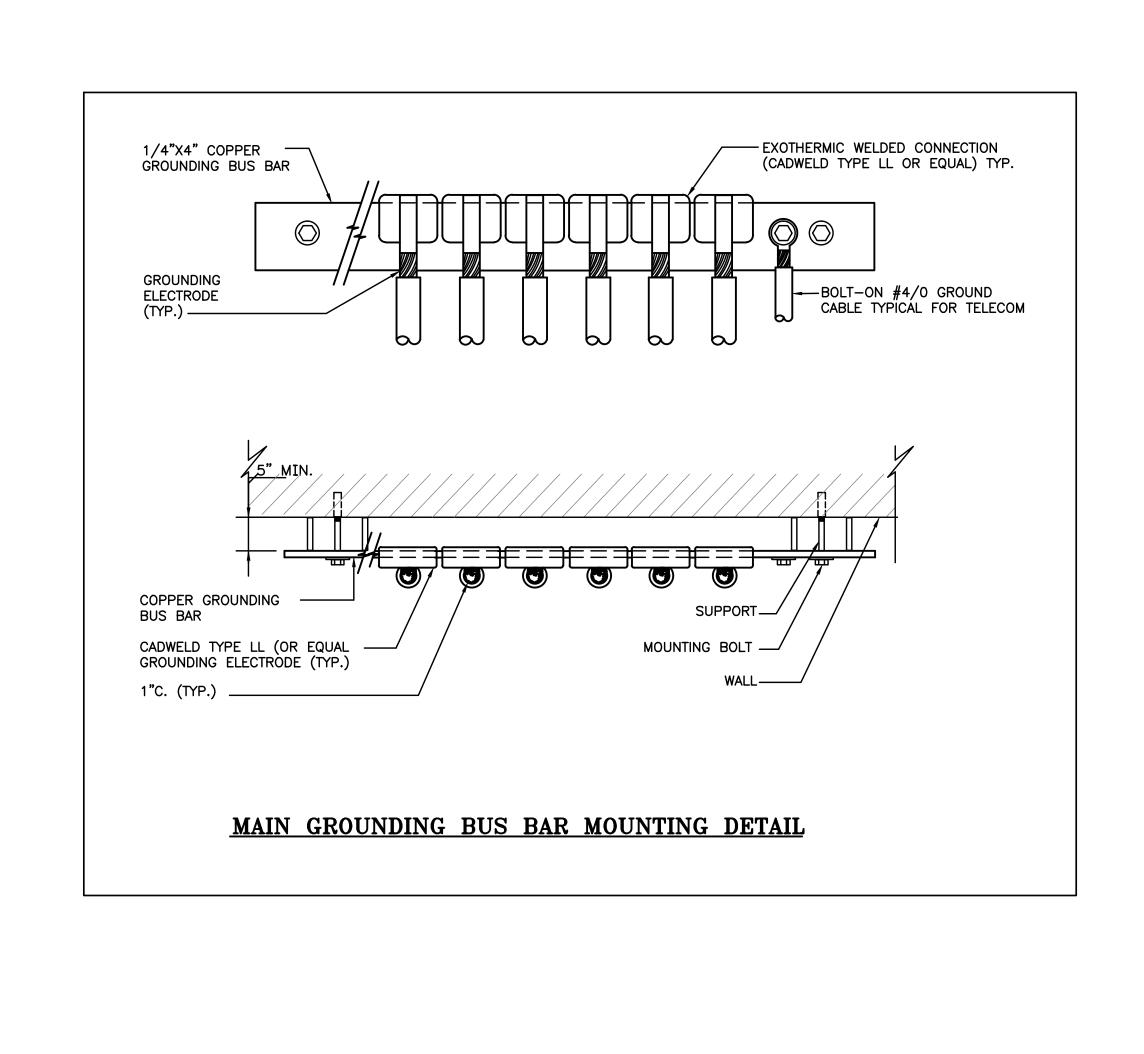

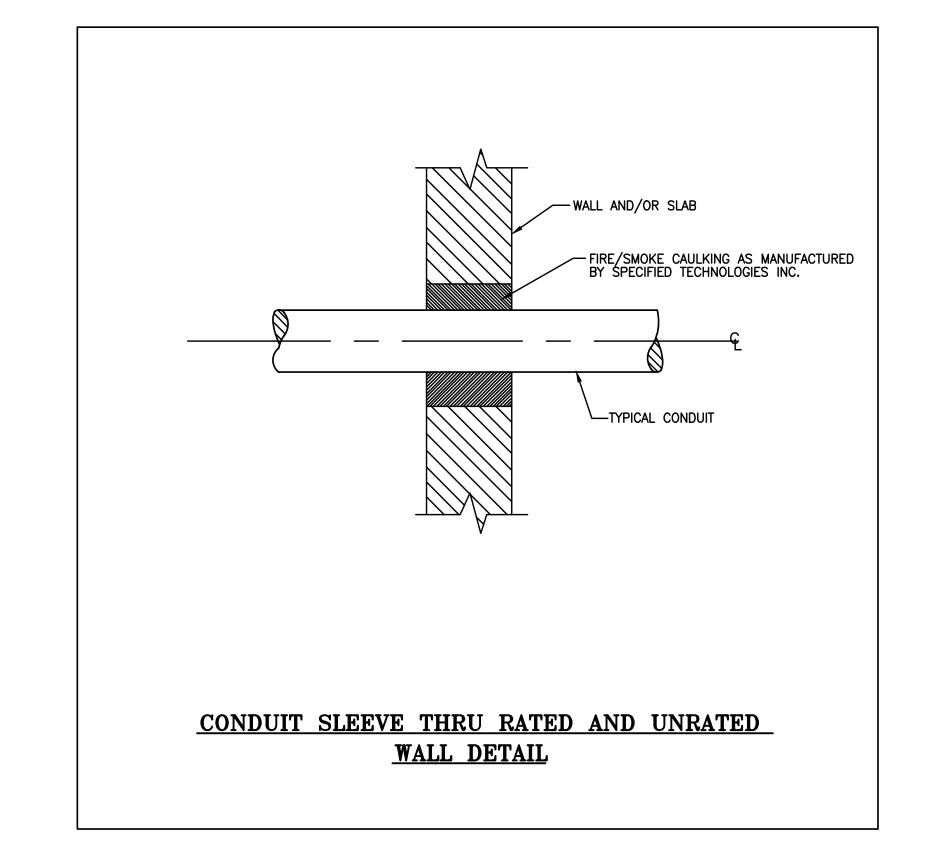

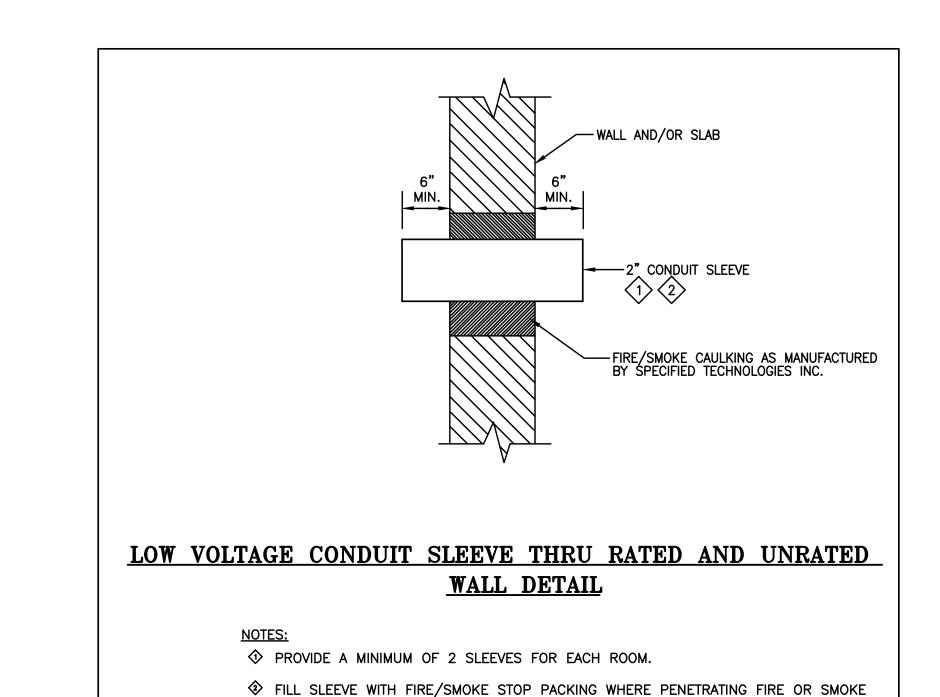

RATED WALL AND/OR ŚLAB.

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LIC PURVES STREET DEVELOPMENT

44-30 PURVES STREET, QUEENS, NY

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ELECTRICAL DETAILS

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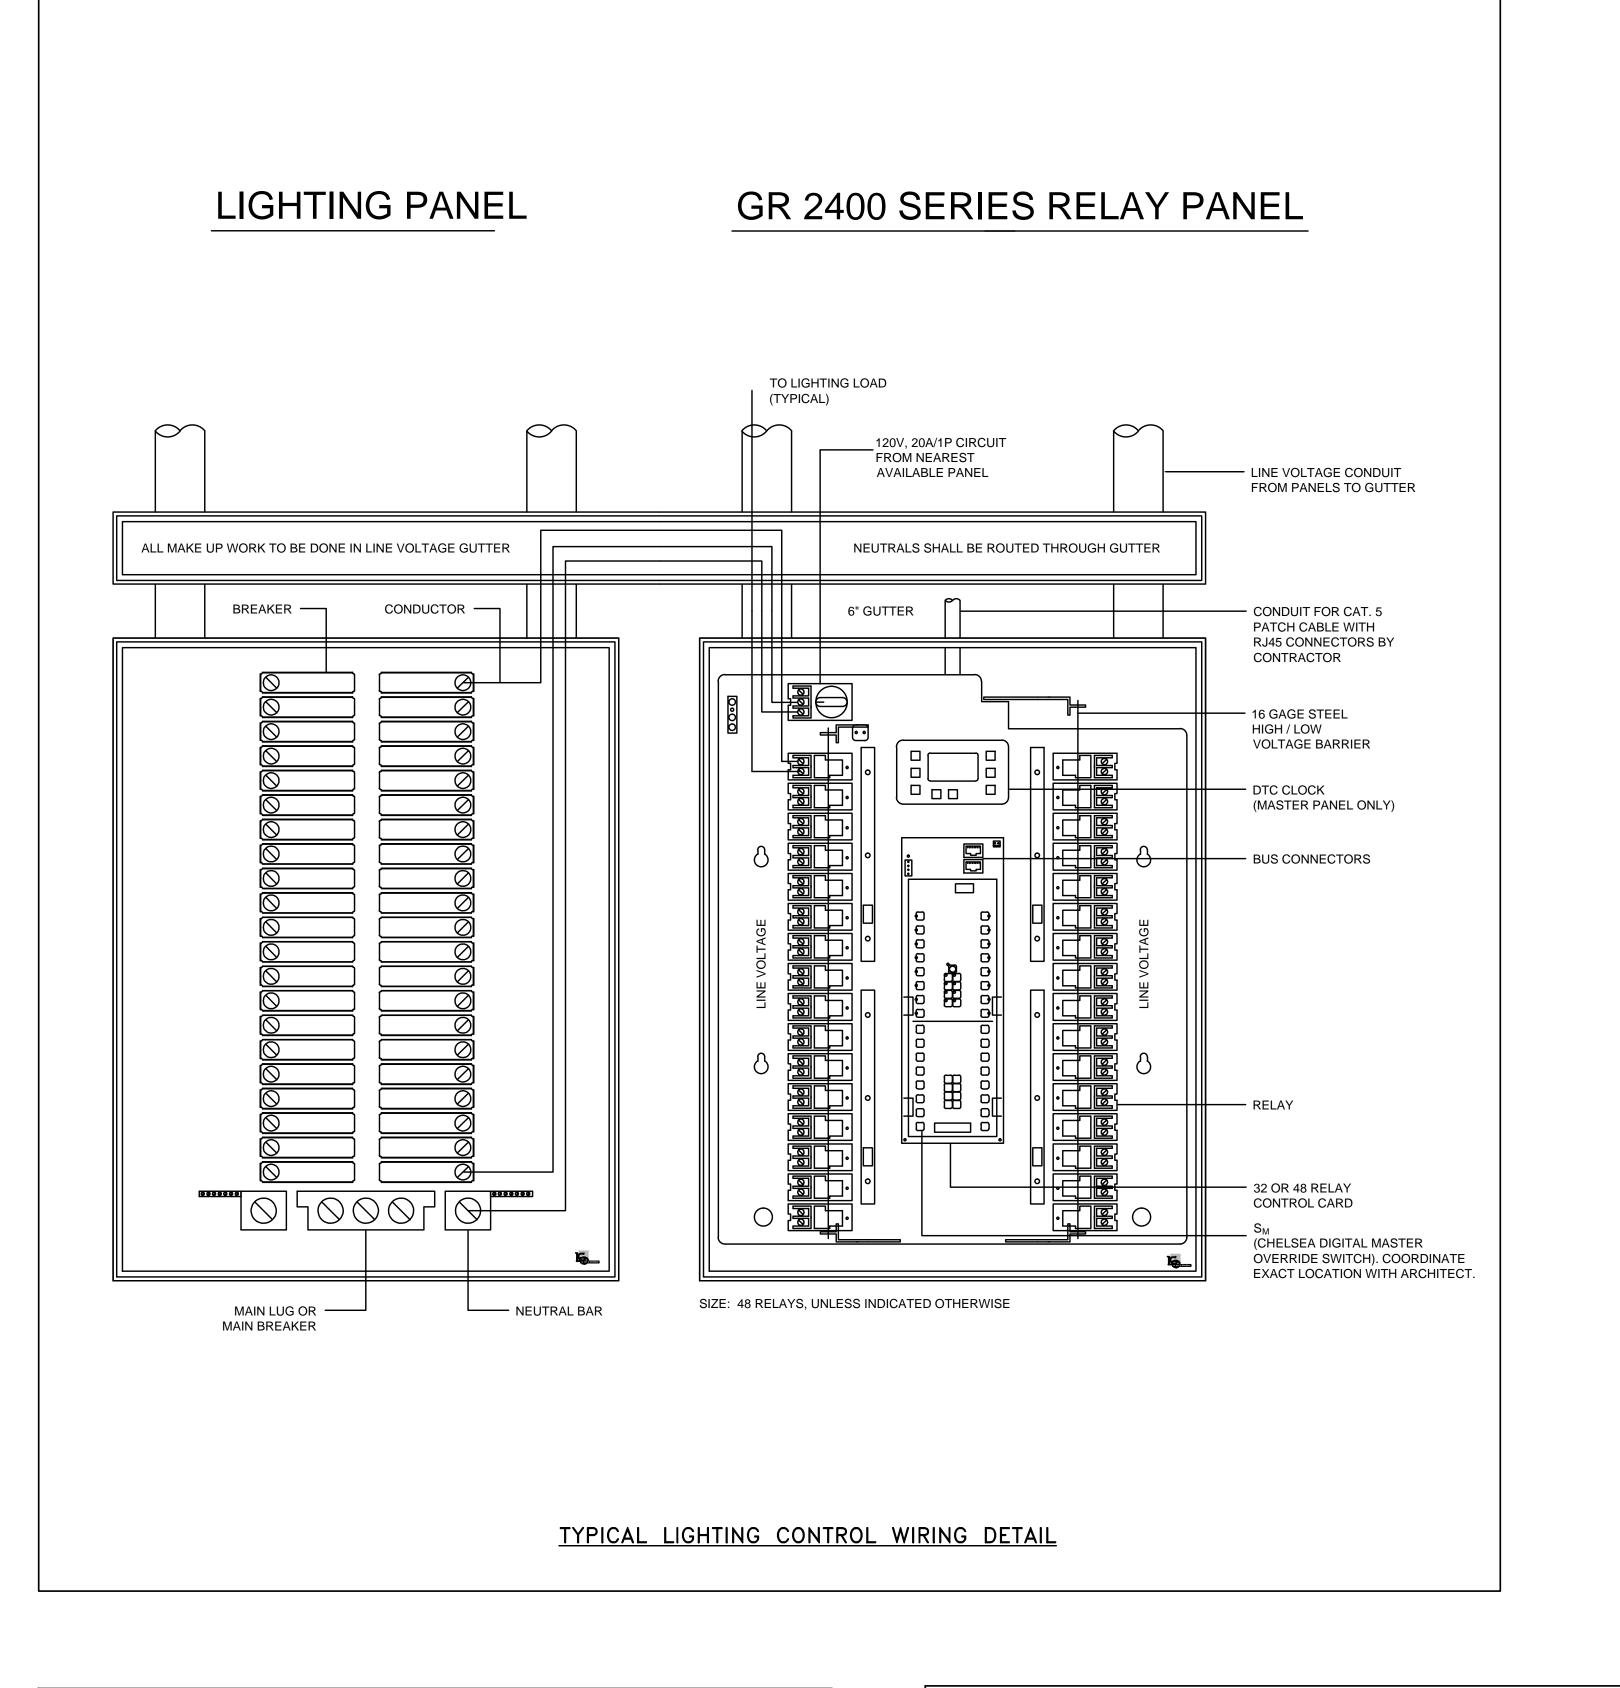
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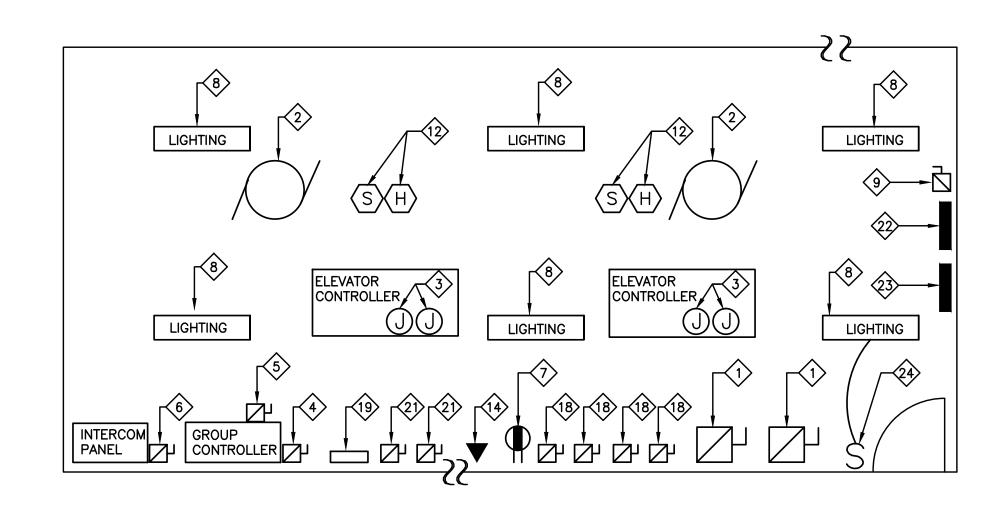
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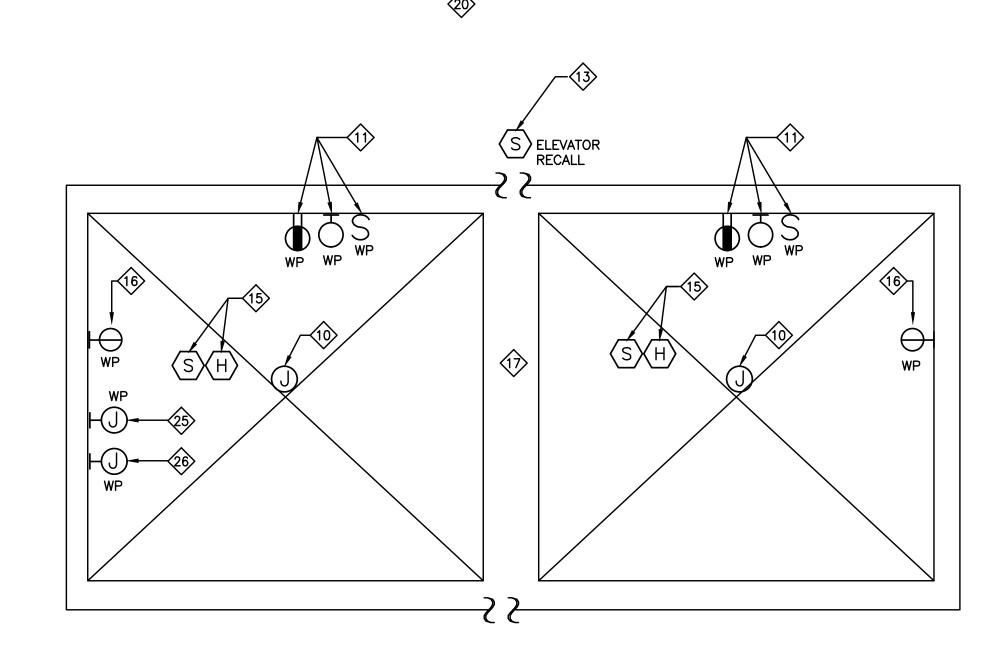
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# TYPICAL ELEVATOR MACHINE ROOM FOR TWO OR MORE ELEVATORS PER BANK



## TYPICAL ELEVATOR SHAFT FOR TWO OR MORE ELEVATORS PER BANK

#### **ELEVATOR MACHINE ROOM DETAIL REFERENCE NOTES:**

PRIOR TO INSTALLING ELECTRICAL EQUIPMENT AND DEVICES IN ELEVATOR MACHINE ROOM, ELECTRICAL CONTRACTOR SHALL COORDINATE WITH ELEVATOR VENDOR/INSTALLER, IT/AV/SECURITY CONSULTANTS FOR EXACT LOCATION OF EQUIPMENT/DEVICES AND ELECTRICAL CONNECTIONS IN ELEVATOR MACHINE ROOM.

#### **ELEVATOR MACHINE ROOM DETAIL REFERENCE NOTES:**


- (1) SHUNT TRIP FUSED DISCONNECT SWITCH. COORDINATE RATING AND FEEDER REQUIREMENTS WITH ELEVATOR CONSULTANT. PROVIDE (1) N/O AND (1) N/C AUXILIARY CONTACT IN EACH DISCONNECT SWITCH FOR HYDRAULIC ELEVATORS FOR USE WITH BATTERY LOWERING DEVICE.
- (2) ELEVATOR MOTOR. RATING AS PER ELEVATOR CONSULTANT. (3) A. ONE 120V, 20A CIRCUIT DEDICATED TO THE ELEVATOR CAB LIGHTING AND FAN. PROVIDE EMERGENCY CIRCUIT WHEN EMERGENCY GENERATOR IS REQUIRED.
- B. ONE 120V, 20A CIRCUIT DEDICATED TO THE ELEVATOR CAB AIR CONDITIONING AND HEATING. PROVIDE EMERGENCY CIRCUIT WHEN EMERGENCY GENERATOR IS REQUIRED.
- 120/208V, 30A, 2P FUSED DISCONNECT SWITCH DEDICATED TO THE GROUP CONTROLLER. GROUP CONTROLLER IS PROVIDED WHEN TWO OR MORE ELEVATORS PER BANK ARE INSTALLED.
- 120V, 20A FUSED DISCONNECT SWITCH DEDICATED TO THE GROUP CONTROLLER. PROVIDE EMERGENCY CIRCUIT WHEN EMERGENCY GENERATOR IS REQUIRED.
- 120V, 20A FUSED DISCONNECT SWITCH DEDICATED TO THE INTERCOM. PROVIDE EMERGENCY CIRCUIT WHEN EMERGENCY GENERATOR IS REQUIRED.
- PROVIDE MINIMUM OF ONE GFCI DUPLEX MAINTENANCE OUTLETS IN EACH ELEVATOR MACHINE
- (8) PROVIDE REQUIRED LIGHTING TO MAINTAIN MINIMUM OF TEN FOOT-CANDLES AT FLOOR LEVEL. PROVIDE EMERGENCY BACKUP BY MEANS OF THE BATTERY/BALLAST OR EMERGENCY GENERATOR.
- PREQUIRED DISCONNECT SWITCH DEDICATED TO THE ELEVATOR MACHINE ROOM VENTILATION. COORDINATE RATING AND FEEDER REQUIREMENTS WITH HVAC CONTRACTOR


A. PROVIDE EMERGENCY CIRCUIT WHEN EMERGENCY GENERATOR IS REQUIRED.


- 100 120V, 20A CIRCUIT DEDICATED TO THE TRAIL CABLE OUTLET BOX LOCATED ON TOP OF EACH
- B. PROVIDE DEDICATED 120V, 20A FUSED DISCONNECT SWITCH IN ELEVATOR MACHINE ROOM.
- 120V, 20A DEDICATED CIRCUIT IN ELEVATOR PIT TO ENERGIZE LIGHT, LIGHT SWITCH AND DUPLEX GFCI RECEPTACLE OUTLET. ALL DEVICES LOCATED IN ELEVATOR PIT SHALL BE WEATHERPROOF
- SMOKE DETECTOR IS REQUIRED. PROVIDE HEAT DETECTOR WHEN ELEVATOR MACHINE ROOM IS SPRINKLERED. LOCATE WITHIN TWO FEET FROM SPRINKLER HEAD.
- 13> ELEVATOR RECALL SMOKE DETECTOR IN EACH ELEVATOR LOBBY. QUANTITY AS PER NFPA 72. TELEPHONE FOR EMERGENCY COMMUNICATION WITH ELEVATOR CAR. PROVIDE REQUIRED CONDUIT
- A. WHEN ELEVATOR SHAFT IS SPRINKLERED, PROVIDE SMOKE AND HEAT DETECTORS. LOCATE
- HEAT DETECTOR WITHIN 24 INCHES FROM SPRINKLER HEAD. B. WHEN ELEVATOR SHAFT IS VENTILATED, PROVIDE SMOKE DETECTOR ON TOP OF THE SHAFT
- TO INITIATE VENTILATION OF THE SHAFT. C. FOR HYDRAULIC ELEVATORS, PROVIDE SMOKE DETECTORS IN AN ELEVATOR PIT.
- WHEN ELEVATOR PIT IS SPRINKLERED, PROVIDE HEAT DETECTOR. LOCATE HEAT DETECTOR WITHIN 24 INCHES FROM SPRIKLER HEAD.


INSTALLATION OF THE FIRE ALARM, COMMUNICATION AND SECURITY SYSTEMS. COORDINATE EXACT

- 120V, 20A CIRCUIT DEDICATED TO SUMP PUMP AND TERMINATED IN NON-GFI SIMPLEX RECEPTACLE OUTLET IN ELEVATOR PIT.
- PROVIDE EMPTY CONDUITS, JUNCTION BOXES, ETC. IN ELEVATOR SHAFT REQUIRED FOR
- REQUIREMENTS WITH ASSOCIATED CONSULTANT/MANUFACTURER. 18 120V, 20A DEDICATED FUSED DISCONNECT SWITCH ASSOCIATED WITH CAB LIGHTING AND AIR
- CONDITIONING CIRCUITS. QUANTITY AS REQUIRED. PROVIDE DRY, NO/NC CONTACTS IN EACH ELEVATOR CONTROLLER. WHEN EMERGENCY GENERATOR
- IS REQUIRED, TRANSFER SIGNAL FROM AUTOMATIC TRANSFER SWITCH SHALL BE AVAILABLE FOR THE ELEVATOR CONTROLLER TO IDENTIFY THAT TRANSFER TO EMERGENCY POWER HAS OCCURRED AND ANOTHER SIGNAL PRIOR TO TRANSFER BACK TO NORMAL POWER. QUANTITY AS REQUIRED.
- WHEN ONLY ONE ELEVATOR IS PROVIDED PER BANK, DELETE REQUIREMENTS ASSOCIATED WITH
- GROUP CONTROLLER. (2) 120V, 20A FUSED DISCONNECT SWITCH ASSOCIATED WITH CIRCUIT REQUIRED FOR TRAIL CABLE.
- ②② WHEN MORE THAN TWO ELEVATORS PER BANK ARE INSTALLED, IN LIEU OF ITEMS 18 AND 21 PROVIDE 100A BUS, 120/208V, 3 PHASE, 4 WIRE NORMAL POWER PANEL WITH 100A UNFUSED MAIN DISCONNECT SWITCH AND FOLLOWING BRANCH CIRCUIT PROTECTIVE DEVICES:
  - A. 1-30/2P FUSED DISCONNECT SWITCH PER CONTROLLER.
- B. 5-20A/1P FUSED DISCONNECT SWITCHES PER ELEVATOR CAB.
- WHEN MORE THAN TWO ELEVATORS PER BANK ARE INSTALLED, IN LIEU OF ITEMS 18 AND 21 PROVIDE 100A BUS, 120/208V, 3 PHASE, 4 WIRE EMERGENCY POWER PANEL WITH 100A UNFUSED MAIN DISCONNÉCT SWITCH AND FOLLOWING BRANCH CIRCUIT PROTECTIVE DEVICES:
- A. 5-20A/1P FUSED DISCONNECT SWITCHES PER ELEVATOR CAB.
- (24) ELEVATOR MACHINE ROOM LIGHTING SWITCH.
- PROVIDE 120V, 20A DEDICATED CIRCUIT FOR SHAFT LIGHTING.
- PROVIDE 120V, 20A DEDICATED CIRCUIT FOR SHAFT RECEPTACLES.

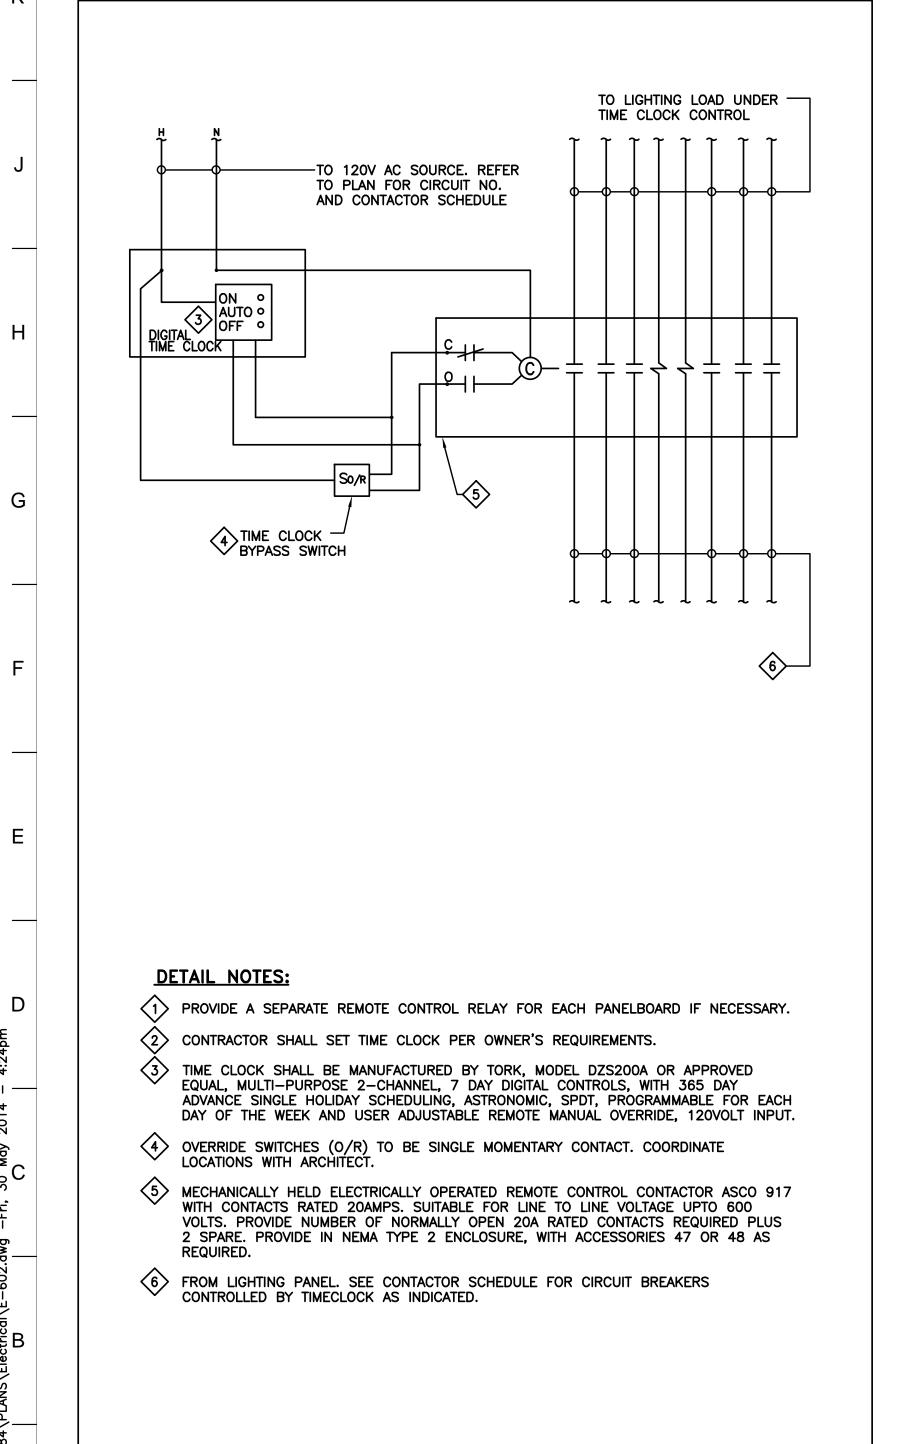

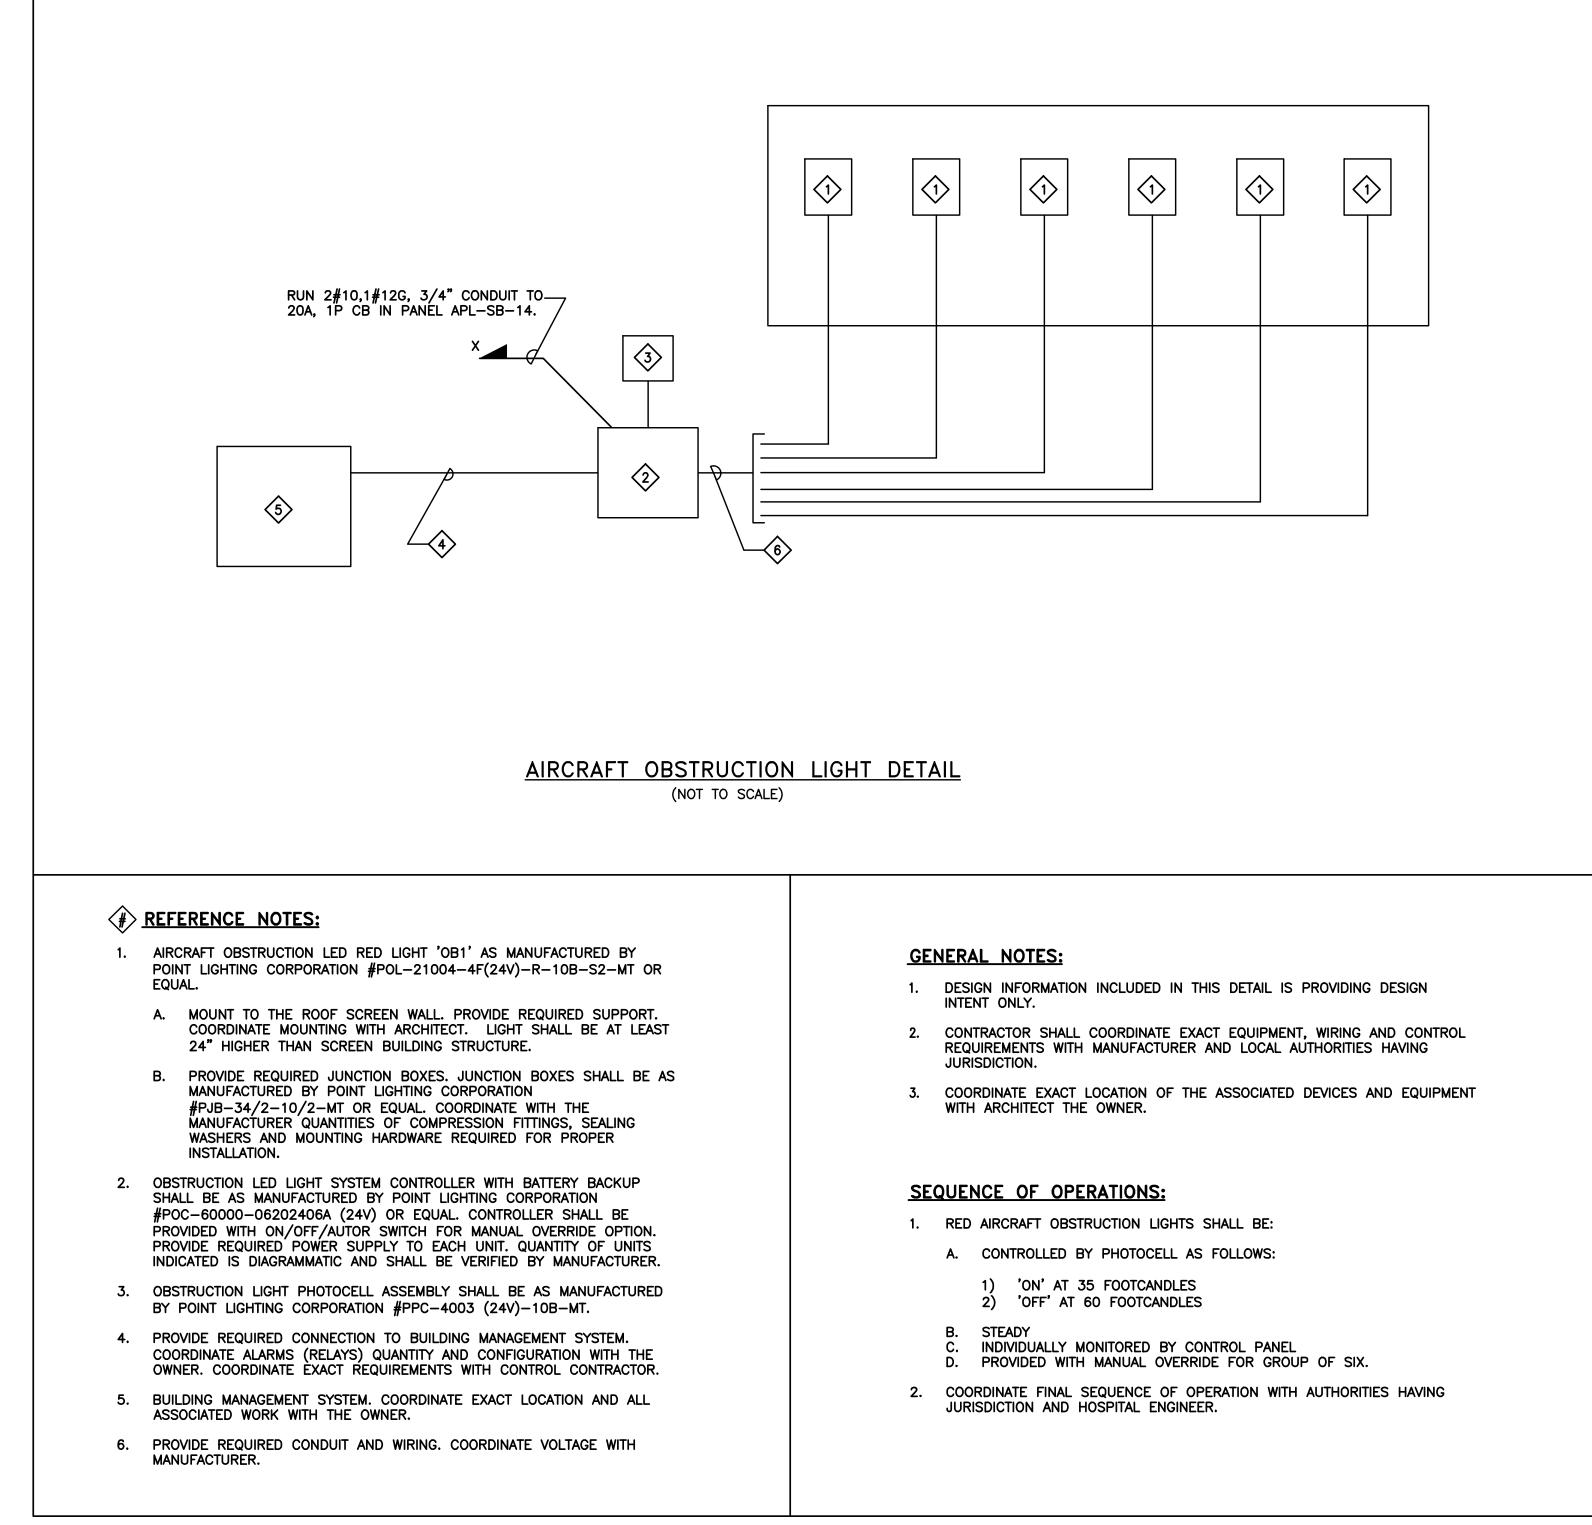

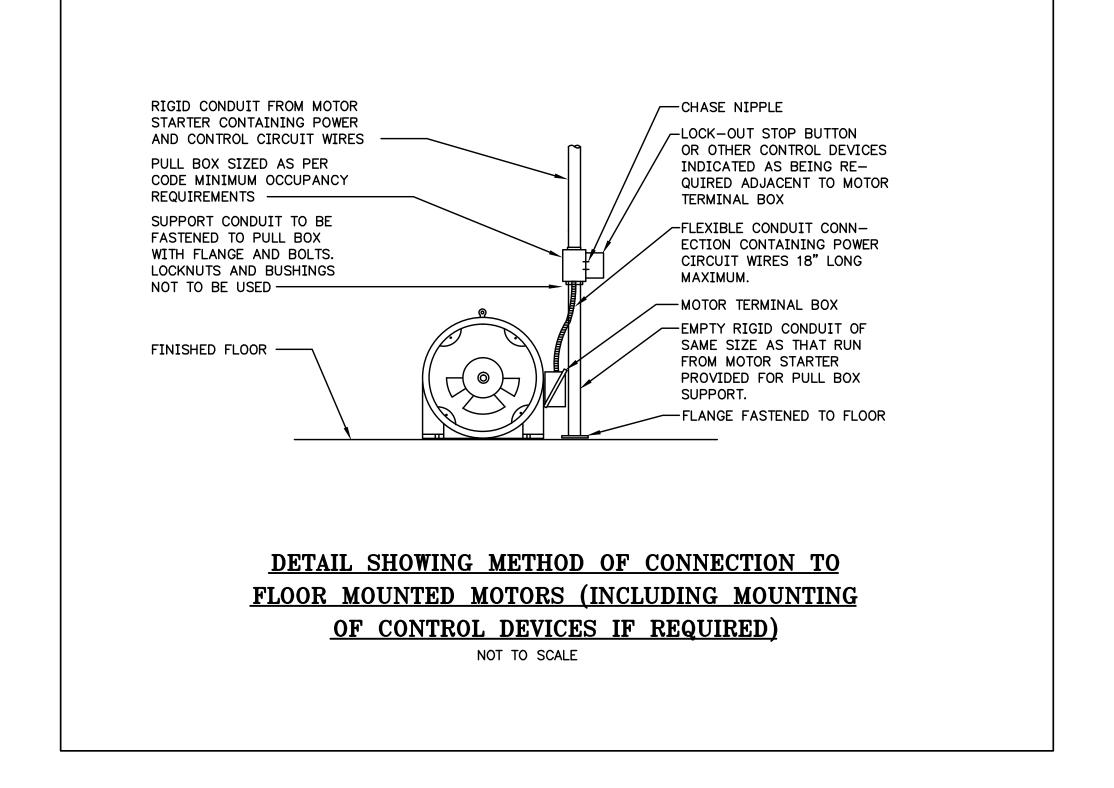

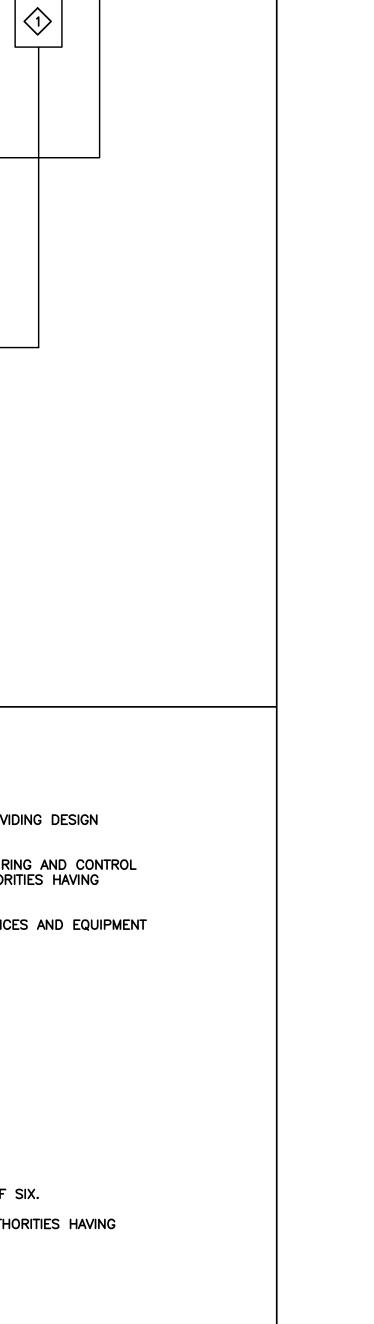

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**ELECTRICAL DETAILS** 

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18 West 18th Street, New York, NY 10011 212.532.2211

485C Route 1 South, Iselin, NJ 08830 908.272.3300

VAN DEUSEN & ASSOCIATES

5 Regent Street, Livingston, NJ 07039 973.994.9220

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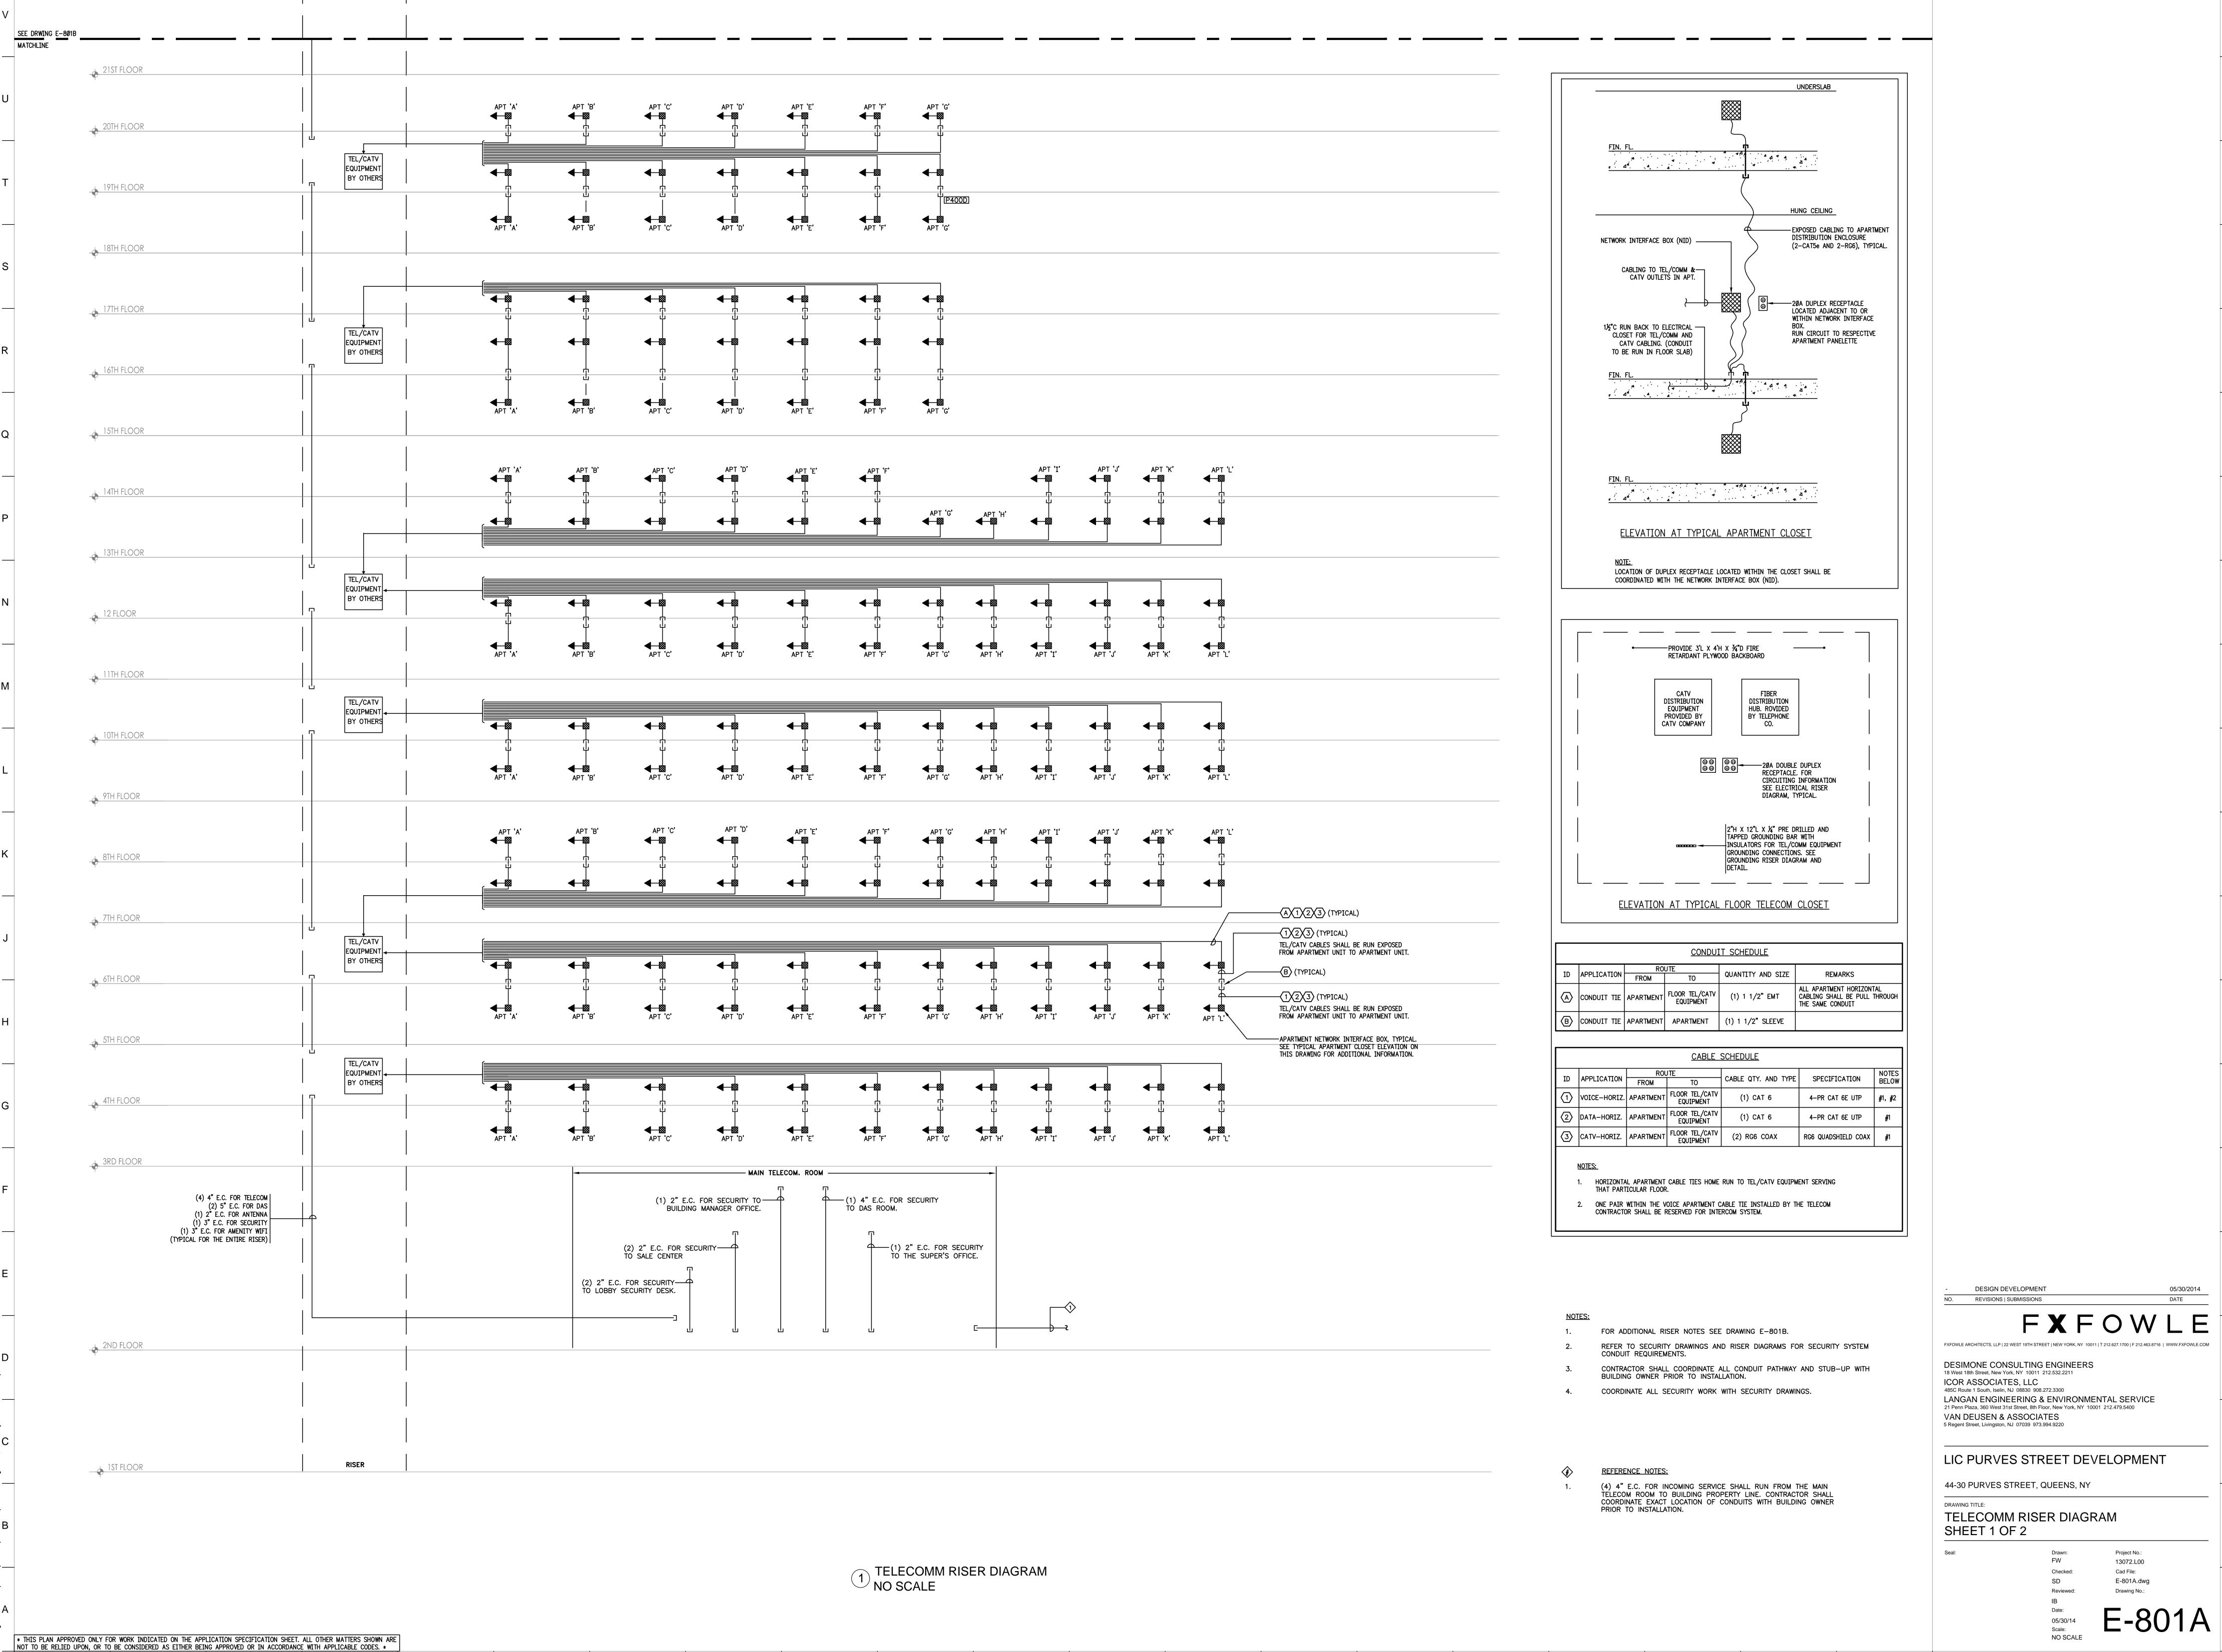
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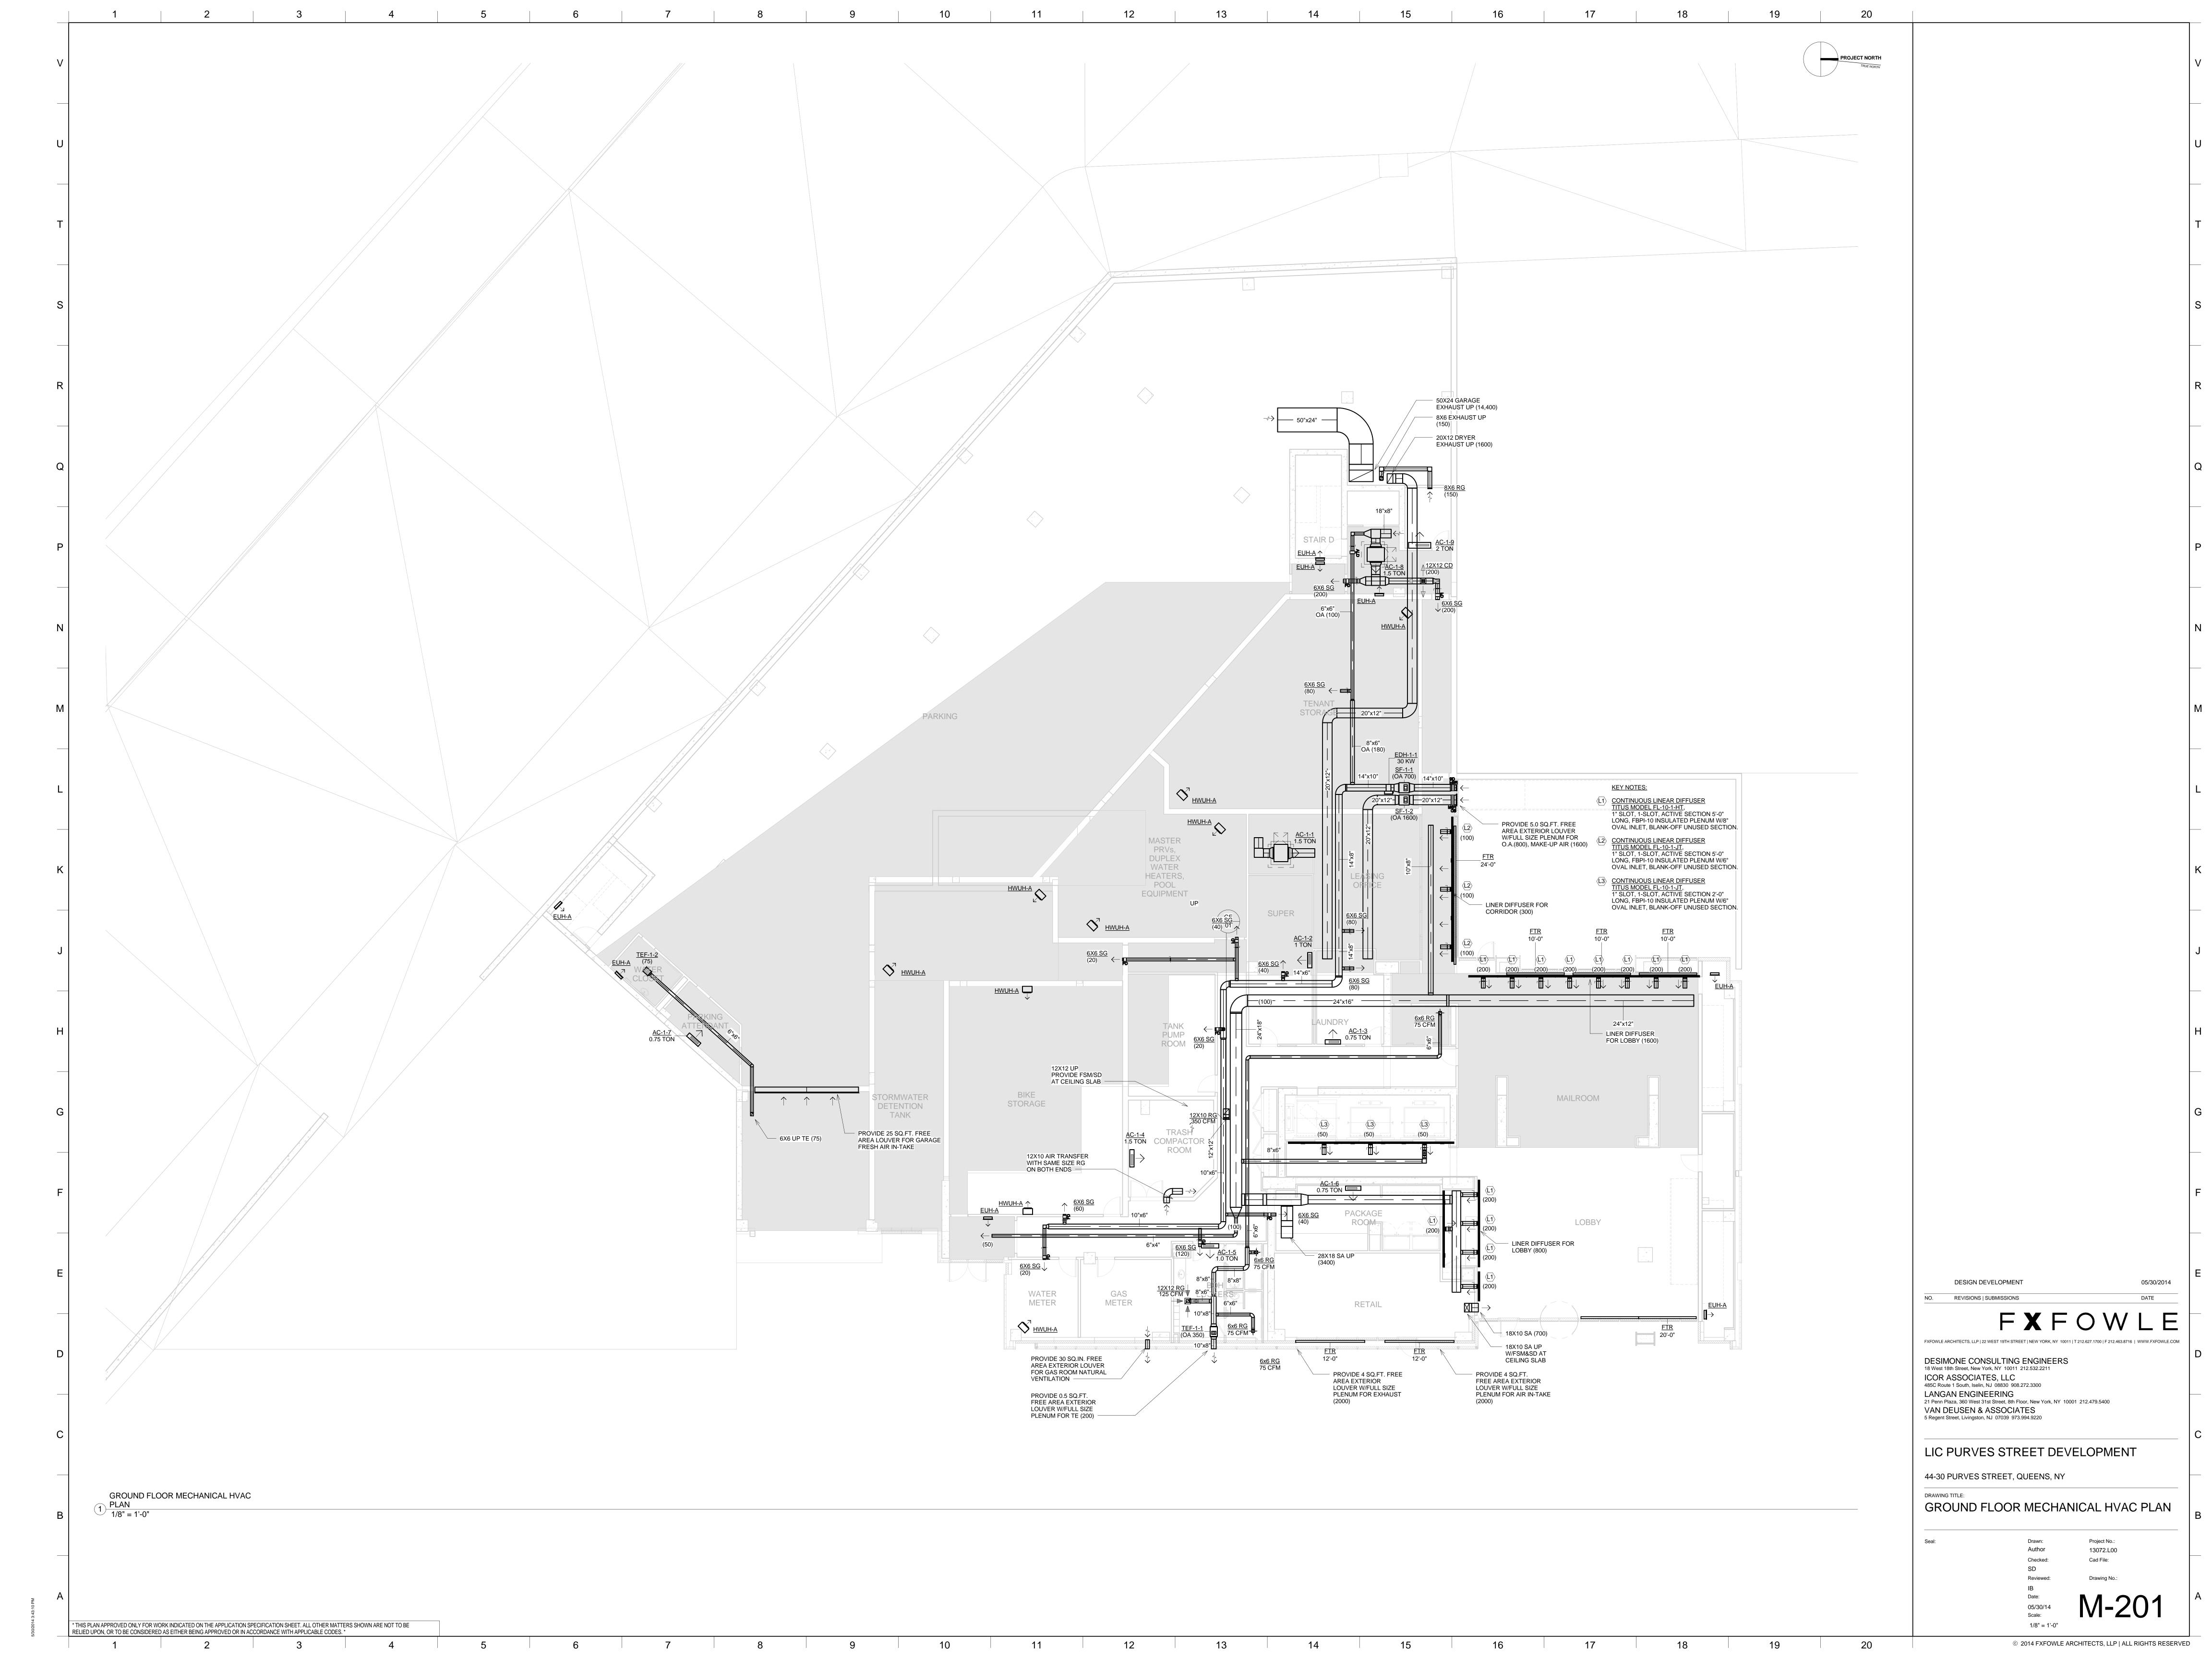
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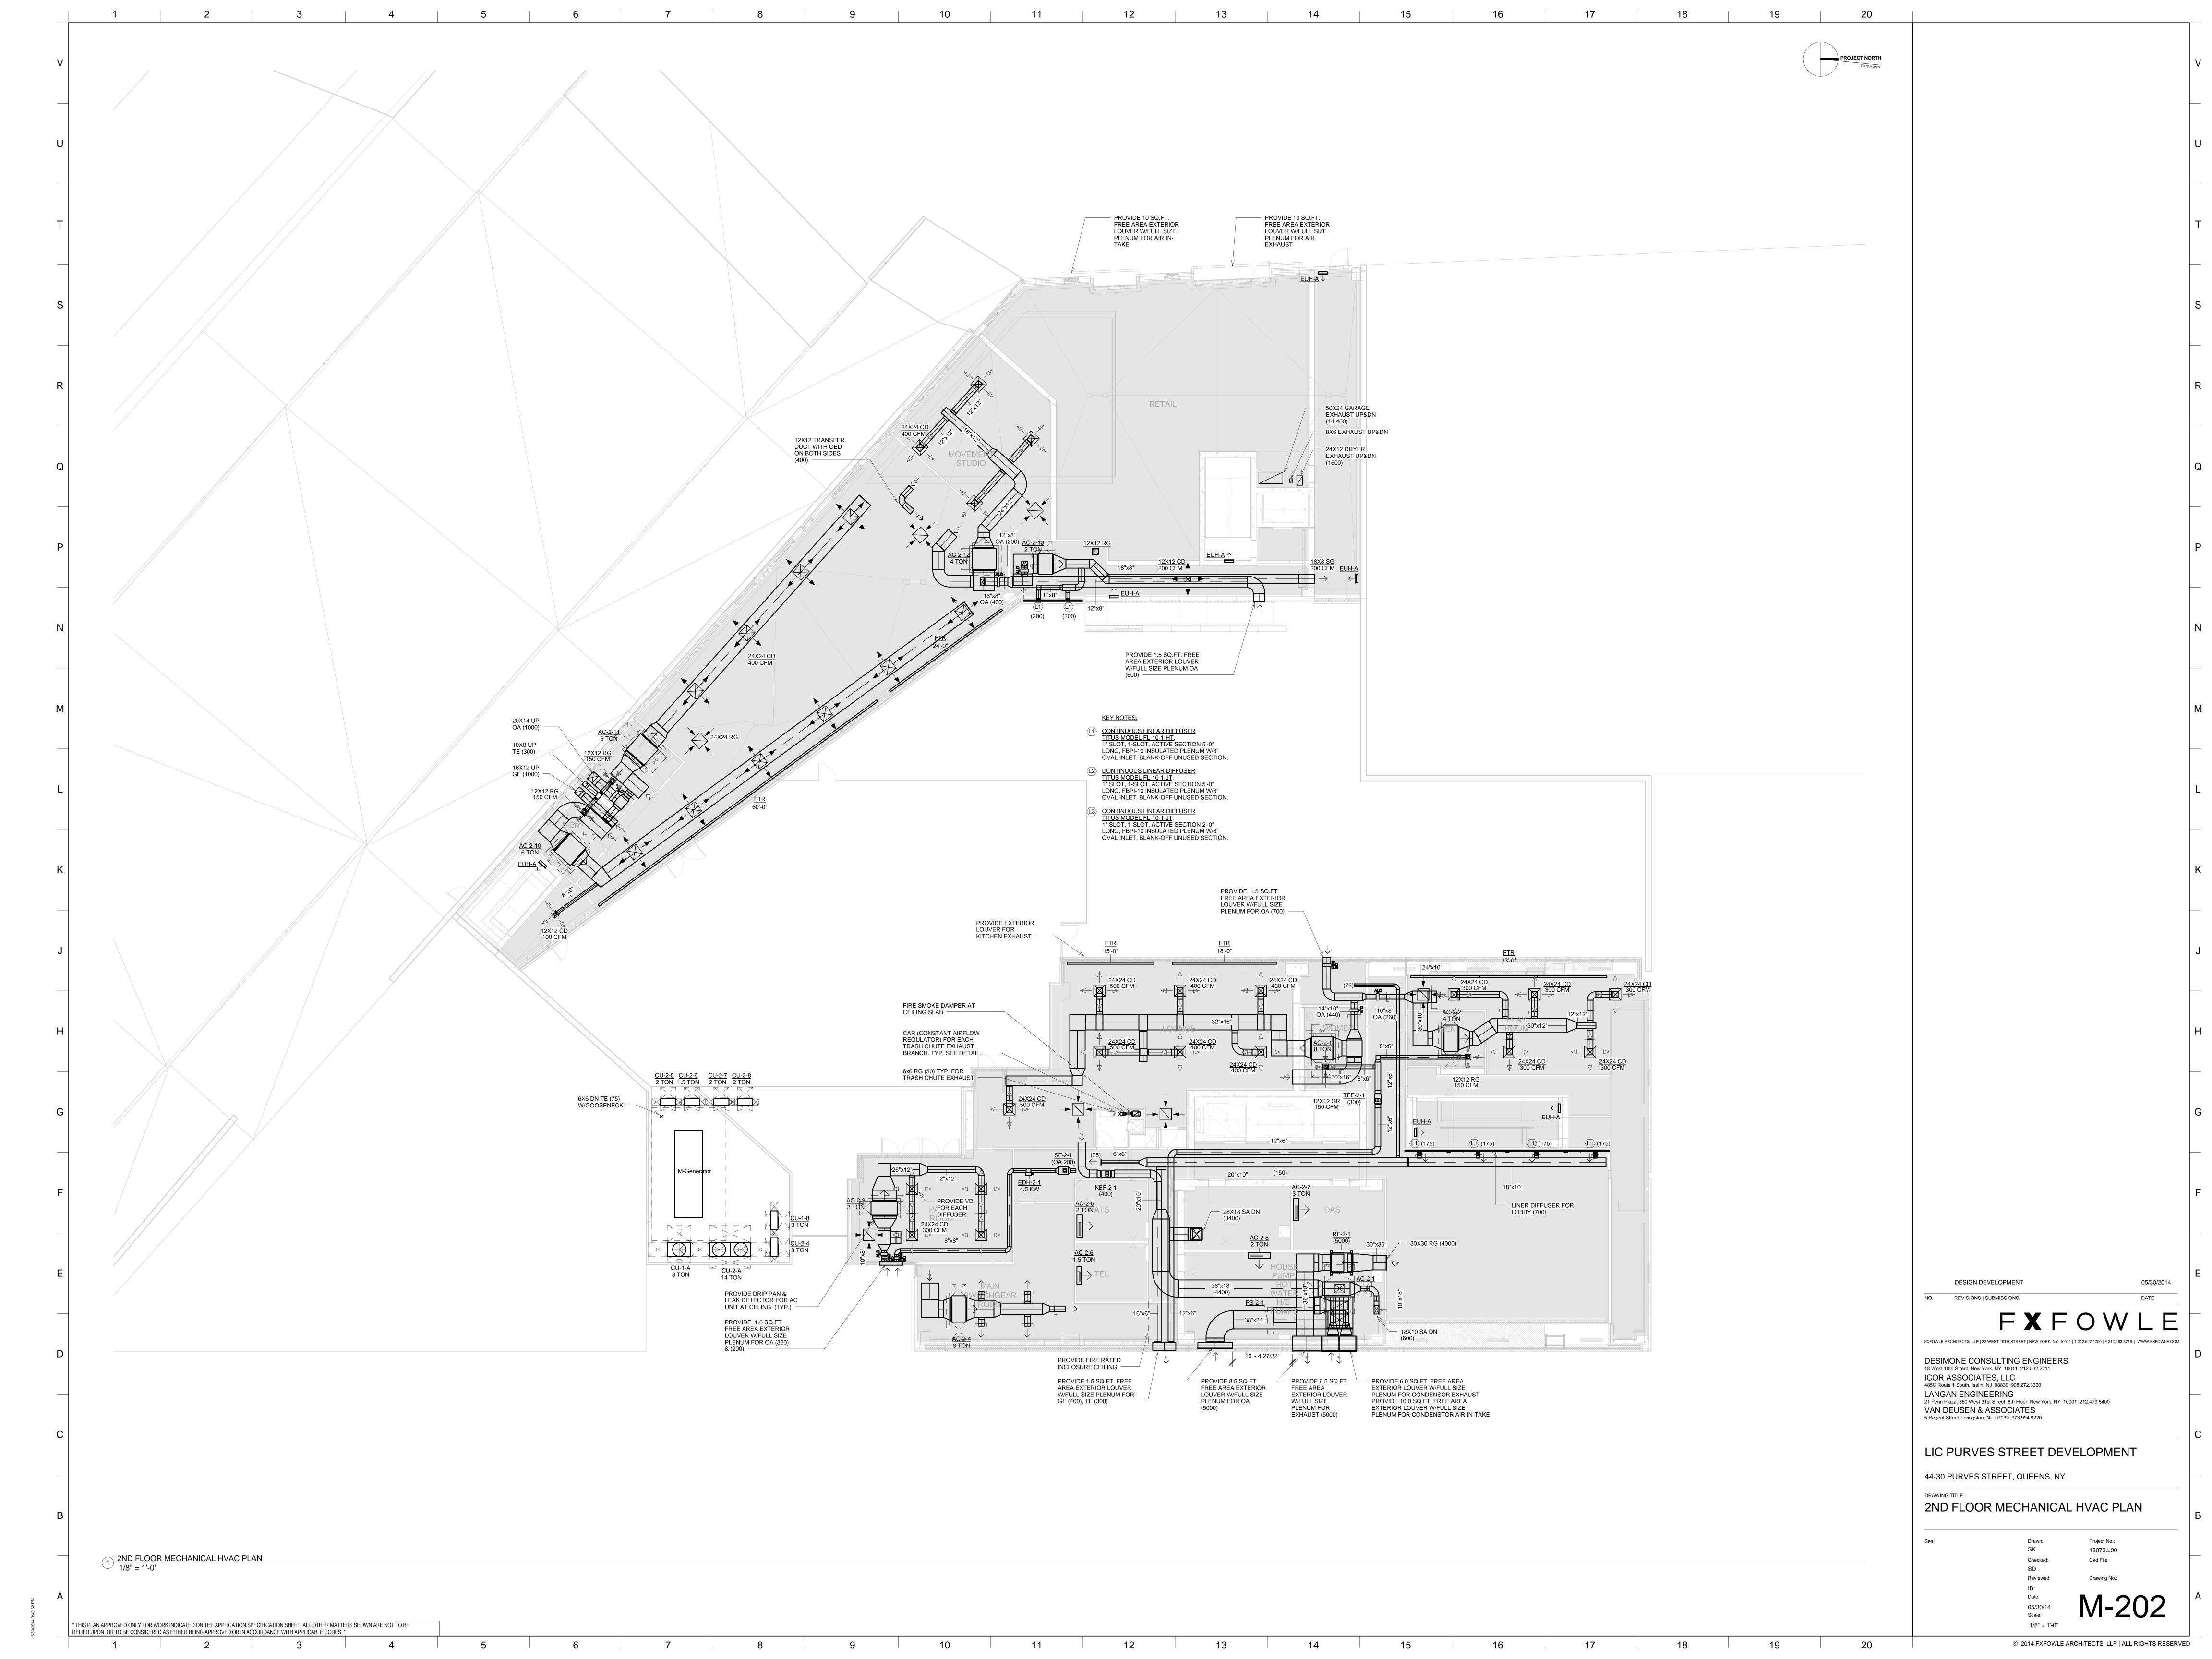
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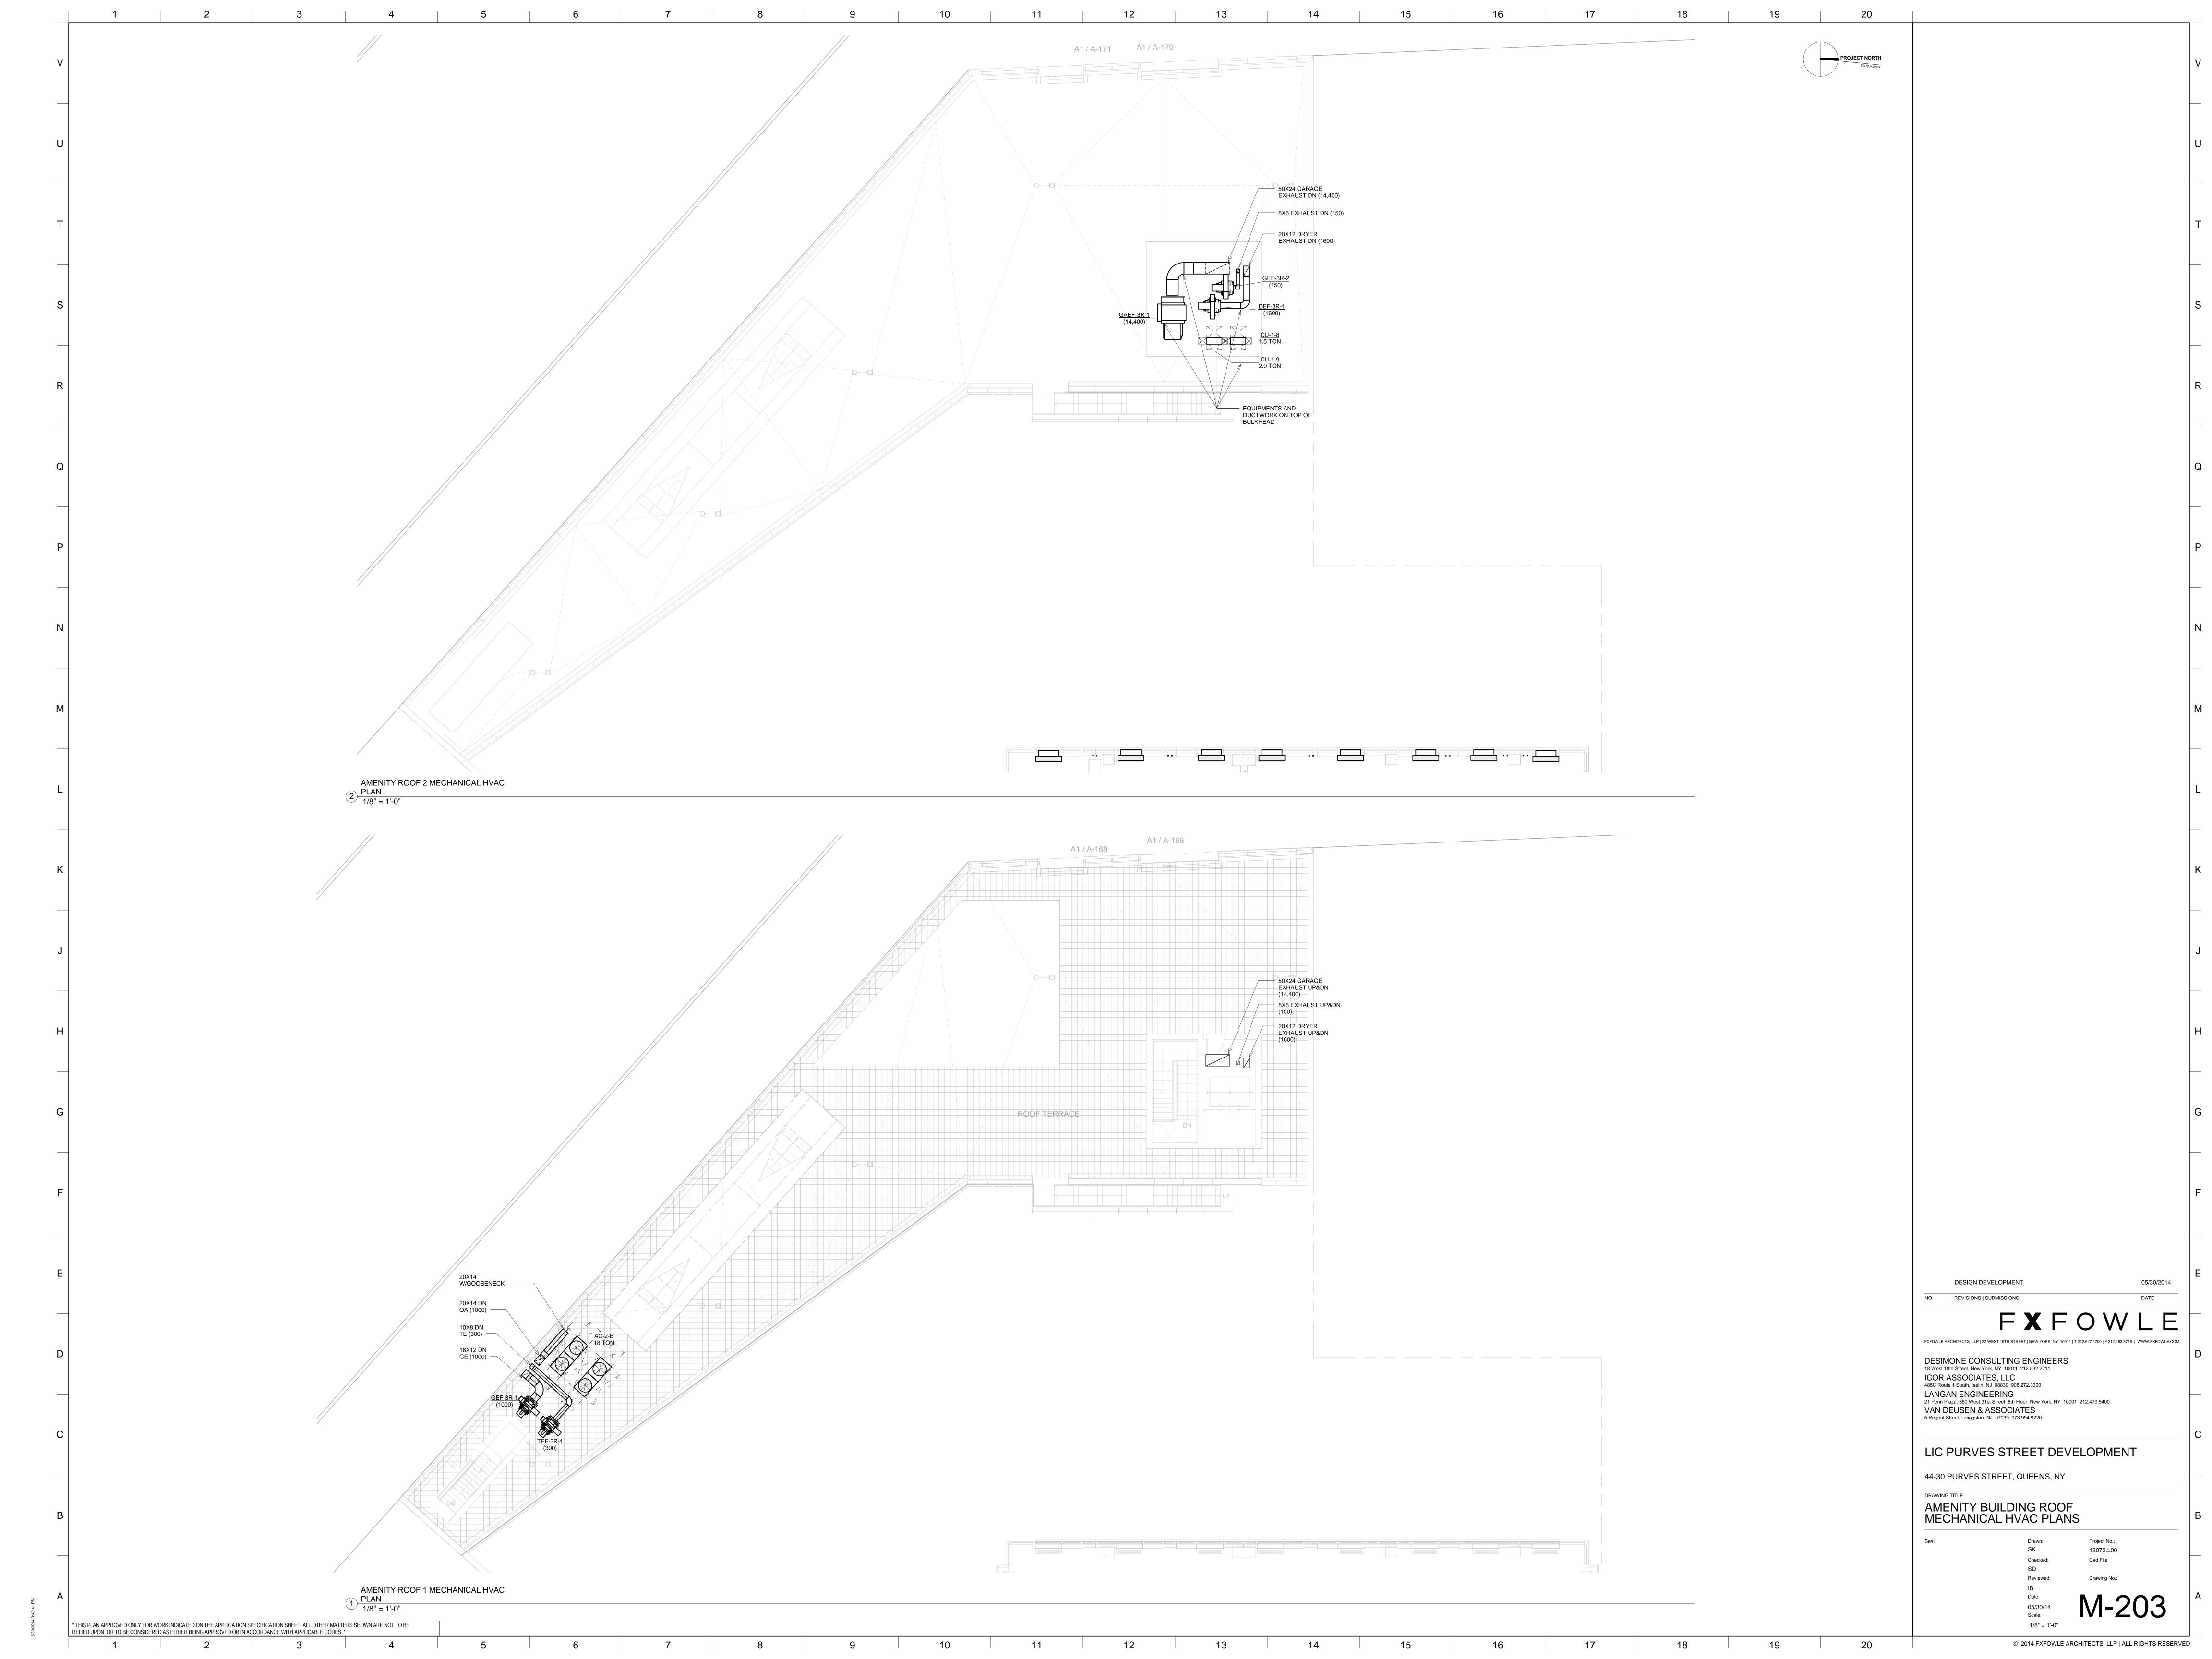
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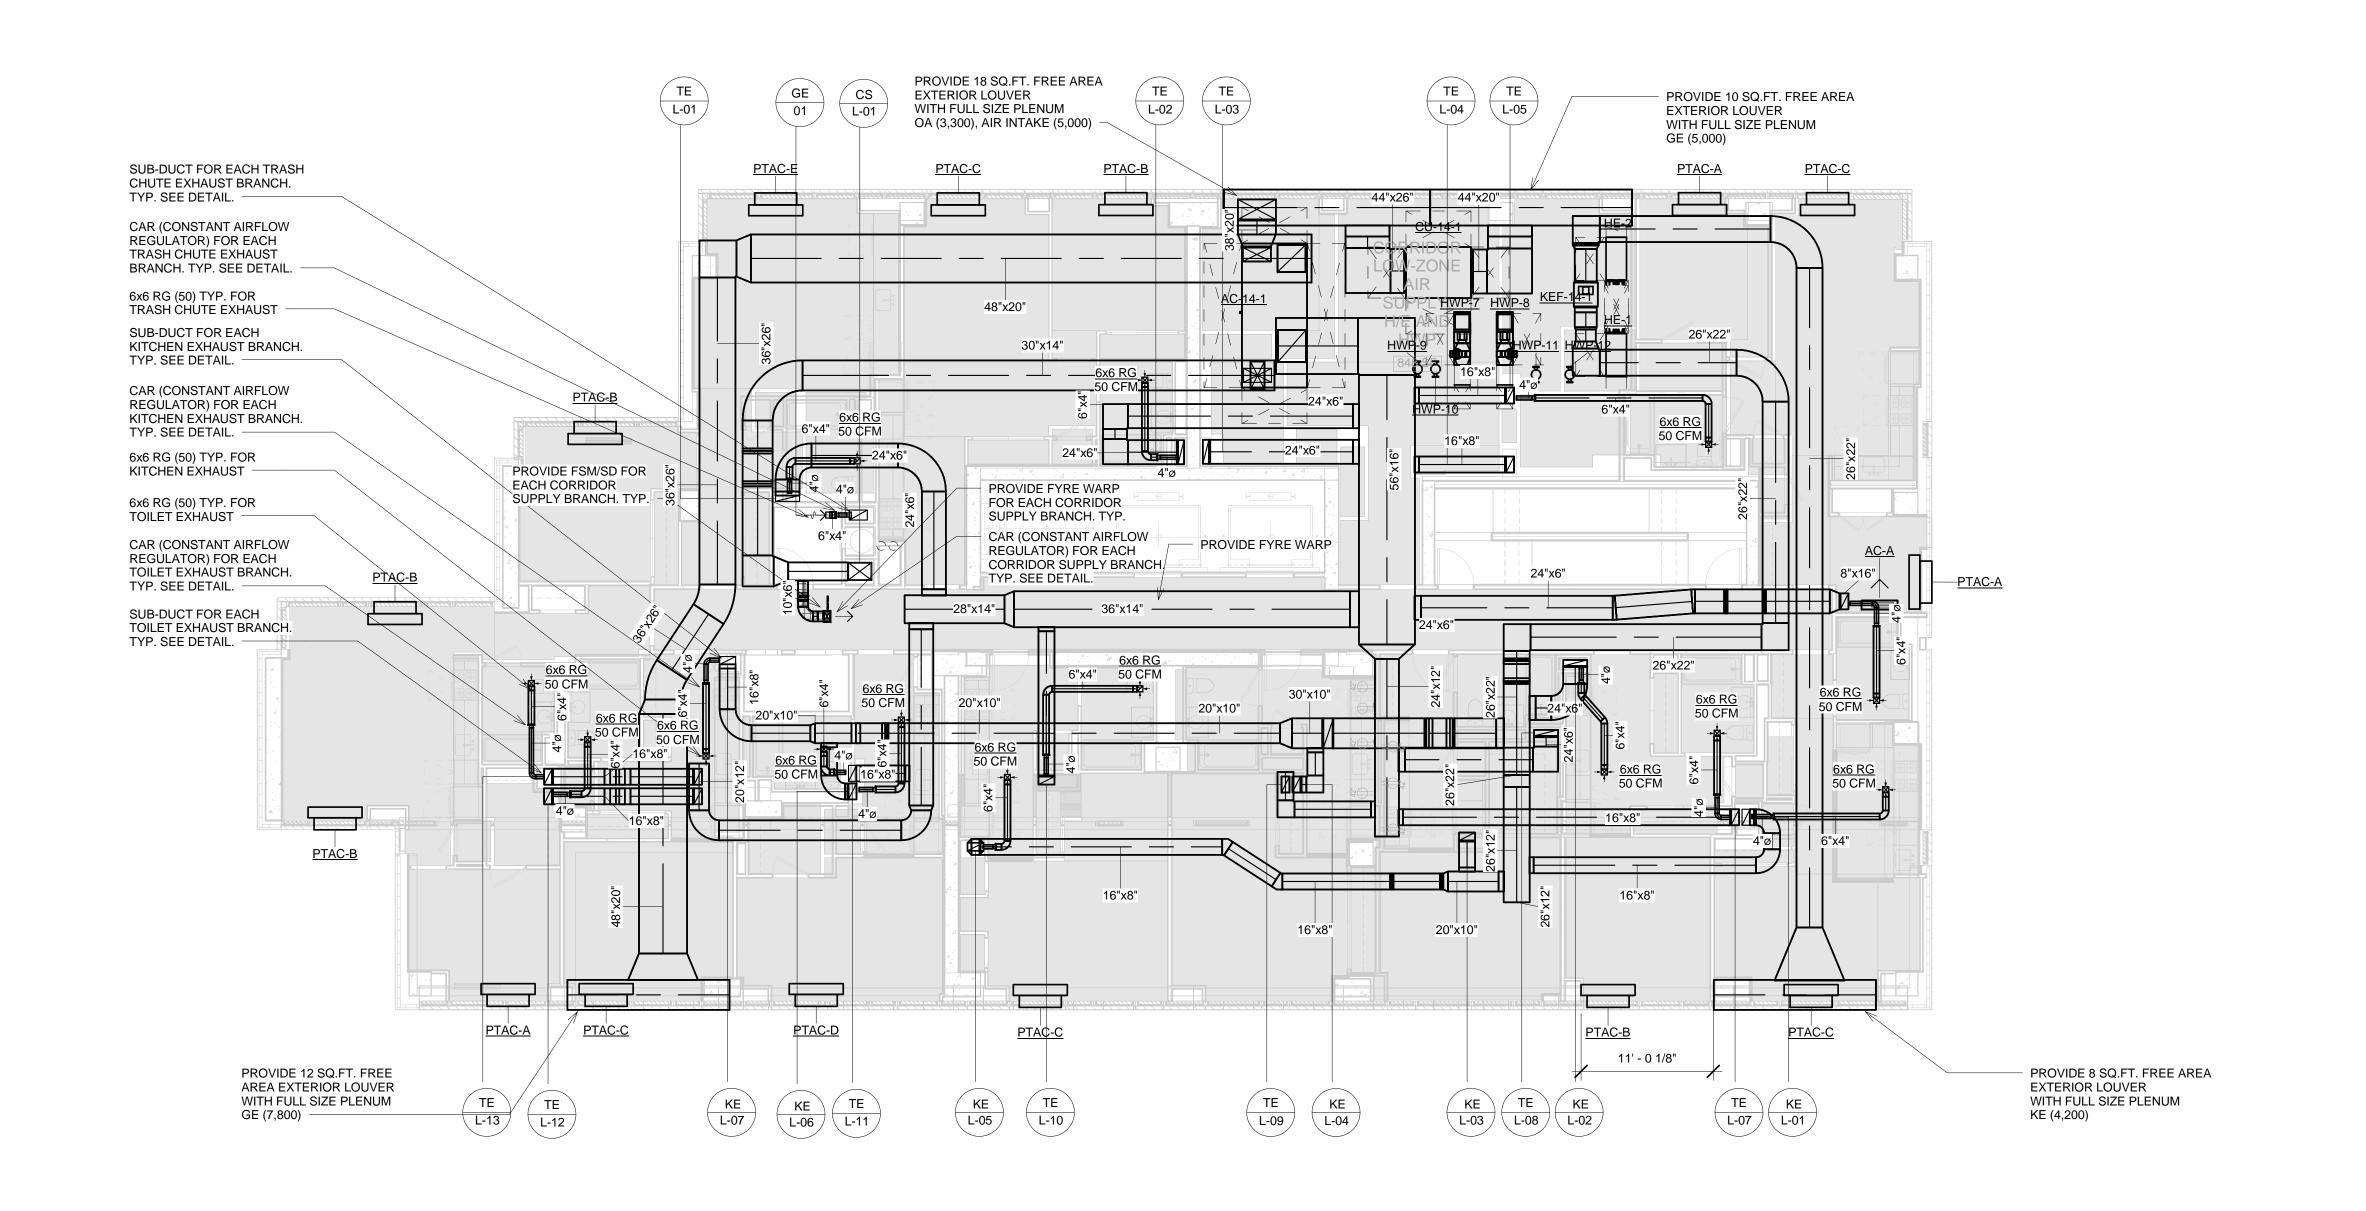
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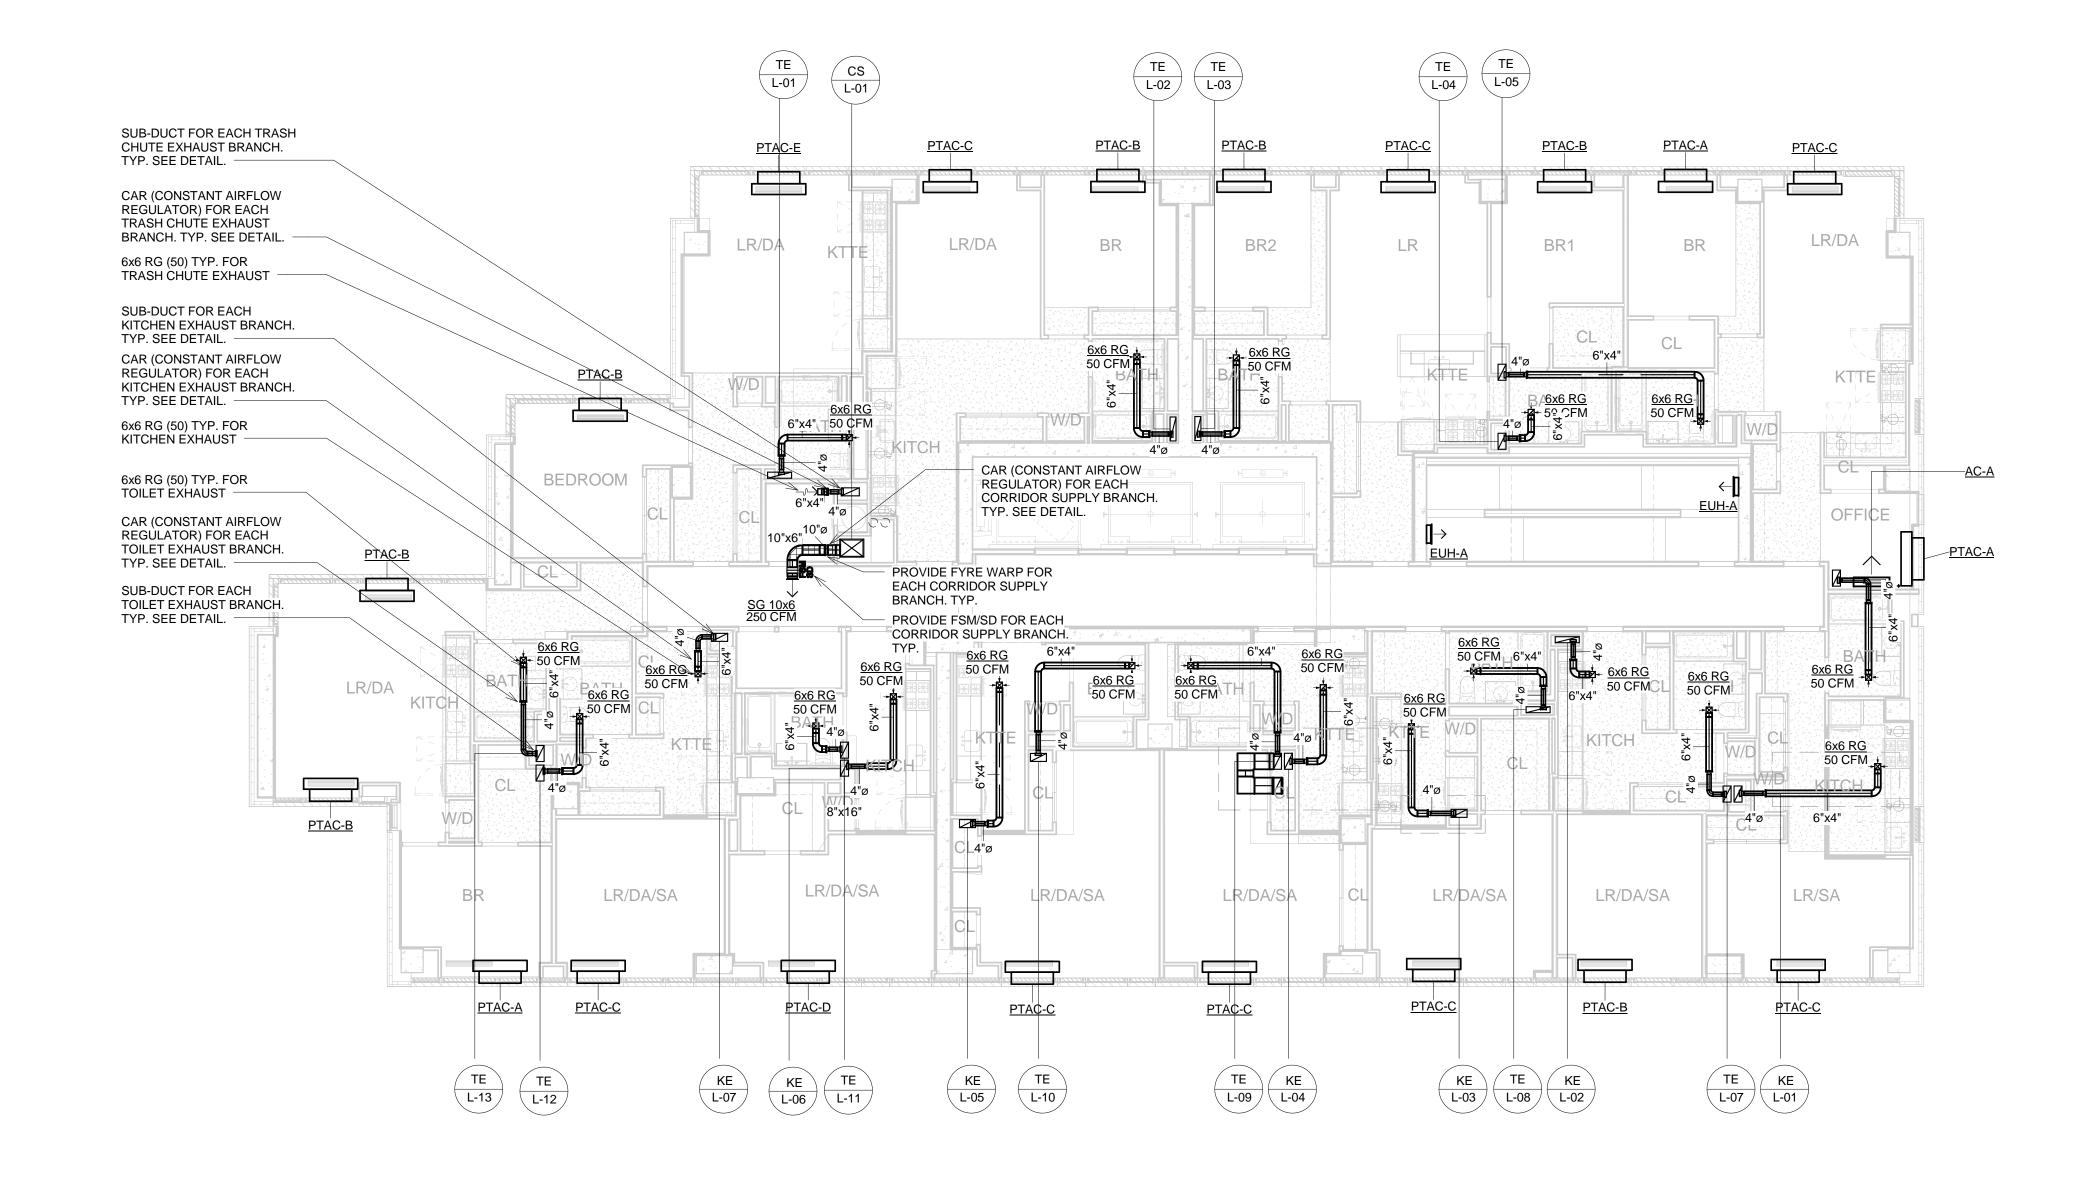












3RD - 13TH FLOOR MECHANICAL HVAC
PLAN
1/8" = 1'-0"

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2 14TH FLOOR MECHANICAL HVAC PLAN 1/8" = 1'-0"

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ICOR ASSOCIATES, LLC
485C Route 1 South, Iselin, NJ 08830 908.272.3300
LANGAN ENGINEERING
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44-30 PURVES STREET, QUEENS, NY

3RD - 14TH FLOOR MECHANICAL HVAC PLANS


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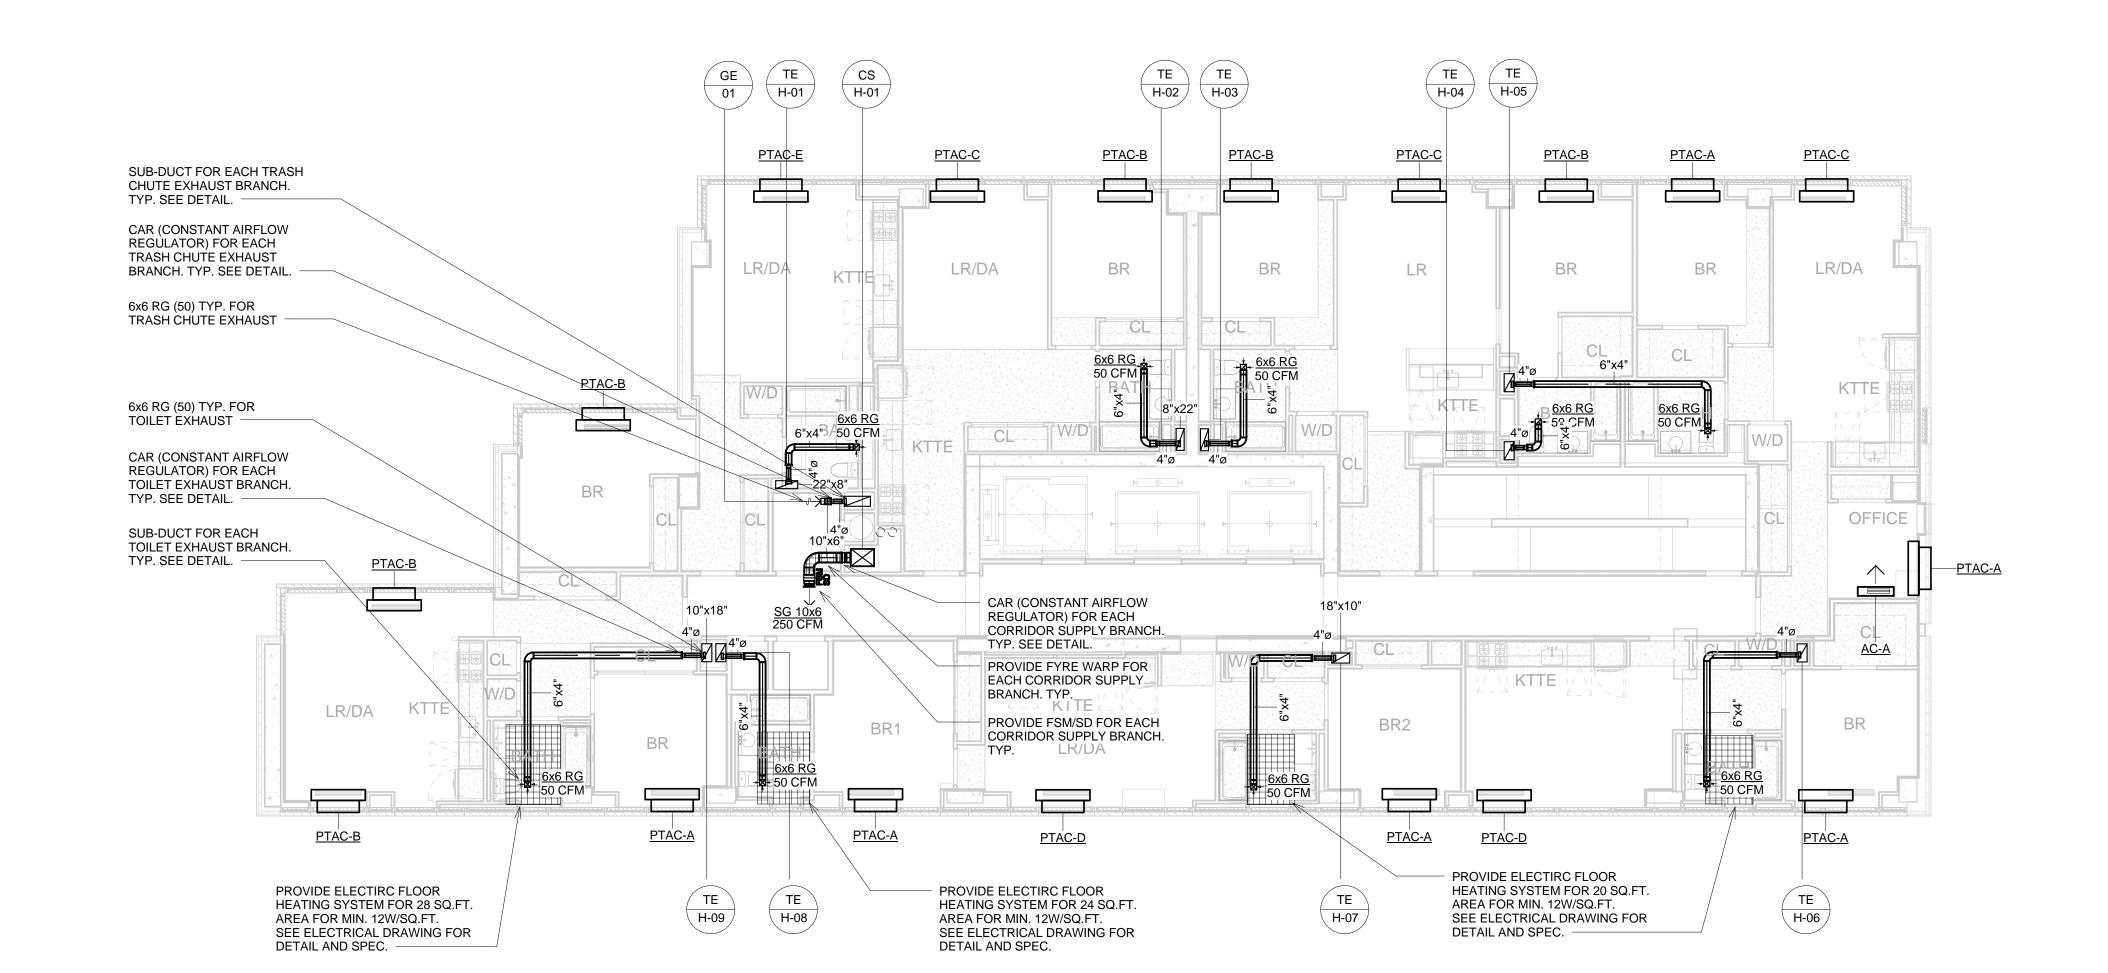
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2 32ND FLOOR MECHANICAL HVAC PLAN 1/8" = 1'-0"



15TH - 31ST FLOOR MECHANICAL HVAC
PLAN
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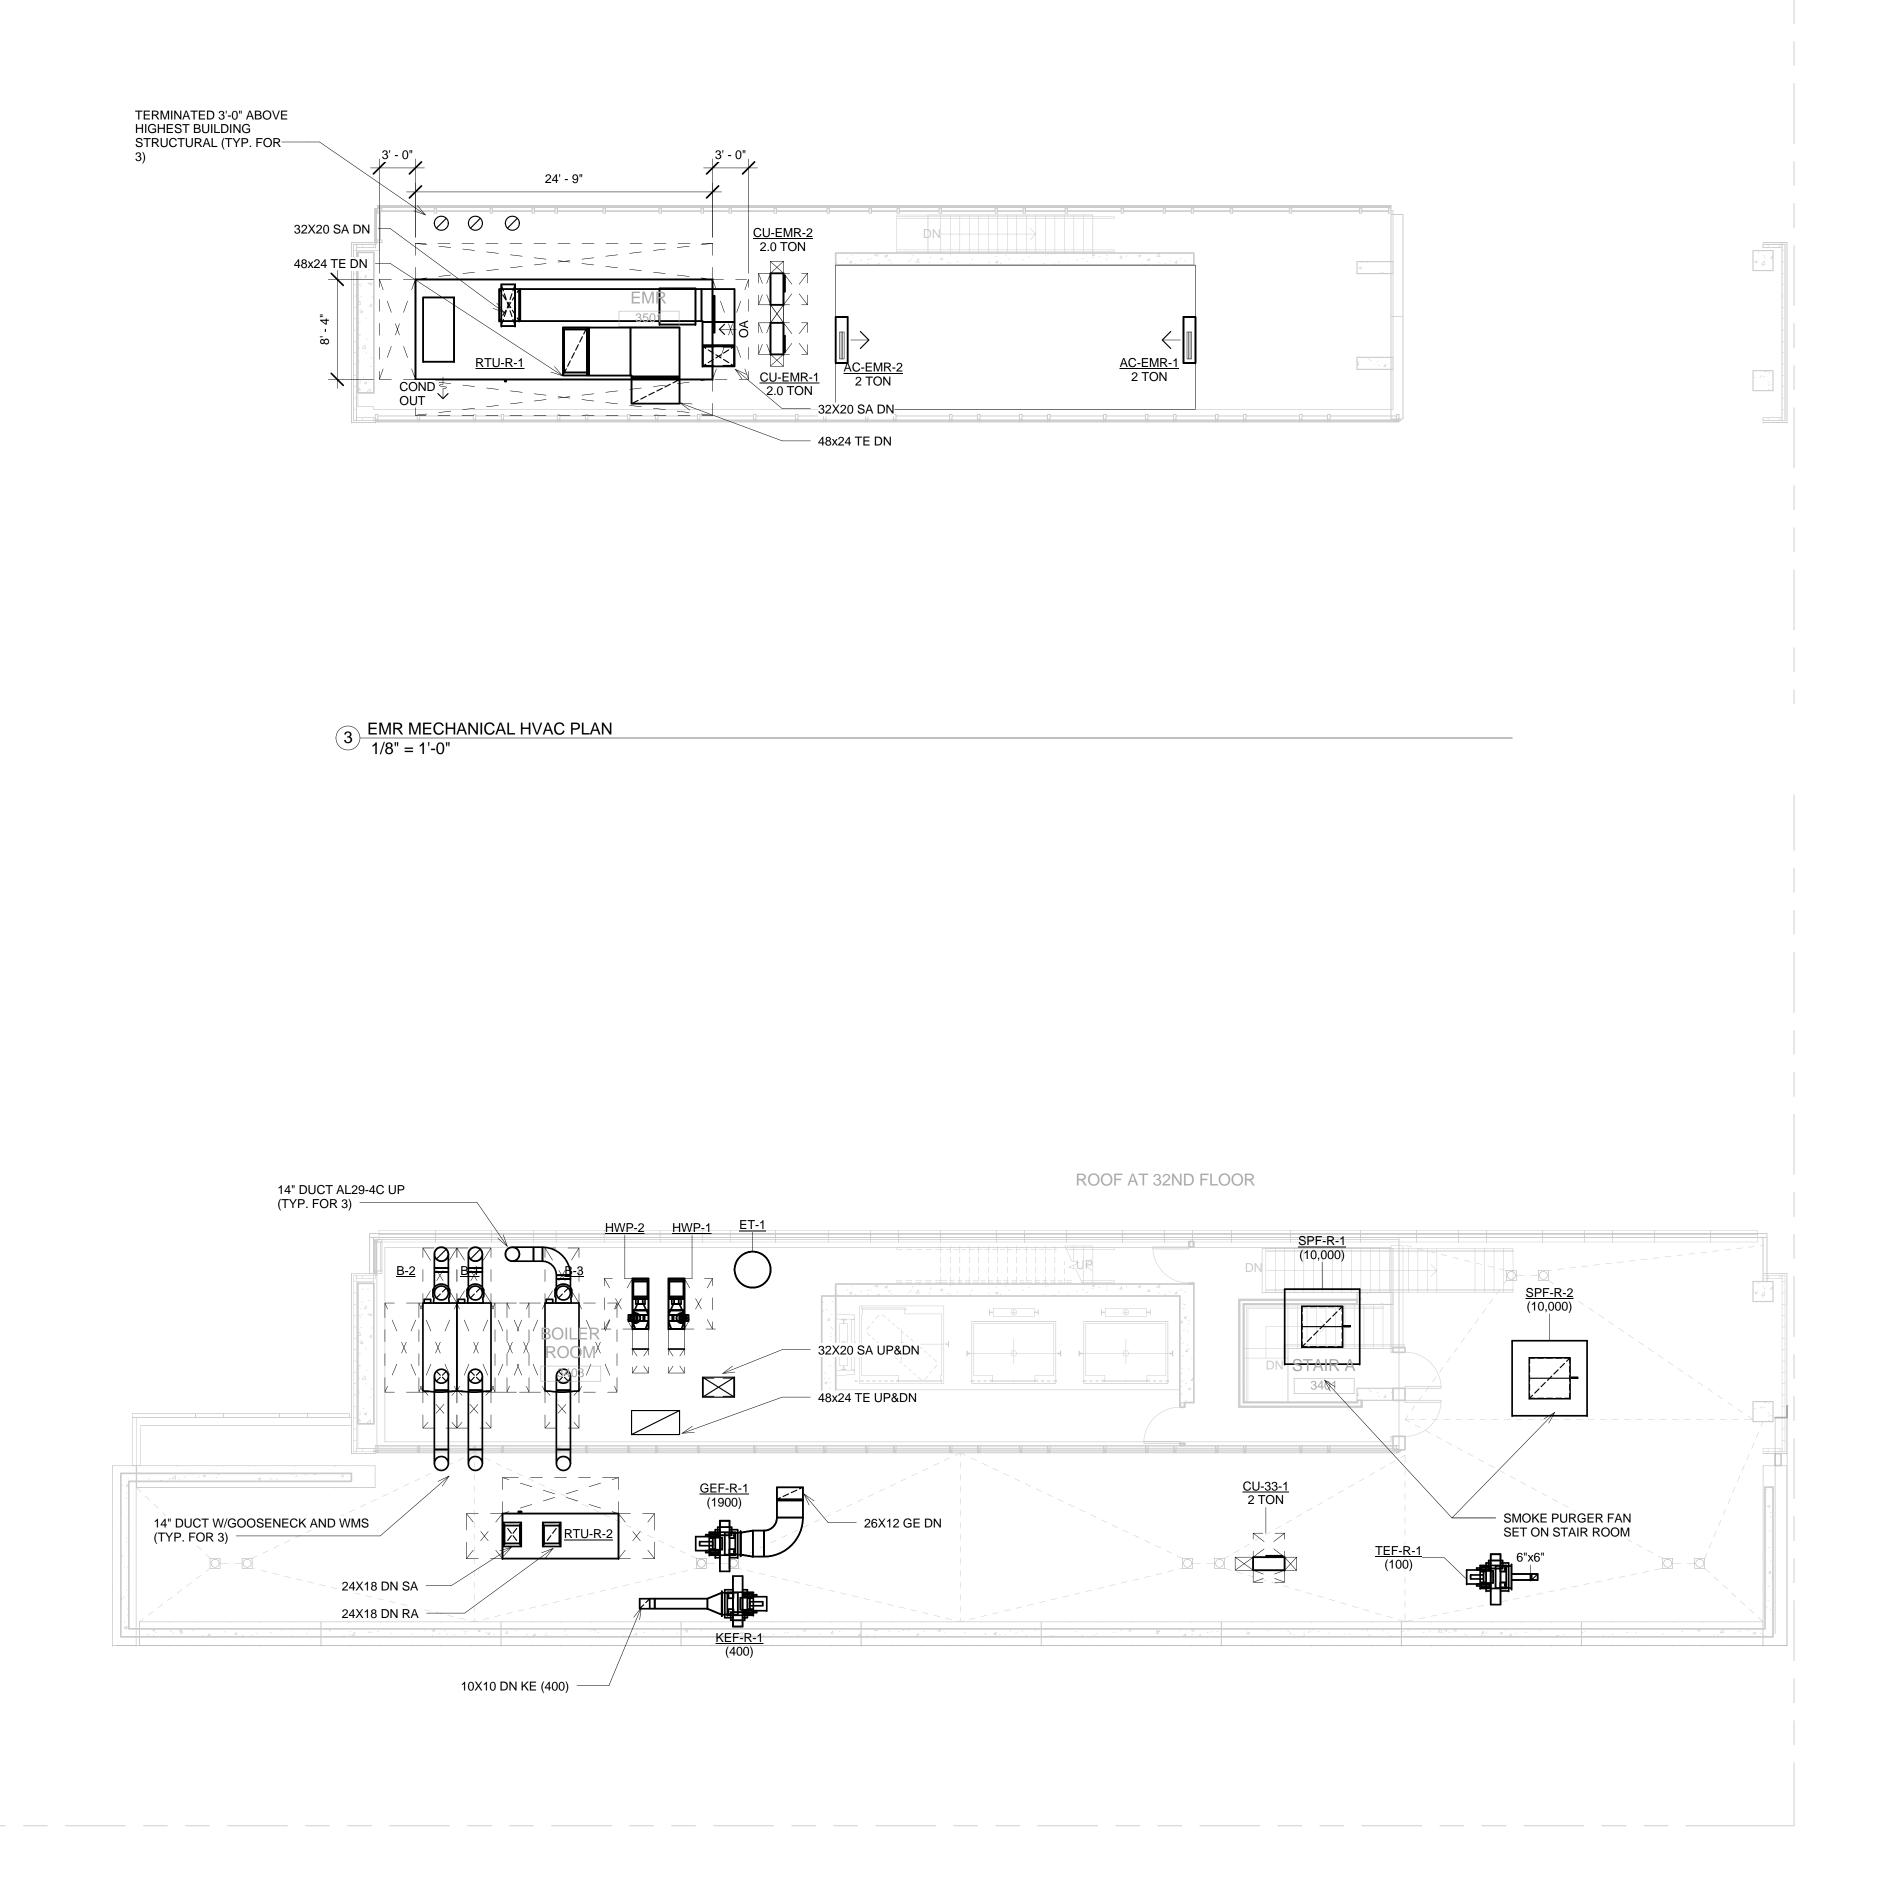
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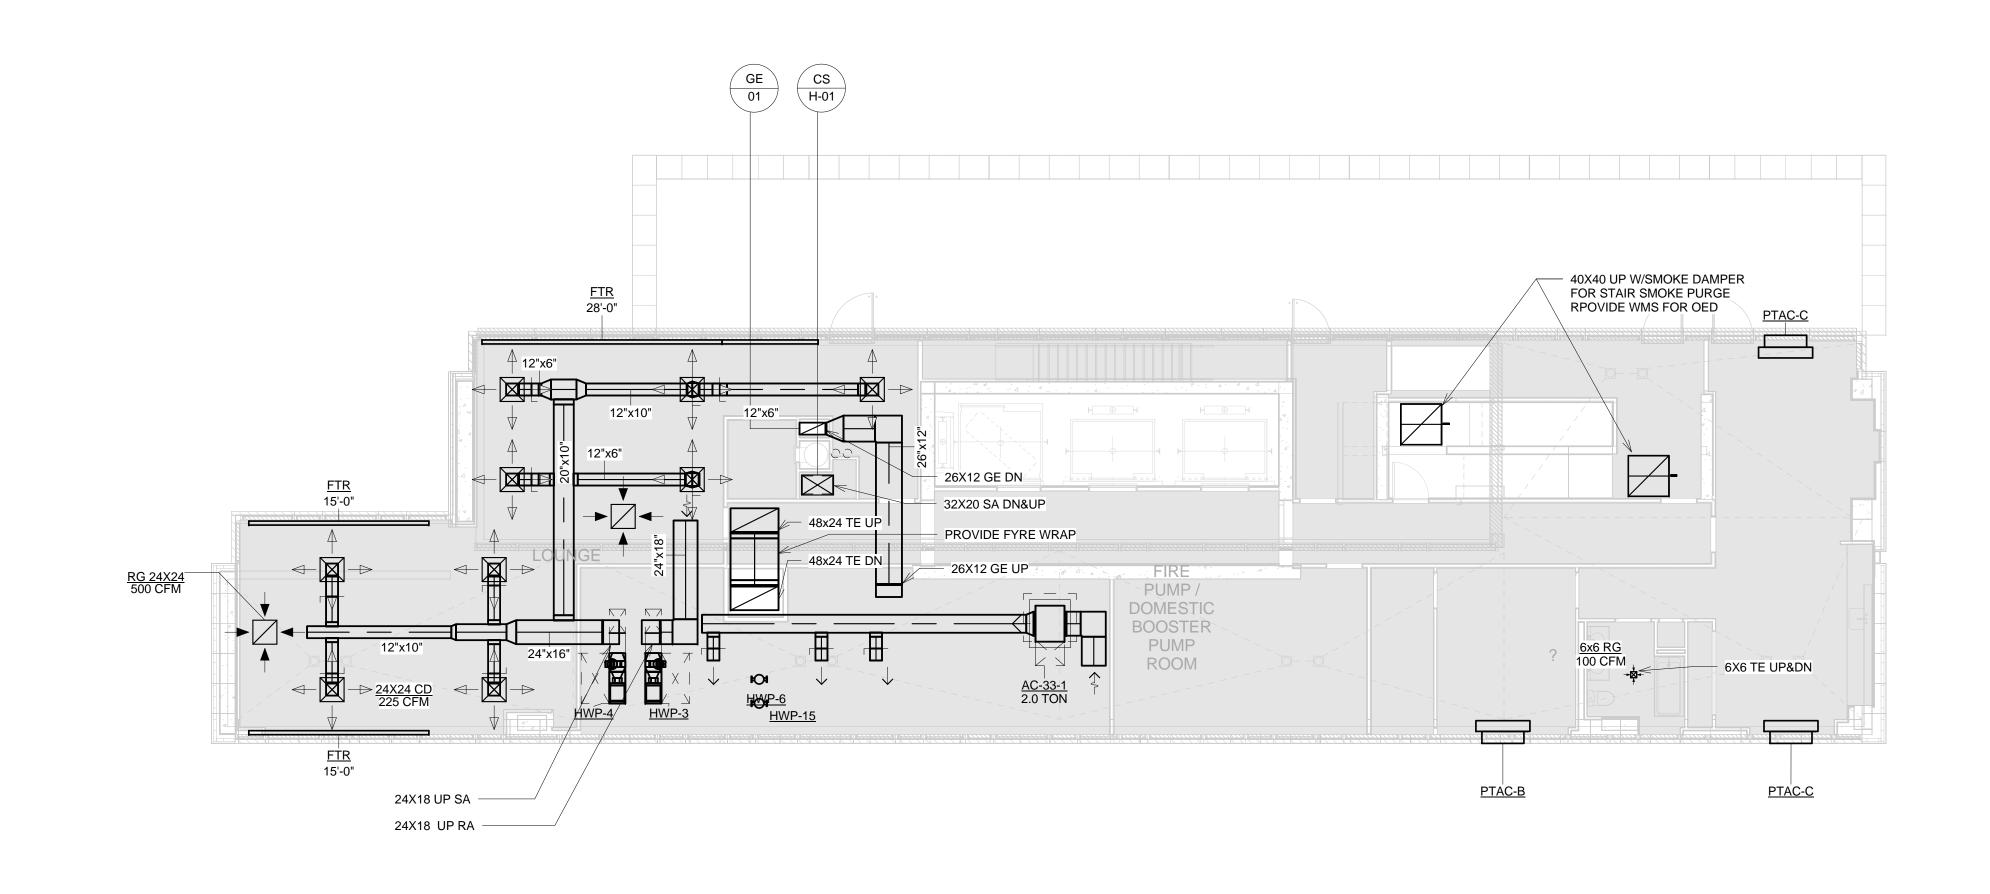
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2 LOWER ROOF MECHANICAL HVAC PLAN 1/8" = 1'-0"

1 33RD FLOOR MECHANICAL HVAC PLAN 1/8" = 1'-0"

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DRAWING TITLE:

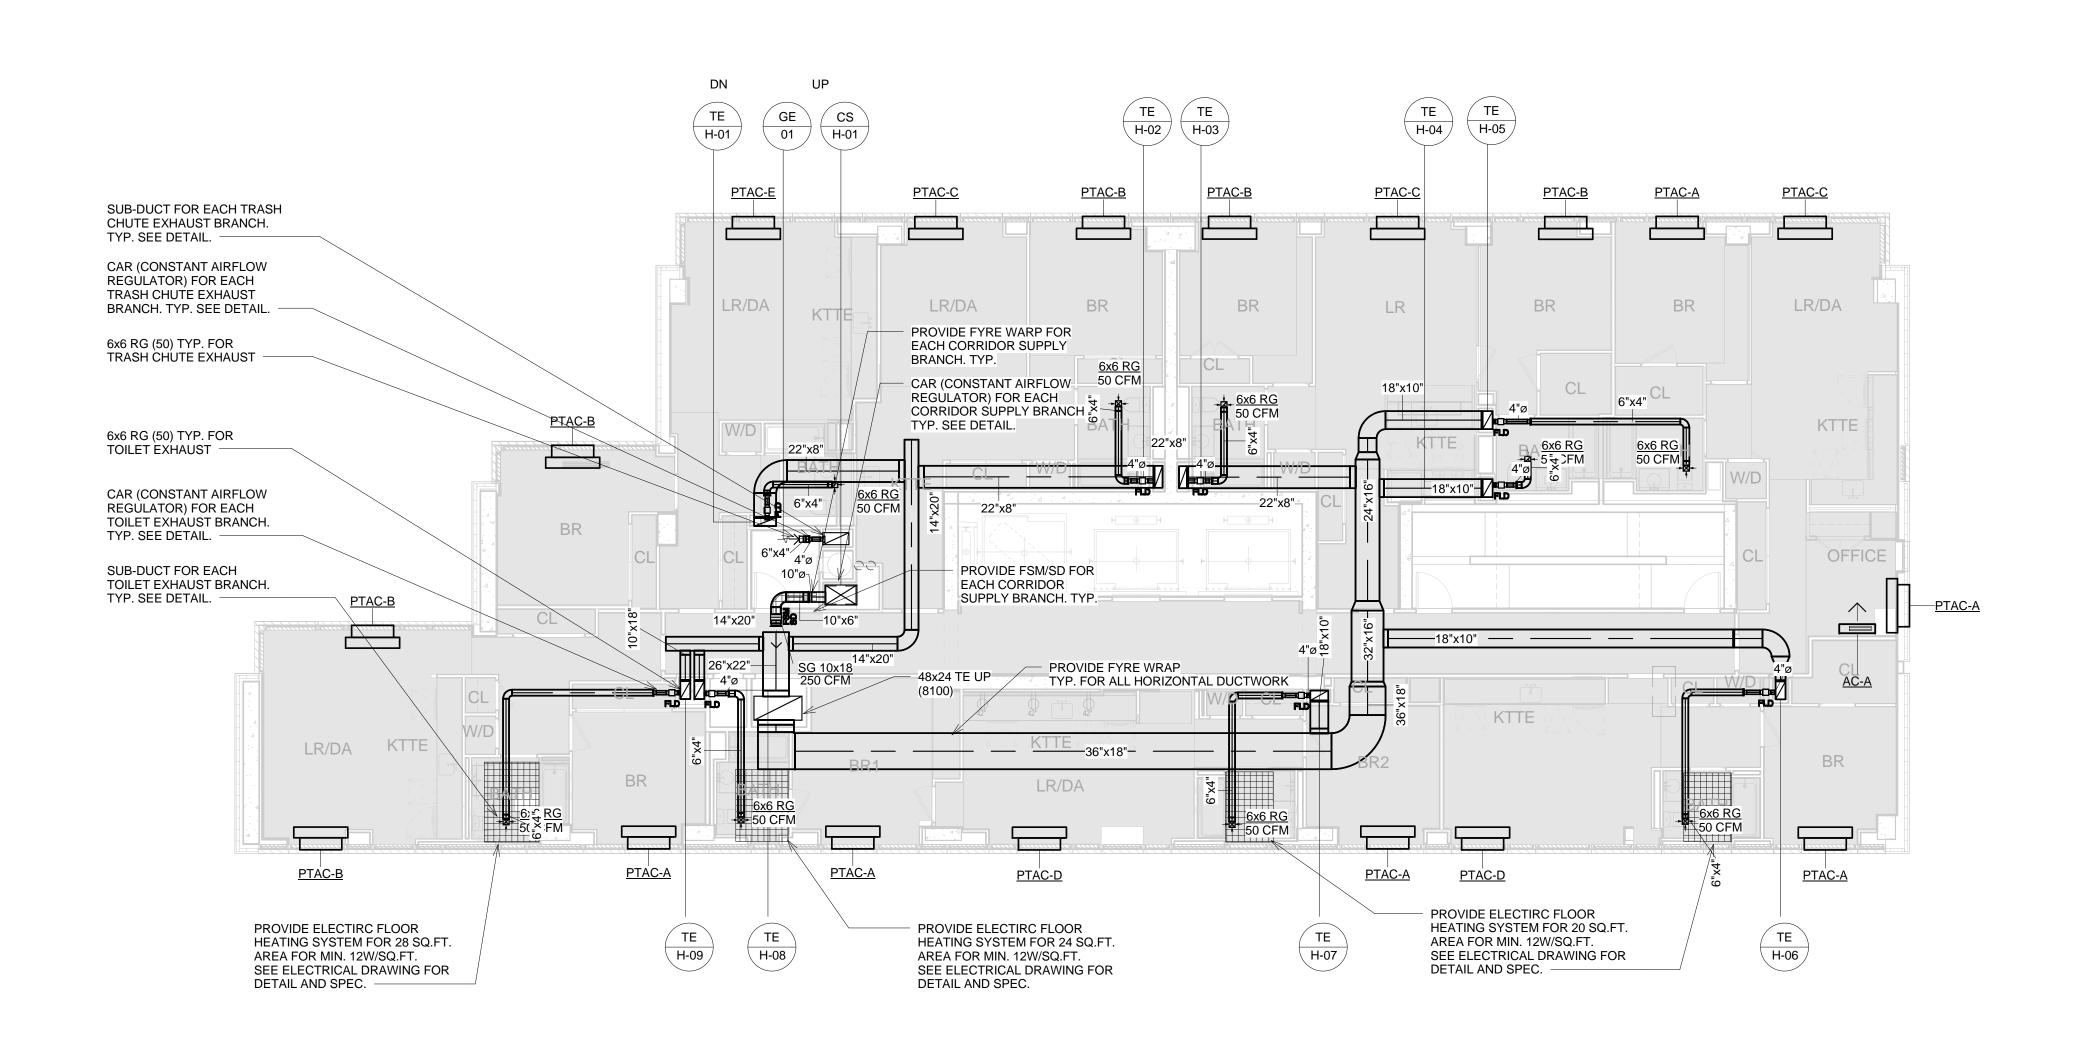33RD FLOOR, LOWER ROOF & EMR
MECHANICAL HVAC PLANS

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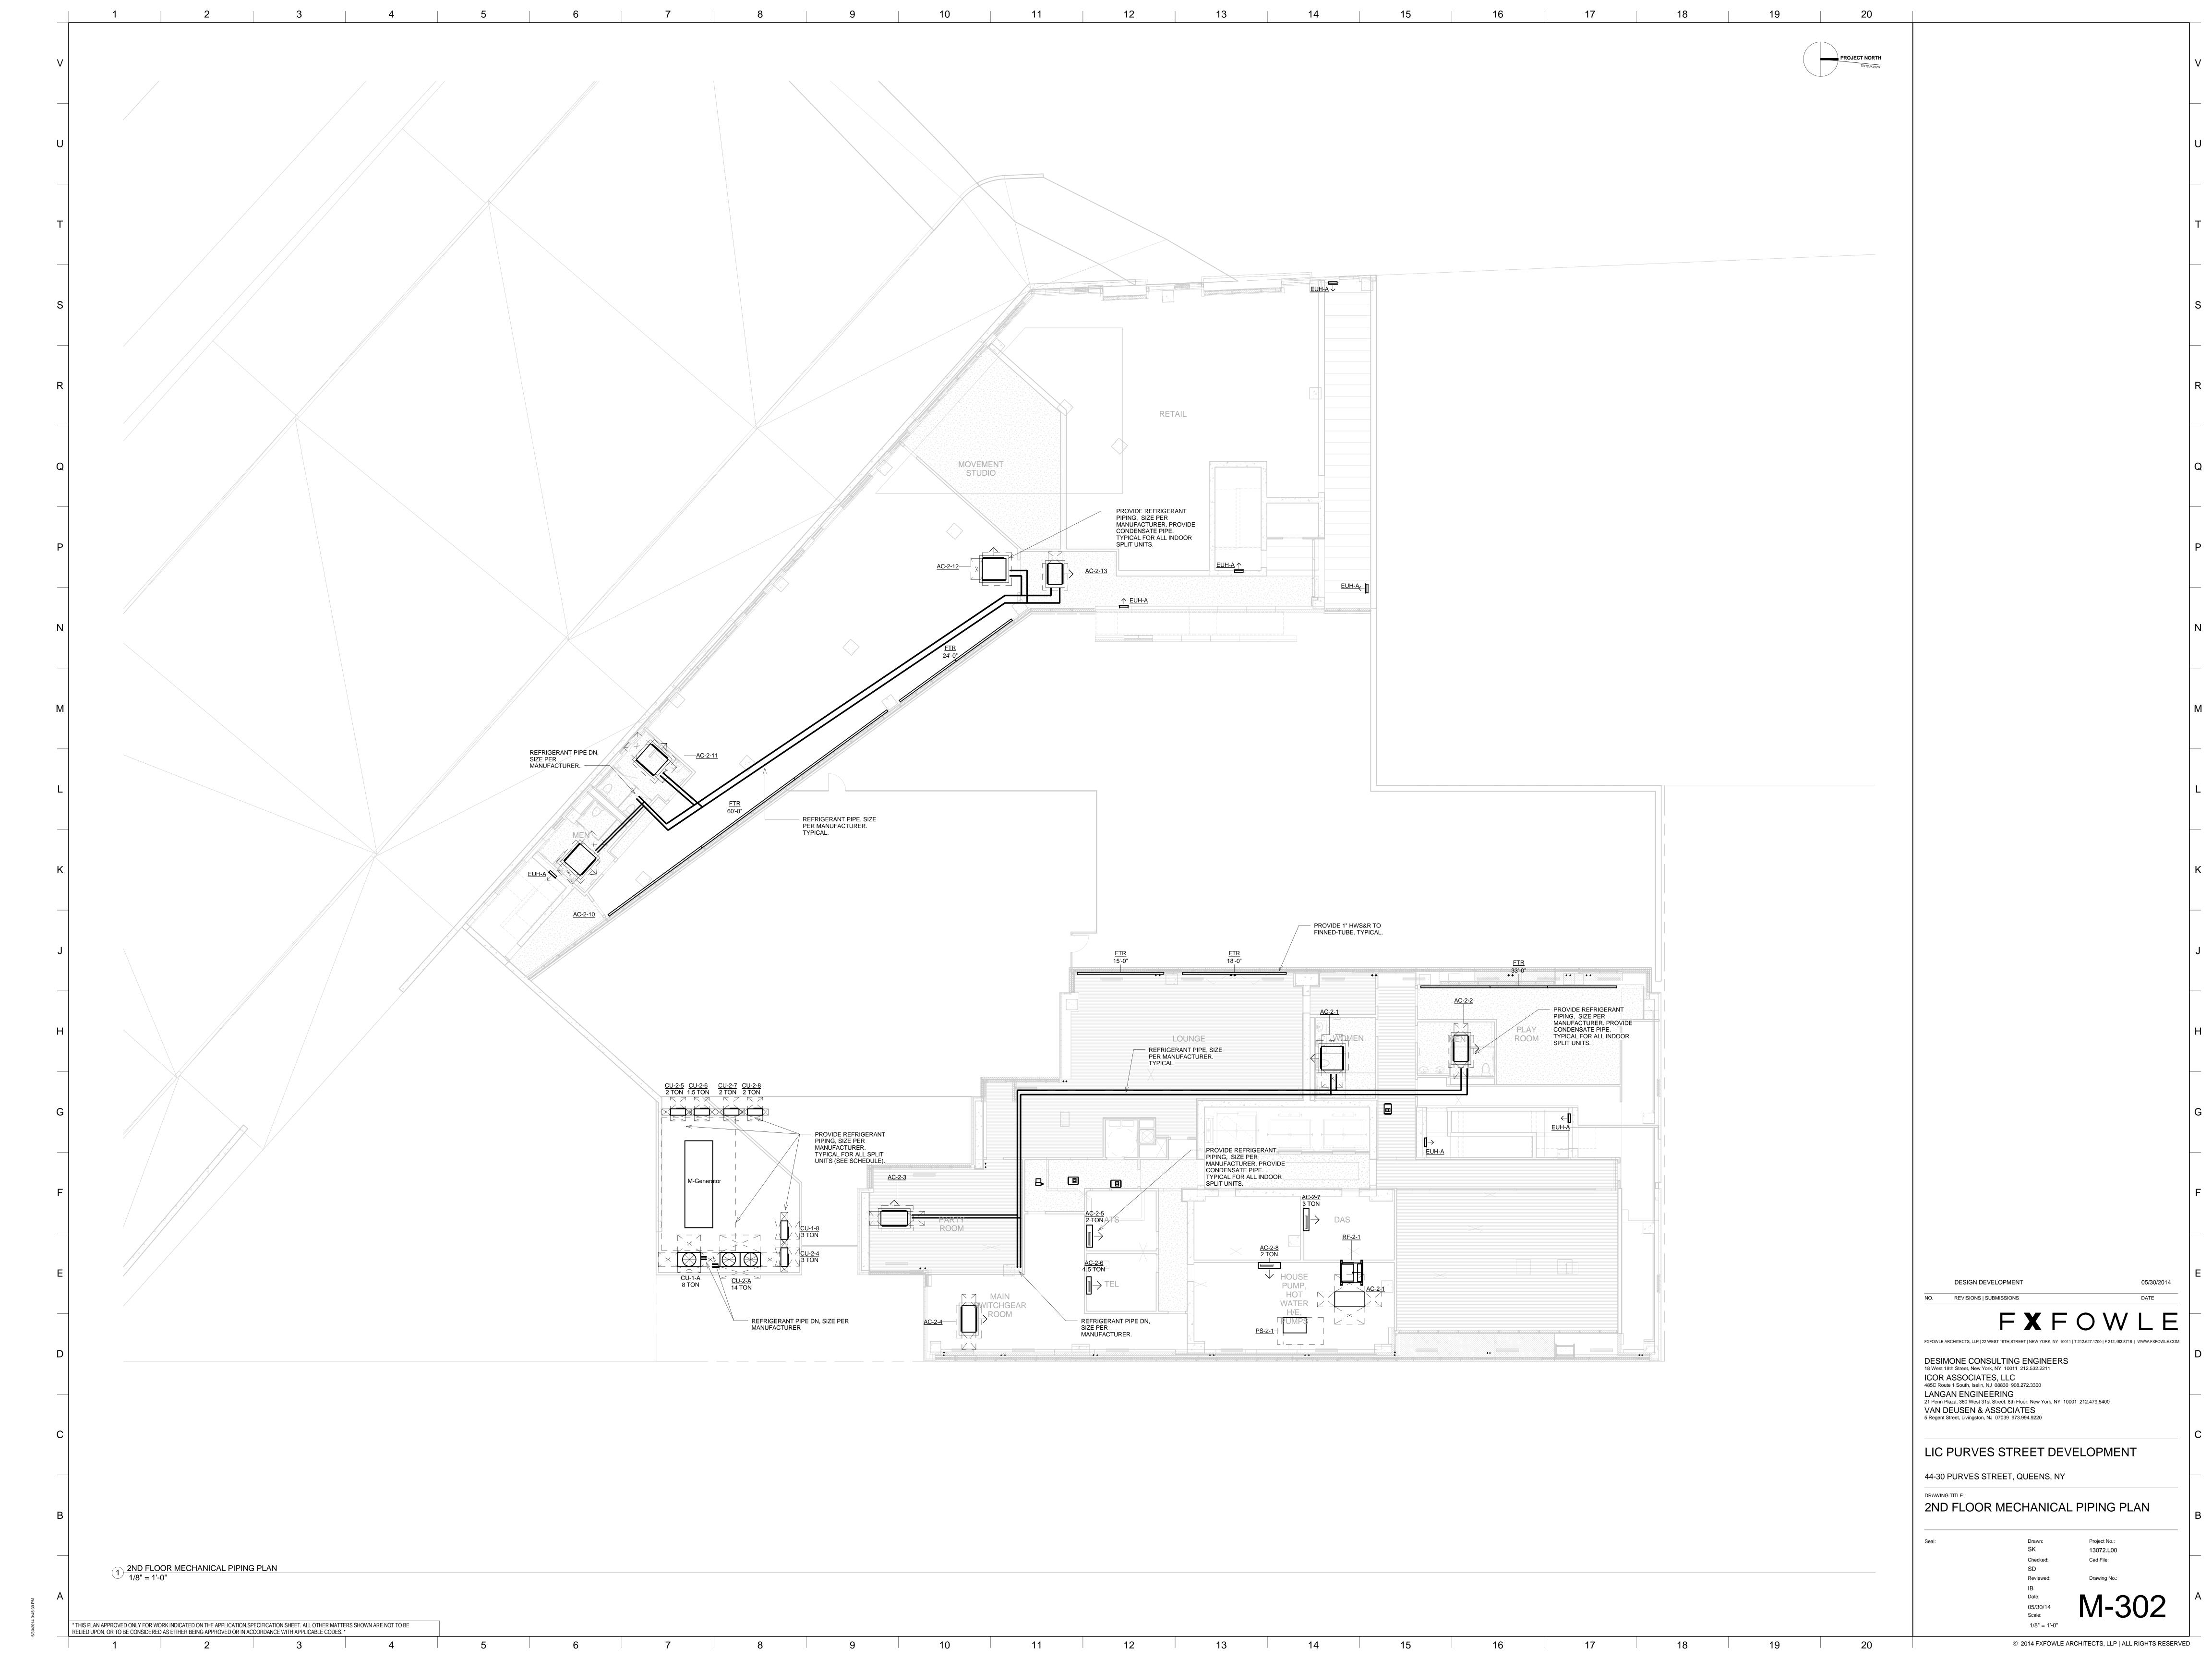
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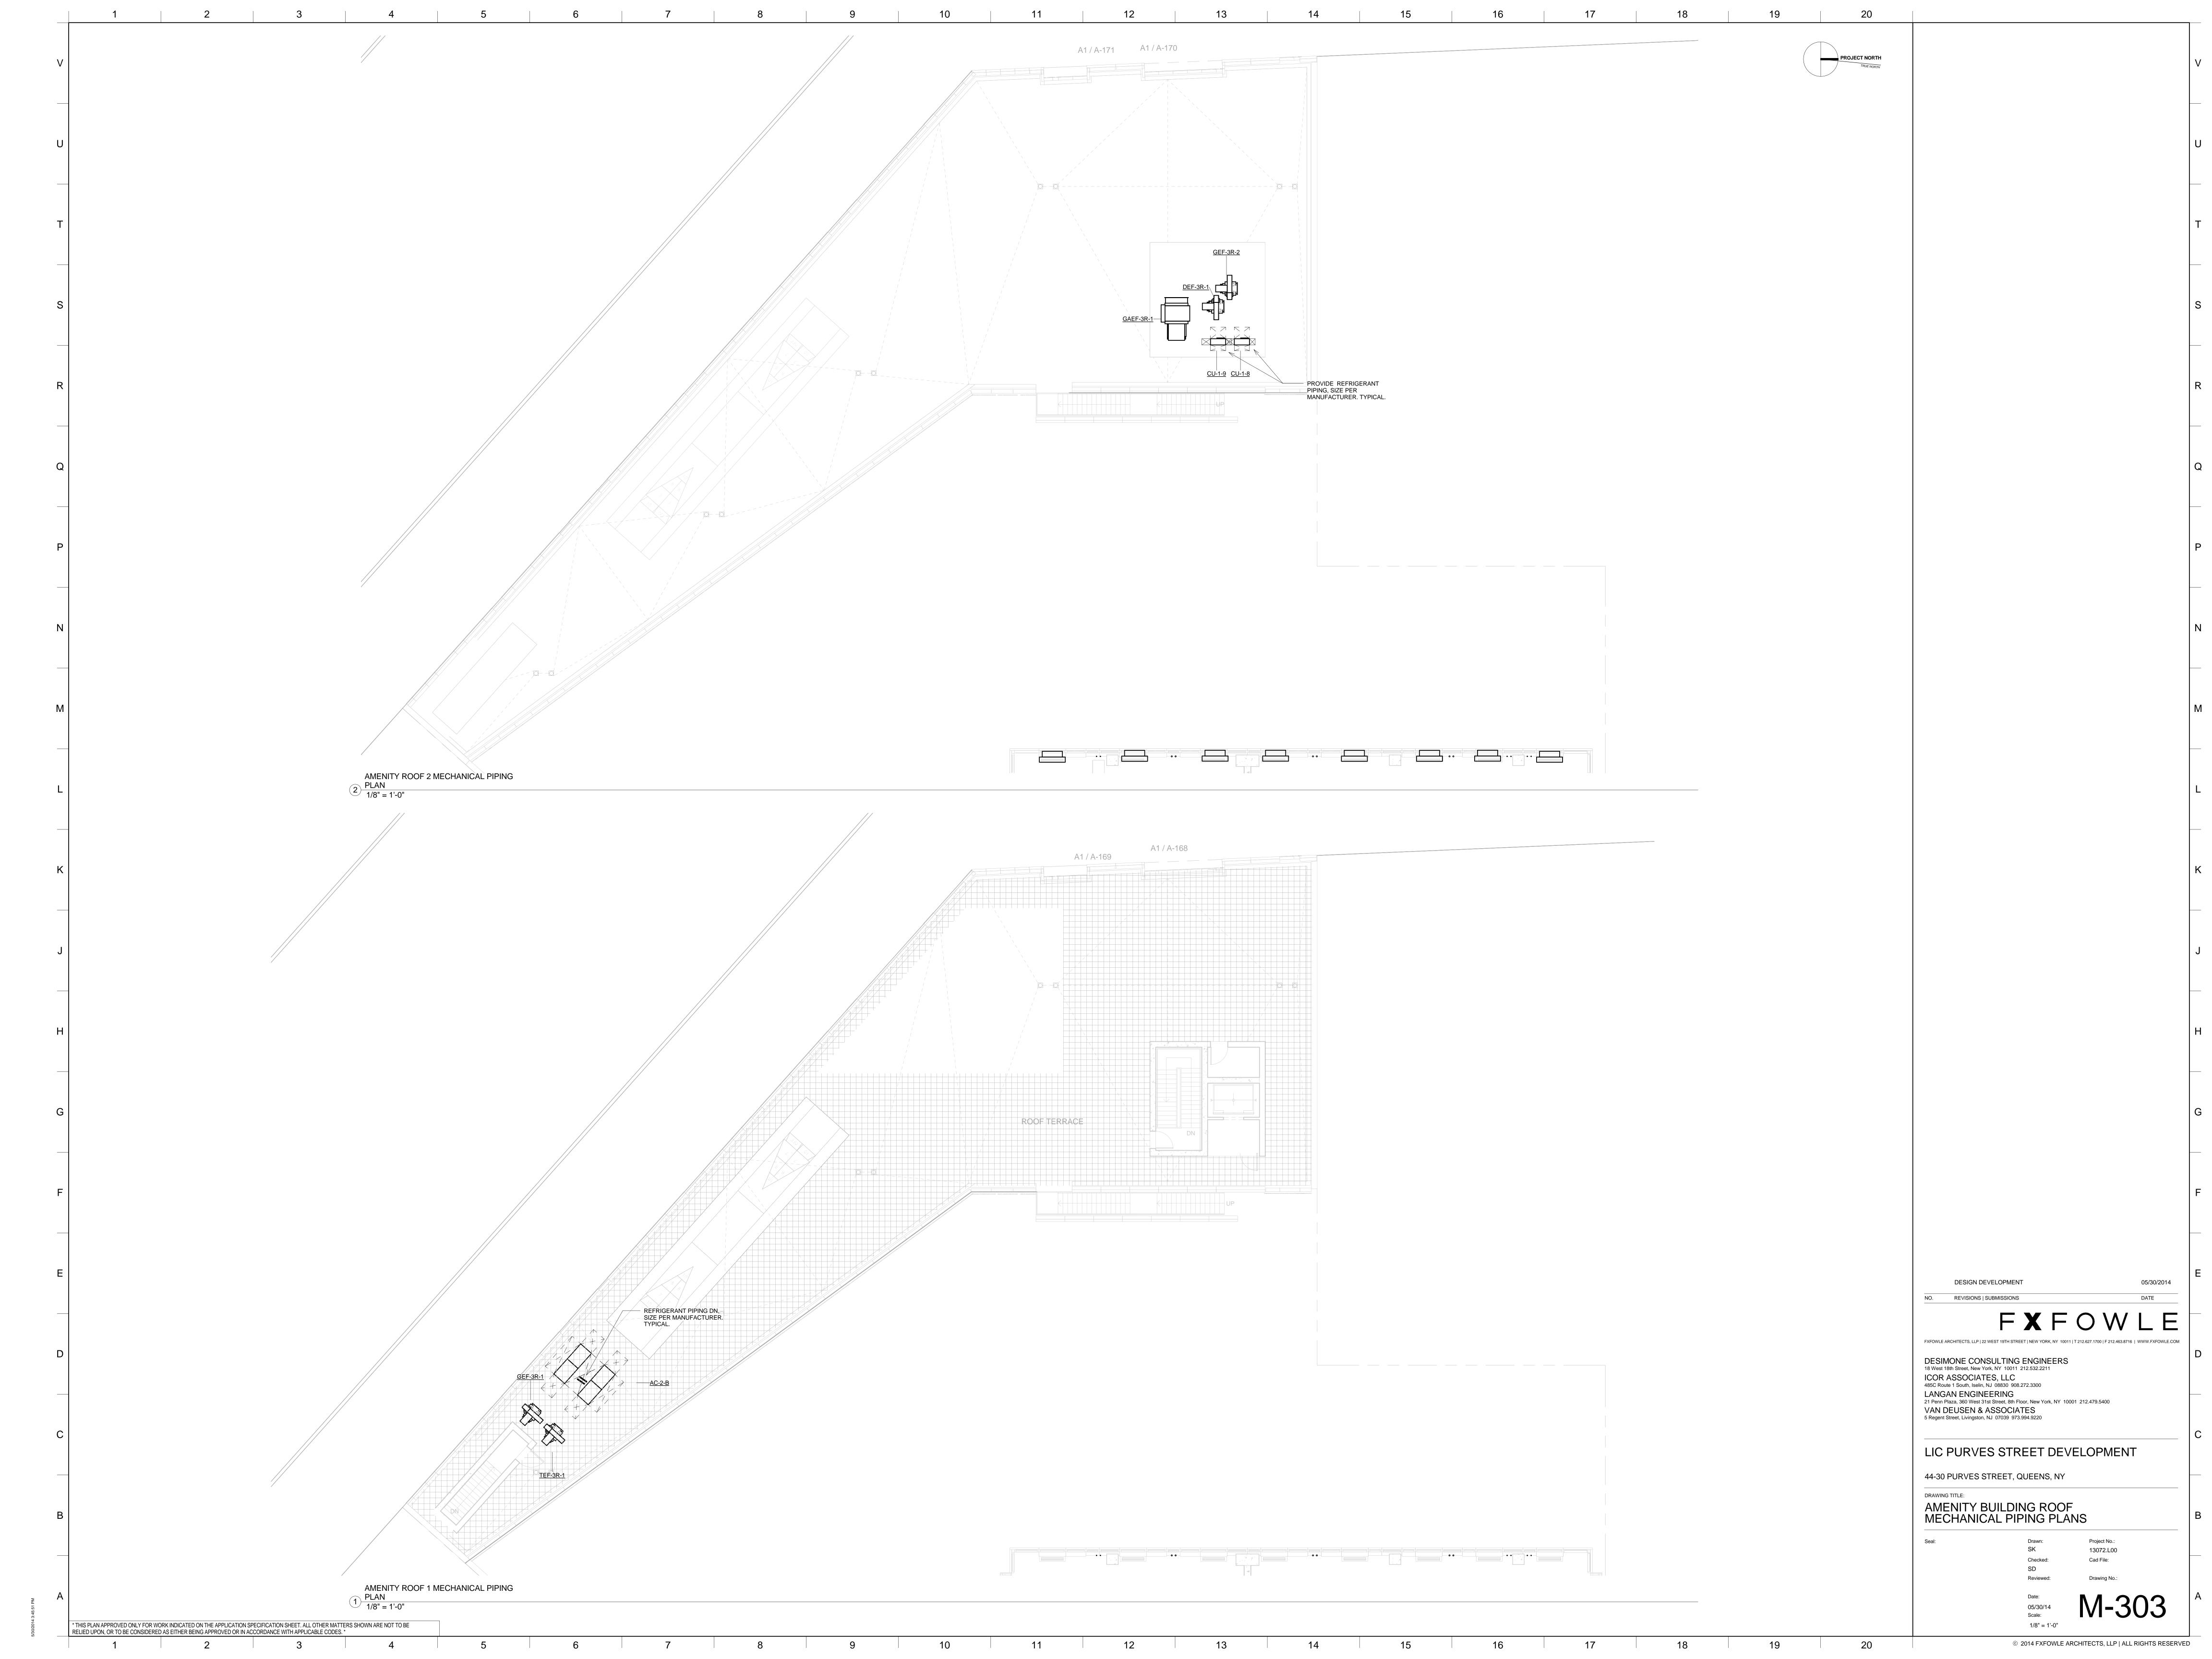
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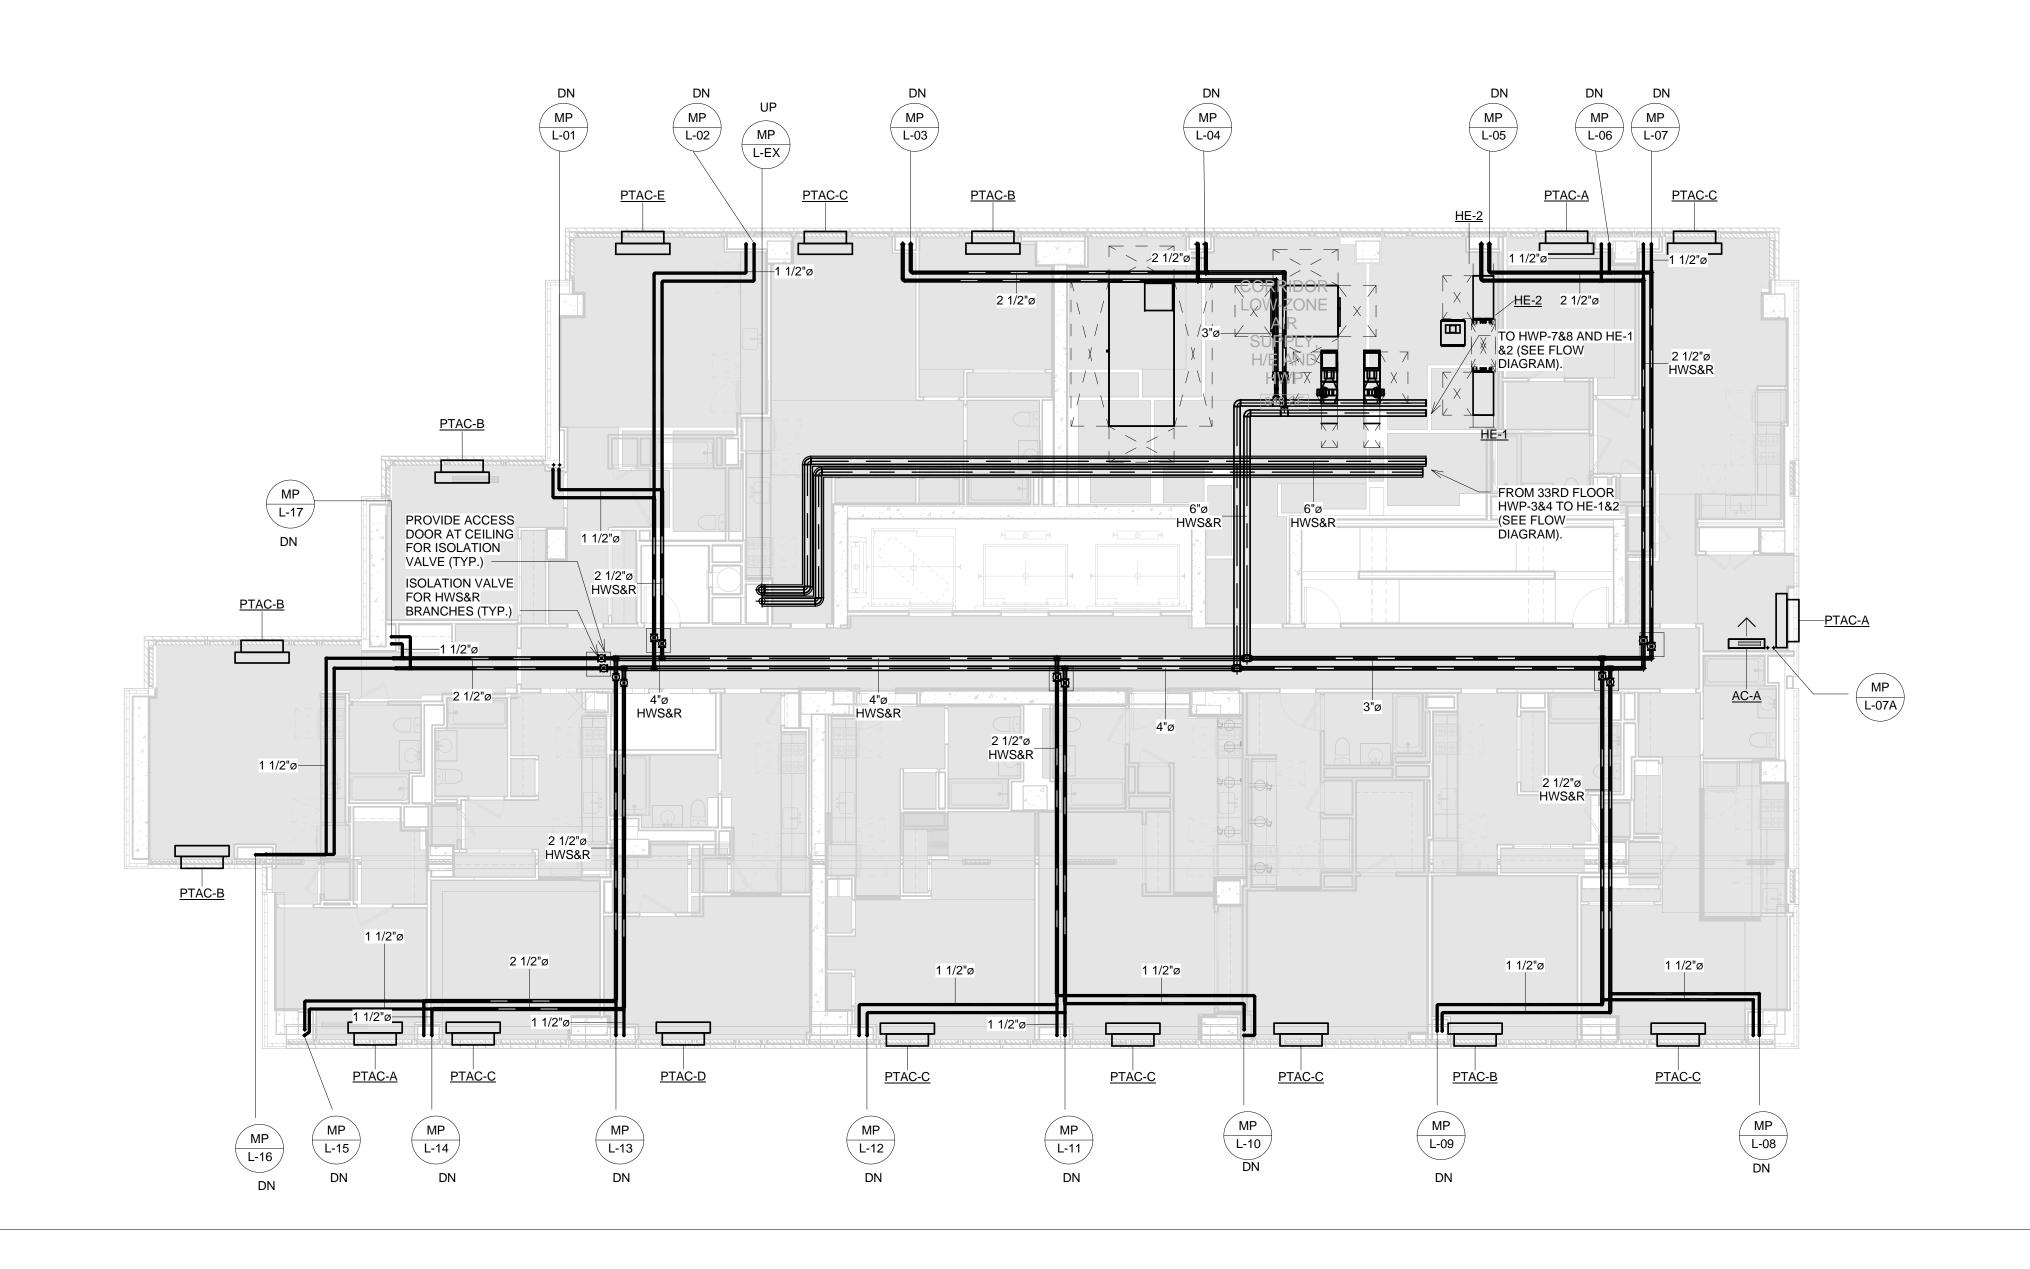
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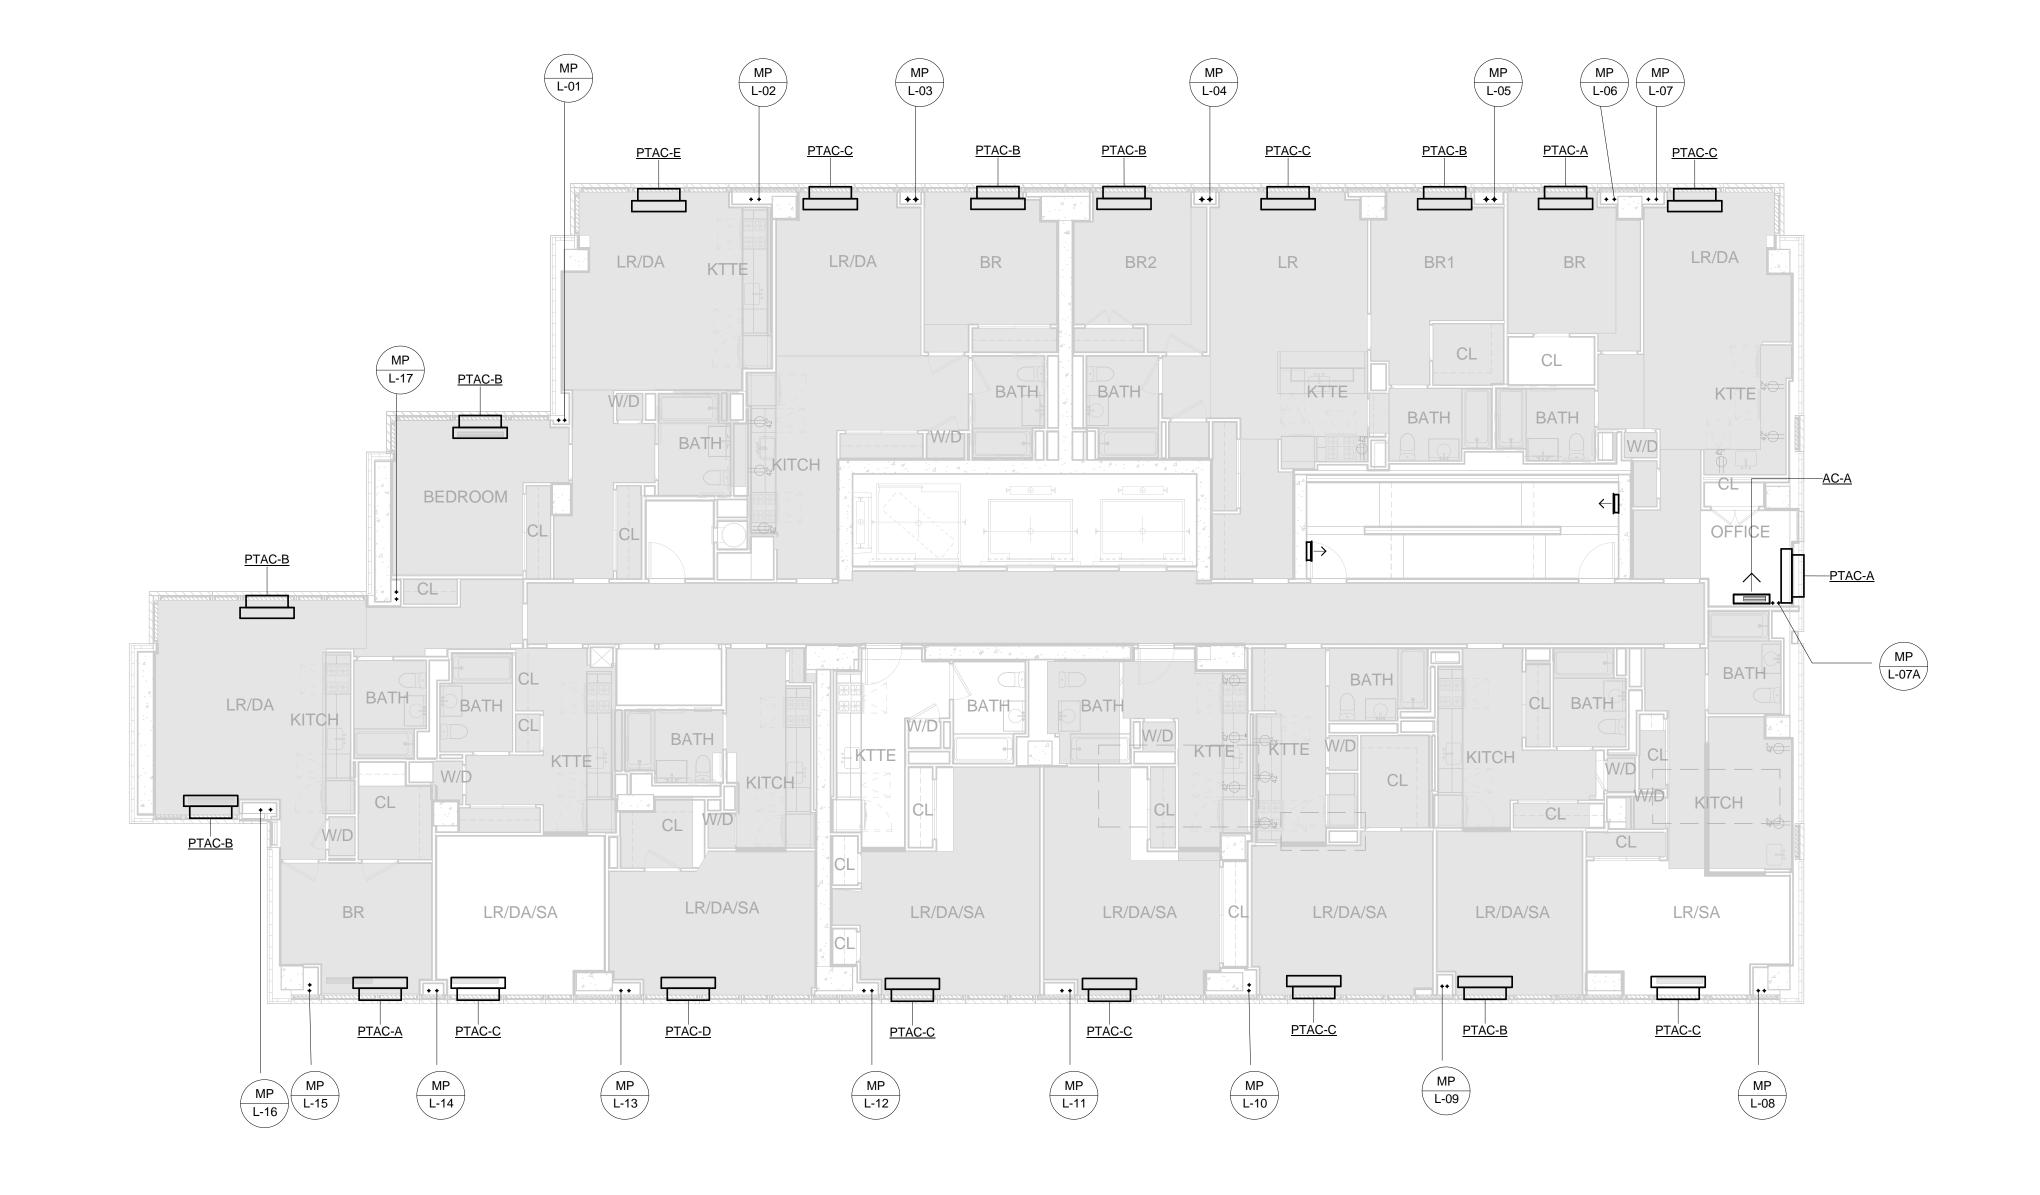
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PROJECT NORTH

LIC PURVES STREET DEVELOPMENT

44-30 PURVES STREET, QUEENS, NY

DRAWING TITLE: 3RD - 14TH FLOOR MECHANICAL PIPING PLANS

Project No.: 13072.L00 Cad File:

05/30/14 Scale: 1/8" = 1'-0"


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3RD - 13TH FLOOR MECHANICAL PIPING

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1/8" = 1'-0"

2 14TH FLOOR MECHANICAL PIPING PLAN 1/8" = 1'-0"



LR/DA KTTE MP H-15 PTAC-B KTTE LR/DA KTTE LR/DA PTAC-A PTAC-A PTAC-D PTAC-D PTAC-A MP H-10 MP H-09 H-11
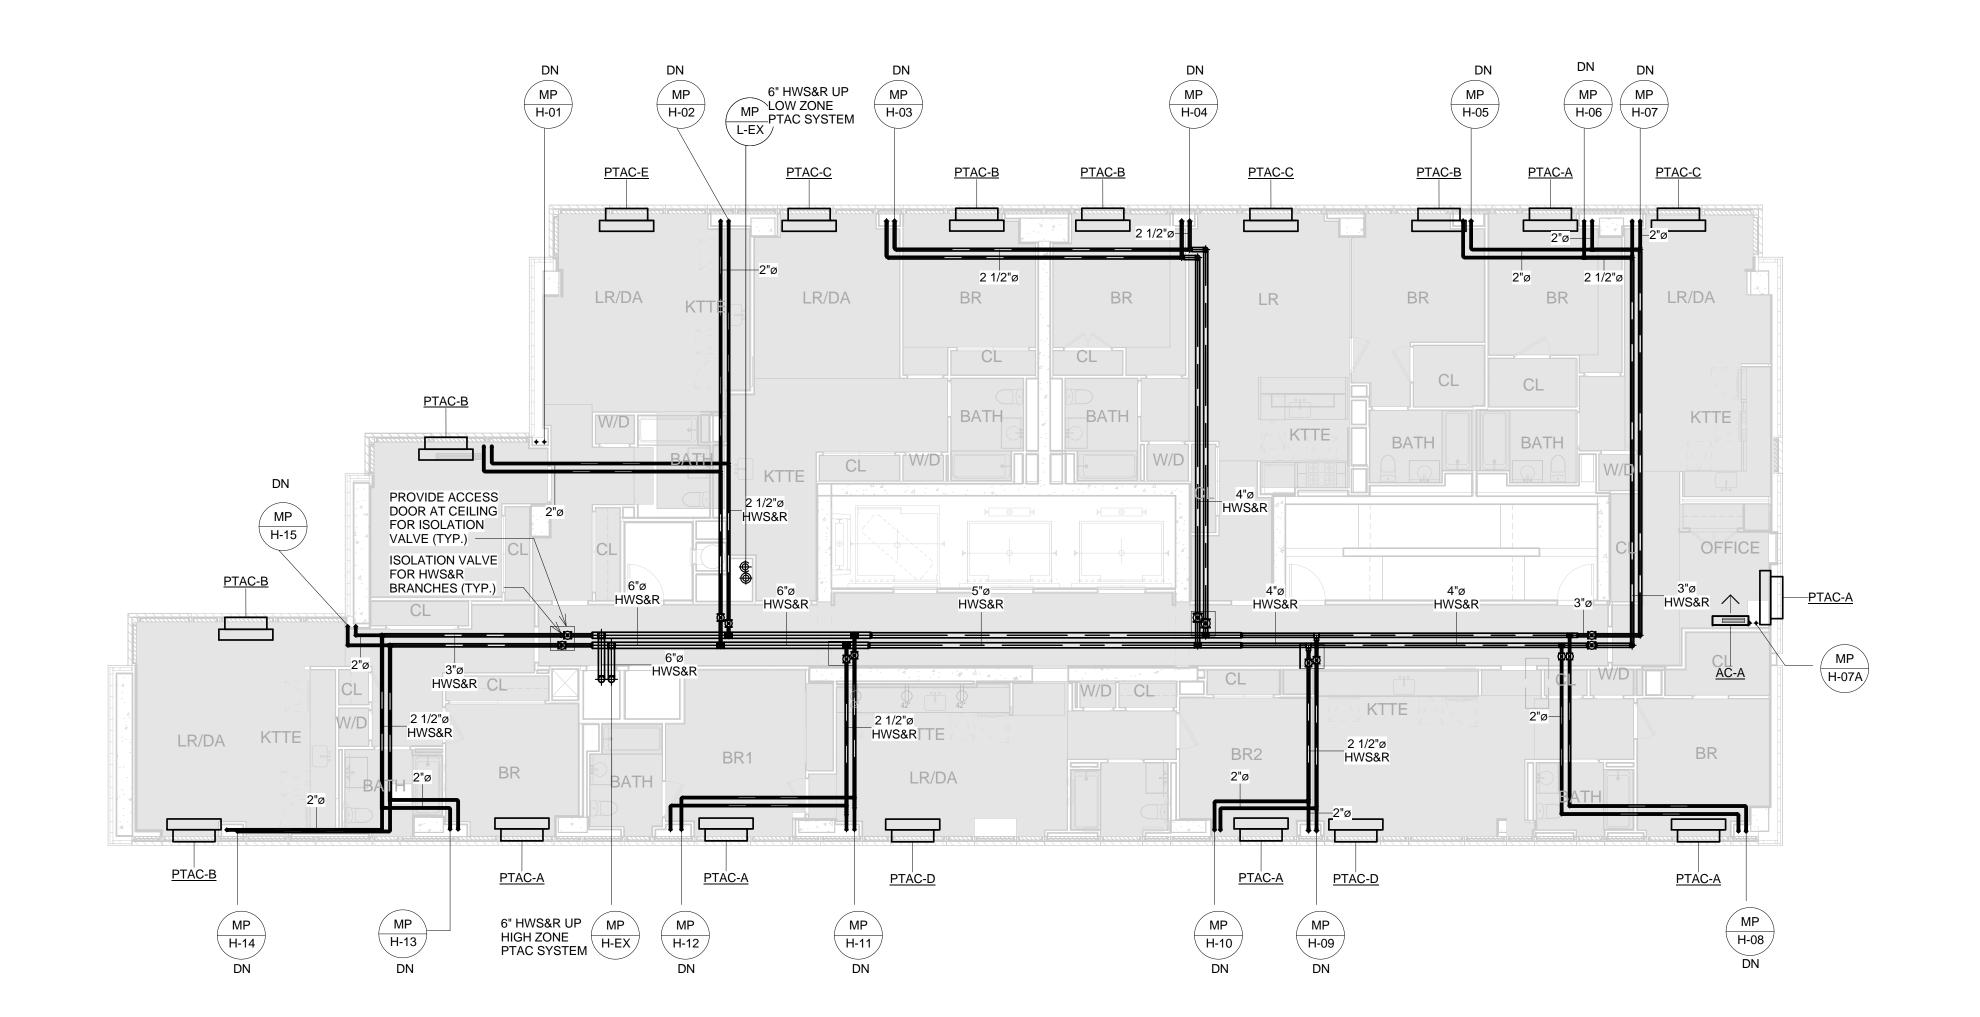
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PROJECT NORTH

TRUE NORTH

LIC PURVES STREET DEVELOPMENT

44-30 PURVES STREET, QUEENS, NY

15TH - 32ND FLOOR MECHANICAL PIPING PLANS

Project No.: 13072.L00 Cad File:


15TH - 31ST FLOOR MECHANICAL PIPING

2 32ND FLOOR MECHANICAL PIPING PLAN 1/8" = 1'-0"


1 PLAN 1/8" = 1'-0"

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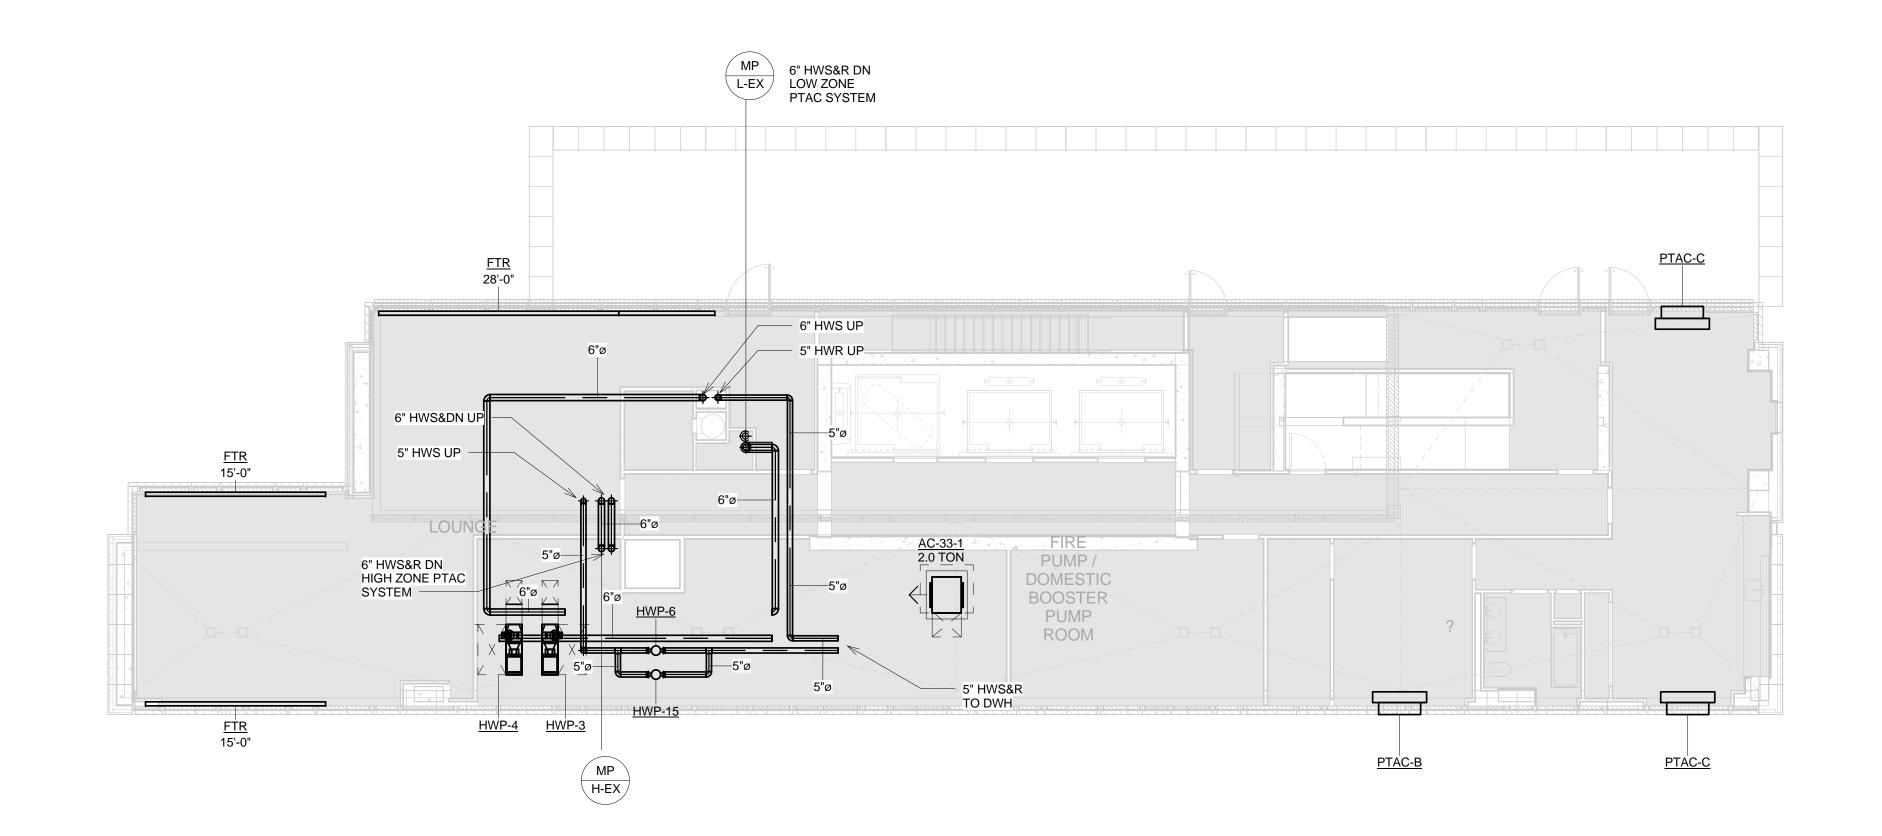
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3 EMR MECHANICAL PIPING PLAN 1/8" = 1'-0"

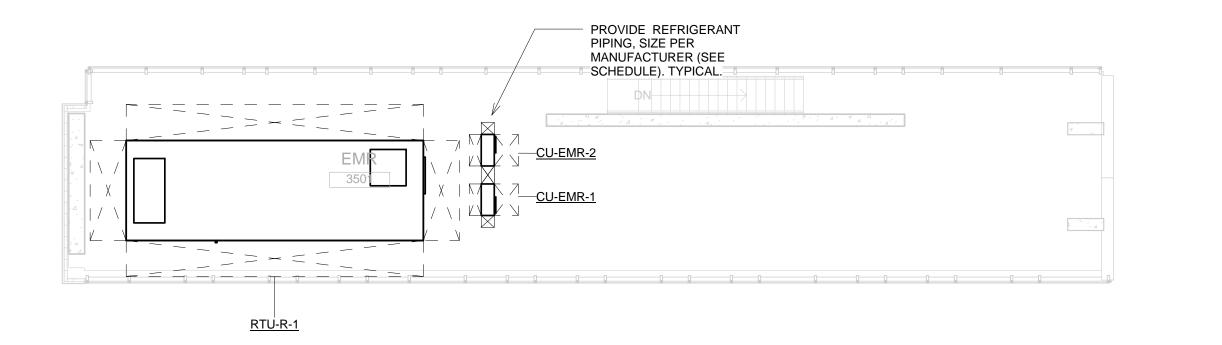

LOWER ROOF MECHANICAL PIPING
PLAN
1/8" = 1'-0"

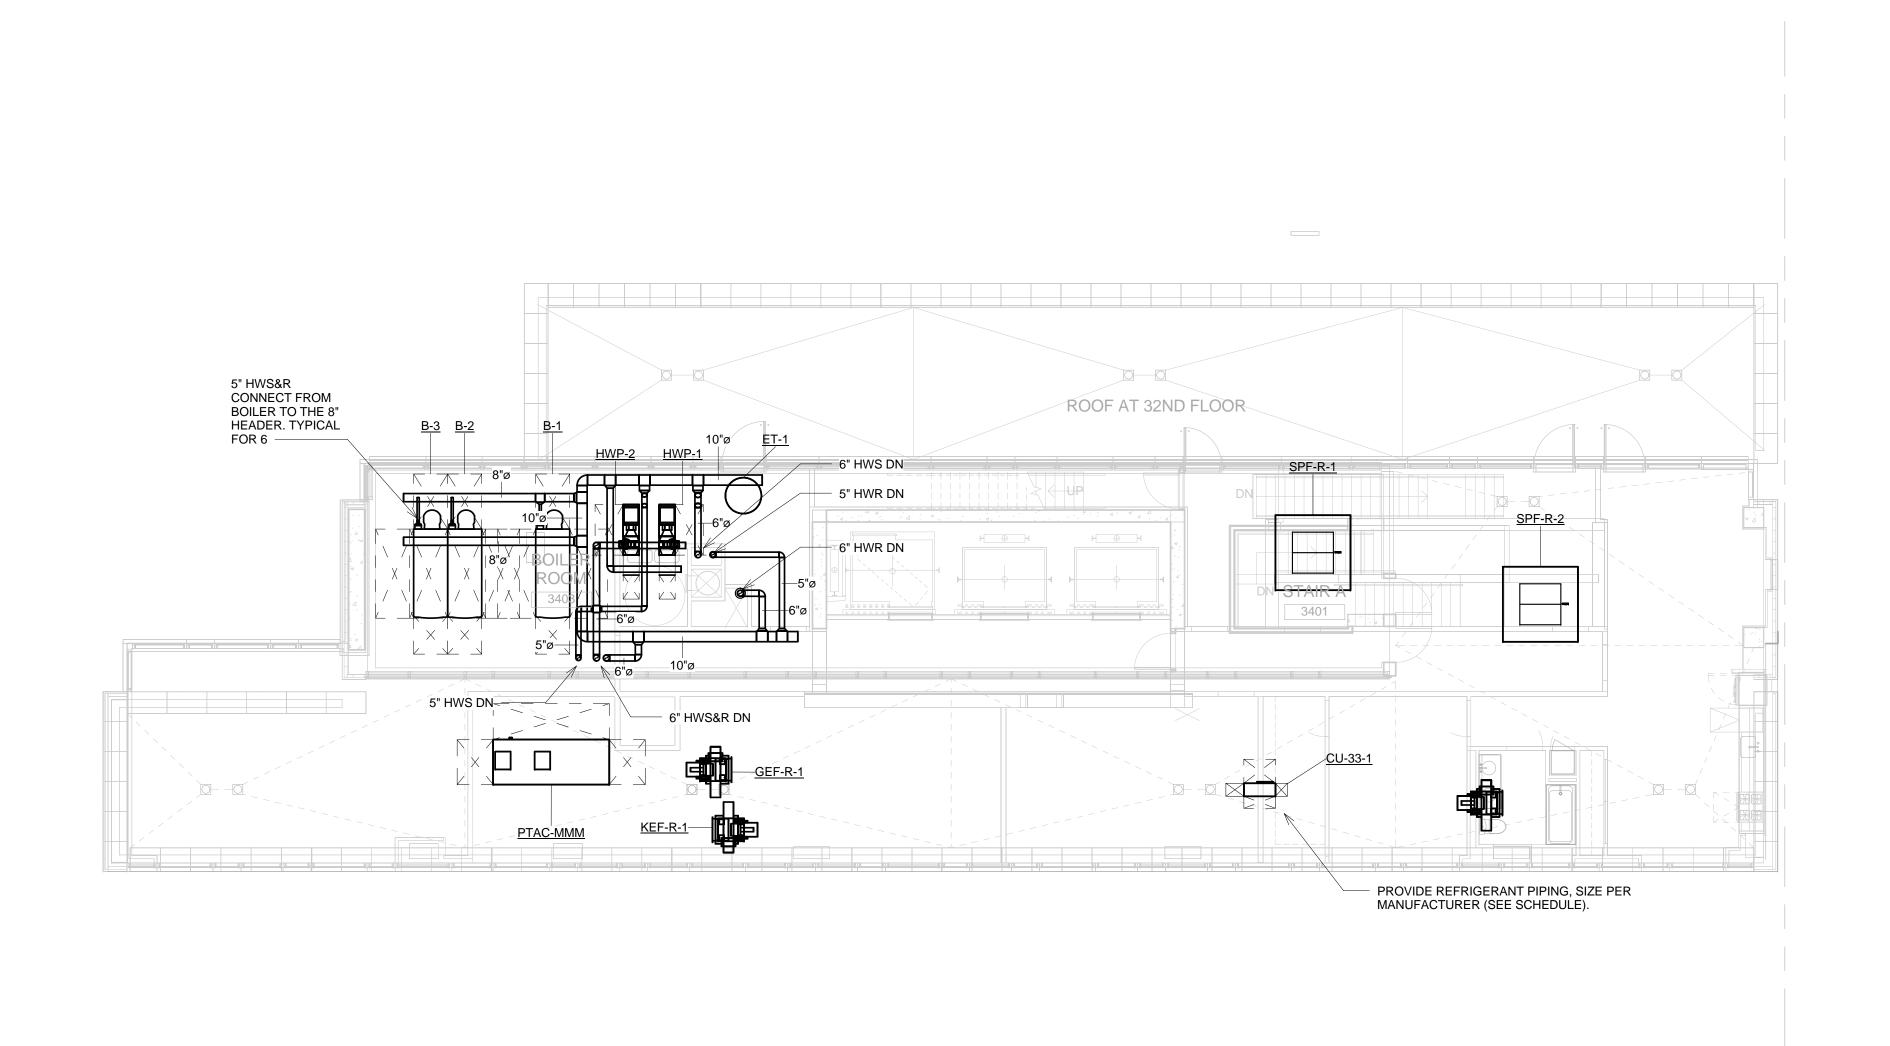

1) 33RD FLOOR MECHANICAL PIPING PLAN 1/8" = 1'-0"

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ICOR ASSOCIATES, LLC
485C Route 1 South, Iselin, NJ 08830 908.272.3300
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LIC PURVES STREET DEVELOPMENT

44-30 PURVES STREET, QUEENS, NY


33RD FLOOR, LOWER ROOF & EMR MECHANICAL PIPING PLAN

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SD
Reviewed:


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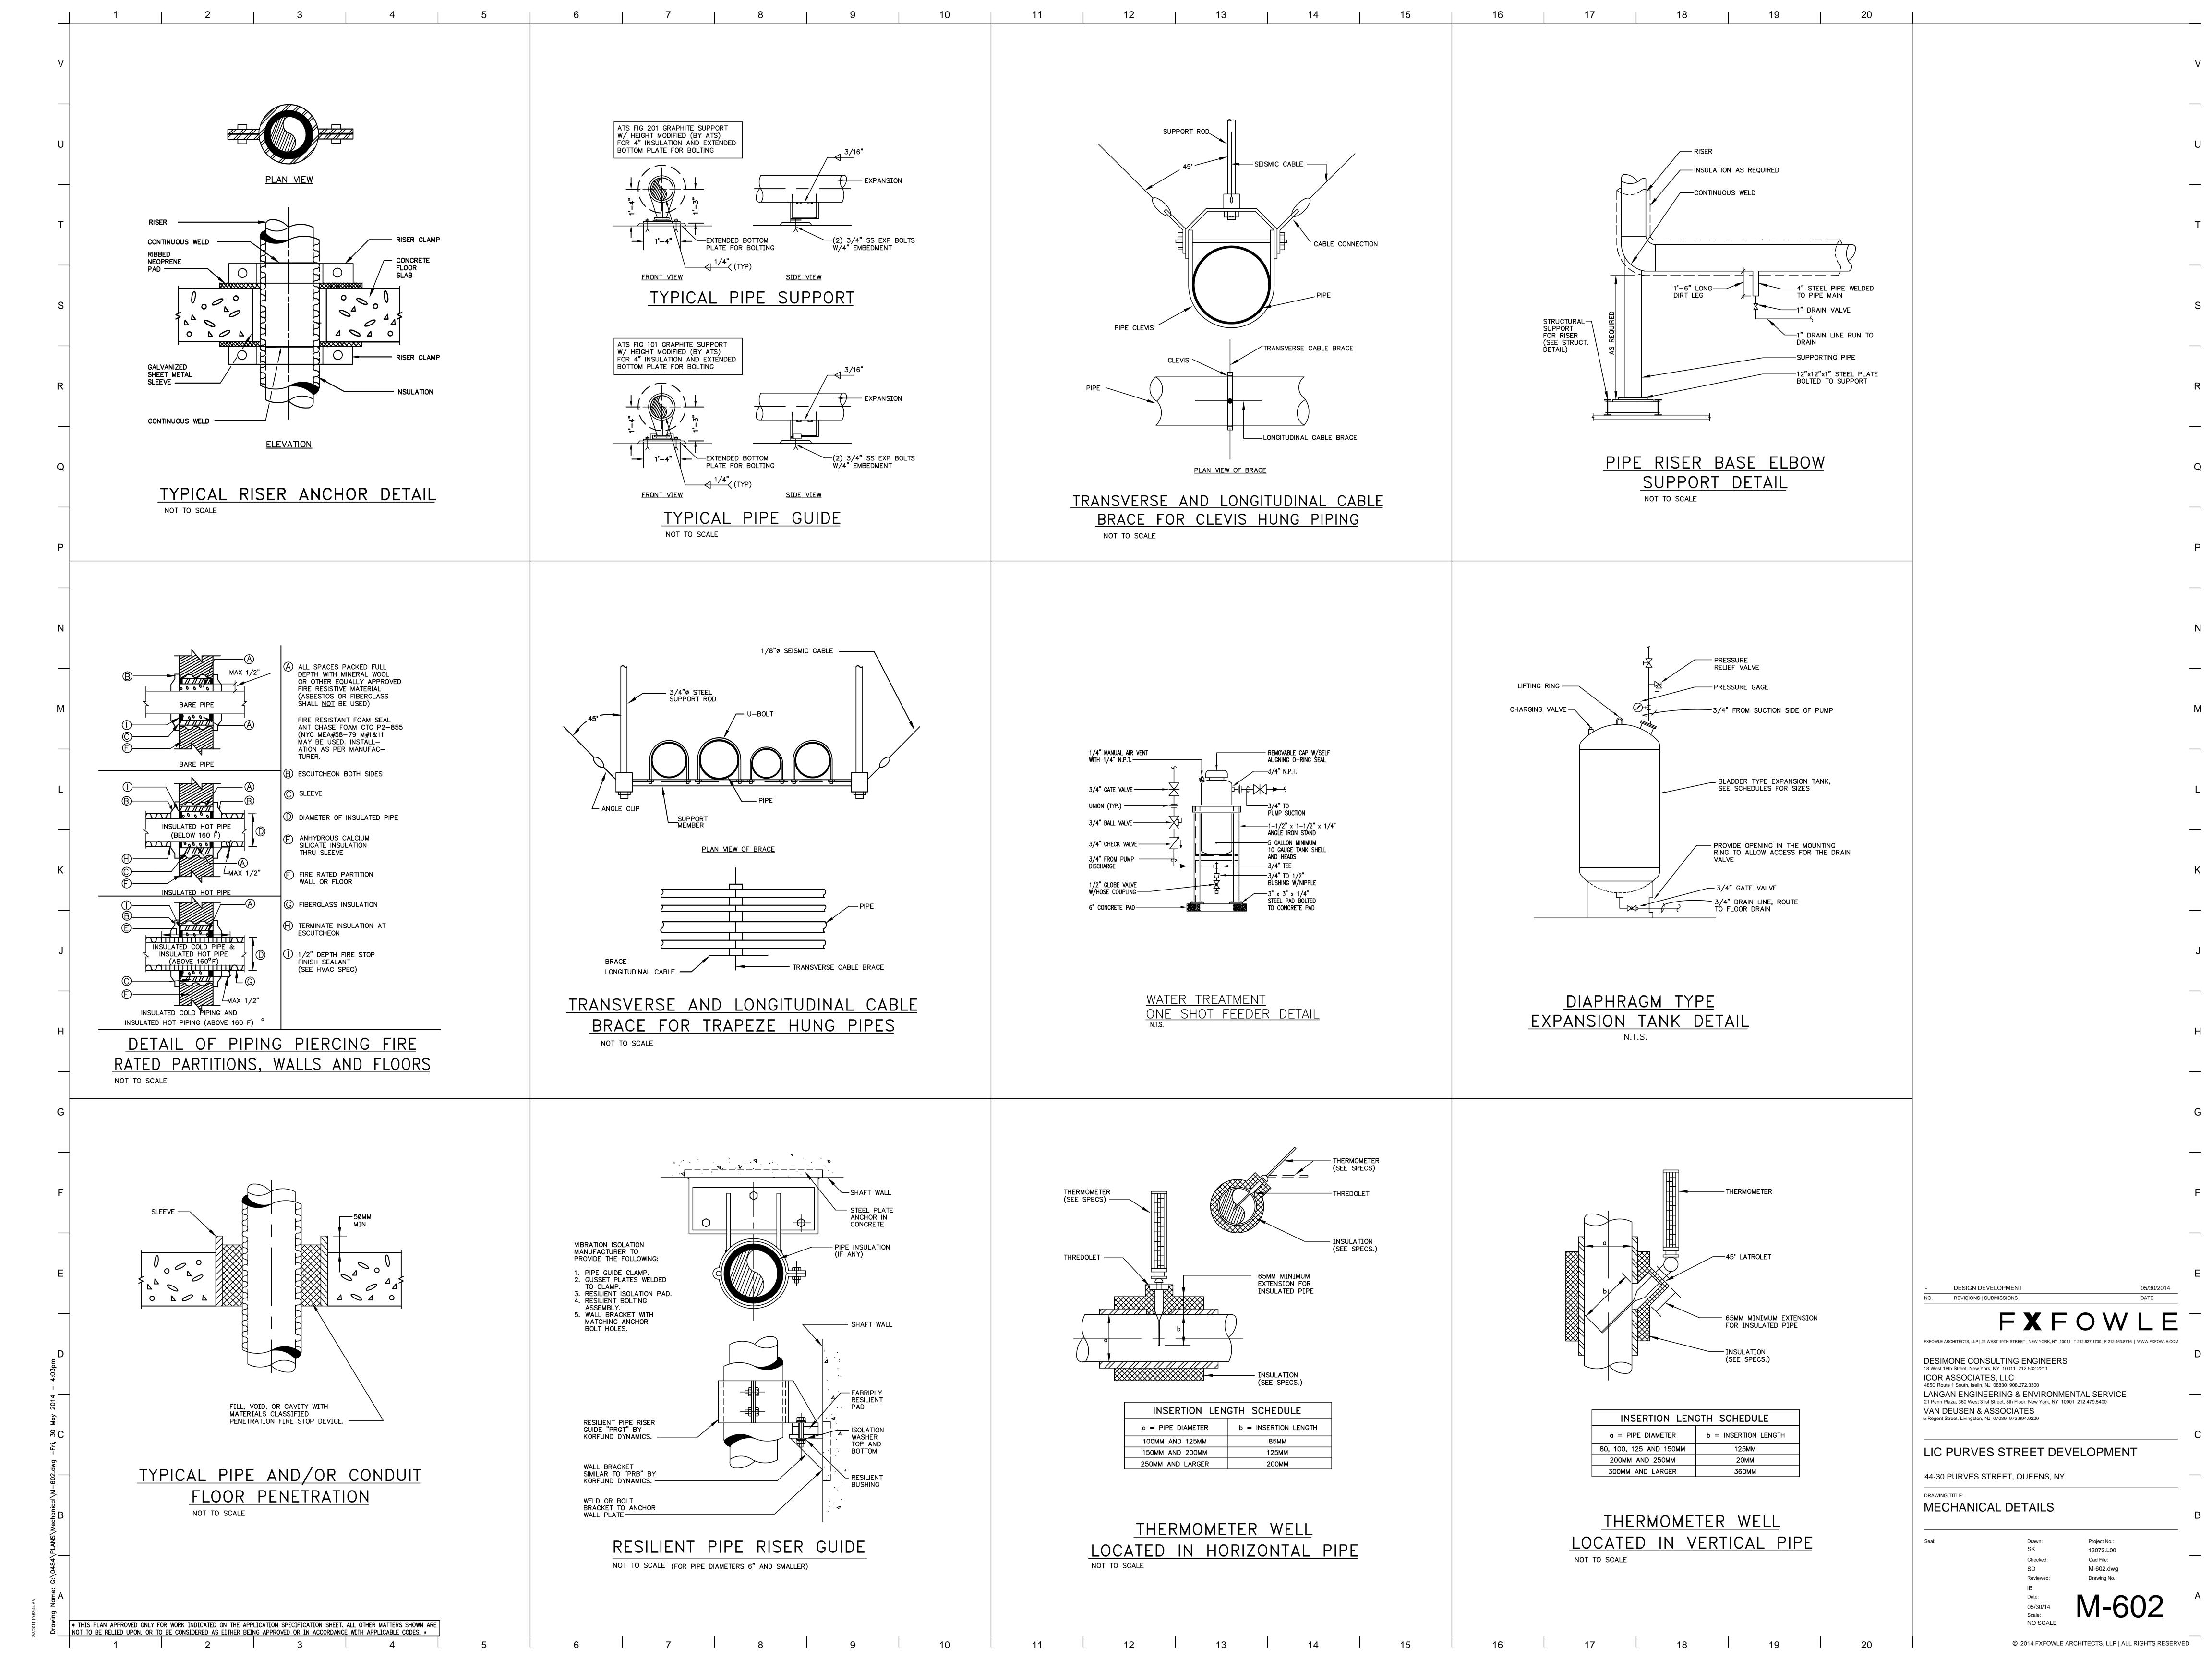
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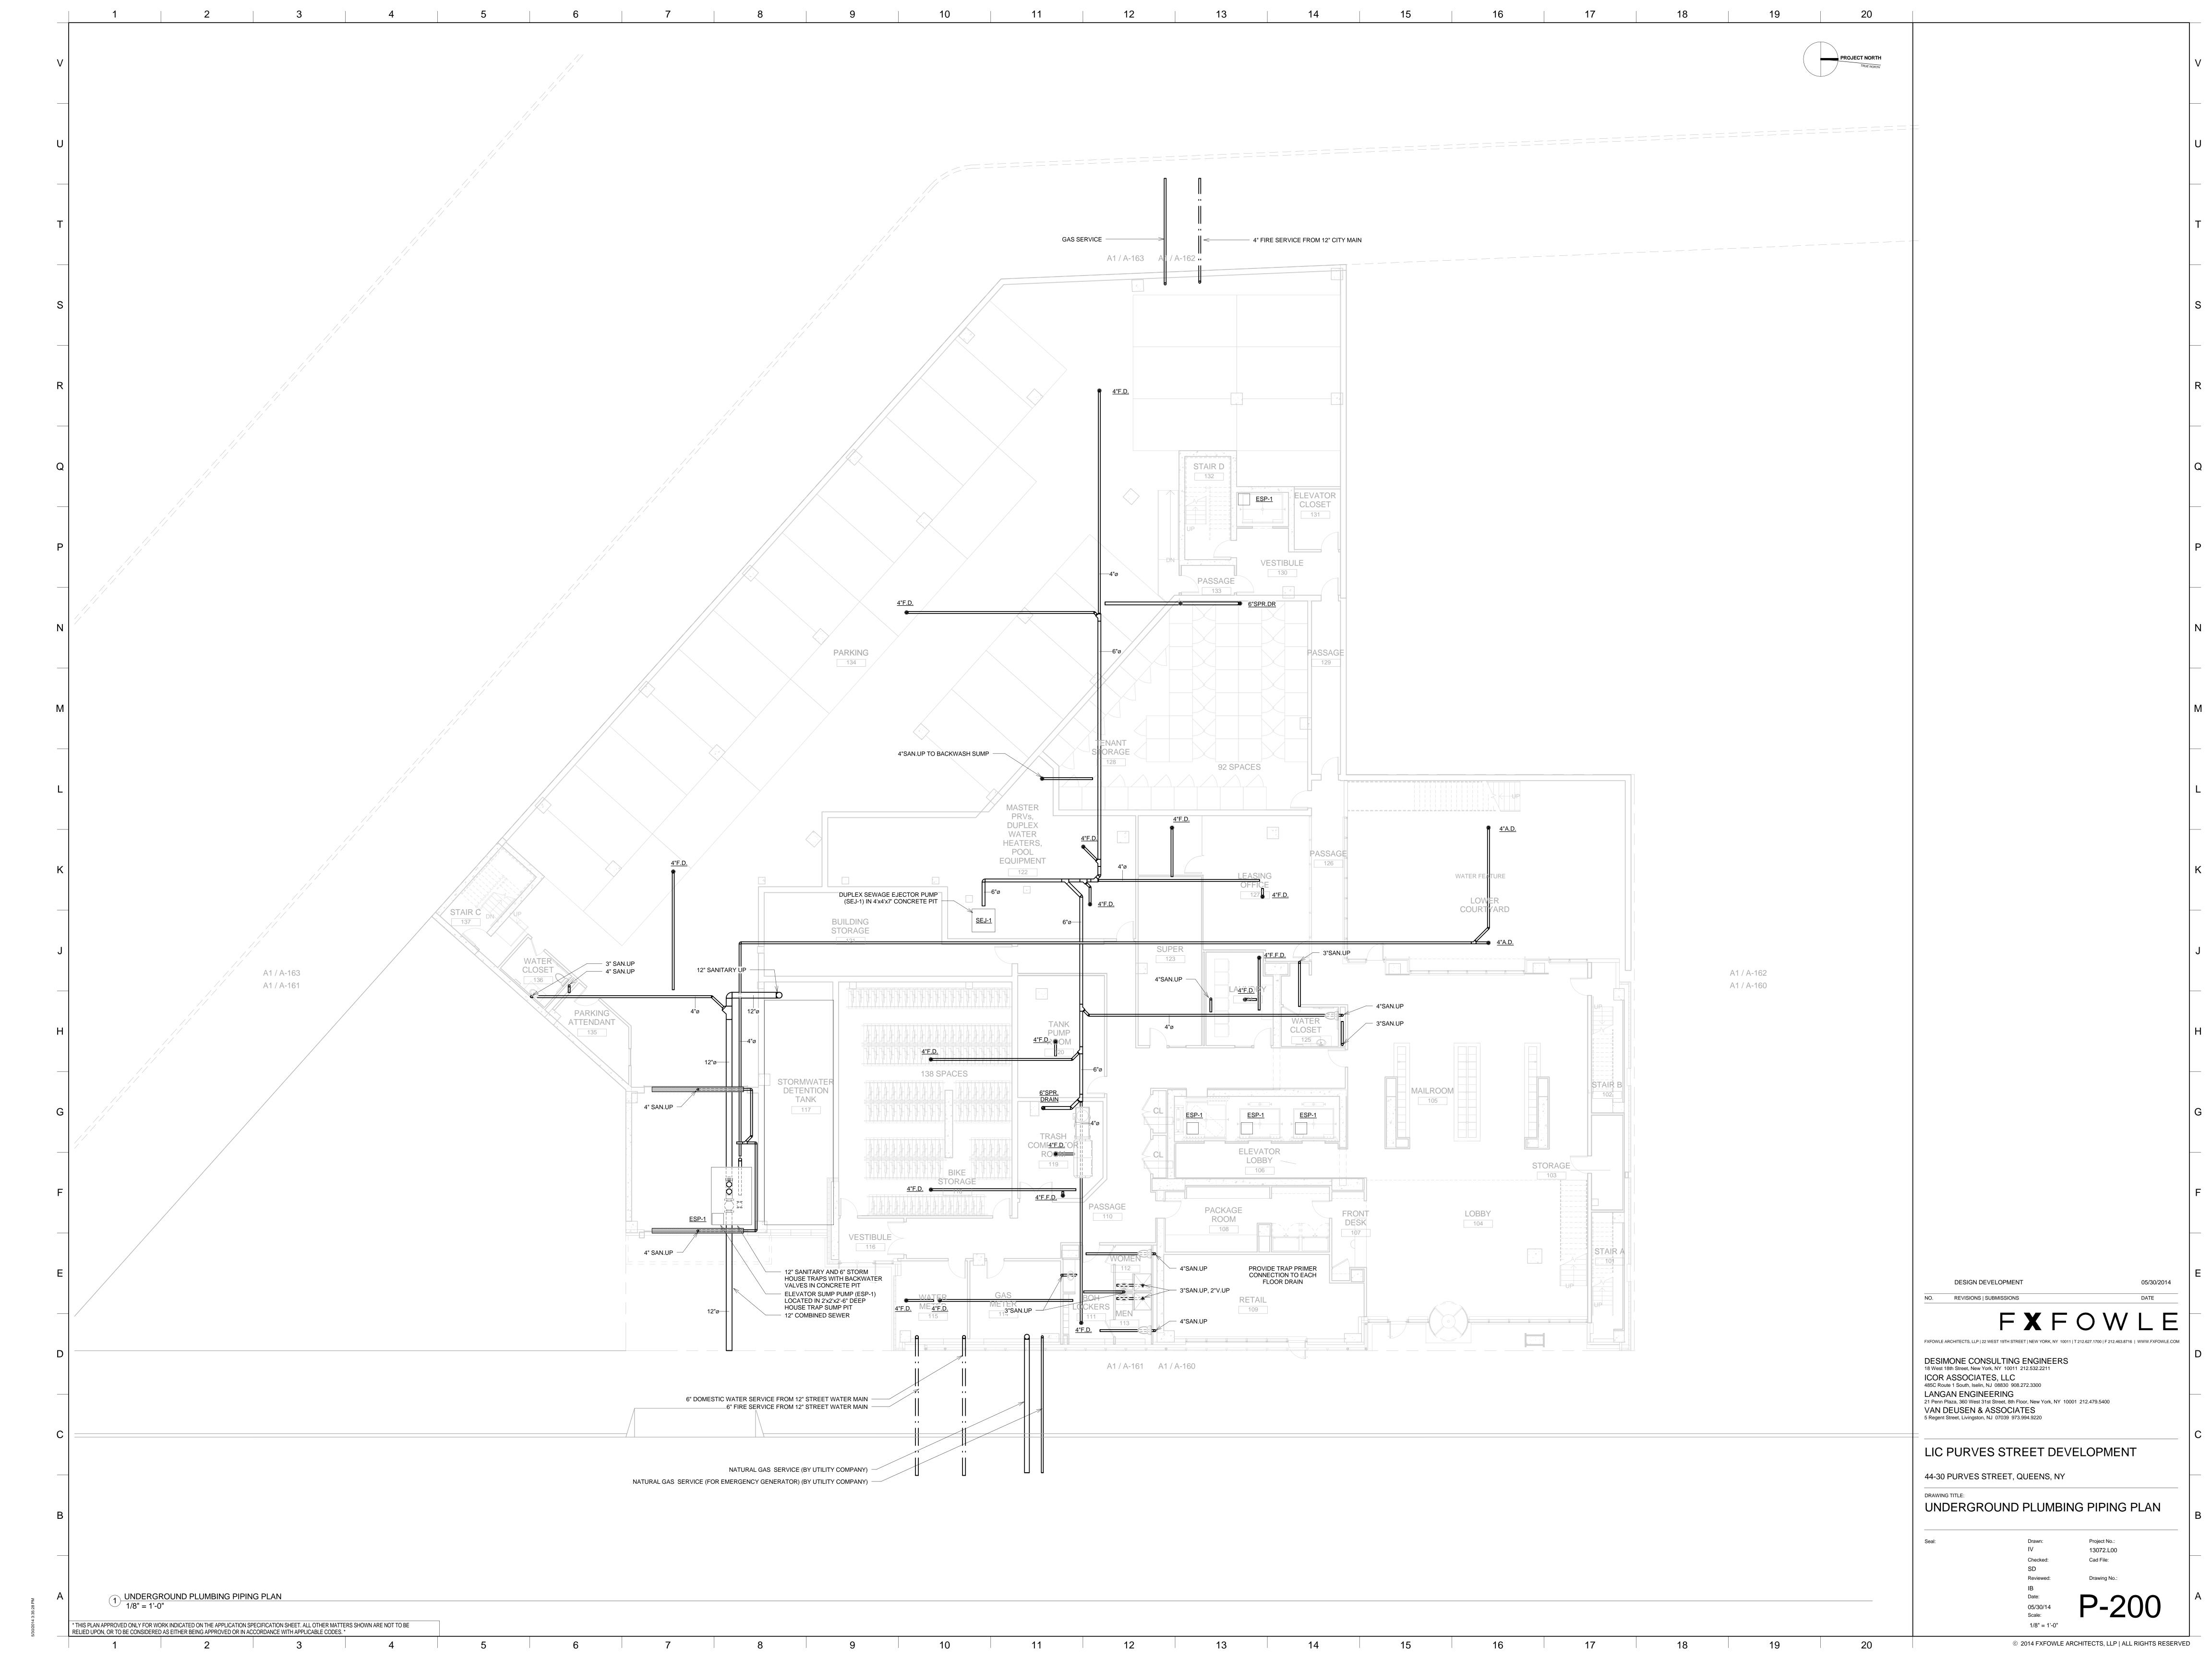
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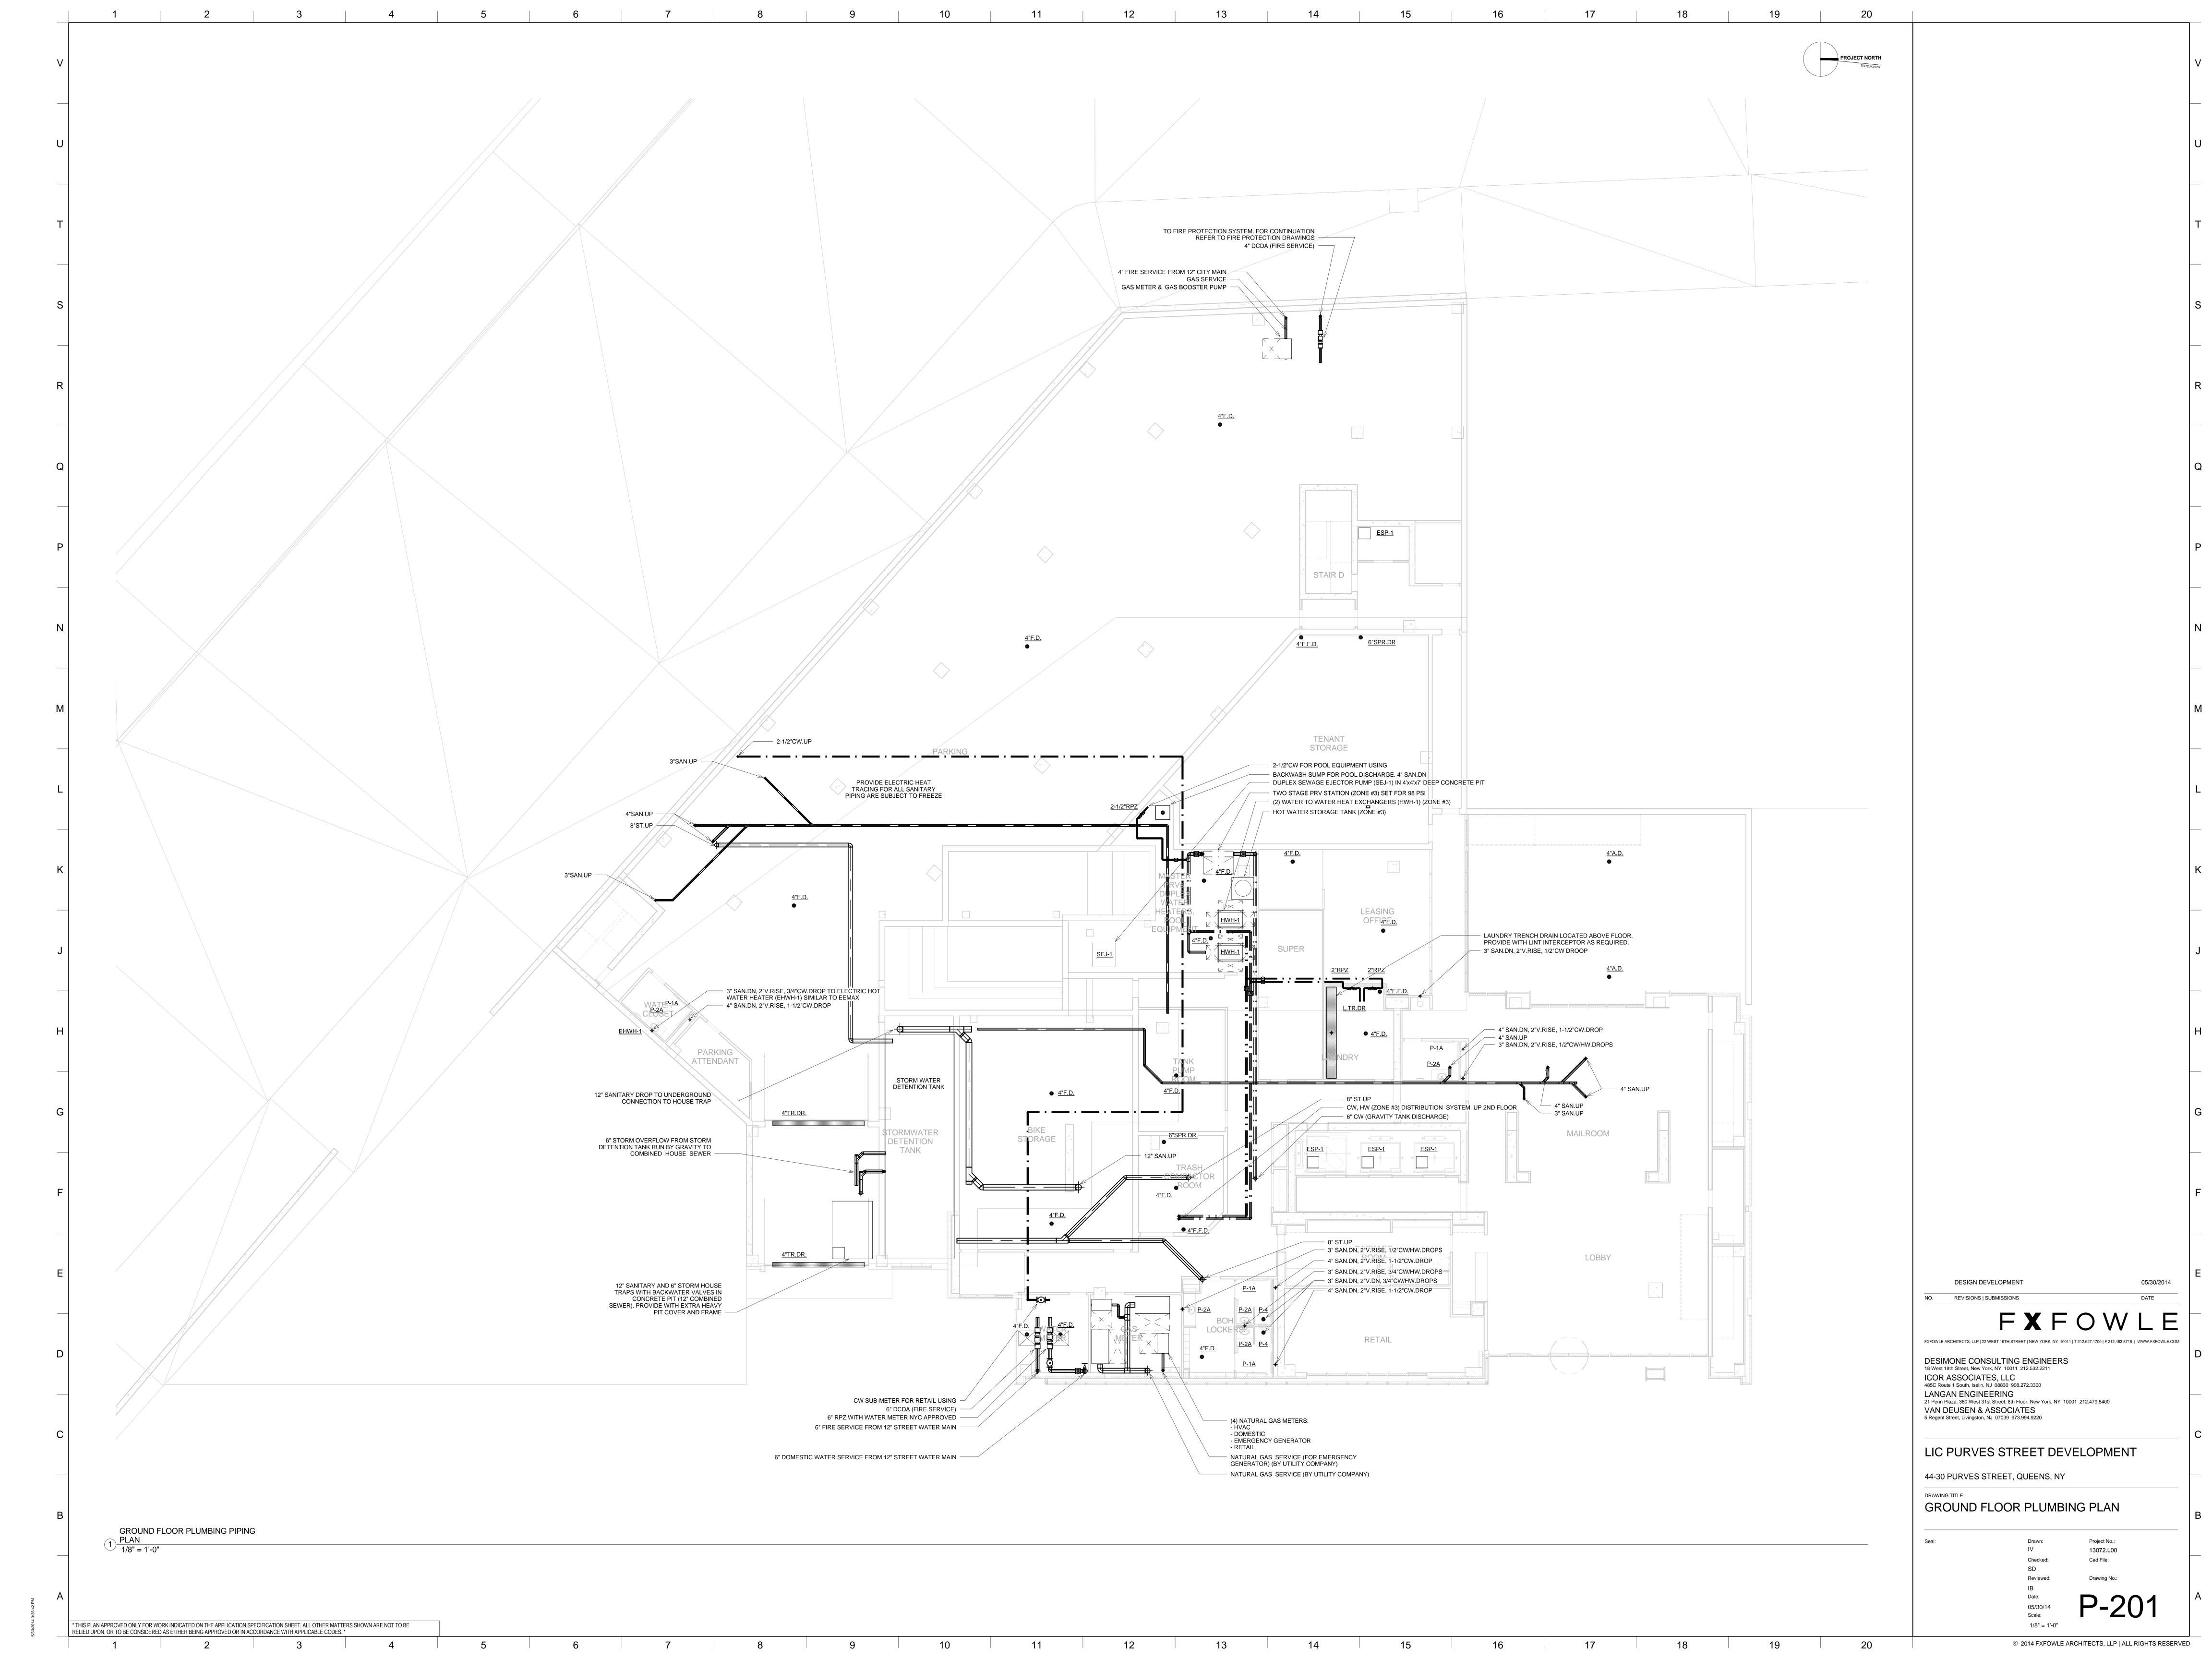








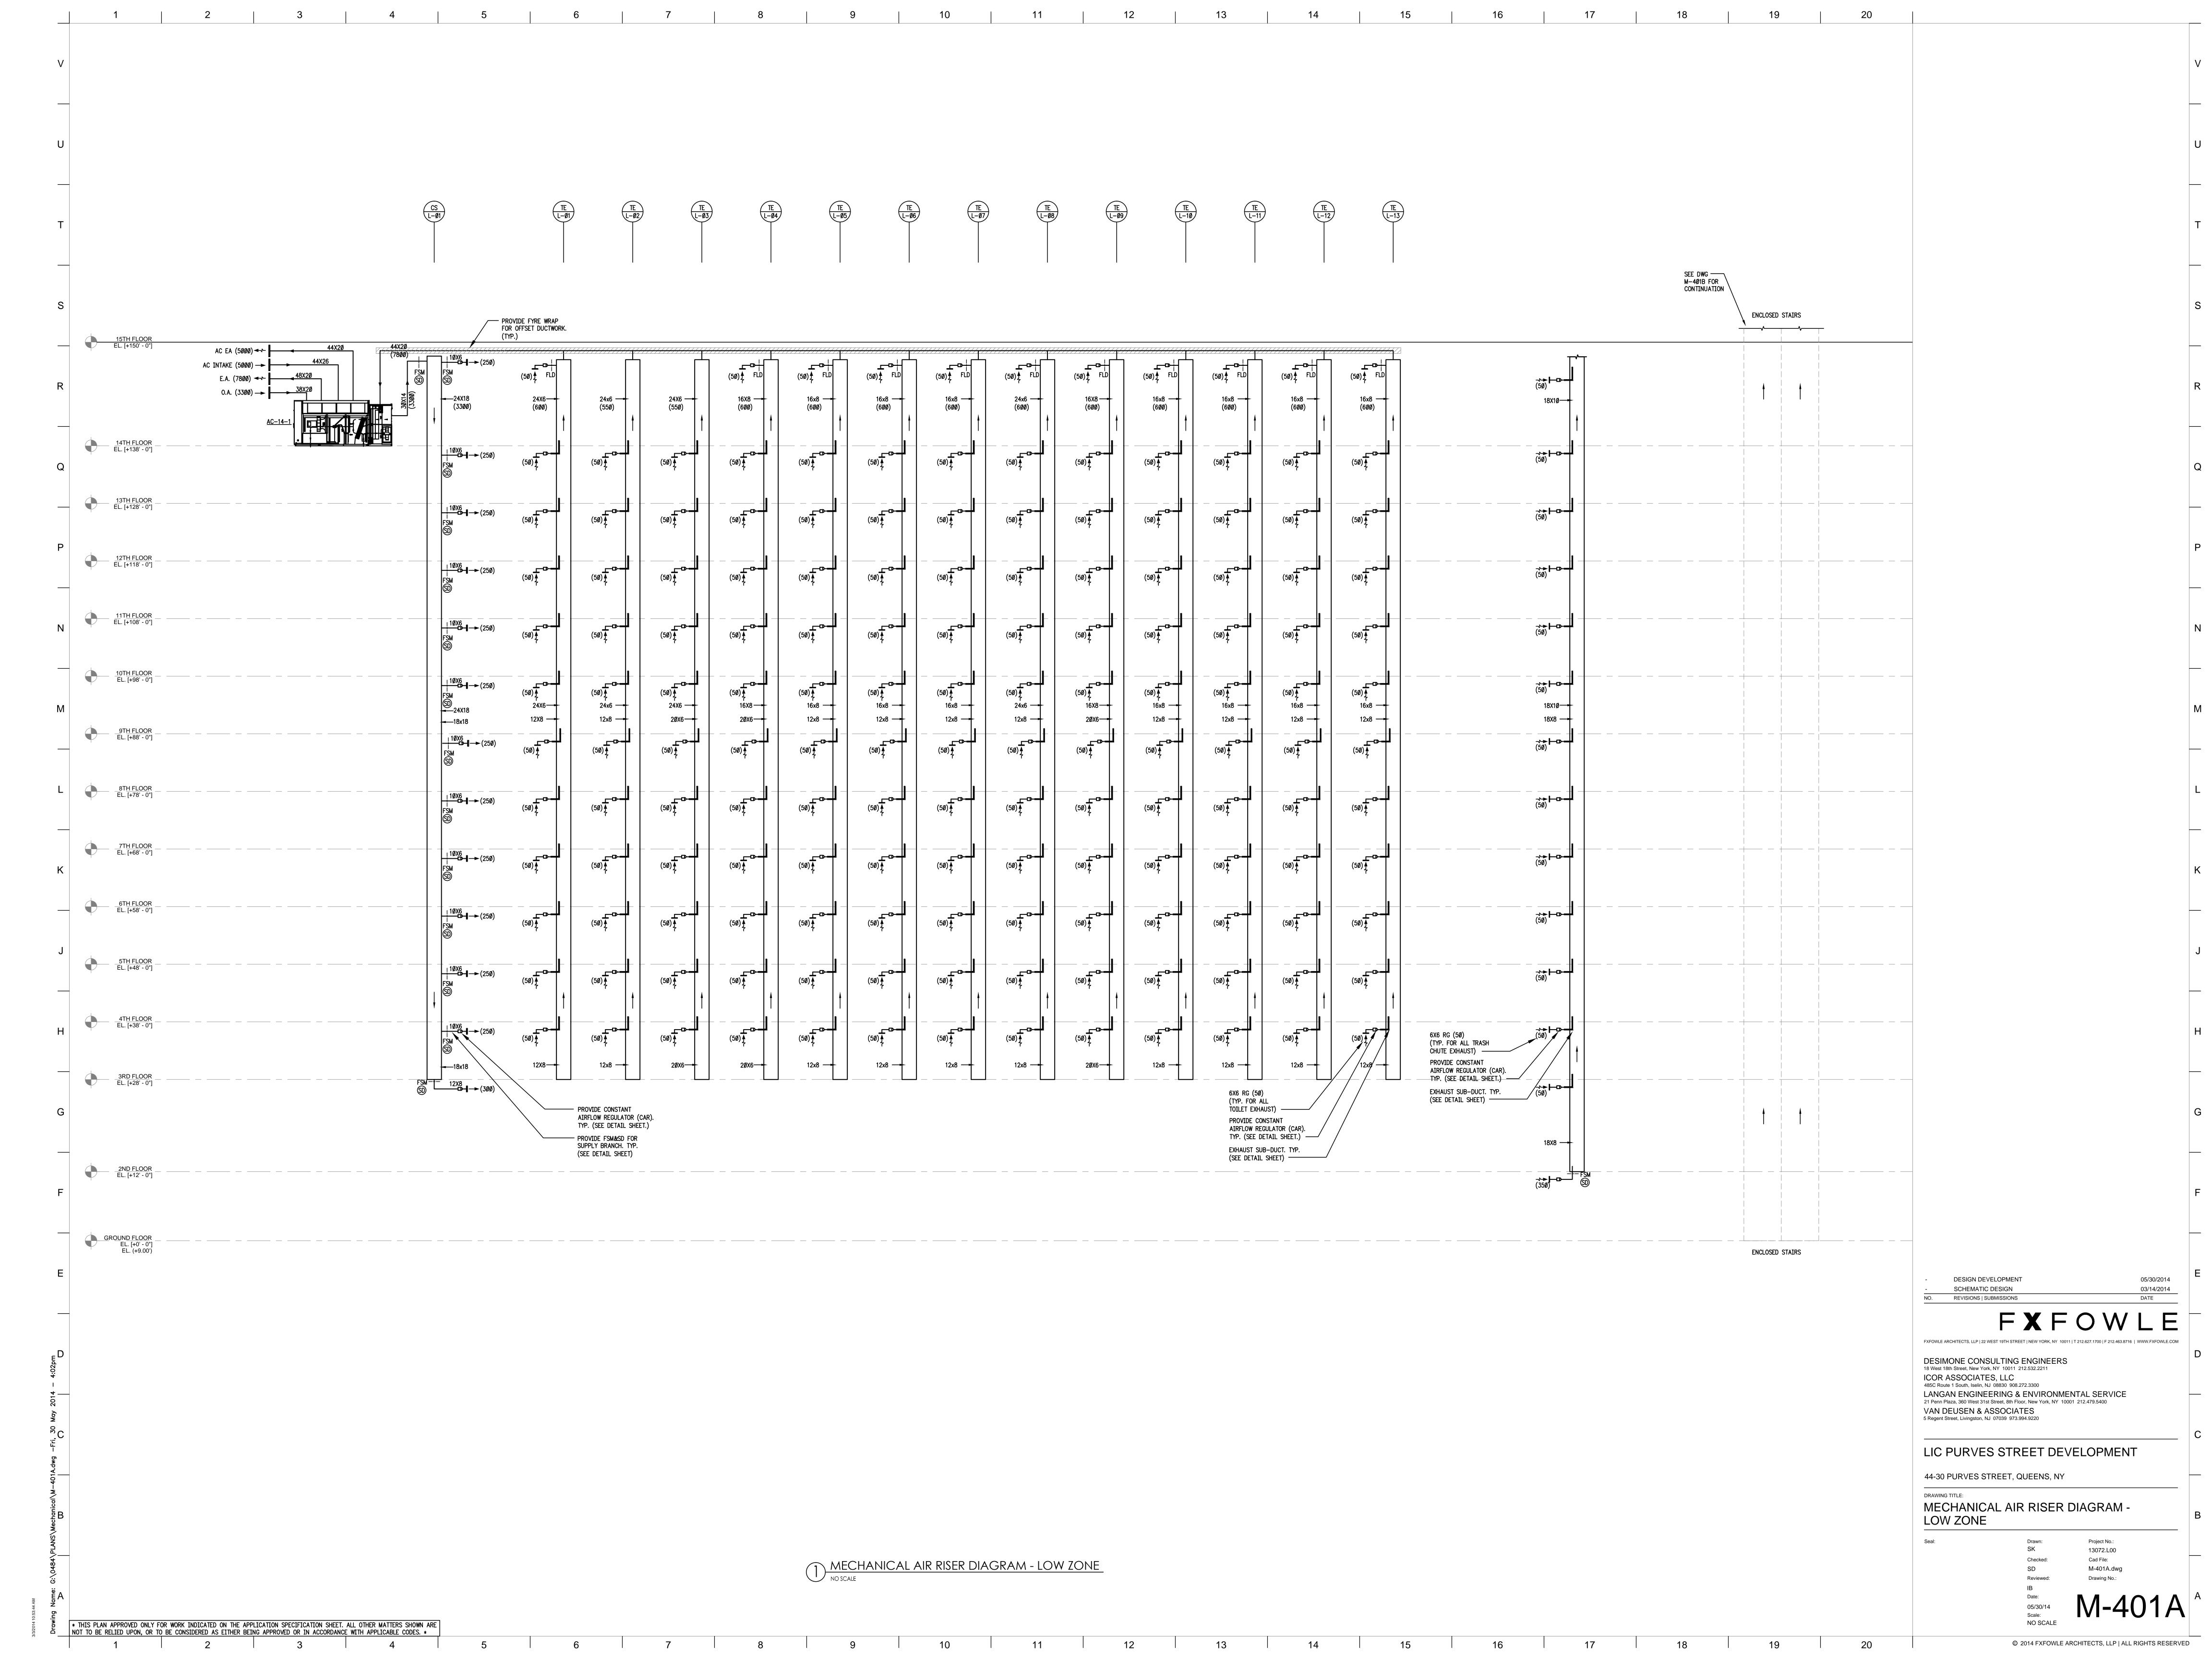



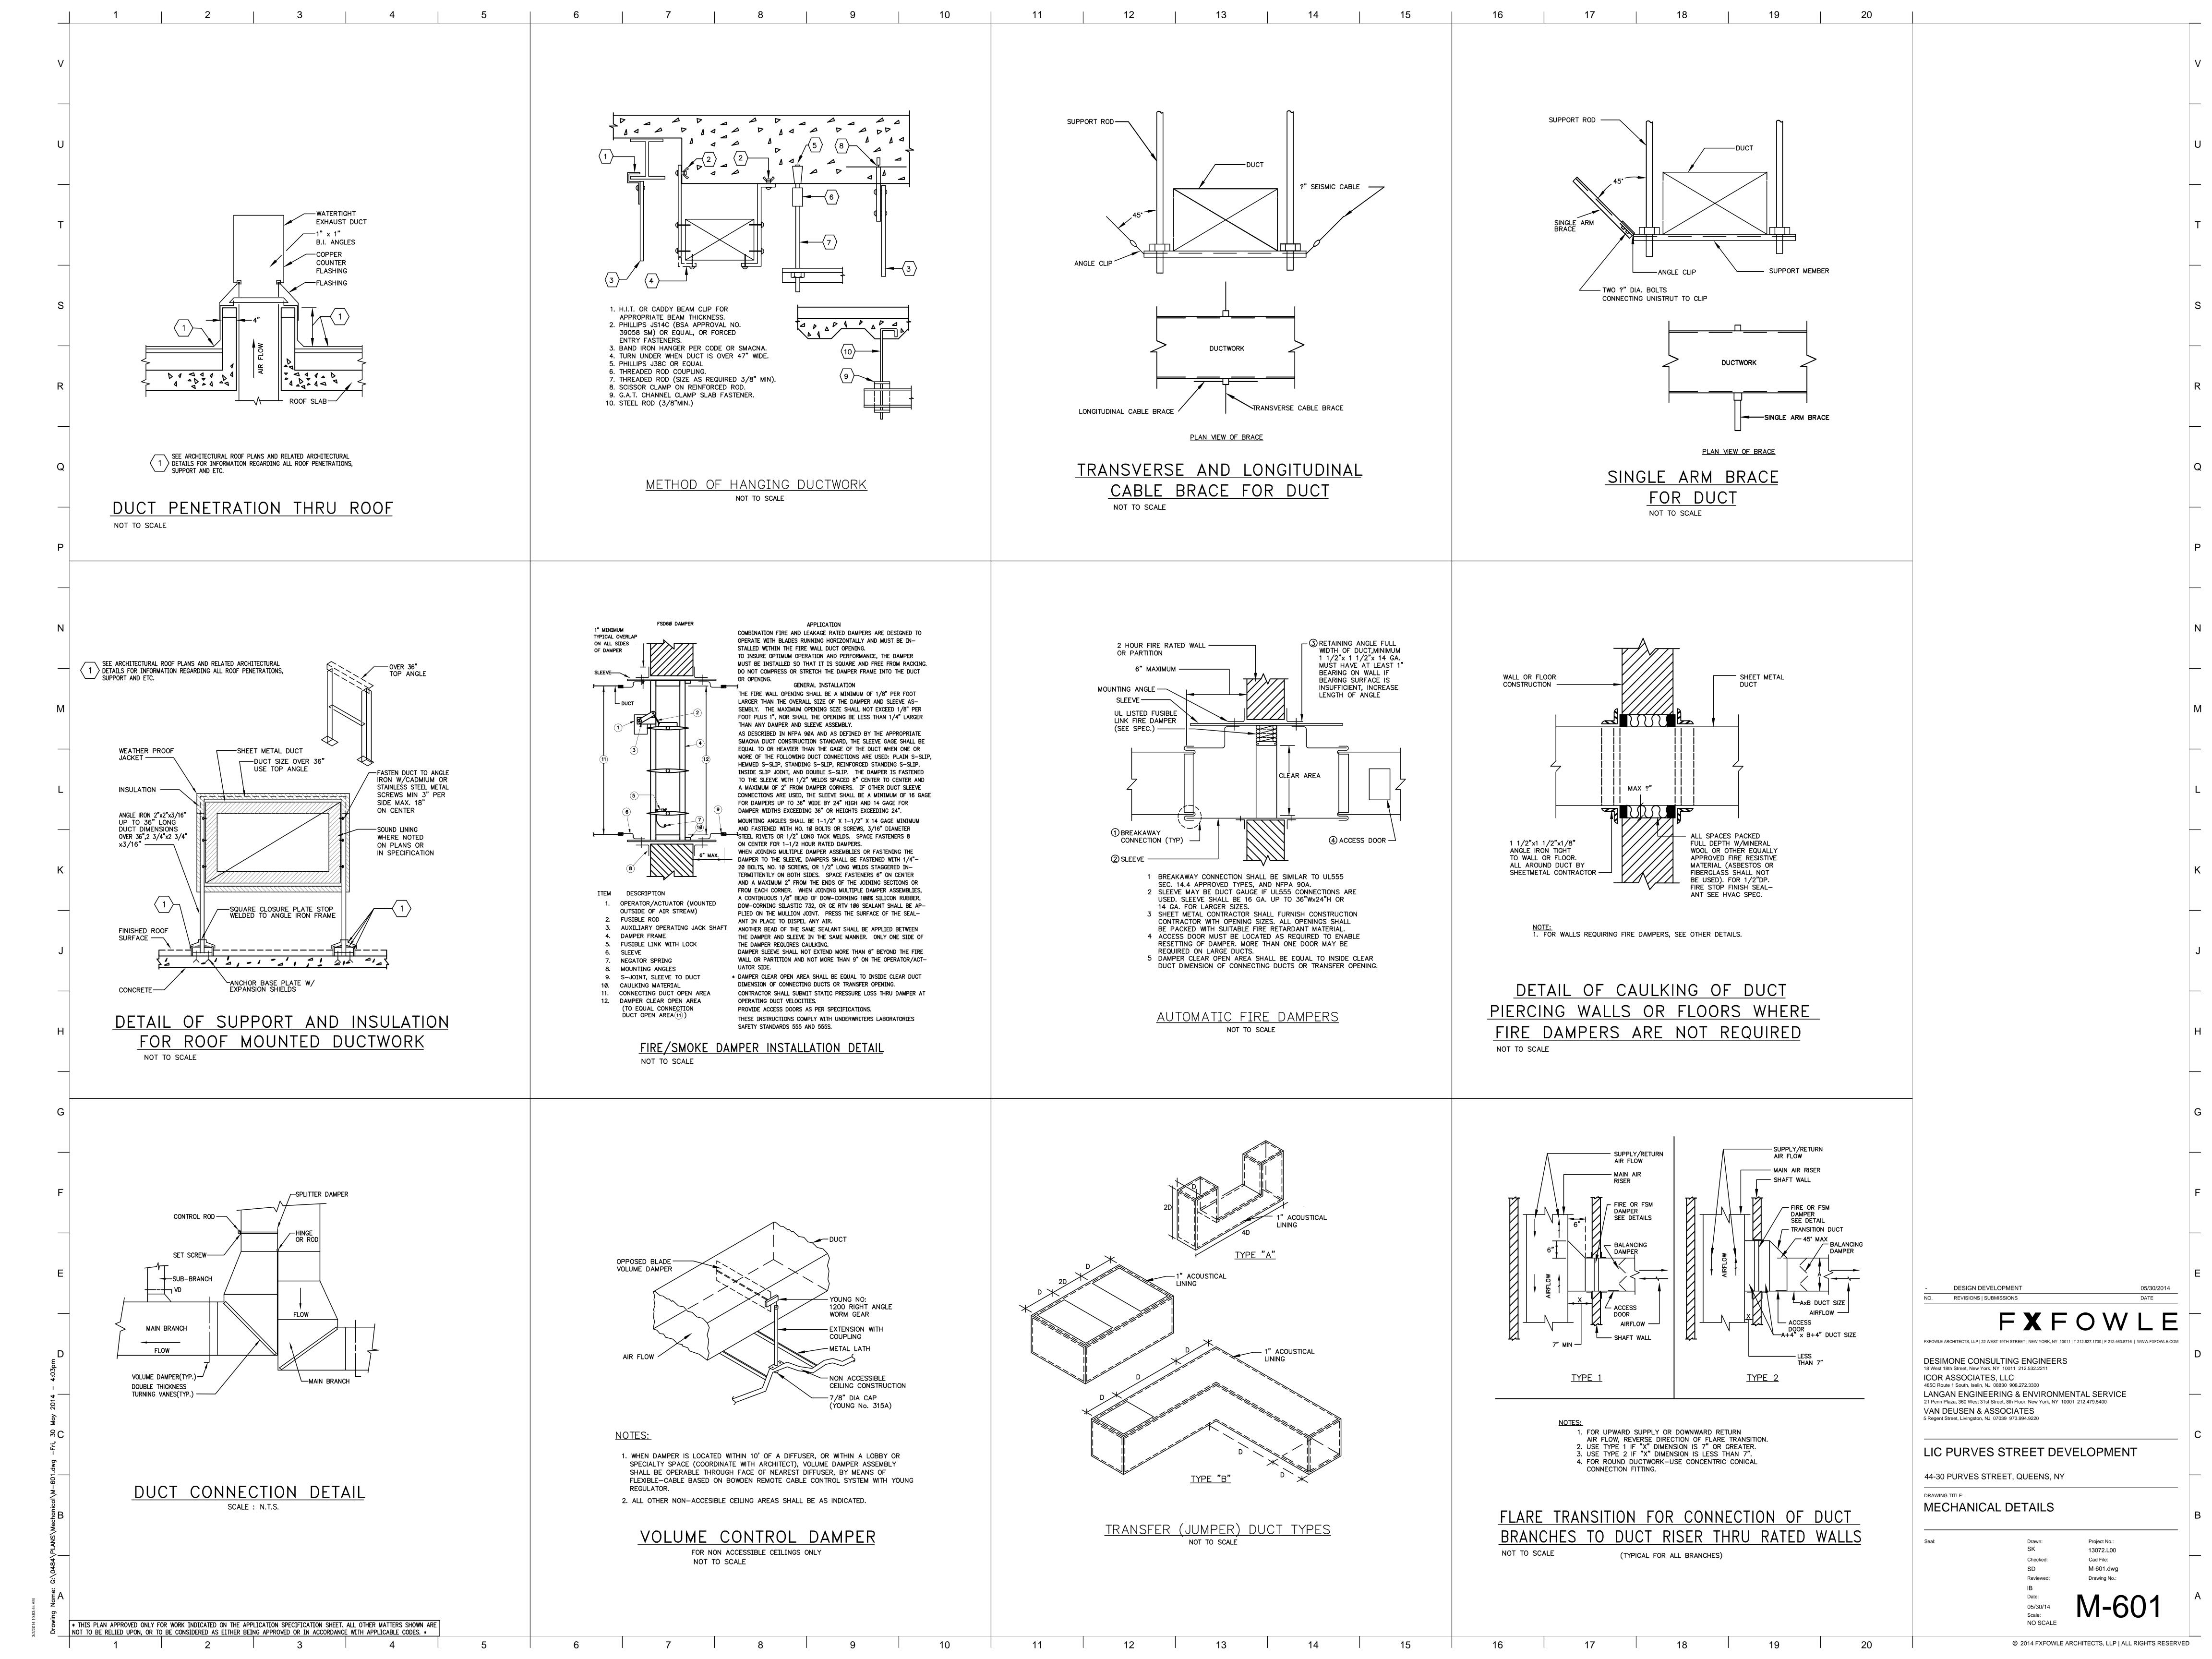

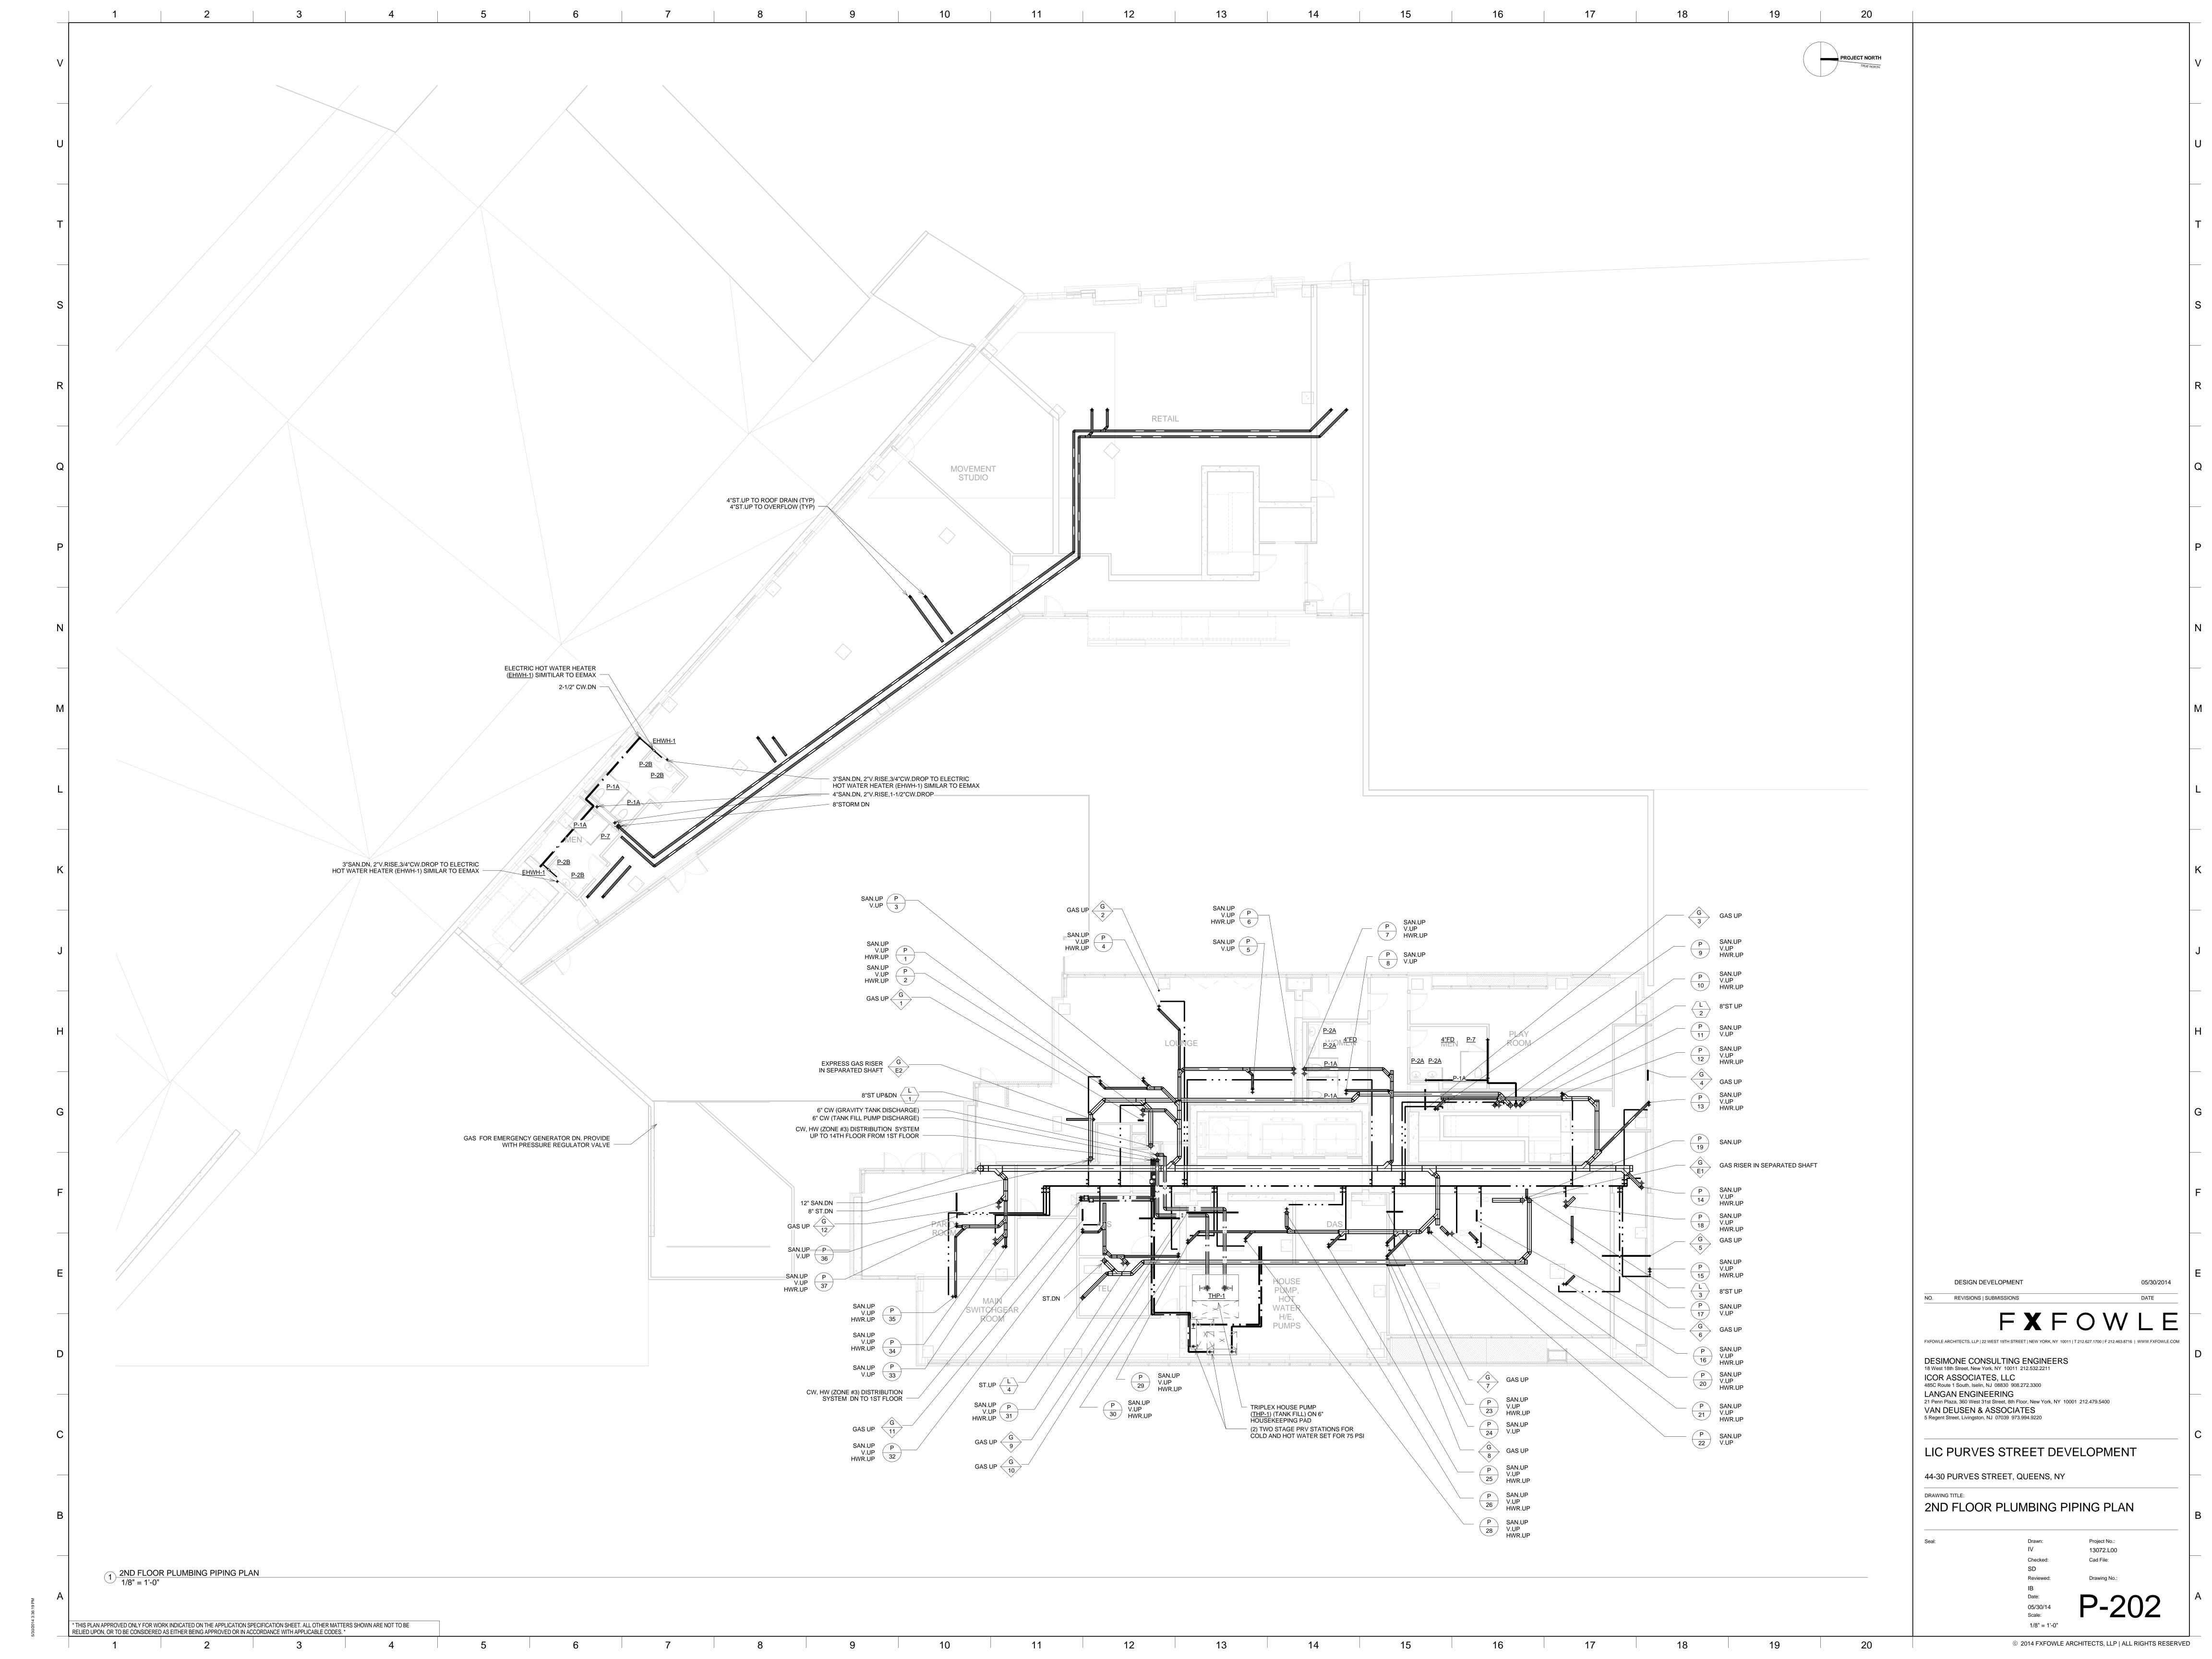

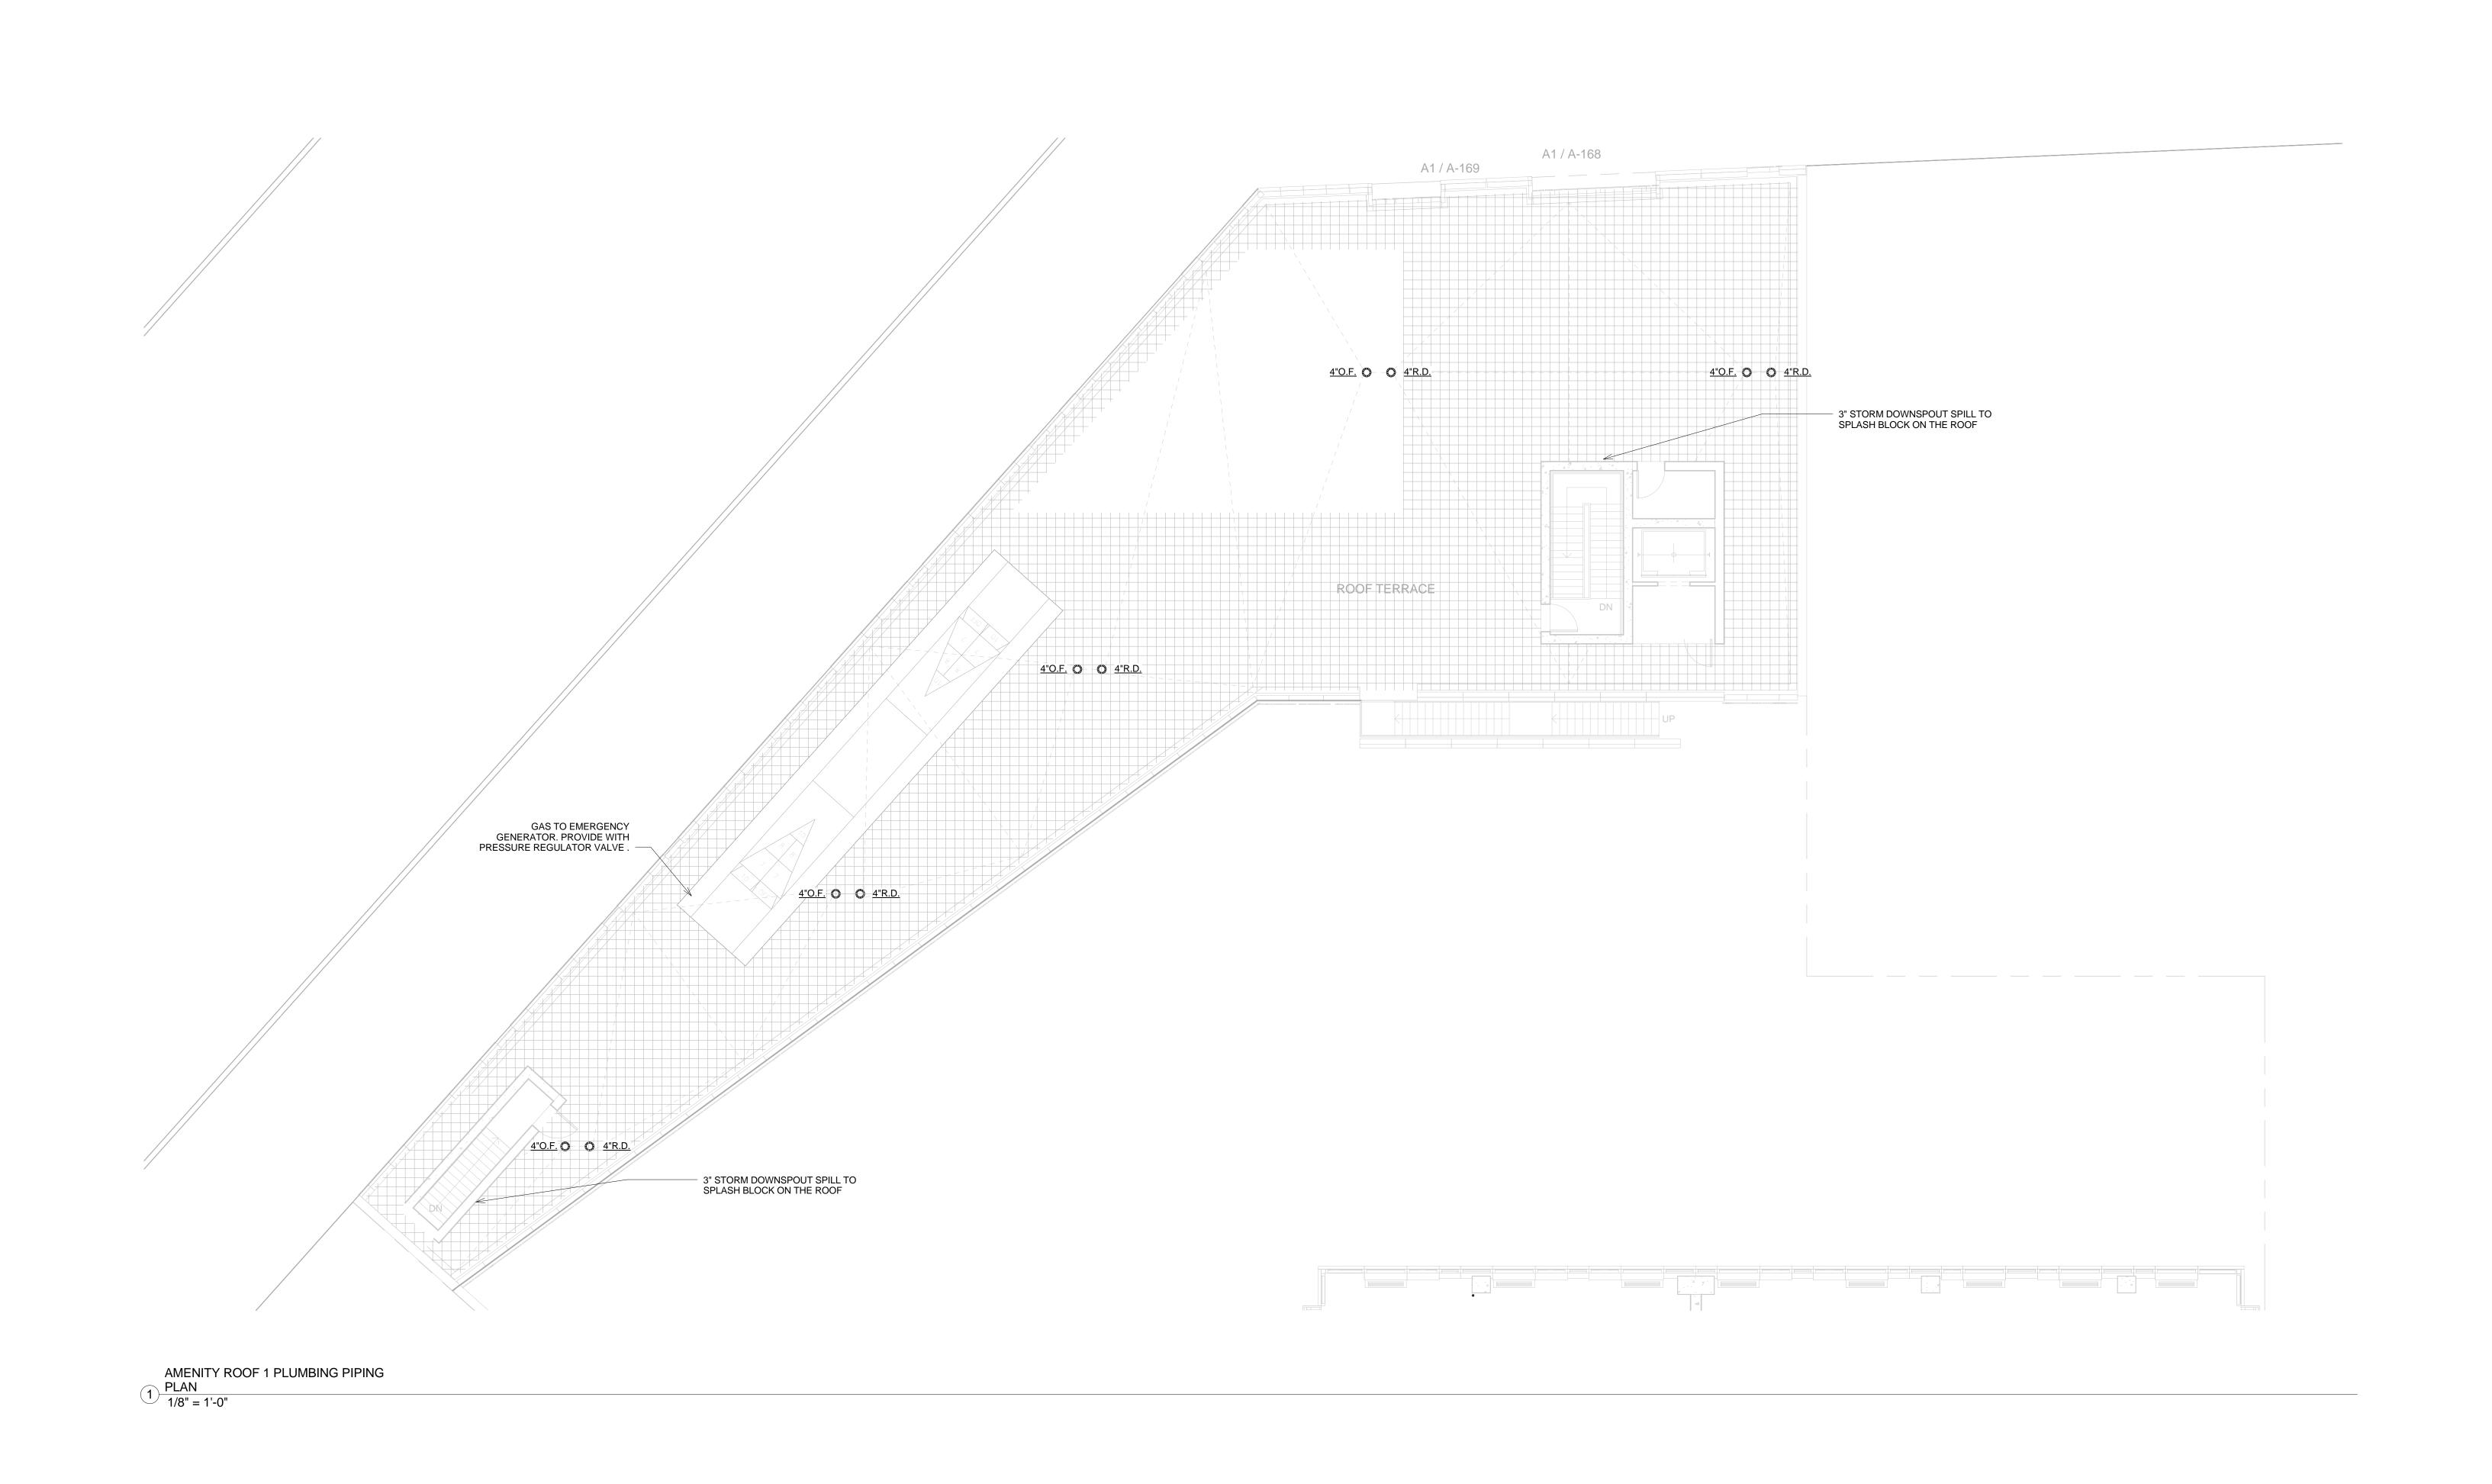

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ICOR ASSOCIATES, LLC
485C Route 1 South, Iselin, NJ 08830 908.272.3300

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LIC PURVES STREET DEVELOPMENT

44-30 PURVES STREET, QUEENS, NY

AMENITY BUILDING ROOF PLUMBING PIPING PLAN

Drawn: Project No.:

IV 13072.L00


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1/8" = 1'-0"




2 14TH FLOOR PLUMBING PIPING PLAN 1/8" = 1'-0"

3RD - 13TH FLOOR PLUMBING PIPING

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1 PLAN 1/8" = 1'-0"

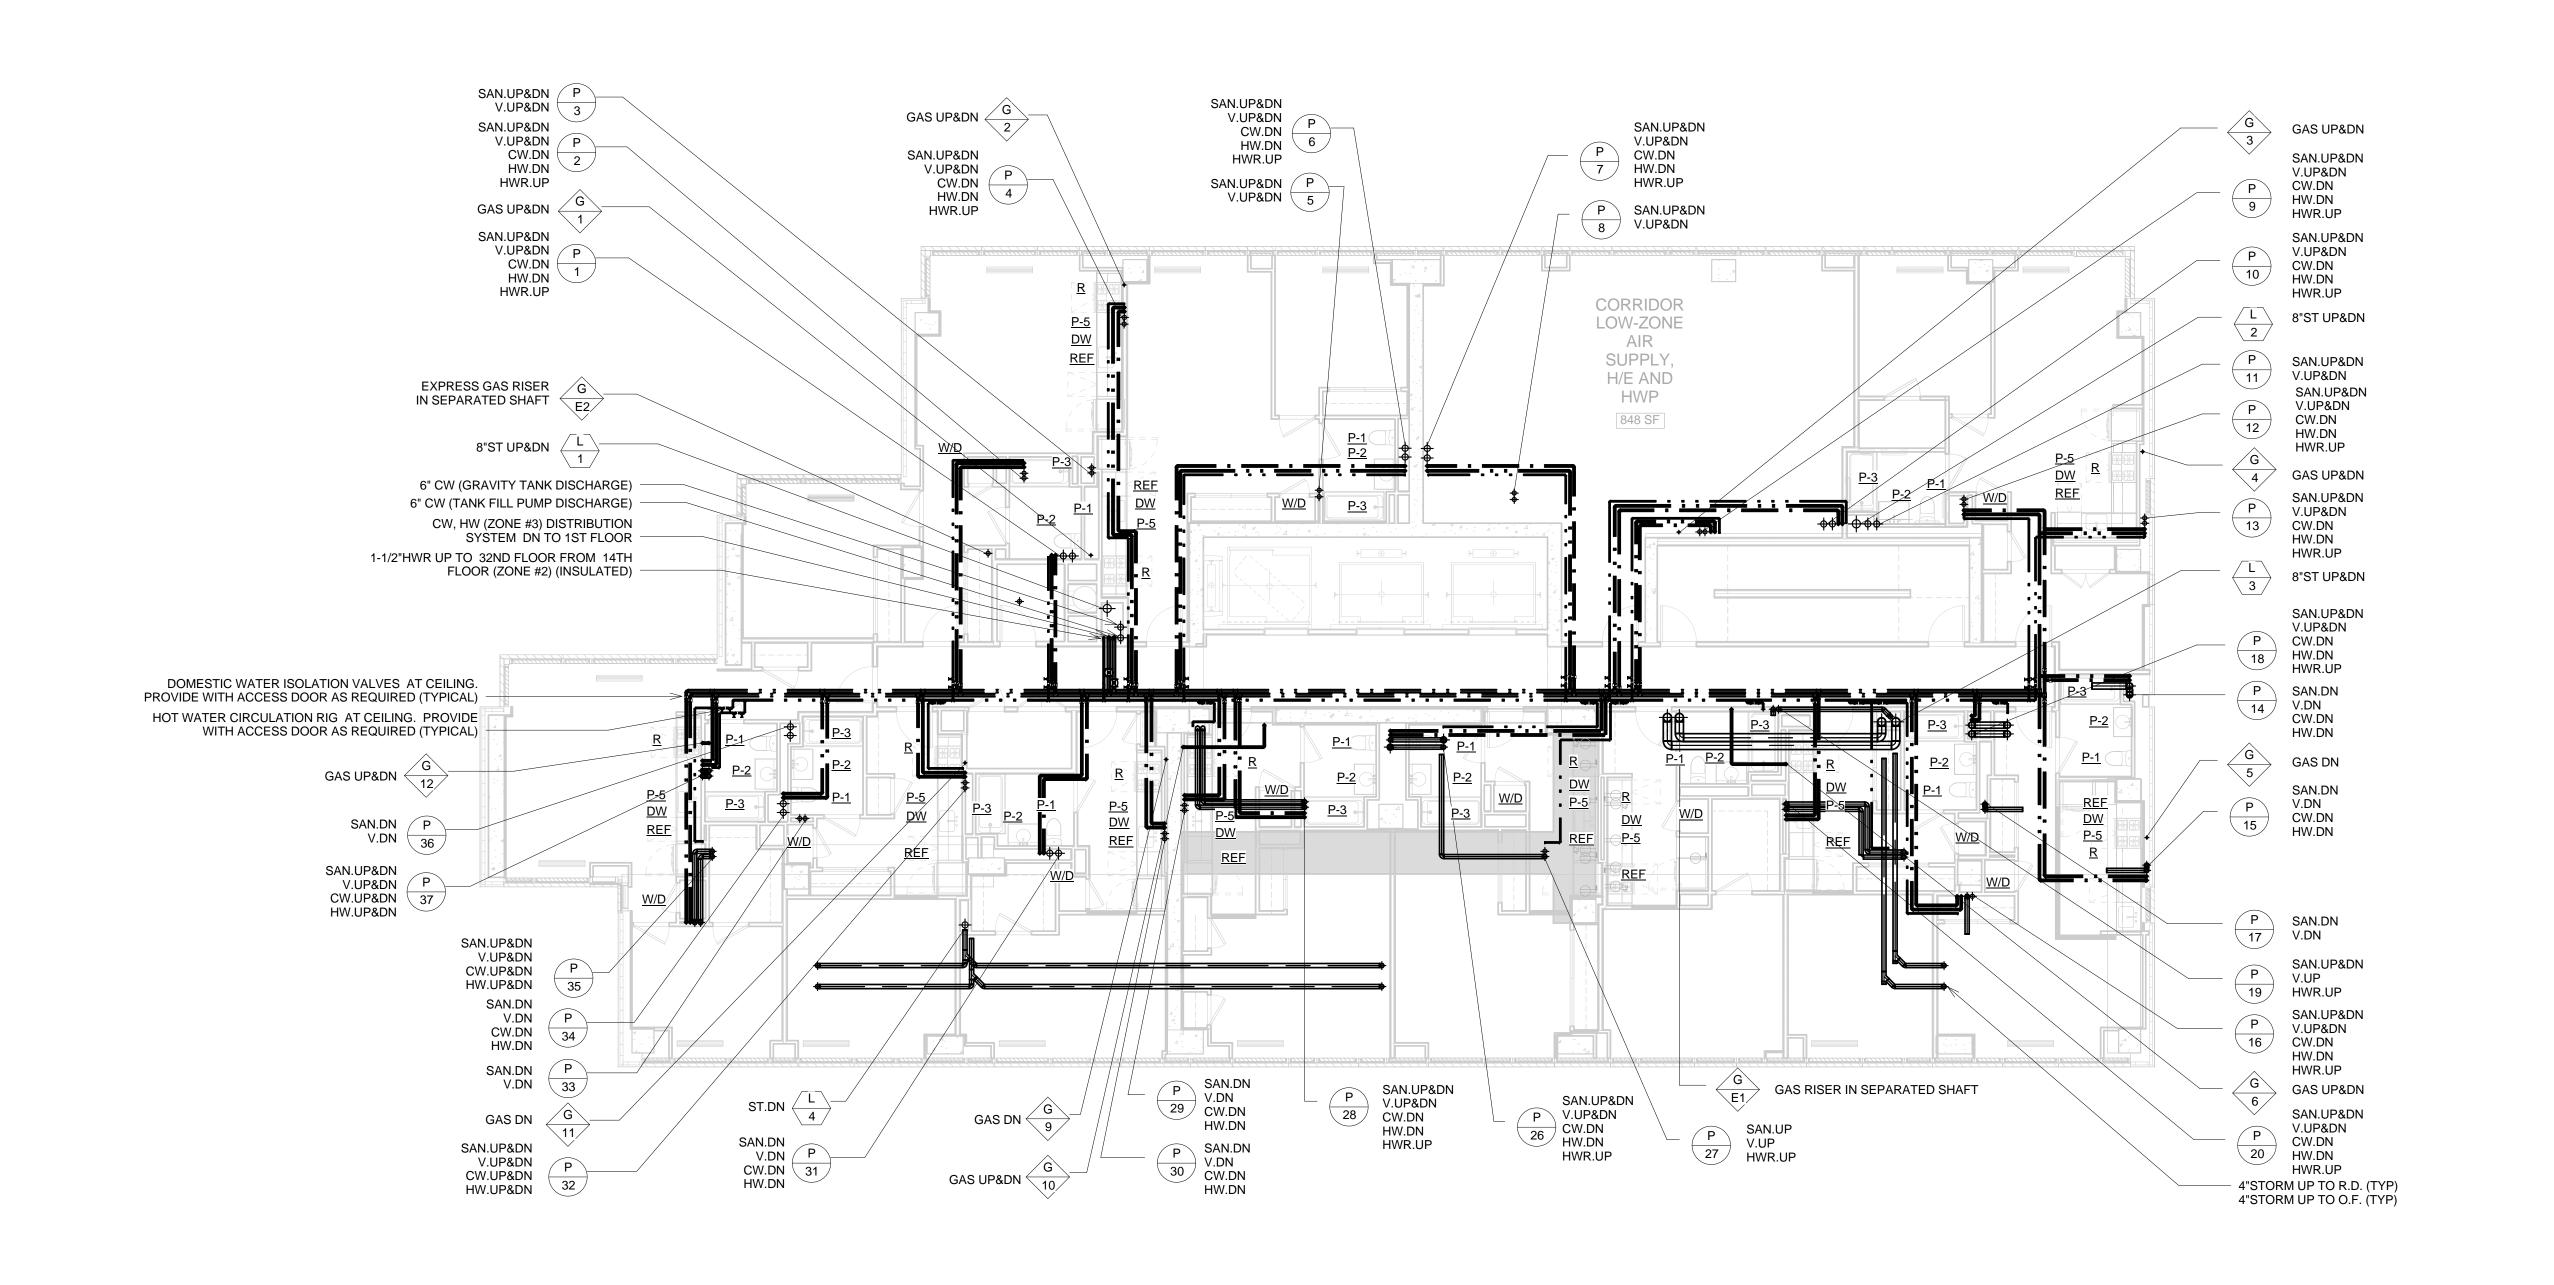
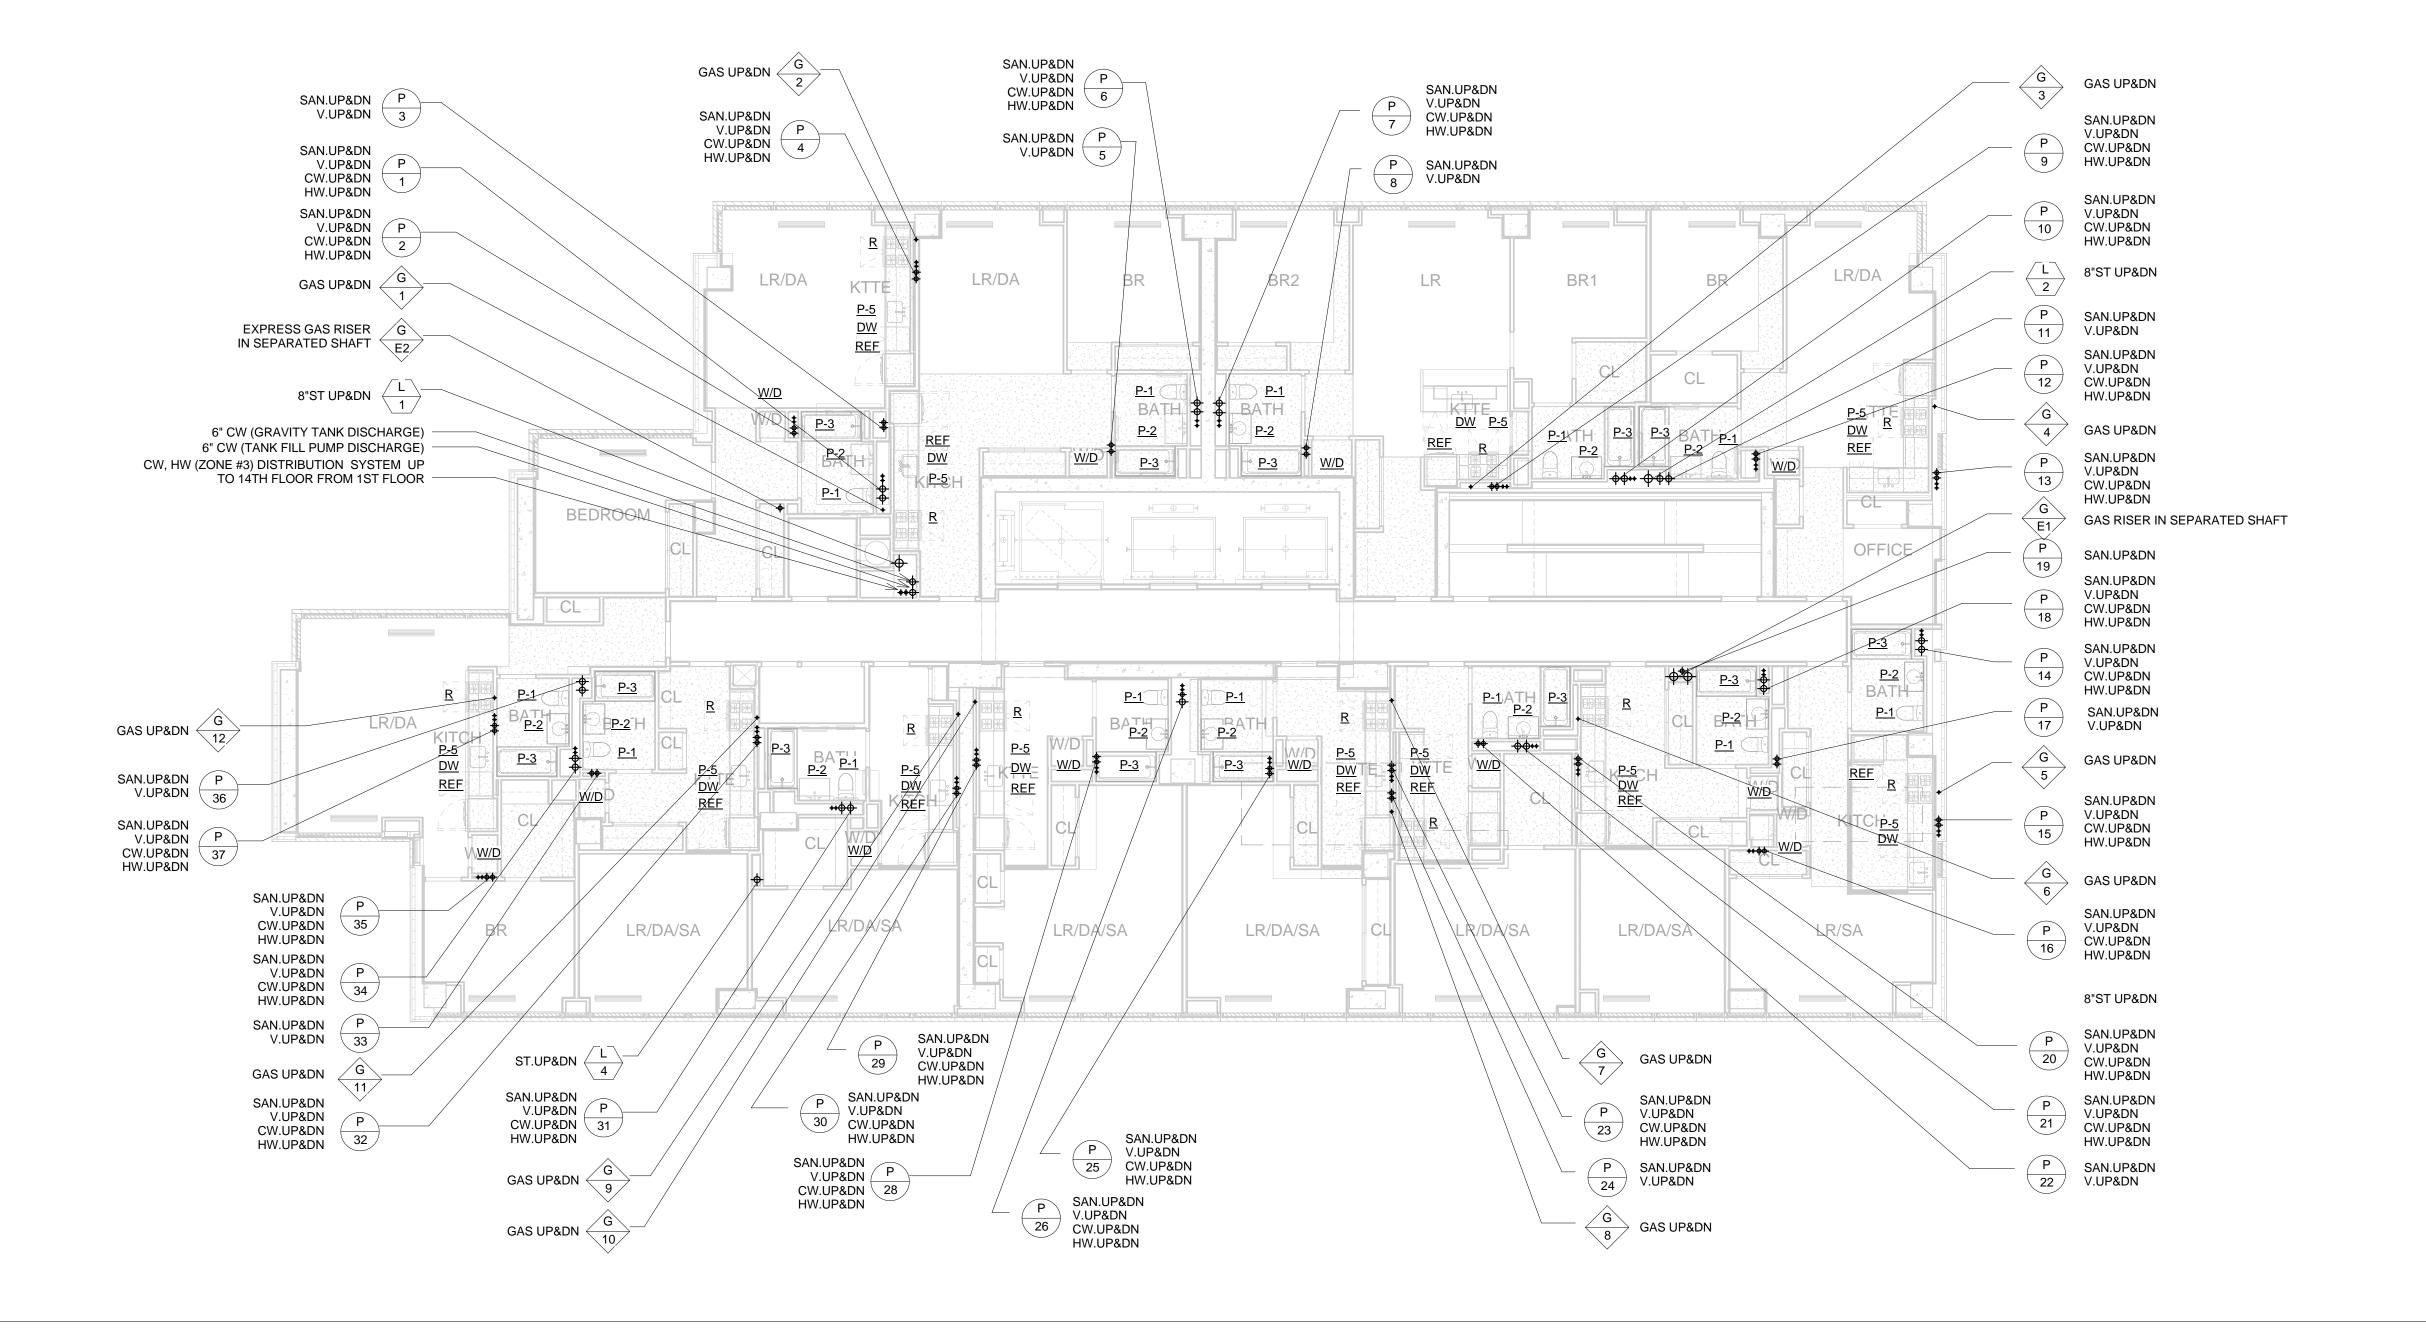
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485C Route 1 South, Iselin, NJ 08830 908.272.3300
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PROJECT NORTH

TRUE NORTH

LIC PURVES STREET DEVELOPMENT

44-30 PURVES STREET, QUEENS, NY

3RD - 14TH FLOOR PLUMBING PIPING PLANS

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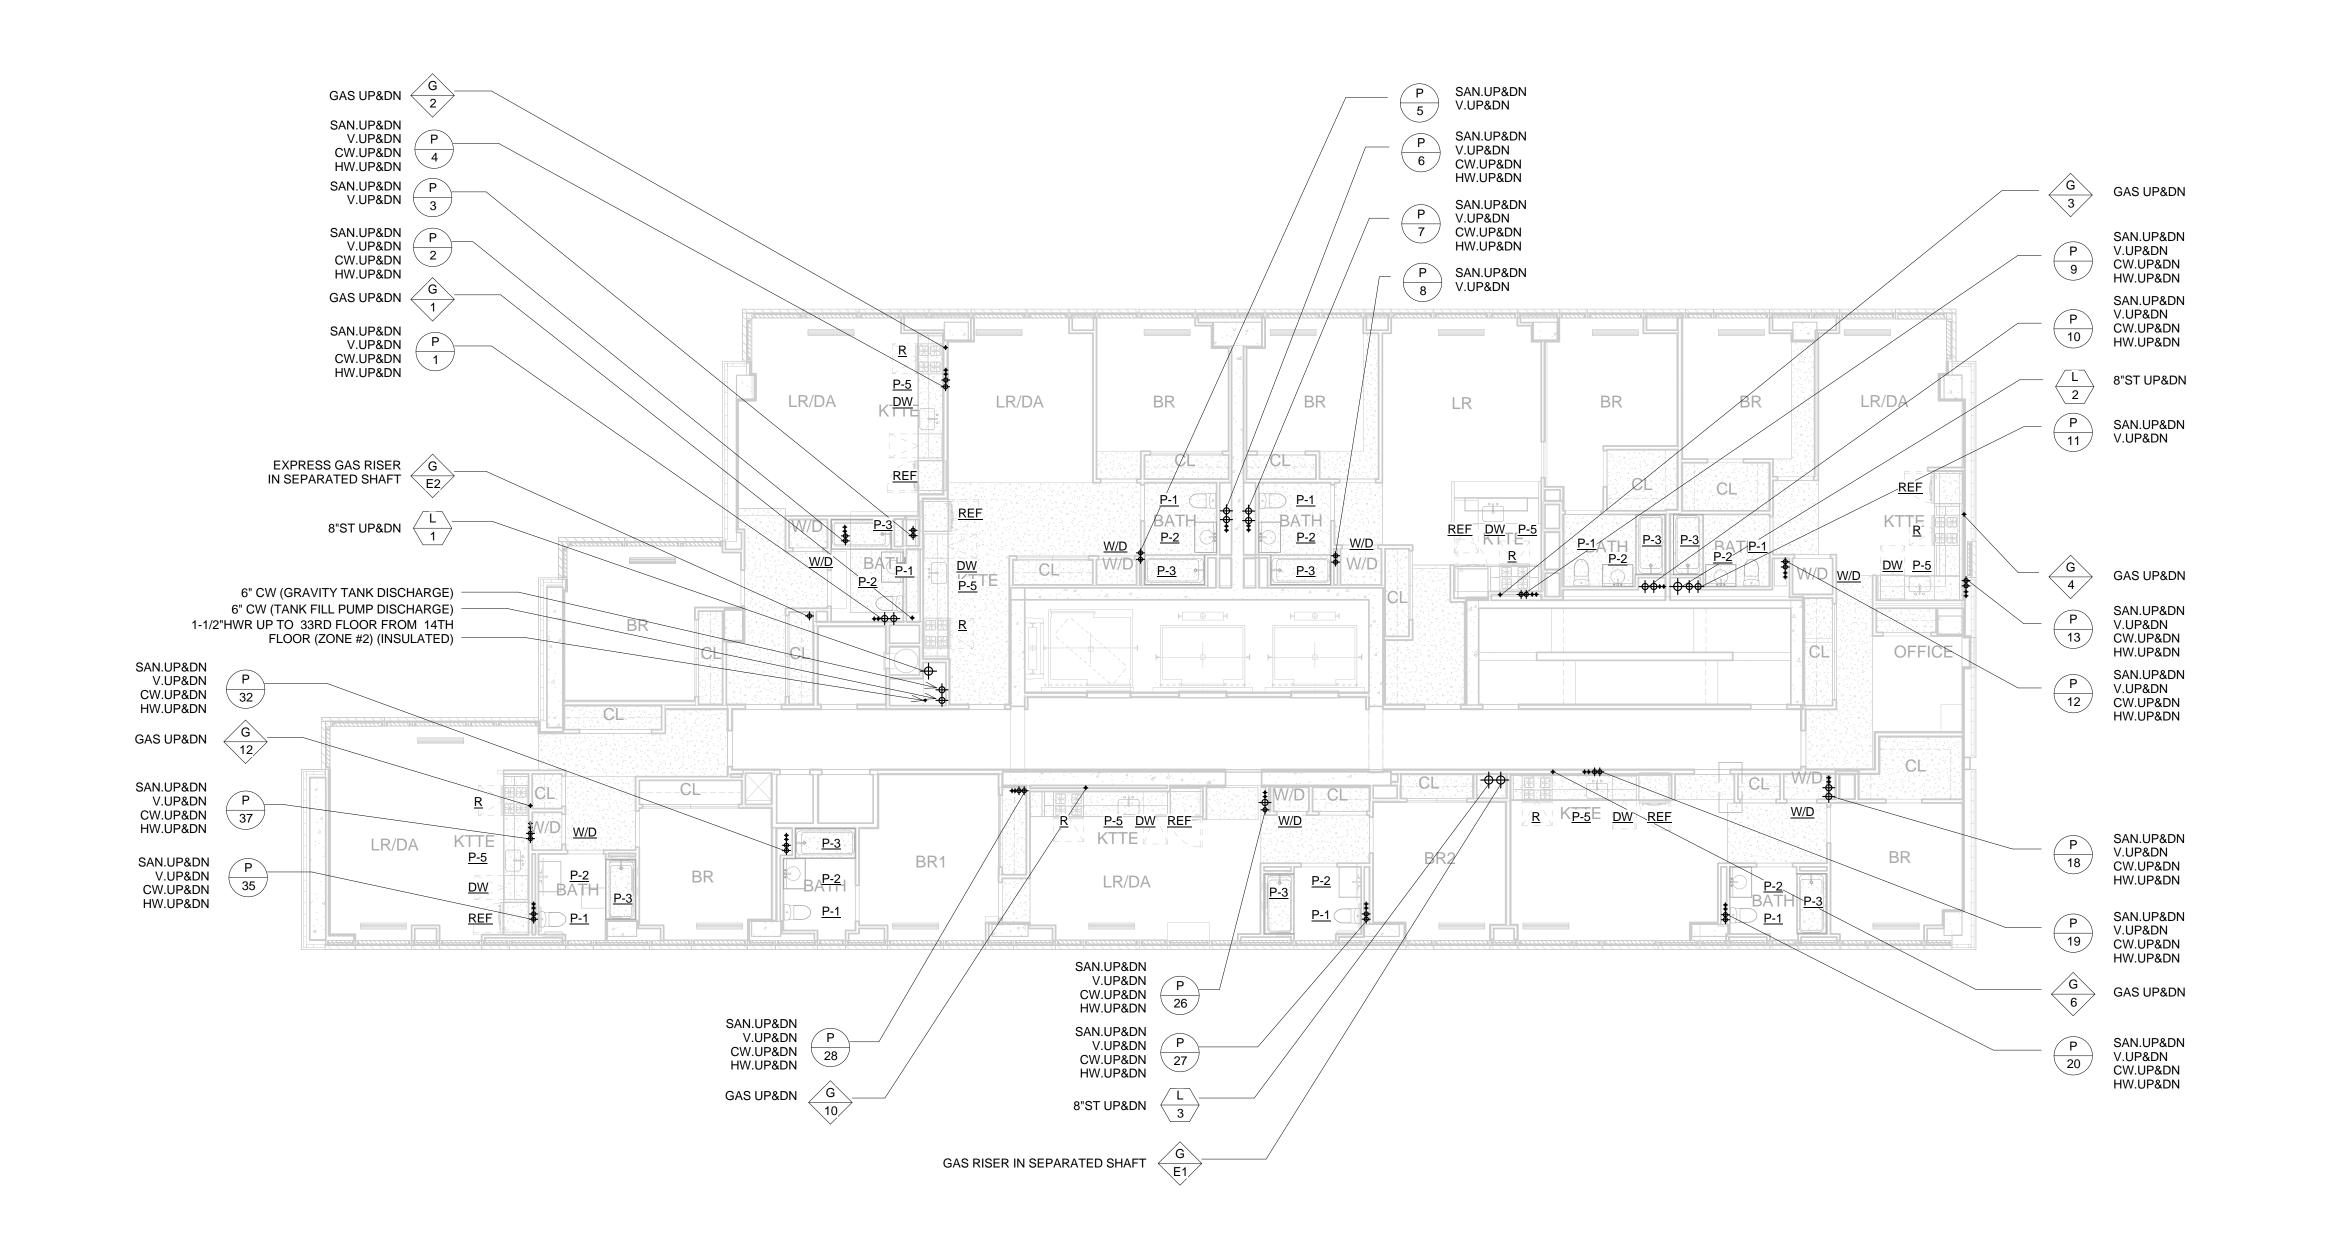
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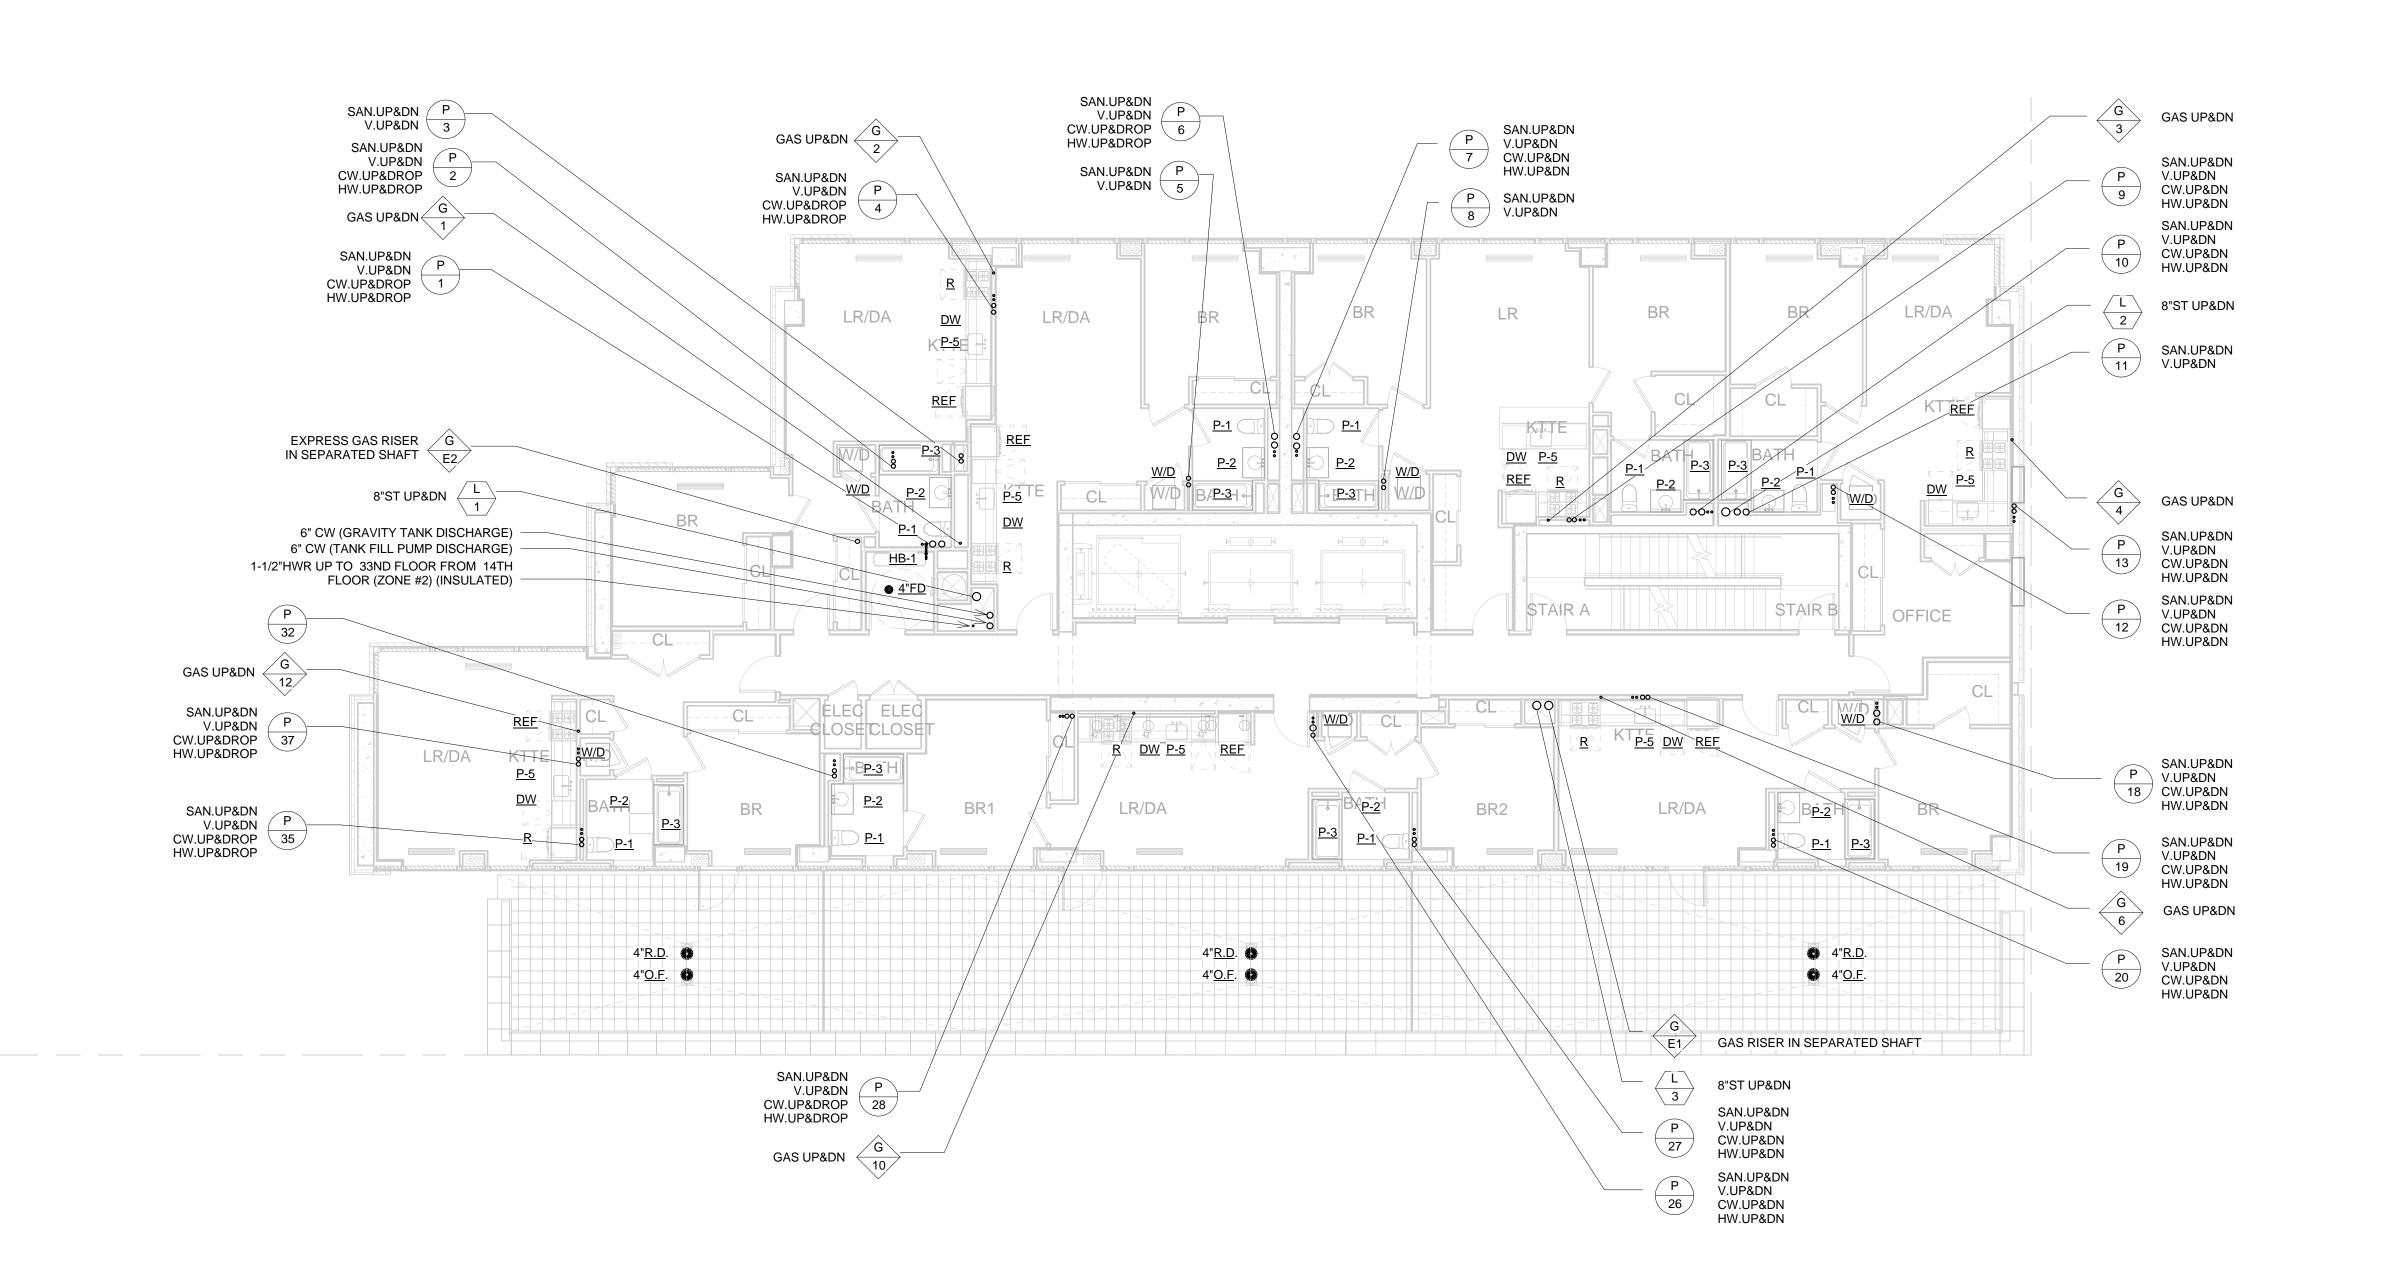
1/8" = 1'-0"



16TH - 25TH & 27TH - 31ST FLOOR 2 PLUMBING PIPING PLAN
1/8" = 1'-0"

1 15TH FLOOR PLUMBING PIPING PLAN 1/8" = 1'-0"

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PROJECT NORTH

TRUE NORTH

#### LIC PURVES STREET DEVELOPMENT


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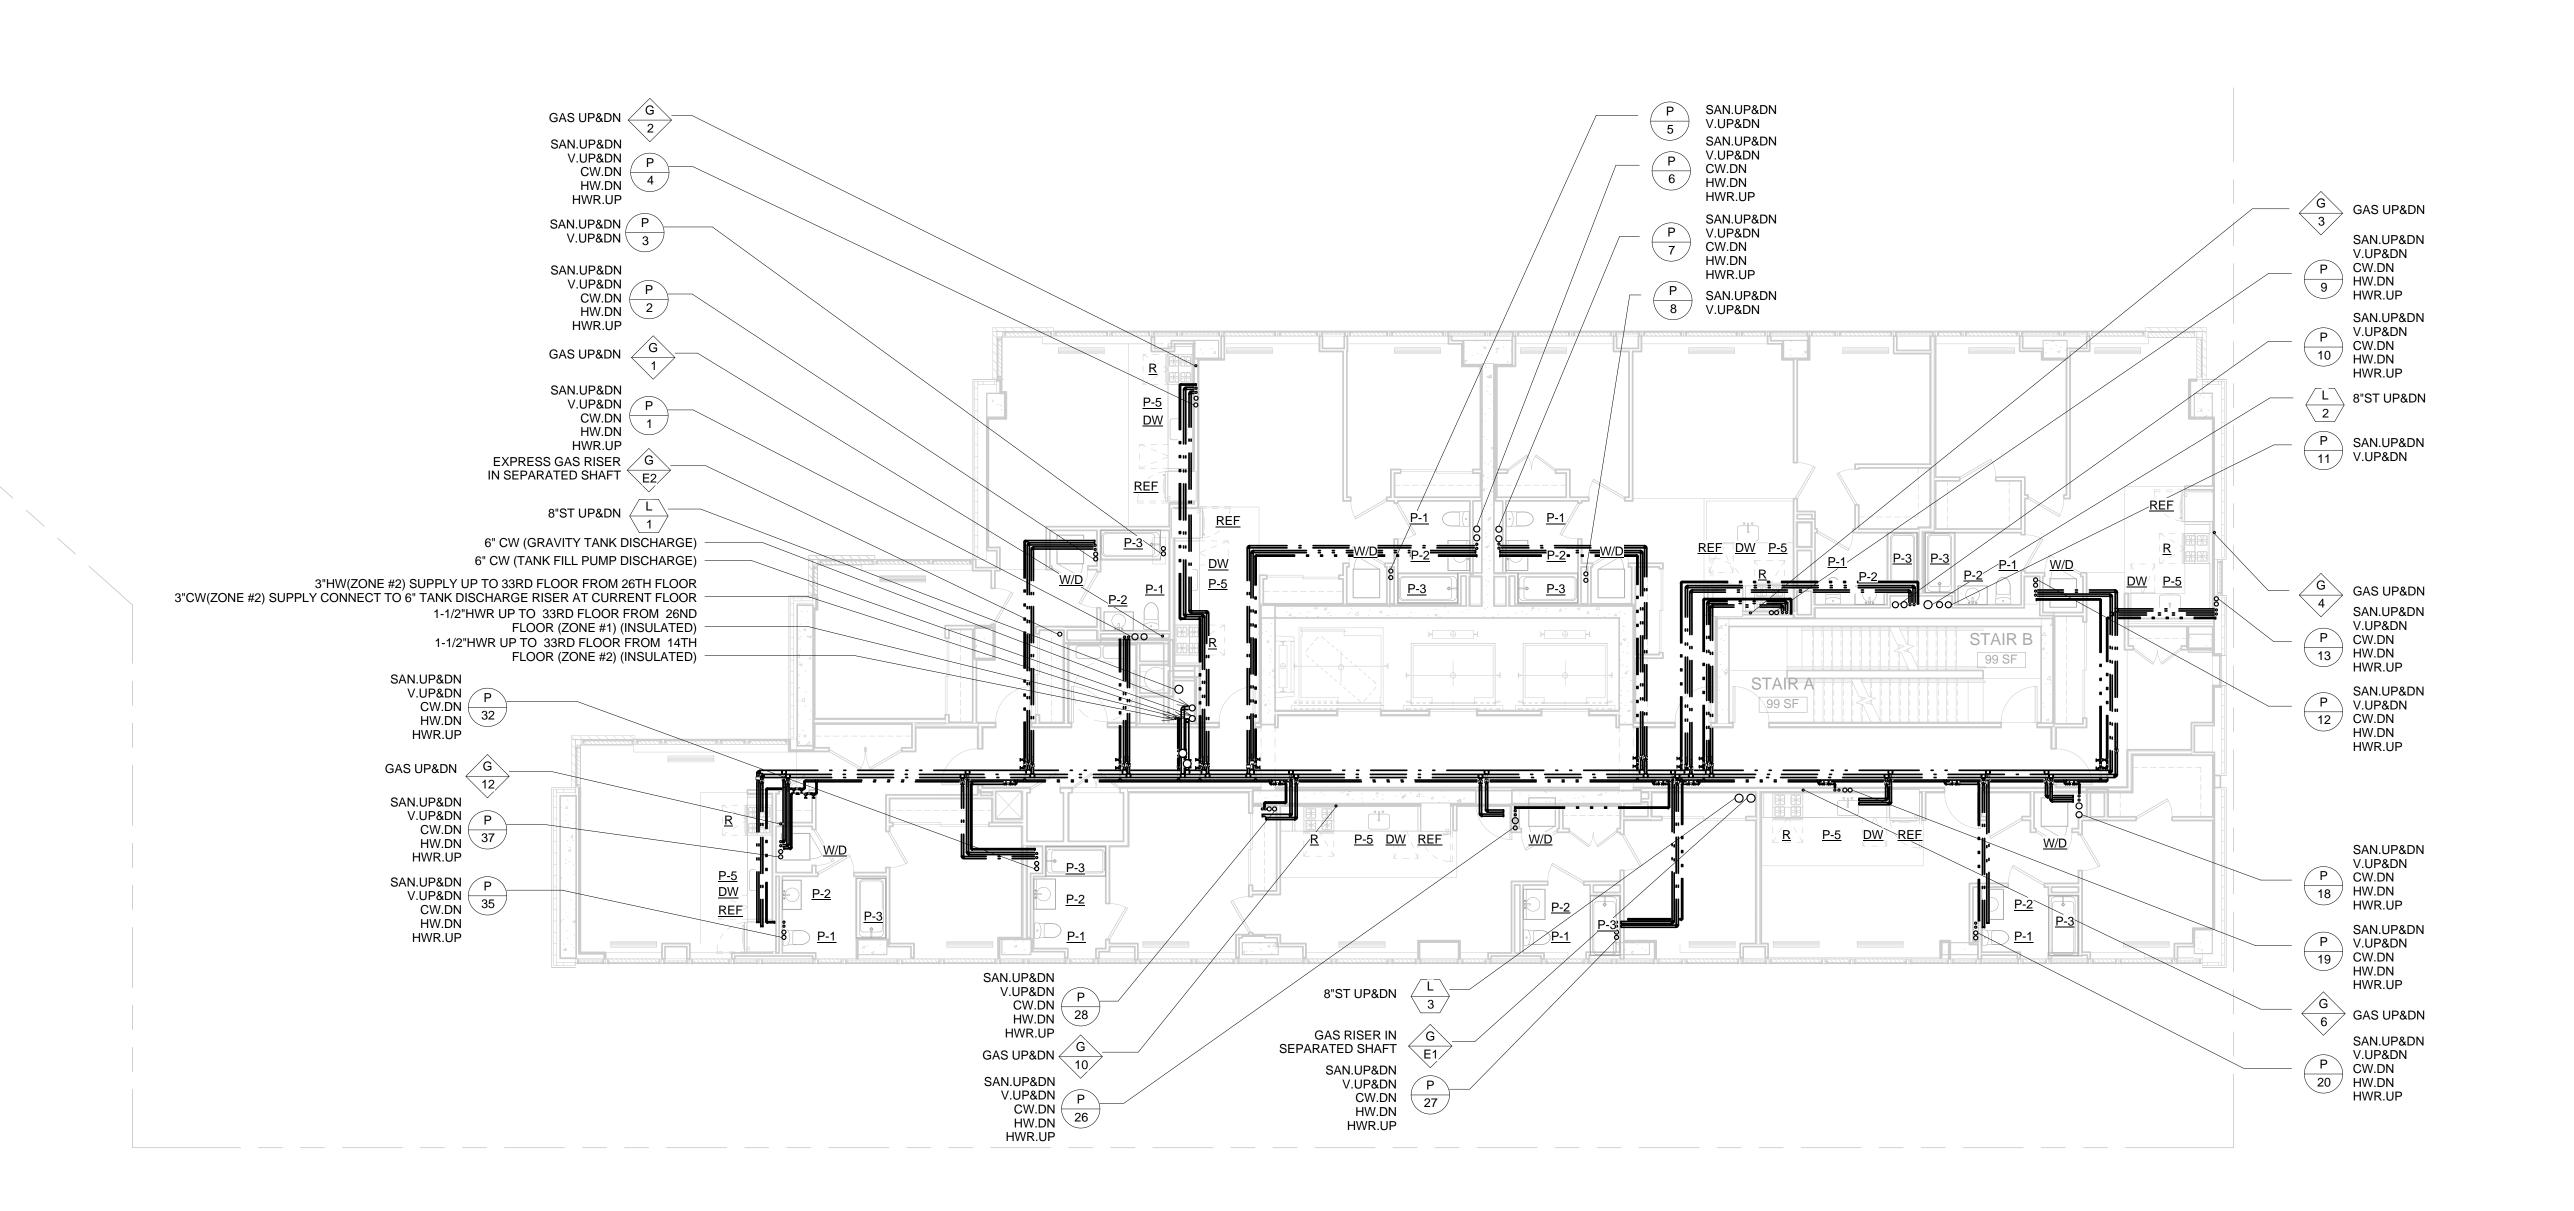
15TH, 16TH-25TH & 27-31ST FLOOR PLUMBING PIPING PLANS

05/30/14 1/8" = 1'-0"

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Project No.: 13072.L00 Cad File:



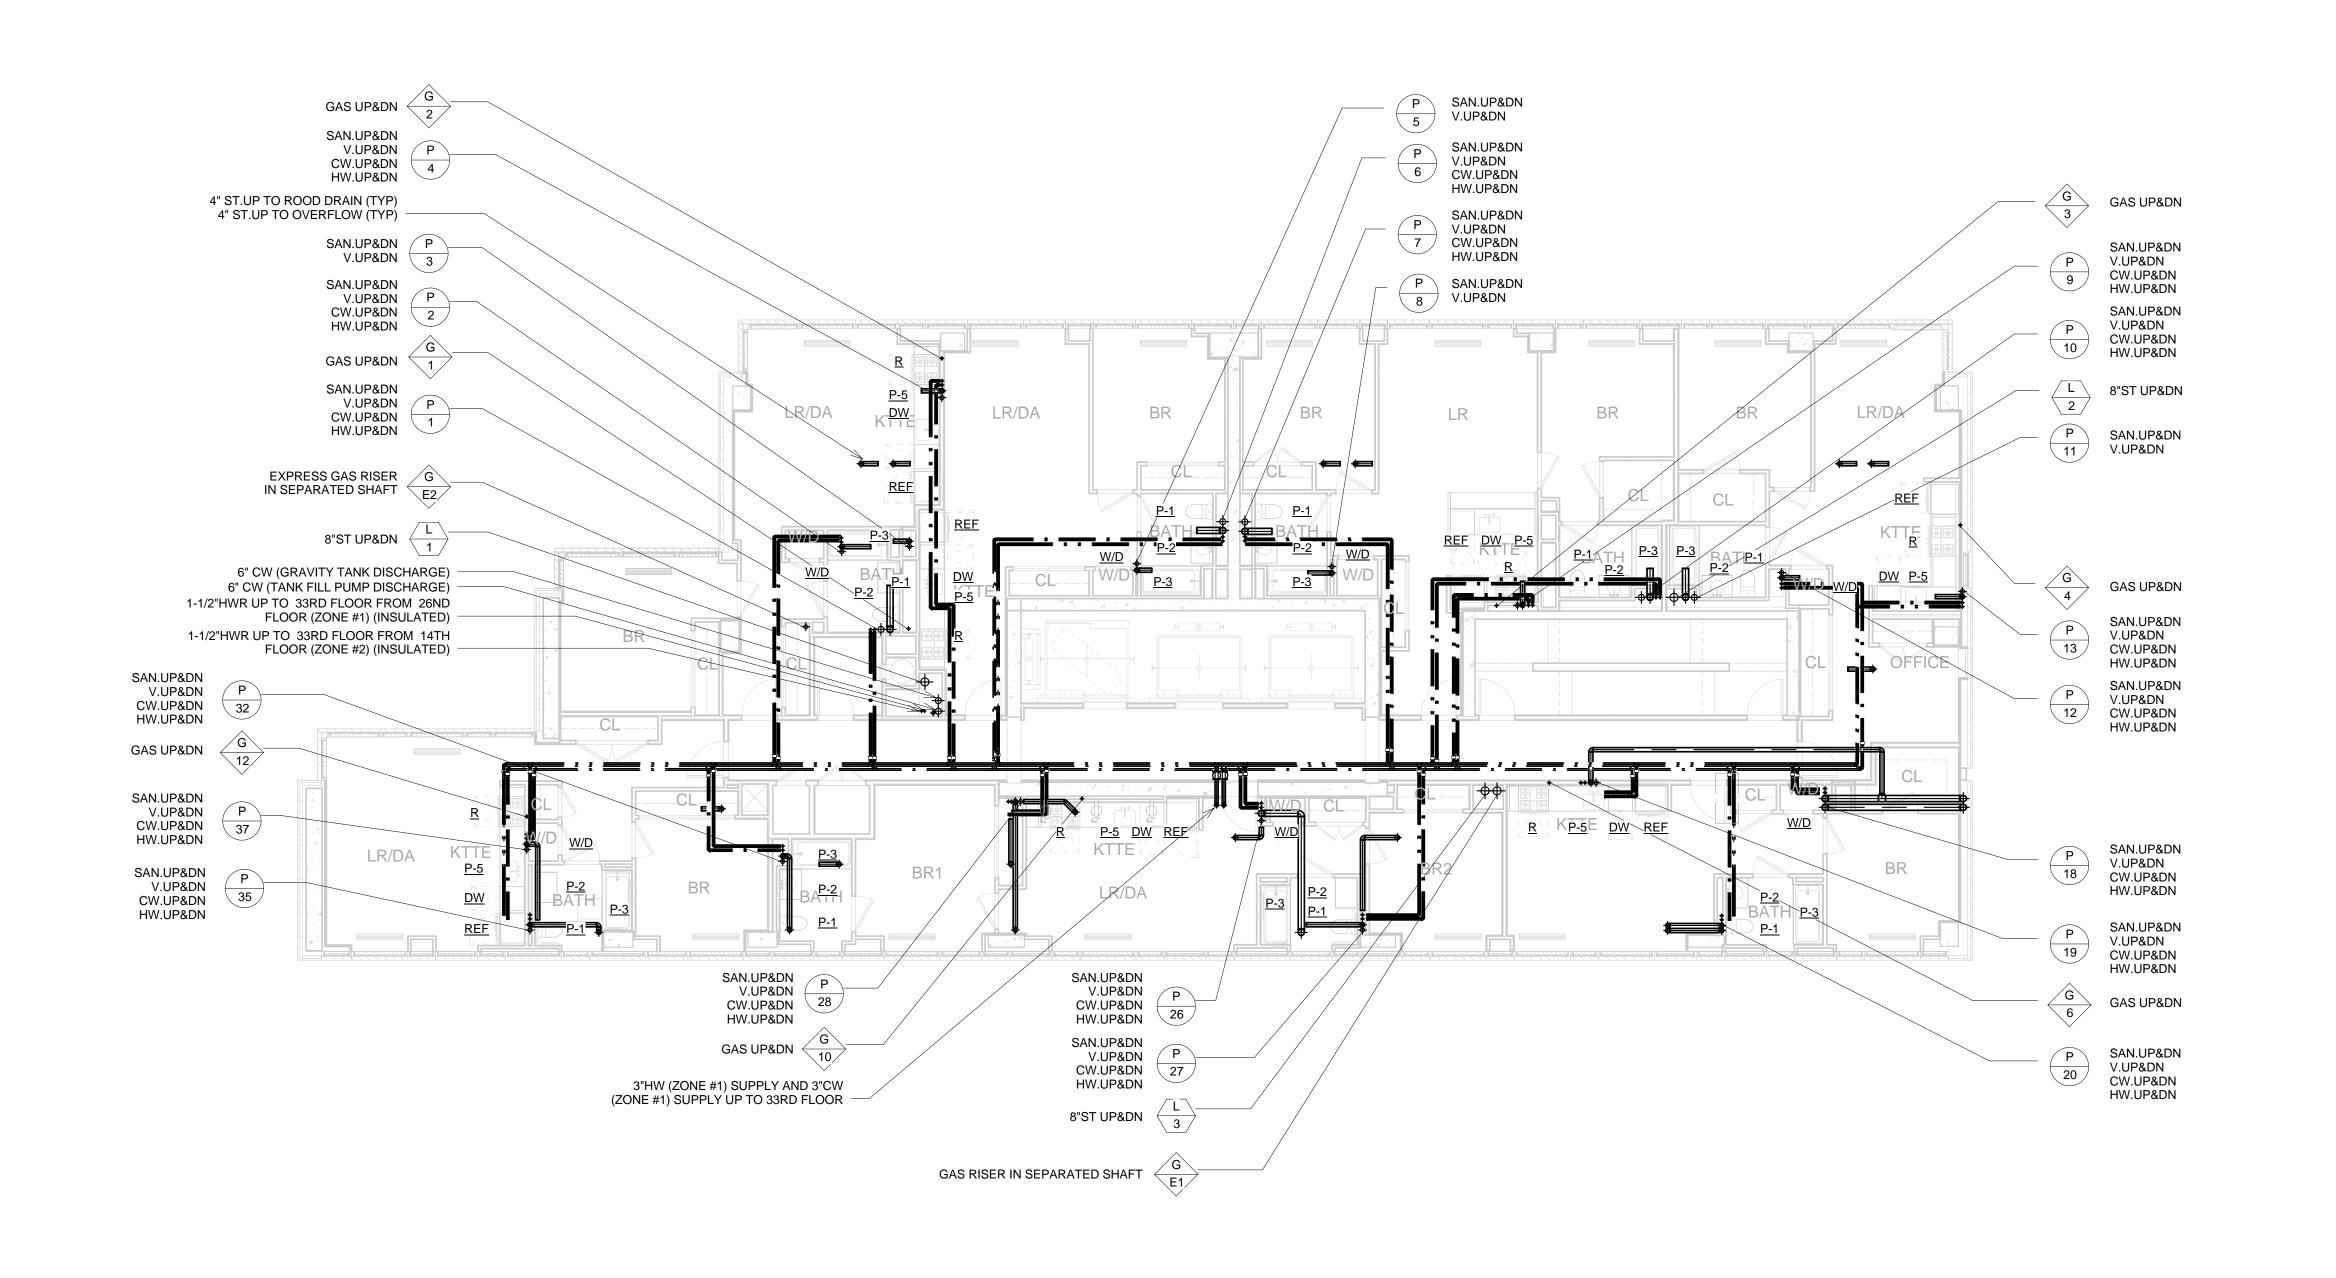

2 32ND FLOOR PLUMBING PIPING PLAN 1/8" = 1'-0"

1 26TH FLOOR PLUMBING PIPING PLAN 1/8" = 1'-0"

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ICOR ASSOCIATES, LLC
485C Route 1 South, Iselin, NJ 08830 908.272.3300
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PROJECT NORTH

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LIC PURVES STREET DEVELOPMENT

44-30 PURVES STREET, QUEENS, NY

DRAWING TITLE:


26TH & 32ND FLOOR PLUMBING PIPING PLANS

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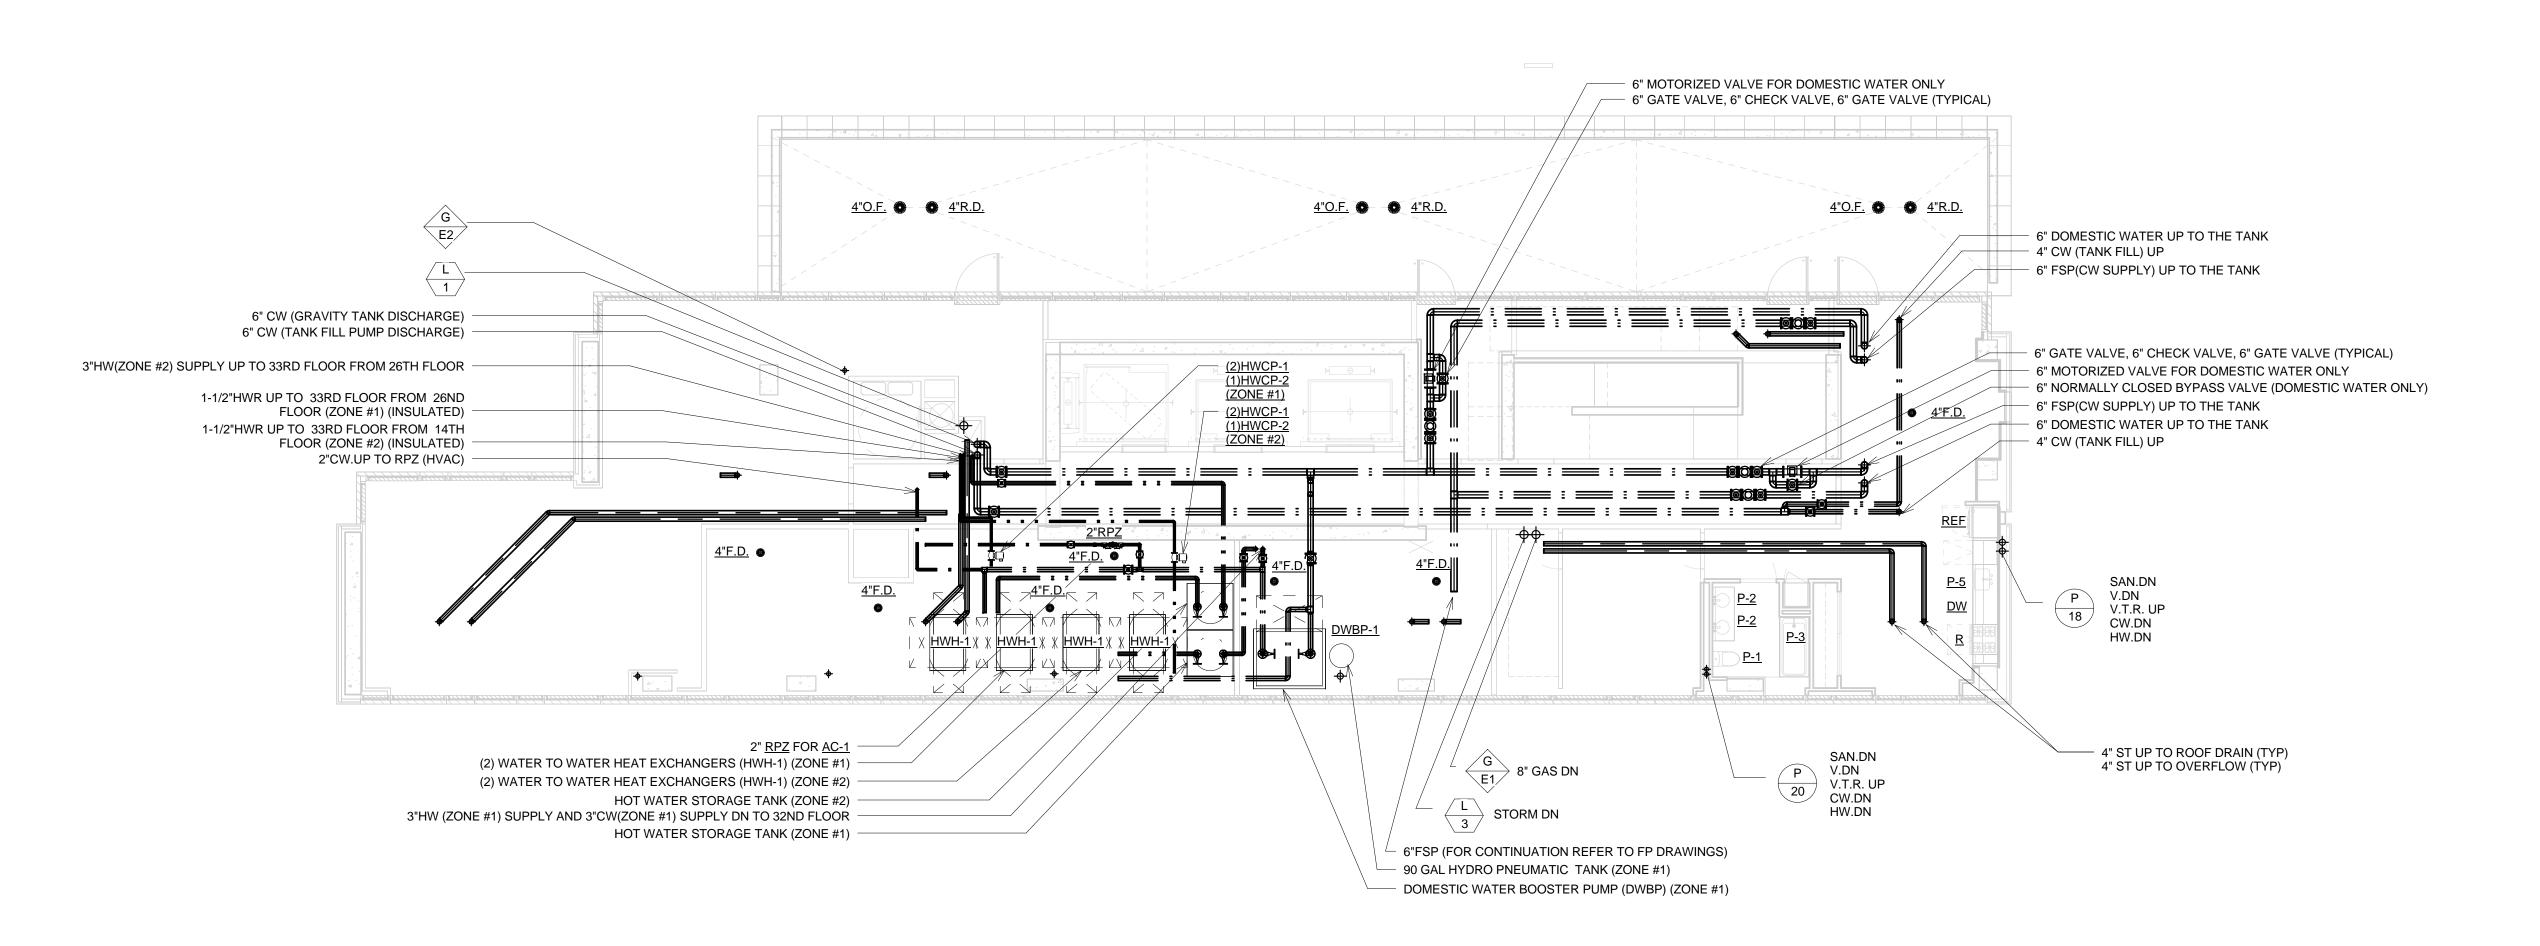
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05/30/14
Scale:
1/8" = 1'-0"

1/8" = 1'-0"

3 UPPER ROOF PLUMBING PIPING PLAN
1/8" = 1'-0"

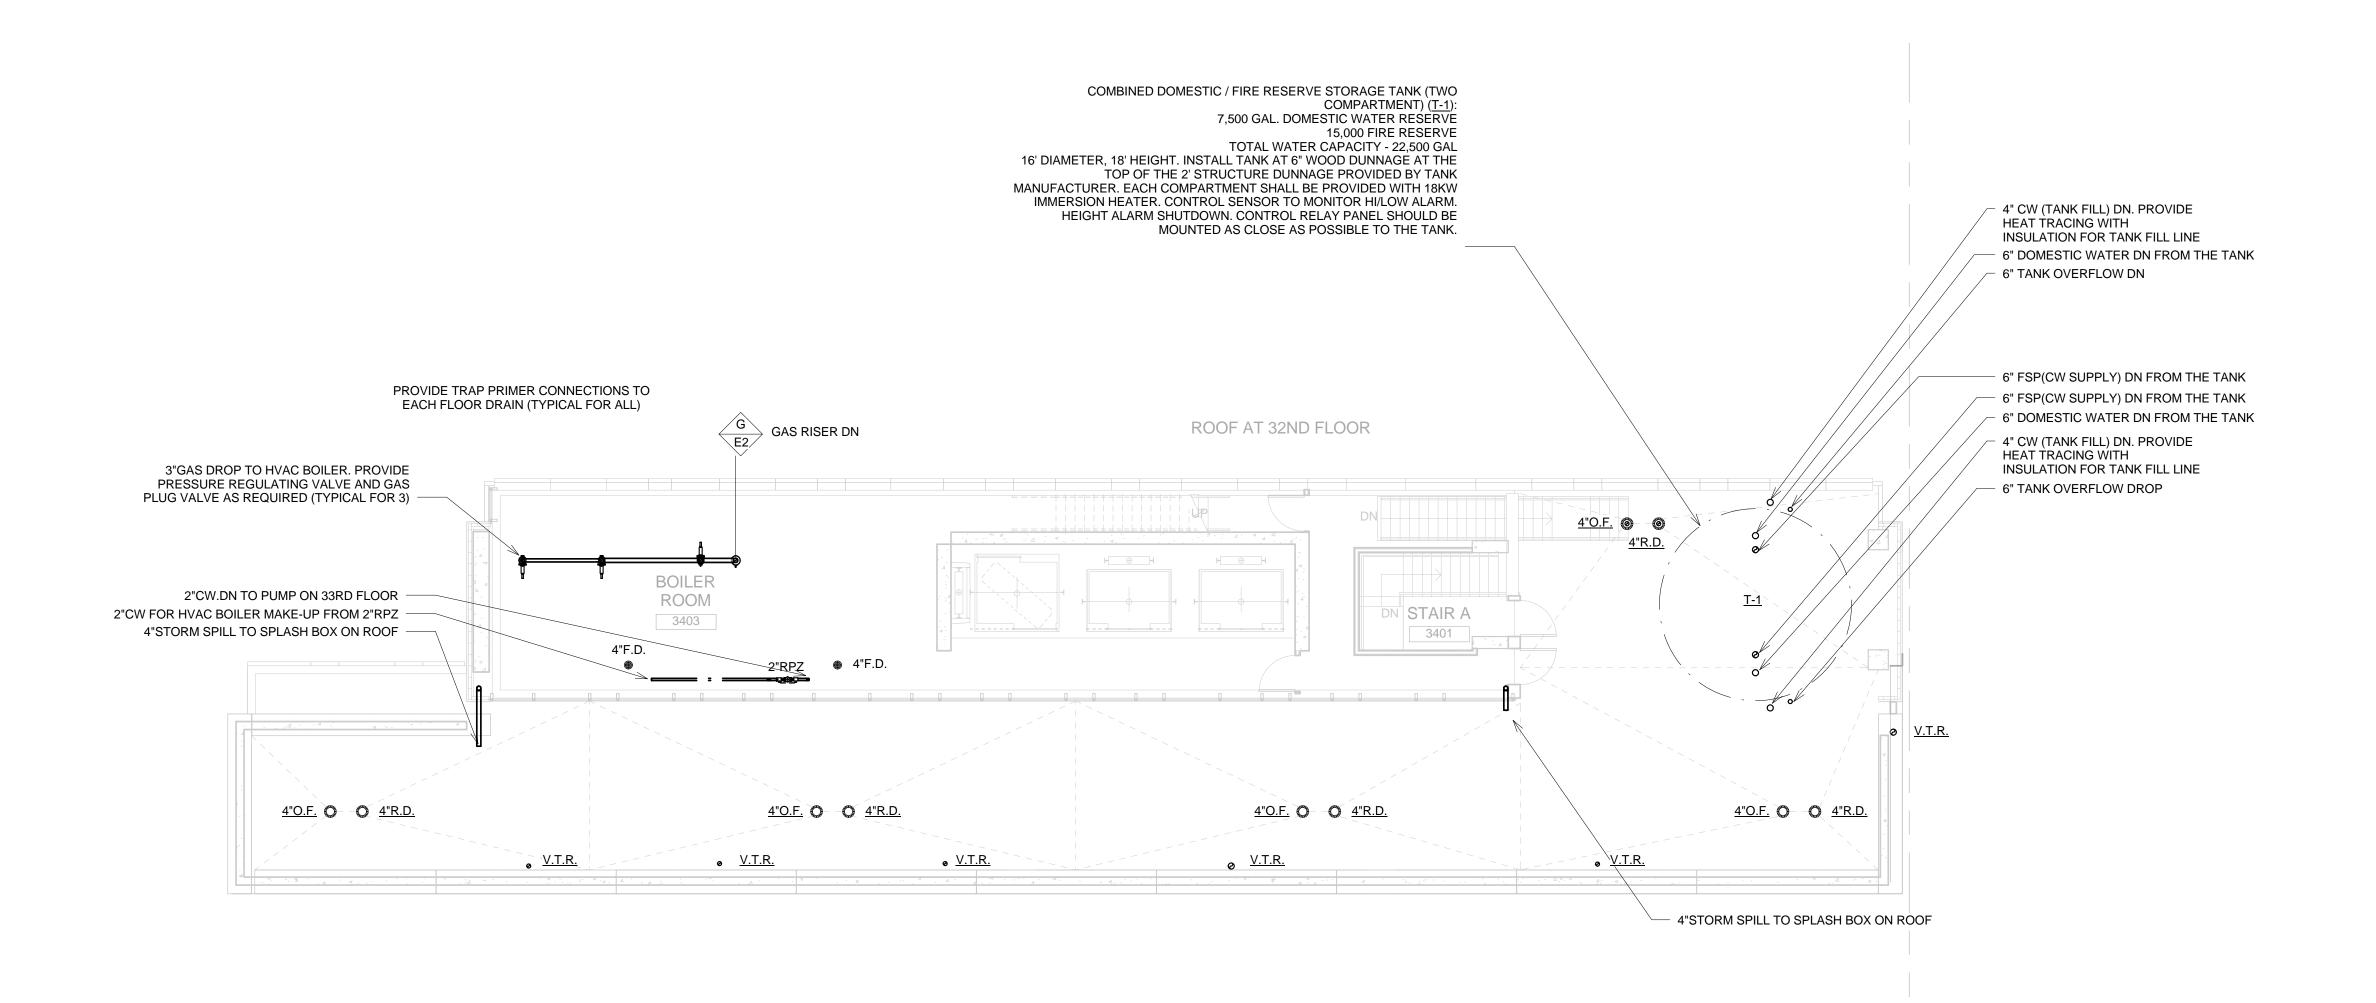

2 LOWER ROOF PLUMBING PIPING PLAN
1/8" = 1'-0"



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LIC PURVES STREET DEVELOPMENT

44-30 PURVES STREET, QUEENS, NY

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DRAWING TITLE:

33RD FLOOR, LOWER & UPPER ROOF PLUMBING PIPING PLANS

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Reviewed: Drawing No.
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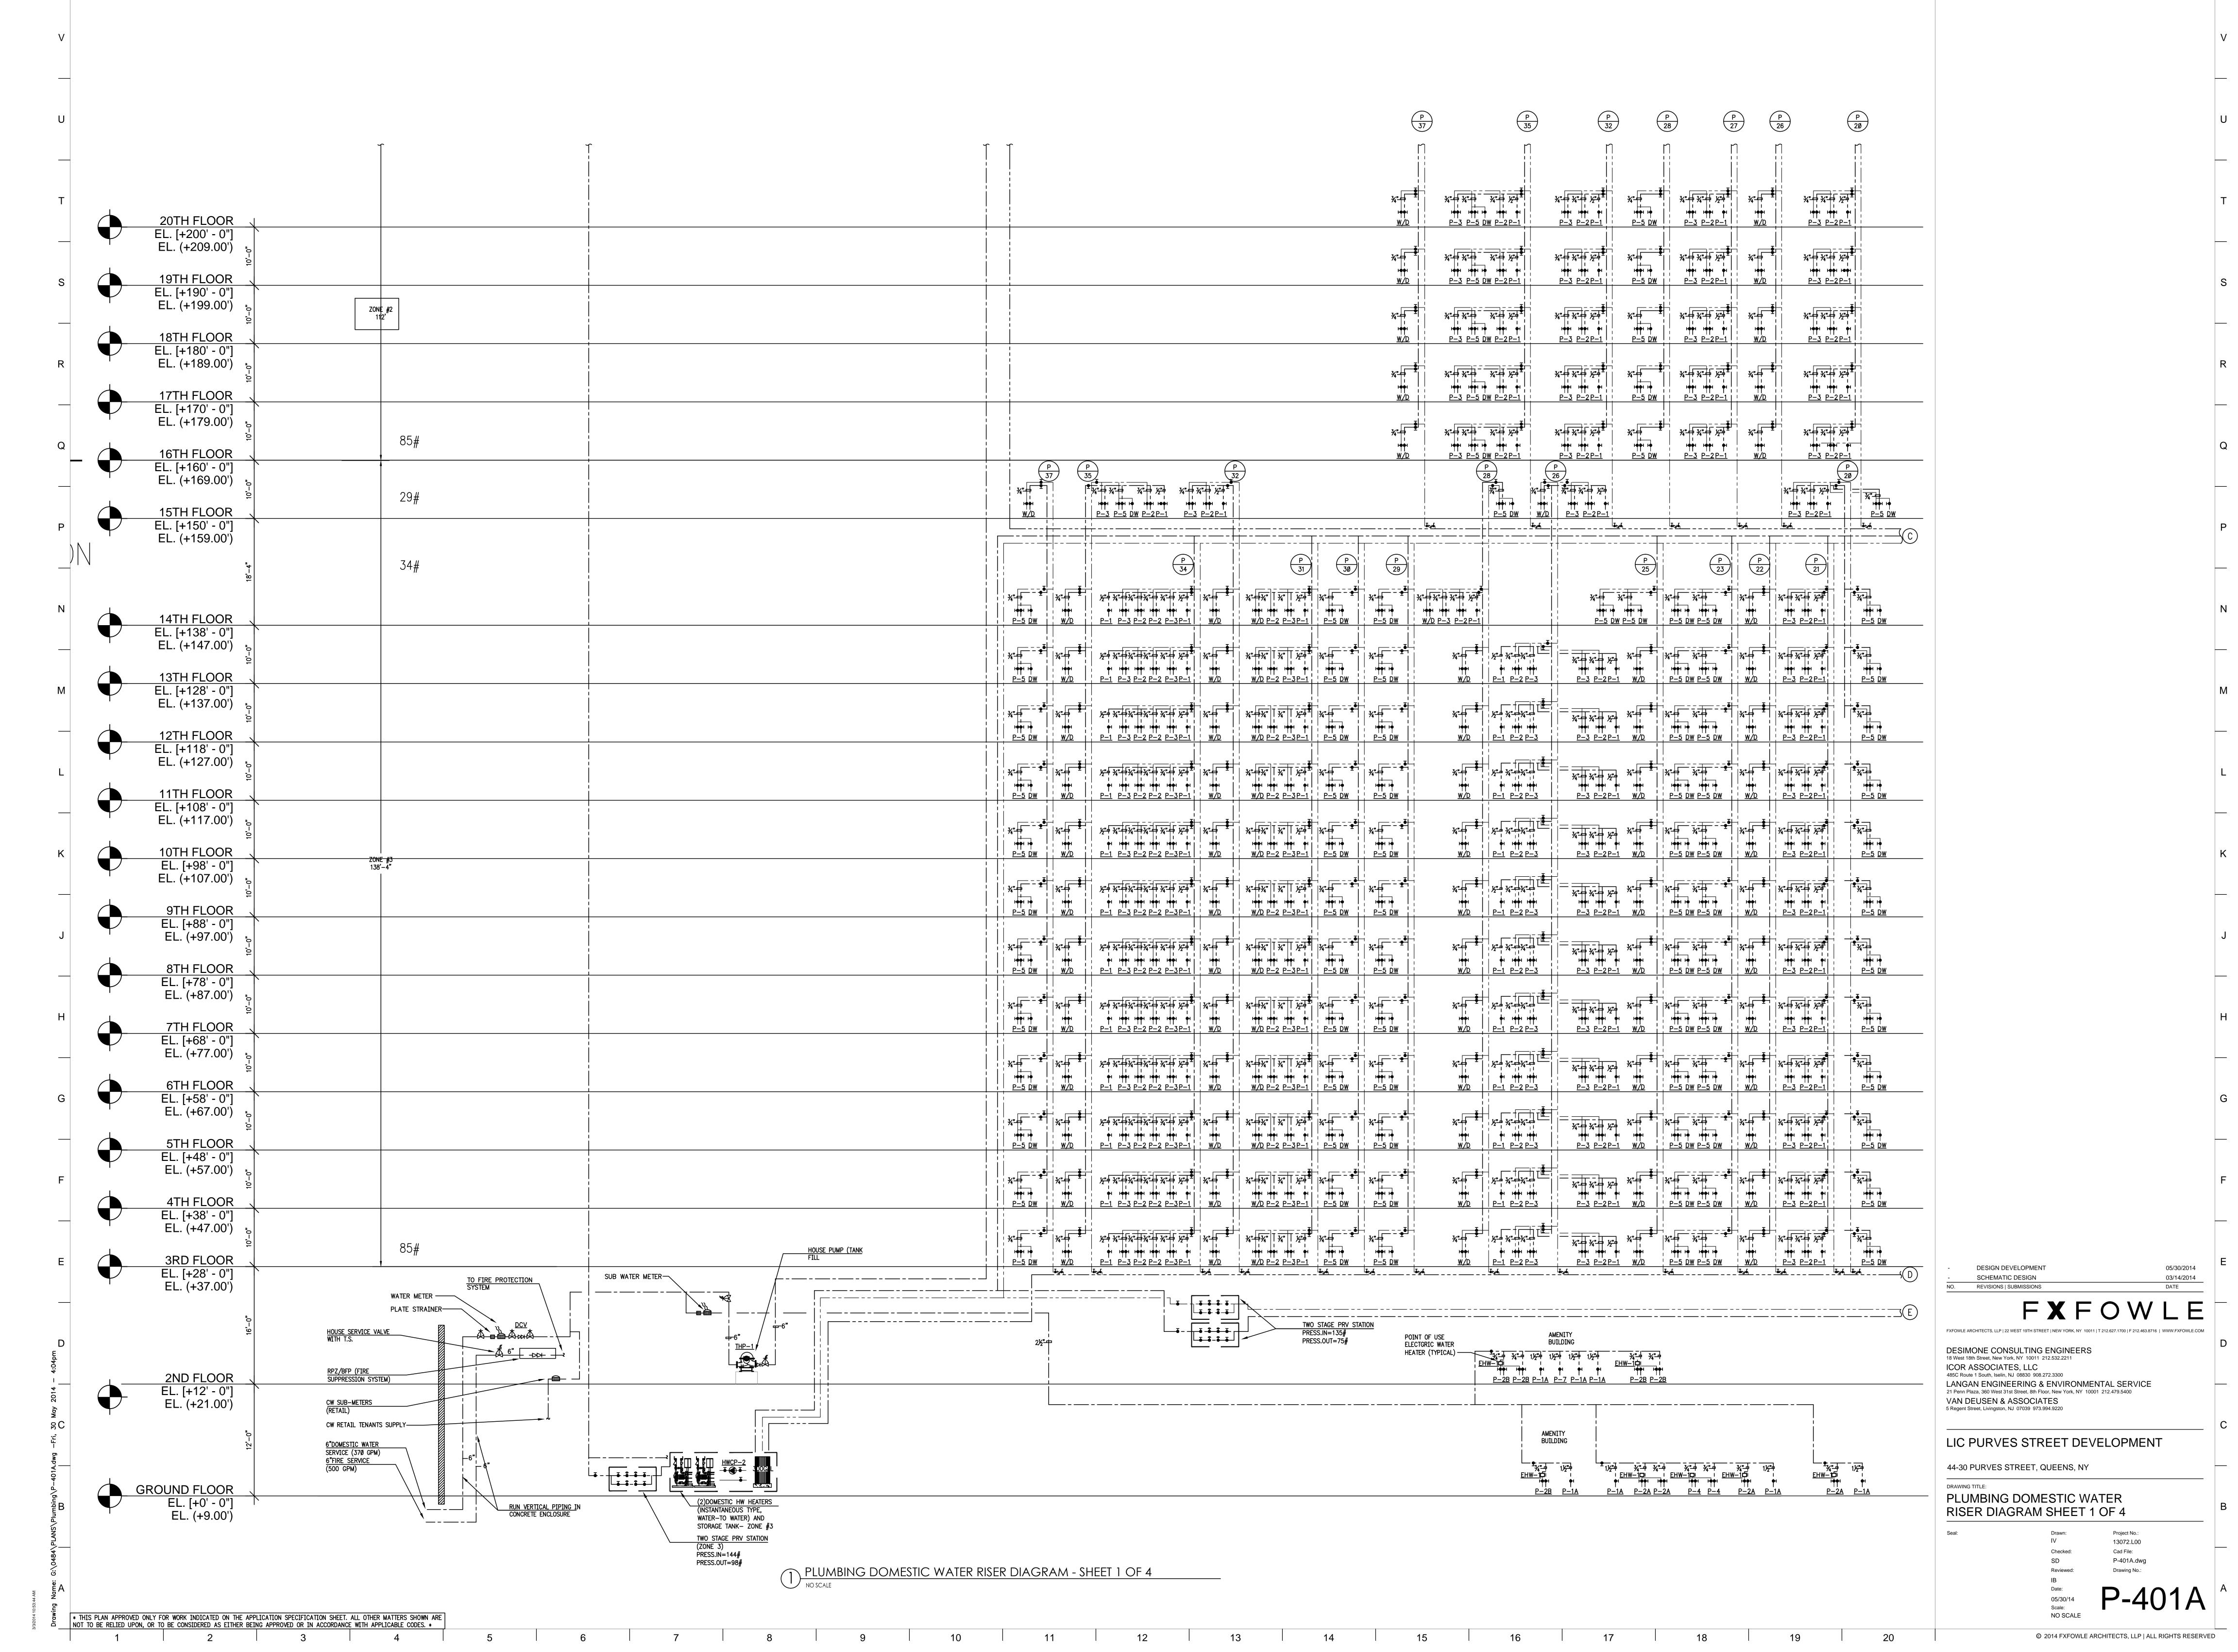
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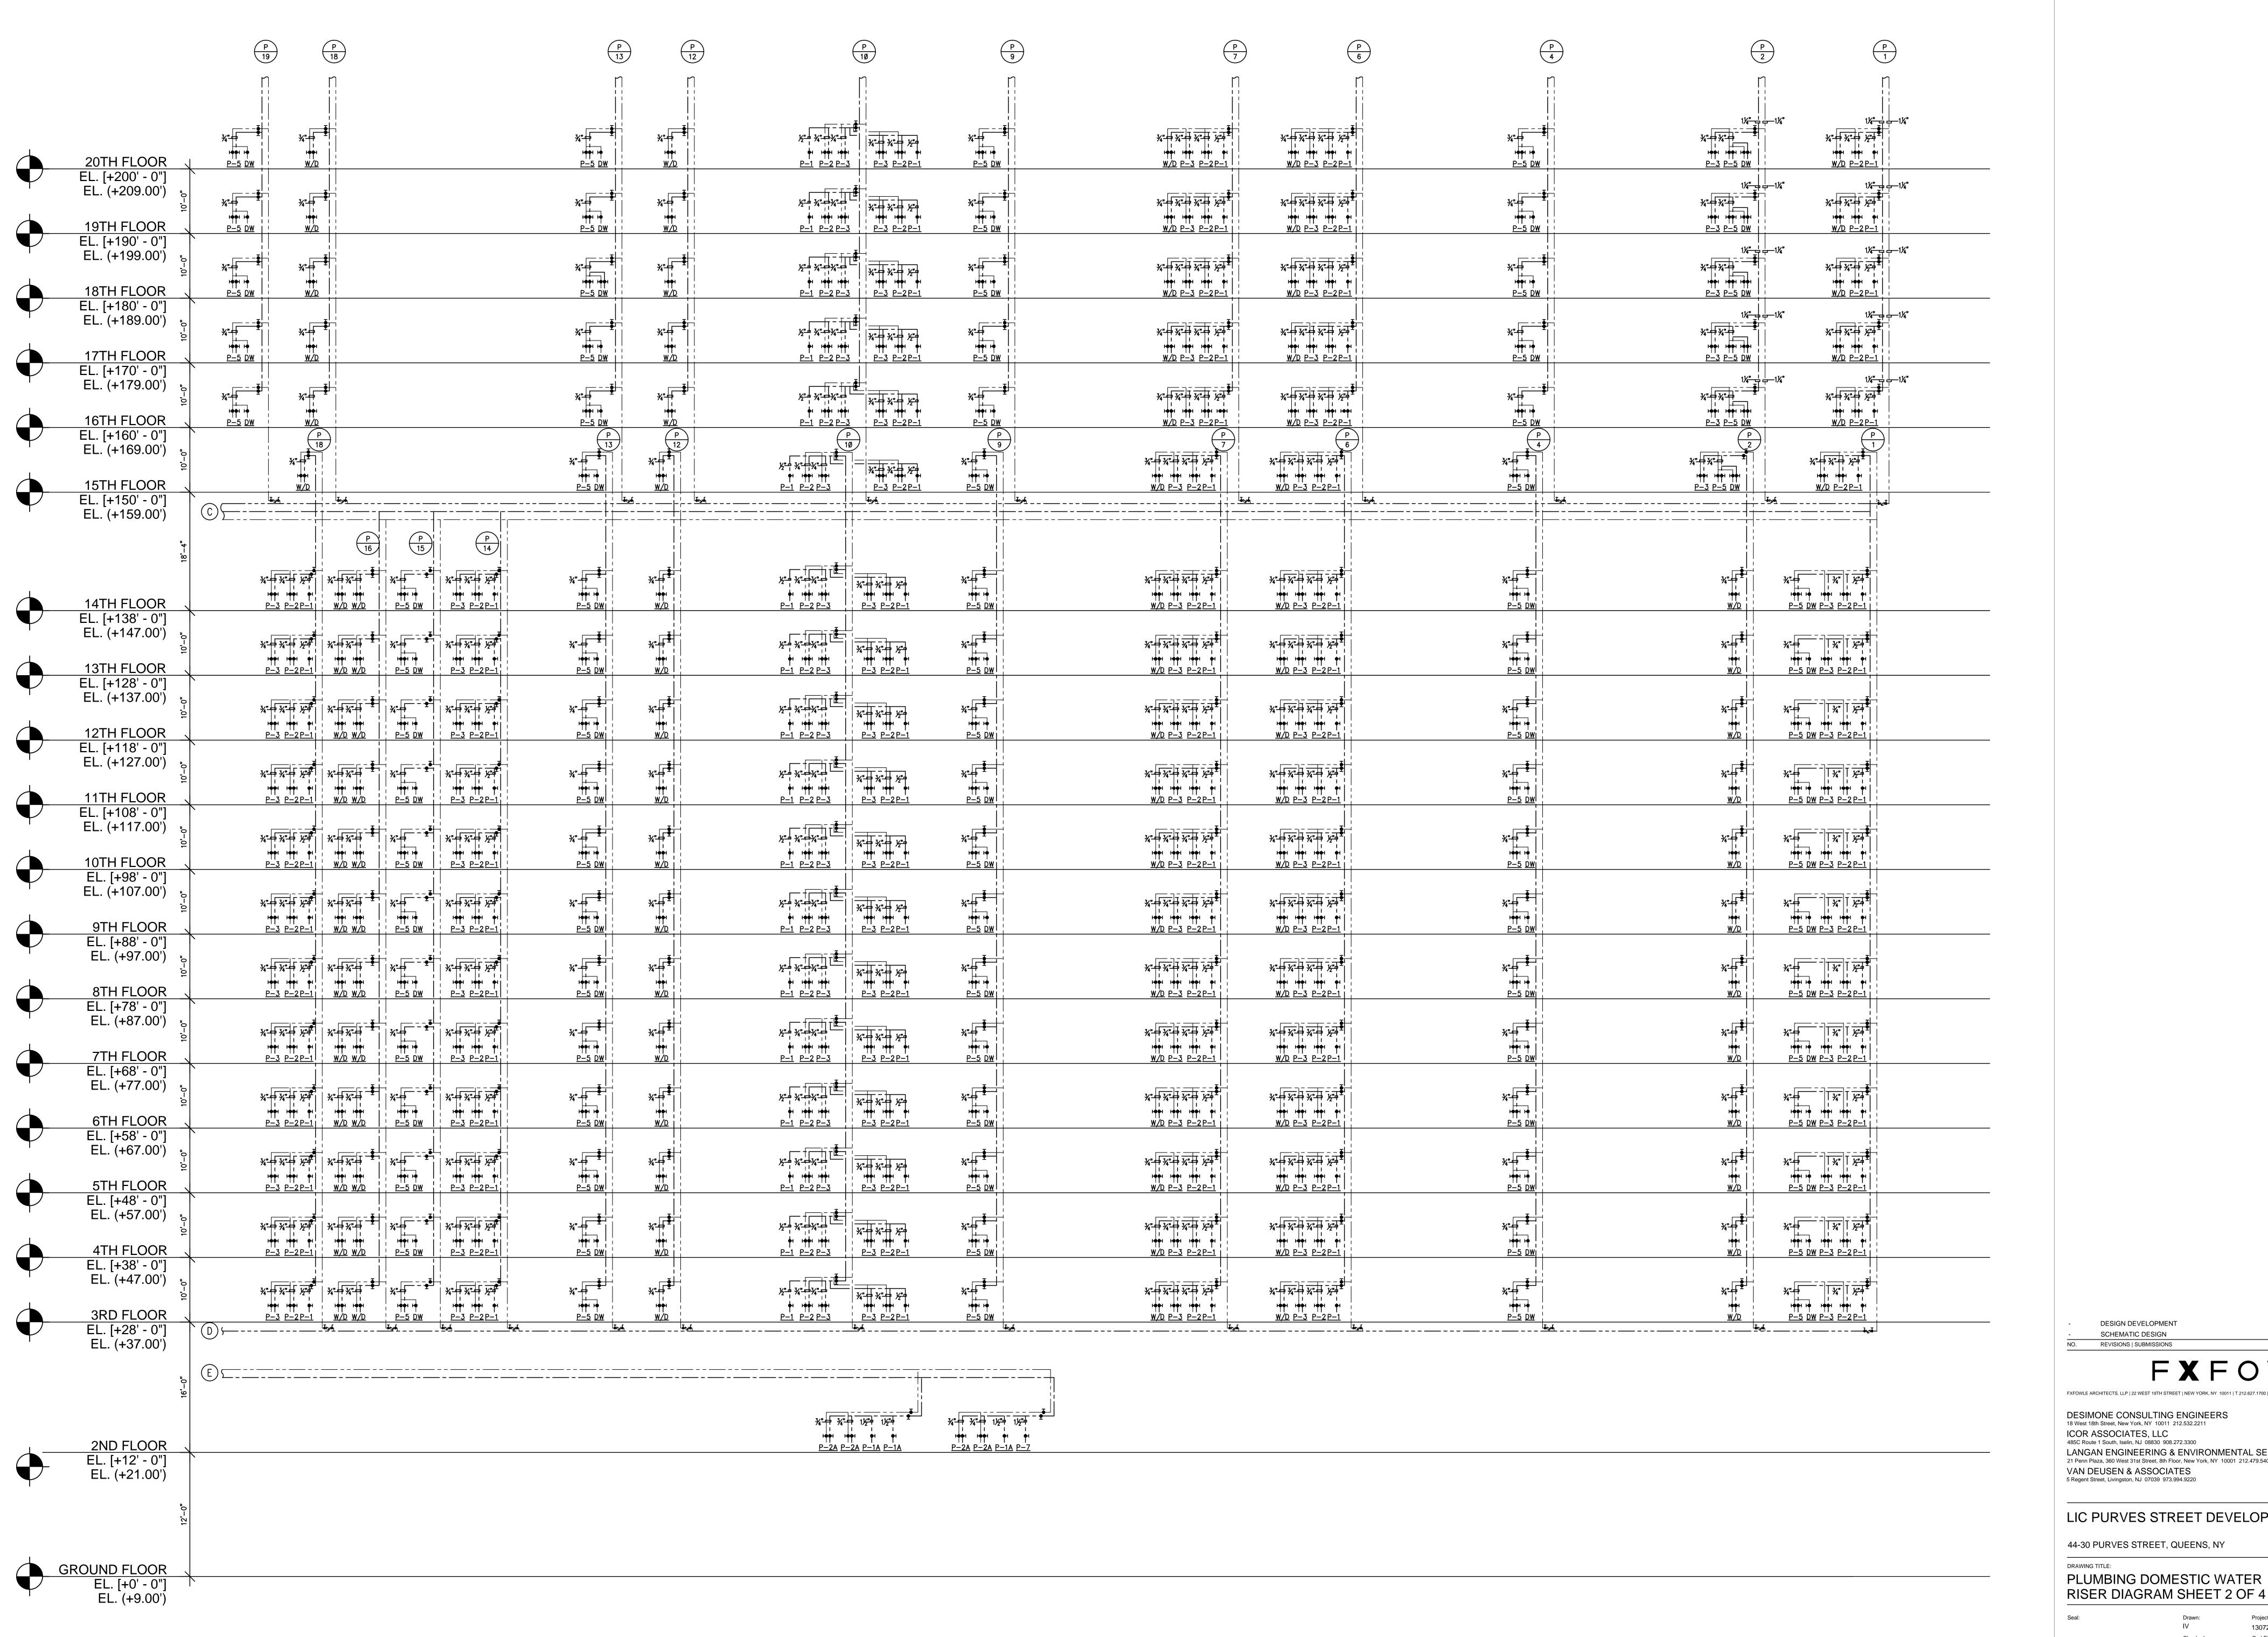
33RD FLOOR PLUMBING PIPING PLAN

1/8" = 1'-0"

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### LIC PURVES STREET DEVELOPMENT

44-30 PURVES STREET, QUEENS, NY

20

DRAWING TITLE: PLUMBING DOMESTIC WATER

> Project No. 13072.L00 Cad File: P-401B.dwg


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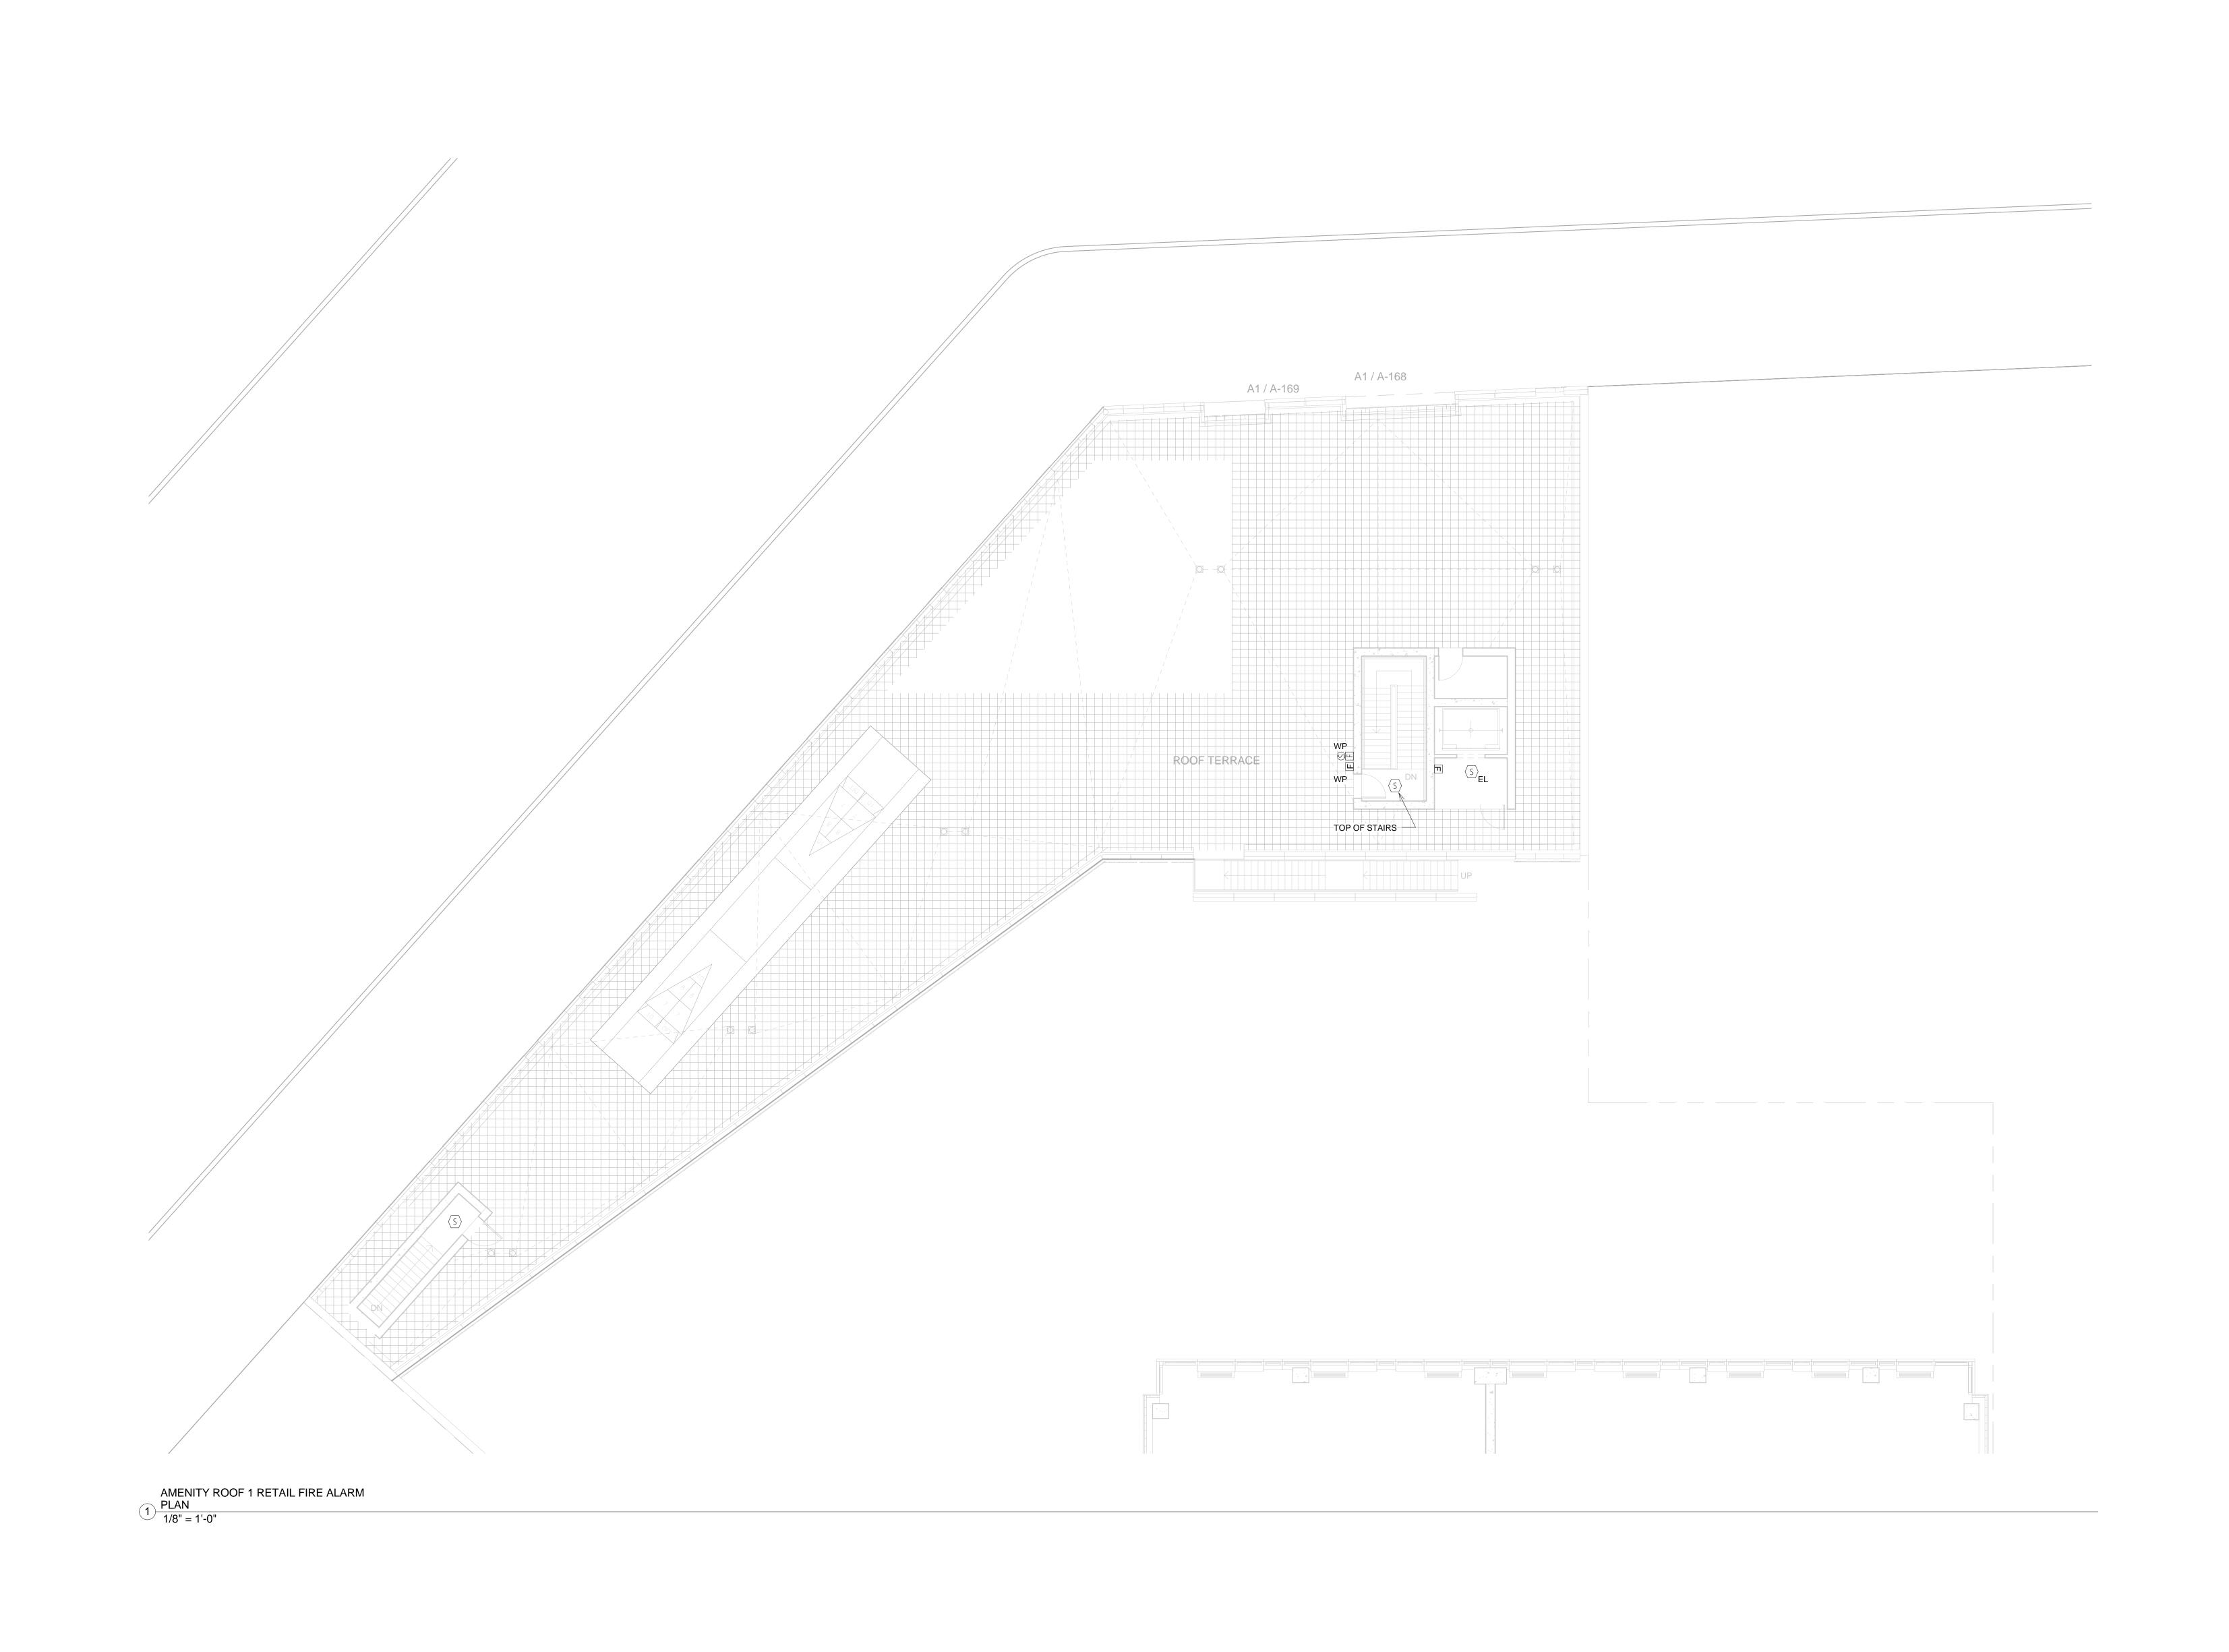
NO SCALE

PLUMBING DOMESTIC WATER RISER DIAGRAM - SHEET 2 OF 4
NO SCALE

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LIC PURVES STREET DEVELOPMENT


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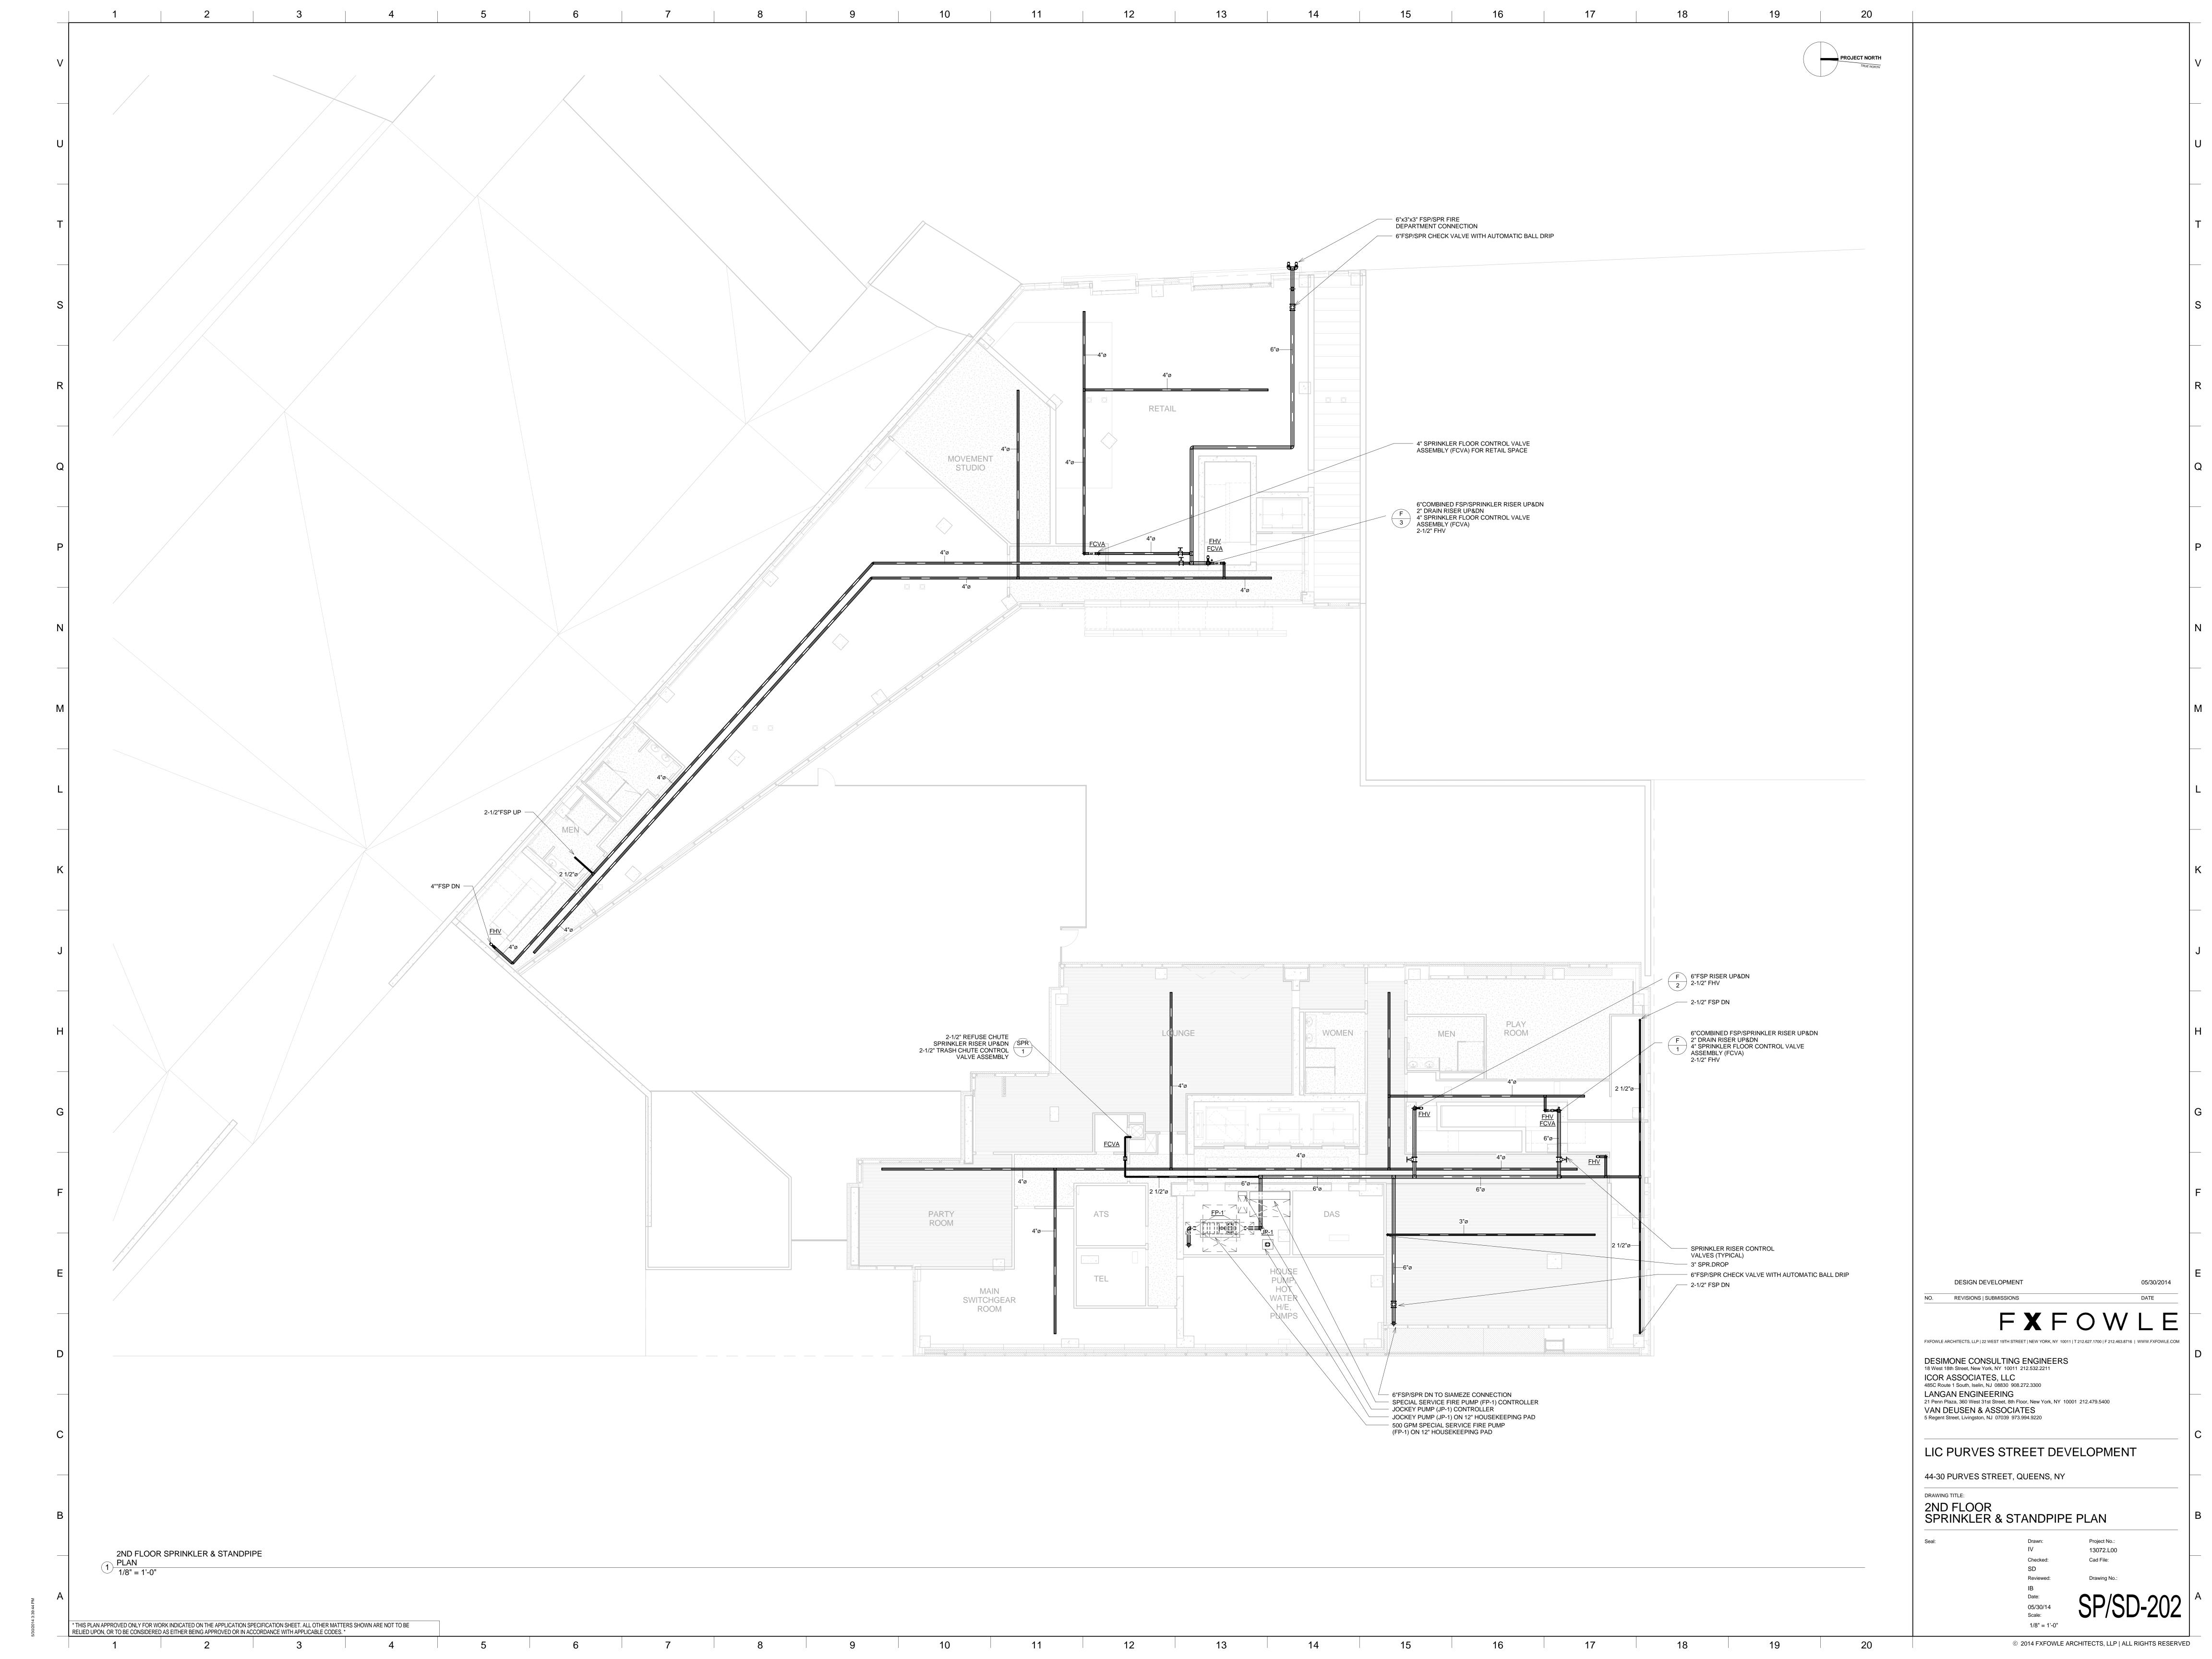
AMENITY BUILDING ROOF FIRE ALARM PLAN


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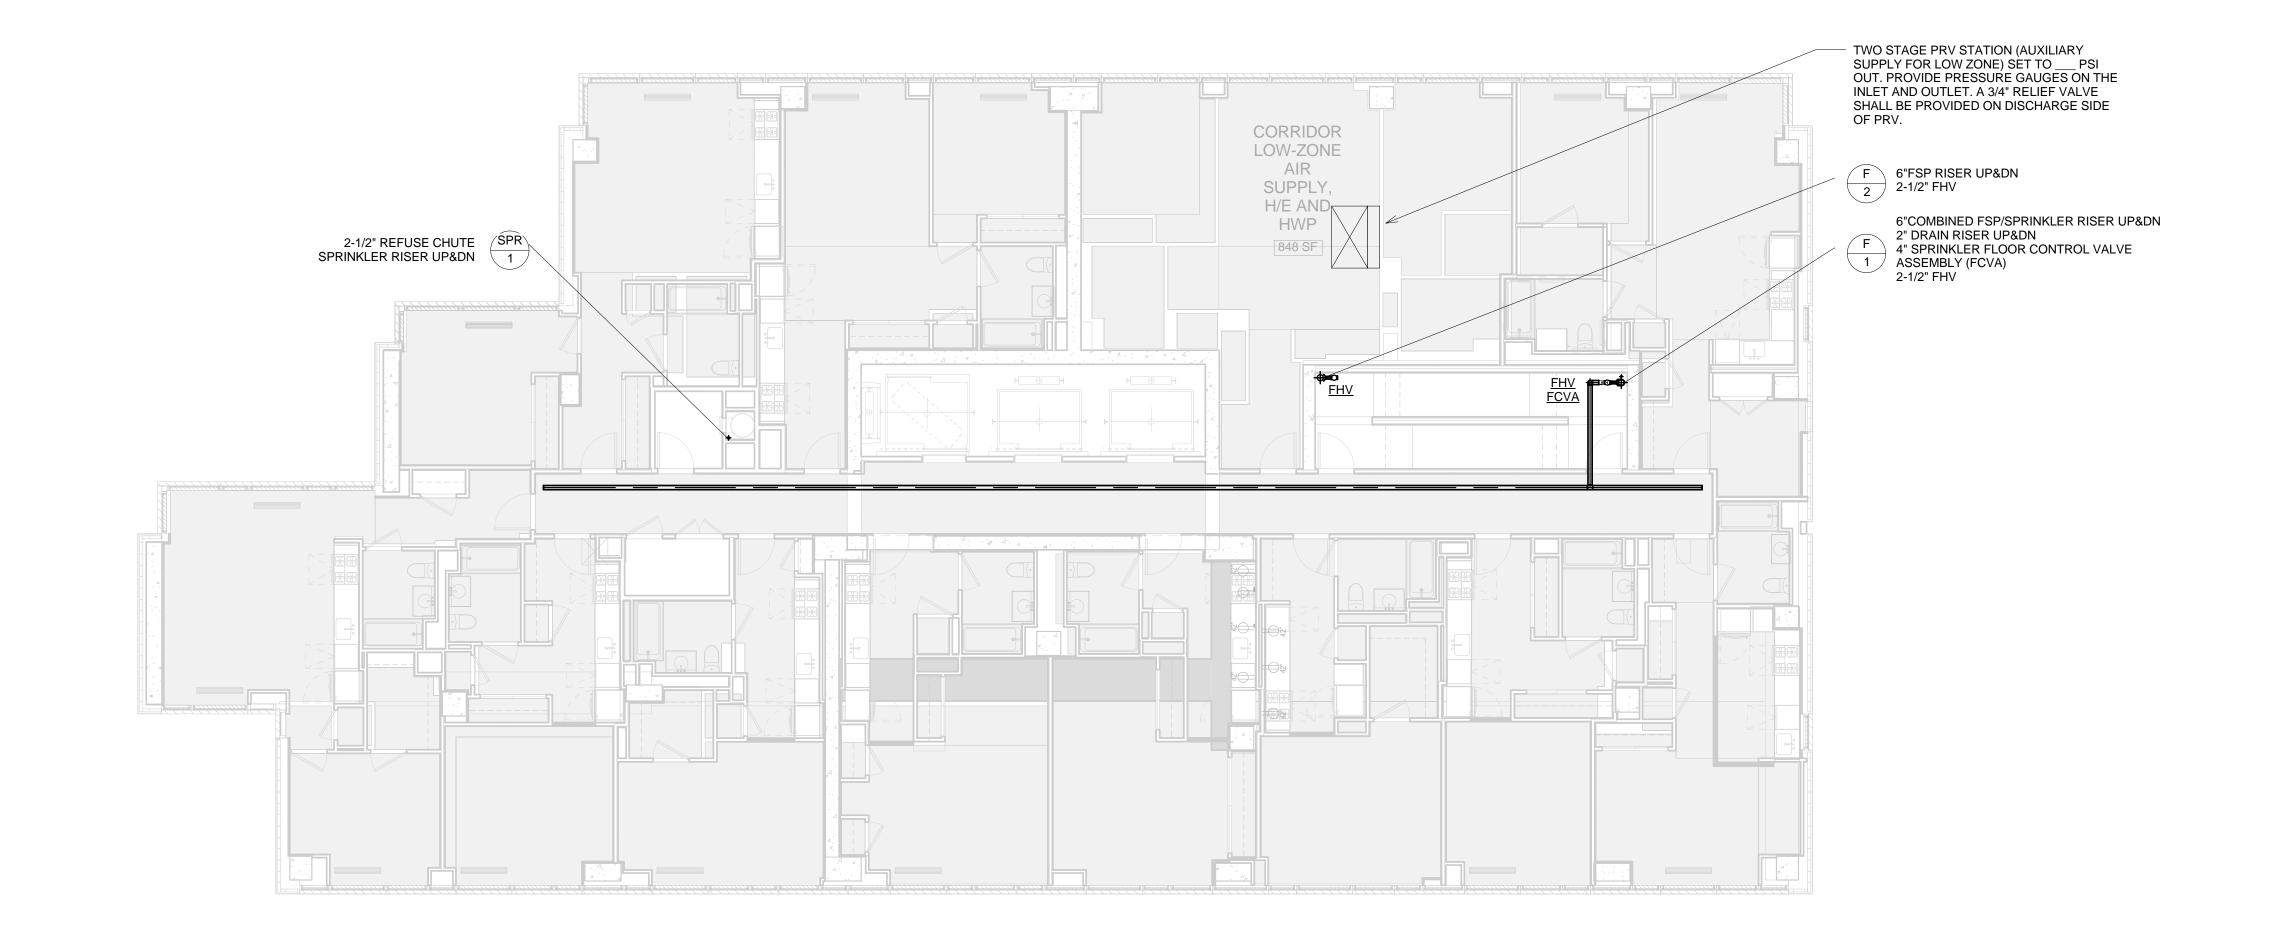
44-30 PURVES STREET, QUEENS, NY

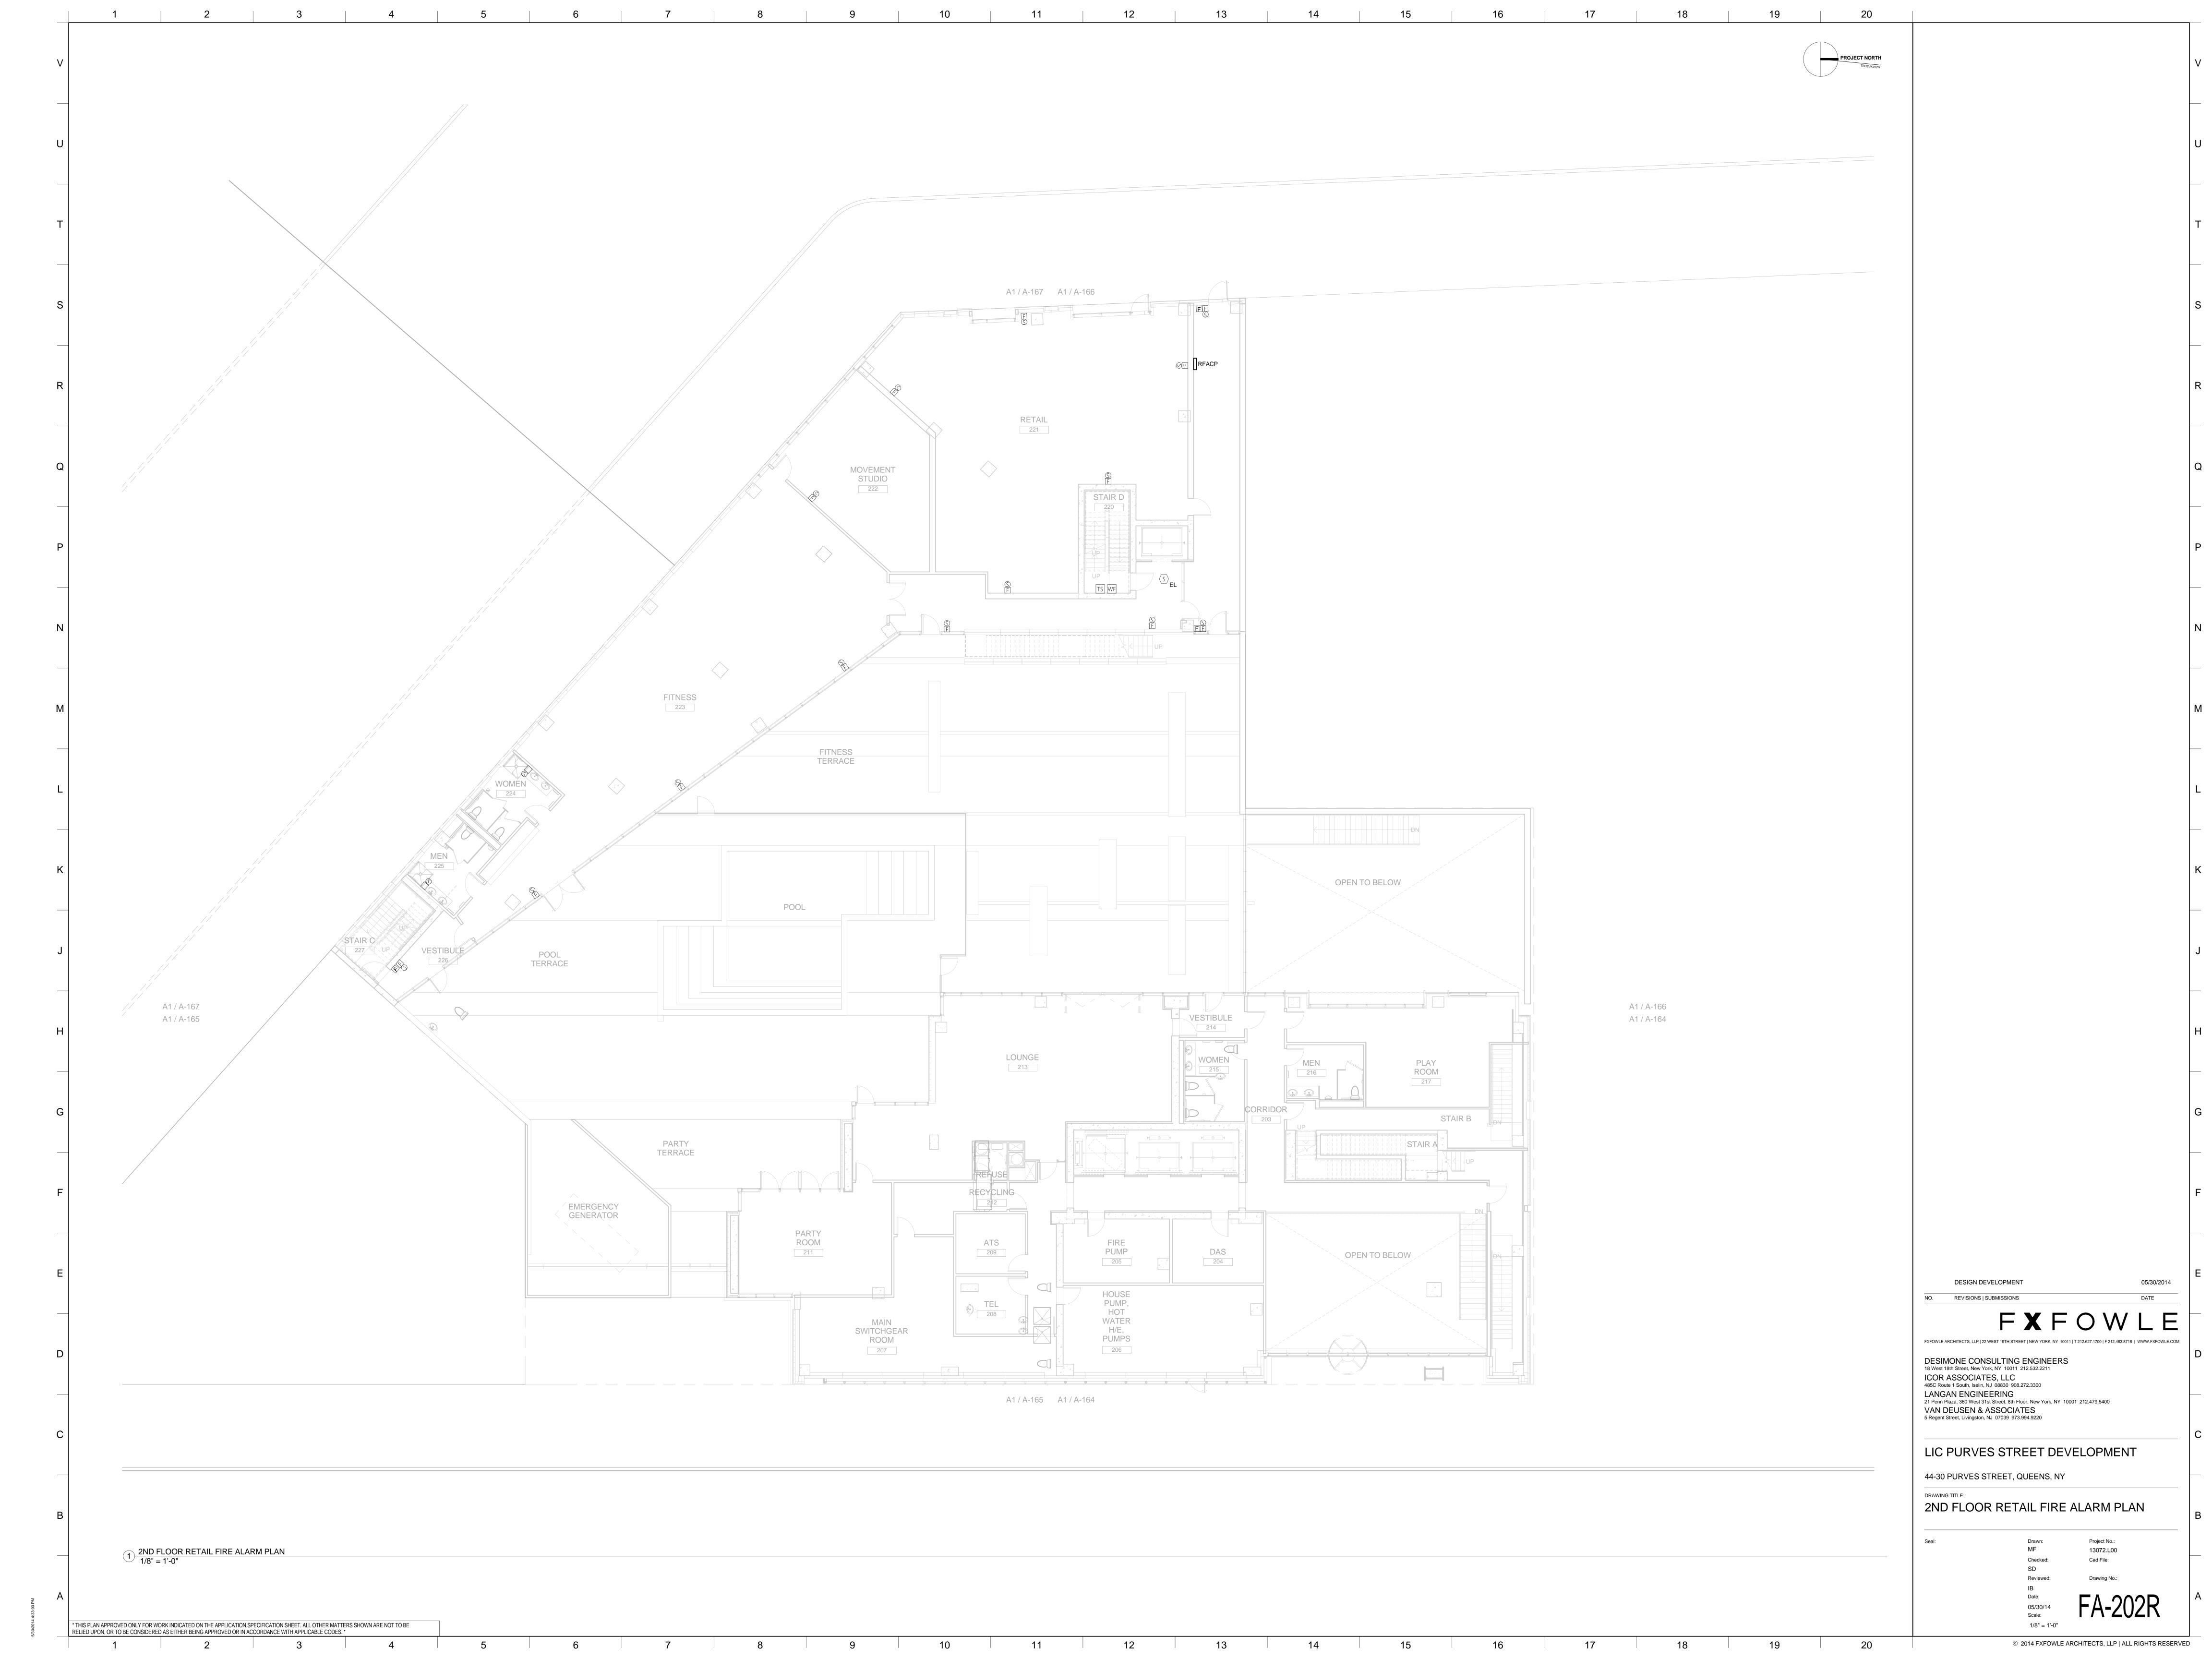AMENITY BUILDING ROOF SPRINKLER & STANDPIPE PLAN

05/30/14 Scale: 3P/3D-2U 1/8" = 1'-0"


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13072.L00

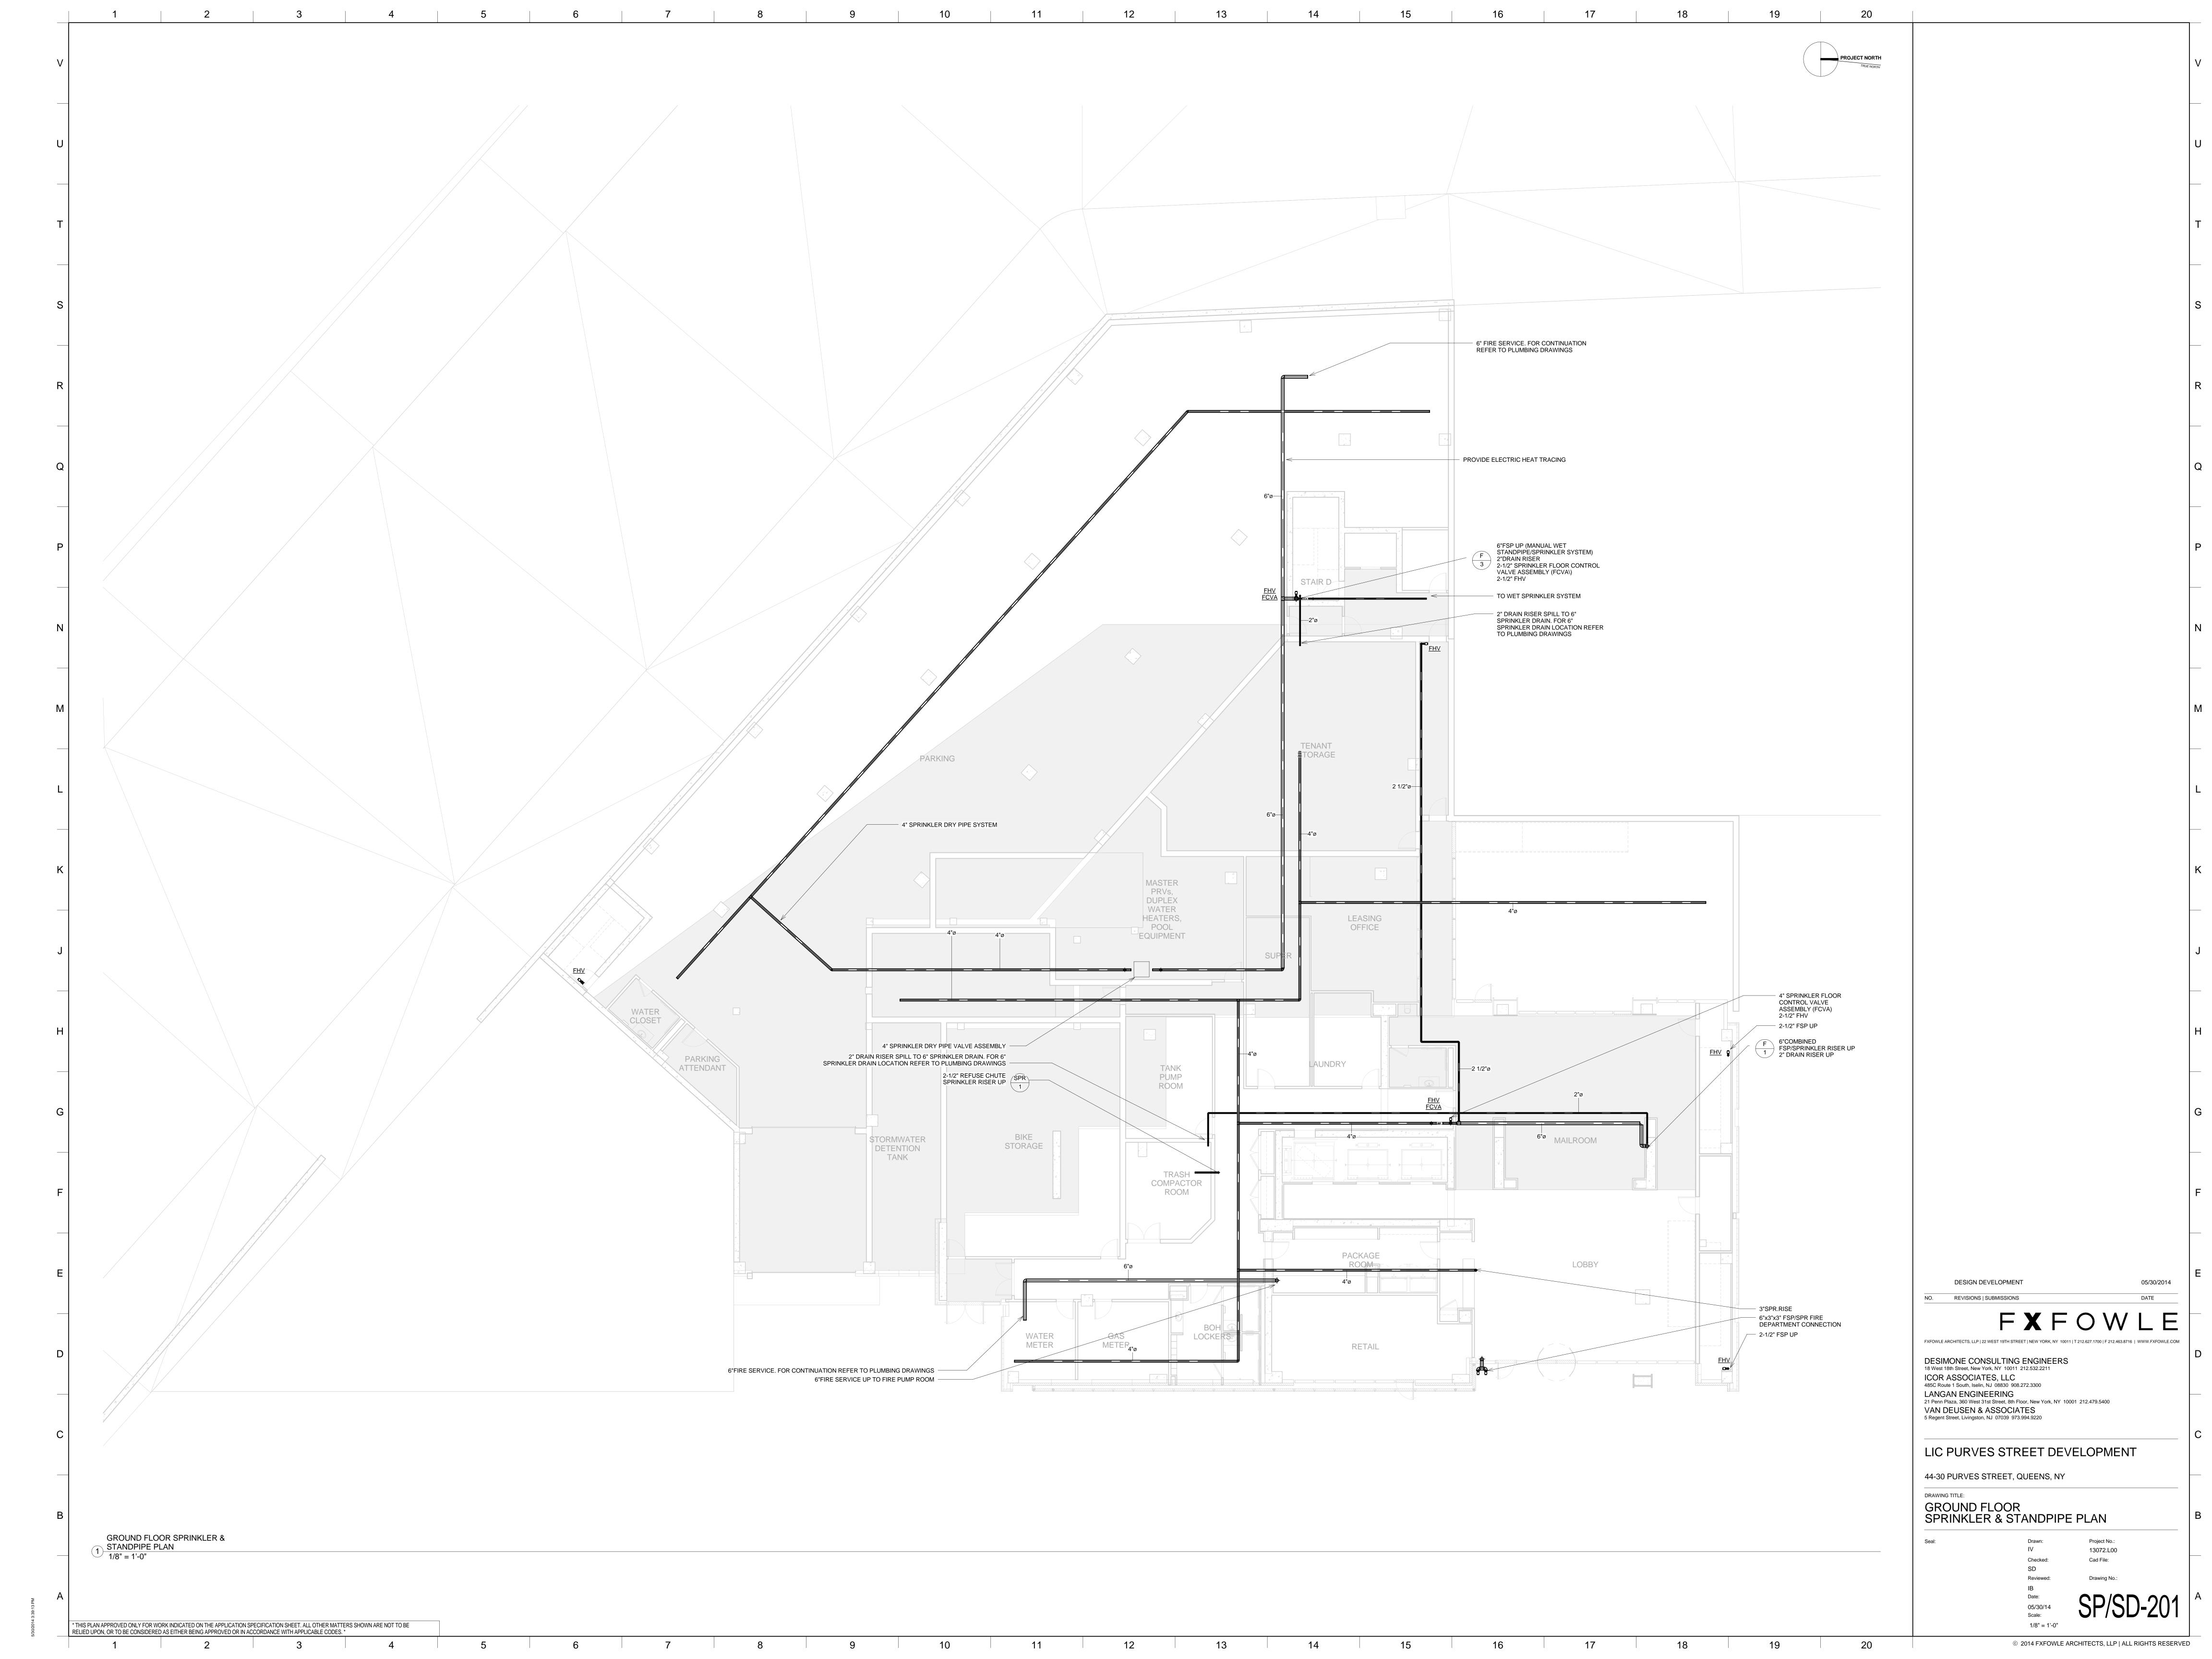

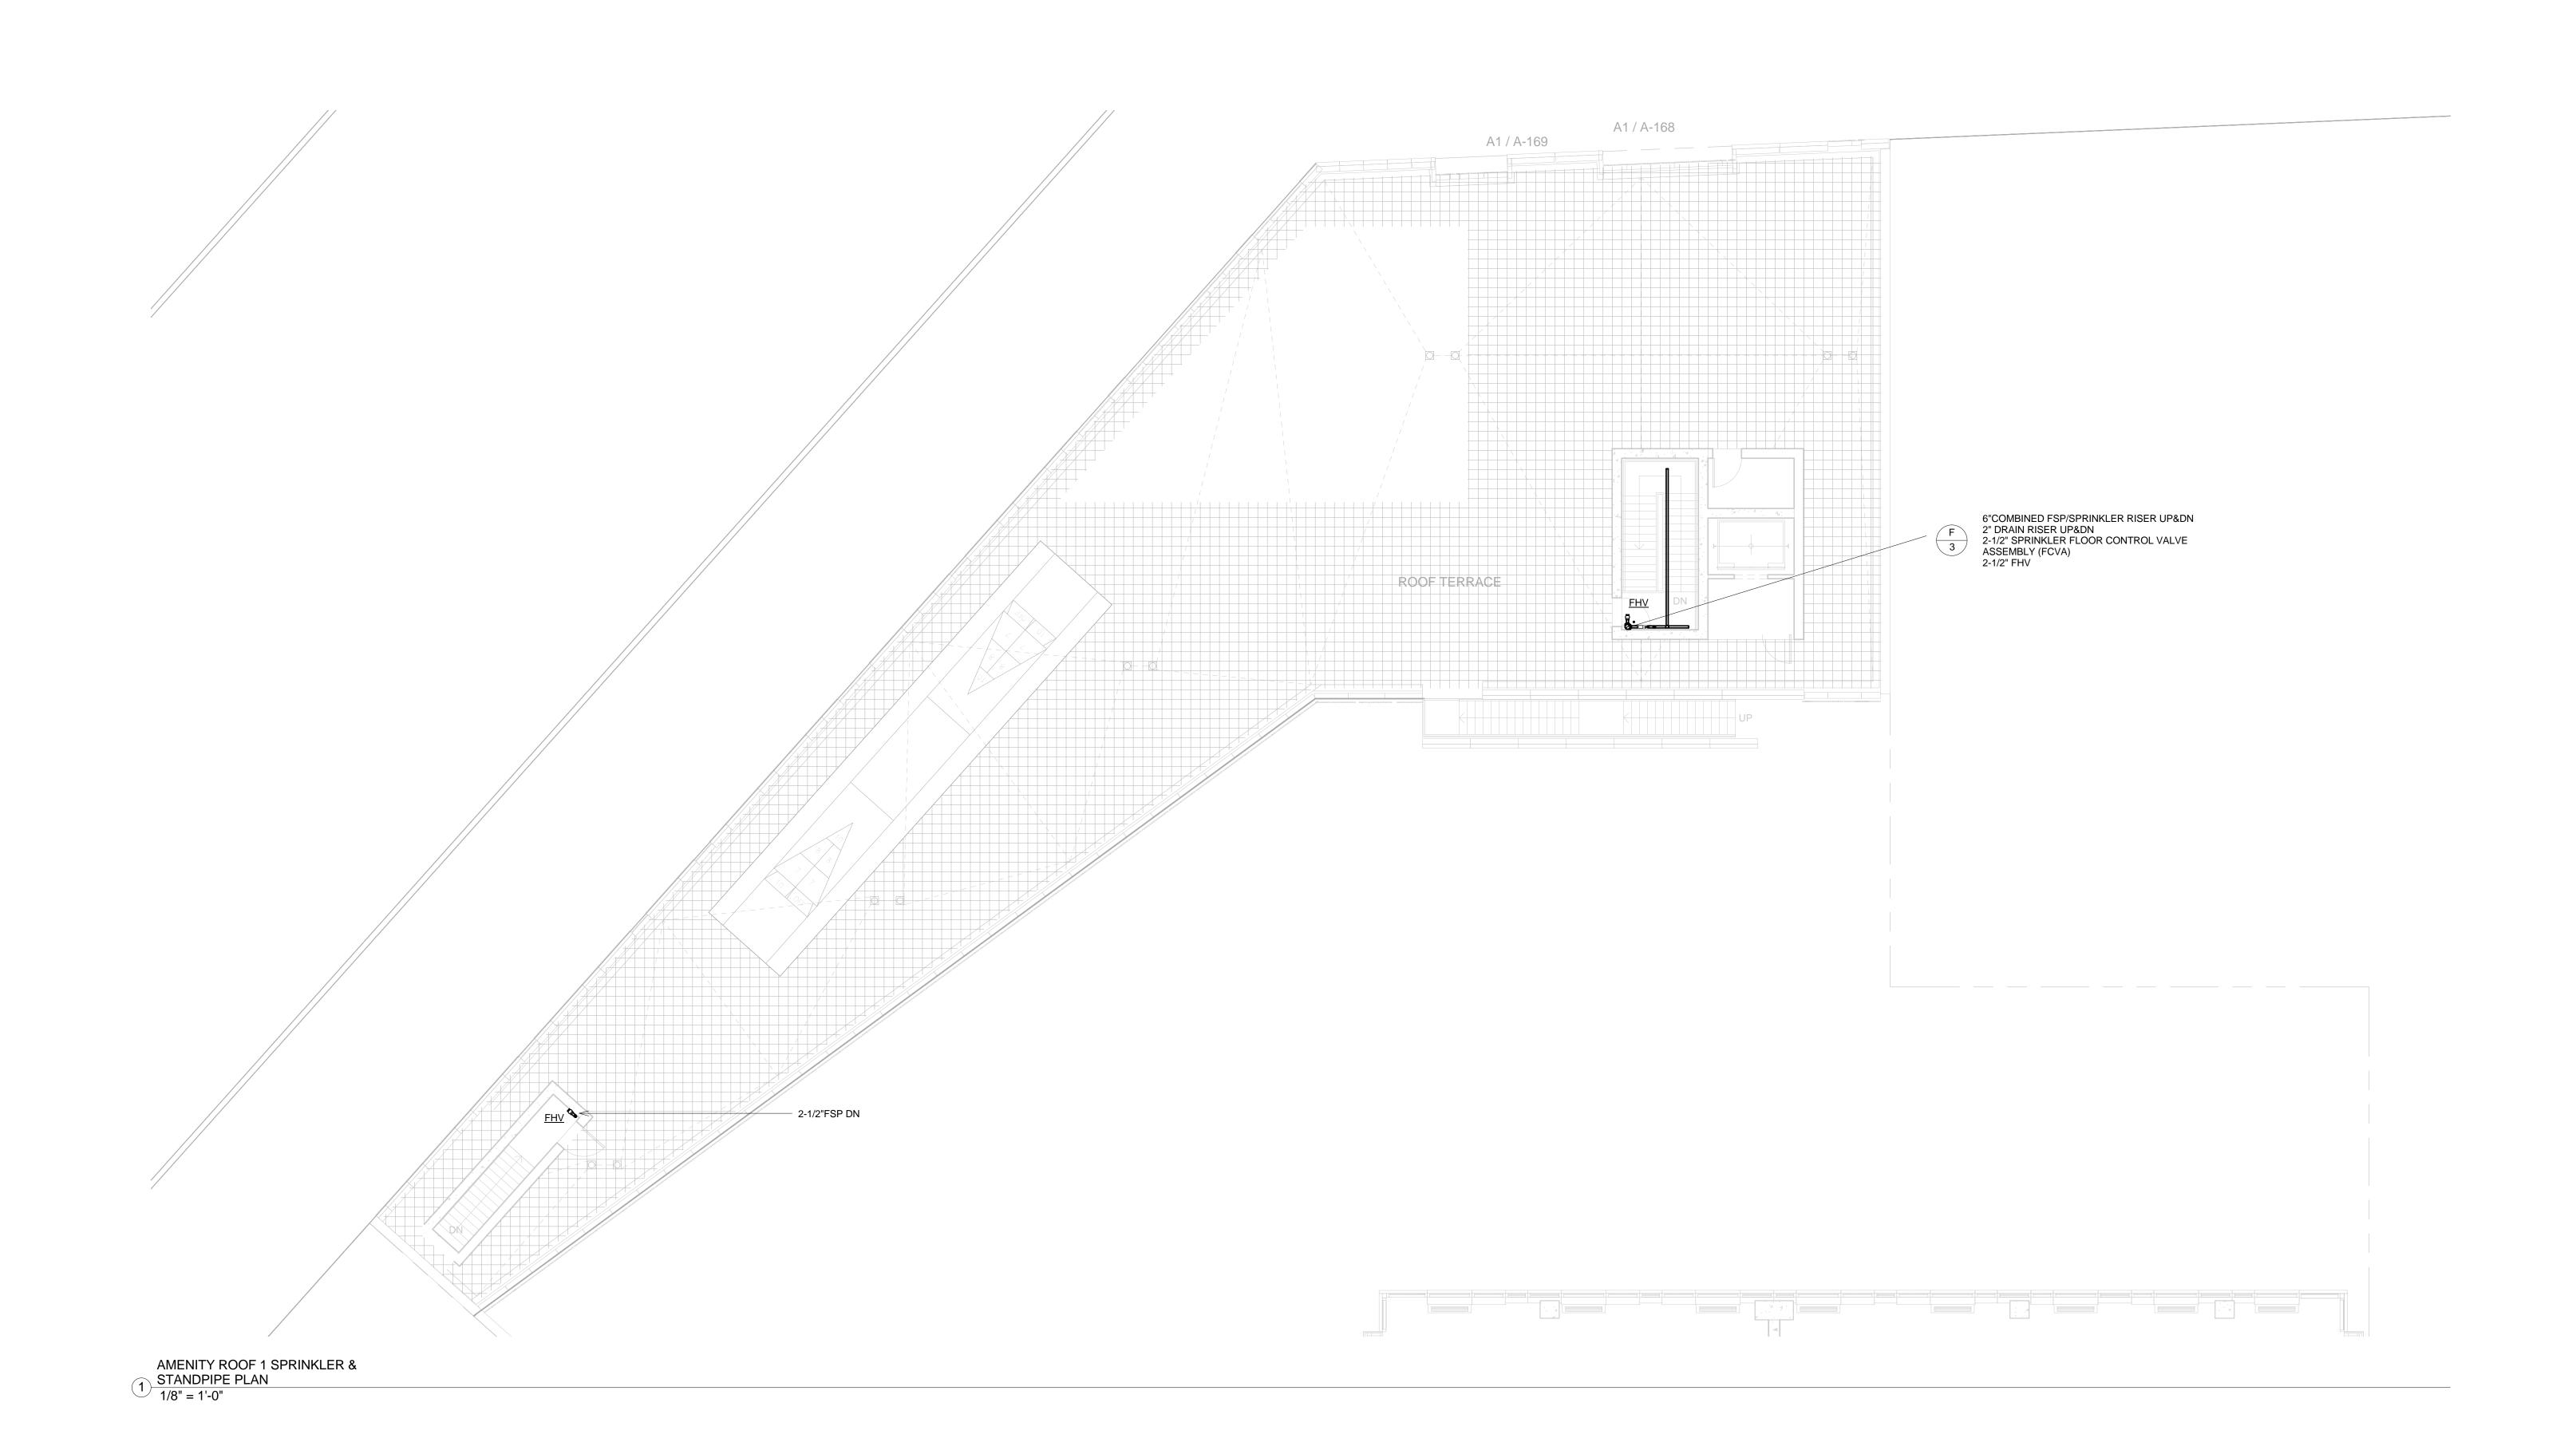14TH FLOOR SPRINKLER & STANDPIPE 2 PLAN 1/8" = 1

1/8" = 1'-0"

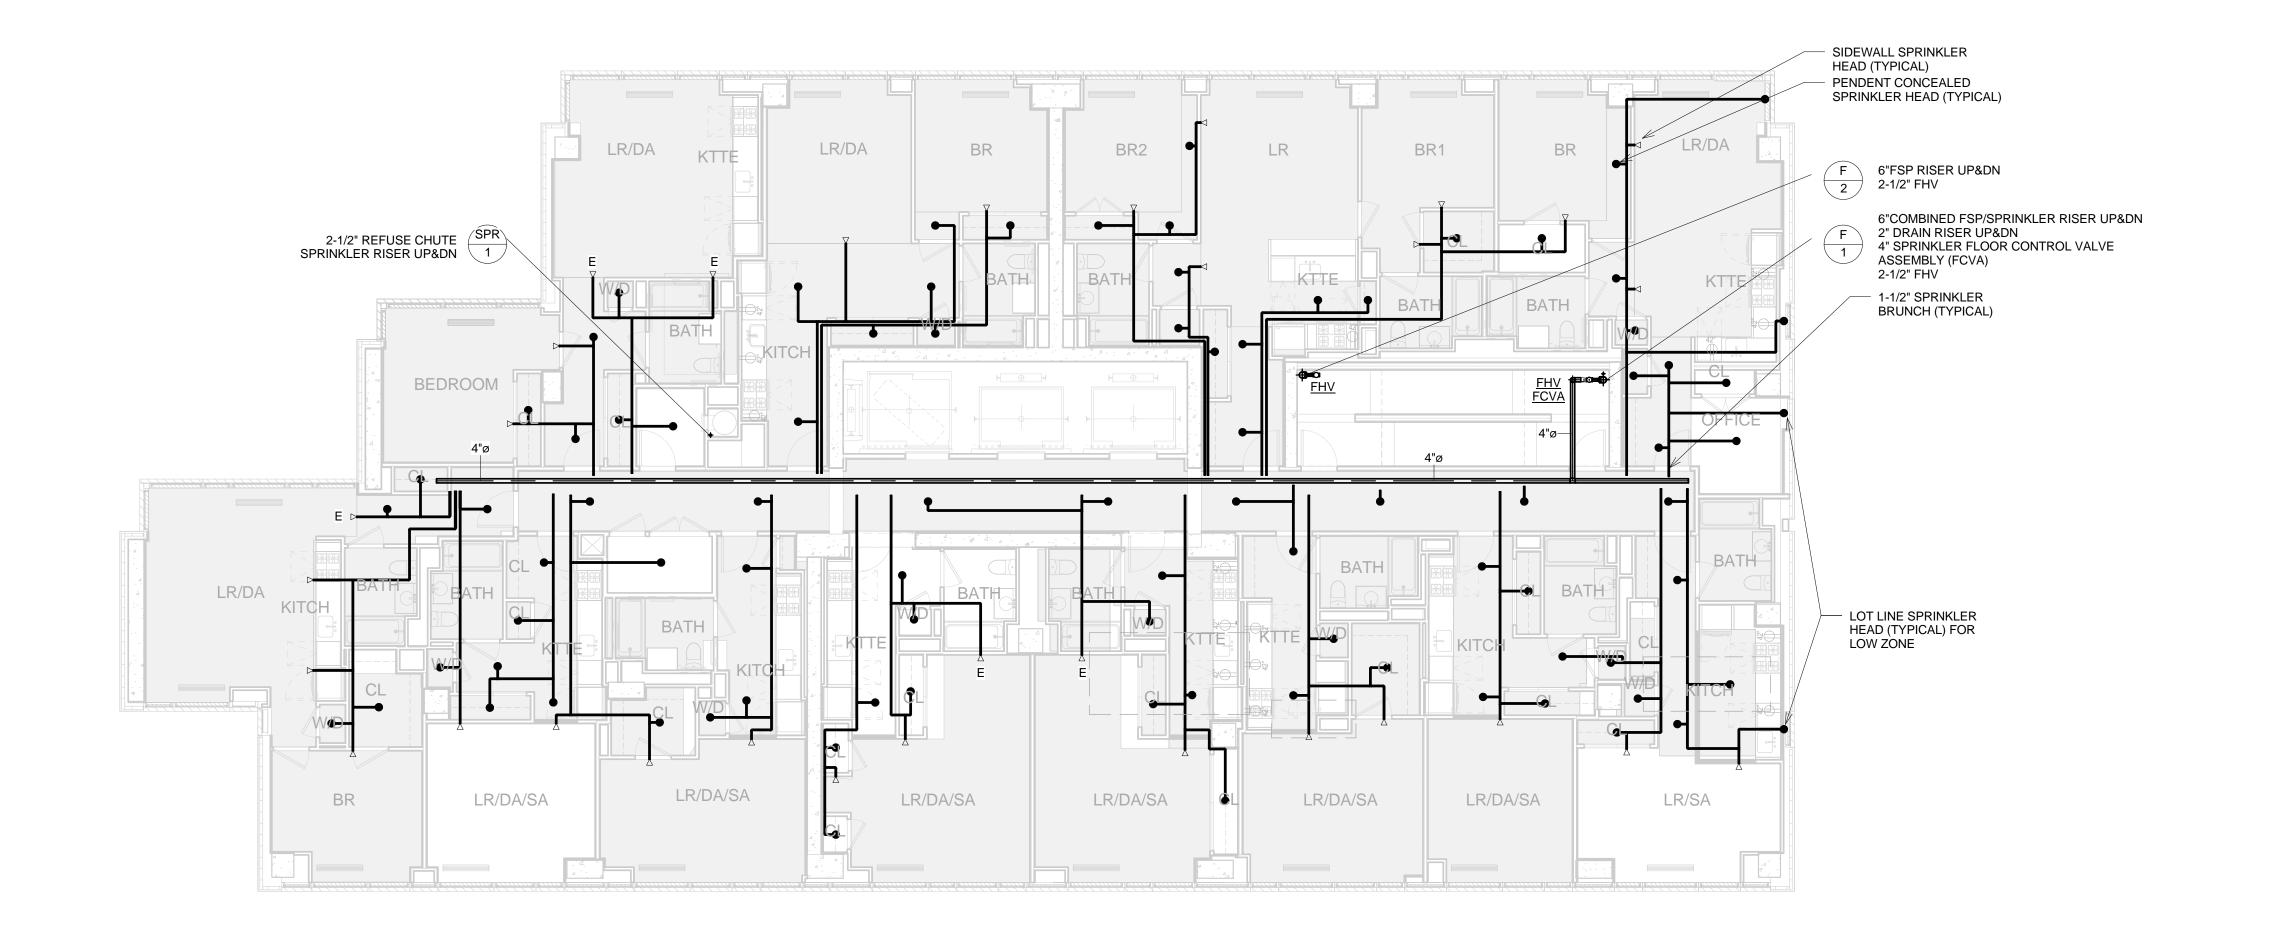

3RD - 13TH FLOOR SPRINKLER &

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1 STANDPIPE PLAN
1/8" = 1'-0"

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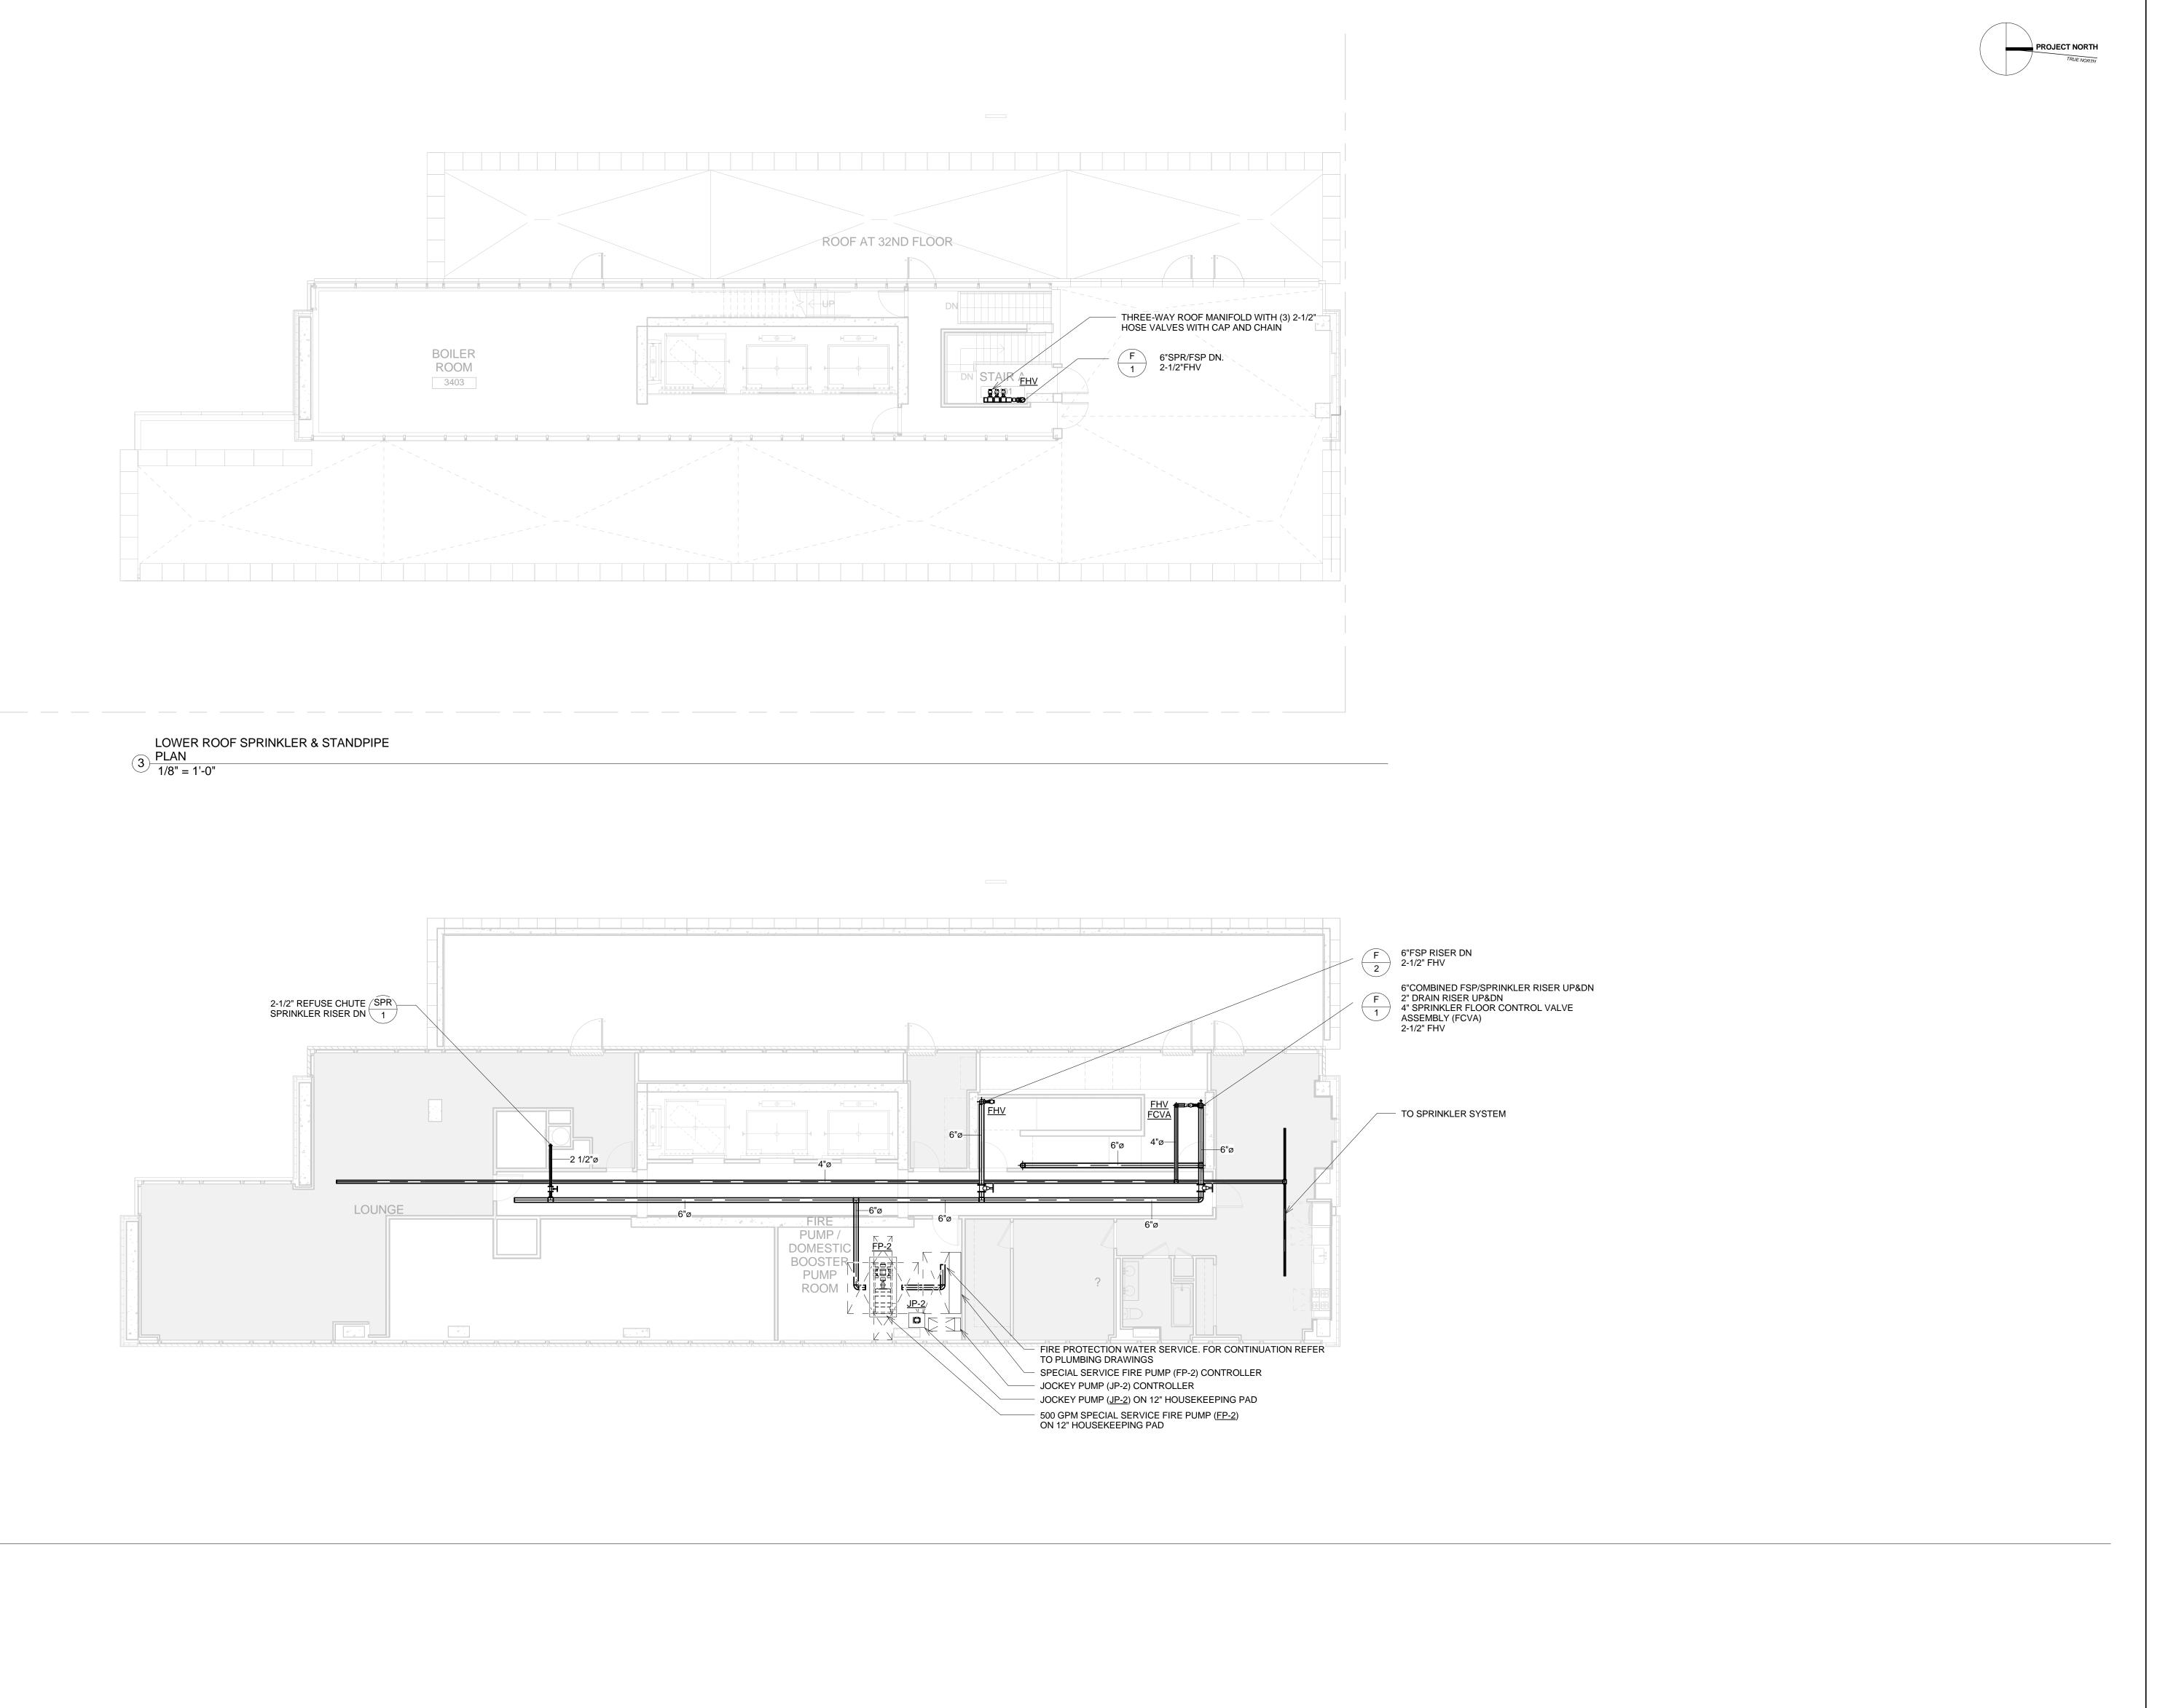
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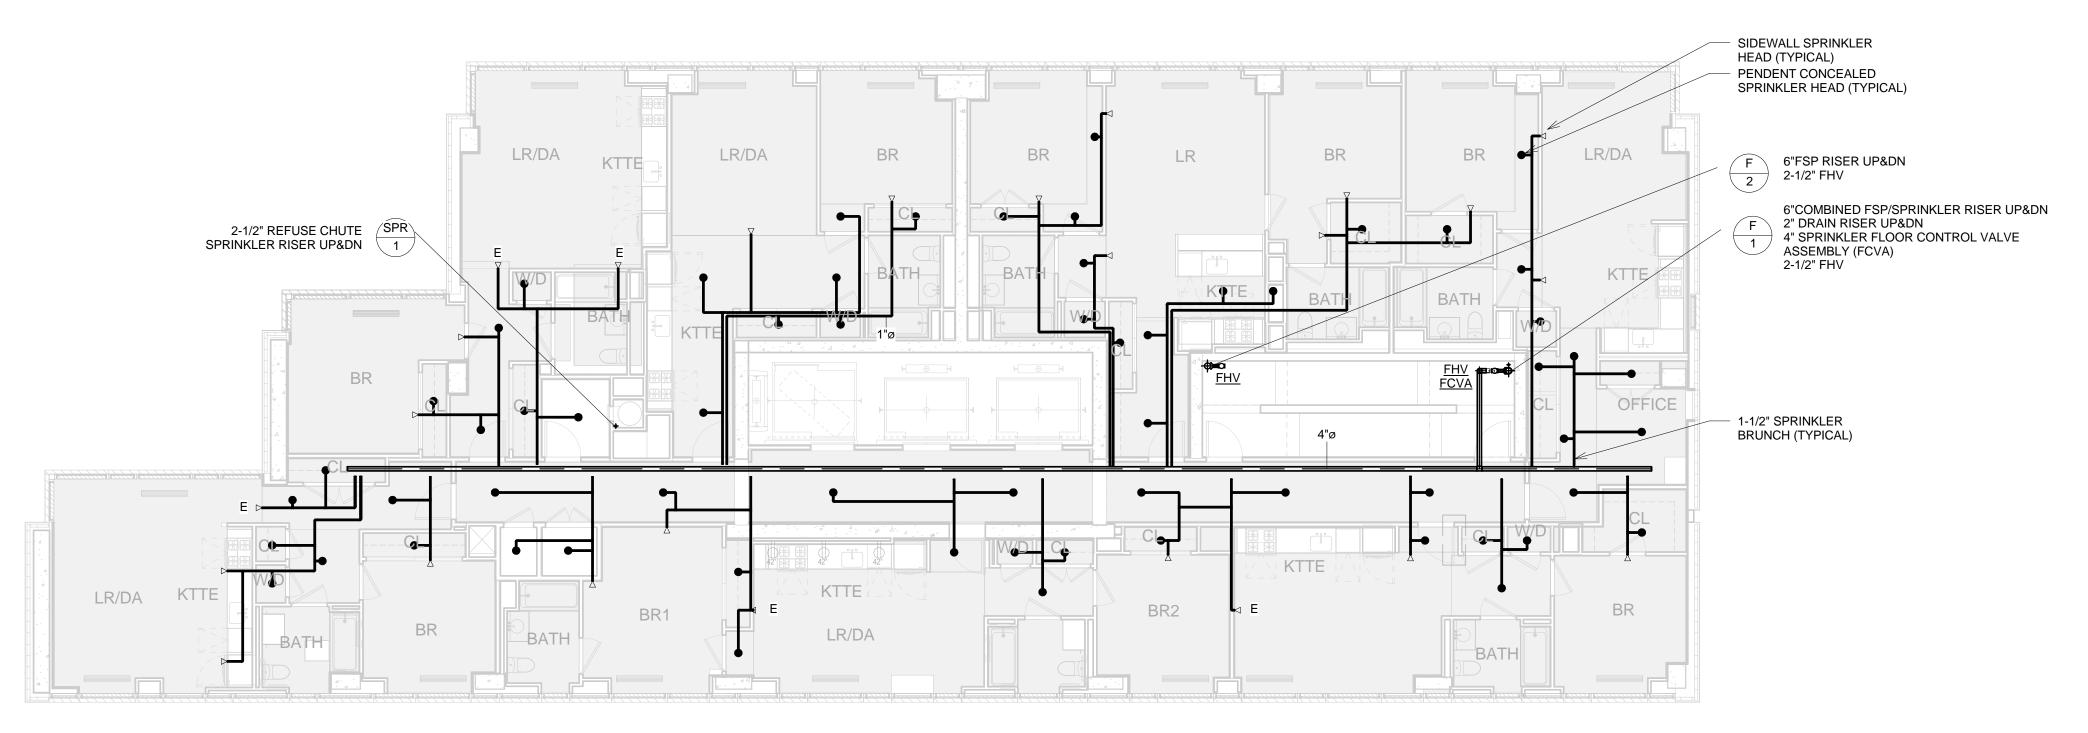
44-30 PURVES STREET, QUEENS, NY

DRAWING TITLE:

3RD - 14TH FLOOR SPRINKLER & STANDPIPE PLANS

Project No.: 13072.L00 Cad File:





DRAWING TITLE:

15TH FLOOR - LOWER ROOF SPRINKLER & STANDPIPE PLANS

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LIC PURVES STREET DEVELOPMENT

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44-30 PURVES STREET, QUEENS, NY

15TH - 32ND FLOOR SPRINKLER & STANDPIPE PLAN

1/8" = 1'-0"

33RD FLOOR SPRINKLER & STANDPIPE

2 PLAN 1/8" = 1'-0"

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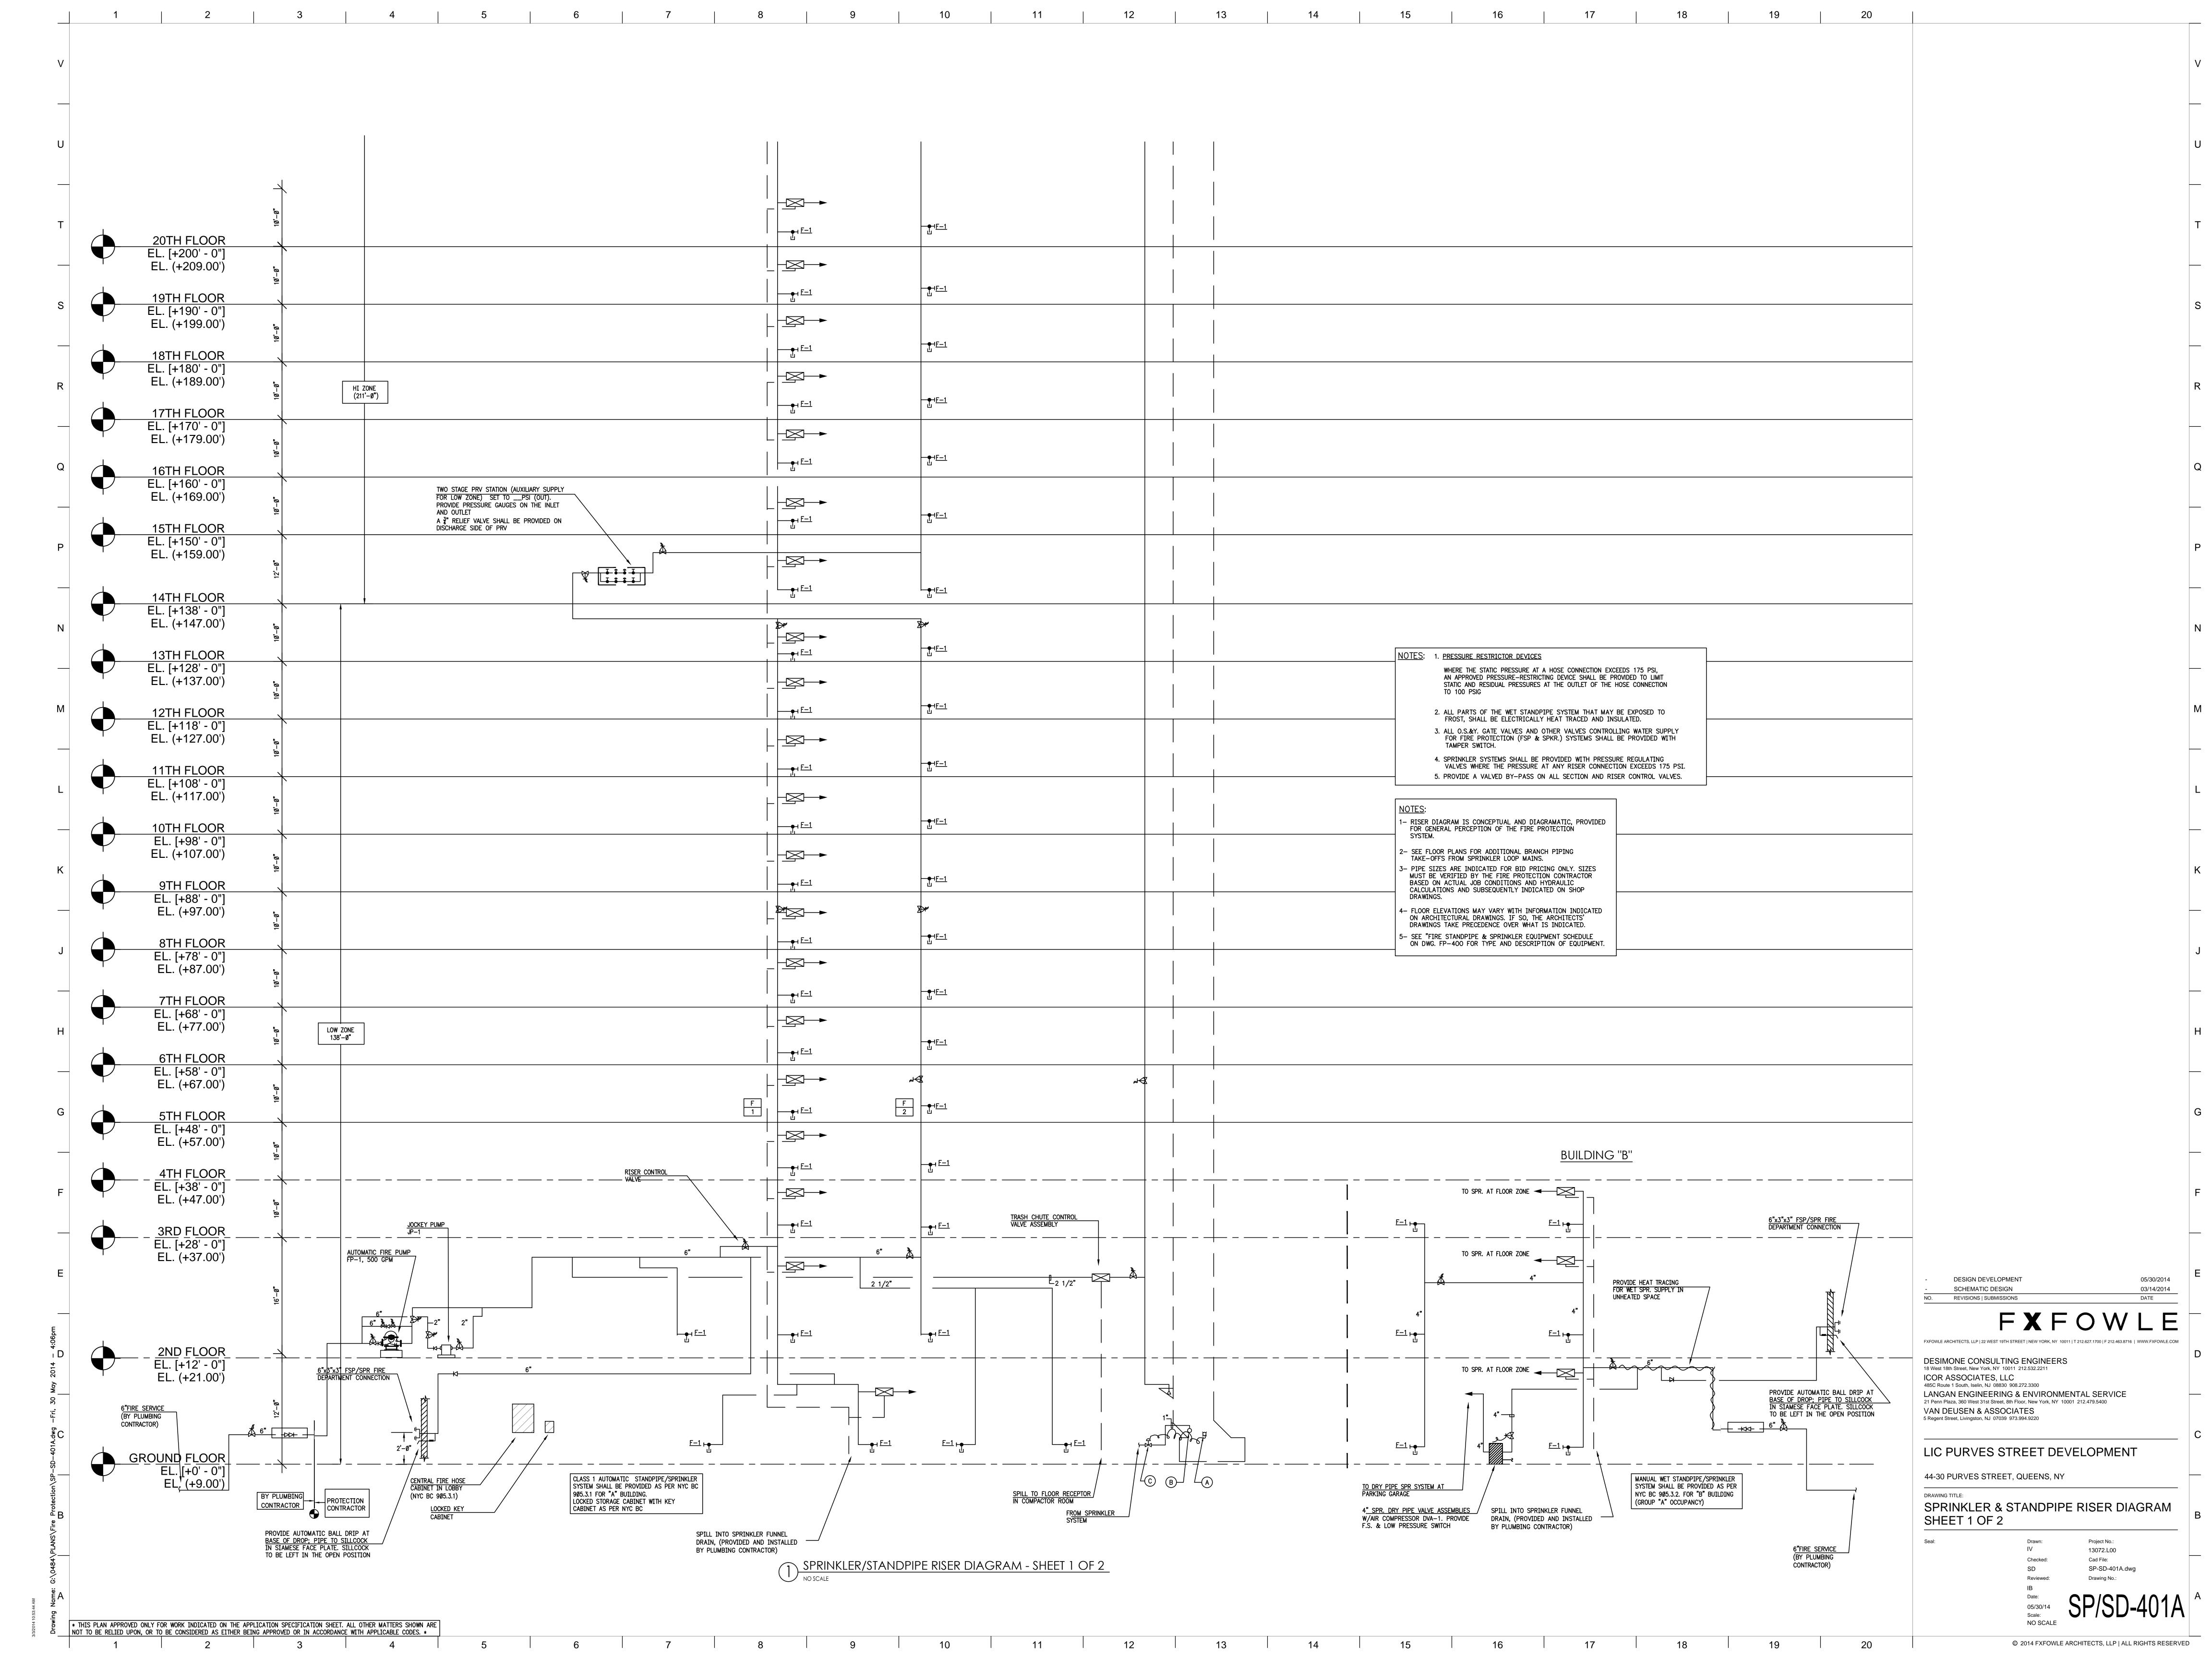
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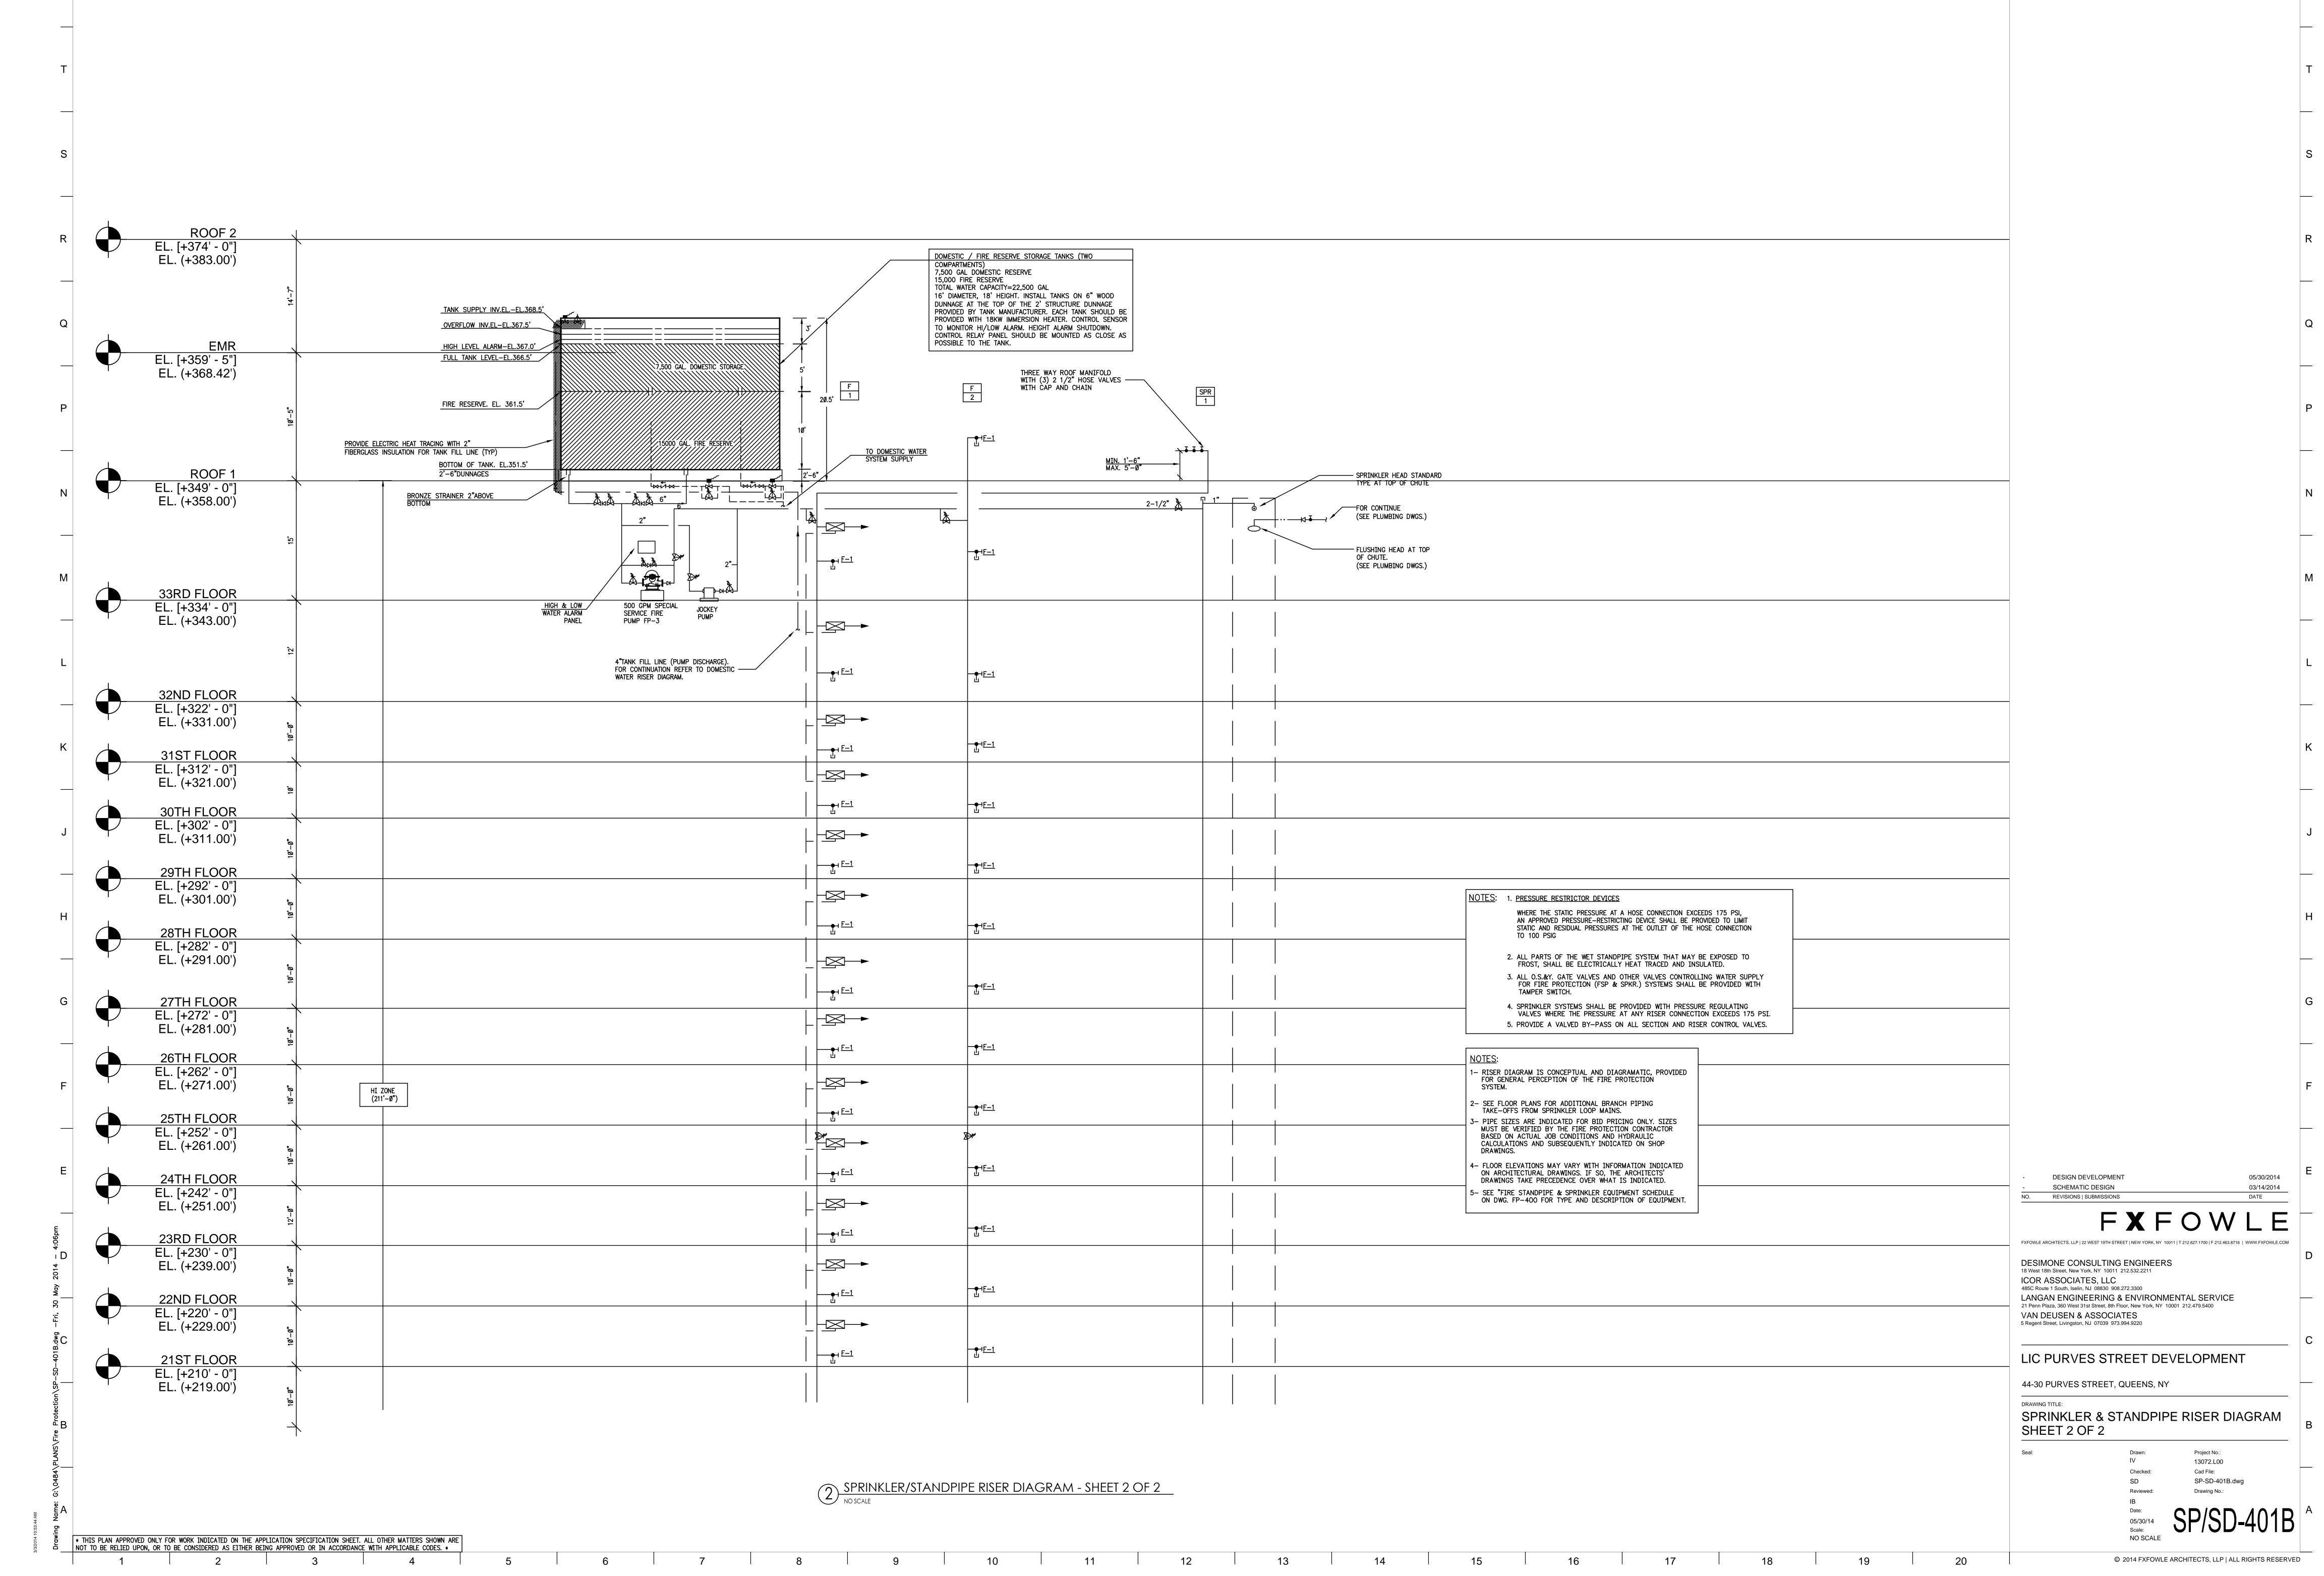
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DATE

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FXFOWLE ARCHITECTS, LLP | 22 WEST 19TH STREET | NEW YORK, NY 10011 | T 212.627.1700 | F 212.463.8716 | WWW.FXFOWLE.COM





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	VICTAULIC FTG. No.	SIZE	TYPE	GROOVED	HOLE CUT	PIII PLATN FND	VIC RING	150#WWP	175#WWP	200#WWP	250#WWP	350#WWP	NOTE	NOTE B	NOTE	POO#WWP ZOWWPP	720#WWP	CENIEBAI NOTE	GENERAL	DECALITRED	NE COINED		SPKR SYSTEM		IN-COMING SERVICE			RISERS	HORIZONTAL RUN	CETCAIL BENITEMENTS	PYPANSTON INTO
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		( <u>\</u>	SCHEDULE O	F SPRINKLER I	HEADS				
SYMBOL	MANUFACTURER & MODEL No.	TYPE	LOCATION	FINISH & REMARKS	TEMP. RATING	'K' FACTOR	MIN. PRESS.	APPROVALS	SIN
0	VICTAULIC, MOD.V27Ø3	UPRIGHT, STANDARD RESPONSE	WHERE INDICATED, ORDINARY HAZARD	BRASS FINISH 1/2" ORIFICE	165° F	5.6	7#	UL/FM	R3125 R3115
•	VICTAULIC, MOD.V27Ø7	PENDENT, STANDARD RESPONSE	WHERE INDICATED, ORDINARY HAZARD	BRASS FINISH 1/2" ORIFICE	165° F	5.6	7#	UL/FM	R3125 R3115
•	VICTAULIC, MOD.V3426  VICTAULIC, MOD.V38Ø1	RESIDENTIAL, RECESSED PENDENT QUICK RESPONSE  CONCEALED, ADJUSTABLE INLET STANDARD RESPONSE	APARTMENTS, CORRIDORS WHERE INDICATED/LIGHT HAZARD  LOBBY ORDINARY HAZARD	CHROME PLATED OR WHITE PAINTED AS PER ARCH. SPECIFICATION  CHROME HEAD/ WHITE ESCUTCHEON OR AS PER ARCH.	165° F	6.9		UL/FM	R5413
×	VICTAULIC, MOD.V27Ø7	HIGH TEMPERATURE PENDENT	BOILER ROOM, UNIT HEATER, ETC.	SPECIFICATION  WHITE POLY. FINISH	250° F	5.6		UL/FM/BSA	R3615
•	VICTAULIC, MOD.V2738	HORIZONTAL SIDEWALL QUICK RESPONCE	APARTMENTS			4.2		UL/FM	
4	VICTAULIC, MOD.V3416	HORIZONTAL SIDEWALL QUICK RESPONSE EXTENDED COVERAGE/LIGHT HAZARD	APARTMENTS						

PLAIN BRASS OR

NICKEL TEFLON

AS PER FM APPROVED

SPRINKLER HEADS MINIMUM FLOW & MINIMUM PRESSURE REQUIREMENTS TO BE BASED ON HYDRAULIC CALCULATION DESIGN DENSITIES.

5. ALL SPRINKLER HEAD FINISHES TO BE APPROVED BY ARCHITECT.

6. SPRINKLER COVERAGE SHOULD BE PROVIDED BELOW ANY OBSTRUCTION 4' WIDE AND AS INDICATED ON PLANS

NON-HEATED SPACE

(IF REQUIRED)

**GENERAL NOTE:** 

1. FITTINGS AND PRESSURE RATINGS ARE UL LISTED. REFER TO MANUFACTURER FOR FACTORY MUTUAL

APPROVED FITTING PRESSURE RATING.

155° F

5.6

NOTES:

▼ VICTAULIC, MOD.V361Ø

- 1. SPRINKLER HEADS SHALL BE INSTALLED AS PER MANUFACTURER'S RECOMMENDATIONS.
- 2. PROVIDE METAL WIRE GUARDS WHERE SPRINKLERS ARE SUBJECT TO DAMAGE AND SPRINKLER HEADS LOCATED UNDER HVAC DUCTS IN MECHANICAL EQUIPMENT ROOMS WHEN LOCATED LOWER THAN 7'-0" A.F.F. ETC.

HORIZONTAL SIDEWALL

QUICK RESPONSE

'A' 007 ZEROFLEX UL/FM APPROVED WITH LT. WALL PIPE ROLL GROOVE 350 PSI WWP
'B' 007 ZEROFLEX UL/FM APPROVED WITH LT. WALL PIPE ROLL GROOVE 400 PSI WWP
'C' 77 UL/FM APPROVED WITH LT. WALL PIPE ROLL GROOVE 450 PSI WWP
'D' 75 UL/FM APPROVED WITH LT. WALL PIPE ROLL GROOVE 450 PSI WWP

- 3. ALL SPRINKLER HEADS THROUGHOUT THE FACILITY SHALL BE OF THE ORDINARY TEMPERATURE RATING
- EXCEPT AS FOLLOWS: a. SPRINKLER HEADS LOCATED CLOSE TO HEATERS, STEAM PIPING OR LOW-PRESSURE BLOW-OFF VALVE SHALL BE OF THE TEMPERATURE RATING AS REQUIRED BY NFPA 13.
- b. ALL HEAT GENERATING EQUIPMENT WHICH CAN AFFECT THE TEMPERATURE RATING OF THE SPRINKLER HEADS SHALL BE CLEARLY IDENTIFIED ON THE SHOP DRAWINGS PRIOR TO SUBMISSION FOR APPROVAL.
- C. SPRINKLERS AT SKYLIGHT SHOULD BE INTERMEDIATE TEMP. RATING

1. FOR REQUIRED PRESSURE RATINGS, SEE RISER DIAGRAM. 2. ALL MATERIALS SELECTED ON THIS SCHEDULE MUST BE APPROVED BY THE LOCAL AUTHORITIES. 3. TO BE USED DOWNSTREAM OF FLOOR CONTROL VALVE ASSEMBLY:UP TO 2"-THREADED OR FLANGED: 2½" AND UP-GROOVED (VICTAULIC). 4. TO BE USED ON RISERS AND MAINS. BURIED BUILDING FIRE SERVICE FIRE STANDPIPE DRY SPRINKLER SYSTEM

NOTE: TH	IIS VALVE S	SCHEDUL	Ε	IS	B/	\SE	ΞD	OI	N	ST	oc	Κŀ	IAN	1 \	/AL	.VE	S		
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	V	ALVE SPI	EC	IFI	CAT	ΓΙΟ	N							LO	CA	(TIC	NC		
TYPE	STOCKHAM FIG. NO.	SIZE	FLANGED	SCREWED	W/ADAPTER	0.S.&Y.	N.R.S.	BRONZE	I.B.B.M.	175# WWP	200# WWP	BURIED SERV.	FIRE SERV.	FSP ZONE 1	FSP ZONE 2	FSP ZONE 3	FSP ZONE 4	IVI	SPKR. SERVICE
	F667	2"-12"	•			•			•						•	•	•		П
	30-OFU	2"-12"	•			•													
GATE	G743	2"-16"			•		•		•		•	•	•						•
VALVES	G634	2.5"-12"	•			•			•	•				•				•	
	B133	3/4"-2"		•		•		•		•								•	
	G633	2.5",3",4"		•		•		•		•				•	•			•	
	B319	1/4"-3"		•				•			•							•	
CHECK	G932B	2"-10"	•						•		•								
	F947	2"-10"	•						•						•	•	•		
VALVES	G939	2.5"-12"	•						•	•				•				•	
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NOTE: FOR PRESSURE RATING OF VALVES, REFER TO RISER DIAGRAM.

- DESIGN CRITERIA FOR ELECTRICAL/TELEPHONE SPACES
- 1. ALL SWITCHGEAR SPACES SHALL BE EXEMPT OF SPRINKLER PROTECTION.

2. EMERGENCY GENERATOR ROOM SHALL BE EXEMPT OF SPRINKLER PROTECTION

- 3. ALL TELEPHONE SPACES SHALL BE PROVIDED WITH SPRINKLER PROTECTION.
- "GENERAL"-FIRE PROTECTION CONTRACTOR NOTES 1.- DUE TO TIGHT CONSTRUCTION CONDITIONS, AND LIMITED SPACE WITH-IN CEILING CAVITY, THE F.P. (SPRINKLER) CONTRACTOR MUST COORDINATE WITH ALL OTHER TRADES AND WHEN NECESSARY PROVIDE FOR HOLES THRU STRUCTURAL MEMBERS, BUT ONLY AFTER WRITTEN APPROVAL BY THE ARCHITECT/ENGINEERS. THE LOCATION OF ALL NEW SPRINKLER PIPING IS APPROXIMATE AND INDICATED FOR BID PURPOSE ONLY. THE FIRE PROTECTION CONTRACTOR MUST COORDINATE THE SPRINKLER PIPING SYSTEM (WITH ALL OTHER TRADES BUT MOST IMPORTANT WITH THE H.V.A.C. ELECTRICAL AND COMMUNICATION CONTRACTORS) SO THAT IT CAN BE PROPERLY SUPPORTED FROM BUILDING STRUCTURE ABOVE WITHOUT USING ANY EXCESSIVE AMOUNT OF SUPPLEMENTAL STEEL. 2.— ALL CONDITIONS COULD NOT BE COMPLETELY DETAILED ON THE DRAWINGS AND ARE NOT LIMITED TO PIPING AND SPRINKLER HEADS, EQUIPMENT, ETC. THE
- REFLECTING CEILING PLANS.

FIRE PROTECTION CONTRACTOR SHALL INCLUDE ALL

REQUIRED CHANGES IN MAKING UP THERE BID PROPOSAL.

3.- FOR CEILING HEIGHTS LIGHTING, ETC. SEE ARCH. 4.- SPRINKLER BRANCH PIPE SIZES SHALL BE A MINIMUM OF 1 INCH.

	SCHEDULE OF FIRE PROTECTION EQUIPMENT
NOTES:	1. ALL EQUIPMENT TO BE UL/FM APPROVED, MANUFACTURED BY POTTER-ROEMER INC. UNLESS OTHERWISE NOTED
	<ol> <li>ALL EQUIPMENT HOSE THREADS AS PER LOCAL FIRE DEPARTMENT REQUIREMENTS. THIS CONTRACTOR SHALL VERIFY LOCAL FIRE DEPARTMENT HOSE THREADS REQUIRED ON SHOP DRAWING SUBMISSION OF EQUIPMENT. ALL LETTERING OF SIAMESE SHALL BE AS REQUIRED BY THE LOCAL FIRE DEPARTMENT.</li> </ol>

3. PROVIDE ALL SIGNAGE AS REQUIRED BY THE LOCAL FIRE DEPARTMENT, COORDINATE

ITEM	MODEL NO.	FINISH & CONSTRUCTION	<u>REMARKS</u>
2 1/2" ANGLE FIRE HOSE VALVE (FHV)	POTTER ROEMER MOD.4Ø95 WITH FLOW RESTRICTOR	CAST BRASS VALVE W/INTERNAL PARTS OF BRASS AND STAINLESS STEEL-POLISHED CHROME PLATED FINISH	65 PSI MIN — 175 PSI MAX AT OUTLET OF EACH HOSE VALVE VALVE WITH FIG. # 4625 CAP AND CHAIN
F-1 FIRE HOSE VALVE CABINET	POTTER ROEMER MOD.181Ø	FHV INSTALLATION (RECESSED, TRIMLESS, SEMI-RECESSED) TO BE COORDINATED W/ARCHITECT	AT STAIR LANDING VALVE SHOULD BE EXPOSED— NO CABINET PROVIDED.
FIRE DEPARTMENT INLET 6"x2 ½"x 2 ½"	POTTER ROEMER 57-99-Ø3 (OR AS APPROVED BY LOCAL FIRE DEPARTMENT)	CAST BRASS BODY	
WALL PLATE FOR FLUSH FIRE DEPARTMENT CONNECTION	POTTER ROEMER, 56Ø5-SS	POLISHED STAINLESS STEEL	
AUTOMATIC BALL DRIP 3/4"	POTTER ROEMER MOD.5982	CAST BRASS	STRAIGHT DESIGN
ZONE CONTROL RISER VALVE ASSEMBLY	VICTAULIC, SERIES 747M, 705W, 717	FCVA. IN PORTIONS OF SYS	TTAL 10.96. PROVIDE CHECK VALVE AT EACH TEMS WHERE PRESSURE EXCEEDING 175 PSI E INSTALLED AND SET FOR AN OUTLET 165 PSI
ROOF MANIFOLD	POTTER ROEMER MOD.5892 6"x 2 ½"x 2 ½" x2 ½"	CAST BRASS	PROVIDE (3) 2 ½" HOSE VALVES, CAPS AND CHAINS
LOBBY STORAGE HOSE CABINET	1302 - NYC (RECESSED) 1352 - NYC (SURFACE)		"RESIDENTIAL" LOBBY. CABINET CONTENTS — 2008—NYC
LOBBY KEY CABINET	1950-NYC		"RESIDENTIAL" LOBBY.
DRY PIPE VALVE ASSEMBLY, DVA-1	VICTAULIC, 768, NXT	COMPLETE PACKAGE WITH PRESSURE SWITCHES, GAUGES, CONTROL VALVE WITH TRIM ASSEMBLY AND DRAIN ASSEMBLY. PROVIDE 1 HP AIR COMPRESSOR	PROVIDE AIR COMPREESOR, ∄HP

	DENOTES STYLE & TYPE/ RATING AND MODEL NUM SERVICE & LOCATION	BER FOR	COUPLIN	G 8	<b>₹</b> [	FITT	ING	S	PE	CIF							JLE												
			STYLE & TYPE					L.				PRI	ESSL	JRE	RAT	ING			<b></b> ,		S	ERV.	ICE	<u>&amp; L</u>	OCAT	ION		$oldsymbol{\perp}$	MEA/BSA NU
	"VICTAULIC" FIG NO	SIZE	STYLE & TYPE	GROOVED	HULE CUI	PLAIN END	VIC KING THREADED	150#WWP	175#WWP 200#WWP	250#WWP	300#WWP	355#WWP	400#WWP	430#WWF 500#WWP	600#WWP	/00#WWP 720#WWP	750#WWP	800#WWP 1000#WWP	ALL FP LOCATIONS &	SERVICES PER PSI	STREAM OF F.C.V.A.	FSP	INCOMING SERVICE RISERS	HORIZONTAL RUN			SEISMIC REQUIREMENTS EXPANSION JOINTS	NOT PERMITTED (*)	
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	07 ZERO-FLEX	12"	RIGID		+	++	+	$\vdash$	+	$\forall$	+	+	•	+	$\forall$	+	+	+		-		+	+	$\forall$	+	H	+	$\dashv \vdash$	1
		14"-20"	RIGID		+	++	+	╁┼	+	╁	•	+	+	+	$\dashv$	+	+	+		-		$\vdash$	+	$\forall$	+	$\vdash \vdash$	+	$\dashv \vdash$	1
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1. CONSULT "VICTAULIC" LITERATURE NO. 10.01 FOR APPROVED PRODUCTS PRESSURE RATINGS (CUT GROOVED, ROLL GROOVED, AND LIGHT WALL ROLL GROOVED) U.L. AND F.M. APPROVALS, MEA APPROVALS, ETC. FOR FIRE PROTECTION PIPING SYSTEMS.

ALL COUPLINGS AND FITTINGS REGARDLESS OF MANUFACTURER TO BE INSTALLED PER MANUFACTURER'S FIELD INSTALLATION HANDBOOK. SEE VICTAULIC I-100

FIR	E PUMP SC	HEDULE															
PUMP No	LOCATION	MANUFACTURER	MODEL NO	NO. OF	SERVICE	FLOW (EACH)	PRESSURE	RPM	HP	PHASE	CYCLE	VOLTS	AUTO	PILOT LIGH	IT WORKING	CONNECT AHEAD OF MAIN	REMARKS
				PUMPS		GPM	PSI						CONTROL		PRESSURE	SERVICE SWITCH	
FP-1 (FM/UL/ULC LISTED FP)	2nd floor	PEERLESS	4AEF12 (HORIZONATL SPLIT CASE)	1	FSP/SPRINKLER SYSTEM	500		3550	125	3	6Ø	2Ø8	YES	YES	25Ø	YES	WITH REDUCED VOLTAGE SOLID STATE START CONTROLLER BY FIRETROL, FTA193Ø WITH FTA95Ø EMEGENCY POWER SWITCH
JP-1 (FM/UL/ULC LISTED FP)	2nd floor	GRUNDFOS	CR3-15	1	FSP/SPRINKLER SYSTEM	1Ø		35ØØ	3	3	6Ø	2Ø8	YES	YES	36Ø	NO	WITH FIRETROL CONTROLLER FTA5ØØ
FP-2 (FM/UL/ULC LISTED FP)	MECHANICAL RM2 (MECH 1)	PEERLESS	5AEF8 (HORIZONATL SPLIT CASE)	1	FSP/SPRINKLER SYSTEM	500		3550	5Ø	3	6Ø	2Ø8	YES	YES	175	YES	WITH REDUCED VOLTAGE SOLID STATE START CONTROLLER BY FIRETROL, FTA193Ø WITH FTA95Ø EMEGENCY POWER SWITCH
JP-2 (FM/UL/ULC LISTED FP)	MECHANICAL RM2 (MECH 1)	GRUNDFOS	CR3-8	1	FSP/SPRINKLER SYSTEM	8		35ØØ	1½	3	6Ø	2Ø8	YES	YES	230	NO	WITH FIRETROL CONTROLLER FTA5ØØ

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LIC PURVES STREET DEVELOPMENT 44-30 PURVES STREET, QUEENS, NY


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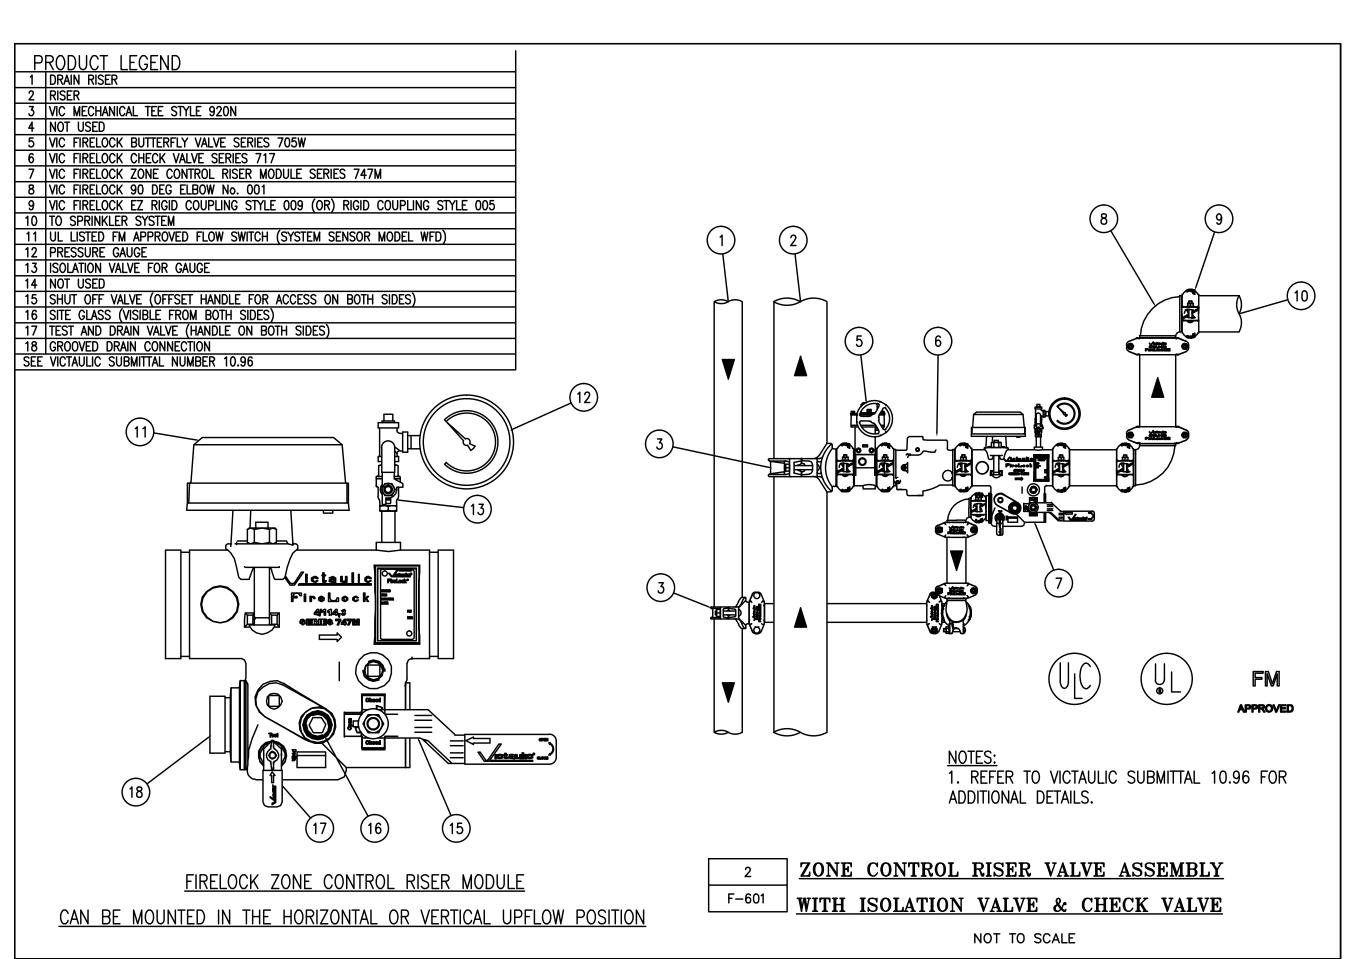
SPRINKLER & STANDPIPE SCHEDULES


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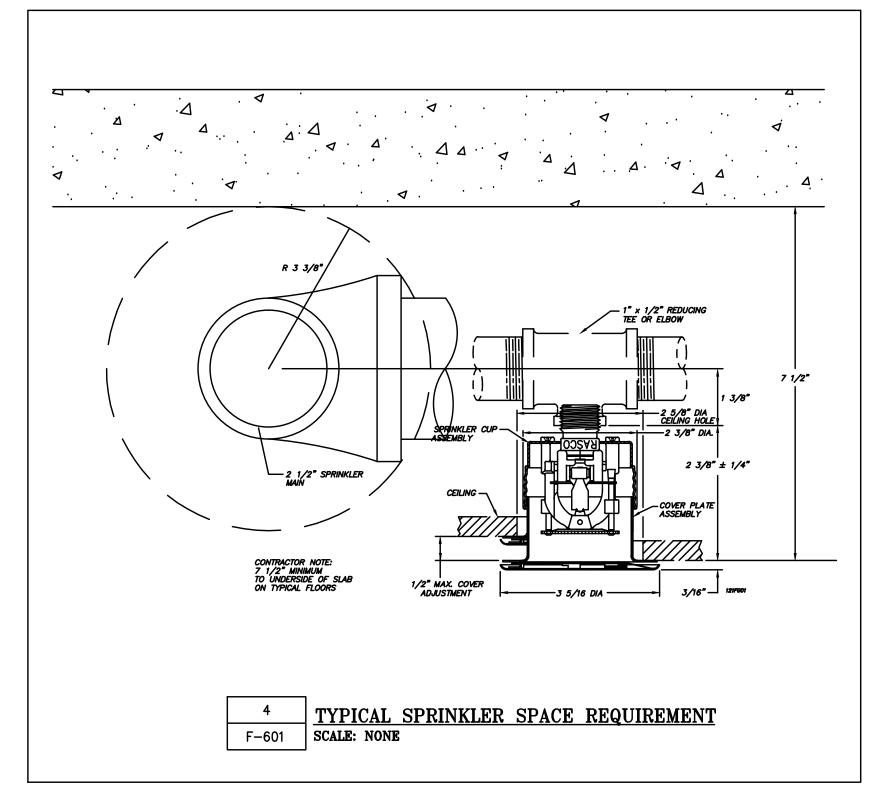
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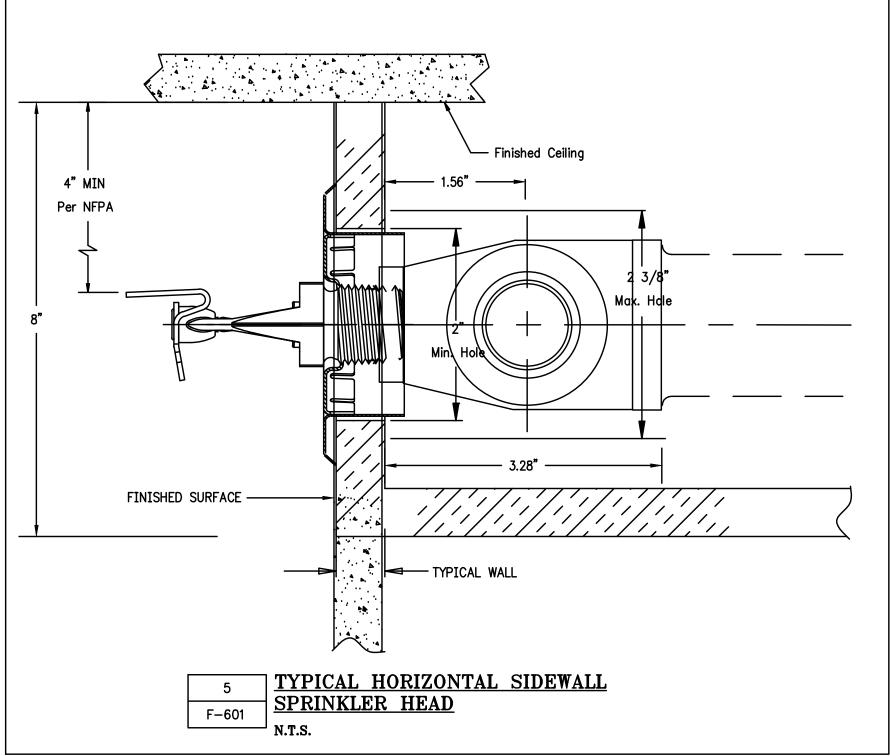
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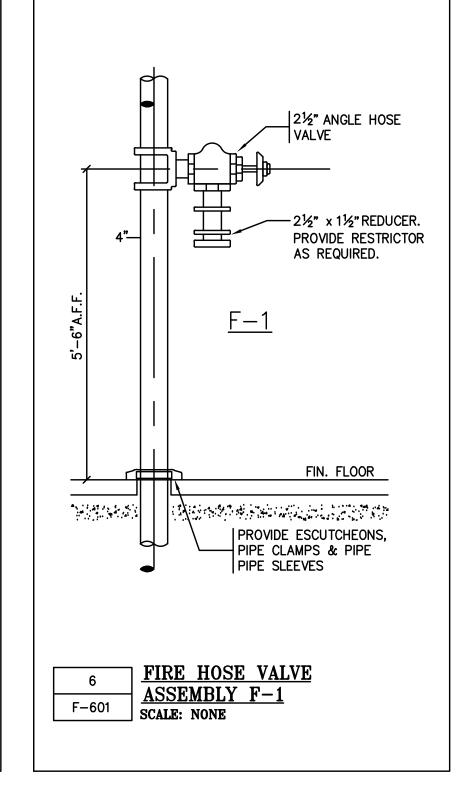











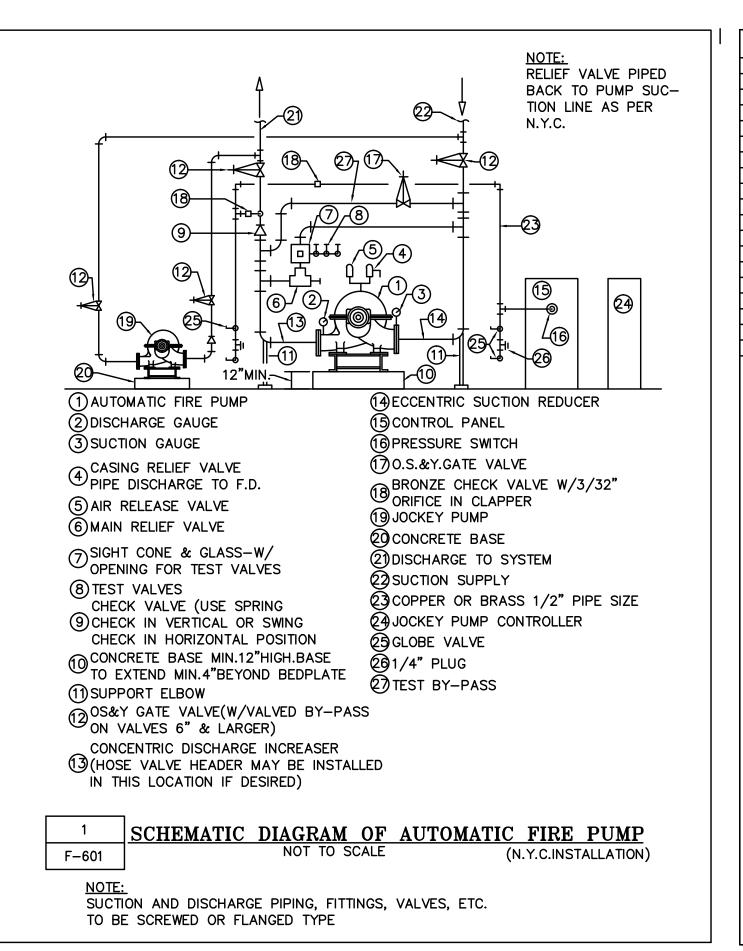


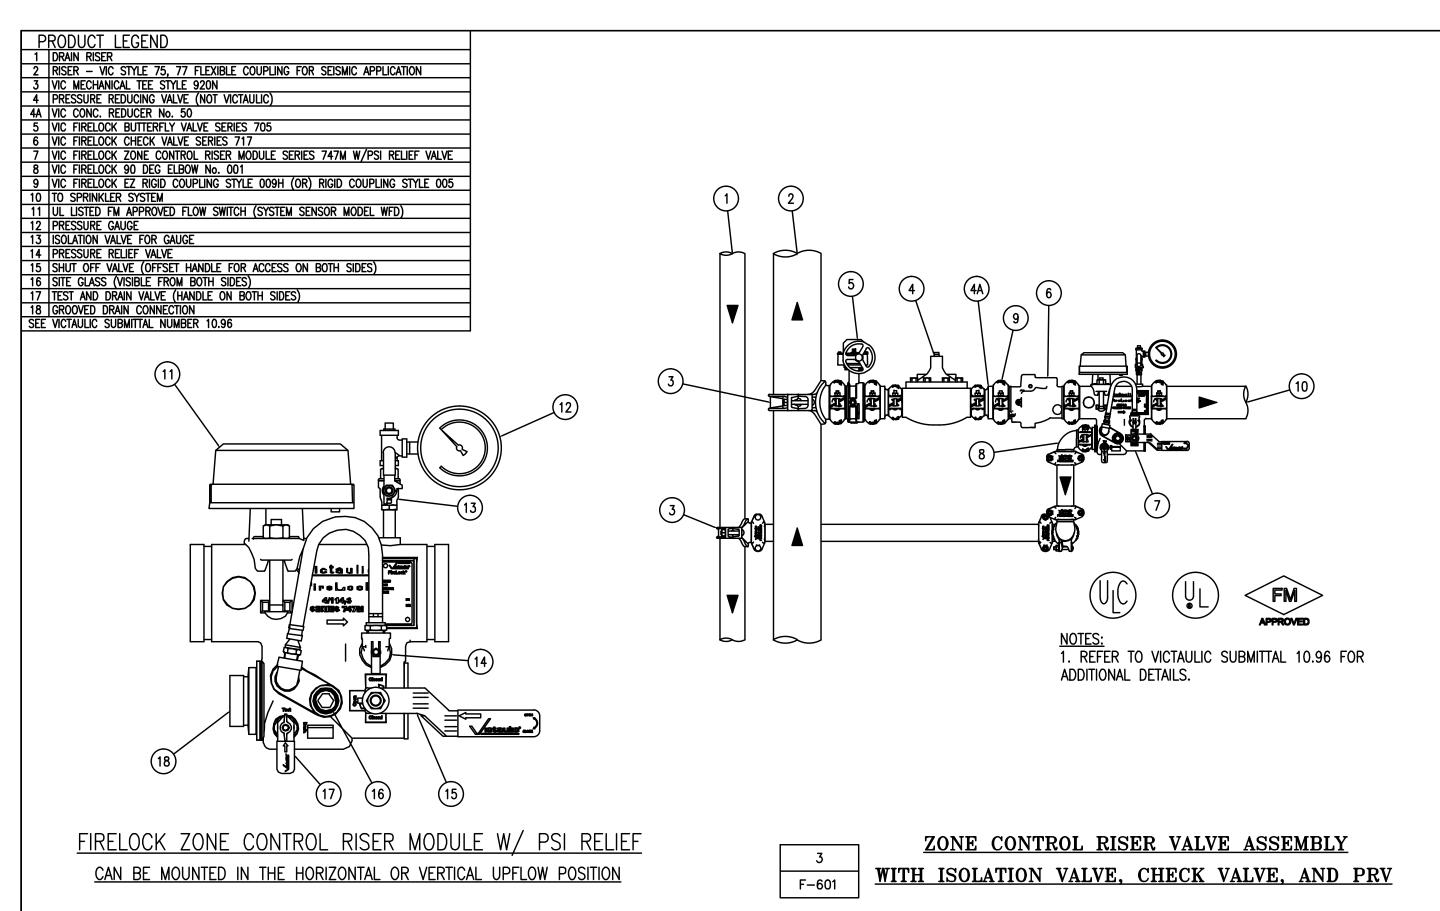

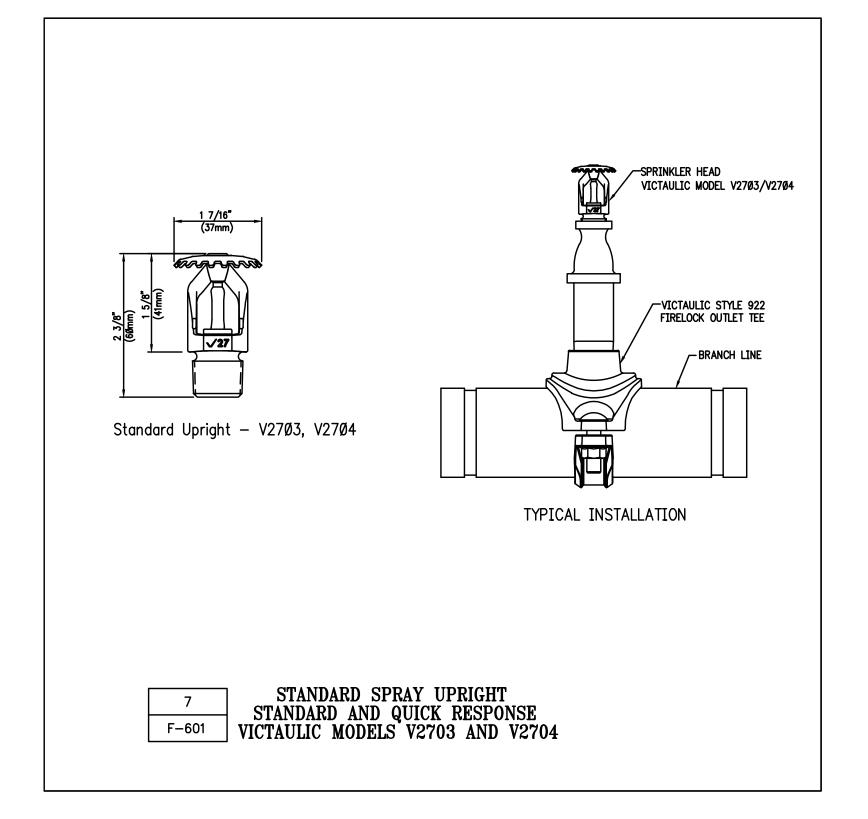

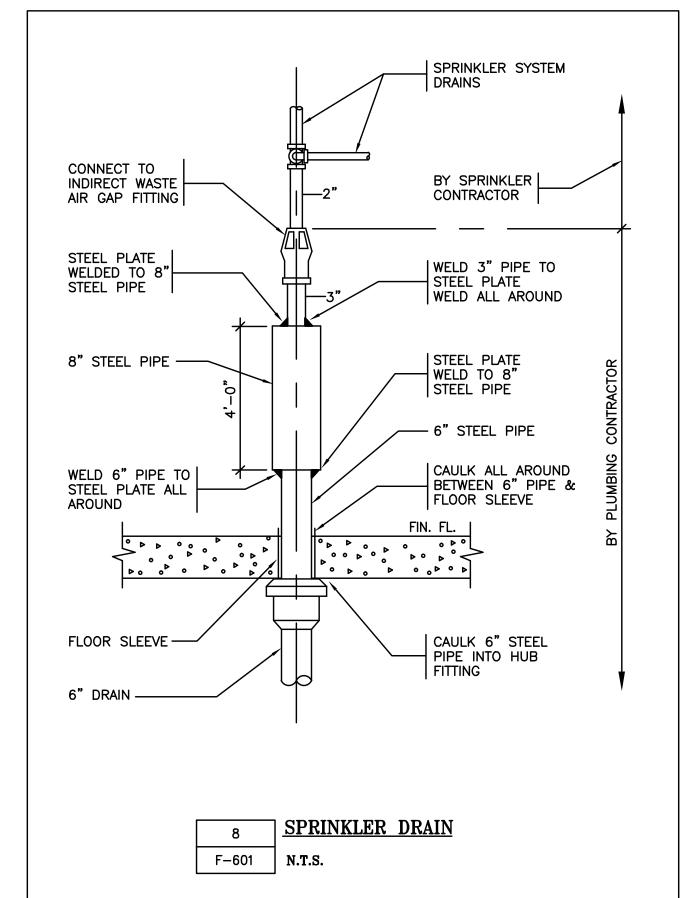

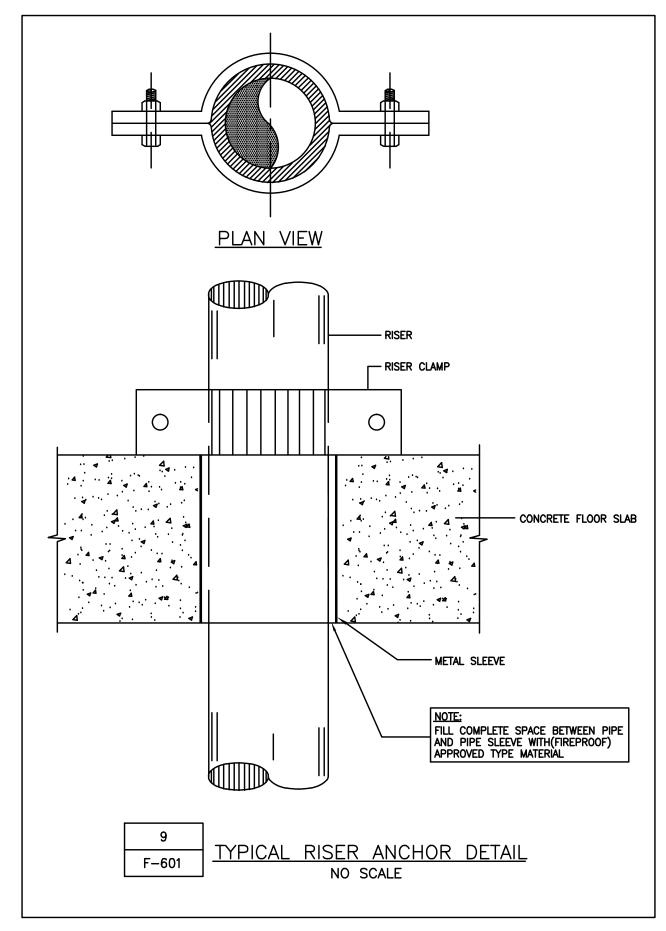

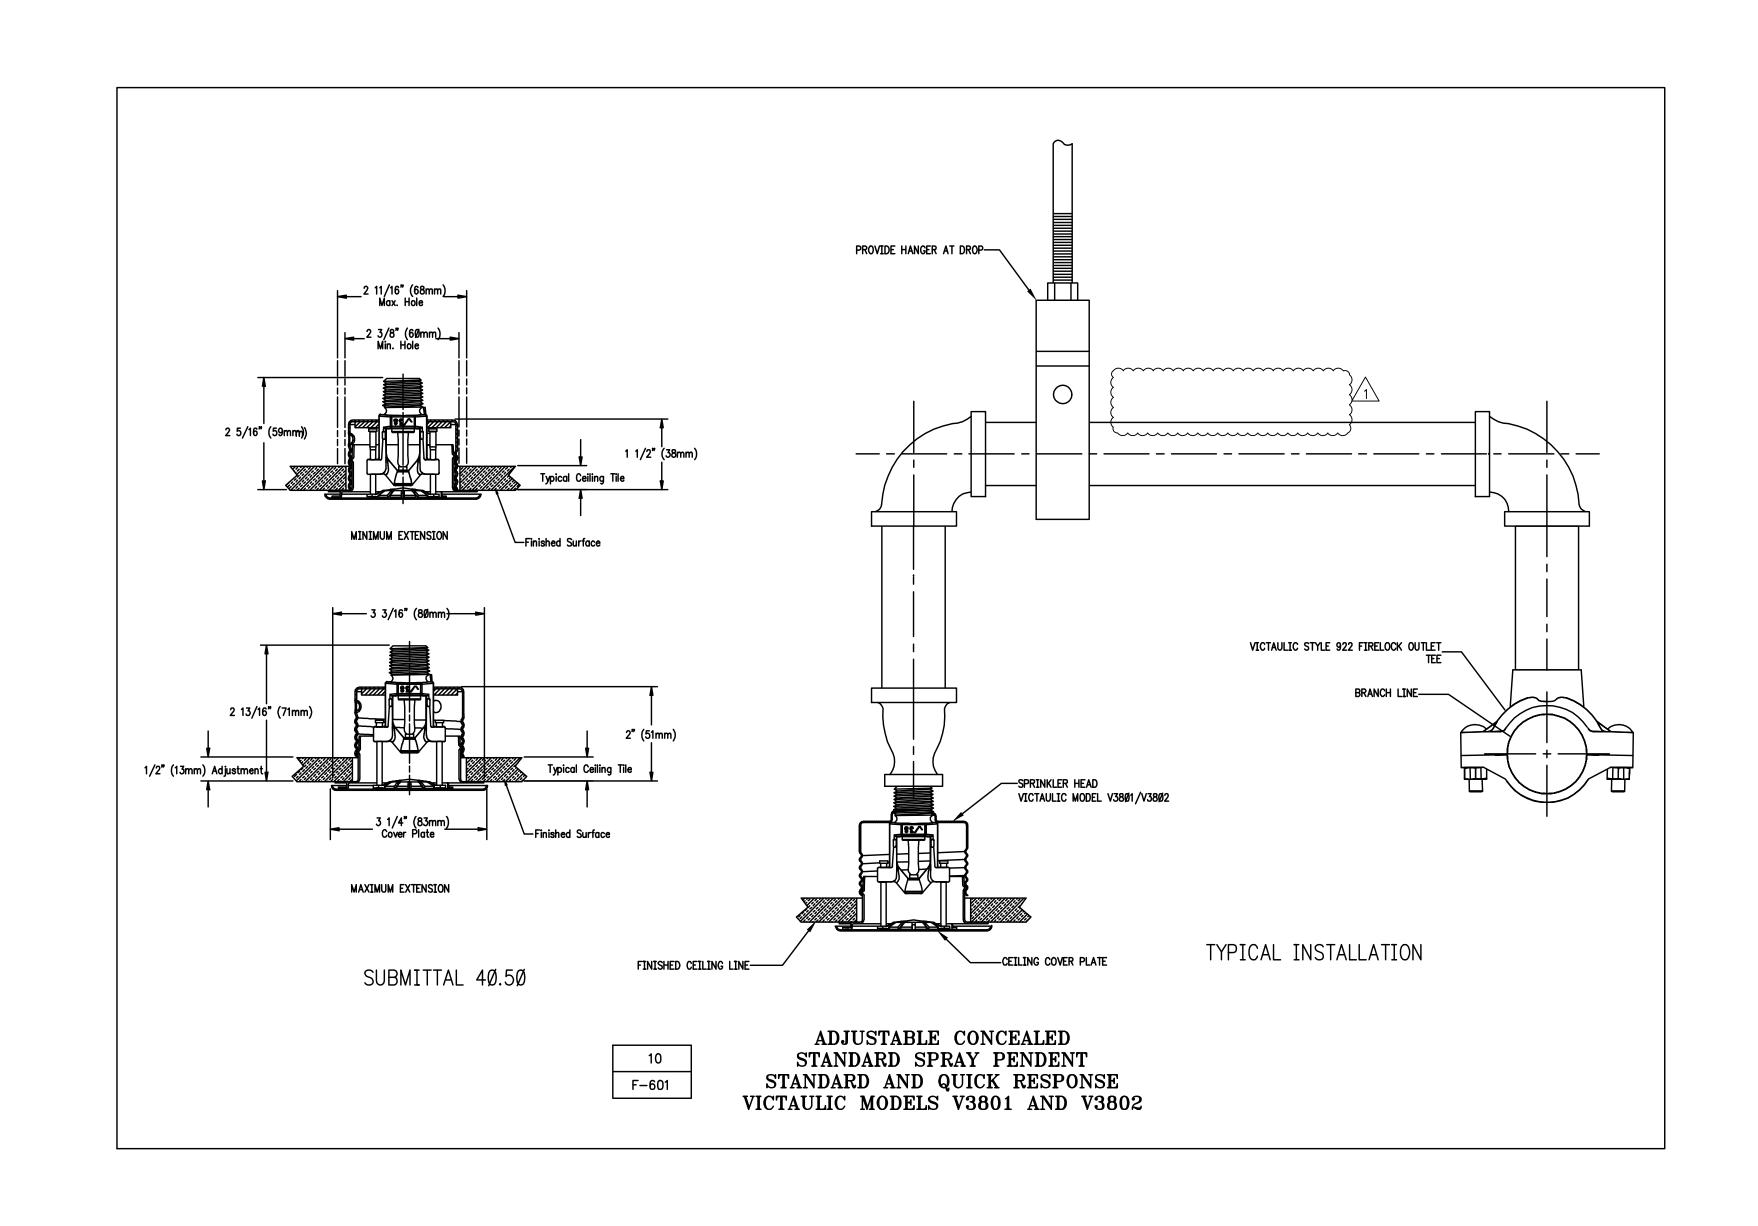

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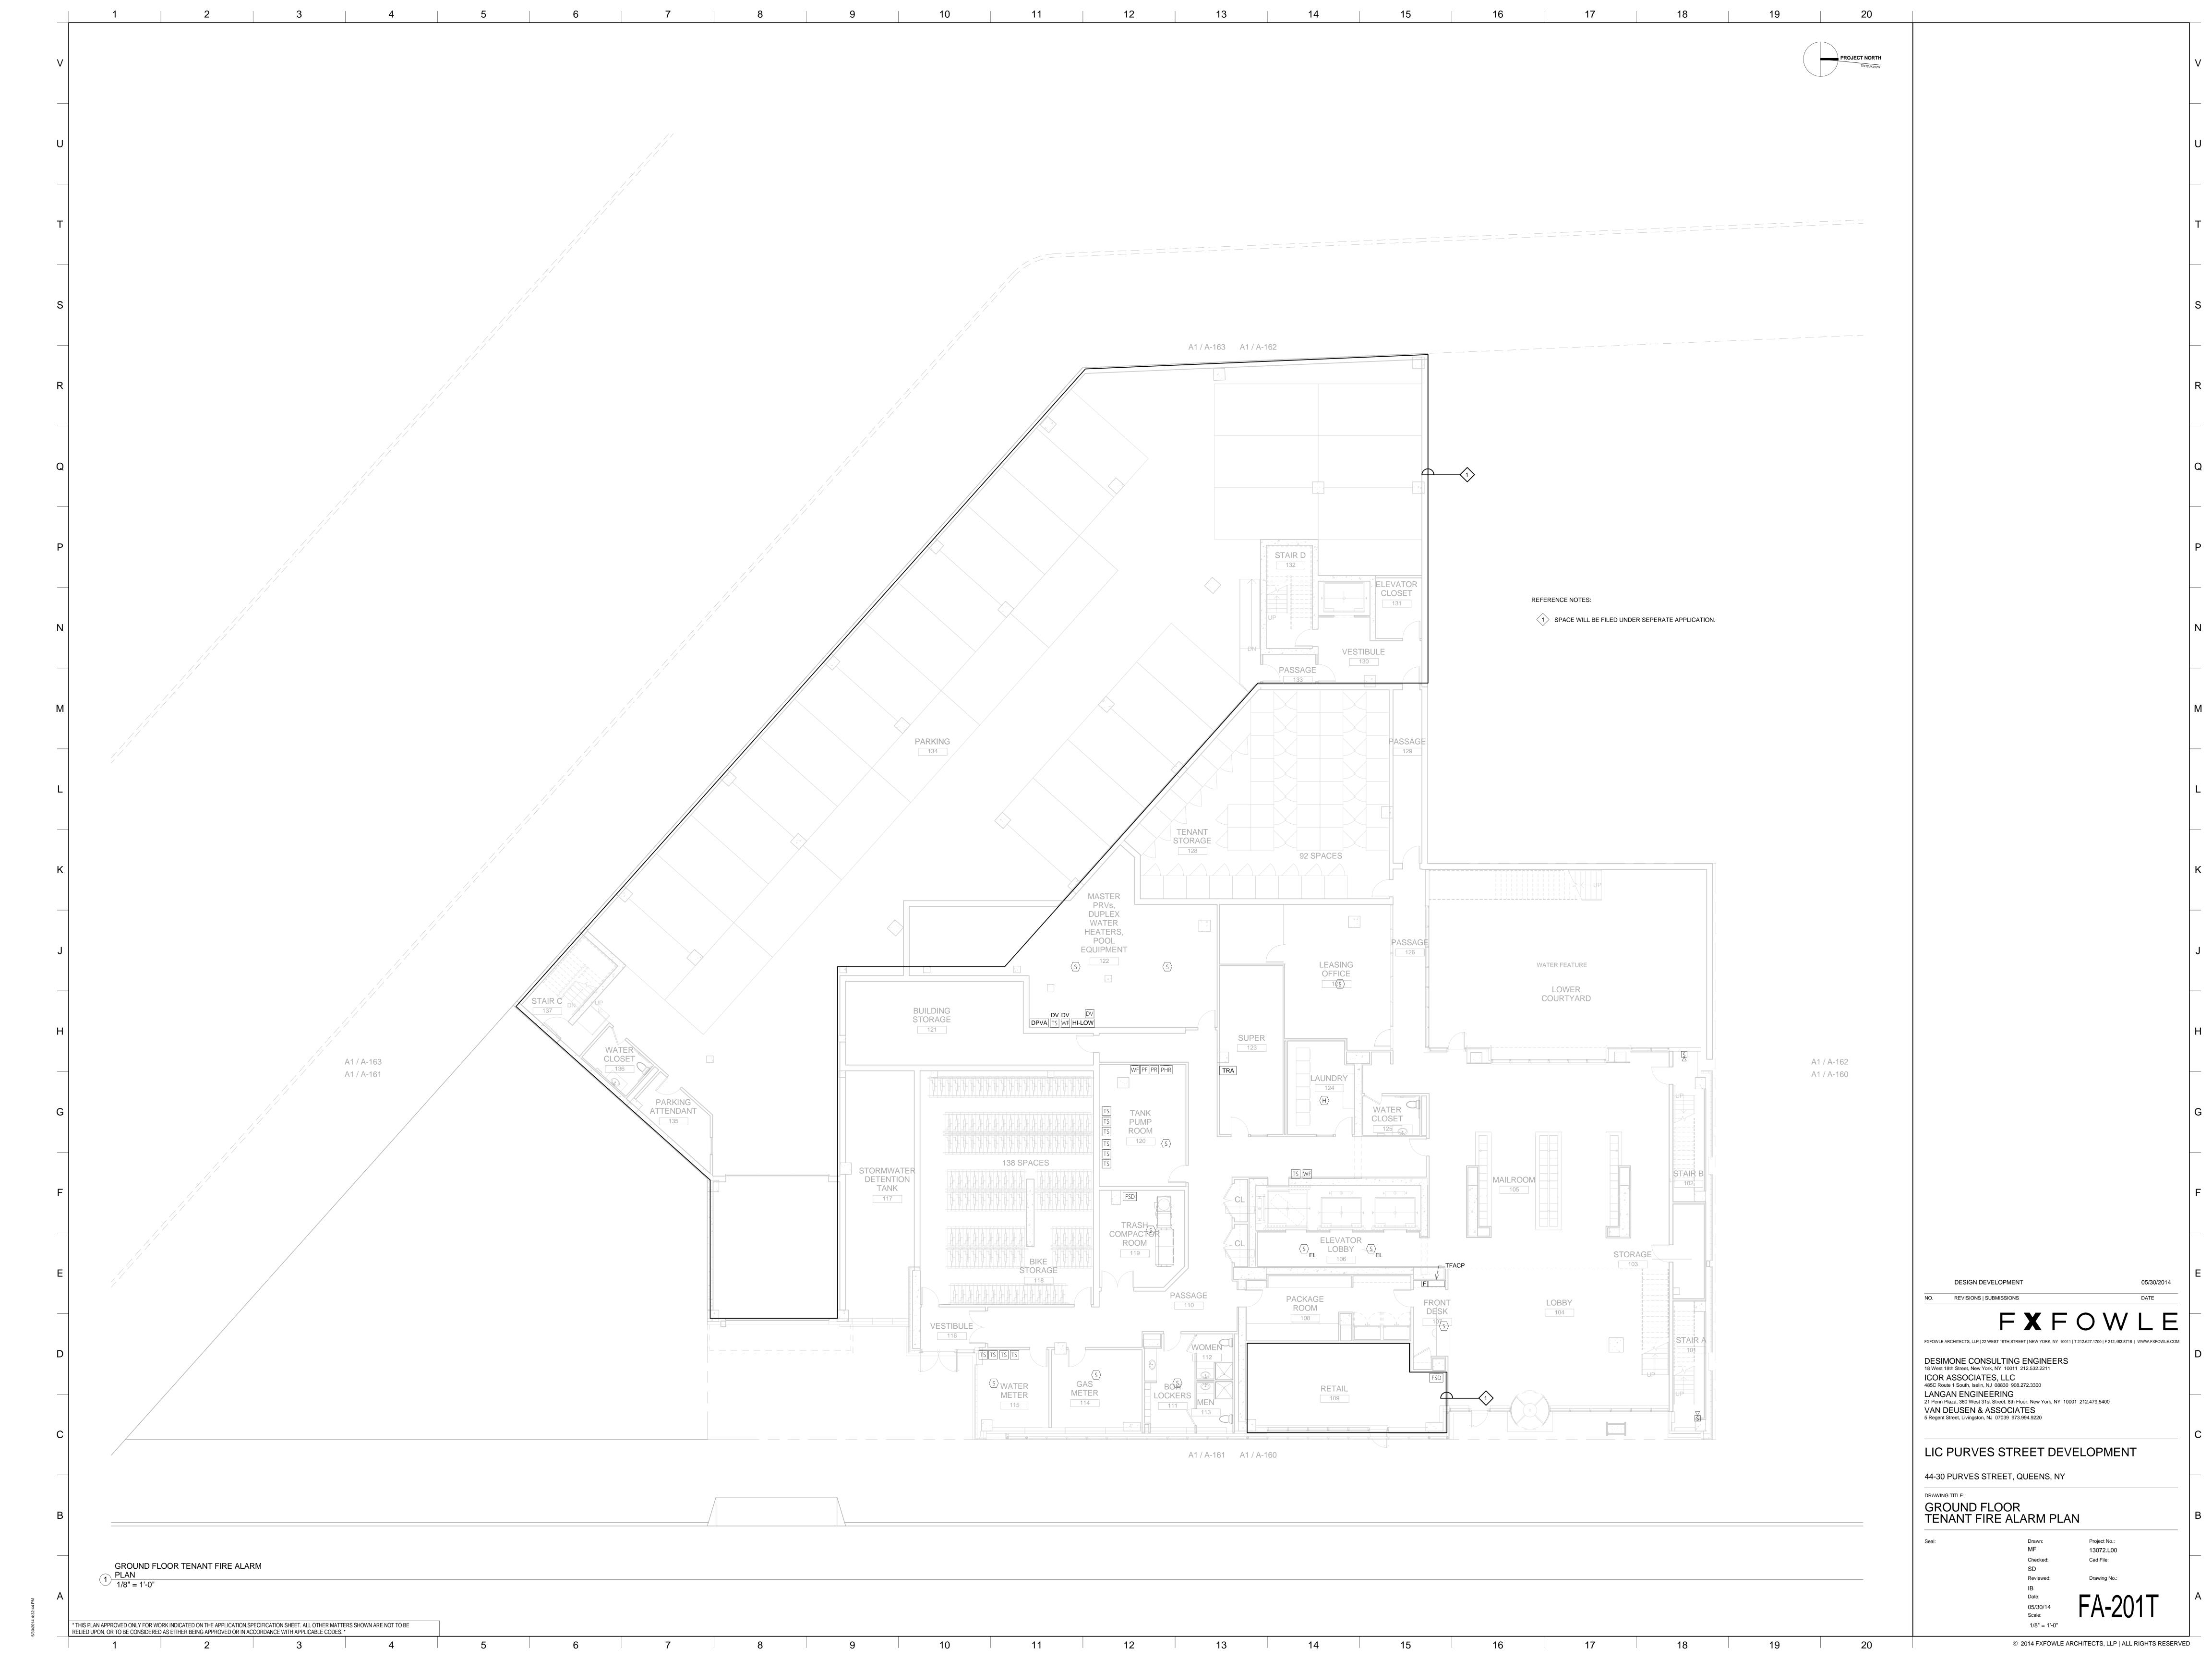
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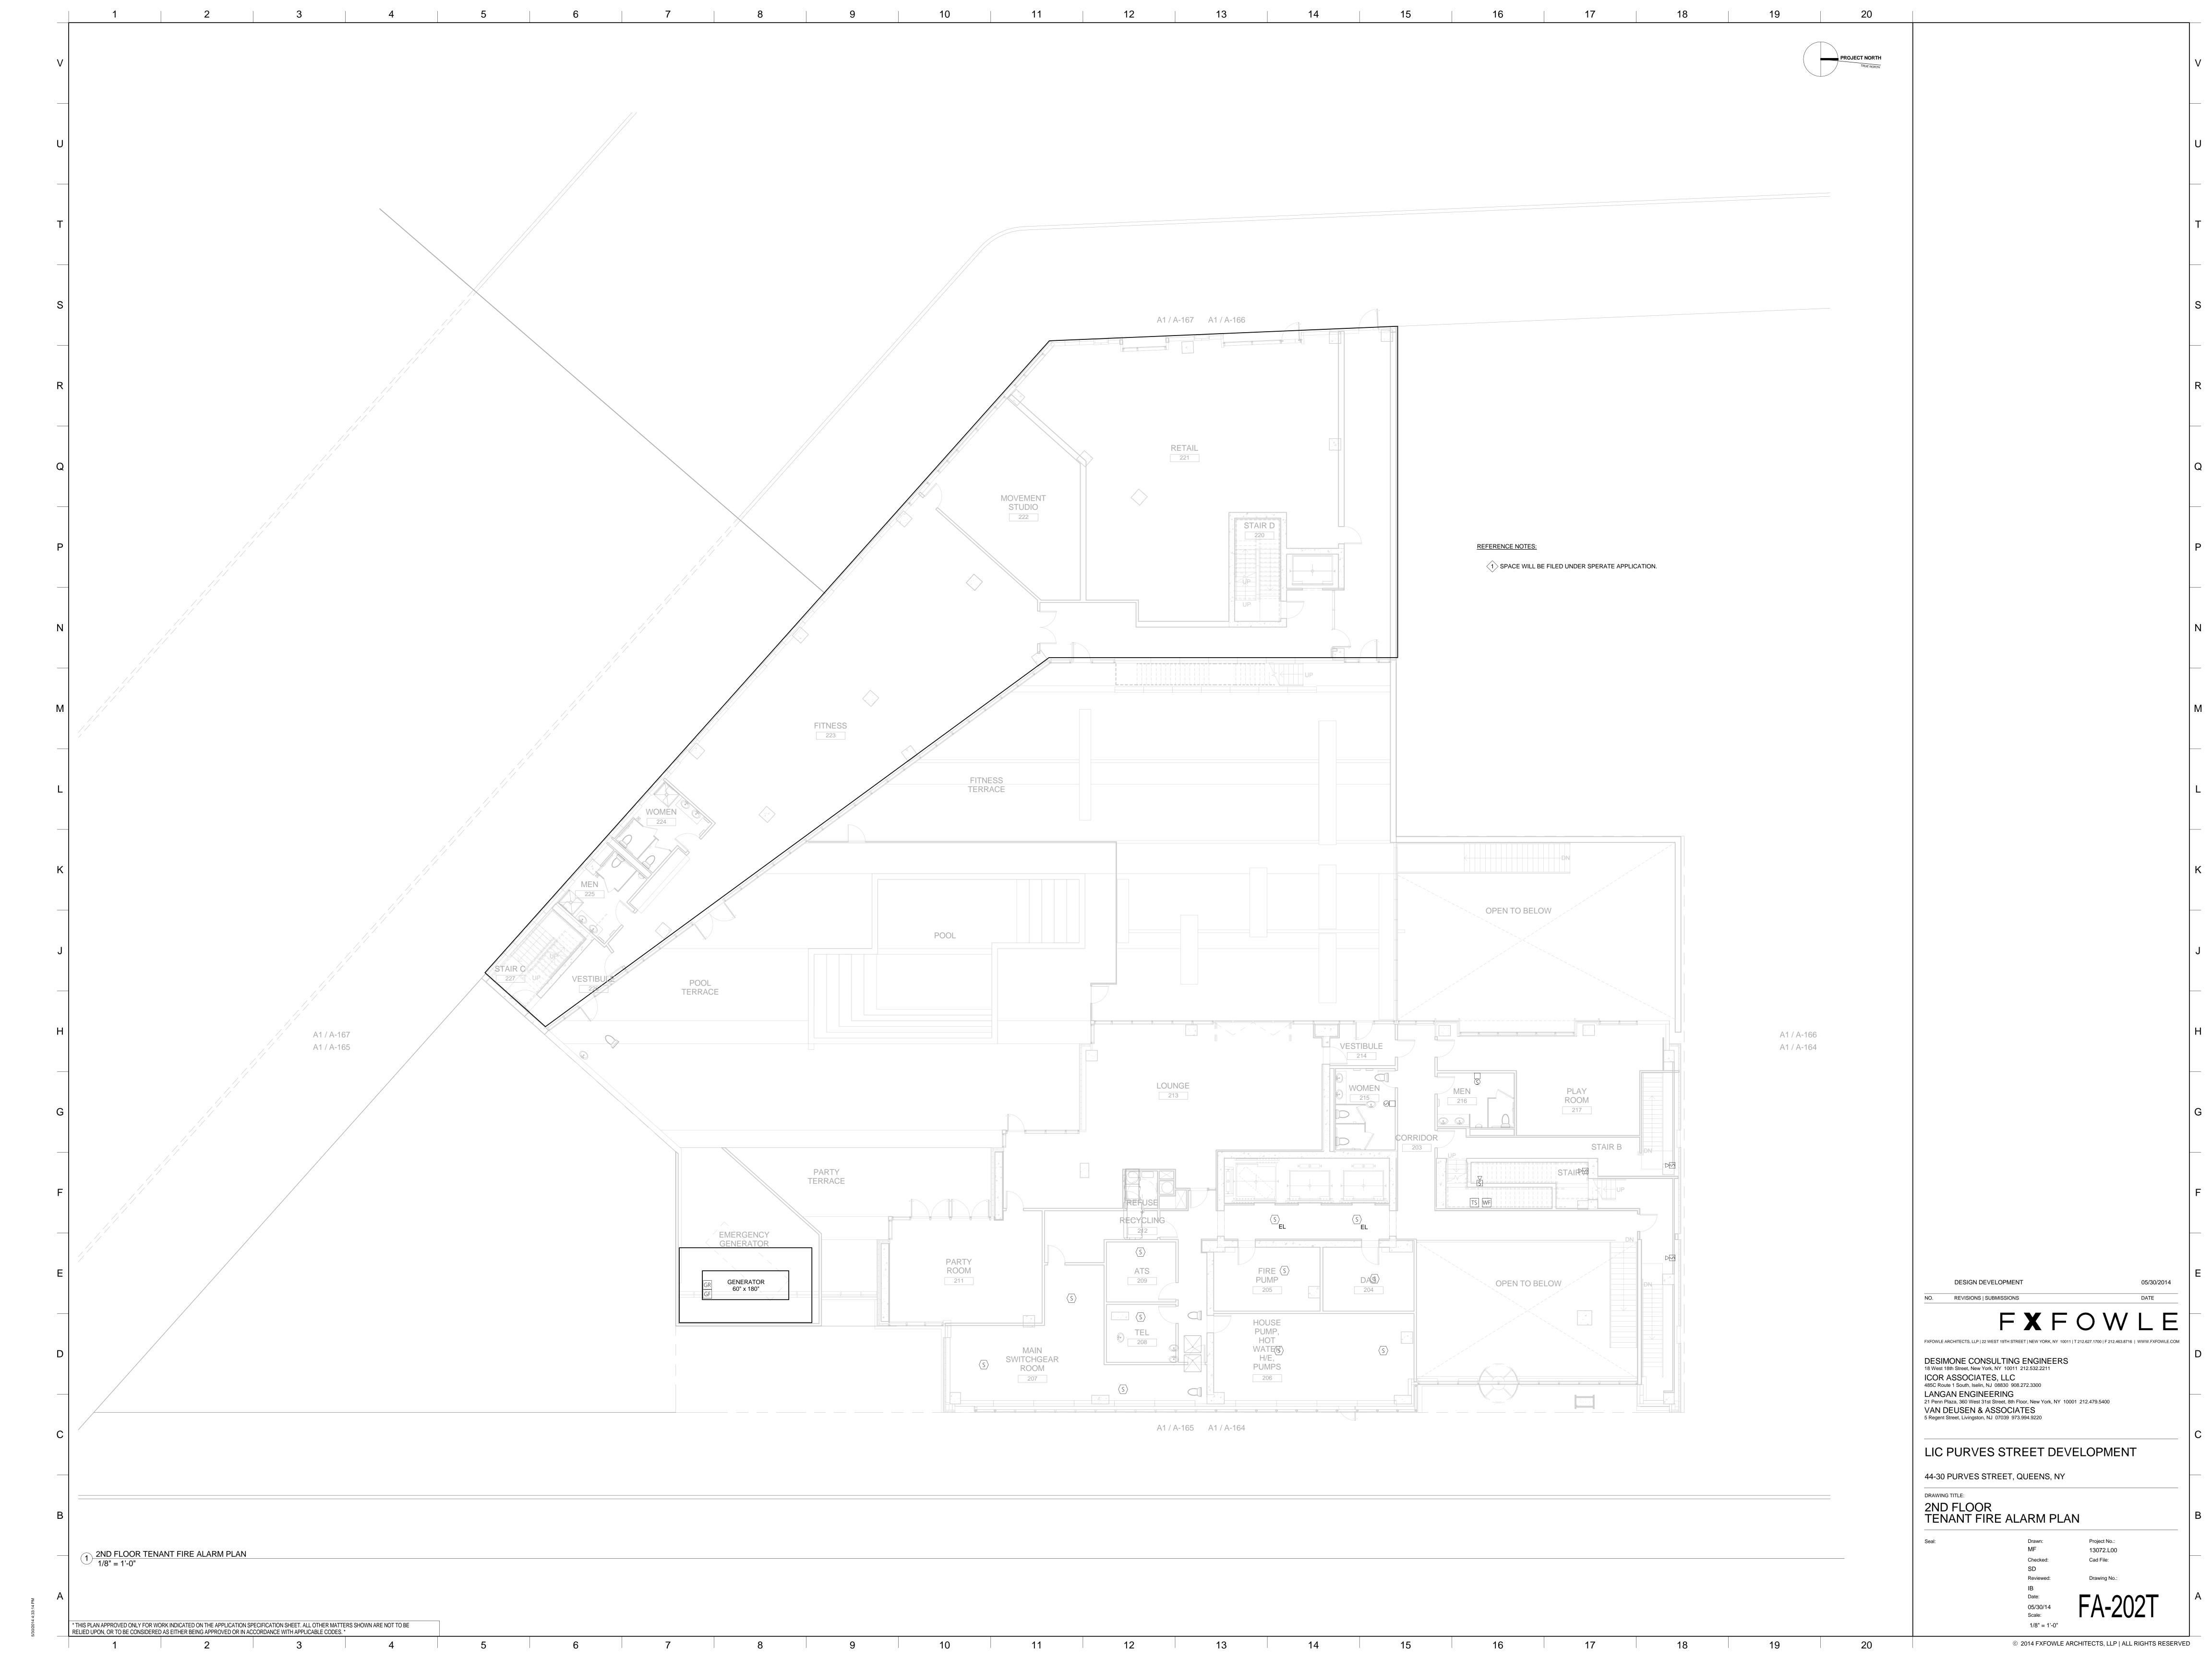
SPRINKLER & STANDPIPE DETAILS


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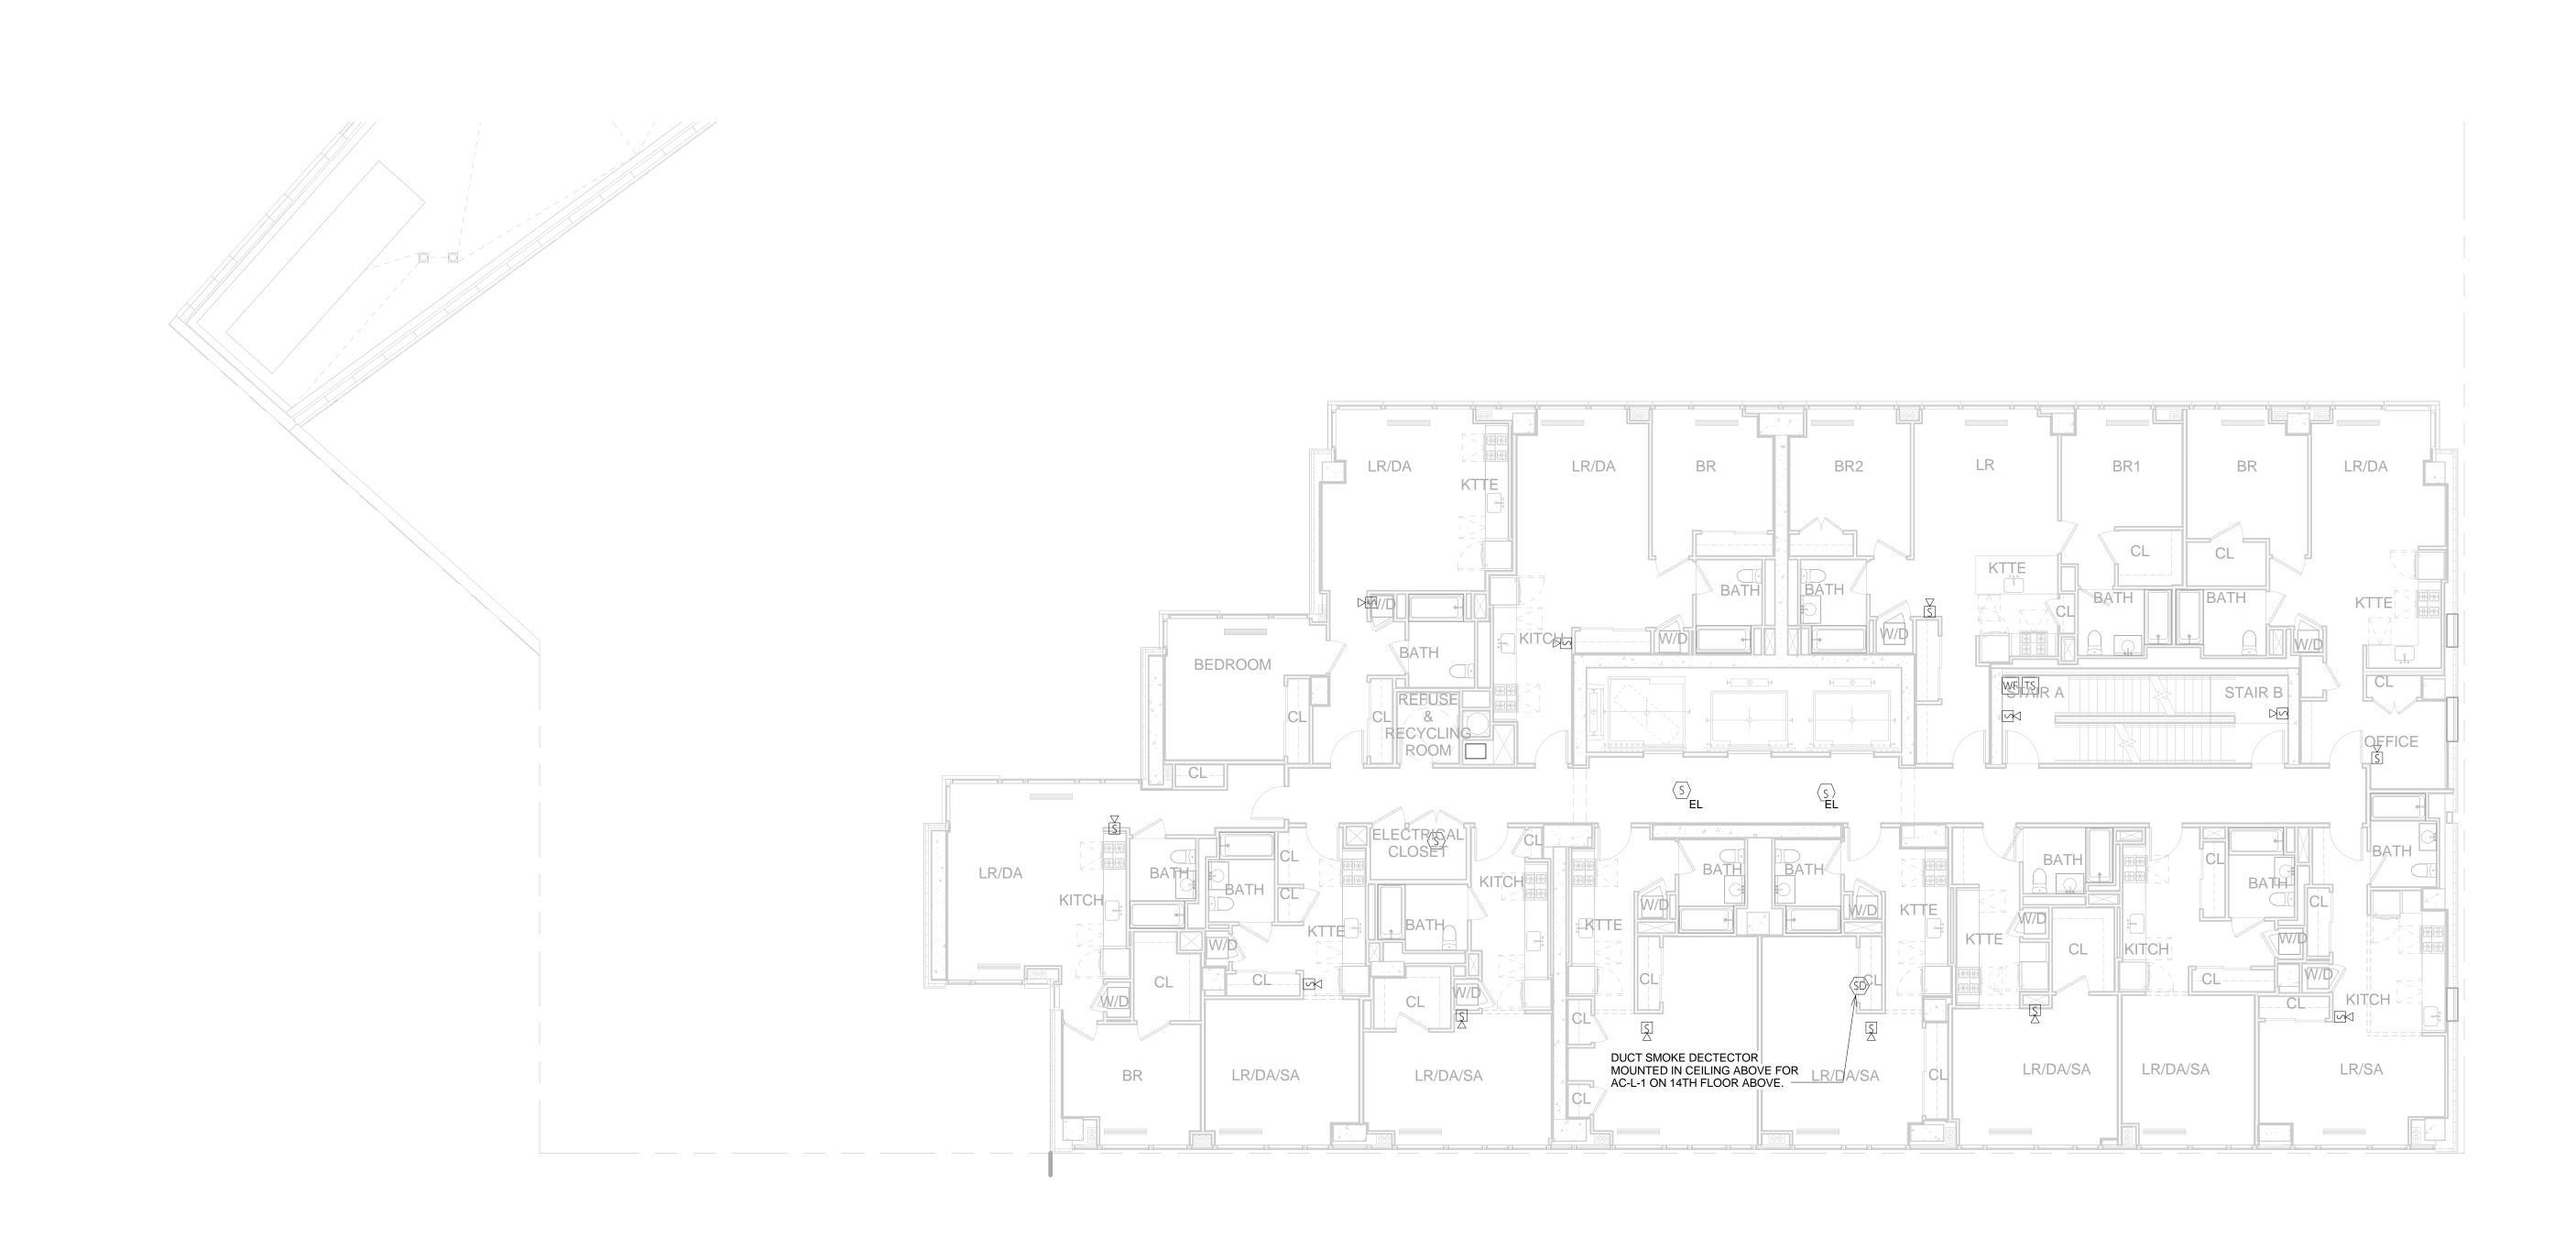
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3RD - 13TH FLOOR TENANT FIRE ALARM

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1 PLAN 1/8" = 1'-0" DESIGN DEVELOPMENT 05/30/2014

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18 West 18th Street, New York, NY 10011 212.532.2211
ICOR ASSOCIATES, LLC
485C Route 1 South, Iselin, NJ 08830 908.272.3300
LANGAN ENGINEERING
21 Penn Plaza, 360 West 31st Street, 8th Floor, New York, NY 10001 212.479.5400
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5 Regent Street, Livingston, NJ 07039 973.994.9220

LIC PURVES STREET DEVELOPMENT

44-30 PURVES STREET, QUEENS, NY

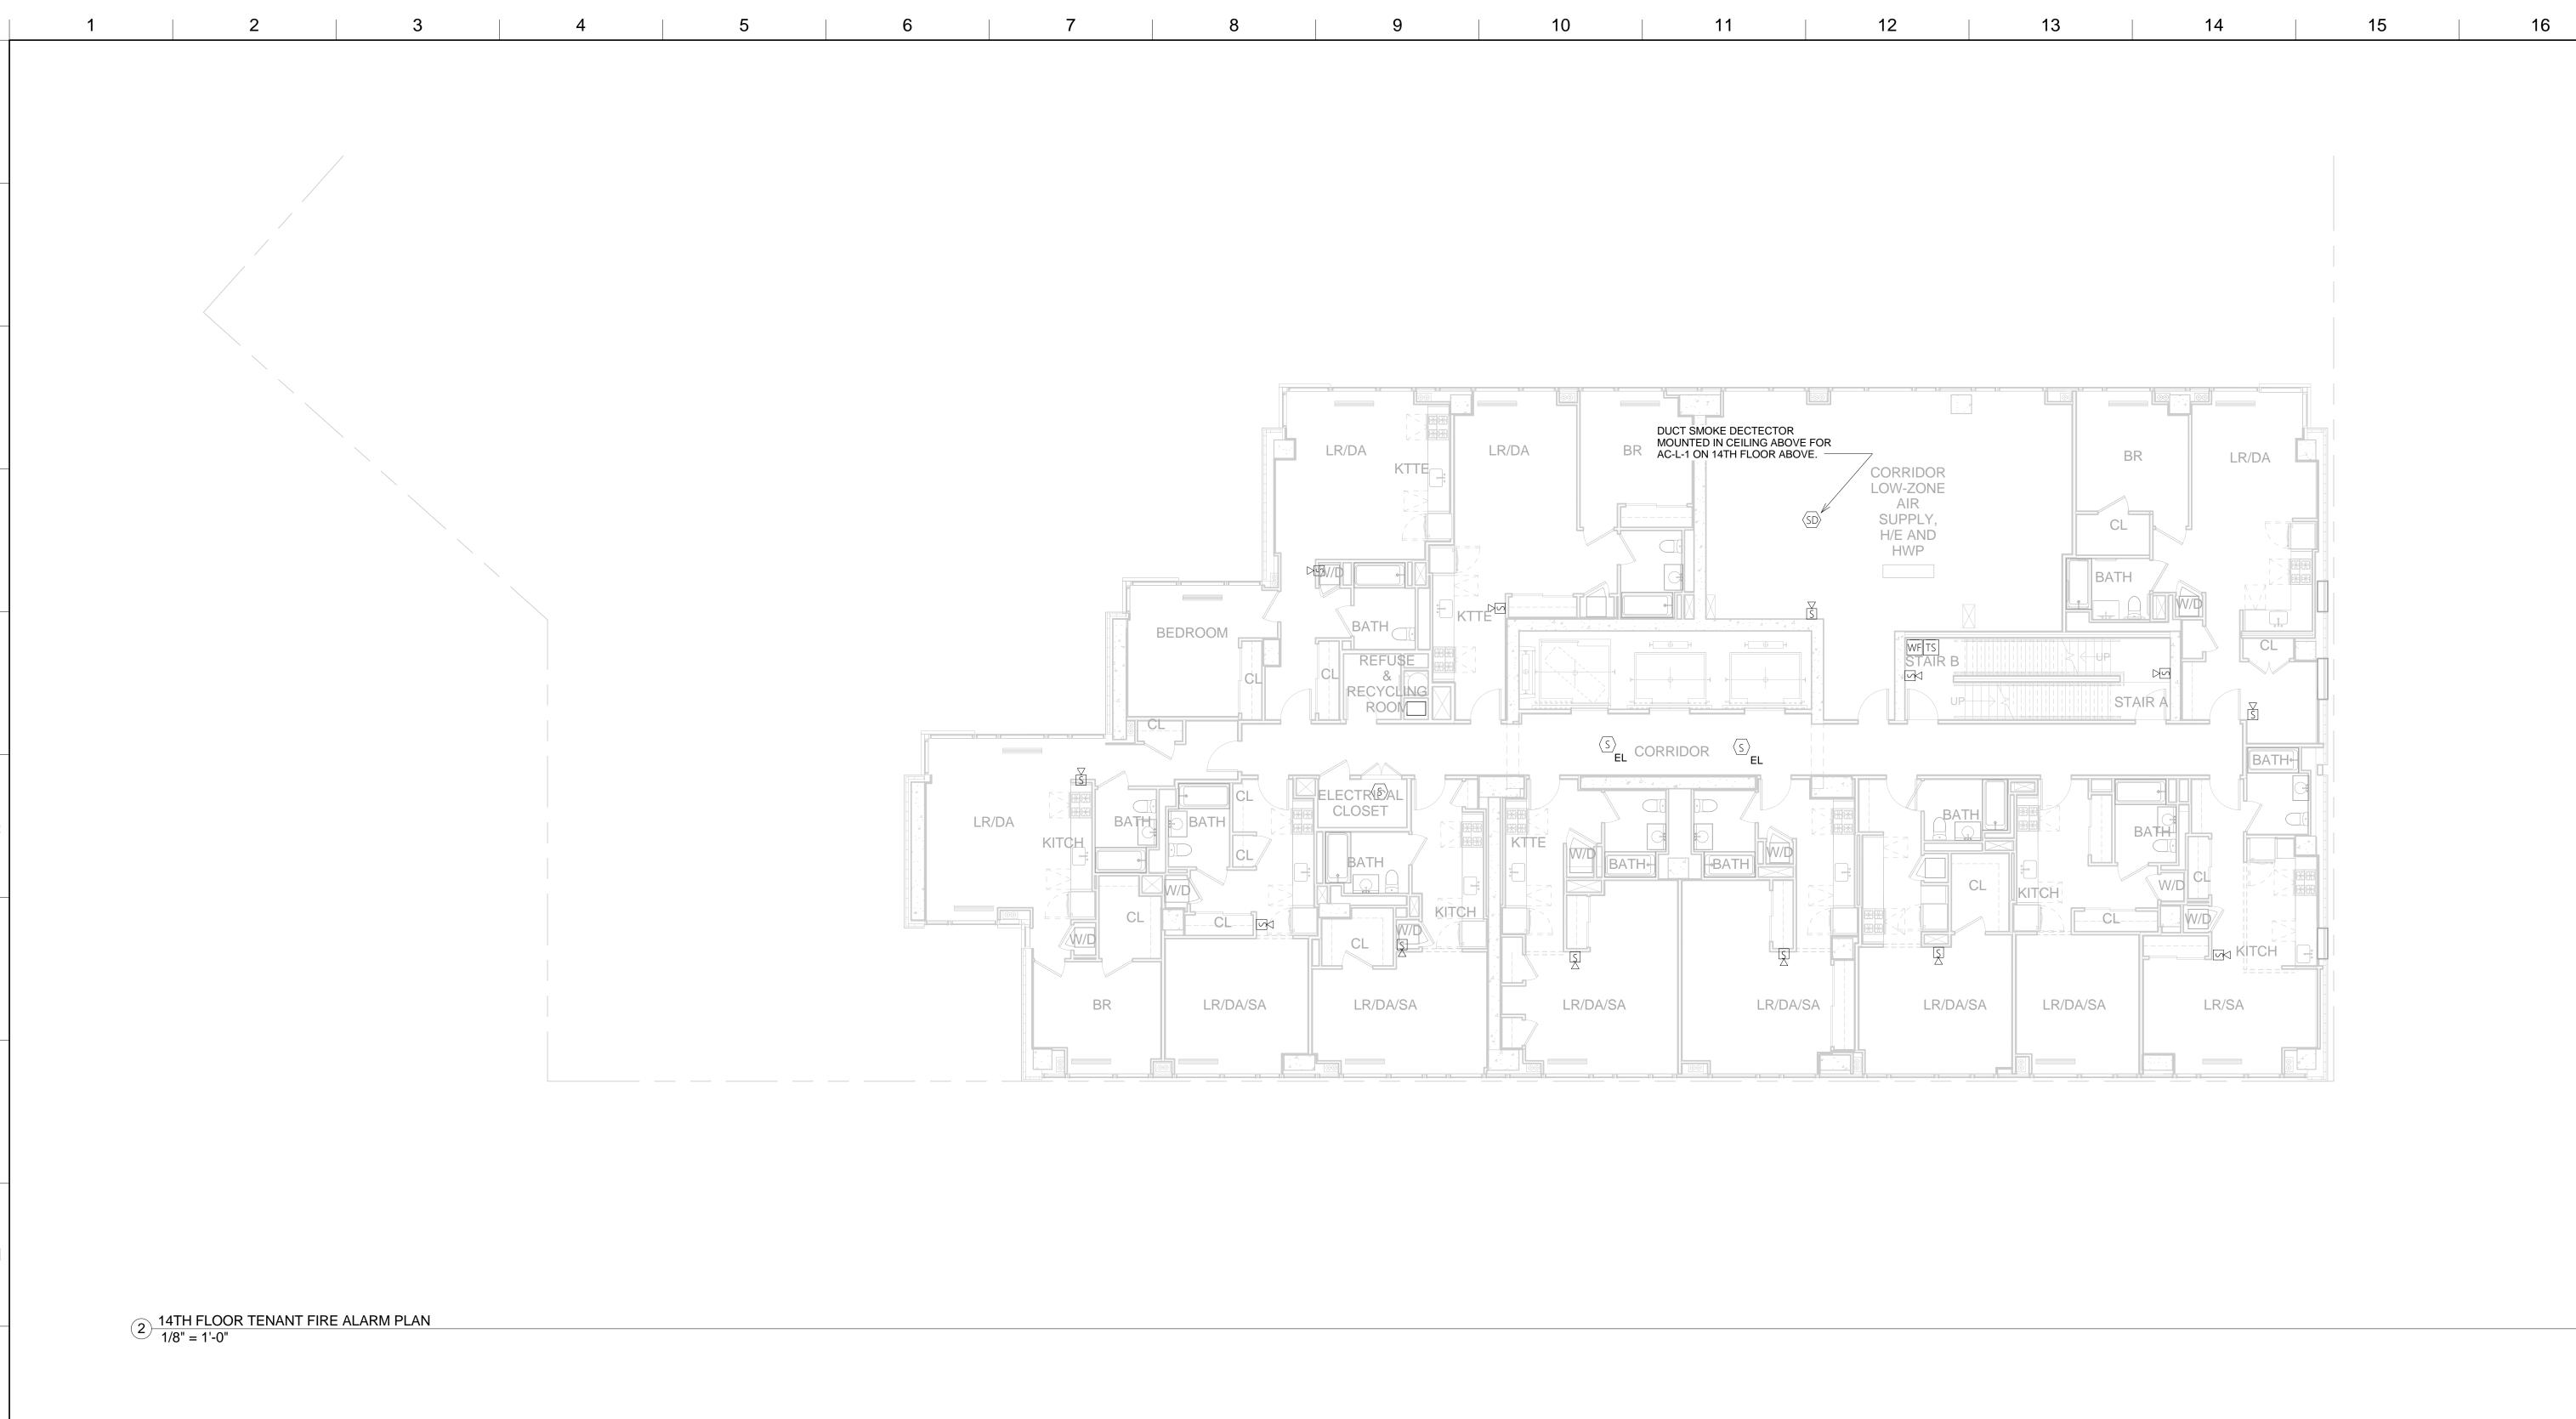DRAWING TITLE:

3RD - 14TH FLOOR

3RD - 14TH FLOOR
TENANT FIRE ALARM PLANS

Seal: Drawn: Pr
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Drawn: Project No.:

MF 13072.L00

Checked: Cad File:

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Reviewed: Drawing No.:

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Date:
05/30/14
Scale:
1/8" = 1'-0"



ROOF AT 32ND FLOOR

BOILER ROOM

LOWER ROOF TENANT FIRE ALARM
PLAN
1/8" = 1'-0"

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18 West 18th Street, New York, NY 10011 212.532.2211

ICOR ASSOCIATES, LLC
485C Route 1 South, Iselin, NJ 08830 908.272.3300

LANGAN ENGINEERING
21 Penn Plaza, 360 West 31st Street, 8th Floor, New York, NY 10001 212.479.5400

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LIC PURVES STREET DEVELOPMENT

44-30 PURVES STREET, QUEENS, NY

LOWER ROOF & EMR TENANT FIRE ALARM PLANS

Drawn: Project No.:
MF 13072.L00
Checked: Cad File:
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1/8" = 1'-0"

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APARTMENT "K" | APARTMENT "J" | APARTMENT "I" | APARTMENT "H" | APARTMENT "G" | APARTMENT "F" | APARTMENT "E" | APARTMENT "D" | APARTMENT "C" | APARTMENT "B" | APARTMENT "A" | ELEV/LOBBY APARTMENT "L" | APARTMENT "K" | APARTMENT "J" | APARTMENT "I" | APARTMENT "H" | APARTMENT "G" | APARTMENT "F" | APARTMENT "E" | APARTMENT "D" | APARTMENT "C" | APARTMENT "B" | APARTMENT "A" | ELEV/LOBBY 13TH FLOOR APARTMENT "L" | APARTMENT "K" | APARTMENT "J" | APARTMENT "I" | APARTMENT "H" | APARTMENT "G" | APARTMENT "F" | APARTMENT "E" | APARTMENT "D" | APARTMENT "C" | APARTMENT "B" | APARTMENT "A" | ELEV/LOBBY 12TH FLOOR APARTMENT "L" | APARTMENT "K" | APARTMENT "J" | APARTMENT "I" | APARTMENT "H" | APARTMENT "G" | APARTMENT "F" | APARTMENT "E" | APARTMENT "D" | APARTMENT "C" | APARTMENT "B" | APARTMENT "A" | ELEV/LOBBY 11TH FLOOR APARTMENT "L" | APARTMENT "K" | APARTMENT "J" | APARTMENT "I" | APARTMENT "H" | APARTMENT "G" | APARTMENT "F" | APARTMENT "D" | APARTMENT "C" | APARTMENT "B" | APARTMENT "A" | ELEV/LOBBY 1ØTH FLOOR (1) 4°C APARTMENT "L" | APARTMENT "K" | APARTMENT "J" | APARTMENT "I" | APARTMENT "H" | APARTMENT "G" | APARTMENT "F" | APARTMENT "E" | APARTMENT "D" | APARTMENT "C" | APARTMENT "B" | APARTMENT "A" | ELEV/LOBBY 9TH FLOOR S DGP-8 APARTMENT "L" | APARTMENT "K" | APARTMENT "J" | APARTMENT "I" | APARTMENT "H" | APARTMENT "G" | APARTMENT "F" | APARTMENT "D" | APARTMENT "C" | APARTMENT "B" | APARTMENT "A" | 8TH FLOOR APARTMENT "L" | APARTMENT "K" | APARTMENT "J" | APARTMENT "I" | APARTMENT "H" | APARTMENT "G" | APARTMENT "F" | APARTMENT "E" | APARTMENT "D" | APARTMENT "C" | APARTMENT "B" | APARTMENT "A" | 7TH FLOOR APARTMENT "L" APARTMENT "K" APARTMENT "J" APARTMENT "I" APARTMENT "H" APARTMENT "G" APARTMENT "F" APARTMENT "E" APARTMENT "D" APARTMENT "C" APARTMENT "B" APARTMENT "A" ELEV/LOBBY STAIRS 6TH FLOOR APARTMENT "L" | APARTMENT "K" | APARTMENT "J" | APARTMENT "I" | APARTMENT "H" | APARTMENT "G" | APARTMENT "F" | APARTMENT "E" | APARTMENT "D" | APARTMENT "C" | APARTMENT "B" | APARTMENT "A" | ELEV/LOBBY STAIRS 5TH FLOOR STAIRS APARTMENT "L" | APARTMENT "K" | APARTMENT "J" | APARTMENT "I" | APARTMENT "H" | APARTMENT "G" | APARTMENT "F" | APARTMENT "D" | APARTMENT "C" | APARTMENT "B" | APARTMENT "A" | 4TH FLOOR TS-WF APARTMENT "L" | APARTMENT "K" | APARTMENT "J" | APARTMENT "I" | APARTMENT "H" | APARTMENT "G" | APARTMENT "F" | APARTMENT "E" | APARTMENT "D" | APARTMENT "C" | APARTMENT "B" | APARTMENT "A" | ELEV/LOBBY 3RD FLOOR (ROOF) LOBBY TS-WF TRA ELEV. LOBBY HOT WATER PUMPS ELEC. RM. FIRE PUMP HOUSE PUMP TELE. SWITCHGEAR RM. ATS ROOM WOMEN MEN DAS ROOM COOL PLAY AREA 2nd FLOOR MOUNTED ON TOP OF STAIRS. PROVIDE TWO DEDICATED PHONE LINES FOR TIE-IN CONNECTION TO FDNY. TS TS TS TS BACK FLOW PREVENTION SUPERS OFFICE LOBBY/LOUNGE WATER METER TANK PUMP ROOM POOL EQUIPMENT ELEVATOR LOBBY BOH LAUNDRY TRASH COMPACTOR ROOM GROUND FLOOR

\* REFERENCE NOTES:

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TENANT FIRE ALARM RISER DIAGRAM SHEET 1 OF 2

VAN DEUSEN & ASSOCIATES 5 Regent Street, Livingston, NJ 07039 973.994.9220 LIC PURVES STREET DEVELOPMENT 44-30 PURVES STREET, QUEENS, NY TENANT FIRE ALARM RISER DIAGRAM SHEET 1 OF 2

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Project No.: 13072.L00 Cad File: TENANT-FA-401AT.dwg

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\* REFERENCE NOTES: 1. REQUIRED CONDUIT AND WIRING TO DEDICATED FUSE CUT OUT IN FUSE CUT OUT PANEL. S-S-S-S-C-S-C-S-C-BOILER ROOM (S)<sub>EL</sub> (S)<sub>EL</sub> (S) (S) MOUNTED ON TOP OF STAIRS. TS WF FIRE PUMP/DOMESTIC WATER APARTMENT "PH" ELEV. LOBBY 33rd FLOOR (ROOF) APARTMENT "G" APARTMENT "F" APARTMENT "E" APARTMENT "D" APARTMENT "C" APARTMENT "B" APARTMENT "A" ELEV/LOBBY 32nd FLOOR APARTMENT "G" APARTMENT "F" APARTMENT "E" APARTMENT "D" APARTMENT "C" APARTMENT "B" APARTMENT "A" 31TH FLOOR S<sub>EL</sub> S<sub>EL</sub> APARTMENT "G" | APARTMENT "F" | APARTMENT "E" | APARTMENT "D" | APARTMENT "C" | APARTMENT "B" | APARTMENT "A" | ELEV/LOBBY **3ØTH FLOOR** SEL SEL APARTMENT "G" APARTMENT "F" APARTMENT "E" APARTMENT "D" APARTMENT "C" APARTMENT "B" APARTMENT "A" 29TH FLOOR S<sub>EL</sub> S<sub>EL</sub> APARTMENT "G" APARTMENT "F" APARTMENT "E" APARTMENT "D" APARTMENT "C" APARTMENT "B" APARTMENT "A" ELEV/LOBBY 28TH FLOOR APARTMENT "G" APARTMENT "F" APARTMENT "E" APARTMENT "D" APARTMENT "C" APARTMENT "B" APARTMENT "A" 27TH FLOOR S<sub>EL</sub> S<sub>EL</sub> APARTMENT "G" APARTMENT "F" APARTMENT "E" APARTMENT "D" APARTMENT "C" APARTMENT "B" APARTMENT "A" ELEV/LOBBY 26TH FLOOR SEL SEL (1) 4°C APARTMENT "G" APARTMENT "F" APARTMENT "E" APARTMENT "D" APARTMENT "C" APARTMENT "B" APARTMENT "A" 25TH FLOOR SEL SEL APARTMENT "G" | APARTMENT "F" | APARTMENT "E" | APARTMENT "D" | APARTMENT "C" | APARTMENT "B" | APARTMENT "A" | ELEV/LOBBY 24TH FLOOR SEL SEL APARTMENT "G" APARTMENT "F" APARTMENT "E" APARTMENT "D" APARTMENT "C" APARTMENT "B" APARTMENT "A" ELEV/LOBBY 23TH FLOOR SEL SEL APARTMENT "G" APARTMENT "F" APARTMENT "E" APARTMENT "D" APARTMENT "C" APARTMENT "B" APARTMENT "A" 22TH FLOOR S<sub>EL</sub> S<sub>EL</sub> APARTMENT "G" APARTMENT "F" APARTMENT "E" APARTMENT "D" APARTMENT "C" APARTMENT "B" APARTMENT "A" ELEV/LOBBY 21TH FLOOR APARTMENT "G" APARTMENT "F" APARTMENT "E" APARTMENT "D" APARTMENT "C" APARTMENT "B" APARTMENT "A" 2ØTH FLOOR SEL SEL DESIGN DEVELOPMENT 05/30/2014 03/14/2014 DATE SCHEMATIC DESIGN REVISIONS | SUBMISSIONS APARTMENT "G" APARTMENT "F" APARTMENT "E" APARTMENT "D" APARTMENT "C" APARTMENT "B" APARTMENT "A" ELEV/LOBBY FXFOWLE 19TH FLOOR FXFOWLE ARCHITECTS, LLP | 22 WEST 19TH STREET | NEW YORK, NY 10011 | T 212.627.1700 | F 212.463.8716 | WWW.FXFOWLE.COM DESIMONE CONSULTING ENGINEERS 18 West 18th Street, New York, NY 10011 212.532.2211 APARTMENT "G" APARTMENT "F" APARTMENT "E" APARTMENT "D" APARTMENT "C" APARTMENT "B" APARTMENT "A" ICOR ASSOCIATES, LLC 18TH FLOOR 485C Route 1 South, Iselin, NJ 08830 908.272.3300 LANGAN ENGINEERING & ENVIRONMENTAL SERVICE 21 Penn Plaza, 360 West 31st Street, 8th Floor, New York, NY 10001 212.479.5400 VAN DEUSEN & ASSOCIATES 5 Regent Street, Livingston, NJ 07039 973.994.9220 APARTMENT "G" APARTMENT "F" APARTMENT "E" APARTMENT "D" APARTMENT "C" APARTMENT "B" APARTMENT "A" LIC PURVES STREET DEVELOPMENT 17TH FLOOR 44-30 PURVES STREET, QUEENS, NY TENANT FIRE ALARM RISER DIAGRAM APARTMENT "G" APARTMENT "F" APARTMENT "E" APARTMENT "D" APARTMENT "C" APARTMENT "B" APARTMENT "A" SHEET 2 OF 2 16TH FLOOR Project No.: 13072.L00 Cad File: TENANT-FA-401BT.dwg MATCH-LINE SEE DRAWINGS E-XXX 1 TENANT FIRE ALARM RISER DIAGRAM SHEET 2 OF 2 \* THIS PLAN APPROVED ONLY FOR WORK INDICATED ON THE APPLICATION SPECIFICATION SHEET. ALL OTHER MATTERS SHOWN ARE NOT TO BE RELIED UPON, OR TO BE CONSIDERED AS EITHER BEING APPROVED OR IN ACCORDANCE WITH APPLICABLE CODES. \*

																SYSTE	EM OUT	rputs										
		CON	NTROL UN	IT ANNUN	CIATION					NOTI	FICATION							REQU	JIRED FIRE	E SAFETY	CONTROL							
		ATE COMMON ALARM SIGNAL	TE AUDIBLE ALARM SIGNAL	ATE COMMON SUPERVISORY SIGNAL INDICATOR	ATE AUDIBLE SUPERVISORY SIGNAL	ATE COMMON TROUBLE SIGNAL INDICATOR	ATE AUDIBLE COMMON TROUBLE SIGNAL	AY PURGE DAMPER STATUS	PLAY SMOKE PURGE FAN RUNNING STATUS	AY/PRINT CHANGE OF STATUS	SMIT AUTOMATIC ALARM SIGNAL TO SUPERVISING STATION	SMIT MANUAL SIGNAL TO SUPERVISING STATION	SMIT WATERFLOW SIGNAL TO SUPERVISING STATION	SMIT SUPERVISORY SIGNAL TO SUPERVISING STATION	SMIT PUMP RUNNING SIGNAL TO SUPERVISING STATION	SMIT PUMP TROUBLE SIGNAL TO SUPERVISING STATION	SMIT TROUBLE SIGNAL TO SUPERVISING STATION	USED	ELEVATORS TO GROUND FLOOR	SMOKE/FIRE DAMPERS IN RATED WALLS	OCK NECESSARY EXITS	APPROPRIATE SMOKE HATCH	DOWN ASSOCIATED FAN	E ASSOCIATED SMOKE DAMPER	SMIT SIGNAL TO BMS	SMIT SIGNAL TO OPEN ASSOCIATED DAMPER	SMIT SIGNAL TO ASSOCIATED SMOKE PURGE FAN TO START	
SYST	EM INPUTS	ACTU,	ACTUA	ACTU	- ACTU	n ACTUA	ACTUA	) DISPLAY	- DISPL	- DISPL	- TRAN	∠ TRAN	- TRAN	TRAN	TRAN	TRANS	TRANS	TON	RECALL	CLOSE	ONLO	OPEN	SHUT	cLosi	TRANS	TRANS	TRANS	DD.
1	MANUAL FIRE ALARM BOXES	X	X		, J	<u> </u>	'	G	"	' ' '		X	-	IVI	IN	U	Г	Q	7	3	<u> </u>	X	V	VV	AA	BB	CC	DD
2	SMOKE DETECTORS	X	\ \ \ \ \ \								X	^									V	X					$\rightarrow$	
	IN-DUCT SMOKE DETECTORS	X	X							^ 	X									X	\ \ \ \ \ \	^	Х	v			$\overline{}$	
4	HEAT DETECTORS	X	X								X									^ X	X		^	^				
5	ELEVATOR SHAFT SMOKE DETECTORS (IF USED)	X	X								X								Х	^ X	^							
6	WATERFLOW	X	Y							Y	^		Х							^ 			v	v				
7	SPRINKLER CONTROL VALVE			X	X					X			~	х					^		^		^	^				
 8	FIRE PUMP RUNNING			X	X					X					х													
9	TANK LOW/HIGH LEVEL			X	X					X				Х	~													
10	FIRE PUMP POWER FAILURE/REVERSAL					х	X			X						x												
11	FIRE ALARM AC FAILURE					X	X			X							х											
12	FIRE ALARM SYSTEM LOW BATTERY					X	X			X							x											
13	OPEN CIRCUIT					Х	Х			Х							x											
14	GROUND FAULT					х	Х			Х							x											
15	TENANT SYSTEM ALARM	Х	x							Χ	Х								Х		x	Х						
16	TENANT SYSTEM TROUBLE					x	Х			Χ							х											
17	DRILL SWITCH									Х																		
18	EMERGENCY GENERATOR RUNNING CONTACT									Х															Χ			
19	EMERGENCY GENERATOR MALFUNCTION CONTACT									Х															X			
20	EMERGENCY GENERATOR FUEL SUPPLY CONTACT									Χ															Χ			
21	EMERGENCY GENERATOR DAY TANK RUPTURE BASIN FUEL CONTACT									Х															Х			
22	EMERGENCY GENERATOR BATTERY SYSTEM DC MALFUNCTION CONTACT									Х															Х			
23	EMERGENCY GENERATOR LOSS OF AC POWER CONTACT									Х															Х			
24	TURN SMOKE CONTROL 2642 KEY TO MANUAL 'ON' POSITION							Х	Х																	х	$\overline{}$	
																											<del></del>	

TENANT FIRE ALARM SYSTEM INPUT/OUTPUT MATRIX

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- DESIGN DEVELOPMENT
- SCHEMATIC DESIGN
- NO. REVISIONS | SUBMISSIONS

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DESIMONE CONSULTING ENGINEERS
18 West 18th Street, New York, NY 10011 | 212.532.2211

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485C Route 1 South, Iselin, NJ 08830 908.272.3300

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21 Penn Plaza, 360 West 31st Street, 8th Floor, New York, NY 10001 212.479.5400

### LIC PURVES STREET DEVELOPMENT

44-30 PURVES STREET, QUEENS, NY

VAN DEUSEN & ASSOCIATES
5 Regent Street, Livingston, NJ 07039 973.994.9220

TENANT FIRE ALARM MATRIX

Drawn:
MF
13072.L00
Checked:
Cad File:
SD
TENANT-FA-501T.dwg
Reviewed:
Drawing No.:

IB
Date:
05/30/14
Scale:
NO SCALE