ELECTRICAL SYMBOLS	3			
THIS IS A MASTER LEGEND AND NOT ALL SYMBOLS OR ABBREVIATIONS ARE USE STANDARD MOUNTING HEIGHTS		POWER EQUIPMENT & DEVICES	WIRING DEVICES & BOXES	ELECTRICAL ONE-LINE
	ED. ANNOTATION 1 ELECTRICAL OR FIRE ALARM PLAN NOTE CALLOUT 1 PLUMBING EQUIPMENT DESIGNATION. (CONTRACTOR FURNISHED AND INSTALLED). REFER TO PLUMBING FIXTURE OR EQUIPMENT SCHEDULES 1 EQUIPMENT DESIGNATION (OWNER FURNISHED, CONTRACTOR INSTALLED) MECHANICAL EQUIPMENT DESIGNATION (CONTRACTOR FURNISHED AND INSTALLED UNLESS NOTED OTHERWISE) 1 DETAIL REFERENCE UPPER NUMBER INDICATES DETAIL NUMBER LOWER NUMBER INDICATES SHEET NUMBER 1 SECTION CUT DESIGNATION CIRCUIT OPANELBOARD. INFORMATION AT ARROWS ARE CIRCUIT NUMBERS AND PANELBOARD FOR TERMINATION. REFER TO P1-3,5,7 PANELBOARD SCHEDULES FOR BRANCH CIRCUIT CONDUCTOR SIZES. CIRCUIT CONTINUATION OR PARTIAL CIRCUIT CONDUIT CONCEALED CONDUIT INJUNDER FLOOR/GROUND CONSTRUCTION	ELECTRICAL PANELBOARD (SURFACE OR FLUSH MOUNT) CONTROL SYSTEM CABINET (CONTROLS, SECURITY, AV) PLYWOOD TERMINAL BOARD FOR TELEPHONE SYSTEM, UNO. SIZE AS NOTED SWITCHBOARD OR MOTOR CONTROL CENTER ON HOUSEKEEPING PAD ELECTRICAL DISTRIBUTION PANELBOARD TRANSFORMER MOTOR DISCONNECT SWITCH - "200/3/150/3R" DENOTES AMPERES/POLE/FUSE/NEMA ENCLOSURE RATING, NF= NON-FUSED, CB= CIRCUIT BREAKER (200/3/CB), NO VALUE (200/3/150) FOR NEMA ENCLOSURE MEANS STANDARD NEMA 1 RATING COMBINATION DISCONNECT (SAFETY) SWITCH AND MOTOR STARTER "30/3/15/1/3R" DENOTES AMPERES/POLE/FUSE/NEMA STARTER SIZE/NEMA ENCLOSURE RATING, NF= NON-FUSED, CB= CIRCUIT BREAKER (309/3/CB/1), NO VALUE (200/3/150/1) FOR NEMA ENCLOSURE MEANS STANDARD NEMA 1 ENCLOSURE RATING MAGNETIC MOTOR STARTER, NEMA SIZE AS NOTED. 3-POLE, UNO MANUAL MOTOR STARTER DISCONNECT VARIABLE FREQUENCY DRIVE	WIRING DEVICES & BOXES SIMPLEX RECEPTACLE - NEMA 5-20R, UNO DUPLEX RECEPTACLE - NEMA 5-20R, UNO DOUBLE DUPLEX RECEPTACLE - NEMA 5-20R, UNO SPECIAL RECEPTACLE - NEMA TYPE AS NOTED TWIST-LOCK TYPE RECEPTACLE OR GFCI GFCI TYPE RECEPTACLE ISOLATED GROUND TYPE RECEPTACLE RECEPTACLE INSTALLED ABOVE COUNTER OR BACKSPLASH RECEPTACLE INSTALLED IN CEILING RECEPTACLE INSTALLED IN FLOOR RECEPTACLE INSTALLED VIA DROP CORD RECEPTACLE INSTALLED VIA DROP CORD RECEPTACLE LETTER DESIGNATIONS AS FOLLOWS: C = AUTOMATICALLY CONTROLLED D = DEMOLISHED E = ENSTING EM = EMERGENCY POWER EM = EME	SWITCH (RATING AS INDICATED) FUSED SWITCH (RATING, POLES AND FUSE TYPE AS INDICATED) PANELBOARD, SINGLE OR MULTI-SECTION (REFER TO SCHEDULES) ISOLATED POWER PANELBOARD W/INTEGRAL TRANSFORMER (REFER TO SCHEDULES) TRANSFORMER (TYPE AND RATINGS AS INDICATED) SHIELDED TRANSFORMER (TYPE AND RATINGS AS INDICATED) AUTOMATIC TRANSFER SWITCH (RATINGS AS INDICATED) AUTOMATIC TRANSFER SWITCH WITH BYPASS (RATINGS AS INDICATED) AUTOMATIC TRANSFER SWITCH WITH BYPASS (RATINGS AS INDICATED)
	EXPOSED CONDUIT LOW VOLTAGE CABLE (NOT ROUTED IN CONDUIT) CONDUIT TURNING DOWN CONDUIT TURNING UP LINETYPE LEGEND THROUGHOUT THE DRAWINGS DIFFERENT LINETYPES ARE USED IN COMBINATION WITH THE SYMBOLS TO INDICATE THE STATUS OF ITEMS AS EXISTING, TO BE DEMOLISHED, TO BE INCLUDED AS PART OF NEW WORK AND/OR ITEMS WHICH ARE ANTICIPATED TO BE PROVIDED IN THE FUTURE. THE STATUS OF ITEMS WHICH ARE ANTICIPATED TO BE PROVIDED IN THE FUTURE. THE STATUS OF ITEMS USING THESE LINETYPES ARE RELATIVE TO THE VIEW IN WHICH THEY APPEAR. PHASING SHOWN IN DRAWINGS IS NOT INTENDED TO FULLY DESCRIBE ALL NECESSARY CONSTRUCTION PHASING, WHICH IS DETERMINED BY THE CONTRACTOR AS PART OF THEIR RESPONSIBILITIES. ANY SUCH PHASES DESCRIBED IN THE CONSTRUCTION DOCUMENTS ARE GENERAL AND ONLY INTENDED TO INDICATE A BROAD ORDER FOR THE SAKE OF DESCRIBING THE PROJECT. THE FOLLOWING LINETYPES MAY BE USED ON ANY DEVICE, EQUIPMENT, NOTE, LINE, SHAPE, ETC. EXISTING NEW FUTURE LIGHTING CONTROL DEVICES \$ SINGLE POLE SWITCH (NO LETTER DESIGNATION) SWITCH LETTER DESIGNATIONS AS FOLLOWS: 2 = TWO POLE 3 = THREE-WAY 4 = FOUR-WAY	RELAY OR CONTACTOR (# = QUANTITY OF RELAYS) LIGHTING CONTROL PHOTOCELL (SHADE INDICATES AIMING) TIME SWITCH LOW-VOLTAGE PUSH-BUTTON (AUTO-OPENER / SECURITY) STOP-START PUSH BUTTON CONTROL STATION MERGENCY POWER OFF BUTTON OVERHEAD PADDLE FAN LIGHT FIXTURE a = SWITCHED BY SWITCH "a" A = LIGHT FIXTURE TYPE "A" NL = NIGHT LIGHT FITURE UNL = WALL MOUNT > = ARROW INDICATES AIMING DIRECTION LIGHT FIXTURE CIRCUITED ON BACK-UP POWER (NOT EGRESS)	ER = EXISTING TO BE RELOCATED GFCI = GROUND-FAULT CIRCUIT INTERRUPTER H = HORIZONTALLY MOUNTED IG = ISOLATED GROUND R = RELOCATED, NEW LOCATION S = MANUALLY SWITCHED TR = TAMPER RESISTANT TV = TELEVISION USB = USB/JUPLEX WP = WEATHER PROOF COVER WR = WEATHER RESISTANT *SYMBOL DEMONSTRATED WITH DUPLEX RECEPTACLE, WHEN USED IN COMBINATION WITH OTHER DEVICES MEANING IS SIMILAR FOR THOSE DEVICE TYPES. **TECHNOLOGY DEVICES & BOXES MULTI-OUTLET ASSEMBLY **TELEPHONE OUTLET **DATA OUTLET MULTI-SERVICE OUTLET; TELEPHONE AND DATA ABOVE COUNTER, TYP WALL, TYP FLOOR, TYP MULTI-SERVICE POWER POLE WITH TELEPHONE, DATA AND POWER	GENERATOR (RATINGS AS INDICATED) NON-SEPARATELY DERIVED SOURCE OR SEPARATELY DERIVED SOURCE WITCHGEAR, SWITCHBOARD AND/OR DISTRIBUTION PANELBOARD (TYPE, RATING, DEVICES AND ACCESSORIES AS INDICATED) DIGITAL COMBINATION DIGITAL VOLT METER/AMMETER CIRCUIT IDENTIFICATION (REFER TO CIRCUIT SCHEDULE) ST SHUNT TRIP UTILITY UTILITY TRANSFORMER RATING AS SPECIFIED OR REQUIRED POTENTIAL TRANSFORMER RATING AS SPECIFIED OR REQUIRED SPD SURGE-PROTECTIVE DEVICE GROUND CONNECTION TEST WELL HEATER
CONDUCTOR GES GROUNDING ELECTRODE SYSTEM GFR GROUND FAULT RELAY G GROUND IG ISOLATED GROUND ISC SHORT CIRCUIT CURRENT JB/J-BOX JUNCTION BOX LF LINEAR FEET LRA LOCKED ROTOR AMPS LTG/LTS LIGHTING/LIGHTS MAU MAKE-UP AIR UNIT MAX MAXIMUM MCA MINIMUM CIRCUIT AMPACITY UVS UNIDERSLAB UH UNIT HEATER UNC UNLESS NOTED OTHERWISE UPS UNINTERUPTIBLE POWER SUPPLY VD VOLTAGE DROP VFD VARIABLE FREQUENCY DRIVE W WIRE W WIRE W WIRE WP WEATHER PROOF WR WEATHER RESISTANT WATERTIGHT XP EXPLOSION-PROOF	D = DIMMER F = FAN SPEED CONTROL K = KEYED LV = LOW VOLTAGE OS = OCCUPANCY SENSOR P = SPST PILOT LIGHT VS = VACANCY SENSOR WP = WEATHER PROOF ALC AUTOMATIC LOAD CONTROL RELAY BTS BRANCH CIRCUIT TRANSFER SWITCH R# RELAY OR CONTACTOR (# = QUANTITY OF RELAYS) LIGHTING CONTROL PHOTOCELL (SHADE INDICATES AIMING) TIME SWITCH LOWER CASE LETTERS DESIGNATE ZONE TO BE CONTROLLED.	EMERGENCY LIGHT FIXTURE WITH EMERGENCY LIGHTING BATTERY PACK OR CONNECTED TO LIFE-SAFETY GENERATOR CIRCUIT NL = NIGHT LIGHT FIXTURE LIGHT FIXTURE WITH DUAL BALLASTS CIRCUITED SEPARATELY (SHADING IMPLIES EMERGENCY LIGHT FIXTURE) LIGHTING TRACK WITH LIGHT FIXTURE TYPES AS INDICATED EXTERIOR SITE PARKING LOT LIGHT FIXTURE EXTERIOR PEDESTRIAN POST TOP LIGHT FIXTURE EXTERIOR LIT BOLLARD LIGHT FIXTURE EXIT SIGN - CEILING / WALL MOUNTED, ARROWS AS INDICATED, FACE HATCHED EMERGENCY LIGHTING UNIT EQUIPMENT WITH BATTERY PACK-CEILING/WALL MOUNTED ADDITIONAL LETTER DESIGNATIONS AS FOLLOWS: D = DEMOLISHED E = EXISTING EM = EMERGENCY POWER ER = EXISTING TO BE RELOCATED R = RELOCATED, NEW LOCATION	OUTLETS A = TYPE, REFER TO PLANS, SCHEDULES AND SPECIFICATIONS A MULTI-SERVICE FLOOR BOX WITH TELEPHONE, DATA AND POWER OUTLETS A = TYPE, REFER TO PLANS, SCHEDULES AND SPECIFICATIONS A POKE THROUGH, A = TYPE, REFER TO PLANS, SCHEDULES AND SPECIFICATIONS THERMOSTAT JUNCTION BOX/OUTLET BOX A NUMBER ADJACENT TO ANY TECHNOLOGY SYMBOL INDICATES TOTAL QUANTITY OF CABLES AND PORTS TO BE INSTALLED AT THAT LOCATION. IF A HOME-RUN IS USED ON ANY FLOOR-BOX OR MULTI-OUTLET ASSEMBLY, IT INDICATES THAT POWER IS ALSO TO BE INSTALLED IN THIS DEVICE.	## BLOCK LOAD KW OR KVA ***********************************

PROJECT NOTES

FULLY COORDINATE ALL WORK WITH ALL GENERAL CONTRACTOR AND ALL SUBCONTRACTORS ON PROJECT.

PROVIDE ALL CONTRACTORS A COMPLETE SET OF FULL-SIZE BID DOCUMENTS.

PRIOR TO SUBMITTING PROPOSAL, BIDDER SHALL EXAMINE ALL GENERAL CONSTRUCTION DRAWINGS AND SHALL HAVE HAD VISITED THE CONSTRUCTION SITE. BIDDER SHALL BE FAMILIAR WITH THE EXISTING CONDITIONS UNDER WHICH THEY WILL HAVE TO OPERATE AND WHICH MAY AFFECT THE WORK.

ELECTRICAL DRAWINGS ARE DIAGRAMMATIC IN NATURE AND AND REPRESENT THE GENERAL SCOPE OF THE WORK AS IT PERTAINS TO THE ENGINEERED SYSTEMS AT HAND. REVIEW THE GENERAL NOTES, SPECIFICATIONS AND PLANS FOR ADDITIONAL REQUIREMENTS THAT MAY NOT BE SPECIFICALLY CALLED OUT IN THIS PORTION OF THE CONSTRUCTION DOCUMENTS. NOTIFY THE ENGINEER OF ANY CONFLICTS OR DISCREPANCIES AND FOR EXACT LOCATION OF ANY SYSTEM COMPONENTS.

ALL WORK SHALL CONFORM TO THE LATEST EDITIONS OF LOCAL, STATE, AND NATIONAL CODES AND ORDINANCES. DRAWINGS AND SPECIFICATIONS GOVERN WHERE THEY EXCEED CODE REQUIREMENTS.

PROVIDE A SEPARATE CODE SIZED GREEN EQUIPMENT GROUND CONDUCTOR IN ALL CONDUITS AND RACEWAYS CONTAINING LINE VOLTAGE CIRCUITS. FOR ALL 20A CIRCUITS, EQUIPMENT GROUND CONDUCTOR SIZE SHALL MATCH PHASE CONDUCTOR SIZE. FOR CIRCUITS UPSIZED FOR VOLTAGE DROP INCREASE EQUIPMENT GROUNDING CONDUCTOR SIZE PER

CONTRACTOR SHALL PROVIDE FINALIZED PANELBOARD SCHEDULES AT COMPLETION OF PROJECT WITH OWNER PROVIDED ROOM NAMES/NUMBERS.

PROVIDE NECESSARY MOUNTING AND SUPPORT HARDWARE FOR LIGHT FIXTURES TO MEET SPECIFIED MOUNTING HEIGHTS. COORDINATE ALL LIGHT FIXTURES AND CONDUIT WIRING RUNS
WITH SITE ELEMENTS.

THE CONTRACTOR SHALL EMPLOY QUALIFIED AND EXPERIENCED WORKMEN FOR THIS WORK.

SHEET LIST

E1 ELECTRICAL SYMBOLS, NOTES, AND **ABBREVIATIONS**

E2 ELECTRICAL SITE AND PHOTOMETRIC PLANS

E3 ELECTRICAL LIGHTING SCHEDULES AND DETAILS

E4 ELECTRICAL ONE-LINE DIAGRAM AND CALCULATIONS

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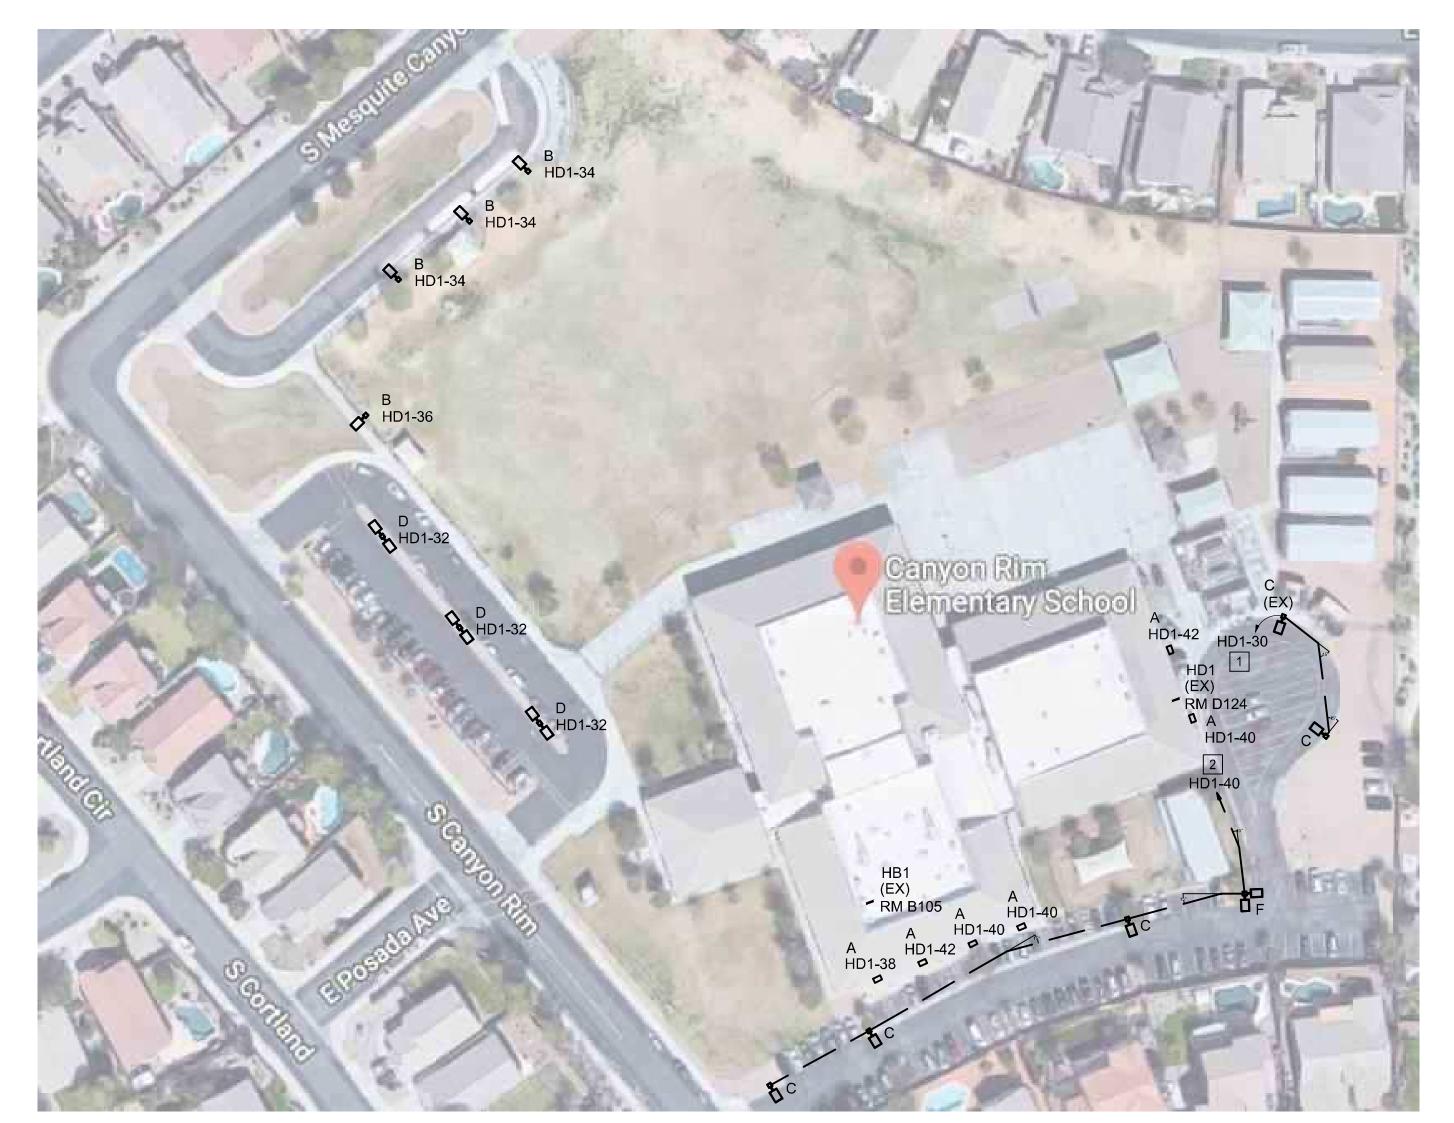
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DATE: ISSUED FOR: 05/16/18 PERMIT/CONSTRUCTION

SHEET NAME

ELECTRICAL SYMBOLS, GENERAL NOTES, ABBREVIATIONS

SHEET NUMBER



1	ELECTRICAL LIGHTING SITE	PLAN	N
• Л	1" = 60'		田田

Description	Symbol	Avg	Max	Min	Max/Min	Avg/Mir
Calc Zone #1	+	1.4 fc	5.4 fc	0.1 fc	54.0:1	14.0:1
Calc Zone #2	+	1.7 fc	3.8 fc	0.3 fc	12.7:1	5.7:1
Calc Zone #3	+	1.4 fc	3.8 fc	0.0 fc	N/A	N/A

1" = 60'	
2.9 *3.4 *2.28 @ 20' 2.9 *3.4 *2.28 @ 20' 2.9 *3.4 *2.28 @ 20' 2.9 *3.5 *6.520' 2.1 *2.5 *3.5 *6.520' 2.2 *2.5 *3.5 *6.520' 2.3 *2.7 *2.5 *3.5 *6.520' 2.3 *2.7 *2.5 *3.5 *6.520' 2.3 *2.7 *2.5 *3.5 *6.520' 2.4 *2.5 *3.5 *6.520' 2.5 *3.5 *6.520' 2.6 *3.6 *3.6 *2.0 *2.5 *3.5 *6.520' 2.7 *2.6 *3.6 *3.6 *2.0 *3.0 *3.0 *3.0 *3.0 *3.0 *3.0 *3.0 *3	
0.9 1.5 1.8 0.0 0.0 0.1 0.2 0.4 0.4 0.0 0.0 0.1 0.2 0.4 0.4 0.0 0.0 0.1 0.3 0.6	
0.4 0.7 1.2 1.8 2.1 1.8 0.3 0.6 1.0 1.6 2.1 2.6 2.2 0.4 1.6 1.7 2.5 2.6 2.2 0.3 1.0 1.5 2.1 2.6 2.2 1.0 1.5 2.1 2.6 2.3 2.1 1.7 1.2 1.7 2.0 2.1 2.0 1.8	Canyon Rim Elementary School
1.3 1.7 2.0 2.1 2.3 2.2 1.9 1.0 1.4 1.8 2.2 2 1.9 1.1 1.6 2.1 3.0 2.9 2.3 2.0 1.2 1.7 2.1 2.3 2.1 2.1 1.9 1.3 1.7 2.0 2.1 2.2 2.2 1.9 1.3 1.6 2.1 2.5 3.4 2.4 1.7 1.4 1.9 2.3 3.0 2.201.6 1.0 1.9 1.3 1.8 1.9 1.6 1.1 08 1.8 1.2 1.2 1.1 0.7 0.4	Elementary School A @ 9' 1.4
0.7 0.7 0.4 0.4 0.4 0.4 0.4 0.4 0.4 0.4 0.4 0.4	0.3 0.7 0.9 1.6 1.4 2.5 2.0 0.5 1.3 1.6 1.6 1.7 2.2 3.2 4.1 3.2 1.8 0.8 0.3 0.1 0.5 1.3 1.6 1.6 1.7 1.9 2.6 2.2 1.4 0.8 0.4 0.1 A @ 9 4.5 2.5 1.0 0.7 1.0 1.7 2.1 1.9 1.5 1.2 1.1 1.0 1.3 1.3 0.9 0.5 0.3 0.1
	A @ 9 3.8 2.3 1.5 5.7 5.5 5.6 5.8 1.1 1.2 1.0 5.9 5.8 5.5 2.6 2.0 1.3 5.8 5.5 5.3 5.3 5.4 5.5 5.6 2.4 1.8 1.1 5.7 5.4 5.8 5.5 2.4 1.8 1.7 1.7 1.0 5.6 5.3 5.2 2.3 C ₂ @ 201 1.5 1.2 1.0 1.7 1.8 1.4 1.1
2 ELECTRICAL LIGHTING PHTOMETR	RIC PLAN

GENERAL NOTES

- 1. SEE LIGHT FIXTURE SCHEDULE ON SHEET E3 FOR MORE INFORMATION.
- 2. SEE DETAIL 1 ON SHEET E3 FOR PREFERRED LIGHT POLE BASE STANDARD.

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KEYED NOTES

- 1. CONTRACTOR SHALL EXTEND EXISTING TIMECLOCK CONTROLLED LIGHTING CIRCUIT TO NEW LIGHT POLE LOCATION INDICATED. PROVIDE 3/4" SCHEDULE 40 PVC CONDUIT AND CONTINUE EXISTING WIRE SIZE.
- 2. CONTRACTOR SHALL PROVIDE A NEW CIRCUIT TO PANEL INDICATED VIA LIGHTING CONTACTAOR IN MAIN ELECTRICAL ROOM. PROVIDE 3/4" SCHEDULE 40 PVC CONDUIT AND WIRE SIZE INDICATED WITHIN PANELBOARD SCHEDULE ON SHEET E4.

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HOOL **LIGHTING** C

SITE

NO O

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SHEET NAME ELECTRICAL LIGHTING SITE PLAN

AND PHOTOMETRICS

SHEET NUMBER


TYPE	LOCATION	DESCRIPTION	BASIS OF DESIGN	MOUNTING		LIGHT ENGINE			DRIVER	
			MANUFACTURER, MODEL		TYPE QTY	TEMP CRI	LUMENS EM LUMENS	TYPE	VOLTAGE	WATTS
Α	BUILDING MOUNTED EXTERIOR	DIE CAST ALUMINUM EXTERIOR LED FIXTURE 20 LED'S @ 1000mA TYPE 3 MEDIUM SPREAD OPTICS	ACUITY - LITHONIA TWH-LED-20C-1000-40K-T3M-MVOLT-DDBXD	EXISTING FIXTURE REPLACEMENT AT 9' AFF.	LED 1	4000K 70 CRI	6983	STANDARD ELECTRONIC DRIVER	MVOLT	72
В	BUS PICKUP/DROPOFF	DIE CAST ALUMINUM EXTERIOR LED FIXTURE PERFORMANCE LEVEL 4 TYPE 3 MEDIUM SPREAD OPTICS	ACUITY - LITHONIA DSX0-LED-P4-40K-T3M-MVOLT-SPA-DDBXD	NEW FIXTURE ON EXISTING POLE MOUNT AT APPROXIMATELY 20' AFF	LED 1	4000K 70 CRI	10256	STANDARD ELECTRONIC DRIVER	MVOLT	92
С	EMPLOYEE/MSITOR PARKING	DIE CAST ALUMINUM EXTERIOR LED FIXTURE PERFORMANCE LEVEL 4 TYPE 4 MEDIUM OPTICS	ACUITY - LITHONIA DSX0-LED-P4-40K-T4M-MVOLT-SPA-DDBXD	NEWFIXTURE ON NEW 20' POLE WITH NEW LIGHT STANDARD INSTALL PREMANUFACTURERED LIGHT BASE PER DETAIL 1 ON SHEET E3	LED 1	4000K 70 CRI	10335	STANDARD ELECTRONIC DRIVER	MVOLT	92
D	PARENT PICKUP/DROPOFF	DIE CAST ALUMINUM EXTERIOR LED FIXTURE PERFORMANCE LEVEL 4 TYPE 5 WIDE OPTICS	ACUITY - LITHONIA DSX0-LED-P4-40K-T5W-MVOLT-SPA-DDBXD	EXISTING FIXTURE HEAD REPLACEMENT ON EXISTING POLE MOUNT AT APPROXIMATELY 20' AFF MOUNT (2) HEADS AT 180 DEGREES FROM EACH OTHER	LED 1	4000K 70 CRI	21778	STANDARD ELECTRONIC DRIVER	MVOLT	92
F	EMPLOYEE/MSITOR CORNER	DIE CAST ALUMINUM EXTERIOR LED FIXTURE PERFORMANCE LEVEL 4 TYPE 4 MEDIUM OPTICS	ACUITY - LITHONIA DSX0-LED-P4-40K-T4M-MVOLT-SPA-DDBXD	NEW FIXTURE ON NEW 20' POLE WITH NEW LIGHT STANDARD MOUNT AT APPROXIMATELY 20' AFF MOUNT (2) HEADS AT 90 DEGREES FROM EACH OTHER	LED 1	4000K 70 CRI	21778	STANDARD ELECTRONIC DRIVER	MVOLT	92

A. BASIS-OF-DESIGN AND ALTERNATE SPECIFICATIONS MAY BE PRICED AND SUPPLIED BY THE APPROVED REGIONAL VENDOR.

B. VERIFY QUANTITIES, MODEL NUMBERS AND DESCRIPTIONS WITH MANUFACTURER PRIOR TO PLACING ORDER. C. VERIFY FINISH AND COLOR PRIOR TO PLACING ORDER.

D. CATALOG NUMBERS SHALL NOT BE CONSIDERED COMPLETE AND MATERIAL SHALL NOT BE ORDERED BY MANUFACTURER AND CATALOG NUMBERS ONLY. FIRST READ THE COMPLETE DESCRIPTION, NOTES AND SPECIFICATIONS IN CONJUNCTION WITH THE CATALOG NUMBER TO DETERMINE THE EXACT MATERIAL AND ACCESSORIES TO BE ORDERED. THE MANUFACTURES LISTED ARE THE BASIS FOR THE DESIGN.

E. CONTRACTOR SHALL PROVIDE ALL LIGHT FIXTURES UNLESS NOTED OTHERWISE.

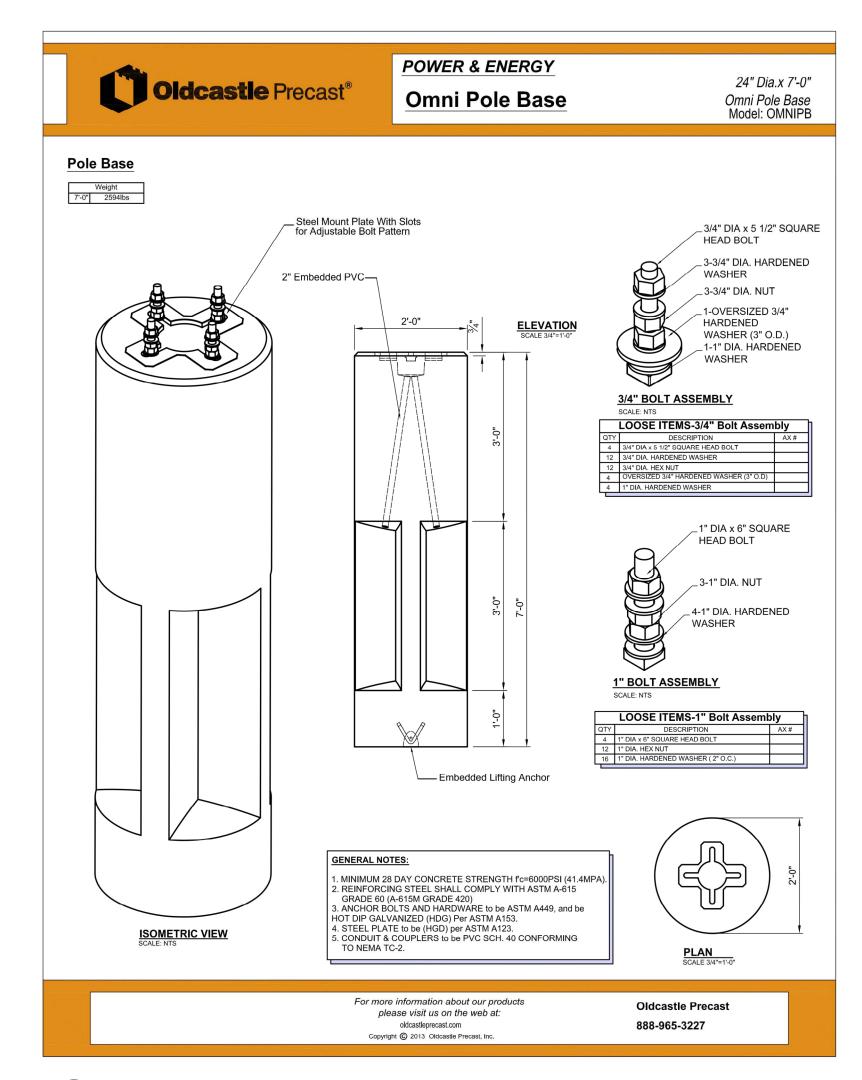



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SCH001 **FIGHTING** SITE **N**0 GPS

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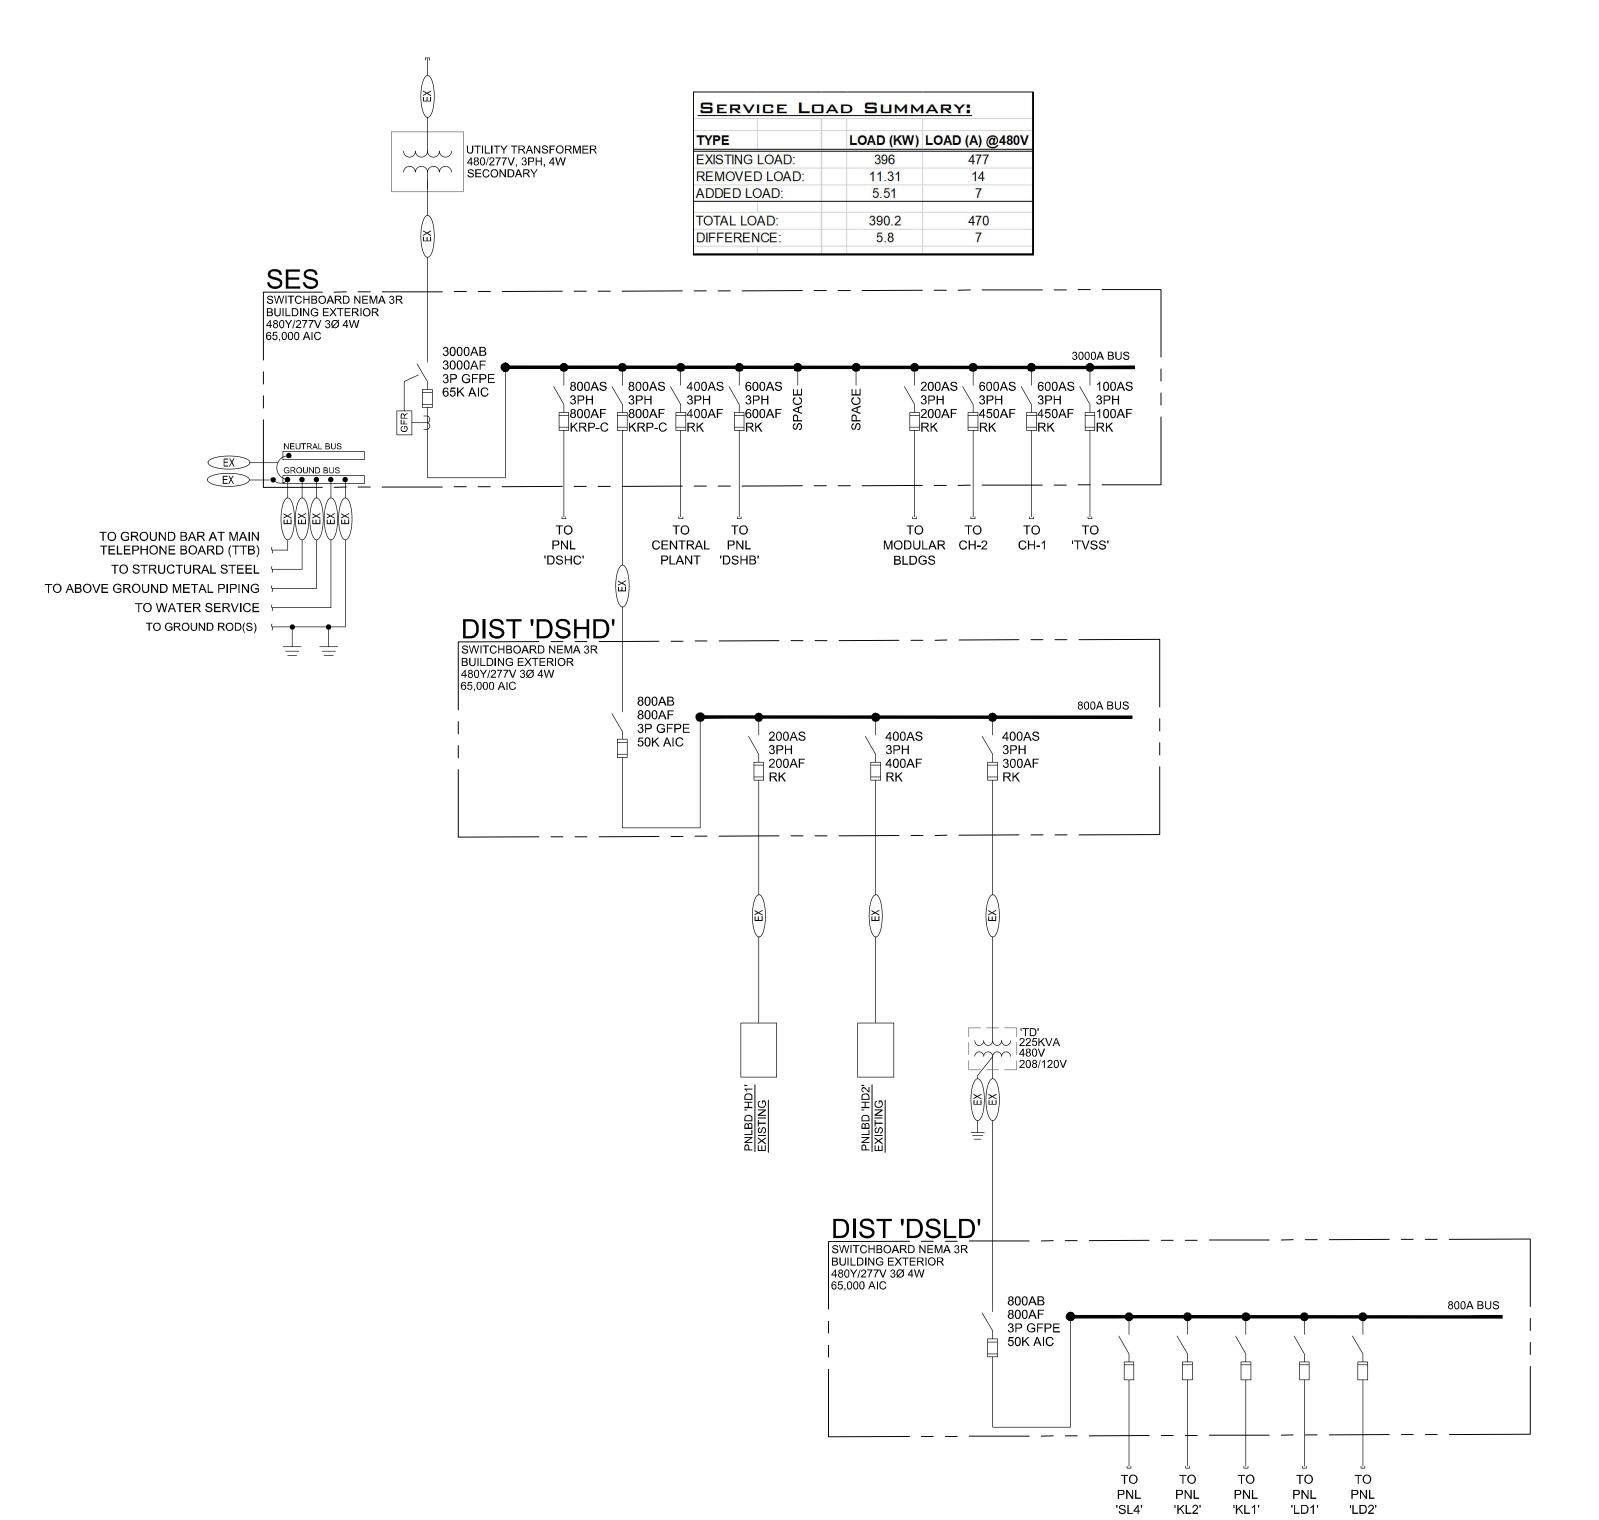
SHEET NAME ELECTRICAL LIGHTING SCHEDULES

SHEET NUMBER

AND DETAILS

	BUS MAIN VOL7	ANELBOARD: HD1 AMPS: 225A SIZE/TYPE: MLO TS/PHASE: 480Y/277V, 3PH, 4W TON: 1	(EX	ISTI	NG)	AIC R	ATING	3 :	140)00 FUI	LY RA	TED			EQUIPMENT GROUND	BUS	
Ī	CKT	DESCRIPTION	VOLT	TAMPS/PH	HASE	WRE	BKR	Р	P	BKR	WRE	VOL	TAMPS/PH	HASE	DESCRIPTION	CKT	Ī
	NO.		Α	В	С	NO.	AMP			AMP	NO.	Α	В	С		NO.	3
ΕX	1	LIGHTING MP D103	3,000			EX	20	1	1	20	EX				SPARE	2	Ī
ΕX	3	LIGHTING MP D103		3,000		EX	20	1	1	20	EX		1,300		LIGHTING D106, 109	4	E
ΕX	5	LIGHTING MP D103		,	3,000	EX	20	1	1	20	EX		,	3,900	LIGHTING CORR. D101	6	E)
EX	7	LIGHTING MP D103	3,000			EX	20	1	1	20					SPARE	8	1
ΕX	9	LIGHTING MP D103		3,000		EX	20	1	1	20					SPARE	10	1
	11	SPARE		7.3			20	1	1	20					SPARE	12	1
ΕX	13	LIGHTING FOOD D123	3,150			EX	20	1	1	20					SPARE	14	1
ΕX	15	LIGHTING D112, 119		3,550		EX	20	1	1	20					SPARE	16	1
ΕX	17	LIGHTING D110, 111		,	3,800	EX	20	1	1	20					SPARE	18	1
ΕX	19	LIGHTING D124, 133	3,800			EX	20	1				11,080				20	E)
ΕX	21	LIGHTING D135, 136		2,150		EX	20	1	3	60	EX		11,080		KILN	22	E
ΕX	23	LIGHTING D137			3,150	EX	20	1						11,080		24	E)
ı	25	SPACE						1	1	20					SPARE	26	1
ı	27	SPACE						1	1	20	8		460		SOUTHEAST CHILDDROP	28	1
ı	29	SPACE						1	1	20	8			644	EAST EXT. LIGHT POLES	30	NI
ı	31	SPACE						1	1	20	8	552			NORTHWEST EXT. LIGHTS	32	NI
ı	33	SPACE						1	1	20	8		276		NORTHWEST EXT. LIGHTS	34	NI
ı	35	SPACE						1	1	20	8			184	NORTHWEST EXT. LIGHTS	36	NI
ı	37		10,000						1	20	8	1,372			BUILDING MTD EXT. LIGHTS	38	NI
ı	39	WATER HEATER EH-3		10,000		EX	50	3	1	20	8		1,341		BUILDING MTD EXT. LIGHTS	40	NI
ı	41				10,000				1	20	8			1,144	BUILDING MTD EXT. LIGHTS	42	N
ĺ		SUBTOTAL	22,950	21,700	19,950							13,004	14,457	16,952	SUBTOTAL		ī
Î		TOTAL PHASE A - VA 35,954	LOAD		CONN. V	/A	DF		LO	AD		C	ONN. VA	DF			í
ı		AMPS 130	COOLING	G			1.00			FRIG				1.00			ı
ŀ		TOTAL PHASE B - VA 36,157	HEATING				0			SN/DIS	SP			1.25			ı
ı		AMPS 131	LIGHTIN		5,973		1.25			CHE				1.00			ı
ı		TOTAL PHASE C - VA 36,902	RECEPT	ACLES			1.0/.5			ISTING			103,040	1.00			ı
ı		AMPS 133	MOTORS				1.00	ı		G MO			,	1.25	TOTAL DEMAND	7	ı
ľ			SUPP HE	EAT			1.00		SH	OWV	NDW			1.25	110,506 VA	Ą	ı
ı		AMPS 131	MISC EQ				1.00			G TRA				1.00	133 A		ı
	EX	ELBOARD NOTES EXISTING TO REMAIN EXISTING CIRCUIT WITH NEW LO	DAD														

Voltage Drop Calculations								
Panel	Circuit	Description	Length	Voltage	Phase	Load (VA/Ph)	Wire Size	% VD
HD1	30	SOUTHEAST POLES	525	277	1	644	8	0.6
HD1	32	DUAL-HEAD WEST POLES	495	277	1	1372	8	1.3
HD1	34	NORTHWEST BUS POLES	650	277	1	1341	8	1.7
HD1	36	WALKWAY POLES	540	277	1	1144	8	1.2
HD1	28	CHILD DROP OFF POLES	150	277	1	1144	8	0.4



1 DNE-LINE DIAGRAM

FEEDER LEGEND

EX EXISTING FEEDER TO REMAIN



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SCHOOL **LIGHTING** SITE GPS

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SHEET NAME ELECTRICAL ONE-LINE DIAGRAM AND CALCULATIONS

SHEET NUMBER