
# PIKE LINCOLN COUNTY PORT CLARKSVILLE SITE REDEVELOPMENT





LINE SEGMENT 0014
HANNIBAL SUBDIVISION
MP 86.510 TO MP 86.822

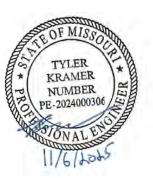

**IFC PLANS** 

DATE: NOVEMBER 6, 2025

VICINITY MAP



1001 E. 101st TERRACE,SUITE 120 KANSAS CITY, MO 64131 Phone: (913) 214-3180

DRAWING NUMBER	DRAWING TITLE	SHEET NUMBER
	GENERAL	
G-001 G-002 G-003 G-004 G-005	COVER SHEET INDEX OF DRAWINGS GENERAL NOTES ABBREVIATIONS LEGEND AND SYMBOLS	1 2 3 4 5
V-001 V-002	SURVEY CONTROL  KEY PLAN/SURVEY CONTROL MAP  SURVEY LIMITS	6 7
CT-001 CT-100 CT-101 CT-102 CT-103 CT-104 CT-601	TRACKWORK  OPERATION PLAN  TYPICAL SECTIONS  TRACK 6196 PLAN AND PROFILE  PROPOSED TRACKS FOR OPERATION  PROPOSED TRACKS FOR OPERATION  SOUTH END DISCONNECT  TRACK GEOMETRY TABLE  EARTHWORK	8 9 10 11 12 13 14
C-301 TO C-302	CROSS SECTIONS	15 TO 16
		DESIGNED BY

Bid Item No.	Description	Unit	Quantity	Unit Price	Extended Price
Civil					
1	Mobilization/Demobilization	LS	1.0		\$0.00
2	Clearing and Grubbing	AC	0.5		\$0.00
3	Remove and Dispose Tracks	TF	935.0		\$0.00
4	Remove and Dispose Turnouts	EA	5.0		\$0.00
5	Excavation	CY	800		\$0.00
6	Onsite Excavation Storage	CY	800		\$0.00
7	Unsuitable Excavation, Unclassified	CY	80		\$0.00
8	Furnish & Install RH DSPD W/ Sign	EA	1		\$0.00
9	Track 6196 Construction, 136lbs	TF	65		\$0.00
10	Track 6113A, 6114, 6110 Construction, 115lbs	TF	602		\$0.00
11	Track Shift	TF	771		\$0.00
12	Transition rails (pair)	EA	2		\$0.00
13	Track Tie Rehab, 6196, 6198, 6110, 6114	TF	2,800		\$0.00
14	Track Rail Rehab, 6196, 6198, 6110, 6114	TF	2,800		\$0.00
15	Install BNSF Rehab #9 LH HTTO	EA	2		\$0.00
16	Furnish Construct and Install #9 SMSG LH HTTO	EA	1		\$0.00
17	Furnish Construct and Install #9 SMSG RH HTTO	EA	2		\$0.00
18	Furnish and Install Cross Buck Signs	EA	2		\$0.00
19	Deflect Track 6198 (15°)	TF	97		\$0.00
20	Subballast, 6", Turnout Pad	CY	100		\$0.00
21	Subballast, Varies, Crossing Approaches	CY	10		\$0.00
22	Subballast, 6", Track 6113A	CY	200		\$0.00
23	Remove Crossing	TF	30		\$0.00
24	Construct Crossing	TF	30		\$0.00
25	Walkway Ballast	CY	40		\$0.00
26	Erosion Control	LS	1	17 10 11	\$0.00
27	Survey Pre Construction	LS	0		\$0.00
28	Survey Post Construction	LS	0		\$0.00
29	Flagging	LS	0		\$0.00
30	ROE	LS	0		\$0.00
				Total:	\$0.00

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LINE SEGMENT 0014 MP 86.510 TO MP 86.822 PIKE LINCOLN COUNTY PORT AUTHORITY CLARKSVILLE SITE REDEVELOPMENT INDEX OF DRAWINGS

CONTRACT NO.	2	2210045
DRAWING NO.		G-002
REVISION		2 <i>OF</i> 16
SCALE	NONE	

## **GENERAL NOTES**

ENGINEER SHALL REFER TO THE BNSF ENGINEER OR BNSF'S DULY AUTHORIZED ENGINEERING REPRESENTATIVE RESPONSIBLE FOR THE MONITORING OF CONSTRUCTION ACTIVITIES AND PROTECTION OF THE INTERESTS OF BNSF DURING CONSTRUCTION.

CONTRACTOR SHALL COMPLY WITH ALL THE LOCAL, STATE AND FEDERAL SAFETY CODES AND REGULATIONS AND THE SPECIFICATIONS FOR THE CONTRACT.

ALL CONSTRUCTION ACTIVITIES SHALL BE SCHEDULED AND COORDINATED THROUGH THE ENGINEER, INCLUDING THE VARIOUS COMPANIES, AGENCIES AND OTHER CONTRACTORS WHO MAY BE AFFECTED BY THIS WORK, ALL REQUIRED PERMITS NEEDED FOR THE WORK SHALL BE OBTAINED BY THE CONTRACTOR UNLESS OTHERWISE NOTED. CONTRACTOR SHALL COMPLY WITH ALL RAILROAD OCCUPANCY REQUIREMENTS INCLUDING INSURANCE REQUIREMENTS.

PRIOR TO COMMENCING WORK, ALL EXISTING SITE CONDITIONS SHALL BE FIELD VERIFIED WITH THE ENGINEER TO ASCERTAIN THE LIMITS OF WORK ACTIVITIES. THE CONTRACTOR SHALL SUBMIT AND RECEIVE THE ENGINEER'S APPROVAL OF THE CONTRACTORS PROJECT SCHEDULE AND OPERATIONS PLAN. EACH ITEM OF WORK SHALL BE DESCRIBED AND ACCOUNTED FOR IN THE CONTRACT DOCUMENTS. THE CONTRACTOR SHALL REFER TO THE SPECIFICATIONS FOR FURTHER INFORMATION REGARDING SUBMITTAL REQUIREMENTS.

### MAINTENANCE OF RAILROAD & ROADS

THE SAFETY AND CONTINUITY OF OPERATIONS FOR BNSF TRAIN TRAFFIC AND SIGNAL EQUIPMENT SHALL BE MAINTAINED AT ALL TIMES. THE CONTRACTOR AND ITS SUBCONTRACTOR(S) SHALL PERFORM THE WORK FOR THE PROJECT ACCORDINGLY. MINIMUM BNSF OPERATING CLEARANCES SHALL BE MAINTAINED UNLESS APPROVED IN WRITING BY THE ENGINEER. WHENEVER THE WORK FOR THE PROJECT MAY AFFECT THE SAFETY OF THE TRAINS OR HAS THE POTENTIAL TO DELAY TRAIN TRAFFIC, THE CONTRACTOR SHALL OBTAIN APPROVAL FROM THE ENGINEER PRIOR TO COMMENCING THE WORK. A FORMAL SUBMITTAL DOCUMENTING THE METHODS OF DOING SUCH WORK MAY BE REQUIRED.

EXISTING RAILROAD SIGNAGE (INCLUDING SPEED SIGNS) SHALL BE MAINTAINED DURING CONSTRUCTION UNLESS OTHERWISE APPROVED IN WRITING. ALL RAILROAD SIGNAGE SHALL BE FULLY RESTORED UPON COMPLETION OF EACH DAY'S WORK IN ACCORDANCE WITH BNSF

ON-SITE CONSTRUCTION BY OTHERS, INCLUDING ROUTINE MAINTENANCE WORK (BNSF FORCES, BNSF SIGNAL CONTRACTOR, FIBER OPTIC, UTILITIES, ETC.) MAY OCCUR AT THE SAME TIME AS THE WORK INDICATED IN THESE PLANS. THE CONTRACTOR SHALL COORDINATE CONSTRUCTION ACTIVITIES THOUGH THE ENGINEER SO AS TO MINIMIZE INTERFERENCE WITH OTHERS.

ROADWAY DISRUPTIONS SHALL BE KEPT TO A MINIMUM. ALL LANE CLOSURES AT GRADE CROSSINGS SHALL BE COORDINATED BEFOREHAND WITH PIKE LINCOLN COUNTY PORT AUTHORITY JURISDICTION. THE ENGINEER SHALL BE INFORMED AS TO SUCH REQUESTS FOR

### DISCREPANCIES

IN THE EVENT THE CONTRACTOR, AS THE WORK PROGRESSES, FINDS ANY DISCREPANCIES BETWEEN THESE PLANS AND PHYSICAL CONDITION OR ANY ERRORS IN THE PLANS OR LAYOUTS AS GIVEN BY STAKING OR INSTRUCTIONS IT SHALL BE THE CONTRACTOR'S DUTY TO INFORM THE ENGINEER IN WRITING.

UTILITY INFORMATION WAS OBTAINED FROM AVAILABLE RECORDS. THE LOCATIONS OF BURIED AND ABOVE GROUND UTILITIES SHOWN ARE APPROXIMATE, AND SUBJECT TO FIELD

THE IMPLIED PRESENCE OR ABSENCE OF UTILITIES IS NOT TO BE CONSTRUED BY THE OWNER, ENGINEER, CONTRACTOR, OR SUBCONTRACTORS TO BE AN ACCURATE AND COMPLETE REPRESENTATION OF UTILITIES THAT MAY OR MAY NOT EXIST ON THE CONSTRUCTION THE LOCATION AND DEPTH OF ALL UTILITIES IN THE VICINITY OF NEW CONSTRUCTION IS TO BE FIELD VERIFIED BY THE CONTRACTOR PRIOR TO COMMENCEMENT OF CONSTRUCTION. THE ENGINEER SHALL BE NOTIFIED IMMEDIATELY IF CONFLICTS ARE

ALL UTILITIES WITHIN THE PROJECT LIMITS SHALL EITHER REMAIN IN PLACE AND SHALL BE PROTECTED BY THE CONTRACTOR WHILE THE WORK CAPTURED IN THESE PLANS IS IN-PROGRESS OR BE RELOCATED, MODIFIED OR REMOVED IN ACCORDANCE WITH THE CONSTRUCTION DRAWINGS AND AGREEMENTS BETWEEN BNSF AND THE INDIVIDUAL UTILITY CONTRACTOR SHALL COMPLY WITH ALL LOCAL AND STATE UTILITY NOTIFICATION AND LOCATING REQUIREMENTS IN THE STATE OF MISSOURI. THE CONTRACTOR SHALL ENSURE THAT REQUIRED NOTIFICATION IS PROVIDED TO APPROPRIATE UTILITY COMPANIES PRIOR TO EXCAVATION OR OTHER WORK WHICH MAY AFFECT UTILITY COMPANY FACILITIES. BURIED AND ABOVE GROUND UTILITY LOCATION, IDENTIFICATION AND MARKING ARE THE SOLE RESPONSIBILITY OF THE CONTRACTOR

THE CONTRACTOR SHALL BECOME FAMILIAR WITH LEGISLATION OUTLINING PROCEDURES FOR LOCATING UTILITIES BY HAND EXCAVATION AND COMPLY WITH ITS DIRECTIVE, CONTRACTOR IS TO COORDINATE WITH BNSF REGARDING THE RELOCATION OF ANY UTILITIES THAT REQUIRE RELOCATION.

SITE SAFETY, INCLUDING THE AVOIDANCE OF HAZARDS ASSOCIATED WITH THE BURIED AND ABOVE GROUND UTILITIES REMAINS THE SOLE RESPONSIBILITY OF THE CONTRACTOR.

### BNSF SIGNAL AND TELECOM

CALL 1-800-533-2891 TO ARRANGE FOR A BNSF UNDERGROUND CABLE LOCATE, BNSF FORM UNDERGROUND CABLE LOCATION AND ACKNOWLEDGEMENT' WILL BE COMPLETED BY A BNSF REPRESENTATIVE AND A COPY PROVIDED TO THE CONTRACTOR, THE CONTRACTOR MUST HAVE THIS FORM IN POSSESSION AT THE JOB SITE AT ALL TIMES. (REFERENCE 2015 BNSF STANDARD CONSTRUCTION SPECIFICATION, PARTS 1300(1.21), 1300(1.22)(B), 1600(1.6)(G), 1600(1.10)(A)(4)(C), 1700(1.1)(C)(46 & 47), AND THE 2019 BNSF UTILITY

AERIAL IMAGERY OBTAINED FROM BING MAPS IN 2025. GROUND CONTROL, TOP OF RAIL, AND TOPOGRAPHIC SURVEY WITHIN THE PROJECT LIMITS WAS PERFORMED BY DESIGN 9 IN MARCH 2025.

ALL MAPPING AND SURVEY INFORMATION WAS DEVELOPED OR CONVERTED TO THE MODOT VRS S. TATE PLAN, MISSOURI EAST COORDINATE SYSTEM. VERTICAL DATUM IS BASED ON NAVD88 AND HORIZONTAL DATUM IS BASED ON NAD83

IT SHALL BE THE CONTRACTOR'S RESPONSIBILITY TO UTILIZE PROVIDED HORIZONTAL AND VERTICAL CONTROL POINTS TO ASSURE THAT ALL PROJECT ELEMENTS ARE CONSTRUCTED AT THE CORRECT VERTICAL AND HORIZONTAL LOCATIONS.

RIGHT-OF-WAY AND PARCEL BOUNDARY INFORMATION REPRESENTED ON THESE DRAWINGS IS BASED ON STATION AND RIGHT-OF-WAY MAPS PROVIDED BY BNSF, ALL BOUNDARY LINES ARE APPROXIMATE UNLESS SPECIFICALLY NOTED OTHERWISE.

### GENERAL EARTHWORK NOTES

EMBANKMENT QUANTITIES SHOWN ON THE PLANS ARE MEASURED TO THE NEAT LINES AS COMPACTED QUANTITIES, NO ADJUSTMENTS TO GRADING QUANTITIES HAVE BEEN MADE FOR COMPACTION, SHRINKAGE, SWELLING, OR CLEARING AND GRUBBING, REFER TO THE 2015 BNSF STANDARD CONSTRUCTION SPECIFICATION, PART 3200(4.3)(A).

MAINTAIN A DRY, SUBGRADE CONDITION DURING PREPARATION. GRADE SURFACE AWAY FROM

DURING BENCHING, THE EXISTING EMBANKMENT MATERIAL SHALL BE FIELD CLASSIFIED FOR COMPATIBILITY WITH THE NEW EMBANKMENT SOIL TO BE PLACED AGAINST THE SLOPE, IT IS NOT RECOMMENDED THAT THE NEW EMBANKMENT FILL HAVE A PERMEABILITY LESS THAN THE EXISTING EMBANKMENT SOIL IN ORDER TO PREVENT TRAPPING WATER WITHIN THE

SUBGRADE AND EMBANKMENT SOILS MAY REQUIRE MOISTURE CONDITIONING TO ACHIEVE

LIMITS OF GRADING AS SHOWN ON THE PLANS ARE APPROXIMATE. WHERE LIMIT OF GRADING IS ADJACENT TO A BRIDGE, CROSSING OR OTHER FACILITY, GRADING SHALL PROVIDE FOR A CONTINUOUS GRADE SO THAT THE RAILROAD CAN SUBSEQUENTLY LAY TRACK WITH NO ADDITIONAL GRADING WORK.

## **EXCAVATED MATERIAL**

ALL EXCAVATED MATERIAL SHALL REMAIN ONSITE UNLESS ARRANGEMENTS HAVE BEEN MADE TO TRANSPORT THE MATERIAL TO AN APPROVED DISPOSAL SITE.

ALL EXCESS MATERIALS GOING TO AN APPROVED DISPOSAL SITE SHALL BE TESTED BEFORE LEAVING THE BNSF ROW. CONTAMINATED OR OTHERWISE UNSAFE EXCAVATED MATERIALS SHALL BE HANDLED ACCORDING TO THE ENGINEER.

RAIL, BALLAST, TIES, AND SIGNAL WORK WILL BE INSTALLED BY BNSF UP TO THE 14FT CLEAR POINT UNLESS OTHERWISE SPECIFIED.

THIS PROJECT WAS DESIGN IN ACCORDANCE WITH THE BNSF RAILWAY COMPANY'S "GUIDELINES FOR INDUSTRY TRACK PROJECTS", DATED JULY 2023.

### AUTHORITY INFORMATION

CITY OF CLARKSVILLE, MO PHONE: (573) 242-3336 EMAIL: CITYCLERK@CLARKSVILLEMO.US

PIKE COUNTY PHONE: (573) 324-3902

LINCOLN COUNTY PHONE: (636) 528-6300

PHONE: (573) 508-7557 EMAIL: LEVI.WOODS@MODOT.MO.GOV

# **VARIANCES ARE AS FOLLOWS:**

BNSF INDUSTRY TRACK GUIDELINES STATE TURNOUT OUT 1) PAD WIDTH SHALL BE 45 FEET FROM CENTERLINE OF TRACK. TURNOUT OUT PAD SIZE - DUE TO ROW/PROPOERTY CONSTRAINTS. THE PAD WIDTH IS 26 FEET AS INDICATED ON THE PLANS AND CROSS SECTIONS.



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11/06/202

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LINE SEGMENT 0014 MP 86.510 TO MP 86.822 PIKE LINCOLN COUNTY PORT AUTHORITY CLARKSVILLE SITE REDEVELOPMENT **GENERAL NOTES** 

2210045 G-003 3 *OF* 16 NONE

&	AND	ga	GAGE
AREMA	AMERICAN RAILWAY ENGINEERING AND	ĞB	GRADE BREAK
_	MAINTENANCE-OF-WAY ASSOCIATION	GM	GAS METER
@	AT PECPEE(C)	GRD or GR GV	GROUND/GRADE GAS VALVE
ı	DEGREE(S) FOOT or FEET or MINUTE(S)	GV	GAS VALVE
п	INCH or INCHES or SECOND(S)	HBD	HOT BEARING DETECTOR
%	PERCENT	HGL	HYDRAULIC GRADE LINE
#	POUND or NUMBER	HORIZ	HORIZONTAL
Δ	CENTRAL ANGLE OF CIRCULAR CURVE	HTTO	HAND-THROW TURNOUT
		НО	HOUSE
ABD	ACOUSTIC BEARING DETECTOR	HP	HIGH POINT or HIGH PRESSURE
ABS	AUTOMATIC BLOCK SIGNAL SYSTEM	HWD	HIGH WATER DETECTOR
AC	ASPHALT CONCRETE	HWY	HIGHWAY
AEI AP	AUTOMATIC EQUIPMENT IDENTIFICATION DETECTOR ANGLE POINT	1	TOTAL INTERSECTION ANGLE
APE	AREA OF POTENTIAL EFFECT	i TOWER	INTERLOCKING TOWER
APPROX	APPROXIMATELY	IND	INDUSTRY
APWA	AMERICAN PUBLIC WORKS ASSOCIATION	INTLK	INTERLOCKING
ATS	AUTOMATIC TRAIN STOPS	IN∨	INVERT
AVE	AVENUE		
		<u>јс</u> т	JUNCTION
BC	BEGINNING OF CURVE	JТ	JOINT
BFD	BROKEN FLANGE DETECTOR	1	LENCTH
BLVD	BOULEVARD	L Lc	LENGTH LENGTH OF CURVE (CIRCULAR)
BM	BENCHMARK	LF	LINEAR FOOT or LINEAR FEET
BR	BRIDGE	LH	LEFT HAND
BR SIG	BRIDGE SIGNAL	LP	LOW POINT
BXC	CONCRETE BOX	Ls or LS	LENGTH OF SPIRAL or LINE SEGMENT
BXC2 BXC3	CONCRETE TOUBLE BOX	LT	LEFT
BXCM	CONCRETE TRIPLE BOX CONCRETE MULT-OPENING BOX		
BXM	MASONARY BOX	M	MAIN
BXM2	MASONRY DOUBLE BOX	MAIN	MAIN TRACK
BXMM	MASONRY MULTI-OPENING BOX	MAX	MAXIMUM
BXT	TIMBER BOX	MH	MANHOLE
BXT2	TIMBER DOUBLE BOX	MHW	MEAN HIGH WATER (TIDAL)
BXTM	TIMBER MULTI-OPENING BOX	MLW	MEAN LOW WATER (TIDAL)
		MIN MP	MINIMUM MASONRY PIPE or MILEPOST or MEDIUM PRESSURE
CANT SIG	CANTILEVER SIGNAL	MTC	MAINTENANCE
CAPA	CORRUGATED ARCH PIPE - ALUMINUM	MIC	MAINTENANCE
CAPS	CORRUGATED ARCH PIPE - STEEL	N	NORTH or NORTHERLY or NORTHING
CB	CATCH BASIN	NO	NUMBER or NORTHERN
CC	CENTER OF CURVE	NSR	NORFOLK SOUTHERN RAILWAY
CIP	CAST IRON PIPE OR CAST IN PLACE	NTS	NOT TO SCALE
€ CLR	CENTERLINE CLEAR	NW	NORTHWEST
CONC	CONCRETE		
CO	COUNTY	OCS	OUT OF SERVICE
CP	CONCRETE PIPE OR CONTROL POINT	OD	OUTSIDE DIAMETER
CPA	CORRUGATED PIPE - ALUMINUM	OFF.	OFFSET
CPKC	KANSAS CITY SOUTHERN RAILWAY	OH	OVERHEAD  ORDINARY LUCIU MATER (NON TIDAL MATERS)
CPP	CORRUGATED PIPE - PLASTIC	OHW OP	ORDINARY HIGH WATER (NON-TIDAL WATERS) OVERPASS
CPS	CORRUGATED PIPE - STEEL	OPP	OPPOSITE
CS	CURVE TO SPIRAL	OTM	OTHER TRACK MATERIAL
CT	CONCRETE TIES	<b>3</b>	O THEIR THOUSE THE EARLY
CTC	CENTRALIZED TRAFFIC CONTROL	P or PSGR	PASSENGER
CTLVR CY	CANTILEVER CUBIC YARD	(P)	PROPOSED
CI	COBIC TARD	PAC	CONCRETE ARCH PIPE
DC	DEGREE OF CURVE	PB	PULLBOX
DED	DRAGGING EQUIPMENT DETECTOR	PC	POINT OF CURVE
DESC	DESCRIPTION	PCC	POINT OF COMPOUND CURVATURE or PORTLAND CEMENT CONCRETE
DESLTD	DRAGGING EQUIP. & SHIFTED LOAD W/ TOP DETECTOR	PED PGL	PEDESTRIAN PROFILE GRADE LINE
DI	DUCTILE IRON	PGL PI	POINT OF INTERSECTION
DIP	DUCTILE IRON PIPE	PIP	PROTECT IN PLACE
DIV	DIVISION	PL	CLAY TILE PIPE
DOT	DEPARTMENT OF TRANSPORTATION	PK	PARKWAY
DR DSPD	DRIVE	PO	POWER
DSPD DU	DOUBLE SWITCH POINT DERAIL DUCT	POB	POINT OF BEGINNING
DWG	DRAWING	POE	POINT OF ENDING
D110	5.0.000	POT	POINT ON TANGENT
Е	EAST or EASTERLY or EASTING	РОТО	POWER TURNOUT
(E)	EXISTING	PP	PLASTIC PIPE (SMOOTH WALL)
Ea	SUPERELEVATION, ACTUAL	PRC PS	POINT OF REVERSE CURVATURE POINT OF SWITCH or STEEL PIPE (SMOOTH WALL)
EC	END OF CURVE	PSGR	PASSENGER
EGL	ENERGY GRADE LINE	PSP	STRUCTURAL STEEL PLATE PIPE
EL or ELEV	ELEVATION	PSAP	STRUCTURAL STEEL ARCH PLATE PIPE
EPC	ELIPTICAL PIPE - CONCRETE	PT	POINT OF TANGENT or POINT
EQ	EQUAL or EQUATION EOUATION AHEAD	PUB	PUBLIC
EQNAHD EQNBK	EQUATION AHEAD EQUATION BACK	PV	VITREOUS PIPE (SMOOTH WALL)
EW	EACH WAY	PVC	POINT OF VERTICAL CURVE or POLYVINYL CHLORIDE (PIPE)
Eu	SUPERELEVATION, UNBALANCED	PVI	POINT OF VERTICAL INTERSECTION
		PVT	POINT OF VERTICAL TANGENT
F/G	FLASHING SIGNAL WITH AUTOMATIC GATES		
FH	FIRE HYDRANT	R	RADIUS or RATE OF CHANGE
FL	FLOWLINE or FLASHING SIGNAL	(R)	REMOVE
FS	FINISHED SURFACE	R/W	RIGHT-OF-WAY
FT	FOOT or FEET	• •	

RCP RD RES LIM RH RL RPM RR RT	REINFORCED CONCRETE PIPE ROAD RESTRICTED LIMITS RIGHT HAND RAIL LUBRICATOR RAISED PAVEMENT MARKER RAILROAD RIGHT
S SC SDMH SF SIG SLD SLT SO SMH or SSMH SSPD STA STD ST SUB S SW	SOUTH OR SOUTHERLY OR SLOPE SPIRAL TO CURVE STORM DRAIN MANHOLE SQUARE FOOT OR SQUARE FEET SIGNAL SHIFTED LOAD DETECTOR SHIFTED LOAD WITH TOP DETECTOR SOUTHERN SANITARY SEWER MANHOLE SINGLE SWITCH POINT DERAIL STATION STANDARD STREET OR SPIRAL TO TANGENT OR SIDING TRACK OR STAGING TRACK SUBDIVISION SPRING SWITCH
T TC TO TO T/R or TOR TF TN TRK TS TT TWC TYP	TANGENT OF TALGO TRACK CENTER(S) OF TOP OF CURB TURNOUT TOP OF RAIL TRACK FOOT OF TRACK FEET TONS TRACK TANGENT TO SPIRAL TIMBER TRANSITION TIES TRACK WARRANT CONTROL TYPICAL
UC UD UDG OR UG	UNDERCUT UNDERDRAIN UNDERGROUND

UD UDG OR UG UNO UP UPRR UNDERDRAIN UNDERGROUND UNLESS NOTED OTHERWISE UNDERPASS UNION PACIFIC RAILROAD

V VAR VERT VELOCITY VARIES VERTICAL

WEST or WESTERLY WATER METER WHEEL IMPACT LOAD DETECTOR WATER VALVE W WM WILD WV

CROSSBUCKS CROSSING CROSSOVER XBUCKS XING XO

YARD YARD LIMIT

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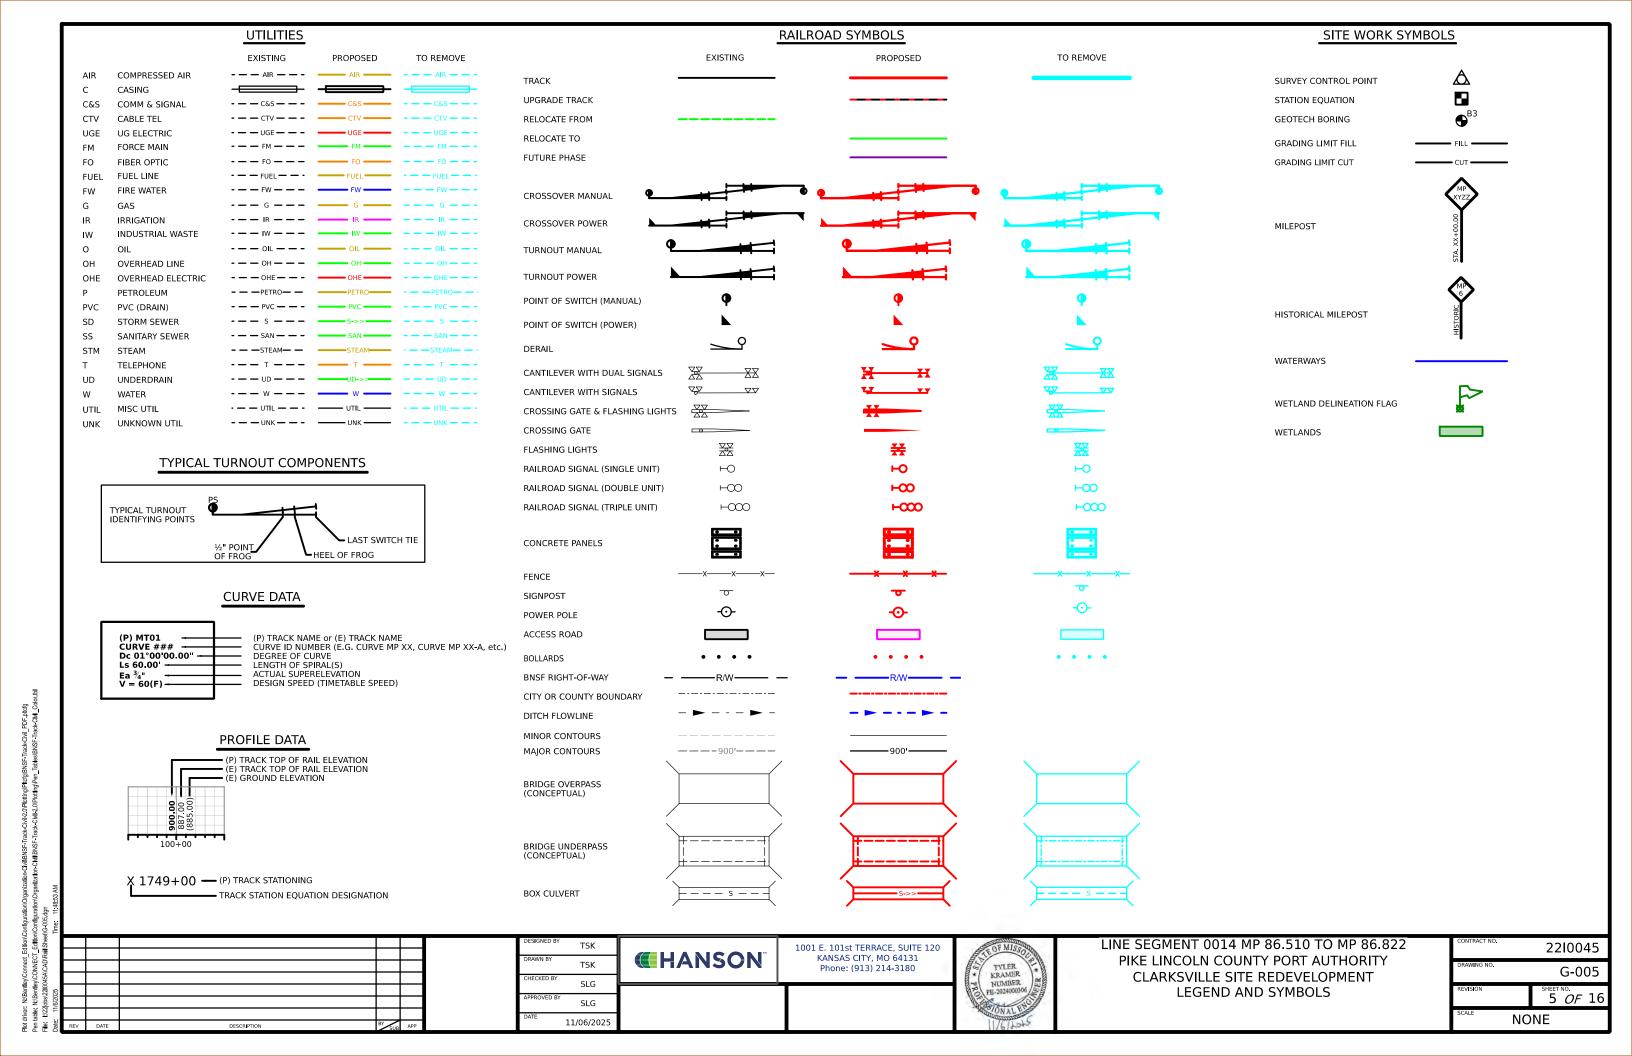
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LINE SEGMENT 0014 MP 86.510 TO MP 86.822 PIKE LINCOLN COUNTY PORT AUTHORITY CLARKSVILLE SITE REDEVELOPMENT

CONTRACT NO.		2210045
DRAWING NO.		G-004
REVISION		SHEET NO. 4 <i>OF</i> 16
SCALE	NO	NE

ABBREVIATIONS



SURVEY CONTROL TABLE				
POINT NO.	NORTHING	EASTING	ELEVATION	DESCRIPTION
CP-11	1291686.299	695741.513	456.89	rebar cap dni base 4 ft os 25 mph post
CD 12	1201700 005	605736 005	457 710	nk nail dni chk 7ft from conc edge







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LINE SEGMENT 0014 MP 86.510 TO MP 86.822
PIKE LINCOLN COUNTY PORT AUTHORITY
CLARKSVILLE SITE REDEVELOPMENT
KEY PLAN AND SURVEY CONTROL

CONTRACT NO.	2210045
DRAWING NO.	V-001
REVISION	6 <i>OF</i> 16
AS NO	OTED

Pen lable: N:Bentley/CON/ECT\_Edition/Configuration/Organization-CMIBNSF-Track-CMI-2.0Plotting/Pen\_Tai PER: KY20Pois/ZMO65A/CAD/Rail/Sheet/V002-60

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11/06/2025

**(HANSON**)

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100' 0 50' 100' 200'
GRAPHIC SCALE:

TYLER KRAMER NUMBER PE 2024000306

LINE SEGMENT 0014 MP 86.510 TO MP 86.822
PIKE LINCOLN COUNTY PORT AUTHORITY
CLARKSVILLE SITE REDEVELOPMENT
SURVEY LIMITS

CONTRACT NO. 2210045

DRAWING NO. V-002


REVISION SHEET NO. 7 OF 16

SCALE AS NOTED


TRACK	CLEAR LENGTH (FT.)	# OF RAILCARS (60 FT. EA.)
6197	2,980	49
6113	2,870	47
6114	950	15
6110	950	15
6616	1,145	19
6617	1,145	19

# **SUMMARY OF OPERATIONS**

TO REINITIATE RAIL SERVICE AT THE PLCPA FACILITY NORTH OF CLARKSVILLE, MO, TRACK 6114 AND 6110 WILL BE DESIGNATED AS RECEIVING & DEPARTURE (R&D) TRACKS, RESPECTIVELY. AS INDICATED IN THE TABLE, THE MAXIMUM NUMBER OF RAILCARS PER TRACK IS 15 (ASSUMING 60-FOOT RAILCARS). ALL OTHER PLCPAOWEND STORAGE TRACKS WILL BE USED FOR RAILCAR STORAGE OR OTHER PURPOSES.

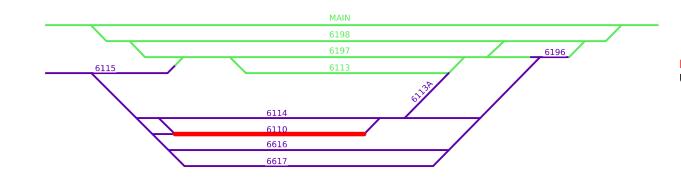

RED RAILCARS ARE PLACED ON TRACK 6110 TO BE PICKED UP BY BNSF

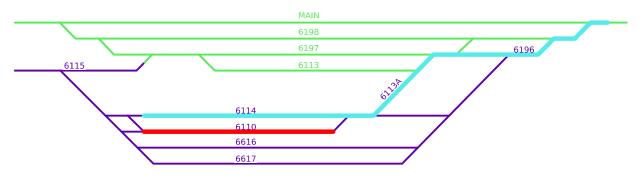

BNSF SHOVED INBOUND BLUE RAILCARS ONTO TRACK 6114



BNSF PULLS OUTBOUND RED RAILCARS FROM TRACK 6110

-						
52						
11/6/2025						
:						
Date	REV	DATE	DESCRIPTION	BY SUB	APP	

TSK	
TSK	
SLG	
SLG	
11/06/2025	


**€**HANSON

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LINE SEGMENT 0014 MP 86.510 TO MP 86.822
PIKE LINCOLN COUNTY PORT AUTHORITY
CLARKSVILLE SITE REDEVELOPMENT
OPERATION PLAN

CONTRACT NO.	2210045
DRAWING NO.	CT-001
REVISION	8 <i>OF</i> 16
AS NO	OTED



# BNSF SCOPE OF WORK

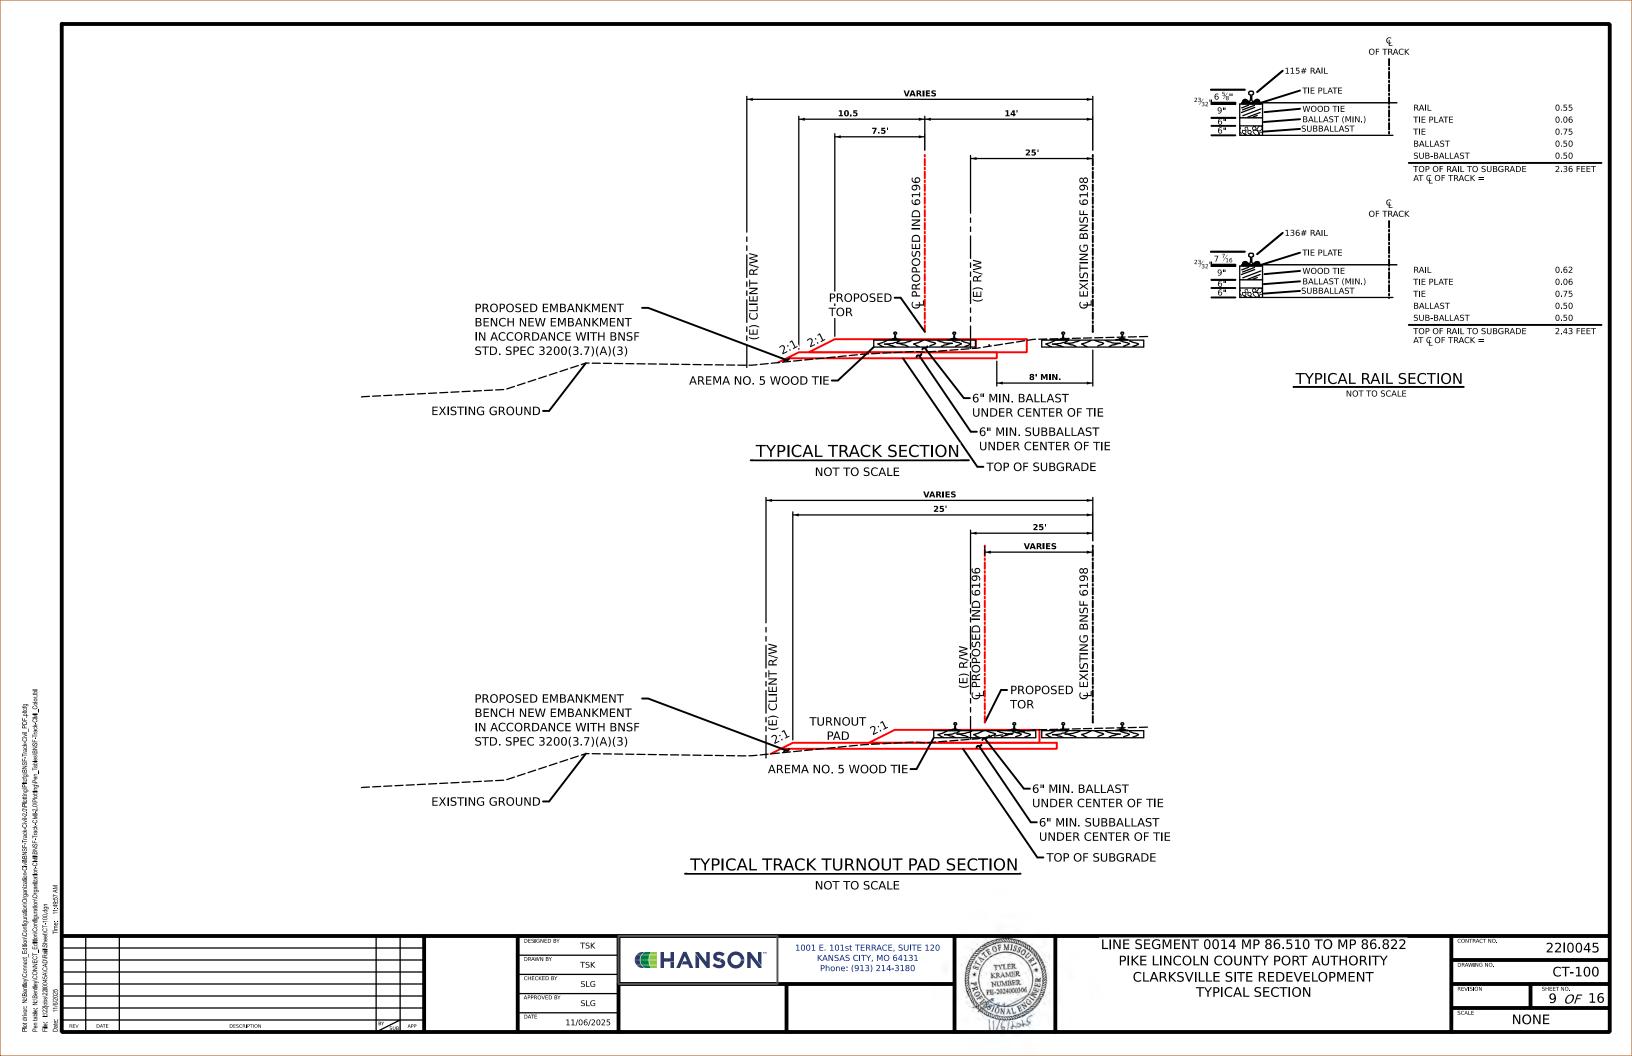CONSTRUCT 113 TRACK FEET INCLUDING A NO. 11-115 LB. LH HTTO TURNOUT FROM POINT OF SWITCH TO CLEAR POINT.

REMOVE 125 TRACK FEET OF 136lb EXISTING TRACK 6198.


# CLIENT SCOPE OF WORK

CONSTRUCT REMAINING TRACK FROM CLEAR POINT TO PS OF DERAIL. 136LB RAIL AND STANDARD 16'6" DOUBLE SWITCH POINT DERAIL 136 LB.


INSTALL TRANSITION RAILS AT TIE IN LOCATION. TRANSITION FROM 136LB TO 115LB RAIL. REMOVE 192 TRACK FEET OF EXISTING TRACK 6196.

PERFORM ALL GRADING AND BALLAST/ SUBBALLAST PLACEMENT.

TRACK CONSTRUCTION TO MEET OR EXCEED THE REQUIREMENTS OUTLINE FOR "GUIDELINES FOR INDUSTRY TRACK PROJECTS." RAIL SHALL BE NEW 136LB AND 115LB AREMA NO. 5 WOOD TIES.
NO. 11-136LB LH HTTO BNSF STANDARD TURNOUT.

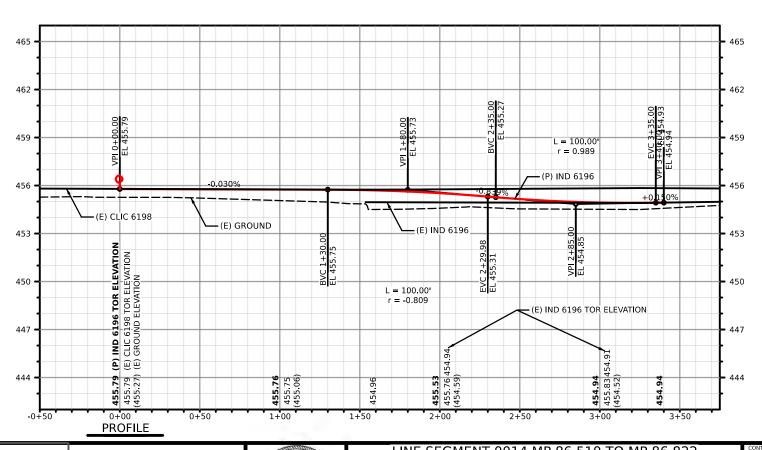




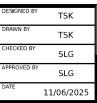





**HANSON** 



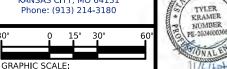

LINE SEGMENT 0014 MP 86.510 TO MP 86.822
PIKE LINCOLN COUNTY PORT AUTHORITY
CLARKSVILLE SITE REDEVELOPMENT
TRACK 6196 PLAN AND PROFILE

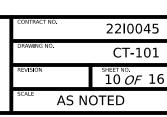

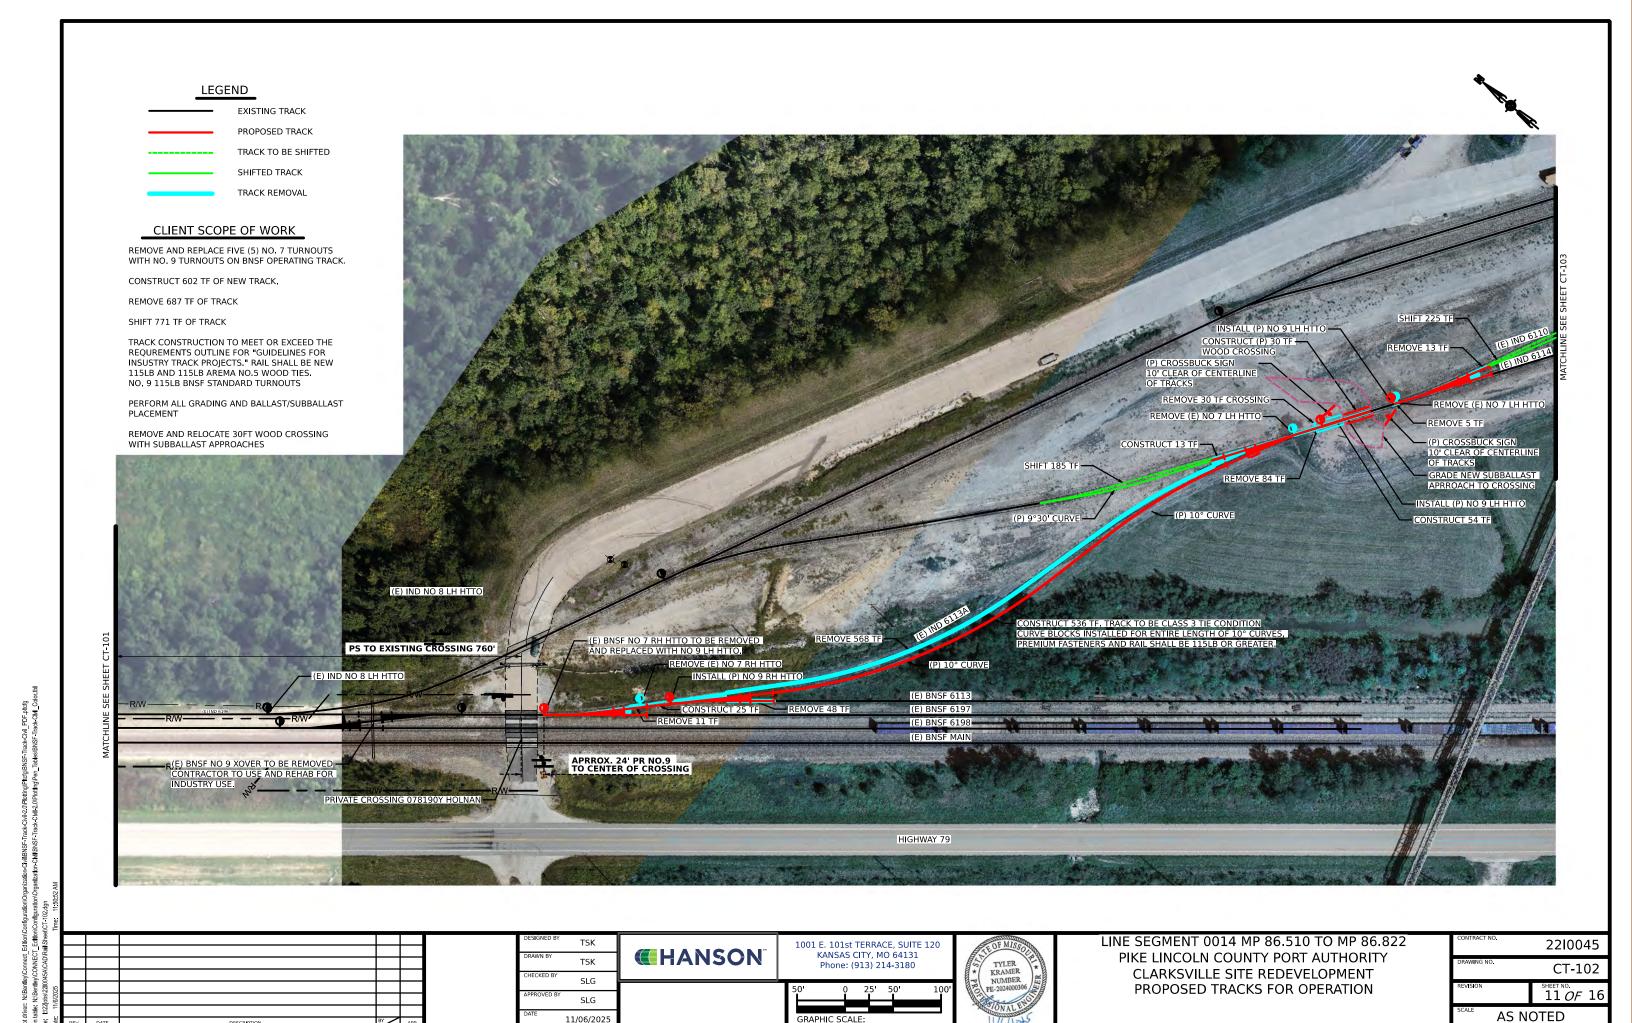



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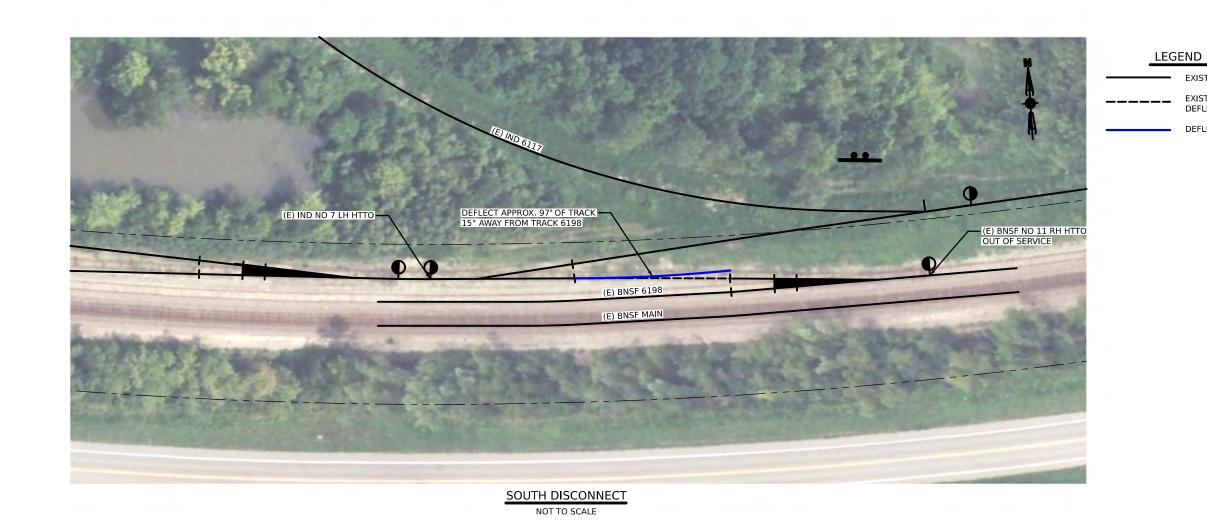
LIENT SCOPE OF WORK

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12 *OF* 16

**AS NOTED** 

PROPOSED TRACKS FOR OPERATION



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LINE SEGMENT 0014 MP 86.510 TO MP 86.822
PIKE LINCOLN COUNTY PORT AUTHORITY
CLARKSVILLE SITE REDEVELOPMENT
SOUTH DISCONNECT

2210045

DRAWING NO. CT-104

REVISION SHEET NO. 13 *OF* 16

SCALE AS NOTED

EXISTING TRACK

EXISTINTG TRACK TO BE DEFLECTED

DEFLECTED TRACK

# GEOMETRY TABLE

	TRACK ALIGNMENT: PROPOSED YARD TRACK (CHORD DEFFINITION)												
CURVE ID	ELEMENT DESCRIPTION	PROPOSED YARD TRACK STATION	NORTHING	EASTING	BEARING	DEGREE OF CURVATURE (CHORD)	RADIUS (FT)	DELTA	TANGENT LENGTH (FT)	CHORD LENGTH (DOES NOT INCLUDE SPIRALS) (FT)	I (TOTAL CENTRAL ANGLE, INCLUDING SPIRALS)	THETA	SPIRAL LENGTH (Ls)(FT)
NO. 11 LHTO (HT)	PS/POB/START	0+00.00	1,292,110.44	695,182.29	S39°S5'36"E	7 7 1				11			
	PITO	0+31.25	1,292,219.45	695,072.78									
CURVE C-01	PC	1+34.04	1,292,146.92	695,145.64	S45'07'54"E					1			
	PI	1+85.76	1,292,110.44	695,182.29		05°00'00"	1146.28	05°10'03" RT	103.38	103.35			
	PT	2+37.38	1,292,070.81	695,215.50	S39'57'51"E				2				
	POE	4+00	1,291,946.16	695,319.96	S39*57'51"E				162.63				

11/6/2025 Time				
200				
E L				
3				
404				
25				
:Joons 1/6/20				
7 =				
Date:	REV	DATE	DESCRIPTION BY SUB	APP



TSK

TSK

SLG

SLG


TYLER KRAMER NUMBER PE-2024()00306


LINE SEGMENT 0014 MP 86.510 TO MP 86.822 PIKE LINCOLN COUNTY PORT AUTHORITY CLARKSVILLE SITE REDEVELOPMENT TRACK GEOMETRY TABLE

CONTRACT NO.	2210045		
DRAWING NO.	CT-601		
REVISION	14 <i>OF</i> 16		
NONE			

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TYLER KRAMER NUMBER PE-20400366

LINE SEGMENT 0014 MP 86.510 TO MP 86.822
PIKE LINCOLN COUNTY PORT AUTHORITY
CLARKSVILLE SITE REDEVELOPMENT
CROSS SECTIONS

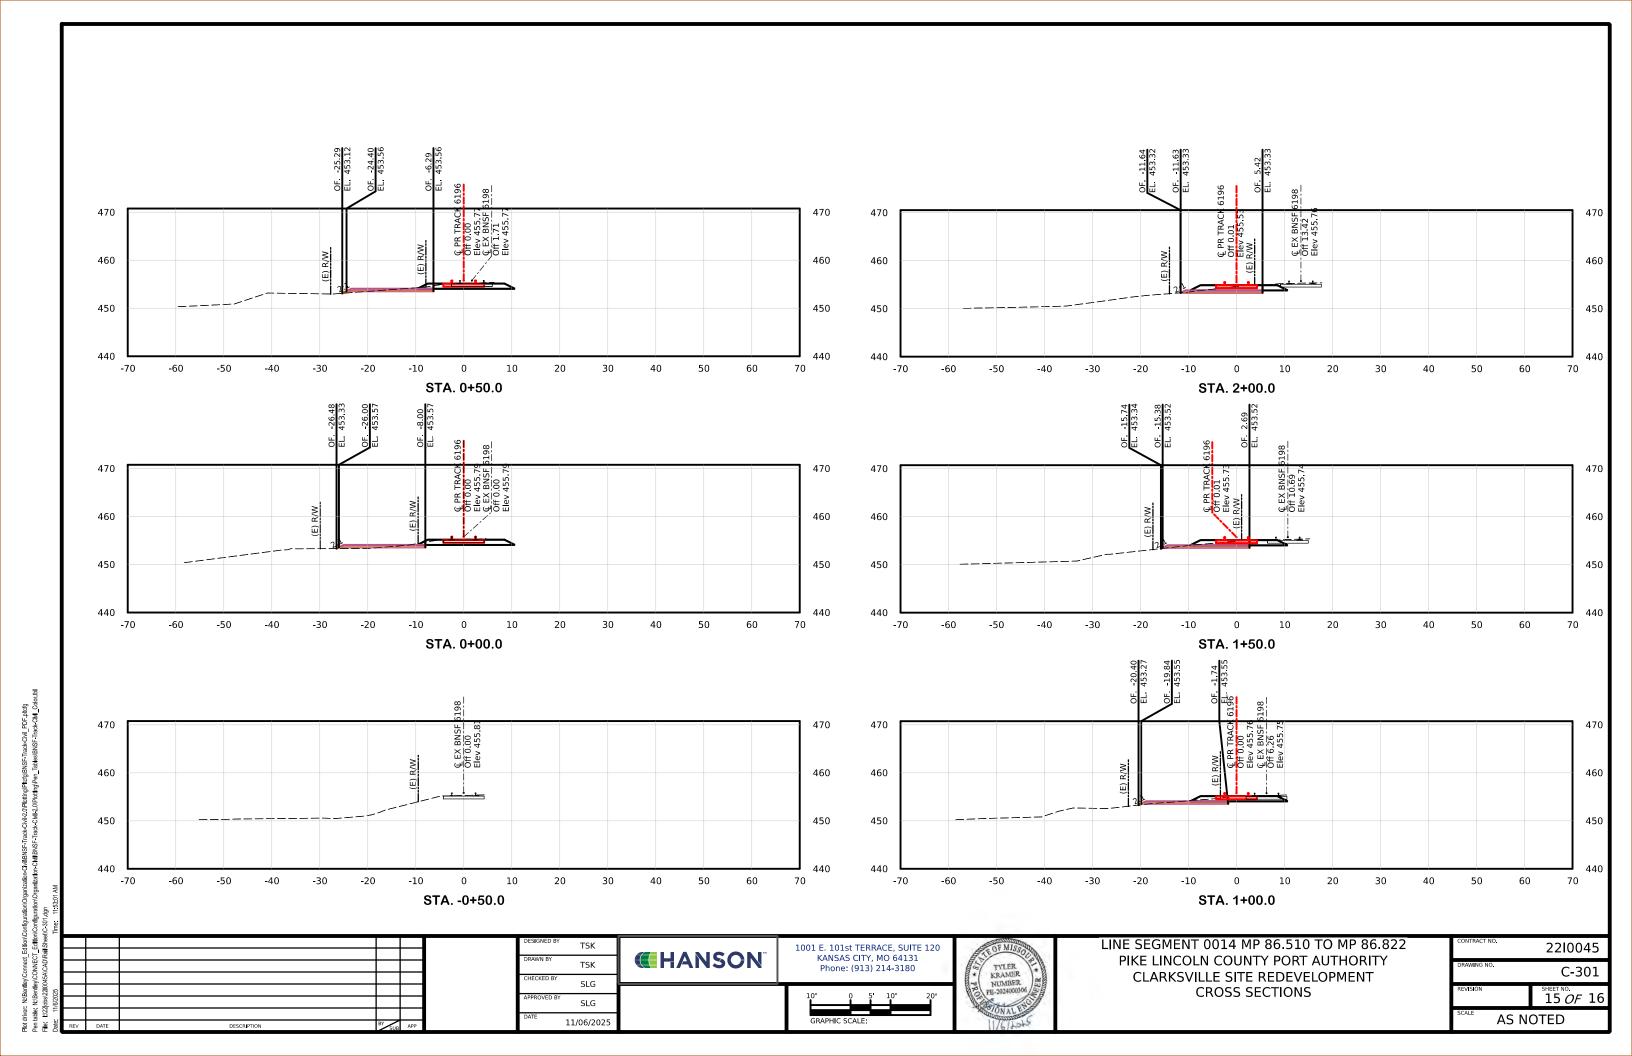CONTRACT NO. 2210045

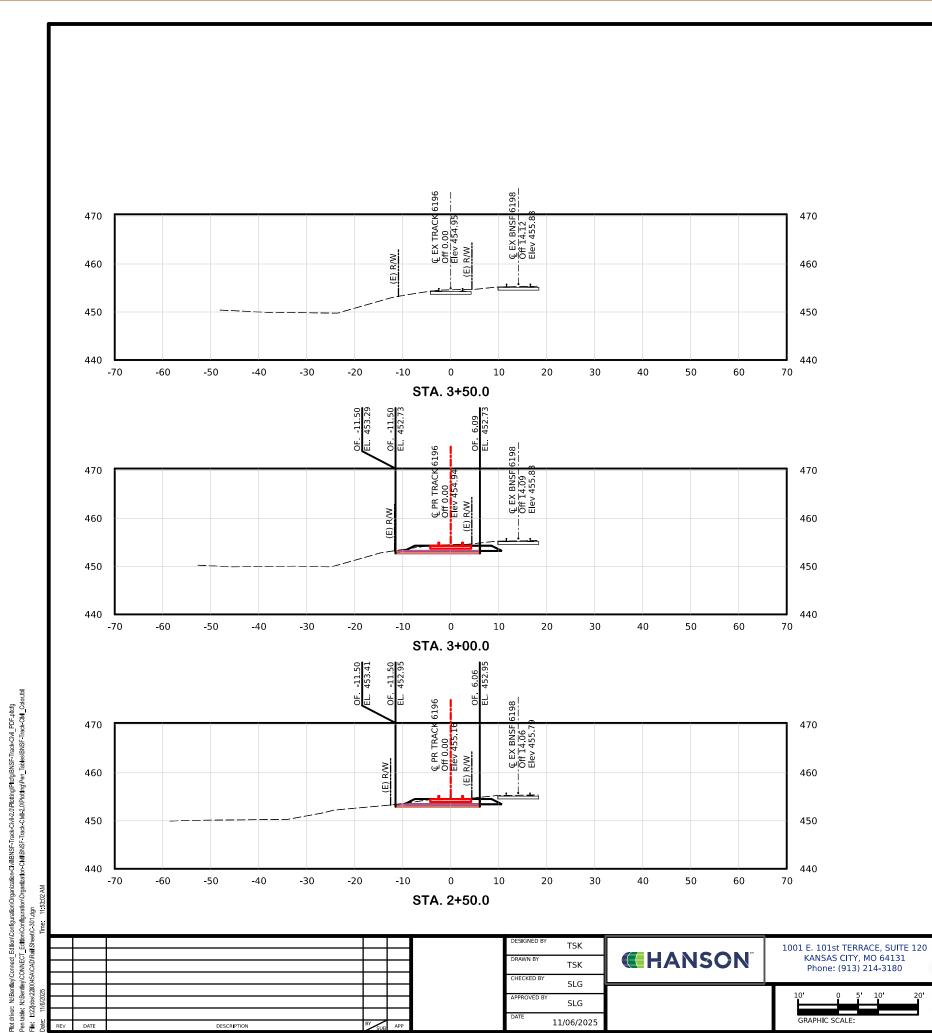DRAWING NO. C-302

REVISION SHEET NO. 16 OF 16

SCALE AS NOTED