Lansdale Freight House 111 S. Broad Street, Lansdale, Pennsylvania 19446

BUILDING REHABILITATION

for:

Discover Lansdale

P.O. Box 1112, Lansdale, Pennsylvania 19446

DESIGN TEAM:

ARCHITECT



VILLAGE ARCHITECTURE & PO BOX 544

CONTACT: Jessica Zeigler-Cihlar AIA 610-389-9387 jzc@village-architecture.com STRUCTURAL ENGINEER



STRUCTURAL ENGINEERING & LANSDALE, PA 19446


CONTACT: Kenneth Seiler PE 215-361-2301 x204 kens@ringconsulting.com MECHANICAL, PLUMBING, AND ELECTRICAL ENGINEER



MARTARANO ENGINEERING, INC. 1105 BERKSHIRE BLVD. WYOMISSING PA, 19610

CONTACT: Angelo L. Martarano PE 484-706-9779 amartarano@martaranoengineering.com



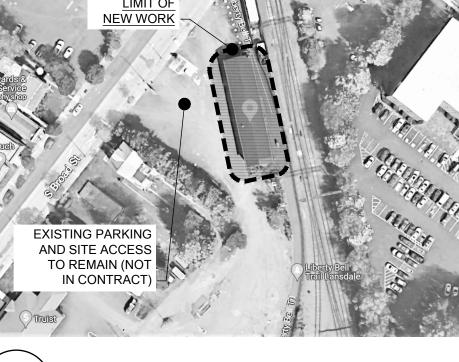


AERIAL SITE PLAN

MASTER DRAWING LIST

DRAWING LIST

DWG No. DRAWING TITLE

CO-2	
	GENERAL NOTES AND PROJECT SCOPE OF WORK
	CIVIL (NOT IN CONTRACT)
CS1501	GRADING PLAN - FOR REFERENCE ONLY
	ARCHITECTURAL
A-1	DEMOLITION PLANS AND NOTES
A-2	CODE SPECIFICATIONS AND DETAILS
A-3	CODE SPECIFICATIONS AND DETAILS
A-4	CODE PLANS AND DETAILS
A-5	PRESERVATION REPAIRS - EXTERIOR
A-6	PRESERVATION REPAIRS - INTERIOR
A-7	PRESERVATION REPAIR NOTES
A-8	PRESERVATION SPECIFICATIONS
A-9	PRESERVATION SPECIFICATIONS
A-10	FIRST FLOOR AND MEZZANINE PLANS
A-11	ROOF AND REFLECTED CEILING PLANS
A-12	NEW WORK ELEVATIONS AND DETAILS
A-13	ARCHITECTURAL DETAILS
A-14	ARCHITECTURAL DETAILS
A-15	DOOR AND WINDOW SCHEDULE
A-16	ARCHITECTURAL SPECIFICATIONS
A-17	ARCHITECTURAL SPECIFICATIONS
A-18	ARCHITECTURAL SPECIFICATIONS
A-19	ARCHITECTURAL SPECIFICATIONS AND PARTITIONS
	STRUCTURAL
S0.1	COVER SHEET & GENERAL NOTES
S1.0	FOUNDATION PLAN
S1.1	FIRST FLOOR FRAMING PLAN
S1.2	MEZZANINE & CEILING FRAMING PLAN
S1.3	ROOF FRAMING PLAN
S2.0	EXISTING BUILDING SECTION
S3.0	DETAILS
S3.1	DETAILS
	I MECHANICAL DITIMBING & ELECTRICAL
	MECHANICAL, PLUMBING, & ELECTRICAL
M100	MECHANICAL - LEGEND AND ABBREVIATIONS
M200	MECHANICAL - LEGEND AND ABBREVIATIONS MECHANICAL - NEW WORK
M200 M300	MECHANICAL - LEGEND AND ABBREVIATIONS MECHANICAL - NEW WORK MECHANICAL - SCHEDULES
M200 M300 M301	MECHANICAL - LEGEND AND ABBREVIATIONS MECHANICAL - NEW WORK MECHANICAL - SCHEDULES MECHANICAL - SCHEDULES
M200 M300 M301 P100	MECHANICAL - LEGEND AND ABBREVIATIONS MECHANICAL - NEW WORK MECHANICAL - SCHEDULES MECHANICAL - SCHEDULES PLUMBING - LEGEND AND ABBREVIATIONS
M200 M300 M301 P100 P200	MECHANICAL - LEGEND AND ABBREVIATIONS MECHANICAL - NEW WORK MECHANICAL - SCHEDULES MECHANICAL - SCHEDULES PLUMBING - LEGEND AND ABBREVIATIONS PLUMBING - NEW WORK
M200 M300 M301 P100 P200 P201	MECHANICAL - LEGEND AND ABBREVIATIONS MECHANICAL - NEW WORK MECHANICAL - SCHEDULES MECHANICAL - SCHEDULES PLUMBING - LEGEND AND ABBREVIATIONS PLUMBING - NEW WORK PLUMBING - GAS - NEW WORK
M200 M300 M301 P100 P200 P201 P300	MECHANICAL - LEGEND AND ABBREVIATIONS MECHANICAL - NEW WORK MECHANICAL - SCHEDULES MECHANICAL - SCHEDULES PLUMBING - LEGEND AND ABBREVIATIONS PLUMBING - NEW WORK PLUMBING - GAS - NEW WORK PLUMBING - SANITARY RISER AND SCHEDULES
M200 M300 M301 P100 P200 P201 P300 P301	MECHANICAL - LEGEND AND ABBREVIATIONS MECHANICAL - NEW WORK MECHANICAL - SCHEDULES MECHANICAL - SCHEDULES PLUMBING - LEGEND AND ABBREVIATIONS PLUMBING - NEW WORK PLUMBING - GAS - NEW WORK PLUMBING - SANITARY RISER AND SCHEDULES PLUMBING - SPECIFICATIONS
M200 M300 M301 P100 P200 P201 P300 P301 E001	MECHANICAL - LEGEND AND ABBREVIATIONS MECHANICAL - NEW WORK MECHANICAL - SCHEDULES MECHANICAL - SCHEDULES PLUMBING - LEGEND AND ABBREVIATIONS PLUMBING - NEW WORK PLUMBING - GAS - NEW WORK PLUMBING - SANITARY RISER AND SCHEDULES PLUMBING - SPECIFICATIONS ELECTRICAL - LEGEND & GENERAL NOTES
M200 M300 M301 P100 P200 P201 P300 P301 E001	MECHANICAL - LEGEND AND ABBREVIATIONS MECHANICAL - NEW WORK MECHANICAL - SCHEDULES MECHANICAL - SCHEDULES PLUMBING - LEGEND AND ABBREVIATIONS PLUMBING - NEW WORK PLUMBING - GAS - NEW WORK PLUMBING - SANITARY RISER AND SCHEDULES PLUMBING - SPECIFICATIONS ELECTRICAL - LEGEND & GENERAL NOTES ELECTRICAL - FIRST FLOOR LIGHTING
M200 M300 M301 P100 P200 P201 P300 P301 E001 E101 E101A	MECHANICAL - LEGEND AND ABBREVIATIONS MECHANICAL - NEW WORK MECHANICAL - SCHEDULES MECHANICAL - SCHEDULES PLUMBING - LEGEND AND ABBREVIATIONS PLUMBING - NEW WORK PLUMBING - GAS - NEW WORK PLUMBING - SANITARY RISER AND SCHEDULES PLUMBING - SPECIFICATIONS ELECTRICAL - LEGEND & GENERAL NOTES ELECTRICAL - FIRST FLOOR LIGHTING
M200 M300 M301 P100 P200 P201 P300 P301 E001 E101 E101A E102	MECHANICAL - LEGEND AND ABBREVIATIONS MECHANICAL - NEW WORK MECHANICAL - SCHEDULES MECHANICAL - SCHEDULES PLUMBING - LEGEND AND ABBREVIATIONS PLUMBING - NEW WORK PLUMBING - GAS - NEW WORK PLUMBING - SANITARY RISER AND SCHEDULES PLUMBING - SPECIFICATIONS ELECTRICAL - LEGEND & GENERAL NOTES ELECTRICAL - FIRST FLOOR LIGHTING ELECTRICAL - MEZZANINE LIGHTING
M200 M300 M301 P100 P200 P201 P300 P301 E101 E101A E102 E201	MECHANICAL - LEGEND AND ABBREVIATIONS MECHANICAL - NEW WORK MECHANICAL - SCHEDULES MECHANICAL - SCHEDULES PLUMBING - LEGEND AND ABBREVIATIONS PLUMBING - NEW WORK PLUMBING - GAS - NEW WORK PLUMBING - SANITARY RISER AND SCHEDULES PLUMBING - SPECIFICATIONS ELECTRICAL - LEGEND & GENERAL NOTES ELECTRICAL - FIRST FLOOR LIGHTING ELECTRICAL - MEZZANINE LIGHTING ELECTRICAL - FIRST FLOOR POWER
M200 M300 M301 P100 P200 P201 P300 P301 E001 E101 E101A E102 E201 E202	MECHANICAL - LEGEND AND ABBREVIATIONS MECHANICAL - NEW WORK MECHANICAL - SCHEDULES MECHANICAL - SCHEDULES PLUMBING - LEGEND AND ABBREVIATIONS PLUMBING - NEW WORK PLUMBING - GAS - NEW WORK PLUMBING - SANITARY RISER AND SCHEDULES PLUMBING - SPECIFICATIONS ELECTRICAL - LEGEND & GENERAL NOTES ELECTRICAL - FIRST FLOOR LIGHTING ELECTRICAL - MEZZANINE LIGHTING ELECTRICAL - FIRST FLOOR POWER ELECTRICAL - MEZZANINE POWER
M200 M300 M301 P100 P200 P201 P300 P301 E001 E101 E101A E102 E201 E202 E301	MECHANICAL - LEGEND AND ABBREVIATIONS MECHANICAL - NEW WORK MECHANICAL - SCHEDULES MECHANICAL - SCHEDULES PLUMBING - LEGEND AND ABBREVIATIONS PLUMBING - NEW WORK PLUMBING - GAS - NEW WORK PLUMBING - SANITARY RISER AND SCHEDULES PLUMBING - SPECIFICATIONS ELECTRICAL - LEGEND & GENERAL NOTES ELECTRICAL - FIRST FLOOR LIGHTING ELECTRICAL - MEZZANINE LIGHTING ELECTRICAL - FIRST FLOOR POWER ELECTRICAL - MEZZANINE POWER ELECTRICAL - FIRST FLOOR MECH POWER
M200 M300 M301 P100 P200 P201 P300 P301 E001 E101 E101A E102 E201 E202 E301 E401	MECHANICAL - LEGEND AND ABBREVIATIONS MECHANICAL - NEW WORK MECHANICAL - SCHEDULES MECHANICAL - SCHEDULES PLUMBING - LEGEND AND ABBREVIATIONS PLUMBING - NEW WORK PLUMBING - GAS - NEW WORK PLUMBING - SANITARY RISER AND SCHEDULES PLUMBING - SPECIFICATIONS ELECTRICAL - LEGEND & GENERAL NOTES ELECTRICAL - FIRST FLOOR LIGHTING ELECTRICAL - MEZZANINE LIGHTING ELECTRICAL - FIRST FLOOR POWER ELECTRICAL - MEZZANINE POWER ELECTRICAL - FIRST FLOOR MECH POWER ELECTRICAL - SINGLE LINE & SCHEDULES
M200 M300 M301 P100 P200 P201 P300 P301 E001 E101 E101A E102 E201 E202 E301 E401 E501	MECHANICAL - LEGEND AND ABBREVIATIONS MECHANICAL - NEW WORK MECHANICAL - SCHEDULES MECHANICAL - SCHEDULES PLUMBING - LEGEND AND ABBREVIATIONS PLUMBING - NEW WORK PLUMBING - GAS - NEW WORK PLUMBING - SANITARY RISER AND SCHEDULES PLUMBING - SPECIFICATIONS ELECTRICAL - LEGEND & GENERAL NOTES ELECTRICAL - FIRST FLOOR LIGHTING ELECTRICAL - FIRST FLOOR LIGHTING ELECTRICAL - MEZZANINE LIGHTING ELECTRICAL - MEZZANINE LIGHTING ELECTRICAL - FIRST FLOOR POWER ELECTRICAL - SINGLE LINE & SCHEDULES ELECTRICAL - SINGLE LINE & SCHEDULES ELECTRICAL - DETAILS
M200 M300 M301 P100 P200 P201 P300 P301 E001 E101 E101A E102 E201 E202 E301 E401	MECHANICAL - LEGEND AND ABBREVIATIONS MECHANICAL - NEW WORK MECHANICAL - SCHEDULES MECHANICAL - SCHEDULES PLUMBING - LEGEND AND ABBREVIATIONS PLUMBING - NEW WORK PLUMBING - GAS - NEW WORK PLUMBING - SANITARY RISER AND SCHEDULES PLUMBING - SPECIFICATIONS ELECTRICAL - LEGEND & GENERAL NOTES ELECTRICAL - FIRST FLOOR LIGHTING ELECTRICAL - MEZZANINE LIGHTING ELECTRICAL - FIRST FLOOR POWER ELECTRICAL - MEZZANINE POWER ELECTRICAL - FIRST FLOOR MECH POWER ELECTRICAL - SINGLE LINE & SCHEDULES
M200 M300 M301 P100 P200 P201 P300 P301 E001 E101 E101A E102 E201 E202 E301 E401 E501	MECHANICAL - LEGEND AND ABBREVIATIONS MECHANICAL - NEW WORK MECHANICAL - SCHEDULES MECHANICAL - SCHEDULES PLUMBING - LEGEND AND ABBREVIATIONS PLUMBING - NEW WORK PLUMBING - GAS - NEW WORK PLUMBING - SANITARY RISER AND SCHEDULES PLUMBING - SPECIFICATIONS ELECTRICAL - LEGEND & GENERAL NOTES ELECTRICAL - FIRST FLOOR LIGHTING ELECTRICAL - MEZZANINE LIGHTING ELECTRICAL - FIRST FLOOR POWER ELECTRICAL - MEZZANINE POWER ELECTRICAL - SINGLE LINE & SCHEDULES ELECTRICAL - SINGLE LINE & SCHEDULES ELECTRICAL - DETAILS ELECTRICAL - LEGEND & GENERAL NOTES
M200 M300 M301 P100 P200 P201 P300 P301 E001 E101 E101A E102 E201 E202 E301 E401 E501 E601	MECHANICAL - LEGEND AND ABBREVIATIONS MECHANICAL - NEW WORK MECHANICAL - SCHEDULES MECHANICAL - SCHEDULES PLUMBING - LEGEND AND ABBREVIATIONS PLUMBING - NEW WORK PLUMBING - OAS - NEW WORK PLUMBING - SANITARY RISER AND SCHEDULES PLUMBING - SPECIFICATIONS ELECTRICAL - LEGEND & GENERAL NOTES ELECTRICAL - FIRST FLOOR LIGHTING ELECTRICAL - MEZZANINE LIGHTING ELECTRICAL - MEZZANINE LIGHTING ELECTRICAL - MEZZANINE POWER ELECTRICAL - SINGLE LINE & SCHEDULES ELECTRICAL - SINGLE LINE & SCHEDULES ELECTRICAL - DETAILS ELECTRICAL - LEGEND & GENERAL NOTES
M200 M300 M301 P100 P200 P201 P300 P301 E001 E101 E101A E102 E201 E202 E301 E401 E501 E601	MECHANICAL - LEGEND AND ABBREVIATIONS MECHANICAL - NEW WORK MECHANICAL - SCHEDULES MECHANICAL - SCHEDULES PLUMBING - LEGEND AND ABBREVIATIONS PLUMBING - NEW WORK PLUMBING - SANITARY RISER AND SCHEDULES PLUMBING - SPECIFICATIONS ELECTRICAL - LEGEND & GENERAL NOTES ELECTRICAL - FIRST FLOOR LIGHTING ELECTRICAL - MEZZANINE LIGHTING ELECTRICAL - MEZZANINE POWER ELECTRICAL - FIRST FLOOR MECH POWER ELECTRICAL - SINGLE LINE & SCHEDULES ELECTRICAL - SINGLE LINE & SCHEDULES ELECTRICAL - DETAILS ELECTRICAL - LEGEND & GENERAL NOTES APPENDIX SHEET NO. 1. SITE PLAN
M200 M300 M301 P100 P200 P201 P300 P301 E001 E101 E101A E102 E201 E202 E301 E401 E501 E601	MECHANICAL - LEGEND AND ABBREVIATIONS MECHANICAL - NEW WORK MECHANICAL - SCHEDULES MECHANICAL - SCHEDULES PLUMBING - LEGEND AND ABBREVIATIONS PLUMBING - NEW WORK PLUMBING - GAS - NEW WORK PLUMBING - SANITARY RISER AND SCHEDULES PLUMBING - SPECIFICATIONS ELECTRICAL - LEGEND & GENERAL NOTES ELECTRICAL - FIRST FLOOR LIGHTING ELECTRICAL - MEZZANINE LIGHTING ELECTRICAL - FIRST FLOOR POWER ELECTRICAL - FIRST FLOOR POWER ELECTRICAL - SINGLE LINE & SCHEDULES ELECTRICAL - DETAILS ELECTRICAL - LEGEND & GENERAL NOTES APPENDIX SHEET NO. 1. SITE PLAN SHEET NO. 2. FOUNDATION PLAN AND FLOOR PLAN
M200 M300 M301 P100 P200 P201 P300 P301 E001 E101 E101A E102 E201 E202 E301 E401 E501 E601	MECHANICAL - LEGEND AND ABBREVIATIONS MECHANICAL - NEW WORK MECHANICAL - SCHEDULES MECHANICAL - SCHEDULES PLUMBING - LEGEND AND ABBREVIATIONS PLUMBING - NEW WORK PLUMBING - SANITARY RISER AND SCHEDULES PLUMBING - SPECIFICATIONS ELECTRICAL - LEGEND & GENERAL NOTES ELECTRICAL - FIRST FLOOR LIGHTING ELECTRICAL - MEZZANINE LIGHTING ELECTRICAL - MEZZANINE POWER ELECTRICAL - FIRST FLOOR MECH POWER ELECTRICAL - SINGLE LINE & SCHEDULES ELECTRICAL - SINGLE LINE & SCHEDULES ELECTRICAL - DETAILS ELECTRICAL - LEGEND & GENERAL NOTES APPENDIX SHEET NO. 1. SITE PLAN

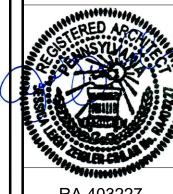


JUNE 6, 2024


JUNE 6, 2024 ISSUED FOR BID AND PERMIT


COVER SHEET

Lansdale 1111 S. Broad Street, I


\co-1/

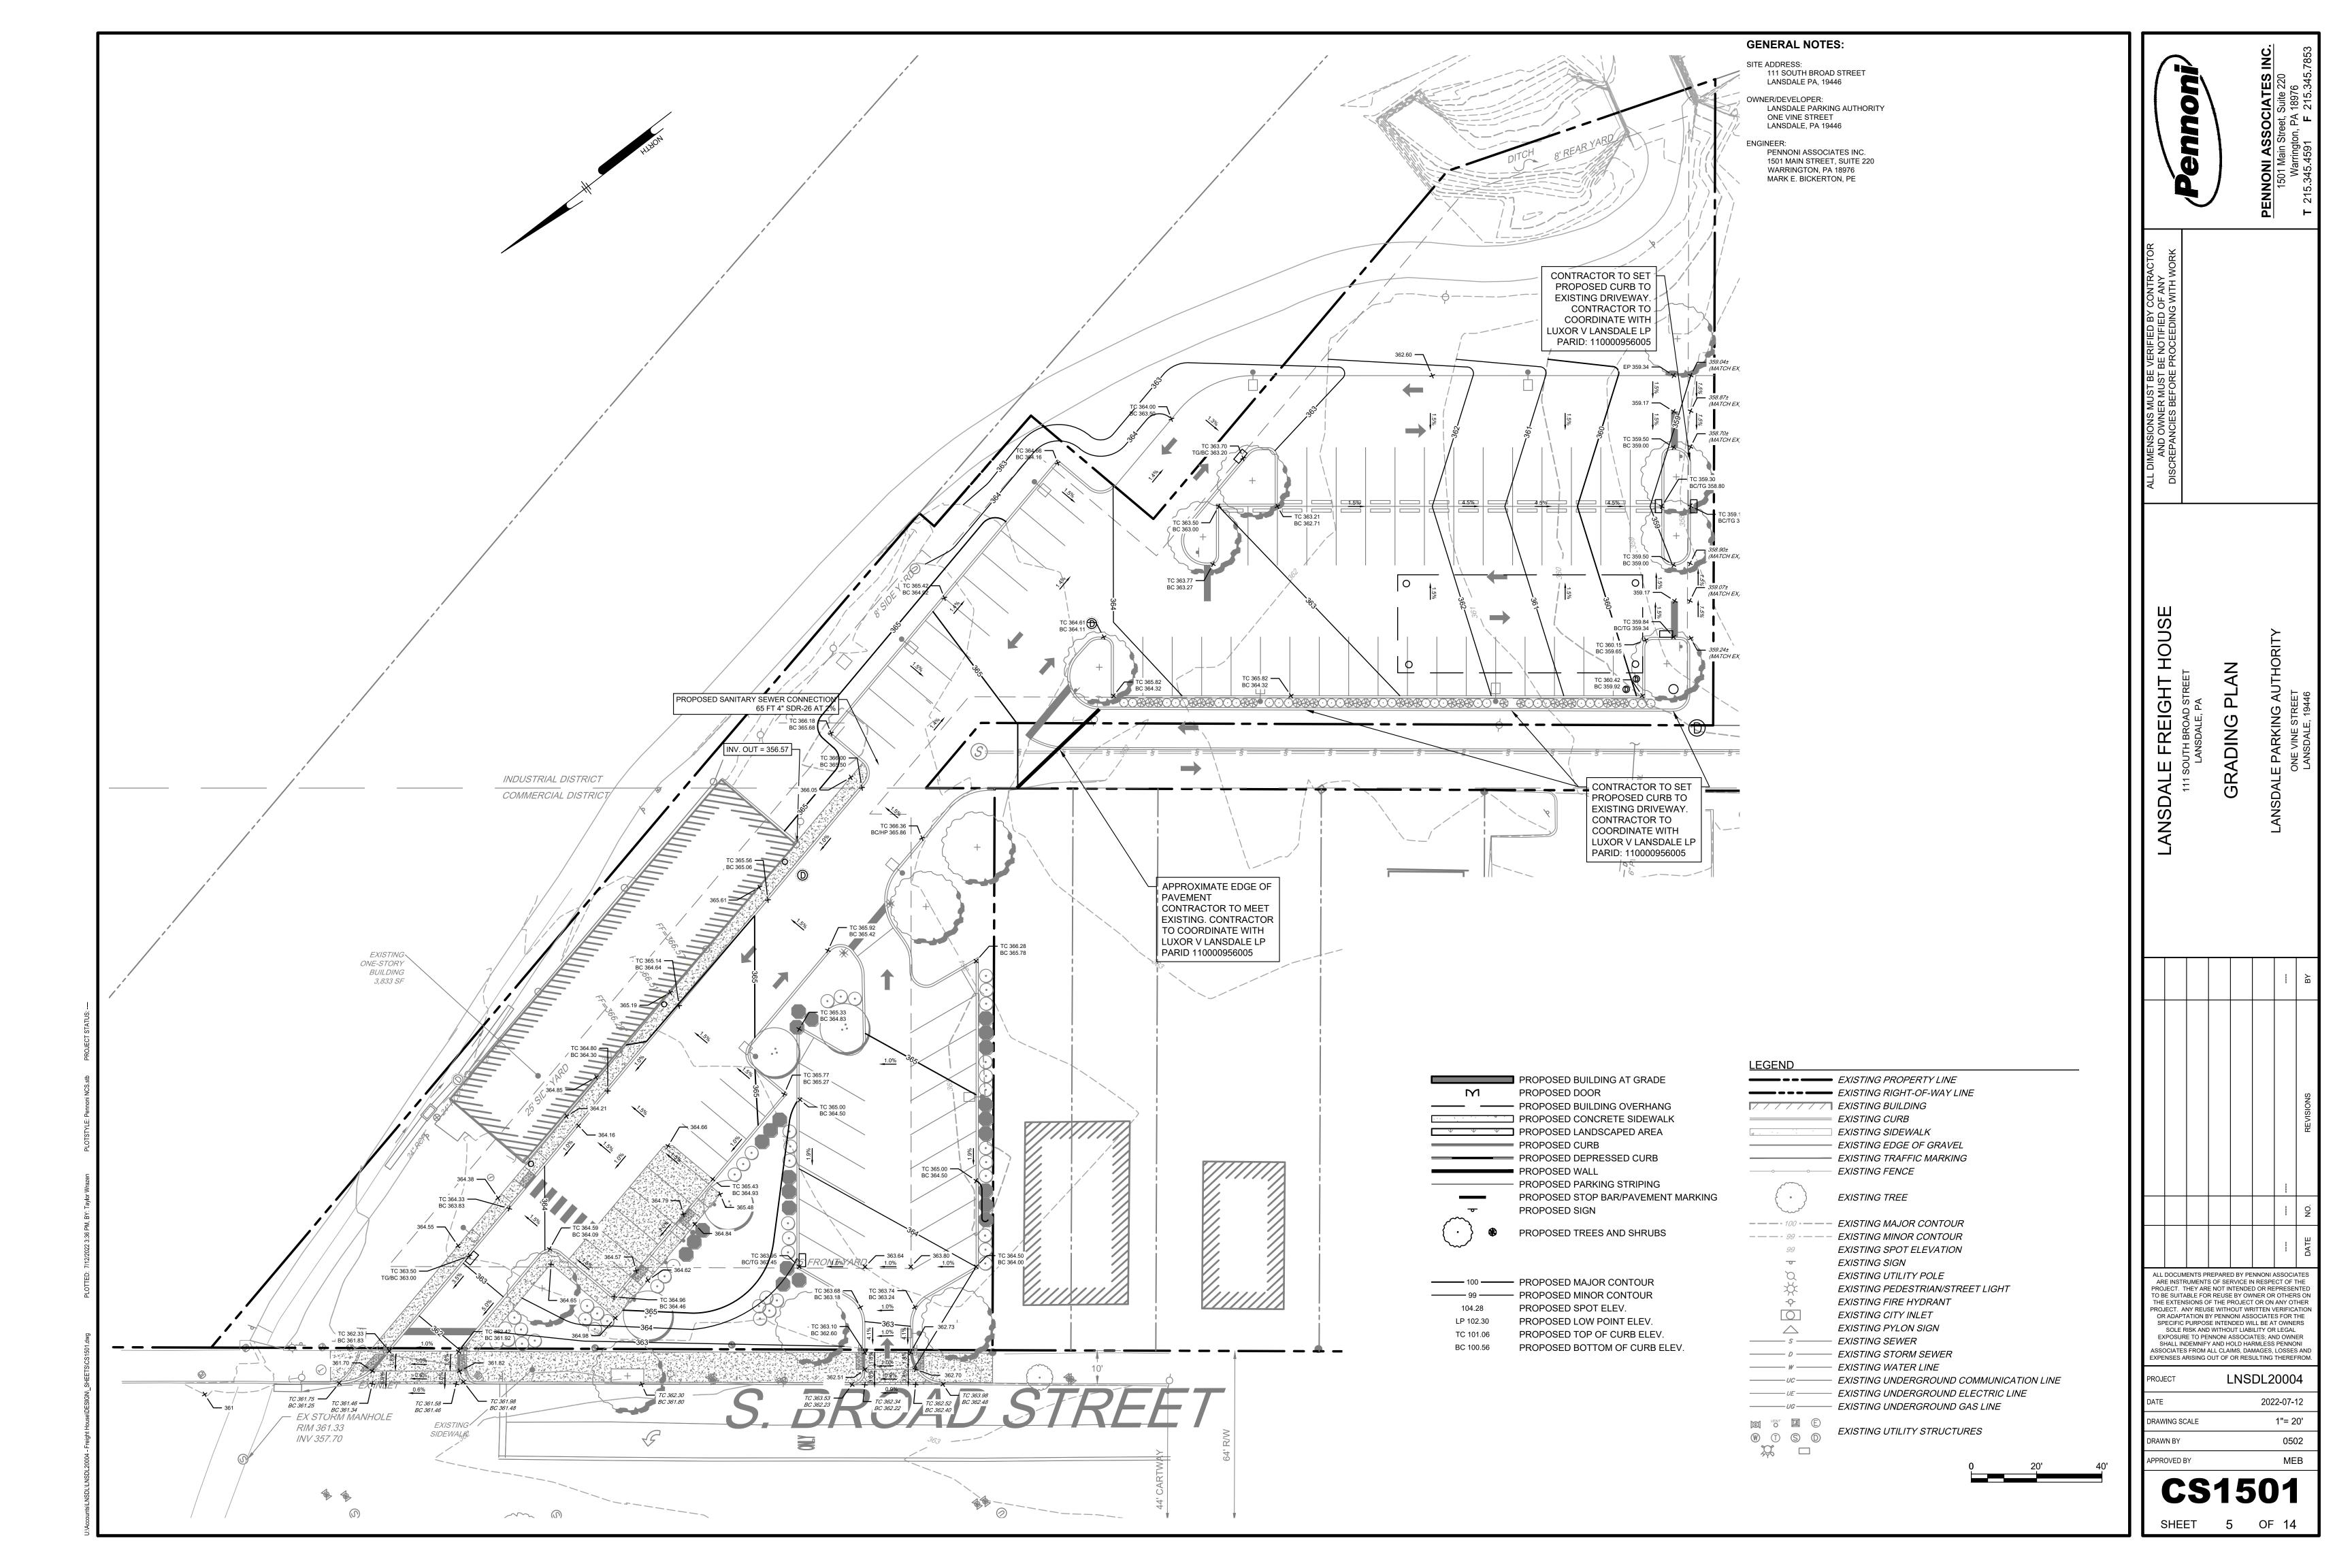

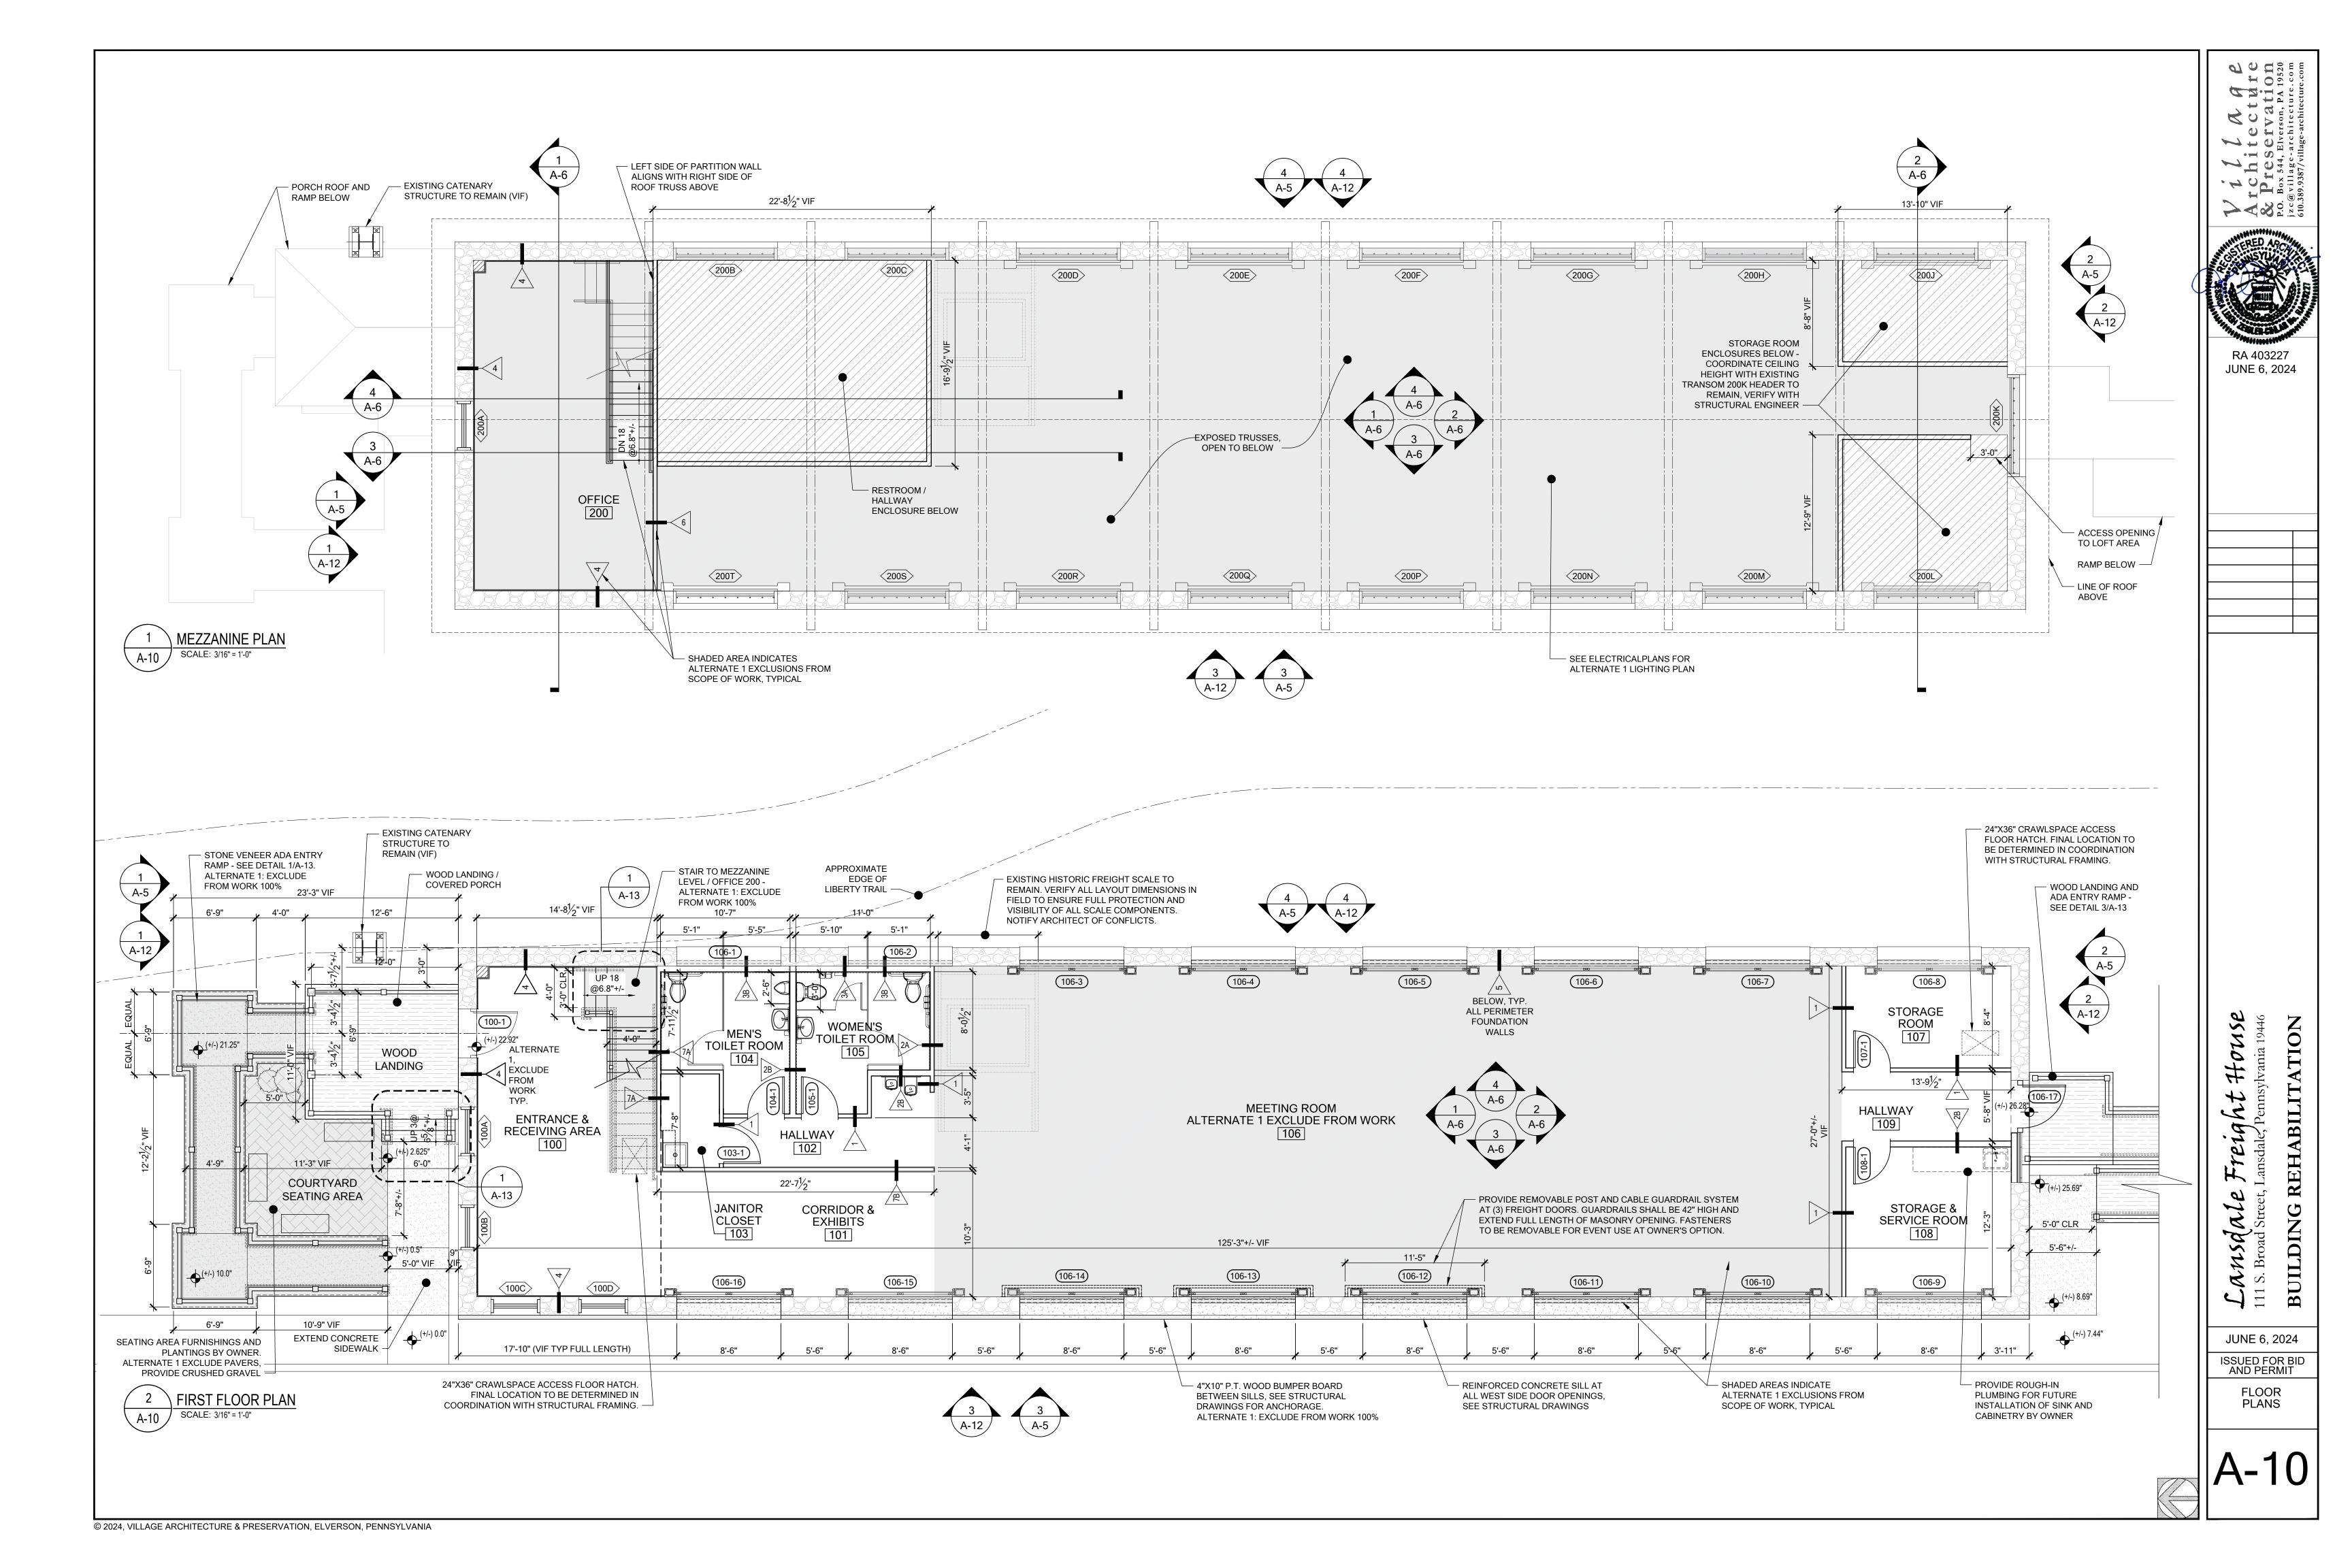

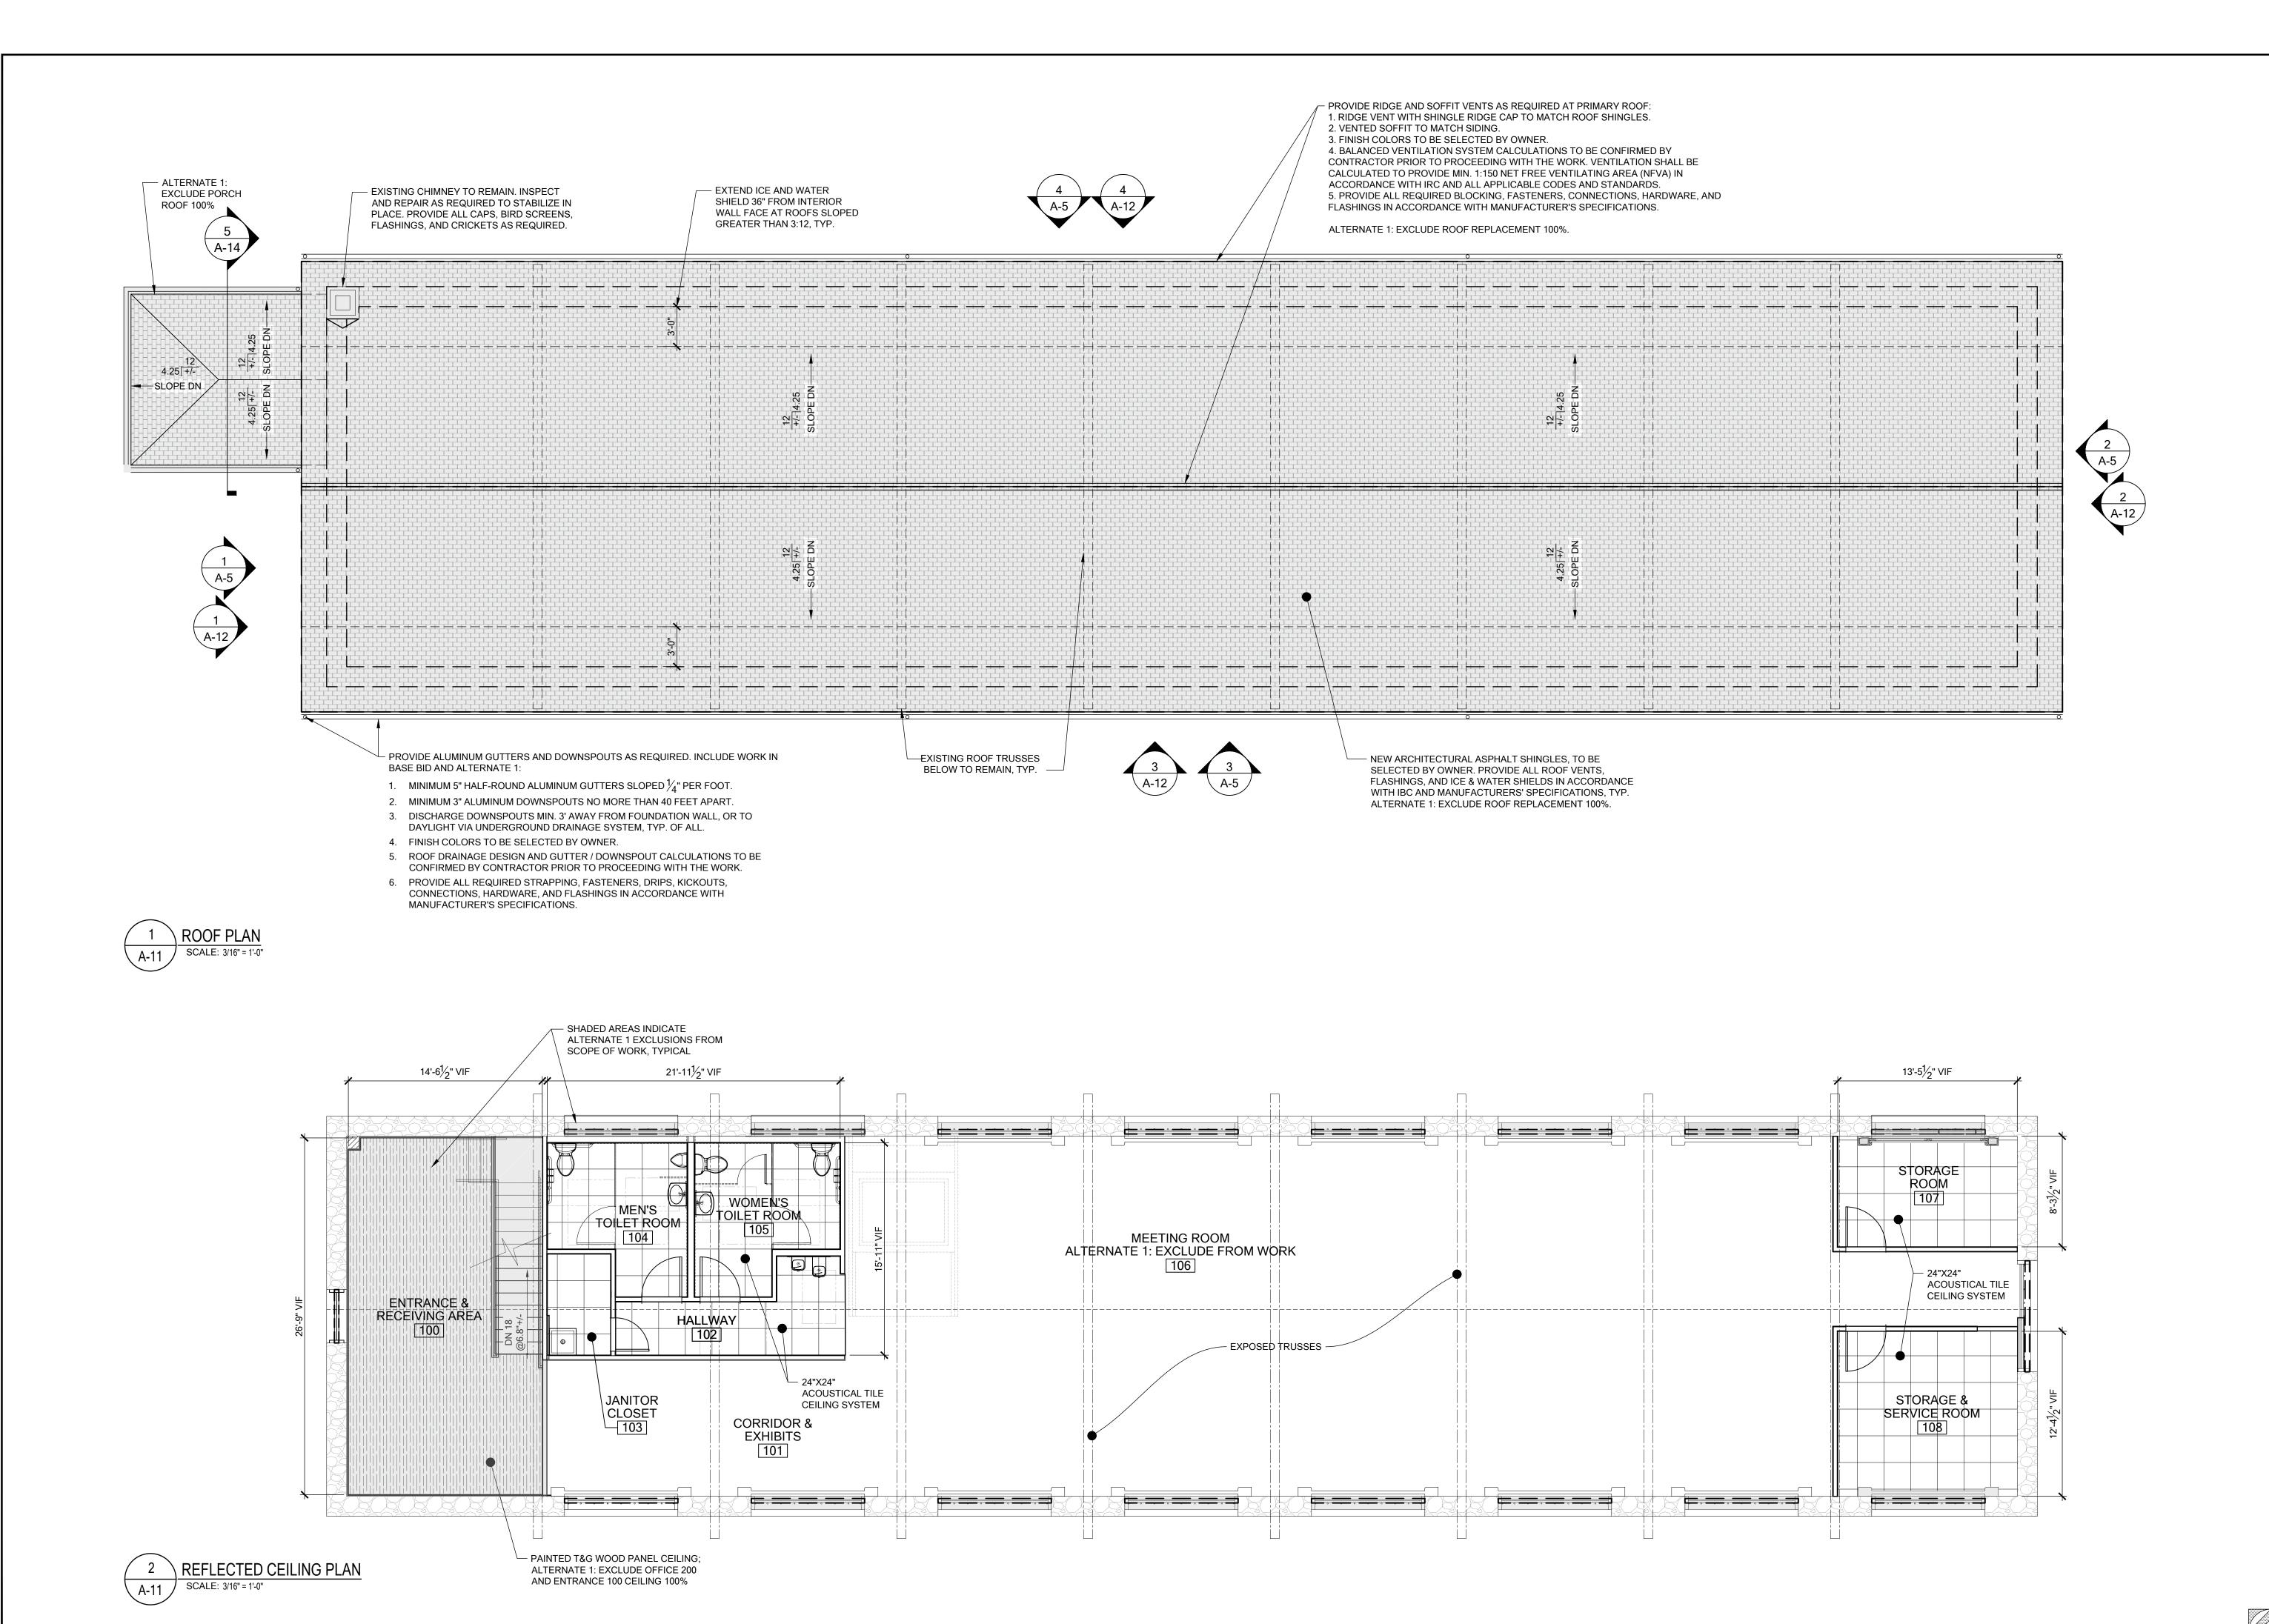

rchitecture Preservation o. Box 544, Elverson, PA 19520 c@village-architecture.com 0.389.9387/village-architecture.com

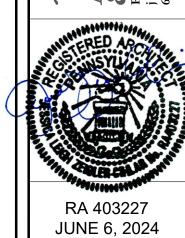



Lansdale Freight House 111 S. Broad Street, Lansdale, Pennsylvania 1946 BUILDING REHABILITATION

JUNE 6, 2024
ISSUED FOR BID
AND PERMIT

ROOF AND REFLECTED CEILING PLANS

A-11

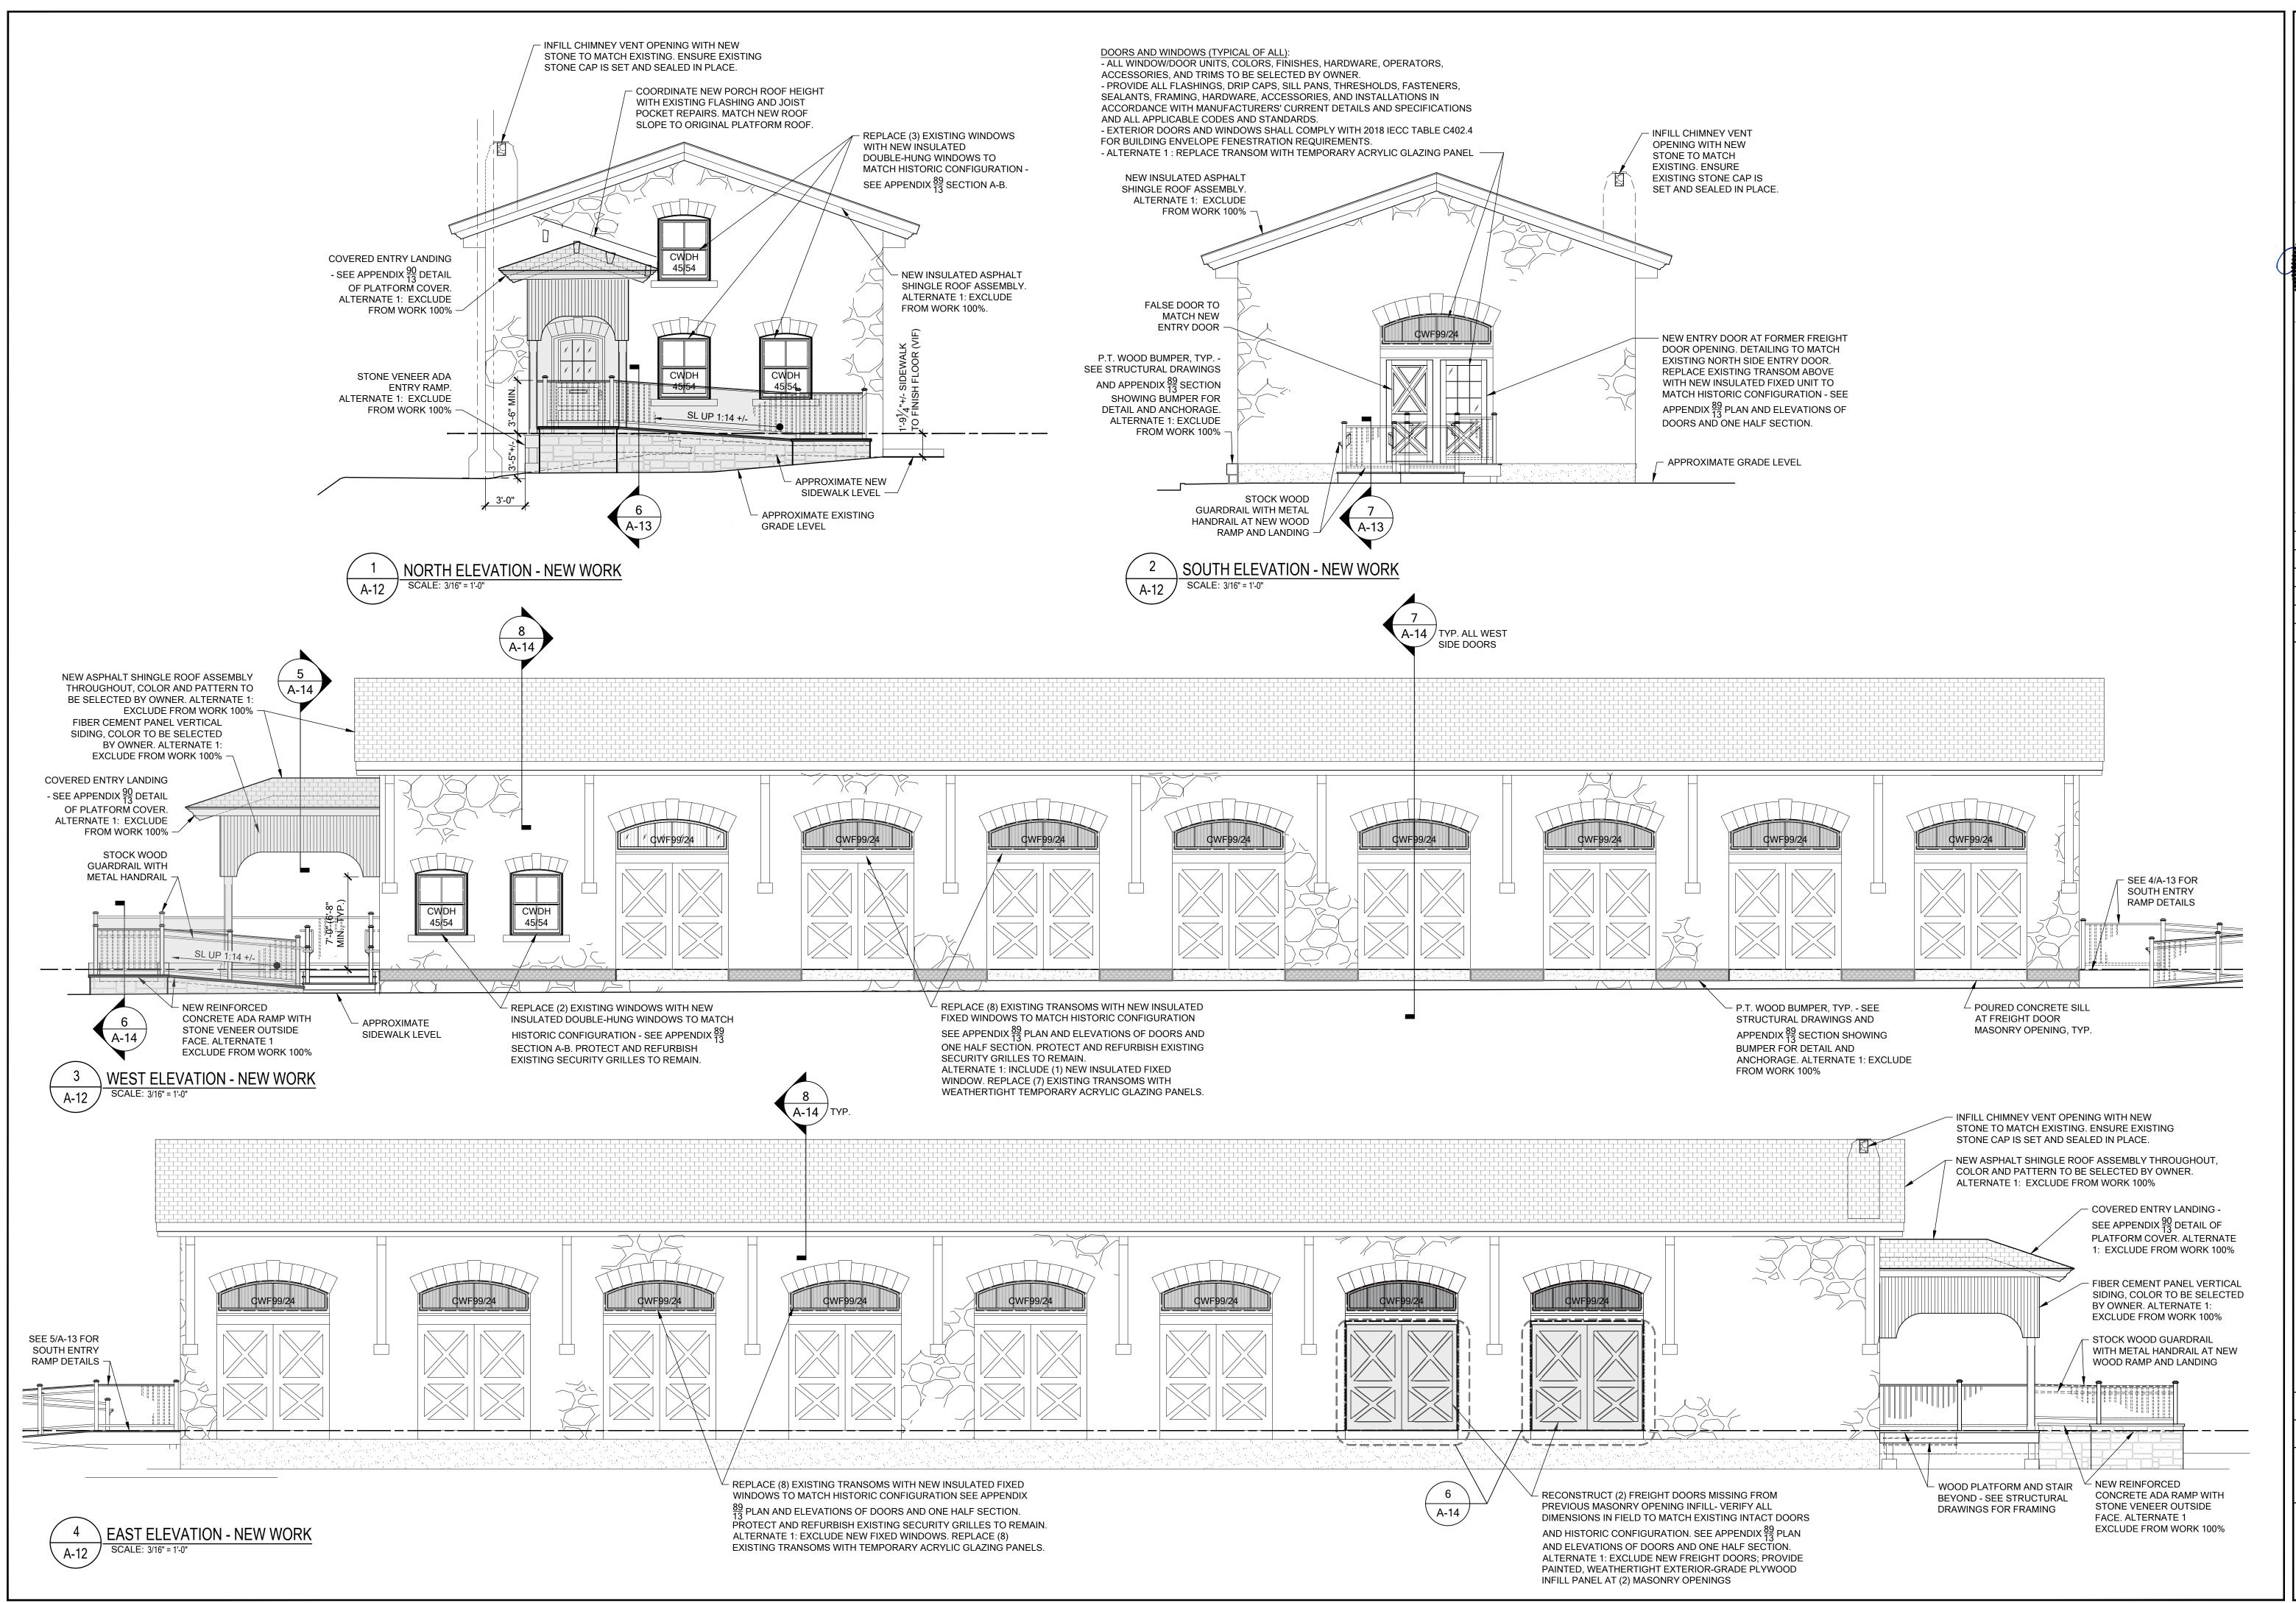

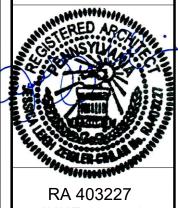


JUNE 6, 2024


House REHABILITATION

ansdale BUILDIN

JUNE 6, 2024 ISSUED FOR BID AND PERMIT

NEW WORK ELEVATIONS AND DETAILS

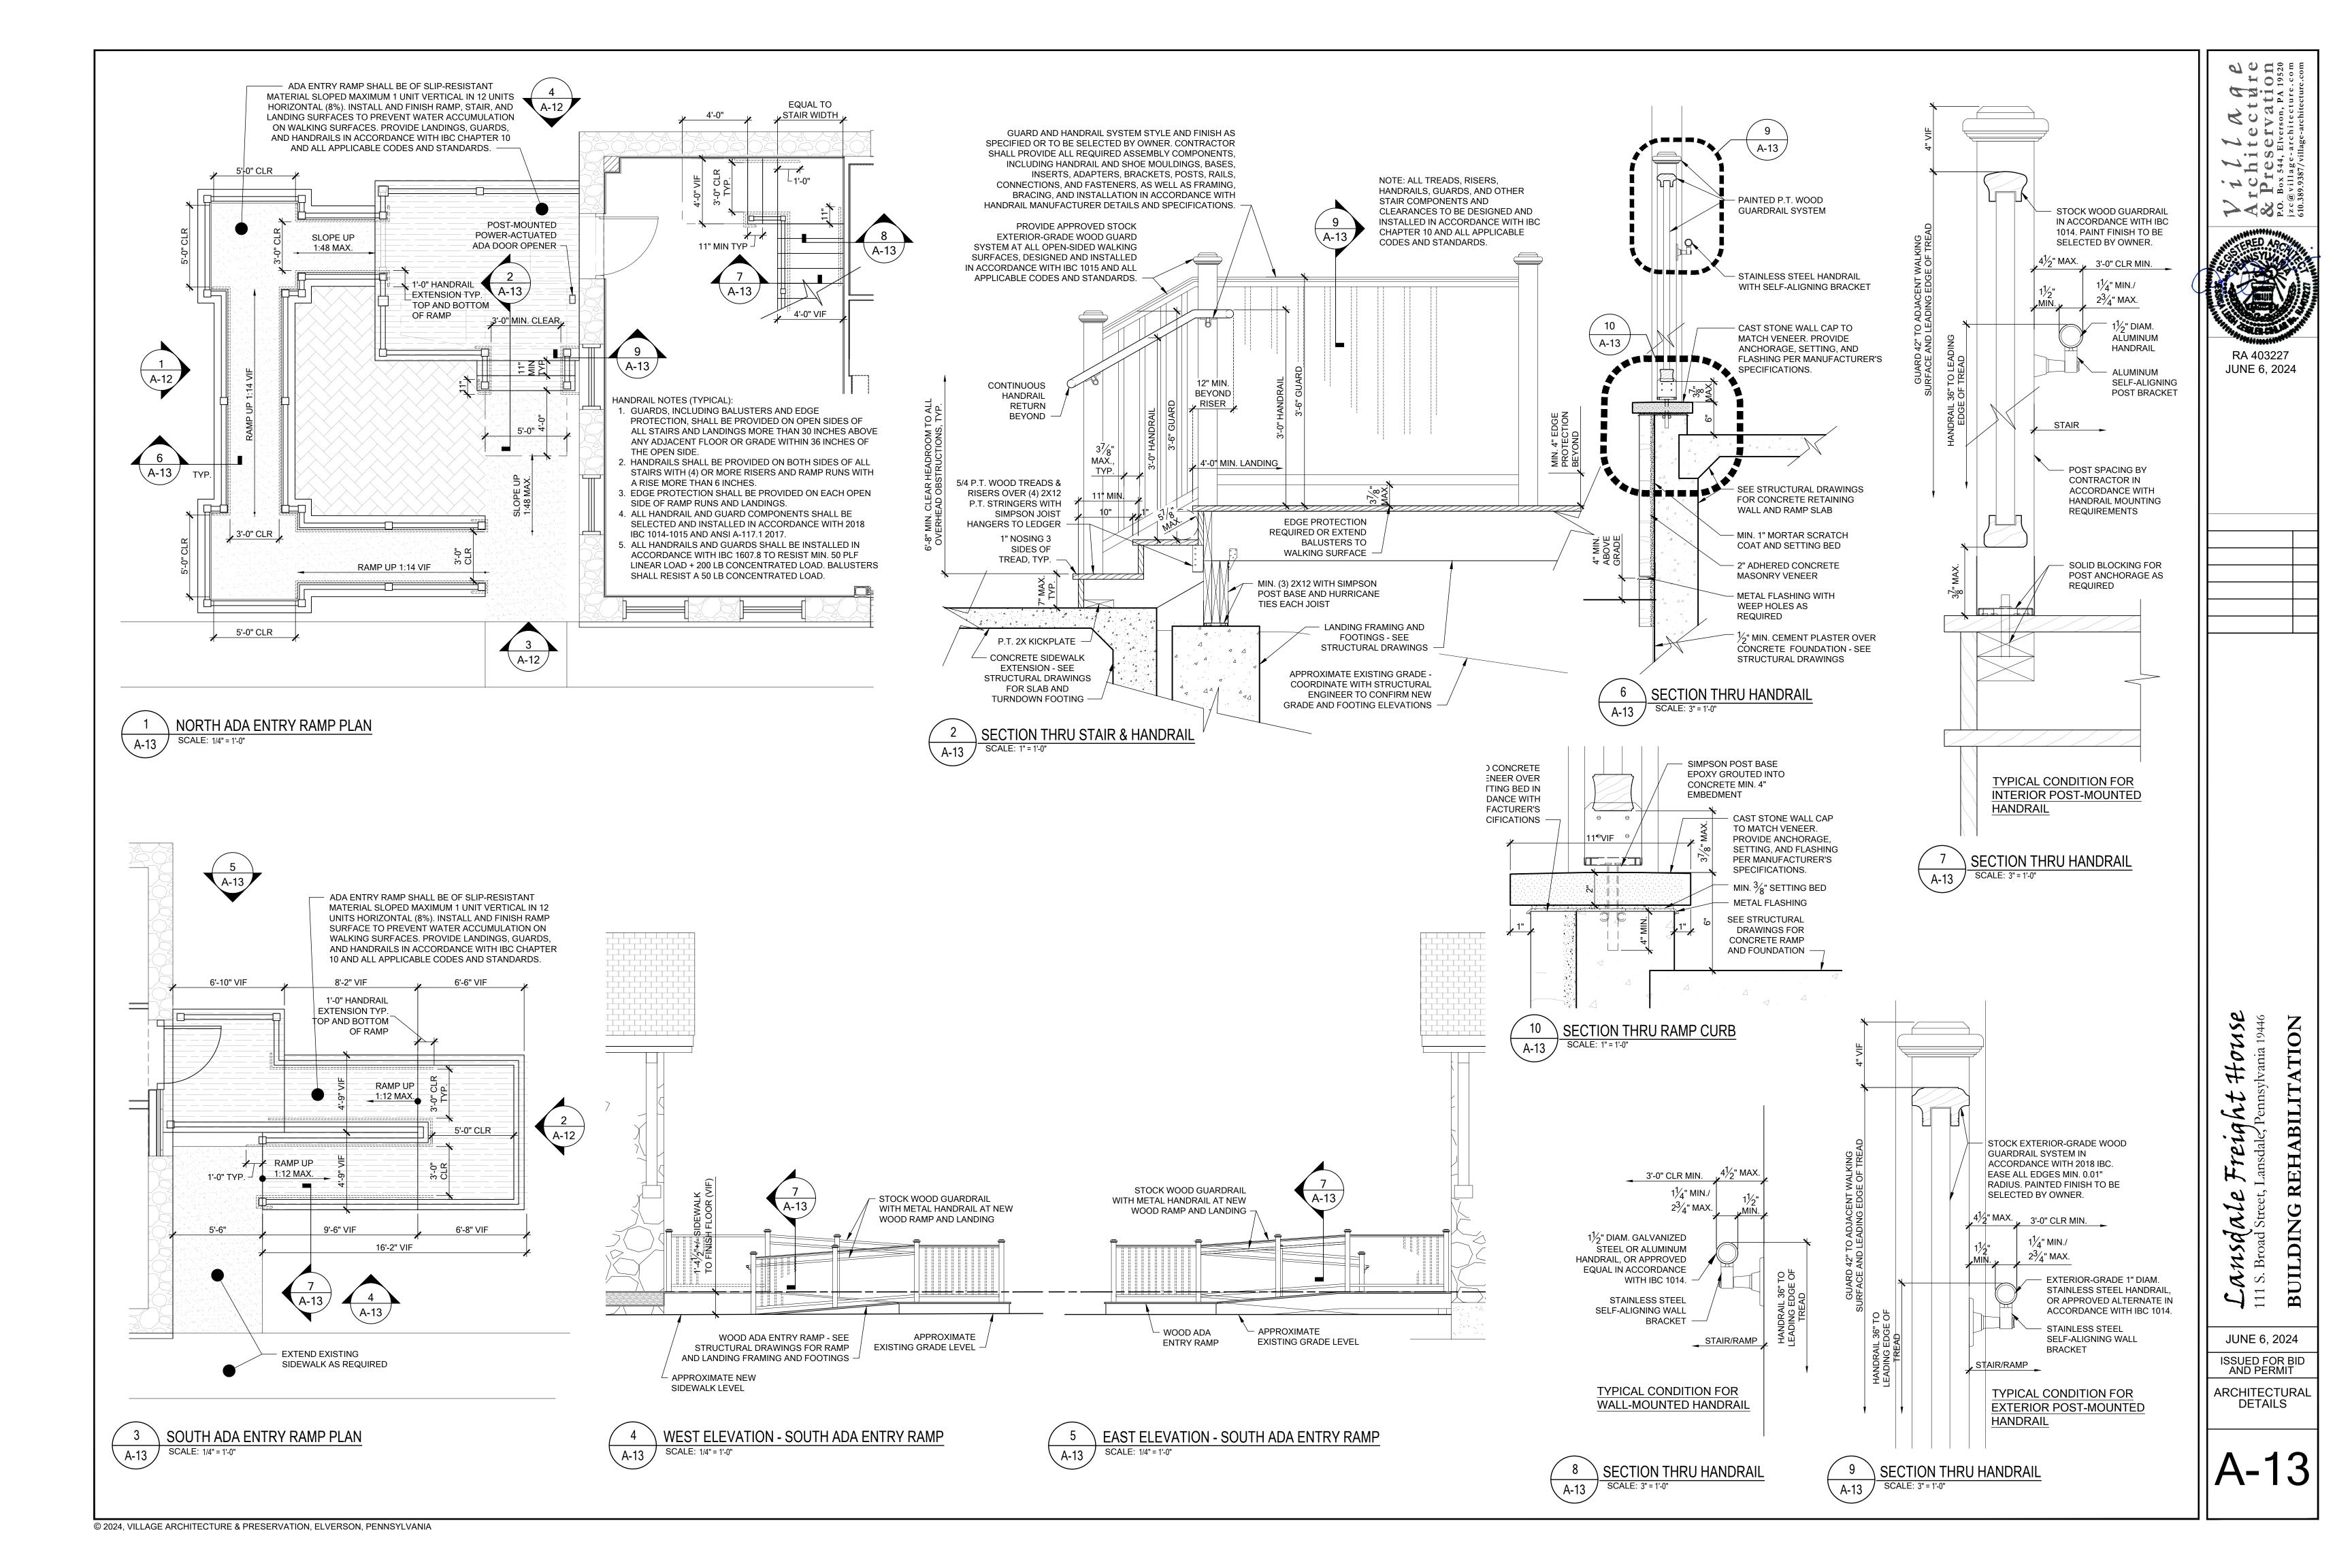

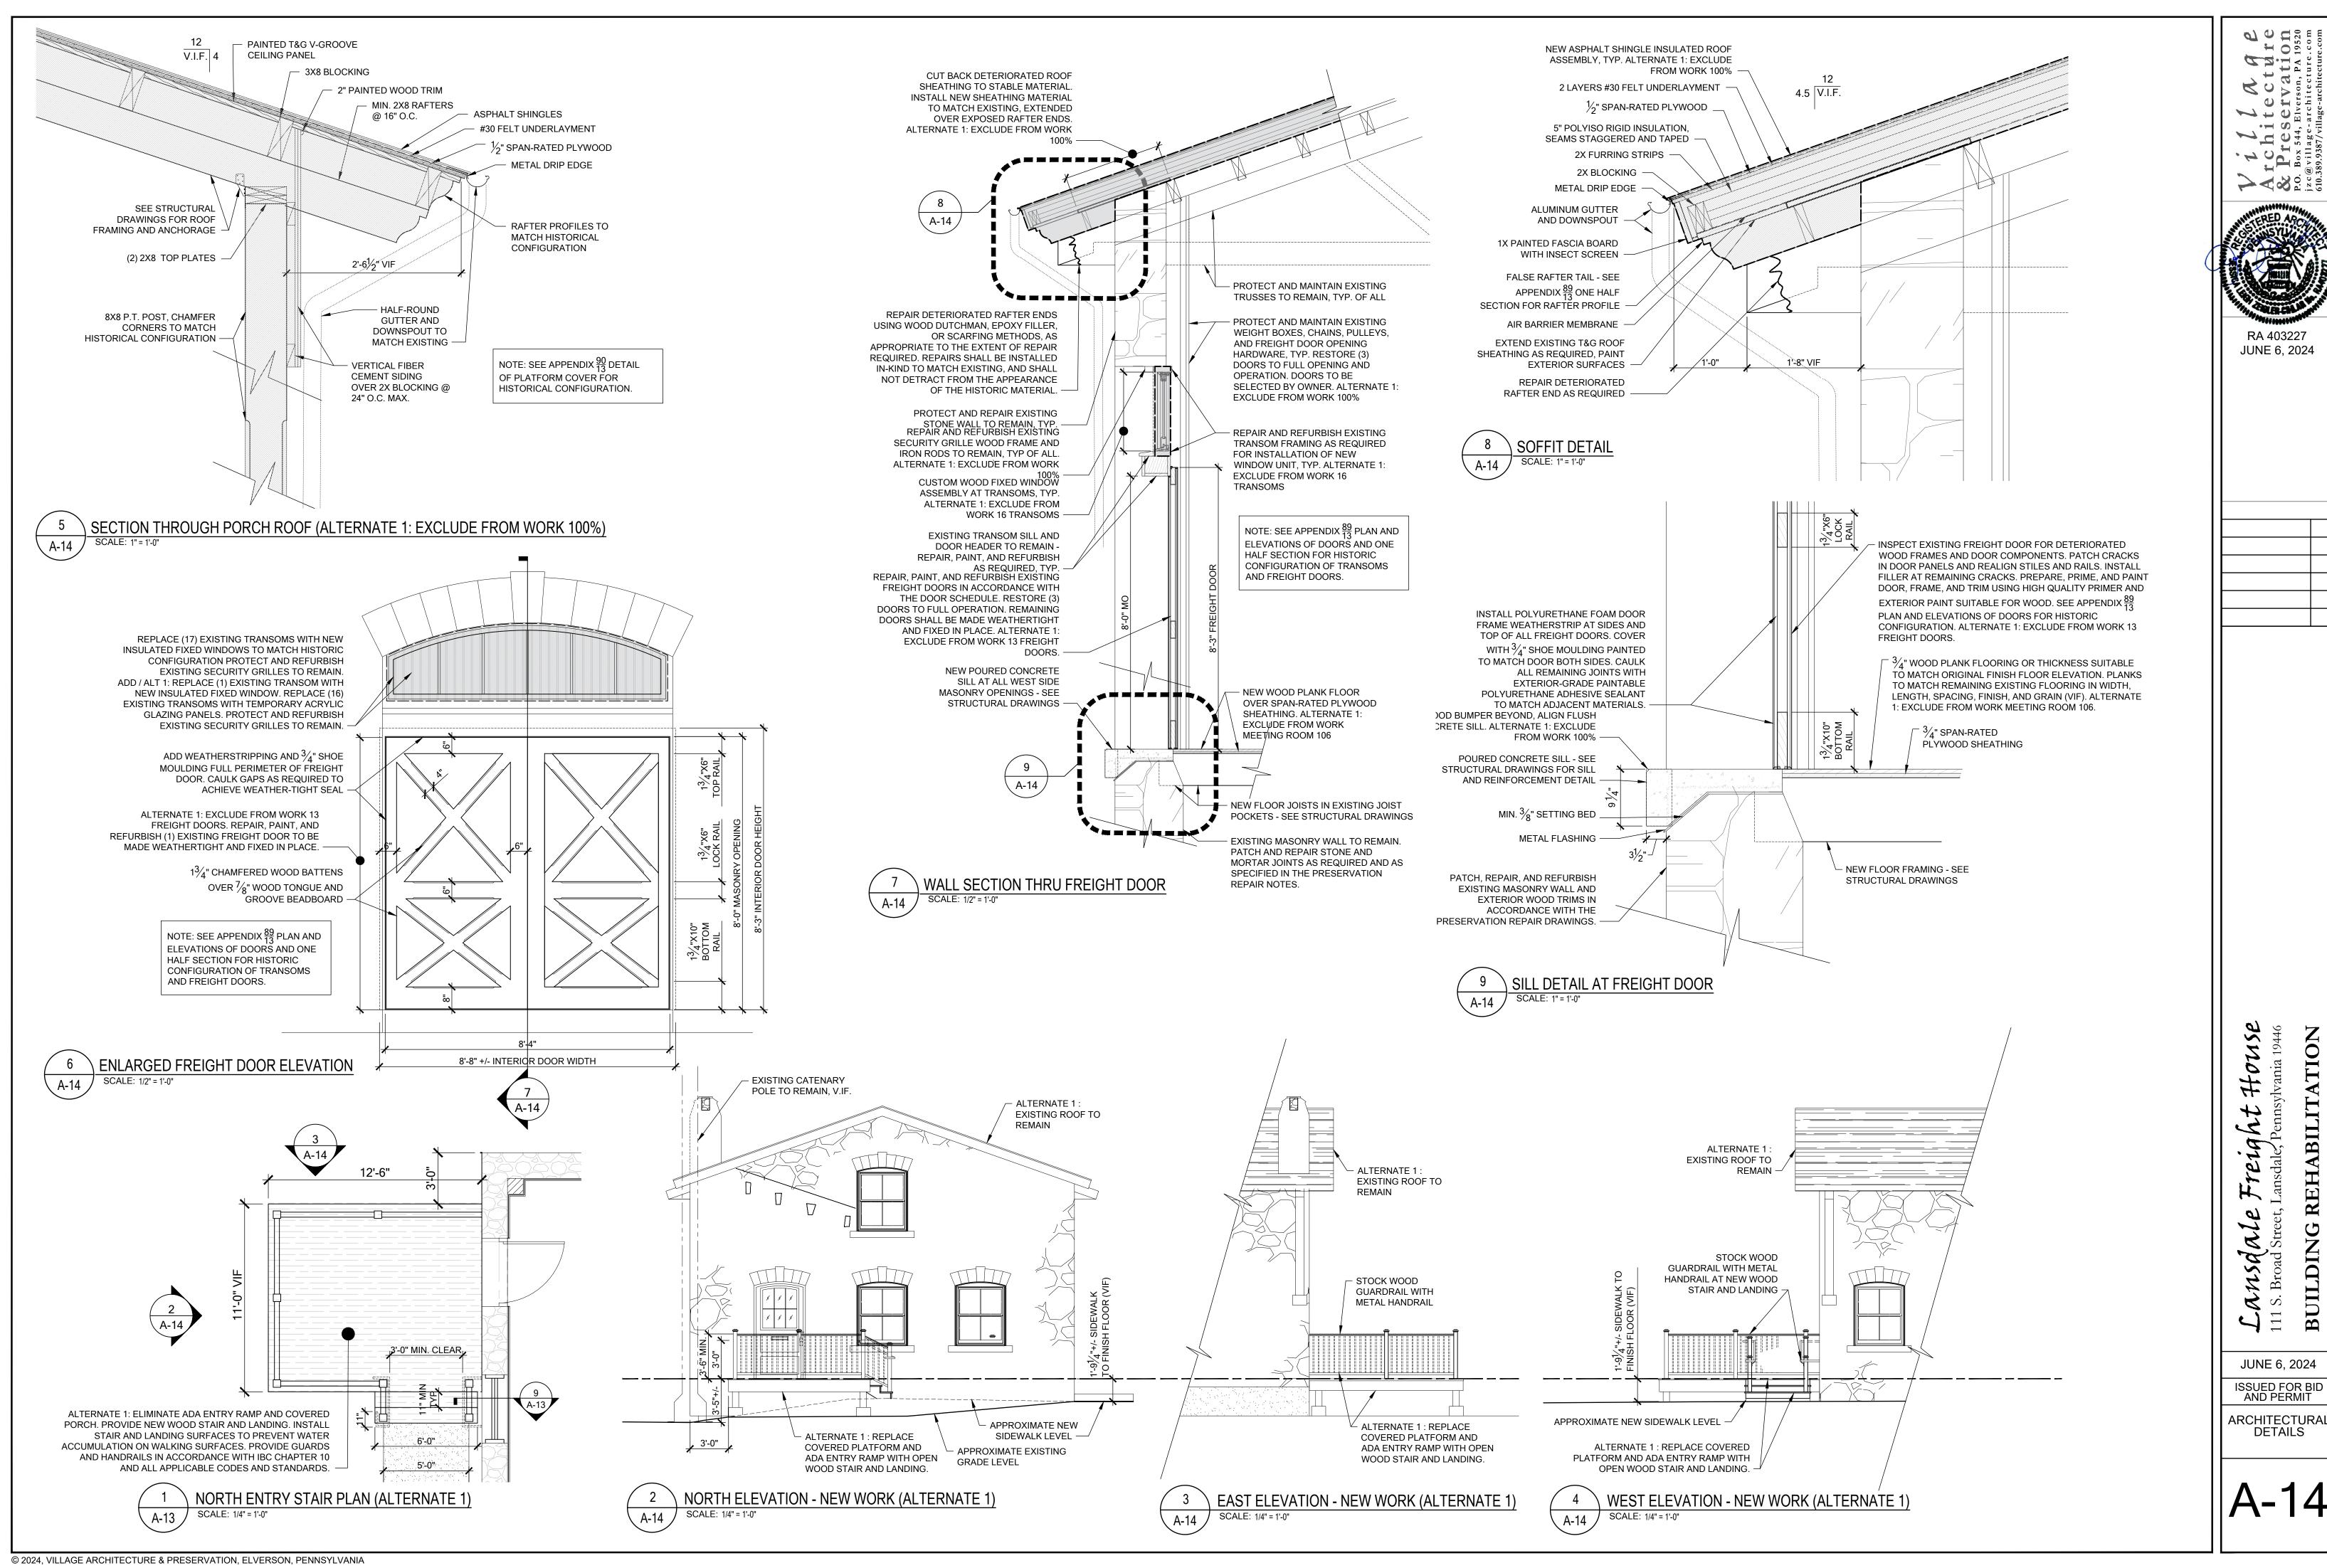

F

 \cdot


RA 403227

JUNE 6, 2024

REHABILITATION

BUILDIN

DETAILS

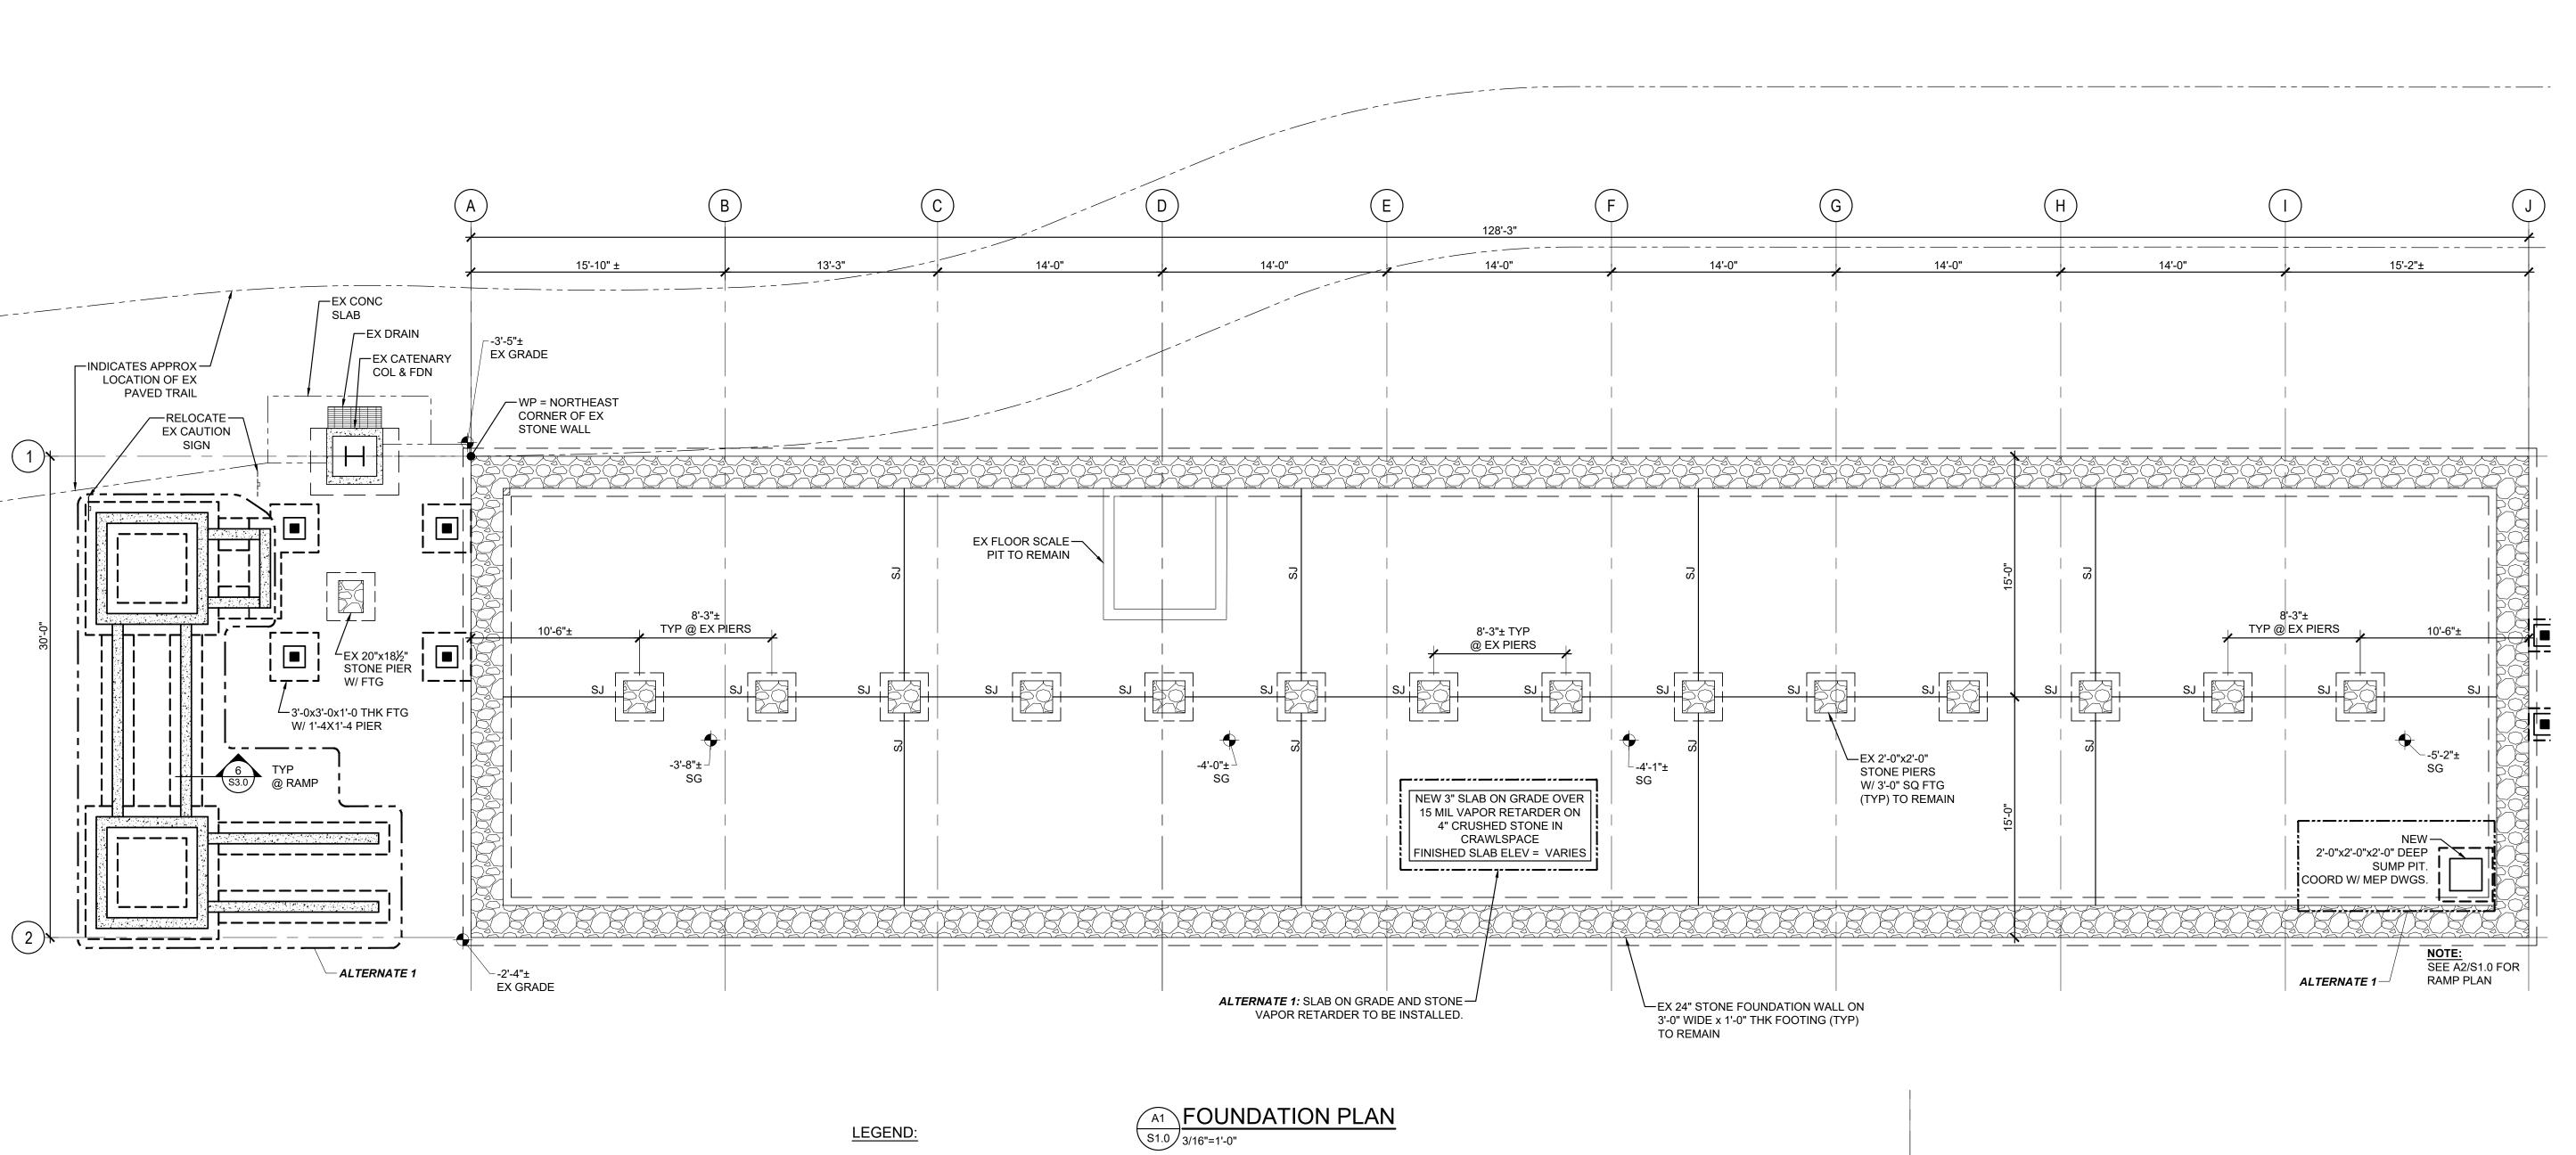

STUD LOAD BEARING INTERIOR
 WALLS ABOVE

2. STUD LOAD BEARING INTERIOR

3. ——I HANGER

4. ← → JOIST SPAN DIRECTION

5. POST


6. POST LOAD FROM ABOVE

NOTES:

- 1. DATUM = MAIN LEVEL FINISHED FLOOR = (+0'-0"). GC TO DETERMINE FIN FLOOR ELEVATION ON INITIAL SURVEY OF EXISTING CONDITIONS (GRADE VARIES).
- CONTRACTOR TO FIELD VERIFY SIZE AND CONFIGURATION OF ALL EXISTING CONDITIONS PRIOR TO START OF CONSTRUCTION.
- 3. SG INDICATES APPROXIMATE EXISTING SUBGRADE.
- 4. EX DENOTES EXISTING.
- 5. SJ INDICATES SLAB CONSTRUCTION OR SHRINKAGE JOINT. REFER S3.0 FOR TYPICAL SLAB DETAILS.
- 6. BOTTOM OF NEW EXTERIOR FOOTINGS ARE SHOWN AT 3'-0" MINIMUM BELOW FINISHED GRADE. COORDINATE WITH FINAL GRADES TO MAINTAIN THE 3'-0" FROST DEPTH.
- 7. LOWER BOTTOM OF FOOTING ELEVATIONS AS REQUIRED WHERE NEW UTILITIES CROSS UNDER WALL FOOTINGS.
- 8. EXISTING UTILITIES WITHIN THE EXISTING BUILDING TO BE ABANDONED, ARE TO BE REMOVED IN THEIR ENTIRETY
- 9. COORDINATE EXTENT OF REPAIR WORK WITH ARCHITECTURAL DRAWINGS.
- 10. COORDINATE ALL DIMENSIONS AND NEW CONSTRUCTION LAYOUT WITH ARCHITECTURAL DRAWINGS.
- 11. COORDINATE EXISTING STONE LOCATIONS AND EXTENTS WITH ARCHITECTURAL DRAWINGS.

13. EXISTING FOUNDATIONS SHOWN ON THIS DRAWING ARE SCHEMATIC ONLY AND HAVE NOT BEEN FIELD

- 12. DO NOT UNDERMINE EXISTING WALL & PIER FOOTINGS WITH EXCAVATION FOR CRAWLSPACE SLAB. CONTACT ENGINEER TO REVIEW CONDITIONS IF EXCAVATION WILL EXTEND BELOW EXISTING FOUNDATIONS.
- VERIFIED.
- 14. EXISTING FOUNDATION INFORMATION IS BASED ON LIMITED FIELD SURVEY PERFORMED BY RING CONSULTING GROUP, P.C., AND "FREIGHT HOUSE AT LANSDALE" DRAWINGS BY PHILADELPHIA & READING RAILWAY COMPANY CHIEF ENGINEERS OFFICE, DATED FEBRUARY 24TH, 1902.
- 15. COORDINATE W/ DRAWINGS C-0.2 FOR ALTERNATES.

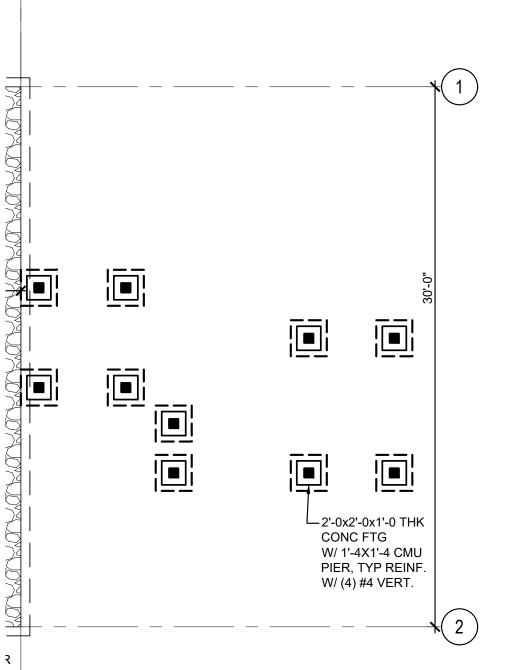


REAR RAMP FOUNDATION PLAN
3/16"=1'-0"



STRUCTURAL ENGINEERING
PROJECT MANAGEMENT
512 WEST THIRD STREET
LANSDALE PENNSYLVANIA 19446

T: 215.361.2301 INFO@RINGCONSULTING.COM

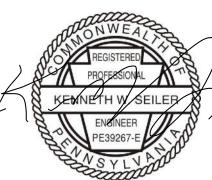

ELECTRONICALLY APPLIED 06/06/2024

KENNETH W. SEILER, P.E.
PA LICENSE #PE-039267-E

© Ring Consulting Group, P.C.
These documents are property of Ring
Consulting Group, P.C. and may not be used
without explicit permission. It is a violation of the
law for any person, unless acting under the
direction of Ring Consulting Group, P.C., to alter
these plans in any way.

- 06-06-2024 BID & PERMIT
REV DATE DESCRIPTION

DISCOVER LANSDALE

PO BOX 1112 LANSDALE, PA 19446

PROJECT

CLIENT

LANSDALE
FREIGHT HOUSE
BUILDING
REHABILITATION

111 S. BROAD STREET LANSDALE, PA 19446

DRAWING TITLE

DRAWN BY

CHECKED BY

KWS

DATE

1-26-2024

SCALE


AS NOTED

PROJECT NO.

16-1435

FOUNDATION PLAN

DRAWING NO.

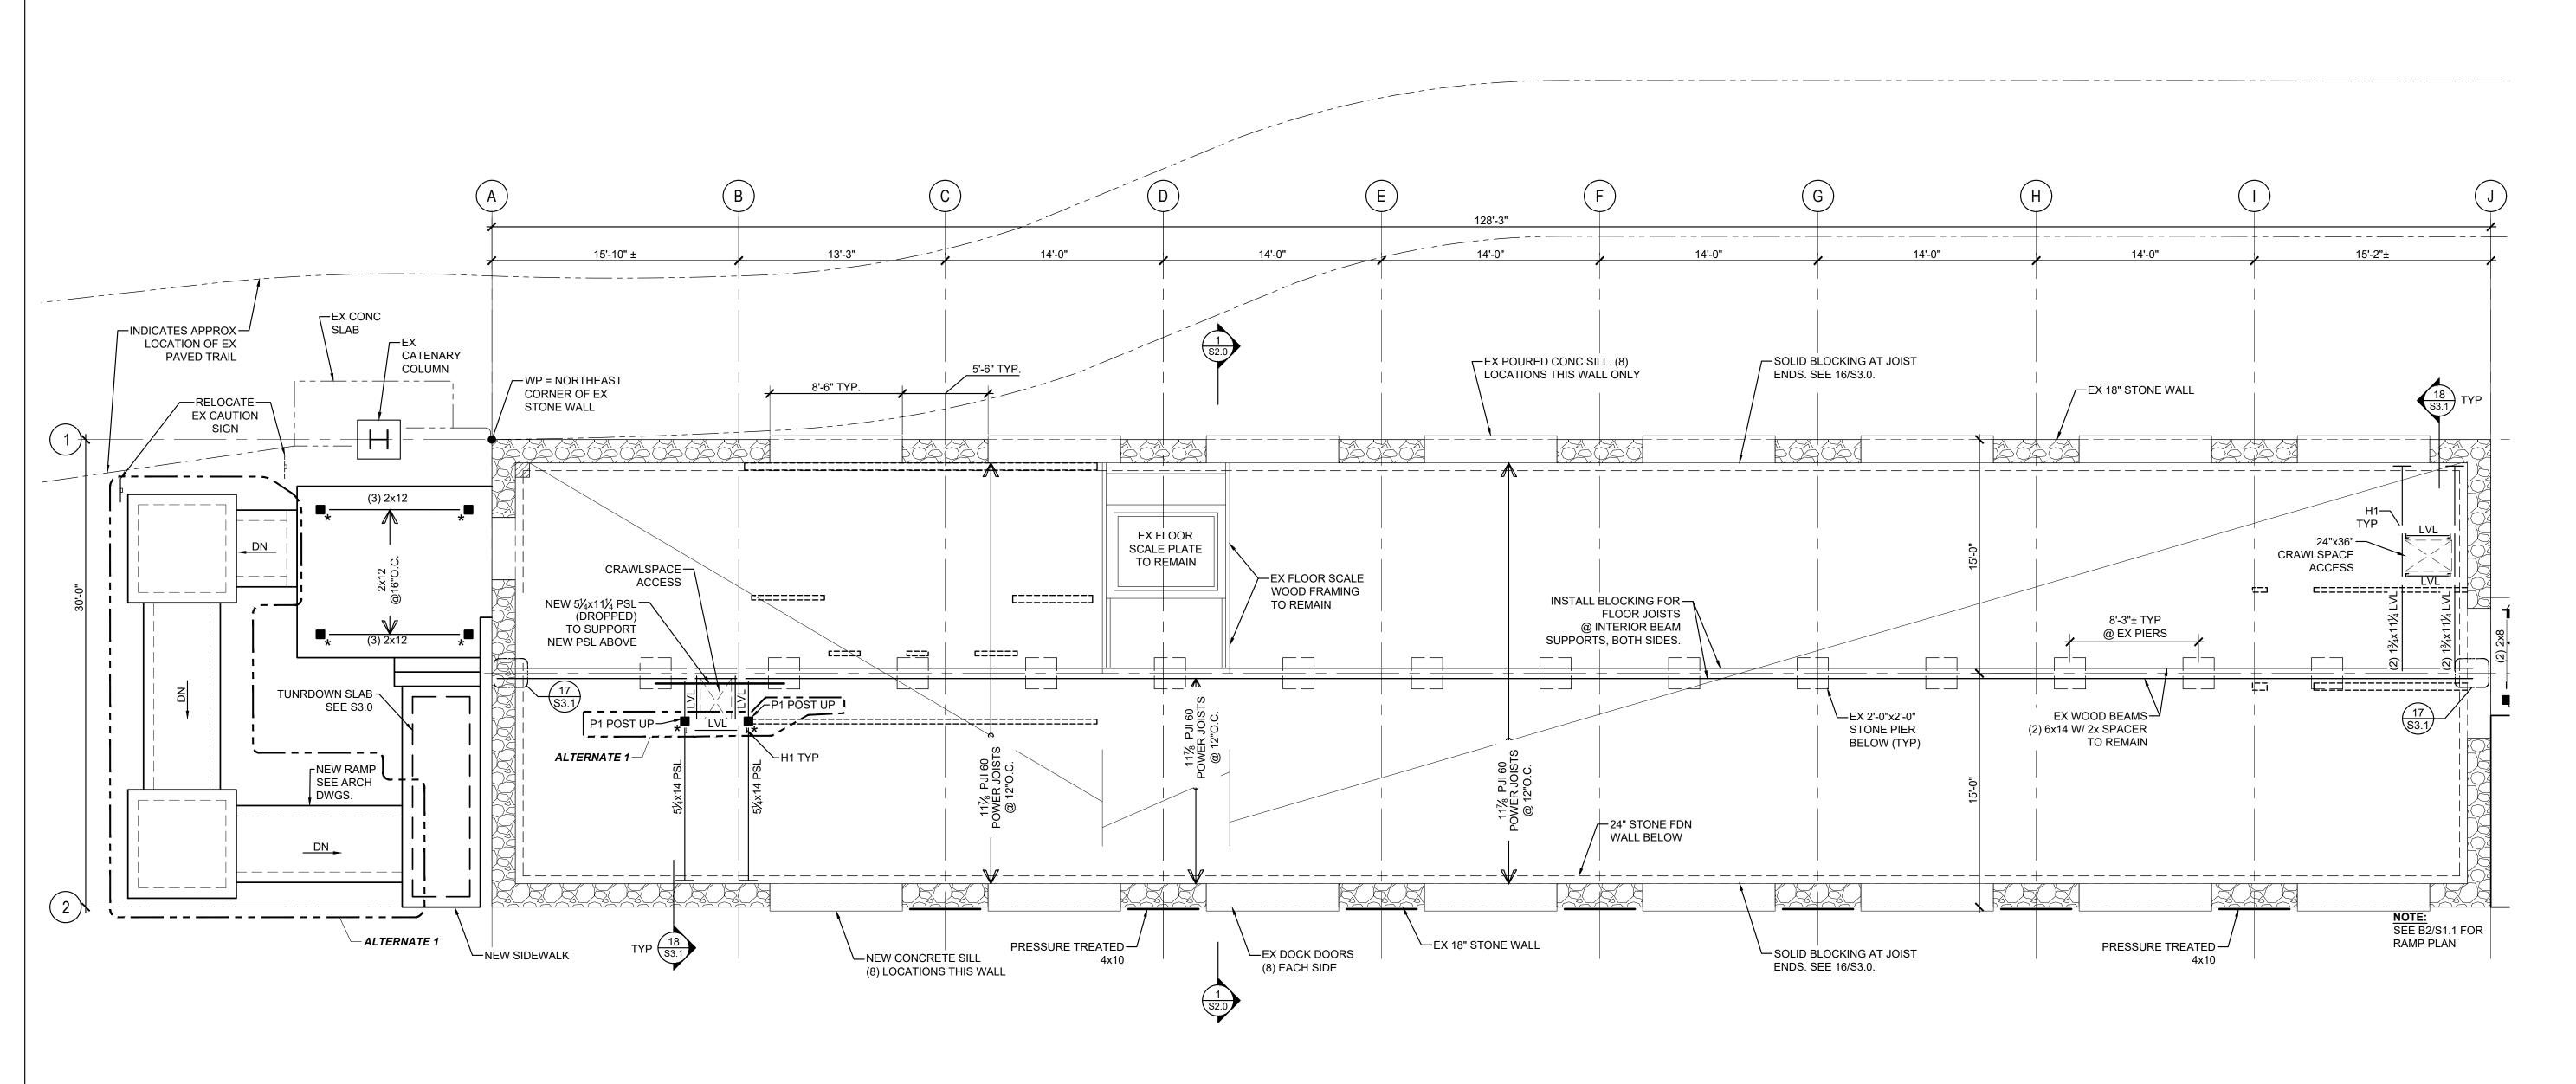

HANGER SCHEDULE		
TAG	TYPE	NOTES
H1	HUS1.81/10	TYP @ 1¾x11¼ LVL
H2	LBV1.81/9.25	TYP @ 1¾x9¼ LVL
НЗ	SIMPSON LU JOIST HANGER	TYP @ CJ TO STONE

POST SCHEDULE			
TAG	TYPE	NOTES	
P1	51/4×51/4 PSL POST	POST CAP (TYP): SIMPSON ECCQ POST CAP	
P2	6x6 PT POST	POST BASE (TYP): SIMPSON PBS STANDOFF POST BASE, GALVANIZED	


<u>LEGEND:</u>

- 1. [___] STUD LOAD BEARING INTERIOR WALLS ABOVE
- 2. STUD LOAD BEARING INTERIOR
- 3. ——ı HANGER
- 4. ← → JOIST SPAN DIRECTION
- 5. POST
- 6. POST LOAD FROM ABOVE

FIRST FLOOR FRAMING PLAN

\$1.1 3/16"=1'-0"

- DATUM = MAIN LEVEL FINISHED FLOOR = (+0'-0"). GC TO DETERMINE FIN FLOOR ELEVATION ON INITIAL SURVEY OF EXISTING CONDITIONS (GRADE VARIES).
- CONTRACTOR TO FIELD VERIFY SIZE AND CONFIGURATION OF ALL EXISTING CONDITIONS PRIOR TO START OF CONSTRUCTION.
- COORDINATE W/ ARCHITECTURAL DRAWINGS FOR TOP OF FLOOR FRAMING ELEVATIONS TO ACCOMMODATE SUBFLOOR AND FINISHES.
- 4. EX DENOTES EXISTING.
- 5. FJ DENOTES FLOOR JOIST.
- 6. LVL DENOTES LAMINATED VENEER LUMBER.
- 7. PSL DENOTES PARALLAM BEAM.
- 8. POST SIZES ARE AS INDICATED ON THE PLANS. MINIMUM POST SIZE SHALL CONSIST OF A DOUBLE WALL STUD AS FOLLOWS (UNLESS NOTED OTHERWISE):
 - a. 2x8 WALL = (2) 2x8 POST
 - b. 2x6 WALL = (2) 2x6 POSTc. 2x4 WALL = (2) 2x4 POST
- 9. PROVIDE BLOCKING AT FLOOR VENTS. COORDINATE VENT LOCATIONS WITH MECHANICAL CONTRACTOR.
- 10. COORDINATE LOCATION OF FLOOR FRAMING W/STAIR FOR POST LOCATIONS.
- 11. COORDINATE EXTENT OF REPAIR WORK WITH ARCHITECTURAL DRAWINGS.
- 12. COORDINATE ALL DIMENSIONS AND NEW BUILDING LAYOUT WITH ARCHITECTURAL DRAWINGS.
- 13. COORDINATE EXISTING STONE LOCATIONS AND EXTENTS WITH ARCHITECTURAL DRAWINGS.
- DO NOT CUT EXISTING FLOOR BEAMS. CONSULT ARCHITECT/ENGINEER FOR FIELD CONDITION & REVIEW AS REQUIRED.
- 15. FIELD VERIFY SIZE, DEPTH AND EXTENTS OF ALL EXISTING FRAMING AND JOIST POCKET CONDITIONS PRIOR TO START OF CONSTRUCTION. EXISTING FRAMING SHOWN ON THIS DRAWING IS SCHEMATIC ONLY AND HAS NOT BEEN FIELD VERIFIED.
- 16. EXISTING FRAMING INFORMATION IS BASED ON LIMITED FIELD SURVEY PERFORMED BY RING CONSULTING GROUP, P.C., AND "FREIGHT HOUSE AT LANSDALE" DRAWINGS BY PHILADELPHIA & READING RAILWAY COMPANY CHIEF ENGINEERS OFFICE, DATED FEBRUARY 24TH, 1902.
- 17. COORDINATE W/ DRAWINGS C-0.2 FOR ALTERNATES.

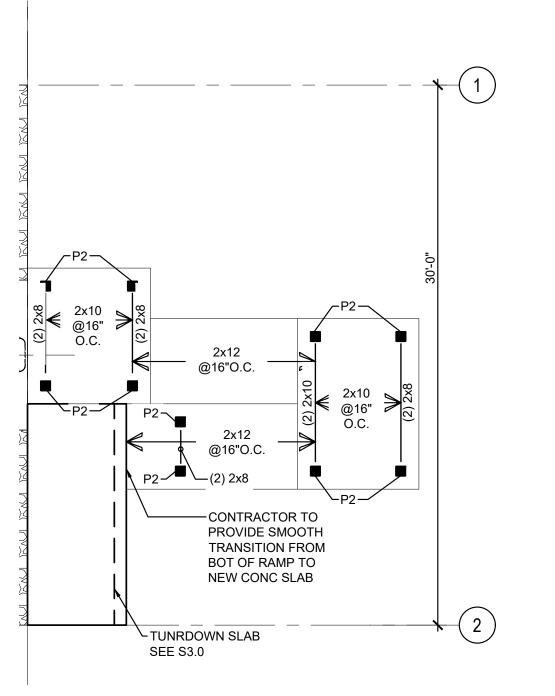


REAR RAMP FRAMING PLAN
3/16"=1'-0"



RING CONSULTING GROUP, P.C.

STRUCTURAL ENGINEERING PROJECT MANAGEMENT 512 WEST THIRD STREET LANSDALE PENNSYLVANIA 19446 T: 215.361.2301

INFO@RINGCONSULTING.COM

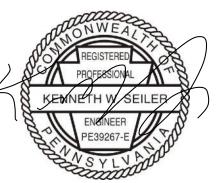

ELECTRONICALLY APPLIED 06/06/2024
KENNETH W. SEILER, P.E.
PA LICENSE #PE-039267-E

© Ring Consulting Group, P.C.
These documents are property of Ring
Consulting Group, P.C. and may not be used
without explicit permission. It is a violation of the
law for any person, unless acting under the
direction of Ring Consulting Group, P.C., to alter
these plans in any way.

- 06-06-2024 BID & PERMIT
REV DATE DESCRIPTION

DISCOVER LANSDALE

PO BOX 1112 LANSDALE, PA 19446

PROJECT

CLIENT

LANSDALE FREIGHT HOUSE BUILDING REHABILITATION

111 S. BROAD STREET LANSDALE, PA 19446

DRAWN BY

CHECKED BY

KWS

DATE

1-26-2024

SCALE

AS NOTED


PROJECT NO.

16-1435

FIRST FLOOR FRAMING PLAN

DRAWING NO.

DRAWING TITLE

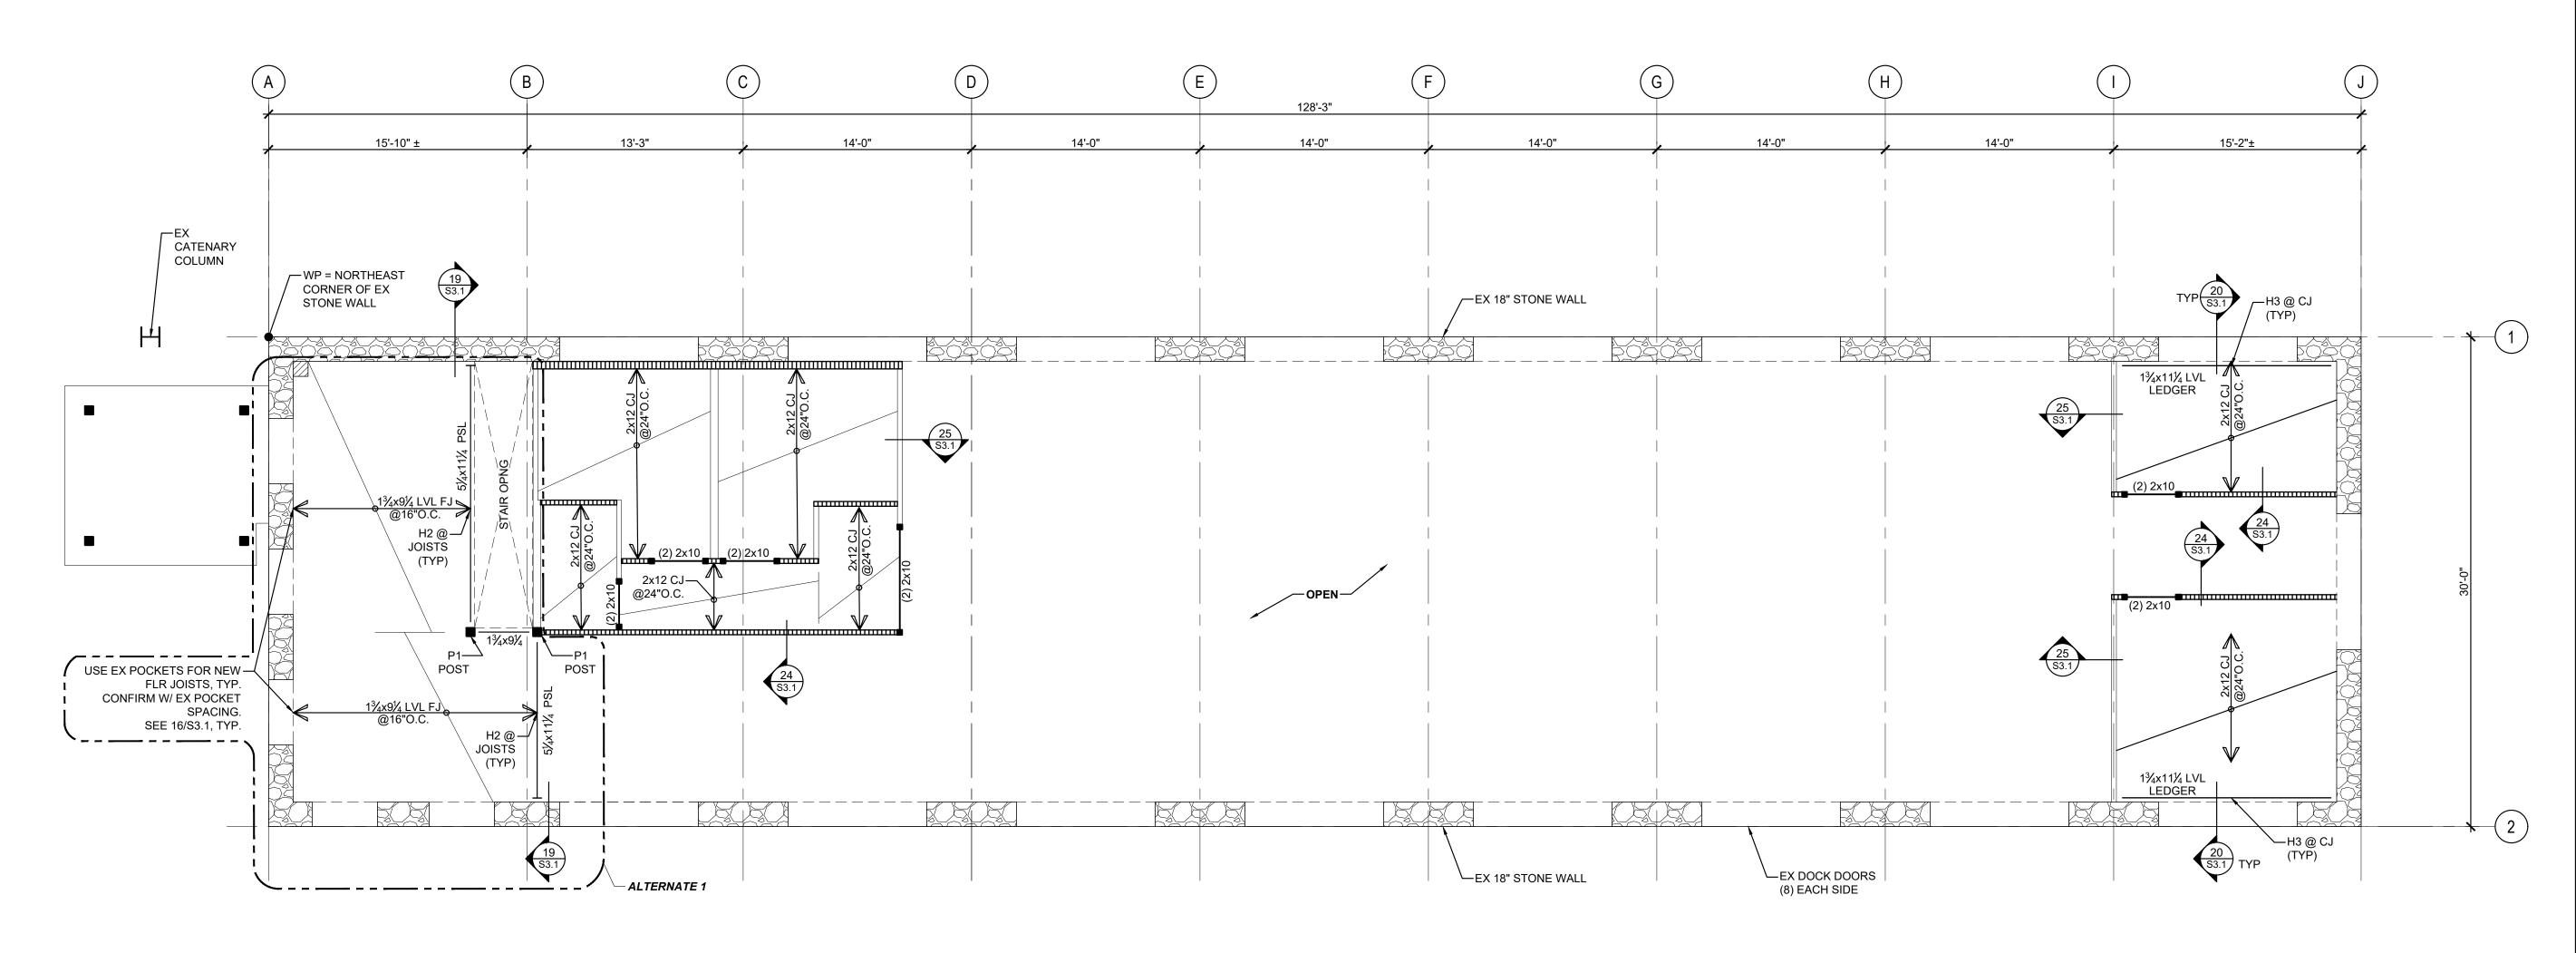

HANGER SCHEDULE		
TAG	TYPE	NOTES
H1	HUS1.81/10	TYP @ 1¾x11¼ LVL
H2	LBV1.81/9.25	TYP @ 1¾x9¼ LVL
НЗ	SIMPSON LU JOIST HANGER	TYP @ CJ TO STONE

POST SCHEDULE			
TAG	TYPE	NOTES	
P1	5¼x5¼ PSL POST	POST CAP (TYP): SIMPSON ECCQ POST CAP	
P2	6x6 PT POST	POST BASE (TYP): SIMPSON PBS STANDOFF POST BASE, GALVANIZED	

© MEZZANINE & CEILING FRAMING PLAN

S1.2 3/16"=1'-0"

NOTES:

- 1. DATUM = MAIN LEVEL FINISHED FLOOR = (+0'-0"). GC TO DETERMINE FIN FLOOR ELEVATION ON INITIAL SURVEY OF EXISTING CONDITIONS (GRADE VARIES).
- CONTRACTOR TO FIELD VERIFY SIZE AND CONFIGURATION OF ALL EXISTING CONDITIONS PRIOR TO START OF CONSTRUCTION
- 3. COORDINATE W/ ARCHITECTURAL DRAWINGS FOR TOP OF FLOOR FRAMING ELEVATIONS TO ACCOMMODATE SUBFLOOR AND FINISHES.
- 4. EX DENOTES EXISTING.
- 5. CJ DENOTES CEILING JOIST.
- 6. FJ DENOTES FLOOR JOIST.
- 7. LVL DENOTES LAMINATED VENEER LUMBER.
- 8. PSL DENOTES PARALLAM BEAM.
- 9. POST SIZES ARE AS INDICATED ON THE PLANS. MINIMUM POST SIZE SHALL CONSIST OF A DOUBLE WALL STUD
- AS FOLLOWS (UNLESS NOTED OTHERWISE):
 a. 2x8 WALL = (2) 2x8 POST
- b. 2x6 WALL = (2) 2x6 POST c. 2x4 WALL = (2) 2x4 POST
- 10. COORDINATE LOCATION OF FLOOR FRAMING W/STAIR FOR POST LOCATIONS.
- 11. COORDINATE EXTENT OF REPAIR WORK WITH ARCHITECTURAL DRAWINGS.
- 12. COORDINATE ALL DIMENSIONS AND NEW BUILDING LAYOUT WITH ARCHITECTURAL DRAWINGS.
- 13. COORDINATE EXISTING STONE LOCATIONS AND EXTENTS WITH ARCHITECTURAL DRAWINGS.
- 14. DO NOT CUT EXISTING FLOOR BEAMS. CONSULT ARCHITECT/ENGINEER FOR FIELD CONDITION & REVIEW AS REQUIRED.
- 15. FIELD VERIFY SIZE, DEPTH AND EXTENTS OF ALL EXISTING FRAMING AND JOIST POCKET CONDITIONS PRIOR TO START OF CONSTRUCTION. EXISTING FRAMING SHOWN ON THIS DRAWING IS SCHEMATIC ONLY AND HAS NOT BEEN FIELD VERIFIED.
- 16. EXISTING FRAMING INFORMATION IS BASED ON LIMITED FIELD SURVEY PERFORMED BY RING CONSULTING GROUP, P.C., AND "FREIGHT HOUSE AT LANSDALE" DRAWINGS BY PHILADELPHIA & READING RAILWAY COMPANY CHIEF ENGINEERS OFFICE, DATED FEBRUARY 24TH, 1902.
- 17. COORDINATE W/ DRAWINGS C-0.2 FOR ALTERNATES.

LEGEND:

- 1. [___] STUD LOAD BEARING INTERIOR WALLS ABOVE
- 2. STUD LOAD BEARING INTERIOR
- 3. ——I HANGER
- 4.

 JOIST SPAN DIRECTION
- 5. POST
- 6. POST LOAD FROM ABOVE

RING CONSULTING

GROUP, P.C.
STRUCTURAL ENGINEERING
PROJECT MANAGEMENT
512 WEST THIRD STREET


LANSDALE PENNSYLVANIA 19446
T: 215.361.2301
INFO@RINGCONSULTING.COM



ELECTRONICALLY APPLIED 06/06/2024

KENNETH W. SEILER, P.E.
PA LICENSE #PE-039267-E

© Ring Consulting Group, P.C.
These documents are property of Ring
Consulting Group, P.C. and may not be used
without explicit permission. It is a violation of the
law for any person, unless acting under the
direction of Ring Consulting Group, P.C., to alter
these plans in any way.

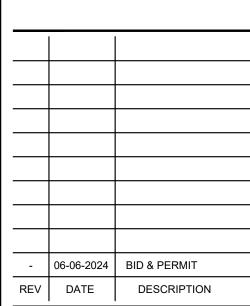

DISCOVER LANSDALE

PO BOX 1112 LANSDALE, PA 19446

PROJECT

CLIENT


LANSDALE
FREIGHT HOUSE
BUILDING
REHABILITATION

111 S. BROAD STREET LANSDALE, PA 19446

DRAWN BY	SDP
CHECKED BY	KWS
DATE	1-26-2024
SCALE	AS NOTED
PROJECT NO.	16-1435
DRAWING TITLE	

MEZZANINE & CEILING FRAMING PLAN

DRAWING NO.

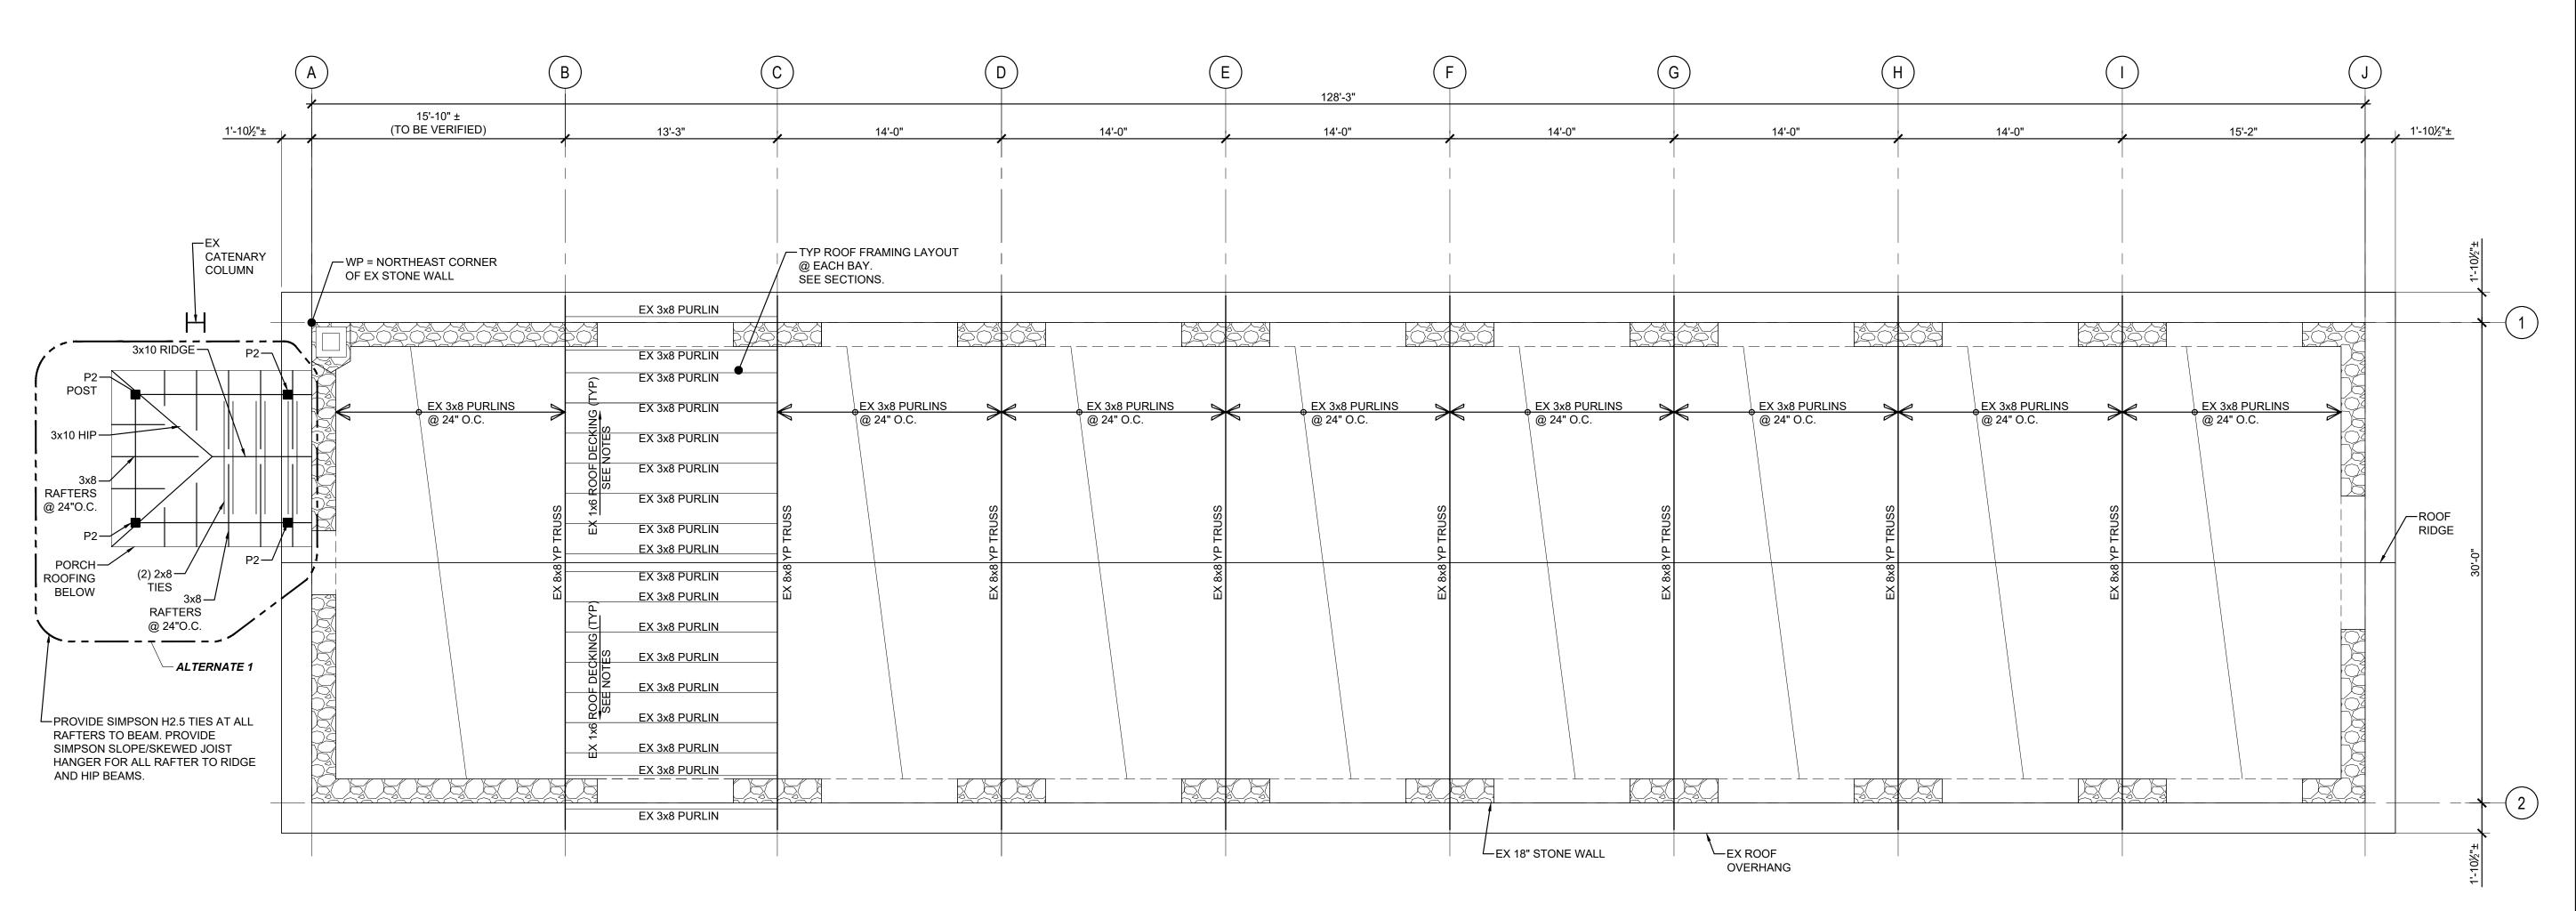

POST SCHEDULE			
TAG	TYPE	NOTES	
P1	5¼x5¼ PSL POST	POST CAP (TYP): SIMPSON ECCQ POST CAP	
P2	6x6 PT POST	POST BASE (TYP): SIMPSON PBS STANDOFF POST BASE, GALVANIZED	

POOF FRAMING PLAN 3/16"=1'-0"

NOTES:

- CONTRACTOR TO FIELD VERIFY SIZE AND CONFIGURATION OF ALL EXISTING CONDITIONS PRIOR TO START OF CONSTRUCTION.
- COORDINATE W/ ARCHITECTURAL DRAWINGS FOR TOP OF FLOOR FRAMING ELEVATIONS TO ACCOMMODATE SUBFLOOR AND FINISHES.
- 3. EX DENOTES EXISTING.
- 4. TOP OF ROOF FRAMING VARIES. REFER TO ARCHITECTURAL DRAWING FOR ELEVATIONS.
- 5. COORDINATE EXTENT OF REPAIR WORK WITH ARCHITECTURAL DRAWINGS.
- 6. COORDINATE ALL DIMENSIONS AND NEW BUILDING LAYOUT WITH ARCHITECTURAL DRAWINGS.
- 7. COORDINATE EXISTING STONE LOCATIONS AND EXTENTS WITH ARCHITECTURAL DRAWINGS.
- 8. DO NOT CUT EXISTING ROOF PURLINS OR TRUSSES. CONSULT ARCHITECT/ENGINEER FOR FIELD CONDITION & REVIEW AS REQUIRED.
- 9. FIELD VERIFY SIZE, DEPTH AND EXTENTS OF ALL EXISTING FRAMING PRIOR TO START OF CONSTRUCTION. EXISTING FRAMING SHOWN ON THIS DRAWING IS SCHEMATIC ONLY AND HAS NOT BEEN FIELD VERIFIED.
- 10. EXISTING FRAMING INFORMATION IS BASED ON LIMITED FIELD SURVEY PERFORMED BY RING CONSULTING GROUP, P.C., AND "FREIGHT HOUSE AT LANSDALE" DRAWINGS BY PHILADELPHIA & READING RAILWAY COMPANY CHIEF ENGINEERS OFFICE, DATED FEBRUARY 24TH, 1902.
- EXISTING TRUSSES, PURLINS, & ROOF DECK TO REMAIN. NEW INSULATION AND PLYWOOD SHEATHING ADDED ON TOP OF EX DECKING. SEE ARCH DWGS.
- 12. COORDINATE W/ DRAWINGS C-0.2 FOR ALTERNATES.

LEGEND:

1. [___] STUD LOAD BEARING INTERIOR WALLS ABOVE

2. STUD LOAD BEARING INTERIOR WALLS

3. ——ī HANGER

4.

JOIST SPAN DIRECTION


5. POST

6. POST LOAD FROM ABOVE



STRUCTURAL ENGINEERING PROJECT MANAGEMENT

512 WEST THIRD STREET LANSDALE PENNSYLVANIA 19446 T: 215.361.2301 INFO@RINGCONSULTING.COM

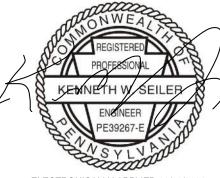

ELECTRONICALLY APPLIED 06/06/2024

KENNETH W. SEILER, P.E.
PA LICENSE #PE-039267-E

© Ring Consulting Group, P.C.

These documents are property of Ring
Consulting Group, P.C. and may not be used
without explicit permission. It is a violation of the
law for any person, unless acting under the
direction of Ring Consulting Group, P.C., to alter
these plans in any way.

- 06-06-2024 BID & PERMIT
REV DATE DESCRIPTION

CLIENT

DISCOVER LANSDALE

PO BOX 1112 LANSDALE, PA 19446

PROJECT


LANSDALE
FREIGHT HOUSE
BUILDING
REHABILITATION

111 S. BROAD STREET LANSDALE, PA 19446

DRAWN BY	SDP
CHECKED BY	KWS
DATE	1-26-2024
SCALE	AS NOTED
PROJECT NO.	16-1435
DRAWING TITLE	

ROOF FRAMING PLAN

DRAWING NO.

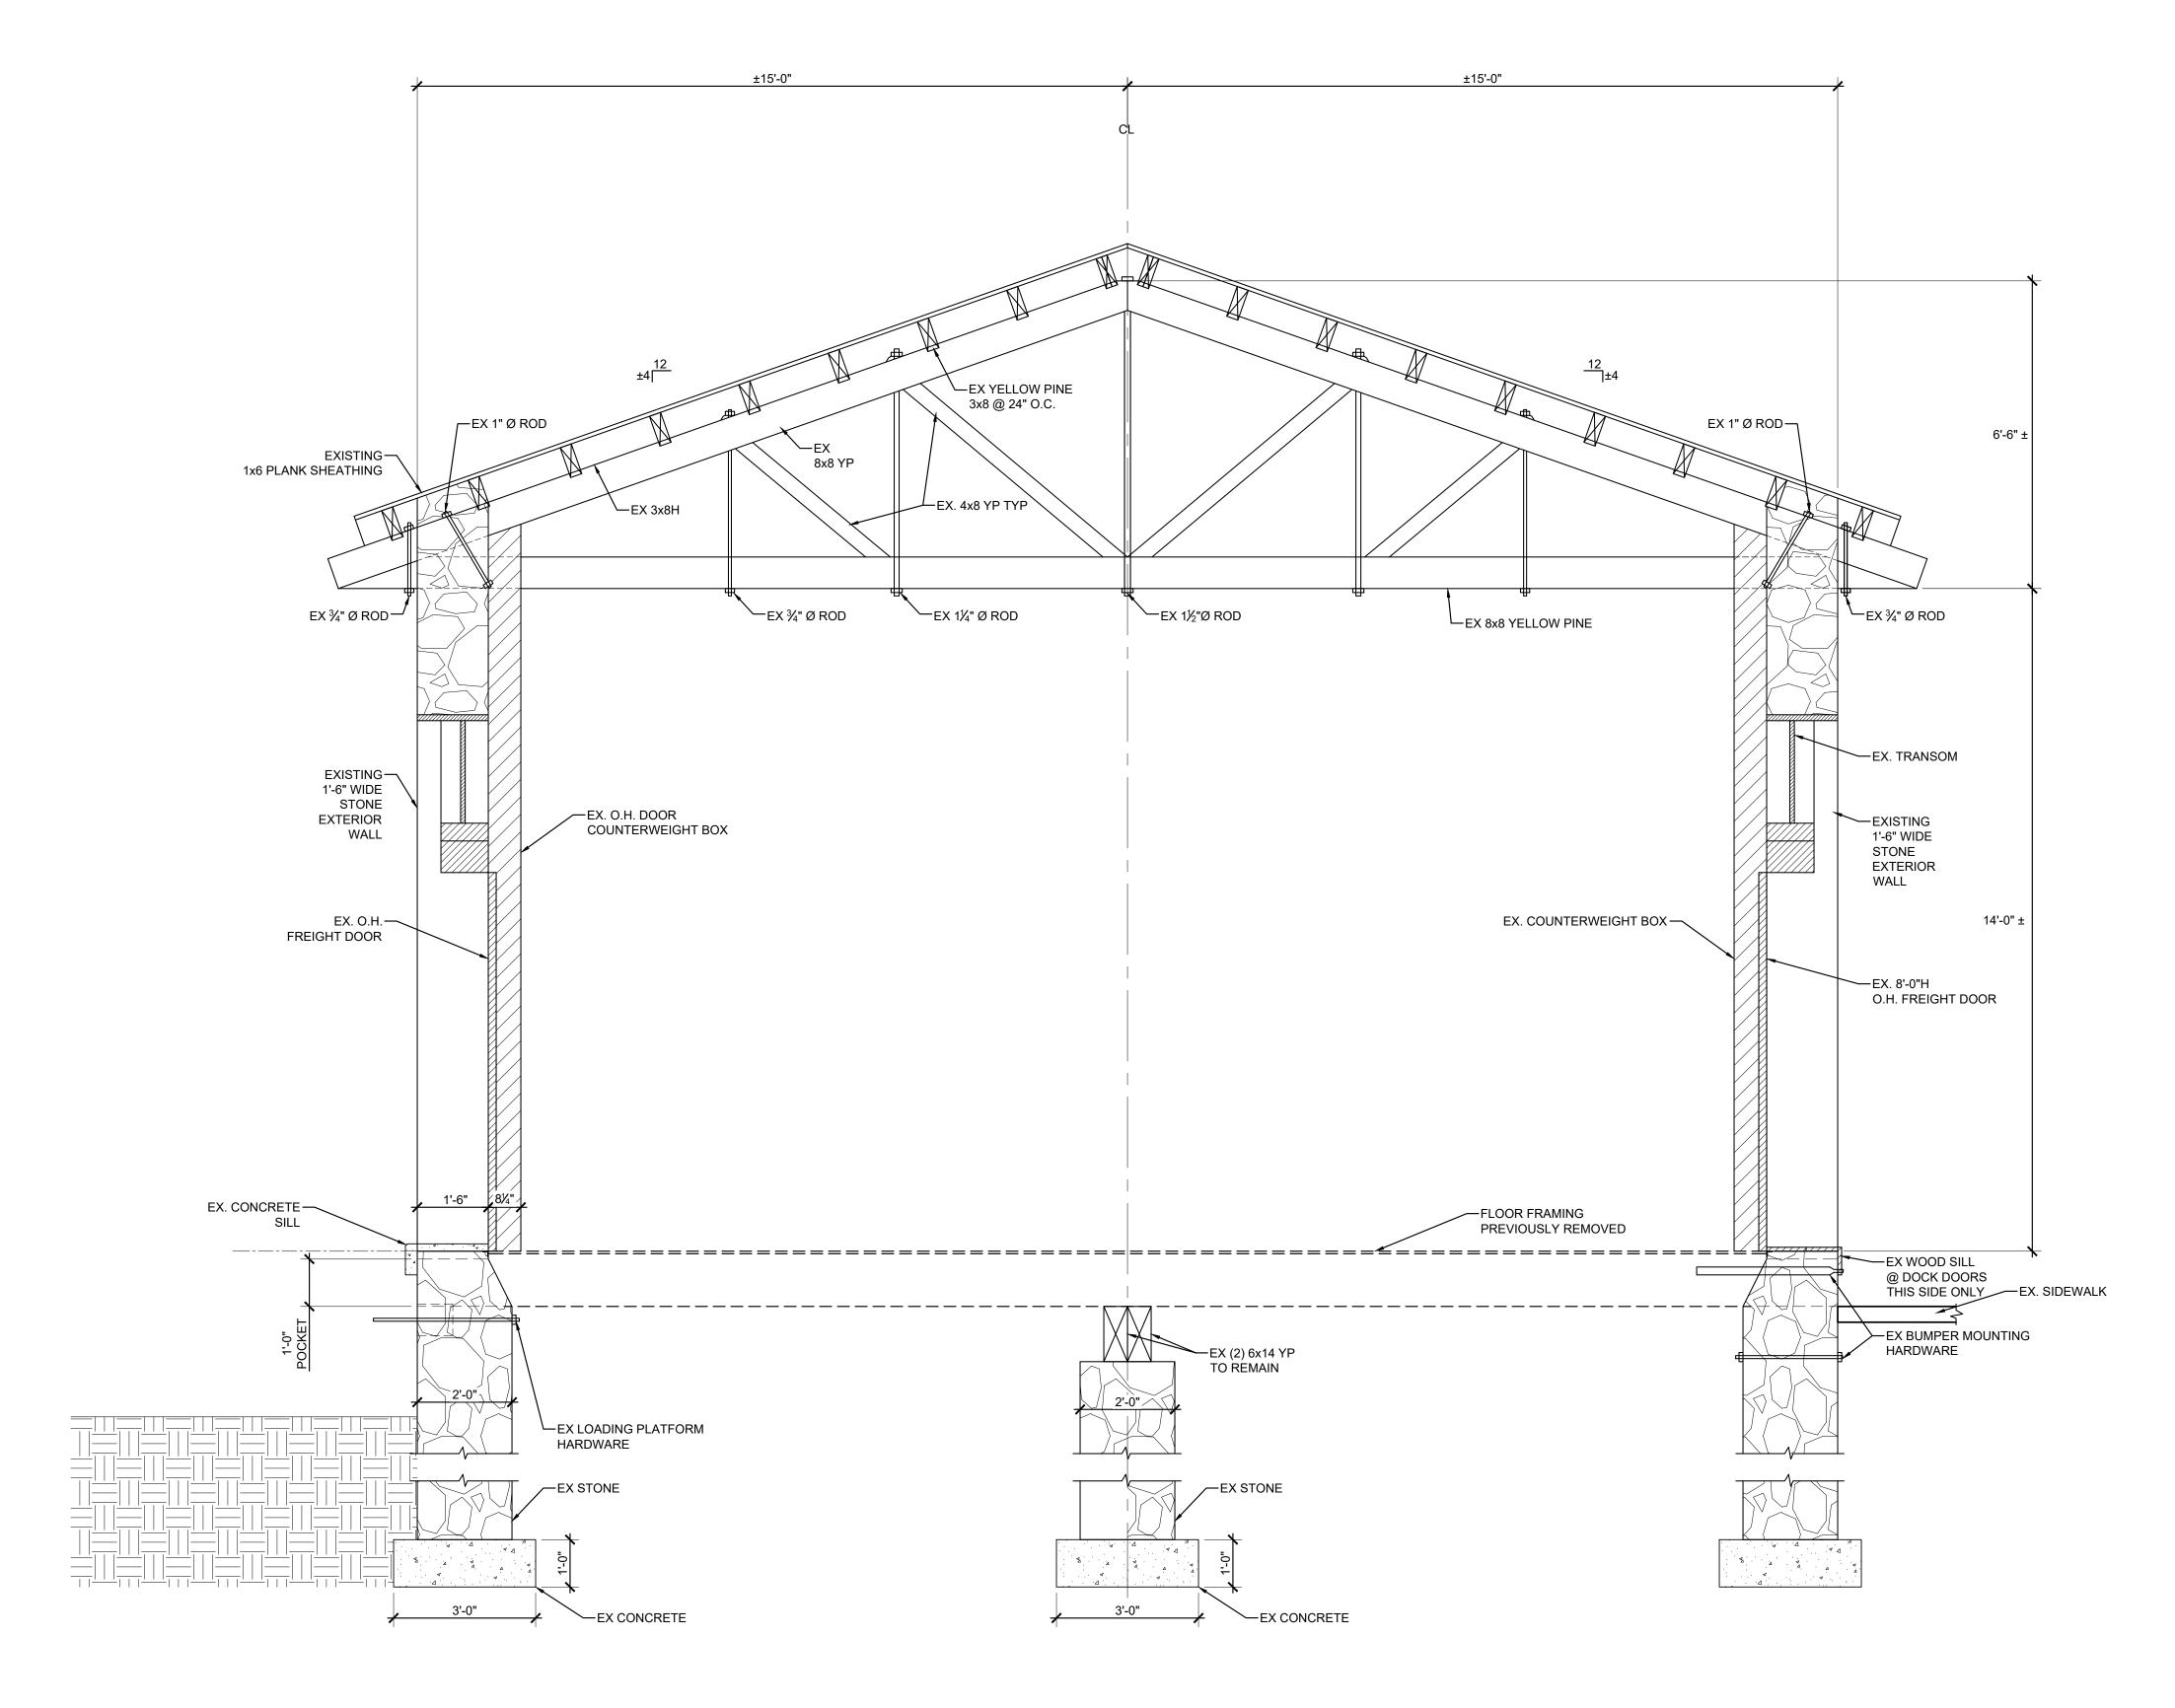


EXISTING BUILDING SECTION
1/2"=1'-0"

NOTES:

- 1. CONTRACTOR TO FIELD VERIFY SIZE AND CONFIGURATION OF ALL EXISTING CONDITIONS PRIOR TO START OF CONSTRUCTION.
- 2. EXISTING FRAMING INFORMATION IS BASED ON LIMITED FIELD SURVEY PERFORMED BY RING CONSULTING GROUP, P.C., AND "FREIGHT HOUSE AT LANSDALE" DRAWINGS BY PHILADELPHIA & READING RAILWAY COMPANY CHIEF ENGINEERS OFFICE, DATED FEBRUARY 24TH, 1902.
- 3. THIS DRAWING IS FOR REFERENCE ONLY. REFER TO ARCHITECTURAL DWGS FOR ADDITION INFORMATION.



STRUCTURAL ENGINEERING PROJECT MANAGEMENT 512 WEST THIRD STREET LANSDALE PENNSYLVANIA 19446 T: 215.361.2301 INFO@RINGCONSULTING.COM

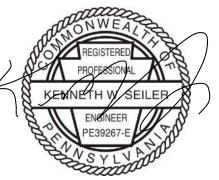

ELECTRONICALLY APPLIED 06/06/2024

KENNETH W. SEILER, P.E.
PA LICENSE #PE-039267-E

© Ring Consulting Group, P.C.
These documents are property of Ring
Consulting Group, P.C. and may not be used
without explicit permission. It is a violation of the
law for any person, unless acting under the
direction of Ring Consulting Group, P.C., to alter
these plans in any way.

-	06-06-2024	BID & PERMIT
REV	DATE	DESCRIPTION

CLIENT

DISCOVER LANSDALE

PO BOX 1112 LANSDALE, PA 19446

PROJECT

LANSDALE Freight House Building Rehabilitation

111 S. BROAD STREET LANSDALE, PA 19446

DRAWN BY	SDP
CHECKED BY	KWS
DATE	1-26-2024
SCALE	AS NOTED
PROJECT NO.	16-1435
DRAWING TITLE	

EXISTING BUILDING SECTION

DRAWING NO.

S2.0