
Emmaus Moravian Church Sanctuary Reconstruction

ESTATE EMMAUS ST JOHN, USVI

Owner Moravian Church Virgin Islands Conference
Architect Formwright
Historic Preservation Architect CTS Group
Structural Engineer Systems Engineering

SHEET INDEX			Archite	ectural Restoration			Structural
	Sheet No.	Sheet Title	Sheet No.	Sheet Title	Sheet No.	Sheet Title	Sheet No. Sheet Title
General	AD2.11	Existing and Demolition Interior Elevations	AR-100	Basement Floor Plan	AR-504	Railing Elevation and Details	S-001 Structural Notes
Sheet No. Sheet Title	A1.01	Basement Floor Plan	AR-101	First Floor Plan	AR-505	Pulpit Details	S-101 Basement Floor Plan
G0.01 Cover	A1.02	Main Floor Plan	AR-102	Top of Wall Plan	AR-601	Shutter & Door Elevations, Plans, and Details	S-102 Main Floor Plan
G0.02 Code Information, Notes, and Symbols	A1.03	Roof Plan	AR-110	Reflected Ceiling Plan	AR-602	Shutter & Door Details	S-103 Roof Plan
	A2.01	Exterior South Elevation	AR-201	Exterior Elevations	AR-610	Shutter Elevations	S-501 Structural Details
Architectural	A2.02	Exterior North Elevation	AR-202	Concrete and Stucco Repair Details	AR-611	Shutter Elevations	S-502 Structural Details
Sheet No. Sheet Title	A2.03	Exterior West Elevation	AR-301	Interior Elevations	AR-612	Shutter Elevations	
AS1.01 Site Plan	A2.04	Exterior East Elevation	AR-302	Interior Elevations	AR-613	Shutter Elevations	Electrical
AD1.01 Basement Existing and Demolition Floor Plan	A3.01	Building Sections	AR-401	Truss Details	AR-701	Window Elevations and Plans	Sheet No. Sheet Title
AD1.02 Main Existing and Demolition Floor Plan	A3.02	Building Sections	AR-402	Truss Details	AR-702	Window Elevations and Plans	E-101 Basement Floor Plan
AD2.01 Existing and Demolition South Elevation	A5.01	Details	AR-403	Truss Structure Axon			E-102 Main Floor Plan
AD2.02 Existing and Demolition North Elevation	A7.01	Main Floor Finish Plan	AR-501	Vestry Elevations			
AD2.03 Existing and Demolition West Elevation			AR-502	Choir Elevations and Details			
AD2.04 Existing and Demolition East Elevation			AR-503	Railing Elevation and Details			

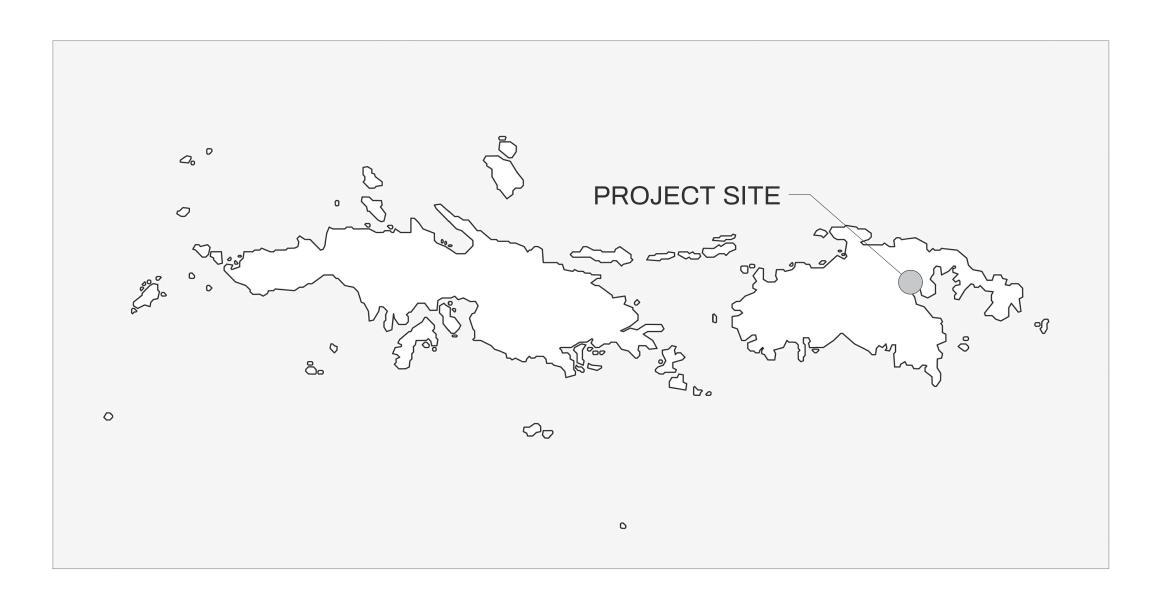



ST THOMAS / ST JOHN MAP VICINITY MAP


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EMMAUS MORAVIAN CHURCH SANCTUARY RECONSTRUCTION

PARCEL 10 ESTATE EMMAUS ST JOHN, USVI

7/5/2024

2022-009

April 21, 2023

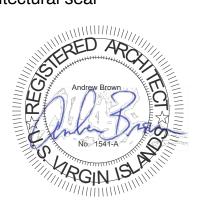issue

Building Permit Set

revisions

title

COVER

project number date

et

G0.01

By executing the contract, the contractor represents that he has visited the site, familiarized himself with the local conditions, codes and owner requirements under which the work is to be performed, and correlated his observations with the requirements of the Contract Documents. This shall be done prior to the bid.

The intent of the Contract Documents is to include all items necessary for proper execution and completion of the work. The Contract Documents are complimentary, and what is required by one shall be as binding as if required by all. Work not covered in the Contract Documents will not be required unless it is consistent therewith and is reasonably inferable therefrom as being necessary to produce the intended results. Words and abbreviations which have well known technical or trade meanings are used in the Contract Documents in accordance with such meanings.

The Drawings and Specifications are intended to be fully explanatory and supplementary. Moreover, should anything be shown, indicated, or specified on one and not the other, it shall be

Should either the drawings and the specifications, or any particular specification, and the General Conditions contradict each other in any point, or require clarification, the Contractor must call the same to the attention of the Architect, and his decision shall be obtained prior to the submission of bids - otherwise, the Architect's interpretation will govern the performance of the work and no allowance shall be made in behalf of the Contractor for error or negligence on his part in this connection. The Contractor shall bear all costs (including overtime, air frieght, etc.) due to his errors and/ or ommisions prior to bidding.

Should any error or inconsistency appear in the drawings or specifications, the Contractor, before proceeding with work, must clearly bring the same to the attention of the Architect for proper adjustment, and in no case proceed with the work in uncertainty nor with insufficient drawings.

The Contractor and each subcontractor shall be responsible for verification of all measurements at and in the proposed construction building or site or surroundings. No charge or compensation shall be allowed due to differences between actual dimensions and dimensions indicated on the drawings. Any such discrepancy in dimensions which may be found shall be submitted to the Architect.

Contractor shall follow sizes in specifications or figures on drawings in preference to scale measurements and follow detail drawings in preference to general drawings, and follow actual field conditions.

Where it is obvious that a drawing illustrates only a part of a given work, or of a number of items, the remainder shall be deemed repetitious and so constructed.

Contractor is to verify that all equipment (fixtures) are in accordance with plans and specifications. The Contractor is to report immediately by phone and within 24 hours in writing to the Architect, any and all equipment that is damaged, omitted, or not in accordance with plans and specifications.

The Contractor is to assure that the placement of equipment is possible before construction of all interior partitions are completed.

GENERAL NOTES

Reconstruction and restoration of the Emmaus Moravian Church to pre-hurricane Irma conditions including roof replacement, structural reinforcing, plastering, woodwork, painting, and electrical work.

Exterior scope of work will include, but not limited to:

- 1. construction of new roof, including structural system
- 2. refurbishment of wood shutters
- 3. replacement of windows4. plastering and painting
- 5. guttering and flashing

Interior scope of work will include, but not limited to:

- plastering and painting
- 2. reconstruction of original ceiling truss structure
- 3. refurbishment and reconstruction of vestry, choir loft, and pulpit
- 4. refurbishment and replacement of flooring5. installation of new lighting and electrical service

PROJECT DESCRIPTION

ABV A/C	ABOVE AIR CONDITIONING	NOM N.T.S.	NOMINAL NOT TO SCALE	ZONING = R-1	EXISTING	PROPOSED
A.C.T.	ACOUSTICAL TILE	O.C.	ON CENTER	DENSITY		
AFF	ABOVE FINISHED FLOOR	PL.	PLATE	PERMITTED:	N/A	no change
ALUM	ALUMINUM	PL.LAM.	PLASTIC LAMINATE	ACTUAL:	N/A N/A	no change
AVG BLKG	AVERAGE BLOCKING	PLYWD PREFAB	PLYWOOD PREFABRICATED	ACTORE.	13/73	no onango
	CENTER LINE	P.T.	PRESSURE TREATED	LOT AREA		
G G	CONTROL JOINT	PVC	POLYVINYL CHLORIDE	REQUIRED:	20,000 sf	no change
CLG.	CEILING	R.D.	ROOF DRAIN	ACTUAL:	1.89 acres	no change
CMU	CONCRETE MASONRY UNIT	REF	REFRIGERATOR	OCCUPANCY		
COL	COLUMN	REINF	REINFORCING		050/	
CONC	CONCRETE	REQ'D	REQUIRED	PERMITTED: ACTUAL:	25%	no change
CONT	CONTINUOUS	REV	REVERSED	ACTUAL.	6.8% (5,670 SF)	no change
C.T.	CERAMIC TILE	R.O. SF	ROUGH OPENING	LOT WIDTH		
D DET	DRYER DETAIL	SIM	SQUARE FEET SIMILAR	DECLUDED.	1001	
DET	DRINKING FOUNTAIN	S.O.G.	SLAB ON GRADE	REQUIRED: ACTUAL:	100' 275'	no change no change
DS	DOWNSPOUT	SPEC	SPECIFICATIONS		215	no change
DIA	DIAMETER	STD	STANDARD	FRONT SETBACK		
EA.	EACH	STL	STEEL	REQUIRED:	15'	no change
EL/ELEV	ELEVATION	STRUCT	STRUCTURAL	ACTUAL:	97'	no change
EQ	EQUAL	SUB FL	SUB FLOOR			
EWC	ELECTRIC WATER COOLER	SUSP.	SUSPENDED	REAR SETBACK		
EXT	EXTERIOR	T&G	TONGUE AND GROOVE	REQUIRED:	15'	no change
EXT'G	EXISTING	TEL	TELEPHONE	ACTUAL:	88'	no change
FD	FLOOR DRAIN	TEMP	TEMPERATURE	SIDE SETBACK		
GA	GAUGE	T.O.S.	TOP OF SLAB	SIDE SETBACK		
GALV	GALVANIZED	T.O.W.	TOP OF WALL	REQUIRED:	15'	no change
GWB HORIZ	GYPSUM WALLBOARD HORIZONTAL	TYP U.N.O.	TYPICAL UNLESS NOTED OTHERWISE	ACTUAL:	23'	no change
LAV	LAVATORY	VCT	VINYL COMPOSITION TILE	HEIGHT		
L.F.	LINEAR FEET	VERT	VINTE COMPOSITION TILE VERTICAL		T 0: :	
L.V.L.	LAMINATED VENEER LUMBER	V.I.F.	VERIFY IN FIELD	PERMITTED:	Two Stories	no change
MFR	MANUFACTURER	W	WASHER	ACTUAL:	Two Stories	no change
MIN	MINIMUM	WH	WATER HEATER	PUBLIC WORKS DRAWIN	IG NUMBER	
MISC	MISCELLANEOUS	WP	WATERPROOF	A9-134-T70		
M.O.	MASONRY OPENING	W/	WITH	NO 104-110		
MTL	METAL	WWF	WELDED WIRE FABRIC			
N.I.C.	NOT IN CONTRACT	W.I.C.	WALK-IN-CLOSET			

PLYWOOD

WOOD BLOCKING

EARTH


CONTINUOUS WOOD
FRAMING

CONCRETE MASONRY
UNIT

CAST-IN-PLACE
CONCRETE
CONCRETE

RIGID INSULATION

MATERIAL LEGEND

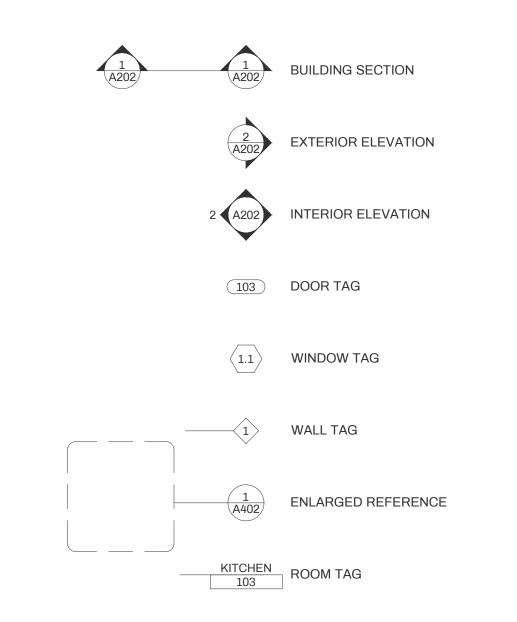


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973-635-5900

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EMMAUS MORAVIAN CHURCH SANCTUARY RECONSTRUCTION

PARCEL 10 ESTATE EMMAUS ST JOHN, USVI

7/5/2024

issue

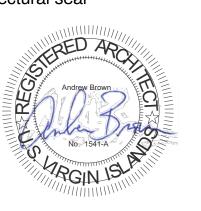Building Permit Set

revisions

title CODE INFORMATION, NOTES, AND

SYMBOLS project number 2022-009

November 30, 2023

sheet

G0.02

ABBREVIATIONS ZONING REQUIREMENTS APPLICABLE CODES DRAWING SYMBOLS

TYPE OF CONSTRUCTION

Non-sprinklered

2021 INTERNATIONAL BUILDING CODE

2020 NATIONAL ELECTRICAL CODE

2021 UNIFORM PLUMBING CODE

2021 INTERNATIONAL MECHANICAL CODE

2021 INTERNATIONAL ENERGY CONSERVATION CODE

Primary structural frame: 0

Floor and roof construction: 0

SPRINKLERS

OCCUPANT LOAD

Type III-A: Ordinary, Non-combustible exterior walls

OCCUPANCY CLASSIFICATION AND USE DESIGNATION

FIRE-RESISTANCE RATING REQUIREMENTS (HOURS)

Main Floor Sanctuary: 304 (2,128 sf @ 7 sf per)


CONSTRUCTION TYPE AND OCCUPANCY

TITLE 29 OF THE VIRGIN ISLANDS CODE: PUBLIC PLANNING AND DEVELOPMENT

TITLE 29 OF THE VIRGIN ISLANDS CODE: COASTAL ZONE MANAGEMENT

Interior Nonbearing walls and partitions: 0

Assembly Group A-3: Places of religious worship

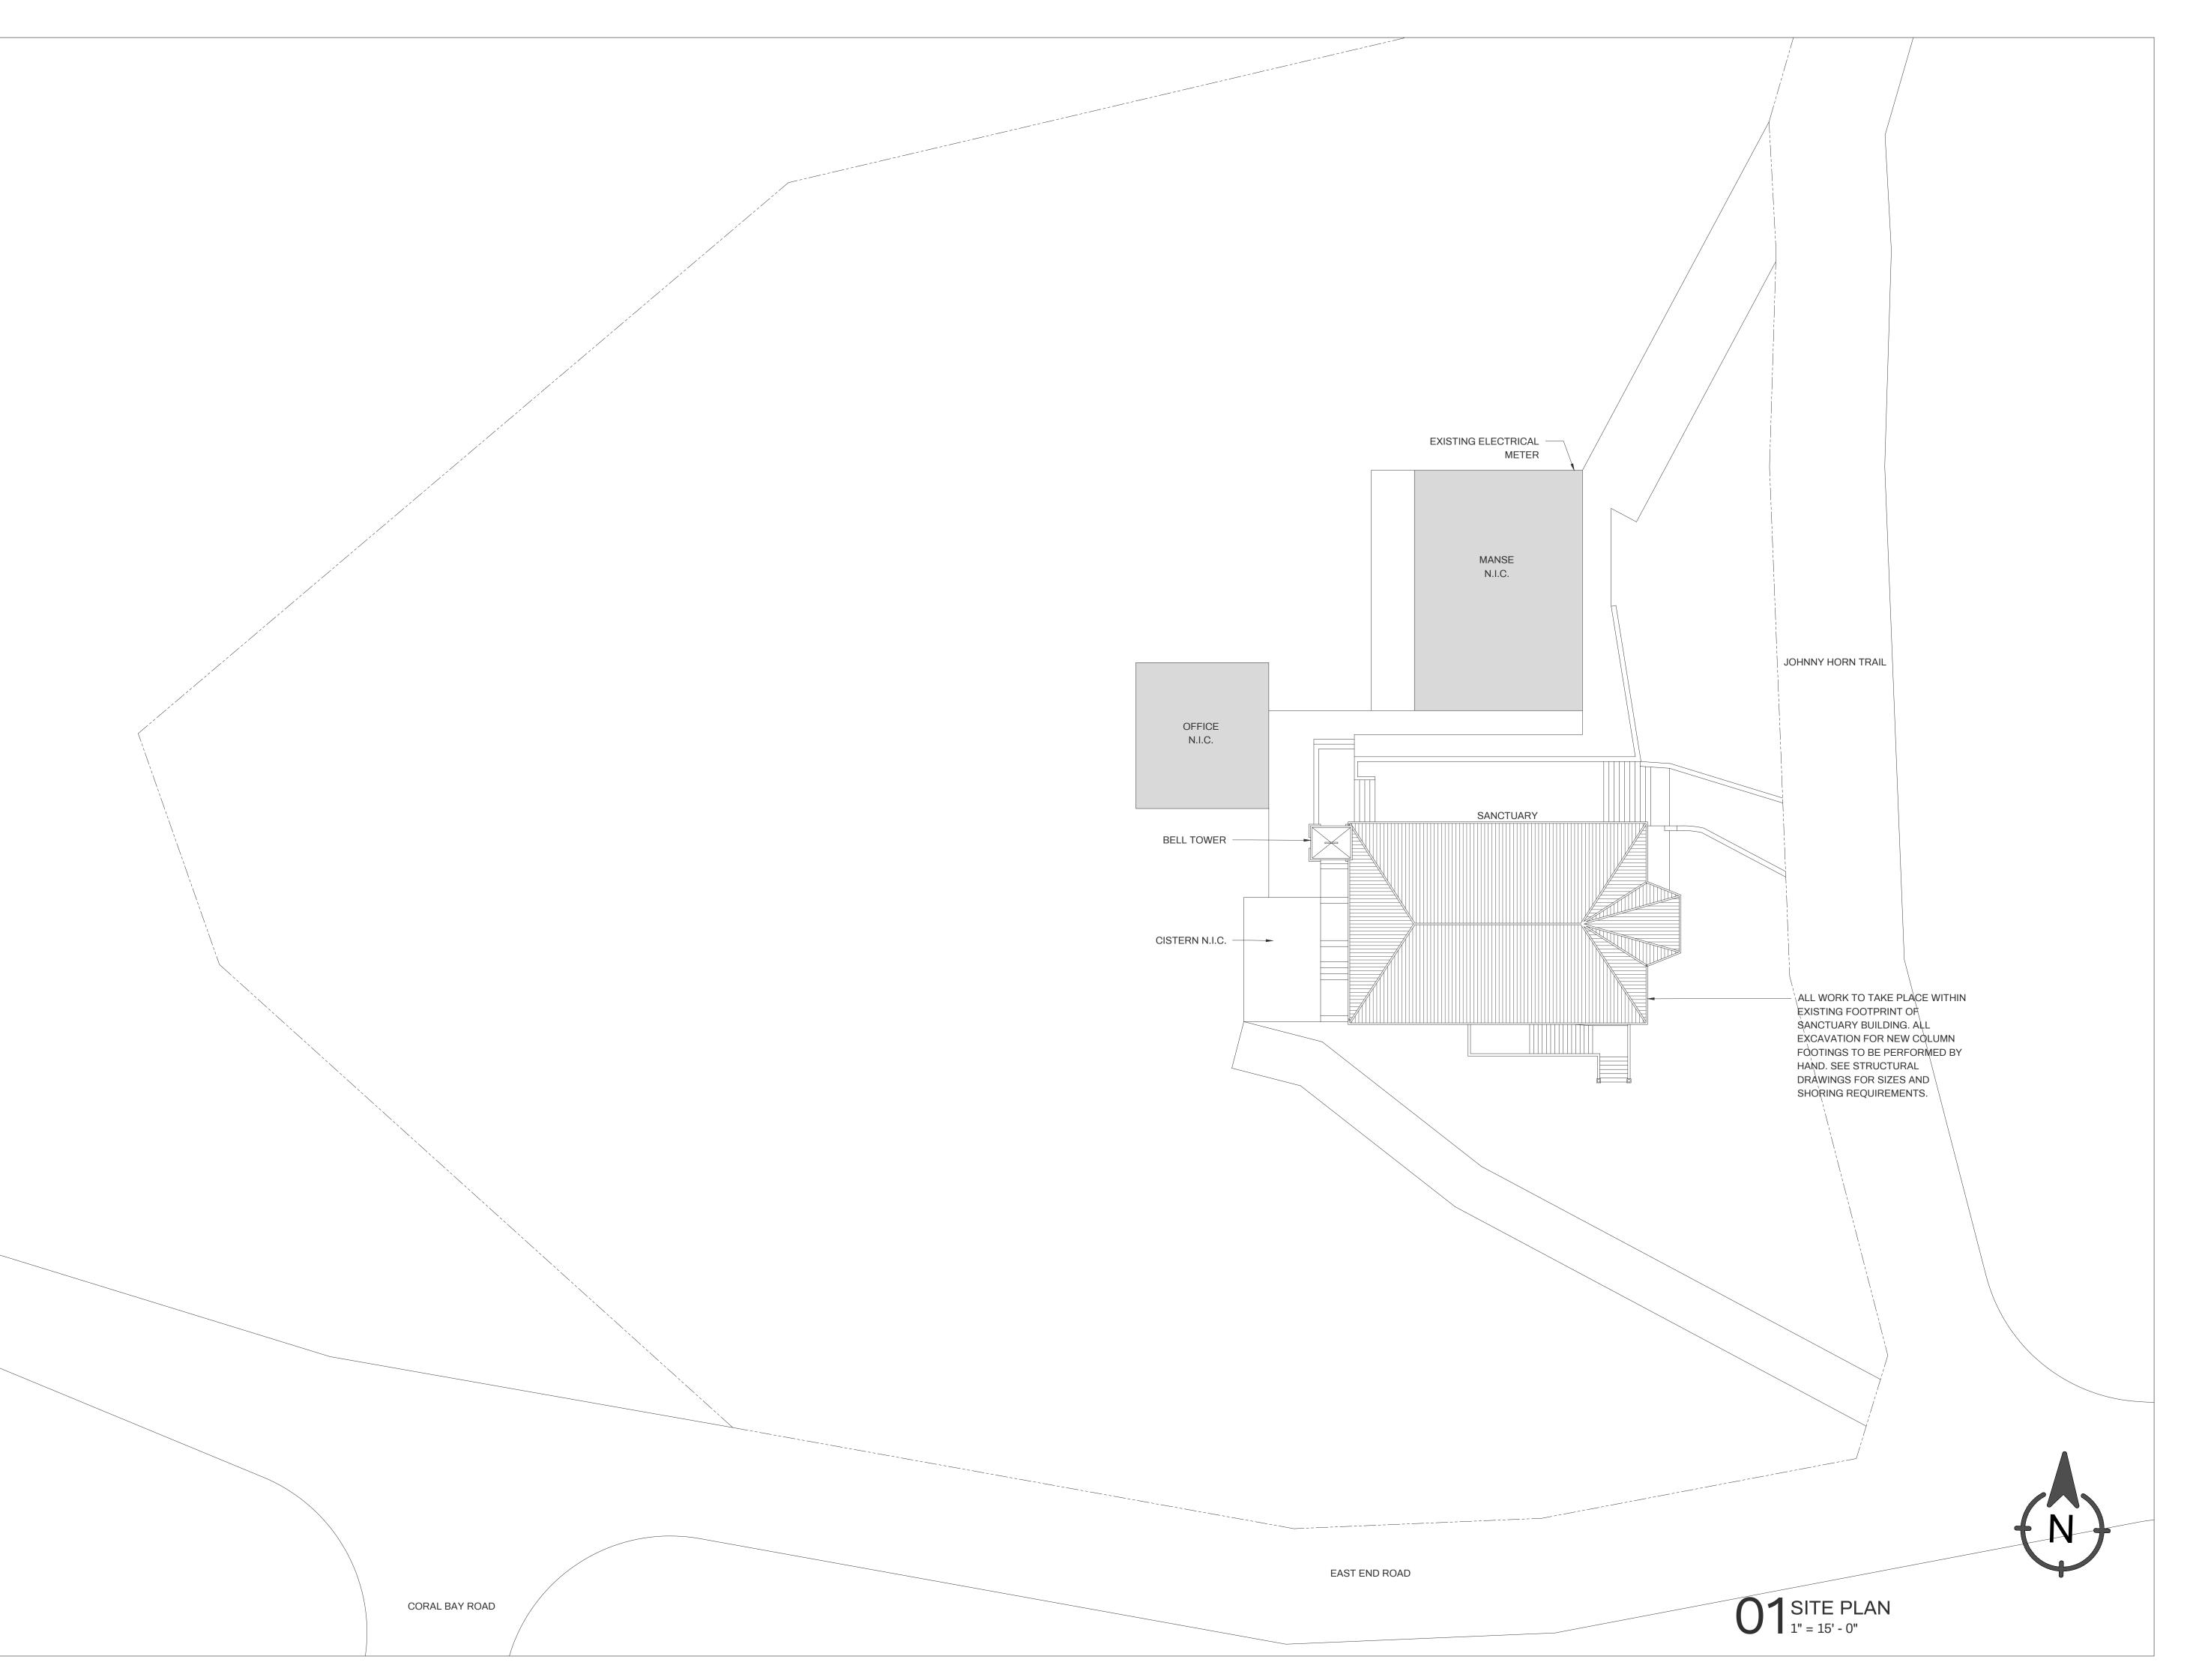




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issue

Building Permit Set

revisions

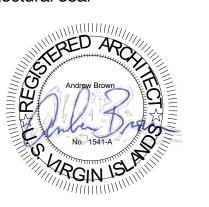title

SITE PLAN

project number date


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2022-009

April 21, 2023

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EMMAUS MORAVIAN
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RECONSTRUCTION

PARCEL 10 ESTATE EMMAUS ST JOHN, USVI

7/5/2024

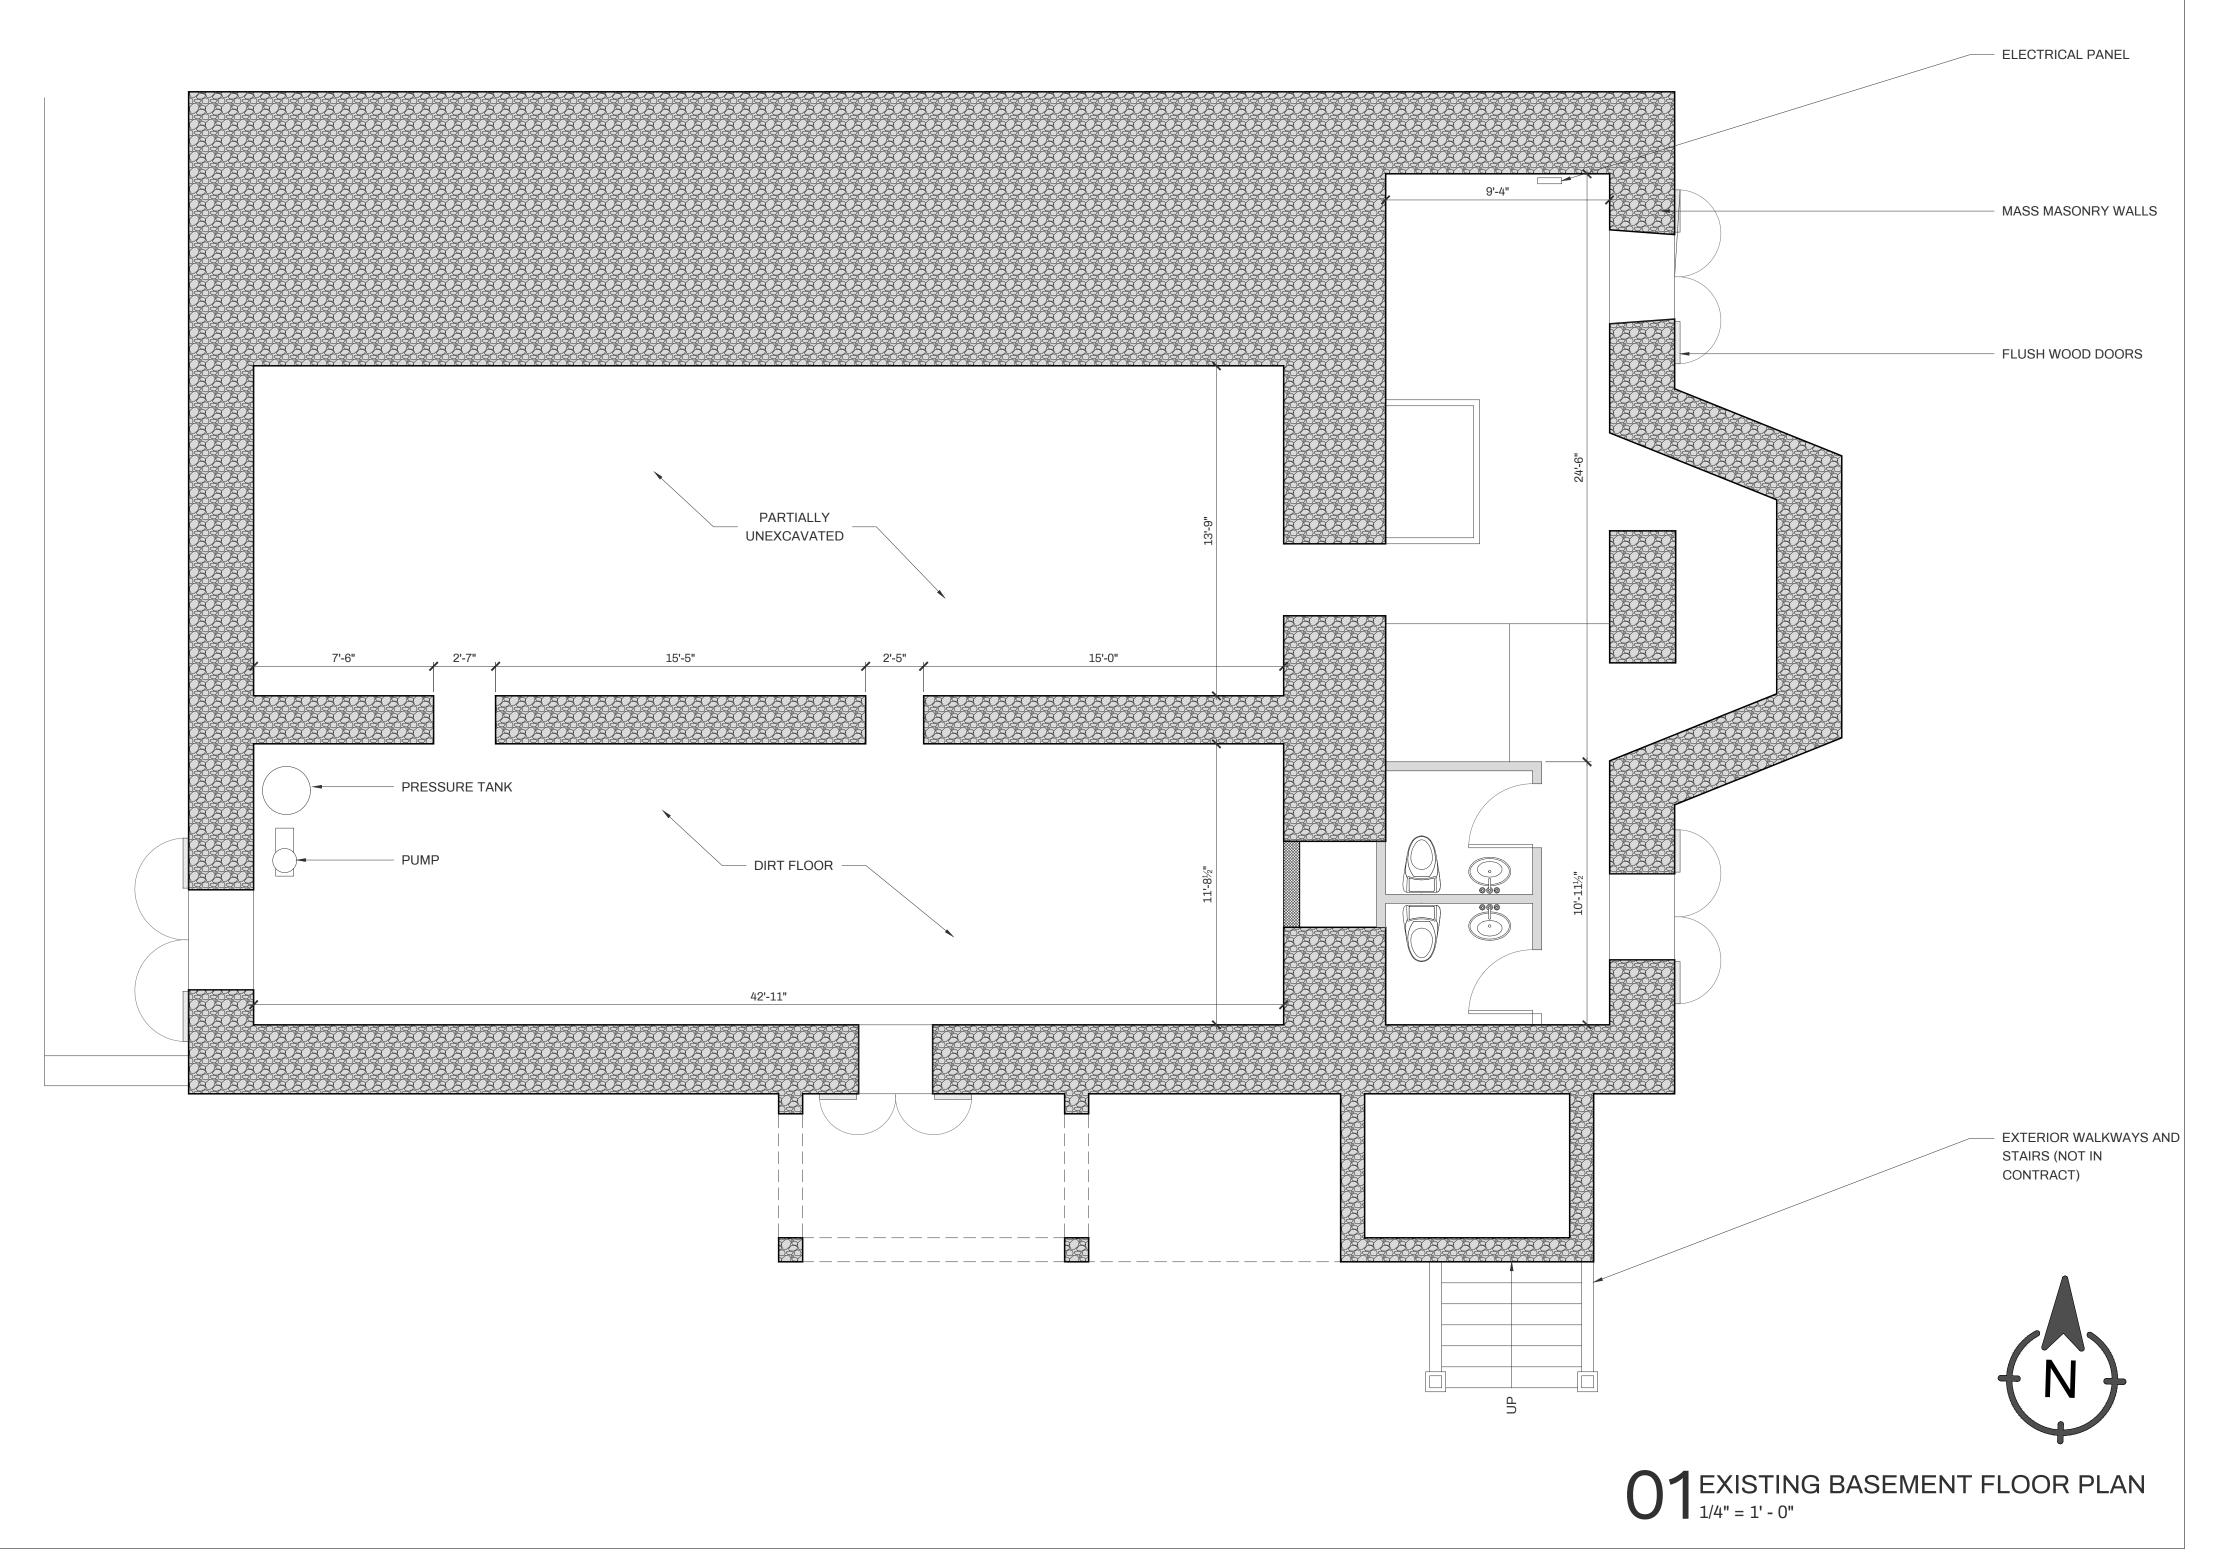2022-009

issue

Building Permit Set

revisions

titl


EXISTING BASEMENT FLOOR PLAN

project number

date January 13, 2023

sheet

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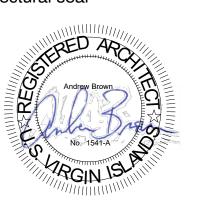


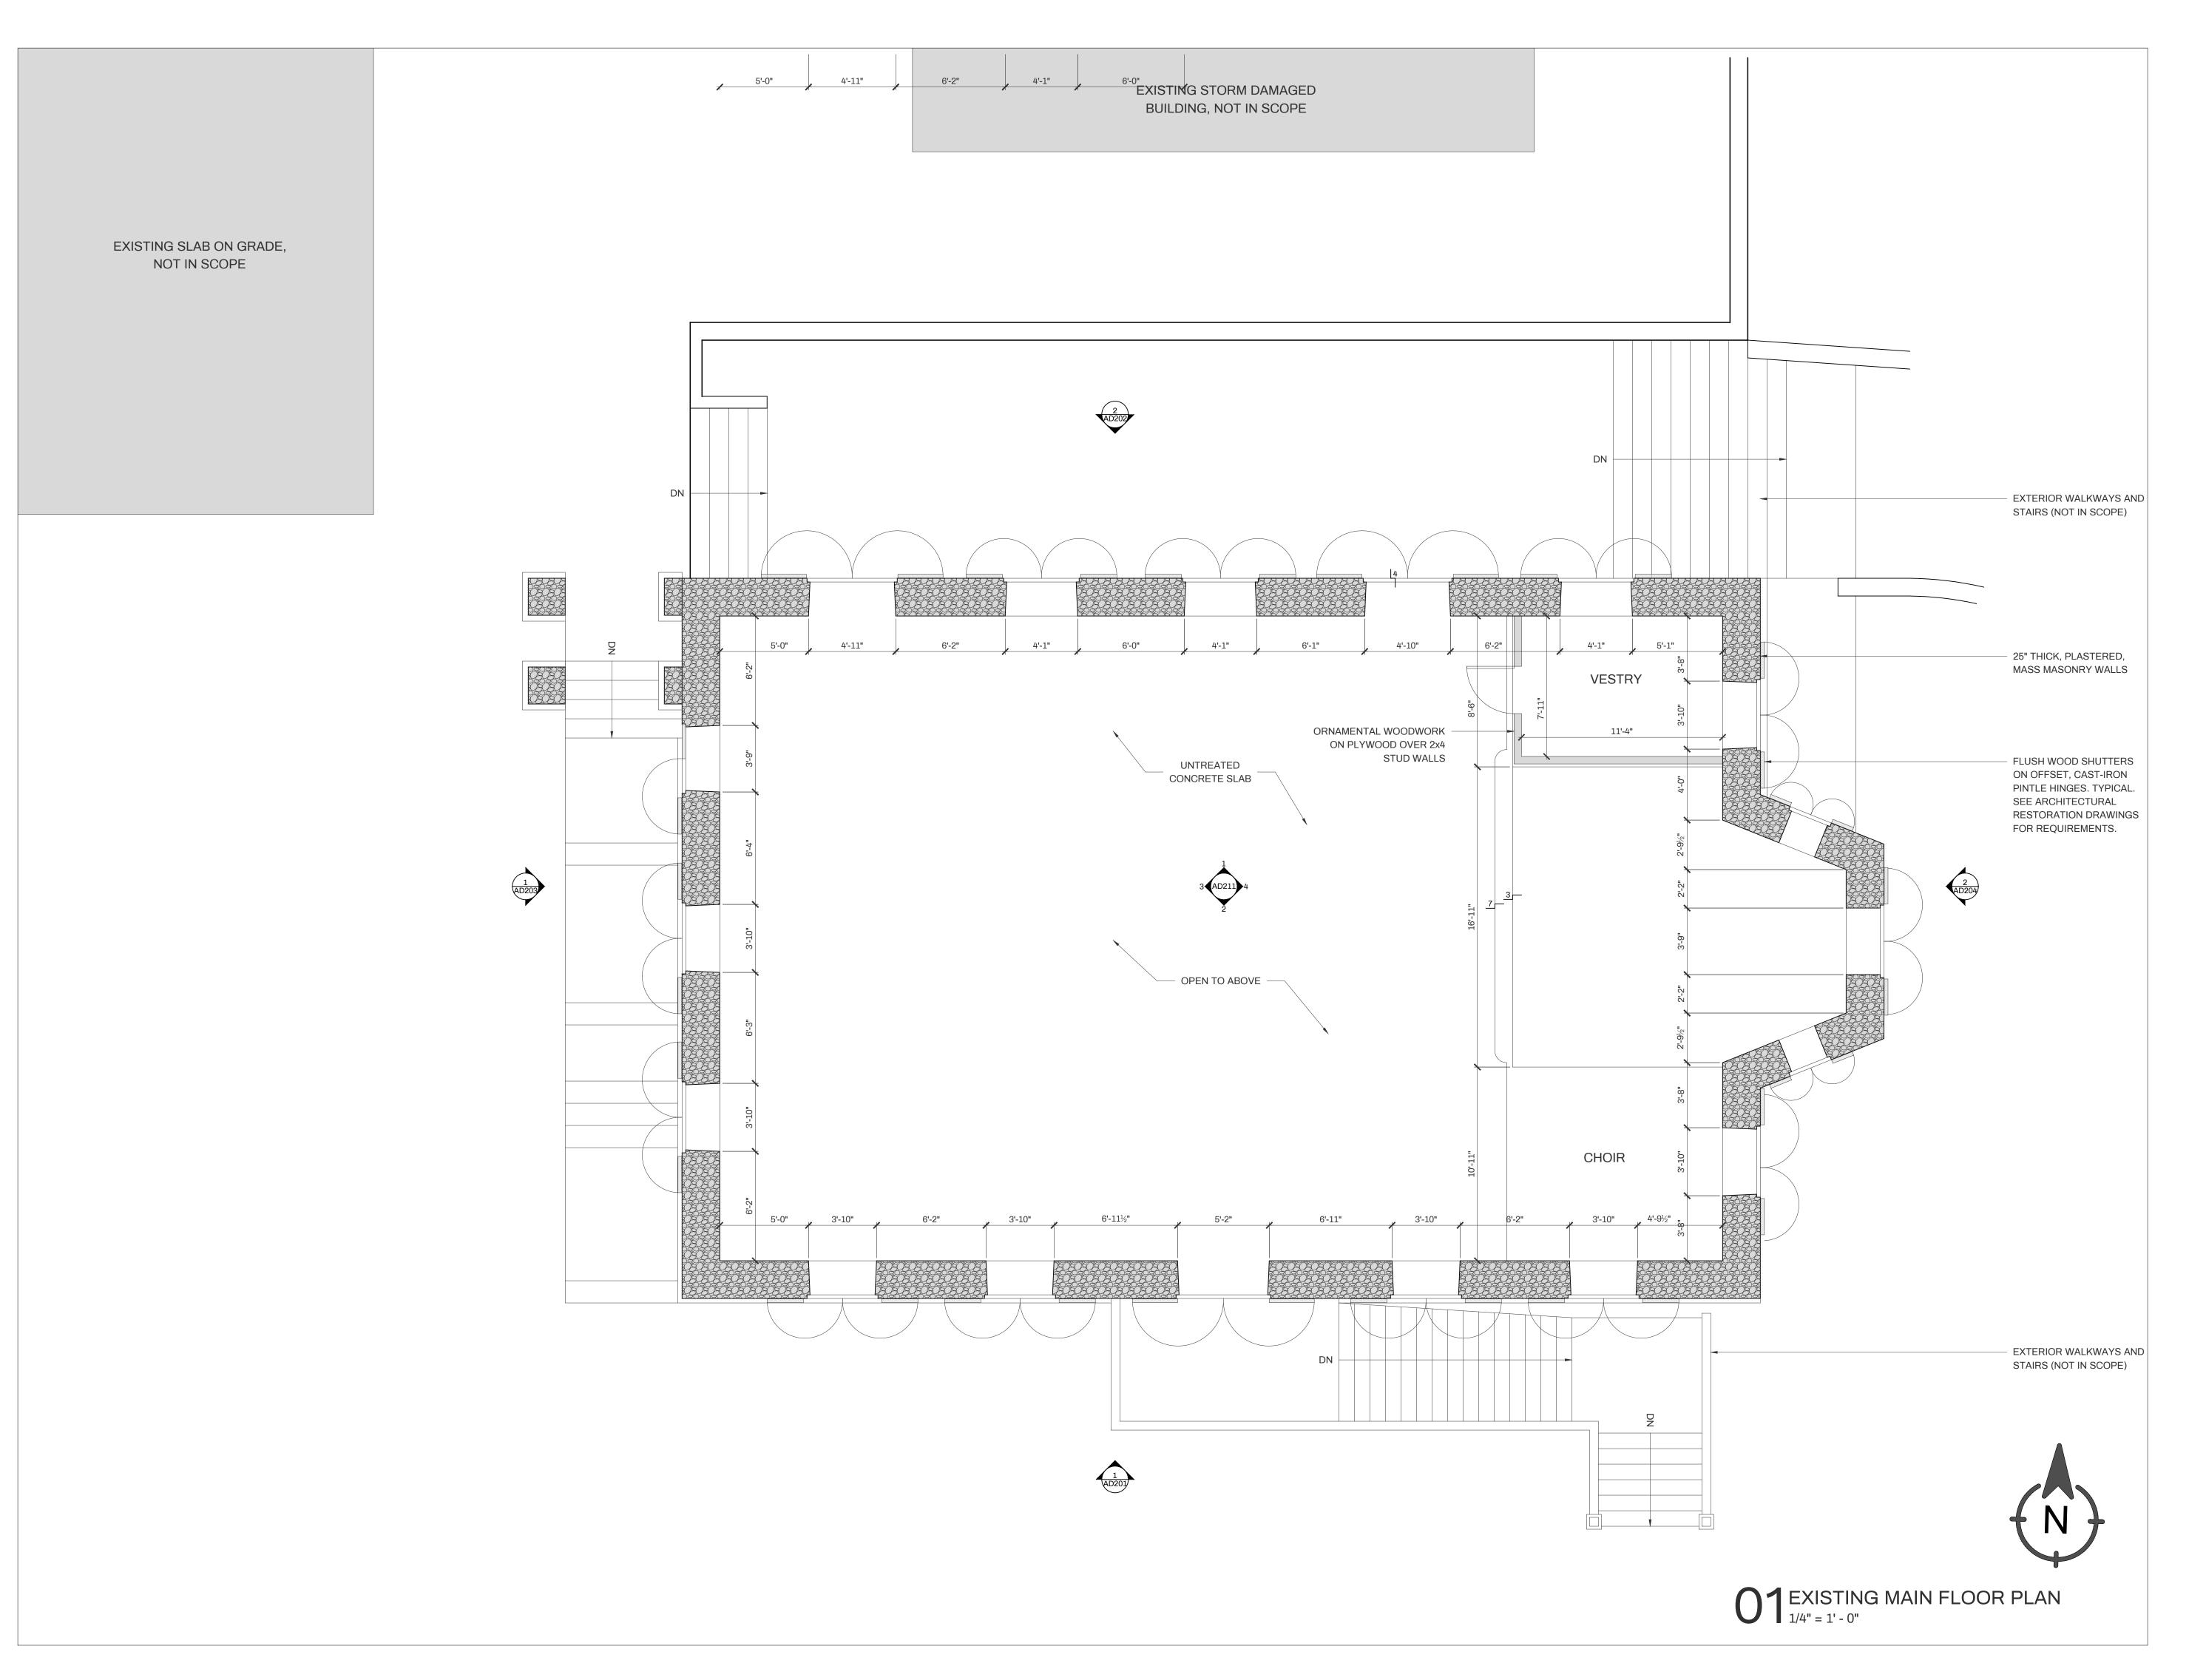

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7/5/2024

2022-009

January 13, 2023

issue

Building Permit Set

revisions


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EXISTING MAIN FLOOR PLAN

project number

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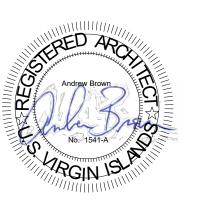




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EMMAUS MORAVIAN CHURCH SANCTUARY RECONSTRUCTION

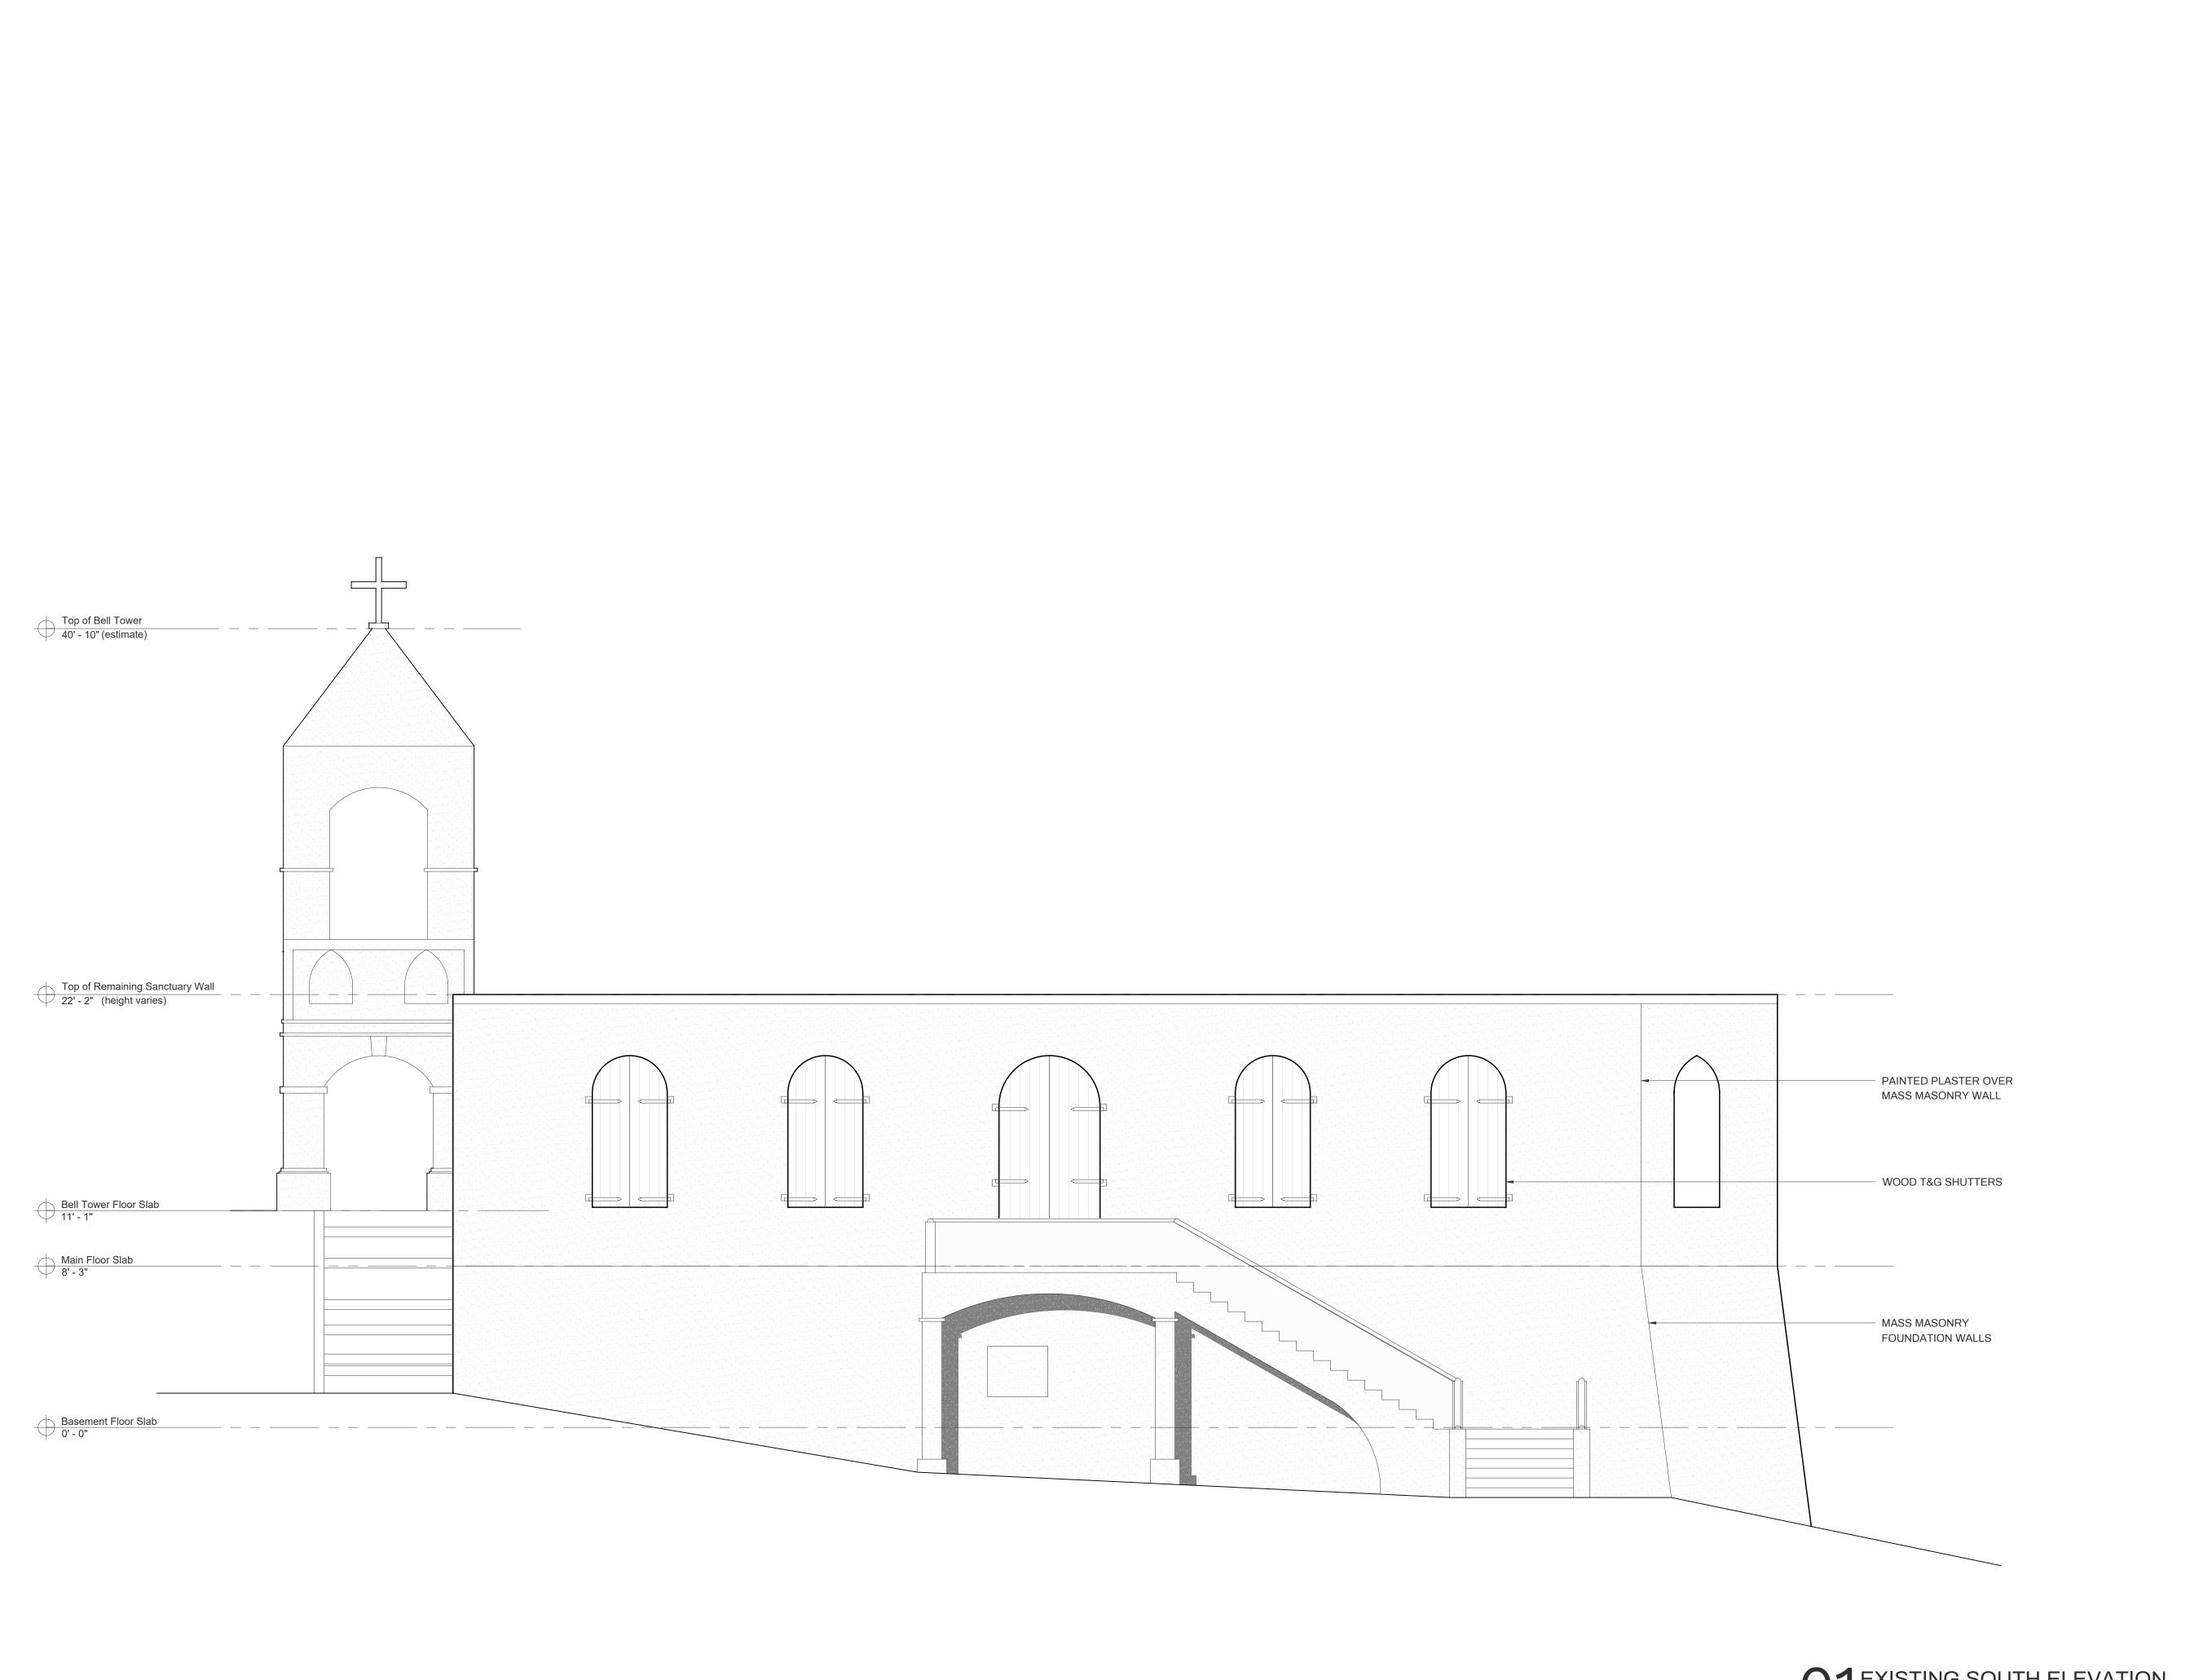PARCEL 10 ESTATE EMMAUS ST JOHN, USVI

7/5/2024

is

Building Permit Set

revisions

EXISTING EXTERIOR ELEVATIONS

project number

2022-009 January 13, 2023

shee

AD2.01

2 EXISTING SOUTH ELEVATION
1/4" = 1' - 0"



2 EXISTING NORTH ELEVATION
1/4" = 1' - 0"


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7/5/2024

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Building Permit Set

revisions

EXISTING EXTERIOR ELEVATIONS


project number

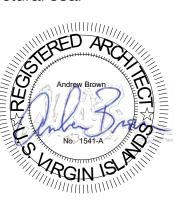January 13, 2023

2022-009

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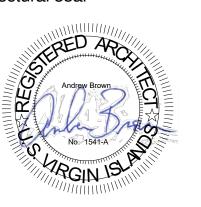


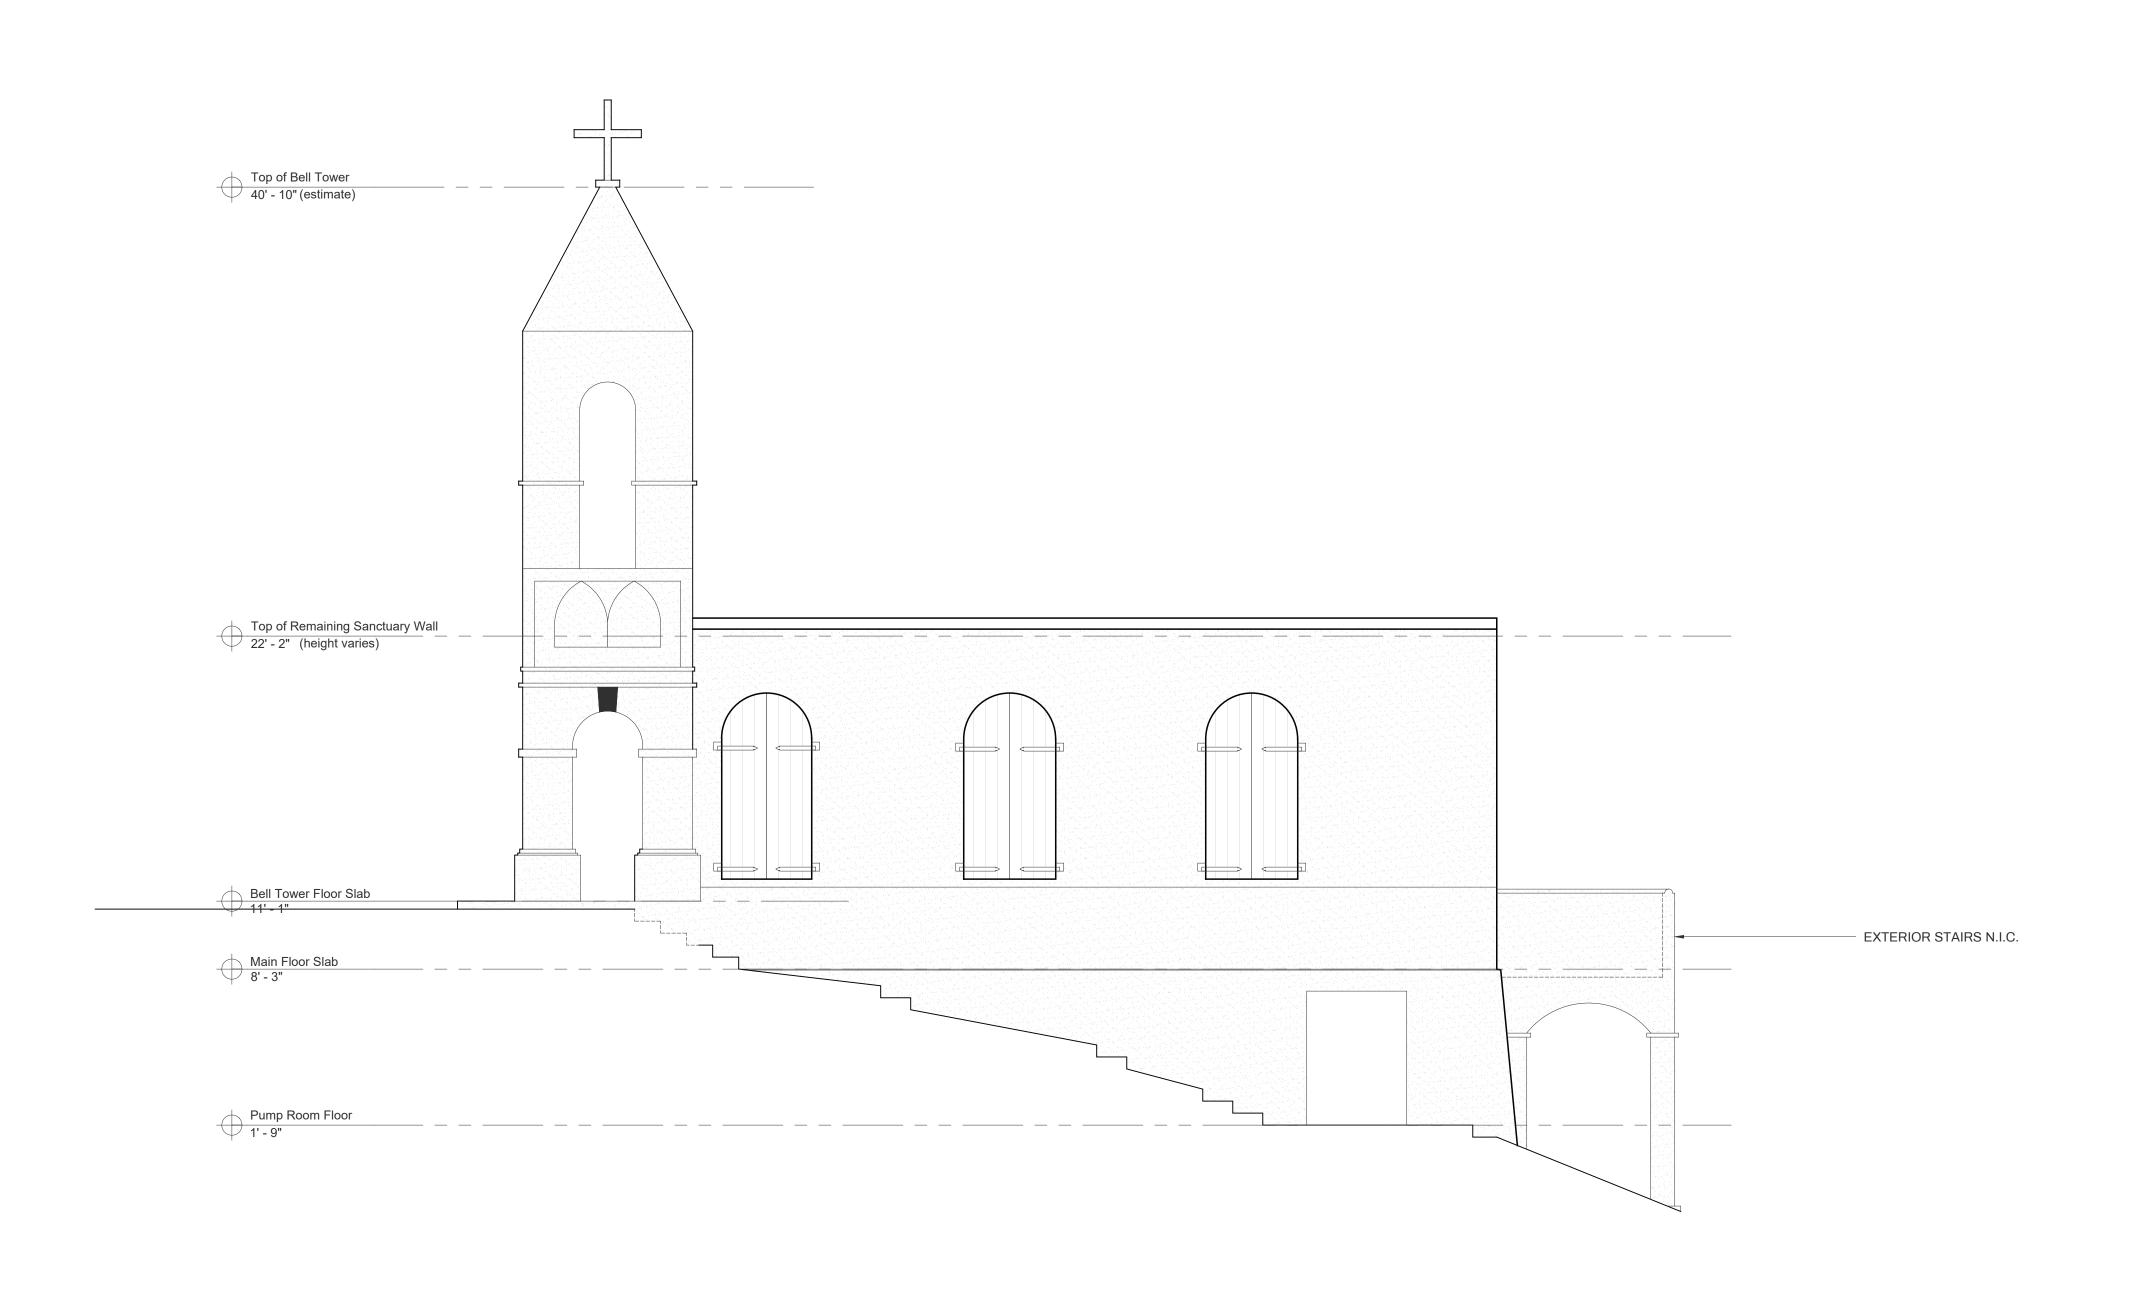

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PARCEL 10 ESTATE EMMAUS ST JOHN, USVI

7/5/2024

issue

Building Permit Set

revisions

1

EXISTING EXTERIOR ELEVATIONS

project number

January 13, 2023


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AD2.03

2 EXISTING WEST ELEVATION

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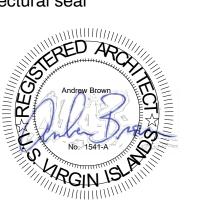




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7/5/2024

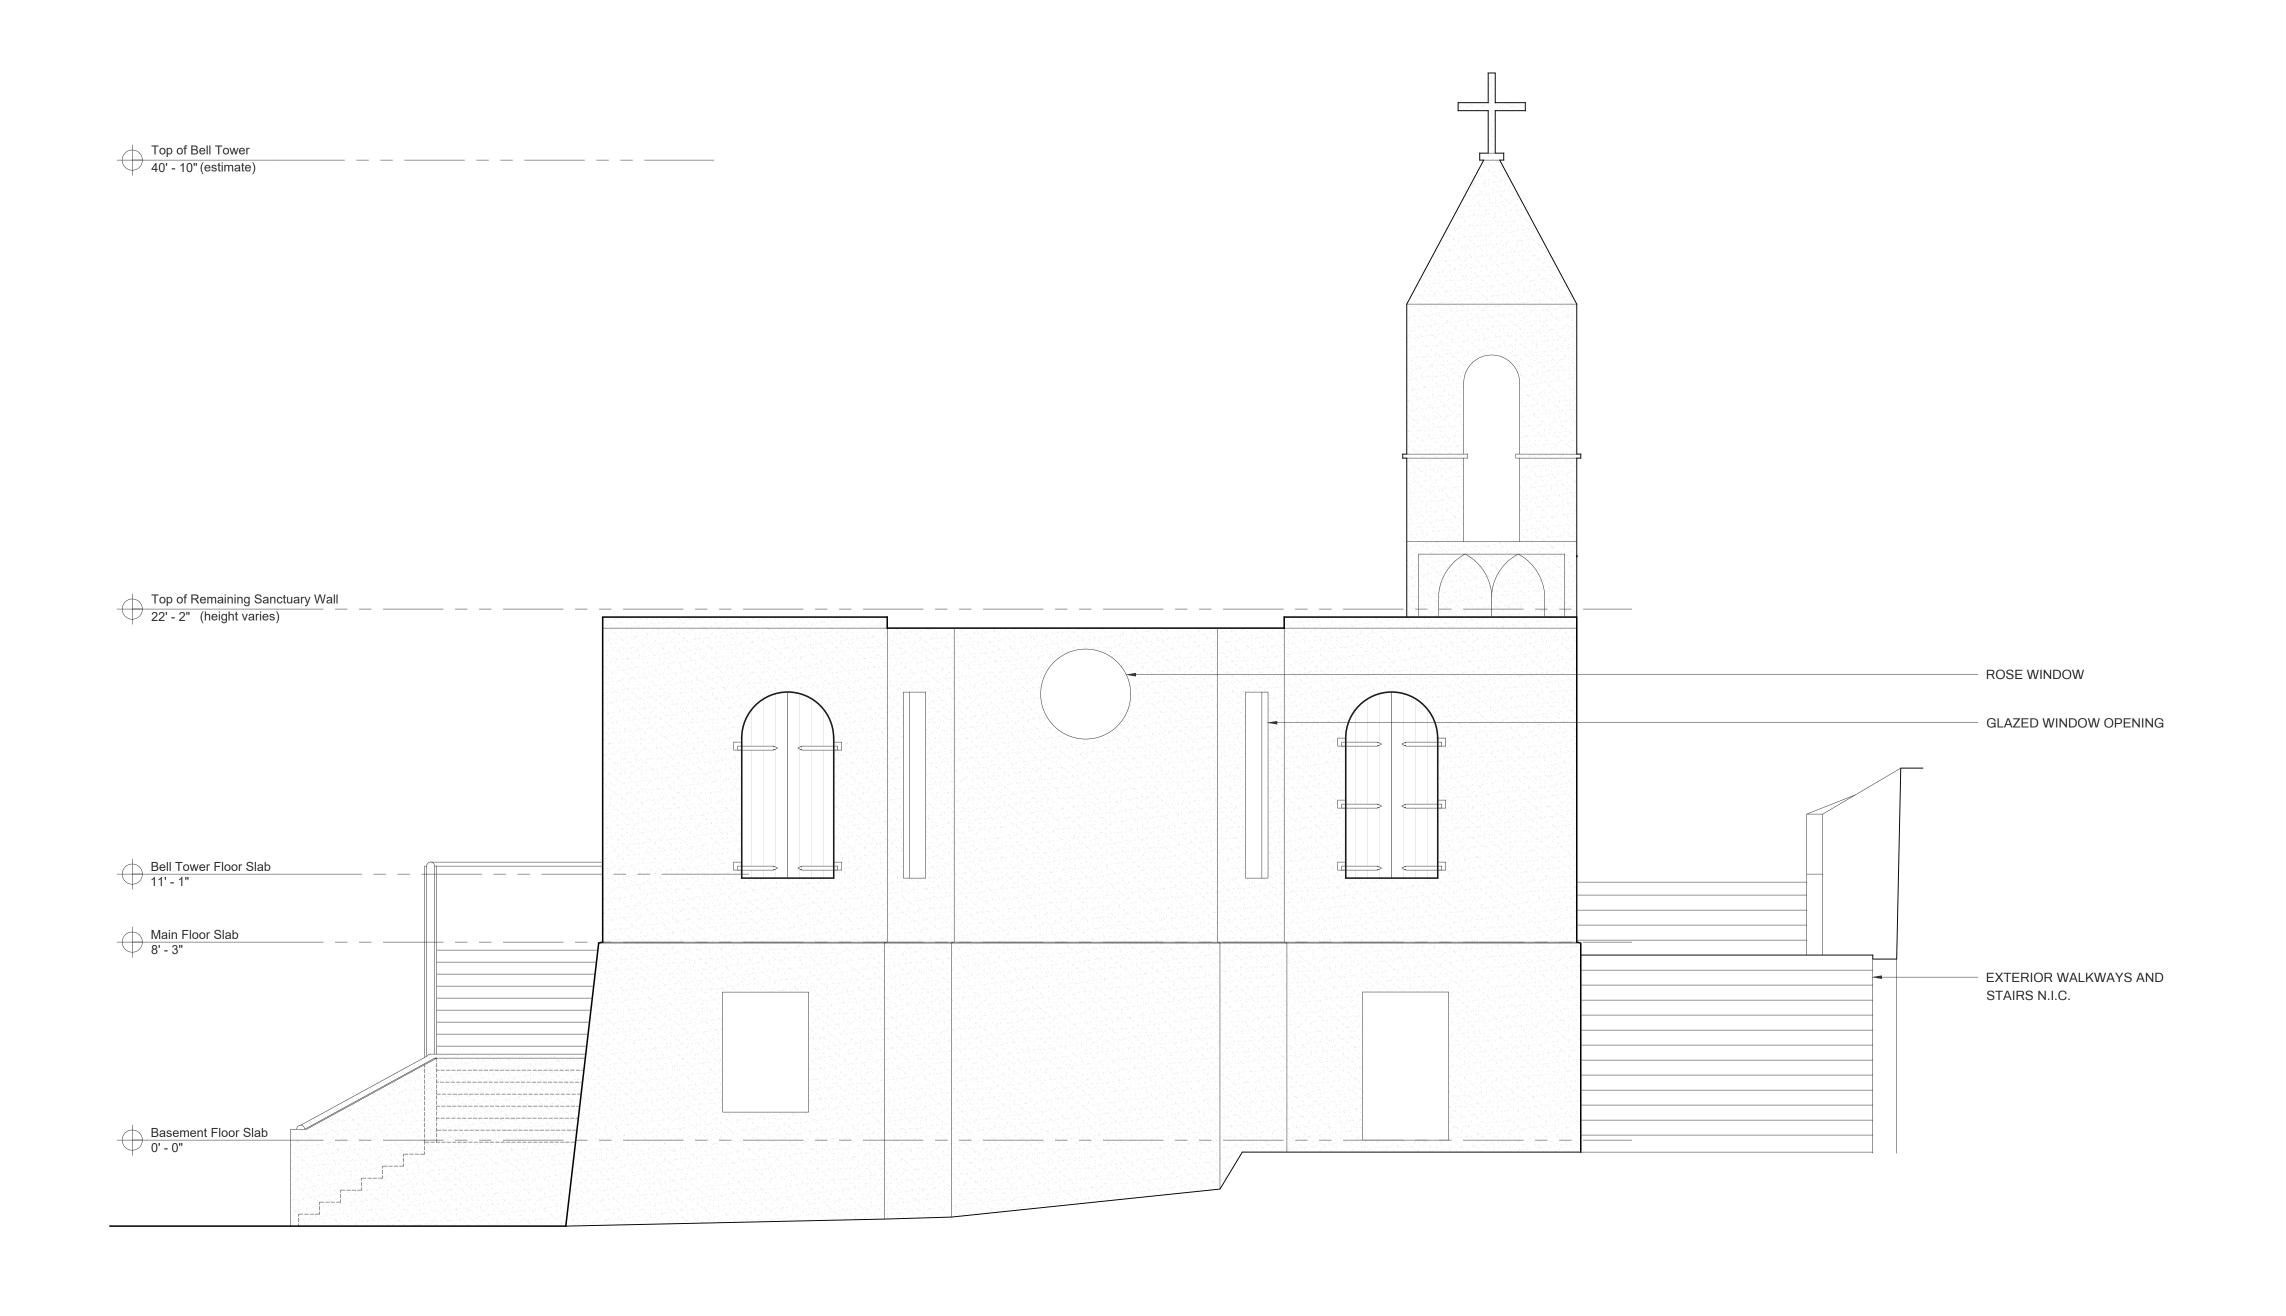issue

Building Permit Set

revisions

EXISTING EXTERIOR ELEVATIONS

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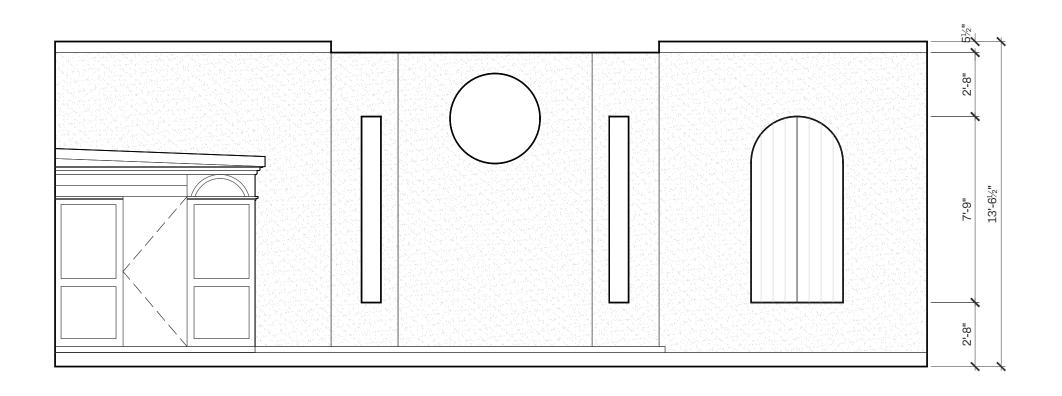
2022-009 January 13, 2023

sheet

AD2.04

2 EXISTING SOUTH ELEVATION

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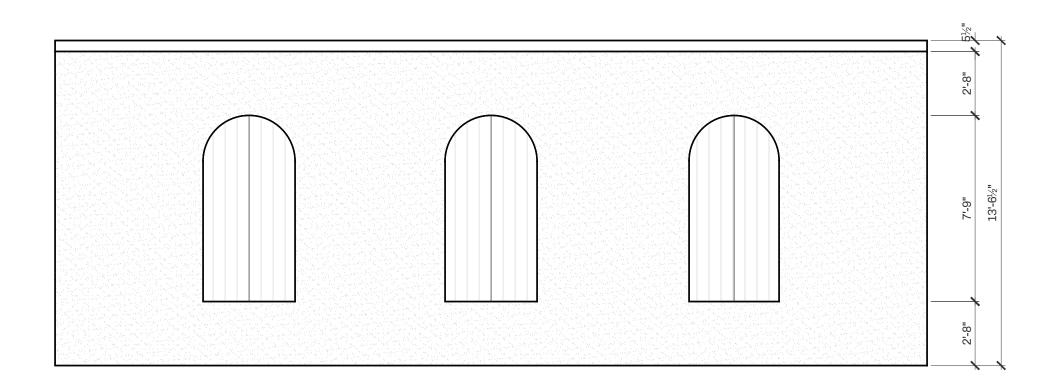



PRIOR TO PARTIAL WALL DEMOLITION AND $\,-\,$ PREPARATION FOR NEW RING BEAM, CONTRACTOR TO NOTE ELEVATION OF EXISTING BEAM POCKETS IN MASS MASONRY WALL. NEW BEAMS TO BE SET AT SAME HEIGHT AS ORIGINAL SEE ARCHITECTURAL RESTORATION DRAWINGS FOR EXTENT OF PLASTER REPAIR AND DETAILS SEE ARCHITECTURAL RESTORATION DRAWINGS FOR EXTENT OF SHUTTER REPAIR, REPLACEMENT AND DETAILS

04 EXISTING INTERIOR E ELEVATION

2 EXISTING INTERIOR S ELEVATION

1/4" = 1' - 0"



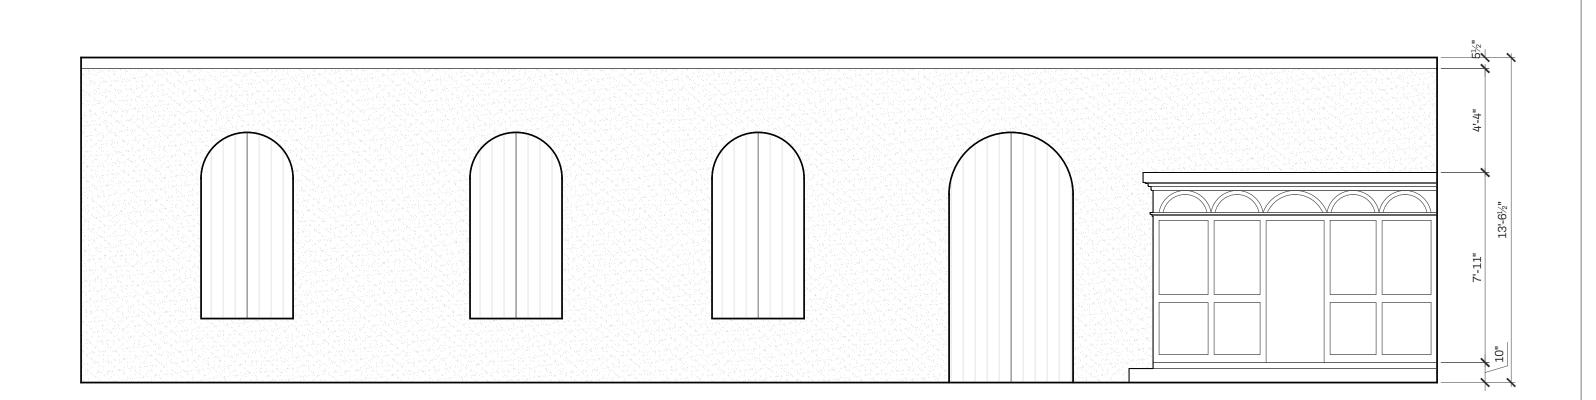

O3 EXISTING INTERIOR W ELEVATION

1/4" = 1' - 0"

O1 EXISTING INTERIOR N ELEVATION
1/4" = 1' - 0"


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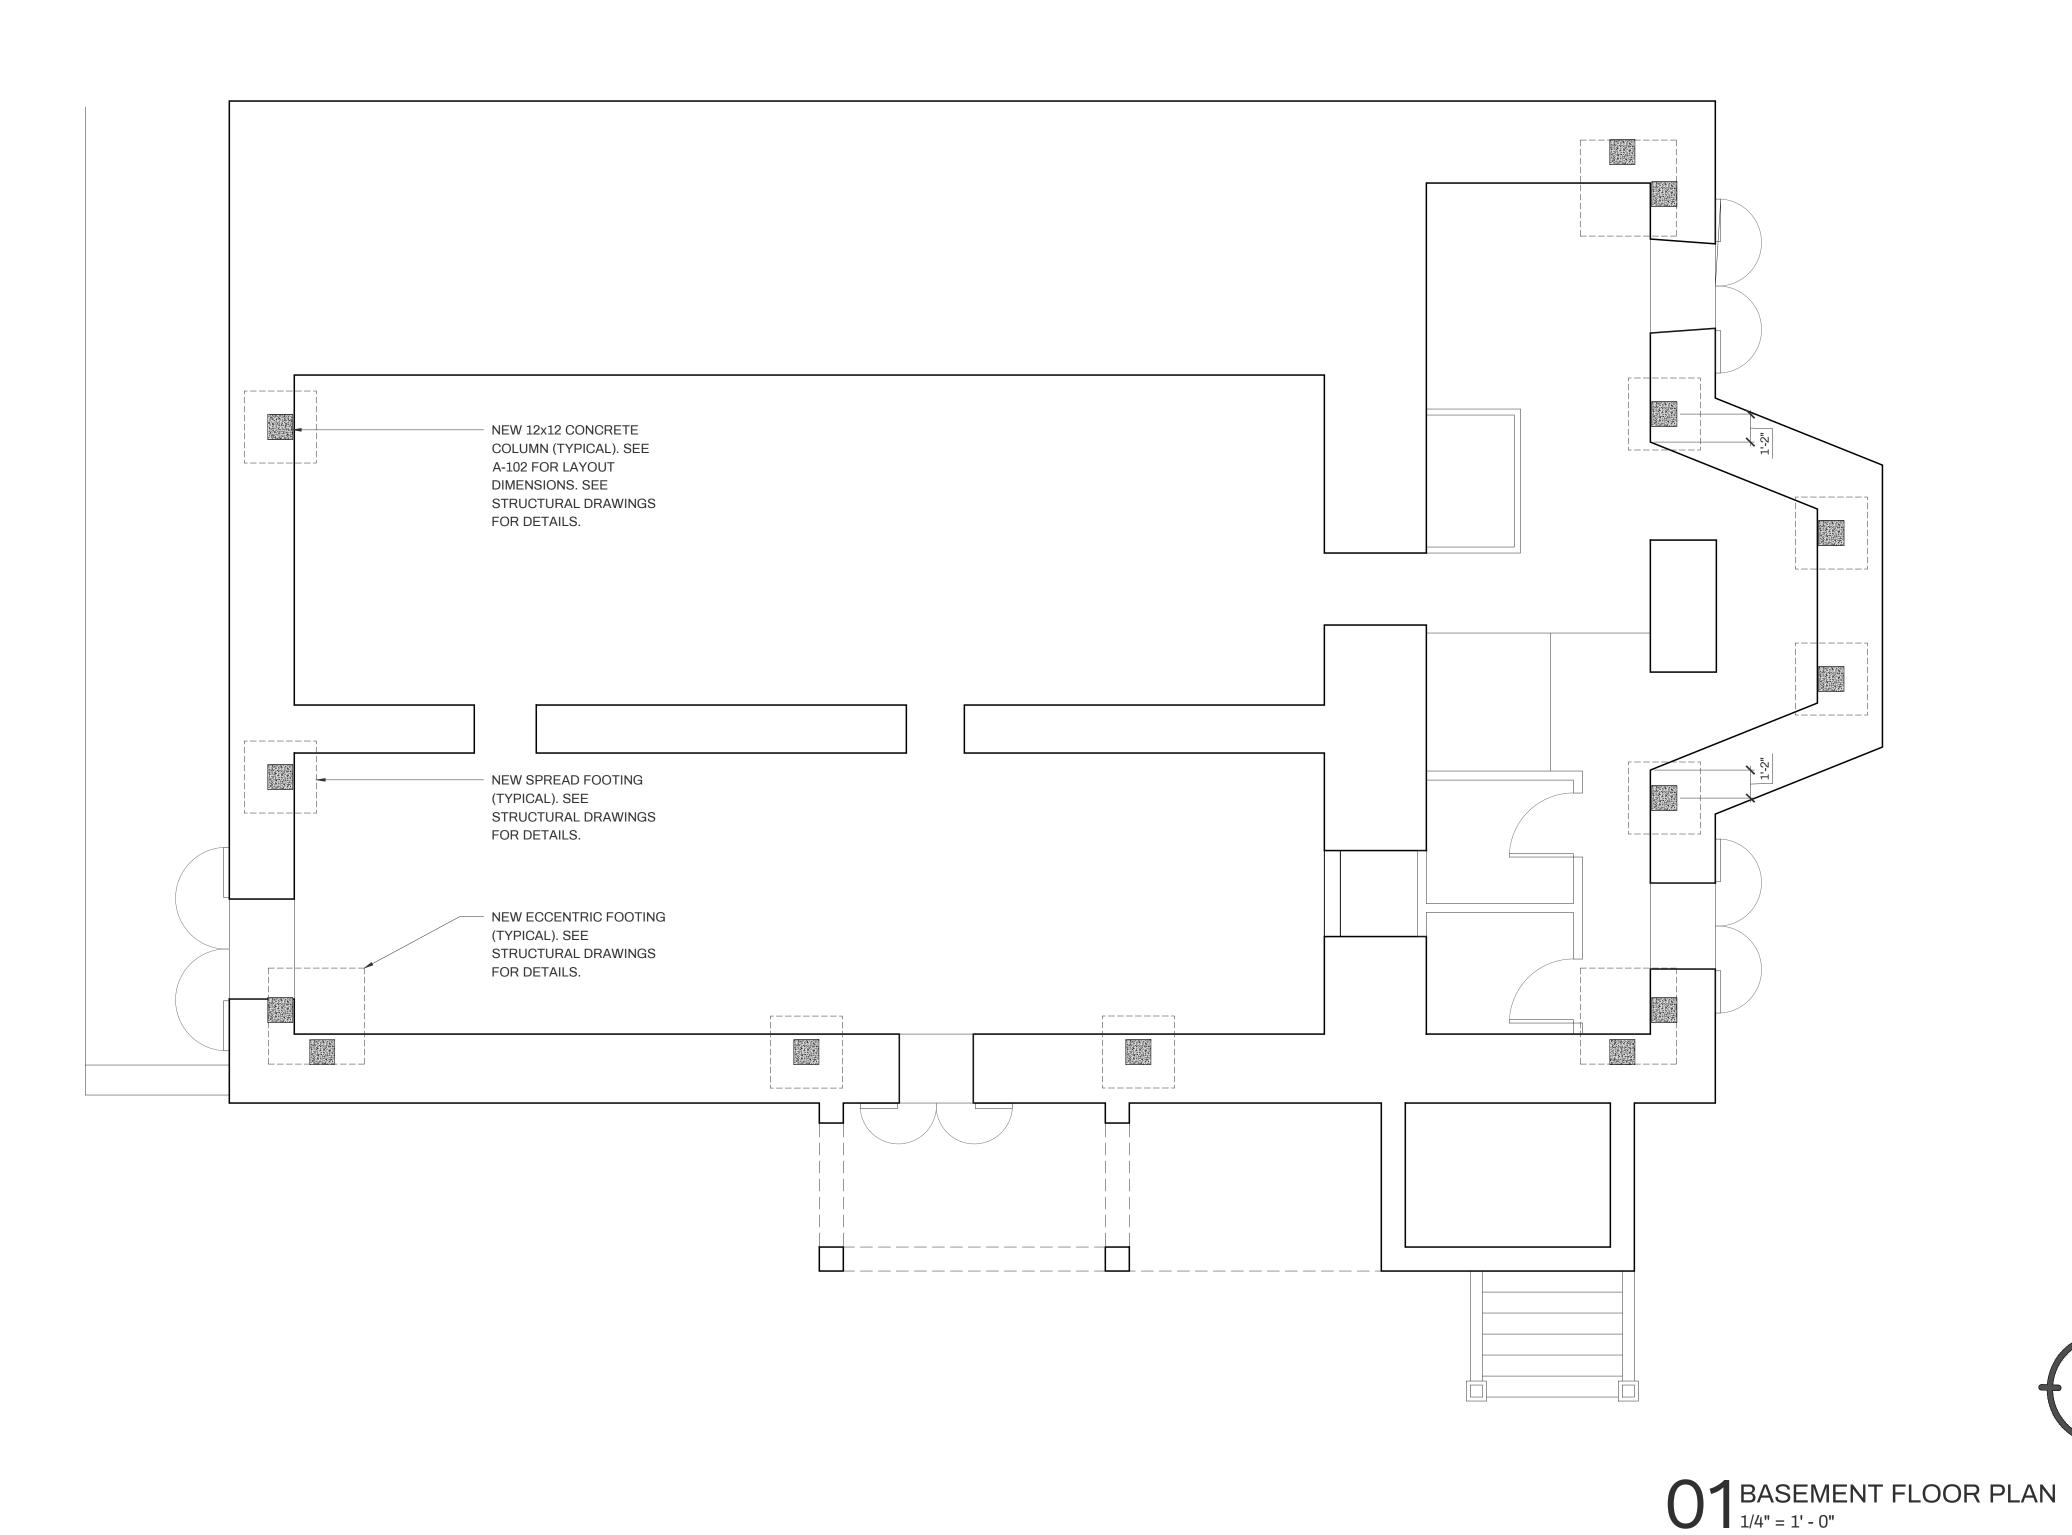
Building Permit Set

revisions

EXISTING INTERIOR ELEVATIONS

2022-009 January 13, 2023

AD2.11

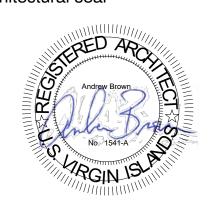




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7/5/2024

issue

Building Permit Set

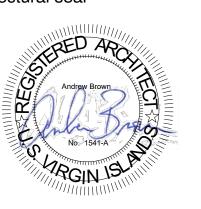revisions

1

BASEMENT FLOOR PLAN


project number

April 21, 2023

2022-009

sheet

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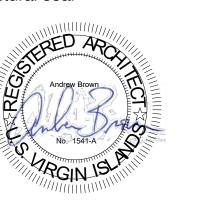


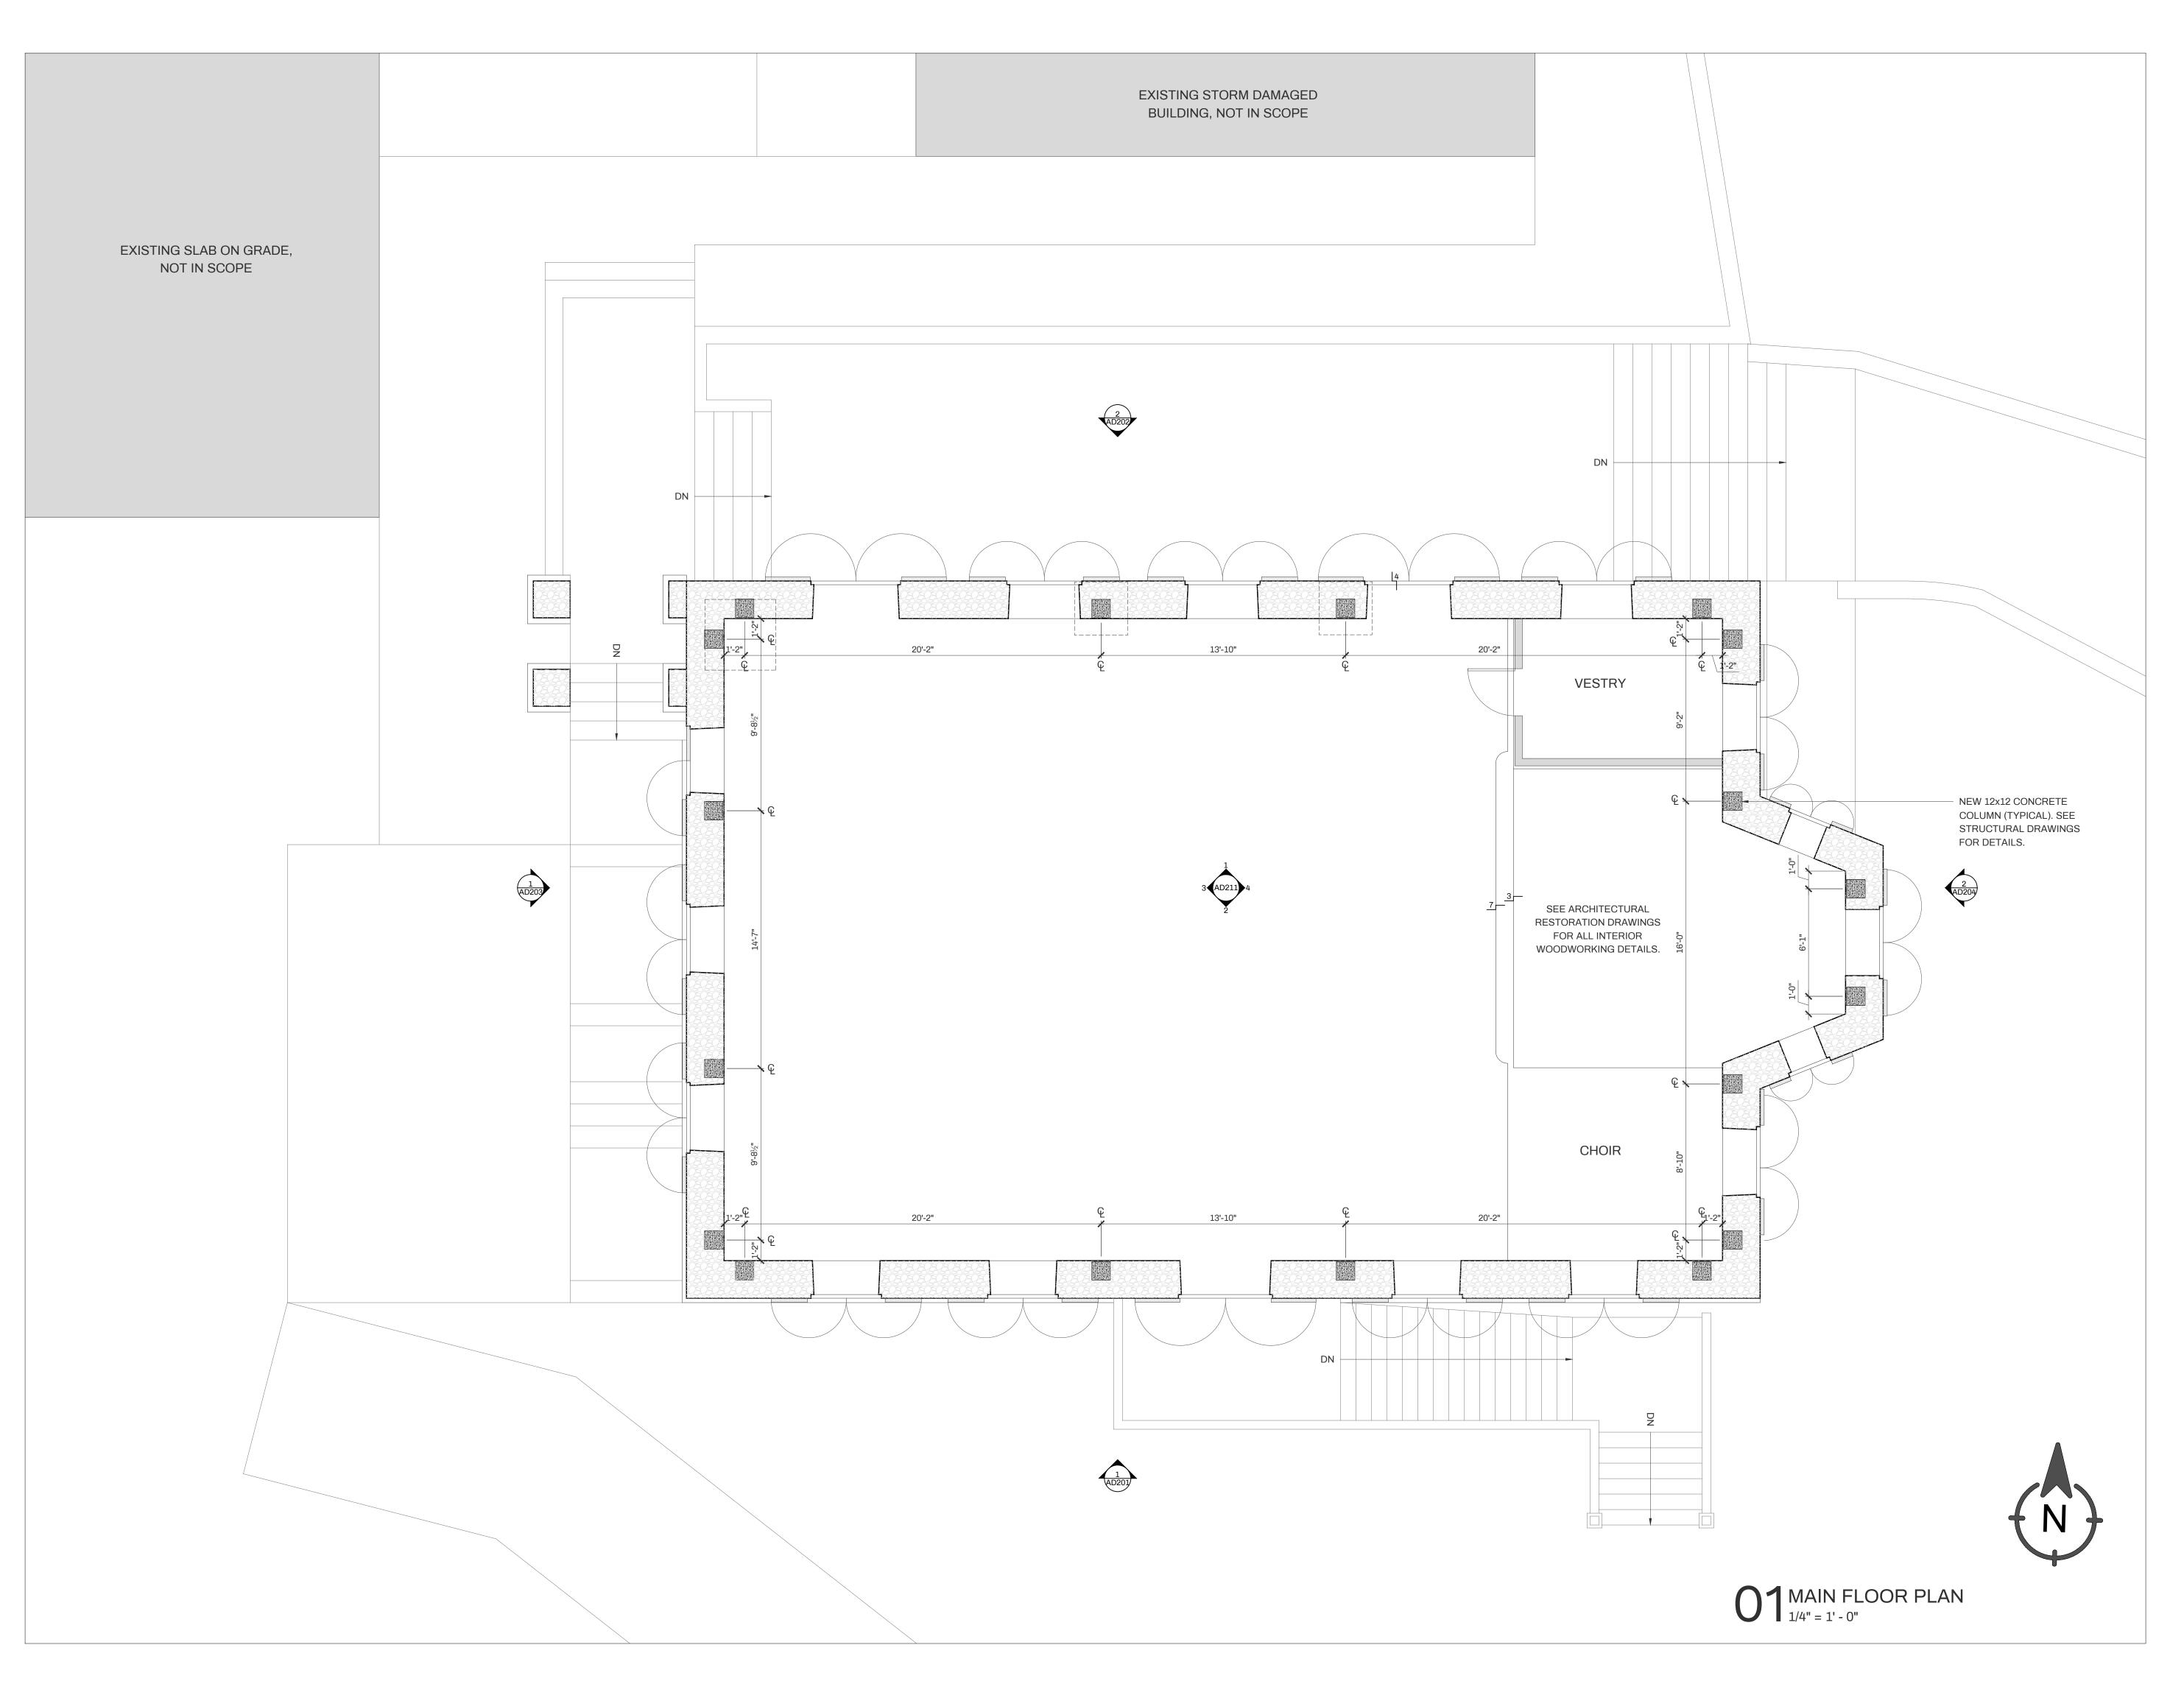

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7/5/2024

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revisions

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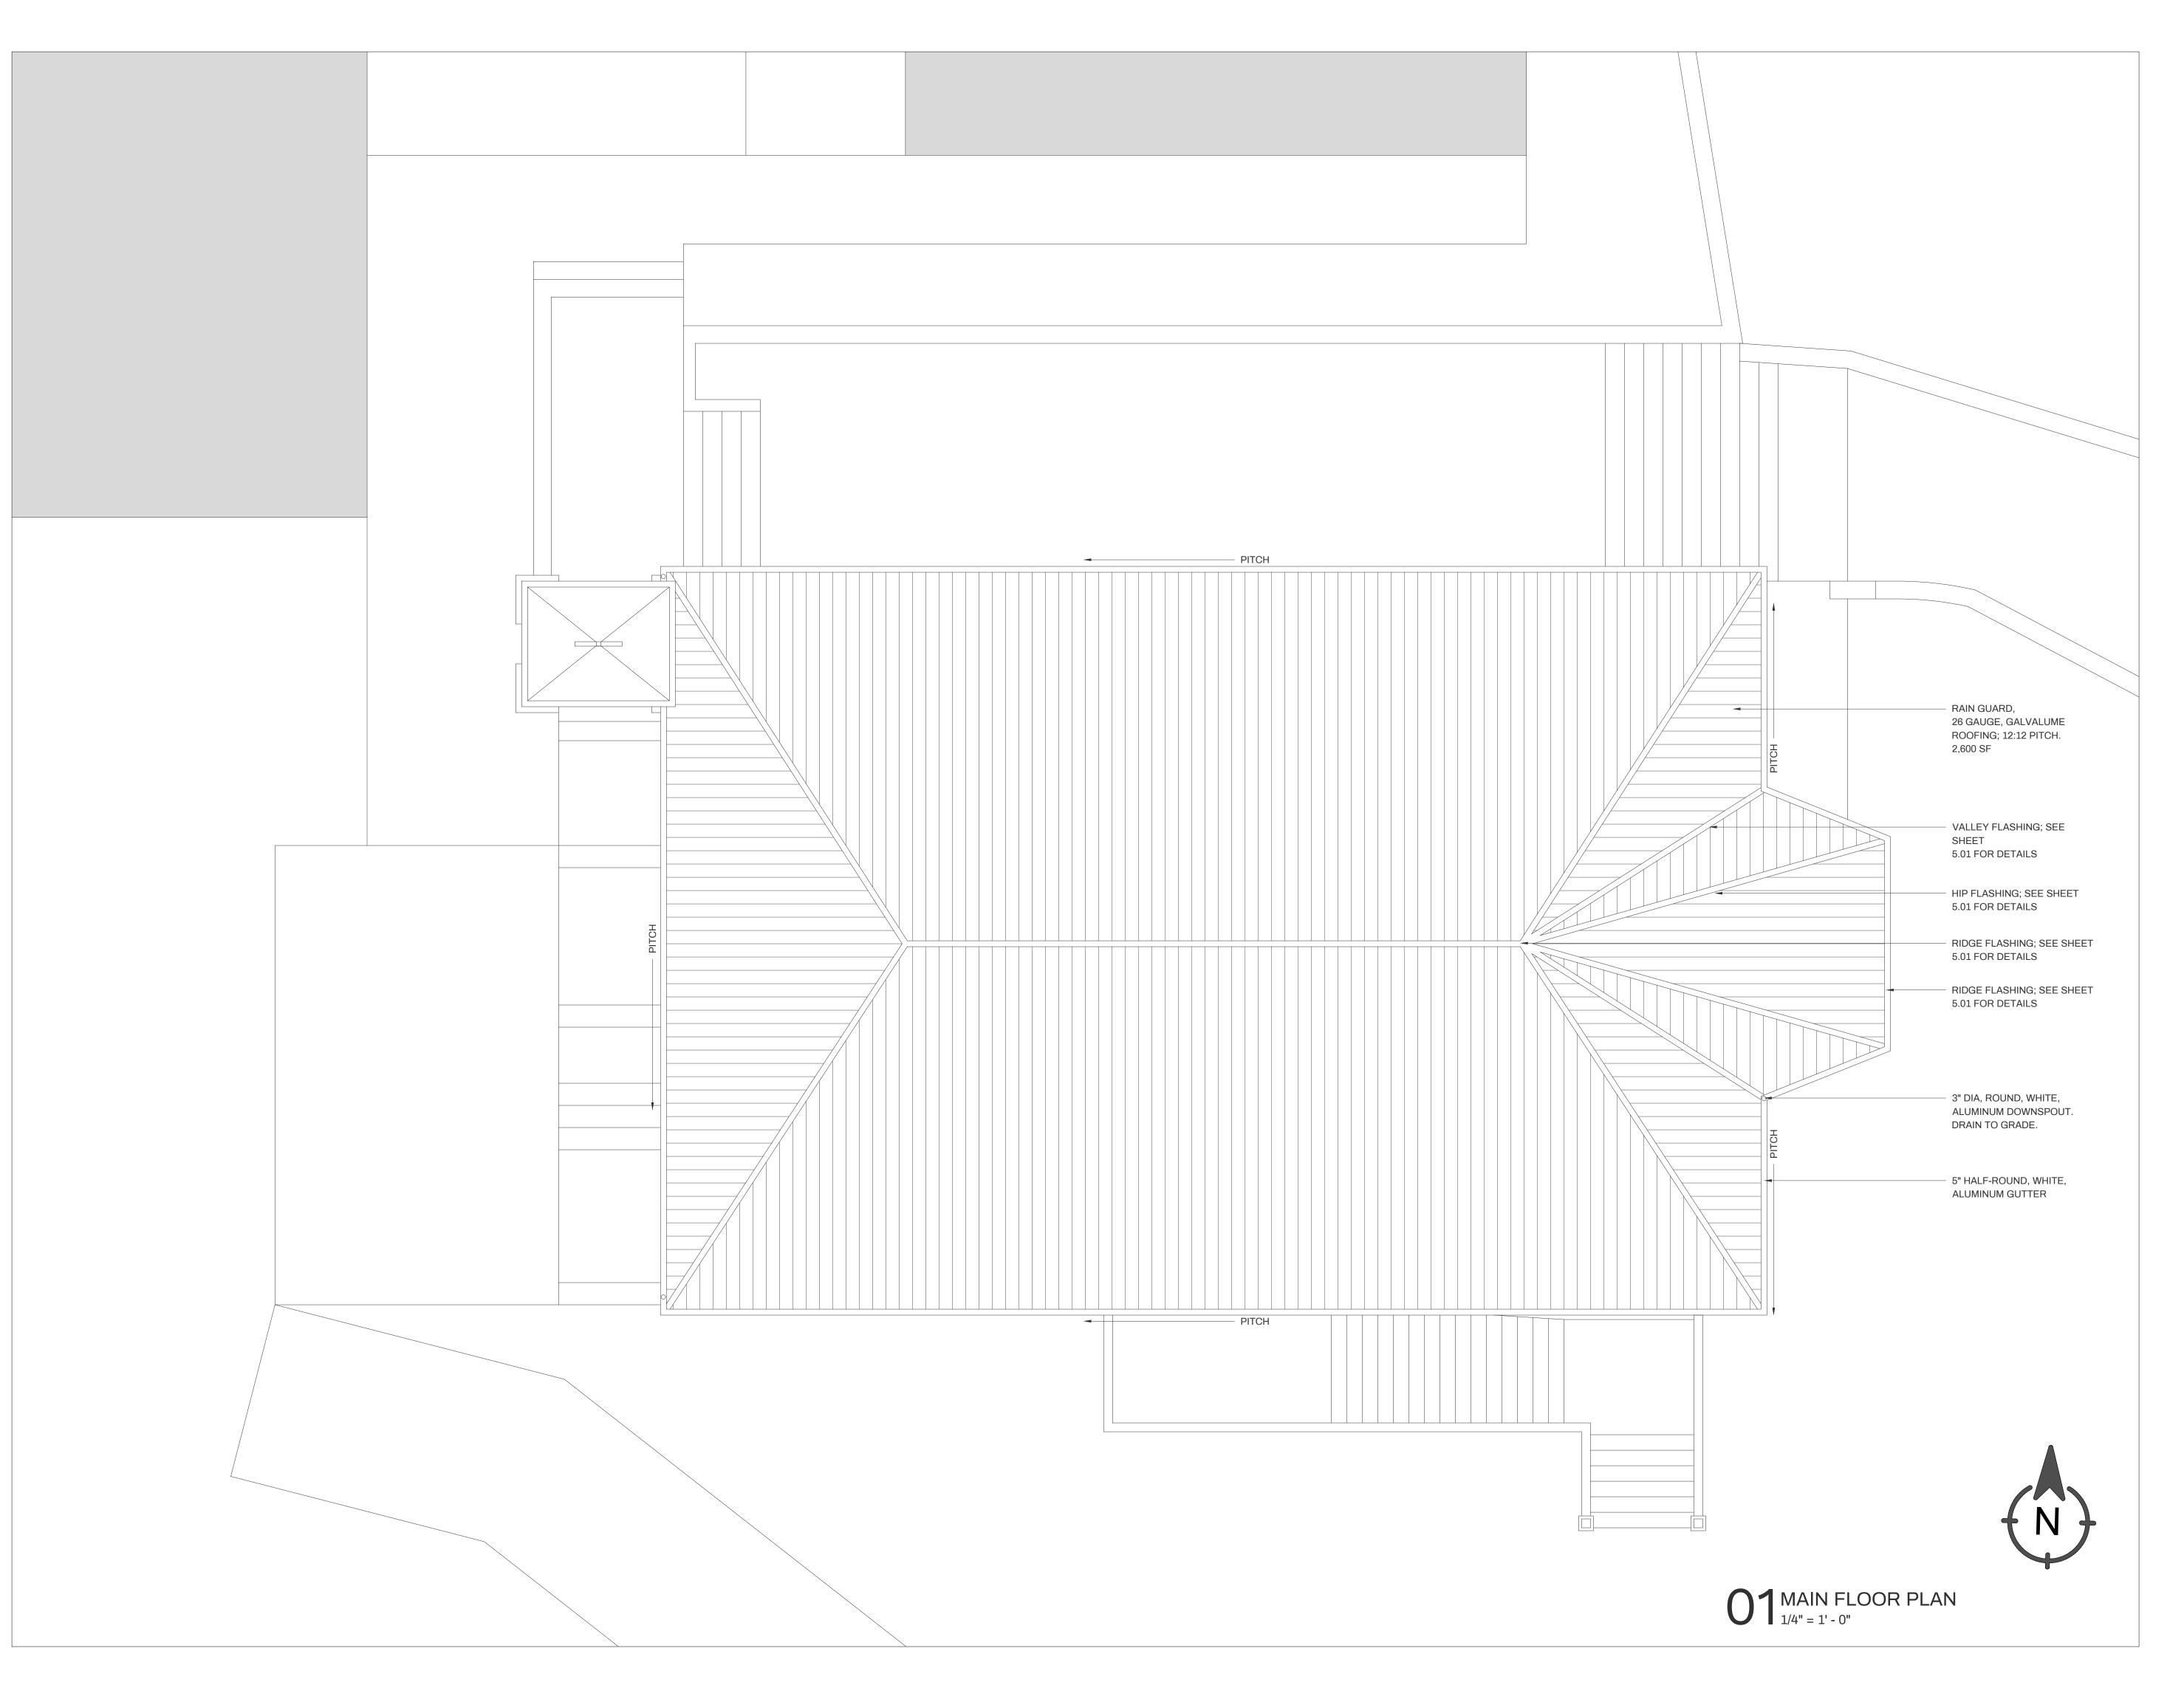
MAIN FLOOR PLAN

project number

2022-009 April 21, 2023

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A1.02






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PARCEL 10 ESTATE EMMAUS ST JOHN, USVI

7/5/2024

issue

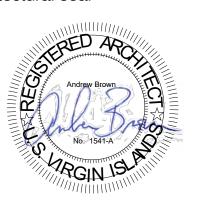Building Permit Set

revisions


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ROOF PLAN

project number 2022-009 date April 21, 2023

sheet

A1.03




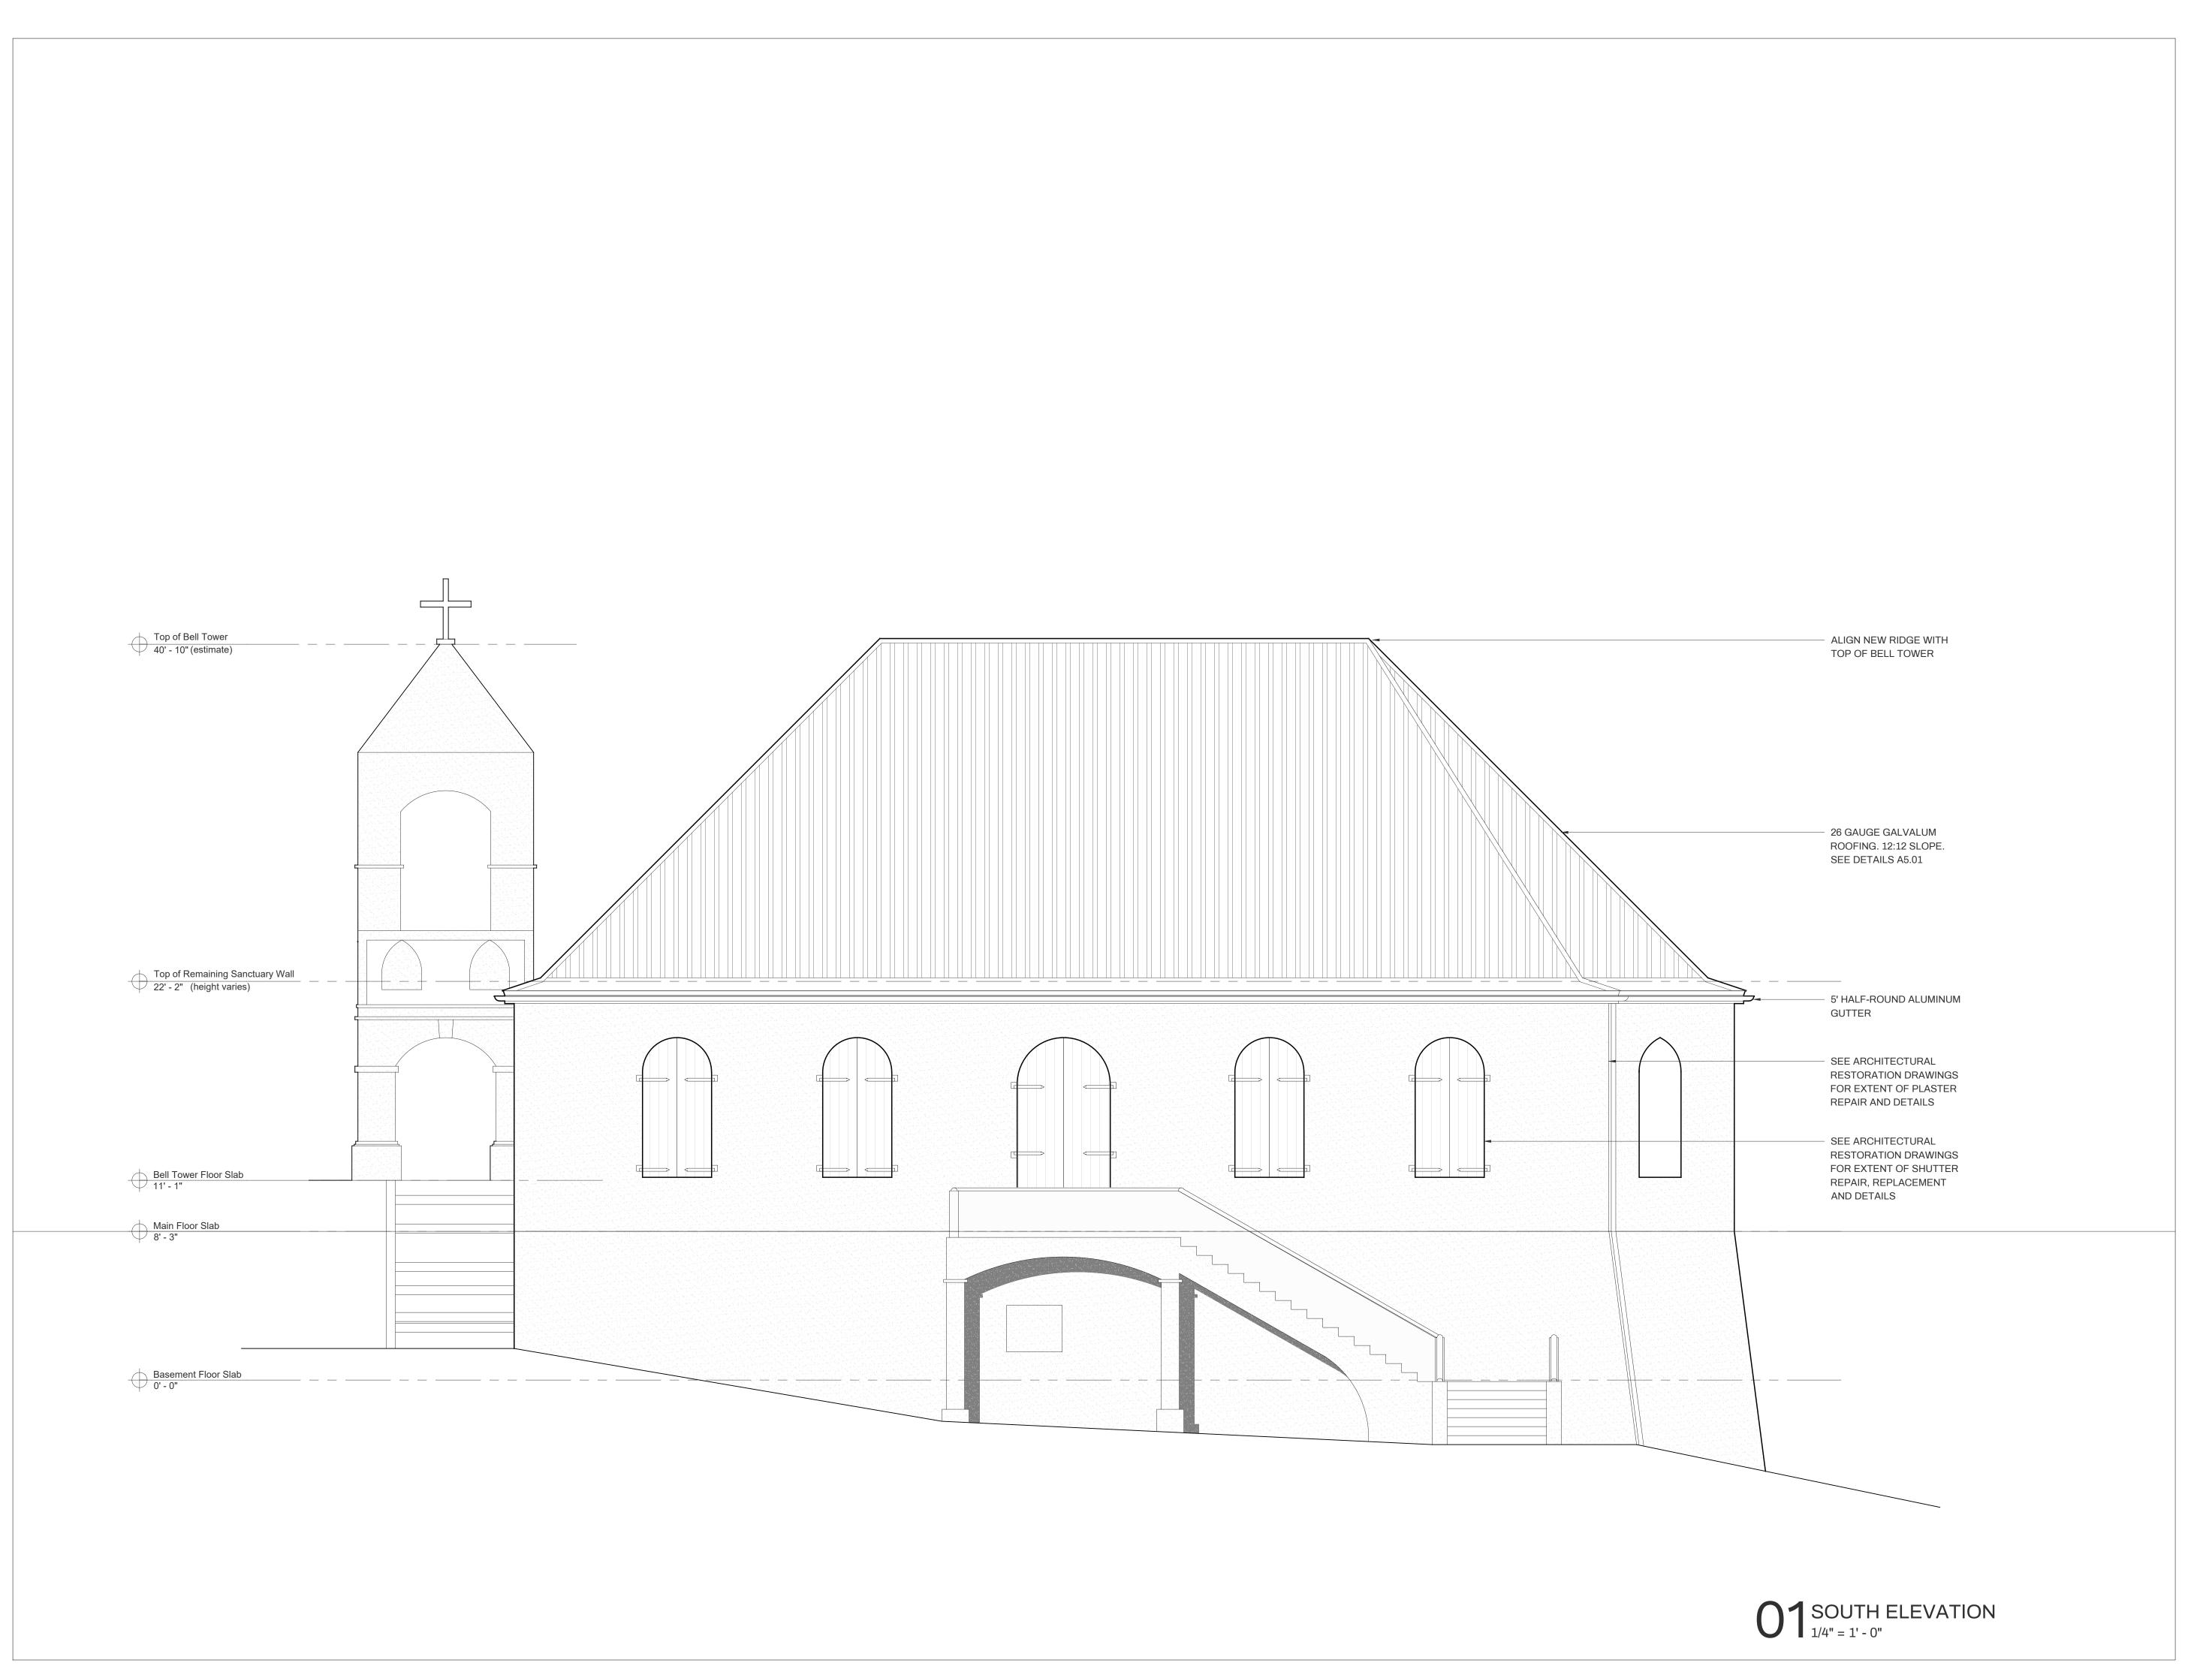

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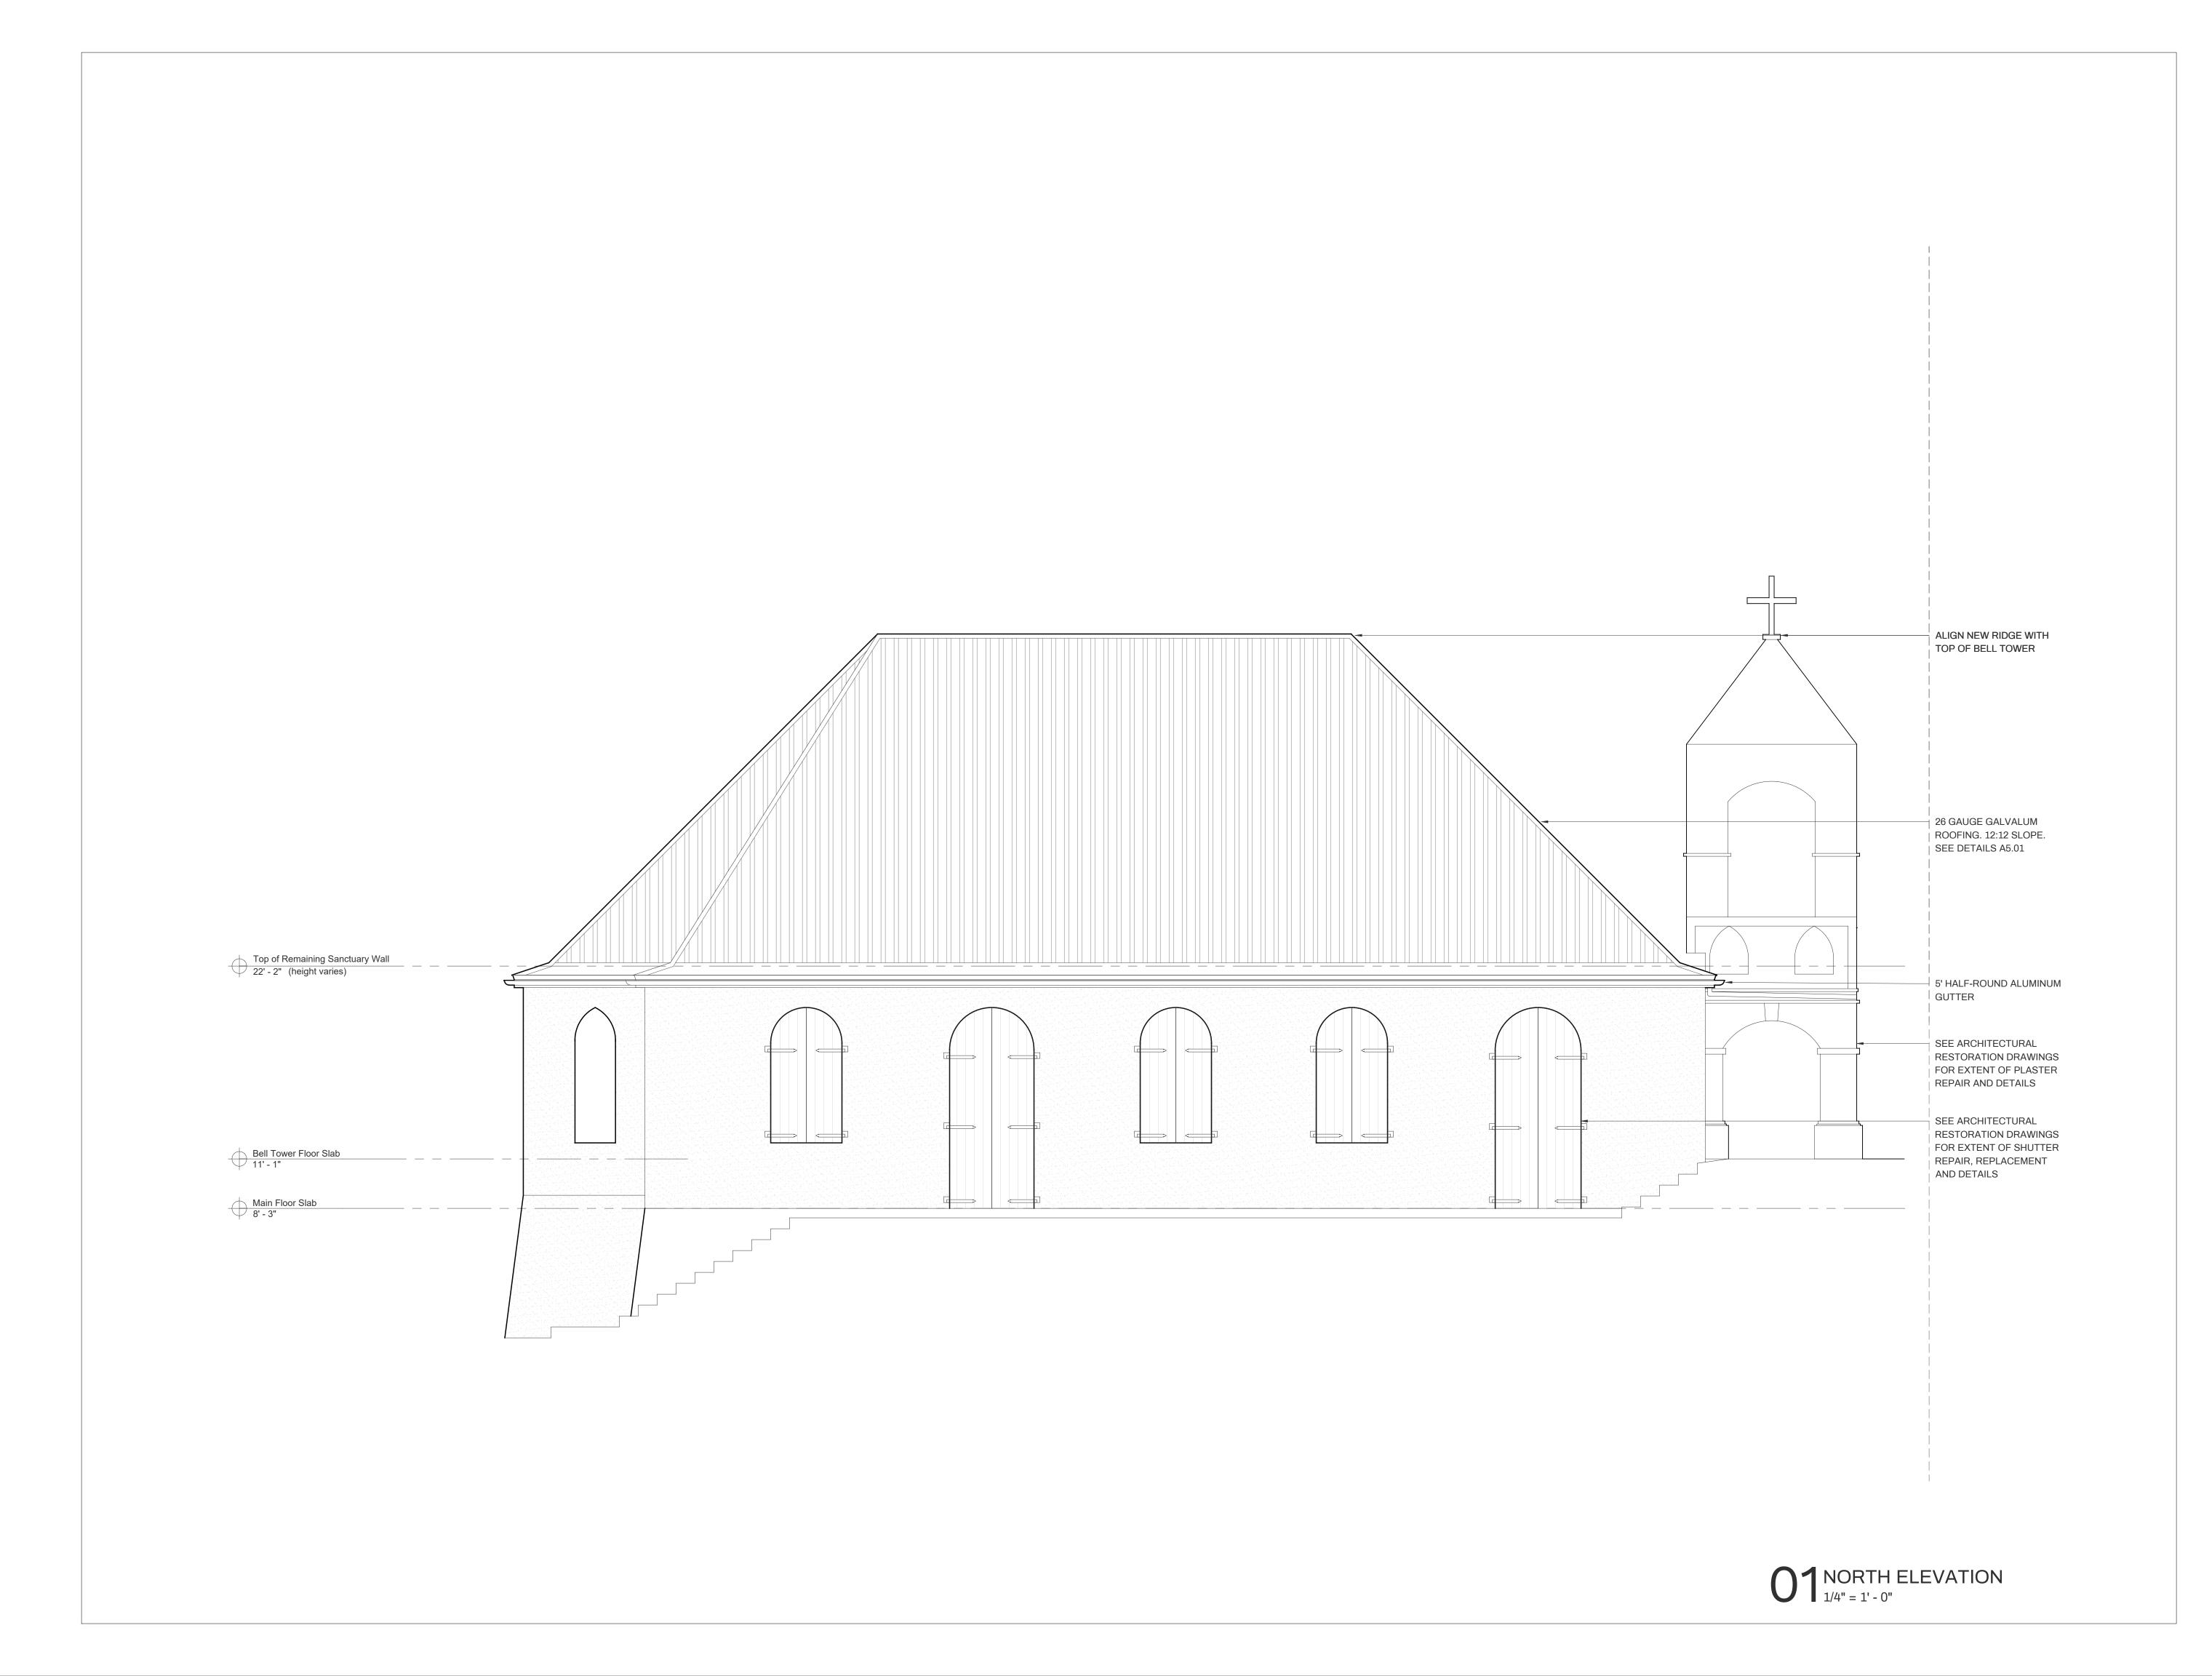
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EXTERIOR ELEVATIONS

project number

2022-009 April 21, 2023

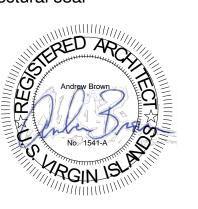sheet






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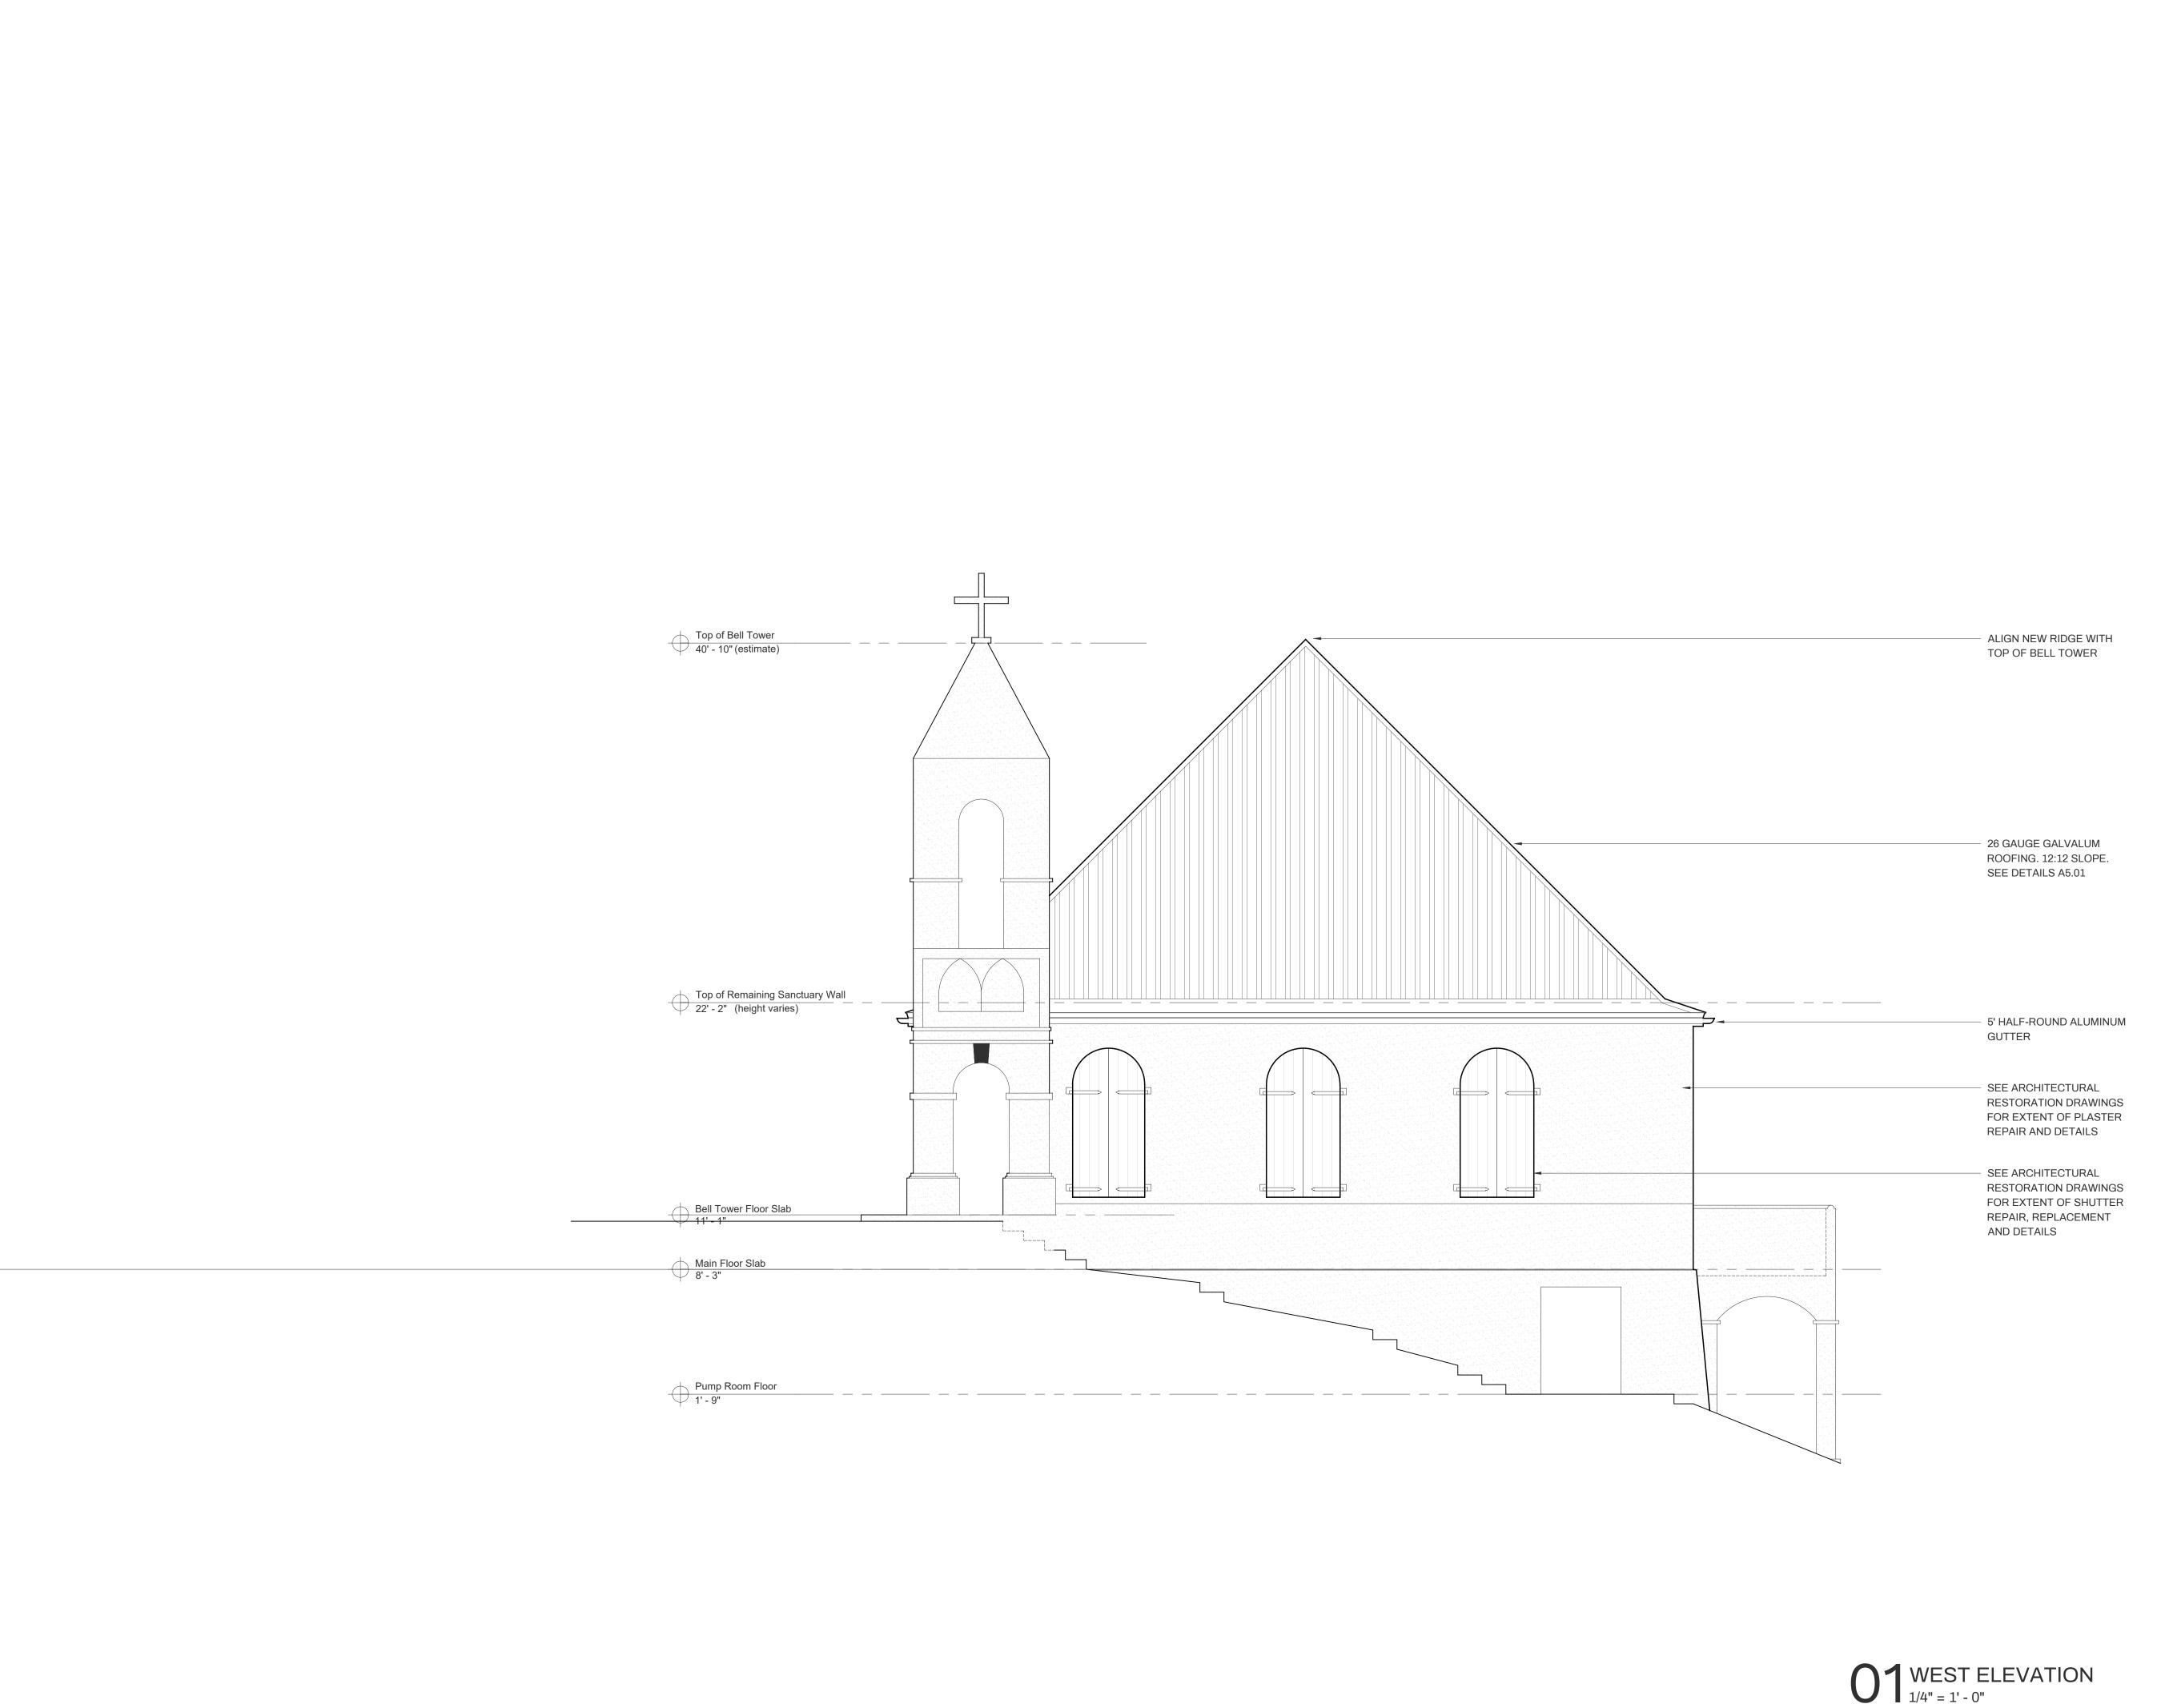
EXTERIOR ELEVATIONS

project number

April 21, 2023

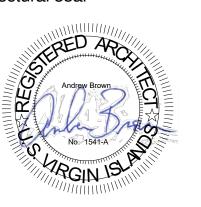2022-009

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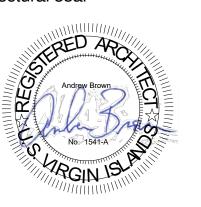




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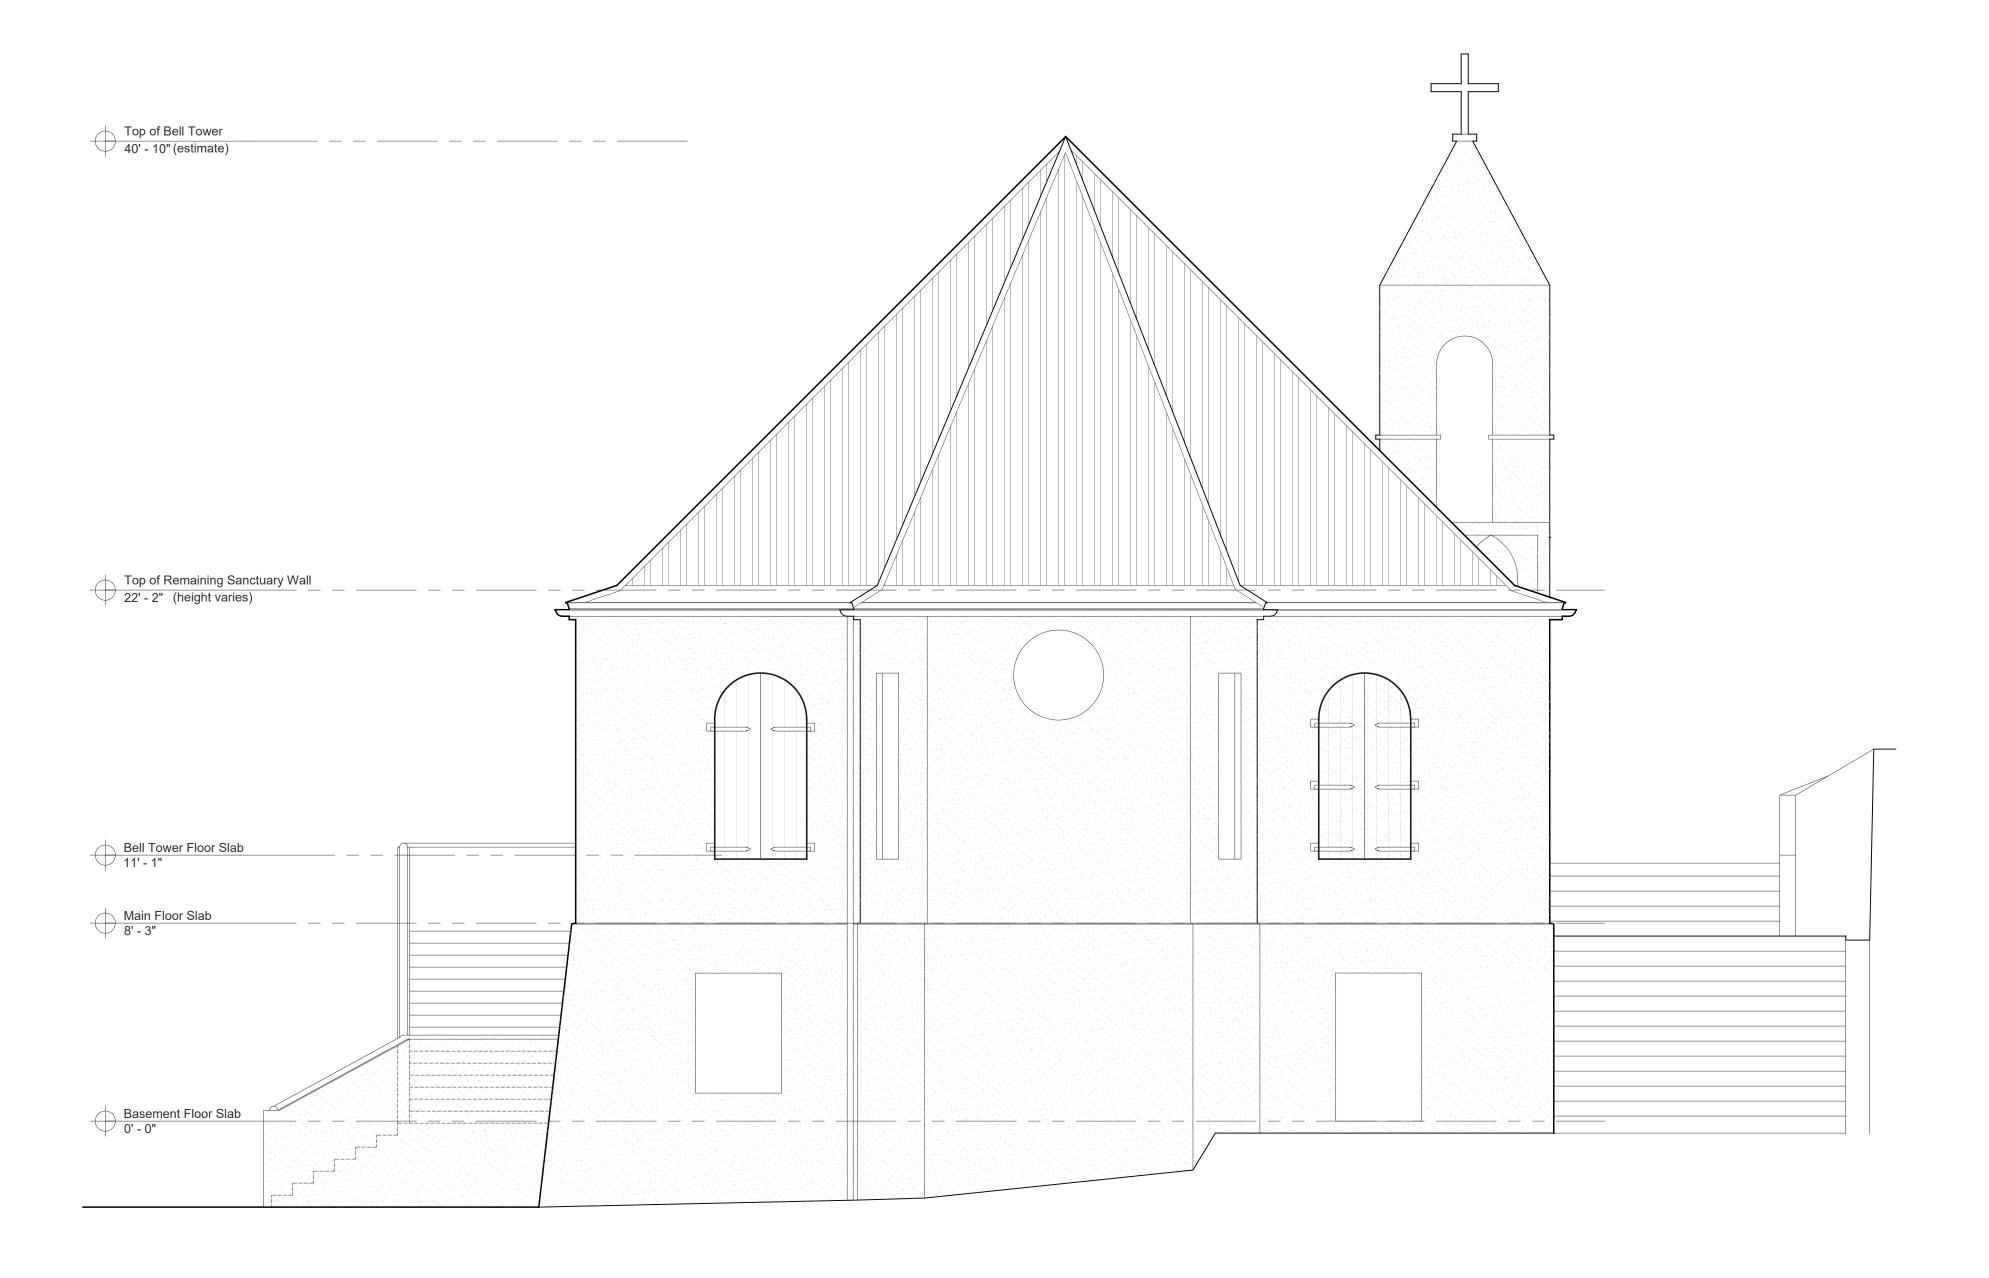
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EXTERIOR ELEVATIONS

project number

January 13, 2023

2022-009






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PARCEL 10 ESTATE EMMAUS ST JOHN, USVI

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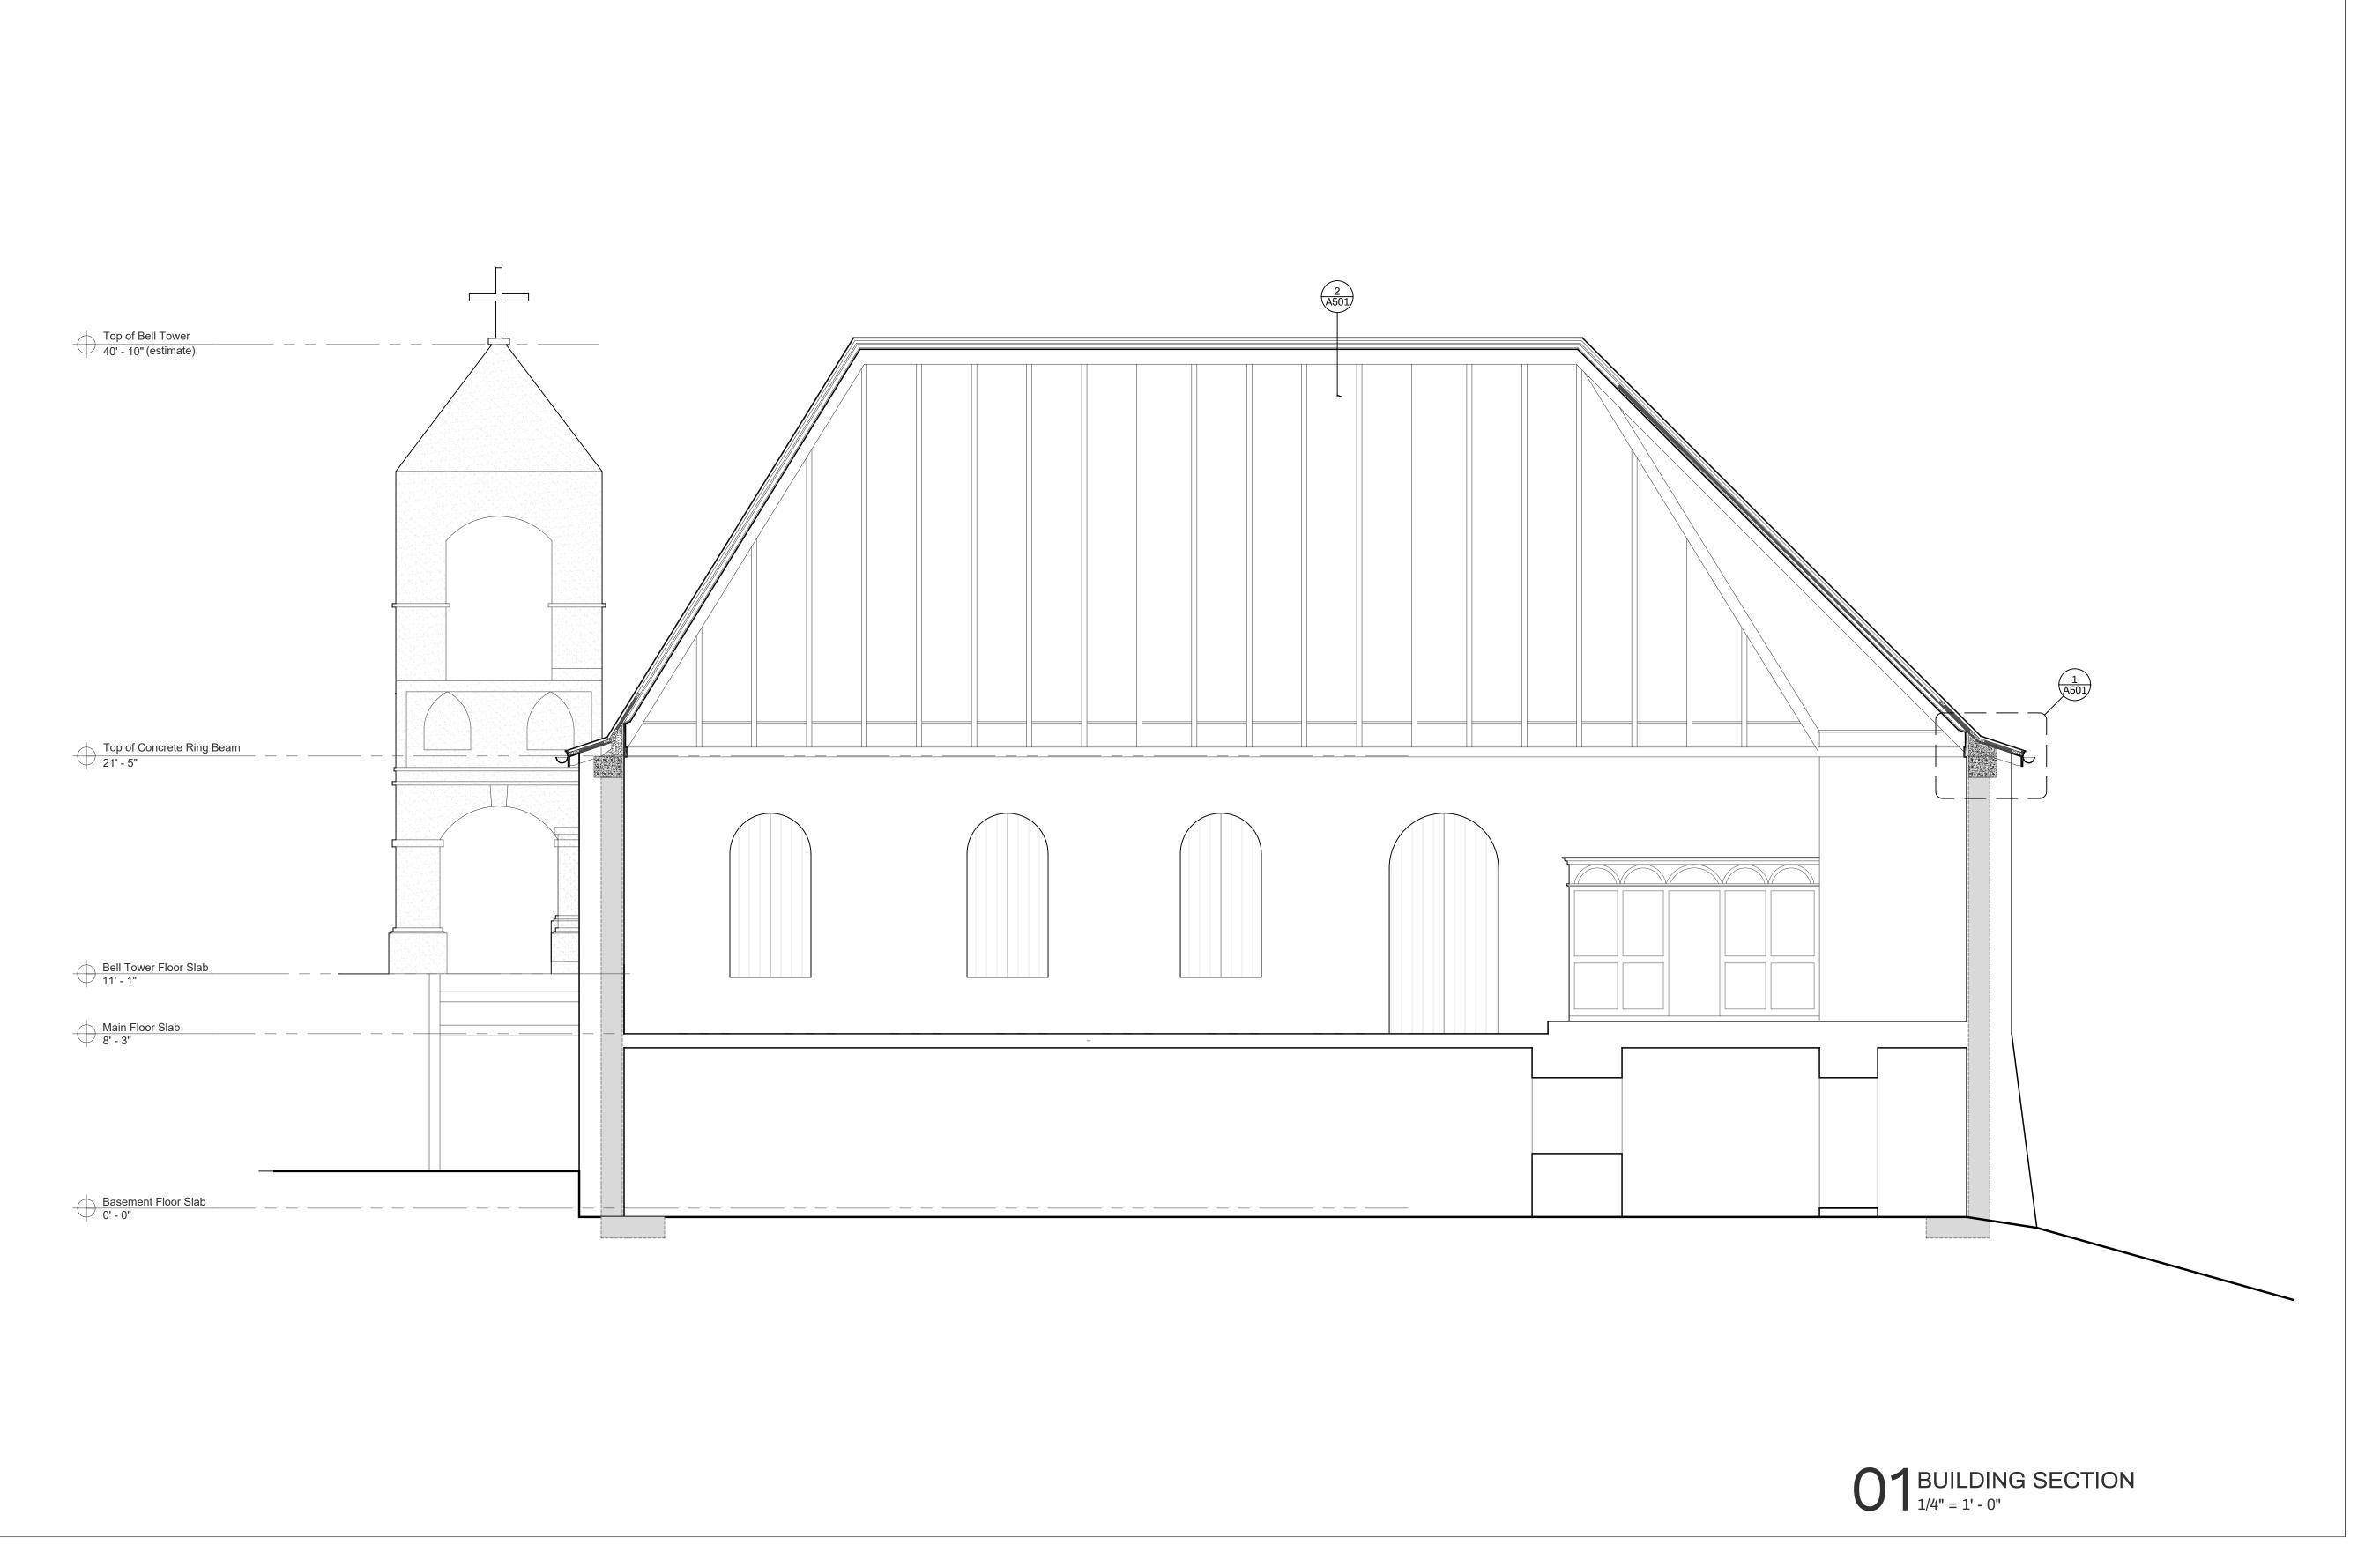
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EXTERIOR ELEVATIONS

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Der 2022-009 January 13, 2023
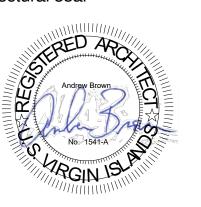
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EMMAUS MORAVIAN
CHURCH
SANCTUARY
RECONSTRUCTION

PARCEL 10 ESTATE EMMAUS ST JOHN, USVI

7/5/2024

2022-009

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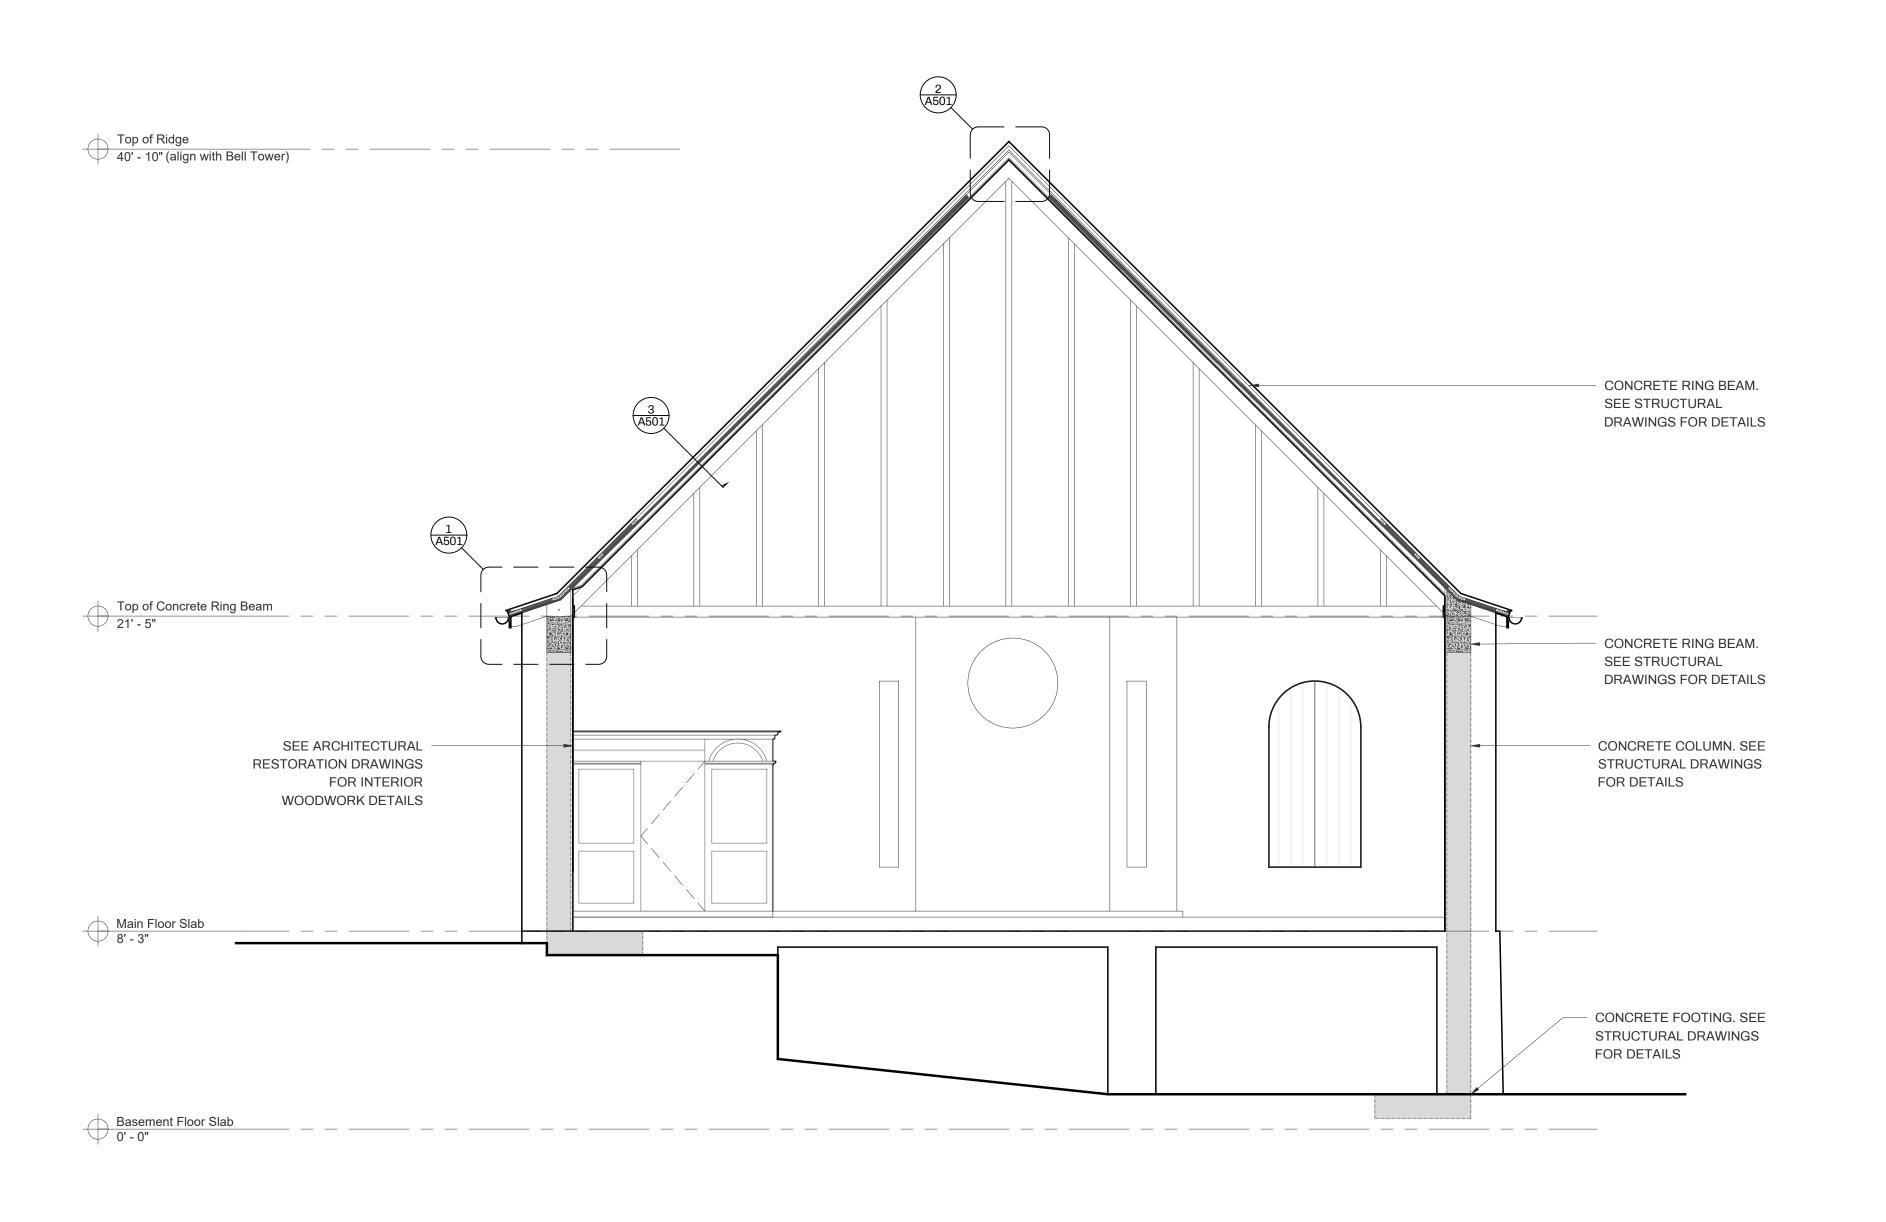
BUILDING SECTION

project number

date April 21, 2023

sheet

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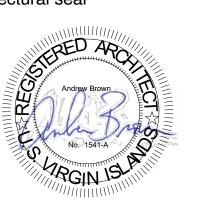




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PARCEL 10 ESTATE EMMAUS ST JOHN, USVI

7/5/2024

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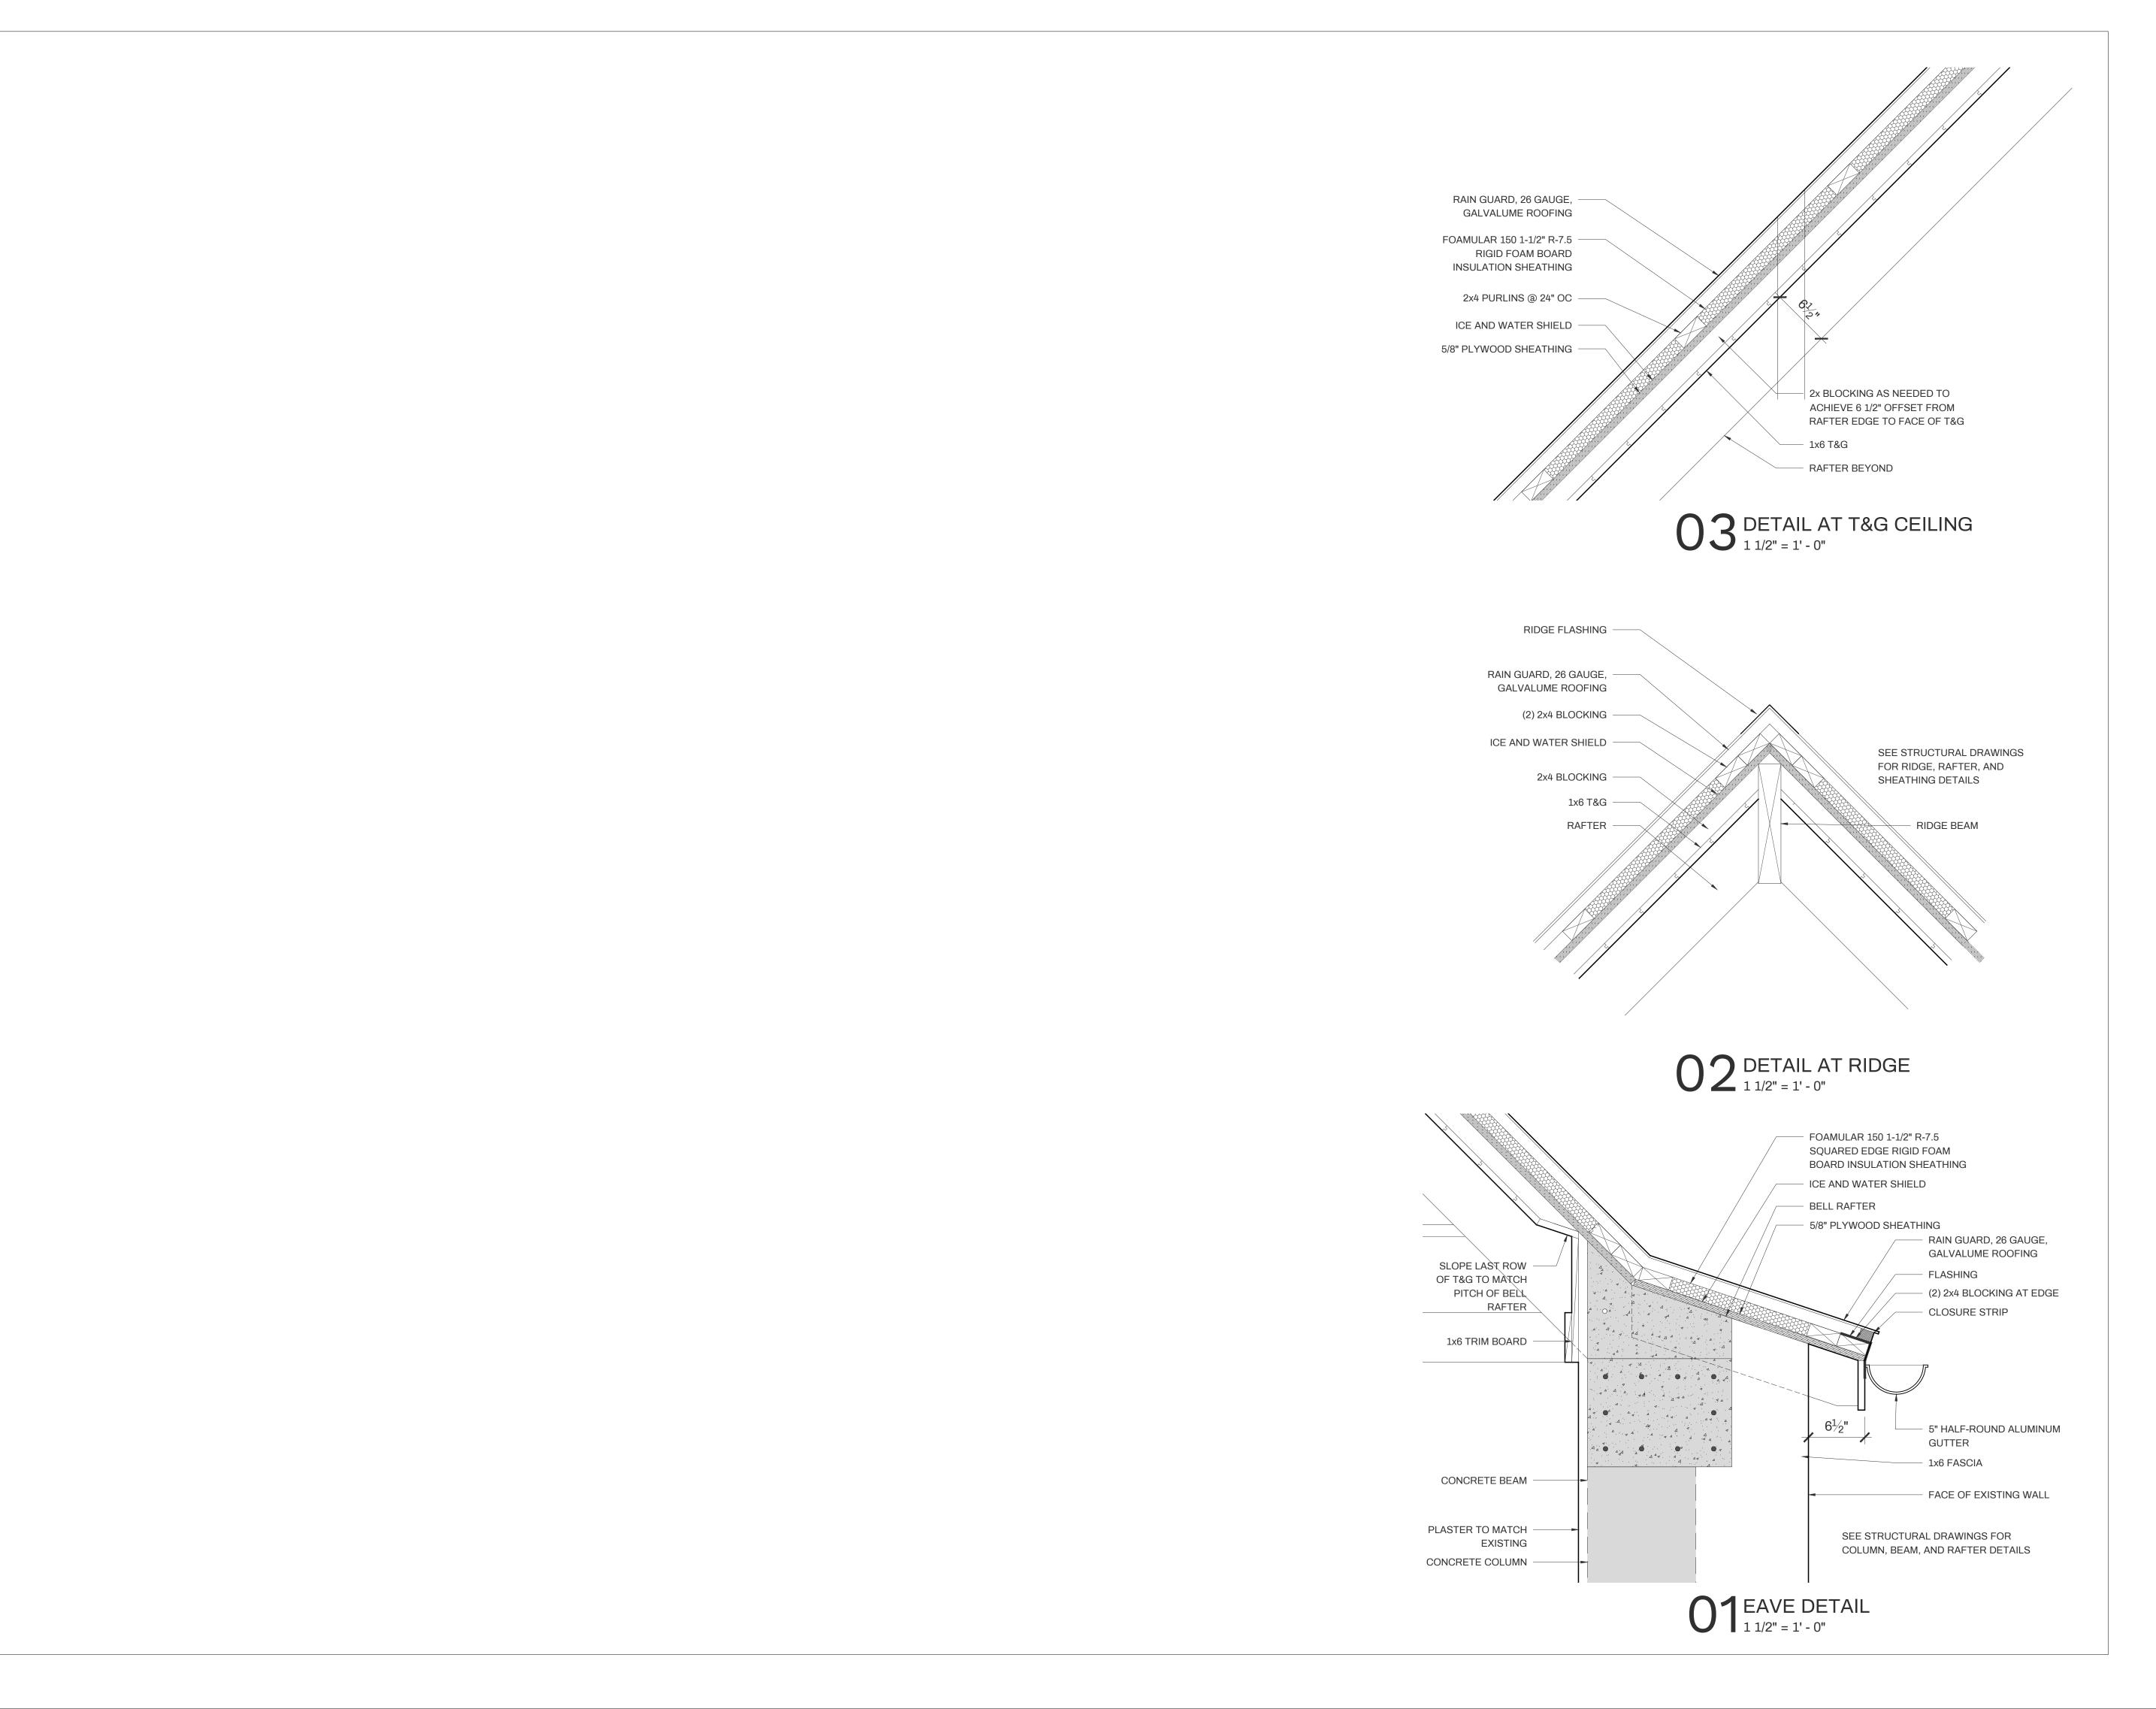
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project number

2022-009 April 21, 2023

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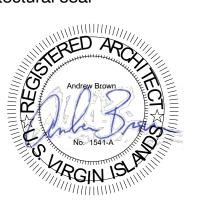




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PARCEL 10 ESTATE EMMAUS ST JOHN, USVI

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2022-009

April 21, 2023

issue

Building Permit Set

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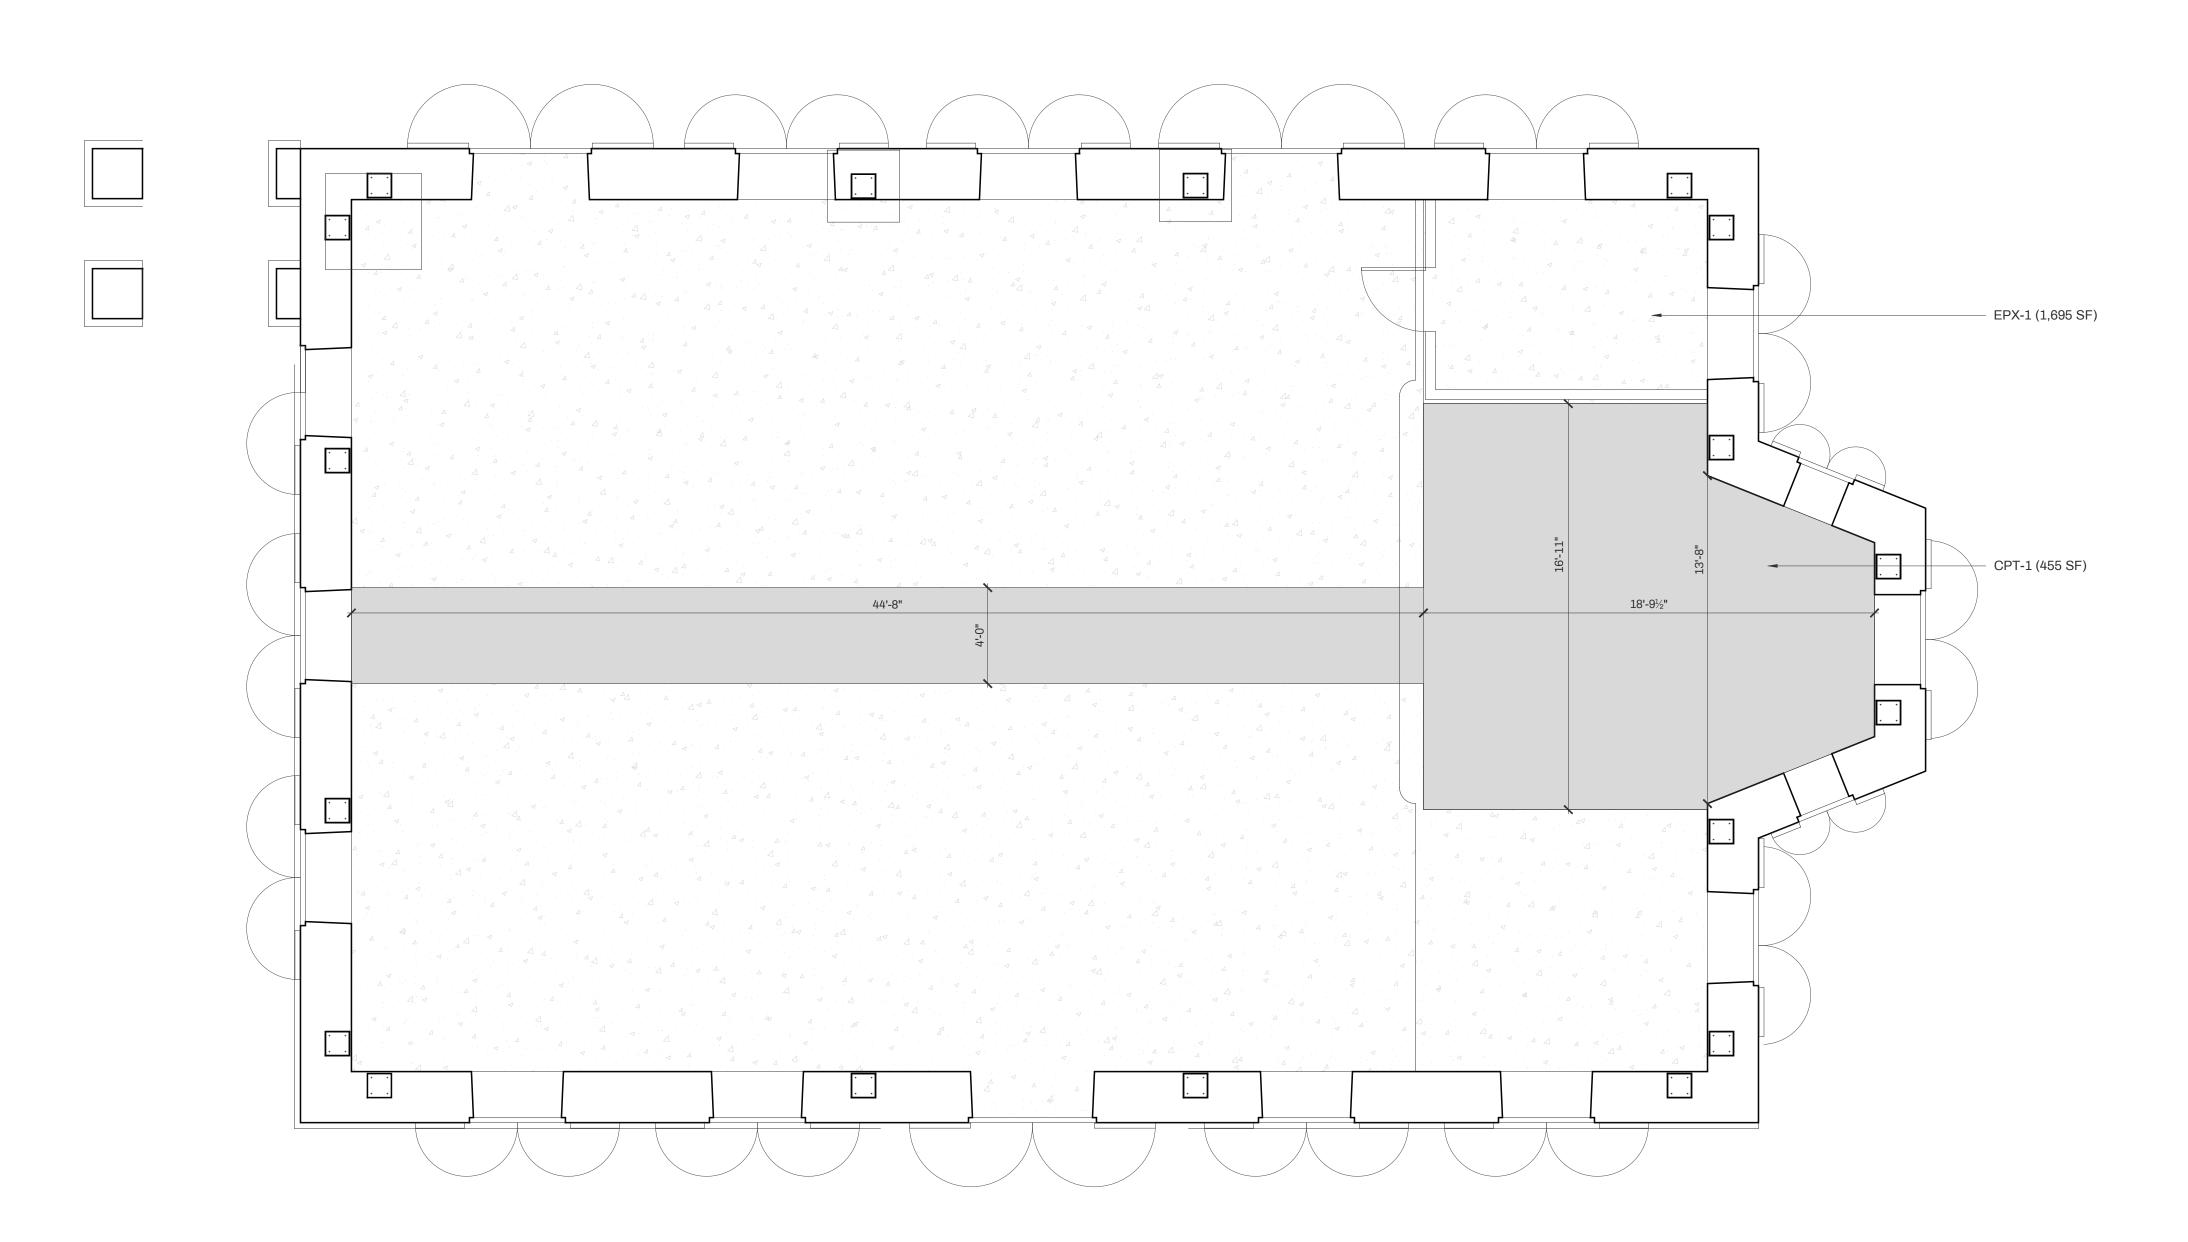
DETAILS

project number

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A5.01

FINISH LEGEND								
MARK	MANUFACTURER	MODEL/DESCRIPTION	SIZE	COLOR	NOTES			
CARPET								
CPT-1	MANNINGTON	RUFFIAN II	see plans	BLUE BALANCE (3501)	AISLE RUNNER AND APSE			
EPOXY FLOOR COATING								
EPX-1	WATCO	CLEAR COAT B621952	see plans	BLACK/WHITE CHIPS	J511679 - VINYL CHIPS - BLACK/WHITE			



MAIN FLOOR FINISH PLAN
1/4" = 1' - 0"

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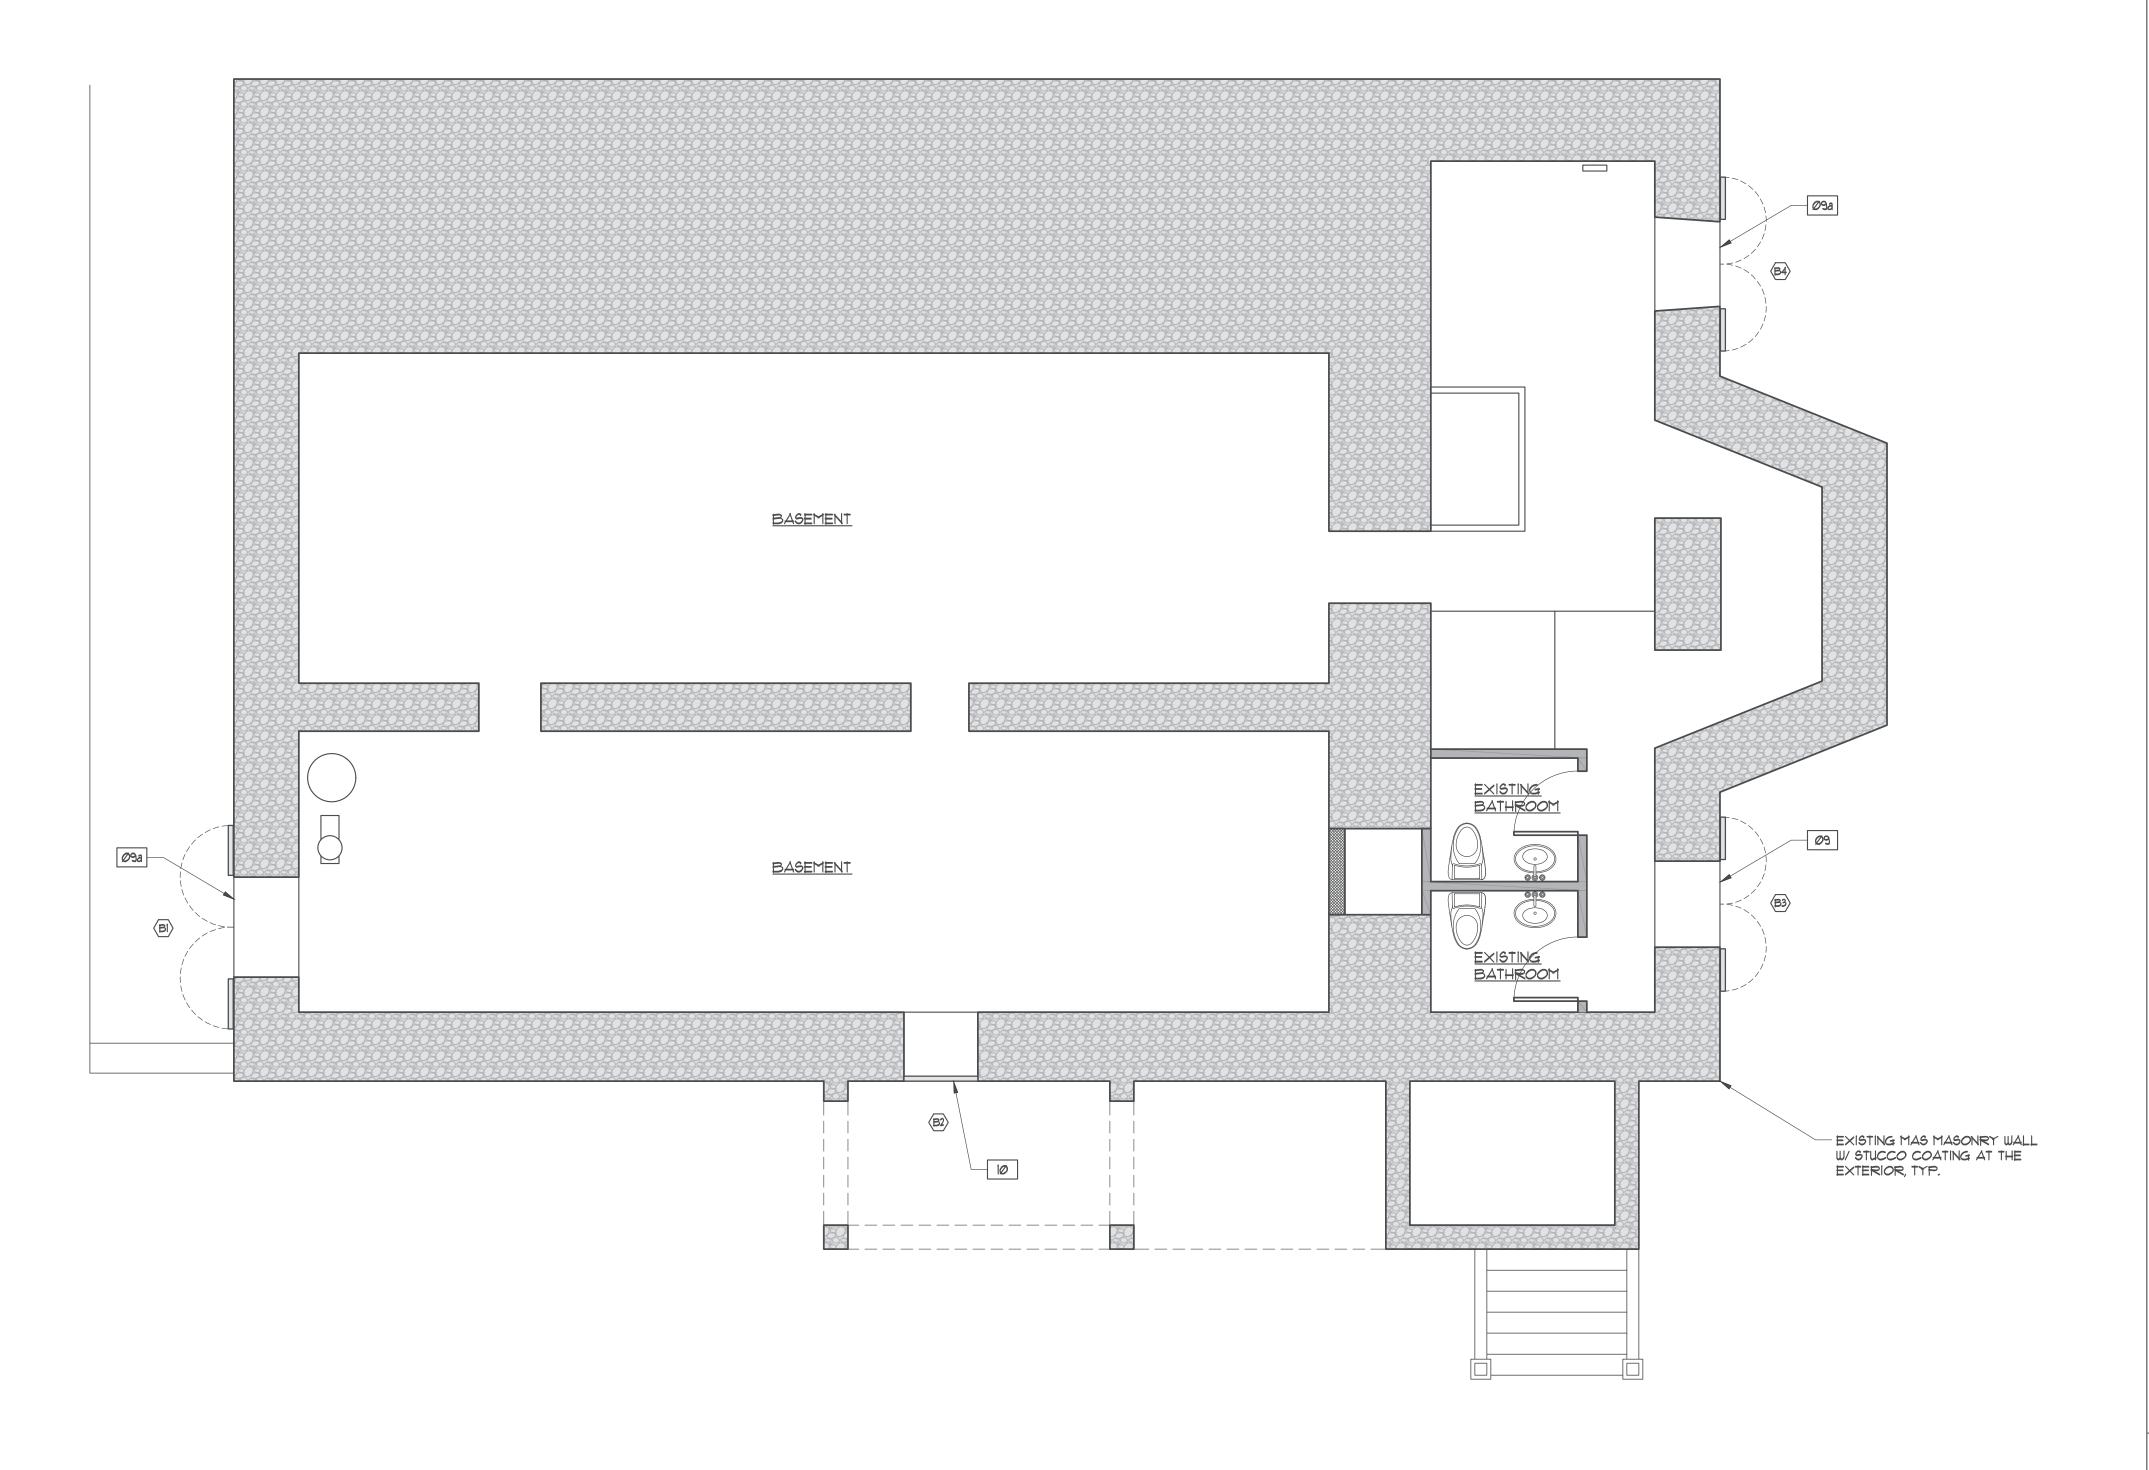
MAIN FLOOR FINISH PLAN

project number

2022-009 April 21, 2023

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A7.01



BASEMENT FLOOR PLAN

ARIOO / 1/4"=1'-0"

NORTH

GENERAL RESTORATION WORK

- "AR" DRAWINGS REFER TO RESTORATION SCOPE OF WORK ONLY. SEE ARCHITECTURAL, STRUCTURAL, AND MEP DRAWINGS FOR ADDITIONAL INFORMATION AND
- SEE INTERIOR ELEVATIONS FOR INTERIOR STUCCO REPAIR WORK.
- 3. SEE EXTERIOR ELEVATIONS FOR EXTERIOR STUCCO REPAIR WORK

PLAN SCOPE OF WORK NOTES:

- REPAIR/RESTORE EXISTING VESTRY AS DETAILED ON AR-501
- 03 RECREATE ALTAR RAIL AS DETAILED ON AR-504
- 04 RECREATE PULPIT AS DETAILED ON AR-505
- RECREATE STAINED GLASS WINDOW AND FRAME AS DETAILED ON AR-701
- RESTORE EXISTING WOOD SHUTTER AS DETAILED. REMOVE EXISTING HARDWARE AND REPLACE WITH MARINE-GRADE STAINLESS STEEL HARDWARE TO MATCH EXISTING. SEE SHUTTER RESTORATION DRAWINGS, AR-601 - AR-613.
- @1 RESTORE EXISTING WOOD SHUTTER AT DOORWAY AS DETAILED. REMOVE EXISTING HARDWARE AND REPLACE WITH MARINE-GRADE STAINLESS STEEL HARDWARE TO MATCH EXISTING. SEE SHUTTER RESTORATION DRAWINGS, AR-601 - AR-613.
- REMOVE EXISTING DAMAGED WOOD SHUTTER/DOOR AND PROVIDE NEW WD. SHUTTER/DOOR TO MATCH EXISTING AS DETAILED. PROVIDE NEW MARINE-GRADE STAINLESS STEEL HARDWARE TO MATCH EXISTING SEE 3+3A/AR601 AND

- PROVIDE NEW WOOD ACCESS HATCH AS DETAILED ON 2/AR-613.

- RECREATE CHOIR RAILING AND CANOPY AS DETAILED ON AR-502 & AR-503

- RESTORE EXISTING WINDOW AND FRAME AS DETAILED. SEE WINDOW RESTORATION DRAWINGS, AR-702.
- PROVIDE NEW WOOD SHUTTER AS DETAILED ON AR-613.
- 09a PROVIDE NEW WOOD DOOR AS DETAILED ON AR-613

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PARCEL 10 **ESTATE EMMAUS** ST JOHN, USVI

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BASEMENT FLOOR PLAN


2022-009

11/28/2023



SCOPE OF WORK TAG - QUANTITY OF SCOPE OF WORK ITEM AT IDENTIFIED AREA

> OPENING TAG, SEE AR-610 TO AR-702

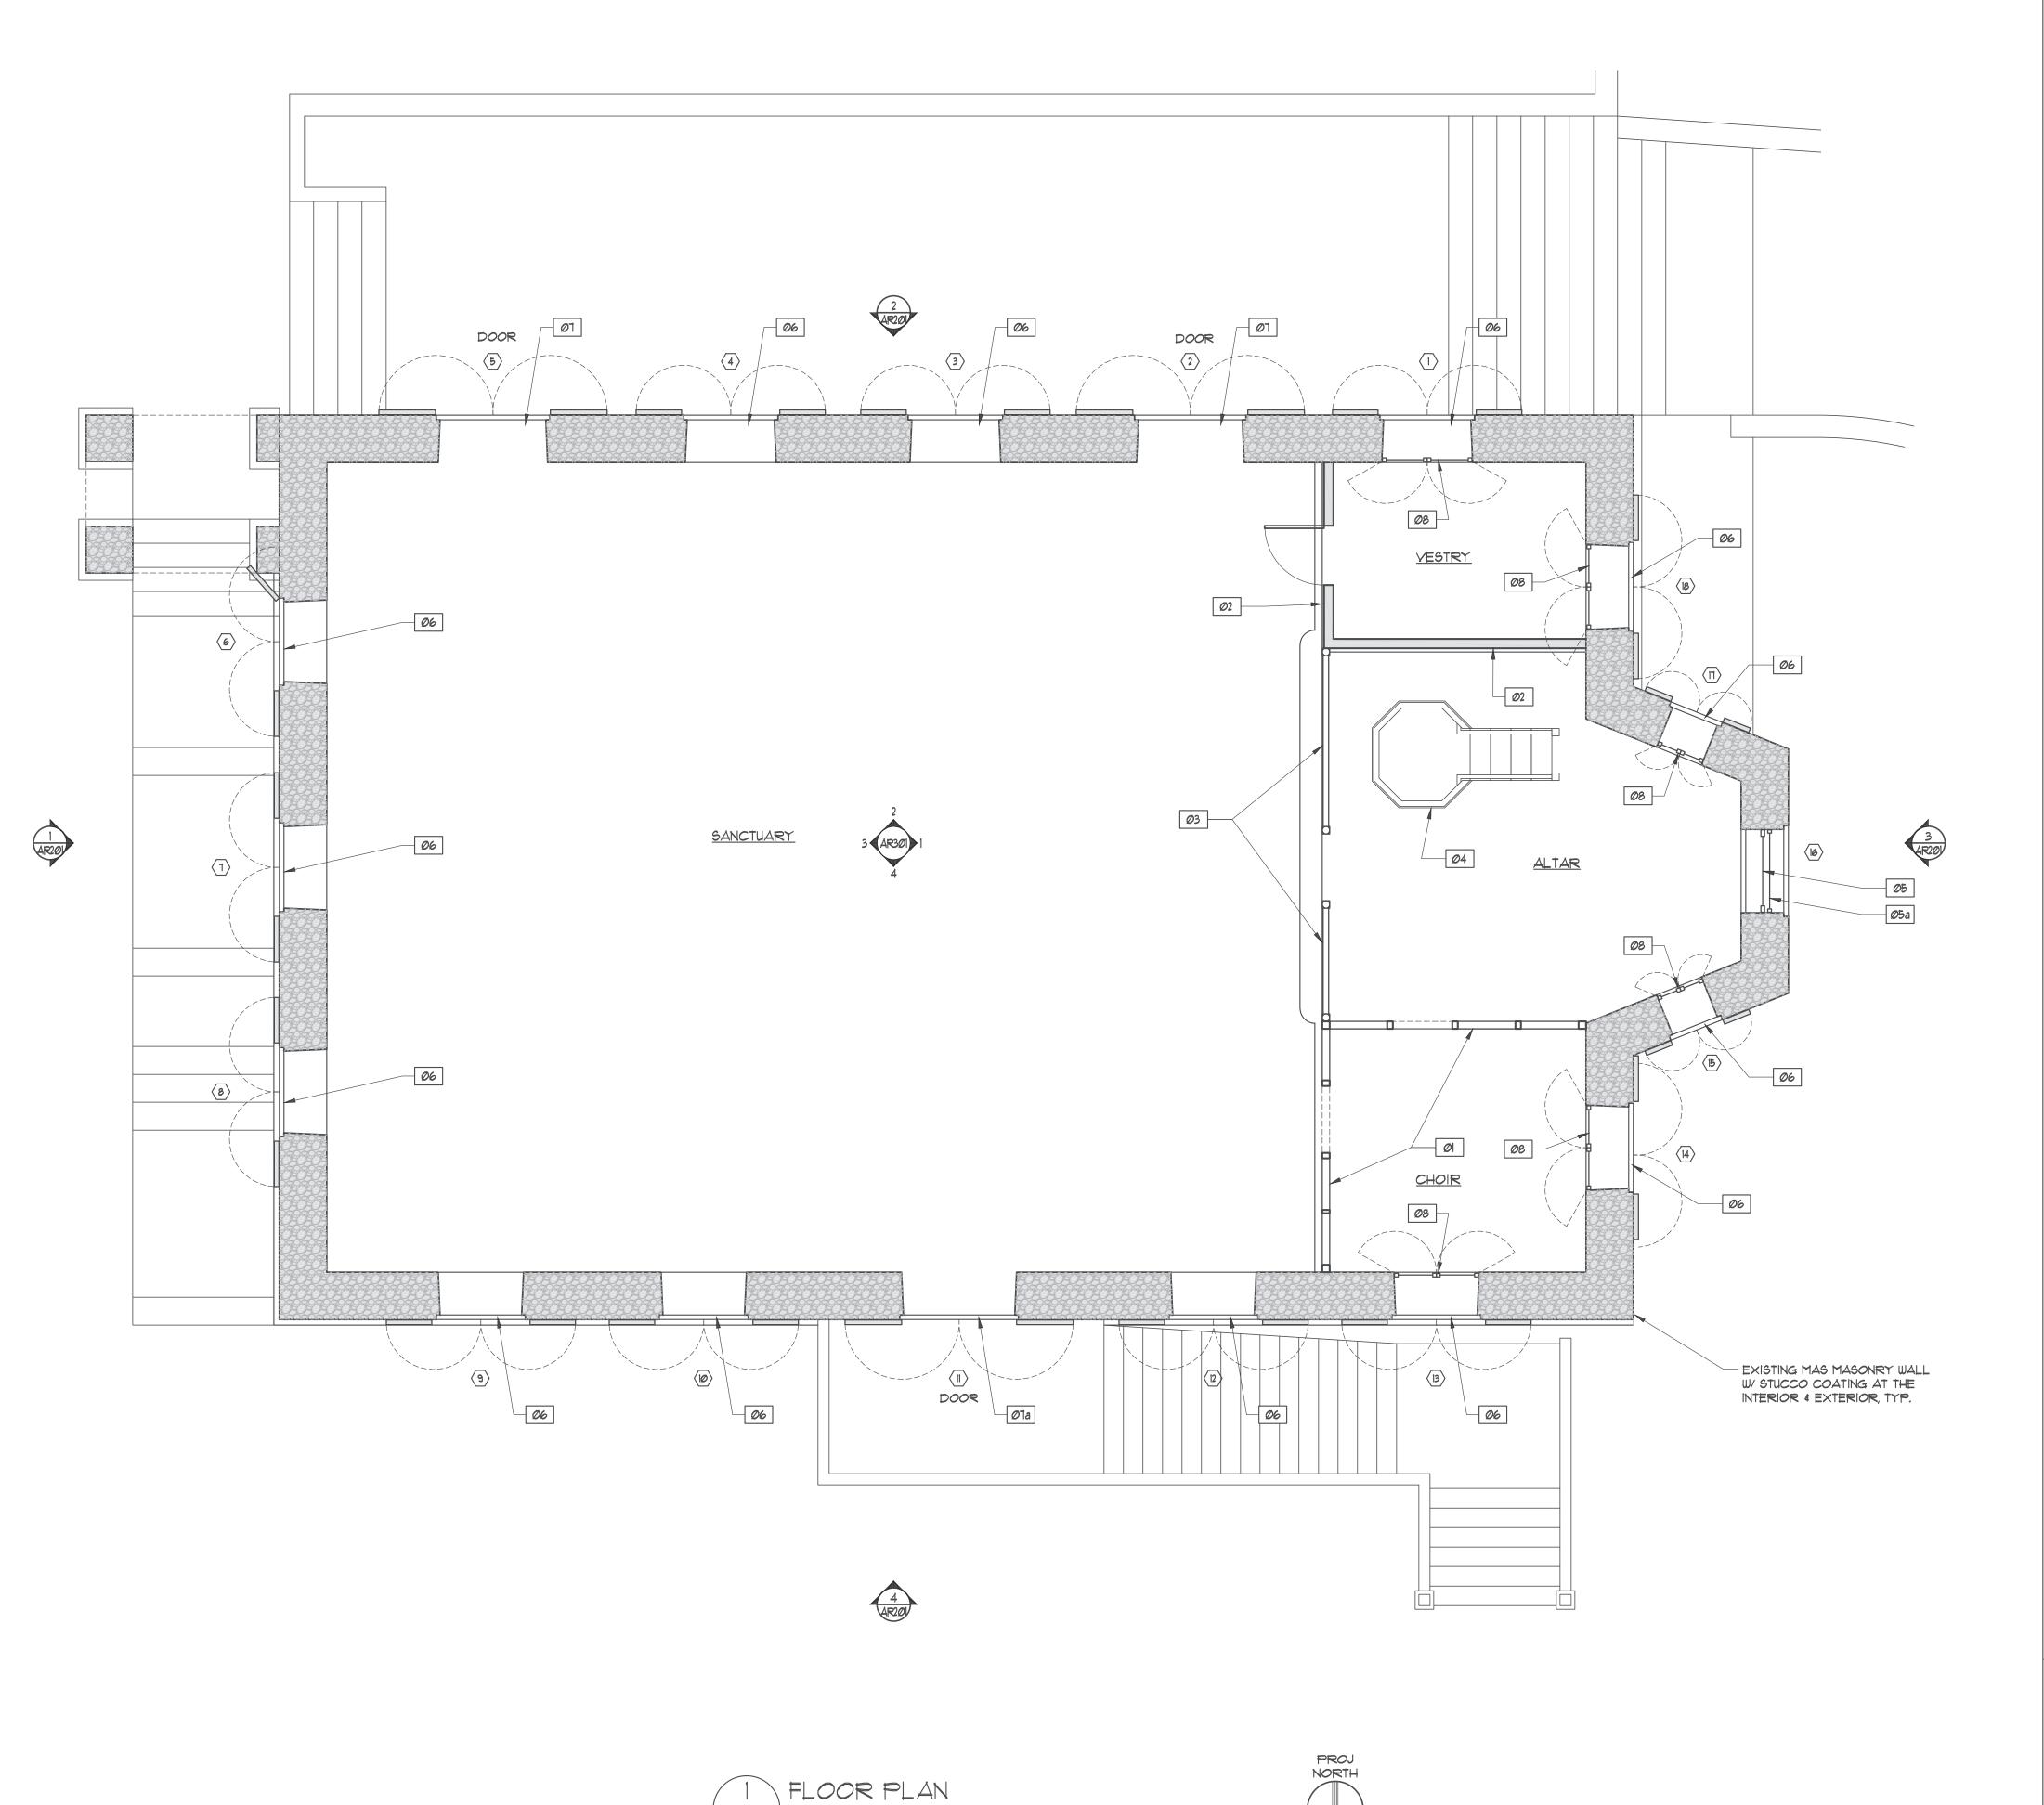

ARIØI / 1/4"=1'-0"

GENERAL RESTORATION WORK NOTES:

- 1. "AR" DRAWINGS REFER TO RESTORATION SCOPE OF WORK ONLY. SEE ARCHITECTURAL, STRUCTURAL, AND MEP DRAWINGS FOR ADDITIONAL INFORMATION AND WORK.
- 2. SEE INTERIOR ELEVATIONS FOR INTERIOR STUCCO REPAIR WORK.
- 3. SEE EXTERIOR ELEVATIONS FOR EXTERIOR STUCCO REPAIR WORK.

PLAN SCOPE OF WORK NOTES:

- PECREATE CHOIR RAILING AND CANOPY AS DETAILED ON AR-502 & AR-503
- REPAIR/RESTORE EXISTING VESTRY AS DETAILED ON AR-501
- 03 RECREATE ALTAR RAIL AS DETAILED ON AR-504
- 04 RECREATE PULPIT AS DETAILED ON AR-505
- RECREATE STAINED GLASS WINDOW AND FRAME AS DETAILED ON AR-101
- RESTORE EXISTING WOOD SHUTTER AS DETAILED. REMOVE EXISTING HARDWARE AND REPLACE WITH MARINE-GRADE STAINLESS STEEL HARDWARE TO MATCH EXISTING. SEE SHUTTER RESTORATION DRAWINGS, AR-601 AR-613.
- RESTORE EXISTING WOOD SHUTTER AT DOORWAY AS DETAILED. REMOVE EXISTING HARDWARE AND REPLACE WITH MARINE-GRADE STAINLESS STEEL HARDWARE TO MATCH EXISTING. SEE SHUTTER RESTORATION DRAWINGS, AR-601 AR-613.
- REMOVE EXISTING DAMAGED WOOD SHUTTER/DOOR AND PROVIDE NEW WD. SHUTTER/DOOR TO MATCH EXISTING AS DETAILED. PROVIDE NEW MARINE-GRADE STAINLESS STEEL HARDWARE TO MATCH EXISTING SEE 3+3A/AR6ØI AND
- RESTORE EXISTING WINDOW AND FRAME AS DETAILED. SEE WINDOW RESTORATION DRAWINGS, AR-702.
- 99 PROVIDE NEW WOOD SHUTTER AS DETAILED ON AR-613.
- 09a PROVIDE NEW WOOD DOOR AS DETAILED ON AR-613

PROVIDE NEW WOOD ACCESS HATCH AS DETAILED ON 2/AR-613.

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EMMAUS MORAVIAN CHURCH SANCTUARY RECONSTRUCTION

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PARCEL 10 ESTATE EMMAUS ST JOHN, USVI

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title

FIRST FLOOR PLAN

project number 2022-009

AR-101

11/28/2023


LEGEND:

SCOPE OF WORK TAG (5)—
QUANTITY OF SCOPE

OF WORK ITEM AT IDENTIFIED AREA

TO AR-702

OPENING TAG, SEE AR-610

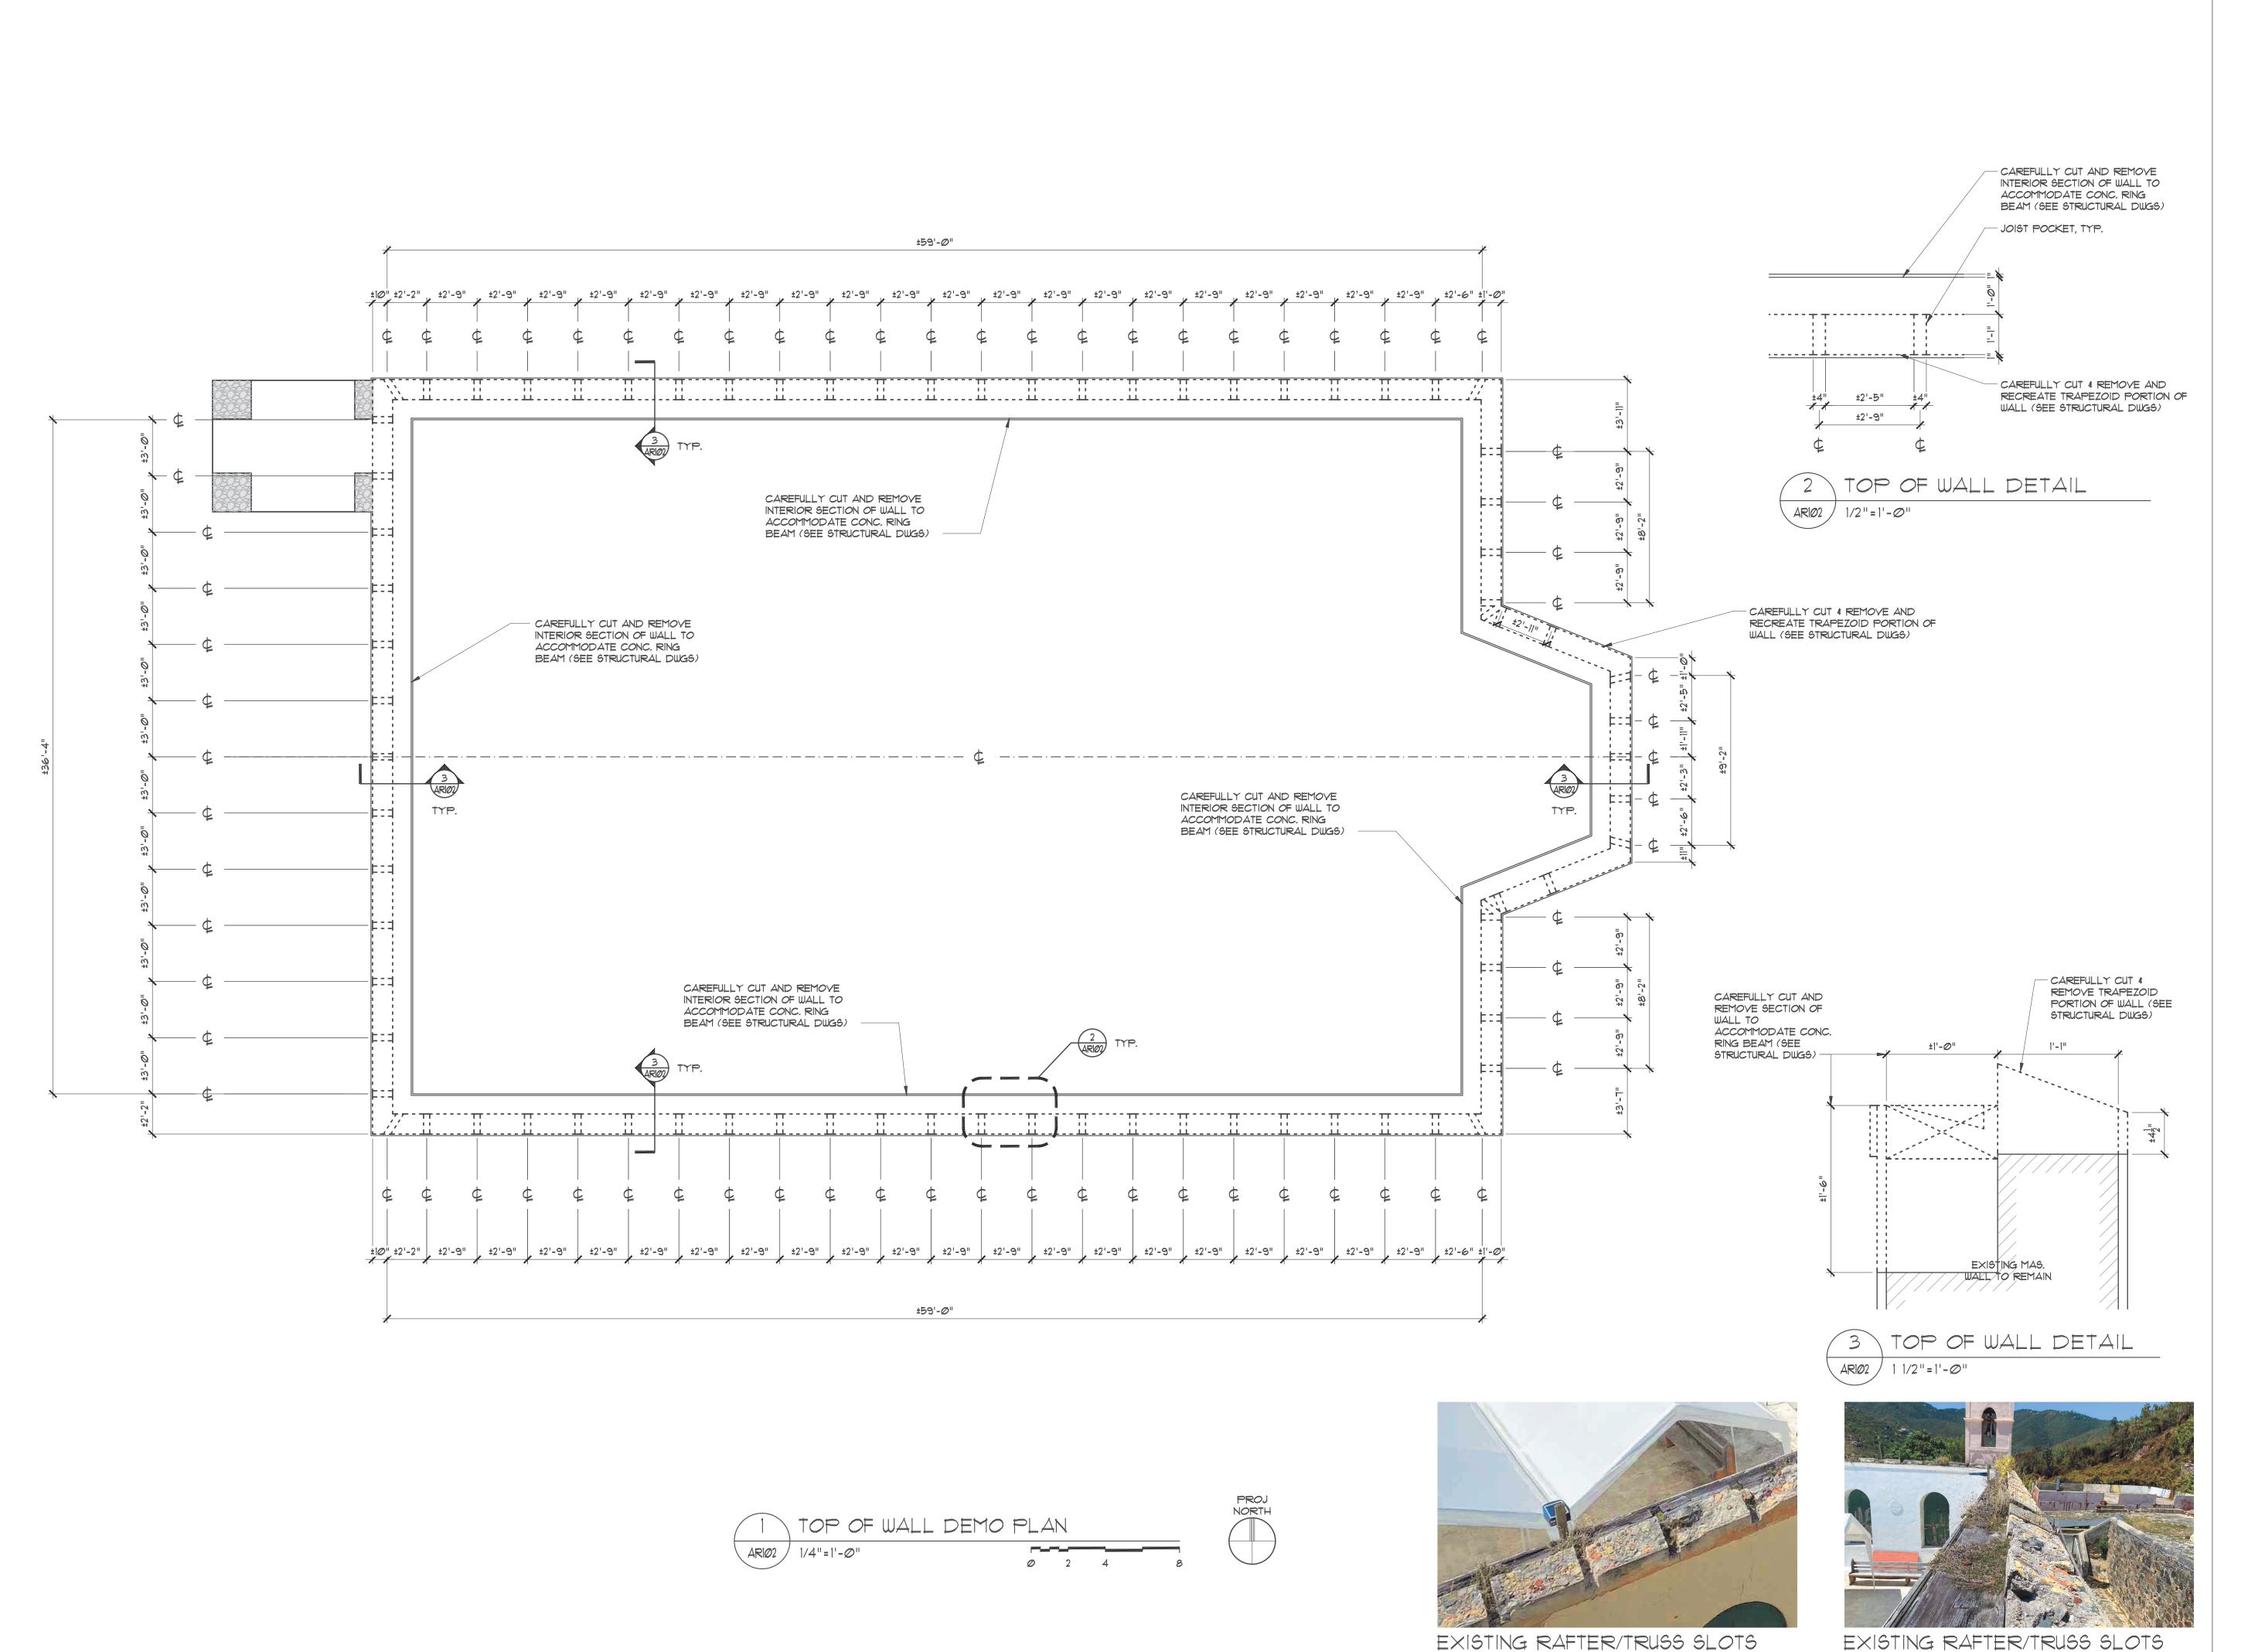




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PARCEL 10 ESTATE EMMAUS ST JOHN, USVI

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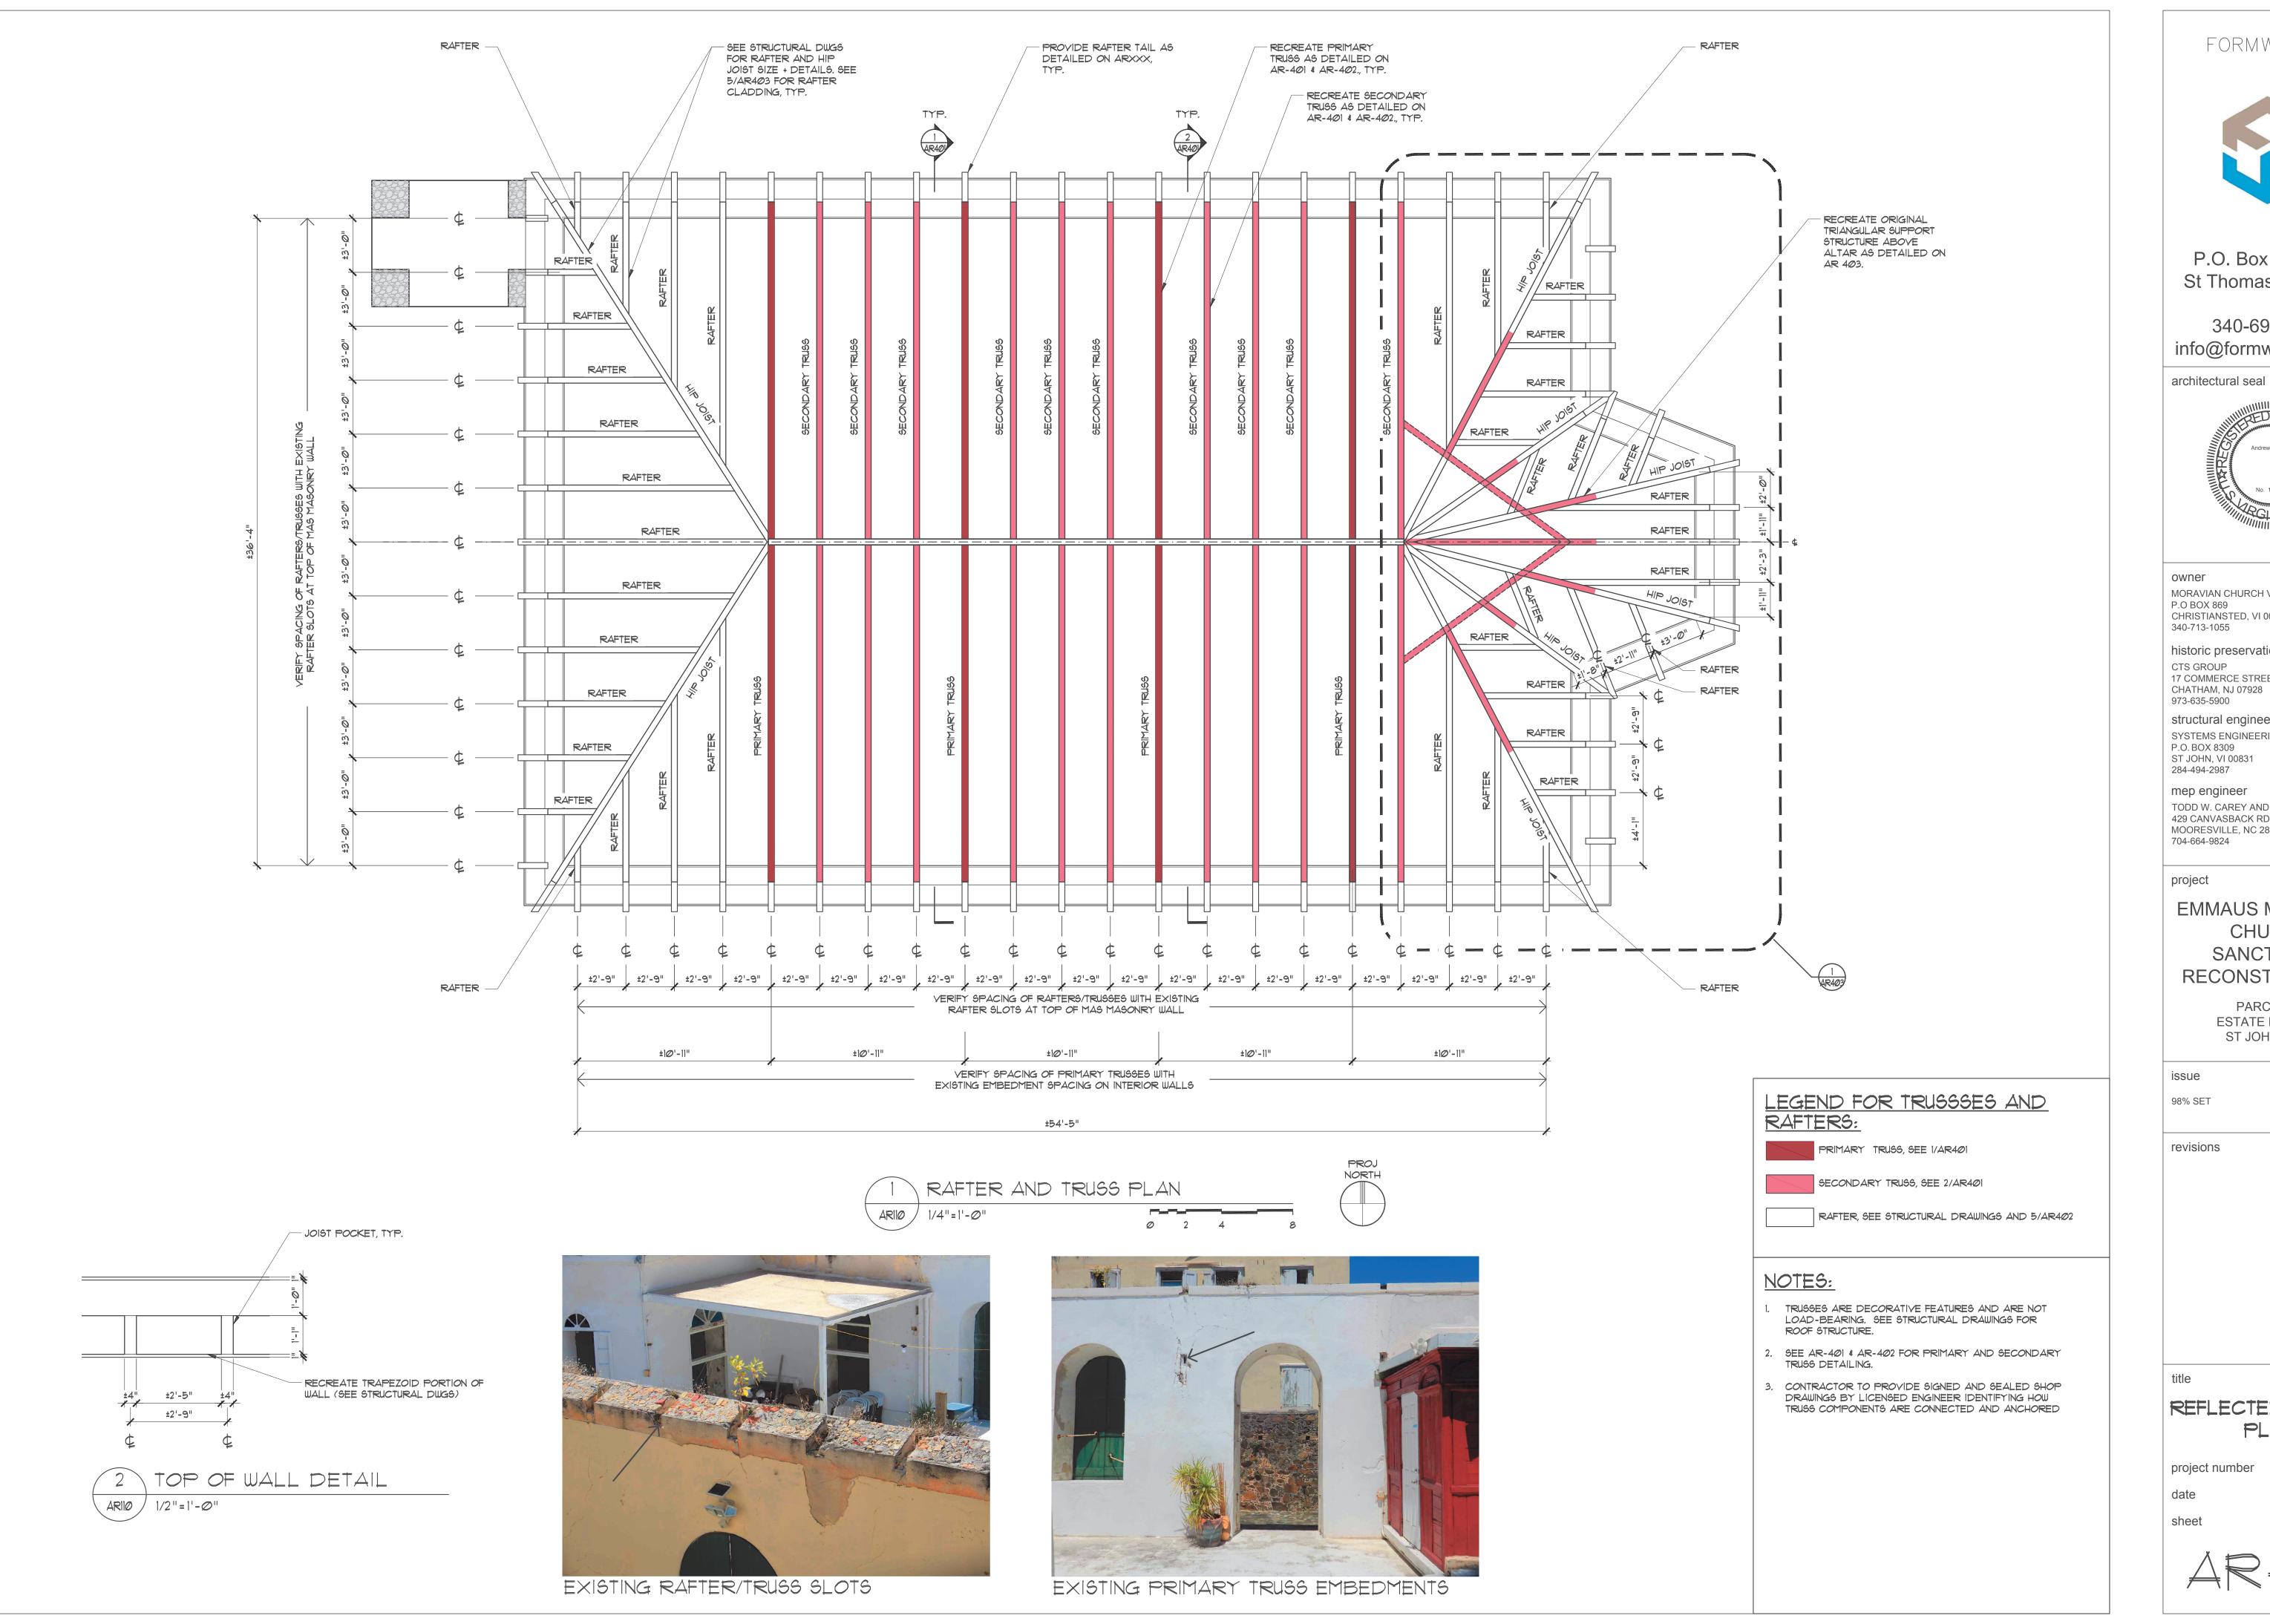
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TOP OF WALL PLAN

project number 2022-009 date 11/28/2023

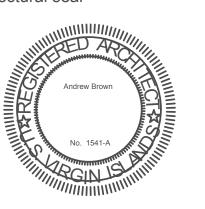sheet

AR-102






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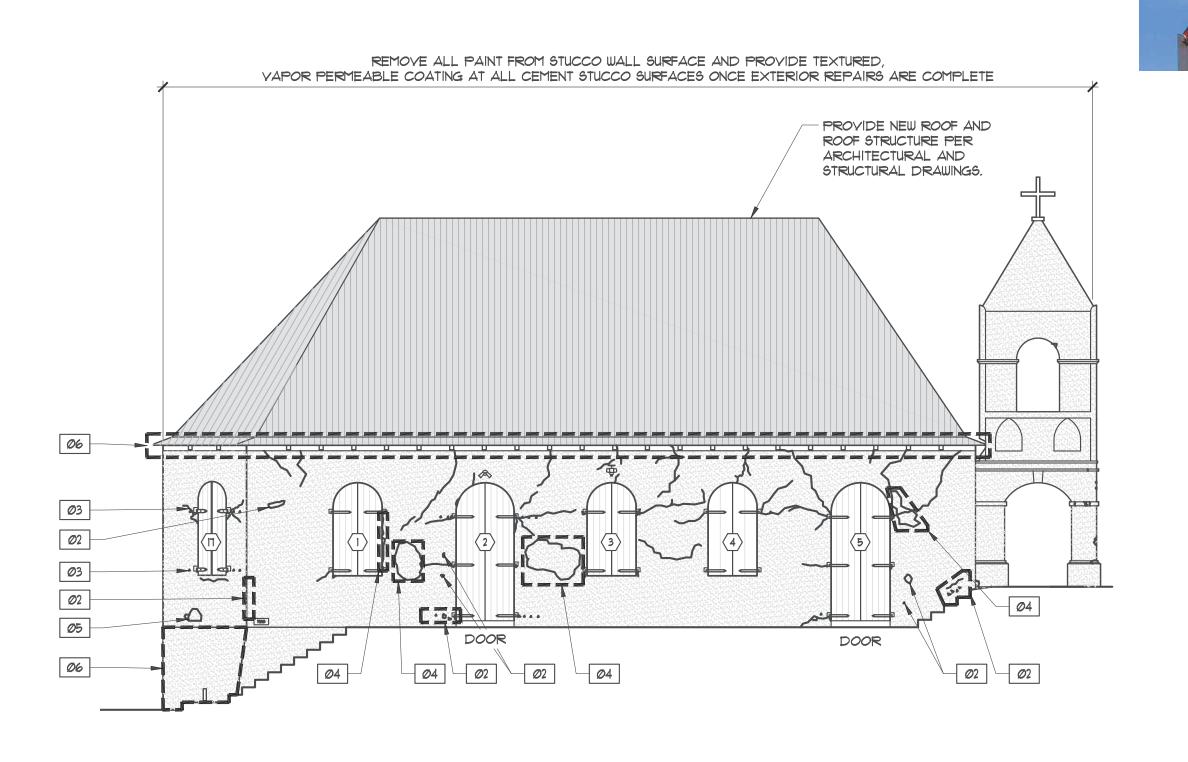
EMMAUS MORAVIAN CHURCH SANCTUARY RECONSTRUCTION


PARCEL 10 ESTATE EMMAUS ST JOHN, USVI

11/21/2023

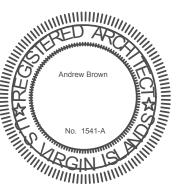REFLECTED CEILING PLAN

2022-009 project number 11/28/2023



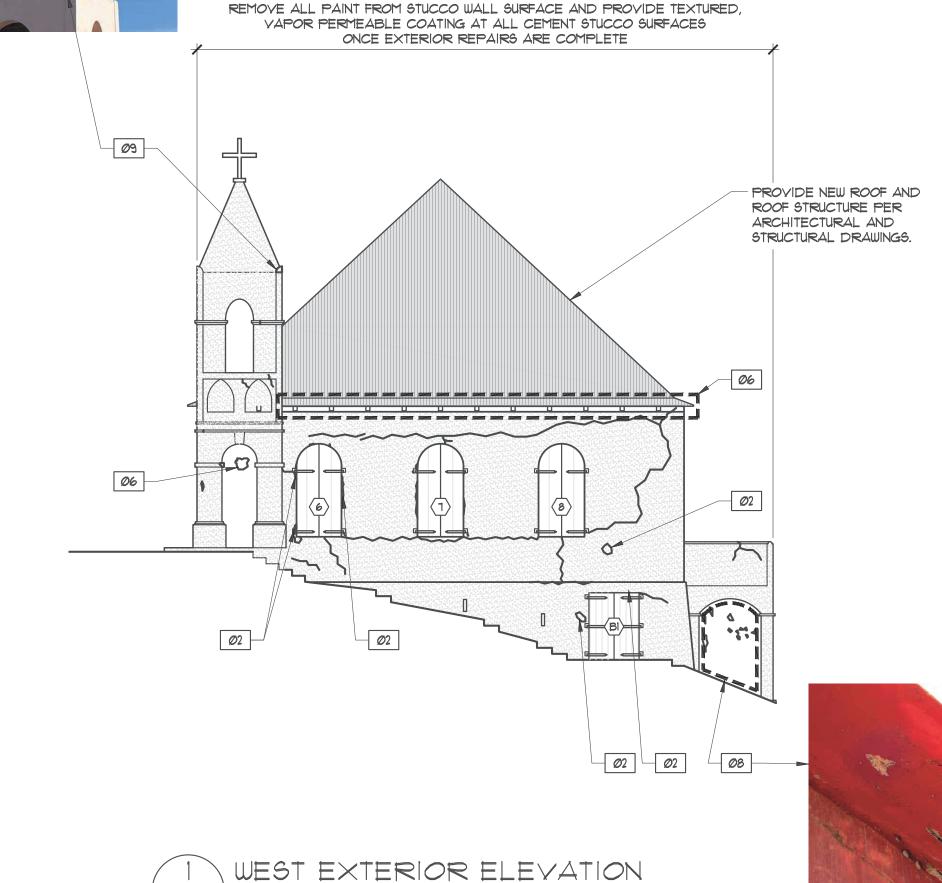

AR201 / 1/8"=1'-0"

AR201 /

1/8"=1'-0"

REMOVE ALL PAINT FROM STUCCO BLANK ACES ONCE EXTERIOR REPAIRS ARE COMPLETE

VAPOR PERPEASULE COATING AT ALL CEMENT STUCCO BLANKACES ONCE EXTERIOR REPAIRS ARE COMPLETE

PROVIDE NEW ROOF STRUCTURE FER ASCRITECTURE. AND STRUCTURE ALL DRAWINGS.


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NORTH EXTERIOR ELEVATION

AR201 / 1/8"=1'-0"

4 SOUTH EXTERIOR ELEVATION

AR201 1/8"=1'-0"

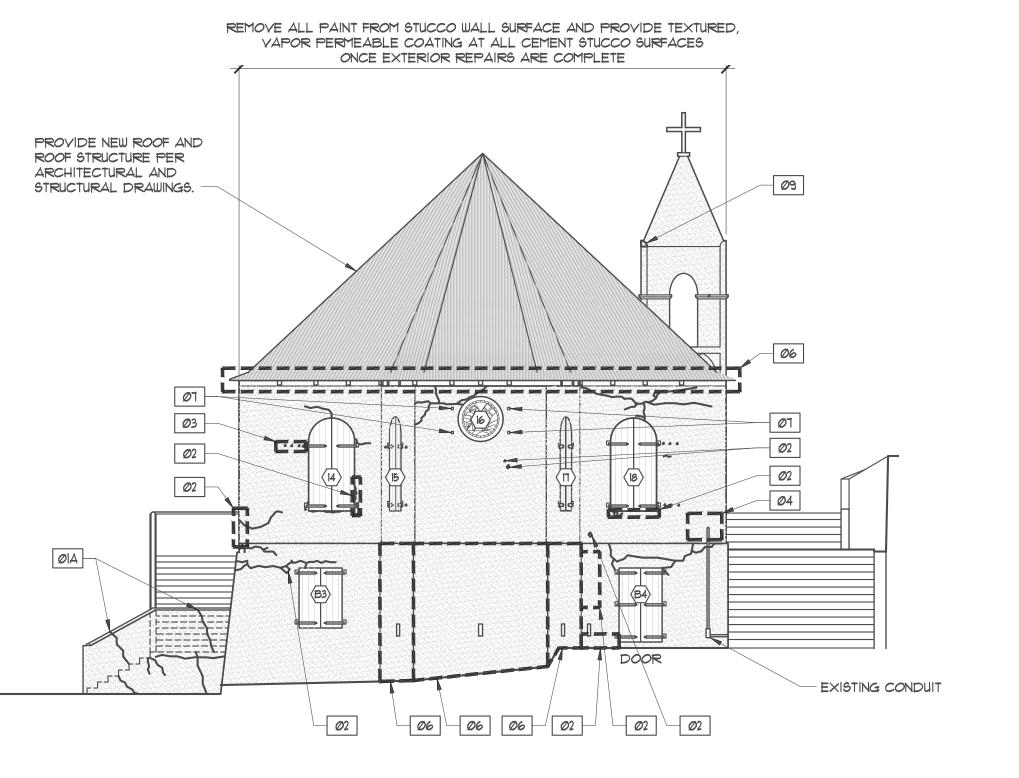

EAST EXTERIOR ELEVATION

EXPOSED REBAR @

UNDERSIDE OF STAIR

GENERAL EXTERIOR REPAIR SCOPE OF WORK:

- 1. PROVIDE NEW ROOF AND ROOF STRUCTURE PER ARCHITECTURAL AND STRUCTURAL DRAWINGS.
- REMOVE ALL EXISTING PAINT FROM STUCCO WALL SURFACE.
 PROVIDE TEXTURED, VAPOR PERMEABLE, COATING OVER ALL CEMENT STUCCO SURFACES ONCE EXTERIOR REPAIRS
- ARE COMPLETE.

 4. REPAIR STUCCO WALL AS DETAILED ON DRAWINGS.
- REPAIR STUCCO WALL AS DETAILED ON DRAWINGS.
 RESTORE WOOD SHUTTERS AND DOORS AS DETAILED ON DRAWINGS.
- 6. PROVIDE NEW WOOD SHUTTERS AND DOORS AS DETAILED ON DRAWINGS.

KEYED SCOPE OF WORK:

- ØI REPAIR CRACKED STUCCO AS DETAILED ON 1/AR2Ø2.
- @Ia REPAIR AND PIN CRACKED STUCCO AS DETAILED ON X/ARXXX.
- REPAIR ERODED/SPALLED STUCCO AS DETAILED ON 2a/AR202.
- 03 REMOVE EMBED AND PATCH HOLE.
- REMOVE NON-MATCHING PATCH AND REPAIR ERODED/SPALLED STUCCO AS DETAILED ON 2/AR202.
- INFILL HOLE IN WALL AND PROVIDE STUCCO FINISH AROUND PIPE PENETRATION.
- REMOVE AREA OF DAMAGED STUCCO AND PROVIDE NEW 1" STUCCO COATING TO MATCH EXISTING IN COMPOSITION AND TEXTURE.
- 01 PREPARE AND PAINT EXISTING METAL EMBEDS.
- AT UNDERSIDE OF STAIR, REMOVE ALL FAILING STUCCO, REPAIR AT EXPOSED REBAR AS DETAILED ON 3 & 4/AR202, AND PROVIDE NEW STUCCO COATING AT ALL DAMAGED/REMOVED AREAS.
- 09 AT TOWER, PROVIDE NEW CORNER CAP TO MATCH EXISTING.

STUCCO REPAIR ALLOWANCES:

- 1. IN ADDITION TO WORK IDENTIFIED ON DRAWINGS, PROVIDE AN ADDITIONAL 200 LF OF CRACKED STUCCO REPAIR.
- 2. IN ADDITION TO WORK IDENTIFIED ON DRAWINGS, PROVIDE AN ADDITIONAL 300 SF OF DAMAGED STUCCO REPLACEMENT.
- 3. IN ADDITION TO WORK IDENTIFIED ON DRAWINGS, PROVIDE AND ADDITIONAL 200 SF OF SPALLED/GOUGED STUCCO REPAIRS.

LEGEND:

SCOPE OF WORK TAG

- QUANTITY OF SCOPE OF WORK ITEM AT IDENTIFIED AREA

CRACKED STUCCO - REPAIR
AS DETAILED ON 1/AR202.

SPALLED/GOUGED STUCCO REPAIR AS DETAILED ON
2a/AR202.


OPENING TAG, SEE AR-610 TO AR-702 FORMWRIGHT



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PARCEL 10 ESTATE EMMAUS ST JOHN, USVI

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98% SET

11/21/2023

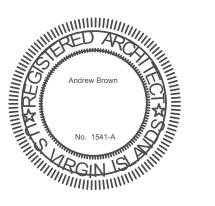
revisions

EXTERIOR ELEVATIONS


project number 2022-009

date 11/28/2023 sheet

AR-201

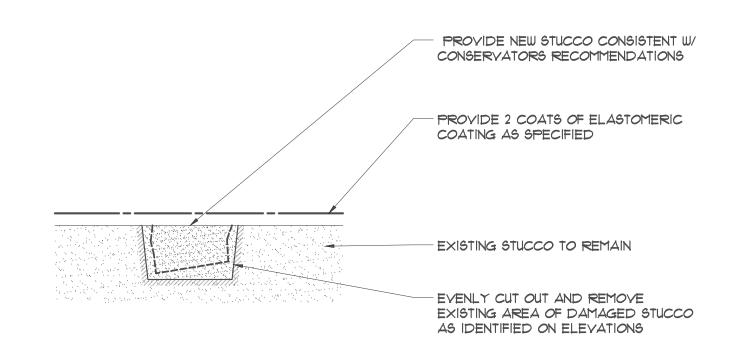

STUCCO SPALL REPAIR AR202 / 3"=1'-0"

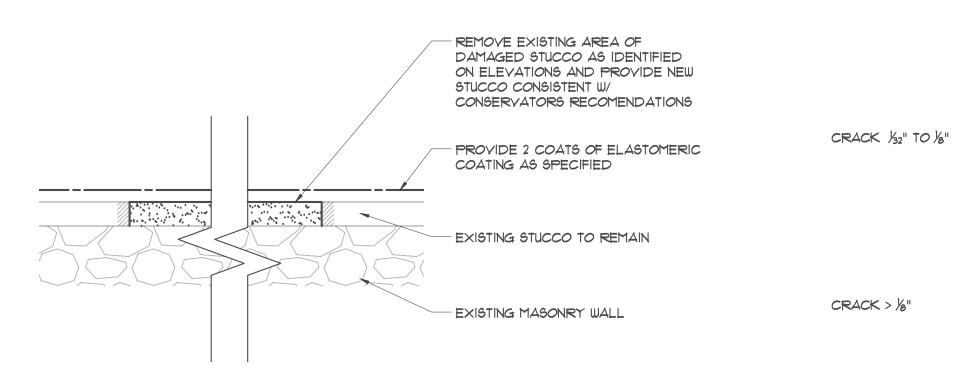

STUCCO REPLACEMENT AR202 / 3"=1'-0"

FILLING ALL POURS AND YOIDS.

EXISTING CONCRETE STRUCTURE.

AR202 / 11/2" = 1'-0"


5. WET CURE AND PROTECT AS PER THE

MANUFACTURERS TECHNICAL DATA SHEET.

6. FOR VERTICAL APPLICATIONS GREATER THAN

2" DEEP, A SECOND LIFT MUST BE APPLIED.

OVERHEAD SPALL / PATCH REPAIR

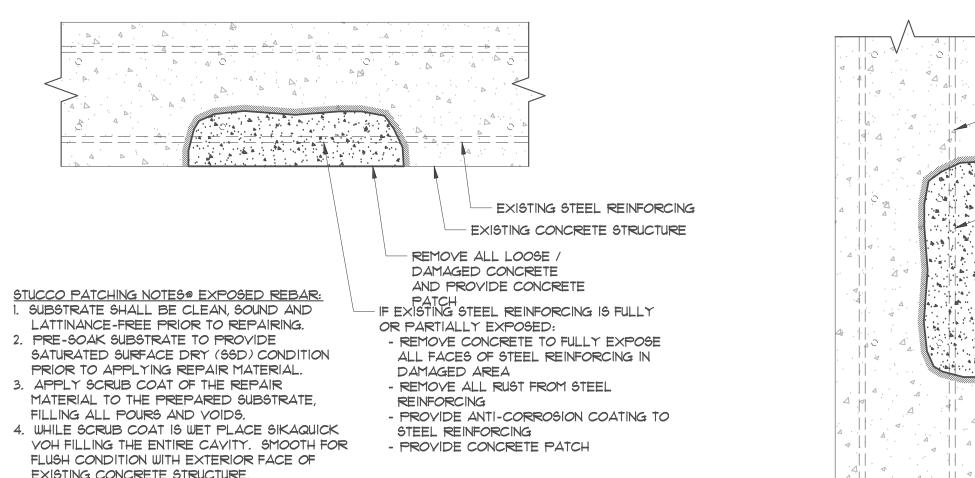

CRACK < 1/32"

AR202 / 3"=1'-0"

EXISTING CONCRETE STRUCTURE EXISTING STEEL REINFORCING REMOVE ALL LOOSE / DAMAGED CONCRETE AND PROVIDE CONCRETE PATCH IF EXISTING STEEL REINFORCING IS FULLY OR PARTIALLY EXPOSED: - REMOVE CONCRETE TO FULLY EXPOSE ALL FACES OF STEEL REINFORCING IN DAMAGED - REMOVE ALL RUST FROM STEEL REINFORCING - PROVIDE ANTI-CORROSION COATING TO STEEL REINFORCING - PROVIDE CONCRETE PATCH STUCCO PATCHING NOTES @ EXPOSED REBAR: 1. SUBSTRATE SHALL BE CLEAN, SOUND AND LATTINANCE-FREE PRIOR TO REPAIRING. 2. PRE-SOAK SUBSTRATE TO PROVIDE SATURATED SURFACE DRY (SSD) CONDITION PRIOR TO APPLYING REPAIR MATERIAL. 3. APPLY SCRUB COAT OF THE REPAIR MATERIAL TO THE PREPARED SUBSTRATE, FILLING ALL POURS AND YOIDS. 4. WHILE SCRUB COAT IS WET PLACE SIKAQUICK YOH FILLING THE ENTIRE CAVITY. SMOOTH FOR FLUSH CONDITION WITH EXTERIOR FACE OF EXISTING CONCRETE STRUCTURE. 5. WET CURE AND PROTECT AS PER THE MANUFACTURERS TECHNICAL DATA SHEET.

STUCCO CRACK REPAIR DETAILS

6. FOR VERTICAL APPLICATIONS GREATER THAN 3" DEEP, A SECOND LIFT MUST BE APPLIED. VERTICAL SPALL / PATCH REPAIR (AR202 / 1 1/2" = 1'-0"

FORMWRIGHT

PROVIDE 2 COATS OF ELASTOMERIC COATING AS SPECIFIED

PROVIDE 2 COATS OF

ELASTOMERIC COATING AS SPECIFIED

SEAL W/ SEALANT AS

PROVIDE 2 COATS OF

ELASTOMERIC COATING

- SEAL W/ SEALANT AS

ROUTE OUT EXISTING

AS SPECIFIED

SPECIFIED

CRACK


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EMMAUS MORAVIAN CHURCH SANCTUARY RECONSTRUCTION

PARCEL 10 ESTATE EMMAUS ST JOHN, USVI

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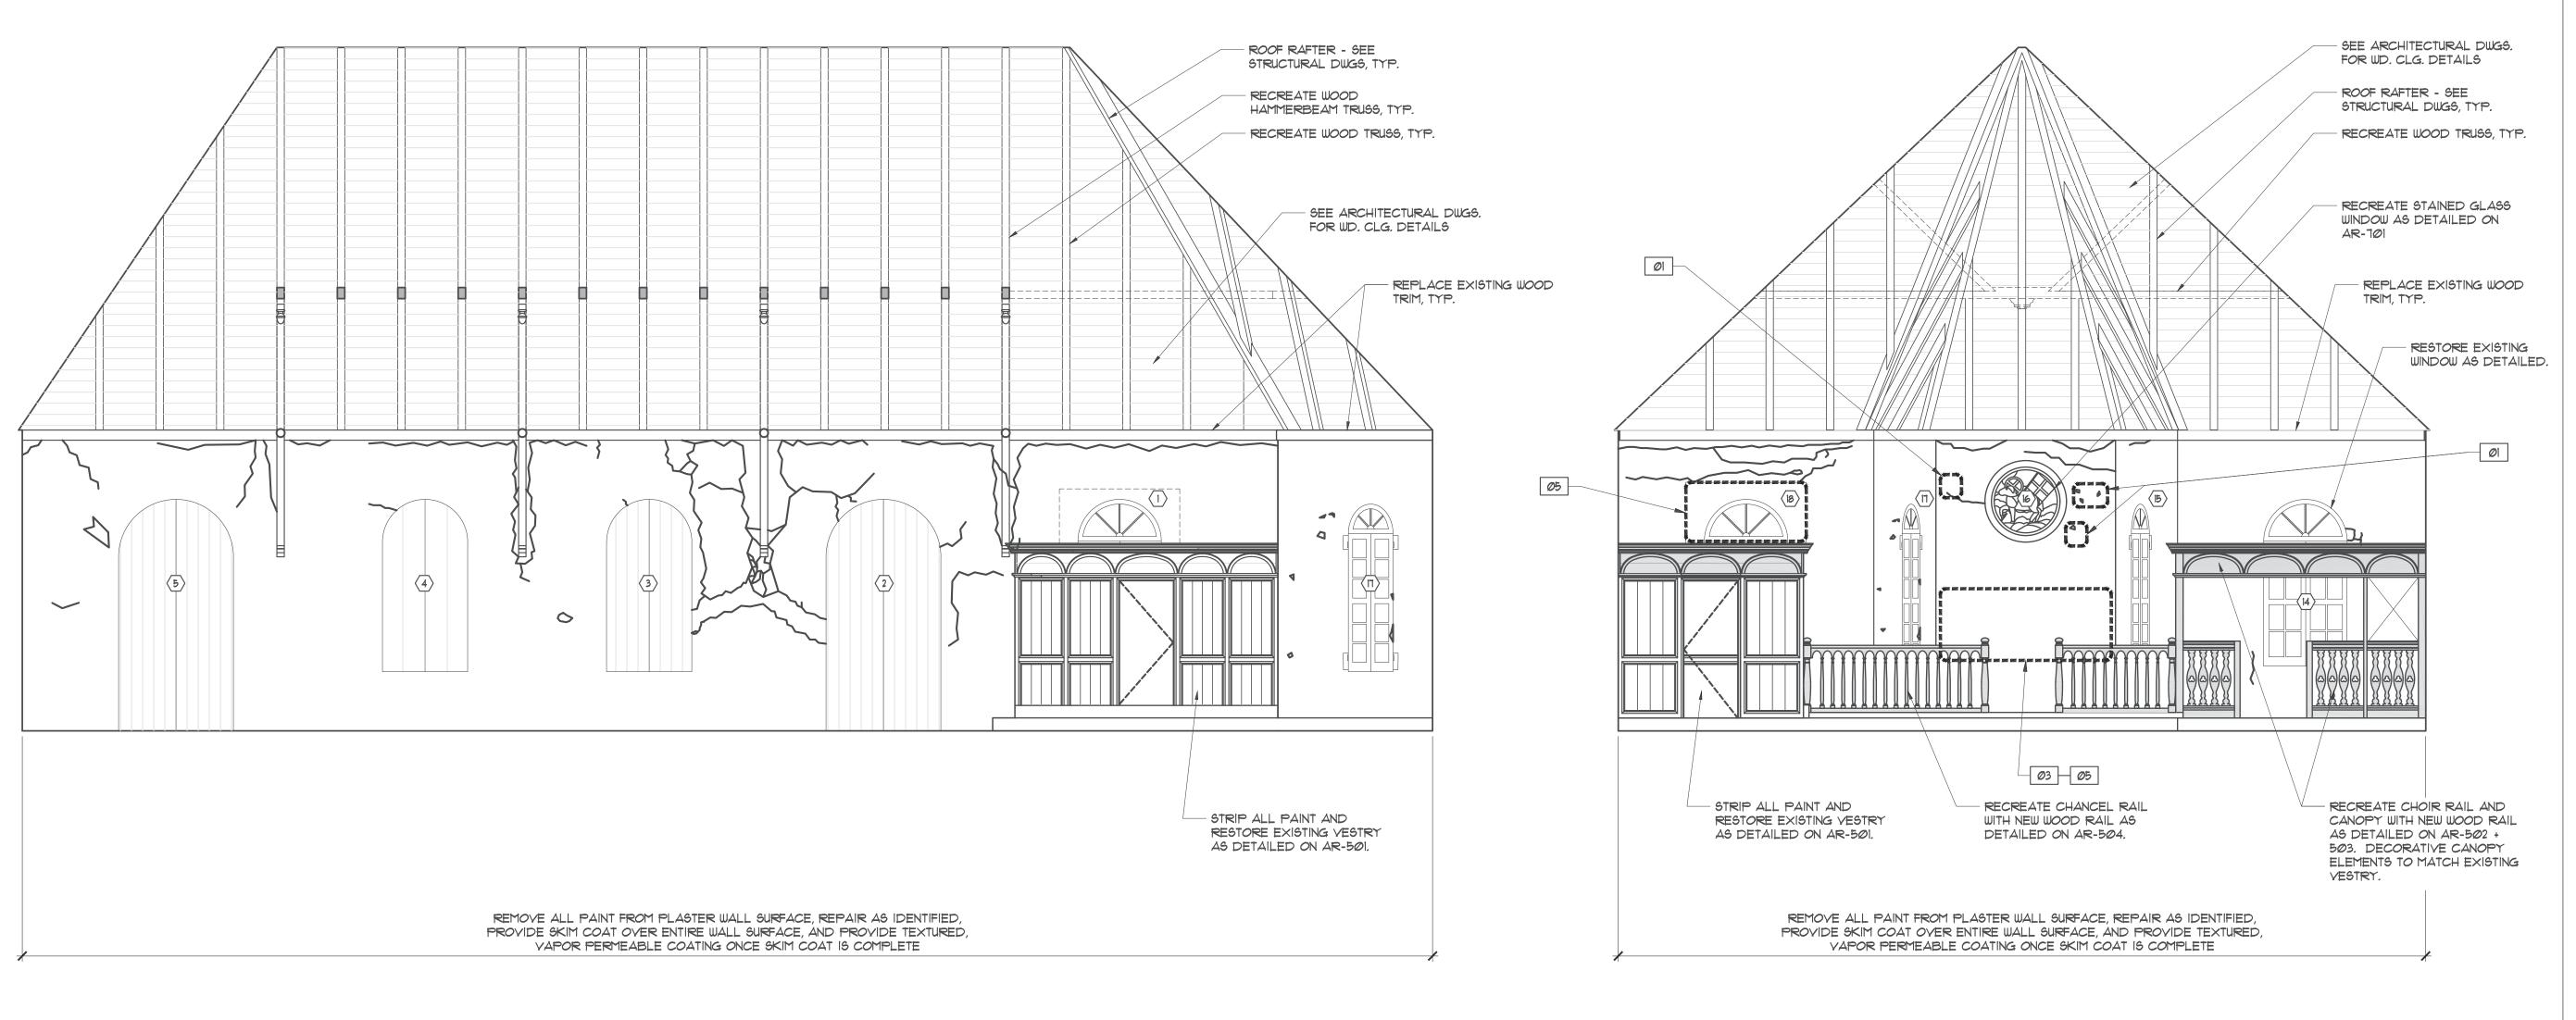
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CONCRETE AND STUCCO REPAIR DETAILS

project number

11/28/2023

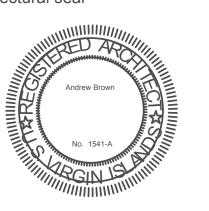2022-009



2 NORTH INTERIOR ELEVATION

AR301 1/4"=1'-0"

1 EAST INTERIOR ELEVATION

AR301 1/4"=1'-0"

GENERAL INTERIOR WORK NOTES:

- 1. REMOVE ALL PAINT FROM STUCCO WALL SURFACE.
- 2. REMOVE ALL LOOSE/FAILING STUCCO FROM WALL
- 3. REPAIR DAMAGED STUCCO AS DETAILED.

SURFACES.

- 4. PROVIDE STUCCO SKIM COAT AT ALL INTERIOR WALL
- 5. PROVIDE TEXTURED, VAPOR PERMEABLE PAINT
- 6. PROVIDE TEXTURED, VAPOR PERMEABLE PAIN COATING ONCE REPAIRS ARE COMPLETE.
- 6. RESTORE WOOD VESTRY AS DETAILED ON AR-501.
- 1. RECREATE CHOIR LOFT CANOPY AND RAIL AS
- DETAILED ON AR-502 AND AR-503.

 8. RECREATE CHANCEL RAIL AS DETAILED ON AR-504.

INTERIOR REPAIR SCOPE OF WORK NOTES:

- ØI REPAIR CRACKED STUCCO AS DETAILED ON 1/AR202.
- REPAIR ERODED/SPALLED STUCCO AS DETAILED ON 2a/AR202
- 03 REMOVE EMBED AND PATCH HOLE.
- REMOVE NON-MATCHING PATCH AND REPAIR ERODED/SPALLED STUCCO AS DETAILED ON 2/AR202.
- REMOVE EXISTING PLY WD. COVER TO EXPOSE WINDOW.
 RESTORE WINDOW AS DETAILED ON ARTIO2

LEGEND:

SCOPE OF WORK TAG (5)-QUANTITY OF SCOPE

OF WORK ITEM AT
IDENTIFIED AREA

CRACKED STUCCO - REPAIR AS DETAILED ON 1/AR202.

SPALLED/GOUGED STUCCO - REPAIR AS DETAILED ON 2a/AR202.


OPENING TAG, SEE AR-610 TO AR-702 FORMWRIGHT



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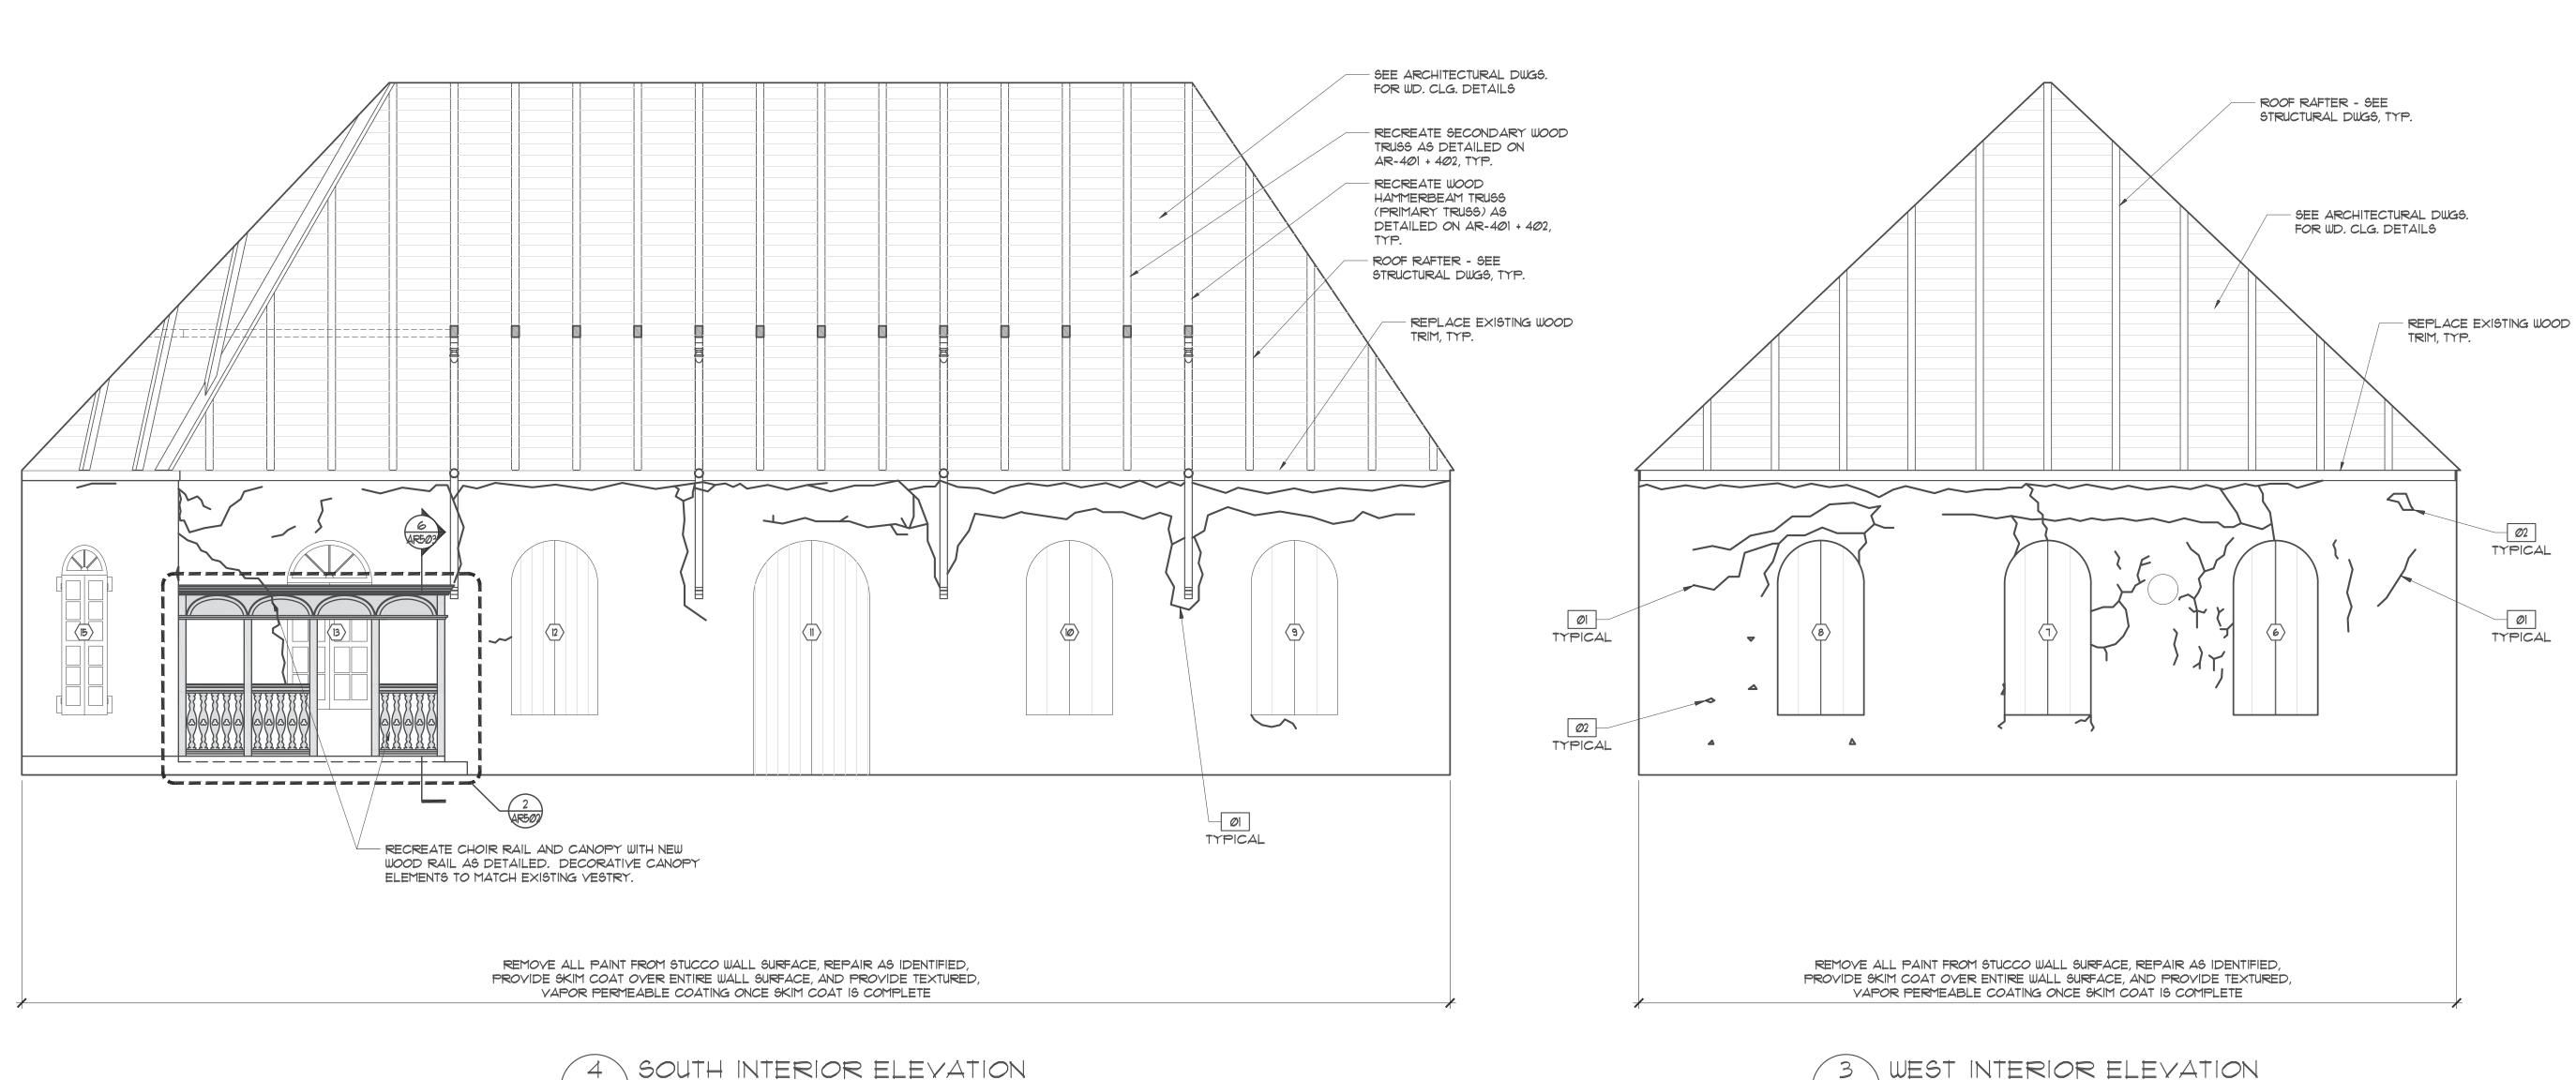
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INTERIOR ELEVATIONS

project number 2022-009 date 11/28/2023

sheet

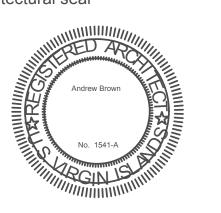AR=301



SOUTH INTERIOR ELEVATION

AR301 / 1/4"=1'-0"

WEST INTERIOR ELEVATION AR301 / 1/4"=1'-0"

GENERAL INTERIOR WORK NOTES:

- 1. REMOVE ALL PAINT FROM STUCCO WALL SURFACE.
- 2. REMOVE ALL LOOSE/FAILING STUCCO FROM WALL
- 3. REPAIR DAMAGED STUCCO AS DETAILED.
- 4. PROVIDE STUCCO SKIM COAT AT ALL INTERIOR WALL
- 5. PROVIDE TEXTURED, VAPOR PERMEABLE PAINT COATING ONCE REPAIRS ARE COMPLETE.
- 6. RESTORE WOOD VESTRY AS DETAILED ON AR-501.
- 1. RECREATE CHOIR LOFT CANOPY AND RAIL AS
- DETAILED ON AR-502 AND AR-503.
- 8. RECREATE CHANCEL RAIL AS DETAILED ON AR-504.

INTERIOR REPAIR SCOPE OF WORK NOTES:

- ØI REPAIR CRACKED STUCCO AS DETAILED ON 1/AR202.
- REPAIR ERODED/SPALLED STUCCO AS DETAILED ON 2a/AR202
- Ø3 REMOVE EMBED AND PATCH HOLE.
- REMOVE NON-MATCHING PATCH AND REPAIR ERODED/SPALLED STUCCO AS DETAILED ON 2/AR202.
- REMOVE EXISTING PLY WD. COVER TO EXPOSE WINDOW.
 RESTORE WINDOW AS DETAILED ON ARTIO2

LEGEND:

(8)

XX SCOPE OF WORK TAG (5) QUANTITY OF SCOPE

> OF WORK ITEM AT IDENTIFIED AREA

> > CRACKED STUCCO - REPAIR AS DETAILED ON 1/AR202.

SPALLED/GOUGED STUCCO -REPAIR AS DETAILED ON 2a/AR2Ø2.

> OPENING TAG, SEE AR-610 TO AR-702


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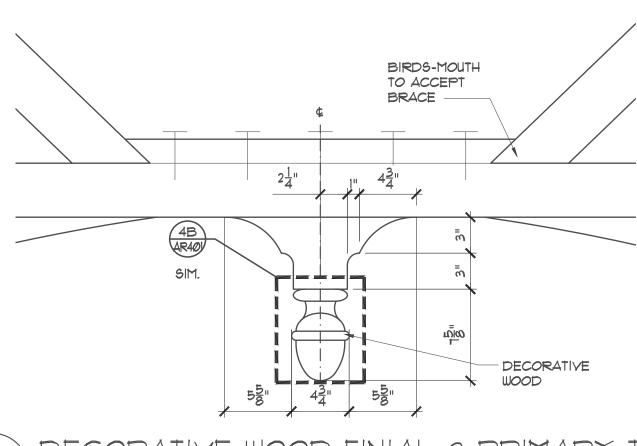
INTERIOR ELEVATIONS

2022-009 project number 11/28/2023

sheet





HISTORIC PHOTO OF DECORATIVE TRUSS FINIALS

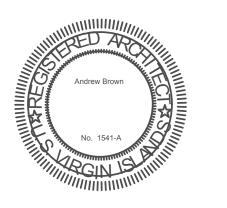

4 DECORATIVE WOOD FINIAL @ PRIMARY TRUSS

AR401 / 1 1/2"=1'-0"

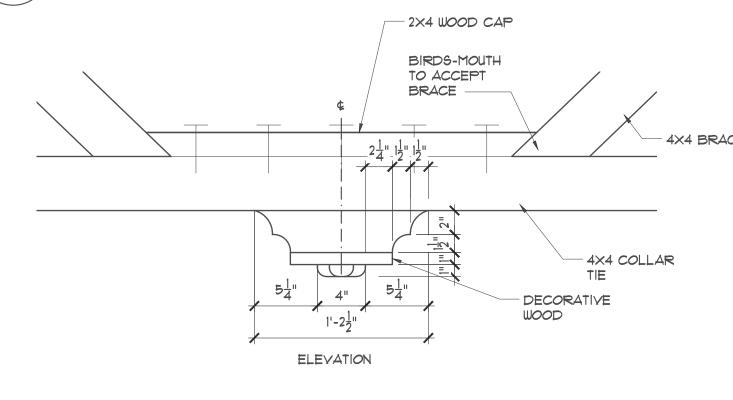

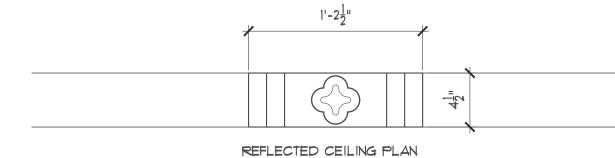


4A DECORATIVE WOOD DETAIL, @ SECONDARY TRUSS

AR401) 1 1/2"=1'-0"

FRONT ELEVATION



HISTORIC PHOTO OF DECORATIVE TRUSS FINIALS

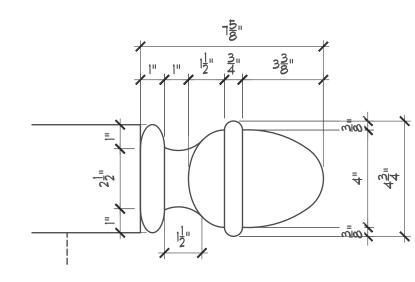


4B DECORATIVE WOOD FINIAL

AR401 3"=1'-0"




PHOTO OF EXISTING TRUSS BASE

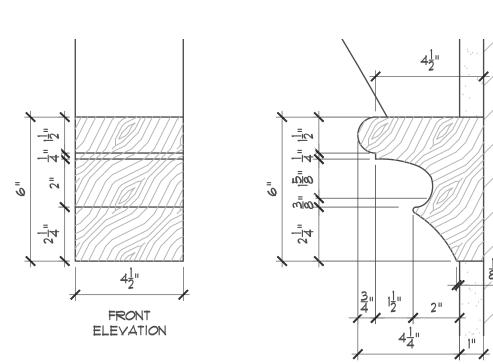

5 WOOD TRUSS DECORATIVE BASE

AR401 3"=1'-0"

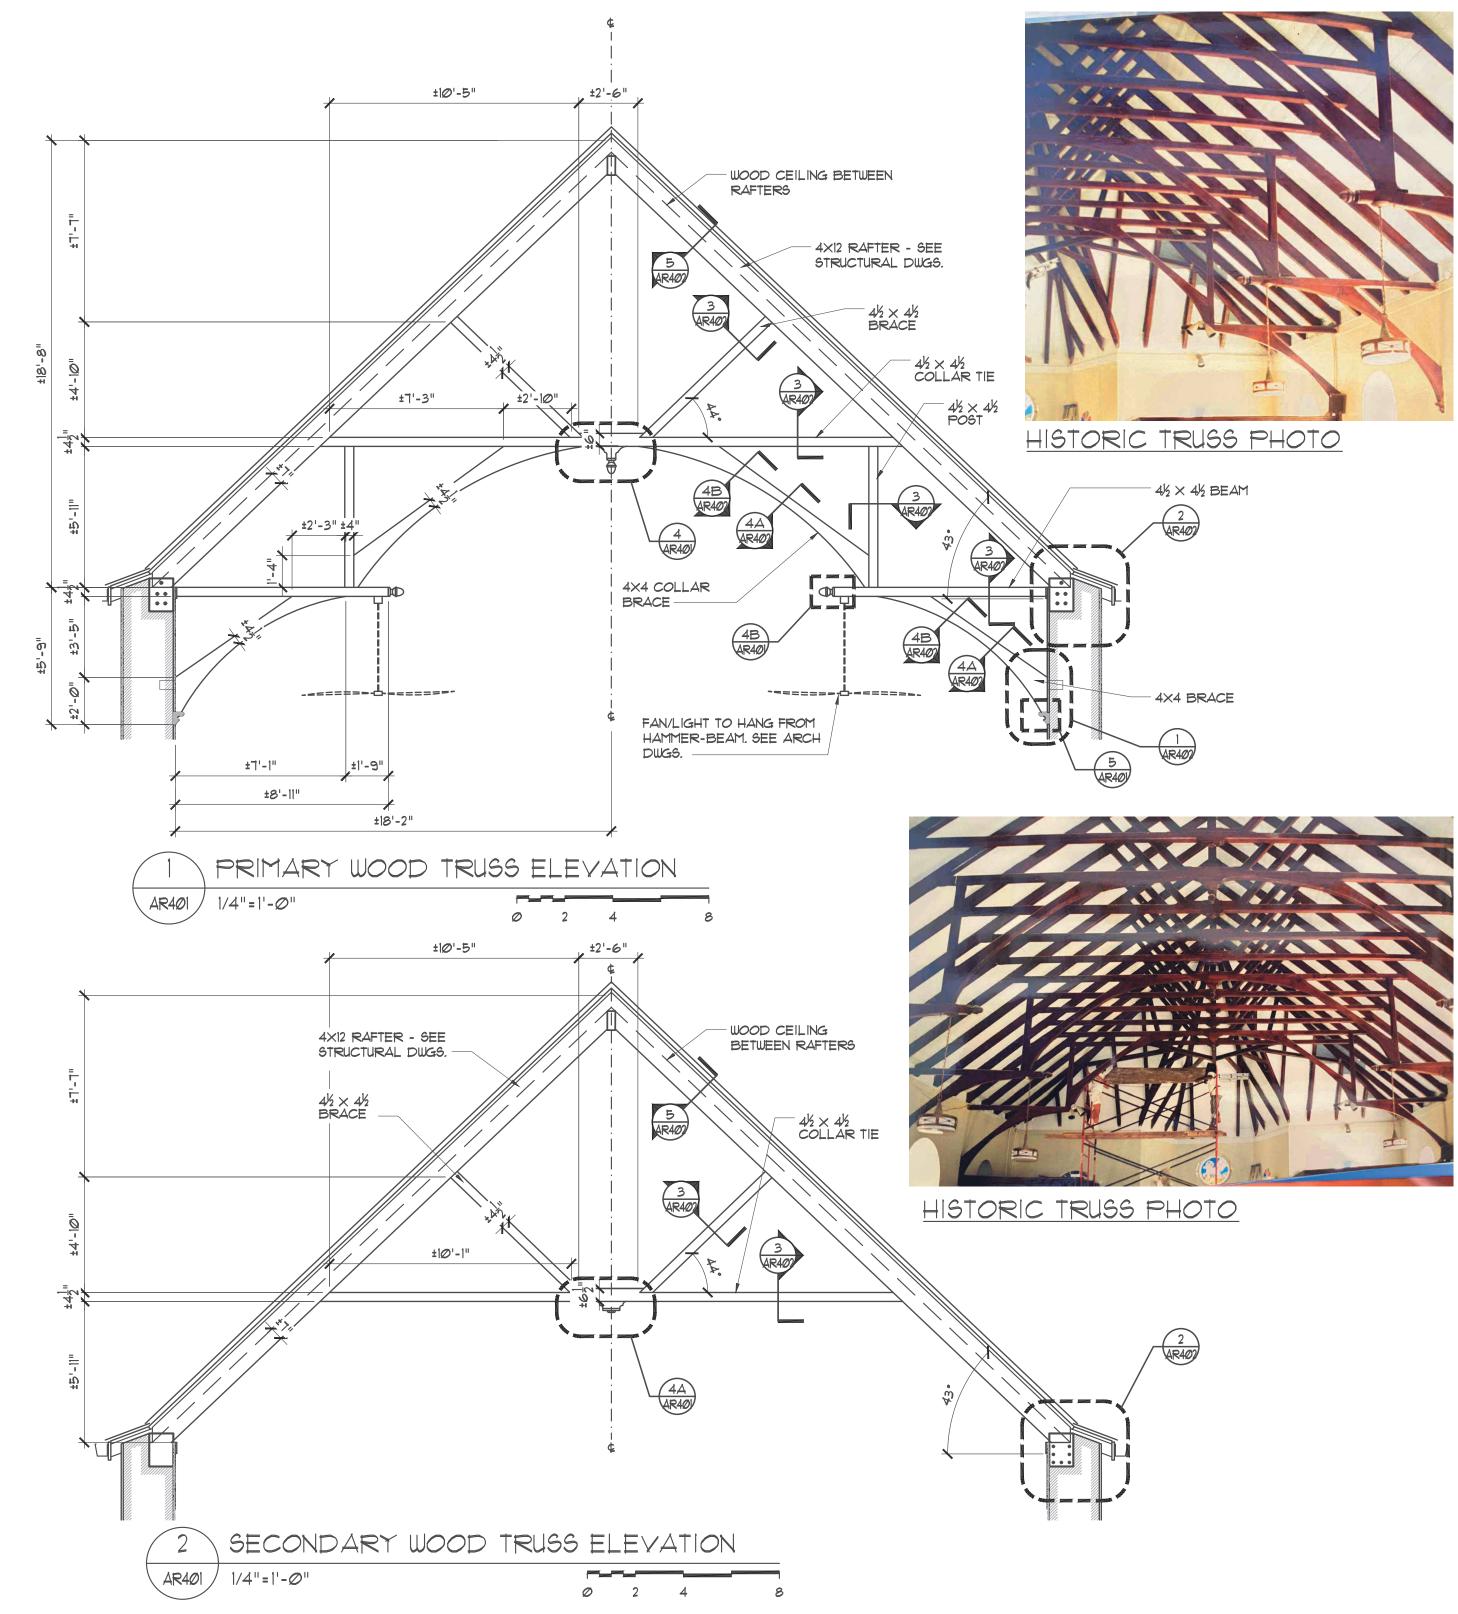

NOTES:

- TRUSSES ARE DECORATIVE FEATURES AND ARE NOT LOAD-BEARING. SEE STRUCTURAL DRAWINGS FOR ROOF STRUCTURE.
- 2. SEE AR-110 FOR RAFTER AND TRUSS PLAN.
- CONTRACTOR TO PROVIDE SIGNED AND SEALED SHOP DRAWINGS BY LICENSED ENGINEER IDENTIFYING HOW TRUSS COMPONENTS ARE CONNECTED AND ANCHORED
- 4. STAIN ALL RAFTER AND TRUSS CLADDING TO MATCH COLOR SHOWN IN PHOTOGRAPHS.


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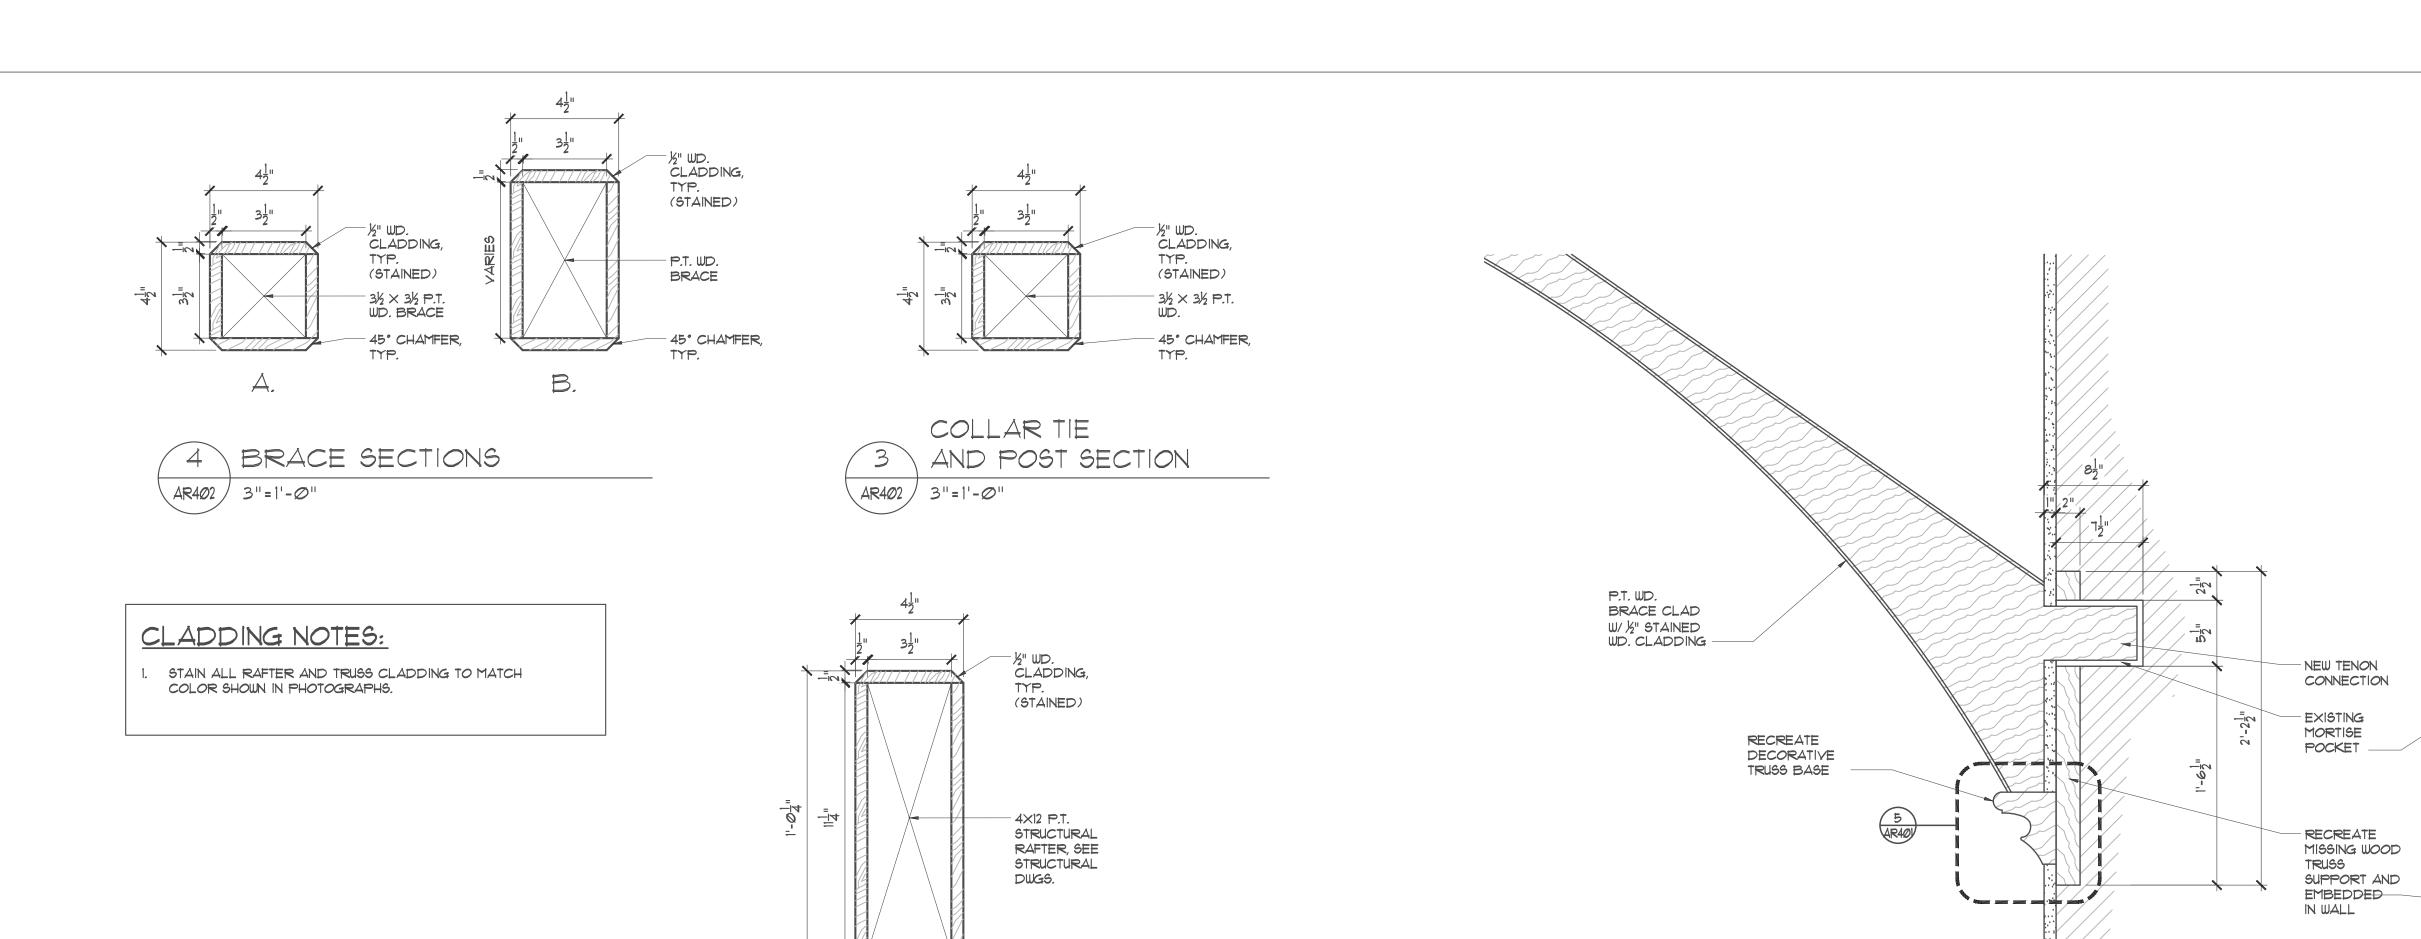
TRUSS DETAILS

project number 2022-009

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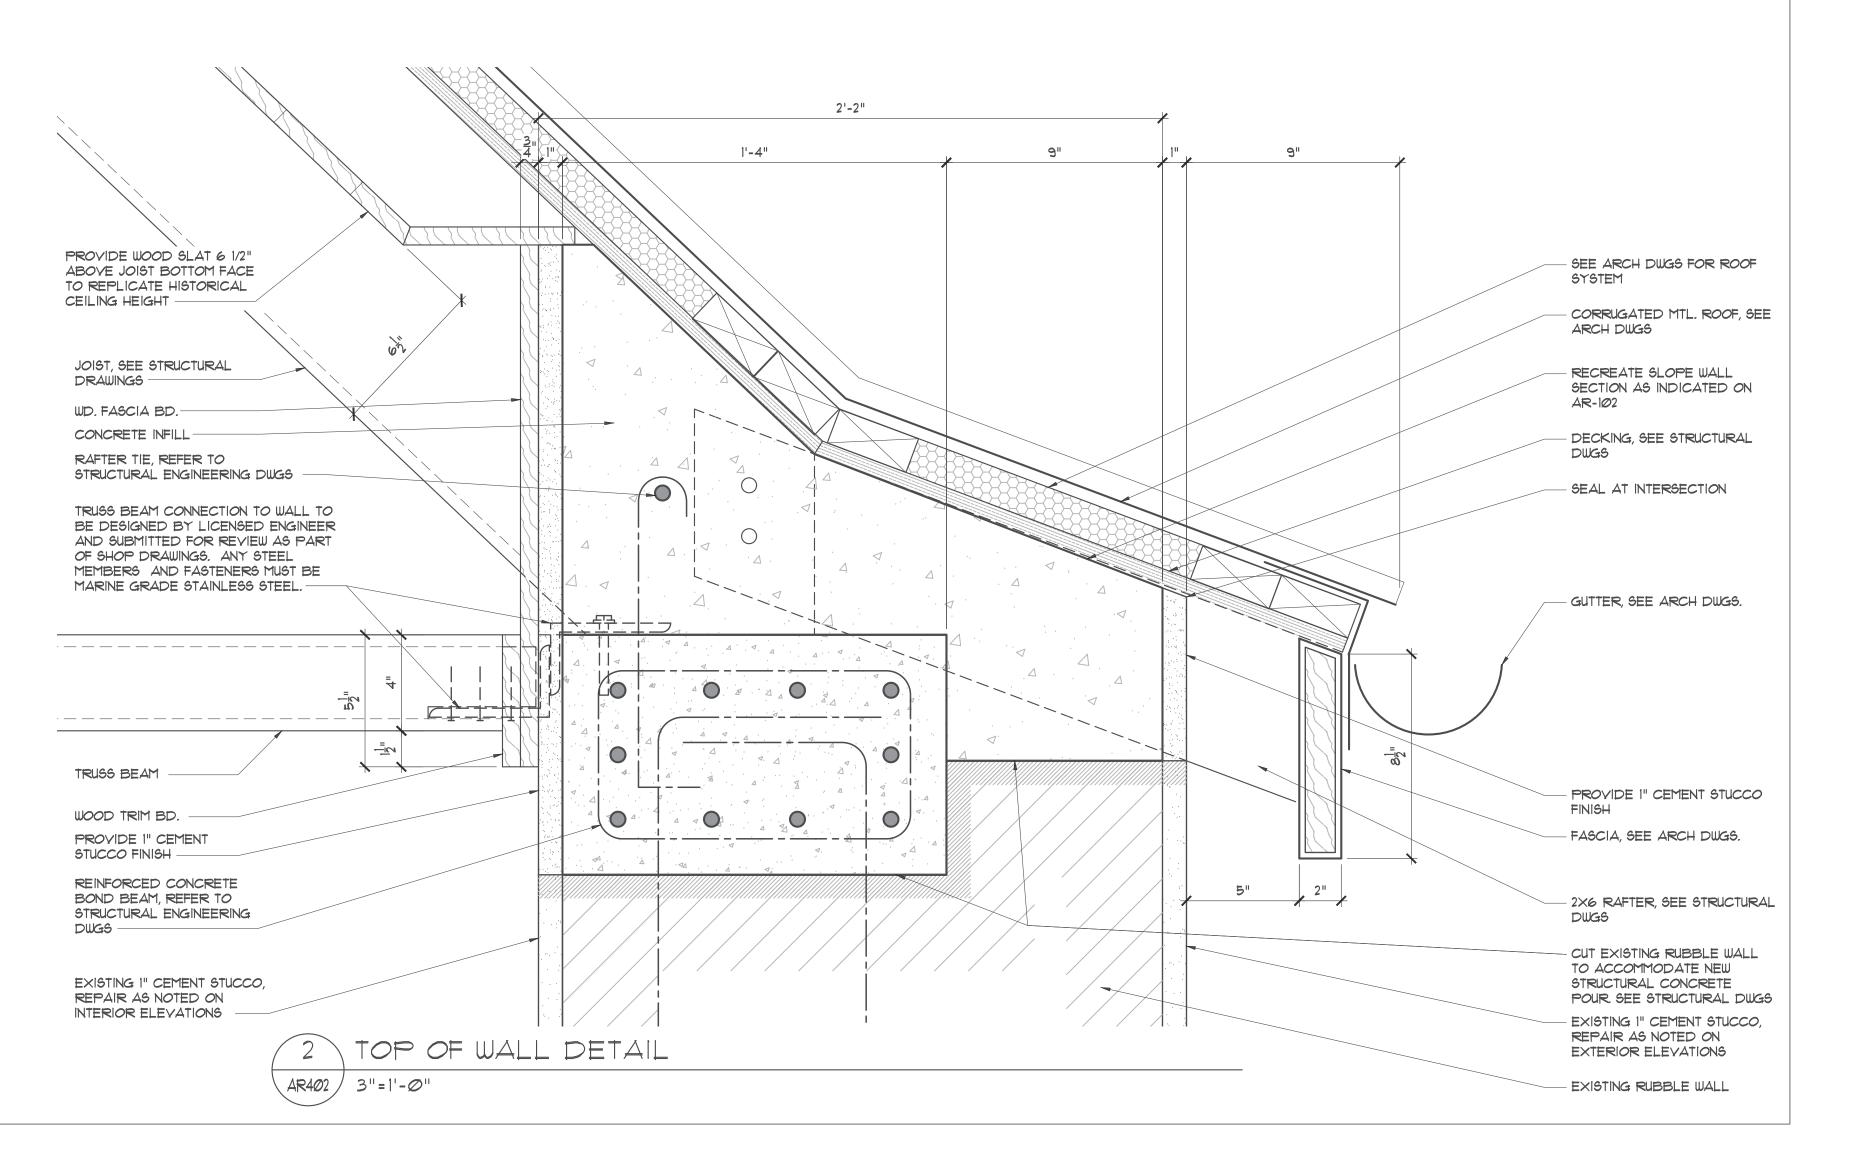
5 STRUCTURAL RAFTER CLADDING SECTION

AR402 3"=1'-0"

45° CHAMFER,

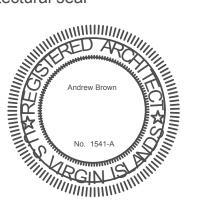1 WOOD TRUSS BASE SECTION

AR402 1 1/2"=1'-0"




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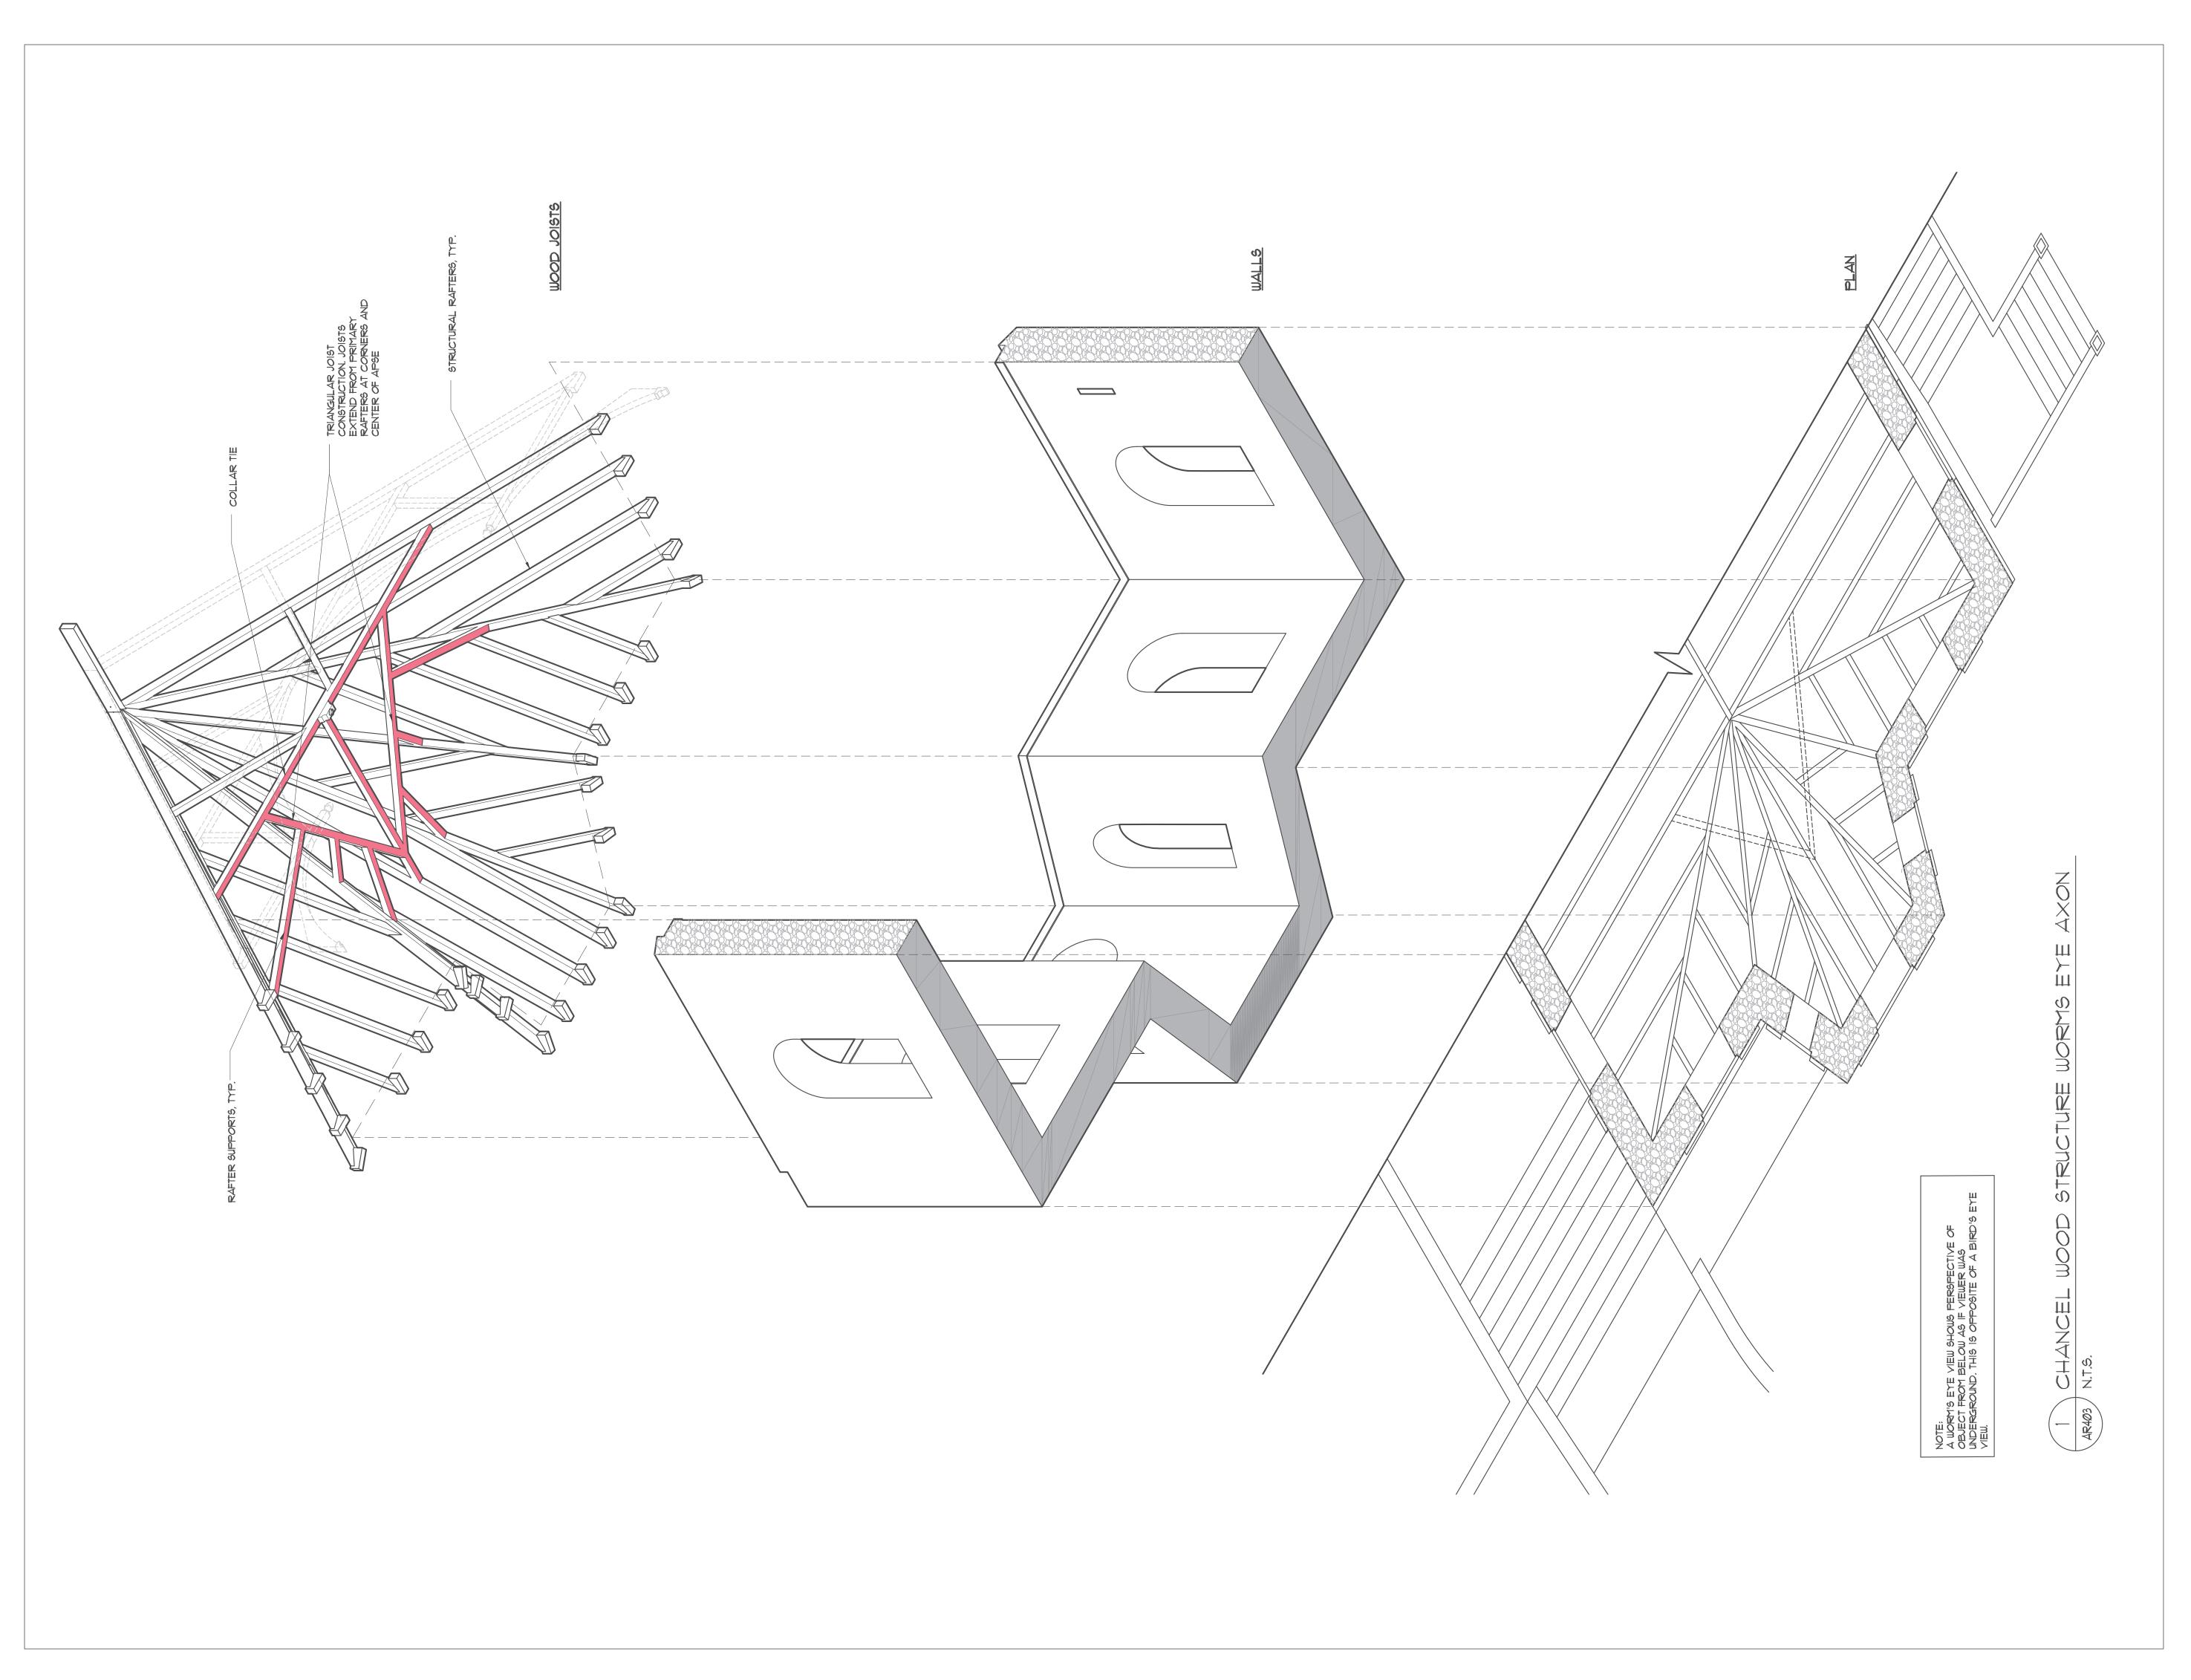
TRUSS DETAILS

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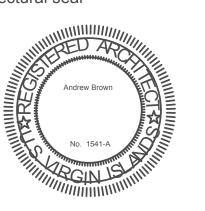




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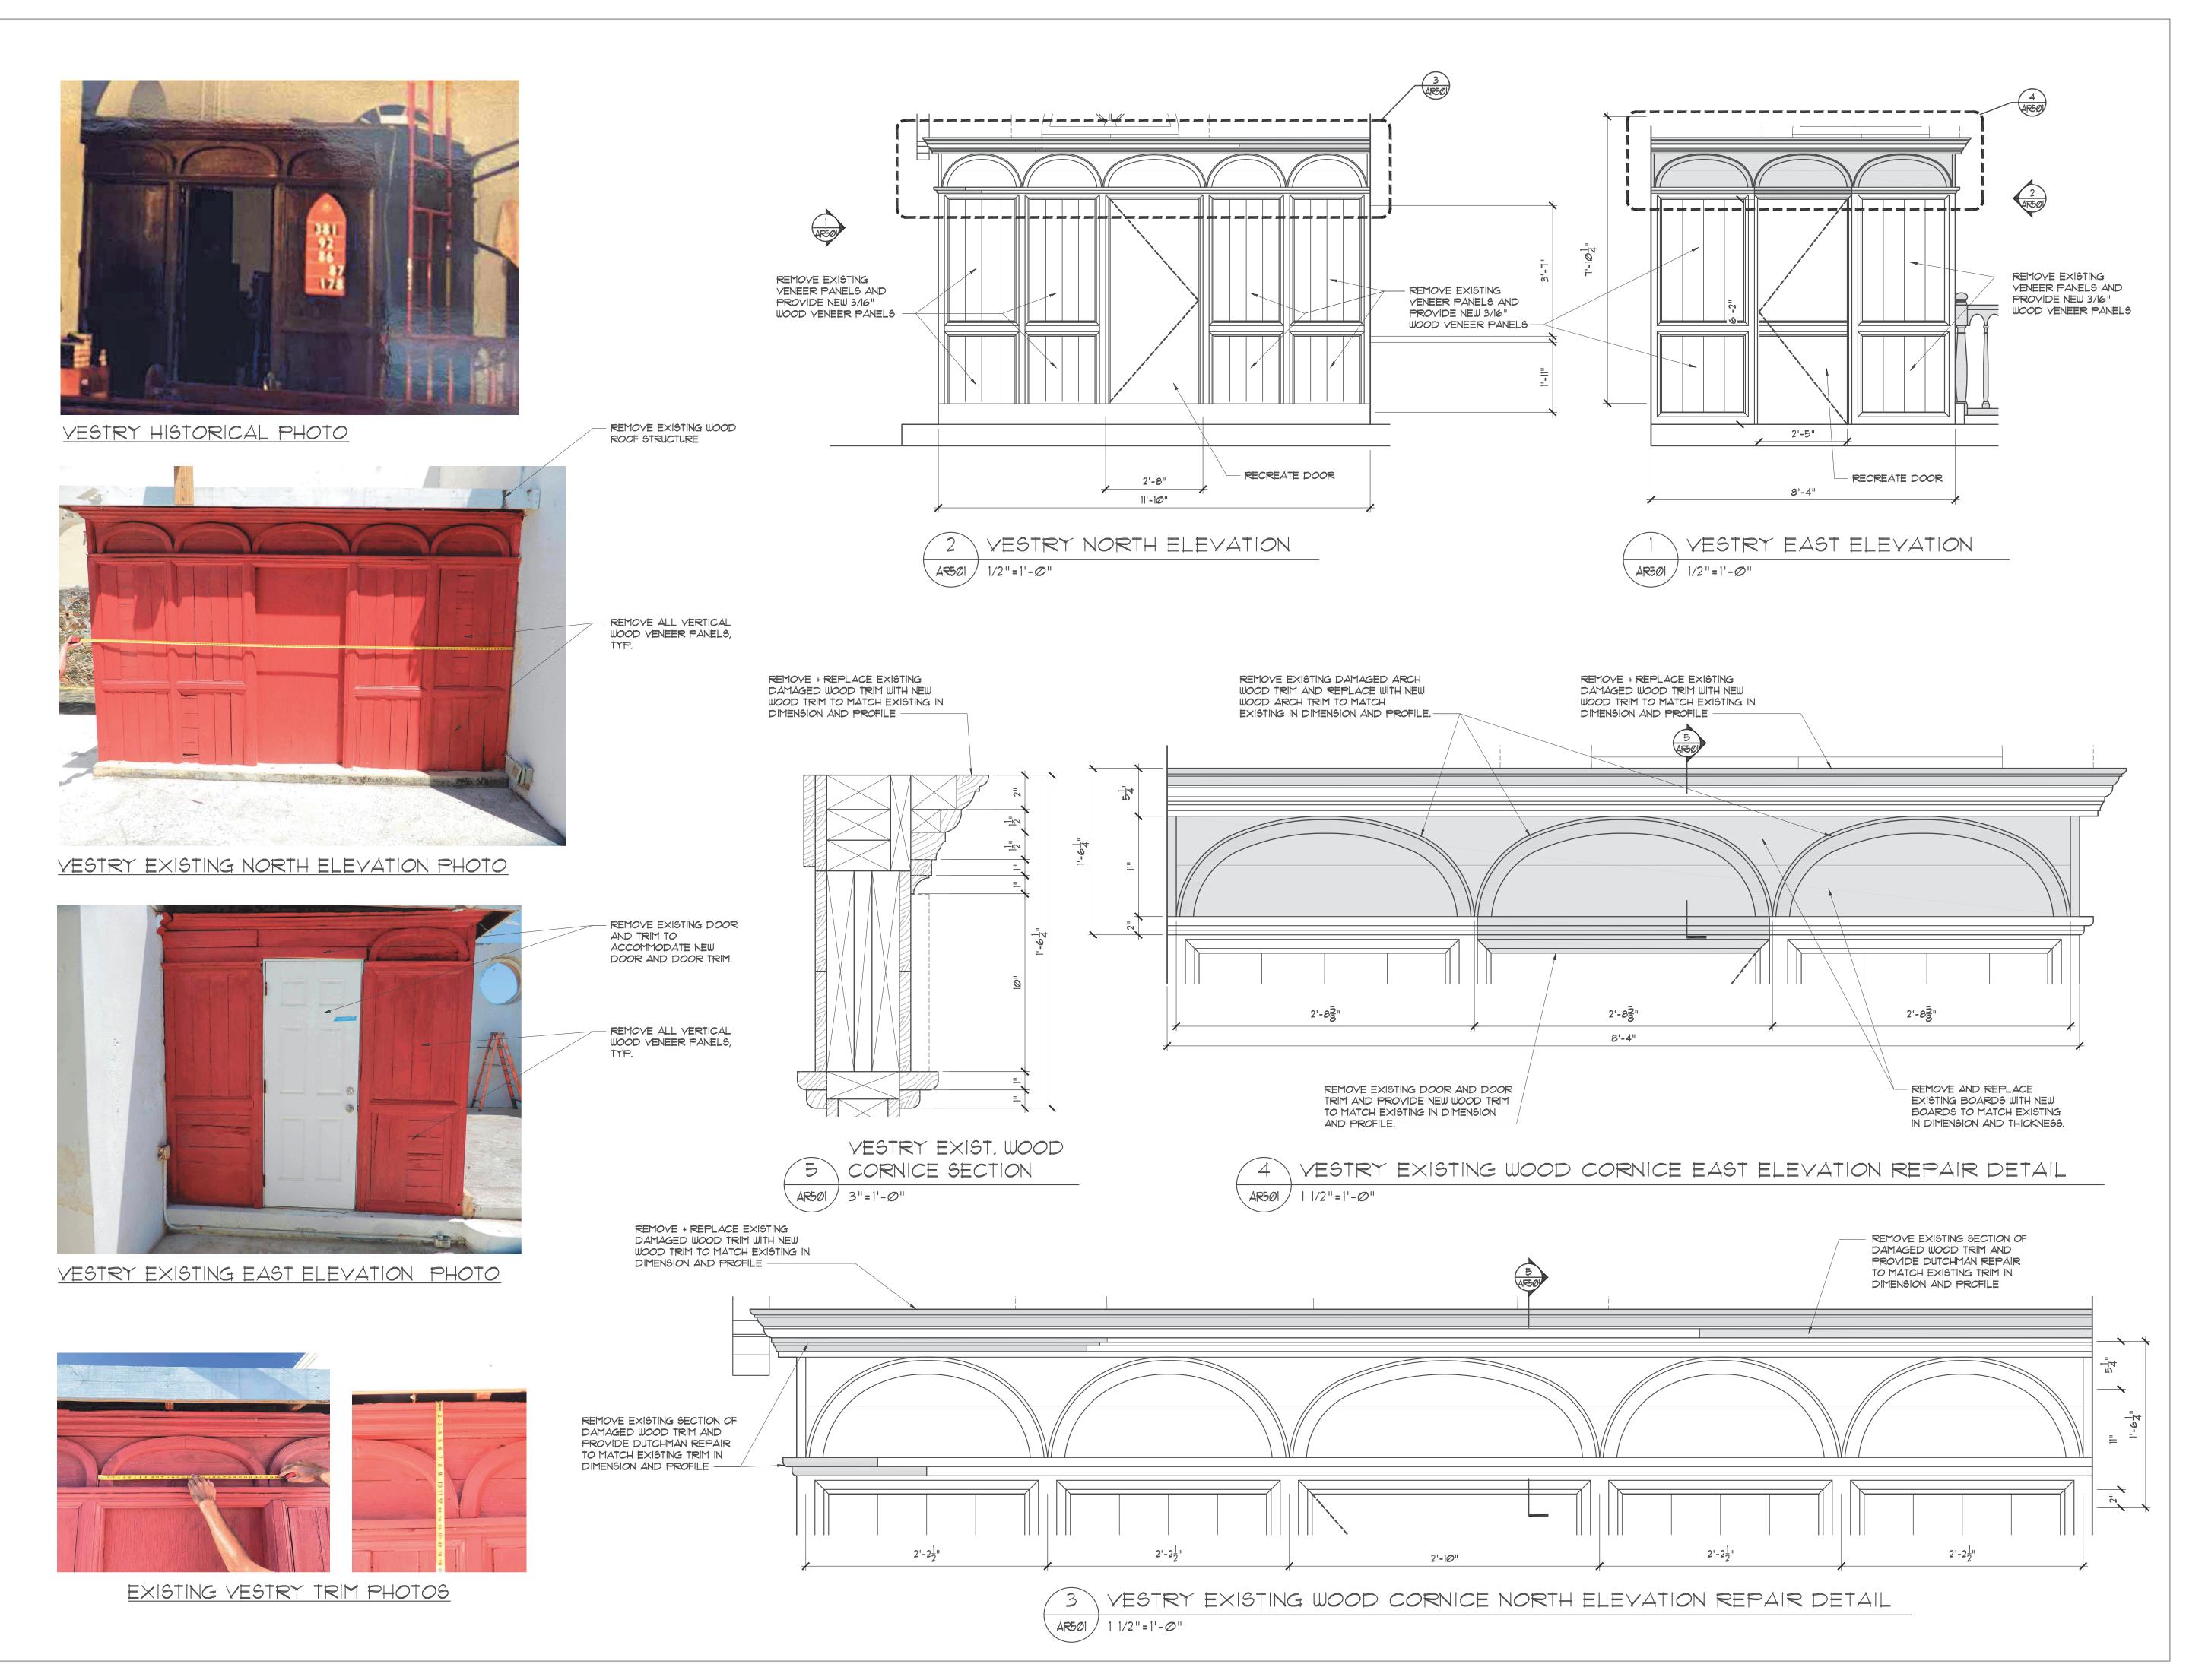
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project number 2022-009

date

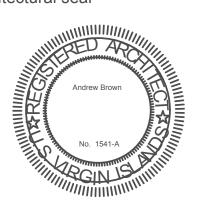1/2

11/28/2023






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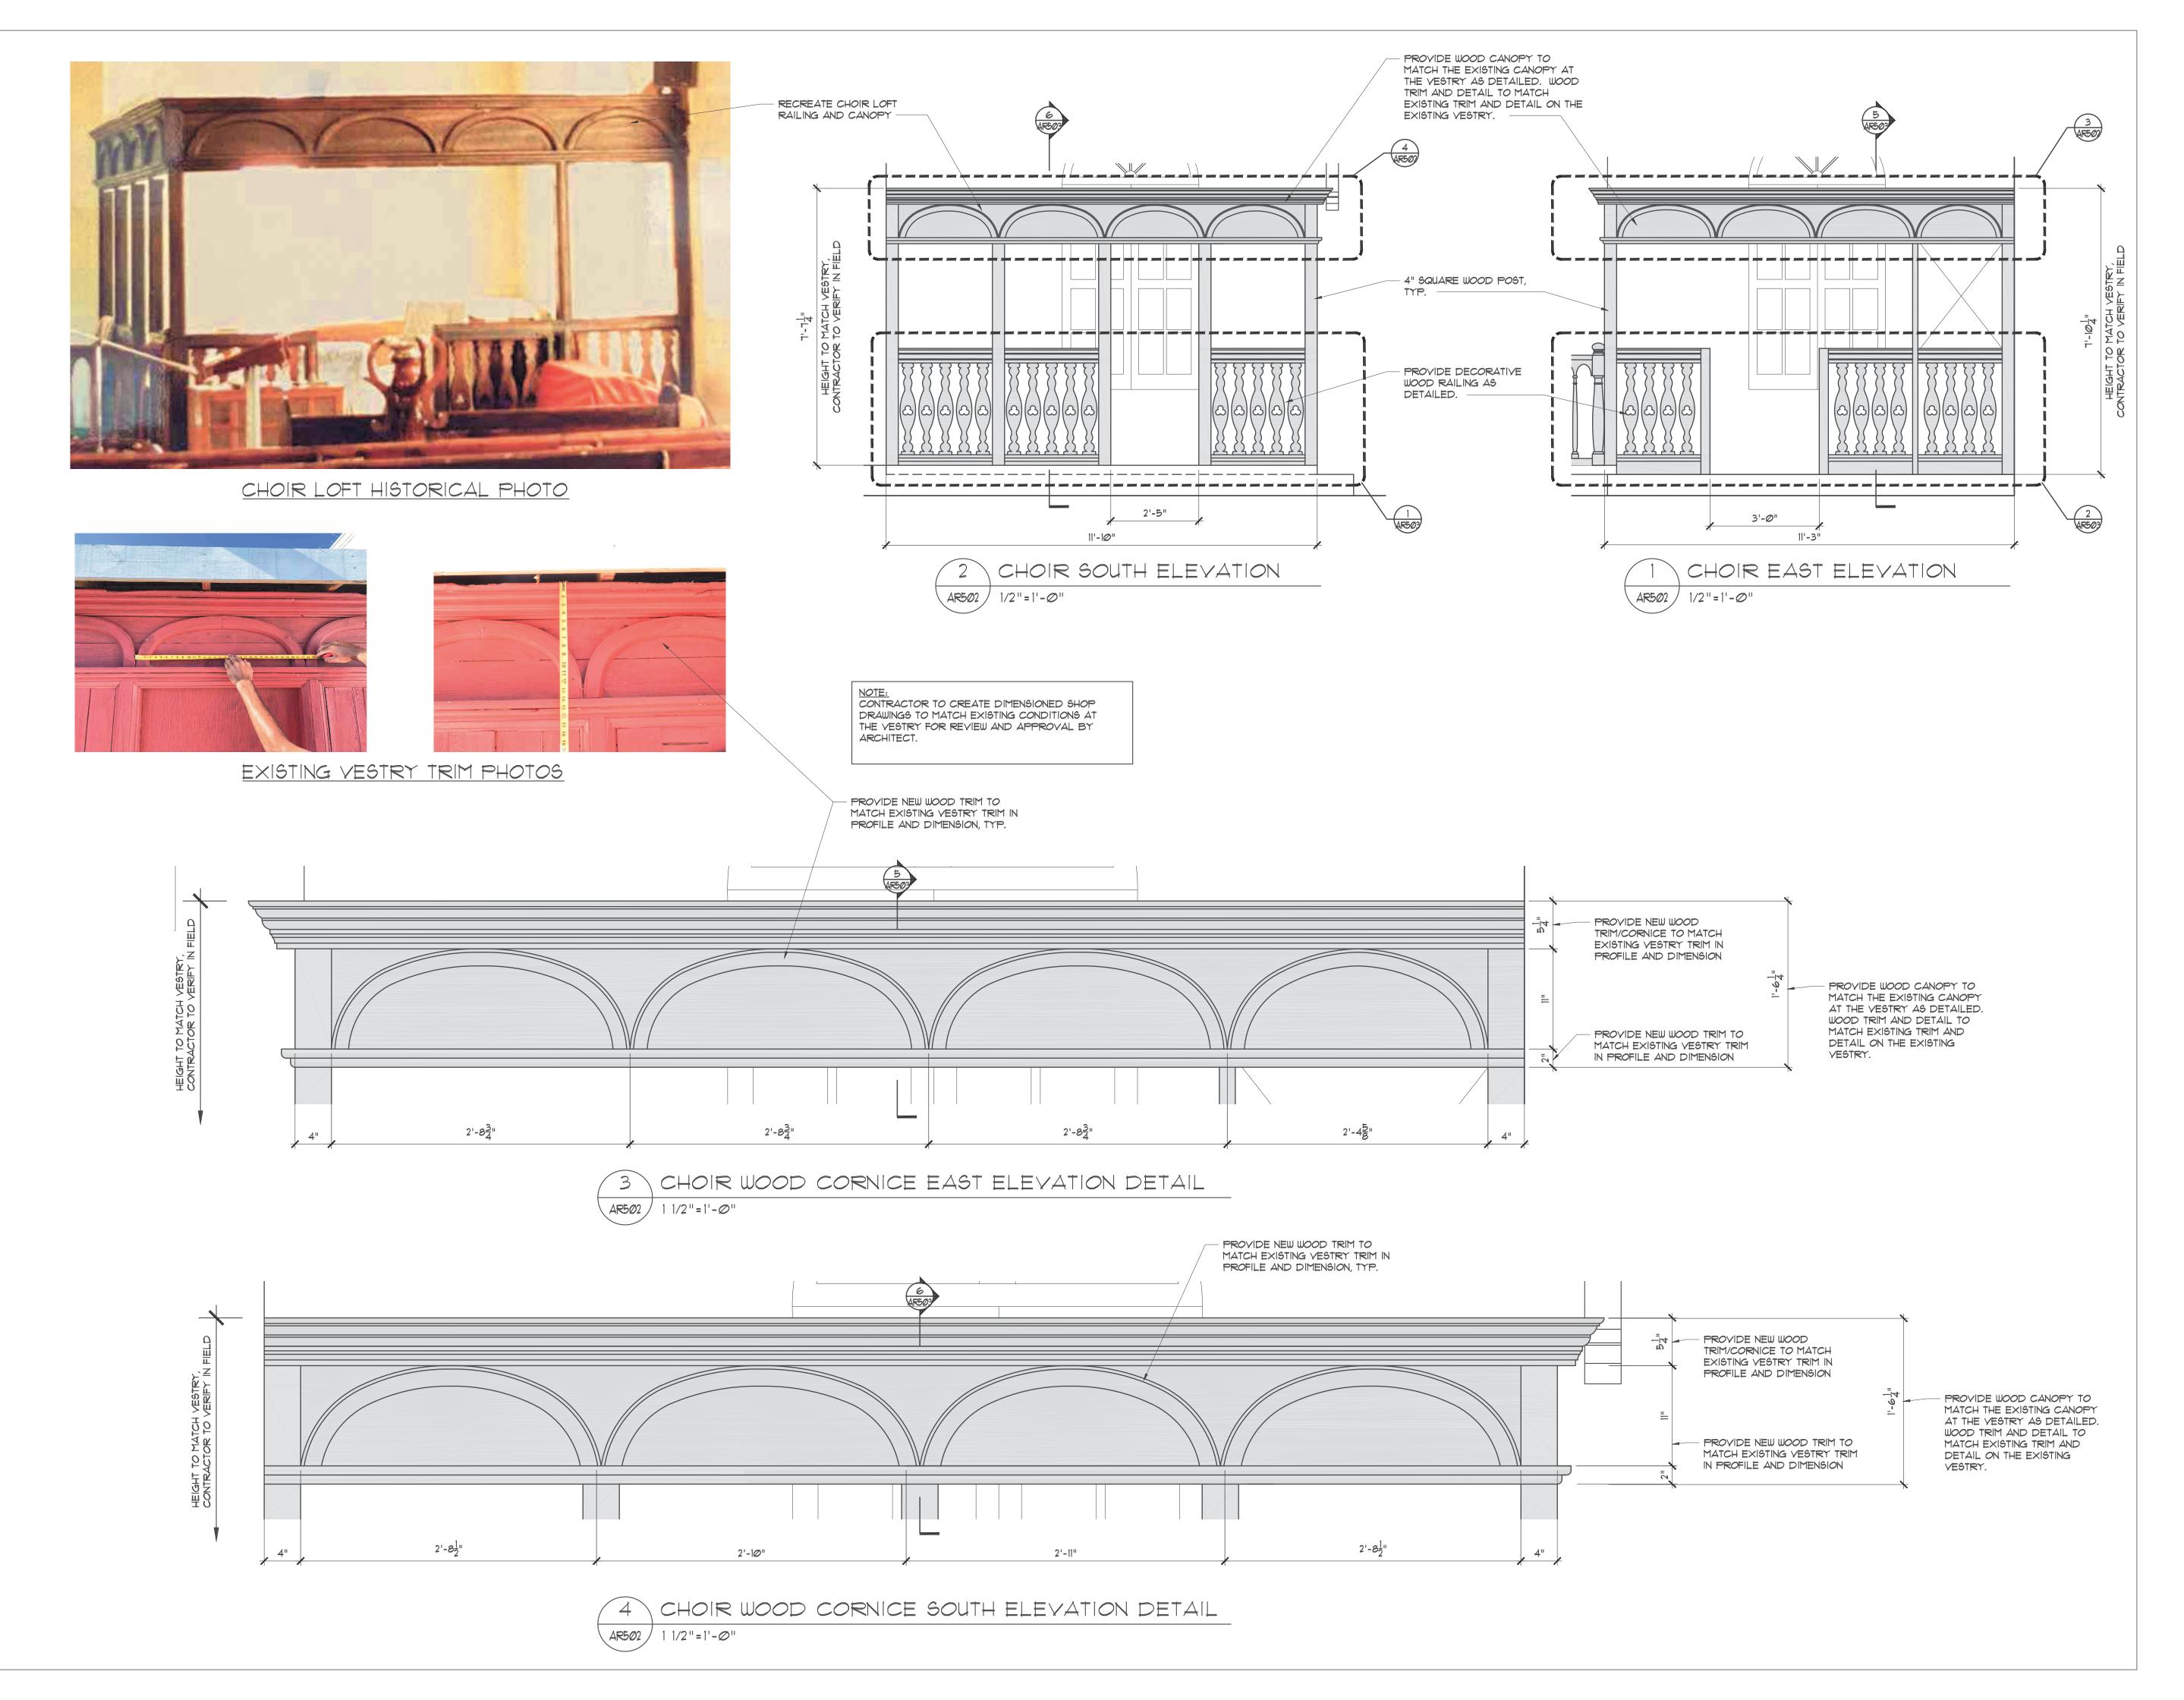
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YESTRY ELEVATIONS

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11/28/2023

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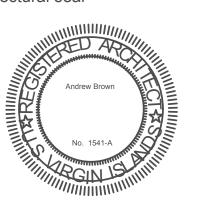


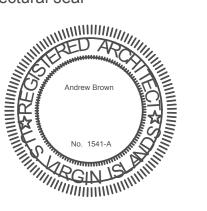

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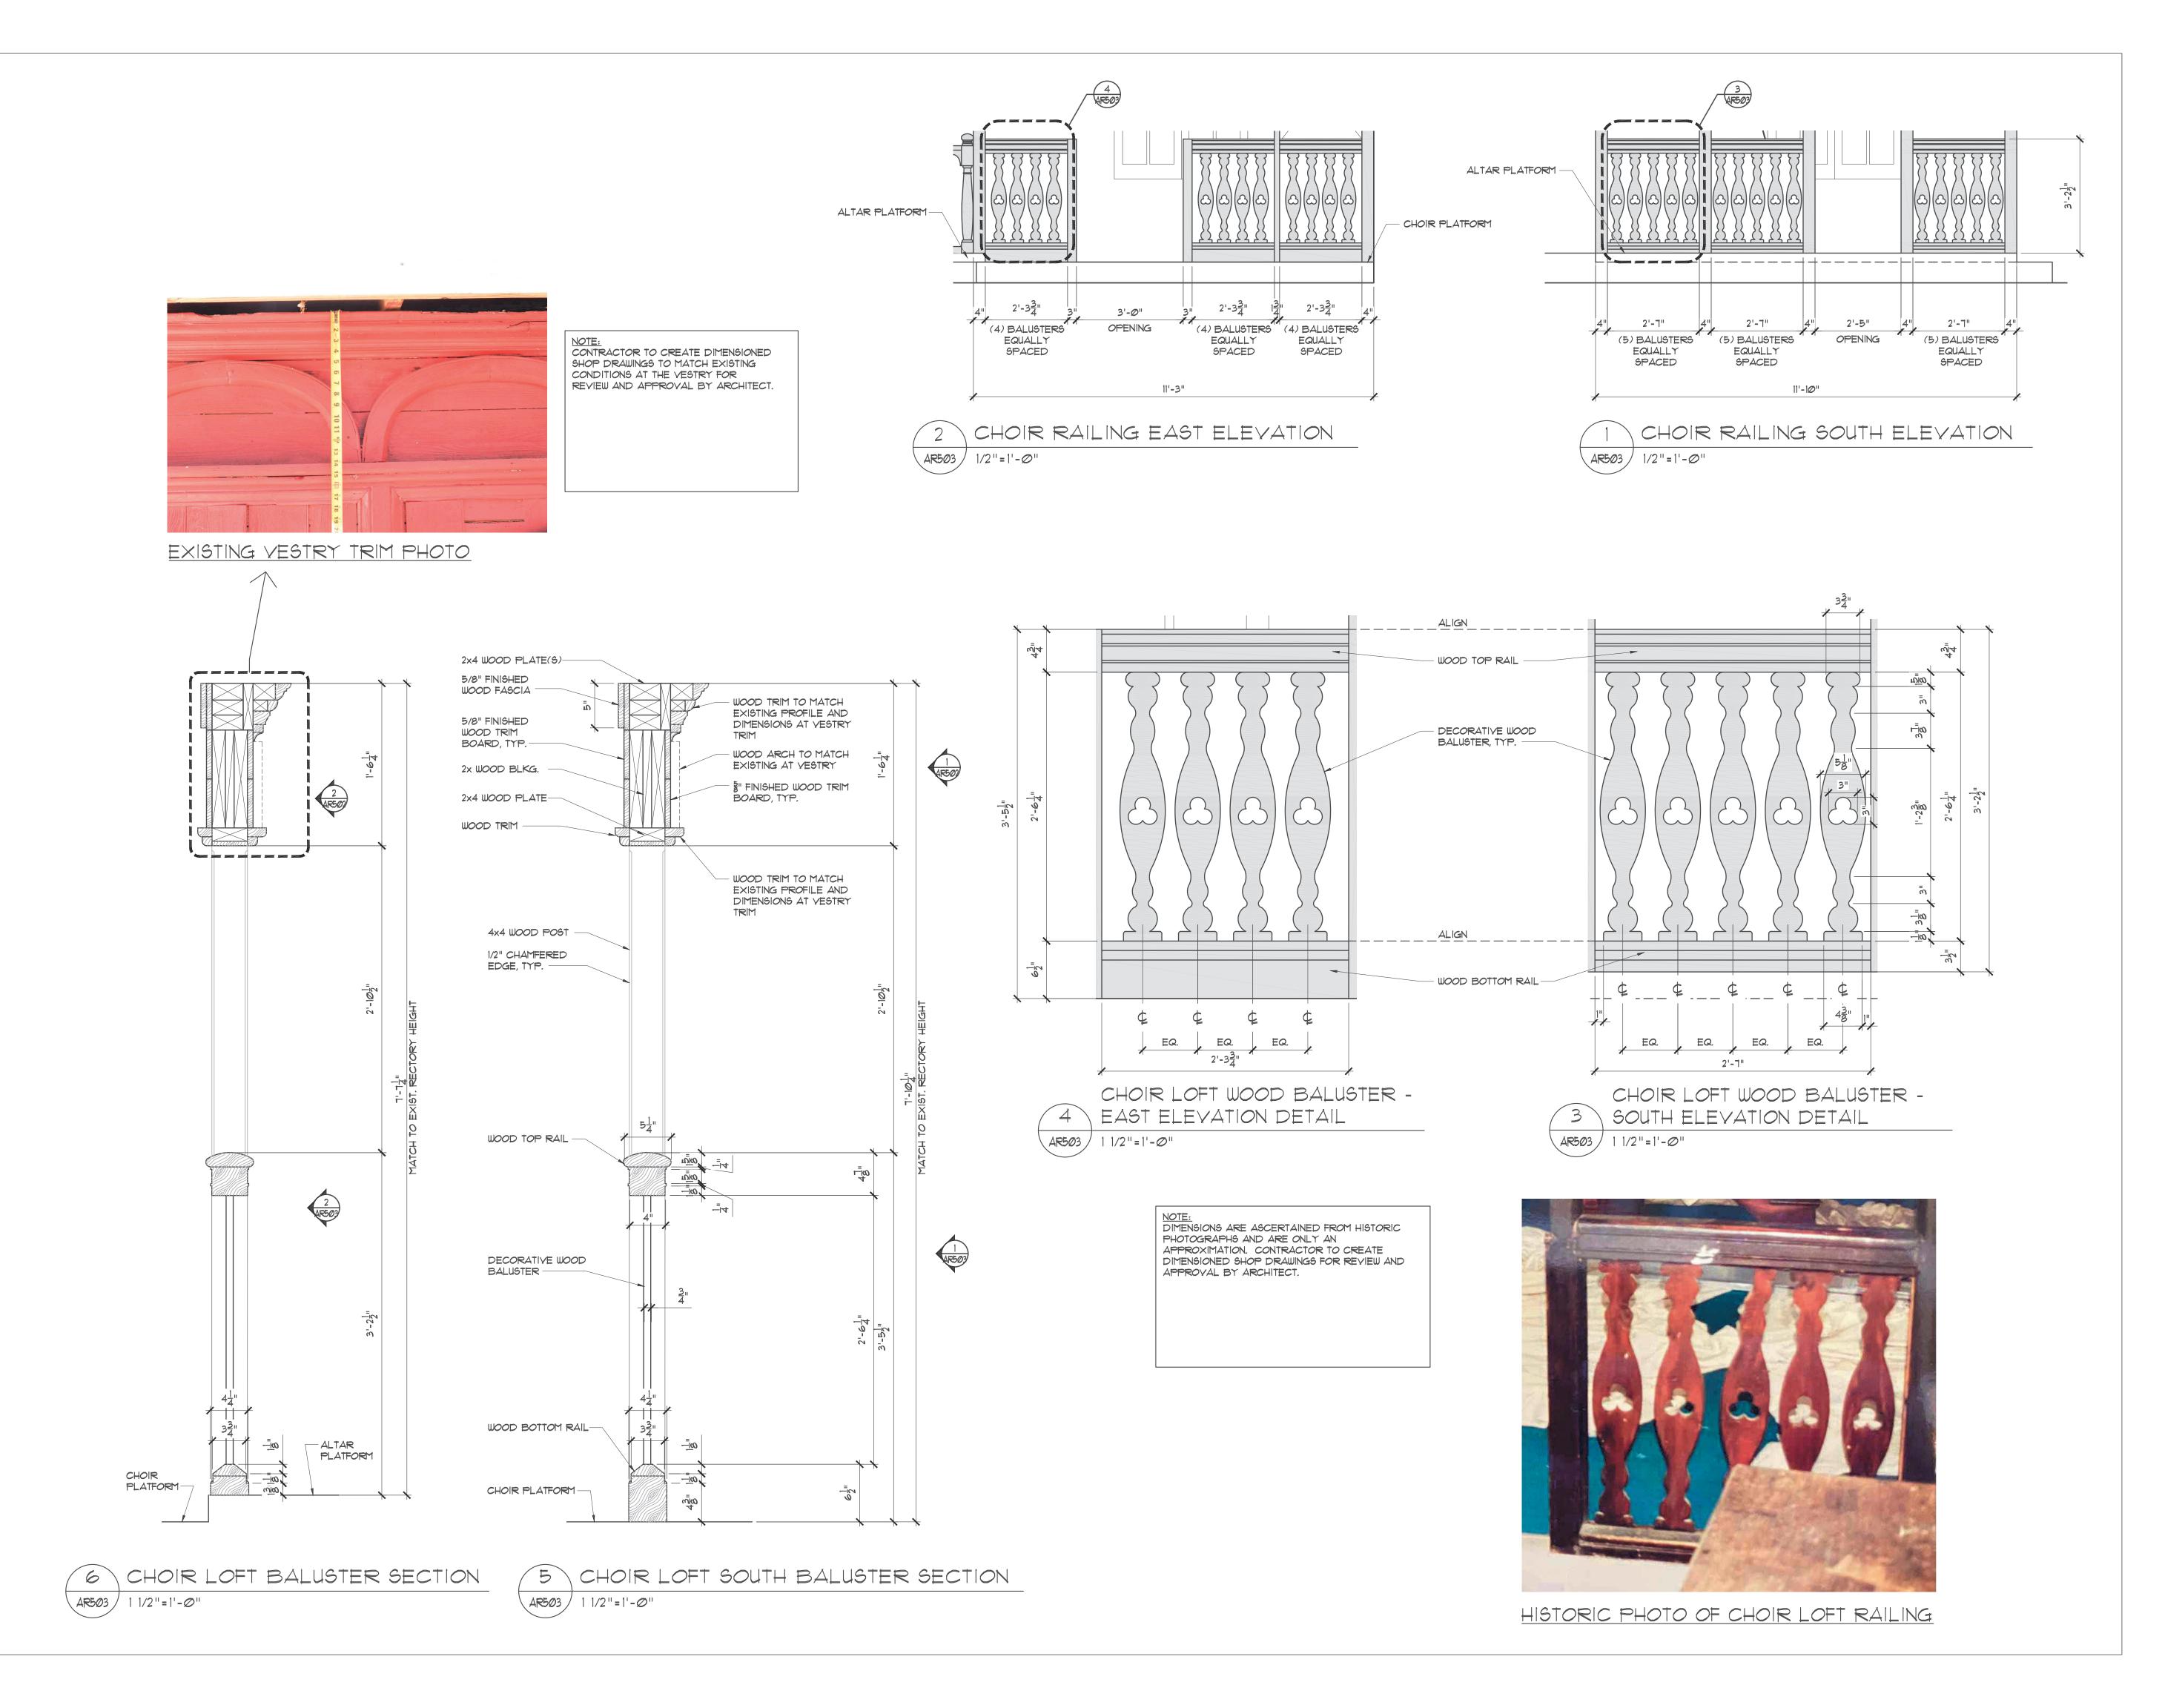
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CHOIR ELEVATIONS AND DETAILS

project number

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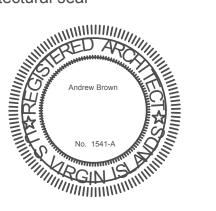




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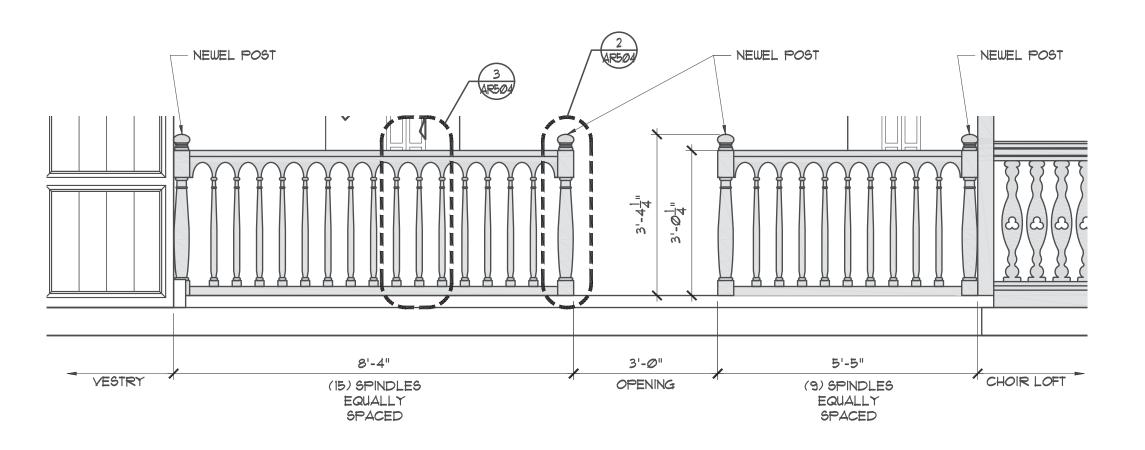
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RAILING ELEVATIONS AND DETAILS

project number date


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AR-503




1 CHANCEL RAILING ELEVATION

AR504 1/2"=1"-0"

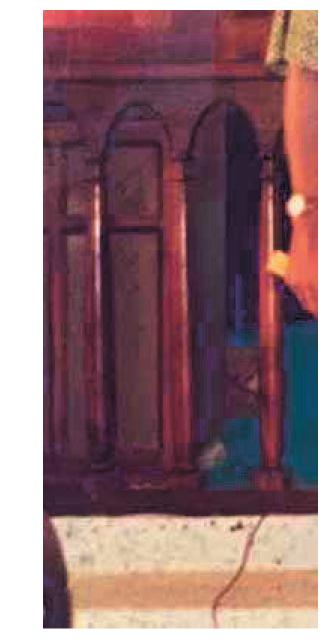


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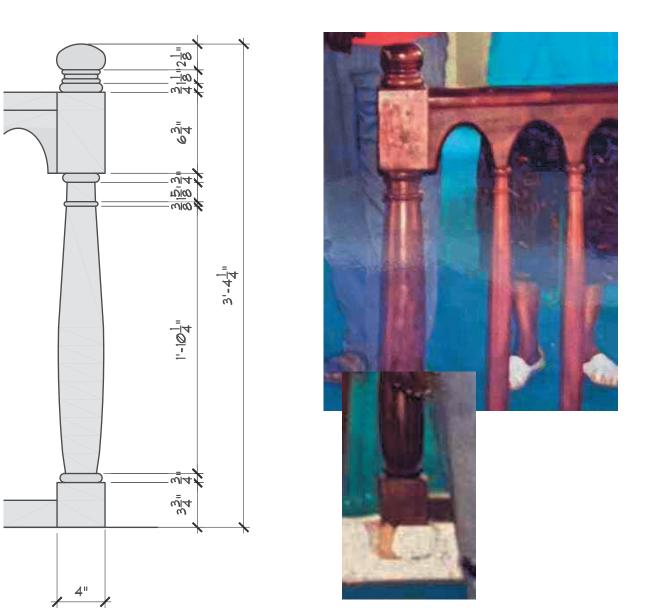
4 CHANCEL RAIL SECTION

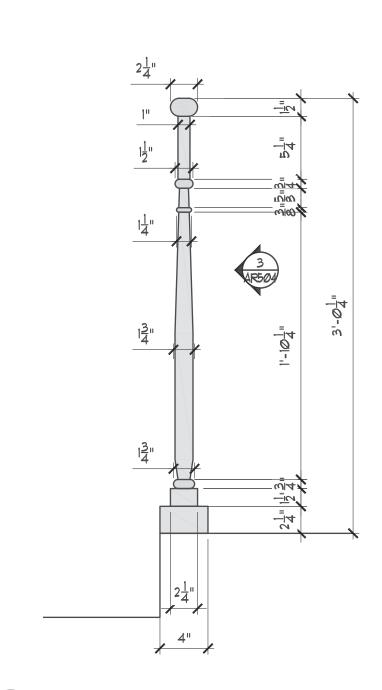AR504 1 1/2"=1'-0"



3 CHANCEL RAIL DETAIL

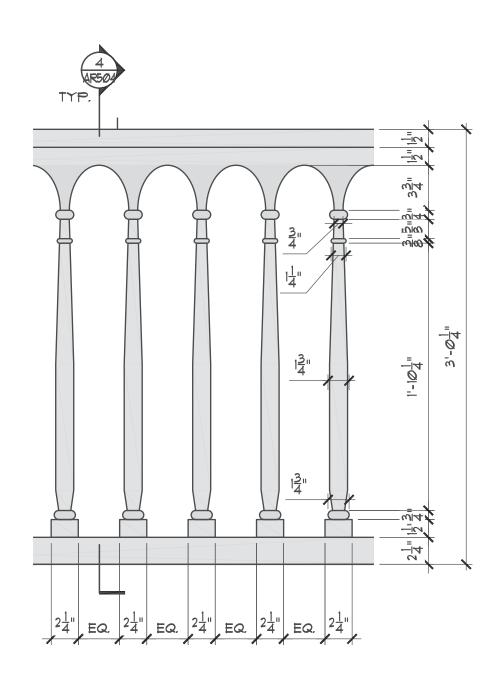AR504 1 1/2"=1'-0"



HISTORIC PHOTO OF NEWEL POST





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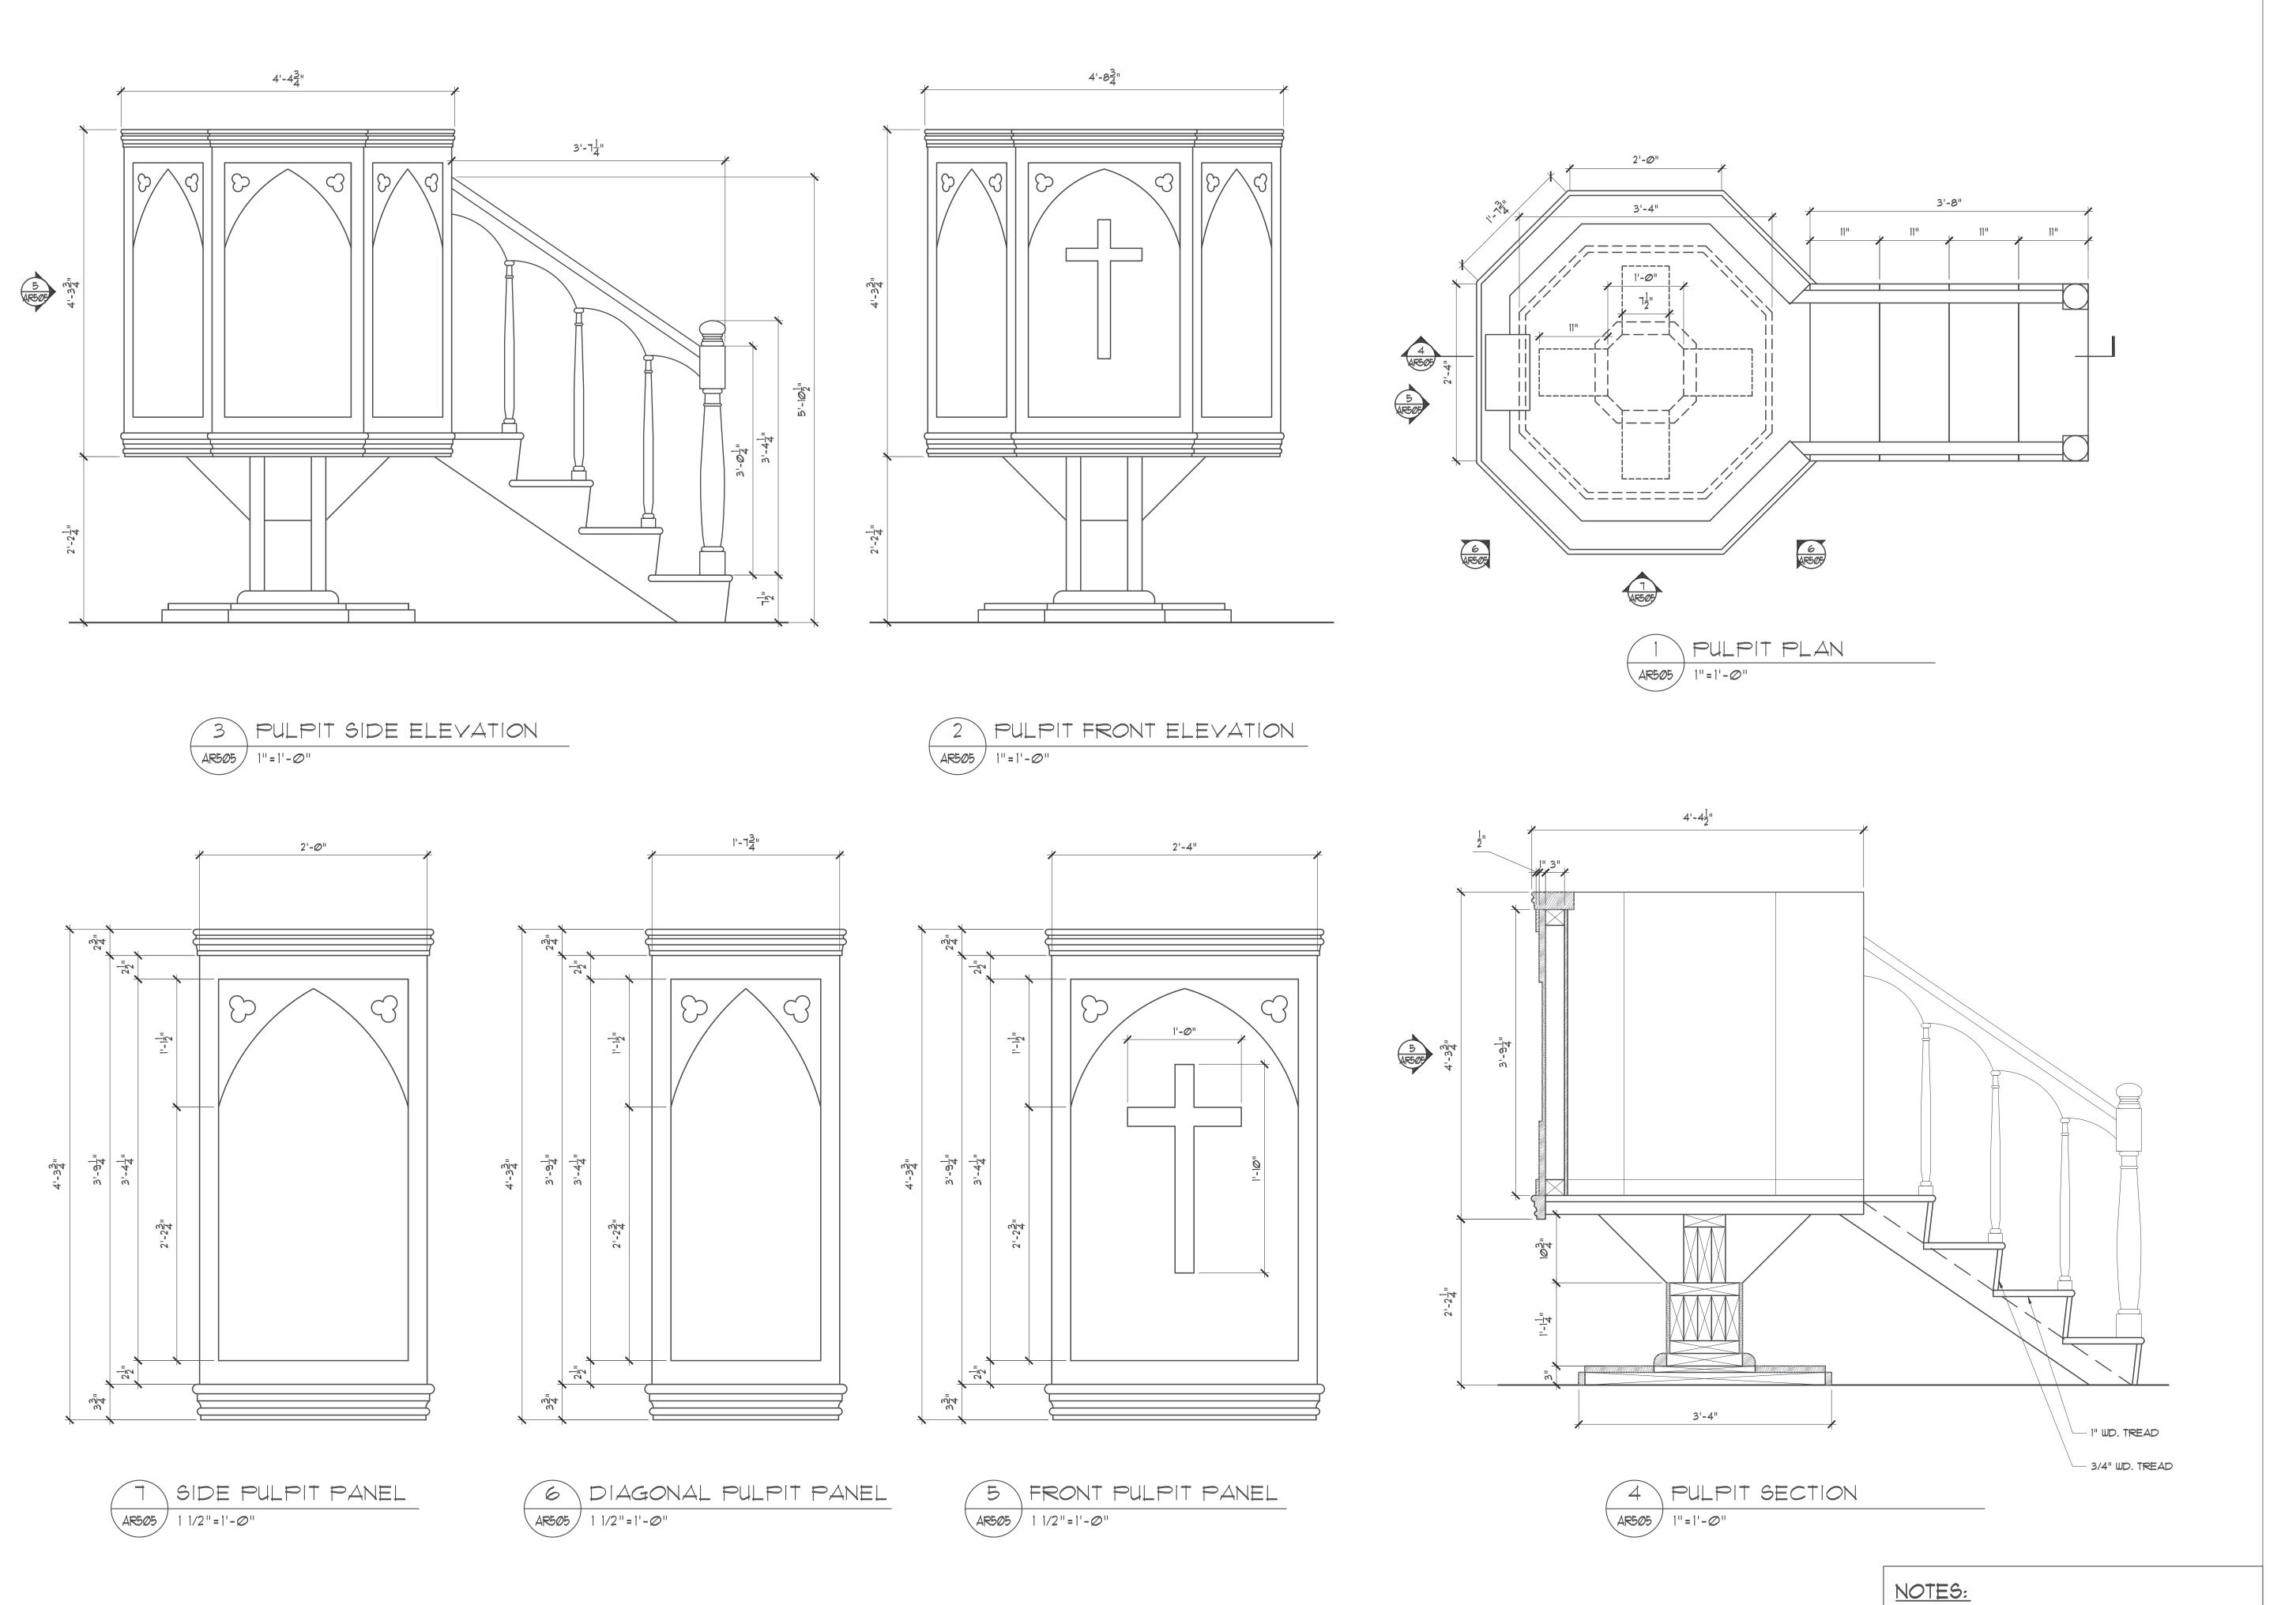
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RAILING ELEVATIONS AND DETAILS

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AR-504






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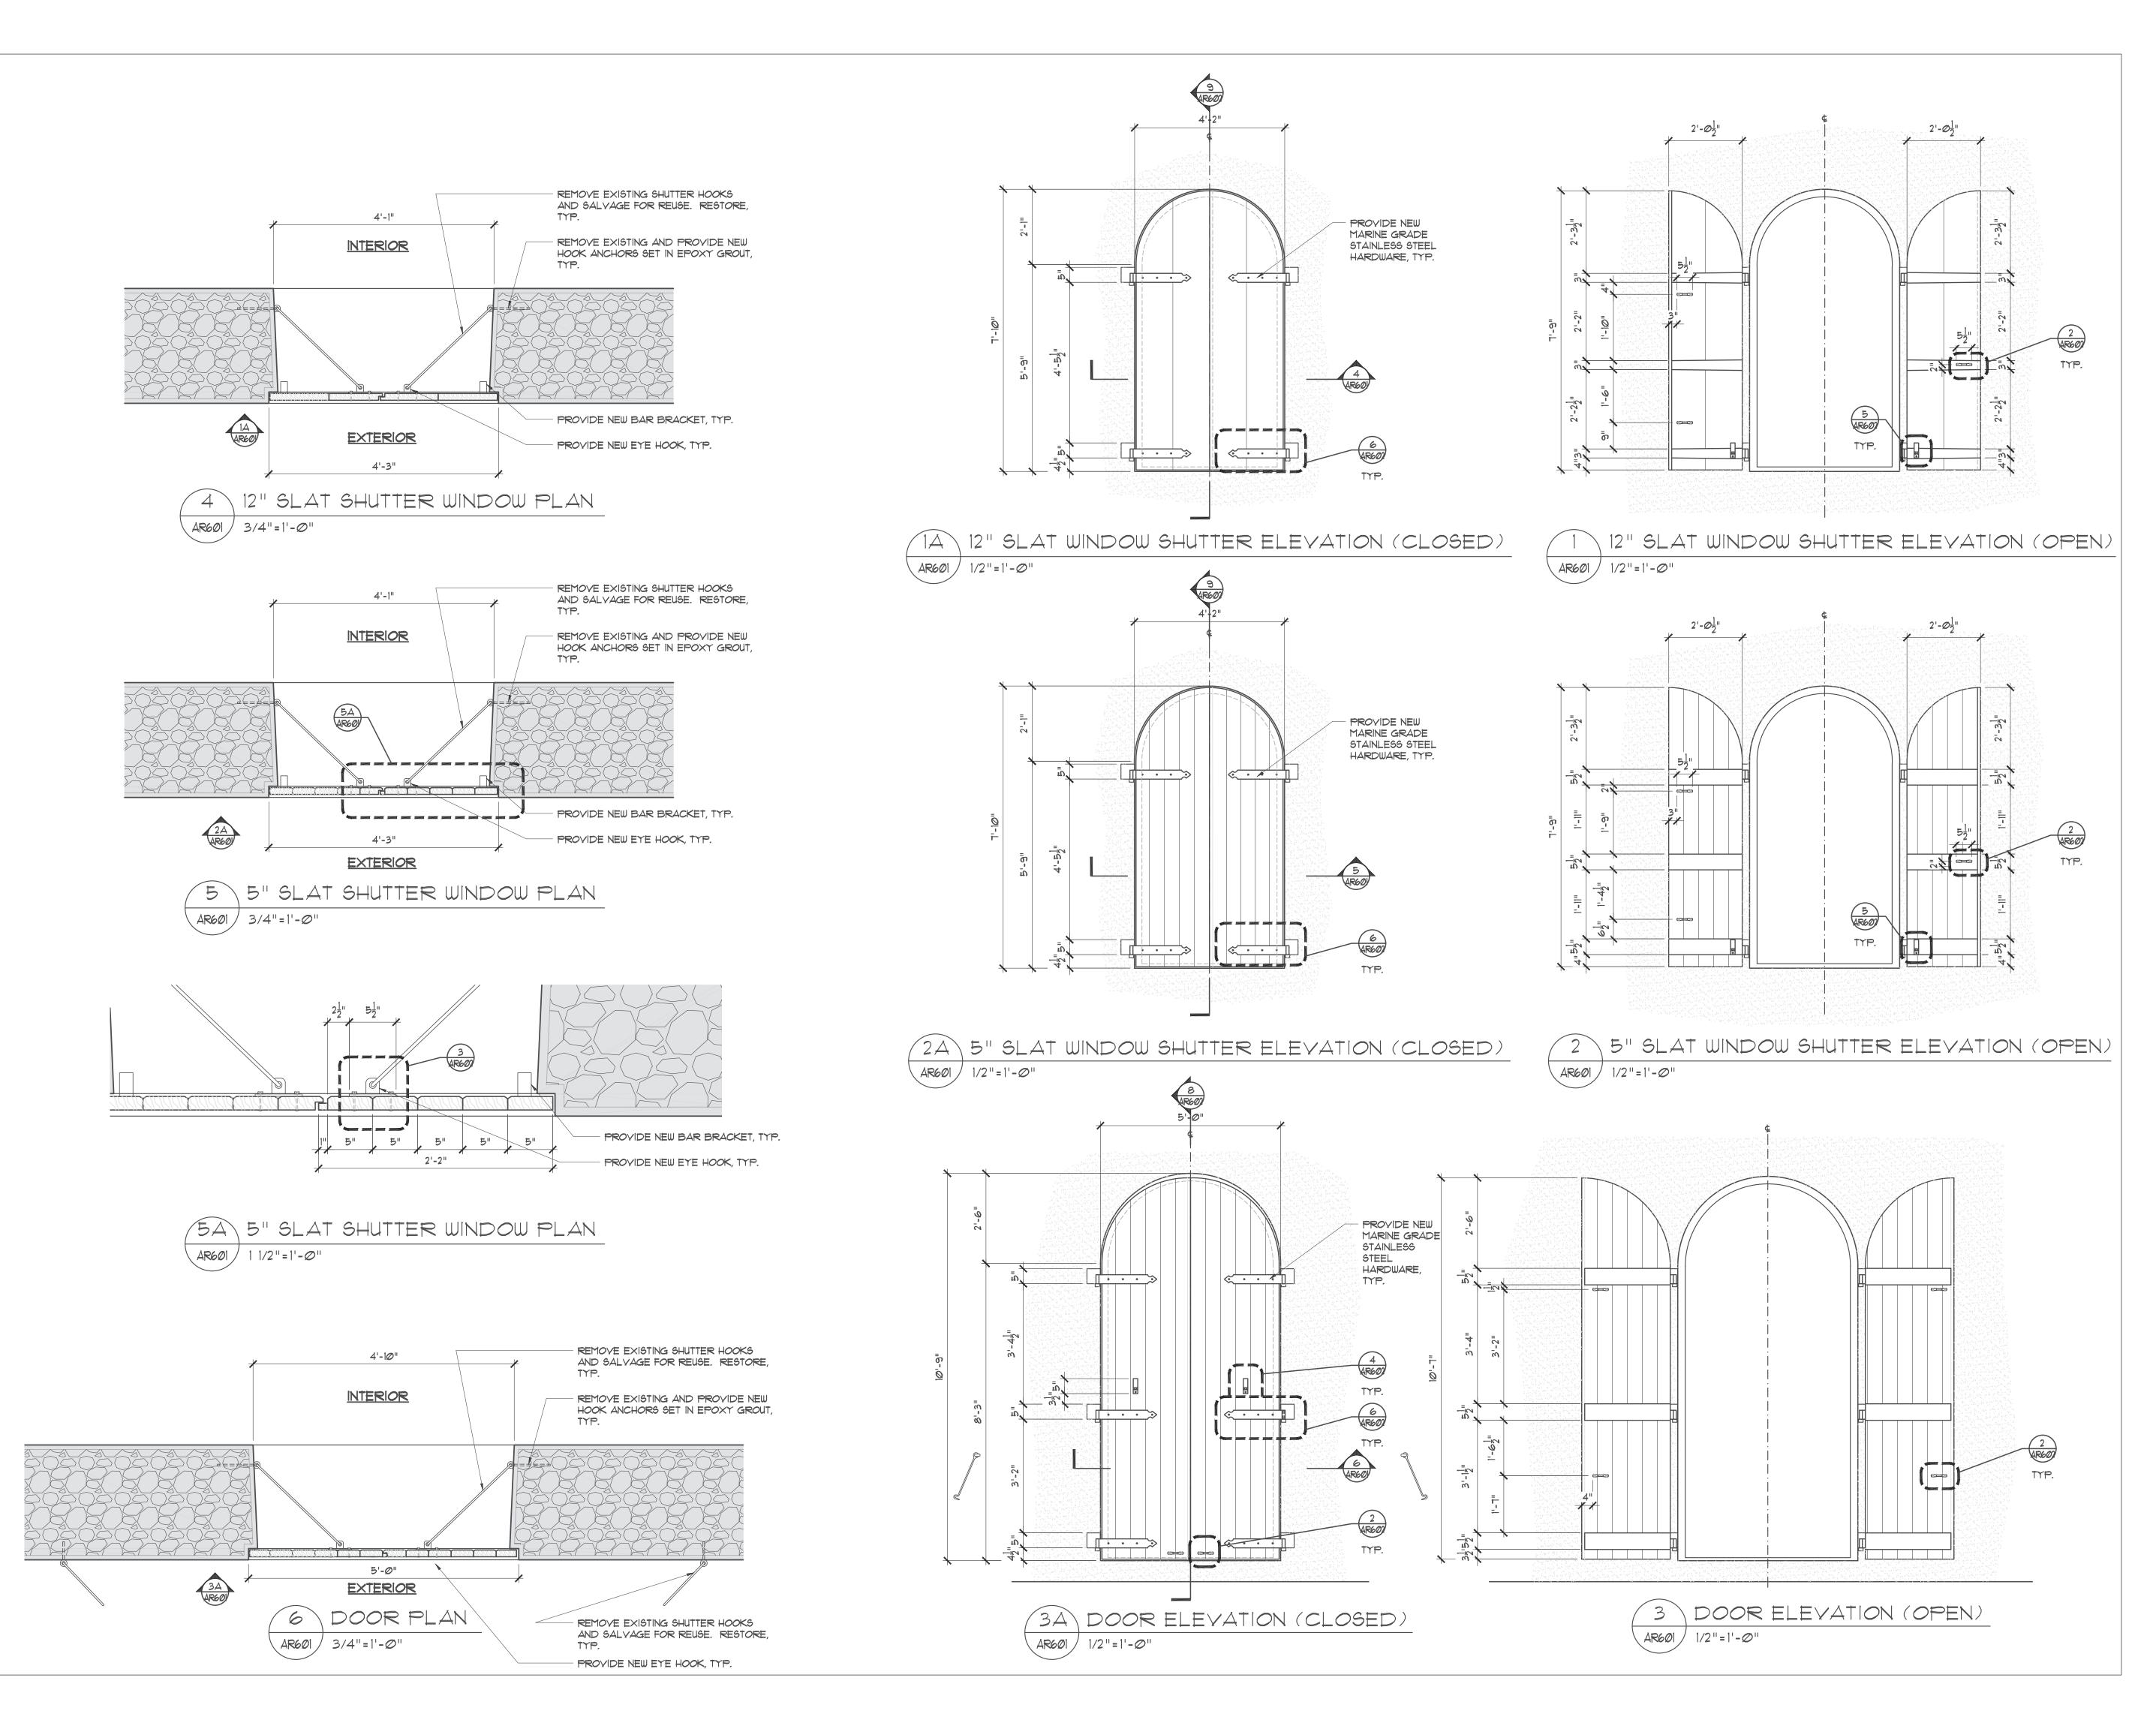
PULPIT DETAILS

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CONTRACTOR TO PROVIDE SIGNED AND SEALED SHOP DRAWINGS BY LICENSED ENGINEER

AR-505

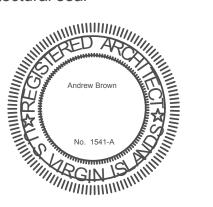




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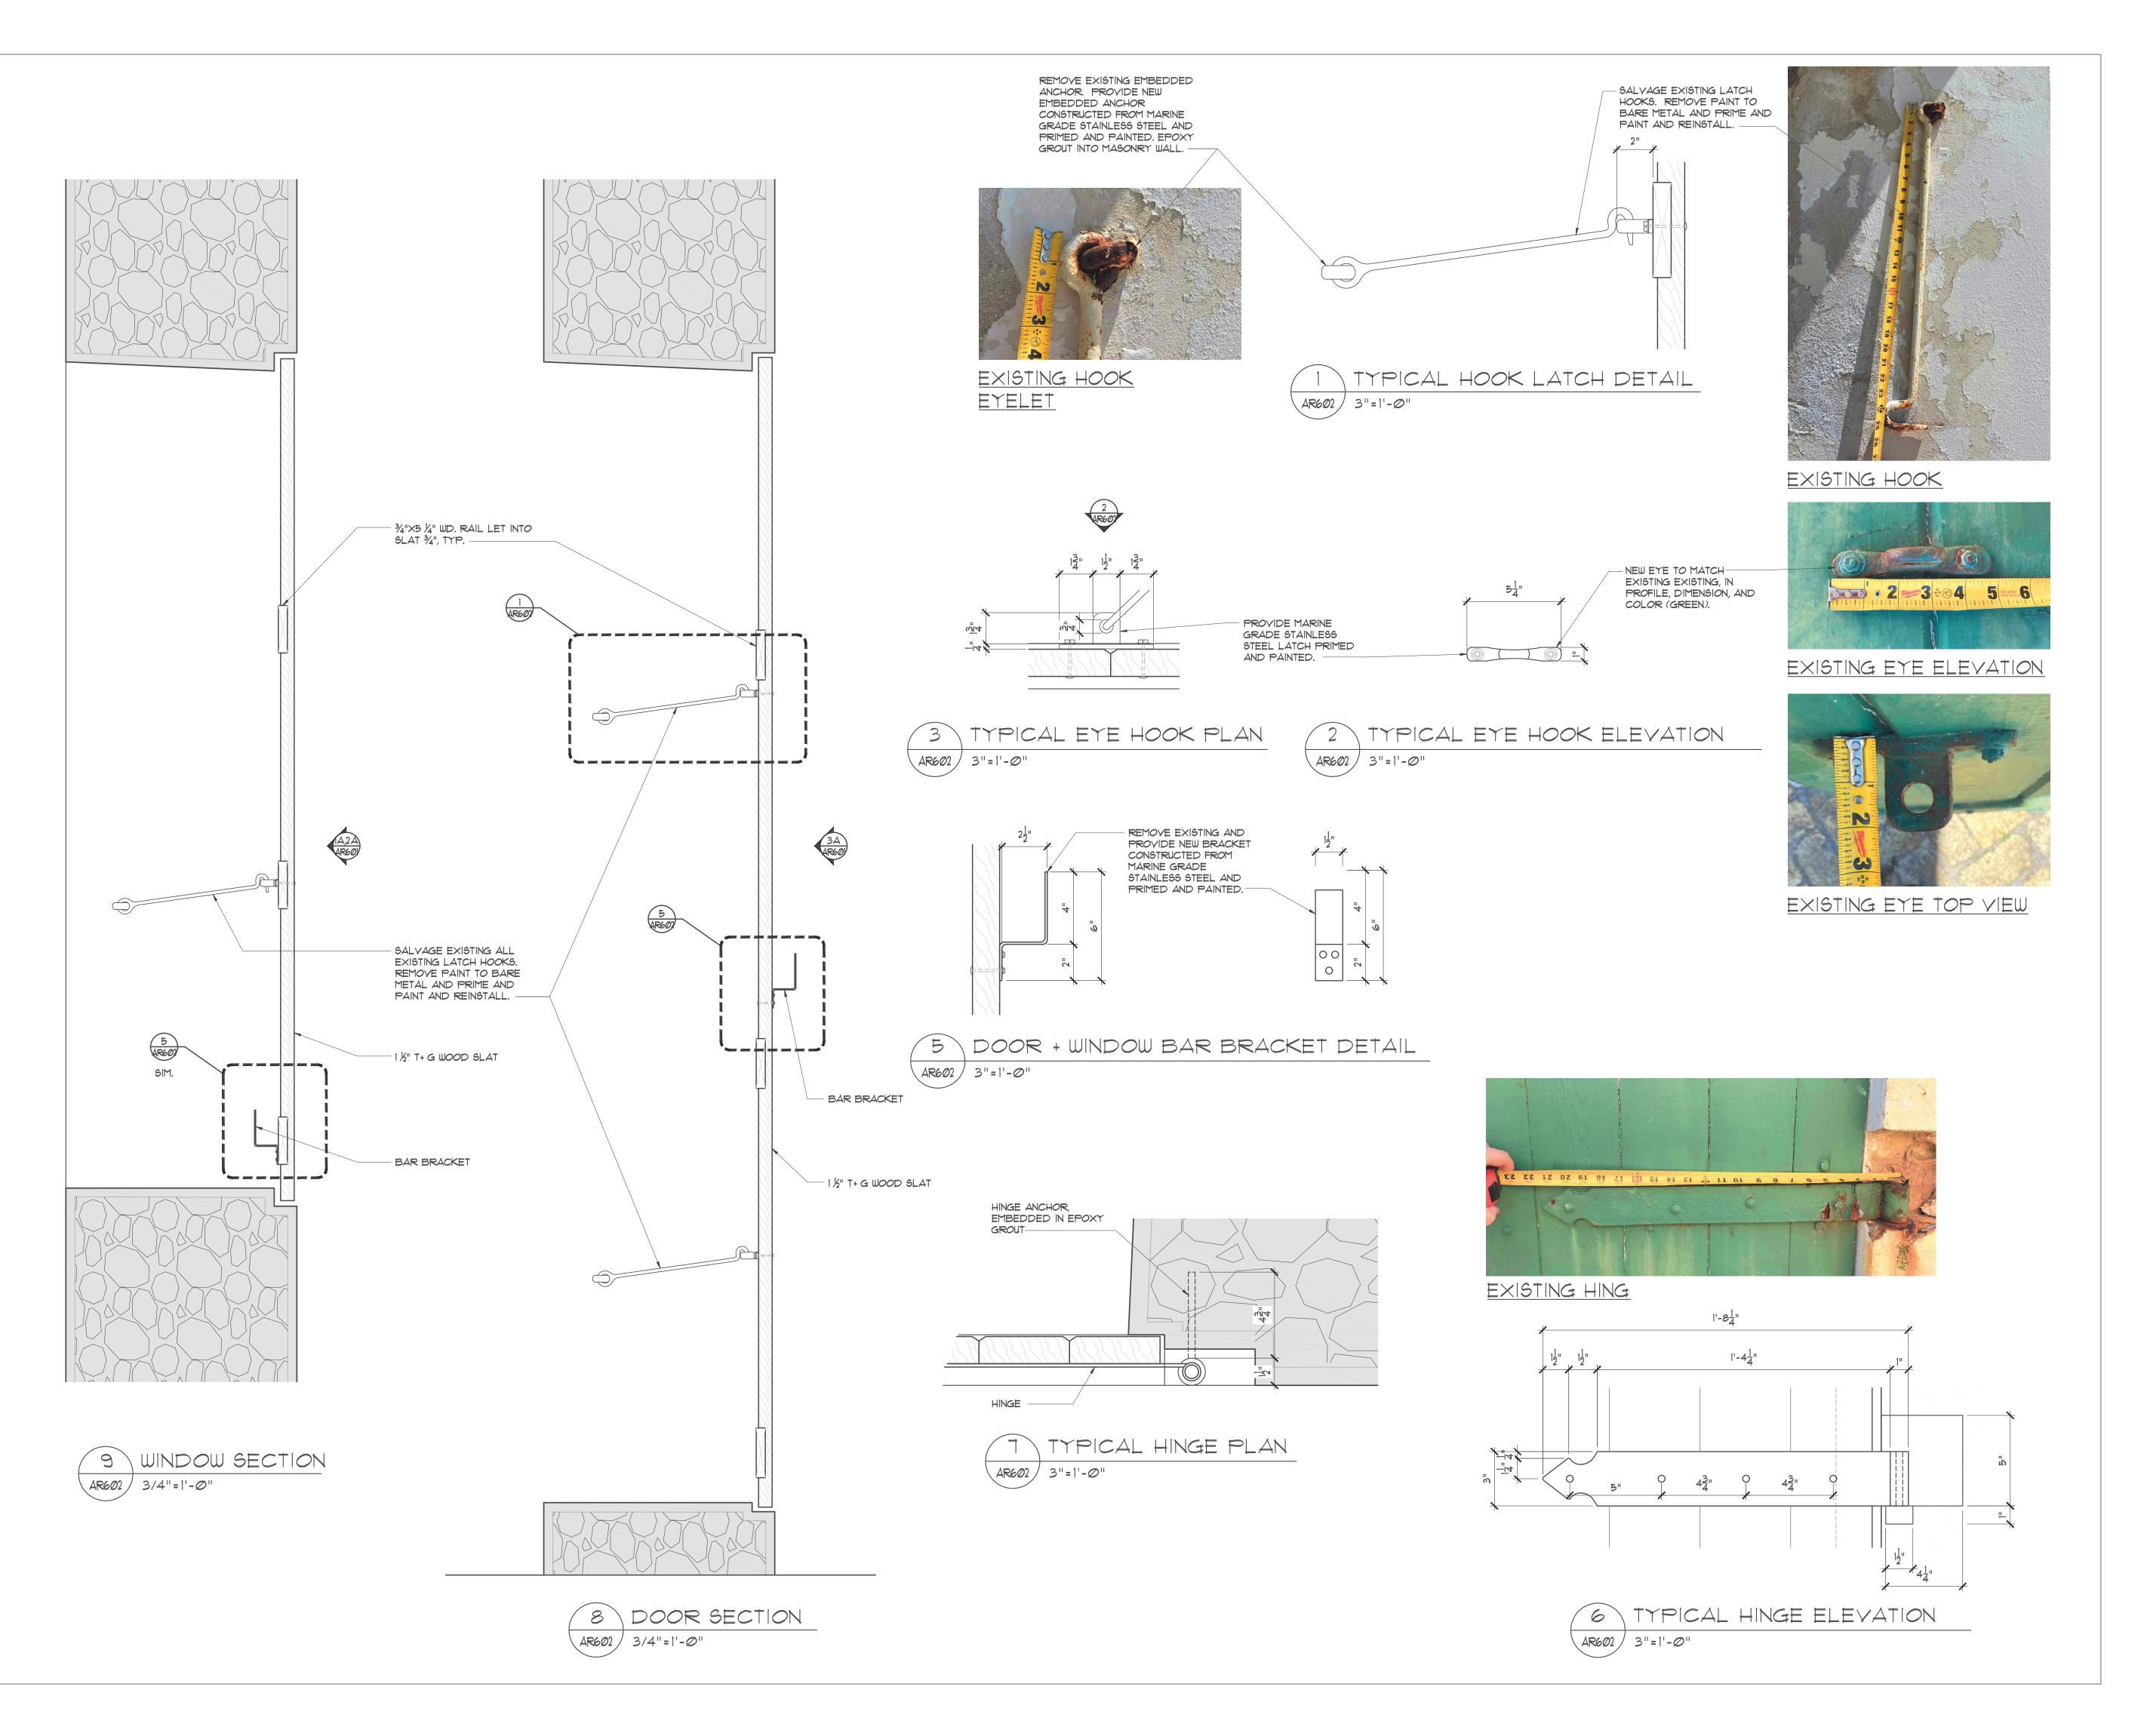
SHUTTER & DOOR
ELEVATIONS AND
PLANS & DETAILS
Project number 2022-009

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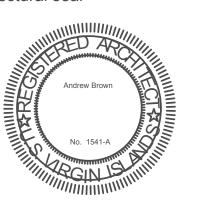


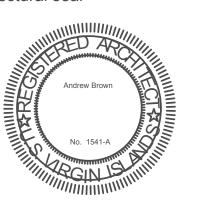

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EMMAUS MORAVIAN CHURCH SANCTUARY RECONSTRUCTION

PARCEL 10 ESTATE EMMAUS ST JOHN, USVI

11/21/2023

issue

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title


SHUTTER + DOOR DETAILS

project number

sheet

2022-009

11/28/2023

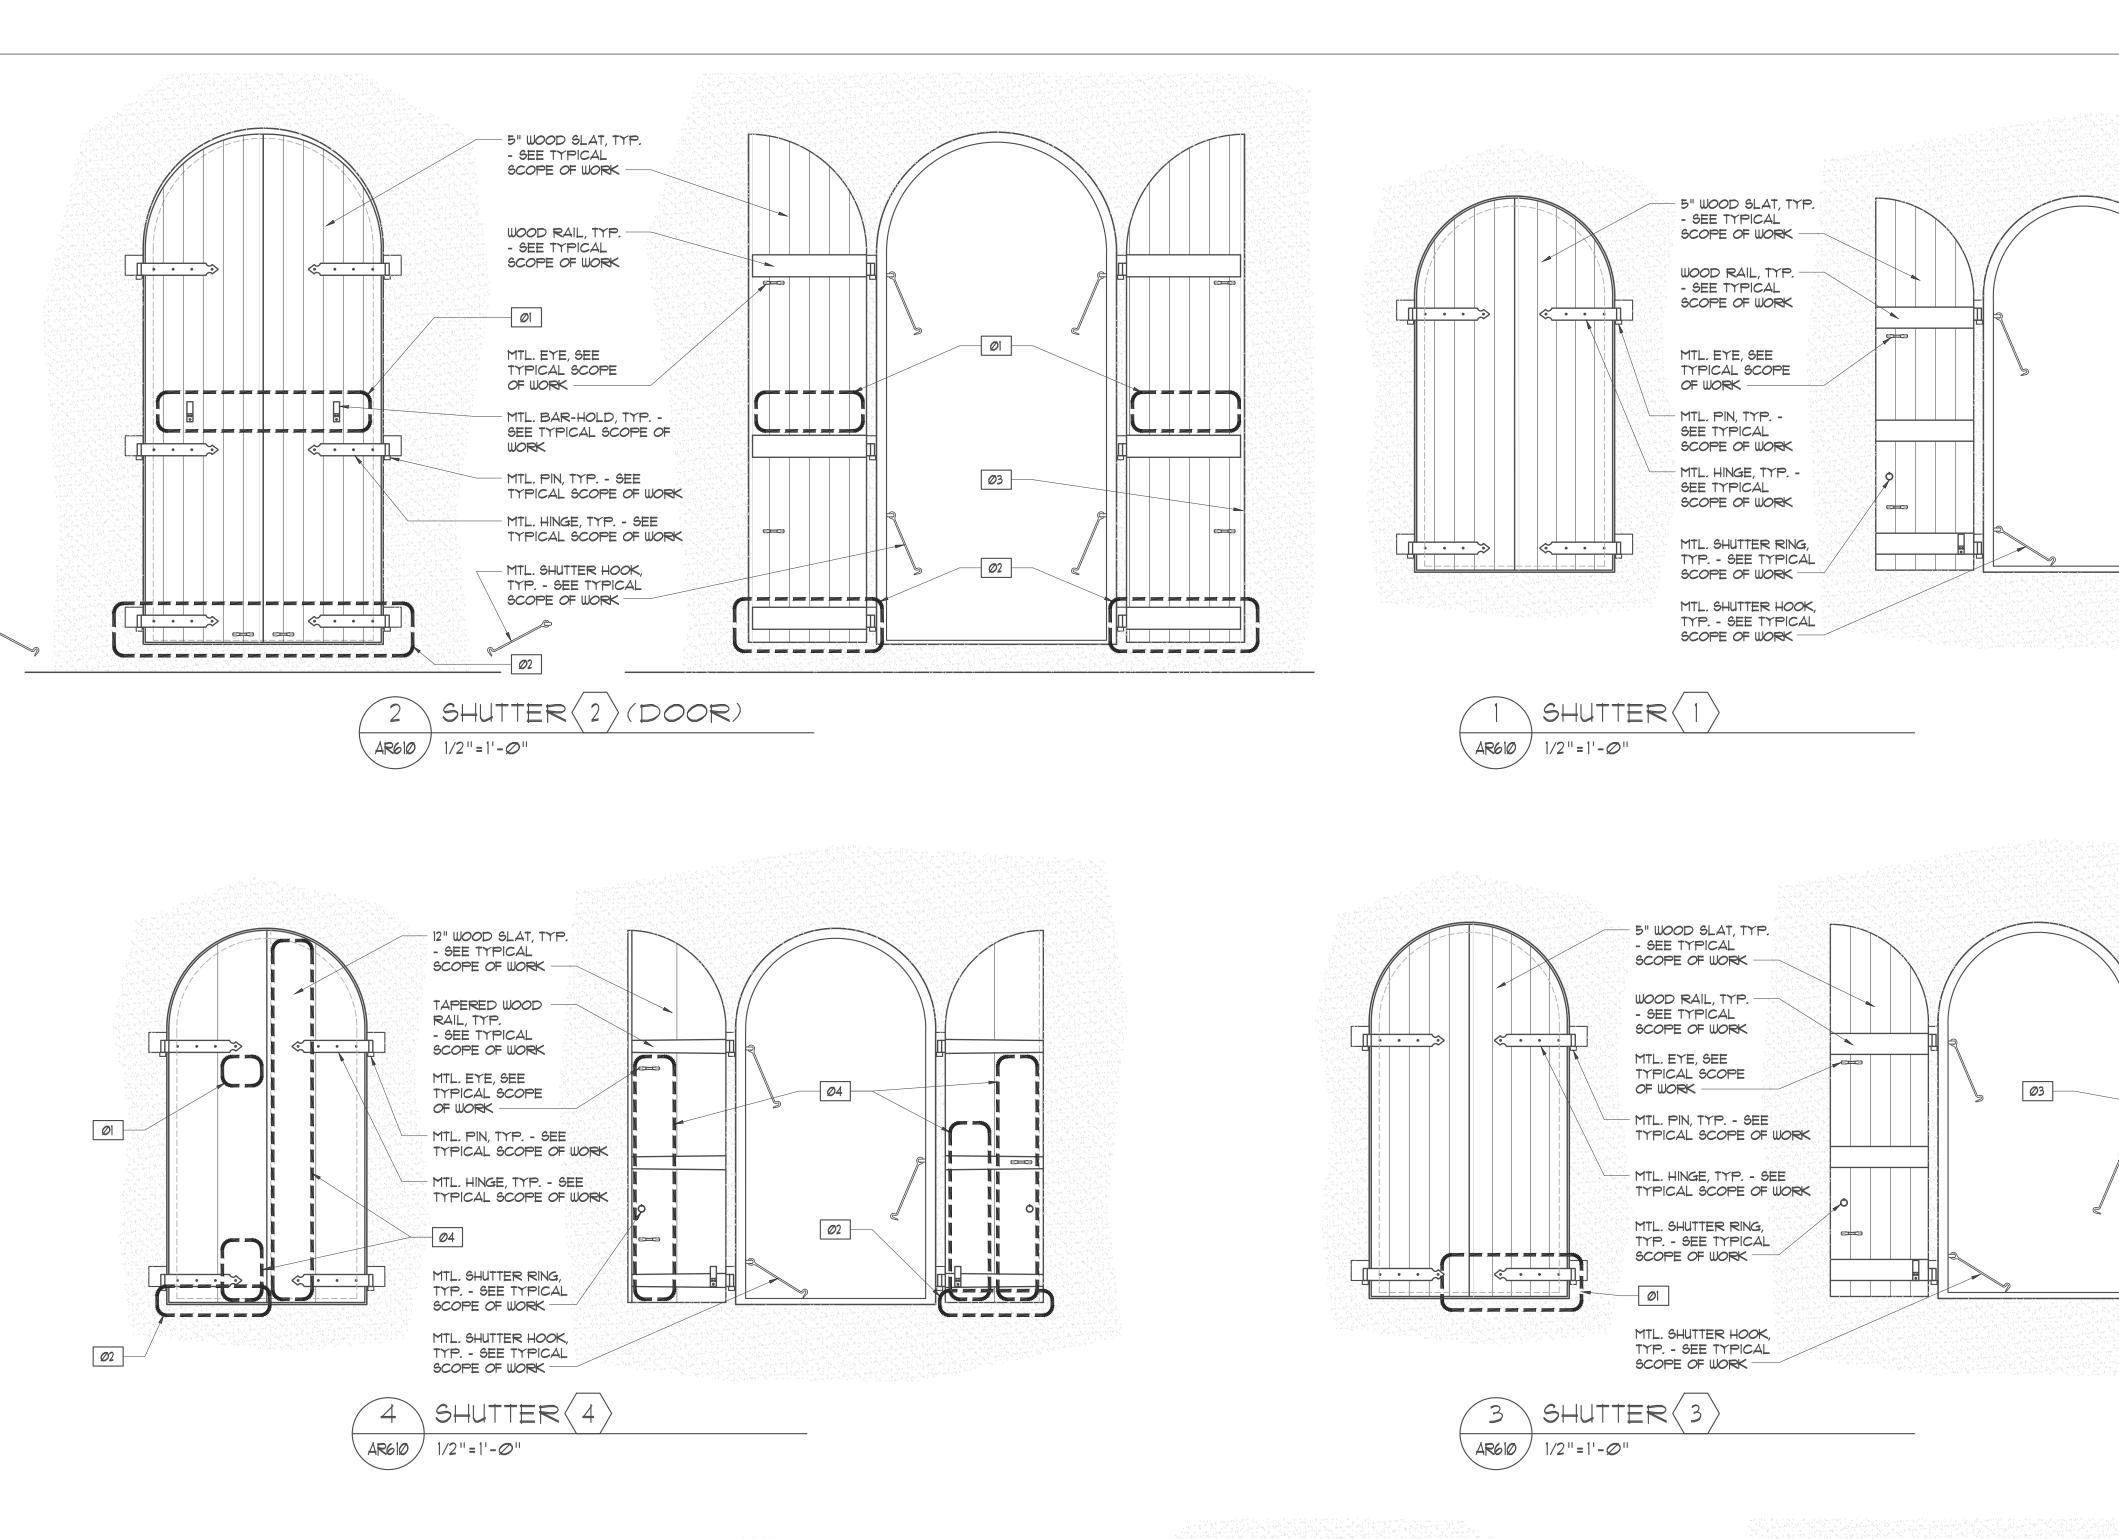

- 12" WOOD SLAT, TYP. - SEE TYPICAL

SCOPE OF WORK

TAPERED WOOD RAIL, TYP. - SEE TYPICAL

SCOPE OF WORK

TYPICAL SCOPE

MTL. PIN, TYP. - SEE

TYPICAL SCOPE OF WORK

TYPICAL SCOPE OF WORK

MTL. HINGE, TYP. - SEE

MTL. SHUTTER RING,

TYP. - SEE TYPICAL

MTL. SHUTTER HOOK, TYP. - SEE TYPICAL

AR610 / 1/2"=1'-0"


SCOPE OF WORK -

SCOPE OF WORK

Ø4

MTL. EYE, SEE

OF WORK -

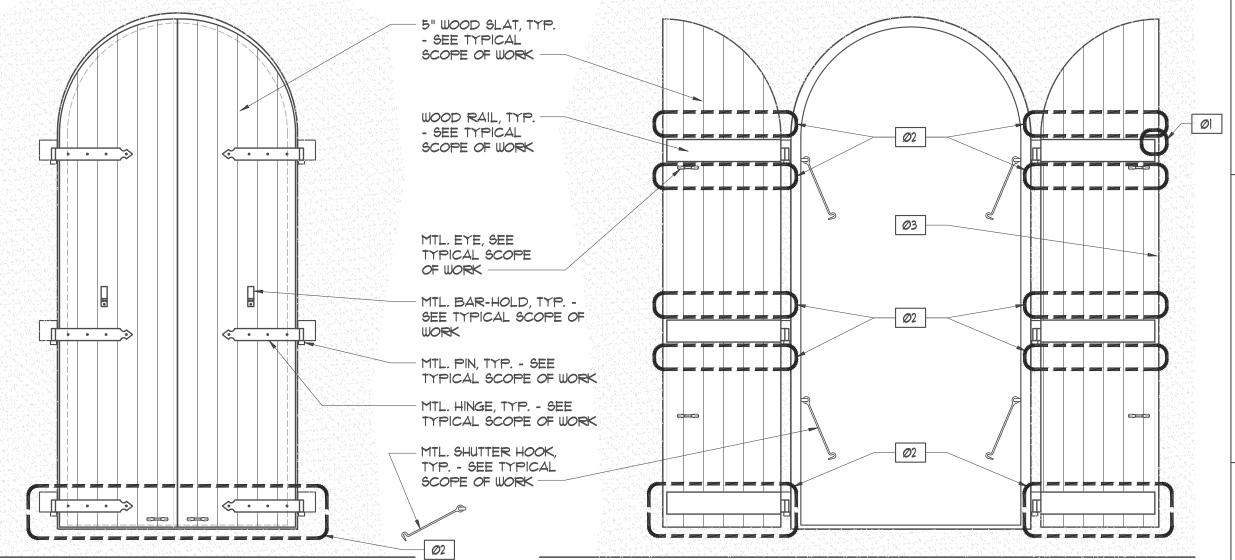

5 SHUTTER (5) (DOOR)

AR610 1/2"=1'-0"

TYPICAL SHUTTER RESTORATION SCOPE OF WORK:

- 1. REMOVE ALL HARDWARE AND FASTENERS FROM SHUTTERS AND FROM MASONRY WALLS. SALVAGE SHUTTER HOOKS FOR REUSE.
- ON ALL SHUTTER HOOKS, REMOVE PAINT DOWN TO BARE METAL AND COAT WITH ???? OR APPROVED
- 3. CONSOLIDATE AND FILL EXISTING HARDWARE PENETRATIONS.

EQUAL. INSTALL FOR REUSE.

- PROVIDE NEW MARINE-GRADE STAINLESS STEEL HARDWARE AND FASTENERS PAINTED AS SPECIFIED.
- HINGES - BAR BRACKETS

AND SHAPE.

- LATCH ANCHOR - EYE HOOK LATCH
- 5. REMOVE ALL PAINT FROM SHUTTER SURFACES.
- 6. SAND AND PLANE EXISTING WOOD SHUTTER PLANKS TO REMOVE DETERIORATED WOOD FIBERS.
- I. PREPARE AND PAINT WOOD PLANKS AS SPECIFIED.
- 8. REINSTALL WOOD SHUTTERS AND NEW AND EXISTING HARDWARE.

KEYED SHUTTER WORK NOTES:

- FILL HOLES, SPLITS, AND CHECKS AND REFINISH DAMAGED AREA OF WOOD SHUTTER.
- PROVIDE CONSOLIDATION REPAIR @ DAMAGED/ROTTED PORTION OF WOOD SHUTTER.
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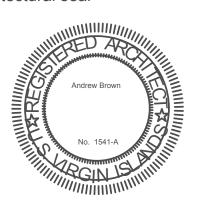
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PARCEL 10 ESTATE EMMAUS ST JOHN, USVI

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SHUTTER ELEVATIONS

date

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2022-009

11/28/2023

AR-610

SHUTTER PAINT SCHEDULE:

WOOD COMPONENTS:

PRIMER: (1 COAT) SHERWIN WILLIAMS, EXTERIOR OIL-BASED WOOD PRIMER

FINISH: (2 COATS) SHERWIN WILLIAMS, EMERALD RAIN REFRESH EXTERIOR ACRYLIC LATEX

HARDWARE AND FASTENERS:


PRIMER: (1 COAT) SHERWIN WILLIAMS, DTM WASH PRIMER

FINISH: (2 COATS) SHERWIN WILLIAMS, PRO INDUSTRIAL WATER BASED ALKYD URETHANE (SEMI-GLOSS)

CONSOLIDATION REPAIR PROCEDURE:

LIGHTLY SAND CONSOLIDATED AREA.

- REMOVE ALL LOOSE MATERIAL FROM DAMAGED AREA.
 APPLY CONSOLIDANT AND ALLOW TO PROPERLY CURE.
- 4. PATCH AREA WITH TWO-PART EPOXY AND ALLOW TO PROPERLY CURE.
- 5. SAND AND PAINT.

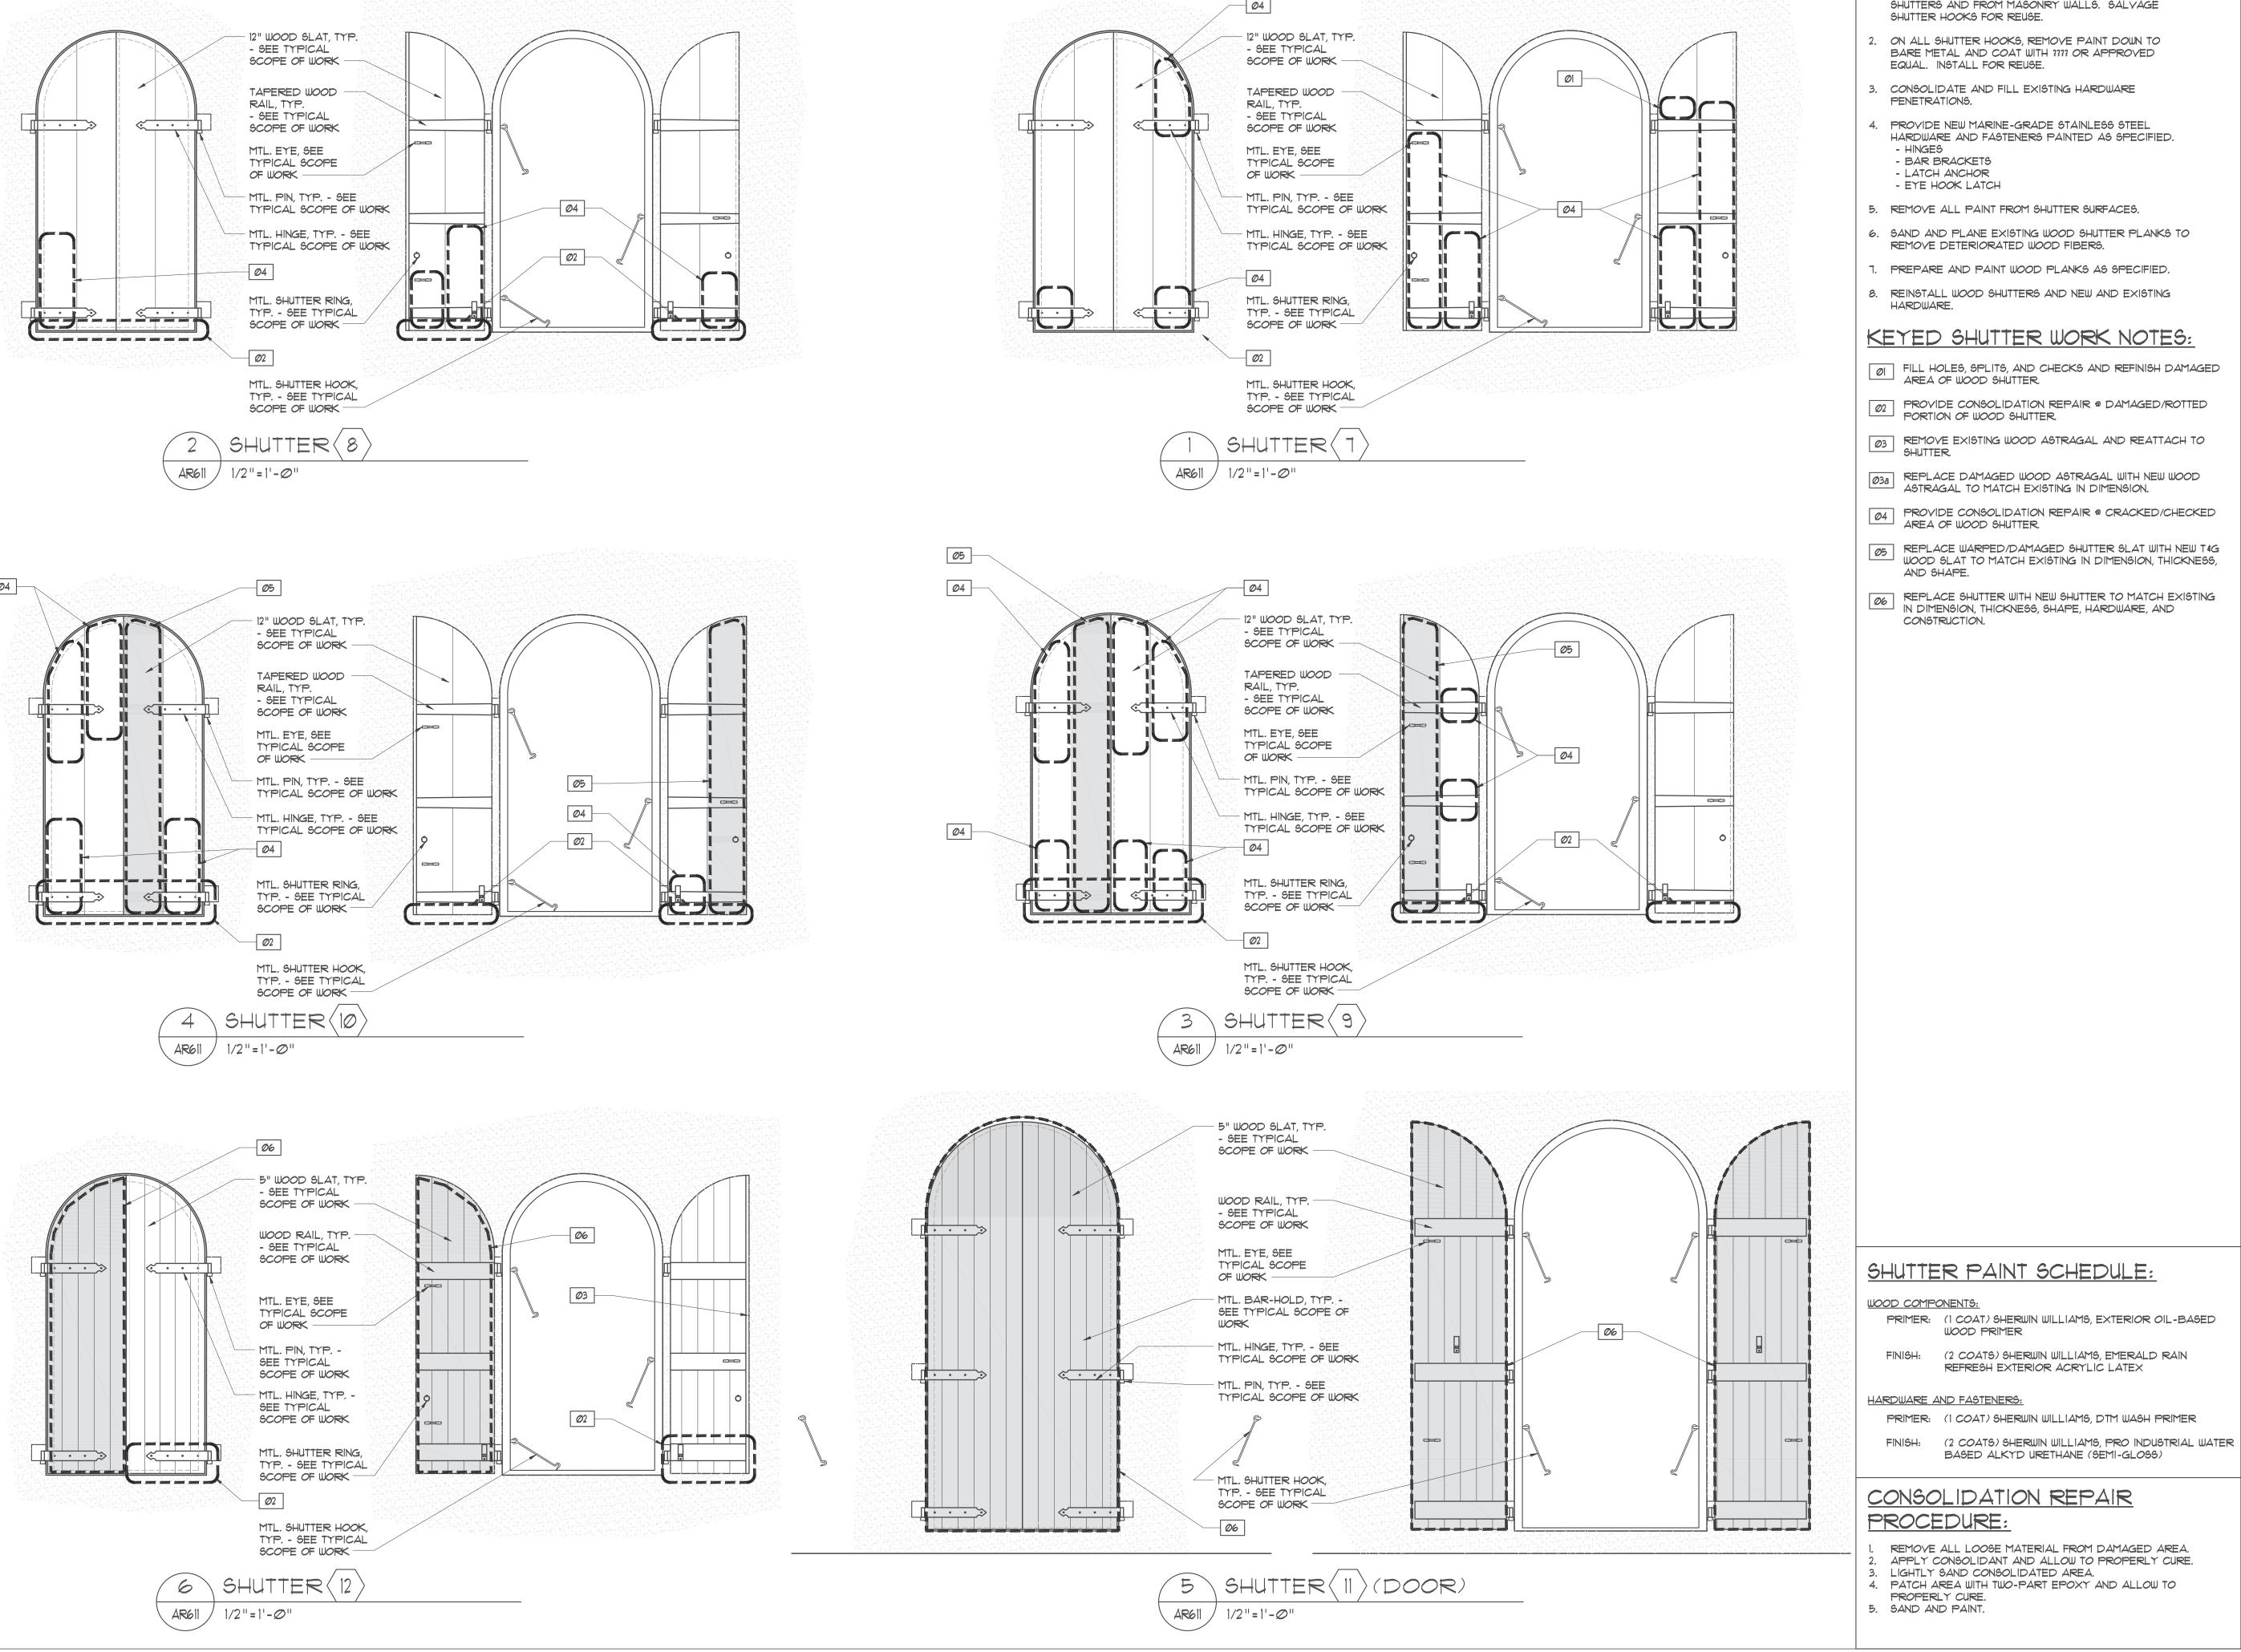

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WOOD PRIMER

REFRESH EXTERIOR ACRYLIC LATEX

BASED ALKYD URETHANE (SEMI-GLOSS)

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PARCEL 10 **ESTATE EMMAUS** ST JOHN, USVI

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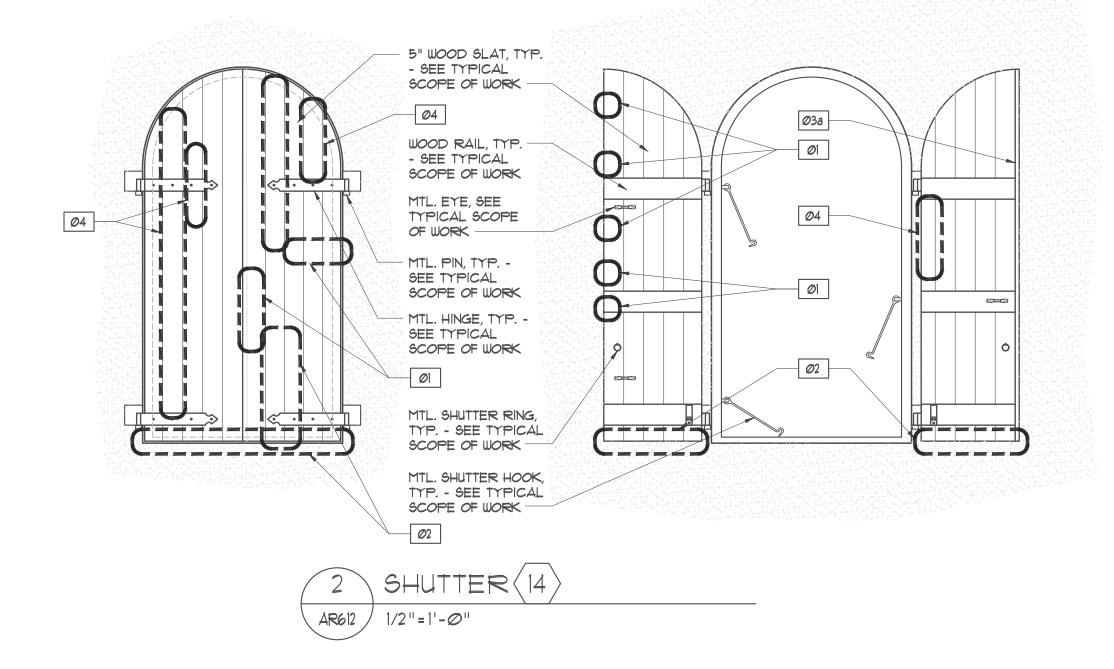
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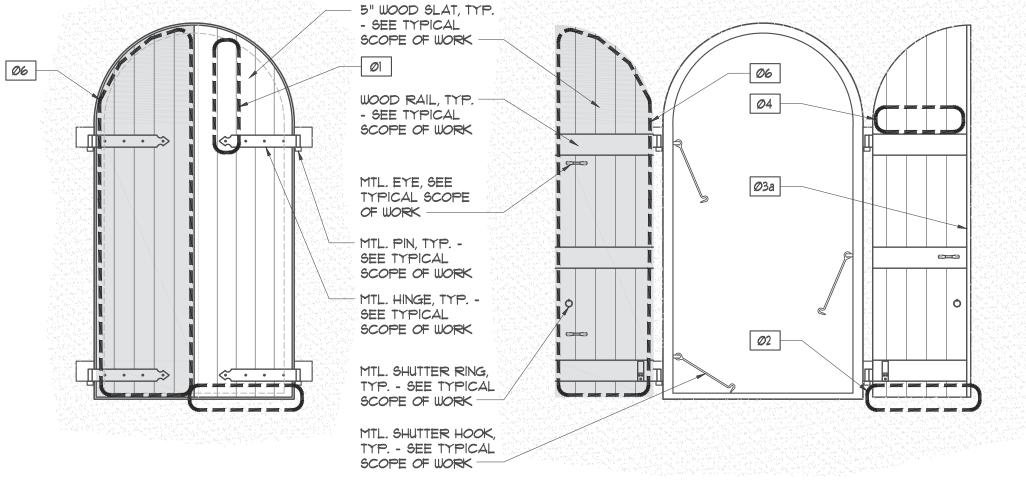
SHUTTER ELEVATIONS

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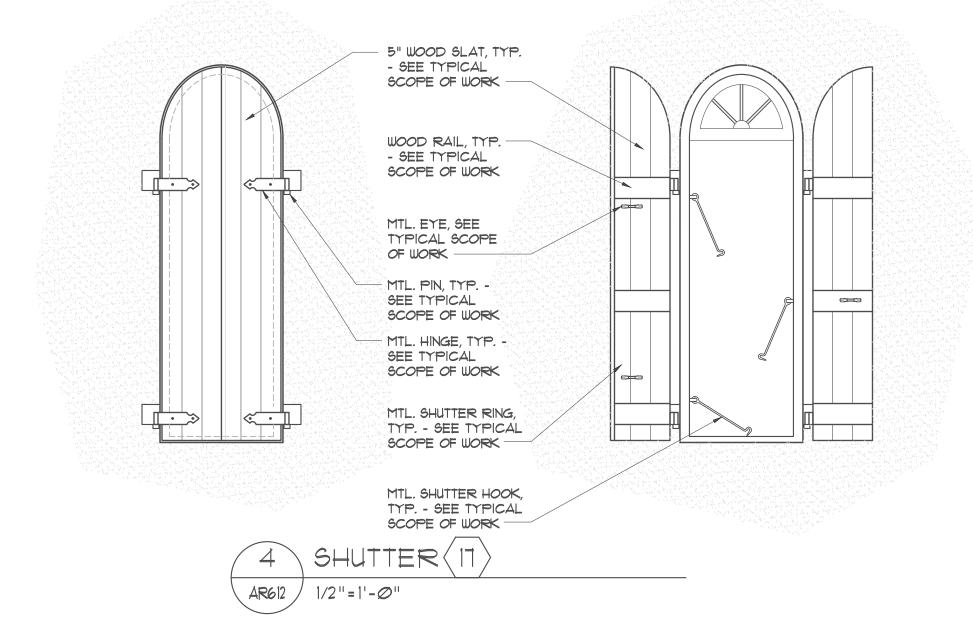
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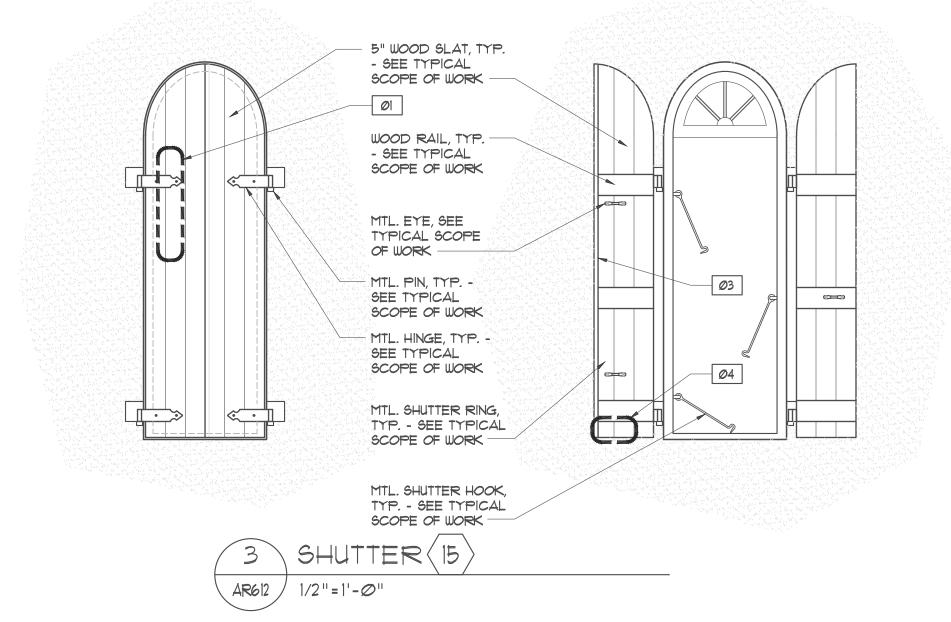
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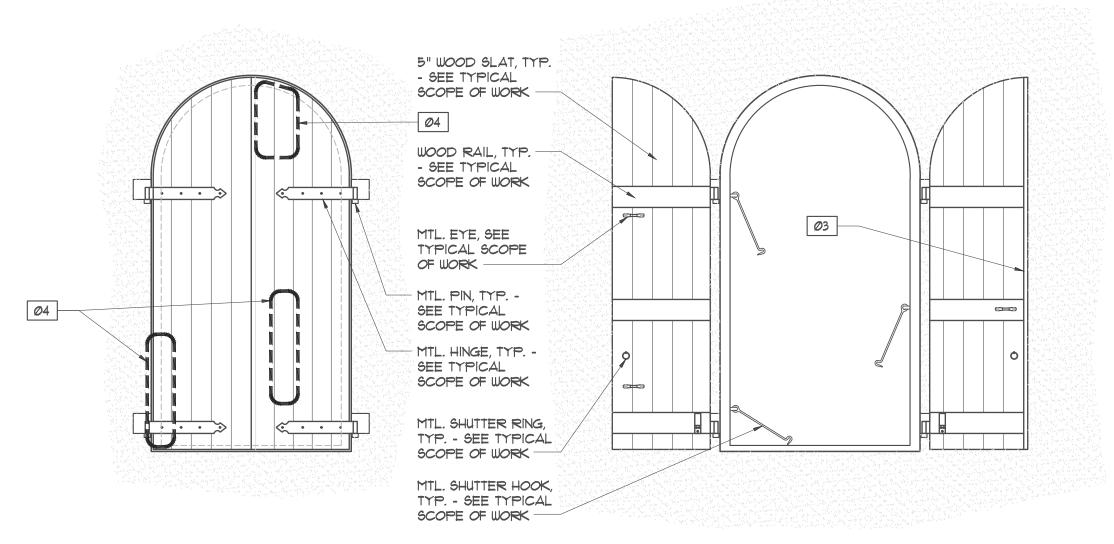












1/2"=1'-@"

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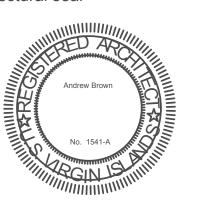


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PARCEL 10 ESTATE EMMAUS ST JOHN, USVI

11/21/2023

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SHUTTER ELEVATIONS

2022-009 project number

sheet

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PRIMER: (1 COAT) SHERWIN WILLIAMS, EXTERIOR OIL-BASED WOOD PRIMER

FINISH: (2 COATS) SHERWIN WILLIAMS, EMERALD RAIN REFRESH EXTERIOR ACRYLIC LATEX


HARDWARE AND FASTENERS:

PRIMER: (1 COAT) SHERWIN WILLIAMS, DTM WASH PRIMER


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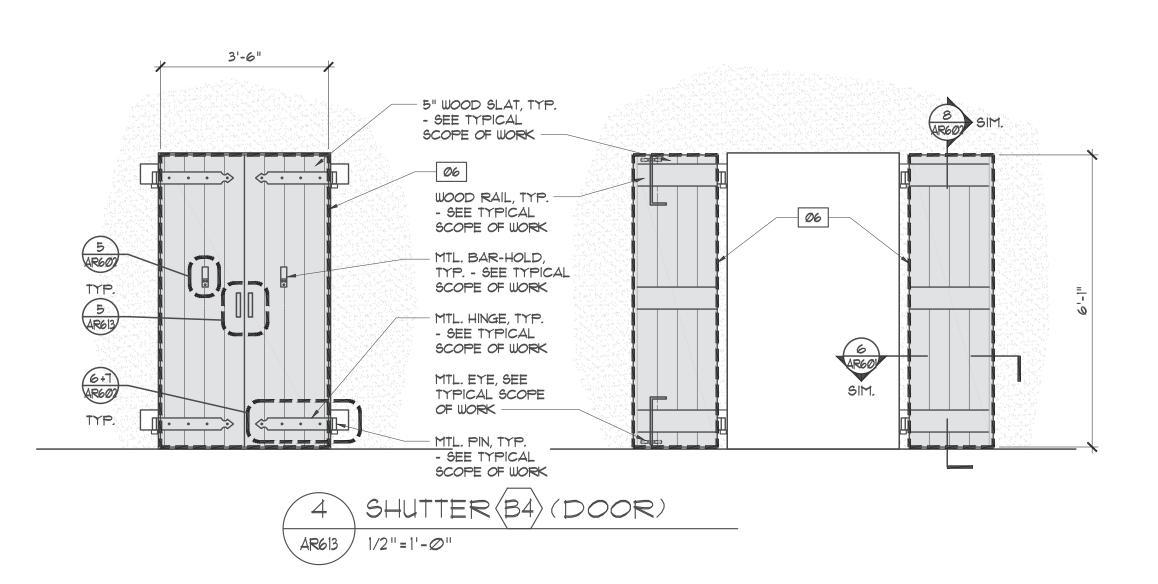
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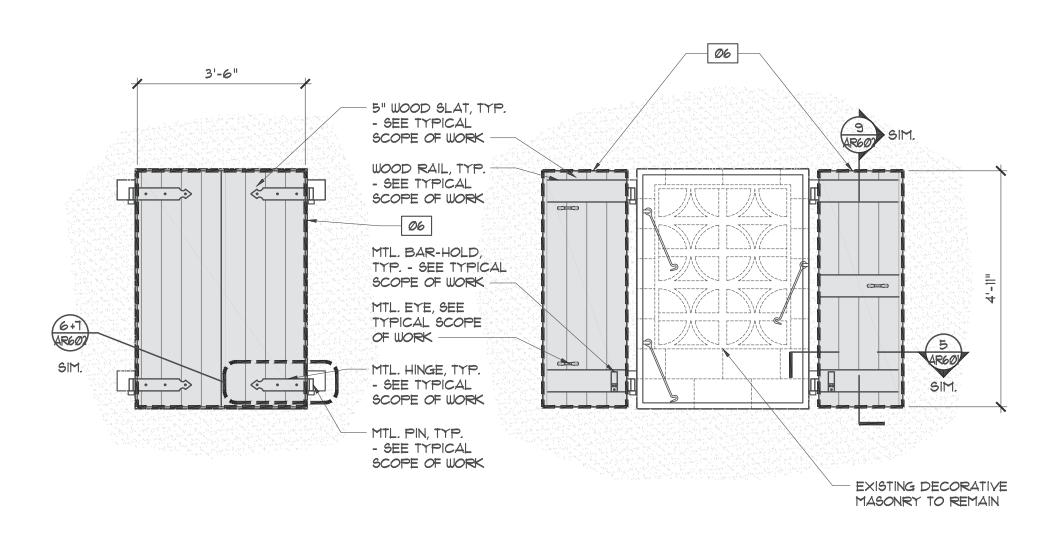




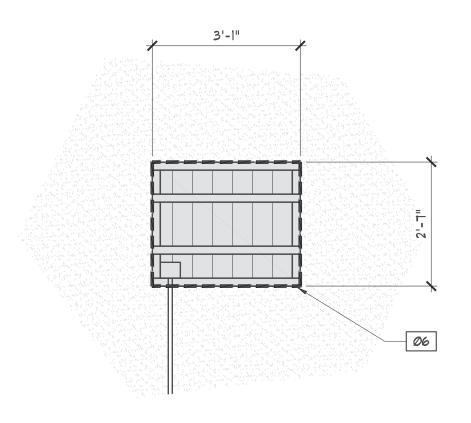

SHUTTER (BI) (DOOR) AR613 / 1/2"=1'-0"



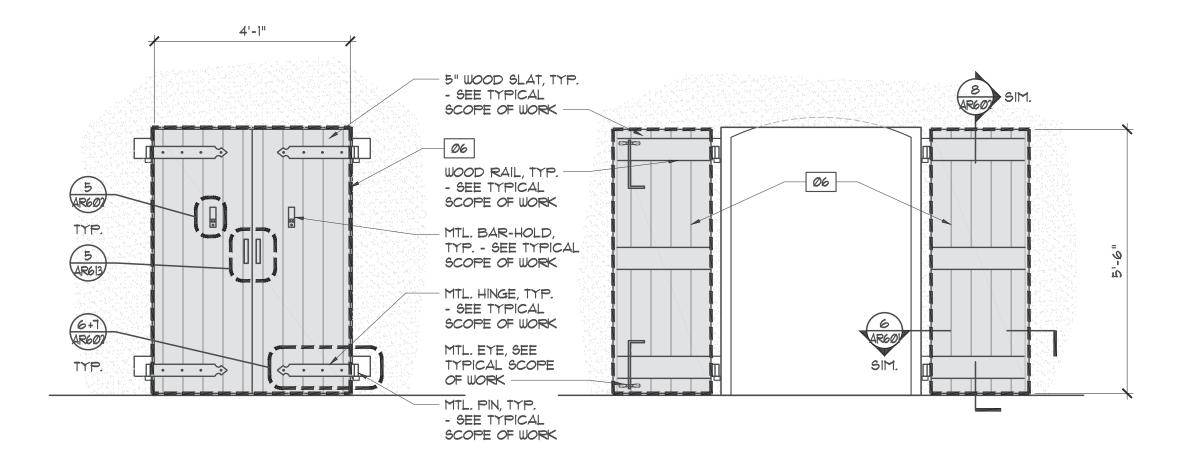

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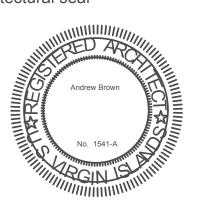
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PARCEL 10 ESTATE EMMAUS ST JOHN, USVI

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SHUTTER ELEVATIONS

2022-009 project number 11/28/2023

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WOOD COMPONENTS:

PRIMER: (1 COAT) SHERWIN WILLIAMS, EXTERIOR OIL-BASED WOOD PRIMER

FINISH: (2 COATS) SHERWIN WILLIAMS, EMERALD RAIN REFRESH EXTERIOR ACRYLIC LATEX


HARDWARE AND FASTENERS:


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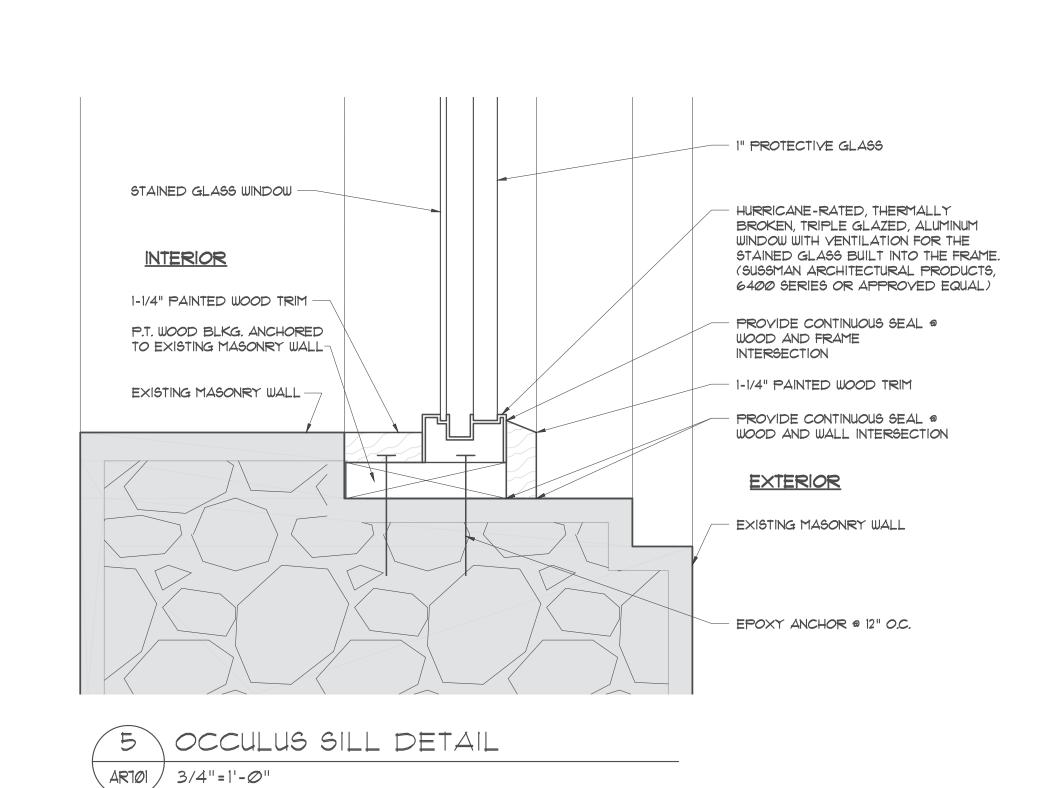
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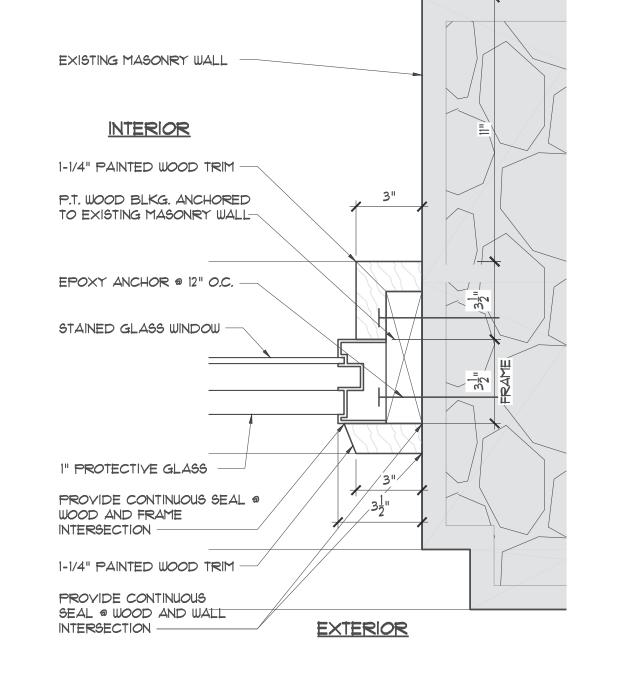
CONSOLIDATION REPAIR

- PROCEDURE:
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- PROPERLY CURE.
- 4. PATCH AREA WITH TWO-PART EPOXY AND ALLOW TO 5. SAND AND PAINT.





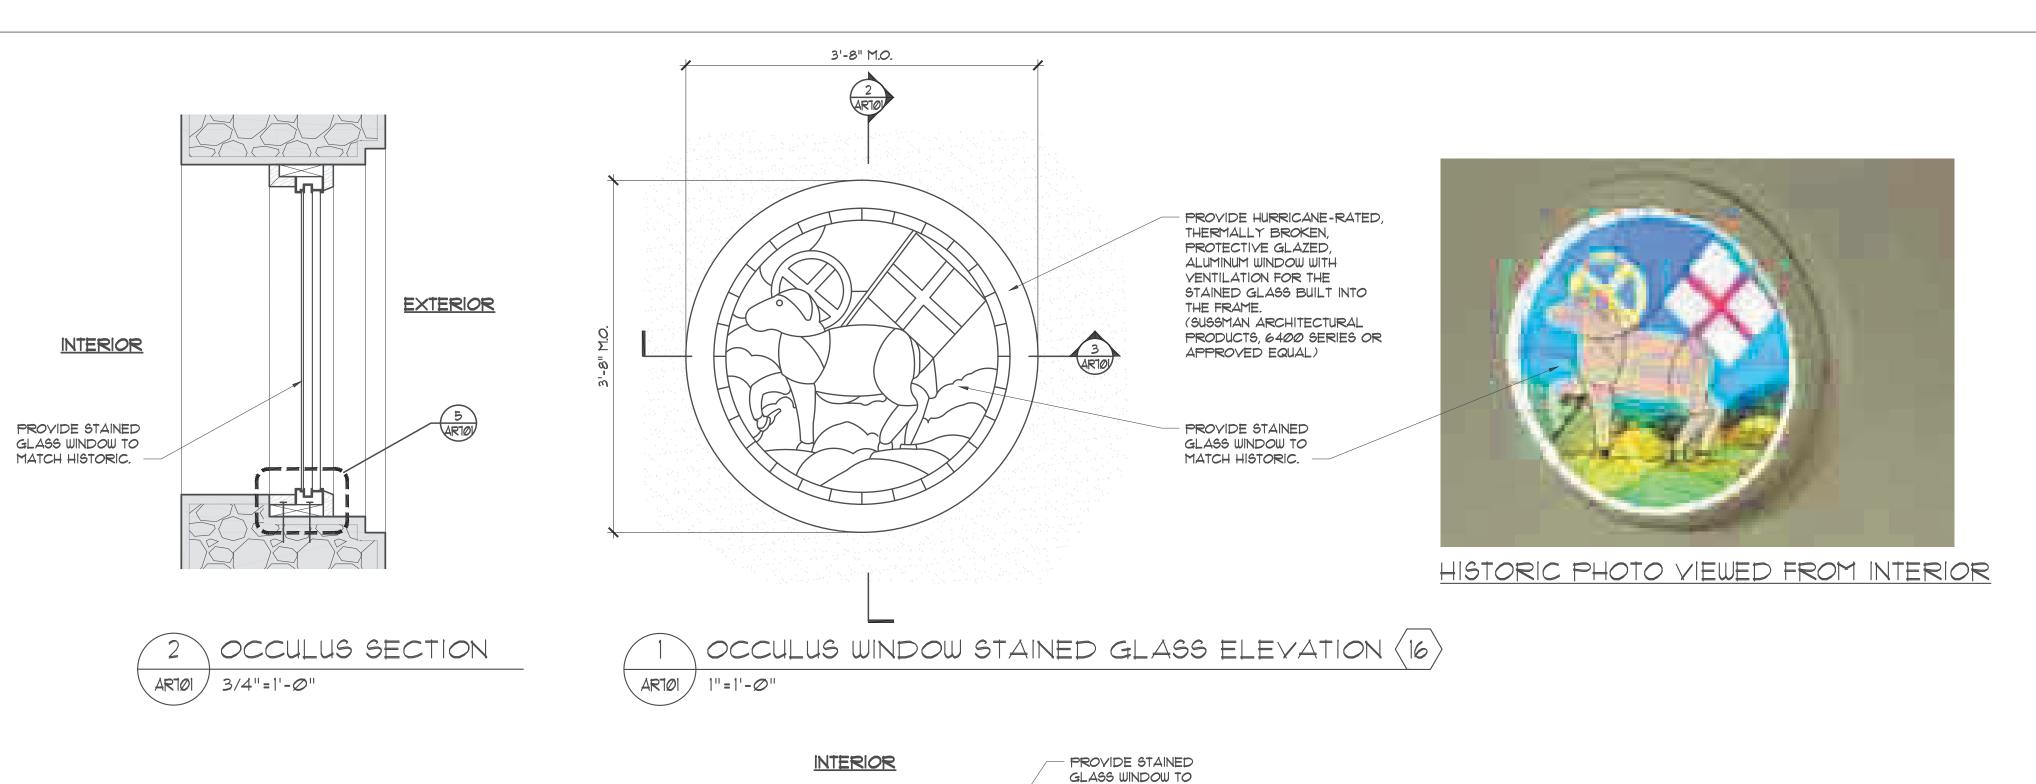

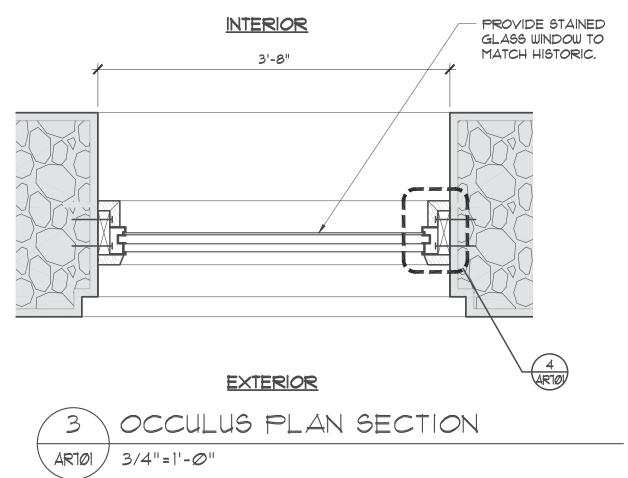

4 OCCULUS JAMB/HEAD DETAIL

ARTOI 3/4"=1'-0"


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WINDOW ELEVATIONS AND PLANS

project number 2022-009

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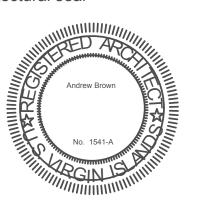




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WINDOW ELEVATIONS
AND PLANS

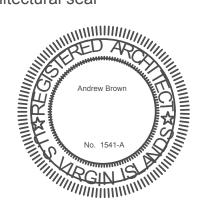project number 2022-009 date 11/28/2023

sheet

AR = 702

STRUCTURAL GENERAL NOTES

1.0 LIVE LOADS USED IN DESIGN

1.1 ROOF LIVE 20 PSF

1.2 TYPICAL FLOOR 100 PSF

1.3 WIND DESIGN 1.3.1 WIND VELOCITY 165 MPH V 3S

1.3.2 WIND EXPOSURE D 1.3.3 HURRICANE RATED WINDOWS SHALL RESIST

THE FOLLOWING PRESSURES: POSITIVE 75 PSF, NEGATIVE 90 PSF

1.4 EARTHQUAKE ZONE 4 (UBC REFERENCE)

1.4.1 SEISMIC DESIGN CATEGORY D

1.4.2 SITE CLASS C/D

1.4.3 SPECTRAL RESPONSE ACCELERATIONS Ss 1.4, S1 0.47 1.4.4 SPECTRAL RESPONSE COEFFICIENTS

Sds 0.84, SD1 0.752 1.5 FLOOD DATA: SEE SPECIFIC SITE NOTE

2.0 FOUNDATIONS

2.1 MAXIMUM SOIL DESIGN PRESSURE(ASSUMED) 3000 PSF 2.2 ALL FOOTINGS ARE TO BE PLACED ON FIRM, UNDISTURBED NATURAL GROUND, APPROVED BY THE ENGINEER. SEE

SPECIFICATION FOR INFORMATION ON PILED FOUNDATIONS 2.3 DO NOT PLACE BACKFILL AGAINST BASEMENT WALLS UNTIL BASEMENT AND FIRST FLOORS ARE IN PLACE.

2.4 CENTER ALL FOOTINGS UNDER WALLS, COLUMNS OR GRID LINES UNLESS OTHERWISE NOTED IN THE DRAWINGS

3.0 CONCRETE

3.1 ALL CAST-IN-PLACE CONCRETE SHALL BE MADE WITH TYPE-2 PORTLAND CEMENT, STONE AGGREGATE AND SHALL DEVELOP 5000 PSI COMPRESSIVE STRENGTH IN 28-DAYS. 3.2 SLABS, TOPPINGS, FOOTINGS BEAMS AND WALLS SHALL

NOT HAVE JOINTS IN HORIZONTAL PLANE. ANY STOP IN CONCRETE WORK MUST BE MADE AT CENTER OF SPAN WITH VERTICAL BULKHEADS AND SHEAR KEYS, UNLESS OTHERWISE SHOWN. ALL CONSTRUCTION JOINTS SHALL BE AS DETAILED OR AS APPROVED BY THE ENGINEER. SEE NOTE 4.0 BELOW.

3.3 ALL CONCRETE WORK AND REINFORCEMENT DETAILING SHALL BE IN ACCORDANCE WITH ACI BUILDING CODE 318-19 ALL EXPOSED EDGES OF CONCRETE WORK SHALL HAVE 1/2" MIN. CHAMFER. USE STANDARD HOOKS ON DOWELS UNLESS OTHERWISE NOTED.

3.4 MIXING, PLACING AND CURING OF ALL CONCRETE TO BE BY THE RECOMMENDATIONS IN ACI 305R-20, HOT WEATHER CONCRETING.

3.5 ALL CONCRETE SHALL BE MADE WITH GRACE DCI S CORROSION PROTECTING ADMIXTURE (EXCEPT CISTERN WALLS AND CISTERN GROUND SLABS) IN ACCORDANCE WITH THE MANUFACTURERS SPECIFICATIONS.

3.6 PLACE JOINTS IN SLABS ON GRADE TO CREATE AREAS NO GREATER THAN 400 SQ. FT. COORIDNATE JOINT LOCATIONS W/ ARCHITECT TO MINIMISE IMPACT ON FLOOR FINISH. SAW CUTS CAN BE USED BUT MUST BE MADE WITHIN 3 HOURS OF PLACEMENT OF THE SLAB.

4.0 REINFORCEMENT

4.1 ALL REINFORCEMENT SHALL BE HIGH STRENGTH DEFORMED BARS CONFORMING TO ASTM A615-20 GRADE 60, EXCEPT TIES, STIRRUPS AND PLATE ANCHORS, WHICH SHALL BE ASTM DESIGNATION A615 / A615M - 20, GRADE 40 STEEL.

4.2 WELDED WIRE FABRIC SHALL CONFORM TO ASTM A185-07 AND SHALL BE LAPPED ONE FULL MESH AT SIDES AND END SPLICES AND WIRED TOGETHER.

4.3 CONCRETE PROTECTION FOR REINFORCEMENT

(REBAR-COVER)

4.3.1 CONCRETE CAST AGAINST EARTH AND PERMANENTLY EXPOSED TO EARTH

4.3.2 CONCRETE CAST IN FORMS AND EXPOSED TO EARTH

OR WEATHER 4.3.3 CONCRETE NOT EXPOSED TO EARTH OR WEATHER

SLABS AND WALLS 1-1/2" BEAMS AND COLUMNS -

PRIMARY REINFORCEMENT, TIES, STIRRUPS AND SPIRALS 1-1/2"

4.4 ALL BAR LENGTHS ARE DRAWN TO SCALE UNLESS OTHERWISE NOTED. NO SPLICES OF REINFORCEMENT SHALL BE MADE EXCEPT AS DETAILED OR AUTHORIZED BY THE ENGINEER. LAP SPLICES WHERE PERMITTED SHALL BE A MINIMUM OF 48 BAR DIAMETERS. MAKE ALL BARS CONTINUOUS AROUND CORNERS AND ALL RECTANGULAR OPENINGS IN CONCRETE.

4.5 PLACE #5 BAR (1-QTY PER 6" THICKNESS) WITH 2'-0" PROJECTION AROUND ALL OPENINGS IN SLABS OR WALLS. ALSO PROVIDE $1 - \#5 \times 4' - 0''$ DIAGONALLY AT EACH CORNER.

4.6 CONTINUOUS TOP AND BOTTOM BARS IN WALLS AND

BEAMS SHALL BE SPICED AS FOLLOWS: 4.6.1 TOP BARS AT MID-SPAN

4.6.2 BOTTOM BARS OVER SUPPORTS

GALVANIZED.

4.7 PROVIDE ALL ACCESSORIES NECESSARY TO SUPPORT REINFORCEMENT AT POSITIONS SHOWN IN THE DRAWINGS. ALL REINFORCEMENT TO BE HELD SECURELY IN PROPER POSITION IN ACCORDANCE WITH ACI 318-19. ALL ACCESSORIES TO BE

4.8 ANY WELDED REINFORCING BARS SHALL CONFORM TO ASTM A706 OR A615, GRADE 60 AND ANSI / AWS D1.4-18.

4.9 ALL TIES AND STIRRUPS SHALL BE 135° SEISMIC HOOKS IN ACCORDANCE WITH ACI 318-19

5.0 MASONRY

NOT USED

6.0 STRUCTURAL STEEL

NOT USED

7.0 METAL DECK

7.1 DECK SHALL BE GALVANIZED STEEL G90 AND OF THE TYPE CALLED FOR ON THE FRAMING PLANS AND SHALL BE CONTINUOUS WHERE POSSIBLE. STEEL SHALL CONFORM TO ASTM A1008/ A1008M.

7.2 DECKING SHALL BE INSTALLED AND ALL OPENINGS IN DECKS CUT AND REINFORCED IN ACCORDANCE WITH MANUFACTURER'S STANDARD DETAILS AND SDI SPECIFICATIONS.

7.3 FASTENER REQUIREMENTS SHALL BE AS FOLLOWS, UNLESS OTHERWISE SHOWN IN THE DRAWINGS:

7.3.1 LONGITUDINAL JOINTS BETWEEN ADJACENT ROOF DECKS SHALL BE FASTENED TOGETHER WITH WELDS OR #12 TEK SCREWS AT 12". ROOF DECK ATTACHMENT SHALL BE 36/7 AT EAVES AND RIDGE AND 36/5 ELSEWHERE. USE 1/4" TEK SCREWS.

7.3.2 ATTACH FLOOR DECK (PERMANENT CONCRETE FORM) TO EACH INTERMEDIATE SUPPORT W/ 5/8" PUDDLE WELDS IN 36/4 PATTERN. EACH END LAP TO BE WELDED AT 10" O.C. EACH SIDE LAP IS WELDED AT EACH END PLUS TWO INTERMEDIATE WELDS (4 WELDS PER SHEET PER SIDE). USE 5/8" PUDDLE WELD AND WASHERS.

7.4 ALL CUT EDGES OF METAL DECKING SHALL BE SUITABLY SEALED OR COATED TO PROVIDE CORROSION PROTECTION.

8.0 LIGHT - GAGE METAL FRAMING

8.1 LIGHT-GAGE METAL FRAMING SHALL BE GALVANIZED G90 ACCORDING TO ASTM A653/ A653M AND OF THE SIZE AND GAGE SHOWN ON THE DRAWINGS.

8.2 FRAMING ROLLED FROM STEEL - 18 GAGE AND LIGHTER SHALL CONFORM TO ASTM A653/ A653M, GRADE A, WITH A MINIMUM YIELD STRESS OF 33,000 PSI.

8.3 FRAMING FROM STEEL - GAGE 16 AND HEAVIER SHALL CONFORM TO ASTM A653/ A653M. GRADE D WITH A MINIMUM YIELD STRESS OF 56,000 PSI.

9.0 DRY PACKING AND NON-SHRINK GROUT

9.1 DRY PACK OR NON-SHRINK GROUT SHALL BE PROVIDED AS FOLLOWS:

9.1.1 BETWEEN COLUMNS BASES AND FOOTINGS 9.1.2 MATERIAL SHALL MEET ASTM C1107/ C1107M AND

BE NON-METALLIC 9.1.3 CURE MATERIAL 3-DAYS MINIMUM, BEFORE

APPLICATION OF ANY SUPERIMPOSED LOADS.

10.0 TIMBER

RAFTERS.

EACH RAFTER.

10.1 ALL STRUCTURAL TIMBER SHALL BE SOUTHERN YELLOW PINE NO. 1 OR BETTER UNLESS SHOWN OTHERWISE. MINIMUM BENDING STRESS 1200 PSI. MODULUS OF ELASTICITY 1600 KSI AND SERVICE MOISTURE CONTENT OF NO MORE THAN 19%.

10.2 ALL STRUCTURAL PLYWOOD SHALL BE PRESSURE TREATED STRUCTURAL 1 EXTERIOR GRADE. 10.3 PROVIDE FULL DEPTH BLOCKING AT 8 FT CENTERS

MAXIMUM FOR ALL FLOOR SPANS OVER 8 FT. 10.4 PROVIDE DOUBLE 2" x4" PURLINS AT EAVES AND RIDGE. 10.5 TONGUE AND GROOVE DECKING SHALL BE ATTACHED WITH

2 # 7 SCREWS x 2 1/2" LONG EACH BOARD AT EACH

RAFTER. TONGUES FACING UP THE SLOPE. 10.6 PLYWOOD SHALL BE ATTACHED TO TONGUE AND GROOVE DECKING WITH # 10 SCREWS x 2 1/2" LONG @ 6" O/C ALONG EDGES AND 12" O/C AT INTERMEDIATE RAFTERS. STAGGER PLYWOOD EDGES RUNNING PARALLEL TO

10.7 BUILDING FELT SHALL BE LAID PARALLEL TO THE EAVES WITH A MINIMUM 2' END LAP AND 6" LAP BETWEN LAYERS. 10.8 PURLINS SHALL BE ATTACHED THROUGH DECKING TO

RAFTERS WITH #12 x 5" SCREWS TWO PER PURLIN AT

10.9 METAL ROOFING SHALL BE 24GA MINIMUM AND ATTACHED TO PURLINS WITH # 14 SCREWS 21/4" LONG AT 4" O/C ALONG RIDGE, EAVES, GABLE AND HIPS AND AT 8" O/C ELSEWHERE. AROUND THE PERIMETER OF THE BUILDING AND AT HIPS AND RIDGES, SCREWS SHALL BE AT EACH CORRUGATION IN A STAGGERED PATTERN ENGAGING BOTH OF THE DOUBLED PURLINS. OVERLAP CORRUGATED METAL PANELS AT LEAST 2

CORRUGATIONS ALONG SEAM AND APPLY A BEAD OF CALK AT THE OVERLAP. 10.10 USE GALVANIZED ROOFING SCREWS WITH NEOPRENE

WASHERS ONLY AT RIDGES OF CORRUGATION 10.11 JOIN DOUBLE AND TRIPLE MEMBERS WITH MIN. 5/8" Ø BOLTS @ 24" O.C. UNLESS STATED OTHERWISE

11.0 GENERAL

11.1 IF ANY CONDITIONS VARY FROM THE DRAWINGS OR THE CONTRACTOR REQUIRES FURTHER CLARIFICATION, ASK THE ARCHITECT AND SITE ENGINEER TO VERIFY. DO NOT PROCEED W/ ANY WORK WITHOUT AGREEMENT BETWEEN THE ARCHITECT AND SITE ENGINEER.

11.2 ENGINEER'S APPROVAL MUST BE SECURED FOR ALL STRUCTURAL SUBSTITUTIONS.

11.3 PRIOR TO INSTALLATION OF MECHANICAL AND ELECTRICAL EQUIPMENT OR OTHER ITEMS TO BE ATTACHED TO THE STRUCTURE, ENGINEER'S APPROVAL OF CONNECTIONS AND SUPPORTS SHALL BE OBTAINED. UNLESS OTHERWISE SPECIFICALLY DETAILED ON ARCHITECTURAL AND STRUCTURAL DRAWINGS, RESPECTIVE SUBCONTRACTOR SHALL FURNISH ALL HANGERS, CONNECTIONS, ETC. REQUIRED FOR INSTALLATIONS OF HIS ITEMS.


11.4 PROVIDE ALL EMBEDDED ITEMS IN STRUCTURE AS NOTED ON ARCHITECTURAL, MECHANICAL, ELECTRICAL AND STRUCTURAL DRAWINGS. MISCELLANEOUS EMBEDDED ITEMS AND ANCHOR BOLTS SHALL BE FURNISH BY STEEL SUPPLIER AND INSTALLED BY CONTRACTOR.

11.5 PROVIDE ASPHALTIC MASTIC COATINGS ON ALL STEEL EXPOSED TO THE EARTH.

1.6 SUBMIT SHOP AND ERECTION DRAWINGS FOR ALL REINFORCING, STEEL JOIST, STRUCTURAL STEEL AND METAL DECK TO ENGINEER FOR WRITTEN APPROVAL. THE MANUFACTURE OR FABRICATION OF ANY ITEMS PRIOR TO WRITTEN APPROVAL OF SHOP DRAWINGS SHALL BE AT ENTIRELY

THE RISK OF THE CONTRACTOR. 11.7 ALL MAJOR STEEL AND STEEL JOIST SHOP DRAWINGS SUBMITTED SHALL INCLUDE CALCULATIONS AND BEAR THE STAMP OF A REGISTERED PROFESSIONAL ENGINEER.

11.8 CONTRACTOR TO VERIFY ALL DIMENSIONS BEFORE PROCEEDING WITH ANY WORK. DO NOT SCALE FROM DRAWINGS. 11.9 PLACE ALL CONDUIT AND SERVICES UNDER ALL SLABS ON GRADE. WHERE CONDUIT AND SERVICES ARE IN BEAMS, COLUMNS AND SUSPENDED SLABS ENSURE THAT MINIMUM COVER OF 1-1/2" TO ALL REINFORCEMENT IS MAINTAINED. DO NOT BUNDLE CONDUIT IN SLABS.

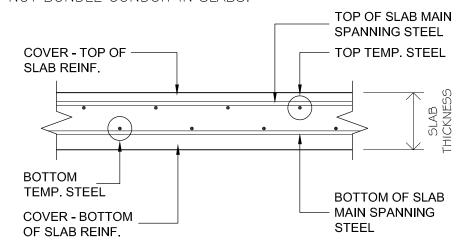

11.10 REINFORCEMENT LAYOUT DESIGNATION

11.11 TYPICAL LINTELS. SMALL SPAN LINTELS ARE DEFINED AS HORIZONTAL SIMPLY SUPPORTED ELEMENTS SUPPORTING NO MORE THAN 4-FT OF 8" CMU MASONRY IN AN INTERIOR OR EXTERIOR AXIAL


CONDITION AND NOT SUBJECT TO TORSION OR ASYMMETRIC

LINTEL SCHEDULE LINTEL REINFORCEMENT SPAN (MAX.) TYPE WIDE DEPTH BOT. TOP TIES 5 FT 6" | 12" | 1 - #5 | 1 - #5 | #3 @ 4" O.C. 5 FT 12" | 2 - #5 | 2 - #5 | #3 @ 4" O.C. L-03 | 8" | 12" | 3 - #5 | 3 - #5 | #3 @ 4" O.C. 10 FT

ABBREVIATIONS AND SYMBOLS


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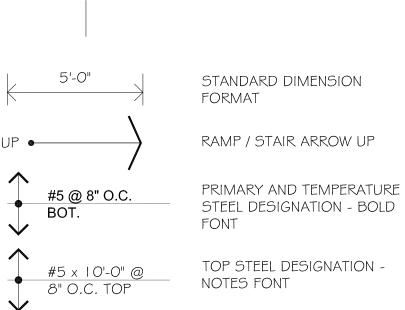
4 — #5	REBAR DESIGNATION IN A BEAM. QTY = 4 NO.
	BARS, $\#5 = 5/8$ " (INCH) DIAMETER
C-02	COLUMN REFERENCE NUMBER
CONC.	CONCRETE
DETL#	DETAIL REFERENCE NUMBER
DIA.	DIAMETER
EA.	EACH
E.W.	EACH WAY
F-04	FOOTING REFERENCE NUMBER
HORIZ.	HORIZONTAL
O.C.	ON CENTER
QTY	QUANTITY
REINF.	REINFORCING OR REINFORCEMENT
SSL:-	STRUCTURAL SLAB LEVEL
TEMP. STEEL	TEMPERATURE AND SHRINKAGE STEEL
VERT.	VERTICAL
W/	WITH
W12X256	WIDE FLANGE BEAM. STRUCTURAL BEAM
WWF.	WELDED WIRE FABRIC = STRUCTURAL MESH

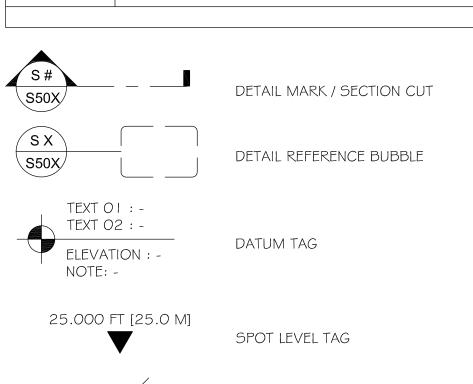

COLUMN / FOOTING

DESIGNATION



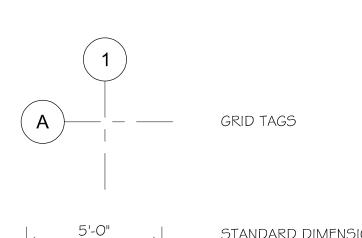


(SPECIFIC NOTE)

OF SLAB


"THICK CONC. SLAB


(TYPE) WWF IN CENTER

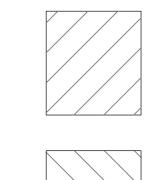


CISTERN SLABS - TYPICAL FORMAT SPECIFIC NOTE) " THICK CONC. SLAB TYPE) WWF IN CENTER OF SLAB

FLOOR SLAB ON GRADE - TYPICAL FORMAT

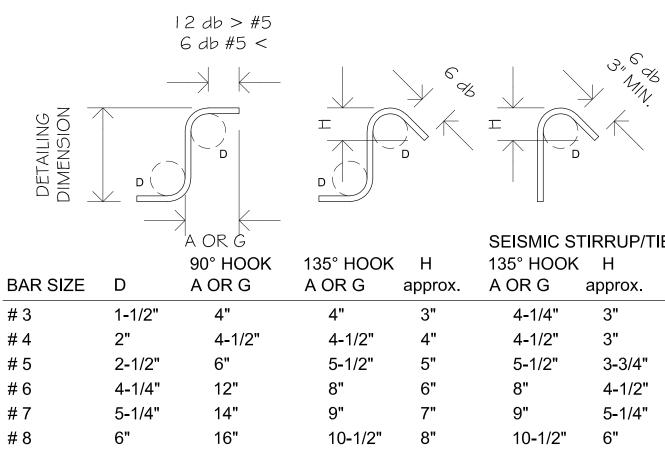

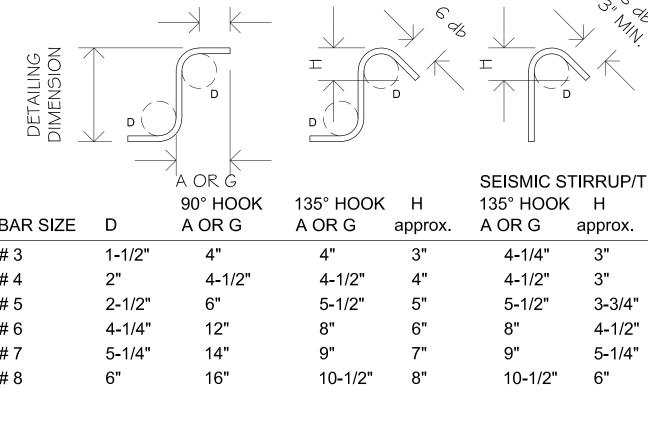

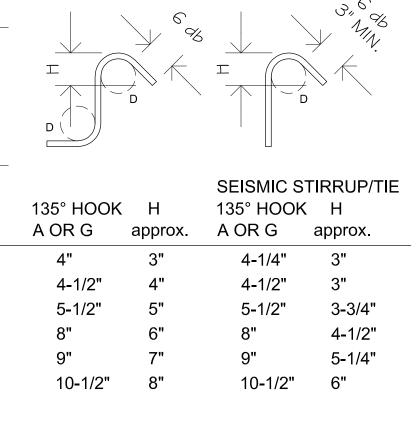

TOTAL

ENGINEERING Ltd.

P.O Box 8309

CRUZ BAY

St. JOHN

V.I. 00831


Tel (340) 513-2817


Fax (284) 494-0775

RICHARD (


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REVISIONS

NOV 2023 RT

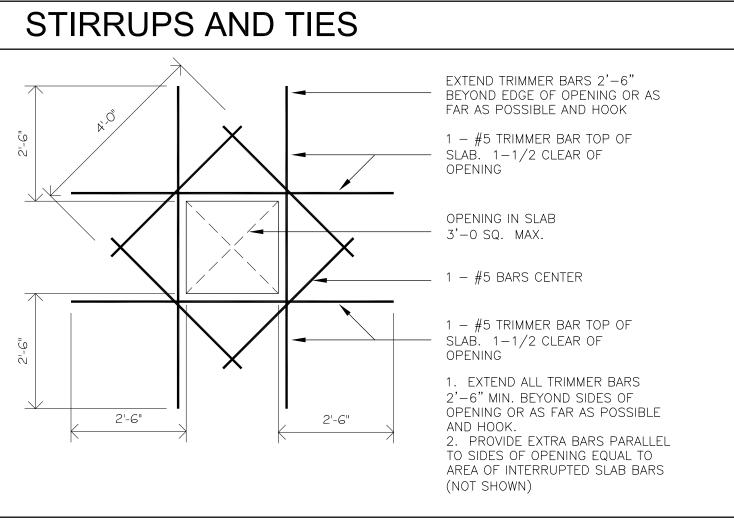MAY 2023

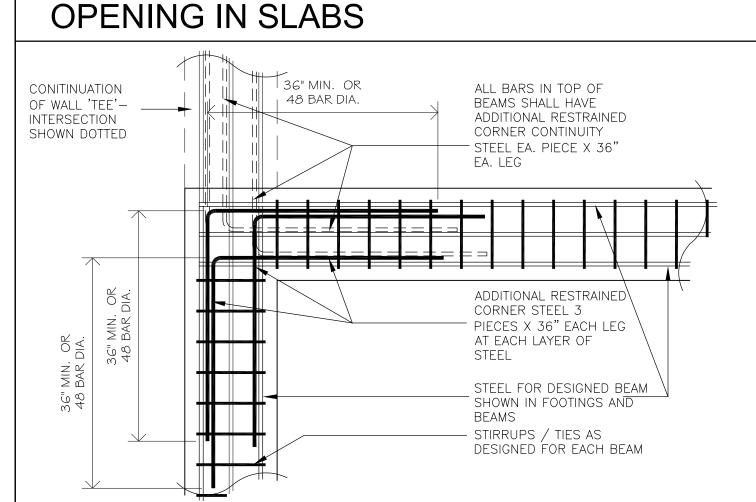SCALE: **AS_SHOWN**

SSUE.: **PRELIMINARY**

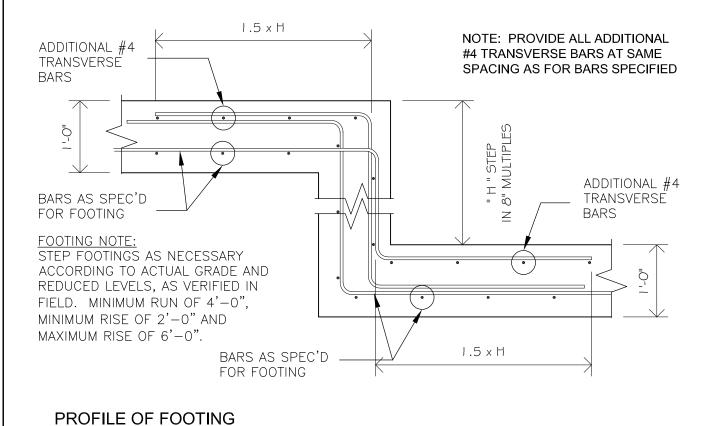DATE


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DRAWN: BM

APPR.: RT

DRAWING

STEPPED FOOTING - TYPICAL SCALE: N/A




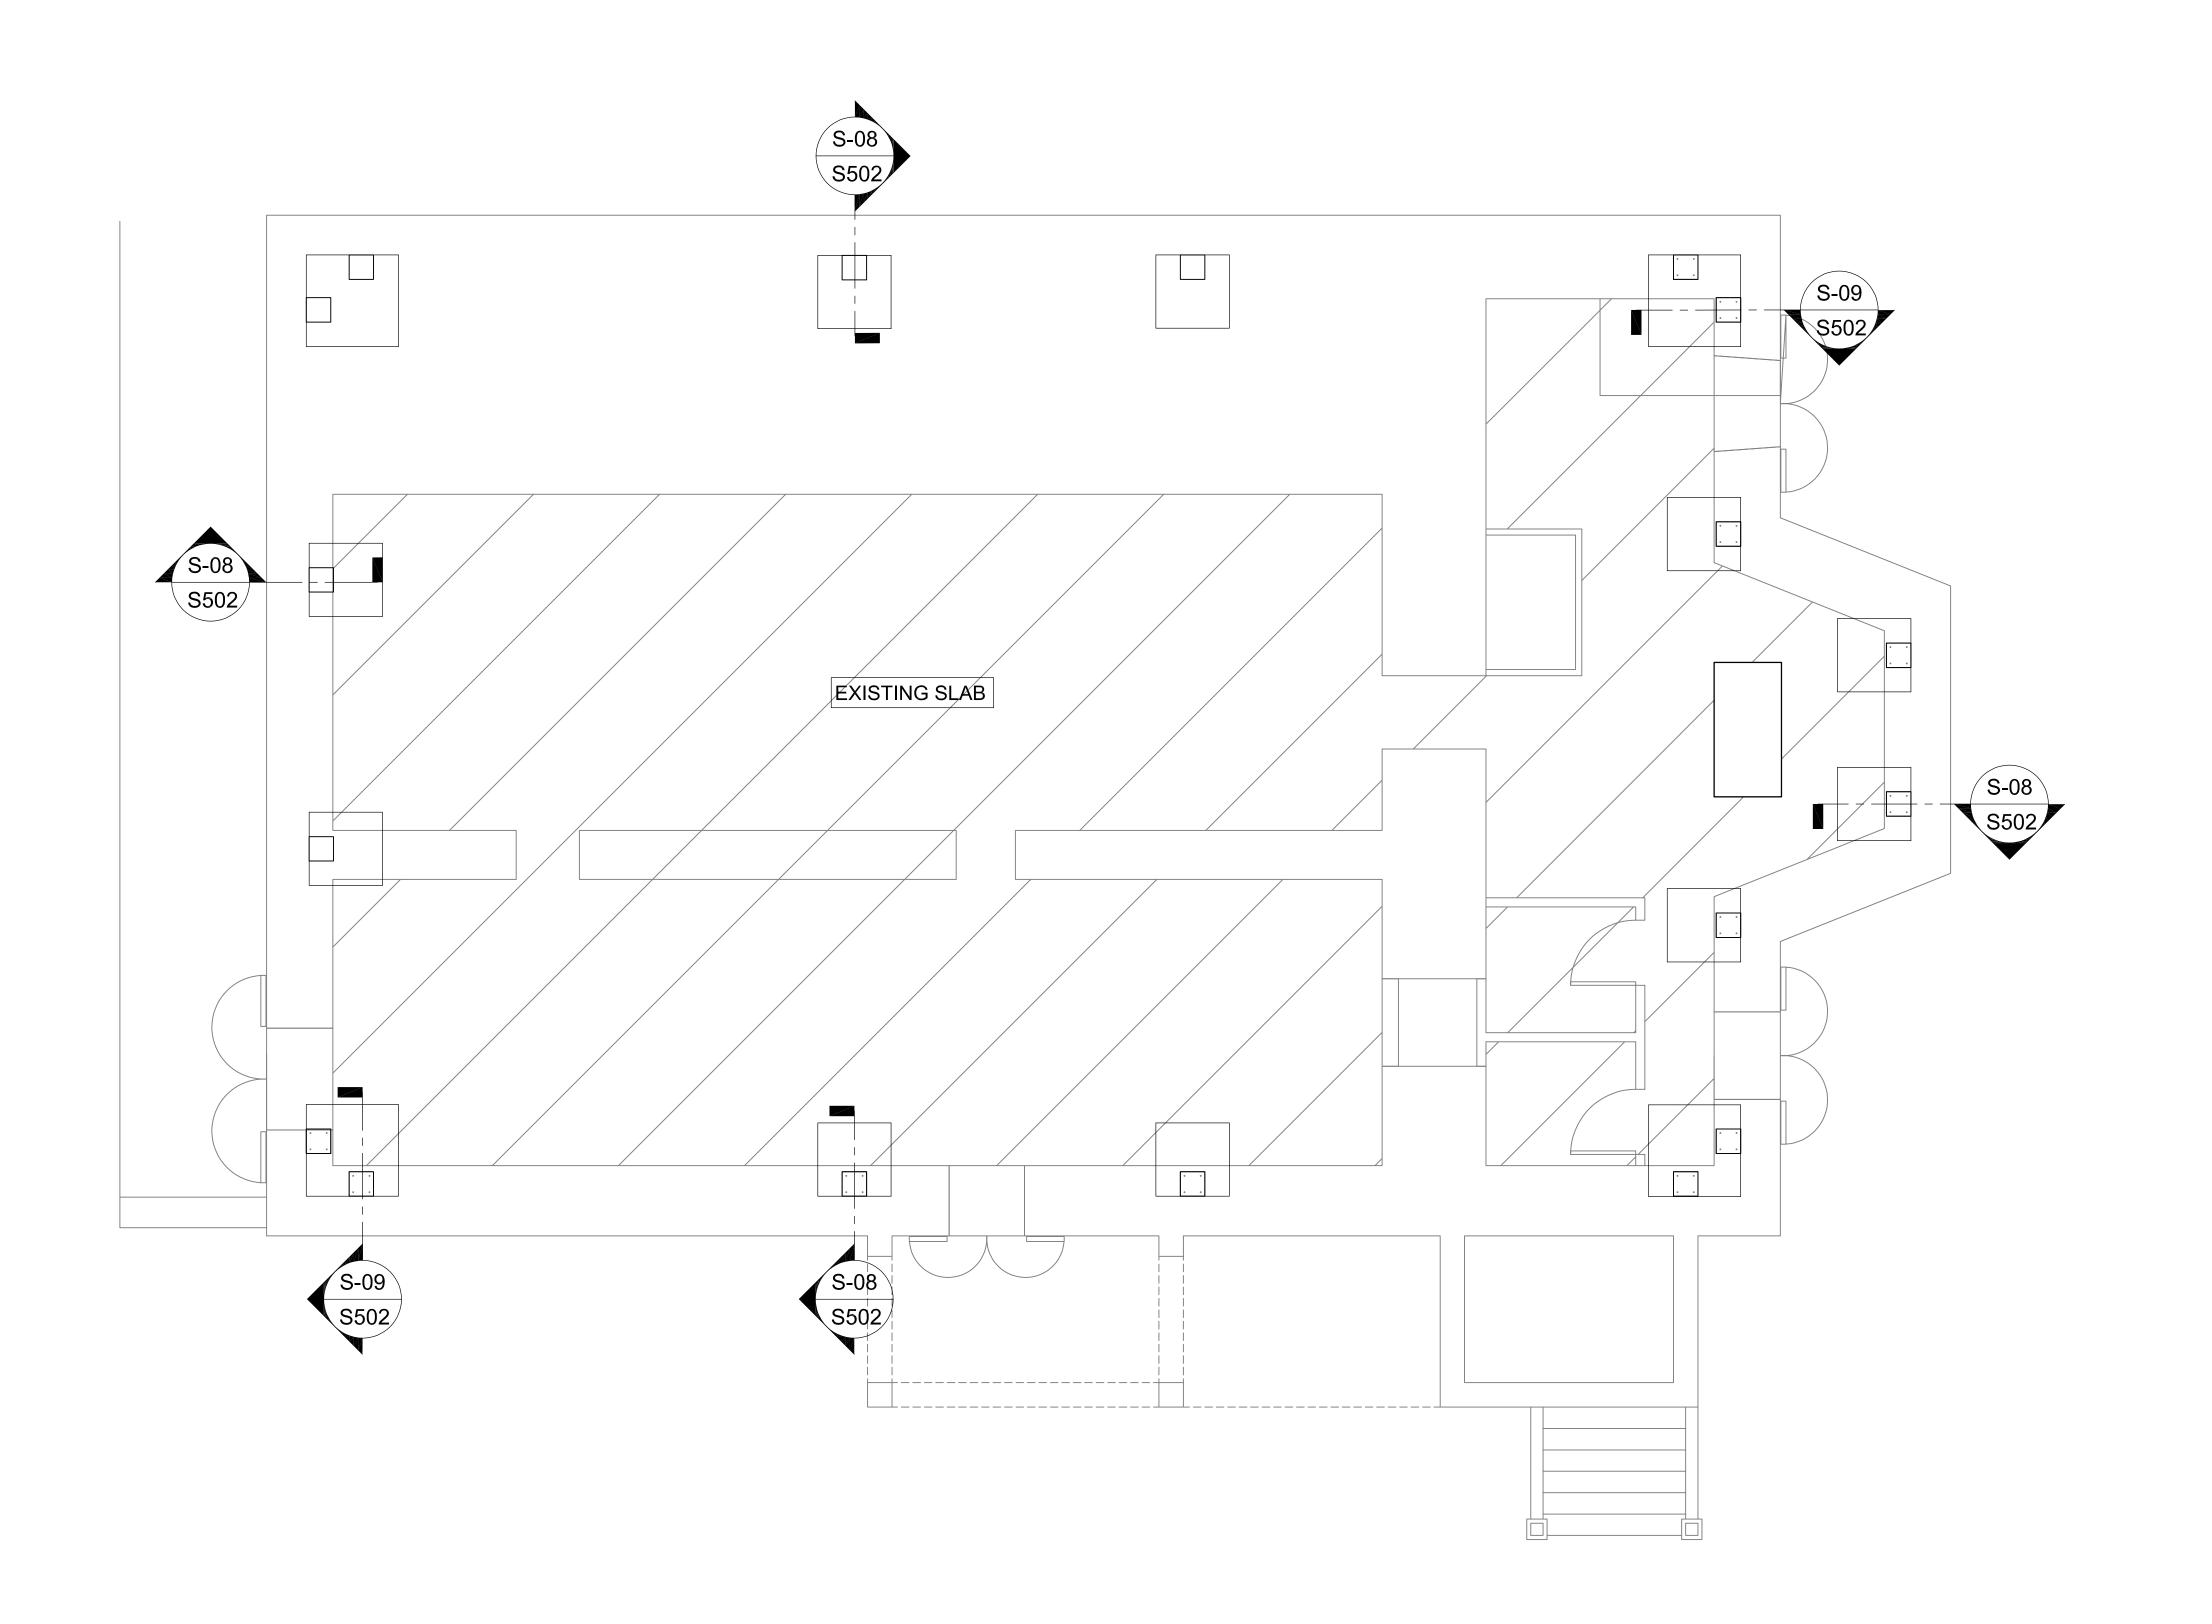

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EMMAUS MORAVIAN CHURCH
SANCTUARY
PARCEL NO. 10 ESTATE EMMAUS
ST.JOHN USVI

S 10

SCALE: AS_SHOWN

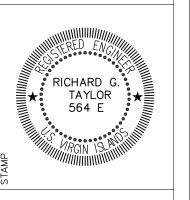
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DRAWING


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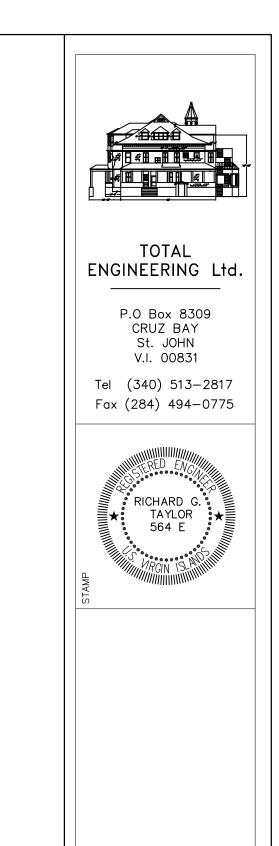
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EMMAUS MORAVIAN CHURCH

SANCTUARY

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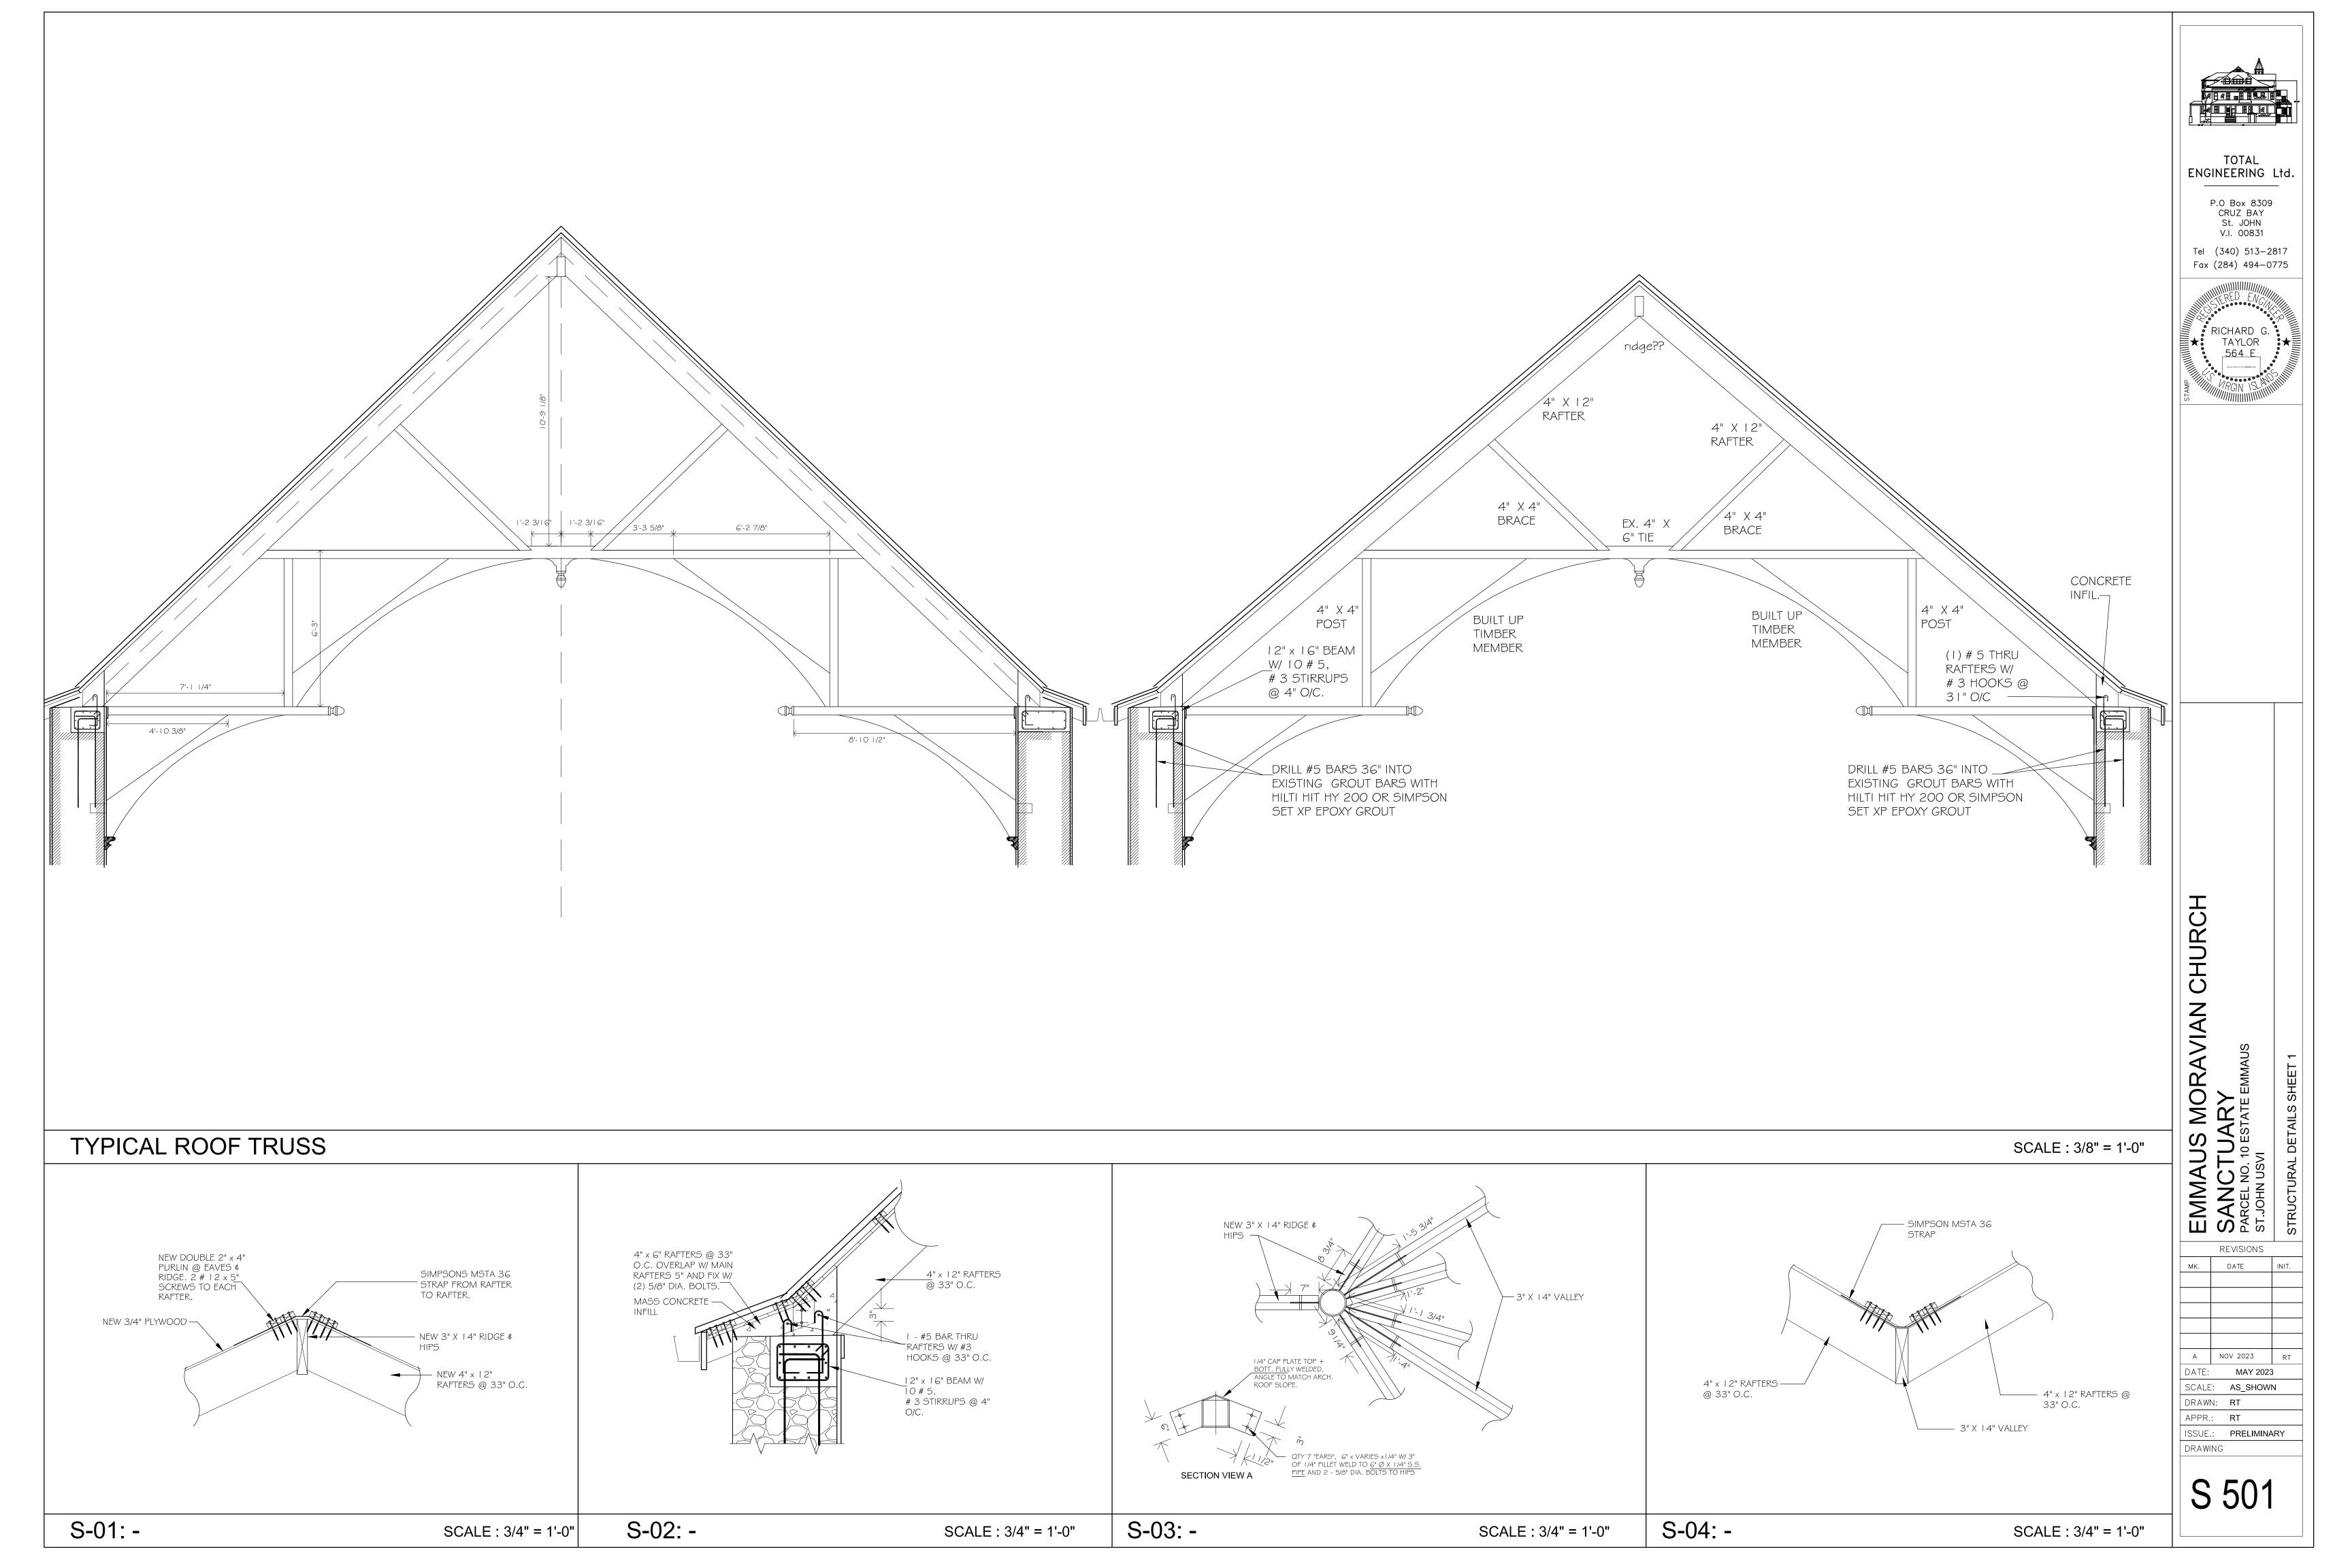
ROOF PLAN


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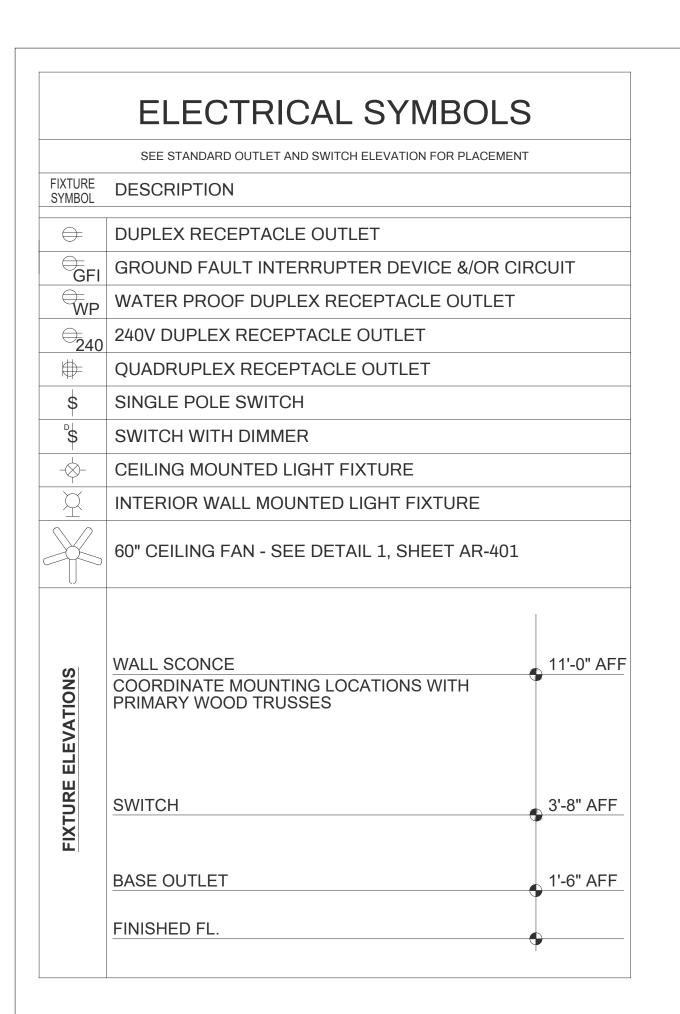
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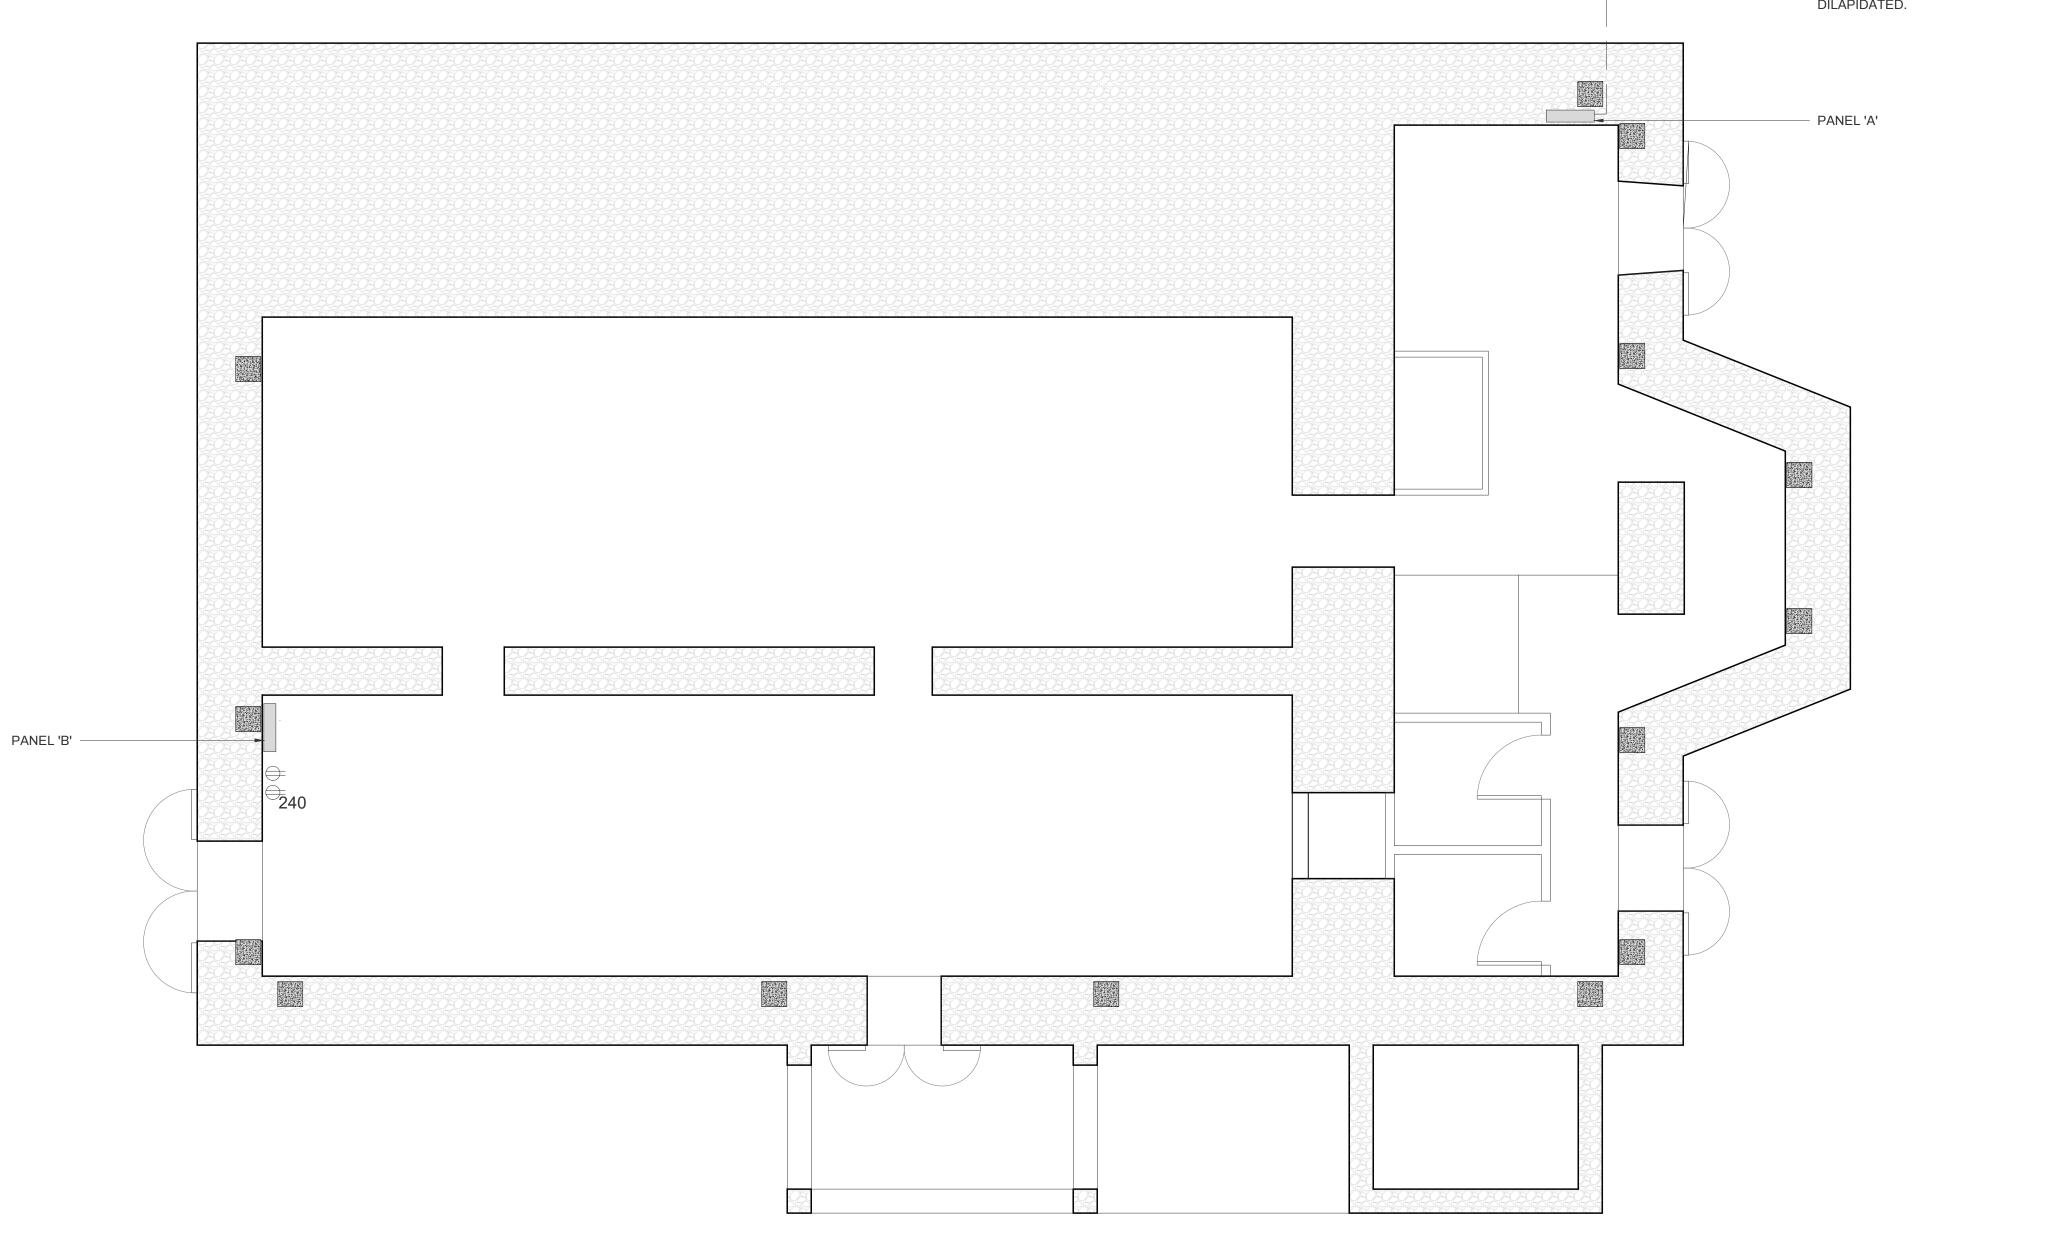
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 EXISTING 200A RATED WAPA METER ON ADJACENT MANSE BUILDING TO BE REUSED. INSPECT FOR REUSE AND REPORT TO ARCHITECT IF EQUIPMENT IS TOO DILAPIDATED FOR REUSE.

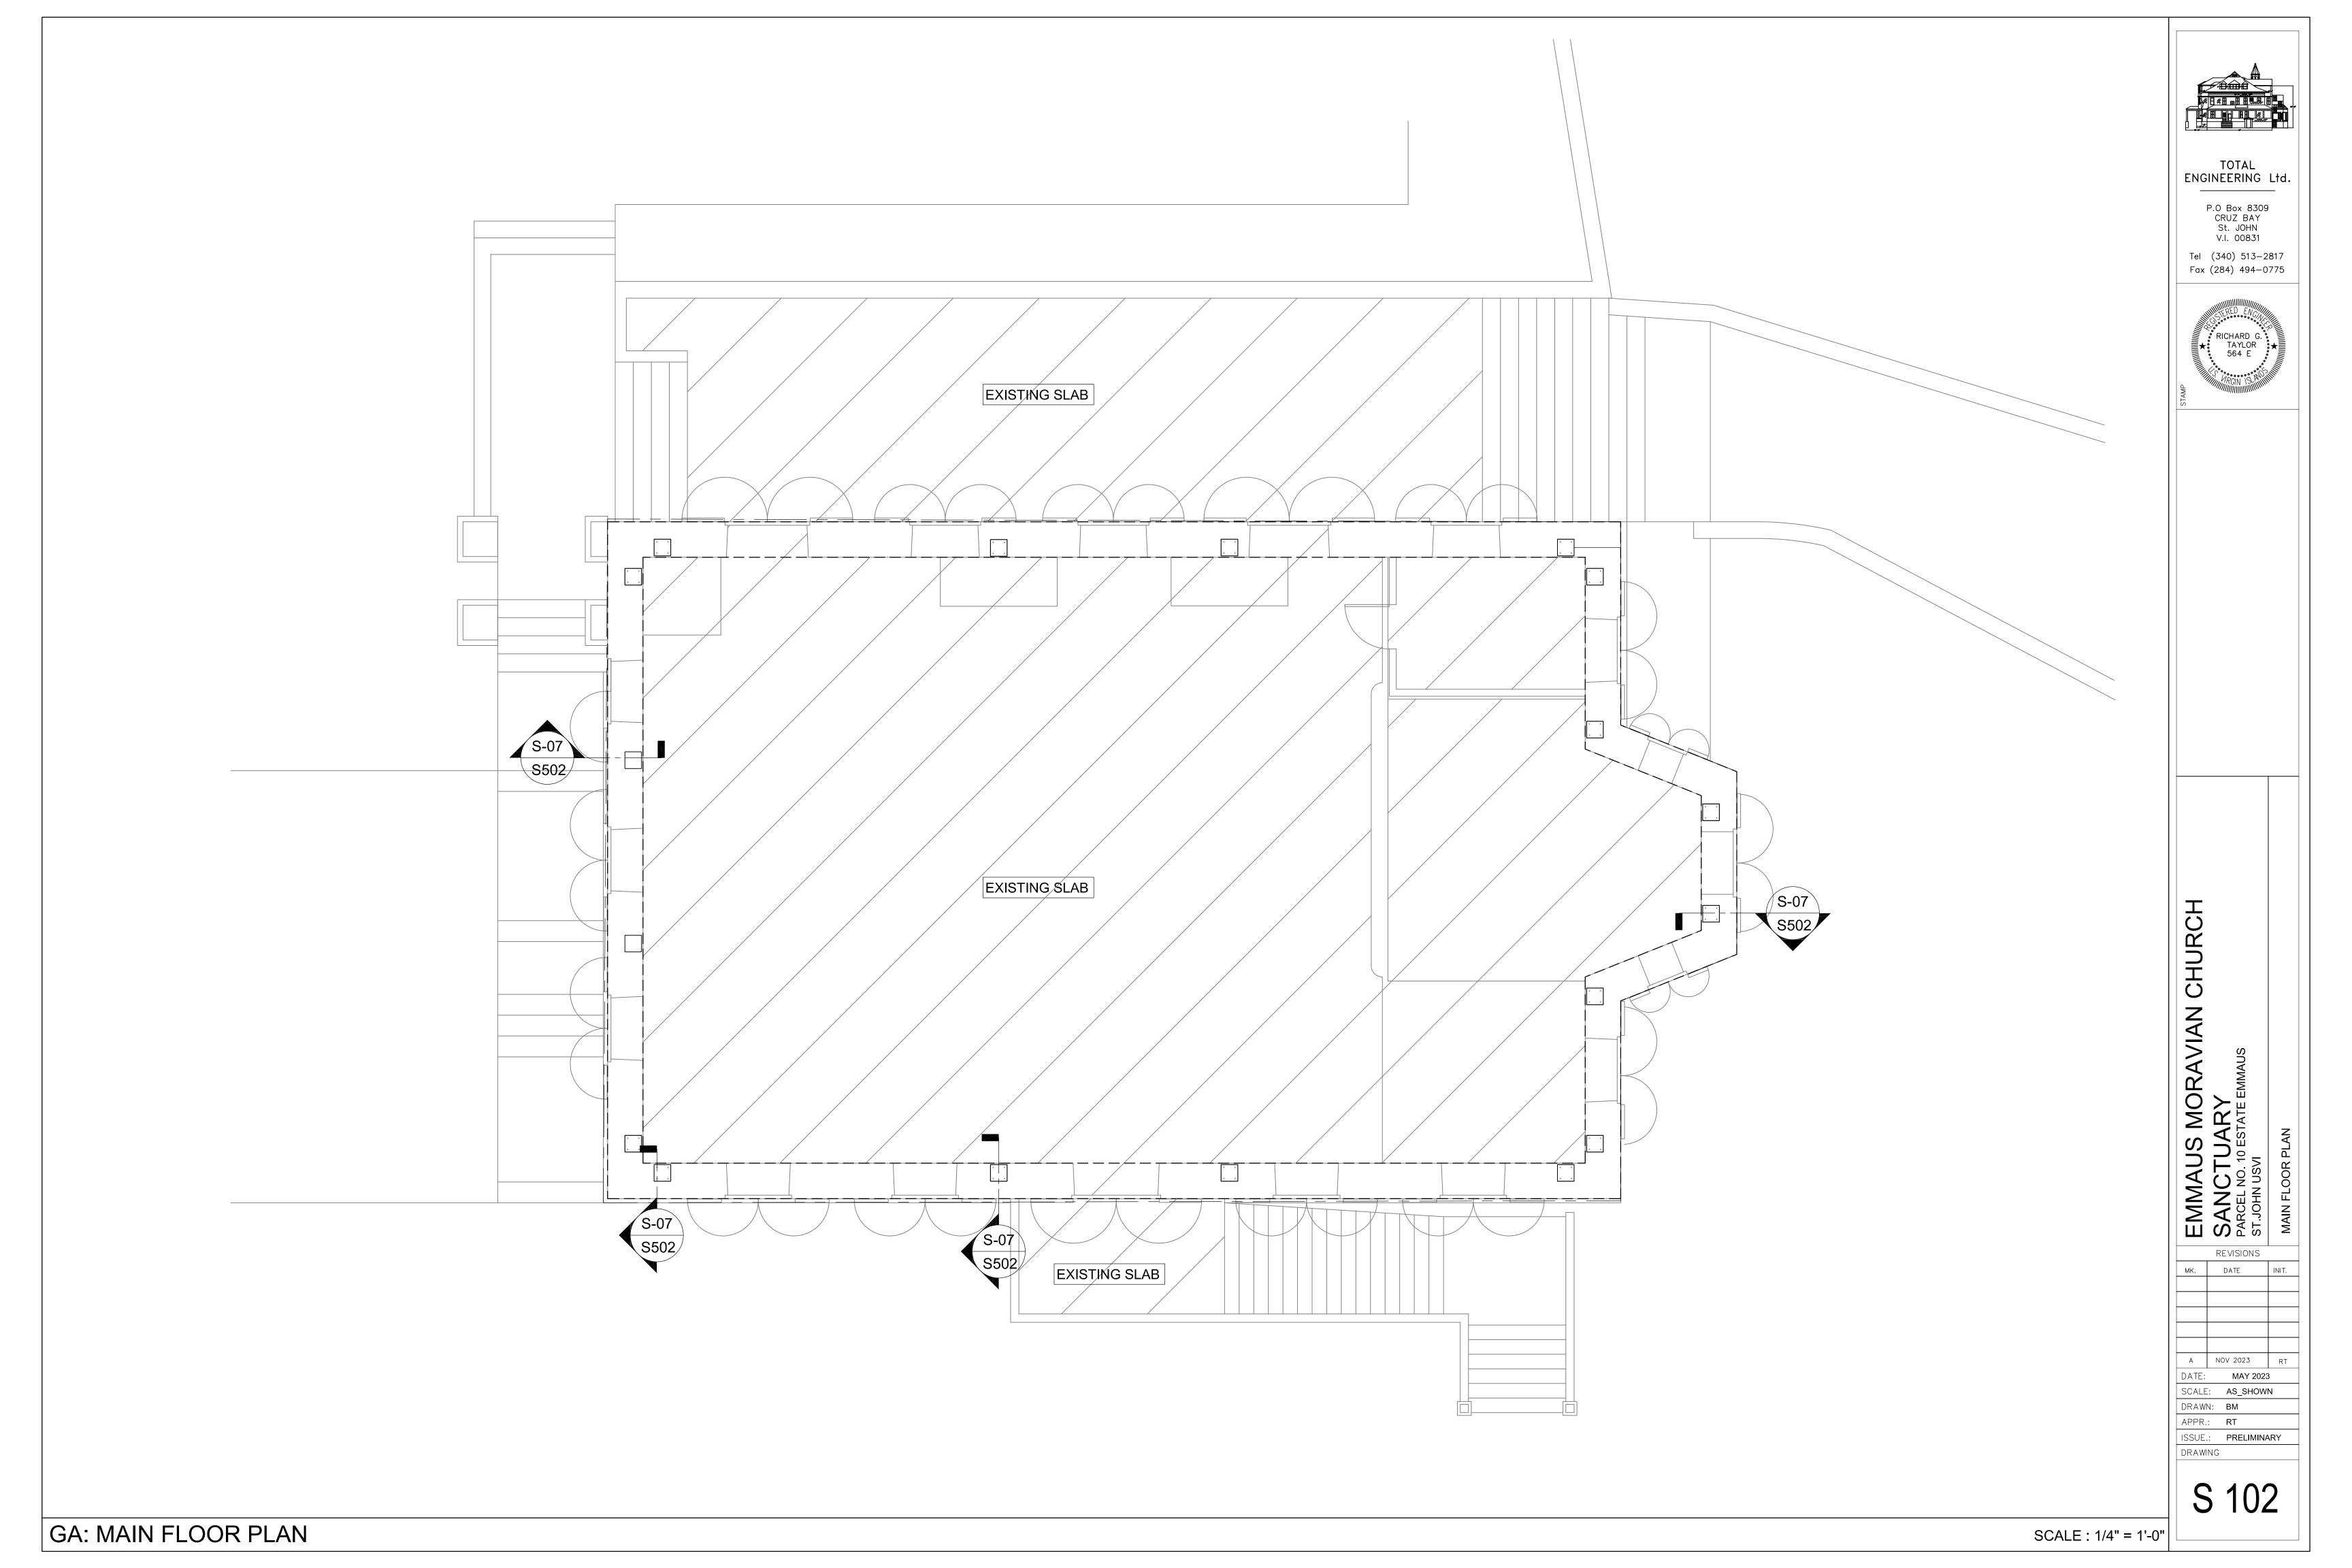- EXISTING 200A 120/240VAC SINGLE PHASE, 3 WIRE, UNDERGROUND SERVICE. VERIFY CONDITION OF WIRING FOR REUSE. REMOVE AND REPLACE IF DILAPIDATED.

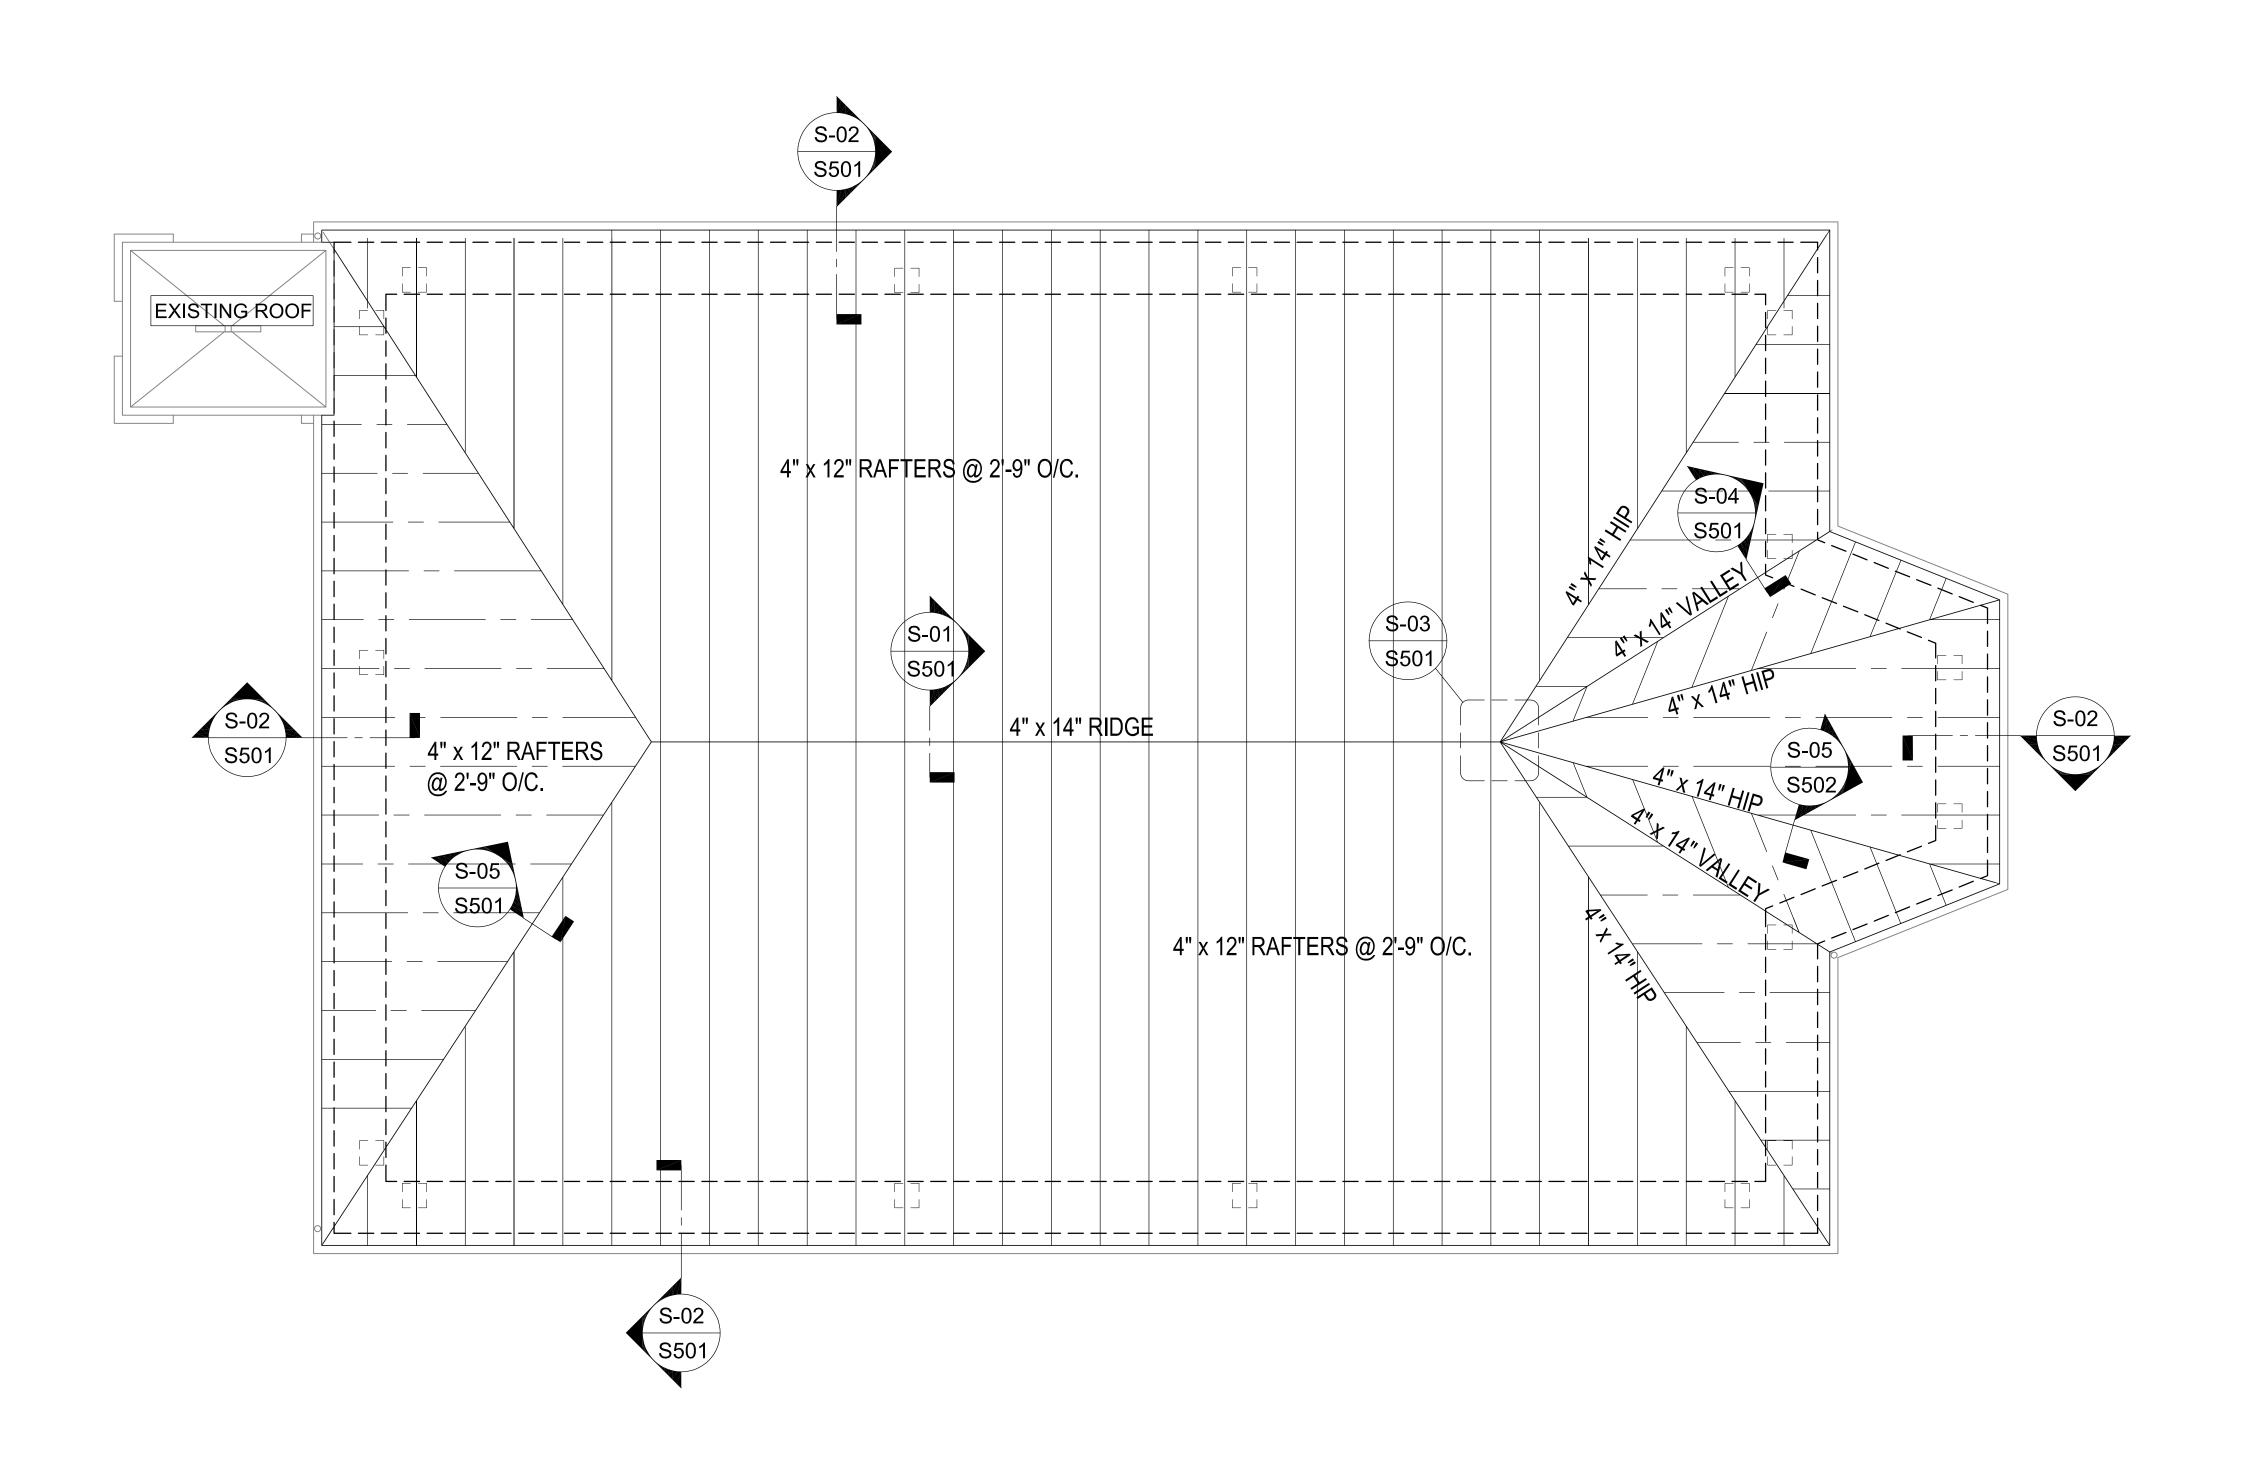D1 BASEMENT ELECTRICAL PLAN
1/4" = 1' - 0"

MORAVIAN CHURCH VI CONFERENCE P.O BOX 869 CHRISTIANSTED, VI 00821-5187 340-713-1055

FORMWRIGHT

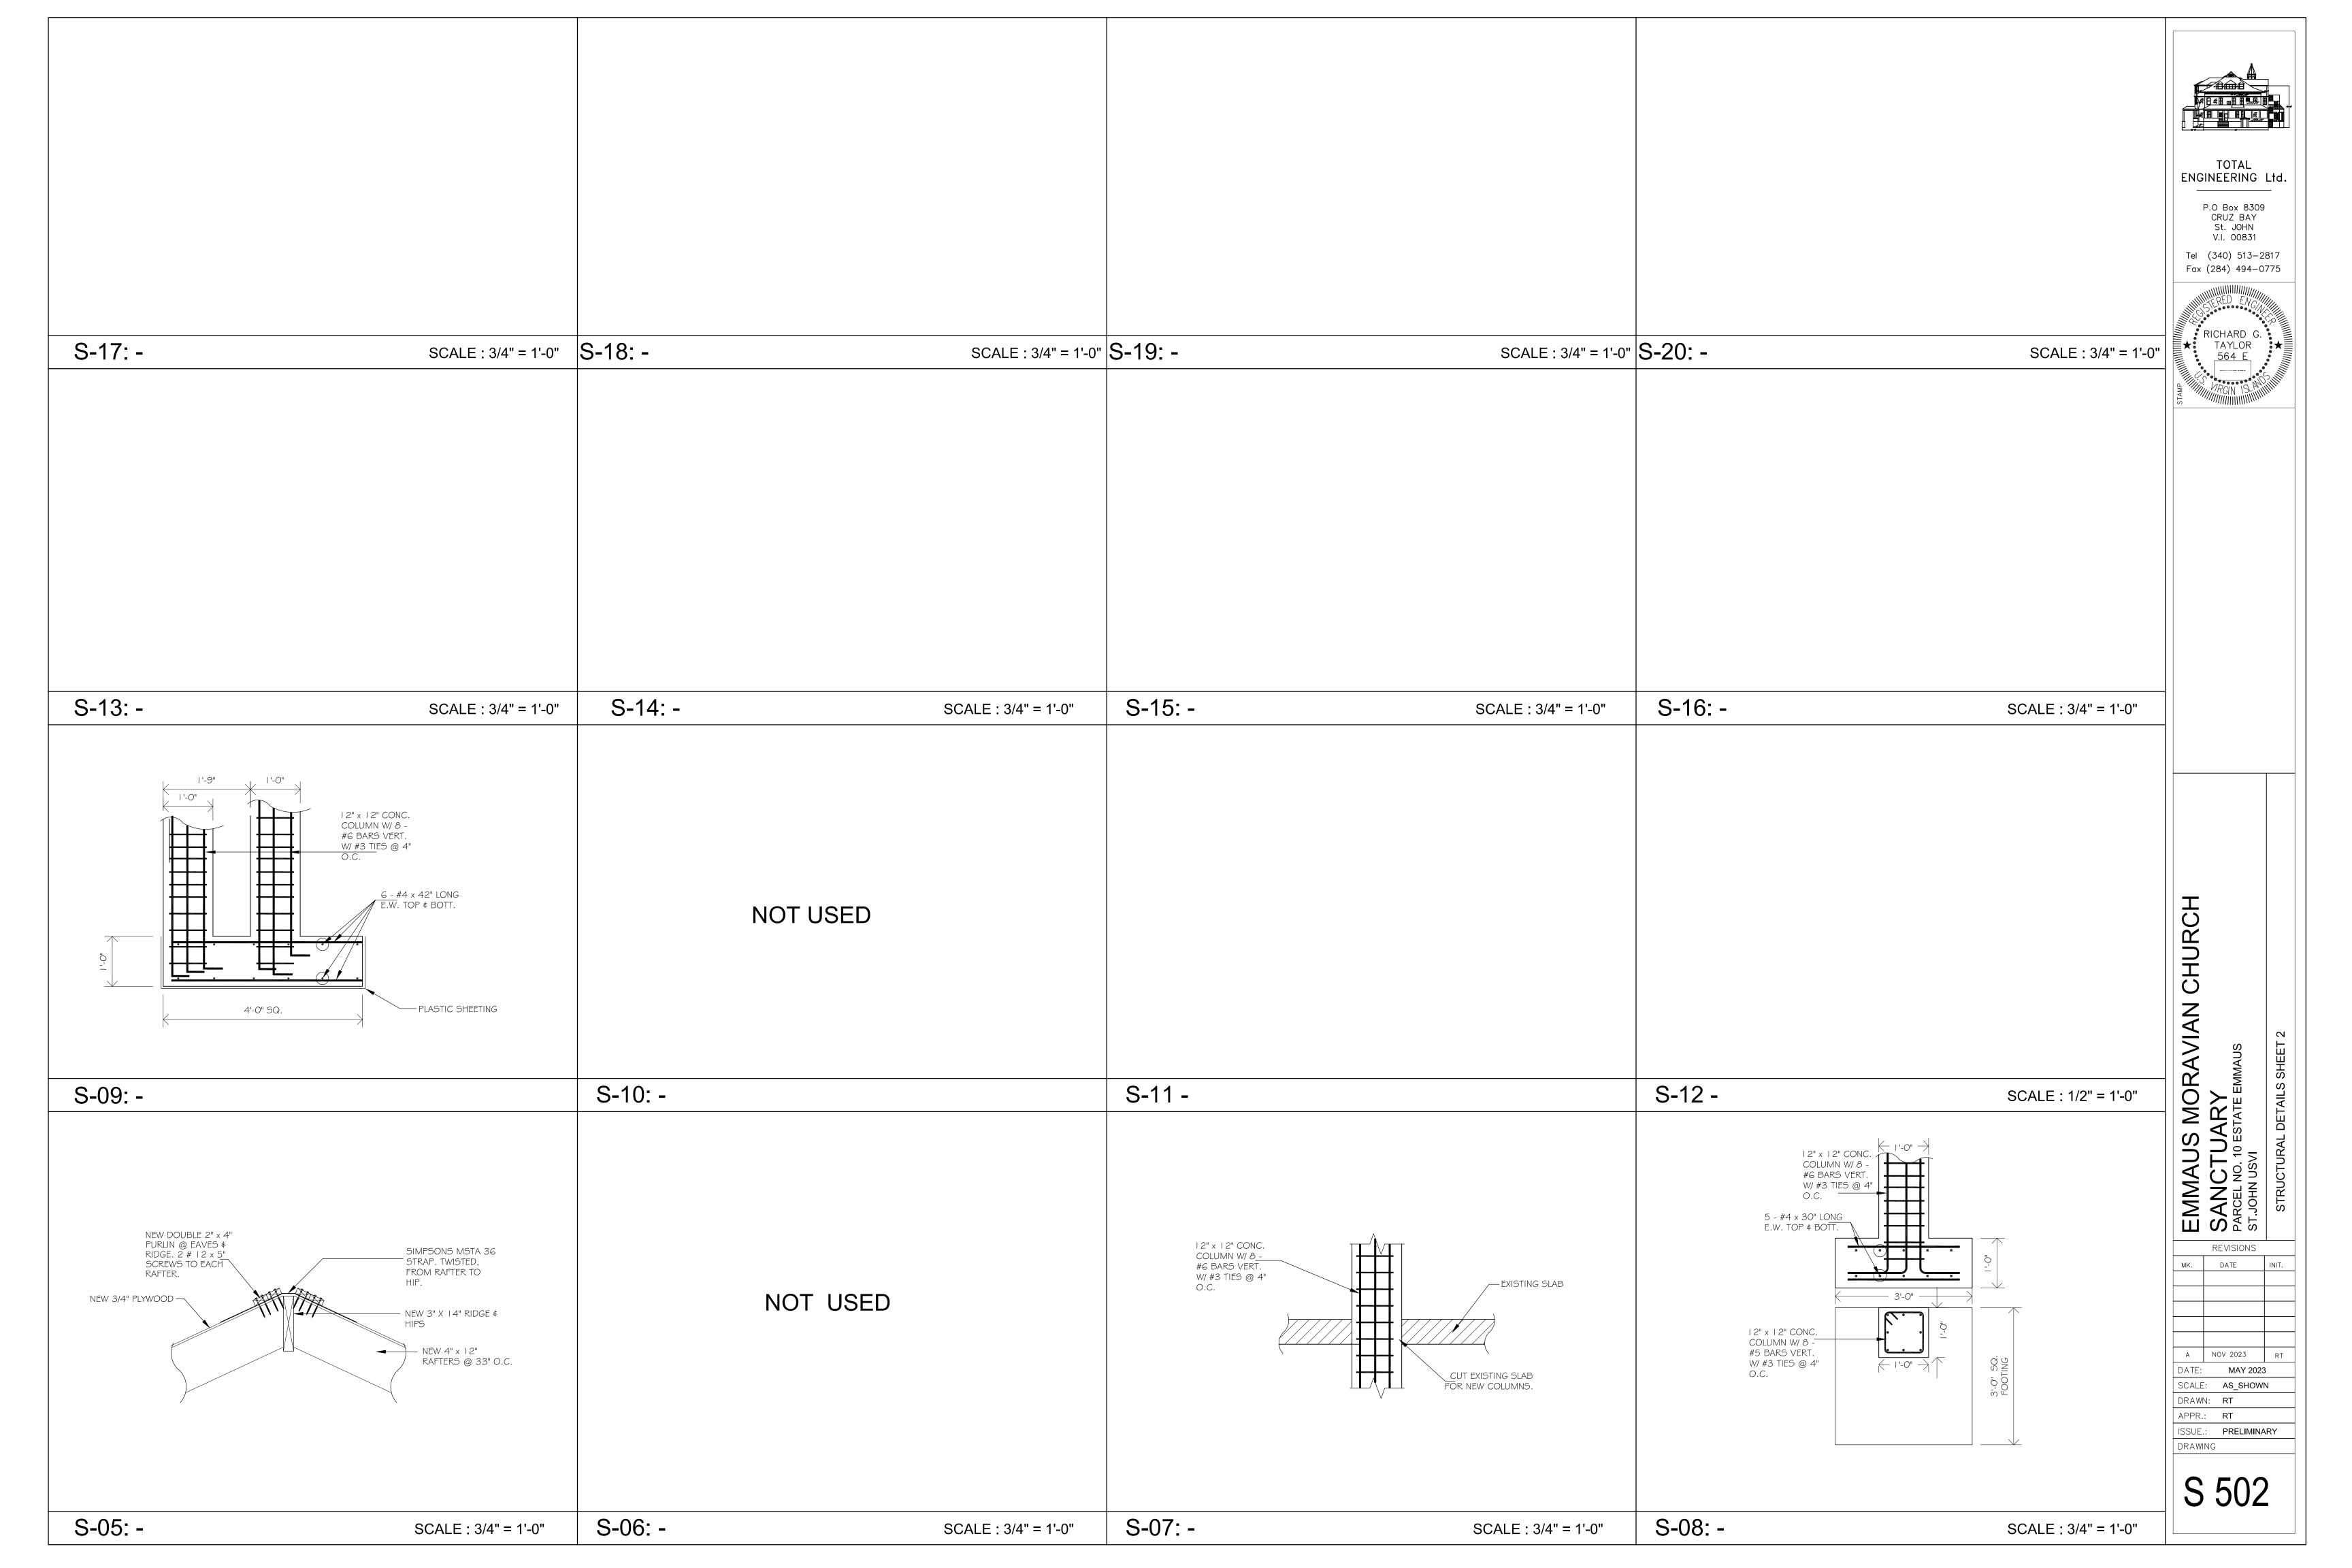P.O. Box #600413

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architectural seal

historic preservation architect CTS GROUP 17 COMMERCE STREET CHATHAM, NJ 07928 973-635-5900

structural engineer SYSTEMS ENGINEERING P.O.BOX 8309 ST JOHN, VI 00831 284-494-2987

project

EMMAUS MORAVIAN CHURCH SANCTUARY RECONSTRUCTION

PARCEL 10 ESTATE EMMAUS ST JOHN, USVI

7/5/2024

Building Permit Set

revisions

BASEMENT ELECTRICAL PLAN

October 10, 2023

2022-009

E1.01

ELECTRICAL SYMBOLS SEE STANDARD OUTLET AND SWITCH ELEVATION FOR PLACEMENT FIXTURE SYMBOL DESCRIPTION GFI GROUND FAULT INTERRUPTER DEVICE &/OR CIRCUIT WP WATER PROOF DUPLEX RECEPTACLE OUTLET 240V DUPLEX RECEPTACLE OUTLET QUADRUPLEX RECEPTACLE OUTLET \$ SINGLE POLE SWITCH SWITCH WITH DIMMER - CEILING MOUNTED LIGHT FIXTURE INTERIOR WALL MOUNTED LIGHT FIXTURE 60" CEILING FAN - SEE DETAIL 1, SHEET AR-401 WALL SCONCE 11'-0" AFF COORDINATE MOUNTING LOCATIONS WITH PRIMARY WOOD TRUSSES 3'-8" AFF 1'-6" AFF BASE OUTLET FINISHED FL.

ELECTRICAL FIXTURE SCHEDULE

CEILING-1 GANNON 1 - LIGHT SINGLE DOME PENDANT MATTE WHITE BY

ZIPCODE DESIGN


SCONCE-1 SPI LIGHTING, ECHO BLADE, EIW12180 16 in, 3000K

FAN-1 MINKA-AIRE F1000-WH, DYNO, 52" CEILING FAN WITH 1244 LUMEN LED LIGHT & REMOTE, WHITE

SWITCH-1 DIVA LED+ DIMMER SWITCH 150-WATT/SINGLE-POLE, WHITE

SWITCH-2 LUTRON DIVA 3-SPEED FAN CONTROL, SINGLE-POLE, WHITE

WITCH-3 LUTRON CLARO ON/OFF SWITCH, 15-AMP/SINGLE-POLE, WHITE, CA-1PSW-WH

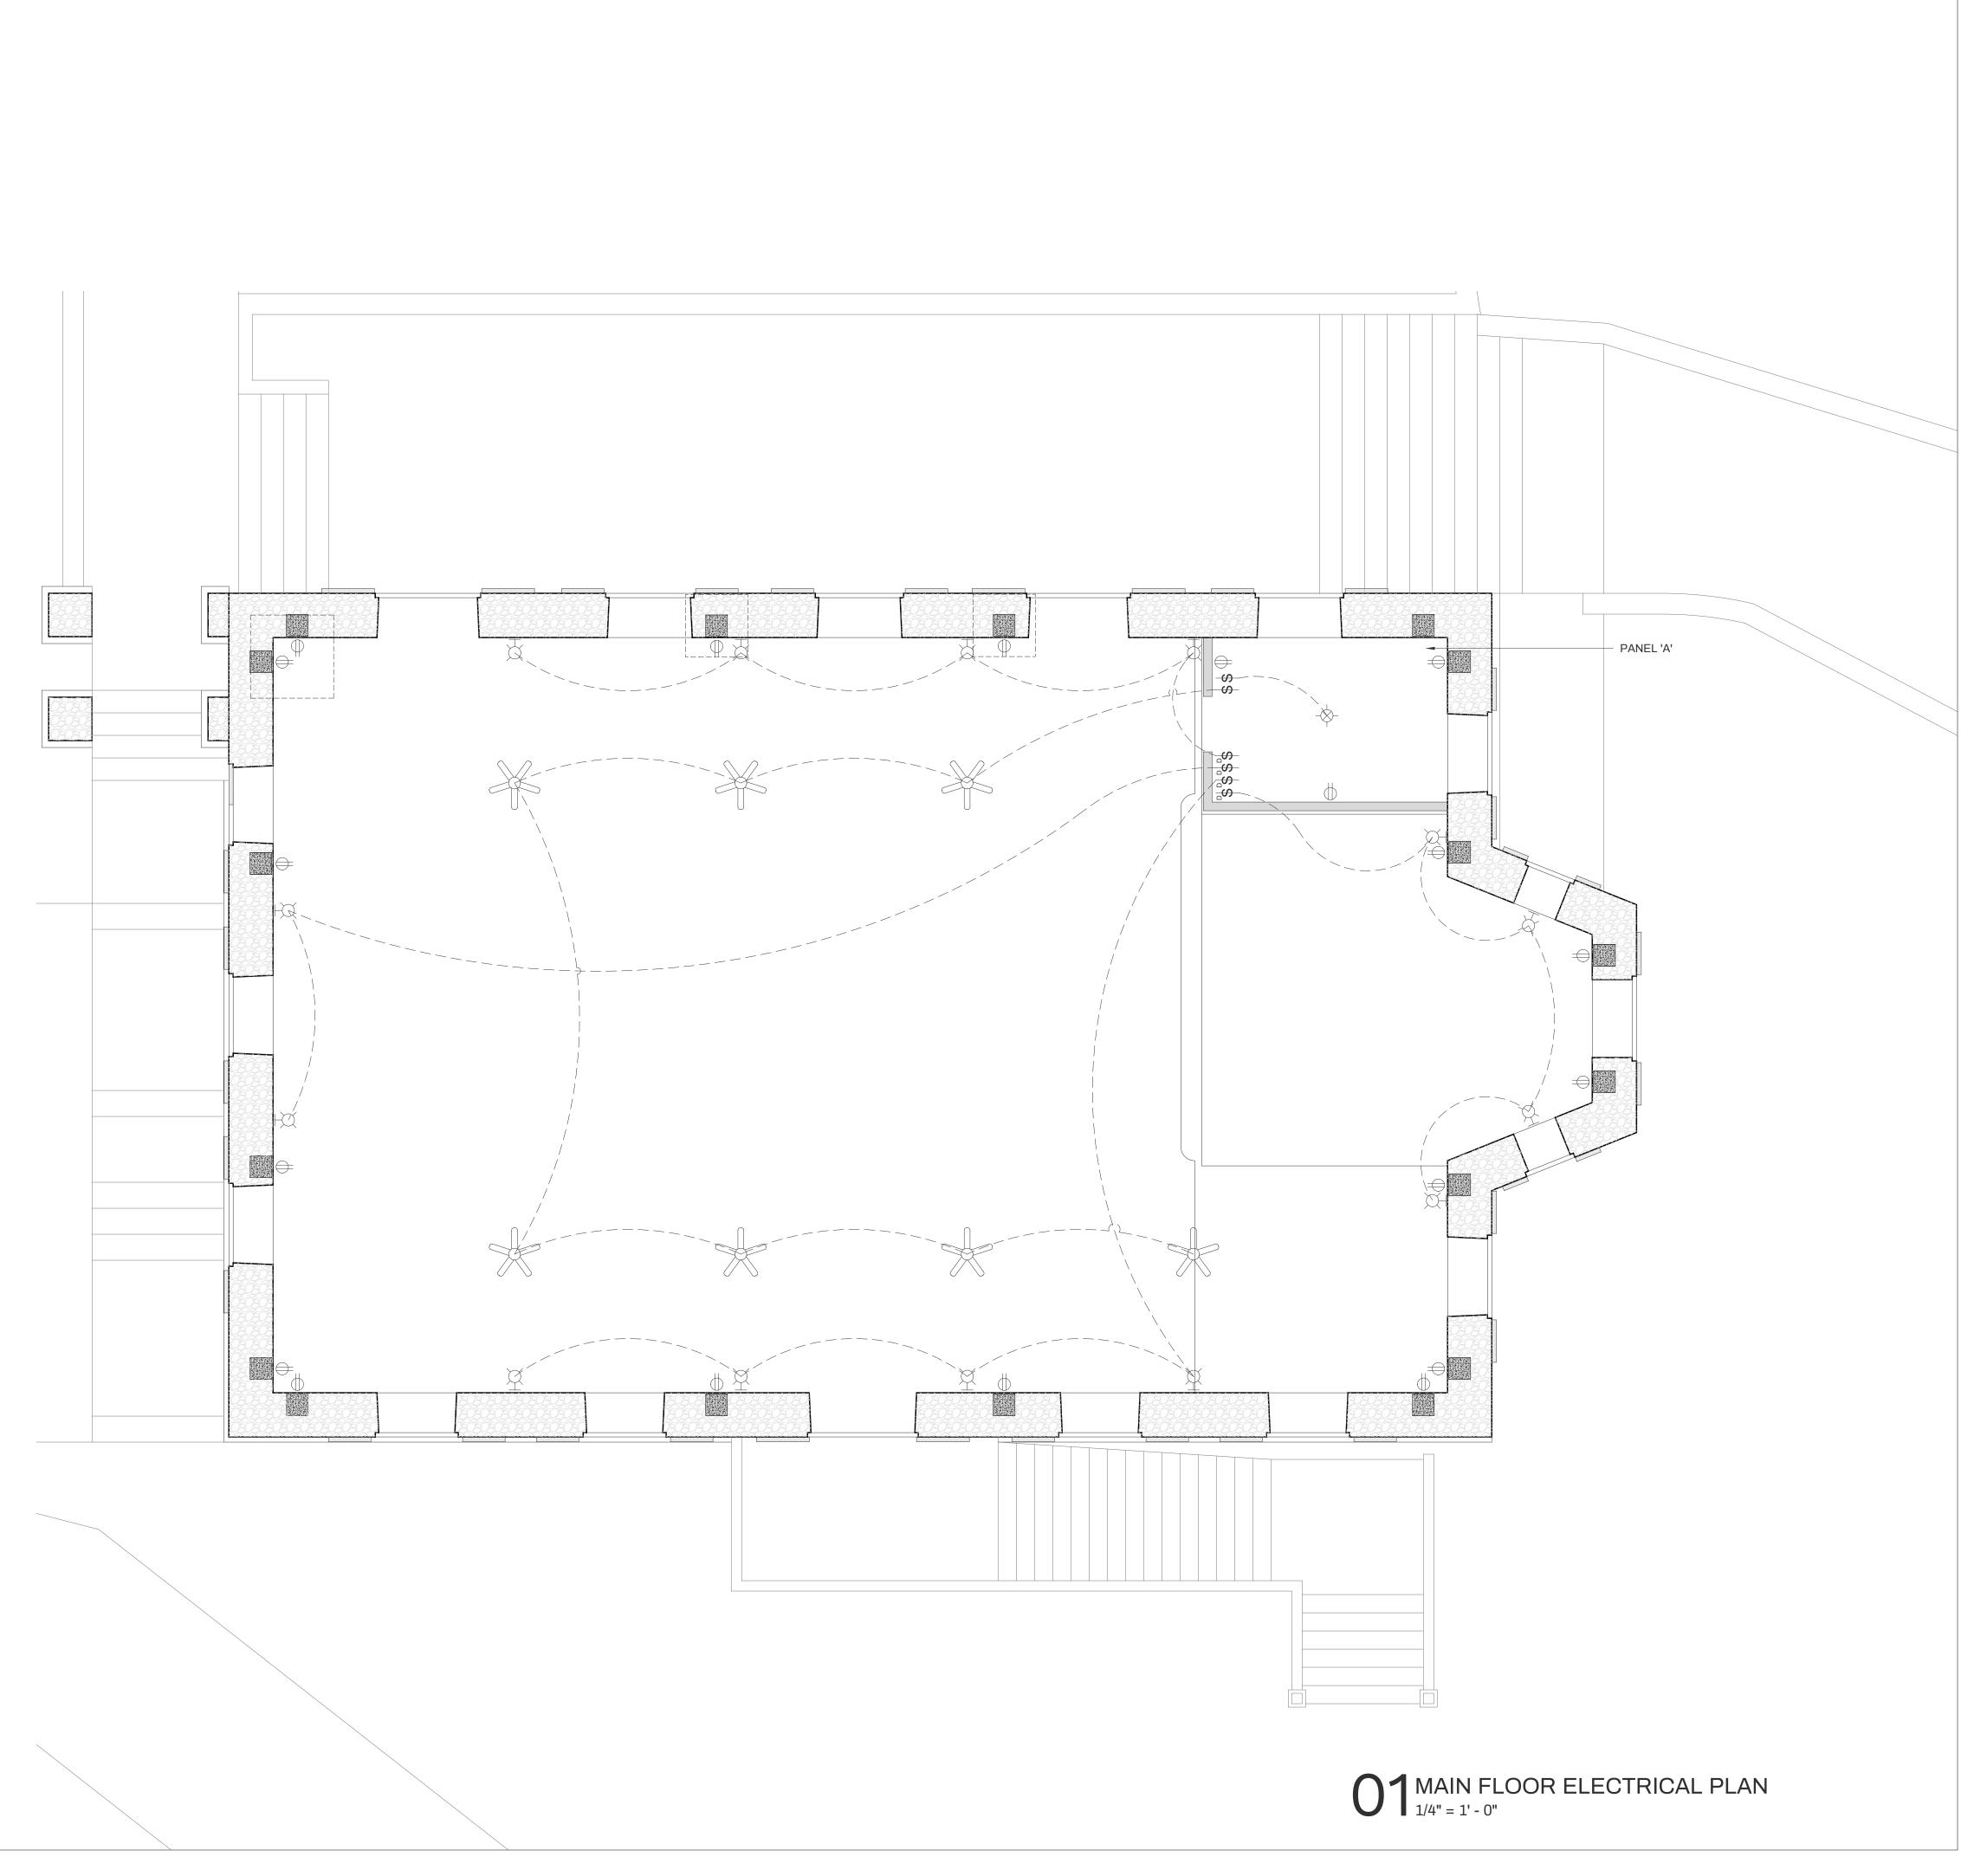






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architectural seal



owner
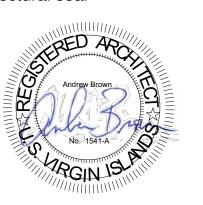
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structural engineer SYSTEMS ENGINEERING P.O.BOX 8309 ST JOHN, VI 00831 284-494-2987

project

EMMAUS MORAVIAN CHURCH SANCTUARY RECONSTRUCTION

PARCEL 10 ESTATE EMMAUS ST JOHN, USVI

7/5/2024

issue

Building Permit Set

revisions

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MAIN FLOOR ELECTRICAL PLAN

project number

2022-009 October 10, 2023

sheet

E1.02