


BLACK GAP W.M.A.



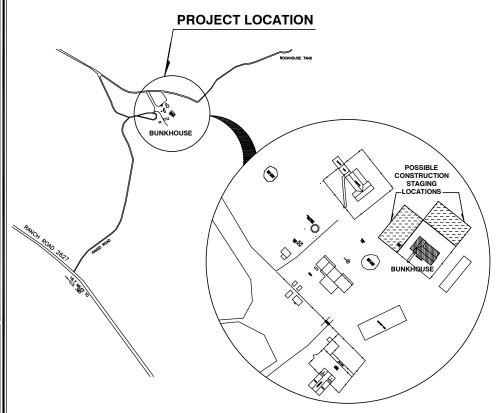



Bunkhouse rear view, looking towards Restroom

SITE ADDRESS:

Black Gap WMA FM 2627, Alpine, Texas 79830 N 29 28'06.0 W 102 50'34.3 (55 miles south of Marathon, 18 mi down FM 2627)

PROJECT

BLACK GAP WILDLIFE MANAGEMENT AREA **BUNKHOUSE RESTROOM REPAIRS**

PROJECT NO: 1112121

DATE:MAY 30, 2025

INDEX OF DRAWINGS

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- PLUMBING NOTES
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- PLUMBING RISERS
- ELECTRICAL LIGHTING PLAN

SCOPE OF WORK

Renovation and ADA upgrades to the Restroom at the historic Bunkhouse at Black Gap Wildlife Management Area. Interior work, replacement of plumbing fixtures and lines, electrical and light fixtures, mechanical heat and ventilation.

History of the Bunkhouse: Drawings for the bunkhouse are dated <u>1951</u> and the building was constructed in 1952, renovation of <u>electrical system in 1982</u>, utility renovation included water & gas lines in 2000, <u>Asbestos abatement included pipe insulation in the attic in 2001</u>, the <u>HVAC was replaced</u> in 2004, and <u>electrical and HVAC</u> upgrades in 2017.

DESIGN TEAM

ARCHITECT

Juana M Salazar, RA, AIA Arch of Record, Tx Arch Lic#19492 TPWD INF Design Project Manager 512-389-4428 Juana.Salazar@tpwd.texas.gov

MEP Engineer

SITE LOCATION MAP

Stephen Herrera, P. E. TPWD INF Design Manager 512-389-4743 Stephen.Herrera@tpwd.texas.gov

BUILDING CODE SUMMARY

OCIATION
NATIONAL ELECTRIC CODE, NFPA-70 2020

uana Salazar 6/19/2025 2:19:14 PM

TEXAS PARKS &

WILDLIFE

TEXAS PARKS AND WILDLIFE

INFRASTRUCTURE DIVISION

4200 SMITH SCHOOL ROAD AUSTIN, TEXAS 78744-3292





RELEASED **FOR**

INFRASTRUCTURE DIVISION

SOLICITATION FOR RELEASED CDs

NORTH SYMBOLS

DIMENSION LINE

PROPERTY LINE

CENTER LINE

LINE ABOVE, BELOW, OR BEYOND THIS DETAIL VIEW. ALSO USED FOR ITEMS TO BE REMOVED WHEN NOTED.

BREAK LINE

ROOM NAME XXX


ROOM IDENTIFICATION NAME/SCHEDULE NUMBER



DOOR NUMBER



ELEVATION VIEW KEY

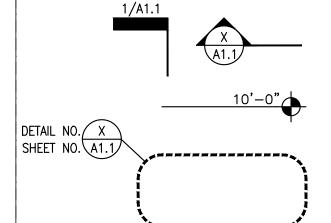

DETAIL

DETAIL AND WALL SECTION KEY REFERENCES

SPOT SITE ELEVATION

ENLARGED DETAIL CALL-OUTS

DRAWING AND DETAIL TITLE DESIGNATION

REVISION REFERENCE, CLOUD AREA IS REVISED

INSUL.

MAX.

M.E.P.

MIN.

MIO.

N.A.

INSULATION

MECHANICAL, ELECTRICAL, PLUMBING

MAXIMUM MECHANICAL

MINIMUM

NOT APPLICABLE

METAL

ABBREVIATIONS

A.C.I.	AMERICAN CONCRETE INSTITUTE
A.F.F.	ABOVE FINISH FLOOR
ALUM.	ALUMINUM
A.K.A.	ALSO KNOWN AS
APA	THE ENGINEERED WOOD ASSOCIATION
ASTM	ASTM INTERNATIONAL
BD.	BOARD
B.F.F.	BELOW FINISH FLOOR
BLK'G.	BLOCKING
BM.	BEAM
BOT.	ВОТТОМ
C.L.	CENTER LINE
CLG.	CEILING
C.M.U.	CONCRETE MASONRY UNIT
COL.	COLUMN
CONC.	CONCRETE
CONT.	CONTINUOUS
C.Y.	CUBIC YARD
DBL.	DOUBLE
DIA.	DIAMETER
DIM.	DIMENSION
DTL.	DETAIL
EA.	EACH
E.J.	EXPANSION JOINT
ELECT.	ELECTRICAL
ELV.	ELEVATION
EQ.	EQUAL
EXIST.	EXISTING
F.F.	FINISH FLOOR
FIN.	FINISH
FT.	FOOT OR FEET
GA.	GAUGE
GALV.	GALVANIZED
GFI	GROUND FAULT INTERRUPTER
H.M.	HOLLOW METAL
HT.	HEIGHT
HVAC	HEATING, VENTILATION AND AIR COND

	N.I.C.	NOT IN CONTRACT
	0.C.	ON CENTER
		OWNERS DESIGNATED REPRESENTATIVE
	0.F.	OUTSIDE FACE .
		OVERHEAD
		OPPOSITE
		ORIENTED STRAND BOARD
	OSHA	OCCUPATIONAL SAFETY AND HEALTH
		ADMINISTRATION
		PLUMBING
	PLYWD.	
		PRESSURE TREATED
		POLYVINYL CHLORIDE
		REFLECTED CEILING PLAN
		REINFORCEMENT BAR
		REFERENCE
		REINFORCEMENT
	REQ'D.	REQUIRED
	R.O.	ROUGH OPENING
	S.D.S.	SAFETY DATA SHEET
	SIM.	SIMILAR
	SPEC.	SPECIFICATIONS
	SQ.	SQUARE
	S.S.	STAINLESS STEEL
	STL.	STEEL
	TEMP.	TEMPORARY
	T&G	TONGUE & GROOVE
	T.O.C.	TOP OF CONCRETE
		TOP OF WALL
	TPWD	TEXAS PARKS & WILDLIFE DEPT.
	TYP.	TYPICAL
	UL	UNDERWRITERS LABORATORY
	U.O.N.	UNLESS OTHERWISE NOTED
	V.I.F.	VERIFY IN FIELD
		VERTICAL
	WL	WILDLIFE DIVISION OF TPWD
1	W/	WITH
		75520

TEXAS PARKS 8 WILDLIFE

BLACK GAP WMA BUNKHOUSE RESTROOM REPAIRS

DESIGNED BY: JS DRAWN BY: JS REVIEWED BY: JS

SOLICITATION

FOR

RELEASED

CDs

100%

REVISED:

G2

GENERAL NOTES

A. GENERAL NOTES:

- 1. THE CONTRACT DOCUMENTS INCLUDE THE COMPLETE PLAN SET AND ALL SUBSEQUENT OFFICIALLY ISSUED MODIFICATIONS. IT IS THE GENERAL CONTRACTOR'S RESPONSIBILITY TO COORDINATE THE WORK OF ALL TRADES AND ISSUE COMPLETE DOCUMENTS NECESSARY FOR EXECUTION OF THE PROJECT.
- 2. DO NOT SCALE THE DRAWINGS. SHOULD DIMENSIONS BE MISSING OR CONFLICTING, NOTIFY THE ARCHITECT PRIOR TO PROCEEDING WITH RELATED WORK.
- 3. THE GENERAL CONTRACTOR SHALL COORDINATE THE INSTALLATION OF ALL CONTRACTED OR OWNER-PROVIDED ITEMS.
- 4. THE GENERAL CONTRACTOR SHALL MAINTAIN A 'NEAT', CLEAN AND SAFE SITE. THE PROJECT SHALL MINIMIZE THE CREATION OF CONSTRUCTION WASTE ON THE JOB SITE. THE INEVITABLE WASTE AND DEBRIS GENERATED SHALL BE DISPOSED OF LEGALLY.
- 5. SECURITY AND SAFETY ARE THE CONTRACTOR'S RESPONSIBILITY. THE SITE SHALL BE SECURED DURING CONSTRUCTION.
- 6. PROVIDE AND COORDINATE BLOCKOUTS, SLEEVES, INSERTS, BOLTS, REINFORCEMENT BARS, PLATES, ETC. PRIOR TO PLACING CONCRETE, MASONRY OR WALL FINISHES.
- 7. VERIFY LOCATIONS OF UTILITIES PRIOR TO EXCAVATION, TRENCHING, ETC. CONTRACTOR SHALL REPAIR OR REPLACE ALL UTILITIES DAMAGED AS A RESULT OF CONSTRUCTION OPERATIONS
- 8. NO ASBESTOS CONTAINING MATERIALS, IN ANY FORM, SHALL BE USED OR INCORPORATED INTO THE PROJECT
- 9. SEPARATE DISSIMILAR METALS FROM CONTACT WITH EACH OTHER.

B. GENERAL DEMOLITION NOTES:

- 1. THE CONTRACTOR SHALL PROVIDE ALL LABOR, EQUIPMENT, TOOLS, MATERIALS, AND INCIDENTALS NECESSARY TO PERFORM ALL OPERATIONS INVOLVED IN THE REMOVAL, TRANSPORT, STORAGE OR DISPOSAL OF VARIOUS REMOVED BUILDING MATERIALS AND DEBRIS AND COMPLY WITH ALL APPLICABLE LAWS REGULATING DISPOSAL.
- 2. THE CONTRACTOR SHALL BE RESPONSIBLE FOR THE OWNER'S PROPERTY THAT MAY BE DAMAGED BY DEMOLITION AND SHALL PROVIDE AND MAINTAIN ALL METHODS OF NECESSARY PROTECTION. RESTORE ANY DAMAGED WORK TO ORIGINAL CONDITION.
- 3. THE CONTRACTOR SHALL TAKE SPECIAL PRECAUTIONS ABOVE AND BELOW GRADE DURING DEMOLITION SO AS NOT TO DAMAGE ANY MECHANICAL OR ELECTRICAL ITEMS REQUIRED TO REMAIN IN SERVICE, RELOCATED OR BE INCORPORATED INTO THE WORK.
- 4. THE CONTRACTOR SHALL TAKE SPECIAL PRECAUTION IN ALL DEMOLITION WORK AND PROVIDE ALL NECESSARY BARRICADES, BARRIER WALLS, SHORING, SCAFFOLDING, WARNING SIGNAGE, ETC.
- 5. THE CONTRACTOR SHALL CONSTRUCT TEMPORARY WEATHER TIGHT CLOSURES TO SEAL OFF ANY WALL OPENINGS IN THE EXISTING BUILDINGS UPON REMOVAL OF EXISTING DOOR, TRANSOM, ETC.
- 6. THE CONTRACTOR SHALL TAKE CARE TO AVOID DAMAGE TO ANY PART OF THE BUILDING STRUCTURE. NOTIFY THE OWNER AND ARCHITECT IMMEDIATELY OF ANY STRUCTURAL CONCERNS.

- 7. CONTRACTOR SHALL PROVIDE AND MAINTAIN FOR ALL PROTECTION PROVISIONS PER OSHA REQUIREMENTS.
- 8. THE CONTRACTOR SHALL COORDINATE ALL WORK WITH THE OWNER SO AS TO MINIMIZE INTERRUPTION OF WILDLIFE MANAGEMENT AREA PARK OPERATIONS OR ACTIVITIES.
- 9. THE CONTRACTOR SHALL PROVIDE TEMPORARY POWER AND LIGHTS IN ALL WORK AREAS UNLESS NOTED OTHERWISE. SEE SPECIFICATION G.——CONSTRUCTION SITE.
- 10. THE CONTRACTOR SHALL PROTECT LAWNS AND LANDSCAPES. COORDINATE ALL TREES AND LANDSCAPE PROTECTION WITH THE CONSTRUCTION PROJECT MANAGER AND PARK SUPERINTENDENT.

B. ALTERNATES:

NO ALTERNATES ARE REQUESTED OR ACCEPTED WITH THE BASE BID. ANY NECESSARY CHANGES DISCOVERED DURING THE PROJECT WILL BE HANDLED THROUGH CHANGE ORDERS.

C. EXISTING CONDITIONS:

- 1. CONTRACTOR SHALL FIELD VERIFY ALL EXISTING DIMENSIONS, ELEVATIONS AND CONDITIONS. DIMENSIONS SHOWN ON THE DRAWINGS ARE APPROXIMATE. DO NOT SCALE THE DRAWINGS.
- 2. FIELD MEASUREMENTS WILL BE REQUIRED TO COMPLETE THE WORK. THE CONTRACTOR SHALL OBTAIN ALL FIELD MEASUREMENTS AS NECESSARY TO FABRICATE ITEMS OF WORK AND IN ORDER TO COORDINATED WITH AND MATCH NEW CONSTRUCTION TO EXISTING CONDITIONS.
- 3. EXISTING CONDITONS SHOWN ON THESE DRAWINGS WERE TAKEN FROM ARCHIVED AND/OR RECORD DRAWINGS, AND FROM SITE SURVEYS. SOME INFORMATION ON THE DRAWING REGARDING EXISTING FEATURES IS AN EDUCATED GUESS DUE TO UNKNOWN (CONCEALED) CONDITIONS AT THE TIME OF PREPARATION. IF CONDITIONS EXIST THAT DIFFER FROM THE DRAWING OR ARE NOT ADEQUATELY DETAILED. INFORM THE ARCHITECT FOR DIRECTION. EXTRA SKETCHES, DRAWINGS, DETAILS, CLARIFICATIONS. AND INTERPRETATIONS WILL BE PROVIDED BY THE ARCHITECT. DO NOT PROCEED WITHOUT WRITTEN CLARIFICATION.
- 4. DRAWINGS IN THIS SET ARE NOT TO BE CONSIDERED MEASURED DRAWINGS OF AS—CONSTRUCTED CONDITIONS.



BLACK GAP WMA
BUNKHOUSE RESTROOM REPAIRS

DATE: MAY 30, 2025 DESIGNED BY: JS DRAWN BY: JS REVIEWED BY: JS REVISED:

> SHEET TITLE GENERAL

SHEET NUMBER

A0.0

A. ALL WORK:

ALL WORK REQUIRED HEREIN SHALL INCLUDE ANY AND ALL APPURTENANT WORK AND ITEMS NECESSARY FOR FULLY FUNCTIONAL AND OPERATIONAL SYSTEMS, COMPLETE AND IN PLACE, IN ACCORDANCE WITH THE BIDDING AND CONTRACT DOCUMENTS.

B. MATERIAL:

- 1. UNLESS OTHERWISE NOTED, MATERIALS SHALL BE NEW; PROVIDED AND INSTALLED IN ACCORDANCE WITH THE MANUFACTURER'S SPECIFICATIONS AND WARRANTY REQUIREMENTS.
- 2. <u>WOOD</u>
- 2.1. INTERIOR PARTITION WALL ROUGH CARPENTRY: 2X4.
- 2.2. CEILING ROUGH CARPENTRY: FRAMING TO MATCH EXISTING CEILING CONSTRUCTION VERIFY IN FIELD. ASSUME 10% REPLACEMENT OF 2X4 CEILING JOISTS FOR BIDDING.
- 3. <u>DOOR</u>
- 3.1. SOLID CORE WOOD DOOR. SEE DRAWING FOR HARDWARE NOTES.
- 3.2. WOOD FRAME TO MATCH EXISTING FRAME. ANCHOR FRAME TO CMU WALL AS NECESSARY.
- 4. <u>DOOR HARDWARE:</u> COORDINATE ANY KEYING WITH OWNER.
- 5. <u>PAINT</u>: ALL PRIMERS AND PAINTS BY SAME MANUFACTURER. USE PRIMERS AND PAINT COMBINATIONS RECOMMENDED OR REQUIRED BY MANUFACTURER FOR THE SURFACE TO BE PAINTED. REFER TO FINISH SCHEDULE ON A0.2.
- 6. <u>TOILET ACCESSORIES</u>. REFER TO ACCESSORY SCHEDULE ON A2.1.
- 7. EXHAUST FAN: REF. EXHAUST FAN ON MECHANICAL DRAWINGS.

C.SUBMITTALS:

- 1. SEE SUBMITTALS TABLE ON A0.2 FOR REQUIREMENTS PRIOR TO WORK & AT CLOSE-OUT.
- 2. UPDATED SUBMITTAL LOG IS REQUIRED FOR INVOICING.
- 3. SUBMITTALS REQUIRE APPROVAL BEFORE PURCHASING OR INSTALLATION.

D.INSTALLATION:

1. ALL WORK WILL BE PERFORMED IN ACCORDANCE WITH THE MANUFACTURER'S INSTALLATIONS, INSTRUCTIONS AND GOOD INDUSTRY PRACTICES, STANDARDS, AND WORKMANSHIP.

2. WOOD

- 2.1. INSTALL INTERIOR FINISH CARPENTRY LEVEL, PLUMB, TRUE AND ALIGNED WITH ADJACENT MATERIALS.
- 2.1.1. USE CONCEALED SHIMS WHERE NECESSARY FOR ALIGNMENT.
- 2.1.2. SCRIBE AND CUT INTERIOR FINISH CARPENTRY TO FIT ADJOINING WORK. REFINISH AND SEAL CUTS AS RECOMMENDED BY MANUFACTURER.
- 2.2 FASTEN BY BLIND NAILING, CONCEALED FASTENERS, TYPICAL, WHERE FACE FASTENING IS UNAVOIDABLE, COUNTERSINK FASTENERS, FILL SURFACE FLUSH AND SAND UNLESS OTHERWISE INDICATED.
- 2.3 INSTALL IN FULL LENGTHS WITHOUT END JOINTS.
- 2.4 ADJUST JOINERY FOR UNIFORM APPEARANCE.
- 2.5 CLEAN INTERIOR FINISH CARPENTRY.
- 2.6 RESTORE DAMAGED OR SOILED AREAS.
- 2.7 PROTECT INSTALLED PRODUCTS FROM DAMAGE FROM WEATHER AND OTHER CAUSES DURING CONSTRUCTION.
- 2.8 REMOVE AND REPLACE FINISH CARPENTRY MATERIALS THAT ARE WET, MOISTURE—DAMAGED, AND MOLD DAMAGED.
- 3. DOORS
- 3.1. USE TEMPLATE PROVIDED BY HARDWARE MANUFACTURER FOR MORTISED AND SURFACE—MOUNTED DOOR HARDWARE.
- 3.2. INSTALL WOOD DOOR AND FRAME PLUMB, RIGID, PROPERLY ALIGNED, AND FASTEN SECURELY IN PLACE. COMPLY WITH APPROVED SHOP DRAWINGS.

- 4. DOOR HARDWARE
- 4.1. DO NOT INSTALL SURFACE-MOUNTED ITEMS UNTIL FINISHES HAVE BEEN COMPLETED ON SUBSTRATES INVOLVED.
- 4.2. SET THRESHOLD IN FULL BED OF SEALANT.
- 4.3. APPLY PERIMETER GASKETING TO HEAD AND JAMB, FORMING SEAL BETWEEN DOOR AND FRAME.
- 4.4. INITIAL ADJUSTMENT: ADJUST AND CHECK EACH OPERATING ITEM OF DOOR HARDWARE TO ENSURE PROPER OPERATION OR FUNCTION OF EACH UNIT. REPLACE UNITS THAT CANNOT BE ADJUSTED TO OPERATE AS INTENDED.
- 4.5. DOOR CLOSER: ADJUST SWEEP PERIOD TO COMPLY WITH ACCESSIBILITY REQUIREMENTS AND REQUIREMENTS OF AUTHORITIES HAVING JURISDICTION.
- 4.6. CLEAN ADJACENT SURFACES SOILED BY DOOR HARDWARE INSTALLATION.
- 4.7. CLEAN OPERATING ITEMS AS NECESSARY TO RESTORE PROPER FUNCTION AND FINISH.
- 4.8. PROVIDE FINAL PROTECTION AND MAINTAIN CONDITIONS THAT ENSURE DOOR HARDWARE IS WITHOUT DAMAGE OR DETERIORATION AT TIME OF SUBSTANTIAL COMPLETION.
- 5. PAINT
- 5.1. EXAMINE SUBSTRATES AND CONDITIONS, WITH APPLICATOR PRESENT, FOR COMPLIANCE WITH REQUIREMENTS FOR MAXIMUM MOISTURE CONTENT AND OTHER CONDITIONS AFFECTING PERFORMANCE OF THE WORK. MAXIMUM MOISTURE CONTENT OF SUBSTRATES: WHEN MEASURED WITH ELECTRONIC MOISTURE METER AS FOLLOWS: WOOD: 15 PERCENT
- 5.2. VERIFY SUITABILITY OF SUBSTRATES, INCLUDING SURFACE CONDITIONS AND COMPATIBILITY, WITH FINISHES AND PRIMERS.
- 5.3. PROCEED WITH COATING APPLICATION ONLY AFTER UNSATISFACTORY CONDITIONS HAVE BEEN CORRECTED.
- 5.4. REMOVE HARDWARE, COVERS, PLATES AND SIMILAR ITEMS ALREADY IN PLACE THAT ARE REMOVABLE AND NOT TO BE PAINTED. IF REMOVAL IS IMPRACTICAL OR IMPOSSIBLE BECAUSE OF SIZE OR WEIGHT OF ITEM, PROVIDE SURFACE—APPLIED PROTECTION BEFORE SURFACE PREPARATION AND PAINTING. AFTER COMPLETING PAINTING OPERATIONS, USE WORKERS SKILLED IN THE TRADES INVOLVED TO REINSTALL ITEMS THAT WERE REMOVED. REMOVE SURFACE—APPLIED PROTECTION.
- 5.5. CLEAN SUBSTRATES OF SUBSTANCES THAT COULD IMPAIR BOND OF PAINTS, INCLUDING DUST, DIRT, OIL, GREASE AND INCOMPATIBLE PAINTS AND ENCAPSULANTS.
- 5.6. PAINT BOTH SIDES AND EDGES OF EXTERIOR DOOR AND ENTIRE EXPOSED SURFACE OF EXTERIOR DOOR FRAME.
- 5.7. AT END OF EACH WORKDAY, REMOVE RUBBISH, EMPTY CANS, RAGS AND OTHER DISCARDED MATERIALS FROM PROJECT SITE.
- 5.8. DO NOT CLEAN EQUIPMENT WITH FREE-DRAINING WATER AND PREVENT SOLVENTS, THINNERS, CLEANERS AND OTHER CONTAMINANTS FROM ENTERING INTO WATERWAYS, SANITARY AND STORM DRAIN SYSTEMS AND GROUND.
- 5.9. DISPOSE OF CONTAMINANTS IN ACCORDANCE WITH REQUIREMENTS OF AUTHORITIES HAVING JURISDICTION.
- 5.10. ALLOW EMPTY PAINT CANS TO DRY BEFORE DISPOSAL.
- 5.11. AFTER COMPLETING PAINT APPLICATION, CLEAN SPATTERED SURFACES. REMOVE SPATTERED PAINTS BY WASHING, SCRAPING, OR OTHER METHODS. DO NOT SCRATCH OR DAMAGE ADJACENT FINISHED SURFACES.
- 5.12.PROTECT WORK OF OTHER TRADES AGAINST DAMAGE FROM PAINT APPLICATION. CORRECT DAMAGE TO WORK OF OTHER TRADES BY CLEANING, REPAIRING, REPLACING AND REFINISHING, AS APPROVED BY ARCHITECT AND/OR TPWD CONSTRUCTION MANAGER, AND LEAVE IN UNDAMAGED CONDITION.
- 5.13.AT COMPLETION OF CONSTRUCTION ACTIVITIES OF OTHER TRADES, TOUCH UP AND RESTORE DAMAGED OR DEFACED PAINTED SURFACES.
- 6. TOILET ACCESSORIES
- 6.1. REMOVE TEMPORARY LABELS AND PROTECTIVE COATINGS.
- 6.2. ADJUST ACCESSORIES FOR UNENCUMBERED, SMOOTH OPERATION. REPLACE DAMAGED OR DEFECTIVE ITEMS.
- 6.3. CLEAN AND POLISH EXPOSED SURFACES IN ACCORDANCE WITH MANUFACTURER'S WRITTEN INSTRUCTIONS.



BUNKHOUSE RESTROOM REPAIRS

DATE: MAY 30, 2025 DESIGNED BY: JS DRAWN BY: JS REVIEWED BY: JS REVISED:

> SHEET TITLE RESTROOM

> SHEET NUMBER

AO.1

SITE SHALL BE CLEANED DAILY OF CONSTRUCTION TRASH AND LEFT IN A CLEAN ORDERLY MANNER. RUN MAGNET OVER SITE AND REMOVE ALL ERRANT FASTENERS. CONTRACTOR MUST PROVIDE DUMPSTER AND LEGALLY DISPOSE OF WASTE OFF-SITE.

F. STORAGE AND PROTECTION OF MATERIALS:

- 1. THE O.D.R. IN COORDINATION WITH THE PARK SUPERINTENDENT SHALL DESIGNATE AN AREA NEAR THE WORK SITE FOR CONTRACTOR'S USE FOR THE STORAGE OF MATERIALS, SUPPLIES,
- 2. THE CONTRACTOR SHALL BE RESPONSIBLE FOR THE PROPER CARE AND PROTECTION OF ALL MATERIALS, SUPPLIES, AND EQUIPMENT STORED ON THE JOB SITE.
- 3. ALL MATERIAL OR ITEMS DELIVERED TO THE JOB SITE MUST BE ADEQUATELY HOUSED OR OTHERWISE PROTECTED BY THE CONTRACTOR AGAINST DETERIORATION, DAMAGE, OR LOSS, ALL MATERIALS MUST BE STORED ON DUNNAGE AND NOT DIRECTLY ON THE GROUND. THE OWNER WILL NOT BE RESPONSIBLE FOR ANY DAMAGE OR LOSS OF SUCH STORED MATERIALS

4. THE CONTRACTOR SHALL ADEQUATELY PROTECT THE SITE AND BUILDING FROM DAMAGE DURING THE PERFORMANCE OF THE WORK. IF ANY DAMAGE OCCURS. CONTRACTOR SHALL, AT NO COST TO THE OWNER, MAKE REPAIRS TO OWNER'S SATISFACTION.

G.SAFETY:

- THE CONTRACTOR SHALL EXERCISE PROPER PRECAUTIONS WHEN CONDUCTING WORK HEREIN.
- 2. THE CONTRACTOR SHALL FOLLOW ALL SAFETY RULES SET FORTH BY OSHA, STATE OF TEXAS, AND GOOD CONSTRUCTION PRACTICES.
- 3. ALL STANDARD SAFETY PRECAUTIONS SHALL BE TAKEN BY THE CONTRACTOR.
- 4. THE CONTRACTOR IS RESPONSIBLE FOR ENFORCING SAFETY FOR HIS EMPLOYEES AND COMPLYING WITH ANY ADDITIONAL PARK SAFETY REGULATIONS.

H.UNKNOWN CONDITIONS:

IN THE EVENT UNKNOWN CONDITIONS ARE ENCOUNTERED WHICH DIFFER MATERIALLY FROM THE CONDITIONS SHOWN AND SPECIFIED HEREIN, TO INCLUDE BUT NOT LIMITED TO DETERIORATED MATERIALS, THE CONTRACTOR SHALL NOT PROCEED WITH ADDITIONAL WORK WITHOUT PROPER PRIOR WRITTEN AUTHORIZATION BY O.D.R.. ANY ADDITIONAL WORK AS DESCRIBED HERE SHALL BE AUTHORIZED BY CHANGE ORDER ONLY.

I. MATERIALS AND FINISHES:

DIV 8: DOOR 36" X 80", SIMILAR TO THE 6 LITE, CRAFTSMAN, 2 PANEL, SMOOTH FINISH DOOR HARDWARE BY SCHLAGE, CLASSROOM LOCK, CATALOG NO. ND70TD (BROADWAY OR SELECTED BY OWNER), SATIN NICKEL 619 FINISH, NEW LEVER INSTALLED AT 34" TO 48" ABOVE FINISH FLOOR. KEYEL AS DIRECTED BY OWNER. THRESHOLD: ZERO 655D-E-V3-226. SURFACE CLOSER: 1461 HD/HDPA FC TBSRT IN SATIN NICKEL FINISH. DOOR AND ALL HARDWARE ADA COMPLIANT.

WETWALL PANELS SHOWER WALLS, WILSONART IN 'LEGACY ASH', INSTALL VERTICAL GRAIN. SEAL JOINTS. TILE AT SHOWER FLOOR: PORCELAIN TILE BY DALTILE. "BRYNE". "MIST" BR31, 12"X24", MATTE FINISH.

DIV 10: PHENOLIC (PLASTIC) TOILET PARTITIONS BY BRADLEY IN 'SHADOW', OR SOLID COLOR REINFORCED COMPOSITE (SCRC) BOBRICK TOILET PARTITIONS IN SCO4 'FOREST GREEN'.

DIV 12: SOLID SURFACE COUNTERTOP, BACKSPLASH, AND TRIM, BY WILSONART, TEMPO SERIES, 3/4" THICK, 'NATURAL CANVAS' OR 'ARCTIC DRIFT'.

COUNTERTOP SINK, BY AMERICAN STANDARD, "RONDALYN" VITREOUS CHINA, IN "WHITE", SELF RIMMING, WITH CUTOUT TEMPLATE FOR INSTALLATION. ADA COMPLIANT.

TOILET, BY AMERICAN STANDARD, "COLONY" CHAIR HEIGHT ELONGATED 12" ROUGH TOILET VITREOUS CHINA, IN "WHITE", ADA COMPLIANT.

URINAL, BY AMERICAN STANDARD, "ALLBROOK" FLOWISE UNIVERSAL URINAL VITREOUS CHINA, IN "WHITE", INCLUDE FLUSH VALVE. PROVIDE NECESSARY REINFORCEMENT FOR WALL SUPPORTS. FAUCETS AT SINKS/LAVS, BY AMERICAN STANDARD, "CHANCELLOR", DUAL CONTROL CENTER-SET BATH FAUCET. WITH LEVER HANDLES, IN POLISHED CHROME FINISH.

SHOWER SYSTEM, BY SPEAKMAN, SLV-1080-ADA, NEO TRIM AND HANDICAP SHOWER SYSTEM, WITH SHOWER ARM AND FLANGE, HAND SHOWER WITH 60" HOSE, PAUSE/TRICLE ADAPTOR, 24" ADA SLIDE BAR. INCLUDE PLUMBING VALVE. IN POLISHED CHROME FINISH.

OR, SHOWER SYSTEM, BY AMERICAN STANDARD, "SPECTRA" FILTER SHOWER RAIL, WITH 4 FUNCTION HAND SHOWER, SLIDE BAR WITH GLIDE HOLDER, 60" HOSE, KDF FILTER

HEATER EXHAUST FAN, BY BROAN, POWERHEAT SERIES BHFLED80, RECESS CEILING MOUNTED, 12A, 120V, 80CFM, LED LAMP, INFRARED/RADIANT, 4"DIA DUCT SIZE, BRIGHT WHITE, 14 1"L X 8 1" W X 5 3"H. SEE MECHANICAL DRAWINGS.

VANITY WALL SCONCE LIGHT FIXTURE, BY WESTINGHOUSE, SYLVESTRE SERIES 6227900, 120V, 3-LAMP, INCANDESCENT/LED, METAL FIXTURE, IN BRUSHED NICKEL FINISH. SEE ELECTRICAL DRAWINGS.

	LIST OF WALL/FLOOR/CEILING FINISHES							
TAG	DESCRIPTION	MANUFACTURER	SERIES / PATTERN	COLOR	SIZE	FINISH	COMMENTS	
PT-1	PAINT, AT WALLS	BENJAMIN MOORE		OC-42 OLD PRAIRIE		SEMI- GLOSS		
PT-2	PAINT AT CEILING		HISTORIC COLOR COLLECTION	HC-84 ELEMIRA WHITE	N/A	SEMI- GLOSS		
PT-3	,	LICODE	(USE SAME PAINT MANUFACTURER)	MATCH EXISTING	N/A		EXTERIOR TRIM TO MATCH EXIST	
SC-1	SEALED CONC.	N/A	,	N/A	N/A	POLISHED		
TL-1	PORCELAIN TILE	DALTILE	BRYNE	MIST	12"x24"		SHOWER FLOOR	
CT-1	COUNTERTOP	WILSONART	SOLIDSURFACE	ARCTIC DRIFT	24"X		SINK COUNTER	
SW-1	SHOWER WALLS	WILSONART	WET WALL PANELS	LEGACY ASH	48"X		SEAL JOINTS	

REQUIRED	SUB	MITTA	LS P	RIOR		NSTAL	LATIO	N	
MATERIAL DR PRDDUCT, SEE MEP DRAWINGS FOR OTHER REQ'D SUBMITTALS	MANUFACTURER'S PRDDUCT DATA	INSTALLATION INSTRUCTIONS	SAFETY DATA SHEETS	LEGIBLE PHOTO OF MATERIAL	LEGIBLE PHOTO OF PRODUCT LABEL	SAMPLE TO ARCHITECT	SAMPLE TO CONSTR. MNG'R.	OTHER / NOTES	
DOOR / FRAME	YES	YES			YES			SHOP DRAWING	
DOOR HARDWARE	YES	YES							
PAINT	YES		YES			YES		PROVIDE SAMPLES	
FLOOR SEALER FINISH	YES		YES			YES		PROVIDE SAMPLES	
PARTITIONS	YES	YES				YES		PROVIDE SAMPLES	_
COUNTERTOP	YES					YES		PROVIDE SAMPLES	8.0
TOILET ACCESSORIES	YES	YES							REGION OF THE COLUMN TWO IS NOT THE COLUMN TWIND TWO IS NOT THE COLUMN TWO IS NOT THE COLUMN TWO IS NOT THE CO
EXHAUST FAN / LIGHT	YES	YES							78.0
LIGHT FIXTURES	YES								05-30-20



RESTROOM REPAIRS GAP WMA BUNKHOUSE

DESIGNED BY: JS DRAWN BY: JS REVIEWED BY: JS REVISED:

SHEET TITLE

A0.2

SOLICITATION



BUNKHOUSE RESTROOM REPAIRS
PROJECT NUMBER: 1112121

DATE: MAY 30, 2025 DESIGNED BY: JS DRAWN BY: JS REVIEWED BY: JS REVISED:

SOLICITATION

RELEASED FOR

CDs

100%

REVISED:







VIEW FROM DOORWAY SCALE: NOT TO SCALE




EXISTING TOILET 2


SCALE: NOT TO SCALE



EXISTING SINKS/LAVS SCALE: NOT TO SCALE

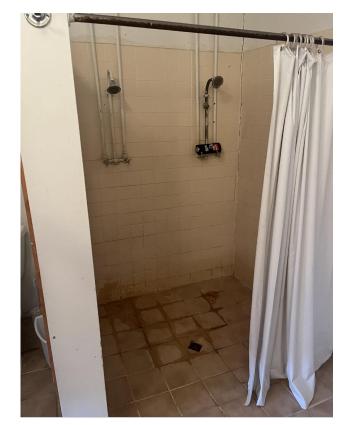

EXISTING SHOWERS SCALE: NOT TO SCALE

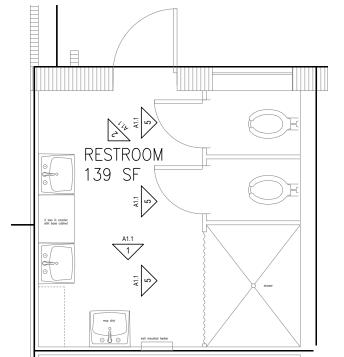

KEYNOTE PLAN NOT TO SCALE



DATE: MAY 30, 2025 DESIGNED BY: JS DRAWN BY: JS REVIEWED BY: JS REVISED:

EXISTING RESTROOM PHOTOS


BUNKHOUSE RESTROOM REPAIRS
PROJECT NUMBER: 1112121

TEXAS PARKS 8 WILDLIFE

> SOLICITATION RELEASED FOR

> CDs

- 2. DISCONNECT EXISTING WATER, SEWER, AND ELECTRICAL FROM RESTROOM.
- 3. ADD COVER TO HVAC SUPPLY AND RETURN GRILLES.
- 4. REMOVE EXISTING PLUMBING LINES IN EXISTING CONCRETE FLOOR. KEEP DEBRIS AND DUST TO MINIMUM.
- 5. NOTIFY OWNER AND ARCHITECT IF UNCOVERED CONDITIONS VARY FROM PLANS.
- 6. FIELD VERIFY ALL DIMENSIONS.
- 7. REMOVE EXISTING PLASTER ON CMU WALLS AS NECESSARY TO MEET REQUIRED ADA/TAS DIMENSIONS.
- 8. PROVIDE PATCHING OF CRACKS IN EXISTING PLASTER AS NECESSARY. PREP TO PAINT.

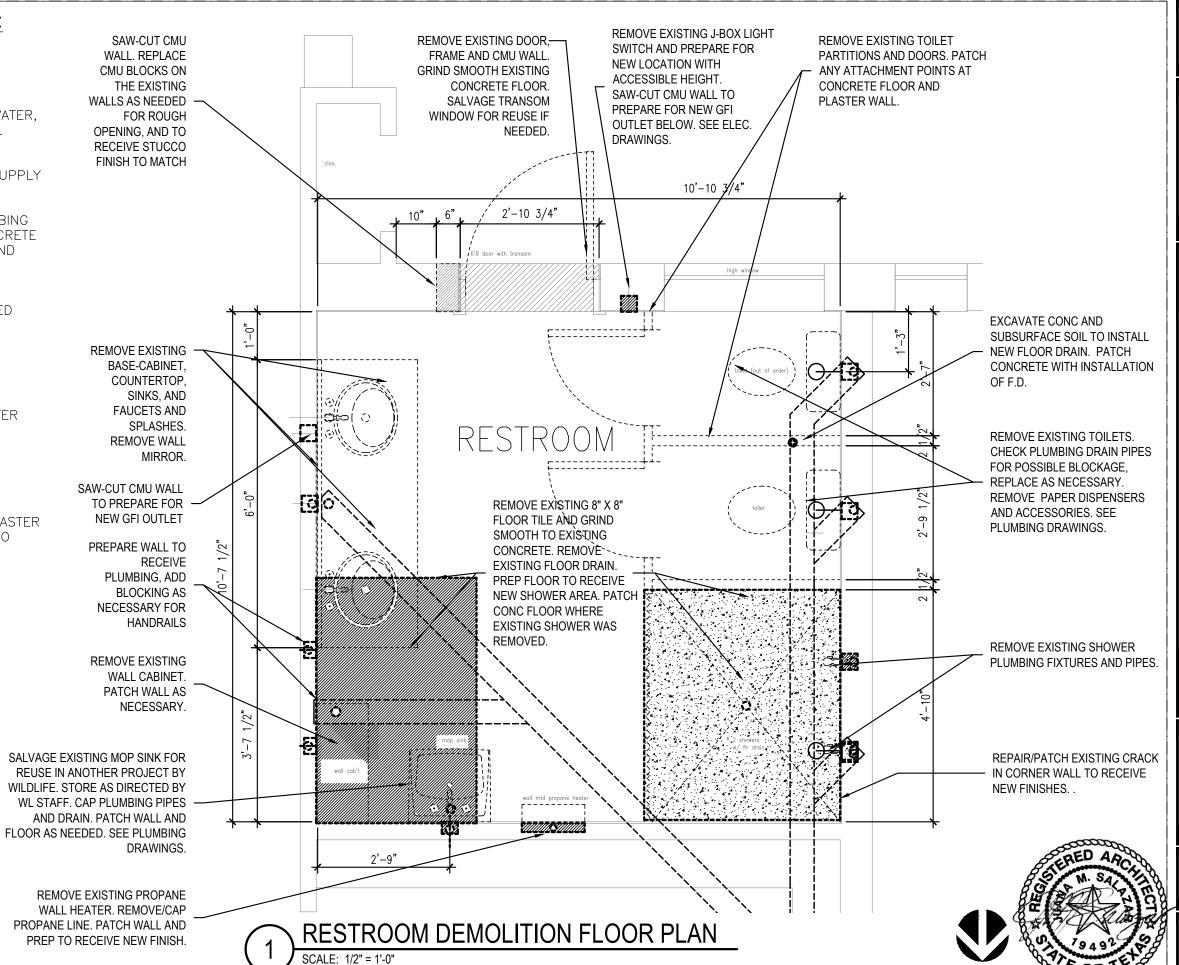



BLACK GAP WMA
BUNKHOUSE RESTROOM REPAIRS

DATE: MAY 30, 2025 DESIGNED BY: JS DRAWN BY: JS REVIEWED BY: JS REVISED: SOLICITATION

FOR

RELEASED

CDs

00%

REVISED: REVISED:

SHEET TITLE
RESTROOM
DEMOLITION

PLAN

AD1

_1'-0" VERIFY

3'-6" ROUGH OPENING FOR NEW DOOR

2'-8" EXISTING DOOR WIDTH, TO BE MODIFIED

DEMO AT DOOR / TRANSOM NOTES:

- 1. REMOVE WOOD DOOR, WOOD FRAME, THRESHOLD, AND WINDOW TRANSOM AND WOOD FRAME ABOVE. SALVAGE AND KEEP FOR REFERENCE FOR EXISTING SHAPES AND DIMENSIONS.
- 2. REMOVE AND/OR REPAIR AS NECESSARY THE CMU WALL AT JAMB TO MAKE ROUGH OPENING FOR NEW ADA DOORWAY.
- 3. REMOVE AND/OR REPAIR AS NECESSARY THE CMU WALL AT THE TRANSOM'S HEADER.
- 4. PROVIDE SHORING SUPPORT AS NECESSARY.
- 5. SEE A5.0 FOR NEW CONSTRUCTION.

DEMOLITION NOTES:

** 1/2"

- 1. DEMOLISH EXISTING RESTROOM, INCLUDING SHOWER
- 2. DISCONNECT EXISTING WATER, SEWER, AND ELECTRICAL FROM RESTROOM.
- 3. ADD COVER TO HVAC SUPPLY AND RETURN GRILLES.
- 4. REMOVE EXISTING PLUMBING LINES IN EXISTING CONCRETE FLOOR. KEEP DEBRIS AND DUST TO MINIMUM.
- 5. NOTIFY OWNER AND ARCHITECT IF UNCOVERED CONDITIONS VARY FROM PLANS.
- 6. FIELD VERIFY ALL DIMENSIONS.
- 7. REMOVE EXISTING PLASTER ON CMU WALLS AS NECESSARY TO MEET REQUIRED DIMENSIONS.
- 8. PROVIDE PATCHING OF CRACKS IN EXISTING PLASTER AS NECESSARY. PREP TO PAINT.




SOLICITATION

- 2. THE EXISTING FLOOR GRADE ELEVATION OF THE PORCH SHALL BE NOT MORE THAN $\frac{1}{2}$ " LOWER THAN THE NEW FLOOR GRADE ELEVATION OF THE RESTROOM. THE THRESHOLD AT THE DOOR SHALL NOT BE MORE THAN 17" MAXIMUM TOTAL HEIGHT AT NO MORE THAN $\frac{1}{4}$ " INCREMENTS, TO COMPLY WITH ACCESSIBILITY REQUIREMENTS.
- 3. REFER TO ELECTRICAL AND PLUMBING DRAWINGS FOR ITEMS REQUIRED BUT NOT SHOWN ON ARCHITECTURAL DRAWINGS.
- 4. DO NOT CUT ANY STRUCTURAL ELEMENTS IN A MANNER THAT WILL DIMINISH THEIR LOAD BEARING/CARRYING CAPACITY. NOTIFY ARCHITECT (AND ARCHITECT'S STRUCTURAL ENGINEER) AND DO NOT PROCEED WITH ANY STRUCTURAL CUT WITHOUT WRITTEN APPROVAL.

B. PLAN NOTES:

- 1. REPAIR AND RENOVATE NEW RESTROOM.
- 2. RECONNECT EXISTING WATER, SEWER, AND ELECTRICAL TO NEW RESTROOM.

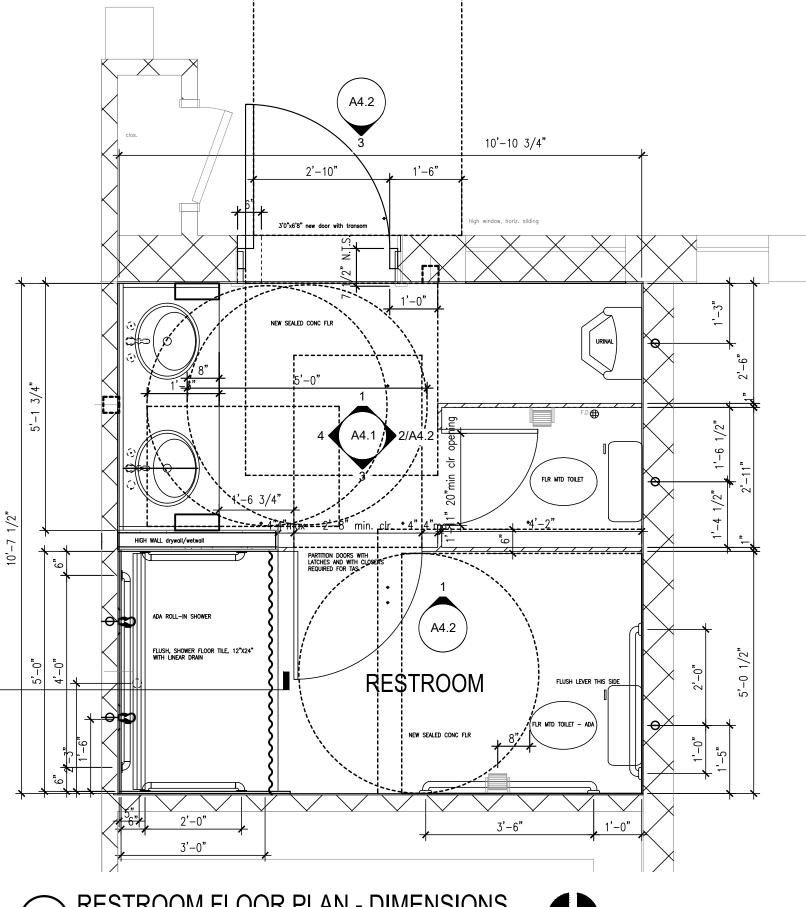



BUNKHOUSE RESTROOM REPAIRS BLACK GAP WMA

DESIGNED BY: JS DRAWN BY: JS REVIEWED BY: JS SOLICITATION

FOR

REVISED:

RESTROOM FLOOR PLAN - DIMENSIONS


2. SEE THE ACCESSORY SCHEDULE AND MOUNTING HEIGHTS BELOW.

ACCESSORY SCHEDULE

- NEW 42" L. GRAB BAR, MOUNT AT 33-36" AFF TO TOP OF GRAB BAR, BOBRICK B-5806 OR B-9806, OR BOSTON HARBOR, IN STL STL.
- T=2 NEW 36" L. GRAB BAR, MOUNT AT 33-36" AFF TO TOP OF GRAB BAR, BOBRICK B-5806 OR B-9806, OR BOSTON HARBOR, IN STL STL.
- NEW 24" L. GRAB BAR, MOUNT AT 33-36" AFF TO TOP OF GRAB BAR, BOBRICK B-5806 OR B-9806, OR BOSTON HARBOR, IN STL STL.
- T-3g NEW 48" L. GRAB BAR, MOUNT AT 33-36" AFF TO TOP OF GRAB BAR, BOBRICK B-5806 OR B-9806, OR BOSTON HARBOR, IN STL STL.
- T=4 NEW MULTI-ROLL TOILET TISSUE DISPENSER, PARTITION MOUNTED, MOUNT AT 19-24" AFF TO CENTERLINE, BOBRICK B-7686
- NEW SURFACE MOUNTED SOAP DISPENSER MOUNTED AT 48" AFF MAX TO OPERATOR, BOBRICK B-2111
- NEW SURFACE-MTD PAPER TOWEL DISPENSER, SATIN FINISH, BOBRICK B-262 OR EQUAL. DISPENSER MOUNT AT 48" AFF.
- T=7 NEW 24" x 36" MIRROR WITH CHANNEL FRAME & SHELF MOUNTED AT 40" AFF MAX TO BOTTOM OF REFLECTIVE SURFACE, BOBRICK B-165 OR RENIN 201240 SOMERSET FRAMELESS MIRROR, CLEAR FRAME.
- T-8 SURFACE MOUNTED SANITARY DISPOSAL. BOBRICK B-270
- T-9 SHOWER CURTAIN AND ROD AS SPEC. MOUNT CURTAIN ROD 6'-6" AFF TO CENTER OF ROD
- [-10] ROBE HOOKS MOUNTED AT 54" AFF & 48" AFF @ ADA STALL
- [-11] SOAP DISH AT SHOWER MOUNTED AT 48" MAX TO CENTER LINE
- T-12 BATH TOWEL HOLDER, MOUNT AT 33-48" AFF TO CENTERLINE

NOTES

- 1. MOUNT MIRRORS ON CENTER WITH LAVATORIES
- 2. ALL ITEMS FURNISHED AND INSTALLED BY CONTRACTOR
- MOUNT ACCESSORIES ACCORDING TO TEXAS ACCESSIBILITY STANDARDS (T.A.S.)

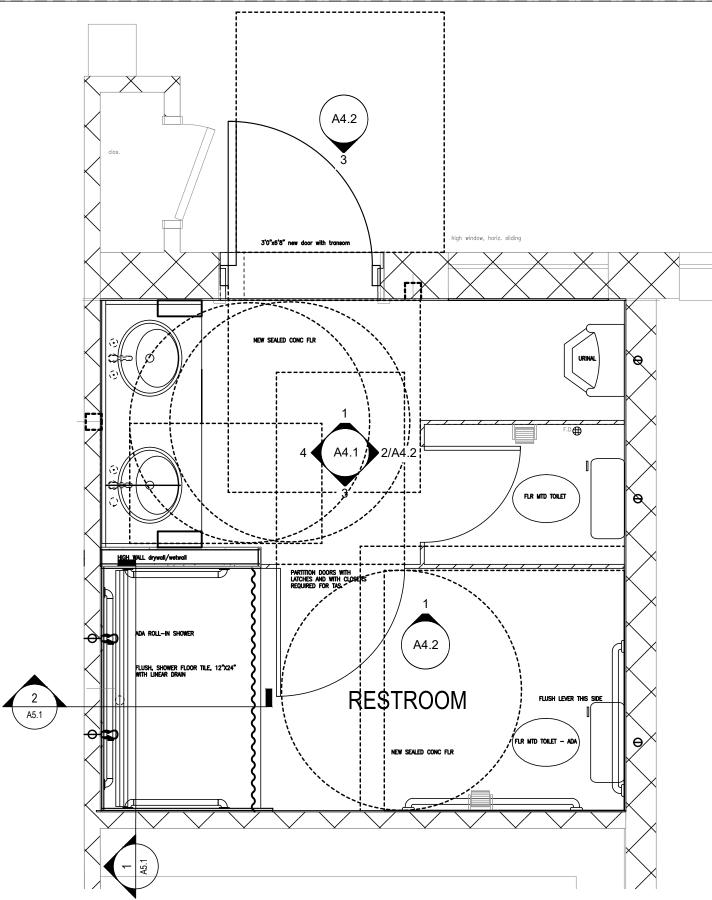

RESTROOM FLOOR PLAN - ACCESSORIES

SCALE: 1/2" = 1'-0"





TEXAS
PARKS &
WILDLIFE

BLACK GAP WMA BUNKHOUSE RESTROOM REPAIRS

> DATE: MAY 30, 2025 DESIGNED BY: JS DRAWN BY: JS REVIEWED BY: JS REVISED:

REVISED: REVISED:

> SHEET TITLE RESTROOM FLOOR PLAN

SHEET NUMBER


A2.1

2. SEE SHEET A0.2 FOR SCHEDULE LIST OF WALL/FLOOR/CEILING FINISHES.

LEGEND:

FLOOR TILE

POLISHED CONCRETE FLOOR

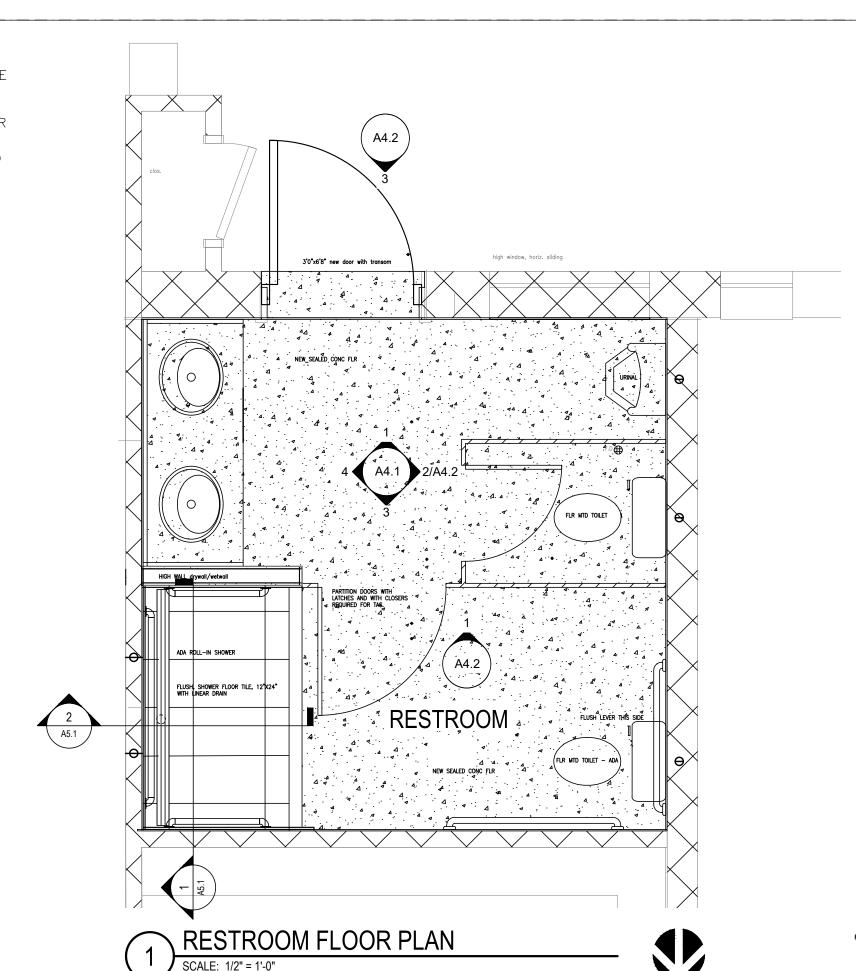

NORTH



BUNKHOUSE RESTROOM REPAIRS
PROJECT NUMBER: 1112121

DATE: MAY 30, 2025
DESIGNED BY: JS
DRAWN BY: JS
REVIEWED BY: JS
REVISED:

SOLICITATION

FOR

100%

REVISED: REVISED:

SHEET TITLE
RESTROOM
FLOOR PLAN


HEET NUMBER

A2.2

- 1. REFER TO MEP DRAWINGS FOR ITEMS REQUIRED BUT NOT SHOWN ON ARCHITECTURAL DRAWINGS.
- 2. DO NOT CUT ANY STRUCTURAL ELEMENTS IN A MANNER THAT WILL DIMINISH THEIR LOAD BEARING/CARRYING CAPACITY. NOTIFY ARCHITECT AND DO NOT PROCEED WITH ANY STRUCTURAL CUT WITHOUT WRITTEN APPROVAL.

B. PLAN NOTES:

- 1. REPAIR AND RENOVATE NEW RESTROOM.
- 2. RECONNECT EXISTING WATER, SEWER, ELECTRICAL, AND MECHANICAL TO NEW RESTROOM.

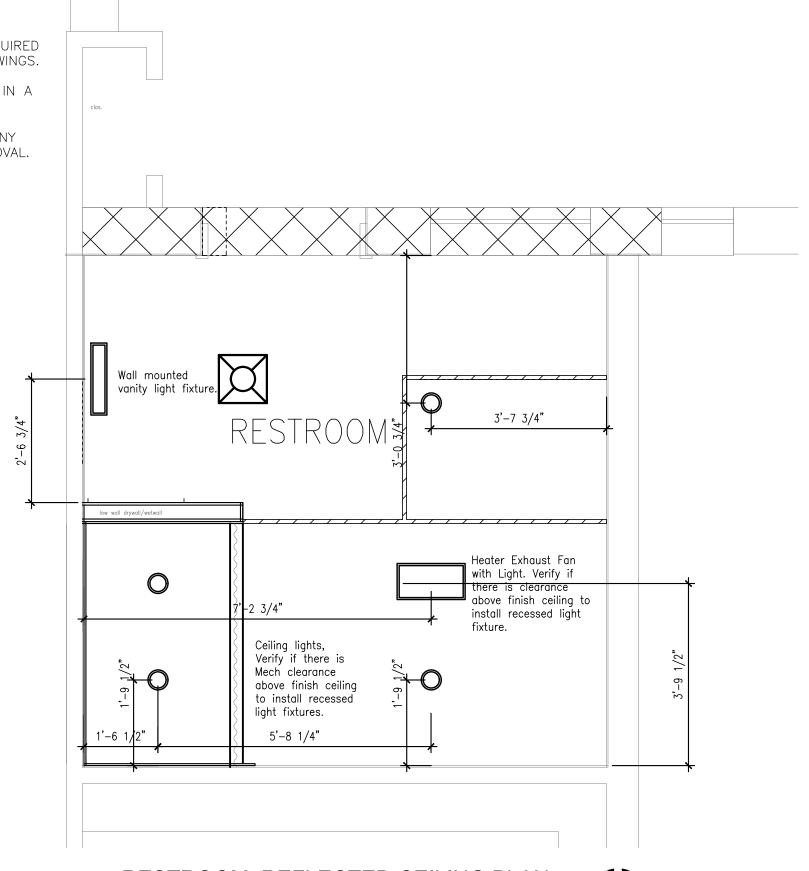

RESTROOM REFLECTED CEILING PLAN







BLACK GAP WMA BUNKHOUSE RESTROOM REPAIRS

DESIGNED BY: JS
DRAWN BY: JS
REVIEWED BY: JS

SOLICITATION

FOR


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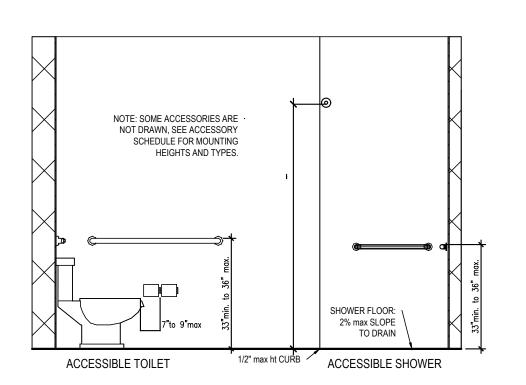
CDs

100%


REVISED:

A3.0




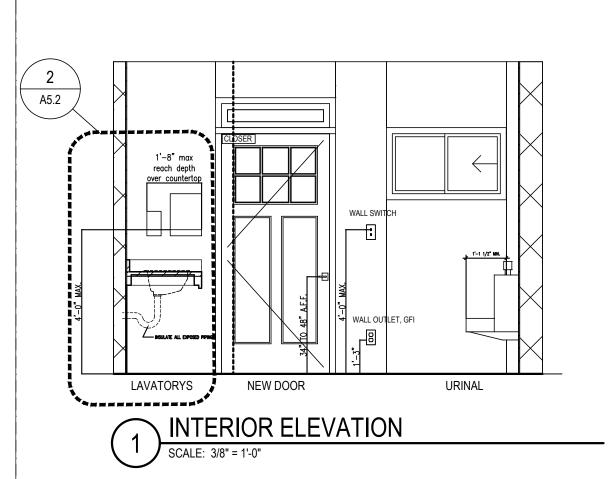

INTERIOR ELEVATION

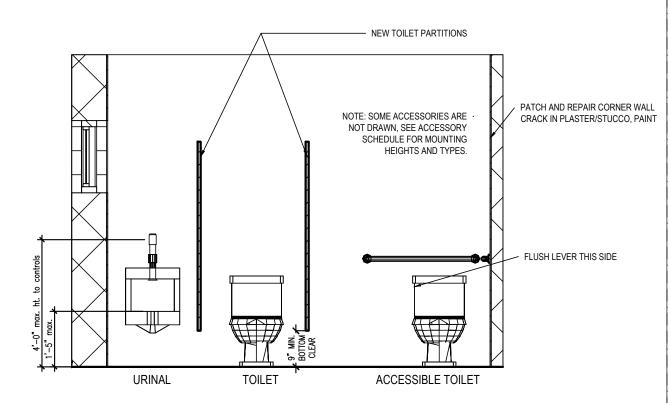

INTERIOR ELEVATION

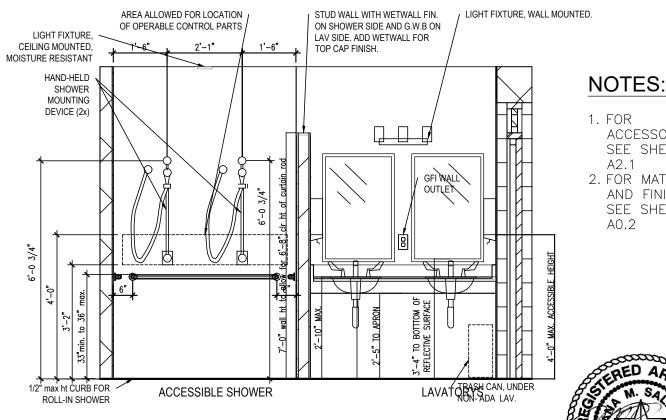

1. FOR ACCESSORIES, SEE SHEET A2.1

2. FOR MATERIALS AND FINISHES, SEE SHEET A0.2

DESIGNED BY: JS
DRAWN BY: JS
REVIEWED BY: JS
REVISED: REVISED:

DATE: MAY 30, 2025

SHEET TITLE RESTROOM INTERIOR

INTERIOR ELEVATION

SCALE: 3/8" = 1'-0"

BLACK GAP WMA BUNKHOUSE RESTROOM REPAIRS


TEXAS PARKS 8

WILDLIFE


SOLICITATION

100%


FOR RELEASED CDs

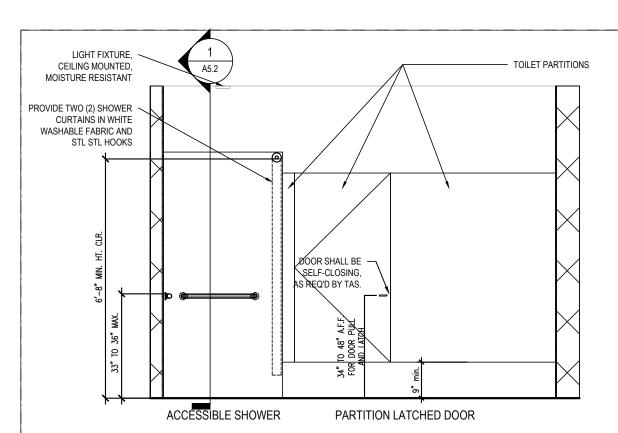


INTERIOR ELEVATION - PARTITION

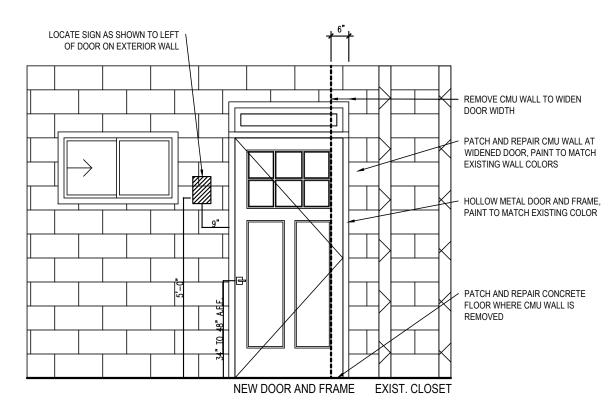



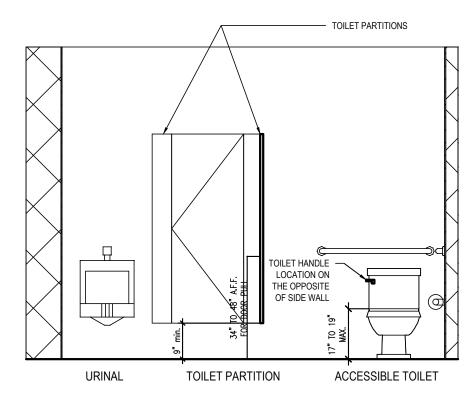

INTERIOR ELEVATION - PARTITION

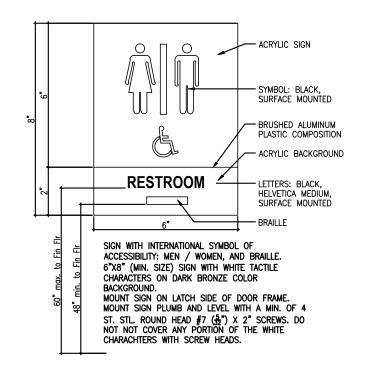

NOTES:

- 1. FOR ACCESSORIES, SEE SHEET A2.1
- 2. FOR MATERIALS AND FINISHES, SEE SHEET AO.2



DATE: MAY 30, 2025 DESIGNED BY: JS DRAWN BY: JS REVIEWED BY: JS REVISED: REVISED:

BLACK GAP WMA BUNKHOUSE RESTROOM REPAIRS

TEXAS

PARKS 8

WILDLIFE

SHEET TITLE INTERIOR

ADA RESTROOM SIGN SCALE: 3" = 1'-0"

SOLICITATION FOR RELEASED CDs



BLACK GAP WMA
BUNKHOUSE RESTROOM REPAIRS
PROJECT NUMBER: 1112121

DATE: MAY 30, 2025 DESIGNED BY: JS DRAWN BY: JS REVIEWED BY: JS REVISED: SOLICITATION

RELEASED FOR

CDs

100%

SED: SED:

SHEET TITLE
RESTROOM
3D
VIEWS

SHEET NUMBER

A4.3

BUNKHOUSE RESTROOM REPAIRS
PROJECT NUMBER: 1112121

TEXAS

WILDLIFE

DATE: MAY 30, 2025 DESIGNED BY: JS DRAWN BY: JS REVIEWED BY: JS REVISED:

PROVIDE DOOR STOP. ON WALL OR FLOOR.

SEALANT.

MATCH

PROVIDE JAMB SEAL SET AND HEADER SEAL.

PROVIDE THRESHOLD (METAL OR STONE TO BE

PROVIDE PUSH PLATE, 4"X16", FINISH TO MATCH

TRANSOM FIXED WINDOW TO BE WIDENED. WOOD

HEADER, JAMBS, AND SILL TO MATCH EXISTING. IF

GLASS IS REPLACED, ADD SECOND PANE TO INSULATE.

PROVIDE KICK PLATES, INSIDE AND OUT, FINISH TO


SELECTED BY OWNER). INSTALL WITH WEATHERPROOF

EET TITLE

RESTROOM WALL AND DOOR DETAILS

HEET NUMBER

A5.0

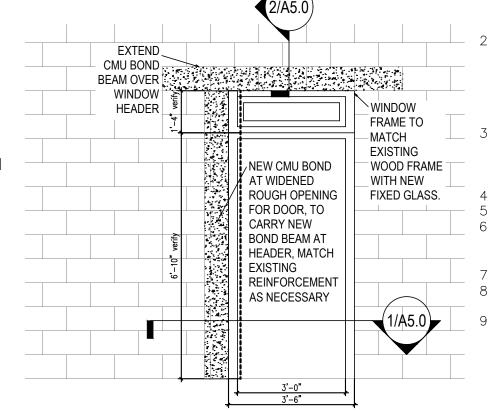

BOND BEAM AT HEADER

NECESSARY

INTERIOR

ON EXTERIOR

PAINTED PLASTER


ON CMU BLOCK ON

PAINTED CMU BLOCK

INT ELEV AT ROUGH OPENING

SCALE: 3/8" = 1'-0"

- RELEASED FOR SOLICITATION

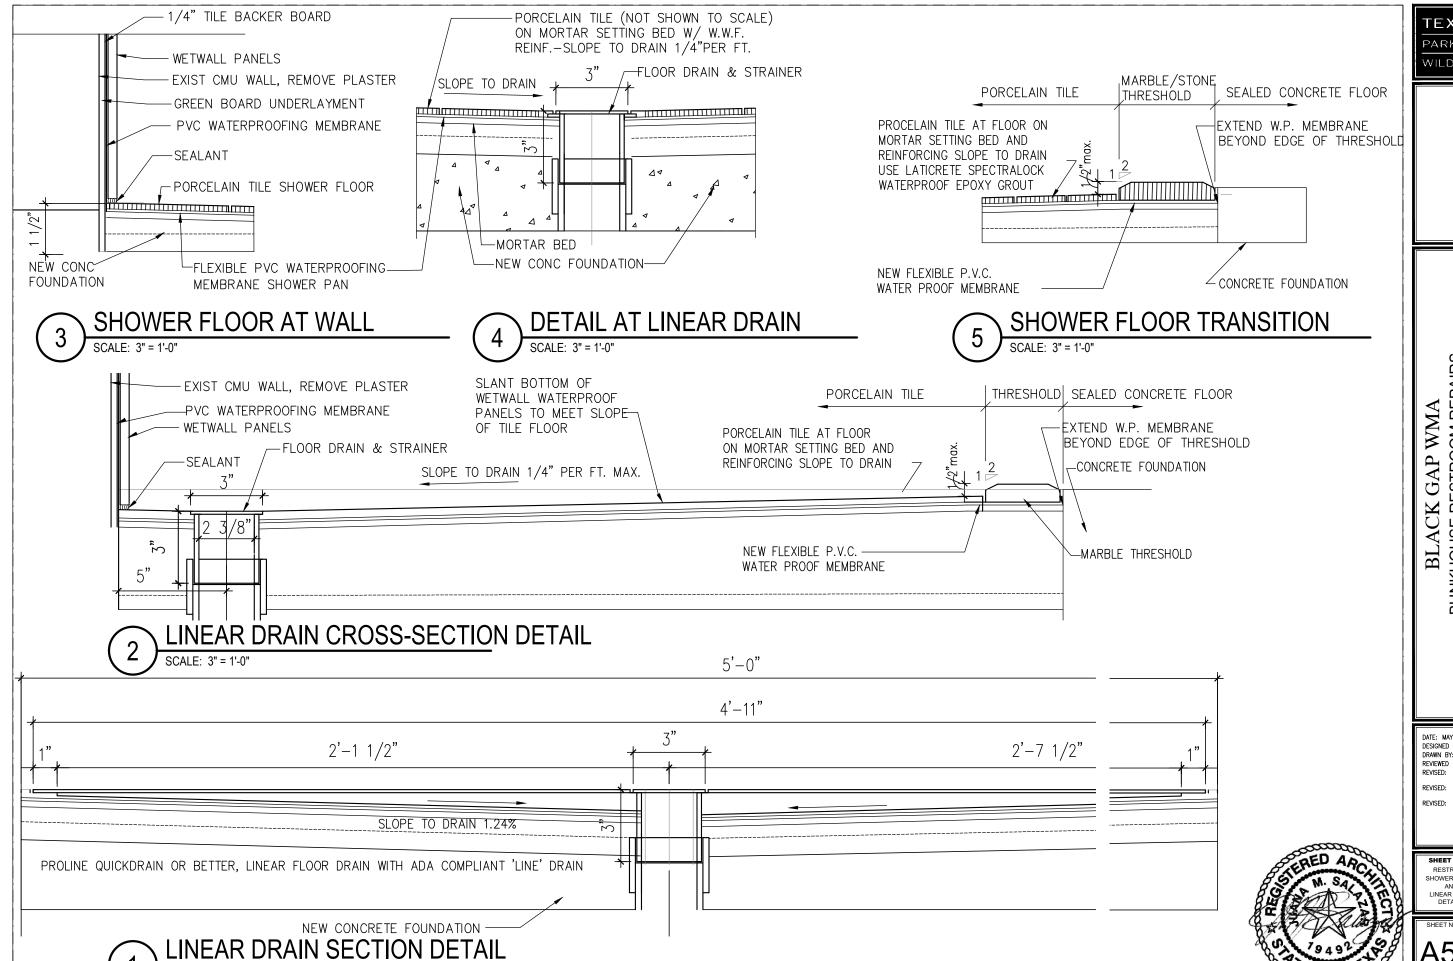

TEXAS PARKS 8 WILDLIFE

BUNKHOUSE RESTROOM REPAIRS

DESIGNED BY: JS DRAWN BY: JS REVIEWED BY: JS

SOLICITATION


FOR

100%

SHEET TITLE SHOWER FLOOR

A5.1

WALL SECTION

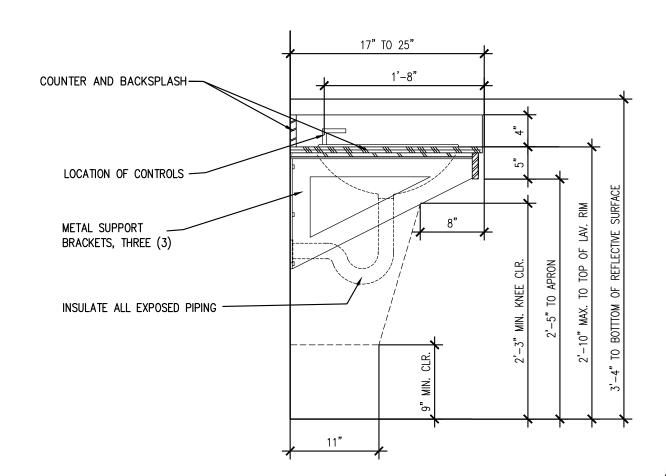

SECTION AT SINK/LAV COUNTER

SCALE: 3/4" = 1'-0"



BLACK GAP WMA BUNKHOUSE RESTROOM REPAIRS

DATE: MAY 30, 2025 DESIGNED BY: JS DRAWN BY: JS REVIEWED BY: JS REVISED:

REVISED:

A5.2

Dtls Bunkhse

SOLICITATION

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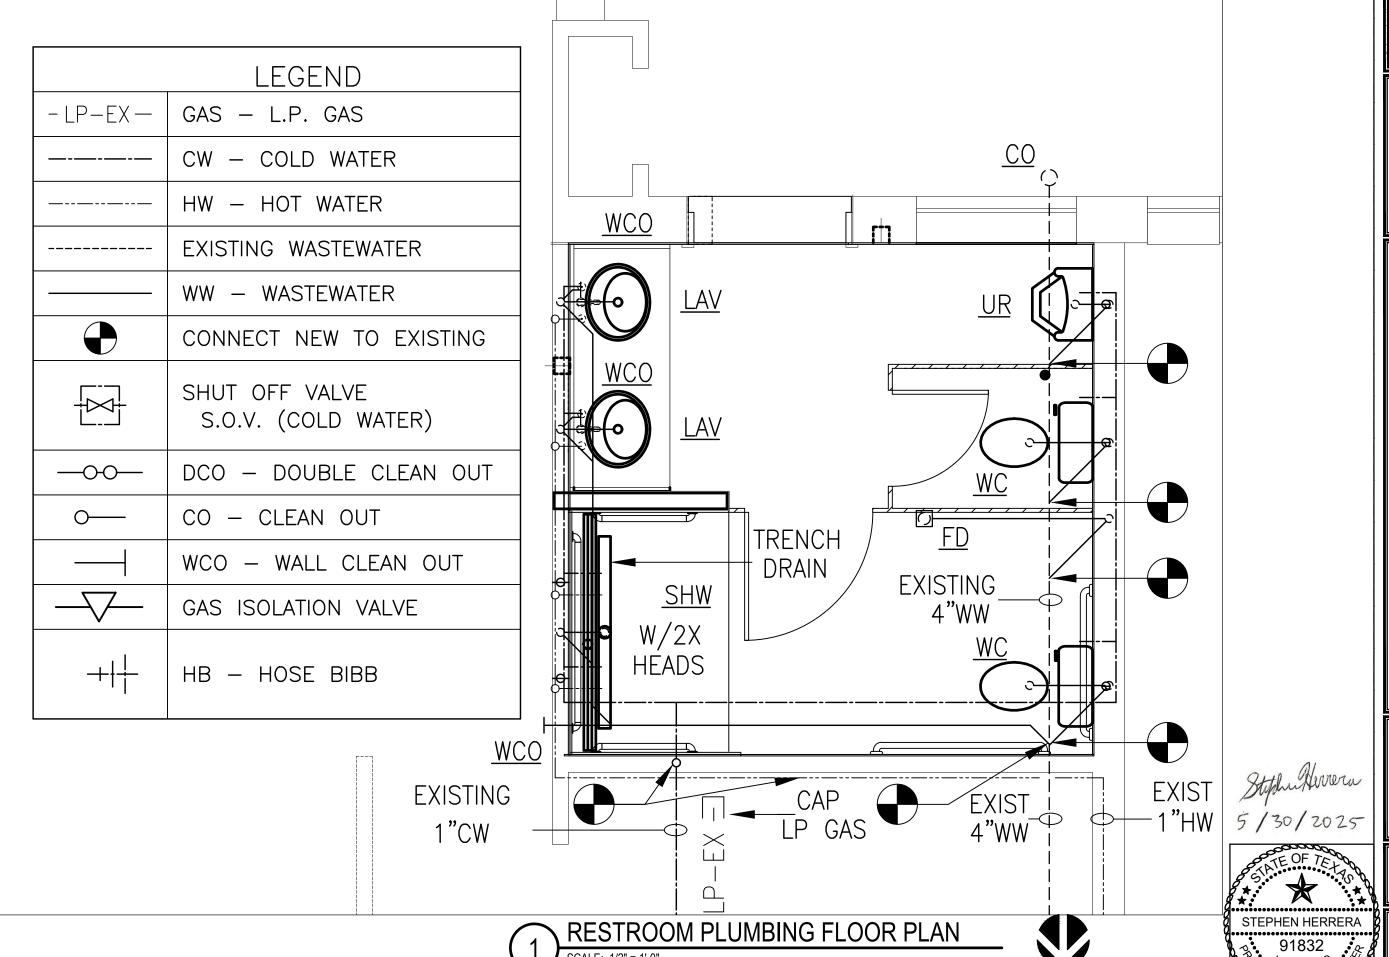
TEXAS PARKS 8 WILDLIFE

BUNKHOUSE RESTROOM REPAIRS

DATE: MAY 30, 2025 DESIGNED BY: SH DRAWN BY: SH REVIEWED BY: SH REVISED:

BUNKHOUSE FLOOR PLAN

CDs



TEXAS PARKS WILDLIFE

BLACK GAP WMA BUNKHOUSE RESTROOM REPAIRS

P2

- 2. CONTRACT DOCUMENTS: THE PLUMBING / MECHANICAL DRAWINGS ARE NECESSARILY DIAGRAMMATIC BY THEIR NATURE, AND ARE NOT INTENDED TO SHOW EVERY CONNECTION IN DETAIL OR EVERY PIPE OR CONDUIT IN ITS EXACT LOCATION. THESE DETAILS ARE SUBJECT TO THE REQUIREMENTS OF STANDARDS REFERENCED IN THESE SPECIFICATIONS. WORK SHALL BE ORGANIZED AND LAID OUT SO THAT IT WILL BE CONCEALED IN FURRED CHASES AND CEILINGS, ETC. IN FINISHED PORTIONS OF THE BUILDINGS, UNLESS SPECIFICALLY NOTED TO BE EXPOSED. ALL WORK SHALL BE INSTALLED PARALLEL OR PERPENDICULAR TO 6. THE LINES OF THE BUILDING UNLESS NOTED OTHERWISE.
- 3. <u>SUBSTITUTION OF MATERIALS AND EQUIPMENT:</u> SOME SPECIFIC PRODUCTS MAY BE MENTIONED BY NAME AND/OR MANUFACTURER TO SET A STANDARD OF QUALITY FOR ACCEPTANCE AND TO SERVE AS A REFERENCE IN COMPARISON WITH OTHER PRODUCTS. IT IS NOT THE INTENT OF THE DRAWINGS AND/OR SPECIFICATIONS TO LIMIT PRODUCTS TO ANY PARTICULAR MANUFACTURE OR TO DISCRIMINATE AGAINST AN "APPROVED EQUAL" PRODUCT AS PRODUCED BY ANOTHER MANUFACTURER.
- 4. MANUFACTURER'S RECOMMENDATIONS: THE MANUFACTURER'S PUBLISHED RECOMMENDATIONS SHALL BE FOLLOWED IN THE DELIVERY, STORAGE, PROTECTION, INSTALLATION, PIPING, AND WIRING OF ALL EQUIPMENT AND MATERIAL. THE CONTRACTOR SHALL PROMPTLY NOTIFY THE OWNER, IN WRITING, OF ANY CONFLICT BETWEEN THE REQUIREMENTS OF THE CONTRACT DOCUMENTS AND THE MANUFACTURERS' DIRECTIONS, AND SHALL OBTAIN THE ENGINEER'S INSTRUCTIONS BEFORE PROCEEDING WITH THE WORK. SHOULD THE CONTRACTOR PERFORM ANY SUCH WORK THAT DOES NOT COMPLY WITH THE MANUFACTURERS' DIRECTIONS OR SUCH INSTRUCTIONS FROM THE OWNER, THE CONTRACTOR SHALL BEAR ALL COSTS ARISING IN 100 CONNECTION WITH THE DEFICIENCIES.
 - PIPING MATERIALS

WATER PIPING (BELOW GRADE): PEX, COPPER TYPE K OR L WATER PIPING (ABOVE GRADE): PEX, COPPER TYPE L

COLD WATER PIPING INSULATION: MIN. 3/4" FLEX. ELASTOMERIC, 1" MINERAL FIBER HOT WATER PIPING INSULATION: MIN 1" FLEX. ELASTOMERIC, 1" MINERAL FIBER

WASTEWATER & VENT (BELOW GRADE): SCHEDULE 40 PVC WITH METAL TRACING TAPE

WASTEWATER & VENT (ABOVE GRADE): SCHEDULE 40 PVC, CAST IRON

CONDENSATE PIPING: SCHEDULE 40 PVC T & P PIPING: COPPER TYPE K OR L

GAS PIPING (BELOW GRADE): POLYETHYLENE PLASTIC PIPE WITH METAL TRACING TAPE

LOCATE PIPE AT AN 18" DEPTH

GAS PIPING (ABOVE GRADE): SCHEDULE 40 METALLIC PIPE, POLYETHYLENE PLASTIC PIPE

GAS PIPING (FITTINGS): EPOXY COATED BRASS FITTINGS

GAS PIPING (FINAL CONNECTIONS): CORRUGATED STAINLESS STEEL TUBING (MAX 2' LENGTH)
AT EACH APPLIANCE/UNIT.

OTHER ACCEPTABLE MATERIALS ARE LISTED IN THE 2021 IPC & 2021 IFGC

- INSTALLATION: FURNISH AND INSTALL ALL LABOR, MATERIALS, EQUIPMENT, TOOLS, AND SERVICES AND PERFORM ALL OPERATIONS REQUIRED IN CONNECTION WITH THE INSTALLATION OF A COMPLETE PLUMBING SYSTEM, PIPING, PLUMBING FIXTURES, VALVES, ETC. AS INDICATED ON THE DRAWINGS, REASONABLE IMPLIED THERE FROM, OR AS SPECIFIED HEREIN, UNLESS SPECIFICALLY EXCLUDED. INSTALL ALL COMPONENTS LEVEL AND PLUMB. PIPING SHALL BE INSTALLED IN SUCH A MANNER AS NOT TO OBSTRUCT ACCESS TO MAINTENANCE AREAS, EQUIPMENT, PANELS, INSTRUMENTS, ETC. ALL PIPING PENETRATIONS OF WALLS AND FLOORS SHALL BE SLEEVED. PENETRATIONS THROUGH FLOORS AND FIRE RATED WALLS SHALL BE SEALED WITH FIRE RATED SEALANT.
 - PIPE SUPPORTS AND HANGERS: SHALL BE PROVIDED FOR ALL HORIZONTAL AND VERTICAL PIPING. FOR SUPPORTS ON INSULATED LINES, PROVIDE SADDLES AT LEAST 6 INCHES LONG. MOUNT INDOOR PIPING ON UNI-STRUT STANDOFFS OR HANG ON THREADED ROD WITH PIPE HANGERS. FOR UNINSULATED COPPER PIPE. USE COPPER PLATED OR PLASTIC LINED HANGERS OR CLAMPS.
- 7. <u>SUPPORTS GENERAL:</u> PERFORATED STRAP IRON OR WIRE WILL NOT, UNDER ANY CIRCUMSTANCES, BE ACCEPTABLE AS HANGER MATERIAL.
- 3. <u>TESTS:</u> ALL TESTS SPECIFIED OR INDICATED SHALL BE PERFORMED BY THE CONTRACTOR AND WITNESSED BY THE OWNER'S REPRESENTATIVE.
- CUTTING INTO WALLS & FLOOR: THE WALLS & FLOORS SHALL BE CUT TO ALLOW PIPING TO BE PROPERLY PLACED TO SERVE PLUMBING FIXTURES EFFECTIVELY. SPECIAL CARE SHALL BE TAKEN TO MINIMIZE THE AMOUNT OF EXISTING BUILDING MATERIALS REMOVED. REPAIRS SHALL BE MADE AS REQUIRED AND EXACT LOCATIONS SHALL BE DETERMINED.
- 10. <u>NEW PLUMBING FIXTURES:</u> NEW PLUMBING FIXTURES SHALL BE INSTALLED AS SPECIFIED ON THE SCHEDULES & NOTES OF THIS DRAWING SET.
- 11. <u>ACCESS DOORS:</u> PROVIDE ACCESS DOORS TO SHUTOFF VALVES IN WALLS FOR PLUMBING FIXTURES, SUCH AS SHOWERS, SINKS & WATER CLOSETS. WHERE SHUTOFF VALVES ARE EXPOSED & ACCESSIBLE FOR PLUMBING FIXTURES, SUCH AS SHOWERS, SINKS AND LAVS, ACCESS DOORS SHALL NOT BE NECESSARY.

EXISTING GAS WATER HEATERS

EXISTING GAS WATER HEATER (WH) LOCATED IN BUNKHOUSE SHALL REMAIN.

GAS WATER HEATER: RHEEM MODEL# XP40T06EC32U1, 40 GAL, 32,000 BTUH, DATE: 9/18/2023

GENERAL NOTE

EXISTING PLUMBING (WATER, WASTE, GAS & VENT LINES) IS LOCATED IN THE FLOORS/WALLS/CEILINGS. EXACT ROUTINGS OF THESE EXISTING PLUMBING LINES ARE NOT ALL KNOWN. CONTRACTOR SHALL FIELD VERIFY LINES BEFORE CONSTRUCTION COMMENCES. SAW CUTTING THRU SLAB IS PERMISSABLE AS NEEDED.

Stylm Herrera 5/30/2025



REVISED:

SHEET NUMBER

P3

PLUMBING FIXTURE SCHEDULE


ŀ	DESCRIPTION			S	IZE		
MARK		BRAND / MODEL NUMBER	COLD WATER	HOT WATER	WASTEWATER	VENT	NOTES
WC (ADA)	WATER CLOSET: FLOOR MOUNTED, TANK TYPE, WHITE VITREOUS CHINA, PRESSURE ASSISTED SIPHON JET FLUSH ACTION, 1.0 GPF, ELONGATED BOWL	AM STD / COLONY	3/4"	-	3"	2"	1
	FLUSH VALVE: HIGH EFFICIENCY PRESSURE ASSISTED SEAT: PROVIDED WITH LID	SLOAN / FLUSHMATE IV KOHLER / K-4664					
UR (ADA)	URINAL: WALL MOUNTED, WHITE VITREOUS CHINA, WITH HANGAR, PROVIDE WITH CONCEALED ARM CARRIER, 0.5GPF FLUSH VALVE: HIGH EFFICIENCY DIAPHRAGM TYPE FLUSHOMETER VALVE	AM STD / ALLBROOK SLOAN / ROYAL 186-0.5	3/4"	-	2"	2"	1
LAV (ADA)	LAVATORY: SELF RIMMING, WHITE VITREOUS CHINA, WITH OVERFLOW, PROVIDE WITH MOUNTING KIT 047194-0070A TO ATTACH TO COUNTER	AM STD / RONDALYN	1/2"	1/2"	2"	1-1/2"	1
	FAUCET: ADA LEVER HANDLES, POP-UP DRAIN W/P-TRAP, 4" CENTERS HANDLES: ADA LEVER HANDLES	AM STD / CHANCELLOR					
	COVERS: ANTIMICROBIAL, WHITE, UNDERSINK PROTECTION	TRUEBRO / LAV GUARD 2					
SHW (ADA)	ADA TRANSFER SHOWER: CUSTOM HAND TILED SHOWER, 60"X36" INSIDE DIMENSIONS, 6'-8" TILE HEIGHT, BARRIER FREE THRESHOLD. PROVIDE WITH GRAB BARS, FOLDING SHOWER SEAT, & SHOWER ROD.	-/-	1/2"	1/2"	2"	1-1/2"	1
	SHOWER FAUCET W/ LEVER HANDLE, SHOWER HEAD, HAND SHOWER: SHOWERHEAD W/ ARM & FLANGE, 3 FUNCTION HAND SHOWER WITH 60" HOSE ASSEMBLY AND 24" SLIDE BAR, METAL CONSTRUCTION W/ POLISHED CHROME FINISH, EPA WATER SENSE 2.0 GPM	AM STD / SPECTRA OR SPEAKMAN / SLV-1080-ADA					
	THERMOSTATIC MIXING VALVE: THERMOSTATIC VALVE TRIM, SINGLE METAL ADA SINGLE SWING VALVE, POLISHED CHROME FINISH.	KOHLER / K-TS6913-4 TRITON					
	SHOWER DRAIN: LINEAR DRAIN, W/ SATIN NICKEL BRONZE STRAINER	QUICKDRAIN / SL4048					
WCO	WALL CLEAN OUT: 6" DIAMETER ROUND S.S. COVER.	DANCO / A0052184	_	-	3",4"	_	1
CO &	CLEAN OUT & DOUBLE CLEAN OUT: SCHEDULE 40 PVC, 3" PLUG AND CAP. SCHEDULE 40 PVC, 4" PLUG AND CAP.	GENOVA PRODUCTS/ 71630 GENOVA PRODUCTS/ 41639	-	- -	3" 4"	_	1 1
FD	FLOOR DRAIN: DURA-COATED CAST IRON BODY W/ BOTTOM OUTLET, COMBINATION INVERTIBLE MEMBRANE CLAMP AND ADJUSTABLE COLLAR W/ SEEPAGE SLOTS AND "TYPE-B" POLISHED NICKEL BRONZE, LIGHT- DUTY STRAINER	ZURN / Z415B	-	-	3"	2"	1
	P-TRAP GASKET: ELASTOMERIC GASKET INSERT TO PREVENT WATER EVAPORATION FROM FLOOR DRAIN TO KEEP TRAP PRIMED. FOR WATER TIGHT SEAL, USE AN ADHESIVE TYPE CAULK UNDER THE TOP FLANGE AND THE GASKET MATERIALS.	PROSET / TRAP GUARD TG33G	-	-	3"	-	1

1. SPECIFIC BRANDS & MODELS ARE SHOWN. ALTERNATIVE EQUALS ARE ACCEPTABLE.



BLACK GAP WMA BUNKHOUSE RESTROOM REPAIRS PROJECT NUMBER: 1112121

REVISED: REVISED:

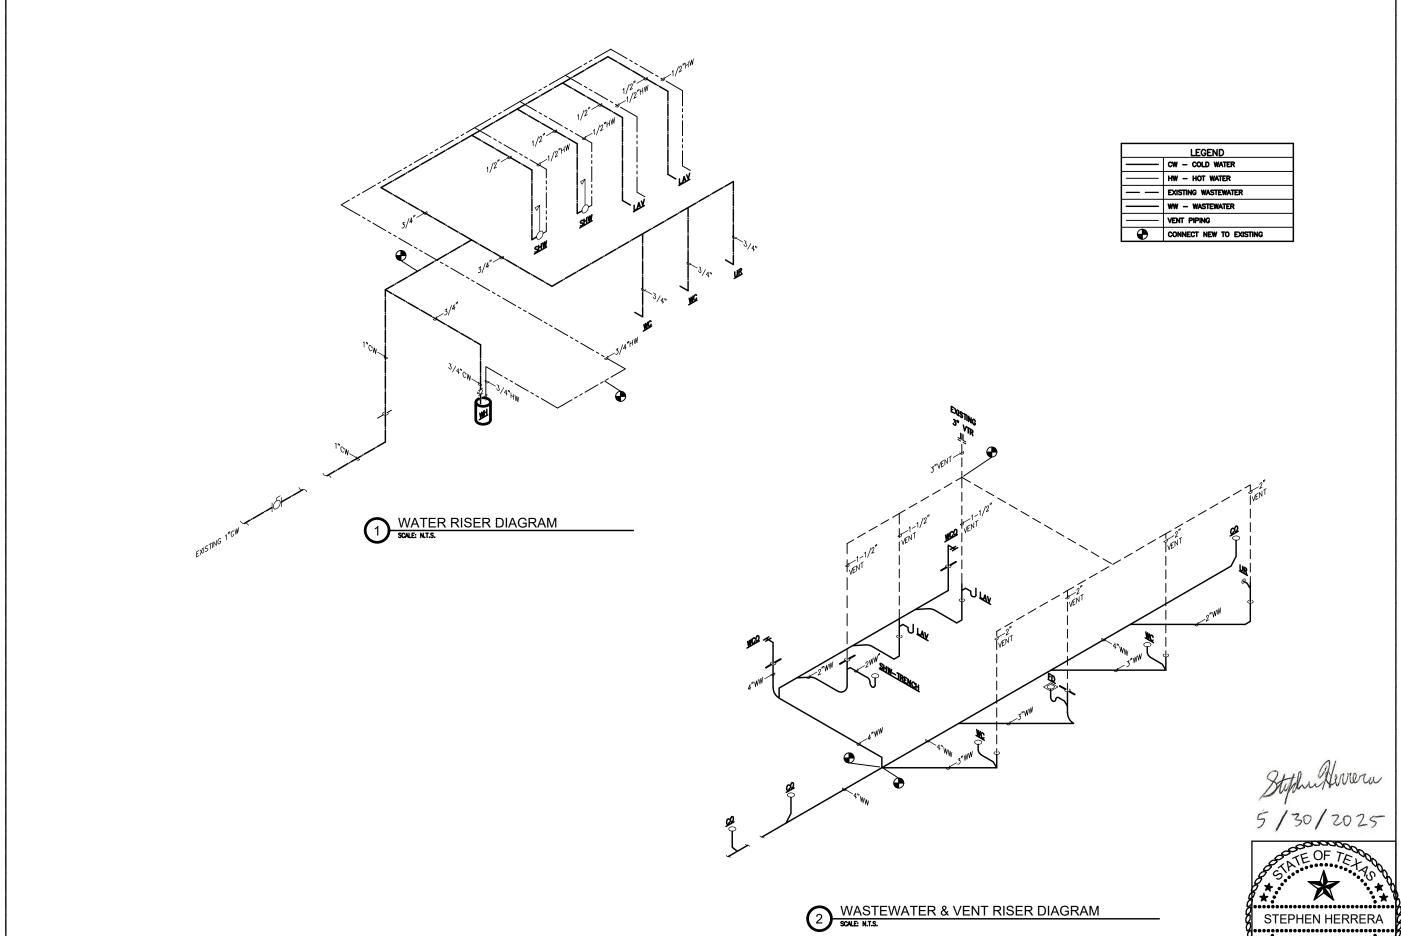

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TEXAS PARKS 8 WILDLIFE

BLACK GAP WMA
BUNKHOUSE RESTROOM REPAIRS
PROJECT NUMBER: 1112121

DATE: MAY 30, 2025 DESIGNED BY: SH DRAWN BY: SH REVIEWED BY: SH REVISED:

REVISED:

SHEET TITLE

PLUMBING RISERS

P5

LIGHT FIXTURE SCHEDULE LAMP VOLTAGE **FIXTURE** MANUFACTURER CATALOG NUMBER DESCRIPTION SYLVESTRE SERIES 6227900 DIM: 15.75" X 8.25" Α WESTINGHOUSE 60W LED 120V LED 3 LAMP WALL FIXTURE RE-6150WH 6" ROUND LED В EATON LIGHTING E7RICAT 120V SHOWER LENS/TRIM WHITE WET LOCATION FIXTURE **BROAN** BHFLED80 (80CFM) 1300W HEATER, LED 120V LIGHT/HEATER/EXHAUST FAN 12 AMP 27W, 1.5 SONES


- ALL FIXTURE FINISHES AND OPTIONS MUST BE APPROVED BY OWNER OR ARCHITECT.
- ADDITIONAL LIGHT SWITCHES MAY BE INSTALLED IF APPROVED BY OWNER OR ARCHITECT.

ELECTRICAL KEYNOTES: (#)

- 1. LIGHT SWITCH SHALL CONTROL LIGHTS AND EXHAUST FAN.
- 2. SWITCH SHALL CONTROL HEATER SEPARATELY.
- AVOID EXISTING MECHANICAL DUCTWORK (S/A) & (R/A) ABOVE CEILING. APPROXIMATE LOCATIONS OF DUCT
- RECEPTACLE SHALL BE LOCATED ABOVE COUNTER HEIGHT. LIGHT FIXTURE IS MOUNTED ABOVE MIRROR ON WALL. EXACT HEIGHTS TO BE DETERMINED BY ACCESSIBILITY REQUIREMENTS.
- 5. EXISTING SUPPLY (S/A) CEILING GRILL TO REMAIN.

NOTES:


- 1. UTILIZE EXISTING CAPPED CIRCUITS FOR LIGHTS, PLUGS AND EXHAUST FAN.
- 2. CONNECT NEW EXHAUST FAN OUTLET TO EXISTING EXHAUST DUCTWORK. NEW DUCT TRANSITION MAY BE NECESSARY. EXISTING SIZE OF DUCT SHALL BE VERIFIED IN THE FIELD BEFORE CONSTRUCTION BEGINS.
- 3. PATCH WALL & CEILING OPENINGS FROM REMOVED FIXTURES.
- 4. EXISTING ELECTRICAL PANEL LOCATED IN UTILITY ROOM NEXT TO RESTROOM.

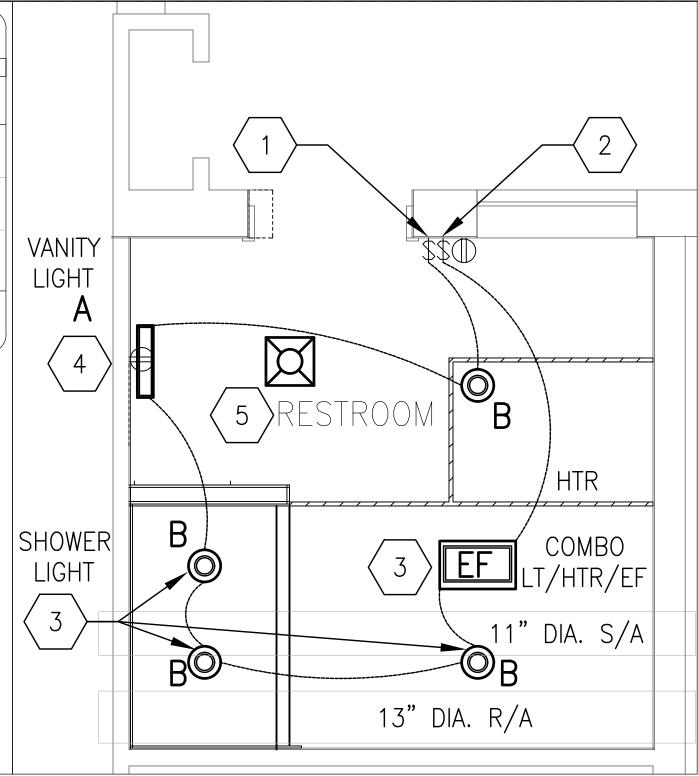



RESTROOM ELECTRICAL REFLECTED CEILING PLAN



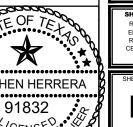

TEXAS PARKS 8 WILDLIFE

BUNKHOUSE RESTROOM REPAIRS BLACK GAP WMA

DESIGNED BY: SH DRAWN BY: SH REVIEWED BY: SH REVISED: REVISED:

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