Date: May 7, 2021

#### ADDENDUM NO. 1

## PROJECT NO: 1110169 TITLE OF PROJECT: Visitor Center Repairs and HQ Restroom Replacement

**FACILITY LOCATION: Monahans Sandhills State Park** 

#### **NOTICE TO ALL BIDDERS:**

This addendum shall be considered part of the Contract Documents and is issued to change, amplify, or delete from or otherwise explain the documents where provisions of this addendum differ from those of the original contract documents. This addendum shall have precedence over the original contract documents and shall govern.

Bidders are hereby notified that they shall incorporate this addendum in their bid, and it shall be construed that the Contractor's Bid shall reflect with full knowledge, all items, changes and modifications to the contract documents herein specified.

Bidders are advised to check for updates, addenda issuance, and bid opening date changes on the Electronic State Business Daily at:

### http://www.txsmartbuy.com/esbd

Please see attached revisions to clarify Contract Documents, Specification, and Drawings.

#### 1. CONTRACT DOCUMENTS:

Notice To Bidders revised Construction Estimate amount.

Revised Contractor's Bid (Bid Schedule 2021 0414).

#### 2. DRAWINGS (REISSUED SHEETS WITH MODIFICATIONS):

Sheet C-03 (12 of 85) – Demolition Control Plan

Sheet C-06 (15 of 85) – Dimensioning Plan

Sheet C-07 (16 of 85) – Grading Plan

Sheet C-09 (18 of 85) – Pavilion Alternate Grading & Dimensioning Plan

Sheet A-01 (19 of 85) – Architectural Site Plans Overall

Sheet A-02 (20 of 85) – Architectural Site Plan Visitors Center & Site Details

Sheet A-04 (22 of 85) – Door/Room Finish Schedules, Door & Signs Types

Sheet A-13 (31 of 85) - Floor & Roof Plans Comfort Station & Section House

Sheet A-17 (35 of 85) - Exterior Elevations Section House

Sheet A-21 (39 of 85) - Roof Details – Section House

Sheet M-03 (61 of 85) - Mechanical Demolition

Sheet E-02 (68 of 85) – Electrical Site Lighting Plan

Sheet E-03 (69 of 85) – Electrical Demolition

Sheet E-05 (71 of 85) – Electrical Power Enlarged

Sheet E-08 (74 of 85) – Electrical Riser

Sheet E-09 (75 of 85) - Electrical Schedules

Sheet P-03 (79 of 85) - Plumbing Sewer & Vent Enlarged Floor Plan – Visitor Center

#### 3. QUESTIONS WITH ANSWERS:

- Q: Will the exterior electrical that is surfaced mounted need to be addressed on how to bid? Please see attached photos
- A: Surface mounted conduit and J boxes that are currently painted the sand color is to be painted color to match surface to which is it attached or nearest surface (e.g. conduit run along underside of porch paint to match soffit/rafter color)

For exterior electrical outlets where the exterior enclosure has been painted sand, paint the enclosure to match surface to which is it attached. Mask off outlet.

For wall mounted light fixtures, mask off fixture.

For under soffit light fixtures at porch, remove light fixtures prior to painting and reinstall after painting complete.

This information will also be provided on appropriate sheets.

- Q: The existing utility service pedestal to remain. Removing the 120/240V 3-phase, 200A service disconnect. To be replaced with a new Panel-DP. (please see the attached photos). There would not be a main to feed existing disconnect "A" and water well disconnect from panel-DP. The way the wires are tapped inside the pedestal from the load side of service disconnect "MS". Would the 200A meter service be enough for panels DP, AC, A, and R with existing and future loads when added?
- A: Existing Panel A will be feed from New Panel-DP loads will be revised. Refer to Addendum #1 sheet E-08/ detail #1 and #2.


- Q: Panel-A has an existing 2-pole 60A breaker feeding existing Panel-B. The new Panel-B requires a 100A breaker. We recommend that the 2-pole 60A breaker be upgraded to a 2-pole 100A.
- A: This will need to be changed to a 100amp, single phase 2-pole breaker. Refer to Addendum #1 sheet E-09/ Panel schedule "A".
- Q: To get power to the GC's job trailer in the east parking lot. Will there be a problem to place utility poles on each side of entry roadway? This is needed to cross power over from new Panel DP for temporary power.
- A: Power poles will be acceptable per TPWD so long as they are removed at the close of the project and provide a minimum 14' clearance for road traffic.
- Q: In the existing electrical room, there is a communications pipe coming from underground (please see attached photos). Would this pipe need to be relocated to accommodate the new door or leave as is?
- A: Demark well be called to be relocated and communication stub up will remain. Does not conflict with door. Refer to Addendum #1 sheet E-03.

Bidders shall acknowledge receipt of this addendum in the space provided on the Contractor's Bid Schedule form located above the signature block. WARNING: BIDDER'S FAILURE TO ACKNOWLEDGE RECEIPT OF ADDENDA MAY RESULT IN REJECTION OF BID.

#### **END OF ADDENDUM NUMBER 1**

Sincerely,

MICHAEL POLENDO, CTCD, CTCM Contract Manager Infrastructure Division

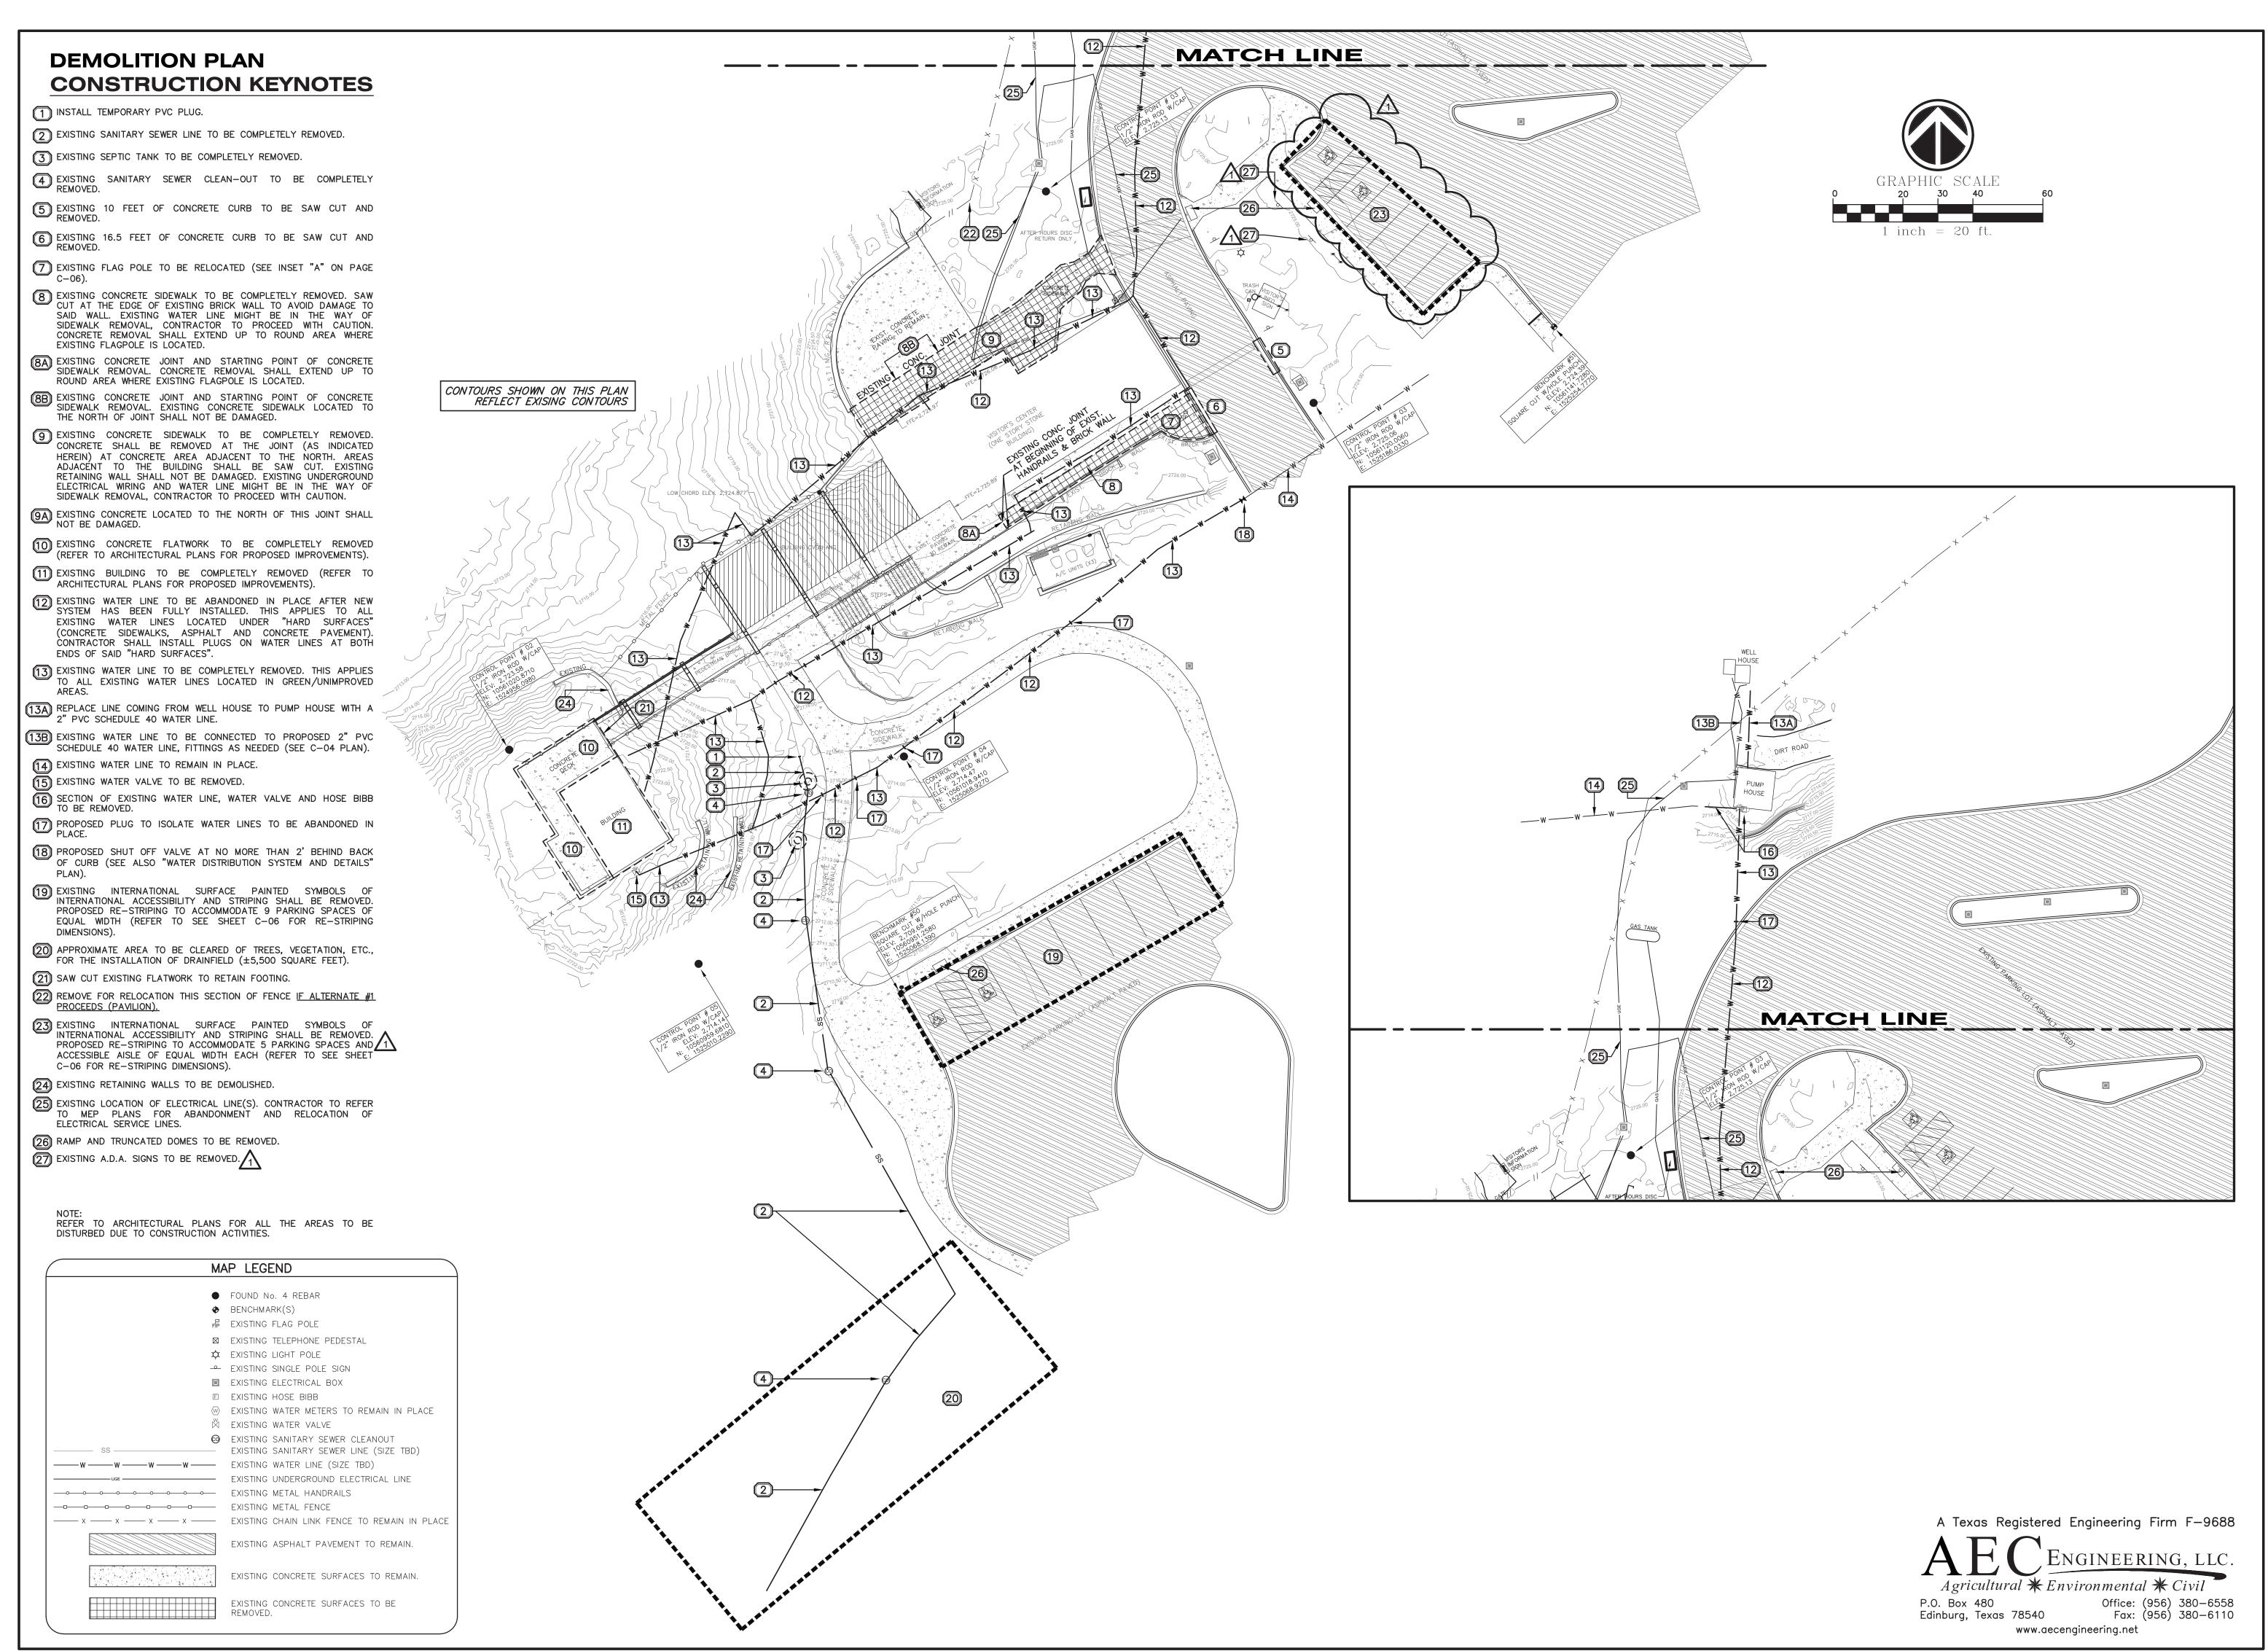





THE SEAL APPEARING O THIS DOCUMENT WAS AUTHORIZED BY CUMENT WITHOUT PRO NOTIFICATION TO TH RESPONSIBLE ENGINEER TEXAS ENGINEERING PRACTICE LAW

ation

ark tate undhills ction 0 Sec Sec Monahan ente

DATE: 03/19/2021 DESIGNED BY: J.D'Z. DRAWN BY: J.D'Z. REVIEWED BY: C.G.


1 ADD1 5/07/21 PARKING SPACES STRIPING TO BE REMOVED.

A.D.A. SIGNS TO BE

REMOVED.

SHEET TITLE

DEMOLITION CONTROL PLAN

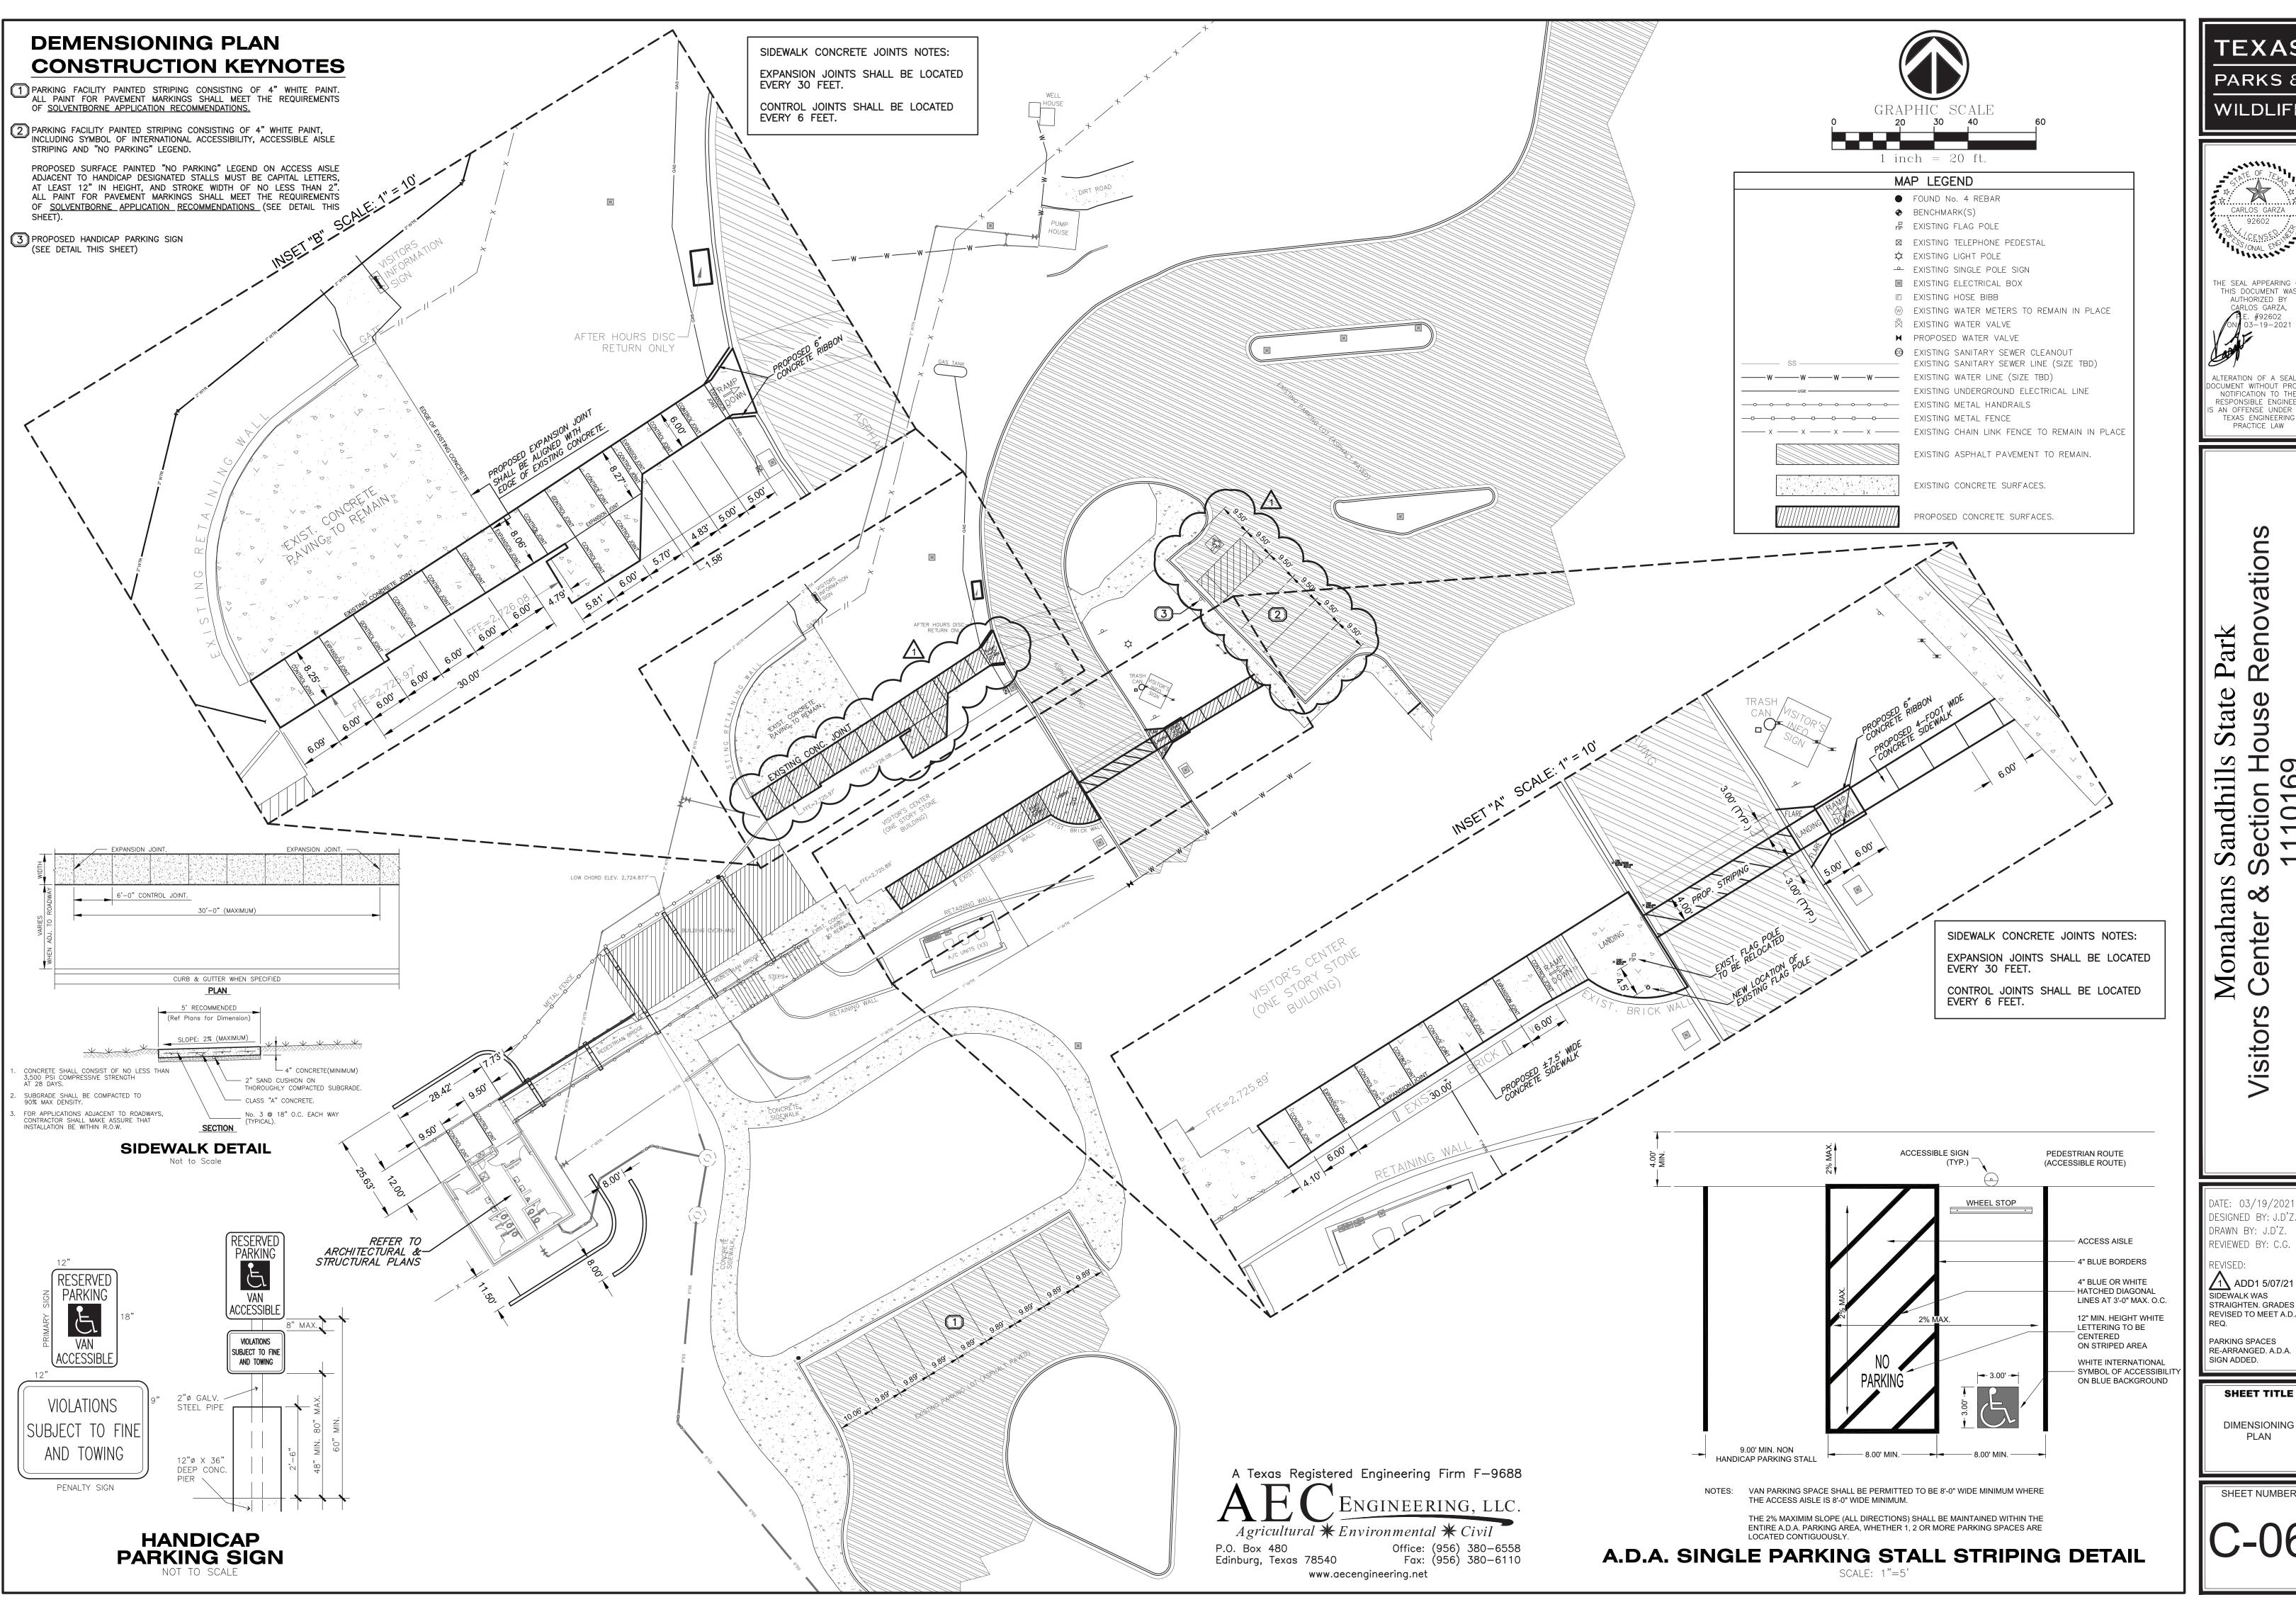

PARKS & WILDLIFE



THE SEAL APPEARING O THIS DOCUMENT WAS AUTHORIZED BY CUMENT WITHOUT PRO NOTIFICATION TO THE RESPONSIBLE ENGINEER


PRACTICE LAW

ation ark State andhill ction 0 Sec Sec Monahans enter Visitors

DESIGNED BY: J.D'Z. DRAWN BY: J.D'Z. REVIEWED BY: C.G. 1 ADD1 5/07/21 SIDEWALK WAS STRAIGHTEN. GRADES REVISED TO MEET A.D.A.

PARKING SPACES RE-ARRANGED. A.D.A. SIGN ADDED.

> SHEET TITLE DIMENSIONING

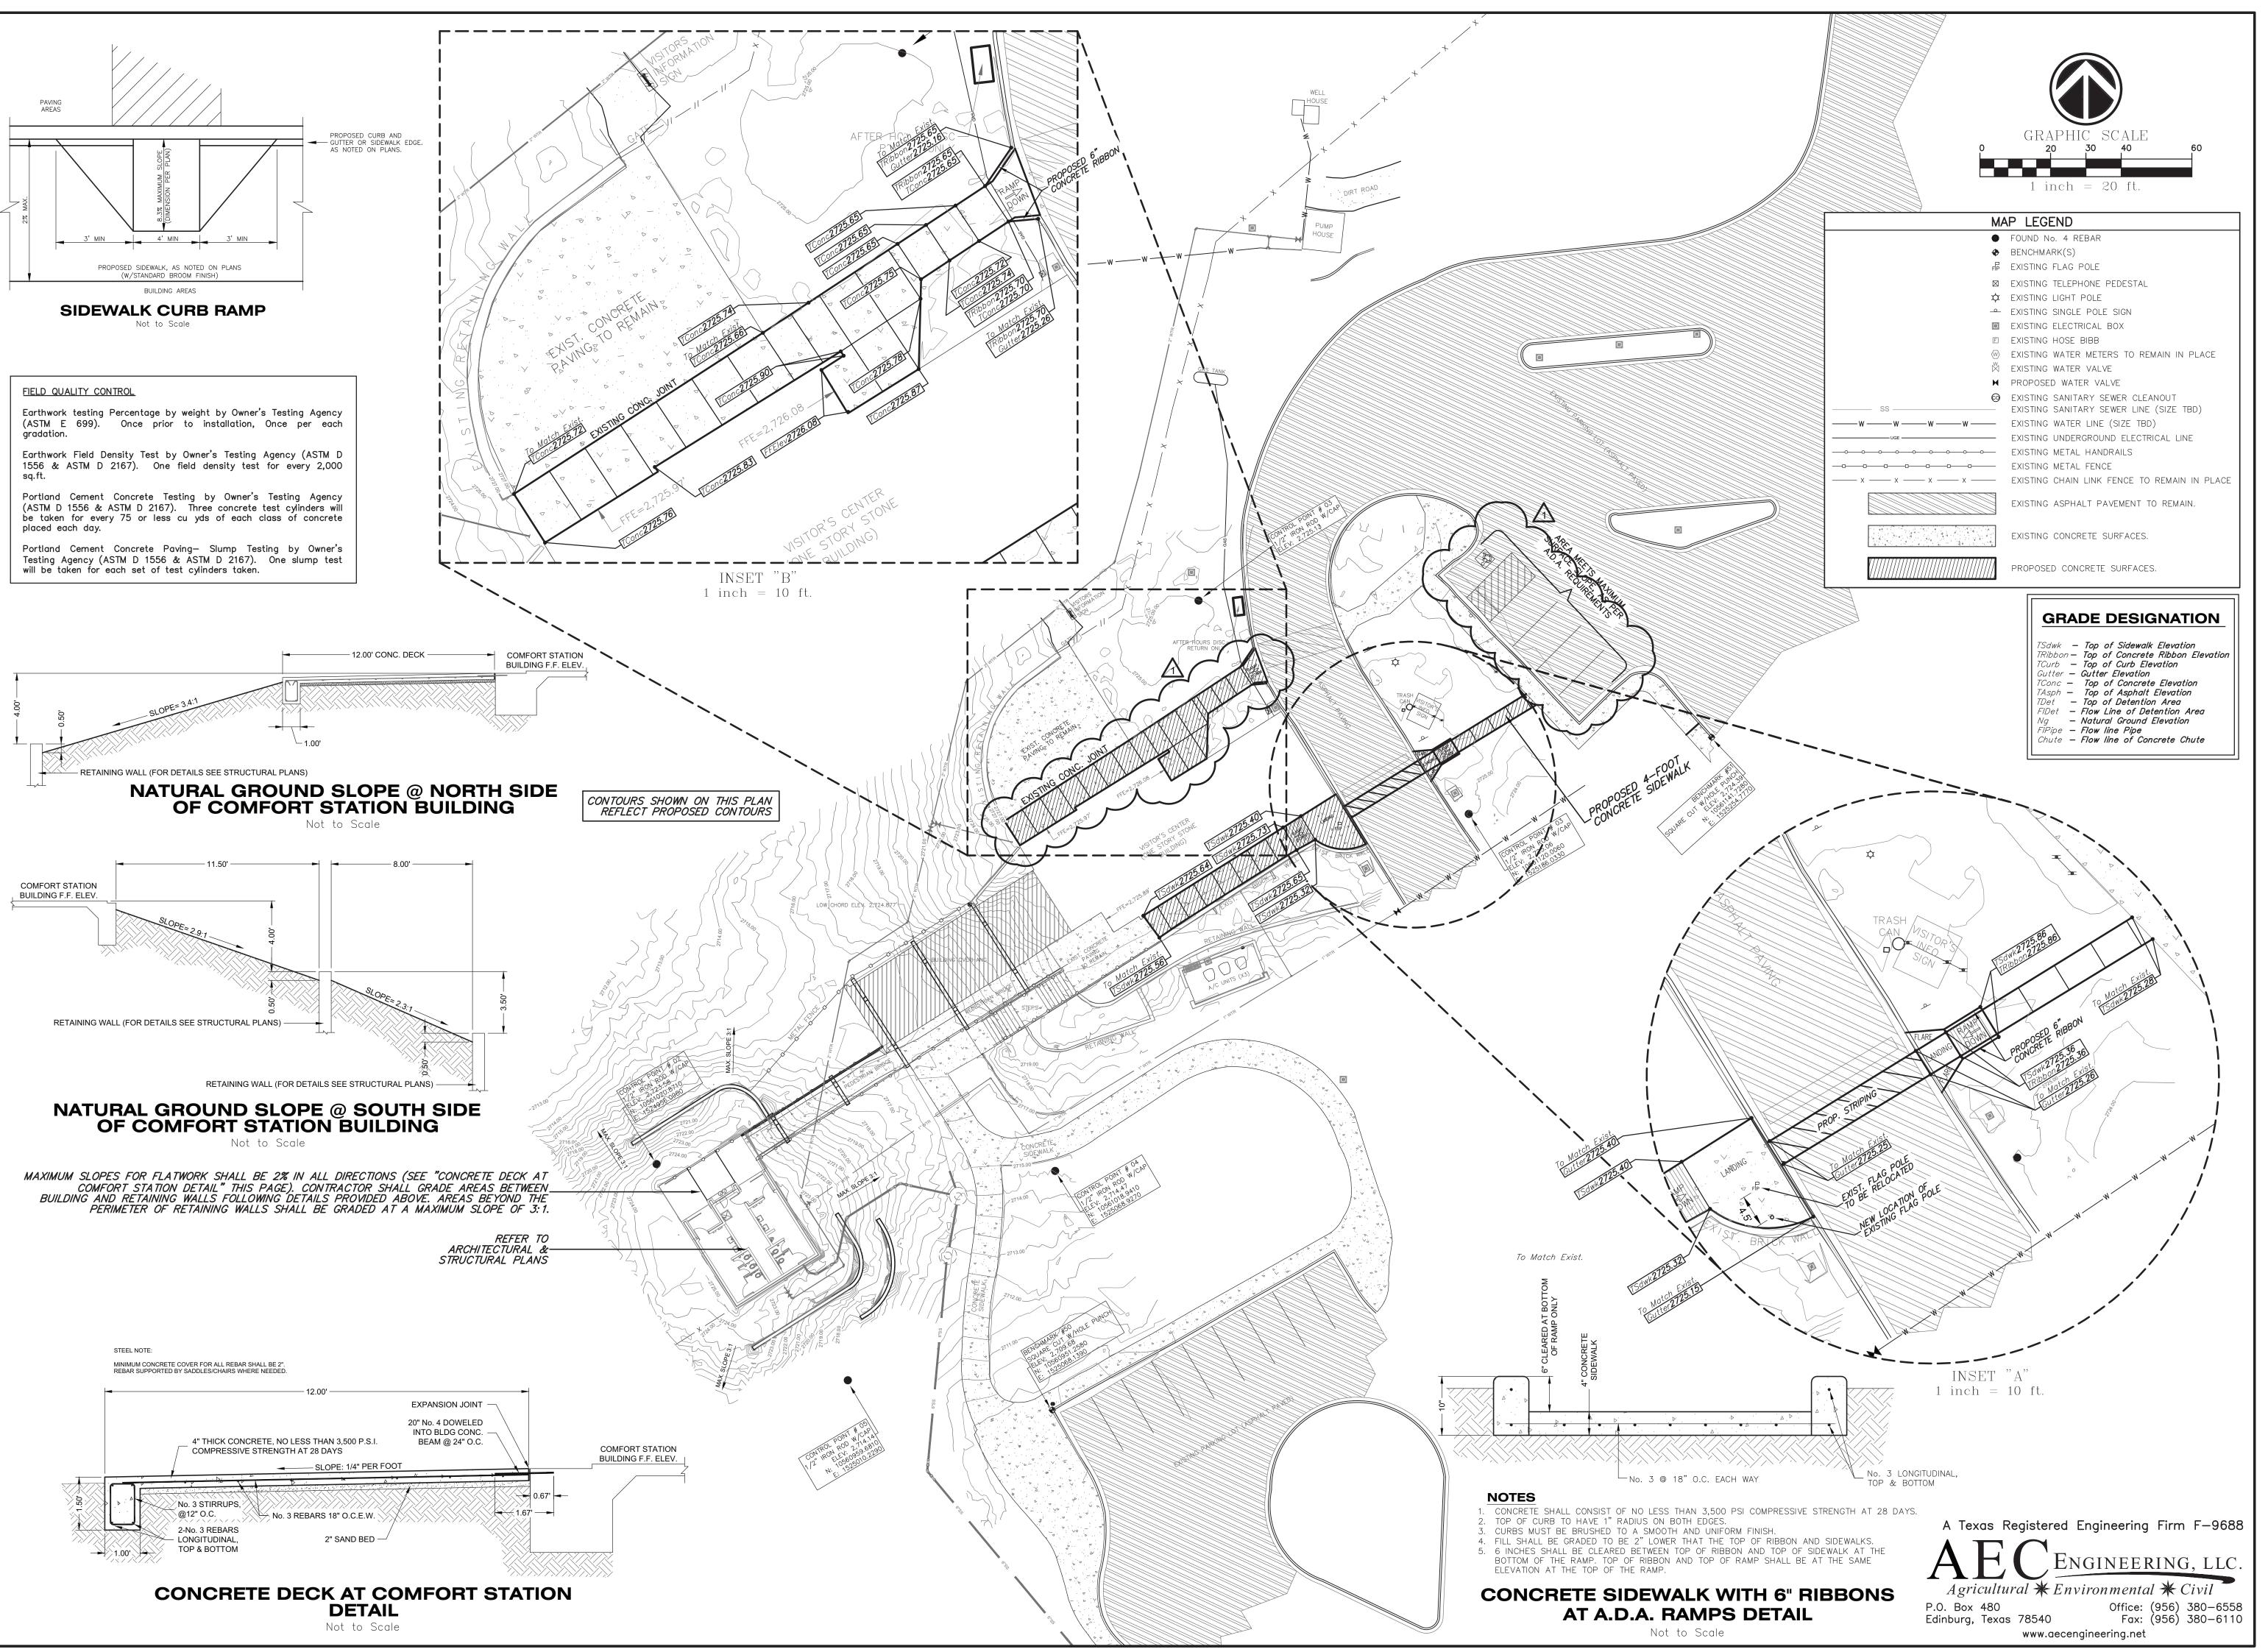

PARKS & **WILDLIFE** 



THE SEAL APPEARING O THIS DOCUMENT WAS AUTHORIZED BY CUMENT WITHOUT PRO NOTIFICATION TO THE

TEXAS ENGINEERING PRACTICE LAW

ation

ark State ction 0 Monahan Visitors

DESIGNED BY: J.D'Z. DRAWN BY: J.D'Z. REVIEWED BY: C.G.


ADD1 5/07/21 SIDEWALK WAS STRAIGHTEN. GRADES REVISED TO MEET A.D.A.

SIGN ADDED.

PARKING SPACES RE-ARRANGED. A.D.A.

SHEET TITLE

**GRADING PLAN** 

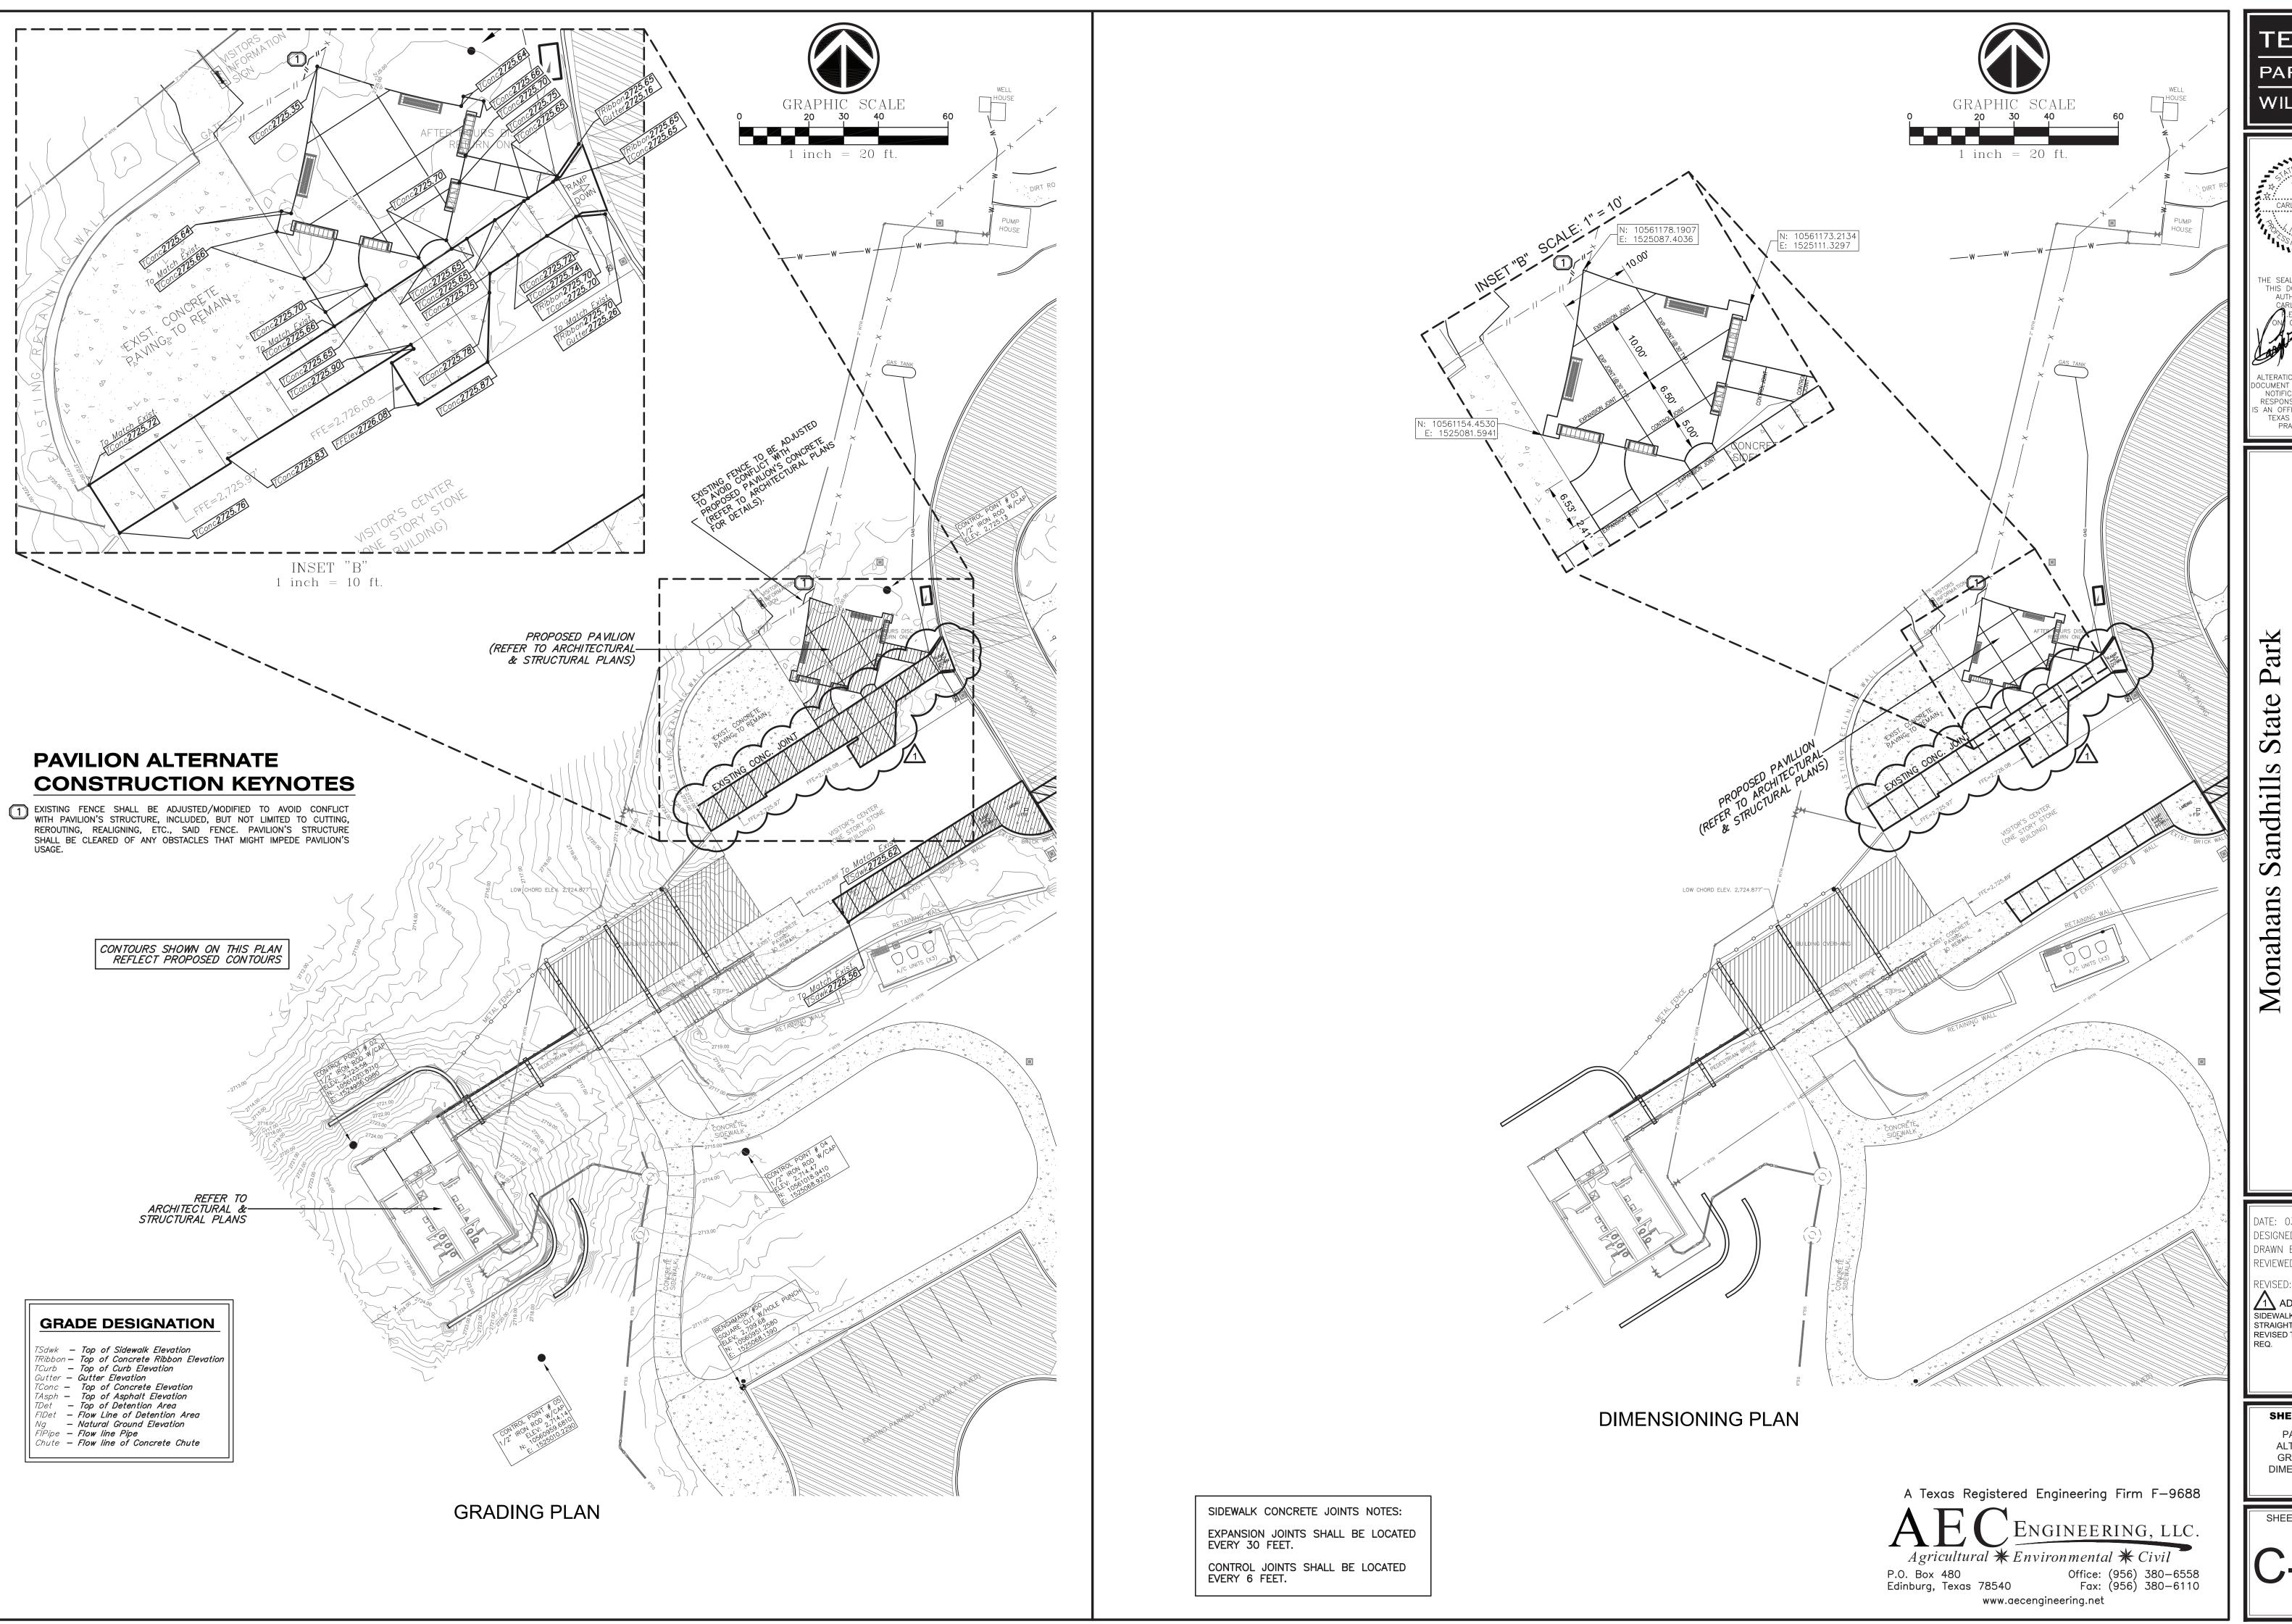

PARKS & WILDLIFE





THIS DOCUMENT WAS
AUTHORIZED BY DOCUMENT WITHOUT PROPE NOTIFICATION TO THE RESPONSIBLE ENGINEER IS AN OFFENSE UNDER TH TEXAS ENGINEERING PRACTICE LAW

ations Sandhills Section Ho 1110169 ction Ho Center


DESIGNED BY: J.D'Z. DRAWN BY: J.D'Z. REVIEWED BY: C.G.

Visitors


ADD1 5/07/21
SIDEWALK WAS
STRAIGHTEN. GRADES
REVISED TO MEET A.D.A.

SHEET TITLE


**PAVILION** ALTERNATE **GRADING &** DIMENSIONING PLAN

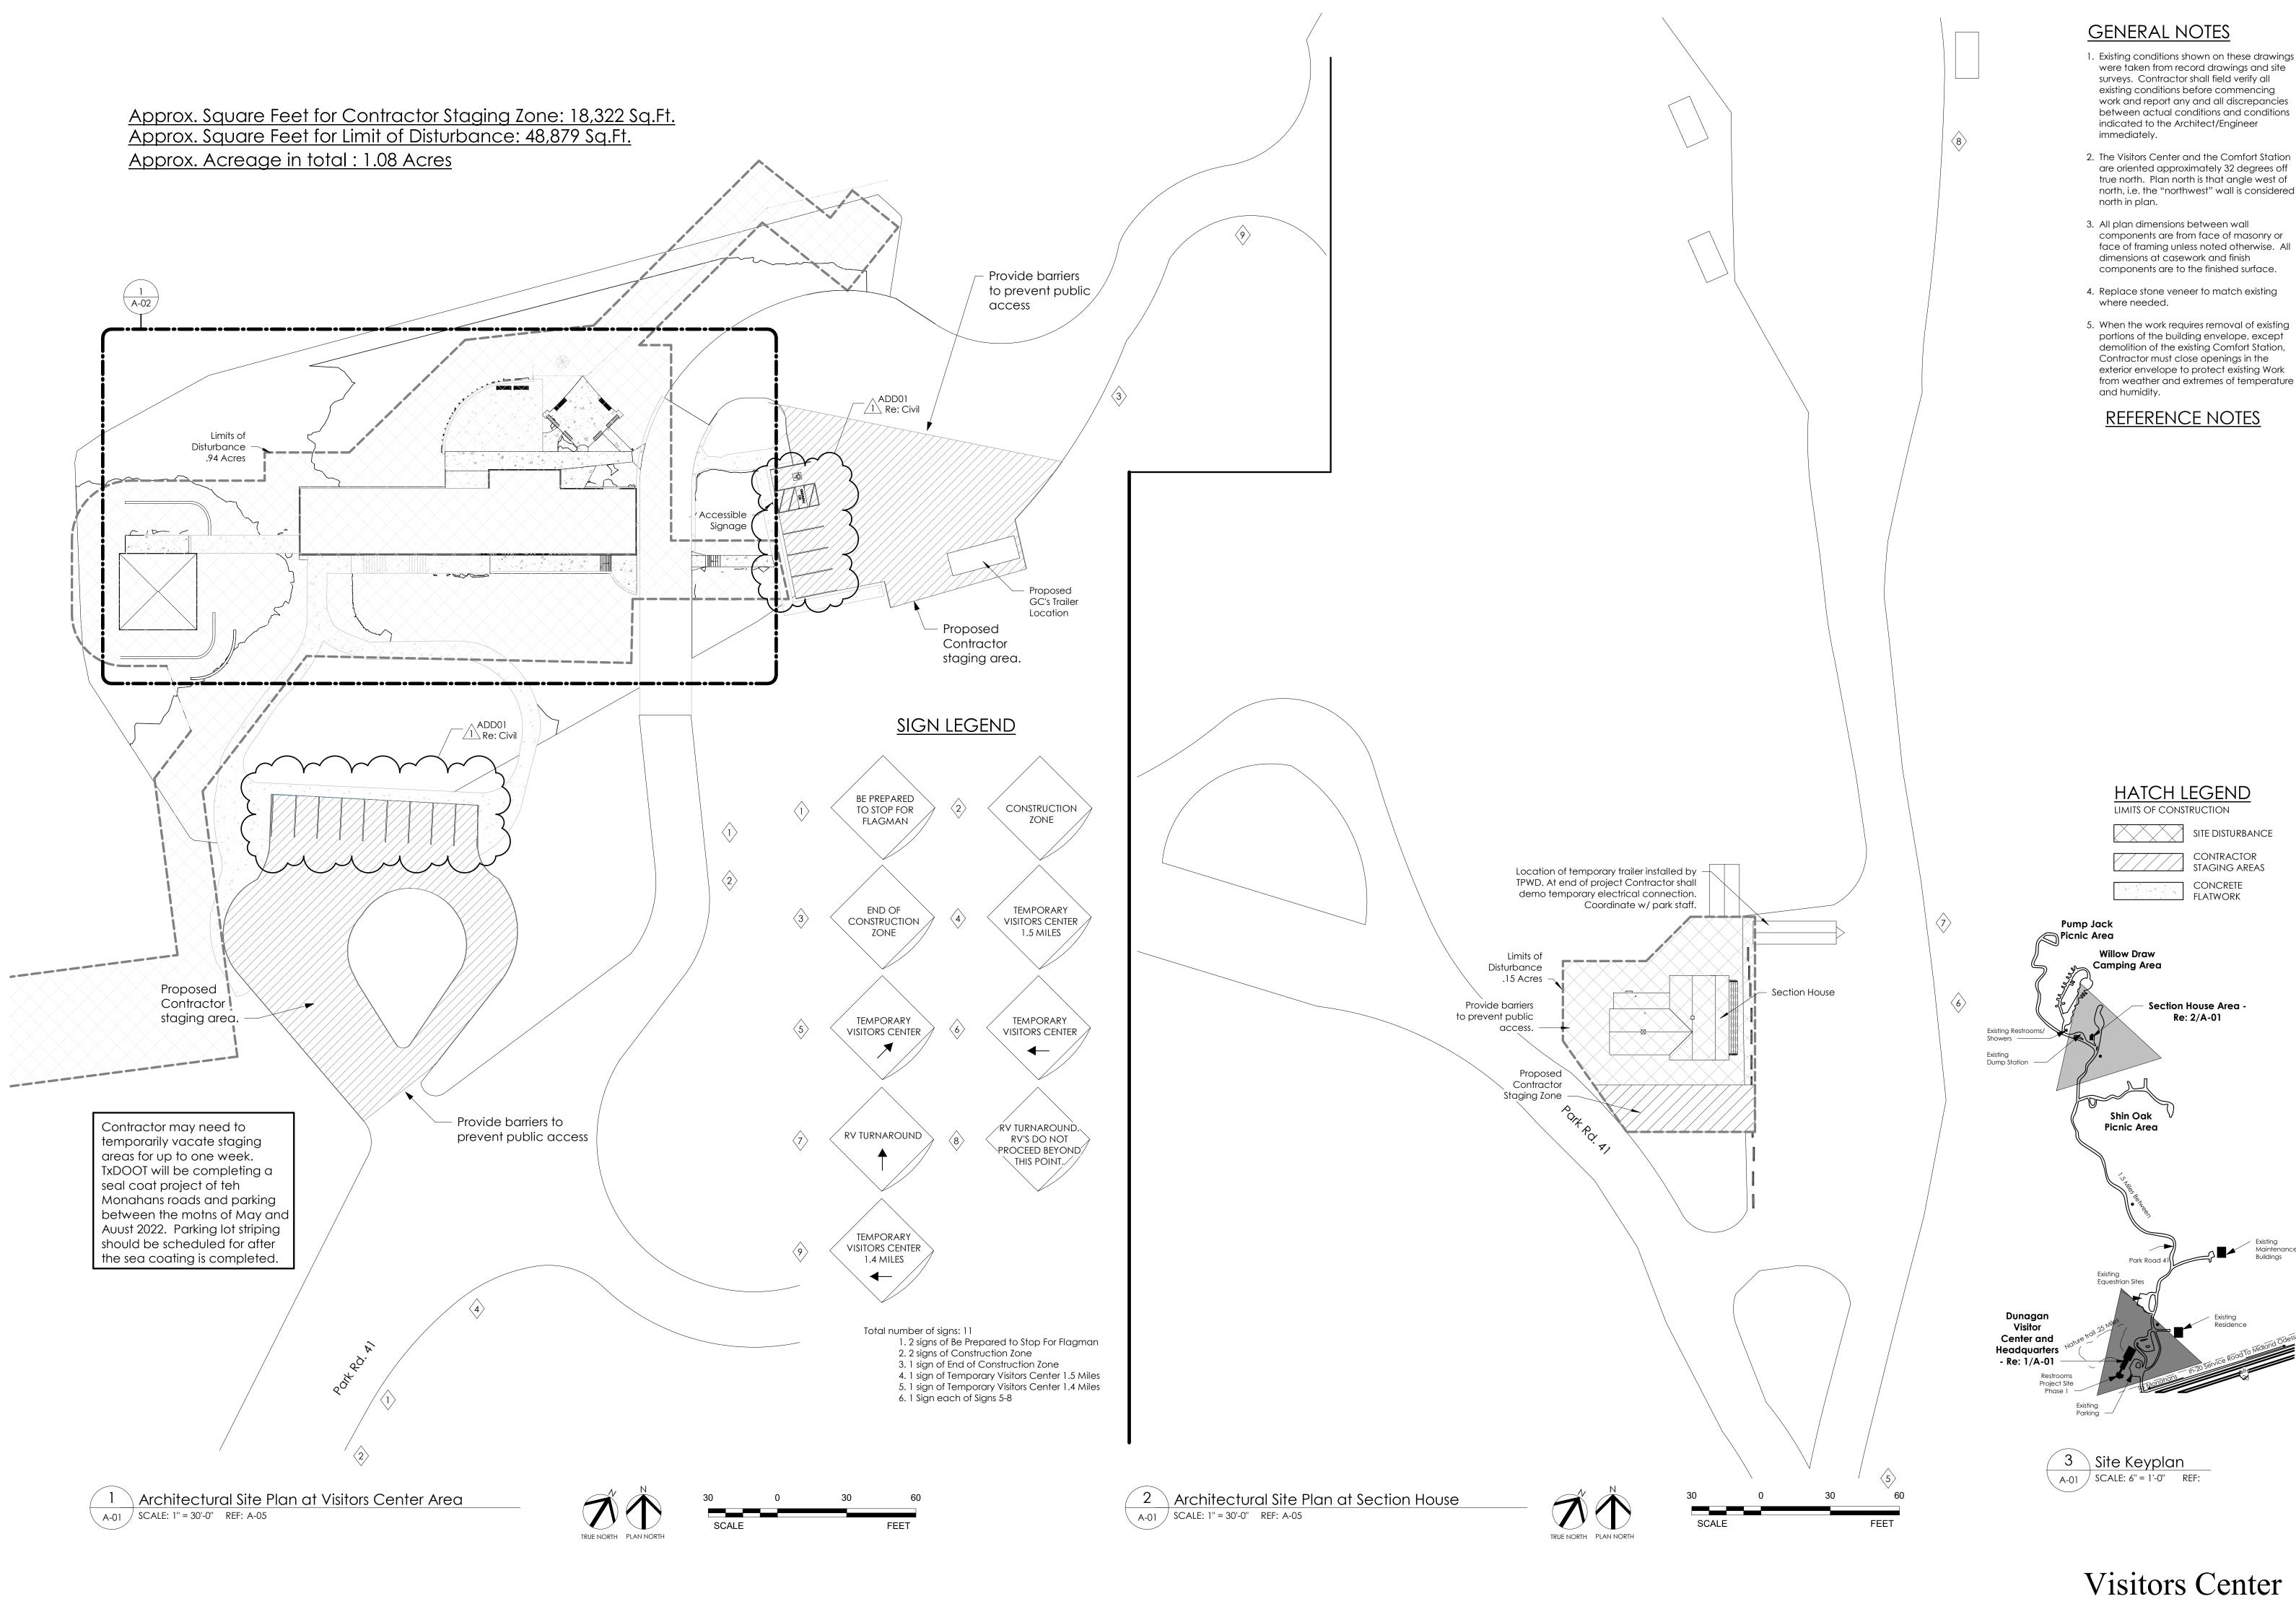

1. Existing conditions shown on these drawings were taken from record drawings and site surveys. Contractor shall field verify all existing conditions before commencing work and report any and all discrepancies between actual conditions and conditions indicated to the Architect/Engineer

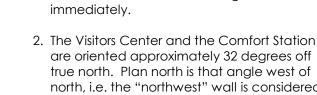

- 3. All plan dimensions between wall components are from face of masonry or
- face of framing unless noted otherwise. All dimensions at casework and finish components are to the finished surface.
- 5. When the work requires removal of existing portions of the building envelope, except demolition of the existing Comfort Station, Contractor must close openings in the exterior envelope to protect existing Work from weather and extremes of temperature

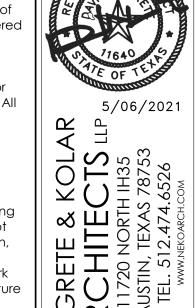

PARKS &

**WILDLIFE** 

B

S

Monahan

Visitors

SITE DISTURBANCE CONTRACTOR STAGING AREAS

CONCRETE FLATWORK

> DATE: 5/06/2021 DESIGNED BY: BWM DRAWN BY: NDM REVIEWED BY: BWM RĘVISED: \ ADD01 5/07/2021 REVISED:

REVISED:

SHEET TITLE Architectural Site Plans Overall

SHEET NUMBER

100%

locations of lesser

dimension.

A-02 | SCALE: 1/2" = 1'-0" | REF:

PARKS & **WILDLIFE** 





DATE: 5/06/2021 DESIGNED BY: BWM DRAWN BY: NDM REVIEWED BY: BWM REVISED: 1 ADD01 5/07/2021 REVISED:

REVISED:

SHEET TITLE Architectural Site Plan Visitors Center & Site Details

SHEET NUMBER

100%

Visitors Center

3 Signage Size
A-04 SCALE: 3" = 1'-0" REF:

SIGN SCHEDULE			
Room Installed	Location	Text L1	Sign Type
103	Mount to West wall East of door 103	EXIT	Α
105	Mount on end of stone wall East of door 105	EXIT	Α
105	Mount 18" from West of Staff restroom frame door 106	STAFF RESTROOM	E
203	Mount on East face of faux gyp board column. Center on column.	EXIT	В
404	Mount on East wall with CL 9" from Northend of wall.	MEN	С
405	Mount on West wall with CL 9" from North end of wall.	WOMEN	D

3' - 0''

**GLASS DOOR** 

└-10 2219.A13 08 1416

ADD01

∧ ADD01

2' - 7"

INFILL PANEL

√ <sup>\_</sup>08 4113.D4

─08 4113.F4

# **GENERAL NOTES**

- 1. Existing conditions shown on these drawings were taken from record drawings and site surveys. Contractor shall field verify all existing conditions before commencing work and report any and all discrepancies between actual conditions and conditions indicated to the Architect/Engineer immediately.
- 2. The Visitors Center and the Comfort Station are oriented approximately 32 degrees off true north. Plan north is that angle west of north, i.e. the "northwest" wall is considered
  - north in plan. 3. All plan dimensions between wall components are from face of masonry or face of framing unless noted otherwise. All dimensions at casework and finish

components are to the finished surface.

- 4. Replace stone veneer to match existing where needed.
- 5. When the work requires removal of existing portions of the building envelope, except demolition of the existing Comfort Station, Contractor must close openings in the exterior envelope to protect existing Work from weather and extremes of temperature and humidity.

## REFERENCE NOTES

08 1213.13.A2 5 1/2" Equal Rabbet HM Door Frame 08 1213.13.A4 6 3/4" Equal Rabbet HM

Door Frame 08 1213.13.A5 7 3/4" Equal Rabbet HM Door Frame

08 1313.13 Standard Hollow Metal 08 1313.13.B0 Standard Hollow Metal Door - Thermally Insulated

08 4113.D4

08 8000.M5

10 1416

10 2219

- Finish Floor

6' - 0''

9

1 3/4" SOLID CORE

WOOD DOOR

3' - 0''

3' - 0''

Flush Wood Doors 08 4113.A4 Aluminum Framing 2"x4-1/2" Aluminum Framing 2"x4-1/2" 08 4113.B1 Thermally Broken 08 4113.B2 Aluminum Framing 2"x6" Thermally Broken

Insulated Infill Panel 08 4113.F1 Narrow Stile Aluminum Entrance 08 4113.F4 Narrow Stile Aluminum Thermally Broken Entrance 08 8000.C1 1/4" Tempered Glass -


Anodized Aluminum Faced

1" Tempered Low-E Insulated Glazing (Triple Silver) - Tinted Light Green Cast Plaques Demountable Partitions Demountable Aluminum 10 2219.A13 Framed Partition (Bottom





5/06/2021

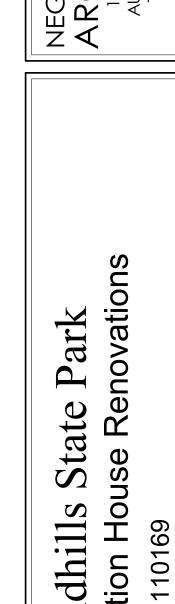

Sa

Monahans (


Visitors

DATE: 5/06/2021 DESIGNED BY: BWM DRAWN BY: NDM REVIEWED BY: BWM REVISED: 1\ ADD01 5/07/2021 REVISED:

REVISED:

SHEET TITLE Door/Room Finish Schedules, Door & Signs Types

100%

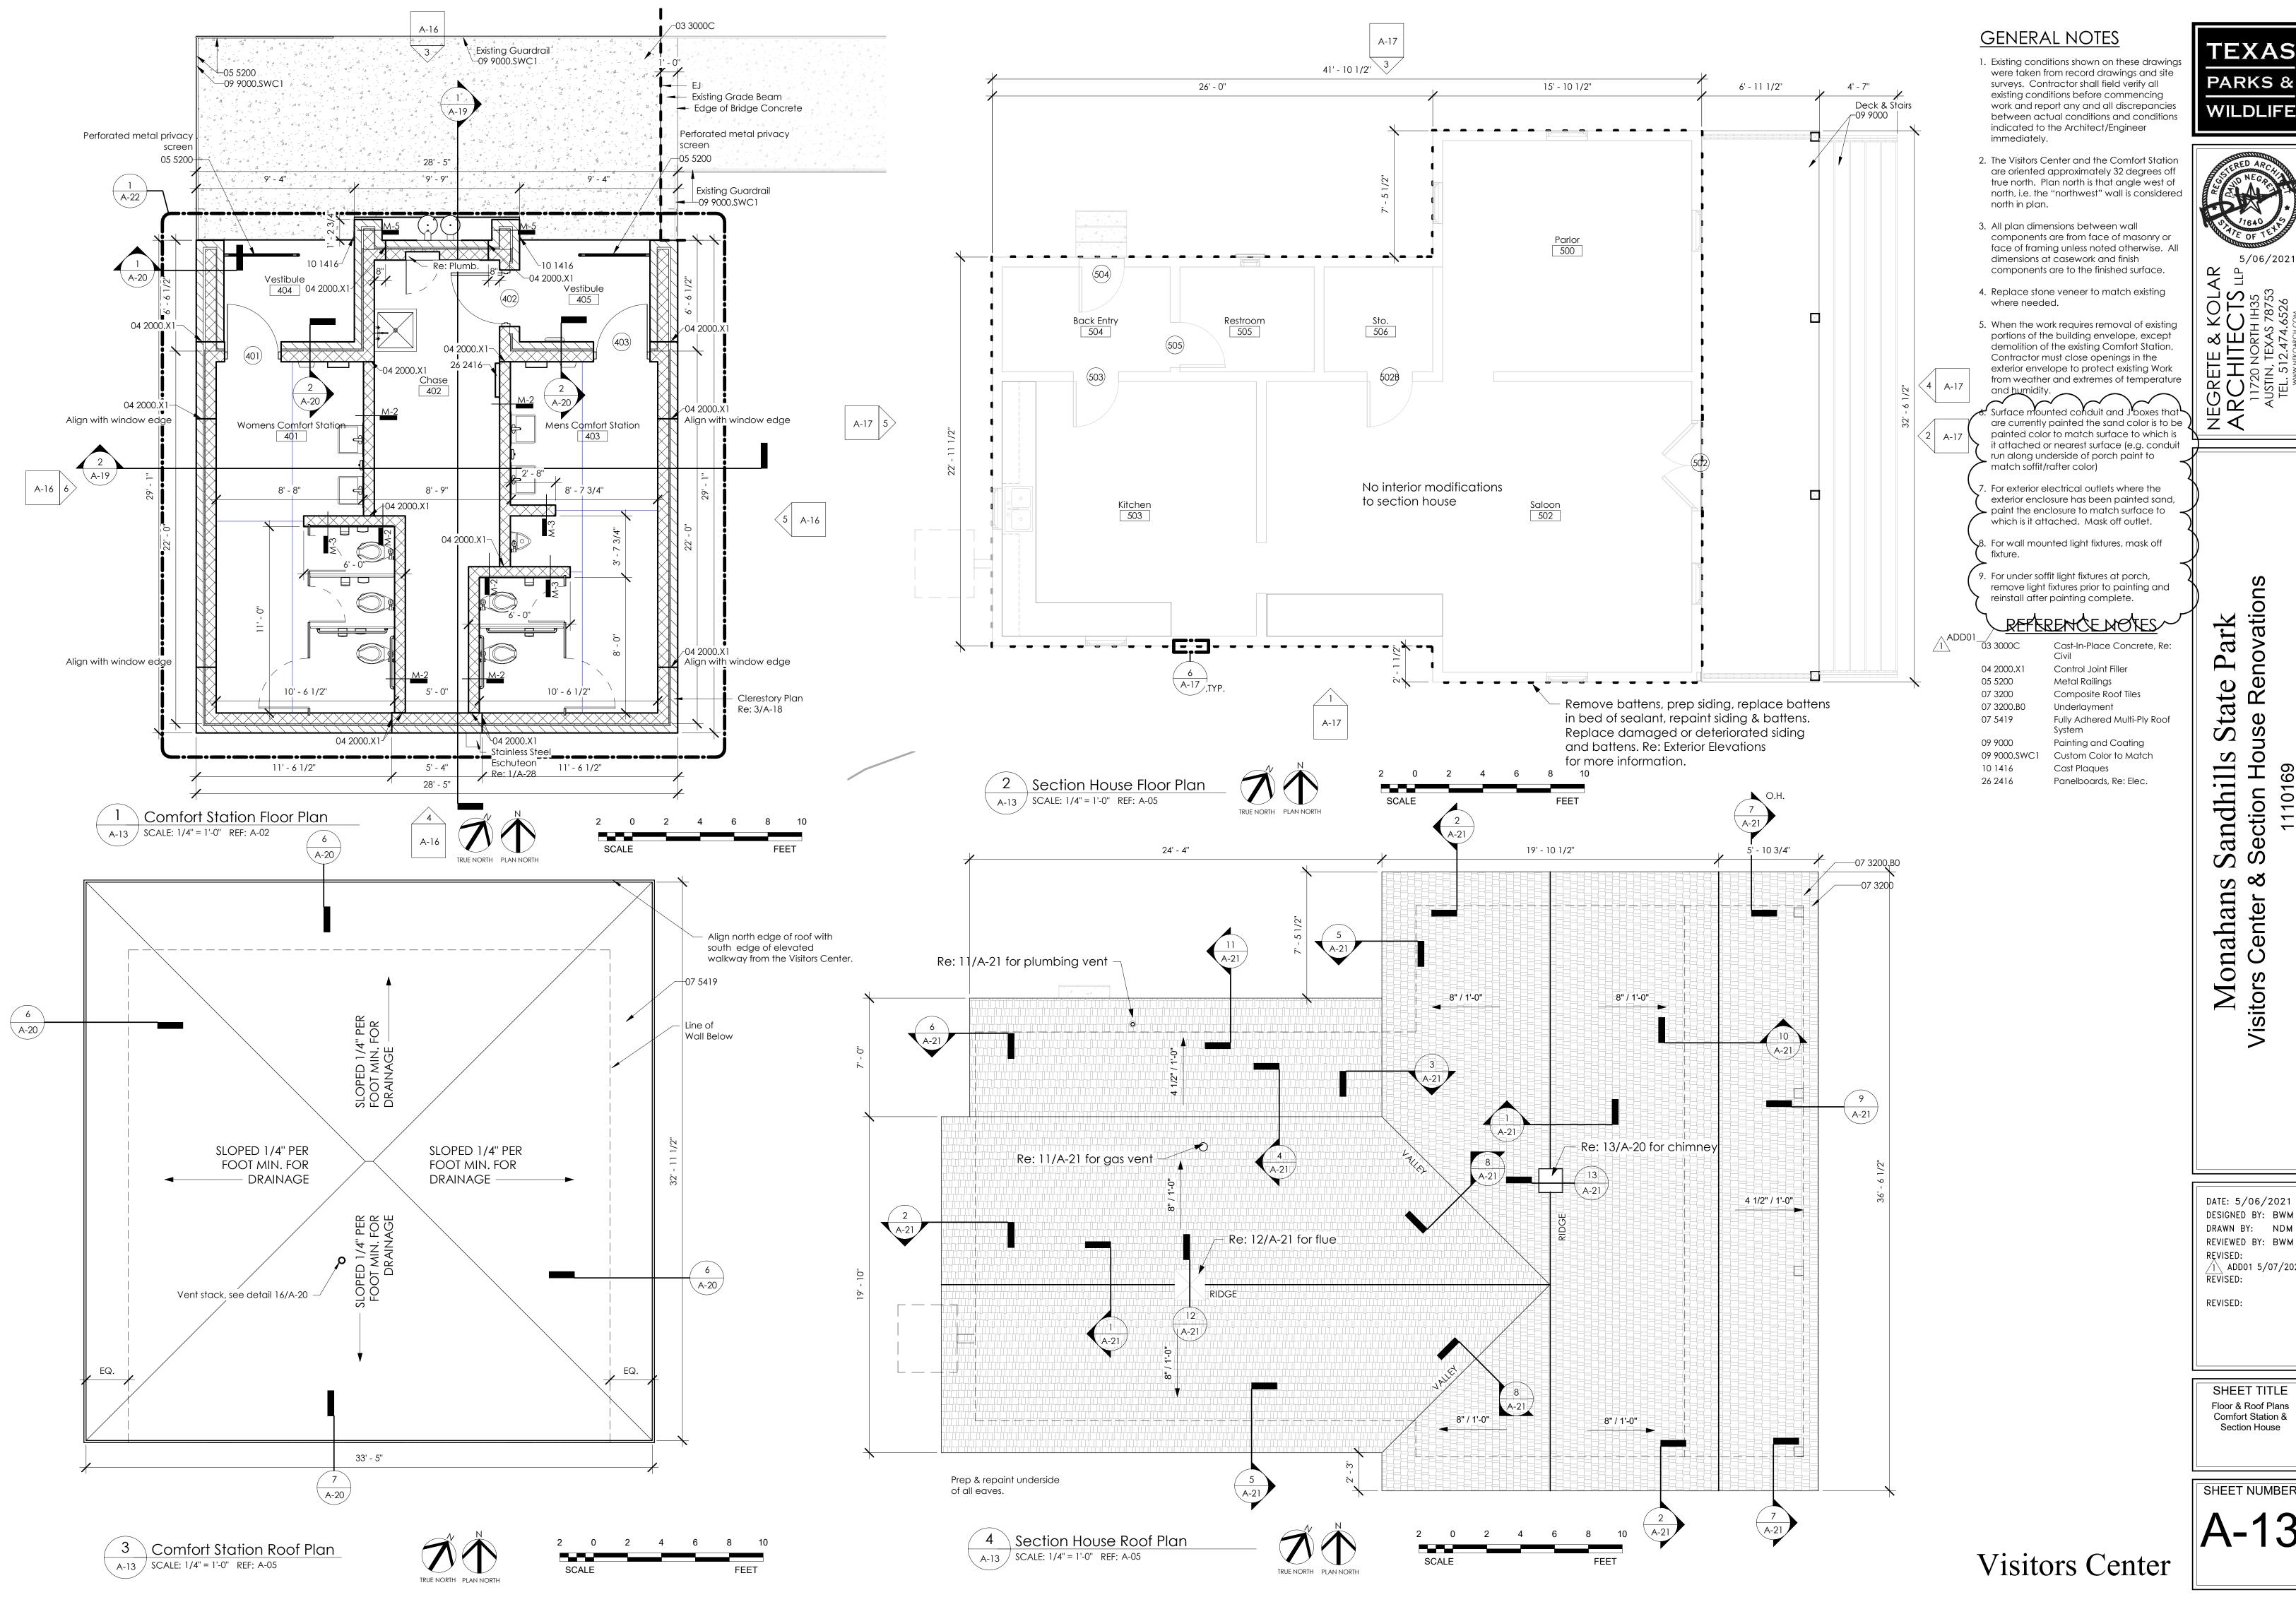

SHEET TITLE Floor & Roof Plans Comfort Station & Section House

1\ ADD01 5/07/2021

PARKS &

**WILDLIFE** 

ark

10

Sa Se

Monahan

Visitors Center

A-13 Constru

A-17 | SCALE: 1/4" = 1'-0" | REF: A-13

Tow Construction [

PARKS &

**WILDLIFE** 

novations

Park

Sa

Monahans S Visitors Center &

DATE: 5/06/2021 DESIGNED BY: BWM

DRAWN BY: NDM REVIEWED BY: BWM

REVISED:

REVISED:

REVISED: 1 ADD01 5/07/2021

SHEET TITLE Exterior Elevations Section House

Visitors Center