

U.S. FISH & WILDLIFE SERVICE

INKS DAM RESIDENCE #3 REHAB DESIGN

ASSET #: 10006240




IN	DEX OF DRAWINGS
C-1	COVER/INDEX OF DRAWINGS
A-1	FLOOR PLAN
A-2	GYPSUM BOARD AND INSULATION PLAN
P-1	PLUMBING NOTES, SYMBOLS AND DETAILS
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E-4	GARAGE PLAN
E-5	ELECTRICAL SCHEDULES



100% DESIGN SUBMITTAL JULY 31, 2020

DESIGNED: JKB


DATE: 7/31/20 DRAWING NO. C-1

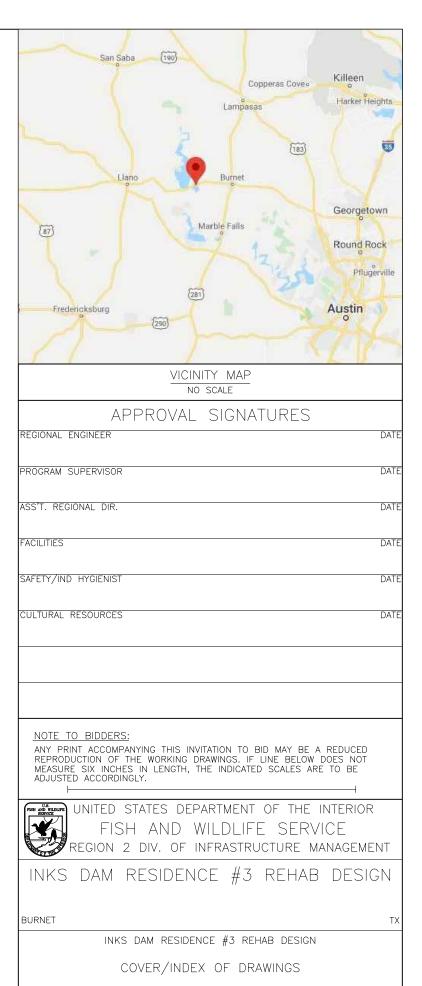


SHEET 1 OF

GENERAL NOTES:

- DIMENSIONS SHOWN OF EXISTING WALLS ARE APPROXIMATE.
- 2. CONTRACTOR SHALL COMPLY WITH ALL APPLICABLE CODES AND REGULATIONS.
- 3. ALL GYPSUM BOARD WALLS AND WOOD TRIM SHALL RECEIVE A PROTECTIVE COATING OF PRIMER AND PAINT AFTER OTHER WORK IS COMPLETED. REFER TO SPECIFICATION 099600 PROTECTIVE COATINGS FOR DETAILS.
- 4. ALL CEILING HEIGHTS ARE 8'-0".

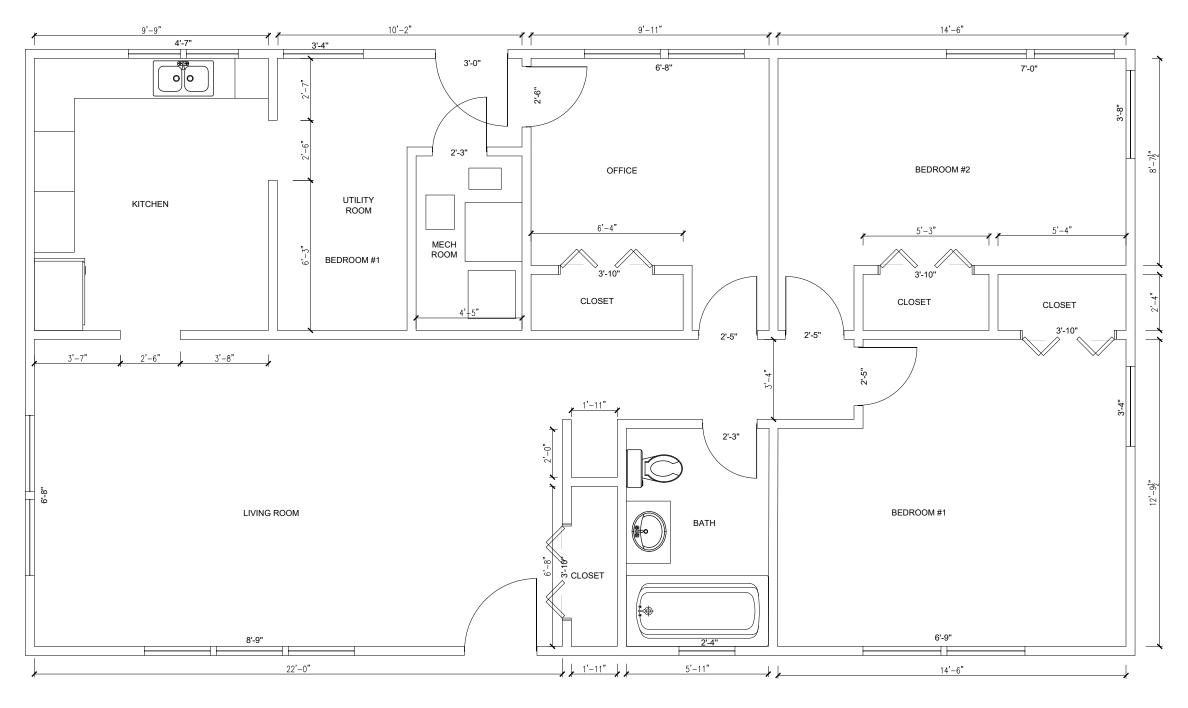

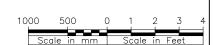

INKS DAM						SUB-SHEET
		FLOOF	R PLAN			A-1
INKS DAM	RESIDENCE	#3 REHAB	DESIGN			
DESIGNED	DRAWN	CHECKED	DATE	DRAWING	NO.	SHEET




0 0 BEDROOM #2 CRAWL SPACE ACCESS ACCESS DEMOLISH CEILING (TYP IN ENTIRE RESIDENCE) RETAIN FANS FOR RE-INSTALLATION BEDROOM #1

GENERAL NOTES:

- PRIOR TO ANY ELECTRICAL AND PLUMBING DEMOLITION OR CONSTRUCTION, ALL INDICATED GYPSUM BOARD MUST BE DEMOLISHED AND REMOVED FROM RESIDENCE.
- 2. GYPSUM BOARD AND INSULATION SHALL BE DEMOLISHED FROM ALL CEILINGS, EXTERIOR WALLS AND PAINTED INTERIOR WALLS. ALL GYPSUM BOARD AND INSULATION DEBRIS AND DUST MUST BE REMOVED OFF OF HATCHERY PROPERTY AND PROPERLY DISPOSED OF PRIOR TO ELECTRICAL AND PLUMBING CONTRACTORS BEGINNING WORK
- 3. A QUALIFIED ASBESTOS ABATEMENT CONTRACTOR SHALL BE USED DURING DEMOLITION PHASE FOR PROPER SETUP AND CONTAINMENT.
- 4. INSTALL NEW R11 INSULATION ON ALL EXTERIOR WALLS AND APPLY GYPSUM BOARD. INSTALL NEW GYPSUM BOARD ON INTERIOR WALLS WHERE REMOVED. INSTALL NEW GYPSUM BOARD ON CEILINGS. MUD, TAPE, SAND AND PAINT TO MATCH EXISTING CONDITIONS. PAINT ALL PAINTED WOOD TRIM. ALL COLORS SHALL BE COORDINATED WITH THE OWNER PRIOR TO PAINTING.
- REPAIR OR REPLACE WOOD TRIM THAT IS DAMAGED OR UNUSABLE.
- 6. BLOW IN NEW R38 INSULATION IN ATTIC TO A MINIMUM DEPTH OF THE MANUFACTURES RECOMMENDATIONS..
- CONTRACTOR SHALL PROTECT EXISTING FLOORING DURING CONSTRUCTION AND SHALL REPAIR NECESSARY DAMAGES TO RETURN FLOOR TO CONDITIONS BEFORE CONSTRUCTION.
- ALL ELECTRICAL AND PLUMBING DEMOLISHED DEBRIS MUST BE REMOVED OFF OF HATCHERY PROPERTY AND PROPERLY DISPOSED OF.

KNOWN LEAD PAINT AND ASBESTOS LOCATIONS:

- A LEAD-BASED PAINT INSPECTION WAS COMPLETED IN 2000 AND IDENTIFIED THE FOLLOWING FINDINGS;
- a. INTERIOR PAINT WAS FOUND IN "GOOD" CONDITION AND THE AMOUNT OF LEAD IS INDICATIVE OF 1950S OR EARLY 1960S PAINT
- b. EXTERIOR WOOD PAINT ON THE SOFFIT AND ROOF TRIM OF THE CARPORT WAS IN "POOR" CONDITION AND CONTAINS MORE THAN 10SQFT OF LBP.
- c. EXTERIOR WOOD PAINT ON THE GABLE, SOFFIT AND ROOF TRIM OF THE SOUTH SIDE OF THE RESIDENCE WAS IN "POOR" CONDITION AND CONTAINS MORE THAN 10SQFT OF LBP.
- 2. AN ASBESTOS SURVEY WAS COMPLETED IN 1999 AND IDENTIFIED ASBESTOS IN THE FOLLOWING AREAS:
- a. WALL SKIM COAT THROUGHOUT RESIDENCE.
- b. MECHANICAL ROOM FLOOR TILE.
- c. GARAGE SHINGLES.
- ALL GYPSUM BOARD ON EXTERIOR WALLS SHALL BE REMOVED. ALL PAINTED GYPSUM BOARD ON INTERIOR WALLS SHALL BE REMOVED.
- 4. MECHANICAL ROOM FLOOR TILE WITH ASBESTOS SHALL REMAIN IN PLACE AND UNDISTURBED.
- 5. GARAGE SHINGLES WITH ASBESTOS SHALL REMAIN IN PLACE AND UNDISTURBED.

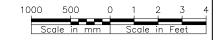

SUB-SHEET AND INSULATION PLAN

INKS DAM RESIDENCE #3 REHAB DESIGN

DEMOLITION LEGEND

. //////, DEMO ALL MATERIAL ON EXTERIOR WALLS FROM FLOOR TO CEILING IN PREPARATION FOR NEW INSULATION.

DEMO ALL PAINTED GYPSUM BOARD ON INTERIOR WALLS SHALL BE REMOVED.

	ons	LEGEND				
AFF	ABOVE FINISHED FLOOR		POTABLE COLD WATER			
CFH	CUBIC FEET PER HOUR					
СО	CLEAN OUT		POTABLE HOT WATER			
CP	CIRCULATING PUMP		POTABLE HOT CIRCULATION WATER			
DHWR	DOMESTIC HOT WATER RETURN	NG	NATURAL GAS			
DHWS	DOMESTIC HOT WATER SUPPLY					
DS	DRENCH SHOWER		FLOOR CLEANOUT			
ECR	ENGINE COOLING WATER RETURN	I	WALL CLEANOUT			
ECS	ENGINE COOLING WATER SUPPLY		BUTTERFLY VALVE			
ES/EW	EMERGENCY SHOWER AND EYE WASH					
ET	EXPANSION TANK		GLOBE VALVE			
EWC	ELECTRIC WATER COOLER	—— — ———	BALL VALVE			
EWH	ELECTRIC WATER HEATER	<u></u>	BACKFLOW PREVENTER			
FCO	FLOOR CLEAN OUT		SANITARY DRAIN			
FD	FLOOR DRAIN					
FW	FIRE PROTECTION WATER		VENT PIPING			
GPM	GALLONS PER MINUTE	→	CHECK VALVE			
НВ	HOSE BIBB		DOWN PIPE			
HWR	HOT WATER RETURN		DOWNTHE			
HWS	HOT WATER SUPPLY	——————————————————————————————————————	VALVE IN RISER			
LAV	LAVATORY	— —	FLOOR DRAIN			
MSB	MOP SERVICE BASIN					
NG	NATURAL GAS					
PW	POTABLE WATER					
RPBFP	REDUCED PRESSURE BACK FLOW PREVENTER					
SD	SANITARY DRAIN					
SH	SHOWER					
SK	SINK					
THW	TEMPERED HOT WATER					
TMV	THERMOSTATIC MIXING VALVE					
TW	TEMPERED WATER					
U	URINAL					
UW	UTILITY WATER					
VTR	VENT THROUGH ROOF					
WC	WATER CLOSET					
WCO	WALL CLEAN OUT					
WCO	WATER HEATER					

1.	THE ENTIRE PLUMBING SYSTEM SHALL BE IN ACCORDANCE WITH THE
	2015 EDITION OF THE INTERNATIONAL PLUMBING CODE AND LOCAL PLUMBING
	STATUTES/ORDINANCES.

2. THE PIPING INDICATED ON THESE PLANS ARE DIAGRAMATIC. ALL WORK SHALL BE COORDINATED WITH ALL OTHER TRADES PRIOR TO INSTALLATION. SUBCONTRACTOR SHALL COORDINATE ROUTING OF ALL PIPING WITH EXISTING CONDITIONS AND SHALL PROVIDE ANY NECESSARY OFFSETS, REROUTING, TEES, ELBOWS, ETC. REQUIRED FOR A COMPLETE AND COORDINATED INSTALLATION.

GENERAL PLUMBING NOTES

- 3. ALL PLUMBING & PIPING SYSTEMS SHALL BE SUPPORTED AS REQUIRED BY THE LOCAL CODE REQUIREMENTS AND PER MANUFACTURER'S RECOMMENDATIONS.
- ALL PIPING PENETRATIONS THROUGH NEW, EXISTING WALL, OR FLOOR SHALL BE SEALED TO EQUAL THE RATING OF THE NEW, EXISTING WALL OR FLOOR.
- 5. TEST POTABLE WATER SYSTEM UNDER A WATER PRESSURE NOT LESS THAN 1-1/2 TIME THE WORKING PRESSURE, BUT NOT LESS THAN 125 PSI. SEE SPECIFICATION 220000 FOR SPECIFIC TESTING AND REPORTING REQUIREMENTS.
- 6. TEST THE DRAINAGE AND VENTING SYSTEMS WITH WATER. SEE SPECIFICATION 220000 FOR SPECIFIC TESTING AND REPORTING REQUIREMENTS.
- TEST GAS PIPING SYSTEM UNDER A PRESSURE NOT LESS THAN 1-1/2 TIME THE WORKING PRESSURE, BUT NOT LESS THAN 3 PSIG. SEE SPECIFICATION 220000 FOR SPECIFIC TESTING AND REPORTING REQUIREMENTS.
- ALL (VTR'S) VENT THRU ROOF PENETRATIONS INDICATED ON PLANS ARE PRELIMINARY. FINAL LOCATIONS SHALL BE COORDINATED WITH ALL TRADES.


	EXISTING PLUMBING FIX	TURE CON	NECTION SCHED	DULE	
ID	DESCRIPTION	WASTE	VENT	CW	HW
WC-1	TANK TYPE WATER CLOSET	3"	2"	1/2"	-
LAV-1	LAVATORY	2"	1-1/2"	1/2"	1/2"
BT-1	BATHTUB	3"	1-1/2"	1/2"	1/2"
SK-1	SINK	3"	2"	1/2"	3/4"
CW-1	CLOTHES WASHER	2"	1-1/2"	1/2"	1/2"




PLUMBING NOTES, SYMBOLS AND DETAILS

INKS DAM RESIDENCE #3 REHAB DESIGN

DESIGNED DRAWN CHECKED DATE P-1 SS DIAWN AK 7/31/20 P-1 SHEET 4 OF 12

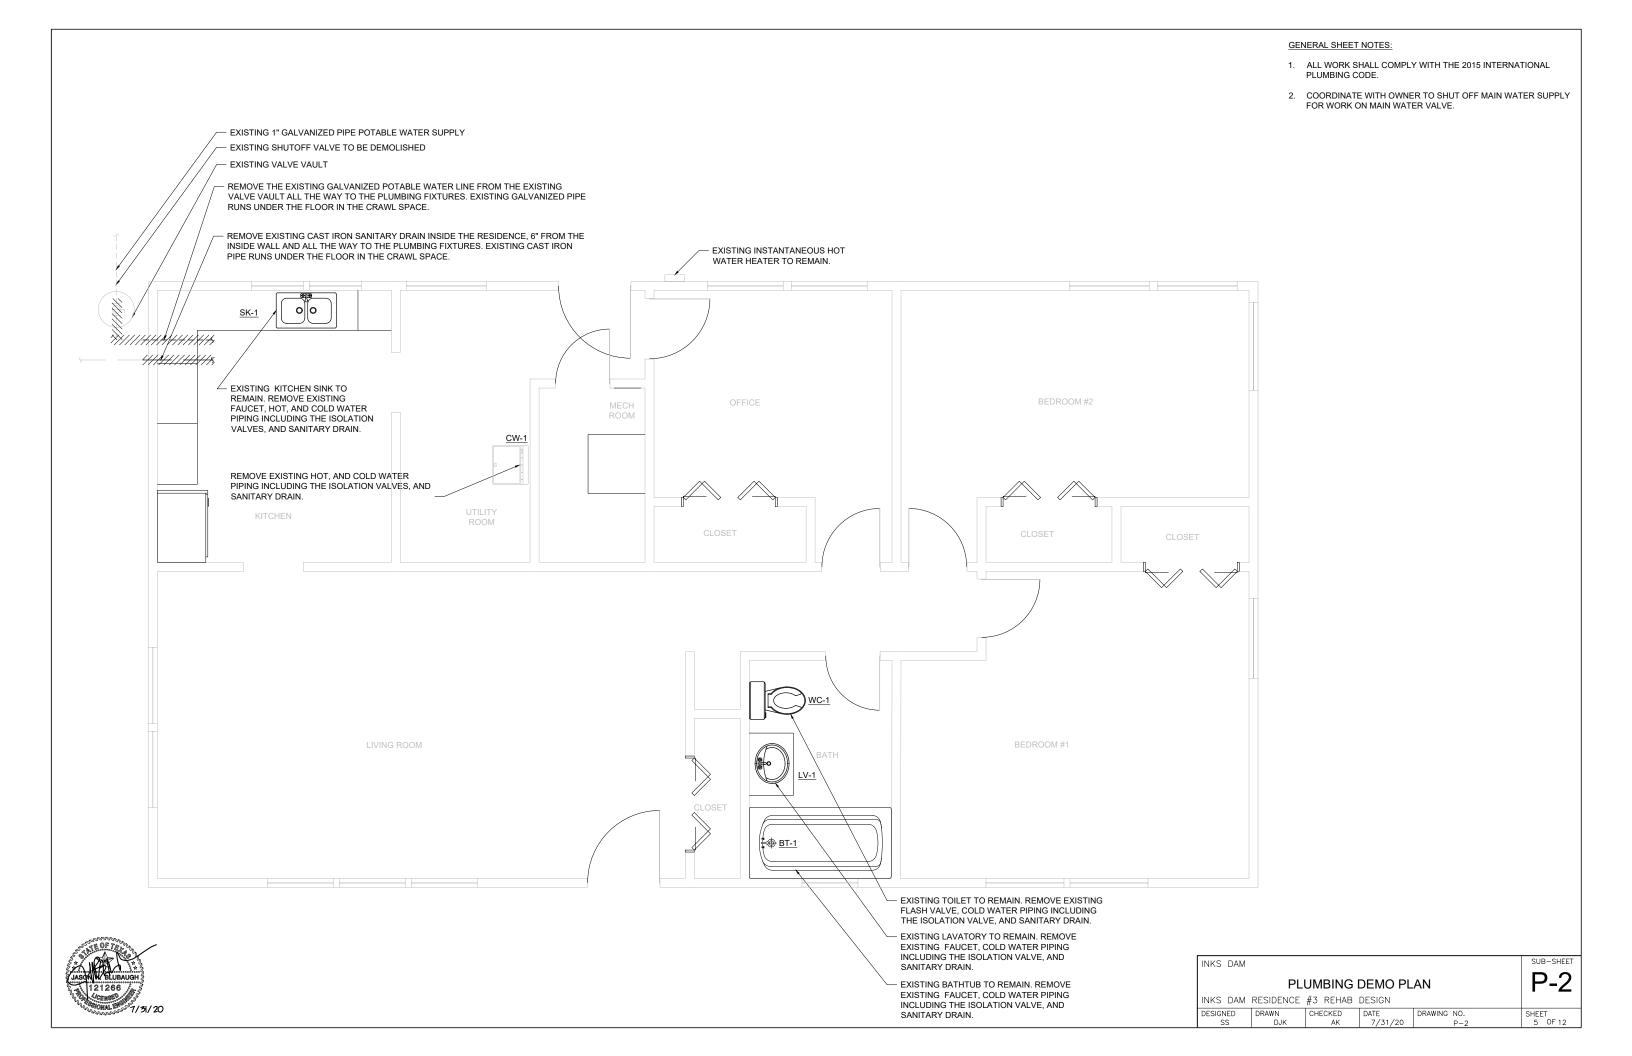

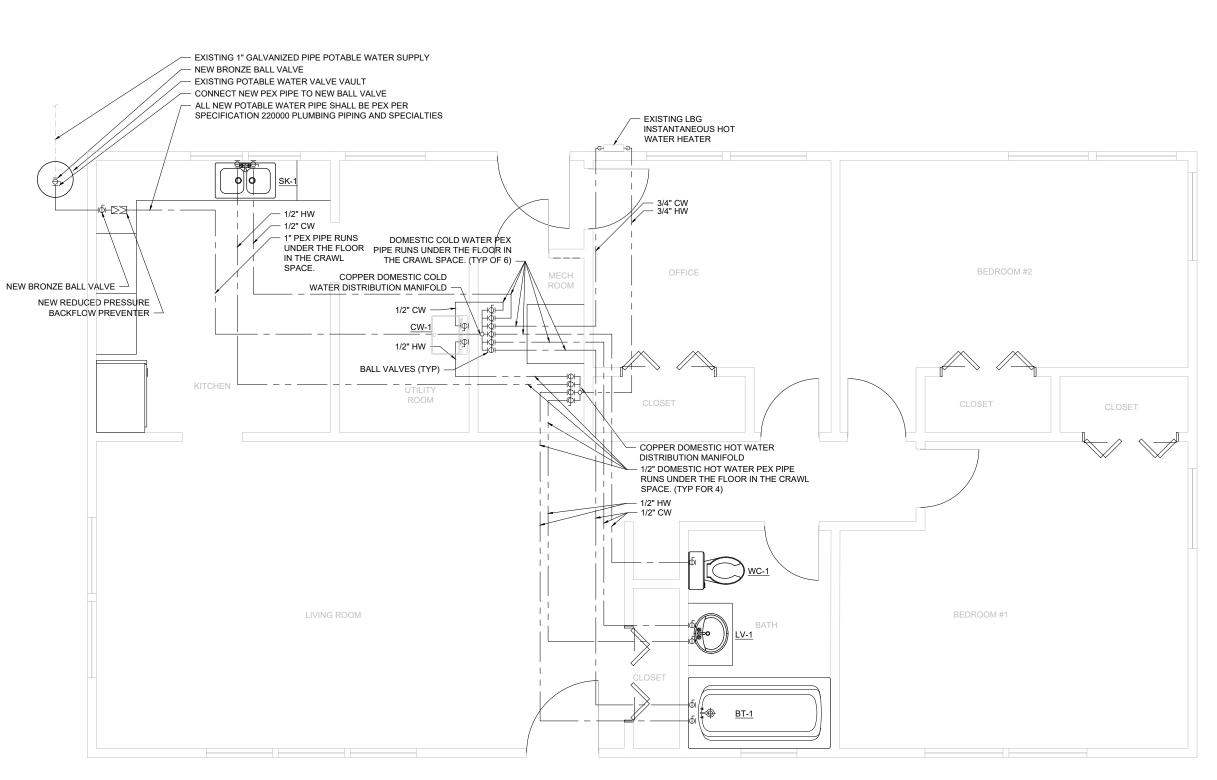

GENERAL SHEET NOTES:

- ALL WORK SHALL COMPLY WITH THE 2015 INTERNATIONAL PLUMBING CODE.
- 2. COORDINATE WITH OWNER TO SHUT OFF MAIN WATER SUPPLY FOR WORK ON MAIN WATER VALVE.
- 3. RETAIN VALVE IN EXTERIOR VALVE VAULT. REPLACE SUPPLY PIPING FROM VALVE TO NEW COLD WATER MANIFOLD WITH PEX TO MATCH EXISTING SIZE. USE DIELECTRIC FITTING AT THE CONNECTION TO THE EXISTING PIPE.
- 4. WATER SUPPLY LINE ENTERS CRAWLSPACE AT OR BELOW
 EXISTING GROUND LEVEL. RAISE NEW PEX PIPE SUPPLY LINE TO
 ABOVE EXISTING GROUND LEVEL AND FEED COLD WATER
 MANIFOLD IN MECHANICAL ROOM.
- 5. ALL NEW POTABLE WATER PIPE SHALL BE PEX PER SPECIFICATION 220000 PLUMBING PIPING AND SPECIALITIES.
- PROVIDE PIPE INSULATION ON ALL HOT AND COLD LINES PER SPECIFICATION 220000 PLUMBING PIPING AND SPECIALTIES.
- 7. REPLACE TOILET FLUSH VALVE. SEE SPECIFICATION 220000.
- 8. CLOTHES WASHER SUPPLY PART OF WATER DRAIN ROUGH IN BOX. INSTALL ROUGH IN BOX AT 42" AFF.
- 9. IF EXTERIOR HOSE BIBS EXIST ON THE RESIDENCE SUBMIT A SEPARATE COST PROPOSAL FROM THE BASE BID FOR THEIR REMOVAL AND REPLACEMENT.
- INSPECT AND MAKE APPROPRIATE REPAIRS TO ALL ROOF AND EVE VENTS TO PREVENT WATER AND RODENT ACCESS TO THE ATTIC SPACES.
- 11. CONTRACTOR SHALL PROTECT EXISTING FLOORING DURING CONSTRUCTION AND SHALL REPAIR NECESSARY DAMAGES TO RETURN FLOOR TO CONDITIONS BEFORE CONSTRUCTION.


PLUMBING POTABLE WATER

INKS DAM RESIDENCE #3 REHAB DESIGN

DESIGNED SS DJK CHECKED AK 7/31/20 DRAWING NO. SHEET 6 OF 12

GENERAL SHEET NOTES:

- 1. ALL WORK SHALL COMPLY WITH THE 2015 INTERNATIONAL PLUMBING CODE.
- 2. INTERCEPT SANITARY DRAINS BELOW FLOOR AND REPLACE BRANCH AND MAIN LINES WITH PVC PIPE. TRANSITION NEW MAIN TO EXISTING MAIN SEWER LINE AT 6" INSIDE RESIDENCE SOUTH WALL.
- 3. ALL NEW SANITARY DRAINS AND VENTS SHALL BE POLYVINYL CHLORIDE (PVC), GRAVITY PIPE ASTM D2665/D1785.
- 4. SLOPE DRAINAGE PIPING 1/4" PER LINEAR FOOT OF DRAIN PIPE.
- CLOTHES WASHER DRAIN PART OF WATER SUPPLY ROUGH IN BOX. INSTALL DRAIN P-TRAP AT 12" AFF AND ROUGH IN BOX AT 42" AFF.

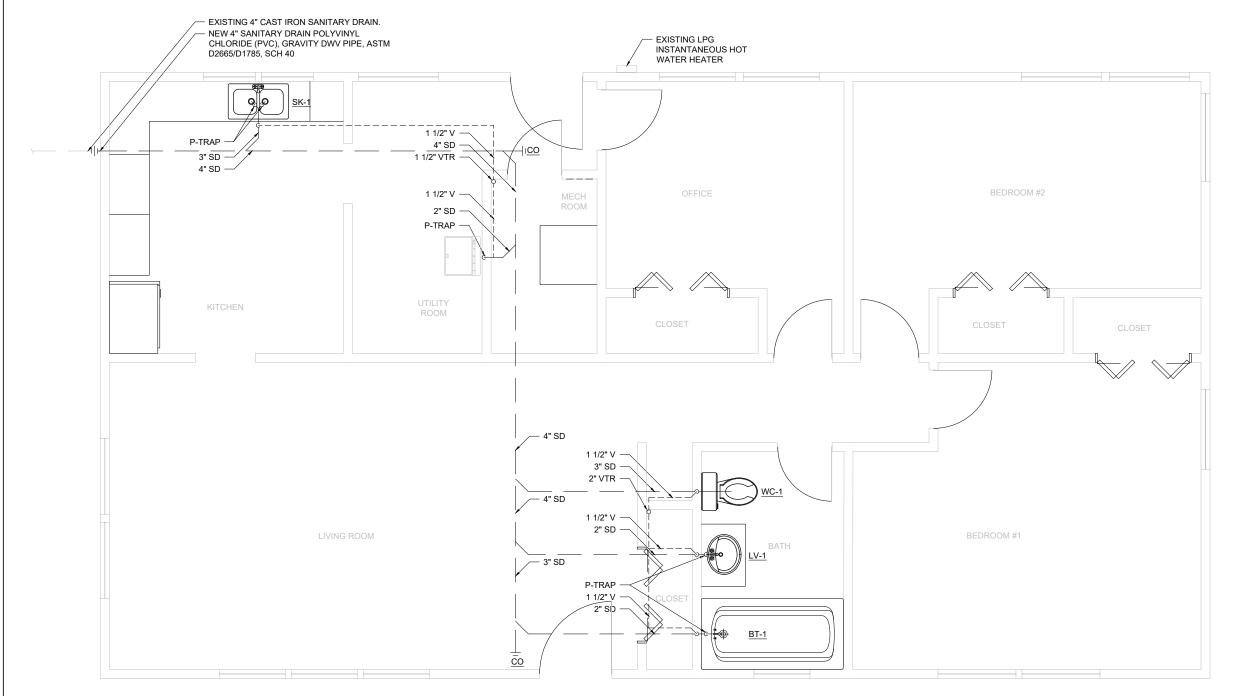

INKS DAM						SUB-SHEET
	PLUM	IBING SA	NITARY [DRAIN		P-4
INKS DAM	RESIDENCE	#3 REHAB	DESIGN			
DESIGNED	DRAWN	CHECKED	DATE	DRAWING		SHEET
SS	DJK	AK	7/31/20		P-4	7 OF 12





DUPLEX 5-20R RECEPTACLE # CIRCUIT NUMBER

OVER COUNTER DUPLEX 5-20R RECEPTACLE W/ INTEGRAL GROUND FAULT

OVER COUNTER DUPLEX 5-20R RECEPTACLE

WP GF

WEATHERPROOF DUPLEX 5-20R RECEPTACLE W/ INTEGRAL GROUND FAULT

220V RECEPTACLE

CABLE RECEPTACLE

1-GANG LINE VOLTAGE SWITCH W/OCCUPANCY SENSOR


1-GANG LINE VOLTAGE SWITCH x SWITCH LEG


3-WAY LINE VOLTAGE SWITCH

LIGHT FIXTURE # X FIXTURE TYPE # CIRCUIT NUMBER x SWITCH LEG


* SMOKE ALARM # CIRCUIT NUMBER


CARBON MONOXIDE DETECTOR
CIRCUIT NUMBER

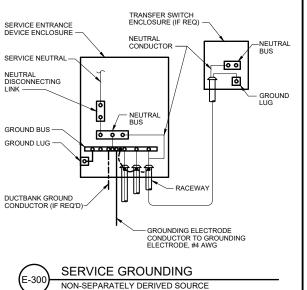

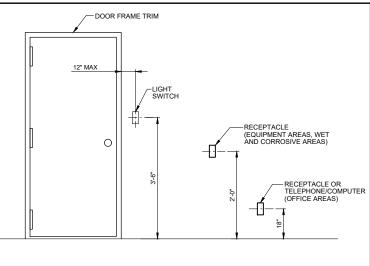




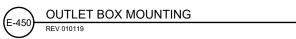

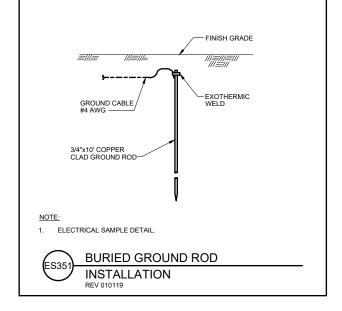




INKS DAM					SUB-SHEET
	ELECTR	ICAL SYN	IBOLS &	DETAILS	E-1
INKS DAM	RESIDENCE	#3 REHAB	DESIGN		
DESIGNED	DRAWN	CHECKED	DATE 7/31/20	DRAWING NO.	SHEET 8 OF 12

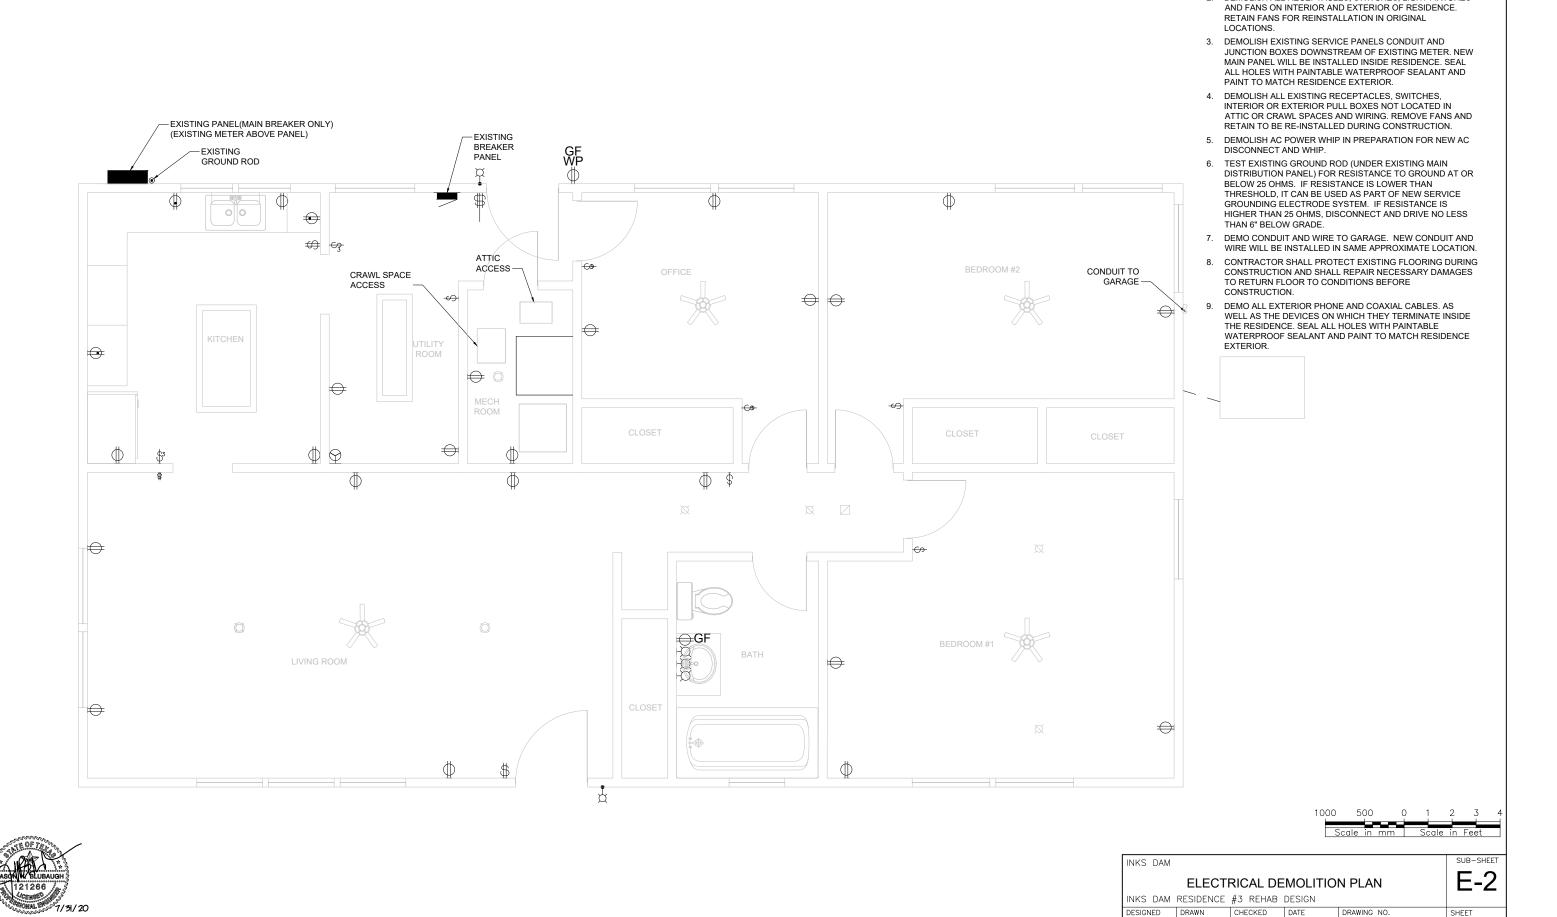

GENERAL NOTES:


COORDINATE WITH LOCAL POWER COMPANY TO
 DISCONNECT POWER TO EXISTING SERVICE PRIOR TO
 WORK.

 DEMOLISH ALL RECEPTACLES, SWITCHES, LIGHT FIXTURES

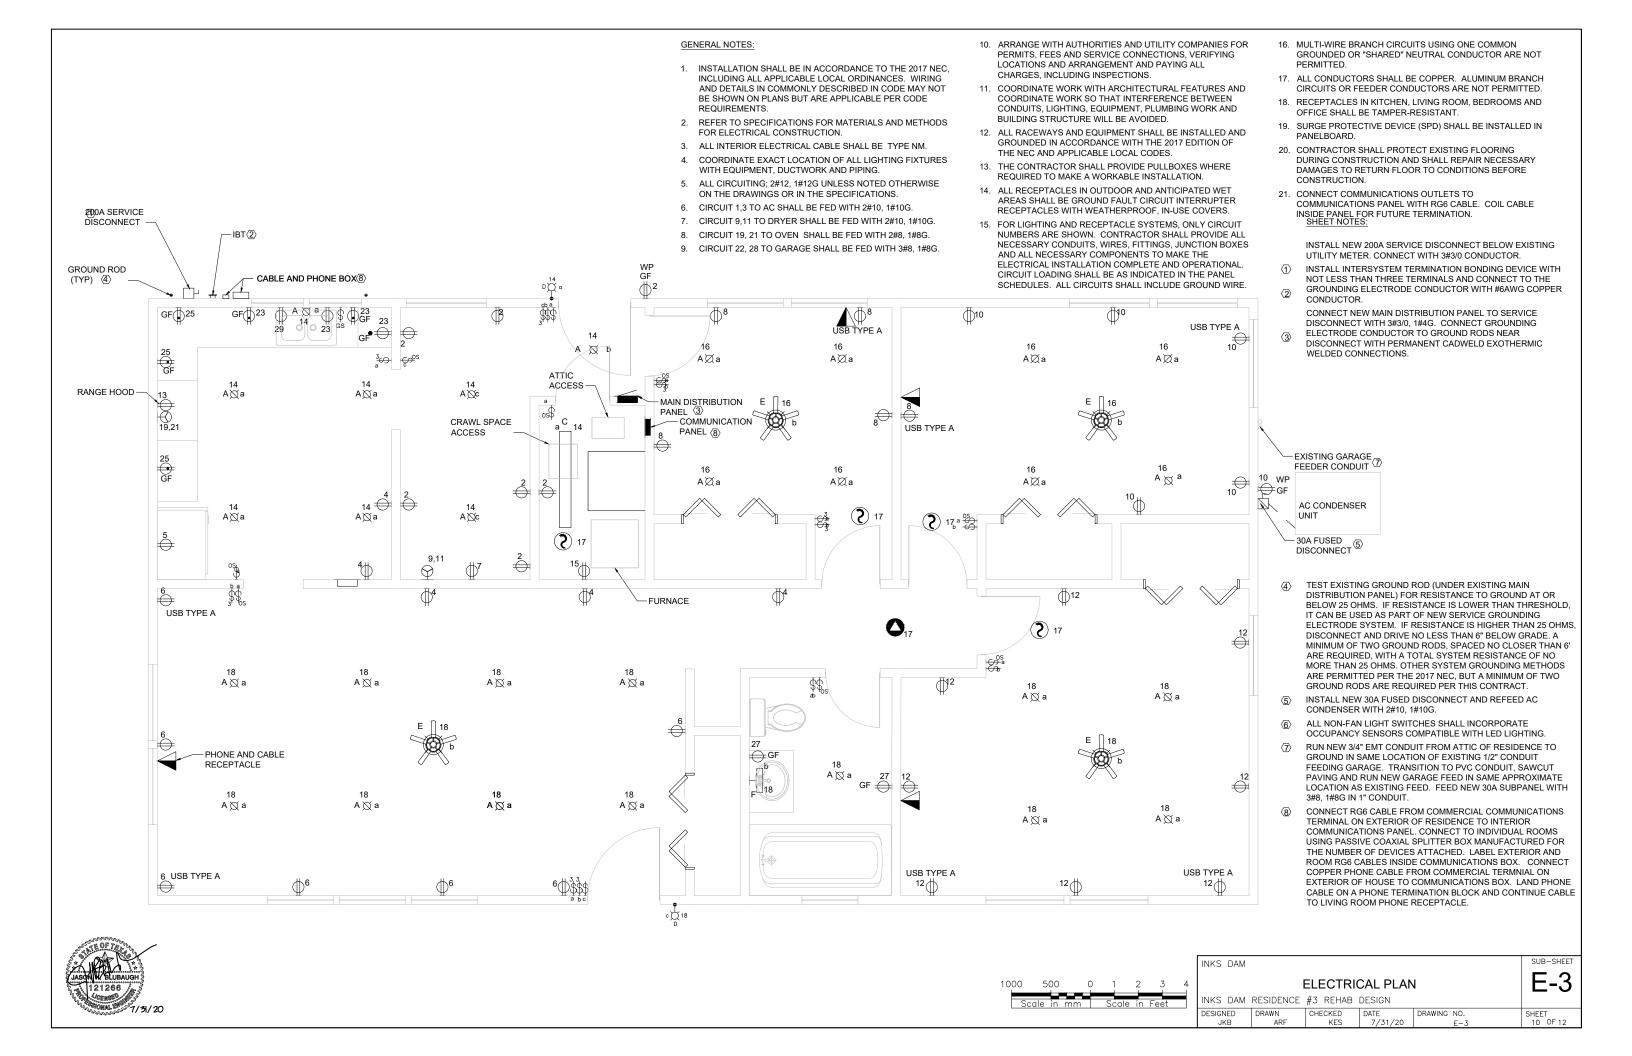


\bigcirc 6 DEMO ALL EXISTING CONDUIT, RECEPTACLES, SWITCHES AND LIGHT FIXTURES $4'-9\frac{1}{2}"$ 1'-11" \mathbb{Q} FLOOR PLAN 1/2" = 1' - 0" ELECTRICAL DEMO PLAN 1/2" = 1' - 0"

NOTE: ALL WIRE IN GARAGE SHALL BE TYPE XHHW AND RUN IN NEW CONDUIT.

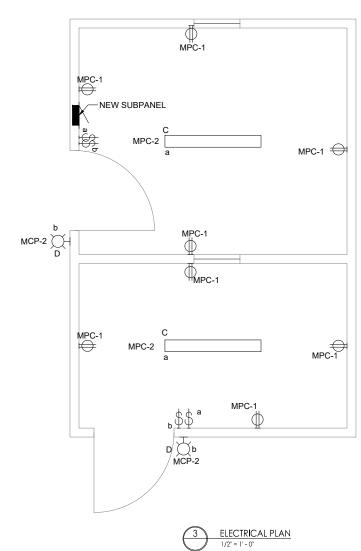

GENERAL NOTES:

- INSTALLATION SHALL BE IN ACCORDANCE TO THE 2017 NEC, INCLUDING ALL APPLICABLE LOCAL ORDINANCES. WIRING AND DETAILS IN COMMONLY DESCRIBED IN CODE MAY NOT BE SHOWN ON PLANS BUT ARE APPLICABLE PER CODE REQUIREMENTS.
- 2. REFER TO SPECIFICATIONS FOR MATERIALS AND METHODS FOR ELECTRICAL CONSTRUCTION.
- 3. COORDINATE EXACT LOCATION OF ALL LIGHTING FIXTURES WITH EQUIPMENT, DUCTWORK AND PIPING.
- 4. ALL CIRCUITING; 2#12, 1#12G UNLESS NOTED OTHERWISE ON THE DRAWINGS OR IN THE SPECIFICATIONS.
- 5. COORDINATE WORK WITH ARCHITECTURAL FEATURES AND COORDINATE WORK SO THAT INTERFERENCE BETWEEN CONDUITS, LIGHTING, EQUIPMENT, PLUMBING WORK AND BUILDING STRUCTURE WILL BE AVOIDED.
- ALL RACEWAYS AND EQUIPMENT SHALL BE INSTALLED AND GROUNDED IN ACCORDANCE WITH THE 2017 EDITION OF THE NEC AND APPLICABLE LOCAL CODES.
- 7. THE CONTRACTOR SHALL PROVIDE PULLBOXES WHERE REQUIRED TO MAKE A WORKABLE INSTALLATION.
- 8. ALL RECEPTACLES IN OUTDOOR AND ANTICIPATED WET AREAS SHALL BE GROUND FAULT CIRCUIT INTERRUPTER RECEPTACLES WITH WEATHERPROOF, IN-USE COVERS.
- 9. FOR LIGHTING AND RECEPTACLE SYSTEMS, ONLY CIRCUIT NUMBERS ARE SHOWN. CONTRACTOR SHALL PROVIDE ALL NECESSARY CONDUITS, WIRES, FITTINGS, JUNCTION BOXES AND ALL NECESSARY COMPONENTS SHOWN OR NOT SHOWN ON THE DRAWINGS, TO MAKE THE ELECTRICAL INSTALLATION COMPLETE AND OPERATIONAL. CIRCUIT LOADING SHALL BE AS INDICATED IN THE PANEL SCHEDULES. ALL CIRCUITS SHALL INCLUDE GROUND WIRE.
- MULTI-WIRE BRANCH CIRCUITS USING ONE COMMON GROUNDED OR "SHARED" NEUTRAL CONDUCTOR ARE NOT PERMITTED.
- 11. ALL CONDUCTORS SHALL BE COPPER. ALUMINUM BRANCH CIRCUITS OR FEEDER CONDUCTORS ARE NOT PERMITTED.
- 12. RUN NEW 1" EMT CONDUIT FROM ATTIC OF RESIDENCE TO GROUND IN SAME LOCATION OF EXISTING 1/2" CONDUIT FEEDING GARAGE. TRANSITION TO PVC CONDUIT, SAWCUT PAVING AND RUN NEW GARAGE FEED IN SAME APPROXIMATE LOCATION AS EXISTING FEED. FEED NEW 30A SUBPANEL WITH 3#8, 1#8G IN 1" CONDUIT.

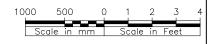

INKS DAM					SUB-SHEET
		GARAG	E PLAN		E-4
INKS DAM	RESIDENCE	#3 REHAB	DESIGN		
DESIGNED	DRAWN	CHECKED	DATE 7 / 71 / 20	DRAWING NO.	SHEET

2017.000	emen			29-20-4	BUS AMPS:			200		VOLTS:	240/120V
MAIN REAR HALL	PANELI			MA	IN BKR AMPS:	_		200 N-WALL		PHASE:	1 3
REAR HALL	LOCATI	UN			MOUNTING:	_	- 3	N-WALL		WIRE:	3
		VA.	С	В	-	В	С		VA		
LOAD DESCRIPTION	PH.A	PH.B	K	K R		K R	K	PH:A	PH.B	LOAD DESC	RIPTION
AC CONDENSOR	2.16		1	30		20	2	1.26		MECH/U	TILITY/W OUTDOOR RE
AC CONDENSOR		2.16	3			20	4		0.9	N	KITCHEN/W LIVING RE
REFRIGERATOR	0,72		5	20		20	6	1.26			LIVING ROOM RE
CLOTHES WASHER		0.4	7	20		20	80		0.9		OFFICE RE
CLOTHES DRYER	1,5		9	30		20	10	1.08		BEDF	OOM2/N OUTDOOR RE
CLOTHES DRYER		1.5	11	2,50		20	12		1.44		BEDROOM 1 RE
RANGE HOOD	0.24		13	20		20	14	0.2		KITCHEN/	MECH/UTILITY LIGHTIN
FURNACE		1.14	15	20		20	16		0.48	OFFIC	E/BEDROOM 2 LIGHTIN
SMOKE DETECTORS	0.18		17	20		20	18	0.61		LIVING ROO	и/BEDROOM 1 LIGHTIN
OVEN		3.0	19	40		30	20		2.88		GARAG
OVEN	3,0		21.	- 40		30	22	2.88			GARAG
KITCHEN COUNTER 1		0.54	23	20		20	24		1.2	ON-D	EMAND WATER HEATE
KITCHEN COUNTER 2	0.54		25	20		20	26	0.0		20011110	SPAF
BATHROOM		0.36	27	20		20	28		0.0		SPAF
DISHWASHER	1.2		29	20		20	30	0.0			SPAF
SPACE		0.0	31			J.	32		0.0		SPAC
SPACE	0.0		33				34	0.0			SPAC
SPACE		0,0	35				36		0.0		SPAC
SPACE	0.0		37	× 12		- 60	38	0.0			SPAC
SPACE		0.0	39			-20	40		0.0		SF
SPACE	0.0		41			20	42	0.0			SF
	9.54	9.1			TOTAL			7.29	7.8		
	PHASE	LOAD		TOTAL	LOAD						
	16.83	16.9		33,73	KVA						

GENERAL NOTES:

- CIRCUIT BREAKERS IN BEDROOMS, LIVING ROOM, OFFICE AND PORCH SHALL BE ARC-FAULT TYPE.
- 2. CIRCUIT BREAKER FOR DISHWASHER SHALL BE GFCI TYPE.

MAIN GARAGE	PANELBOARD LOCATION	BUS AMPS: MAIN BKR AMPS: MOUNTING:	30 30 IN-WALL	VOLTS: 240/120V PHASE: 1 WIRE: 3
LOAD DESCRIPTION	PH.A PH.B	C B K K	B C KVA K K PH.A PH.B B T	LOAD DESCRIPTION
RECEPTACLES	1.44	1 20		
LIGHTING	0.12	2 20		
	1.44 0.12	TOTAL	0.0 0.0	
	PHASE LOAD	TOTAL LOAD	W (0 14	
	1.44 0.12	1.56 KVA		

CAN FIXTURE COLOR TEMPURATURE SCHEDULE					
ROOM	COLOR TEMP				
BEDROOM	2700K				
OFFICE	5000K				
KITCHEN	4000K				
UTILITY	5000K				
MECHANICAL	5000K				
LIVING ROOM	2700K				

TYPE	DESCRIPTION	MANUFACTURER	MODEL	LAMP	VOLTAGE	COLOR TEMP	REMARKS
Α	6" CANLESS RECESSED FIXTURE	COMMERCIAL ELECTRIC	CER608943K50WH	LED	120V	2700K-5000K	5 SETABLE COLOR TEMPERATURES
С	4' LINEAR FLUSH MOUNT STRIP LIGHT	SUNLIGHT	HD02402-1	LED	120V	5000K	
D	1-LIGHT AGED IRON OUTDOOR WALL LANTERN SCONCE	HOME DECORATORS COLLECTION	FEU1611LM	LED	120V	3000K	DUSK TO DAWN
E	REUSE EXISTING FIXTURE, REPLACE BULBS WITH LED	NA	NA	LED	120V	2700K	PER BULB
F	24" 3-LIGHT ANTIQUE BRONZE VANITY LIGHT WALABASTER GL	ASS PROGRESS LIGHTING	P2103-20	LED	120V	2700K	PERBULB



INKS DAM						SUB-SHEET
	ELECTRICAL SCHEDULES					
INKS DAM	RESIDENCE	#3 REHAB	DESIGN			
DESIGNED JKB	DRAWN ARF	CHECKED KES	DATE 7/31/20	DRAWING	NO. E-5	SHEET 12 OF 12