NORTH TEXAS STATE HOSPITAL - WICHITA FALLS CAMPUS MECHANICAL UPGRADE **BUILDING 700**

M & C PROJECT NO. 22-147-WFH



Texas Health and Human **Services Commission**

Maintenance and Construction

CONSULTANTS TO THE OWNER


BAIRD, HAMPTON & BROWN building partners

6300 Ridglea Pl., Ste. 700 Fort Worth, TX 76116 mail@bhbinc.com • (817)338-1277 • bhbinc.com

ARCHITECT / ENGINEER

PHONE No.

LES BROWN, PE, LEED AP SENIOR MECHANICAL ENGINEER (682) 348-0772

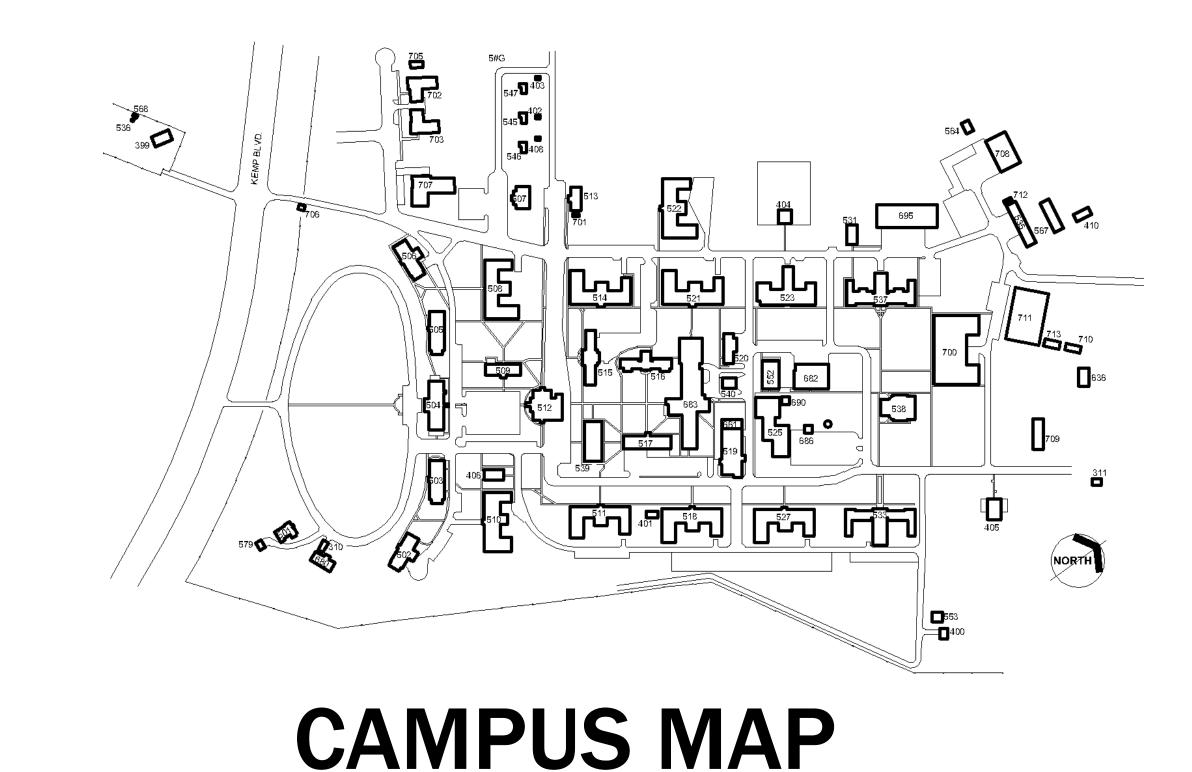

CAMPUS NORTH

DATE : 08/01/22 CHECKED BY : BHB

> Project Status 100% CD SUBMITTAL

PROJECT CONSTRUCTION NOTES

THE PROJECT IS LOCATED IN THE CITY OF WICHITA FALLS,
WICHITA COUNTY, STATE OF TEXAS. ALL DESIGN AND CONSTRUCTION
WORK SHALL COMPLY WITH APPLICABLE STATUTES, ORDINANCES, REGULATIONS,
LAWS AND CODES OF THE ABOVE MENTIONED JURISDICTIONS, AND ALL OTHER
APPLICABLE REGULATIONS, REQUIREMENTS CODES AND STANDARDS, INCLUDING
BUT NOT LIMITED TO THE FOLLOWING:

INTERNATIONAL BUILDING CODE (IBC)

NFPA 101, LIFE SAFTY CODE (LSC)
NFPA 13 STANDARD FOR THE INSTALLATION OF SPRINKLER SYSTEMS
NFPA 72, FIRE ALARM CODE

TEXAS ACCESSIBILITY STANDARDS
AMERICANS WITH DISABILITIES ACT ACCESSIBILITY


LATEST EDITION LATEST EDITION

2015 EDITION

2012 EDITION

2010 EDITION 2010 EDITION

STATE OF TEXAS, AND THE UNITED STATES FEDERAL GOVERNMENT, INCLUDING BUT NOT LIMITED TO OSHA, EPA AND OTHER AUTHORITIES, AGENCIES OR ENTITIES HAVING JURISDICTIONAL AUTHORITY.

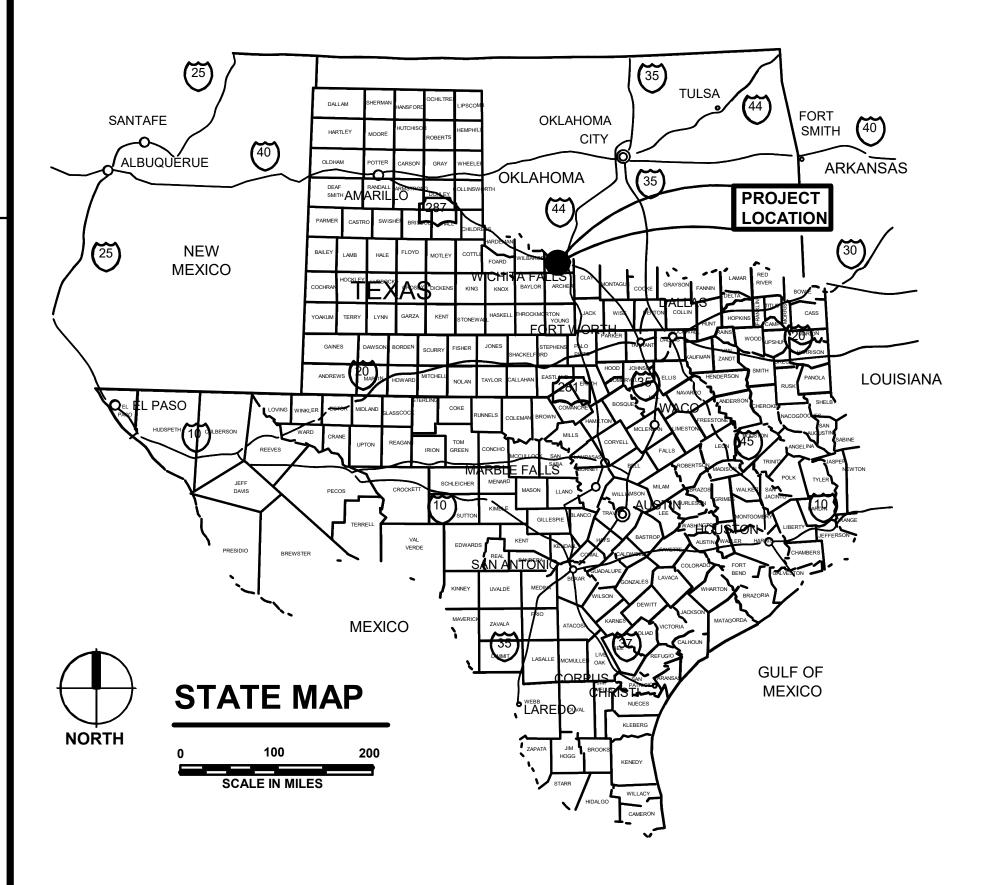

PROJECT LOCATION

6515 KEMP BLVD WICHITA FALLS, TEXAS WICHITA, COUNTY

	INDEX OF DRAWINGS
SHEET NO.	SHEET NAME
GENERAL	
G-000	COVER SHEET
G-001	INDEX OF DRAWINGS
G-002	GENERAL INFORMATION
G-003	CAMPUS MAP
ARCHITECTUR	AL
A-100	EXISTING FLOOR PLAN
A-101	REFLECTED CEILING PLAN - DEMOLITION
A-102	ROOF PLAN
A-201	ENLARGED FLOOR PLANS
A-501	MISC. DETAILS
MECHANICAL -	DEMOLITION
MD-101	DEMOLITION - MECHANICAL ROOF PLAN
MECHANICAL	
M-101	MECHANICAL FLOOR PLAN
M-102	MECHANICAL ROOF PLAN
M-210	MECHANICAL SCHEDULES & DETAILS
ELECTRICAL -	DEMOLITION
ED-101	DEMOLITION - ELECTRICAL PLAN
ELECTRICAL	
E-101	ELECTRICAL FLOOR PLAN
E-102	ELECTRICAL ROOF PLAN
E-210	ELECTRICAL SCHEDULES & DETAILS





909 W 45TH ST, BLDG 3 AUSTIN, TEXAS 78756

MANAGING CONSULTANT:



ARCHITECT PROJ NO: **2022.012.000**

QC DATE: **08/01/22** BY: **CAH**

TE OF TEXAS

KEN RANDALL

84937

CENSE

08/01/22

HHSC BUILDING NO:

INDEX OF DRAWINGS

HHSC PROJ NO: 22-147-WFH

DATE:**08/01/22** REV:

FILE NAME:

VERIFY SC.

BAR IS ONE INCH ON ORIGINAL DRAWING. IF NOT ONE INCH ON THIS SHEET, ADJUST SCALES ACCORDINGLY

DRAWING NUMBER:

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APPROX SCALE:

G-001

ABBREVIATIONS LEGEND

A/C - AIR CONDITIONING **ACOUST. - ACOUSTICAL** ADJ. - ADJUSTABLE A.F.F. - ABOVE FINISH FLOOR ALUM. - ALUMINUM **ALT. - ALTERNATE APPROX. - APPROXIMATELY** ASB. - ASBESTOS ASPH. - ASPHALT

BB - BASE BID BD. - BOARD **BITUM. - BITUMINOUS** BLDG. - BUILDING B.N. - BULL NOSE BO - BID OPTION(S) **BOTT. - BOTTOM** B.O.C. - BACK OF CURB

Ç - CENTERLINE CAB. - CABINET C.B. - CHALK BOARD C.C. - CENTER TO CENTER CER. - CERAMIC C.F.M. - CUBIC FEET PER MINUTE C.G. - CORNER GUARD CHAM. - CHAMFER C.J. - CONTROL JOINT C.L. - CENTER LINE CLR. - CLEAR CLG. - CEILING **CLKG. - CAULKING** CLOS. - CLOSURE **C.M.U. - CONCRETE MASONRY UNITS**

COL. - COLUMN **COMP. - COMPOSITION** CONC. - CONCRETE **CONN. - CONNECTION CONST. - CONSTRUCTION CONT. - CONTINUOUS CONTR. - CONTRACTOR** CORR. - CORRIDOR C.T. - CERAMIC TILE CTG. - COATING C.W. - COLD WATER

D.E.B. -DETENTION EASEMENT BOUNDARY DBL. - DOUBLE **DEMO - DEMOLITION** DTL - DETAIL D.F. - DRINKING FOUNTAIN DIA. - DIAMETER DIAG. - DIAGONAL, DIAGRAM DIM. - DIMENSION **DIR. - DIRECT, DIRECTION DISP. - DISPENSER** D.L. - DEAD LOAD DN. - DOWN DR. - DOOR D.S. - DOWNSPOUT DWG. - DRAWING

E. - EAST EA. - EACH E.F. - EACH FACE

E.J. - EXPANSION JOINT

ELEC. - ELECTRICAL ELEV. - ELEVATION ENCL.- ENCLOSE ETR - EXISTING TO REMAIN EQ. - EQUAL / EQUIVALENT **EQUIP. - EQUIPMENT** E.W.C - ELECTRIC WATER COOLER E.W. - EACH WAY

EXH. - EXHAUST EXIST. - EXISTING EXP. - EXPANSION, EXPOSED **EXT. - EXTERIOR EXIST. - EXISTING**

F.D. - FLOOR DRAIN F.E.B.- FIRE EXTINGUISHER BRACKET F.E.C.- FIRE EXTINGUISHER CABINET F.F. - FINISH FLOOR F.H. - FIRE HYDRANT FIN. - FINISH FIX. - FIXTURE FL. - FLOW LINE FLR. - FLOOR FLUOR. - FLUORESCENT F.O.B. - FACE OF BRICK F.O.C. - FACE OF CURB **FOUND. - FOUNDATION** FT. - FOOT, FEET FTG. - FOOTING **FUR. - FURNACE** FUT. - FUTURE

GA. - GAGE **GALV. - GALVANIZED GLAZ.- GLAZED** GR. - GRADE **GYP. - GYPSUM GWB - GYPSUM WALL BOARD**

HGT.- HEIGHT H.C. - HOLLOW CORE **HCP. - HANDICAPPED HDPE - HIGH-DENSITY POLYETHELYENE** HI. - HIGH H.M. - HOLLOW METAL HORIZ. - HORIZONTAL H.P. - HIGH POINT, HORSE POWER HR. - HOUR HTG. - HEATING H.V.A.C.- HEATING/VENTILATION/AIR CONDITIONING H.W. - HOT WATER **HWY. - HIGHWAY**

IN. - INCH INCL. - INCLUSIVE, (DES), (DING) **INSUL. - INSULATION INT. - INTERIOR** INTER. - INTERMEDIATE INV. - INVERT

JAN. - JANITORIAL JT. - JOINT JST. - JOIST

LAB. - LABORATORY LAV. - LAVATORY L - LONG, LENGTH L.H. - LEFT HAND L.P. - LIGHT POLE LT. - LIGHT

MAINT. - MAINTENANCE

MAS. - MASONRY MAT'L - MATERIAL MAX. - MAXIMUM M.E. - MATCH EXISTING **MECH. - MECHANICAL** MED. - MEDIUM M.E.P. - MECHANICAL/ELECTRICAL/PLUMBING **MEZZ. - MEZZANINE** MF. - MANIFOLD M.H. - MANHOLE MIN. - MINIMUM, MINUTE MISC. - MISCELLANEOUS

N. - NORTH N.I.C. - NOT IN THIS CONTRACT NO. - NUMBER N.T.S. - NOT TO SCALE

MOD. - MODULAR, MODEL

MTL. - METAL

O.S. - OTHERWISE SPECIFIED O.C. - ON CENTER O.C.E.W. - ON CENTER EACH WAY OFF. - OFFICE O.H.- OPPOSITE HAND O.H.E. - OVERHEAD ELECTRIC LINE OPP. - OPPOSITE

OVH - OVERHEAD


PARA. - PARAGRAPH PLAS. LAM. - PLASTIC LAMINATE PH. - PHASE PLYWD. - PLYWOOD POL. - POLISHED P.P. - POLISHED PLATE PR. - PAIR PREC. - PRECAST PRELIM. - PRELIMINARY P.S.F. - POUNDS PER SQUARE FOOT P.S.I. - POUNDS PER SQUARE INCH PT. - POINT P.T.D. - PAPER TOWEL DISPENSER

QTY. - QUANTITY

P.V.C. - POLYVINYL CHLORIDE

TYPICAL DTL/SECTION MARKS

KEY FOR THIS DESCRIPTION A2 = DETAIL / SECTION IDENTIFICATION NUMBER A-101 = SHEET NO. ON WHICH DETAIL

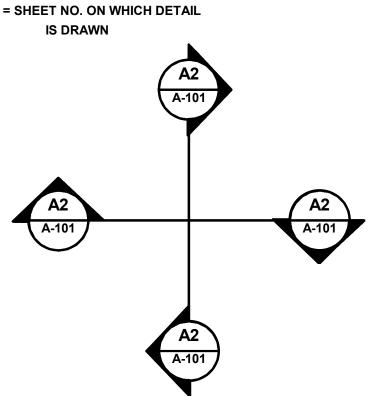

DETAIL IDENTIFICATION

MATERIAL SYMBOLS

CONCRETE PAVING / WALKS

WOOD BLOCKING CONTINUOUS

WOOD BLOCKING NON-CONTINUOUS

CONCRETE IN SECTION

C.M.U. (IN PLAN)

INSULATION

PLYWOOD

SHEET NO. ON WHICH DETAIL

T.B.T.&P. - TAPE, BED, TEXTURE & PAINT **TEMP. - TEMPERATURE, TEMPORARY** THK. - THICK THRSLD. - THRESHOLD T.O.B. - TOP OF BEAM T.O.C. - TOP OF CURB T.W. - TOP OF WALL TYP. - TYPICAL

RAD. - RADIUS

RECP. - RECEPTACLE

REINF. - REINFORCED

REQ'D. - REQUIRED

RESIL. - RESILIENT

RET. - RETAINING

R.H. - RIGHT HAND

SAN. - SANITARY

SECT. - SECTION

SCR. - SCREEN

SEP. - SEPARATE

SEQ. - SEQUENCE

SERV. - SERVICE

SHT. - SHEET

SQ. - SQUARE

STD. - STANDARD

SUSP. - SUSPENDED

SUP. - SUPPORT

SYM. - SYMBOL

SYS. - SYSTEM

SIM. - SIMILAR

S.C. - SOLID CORE

SCHED. - SCHEDULED

SPEC. - SPECIFICATION

REV. - REVISION

RM. - ROOM

RESIST. - RESISTANT

REF. - REFERENCE

R.C.P.- REFLECTED CEILING PLAN

REG. - REGULATOR, REGISTER

U.N.O.- UNLESS NOTED OTHERWISE V.E.S. - VINYL EDGE STRIP **VEST. - VESTIBULE** V.F. - VINYL FABRIC VIN. - VINYL V.S. - VENT STACK V.T.R. - VENT THROUGH ROOF V.W.C. - VINYL WALL COVERING

W/ - WITH W/O - WITHOUT W. - WIDTH W.C. - WATER CLOSET WD. - WOOD WT. - WEIGHT WTR. - WATER W.W.F. - WELDED WIRE FABRIC

TYPICAL TITLE


2004 Quail Creek Drive, Suite 200 Wichita Falls, Texas 76308 Phone: 940.767.7478; Fax: 940.397.0553



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- DETAIL REFERENCE NUMBER DRAWING TITLE 'TITLE'

INTERIOR ELEVATION MARK

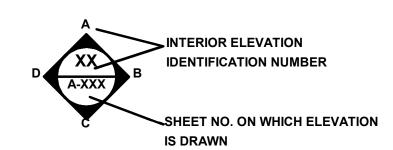

REFERENCE SYMBOLS

XXX **ROOM NUMBER** PANEL TYPE XX XX XX **KEYNOTE - CONDOC SYSTEM** 101-101 DOOR NUMBER **GRID LINE** PARTITION TYPE TOILET ACCESSORY (REF. SPECIFICATIONS) FIN. FLR. DATUM ELEVATION
= 100'-0"

MANAGING CONSULTANT

6300 Ridglea PI., Ste. 700 Fo mail@bhbinc.com • (817)338. 3PELS Firm #44, #10011300, # BHB PROJECT # 20;

ARCHITECT PROJ NO: **2022.012.000**

BY: CAH QC DATE: **08/01/22**



HHSC BUILDING NO:

GENERAL INFORMATION

HHSC PROJ NO: 22-147-WFH

DATE:**08/01/22** REV:

FILE NAME:


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APPROX SCALE: 12" = 1'-0"


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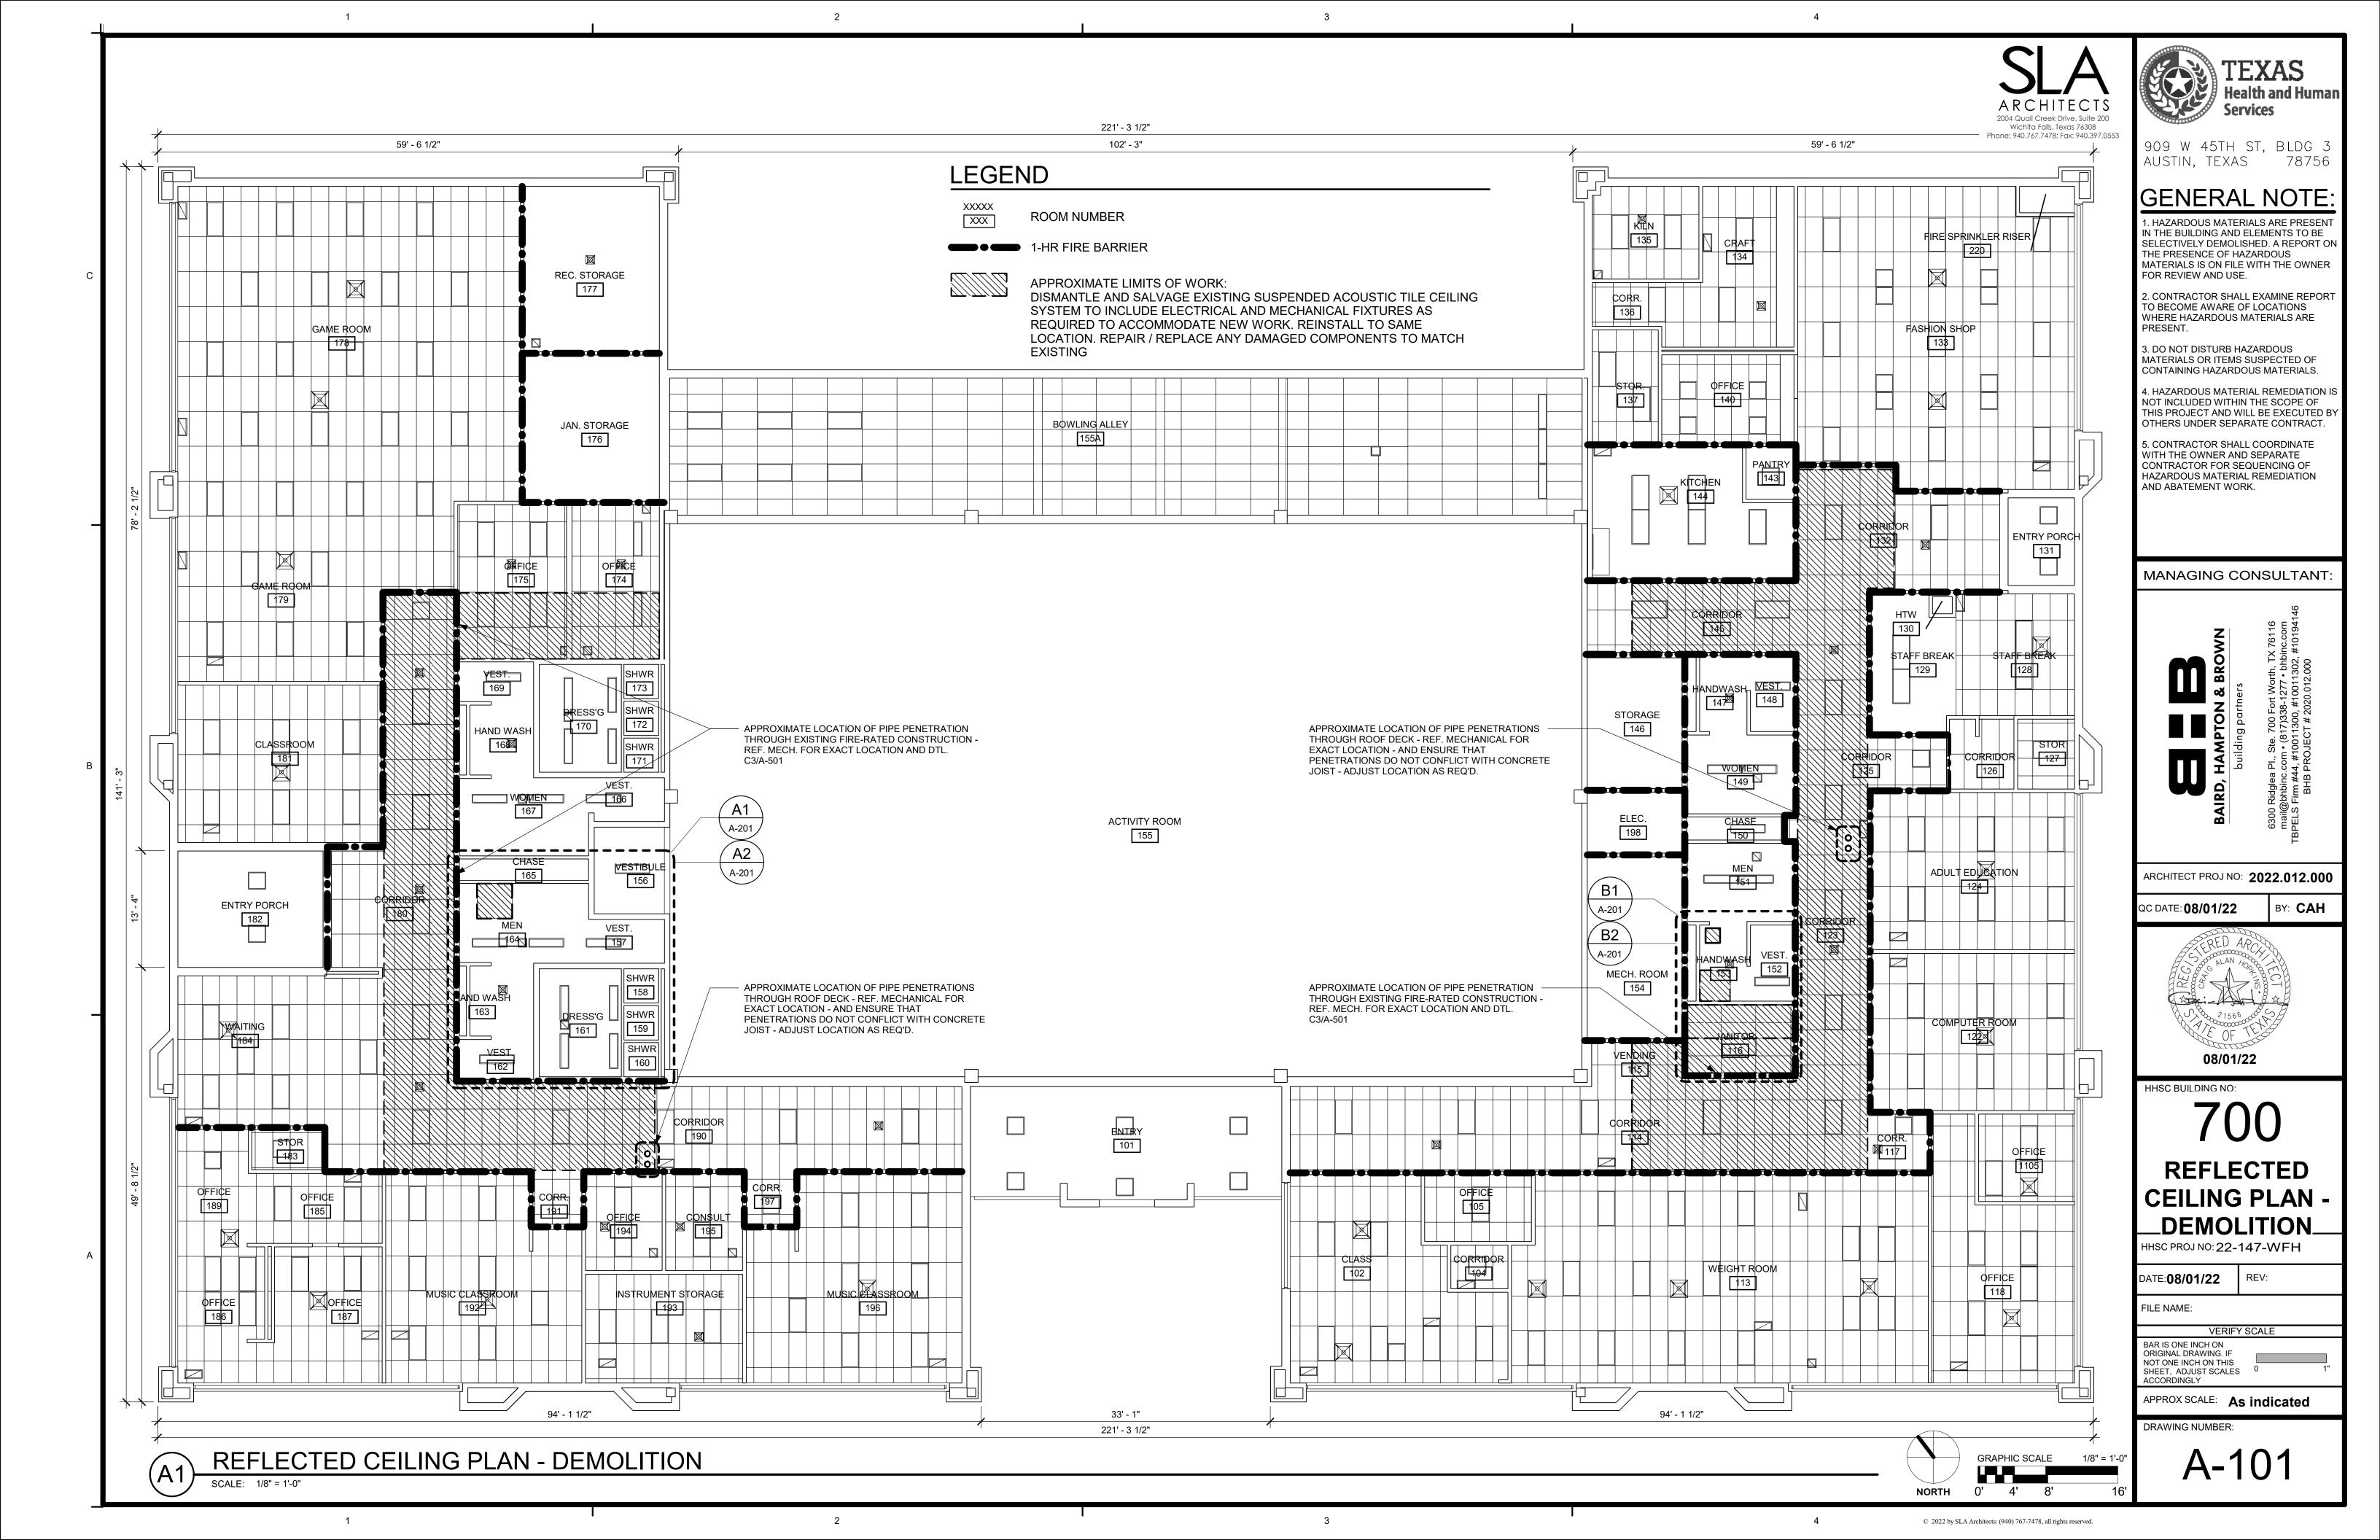
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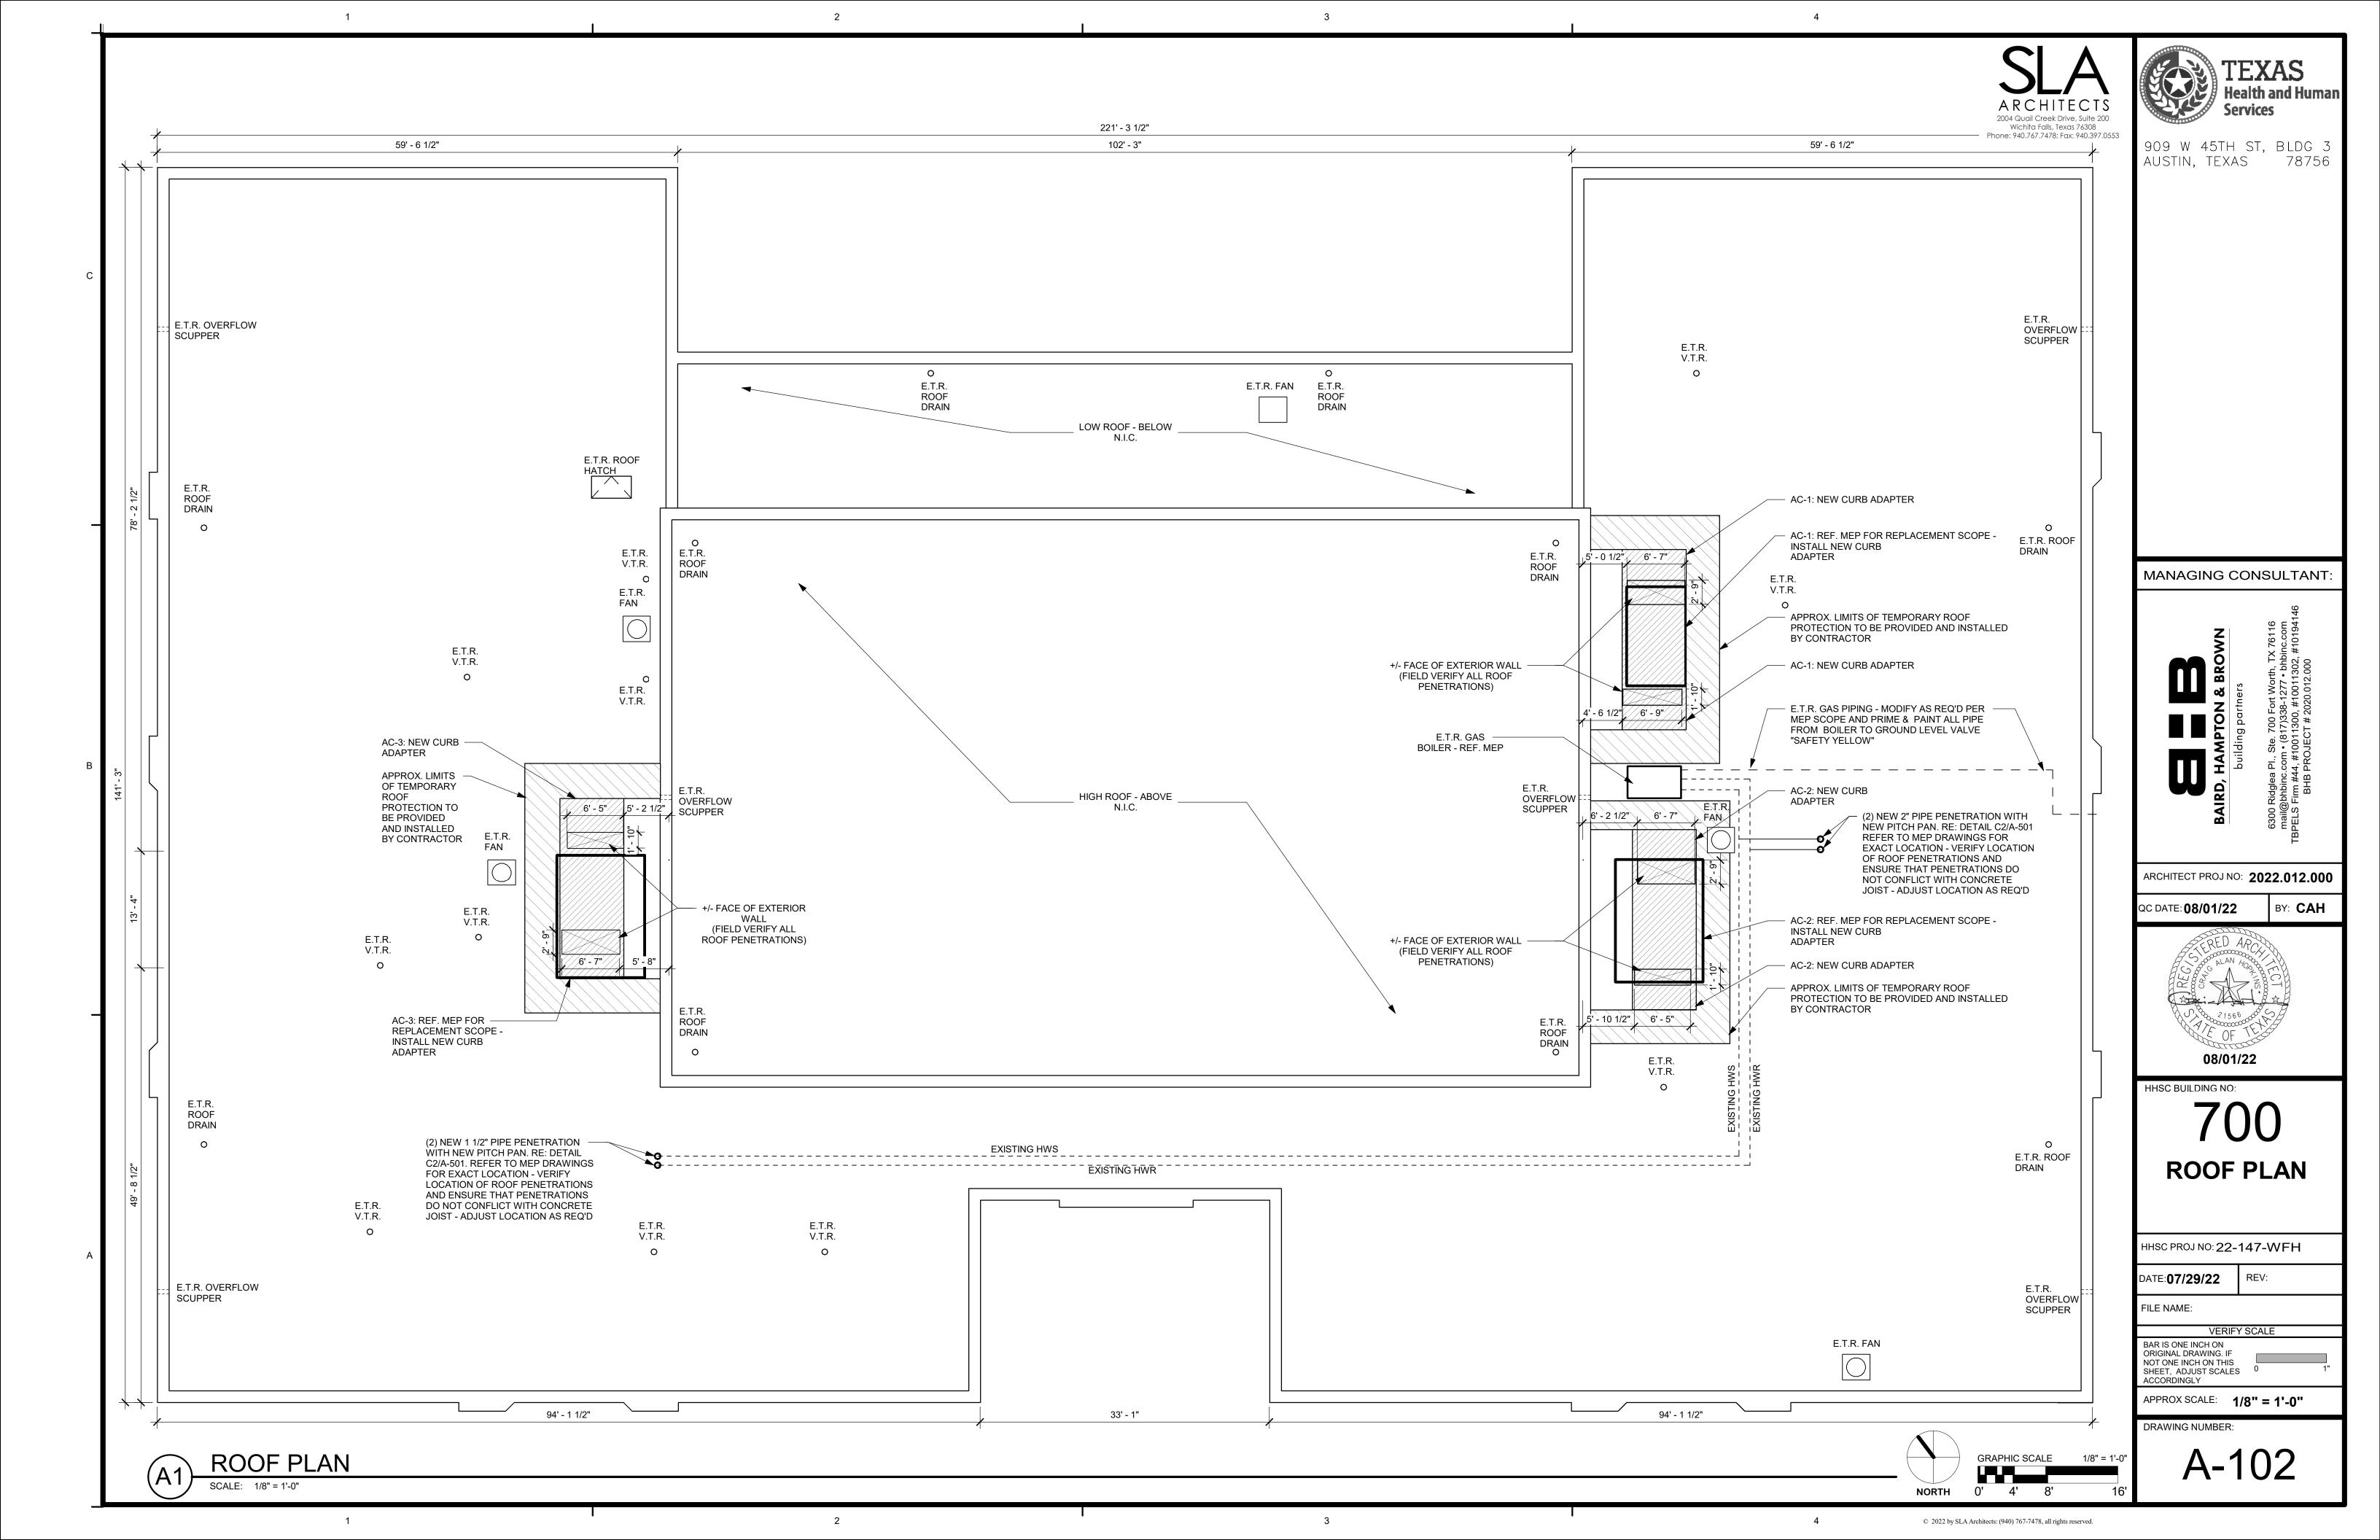
NEW SPOT ELEVATION XXX.XX



TEXAS
Health and Human
Services



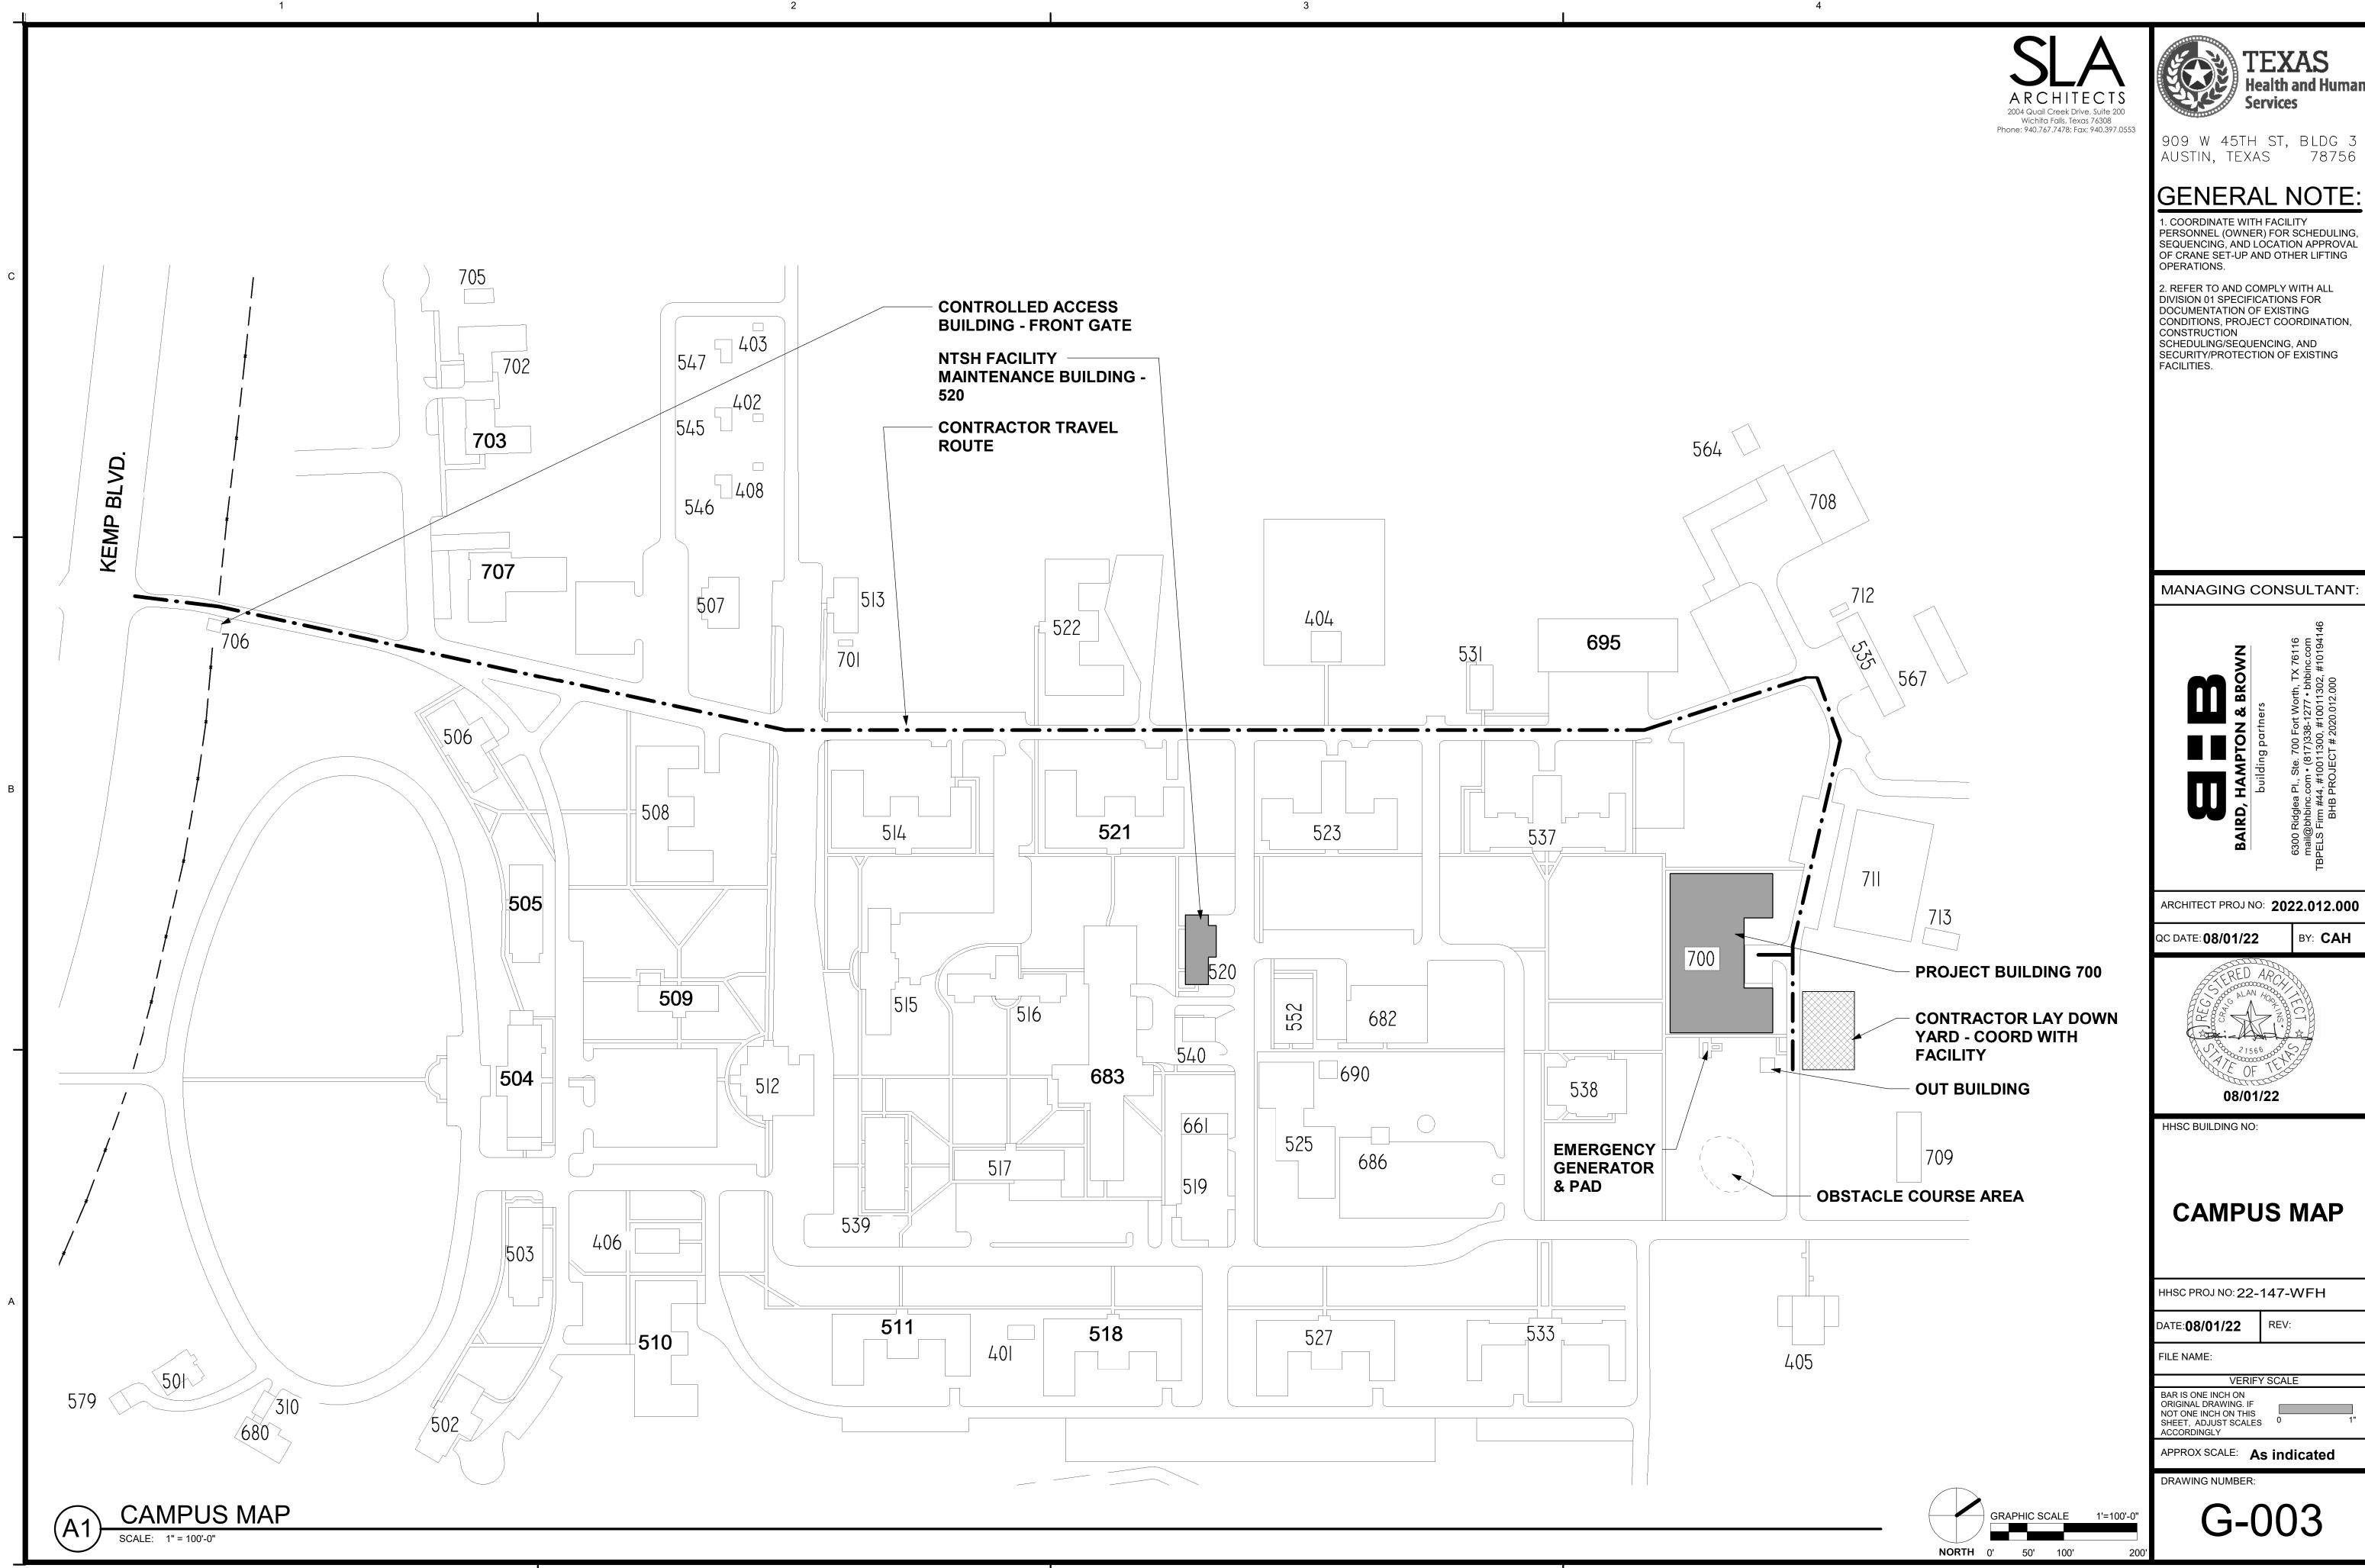

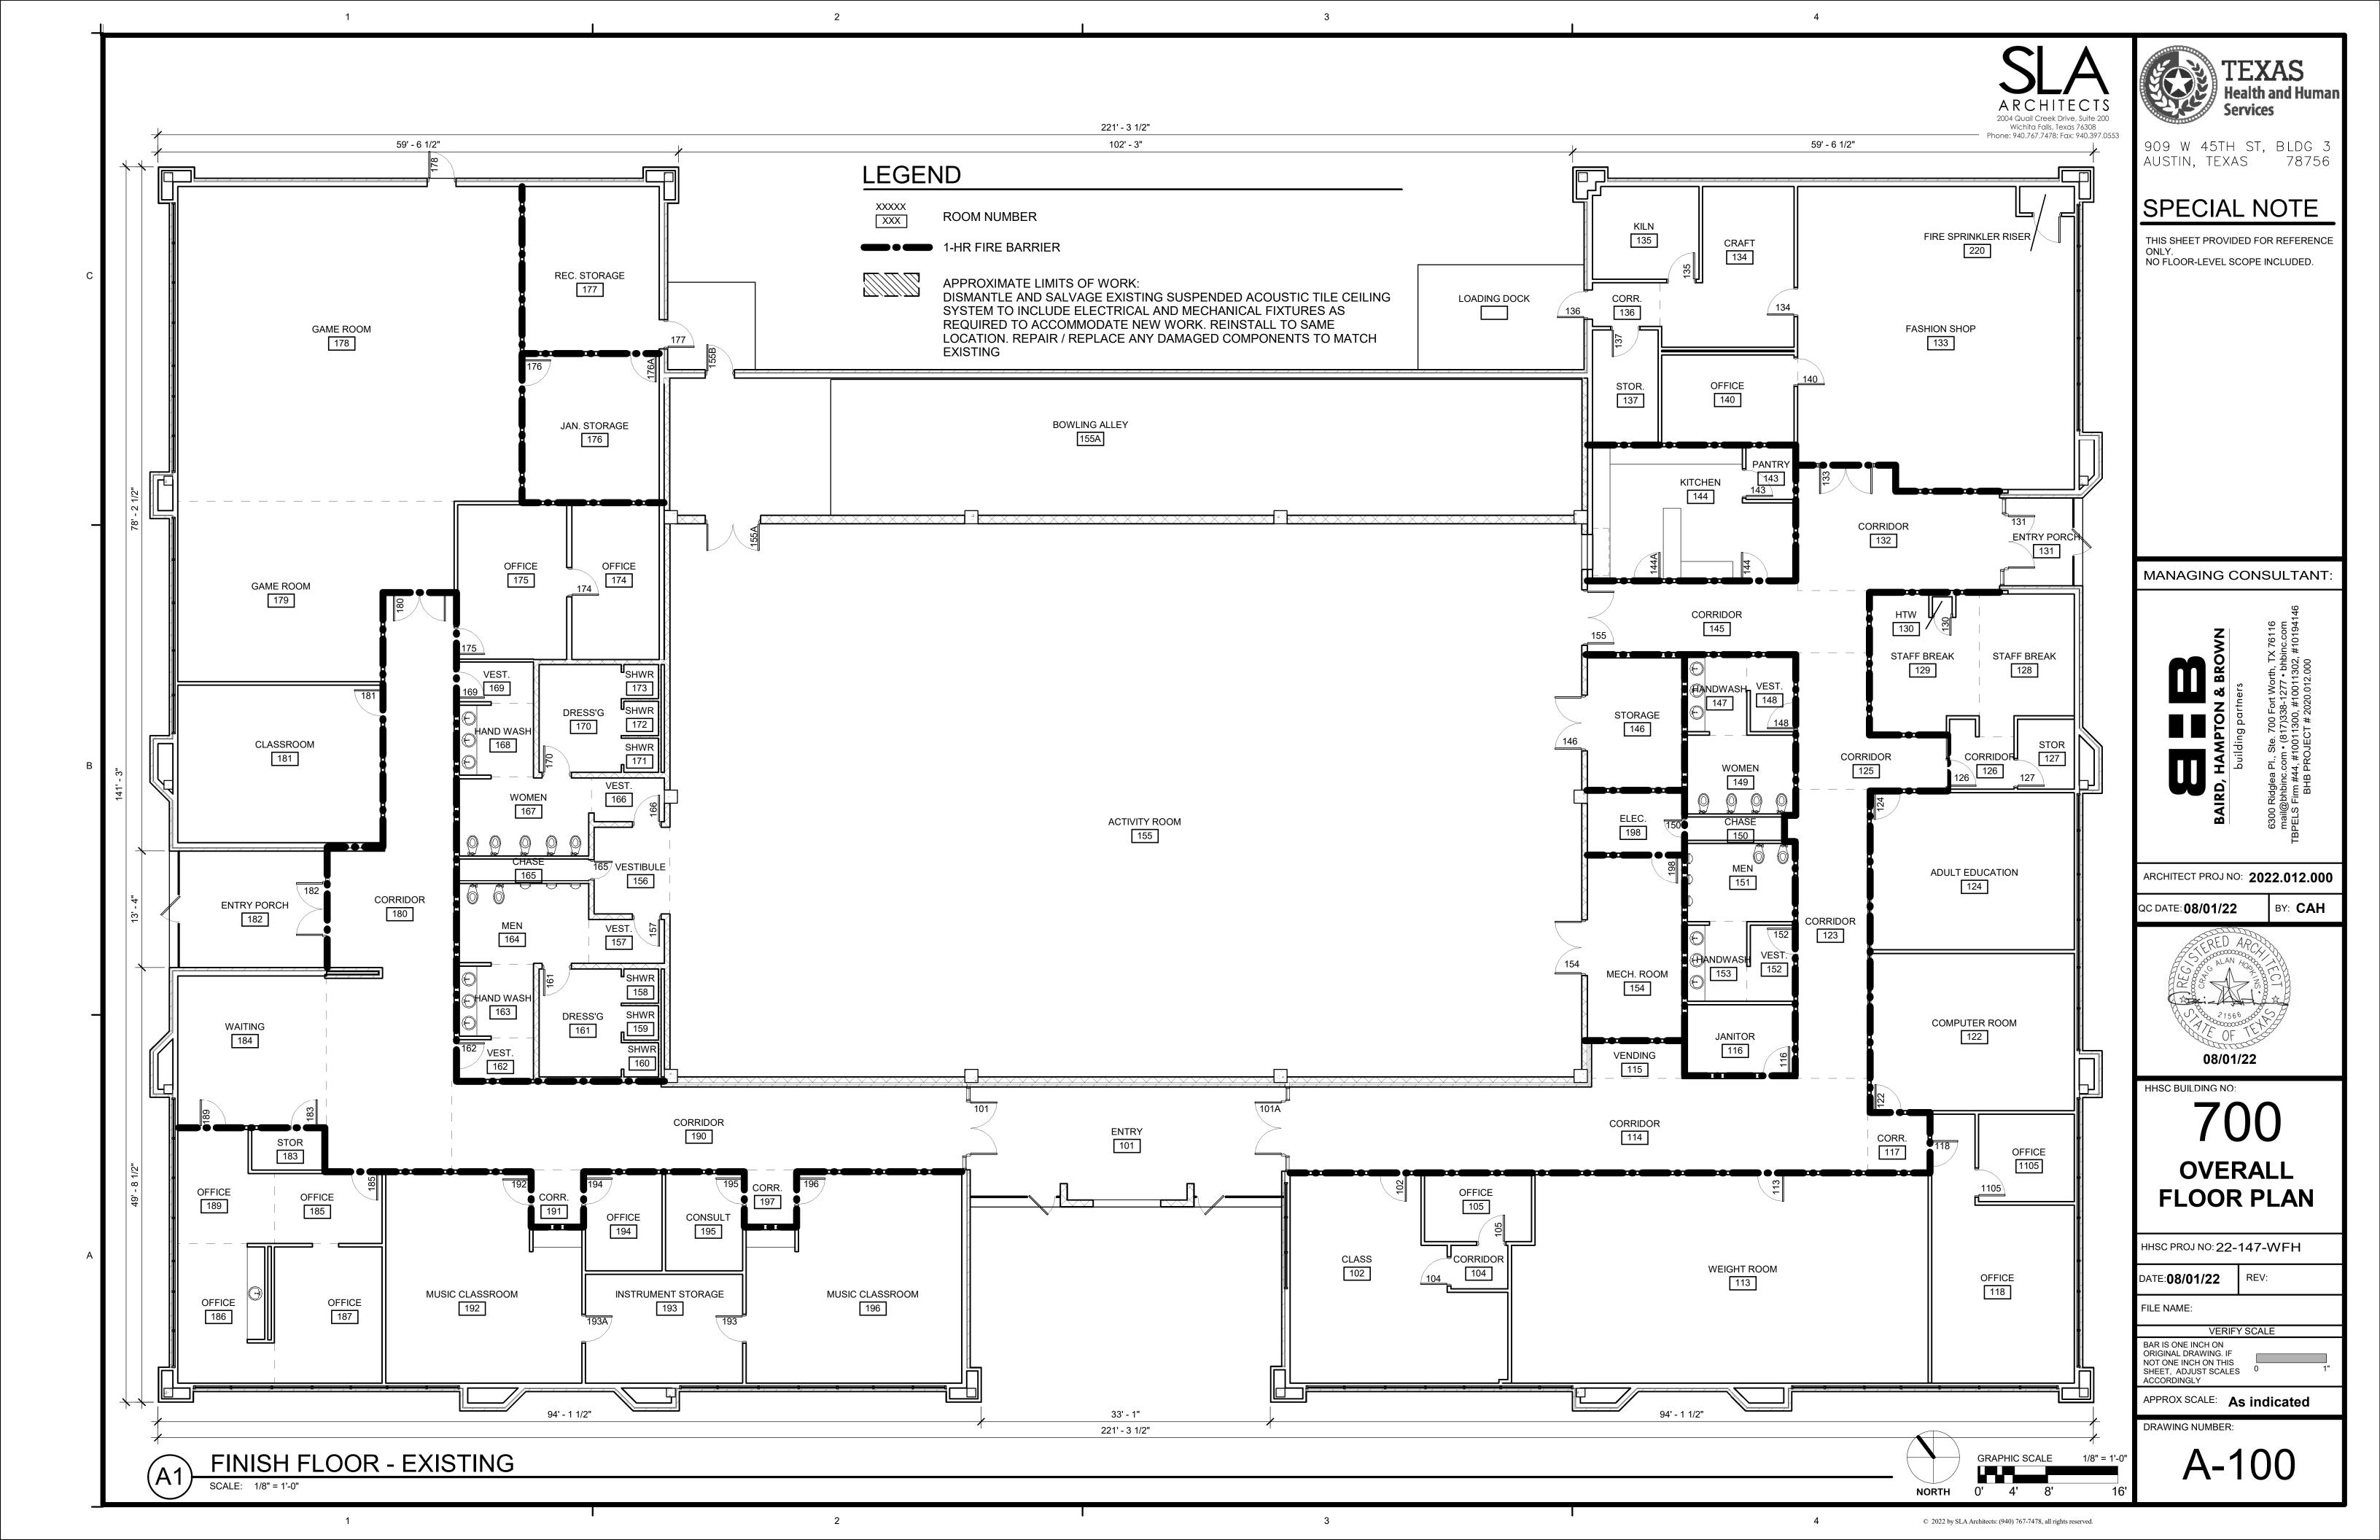



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MANAGING CONSULTANT

ARCHITECT PROJ NO: **2022.012.000**

BY: CAH

QC DATE: **08/01/22**

GENERAL NOTES

- 1. CONTRACTOR TO VERIFY EXISTING CONSTRUCTION AND COORDINATE WITH THE CONTRACT DOCUMENTS PRIOR TO AND DURING CONSTRUCTION.
- 2. CONTRACTOR TO NOTIFY THE ARCHITECT & OWNER IMMEDIATELY IN THE EVENT CONDITIONS DIFFER SUBSTANTIALLY FROM THOSE INDICATED IN THE DOCUMENTS.
- DEMOLITION
- 3. THE GENERAL CONTRACTOR SHALL COORDINATE WITH ALL SUBCONTRACTORS ON DEMOLITION REQUIRED FOR THE VARIOUS DISCIPLINES UNDER THIS CONTRACT.
- 4. DASHING INDICATES LIMITS OF DEMOLITION. DEMOLITION OF ITEMS INDICATED ON PLANS REFERS TO THE ITEM AND ITS RELATED ASSEMBLIES UNLESS NOTED
- 5. PROVIDE AND INSTALL ADEQUATE SHORING OF ALL EXISTING LOAD BEARING CONSTRUCTION AS REQUIRED FOR THE BUILDING TO REMAIN STRUCTURALLY SOUND UNTIL NEW CONSTRUCTION IS IN PLACE.
- 6. ALL AREAS WHERE DEMOLITION HAS OCCURRED OR WHERE ITEMS WERE REMOVED SHALL BE REPAIRED, AS INDICATED ON THESE DOCUMENTS OR BY USING MATERIALS SIMILAR TO MATERIALS ADJACENT TO THE DEMOLISHED OR DISTURBED AREA. THE REPAIR SHALL PROVIDE A FINISHED APPEARANCE, SUCH THAT IT IS NOT READILY APPARENT, THAT IT HAS BEEN ALTERED OR DISTURBED.
- 7. THE OWNER RETAINS FIRST RIGHTS OR REFUSAL OF ALL ITEMS REMOVED DURING DEMOLITION.

HAZARDOUS MATERIALS

- 8. HAZARDOUS MATERIALS ARE PRESENT IN THE BUILDING AND ELEMENTS TO BE SELECTIVELY DEMOLISHED. A REPORT ON THE PRESENCE OF HAZARDOUS MATERIALS IS ON FILE WITH THE OWNER FOR REVIEW AND USE.
- 9. CONTRACTOR SHALL EXAMINE REPORT TO BECOME AWARE OF LOCATIONS WHERE HAZARDOUS MATERIALS ARE PRESENT.
- 10. DO NOT DISTURB HAZARDOUS MATERIALS OR ITEMS SUSPECTED OF CONTAINING HAZARDOUS MATERIALS.
- 11. HAZARDOUS MATERIAL REMEDIATION IS NOT INCLUDED WITHIN THE SCOPE OF THIS PROJECT AND WILL BE EXECUTED BY OTHERS UNDER SEPARATE CONTRACT.
- 12. CONTRACTOR SHALL COORDINATE WITH THE OWNER AND SEPARATE CONTRACTOR FOR SEQUENCING OF HAZARDOUS MATERIAL REMEDIATION AND ABATEMENT

NEW CONSTRUCTION

13. ALL DIMENSIONS ARE TO FACE OF FINISH, FACE OF MASONRY OR CENTER LINE OF COLUMNS UNLESS OTHERWISE NOTED

LEGEND


ROOM NUMBER


LIMITS OF DEMOLITION. DISMANTLE AND SALVAGE EXISTING SUSPENDED ACOUSTIC TILE CEILING SYSTEM TO INCLUDE ELECTRICAL


XXX

■●●■ 1-HR FIRE BARRIER


AND MECHANICAL FIXTURES

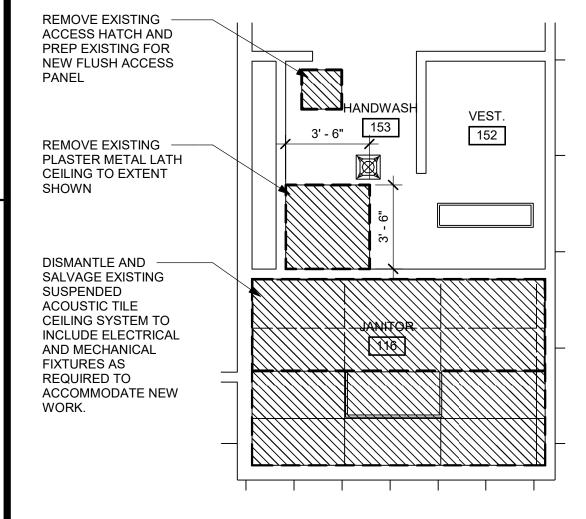

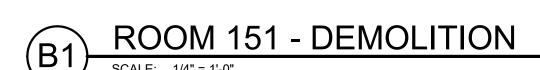


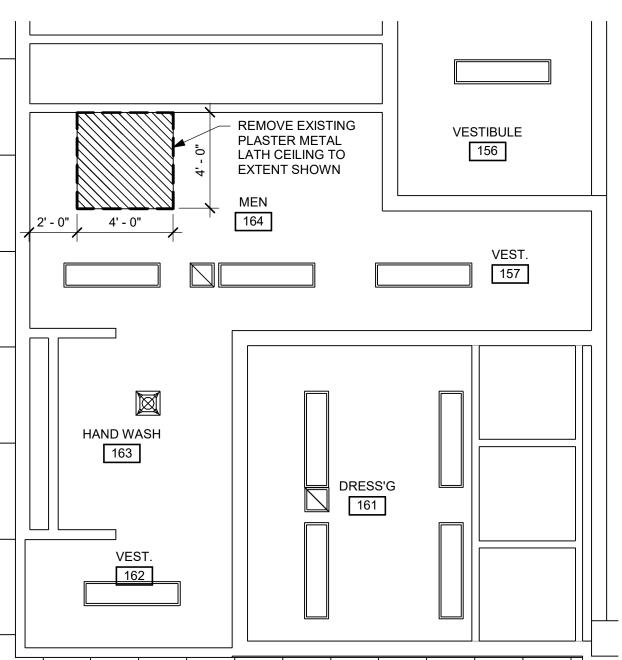

ROOM 164 - DEMOLITION

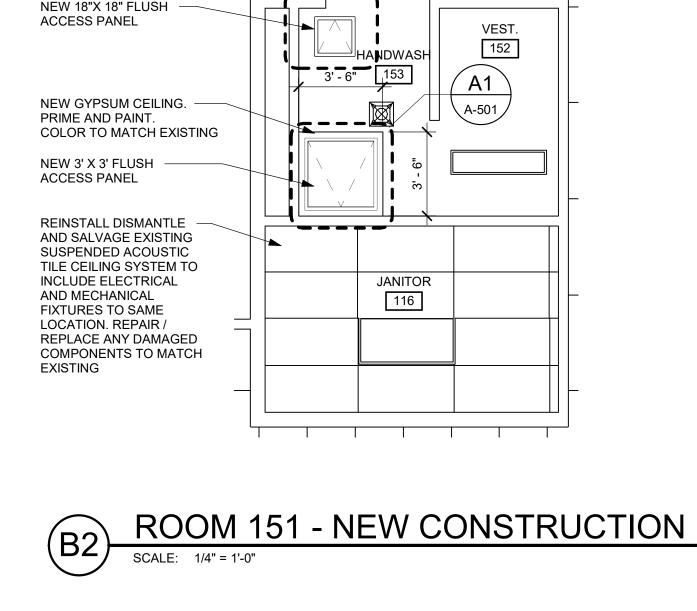

A-501

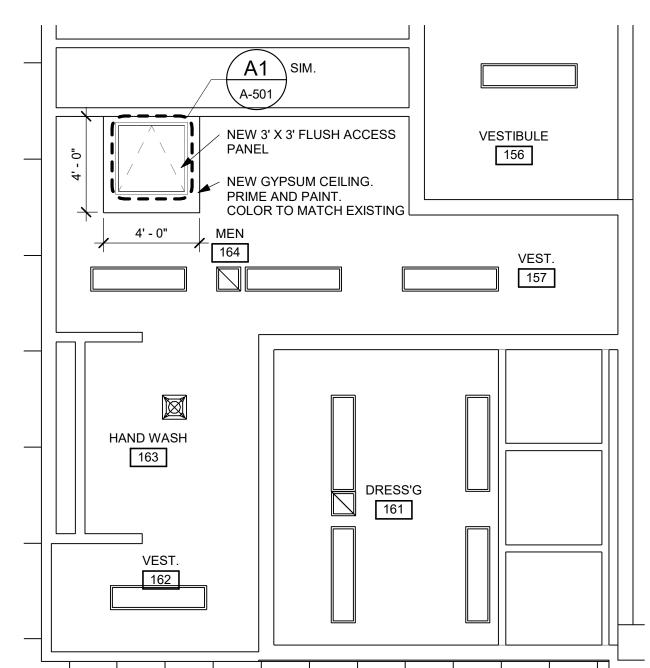

ROOM 164 - NEW CONSTRUCTION



1/4" = 1'-0"

APPROX SCALE: As indicated

ENLARGED

FLOOR PLANS

HHSC PROJ NO: 22-147-WFH


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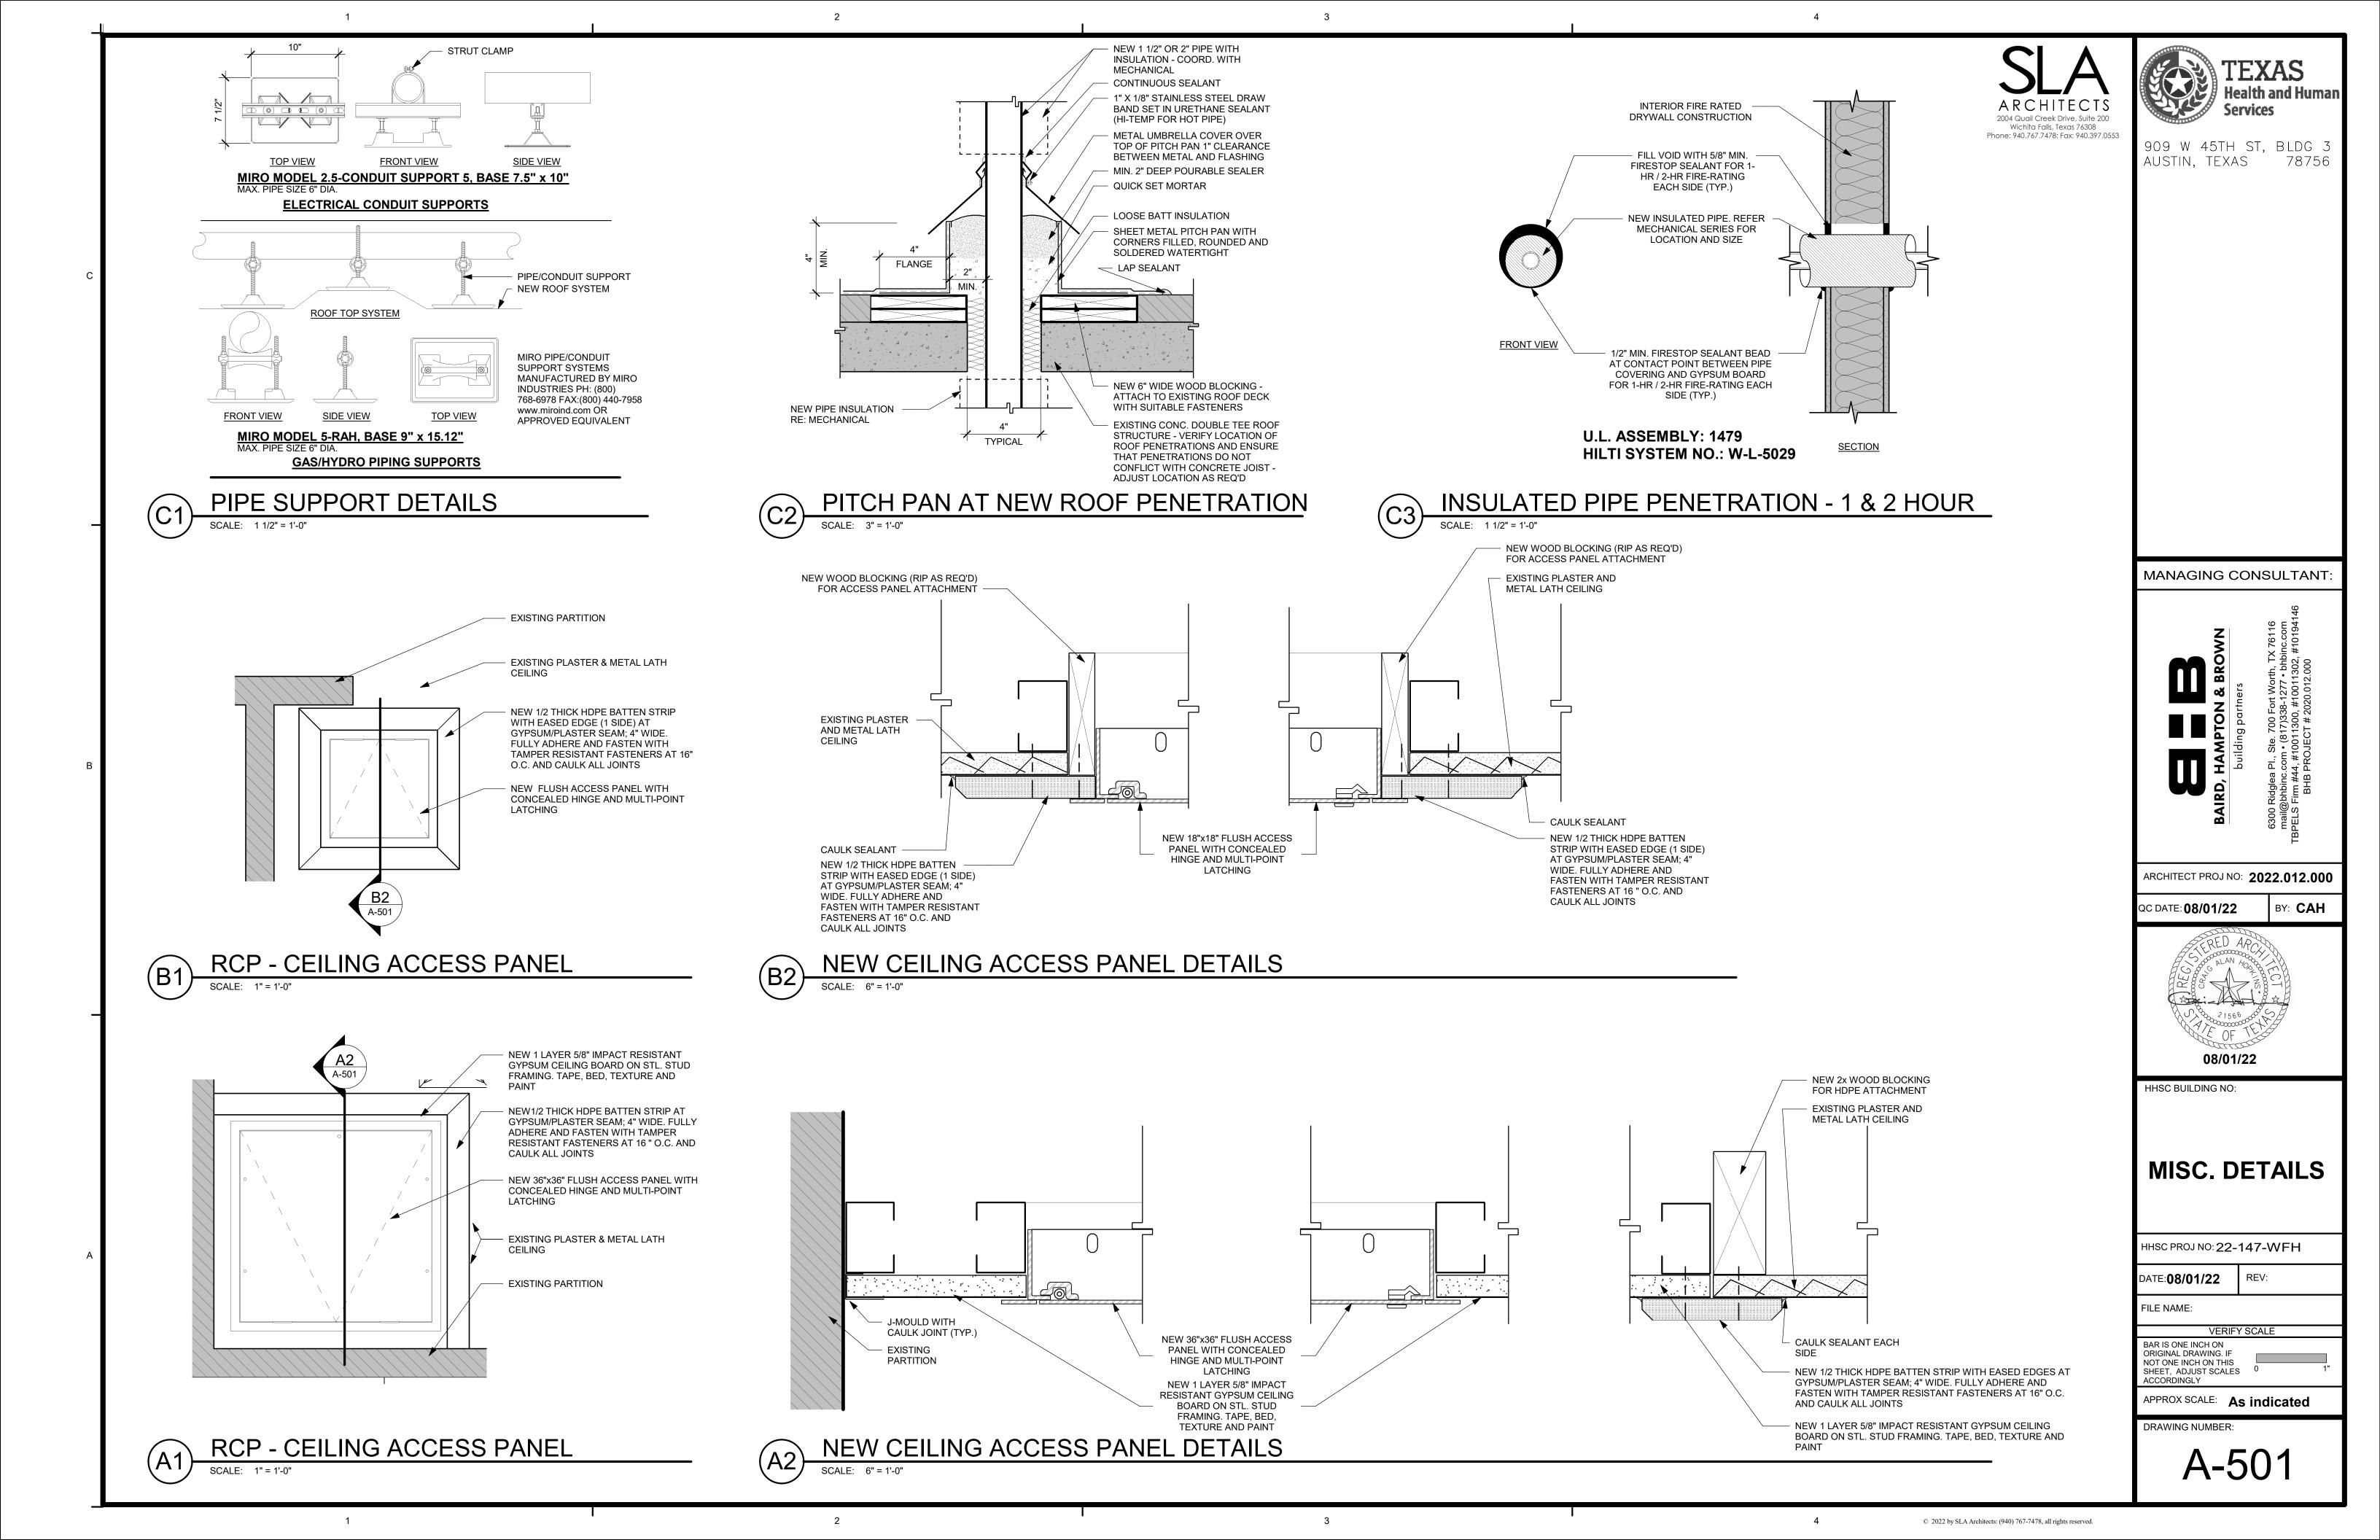
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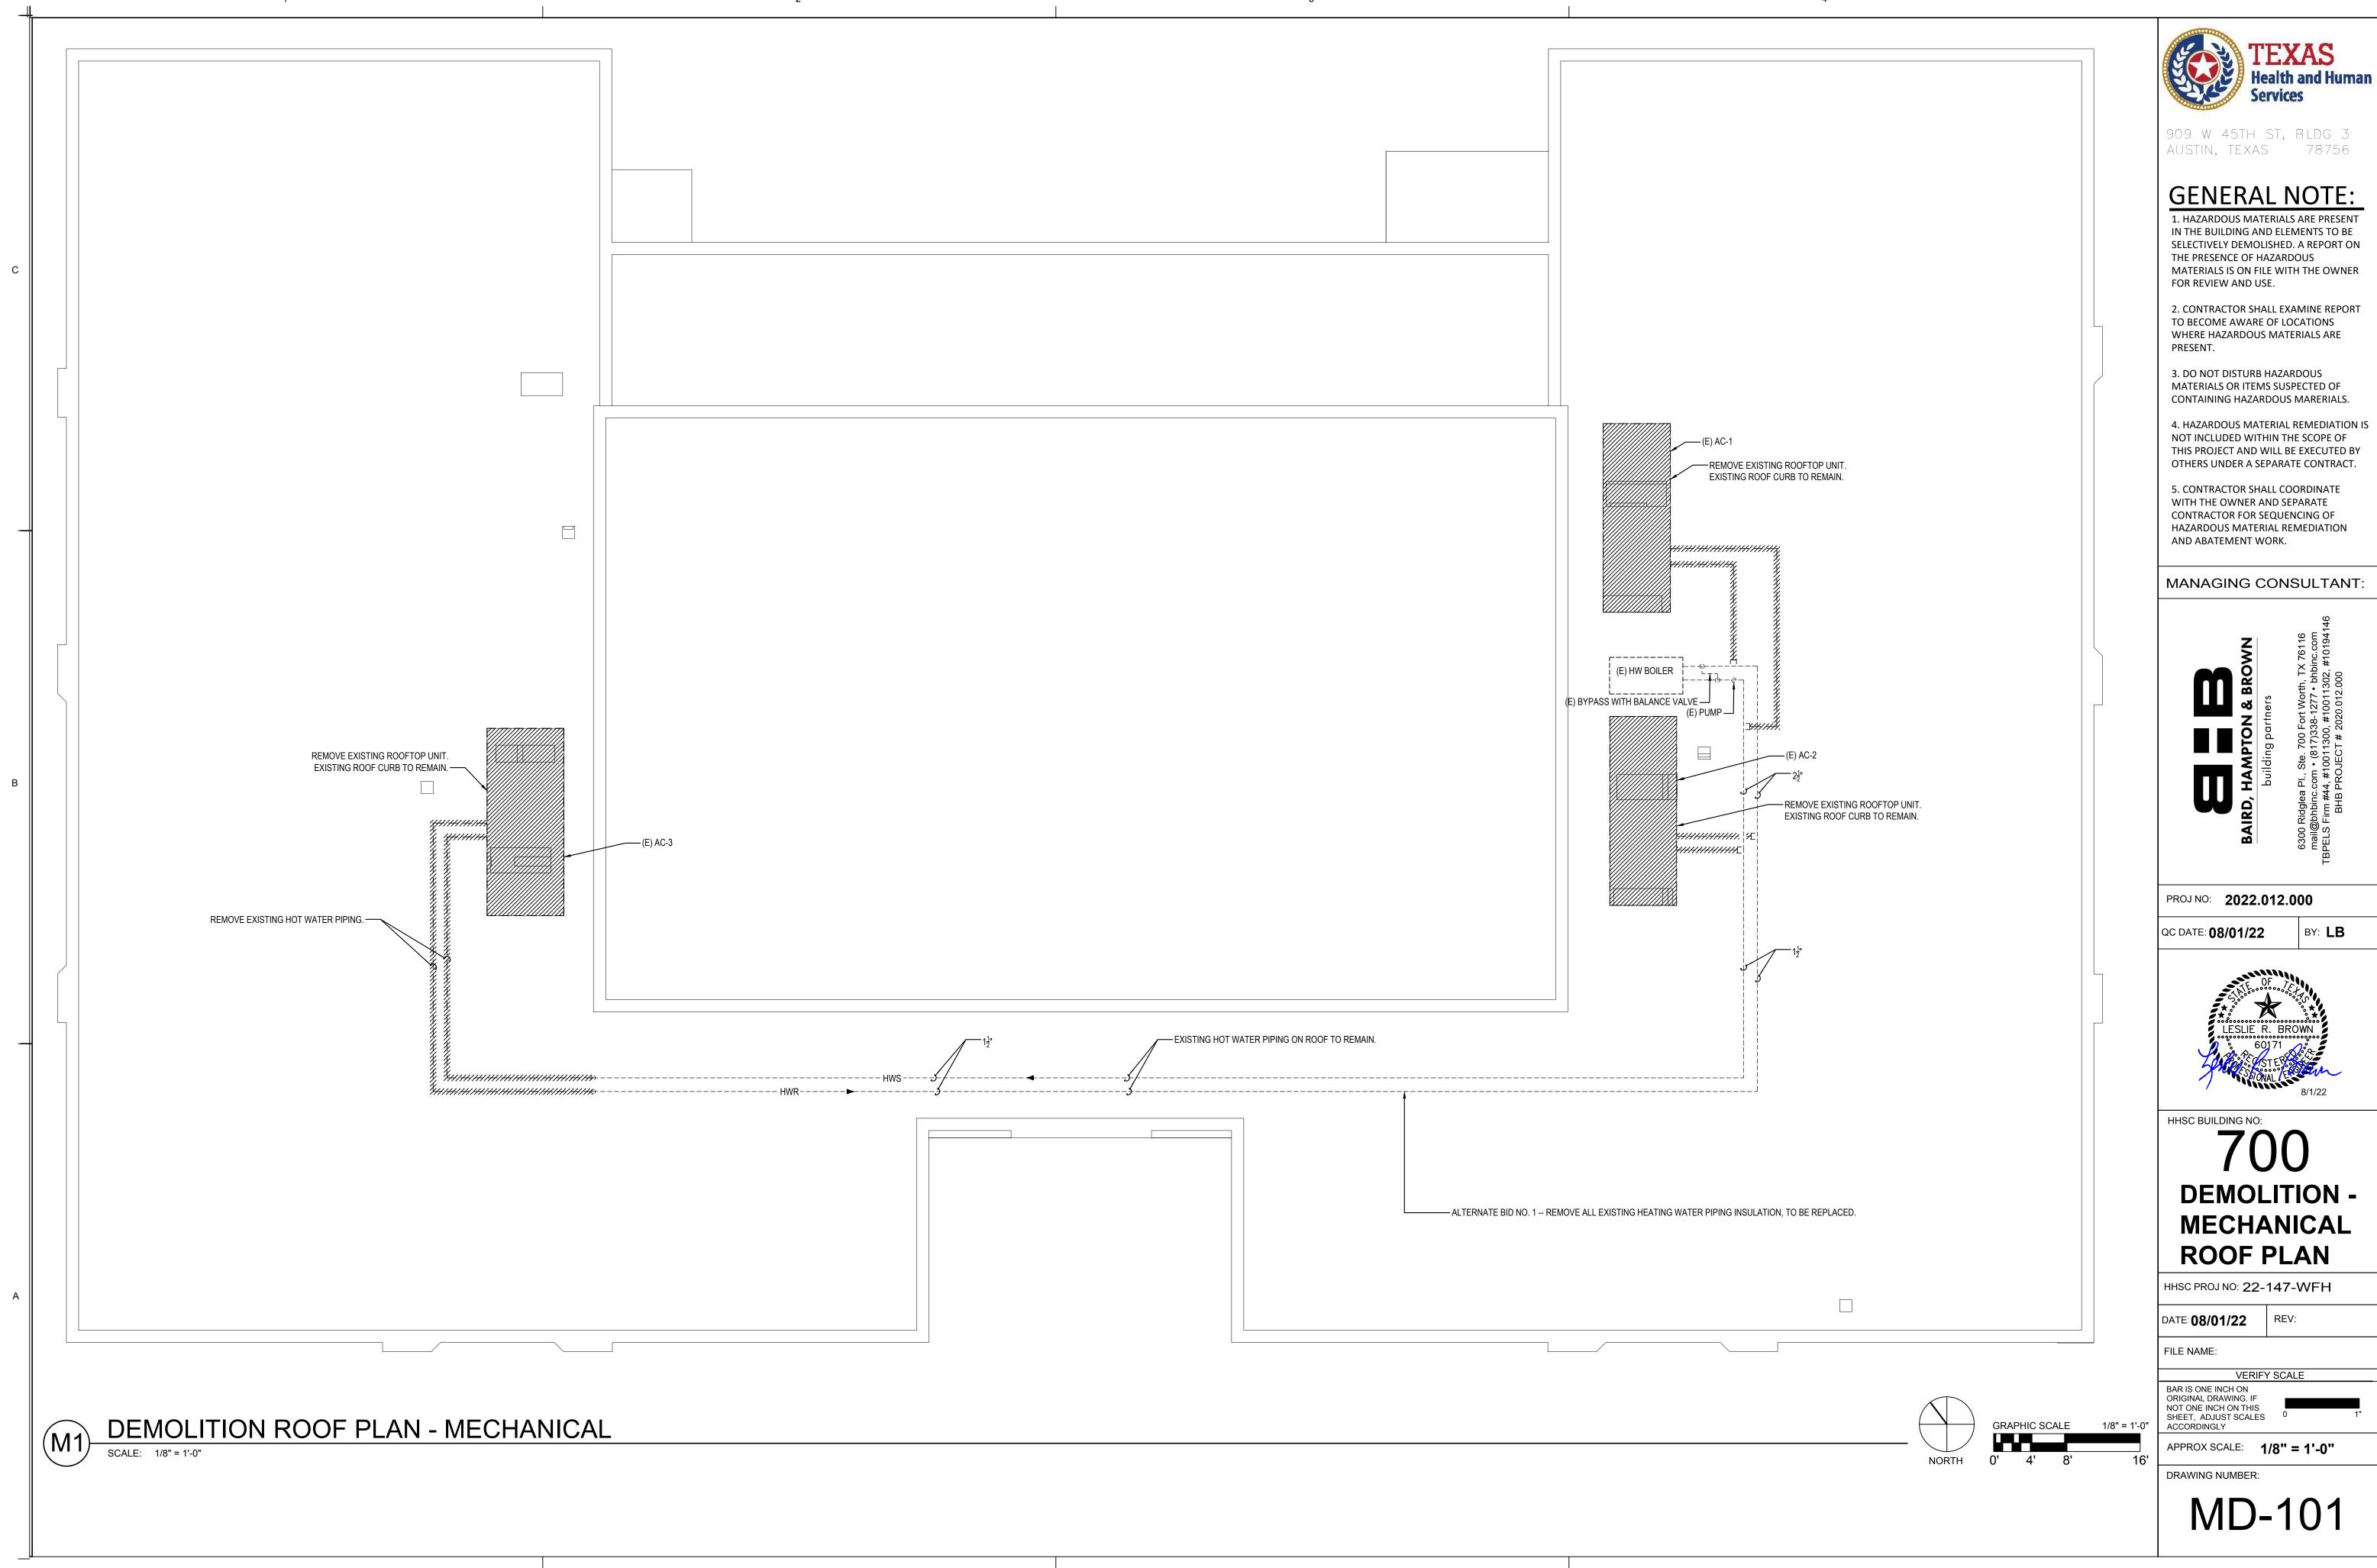
SHEET, ADJUST SCALES

A-201


GRAPHIC SCALE






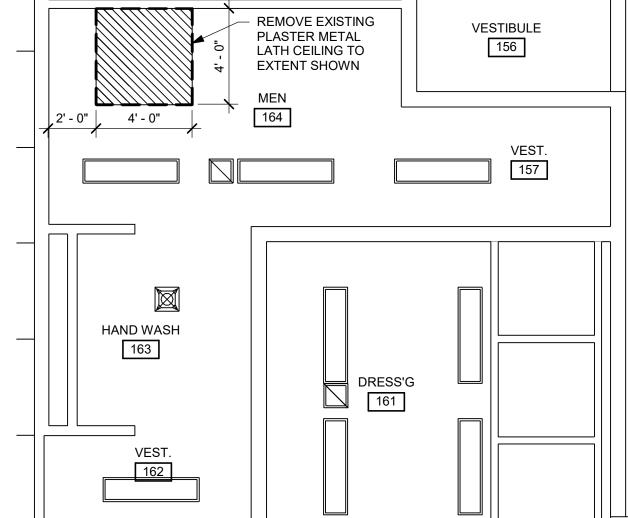

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						VARIA	BLE A	IR VO	LUME R	OOFTO	P UNIT S	SCHE	DULE ((NOM	20 T	ON)		
						5	COOLING			HEA	TING		ELECT	RICAL				
UNIT NO.	SUPPLY CFM MAXIMUM	SUPPLY CFM MINIMUM	O.A. CFM	EXT. S.P. (IN. OF WTR.)	TOTAL BTUH	SEN. BTUH	E./	A.T. Wb (°F)	AMBIENT TEMP. (°F)	INPUT BTUH	OUTPUT BTUH	UNIT MCA	MOCP	VOLTS	PHASE	MIN. EER	MANUFACTURER & MODEL NUMBER	REMARKS
AC-2	8,000	2,400	1,150	2.0	243,000	180,000	80	67	105	NONE	NONE	51	60	480	3	10.3	CARRIER 50A3-020-LM64AFL	EXISTING UNIT - TRANE 2504 HG 33A24DG4FH
AC-3	8,000	2,400	1,150	2.0	243,000	180,000	80	67	105	NONE	NONE	51	60	480	3	10.3	CARRIER 50A3-020-LM64AFL	EXISTING UNIT - TRANE 2504 HG 33A24DG4FH

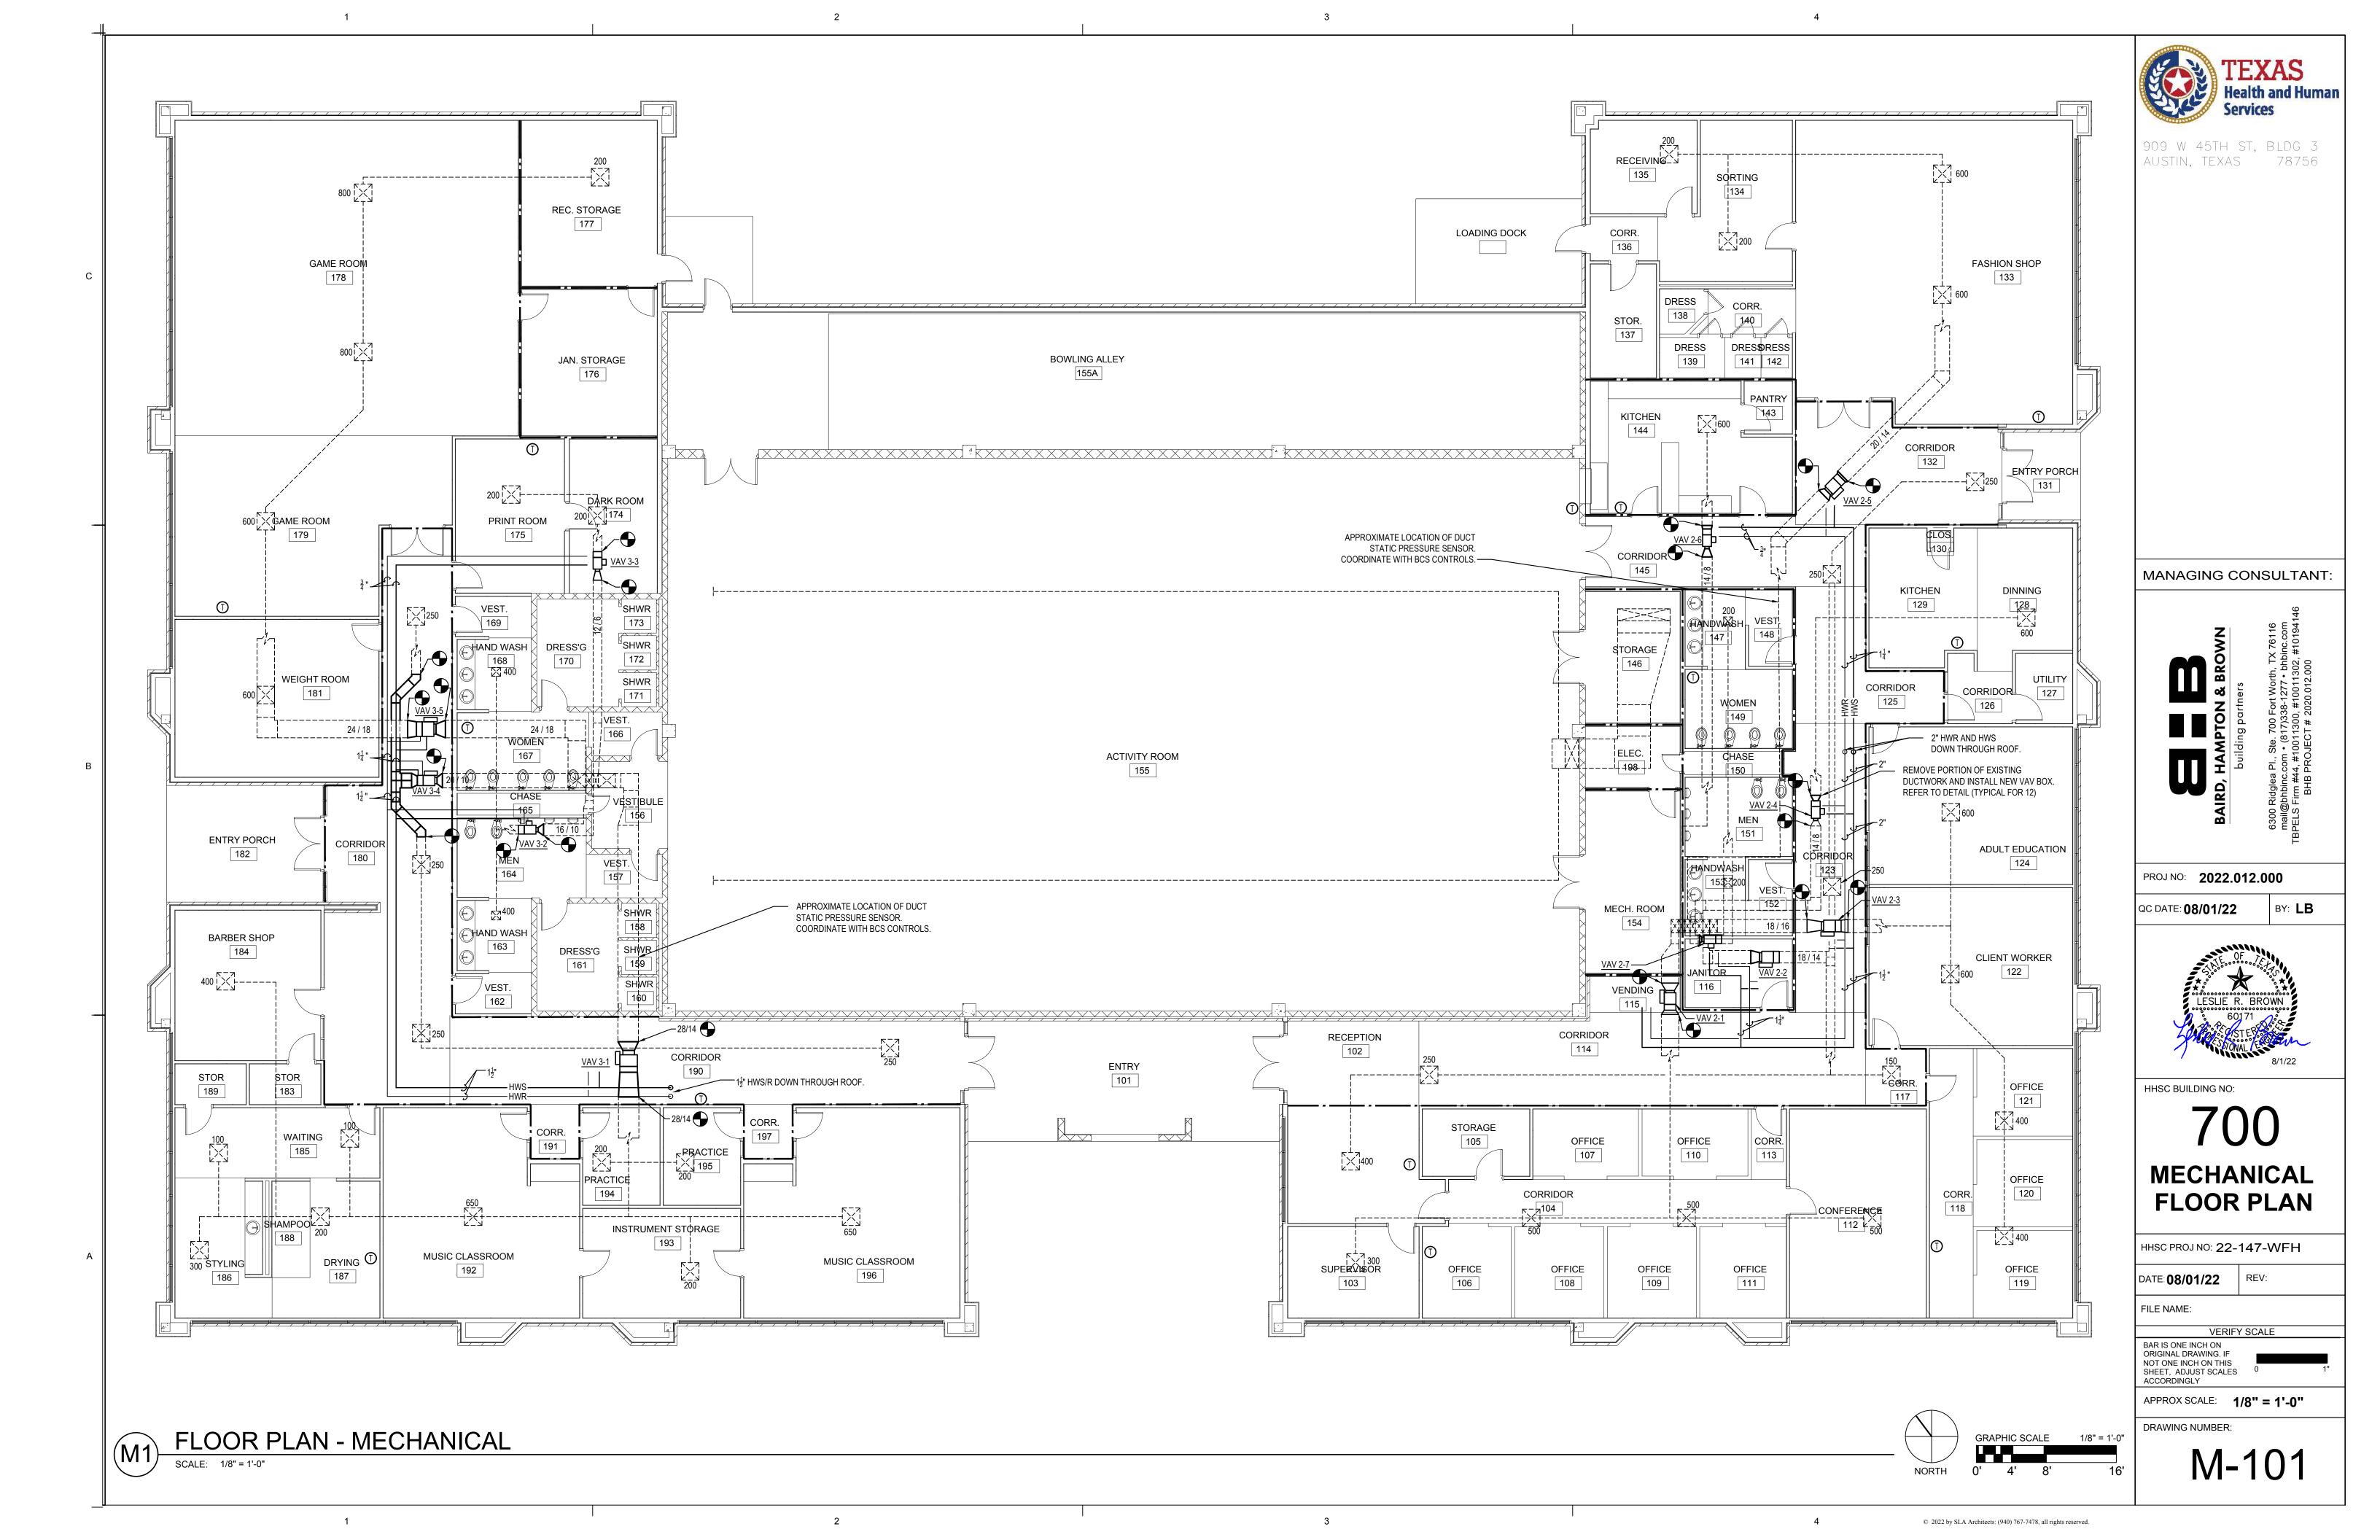PROVIDE FACTORY HAILGUARDS ON ALL UNITS.

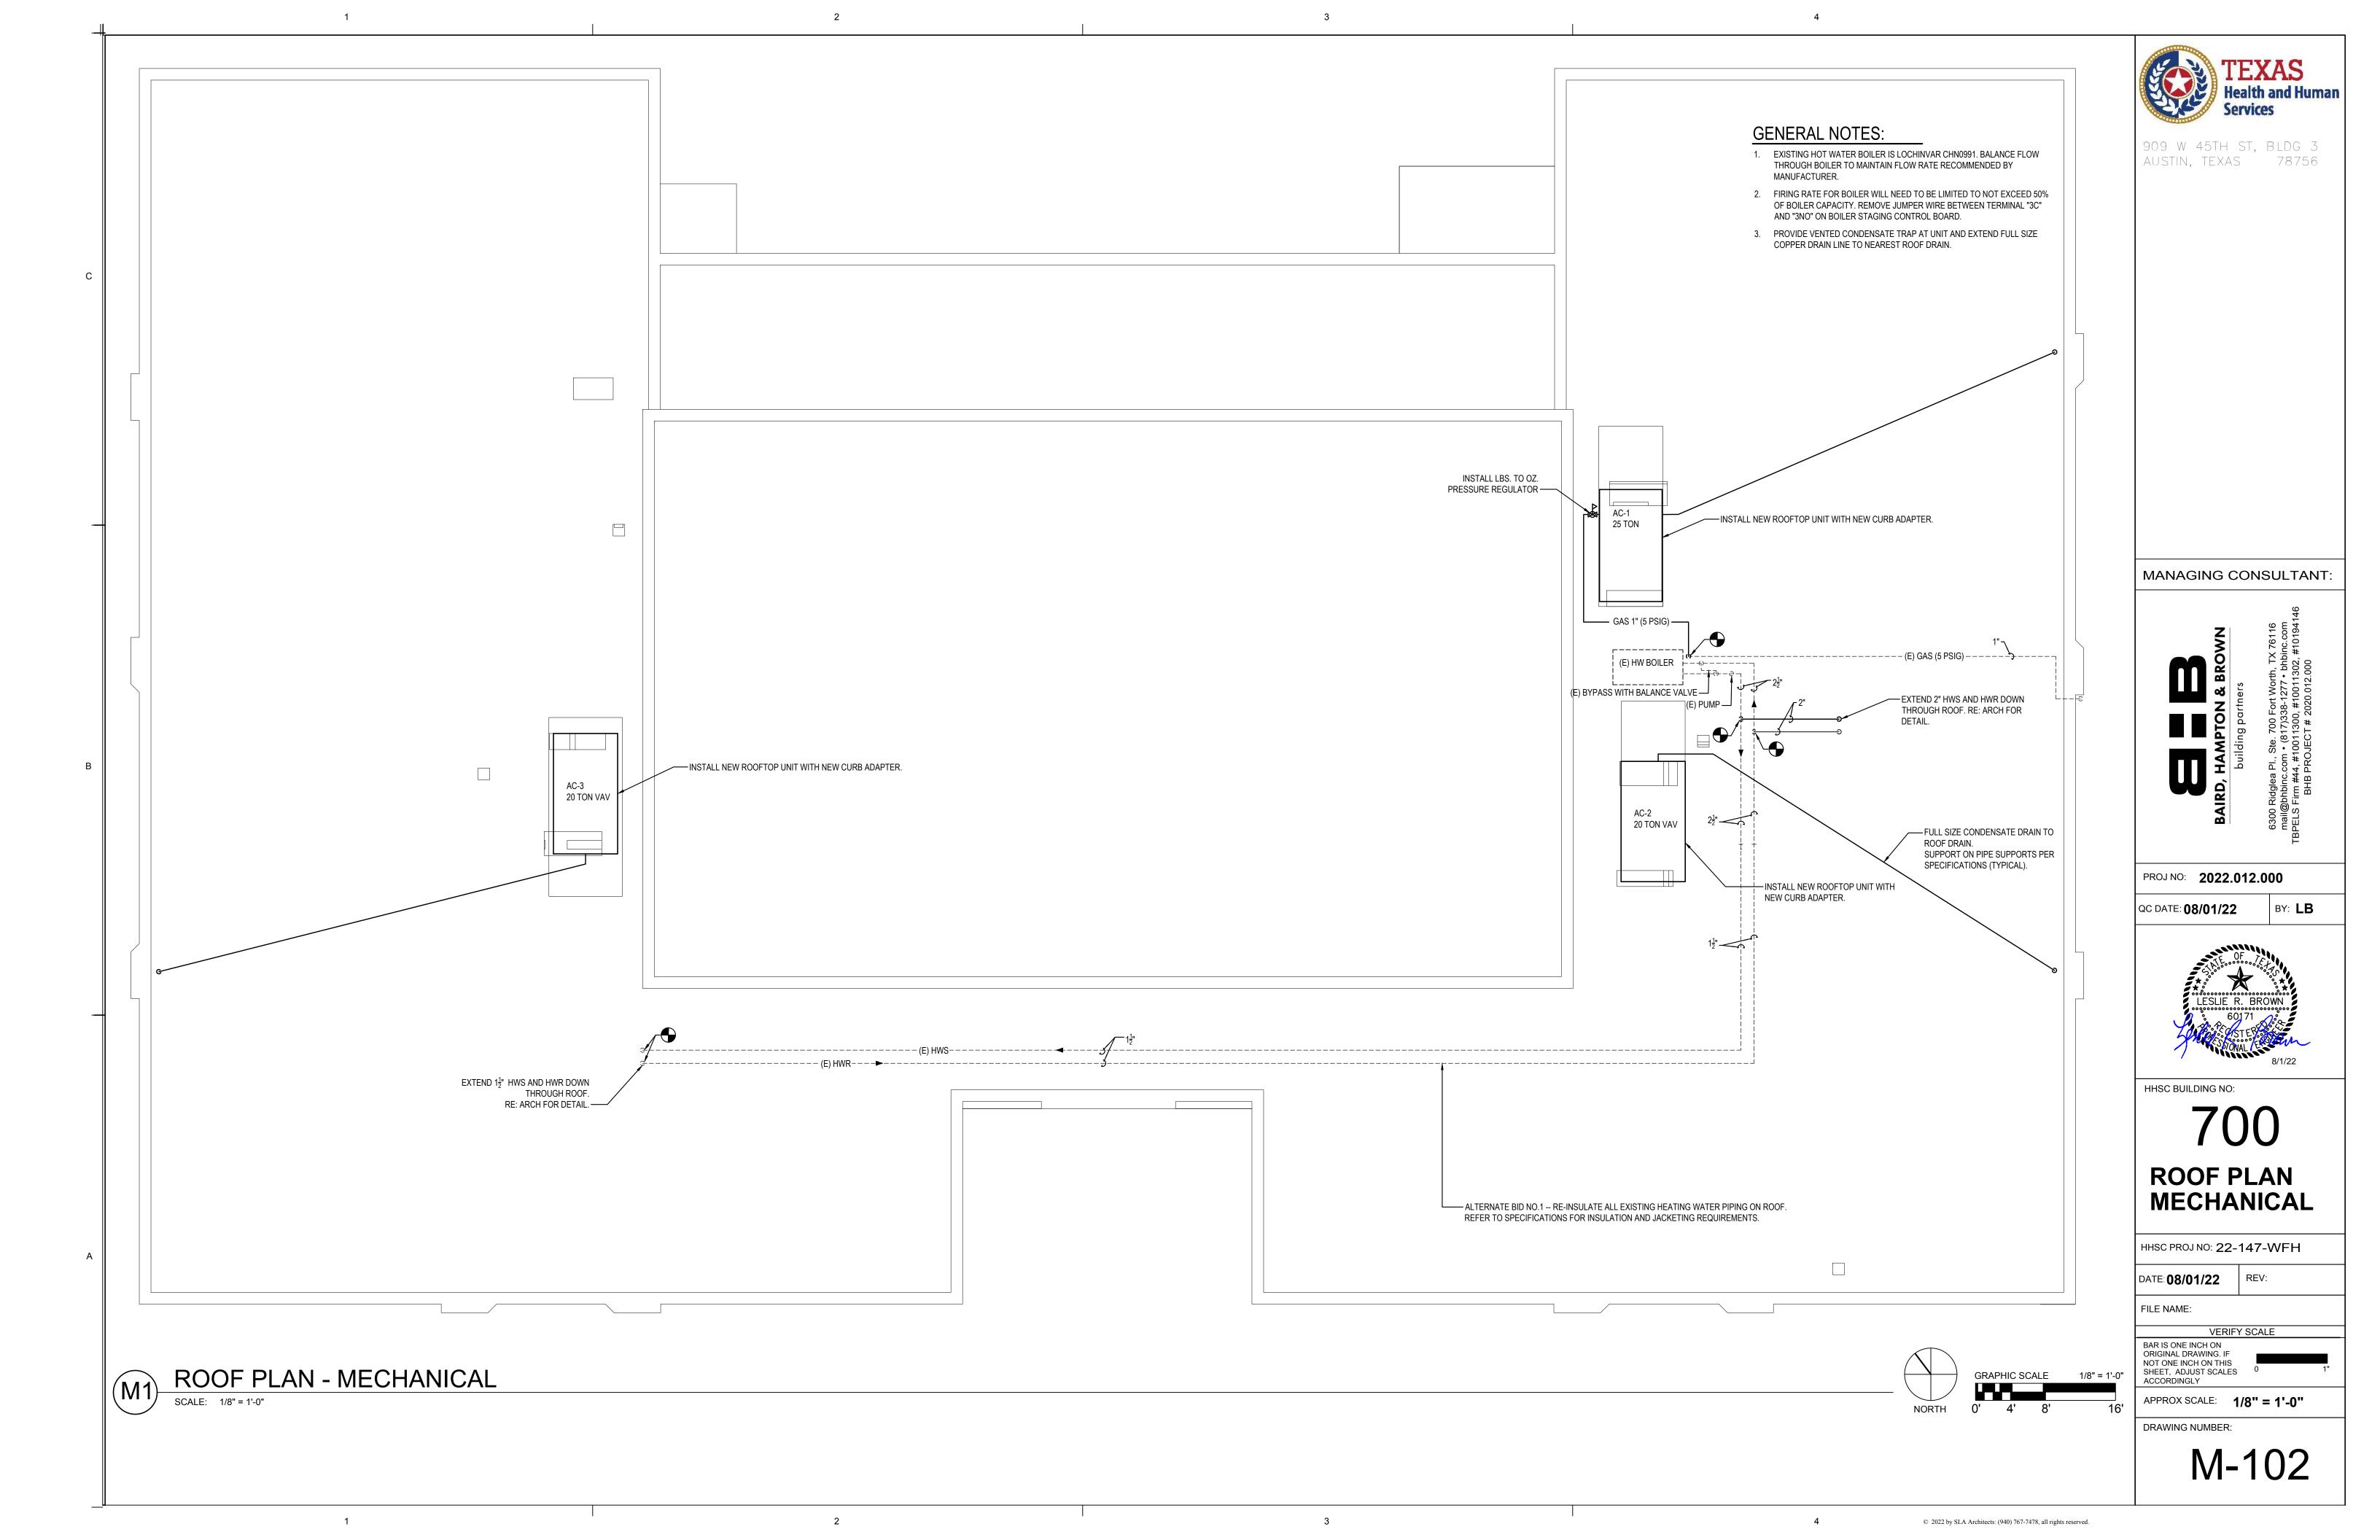NOTES:

5. UNIT SHALL BE PROVIDED WITH CONVENIENCE OUTLET AND FACTORY MOUNTED RETURN AIR SMOKE DETECTOR. EXT. STATIC PRESSURE (S.P.) INCLUDES DUCTWORK, DAMPERS, GRILLES AND FILTERS.

UNITS SHALL BE FURNISHED COMPLETE WITH FACTORY FABRICATED INSULATED CURB ADAPTER.

UNITS SHALL BE FURNISHED COMPLETE WITH ALL NECESSARY OPERATING CONTROLS. 7. PROVIDE EACH UNIT WITH FULL ECONOMIZER CYCLE DAMPERS AND CONTROLS AND BAROMETRIC RELIEF DAMPER.

UNITS SHALL BE A VARIABLE VOLUME COOLING CONTROL. 8. PROVIDE AC-2 WITH MINIMUM SCCR 65 KAIC. PROVIDE AC-3 WITH MINIMUM SCCR 5 KAIC.

						CONS	TANT V	OLUME R	ROOFTC	P UNIT	SCHE	DULE	(NOM	l. 25	TON)		
						COOLING			GAS HI	EATING		ELECTF	RICAL				
UNIT NO.	SUPPLYCFM	O.A. CFM	EXT. S.P. (IN. OF WTR.)	TOTAL BTUH	SEN. BTUH	Db (°F)	E.A.T. Wb (°F)	AMBIENT TEMP. (°F)	INPUT BTUH	OUTPUT BTUH	UNIT MCA	MOCP	VOLTS	PHASE	MIN. EER	MANUFACTURER & MODEL NUMBER	REMARKS
AC-1	10,000	2,150	0.75	290,000	226,000	80	67	105	400,000	324,000	59.8	70	460	3	9.8	CARRIER 48TCFD28B3M6-2W430	EXISTING UNIT - TRANE SSZB 2004 HF 33A34DF4F

NOTES:

EXT. STATIC PRESSURE (S.P.) INCLUDES DUCTWORK, DAMPERS, GRILLES AND FILTERS.

UNIT SHALL BE PROVIDED WITH CONVENIENCE OUTLET AND FACTORY MOUNTED RETURN AIR SMOKE DETECTOR.

UNITS SHALL BE FURNISHED COMPLETE WITH FACTORY FABRICATED INSULATED CURB ADAPTER.

PROVIDE FACTORY HAILGUARDS ON ALL UNITS.

UNITS SHALL BE FURNISHED COMPLETE WITH ALL NECESSARY OPERATING CONTROLS.

PROVIDE EACH UNIT WITH FULL ECONOMIZER CYCLE DAMPERS AND CONTROLS AND BAROMETRIC RELIEF DAMPER.

4. UNITS SHALL BE 2 STAGE COOLING CONTROL AND HAVE 2 SPEED INDOOR FAN.


PROVIDE MINIMUM SCCR 65 KAIC.

				VA	RIABLE	VOLUM	IE TE	RMINAI	L UNITS			
	С	FM	UNIT				١	WATER HEATIN	G COIL			
UNIT NO.	MAX.	MIN.	MAX. P.D.	UNIT N.C.	E.A.T. (°F)	CAP BTUH	ROWS	GPM	PIPING RUNOUT SIZE	E.W.T. (°F)	MAX. P.D. (FT. OF WTR.)	REMARKS
VAV 2-1	1,800	540	0.55	35	35	50,300	3	6.0	1"	180	3.0	CARRIER 35E UNIT SIZE 14
VAV 2-2	1,650	495	0.50	35	35	46,100	3	6.0	1"	180	3.0	CARRIER 35E UNIT SIZE 14
VAV 2-3	2,000	600	0.65	35	35	55,900	3	6.0	1"	180	3.0	CARRIER 35E UNIT SIZE 14
VAV 2-4	600	180	0.55	35	35	16,800	3	2.4	3/4"	180	0.6	CARRIER 35E UNIT SIZE 07
VAV 2-5	1,600	480	0.50	35	35	44,700	4	6.0	1"	180	3.0	CARRIER 35E UNIT SIZE 14
VAV 2-6	600	180	0.55	35	35	16,800	3	2.4	3/4"	180	0.6	CARRIER 35E UNIT SIZE 07
VAV 2-7	400	120	0.40	35	35	11,200	3	2.0	3/4"	180	0.7	CARRIER 35E UNIT SIZE 06
VAV 3-1	3,000	900	0.65	35	35	83,900	2	6.0	1"	180	2.1	CARRIER 35E UNIT SIZE 16
VAV 3-2	800	240	0.40	35	35	22,400	2	2.0	3/4"	180	0.7	CARRIER 35E UNIT SIZE 08
VAV 3-3	400	120	0.40	35	35	11,200	3	2.0	3/4"	180	0.7	CARRIER 35E UNIT SIZE 06
VAV 3-4	1,000	300	0.65	35	35	28,000	3	4.0	1"	180	1.5	CARRIER 35E UNIT SIZE 09
VAV 3-5	3,000	900	0.55	35	35	83,900	2	6.0	1"	180	2.1	CARRIER 35E UNIT SIZE 16

NOTES:

MAX P.D. INCLUDES UNIT INTERNAL LOSS ONLY.

UNIT CONTROLLERS SHALL BE PROVIDED AND INSTALLED BY BCS PROVIDER.

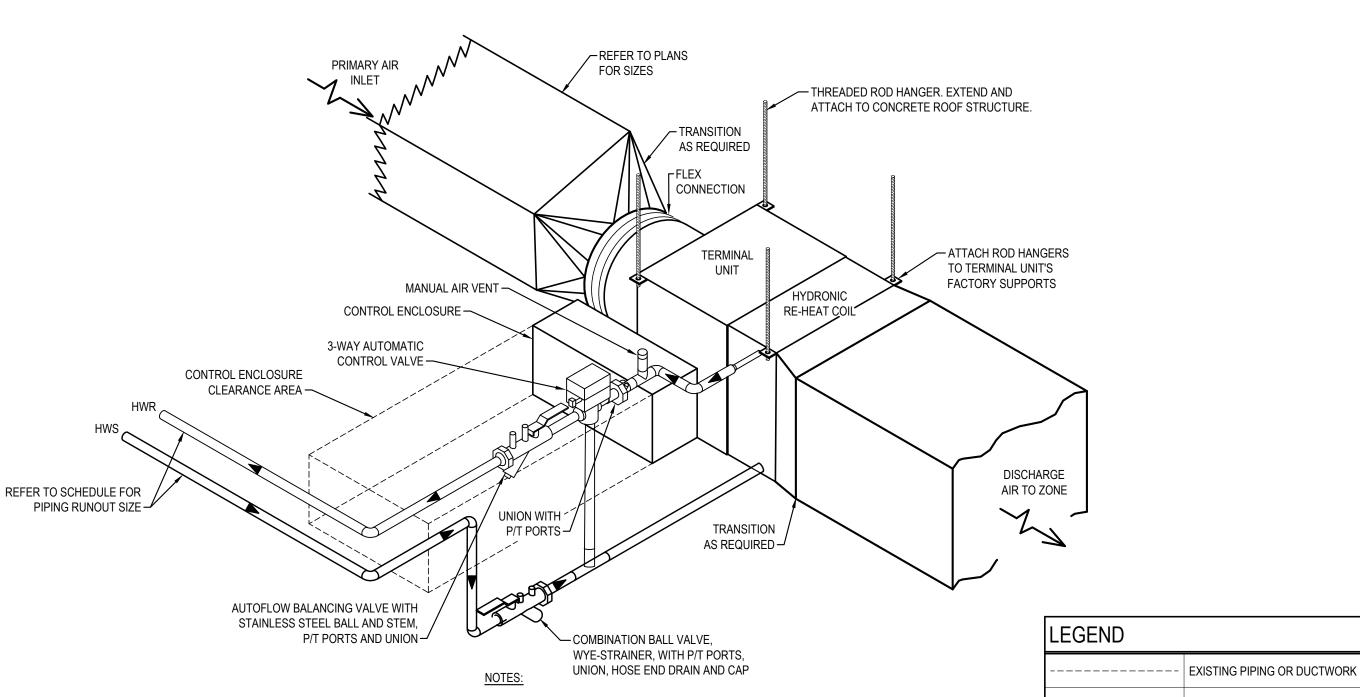

1. THE TERMINAL UNIT'S CONTROL ENCLOSURE SHALL HAVE AN UNOBSTRUCTED, ACCESSIBLE CLEARANCE OF <u>2'-6" MINIMUM</u> DIRECTLY IN FRONT OF ENCLOSURE FROM THE BOTTOM OF THE CEILING UP TO THE TOP OF THE ENCLOSURE.

2. PRIMARY AIR INLET DUCT SHALL HAVE A MINIMUM OF 3 DUCT DIAMETERS OF STRAIGHT RUN UPSTREAM OF THE TERMINAL UNIT INLET.

3. ALL TERMINAL UNIT'S INSTALLED ABOVE A GYP. CEILING SHALL HAVE AN ACCESS PANEL LOCATED DIRECTLY BENEATH THE CONTROL ENCLOSURE. COORDINATE CEILING TYPE AND ACCESS PANEL WITH THE ARCHITECTURAL DRAWINGS AND SPECIFICATIONS.

TERMINAL UNIT DETAIL (VAV w/HYDRONIC RE-HEAT)

NOT TO SCALE

HVAC GENERAL NOTES:

- 1. FURNISH AND INSTALL ALL MATERIALS AND LABOR REQUIRED TO PROVIDE COMPLETE AND OPERABLE HVAC SYSTEMS WITH ALL ITEMS AND APPURTENANCES NECESSARY EVEN THOUGH NOT SPECIFICALLY IDENTIFIED.
- 2. ALL WORK AND/OR MATERIALS SHALL BE INSTALLED BY A LICENSED CONTRACTOR AND SHALL CONFORM TO ALL APPLICABLE NATIONAL AND LOCAL BUILDING AND MECHANICAL
- 3. ALL DUCTWORK SHALL BE FABRICATED AND INSTALLED IN ACCORDANCE WITH SMACNA STANDARDS. INSTALL TURNING VANES IN ALL DUCTWORK ELBOWS.
- 4. ALL INTERIOR DUCTS SHALL BE CONSTRUCTED WITH G-60 OR BETTER GALVANIZED STEEL (ASTM A 653/A 653M) LFQ, CHEM TREAT.
- 5. COORDINATE EXACT ROUTING OF ALL WORK WITH ALL EXISTING CONDITIONS PRIOR TO INSTALLATION OF WORK.
- 6. ALL NEW SUPPLY AIR DUCTWORK AND ALL SUPPLY DUCTWORK WITH ABATED INSULATION IN THE AREA OF NEW VAV BOXES SHALL BE INSULATED WITH 2" THICK, 0.75 LB/CF (MINIMUM) FSK WRAP INSULATION (MINIMUM INSTALLED R-VALUE = R-6).
- 7. ALL DUCT DIMENSIONS SHOWN ARE NET CLEAR INSIDE DIMENSIONS.
- 8. MOUNT ALL TEMPERATURE SENSORS 4'-0" ABOVE FLOOR (TYPICAL).
- 9. THE MECHANICAL CONTRACTOR SHALL HIRE AN INDEPENDENT TESTING AND BALANCING AGENCY CERTIFIED BY THE AABC TO TEST AND BALANCE THE HVAC SYSTEMS. SYSTEMS SHALL BE BALANCED TO PLUS/MINUS 10% OF DESIGN REQUIREMENTS. THE CONTRACTOR SHALL PLACE ALL SYSTEMS AND EQUIPMENT INTO FULL OPERATION FOR TESTING AND BALANCING. PROVIDE FIVE (5) COPIES TO THE OWNER.
- 10. BASE BID, PROVIDE 5 YEAR WARRANTY ON COMPRESSORS, AND 15 YEAR WARRANTY ON HEAT EXCHANGERS.
- 11. ALTERNATE BID NO. 2, PROVIDE FULL 5 YEAR PARTS AND LABOR WARRANTY FOR ALL NEW ROOFTOP UNITS.
- 12. THE WORK WILL NEED TO BE PHASED SO THAT ONLY A PORTION OF THE BUILDING IS WITHOUT HVAC AT ONE TIME. WORK ON AC-3 WILL BE COMPLETED AS ONE PHASE, AND WORK ON AC-1 AND AC-2 WILL BE COMPLETED AS A SEPARATE PHASE OF WORK.
- 13. THERE IS POTENTIAL FOR ANOTHER PROJECT INVOLVING ROOF WORK TO BE ONGOING DURING THIS PROJECT. COORDINATE WITH OWNER.
- 14. HAZARDOUS MATERIALS ARE PRESENT IN THE BUILDING AND ELEMENTS TO BE SELECTIVELY DEMOLISHED. A REPORT ON THE PRESENCE OF HAZARDOUS MATERIALS IS ON FILE WITH THE OWNER FOR REVIEW AND USE.
- 15. CONTRACTOR SHALL EXAMINE REPORT TO BECOME AWARE OF LOCATIONS WHERE HAZARDOUS MATERIALS ARE PRESENT.
- 16. DO NOT DISTURB HAZARDOUS MATERIALS OR ITEMS SUSPECTED OF CONTAINING HAZARDOUS MATERIALS.

NEW PIPING

NEW DUCTWORK

EXISTING CEILING DIFFUSER WITH CFM NOTED

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NEW TEMPERATURE SENSOR

CONNECT NEW TO EXISTING

NEW VAV BOX

XXXKT

1


— - FIRE RATED WALL

- 17. HAZARDOUS MATERIAL REMEDIATION IS NOT INCLUDED WITHIN THE SCOPE OF THIS PROJECT AND WILL BE EXECUTED BY OTHERS UNDER SEPARATE CONTRACT.
- 18. CONTRACTOR SHALL COORDINATE WITH THE OWNER AND SEPARATE CONTRACTOR FOR SEQUENCING OF HAZARDOUS MATERIAL REMEDIATION AND ABATEMENT WORK.

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MANAGING CONSULTANT:

PROJ NO: **2022.012.000**

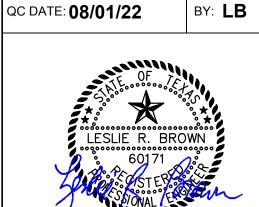

HHSC BUILDING NO:

MECHANICAL SCHEDULES & DETAILS

HHSC PROJ NO: **22-147-WFH**

DATE: **08/01/22**

FILE NAME:


VERIFY SCALE BAR IS ONE INCH ON ORIGINAL DRAWING. IF NOT ONE INCH ON THIS

SHEET, ADJUST SCALES

ACCORDINGLY APPROX SCALE: 1/8" = 1'-0"

DRAWING NUMBER:

M-210

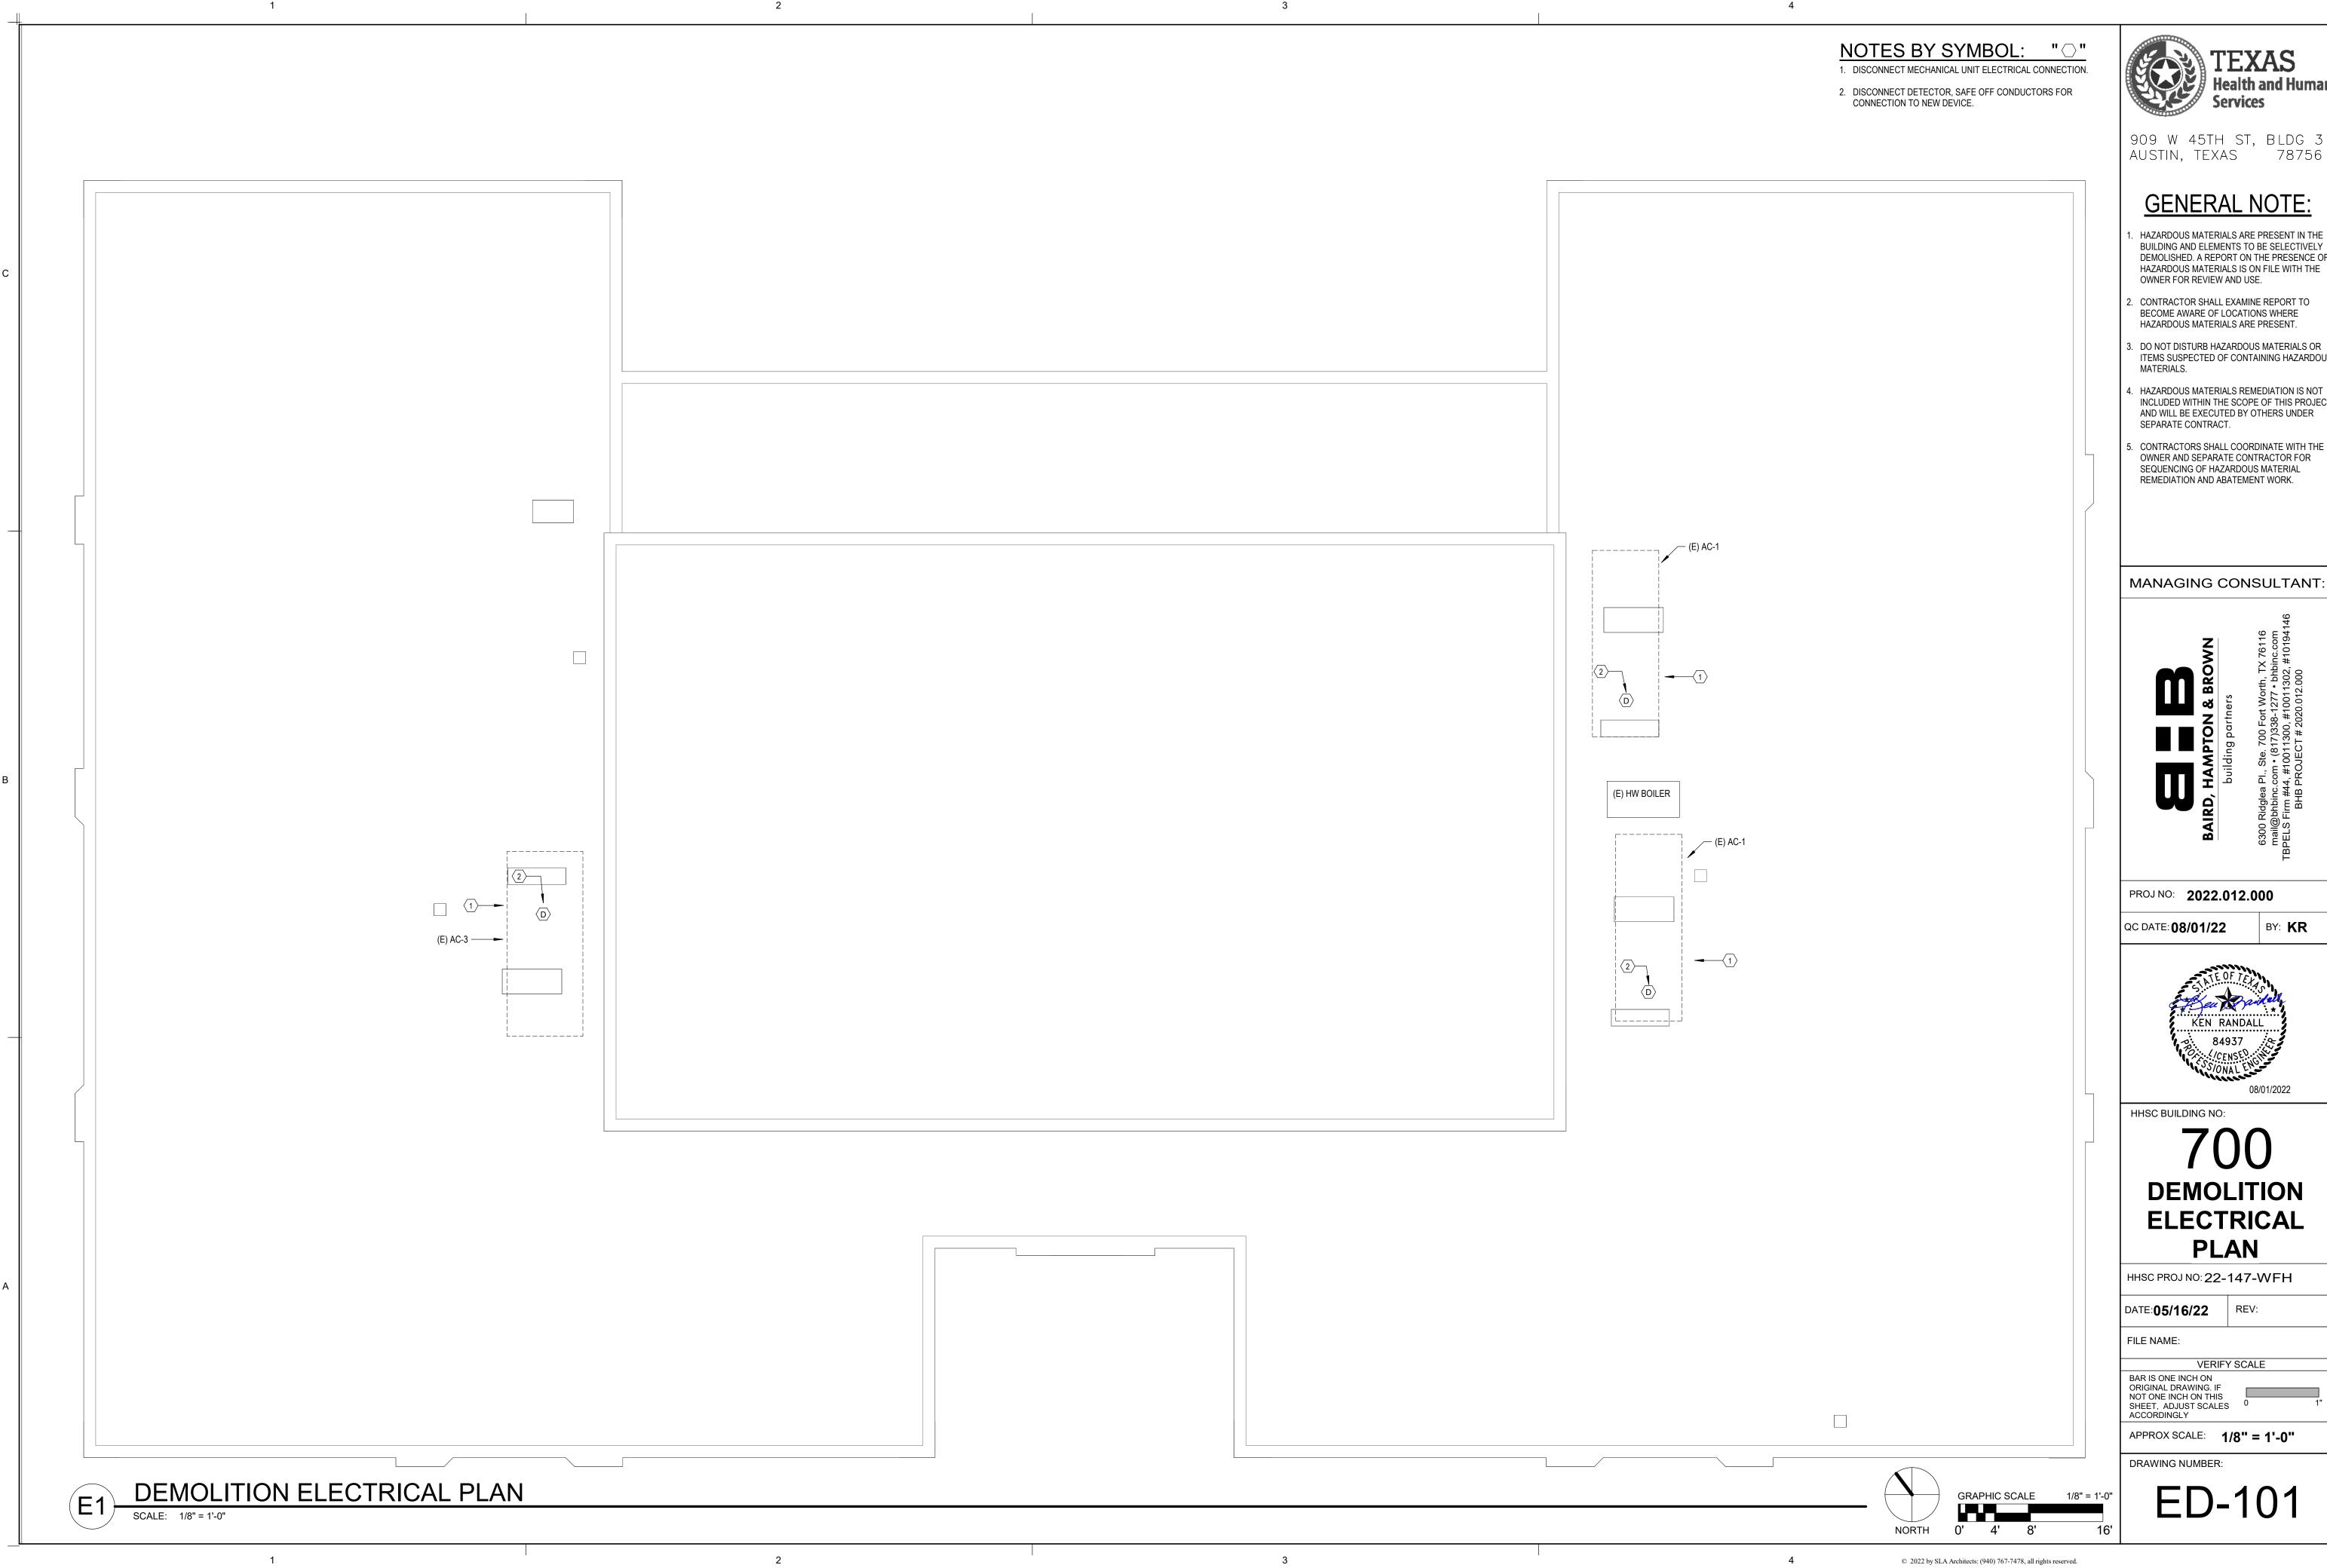




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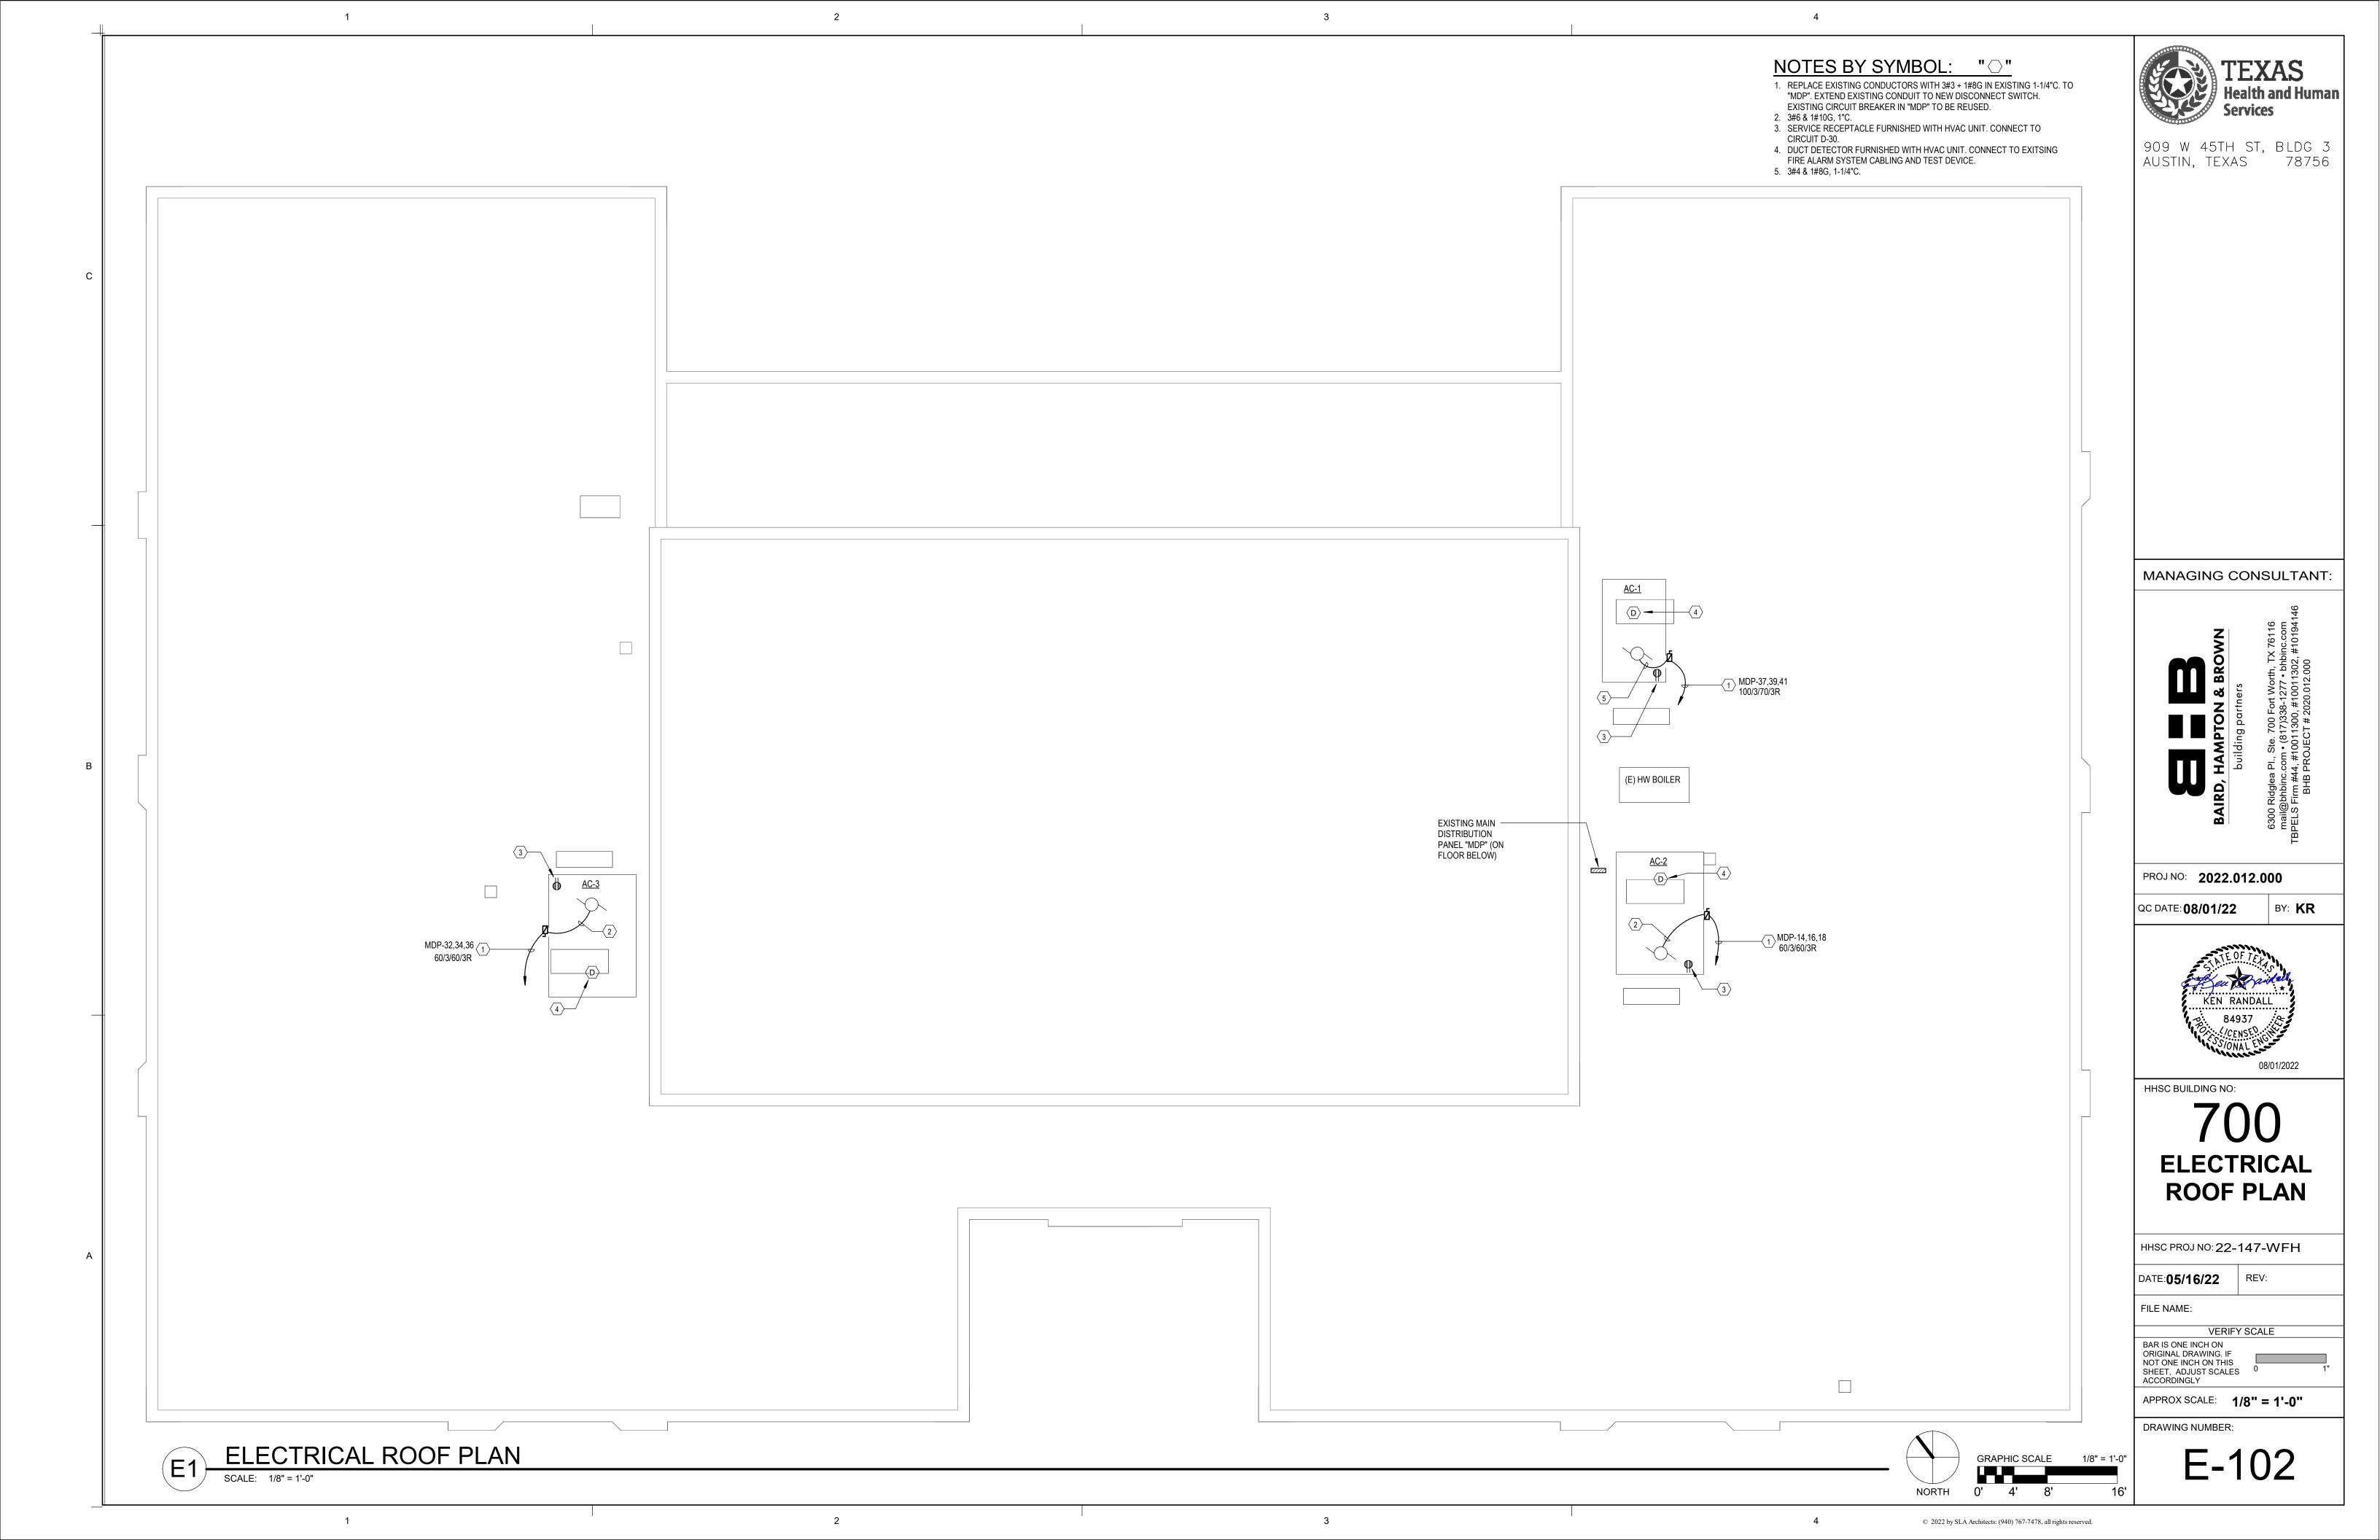
BUILDING AND ELEMENTS TO BE SELECTIVELY DEMOLISHED. A REPORT ON THE PRESENCE OF HAZARDOUS MATERIALS IS ON FILE WITH THE

. DO NOT DISTURB HAZARDOUS MATERIALS OR ITEMS SUSPECTED OF CONTAINING HAZARDOUS

INCLUDED WITHIN THE SCOPE OF THIS PROJECT AND WILL BE EXECUTED BY OTHERS UNDER

CONTRACTORS SHALL COORDINATE WITH THE OWNER AND SEPARATE CONTRACTOR FOR



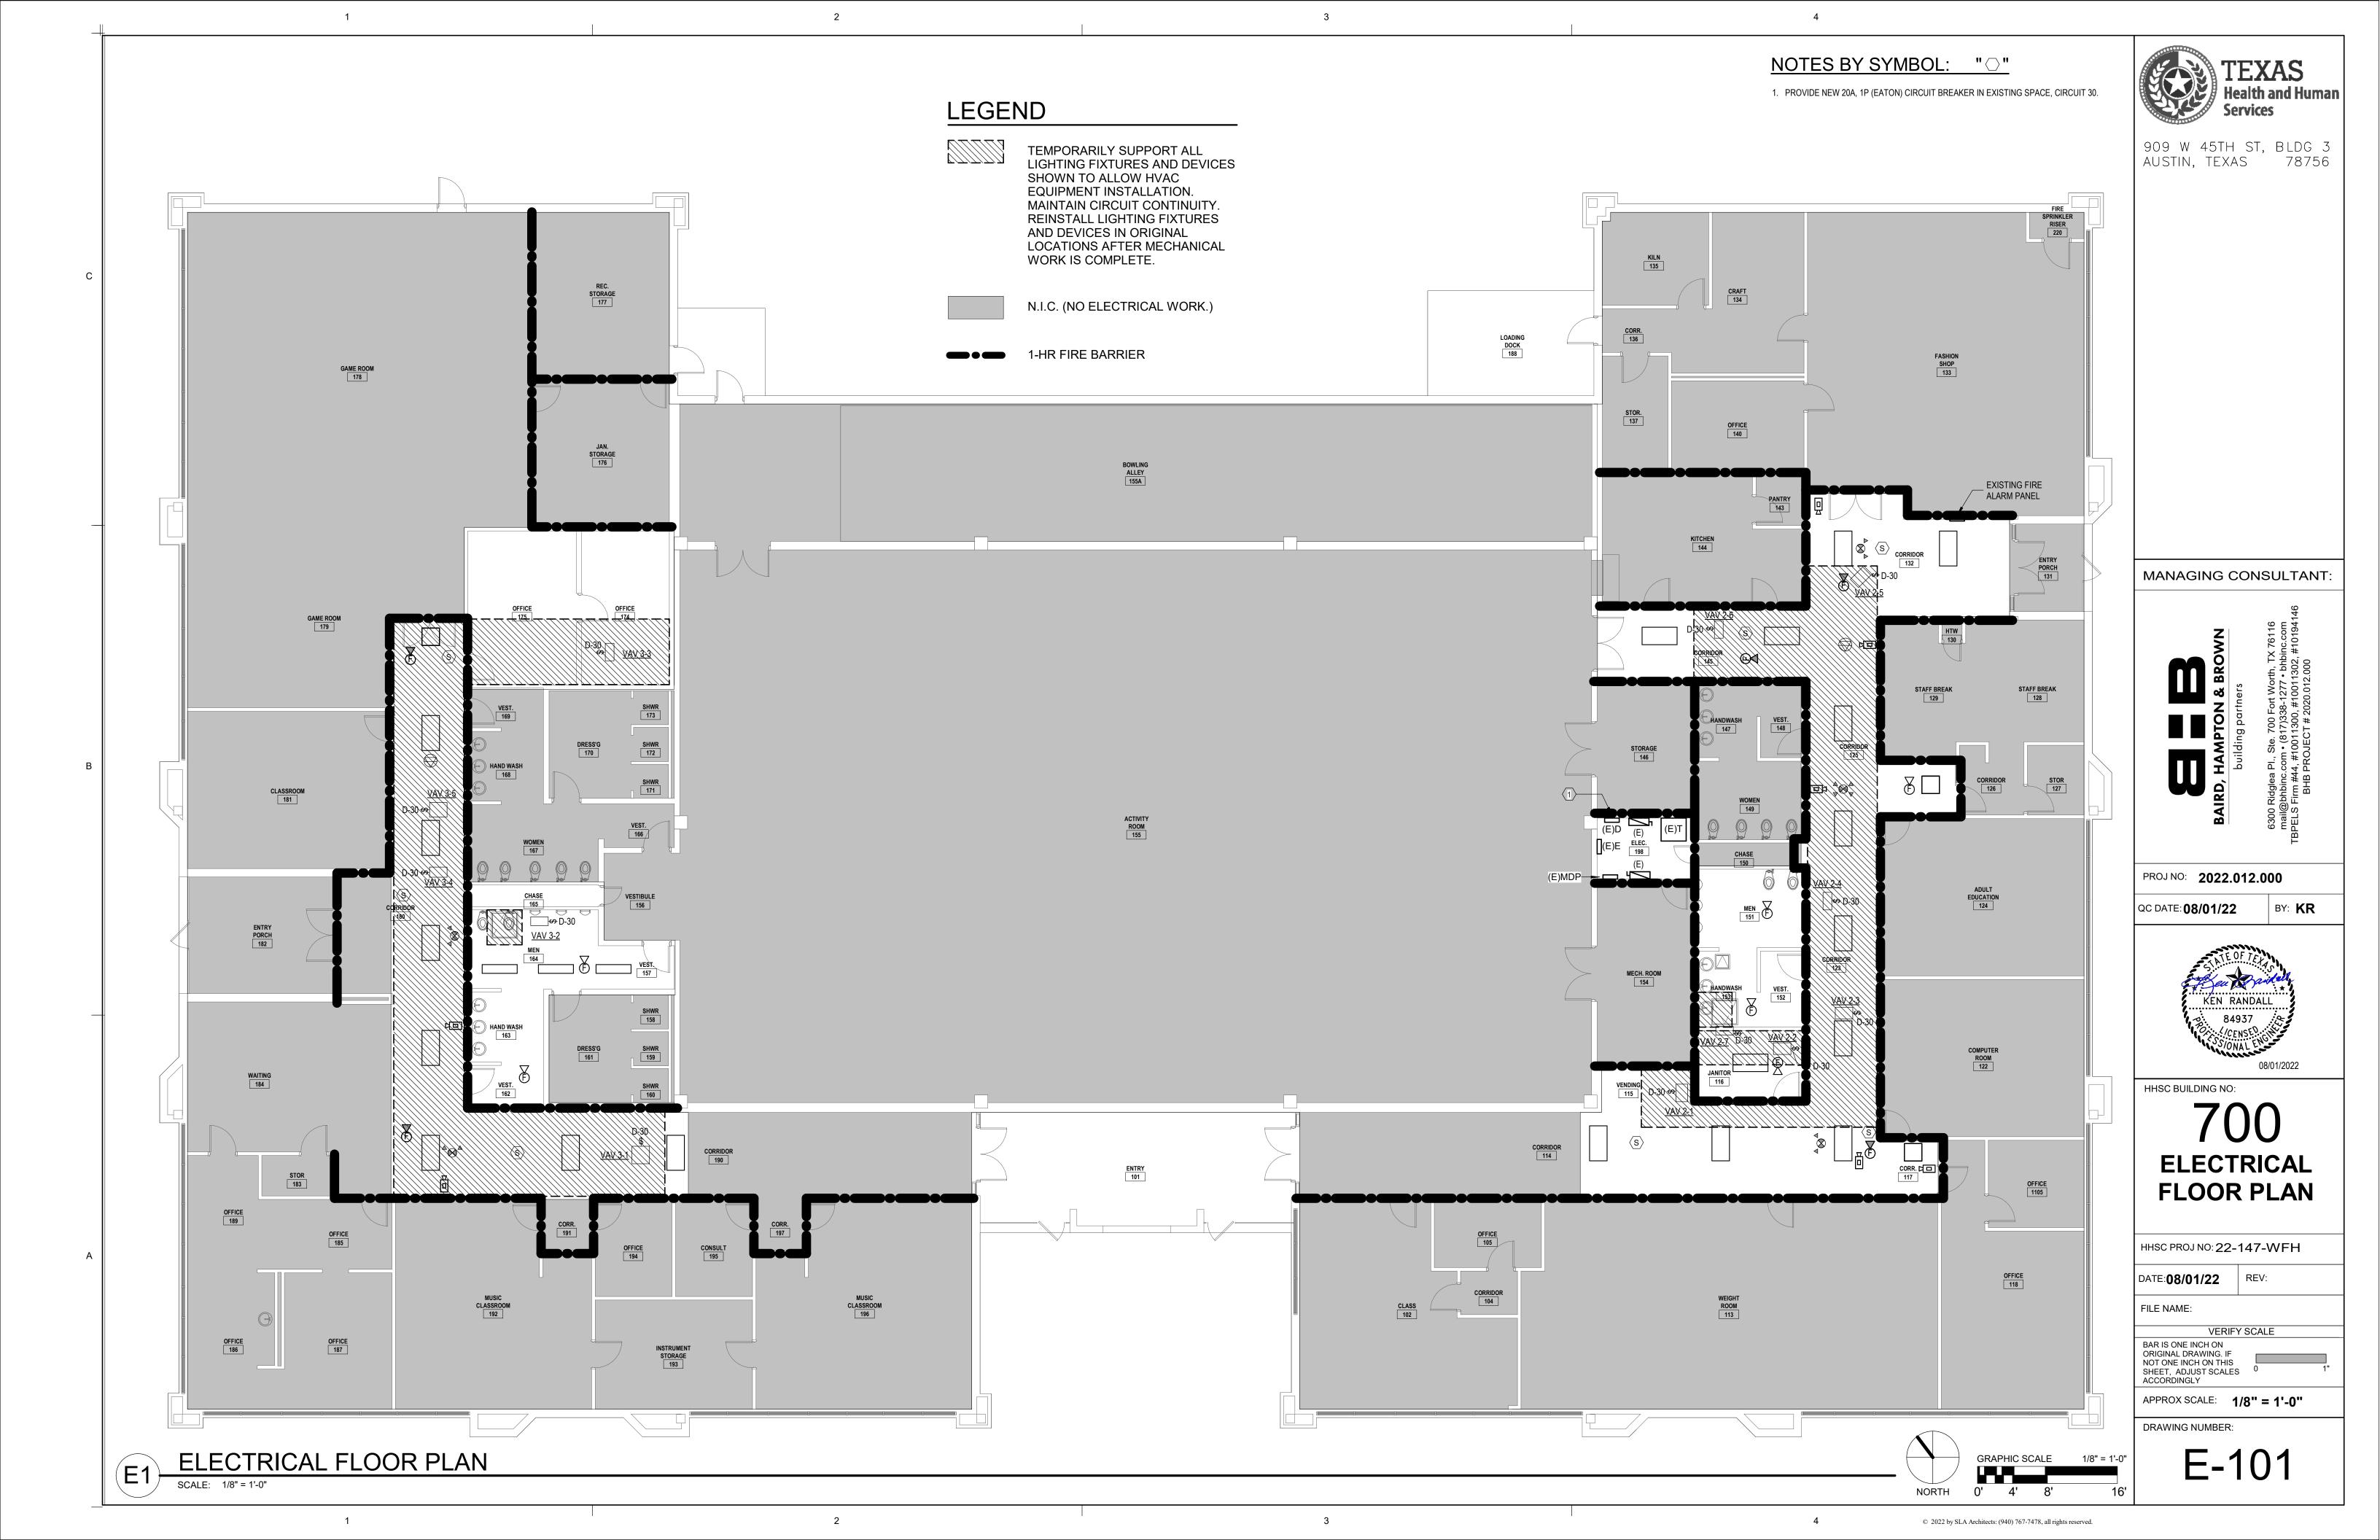

NOTES BY SYMBOL: "○"

1. REUSE EXISTING CIRCUIT BREAKER.



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MANAGING CONSULTANT:

PROJ NO: **2022.012.000**

QC DATE: 08/01/22



BY: **KR**

HHSC BUILDING NO:

ELECTRICAL SCHEDULES & DETAILS

HHSC PROJ NO: 22-147-WFH

DATE:**07/13/22** REV:

FILE NAME:

VERIFY SCALE BAR IS ONE INCH ON ORIGINAL DRAWING. IF NOT ONE INCH ON THIS

APPROX SCALE: 12" = 1'-0"

DRAWING NUMBER:


SHEET, ADJUST SCALES ACCORDINGLY

E-210

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SYMBOL	DESCRIPTION	SYMBOL	DESCRIPTION
	LED LIGHT FIXTURE - REFER TO NOTE 1		SPEAKER (CEILING MTD)
€	FIRE ALARM STROBE/HORN UNIT - CEILING MOUNTED	(S)	CEILING MTD SMOKE DETECTOR
€	FIRE ALARM STROBE ONLY UNIT - CEILING MOUNTED	(D)	DUCT MOUNTED SMOKE DETECTOR
	SECURITY CAMERA		FUSED DISCONNECT SWITCH
	CONDUIT AND HOMERUN TO PANEL - NOTE 1	30/3/30/R	DISCONNECT SIZE / POLES / FUSE SIZE / ENCLOSURE RATING
<u> </u>	EXIT LIGHT FIXTURES	Δ.	MOTOR
$\stackrel{\cong}{\otimes}$ $\bar{\otimes}$		\$	SINGLE POLE SWITCH

2

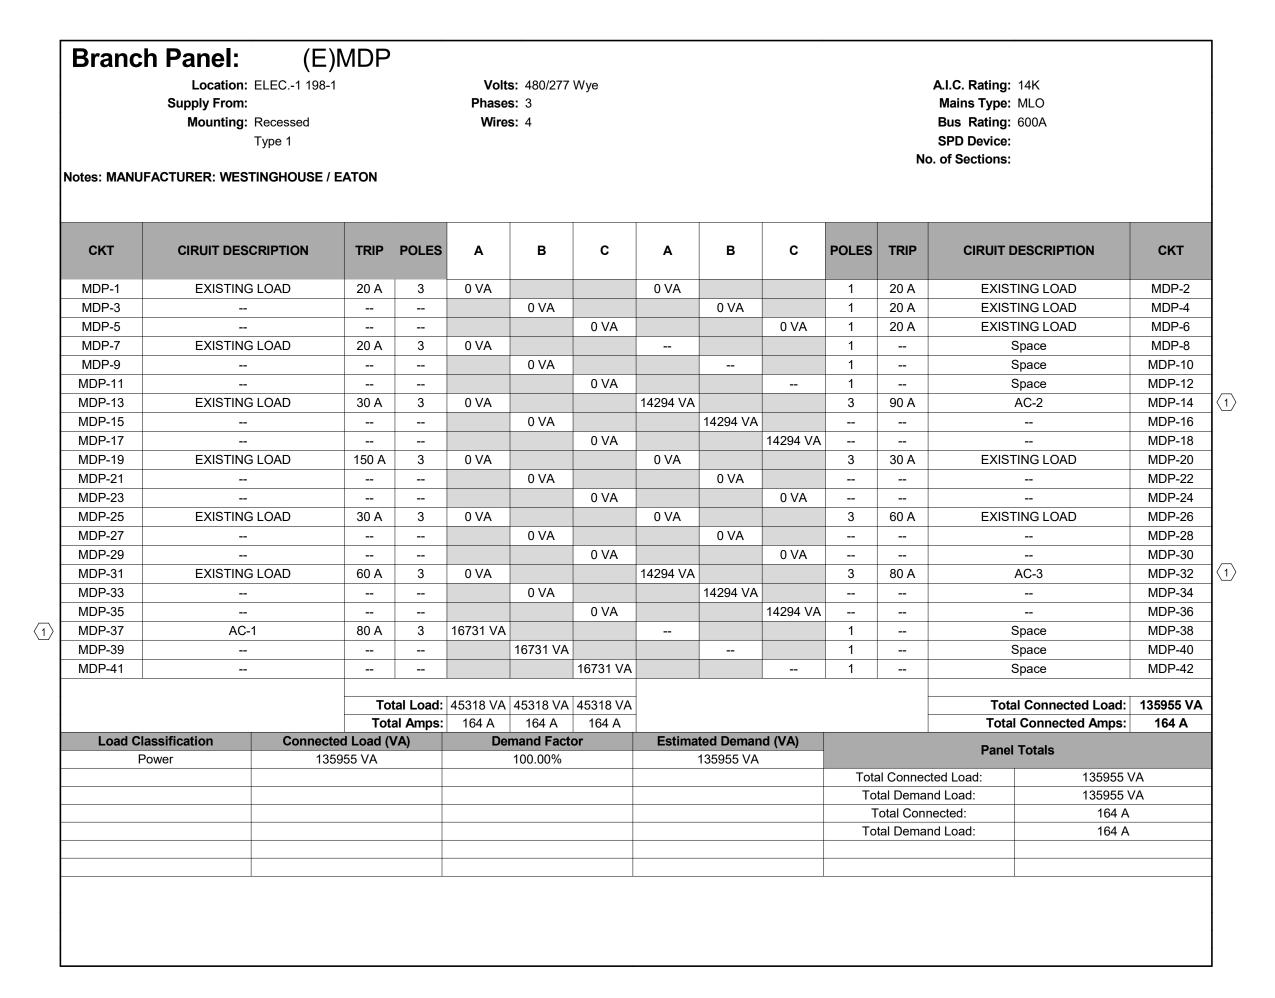

3