


BUILDER@CONTRACTOR IS RESPONSIBLE TO CHECK ALL DIMENSIONS FOR ACCURACY BETWEEN FLOORS, FOUNDATION, AND ELEVATIONS. ALSO VERIFY ALL BEAM, HEADERS, PAD LOCATIONS, AND COLUMN SIZES.

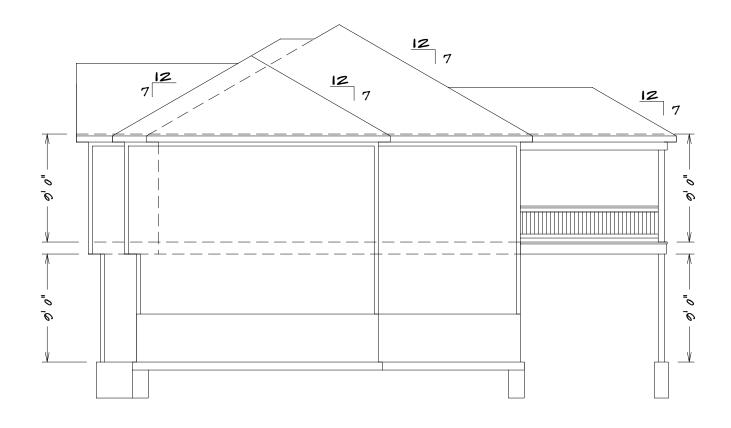


RIGHT ELEVATION 1/8" = 1'0"

## OPTION PLAN #1





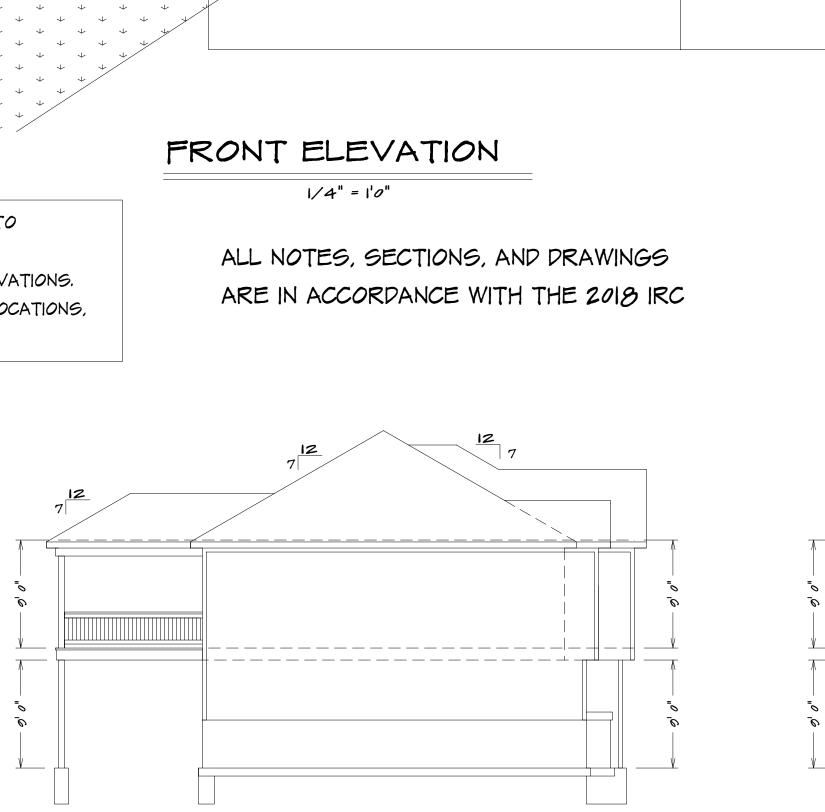

ACTUAL ELEVATIONS MAY VARY FROM ARCHITECTURAL DRAWINGS, DUE TO TERRAIN/BACKFILL PROCESS FRONT ELEVATION IS ARCHITECTURAL DRAWING AND MAY VARY DUE TO MATERIALS AVAILABILITY


12

NOTE:

12

PHONE: Date DRAWN: PLAN NO.   PHONE: PATE REVISED: RH-6II0   PHONE: DATE REVISED: FILE NAME:   LOT NO. DESIGNER: 6II0 FRNI	DATE PRAMN: DATE REVISED: DESIGNER:
	PHONE: PHONE: LOT NO.
PHONE: PHONE: LOT NO.	
	HOME BUYER: BUILPER: SUB-DIVISION:



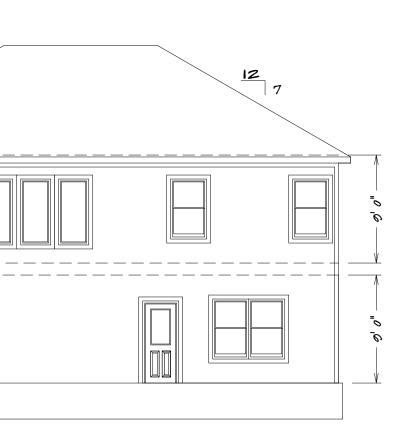


LIVING AREA FIRST FLOOR = 1577 OPTIONAL BASEMENT = 766 UNFINISHED AREA COVERED DECK = 144

### SQUARE FOOTAGE

GARAGE = 640




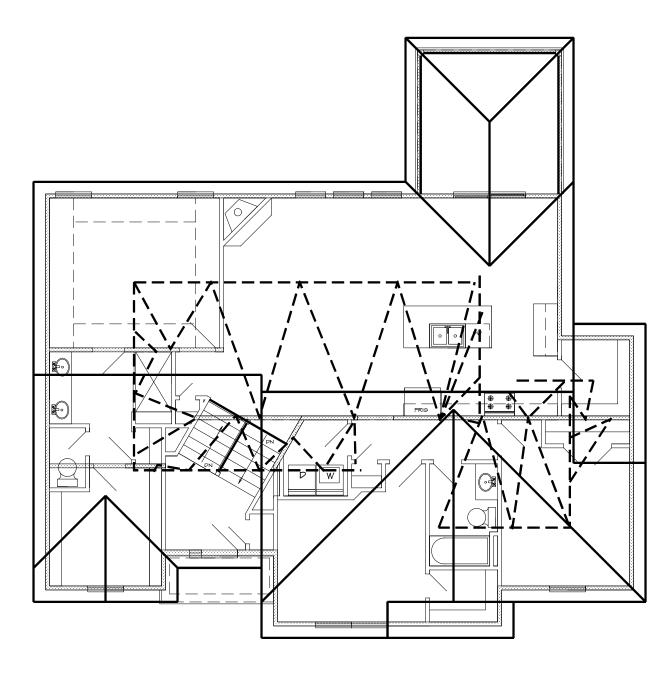

BEARING WALLS

ROOF ELEVATION 1/8" = 1'0"

NOTE ... HIP RIDGE FOR THE MAIN ROOF AS: 2X8 FOR UNBRACED LENGTH UP TO 9'0" 2X10 FOR UNBRACED LENGTH UP TO 10'0" 2X12 FOR UNBRACED LENGTH UP TO 12'0" ALL RAFTERS TO BE #2 2X6 D-FIR 16" O.C. UNLESS OTHER WISE NOTED PURLING RAFTERS TO BEARING WALL LINES CONNECT RAFTERS TO CEILING JOIST W (4) IGJ GALV. NAILS CONNECT RAFTERS TO RIDGE, VALLEY, AND HIP RIDGE WITH (4) IGJ GALV. NAILS VERT. RIDGE AND RAFTER SUPPORTS TO BE EQUAL TO OR GREATER THAN THE DEPTH OF RAFTERS

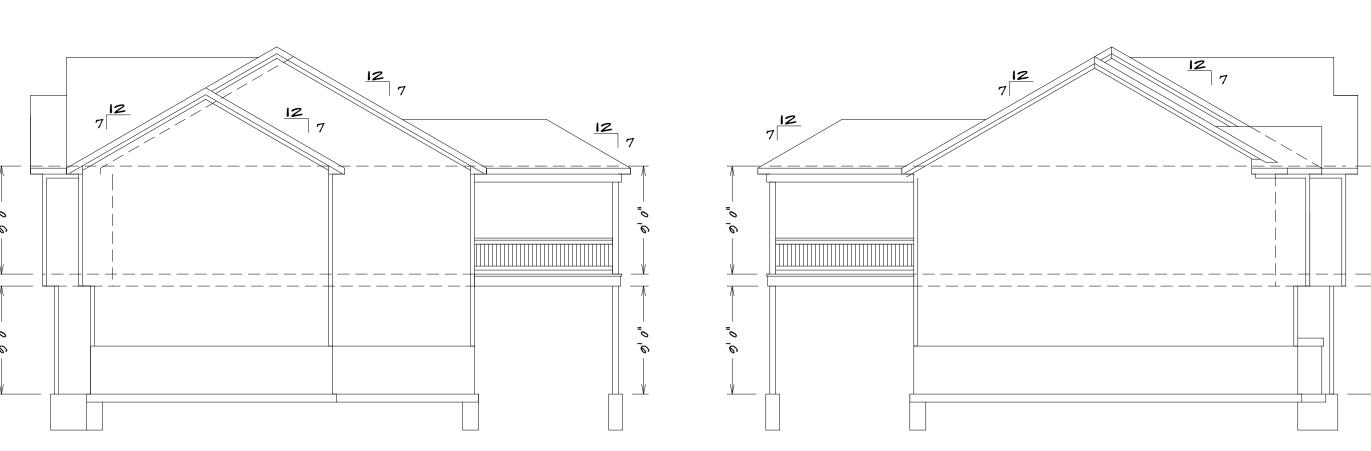


RIGHT ELEVATION |/8" = |'0"


# OPTION PLAN #2



- BUILDER&CONTRACTOR IS RESPONSIBLE TO CHECK ALL DIMENSIONS FOR ACCURACY BETWEEN FLOORS, FOUNDATION, AND ELEVATIONS.

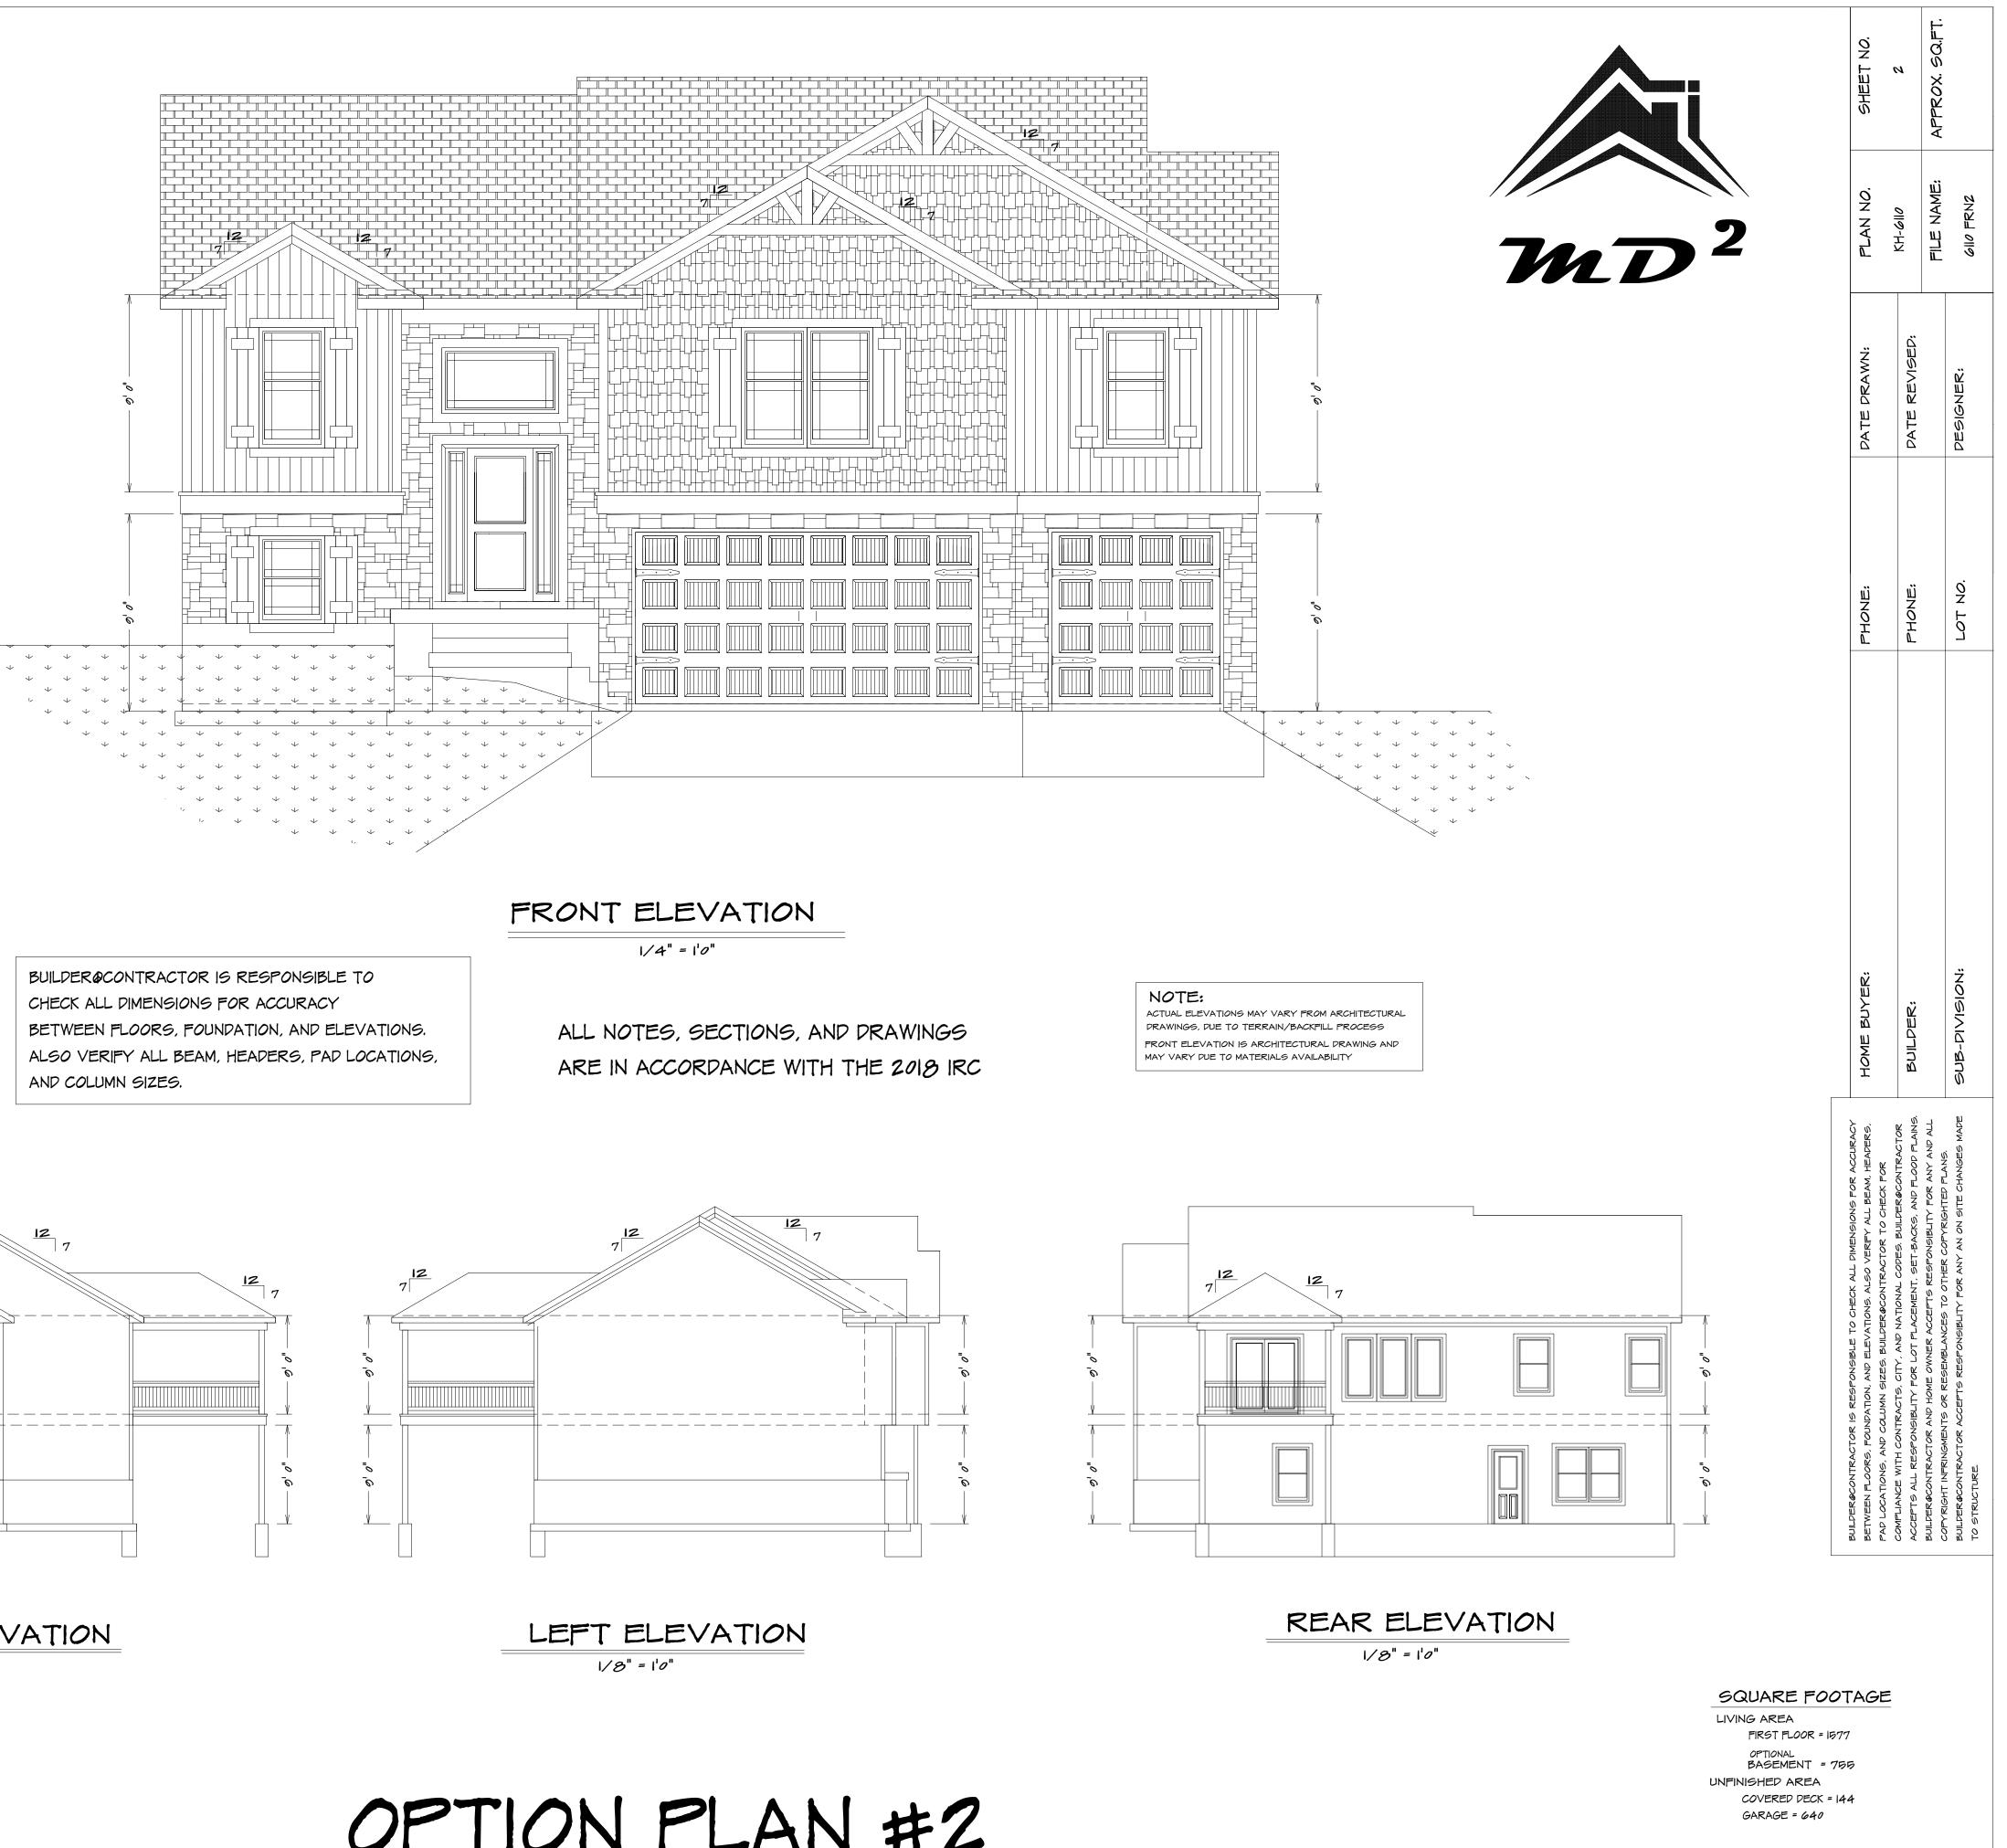




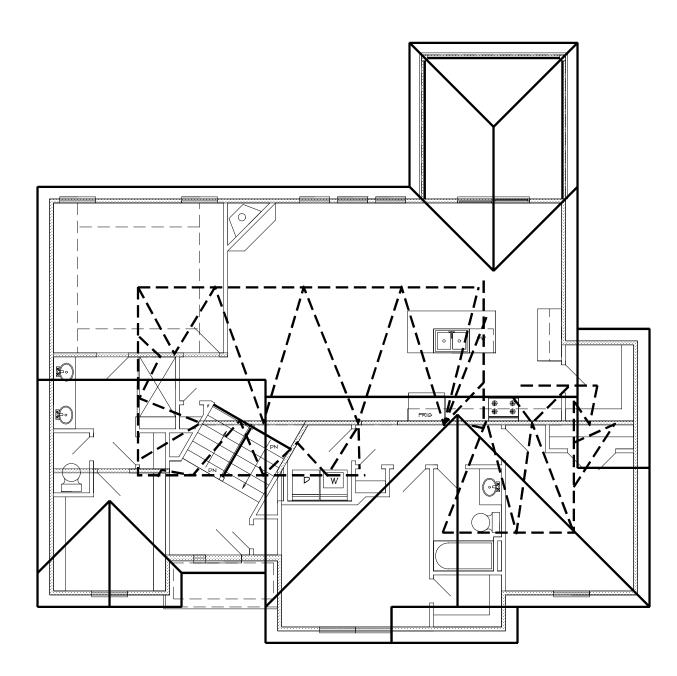

BEARING WALLS

ROOF ELEVATION 1/8" = 1'0"

NOTE... HIP RIDGE FOR THE MAIN ROOF AS: 2X8 FOR UNBRACED LENGTH UP TO 9'0" 2X10 FOR UNBRACED LENGTH UP TO 10'0" 2X12 FOR UNBRACED LENGTH UP TO 12'0" ALL RAFTERS TO BE #2 2X6 D-FIR 16" O.C. UNLESS OTHER WISE NOTED PURLING RAFTERS TO BEARING WALL LINES CONNECT RAFTERS TO CEILING JOIST W (4) IGJ GALV. NAILS CONNECT RAFTERS TO RIDGE, VALLEY, AND HIP RIDGE WITH (4) IGd GALV. NAILS VERT. RIDGE AND RAFTER SUPPORTS TO BE EQUAL TO OR GREATER THAN THE DEPTH OF RAFTERS

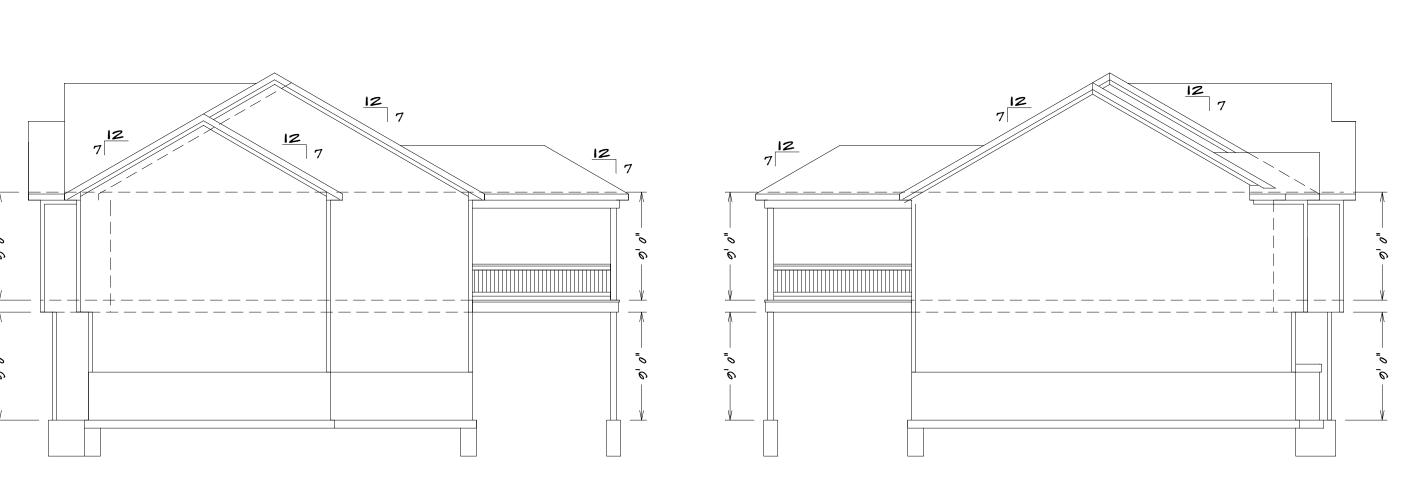


RIGHT ELEVATION |/8" = |'0"


## OPTION PLAN #3






BUILDER&CONTRACTOR IS RESPONSIBLE TO CHECK ALL DIMENSIONS FOR ACCURACY

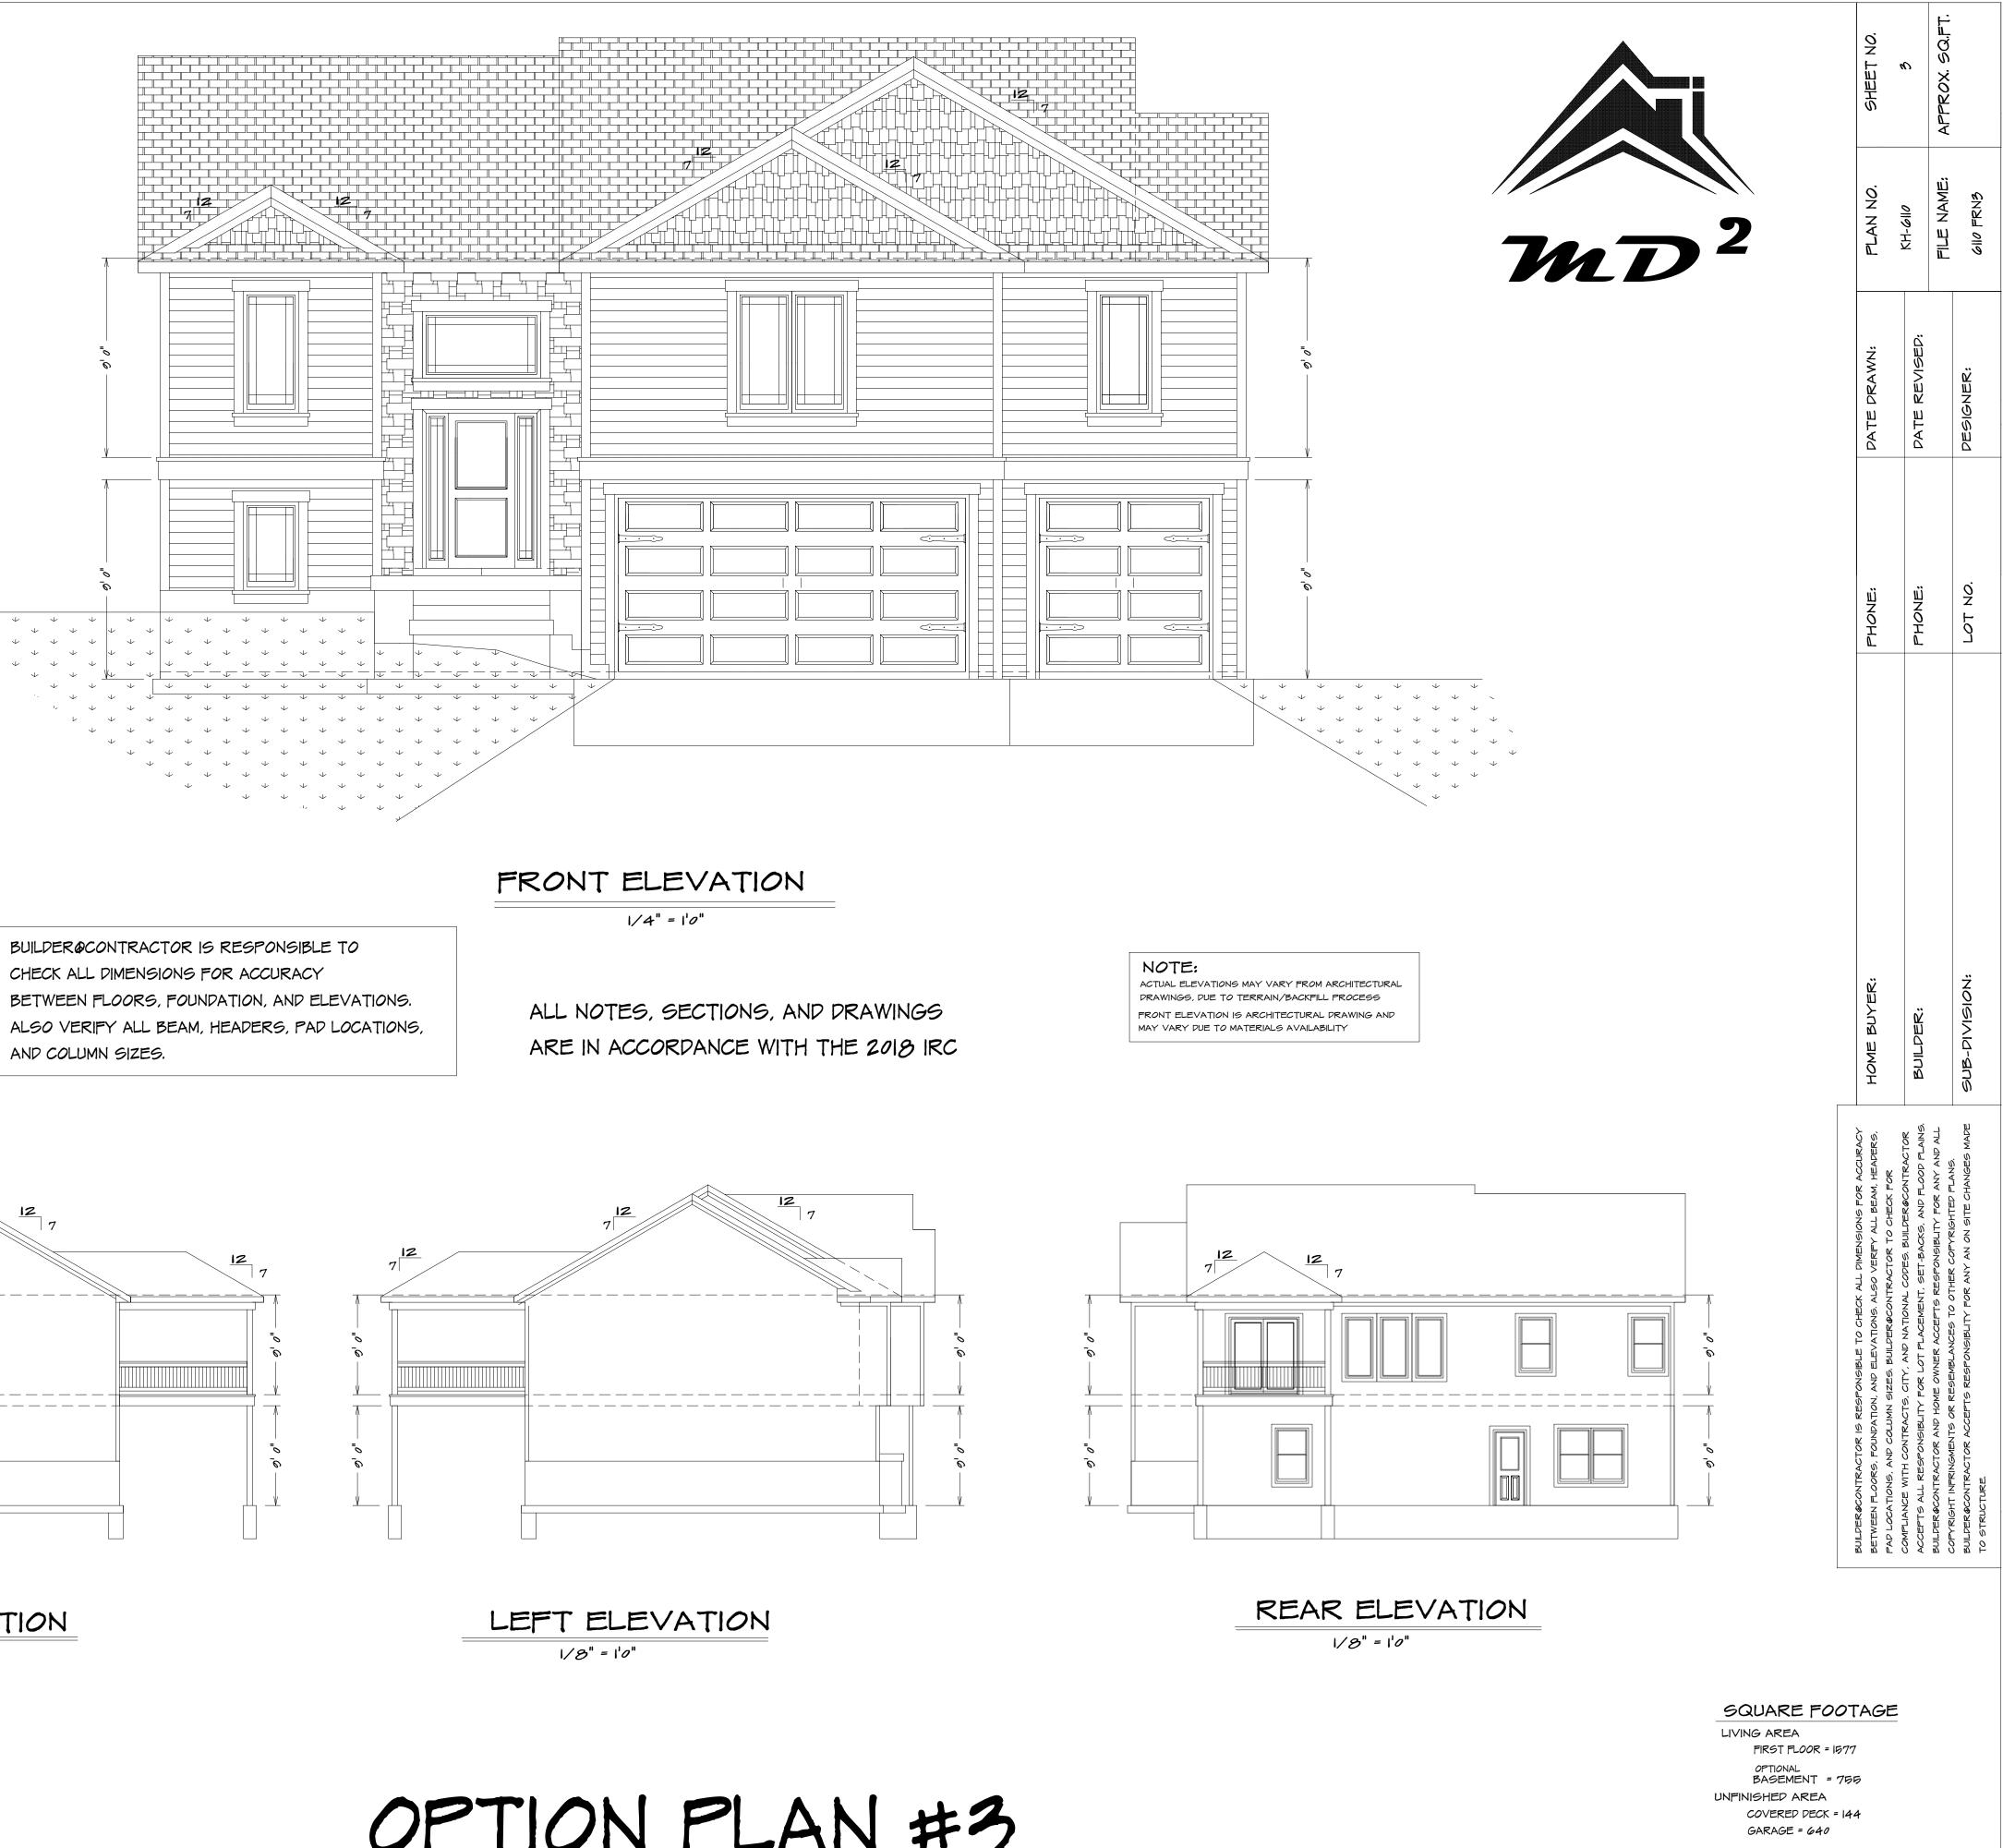

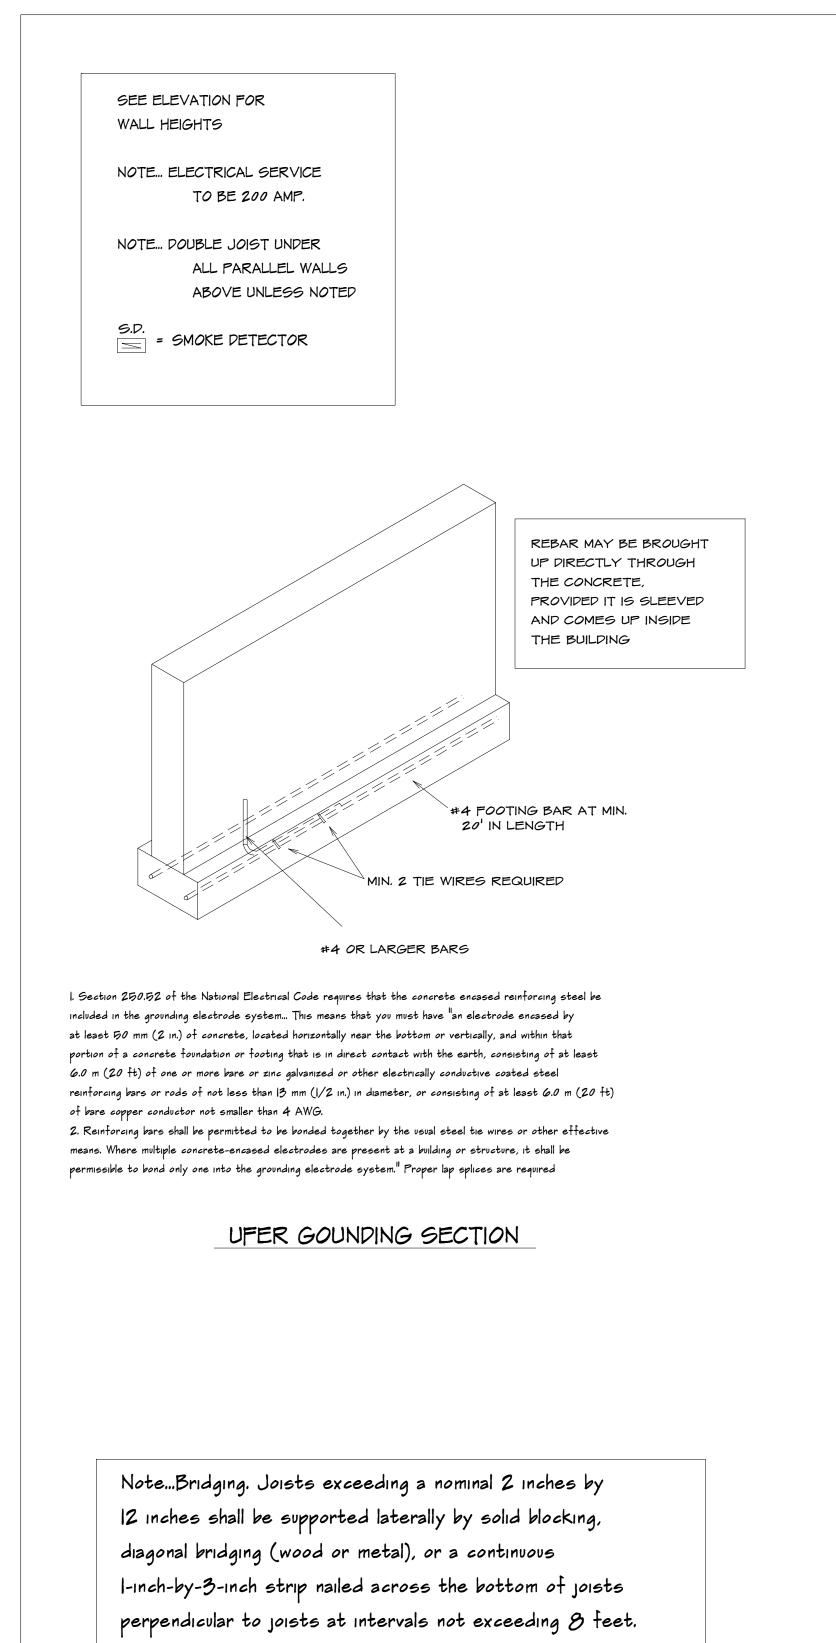

(R502.7.1)

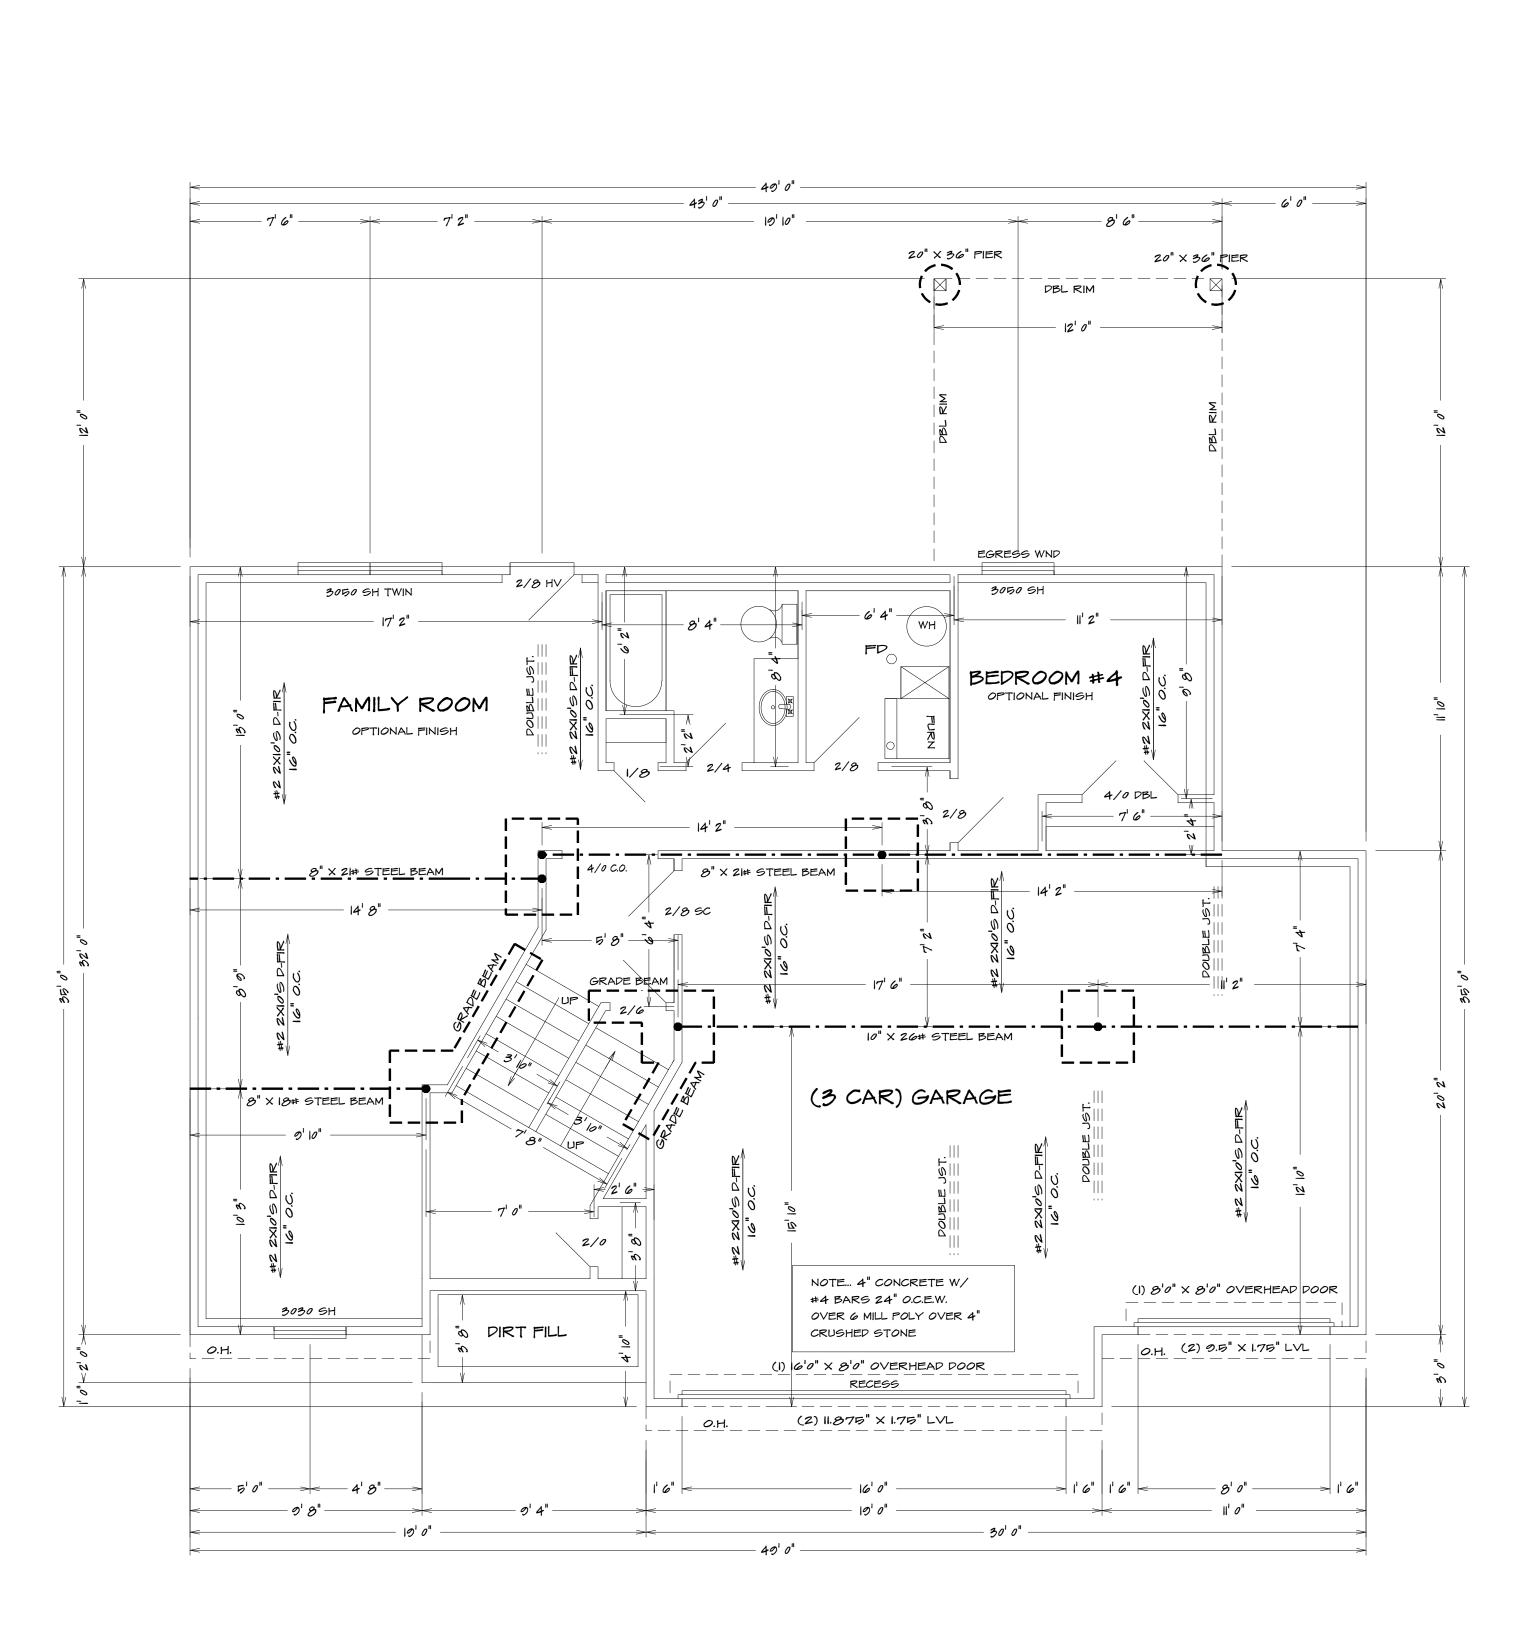

BASEMENT PLAN

ALL NOTES, SECTIONS, AND DRAWINGS ARE IN ACCORDANCE WITH THE 2018 IRC

BUILDER&CONTRACTOR IS RESPONSIBLE TO CHECK ALL PIMENSIONS FOR ACCURACY BETWEEN FLOORS, FOUNDATION, AND ELEVATIONS. ALSO VERIFY ALL BEAM, HEAPERS, PAD LOCATIONS, AND COLUMN SIZES, BUILDER&CONTRACTOR TO CHECK FOR	HOME BUYER:	PHONE:	DATE DRAWN:	FLAN NO.	SHEET NO.
COMPLIANCE WITH CONTRACTS, CITY, AND NATIONAL COPES, BUILDER@CONTRACTOR ACCEPTS ALL RESPONSIBLITY FOR LOT PLACEMENT, SET-BACKS, AND FLOOD PLANS, BUILDER@CONTRACTOR AND HOME OWNER ACCEPTS RESPONSIBLITY FOR ANY AND ALL	Builders	PHONE:	DATE REVISED:	KH-@II0	4
	sub-pivision:	LOT NO.	DESIGNER:	FILE NAME:	APPROX. SQ.FT.

SEE ELEVATION FOR WALL HEIGHTS

NOTE ... ELECTRICAL SERVICE TO BE 200 AMP.

NOTE ... DOUBLE JOIST UNDER ALL PARALLEL WALLS ABOVE UNLESS NOTED

S.D. = SMOKE DETECTOR

### **GENERAL HEADER SPECIFICATIONS:**

REQUIRED AREAS NEEDING HEADERS: WINDOWS/DOORS UP TO 38" R.O. WINDOWS/DOORS 38" UP TO 72" R.O. WINDOWS/DOORS 72" UP TO 96" R.O. 8'0" GARAGE DOORS W/CEILING & ROOF LOAD 9'0" GARAGE DOORS W/CEILING & ROOF LOAD 8'0" GARAGE DOORS W/SECOND FLOOR 9'0" GARAGE DOORS W/SECOND FLOOR 16'0" GARAGE DOOR W/NO SECOND FLOOR 16'0" GARAGE DOORS W/SECOND FLOOR

HEADER DESCRIPTIONS: (2) #2 D-FIR 2X10'S (2) #2 D-FIR 2X10'S W/1/2" GLUE PLY (2) 9 1/2" L.V.L. (2) 9 1/2" L.V.L. (2) 9 1/2" L.V.L. (2) 9 1/2" L.V.L. (2) 11 7/8" L.V.L. (2) 11 7/8" L.V.L. (2) 14" L.V.L.

USE HEADERS FOR OPENINGS ABOVE UNLESS SPECIFIED OTHERWISE.

#### R312.2.1 Window sills.

In dwelling units, where the opening of an operable window is located more than 72 inches (1829 mm) above the finished grade or surface below, the lowest part of the clear opening of the window shall be a minimum of 24 inches (610 mm) above the fininshed floor of the room in which the window is located. Operable sections of windows shall not permit openings that allow passage of a 4-inch-diameter (102 mm) sphere where such openings are located within 24 inches (610 mm) of the finished floor.

#### Exceptions:

- I. Windows whose openings will not allow a 4-inch-diameter (102 mm) sphere to pass through the opening when the opening is in its largest opened position.
- 2. Openings that are provided with window fall prevention devices that comply with ASTM F 2090.
- 3. Windows that are provided with window opening control devices that comply with Section R312.2.2.

R312.2.2 Window opening control devices.

Window opening control devices shall comply with ASTM F 2090. The window opening control device, after operation to release the control device allowing the window to fully open, shall not reduce the minimum net clear opening area of the window unit to less than the area required by Section R310.1.1.


Bathrooms, water closet compartments and other similar rooms shall be provided with aggregate glazing area in windows of not less than 3 square feet, one-half of which must be openable.

#### Exception:

The glazed areas shall not be required where artificial light and a local exhaust system are provided.

The minimum local exhaust rates shall be determined in accordance with Section MI507.

Exhaust air from the space shall be exhausted directly to the outdoors.

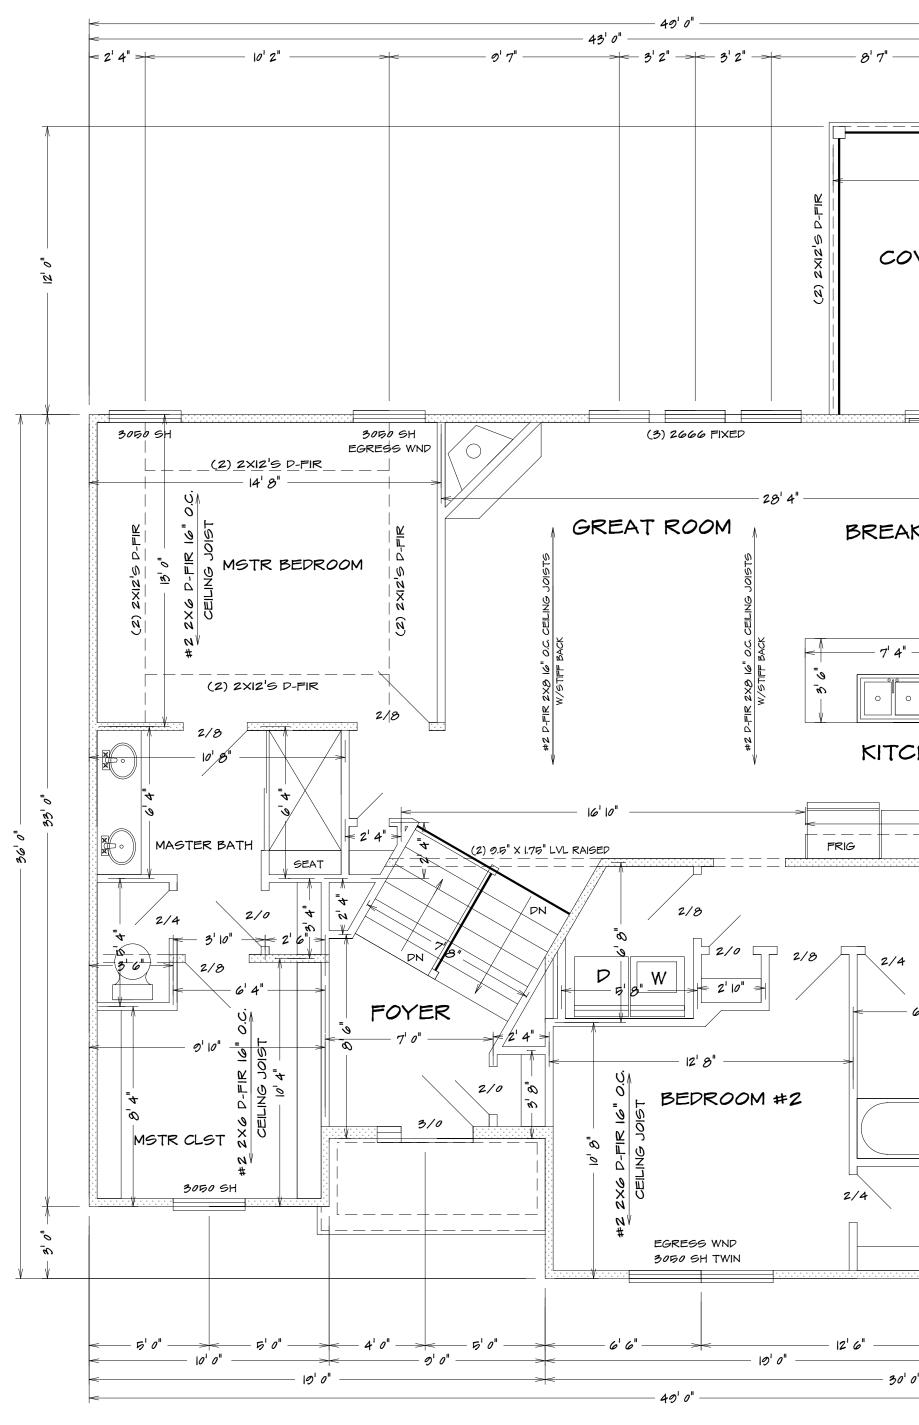

BEARING WALLS

FIRST FLOOR PLAN 1/4" = 1'0"

ALL NOTES, SECTIONS, AND DRAWINGS ARE IN ACCORDANCE WITH THE 2018 IRC

2/4 12'6" - 30' 0" —

8'7" -

- 6' 0"

(2) 2X12'5 D-FIR

COVERED DECK

6/0 SLIDER

- 13' p"& 🛞

2/8

216

BEDROOM #3


56

II' 2"

BREAKFAST

KITCHEN

FRIG

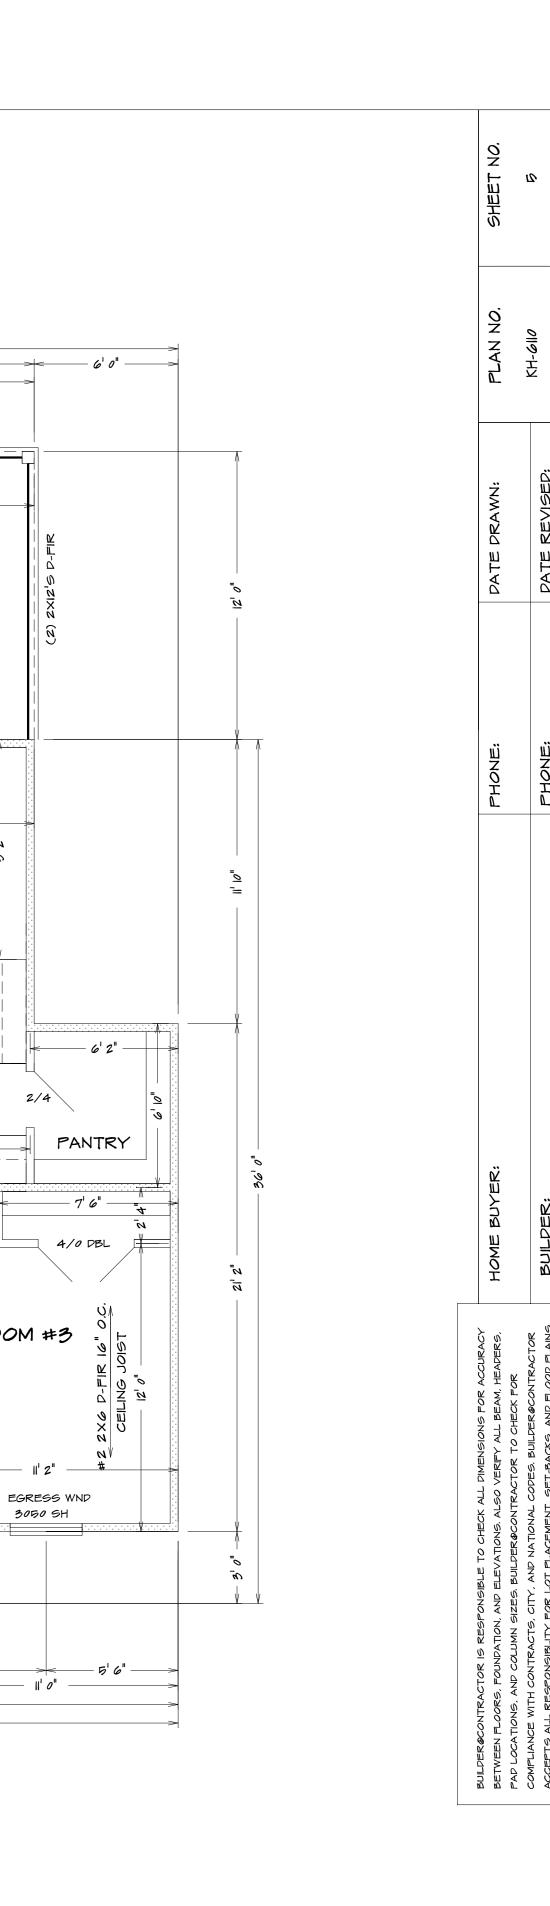

0 Z

0

