

PERMIT HOLDER EXHIBIT PACKET 10 BETHLEHEM PIKE

ZBA Calendar No. MI-2021-003377 Application No. ZP-2021-003377 Wednesday, October 13, 2021 @ 2:00pm

- 1. By-Right Project RCO Presentation
- 2. Zoning Plans
- 3. July Neighbor Presentation
- 4. Letter Opposing Appeal
- 5. Bill No. 210075
- **6. Zoning Code Sections:**
 - A. §14-701(1)(c)
- 7. Woodcock Design Expert Report
- 8. Expert Witness CV
- 9. List of Community Meeting
- 10. Letter to Chestnut Hill Neighbors

Exhibit 1

PROJECT DESCRIPTION AS-OF-RIGHT

LOT INFORMATION			
LOT ADDRESS(ES): 10 BETHLEHEM PIKE, PHILADELPHIA, PA, 19118			
LOT AREA(S): 11,113 SF			
BASE ZONING DISTRICT:	CMX-2		
OVERLAY ZONING DISTRICT: WWO	WISSAHICKON WATERSHEI	D OVERLAY DISTRICT	
USE REGULATIONS			
PROPOSED & PERMITTED USES:	BASEMENT THRU 1ST	RETAIL SALE OF FOOD & BEVERAGE, RESIDENTIAL LOBBY, MECHANICAL	
	2ND THRU 5TH	MULTI-FAMILY HOUSING	
DISTRICT & LOT DIMENSIONS	REQUIRED	PROPOSED	
MIN LOT WIDTH (FT)	N/A	NO CHANGE	
MIN LOT AREA (SF)	N/A	NO CHANGE	
MAX OCCUPIED AREA (% OF LOT)	80%	79.5% (8,839 SF BLDG)	
MAX UNITS ALLOWED	35 (see Note 1)	34	
YARDS			
MIN FRONT YARD DEPTH (FT)	N/A	0' - 0"	
MIN SIDE YARD WIDTH, EACH (FT)	5 FT if used	0' - 0"	
MIN REAR YARD DEPTH (FT)	9'-0" (see Note 2)	10'-0"	
HEIGHT			
MAX HEIGHT (FT)	46'-9 1/2" (see Note 3)	46'-9 1/2"	
MAX FLOOR AREA (% OF LOT AREA)	N/A	N/A	
OFF STREET PARKING REQUIREMENTS			
CAR PARKING	0	0	
BICYCLE PARKING	12 (1 bicycle per 3 units)	12	

NOTES

Note 1: Section 14-602(4)(a)[2](.b) A minimum of 480 sq. ft. of lot area is required per dwelling unit for the lot area in excess of 1,919 sq. ft.; provided that (.c) If the green roof conditions set forth at § 14-602(7) are met, the number of units allowed is twenty-five percent (25%) greater than indicated by the foregoing lot size requirements.

Section 14-702 (7) (b) A floor area, height, or housing unit density bonus, as applicable if the owner of the property enters into a payment-in-lieu agreement that meets the standards set forth in subsection (.6). Per Housing Unit density Bonuses table, 25% increase in units permitted is provied for Moderate Income.

Maximum units allowed = 11,113 SF / 480 SF per unit = 23 units

Green Roof Bonus = 23 units x .25% = 5.75 units (5 rounded down) = 28 units

Moderate Income Density Bonus = 28 units x .25% = 7 units = 35 units allowed.

Note 2: Minimum rear yard depth shall be the greater of 9 feet or 10% of the lot depth per Table 14-701-3.

Minimum rear yard depth = $77'-3" \times .1 = 7'-8 3/4"$, therefore, it shall be 9'-0" or greater.

Note 3: Per table 14-701-3 Dimensional Standards for Commercial Districts, Max Height ft = 38'-0".

Section 14-702 (7) (b) A floor area, height, or housing unit density bonus, as applicable if the owner of the property enters into a payment-in-lieu agreement that meets the standards set forth in subsection (.6). Per Additional Building Height table, 7'-0" of height bonus.

Section 14-202(6) Rules of Measurement - Height, Building or Structure the vertical distance from the average ground level at the base of the structure to the top of the structure.

Building Height= 38'-0" + 7'-0" (height bonus) = 45'-0" Grade at Building Corners = 441', 440.2', 437.85', 436.8', 437.2' Average Grade = 438.61' = +1.81' (1'-9 1/2")

Total Building Height = 38'-0" + 7'-0" + 1'-9 1/2" = 46' - 9 1/2"



0 S R E 10 BETHLEHEM PIKE

10 BETHLEHEM PIKE, PHILADELPHIA PA 19118

PROJECT DESCRIPTION AS-OF-RIGHT

 SCALE
 DRAWN
 PROJECT NO.

 12" = 1'-0"
 JAV
 567

SHEET NO.

A01

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VIEW FROM BETHLEHEM PIKE



VIEW TOWARD BETHLEHEM PIKE (FROM SUMMIT ST)



VIEW FROM SUMMIT ST


10 BETHLEHEM PIKE

10 BETHLEHEM PIKE, PHILADELPHIA PA 19118


SHEET TITLE EXISTING SITE PHOTOS


SCALE DRAWN PROJECT NO. 567

SHEET NO.

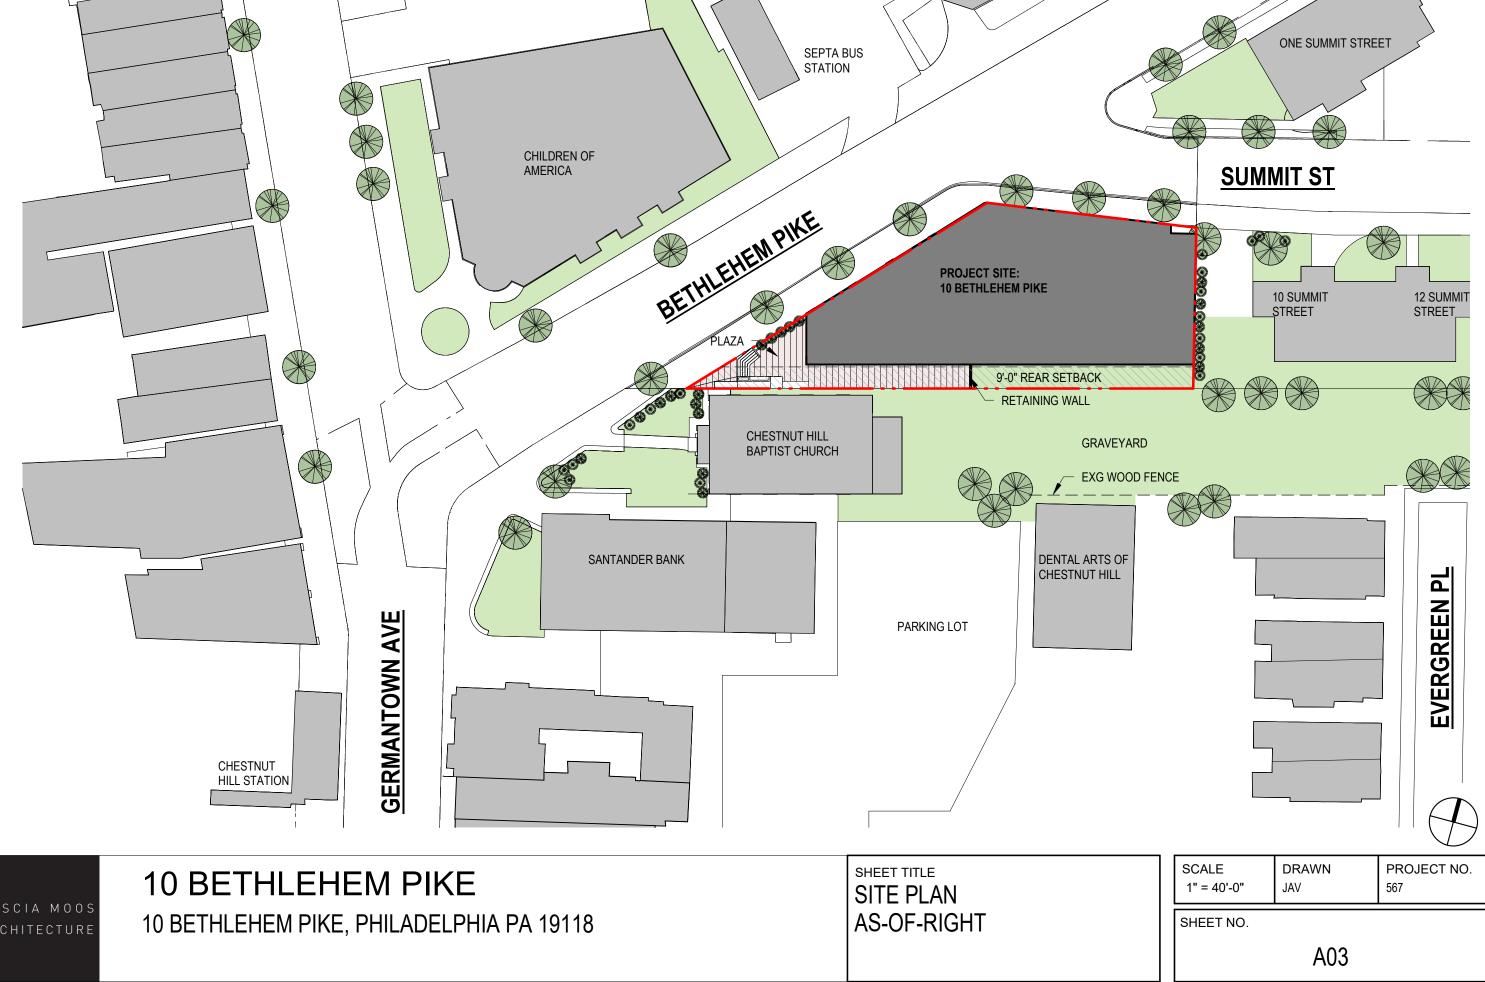

APARTMENT UNIT MIX

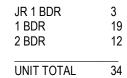

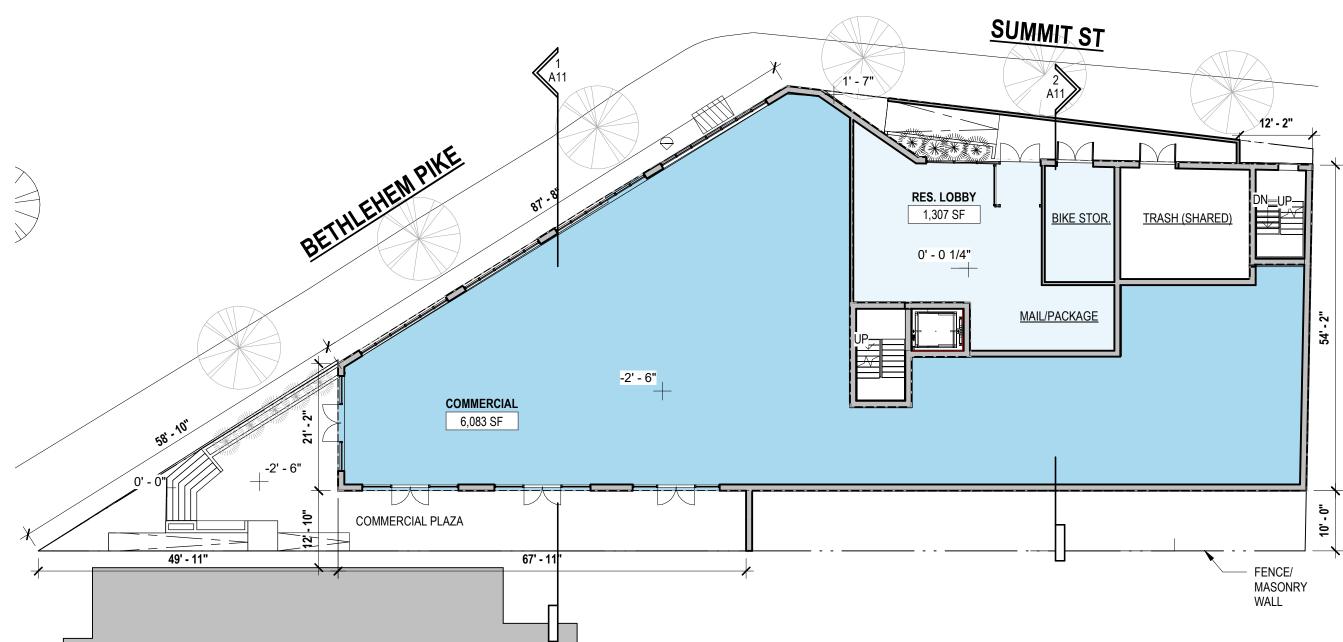



COSCIA MOOS ARCHITECTURE

10 BETHLEHEM PIKE


10 BETHLEHEM PIKE, PHILADELPHIA PA 19118

GROUND FLOOR PLAN AS-OF-RIGHT

1/16" = 1'-0" SHEET NO.	JAV	567
	A04	

LEVEL 2 - APARTMENT MIX

JR 1 BDR 1 BDR	1 4
2 BDR	3
UNIT TOTAL	8

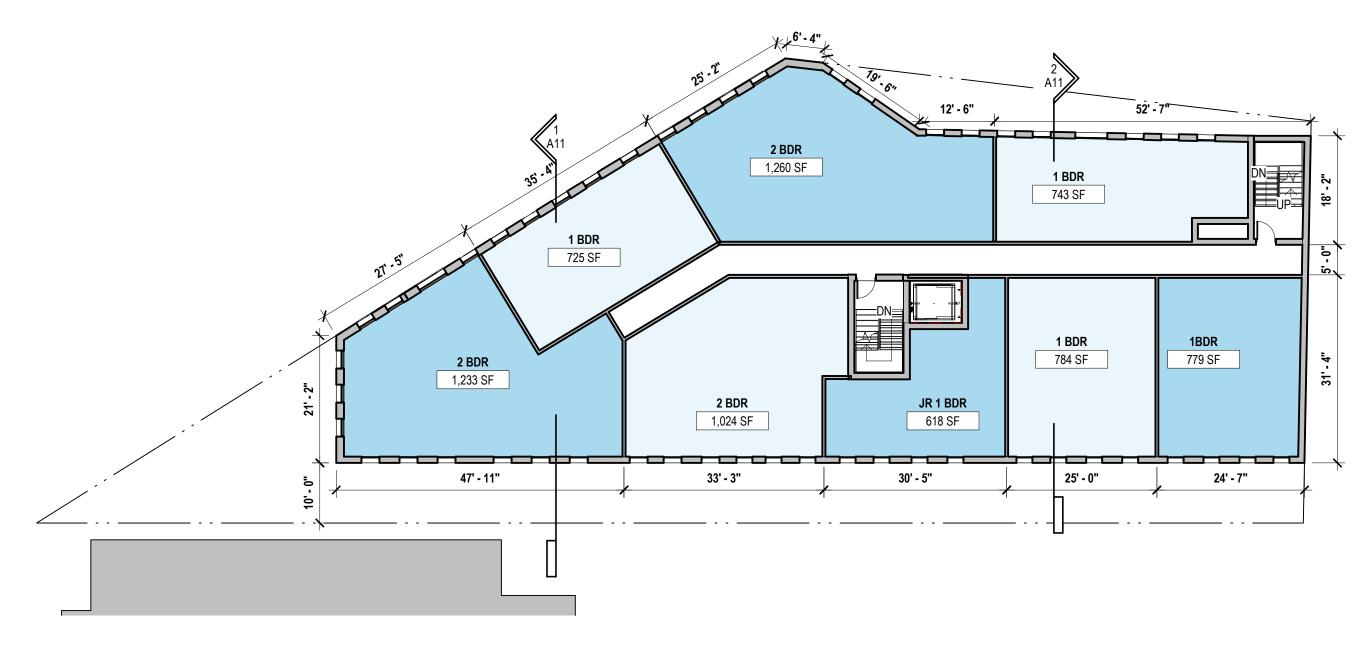



COSCIA MOOS ARCHITECTURE 10 BETHLEHEM PIKE

10 BETHLEHEM PIKE, PHILADELPHIA PA 19118


2ND FLOOR PLAN AS-OF-RIGHT

SCALE	DRAWN	PROJECT NO.
1/16" = 1'-0"	JAV	567
SHEET NO.		

LEVEL 3&4 - APARTMENT MIX



UNIT TOTAL S

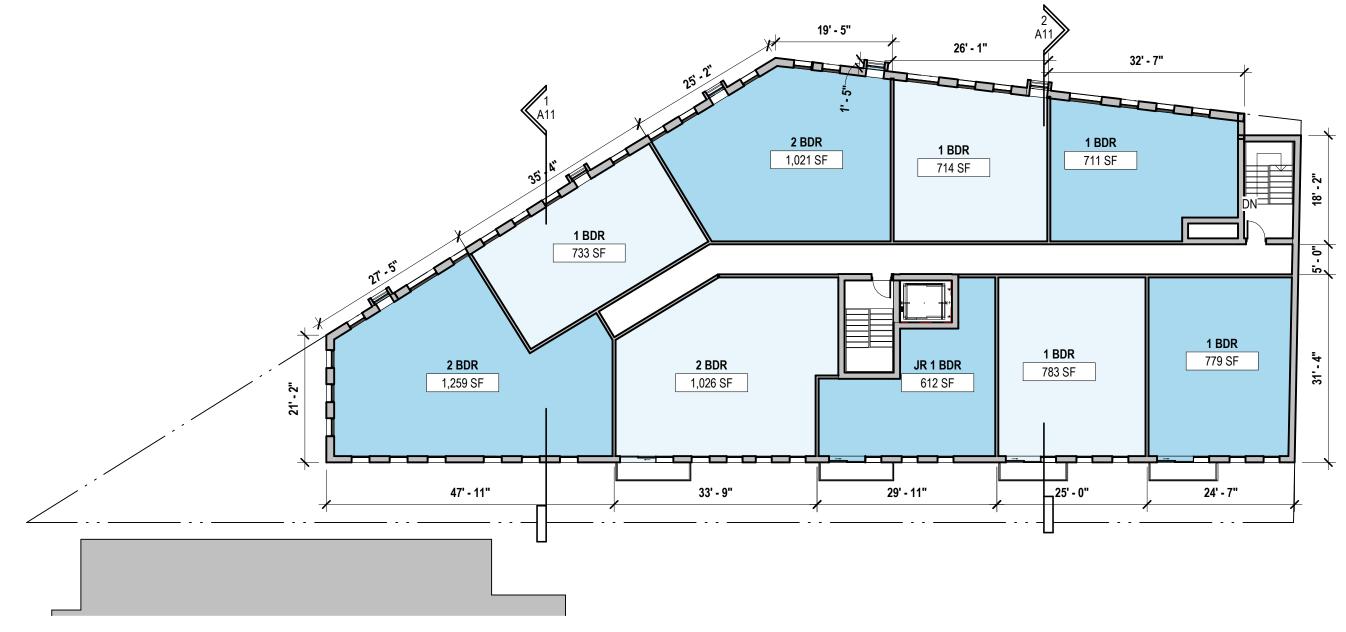



COSCIA MOOS ARCHITECTURE 10 BETHLEHEM PIKE

10 BETHLEHEM PIKE, PHILADELPHIA PA 19118


3RD AND 4TH FLOOR PLAN AS-OF-RIGHT

SCALE	DRAWN	PROJECT NO.
1/16" = 1'-0"	JAV	567

SHEET NO.

JR 1 BDR 1 BDR 2 BDR

UNIT TOTAL

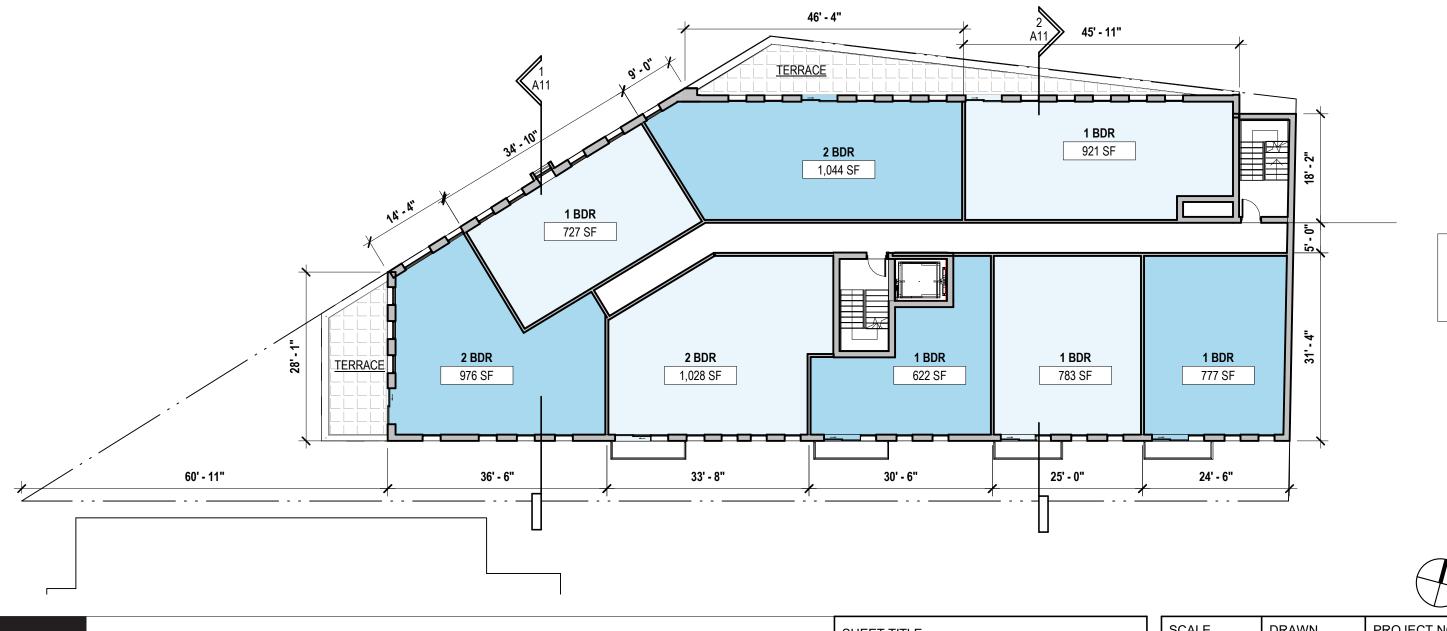

COSCIA MOOS ARCHITECTURE 10 BETHLEHEM PIKE

10 BETHLEHEM PIKE, PHILADELPHIA PA 19118

SHEET TITLE

5TH FLOOR PLAN

AS-OF-RIGHT


 SCALE
 DRAWN
 PROJECT NO.

 1/16" = 1'-0"
 JAV
 567

SHEET NO.

ROOF AREA: 7,971 SF

GREEN ROOF REQUIRED: 60% OF ROOF AREA GREEN ROOF MINIMUM: 4783 SF GREEN ROOF PROVIDED: 4783 SF

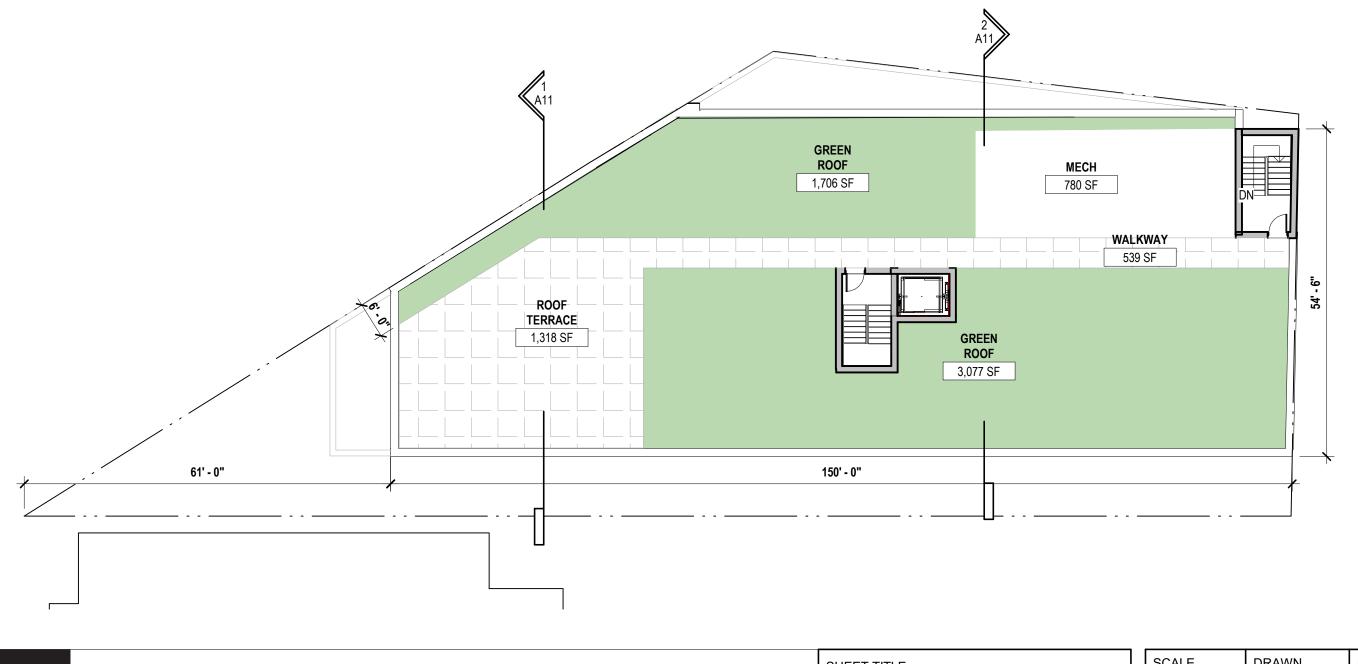


COSCIA MOOS ARCHITECTURE 10 BETHLEHEM PIKE

10 BETHLEHEM PIKE, PHILADELPHIA PA 19118

ROOF PLAN AS-OF-RIGHT
 SCALE
 DRAWN
 PROJECT NO.

 1/16" = 1'-0"
 JAV
 567

SHEET NO.

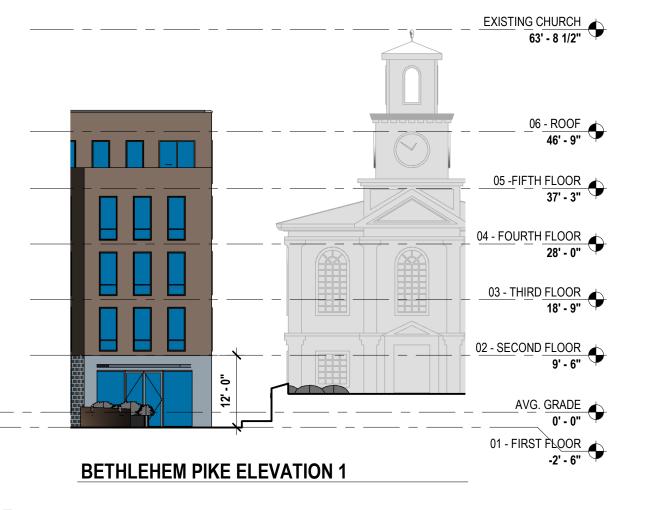





10 BETHLEHEM PIKE

10 BETHLEHEM PIKE, PHILADELPHIA PA 19118

ELEVATIONS AS-OF-RIGHT SCALE 1/16" = 1'-0" DRAWN 567

SHEET NO. A09

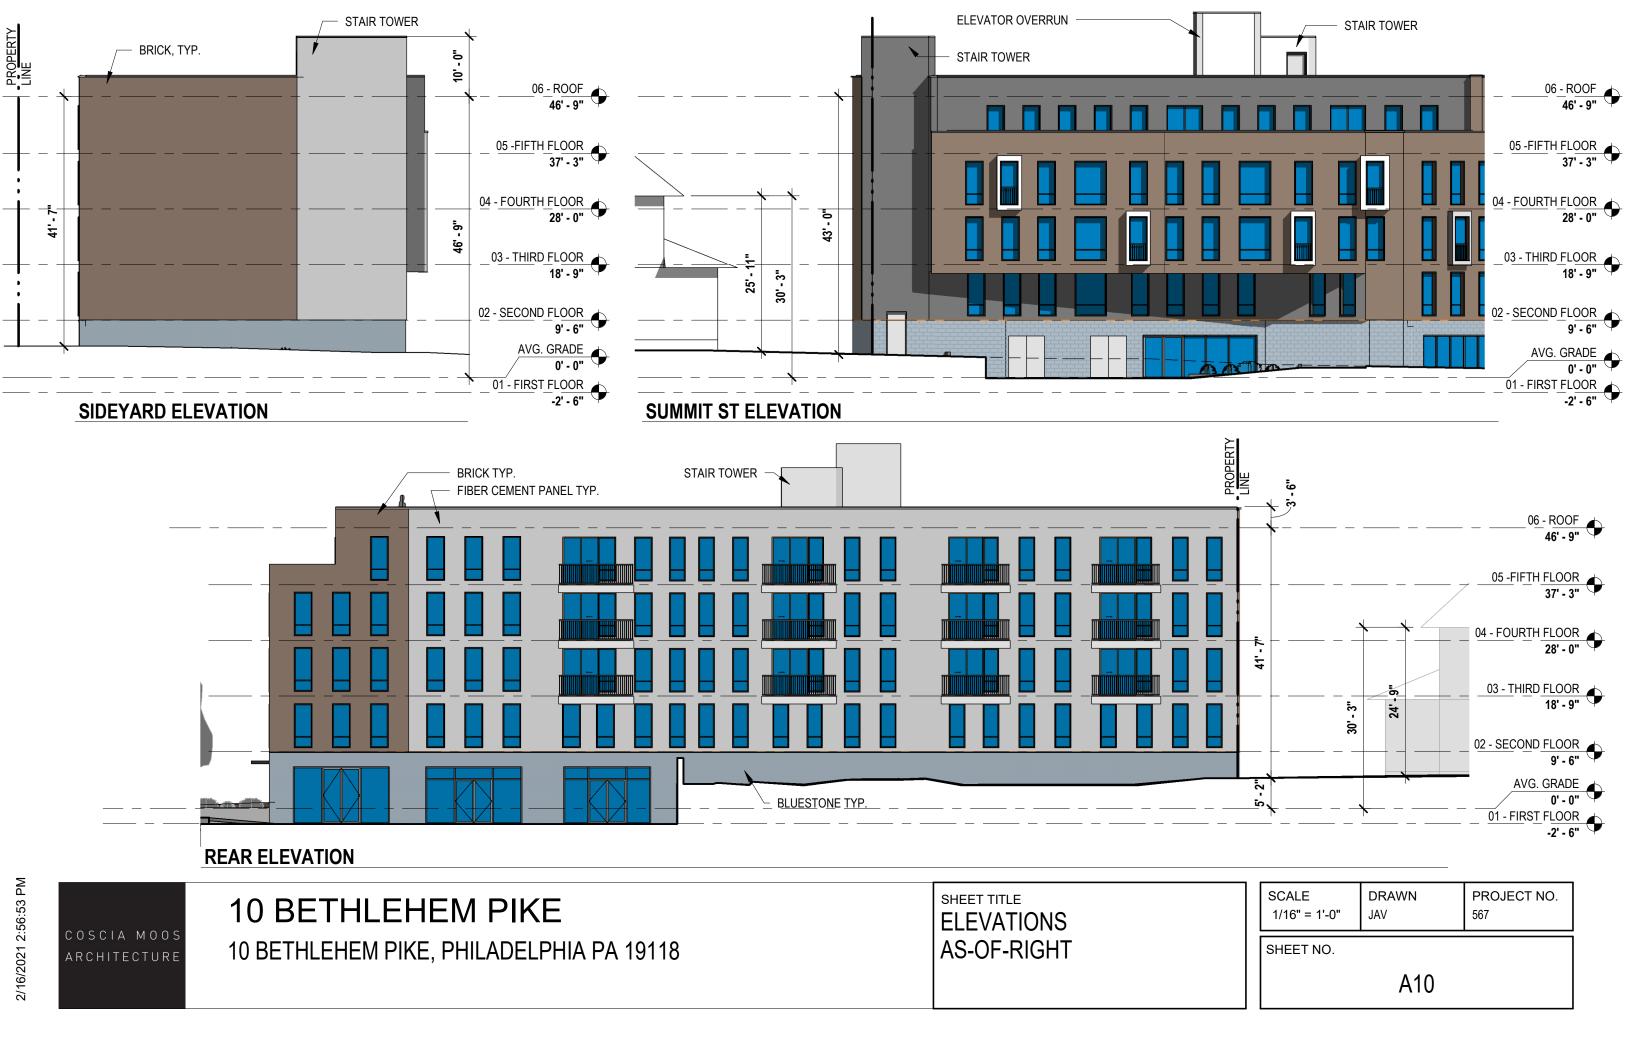

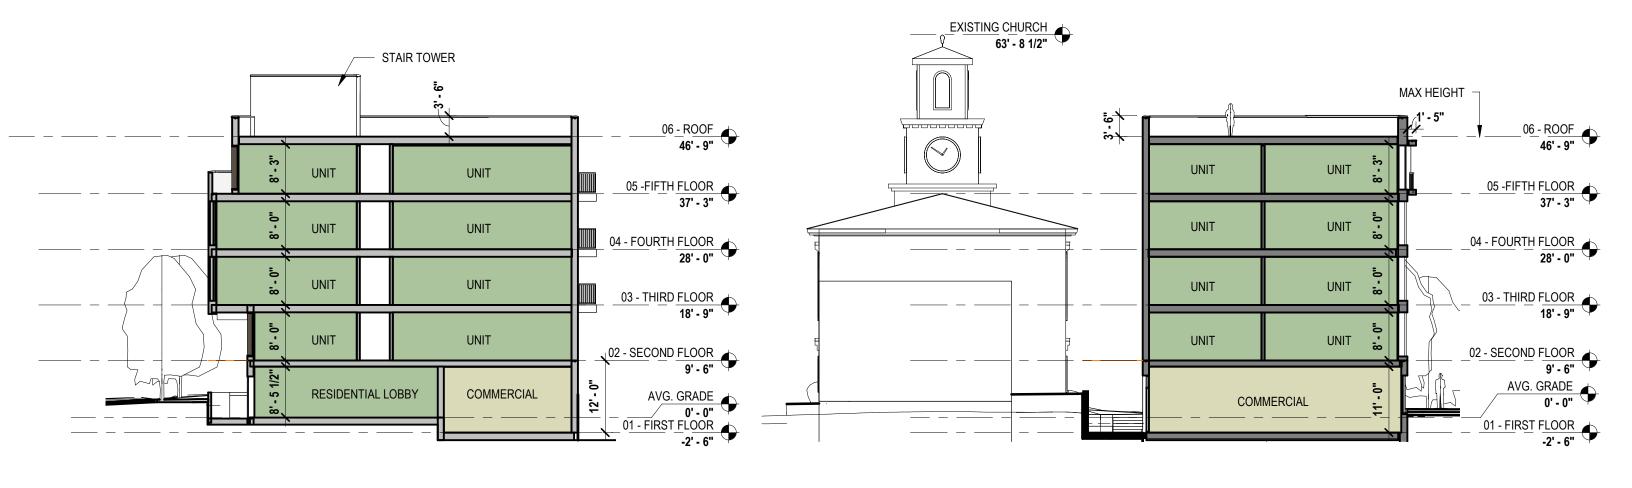

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COSCIA MOOS ARCHITECTURE

CROSS SECTION - 1

10 BETHLEHEM PIKE

10 BETHLEHEM PIKE, PHILADELPHIA PA 19118

SECTIONS AS-OF-RIGHT

CROSS SECTION - 2

DRAWN JAV	PROJECT NO. 567

SHEET NO.



10 BETHLEHEM PIKE

10 BETHLEHEM PIKE, PHILADELPHIA PA 19118

3D VIEW AS-OF-RIGHT
 SCALE
 DRAWN
 PROJECT NO.

 12" = 1'-0"
 JAV
 567

SHEET NO.



10 BETHLEHEM PIKE

10 BETHLEHEM PIKE, PHILADELPHIA PA 19118

3D VIEW AS-OF-RIGHT
 SCALE
 DRAWN
 PROJECT NO.

 1 1/2" = 1'-0"
 JAV
 567

SHEET NO.



10 BETHLEHEM PIKE

10 BETHLEHEM PIKE, PHILADELPHIA PA 19118

SHEET TITLE 3D VIEW AS-OF-RIGHT SCALE DRAWN PROJECT NO. 1 1/2" = 1'-0"

SHEET NO.

PROJECT DESCRIPTION 55'-0" SCHEME

LOT INFORMATION		
LOT ADDRESS(ES): 10 BET	HLEHEM PIKE, PHILADELP	PHIA, PA, 19118
LOT AREA(S): 11,113 SF		
BASE ZONING DISTRICT:	CMX-2	
OVERLAY ZONING DISTRICT: WWO V	WISSAHICKON WATERSHE	D OVERLAY DISTRICT
USE REGULATIONS		
PROPOSED & PERMITTED USES:	BASEMENT THRU 1ST	RETAIL SALE OF FOOD & BEVERAGE, RESIDENTIAL LOBBY, MECHANICAL
	2ND THRU 5TH	MULTI-FAMILY HOUSING
DISTRICT & LOT DIMENSIONS	REQUIRED	PROPOSED
MIN LOT WIDTH (FT)	N/A	NO CHANGE
MIN LOT AREA (SF)	N/A	NO CHANGE
MAX OCCUPIED AREA (% OF LOT)	80%	76% (8,462 SF BLDG)
MAX UNITS ALLOWED	35 (see Note 1)	34
YARDS		
MIN FRONT YARD DEPTH (FT)	N/A	0' - 0"
MIN SIDE YARD WIDTH, EACH (FT)	5 FT if used	5' - 0"
MIN REAR YARD DEPTH (FT)	9'-0" (see Note 2)	10'-0"
HEIGHT		
MAX HEIGHT (FT)	46'-9 1/2" (see Note 3)	55'-0"
MAX FLOOR AREA (% OF LOT AREA)	N/A	N/A
OFF STREET PARKING REQUIREMEN	TS	
CAR PARKING	0	9
BICYCLE PARKING	12 (1 bicycle per 3 units)	12

NOTES

Note 1: Section 14-602(4)(a)[2](.b) A minimum of 480 sq. ft. of lot area is required per dwelling unit for the lot area in excess of 1,919 sq. ft.; provided that (.c) If the green roof conditions set forth at § 14-602(7) are met, the number of units allowed is twenty-five percent (25%) greater than indicated by the foregoing lot size requirements.

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Minimum rear yard depth = 77'-3" x .1 = 7'-8 3/4", therefore, it shall be 9'-0" or greater.

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Building Height= 38'-0" + 7'-0" (height bonus) = 45'-0" Grade at Building Corners = 441', 440.2', 437.85', 436.8', 437.2' Average Grade = 438.61' = +1.81' (1'-9 1/2")

Total Building Height = 38'-0" + 7'-0" + 1'-9 1/2" = 46' - 9 1/2"



COSCIA MOOS ARCHITECTURE 10 BETHLEHEM PIKE


10 BETHLEHEM PIKE, PHILADELPHIA PA 19118

PROJECT DESCRIPTION 55'-0" SCHEME


 SCALE
 DRAWN
 PROJECT NO.

 12" = 1'-0"
 JAV
 567

SHEET NO.

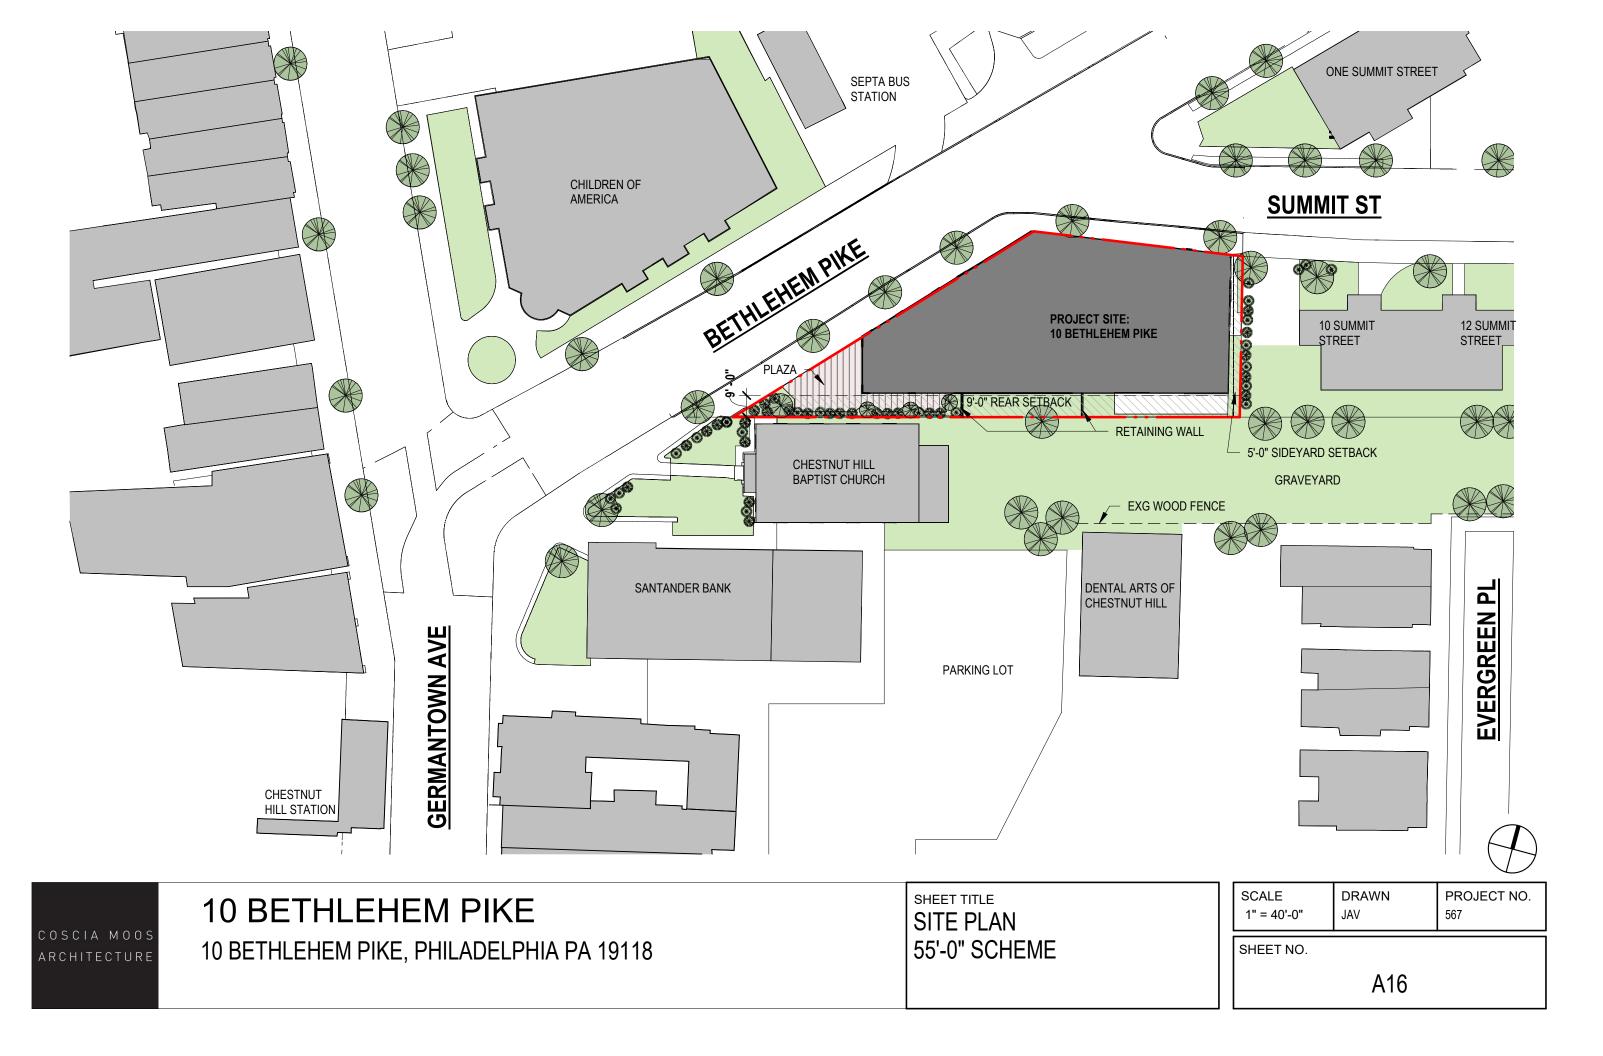

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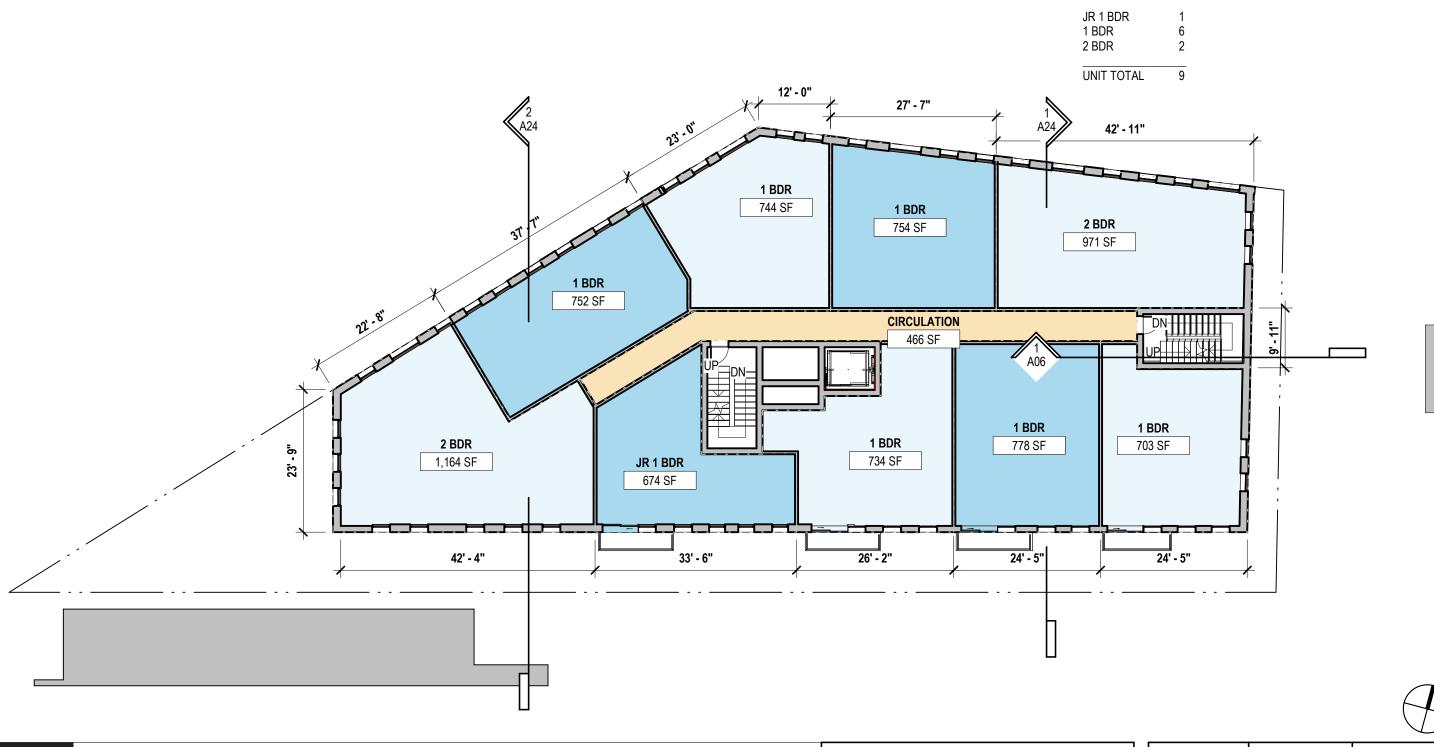
10 BETHLEHEM PIKE

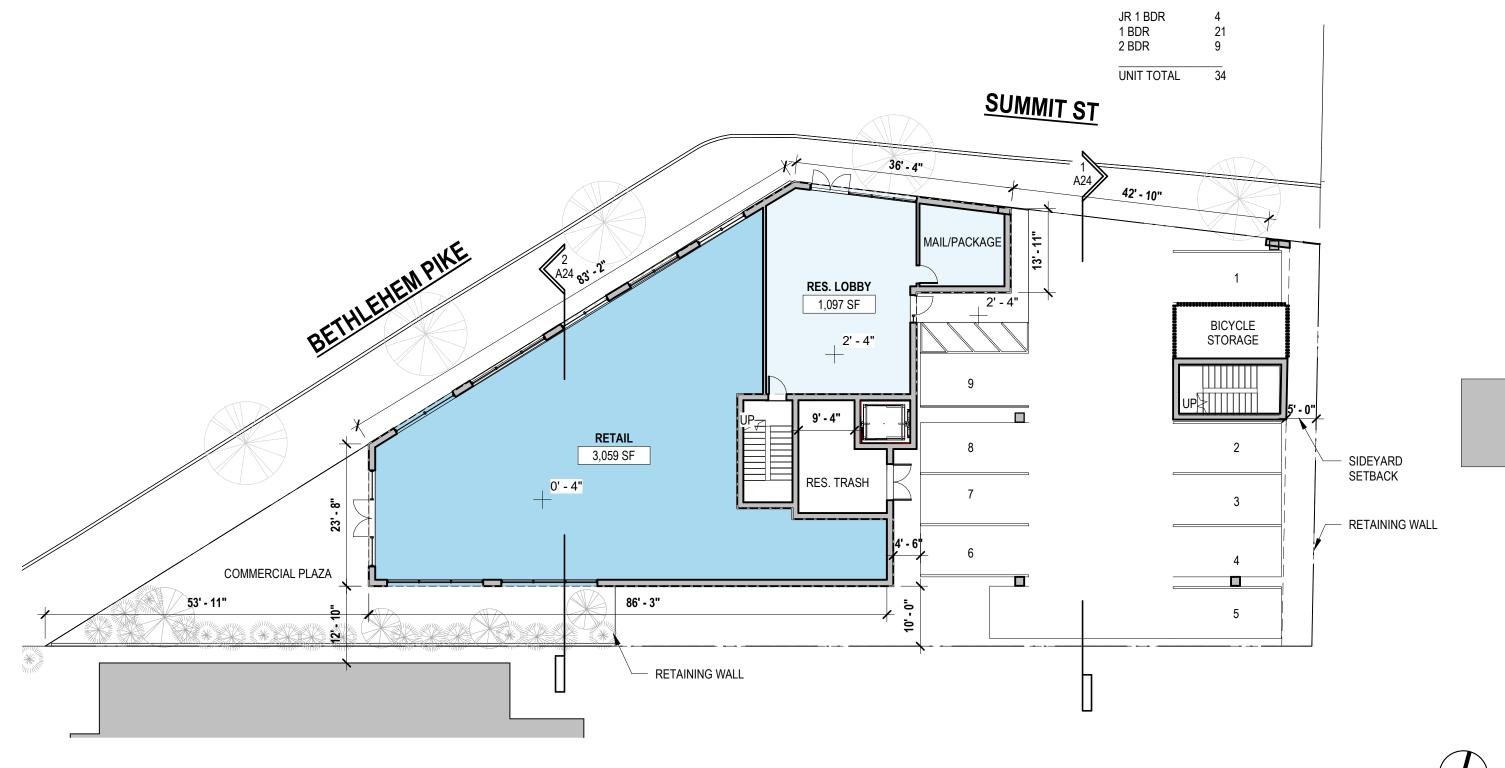10 BETHLEHEM PIKE, PHILADELPHIA PA 19118

GROUND FLOOR PLAN 55'-0" SCHEME

SCALE 1/16" = 1'-0"	DRAWN JAV	PROJECT NO. 567
SHEET NO.		
	A17	

APARTMENT UNIT MIX



10 BETHLEHEM PIKE

10 BETHLEHEM PIKE, PHILADELPHIA PA 19118

SHEET TITLE **TYPICAL FLOOR** 55'-0" SCHEME

SCALE	DRAWN	PROJECT NO.
1/16" = 1'-0"	JAV	567
SHEET NO		


SHEET NO.

TYPICAL FLOOR (LEVEL 2,3 &4)





UNIT TOTAL

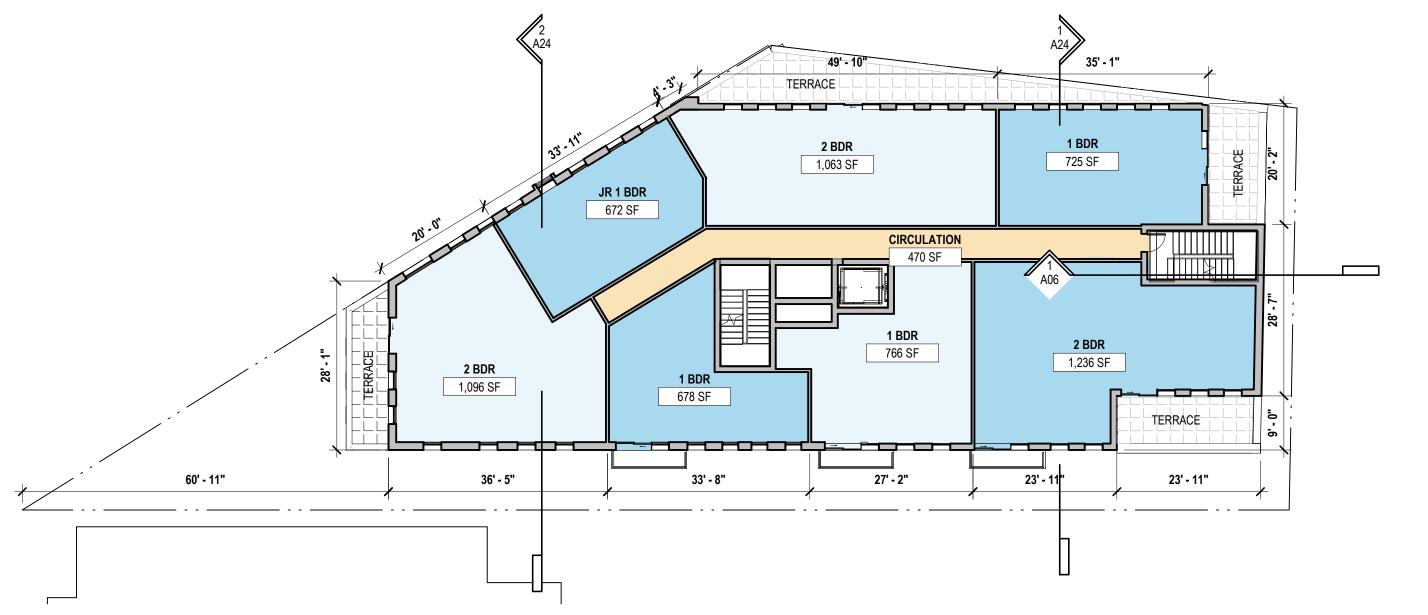



COSCIA MOOS ARCHITECTURE

10 BETHLEHEM PIKE

10 BETHLEHEM PIKE, PHILADELPHIA PA 19118


SHEET TITLE
FIFTH FLOOR
55'-0" SCHEME

SCALE	DRAWN	PROJECT NO.
1/16" = 1'-0"	JAV	567
SHEET NO.		

II NO.

ROOF AREA: 7,333 SF

GREEN ROOF REQUIRED: 60% OF ROOF AREA GREEN ROOF MINIMUM: 4400 SF GREEN ROOF PROVIDED: 4400 SF

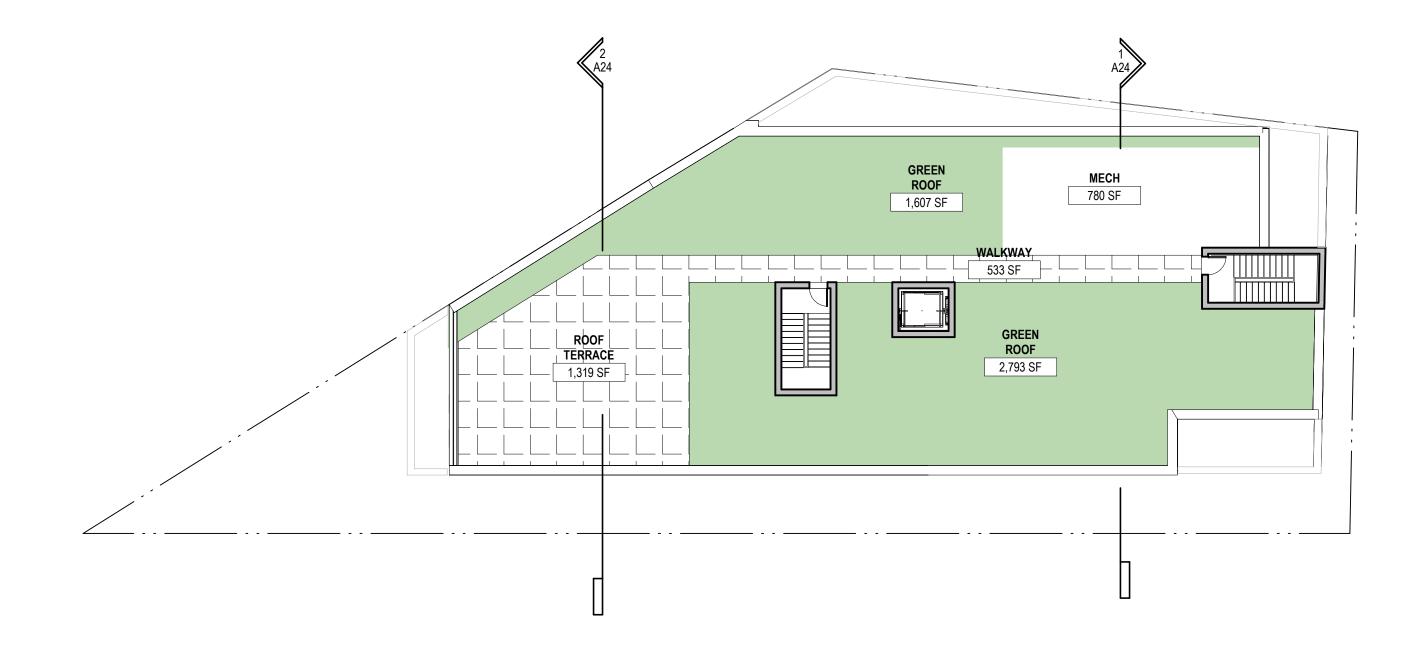




COSCIA MOOS ARCHITECTURE

10 BETHLEHEM PIKE

10 BETHLEHEM PIKE, PHILADELPHIA PA 19118

ROOF PLAN 55'-0" SCHEME

SCALE 1/16" = 1'-0"	DRAWN JAV	PROJECT NO. 567
SHEET NO.		
	A20	

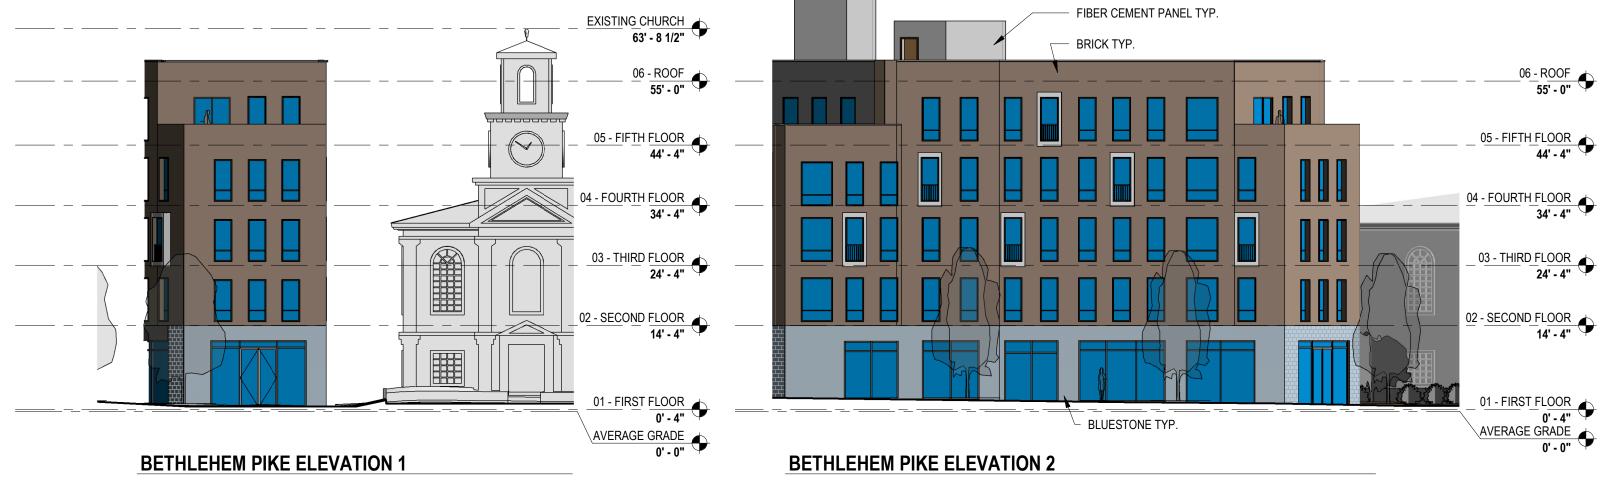


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COSCIA MOOS ARCHITECTURE 10 BETHLEHEM PIKE

10 BETHLEHEM PIKE, PHILADELPHIA PA 19118

BUILDING ELEVATIONS 55'-0" SCHEME

SCALE 1/16" = 1'-0"	DRAWN JAV	PROJECT NO. 567
SHEET NO.		
	A21	

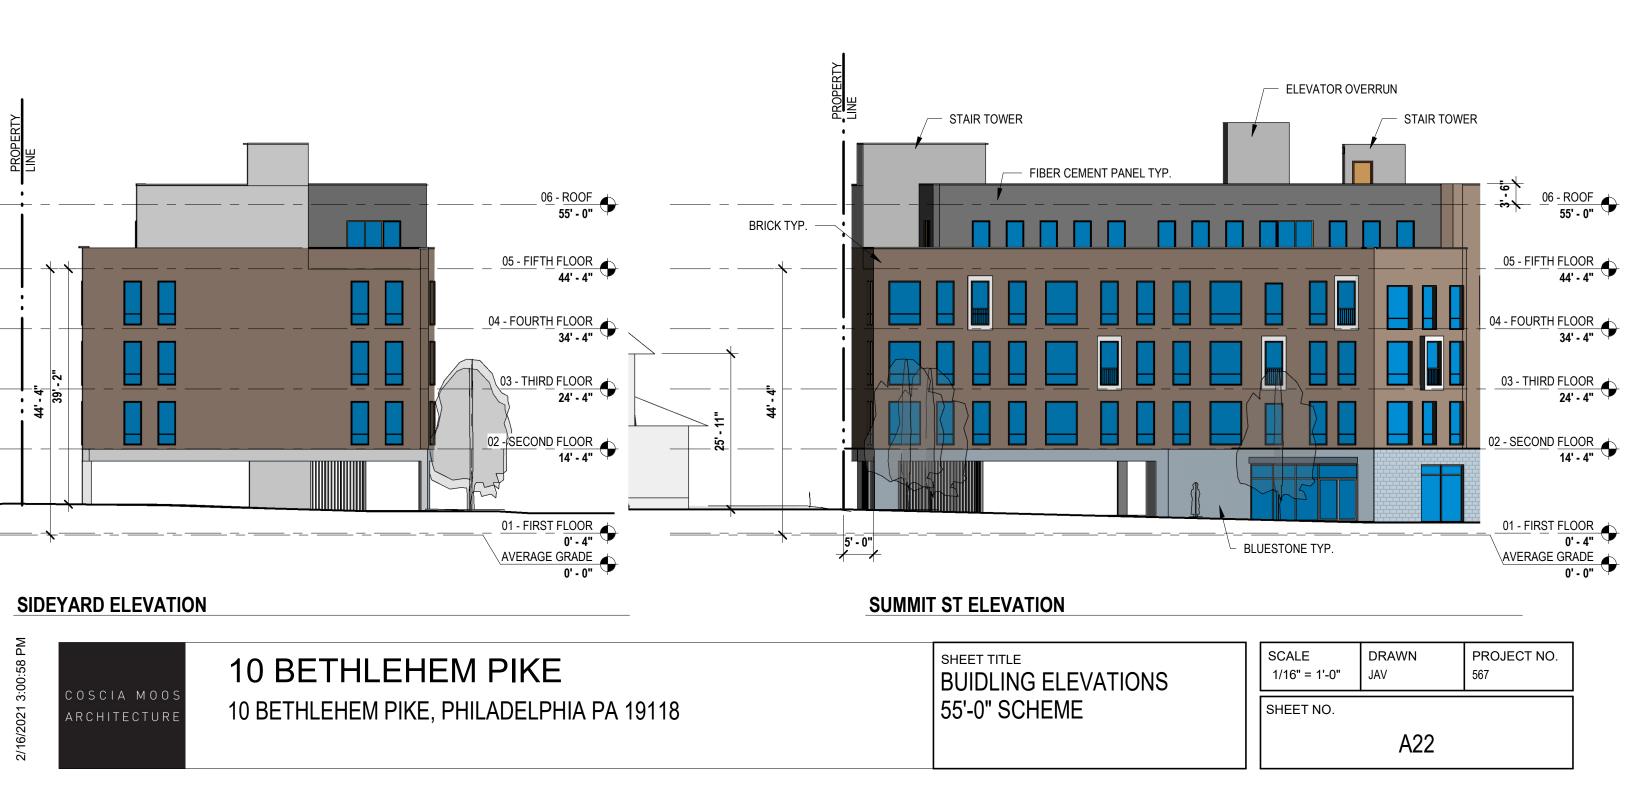

10 BETHLEHEM PIKE


10 BETHLEHEM PIKE, PHILADELPHIA PA 19118

BUILDING ELEVATIONS
55'-0" SCHEME

 SCALE
 DRAWN
 PROJECT NO.

 1/16" = 1'-0"
 JAV
 567

SHEET NO.

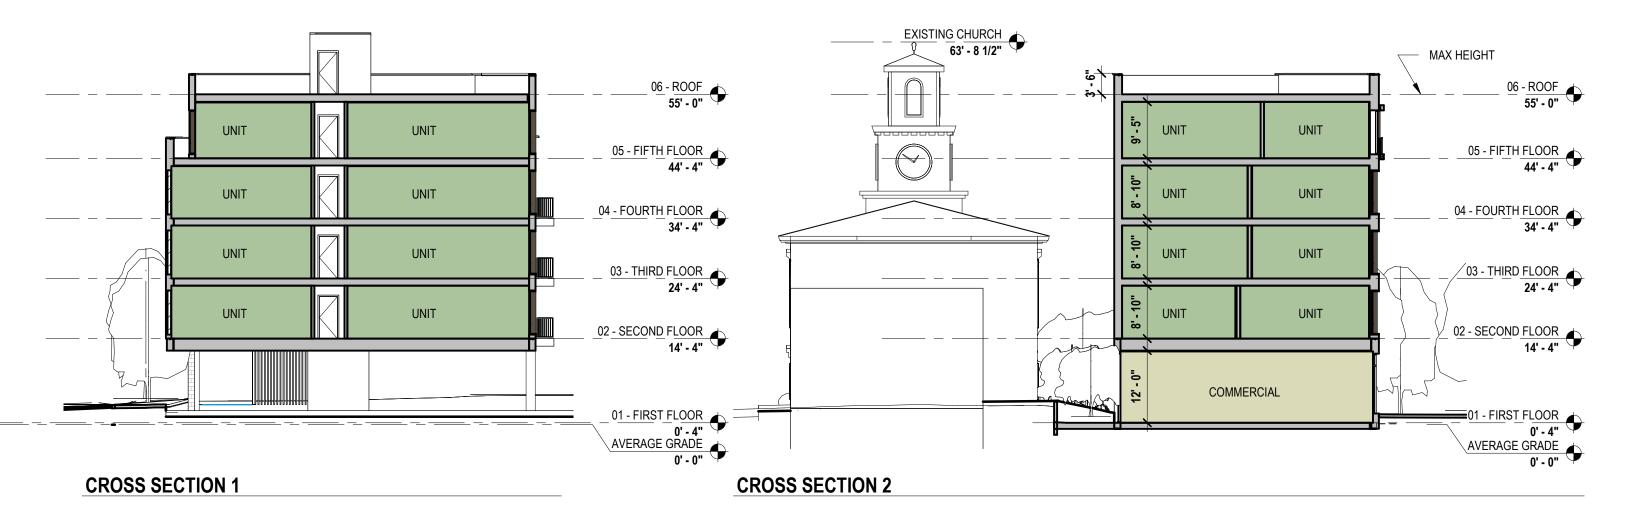



10 BETHLEHEM PIKE

10 BETHLEHEM PIKE, PHILADELPHIA PA 19118

SECTIONS 55'-0" SCHEME

SCALE 1/16" = 1'-0"	DRAWN JAV	PROJECT NO. 567			
SHEET NO.					
A24					



10 BETHLEHEM PIKE

10 BETHLEHEM PIKE, PHILADELPHIA PA 19118

3D VIEW 55'-0" SCHEME

SCALE	DRAWN	DDO IECT NO
00/122		PROJECT NO.
1 1/2" = 1'-0"	JAV	567

SHEET NO.



10 BETHLEHEM PIKE

10 BETHLEHEM PIKE, PHILADELPHIA PA 19118

SHEET TITLE
3D VIEW
55'-0" SCHEME

 SCALE
 DRAWN
 PROJECT NO.

 1 1/2" = 1'-0"
 JAV
 567

SHEET NO.



10 BETHLEHEM PIKE


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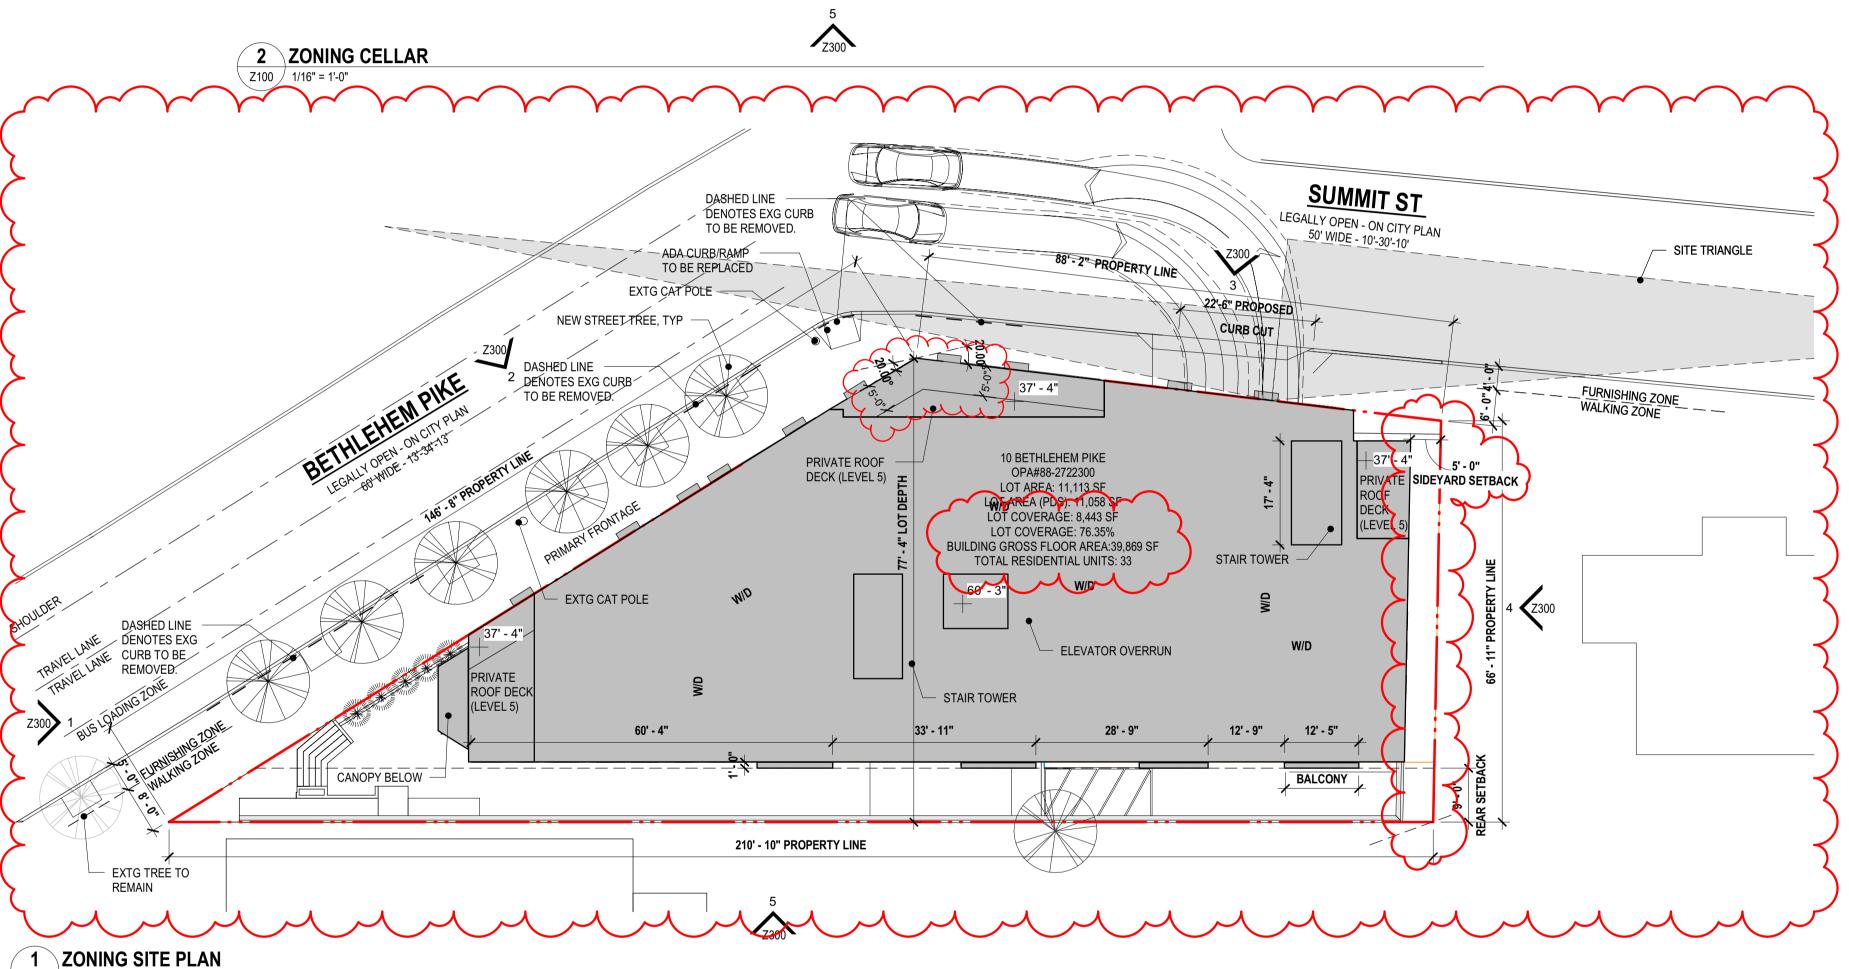
3D VIEW 55'-0" SCHEME
 SCALE
 DRAWN
 PROJECT NO.

 1 1/2" = 1'-0"
 JAV
 567

SHEET NO.

Exhibit 2



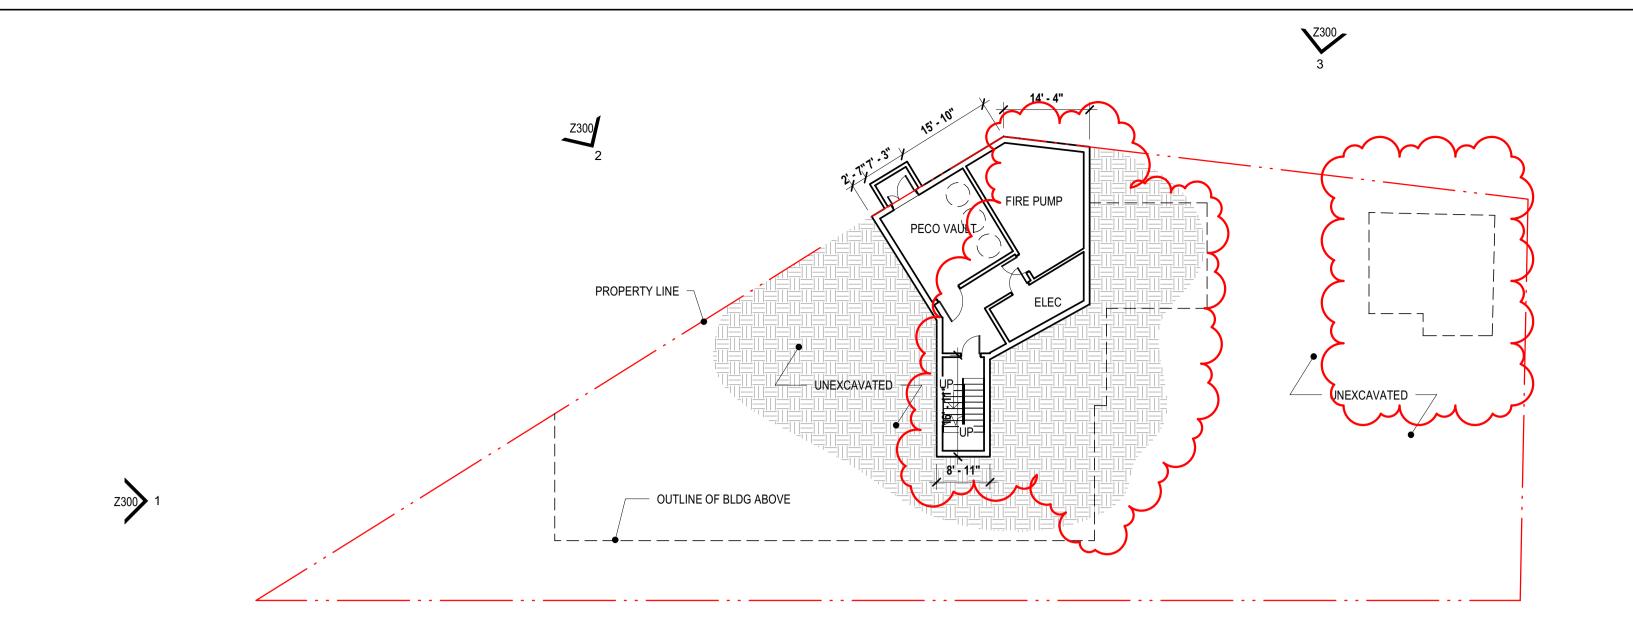

PERIMETER SCREENING FROM REQUIRED PROVIDED (See Note 8) ADJACENT RESIDENTIAL LOTS INTERIOR LANDSCAPE REQMNTS 660 SF OPEN PARKING 114 SF (See Note 9)

LOT INFORMATION						
LOT ADDRESS(ES): 10 BETHLEHEM PIKE, PHILADELPHIA, PA, 19118						
OPA NUMBER: #88-2722300						
LOT AREA(S):	11,113 SF					
LOT AREA(S) - PDS:	11,058 SF					
BASE ZONING DISTRICT:	CMX-2					
OVERLAY ZONING DISTRICT: WWO	WISSAHICKON WATERSHEI	O OVERLAY DISTRICT				
USE REGULATIONS						
PROPOSED & PERMITTED USES:	BASEMENT THRU 1ST	RETAIL SALE OF FOOD 8				
		BEVERAGE,				
		RESIDENTIAL LOBBY, MECHANICAL				
	2ND THRU 5TH	MULTI-FAMILY HOUSING				
DIMENSIONAL STANDARDS (14-701-						
DISTRICT & LOT DIMENSIONS	REQUIRED	PROPOSED				
MIN LOT WIDTH (FT)	N/A	NO CHANGE				
MIN LOT AREA (SF)	N/A	NO CHANGE				
MAX OCCUPIED AREA (% OF LOT	80%	76.35% (8,443 SF BLDG)				
MAX UNITS ALLOWED	33 (see Note 1)	33				
YARDS	25 (555 11515 1)	\ ~~ ~				
MIN FRONT YARD DEPTH (FT)	N/A	0\-0"				
	5 FT if used	5' - 0"				
. , ,	5 FT if used 9'-0" (see Note 2)	5' - 0"				
MIN SIDE YARD WIDTH, EACH (FT) MIN REAR YARD DEPTH (FT) HEIGHT						
MIN REAR YARD DEPTH (FT) HEIGHT						
MIN REAR YARD DEPTH (FT) HEIGHT MAX HEIGHT (FT)	9'-0" (see Note 2) 46'-9 1/2" (see Note 3)	100				
MIN REAR YARD DEPTH (FT) HEIGHT MAX HEIGHT (FT) MAX FLOOR AREA (% OF LOT AREA)	9'-0" (see Note 2) 46'-9 1/2" (see Note 3) N/A	46'-9 1/2"				
MIN REAR YARD DEPTH (FT) HEIGHT MAX HEIGHT (FT) MAX FLOOR AREA (% OF LOT AREA) LANDSCAPE AND TREES (14-705(2))	9'-0" (see Note 2) 46'-9 1/2" (see Note 3) N/A	46'-9 1/2"				
MIN REAR YARD DEPTH (FT) HEIGHT MAX HEIGHT (FT) MAX FLOOR AREA (% OF LOT AREA) LANDSCAPE AND TREES (14-705(2))	9'-0" (see Note 2) 46'-9 1/2" (see Note 3) N/A	46'-9 1/2" N/A				
MIN REAR YARD DEPTH (FT) HEIGHT MAX HEIGHT (FT) MAX FLOOR AREA (% OF LOT AREA) LANDSCAPE AND TREES (14-705(2)) STREET TREE REQUIREMENT	9'-0" (see Note 2) 46'-9 1/2" (see Note 3) N/A 7 (See Note 4)	46'-9 1/2" N/A				
MIN REAR YARD DEPTH (FT) HEIGHT MAX HEIGHT (FT) MAX FLOOR AREA (% OF LOT AREA) LANDSCAPE AND TREES (14-705(2)) STREET TREE REQUIREMENT OFF STREET PARKING REQUIREME	9'-0" (see Note 2) 46'-9 1/2" (see Note 3) N/A 7 (See Note 4)	46'-9 1/2" N/A				
MIN REAR YARD DEPTH (FT) HEIGHT MAX HEIGHT (FT) MAX FLOOR AREA (% OF LOT AREA)	9'-0" (see Note 2) 46'-9 1/2" (see Note 3) N/A 7 (See Note 4)	46'-9 1/2" N/A				
MIN REAR YARD DEPTH (FT) HEIGHT MAX HEIGHT (FT) MAX FLOOR AREA (% OF LOT AREA) LANDSCAPE AND TREES (14-705(2)) STREET TREE REQUIREMENT OFF STREET PARKING REQUIREME CAR PARKING	9'-0" (see Note 2) 46'-9 1/2" (see Note 3) N/A 7 (See Note 4) NTS (14-802-2)	46'-9 1/2" N/A				
MIN REAR YARD DEPTH (FT) HEIGHT MAX HEIGHT (FT) MAX FLOOR AREA (% OF LOT AREA) LANDSCAPE AND TREES (14-705(2)) STREET TREE REQUIREMENT OFF STREET PARKING REQUIREME CAR PARKING ACCESSIBLE SPACES COMPACT SPACE	9'-0" (see Note 2) 46'-9 1/2" (see Note 3) N/A 7 (See Note 4) NTS (14-802-2) 0 0 0	46'-9 1/2" N/A				
MIN REAR YARD DEPTH (FT) HEIGHT MAX HEIGHT (FT) MAX FLOOR AREA (% OF LOT AREA) LANDSCAPE AND TREES (14-705(2)) STREET TREE REQUIREMENT OFF STREET PARKING REQUIREME CAR PARKING ACCESSIBLE SPACES COMPACT SPACE	9'-0" (see Note 2) 46'-9 1/2" (see Note 3) N/A 7 (See Note 4) NTS (14-802-2) 0 0	46'-9 1/2" N/A				
MIN REAR YARD DEPTH (FT) HEIGHT MAX HEIGHT (FT) MAX FLOOR AREA (% OF LOT AREA) LANDSCAPE AND TREES (14-705(2)) STREET TREE REQUIREMENT OFF STREET PARKING REQUIREME CAR PARKING ACCESSIBLE SPACES	9'-0" (see Note 2) 46'-9 1/2" (see Note 3) N/A 7 (See Note 4) NTS (14-802-2) 0 0 12 (1 bicycle per 3 units)	46'-9 1/2" N/A				
MIN REAR YARD DEPTH (FT) HEIGHT MAX HEIGHT (FT) MAX FLOOR AREA (% OF LOT AREA) LANDSCAPE AND TREES (14-705(2)) STREET TREE REQUIREMENT OFF STREET PARKING REQUIREME CAR PARKING ACCESSIBLE SPACES COMPACT SPACE BICYCLE PARKING	9'-0" (see Note 2) 46'-9 1/2" (see Note 3) N/A 7 (See Note 4) NTS (14-802-2) 0 0 12 (1 bicycle per 3 units)	46'-9 1/2" N/A				
MIN REAR YARD DEPTH (FT) HEIGHT MAX HEIGHT (FT) MAX FLOOR AREA (% OF LOT AREA) LANDSCAPE AND TREES (14-705(2)) STREET TREE REQUIREMENT OFF STREET PARKING REQUIREME CAR PARKING ACCESSIBLE SPACES COMPACT SPACE BICYCLE PARKING	9'-0" (see Note 2) 46'-9 1/2" (see Note 3) N/A 7 (See Note 4) NTS (14-802-2) 0 0 12 (1 bicycle per 3 units)	7 8 0 12				
MIN REAR YARD DEPTH (FT) HEIGHT MAX HEIGHT (FT) MAX FLOOR AREA (% OF LOT AREA) LANDSCAPE AND TREES (14-705(2)) STREET TREE REQUIREMENT OFF STREET PARKING REQUIREME CAR PARKING ACCESSIBLE SPACES COMPACT SPACE BICYCLE PARKING	9'-0" (see Note 2) 46'-9 1/2" (see Note 3) N/A 7 (See Note 4) NTS (14-802-2) 0 0 12 (1 bicycle per 3 units)	7 8 0 12				
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MIN REAR YARD DEPTH (FT) HEIGHT MAX HEIGHT (FT) MAX FLOOR AREA (% OF LOT AREA) LANDSCAPE AND TREES (14-705(2)) STREET TREE REQUIREMENT OFF STREET PARKING REQUIREME CAR PARKING ACCESSIBLE SPACES COMPACT SPACE BICYCLE PARKING OFF STREET LOADING REQUIREME OFF-STREET LOADING BAY WINDOWS (11603 (4))	9'-0" (see Note 2) 46'-9 1/2" (see Note 3) N/A 7 (See Note 4) NTS (14-802-2) 0 0 12 (1 bicycle per 3 units) NTS (14-806) 0 (See Note 6)	46'-9 1/2" N/A 7				
MIN REAR YARD DEPTH (FT) HEIGHT MAX HEIGHT (FT) MAX FLOOR AREA (% OF LOT AREA) LANDSCAPE AND TREES (14-705(2)) STREET TREE REQUIREMENT OFF STREET PARKING REQUIREME CAR PARKING ACCESSIBLE SPACES COMPACT SPACE BICYCLE PARKING OFF STREET LOADING REQUIREME OFF-STREET LOADING BAY WINDOWS (11603 (4))	9'-0" (see Note 2) 46'-9 1/2" (see Note 3) N/A 7 (See Note 4) NTS (14-802-2) 0 0 12 (1 bicycle per 3 units) NTS (14-806) 0 (See Note 6)	46'-9 1/2" N/A 7				

NOTES Note 1: Section 14-602(4)(a)[2](.b) A minimum of 480 sq. ft. of lot area is required per dwelling unit for the lot area in excess of 1,919 sq. ft.; provided that (.c) If the green roof conditions set forth at § 14-602(7) are met, the number of units allowed is twenty-five percent (25%) greater than indicated by the foregoing lot size requirements. Section 14-702 (7) (b) A floor area, height, or housing unit density bonus, as applicable if the owner of the property enters into a payment-in-lieu agreement that meets the standards set forth in subsection (-6). Per Housing Unit density Bonuses table, 25% increase in units permitted is provied for Moderate Income. Maximum units allowed = 1919 sf (3 units) + (11,058 SF-1919sf) / 480 SF per unit = 3 units + 19 units = 22 units. Green Roof Bonus = 22 units x .25% = 5.5 units (5 rounded down) = 27 units Moderate Income Density Bonus = 27 units x .25% = 6.75 (6 rounded down) = 33 units **Cost Calculation:** Lot Area Calculation: Lot Area (PDS) = 11,058 SF x 20 = \$221,160 Unit Calculation: 6 units earned x \$25,000 =\$150,000 Payment will be based on the Lot Area Calculation Note 2: Minimum rear yard depth shall be the greater of 9 feet or 10% of the lot depth per Table Minimum rear yard based on Lot Depth = 77'-4" x .1 = 7'-9" *Proposed primary frontage by applicant is Bethlehem Pike, determination to be made by Comission. Note 3: Per table 14-701-3 Dimensional Standards for Commercial Districts, Max Height ft = 38'-0" Section 14-702 (7) (b) A floor area, height, or housing unit density bonus, as applicable if the owner of the property enters into a payment-in-lieu agreement that meets the standards set forth in subsection (.6). Per Additional Building Height table, 7'-0" of height bonus. Section 14-202(6) Rules of Measurement - Height, Building or Structure: The vertical distance from the average ground level at the base of the structure to the top of the Building Height= 38'-0" + 7'-0" (multi-family height bonus) = 45'-0" Grade at Building Corners = 441', 440.2', 437.85', 436.8', 437.2' Average Grade = 438.61' = +1.81' (1'-9 1/2") Total Building Height From Low Point (436.8") = 38'-0" + 7'-0" + 1'-9 1/2" = 46' - 9 1/2" Note 4: Per 14-705(2)(c)(.2)(.a): At least one street tree per 35 ft. of linear front shall be provided. Street trees may be placed at regular or irregular intervals, provided that there is at least 15 ft. of space between tree trunks. 234'-10" (linear frontage) / 35 = 7 Street Trees (rounded up) Project provides 6 new trees and 1 existing to remain. Note 5: Bay Windows provided in compliance with Section 11-603 (4) Projections Over the Street- Balconies and Bay Windows. Bethlehem Pike - 87'-10" of frontage (three allowed for 63'-0" of frontage) Level 3: 3 bays provided (3 allowed), Level 4: 2 bays provided (3 allowed), Level 5: 1 bay provided (3 allowed) Summit Street - 67'-0" of frontage (three allowed for 63'-0" of frontage) Level 3: 2 bays provided (3 allowed), Level 4: 2 bays provided (3 allowed) Note 6: Per Table 14-803-1: Off Street Loading, Loading Spaces are not required if Residential use is less than 100,000 Gross Floor Area (Sq. Ft.) Note 7: Per 14-604(5), roof decks are permitted for residential use in all zoning districts. Roof deck setback is greater than 5 ft from the front building line. Roof access structures can exceed 125 sf. Stairs do not exceed 10 ft in height above the surface of the roof deck. Per Table 14-701-6, penthouses in Commercial districts for roof structures housing elevators are an exception to dimensional standard Note 8: Per 14-803 (5) (c) (1) When a parking lot abuts a residential district, a contiuous screening wall at least five ft tall shall be provided. The screening material shall be desiged to provide 75% opacity. Note 9: Herbaceous plants or lawn installed in the required landscaped area shall be from the list of appropriate plantings per \$ 14-705 of the Philadelphia Zening Code Note 10: WWO Wissahickon Watershead Overlay District 14-510 (6) Category 5 - No Limit to Impervious Ground Coverage Existing site is currently 95% Impervious (11,058 SF (PSD) with 551 Sq Ft of landscaping). A green roof is being provided to decrease surface water runoff. The infiltration capacity of the site will be increased not diminished. Note 10: Steep Slope Protection 14-704 (2) (a.) A disturbance of lot area greater than 1,400 sq ft or on which the proposed activity will increase the impervious ground cover on the lot by more than 1,400 sq ft. Existing site has 551 sf of existing pervious ground cover. Impervious coverage will not be increased by more than 1,400 sq ft. (b.) Slopes of fifteen percent (15%) of greater on any lot of portion(s) thereof. Steep Slope Calculation Property Line 210'-10": Low Point = 437.8' High Point = 441.5', **Slope = 1.74%**

Civil Engineer

Coscia Moos Architecture

267 761 9416

1616 Walnut Street, Suite 101 hiladelphia, PA 19103

COSCIA MOOS

ARCHITECTURE

Maser Consulting 2 Penn Center, Suite 222 Philadelphia, PA 19102 215 861 9021

Versions

lo. Date Description

03/03/2021 ZONING

00/00/0000 ASI 000

Slope from Site Lowpoint to High Point: Low Point = 436.36' High Point = 441.5', Slope = Maximum Steep Slope calculated at 3.8%, steep slope provisions do not apply.

Property Line 146'-8": Low Point = 436.36' High Point = 437.8', **Slope = 1% overall**,

Property Line 66'-11": Low Point = 440.3' High Point = 441.5', **Slope = 1.79%** Property Line 88'-2": Low Point = 437.5' High Point = 440.3', **Slope = 2.74**%

3.8% at steepest point.

Signature and Seal

10 BETHLEHEM PIKE

10 BETHLEHEM PIKE, PHILADELPHIA PA 19118

ZONING TABLES & PLANS

JAV As indicated

Z100

Per 14-701(1)(d)(.1), the City Planning Commission has determined that: Bethlehem _is the primary street;

 $\sqrt{2100} / 1/16" = 1'-0"$

Opposite of Summit Street is the rear;

Street is the rear street

Applied Electronically by: KEITH DAVIS

April 12, 2021

PHILADELPHIA CITY PLANNING COMMISSION

In accordance with the terms and provisions of Section 14-704(2) of the Philadelphia Code pertaining to:

PHILADELPHIA CITY PLANNING COMMISSION



PROTECTION: oproved 0 - 24%

Applied Electronically by: KEITH DAVIS

April 12, 2021

In accordance with the terms and provisions of Section 14-510 of the Philadelphia Code pertaining to:

WISSAHICKON WATERSHED OVERLAY DISTRICT

✓ APPROVED

Cat 5 DISAPPROVED

Applied Electronically by: **KEITH DAVIS**

April 12, 2021

PHILADELPHIA CITY PLANNING COMMISSION

Philadelphia City Planning Commission mixed income bonus

#Date 4/12/21 Keith F Davis


Development Planning



EXISTING SUMMIT ST STREET VIEW



EXISTING BETHLEHEM PIKE STREET VIEW

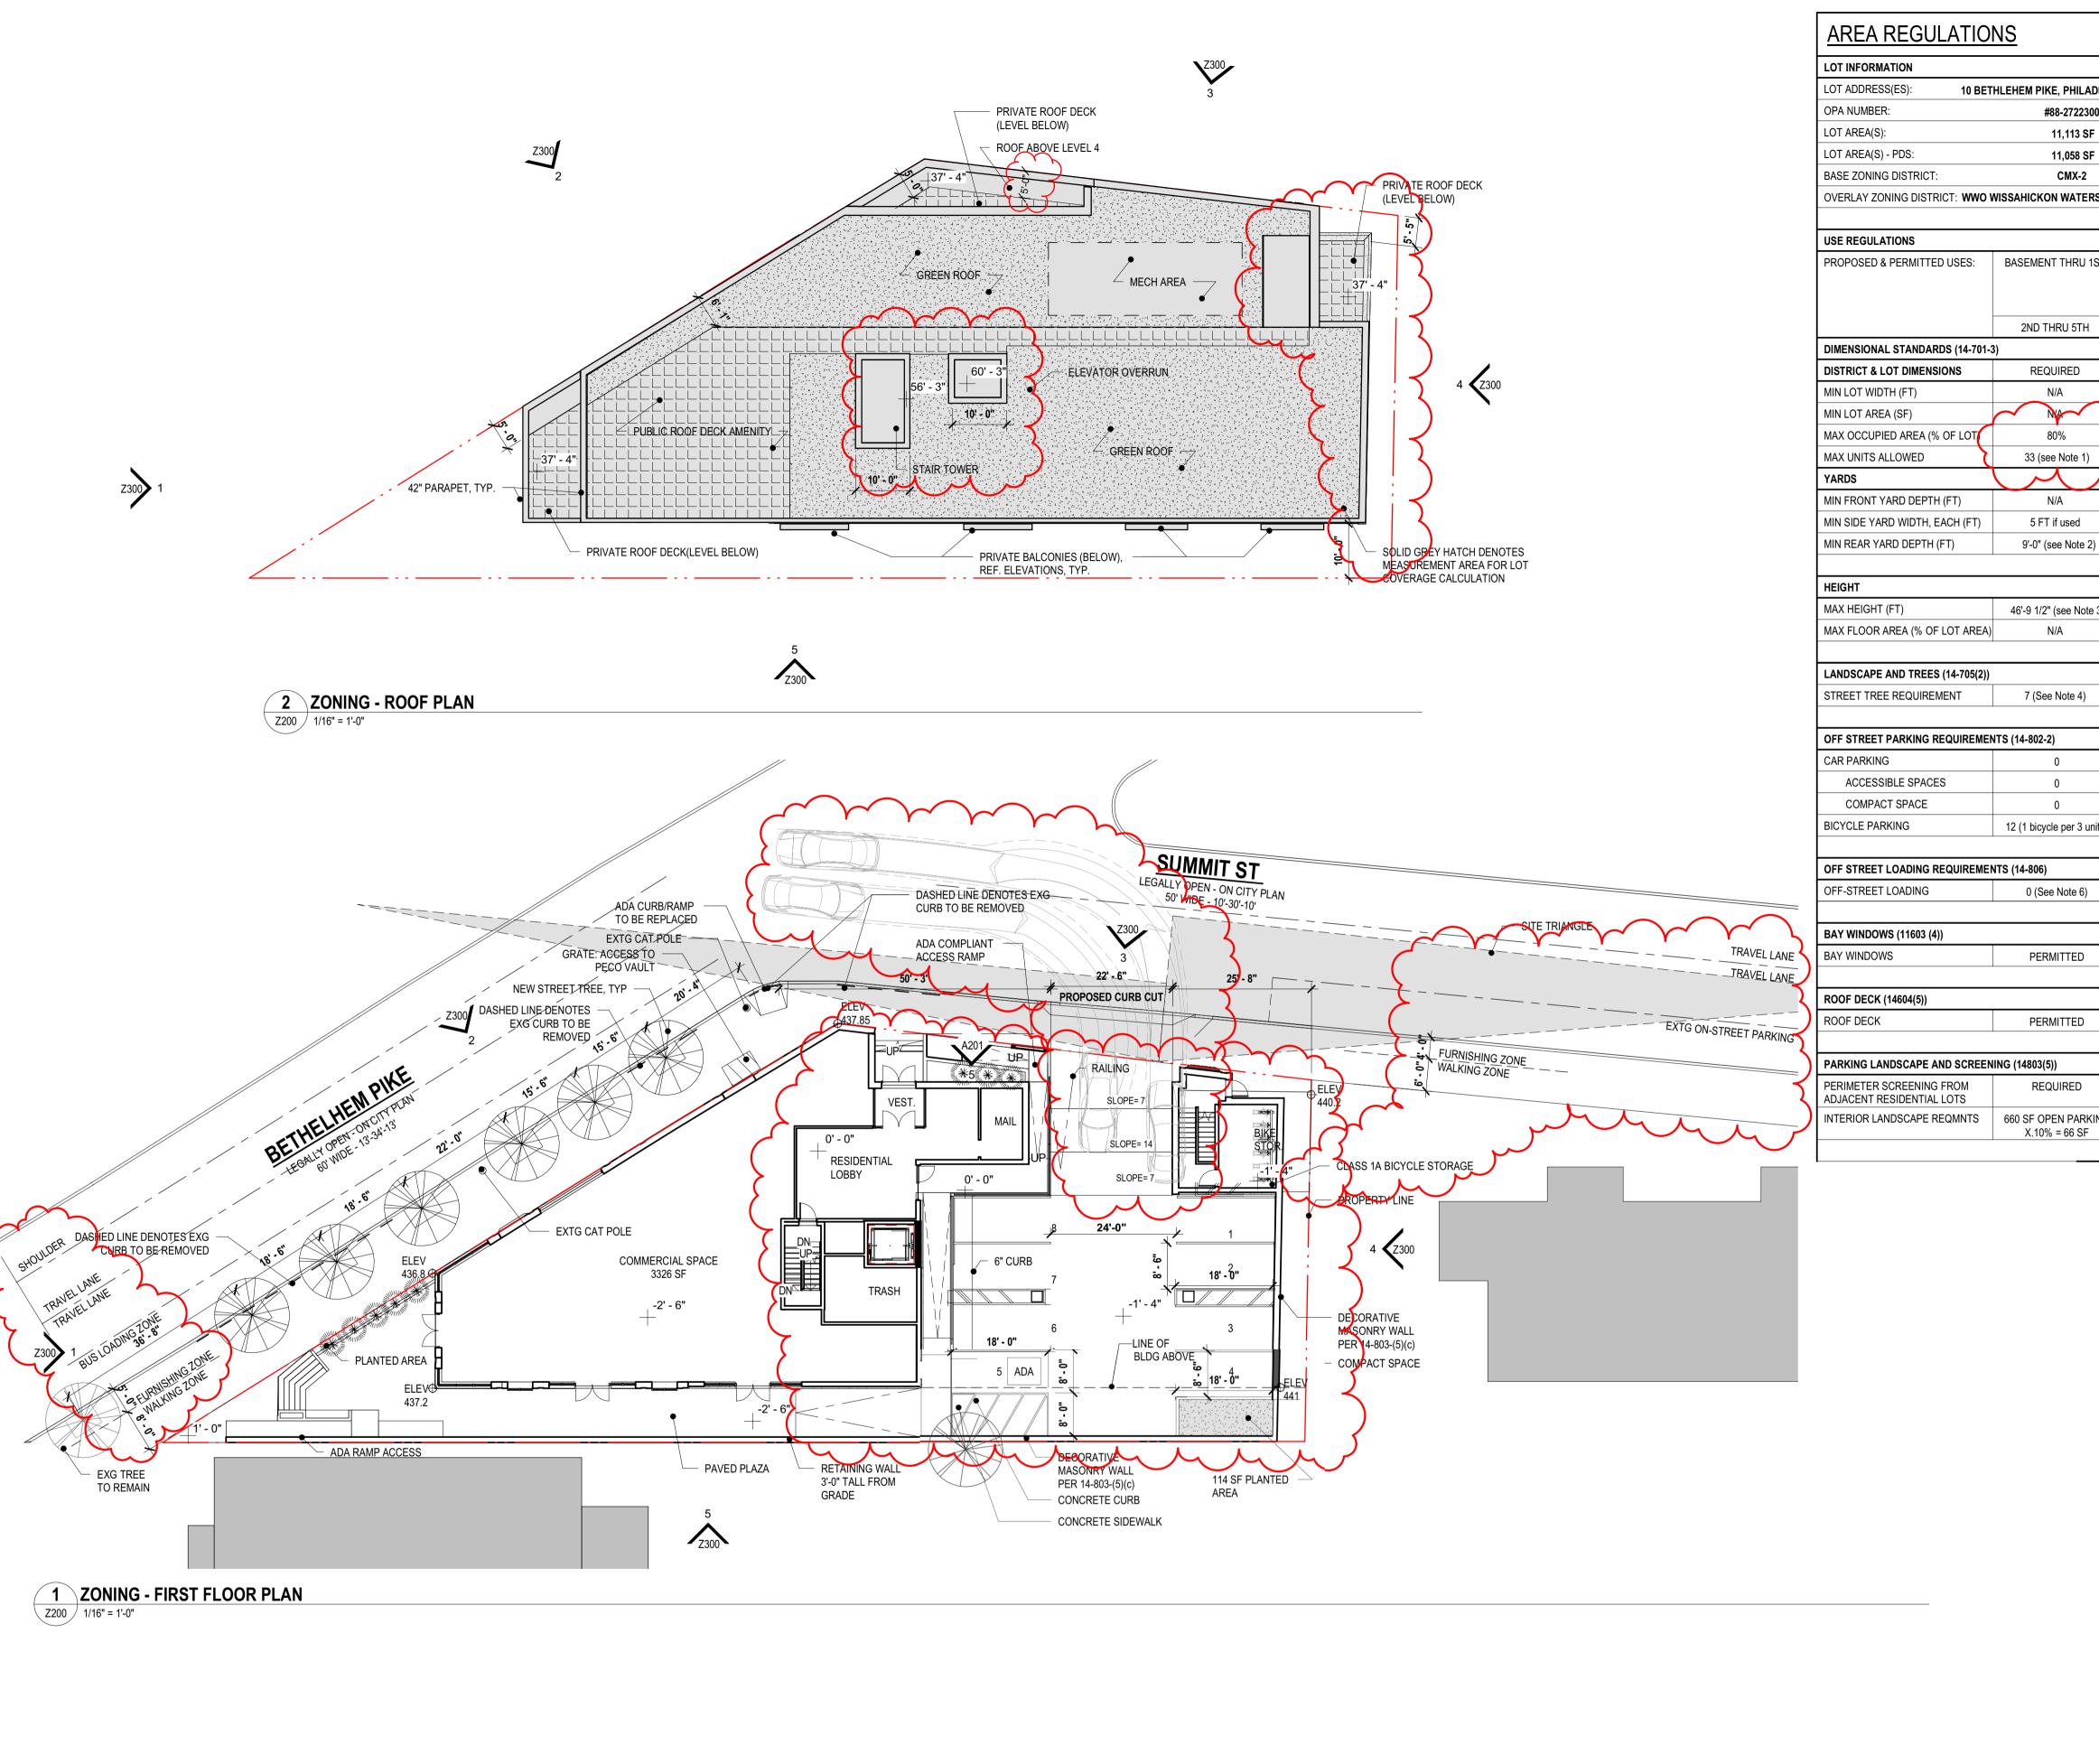

APPROVED R ZONING ONLY

polied Electronically by L&I User:

10 BETHLEHEM PIKE, PHILADELPHIA, PA, 19118 #88-2722300 11,113 SF 11,058 SF CMX-2 OVERLAY ZONING DISTRICT: WWO WISSAHICKON WATERSHED OVERLAY DISTRICT

BASEMENT THRU 1ST RETAIL SALE OF FOOD & BEVERAGE, RESIDENTIAL LOBBY, MECHANICAL 2ND THRU 5TH MULTI-FAMILY HOUSING REQUIRED PROPOSED NO CHANGE NO CHANGE 76.35% (8,443 SF BLDG) 33 (see Note 1) 5 FT if used 5' - 0"

46'-9 1/2" (see Note 3) 46'-9 1/2" N/A

12 (1 bicycle per 3 units)

0 (See Note 6)

PERMITTED PROVIDED (See Note 6)

PERMITTED PROVIDED (See Note 7)

PROVIDED (See Note 8) REQUIRED NTERIOR LANDSCAPE REQMNTS 660 SF OPEN PARKING 114 SF (See Note 9) X.10% = 66 SF

NOTES

Note 1: Section 14-602(4)(a)[2](.b) A minimum of 480 sq. ft. of lot area is required per dwelling unit for the lot area in excess of 1,919 sq. ft.; provided that (.c) If the green roof conditions set forth at § 14-602(7) are met, the number of units allowed is twenty-five percent (25%) greater than indicated by the foregoing lot size requirements. Section 14-702 (7) (b) A floor area, height, or housing unit density bonus, as applicable if the

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Green Roof Bonus = 22 units x .25% = 5.5 units (5 rounded down) = 27 units Moderate Income Density Bonus = 27 units x .25% = 6.75 (6 rounded down) = 33 units

Cost Calculation: Lot Area Calculation: Lot Area (PDS) = 11,058 SF x 20 = \$221,160 Unit Calculation: 6 units earned x \$25,000 =\$150,000 Payment will be based on the Lot Area Calculation

Note 2: Minimum cear yard depth shall be the greater of 9 feet of 10% of the lot depth per Table 14-701-3. Minimum rear yard based on Lot Depth = 77'-4" x .1 = 7'- 9" *Proposed primary frontage by applicant is Bethlehem Pike, determination to be made by Comission.

Note 3: Per table 14-701-3 Dimensional Standards for Commercial Districts, Max Height ft = 38'-0". Section 14-702 (7) (b) A floor area, height, or housing unit density bonus, as applicable if the owner of the property enters into a payment-in-lieu agreement that meets the standards set forth in subsection (.6). Per Additional Building Height table, 7'-0" of height bonus. Section 14-202(6) Rules of Measurement - Height, Building or Structure: The vertical distance from the average ground level at the base of the structure to the top of the

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Note 4: Per 14-705(2)(c)(.2)(.a): At least one street tree per 35 ft. of linear front shall be provided. Street trees may be placed at regular or irregular intervals, provided that there is at least 15 ft. of space between tree trunks.

234'-10" (linear frontage) / 35 = 7 Street Trees (rounded up) Project provides 6 new trees and 1 existing to remain.

Note 5: Bay Windows provided in compliance with Section 11-603 (4) Projections Over the Street- Balconies and Bay Windows. Bethlehem Pike - 87'-10" of frontage (three allowed for 63'-0" of frontage) Level 3: 3 bays provided (3 allowed), Level 4: 2 bays provided (3 allowed), Level 5: 1 bay provided (3 allowed) Summit Street - 67'-0" of frontage (three allowed for 63'-0" of frontage)

Note 6: Per Table 14-803-1: Off Street Loading, Loading Spaces are not required if Residential use is less than 100,000 Gross Floor Area (Sq. Ft.)

Level 3: 2 bays provided (3 allowed), Level 4: 2 bays provided (3 allowed)

Note 7: Per 14-604(5), roof decks are permitted for residential use in all zoning districts. Roof deck setback is greater than 5 ft from the front building line. Roof access structures can exceed 125 sf. Stairs do not exceed 10 ft in height above the surface of the roof deck. Per Table 14-701-6, penthouses in Commercial districts for roof structures housing elevators are an exception to dimensional standard

Note 8: Per 14-803 (5) (c) (1) When a parking lot abuts a residential district, a contiuous screening wall at least five ft tall shall be provided. The screening material shall be desiged to provide 75% opacity.

Note 9: Herbaceous plants or lawn installed in the required landscaped area shall be from the list of appropriate plantings per § 14-705 of the Philadelphia Zening Code

A green roof is being provided to decrease surface water runoff.

will not be increased by more than 1,400 sq ft.

3.8% at steepest point.

Note 10: WWO Wissahickon Watershead Overlay District 14-510 (6) Category 5 - No Limit to Impervious Ground Coverage Existing site is currently 95% Impervious (11,058 SF (PSD) with 551 Sq Ft of landscaping).

The infiltration capacity of the site will be increased not diminished. Note 10: Steep Slope Protection 14-704 (2) (a.) A disturbance of lot area greater than 1,400 sq ft or on which the proposed activity will increase the impervious ground cover on the lot by more than 1,400 sq ft. Existing site has 551 sf of existing pervious ground cover. Impervious coverage

(b.) Slopes of fifteen percent (15%) of greater on any lot of portion(s) thereof. Steep Slope Calculation Property Line 210'-10": Low Point = 437.8' High Point = 441.5', **Slope = 1.74%** Property Line 66'-11": Low Point = 440.3' High Point = 441.5', **Slope = 1.79**% Property Line 88'-2": Low Point = 437.5' High Point = 440.3', **Slope = 2.74**% Property Line 146'-8": Low Point = 436.36' High Point = 437.8', **Slope = 1% overall**,

Slope from Site Lowpoint to High Point: Low Point = 436.36' High Point = 441.5', Slope = Maximum Steep Slope calculated at 3.8%, steep slope provisions do not apply.

Versions

lo. Date Description

03/03/2021 ZONING

00/00/0000 ASI 000

COSCIA MOOS ARCHITECTURE

Coscia Moos Architecture 1616 Walnut Street, Suite 101 Philadelphia, PA 19103 267 761 9416

Civil Engineer

Maser Consulting 2 Penn Center, Suite 222 Philadelphia, PA 19102 215 861 9021

Signature and Seal


10 BETHLEHEM PIKE


10 BETHLEHEM PIKE, PHILADELPHIA PA

ZONING TABLE AND PLANS

03/03/2021 JAV As indicated

Sheet No.

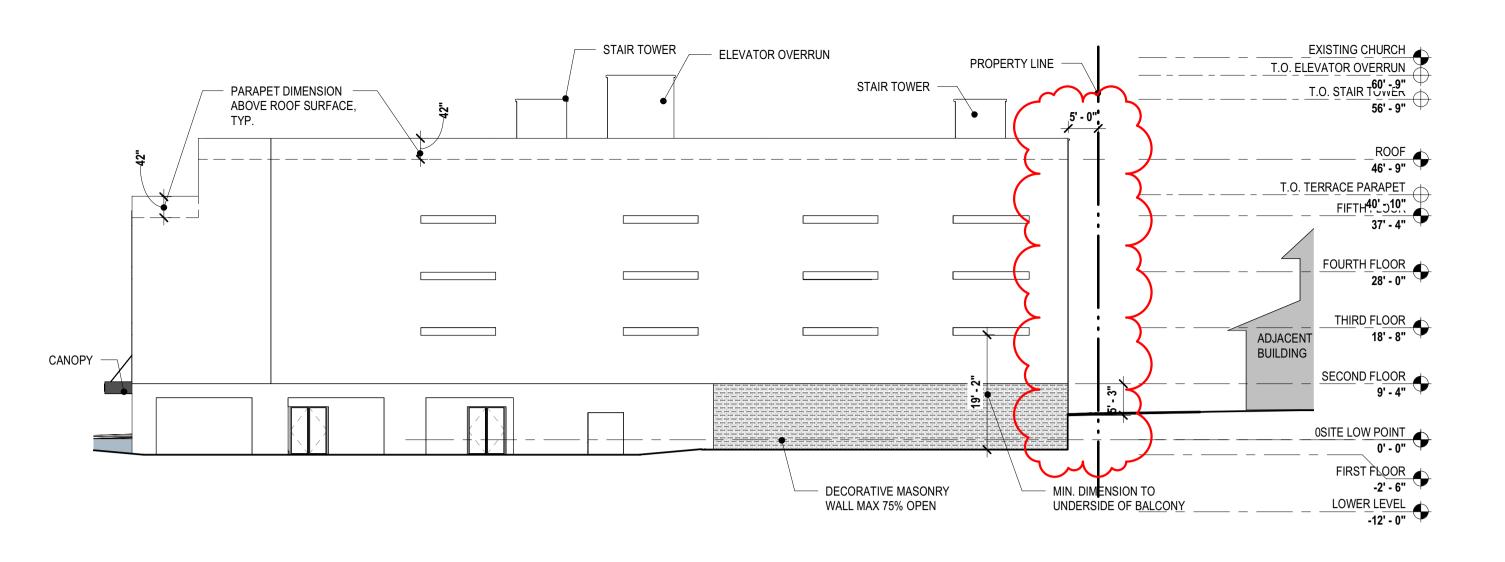

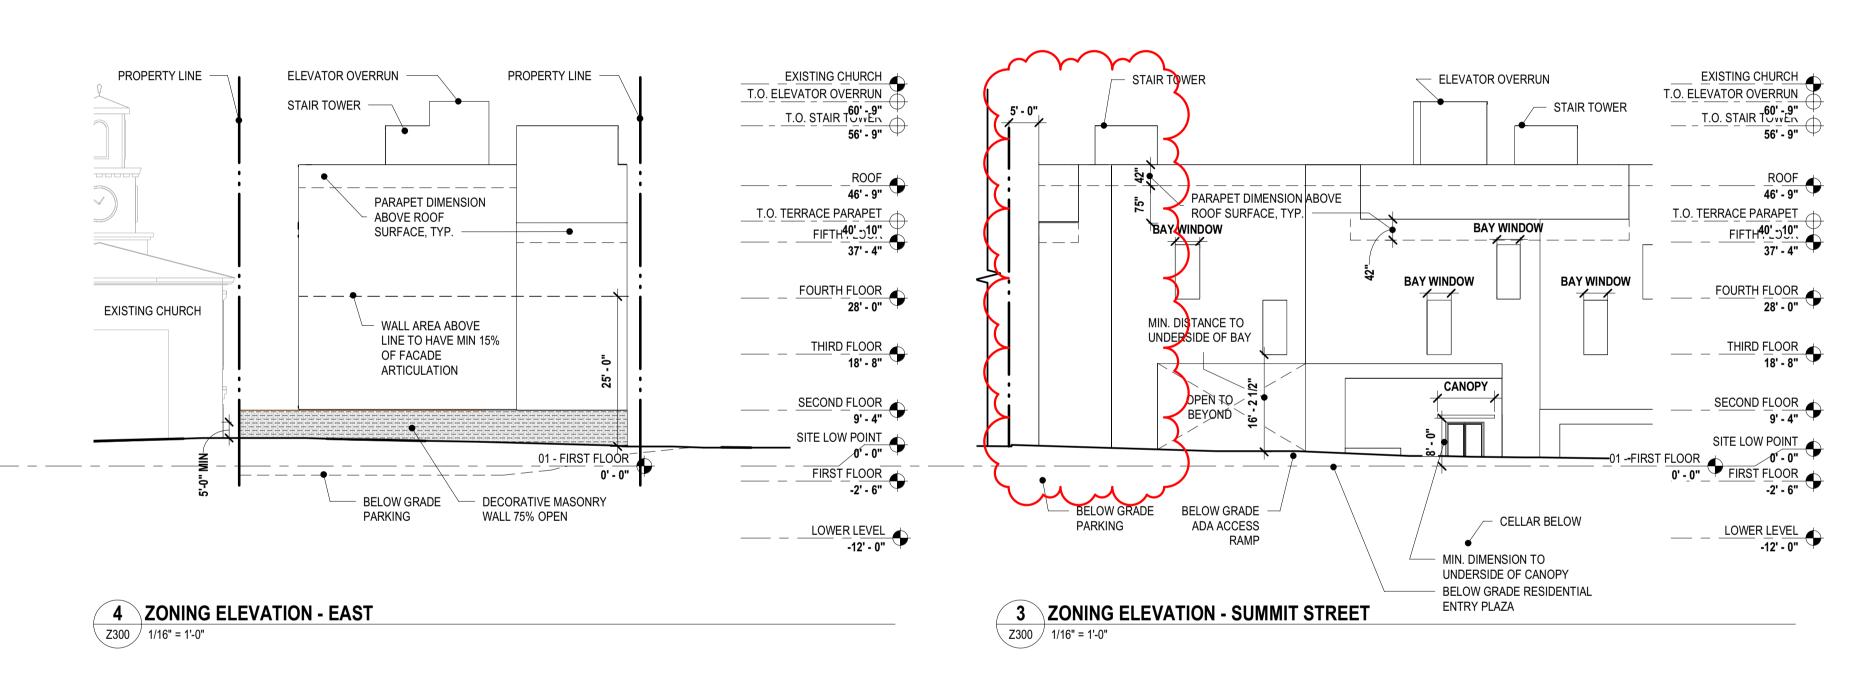


5 ZONING ELEVATION - SOUTH

X300 / 1/16" = 1'-0"

APPROVED

R ZONING ONLY

Applied Electronically by L&I User:

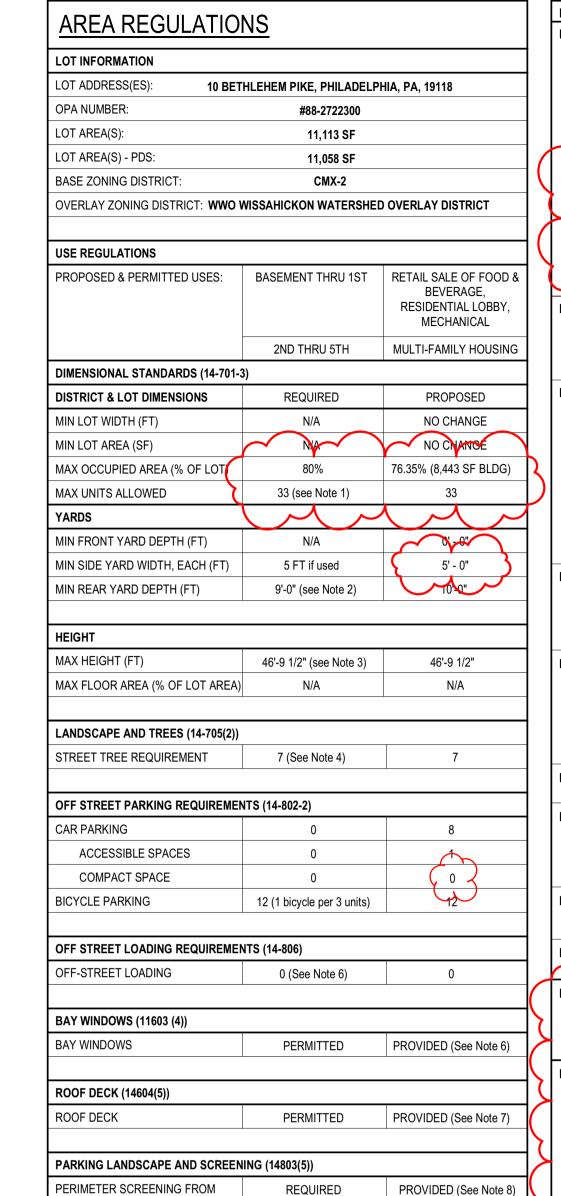

	<u>NS</u>		
LOT INFORMATION			
LOT ADDRESS(ES): 10 BET	HLEHEM PIKE, PHILADELP	PHIA, PA, 19118	
OPA NUMBER:	#88-2722300		
LOT AREA(S):	11,113 SF		
LOT AREA(S) - PDS:	11,058 SF		
BASE ZONING DISTRICT:	CMX-2		IJ
OVERLAY ZONING DISTRICT: WWO V	VISSAHICKON WATERSHE	D OVERLAY DISTRICT	
USE REGULATIONS			
PROPOSED & PERMITTED USES:	BASEMENT THRU 1ST	RETAIL SALE OF FOOD & BEVERAGE, RESIDENTIAL LOBBY, MECHANICAL	
	2ND THRU 5TH	MULTI-FAMILY HOUSING	
DIMENSIONAL STANDARDS (14-701-3			
DISTRICT & LOT DIMENSIONS	REQUIRED	PROPOSED	
MIN LOT WIDTH (FT)	N/A	NO CHANGE	
MIN LOT AREA (SF)	Nya	NO CHANGE	
MAX OCCUPIED AREA (% OF LOT	80%	76.35% (8,443 SF BLDG)	Ы
MAX UNITS ALLOWED	33 (see Note 1)	33)
YARDS	00 (000 Note 1)	1 ~ ~	
MIN FRONT YARD DEPTH (FT)	N/A	0\-0"	
MIN SIDE YARD WIDTH, EACH (FT)	5 FT if used	5' - 0"	
MIN REAR YARD DEPTH (FT)	9'-0" (see Note 2)		
WINT TEACH THE BETTING TO	0 0 (000 11010 2)		
HEIGHT			
MAX HEIGHT (FT)	46'-9 1/2" (see Note 3)	46'-9 1/2"	
MAX FLOOR AREA (% OF LOT AREA)	N/A	N/A	
LANDSCAPE AND TREES (14-705(2))			
STREET TREE REQUIREMENT	7 (See Note 4)	7	
OFF STREET PARKING REQUIREMEN			
CAR PARKING	0	8	
ACCESSIBLE SPACES	0		
COMPACT SPACE	0	0 3	-
BICYCLE PARKING	12 (1 bicycle per 3 units)	12	
OFF STREET LOADING REQUIREMEN	NTS (14-806)		
OFF-STREET LOADING	0 (See Note 6)	0	
BAY WINDOWS (11603 (4))			
BAY WINDOWS	PERMITTED	PROVIDED (See Note 6)	X
ROOF DECK (14604(5))			\setminus
NOO! DEON (14004(3))			
ROOF DECK	PERMITTED	PROVIDED (See Note 7)	/

660 SF OPEN PARKING

X.10% = 66 SF

114 SF (See Note 9)

			ו ו	NO===	
AREA REGULATIO	NS			NOTES	Section 14-602(4)(a)[2](.b) A minimum of 480 sq. ft. of lot area is required per dwelling unit
LOT INFORMATION				NOLE I	for the lot area in excess of 1,919 sq. ft.; provided that (.c) If the green roof conditions set
			1		forth at § 14-602(7) are met, the number of units allowed is twenty-five percent (25%) greater than indicated by the foregoing lot size requirements.
	HLEHEM PIKE, PHILADELPI	HIA, PA, 19118			Section 14-702 (7) (b) A floor area, height, or housing unit density bonus, as applicable if the
OPA NUMBER:	#88-2722300				owner of the property enters into a payment-in-lieu agreement that meets the standards set forth in subsection (-6). Per Housing Unit density Bonuses table, 25% increase in units
LOT AREA(S):	11,113 SF				permitted is provided for Moderate Income. Maximum units allowed = 1919 sf (3 units) + (11,058 SF-1919sf) / 480 SF per unit = 3
LOT AREA(S) - PDS:	11,058 SF		(units + 19 units = 22 units.
BASE ZONING DISTRICT:	CMX-2				Green Roof Bonus = 22 units x .25% = 5.5 units (5 rounded down) = 27 units Moderate Income Density Bonus = 27 units x .25% = 6.75 (6 rounded down) = 33 units
OVERLAY ZONING DISTRICT: WWO N	WISSAHICKON WATERSHED	OVERLAY DISTRICT		_	allowed.
HEE BECHI ATIONS			(Cost Calculation:
USE REGULATIONS	BASEMENT THRU 1ST	DETAIL CALE OF FOOD 9			Lot Area Calculation: Lot Area (PDS) = 11,058 SF x 20 = \$221,160 Unit Calculation: 6 units earned x \$25,000 =\$150,000
PROPOSED & PERMITTED USES:	BASEMENT THRU 151	RETAIL SALE OF FOOD & BEVERAGE,		7	Payment will be based on the Lot Area Calculation
		RESIDENTIAL LOBBY, MECHANICAL		Note 2:	Minimum rear yard depth shall be the greater of 9 feet or 10% of the lot depth per Table 14-701-3.
	2ND THRU 5TH	MULTI-FAMILY HOUSING			Minimum rear yard based on Lot Depth = 77'-4" x .1 = 7'- 9" *Proposed primary frontage by applicant is Bethlehem Pike, determination to be
DIMENSIONAL STANDARDS (14-701-3	3)				made by Comission.
DISTRICT & LOT DIMENSIONS	REQUIRED	PROPOSED		Note 3:	Per table 14-701-3 Dimensional Standards for Commercial Districts, Max Height ft = 38'-0". Section 14-702 (7) (b) A floor area, height, or housing unit density bonus, as applicable if
MIN LOT WIDTH (FT)	N/A	NO CHANGE			the owner of the property enters into a payment-in-lieu agreement that meets the standards
MIN LOT AREA (SF)	NA NA	NO CHAMGE			set forth in subsection (.6). Per Additional Building Height table, 7'-0" of height bonus. Section 14-202(6) Rules of Measurement - Height, Building or Structure: The vertical
MAX OCCUPIED AREA (% OF LOT	80%	76.35% (8,443 SF BLDG)	7		distance from the average ground level at the base of the structure to the top of the structure.
MAX UNITS ALLOWED	33 (see Note 1)	33			Building Height= 38'-0" + 7'-0" (multi-family height bonus) = 45'-0"
YARDS					Grade at Building Corners = 441', 440.2', 437.85', 436.8', 437.2' Average Grade = 438.61' = +1.81' (1'-9 1/2")
MIN FRONT YARD DEPTH (FT)	N/A	0/-0"			Total Building Height From Low Point (436.8") = 38'-0" + 7'-0" + 1'-9 1/2" = 46' - 9 1/2"
MIN SIDE YARD WIDTH, EACH (FT)	5 FT if used	5' - 0"		Note 4:	Per 14-705(2)(c)(.2)(.a): At least one street tree per 35 ft. of linear front shall be provided.
MIN REAR YARD DEPTH (FT)	9'-0" (see Note 2)	1000			Street trees may be placed at regular or irregular intervals, provided that there is at least 15 ft. of space between tree trunks.
					234'-10" (linear frontage) / 35 = 7 Street Trees (rounded up)
HEIGHT		I			Project provides 6 new trees and 1 existing to remain.
MAX HEIGHT (FT)	46'-9 1/2" (see Note 3)	46'-9 1/2"		Note 5:	Bay Windows provided in compliance with Section 11-603 (4) Projections Over the Street- Balconies and Bay Windows.
MAX FLOOR AREA (% OF LOT AREA)	N/A	N/A			Bethlehem Pike - 87'-10" of frontage (three allowed for 63'-0" of frontage) Level 3: 3 bays provided (3 allowed), Level 4: 2 bays provided (3 allowed), Level 5: 1 bay
LANDSCARE AND TREES (44 705(2))			1		provided (3 allowed)
LANDSCAPE AND TREES (14-705(2))	7 (Coo Note 4)	7			Summit Street - 67'-0" of frontage (three allowed for 63'-0" of frontage) Level 3: 2 bays provided (3 allowed), Level 4: 2 bays provided (3 allowed)
STREET TREE REQUIREMENT	7 (See Note 4)	7		Note 6:	Per Table 14-803-1: Off Street Loading, Loading Spaces are not required if
OFF STREET PARKING REQUIREMEN	NTS (14-802-2)				Residential use is less than 100,000 Gross Floor Area (Sq. Ft.)
CAR PARKING	0	8		Note 7:	Per 14-604(5), roof decks are permitted for residential use in all zoning districts. Roof deck setback is greater than 5 ft from the front building line.
ACCESSIBLE SPACES	0	_	1		Roof access structures can exceed 125 sf. Stairs do not exceed 10 ft in height above the
COMPACT SPACE	0	(0)			surface of the roof deck. Per Table 14-701-6, penthouses in Commercial districts for roof structures housing elevators are an exception to dimensional standard
BICYCLE PARKING	12 (1 bicycle per 3 units)	12		Note 8:	Per 14-803 (5) (c) (1) When a parking lot abuts a residential district, a continuous screening
	·	·			wall at least five ft tall shall be provided. The screening material shall be desiged to provide 75% opacity.
OFF STREET LOADING REQUIREMEN	NTS (14-806)			Note 9:	Herbaceous plants or lawn installed in the required landscaped area shall be from
OFF-STREET LOADING	0 (See Note 6)	0		<u>~</u>	the list of appropriate plantings per § 14-705 of the Philadelphia Zening Code
				Note 10	:WWO Wissahickon Watershead Overlay District 14-510 (6) Category 5 - No Limit to Impervious Ground Coverage
BAY WINDOWS (11603 (4))			1		Existing site is currently 95% Impervious (11,058 SF (PSD) with 551 Sq Ft of landscaping).
BAY WINDOWS	PERMITTED	PROVIDED (See Note 6)			A green roof is being provided to decrease surface water runoff. The infiltration capacity of the site will be increased not diminished.
				Note 10	Steep Slope Protection 14-704 (2)
ROOF DECK (14604(5))			کرا		(a.) A disturbance of lot area greater than 1,400 sq ft or on which the proposed activity will increase the impervious ground cover on the lot by more than 1,400 sq ft.
ROOF DECK	PERMITTED	PROVIDED (See Note 7)	1/	Ī	Existing site has 551 st of existing pervious ground cover. Impervious coverage

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Existing site has 551 sf of existing pervious ground cover. Impervious coverage

(b.) Slopes of fifteen percent (15%) of greater on any lot of portion(s) thereof.

Property Line 210'-10": Low Point = 437.8' High Point = 441.5', **Slope = 1.74%**

Property Line 66'-11": Low Point = 440.3' High Point = 441.5', **Slope = 1.79%**

Property Line 88'-2": Low Point = 437.5' High Point = 440.3', **Slope = 2.74%**

Property Line 146'-8": Low Point = 436.36' High Point = 437.8', **Slope = 1% overall**,

Maximum Steep Slope calculated at 3.8%, steep slope provisions do not apply.

Slope from Site Lowpoint to High Point: Low Point = 436.36' High Point = 441.5', Slope =

will not be increased by more than 1,400 sq ft.

Steep Slope Calculation

3.8% at steepest point.

Architect COSCIA MOOS ARCHITECTURE

Versions

Coscia Moos Architecture 1616 Walnut Street, Suite 101 Philadelphia, PA 19103 267 761 9416



Maser Consulting 2 Penn Center, Suite 222 Philadelphia, PA 19102 215 861 9021

Signature and Seal

10 BETHLEHEM PIKE


10 BETHLEHEM PIKE, PHILADELPHIA PA


Sheet Title **ZONING TABLES & ELEVATIONS**

03/03/2021 JAV As indicated

Sheet No.

Z300

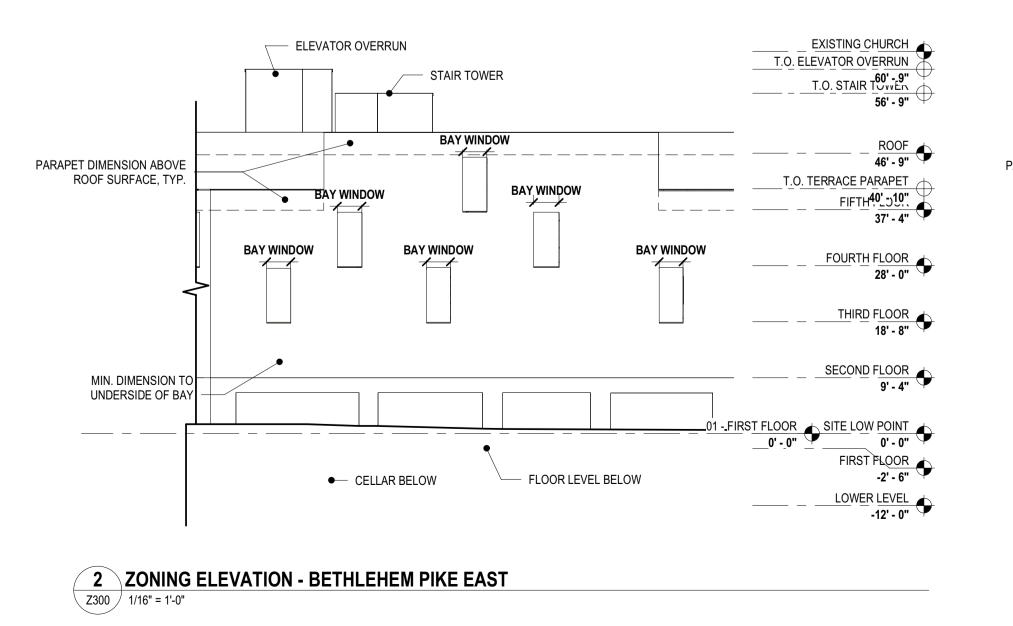


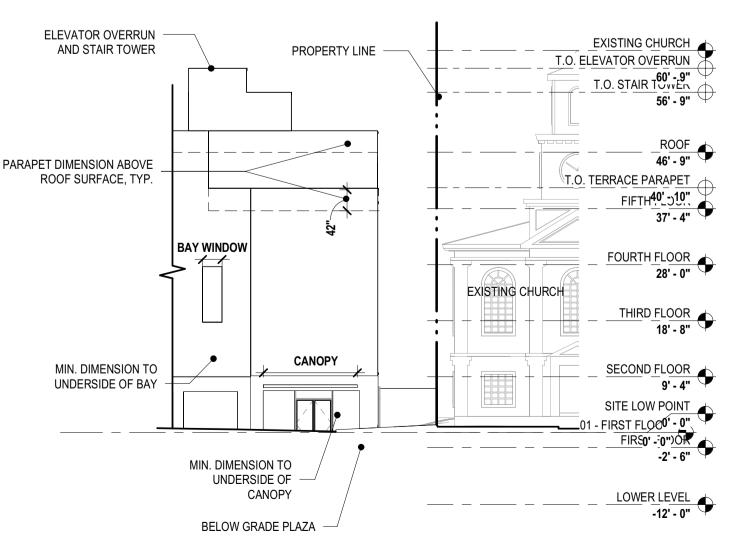

ADJACENT RESIDENTIAL LOTS

INTERIOR LANDSCAPE REQMNTS

1 ZONING ELEVATION - BETHLEHEM PIKE NORTH Z300 1/16" = 1'-0"

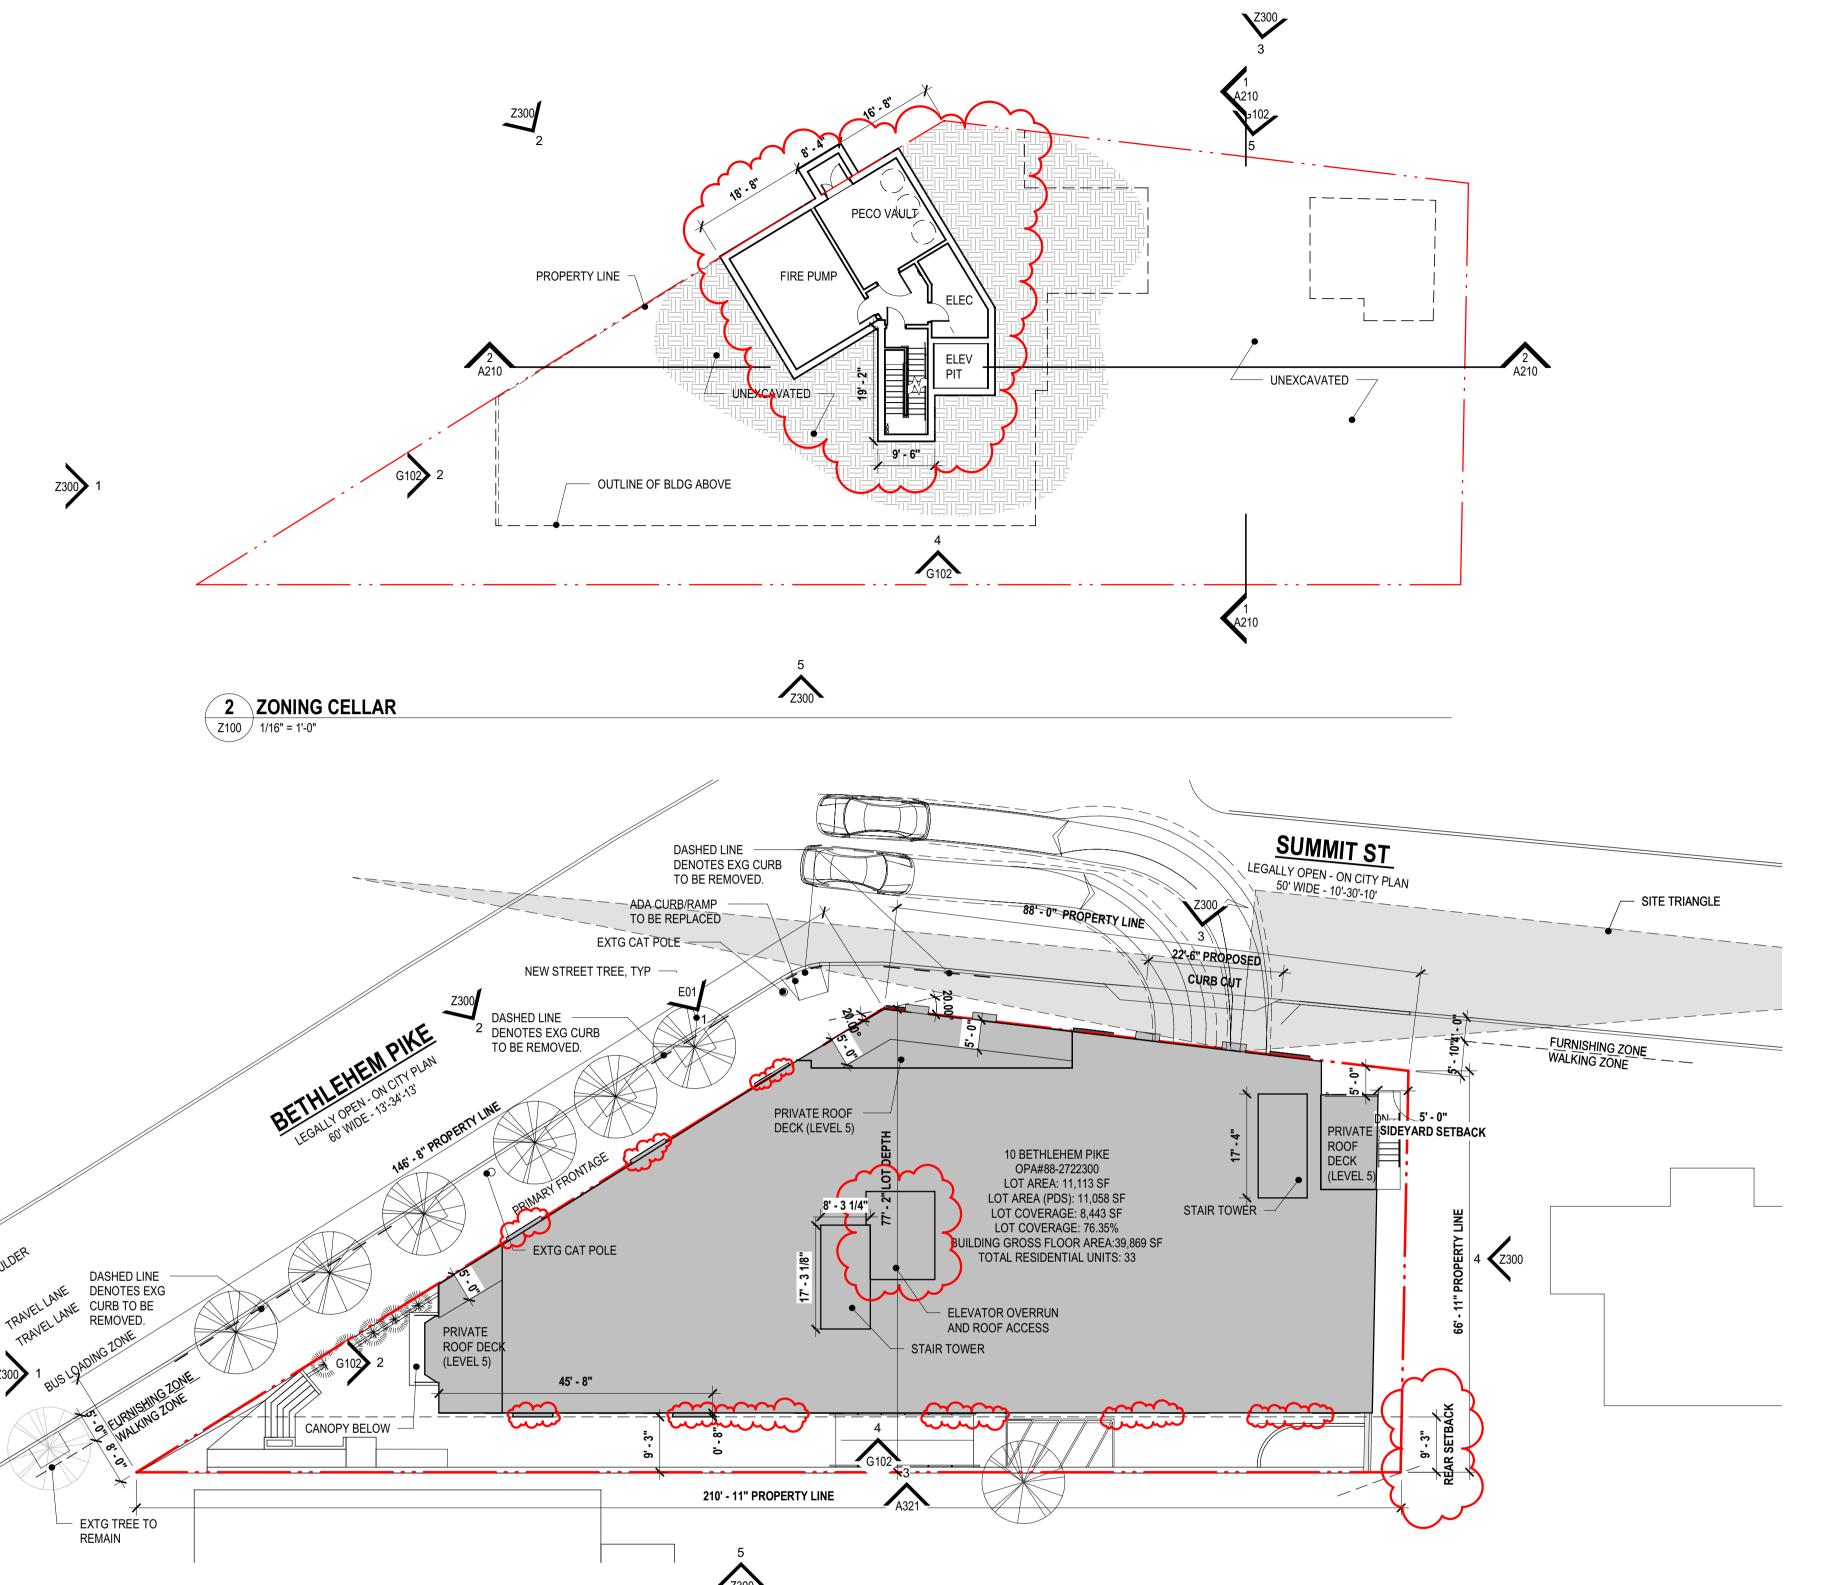

1 ZONING SITE PLAN

Z100 1/16" = 1'-0"

APPROVED FOR ZONING ONLY

WHEN YOUR PLANS CONTAIN ANY OMISSION, ERROR OR DEVIATION FROM THESE APPROVED PLANS IT WILL REQUIRE THE APPROVAL OF THE DEPARTMENT OF LICENSES & INSPECTIONS.

Applied Electronically by L&I User:

LOT INFORMATION					
LOT ADDRESS(ES): 10 BET	HLEHEM PIKE, PHILADELP	HIA, PA, 19118			
OPA NUMBER:	#88-2722300				
LOT AREA(S):	11,113 SF				
LOT AREA(S) - PDS:	11,058 SF				
BASE ZONING DISTRICT:	CMX-2				
OVERLAY ZONING DISTRICT: WWO N	WISSAHICKON WATERSHEE	O OVERLAY DISTRICT			
USE REGULATIONS					
PROPOSED & PERMITTED USES:	BASEMENT THRU 1ST	RETAIL SALE OF FOOD BEVERAGE, RESIDENTIAL LOBBY MECHANICAL			
	2ND THRU 5TH	MULTI-FAMILY HOUSIN			
DIMENSIONAL STANDARDS (14-701-3	3)				
DISTRICT & LOT DIMENSIONS	REQUIRED	PROPOSED			
MIN LOT WIDTH (FT)	N/A	NO CHANGE			
MIN LOT AREA (SF)	N/A	NO CHANGE			
MAX OCCUPIED AREA (% OF LOT)	80%	76.35% (8,443 SF BLDG			
MAX UNITS ALLOWED	33 (see Note 1)	33			
YARDS		1			
MIN FRONT YARD DEPTH (FT)	N/A	0' - 0"			
MIN SIDE YARD WIDTH, EACH (FT)	5 FT if used	5' - 0"			
MIN REAR YARD DEPTH (FT)	9'-0" (see Note 2)	10'-0"			
HEIGHT					
MAX HEIGHT (FT)	46'-9 1/2" (see Note 3)	46'-9 1/2"			
MAX FLOOR AREA (% OF LOT AREA)	N/A	N/A			
LANDSCAPE AND TREES (14-705(2))					
STREET TREE REQUIREMENT	7 (See Note 4)	7			
OFF STREET PARKING REQUIREMEN	NTS (14-802-2)				
CAR PARKING	0	8			
ACCESSIBLE SPACES	0	11			
COMPACT SPACE	0				
BICYCLE PARKING	12 (1 bicycle per 3 units)	12			
OFF STREET LOADING REQUIREMEN	NTS (14-806)				
OFF-STREET LOADING	0 (See Note 6)	0			
BAY WINDOWS (11603 (4))					
BAY WINDOWS	PERMITTED	PROVIDED (See Note 6)			
ROOF DECK (14604(5))					
ROOF DECK	PERMITTED	PROVIDED (See Note 7)			
DADVING LANDOGADE AND CODE	IINO (44000/5))				
PARKING LANDSCAPE AND SCREEN		DDOVIDED (O. 11)			
PERIMETER SCREENING FROM ADJACENT RESIDENTIAL LOTS	REQUIRED 660 SF OPEN PARKING	PROVIDED (See Note 8) 114 SF (See Note 9)			
INTERIOR LANDSCAPE REQMNTS		444 OF (O N - t - O)			

NOTES	
Note 1: Section 14-602(4)(a)[2](.b) A minimum of 480 sq. ft. of lot area is required p	er dwelling unit
for the lot area in excess of 1,919 sq. ft.; provided that (.c) If the green roof	conditions set
forth at § 14-602(7) are met, the number of units allowed is twenty-five perc	ent (25%)

for the lot area in excess of 1,919 sq. ft.; provided that (.c) If the green roof conditions set forth at § 14-602(7) are met, the number of units allowed is twenty-five percent (25%) greater than indicated by the foregoing lot size requirements.

Section 14-702 (7) (b) A floor area, height, or housing unit density bonus, as applicable if the owner of the property enters into a payment-in-lieu agreement that meets the standards set forth in subsection (6). Part leaving that density Boryana table 25% increase in units

forth in subsection (.6). Per Housing Unit density Bonuses table, 25% increase in units permitted is provied for Moderate Income.

Maximum units allowed = 1919 sf (3 units) + (11,058 SF-1919sf) / 480 SF per unit = 3 units + 19 units = 22 units.

units + 19 units = 22 units.

Green Roof Bonus = 22 units x .25% = 5.5 units (5 rounded down) = 27 units

Moderate Income Density Bonus = 27 units x .25% = 6.75 (6 rounded down) = 33 units allowed.

Cost Calculation:

Lot Area Calculation: Lot Area (PDS) = 11,058 SF x 20 = \$221,160

Unit Calculation: 6 units earned x \$25,000 =\$150,000

Payment will be based on the Lot Area Calculation

Note 2: Minimum rear yard depth shall be the greater of 9 feet or 10% of the lot depth per Table 14-701-3.

Minimum rear yard based on Lot Depth = 77'-4" x .1 = 7'-9"

*Proposed primary frontage by applicant is Bethlehem Pike, determination to be made by Comission.

Note 3: Per table 14-701-3 Dimensional Standards for Commercial Districts, Max Height ft = 38'-0". Section 14-702 (7) (b) A floor area, height, or housing unit density bonus, as applicable if the owner of the property enters into a payment-in-lieu agreement that meets the standards set forth in subsection (.6). Per Additional Building Height table, 7'-0" of height bonus. Section 14-202(6) Rules of Measurement - Height, Building or Structure: The vertical distance from the average ground level at the base of the structure to the top of the

Building Height= 38'-0" + 7'-0" (multi-family height bonus) = 45'-0"
Grade at Building Corners = 441', 440.2', 437.85', 436.8', 437.2'
Average Grade = 438.61' = +1.81' (1'-9 1/2")
Total Building Height From Low Point (436.8") = 38'-0" + 7'-0" + 1'-9 1/2"
= 46' - 9 1/2"

Note 4: Per 14-705(2)(c)(.2)(.a): At least one street tree per 35 ft. of linear front shall be provided. Street trees may be placed at regular or irregular intervals, provided that there is at least 15 ft. of space between tree trunks.

234'-10" (linear frontage) / 35 = 7 Street Trees (rounded up)

Project provides 6 new trees and 1 existing to remain.

Note 5: Bay Windows provided in compliance with Section 11-603 (4) Projections over the Street- Balconies and Bay Windows.

Bethlehem Pike - 87'-10" of frontage (three allowed for 63'-0" of frontage)
3 bays provided (3 allowed)

Summit Street - 67'-0" of frontage (three allowed for 63'-0" of frontage)
3 bays provided (3 allowed)

Note 6: Per Table 14-803-1: Off Street Loading, Loading Spaces are not required if Residential use is less than 100,000 Gross Floor Area (Sq. Ft.)

Note 7: Per 14-604(5), roof decks are permitted for residential use in all zoning districts.

Roof deck setback is greater than 5 ft from the front building line.

Roof access structures can exceed 125 sf. Stairs do not exceed 10 ft in height above the surface of the roof deck. Per Table 14-701-6, penthouses in Commercial districts for roof structures housing elevators are an exception to dimensional standard

Note 8: Per 14-803 (5) (c) (1) When a parking lot abuts a residential district, a contiuous screening wall at least five ft tall shall be provided. The screening material shall be desiged to provide 75% opacity.

Note 9: Herbaceous plants or lawn installed in the required landscaped area shall be from the list of appropriate plantings per § 14-705 of the Philadelphia Zoning Code

Note 10: WWO Wissahickon Watershead Overlay District 14-510 (6)

Category 5 - No Limit to Impervious Ground Coverage

Existing site is currently 95% Impervious (11,058 SF (PSD) with 551 Sq Ft of landscaping).

A green roof is being provided to decrease surface water runoff.

The infiltration capacity of the site will be increased not diminished.

Note 10:Steep Slope Protection 14-704 (2)

(a.) A disturbance of lot area greater than 1,400 sq ft or on which the proposed activity will increase the impervious ground cover on the lot by more than 1,400 sq ft.

Existing site has 551 sf of existing pervious ground cover. Impervious coverage will not be increased by more than 1,400 sq ft.

(b.) Slopes of fifteen percent (15%) of greater on any lot of portion(s) thereof. Steep Slope Calculation

Property Line 210'-10": Low Point = 437.8' High Point = 441.5', Slope = 1.74%


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Slope from Site Lowpoint to High Point: Low Point = 436.36' High Point = 441.5', **Slope = 2.92%**Maximum Steep Slope calculated at 3.8%, steep slope provisions do not apply.

CosciaMoos



Signature and Seal

10 BETHLEHEM PIKE

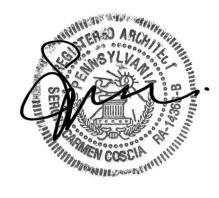10 BETHLEHEM PIKE, PHILADELPHIA PA 19118

PROJECT NO: 567

OWNER: Client Name Client Address

> Client URL Client Phone

ARCHITECT:
Coscia Moos Architecture
1616 Walnut Street

Philadelphia, PA 19103 www.cosciamoos.com 267-761-9416

Consultant 1 Address

Consultant 1 URL

CIVIL ENGINEER:

Consultant 1 Phone
STRUCTURAL ENGINEER:

Consultant 2 Consultant 2 Address

Consultant 2 URL Consultant 2 Phone

Consultant 3
Consultant 3 Address


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Consultant 3 URL
Consultant 3 Phone


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ZONING 03/03/2021
07/30/2021
ISSUED FOR CONSTRUCTION
SCALE: As indicated
DRAWN BY: JAV


ZONING TABLES & PLANS



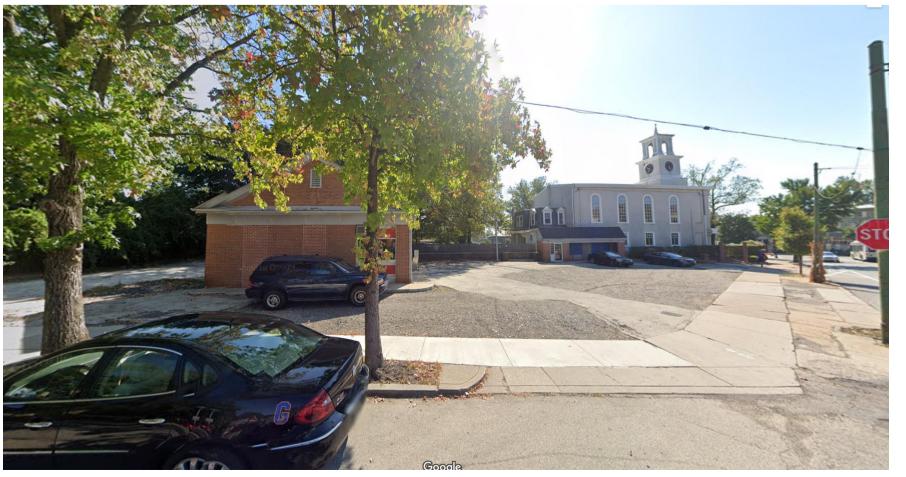

EXISTING SUMMIT ST STREET VIEW

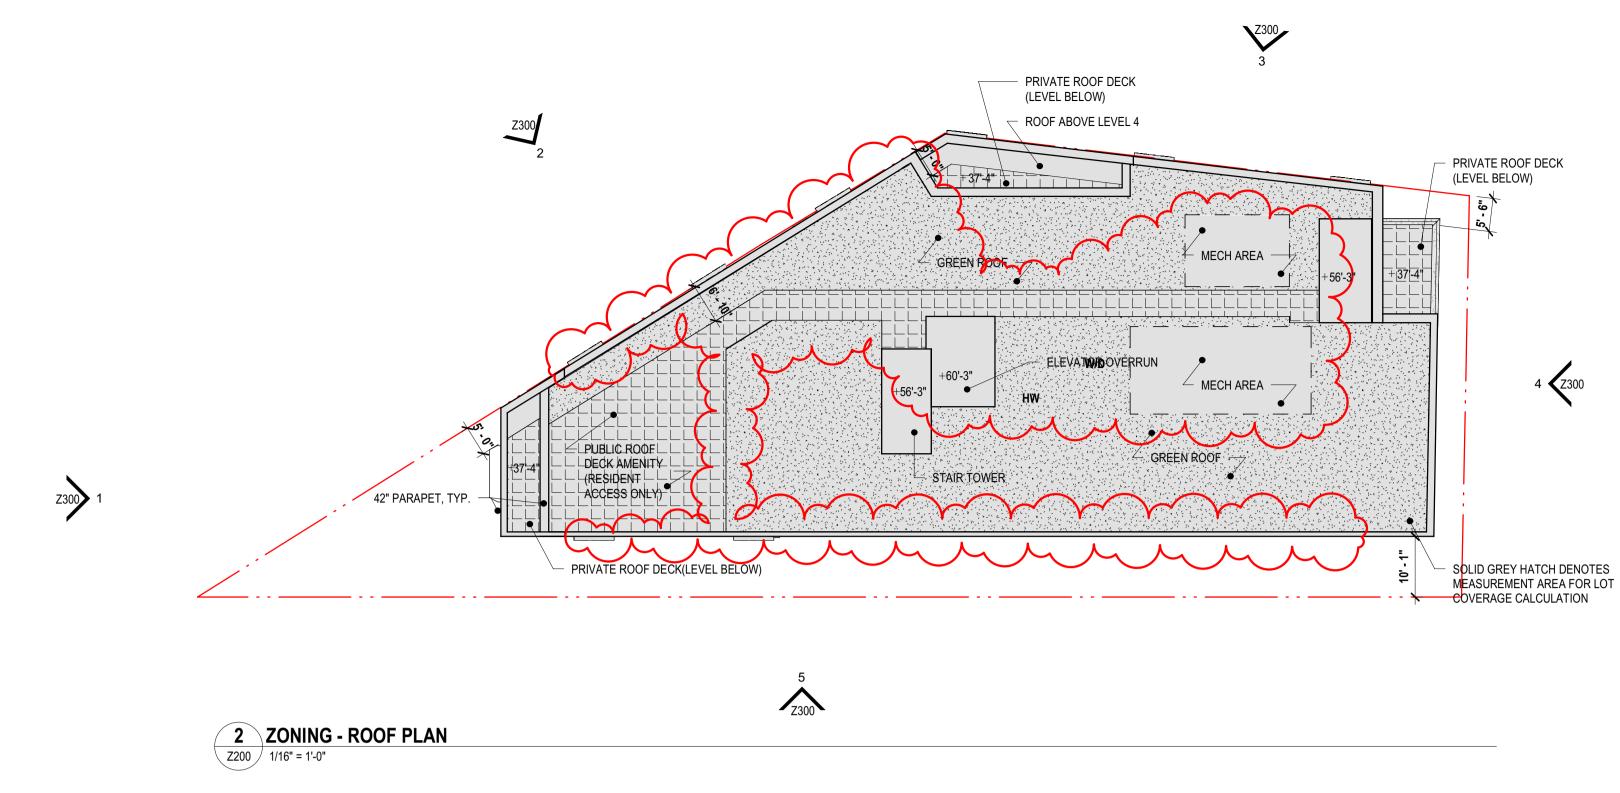

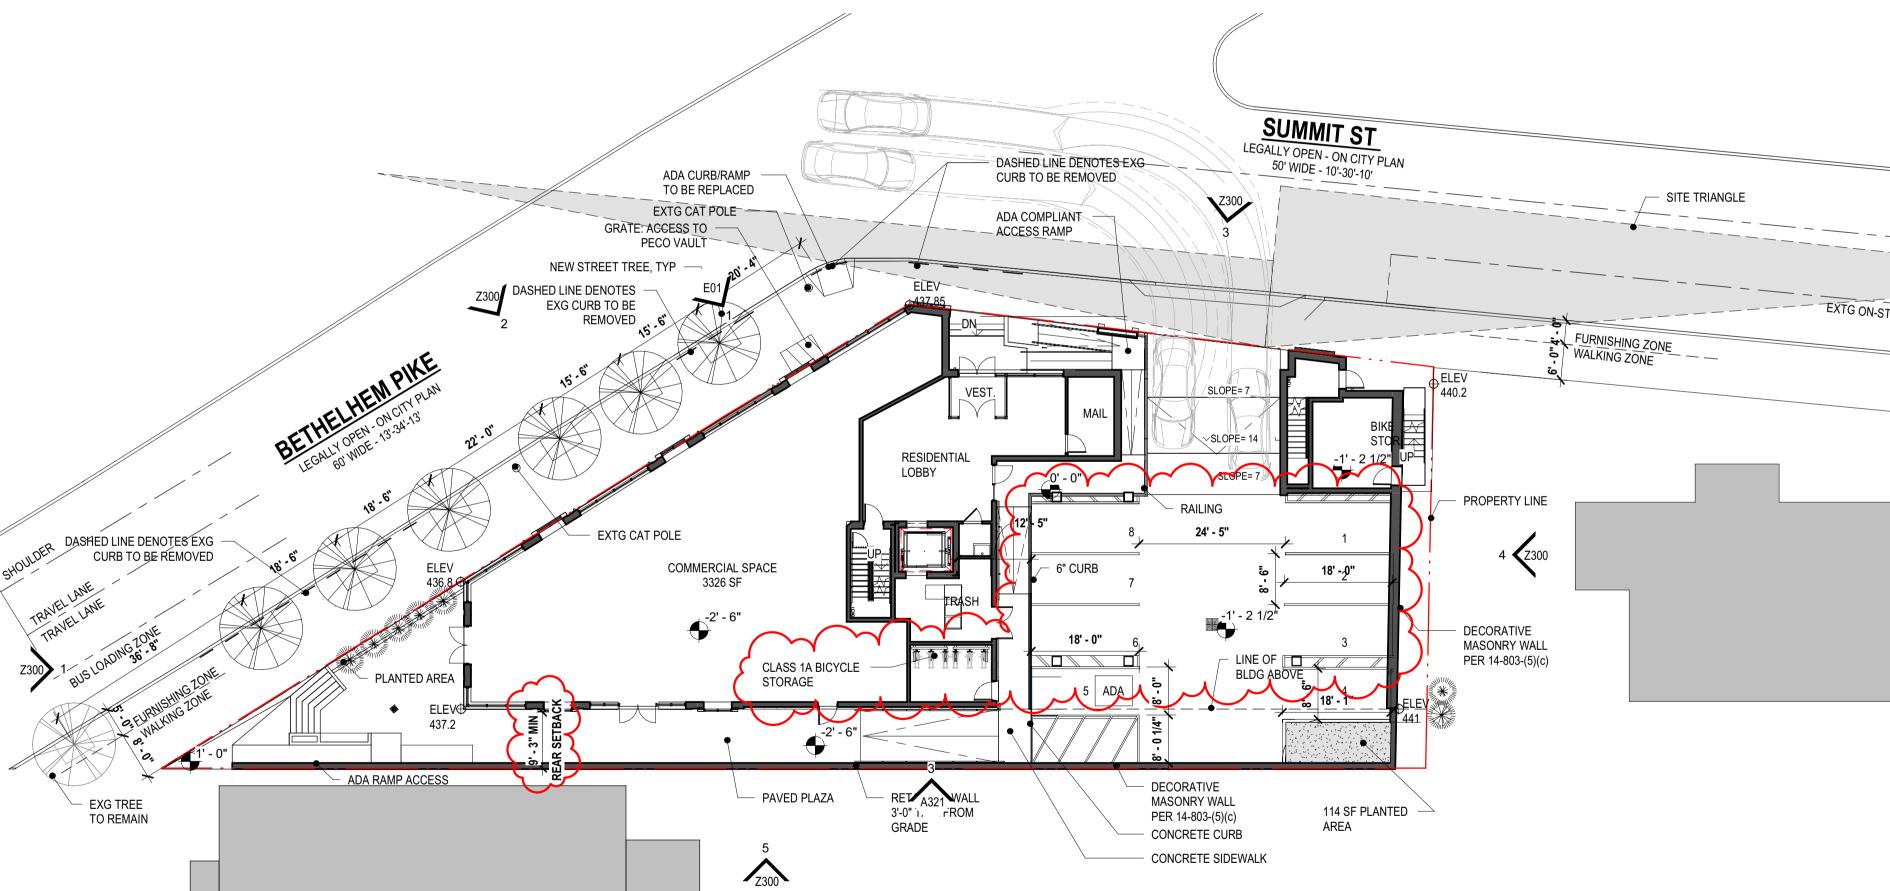

AREA REGULATIONS LOT INFORMATION LOT ADDRESS(ES): 10 BETHLEHEM PIKE, PHILADELPHIA, PA, 19118 OPA NUMBER: #88-2722300 LOT AREA(S): 11,113 SF LOT AREA(S) - PDS: 11,058 SF BASE ZONING DISTRICT: CMX-2 OVERLAY ZONING DISTRICT: WWO WISSAHICKON WATERSHED OVERLAY DISTRICT **USE REGULATIONS** PROPOSED & PERMITTED USES: BASEMENT THRU 1ST RETAIL SALE OF FOOD & BEVERAGE, RESIDENTIAL LOBBY, MECHANICAL 2ND THRU 5TH MULTI-FAMILY HOUSING **DIMENSIONAL STANDARDS (14-701-3)** REQUIRED PROPOSED DISTRICT & LOT DIMENSIONS MIN LOT WIDTH (FT) NO CHANGE MIN LOT AREA (SF) NO CHANGE MAX OCCUPIED AREA (% OF LOT) 76.35% (8,443 SF BLDG) 80% MAX UNITS ALLOWED 33 (see Note 1) YARDS MIN FRONT YARD DEPTH (FT) 0' - 0" MIN SIDE YARD WIDTH, EACH (FT) 5 FT if used 5' - 0" MIN REAR YARD DEPTH (FT) 10'-0" 9'-0" (see Note 2) HEIGHT MAX HEIGHT (FT) 46'-9 1/2" (see Note 3) 46'-9 1/2" MAX FLOOR AREA (% OF LOT AREA) N/A LANDSCAPE AND TREES (14-705(2)) STREET TREE REQUIREMENT 7 (See Note 4) OFF STREET PARKING REQUIREMENTS (14-802-2) **CAR PARKING** ACCESSIBLE SPACES COMPACT SPACE **BICYCLE PARKING** 12 (1 bicycle per 3 units) OFF STREET LOADING REQUIREMENTS (14-806) OFF-STREET LOADING 0 (See Note 6) **BAY WINDOWS (11603 (4))** BAY WINDOWS PERMITTED PROVIDED (See Note 6) **ROOF DECK (14604(5))** ROOF DECK PERMITTED PROVIDED (See Note 7) PARKING LANDSCAPE AND SCREENING (14803(5)) PERIMETER SCREENING FROM REQUIRED PROVIDED (See Note 8)

ADJACENT RESIDENTIAL LOTS INTERIOR LANDSCAPE REQMNTS 660 SF OPEN PARKING 114 SF (See Note 9) X.10% = 66 SF

Note 1: Section 14-602(4)(a)[2](.b) A minimum of 480 sq. ft. of lot area is required per dwelling unit for the lot area in excess of 1,919 sq. ft.; provided that (.c) If the green roof conditions set forth at § 14-602(7) are met, the number of units allowed is twenty-five percent (25%) greater than indicated by the foregoing lot size requirements. Section 14-702 (7) (b) A floor area, height, or housing unit density bonus, as applicable if the

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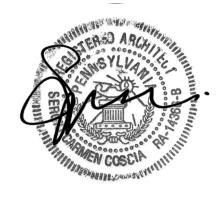
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Signature and Seal

10 BETHLEHEM

10 BETHLEHEM PIKE, PHILADELPHIA PA 19118

PROJECT NO: 567

Client Name Client Address

> Client URL Client Phone

Coscia Moos Architecture 1616 Walnut Street Philadelphia, PA 19103

www.cosciamoos.com

Consultant 1 Address

ARCHITECT:

267-761-9416 **CIVIL ENGINEER:**

Consultant 1 URL Consultant 1 Phone

STRUCTURAL ENGINEER: Consultant 2

Consultant 2 Address

Consultant 2 URL

Consultant 2 Phone

MEPFP ENGINEER: Consultant 3 Consultant 3 Address

Consultant 3 URL Consultant 3 Phone

1 ASI 000 00/00/0000 ZONING 03/03/2021 07/30/2021

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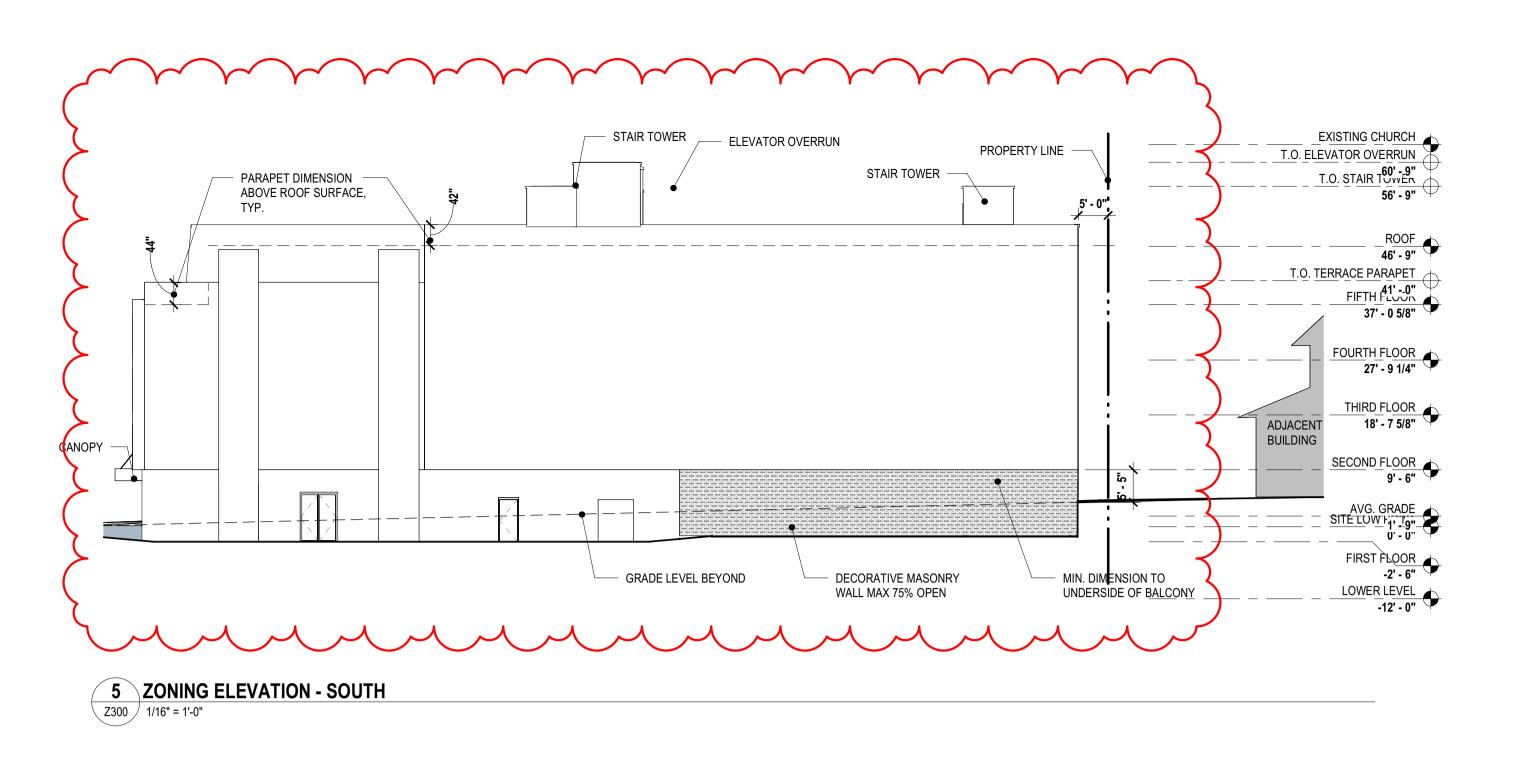
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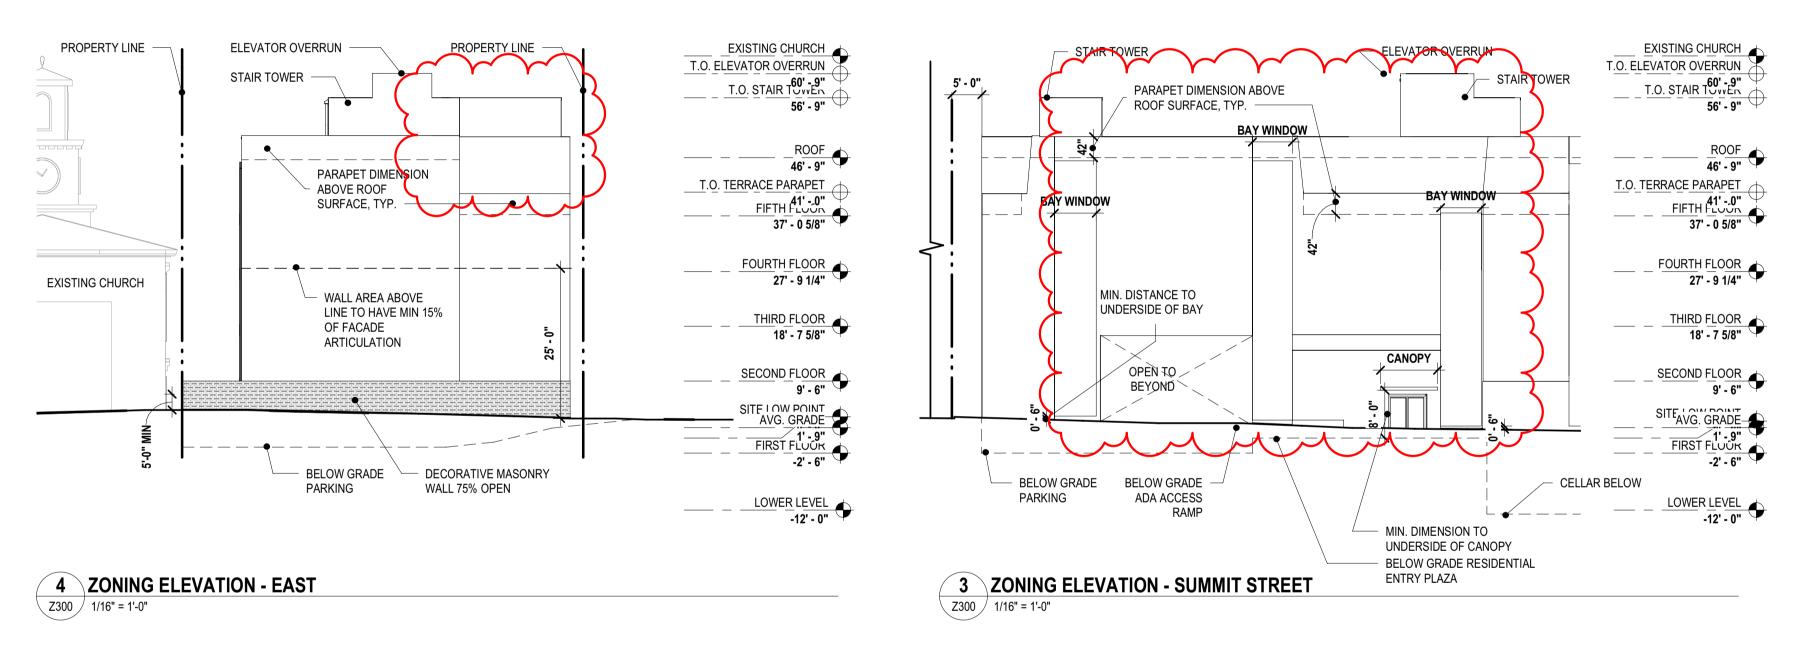
ZONING TABLE AND PLANS



1 ZONING - FIRST FLOOR PLAN

Z200 / 1/16" = 1'-0"





∠ Z300 / 1/16" = 1'-0"

LOT AREA(S):	11,113 SF	
LOT AREA(S) - PDS:	11,058 SF	
BASE ZONING DISTRICT:	CMX-2	
OVERLAY ZONING DISTRICT: WWO V	NISSAHICKON WATERSHE	O OVERLAY DISTRICT
USE REGULATIONS		
PROPOSED & PERMITTED USES:	BASEMENT THRU 1ST	RETAIL SALE OF FOOD BEVERAGE, RESIDENTIAL LOBBY MECHANICAL
	2ND THRU 5TH	MULTI-FAMILY HOUSIN
DIMENSIONAL STANDARDS (14-701-3	3)	
DISTRICT & LOT DIMENSIONS	REQUIRED	PROPOSED
MIN LOT WIDTH (FT)	N/A	NO CHANGE
MIN LOT AREA (SF)	N/A	NO CHANGE
MAX OCCUPIED AREA (% OF LOT)	80%	76.35% (8,443 SF BLDG
MAX UNITS ALLOWED	33 (see Note 1)	33
YARDS		
MIN FRONT YARD DEPTH (FT)	N/A	0' - 0"
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HEIGHT		
MAX HEIGHT (FT)	46'-9 1/2" (see Note 3)	46'-9 1/2"
MAX FLOOR AREA (% OF LOT AREA)	N/A	N/A
LANDSCAPE AND TREES (14-705(2))		
STREET TREE REQUIREMENT	7 (See Note 4)	7
OFF STREET PARKING REQUIREMEN	,	T
CAR PARKING	0	8
ACCESSIBLE SPACES	0	1
COMPACT SPACE	0	03
BICYCLE PARKING	12 (1 bicycle per 3 units)	12
OFF STREET LOADING REQUIREMEN	NTS (14-806)	
OFF-STREET LOADING	, ,	0
OTT-STREET LUADING	0 (See Note 6)	0
BAY WINDOWS (11603 (4))		
BAY WINDOWS	PERMITTED	PROVIDED (See Note 6)
DAT WINDOWS	FERIVITIEU	FINOVIDED (See Note 6)
ROOF DECK (14604(5))		
ROOF DECK	PERMITTED	PROVIDED (See Note 7)
		111111111111111111111111111111111111111
	UNIC (4.4002/5\)	
PARKING LANDSCAPE AND SCREEN	ING (14803(5))	

AREA REGULATIONS LOT INFORMATION LOT ADDRESS(ES) 10 BETHLEHEM PIKE, PHILADELPHIA, PA, 19118 OPA NUMBER: #88-2722300

NOTES Note 1: Section 14-602(4)(a)[2](.b) A minimum of 480 sq. ft. of lot area is required per dwelling unit for the lot area in excess of 1,919 sq. ft.; provided that (.c) If the green roof conditions set forth at § 14-602(7) are met, the number of units allowed is twenty-five percent (25%) greater than indicated by the foregoing lot size requirements. Section 14-702 (7) (b) A floor area, height, or housing unit density bonus, as applicable if the owner of the property enters into a payment-in-lieu agreement that meets the standards set forth in subsection (.6). Per Housing Unit density Bonuses table, 25% increase in units

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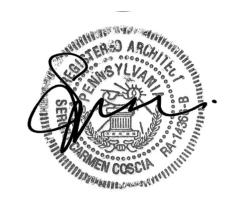
Note 10: WWO Wissahickon Watershead Overlay District 14-510 (6) Category 5 - No Limit to Impervious Ground Coverage Existing site is currently 95% Impervious (11,058 SF (PSD) with 551 Sq Ft of landscaping).

A green roof is being provided to decrease surface water runoff. The infiltration capacity of the site will be increased not diminished.

Note 10: Steep Slope Protection 14-704 (2) (a.) A disturbance of lot area greater than 1,400 sq ft or on which the proposed activity will increase the impervious ground cover on the lot by more than 1,400 sq ft. Existing site has 551 sf of existing pervious ground cover. Impervious coverage will not be increased by more than 1,400 sq ft.

(b.) Slopes of fifteen percent (15%) of greater on any lot of portion(s) thereof. Steep Slope Calculation Property Line 210'-10": Low Point = 437.8' High Point = 441.5', **Slope = 1.74%** Property Line 66'-11": Low Point = 440.3' High Point = 441.5', **Slope = 1.79**% Property Line 88'-2": Low Point = 437.5' High Point = 440.3', **Slope = 2.74%** Property Line 146'-8": Low Point = 436.36' High Point = 437.8', **Slope = 1% overall**, 3.8% at steepest point.

Slope from Site Lowpoint to High Point: Low Point = 436.36' High Point = 441.5', Slope = Maximum Steep Slope calculated at 3.8%, steep slope provisions do not apply.



Signature and Seal

10 BETHLEHEM

10 BETHLEHEM PIKE, PHILADELPHIA PA 19118

PROJECT NO: 567

Client Name Client Address

Client URL Client Phone

ARCHITECT:

Coscia Moos Architecture 1616 Walnut Street Philadelphia, PA 19103

www.cosciamoos.com

267-761-9416 **CIVIL ENGINEER:**

Consultant 1 URL

Consultant 1 Phone

Consultant 1 Address

STRUCTURAL ENGINEER: Consultant 2 Consultant 2 Address

Consultant 2 URL

Consultant 2 Phone

MEPFP ENGINEER: Consultant 3 Consultant 3 Address


Consultant 3 URL Consultant 3 Phone


1 ASI 000 00/00/0000 ZONING 03/03/2021 07/30/2021

> ISSUED FOR CONSTRUCTION SCALE: As indicated

DRAWN BY: JAV

ZONING TABLES & ELEVATIONS

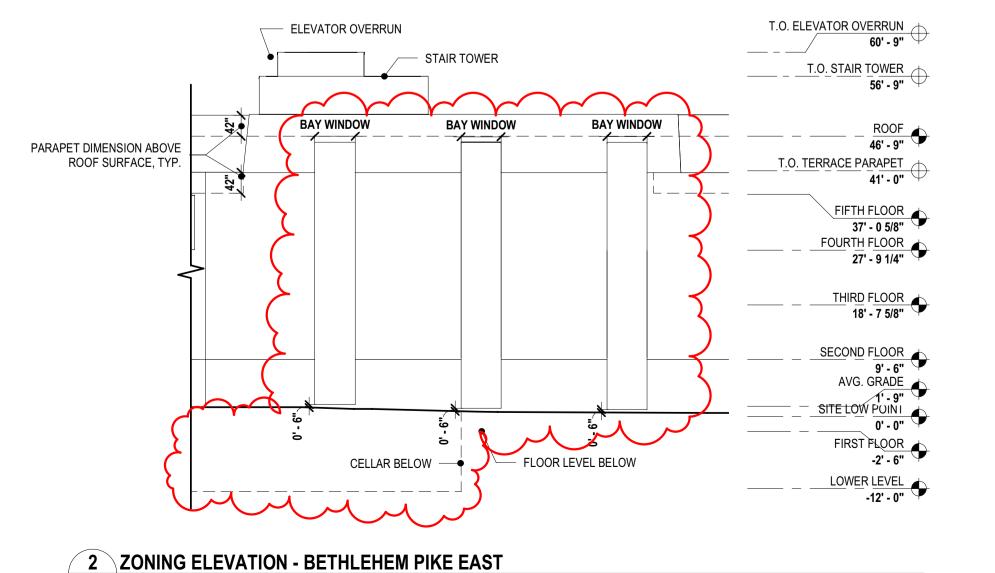

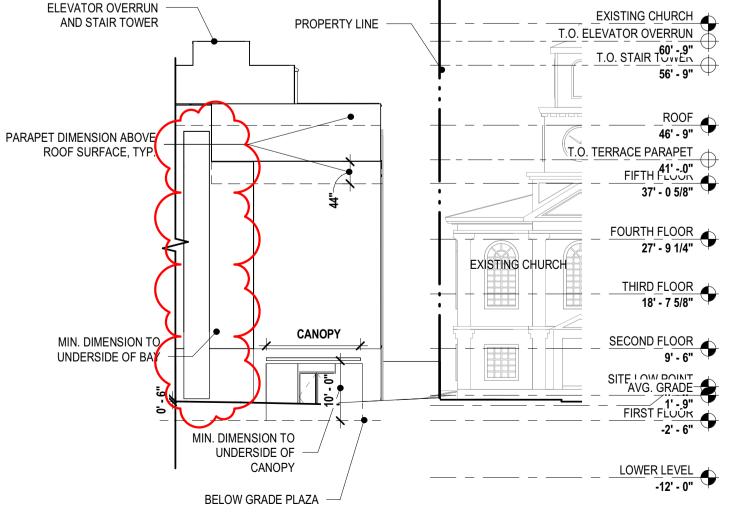

ADJACENT RESIDENTIAL LOTS

INTERIOR LANDSCAPE REQMNTS 660 SF OPEN PARKING

X.10% = 66 SF

114 SF (See Note 9)

1 ZONING ELEVATION - BETHLEHEM PIKE NORTH Z300 / 1/16" = 1'-0"







VIEW FROM BETHLEHEM PIKE




VIEW TOWARD BETHLEHEM PIKE (FROM SUMMIT ST)




VIEW FROM SUMMIT ST



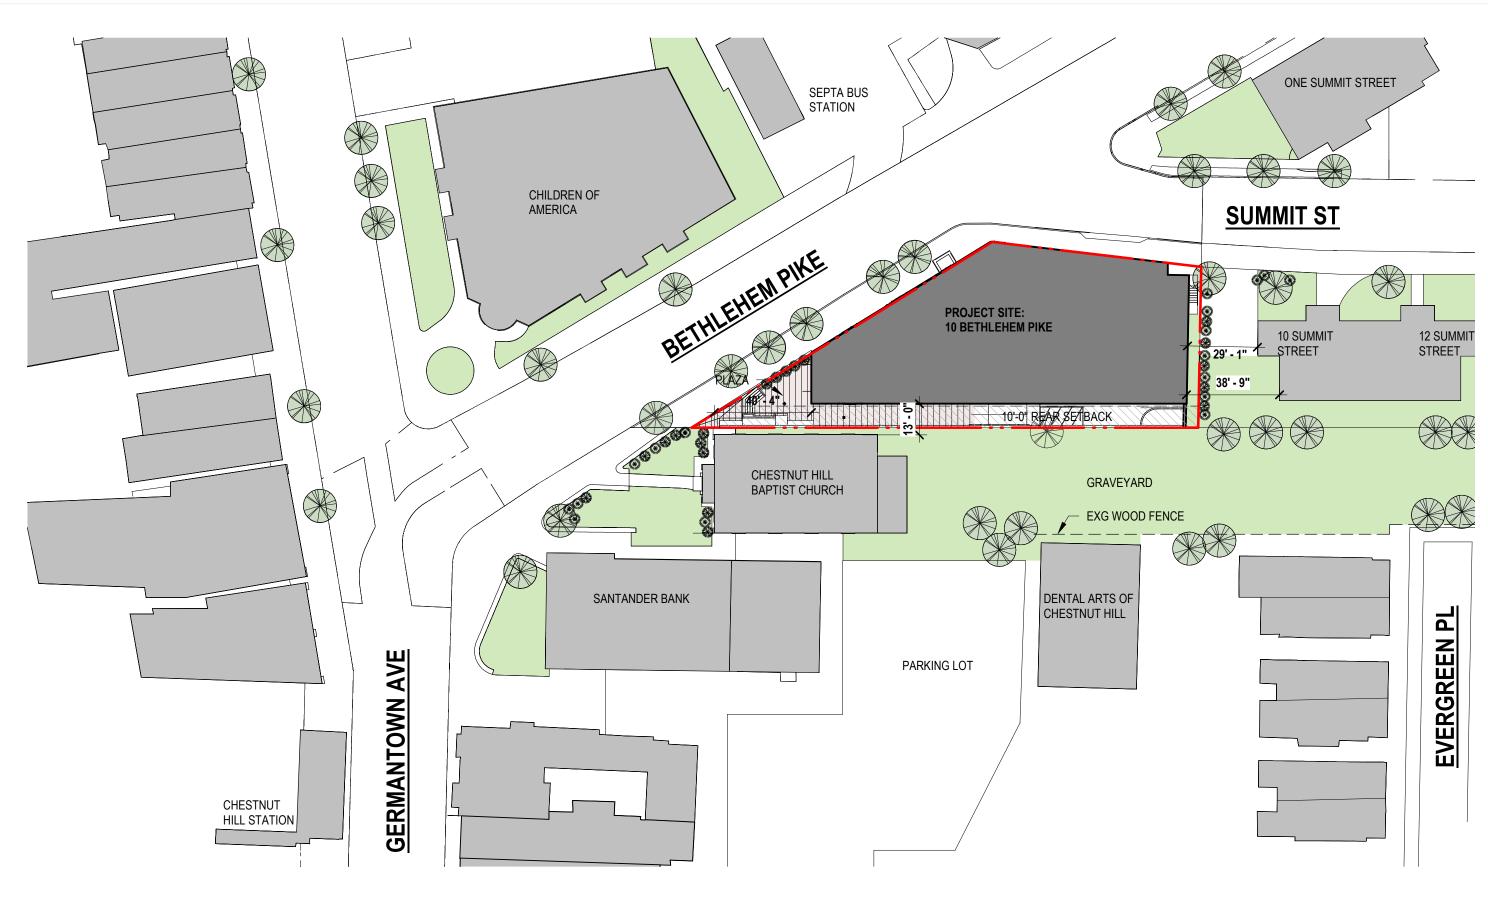




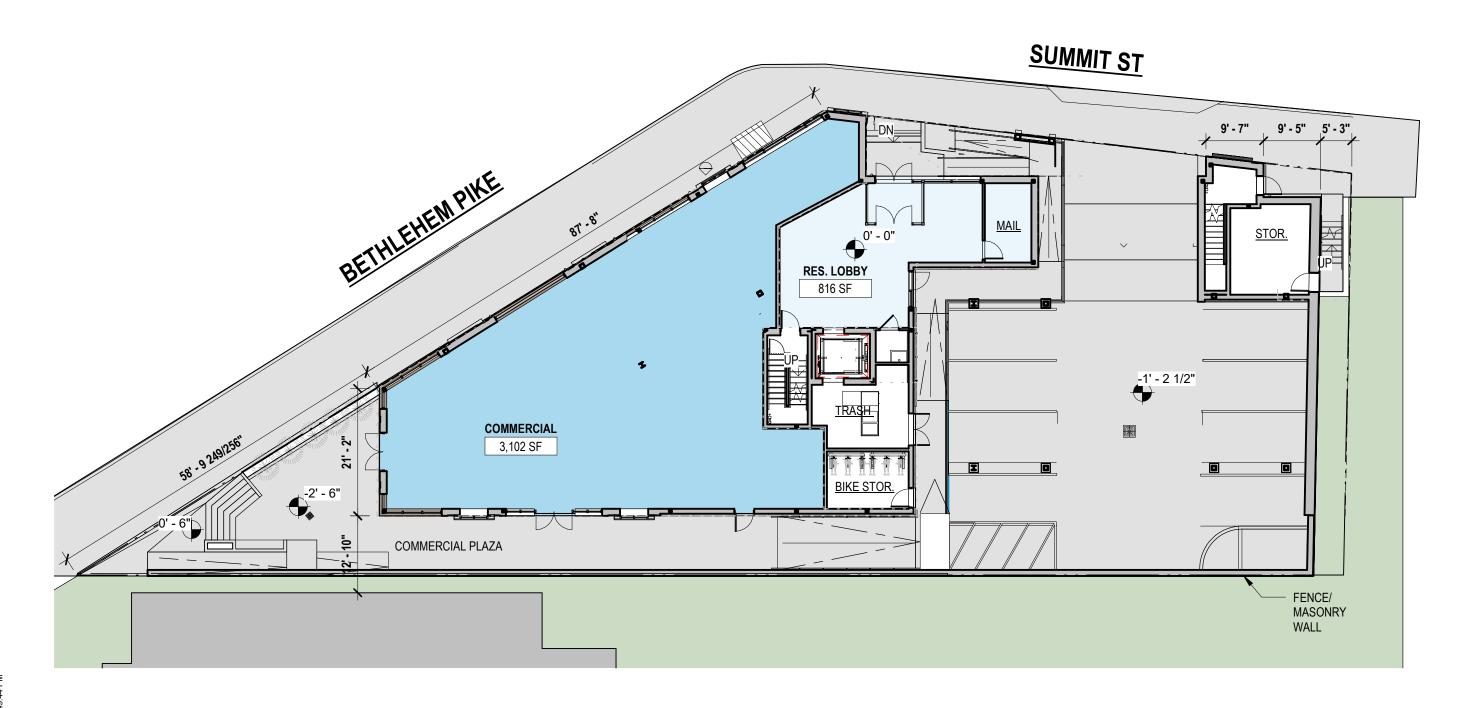



LEVEL 2 - APARTMENT MIX

1 BDR	4
2 BDR	3
UNIT TOTAL	

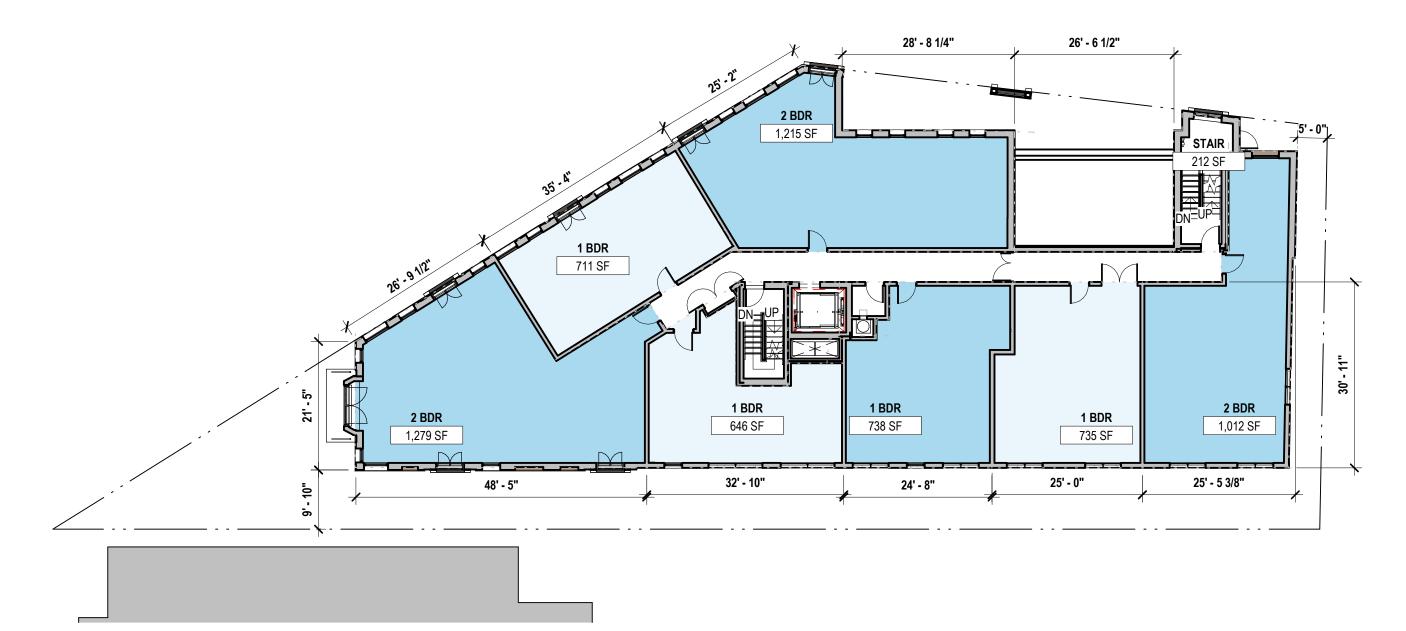




LEVEL 3&4 - APARTMENT MIX

1 BDR 2 BDR


UNIT TOTAL

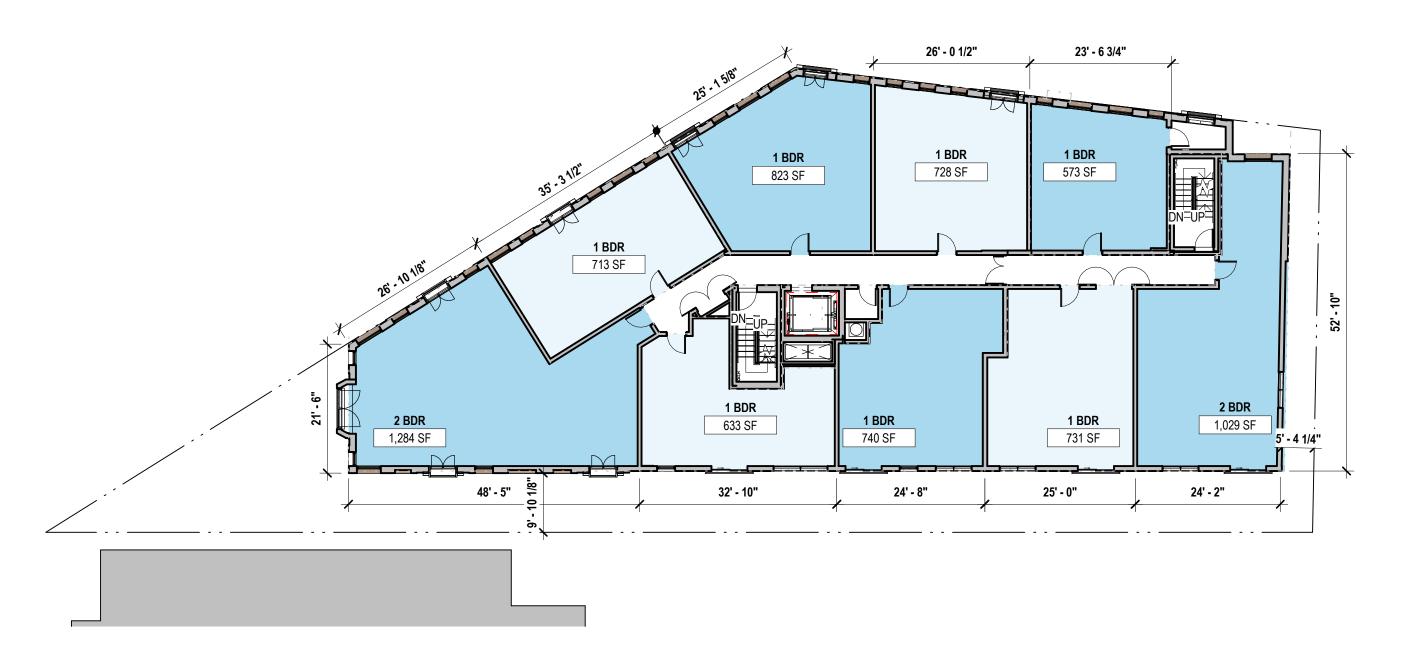



LEVEL 5 - APARTMENT MIX


1 BDR 2 BDR	
UNIT TOTAL	

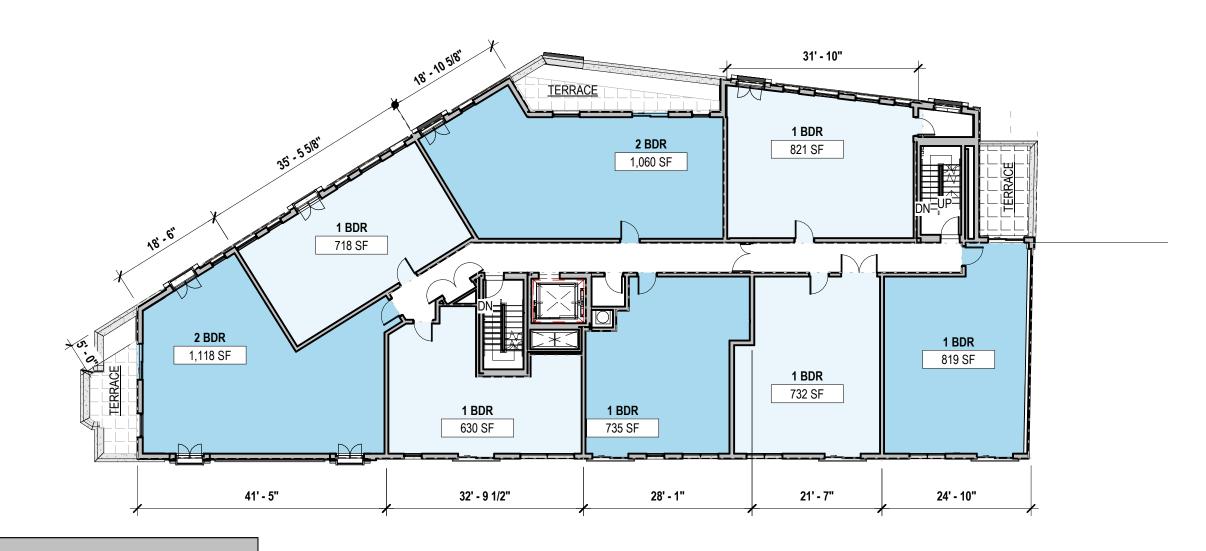




10 BETHLEHEM PIKE 5TH FLOOR PLAN A06



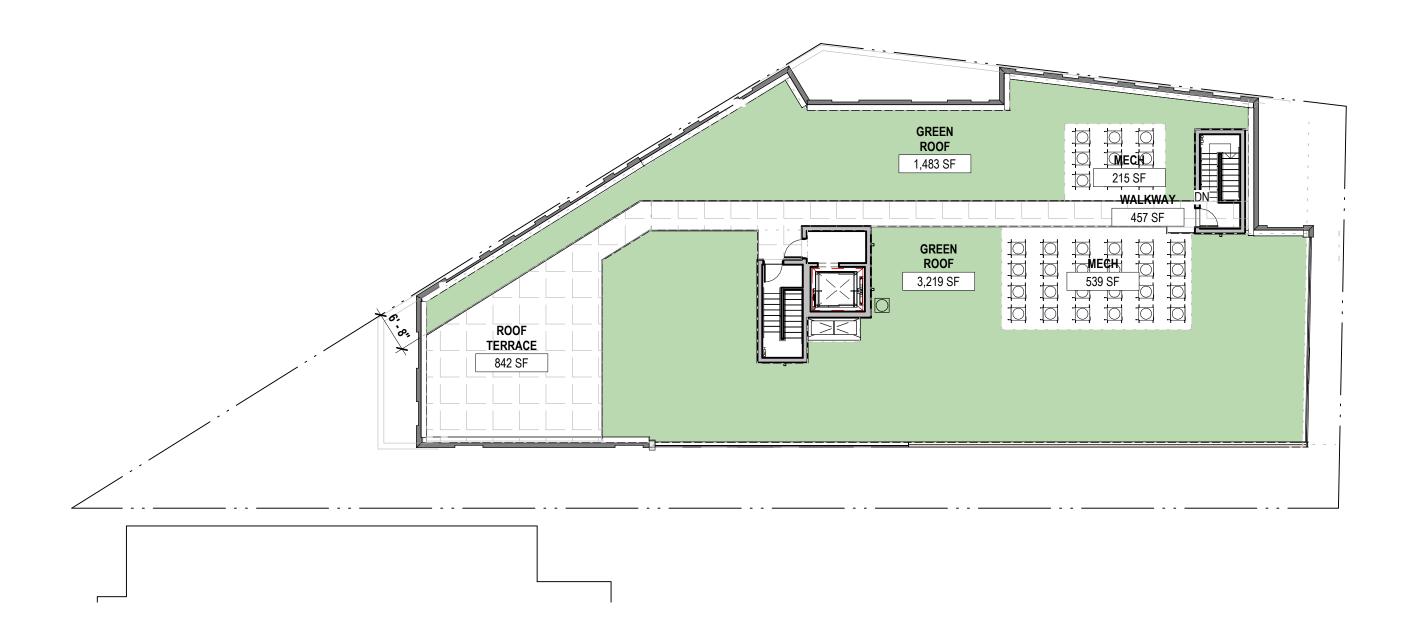


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Carl S. Primavera Direct Dial: (215) 569-1663 Email: cprimavera@klehr.com

October 5, 2021

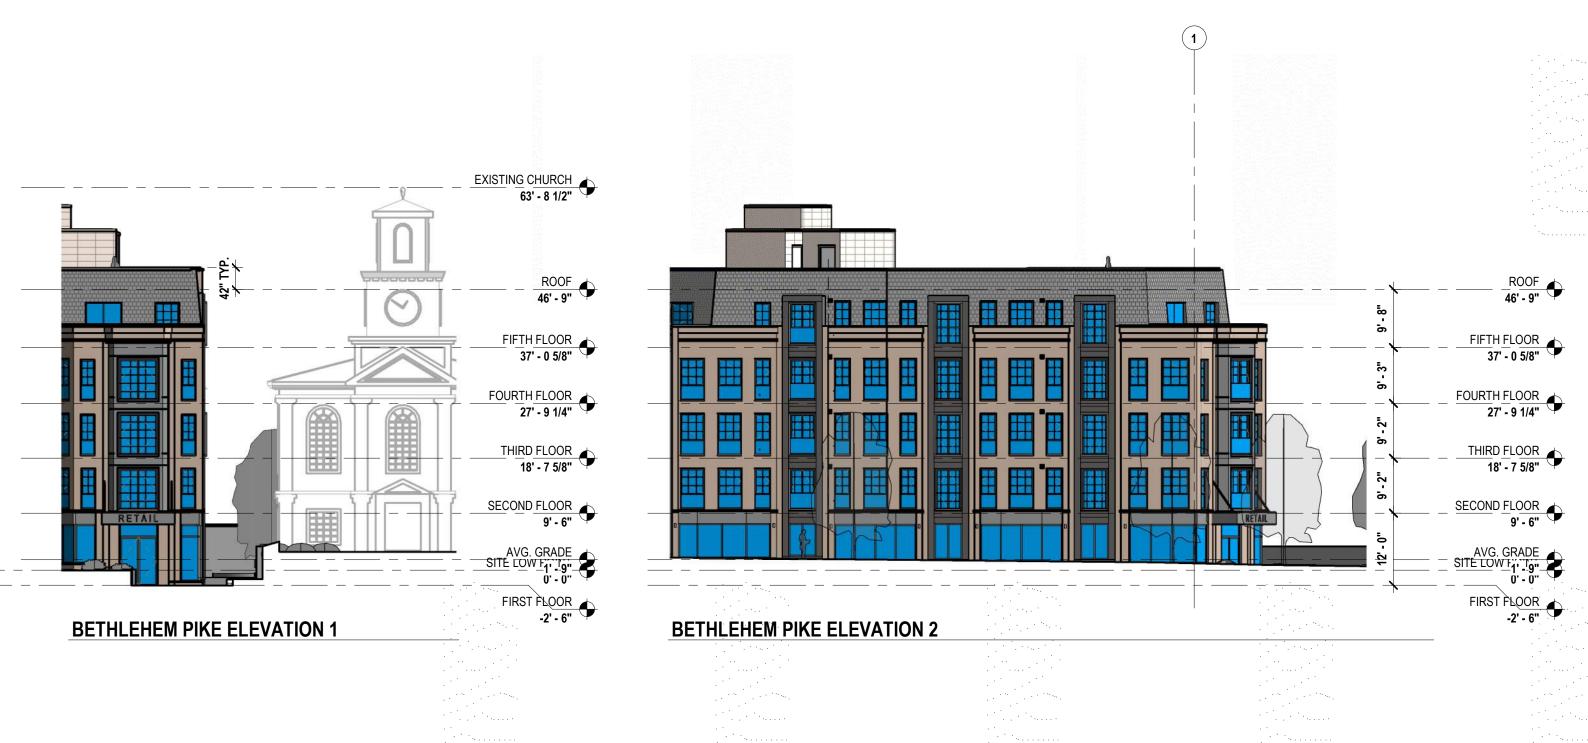VIA ELECTRONIC MAIL

Frank DiCicco, Chairman c/o Sharon Suleto, Esuire Zoning Board of Adjustment City of Philadelphia 1515 Arch Street, 18th Floor Philadelphia, PA 19102 suletazba@gmial.com

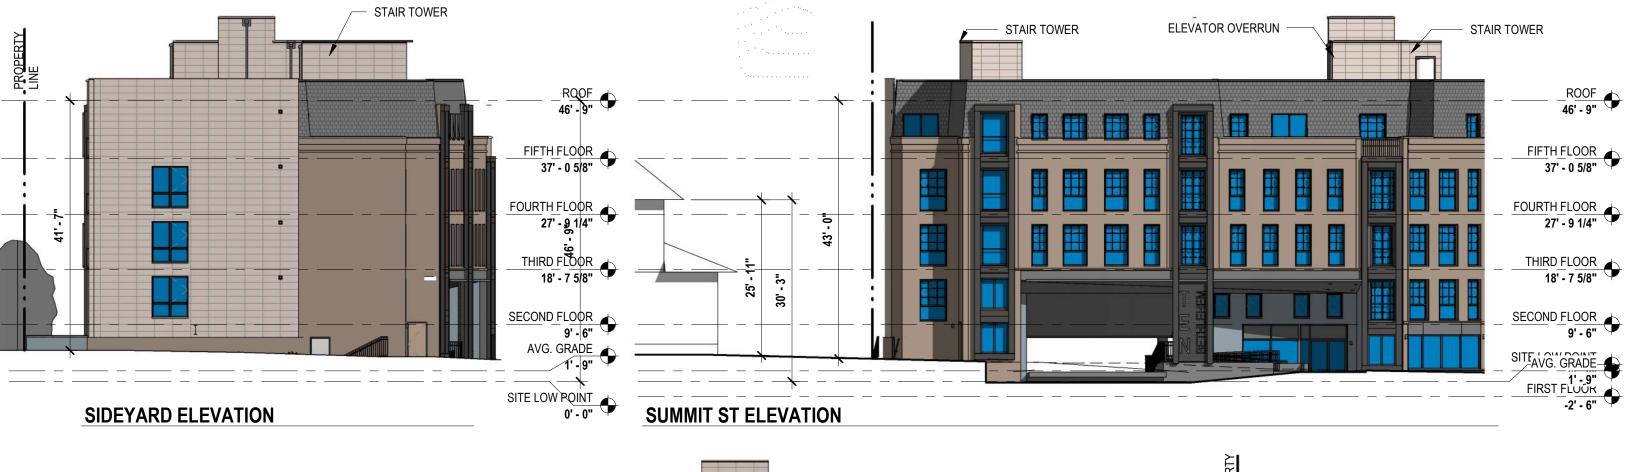Re: 10 Bethlehem Pike (the "Property")

Application No. ZP-2021-002274 (the "Application")

Dear Chairman DiCicco,

This law firm represents the Applicant of ZP-2021-002274 who is also the owner of the Property (the "Owner or Applicant") in the above referenced Appeal. A third-party appeal of the by-right issuance of the Application's Issued Zoning Permit was filed on behalf of the Chestnut Hill Civic Association and additional neighbors (the "Appellants") on May 25, 2021 (the "Appeal").

As outlined below, all the Appellants' claims have either been rendered moot by the issued permit or is a clear misinterpretation of the code. Therefore, we respectfully request that the Zoning Board of Adjustment ("ZBA") deny the Appeal. Below will find an outline each of the Appellant's claims and our subsequent responses.

Claim #1: The proposed project does not meet the dimensional standards o the Zoning Code at Phila. Code. §14-701(1)(c).

Appellant is attempting conflate zoning provisions to create non-existent restriction at the primary frontage on Bethlehem Pike. They are relying on the incorrect interpretation of the cited Code provisions. Appellant appeal relies heavily on Section §14-701(1)(c) of the Philadelphia Zoning Code (the "Code"), which states the following:

Where any **block frontage** on one side of a street is divided into two or more districts, no structure shall be erected nearer to the street line than is permitted under the regulations for the district that covers the largest percentage of the street frontage on that block face;




provided, however, that, when residential districts are included, the front yard depth shall be the highest required of the applicable residential districts.

Appellants go on to explain that the RSD-1 zoning district covers the highest percentage of parcels on the Summit Street Block Face thus subjecting the frontages on that block frontage to a 35 feet setback. Appellants erroneously ignores that fact that the subject property sits on more than one block frontage and thus subject to two separate analysis under §14-701(1)(c.) of the Code.

The Code defines block frontage as "The distance along any street line between the nearest streets intersecting it." See Phila. Code §14-203(40). As such, the block frontage along Summit Street stretches along Summit Steet from the intersection of Bethlehem Pike and Summit Street to the intersection of Prospect Ave and Summit Street (the Summer Street Frontage. but the property is not subject to the summer St frontage only (the "Summit Street Frontage").

The Property is also subject to the street frontage that stretches along Bethlehem Pike from the intersection of Summit St and Bethlehem Pike to the intersection of Bethlehem Pike and Germantown Ave (the "Bethlehem Pike Frontage").

It is clear from the arial map below that the Property is a corner lot that sits at the intersection of Bethlehem Pike and Summit Street.

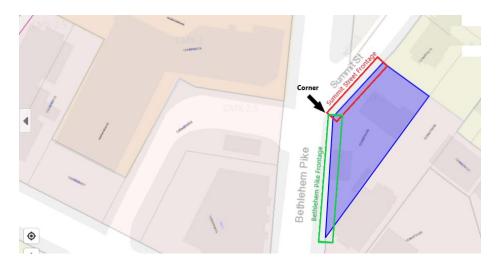

The appellant acknowledges this fact multiple time within their own appeal exhibit. See below:



The Block² containing the Property is bounded by Bethlehem Pike, Summit Street, Prospect Avenue, Evergreen Avenue, and Evergreen Place. The Block is depicted on the below portion of the zoning map from ATLAS (the Property is right on the corner of Bethlehem Pike and Summit Street, and is depicted in red with blue shading below):

The Property in this case is a corner lot fronting on two streets. $\S 14-701(1)(d)$ of the Phila. Code ("Requirements for Lots with Multiple Street Frontages.") states:

The CMX-2 zoning district covers the 100% of the Bethlehem Pike Frontage. Therefore, the CMX-2 setback requirement controls when applying §14-701(1)(c) of the Code to the Bethlehem Pike Frontage. CMX-2 zoning district does not require any front yard setback. The Commercial Dimensional Standards table below clearly shows that:

Overlays CMX-4/CMX-5 CA-1 CA-2 District Name CMX-1 CMX-2 CMX-2.5 CMX-3 See § 14-701(3)(a) (Notes for Table 14-701-3) for information pertaining to bracketed n nbers (e.g., "[2]") in table ce strict and Lot Dimensions in. District Area (sq. ft.) [1] lin. Lot Width (ft.) [1] Buildings ≤ 5 stories with 1 or more dwelling units: 90; termediate: 75 Max. Occupied Area (% of lot) [1] Comer: 80 Comer: 80 Comer: 80 Min. Front Yard Depth (ft.) front lot line 8 if used for If used: Buildings ≤ 4 Min Side Vard Width Fach (ft) [1] 5 if used 5 if used 5 if used wer dwelling units The greater of 9 ft. or 10% of lot depth Min. Rear Yard Depth (ft.) depth Height 38 Max. Height (ft.) Floor Area Ratio CMX-4: 500 CMX-5: 1,200 [2] [1] 500 See also § 14-701(5) Max. Floor Area (% of lot area) (CMX-4 and CMX-5 Bulk and Massing

Table 14-701-3: Dimensional Standards for Commercial Districts⁵⁸¹

Additionally, the Appellants challenges to the Summit Street Frontage setback is rendered moot by the current language of § 14-701(1)(c) of the code. Both the legislative history and the facial language of the Code makes it clear that the § 14-701(1)(c) applies only to Front Yard Depths. The section is unambiguously titled "*Front Yard Depths for Zone Blocks with More than One Zone*" obviously intending the restrictions to apply to Front Yards. See table below:



(c) Front Yard Depths for Zone Blocks with More than One Zone. 556.1

Where any block frontage on one side of a street is divided into two or more districts, no structure shall be erected nearer to the street line than is permitted under the regulations for the district that covers the largest percentage of the street frontage on that block face.

Furthermore, the Legislative history shows that the Philadelphia City Council ("City Council"), clearly intended to clarify that § 14-701(1)(c) applies ONLY to front yards in Bill No. 210075 (the "Bill"). The Bill, passed on March 29, 2021, swapped out the term "Setbacks" for "Front Yard Depth" in both the title and body of § 14-701(1)(c).

Pre-Bill Language:

[Setbacks] for Zone Blocks with More than One Zone.

Where any block frontage on one side of a street is divided into two or more districts, no structure shall be erected nearer to the street line than is permitted under the regulations for the district that covers the largest percentage of the street frontage on that block face; provided, however, **[that]** when residential districts are **[included]** the **[setback]** shall be the highest required of the applicable residential districts.

Post-Bill Language:

Front Yard Depths for Zone Blocks with More than One Zone.

Where any block frontage on one side of a street is divided into two or more districts, no structure shall be erected nearer to the street line than is permitted under the regulations for the district that covers the largest percentage of the street frontage on that block face; provided, however, *that*, when residential districts are *included*, the *front yard depth* shall be the highest required of the applicable residential districts.


Plainly put, the Summit Street frontage is not the "front yard" or the "front" of the Property. The Planning Commission has determined the Bethlehem Pike Frontage is the front of this property. As such, the Summit Street is not subject to §14-701(1)(c). Therefore, this Project is in full compliance with the Code and the ZBA should dismiss this appeal.


¹ Bethlehem Pike Frontage is the logical choice for the front of the property for the following reasons: (1) The Address of the Property is 10 Bethlehem Pike, (2) Bethlehem Pike is the largest frontage on the proper (144 feet), (3) The proposed building is oriented toward Bethlehem Pike, (4) All other properties on Bethlehem Pike Block face are CMX-2.



Claim #2: One of more of the Roof Decks of the proposed project do not meet the dimensional standards of the Zoning Code at Phila. Code. 14-604 (5).

Appellants' claims have no basis in fact. All roof decks in the proposed project have at least a 5 ft minimum from all building lines on a street frontage. As we established above, the building frontages for the Project are on Bethlehem Pike and Summit Street. As you can see from below the proposed roof decks both the deck circled by the Appellant in their appeal is set back from Summit Street Frontage 5 feet and 5 inches:

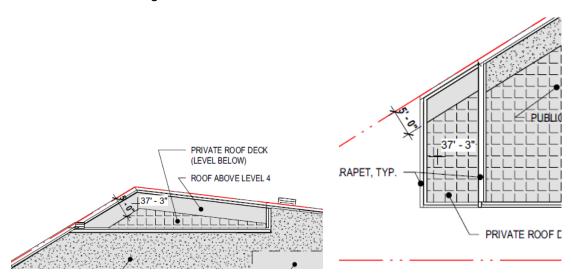

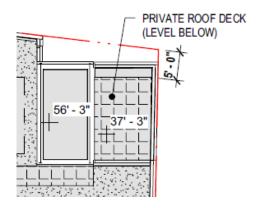

Claim #3: An Outdoor Lighting Plan was required and must be submitted in order for the proposed project to meet the standards of the Zoning Code at Phila. Code. 14-707.

Although separate lighting plans are rarely submitted for zoning permits that are not proposing an athletic field, we do have a lighting plan the reflects and incorporates the over-all proposal



that was reviewed and approved by L&I. We can provide it to the Board should they deem it necessary. As such, the Appellant's claim is moot.

Conclusion

The Appellants' claims have either been rendered moot or is clearly erroneous under the Code. As such this project is clearly by-right and L&I was correct in issuing the Zoning Permit. Therefore, the ZBA must dismiss Appellants' appeal and reject this attempt to delay the Applicants project. Any other decision would be a miscarriage of justice and severely prejudice the Applicant.

Thank you for your time and attention to this request. Please do not hesitate to contact me with any questions.

Very truly yours,

Carl S. Primavera

cc: Tanya Sunkett (ZBA Administrator)

City of Philadelphia

BILL NO. 210075 continued

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* * *

- (e) Zoning Permits Not Required.
 - (.1) Existing permits for roof decks and roof deck access structures may be modified by L&I prior to the issuance of a building permit to allow for one or more of the following modifications, provided the roof deck and the roof deck access structure remain in compliance with the provisions of this § 14-604(5):
 - (.a) A relocation of the roof deck or roof deck access structure to a different location on the roof;
 - (.b) A reduction in the area of the roof deck or the roof deck access structure; or
 - (.c) A reduction in the height of the roof deck access structure.
 - (.2) Modifications allowed under this subsection (e) will not require new zoning permits or Zoning Board of Adjustment hearings. This subsection (e) does not apply to any other modifications to a zoning permit.

* * *

(11) Accessory Dwelling Units.

* *

(h) Location of Entrances.

Only one entrance to a [detached or semi-detached house] *building* containing an accessory dwelling unit may be located on the front facade that faces a street, unless the [house] *building* contained an additional street-facing entrance before the accessory dwelling unit was created.

* * *

CHAPTER 14-700. DEVELOPMENT STANDARDS

§ 14-701. Dimensional Standards.

(1) General Provisions.

* * *

(c) [Setbacks] Front Yard Depths for Zone Blocks with More than One Zone. Where any block frontage on one side of a street is divided into two or more districts, no structure shall be erected nearer to the street line than is permitted under the regulations for the district that covers the largest percentage of the street frontage on that block face; provided, however, [that] that, when residential districts are [included] included, the [setback] front yard depth shall be the highest required of the applicable residential districts.

* * *

(2) Residential District Dimensional Tables.

City of Philadelphia

BILL NO. 210075 continued

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* * *

(b) Notes for Table 14-701-1.

* * *

- [3] In the RSA-5 district, buildings on lots equal to or less than 45 ft. in depth are exempt from the {minimum open} maximum occupied area requirement.
- [4] If abutting lots on both sides of an attached building contain only two stories of enclosed area, the stories above the second story of the attached house shall be set back an additional eight ft. from the minimum {setback} distance between the front facades and the front lot line required by § 14-701(2)(b)[5] below; {shown in this table;} except this requirement shall not apply to corner lots.
- [5] In the RSA-5 district, front [setbacks] *facades* shall comply with the following:
 - (a) On any given street, the distance between the front {setback} facade and the front lot line shall be no {deeper} greater than the distance between the front {setback} facade and the front lot line of the principal building on the immediately adjacent lot on such street with the {deepest} greater distance between its front [setback] facade and its front lot line; and shall be no {shallower} less than the distance between the front {setback} facade and the front lot line of the principal building on the immediately adjacent lot on such street with the {shallowest} lesser distance between its front {setback.} facade and its front lot line.
 - (.b) On any given street, if there is no principal building on an immediately adjacent lot, then the *distance between the* front {setback} facade and the front lot line shall match the distance between the front {setback} facade and the front lot line on the closest building to the subject property that is on the same blockface. If there is no such building, the minimum distance between the front {setback} facade and the front lot line shall be zero.
 - (.c) If the property is bounded by two or more streets, only the primary frontages as designated in § 14-701(1)(d)(.4) (Primary Frontage) shall be subject to the front {setback} facade requirements of (.a) and (.b) above.

* * *

[8] In the RSA-1, RSA-2, and RSA-3 districts, side yards {for} shall comply with the following:

City of Philadelphia

BILL NO. 210075 continued

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	Minimum Required Parking Spaces (spaces per unit/sq. ft. of gross floor area/beds/seats/room)		
	IRMX	ICMX I-1	I-2/3 I-P
*	* *		
Libraries and Cultural Exhibits	None for the first 4,000 sq. ft., then 1/1,000 sq. ft.	None for the first 4,000 sq. ft., then 1/1000 sq. ft.	None for the first 4,000 sq. ft., then 1/1,000 sq. ft.
*	*	*	
Retail Sales Use Category (as noted below)			
*	*	*	
All Other Retail Sales Uses	0	None for first 2,500 sq. ft., then 1/1,000 sq. ft.	None for first 2,500 sq. ft., then 1/1,000 sq. ft.
*	*	*	

* * *

(8) Adjustments and Alternatives.

The minimum parking requirements listed in this Chapter 14-800 may be adjusted as follows:

* * *

- (c) Reduced Need Populations.
 - (.1) The required minimum number of off-street parking spaces may be reduced by 33% for any group living use or multi-family use in which occupancy of at least 80% of the units is restricted for use by those 60 years of age or older. In making the determination as to whether this reduction is available, L&I may rely on an affidavit from the applicant as presumptive evidence, absent evidence to the contrary.
- (9) Off-Site Parking.

Required accessory parking in an RMX-1, RMX-2, RMX-3, CMX-3, CMX-4, or CMX-5 zoning district may be provided on a lot separate from the lot on which the principal use is located; provided that the parking complies with all of the following standards.

(e) If any parking is provided on-site, it shall include required accessory parking for persons with [disabilities] *disabilities, in accordance with § 14-802(5)*, before providing other parking spaces.

§ 14-803. Motor Vehicle Parking Standards.

- (1) Accessory Parking Standards.
 - (b) Location of Accessory Parking.
 - (.1) Residential and Commercial Districts.
 - (.b) Exceptions.

(1) General Provisions.

(a) Applicability.

All primary and accessory structures must comply with the dimensional standards in this (§ 14-701). These dimensional standards may be further limited or modified by other applicable sections of this Zoning Code. General rules for measurement are in § 14-202 (Rules of Measurement).

(b) Dimensional Tables.


Basic dimensional standards for Residential, Commercial, and Industrial districts are listed in Tables 14-701-1 through 14-701-4. Dimensional standards for special purpose districts are included in § 14-404 (SP-INS, Institutional (Special Purpose) District) through § 14-408 (SP-AIR, Airport (Special Purpose) District).

(c) Front Yard Depths for Zone Blocks with More than One Zone. 556.1

Where any block frontage on one side of a street is divided into two or more districts, no structure shall be erected nearer to the street line than is permitted under the regulations for the district that covers the largest percentage of the street frontage on that block face.

(d) Requirements for Lots with Multiple Street Frontages. 557

For a lot fronting on more than one street, each street frontage shall be considered a front. The front yard requirements of the zoning district shall apply to those street frontages and the following side yard, rear yard, and primary frontage requirements shall apply. In all circumstances, the requirements for minimum open area and maximum occupied area remain the same. (See figure below for illustrative purposes only).

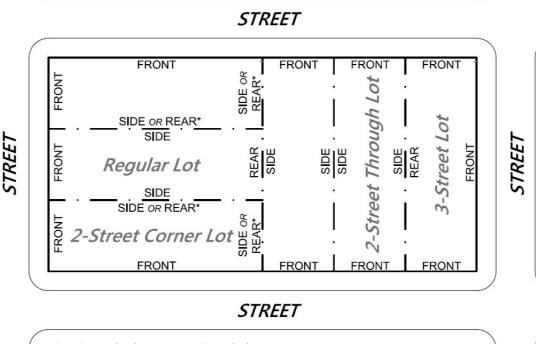

Determination made by Commission. See § 14-701(1)(d)(.1)(.a)

{'{'}For printable PDF version of image, click HERE {'}'}

(.1) Properties Bounded by Two Streets.

When a property is bounded by two streets:

- (.a) That constitute a corner, one of the remaining lot lines shall be deemed a side and the other remaining lot line shall be deemed a rear. Where the determination of side and rear lot lines is necessary for L&I to approve or deny a zoning permit application, the Commission shall determine the side and rear lot lines based on the orientation of the lot, orientation of the primary structure, orientation of the structures on adjacent lots, orientation of structures with frontage on the same blockface, the street type designation of the bounding streets, or any additional criteria stated in the regulations of the Commission for the purposes of clarifying or implementing this determination.
- (.b) That are opposite each other, the remaining two property lines shall be considered sides and the side yard requirements of the zoning district shall apply to the remaining lot lines. The rear yard requirements of the zoning district shall not apply.

(.2) Properties Bounded by Three or More Streets.

When a property is bounded by three or more streets, the remaining lot line shall be considered a rear. The rear yard requirements of the zoning district shall apply to that lot line, except a rear yard is not required for attached buildings or semi-detached buildings but the requirements for lot coverage and open space remain the same. The side yard requirements of the zoning district shall not apply.

(.3) Properties Completely Surrounded By Streets.

When a property is completely surrounded by streets, only the front yard requirements of the zoning district shall apply.

(.4) Primary Frontage.

- (.a) When necessary to apply certain provisions of this Zoning Code, properties bounded by two or more streets shall have at least one street frontage designated as a primary frontage by the Commission.
- (.b) The Commission shall determine which street frontages shall be designated as a primary frontage based on the orientation of the primary structure, the orientation of the structures on adjacent lots, the orientation of other structures with frontage on same block face, the street type designation of the bounding street, or any additional criteria stated in the regulations of the Commission for the purposes of clarifying or implementing this determination.
- (.c) The primary frontage designation shall only apply to those provisions of this Zoning Code where specified, otherwise the front yard and front setback requirements of this Zoning Code shall apply.

(e) Using the Dimensional Tables. 559

All primary and accessory structures are subject to the dimensional standards set forth in the following tables.

- (.1) "Y" indicates that the building type is permitted, subject to compliance with the dimensional standards set forth in the table.
- (.2) "N" indicates that the building type is prohibited.
- (.3) "S" indicates that the building type may be allowed if reviewed and approved in accordance with the special exception procedures of § 14-303(7) (Special Exception Approval).
- (.4) A number in brackets (e.g., "[2]") is a reference to a table note that contains supplemental standards or other explanatory information. Table notes are found in \S 14-701(2)(b) (Notes for Table 14-701-1); \S 14-701(2)(c) (Notes for Table 14-701-2); \S 14-701(3)(a) (Notes for Table 14-701-3); and \S 14-701(4)(a) (Notes for Table 14-701-4).
- (.5) Cross-references to other sections of this Zoning Code are indicated by the word "see" and a specific section number.

Notes

- 556.1 Amended, Bill No. 210075 (approved March 29, 2021); amended, Bill No. 210078-A (approved April 28, 2021).
- 557 Added, Bill No. 150766 (approved December 8, 2015); amended, Bill No. 161003-A (approved May 8, 2017).
- Amended, Bill No. <u>180346-A</u> (approved July 18, 2018).
- Renumbered, Bill No. <u>150766</u> (approved December 8, 2015).

REBUTTAL TO AN APPEAL TO THE ZONING BOARD OF ADJUSTMENT FOR PERMIT NO. **ZP 2021-002274**

FOR THE PROPOSED DEVELOPMENT LOCATED AT:

10 BETHLEHEM PIKE

PHILADELPHIA, PA 19118



T0:

THE ZONING BOARD OF ADJUSTMENT

1515 ARCH STREET PHILADELPHIA, PA 19102

OWNER:

10 BETHLEHEM PIKE PROPERTY OWNER LLC

10 BETHLEHEM PIKE PHILADELPHIA, PA 19118

ARCHITECT:

COSCIA MOOS ARCHITECTURE

1616 WALNUT ST STE 101 PHILADELPHIA, PA 19103 267-761-9416

PREPARED BY:

WOODCOCK DESIGN

1518 WALNUT ST STE 303 PHILADELPHIA, PA 19103 267-738-0956



Proposed Project by Coscia Moos Architecture



Proposed Project by Coscia Moos Architecture

INTRODUCTION

SUMMARY

On April 26, 2021 the City of Philadelphia issued zoning permit #2021-002274 for 10 Bethlehem Pike. The project includes 33 residential units and eight underground parking spaces. The project was designed to be as-of-right.

On May 25th, 2021 a group of near neighbors located on Summit Street. Evergreen Place. Germantown Avenue, and Bethlehem Pike filed an appeal to the Zoning Board of Adjustment to request that the permit be revoked.

The appeal presents several reasons why the project is not in compliance with the zoning code and that a refusal should have been issued, generating a variance.

The appeal states that, because of this as-of rightpermit.

> "....the proposed building will adversely impact the appellants adjacent single-family homes on Summit Street, ... 2 Bethlehem Pike, and the Chestnut Hill Baptist Church." ENDNOTE 1

This report presents a rebuttal of the appeal in three sections.

SECTION 01: LAND USE + DESIGN OVERVIEW Reviews how the proposed project fulfils the land use policy as implemented by the City's comprehensive plan and zoning for the area, and how the City applied the rules to the site to carry out this policy.

SECTION 02: ZONING TECHINALITIES

Reviews the regulatory arguments put forth by the appellants showing how their analysis of the City's zoning regulations and process is incorrect.

SECTION 03: REVIEW OF ADVERSE IMPACTS

Discusses whether the project has the adverse impacts on the area that the appellants represent in their opening charge. We will demonstrate that features of the design respond to the context and will not have an adverse impact the appellants.

FOCUS AREAS AND PRIORITY RECOMMENDATIONS

A focus area is a place within the district that offers multiple opportunities for transformation: economic development, appearance, and function. A long-term vision can provide inspiration and a framework for





SECTION 01: LAND USE + DESIGN OVERVIEW

The City of Philadelphia regulates land use and urban design through its comprehensive plan and zoning code, [14-105(1)] as well as through project reviews undertaken by the city's regulatory agencies [14-105.(3)]. ENDNOTE 2

The city recently replaced its outdated zoning code with a new set of regulations, transferring the old, mapped parcels into new categories.

To guide this process and to assist in adjustments to the map, the Philadelphia City Planning Commission published Philadelphia 2035, a comprehensive plan followed by 18 District Plans.

The District Plans are used by the Commission to quide zoning remapping and project reviews.

The District Plan applicable to the 10 Bethlehem site is the Upper Northeast Plan, summarized in the diagram far left.

A core element of the Northwest District Plan is to attract new residents. The plan states, "development will be guided by a general growth strategy... encouraging housing and commercial development in core growth areas, found along major avenues and near train stations [see pink box below]." The red shading shown below clearly designates the 10 Bethlehem site as a "growth area."



SECTION 01: LAND USE + DESIGN OVERVIEW

Another excerpt from the plan below, clearly demonstrates the rationale for designating the site as a growth area. The 10 Bethlehem Site, adjacent to the yellow tag on the map, is located across the street from the Chestnut Hill bus loop (bus transit station), the Chestnut Hill West (light rail) Station and the Chestnut Hill East (light rail) Station.



Chestnut Hill Bus Loop



Graphic from Northwest District Plan, 2018



Zoning Map from City of Philadelphia

SECTION 01: LAND USE + DESIGN OVERVIEW

The Northwest District Plan, completed in in 2018, involved extensive public input and citizen participation. Using the plan as a guide, the Planning Commission made adjustments to the zoning maps to implement the desired land use policy.

The 10 Bethlehem Pike site remained zoned as a commercial parcel, reflecting both its former use as a gas station and the goal to promote higher density growth around Germantown Avenue.

There are eight commercial zoning classifications developed to establish the correct size, density and degree of auto-dependency for commercial sites. the 10 Bethlehem Pike site is zoned Commercial Mixed Use 2, (CMX 2) at the lower end of the scale. The purpose of this classification is,

> ".... to accommodate active commercial and mixed-use development, including neighborhoodserving retail and service uses. [14-402-1].

The Philadelphia Zoning Code gives the Planning Commission the authority to apply zoning standards to a site using the mapped zoning regulations [14-105.(3)].

Specifically, the code gives the Planning Commission the authority to designate the front, sides, and rear lot lines of a property as set forth in Section 14-301(3). ENDNOTE 2

In doing so, they must make a judgement as to what best accomplishes the goals of the comprehensive plan. [14-105.(1)].

This responsibility is clearly stated in the Zoning code in the following section:


> "The Comprehensive Plan that is adopted by the Planning Commission ("the Commission") serves as the statement of goals, recommendations, and policies guiding the development of the physical environment of the City[14-105(1)]. ENDNOTE 3

In the case of 10 Bethlehem Pike, the Planning Commission designated the "front" of the parcel as Bethlehem Pike. The rationale to designate Bethlehem Pike as the Front can be seen by looking at the development patters as one travels down the arterial. At the corners of blocks you see commercial properties built up to the front lot line. The underlying commercial zoning clearly supports this pattern (see photos below and zoning map of vicinity, far left).

To summarize, the City of Philadelphia conducted a review of this site and came to the conclusion that a) properly determined that the frontage of the property was Bethlehem Pike, and b) correctly applied the dimensional standards of the applicable zoning regulations for CMX-2 to the site and most importantly, was c) consistent with the citizen-driven District Plan for the Upper Northwest.





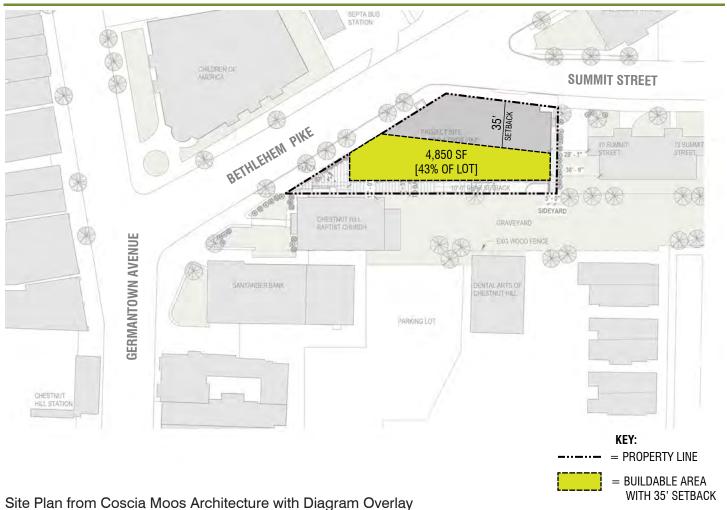

The above illustration shows the resulting buildable area when the requirements of the adjacent residential zoning classification is applied to the site. Instead of supporting the goal of increased growth near commercial streets and transit, only 43% of the site would be buildable. If the provision the appellants say applied to the site, the resulting development would conflict with the city's stated land use policy.



Zoning Map from City of Philadelphia

SECTION 02: ZONING TECHNICALITIES

The appeal of permit ZP 2021-002274 for the 10 Bethlehem Site seeks to disqualify the issued zoning permit for the following reasons:

- Decks must be set back from the front property line five feet,
- There is no lighting plan, and
- A thirty-five foot setback from adjoining residentially zoned sites applies to the commercial site because it is a corner lot with four front yards.

Each of these objections will be reviewed in turn.

Deck Setback: The deck as designed by Coscia Moos Architecture is set back a minimum of 5 feet from the street and is therefore in compliance. The graphics shown in the appeal do not include dimensions, and as a result, the observation is unsubstantiated at best.

Lighting Plan: The appeal states that Section 14-707(2) requires a lighting plan. Instead, the code says that outdoor lighting standards apply to lighting installed on private lots. This provision protects adjoining properties from light and glare. The lighting for this lot is installed on the underside of the structure above, below grade. It is within the jurisdiction of the city's review agencies to refrain from asking for materials irrelevant to the review of a project. In this case, the lighting impacts are not significant and therefore a lighting plan was not required by they City.

Setbacks from Adjacent Lots: The appeal of permit ZP 2021-002274 seeks to apply Chapter 14-700 (1) (a) to the site, selecting what appears to be the most favorable combination of provisions to support the revocation of the permit. The zoning code is quite clear at the beginning of the referenced section 14-700 on how the regulations should be used:

"[14-701 (1)(a) All primary and accessory structures **must comply** (emphasis added) with the dimensional standards in this [chapter]. These dimensional standards **may** (emphasis added) be further limited or modified by other applicable sections of this Zoning Code."

In other words, is not within the purview of appellants, neighbors, or any other individual to select the provisions of the zoning code to apply to a project, it is instead the purview and responsibility

of the Planning Commission. This point appears throughout the Zoning code but clearly evident the following sections of Chapter 14-701.

14-701 (1) (a)(.1) (.4) Primary Frontage. (.a) When necessary to apply certain provisions of this Zoning Code, properties bounded by two or more streets shall have at least one street frontage designated as a primary frontage by the Commission (emphasis added).

(.b) The Commission (emphasis added) shall determine which street frontages shall be designated as a primary frontage based on the orientation of the primary structure, the orientation of the structures on adjacent lots, the orientation of other structures with frontage on same block face, the street type designation of the bounding street, or any additional criteria stated in the regulations of the Commission for the purposes of clarifying or implementing this determination.

It is clear from the language above that it is the Planning Commission's duty to interpret the Code and do decide whether or not to apply a specific section in the dimensional standards.

It is worthwhile to discuss whether the Planning Commission's rationale in selecting Bethlehem Pike as the "front" of the lot was correct. It appears so: 1) the address names the lot. 2) the lot line running along Bethlehem Pike is longer than that of Summit Street and 3) the front door of the proposed commercial space opens onto Bethlehem Pike, reinforcing the main commercial street. By contrast, the diagram at far left shows the absurd result of cherry picking zoning provisions that the code indicates "may" or may not be applied.

To Summarize, the objections in the appeal to the issuance of a zoning permit are invalid as follows:

- The first objection relative to the deck location is dimensionally incorrect.
- The second objection relative to the lack of a lighting plan cites a requirement not applicable to the architectural design.
- The third objection appears to replace the authority and judgement of the Planning Commission with those of the appellants and their attorney.



Front View of Church will be Unchanged



Map showing appellant addresses



Proposed Building is Set Back to Reveal Church

SECTION 03: REVIEW OF ADVERSE IMPACTS

The appeal of permit ZP 2021-002274 for the 10 Bethlehem Site states that the project will have adverse impacts on the surrounding neighbors. This section presents the qualities of the design that respond to the context of the site and the city's land use policy.

The appeal has been filed by individuals who are indicated as near neighbors. The location of the near neighbors is indicated on the map at left, with a green dot for each appellant. The near neighbors are also mapped on an arial photograph to demonstrate their spatial relationship to the property.

As can be seen by the diagram and photographs, the proposed project is not visible to the individuals on Evergreen Street because there is a large grove of trees between the proposed property and these homes. Likewise, the residents located on Summit Street except for the next-door neighbor, will not be able to see the property as the topography slopes down and away from the proposed project.

The proposed project will be constructed very close to the historic church but in this case the designers have made an open space at the west end of the lot to allow a side view of the church building. The front of the church, which is most prominent on Germantown Ave, will remain as is, a highly visible landmark (see rendering, left and photo above renderina).

The appeal does not list the specific adverse impacts on the neighbors, but from conversations with the community the designers have understood that there was a concern for parking. Therefore parking, which was not required by the CMX 2 zoning classification has been added to the project at the ground level and hidden by the building to minimize the impact of the surface lot on the surroundings.

For the above reasons, the adverse impacts alluded to by the appellants are not substantiated when their location relative to the site is considered. For this reason, the appeal should be denied.












Floor Plans from Coscia Moos

SECTION 03: REVIEW OF ADVERSE IMPACTS

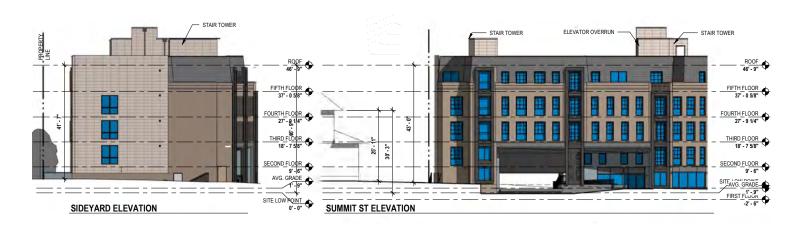

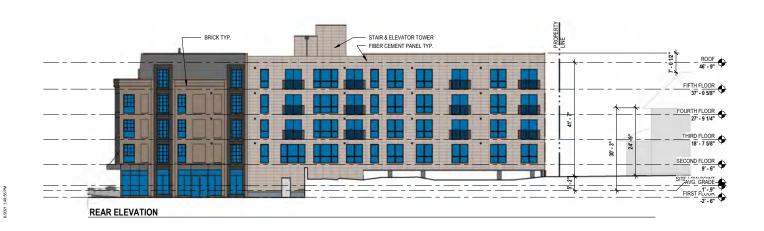

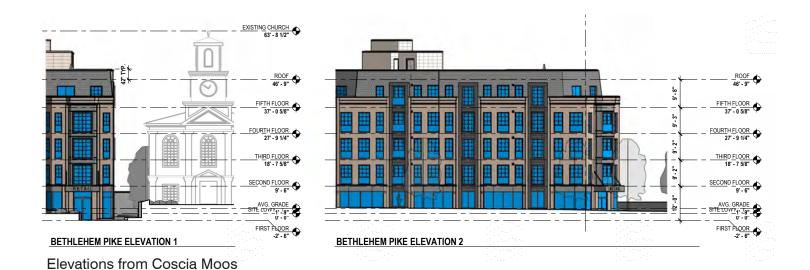



Rendering from Coscia Moos Architecture



Rendering from Coscia Moos Architecture

SECTION 03: REVIEW OF ADVERSE IMPACTS



Rendering from Coscia Moos Architecture

ENDNOTES

Endnote 1: Appeal dated May 25, 2021 sent by the firm of Fineman Krekstein & Harris to the City of Philadelphia, Exhibit C Page 1.

Endnote 2: See Also the following excerpt: Where a Comprehensive Plan or an amendment to the Comprehensive Plan has been adopted pursuant to § 14-304(2) (Comprehensive and Other Plan Adoption), the recommendations of that plan shall be considered by the Commission and Zoning Board as a factor in making any decision on a zoning permit application on a topic or area covered by the adopted plan." [14-105.(3)]

Endnote 3: See also: Review and Prerequisite Approval Authority. (.1) The Commission provides prerequisite approvals for: Zoning permits regarding properties bounded by two streets where the determination of primary frontage(s) or side and rear lot lines is necessary for L&I to approve or deny an application. [14-301(3)(c)(.o)]



Exhibit 8

JANICE WOODCOCK, AIA, LEED-AP

BIOGRAPHY

Janice Woodcock is an urban planner and architect with over 30 years experience working in the Philadelphia area. Woodcock successfully ran her own design practice before her appointment to the City of Philadelphia's Capital Program Office, where she administered the \$3.6 million annual capital budget for Fairmount Park, overseeing the preservation and restoration of historic sites and recreational facilities. She introduced LEED training to City Staff and served on the Mayor's advisory committee for the President's House on Independence Mall.

From there she was appointed Executive Director for Philadelphia's City Planning Commission; chairing the Zoning Code Commission, Central Delaware River Advisory Group, and "Imagine Philadelphia" a study to update Philadelphia's Comprehensive Plan. Her work formed one basis for the City's Comprehensive Plan and Philadelphia 2535 District Plans, a framework that had not been updated since the 1960s.

Woodcock resumed her practice, Woodcock Design, Inc. in 2009. Recent projects include a Master Plan for Germantown High School, the conversion of two waterfront warehouses into 224 apartments, a Master Plan for the Penn Dental School, a Plan of Development for the Central Delaware, the design of the Fillmore Theater, Fabrika Dinner Theater, and renovations for Frankford Friends Lower School. The firm prides itself in creating beautiful spaces at every scale; along the way employing teamwork, follow-through, and attention to clients' goals.

REGISTRATION	Registered Architect, NJ, PA, VA
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LEED Accredited Professional, US Green Building Council

EDUCATION M-Arch, University of Washington College of Architecture and Urban Planning, Seattle, WA

Certificate in Urban Design, University of Washington, Seattle, WA Bachelor of Arts, Sociology/Economics, St. Lawrence University, NY

CAREER HISTORY President, Woodcock Design, Inc; Philadelphia, PA 2009 - Present

Project Architect, KieranTimberlake2008-2009Executive Director, Philadelphia City Planning Commission2006-2008Project Director, City of Philadelphia Capital Program Office2004-2006President, Woodcock Design, Inc; Philadelphia, PA2000-2005Associate, Cecil Baker & Partners; Philadelphia, PA1993-2000Architect, Ewing Cole; Philadelphia, PA1992-1993Urban Planner, Intern Architect, Seattle, Boston, various firms1985-1992

Professional Honors Preservation Achievement Award, Preservation Alliance of Greater Philadelphia,

For the Ajax Building and Fillmore Theater, Woodcock Design Inc. **National AIA Design Award,** AIA's Top 10 Green Buildings, Police

Forensic Science Center, City of Philadelphia; with Cecil Baker & Partners **National Design Award from HUD**, HUD Section 811 Housing, Inglis Gardens

Accessible Housing, Philadelphia; with Cecil Baker & Partners

Design Awards, AIA Philadelphia and AIA Pennsylvania, "Turning on the Lights Upstairs," Study for Converting Philadelphia's Vacant Commercial

Buildings to Residential Use; for the Center City District; with Cecil Baker & Partners

Pesian Awards, AIA Philadelphia and AIA Pennsylvania, Addition to

Design Awards, AIA Philadelphia and AIA Pennsylvania, Addition to the Railroad Museum of Pennsylvania; with Cecil Baker & Partners

COMMUNITY Member, The Carpenter's Company 2019-Present Service Secretary, Christ Church Preservation Trust, Philadelphia 2016-Present

Secretary, Christ Church Preservation Trust, Philadelphia2016-PresentBoard Member, Secretary, American Communities Trust, Baltimore2015-PresentBoard Member, The Neighborhood Center, Camden New Jersey2008 - 2019Vice Chair, Board Member, Philadelphia Art Alliance2005-2013Vestry & Property Chair, Christ Church, Philadelphia2009-2013Board Member, Delaware Valley Green Building Council2005-2008President, AIA Philadelphia2001-2002

Exhibit 9

List of Meetings with Community Stakes Holders

- January 7, 2021 CHCA LUPZ Meeting
- February 16, 2021 CHCA Community Meeting (Development Review)
- February 24, 2021 Phone call with David Mercuris (representing near neighbors and Summit Street Neighbors)
- March 9, 2021 Zoom meeting with Summit Street Neighbors (was blindly presented their letter)
- July 15, 2021 Community Meeting at Church

Exhibit 10



July 27th, 2021

Dear Neighbors,

Thank you for taking the time to meet with us on July 15th. For the past seven months we have engaged with our neighbors and the Chestnut Hill Community Association in order to ensure that the development of 10 Bethlehem Pike adds the greatest possible value to the neighborhood while respecting the rich history of Chestnut Hill. Over the course of our many meetings the ideas of the community have been heard and discussed, and we have made great strides towards reaching this goal.

Over the course of our latest meeting, we directly addressed several questions that have been brought to our attention regarding the project. A list of concerns and our mitigants are as follows:

Concern: The height and scale of the proposed building, as well as the number of set-backs, terraces, or other relief from the street

• Despite the height of the proposed building as well as proposed unit count conforming to code, we have taken measures throughout the plan to address any perception of the scale in comparison to surrounding structures. Our building still remains significantly shorter than the adjacent church building, and from our initial design we have set back the footprint of the building as far as possible from the intersection of Germanton Avenue, revealing the majority of the adjacent church.

Additionally, we have included significant setbacks and terraces on the top floor of the three outward-facing sides of the building. We have also included a mansard roof on the highest floor, the angle and material of which reduces the perceived scale from the street level.

Concern: The materials proposed to be used for the building, are not typical in Chestnut Hill

• Through several alterations of massings and materials we have devised a façade that is constructed of design components that are typical of Chestnut Hill architecture and seen throughout the neighborhood. Our building includes brick and stone that are seen throughout the surrounding community, as well as window fenestrations and a mansard roof that are exemplified throughout the neighborhood.

Concern: Lack of parking proposed

• Our building plan has been altered to include parking on-site, despite the fact that we are not required to do so by the zoning code. Additionally, we have approached neighboring sites to provide parking for ancillary vehicles.

Concern: Potential for the structure to further exacerbate problems with stormwater runoff currently affecting the Baptist church graveyard and some houses on the south side of Summit Street



• Our project includes a green roof, which will substantially improve stormwater runoff in the immediate area. The site is currently asphalt, which does not absorb and drain stormwater and impacts neighboring sites. Our green roof system will help mitigate this issue by providing absorbent vegetative surface on the majority of the roof.

Additionally, we understand that there are concerns over the low water pressure on Summit St. This concern arises from very low pressure at the nearby valves, and while our project will not worsen this, we are committed to working with the Philadelphia Water Department and the Councilwoman's office to improve this for our neighbors.

Concern: Impacts of construction activities on nearby residents

 We are committed to minimizing the impact of the construction activity of the project on the neighborhood and to informing our neighbors of activity on site. We hope to reduce sidewalk re-direction as best as possible and maintain normal daytime working hours. We will establish a constant dialogue with the community regarding weekly construction processes.

Concern: Privacy and light effects on adjacent/near-adjacent residential neighbors

• Our project is setback 10 feet from the property line of the adjacent church and 5 feet from the adjacent property line on Summit Street. Given the setback of these neighboring homes, there will be nominal effect on the privacy and light of the adjacent neighbors.

We share the same goals of responsible development and the desire to work in good faith with the community. We also foresee the redevelopment of 10 Bethlehem Pike as an opportunity to enhance the beauty and livability Chestnut Hill. At this point we believe that our development at 10 Bethlehem Pike has evolved significantly from its original design to address the concerns that the community presented to us. We are hopeful that we can work together to ensure that this project maximizes utility to for the community.

Sincerely,

Zachary Frankel

Principal

Frankel Enterprises