

ANCRAM, NEW YORK


PROJECT LOCATION MAP

N.T.S.

ANCRAM SOLAR

3333 ROUTE 82 ANCRAMDALE, NY 12503

SITE PLAN APPROVAL SPECIAL USE PERMIT NOVEMBER 2024

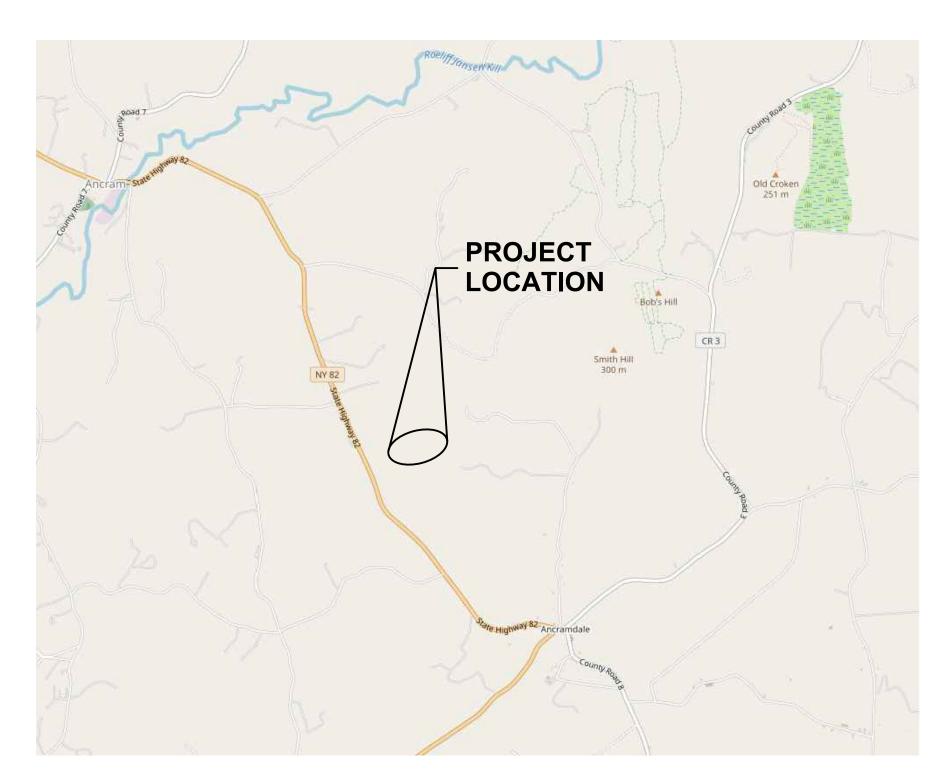



Centerpointe Corporate Park 375 Essjay Road, Suite 200 Williamsville, NY 14221 www.wendelcompanies.com p:716.688.0766 f:716.625.6825

Wendel Project No. 607153

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Ancram PV, LLC c/o RIC Development, LLC 17 State Street, Suite 2320 New York, NY 10004

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3333 State Route 82 Ancramdale, NY 12503



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Wendel WD Architecture, Engineering, Surveying and

FOR PERMITTING
PURPOSES

11/20/24

NOT FOR CONSTRUCTION



NOTE:

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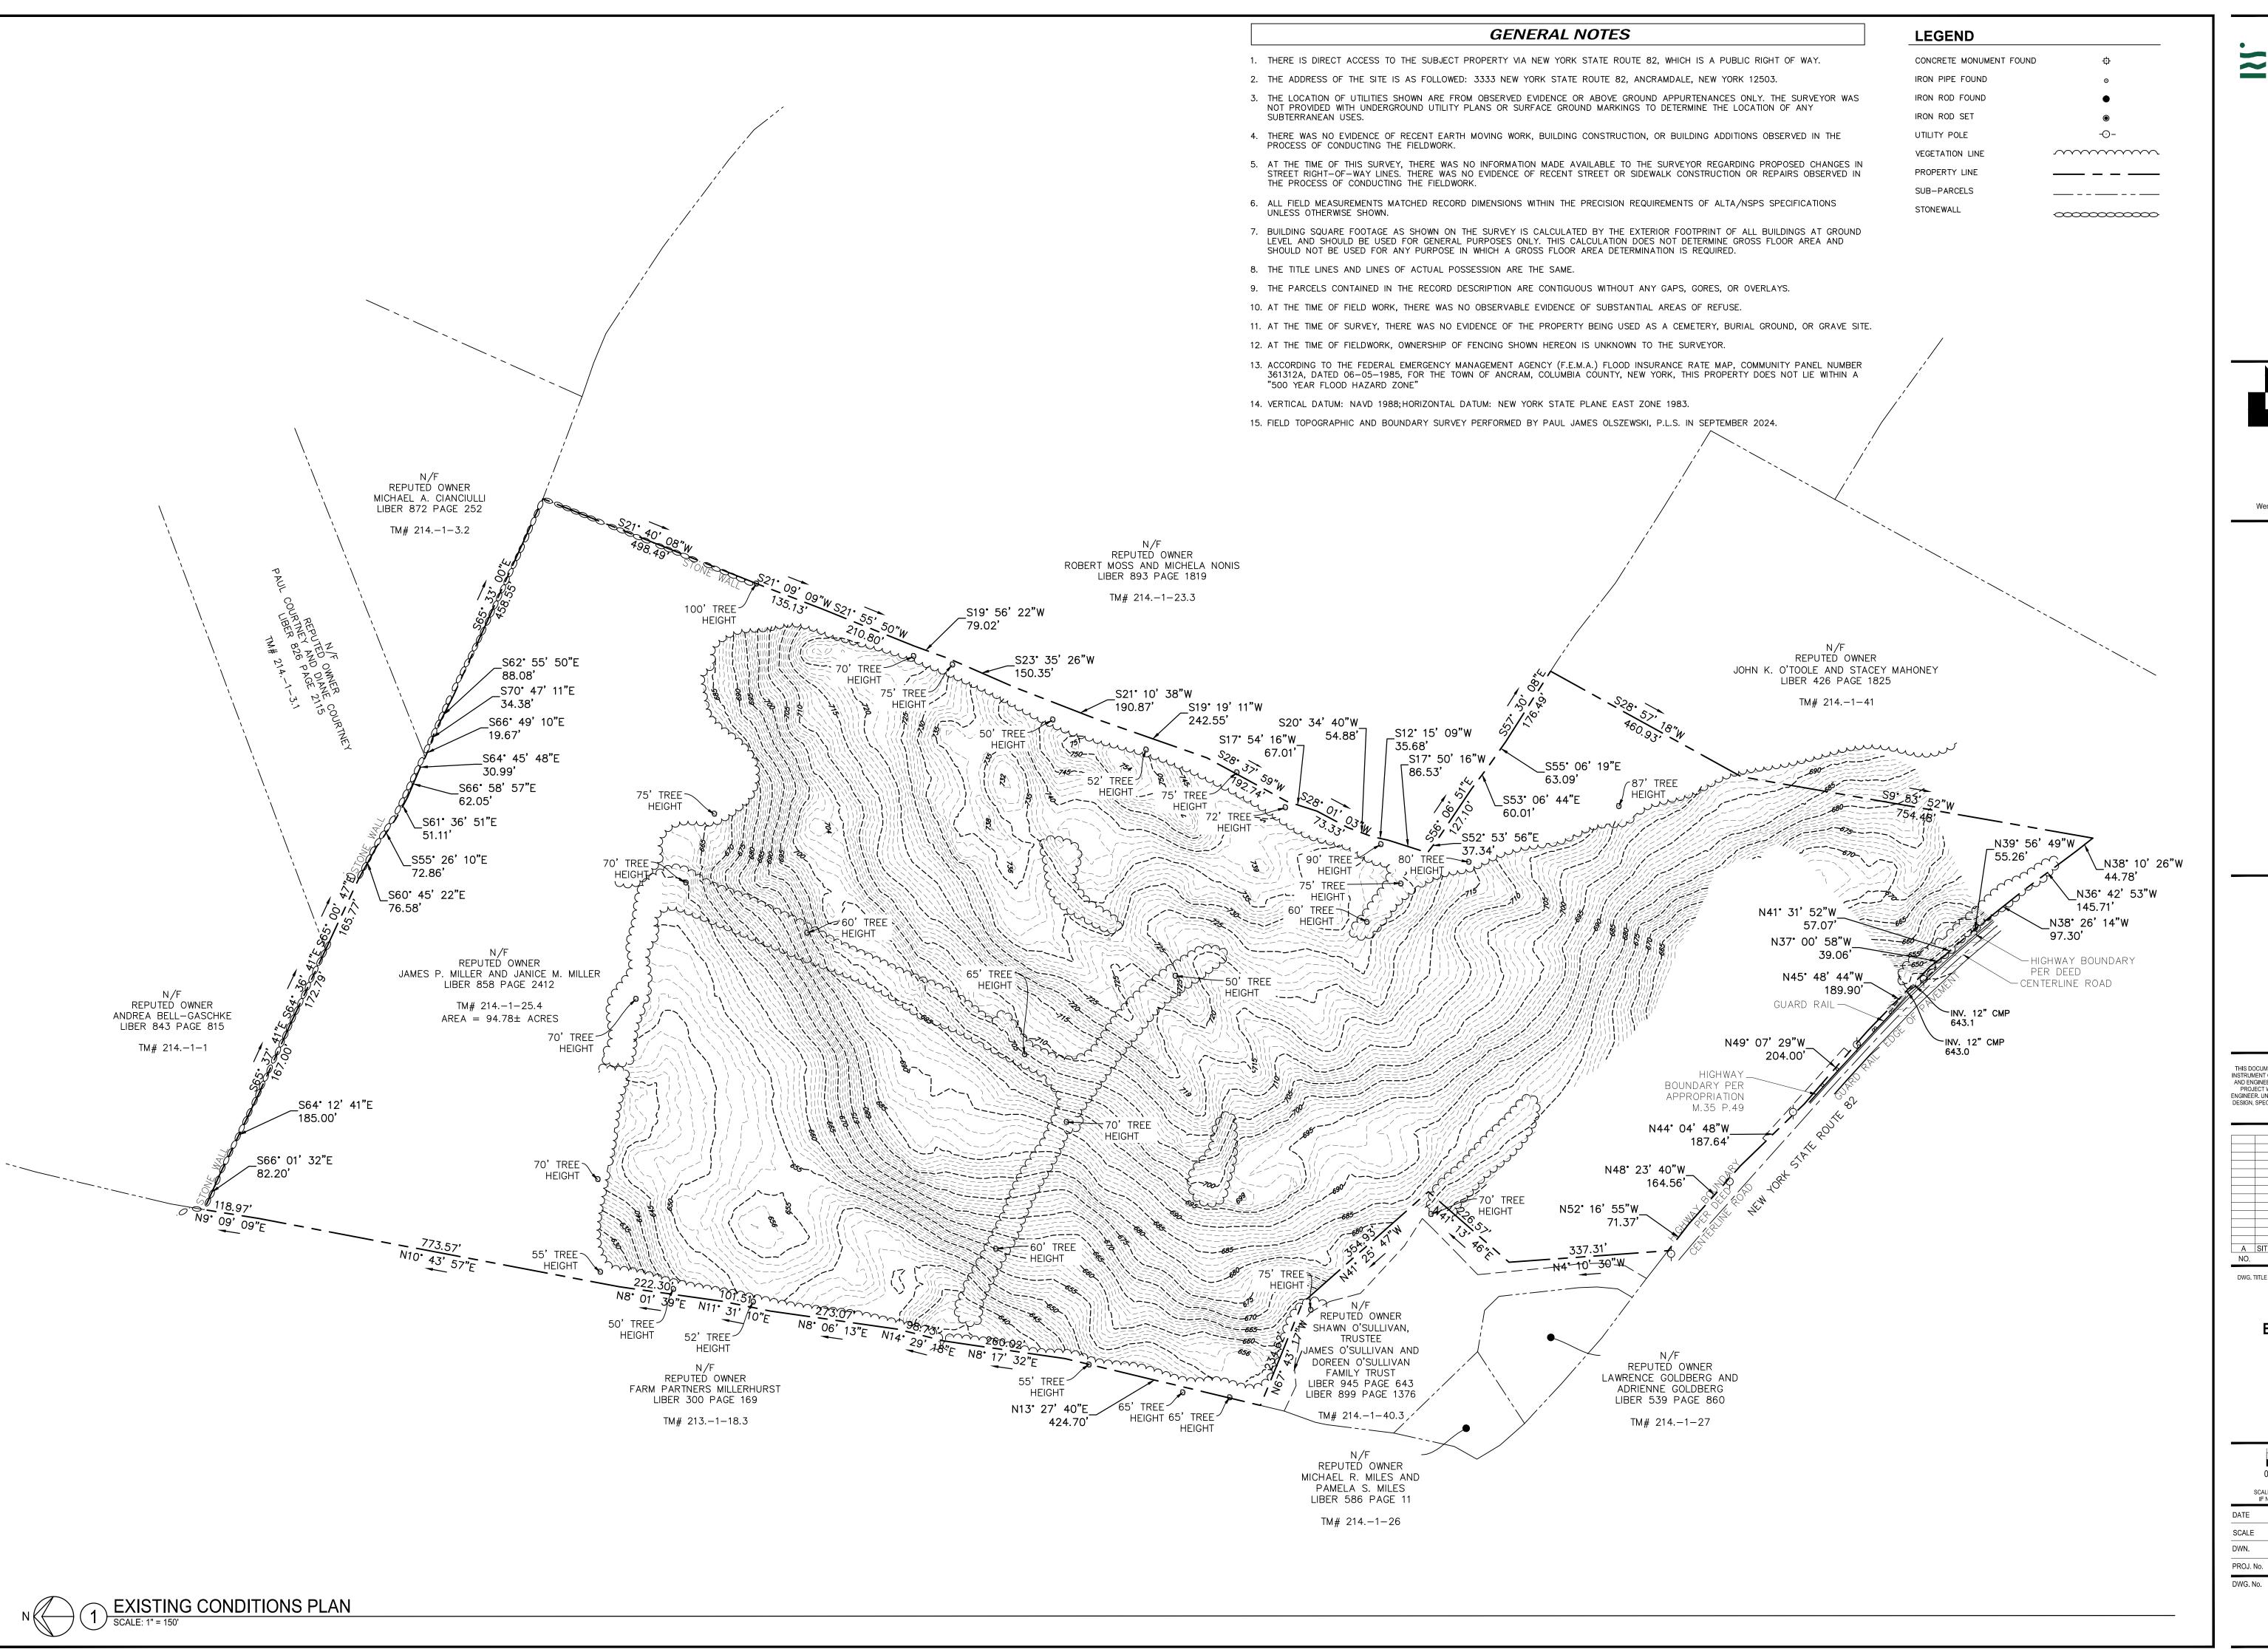
A	SITE PLAN APPROVAL/SUP SUBMISSION	11/20/2024
NO.	REVISIONS	DATE

COVERSHEET

	0 CENE	1" RIC SCALE BAR	2"
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DATE	11/20/2024		
SCALE	AS NOTED		
DWN.	NRF	CHK.	SAR

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Α	SITE PLAN APPROVAL/SUP SUBMISSION	11/20/2024
NO.	REVISIONS	DATE
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EXISTING CONDITIONS PLAN

0 1" 2"
GENERIC SCALE BAR
SCALE BAR SHOWN IS TWO INCHES ON THE ORIGINAL DRAWING.
IF NOT TWO INCHES ON THIS SHEET, ADJUST ACCORDINGLY

DATE 11/20/2024

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PROJ. No. 607153

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GENERAL EROSION & SEDIMENT CONTROL NOTES: 1. THE CONTRACTOR SHALL IMPLEMENT BEST MANAGEMENT

- PRACTICES (BMP'S) THROUGHOUT ALL PHASES OF CONSTRUCTION AS REQUIRED BY THE STORMWATER POLLUTION PREVENTION PLAN (SWPPP). ADDITIONAL BMP'S NOT SHOWN ON THIS PLAN SHALL BE IMPLEMENTED AS REQUIRED BY SITE CONDITIONS AND AS DIRECTED BY THE QUALIFIED INSPECTOR AS A RESULT OF WEEKLY OR BIWEEKLY CONSTRUCTION DURATION INSPECTIONS.
- BMP'S AND OTHER REQUIRED CONTROLS SHALL CONFORM TO FEDERAL, STATE OR LOCAL REQUIREMENTS OR MANUAL OF PRACTICE, AS APPLICABLE. CONTRACTOR SHALL IMPLEMENT ADDITIONAL CONTROLS AS DIRECTED BY PERMITTING AGENCY OR OWNER.
- 3. ALL WASH WATER (CONCRETE TRUCKS, VEHICLE CLEANING, EQUIPMENT CLEANING, ETC.) SHALL BE DETAINED AND PROPERLY TREATED OR DISPOSED.
- 4. SUFFICIENT OIL AND GREASE ABSORBING MATERIALS SHALL BE MAINTAINED ON SITE OR READILY AVAILABLE TO CONTAIN AND CLEAN-UP FUEL OR CHEMICAL SPILLS AND
- 5. DUST ON THE SITE SHALL BE CONTROLLED. THE USE OF MOTOR OILS AND OTHER PETROLEUM BASED OR TOXIC LIQUIDS FOR DUST SUPPRESSION OPERATIONS IS PROHIBITED.
- 6. RUBBISH, TRASH, GARBAGE, LITTER OR OTHER SUCH MATERIALS SHALL BE DEPOSITED INTO SEALED CONTAINERS. MATERIALS SHALL BE PREVENTED FROM LEAVING THE PREMISES THROUGH THE ACTION OF WIND OR STORM WATER DISCHARGE INTO DRAINAGE DITCHES, UNDERGROUND CONVEYANCE SYSTEMS OR WATERS OF THE STATE.
- 7. ALL STORM WATER POLLUTION PREVENTION MEASURES PRESENTED ON THESE PLANS SHALL BE INITIATED AS SOON AS PRACTICABLE.
- 8. ALL DENUDED AREAS THAT WILL BE INACTIVE FOR 14-DAYS OR MORE MUST BE TEMPORARILY STABILIZED WITH THE USE OF FAST-GERMINATING ANNUAL GRASS-GRAIN VARIETIES, STRAW-HAY MULCH, WOOD CELLULOSE FIBERS. TACKIFIERS, NETTING OR BLANKETS.
- 9. DISTURBED PORTIONS OF THE SITE WHERE CONSTRUCTION ACTIVITY HAS PERMANENTLY STOPPED SHALL BE PERMANENTLY STABILIZED AS SHOWN ON THE PLANS. THESE AREAS SHALL BE SEEDED, SODDED AND/OR VEGETATED NO LATER THAN 14 DAYS AFTER THE LAST CONSTRUCTION ACTIVITY OCCURRING IN THESE AREAS. REFER TO THE GRADING PLAN.

PROPOSED TREE LINE

10. IF THE ACTION OF VEHICLES TRAVELING OVER THE GRAVEL CONSTRUCTION ENTRANCES IS NOT SUFFICIENT

TO REMOVE THE MAJORITY OF DIRT OR MUD, THEN THE

TIRES MUST BE WASHED BEFORE THE VEHICLES ENTER A

PUBLIC ROAD. IF WASHING IS USED, PROVISIONS MUST BE

SEDIMENT BEFORE IT IS CARRIED OFF THE SITE. ONLY USE

ALL MATERIALS SPILLED, DROPPED, WASHED OR TRACKED

RESPONSIBLE FOR REMOVING ACCUMULATED SEDIMENT IN

SEDIMENT THAT MAY HAVE COLLECTED IN THE ONSITE

13. ON-SITE SOIL STOCKPILES AND BORROW AREAS SHALL BE

PROTECTED FROM EROSION AND SEDIMENTATION

14. SLOPES SHALL BE LEFT IN A ROUGHENED CONDITION

DURING THE GRADING PHASE TO REDUCE RUNOFF

15. THE GENERAL CONTRACTOR IS TO DESIGNATE/IDENTIFY

AREAS ON THE PLANS (IF DIFFERENT FROM THOSE

DISTURBANCE FOR WASTE DISPOSAL AND DELIVERY AND

16. AREAS TO BE FILLED SHALL BE CLEARED AND STRIPPED OF

17. ALL FILLS SHALL BE COMPACTED AS REQUIRED TO REDUCE

CURRENTLY SHOWN) INSIDE OF THE LIMITS OF

TOPSOIL PRIOR TO PLACEMENT OF FILL.

THROUGH IMPLEMENTATION OF BEST MANAGEMENT

STORM SEWER DRAINAGE SYSTEM IN CONJUNCTION WITH

FROM VEHICLES ONTO ROADWAYS OR INTO STORM

ROADSIDE DRAINAGE SYSTEMS AS WELL AS ANY

MADE TO INTERCEPT THE WASH WATER AND TRAP THE

INGRESS/EGRESS LOCATIONS AS PROVIDED.

DRAINS MUST BE REMOVED IMMEDIATELY.

12. CONTRACTORS OR SUBCONTRACTORS WILL BE

THE STABILIZATION OF THE SITE.

VELOCITIES AND EROSION.

MATERIAL STORAGE.

SITE PREPARATION AND EROSION AND SEDIMENT CONTROL PLAN

PRACTICES.

- **SEQUENCE OF CONSTRUCTION:** 1. CONDUCT A PRE-CONSTRUCTION MEETING. INSTALL STABILIZED CONSTRUCTION ENTRANCES/EXIT(S) AND IDENTIFY LOCATION OF PROJECT SWPPP.
- 2. INSTALL PERIMETER CONTROLS (SILT FENCE / SILT SOCK) ON THE SITE. CLEAR ONLY TO THOSE AREAS NECESSARY TO INSTALL PERIMETER CONTROLS.
- 3. STABILIZE ANY EXISTING DISTURBED AREAS WITHIN THE PROPERTY THAT ARE OUTSIDE THE LIMITS OF CONSTRUCTION DISTURBANCE. 4. ENGAGE A QUALIFIED PROFESSIONAL TO PERFORM AN INITIAL SITE INSPECTION AND ASSESSMENT. IMPLEMENT ANY ADDITIONAL CONTROLS
- RECOMMENDED IN SAID INSPECTION. 5. ENGAGE A QUALIFIED INSPECTOR TO CONDUCT CONSTRUCTION
- DURATION INSPECTIONS ACCORDING TO THE SWPPP. 6. CLEAR AND GRUB SITE WITHIN LIMITS OF CONSTRUCTION. STRIP AND STOCKPILE TOPSOIL.
- 8. INSTALL TEMPORARY CONSTRUCTION ACCESS ROAD(S).
- 9. BEGIN ROUGH GRADING AND MASS EXCAVATION ACTIVITIES. 10. BEGIN INSTALLATION OF SOLAR ARRAYS. 11. INSTALL STORM SEWERS, STORMWATER MANAGEMENT PRACTICES, AND
- OTHER REQUIRED UTILITIES. 12. INSTALL AND MAINTAIN ALL PRACTICES IN CONFORMANCE WITH THE
- PLANS, DETAILS, AND PROJECT SWPPP. 13. TEMPORARILY SEED, THROUGHOUT CONSTRUCTION, DENUDED AREAS
- THAT WILL BE INACTIVE FOR 14 DAYS OR MORE. 14. INSTALL SOLAR PANELS. 15. REMOVE TEMPORARY ACCESS ROADS AND APPLY SOIL RESTORATION
- PRACTICES PER SECTION 5.1.6 OF THE SWDM.
- 16. INSTALL PERVIOUS GRAVEL ROADWAY. 17. PERMANENTLY STABILIZE AREAS AS THEY ARE BROUGHT TO FINAL GRADE.
- 18. COMPLETE FINAL GRADING AND INSTALL LANDSCAPE PLANTINGS. 19. RESTORE SOIL IN ACCORDANCE WITH SECTION 5.1.6 OF THE STORMWATER MANAGEMENT DESIGN MANUAL. FULL SOIL RESTORATION IS
- REQUIRED IN AREAS OF CUT OR FILL AND IN AREAS THAT HAVE BEEN IMPACTED BY CONSTRUCTION EQUIPMENT 20. OBTAIN CONCURRENCE WITH THE CONSTRUCTION MANAGER (CM) THAT
- THE SITE HAS BEEN FULLY STABILIZED THEN: a. REMOVE ALL REMAINING TEMPORARY EROSION AND SEDIMENT CONTROL DEVICES. b. STABILIZE ANY AREAS DISTURBED BY THE REMOVAL OF BMP'S c. ASK THE CM TO CONTACT THE QUALIFIED INSPECTOR TO COMPLETE
- FINAL SITE INSPECTION AND REPORT ACCORDING TO THE SWPPP. ACHIEVED FINAL STABILIZATION. COMPLETE THE NOTICE OF TERMINATION (NOT) AND SUBMIT TO NYSDEC DIVISION OF WATER TO CLOSE THE PERMIT

NOTES TO THE CONTRACTOR:

- 1. ALL SOIL EROSION & SEDIMENT CONTROL MEASURES ARE TO BE INSTALLED IN CONFORMANCE WITH THE PROJECT DETAILS & SPECIFICATIONS CONTAINED WITHIN THE LATEST REVISION OF THE PROJECT STORMWATER POLLUTION PREVENTION PLAN (SWPPP). CONTRACTOR TO UTILIZE THE FOLLOWING EROSION CONTROL MEASURES AS NECESSARY AND AS DIRECTED BY A QUALIFIED INSPECTOR (OR QUALIFIED PROFESSIONAL) TO MINIMIZE SOIL EROSION AND SEDIMENT REMOVAL: SILT FENCE OR SILT SOCKS, CONSTRUCTION ENTRANCE, CHECK DAMS, SEDIMENT TRAPS, AND DUST CONTROL (WATERING).
- 2. IMMEDIATELY DENOTE THE LOCATIONS OF THE FOLLOWING ITEMS ON THE SITE PLANS AFTER THEY ARE IMPLEMENTED AND INSTALLED AND NOTE ANY CHANGES IN LOCATION AS THEY OCCUR THROUGHOUT THE CONSTRUCTION PROCESS: TRAILERS, LAY DOWN AREAS, PORTA-POTTIES, WHEEL WASHES, CONCRETE WASHOUTS, MASON'S AREA, FUEL AND MATERIAL STORAGE CONTAINERS, SOLID WASTE CONTAINERS, ETC.
- 3. THE CONTRACTOR MAY ADJUST OR RELOCATE EROSION AND SEDIMENT CONTROL MEASURES AS NECESSARY THROUGHOUT CONSTRUCTION. CHANGES TO THESE MEASURES MUST BE IMMEDIATELY DENOTED IN THE PROJECT SWPPP AND ON THE SITE PLANS. CHANGES MADE TO THESE MEASURES MUST PROVIDE EQUAL OR GREATER MITIGATION TO THE AREA WHICH SAID MEASURES ARE INTENDED TO PROTECT ON THE SITE PLANS. THE CONTRACTOR MUST TAKE WHATEVER MEANS NECESSARY TO PREVENT SEDIMENT FROM LEAVING THE PROJECT SITE.
- 4. CONTRACTOR IS RESPONSIBLE FOR LOCATING A NEARBY LAYDOWN AND PARKING AREA ON-SITE. THE LAYDOWN AREA MUST AVOID WETLANDS, WETLAND BUFFERS, AND OTHER NATURAL RESOURCES. BEFORE DEMOBILIZATION. CONTRACTOR SHALL RESTORE THE LAYDOWN AREA TO **EXISTING CONDITIONS.**

INSPECTION FREQUENCY:

- 1. AS REQUIRED BY THE GENERAL PERMIT. FOR CONSTRUCTION SITES WHERE SOIL DISTURBANCE ACTIVITIES ARE ON-GOING, THE QUALIFIED INSPECTOR SHALL CONDUCT A SITE INSPECTION AT LEAST ONCE EVERY SEVEN (7) CALENDAR DAYS.
- FOR CONSTRUCTION SITES WHERE SOIL DISTURBANCE ACTIVITIES ARE ON-GOING AND THE OWNER OR OPERATOR HAS RECEIVED THAN FIVE (5) ACRES OF SOIL AT ANY ONE TIME, THE QUALIFIED SEVEN (7) CALENDAR DAYS. THE TWO (2) INSPECTIONS SHALL BE

OSITE PREP NOTES:

1. SITE CLEARING AND GRUBBING TO EXTENTS OF LIMITS OF DISTURBANCE.

2. REMOVE TREES, CLEAR AND GRUB UNDERSTORY VEGETATION.

LEGEND

STONEWALL

PROPERTY LINE SUB-PARCELS EDGE OF VEGETATION/WOODS

3. THE CONSTRUCTION ENTRANCES/EXITS SHALL BE MAINTAINED IN A CONDITION WHICH WILL PREVENT TRACKING OR FLOW OF MUD ONTO

BEST MANAGEMENT PRACTICE MAINTENANCE:

ALL BEST MANAGEMENT PRACTICES (INCLUDING EROSION AND SEDIMENT

FUNCTIONAL CONDITION UNTIL NO LONGER REQUIRED FOR A COMPLETED

PHASE OF WORK OR UNTIL FINAL STABILIZATION OF THE SITE. ALL EROSION

QUALIFIED INSPECTOR IN ACCORDANCE WITH THE CONTRACT DOCUMENTS

1. ALL SEEDED AREAS SHALL BE CHECKED REGULARLY SO THAT A

GOOD STAND IS MAINTAINED. AREAS SHOULD BE FERTILIZED,

PUBLIC RIGHTS-OF-WAY. THIS MAY REQUIRE PERIODIC TOP

SHALL BE CLEANED IMMEDIATELY BY A METHOD OTHER THAN

IF SEASON IS SPRING, SUMMER, OR EARLY FALL; SEED WITH RYEGRASS

(ANNUAL OR PERENNIAL) AT 30 LBS. PER ACRE (APPROX. 1 LB. PER 1,000

'AROOSTOOK' WINTER RYE (CEREAL RYE) AT 100 LBS. PER ACRE (APPROX. 2.5

IF SEASON IS LATE FALL OR EARLY WINTER; SEED WITH CERTIFIED

TEMPORARY VEGETATION SEED MIX:

2. SILT FENCE / SILT SOCK SHALL BE REPAIRED TO ITS ORIGINAL

CONDITIONS IF DAMAGED. SEDIMENT SHALL BE REMOVED WHEN IT

REACHES ONE-HALF THE HEIGHT OF THE SILT FENCE OR SOCK (OR

DRESSING OF THE CONSTRUCTION EXITS AS CONDITIONS DEMAND

4. PRIOR TO LEAVING THE SITE, ALL VEHICLES SHALL BE CLEANED OF

DEBRIS. ANY DEBRIS AND/OR SEDIMENT REACHING PUBLIC STREETS

LESS IF IT INTERFERES WITH THE FUNCTIONALITY OF THE PRACTICE).

CONTROLS) SHOWN ON THIS PLAN. AND AS DESCRIBED IN THE STORM

AND SEDIMENTATION CONTROL MEASURES SHALL BE CHECKED BY A

OR THE APPLICABLE PERMIT, WHICHEVER IS MORE STRINGENT, AND

REPAIRED IN ACCORDANCE WITH THE FOLLOWING:

WATERED, AND RESEEDED AS NEEDED.

FLUSHING.

LBS. PER 1,000 SQUARE FEET).

WATER POLLUTION PREVENTION PLAN, SHALL BE MAINTAINED IN FULLY

----- (LOD) = LIMITS OF DISTURBANCE = 9.92 ACRES = LIMITS OF TEMPORARY DISTURBANCE = 0.13 ACRES TEMPORARY 12" COMPOST FILTER SOCK; RE: 5, C501.

SYMBOL LEGEND

TEMPORARY STABILIZED CONSTRUCTION ENTRANCE; RE: 1, C501.

WASHOUT; RE: 6, C501.

0000000000

(CW) = TEMPORARY CONCRETE (WR) = TEMPORARY WASTE

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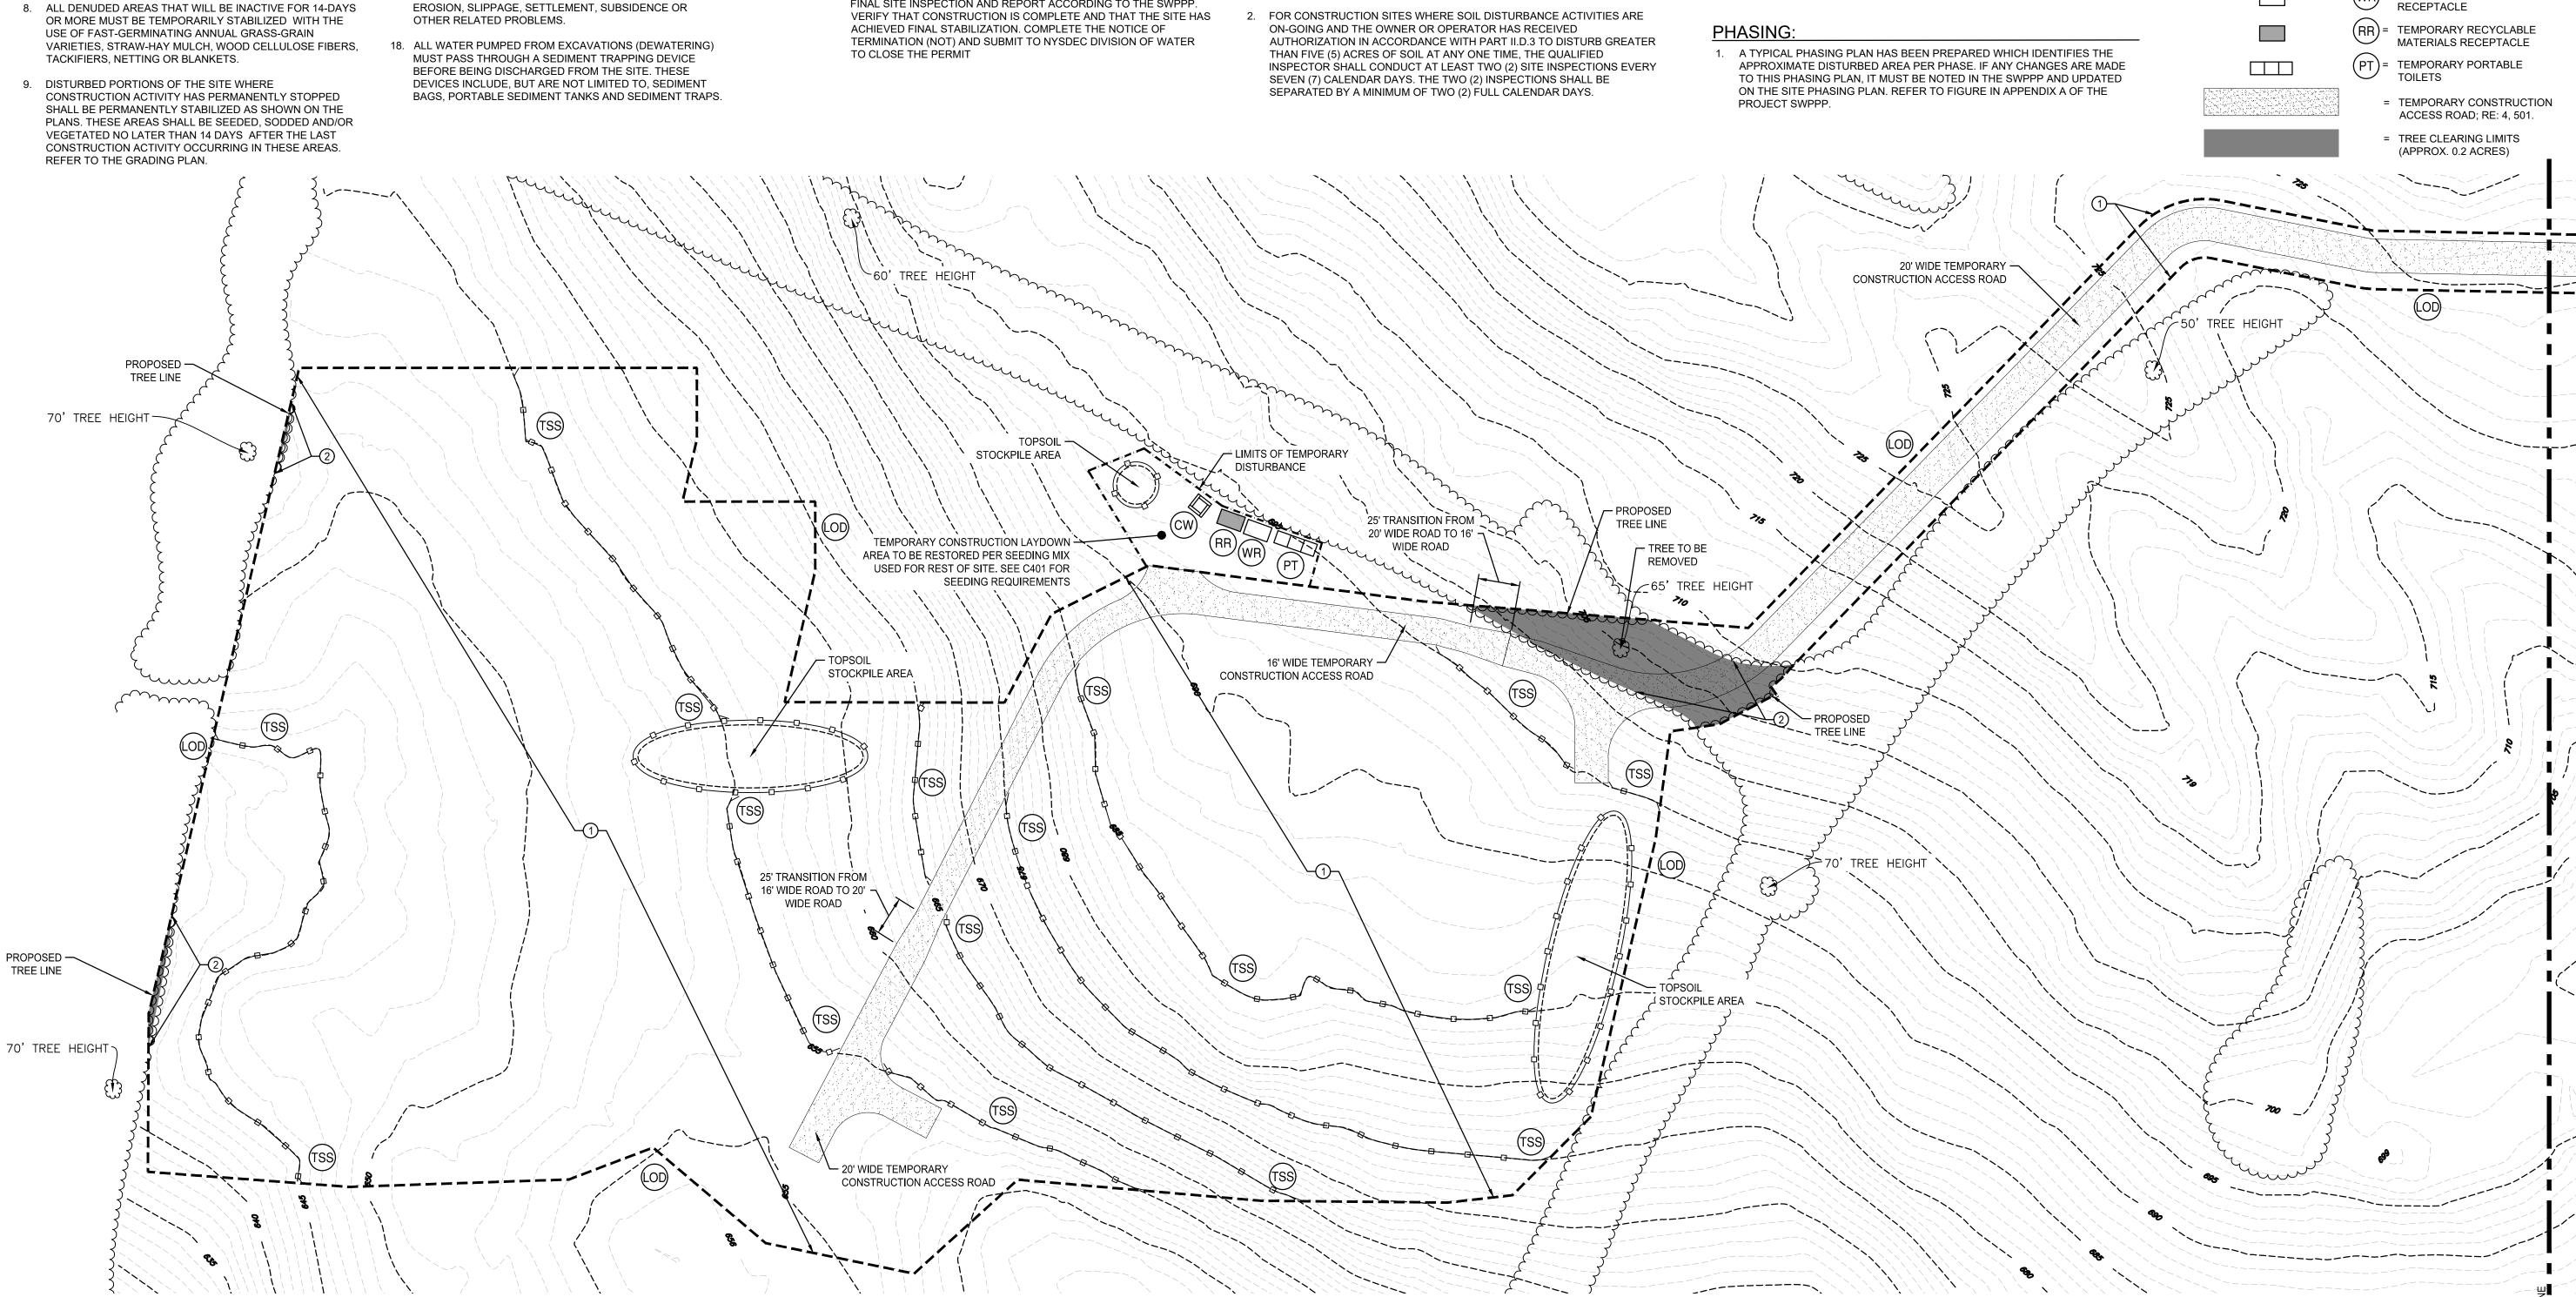
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A SITE PLAN APPROVAL/SUP SUBMISSION 11/20/2024 REVISIONS

SITE PREPARATION AND EROSION AND SEDIMENT CONTROL PLAN

GENERIC SCALE BAR SCALE BAR SHOWN IS TWO INCHES ON THE ORIGINAL DRAWIN

DATE SCALE AS NOTED DWN. CHK. SAR PROJ. No. 607153



GENERAL EROSION & SEDIMENT CONTROL NOTES: 10. IF THE ACTION OF VEHICLES TRAVELING OVER THE 1. THE CONTRACTOR SHALL IMPLEMENT BEST MANAGEMENT

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- 3. ALL WASH WATER (CONCRETE TRUCKS, VEHICLE CLEANING, EQUIPMENT CLEANING, ETC.) SHALL BE DETAINED AND PROPERLY TREATED OR DISPOSED.
- 4. SUFFICIENT OIL AND GREASE ABSORBING MATERIALS SHALL BE MAINTAINED ON SITE OR READILY AVAILABLE TO CONTAIN AND CLEAN-UP FUEL OR CHEMICAL SPILLS AND
- 5. DUST ON THE SITE SHALL BE CONTROLLED. THE USE OF MOTOR OILS AND OTHER PETROLEUM BASED OR TOXIC LIQUIDS FOR DUST SUPPRESSION OPERATIONS IS PROHIBITED.
- 6. RUBBISH, TRASH, GARBAGE, LITTER OR OTHER SUCH MATERIALS SHALL BE DEPOSITED INTO SEALED CONTAINERS. MATERIALS SHALL BE PREVENTED FROM LEAVING THE PREMISES THROUGH THE ACTION OF WIND OR STORM WATER DISCHARGE INTO DRAINAGE DITCHES, UNDERGROUND CONVEYANCE SYSTEMS OR WATERS OF THE STATE.
- 7. ALL STORM WATER POLLUTION PREVENTION MEASURES PRESENTED ON THESE PLANS SHALL BE INITIATED AS SOON AS PRACTICABLE.
- 8. ALL DENUDED AREAS THAT WILL BE INACTIVE FOR 14-DAYS OR MORE MUST BE TEMPORARILY STABILIZED WITH THE USE OF FAST-GERMINATING ANNUAL GRASS-GRAIN VARIETIES, STRAW-HAY MULCH, WOOD CELLULOSE FIBERS, TACKIFIERS, NETTING OR BLANKETS.
- 9. DISTURBED PORTIONS OF THE SITE WHERE CONSTRUCTION ACTIVITY HAS PERMANENTLY STOPPED SHALL BE PERMANENTLY STABILIZED AS SHOWN ON THE PLANS. THESE AREAS SHALL BE SEEDED, SODDED AND/OR VEGETATED NO LATER THAN 14 DAYS AFTER THE LAST CONSTRUCTION ACTIVITY OCCURRING IN THESE AREAS. REFER TO THE GRADING PLAN.

SEQUENCE OF CONSTRUCTION:

GRAVEL CONSTRUCTION ENTRANCES IS NOT SUFFICIENT

TIRES MUST BE WASHED BEFORE THE VEHICLES ENTER A

PUBLIC ROAD. IF WASHING IS USED, PROVISIONS MUST BE

SEDIMENT BEFORE IT IS CARRIED OFF THE SITE. ONLY USE

ALL MATERIALS SPILLED, DROPPED, WASHED OR TRACKED

RESPONSIBLE FOR REMOVING ACCUMULATED SEDIMENT IN

TO REMOVE THE MAJORITY OF DIRT OR MUD. THEN THE

MADE TO INTERCEPT THE WASH WATER AND TRAP THE

FROM VEHICLES ONTO ROADWAYS OR INTO STORM

ROADSIDE DRAINAGE SYSTEMS AS WELL AS ANY

SEDIMENT THAT MAY HAVE COLLECTED IN THE ONSITE

13. ON-SITE SOIL STOCKPILES AND BORROW AREAS SHALL BE

THROUGH IMPLEMENTATION OF BEST MANAGEMENT

PROTECTED FROM EROSION AND SEDIMENTATION

14. SLOPES SHALL BE LEFT IN A ROUGHENED CONDITION

DURING THE GRADING PHASE TO REDUCE RUNOFF

15. THE GENERAL CONTRACTOR IS TO DESIGNATE/IDENTIFY

AREAS ON THE PLANS (IF DIFFERENT FROM THOSE

DISTURBANCE FOR WASTE DISPOSAL AND DELIVERY AND

16. AREAS TO BE FILLED SHALL BE CLEARED AND STRIPPED OF

17. ALL FILLS SHALL BE COMPACTED AS REQUIRED TO REDUCE

EROSION, SLIPPAGE, SETTLEMENT, SUBSIDENCE OR

18. ALL WATER PUMPED FROM EXCAVATIONS (DEWATERING)

BEFORE BEING DISCHARGED FROM THE SITE. THESE

MUST PASS THROUGH A SEDIMENT TRAPPING DEVICE

DEVICES INCLUDE, BUT ARE NOT LIMITED TO, SEDIMENT

BAGS, PORTABLE SEDIMENT TANKS AND SEDIMENT TRAPS.

CURRENTLY SHOWN) INSIDE OF THE LIMITS OF

TOPSOIL PRIOR TO PLACEMENT OF FILL.

STORM SEWER DRAINAGE SYSTEM IN CONJUNCTION WITH

INGRESS/EGRESS LOCATIONS AS PROVIDED.

DRAINS MUST BE REMOVED IMMEDIATELY.

12. CONTRACTORS OR SUBCONTRACTORS WILL BE

THE STABILIZATION OF THE SITE.

VELOCITIES AND EROSION.

OTHER RELATED PROBLEMS.

SITE PREPARATION AND EROSION AND SEDIMENT CONTROL PLAN

MATERIAL STORAGE.

PRACTICES.

- 1. CONDUCT A PRE-CONSTRUCTION MEETING. INSTALL STABILIZED CONSTRUCTION ENTRANCES/EXIT(S) AND IDENTIFY LOCATION OF PROJECT SWPPP.
- 2. INSTALL PERIMETER CONTROLS (SILT FENCE / SILT SOCK) ON THE SITE. CLEAR ONLY TO THOSE AREAS NECESSARY TO INSTALL PERIMETER CONTROLS.
- 3. STABILIZE ANY EXISTING DISTURBED AREAS WITHIN THE PROPERTY THAT ARE OUTSIDE THE LIMITS OF CONSTRUCTION DISTURBANCE. 4. ENGAGE A QUALIFIED PROFESSIONAL TO PERFORM AN INITIAL SITE INSPECTION AND ASSESSMENT. IMPLEMENT ANY ADDITIONAL CONTROLS
- RECOMMENDED IN SAID INSPECTION. 5. ENGAGE A QUALIFIED INSPECTOR TO CONDUCT CONSTRUCTION
- DURATION INSPECTIONS ACCORDING TO THE SWPPP. 6. CLEAR AND GRUB SITE WITHIN LIMITS OF CONSTRUCTION.

9. BEGIN ROUGH GRADING AND MASS EXCAVATION ACTIVITIES.

- STRIP AND STOCKPILE TOPSOIL.
- 8. INSTALL TEMPORARY CONSTRUCTION ACCESS ROAD(S).
- 10. BEGIN INSTALLATION OF SOLAR ARRAYS. 11. INSTALL STORM SEWERS, STORMWATER MANAGEMENT PRACTICES, AND
- OTHER REQUIRED UTILITIES. 12. INSTALL AND MAINTAIN ALL PRACTICES IN CONFORMANCE WITH THE
- PLANS, DETAILS, AND PROJECT SWPPP. 13. TEMPORARILY SEED, THROUGHOUT CONSTRUCTION, DENUDED AREAS
- THAT WILL BE INACTIVE FOR 14 DAYS OR MORE. 14. INSTALL SOLAR PANELS.
- 15. REMOVE TEMPORARY ACCESS ROADS AND APPLY SOIL RESTORATION PRACTICES PER SECTION 5.1.6 OF THE SWDM.
- 16. INSTALL PERVIOUS GRAVEL ROADWAY. 17. PERMANENTLY STABILIZE AREAS AS THEY ARE BROUGHT TO FINAL GRADE.

TO CLOSE THE PERMIT

- 18. COMPLETE FINAL GRADING AND INSTALL LANDSCAPE PLANTINGS. 19. RESTORE SOIL IN ACCORDANCE WITH SECTION 5.1.6 OF THE
- STORMWATER MANAGEMENT DESIGN MANUAL. FULL SOIL RESTORATION IS REQUIRED IN AREAS OF CUT OR FILL AND IN AREAS THAT HAVE BEEN IMPACTED BY CONSTRUCTION EQUIPMENT
- 20. OBTAIN CONCURRENCE WITH THE CONSTRUCTION MANAGER (CM) THAT THE SITE HAS BEEN FULLY STABILIZED THEN:

a. REMOVE ALL REMAINING TEMPORARY EROSION AND SEDIMENT

CONTROL DEVICES. b. STABILIZE ANY AREAS DISTURBED BY THE REMOVAL OF BMP'S c. ASK THE CM TO CONTACT THE QUALIFIED INSPECTOR TO COMPLETE FINAL SITE INSPECTION AND REPORT ACCORDING TO THE SWPPP. VERIFY THAT CONSTRUCTION IS COMPLETE AND THAT THE SITE HAS ACHIEVED FINAL STABILIZATION. COMPLETE THE NOTICE OF TERMINATION (NOT) AND SUBMIT TO NYSDEC DIVISION OF WATER

NOTES TO THE CONTRACTOR:

- 1. ALL SOIL EROSION & SEDIMENT CONTROL MEASURES ARE TO BE INSTALLED IN CONFORMANCE WITH THE PROJECT DETAILS & SPECIFICATIONS CONTAINED WITHIN THE LATEST REVISION OF THE PROJECT STORMWATER POLLUTION PREVENTION PLAN (SWPPP). CONTRACTOR TO UTILIZE THE FOLLOWING EROSION CONTROL MEASURES AS NECESSARY AND AS DIRECTED BY A QUALIFIED INSPECTOR (OR QUALIFIED PROFESSIONAL) TO MINIMIZE SOIL EROSION AND SEDIMENT REMOVAL: SILT FENCE OR SILT SOCKS, CONSTRUCTION ENTRANCE, CHECK DAMS, SEDIMENT TRAPS, AND DUST CONTROL (WATERING).
- 2. IMMEDIATELY DENOTE THE LOCATIONS OF THE FOLLOWING ITEMS ON THE SITE PLANS AFTER THEY ARE IMPLEMENTED AND INSTALLED AND NOTE ANY CHANGES IN LOCATION AS THEY OCCUR THROUGHOUT THE CONSTRUCTION PROCESS: TRAILERS, LAY DOWN AREAS, PORTA-POTTIES, WHEEL WASHES, CONCRETE WASHOUTS, MASON'S AREA, FUEL AND MATERIAL STORAGE CONTAINERS, SOLID WASTE CONTAINERS, ETC.
- 3. THE CONTRACTOR MAY ADJUST OR RELOCATE EROSION AND SEDIMENT CONTROL MEASURES AS NECESSARY THROUGHOUT CONSTRUCTION. CHANGES TO THESE MEASURES MUST BE IMMEDIATELY DENOTED IN THE PROJECT SWPPP AND ON THE SITE PLANS. CHANGES MADE TO THESE MEASURES MUST PROVIDE EQUAL OR GREATER MITIGATION TO THE AREA WHICH SAID MEASURES ARE INTENDED TO PROTECT ON THE SITE PLANS. THE CONTRACTOR MUST TAKE WHATEVER MEANS NECESSARY TO PREVENT SEDIMENT FROM LEAVING THE PROJECT SITE.
- 4. CONTRACTOR IS RESPONSIBLE FOR LOCATING A NEARBY LAYDOWN AND PARKING AREA ON-SITE. THE LAYDOWN AREA MUST AVOID WETLANDS, WETLAND BUFFERS, AND OTHER NATURAL RESOURCES. BEFORE DEMOBILIZATION, CONTRACTOR SHALL RESTORE THE LAYDOWN AREA TO **EXISTING CONDITIONS.**

INSPECTION FREQUENCY:

- 1. AS REQUIRED BY THE GENERAL PERMIT. FOR CONSTRUCTION SITES WHERE SOIL DISTURBANCE ACTIVITIES ARE ON-GOING, THE QUALIFIED INSPECTOR SHALL CONDUCT A SITE INSPECTION AT LEAST ONCE EVERY SEVEN (7) CALENDAR DAYS.
- FOR CONSTRUCTION SITES WHERE SOIL DISTURBANCE ACTIVITIES ARE ON-GOING AND THE OWNER OR OPERATOR HAS RECEIVED AUTHORIZATION IN ACCORDANCE WITH PART II.D.3 TO DISTURB GREATER THAN FIVE (5) ACRES OF SOIL AT ANY ONE TIME, THE QUALIFIED INSPECTOR SHALL CONDUCT AT LEAST TWO (2) SITE INSPECTIONS EVERY SEVEN (7) CALENDAR DAYS. THE TWO (2) INSPECTIONS SHALL BE SEPARATED BY A MINIMUM OF TWO (2) FULL CALENDAR DAYS.

OSITE PREP NOTES: **BEST MANAGEMENT PRACTICE MAINTENANCE:**

1. SITE CLEARING AND GRUBBING TO EXTENTS OF LIMITS OF DISTURBANCE.

2. REMOVE TREES, CLEAR AND GRUB UNDERSTORY VEGETATION.

LEGEND

STONEWALL

PROPERTY LINE SUB-PARCELS EDGE OF VEGETATION/WOODS

3. THE CONSTRUCTION ENTRANCES/EXITS SHALL BE MAINTAINED IN A CONDITION WHICH WILL PREVENT TRACKING OR FLOW OF MUD ONTO

ALL BEST MANAGEMENT PRACTICES (INCLUDING EROSION AND SEDIMENT

CONTROLS) SHOWN ON THIS PLAN, AND AS DESCRIBED IN THE STORM

WATER POLLUTION PREVENTION PLAN, SHALL BE MAINTAINED IN FULLY

AND SEDIMENTATION CONTROL MEASURES SHALL BE CHECKED BY A

OR THE APPLICABLE PERMIT, WHICHEVER IS MORE STRINGENT, AND

REPAIRED IN ACCORDANCE WITH THE FOLLOWING:

WATERED, AND RESEEDED AS NEEDED.

FLUSHING.

LBS. PER 1,000 SQUARE FEET).

PROJECT SWPPP.

PHASING:

FUNCTIONAL CONDITION UNTIL NO LONGER REQUIRED FOR A COMPLETED

PHASE OF WORK OR UNTIL FINAL STABILIZATION OF THE SITE. ALL EROSION

QUALIFIED INSPECTOR IN ACCORDANCE WITH THE CONTRACT DOCUMENTS

1. ALL SEEDED AREAS SHALL BE CHECKED REGULARLY SO THAT A

GOOD STAND IS MAINTAINED. AREAS SHOULD BE FERTILIZED,

2. SILT FENCE / SILT SOCK SHALL BE REPAIRED TO ITS ORIGINAL

PUBLIC RIGHTS-OF-WAY. THIS MAY REQUIRE PERIODIC TOP

SHALL BE CLEANED IMMEDIATELY BY A METHOD OTHER THAN

IF SEASON IS SPRING. SUMMER. OR EARLY FALL: SEED WITH RYEGRASS

(ANNUAL OR PERENNIAL) AT 30 LBS. PER ACRE (APPROX. 1 LB. PER 1,000

'AROOSTOOK' WINTER RYE (CEREAL RYE) AT 100 LBS. PER ACRE (APPROX. 2.5

1. A TYPICAL PHASING PLAN HAS BEEN PREPARED WHICH IDENTIFIES THE

APPROXIMATE DISTURBED AREA PER PHASE. IF ANY CHANGES ARE MADE

TO THIS PHASING PLAN, IT MUST BE NOTED IN THE SWPPP AND UPDATED

ON THE SITE PHASING PLAN. REFER TO FIGURE IN APPENDIX A OF THE

IF SEASON IS LATE FALL OR EARLY WINTER; SEED WITH CERTIFIED

TEMPORARY VEGETATION SEED MIX:

CONDITIONS IF DAMAGED. SEDIMENT SHALL BE REMOVED WHEN IT

REACHES ONE-HALF THE HEIGHT OF THE SILT FENCE OR SOCK (OR


DRESSING OF THE CONSTRUCTION EXITS AS CONDITIONS DEMAND.

4. PRIOR TO LEAVING THE SITE, ALL VEHICLES SHALL BE CLEANED OF

DEBRIS. ANY DEBRIS AND/OR SEDIMENT REACHING PUBLIC STREETS

LESS IF IT INTERFERES WITH THE FUNCTIONALITY OF THE PRACTICE).


----- (LOD) = LIMITS OF DISTURBANCE = 9.92 ACRES = LIMITS OF TEMPORARY DISTURBANCE = 0.13 ACRES TEMPORARY 12" COMPOST _____ FILTER SOCK; RE: 5, C501. TEMPORARY STABILIZED CONSTRUCTION ENTRANCE;

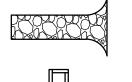


SYMBOL LEGEND

RE: 1, C501. = TEMPORARY CONCRETE WASHOUT; RE: 6, C501. (WR) = TEMPORARY WASTE

0000000000

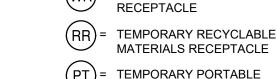

(PT)= TEMPORARY PORTABLE TOILETS

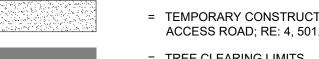

= TEMPORARY CONSTRUCTION

= TREE CLEARING LIMITS (APPROX. 0.2 ACRES)

c/o RIC Development, LLC

17 State Street, Suite 2320

New York, NY 10004

ANCRAM SOLAR


3333 State Route 82

Ancramdale, NY 12503

375 Essjay Road, Suite 200 Williamsville, NY 14221 www.wendelcompanies.com p:716.688.0766 f:716.625.6825

Wendel WD Architecture, Engineering, Surveying and Landscape Architecture, P.C.

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A SITE PLAN APPROVAL/SUP SUBMISSION 11/20/2024

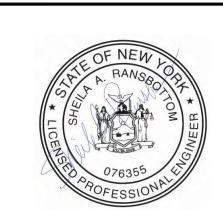SITE PREPARATION AND EROSION AND SEDIMENT CONTROL PLAN

SCALE BAR SHOWN IS TWO INCHES ON THE ORIGINAL DRAW! DATE SCALE AS NOTED DWN. KCS PROJ. No. 607153

DWG. No.

_____ PROPERTY BOUNDARY PROPOSED -TREE LINE PROPOSED -PROPERTY BOUNDARY TREE LINE 20' WIDE TEMPORARY CONSTRUCTION ACCESS ROAD 60' TREE HEIGHT TREE LINE BOUNDARY 20' WIDE TEMPORARY CONSTRUCTION ACCESS ROAD -- PROPOSED TREE LINE -CENTERLINE ROAD PROPERTY BOUNDARY -INV. 12" CMP

LAND TYPE	ACREAGE WITHIN PARCEL	ACREAGE WITHIN LIMITS OF DISTURBANCE (LOD)	PERCENTAGE OF EACH LAND TYPE WITHIN LOD	PERCENTAGE OF OVERALL PARCEL WITHIN LOD
FARMLAND OF STATEWIDE IMPORTANCE	51.95	4.61	8.87%	4.86%
PRIME FARMLAND	7.51	2.87	38.22%	3.03%
NOT PRIME FARMLAND	35.32	2.40	6.80%	2.53%
TOTAL ACRES	94.78	9.92		

SOILS CLASSIFICATION TABLE			
SOIL SYMBOL	SOIL NAME	AREA (AC)	LAND CLASSIFICATION
BIB	BLASDELL CHANNERY LOAM, 3% TO 8% SLOPES	0.01	PRIME FARMLAND
BIC	BLASDELL CHANNERY LOAM, ROLLING	9.24	FARMLAND OF STATEWIDE IMPORTANCE
BID	BLASDELL CHANNERY LOAM, HILLING	4.19	NOT PRIME FARMLAND
FaC	FARMINGTON SILT LOAM, ROLLING, VERY ROCKY	8.89	NOT PRIME FARMLAND
NbC	NASSAU CHANNERY SILT LOAM, ROLLING, VERY ROCKY	4.76	NOT PRIME FARMLAND
StB	STOCKBRIDGE SILT LOAM, 3%TO 8% SLOPES	7.50	PRIME FARMLAND
SuC	STOCKBRIDGE-FARMINGTON SILT LOAMS, ROLLING	42.71	FARMLAND OF STATEWIDE IMPORTANCE
SvD	STOCKBRIDGE-FARMINGTON SILT LOAMS, HILLING, VERY ROCKY	17.48	NOT PRIME FARMLAND

SOILS LEGEND:

FARMLAND OF STATEWIDE IMPORTANCE

PRIME FARMLAND

NOT PRIME FARMLAND

LEGEND:

PROPERTY LINE

LIMITS OF DISTURBANCE

GENERAL NOTES:

EDGE OF VEGETATION/WOODS

- 1. LOCATION AND DESCRIPTION OF SOILS WERE ACQUIRED THROUGH THE WEB SOIL SURVEY WEBSITE AS HOSTED BY THE USDA NATIONAL RESOURCES CONSERVATION SERVICE (NRCS).
- 2. PROJECT PARCEL INFORMATION:
 REPUTED OWNER JAMES P. MILLER & JANICE M. MILLER
 SBL: 214.-1-25.4
 ACREAGE = ± 94.78 AC
- 3. CURRENT AGRICULTURAL USE FOR THE PARCEL IS CORN.
- 4. PER LANDOWNER, NO TILE DRAIN LOCATIONS ARE PRESENT ON SITE. IF ENCOUNTERED, CONTRACTOR SHALL REPAIR AND/OR REPLACE ANY DAMAGED DRAIN TILES DUE TO CONSTRUCTION OF THE PROJECT.

RIC ENERGY
Ancram PV, LLC

c/o RIC Development, LLC 17 State Street, Suite 2320 New York, NY 10004

ANCRAM SOLAR

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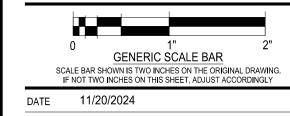


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Α	SITE PLAN APPROVAL/SUP SUBMISSION	11/20/2024
NO.	REVISIONS	DATE

DWG. TITLE

SOIL CONDITIONS MAP




 SCALE
 AS NOTED

 DWN.
 KCS
 CHK.
 SAR

 PROJ. No.
 607153

040

DWG. No.

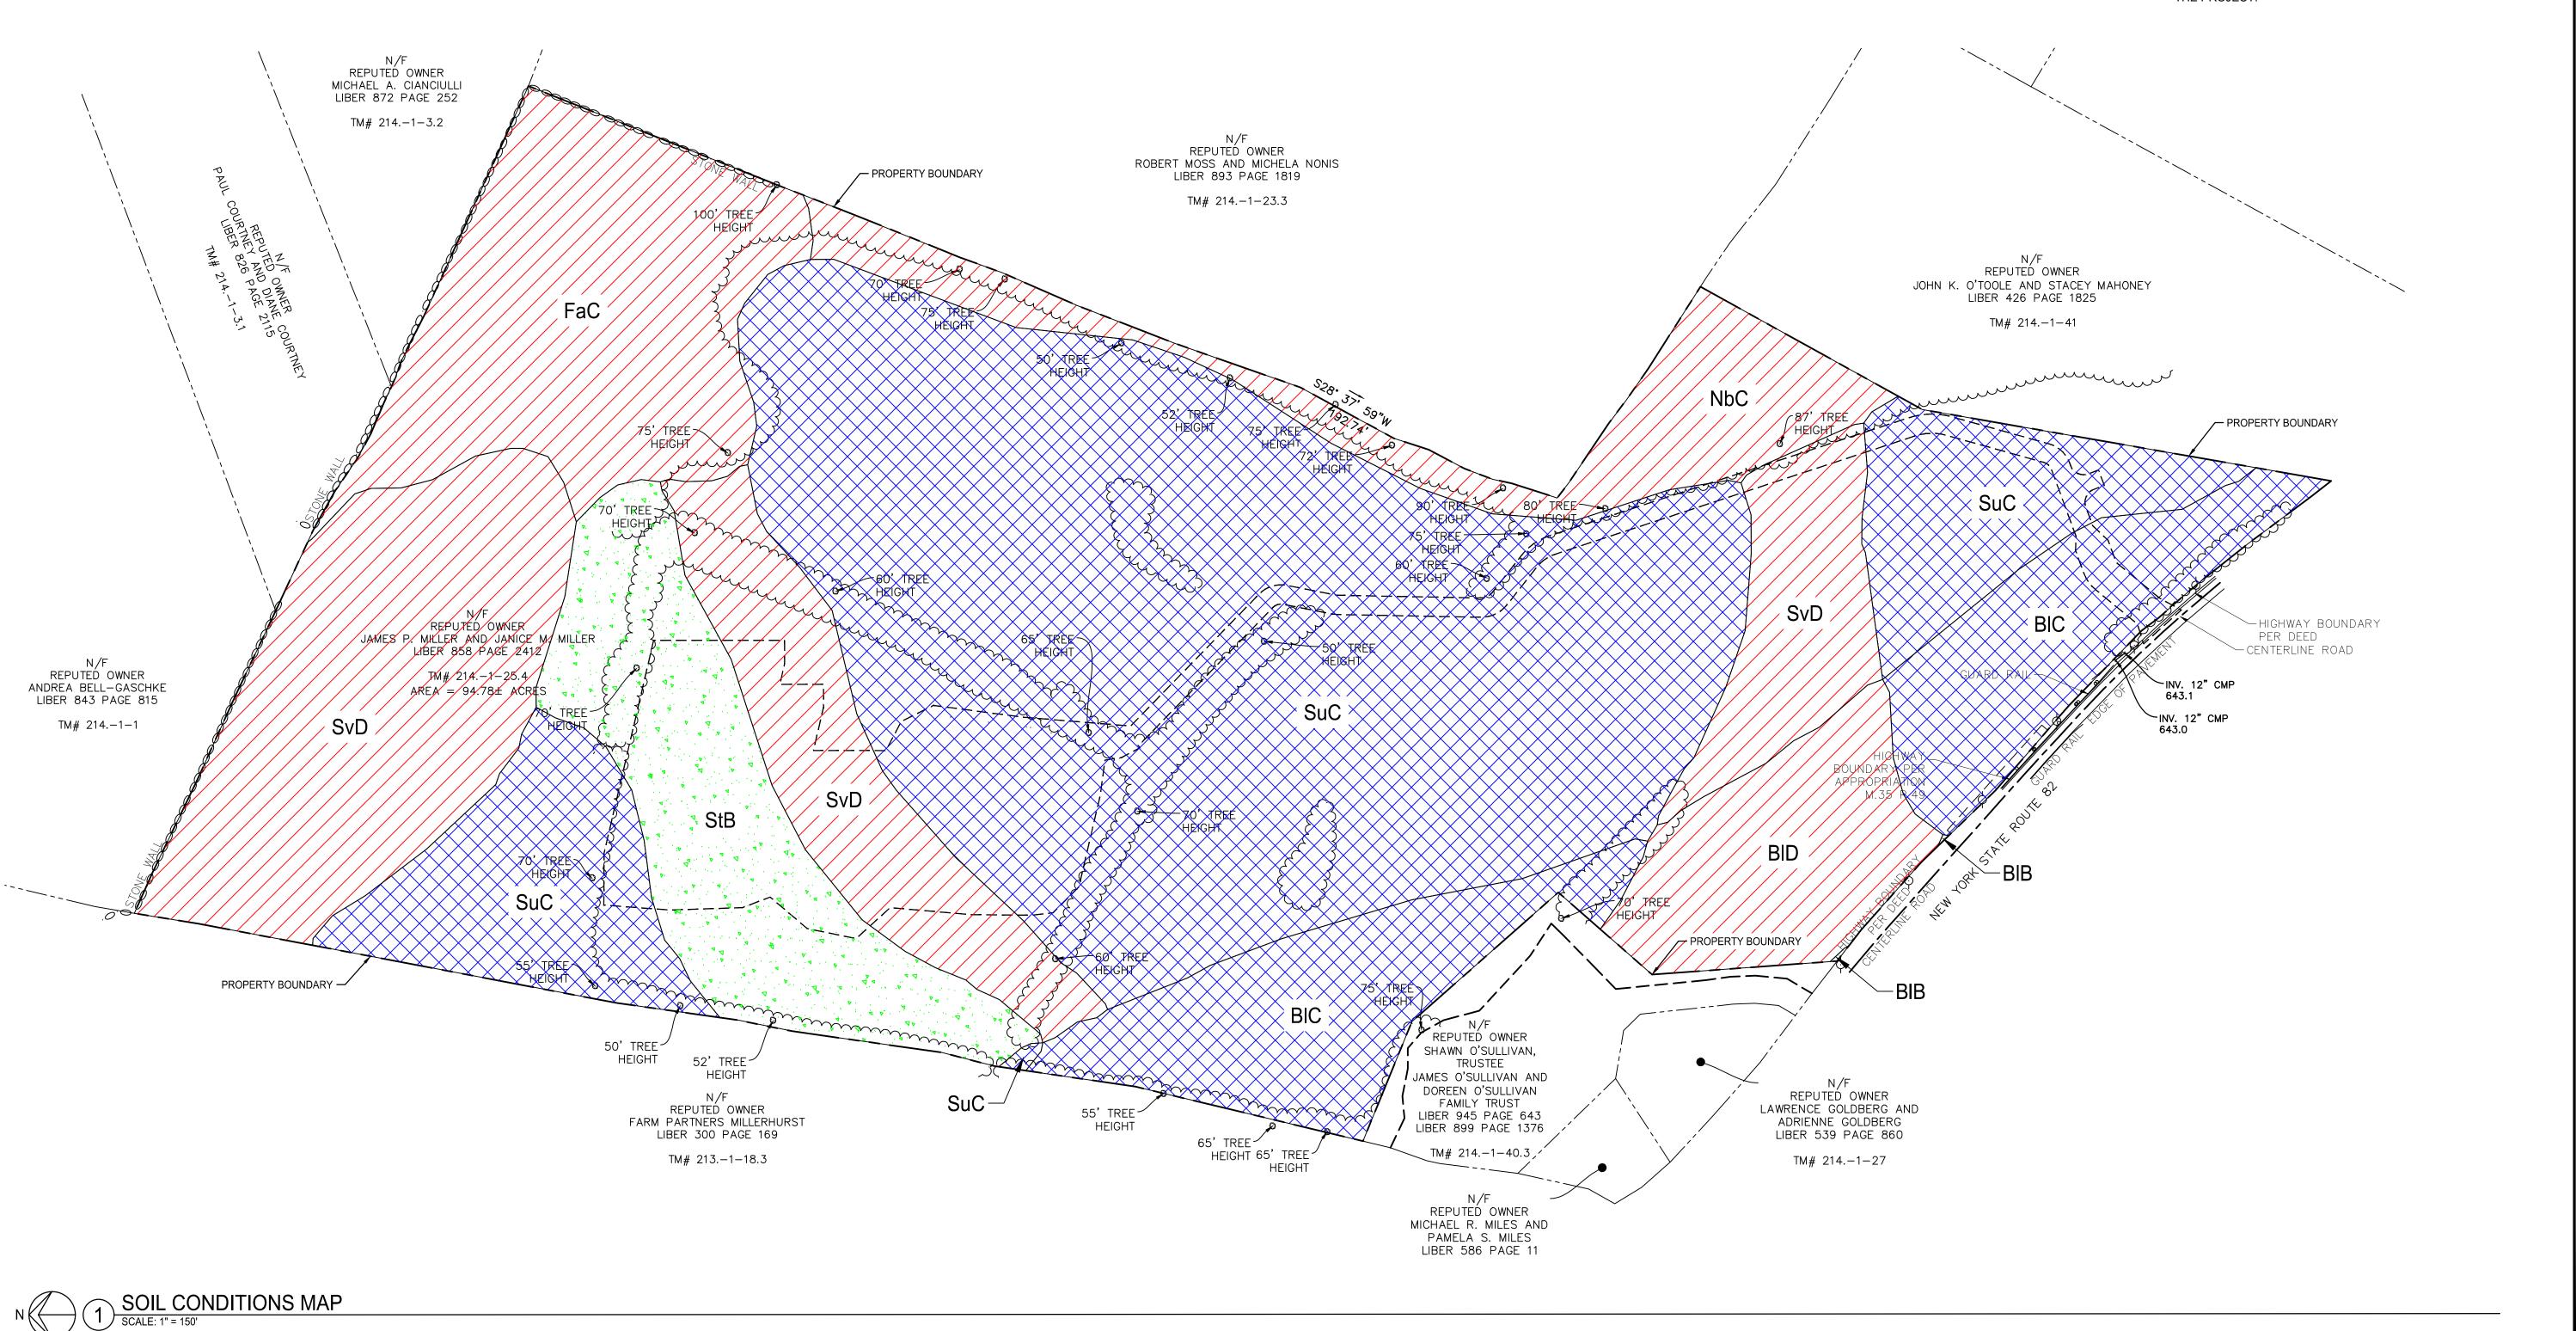

GENERAL NOTES:

THIS DRAWING IS TO SHOW THE ENTIRE PARCEL ON WHICH THE PROJECT SITE IS LOCATED. SEE SHEETS C201 AND C202 FOR ENLARGED SITE PLAN.

SEE SHEET C203 FOR INTERCONNECTION AND DRIVEWAY INFORMATION.

LEGEND:

EDGE OF VEGETATION/WOODS

LIMITED USE PERVIOUS ACCESS ROAD

IMPERVIOUS ACCESS ROAD ENTRANCE

LIMITS OF DISTURBANCE _______

PROPOSED WILDLIFE FRIENDLY FENCE _______

SITE DATA SUMMARY

PROPERTY LOCATION: 3333 STATE ROUTE 82
ANCRAMDALE, COLUMBIA COUNTY, NEW YORK

LOT AREA: 94.78 AC.

MAXIMUM STRUCTURE HEIGHT:

CURRENT ZONING: AG - AGRICULTURE DISTRICT

EXISTING USE: AGRICULTURAL FIELD (CORN)

PROPOSED USE: SOLAR FACILITY

 LOT REQUIREMENTS:
 REQUIRED
 PROPOSED

 FRONT SETBACK (MIN.)
 50 FT
 1446.93 FT

 EAST SIDE SETBACK (MIN.)
 100 FT
 803.79 FT

 WEST SIDE SETBACK (MIN.)
 100 FT
 257.59 FT

 REAR SETBACK (MIN.)
 100 FT
 673.35 FT

 LOT WIDTH AT FRONT SETBACK (MIN.)
 50 FT
 1349.06 FT

15 FT

12 FT

≥ RIC ENE

Ancram PV, LLC c/o RIC Development, LLC 17 State Street, Suite 2320 New York, NY 10004

ANCRAM SOLAR

3333 State Route 82 Ancramdale, NY 12503



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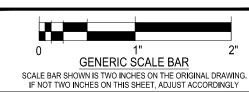


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Α	SITE PLAN APPROVAL/SUP SUBMISSION	11/20/2024
NO.	REVISIONS	DATE

DWG. TITLE


OVERALL SITE LAYOUT PLAN



DATE AS NOTED

DWN. KCS CHK. SAR

PROJ. No. 607153

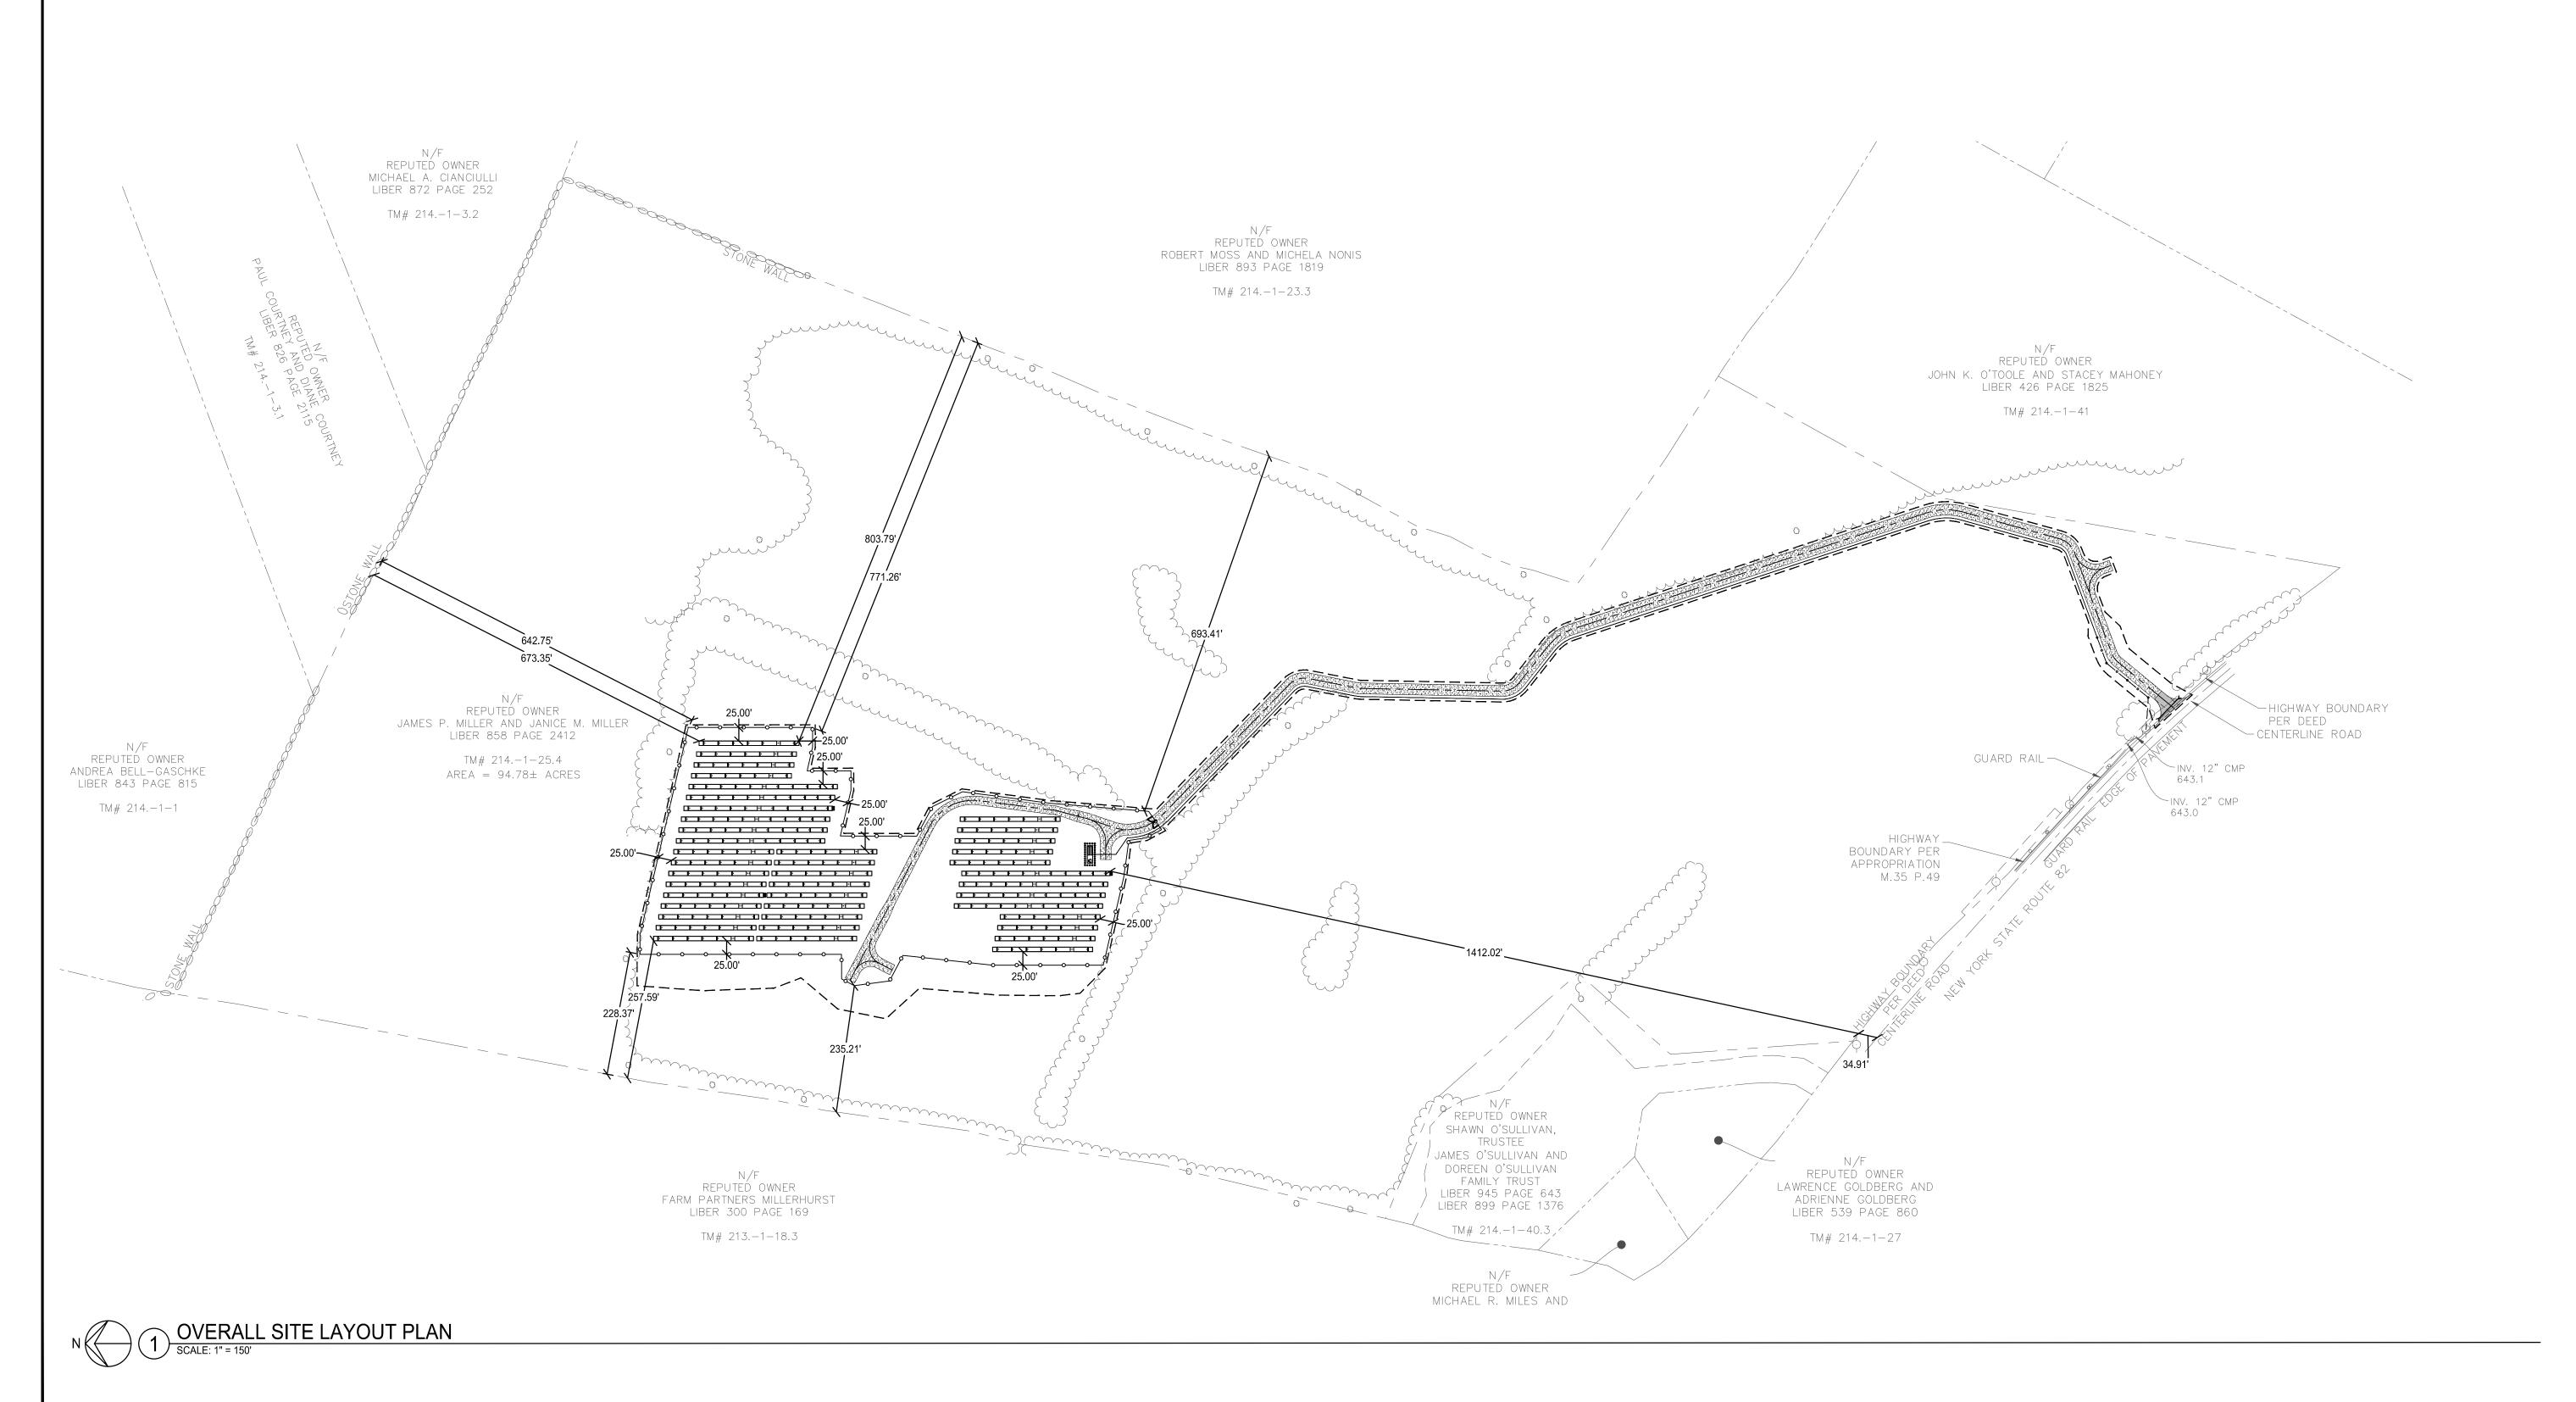

NYSDAM GUIDELINES: 1. TOPSOIL SAMPLING, STOCKPILING, SPREADING, SEEDING AND SITE RESTORATION IS TO BE PERFORMED IN ACCORDANCE WITH THE NYS DEPARTMENT OF AGRICULTURE & MARKETS GUIDELINES FOR SOLAR ENERGY PROJECTS CONSTRUCTION MITIGATION, REVISED 10/18/2019. 2. TOPSOIL SHALL BE STRIPPED AND STOCKPILED SEPARATELY FOR ALL OPEN-CUT TRENCHING OPERATIONS. 3. THE CONTRACTOR SHALL NOTIFY DIG SAFELY NEW YORK (UDIG NY OR CALL 811) PRIOR TO CONSTRUCTION. 4. ALL BURIED UTILITIES LOCATED WITHIN THE GENERATION FACILITY'S SECURITY FENCE MUST HAVE A MINIMUM DEPTH OF 18" COVER IF BURIED IN A CONDUIT AND A MINIMUM DEPTH OF 24" OF COVER IF DIRECTLY BURIED. 5. THERE SHALL BE A DESIGNATED ENVIRONMENTAL MONITOR ON SITE WHENEVER CONSTRUCTION OR RESTORATION WORK IS OCCURRING ON AGRICULTURAL LAND. COORDINATION WITH THE NYSDAM, DIVISION OF LAND AND WATER RESOURCES, IS REQUIRED TO DEVELOP A SCHEDULE FOR INSPECTIONS AND ENSURE COMPLIANCE WITH THE DEPARTMENT'S CURRENT GUIDELINES.

GENERAL NOTES: LEGEND: ACCESS DRIVE ALIGNMENTS AND TURNAROUND LAYOUT WERE LIMITED USE PERVIOUS ACCESS ROAD DESIGNED USING THE 2020 INTERNATIONAL FIRE CODE APPENDIX D FIRE APPARATUS ACCESS ROAD GUIDELINES. IMPERVIOUS ACCESS ROAD ENTRANCE THE LIMITED USE PERVIOUS ACCESS ROAD IS NOT TO BE USED DURING CONSTRUCTION. UPON COMPLETION OF CONSTRUCTION, ACCESS ROAD CENTERLINE THE CONTRACTOR IS RESPONSIBLE FOR REMOVING THE TEMPORARY CONSTRUCTION ACCESS ROAD AND DECOMPACTING PROPERTY LINE THE SUBGRADE SOILS PRIOR TO THE INSTALLATION OF THE LIMITED USE PERVIOUS ACCESS ROAD. EDGE OF VEGETATION/WOODS

- THE LIMIT OF DISTURBANCE SHOWN ON THESE PLANS IS ± 9.92 ACRES AND ENCOMPASSES THE PROJECT'S PROPOSED FEATURES. THESE FEATURES INCLUDE: THE PERVIOUS ACCESS ROAD AND ASSOCIATED GRADING, INSTALLATION OF PANELS AND ASSOCIATED GRADING, CONCRETE TRANSFORMER PADS, UNDERGROUND COLLECTION LINE, SOLAR ARRAY POLE FOUNDATIONS, AND FENCE POST FOUNDATIONS.
- 4. SOILS ON-SITE WILL BE RE-SEEDED AND AMENDED TO THEIR ORIGINAL CONDITION AFTER DECOMMISSIONING.
- ANY EXISTING TILE DRAIN LOCATIONS ARE TO BE VERIFIED BY THE CONTRACTOR PRIOR TO CONSTRUCTION. CONTRACTOR SHALL REPAIR AND/OR REPLACE ANY DAMAGED DRAIN TILES DUE TO CONSTRUCTION OF THE PROJECT.

SITE DATA SUMMARY

LIMITS OF DISTURBANCE

PROPOSED WILDLIFE FRIENDLY FENCE

○ SITE IMPROVEMENT NOTES:

1. LIMITED USE PERVIOUS ACCESS ROAD;

RE. DETAILS 1, 2, AND 3 ON DRAWING C503.

2. WILDLIFE FRIENDLY FENCE; RE. DETAIL 1, C502.

4. SOLAR ARRAY MODULE, TYP; RE. DETAIL 2, C501

3. WILDLIFE FRIENDLY GATE; RE. DETAIL 1, C502.

PROPERTY LOCATION: 3333 STATE ROUTE 82 ANCRAMDALE, COLUMBIA COUNTY, NEW YORK

LOT AREA: 94.78 AC.

CURRENT ZONING: AG - AGRICULTURE DISTRICT **EXISTING USE:** AGRICULTURAL FIELD (CORN)

PROPOSED USE: SOLAR FACILITY

- -	
	LOT REQUI
	FRON
	EAST
	\A/E07

1101 0020 0021 002, 1111 110121	• •
OT REQUIREMENTS:	REQUIRED
FRONT SETBACK (MIN.)	50 FT
EAST SIDE SETBACK (MIN.)	100 FT
WEST SIDE SETBACK (MIN.)	100 FT
REAR SETBACK (MIN.)	100 FT

MAXIMU

LOT WIDTH AT FRONT SETBACK (MIN.)	50 FT
MUM STRUCTURE HEIGHT:	15 FT

803.79 FT


257.59 FT


673.35 FT


1349.06 FT

12 FT

LONG	- 73.606538
ILR	1.4
SYSTEM SIZE (DC)	1,343 kW
SYSTEM SIZE (AC)	957 kW
MODULE TYPE	Q.TRON XL-G2-BFG (635 W)
QUANTITY	2,116 (92 strings)
MODULES PER STRING	23
INVERTER TYPE	Sungrow SG350HX
QUANTITY	3
SOLAR TRACKER TYPE	TRACKER 1P
DIMENSIONS OF THE TRACKER	(3s) 273'-8" x 8'-1" x 5'-8"
(3 strings & 2 strings) (LxWxH)	(2s) 184'-3" x 8'-1" x 5'-8"
TILT ANGLE	±60°
PITCH	20'
FENCE LENGTH	2,825'
ACCESS ROAD LENGTH	3,026'
TOTAL MV LINE LENGTH	2,395'
TOTAL AREA OF DISTURBANCE	9.92 AC
100000	0000 01 1 7 1 00 1 1 1 1 1 1 1 1 1 1 1 1

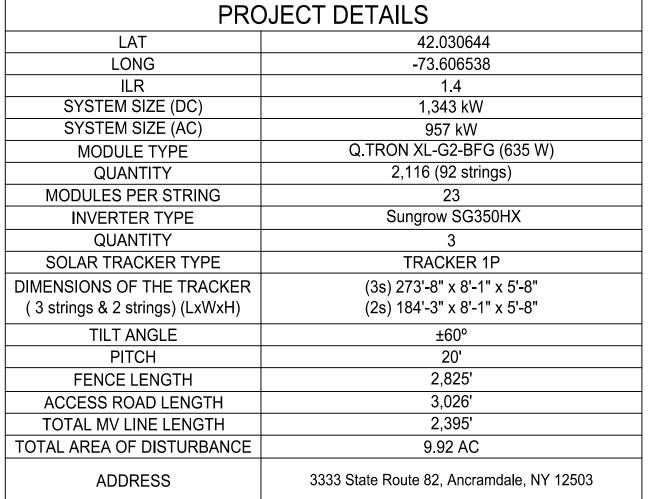

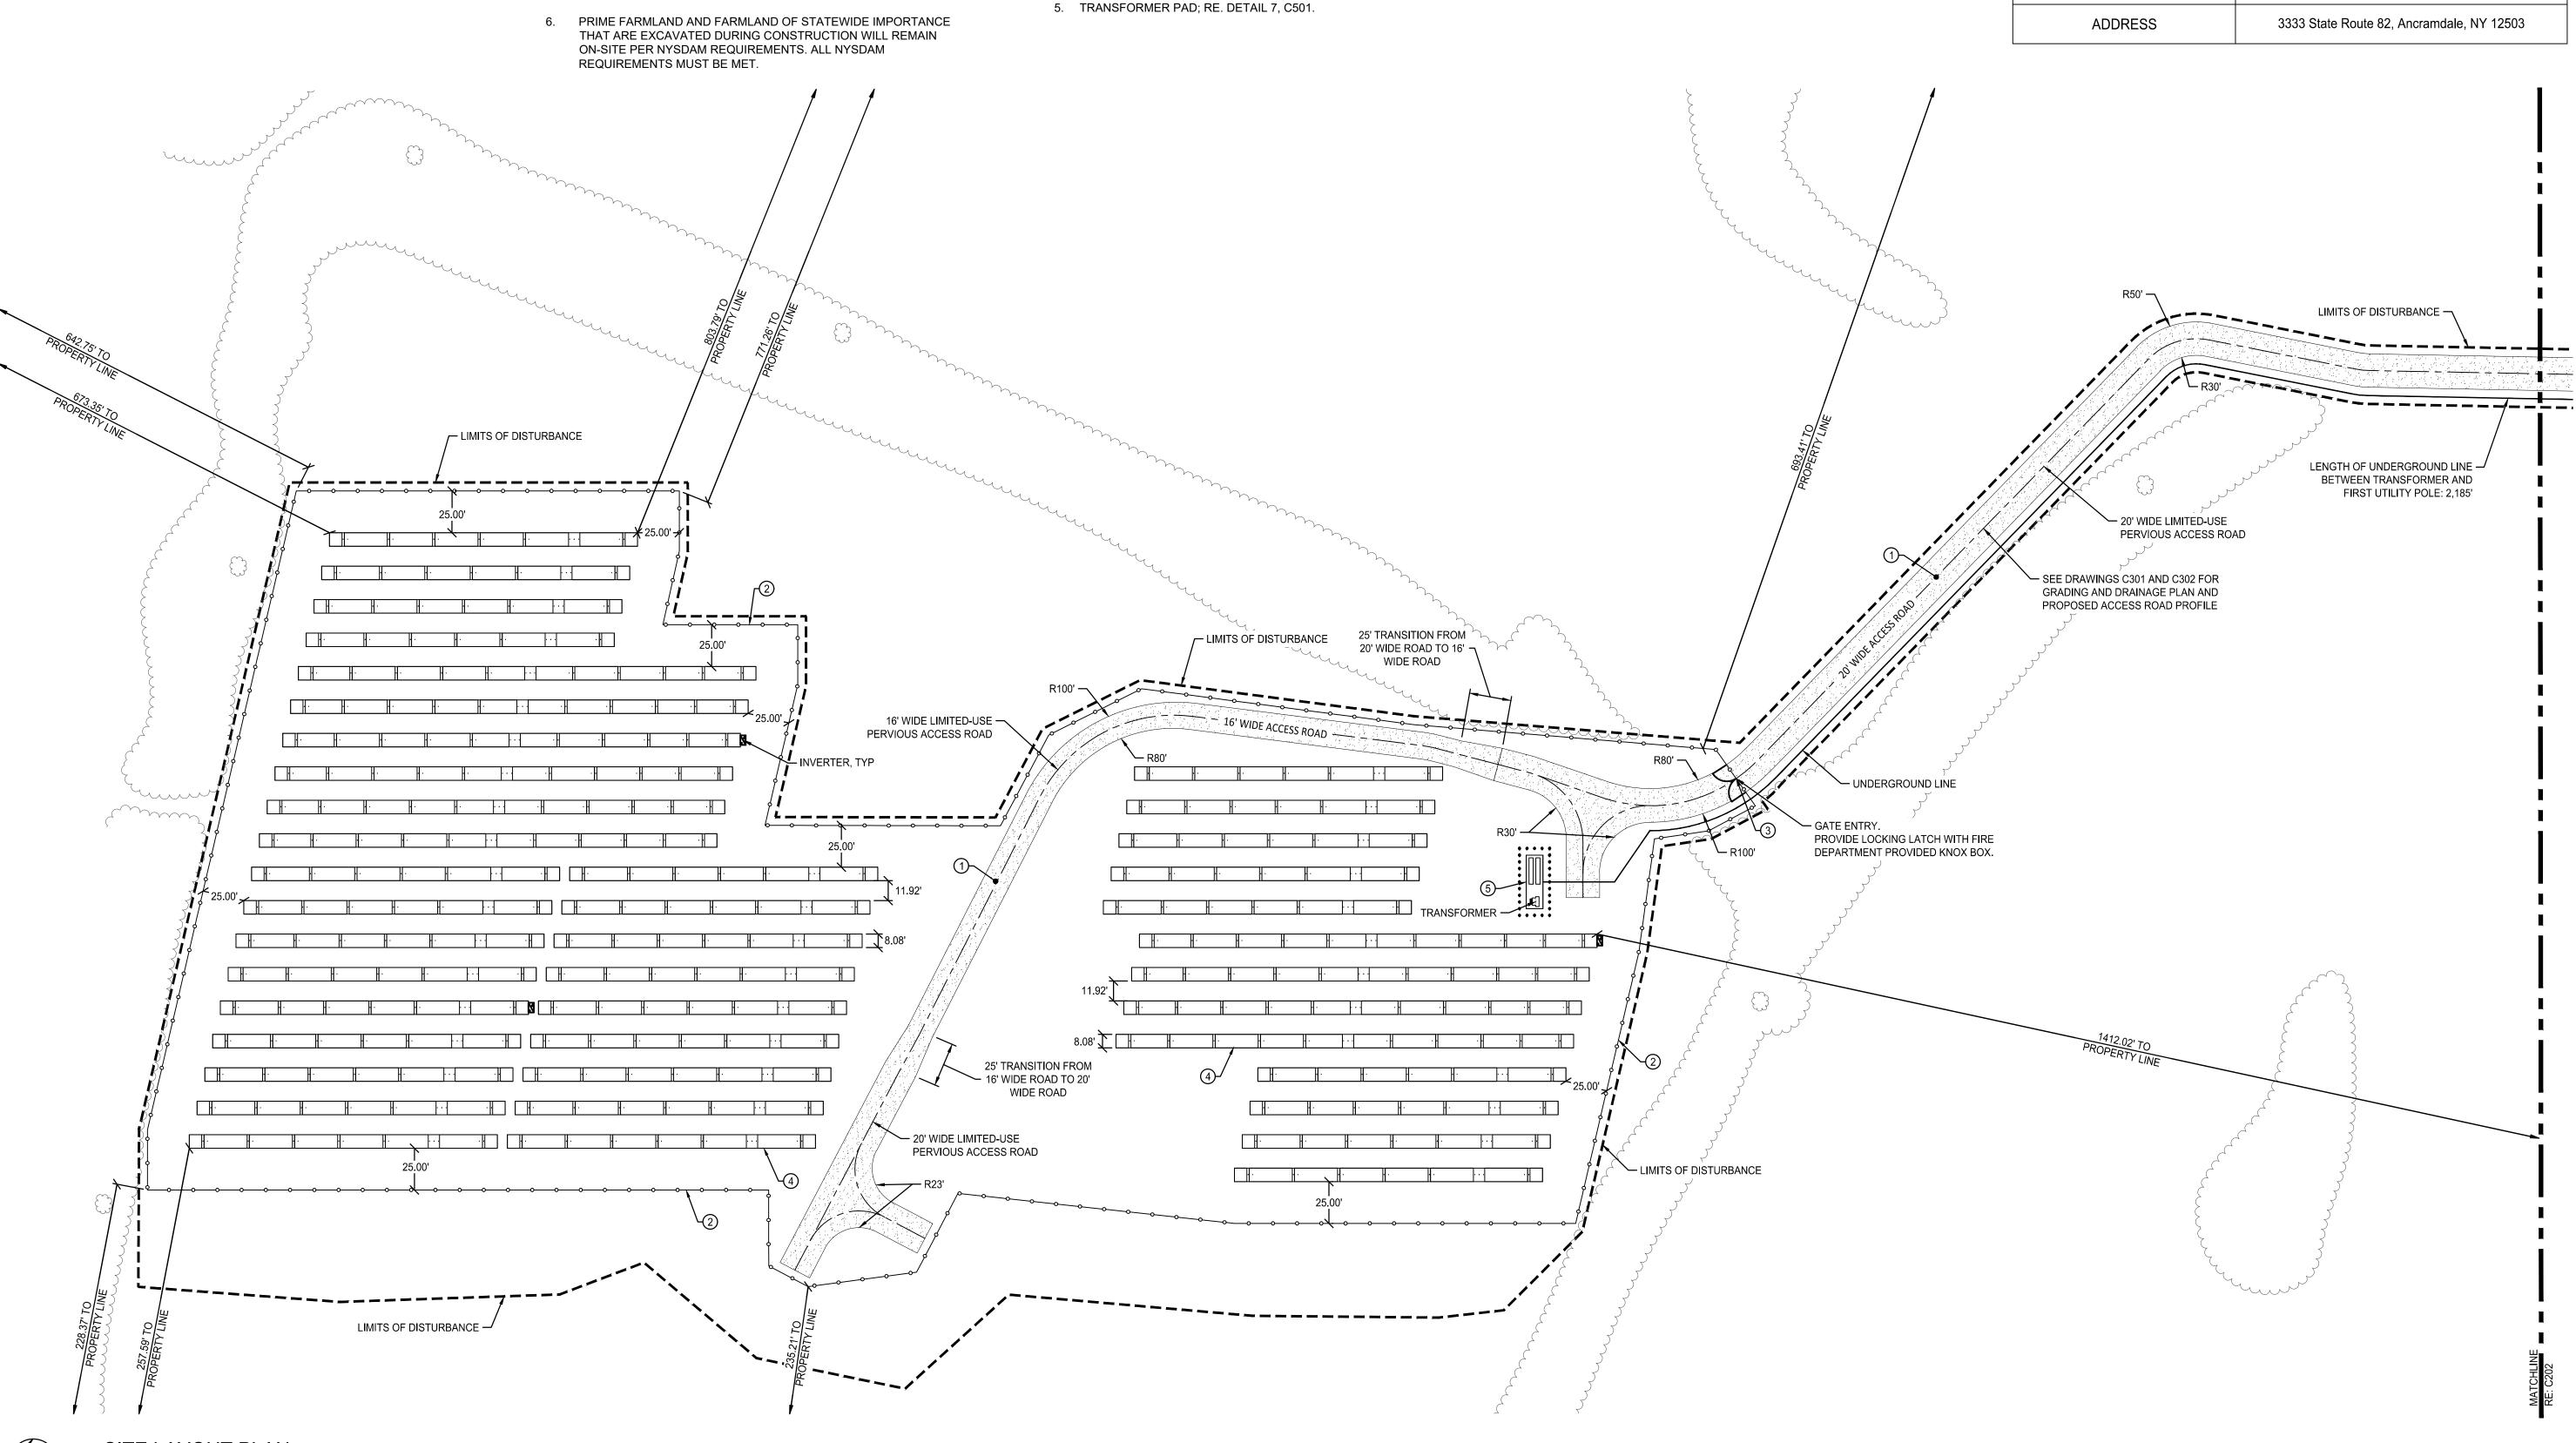

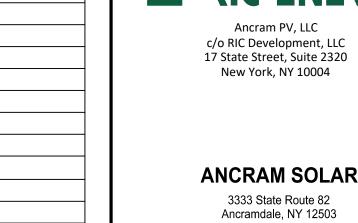



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A S	SITE PLAN APPROVAL/SUP SUBMISSION	11/20/202
NO.	REVISIONS	DATE

SITE LAYOUT PLAN

	H		
	0 '	1"	2"
	(GENERIC SCALE BAI	₹
		WN IS TWO INCHES ON THE OF CHES ON THIS SHEET, ADJUST	
DATE	11/20/2	2024	
00415	VC NO.	TED	

SCALE AS NOTED DWN. KCS CHK. SAR PROJ. No. 607153

NYSDAM GUIDELINES:

- 1. TOPSOIL SAMPLING, STOCKPILING, SPREADING, SEEDING AND SITE RESTORATION IS TO BE PERFORMED IN ACCORDANCE WITH THE NYS DEPARTMENT OF AGRICULTURE & MARKETS GUIDELINES FOR SOLAR ENERGY PROJECTS CONSTRUCTION MITIGATION, REVISED 10/18/2019.
- 2. TOPSOIL SHALL BE STRIPPED AND STOCKPILED SEPARATELY FOR ALL OPEN-CUT TRENCHING OPERATIONS.
- 3. THE CONTRACTOR SHALL NOTIFY DIG SAFELY NEW YORK (UDIG NY OR CALL 811) PRIOR TO CONSTRUCTION.
- 4. ALL BURIED UTILITIES LOCATED WITHIN THE GENERATION FACILITY'S SECURITY FENCE MUST HAVE A MINIMUM DEPTH OF 18" COVER IF BURIED IN A CONDUIT AND A MINIMUM DEPTH OF 24" OF COVER IF DIRECTLY BURIED.
- 5. THERE SHALL BE A DESIGNATED ENVIRONMENTAL MONITOR ON SITE WHENEVER CONSTRUCTION OR RESTORATION WORK IS OCCURRING ON AGRICULTURAL LAND. COORDINATION WITH THE NYSDAM, DIVISION OF LAND AND WATER RESOURCES, IS REQUIRED TO DEVELOP A SCHEDULE FOR INSPECTIONS AND ENSURE COMPLIANCE WITH THE DEPARTMENT'S CURRENT GUIDELINES.

GENERAL NOTES:

- 1. ACCESS DRIVE ALIGNMENTS AND TURNAROUND LAYOUT WERE DESIGNED USING THE 2020 INTERNATIONAL FIRE CODE APPENDIX D FIRE APPARATUS ACCESS ROAD GUIDELINES.
- 2. THE LIMITED USE PERVIOUS ACCESS ROAD IS NOT TO BE USED DURING CONSTRUCTION. UPON COMPLETION OF CONSTRUCTION, THE CONTRACTOR IS RESPONSIBLE FOR REMOVING THE TEMPORARY CONSTRUCTION ACCESS ROAD AND DECOMPACTING THE SUBGRADE SOILS PRIOR TO THE INSTALLATION OF THE LIMITED USE PERVIOUS ACCESS ROAD.
- 3. THE LIMIT OF DISTURBANCE SHOWN ON THESE PLANS IS ± 9.92
 ACRES AND ENCOMPASSES THE PROJECT'S PROPOSED FEATURES.
 THESE FEATURES INCLUDE: THE PERVIOUS ACCESS ROAD AND
 ASSOCIATED GRADING, INSTALLATION OF PANELS AND
 ASSOCIATED GRADING, CONCRETE TRANSFORMER PADS,
 UNDERGROUND COLLECTION LINE, SOLAR ARRAY POLE
 FOUNDATIONS, AND FENCE POST FOUNDATIONS.
- 4. SOILS ON-SITE WILL BE RE-SEEDED AND AMENDED TO THEIR ORIGINAL CONDITION AFTER DECOMMISSIONING.
- 5. ANY EXISTING TILE DRAIN LOCATIONS ARE TO BE VERIFIED BY THE CONTRACTOR PRIOR TO CONSTRUCTION. CONTRACTOR SHALL REPAIR AND/OR REPLACE ANY DAMAGED DRAIN TILES DUE TO CONSTRUCTION OF THE PROJECT.
- PRIME FARMLAND AND FARMLAND OF STATEWIDE IMPORTANCE
 THAT ARE EXCAVATED DURING CONSTRUCTION WILL REMAIN
 ON-SITE PER NYSDAM REQUIREMENTS. ALL NYSDAM
 REQUIREMENTS MUST BE MET.

LEGEND:

PROPERTY LINE

ERE
ENDIX D LIMITED USE PERVIOUS ACCESS ROAD

IMPERVIOUS ACCESS ROAD ENTRANCE

ACCESS ROAD CENTERLINE

EDGE OF VEGETATION/WOODS

LIMITS OF DISTURBANCE

PROPOSED WILDLIFE FRIENDLY FENCE

○ SITE IMPROVEMENT NOTES:

- LIMITED USE PERVIOUS ACCESS ROAD;

 DE DETAILS 1.2 AND 2 ON DRAWING OFF
- RE. DETAILS 1, 2, AND 3 ON DRAWING C503.

 2. WILDLIFE FRIENDLY FENCE; RE. DETAIL 1, C502.
- 3. WILDLIFE FRIENDLY GATE; RE. DETAIL 1, C502.
- 4. SOLAR ARRAY MODULE, TYP; RE. DETAIL 2, C501.
- 5. TRANSFORMER PAD; RE. DETAIL 7, C501.

SITE DATA SUMMARY

PROPERTY LOCATION: 3333 STATE ROUTE 82

<u>LOT AREA:</u> 94.78 AC.

<u>CURRENT ZONING:</u> AG - AGRICULTURE DISTRICT

<u>EXISTING USE:</u> AGRICULTURAL FIELD (CORN)

PROPOSED USE: SOLAR FACILITY

LOT REQUIREMENTS:
FRONT SETBACK

 REQUIREMENTS:
 REQUIRED
 PROPOSED

 FRONT SETBACK (MIN.)
 50 FT
 1446.93 FT

 EAST SIDE SETBACK (MIN.)
 100 FT
 803.79 FT

 WEST SIDE SETBACK (MIN.)
 100 FT
 257.59 FT

 REAR SETBACK (MIN.)
 100 FT
 673.35 FT

 LOT WIDTH AT FRONT SETBACK (MIN.)
 50 FT
 1349.06 FT

ANCRAMDALE, COLUMBIA COUNTY, NEW YORK

15 FT

12 FT

MAXIMUM STRUCTURE HEIGHT:

LONG -73.606538 1.4 ILR SYSTEM SIZE (DC) 1,343 kW SYSTEM SIZE (AC) 957 kW Q.TRON XL-G2-BFG (635 W) MODULE TYPE 2,116 (92 strings) QUANTITY MODULES PER STRING Sungrow SG350HX INVERTER TYPE QUANTITY SOLAR TRACKER TYPE TRACKER 1P DIMENSIONS OF THE TRACKER (3s) 273'-8" x 8'-1" x 5'-8" (2s) 184'-3" x 8'-1" x 5'-8" (3 strings & 2 strings) (LxWxH) TILT ANGLE PITCH 20' 2,825' FENCE LENGTH 3,026' ACCESS ROAD LENGTH 2,395' TOTAL MV LINE LENGTH TOTAL AREA OF DISTURBANCE 9.92 AC

PROJECT DETAILS

42.030644

3333 State Route 82, Ancramdale, NY 12503

LAT

ADDRESS



ANCRAM SOLAR
3333 State Route 82

Ancramdale, NY 12503



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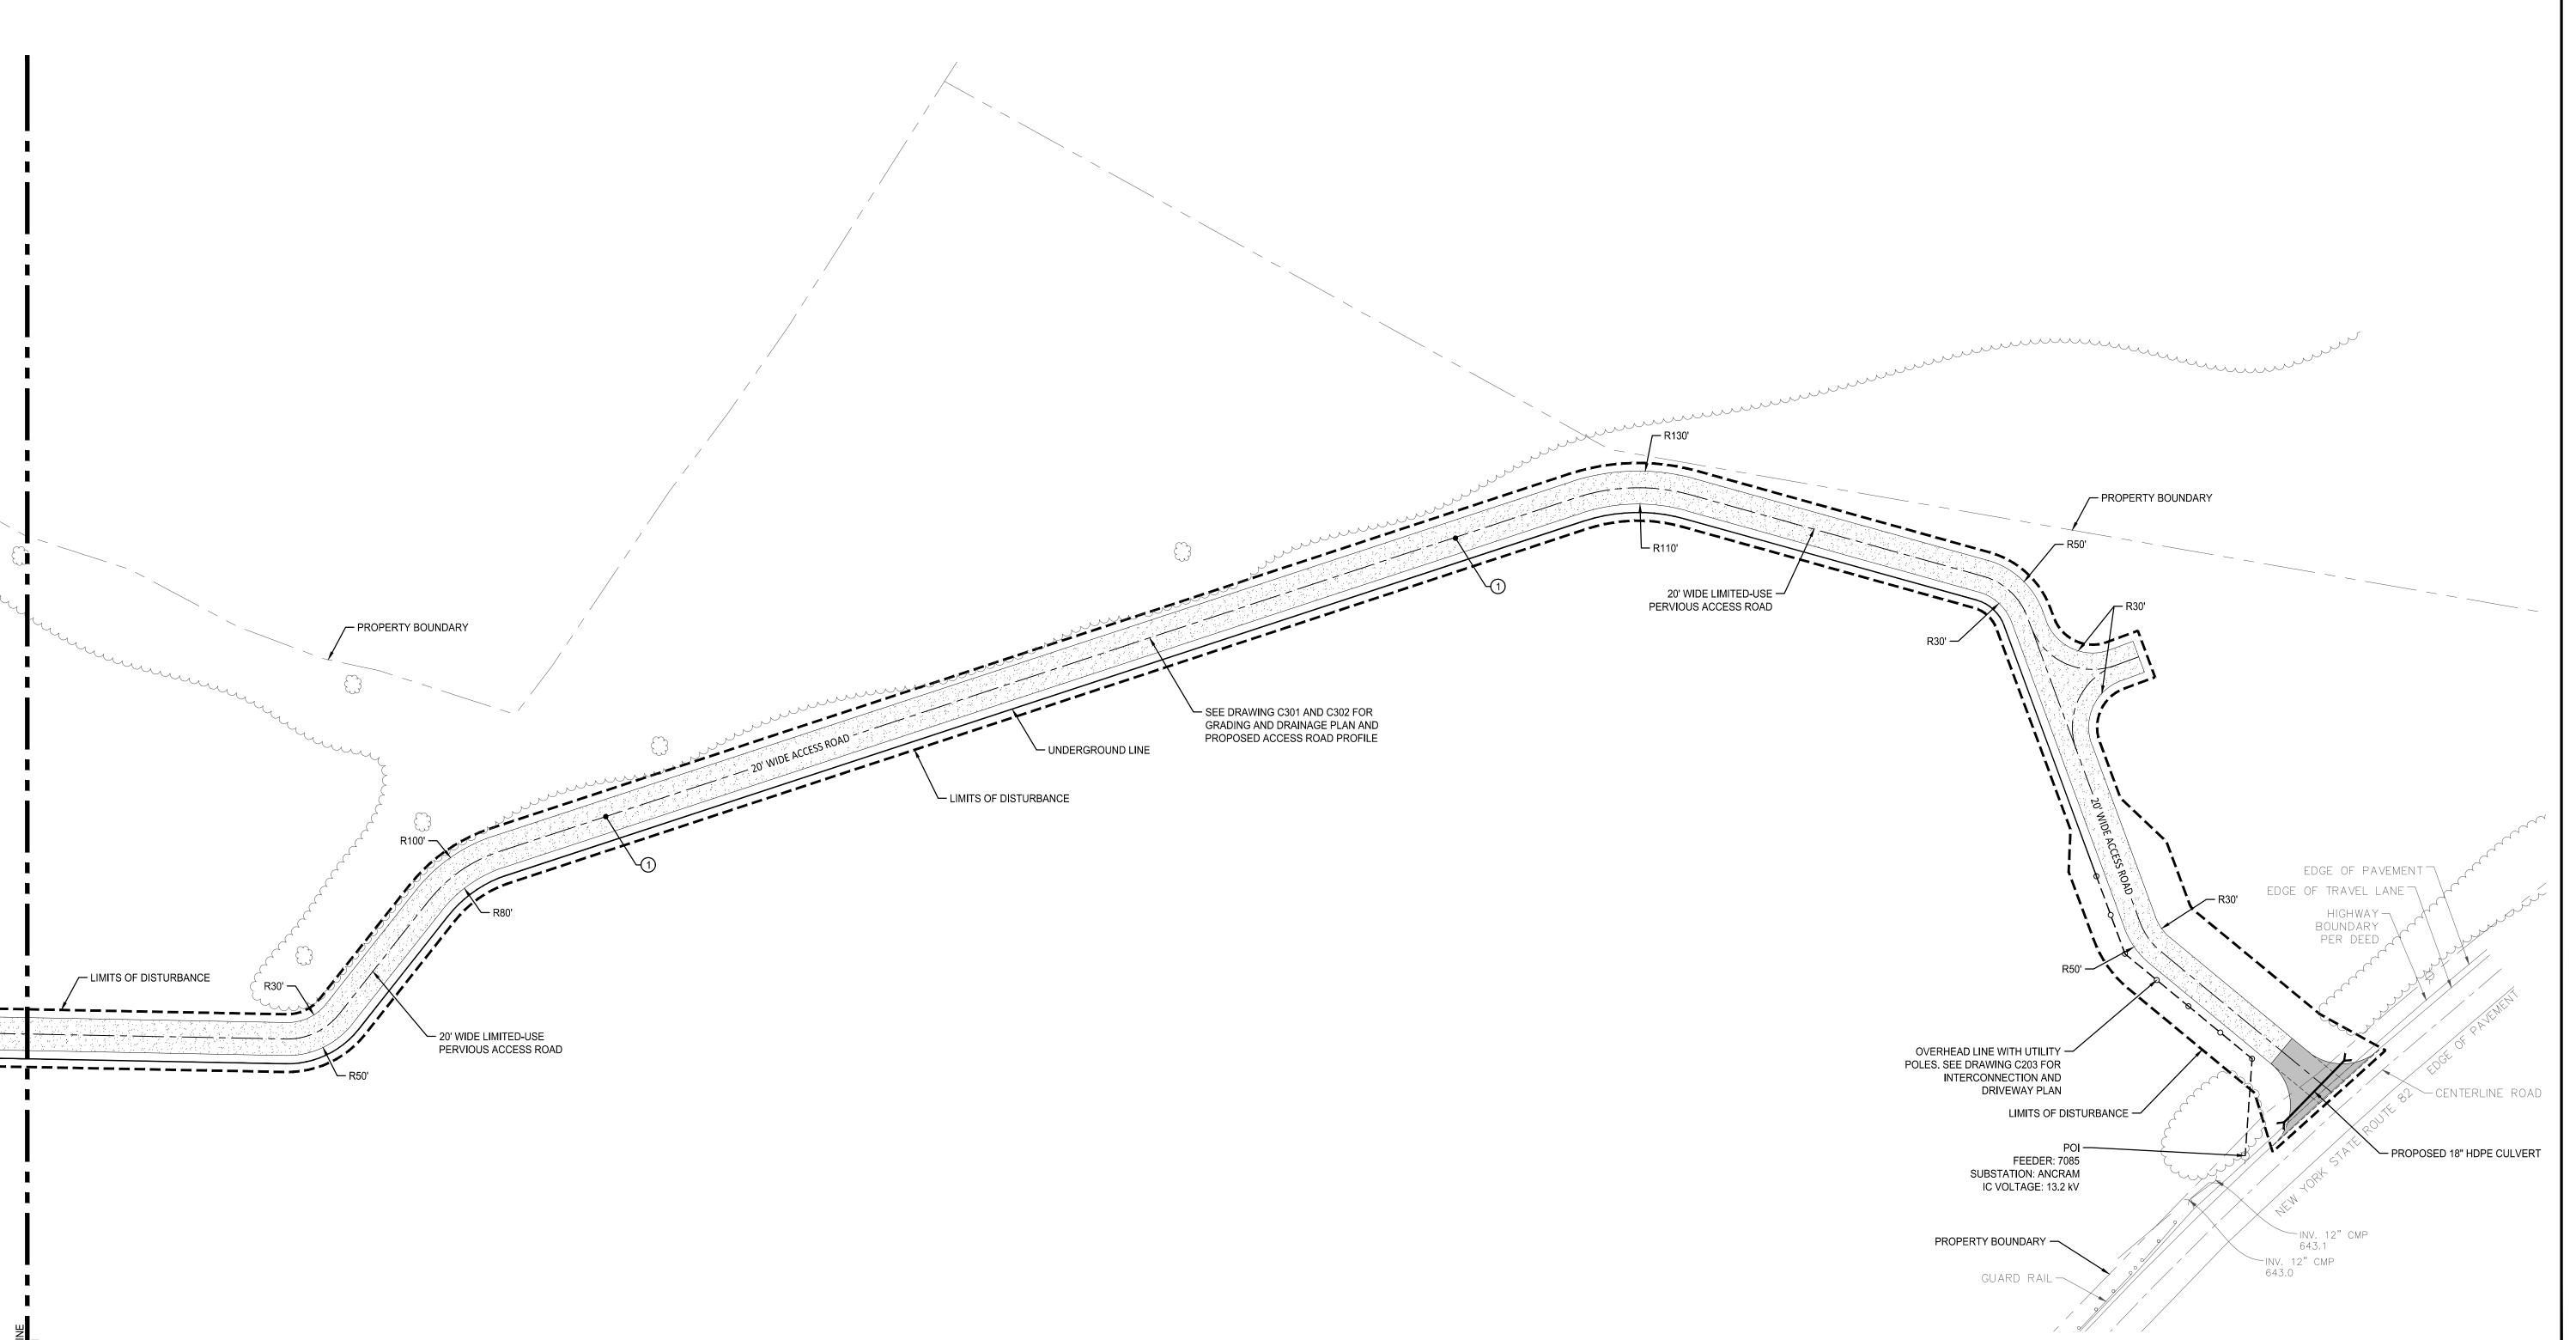
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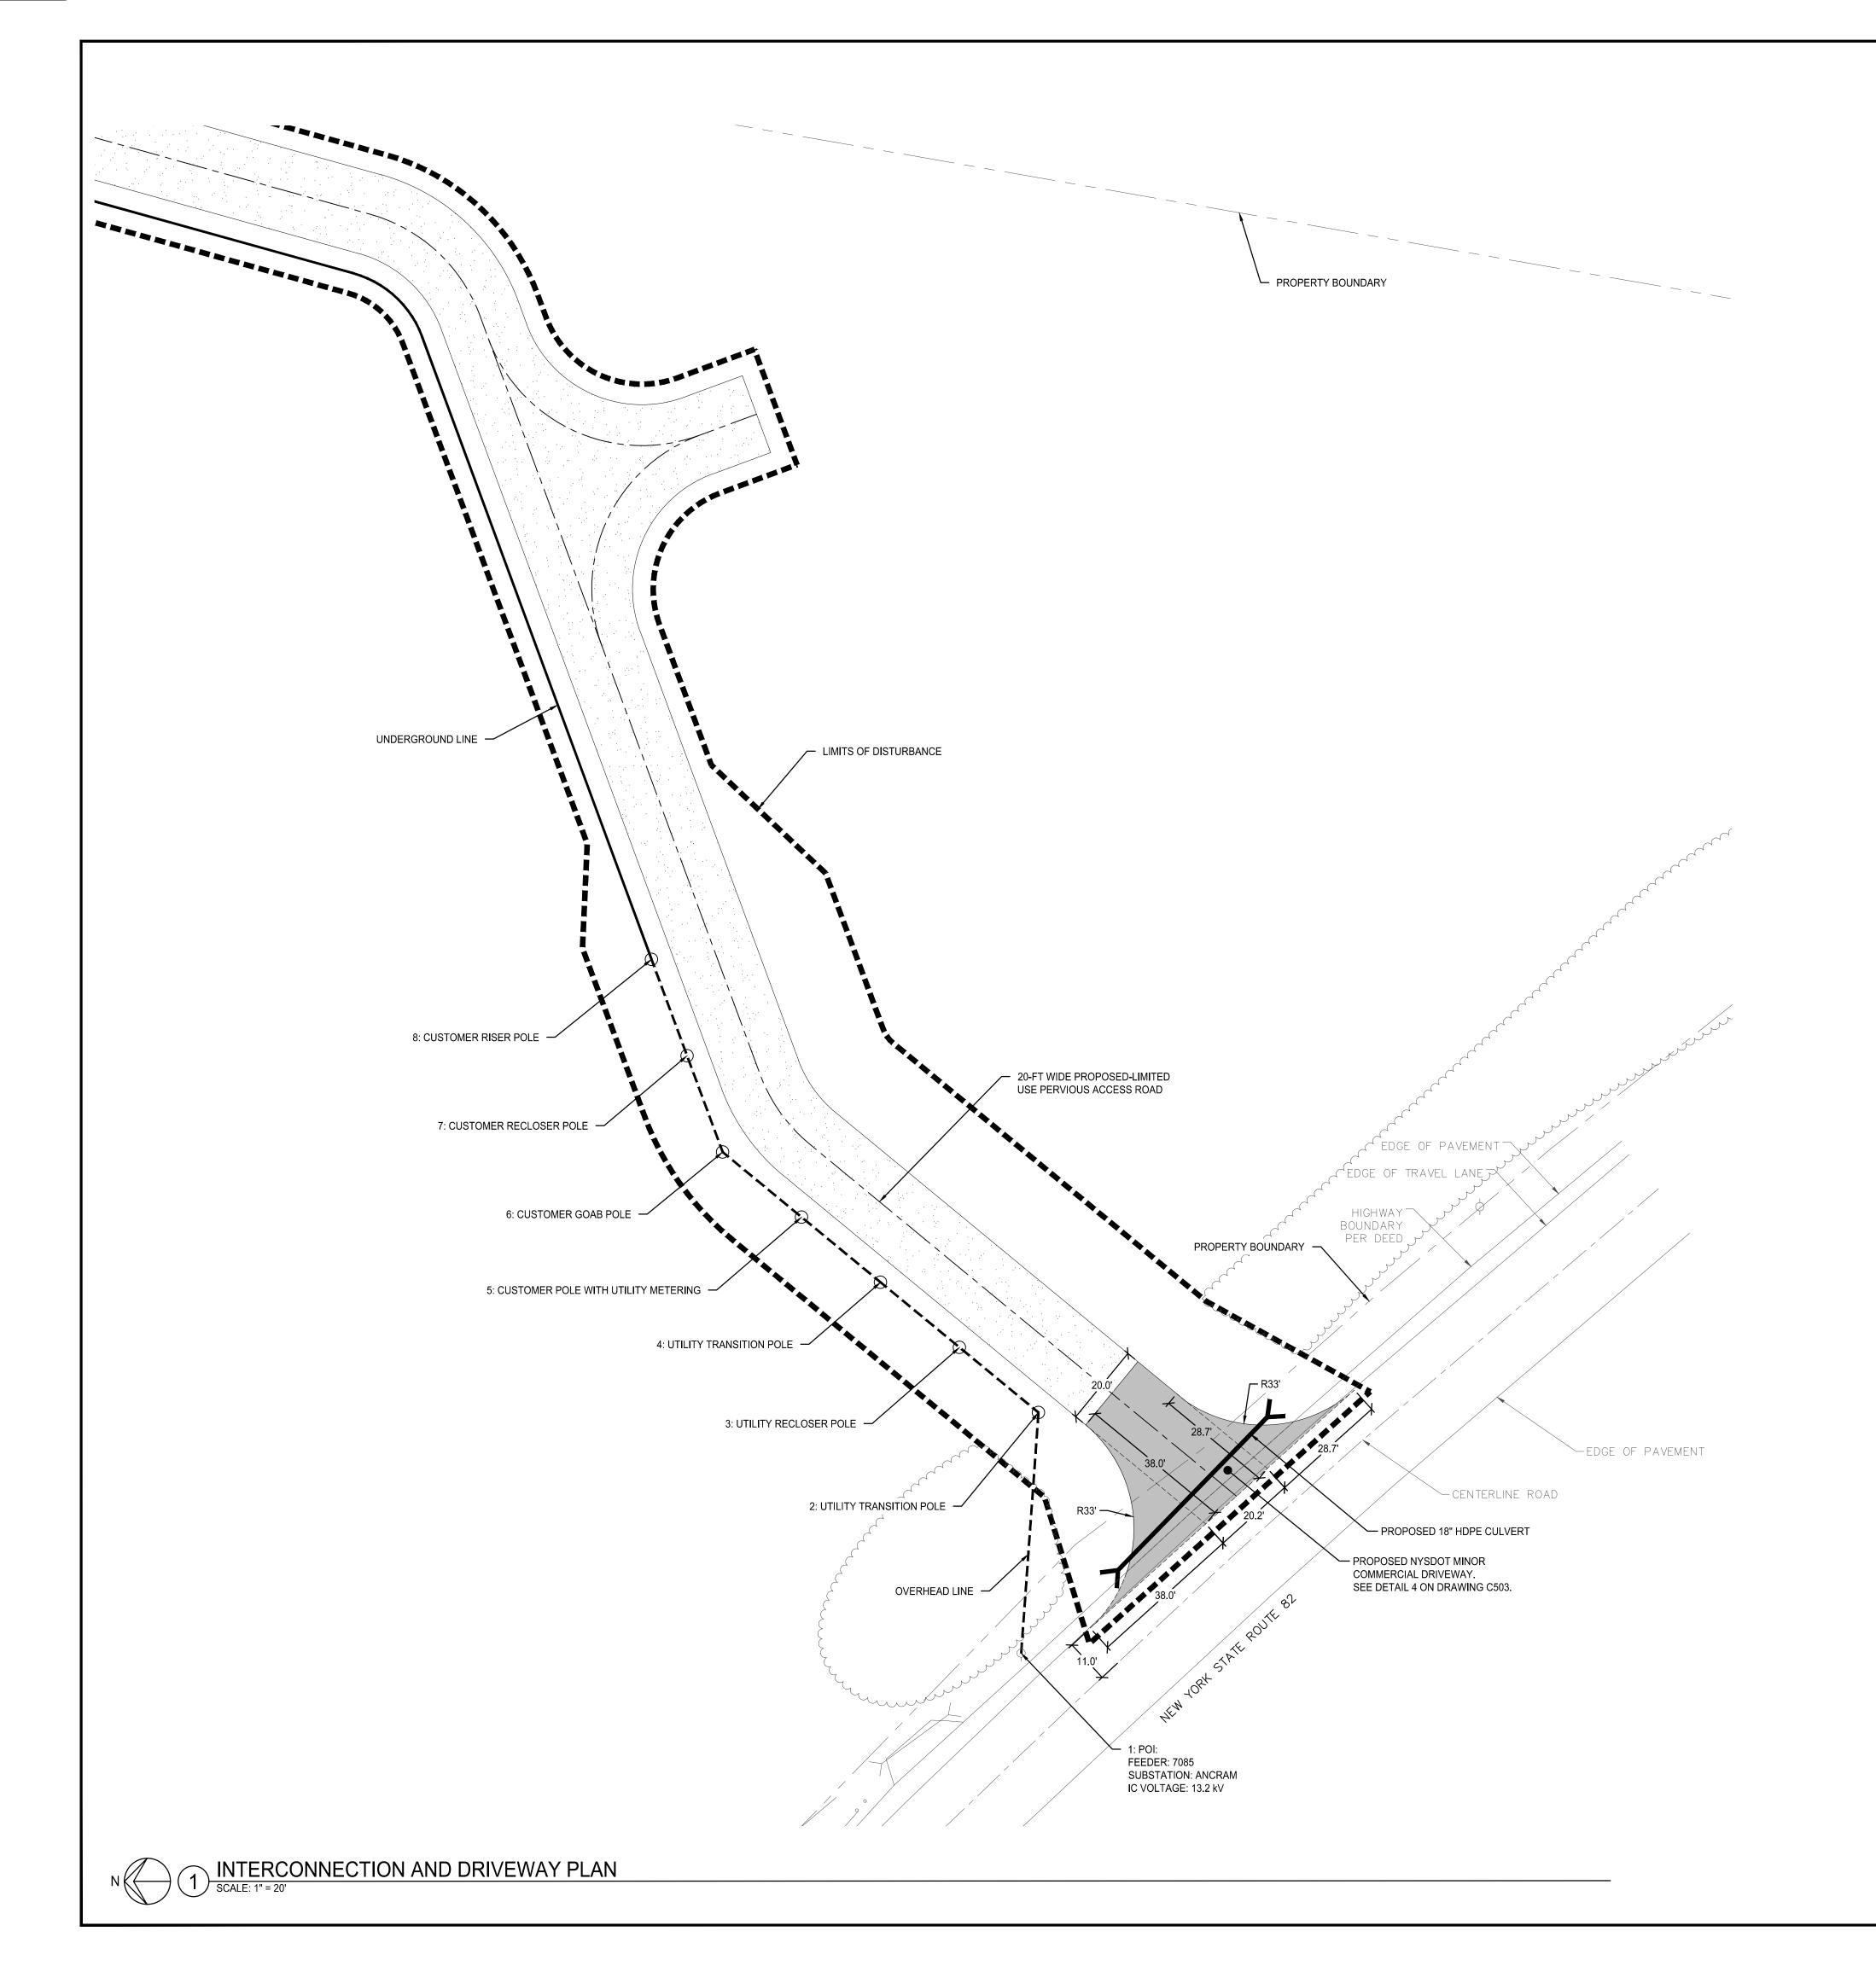
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NO.	REVISIONS	DATE
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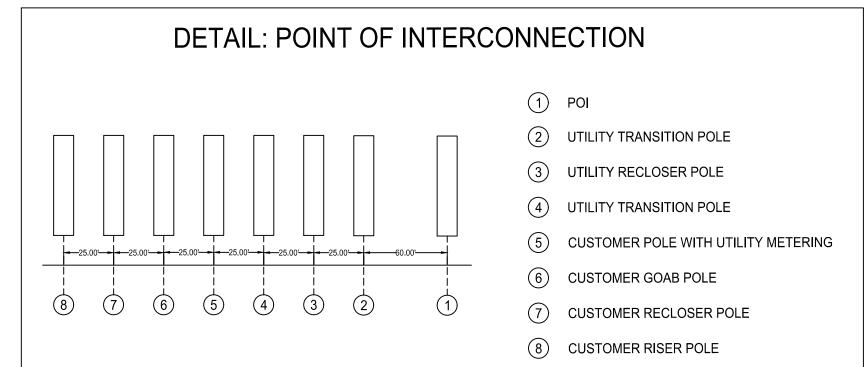
SITE LAYOUT PLAN

	ALE BAR SHOWN IS TWO	1" RIC SCALE BAR D INCHES ON THE ORIGIN THIS SHEET, ADJUST AC	
DATE	11/20/2024	77110 011221,7100001710	O O NO EN
SCALE	AS NOTED		
DWN.	KCS	CHK.	SAR

PROJ. No. 607153







# Inverter	Strings	(kW)	@ 30°C (kVA)	Power (kVA)
INV-1.01	30	438.15	352	313
INV-1.02	31	452.76	352	322
INV-1.03	31	452.76	352	322
LEGEND) :			
LIMITED USE F	PERVIOUS A	CCESS ROAD		

DC Power Nominal Power De-rated

IMPERVIOUS ACCESS ROAD ENTRANCE ACCESS ROAD CENTERLINE PROPERTY LINE EDGE OF VEGETATION/WOODS LIMITS OF DISTURBANCE PROPOSED UNDERGROUND LINE PROPOSED OVERHEAD LINE

PROPOSED UTILITY POLE

EXISTING UTILITY POLE

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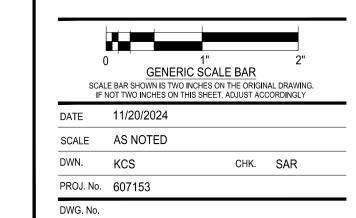
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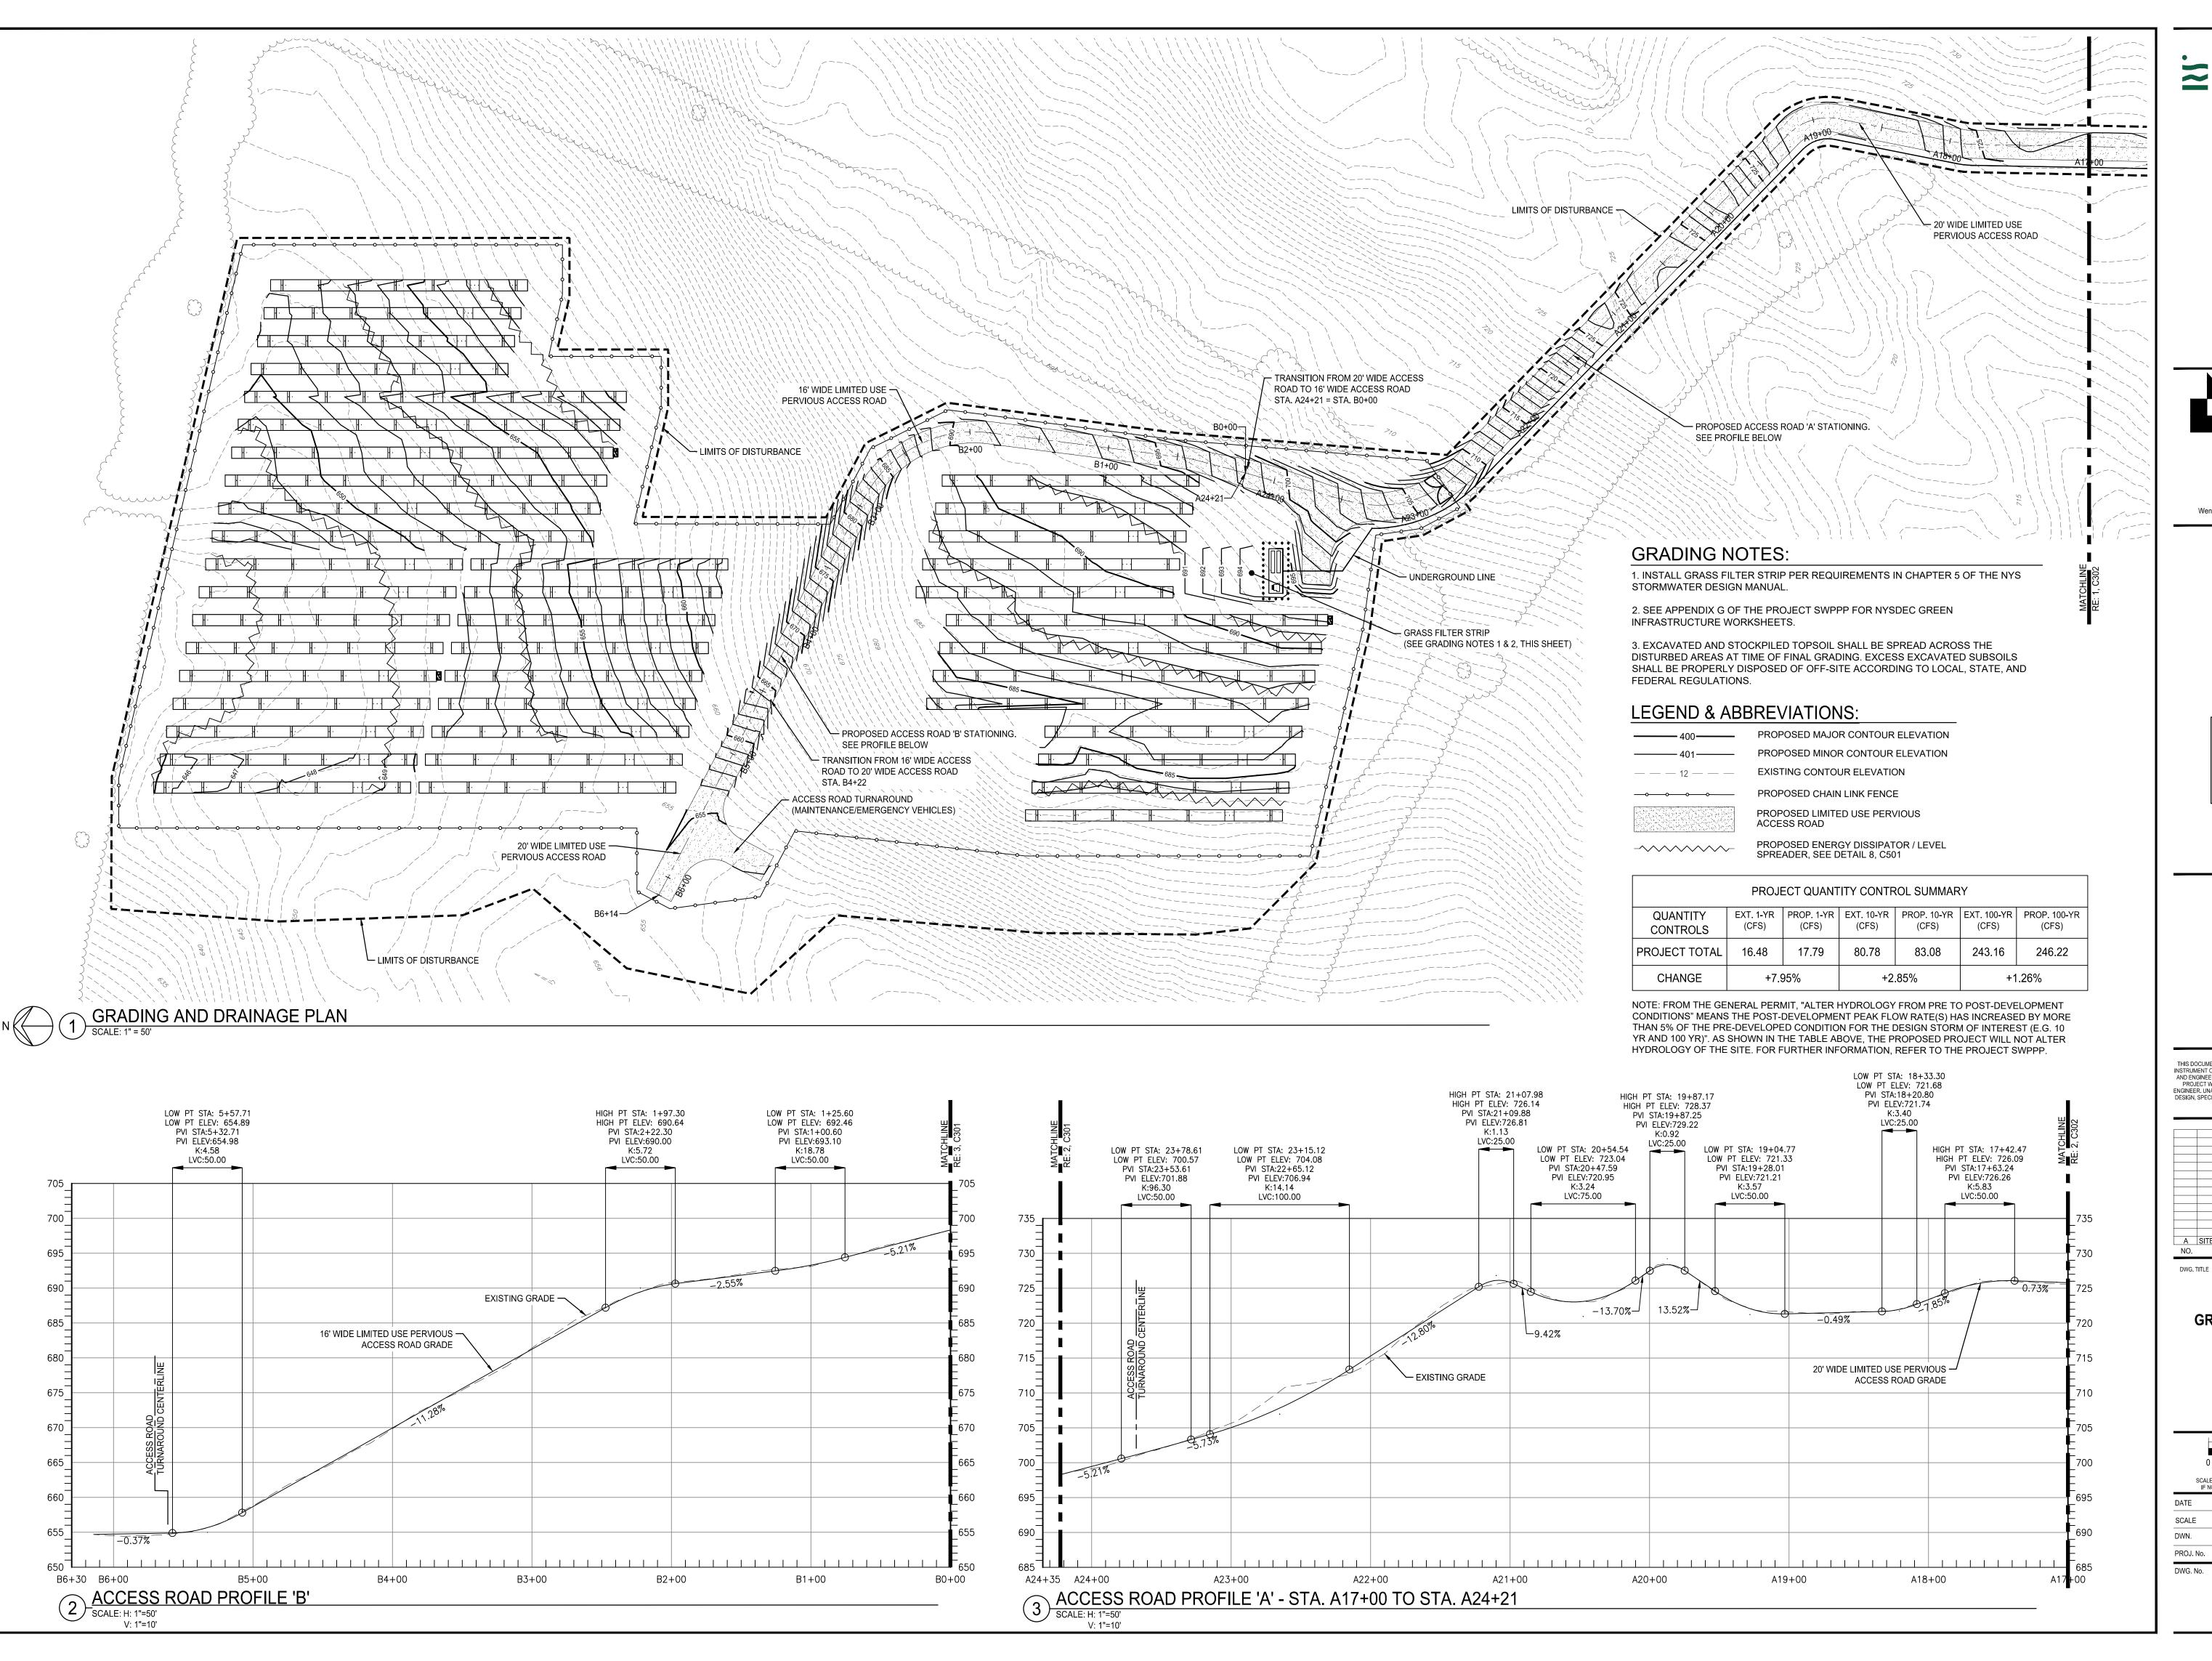
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INTERCONNECTION AND DRIVEWAY PLAN







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NO.	REVISIONS	DATE

GRADING AND DRAINAGE PLAN AND ACCESS ROAD PROFILE

0 1" 2"

GENERIC SCALE BAR


SCALE BAR SHOWN IS TWO INCHES ON THE ORIGINAL DRAWING. IF NOT TWO INCHES ON THIS SHEET, ADJUST ACCORDINGLY

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PLAN AND ACCESS **ROAD PROFILE**

GENERIC SCALE BAR SCALE BAR SHOWN IS TWO INCHES ON THE ORIGINAL DRAWING. IF NOT TWO INCHES ON THIS SHEET, ADJUST ACCORDINGLY

DATE 11/20/2024 SCALE AS NOTED DWN. NRF CHK. SAR

LANDSCAPE NOTES: 3. POLLINATOR SEED MIX SHALL BE "NORTHEAST SOLAR POLLINATOR 3' MIX" (ITEM No. ERNMX-612) BY 4. TURF RESTORATION SEED MIX SHALL BE "LOW GROW FESCUE" BY PREFERRED SEED, OR ACCEPTABLE EQUIVALENT.

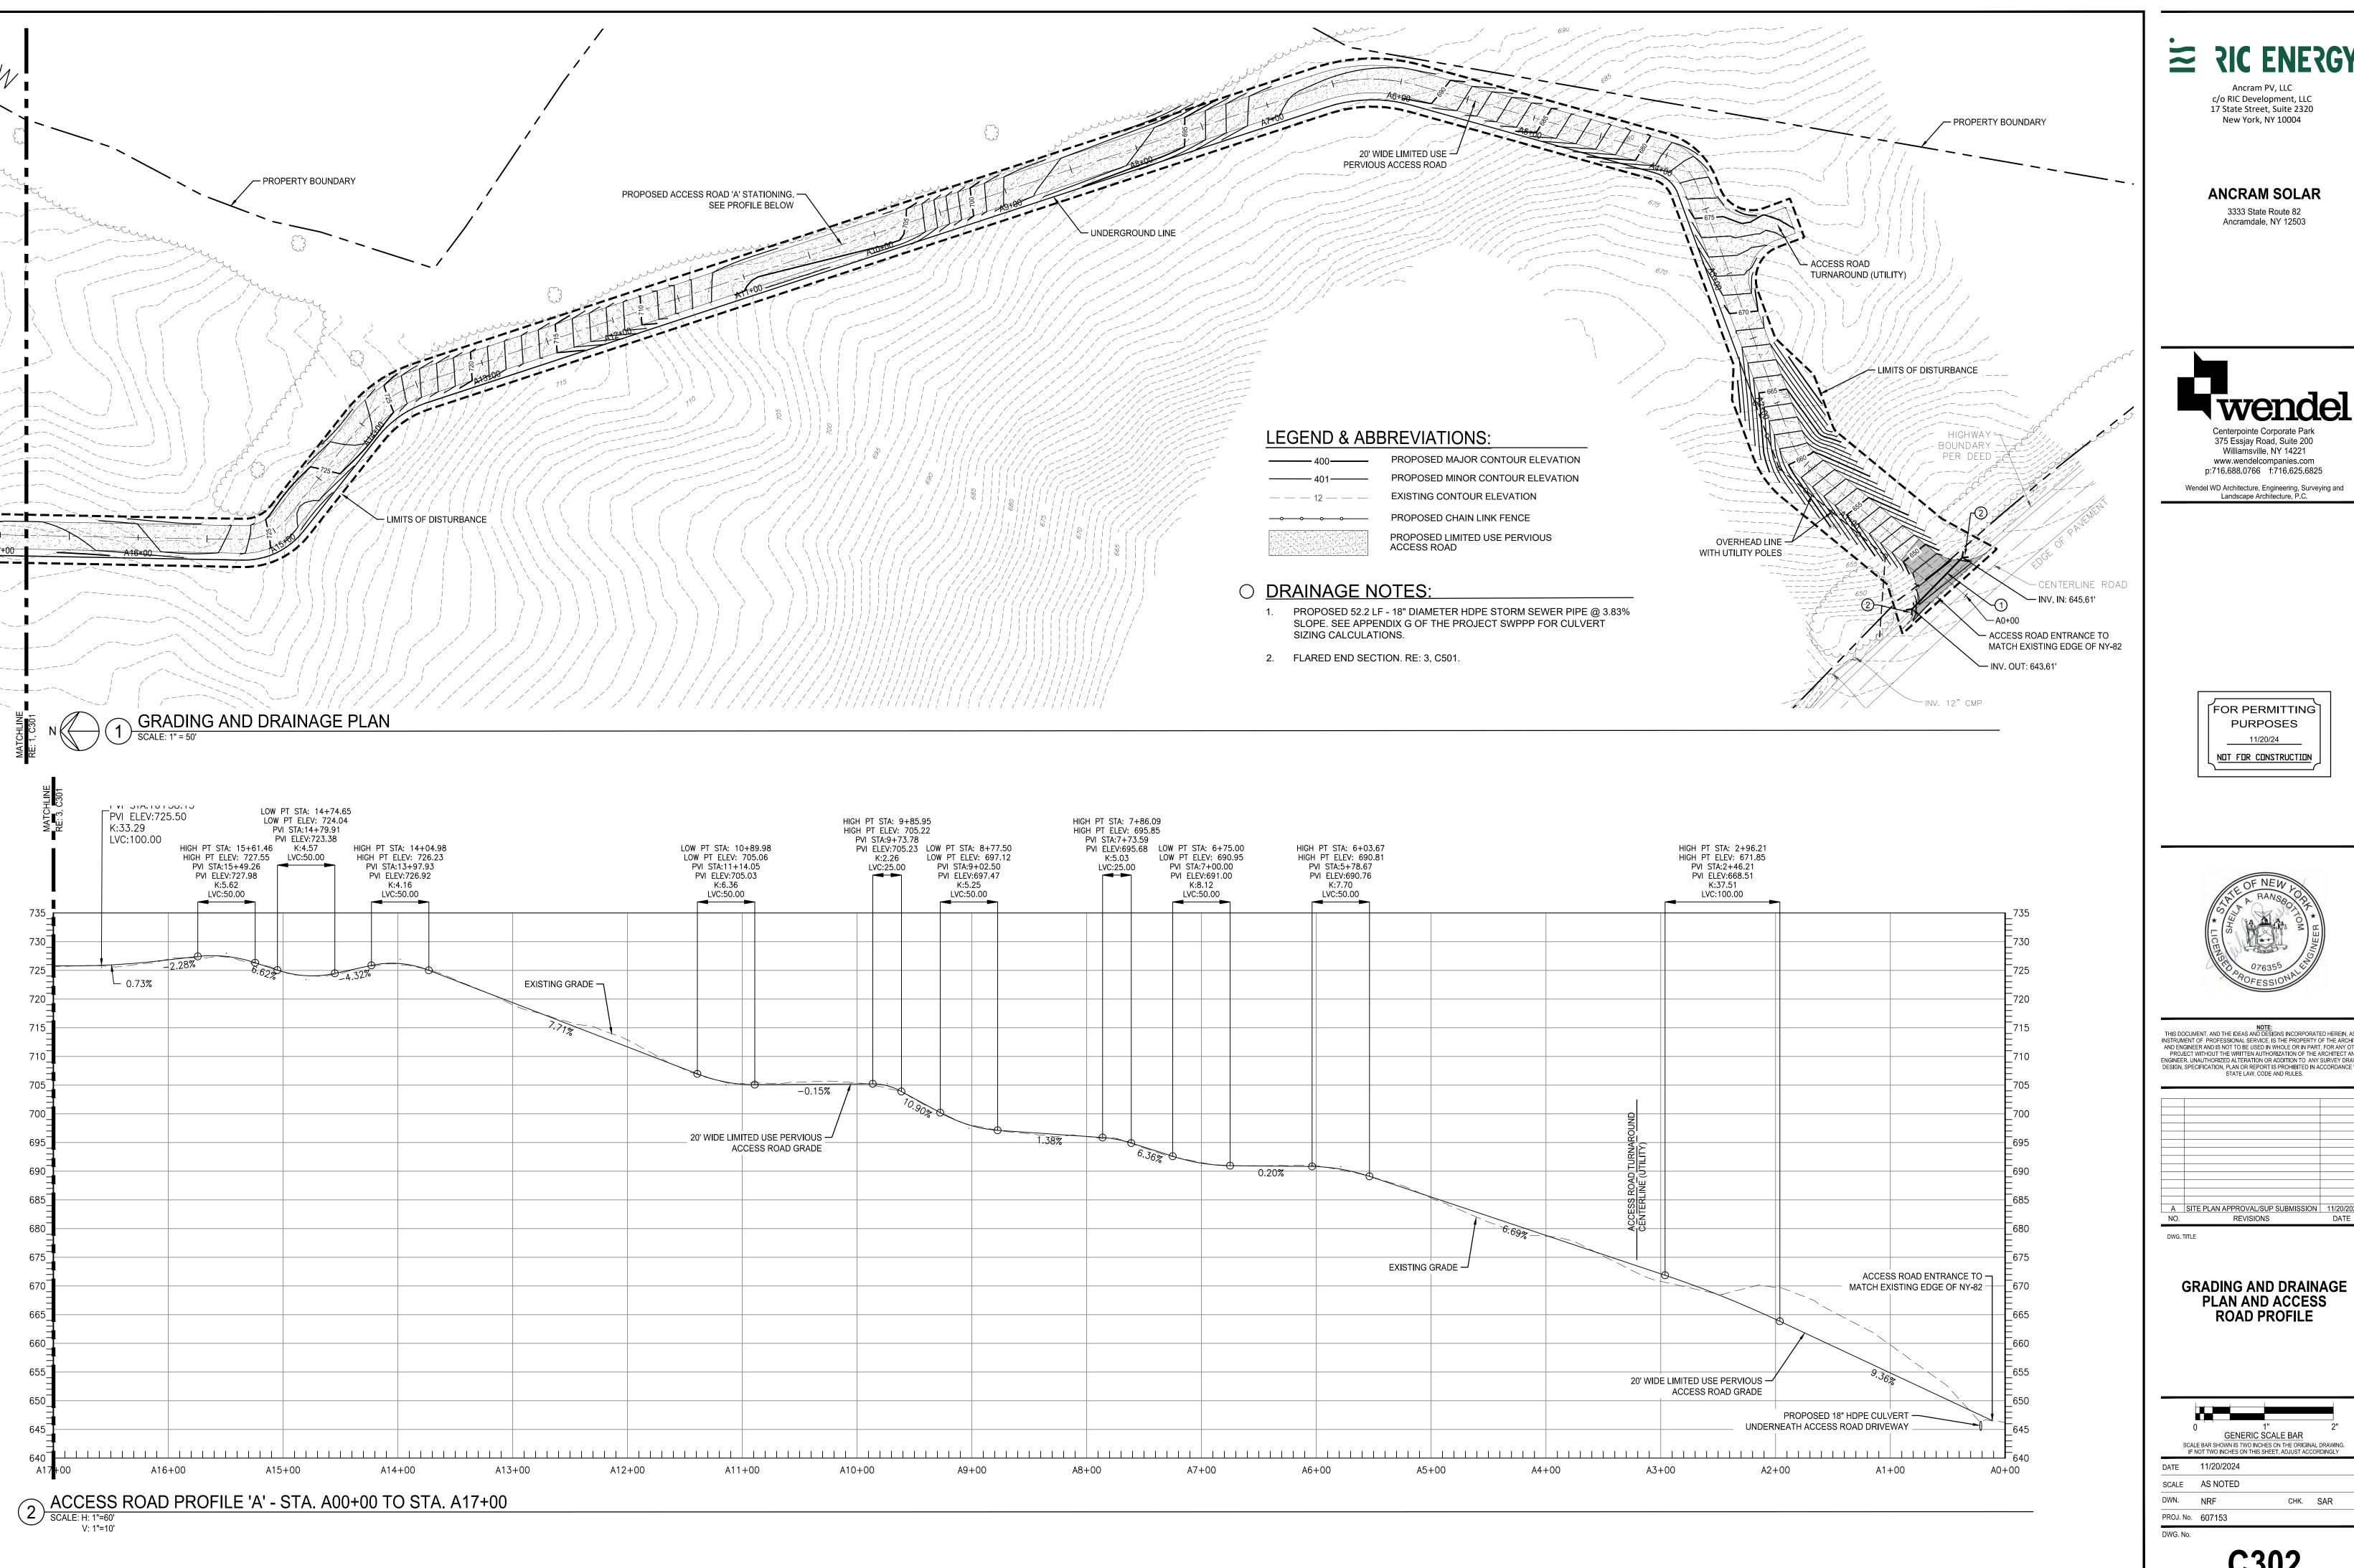- 1. CONTRACTOR SHALL BE RESPONSIBLE FOR VERIFYING ALL QUANTITIES ON THE PLAN PRIOR TO
- 2. UNLESS OTHERWISE SPECIFIED, ALL DISTURBED AREAS SHALL RECEIVE MIN. 4" TOPSOIL, BE FINE GRADED, AND SEEDED. FOLLOW ALL SEED SUPPLIER'S RECOMMENDATIONS FOR SITE PREPARATION, APPLICATION, AND ESTABLISHMENT OF SEED.
- ERNST SEEDS, OR ACCEPTABLE EQUIVALENT.
- 5. CONTRACTOR SHALL INSPECT AND MAINTAIN ALL PLANTINGS INCLUDING GRASSES AND PERENNIALS FOR THE ENTIRETY OF THE GUARANTEE PERIOD; 18 MONTHS. AT THE END OF THE GUARANTEE

PERIOD OWNER SHALL TRIM ONCE PER YEAR IN SPRING TO MANAGE WOODY GROWTH: TRIM PREVIOUS YEAR'S GROWTH TO 2" HEIGHT BEFORE NEW SPRING GROWTH REACHES 2" HEIGHT.

- 6. PLANT PIT BACKFILL FOR TREES AND SHRUBS SHALL BE PLANTING SOIL MIX. REFER TO SPECIFICATIONS FOR PLANTING SOIL MIX COMPOSITION.
- 7. ALL PLANT MATERIAL SHALL BE WELL-FORMED AND DEVELOPED IN GOOD CONDITION, HEALTHY AND DISEASE FREE, AND BE TYPICAL OF THE SPECIES. PLANTS SHALL COMPLY WITH ACCEPTABLE STANDARDS AS SET FORTH IN THE LATEST EDITION OF THE "AMERICAN STANDARD FOR NURSERY STOCK" PUBLISHED BY THE AMERICAN ASSOCIATION OF NURSERYMEN. REFER TO SPECIFICATIONS FOR ADDITIONAL INFORMATION.

LEGEND: LANDSCAPE LEGEND:

LIMITED USE PERVIOUS ACCESS ROAD IMPERVIOUS ACCESS ROAD ENTRANCE ACCESS ROAD CENTERLINE _____


PROPERTY LINE

EDGE OF VEGETATION/WOODS

PROPOSED WILDLIFE FRIENDLY FENCE


LIMITS OF DISTURBANCE

POLLINATOR SEED MIX PER LANDSCAPE NOTES TURF RESTORATION SEED MIX PER LANDSCAPE NOTES **DECIDUOUS TREE**

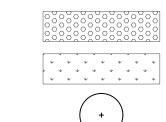

EVERGREEN TREE

DECIDUOUS SHRUB

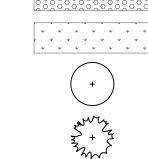

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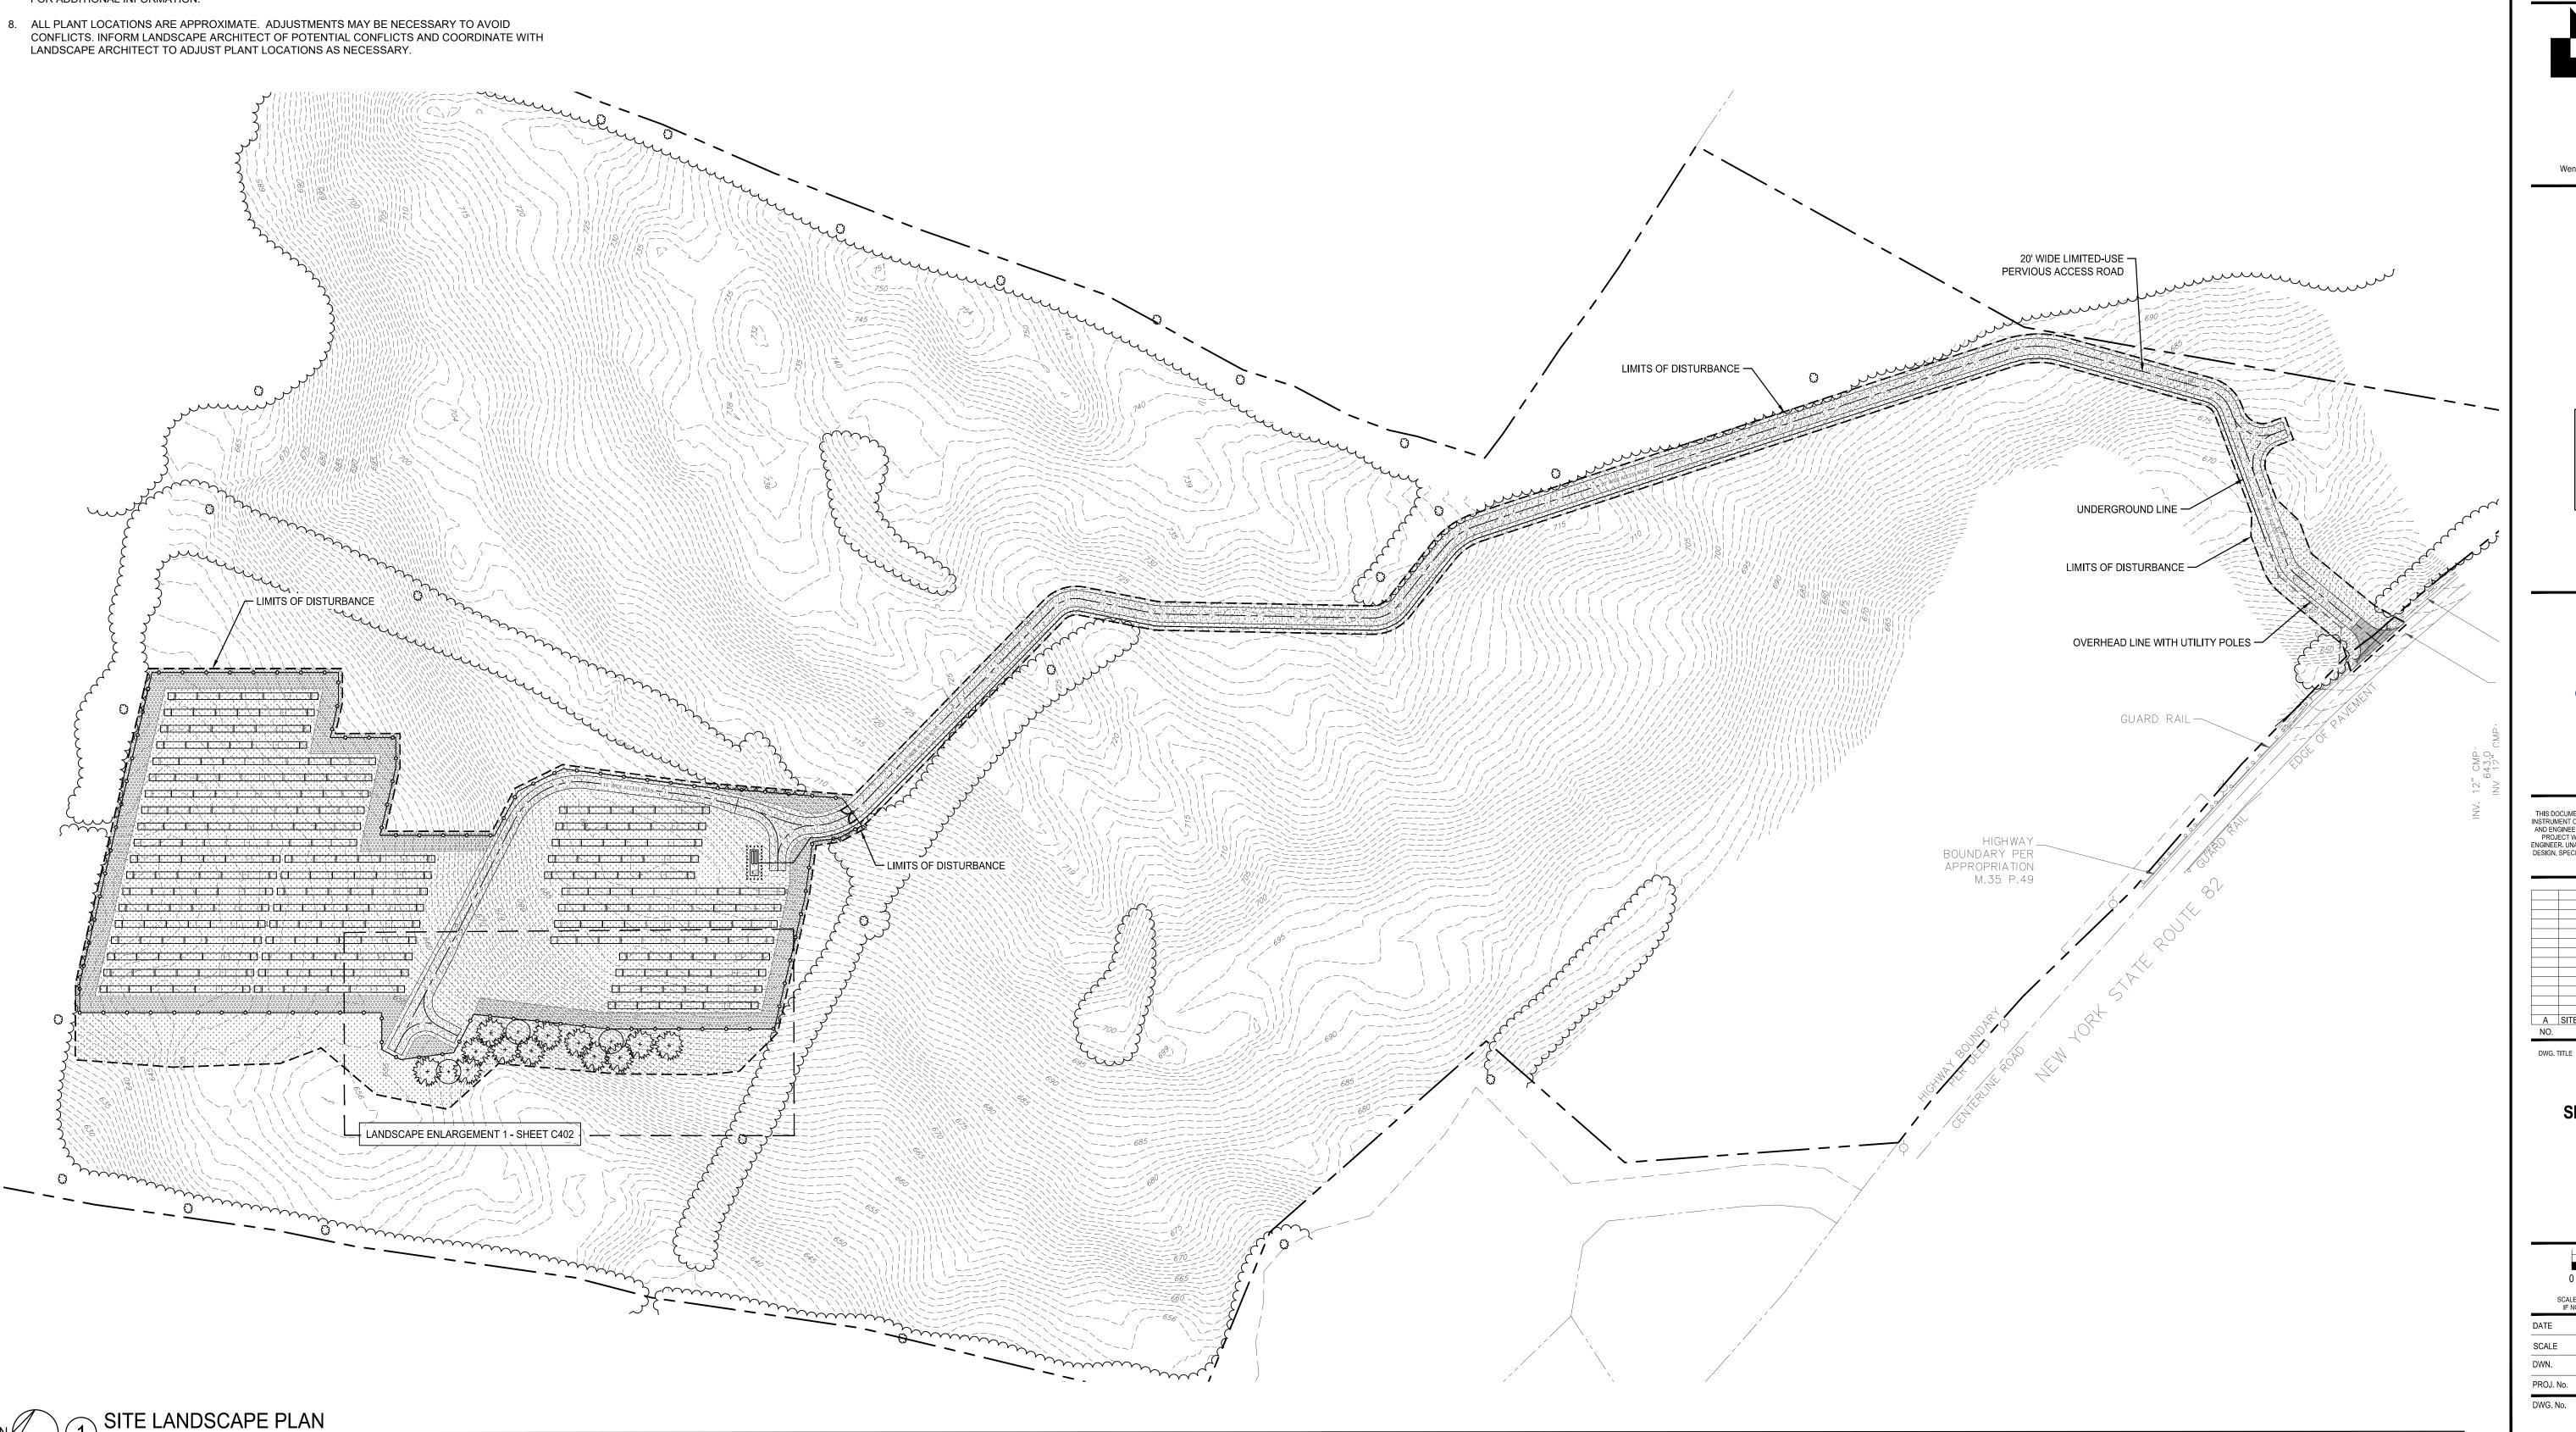
SITE LANDSCAPE PLAN

GENERIC SCALE BAR SCALE BAR SHOWN IS TWO INCHES ON THE ORIGINAL DRAWING. IF NOT TWO INCHES ON THIS SHEET, ADJUST ACCORDINGLY DATE 11/20/2024

SCALE AS NOTED DWN. BD1

PROJ. No. 607153

CHK. DLK



C402 PLANT SCHEDULE: QTY KEY BOTANICAL NAME COMMON NAME SIZE & SPECIFICATIONS 5 Yr. HEIGHT 10 Yr. HEIGHT 20 Yr. HEIGHT TREES 2 ½" Caliper AR | Acer rubrum red maple 12' - 15' HEIGHT 20' - 30' HEIGHT 30' - 50' HEIGHT 7' Min. Height PS Pinus strobus eastern white pine 12' - 17' HEIGHT 25' - 35' HEIGHT 40' - 60' HEIGHT QR Quercus rubra 2 ½" Caliper northern red oak 12' - 15' HEIGHT 25' - 35' HEIGHT 40' - 60' HEIGHT

Canadian hemlock

7' Min. Height

TC Tsuga canadensis

12' - 15' HEIGHT

20' - 30' HEIGHT | 30' - 50' HEIGHT

DESCRIPTION LANDSCAPE NOTES:

- 1. CONTRACTOR SHALL BE RESPONSIBLE FOR VERIFYING ALL QUANTITIES ON THE PLAN PRIOR TO
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- 8. ALL PLANT LOCATIONS ARE APPROXIMATE. ADJUSTMENTS MAY BE NECESSARY TO AVOID CONFLICTS. INFORM LANDSCAPE ARCHITECT OF POTENTIAL CONFLICTS AND COORDINATE WITH LANDSCAPE ARCHITECT TO ADJUST PLANT LOCATIONS AS NECESSARY.

LEGEND:

LIMITED USE PERVIOUS ACCESS ROAD

ACCESS ROAD CENTERLINE

PROPERTY LINE

IMPERVIOUS ACCESS ROAD ENTRANCE

EDGE OF VEGETATION/WOODS LIMITS OF DISTURBANCE _____

LANDSCAPE LEGEND:

PROPOSED WILDLIFE FRIENDLY FENCE

POLLINATOR SEED MIX PER LANDSCAPE NOTES

TURF RESTORATION SEED MIX PER LANDSCAPE NOTES

DECIDUOUS TREE

EVERGREEN TREE

DECIDUOUS SHRUB



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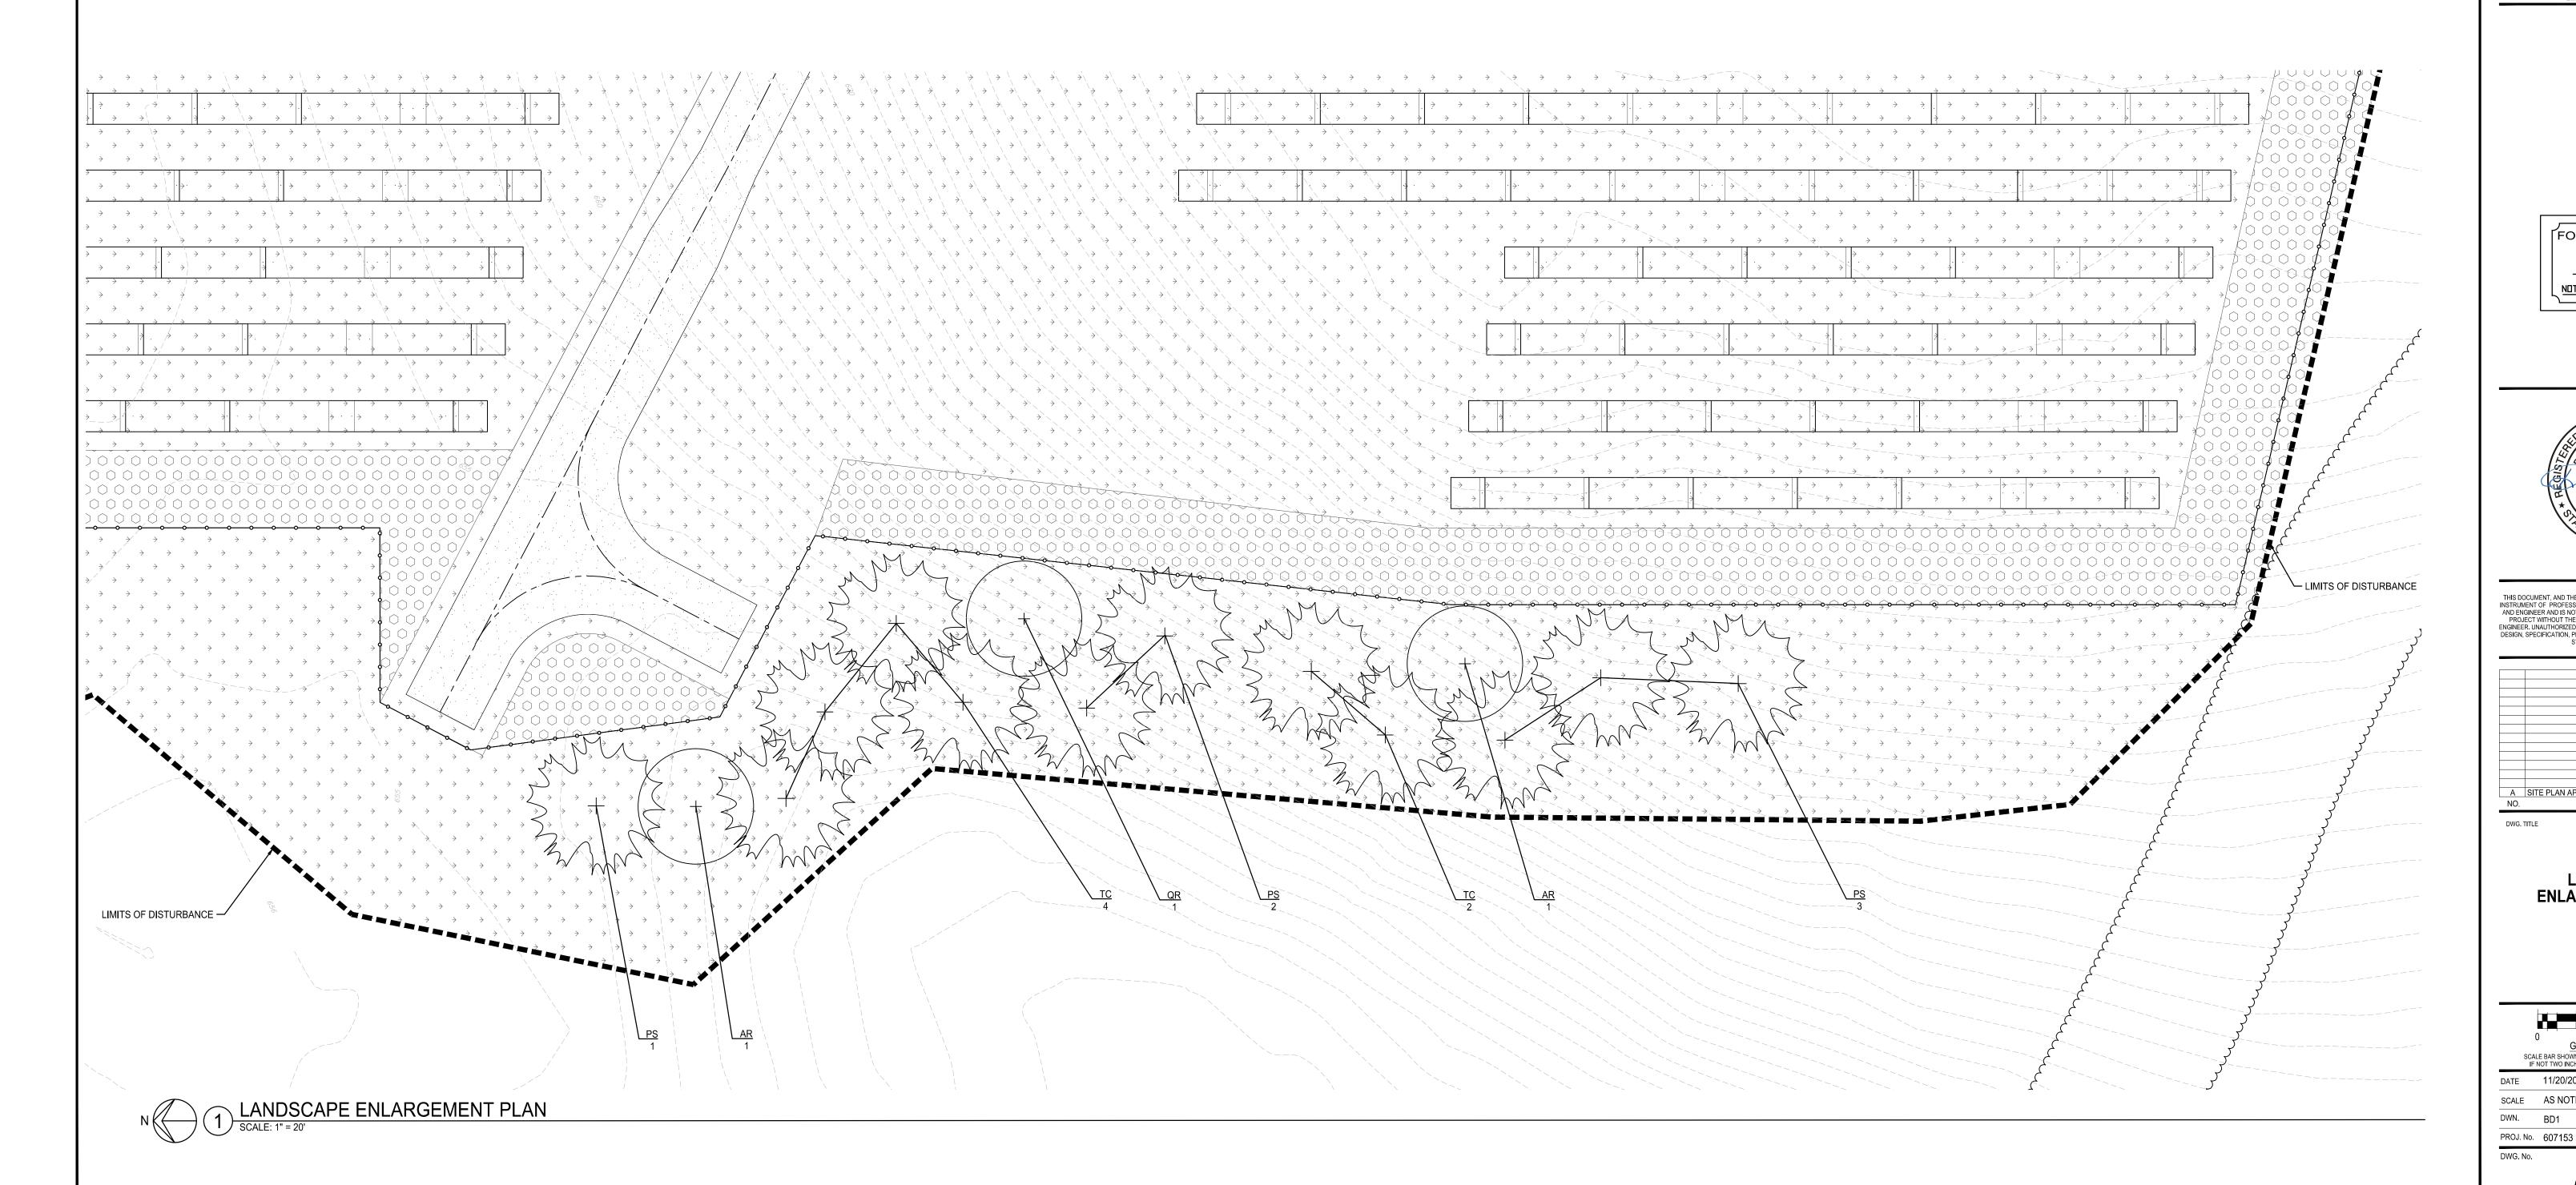
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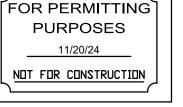
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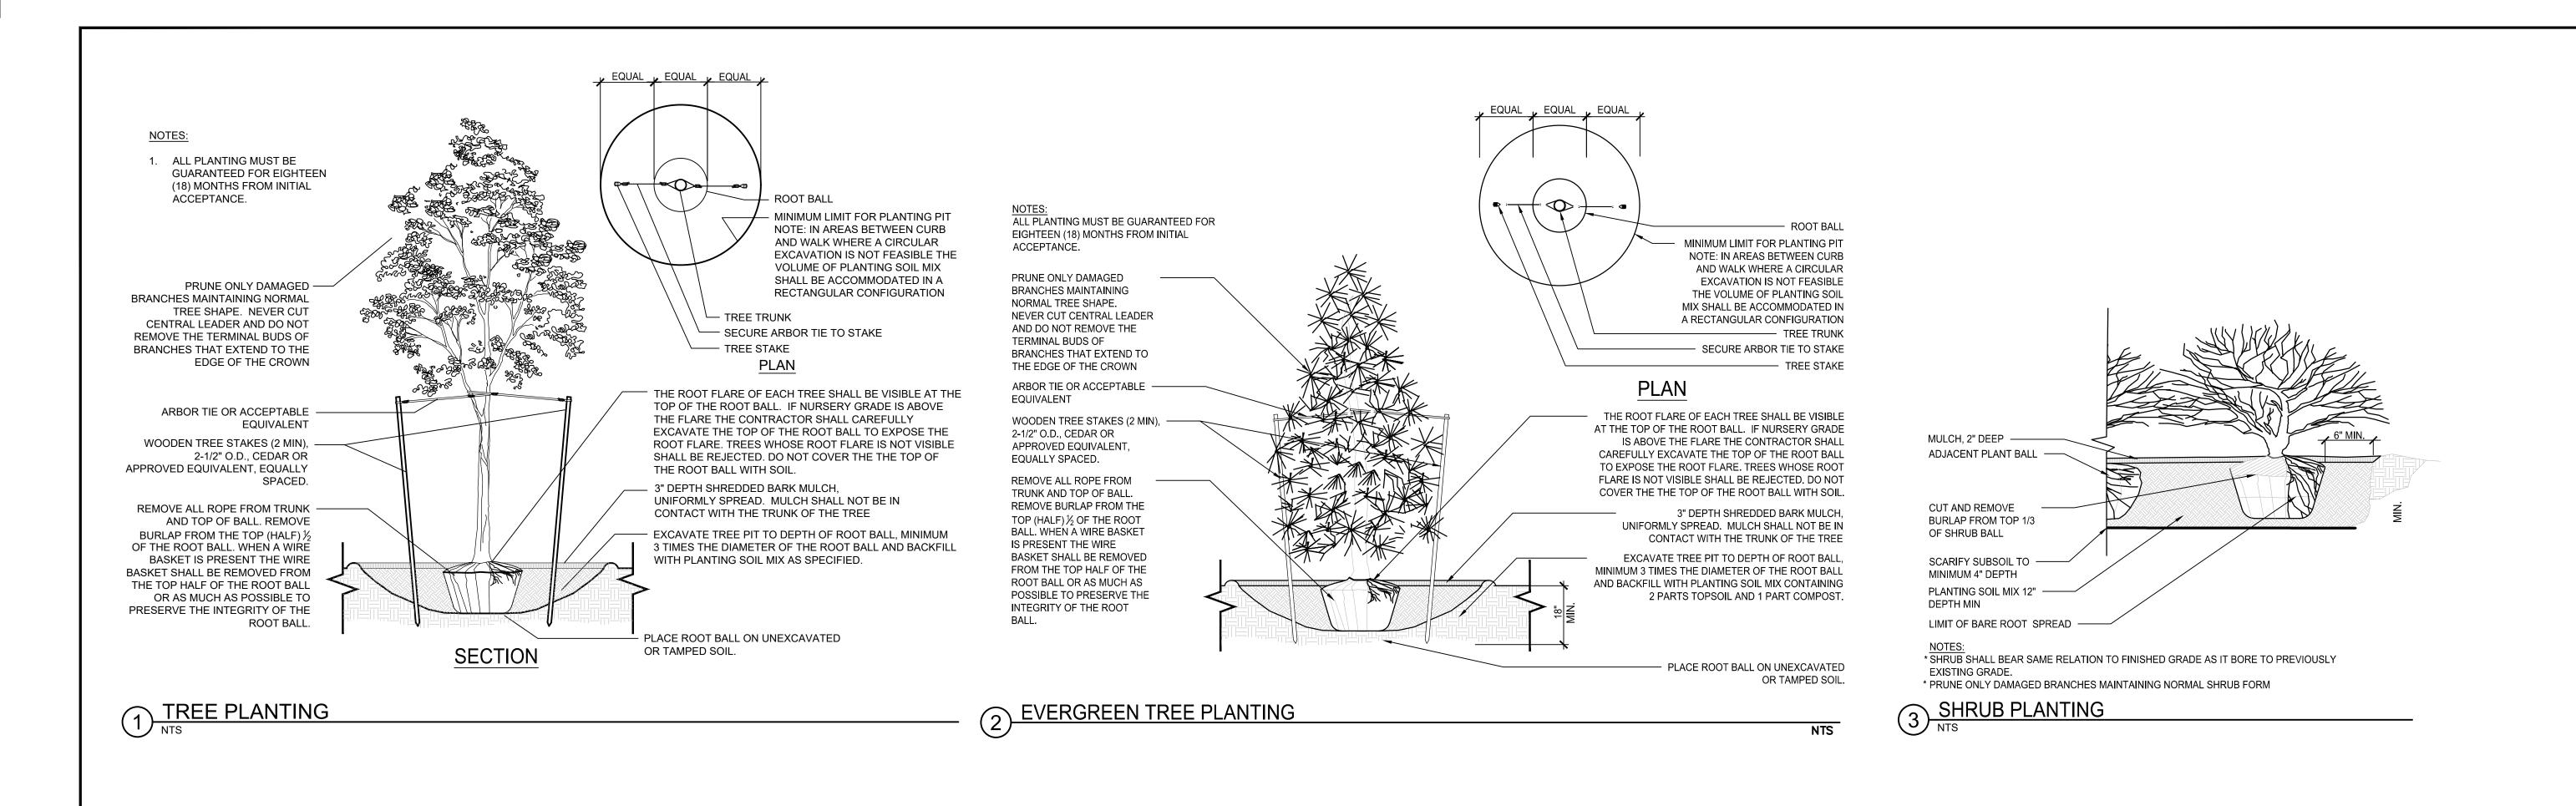
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NO. REVISIONS DATE

LANDSCAPE ENLARGEMENT PLAN

DATE

SCALE AS NOTED DWN. BD1



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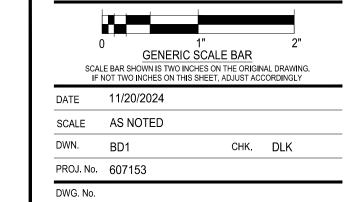



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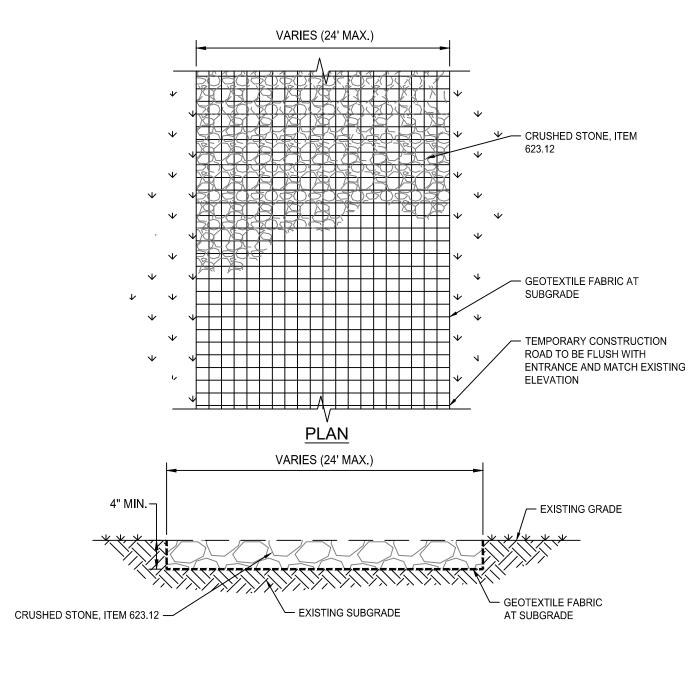
LANDSCAPE SITE DETAILS






- 1. STONE SIZE USE 1" 4" STONE, OR RECLAIMED OR RECYCLED CONCRETE EQUIVALENT.
- 2. LENGTH NOT LESS THAN 50 FEET (EXCEPT ON A SINGLE RESIDENCE LOT WHERE A 30 FOOT MINIMUM LENGTH WOULD APPLY).
- 3. THICKNESS NOT LESS THAN SIX (6) INCHES.
- 4. WIDTH SIXTEEN (16) FOOT MINIMUM, BUT NOT LESS THAN THE FULL WIDTH AT POINTS WHERE INGRESS OR EGRESS OCCURS. TWENTY (20) FOOT IF SINGLE ENTRANCE TO SITE. REFER TO DRAWING C203 FOR APRON DIMENSIONS.
- 5. FILTER CLOTH WILL BE PLACED OVER THE ENTIRE AREA PRIOR TO PLACING OF STONE.
- 6. SURFACE WATER ALL SURFACE WATER FLOWING OR DIVERTED TOWARD CONSTRUCTION ENTRANCES SHALL BE PIPED ACROSS THE ENTRANCE. IF PIPING IS IMPRACTICAL, A MOUNTABLE BERM WITH 5:1 SLOPES WILL BE PERMITTED.
- MAINTENANCE THE ENTRANCE SHALL BE MAINTAINED IN A CONDITION WHICH WILL PREVENT TRACKING OR FLOWING OF SEDIMENT ONTO PUBLIC RIGHTS-OF-WAY, ALL SEDIMENT SPILLED, DROPPED, WASHED OR TRACKED ONTO PUBLIC RIGHTS-OF-WAY MUST BE REMOVED IMMEDIATELY.
- 8. WHEN WASHING IS REQUIRED, IT SHALL BE DONE ON A AREA STABILIZED WITH STONE AND WHICH DRAINS INTO AN APPROVED SEDIMENT TRAPPING DEVICE.
- 9. PERIODIC INSPECTION AND NEEDED MAINTENANCE SHALL BE PROVIDED AFTER EACH RAIN.

TEMPORARY STABILIZED CONSTRUCTION **ENTRANCE DETAIL**

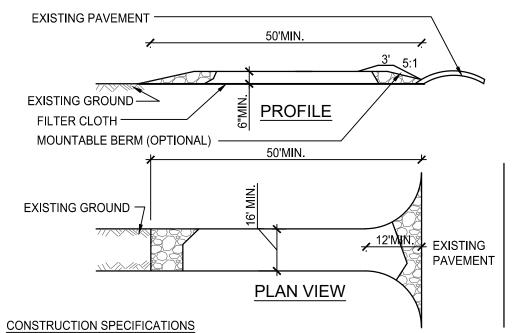

NOTE: THE LIMITED-USE PERVIOUS ACCESS ROAD IS NOT TO BE USED DURING CONSTRUCTION. THE CONTRACTOR WILL PROVIDE A TEMPORARY CONSTRUCTION ACCESS ROAD DURING CONSTRUCTION, THEN REMOVE THE TEMPORARY CONSTRUCTION ACCESS ROAD AND DECOMPACT THE SUBGRADE SOILS PRIOR TO INSTALLATION OF THE LIMITED-USE PERVIOUS ACCESS ROAD AFTER CONSTRUCTION IS COMPLETE. THE TEMPORARY CONSTRUCTION ACCESS ROAD IS EXPECTED TO BE LOCATED IN THE SAME FOOTPRINT AS THE PERMANENT PERVIOUS

TEMPORARY CONSTRUCTION ACCESS ROAD

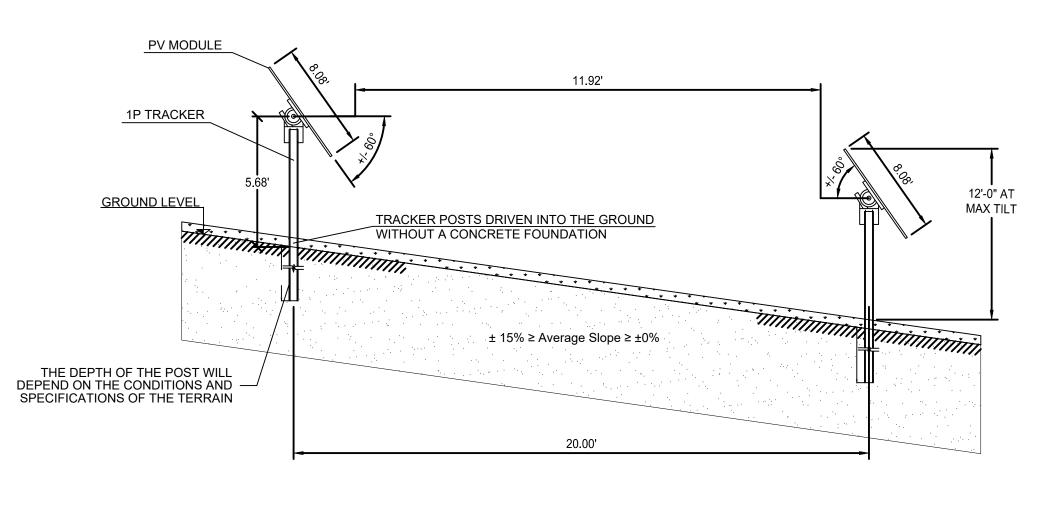

EXISTING CONTOURS -

2"x2" WOODEN STAKES -

4. ACCUMULATED SEDIMENT SHALL BE REMOVED WHEN IT REACHES HALF THE ABOVEGROUND HEIGHT OF THE SOCK AND DISPOSED IN THE MANNER DESCRIBED ELSEWHERE IN THE PLAN.

PLACED 10' O.C.

COMPOST FILTER SOCK MUST MEET THE STANDARDS AND SPECIFICATIONS OUTLINED IN SECTION 5 OF THE NEW YORK STATE STANDARD SPECIFICATIONS FOR EROISON AND SEDIMENT CONTROL, (JULY 2016)

SOCKS SHALL BE INSPECTED WEEKLY AND AFTER EACH RUNOFF EVENT. DAMAGED SOCKS SHALL BE REPAIRED ACCORDING TO MANUFACTURER'S SPECIFICATIONS OR REPLACED WITHIN 24 HOURS OF INSPECTION.

6. BIODEGRADABLE FILTER SOCKS SHALL BE REPLACED AFTER 6 MONTHS; PHOTODEGRADABLE SOCKS AFTER 1 YEAR. POLYPROPYLENE SOCKS SHALL BE REPLACED ACCORDING TO MANUFACTURER'S RECOMMENDATIONS.

DISTURBED

UNDISTURBED


COMPOST FILTER SOCK SHALL BE PLACED AT EXISTING LEVEL GRADE. BOTH ENDS OF THE SOCK SHALL BE EXTENDED AT LEAST 8 FEET UP SLOPE AT 45 DEGREES TO THE MAIN SOCK ALIGNMENT. STAKES MAY BE INSTALLED IMMEDIATELY

7. UPON STABILIZATION OF THE AREA TRIBUTARY TO THE SOCKS, STAKES SHALL BE REMOVED. THE SOCK MAY BE LEFT IN PLACE AND VEGETATED OR REMOVED. IN THE LATTER CASE, THE MESH SHALL BE CUT OPEN AND THE MULCH SPREAD

· 12"Ø COMPOS

FILTER SOCK

ANCRAM SOLAR SINGLE-AXIS TRACKER DETAIL

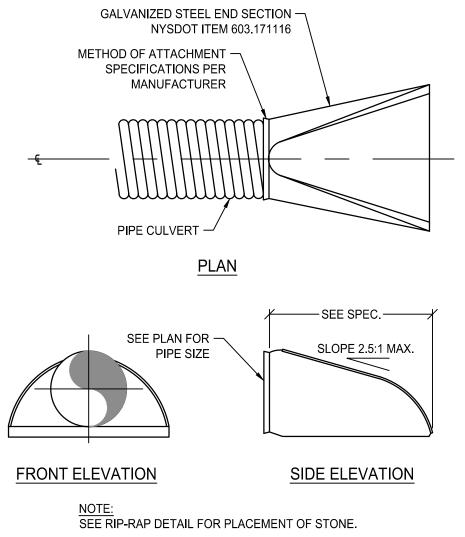

FLARED END SECTION WITH STONE DETAIL

DRAINAGE

PLAN VIEW

GROUND SURFACE NYSDOT ITEM 620.03 -STONE FILLING (LIGHT) ON FABRIC MIRAFI 600X OR APPROVED EQUAL **END VIEW** NYSDOT ITEM 620.03 STONE FILLING (LIGHT) ON FABRIC MIRAFI 600X OR APPROVED EQUAL PIPE OR PIPE ARCH

12"Ø COMPOST FILTER SOCK

> AT LEAST 4 INCHES OF FREEBOARD. TYPICAL DIMENSIONS ARE 10 FEET X 10 FEET X 3 FEET DEEP 3. PREPARE SOIL BASE FREE OF ROCKS OR OTHER

DEBRIS THAT MAY CAUSE TEARS OR HOLES IN THE LINER. FOR LINER, USE 10 MIL OR THICKER UV IMPERMEABILITY OF THE MATERIAL.

4. PROVIDE A SIGN FOR THE WASHOUT IN CLOSE PROXIMITY TO THE FACILITY.

5. KEEP CONCRETE WASHOUT STRUCTURE WATER TIGHT. REPLACE IMPERMEABLE LINER IF DAMAGED (E.G., RIPPED OR PUNCTURED). EMPTY OR REPLACE WASHOUT STRUCTURE THAT IS 75 PERCENT FULL, AND DISPOSE OF ACCUMULATED MATERIAL PROPERLY. DO NOT REUSE PLASTIC LINER. WET-VACUUM STORED LIQUIDS THAT HAVE NOT EVAPORATED AND DISPOSE OF IN AN APPROVED MANNER. PRIOR TO FORECASTED RAINSTORMS, REMOVE LIQUIDS OR COVER STRUCTURE TO PREVENT OVERFLOWS. REMOVE HARDENED SOLIDS, WHOLE OR BROKEN UP, FOR DISPOSAL OR RECYCLING. MAINTAIN RUNOFF DIVERSION AROUND EXCAVATED WASHOUT STRUCTURE UNTIL STRUCTURE IS REMOVED.

-----∠ STRAW BALE **IMPERMEABLE** (TYP.) SHEETING BINDING WIRE - STAPLES (2 PER BALE) STRAW BALE — - IMPERMEABLE SHEETING WOOD OR METAL STAKES SECTION B-B (2 PER BALE) NOTE: CAN BE TWO STACKED BALES OR PARTIALLY EXCAVATED TO REACH 3 FT

10 FT TYP.

┌─ STAKE


- PIPE DIA. OR PIPE ARCH RISE DIMENSION

WASHOUT STRUCTURE WITH STRAW BALES

ONSITE CONCRETE WASHOUT SCALE: N.T.S.

CONSTRUCTION SPECIFICATIONS

- LOCATE WASHOUT STRUCTURE A MINIMUM OF 50 FEET AWAY FROM OPEN CHANNELS, STORM DRAIN INLETS, SENSITIVE AREAS, WETLANDS, BUFFERS AND WATER COURSES AND AWAY FROM CONSTRUCTION TRAFFIC.
- 2. SIZE WASHOUT STRUCTURE FOR VOLUME NECESSARY TO CONTAIN WASH WATER AND SOLIDS AND MAINTAIN
- RESISTANT, IMPERMEABLE SHEETING, FREE OF HOLES AND TEARS OR OTHER DEFECTS THAT COMPROMISE

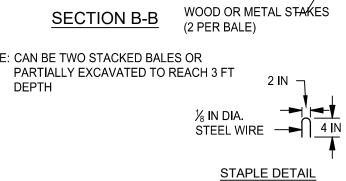

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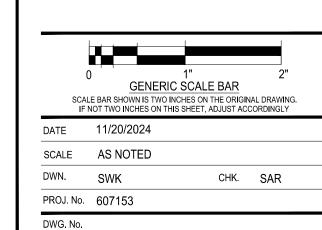
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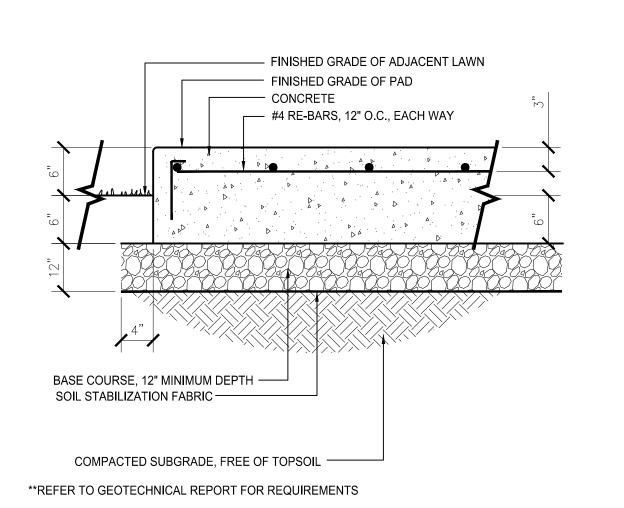
PURPOSES

11/20/24

NOT FOR CONSTRUCTION

SITE DETAILS





NOTE: FINAL GRADING OF EQUIPMENT PADS WILL BE DETERMINED IN DETAILED

DESIGN AND COORDINATED WITH THE ELECTRICAL DESIGN.

- 2"x2" WOODEN STAKES

COMPOST FILTER SOCK

UNDISTURBED AREA

PLACED 10' O.C.

DOWNSLOPE OF THE SOCK IF SO SPECIFIED BY THE MANUFACTURER.


3. TRAFFIC SHALL NOT BE PERMITTED TO CROSS FILTER SOCKS.

COMPOST FILTER SOCK DETAIL

BLOWN/PLACE -

FILTER MEDIA

DISTURBED AREA

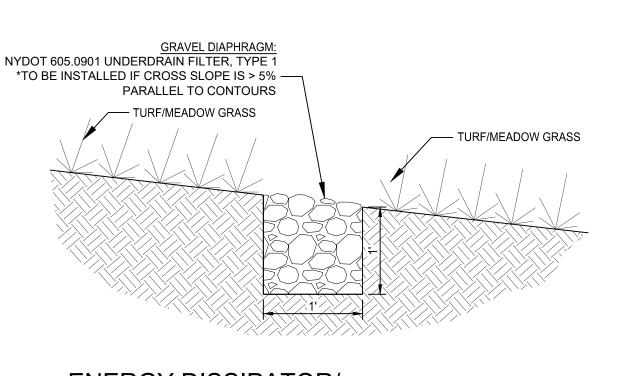


2"x2" WOODEN STAKES -

PLACED 18" O.C.

ENERGY DISSIPATOR/ LEVEL SPREADER DETAIL

FIXED KNOT FENCE BLEVATION VIEW FIXED KNOT FENCE 8'x12" SEE NOTE 5 SEE NOTE 5 TUBULAR GALVANIZED STEEL POST 3' Ø STEEL STRUT 3' Ø 4'-7" 4'-7" 4'-7" 4'-7"

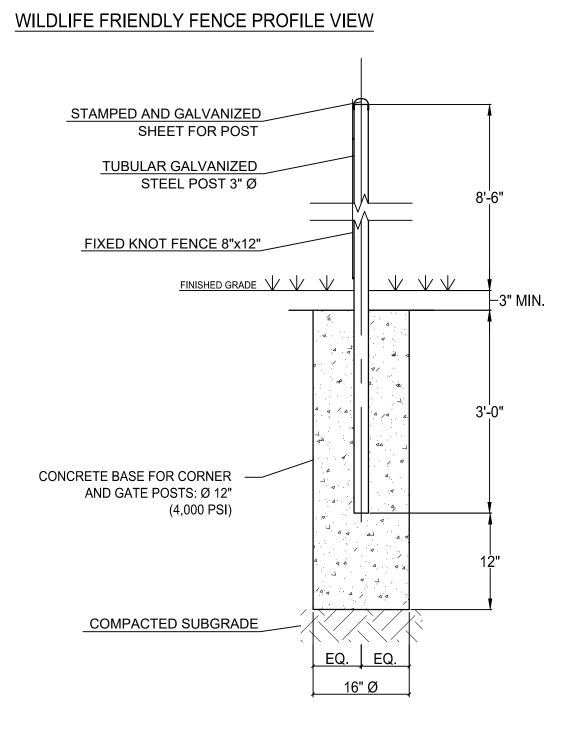

TUBLIARI GALVANIZED
STEEL FRAME 3' B

FIXED KNDT FENCE B'112*

TRUSS ROD

STEEL FRAME 3' B

FIXED KNDT FENCE B'114*

10-0"

10-0"

TUBLIARI GALVANIZED
STEEL FRAME 3' B

FIXED KNDT FENCE B'114*

10-0"

TUBLIARI GALVANIZED
STEEL FRAME 3' B

FIXED KNDT FENCE B'114*

TUBLIARI GALVANIZED
STEEL FRAME 3' B

FIXED KNDT FENCE B'114*

TUBLIARI GALVANIZED
STEEL FRAME 3' B

FIXED KNDT FENCE B'114*

TUBLIARI GALVANIZED
STEEL FRAME 3' B

FIXED KNDT FENCE B'114*

TUBLIARI GALVANIZED
STEEL FRAME 3' B

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STEEL FRAME 3' B

FIXED KNDT FENCE B'114*

TUBLIARI GALVANIZED
STEEL FRAME 3' B

FIXED KNDT FENCE B'114*

TUBLIARI GALVANIZED
STEEL FRAME 3' B

TUBLIARI GALVA

WILDLIFE FRIENDLY FENCE WITH GATE DETAIL

GATE FRONTAL VIEW



FENCE WARNING SIGNS NOTES:

- SIGNS SHALL CONFORM TO THE 2013 OSHA AND ANSI REQUIREMENTS.
- SIGNS SHALL BE 20" WIDE BY 14" HIGH.
- SIGNS SHALL HAVE A MOUNTING HEIGHT BETWEEN 45 TO 66 INCHES.
 SIGN PANELS SHALL BE 10 GAUGE ALUMINUM WITH HIGH VISIBILITY REFLECTIVE SHEETING.
- 5. SIGNS SHALL BE PLACED ON GATE AND ALONG FENCE LINE AS REQUESTED BY OWNER.

ADDRESS: 3333 STATE ROUTE 82
ANCRAMDALE, NY 12503

SITE OWNER: XXXX
SITE OWNER PHONE NUMBER: XXXX

O & M COMPANY: XXXX
O & M COMPANY PHONE NUMBER: XXXX

CONTACT PLATE

NOTES

- 1. PROVIDE LATCHING DEVICES TO HOLD GATES IN OPEN POSITION.
- IF ROCK IS ENCOUNTERED WHEN SETTING POSTS, DRILL HOLES
 4 INCHES LARGER IN DIAMETER THAN POSTS AND BACKFILL
 TO GRADE WITH CLASS "B" CONCRETE.

MOVEMENT OF SMALL MAMMALS AND REPTILES.

- 3. PROVIDE LOCKING LATCH WITH FIRE DEPARTMENT PROVIDED KNOX BOX.
- 4. PER ARTICLE 691.11 OF THE NATIONAL ELECTRICAL CODE, LARGE SCALE PHOTOVOLTAIC (PV) PROJECTS ABOVE 5,000 KW (5 MW) REQUIRE THE PERIMETER FENCE TO BE GROUNDED.
- 5. REGULAR FENCE POSTS SHALL BE INSTALLED EVERY 10 FT, AND POSTS WITH STRUTS EVERY 90 FT.
- 6. THE FENCING DEPICTED IN THESE PLANS AND DETAILS IS NOT DESIGNED TO ACCOMMODATE ADDITIONAL WIND LOADING SUCH AS THE ADDITION OF SCREENING MATERIAL. IF SCREENING "SLATS" OR OTHER TEXTILE SCREENING MATERIAL IS TO BE ADDED TO THE FENCE, THE FENCING SYSTEM MUST BE REDESIGNED AND APPROVED BY THE OWNER AND ENGINEER.

PER PART 5, SECTION G, OF THE TOWN'S DEVELOPMENT CODE, FENCING SHALL BE WILDLIFE FRIENDLY. THEREFORE, TO ADHERE TO THE TOWN'S SOLAR LAW:

- 7. THE FENCE SHALL HAVE AN APPROPRIATE HEIGHT TO PROVIDE SCREENING WHILE ALLOWING SMALL ANIMAL PASSAGE.
- 8. GAPS OR OPENINGS SHALL BE INCORPORATED IN THE FENCE DESIGN TO FACILITATE THE
- 9. IF NEEDED, A BERM OF VEGETATIVE SCREENING SHALL BE INTEGRATED ALONGSIDE THE FENCE USING NATIVE PLANT SPECIES TO PROVIDE SCREENING FROM ADJACENT PROPERTIES TO ATTRACT AND SUPPORT LOCAL WILDLIFE.
- 10. SHARP EDGES OR PROTRUSIONS THAT COULD HARM ANIMALS SHALL BE REMOVED FROM THE FENCE.





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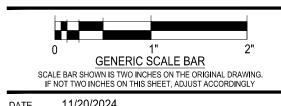
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Α	SITE PLAN APPROVAL/SUP SUBMISSION	11/20/20
NO.	REVISIONS	DATE

DWG. TITLE

SITE DETAILS



DATE 11/20/2024

SCALE AS NOTED

DWN. SWK CHK. SAR

PROJ. No. 607153

DWG. No.

050

GENERAL NOTES:

- 1. USE OF THIS DETAIL/CRITERION IS LIMITED TO ACCESS ROADS USED ON AN OCCASIONAL BASIS ONLY (I.E. PROVIDE ACCESS FOR MOWING, EQUIPMENT REPAIR OR MAINTENANCE, ETC.).
- 2. LIMITED USE PERVIOUS ACCESS ROAD IS LIMITED TO LOW IMPACT IRREGULAR MAINTENANCE ACCESS ASSOCIATED WITH RENEWABLE ENERGY PROJECTS IN NEW YORK STATE.
- 3. REMOVE STUMPS, ROCKS AND DEBRIS AS NECESSARY. FILL VOIDS TO MATCH EXISTING NATIVE SOILS AND COMPACTION LEVEL.
- 4. REMOVED TOPSOIL MAY BE SPREAD IN ADJACENT AREAS AS DIRECTED BY THE PROJECT ENGINEER. COMPACT TO THE DEGREE OF THE NATIVE INSITU SOIL. DO NOT PLACE IN AN AREA THAT IMPEDES STORMWATER DRAINAGE.
- 5. GRADE ROADWAY, WHERE NECESSARY, TO NATIVE SOIL AND DESIRED ELEVATION. MINOR GRADING FOR CROSS SLOPE CUT AND FILL MAY BE REQUIRED.
- 6. REMOVE REFUSE SOILS AS DIRECTED BY THE PROJECT ENGINEER. DO NOT PLACE IN AN AREA THAT IMPEDES STORMWATER DRAINAGE.
- 7. THE LIMITED USE PERVIOUS ACCESS ROAD CROSS SLOPE SHALL BE 2% IN MOST CASES AND SHOULD NOT EXCEED 6%. THE LONGITUDINAL SLOPE OF THE ACCESS DRIVE SHOULD NOT
- 8. LIMITED USE PERVIOUS ACCESS ROAD IS NOT INTENDED TO BE UTILIZED FOR CONSTRUCTION WHICH MAY SUBJECT THE ACCESS TO SEDIMENT TRACKING. THIS SPECIFICATION IS TO BE DEVELOPED FOR POST—CONSTRUCTION USE. SOIL RESTORATION PRACTICES MAY BE APPLICABLE TO RESTORE CONSTRUCTION RELATED COMPACTION TO PRE—EXISTING CONDITIONS AND SHOULD BE VERIFIED BY SOIL PENETROMETER READINGS. THE PENETROMETER READINGS SHALL BE COMPARED TO THE RESPECTIVE RECORDED READINGS TAKEN PRIOR TO CONSTRUCTION, EVERY 100 LINEAR FEET ALONG THE PROPOSED ROADWAY.
- 9. TO ENSURE THAT SOIL IS NOT TRACKED ONTO THE LIMITED USE PERVIOUS ACCESS ROAD, IT SHALL NOT BE USED BY CONSTRUCTION VEHICLES TRANSPORTING SOIL, FILL MATERIAL, ETC. IF THE LIMITED USE PERVIOUS ACCESS IS COMPLETED DURING THE INITIAL PHASES OF CONSTRUCTION, A STANDARD NEW YORK STATE STABILIZED CONSTRUCTION ACCESS SHALL BE CONSTRUCTED AND UTILIZED TO REMOVE SEDIMENT FROM CONSTRUCTION VEHICLES AND EQUIPMENT PRIOR TO ENTERING THE LIMITED USE PERVIOUS ACCESS ROAD FROM ANY LOCATION ON, OR OFF SITE. MAINTENANCE OF THE PERVIOUS ACCESS ROAD WILL BE REQUIRED IF SEDIMENT IS OBSERVED WITHIN THE CLEAN STONE.
- 10. THE LIMITED USE PERVIOUS ACCESS ROAD SHALL NOT BE CONSTRUCTED OR USED UNTIL ALL AREAS SUBJECT TO RUNOFF ONTO THE PERVIOUS ACCESS HAVE ACHIEVED FINAL STABILIZATION.
- 11. PROJECTS SHOULD AVOID INSTALLATION OF THE LIMITED USE PERVIOUS ACCESS ROAD IN POORLY DRAINED AREAS, HOWEVER IF NO ALTERNATIVE LOCATION IS AVAILABLE, THE PROJECT SHALL UTILIZE WOVEN GEOTEXTILE MATERIAL AS DETAILED IN FOLLOWING NOTES.
- 12. THE DRAINAGE DITCH IS OFFERED IN THE DETAIL FOR CIRCUMSTANCES WHEN CONCENTRATED FLOW COULD NOT BE AVOIDED. THE INTENTION OF THIS DESIGN IS TO MINIMIZE ALTERATIONS TO HYDROLOGY, HOWEVER WHEN DEALING WITH 5%—15% GRADES NOT PARALLEL TO THE CONTOUR, A ROADSIDE DITCH MAY BE REQUIRED. THE NYS STANDARDS AND SPECIFICATIONS FOR EROSION AND SEDIMENT CONTROLS FOR GRASSED WATERWAYS AND VEGETATED WATERWAYS ARE APPLICABLE FOR SIZING AND STABILIZATION. DIMENSIONS FOR THE GRASSED WATERWAY SPECIFICATION WOULD BE DESIGNED FOR PROJECT SPECIFIC HYDROLOGIC RUNOFF CALCULATIONS, AND A SEPARATE DETAIL FOR THE SPECIFIC GRASSED WATERWAY WOULD BE INCLUDED IN THIS PRACTICE. RUNOFF DISCHARGES WILL BE SUBJECT TO THE OUTLET REQUIREMENTS OF THE REFERENCED STANDARD. INCREASED POST—DEVELOPMENT RUNOFF FROM THE ASSOCIATED ROADSIDE DITCH MAY REQUIRE ADDITIONAL PRACTICES TO ATTENUATE RUNOFF TO PRE—DEVELOPMENT CONDITIONS.
- 13. IF A ROADSIDE DITCH IS NOT UTILIZED TO CAPTURE RUNOFF FROM THE ACCESS ROAD, THE PERVIOUS ACCESS ROAD WILL HAVE A WELL-ESTABLISHED PERENNIAL VEGETATIVE COVER, WHICH SHALL CONSIST OF UNIFORM VEGETATION (I.E. BUFFER), 20 FEET WIDE AND PARALLEL TO THE DOWN GRADIENT SIDE OF THE ACCESS ROAD. POST-CONSTRUCTION OPERATION AND MAINTENANCE PRACTICES WILL MAINTAIN THIS VEGETATIVE COVER TO ENSURE FINAL STABILIZATION FOR THE LIFE OF THE ACCESS ROAD.
- 14. THE DESIGN PROFESSIONAL MUST ACCOUNT FOR THE LIMITED USE PERVIOUS ACCESS ROAD IN THEIR SITE ASSESSMENT/HYDROLOGY ANALYSIS. IF THE HYDROLOGY ANALYSIS SHOWS THAT THE HYDROLOGY HAS BEEN ALTERED FROM PRE— TO POST—DEVELOPMENT CONDITIONS (SEE APPENDIX A OF GP—0—20—001 FOR THE DEFINITION OF "ALTER THE HYDROLOGY..."), THE DESIGN MUST INCLUDE THE NECESSARY DETENTION/RETENTION PRACTICES TO ATTENUATE THE RATES (10 AND 100 YEAR EVENTS) TO PRE—DEVELOPMENT CONDITIONS.
- 15. CRUSHED STONE CAP OVER GEOTEXTILE FABRIC TO BE INSTALLED ON ANY PORTION OF THE PERMANENT PERVIOUS ACCESS ROAD THAT WILL BE INSTALLED AND USED DURING CONSTRUCTION. UPON FINAL STABILIZATION, THE CAP AND GEOTEXTILE FABRIC IMMEDIATELY BELOW CAP SHALL BE REMOVED AND THE PERVIOUS STONE SECTION SHALL HAVE ADDITIONAL STONE ADDED AND GRADED AS NEEDED.

GEOGRID MATERIAL NOTES:

- 1. THE GEOGRID, OR COMPARABLE PRODUCT, IS INTENDED FOR USE FOR ALL CONDITIONS, IN ORDER TO ASSIST IN MATERIAL SEPARATION FROM NATIVE SOILS AND PRESERVE ACCESS LOADS.
- 2. GRAVEL FILL MATERIAL SHALL CONSIST OF 1-4" CLEAN, DURABLE, SHARP-ANGLED CRUSHED STONE OF UNIFORM QUALITY, MEETING THE SPECIFICATIONS OF NYSDOT ITEM 703-02, SIZE DESIGNATION 3-5 OF TABLE 703-4. STONE MAY BE PLACED IN FRONT OF, AND SPREAD WITH, A TRACKED VEHICLE. GRAVEL SHALL NOT BE COMPACTED.
- 3. GEOGRID SHALL BE MIRAFI BXG110 OR APPROVED EQUAL. GEOGRID SHALL BE DESIGNED BASED ON EXISTING SOIL CONDITIONS AND PROPOSED HAUL ROAD SLOPES.
- 4. IF MORE THAN ONE ROLL WIDTH IS REQUIRED, ROLLS SHOULD OVERLAP A MINIMUM OF SIX
- 5. REFER TO MANUFACTURER'S SPECIFICATION FOR PROPER TYING AND CONNECTIONS.
- 6. LIMITED USE PERVIOUS ACCESS ROAD SHALL BE TOP DRESSED AS REQUIRED WITH ONLY 1-4" CRUSHED STONE MEETING NYSDOT ITEM 703-02 SPECIFICATIONS.

BASIS OF DESIGN: TENCATE MIRAFI BXG110 GEOGRIDS; 365 SOUTH HOLLAND DRIVE, PENDERGRASS, GA; 800-685-9990 OR 706-693-2226; WWW.MIRAFI.COM


GEOWEB MATERIAL NOTES:

- 1. THE GEOWEB, OR COMPARABLE PRODUCT, IS SUGGESTED FOR USE ON ROAD PROFILES EXCEEDING 10%. THE GEOWEB PRODUCT IS INTENDED TO LIMIT SHIFTING STONE MATERIAL DURING USE.
- 2. INSTALLATION TO BE COMPLETED IN ACCORDANCE WITH MANUFACTURER'S SPECIFICATIONS.
- 3. WHERE REQUIRED, A NATIVE SOIL WEDGE SHALL BE PLACED TO ACCOMMODATE ROAD CROSS SLOPE OF 2%. NATIVE SOIL SHALL BE COMPACTED TO MATCH EXISTING SOIL CONDITIONS.
- 4. GRAVEL FILL MATERIAL SHALL CONSIST OF 1-4" CLEAN, DURABLE, SHARP-ANGLED CRUSHED STONE OF UNIFORM QUALITY, MEETING THE SPECIFICATIONS OF NYSDOT ITEM 703-02, SIZE DESIGNATION 3-5 OF TABLE 703-4. STONE MAY BE PLACED IN FRONT OF, AND SPREAD WITH, A TRACKED VEHICLE. GRAVEL SHALL NOT BE COMPACTED.
- 5. GEOWEB SYSTEM SHALL BE PRESTO GEOSYSTEM GEOWEB OR APPROVED EQUAL. GEOWEB SHALL BE DESIGNED BASED ON EXISTING SOIL CONDITIONS AND PROPOSED HAUL ROAD SLOPES.
- 6. LIMITED USE PERVIOUS ACCESS ROAD SHALL BE TOP DRESSED AS REQUIRED WITH ONLY 1-4" CRUSHED STONE, SIZE 3A, MEETING NYSDOT ITEM 703-02 SPECIFICATIONS.
- 7. THE TOP EDGES OF ADJACENT CELL WALLS SHALL BE FLUSH WHEN CONNECTING. ALIGN THE I—SLOTS FOR INTERLEAF AND END TO END CONNECTIONS. THE GEOWEB PANELS SHALL BE CONNECTED WITH ATRA KEYS AT EACH INTERLEAD AND END TO END CONNECTIONS. REFER TO MANUFACTURER'S SPECIFICATION FOR PROPER INSTALLATION, TYING AND CONNECTIONS.
- BASIS OF DESIGN: PRESTO GEOSYSTEMS GEOWEB; 670 NORTH PERKINS STREET, APPLETON, WI; 800-548-3424 OR 920-738-1222; INFO@PRESTOGEO.COM; WWW.PRESTOGEO.COM


WOVEN GEOTEXTILE MATERIAL NOTES:

- 1. SPECIFIED GEOTEXTILE WILL ONLY BE UTILIZED IN PLACID SOILS. PLACID SOILS CONSIST OF POORLY DRAINED SOILS COMPOSED OF FINELY TEXTURED PARTICLES AND ARE PRONE TO RUTTING. PLACID SOILS ARE TYPICALLY PRESENT IN LOW-LYING AREAS WITH HYDROLOGIC SOILS GROUP (HSG) OF C OR D, OR AS SPCIFIED FROM AN ENVIRONMENTAL SCIENTIST, SOIL SCIENTIST, OR GEOTECHNICAL DATA.
- 2. THE CONCERN FOR POTENTIAL REDUCTION OF NATIVE INFILTRATION RATES DUE TO THE GEOTEXTILE MATERIAL WOULD NOT BE A SIGNIFICANT CONCERN IN POORLY DRAINED SOILS WHERE SEGREGATION OF PERVIOUS STONE AND NATIVE MATERIALS IS CRUCIAL FOR LONG TERM OPERATION AND MAINTENANCE


BASIS OF DESIGN: TENCATE MIRAFI RSI-SERIES WOVEN GEOSYNTHETICS; 365 SOUTH HOLLAND DRIVE, PENDERGRASS, GA;800-685-9990 OR 706-693-2226; WWW.MIRAFI.COM

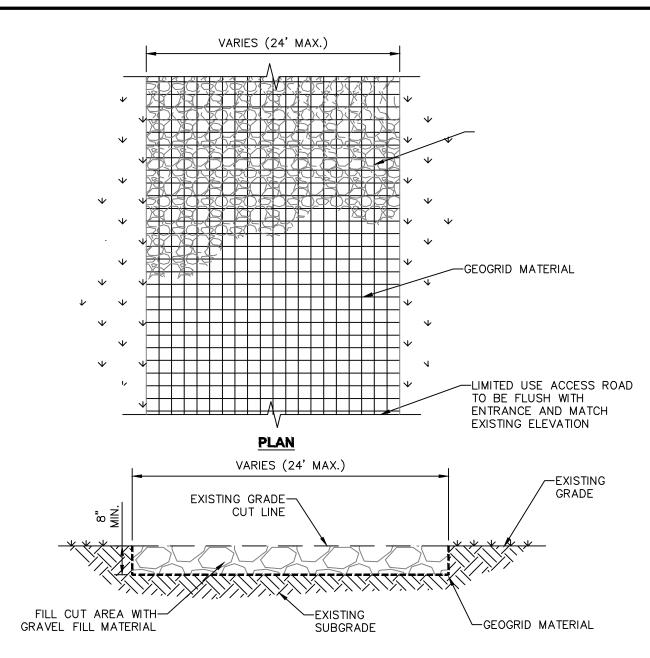

1 LIMITED USE PERVIOUS ACCESS ROAD - 0% TO 10% SLOPES

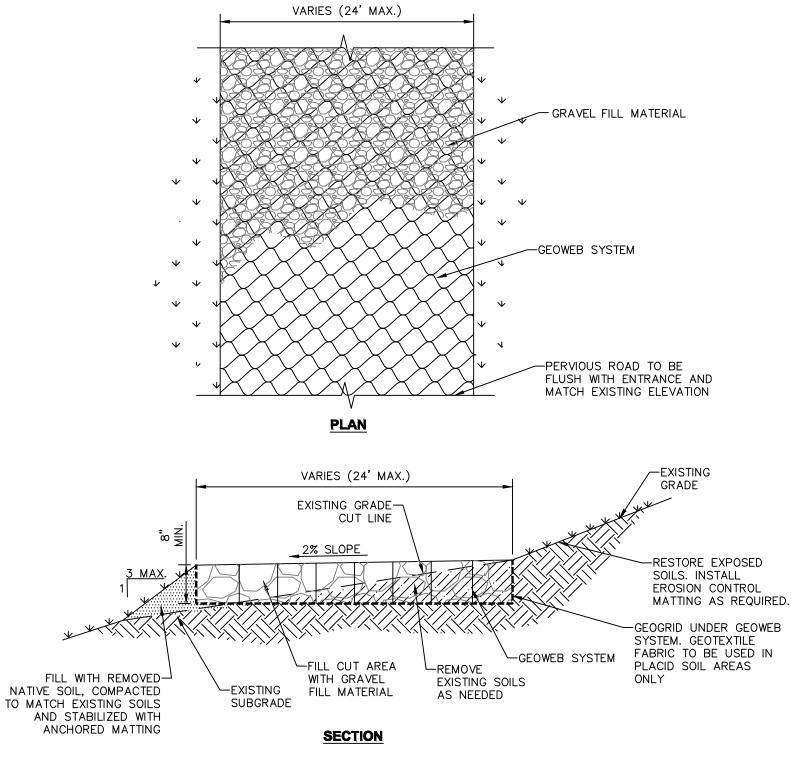

2 LIMITED USE PERVIOUS ACCESS ROAD - 10% AND GREATER SLOPES SCALE: N.T.S.

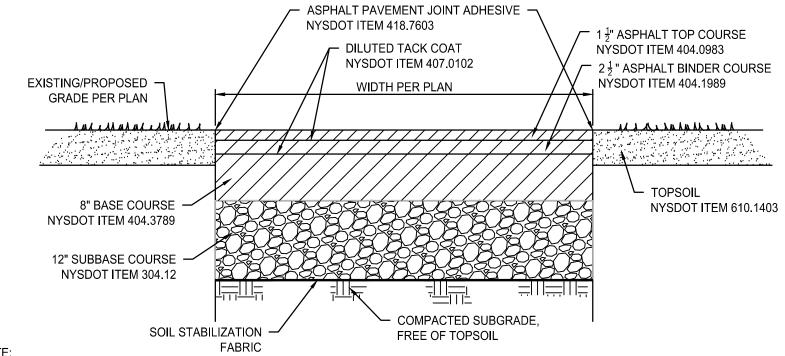


ALL IMPROVEMENTS SHALL ADHERE TO NYSDOT STANDARDS SECTION 608-03.
 THE OVERALL PAVEMENT THICKNESS OF THE DRIVEWAY SHALL VARY TO MATCH THE PAVEMENT DEPTH FOUND AT THE ADJACENT EXISTING TRAVEL LANE.
 IF THE EXISTING PAVEMENT THICKNESS IN THE ADJACENT TRAVEL LANE IS GREATER THAN 10", THE DEPTH OF THE COURSE SHALL VARY, (MAXIMUM 3")

LIFTS) TO MEET THE EXISTING PAVEMENT THICKNESS.

3. DILUTED TACK COAT (407.0102) SHALL BE APPLIED BETWEEN EACH LIFT OF ASPHALT AND ALL VERTICAL FACES. ASPHALT PAVEMENT JOINT ADHESIVE (ITEM 418.7603) SHALL BE USED ON VERTICAL FACES FOR ALL JOINTS IN THE TOP COURSE INCLUDING CURBS, GUTTERS, AND DRAINAGE STRUCTURES.

4. ALL NEW PAVEMENT JOINTS SHOULD BE SEALED WITH AN APPROVED NYSDOT CRACK SEALER.

NYSDOT DRIVEWAY ENTRANCE ASPHALT SECTION WITHIN PAVEMENT LENGTH SCALE: N.T.S.

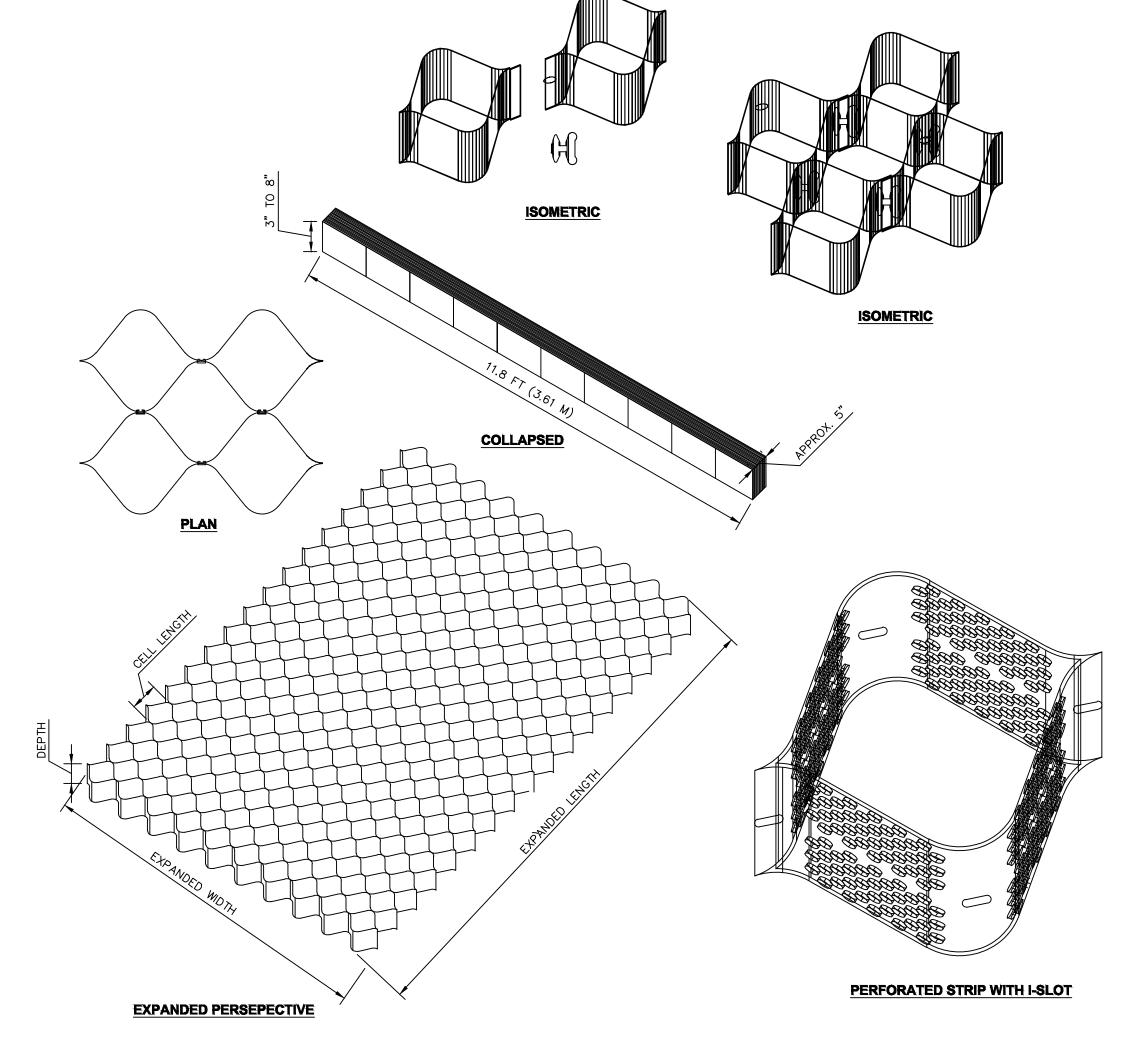

GEOWEB SYSTEM
SCALE: N.T.S.



c/o RIC Development, LLC 17 State Street, Suite 2320 New York, NY 10004

ANCRAM SOLAR

3333 State Route 82 Ancramdale, NY 12503




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A	SITE PLAN APPROVAL/SUP SUBMISSION	11/20/202
NO.	REVISIONS	DATE

SITE DETAILS

DWG. TITLE

PROJ. No. 607153

DWG No.

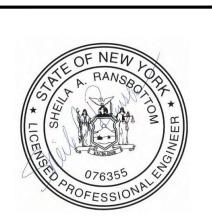O 1" 2"

GENERIC SCALE BAR

SCALE BAR SHOWN IS TWO INCHES ON THE ORIGINAL DRAWING.
IF NOT TWO INCHES ON THIS SHEET, ADJUST ACCORDINGLY

DATE 11/20/2024

SCALE AS NOTED

DWN. SWK CHK. SAR