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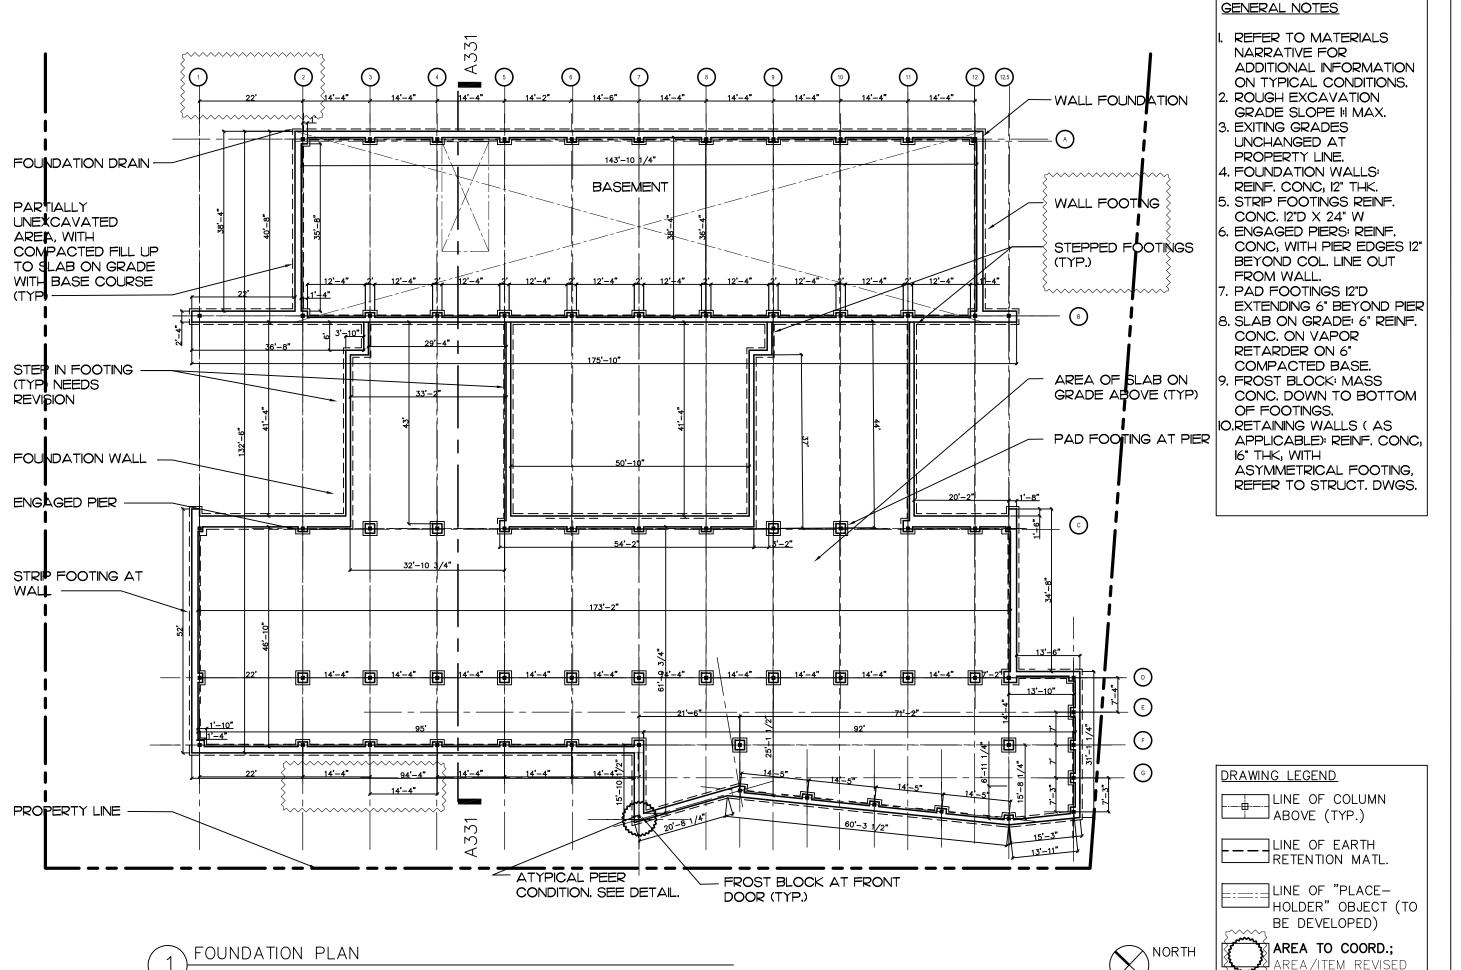
ALLSTON, MA

MACHADO & SILVETTI JALEN DAVIS

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S130 FRAMING PLAN - ROOF (1: 96, 192, 240) SHT. NO.: EXERCISES:. X011 PRECEDENT STUDY - 3D VIEWS X012 PRECEDENT STUDY - DT'LS, MAT'LS & ADDN'L INFO. X021 FOUNDATION SYSTEMS - COMPONENT 3D VIEWS X022 FOUNDATION SYSTEMS - SECT. & PLAN (1: 24) X031 FRAMING SYSTEM OPTIONS - PLAN (1: 48) X032FRAMING SYSTEM OPTIONS - SECTION (1: 48) X033FRAMING SYSTEM OPTIONS - ELEV. & PLAN (1: 24) X041 WALL SYSTEM OPTIONS - SECTION (1: 16) X042WALL SYSTEMS - COMPONENT 3D VIEWS X051 EGRESS STAIR - PLAN (1: 48) X052EGRESS STAIR - SECTION (1: 48) X053STAIR ENCLOSURE OPTIONS - DETAILS (1: 8) X061 EXT. ENCL. SYSTEM DTLS FND. & ROOF (1: 8) X062EXT. ENCL. SYSTEM DTLS OPENINGS (1: 8) X063EXT. ENCL. SYSTEM DTLS OPENINGS (1: 8)		H	7	Ŧ	Н		\exists		X	×			A910	FLOOR FINISHES PLAN (1 : 96, 120)	
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DRAWING SCALE: 1'' = 20' (PRINT SCALE 1:240)

Systems Jalen Davis, Fall 2019


Construction


Project Source
Boston Public Library
Allston, MA
Macho and Silvetti Associates


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Sheet Issued 13.09.2019 ...

Plan Sheet Title Foundation F



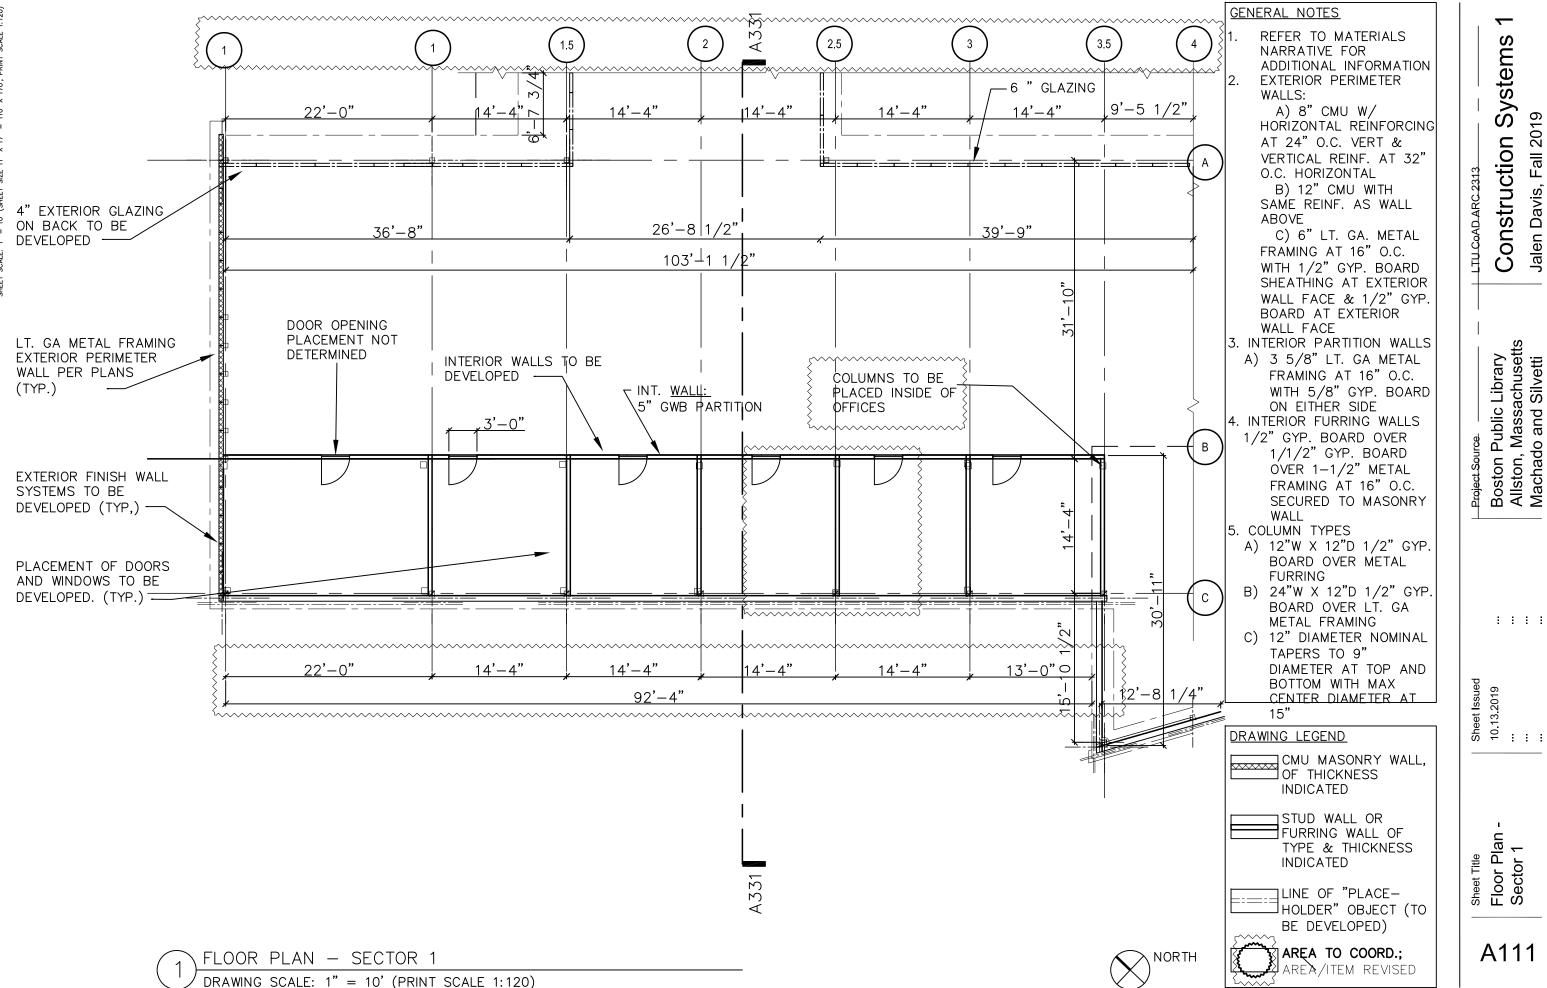

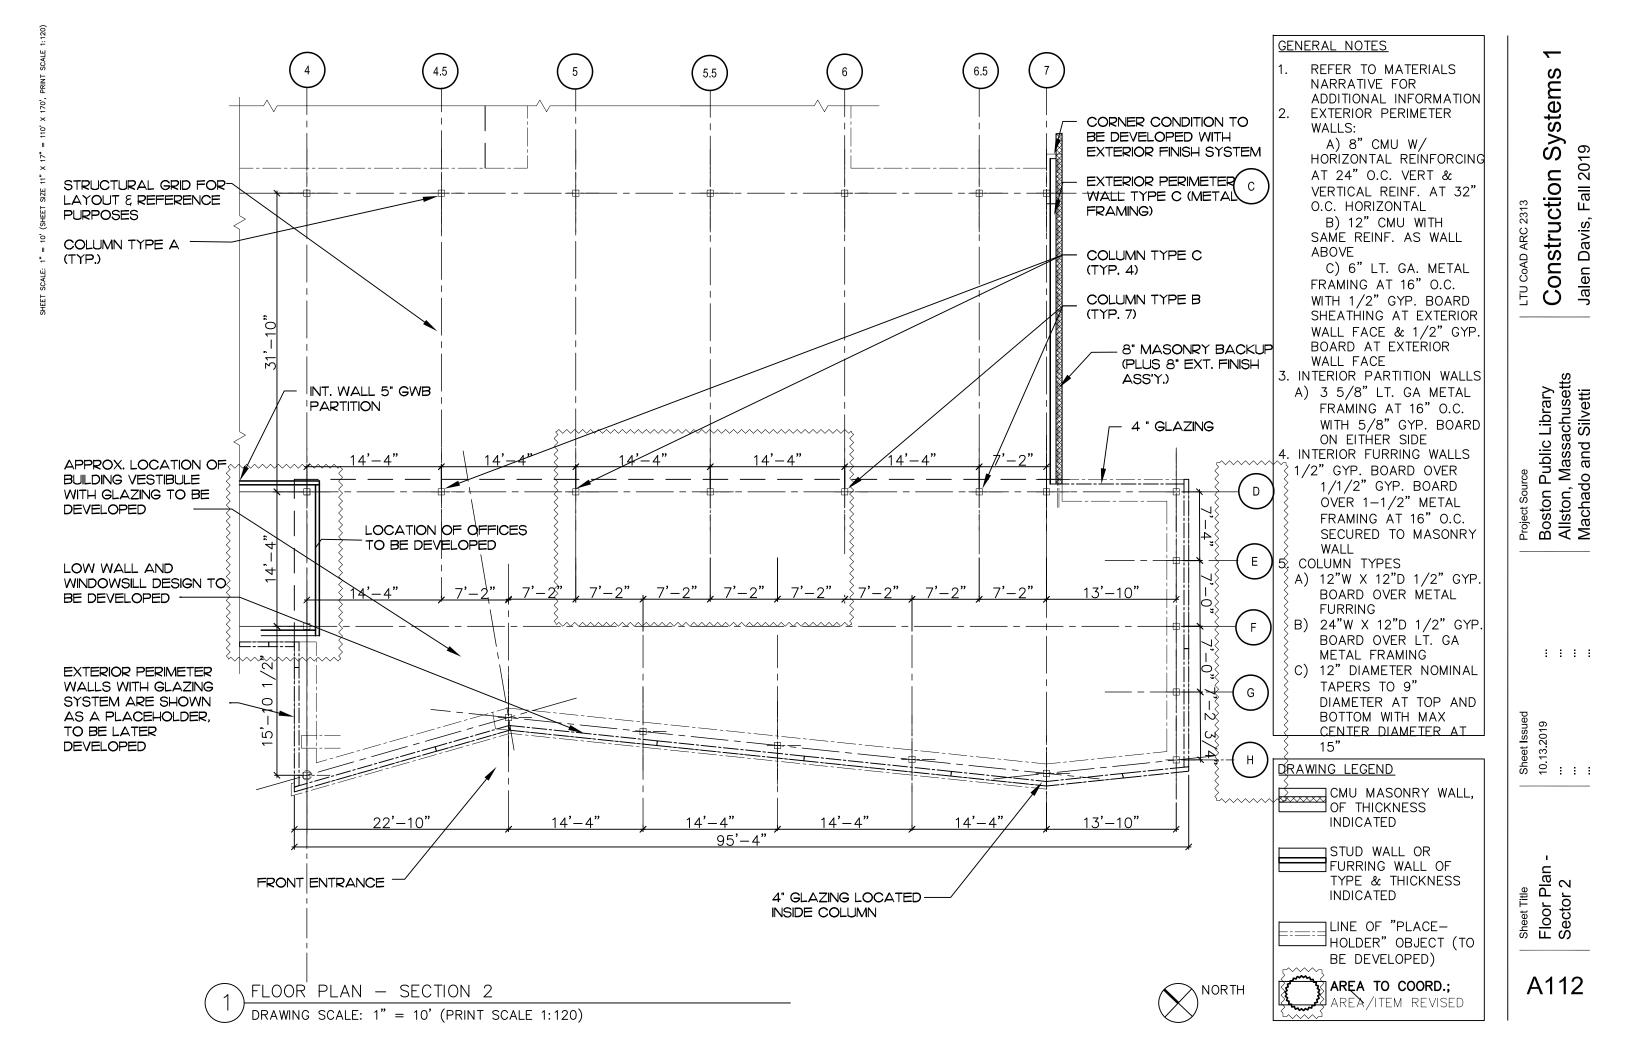

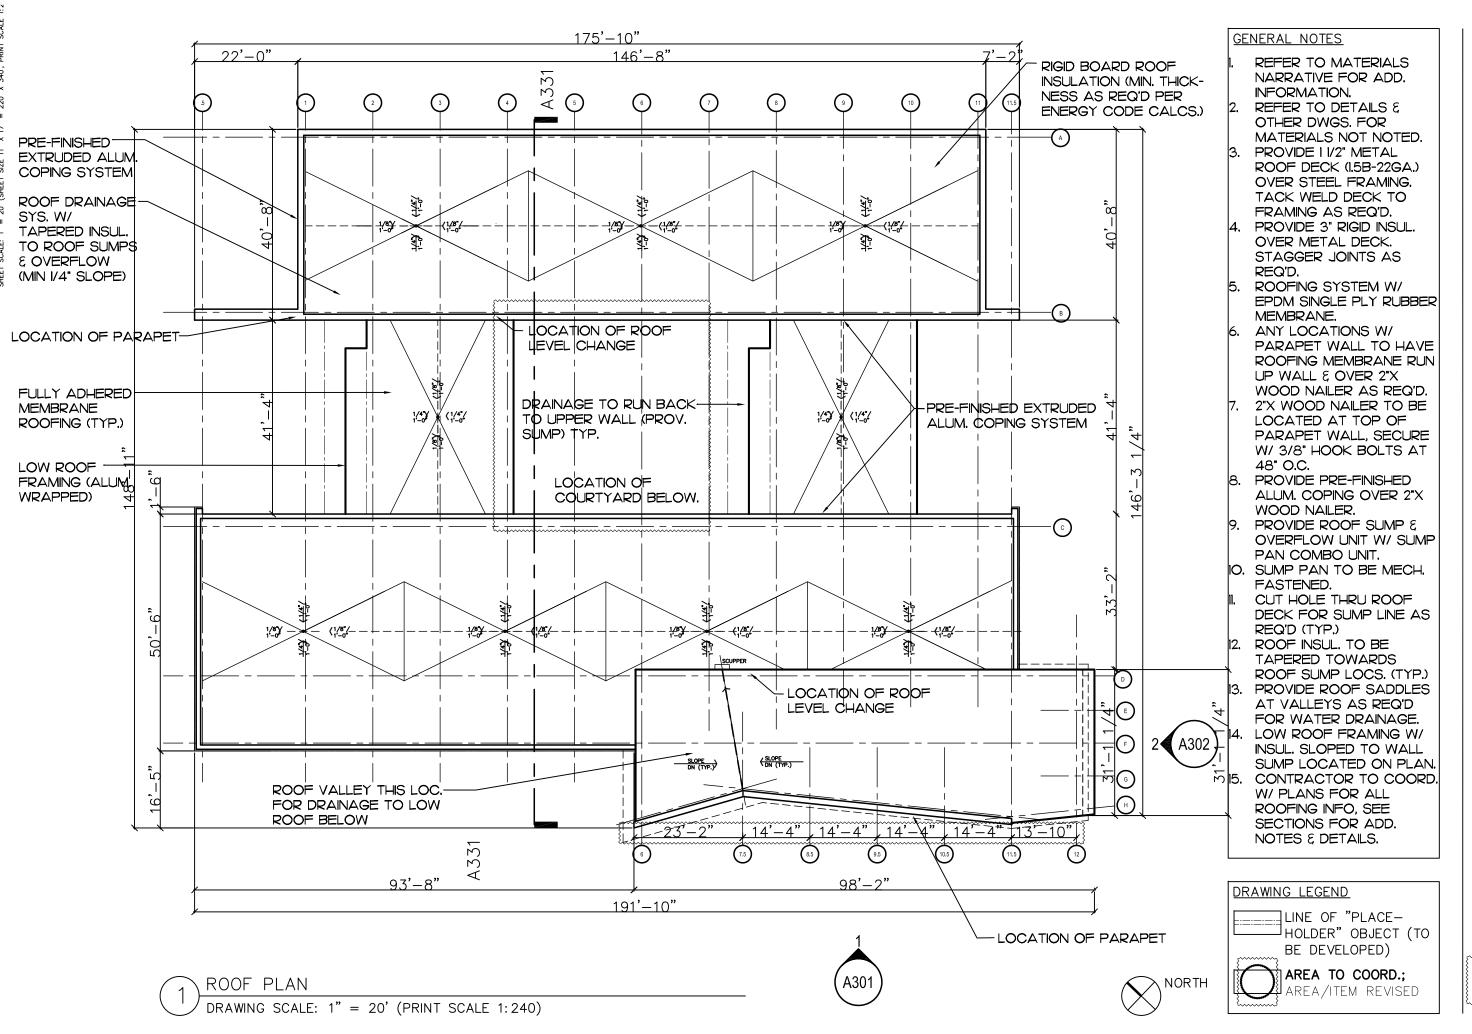Systems

Construction

Jalen Davis, Fall 2019

Project Source
Boston Public Library
Allston, Massachusetts
Machado and Silvetti

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Sheet Issued 10.21.2019 ...

Sheet Title Roof Plan

Systems

Construction Sys

Setts Construction Systic 2019

Boston Public Library Allston, Massachusett

Sheet Issued 11.21.19

Sheet Title Reflected Ceiling Plan


- I. REFER TO MATERIALS NARRATIVE FOR ADDITIONAL INFORMATION
- 2. REFER TO DETAILS & OTHER DWS. FOR MATL'S NOT NOTED
- 3. WD. CLAD. SYS.: 1 THK. HORZ.WD. BATTENS (2" O.C. WITH & HORZ, GAPS)
- 4. MTL. PNL. CLAD. SYS. : I" MTL. PNL. OPEN-JT. SYS.
- 5. FLASH. SYS.: SHT. MTL. FLASHING WITH DRIP, OVER SUBSTRATE AS NOTED
- 6. WD. WINDOW & DOOR SYS.: CLAD WD. FRAME, FIXED& OPERABLE SASH & DOORS, INSUL. GLASS
- 7. ALUM. WINDOW & DOOR SYS.: PRE-SIN. ALUM. SUBFRAMES, OPERABLE SASH & DOORS, INSUL. GLASS
- 8. ALUM. CURTAINWLL SYS.: PRE-FIN. ALUM. FRAMING. INSUL. GLASS

9. EAVE ASS'Y : IX TRIM BD. FASICA PTD., \$" SOFFIT PANELS PTD.

10.MEM ROOFING SYS.: FULLY & SIDE CLOSURES DHERED MEMBRANE ROOFING.

II. MTL. ROOFING SYS.: 3" DP. GALV. CORRUG. METAL PANELS, W. END 12. ROOFING TERMINATION

SYS.: SHT. MTL, COUNTER FLASHING & EDGE TRIM 13. ROOF-FIN ALUM. GUTTER WITH BRACKETS (24"O.C.)

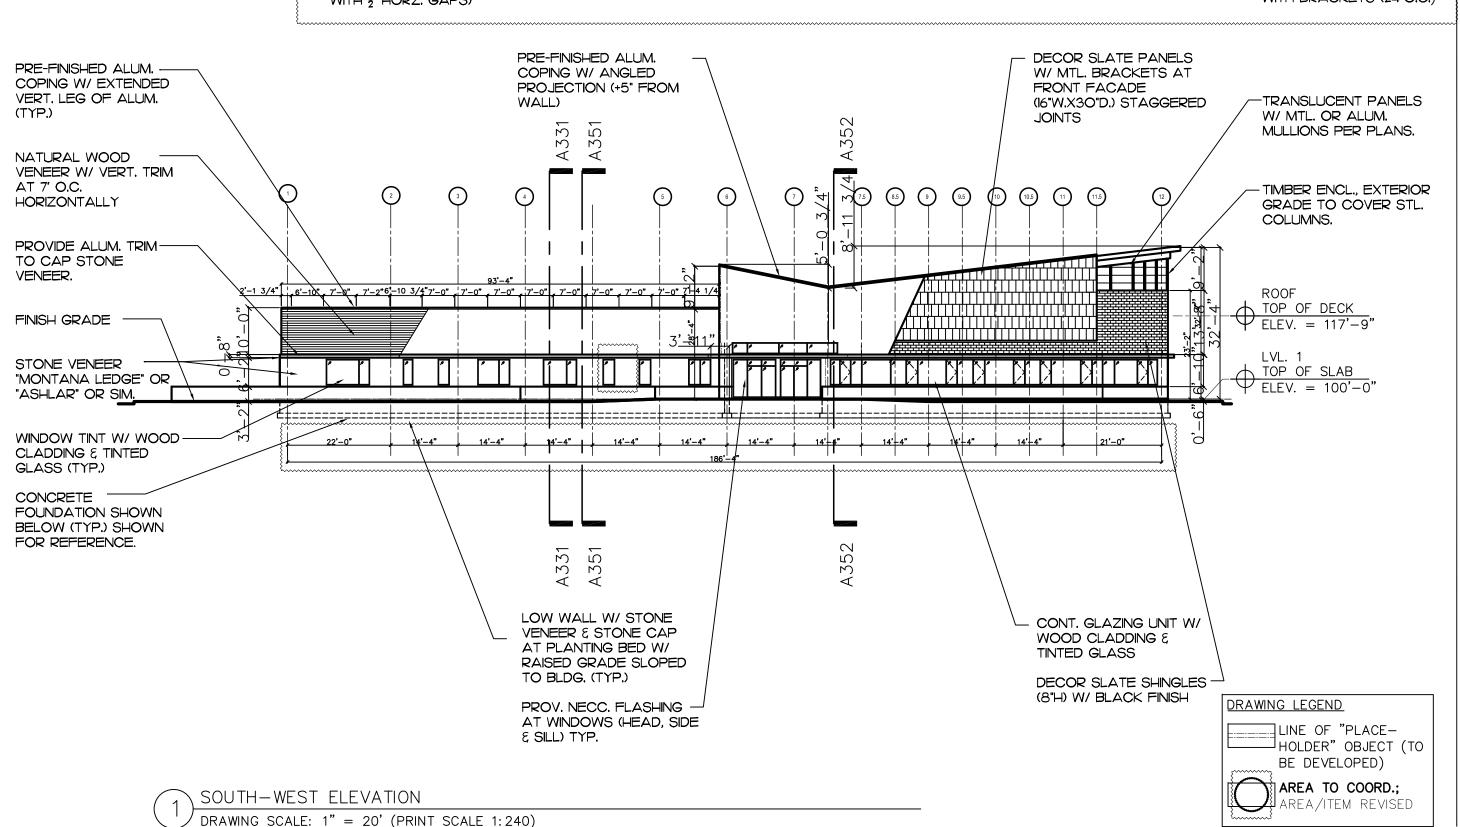


Systems Semester & Year Construction Student Name,


Project Source
Boston Public Library
Allston, Massachusetts
Machado and Silvetti


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Sheet Issued 10.21.2019 ...

Elevation Sheet



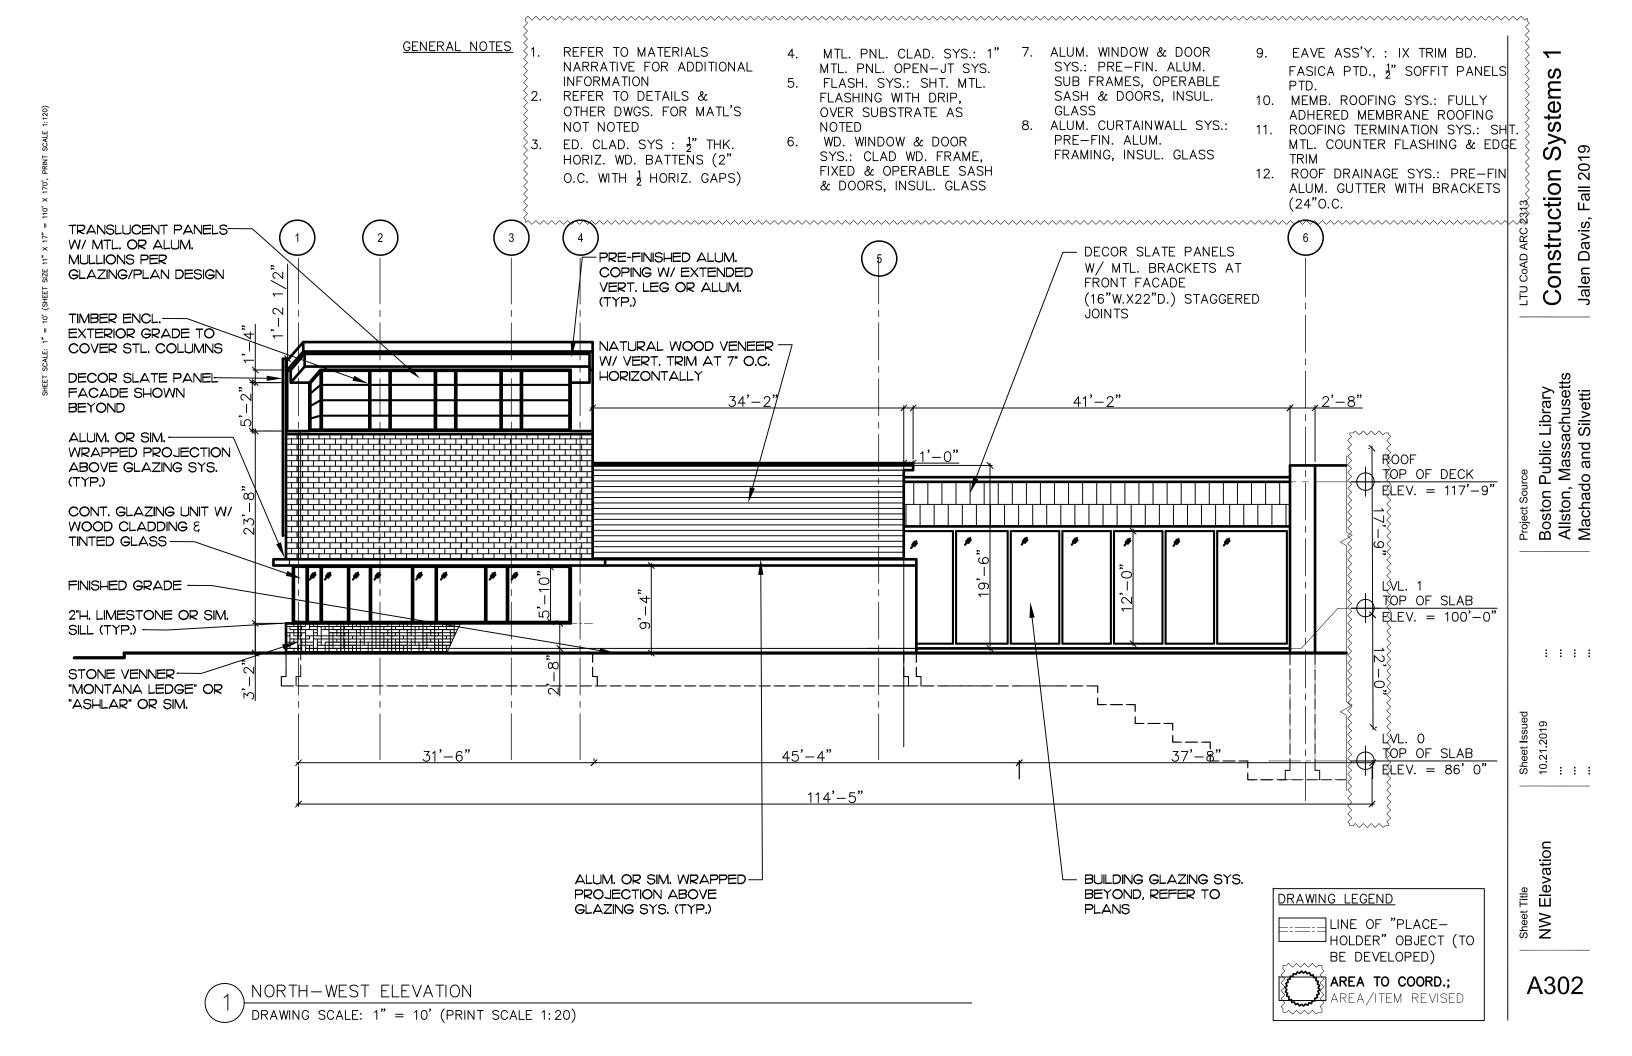

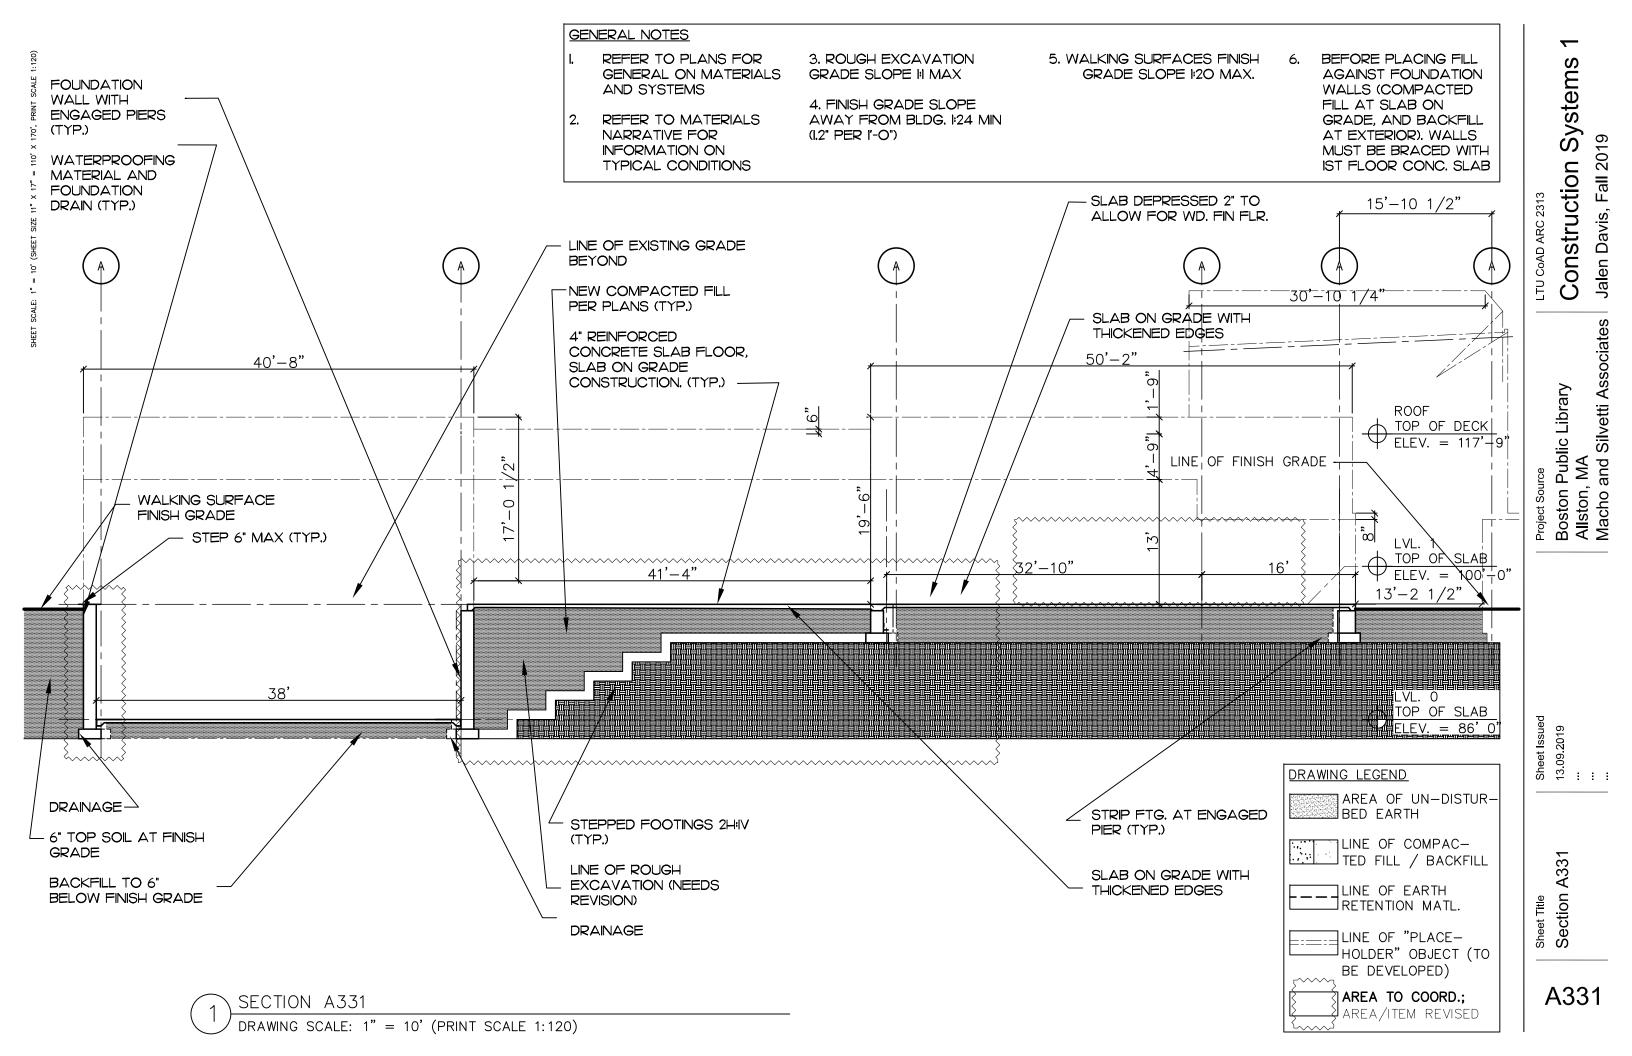

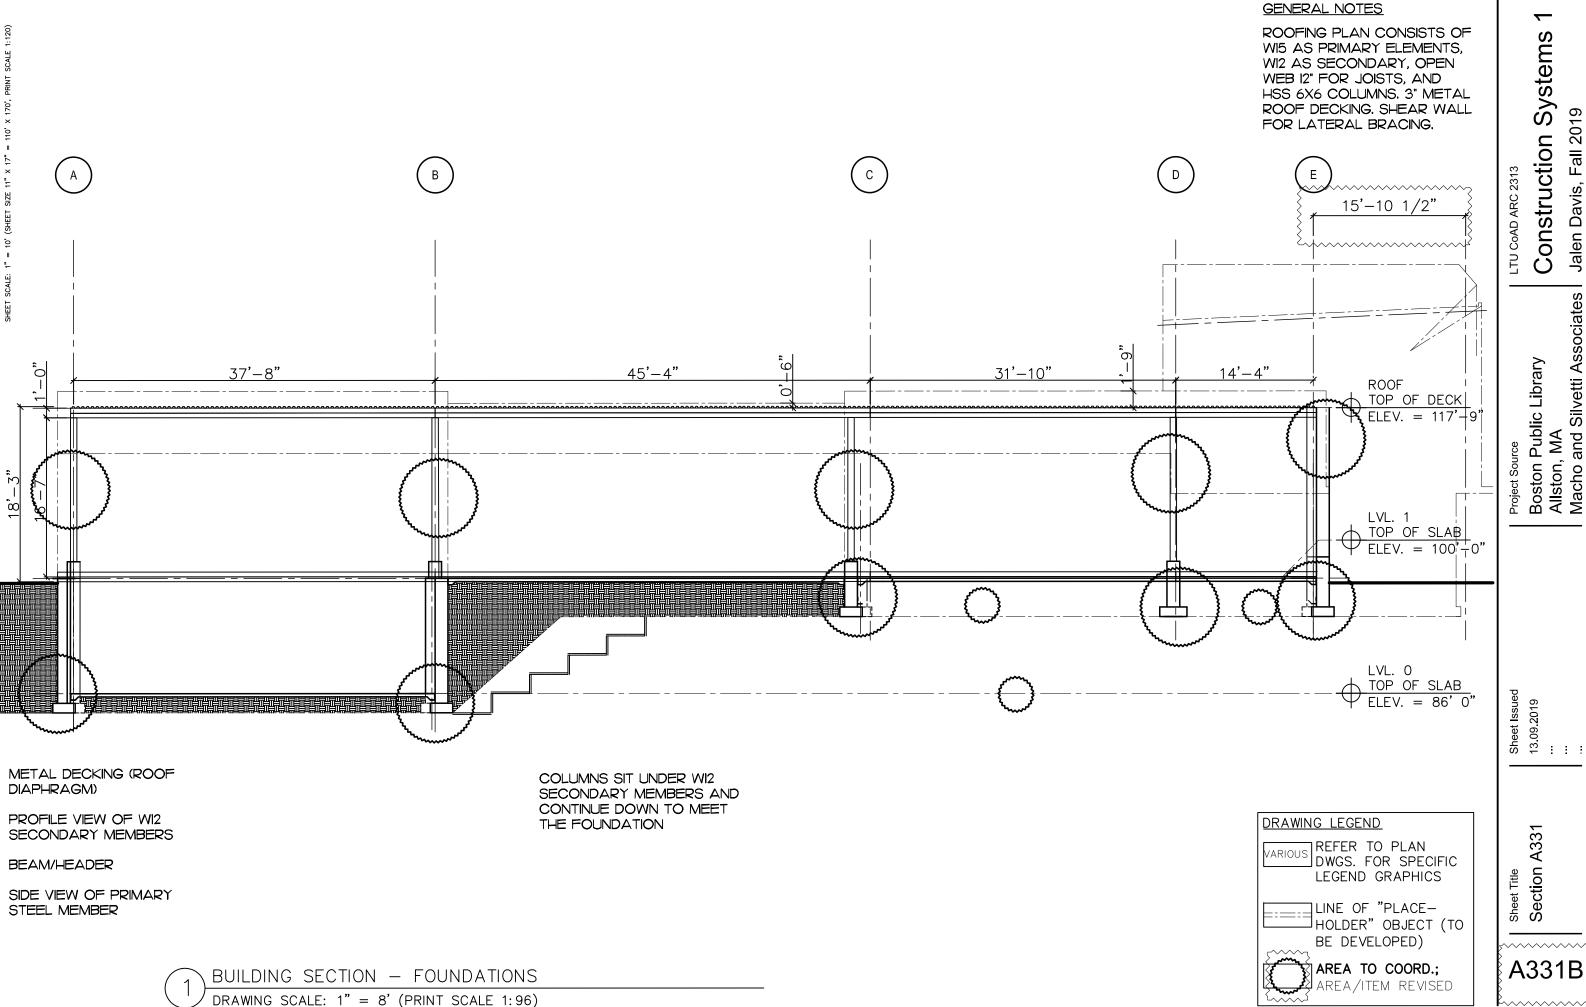Systems

Jalen Davis, Fall 2019 Construction

Project Source

Boston Public Library


Allston, MA


Macho and Silvetti Associates

Sheet Issued 13.09.2019 ...

Sheet Title Section A331

A331B

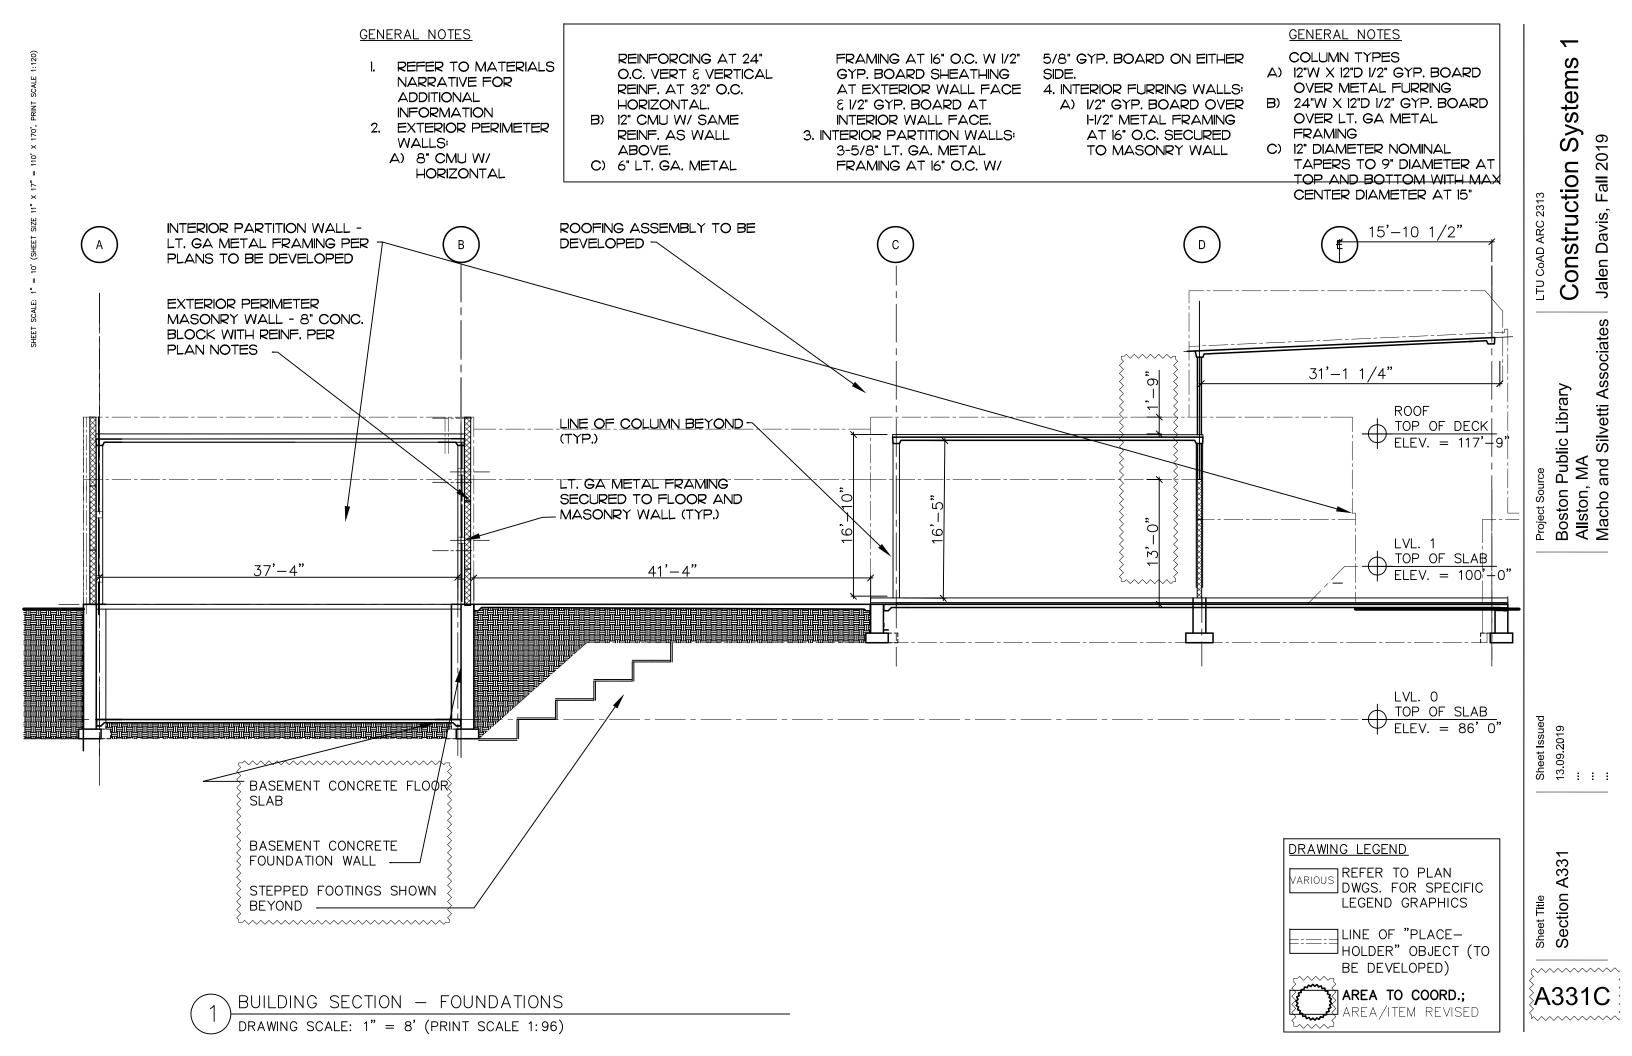

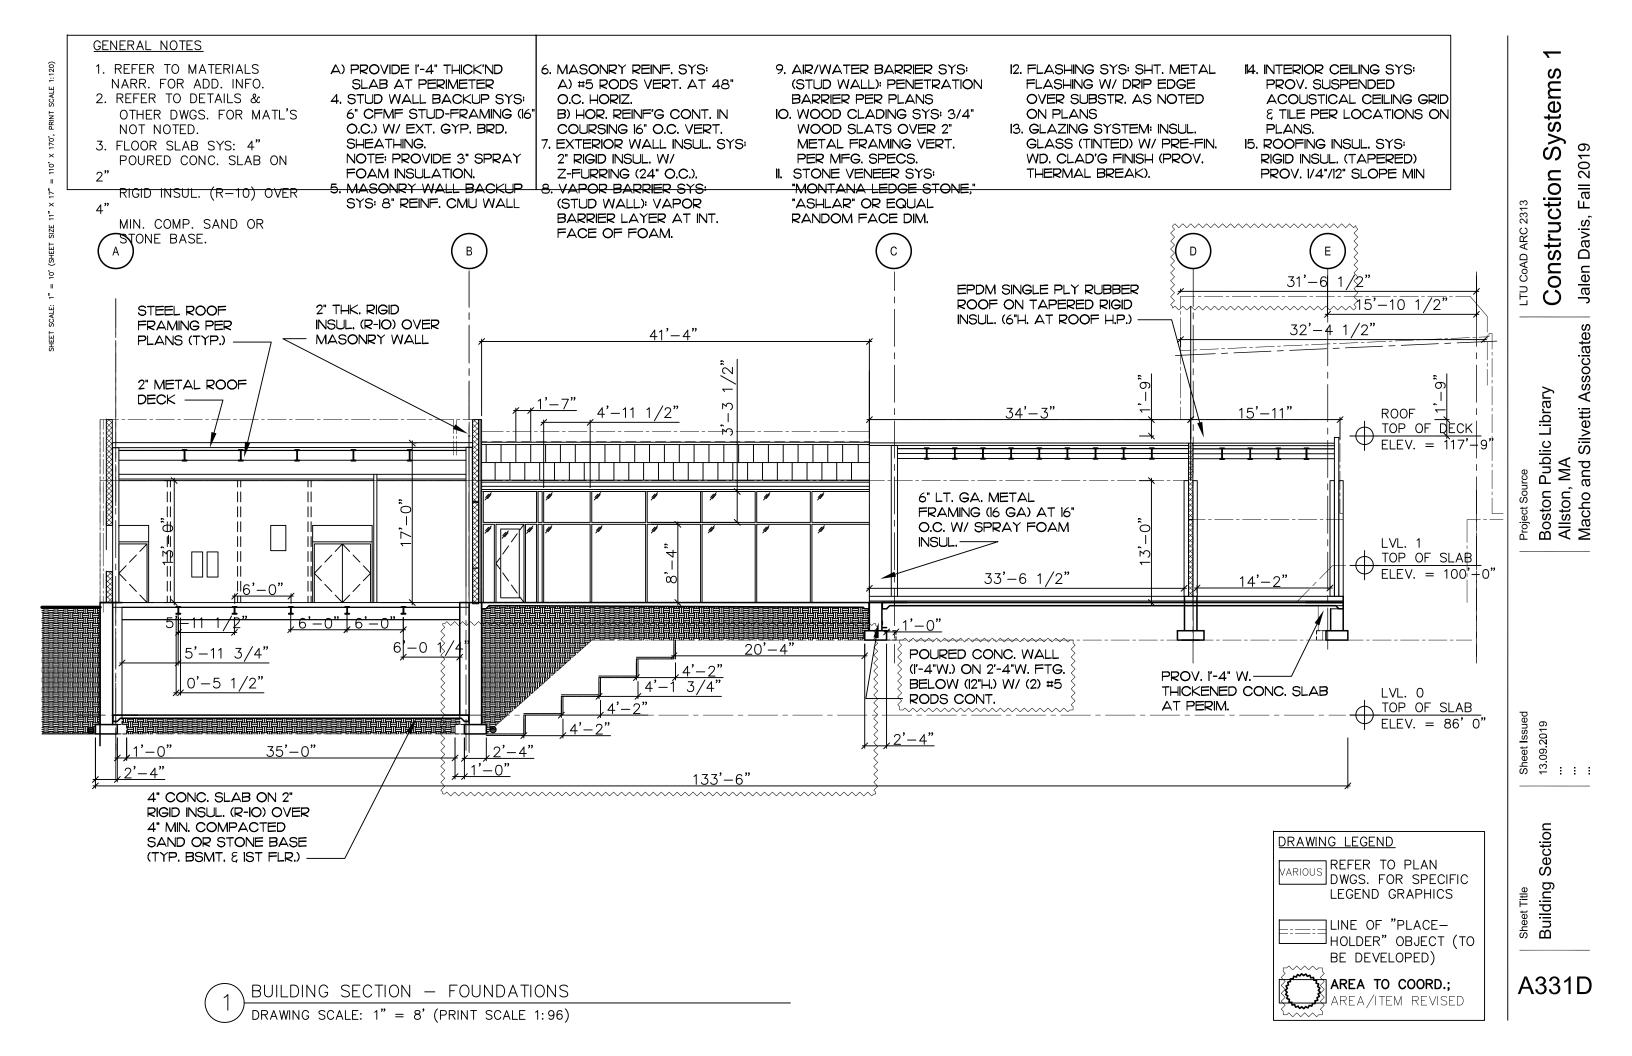

Honan-Allston Public Library

Machado-Silvetti Associates

Allston, MA

Construction Systems 1

Jalen Davis, Fall 2019

Wall Section

13.09.19


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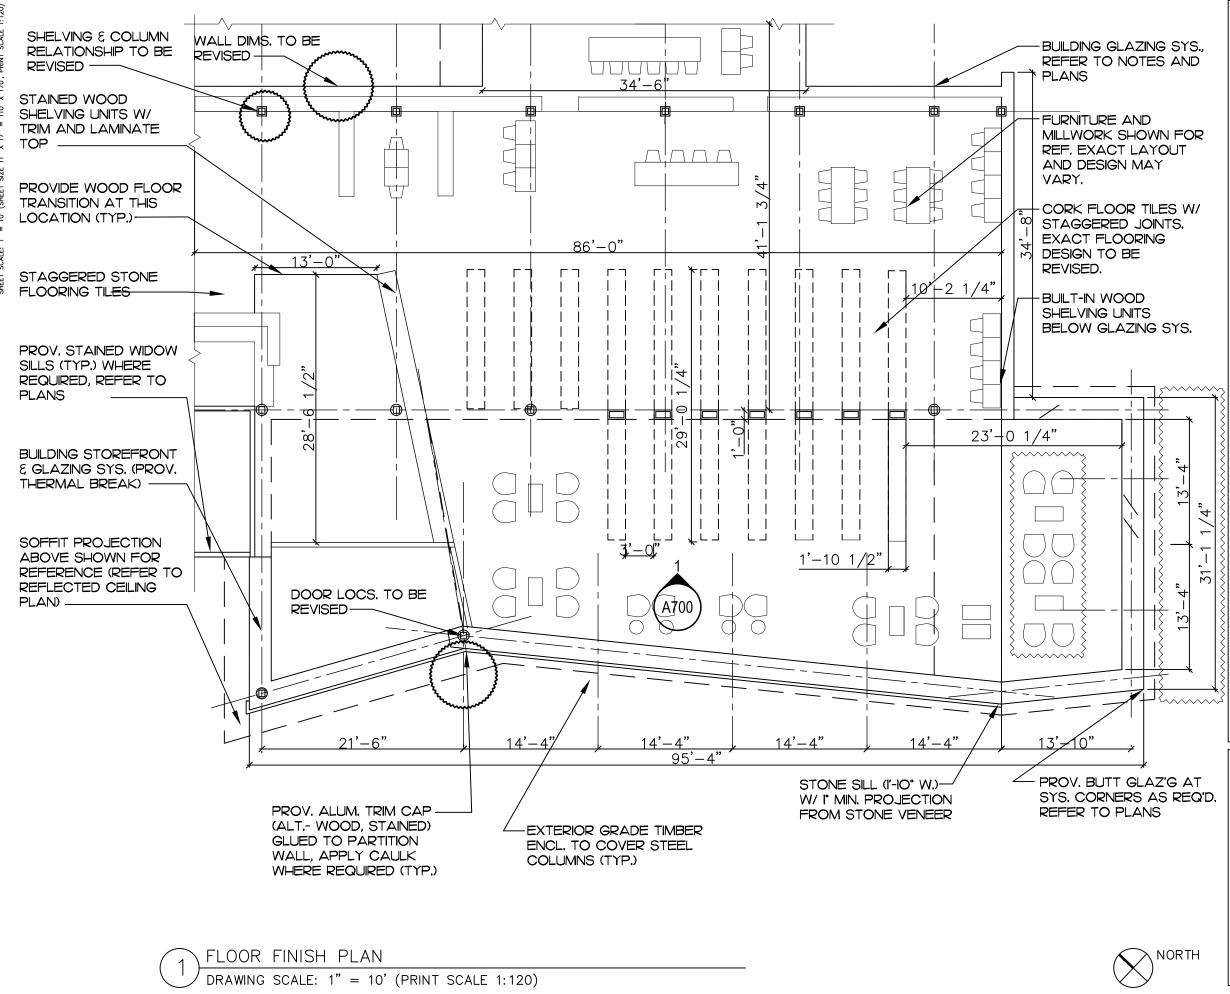
Boston Public Library Allston, Massachusetts Machado and Silvetti

Sheet Issued 11.21.19

Sheet Title Floor Finish Plan

A910

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GENERAL NOTES

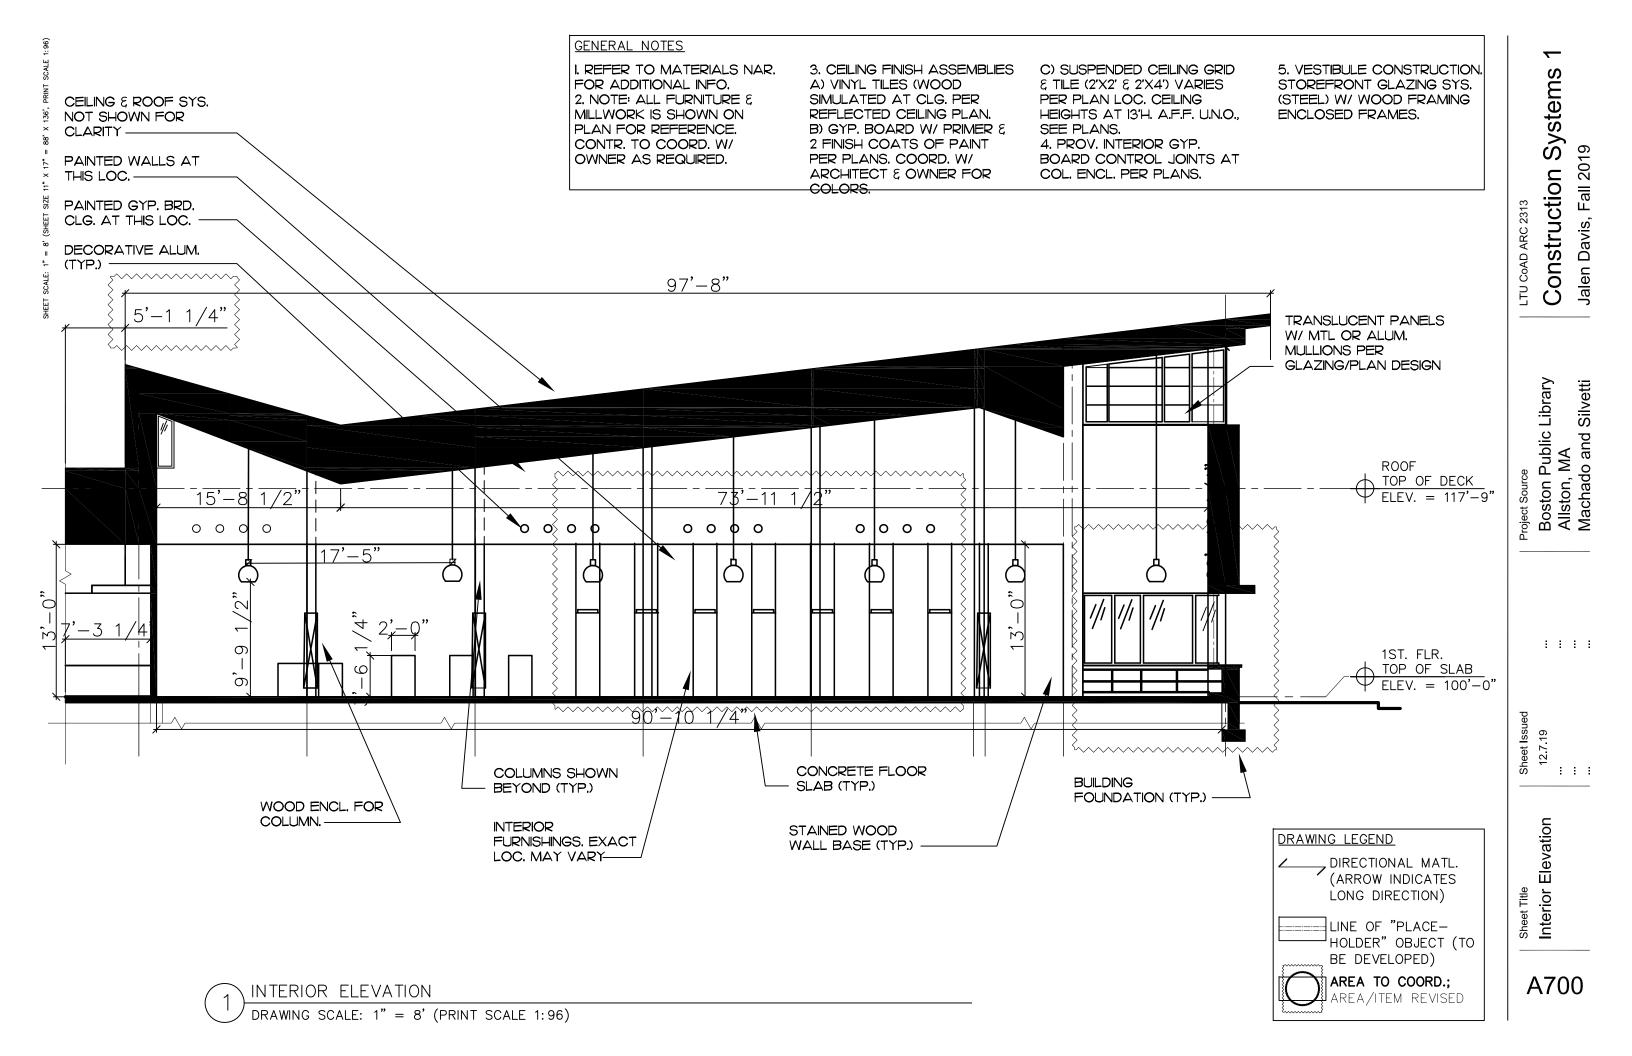- 1. REFER TO MATERIALS
  NARR. FOR ADDITIONAL INFO.
  2. NOTE: ALL FURNITURE &
  MILLWORK IS SHOWN ON PLAN
  FOR REFERENCE. CONTR. TO
  COORD. W/ OWNER AS
  REQUIRED.
- 3. FLOOR FINISH ASSEMBLIES:
  A) VINYL TILES (WOOD
  SIMULATED AT CLG.) REFER
  TO REFLECTED CEILING PLAN.
  B) STONE TILE W/
- STAGGERED PATTERN, TIGHT JOINTS. LOCATE AT VESTIBULE & LOBBY PER PLANS.
- C) CERAMIC TILE 12" X 24" LOCATED IN TOILET ROOMS PER PLANS.
- D) CORK TILE FLOORING W/ STAGGERED PATTERN LOCATED IN ALL AREAS UNLESS OTHERWISE NOTED.
- E) WOOD TRANSITION STRIP
  LOCATED AT ALL STONE TILE
  TO CORK TILE TRANSITIONS,
  AND CORK TILE TO CERAMIC
  TILE TRANSITIONS.
- 4. WALL BASE ASSEMBLIES
  A) PROVIDE WOOD BASE ALL
  AREAS UNLESS NOTED
  OTHERWISE.
- B) TOILET ROOMS W/ TILE
  WALLS (FLOOR TO CLG.) NO
  BASE REQUIRED.
- C) PROVIDE STONE TILE BASE AT STONE TILE LOCATIONS PER PLANS. WALL BASE TO BE 4"H MIN.
- 5. PROVIDE INTERIOR GYP. BOARD CONTROL JOINTS WHERE APPLICABLE & PER PLANS (LOCATED AT COL. ENCLOSURES.)
  6. VESTIBILIE CONST
- 6. VESTIBULE CONST. STOREFRONT GLAZING SYS.


## DRAWING LEGEND

DIRECTIONAL MATL.
(ARROW INDICATES
LONG DIRECTION)

LINE OF "PLACE— HOLDER" OBJECT (TO BE DEVELOPED)

AREA TO COORD.;

AREA/ITEM REVISED

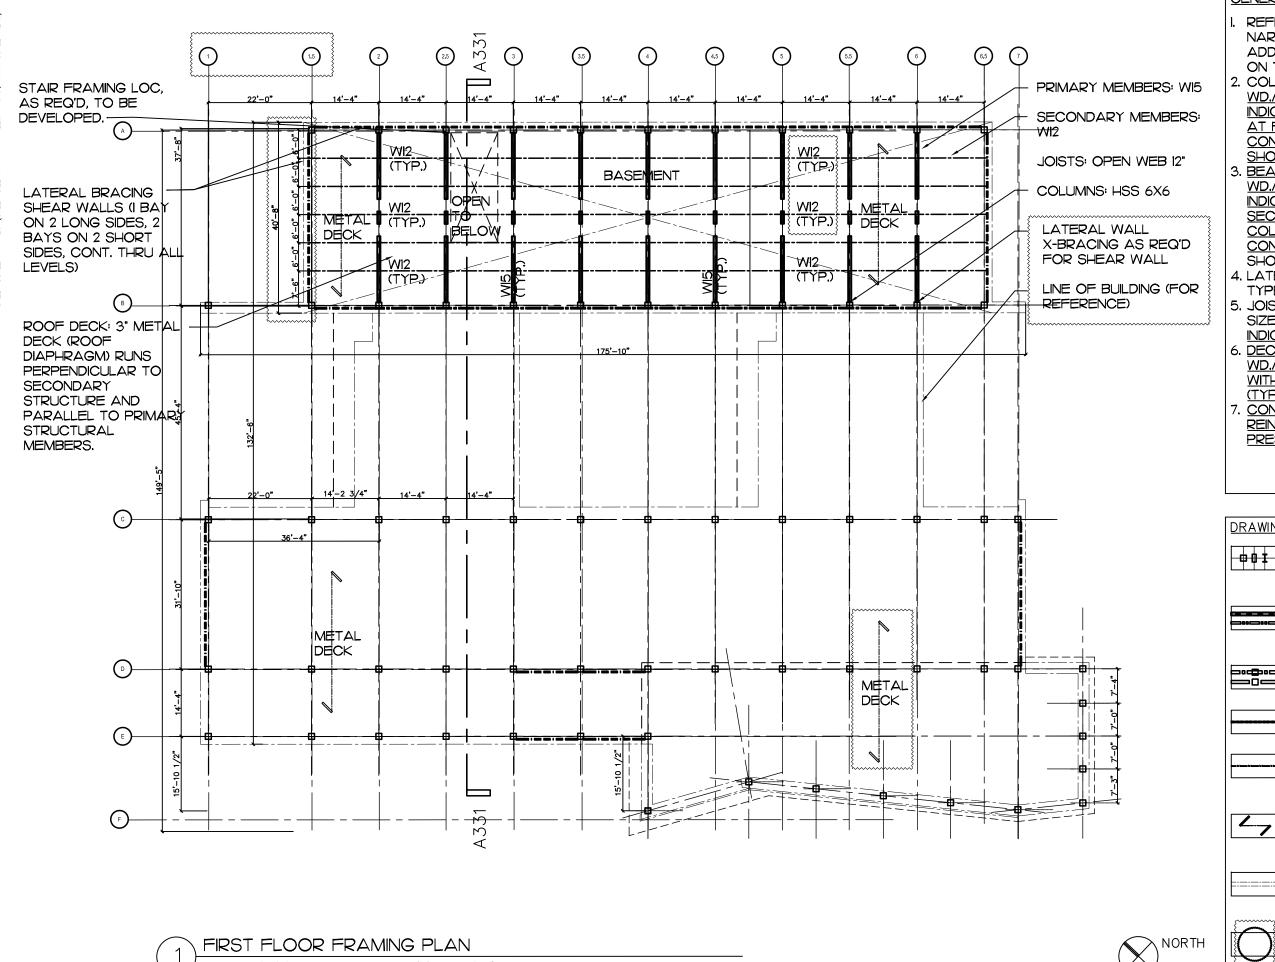

GENERAL NOTES

REFER TO MATERIALS NARRATIVE FOR ADDITIONAL INFORMATION ON TYPICAL CONDITIONS.

2. COLUMNS/POSTS: SIZE & WD./STEEL/CFMF AS INDICATED. BASE PLATE AT FOUND. BM./HEADER CONNECTION-TYPES AS SHOWN. (TYP.)

Systems

Construction

Project Source Boston Public Library Boston, MA Machado Silvetti

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Sheet Issued 27.09.2019 ...

CoAD ARC 2313

Davis, Fall 2019

3. BEAMS/HEADERS:SIZE & WD./STEEL/CFMF AS INDICATED. PRIMARY OR SECONDARY AS SHOWN. COL./POST **CONNECTION-TYPES AS** SHOWN. (TYP.)

4. LATERAL BRACING: OF TYPE INDICATED. (TYP.)

5. JOISTS (FLOOR/ROOF): SIZE & WD./STEEL/CFMF AS INDICATED. (TYP.)

6. DECKING (FLOOR/ROOF): WD./STEEL AS INDICATED, WITH SPAN AS SHOWN. (TYP.)

7. CONC. SLAB: THICKNESS REINF, AS INDICATED (IF PRESENT). (TYP.)

DRAWING LEGEND

COLUMN/POST/BM./ HEADER, OF TYPE INDICATED

PRIMARY/SECONDARY ∃BM. FRAMING, OF TYPE INDICATED

BM. OVER COLUMN / BM. INTO COLUMN

> LATERAL BRACING, JOF TYPE INDICATED

JOIST INFILL FRAMING, OF TYPE INDICATED

DECK, OF TYPE INDICATED (DIREC-TION OF SPAN)

> LINE OF "PLACE-HOLDER" OBJECT (TO BE DEVELOPED)



AREA TO COORD.; AREA/ITEM REVISED

Sheet Title First Floor Framing Plan S110

DRAWING SCALE: I" = 8' (PRINT SCALE 1:240)

GENERAL NOTES

REFER TO MATERIALS NARRATIVE FOR **ADDITIONAL** INFORMATION ON TYPICAL CONDITIONS

2. COLUMNS/POSTS: SIZE 8 WD./STEEL/CFMF AS INDICATED. BASE PLATE AT FOUND. BM./HEADER CONNECTION-TYPES AS SHOWN, (TYP.)

BEAMS/HEADERS: SIZE 8 WD./STEEL/CFMF AS INDICATED. PRIMARY OR SECONDARY AS SHOWN COL,/POST CONNECTION-TYPES AS SHOWN. (TYP.)

LATERAL BRACING: OF TYPE INDICATED. (TYP.)

- JOISTS (FLOOR/ROOF): SIZE WD./STEEL/CFMF AS INDICATED. (TYP.)
- 6. DECKING (FLOOR/ROOF) WD./STEEL AS INDICATED, WITH SPAN AS SHOWN. (TYP.)
- 7. CONC. SLAB: THICKNESS **E REINF. AS INDICATED** (IF PRESENT.) (TYP.)

DRAWING LEGEND

COLUMN/POST/BM./ HEADER, OF TYPE INDICATED

PRIMARY/SECONDARY ∃BM. FRAMING, OF TYPE INDICATED

BM. OVER COLUMN / BM. INTO COLUMN

> LATERAL BRACING, JOF TYPE INDICATED

JOIST INFILL FRAMING, JOF TYPE INDICATED

DECK, OF TYPE INDICATED (DIREC-TION OF SPAN)

LINE OF "PLACE-HOLDER" OBJECT (TO BE DEVELOPED)

NORTH

AREA TO COORD.; AREA/ITEM REVISED Project Source Boston Public Library Boston, MA Machado Silvetti 1111

Systems

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Davis, Fall 2019

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Sheet Issued 27.09.2019 ...

Sheet Title
Roof Plan/
Roof Framing Plan
Sheet Title

S120

DRAWING SCALE: I" = 20' (PRINT SCALE 1:240)