# PRONOIA EFFECTS UIW DATA CENTER

2019-05-16

ARCHITECTS: FORTE ARCHITECTS, INC.

Wenatchee, Washington

STRUCTURAL ENGINEER: PHILLIP VAN HEYNINGEN

Cashmere, Washington

SHEETS 1-16 PRELIMINARY SUBMITTAL

DEFERRED SUBMITTAL

DEFERRED SUBMITTAL

CIVIL ENGINEER: PACE ENGINEERING Wenatchee, Washington

METAL BUILDING: AMERICAN BUILDINGS COMPANY

(Via Sparks Construction)

#### GENERAL DRAWING

AO.1 COVER SHEET, PROJECT TEAM, SHEET INDEX GENERAL NOTES, ABBREVIATIONS, SYMBOLS, VICINITY MAP - WALL TYPES AO.3 LIFE SAFETY FLOOR PLANS

CIVIL DRAWING

C1 COVER SHEET C2 LEGEND AND SYMBOLS C3 CONSTRUCTION NOTES C4 EROSION AND SEDIMENT CONTROL PLAN C5 EROSION CONTROL NOTES AND DETAILS

C6 SITE GRADING AND UTILITIES C7 CROSS SECTIONS AND PROFILES

C8 DETAILS C9 DETAILS ARCHITECTURAL DRAWING

FLOOR PLANS EXTERIOR ELEVATIONS A3.2 BUILDING SECTIONS

REFLECTED CEILING PLAN & ROOF PLAN

DETAILS

STRUCTURAL DRAWING

METAL BUILDING DRAWINGS S1.0 STRUCTURAL NOTES S1.1 FOUNDATION PLAN S2.1 INTERIOR FRAMING PLANS

METAL BUILDING DRAWING

METAL BUILDING DRAWINGS SHEETS 1-16 INITIAL SUBMITTAL

ARCHITECTS

ADDRESS: 240 North Wenatchee Ave. Wenatchee, WA 98801 PHONE: (509) 293-5566

WEBSITE: www.fortearchitects.com

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DATE 2019-05-16 DRAWN BY KL

CHECK BY TB

COVER SHEET

HORIZ.

I.D.

Horizontal

Heat Strengthen

Inside Diameter

Intake Hood

M.R.

M.M.F.

MT.

Mater Resistant

Mindow Treatment

Melded Mire Fabric

# ARCHITECTURAL SYMBOLS PROPERTY LINE/CORNER EXISTING POINT ELEVATION 12.50 FINISH POINT ELEVATION (12.50) EXISTING POINT ELEVATION (To Be Changed) **UTILITY LINES:** --- NG---- NATURAL GAS ----- W ----- WATER. ---- UGE --- UNDERGROUND ELECTRICAL OVERHEAD ELECTRICAL/COMMUNICATIONS SANITARY SEWER STORM DRAIN ----- SD---UNDERGROUND TELEPHONE/COMM. FENCE INVISIBLE LINE ABOVE INVISIBLE LINE BELOW -- - --- CENTER LINE \_\_\_ FINISH FLOOR, BEARING, ELEV. HEIGHT or Building Level Line B -- GRID LINE (101) DOOR NUMBER (A) WINDOW NUMBER KEY PARTITION AND WALL KEY CABINET KEY TEMPERED GLASS REQUIRED MATCH LINE DETAIL NUMBER/TITLE/ **INTERIOR ELEVATION** NUMBER DETAIL KEY **BUILDING SECTION KEY** WALL SECTION KEY With Sheet Number) INTERIOR ELEVATION KEY (Elevation Number With Sheet Number) **EXTERIOR ELEVATION KEY** ASPHALTIC CONCRETE PAVEMENT

CONCRETE WALK OR SURFACE

MASONRY WALK OR SURFACE

MAIN BEARING POINT IN WALL

METAL FRAME WALL (PLAN)

WOOD FRAME WALL (PLAN)

WOOD FRAMING MEMBER

WOOD BLOCKING MEMBER

GWB, PLASTER, CEMENT BOARD

LOOSE FILL/BATT INSULATION

WOOD FINISH MEMBER

CONCRETE WALL (PLAN)

(Member as Indicated)

(Nominal Size Noted)

(Nominal Size Noted)

PARTICLE BOARD

RIGID INSULATION

ASPHALTIC PAVEMENT

EARTH (SECTION)

(Net Size Noted)

PLYWOOD

CONCRETE

METAL

1 HOUR WALL

700 700

IN DETAIL-SECTION:

\_\_\_

 $\overline{\times}$ 

**⊔** 

-27 - V 1.4 - 3

3.....

#### GENERAL NOTES

- ALL WORK SHALL CONFORM TO ALL APPLICABLE CODES AND ORDINANCES, THE MORE STRINGENT IS TO GOVERN; DISCREPANCIES BETWEEN CONTRACT DOCUMENTS AND CODES SHALL BE BROUGHT TO THE ARCHITECT'S ATTENTION PROMPLTY AND A RESOULTION OBTAINED BEFORE PROCEEDING.
- DRAWINGS ARE<u>not to be scale</u>d dimensional data shall be obtained from written INFORMATION ONLY. VERIFY ALL DIMENSIONS BEFORE PROCEEDING. ANY DIMENSIONAL DEVIATION FROM THAT SHOWN ON THE DRAWINGS, WHICH MAY AFFECT THE INTENT OF THE DESIGN OR PROPER INCORPORATION OF ELEMENTS, SHALL BE BROUGHT TO THE ARCHITECT'S ATTENTION PROMPTLY AND A RESOLUTION OBTAINED BEFORE PROCEEDING.
- THE ARCHITECT SHALL BE INFORMED IMMEDIATELY OF ANY DISCREPANCY BETWEEN THE CONTRACT DOCUMENTS AND THE SITE CONDITIONS.
- 4. THE TERM "FINISHED FLOOR" (FIN. FLR. OR F.F) REFERS TO THE TOP OF FINISHED SLAB WHERE CONCRETE FLOORS OCCUR.
- 5. EXTERIOR DIMENSIONS ARE TO THE FACE OF CONCRETE / MASONRY / SHEATHING OR REFERENCED FROM GRIDLINES UNLESS OTHERWISE NOTED. INTERIOR DIMENSIONS ARE TO THE FACE OF FRAMING OR FACE OF MASONRY, UNLESS INDICATED AS A CENTERLINE OR SPECIFICALLY NOTED OTHERWISE. CLEAR DIMENSIONS SHALL BE FROM FINISH TO FINISH.
- NOTATIONS OR DETAILS KEYED TO VARIOUS DRAWING SYMBOLS, PATTERNS, ETC. SHALL APPLY TYPICALLY TO ALL SIMILARLY INDICATED ITEMS. LOCTIONS. OR CONDITIONS NOT OTHERWISE KEYED.
- 7. PRESERVE AND PROTECT EXISTING UTILITIES AND BUILDING COMPONENTS WHICH MAY BE PRESENT AND ARE NOT SCHEDULED OR REQUIRED TO BE CHANGED OR REMOVED.
- ADJUST NEW CONSTRUCTION TO ALIGN WITH EXISTING CONSTRUCTION SUCH THAT FINISHES MAY BE APPLIED ALONG STRAIGHT AND TRUE LINES, UNLESS SPECIFICALLY NOTED OTHERWISE.
- ...9. ALL REFERENCES TO NORTH, SOUTH, EAST, AND WEST SHALL BE BASED UPON "PROJECT NORTH" AS SHOWN IN THE DRAWINGS.
- 10. TYPICAL WALL CORNERS ARE 90 DEGREES.

#### PROJECT INFORMATION

#### **JOB ADDRESS:**

PRONOIA EFFECTS **UIW DATA CENTER** 501 URBAN INDUSTRIAL WAY EAST WENATCHEE WA 98802

OWNER'S NAME AND ADDRESS: PRONOIA EFFECTS

1506 Seneca Place Wenatchee WA 98801

#### **DESIGN CRITERIA**

**CODE DATA** 

Code Analysis:	IBC 2015	Occupancy Groups:
Roof (Snow) Load:	40 PSF	
Wind Zone: Seismic Zone:	85 mph Nominal D	Non Separated (per IBC 2015 508.3)
LDING DATA:		
Construction Type:	IIIB	

12,365 sq. ft.

12,365 sq. ft.

 $NO^{-}$ 

19,000 sq. ft. (B most restrictive)

#### OCCUPANCY DATA:

Occupancy Groups: B (100sqft per Occ.)

S-1 (300sqft per Occ.) S-2 (300sqft per Occ.) Non Separated

R-25 + R-11 Energy Saver System Insulation

#### PARTITION SCHEDULE

Basic Allowable Area:


**Building Footprint:** 

**Building Floor Area:** 

Sprinklers:

#### NOTE

ALL WALLS RUN CONTINUOUS BETWEEN SYMBOLS OR TO NEXT WALL INTERSECTION

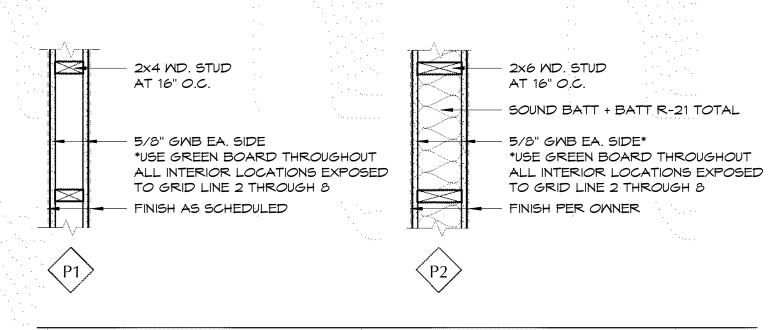

**INTERIOR WALL TYPES** 


#### VICINITY MAP





#### **ENERGY DATA:**

Climate Zone: **Energy Code Analysis Method:** Perscriptive Space Heat Type: Electric Roof: Opaque Walls: R-25 Energy Saver System Insulation Heated Slab: Below Grade (Foundation) Walls: 2" R10 TO TOP OF FOOTING **Insulated Overhead Doors:** U = 0.39Fixed Non-Metal Windows: U = 0.30Storefront Entrance Glazing: N/A Other Exterior Doors: U = 0.37

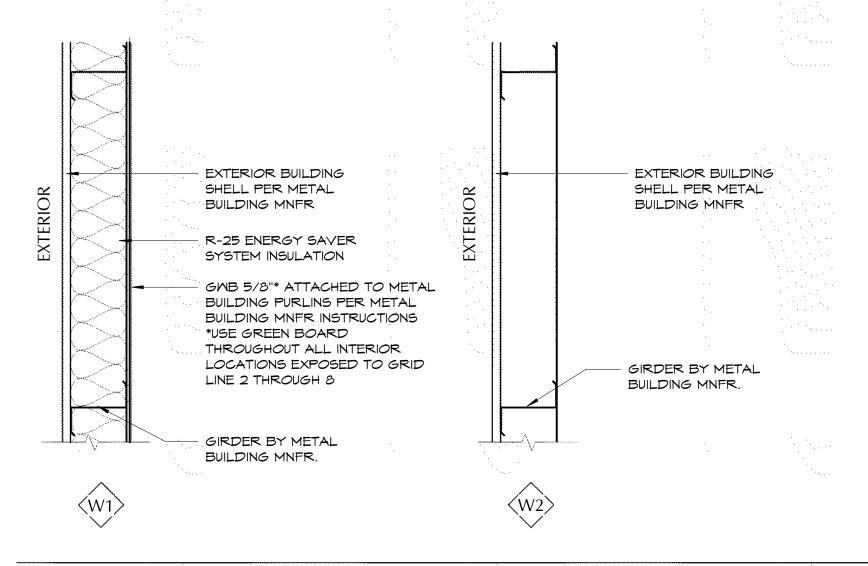

EXTERIOR WALL TYPES (SEE METAL BUILDING DRAWINGS FOR DETAILS)

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DWG ID GENERAL NOTES


A0.2

JOB NO. 1858

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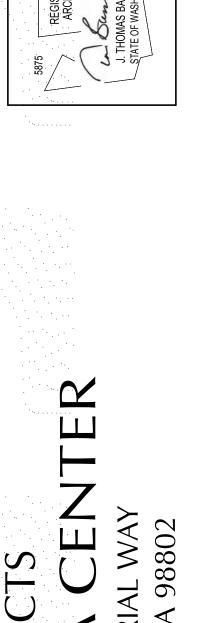
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PROJECT NORTH



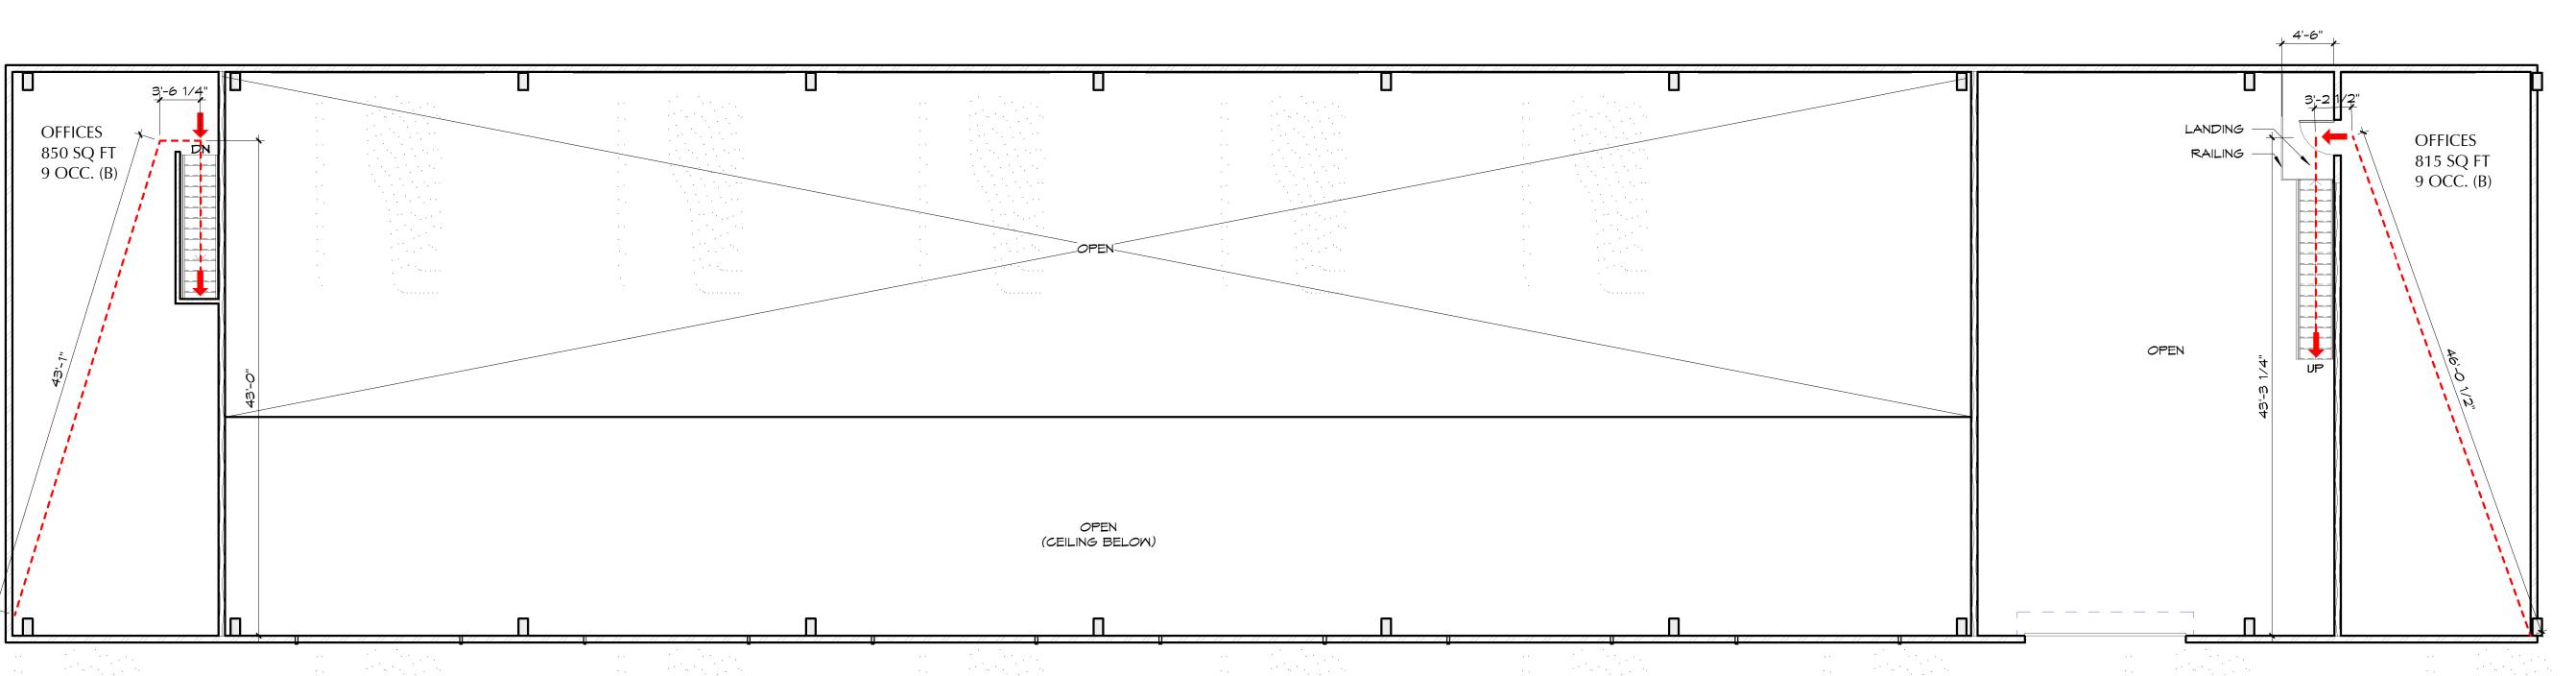

ARCHITECTS

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WEBSITE: www.fortearchitects.com


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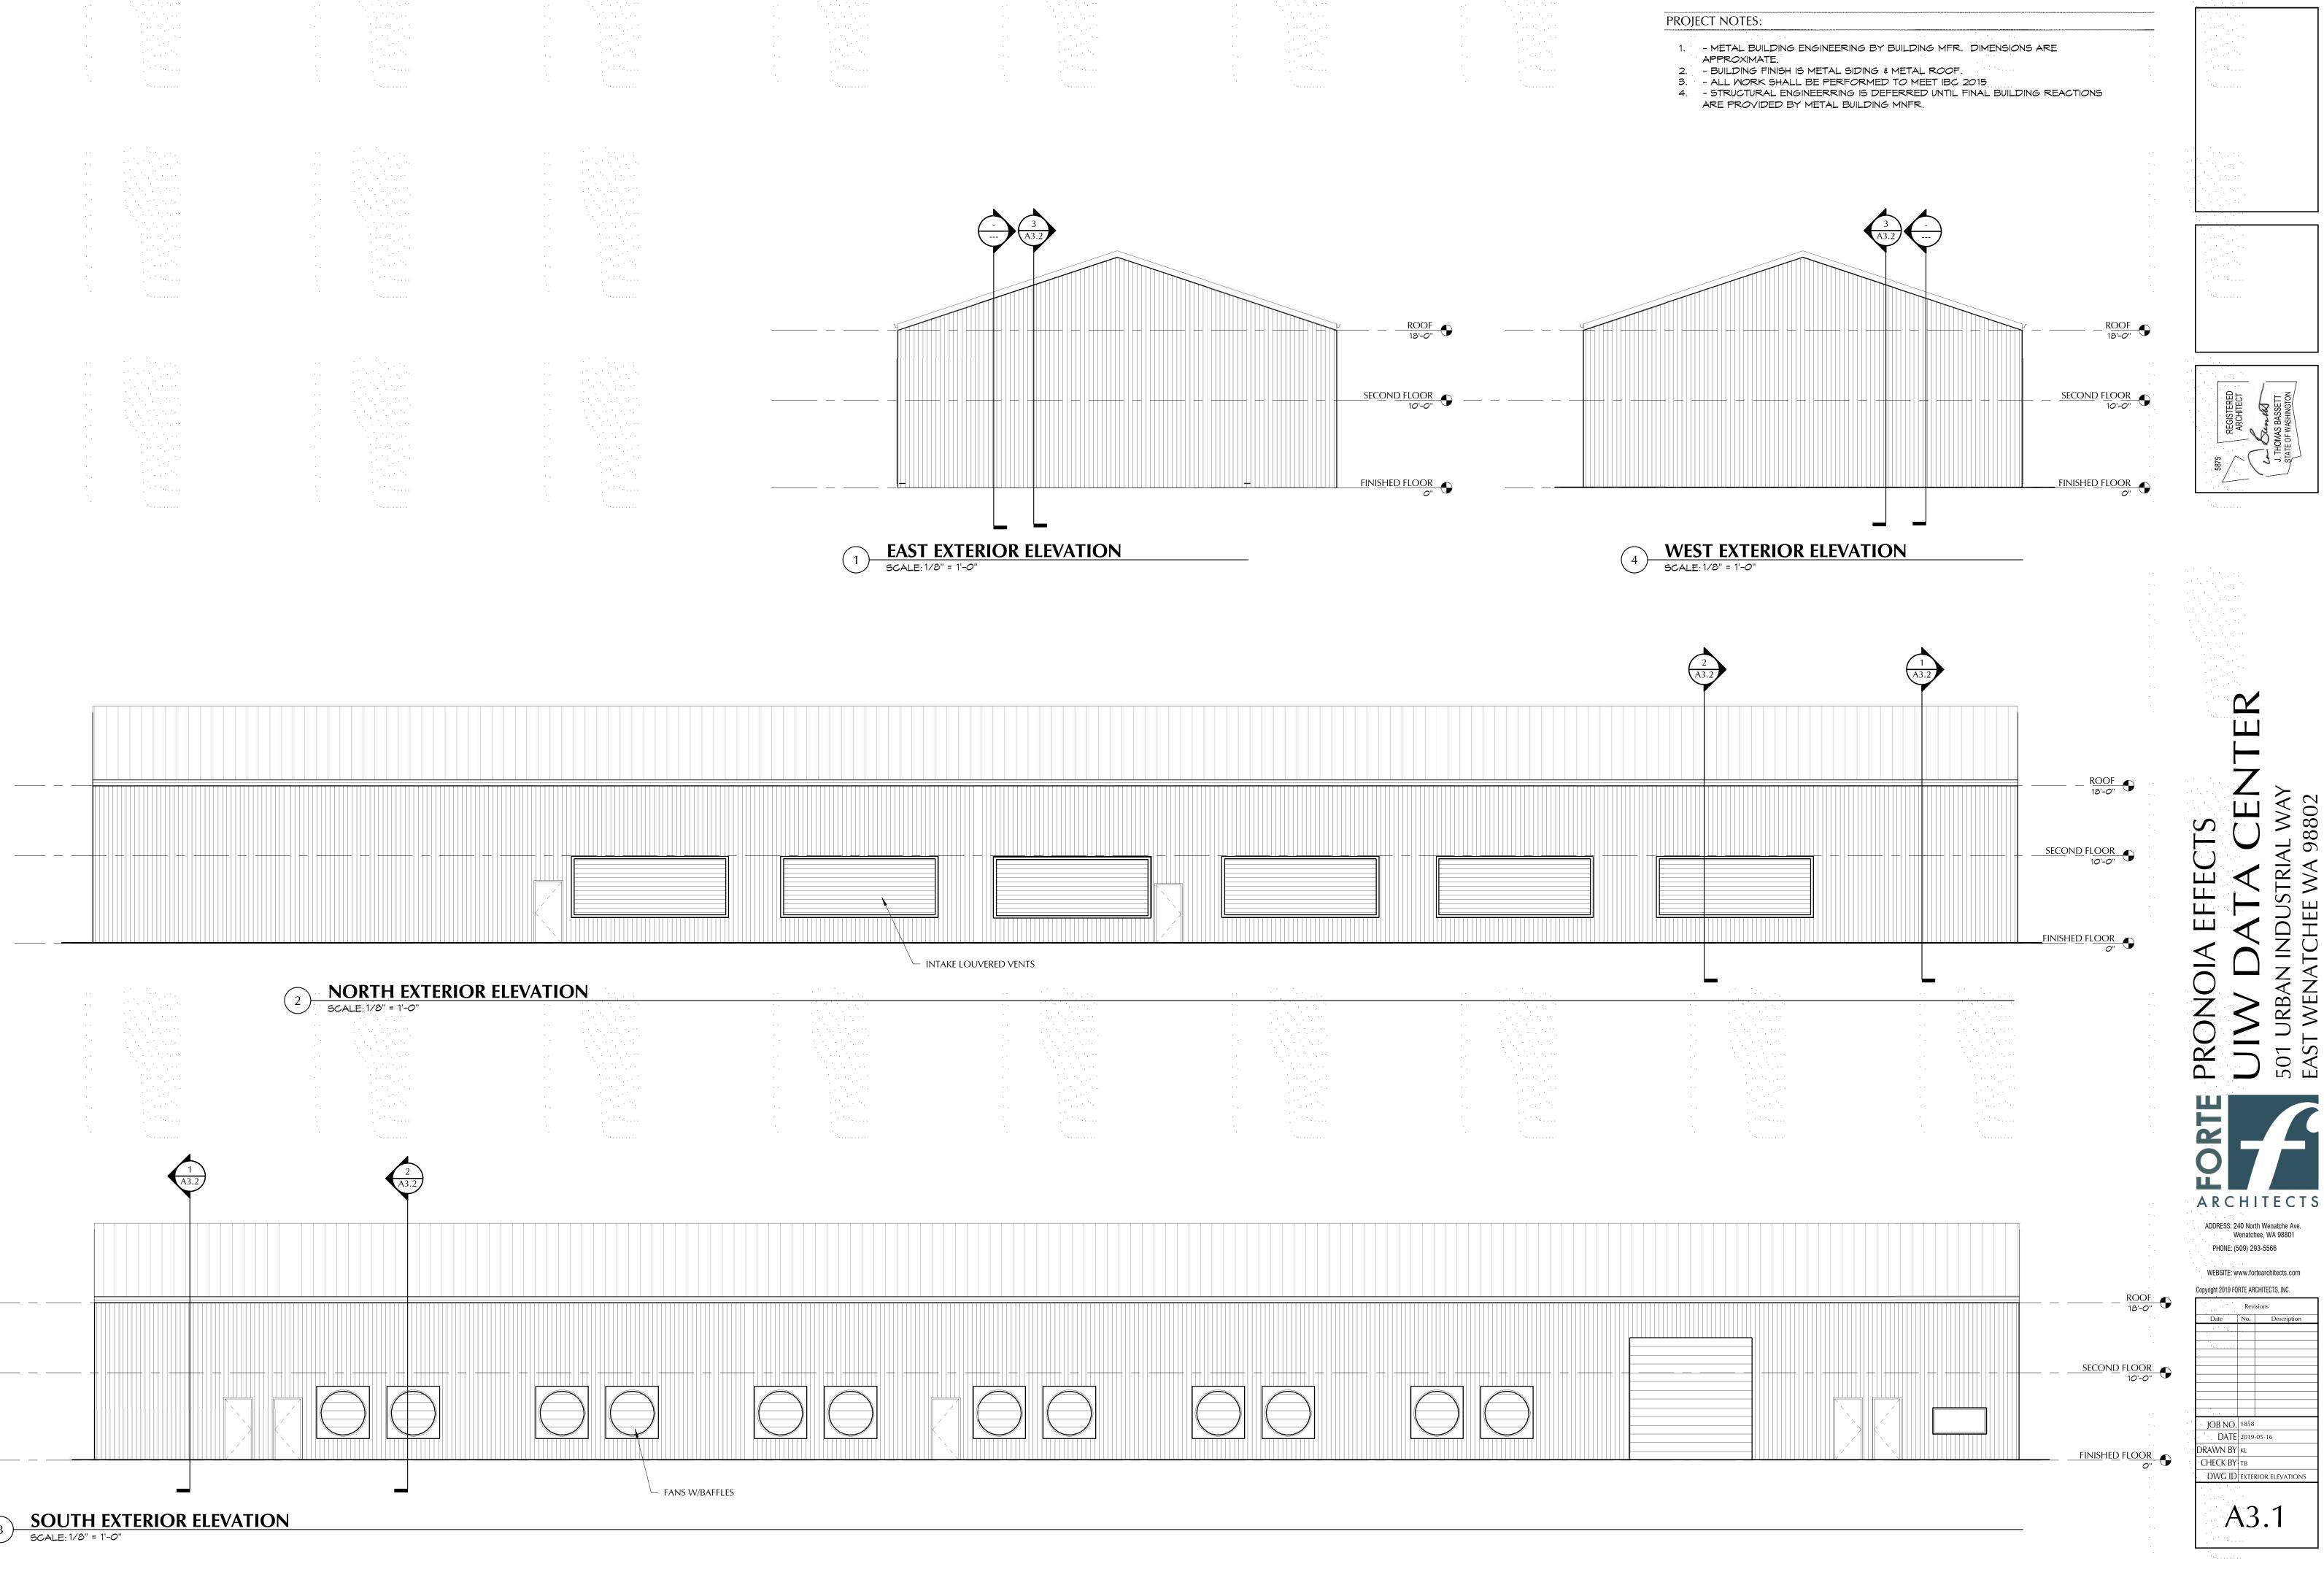
JOB NO. 1858 DATE 2019-05-16


DWG ID LIFE SAFETY PLANS

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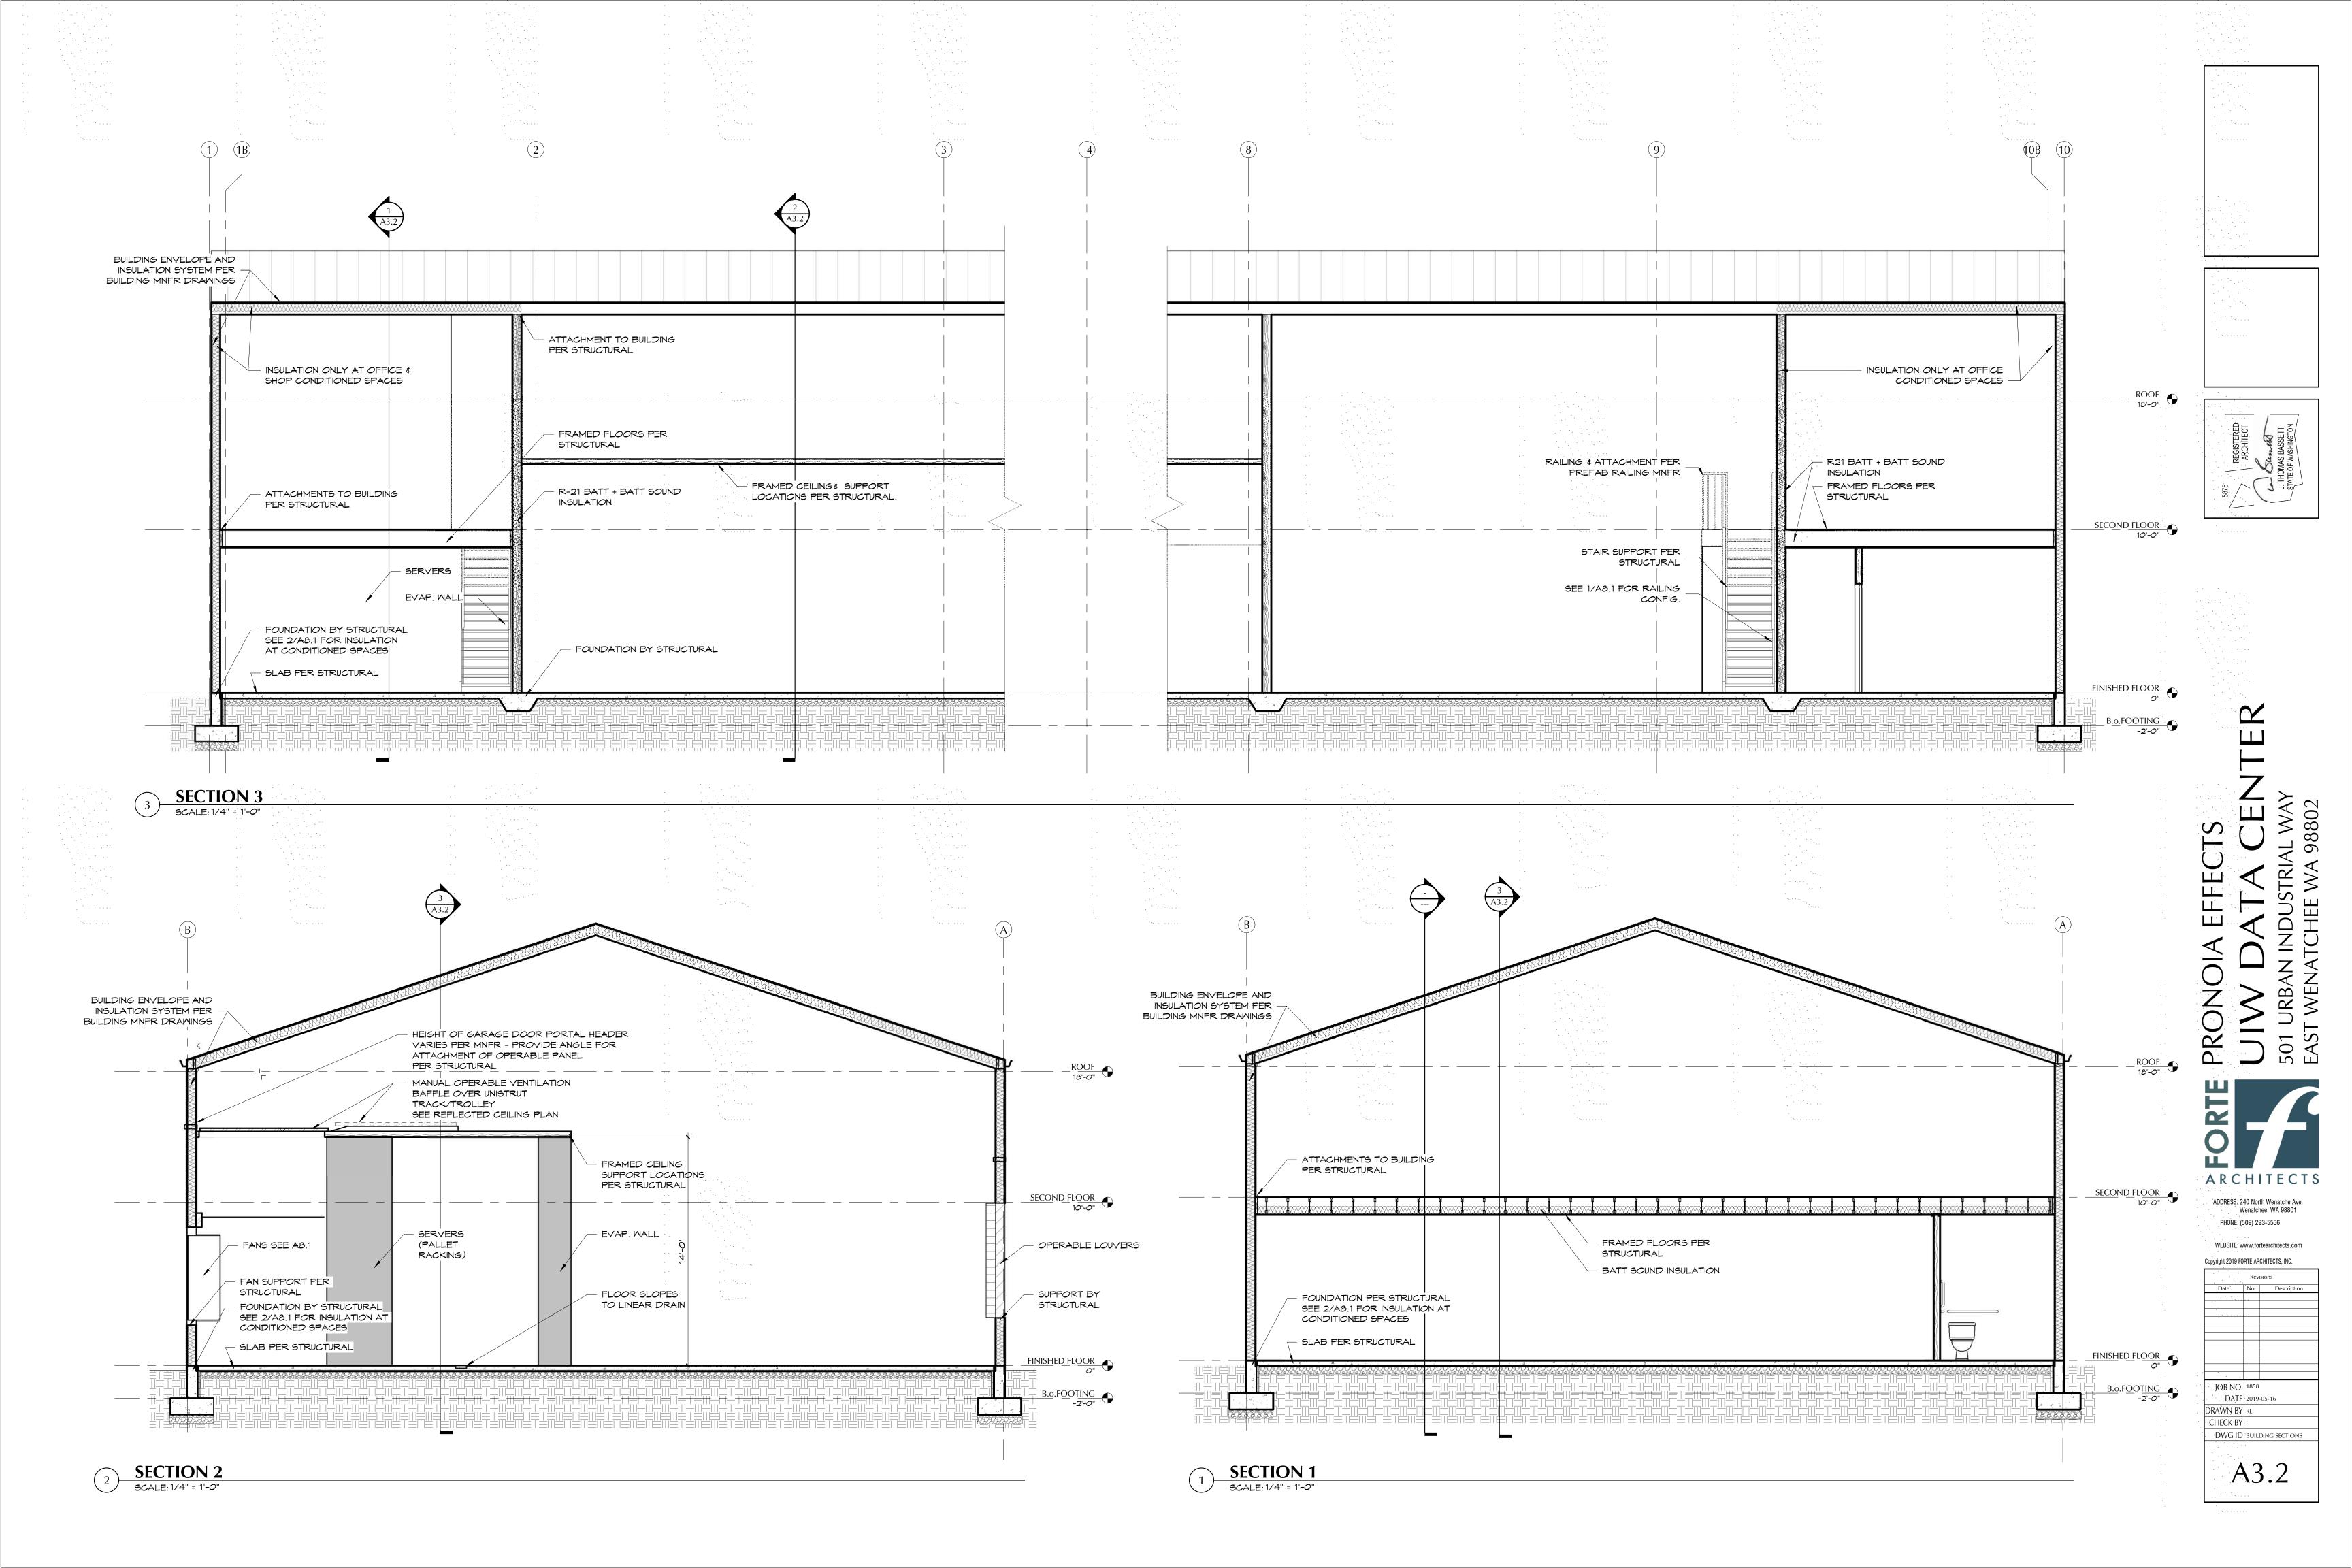


UIW DATA CEN
501 URBAN INDUSTRIAL WAY
EAST WENATCHEE WA 98802

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DWG ID EXTERIOR ELEVATIONS

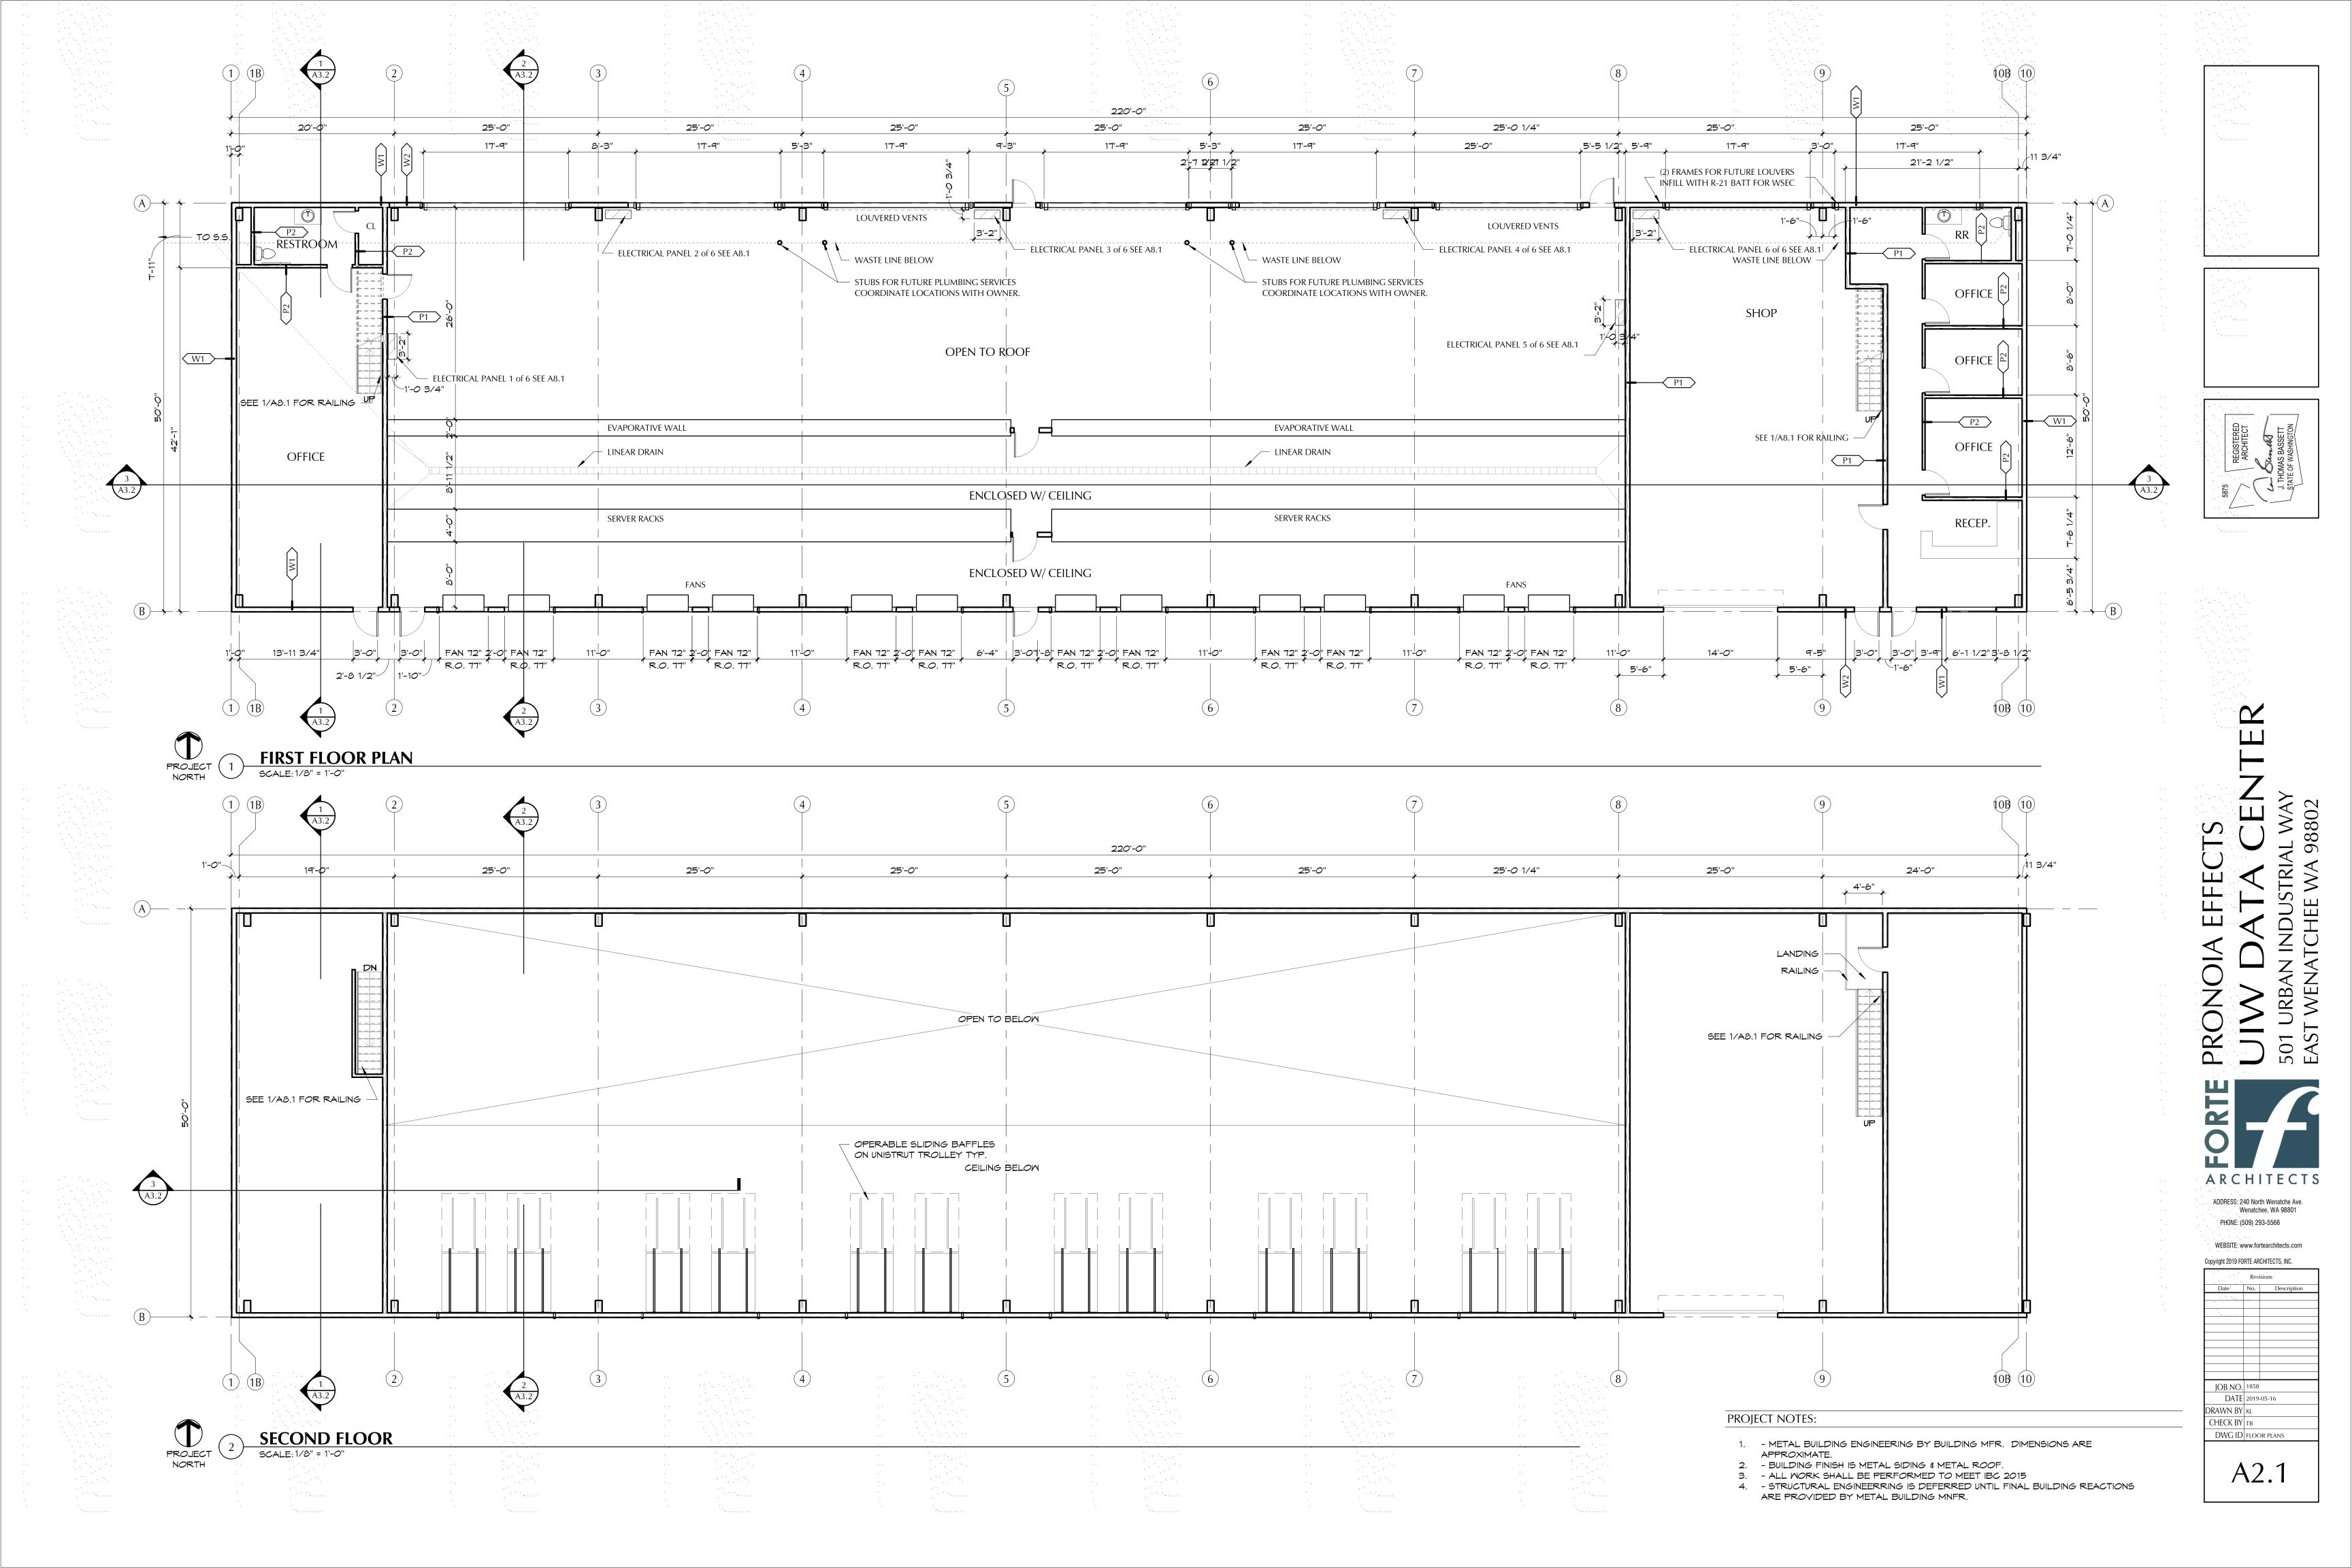

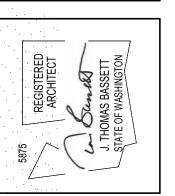PROJECT







A6.1

DWG ID REFLECTED CEILING & ROOF

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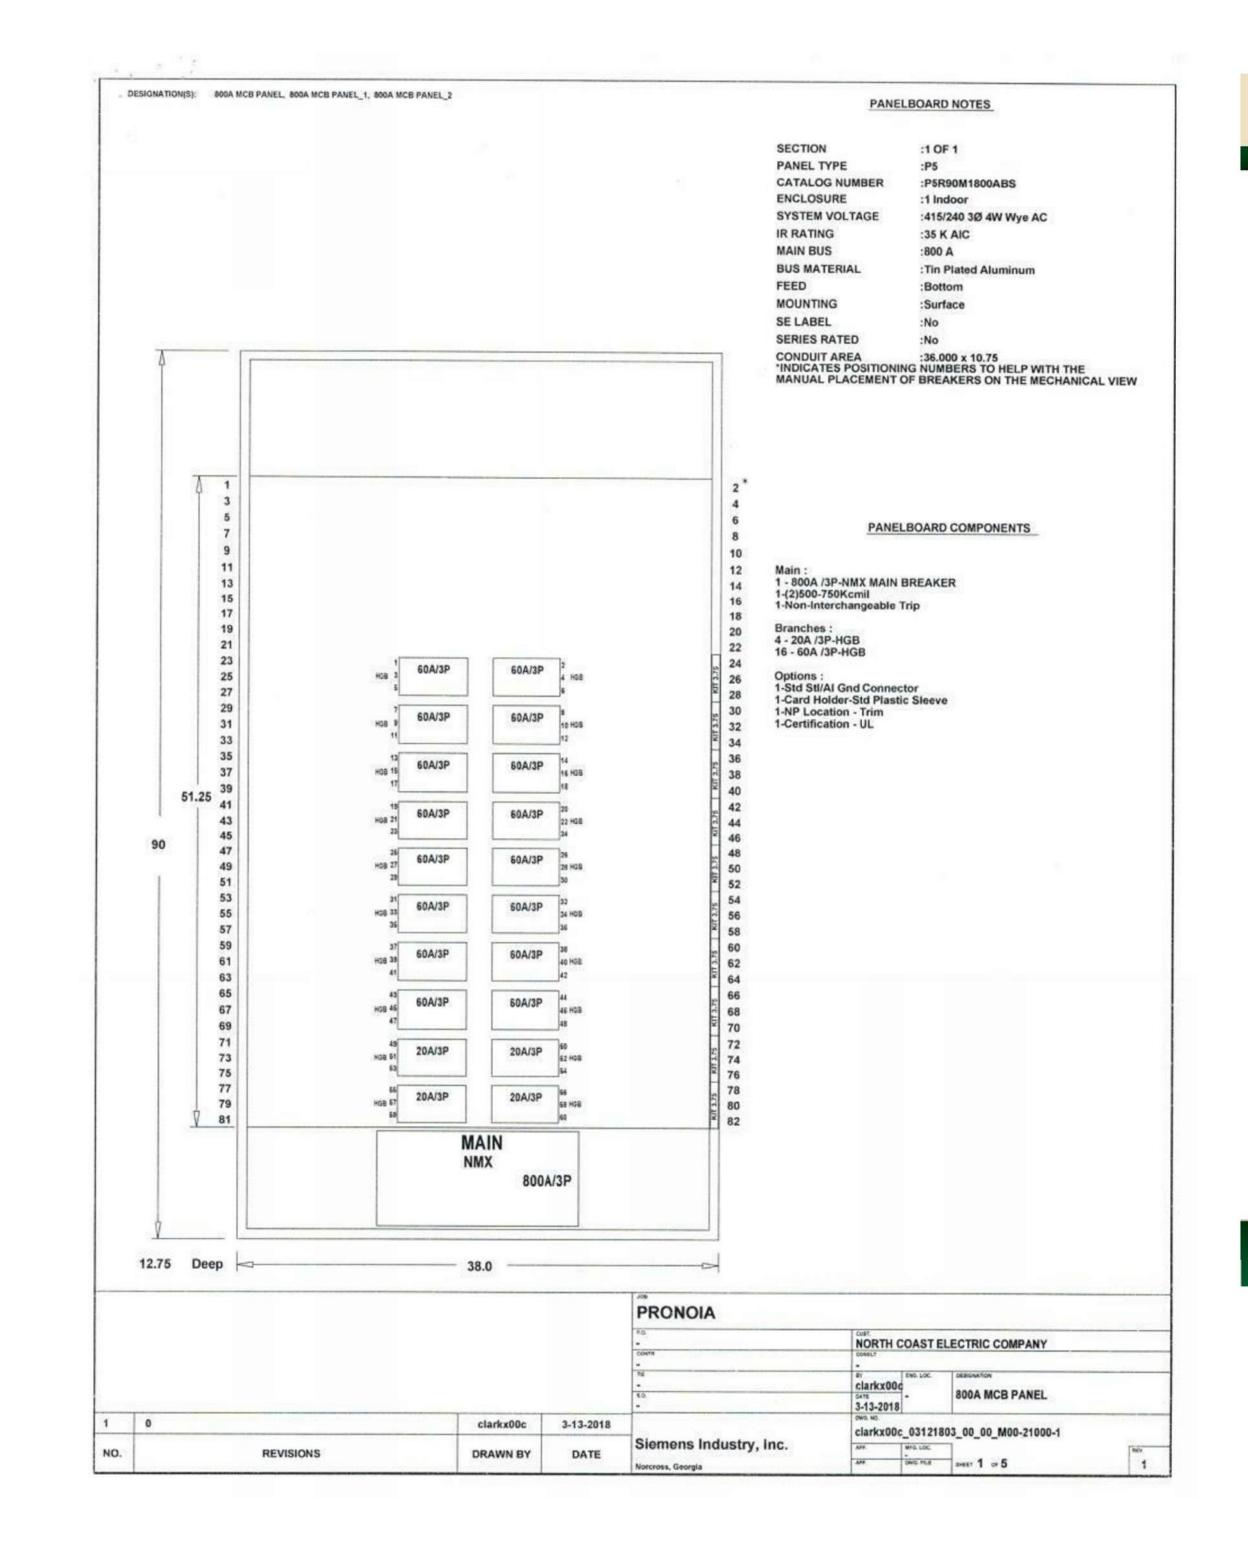
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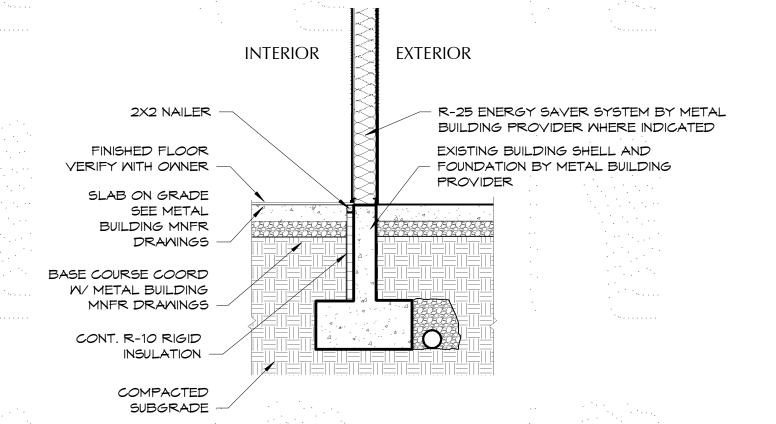
UIW DATA CE 501 URBAN INDUSTRIAL WA EAST WENATCHEE WA 98802

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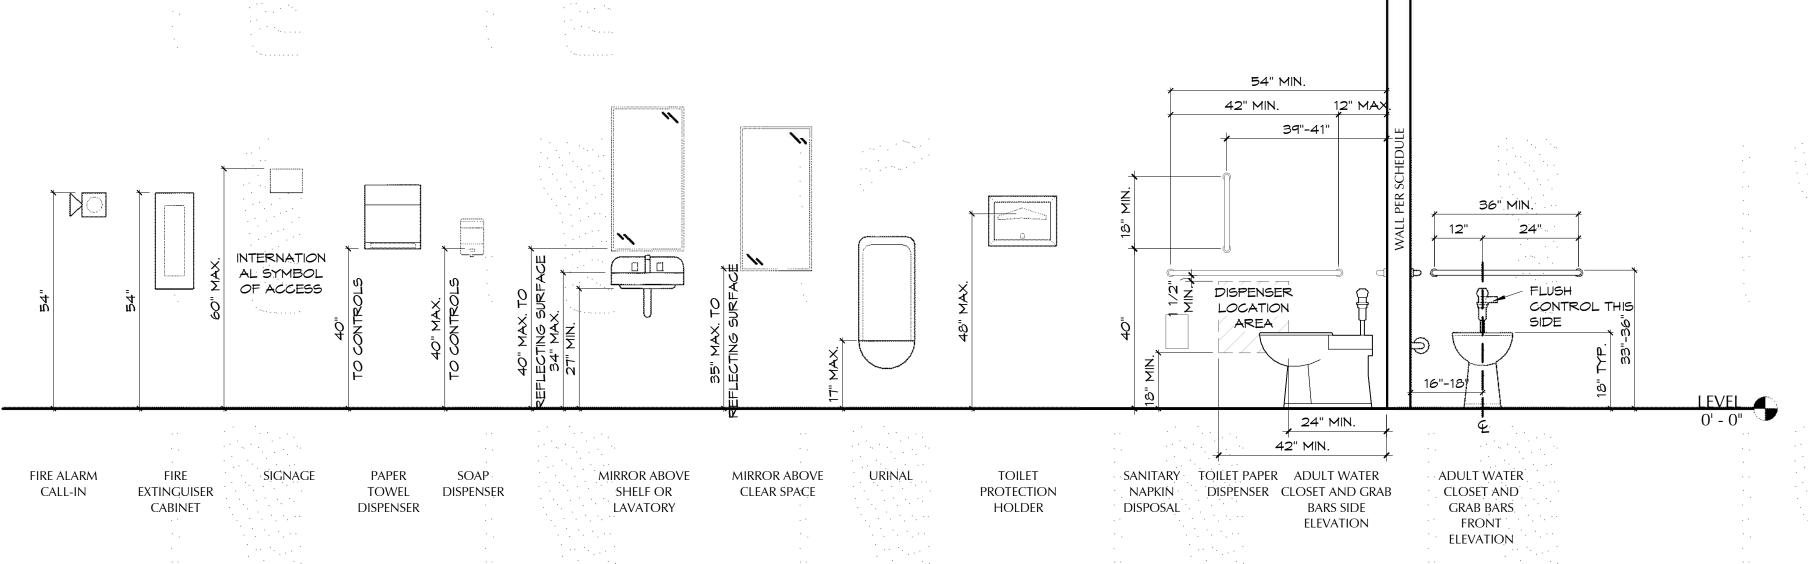
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### FOUNDATION INSULATION TYP.



## **ADA ACCESSIBLE HEIGHTS**

SCALE: 1/2" = 1'-0"



# **Mega Torque With VFD**

72" Fiberglass Torque Drive Exhaust Fan with Variable Frequency Drive



#### **Features**


- FANtastic performance combined with great efficiency
- Maintains a continuous high level of performance with
- no power loss or reduction from aging belts and pulleys
- Premium-efficient industrial motor
- Comes with VFD (Variable Frequency Drive) - Pre-wired to motor and pre-set for easy installation - Soft starts fan to reduce loads on fan during start up
- and helps to extend fan life
- Compatible with most J&D controls
- NEMA 4x enclosure w/ cooling fins mounted in air flow
- to ensure low temperature during operation Short wire length between motor and VFD to eliminate
- electrical noise and extend motor life
- Pre-installed filters to eliminate interference with RFID readers and other electronics
- UV resistant fiberglass housing and cone with smooth molded exterior
- Smooth and quiet operation
- Innovative 5 blade aluminum propeller
- Aluminum shutter
- One-piece molded cone with heavy-duty galvanized guard Heavy gauge stainless steel shutter clips
- Drainage holes in the bottom of the housing to drain moisture
- 3 Year Warranty on motor and torque drive
- 10 Year Warranty on propeller
- 20 Year Warranty on fiberglass housing and cone


VMTA72A5C33E-VFD240 72" 3 1 41,437 20.4 Torque 5-Alm Three Phase Wired for 480V With Cone Aluminum Shutter VMTA72A5C33E-VFD480 72" 3 1 41,437 20.4 Torque 5-Alm VRS75 Shutter Motor Kit, for 3 Panel Aluminum Shutter VRS75-C | Shutter Motor Kit, for 3 Panel Aluminum Shutter w/Cord Rough Opening | Side-By-Side Recommended OC Dimension for Fan with Cone | 77" W x 77"H | Minimum 81" Bold red text is data based on testing performed by an accredited lab using ANSI/AMCA 210-07 standard.


Three Phase Wired for 240V

NOTE: It is highly recommended that a motorized shutter kit be

MARNING: This product can expose you to chemicals including lead, which is known to the State of California to cause cancer and birth defects or other reproductive harm. For more information go to www.P65Warnings.ca.gov/product. Due to our continual effort to provide the best products available and adhere to market conditions; literature, products, prices and availability are subject to change without notice.

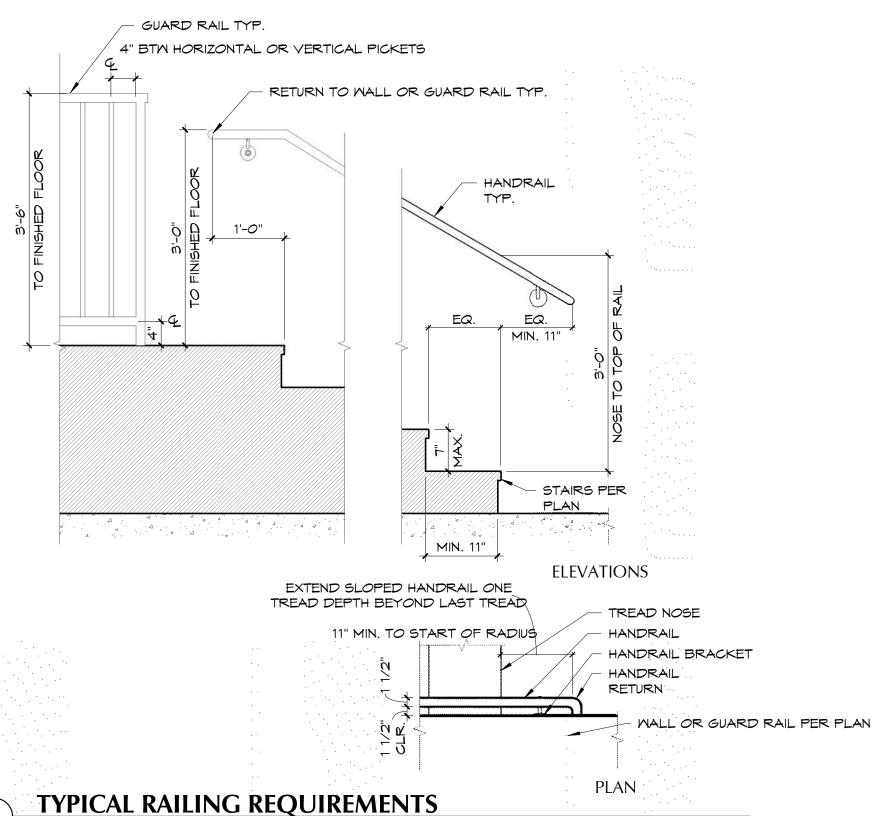

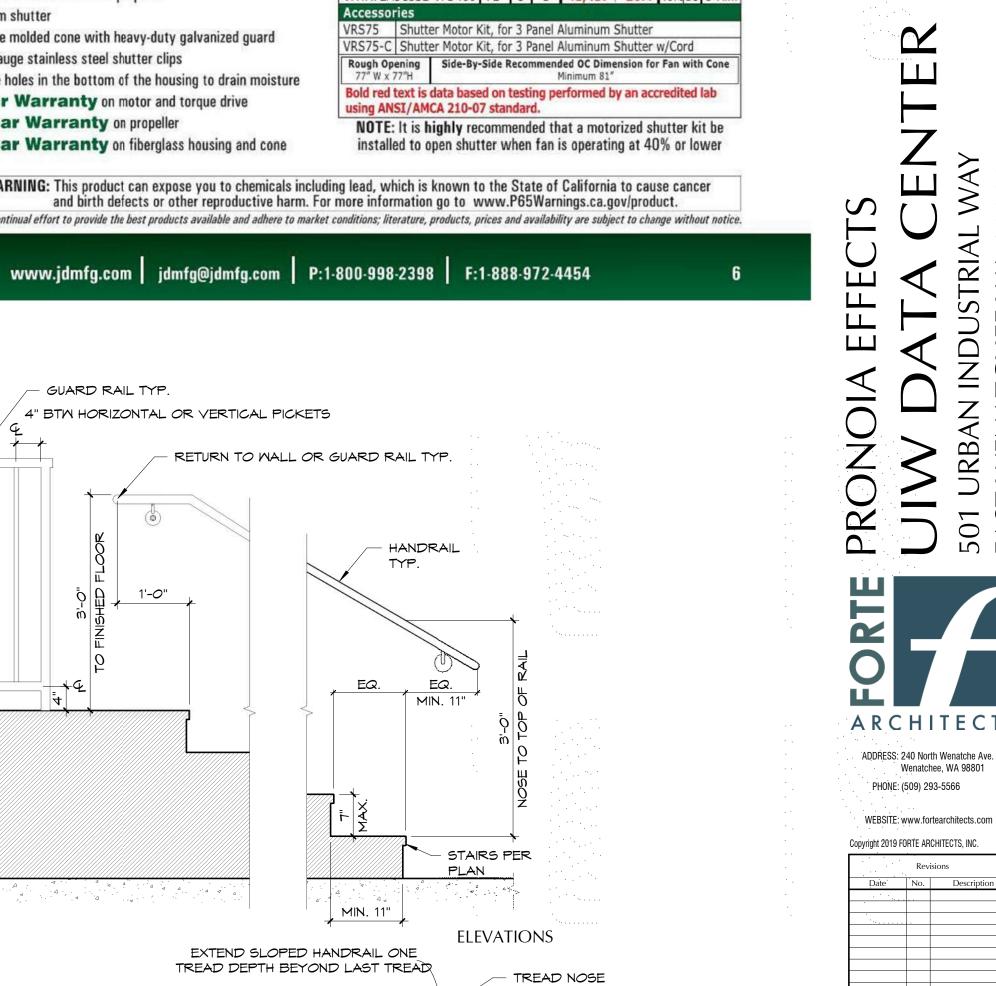

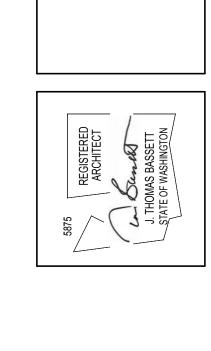

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