

# 113 SUNRIDGE ST.

PROJECT # 06.30.21114

R311.7.8.2)

**WALLS** 

2304.9.7)

R317.3).

R302.11)

**STAIRWAYS** 

DECAY OR PRESSURE TREATED. (CRC R317.1)

HAS A RISE OF 30" OR LESS). (CRC R311.7)

EXTERIOR STAIR STRINGERS MUST BE NATURALLY RESISTANT TO

HEADROOM 6'-8" MINIMUM; WIDTH 36" MINIMUM, 31.5" BETWEEN A HANDRAIL

STAIRWAYS WITH SOLID RISERS WHERE THE TREAD DEPTH IS LESS THAN 17

INCHES. THE LEADING EDGE OF TREADS SHALL PROJECT NOT MORE THAN

1.25 INCHES BEYOND THE TREAD BELOW. OPEN RISERS ARE PERMITTED, PROVIDED THE OPENING BETWEEN THE TREADS DOES NOT PERMIT THE

PASSAGE OF A 4" SPHERE. (OPENINGS ARE NOT LIMITED WHEN THE STAIR

SIDE 34" TO 38" ABOVE THE TREAD NOSING. CIRCULAR HANDRAILS SHALL

PERIMETER DIMENSION OF 4"-6.25" WITH A MAXIMUM CROSS SECTIONAL

PARAMETER OVER 6.25". A MINIMUM CLEARANCE OF 1.5" SHALL BE

4. GUARDS SHALL BE 42" MINIMUM HEIGHT (UNLESS ACTING AS A

OPEN SIDES OF STAIRS MAY HAVE 4 3/8" OPENINGS). (CRC R312)

MINIMUM. (SEE CRC R311.7.6 FOR EXCEPTIONS).

3. STAIRWAYS WITH 4 OR MORE RISERS SHALL HAVE A HANDRAIL ON ONE

HAVE AN OUTSIDE DIAMETER OF 1.25"-2"; IF NOT CIRCULAR, IT SHALL HAVE A

DIMENSION OF 2.25". SEE R311.7.8.3 ITEM# 2 FOR TYPE II HANDRAILS WITH A

MAINTAINED FROM THE WALL OR OTHER SURFACE. HANDRAILS SHALL BE RETURNED, TERMINATE IN NEWEL POSTS, OR SAFETY TERMINALS. (CRC

HANDRAIL/GUARD FOR A STAIRWAY; THE GUARD HEIGHT MAY BE 34"-38" IN

HEIGHT), WITH OPENINGS LESS THAN 4" INCHES CLEAR (GUARDS ON THE

6. USABLE SPACES UNDERNEATH ENCLOSED/UNENCLOSED STAIRWAYS

SHALL BE PROTECTED BY A MINIMUM OF ½" GYPSUM BOARD. (CRC R302.7)

POSITIVE POST TO BEAM CONNECTION SHALL BE PROVIDED TO

TREATED LUMBER SHALL BE OF A CORROSION RESISTANT TYPE (CRC

3. FIRE-BLOCK IN CONCEALED SPACES OF STUD WALLS/PARTITIONS,

VERTICALLY AT CEILING/FLOOR LEVELS, & HORIZONTALLY AT 10FT.

OF 15LB FELT (OR EQUIVALENT) UNDER STONE VENEER.

ENSURE AGAINST UPLIFT AND LATERAL DISPLACEMENT. (CRC R502.9 & CBC

2. ALL FASTENERS USED FOR ATTACHMENT OF SIDING & INTO PRESSURE

INTERVALS. FIRE-BLOCK AT SOFFITS, DROP CEILINGS/SIMILAR LOCATIONS &

IN CONCEALED SPACES AT THE TOP/BOTTOM OF STAIR STRINGERS. (CRC

4. PROVIDE APPROVED BUILDING PAPER UNDER THE BUILDING SIDING

MINIMUM OF 2 LAYERS OF GRADE D PAPER UNDER STUCCO AND 2 LAYERS

5. STUCCO SHALL HAVE A MINIMUM CLEARANCE TO EARTH OF 4 INCHES

AND 2 INCHES TO PAVED SURFACES WITH AN APPROVED WEEP SCREED.

(CRC R703.7.2.1) MASONRY STONE VENEER SHALL BE FLASHED BENEATH

THE FIRST COURSE OF MASONRY AND PROVIDED WITH WEEP HOLES

IMMEDIATELY ABOVE THE FLASHING. (CRC R703.8.5 AND R703.8.6)

AND APPROVED FLASHING AT EXTERIOR OPENINGS (CRC R703.2). SPECIFY A

5. PROVIDE LANDINGS AT THE TOP/BOTTOM OF THE STAIRWAY THE

WIDTH OF THE STAIRWAY. THE DEPTH OF THE LANDING SHALL BE 36"

BETWEEN RISER HEIGHTS 3/8" MAXIMUM. A NOSING NOT LESS THAN .75

RISE SHALL BE MAXIMUM 7.75"; RUN SHALL BE 10" MINIMUM

ON ONE SIDE AND 27" WITH HANDRAILS ON TWO SIDES. VARIATION

INCHES BUT NOT MORE THAN 1.25 INCHES SHALL BE PROVIDED ON

# **SHEET INDEX**

TS-1 INDEX SHEET A-1 PROPOSED FLOOR PLAN A-1.1 PROPOSED KITCHEN#01DETAILS A-1.2 PROPOSED KITCHEN#02 DETAILS A-1.3 PROPOSED FINISHES

NOTE

IN FIELD FOR CODE COMPLIANCE

# PROJECT TEAM

# **ENGINEERING**

**ACC & ENGINEERING** 768 N ETHAN WAY, ANAHEIM, CA 92805 United States

**BEN HAMED** 

**OWNER** 

**WESAM ABOUELATA** 

# CONSTRUCTION

**HORIZONS CONSTRUCTION** 432 W MEATS AVE, ORANGE, CA 92865 **UNITED STATES** KINAN KOTRASH

## PROJECT INFORMATION

### SUMMARY OF SCOPE:

INTERIOR IMPROVEMENTS INCLUDE UPGRADE TO THE KITCHEN, BATHROOMS, FLOORINGS, WALLS, CEILINGS, LIGHT FIXTURES & CASEWORK.

### **PROJECT ADDRESS:**

113 SUNRIDGE ST. PLAYA DEL REY CA 90293

### **LEGAL JURISDICTION:**

CITY OF LOS ANGELOS **EXITING BUILDING CONSTRUCTION TYPE:** 

TYPE V - NON - RATED

## **OCCUPANCY CLASSIFICATION:**

**GROUP R-1** 





Ben Hamed **Project Engineer ACC & ENGINEERING** 768 N Ethan way, Anaheim CA 92805

Phone No.: 951-903-2284

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# **ENERGY CODE**

ALL DUCTS IN CONDITIONED SPACES MUST INCLUDE R-4.2 INSULATION. (CALIFORNIA ENERGY CODE 150.1(C)9)

INSULATE THE FIRST 5' OF HOT/COLD WATER LINES, ALL LINES 3/4 INCH IN DIAMETER OR LARGER, ALL RECIRCULATION PIPING, PIPING TO STORAGE TANKS AND ALL HOT WATER PIPES TO KITCHEN FIXTURES FROM THE WATER HEATER. (CALIFORNIA ENERGY CODE 150(J)(2))

ISOLATION WATER VALVES REQUIRED FOR INSTANTANEOUS WATER HEATERS 6.8KBTU/HR AND ABOVE. VALVES SHALL BE INSTALLED ON BOTH COLD AND HOT WATER LINES. EACH VALVE WILL NEED A HOSE BIB OR OTHER FITTING ALLOWING FOR FLUSHING THE WATER HEATER WHEN THE VALVES ARE CLOSED. (CEC 110.3(C)7)

4. 4. PROJECT SHALL MEET THE MINIMUM VENTILATION AND ACCEPTABLE INDOOR AIR QUALITY REQUIREMENTS PER ASHRAE STANDARD 62.2. WINDOW OPERATION IS NOT A PERMISSIBLE METHOD OF PROVIDING THE WHOLE BUILDING VENTILATION AIRFLOW REQUIRED. THIS IS SUBJECT TO HERS TESTING. THE FOLLOWING LABEL MUST BE ATTACHED TO THE FAN SWITCH: "TO MAINTAIN MINIMUM LEVELS OF OUTSIDE AIR VENTILATION REQUIRED FOR GOOD HEALTH, THE FAN CONTROL SHOULD BE ON AT ALL TIMES WHEN THE BUILDING IS OCCUPIED, UNLESS THERE IS SEVERE OUTDOOR AIR CONTAMINATION." (CALIFORNIA ENERGY CODE 150.0(O))

WILDLAND URBAN INTERFACE (WUI) BUILDINGS CONSTRUCTED AFTER JANUARY 1, 2008

EXTERIOR WALL COVERINGS SHALL BE NONCOMBUSTIBLE, IGNITION RESISTANT, HEAVY TIMBER, LOG WALL OR FIRE RESISTIVE CONSTRUCTION. (CRC R337.7)

8. 2. EXTERIOR WALL COVERINGS SHALL EXTEND FROM THE FOUNDATION TO THE ROOF AND TERMINATE AT

9. 2 INCH NOMINAL SOLID BLOCKING BETWEEN RAFTERS AND OVERHANGS. (CRC R337.7.3.1)

10. 3. OPEN/ENCLOSED ROOF EAVES AND SOFFITS, EXTERIOR PORCH CEILINGS, FLOOR PROJECTIONS, UNDER-FLOOR AREAS AND UNDERSIDES OF APPENDAGES TO COMPLY WITH IGNITION RESISTANT CONSTRUCTION REQUIREMENTS. (CRC R337.5-9) (SHOW COMPLIANCE ON THE PLANS).

11. 4. SPACES CREATED BETWEEN ROOF COVERINGS AND ROOF DECKING SHALL BE FIRE STOPPED BY APPROVED MATERIALS OR HAVE ONE LAYER OF MINIMUM 72LB MINERAL SURFACED NONPERFORATED CAP SHEET

COMPLYING WITH ASTM D 3909. (CRC R337.5.2) 12. 5. VALLEY FLASHING SHALL BE NOT LESS THAN 26AWG AND INSTALLED OVER NOT LESS THAN ONE LAYER OF MINIMUM 72LB MINERAL SURFACED NON-PERFORATED CAP SHEET COMPLYING WITH ASTM D 3909

AND AT LEAST 36 INCHES WIDE RUNNING THE FULL LENGTH. (CRC R337.5.3) 13. 6. ATTIC GABLE AND EAVES ABOVE 12FT AND UNDER-FLOOR VENTILATION SHALL BE PROVIDED WITH FULLY COVERED METAL WIRE MESH, VENTS, OR OTHER MATERIALS THAT HAVE A MINIMUM 1/16 INCH AND MAXIMUM 1/8 INCH OPENINGS, NON-COMBUSTIBLE AND CORROSION RESISTANT. ALL OTHER EAVE VENTS SHALL BE LISTED/APPROVED TO RESIST THE INTRUSION OF FLAME AND BURNING EMBERS. (CRC R337.6)

14. 7. EXTERIOR DOORS INCLUDING GARAGE DOORS SHALL BE NONCOMBUSTIBLE, IGNITION RESISTANT MATERIAL, MINIMUM 1 3/8 INCH SOLID CORE, MINIMUM 20 MINUTE FIRE RESISTIVE RATING OR SHALL BE TESTED TO MEET THE PERFORMANCE REQUIREMENTS OF SFM STANDARD 12-7A-1. (CRC R337.8.3)

15. 8. THE WALKING SURFACE MATERIAL OF DECKS, PORCHES, BALCONIES AND STAIRS WITHIN 10FT OF GRADE LEVEL SHALL BE IGNITION RESISTANT MATERIAL, EXTERIOR FIRE RETARDANT TREATED WOOD OR NONCOMBUSTIBLE MATERIAL. (CRC R337.9)

2,314 SQ.FT. **EXISTING LOT AREA EXISTING LOT COVERAGE (RESIDENCE)** (E) 1ST STORY 917 SF

(E) 2ND STORY 1,197 SF 200 SF (GARAGE)

TOTAL EXISTING 2314 SF

NO NEW ADDITIONS TO EXISTING AREA.

# **APPLICABLE CODES**

2019 CALIFORNIA BUILDING CODE (CBC) / 2018 INTERNATIONAL BUILDING CODE (IBC)

2019 CALIFORNIA EXISTING BUILDING CODE (CEBC) / 2018 INTERNATIONAL EXISTING BUILDING CODE (IEBC)

2019 CALIFORNIA HISTORICAL BUILDING CODE (CHBC)

2019 CALIFORNIA RESIDENTIAL CODE (CRC) / 2018 INTERNATIONAL RESIDENTIAL CODE (IRC)

2019 CALIFORNIA ELECTRICAL CODE (CEC) / 2017 NATIONAL ELECTRICAL CODE (NEC)


2019 CALIFORNIA MECHANICAL CODE (CMC) / 2018 UNIFORM MECHANICAL CODE (UMC)

2019 CALIFORNIA PLUMBING CODE (CPC) / 2018 UNIFORM PLUMBING CODE (UPC)

2019 CALIFORNIA GREEN BUILDINGS STANDARDS CODE (CALGREEN)

2019 CALIFORNIA ENERGY CODE

## VICINITY MAP

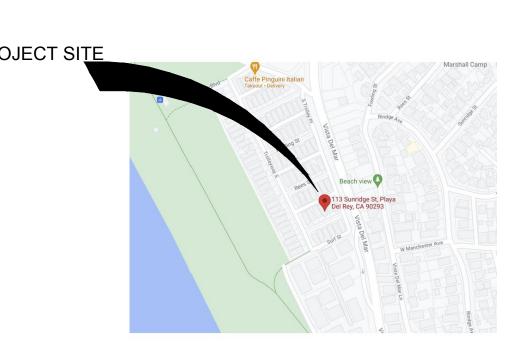



**SCALE: AS NOTED** 

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DATE 03/25/2021



SHEET TITLE

**INDEX SHEET** 

TS-1

# DIMENSIONS TO BE VERIFIED



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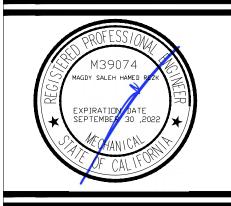
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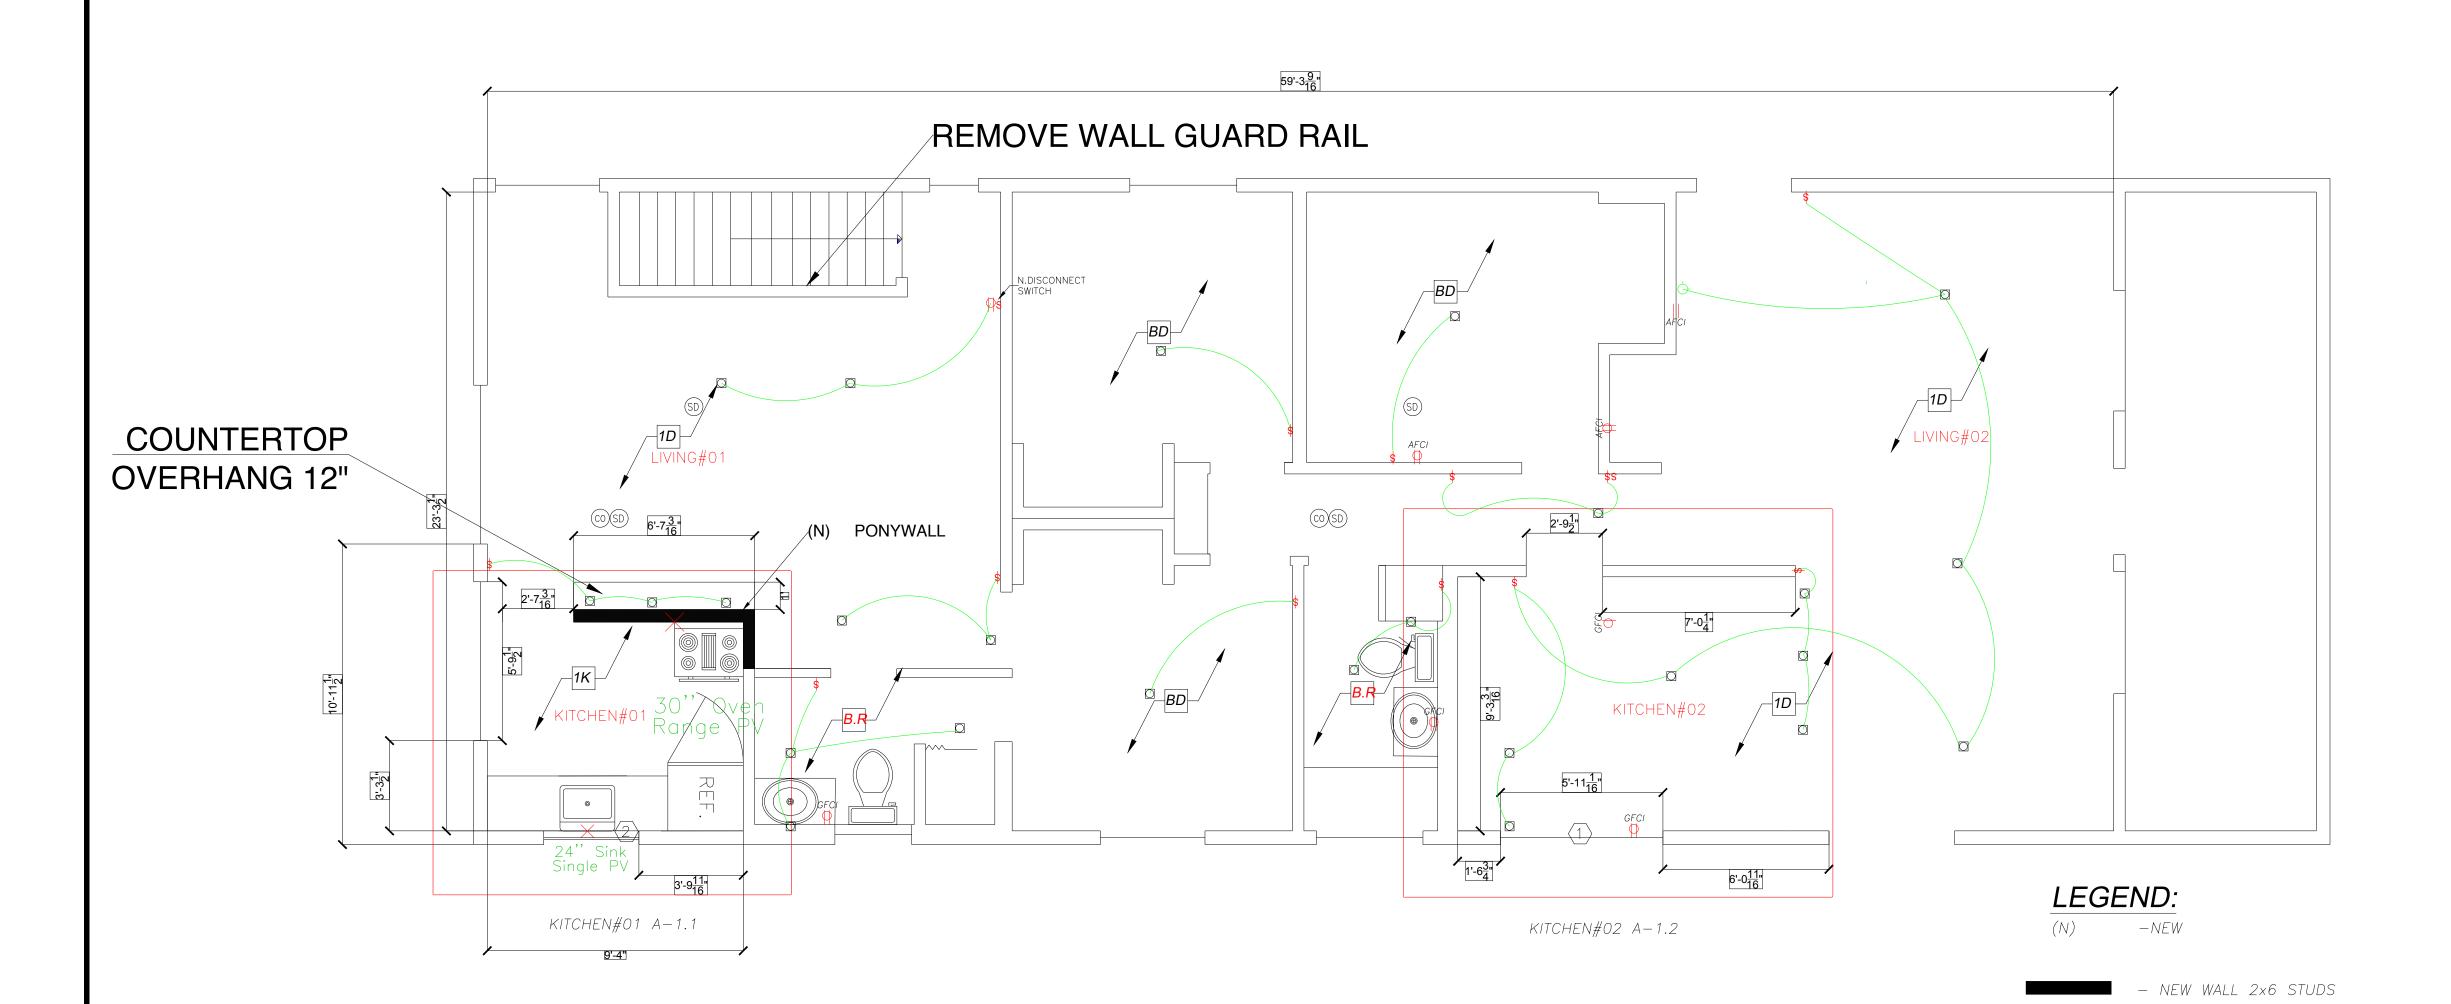
DATE 03/25/2021



SHEET TITLE

FLOOR PLAN

A-1.0



DOOR MARK         QUANTITY         SIZE:WxH         MATERIAL         TYPE         NOTES           1         ONE         60"x80"x1 3/8"         HD         INTERIOR DBL DR           2         ONE         30"x80"x1 3/8"         HD         INTERIOR           3         ONE         28"x80"x1 3/8"         HD         INTERIOR           4         ONE         36"x80"x1 3/8"         BARN DR         INTERIOR	NEW DOOR SCHEDULE												
2 ONE 30"x80"x1 3/8" HD INTERIOR 3 ONE 28"x80"x1 3/8" HD INTERIOR													
3 ONE 28"x80"x1 3/8" HD INTERIOR													
,													
(4) ONE 36"x80"x1 3/8" BARN DR INTERIOR													
, ,													
5 ONE 30"x80"x3/8" GLASS TEMPER SHOWER	)												
6 ONE 120"x80"x3/8" SOLID EXTERIOR DBL DR													
7													

A) EXTERIOR DOORS DOORS SHALL BE OF APPROVED NON-COMBUSTIBLE CONSTRUCTION, 20 MINUTE RATED, 1 3/8" SOLID CORE RAILS/STILES.(CRC R337.8)

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		NEW WINDOW SCHEDULE										
UANTITY	GLAZING	OPERATION	SIZE	AREA S.F	ORIENTATION	U-FACTOR	SHGC	EXT. SHADING				
THREE	DUAL PANE	SL-HUNG	48"x48"	16	SOUTH	0.30MAX	0.23	BUG SCREEN				
TWO	DUAL PANE	SL-HUNG	36"x12"	3	EAST	0.30MAX	0.23	TEMPERED				
	THREE	THREE DUAL PANE	THREE DUAL PANE SL-HUNG	THREE DUAL PANE SL-HUNG 48"x48"	THREE DUAL PANE SL-HUNG 48"x48" 16	THREE DUAL PANE SL-HUNG 48"x48" 16 SOUTH	THREE DUAL PANE SL-HUNG 48"x48" 16 SOUTH 0.30MAX	THREE DUAL PANE SL-HUNG 48"x48" 16 SOUTH 0.30MAX 0.23				

EXTERIOR WINDOWS, WINDOW WALLS, GLAZED DOORS AND GLAZED OPENINGS WITHIN DOORS SHALL BE DUAL GLAZED WITH A MINIMUM OF ONE TEMPERED PANE DUAL GLAZING, OR BE GLASS BLOCK UNITS, OR BE 20 MINUTE FIRE-RATED (CRC R337.8)

	ROOM ID	WALL 1	WALL 2	WALL 3	WALL 4	FLOOR	CEILING
) 1	1D	P-1	P-1	P-1	P-1	VP - 1	P-1 & P-2
L	1K	P-1	P-1	P-1	P-1	VP - 1	P-1 & P-2
	1BR	WC-1	WC - 1	WC - 1	WC - 1	WC-2	P-1

ROOM FINISH SCHEDULE

A) EXTERIOR DOORS DOORS SHALL BE OF APPROVED NON-COMBUSTIBLE CONSTRUCTION, 20 MINUTE RATED, 1 3/8" SOLID CORE RAILS/STILES.(CRC R337.8)

P-2 = SAND DOLLAR DE6171 PAINT COLOR FOR THE BEAMS

VP-1 = American Home Grey 6 in. x 36 in. Glue Down Vinyl

WC-1 = RESTORE ASH GRAY 4-1/4 IN. X 4-1/4 IN.





WC-1





2x6 @ PLUMBING

WHOLE HOUSE FAN: AIR KING LIMITED MODEL: EVD50 LOW SPEED 50 CFM HIGH/80 CFM. ( CONTINUOUS) RATED AT MAXIMUM 1.0 SONES ENERGY STAR RATED, EXHAUST TO TERMINATE OUTSIDE

- A BATH (ENERGY STAR)EXHAUST FAN W/HUMINITY CONTROL SENSOR.

SMOKE DETECTORS (HARD WIRED) w/BATTERY BACK—UP SMOKE ALARMS SHOULD SOUND AN ALARM AUDIBLE IN ALL

SLEEPING AREAS OF THE DWELLING UNIT WHICH THEY SERVE.

RETROFIT ALARMS CAN BE BATTERY OPERATED.(INTERCONNECTED)

- CARBON MONOXIDE ALARMS (DETECTORS) SHALL RECEIVE THEIR PRIMARY POWER FROM THE BUILDING WIRING WHERE SUCH WIRING IS SERVED FROM A COMMERCIAL SOURCE AND SHALL BE EQUIPPED

AFCI – ALL BRANCH CIRCUITS THAT SUPPLY 125-VOLT, SINGLE-PHASE,15-

LIBRARIES, DENS, BEDROOMS, SUNROOMS, RECREATION ROOMS,

SHALL BE PROTECTED BY AN ARC-FAULT CIRCUIT INTERRUPTER,

GFCI/AFCI (PROVIDE A 20A. DEDICATED CIRCUIT FOR BATHROOM RECEPTACLES)

AND 20-AMPERE OUTLETS OR DEVICES INSTALLED IN DWELLING UNIT

CLOSETS, HALLWAYS, LAUNDRY AREAS OR SIMILAR ROOMS OR AREAS

☐ LED RECESSED LIGHT IC + AT RATED

COMBINATION TYPE LISTED TO PROVIDE PROTECTION OF THE ENTIRE

KITCHEN, FAMILY ROOMS, DINING ROOMS, LIVING ROOMS, PARLORS,

WITH A BATTERY BACKUP. (INTERCONNECTED)

- GROUND FAULT CIRCUIT INTERRUPTER

WP – WEATHER PROTECTED GROUND FAULT INTERRUPTER GFCI

THE OUTLET A MINIMUM OF 3 FT. FROM AN OPENING OR PROPERTY LINE. A MIN. RATE OF 50 CFM IS REQUIRED. FAN SHALL MEET ASHRA STANDARD 62.2. A MAX. OF 3 SONE RATING

EXHAUST MUST VENT TO OUTDOORS IN AN APPROVED DUCT. TERMINATE

- EXISTING WALLS TO REMAIN

IS REQUIRED

BRANCH CIRCUIT.

SINGLE POLE SWITCH

- 100 AMP DUAL METERED

- VACANCY SENSOR

— WALL FURNACE


- 3WAY SWITCH

ROOM FINISH LEGEND

P-1 = WARM WHITE DEW380 PAINT COLOR

GLAZED CERAMIC WALL TILE.

WC-2 = IMAGICA - 23" X 23" SQUARE WALL & FLOOR TILE - UNPOLISHED CONCRETE VISUAL

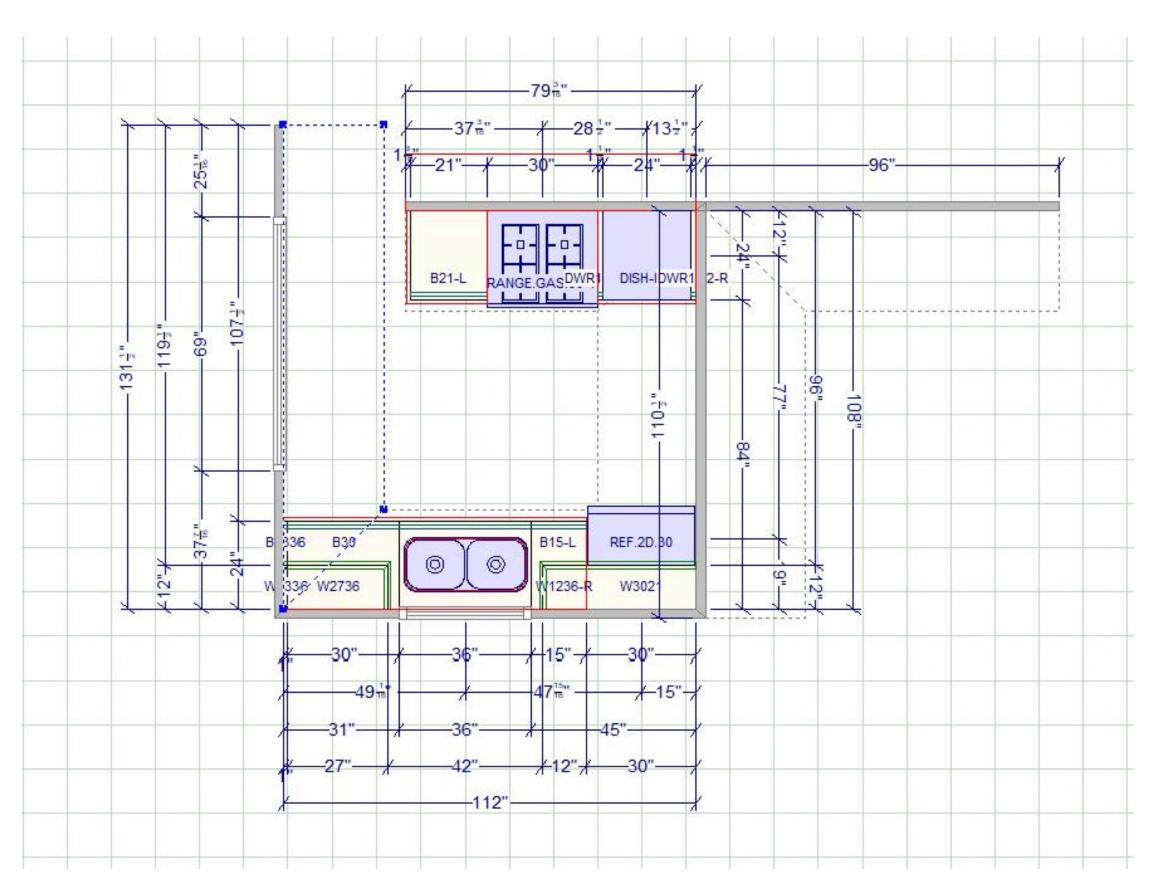







Project Engineer

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SCALE: AS NOTED


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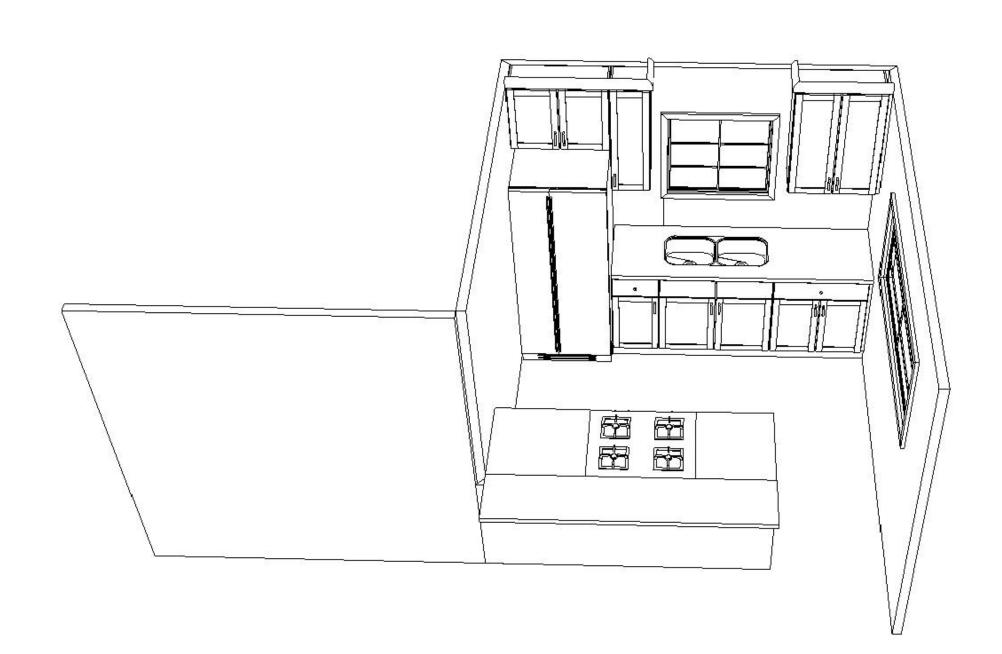
SHEET TITLE

**INDEX SHEET** 


# KITCHEN#01 FLOOR PLAN






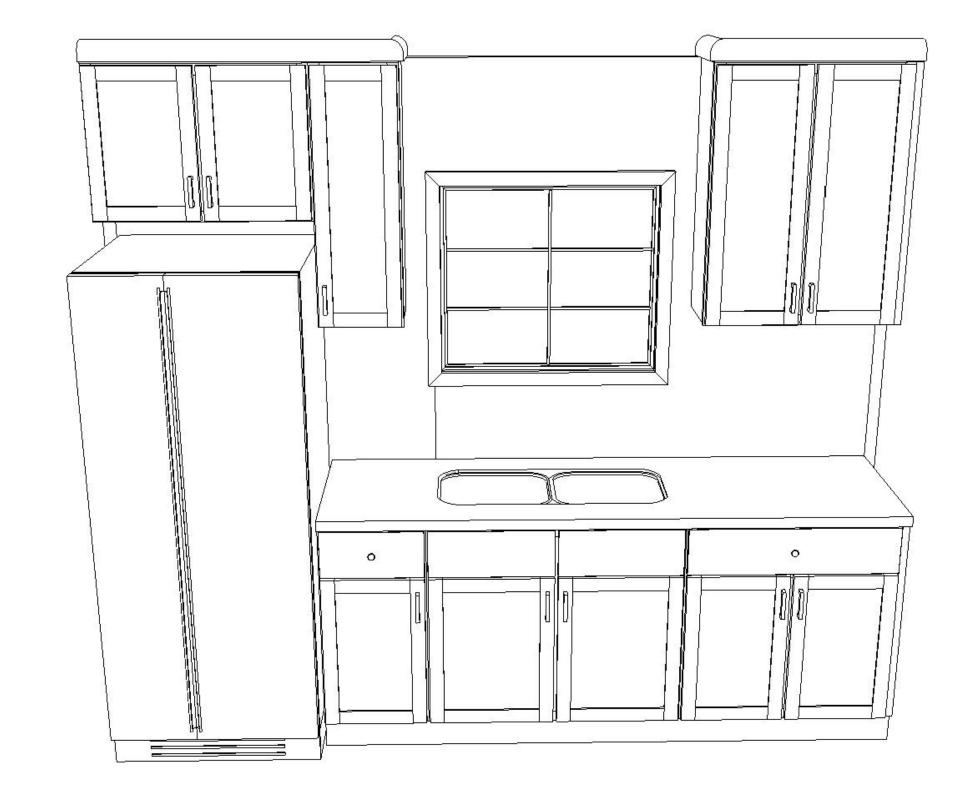


KITCHEN#01 ISOMETRIC

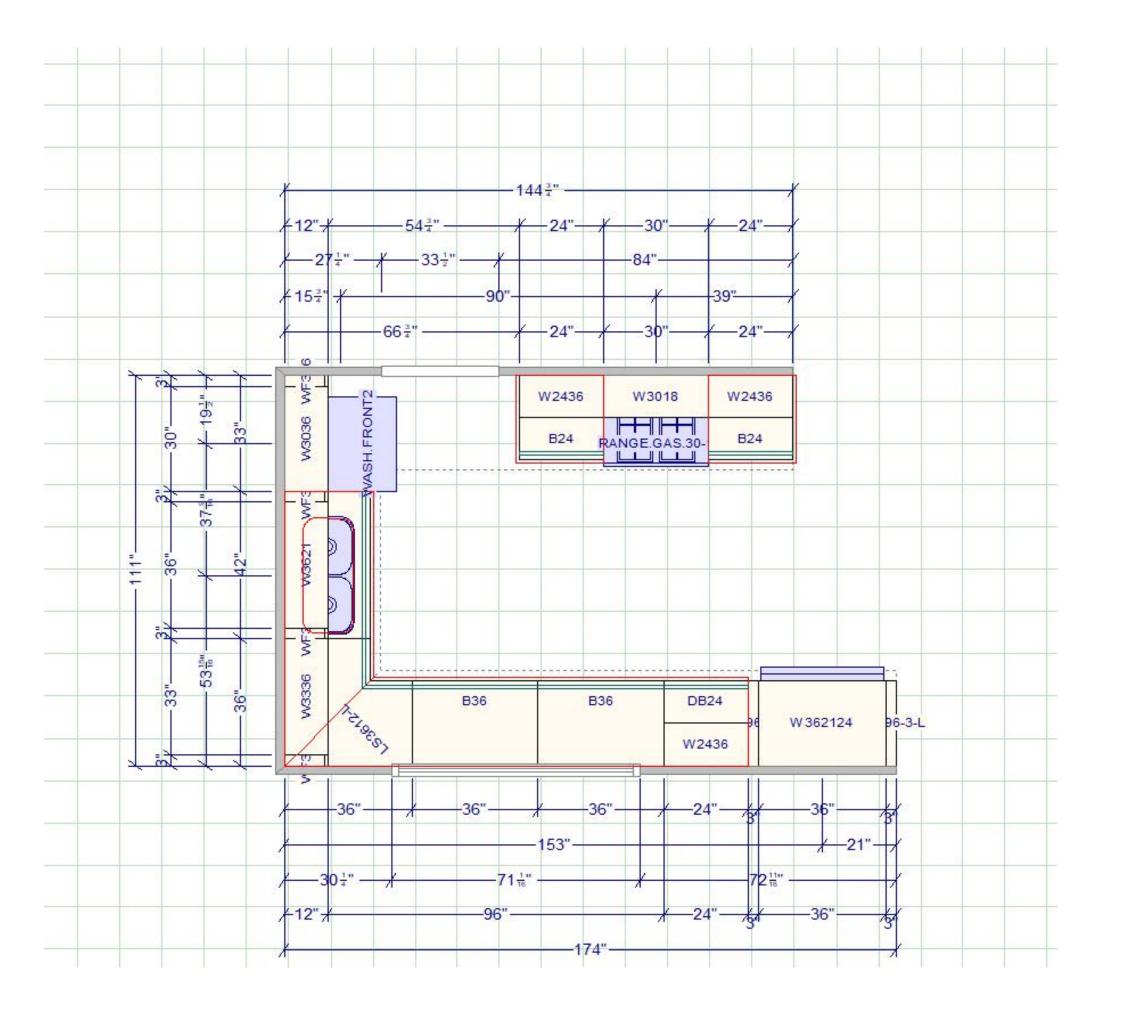

# KITCHEN#02 FLOOR PLAN

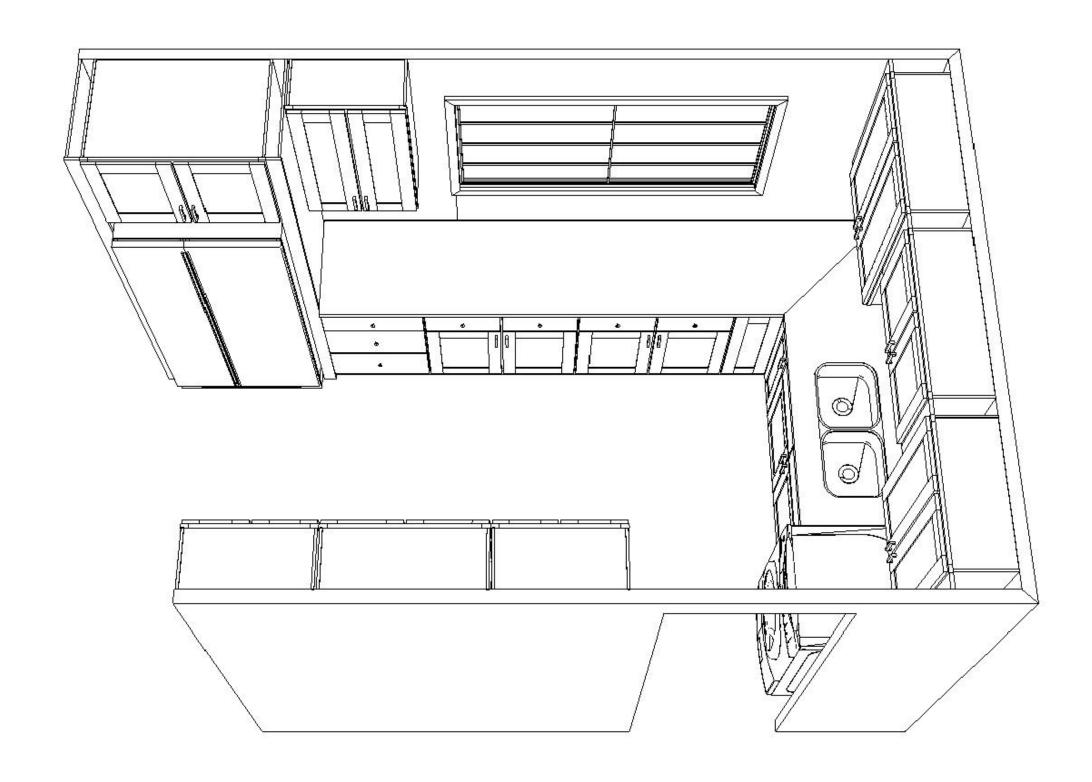

KITCHEN#02 ISOMETRIC

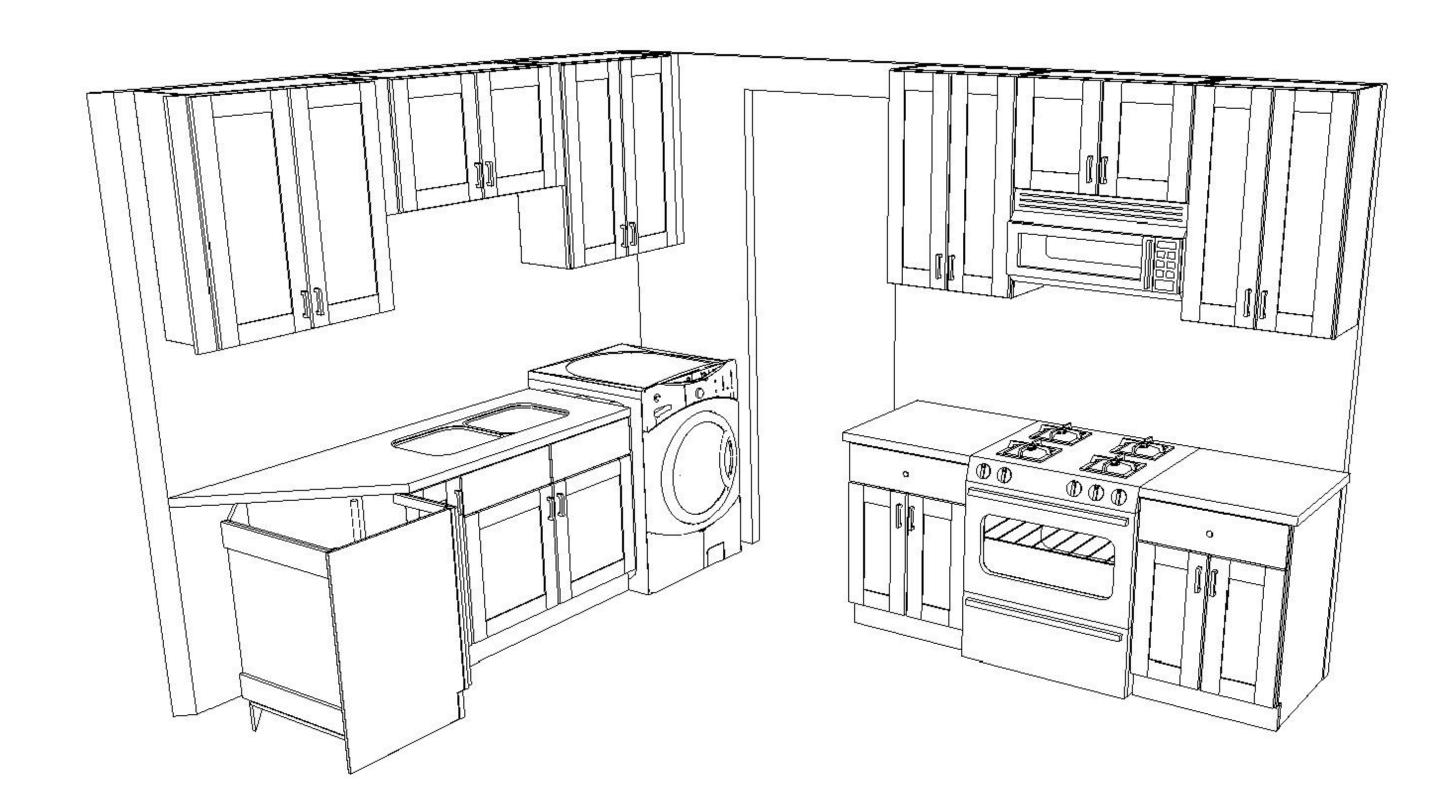

# KITCHEN#02 ELEVATION



KITCHEN#02 RENDERED IMAGE (3D)





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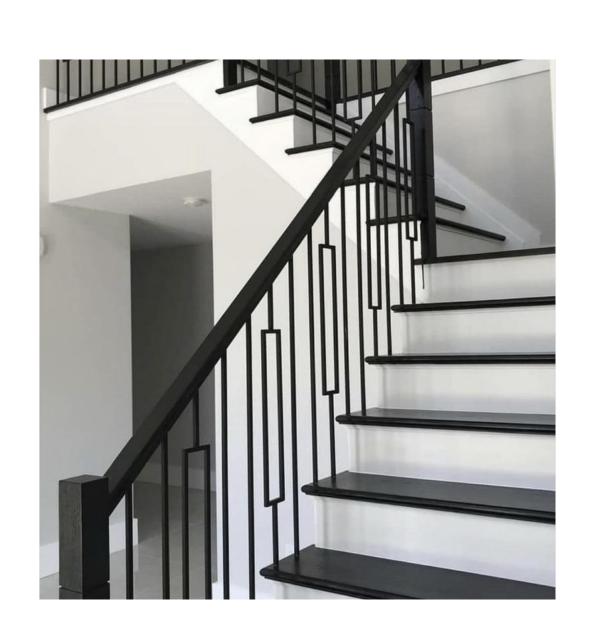
UNRIDGE ST

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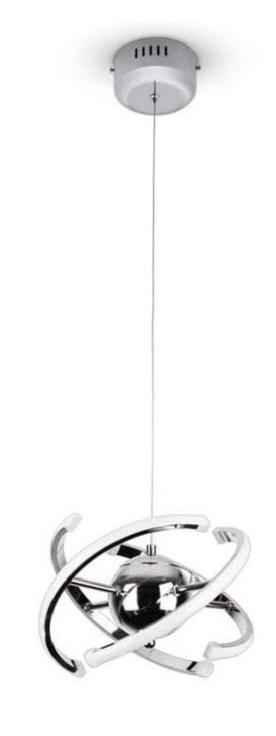


SHEET TITLE PROPOSED KITCHEN#02

A-1.2



NEW PROPOSED
GUARDRAIL SYSTEM



NEW PROPOSED PENDANT LIGHTS AT KITCHEN#01 BAR



NEW PROPOSED FAUCETS @ KITCHENS



NEW PROPOSED VANITY LIGHTS FOR BATHROOMS



HORIZONS CONSTRUCTION

Ben Hamed Project Engineer

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3

ACC & ENGINEERING 768 N Ethan way, Anaheim CA 92805

Phone No.: 951-903-2284

# 21.6"

# 31.5.V.

# **Cabinet Material**

**MDF Board** 

# Installation

**Under-Mount** 

# Cabinet Color

White

# Package one

- 1 × Vanity Cabinet
- 1 × Mirror
- 1 × Installation instruction


# Package two

- 1 × Ceramic Sink
- 1 × Faucet

**NEW PROPOSED VANITY &** 

BATHROOMS FIXTURES.

- 1 × Pop Up Drain
- Other accessories

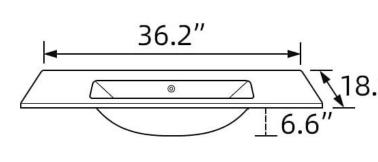



NEW PROPOSED BATHROOMS TOILET







REVERSIBLE INSTALLATION


DESIGNED AND ENGINEERED TO

ACCOMMODATE THE NEED FOR LEFT

OR RIGHT SIDE INSTALLATION

SCALE : AS NOTED

DATE 03/25/2021

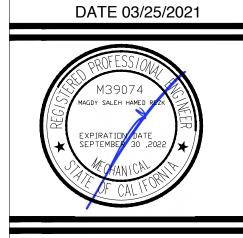

NEW PROPOSED FRAMELESS SHOWER DOOR

SHEET TITLE PROPOSED FINISHES

A-1.3