WEST BRADFORD TOWNSHIP NEW MUNICIPAL BUILDING

PROJECT TEAM

WEST BRADFORD TOWNSHIP 1385 CAMPUS DRIVE WEST BRADFORD, PA 19335 PHONE: 610.269.4174

CONTACT: X

PHONE: 610-903-0060

CIVIL ENGINEER: EDWARD B. WALSH & ASSOCIATES 125 DOWLIN FORGE ROAD EXTON, PA 19341

CONTACT: LARRY BAKER, PE **MEP ENGINEER:** SHARPE ENGINEERING, INC. 130 FUTURA DRIVE, SUITE 200 LIMERICK TWP., PA 19464 PHONE: 610-489-8212

ARCHITECT:

BLUE BELL, PA 19422

PHONE: 610.834.7805

1547 OREGON PIKE

LANCASTER, PA 17601

PHONE: 717-290-7400

KIMMEL BOGRETTE ARCHITECTURE + SITE, INC.


428 NORRISTOWN ROAD, SUITE 200

CONTACT: IONATHON TRUMP, RA

STRUCTURAL ENGINEER: BAKER INGRAM and ASSOCIATES

CONTACT: RYAN FRONHEISER, PE

AREA MAP

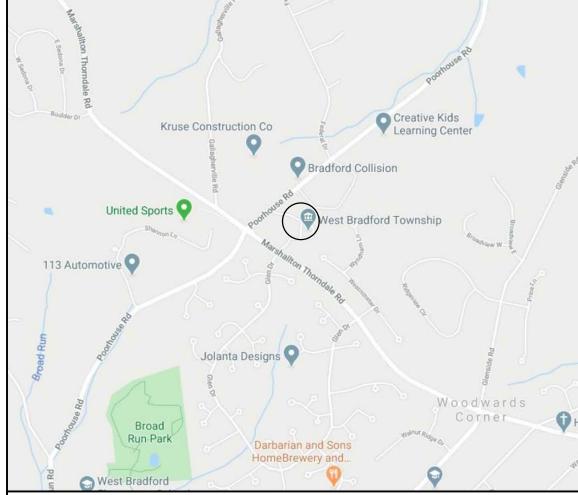

CONCEPTUAL RENDERING



 st conceptual image may not exactly reflect scope of work, refer to contract documents for complete scope,

DRAWING LIST

CIVIL

I OF 7 - COVER SHEET

2 OF 7 - EXISTING FEATURES PLAN /

DEMOLITION PLAN 3 OF 7 - SITE PLAN

4 OF 7 - GRADING PLAN 5 OF 7 - PHASING PLAN

6 OF 7 - EROSION AND SEDIMENT CONTROL

7 OF 7 - DETAIL SHEET

ARCHITECTURAL

CS-I - COVER SHEET

A0.1 - CODE PLANS

A0.2 - PHASING PLANS

AI.I - DEMOLITION PLANS A2.1 - BASEMENT PLAN

A2.2 - FIRST FLOOR PLAN

A2.3 - ROOF PLAN

A3.1 - EXTERIOR ELEVATIONS A3.2 - BUILDING SECTIONS

A3.3 - BUILDING SECTIONS

A4.1 - ENLARGED FLOOR PLANS

A5.I - INTERIOR ELEVATIONS

A5.2 - INTERIOR ELEVATIONS A5.3 - INTERIOR ELEVATIONS

A5.4 - INTERIOR ELEVATIONS

A6.1 - REFLECTED CEILING PLAN

A6.2 - REFLECTED CEILING PLAN

A8.1 - WALL SECTIONS

A8.2 - PLAN & SECTION DETAILS

A8.3 - PLAN & SECTION DETAILS A8.4 - PLAN & SECTION DETAILS

A10.1 - DOOR & FINISH SCHEDULES

A10.2 - WINDOW SCHEDULE & DETAILS

E0.1 - COVER SHEET

ELECTRICAL

M6.1 - SCHEDULES

M6.2 - SCHEDULES

M5.I - DETAILS

M5.2 - DETAILS

STRUCTURAL

SI.I - STRUCTURAL NOTES

S2.2 - ROOF FRAMING PLAN

S4.1 - FRAMING SECTIONS

S6.2 - TYPICAL DETAILS

MECHANICAL

M0.1 - COVER SHEET

S3.1 - FOUNDATION SECTIONS

S6.1 - TYPICAL FOUNDATION DETAILS

MI.I - BASEMENT DEMOLITION PLAN

M2.I - BASEMENT DUCTWORK PLAN

M3.2 - GROUND FLOOR PIPING PLAN

M4.1 - PARTIAL PLANS & SECTIONS

M5.3 - GEOTHERMAL BORE DETAILS

M5.4 - GEOTHERMAL BORE DETAILS

M3.I - BASEMENT PIPING PLAN

S2.1 - FOUNDATION & FLOOR FRAMING PLAN

S6.3 - COLD-FORMED METAL TYPICAL DETAILS

MI.2 - GROUND FLOOR DEMOLITION PLAN

M2.2 - GROUND FLOOR DUCTWORK PLAN

M3.3 - GEOTHERMAL BORE FIELD SITE PLAN

EI.I - BASEMENT DEMOLITION PLAN

E1.2 - GROUND FLOOR DEMOLITION PLAN

E2.1 - BASEMENT LIGHTING PLAN

E2.2 - GROUND FLOOR LIGHTING PLAN E3.1 - BASEMENT POWER PLAN

E3.2 - GROUND FLOOR POWER PLAN

E4.I - BASEMENT FIRE ALARM PLAN

E4.2 - GROUND FLOOR FIRE ALARM PLAN

E5.1 - SITE PLAN

E5.2 - COMMUNICATIONS PATHWAYS

E6.1 - PANEL SCHEDULES

E6.2 - LIGHT FIXTURE SCHEDULE E6.3 - SINGLE LINE DIAGRAM

PLUMBING

P0.1 - COVER SHEET

PI.I - BASEMENT DEMOLITION PLAN

PI.2 - GROUND FLOOR DEMOLITION PLAN P2.I - BASEMENT NEW WORK PLAN

P2.2 - GROUND FLOOR NEW WORK PLAN

P2.3 - GROUND FLOOR NEW WORK PLAN

P4.I - DETAILS P4.2 - RISER DIAGRAM & DETAILS

A5.1 - SCHEDULES

FIRE PROTECTION

FP0.1 - COVER SHEET

FP2.I - BASEMENT NEW WORK PLAN

FP4.2 - DETAILS

FP2.2 - GROUND FLOOR NEW WORK PLAN

FP4.I - DETAILS

COVER

19. CONSTRUCTION REQUIRED TO BE FIRE RATED SHALL CONFORM TO MATERIALS AND METHODS OF TESTED SYSTEMS BY UNDERWRITERS LABORATORIES (U.L.).

20. ALL LUMBER IN CONTACT WITH EITHER CMU OR CONCRETE SHALL BE PRESSURE-TREATED LUMBER

23. PERFORM ALL WORK IN ACCORDANCE WITH APPLICABLE AUTHORITIES HAVING JURISDICTION.

24. FINISH FLOOR ELEVATION DATUM INDICATED ON THE CIVIL DRAWINGS 403.50' = ELEVATION +0'-0" ON THE ARCHITECTURAL DRAWINGS.

25. THIS PROJECT WILL ALLOW "EQUAL" SUBSTITUTIONS TO SPECIFIED ITEMS, PROVIDED ALL OF THE TERMS OF THE SPECIFICATIONS ARE MET, AND THAT THE "EQUAL" ITEM IS APPROVED BY THE ARCHITECT AND OWNER. CONTRACTOR SHALL SUBMIT DOCUMENTATION COMPARING SPECIFIED PRODUCT TO PROPOSED SUBSTITUTION AND SHALL DEMONSTRATE IT IS AN "EQUAL" PRODUCT. SEE SPECIFICATIONS FOR COMPLETE INFO.

SHOP DRAWING PHASE. THE ARCHITECT RESERVES THE RIGHT TO REASONABLY MODIFY LOCATIONS OF EXTERIOR LOUVERS, DIFFUSERS, AND EXPOSED DUCTWORK WHERE CURRENTLY SHOWN ON THE MECHANICAL DRAWINGS FOR AESTHETIC REASONS.

27. ANY EXPOSED INSULATION SHALL HAVE A FLAME SPREAD INDEX OF NOT MORE THAN 25 AND A SMOKE-DEVELOPED INDEX OF NOT MORE THAN 450.

28. THESE PLANS SHOW THE APPROXIMATE LOCATIONS AND INVERTS OF EXISTING SITE UTILITIES. THE CONTRACTOR IS RESPONSIBLE FOR LOCATING EXISTING SITE UTILITIES AND COORDINATING THE INSTALLATION OF ALL NEW UTILITY RUNS FROM THEIR SOURCE TO THE NEW BUILDING WITH EXISTING SITE FEATURES, STREET CROSSINGS, AND UTILITY CROSSINGS, INCLUDING BUT NOT LIMITED TO EXISTING SANITARY SEWER LINES, UNDERGROUND PIPE LINES, ELECTRICAL DUCTBANKS, AND STORM WATER LINES. FINAL ROUTES, DEPTHS, COVERAGE'S, SWEEPS, AND UTILITY AUTHORITY REQUIREMENTS ARE TO BE COORDINATED WITH AUTHORITIES HAVING JURISDICTION PRIOR TO THE START OF ANY AND ALL WORK.

INTERNATIONAL BUILDING CODE.

WHETHER OR NOT SHOWN OR DESCRIBED, WHICH REASONABLY MAY BE INFERRED TO BE REQUIRED OR USEFUL FOR THE COMPLETION OF THE WORK IN ACCORDANCE WITH APPLICABLE LAWS, CODES, AND CUSTOMARY STANDARDS OF THE INDUSTRY.

DOCUMENTS AND ACCEPTABLE TO THE OWNER.

32. EACH CONTRACTOR SHALL FULLY REVIEW THE COMPLETE SET OF CONTRACT DOCUMENTS AS SOME WORK OF EACH CONTRACTOR/TRADE MAY BE SHOWN THROUGHOUT THE DOCUMENTS. CONTRACTORS SHALL SUBMIT COORDINATION DRAWINGS DETAILING THE INTERFACE OF THE MECHANICAL, ELECTRICAL, PLUMBING, AND FIRE PROTECTION WITH THE BUILDING STRUCTURE AT THE BEGINNING OF THE SHOP DRAWING PHASE AND PRIOR TO THE INSTALLATION OF THE WORK AS DETAILED IN THE SPECIFICATIONS.

33. FINISHED GRADE IS TO PROVIDE POSITIVE DRAINAGE AWAY FROM THE BUILDING AND ITS DOORS.

34. ALL CONCEALED FLASHING SHALL BE COPPER OR STAINLESS STEEL (THICKNESS AS SPECIFIED). ALL EXPOSED FLASHING SHALL BE .040" THICK ALUMINUM.

36. BLOCKING: THE GENERAL CONTRACTOR SHALL PROVIDE ALL NECESSARY BLOCKING TO HANG AND SUPPORT ALL FIXTURES, EQUIPMENT AND SYSTEMS AND ACCESSORIES REQUIRED FOR THE JOB REGARDLESS OF WHETHER THE ITEM IS INCLUDED IN THE SCOPE OF WORK OR TO BE PROVIDED BY THE OWNER OR OTHER TRADES.

37. CONTRACTOR SHALL PREVENT MOVEMENT OF STRUCTURE, PROVIDE AND PLACE BRACING AND SUPPORTS OR SHORING AND BE RESPONSIBLE FOR SAFETY AND SUPPORT OF STRUCTURE AND ASSUME LIABILITY FOR SUCH MOVEMENT, SETTLEMENT, DAMAGE, OR INJURY. CONTRACTOR SHALL CEASE OPERATION AND NOTIFY THE OWNER IMMEDIATELY IF SAFETY OF STRUCTURE APPEARS ENDANGERED AND TAKE PRECAUTIONS TO PROPERLY SUPPORT STRUCTURE. DO NOT RESUME OPERATIONS UNTIL SAFETY IS RESTORED.

21. EACH CONTRACTOR SHALL PROVIDE ACCESS PANELS AS REQUIRED FOR THEIR OWN WORK. ACCESS PANELS IN GWB SHALL BE TRIMLESS (W/ CONCEALED FLANGE TO RECEIVE GWB), AS SPECIFIED IN THE ARCHITECTURAL SPECIFICATIONS.

22. DIMENSIONS INDICATED ON FLOOR PLANS FOR STUD PARTITIONS ARE "ACTUAL", AND ARE TO FACE OF STUD. DIMENSIONS INDICATED ON FLOOR PLANS TO C.M.U. WALLS ARE "ACTUAL". DIMENSIONS TO EXTERIOR WALLS ARE TO OUTSIDE FACE OF SHEATHING, TYPICAL UNLESS OTHERWISE NOTED.

MECHANICAL CONTRACTOR SHALL ALLOW SUFFICIENT TIME FOR THE ARCHITECT TO LOCATE EXTERIOR LOUVERS, DIFFUSERS AND EXPOSED DUCTWORK DURING THE COORDINATION &

29. CONTRACTOR SHALL BE RESPONSIBLE TO COORDINATE WITH OWNER'S SPECIAL INSPECTION AGENCY FOR ALL ITEMS REQUIRING INSPECTION AS PER CHAPTER 17 OF THE

30. THE CONTRACTOR ACKNOWLEDGES AND AGREES THAT THE CONTRACT DOCUMENTS ARE SUFFICIENT TO PROVIDE FOR THE COMPLETION OF THE WORK AND INCLUDE WORK,

31. ALL WORK PERFORMED SHALL BE BY EXPERIENCED CRAFTSMEN SKILLED IN THEIR TRADE AS REQUIRED TO COMPLETE THE WORK IN A MANNER CONSISTENT WITH THE CONTRACT

GENERAL REQUIREMENTS

IT IS THE INTENT OF THESE DRAWINGS TO SHOW THE CONSTRUCTION OF ADDITIONS AND ALTERATIONS OF AN EXISTING 1-STORY, XX SQUARE FEET MUNICIPAL BUILDING.

ALL WORK IS TO BE DONE IN ACCORDANCE WITH STATE AND LOCAL CODE REQUIREMENTS

3. ALL WORK SHOWN IS NEW, UNLESS OTHERWISE NOTED.

LOCATIONS PRIOR TO INSTALLATION.

ALL CONTRACTORS SHALL COORDINATE THE INSTALLATION OF THEIR SCOPE OF WORK WITH THE ARCHITECTURAL, MEP, AND STRUCTURAL DOCUMENTS AND DESIGN INTENT. TO THE EXTENT THAT CONFLICTS ARISE, THE CONTRACTORS SHALL IDENTIFY ANY CONFLICTS BETWEEN THE DESIGN, DESIGN INTENT, AND THEIR SCOPE OF WORK PRIOR TO FABRICATING OR ATTEMPTING THE INSTALLATION OF WORK SO THAT SUCH CONFLICT(S) CAN BE RESOLVED WITHOUT DISRUPTION OF THE WORK PROGRESS. ANY SUCH CONFLICTS ARE TO BE REPORTED TO THE ARCHITECT DURING THE COORDINATION DRAWING PROCESS OR EARLIER.

IT SHALL BE THE RESPONSIBILITY OF THE PLUMBING, MECHANICAL, FIRE PROTECTION, AND ELECTRICAL CONTRACTORS TO MEET OR EXCEED THE REQUIREMENTS OF THE APPLICABLE GOVERNING CODES & TO COORDINATE THEIR WORK WITH THE ARCHITECTURAL / STRUCTURAL DRAWINGS WHICH ARE PROPRIETARY. THE GENERAL CONTRACTOR SHALL NOTIFY THE ARCHITECT OF ANY CONFLICTS.

. NO PRODUCTS CONTAINING ASBESTOS OR OTHER HAZARDOUS MATERIAL SHALL BE INSTALLED ON THIS PROJECT OR USED DURING THE CONSTRUCTION OF THE PROJECT.

THE CONTRACTORS ARE TO PROVIDE FIELD ENGINEERING SERVICES AS REQUIRED FOR PROPER COMPLETION OF THE WORK INCLUDING, BUT NOT LIMITED TO, THE FOLLOWING: A. ESTABLISHING AND MAINTAINING LINES, LEVELS, ELEVATIONS, LAYOUTS, STAKES, ETC.

B. STRUCTURAL DESIGN OF SHORES, FORMS, ANCHORS, SUPPORTS, OR SIMILAR

ITEMS AS PART OF THE CONTRACTORS MEANS AND METHODS OF CONSTRUCTION.

. ALL FIXTURES AND APPLIANCES REQUIRING PLUMBING OF ANY KIND, INCLUDING BUT NOT LIMITED TO HOT AND COLD WATER SUPPLY AND DRAINAGE OR VENTING, SHOWN IN THE

CONTRACT DOCUMENTS ARE TO BE PLUMBED BY THE PLUMBING CONTRACTOR REGARDLESS OF WHETHER THE ITEMS OR PLUMBING FIXTURES ARE SHOWN ON THE PLUMBING DRAWINGS.

ELECTRICAL: ALL DEVICES REQUIRING POWER, WIRING, OR GROUNDING SHOWN IN THE CONTRACT DOCUMENTS, ARE TO BE WIRED BY THE ELECTRICAL CONTRACTOR REGARDLESS OF WHETHER THE ITEM IS SPECIFICALLY SHOWN ON THE ELECTRICAL DRAWINGS. CONSULT THE ELECTRICAL ENGINEER FOR ANY ITEM NOT SHOWN ON CIRCUIT PANEL SCHEDULES FOR FINAL ROUTING. NO CHANGE ORDERS WILL BE APPROVED FOR ITEMS SHOWN IN THE CONTRACT DOCUMENTS THAT WERE NOT ACCOUNTED FOR BY THE ELECTRICAL CONTRACTOR REGARDLESS WHERE THE ITEMS ARE LOCATED IN THE CONTRACT DOCUMENTS.

0. CONTRACTOR SHALL PROVIDE CONSTRUCTION FACILITIES AND TEMPORARY UTILITIES SUCH AS: HEAT, WATER, ELECTRICITY, TELEPHONE, SANITARY FACILITIES, ENCLOSURES, TARPAULINS, BARRICADES, CANOPIES, AND TEMPORARY FENCING AS REQUIRED TO PROTECT THE SITE, THE PUBLIC, AND THE USER OF THE BUILDING, AS REQUIRED AND OUTLINED IN THE

I. THE RISK OF LOSS OF ITEMS STORED ON THE SITE SHALL BE EACH CONTRACTORS RESPONSIBILITY. THE CONTRACTORS SHALL PROVIDE THE APPROPRIATE INSURANCE COVERAGE TO MEET THE ABOVE REQUIREMENTS

12. THE CONTRACTORS SHALL PROCURE AND OBTAIN ALL THE NECESSARY PERMITS AND/OR APPROVALS EXCEPT FOR LAND DEVELOPMENT APPROVAL

CONTRACTOR SHALL ADHERE TO THE MORE STRINGENT REQUIREMENT UNLESS DIRECTED OTHERWISE BY THE ARCHITECT.

I3. ANY ITEM NOT COMPATIBLE WITH THE SUBSTRATE SHALL BE ISOLATED AS PER MANUFACTURERS' RECOMMENDATIONS.

14. ELECTRICAL CONTRACTOR SHALL SUPPLY & INSTALL EMERGENCY LIGHTING & EXIT SIGNS AS REQUIRED BY CODE AND IN ALL LOCATIONS APPROVED BY THE FIRE MARSHALL. CONTRACTOR SHALL REVIEW LOCATIONS WITH CODE OFFICIAL/FIRE MARSHALL PRIOR TO INSTALLATION.


I5. CONTRACTOR SHALL COORDINATE INSTALLATION OF ALL SITE UTILITIES WITH LOCAL AUTHORITIES AND UTILITY PROVIDERS PRIOR TO BEGINNING ANY WORK


16. FIRE STOPPING IS REQUIRED AT ALL PENETRATIONS THROUGH RATED ASSEMBLIES. FIRE STOPPING LOCATIONS ARE NOT INDICATED ON THE DRAWINGS. EACH PRIME CONTRACTOR SHALL PROVIDE FIRE-STOPPING FOR THEIR OWN WORK.


8. THESE DRAWINGS SHALL BE USED IN CONJUNCTION WITH THE WRITTEN BOOK FORMAT SPECIFICATIONS PREPARED FOR THIS PROJECT. THE CONTRACTORS SHALL NOTIFY THE ARCHITECT OF ANY CONFLICTS BETWEEN THE SPECIFICATIONS AND THE DRAWINGS PRIOR TO RECEIPT OF BID. SHOULD ANY CONFLICT BE DISCOVERED DURING CONSTRUCTION, THE


7. FIRE EXTINGUISHERS, EMERGENCY LIGHTS, EXIT SIGNS, PULL STATIONS, AND SMOKE DETECTORS: CONTACT THE GOVERNING INSPECTOR/OFFICIAL AND COORDINATE ALL FINAL

DRAWING SYMBOLS

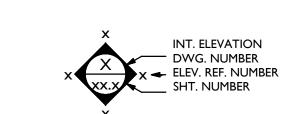

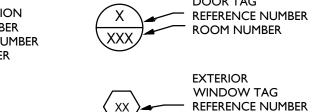

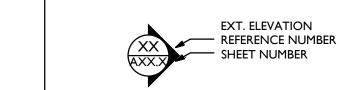


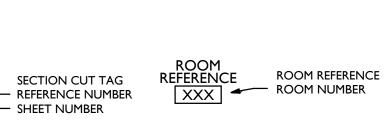



INTERIOR


XX REFERENCE NUMBER

WINDOW TAG

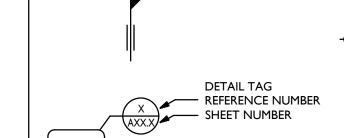

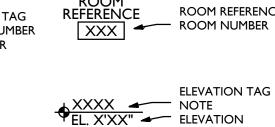

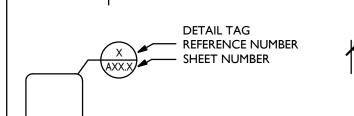

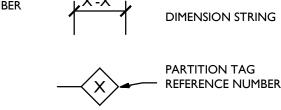

Codes Reviewed:

I) International Building Code 2015

2) American National Standard ANSI A117.1-2009

Proposed Building:

Existing building is a I story approximately 5,700 square feet with partial basement. Existing building is constructed of wood floor, CMU exterior bearing walls and wood trusses. Approximately 4,600 square foot proposed addition will be slab on grade, metal stud exterior bearing walls and wood trusses. As per township ordinance the entire building will have a sprinkler system.

Proposed Construction (Addition):

Slab on grade. Metal stud exterior walls. Wood truss roof.

Building Size:

Existing Basement: 3,200 sf
Existing First Floor: 5,700 sf
Proposed Additions: 4,200 sf
Total First Floor: 9,900 sf


Occupancy:

Public Meeting Room: 1,540 sf / 7 sf per person (net) = 165 people Lobby, Offices, Bathrooms, Storage: 7,575 sf / 100 sf per person (gross) = 76 people Basement Storage / Mechanical: 3,200 sf / 300 sf per person (gross) = 11 people


Total Building Occupant Load = 252 people

I) International Building Code 2018

Section	Heading	Remarks								
302.1	Bldg Class	Use Group:								
		Group B – Civic Administration								
		Group A3 – Public Meeting Room								
Table 506.2	Building	Use Group B -Type 5B construction – I story, sprinkler, 36,000 SF								
	Height and	Actual square footage proposed: 7,575 sf								
	Area	Use Group A3 -Type 5B construction –I story, sprinkler, 24,000 SF								
	7 0	Actual square footage proposed: 1,540 sf								
508.3.2	Non-	Non separated occupancies shall be individually classified per 302.1. The								
	Separated	allowable building area and height shall be based on the most restrictive								
	Occupancies	allowances for the occupancy groups.								
	- Companions	Note: A3 is the most restrictive group								
508.3.3	Separation	No separation is required between non separated occupancies								
Table 509	Incidental Use									
14510 307	Areas	The arm containing in a painips of made and sprinkler system.								
603	Type V	Structural elements, exterior walls and interior walls are of any material								
003	Construction	permitted by code								
Table 601	Fire	Bldg Element Type VB								
	resistance	Primary Structural frame including 0								
	ratings of	Bearing Walls: exterior 0								
	structure	Interior 0								
	elements	Floor construction 0								
		Roof Construction 0								
Table 718.4	Draftstopping	In combustible construction draftstopping shall be installed to subdivide attics.								
14516 7 1 5.1	in Attics	Draftstopping required every 3,000 sf								
	, 100.00	Exception: draftstopping not required with sprinkler system								
803.1.1	Interior	Class A flame spread 0-25, smoke developed 0-450								
	Finish	Class B flame spread 26-75, smoke developed 0-150								
		Class C flame spread 76-200, smoke developed 0-450								
Table 803.11	Interior Finish									
		Vertical exits and exit passage ways B B								
		Exit access corridors B C								
		Rooms and enclosed spaces C C								
903.2.1.3	Sprinklers	Required where one of the following exists								
	Group A-3	I. Fire area exceeds 12,000 SF								
	C. Gup 7 . G	2. Fire area has an occupant load of 300 or more								
		Note: Sprinkler System Provided as per Ordinance								
903.2.2	Sprinklers	Sprinkler only required in Group B for ambulatory health care facilities								
	Group B	Note: Sprinkler System Provided as per Ordinance								
906.1	Portable Fire	As require by fire marshal. Typical at all exits and in labs with open flames.								
	Extinguishers	7 - 1 - 7 - 1 - 1 - 1 - 1 - 1 - 1 - 1 -								
907.2	Fire Alarm &	For A3 and B manual fire alarm NOT required, sprinkler system installed.								
· • · · · ·	detection	1. 5. 7.5 and 5 mandar me diarmines in equilibrial of sprinker system medical								
	systems									
912	FD	Required. Locate as directed by the Township								
/ 1 4	Connection	Troquired. Locate as directed by the Township								
1003.2	Ceiling Ht.	Means of Egress to have 7'-6" min. ceiling ht.								
1003.2	Cennig i it.	I I ICALIS OI LESI ESS LO HAVE / -O HIIIII. CEIIIII HIL.								

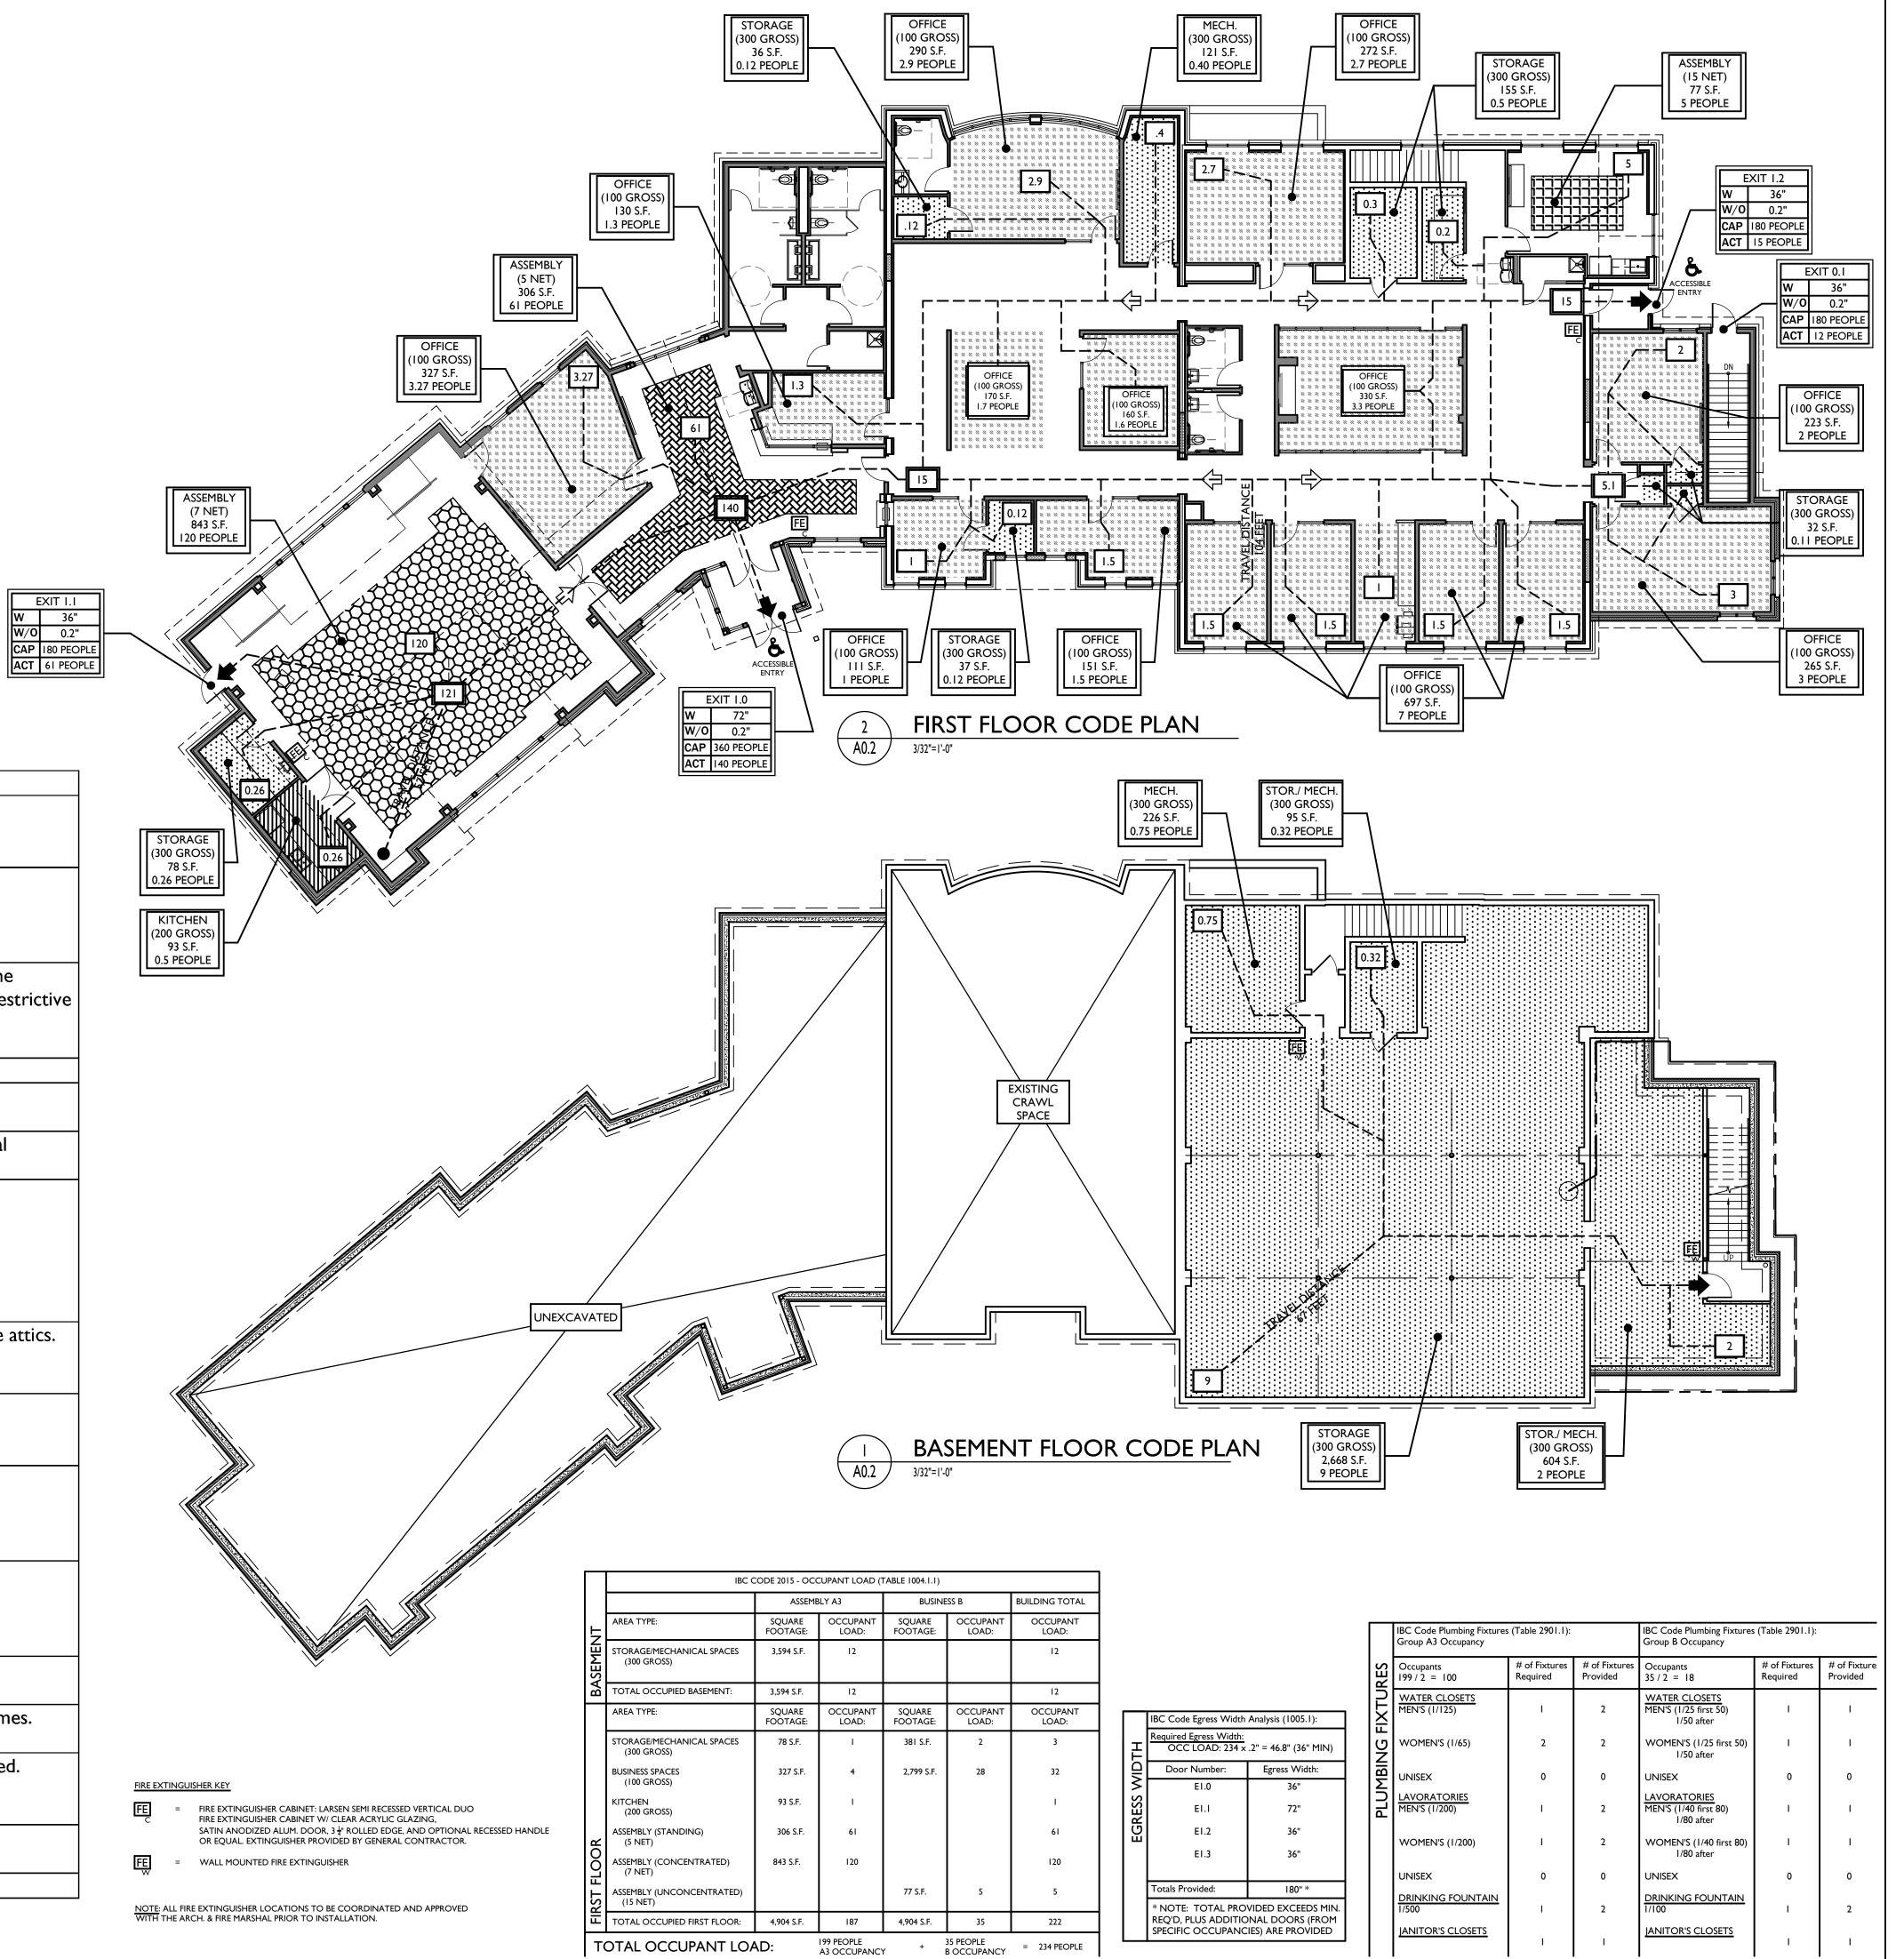


BUILDING RD TOWNSHIP

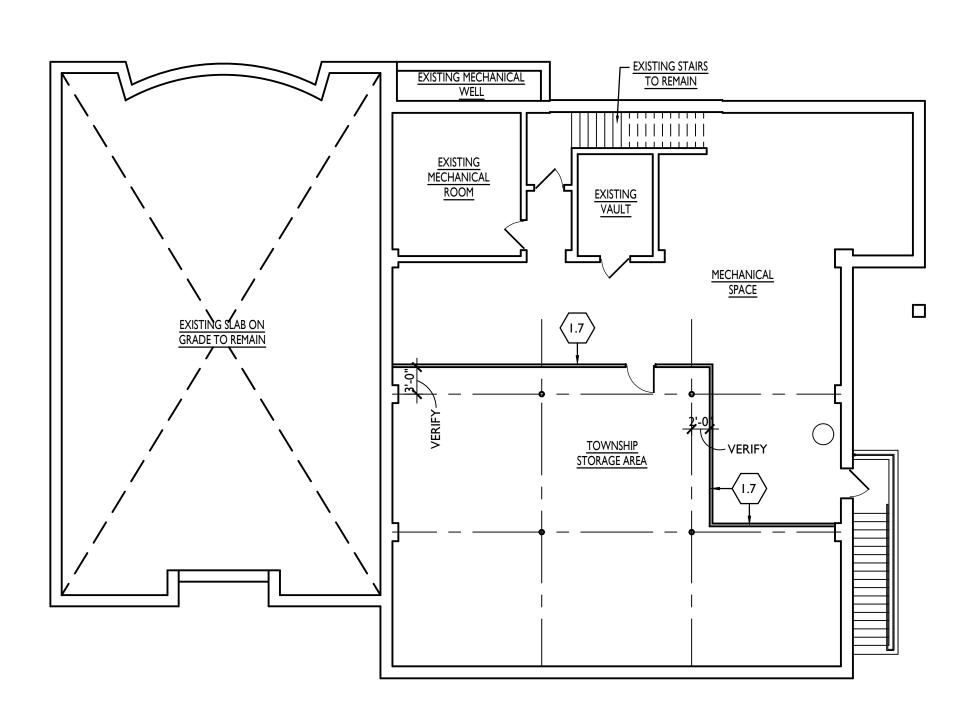

PHASE I: BASEMENT PLAN

3/32"=1'-0"

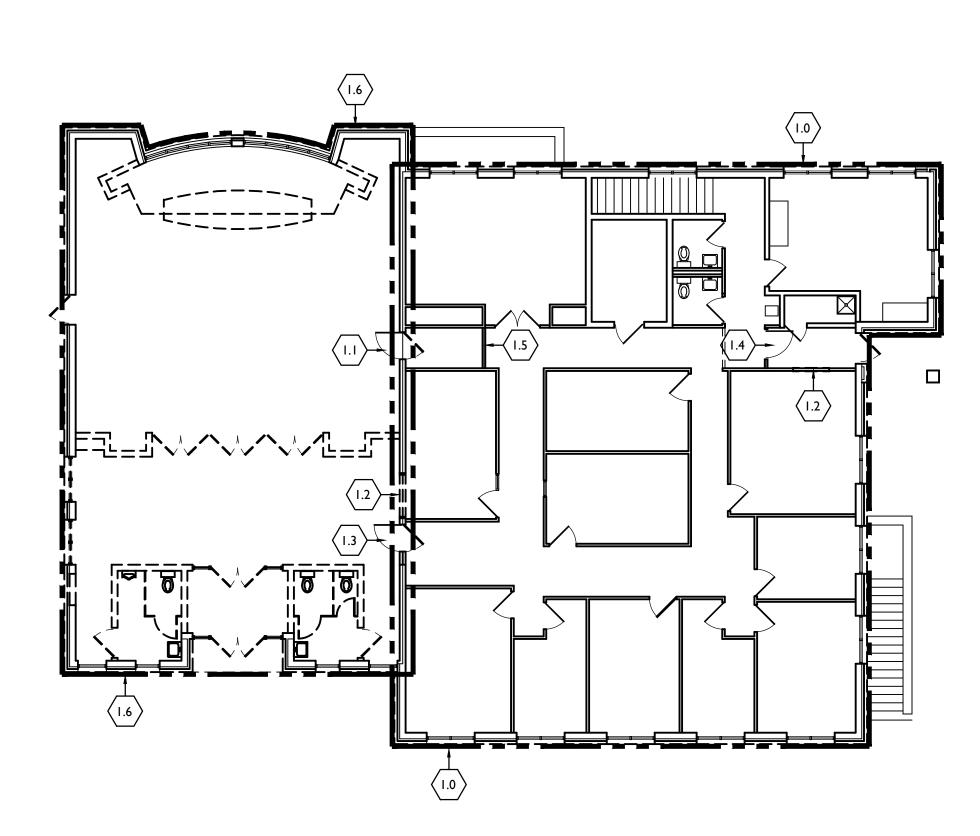

PHASE I: FIRST FLOOR PLAN 3/32"=1'-0"

PHASE I SPECIFIC NOTES:

I.0: THE TOWNSHIP ADMINISTRATION WILL OCCUPY THIS ARA DURING THE INITIAL CONSTRUCTION PHASES. CONTRACTORS ARE TO MAINTAIN ALL UTILITIES AND SERVICES TO THE SPACE DURING CONSTRUCTION.

I.I: REMOVE EXISTING INTERIOR DOOR AND REPLACE WITH TEMPORARY EXTERIOR GRADE INSULATED DOOR FOR CONTRACTOR USE.

I.2: REMOVE EXISTING RECEPTION WALK UP WINDOW AND MAILBOX CASEWORK. CUT OUT WALL AND REINSTALL AS REQUIRED FOR TEMPORARY RECEPTION AREA WHERE SHOWN.


I.3: REMOVE EXISTING INTERIOR DOOR AND REPLACE WITH A TEMPORARY EXTERIOR GRADE INSULATED DOOR WITH EXTERIOR LOCK, PANIC DEVICE AND CLOSER FOR TOWNSHIP USE.

1.4: RELOCATE EXISTING INTERIOR ACCESS CONTROL DOOR (ITEM 1.3) TO THE LOCATION NOTED AND RECONNECT ACCESS CONTROL DEVICES.

I.5: CONSTRUCT A TEMPORARY FLOOR TO CEILING METAL STUD AND DRYWALL PARTITION TO CREATE AN ACCESS SPACE TO THE EXISTING MECHANICAL CHASE.

I.6: DEMOLISH THE EXISTING LOBBY, BATHROOMS AND PUBLIC MEETING ROOM AS REQUIRED FOR THE NEW CONSTRUCTION.

I.7: PROVIDE TEMPORARY FLOOR TO CEILING METAL STUD AND DRYWALL PARTITION WITH TEMPORARY 3'-0" X 7'-0" HOLLOW METAL DOOR AND FRAME WITH STORAGE LOCKSET, TO CREATE TOWNSHIP STORAGE AREA. COORDINATE NEW UTILITIES AS REQUIRED. REMOVE TEMPORARY WALLS AT THE END OF THE PROJECT.

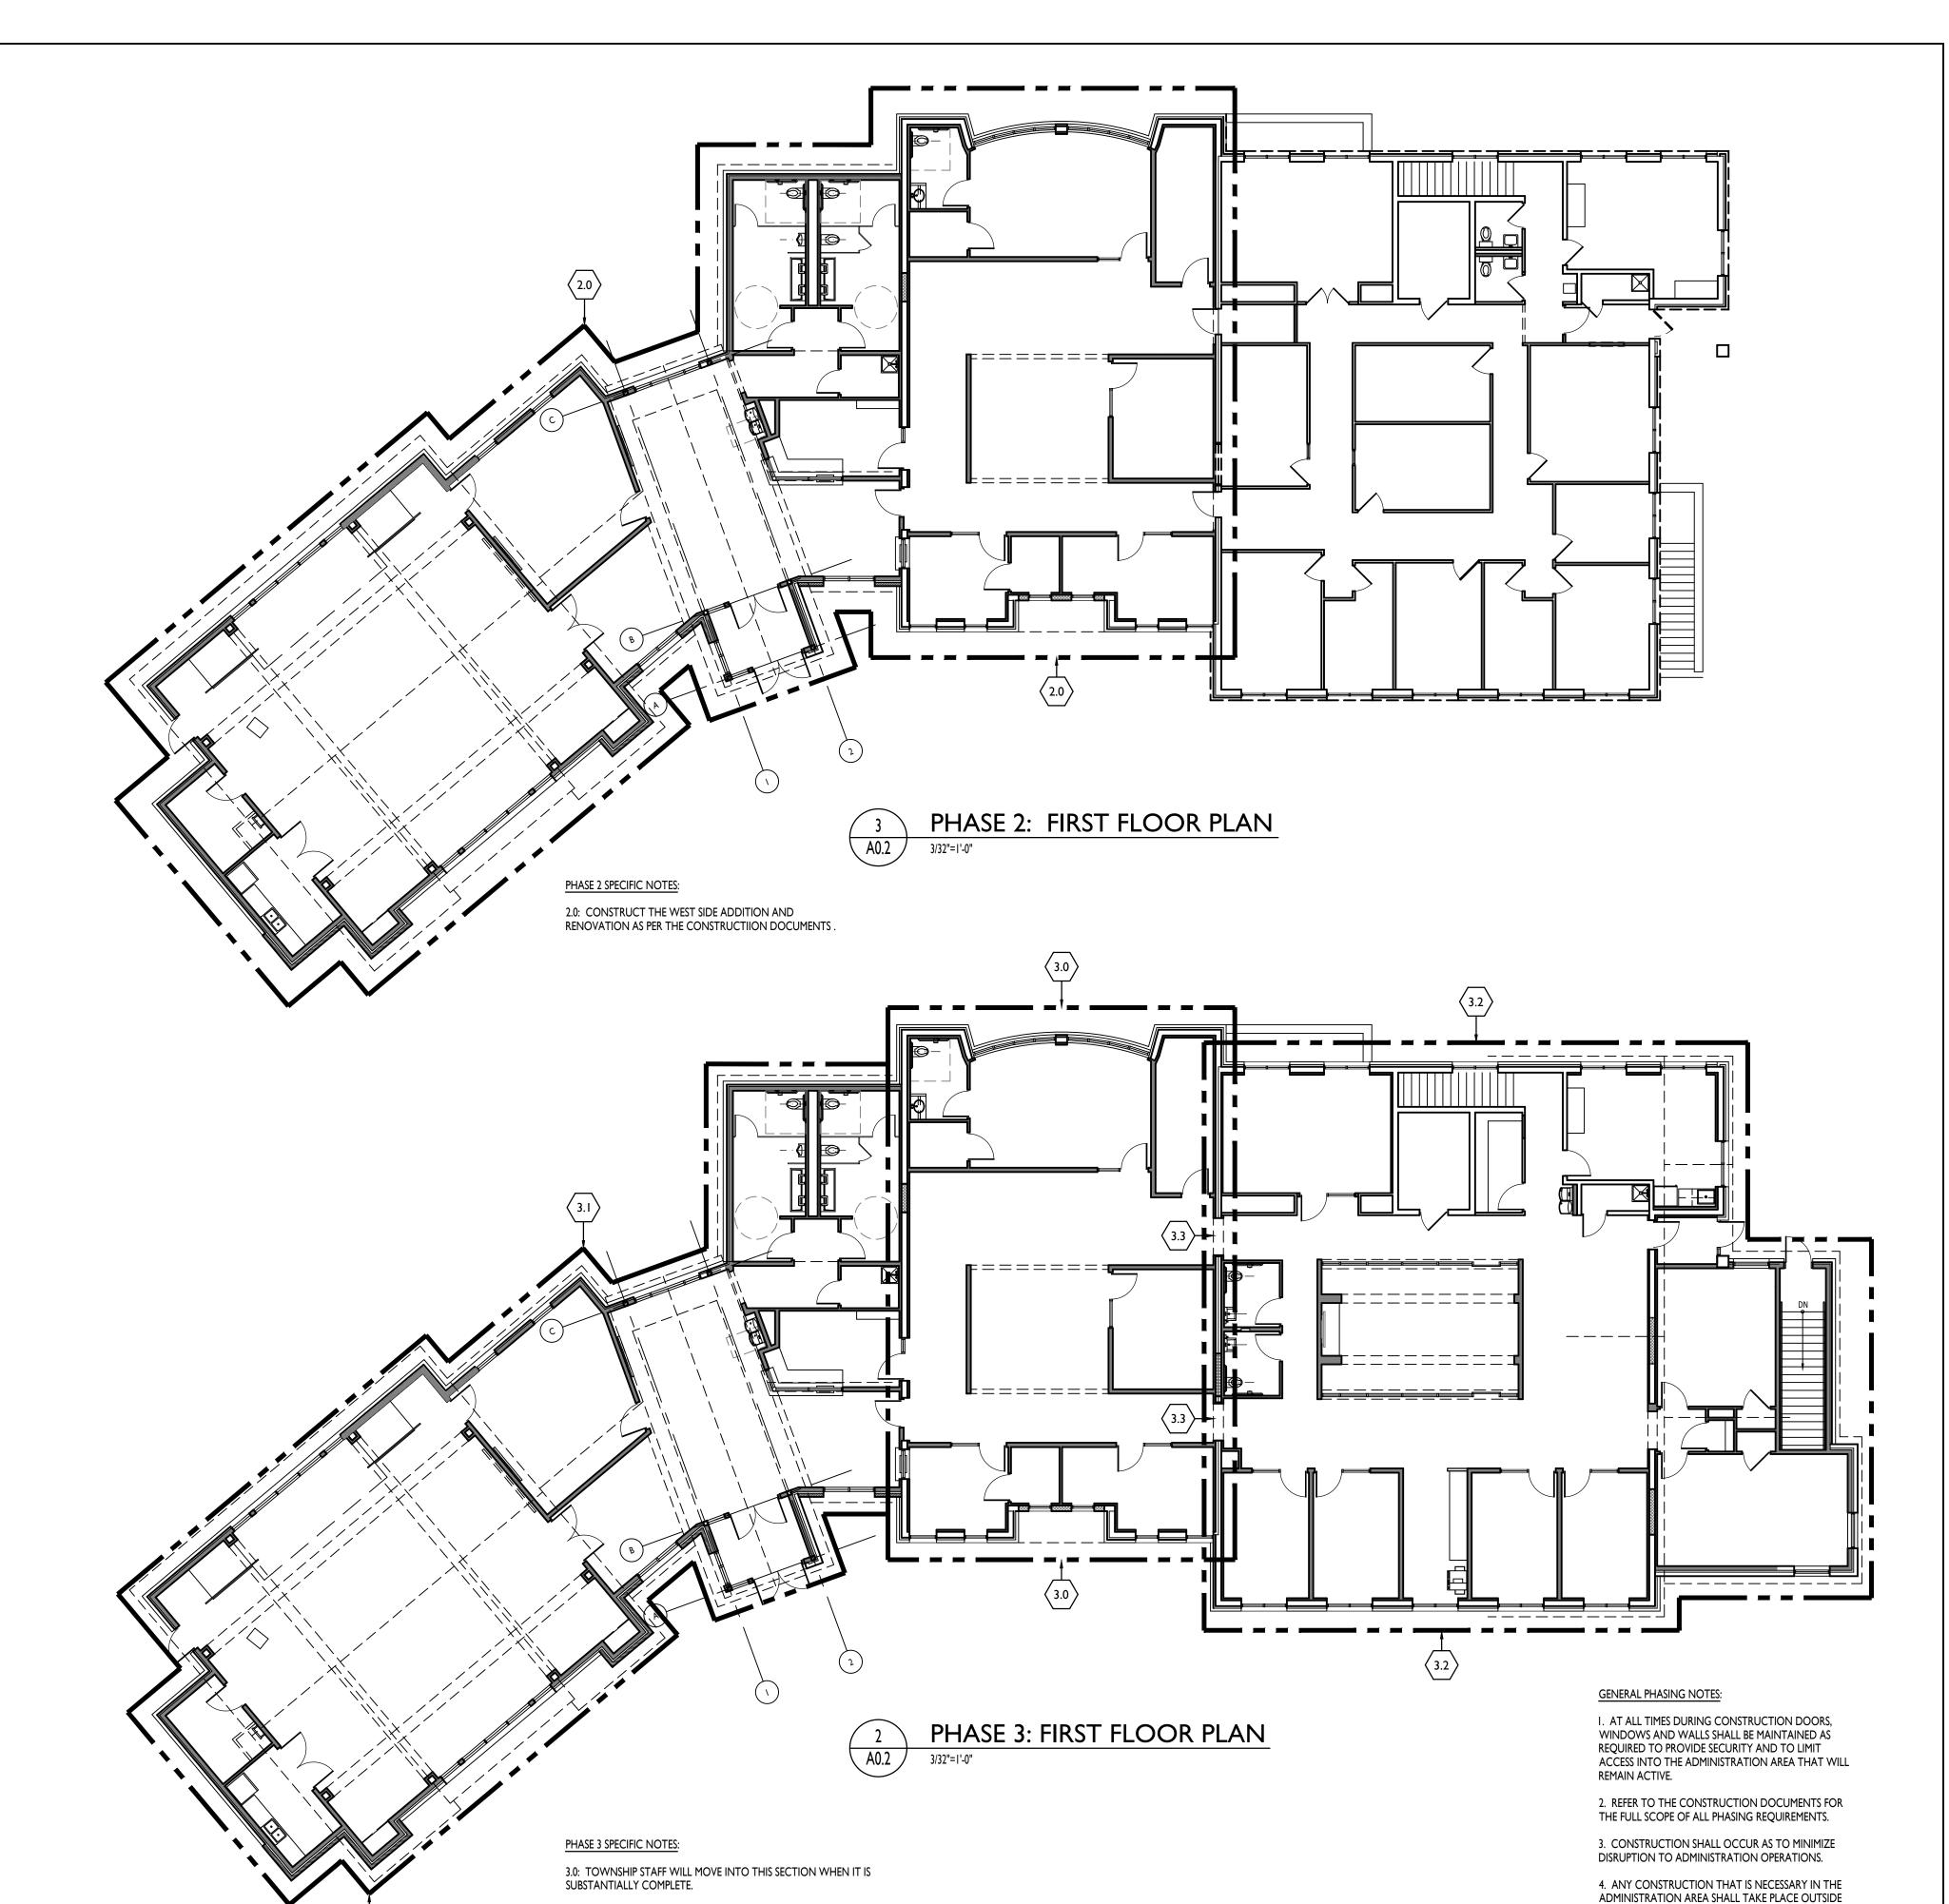

3.1: TOWNSHIP WILL UTILIZE THIS SECTION WHEN SUBSTANTIALLY

ADDITION AND RENOVATIONS.

EXISTING ADJACENT CONSTRUCTION.

3.2: DEMOLISH EXISTING ADMINISTRATION AREA AS REQUIRED FOR THE NEW

CONSTRUCTION. CONSTRUCT NEW EAST SIDE BASEMENT AND FIRST FLOOR

3.3: MAINTAIN EXISTING BARRIERS UNTIL EAST SIDE ADDITIONS AND RENOVATIONS ARE COMPLETE AND THEN REMOVE AND PATCH TO MATCH

ANY REQUIRED OFFICE TRAILERS FOR TOWNSHIP STAFF WILL BE PROVIDED

AND INSTALLED BY THE TOWNSHIP INCLUDING ALL UTILITIES.

Blue Bell, PA 19422
Facsimile: 610.834.7815
E, INC. ALL RIGHTS RESERVED

hitecture +
ad, Suite 200 Bl

482 Norristown Road, Suite Phone: 610.834.7805

AL BUILDING ORD TOWNSHIP

WEST BRADFORD T 1385 CAMPUS DE WEST BRADFORD, F

rawn By: TM, YP
hecked By: JT
ale: AS NOTED

HASING PLANS
Revisions:

AG

MREVISED DURING BIDDING

Progress Prints:

N/15/20 ISSUED FOR BIDDING

/26/21 FOR CONSTRUCTION

| REVISED | REV

A0.2

OF REGULAR TOWNSHIP BUSINESS HOURS OR BE

AFTER COMPLETION OF THE WORK.

TO THE START OF WORK.

FOR COMPLETE SCOPE OF WORK.

COORDINATED IN ADVANCE WITH THE TOWNSHIP.
SPACES SHALL BE FULLY FUNCTIONAL AND CLEAN

5. PRIME CONTRACTORS TO HOLD A PHASING MEETING WITH THE OWNER AND ARCHITECT PRIOR

GENERAL GUIDELINE FOR PHASING ON THE PROJECT AND MAY BE MODIFIED BY THE PRIME CONTRACTORS


WITH APPROVAL FROM THE OWNER AND ARCHITECT.

ALL CONSTRUCTION SCOPE IS NOT SHOWN IN THE

PHASING PLANS. SEE THE CONTRACT DOCUMENTS

6. THE PROVIDED PLANS ARE TO TO PROVIDE A



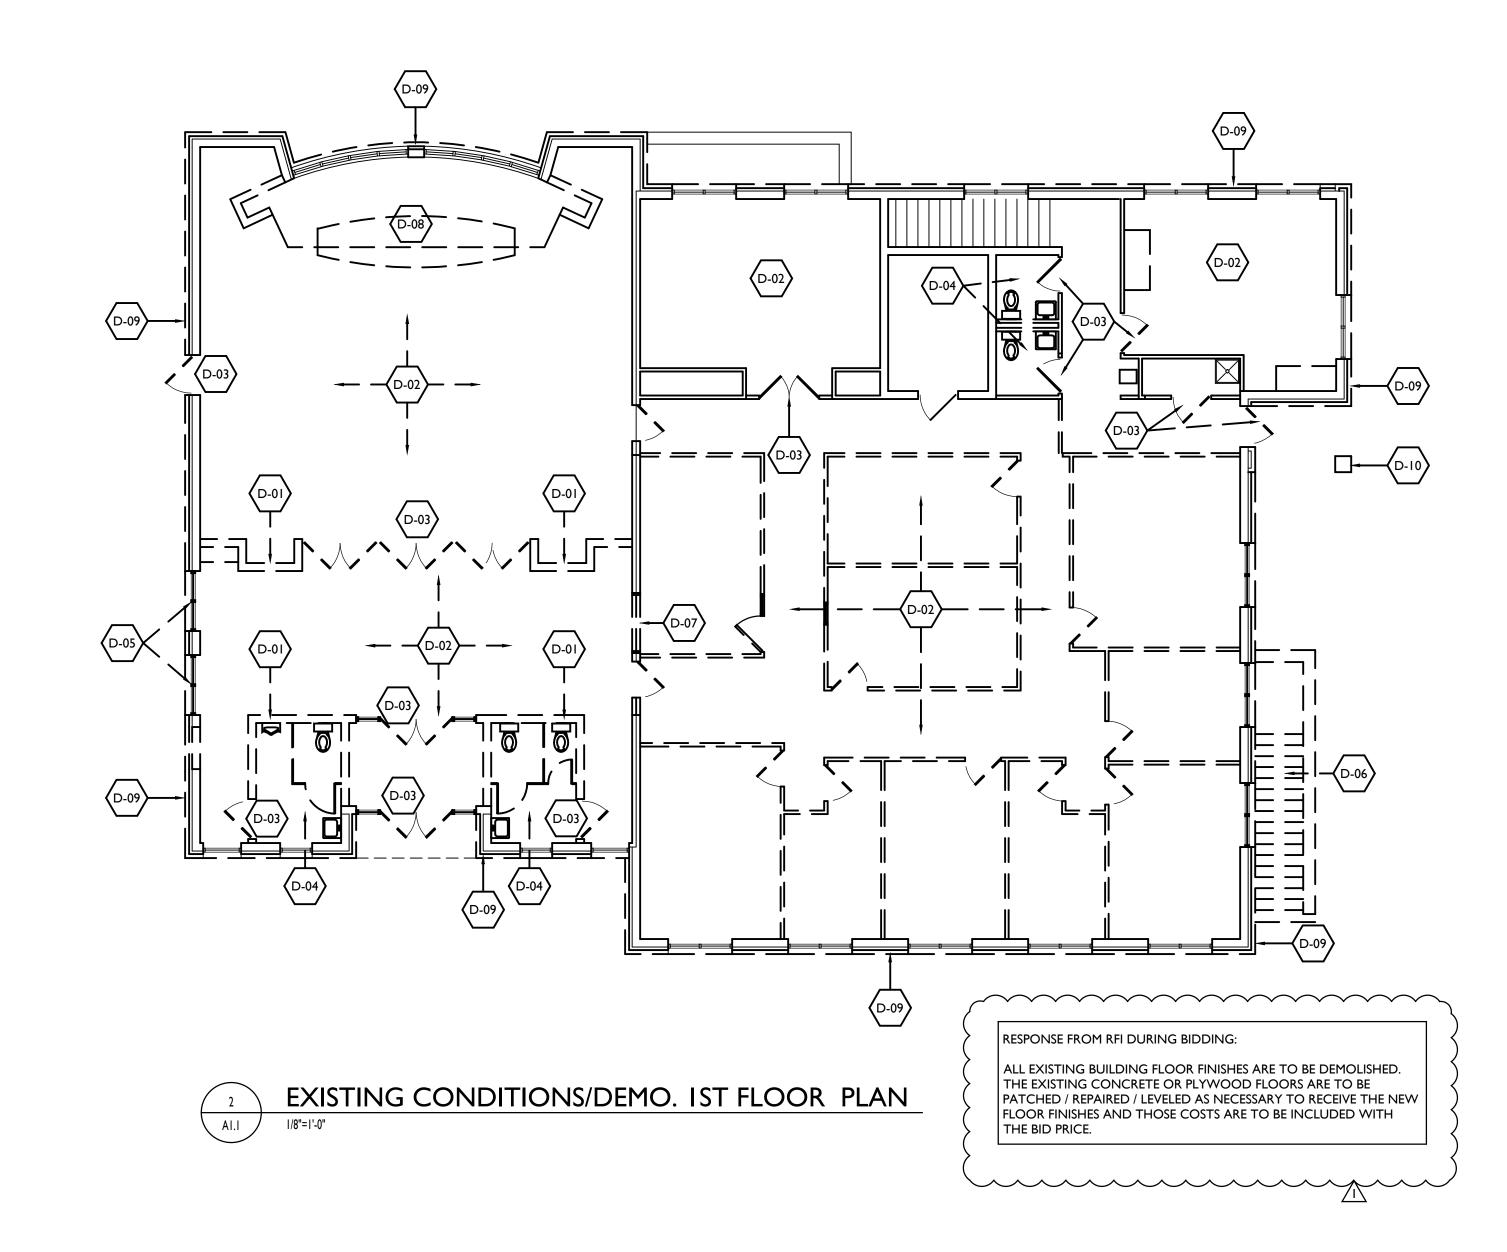

ALL DEMOLITION WORK TO BE PERFORMED IN STRICT SPECIFIC DEMOLITION NOTES ACCORDANCE WITH CURRENT OSHA REQUIREMENTS

- TYPICAL: REMOVE ALL INTERIOR PARTITIONS
 AS INDICATED; SCOPE TO INCLUDE: • REMOVE PARTITION INCLUDING FRAMING, SHEATHING AND FINISHES. • BUILT-IN ITEMS SUCH AS DOORS, SWITCHES, OUTLETS AND SIMILAR ITEMS. • REFER TO ENGINEERING DRAWINGS REGARDING DISCONNECT AND REMOVAL OF ELECTRICAL AND MECHANICAL
- TYPICAL: REMOVE ALL EXISTING SUSPENDED CEILINGS, INCLUDING CEILING GRID AND TILE AND LIGHT FIXTURES, INCLUDING: BUILT-IN ITEMS SUCH AS SMOKE AND HEAT DETECTORS SPEAKERS, AND SIMILAR DEVICES - SEE MECHANICAL AND ELECTRICAL DRAWINGS REGARDING SPECIFIC DEMOLITION REQUIREMENTS.
- REMOVE EXISTING DOOR AND FRAME AS INDICATED.

- REMOVE EXISTING PLUMBING FIXTURES (TOILET, SINK, ETC), INCLUDING ACCESSORIES; SEE ENGINEERING DRAWINGS REGARDING MODIFICATION / REMOVAL OF SERVICES; PATCH WALLS AND FLOORS AS REQUIRED; PREPARE FOR PROPOSED NEW FINISHES.
- REMOVE EXISTING WINDOW AND CUT NEW OPENING IN EXISTING EXTERIOR WALL AS REQUIRED FOR NEW SCHEDULED DOOR AND SIDELIGHT; PROVIDE TEMPORARY SHORING AS REQUIRED.
- REMOVE EXISTING STAIR CONSTRUCTION IN ITS ENTIRETY, i.e.: MASONRY WALLS, CONCRETE STEPS AND ANY EXISTING FINISHES THAT WILL BE EXPOSED IN THE NEW BASEMENT.
- REMOVE EXISTING INTERIOR WINDOW, SALVAGE SPEAKER FOR RE-USE IN NEW RECEPTION WINDOW.

- GENERAL CONTRACTOR TO CAREFULLY REMOVE EXISTING DAIS AND STORE IN SAFE PLACE FOR RE-INSTALLATION IN THE NEW PUBLIC MEETING ROOM LOCATION.
- REMOVE EXISTING SPLIT FACE MASONRY WATER TABLE DOWN TO FOUNDATION, INSTALL NEW MASONRY VENEER AS PER SPECIFICATIONS, ELEVATIONS & DETAILS.
- REMOVE EXISTING MASONRY PIER AND RE-SUPPORT ROOF AS REQUIRED UNTIL NEW SUPPORT WALLS ARE CONSTRUCTED.

GENERAL DEMOLITION NOTES

I. DEMOLITION PLANS SHOW THE APPROXIMATE LAYOUT OF THE EXISTING BUILDING AND ARE NOT INTENDED TO REPRESENT "AS BUILT" CONDITIONS.

2. PARTITIONS SHOWN TO BE REMOVED ARE TO BE REMOVED IN THEIR ENTIRETY FROM FLOOR TO STRUCTURE ABOVE, EXCEPT WHERE NOTED OTHERWISE. REMOVE OR RELOCATE ALL EQUIPMENT, FIXTURES OR FURNISHINGS, AND ACCESSORIES ON THE PARTITION OR WALL. EDGES OF WALLS TO REMAIN SHALL BE SAW CUT OR CLEANLY TOOTHED TO ACCEPT NEW CONSTRUCTION. REPAIR AND PATCH EXISTING WALLS AND PARTITIONS TO REMAIN WHERE INTERSECTING PARTITIONS, WINDOWS, DOORS, FRAMES, ETC. ARE TO BE REMOVED AND WHERE EXISTING CONSTRUCTION WILL NOT BE COVERED UP WITH NEW CONSTRUCTION.

3. DOORS TO BE REMOVED ARE SHOWN DASHED. EXCEPT WHERE NOTED OTHERWISE, REMOVE DOOR, FRAME, AND HARDWARE IN THEIR ENTIRETY. PREPARE OPENING THAT REMAINS FOR INFILL WORK OR FOR NEW DOOR AND FRAME WHERE NEW DOOR IS SCHEDULED.

4. WHERE FINISHES ARE TO BE REMOVED FROM EXISTING CONSTRUCTION TO REMAIN (E.G., FLOOR, CEILINGS, WALLS, ETC.), PATCH REMAINING SUBSTRATE AND PREPARE REMAINING SUBSTRATE AS REQUIRED FOR NEW FINISH. ALL FINISHES SHALL BE REMOVED UNLESS NOTED OTHERWISE.

5. CONTRACTOR SHALL CAREFULLY PROTECT ALL CONSTRUCTION TO REMAIN. ANY DAMAGE WILL BE REPAIRED AS REQUIRED TO MATCH EXISTING AND/OR NEW

CONDITIONS WITHOUT ADDITIONAL COST TO THE OWNER. 6. CONSULT WITH THE OWNER REGARDING ANY ITEMS TO BE SALVAGED FOR REUSE BY THE OWNER. ALL SUCH SALVAGEABLE ITEMS ARE TO BE REMOVED WITH CARE AND SET ASIDE IN A DESIGNATED AREA. ALL OTHER ITEMS SHALL BE PROMPTLY REMOVED FROM THE SITE IN ACCORDANCE WITH THESE PLANS.

7. IT IS MANDATORY THAT ALL DEMOLITION AND REMOVAL OPERATIONS PERFORMED BE CAREFULLY AND CONTINUOUSLY COORDINATED WITH THE PROJECTS REQUIREMENTS.

8. PROVIDE SHORING, BRACING, CHUTES, SCAFFOLDING, BARRICADES, TEMPORARY PARTITIONS AND DOORS, DUST ENCLOSURES, SAFETY AND SECURITY DEVICES AS REQUIRED FOR THE SAFE AND PROPER EXECUTION OF THE WORK.

9. SUBJECT TO APPROVAL BY OWNER, ITEMS OF SALVAGEABLE VALUE TO THE CONTRACTOR MAY BE REMOVED FROM THE STRUCTURE AS THE WORK PROGRESSES. SALVAGED ITEMS MUST BE TRANSPORTED FROM THE SITE AS THEY ARE REMOVED. STORAGE OR SALE

OF REMOVED ITEMS ON THE SITE WILL NOT BE PERMITTED.

10. REFER TO WRITTEN SPECIFICATIONS, MECHANICAL, ELECTRICAL 16. TRANSPORT ALL MATERIALS REMOVED FROM DEMOLISHED AND PLUMBING DEMOLITION PLANS FOR ADDITIONAL DEMOLITION REQUIREMENTS.

II. CONDUCT DEMOLITION OPERATIONS AND THE REMOVAL OF DEBRIS TO ENSURE MINIMUM INTERFERENCE WITH STREETS, WALKS, PEDESTRIAN TRAFFIC AND OTHER ADJACENT OCCUPIED OR USED FACILITIES. DO NOT CLOSE OR OBSTRUCT STREETS, WALKS, OR OTHER OCCUPIED OR USED FACILITIES WITHOUT PERMISSION FROM THE OWNER. PROVIDE ALTERNATE ROUTES AROUND CLOSED OR OBSTRUCTED TRAFFIC WAYS IF REQUIRED BY GOVERNING REGULATIONS. COORDINATE ALL WORK WITH PROPER OFFICIALS

OF THE OWNER. 12. PROVIDE COVERED PASSAGEWAYS TO ENSURE THE SAFE PASSAGE OF PERSONS AROUND THE AREA OF DEMOLITION. CONDUCT OPERATIONS TO PREVENT DAMAGE BY FALLING DEBRIS OR OTHER CAUSE TO ADJACENT FACILITIES AS WELL AS PERSONS.

13. MAINTAIN EXISTING UTILITIES, INDICATED TO REMAIN, KEEP IN SERVICE, AND PROTECT AGAINST DAMAGE DURING DEMOLITION OPERATIONS.

14. CLEAN ADJACENT STRUCTURES AND IMPROVEMENTS OF ALL DUST, DIRT, AND DEBRIS CAUSED BY DEMOLITION OPERATIONS. RETURN AREAS TO EXISTING CONDITION PRIOR TO THE START OF

15. BURNING OF REMOVED MATERIALS FROM DEMOLISHED WORK WILL NOT BE PERMITTED ON THE SITE.


STRUCTURES AND LEGALLY DISPOSE OF OFF THE SITE.


DEMOLITION LEGEND:							
	EXISTING WALLS AND ACCESSORIES TO REMAIN						
====	EXISTING WALLS AND ACCESSORIES TO BE REMOVED						
	EXISTING DOOR AND FRAME TO REMAIN						
	EXISTING DOOR AND FRAME TO BE REMOVED						
	EXISTING WINDOWS TO REMAIN						
	EXISTING WINDOWS TO BE						

REMOVED

DEMOLITION

MUNCIPAL B ST BRADFORI 1385 CAMPU WEST BRADFOR

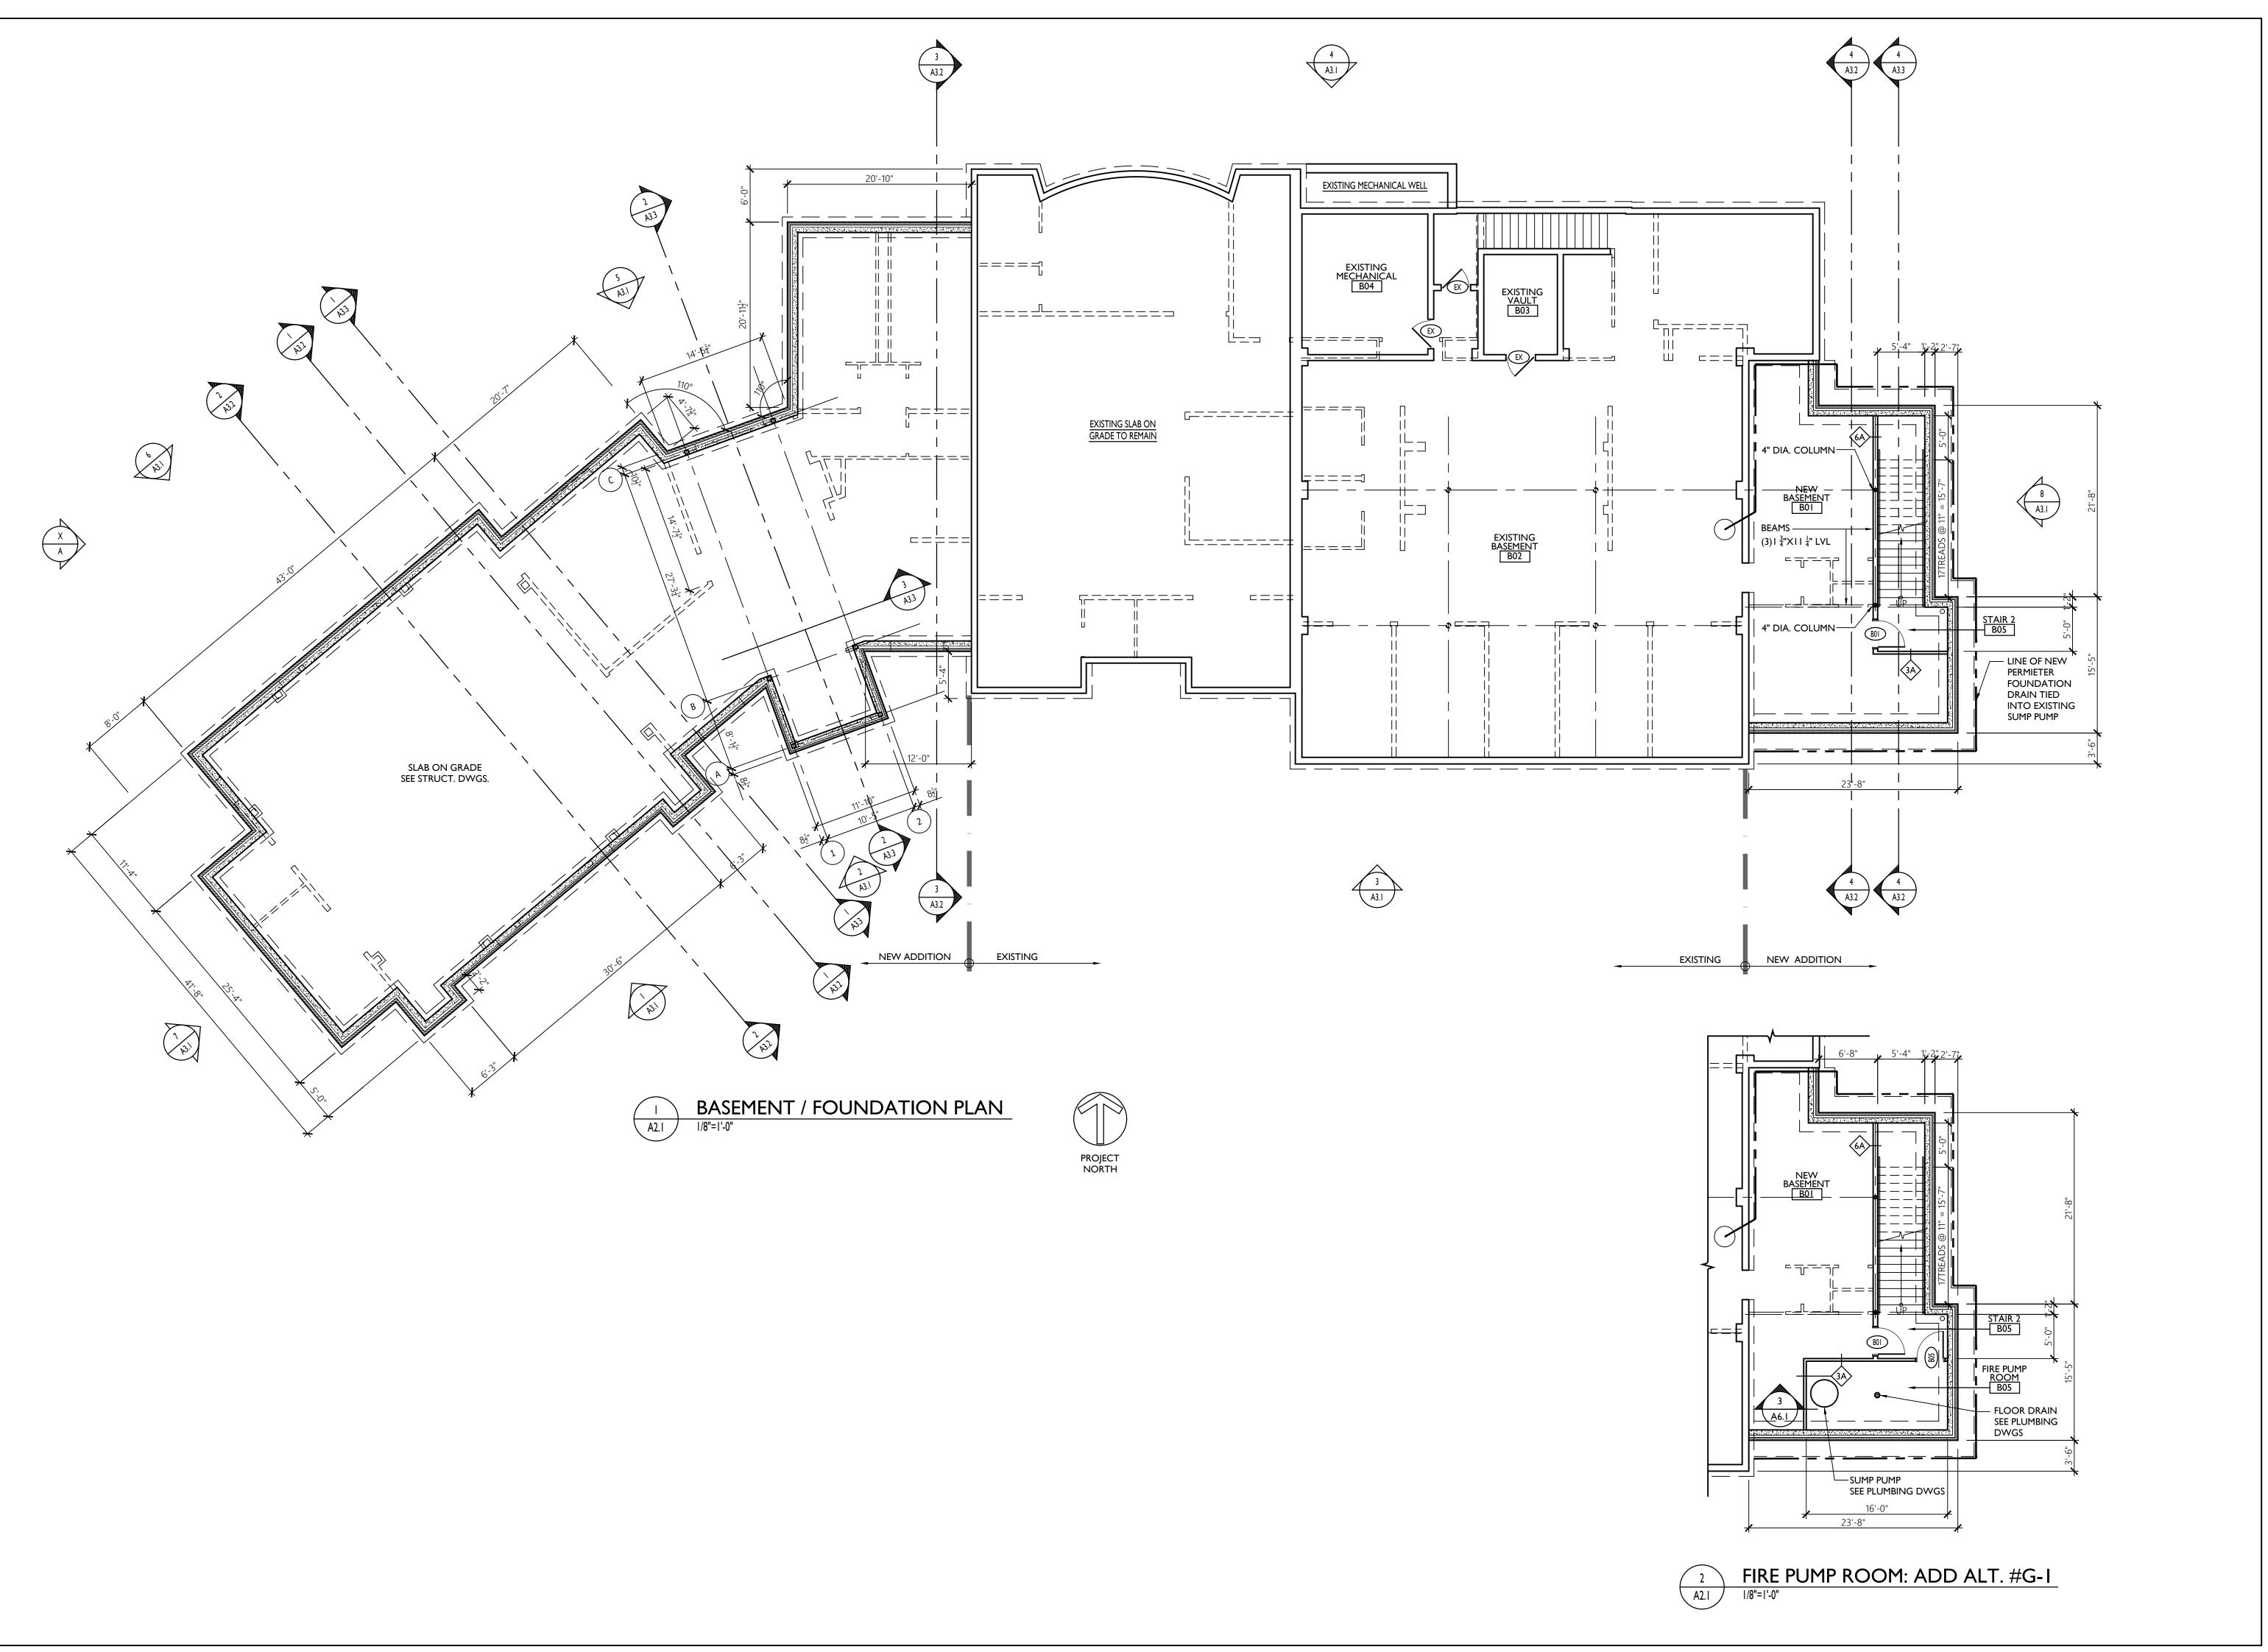

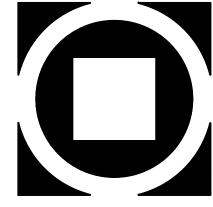

F e + S I t e

Blue Bell, PA 19422

Facsimile: 610.834.7815

Architecture+

MUNCIPAL BUILDING
ST BRADFORD TOWNSH
1385 CAMPUS DRIVE

Drawn By: TM, YP

Checked By: JT

Scale: AS NOTED


rints:

Revisions:

JED FOR BIDDING
CONSTRUCTION
AREVISED DURING BIDDING

Progres 10/15/20 01/26/21 |

A2.1

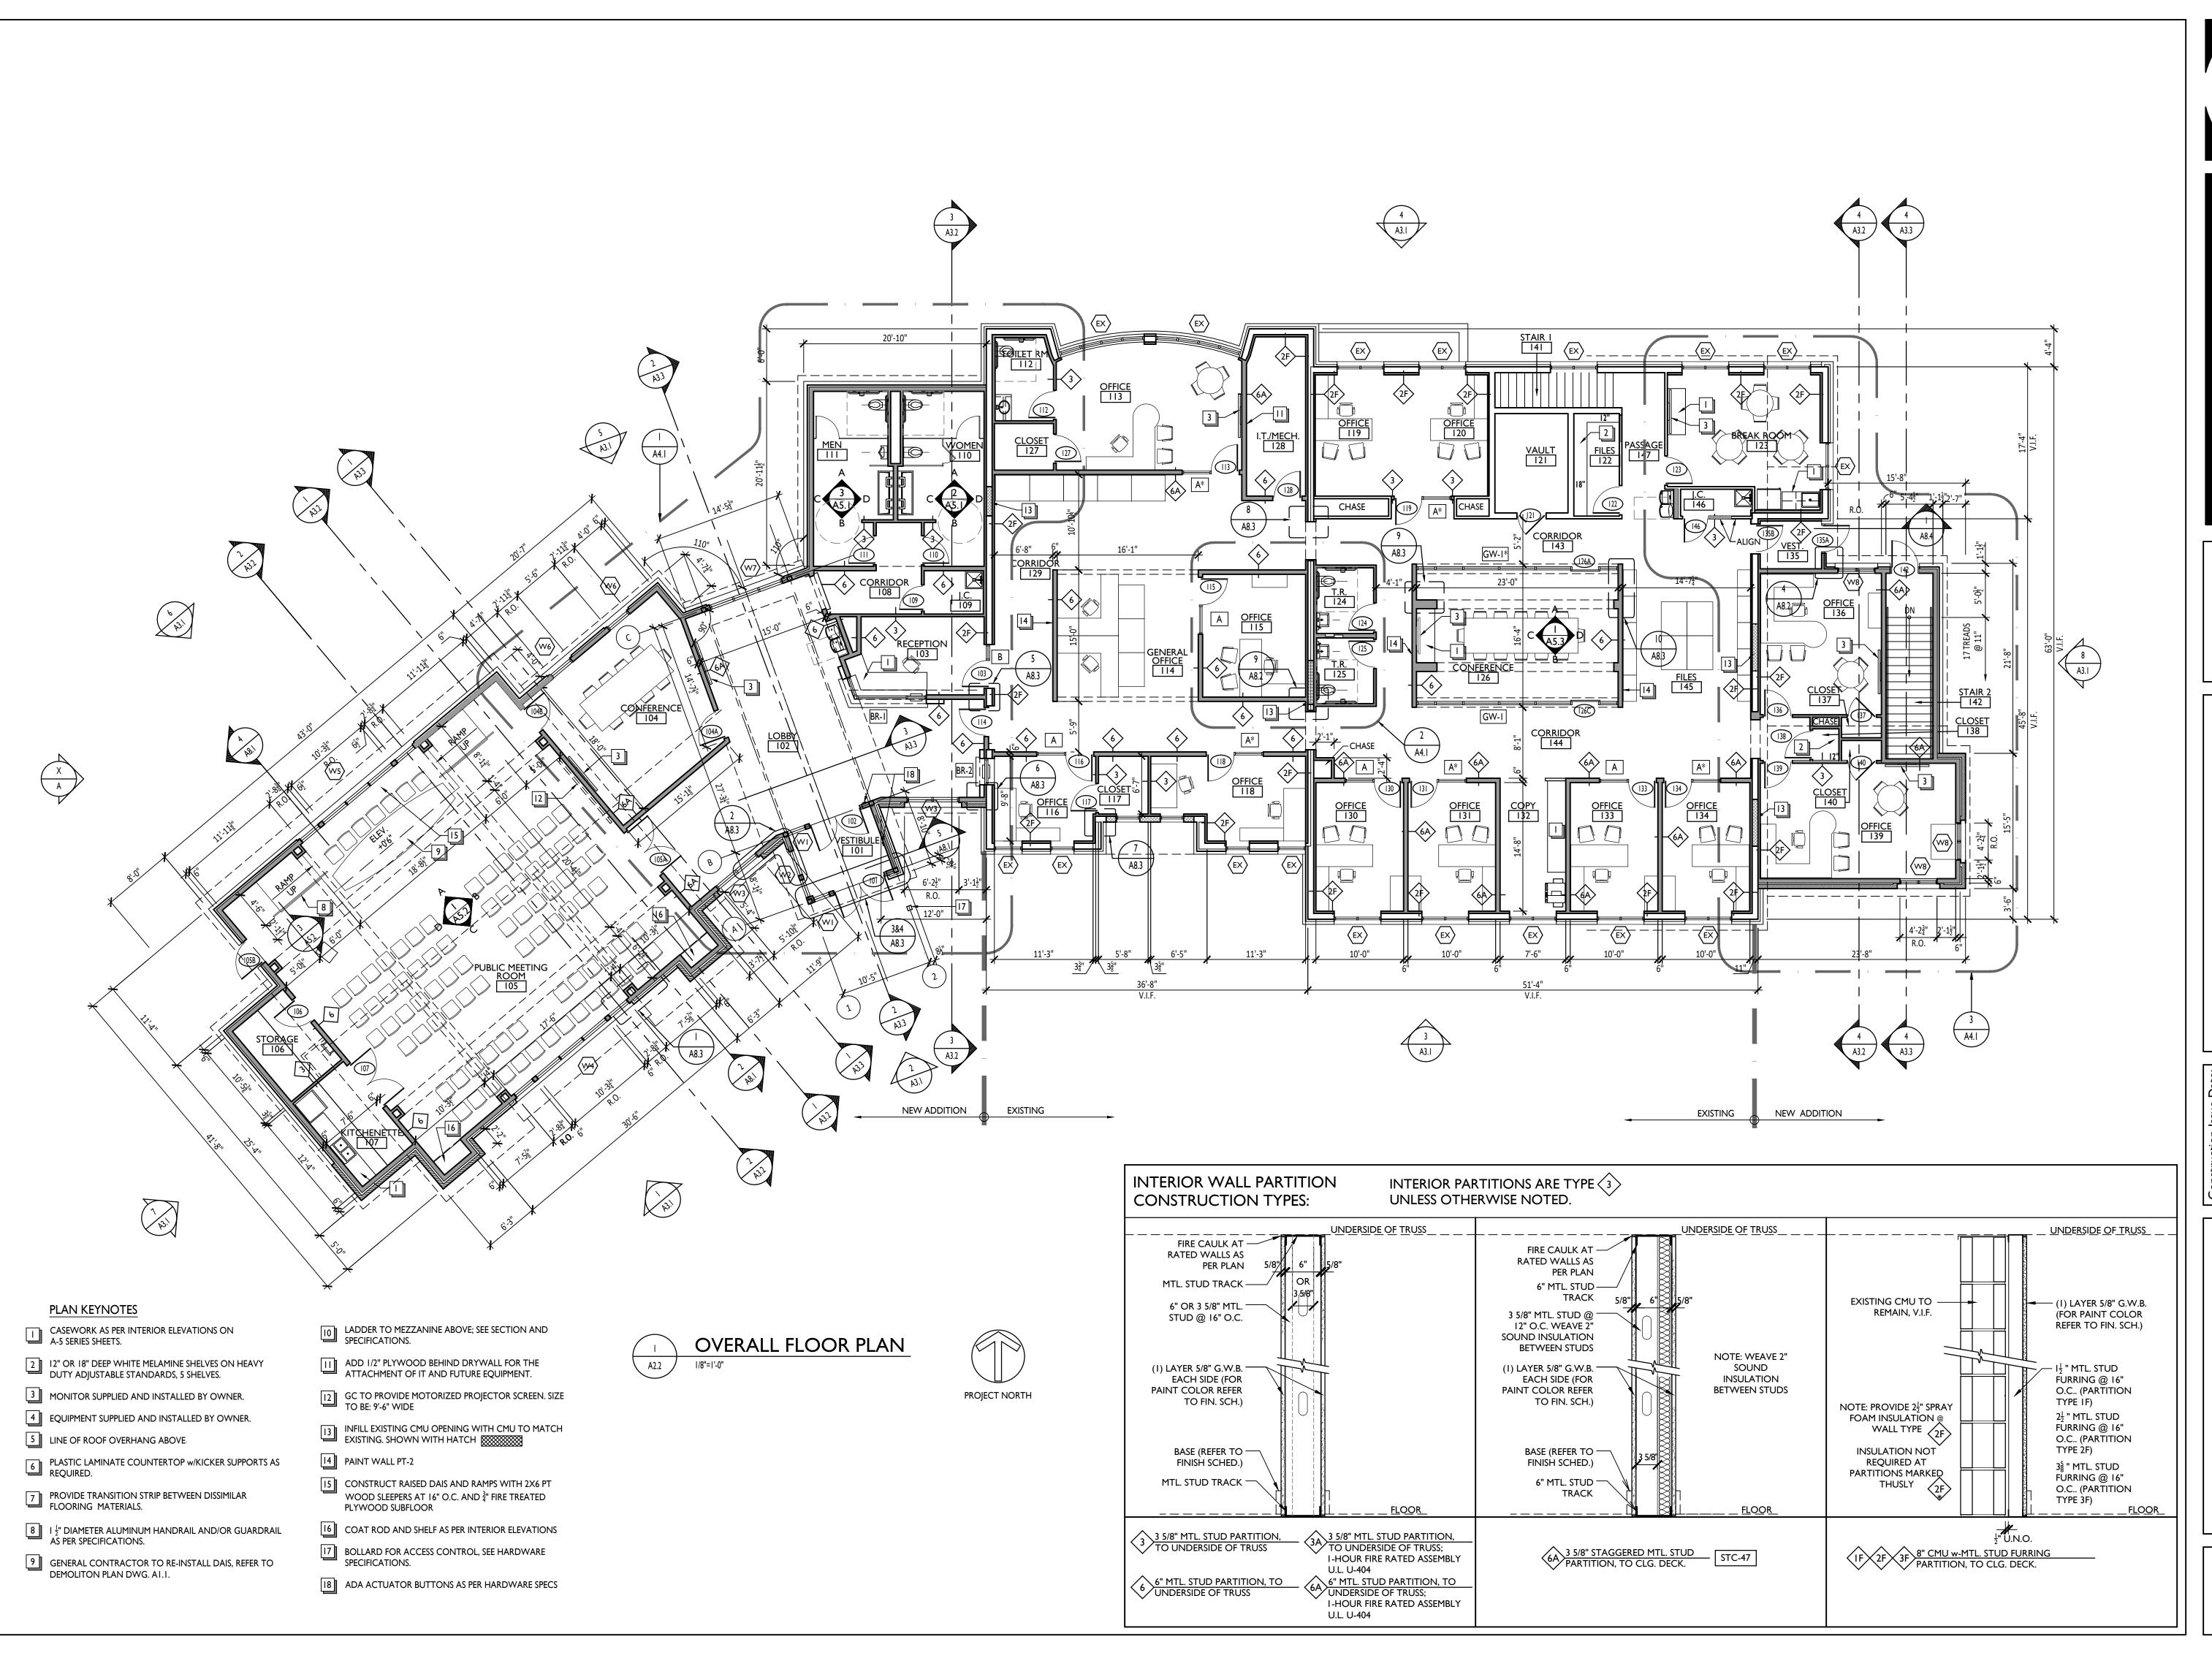

Blue Bell, PA 19422 Facsimile: 610.834.7815

Architecture +

INCIPAL BUILDING SRADFORD TOWNSHIP

Drawn By: TM, YP


Checked By: JT

rints:

DED FOR BIDDING

CONSTRUCTION AREVISED DURING BIDDIN

A2.2

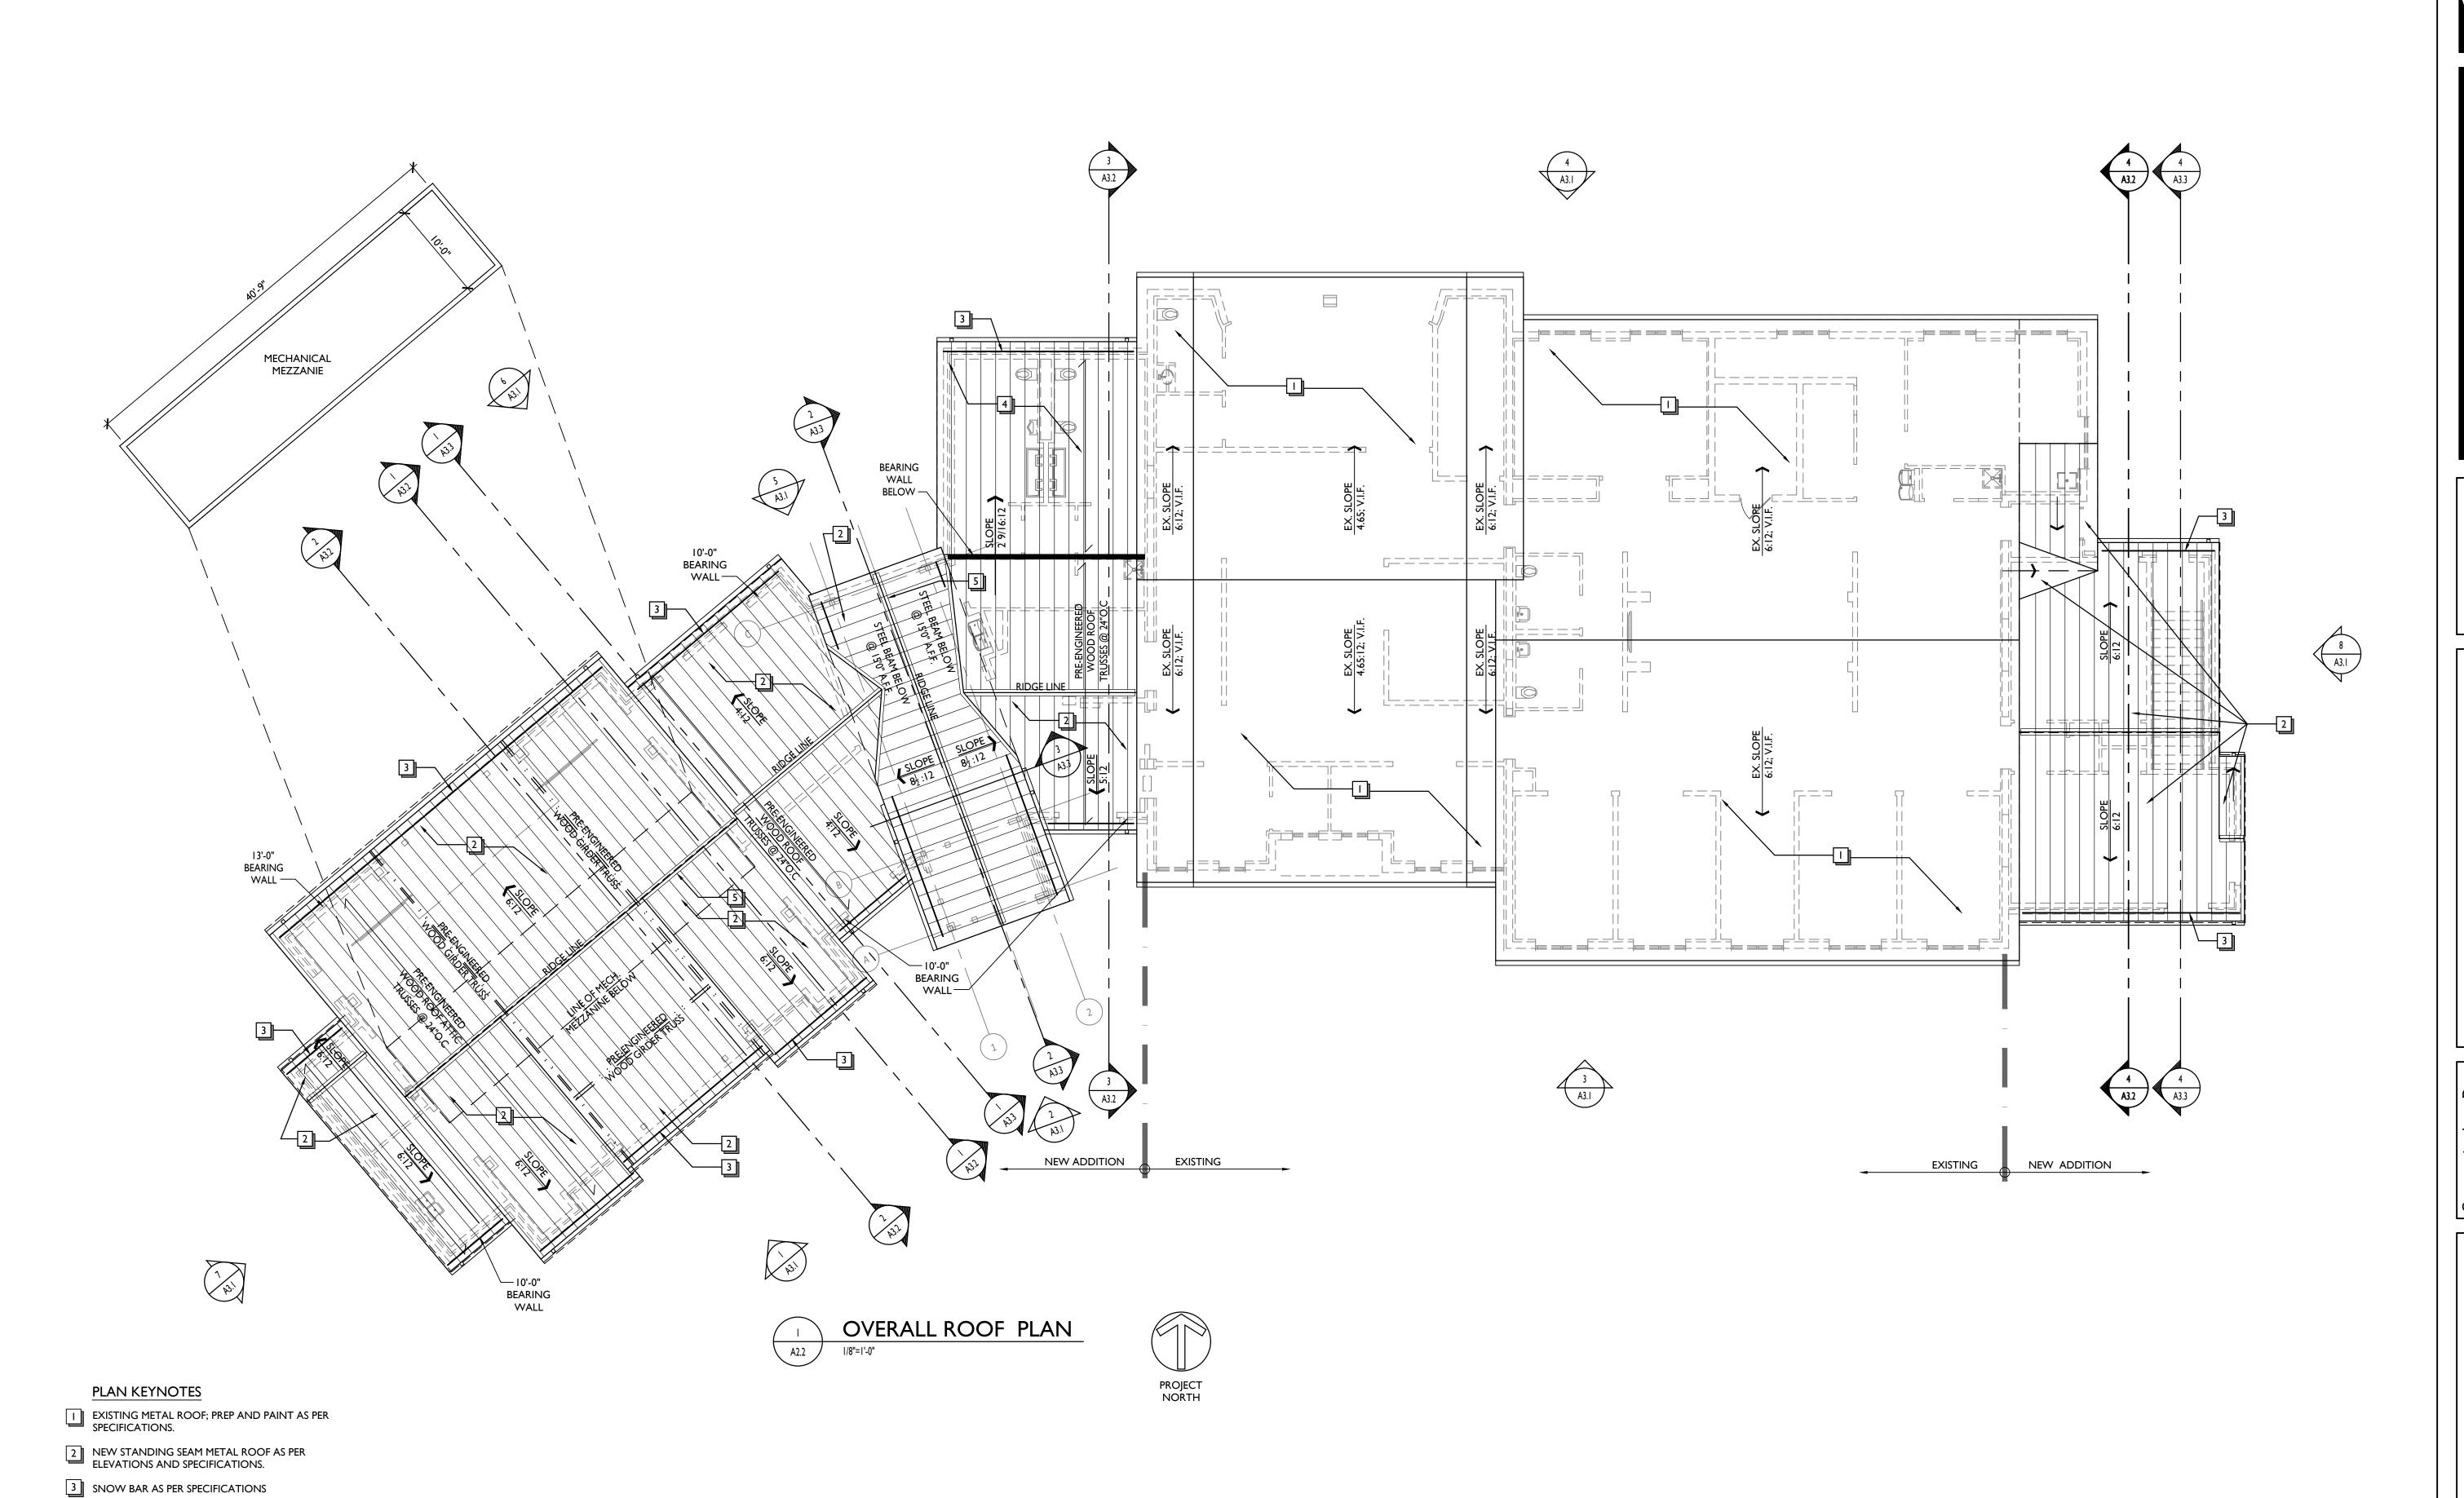

ROLL ROOFING AS PER ELEVATIONS & SPECIFICATIONS.

VENTED RIDGE CAP. PROVIDE MANUFACTURER'S STANDARD METAL AT METAL ROOFS.

Blue Bell, PA 19422 Facsimile: 610.834.7815

·chitecture+


SHIP


WEST BRADFORD TOWN
1385 CAMPUS DRIVE
WEST BRADFORD PA 1933


Drawn By: TM, YP
Checked By: JT
Scale: AS NOTED

Name: ROOF PLAN
Prints: Revisions:
SUED FOR BIDDING
SUED FOR BIDDING
A REVISED DURING BIDDI
A REVISED DURING BIDDI


A2.3

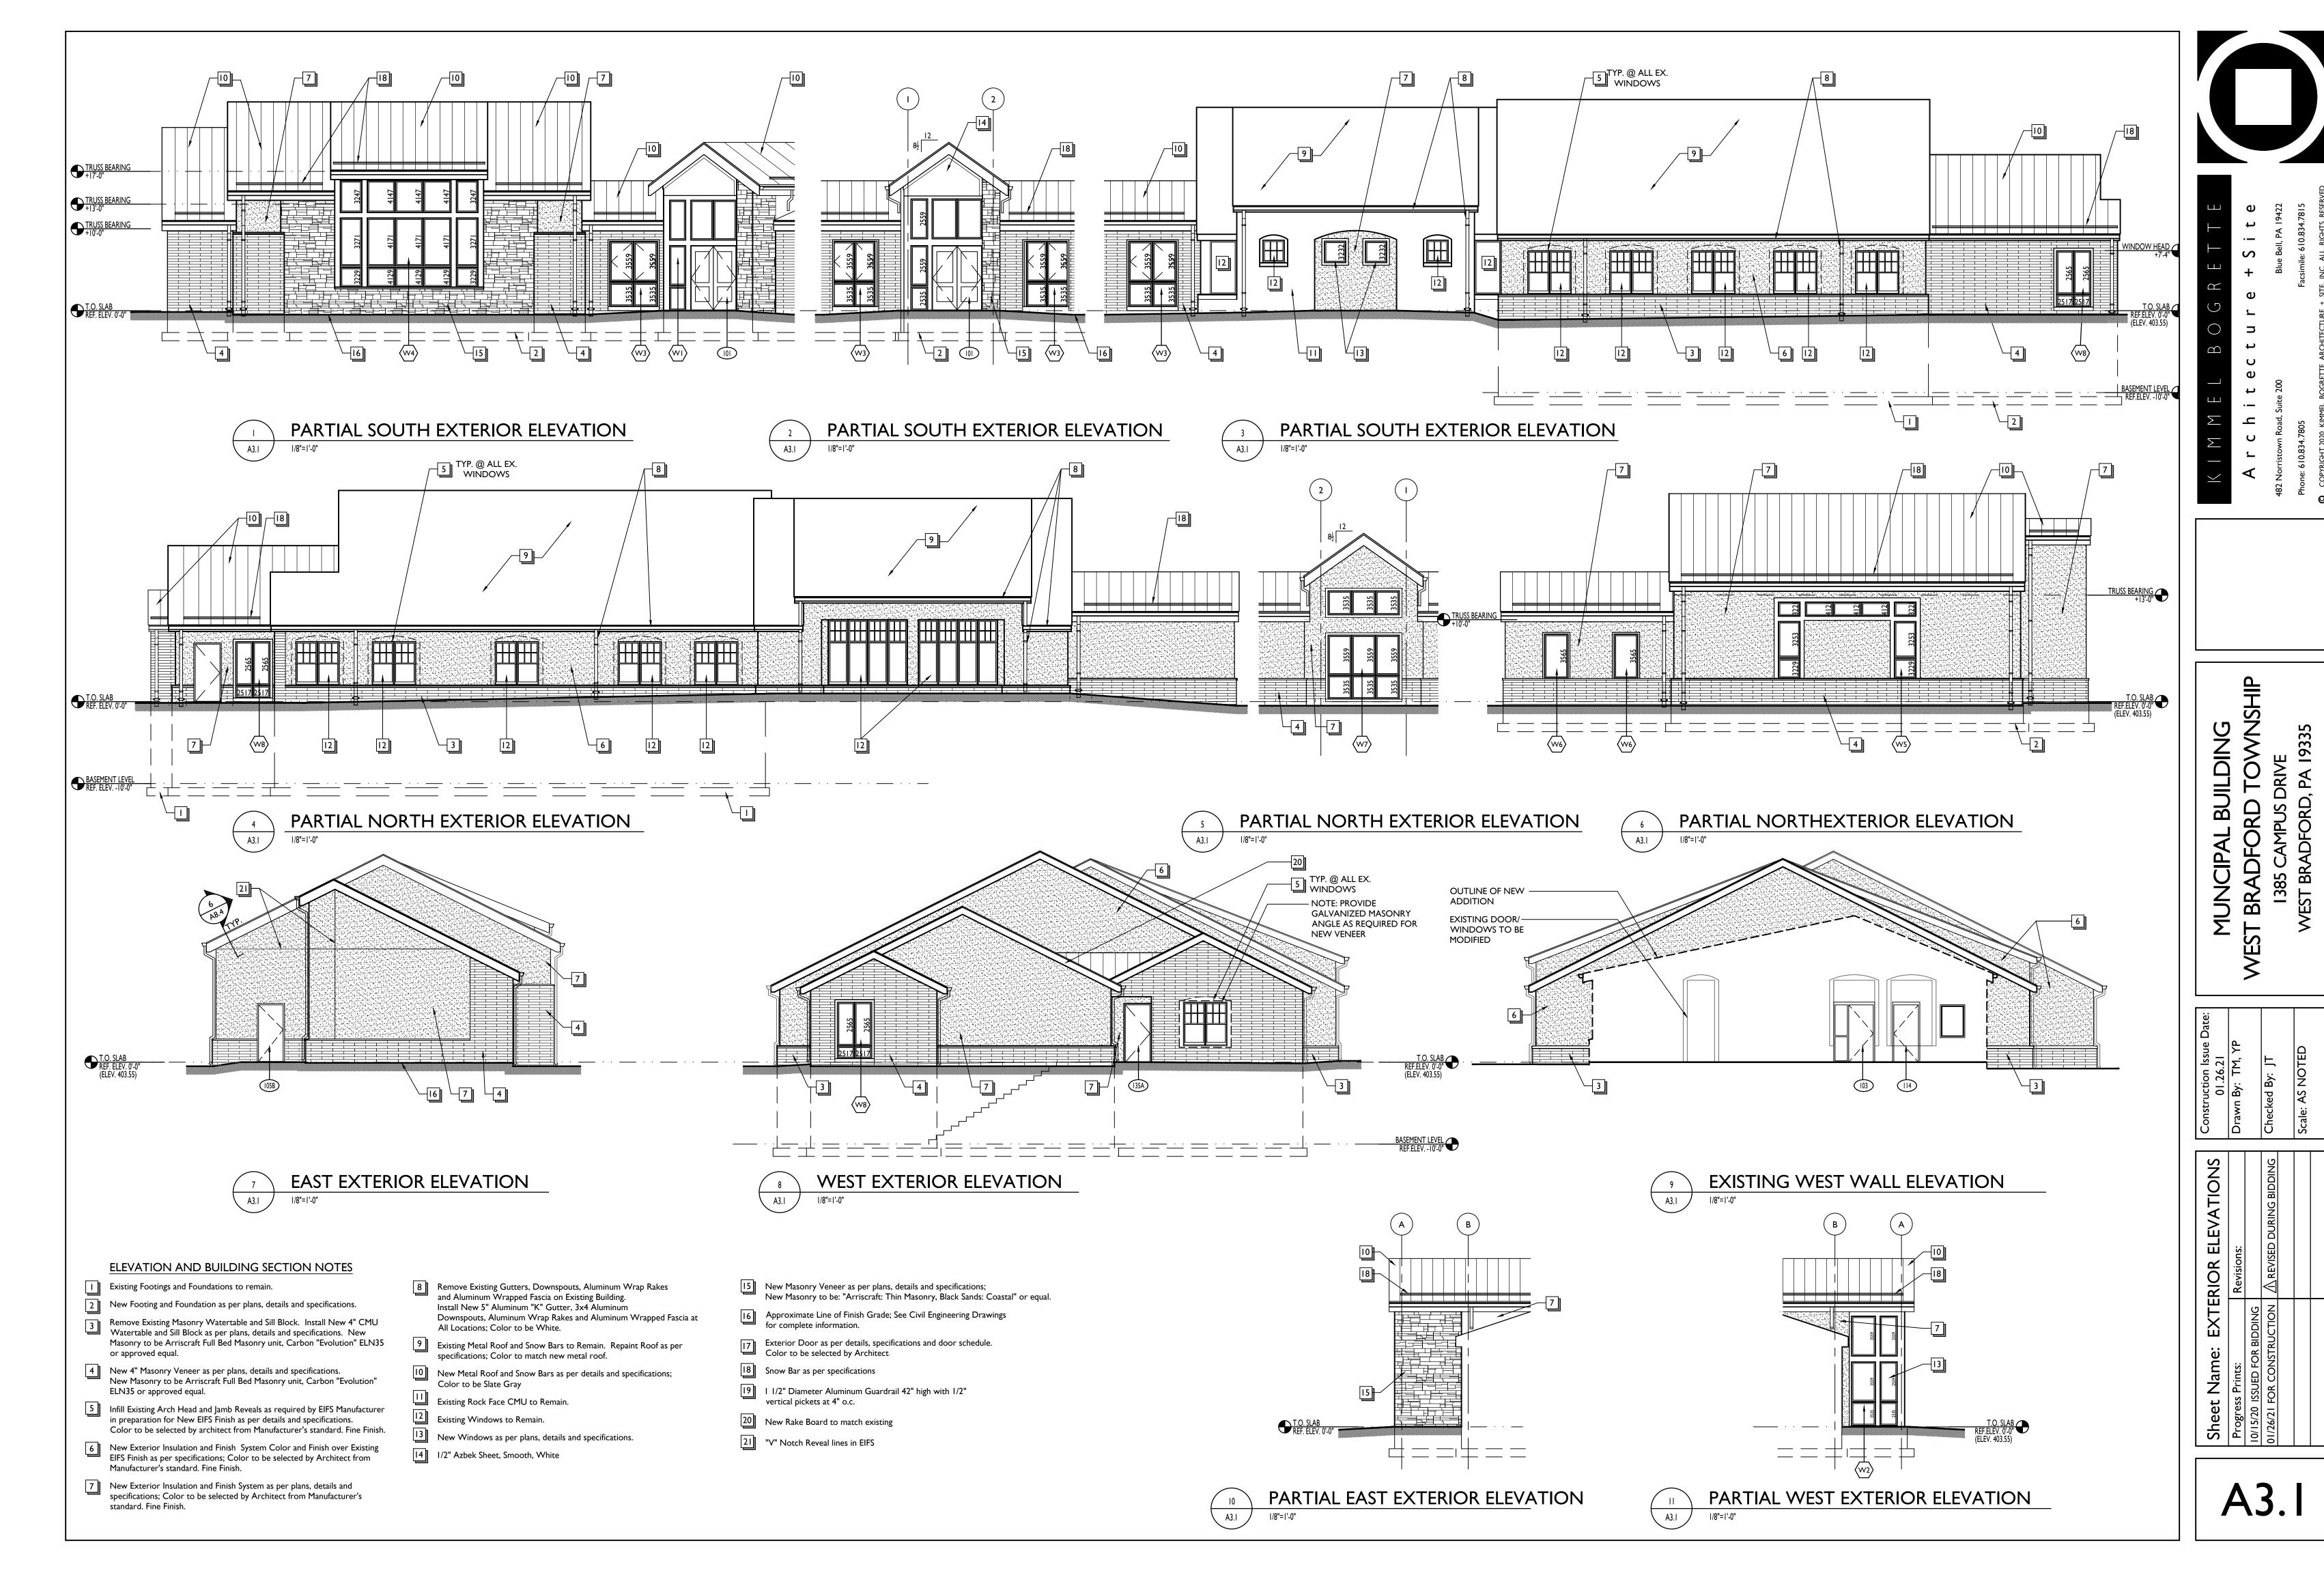


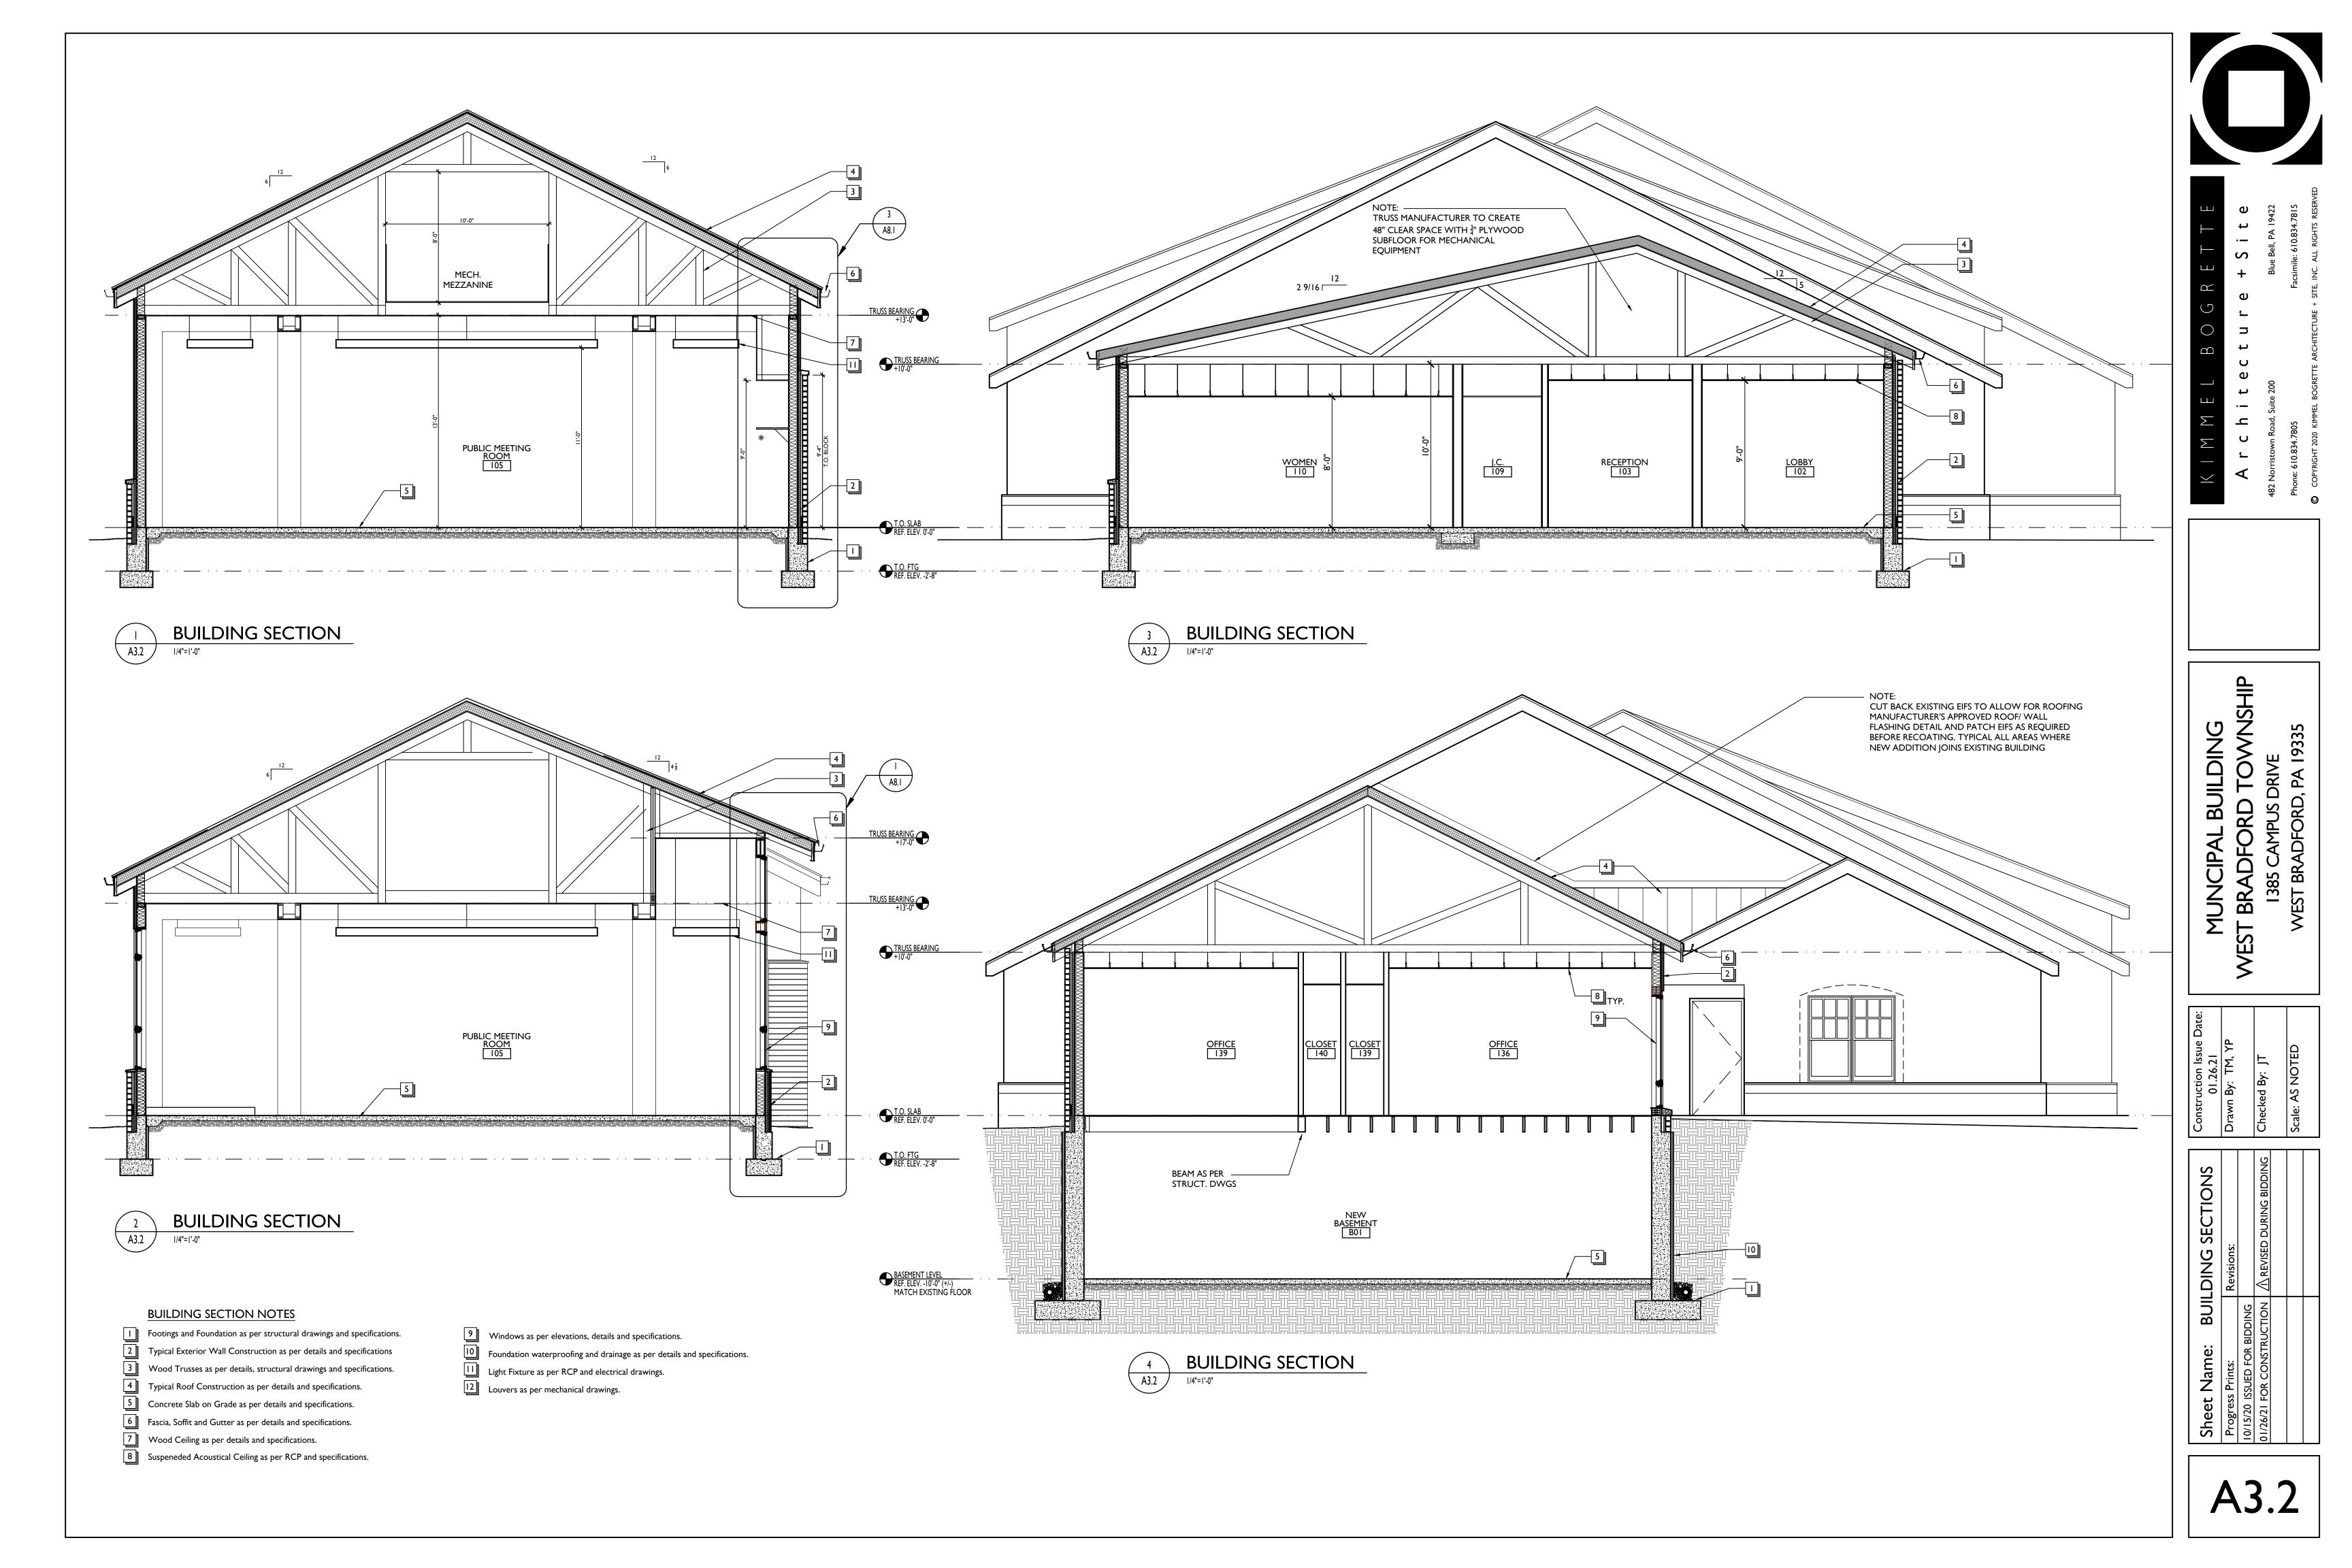

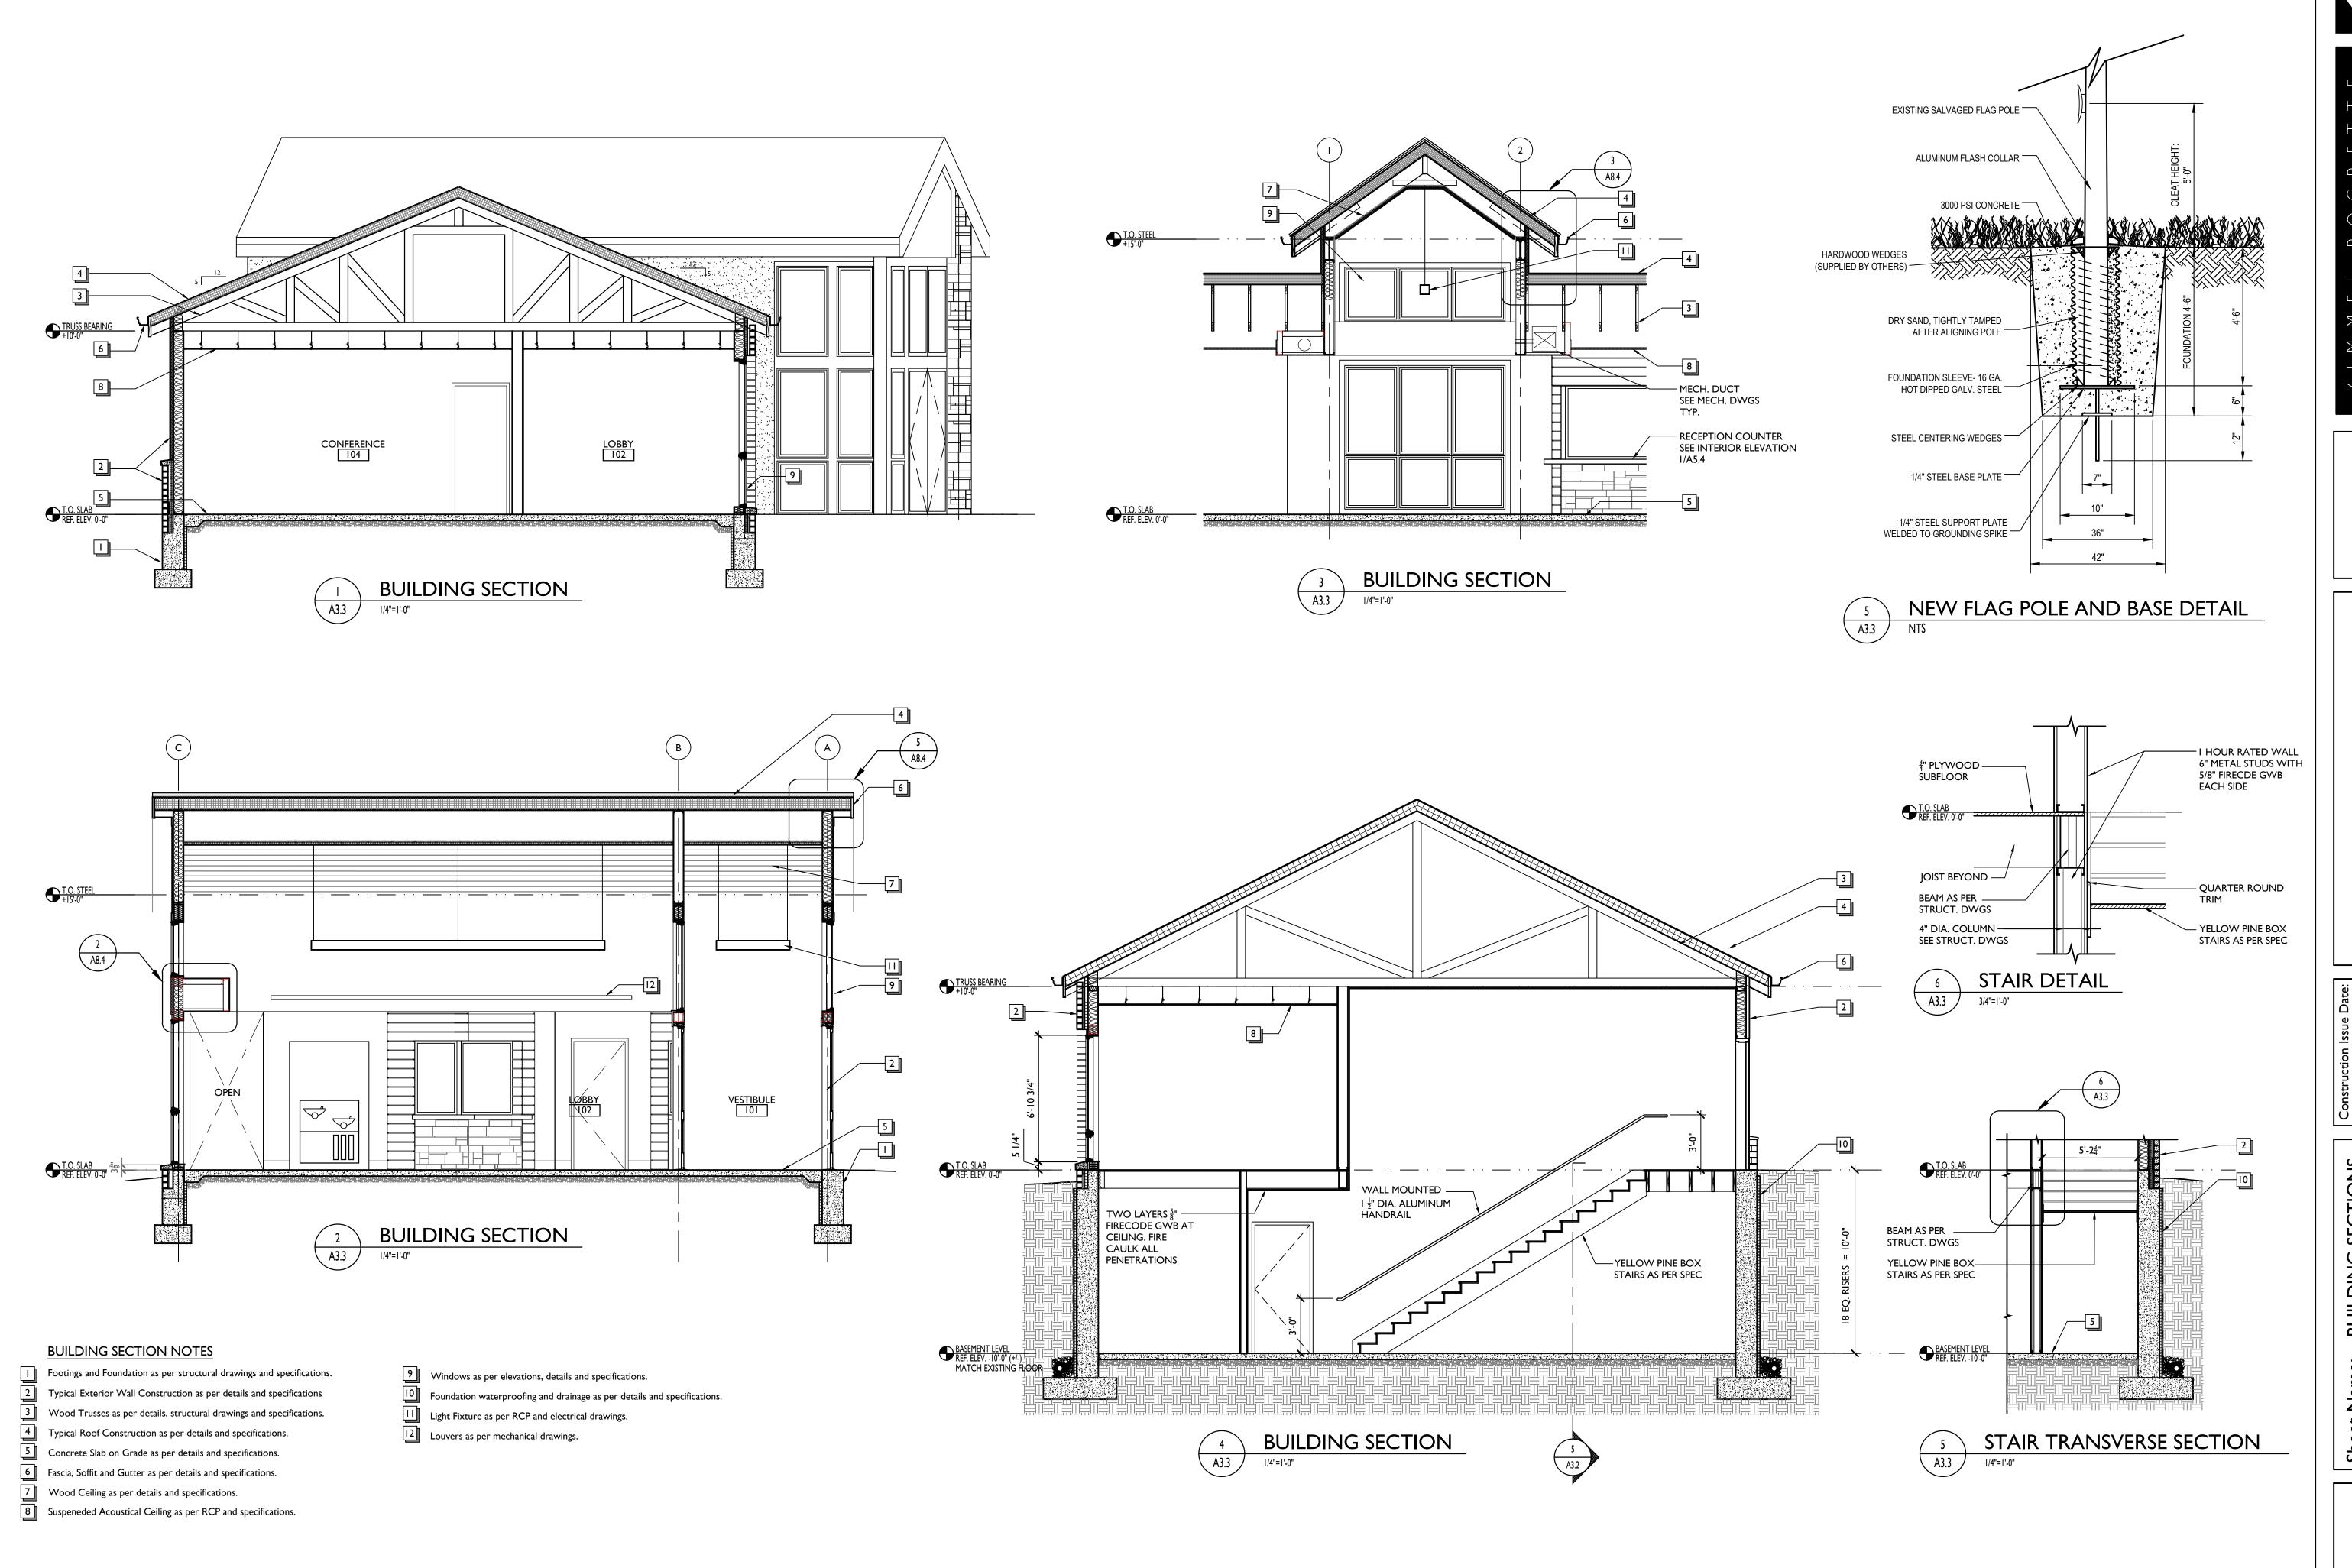

BUILDING SECTIONS

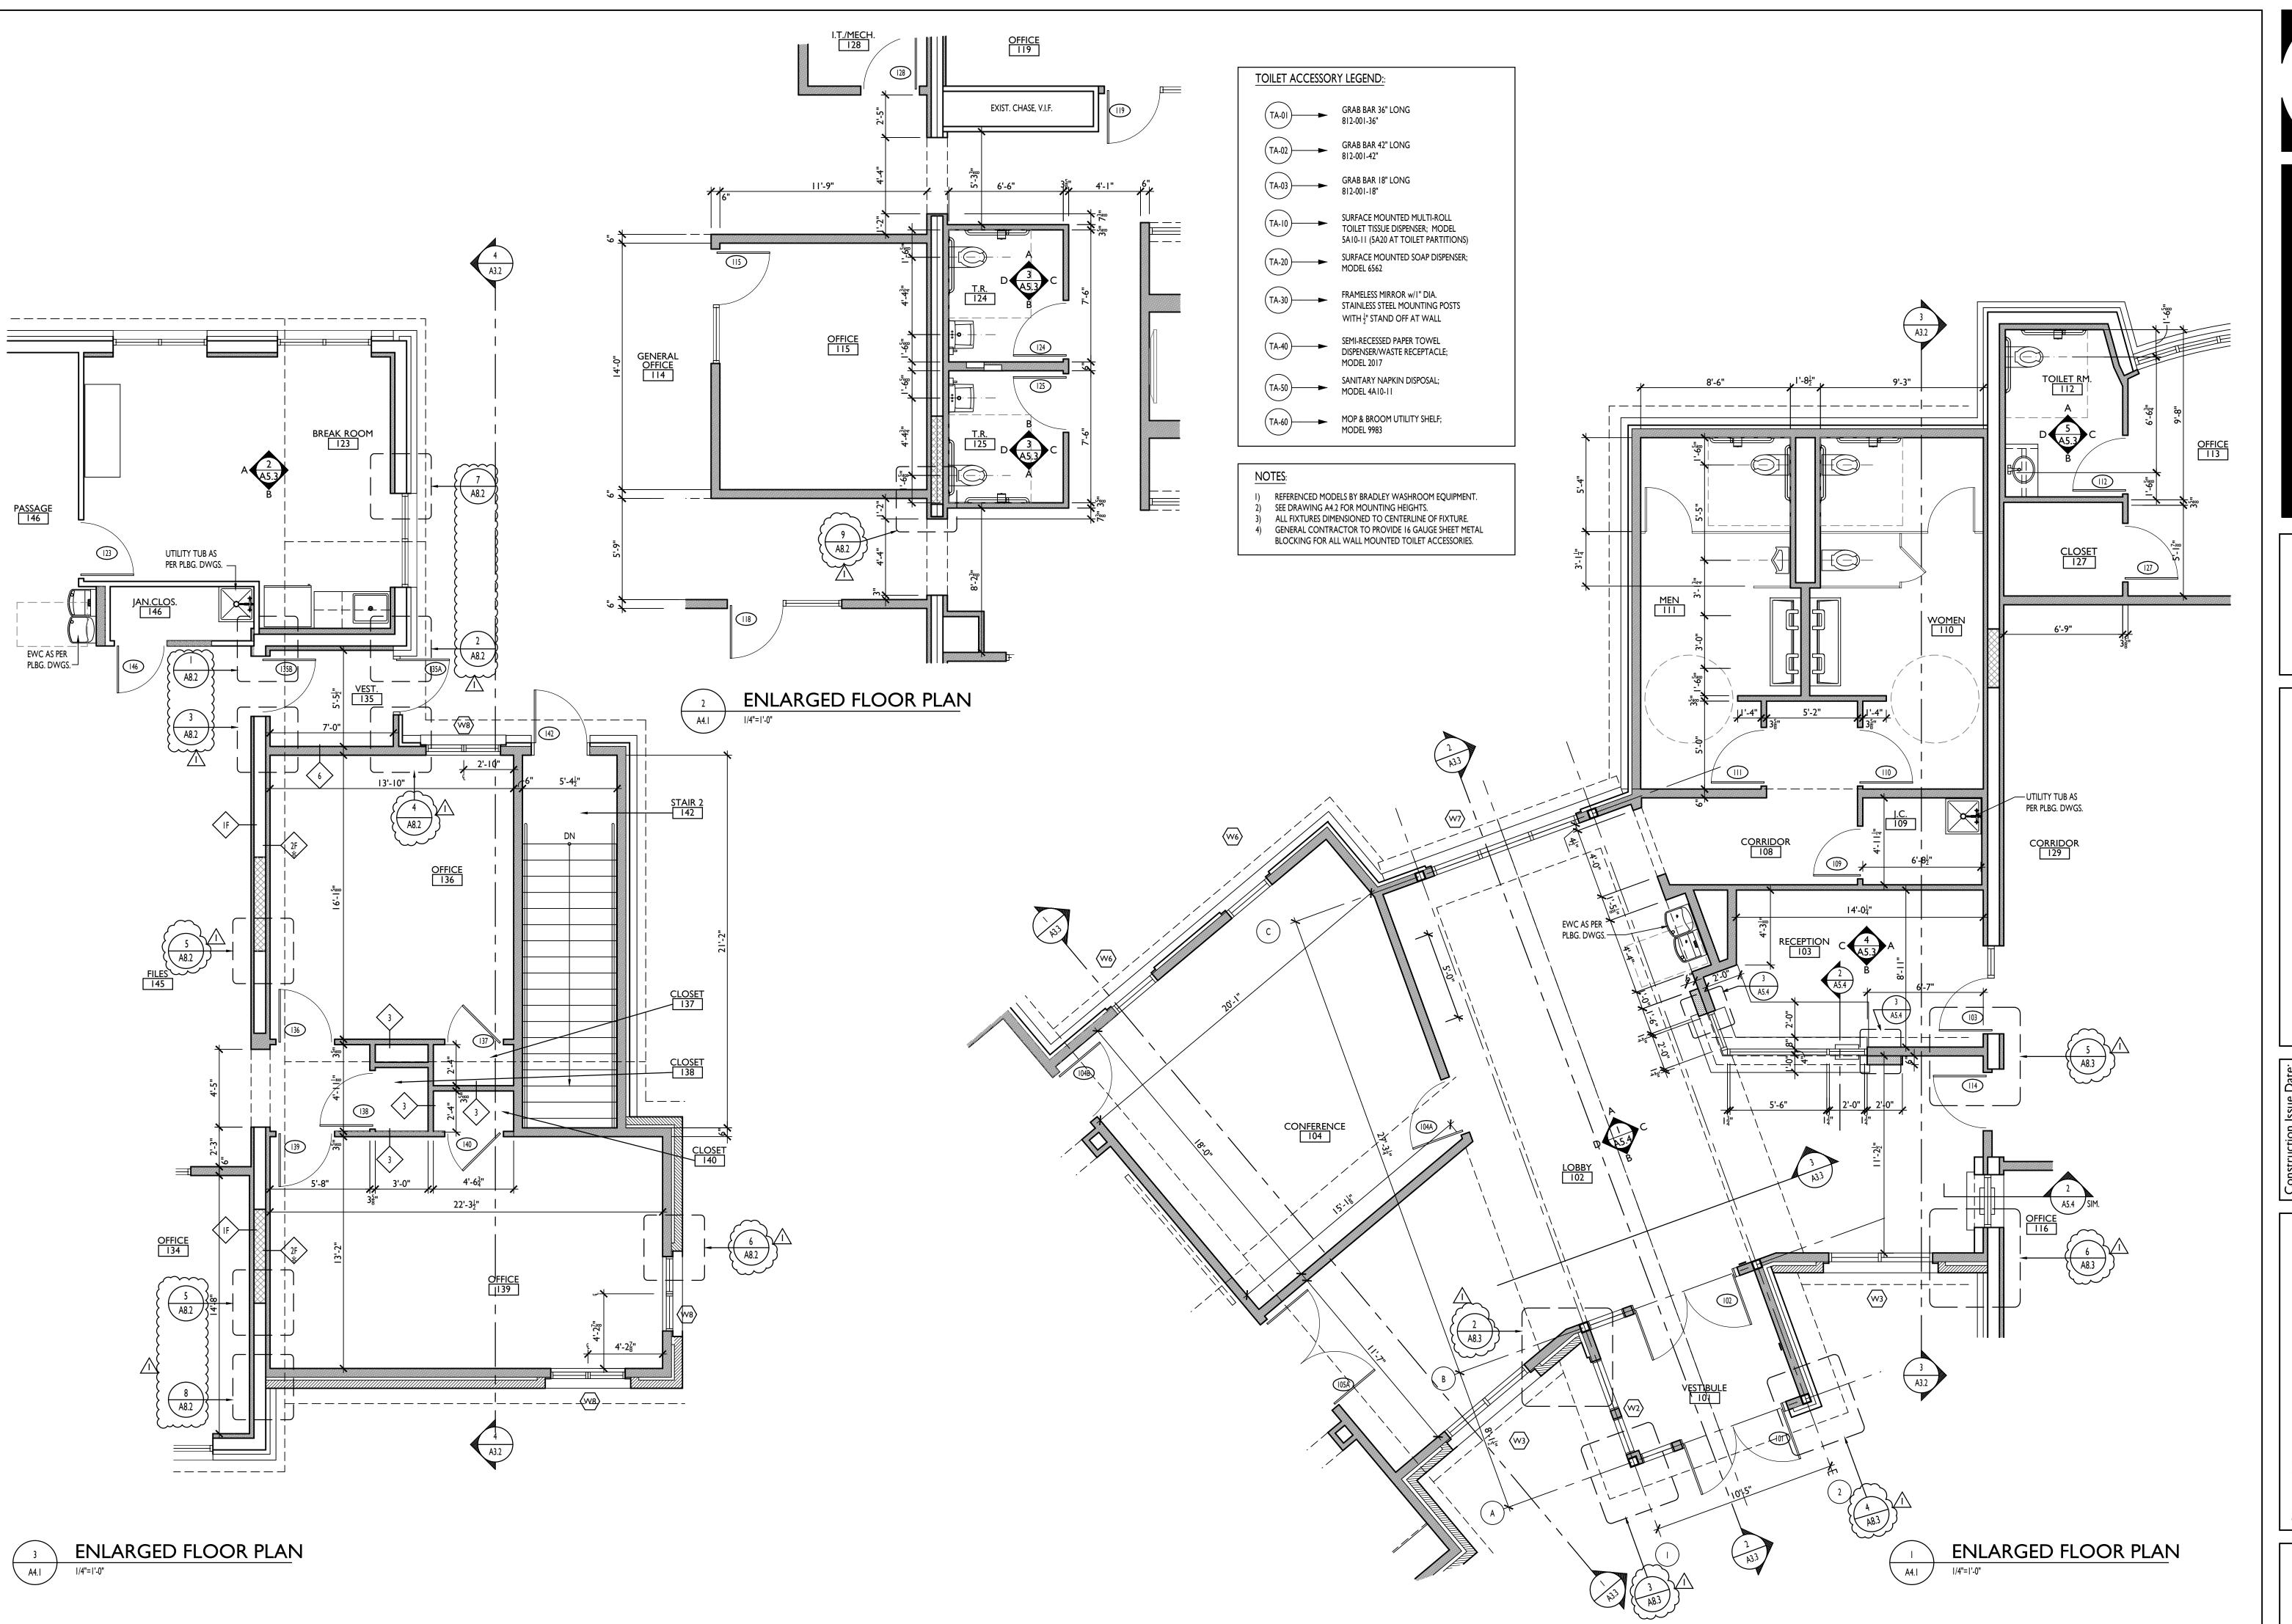

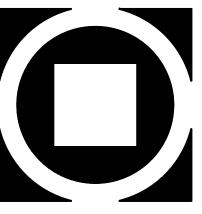

F e + 5 l t e

Blue Bell, PA 19422

Facsimile: 610.834.7815

RE + SITE. INC. ALL RIGHTS RESERVED

Architecture + 9

MUNCIPAL BUILDING
EST BRADFORD TOWNSI
1385 CAMPUS DRIVE

Drawn By: TM, YP

Checked By: JT


Scale: AS NOTED

Revisions:

10 ISSUED FOR BIDDING

11 FOR CONSTRUCTION AREVISED DURING BIDDIN


A4.1

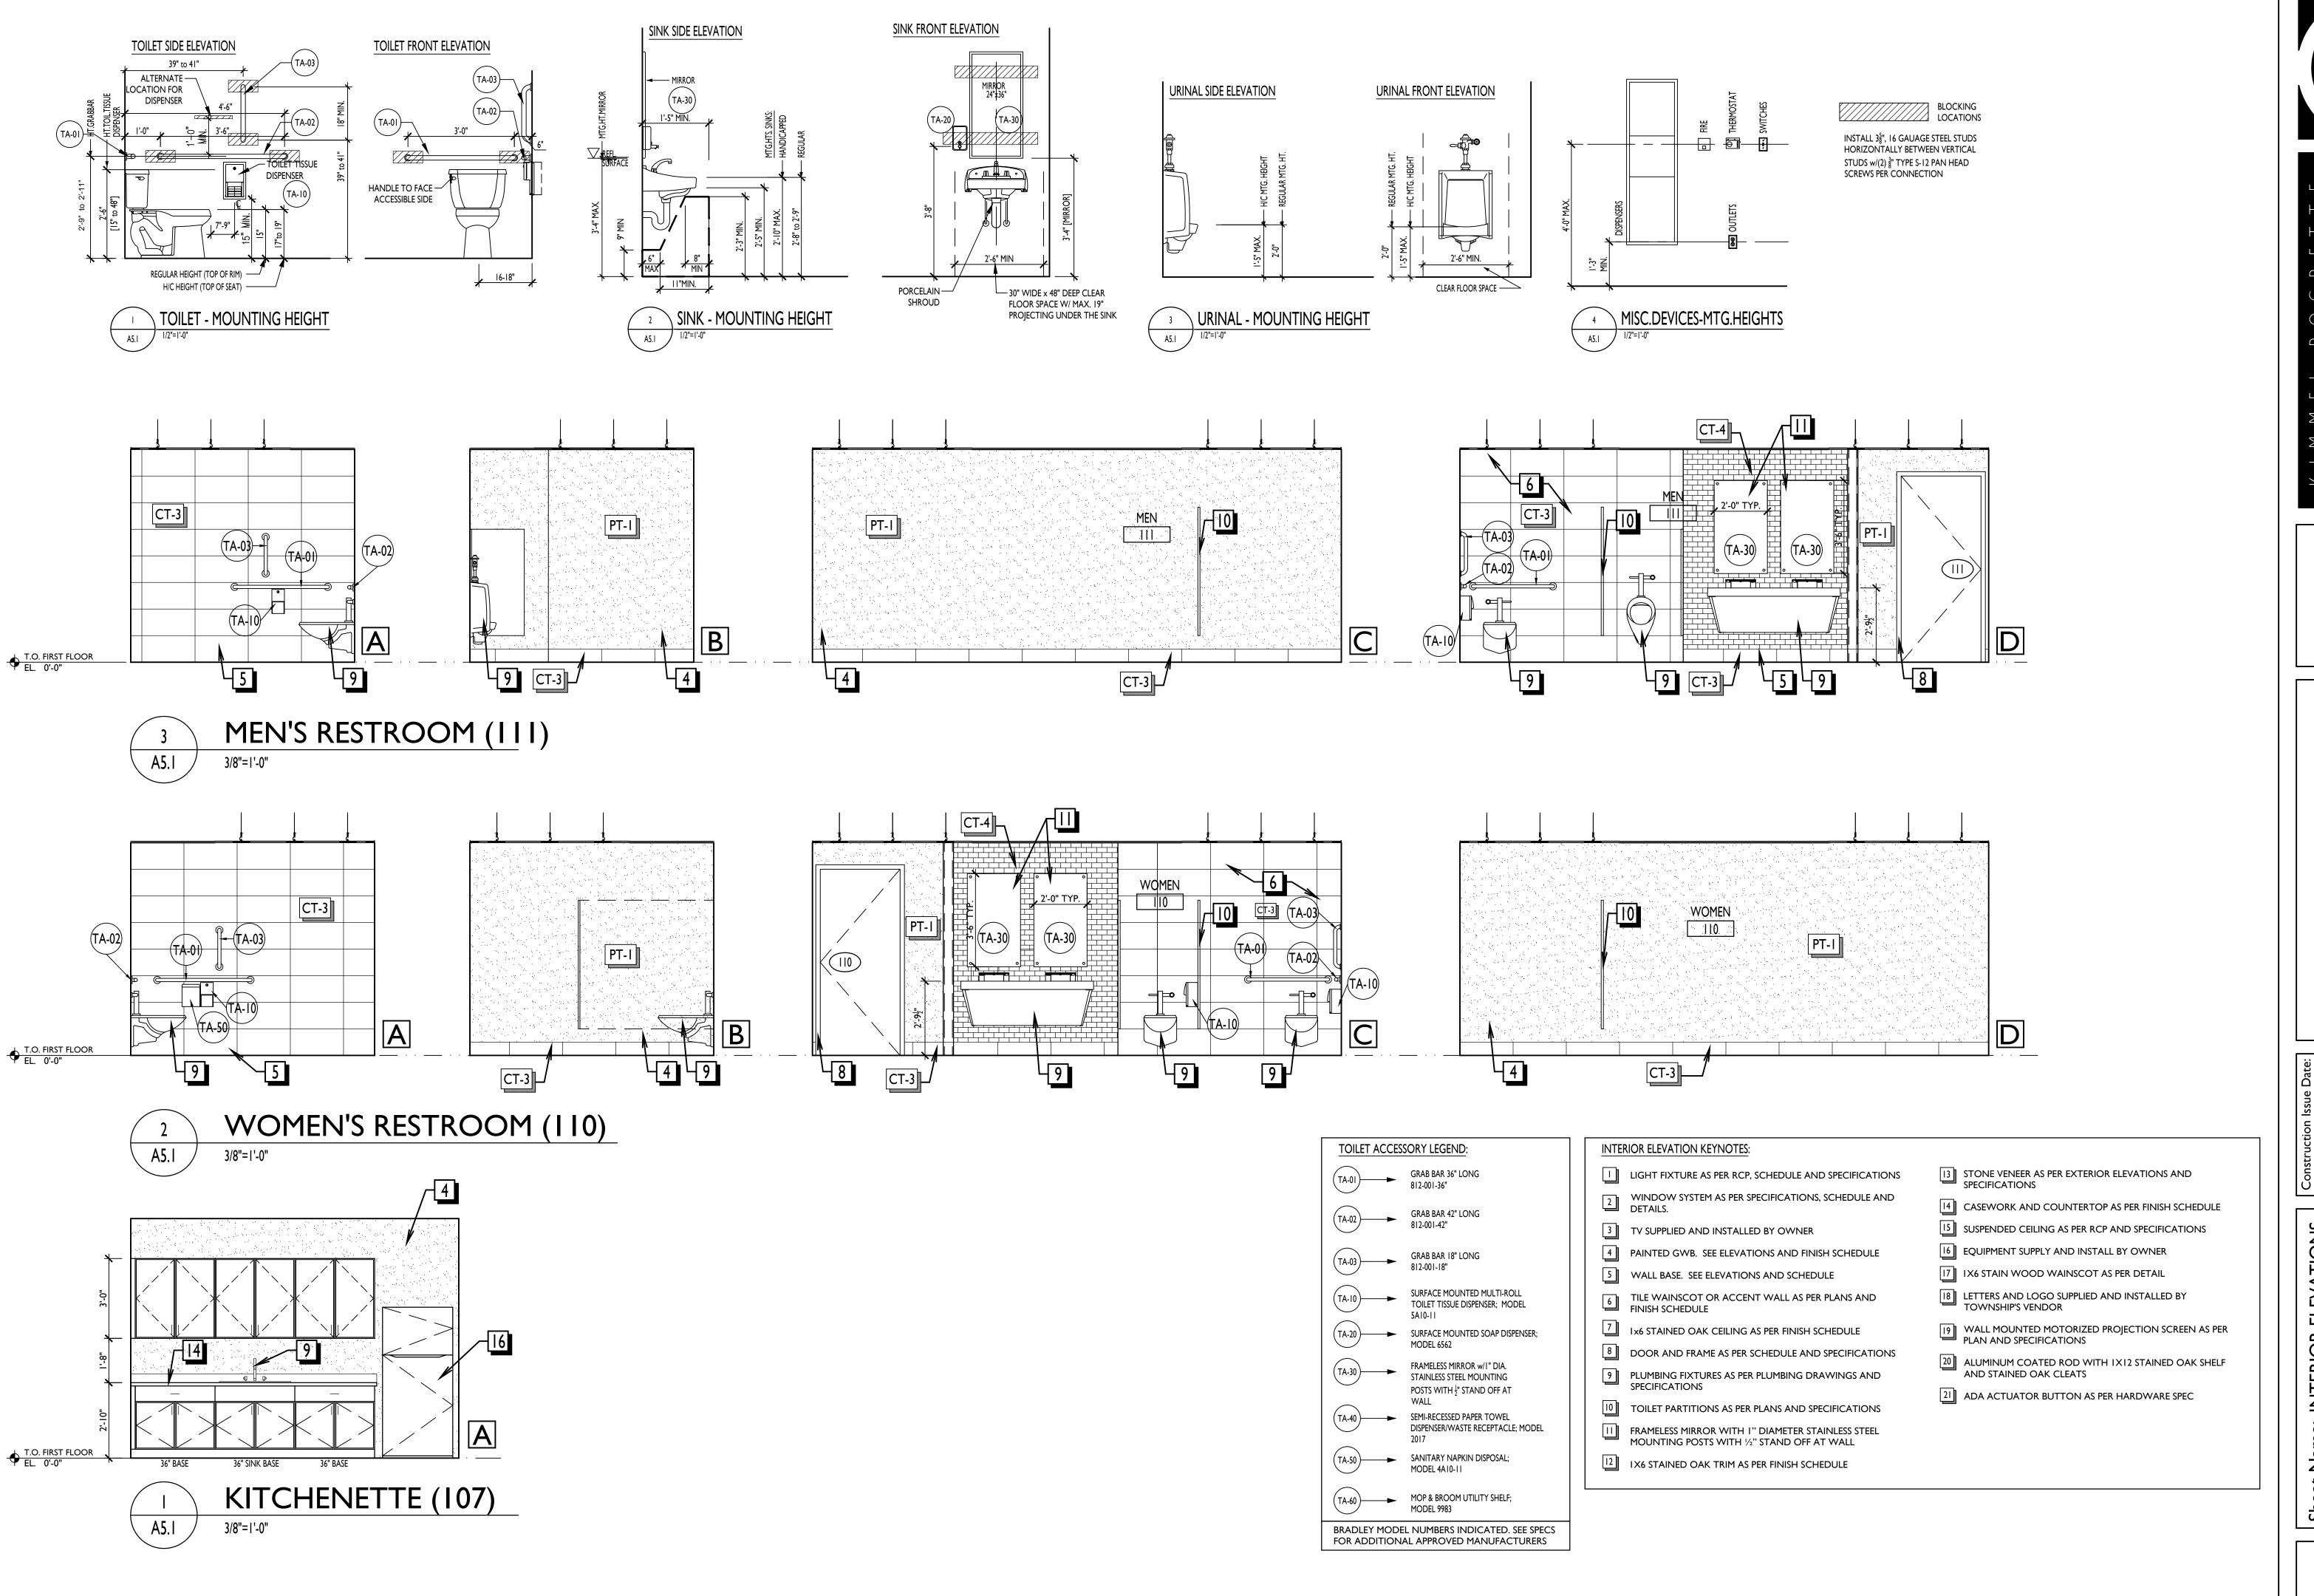

BUILDING

Sheet Name: INTERIOR ELEVATIONS
Progress Prints:

10/15/20 ISSUED FOR BIDDING
01/26/21 FOR CONSTRUCTION
AREVISED DURING BIDDING

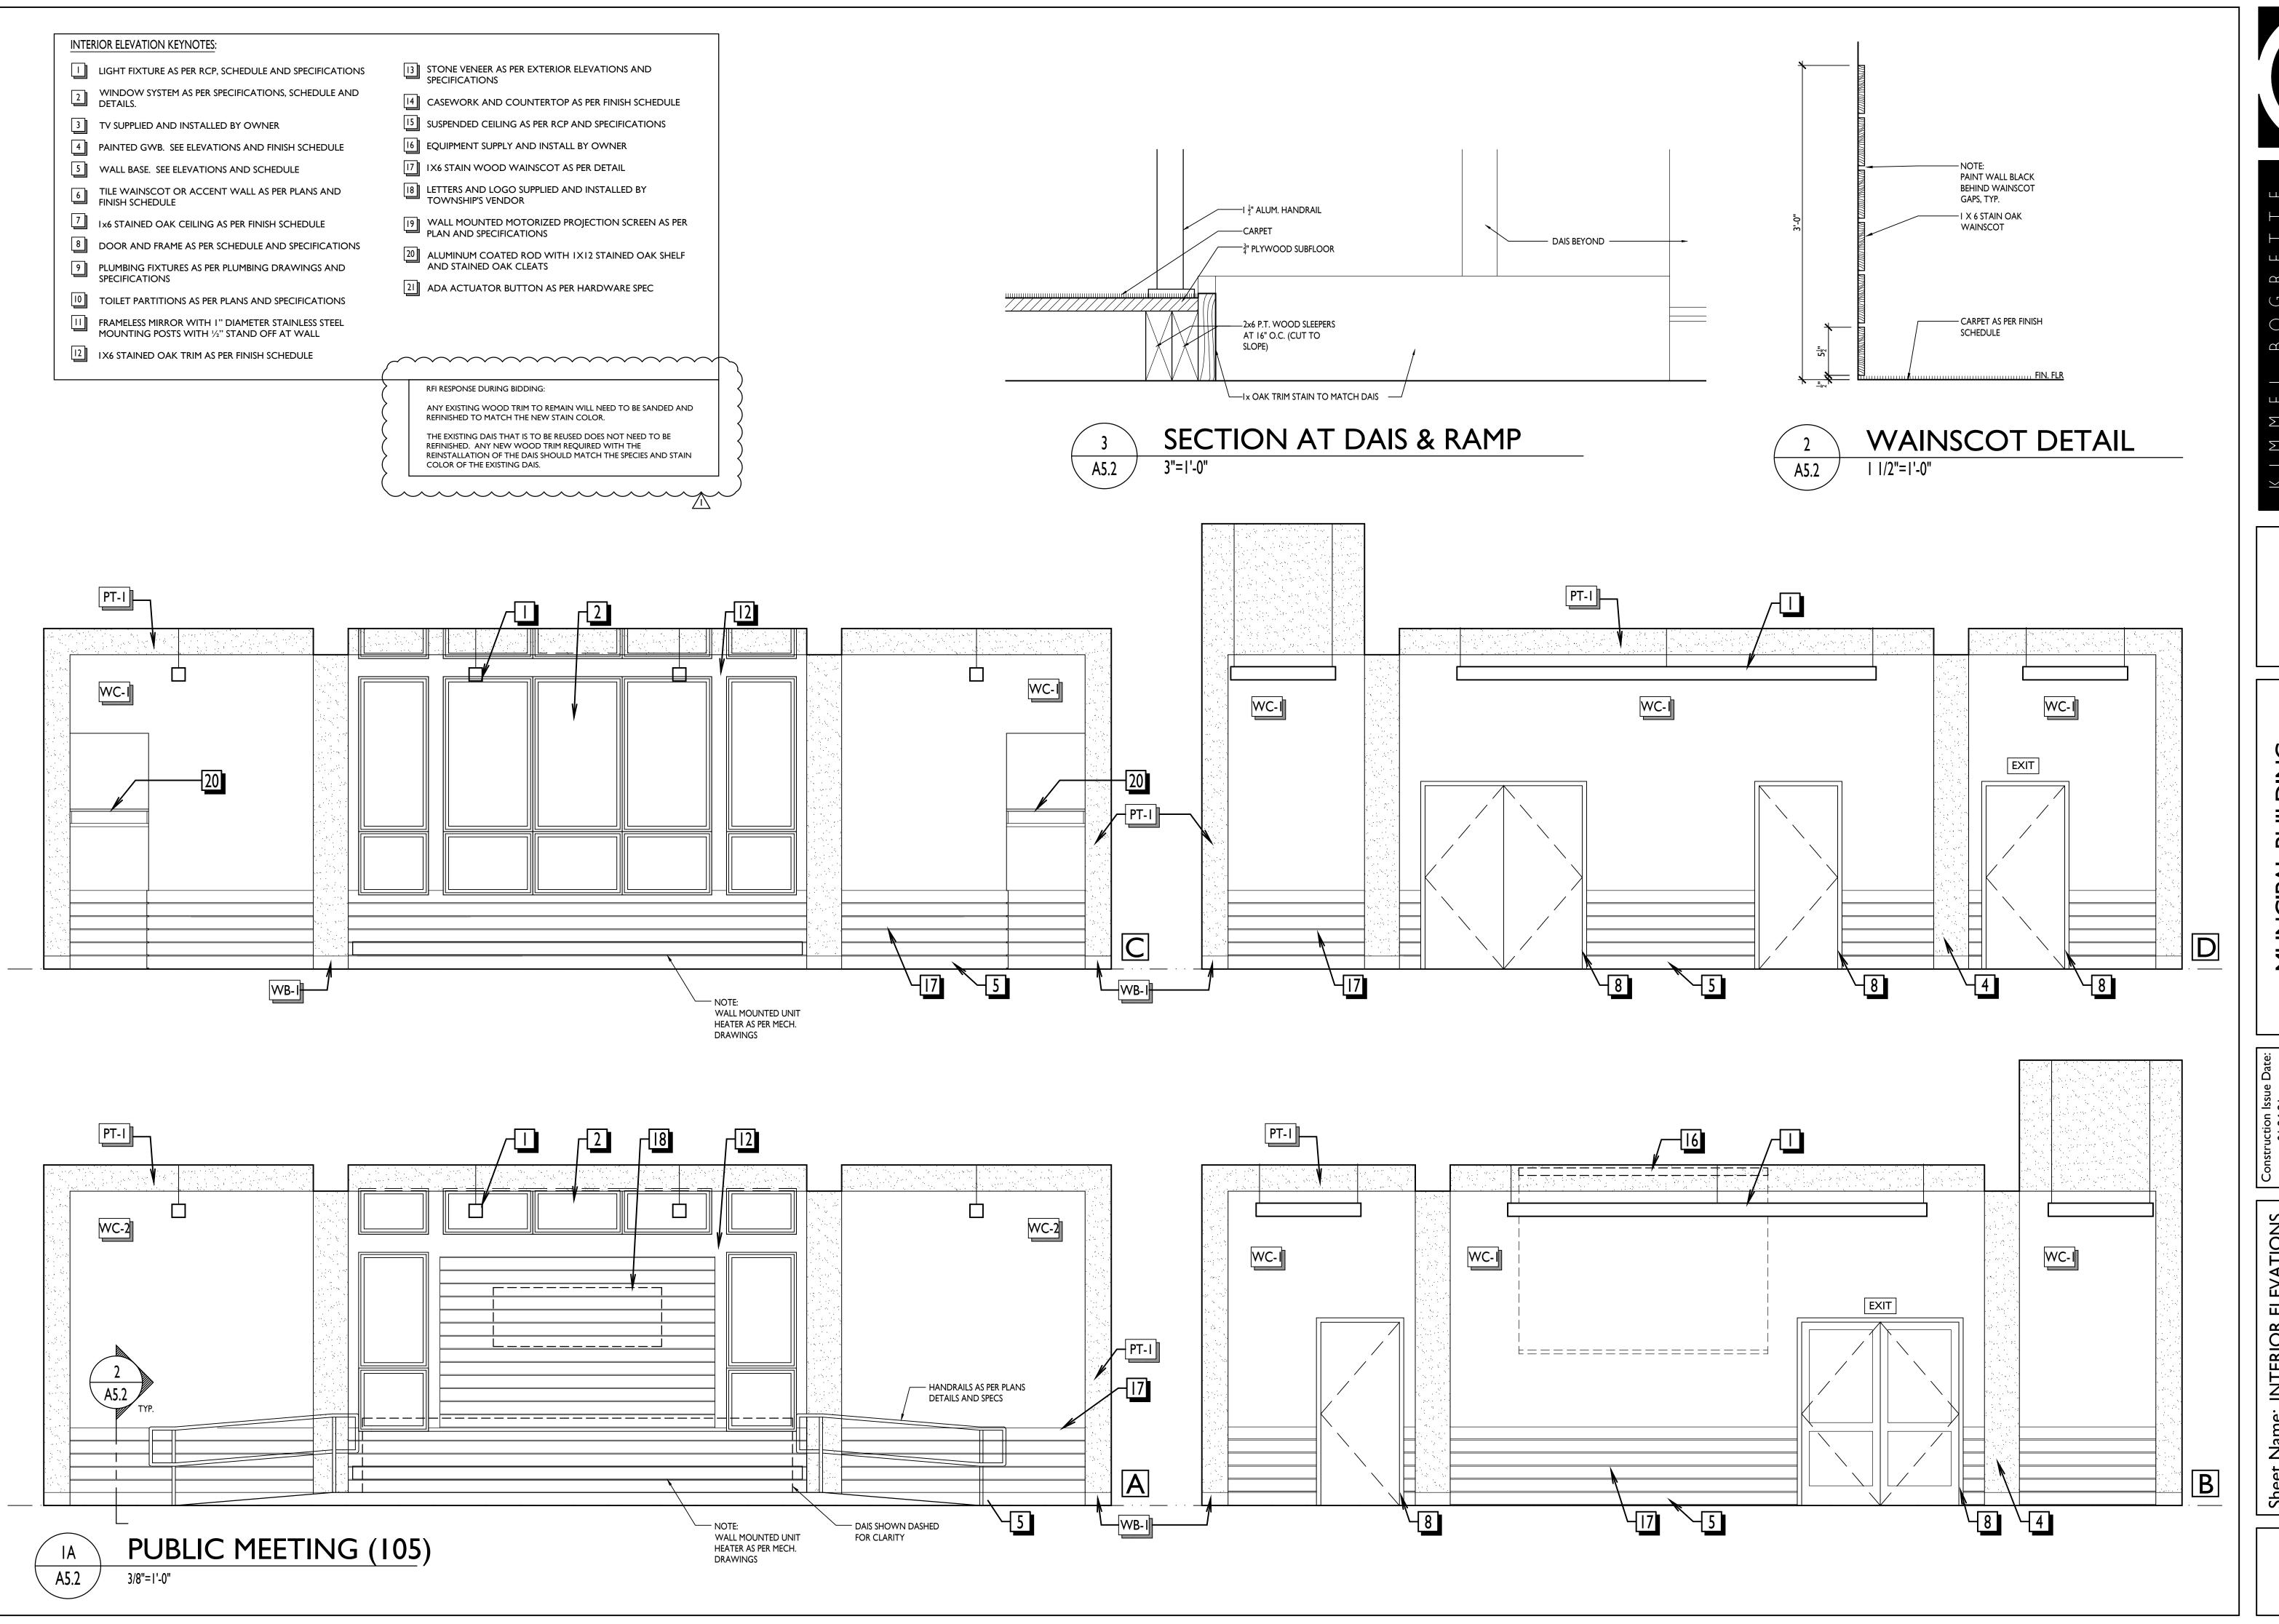

Blue Bell, PA 19422 Facsimile: 610.834.7815

482 Norristown Road, Suite 200 Phone: 610.834.7805

MUNCIPAL BUILDING
T BRADFORD TOWNSH
1385 CAMPUS DRIVE

Drawn By: TM, YP
Checked By: JT
Scale: AS NOTED

Sheet Name: INTERIOR ELEVATIONS


Progress Prints:

10/15/20 ISSUED FOR BIDDING


01/26/21 FOR CONSTRUCTION

A REVISED DURING BIDDING

A5.2

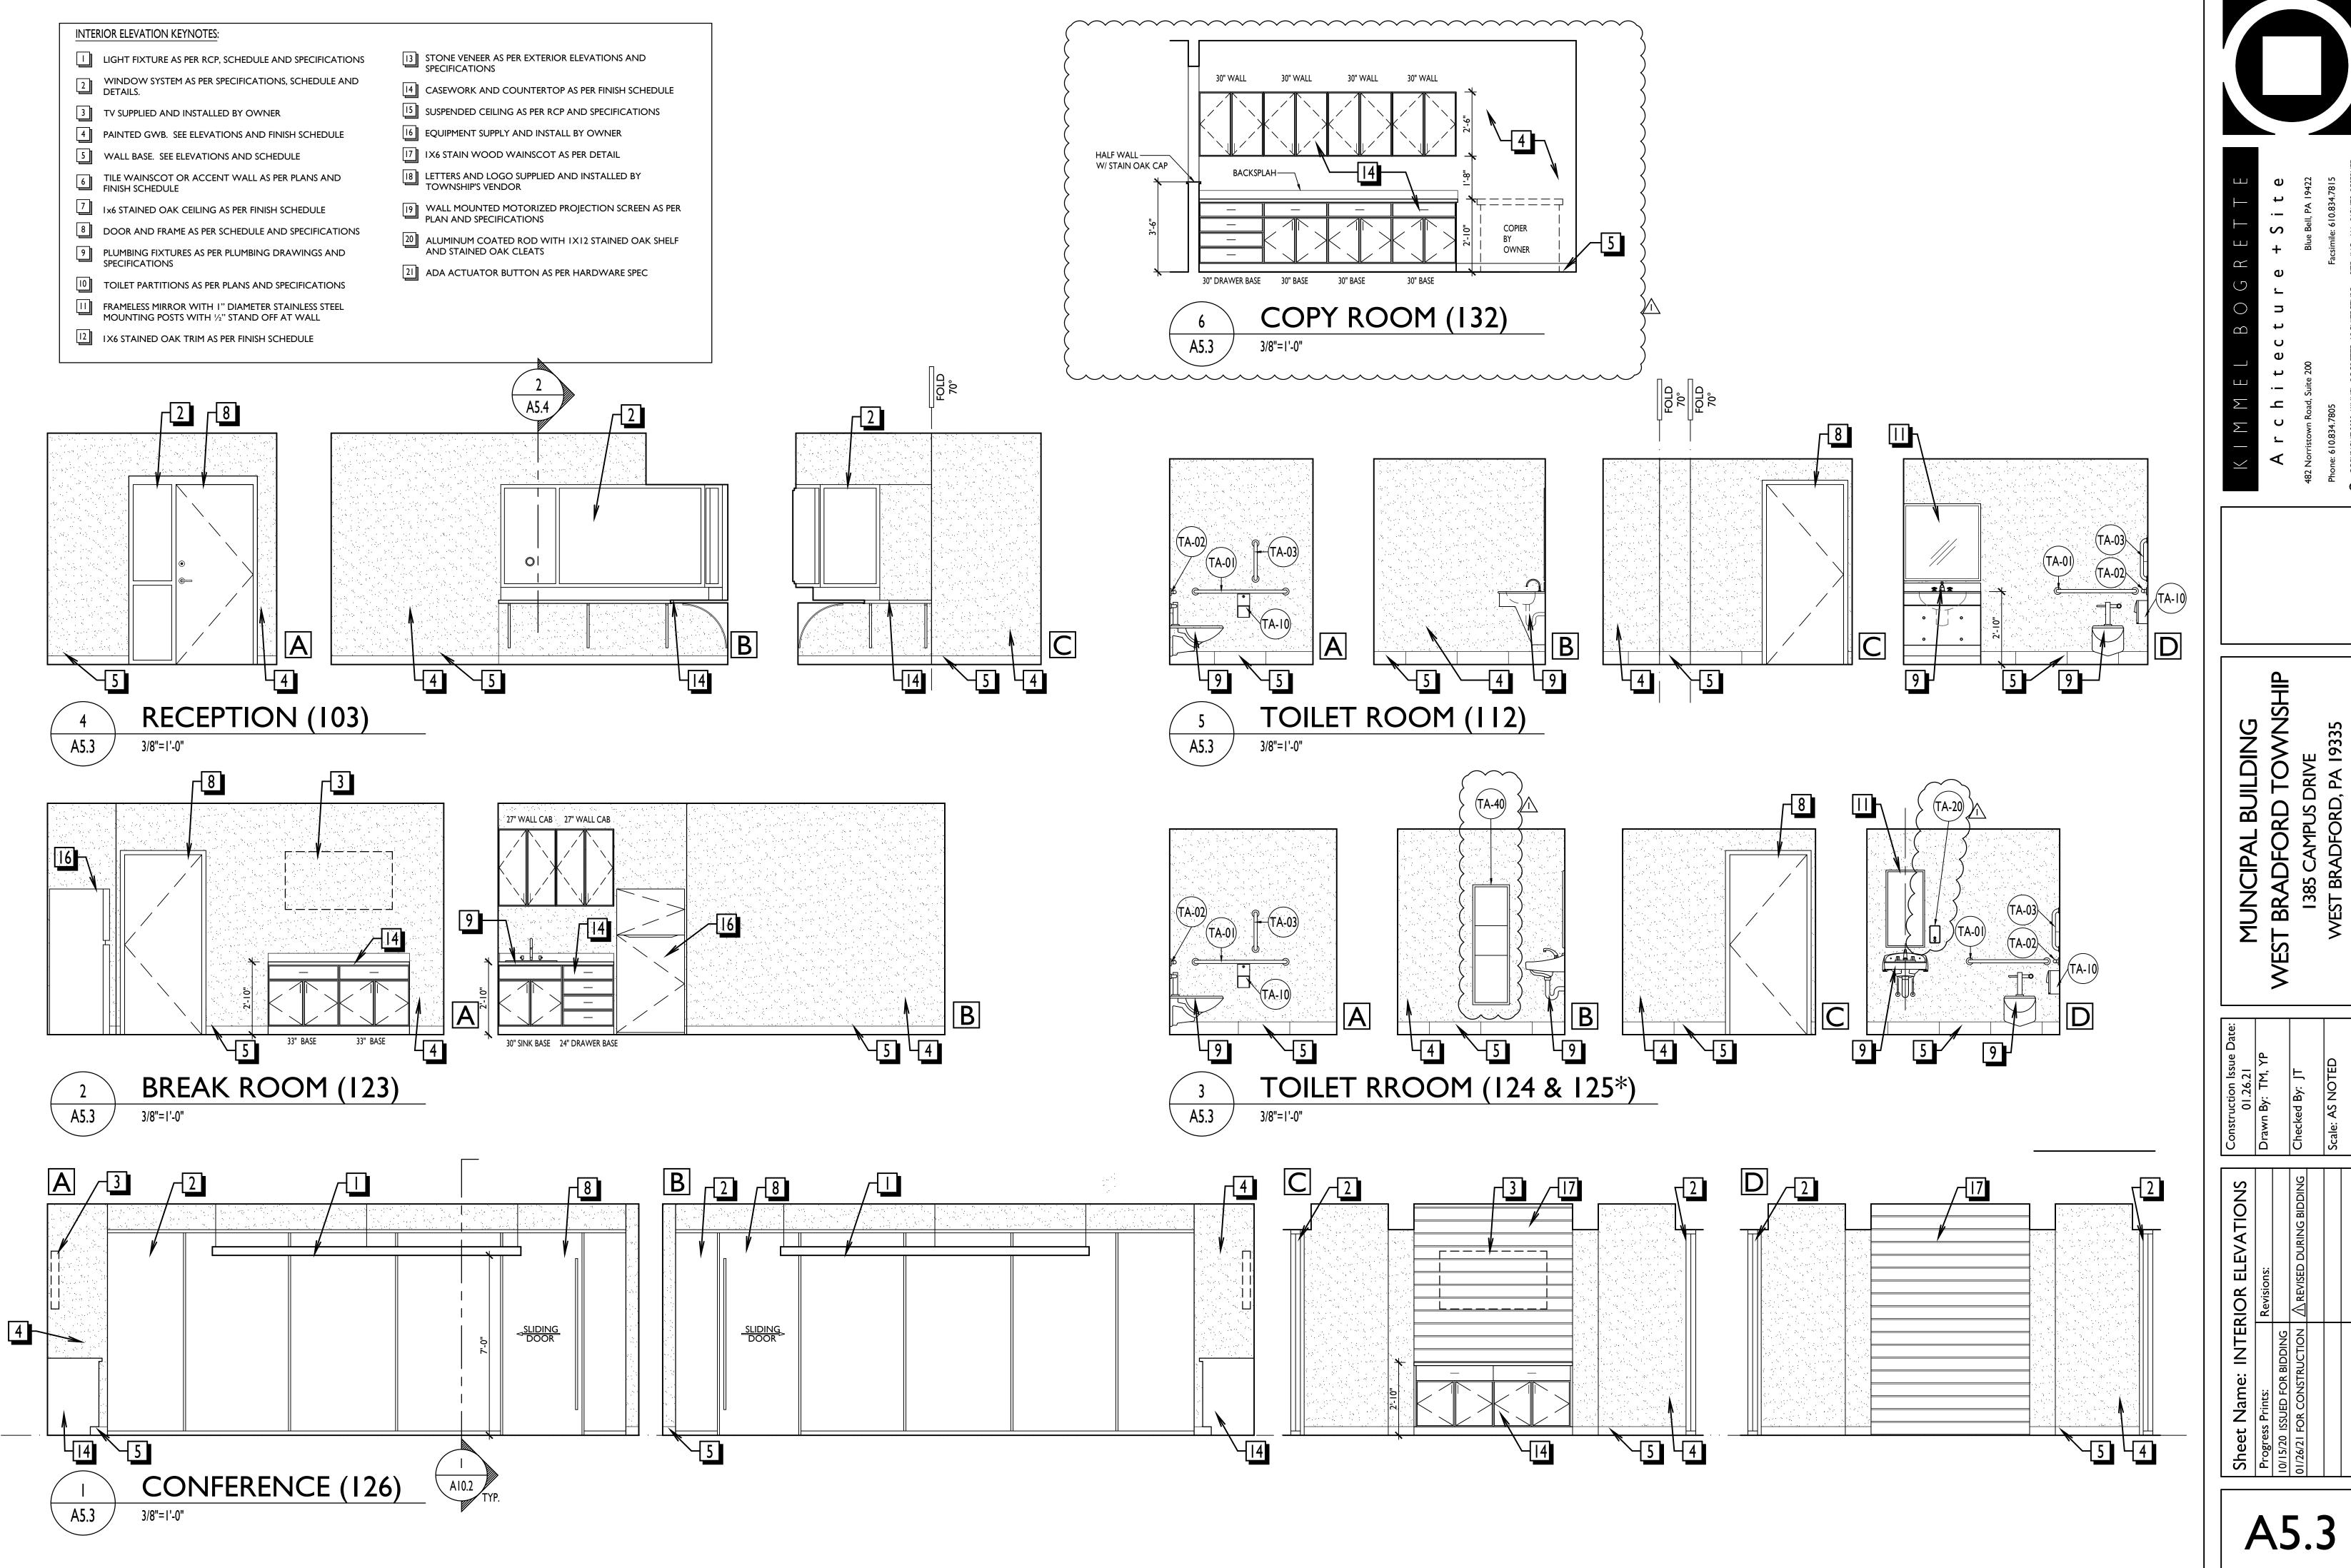

A5.3

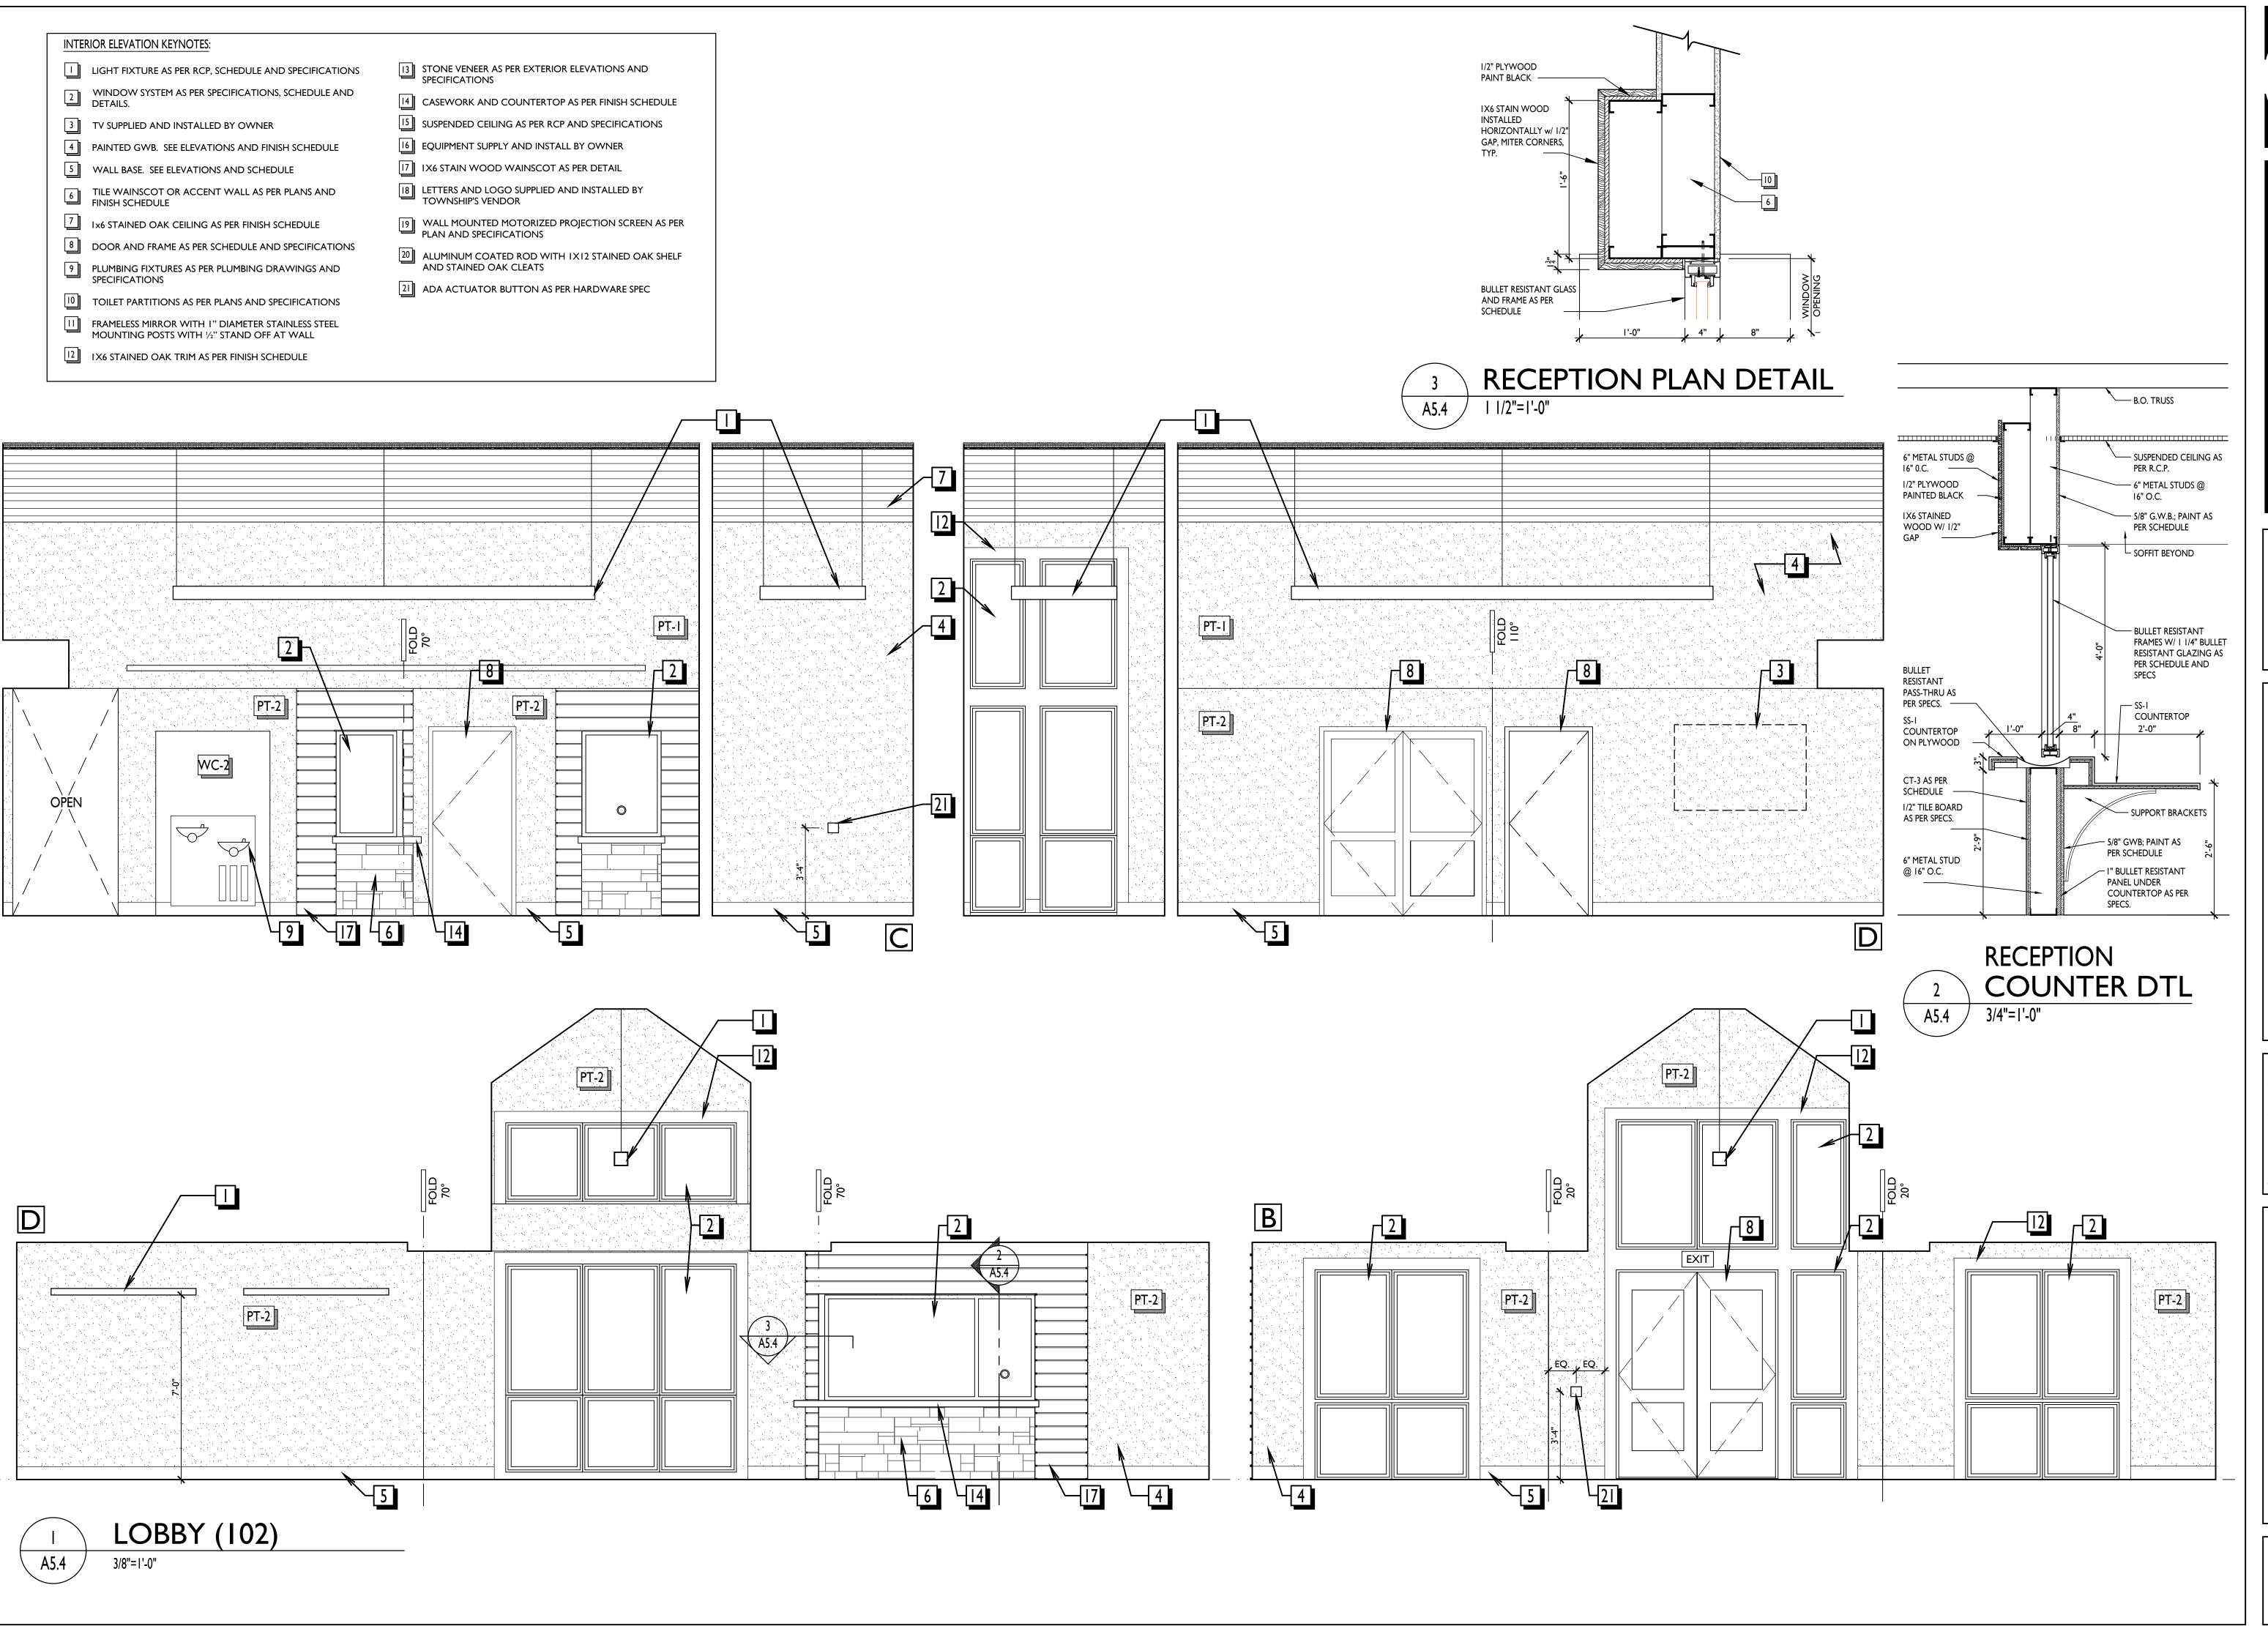

Blue Bell, PA 19422
Facsimile: 610.834.7815
ITECTURE + SITE, INC. ALL RIGHTS RESERVED

Architecture 82 Norristown Road, Suite 200

MUNCIPAL BUILDING
WEST BRADFORD TOWNSHIP
1385 CAMPUS DRIVE
WEST BRADFORD, PA 19335

Drawn By: TM, YP
Checked By: JT
Scale: AS NOTED


Sheet Name: INTERIOR ELEVATIONS

Progress Prints:


10/15/20 ISSUED FOR BIDDING

01/26/21 FOR CONSTRUCTION AREVISED DURING BIDDING

A5.4

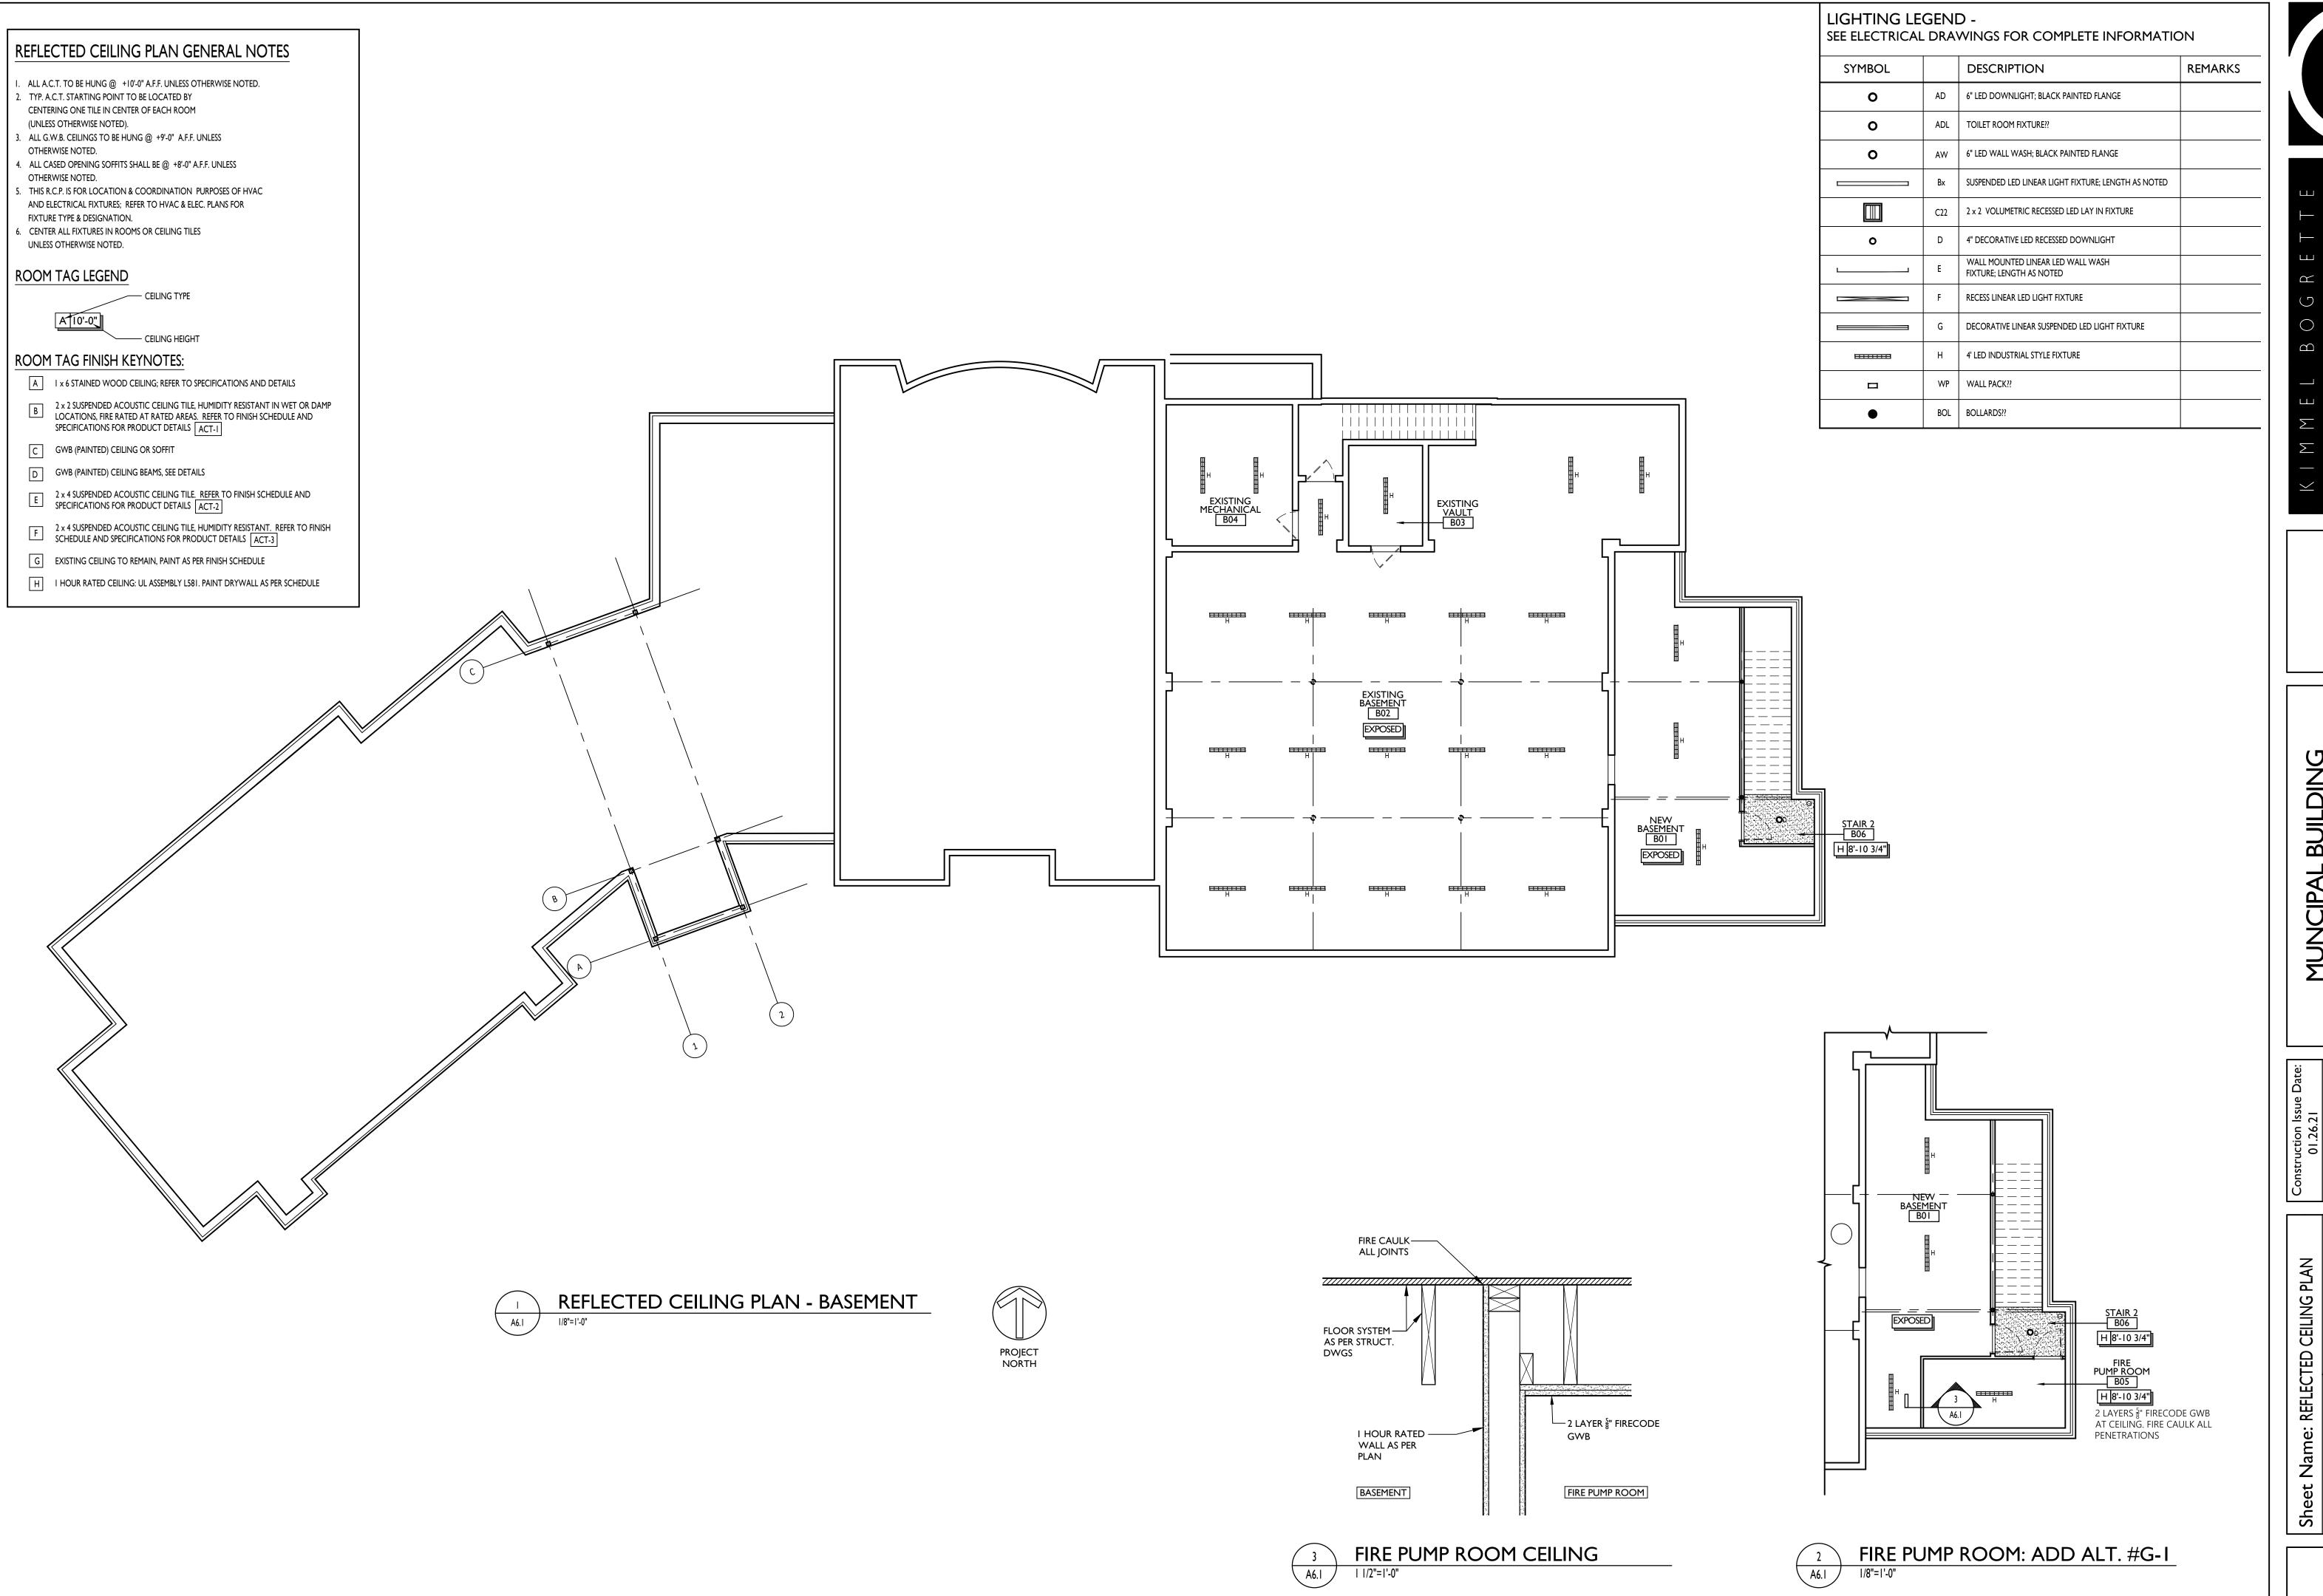

A6.1

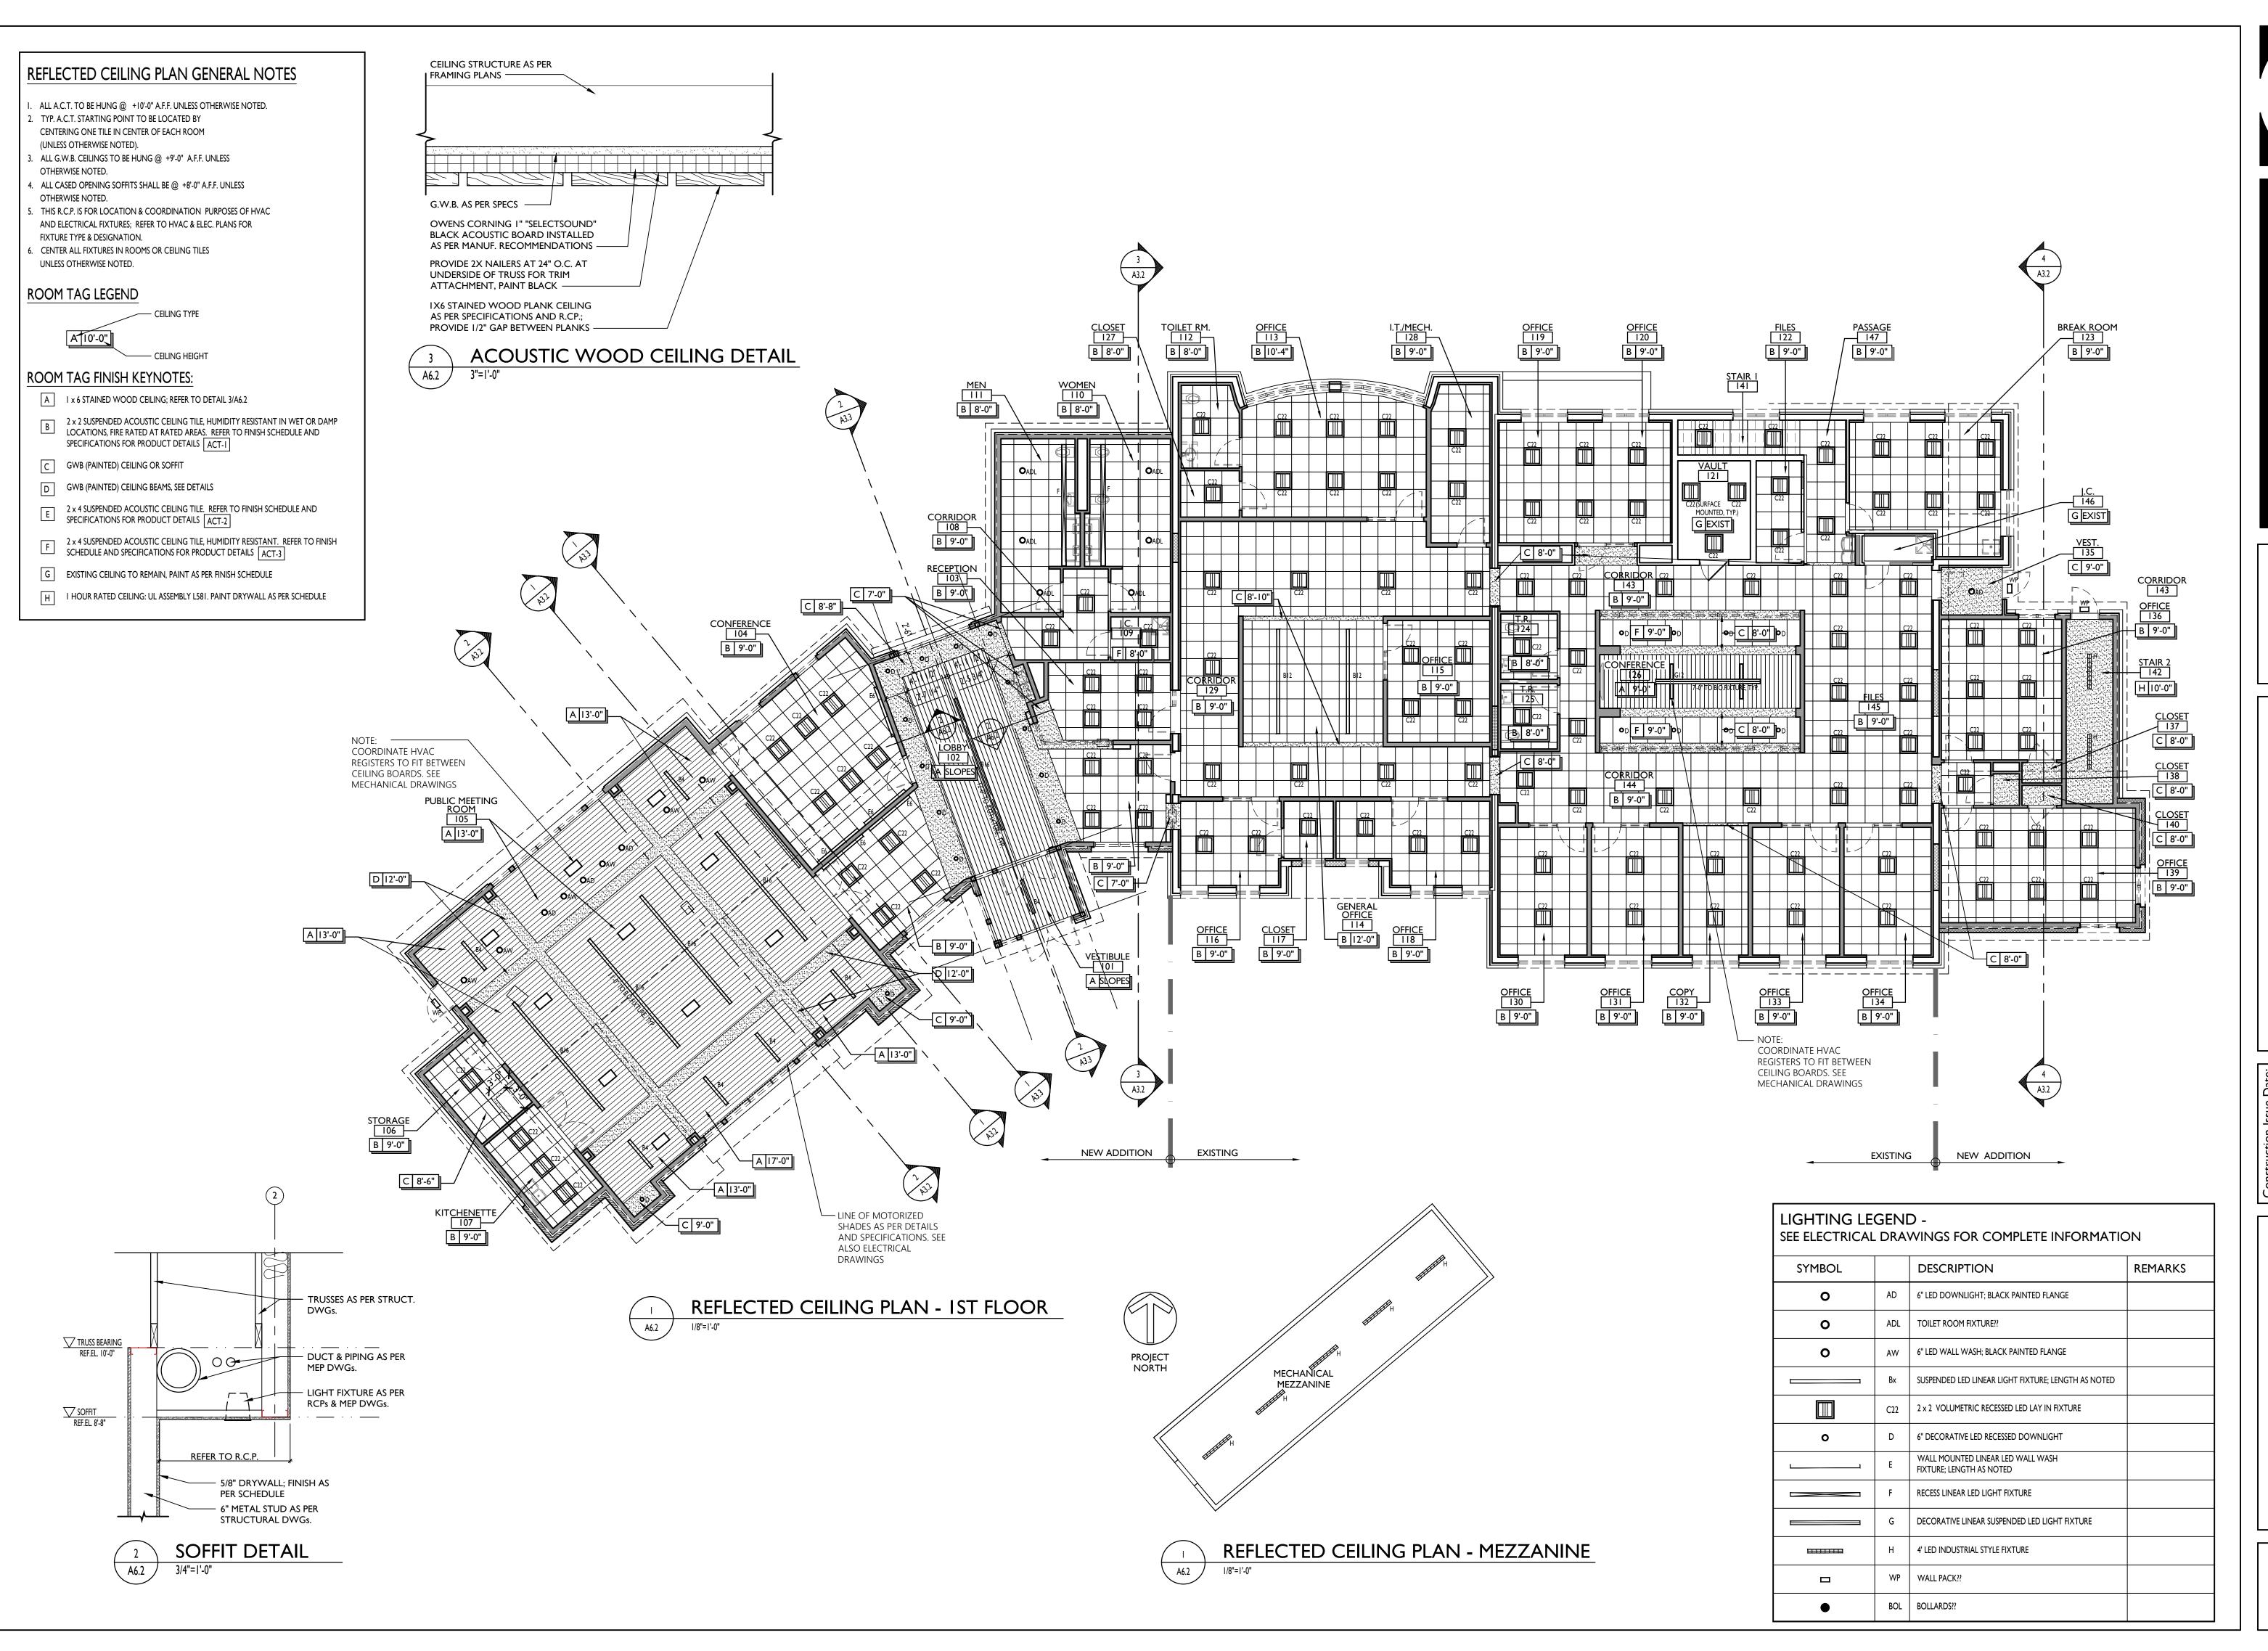

Blue Bell, PA 19422
Facsimile: 610.834.7815

rristown Road, Suite 200 Blue Be

UNCIPAL BUILDING
BRADFORD TOWNSHIF
1385 CAMPUS DRIVE

Drawn By: TM, YP
Checked By: JT
Scale: AS NOTED


ress Prints:


20 ISSUED FOR BIDDING
21 FOR CONSTRUCTION

AREVISED DURING BIDDING

AREVISED DURING BIDDING


A6.2

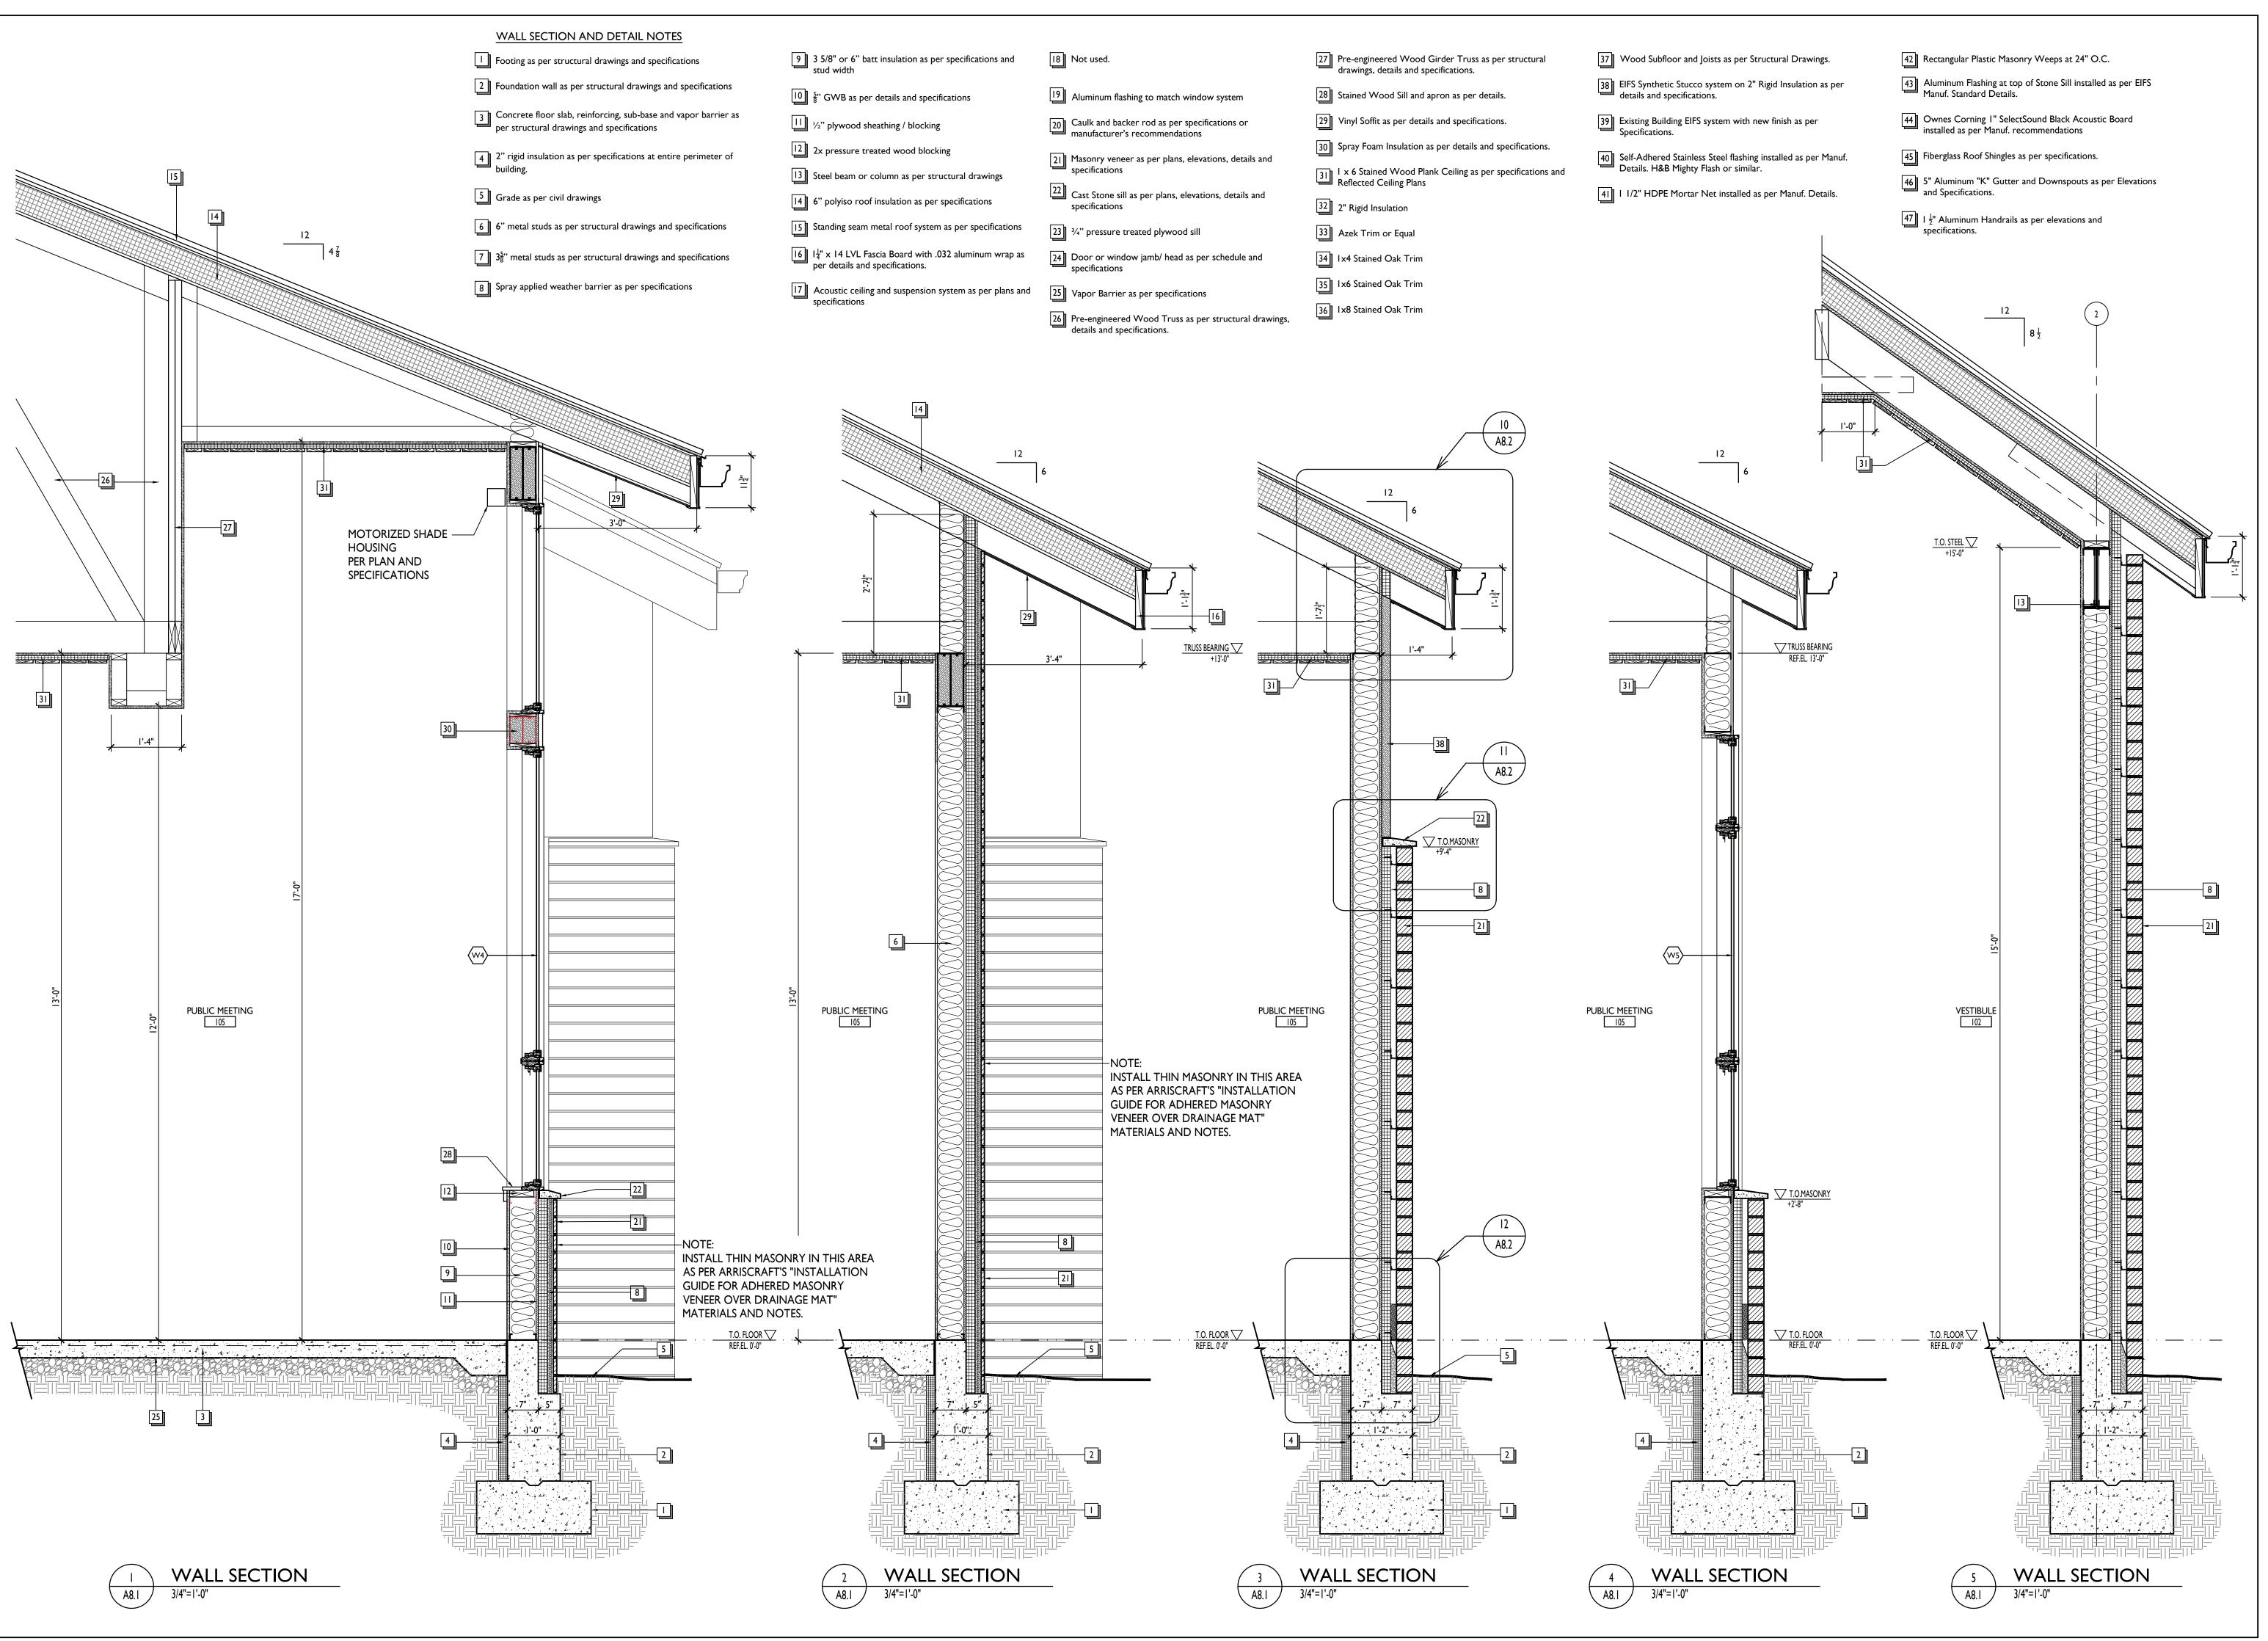


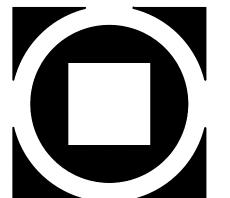

BUILDING RD TOWNSHIP

A8. I

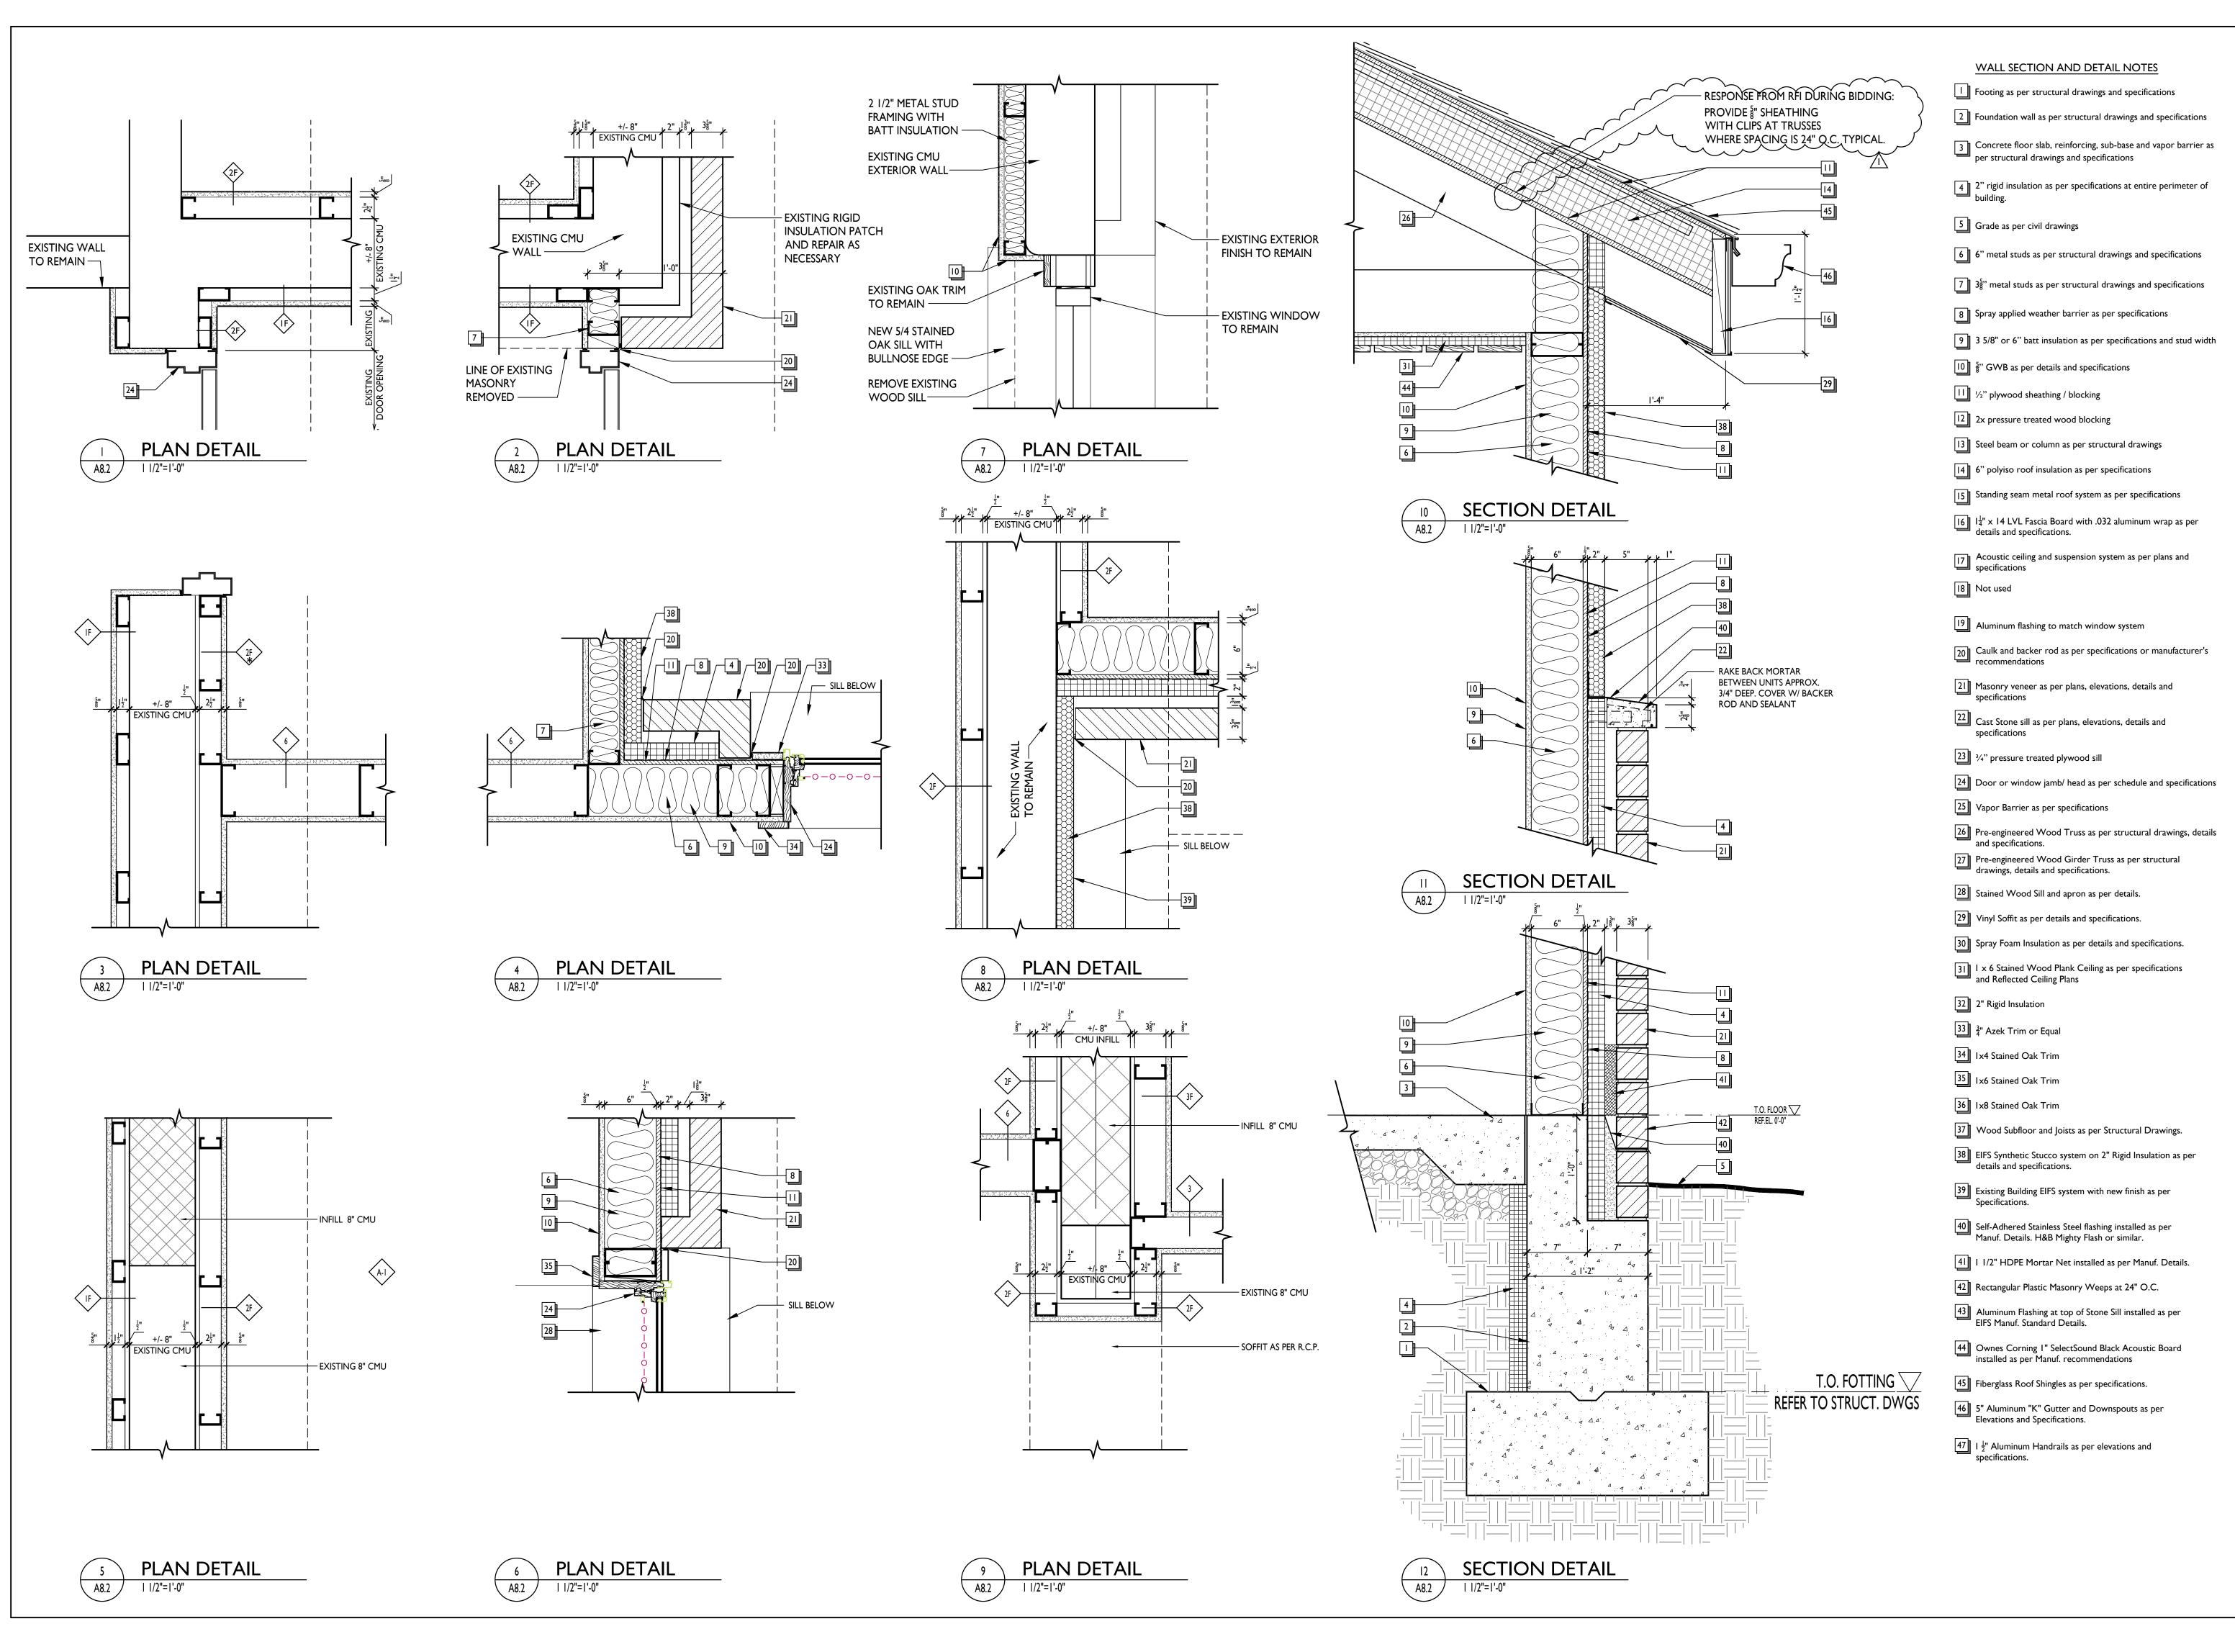

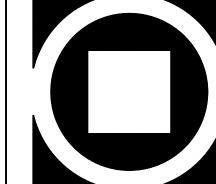

S i t e lue Bell, PA 19422 mile: 610.834.7815

rchiteCture+Si town Road, Suite 200 Blue Bell, P .834.7805 Facsimile: 610.8

MUNCIPAL BUILDING
ST BRADFORD TOWNSHII
1385 CAMPUS DRIVE
WEST BRADFORD, PA 19335

Drawn By: TM, YP
Checked By: JT
Scale: AS NOTED

Sheet Name: PLAN & SECTION DETAILS


Progress Prints:


10/15/20 ISSUED FOR BIDDING

01/26/21 FOR CONSTRUCTION

AREVISED DURING BIDDING


A8.2

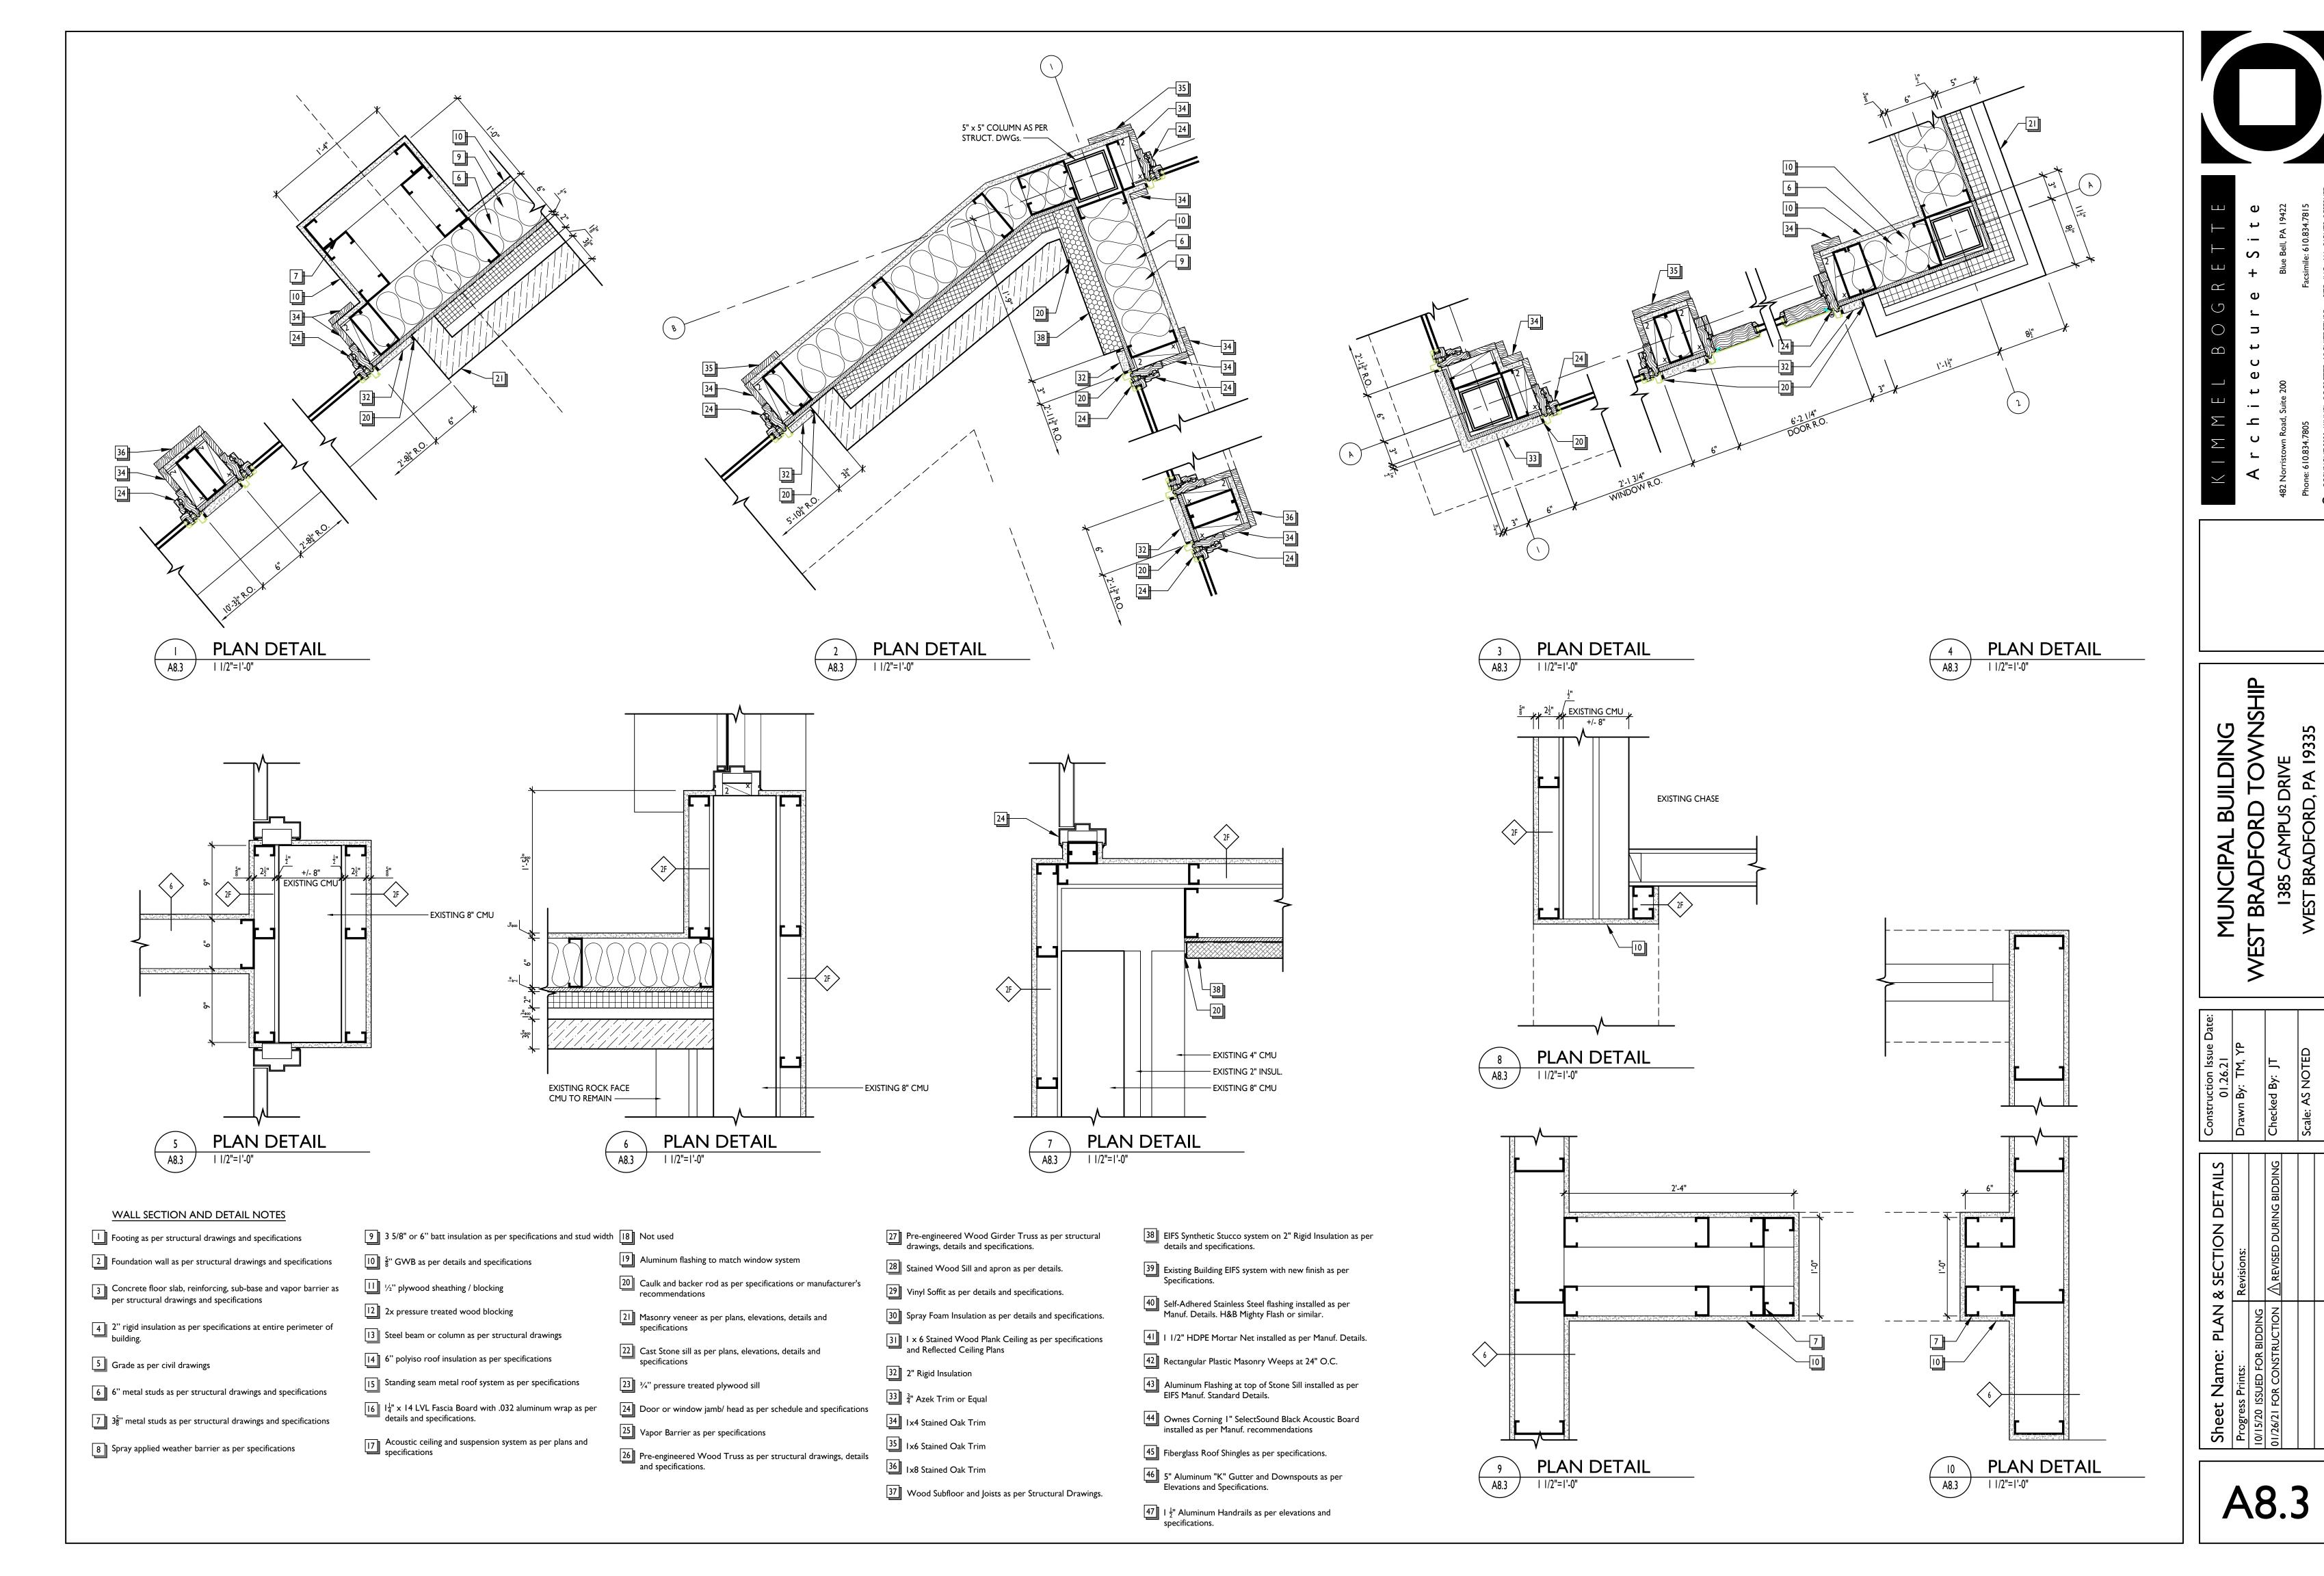


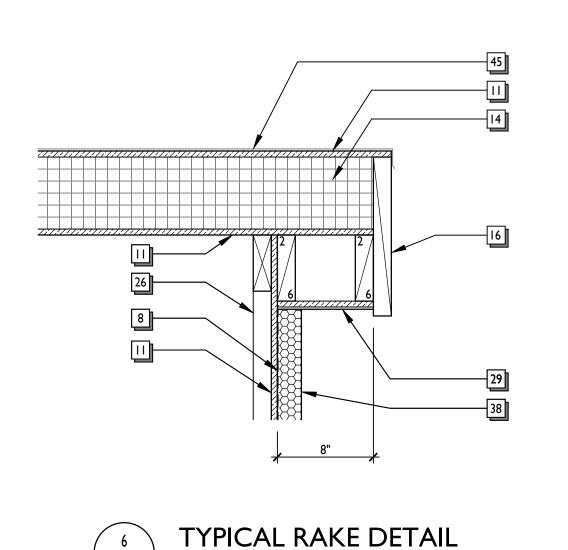


A8.4

| | |/2"=|'-0"

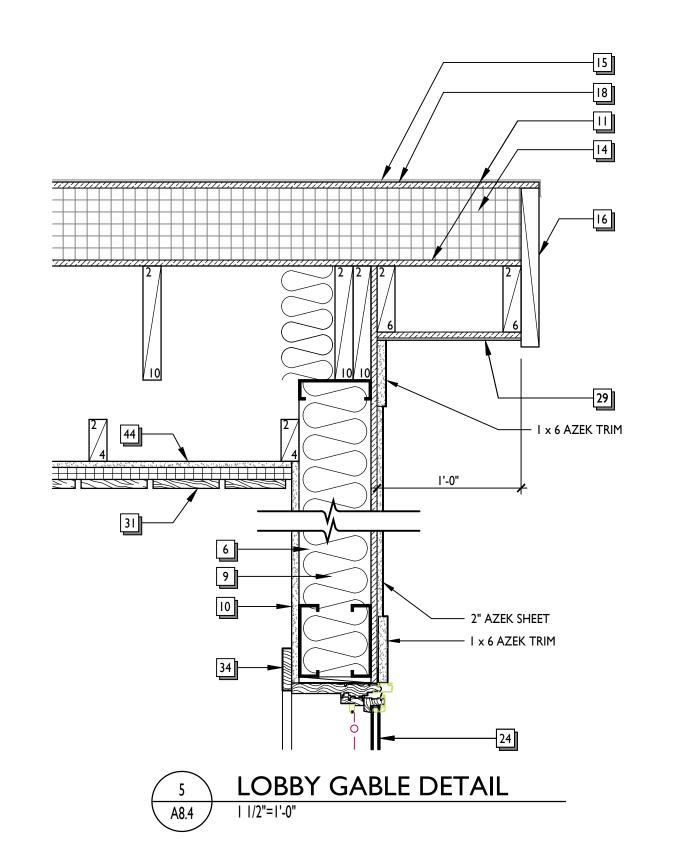

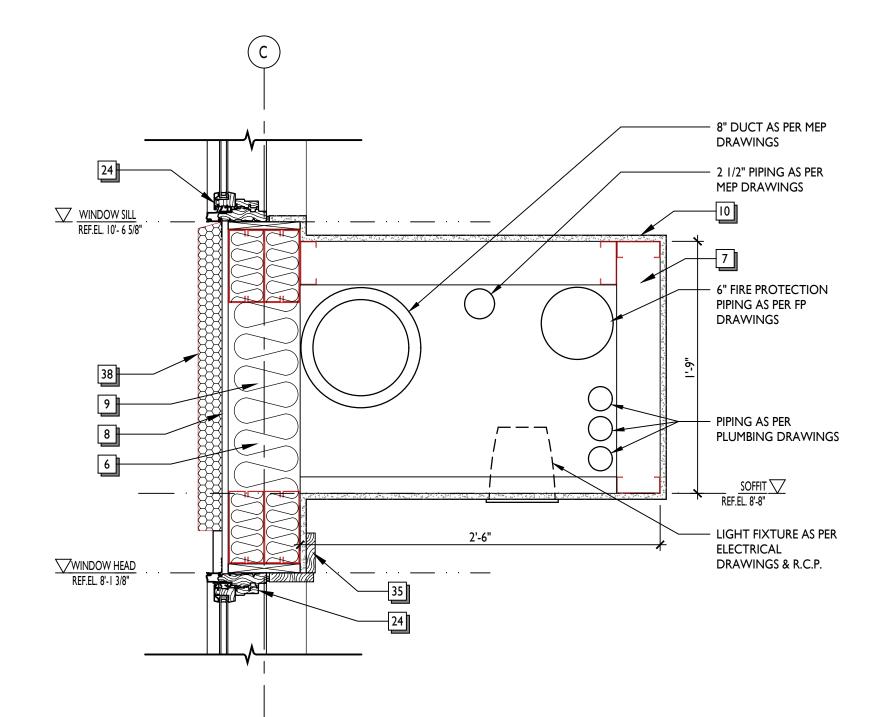



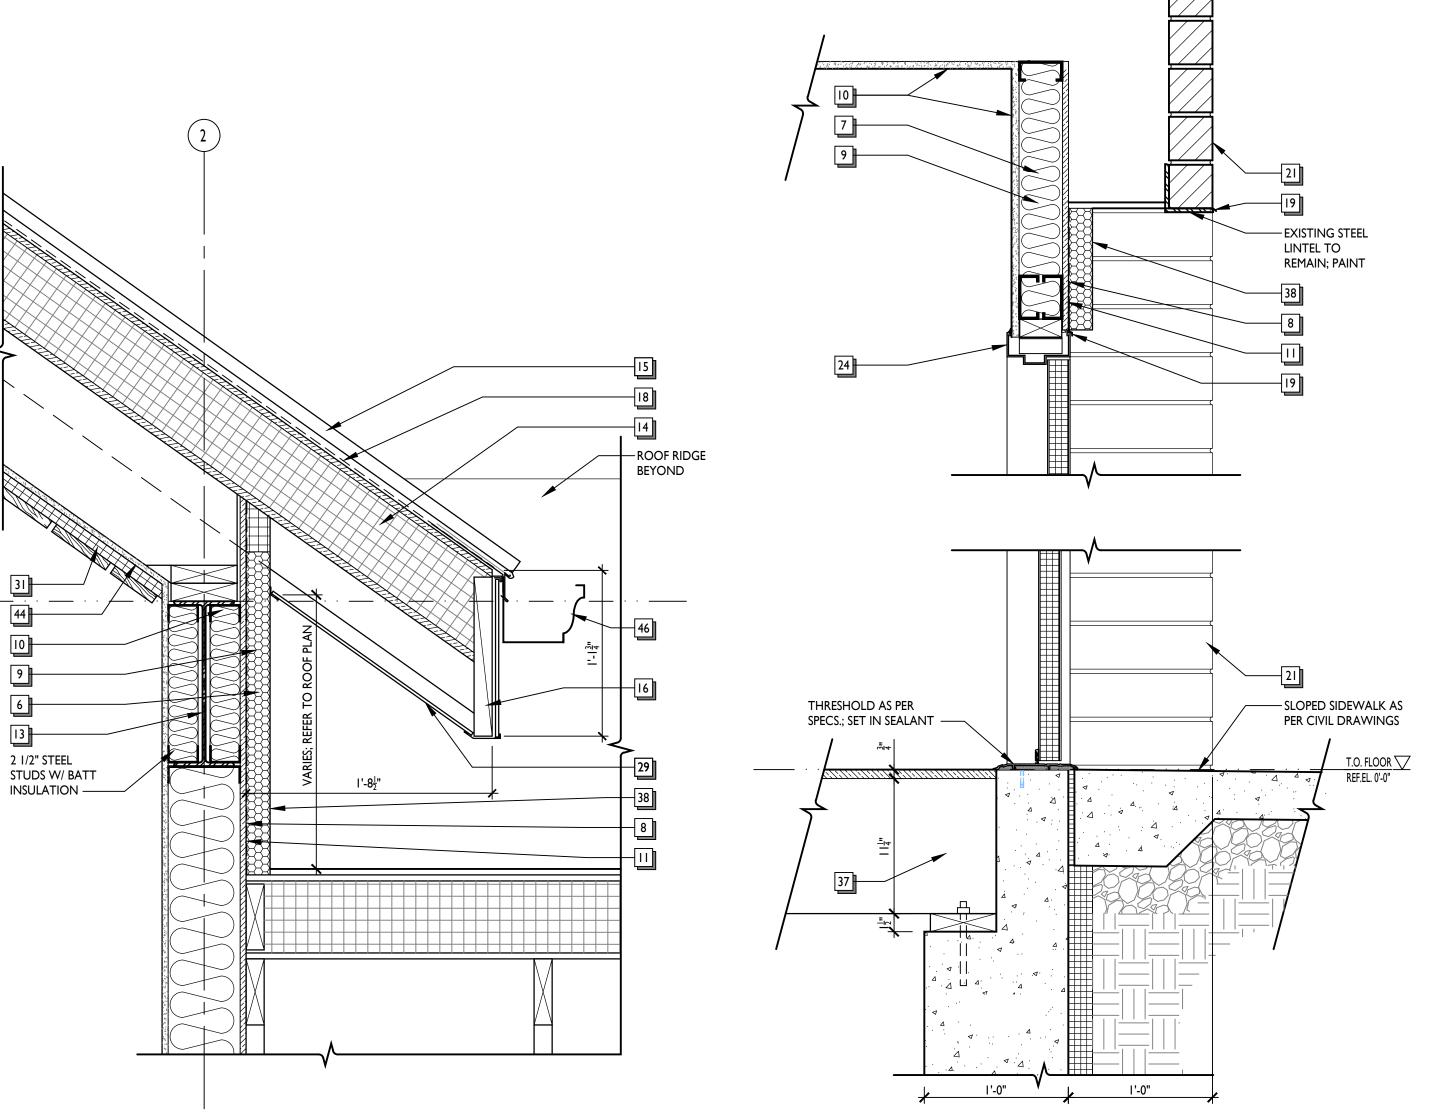


SECTION DETAIL

A8.4 | 1 1/2"=1'-0"

WALL SECTION AND DETAIL NOTES

- Footing as per structural drawings and specifications
- 2 Foundation wall as per structural drawings and specifications
- Concrete floor slab, reinforcing, sub-base and vapor barrier as per structural drawings and specifications
- 2" rigid insulation as per specifications at entire perimeter of building.
- 5 Grade as per civil drawings
- 6" metal studs as per structural drawings and specifications
- $\boxed{7}$ $3\frac{5}{8}$ " metal studs as per structural drawings and specifications
- 8 Spray applied weather barrier as per specifications
- 9 3 5/8" or 6" batt insulation as per specifications and stud width
- $\frac{5}{8}$ " GWB as per details and specifications
- 1/2" plywood sheathing / blocking
- 2x pressure treated wood blocking
- Steel beam or column as per structural drawings
- [14] 6" polyiso roof insulation as per specifications
- Standing seam metal roof system as per specifications
- 16 I_4^{l} x 14 LVL Fascia Board with .032 aluminum wrap as per details and specifications.
- Acoustic ceiling and suspension system as per plans and specifications
- [8] Roof underlayment as per roofing specifications.
- 19 Aluminum flashing to match window system
- Caulk and backer rod as per specifications or manufacturer's
- Masonry veneer as per plans, elevations, details and specifications
- Cast Stone sill as per plans, elevations, details and specifications
- ³/₄" pressure treated plywood sill
- Door or window jamb/ head as per schedule and specifications
- 25 Vapor Barrier as per specifications
- Pre-engineered Wood Truss as per structural drawings, details and specifications.
- Pre-engineered Wood Girder Truss as per structural drawings, details and specifications.
- 28 Stained Wood Sill and apron as per details.
- Vinyl Soffit as per details and specifications.
- 30 Spray Foam Insulation as per details and specifications.
- I x 6 Stained Wood Plank Ceiling as per specifications and Reflected Ceiling Plans
- 32 2" Rigid Insulation
- 33 3" Azek Trim or Equal
- 34 Ix4 Stained Oak Trim
- 35 Ix6 Stained Oak Trim 36 Ix8 Stained Oak Trim
- Wood Subfloor and Joists as per Structural Drawings.
- EIFS Synthetic Stucco system on 2" Rigid Insulation as per details and specifications.
- Existing Building EIFS system with new finish as per Specifications.
- Self-Adhered Stainless Steel flashing installed as per Manuf. Details. H&B Mighty Flash or similar.
- 41 I 1/2" HDPE Mortar Net installed as per Manuf. Details.
- Rectangular Plastic Masonry Weeps at 24" O.C.
- Aluminum Flashing at top of Stone Sill installed as per EIFS Manuf. Standard Details.
- Ownes Corning I" SelectSound Black Acoustic Board installed as per Manuf. recommendations
- Fiberglass Roof Shingles as per specifications.
- 5" Aluminum "K" Gutter and Downspouts as per Elevations and Specifications.
- I $\frac{1}{2}$ " Aluminum Handrails as per elevations and specifications.

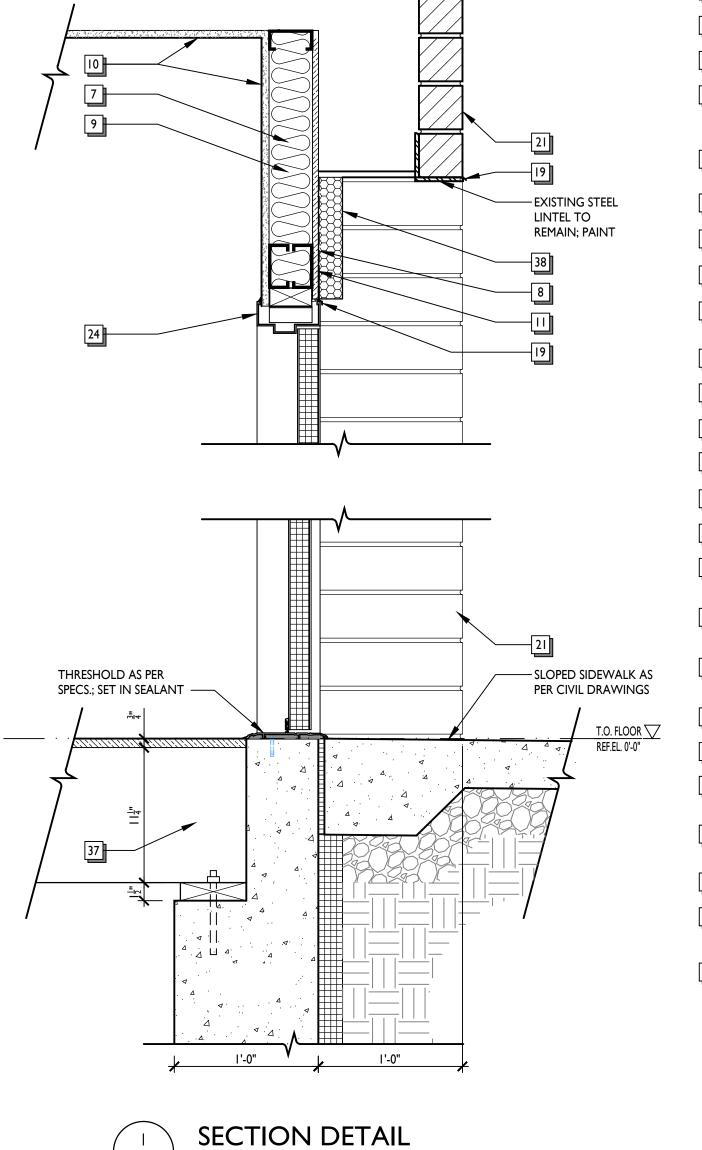



Revisions:


Sheet Name: PLAN & S.
Progress Prints: Rev
10/15/20 ISSUED FOR BIDDING
01/26/21 FOR CONSTRUCTION

A8.4

A REVISED DURING BIDD

AAAN AAAN		DOOM NAME	51.0.00	NA/A11 - 2:2-	TRIM/		WALLS (Pr	oject North)		65111116	DEMARKS.	NOTE
102 LOBBY	AKK	ROOM NAME	FLOOR	WALL BASE	FRAME	N	· · · · · · · · · · · · · · · · · · ·	T* T	W	CEILING	REMARKS	NOTE
193 RECEPTION OPT RB-1 PT-3 PT-1 PT-1 PT-1 PT-1 ACT-1	101	VESTIBULE	CT-I	WB-I	WS-I	PT-I	PT-I	PT-I	PT-I	WS-I	SEE RCP	5
DECOMPRENCE	02	LOBBY	CT-I & CT-2	WB-I	WS-I	SEE INTE	RIOR ELE	VATIONS		WS-I	SEE RCP	3, 5
109 PUBLIC MERTING ROOM	103	RECEPTION	CPT-2	RB-I	PT-3	PT-I	PT-I	PT-I	PT-I	ACT-I		
100 STORAGE	104	CONFERENCE	CPT-I	WB-I	WS-I	PT-I	PT-I	PT-I	PT-I	ACT-I		3
107 KITCHNETTE	105	PUBLIC MEETING ROOM	CPT-I	WB-I	WS-I	SEE INTE	RIOR ELE	VATIONS		WS-I	SEE RCP	3
OR COARDON CT-1	106	STORAGE	~\\\\\\\\\\\\\\\\\\\\\\\\\\\\\\\\\\\\\	RB-2	PT-3	PT-I	PT-I	PT-I	PT-I	ACT-I		3
192 JANTOR	107	KITCHENETTE	· · · · · · · · · · · · · · · · · · ·	RB-2	PT-3	PT-I	PT-I	PT-I	PT-I	ACT-I		3
10 WOMENS RESTROOM	108	CORRIDOR	℃ I-1	WB-I	-	PT-I	PT-I	PT-I	PT-I	ACT-I		3, 5
MINS RISTROOM	109	JANITOR	CT-I	RB-2	PT-3	PT-I	PT-I	PT-I	PT-I	ACT-I		5
12 TOLET ROOM	110	WOMEN'S RESTROOM	CT-I	CT-2	PT-3	CT-3	PT-I	PT-I	CT-3	ACT-I	SEE INTERIOR ELEVATIONS	2, 5
13 OFFICE	Ш	MEN'S RESTROOM	CT-I	CT-3	PT-3	CT-3	PT-I	CT-3	PT-I	ACT-I	SEE INTERIOR ELEVATIONS	2,5
13 OFFICE	12	TOILET ROOM	CT-I	CT-3	PT-3	PT-I	PT-I	PT-I	PT-I	ACT-I		2
14 GENERAL OFFICE CPT-2 RE-1 PT-1 PT-1 PT-1 PT-1 ACT-1 SEE PLANS FOR ACCENT WALL FINSH			CPT-2	RB-I	PT-3	PT-I		PT-I	PT-I			
IF OFFICE CPT-2					-	+	+	PT-I			SEE PLANS FOR ACCENT WALL FINISH	
16 OFFICE					PT-3							
17 CLOSET												
DFICE												
OFFICE												
OFFICE												
MAULT								+				
PILS							+	 			PAINT EXISTING CEILING	
RBEAK ROOM								+			TAINT EXISTING CEILING	
TOILET ROOM												
TOLET ROOM								+				
CONFERENCE								+				2
CLOSET					P1-3						CEE DI ANIC EOD ACCENIT VAVALLE FINICLE	2
128 MECHANICAL LYT-I RB-2 PT-3 PT-I PT-I PT-I PT-I ACT-I					- DT 3			+			SEE PLAINS FOR ACCEINT WALL FINISH	
CORRIDOR												
OFFICE					P1-3	+						
OFFICE CPT.2 NB.2 PT.3 PT.1 PT.1 PT.1 ACT.1											SEE PLANS FOR ACCENT WALL FINISH	
COPY			CPT-2	RB-I								
133 OFFICE			(CPT-2 / 1)									
OFFICE												
135												
136								+				
137 CLOSET			LVT-L								PAINT EXISTING CEILING	
138 CLOSET							+	+				
139 OFFICE	137		CPT-2_I		PT-3	PT-I	PT-I	PT-I	PT-I	ACT-I		
140 CLOSET												
INTERIOR STAIR	139			RB-2								
EXTERIOR STAIR	140	CLOSET	\ CPT-2,[\	RB-2	PT-3	PT-I	PT-I	PT-I	PT-I	ACT-I		
CORRIDOR	141	INTERIOR STAIR	LVT-I	RB-2	PT-3	PT-I	PT-I	PT-I	PT-I	ACT-I	REMOVE AND REINSTALL EXIST HANDRAILS	4
144 CORRIDOR	142	EXTERIOR STAIR									EXPOSED CONCRETE STEPS	
144 CORRIDOR	143		LVT-I	RB-2		PT-I	PT-I	PT-I	PT-I	ACT-I	SEE PLANS FOR ACCENT WALL FINISH	
45 FILES					-			PT-I				_
146 JANITOR					-		+				-	
147 PASSAGE					PT-3							
SOI NEW BASEMENT CONC NONE PT-3 EXPOSED SO2 EXISTING BASEMENT EXIST CONC NONE EXPOSED SO3 EXISTING VAULT EXIST CONC NONE EXPOSED SO4 EXISTING MECHANICAL EXIST CONC NONE EXPOSED							+					
EXISTING BASEMENT EXIST CONC NONE EXPOSED SO3 EXISTING VAULT EXIST CONC NONE EXPOSED SO4 EXISTING MECHANICAL EXIST CONC NONE EXPOSED	- /		_,			1		· · · · · · · · · · · · · · · · · · ·	<u> </u>	1.5.		
EXISTING BASEMENT EXIST CONC NONE EXPOSED SOS EXISTING VAULT EXIST CONC NONE EXPOSED SOS EXISTING MECHANICAL EXIST CONC NONE EXPOSED SOS EXISTING MECHANICAL EXIST CONC NONE EXPOSED	301	NEW BASEMENT	CONC	NONF	PT-3	_	_	 	_	EXPOSED		
EXISTING VAULT EXIST CONC NONE EXPOSED EXISTING MECHANICAL EXIST CONC NONE EXPOSED								 				
BO4 EXISTING MECHANICAL EXIST CONC NONE EXPOSED											+	
								+			+	
NOT A 1904 A					рт э	-				_		
101 MECHANICAL MEZZANINE PLYWOOD NONE - PT-I PT-I PT-I GWB						DT I			- pT '			

INTERIOR F	INISH KEY					
DESIGNATION	MATERIAL TYPE	MANUFACTURER	MODEL	MANUF.NO.	COLOR	REMARKS
ACT-I	ACOUSTIC CEILING TILE	ARMSTRONG	2×2 ULTIMA	1912	WHITE	9/16" GRID
CPT-I	CARPET TILE	INTERFACE	WEI53 WHOLE EARTH	125000AK00	104436 CAPPUCCINO	PUBLIC MEETING ROOM
CPT-2	CARPET TILE	INTERFACE	SNOW MOON, EVENSONG	139000AK00	105331 SUNRISE MOON	OFFICES
CT-I	FLOOR TILE	DALTILE	IRONCRAFT	IC14	RUSTED BRONZE	12"X24" LIGHT POLISH, SEE FINISH PLAN
CT-2	FLOOR TILE	DALTILE	IRONCRAFT	IC15	SABLE BLACK	12"X24" LIGHT POLISH, SEE FINISH PLAN
CT-3	WALL TILE	DALTILE	IRONCRAFT	ICI5	SABLE BLACK	12"x24" STACK BOND. SCHLUTER "JOLLY" CAP ON 6 BASE
CT-4	MOSAIC TILE	DALTILE	IRONCRAFT	IC18	IC18 SABLE BRONZE	BATHROOMS, RECEPTION DESKS, BACKSPLASH
LVT-I	LUXURY VINYL TILE	INTERFACE	TEXTURED STONES, LEVEL SET	A003	A00306 MARBLE	50CM X50CM, ASHLAR PATTERN
PLAM-I	LAMINATE	FORMICA	EARTHEN TWILL	8828-58	MATTE FINISH	PUBLIC MEETING ROOM CASEWORK
PLAM-2	LAMINATE	FORMICA	SARUM TWILL	8827-58	MATTE FINISH	BREAK ROOM
PT-I	WALL PAINT	SHERMAN WILLIAMS	SW 7023	241-C2	REQUISITE GRAY	MAIN WALL PAINT, JAMBS
PT-2	WALL PAINT	SHERMAN WILLIAMS	SW 6249	225-C5	STORM CLOUD	ACCENT WALLS
PT-3	WALL PAINT	SHERMAN WILLIAMS	SW 6075	242-C6	GARRET GRAY	JAMBS
RB-I	RUBBER BASE	ROPPE	WALL BASE	174	SMOKE	TYPICAL WALL BASE
RB-2	RUBBER BASE	ROPPE	WALL BASE	194	BURNT UMBER	BREAK ROOM
RB-3	RUBBER BASE	ROPPE	WALL BASE	177	STEEL BLUE	AT ACCENT WALLS
SS-I	SOLID SURFACE	CAMBRIA	WAVERTON	~		TRANSACTION COUNTERS
SS-2	SOLID SURFACE	HI MACS		Z002	STRATO SAND	COUNTERTOPS
SS-3	SOLID SURFACE	GEO SERIES			SIENA	PUBLIC RESTROOM SINK
TP-I	TOILET PARTITION	SANTANA	HINY HIDDERS		SHALE	GRIP EX FINISH
WB-I	1x6 OAK WOOD BASE					STAIN TO MATCH DOOR COLOR, SEE SPECS
WC-I	WALL COVERING	KOROSEAL	COLOUR AND DESIGN	CD2-BLS-15	NAPA CABIN	PUBLIC MEETING ROOM
WC-2	WALL COVERING	KOROSEAL	COLOUR AND DESIGN	CD2-CSS-35	COPPER WIRE	DRINKING FOUNTAIN
WS-I	WOOD STAIN	SHERMAN WILLIAMS				STAIN TO MATCH DOOR COLOR, SEE SPECS

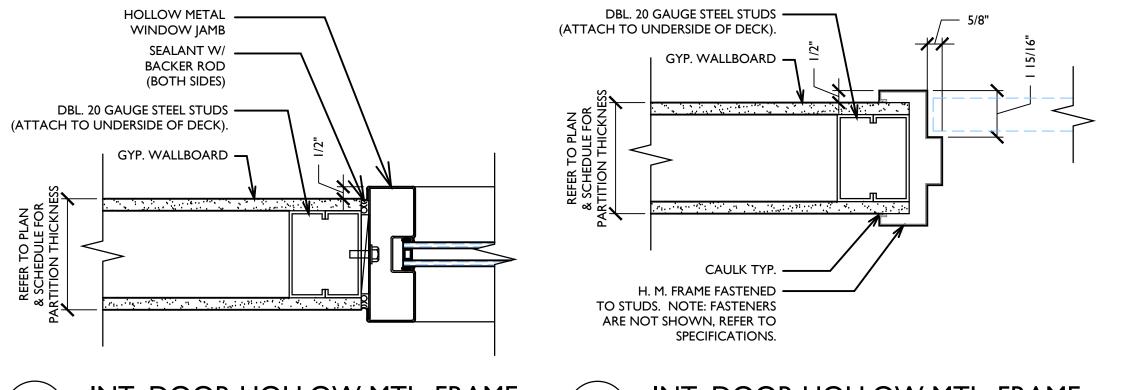





NOTE 3: SEE DETAIL FOR STAINED WOOD CASING ON HM DOOR FRAME. WOOD ON ONE OR BOTH SIDES
NOTE 4: PROVIDE ROPPE STAIR TREAD #96 (WITH RISER) IN COLOR R194 BURNT UMBER. STRINGER TRIM IN COLOR 174 SMOKE
NOTE 5: SEE FLOOR FINISH PLAN FOR PATTERN AND DIRECTION
CENTED ALL NOTE, ALL EXISTING VACOOD TRIM TO REMAIN TO BE SANDED AND RESTAINED VAC


GENERAL NOTE: ALL EXISTING WOOD TRIM TO REMAIN TO BE SANDED AND RESTAINED WS-I GENERAL NOTE: ALL GRILLES AND DIFFUSERS IN WALLS TO BE PAINTED WALL COLOR UNLESS NOTED OTHERWISE

GENERAL NOTE: PROVIDE VINYL TRANSITION STRIPS BETWEEN DISSIMILAR FLOORING MATERIALS UNLESS DIRECTED OTHERWISE BY ARCHITECT.


OOR	SCHEDU	JLE: F	IRST F	LOOR


NOTE 2: EPOXY PAINT ALL WALLS

				DOOR IN	FORMATION		FRAME IN	FORMATION				
		SIZE										
1ARK	ROOM	WIDTH (INCHES)	HEIGHT (INCHES)	THICK.	MATERIAL	DOOR Type	MATERIAL	FRAME TYPE	JAMB DETAIL	FIRE RATING	HDW SET	REMARKS
101	VESTIBULE	2-36"	96"	1.3/4"	PELLA COMMERCIAL	Α	PELLA COMMERCIAL	SEE SCHED			01	ACCESS CONTROL, AUTO OPENER, PANIC LOCKDOWN
102	LOBBY	2-36"	96"	1.3/4"	PELLA COMMERCIAL	Α	PELLA COMMERCIAL	SEE SCHED			02	AUTO OPENER, SEE SPECS
103	RECEPTION	36"	84"	1.3/4"	s.c. wood	В	H.M.	3.2.7			I7A	PASSAGE
104A	CONFERENCE	36"	96"	1.3/4"	s.c. wood	С	H.M.	3.8			06	ACCESS CONTROL, CLOSER, ACOUSTIC HARDWARE
104B	CONFERENCE	36"	96"	1.3/4"	S.C. WOOD	С	H.M.	3.8			06	ACCESS CONTROL, CLOSER, ACOUSTIC HARDWARE
105A	PUBLIC MEETING ROOM	2-36"	96"	1.3/4"	S.C. WOOD	D	H.M.	6.8			07	ACCESS CONTROL, PANIC DEVICE, CLOSER, PANIC LOCKDOWN
105B	PUBLIC MEETING ROOM	36"	84"	1.3/4"	GALV. STL. (INSULATED)	E	H.M. (GALV)	3.7			08	PANIC DEVICE, CLOSER, WEATHERSTRIP, NO EXTERIOR ACCESS
106	STORAGE	36"	84"	1.3/4"	S.C. WOOD	В	H.M.	3.7			09	STORAGE SET
107	KITCHENETTE	2-36"	84"	1.3/4"	S.C. WOOD	В	H.M.	6.7			10	STORAGE SET, THROW BOLT
109	JANITOR	36"	84"	1.3/4"	S.C. WOOD	В	H.M.	3.7			11	STORAGE SET
110	WOMEN'S ROOM	36"	84"	1.3/4"	S.C. WOOD	В	H.M.	3.7			12	PUSH / PULL, CLOSER
111	MEN'S ROOM	36"	84"	1.3/4"	S.C. WOOD	В	H.M.	3.7			12	PUSH / PULL, CLOSER
112	TOILET ROOM	36"	84"	1.3/4"	S.C. WOOD	В	H.M.	3.7			13	PRIVACY SET
113	OFFICE	36"	84"	1.3/4"	S.C. WOOD	В	H.M.	3.3.7			14	OFFICE SET
114	ADMINISTRATION	36"	96"	1.3/4"	S.C. WOOD	С	H.M.	3.8			17	ACCESS CONTROL, CLOSER, BUZZER FROM 103 and 116
115	OFFICE	36"	84"	1.3/4"	S.C. WOOD	В	H.M.	3.3.7			14	OFFICE SET
116	OFFICE	36"	84"	1.3/4"	S.C. WOOD	В	H.M.	3.3.7			17B	OFFICE SET
117	CLOSET	36"	84"	1.3/4"	S.C. WOOD	В	H.M.	3.7			05A	PASSAGE SET
118	OFFICE	36"	84"	1.3/4"	S.C. WOOD	В	H.M.	3.3.7			16	OFFICE SET
119	OFFICE	36"	84"	1.3/4"	S.C. WOOD	В	H.M.	3.3.7			15	OFFICE SET
121	VAULT			11071	5.5. 11 5 5 5						23	EXISTING DOOR TO REMAIN, REPAINT
122	FILES	36"	84"	1.3/4"	S.C. WOOD	В	H.M.	3.7			18	CLASSROOM SET
123	BREAK ROOM	36"	84"	1.3/4"	S.C. WOOD	В	H.M.	3.7			05	PASSAGE SET
124	POWDER ROOM	36"	84"	1.3/4"	S.C. WOOD	В	H.M.	3.7			20	PRIVACY SET, CLOSER
125	POWDER ROOM	36"	84"	1.3/4"	S.C. WOOD	В	H.M.	3.7			20	PRIVACY SET, CLOSER
126A	CONFERENCE	36"	01	1.57-1	3.C. 1100D	Б	11.11.	3.7			24	SLIDING DOOR AND FRAME BY WINDOW MANU.
126C	CONFERENCE	36"									24	SLIDING DOOR AND FRAME BY WINDOW MANU.
127	STORAGE	36"	84"	1.3/4"	S.C. WOOD	В	H.M.	3.7			05	PASSAGE SET
128	IT / MECHANICAL	36"	84"	1.3/4"	S.C. WOOD	В	H.M.	3.7			17	ACCESS CONTROL, CLOSER
130	OFFICE	36"	84"	1.3/4"	S.C. WOOD	В	H.M.	3.3.7			14	OFFICE SET
	OFFICE	36"	84"	1.3/4"	S.C. WOOD	В	H.M.	3.3.7			14	OFFICE SET
131	OFFICE	36"	84"	1.3/4"	S.C. WOOD	В	H.M.	3.3.7				OFFICE SET
133	OFFICE	1	84"				H.M.	3.3.7			14	OFFICE SET
134		36"		1.3/4"	S.C. WOOD	В					14	
135A	VESTIBULE VESTIBULE	36" 36"	84"	1.3/4"	GALV. STL. (INSULATED)	E	H.M. (GALV)	3.7			03	PANIC DEVICE, CLOSER, WEATHERSTRIP, ACCESS CONTROL, PANIC LOCKDOWN
135B			84"	1.3/4"	S.C. WOOD	В	H.M.	3.7			04	PUSH / PULL, CLOSER
136	OFFICE	36"	84"	1.3/4"	S.C. WOOD	В	H.M.				14	OFFICE SET
137	CLOSET	36"	84"	1.3/4"	S.C. WOOD	В	H.M.	3.7			05	PASSAGE SET
138	CLOSET	36"	84"	1.3/4"	S.C. WOOD	В	H.M.				19	CLASSROOM SET
139	OFFICE	36"	84"	1.3/4"	S.C. WOOD	В	H.M.	3.7			14	OFFICE SET
140	CLOSET	36"	84"	1.3/4"	S.C. WOOD	B -	H.M.	3.7			05	PASSAGE SET
142	STAIR 2	36"	84"	1.3/4"	GALV. STL. (INSULATED)	E	H.M. (GALV)	3.7			03	PANIC DEVICE, CLOSER, WEATHERSTRIP, ACCESS CONTROL, PANIC LOCKDOWN
146	JANITOR	36"	84"	1.3/4"	S.C. WOOD	В	H.M.	3.7			22	STORAGE SET
B0 I	BASEMENT STAIR	36"	84"	1.3/4"	GALV. STL. (INSULATED)	E	H.M. (GALV)	3.7			03	PANIC DEVICE, CLOSER, WEATHERSTRIP, ACCESS CONTROL, PANIC LOCKDOWN
BO5	FIRE PUMP ROOM	36"	84"	1.3/4"	GALV. STL. (INSULATED)	E	H.M. (GALV)	3.7		60	25	STORAGE SET, CLOSER

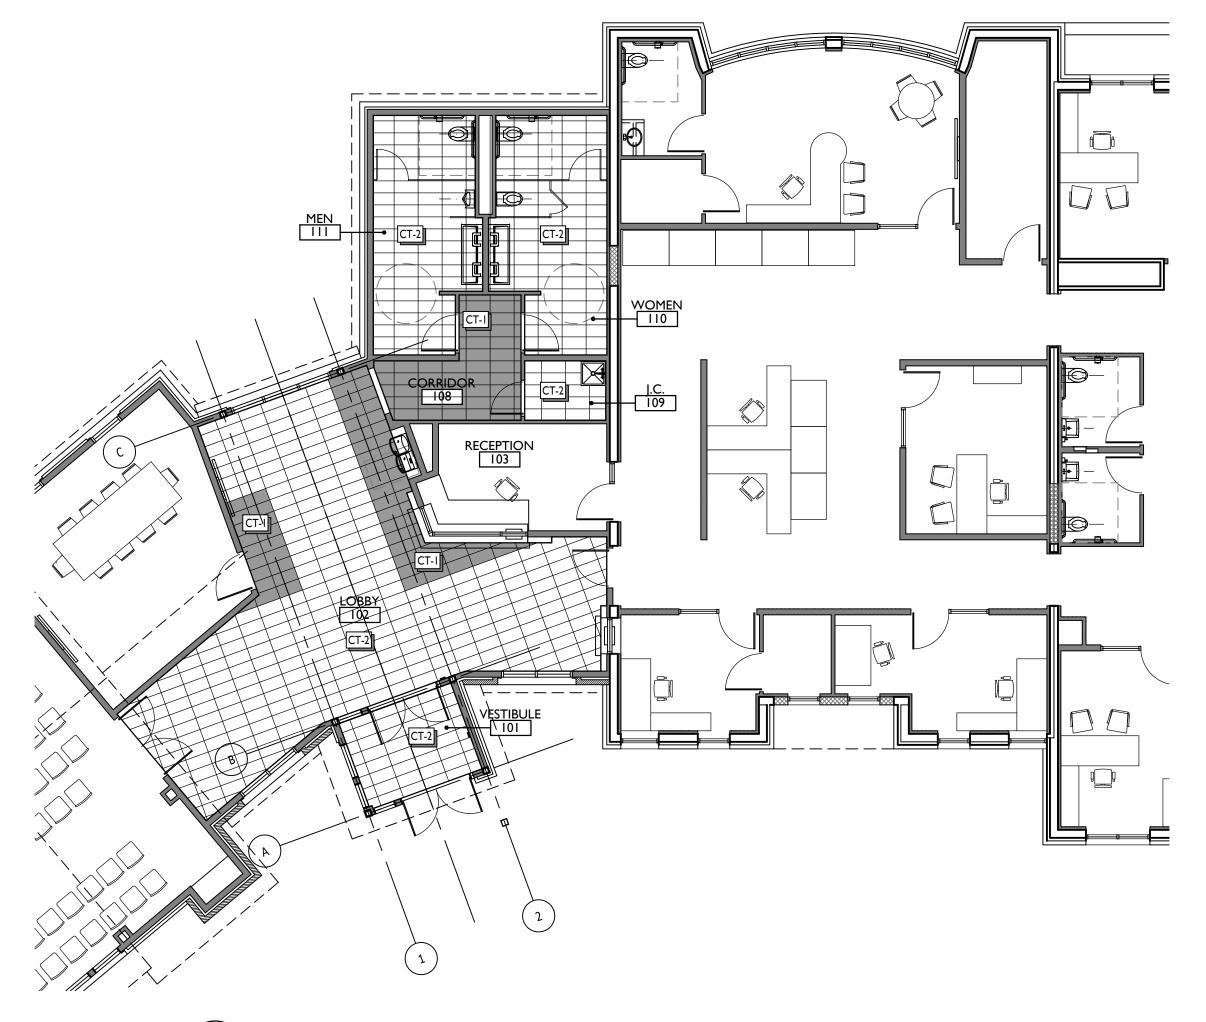




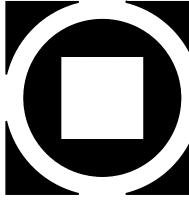

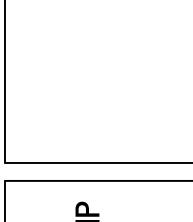

BUILDING RD TOWNSHIP

AI0.I

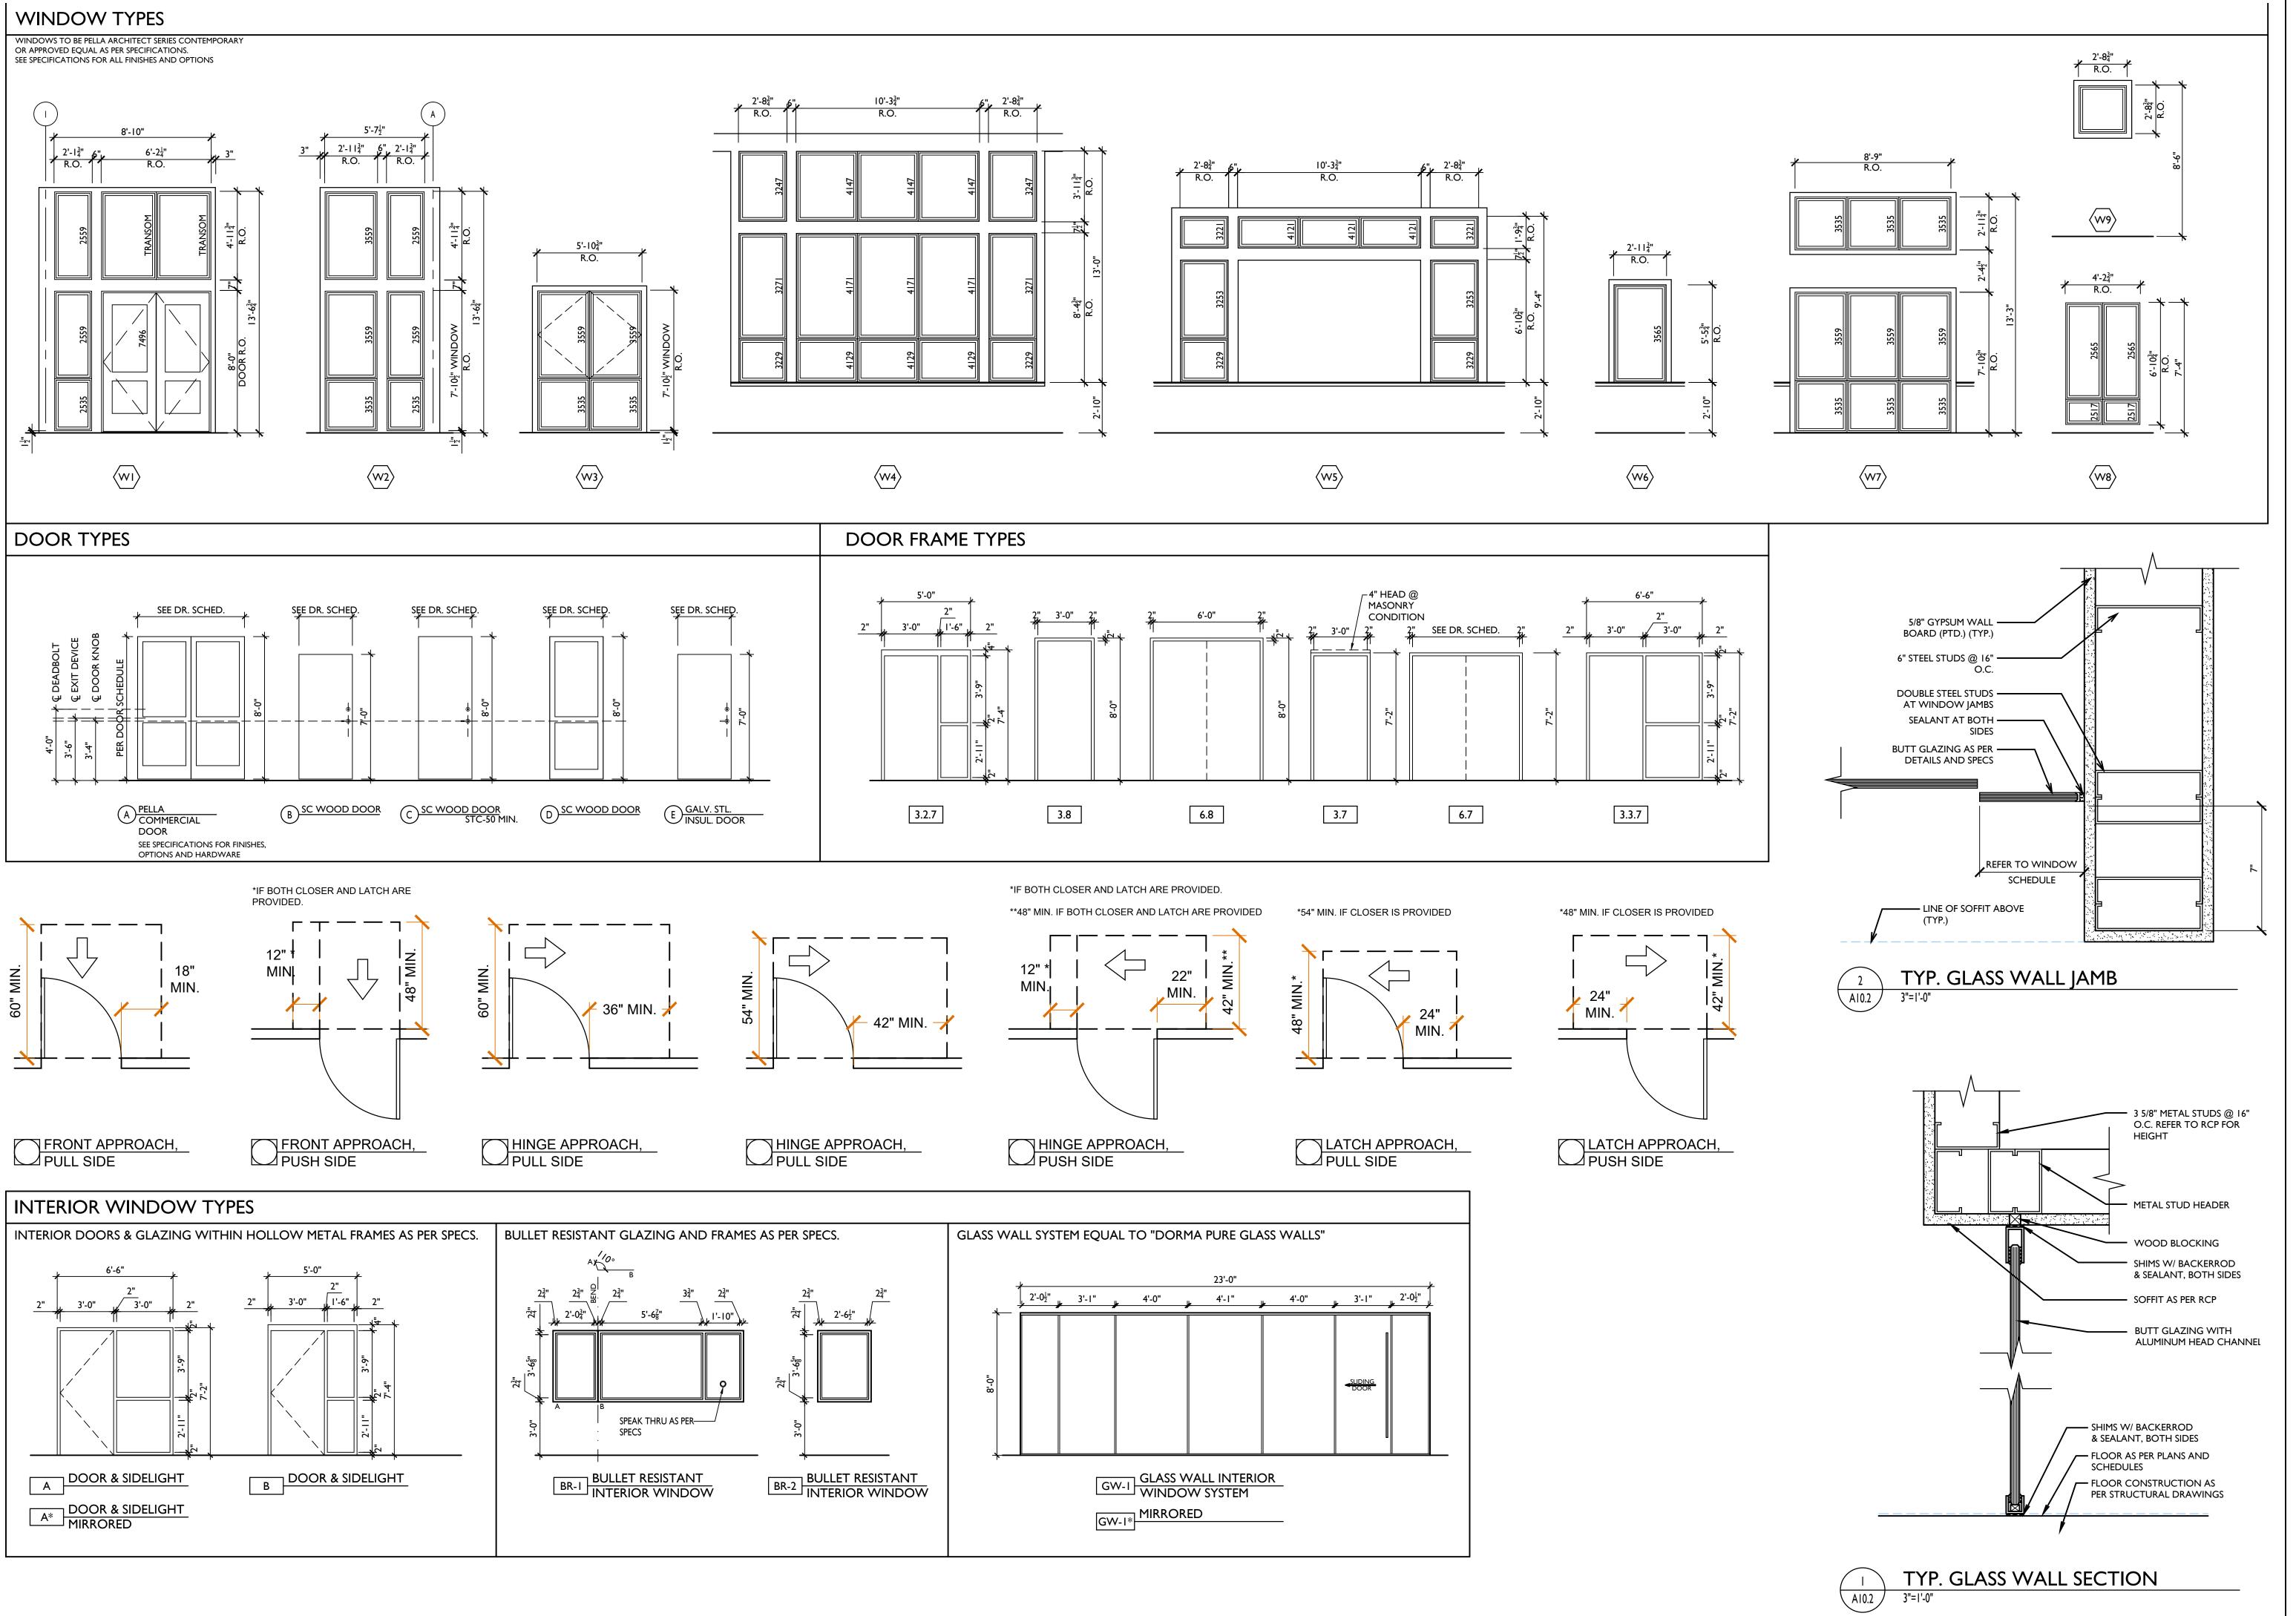

tecture + Site

Blue Bell, PA 19422

482 Norristown Road, Suite 200
Phone: 610.834.7805

MUNCIPAL BUILDING

EST BRADFORD TOWNSHIP

1385 CAMPUS DRIVE

WEST BRADFORD, PA 19335

Drawn By: TM, YP

Checked By: JT

Scale: AS NOTED

Tame:

DETAILS

Ints:
Revisions:
D FOR BIDDING
CONSTRUCTION
REVISED DURING BIDDING
S

410.2