## WINDOW AND DOOR REPLACEMENT FOR 13TH AND UNION ELEMENTARY SCHOOL

# READING SCHOOL DISTRICT

1600 NORTH 13TH STREET, READING, BERKS COUNTY, PA



**LOCATION MAP** 

SITE MAP





## ICC ELECTRICAL CODE 2018 LOCAL CODE AMENDMENTS NONE


READING SCHOOL DISTRICT - 13TH AND UNIC	N ELEMENTARY
INTERNATIONAL BUILDING CODE (2018)	)
(SECTION 305) USE GROUP CLASSIFICATION (SECTION 602) TYPE OF CONSTRUCTION SPRINKLERED TOTAL BUILDING AREA	E II YES 82,176 SF

TOTAL BUILDING AREA CALCULATION		
BASEMENT FIRST FLOOR SECOND FLOOR	10,871 SF 42,754 SF 28,551 SF	
TOTAL	82,176 SF	

CODE COMPLIANCE INFORMATION		
INTERNATIONAL EXISTING BUILDING CODE (2018)		
COMPLIANCE METHOD - CHAPTER 3 (SECTION 301.3.2)	WORK AREA COMPLIANCE	
CLASSIFICATION OF WORK- CHAPTER 6 (SECTION 603)	ALTERATION - LEVEL 1	
NO ADDITIONS TO THE EXISTING BUILDING AREA	ARE PROPOSED.	
REPLACEMENT OF EXISTING DOORS AND WINDOWS	AND MINOR REPAIRS	

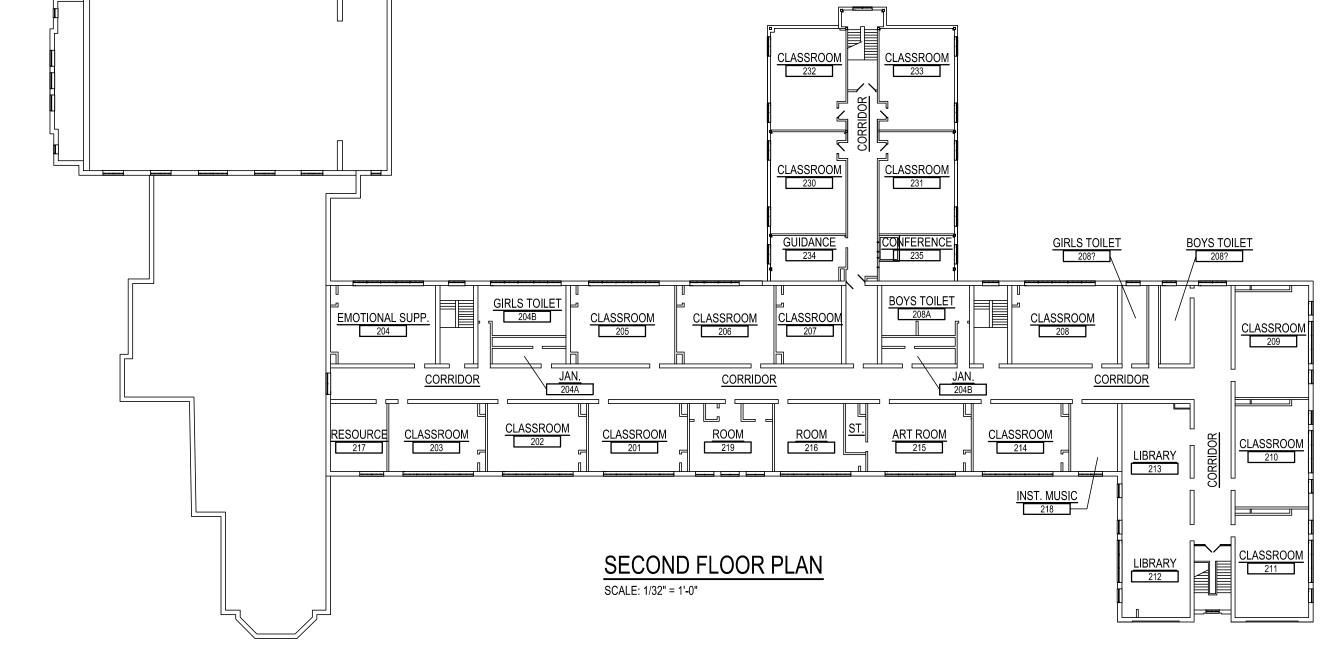

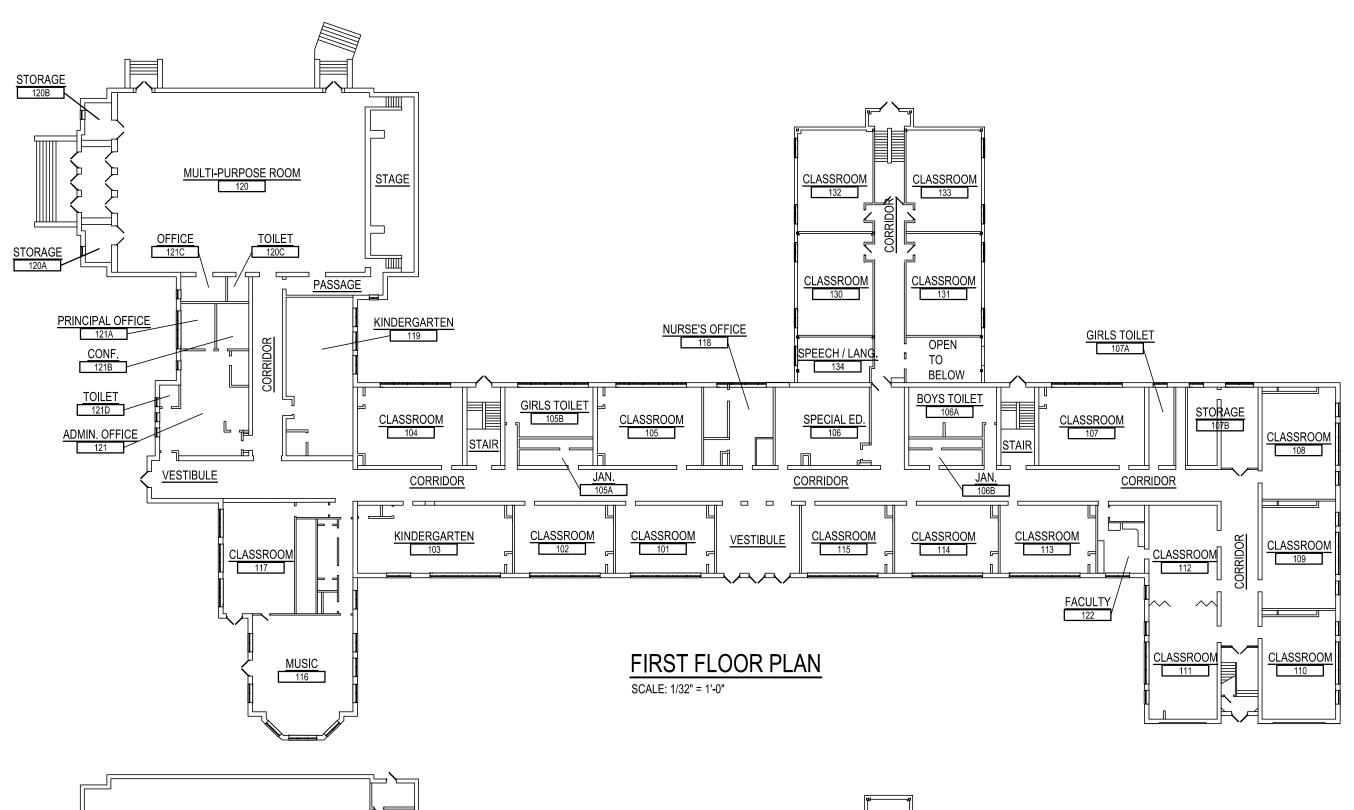

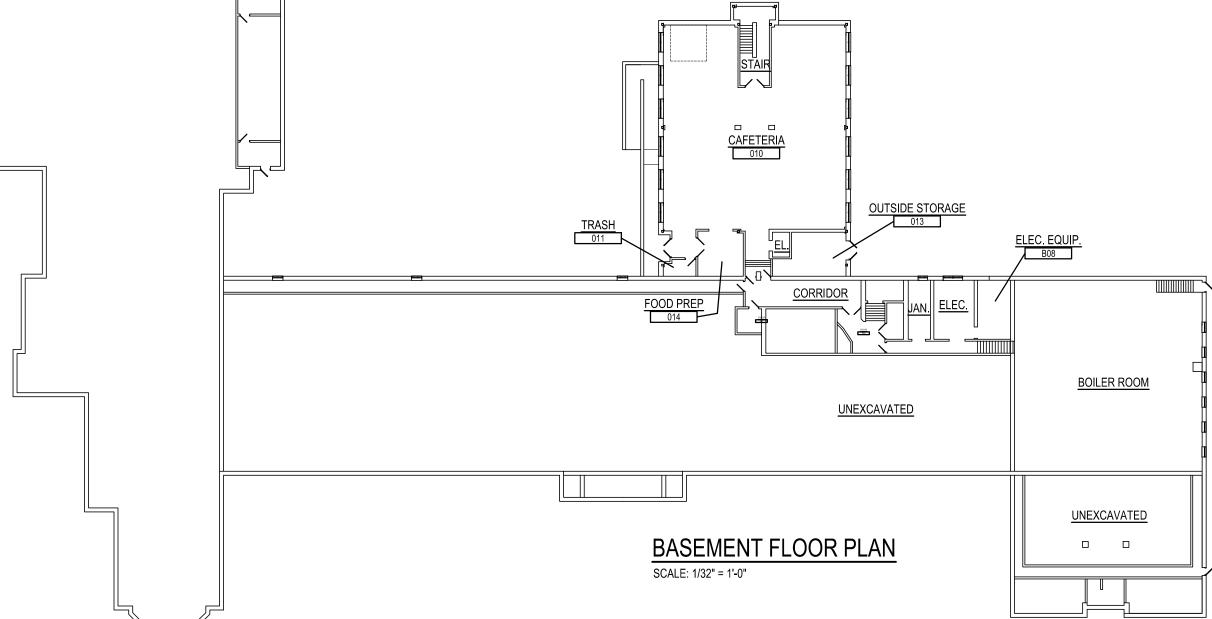

### DRAWING INDEX


#### ARCHITECTURAL

1/16" BASEMENT AND FIRST FLOOR PLANS

1/8" EXTERIOR ELEVATIONS

DOOR SCHEDULE, TYPES, AND DETAILS

BASEMENT AND FIRST FLOOR REFLECTED CEILING PLANS

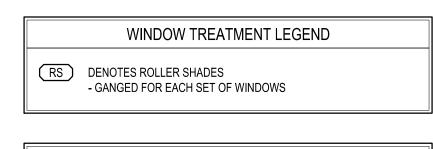

VISUAL	DISPLAY BOARD LEGEND
	TACKBOARD SYMBOL:
4	4'-0"W X 4'-0"H (SEE NOTE 1)

DENOTES EXISTING TYPICAL VISUAL DISPLAY BOARD NOTES:

1. ALL TACKBOARDS SHALL BE 4'-0" HIGH UNLESS OTHERWISE NOTED. 2. THE NUMBER IN THE SYMBOL DENOTES THE WIDTH OF THE UNIT. 3. ALL TACKBOARD JOINTS TO BE WRAPPED & BUTT JOINTED 4. VERIFY ALL MOUNTING HEIGHTS WITH OWNER PRIOR TO INSTALLATION

> TYPICAL ELEVATION CONTINUOUS ALUMINUM TRIM TACKBOARD INDICATED -

### WINDOW TREATMENT DEMOLITION NOTE TACKBOARD WINDOW TAG

SYMBOL LEGEND

#### **ABBREVIATIONS**

AC - ACOUSTICAL ALUM - ALUMINUM APT - ALUMINUM PLATE THRESHOLD AT - ALUMINUM THRESHOLD

COORD - COORDINATE D - DEPTH **DEMO - DEMOLITION** DIA - DIAMETER DN - DOWN

**ELEV - ELEVATION** EP - END PANEL EQ - EQUAL EW - EACHWAY

FEP - FINISHED END PANEL FTP - FINISHED TOP PANEL FP - FILLER PANEL FS - FACTORY STAINED

HC - HVAC CONTRACTOR HORZ - HORIZONTAL HM - HOLLOW METAL

MAX - MAXIMUM MFR - MANUFACTURER MIN - MINIMUM MO - MASONRY OPENING NIC - NOT IN CONTRACT


OH - OVERHEAD PTD - PAINTED R - RADIUS REINF - REINFORCED RO - ROUGH OPENING

SF - SQUARE FEET SS - STAINLESS STEEL TYP - TYPICAL V - VERTICAL


UNO - UNLESS NOTED OTHERWISE VIF - VERIFY IN FIELD W - WIDE WD - WOOD





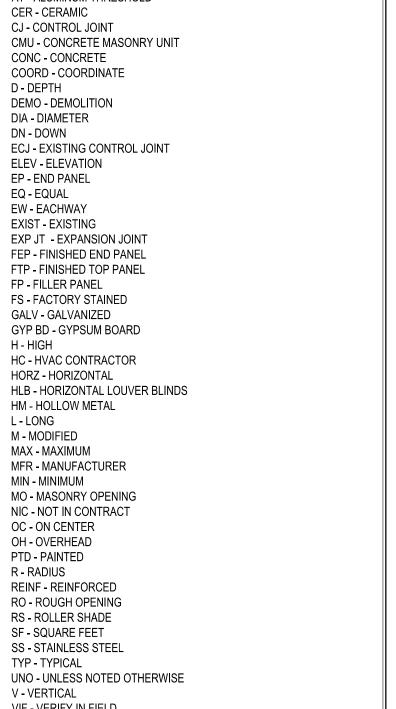

All DIMENSIONS and EXISTING CONDITIONS shall be CHECKED and VERIFIED by the CONTRACTOR at the SITE. DRAWN BY: DATE:

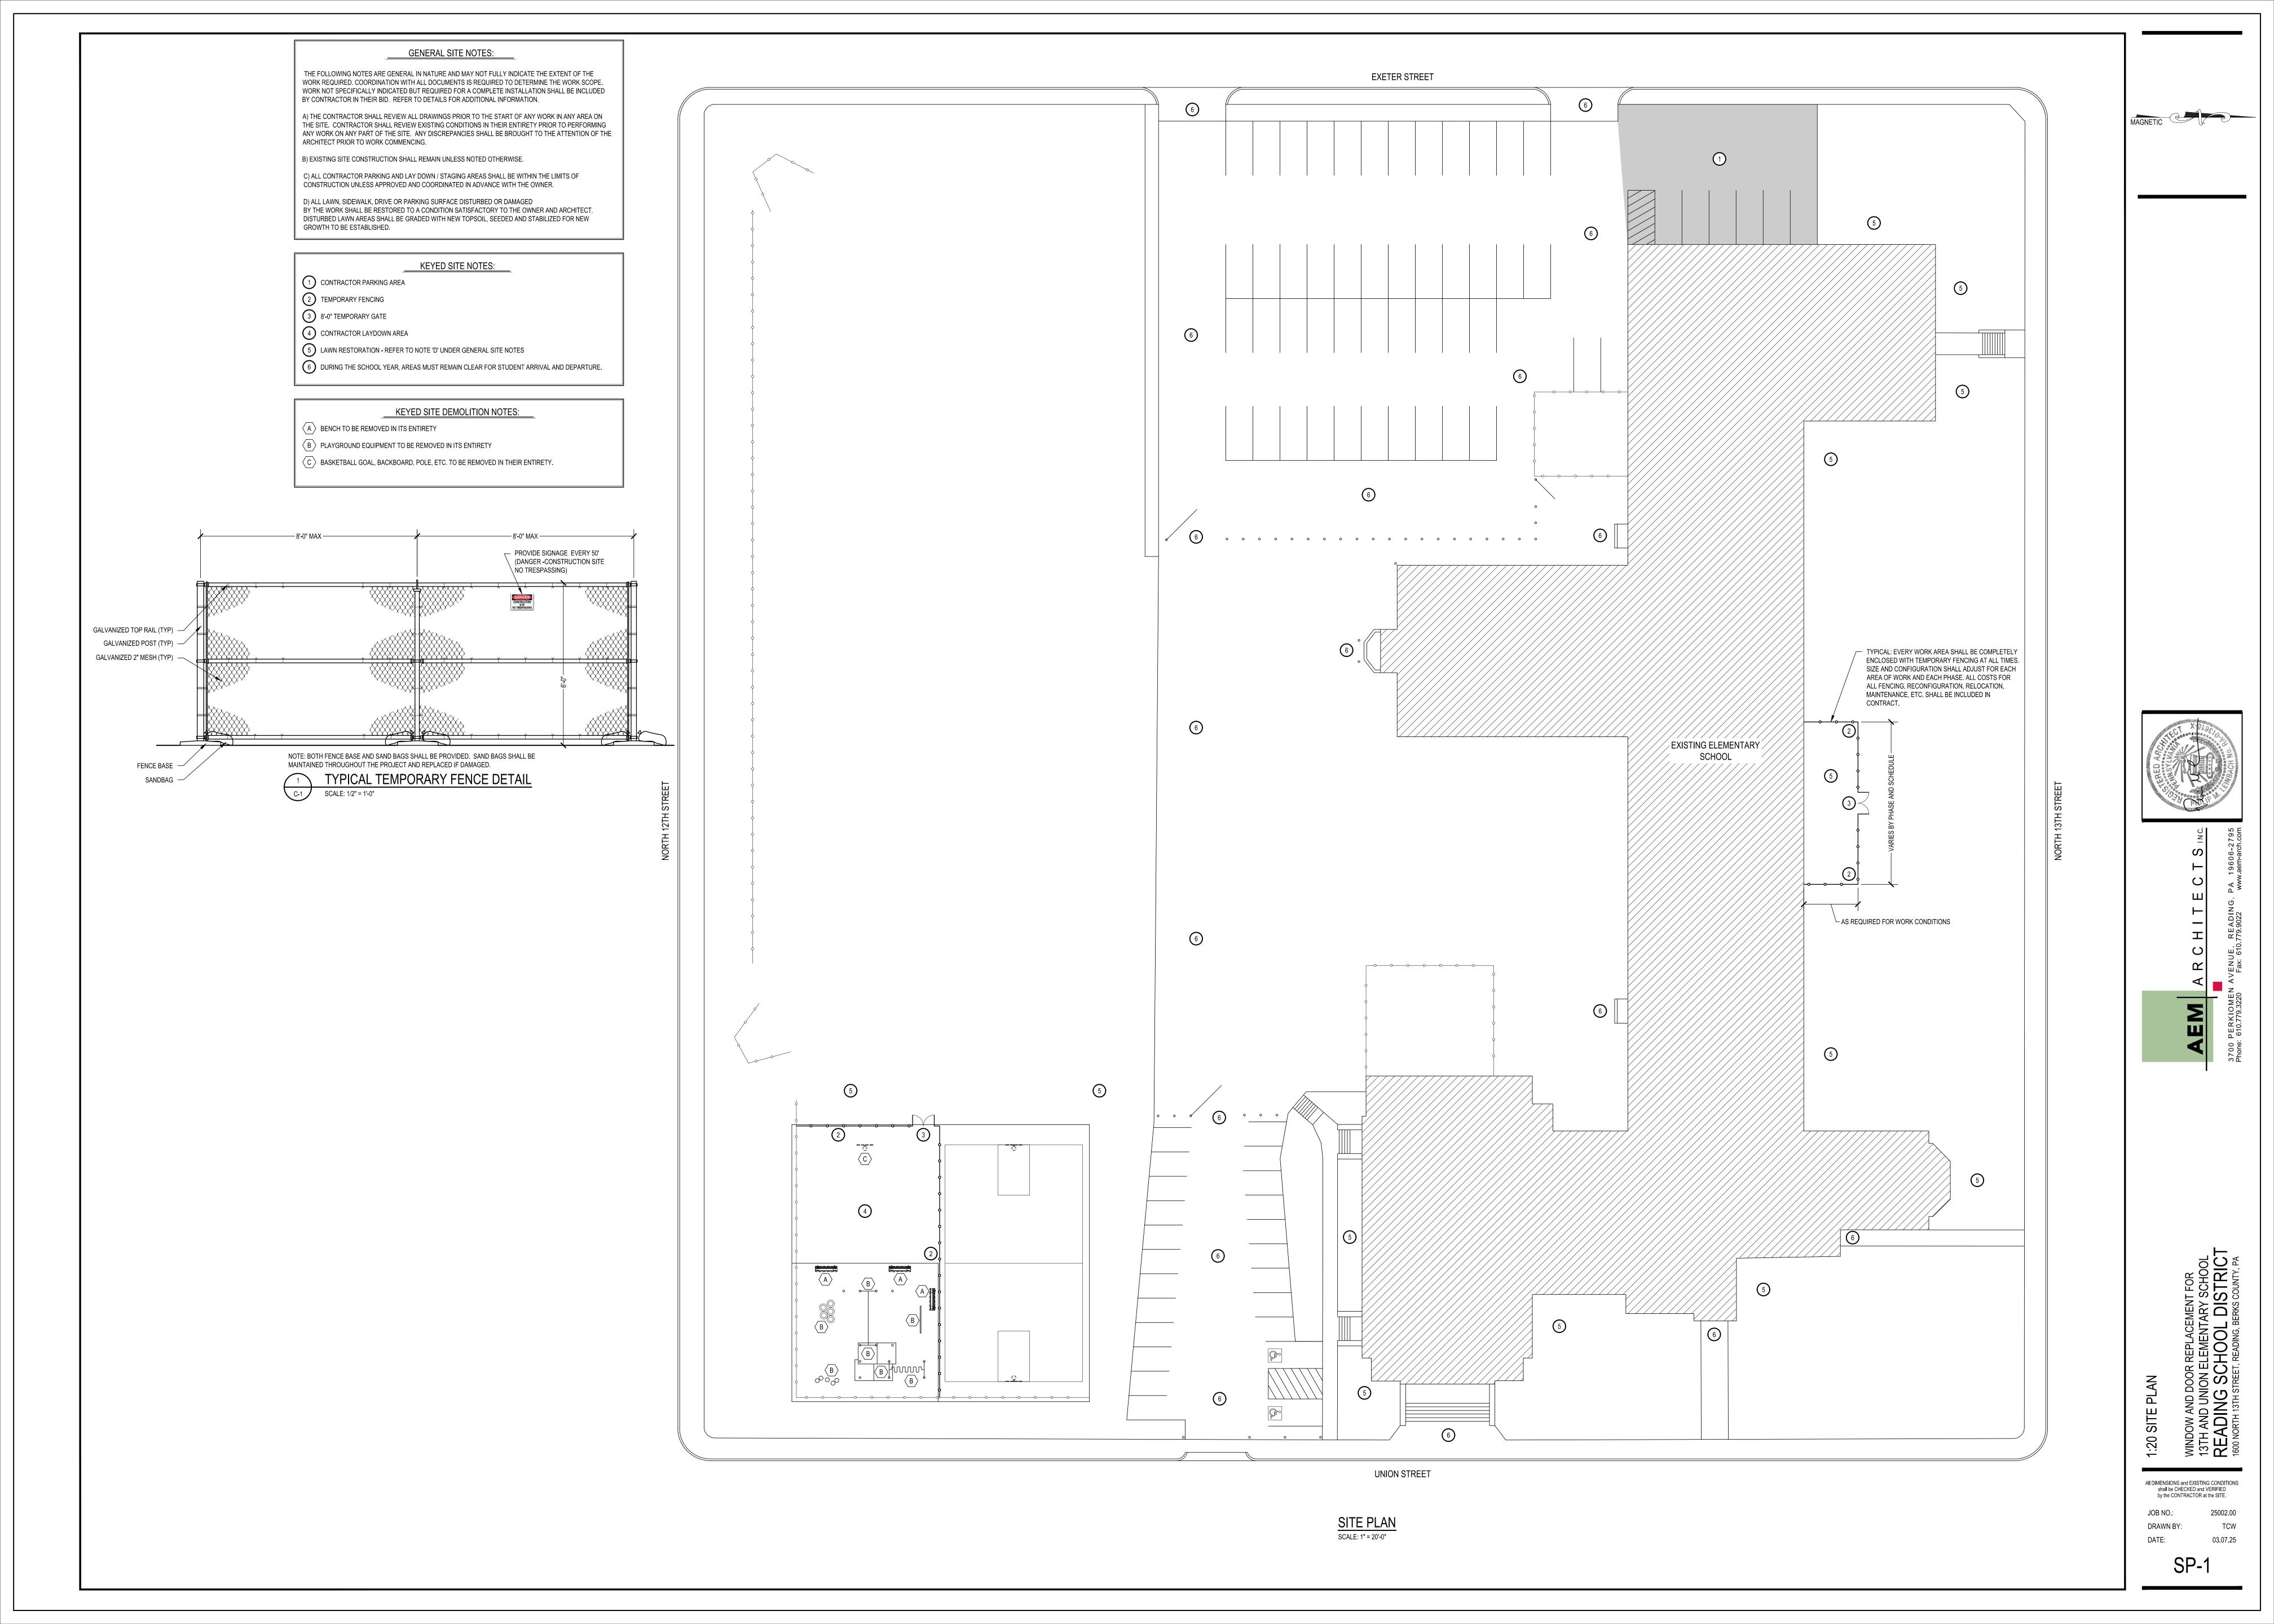

PHASE	1		PHASING LEGEND TIMELINE	DEMARKS	
PHASE 1		DESCRIPTION  ALL EXTERIOR DOORS, PARTIAL WINDOW REPLACEMENT ON UNION, 12TH, AND 13TH STREETS, AND MASONRY REPAIRS	TIMELINE  JUNE 10 TO AUGUST 15, 2025	REMARKS	DRAWING PH-1
PHASE 2		13TH STREET ELEVATION PARTIAL WINDOW REPLACEMENT	AUGUST 18 TO SEPT 5 2025		PH-1
PHASE 3		13TH STREET ELEVATION PARTIAL WINDOW REPLACEMENT	SEPT 8 TO SEPT 26, 2025		PH-1
PHASE 4		13TH STREET ELEVATION PARTIAL WINDOW REPLACEMENT	SEPT 29 TO OCT 17, 2025	INSTRUMENTAL MUSIC 218 AND FACULTY 122 COMPLETE PHASE 4 OR PHASE 5	PH-1
PHASE 5		13TH STREET ELEVATION PARTIAL WINDOW REPLACEMENT	OCT 20 TO NOV 7, 2025	INSTRUMENTAL MUSIC 218 AND FACULTY 122 COMPLETE PHASE 4 OR PHASE 5	PH-1
PHASE 6		EXETER STREET ELEVATION PARTIAL WINDOW REPLACEMENT	NOV 10 TO NOV 28, 2025		PH-1
PHASE 7		EXETER STREET ELEVATION PARTIAL WINDOW REPLACEMENT	DEC 1 TO DEC 19, 2025		PH-1
PHASE 8		2000 ADDITION DOOR AND WINDOW REPLACEMENT	DEC 22 TO JAN 30, 2026		PH-1
PHASE 8A		CAFETERIA AND EXTERIOR DOORS	DEC 22 TO JAN 2, 2026	WORK MUST BE COMPLETED OVER WINTER BREAK	PH-1
PHASE 8B		EXETER STREET ELEVATION WINDOW REPLACEMENT	JAN 5 TO JAN 16, 2026	1ST AND 2ND STORY WINDOWS	PH-1
PHASE 8C		UNION STREET ELEVATION WINDOW REPLACEMENT	JAN 19 TO JAN 30, 2026	1ST AND 2ND STORY WINDOWS	PH-1
NOTES:		I OR SPECIFIC PHASING LOCATIONS	l	1	l

EXISTING ROOF OR FLOOR STRUCTURE —

EXISTING ACOUSTICAL TILE CEILING OR —

BARRIER SUPPORT POLES FROM FLOOR -TO CEILING SPACED AS REQUIRED FOR A RIGID INSTALLATION

DUST-PROOF PLASTIC BARRIER -

PROTECT EXISTING FLOORS FROM DAMAGE AND DISCOLORING

PLASTER CEILING


OCCUPIED/CORRIDOR SIDE


NOTE:
ALL TEMPORARY DUST PARTITIONS SHALL
BE CONSTRUCTED TO PREVENT DUST
FROM ENTERING THE OCCUPIED AREAS
OF THE SCHOOL.

CONSTRUCTION SIDE

TYPICAL TEMPORARY

DUST PARTITION
SCALE: 3/4" = 1'-0"

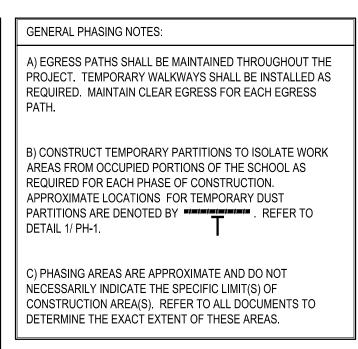


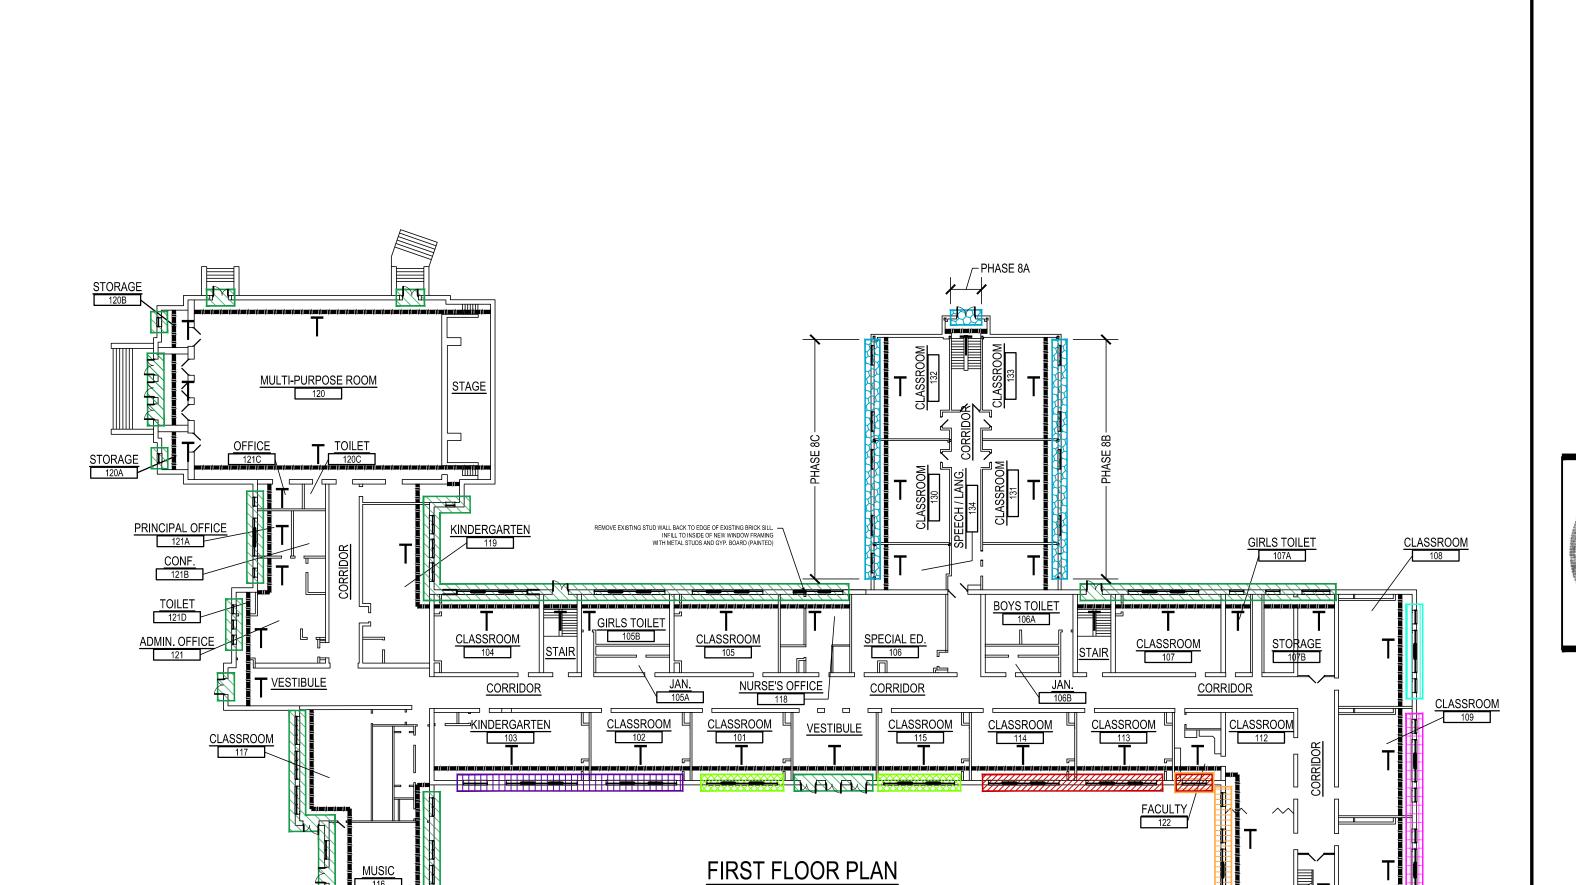

SCALE: 1/32" = 1'-0"

SECOND FLOOR PLAN

SCALE: 1/32" = 1'-0"

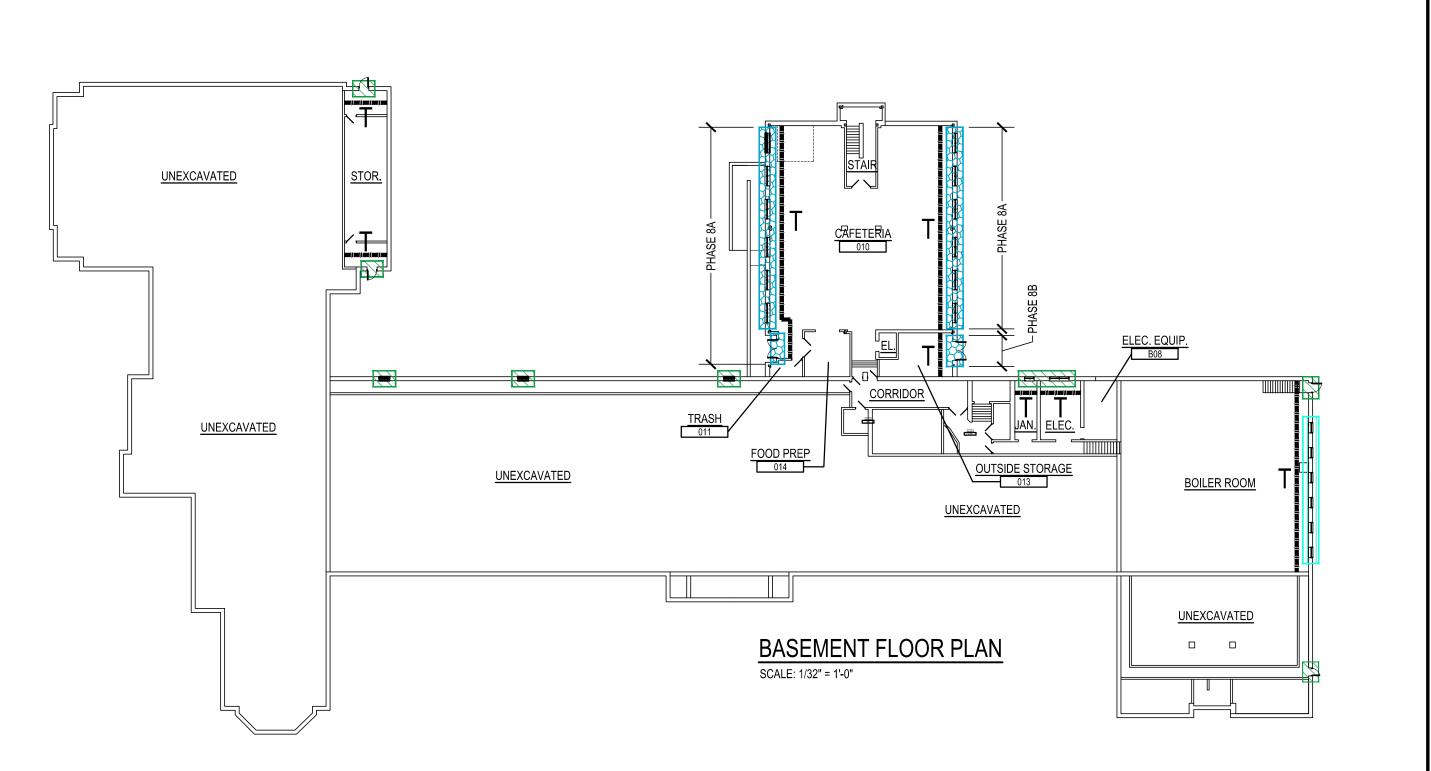






MAGNETIC MAGNETIC

All DIMENSIONS and EXISTING CONDITIONS shall be CHECKED and VERIFIED by the CONTRACTOR at the SITE.

JOB NO.: 25002.00


DRAWN BY: SRH

DATE: 03.07.25

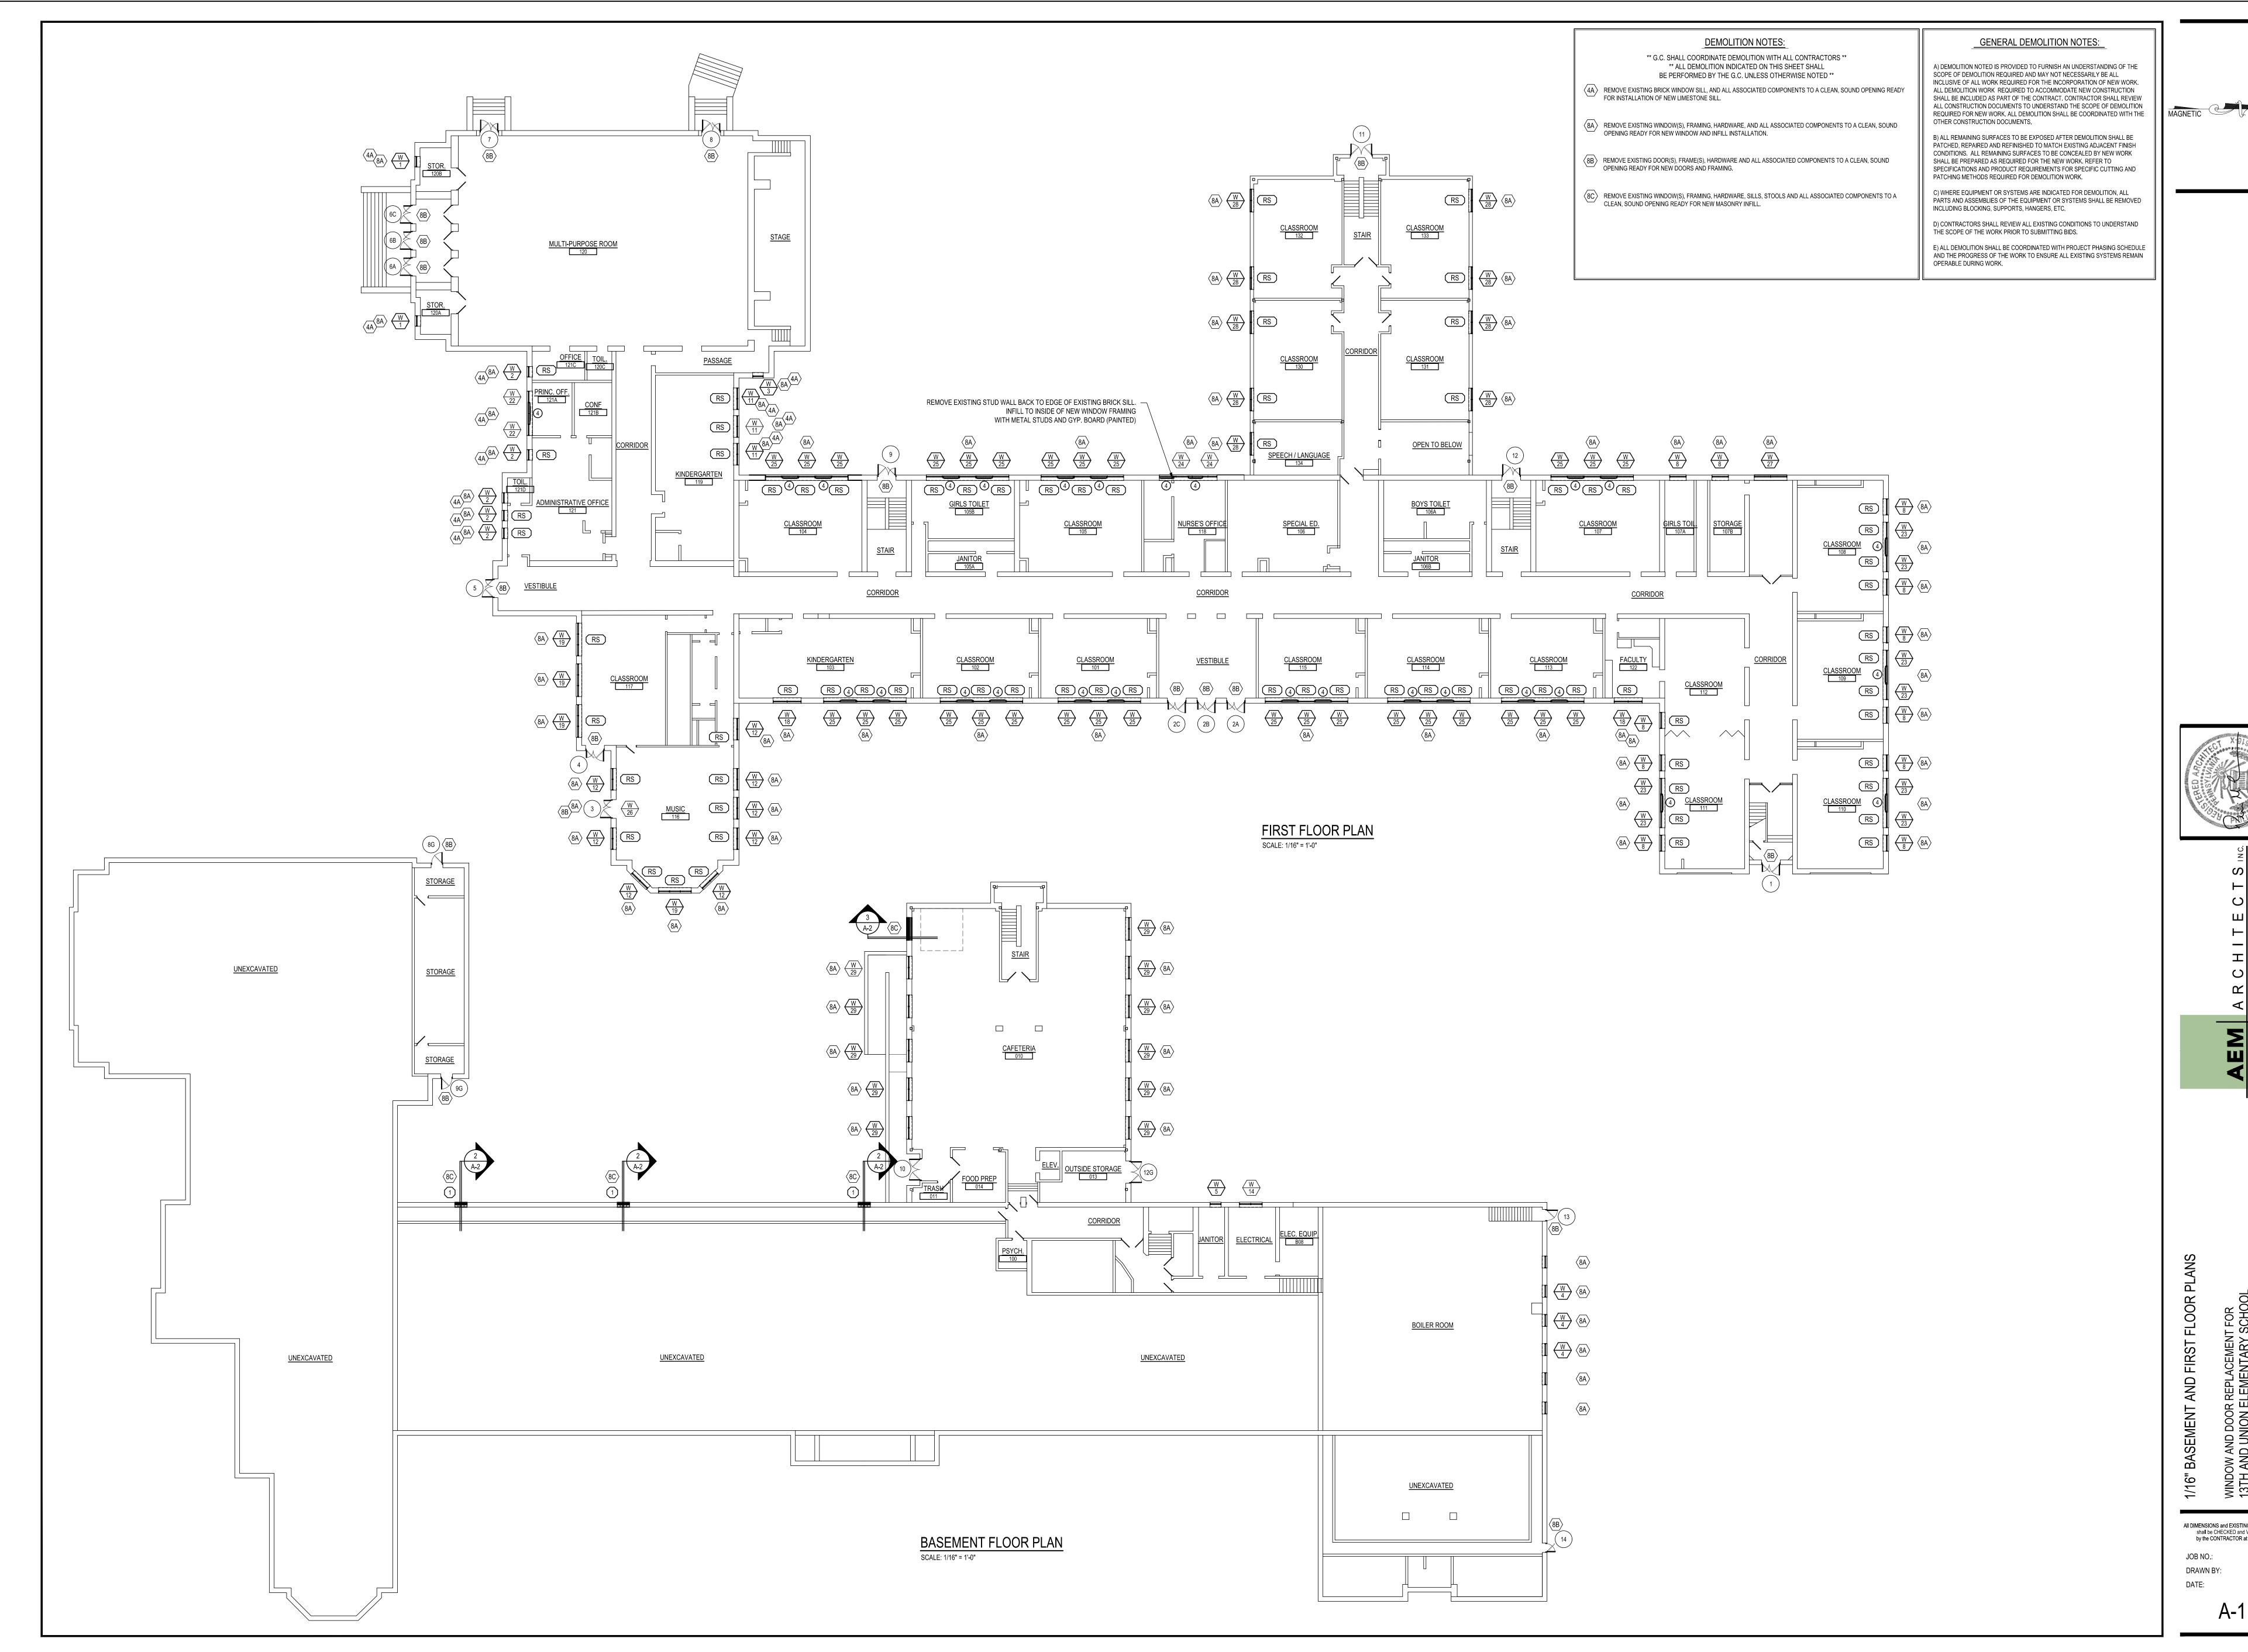

EPLACEMENT FOR
EMENTARY SCHOOL
HOOL DISTRICT
EADING, BERKS COUNTY, PA


All DIMENSIONS and EXISTING CONDITIONS shall be CHECKED and VERIFIED by the CONTRACTOR at the SITE.

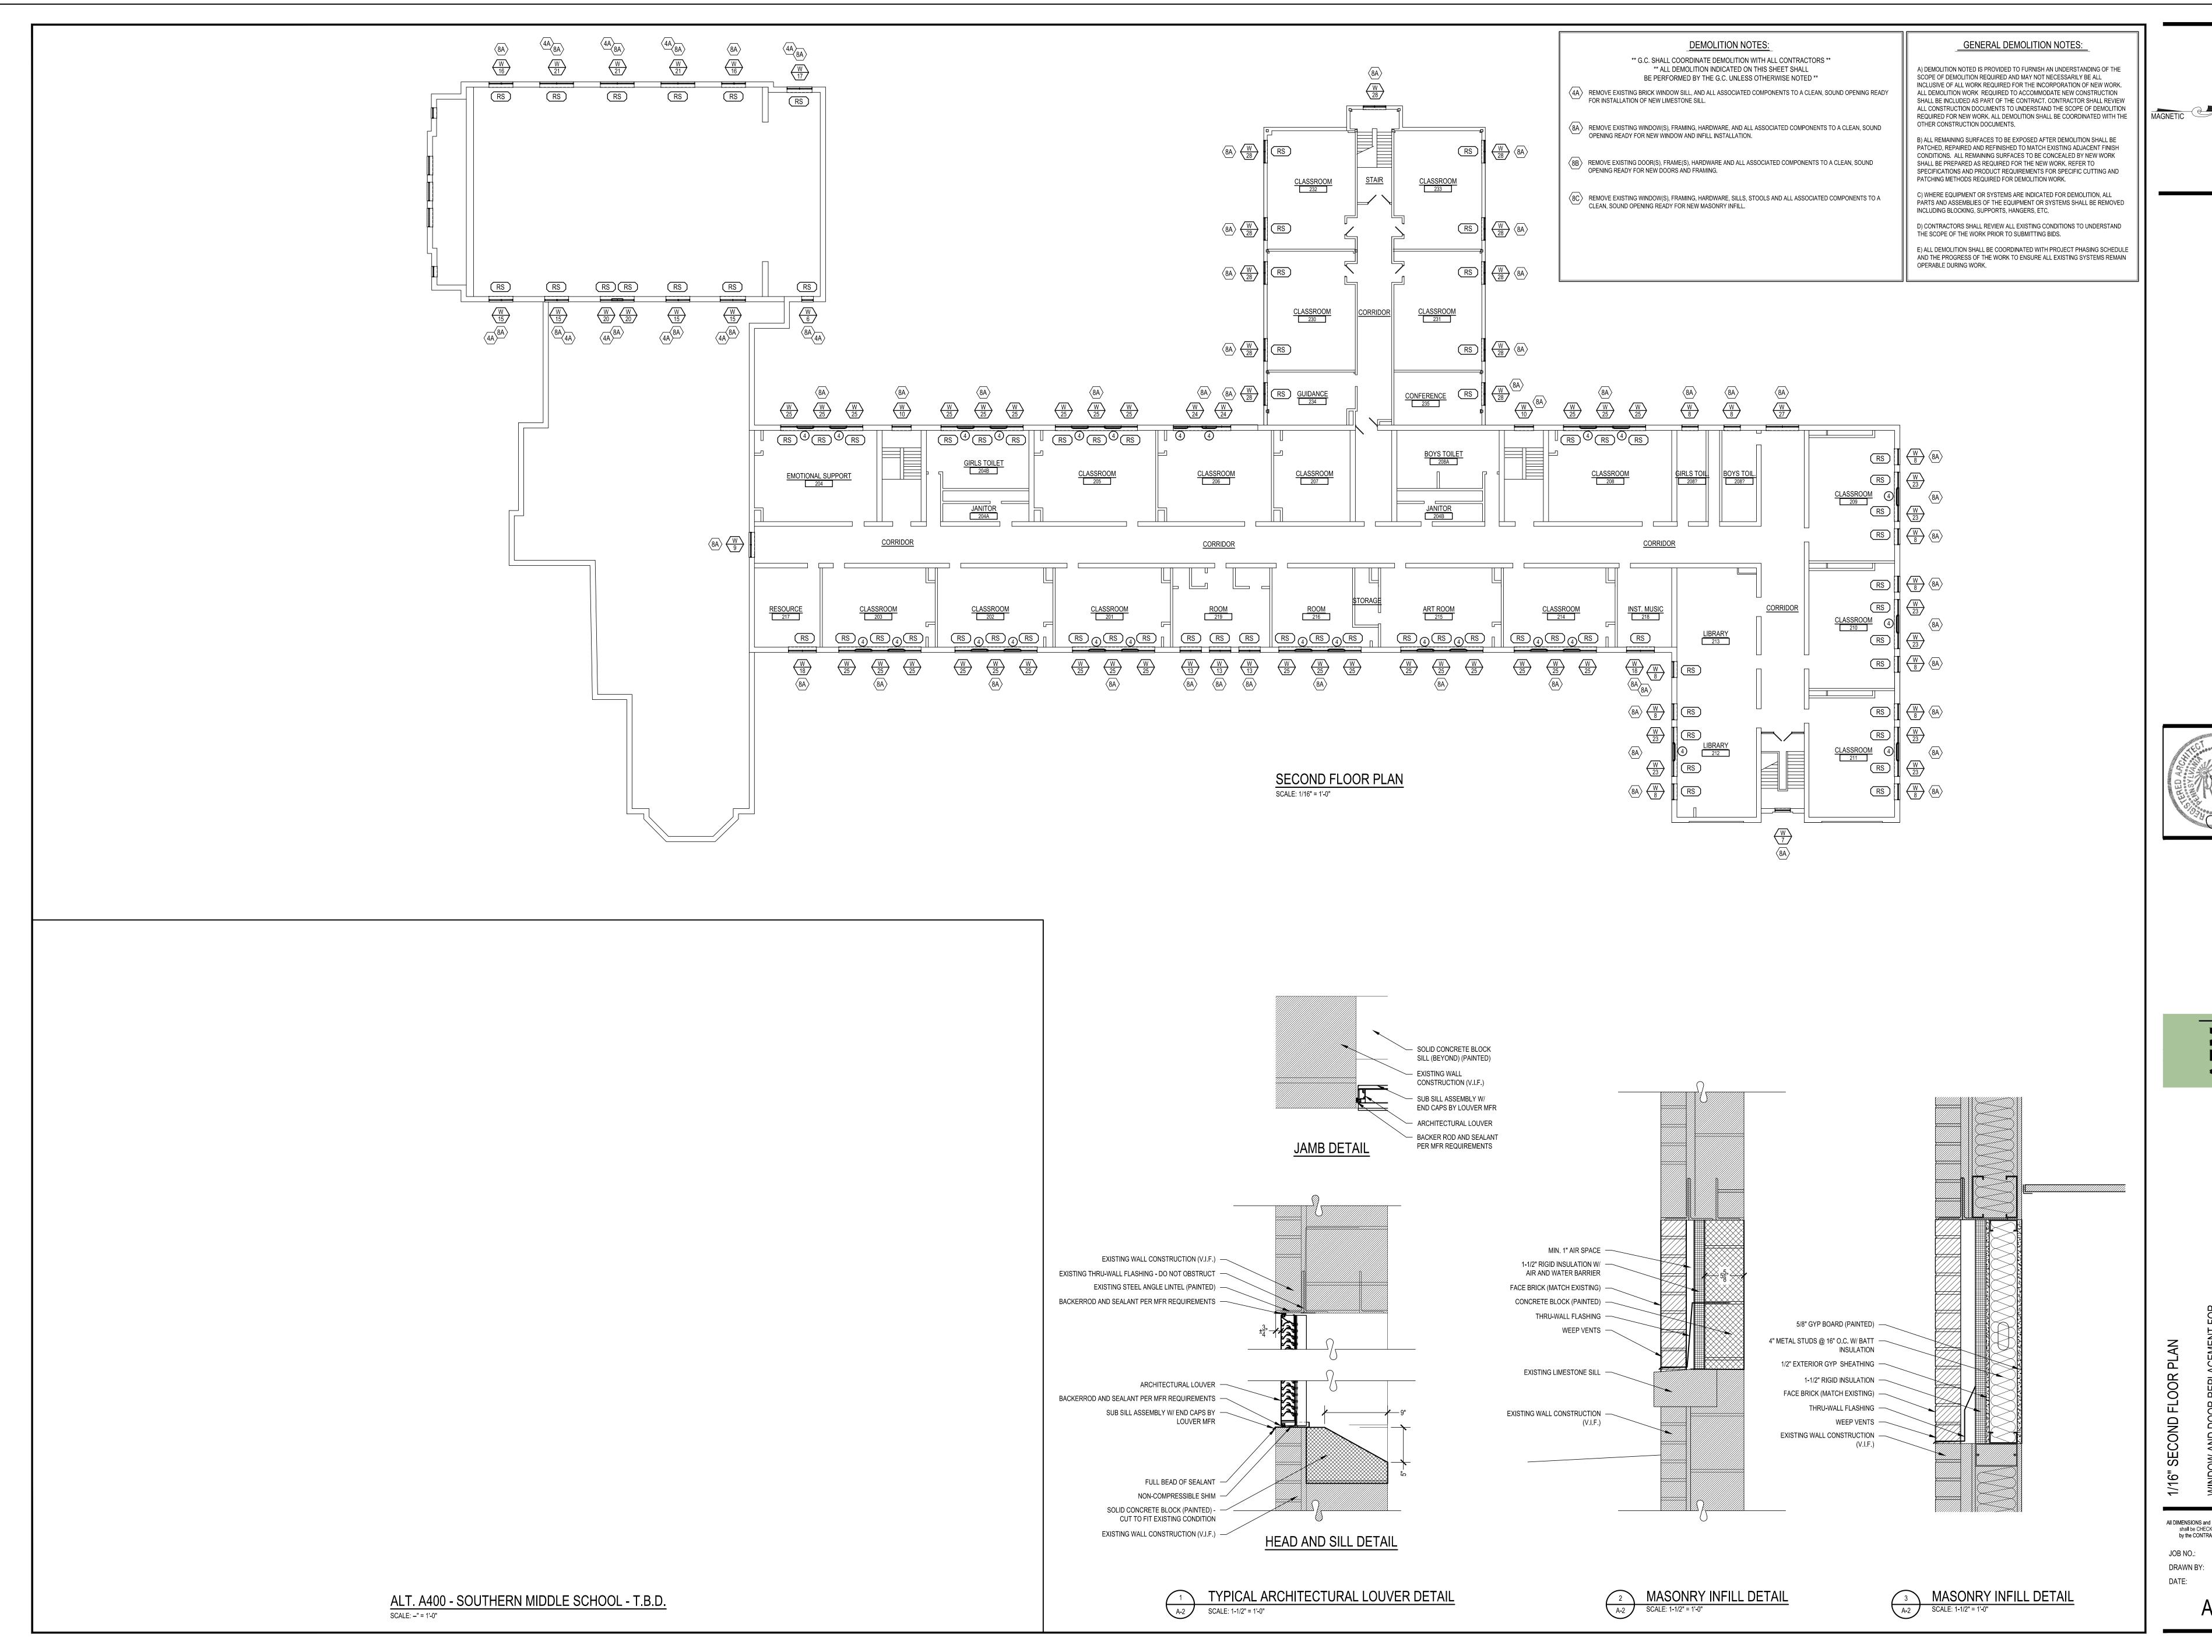



WINDOW AND DOOR REF 13TH AND UNION ELEN READING SCHC 1600 NORTH 13TH STREET, REA

All DIMENSIONS and EXISTING CONDITIONS shall be CHECKED and VERIFIED by the CONTRACTOR at the SITE. 03.07.25



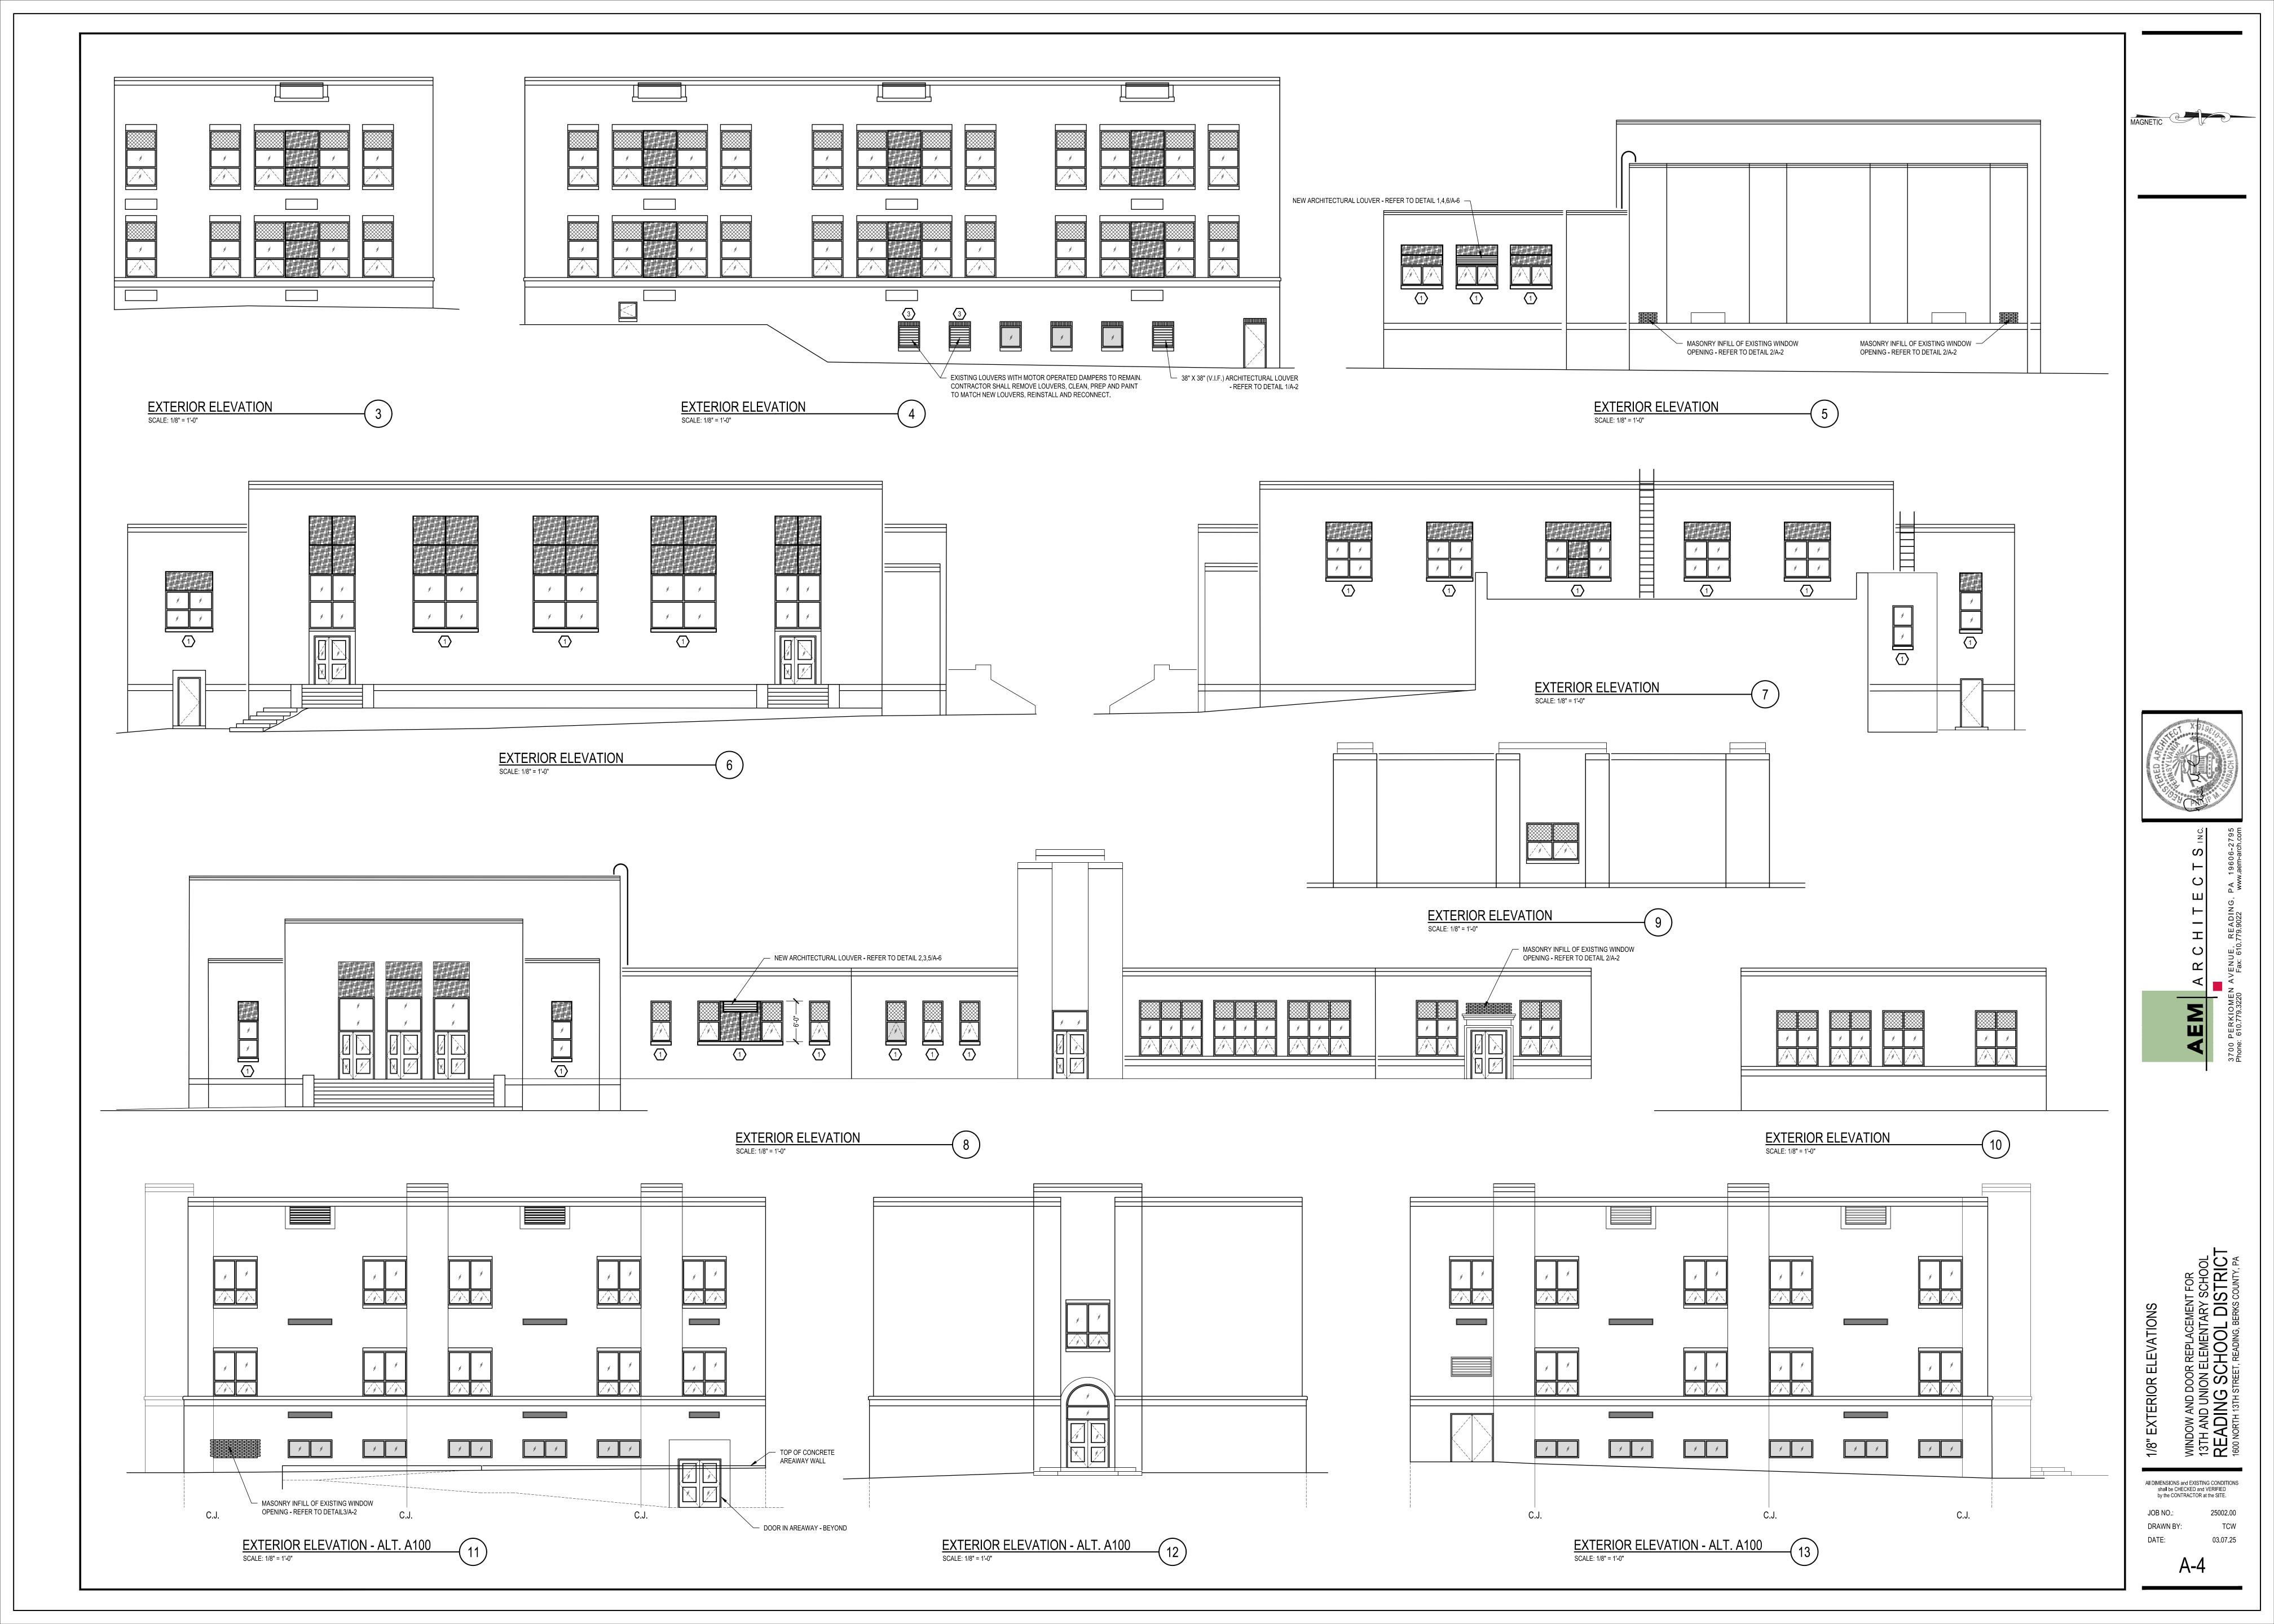


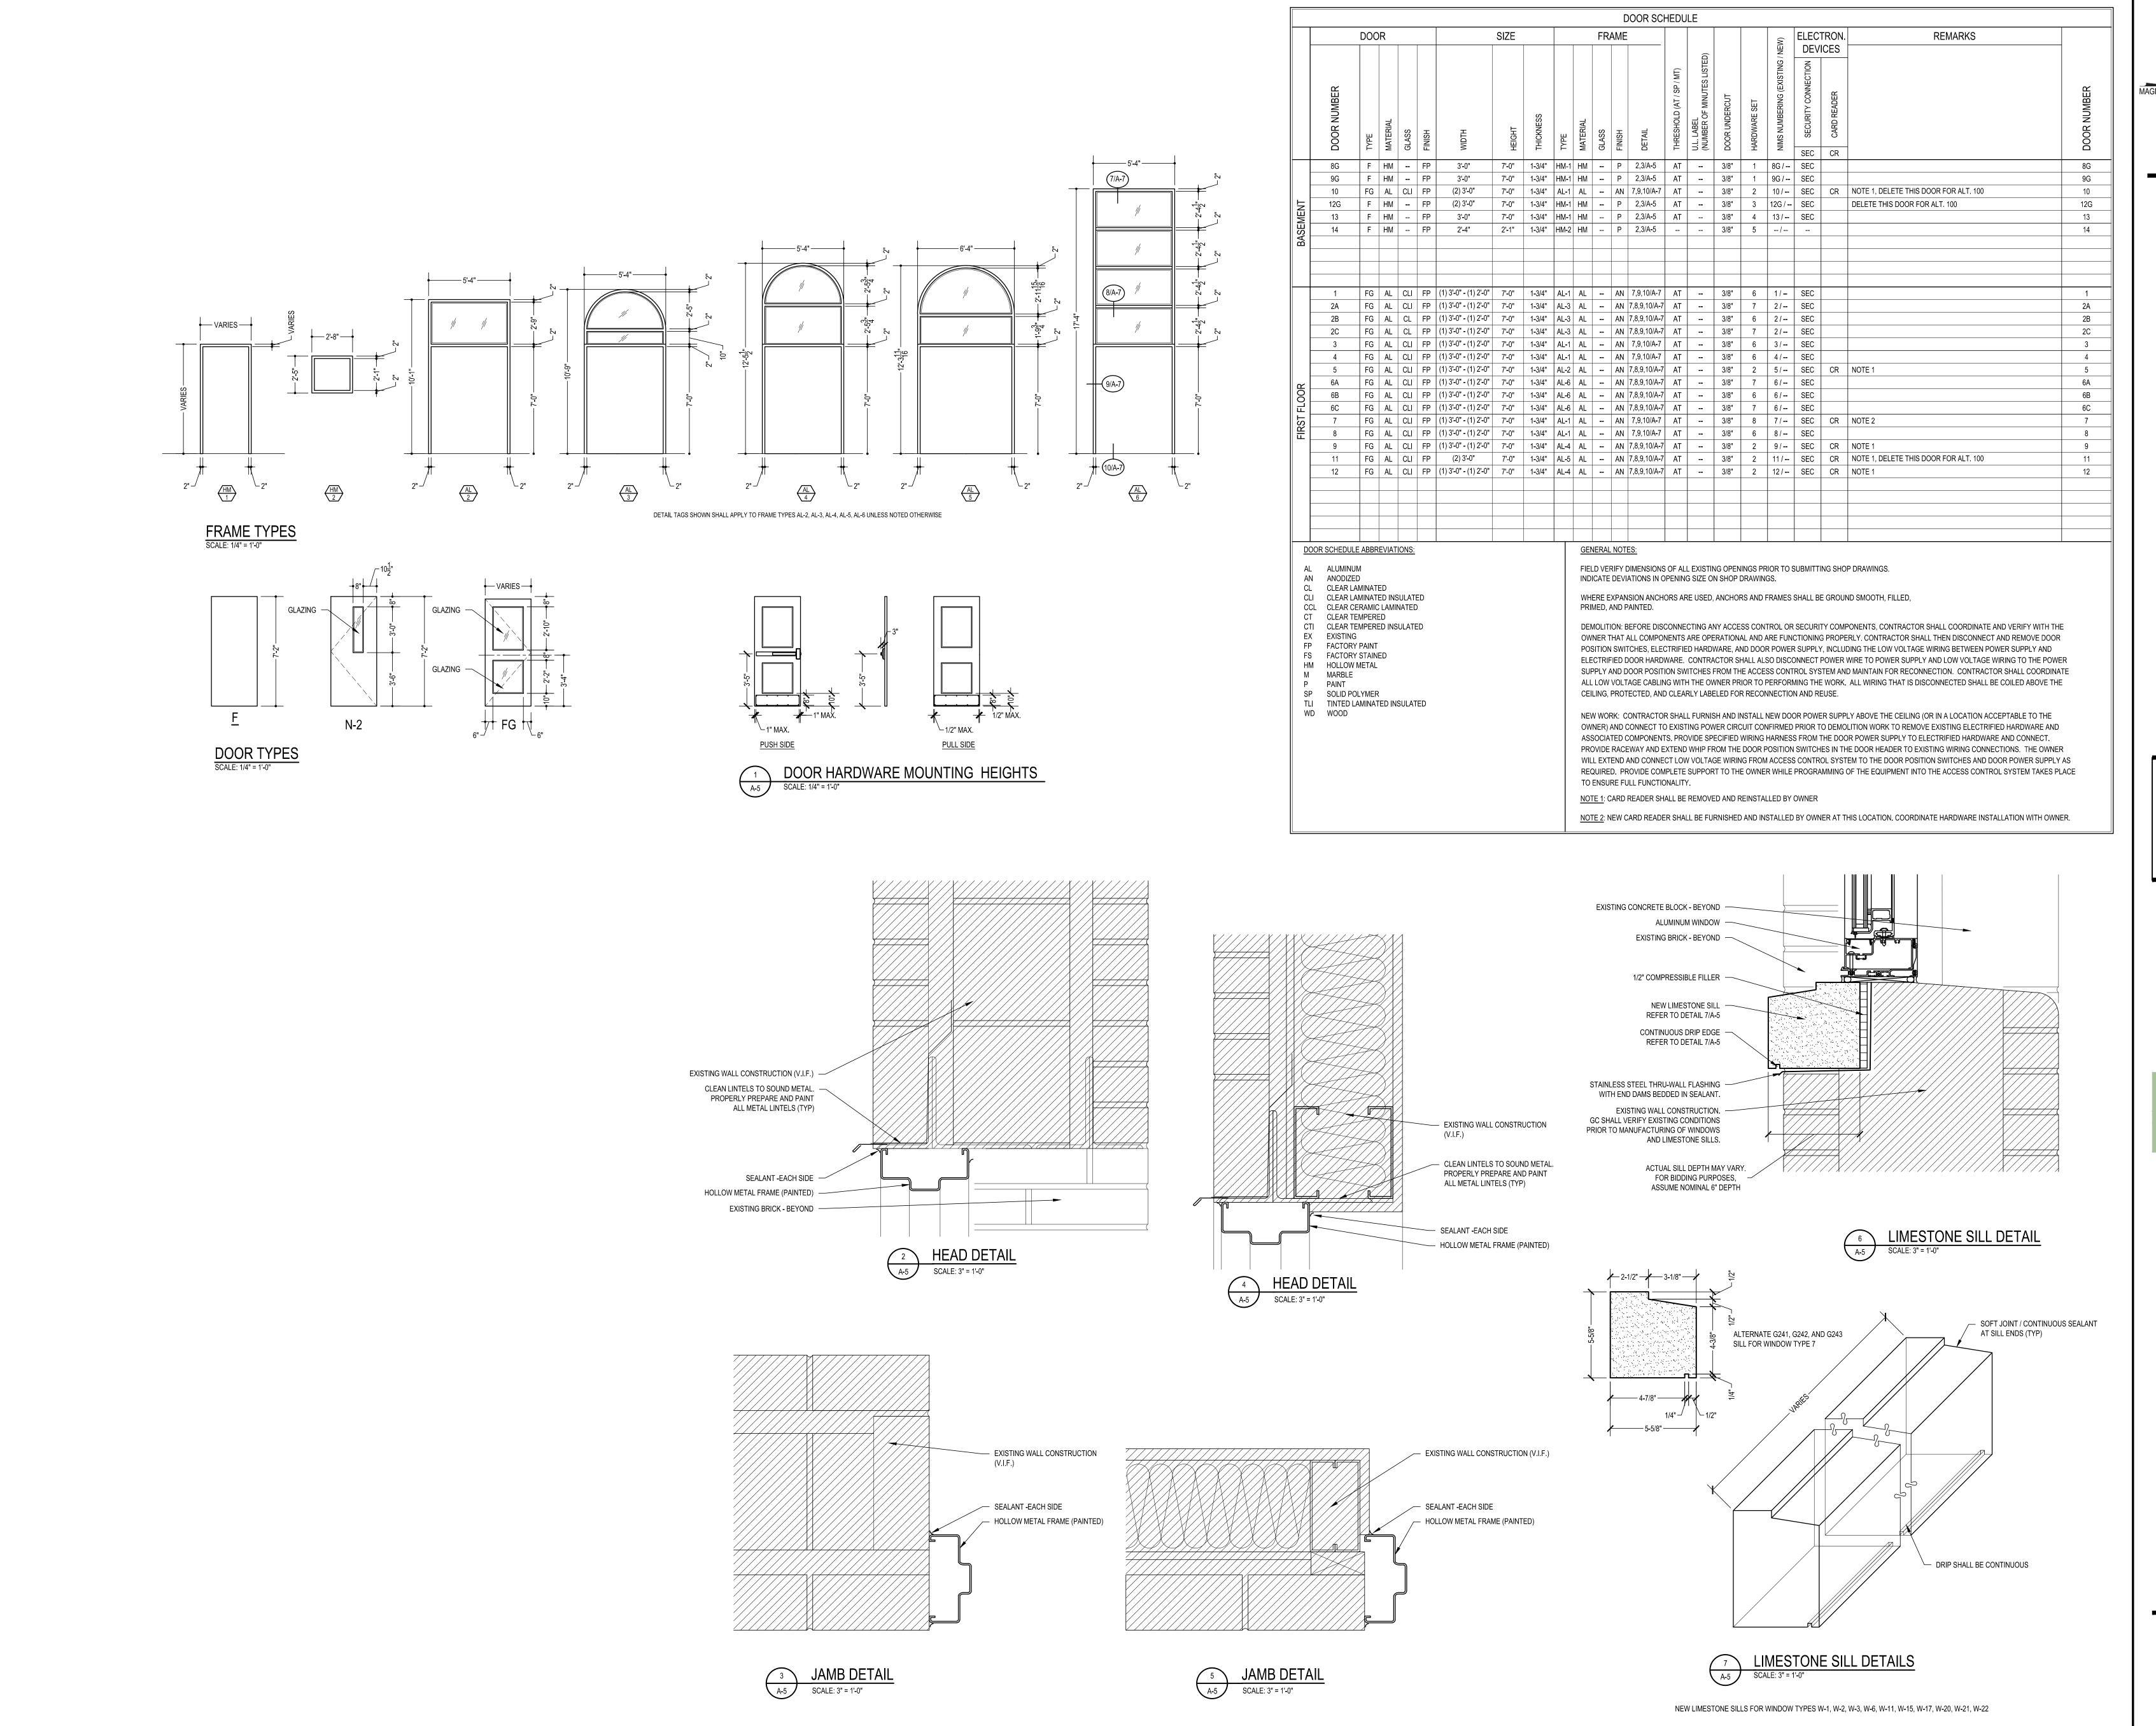

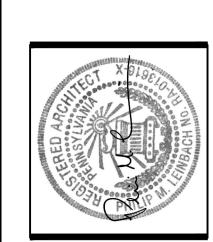


All DIMENSIONS and EXISTING CONDITIONS shall be CHECKED and VERIFIED by the CONTRACTOR at the SITE. DRAWN BY:


DATE: 03.07.25

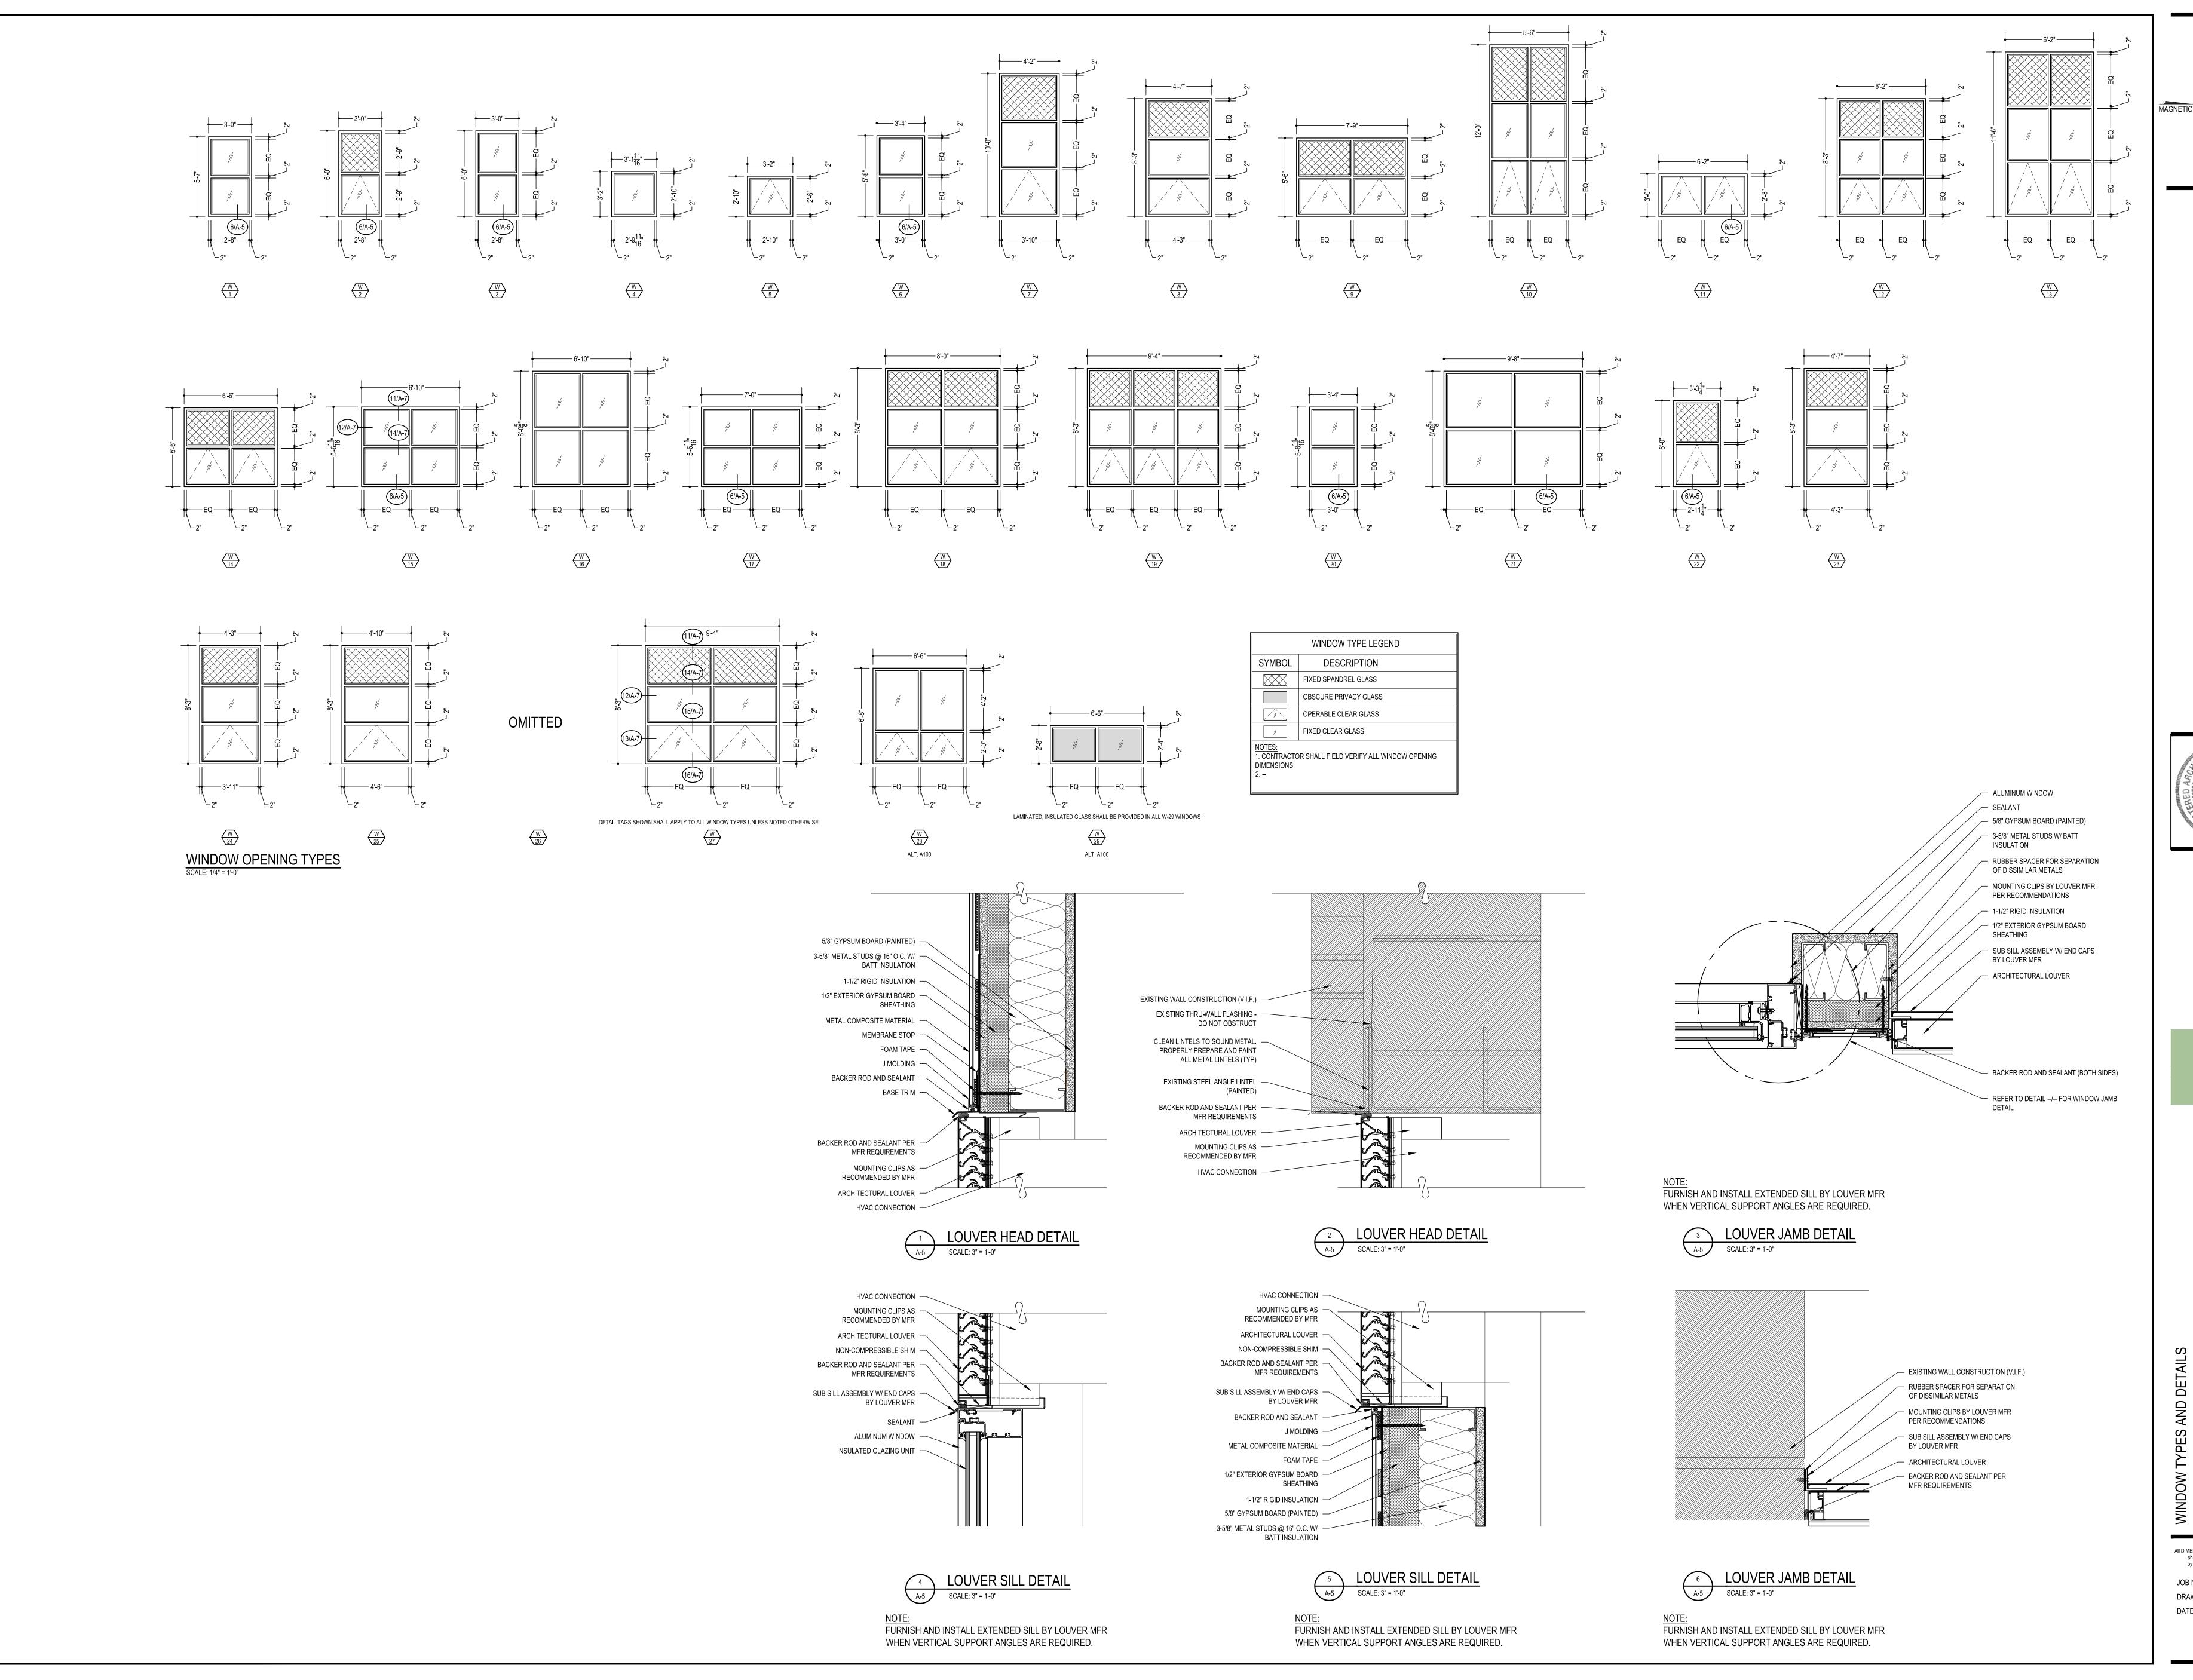

WINDOW AND DOOR REF 13TH AND UNION ELEN READING SCHC 1600 NORTH 13TH STREET, REA All DIMENSIONS and EXISTING CONDITIONS shall be CHECKED and VERIFIED by the CONTRACTOR at the SITE.

DRAWN BY: DATE: 03.07.25

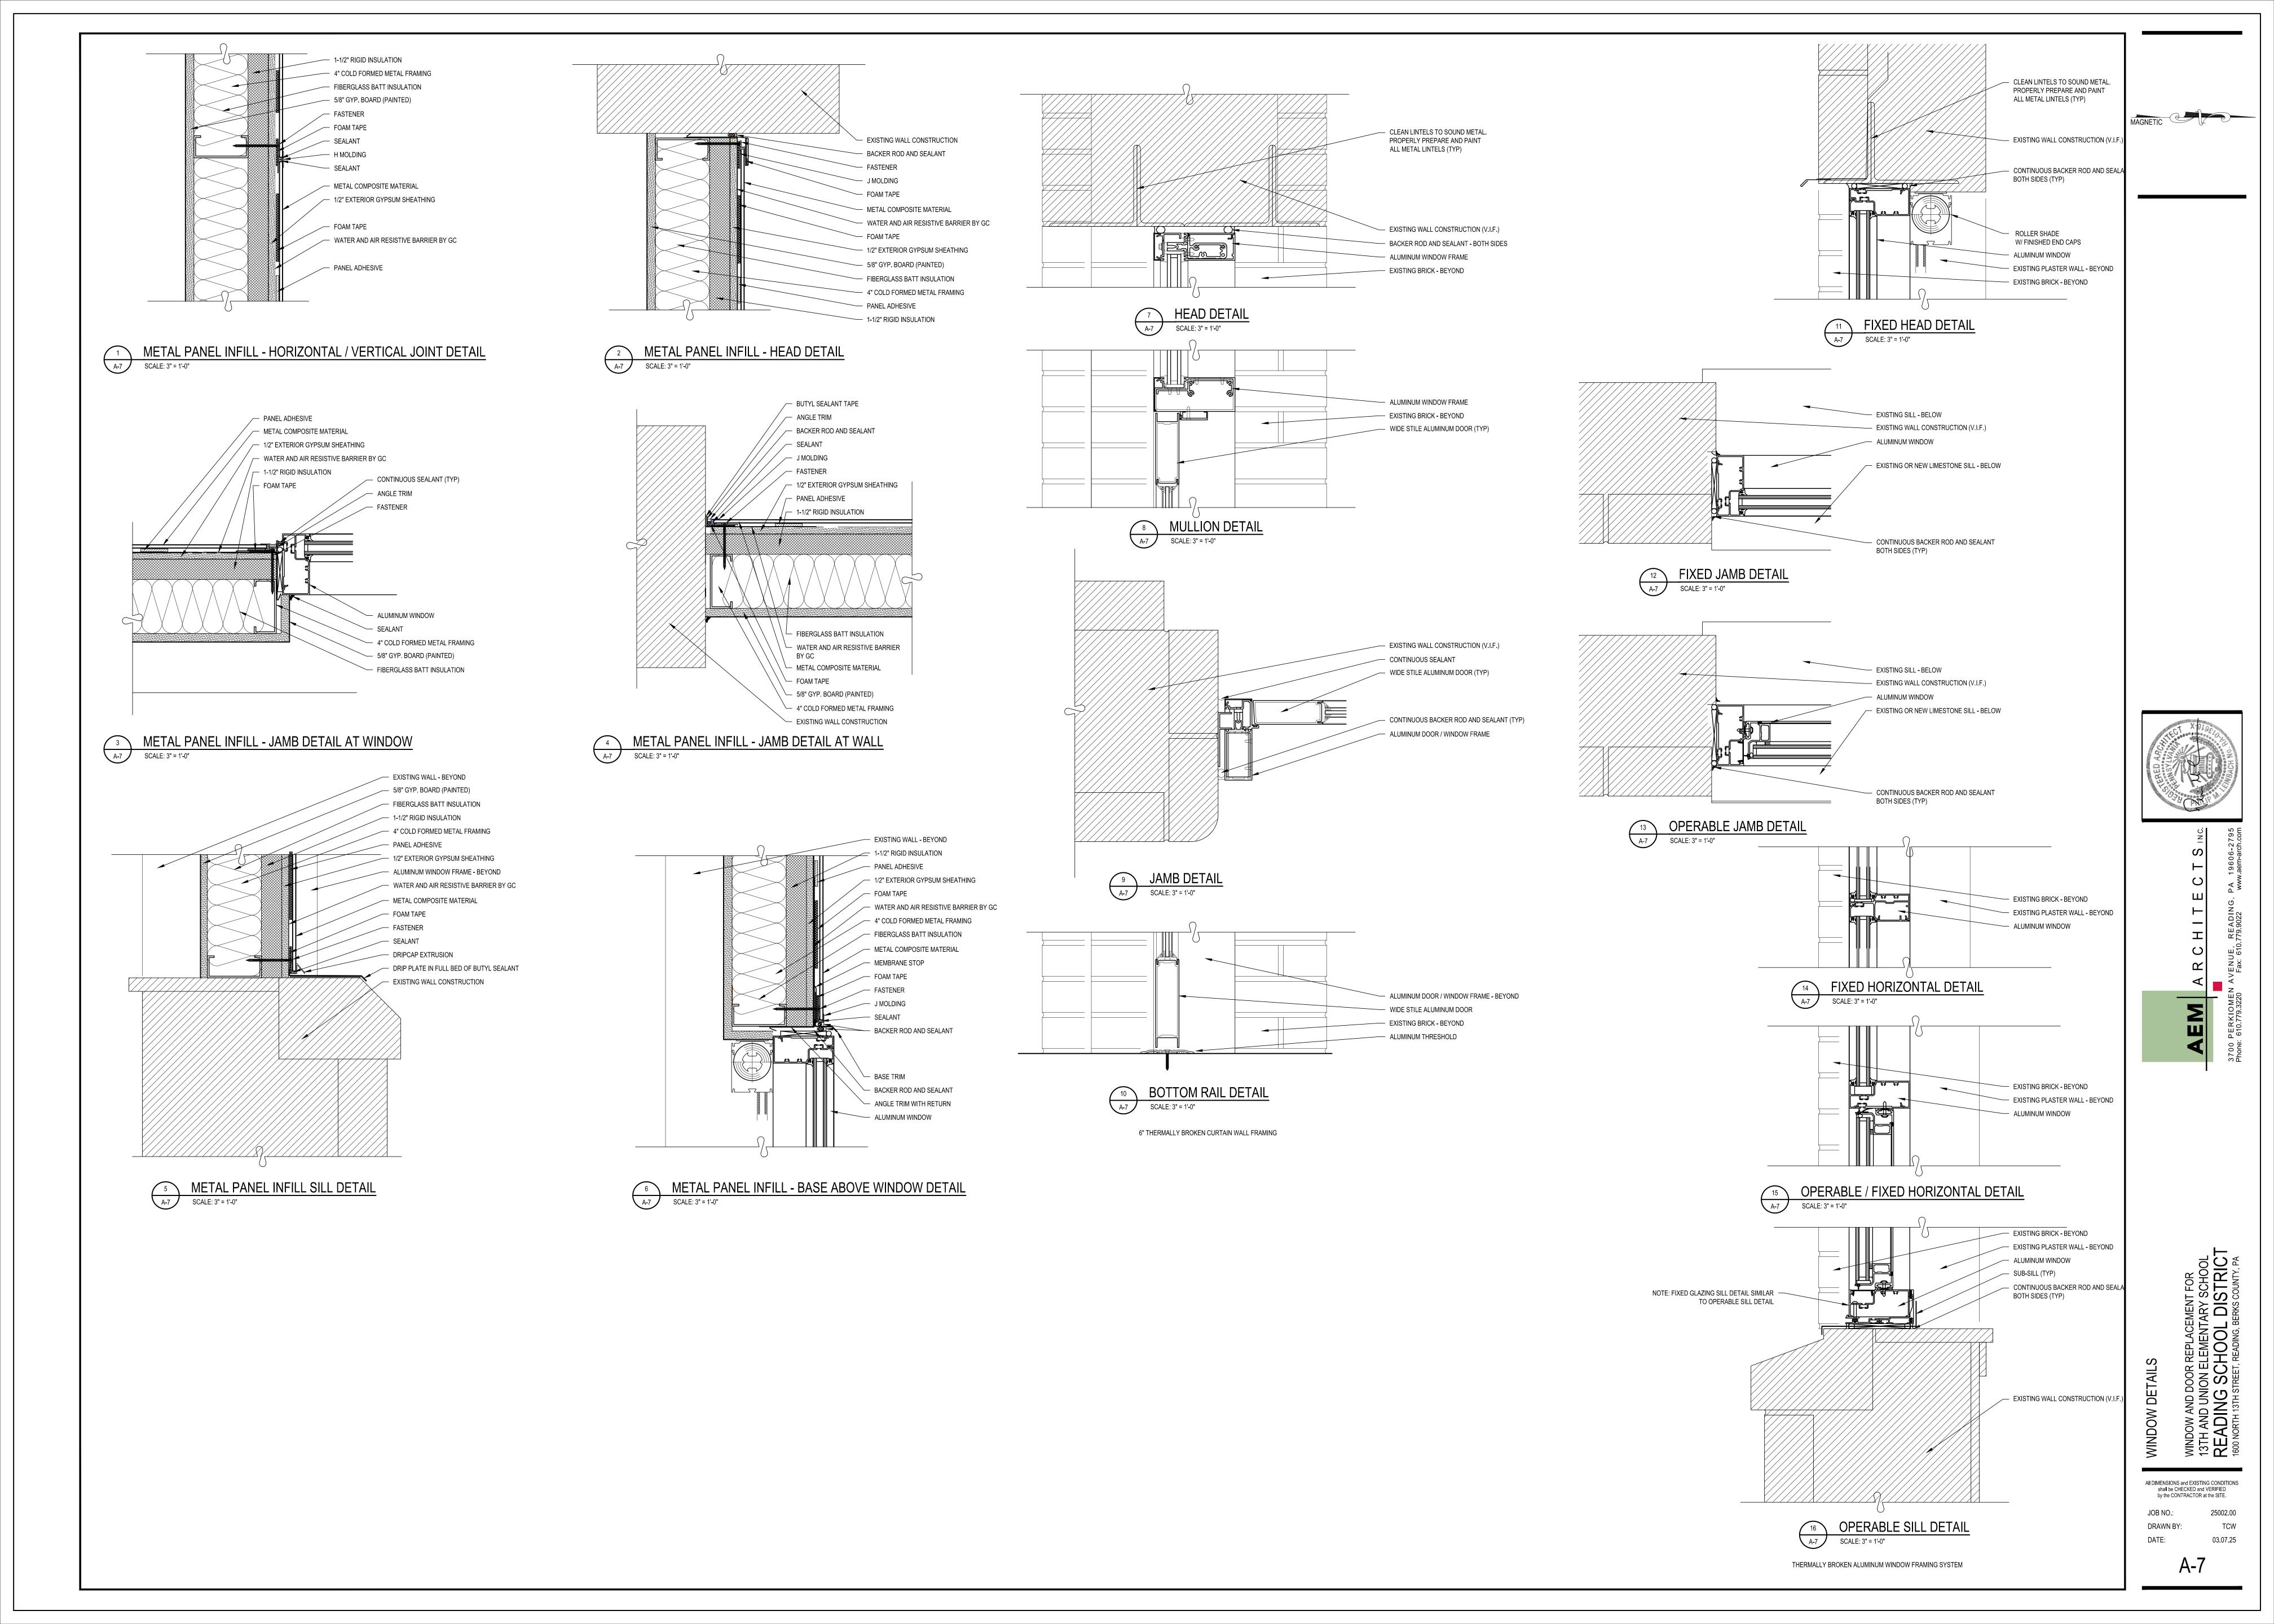

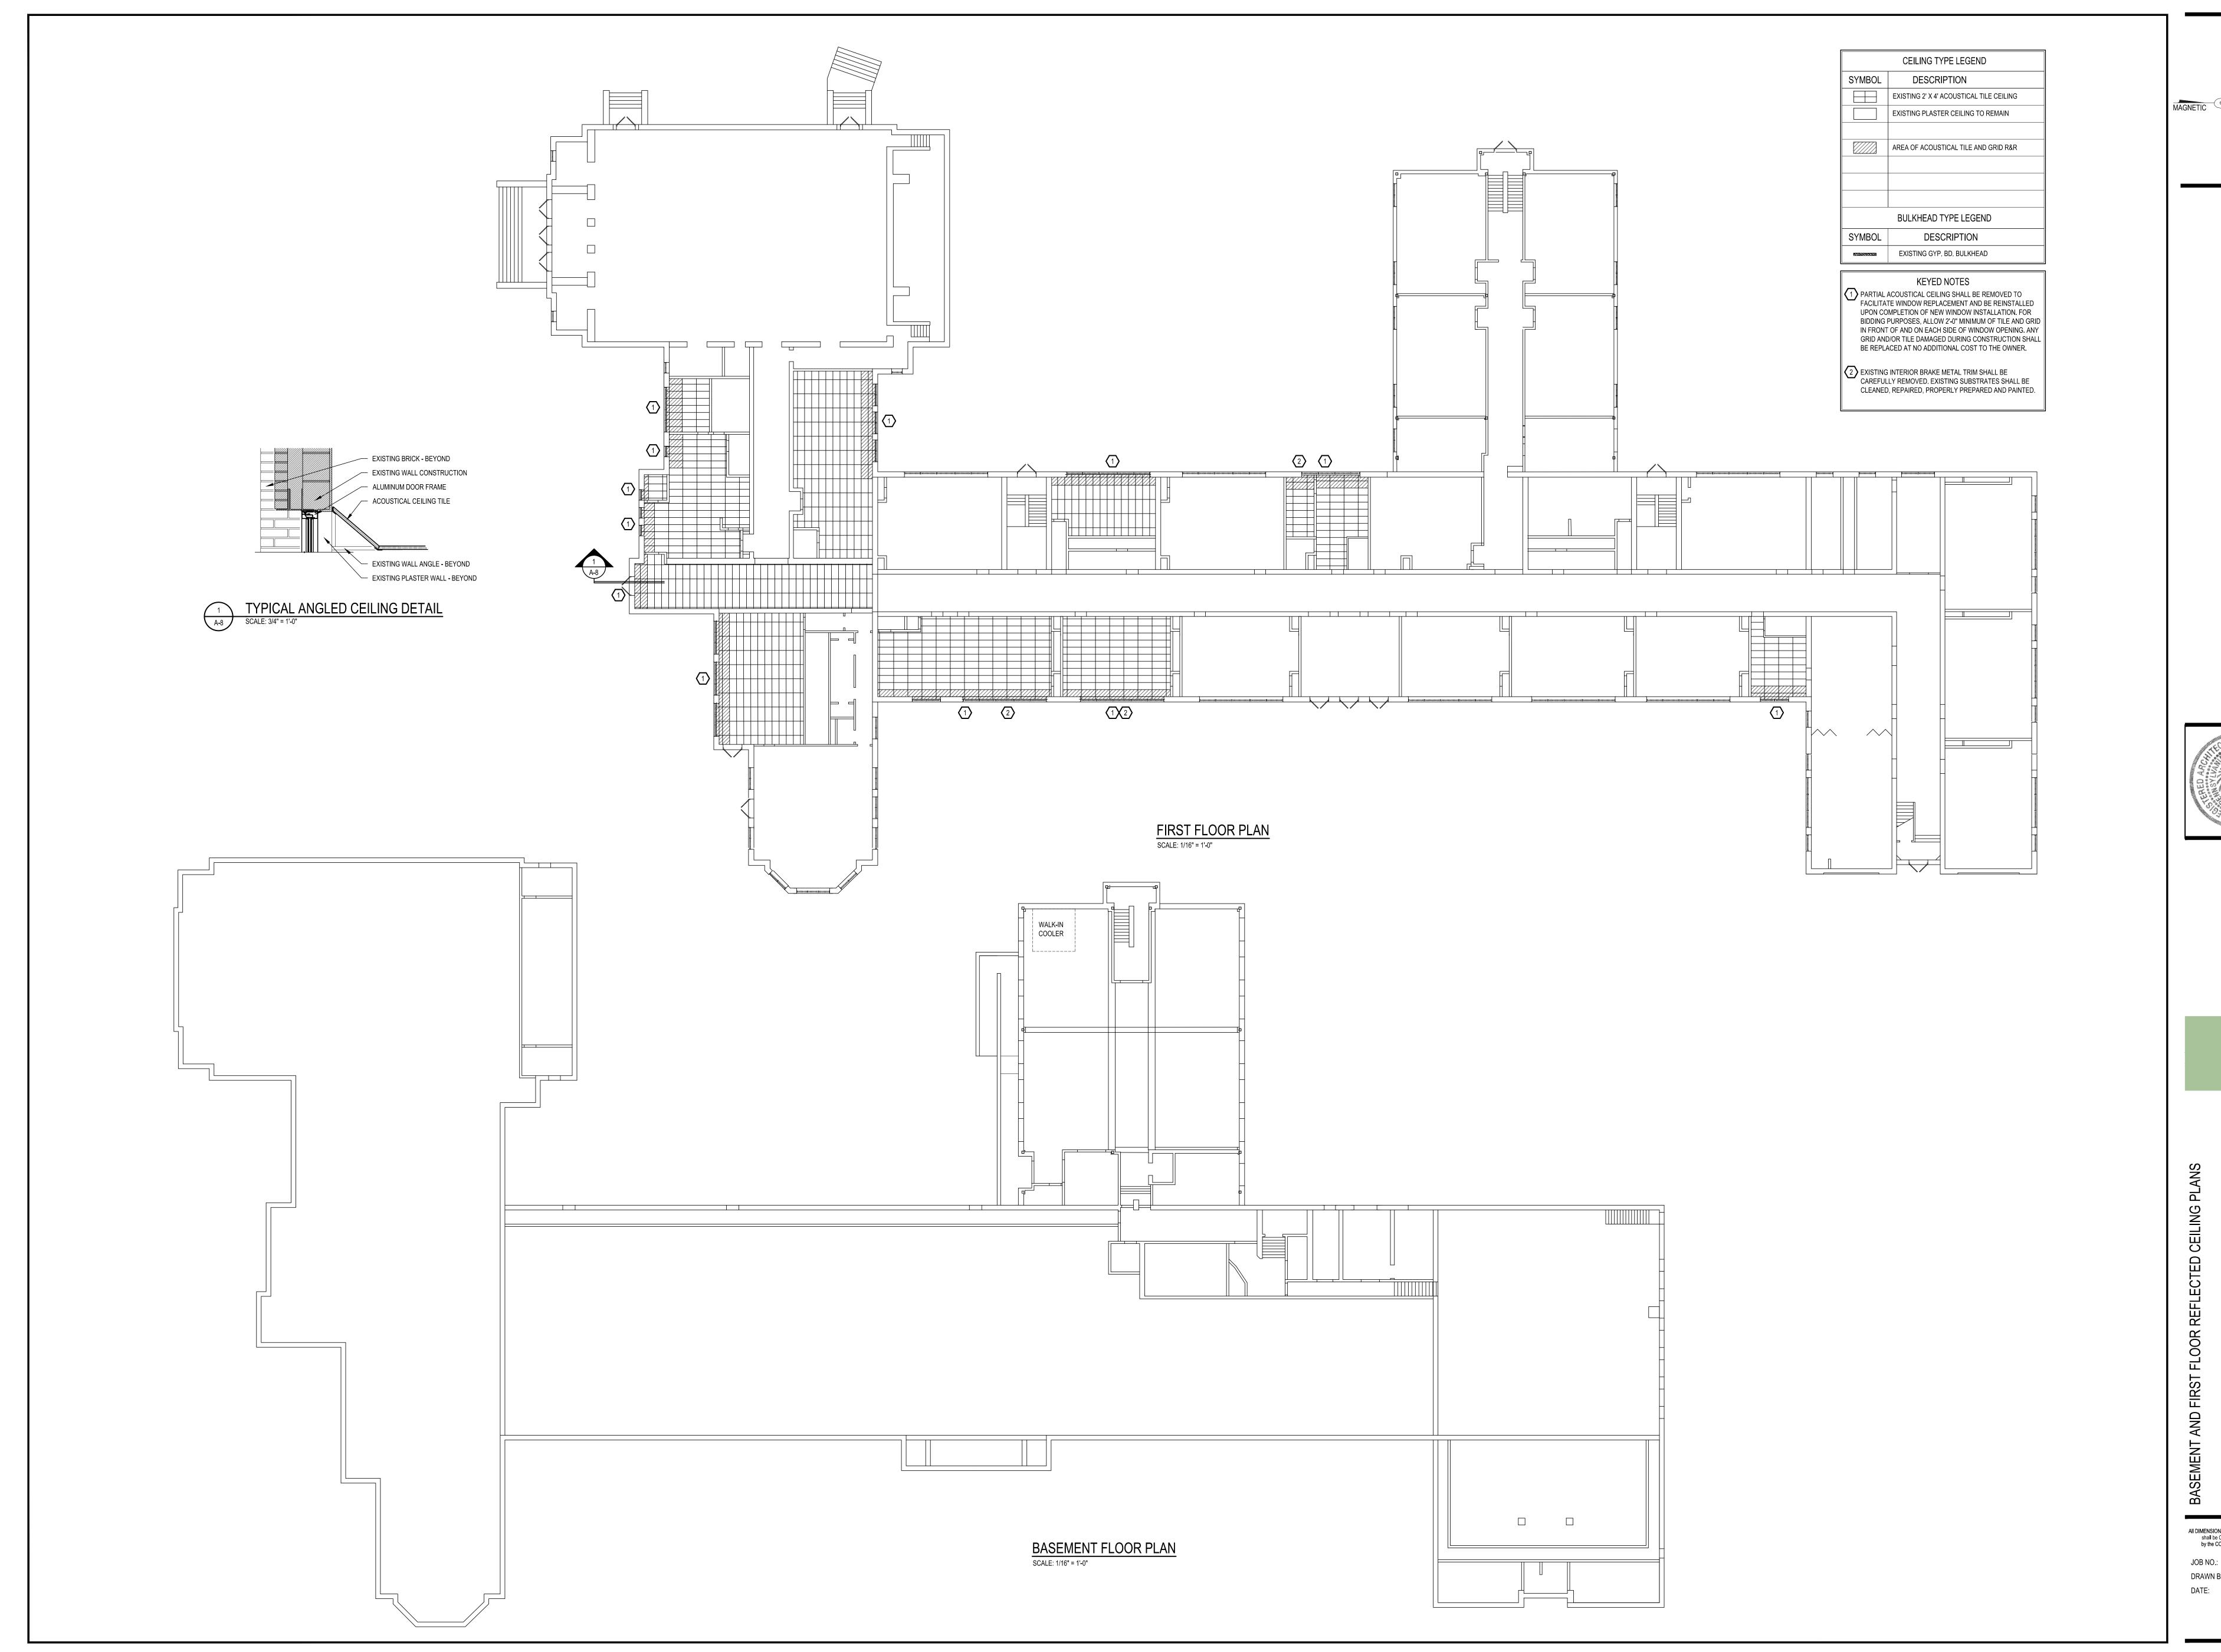

SYLVA SYLVA SYLVA SYLVA SOLO SYLVA SY

ARCHITECTS IN CIOMEN AVENUE, READING, PA. 19606-279

AEM AR O S 3700 PERKIOMEN AVENUE Phone: 610.779.3220 Fax: 6

ND DOOR REPLACEMENT FOR UNION ELEMENTARY SCHOOL


IG SCHOOL DISTRICT


All DIMENSIONS and EXISTING CONDITIONS shall be CHECKED and VERIFIED by the CONTRACTOR at the SITE.

JOB NO.: 25002.00

DRAWN BY: TCW

A-8

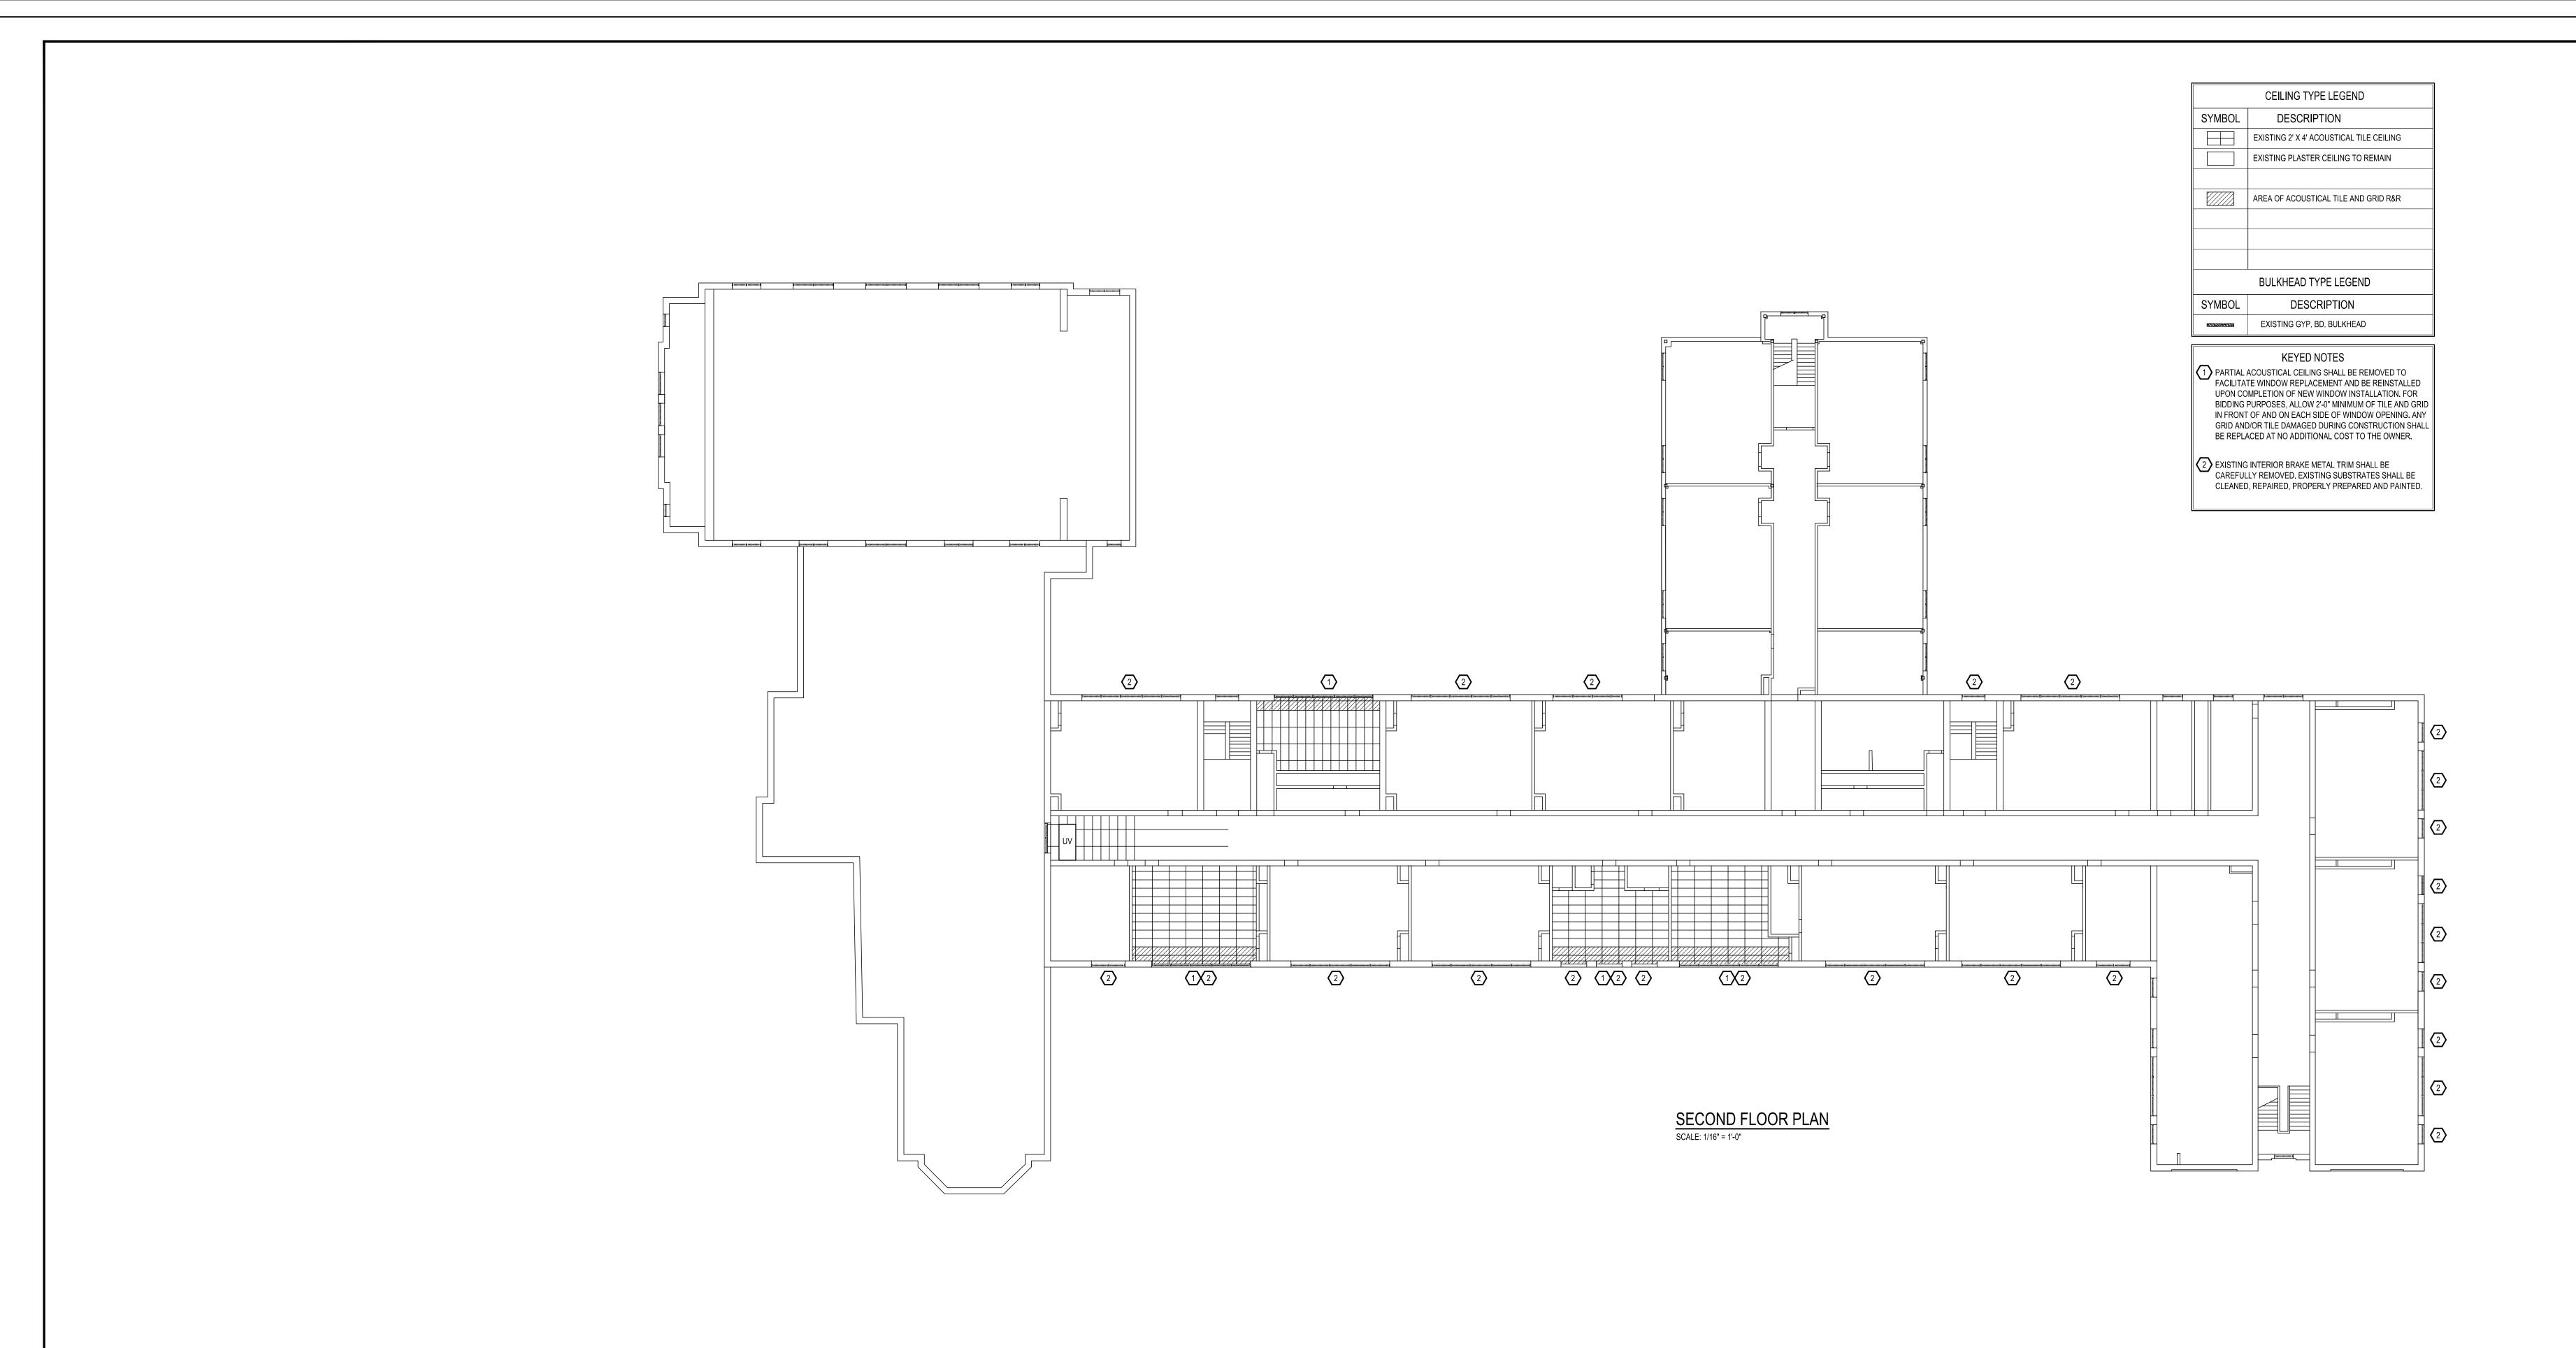

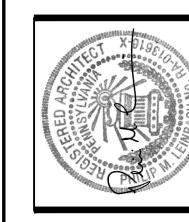

All DIMENSIONS and EXISTING CONDITIONS shall be CHECKED and VERIFIED by the CONTRACTOR at the SITE. DRAWN BY: