ABBREVIATIONS ACCOMMODATE ACCORDANCE LAMINATE(D)(ION) LEAD EXPANSION SHIELD ACOUSTIC ADJUSTABLE/ADJACENT **ALTERNATE** ALUMINUM MANUFACTURER ANCHOR BOLTS MASONRY OPENING MAXIMUM ARCHITECT(URAL) ASPHALT CONCRETE PAVING MECHANICAL MECHANICAL CONTRACTOR MELAMINE COATED PARTICLE BOARD BEARING PLATE MOLDING, MOULDING BITUMINOUS BITUMINOUS DAMPPROOFING NOT APPLICABLE BLOCK BOARD BOTTOM BRICK BUILDING CABINET CAST IRON CEILING CENTER LINE CERAMIC TILE NATURAL NOT IN CONTRACT NOT TO SCALE NUMBER ON CENTER OFFICE OPEN PLAN OFFICE OPEN WEB STEEL JOISTS CLG CL CER T CIRC CJ CLO COL COMP CONC CONF CMU CONST CONT COORD DEM DTL OPENING OUTSIDE DIAMETER OVERHEAD CERAMIC TILE CIRCULATION CONTROL JOINT CLOSET COLUMN COMPUTER CONCRETE CONFERENCE CONCRETE MASONRY UNITS PARTITION PAINT(ED) PLUMBING CONTRACTOR PLYWOOD PRESSURE TREATED CONSTRUCTION POLYVINYL CHLORIDE RAIN WATER CONDUCTOR CONTINUOUS COORDINATE RECEPTION RECEPTION REINFORCING REINFORCING BARS REPRESENTATIVE REQUIRED RIGHT OF WAY ROOF ROOF ROOF DECKING ROOF DECKING DEMOLISH, DEMOLITION DIAMETER DIMENSION DOOR DOWN DOWNSPOUT DRINKING FOUNTAIN ELEVATION ROOM ROUGH OPENING SALVAGE & DELIVER TO OWNER SHEET SKYLIGHT SLATE SOLID CORE SPECIFICATION SPRINKLER STAINLESS STEEL STANDARD ELECTRIC(AL) ELECTRIC WATER COOLER ELECTRICAL CONTRACTOR LEVATION, ELEVATOR EXPANDED POLYSTERENE EQUAL EXISTING EXPANSION JOINT EXPOSED EXTERIOR EXTRUDED POLYSTYRENE FIBERGLASS BATT STORAGE STRUCTURE/STRUCTURAL STRUCTURAL STEEL FIRE EXTINGUISHER FIRE EXTINGUISHER CABINET FIRE RESISTANT TREATED WOOD FLASHING FLOOR TONGUE AND GROOVE FLOOR DRAIN TOP OF TOP OF CURB TOP OF FOOTER GALVÁNIZED TOP OF STEEL TOP OF WALL TYPICAL UNLESS NOTED OTHERWISE GENERAL CONTRACT(OR) GWB GWB-X HVAC HC GYPSUM DRYWALL (WALLBOARD) GWB, TYPE X (FIRE RESISTIVE CLASSIFICATION) VINYL COMPOSITION TILE HEATING, VENTILATING AND AIR CONDITIONING VERIFY IN FIELD VINYL WALL BASE VINYL WALL COVERING HL-CMU HOLLOW LOADBEARING CMU HORIZONTAL WELDED WIRE FABRIC WITHOUT INSIDE DIAMETER WOLMANIZED INSULATE(D)(ION) NOTE: NOT ALL ABBREVIATIONS LISTED ARE APPLICABLE TO THIS PROJECT

DEMOLITION AND ALTERATIONS FOR


BEAVER STREET STORAGE FACILITY

LANCASTER, PA

HAMMEL ASSOCIATES ARCHITECTS, LLC Lancaster, PA

(717) 393.3713 FAX (717) 393.8227 WEB: WWW.HAMMELARCH.COM EMAIL: INFO@HAMMELARCH.COM

MOORE ENGINEERING COMPANY Mechanical, Plumbing and Electrical Consulting Engineers Lancaster, PA 717.285.3141

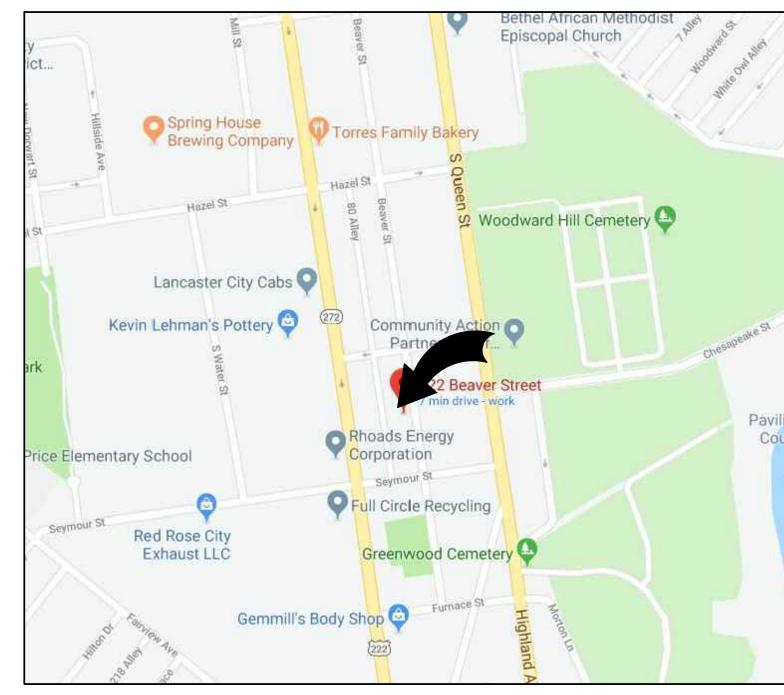

LOCATION MAP NOT TO SCALE




ACTUAL NORTH



REVISIONS

ANNOTATION SYMBOLS

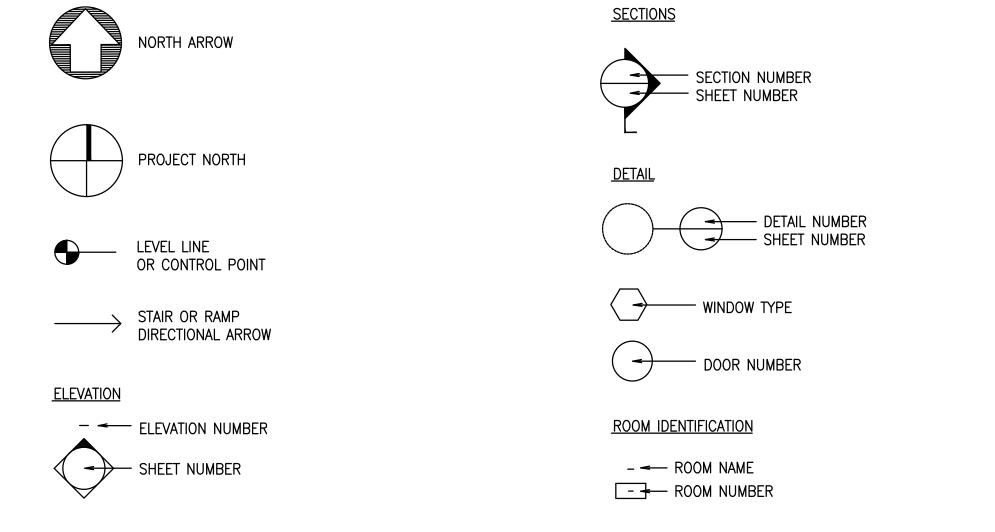

CONSTRUCTION NOTES

- REVIEW DETAILS, & PROVIDE FIRE TREATED SOLID WOOD BLOCKING INSIDE FIRE-RATED STUD WALLS & SOLID WOOD BLOCKING INSIDE STUD WALLS WHERE
- WHERE EXISTING CONSTRUCTION IS CUT & PATCHED, REPAIR ALL ADJACENT SURFACES DISTURBED BY CUTTING & PATCHING & PREPARE TO RECEIVE NEW CONSTRUCTION &/OR NEW SCHEDULED FINISHES. REPAIRS SHALL MATCH EXISTING ADJACENT &/OR SIMILAR SURFACES & MATERIALS. TRANSITIONS BETWEEN NEW & EXISTING CONSTRUCTION SHALL BE SMOOTH & UNNOTICEABLE.

ALL FINISHED SURFACES IN THIS PROJECT ARE TO BE PATCHED & REPAIRED TO MATCH ADJACENT OR SIMILAR CONSTRUCTION & PREPARED TO RECEIVE

- SPECIFIED FINISHES. TRANSITIONS BETWEEN NEW REPAIRS & EXISTING CONSTRUCTION SHALL BE SMOOTH & UNNOTICEABLE.
- 4. ALL MTL THAT COMES INTO CONTACT WITH PT WOOD SHALL BE STAINLESS OR GALV. STEEL. THIS INCLUDES BUT IS NOT LIMITED TO FASTNERS. FLASHING AND JOIST HANGERS. STRUCTURAL STL SHALL BE PRIMED AND PAINTED PRIOR TO CONTACT WITH PT WOOD.
- 5. REPAIR ANY DAMAGE TO EXISTING OR NEW FIRE-RATED ENCLOSURES, CEILINGS AND WALLS.
- 6. SEAL AND FIRESTOP ALL PENETRATIONS AND OPENINGS IN ANY FIRE-RATED CONSTRUCTION USING PROPER FIRESTOPPING PRODUCTS INSTALLED IN ACCORDANCE WITH THE MANUFACTURER'S SPECIFICATIONS.
- 7. ALL MEANS OF EGRESS TO BE FREE & CLEAR AT ALL TIMES.

JOINT SEALER SCHEDULE

DRAWING	G DESIGNATION	DESCRIPTION OF JOINT CONSTRUCTION AND LOCATION WHERE JOINT SEALER IS
*	SEALANT TYPE	TYPICALLY APPLIED. (SEE NOTE BELOW)
ES-1	ONE-PART NONACID- CURING SILICONE SEALANT	EXTERIOR & INTERIOR VERTICAL JOINTS BETWEEN METAL & CONCRETE, UNIT MAS MORTAR, OR STONE; INTERIOR & EXTERIOR PERIMETER JOINTS OF METAL & WOOD FIN EXTERIOR WALLS; & EXTERIOR OVERH JOINTS.
ES-2	MULTI-PART POURABLE URETHANE SEALANT	EXTERIOR & INTERIOR JOINTS IN HORIZO SURFACES OF CONCRETE; BETWEEN MET CONCRETE, MORTAR & MASONRY.
ES-3	ONE-PART ACID-CURING SILICONE SEALANT	NOT USED
ES-4	ONE-PART MILDEW- RESISTANT SILICONE SEALANT	NOT USED
ES-5	TWO-PART URETHANE SEALANT	NOT USED
LS	ACRYLIC-EMULSION SEALANT	NOT USED
BAS-1	BUTYL-ASPHALT SEALANT, AC-20 IN ACCORDANCE WITH PA. DEPT. TRANSPORTATION TITLE 408 SPECIFICATIONS.	NOT USED
FSS-1	FOAMED-IN-PLACE FIRE-STOPPING SEALANT	NOT USED
FSS-2	ONE-PART FIRE-STOPPING SEALANT	NOT USED

DESIGNATIONS LISTED ABOVE.

BUILDING DATA (2015 IEBC)

UPANCY:	USE GROUP S-1
STRUCTION TYPE:	2B
DING HEIGHT:	20'-0"± EXISTING
ALARM SYSTEM:	NO
RGENCY LIGHTING:	YES
DMATIC SPRINKLERS:	NO
DMATIC FIRE	
TECTION SYSTEM:	NO
SEPARATION:	NO
<u>DING AREA:</u>	
EXISTING 10.039 SF	
EXISTING 10,039 SF	
JILDING CO	ODE REQUIREME
	ODE RE

S AND

1. COMMONWEALTH OF PENNSYLVANIA, DEPARTMENT OF LABOR & INDUSTRY:

- A. PENNSYLVANIA UNIFORM CONSTRUCTION CODE: 2015 INTERNATIONAL EXISTING BUILDING CODE AND REFERENCED STANDARDS
- B. CITY OF LANCASTER BUILDING ORDINANCE AND ALL REFERENCED REGULATIONS (BUILDING, EXISTING BUILDING, PLUMBING, ELECTRICAL, MECHANICAL, FUEL GAS, PERFORMANCE, RESIDENTIAL, FIRE, ACCESSIBILITY AND ENERGY CODE WHERE APPLICABLE)

DRAWING INDEX

CS1.1	COVER SHEET
ARCH	HITECTURAL
DA1.1	DEMOLITION & ALTERATION PLAN
A1.1	FLOOR PLAN
A1.2	ROOF PLAN
A1.3	REFLECTED CEILING PLAN
A4.1	ENLARGED FLOOR PLAN AND INTERIOR ELEVATIONS
A5.1	DETAILS
A6.1	ROOM FINISH AND DOOR SCHEDULES, DOOR AND FRAME TYPES AND DET
MECH	HANICAL
M1.0	MECHANICAL DEMOLITION
M2.0	MECHANICAL PLAN
M3.0	MECHANICAL SCHEDULES, DETAILS, AND NOTES
PLUN	IBING
P1.0	PLUMBING DEMOLITION
	PLUMBING PLAN
P3.0	
ELECT	TRICAL
E1.1	SCHEDULES
	ELECTRICAL DEMOLITION
E3.1	LIGHTING PLAN
	POWER PLAN

ALTERNATE GC-1:

PATCH DAMAGED AREA OF EPDM ROOF ALONG SOUTH PARAPET WALL AS INDICATED ON A1.2, INCLUDING REPLACEMENT OF ANY DAMAGED ROOF EDGE.

ADD ALTERNATE:

COMPLETE TEAR OFF AND REPLACEMENT OF EPDM, AS INDICATED OR A1.2 & A5.1.

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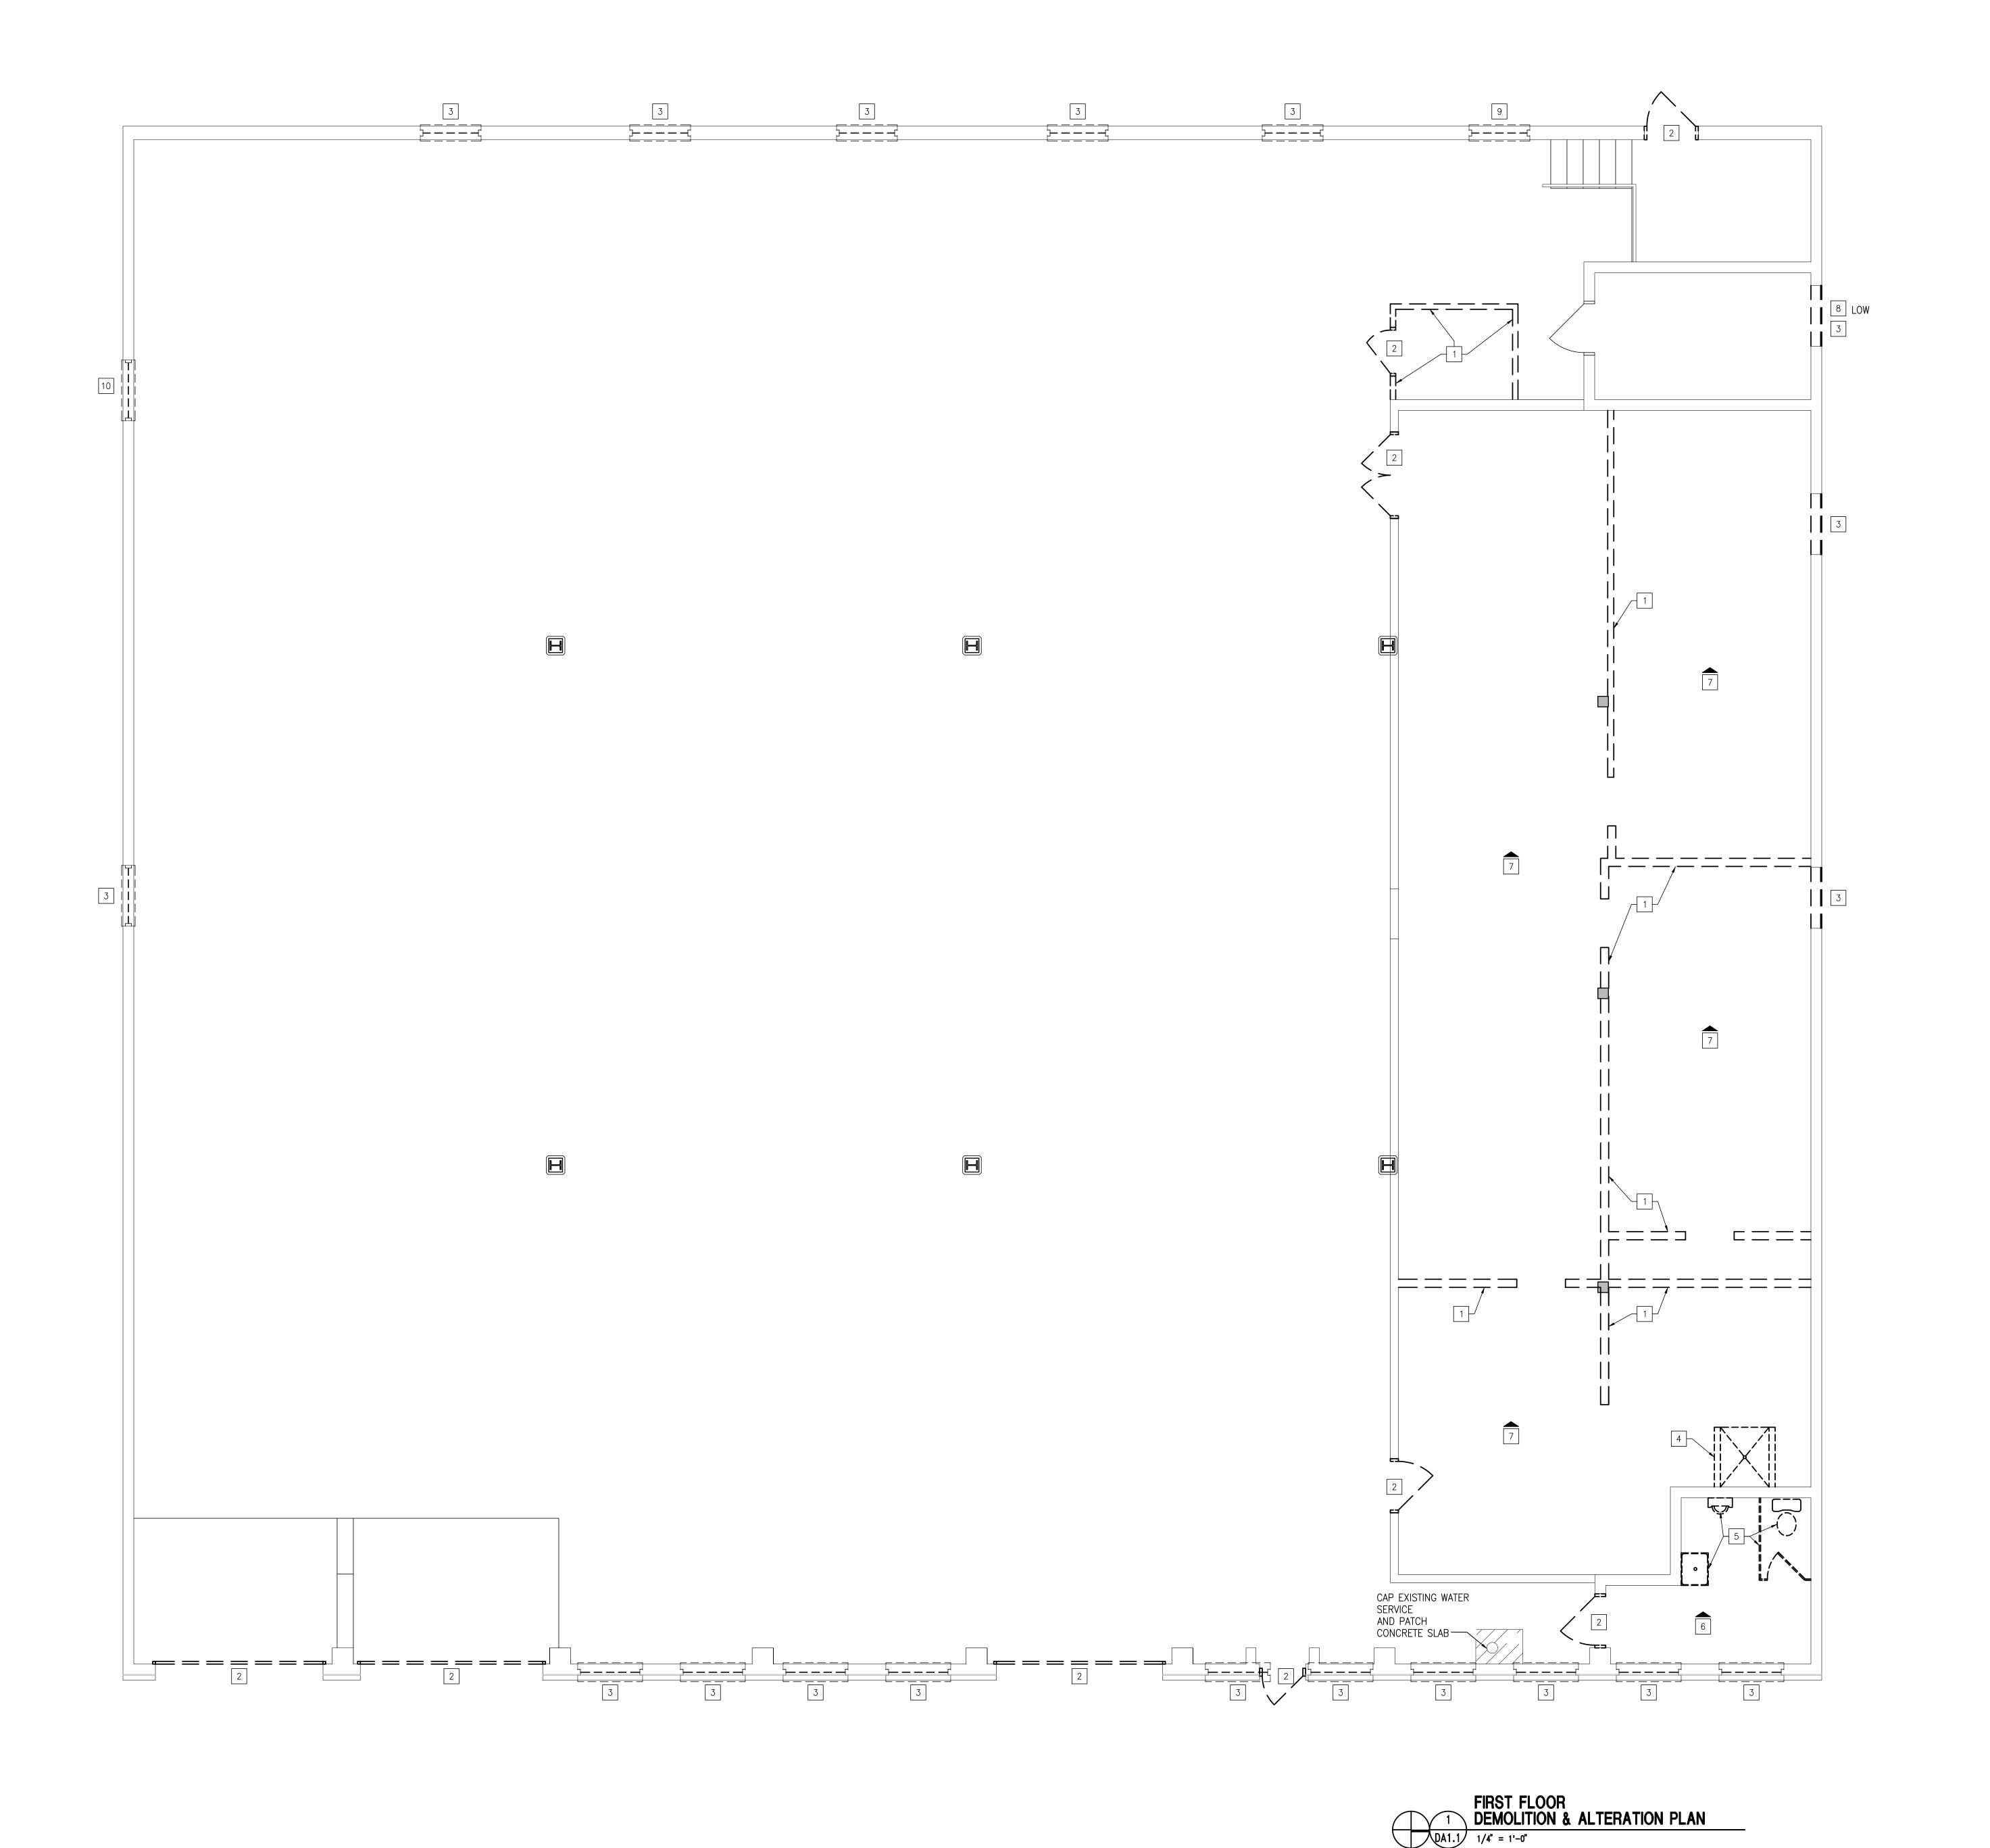
CITY OF LANCASTER

PROJECT DESCRIPTION

DEMOLITION AND ALTERATIONS FOR BEAVER STREET STORAGE FACILITY 622 BEAVER ST LANCASTER, PA

SHEET TITLE COVER SHEET

SCALE AS NOTED ISSUE DATE 8.15.2019 FILE NUMBER 1853 DRAWN BY ANE | CHECKED BY TLV



ALL DIMENSIONS, MEASUREMENTS AND PROJECT CONDITIONS SHALL BE CHECKED AND VERIFIED IN THE FIELD BY THE CONTRACTOR. REFER ALL DIFFERENCES, IN WRITING, TO THE ARCHITECT FOR CONSIDERATION PRIOR TO PROCEEDING WITH THE WORK. THE CONTRACTOR SHALL BEAR THE COST OF RECTIFYING WORK NOT APPROVED BY THE ARCHITECT, CAUSED BY LACK OF COORDINATION AND

OR NOTIFICATION.

└┴┘ INDICATED

DEMOLITION & ALTERATION LEGEND:

- REMOVE PORTION OF WOOD FRAMED WALL AS
- REMOVE EXISTING DOOR/FRAME AND PREPARE OPENING FOR NEW DOOR AS SCHEDULED.
- INFILL AS PER 1/A5.1
- 4 REMOVE SHOWER STALL & WOOD FRAMING
- REMOVE ALL CASEWORK, FIXTURES, AND/OR EQUIPMENT, RELOCATE, SALVAGE, OR DISPOSE OF EQUIPMENT AS DIRECTED BY OWNER. TERMINATE OR

REMOVE EXISTING WINDOW & PREPARE FOR NEW

- RELOCATE ELECTRICAL, MECHANICAL AND/OR PLUMBING CONNECTIONS AS NOTED ON MEP DWGS.

 REMOVE EXISTING CEILING IN ITS ENTIRETY,
- INCLUDING GRID, TILE, FRAMING, OR GWB.

 PATCH CEILING AS REQUIRED AFTER REMOVAL OF EXISTING FRAMED WALLS
- REMOVE EXISTING LOUVER & PREPARE FOR NEW LOUVER AS SCHEDULED ON MECHANICAL DWG'S
- INFILL BALANCE OF OPENING AS PER 1/A5.1

 REMOVE EXISTING WINDOW & PREPARE FOR NEW
- REMOVE EXISTING WINDOW & PREPARE FOR NEW EXHAUST FAN AS SCHEDULED ON MECHANICAL DWG'S

LOUVER AS SCHEDULED ON MECHANICAL DWG'S

NOTE APPLIES TO CEILING

NOTE APPLIES TO FLOOR

GENERAL DEMOLITION AND ALTERATION NOTES:

1. REMOVE THE ENTIRE DOOR AND WINDOW ASSEMBLY INCLUDING FRAME, SIDELIGHTS, TRANSOMS, HARDWARE, THRESHOLDS & PORTIONS OF ADJACENT WALL OR PARTITION WHERE INDICATED TO ACCOMMODATE NEW WORK

- 2. THE OWNER SHALL REMOVE LOOSE FURNISHINGS, EQUIPMENT & OTHER LOOSE ITEMS PRIOR TO DEMOLITION ACTIVITIES.
- REMOVE ALL CONSTRUCTION AS REQUIRED TO EXECUTE NEW WORK EVEN IF NOT SPECIFICALLY NOTED.
- 4. REMOVE ALL FASTENERS, SUPPORTS AND SIMILAR SYSTEMS.
- 5. PREPARE SURFACES OF WALLS, DOORS AND/OR FRAMES TO REMAIN FOR NEW FINISHES. MATCH EXISTING ADJACENT FINISHES UNO.
- 6. PROVIDE TEMPORARY SHORING TO SUPPORT EXISTING CONSTRUCTION SCHEDULED TO REMAIN.
- 7. ANY PLUMBING, ELECTRICAL OR MECHANICAL EQUIPMENT SCHEDULED TO BE REMOVED THAT IS TIED INTO SYSTEMS THAT ARE TO REMAIN, ARE TO BE REMOVED AND TIED OFF IN A MANNER THAT ALLOWS FOR THE CONTINUOUS OPERATION OF THE SYSTEM.

REVISIONS

KEY PL

HAA

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CITY OF LANCASTER

PROJECT DESCRIPTION


DEMOLITION AND ALTERATIONS FOR BEAVER STREET STORAGE FACILITY 622 BEAVER ST LANCASTER, PA

SHEET TITLE DEMOLITION AND ALTERATION PLAN

ISSUE DATE 8.15.2019 SCALE AS NOTED


FILE NUMBER 1853 DRAWN BY AJB CHECKED BY CAD

DA1.1

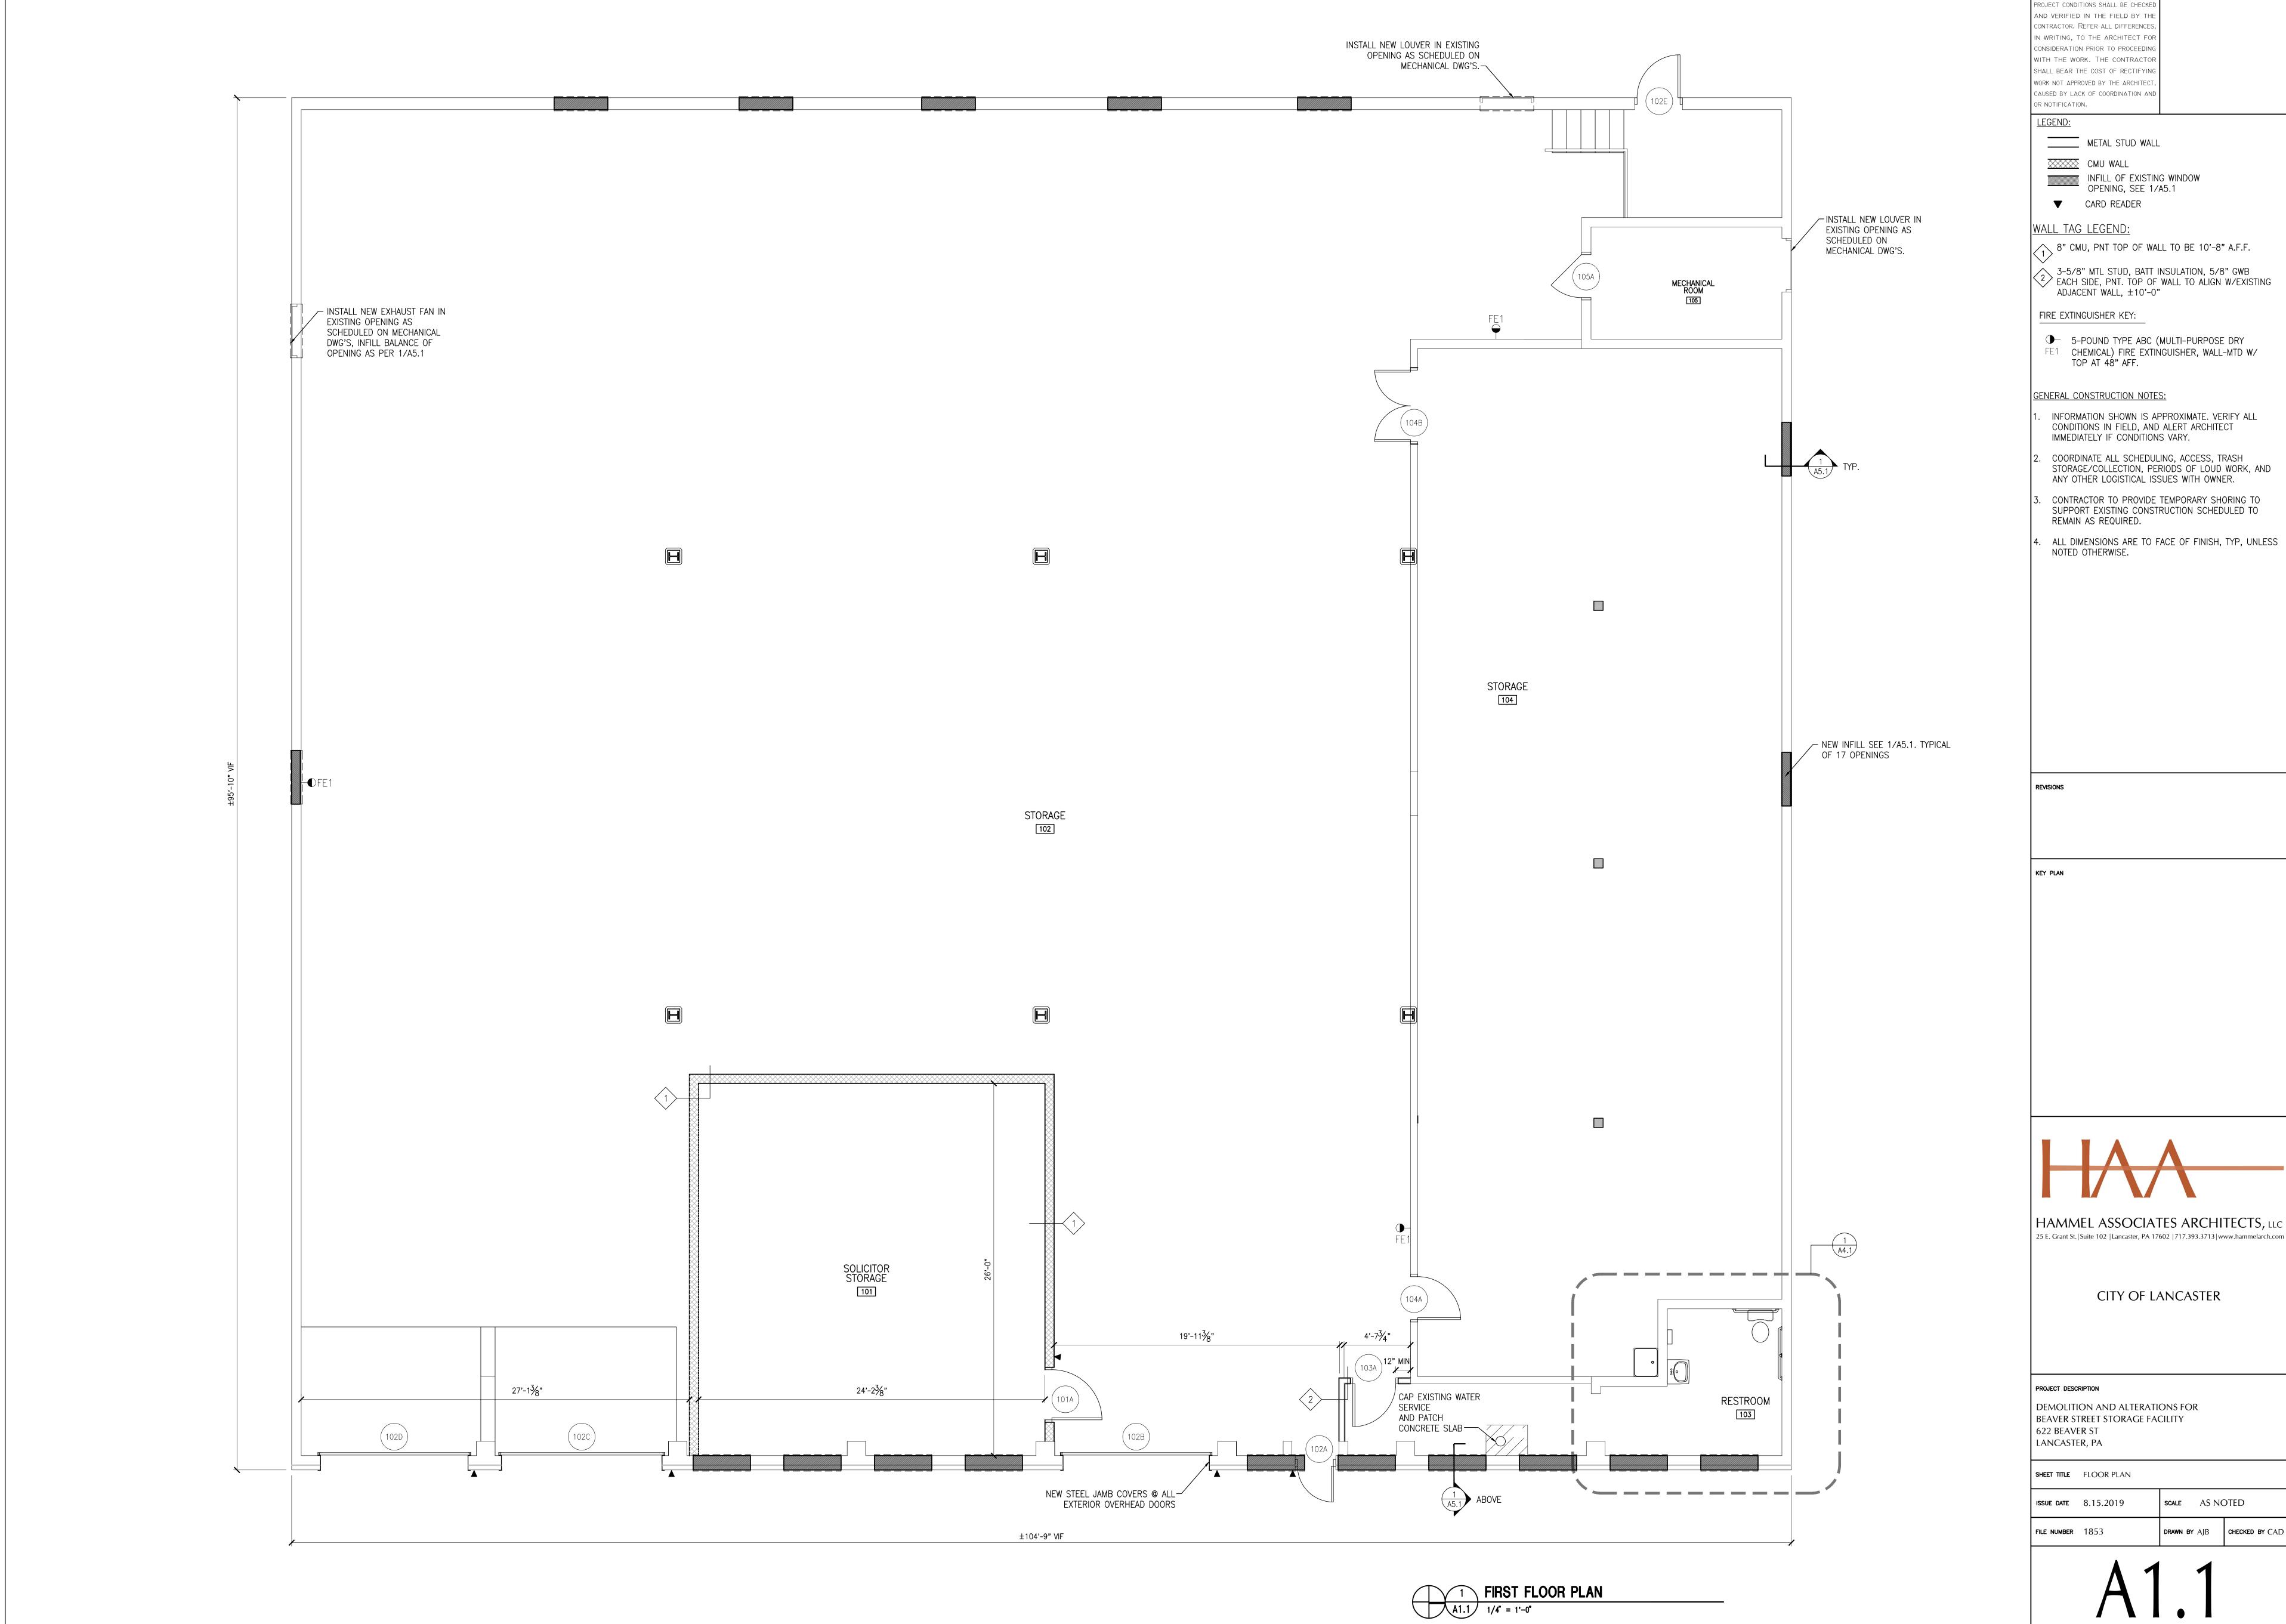

ALL DIMENSIONS, MEASUREMENTS AND STAMP PROJECT CONDITIONS SHALL BE CHECKED

DRAWN BY AJB CHECKED BY CAD

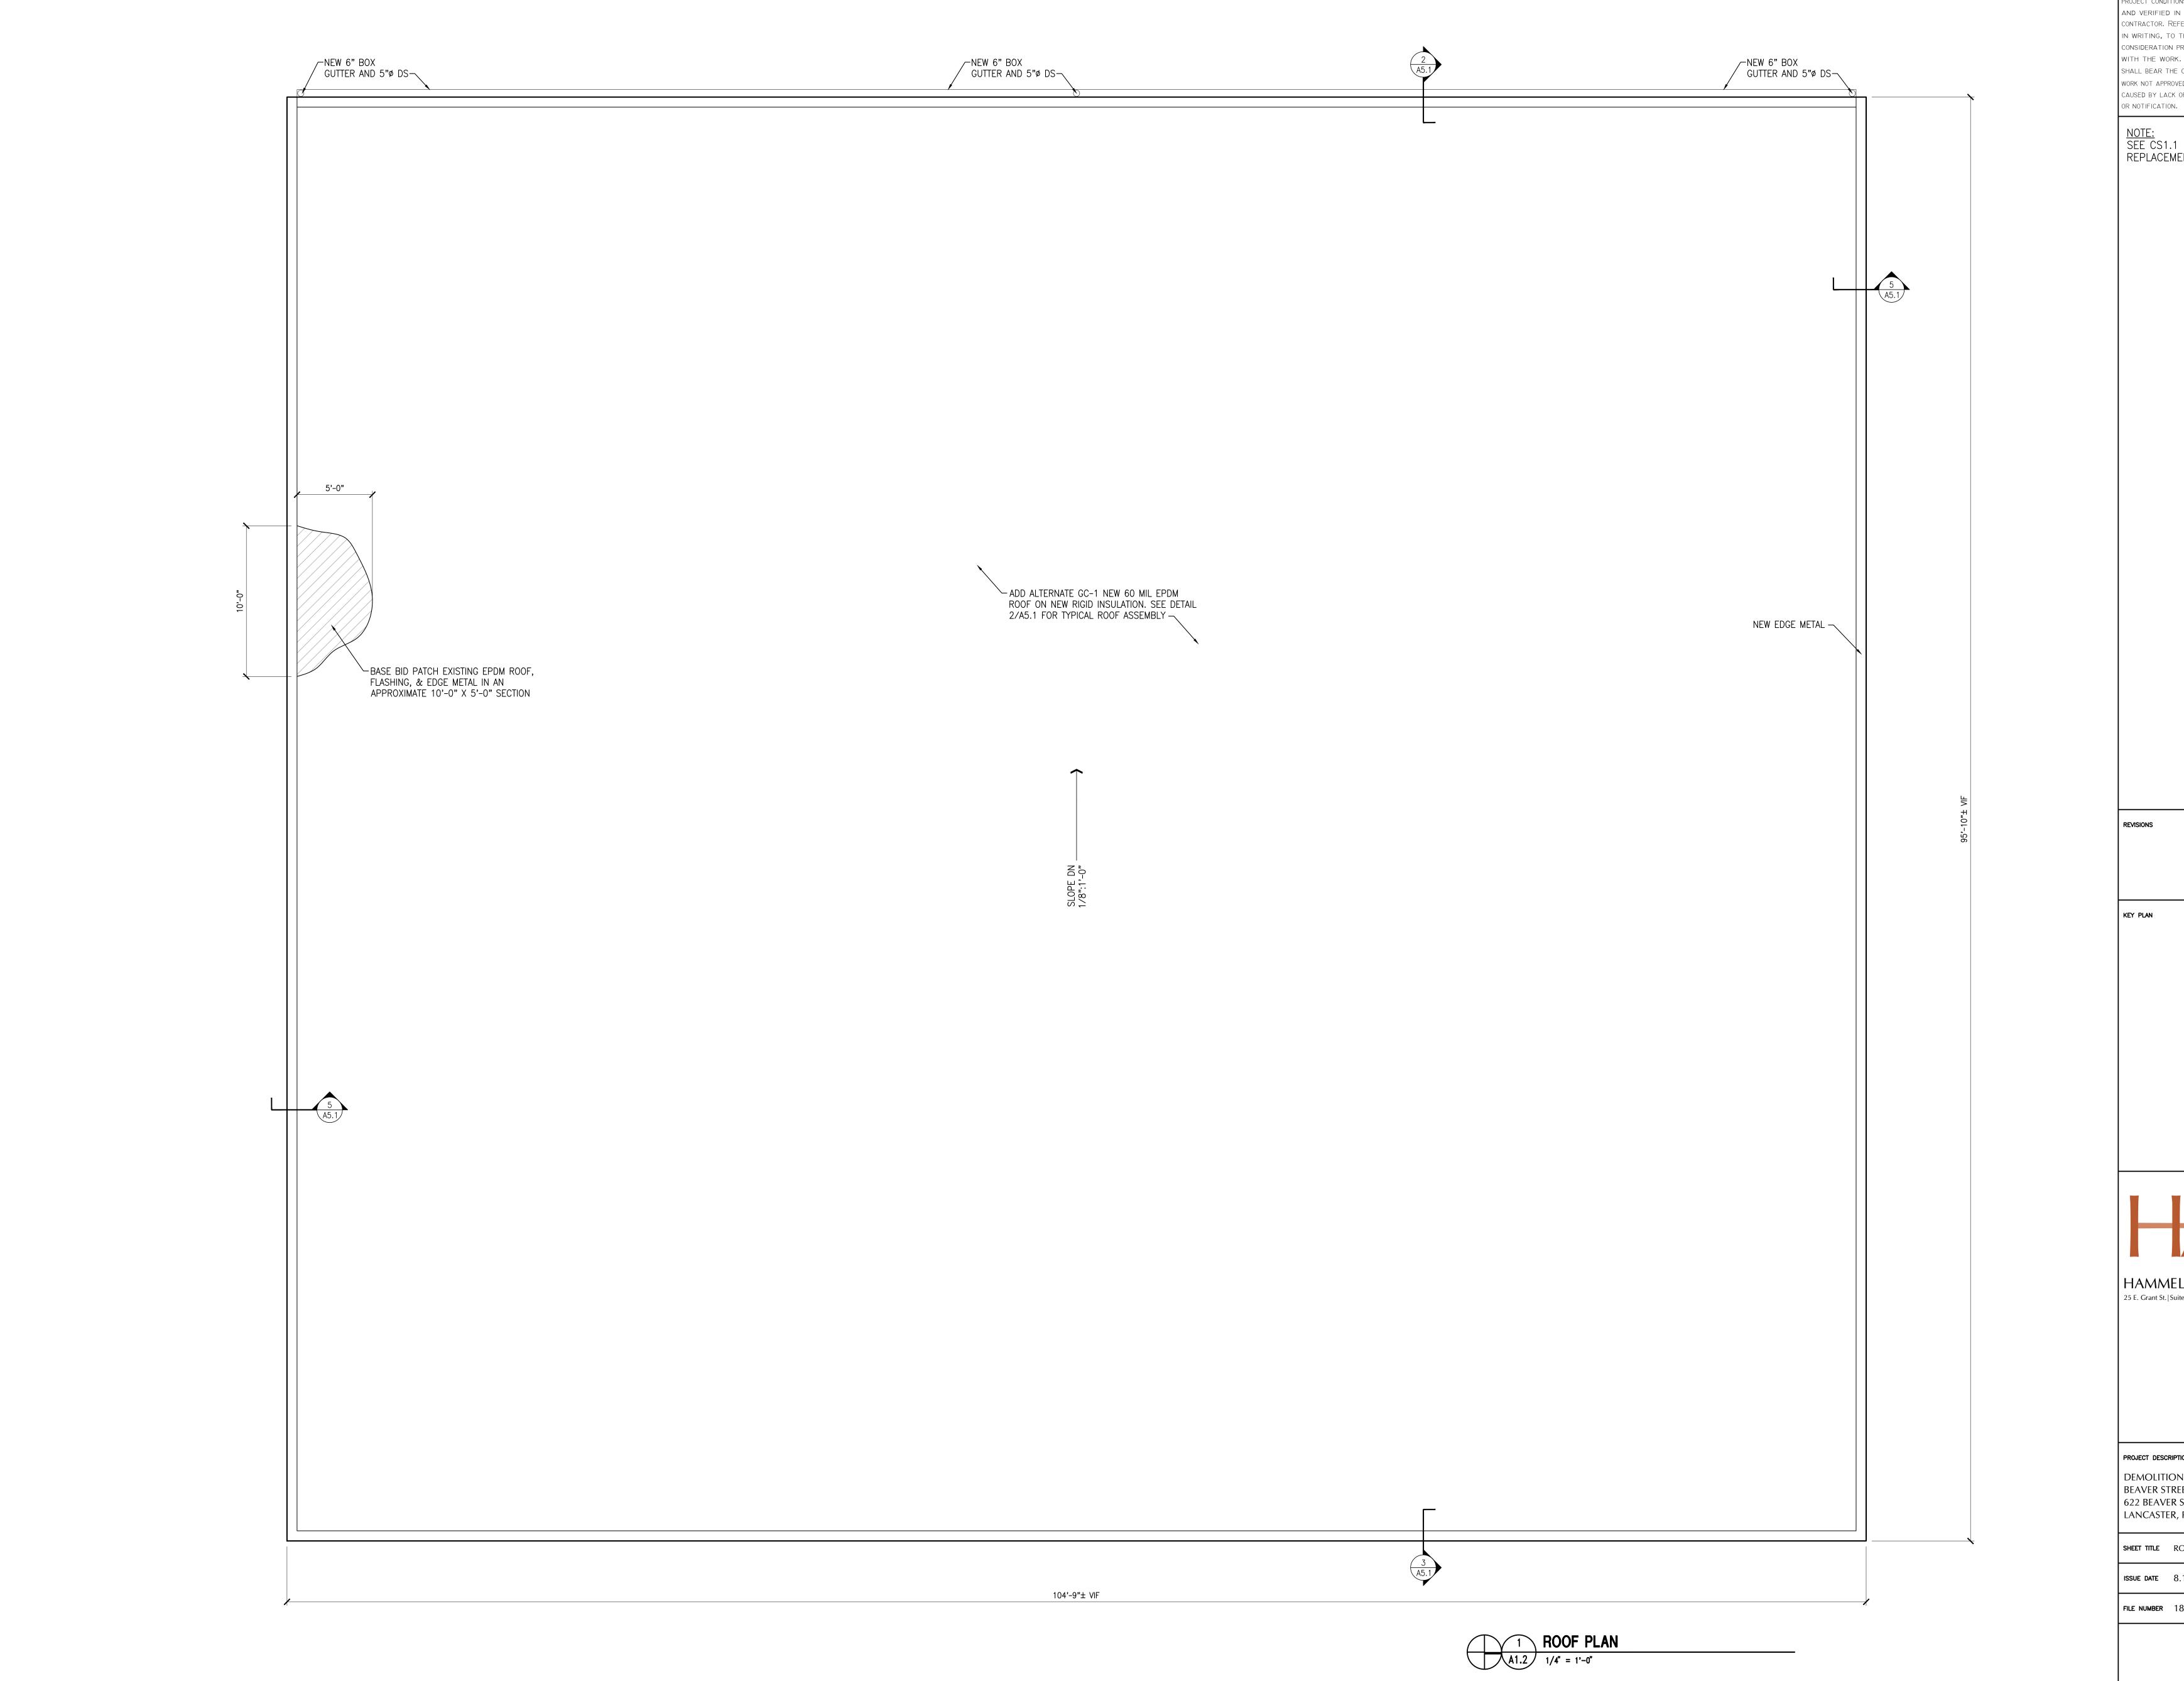

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NOTE: SEE CS1.1 FOR DESCRIPTION OF ROOF REPLACEMENT ALTERNATE GC-1.

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CITY OF LANCASTER

PROJECT DESCRIPTION

DEMOLITION AND ALTERATIONS FOR BEAVER STREET STORAGE FACILITY 622 BEAVER ST LANCASTER, PA

SHEET TITLE ROOF PLAN

ISSUE DATE 8.15.2019 SCALE AS NOTED FILE NUMBER 1853 DRAWN BY AJB CHECKED BY CAD



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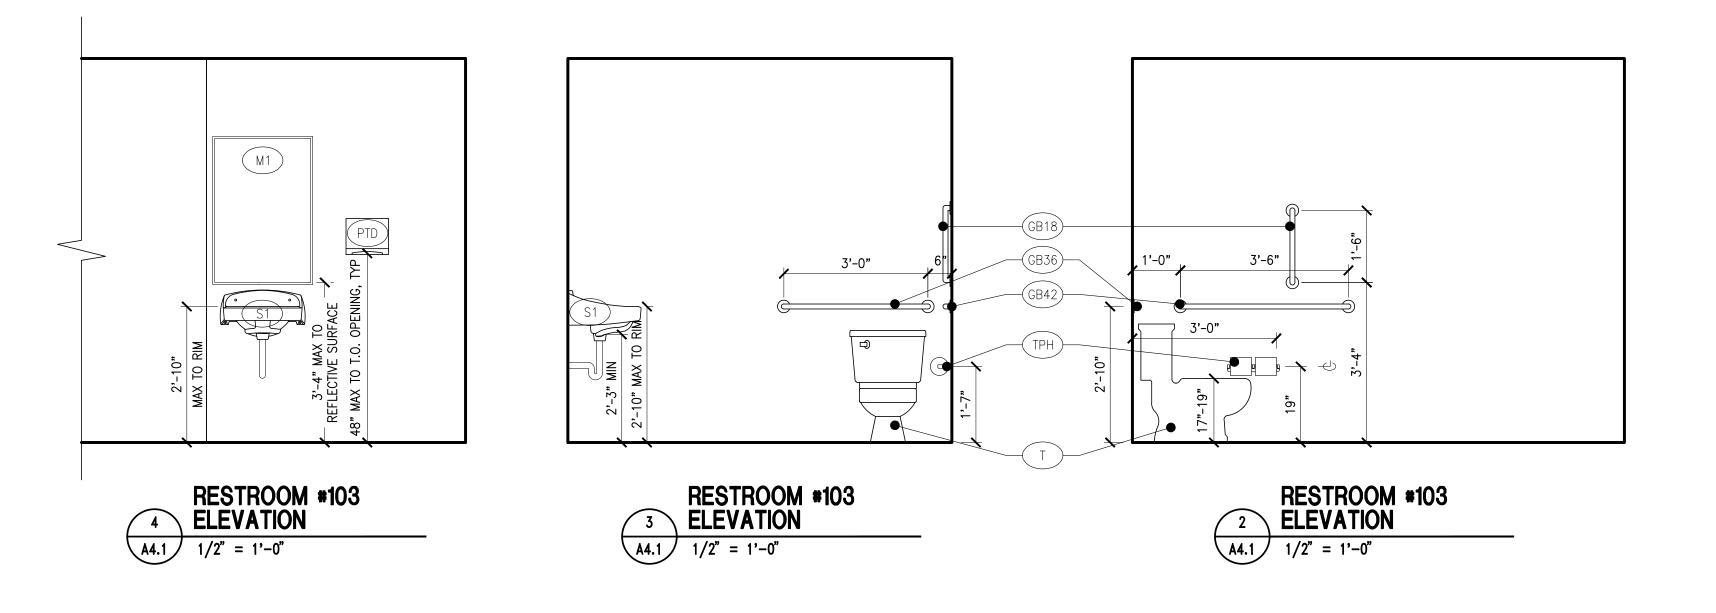
ALL DIMENSIONS, MEASUREMENTS AND STAMP


	PLUMBING	FIXTURES AND ACCESSO	RY SCHEDULE
ITEM	DESCRIPTION	BASIS OF DESIGN MODEL #	REMARKS: PROVIDE ADA COMPLIANT FIXTURES, TRIM, ACCESSORIES AND INSTALLATION
(GB18)	GRAB BAR 18"	BOBRICK-B-6806X18	CONCEALED FASTENERS
(GB36)	GRAB BAR 36"	BOBRICK-B-6806X36	CONCEALED FASTENERS
(GB42)	GRAB BAR 42"	BOBRICK-B-6806X42	CONCEALED FASTENERS
JS	SLOP SINK		
<u>M1</u>	MIRROR - 24"x36"		24"x36"
PTD	PAPER TOWEL DISPENSER		SURFACE MOUNTED
S1	SINK - WALL MOUNT - PORCELAIN	SEE PLUMBING DRAWINGS FOR MODEL NUMBER	
T	TOILET - FLOOR MOUNT	SEE PLUMBING DRAWINGS FOR MODEL NUMBER	
(TPH)	TOILET PAPER HOLDER		

GENERAL NOTES:

1. PROVIDE UNDERCOUNTER PRE PROTECTION FOR ALL SINKS.

2. PROVIDE STRAINERS & STRAINER COVERS FOR ALL SINKS.



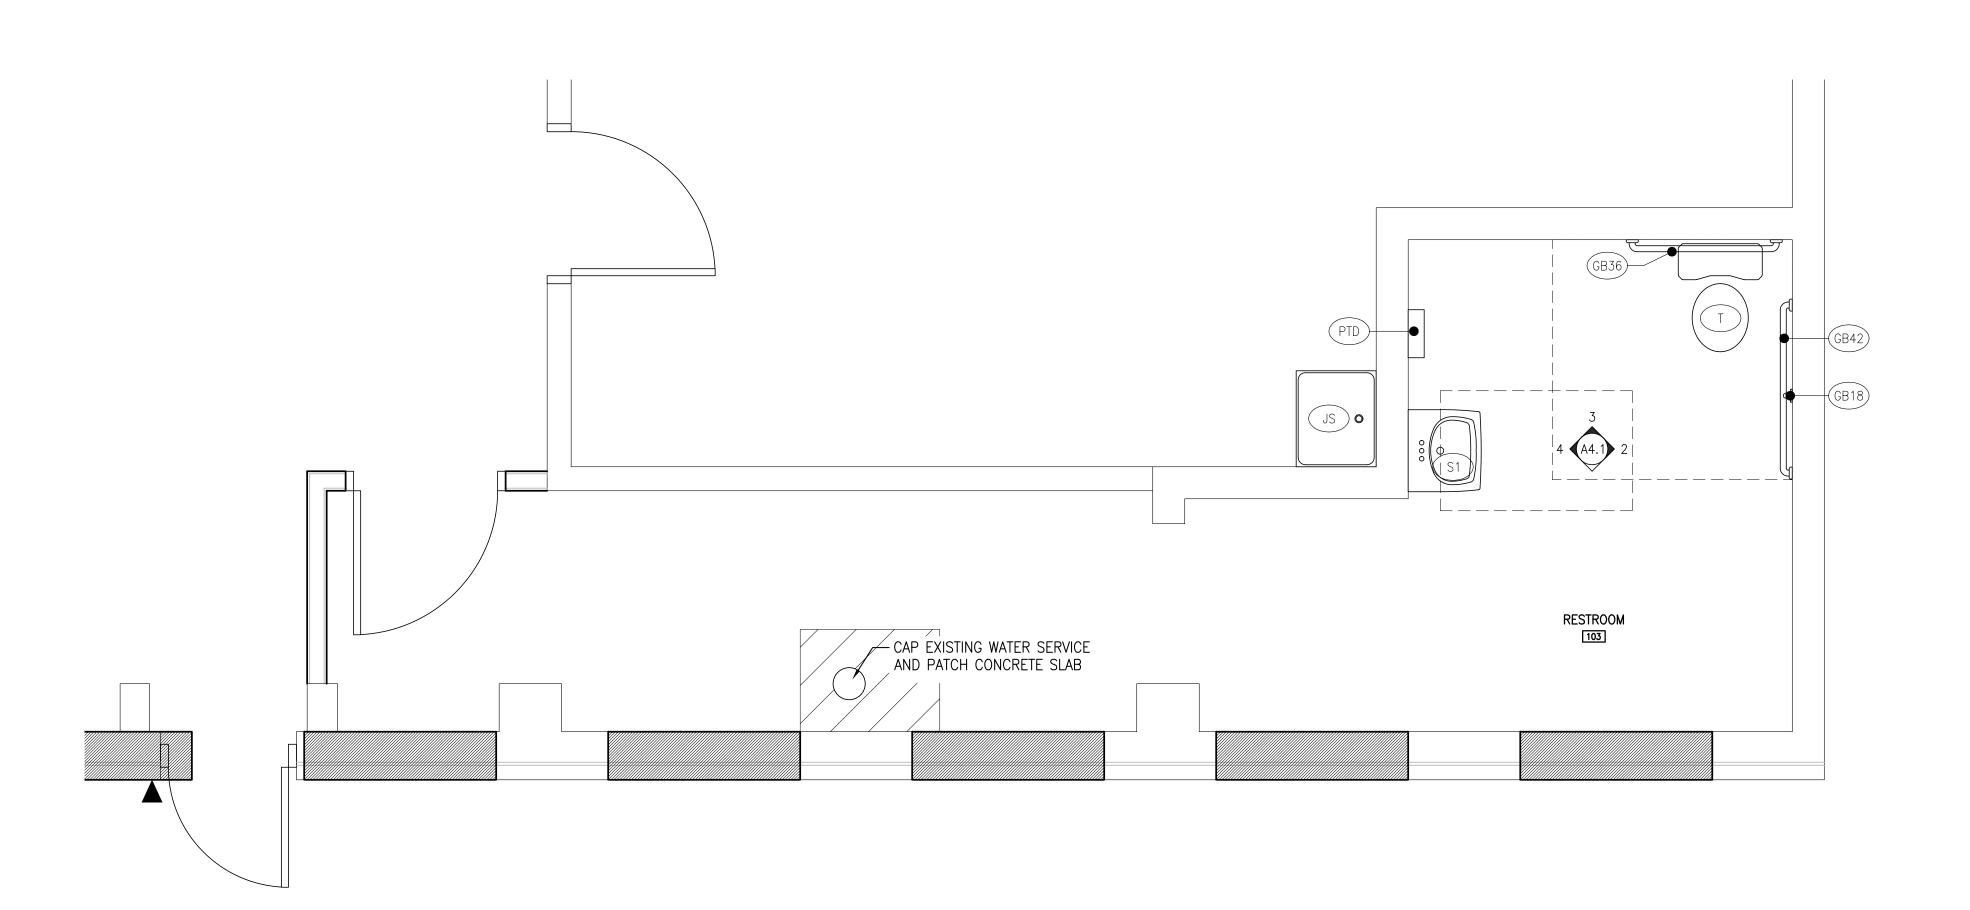



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NOTES:

1. DIMENSIONS ON THIS SHEET FROM FINISHED SURFACE, WHERE NOTED.

2. INSTALL ALL FIXTURES IN ACCORDANCE WITH ALL ADA REGULATIONS.

REVISIONS

KEY PLAN

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CITY OF LANCASTER

PROJECT DESCRIPTION


DEMOLITION AND ALTERATIONS FOR BEAVER STREET STORAGE FACILITY 622 BEAVER ST LANCASTER, PA

SHEET TITLE ENLARGED PLAN AND INTERIOR ELEVATIONS

ISSUE DATE 8.15.2019 SCALE AS NOTED

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A4.1

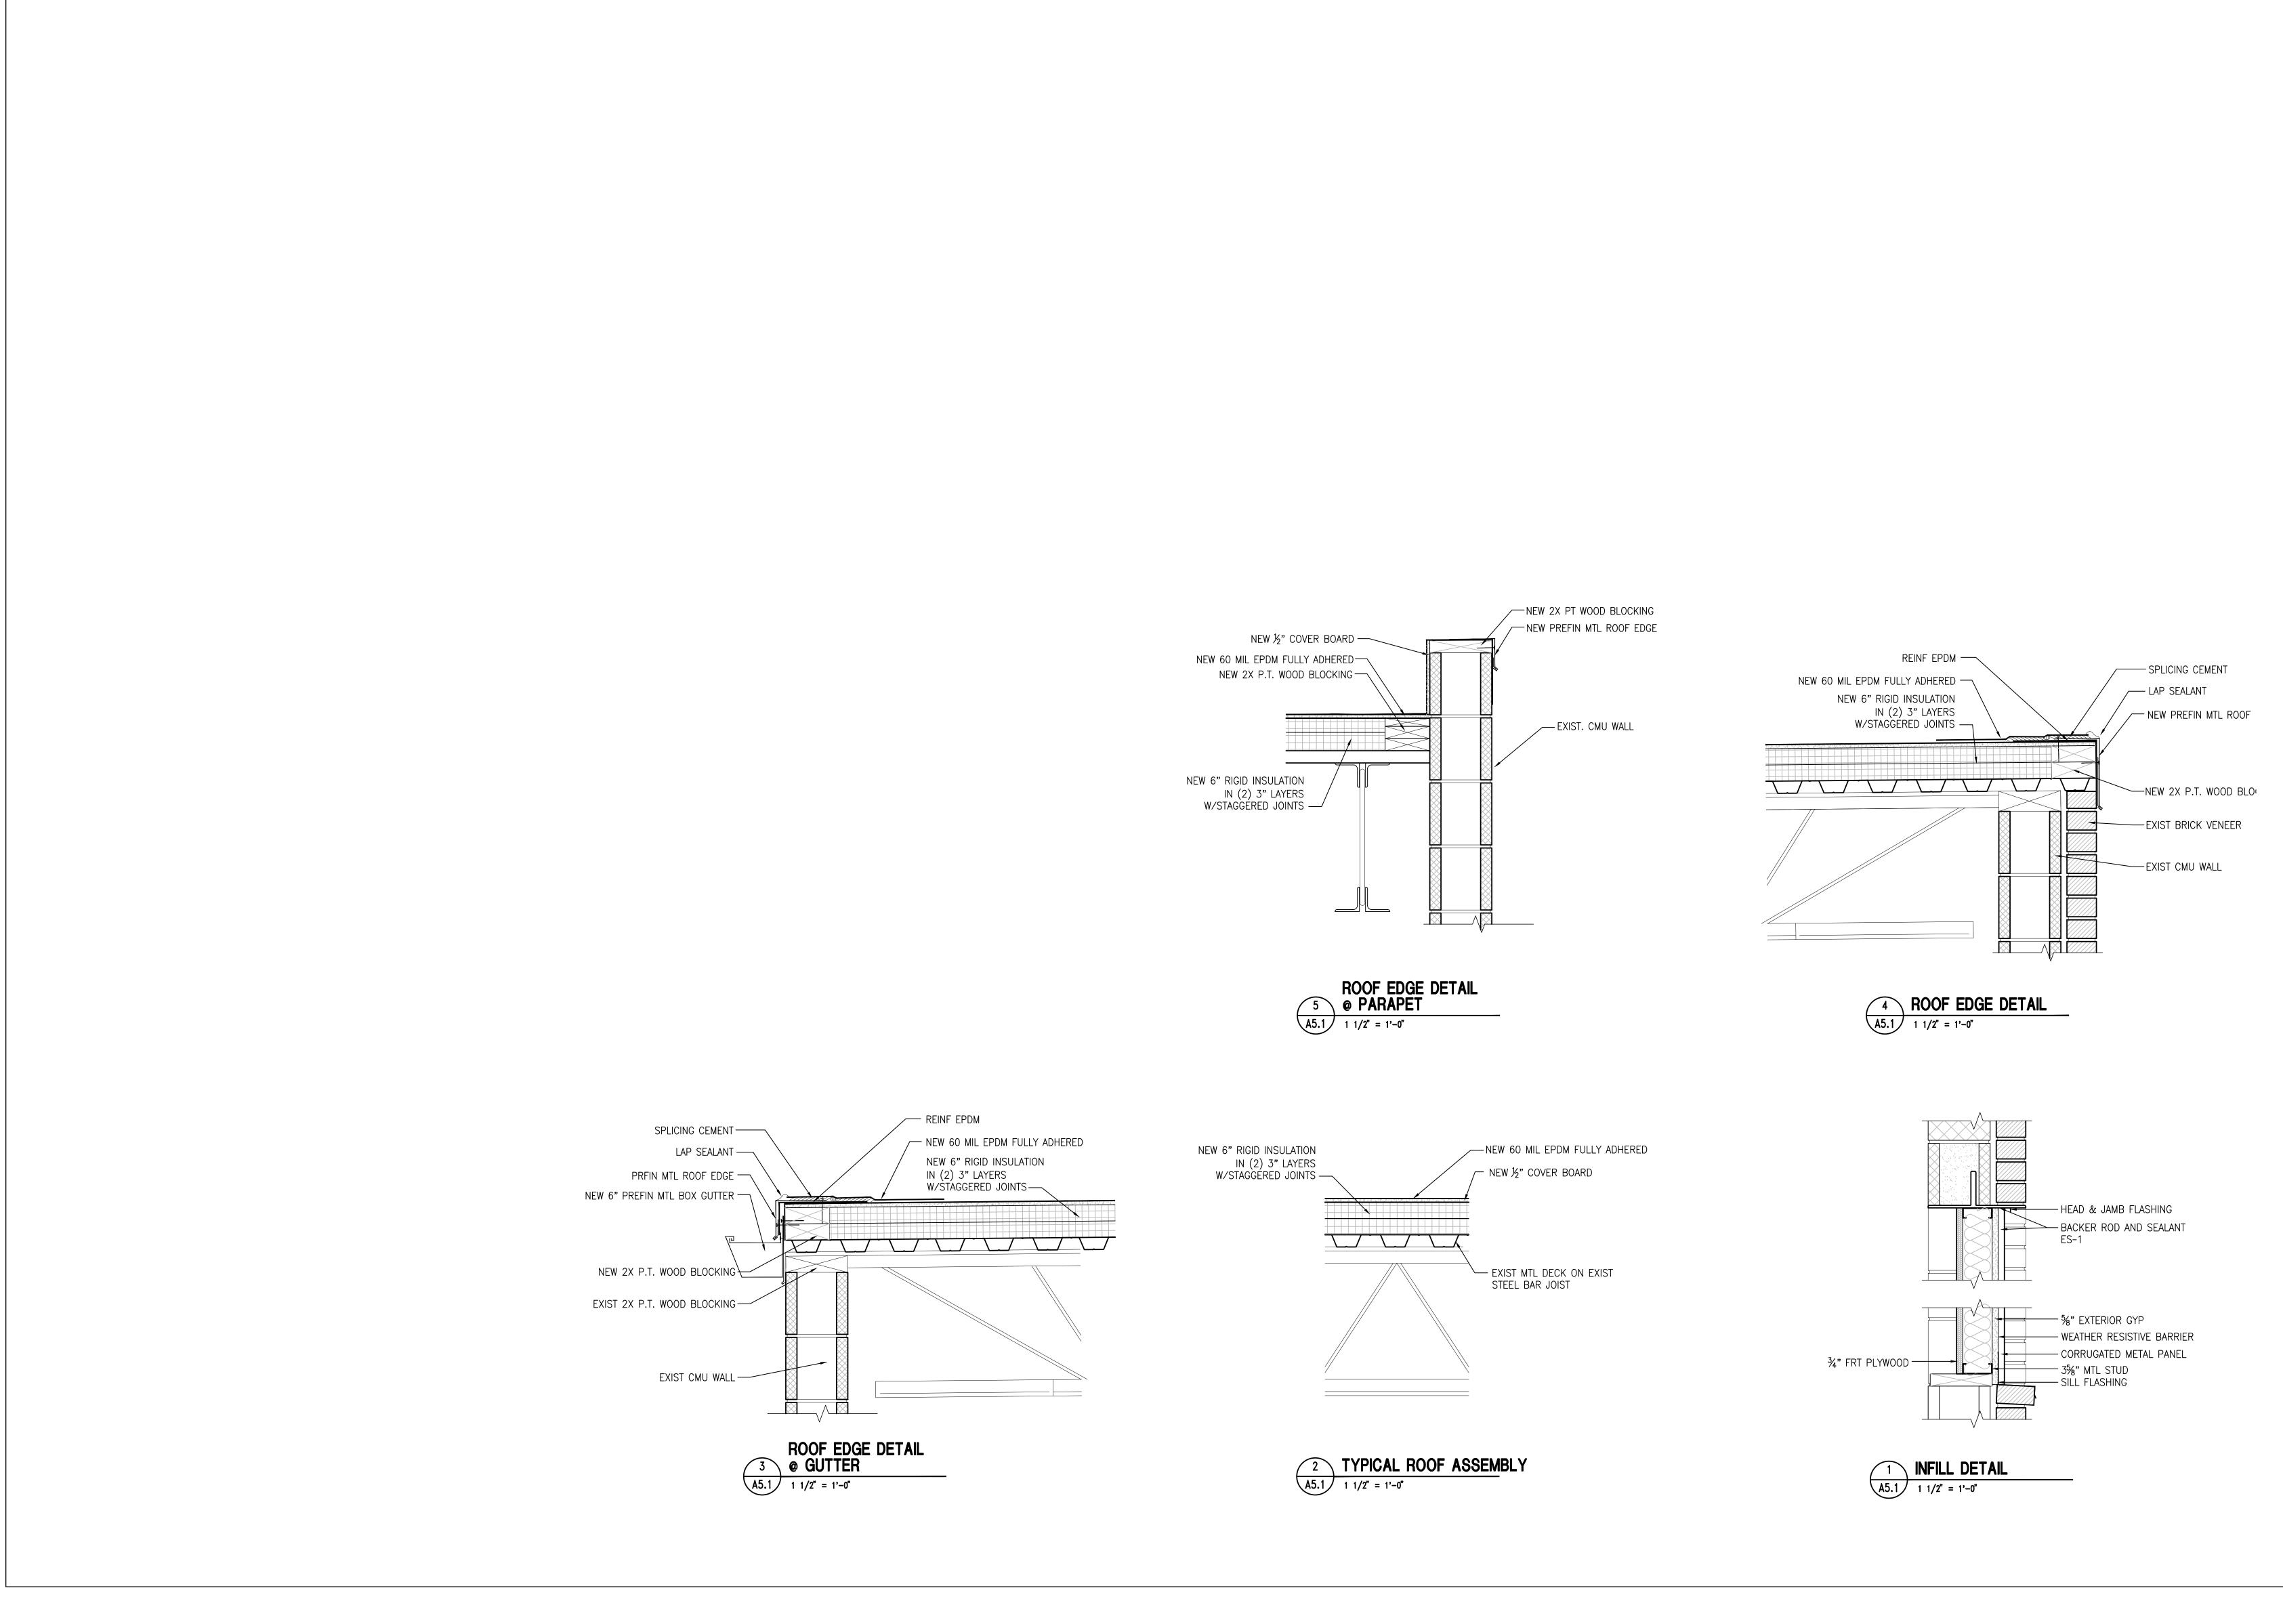

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NOTES:

REVISIONS

1. SEE CS1.1 FOR DESCRIPTION OF ROOF REPLACEMENT ALTERNATE GC-1.

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CITY OF LANCASTER

PROJECT DESCRIPTION


DEMOLITION AND ALTERATIONS FOR BEAVER STREET STORAGE FACILITY 622 BEAVER ST LANCASTER, PA

SHEET TITLE DETAILS


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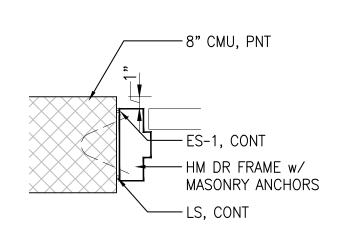
A5.1







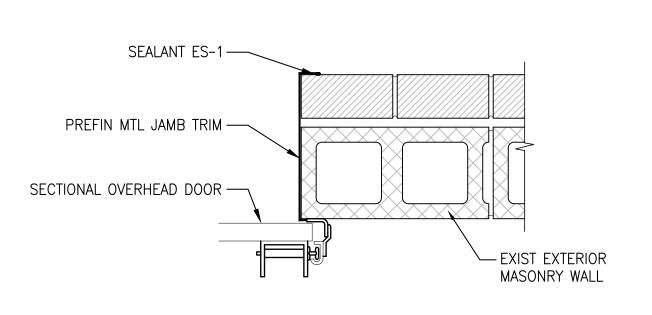



H3 OVERHEAD DOOR HEAD DETAIL A6.1 1 1/2" = 1'-0"

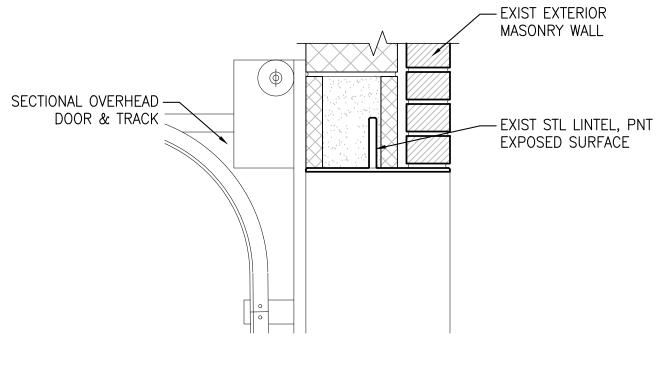

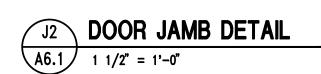


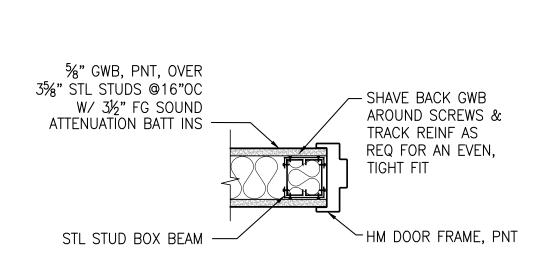

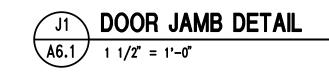

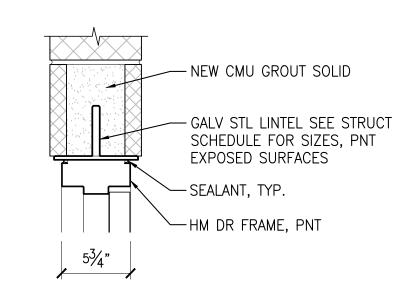

H2 DOOR HEAD DETAIL A6.1 1 1/2" = 1'-0"

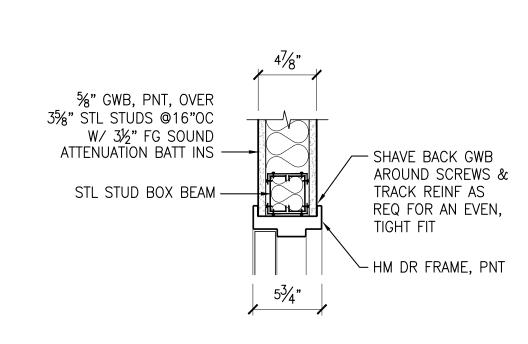

H1 DOOR HEAD DETAIL A6.1 1 1/2" = 1'-0"

(2) DOOR MATERIAL & FINISH

A. HM B. INSULATED STEEL

(4) FRAME MATERIAL & FINISH

A. HM - PNT

(5) HARDWARE GROUPS


1. SEE SPECIFICATION SECTION 080671 FOR DOOR HARDWARE SCHEDULE

(6) REMARKS

(1) DOOR TYPES

		TO REMAIN DOO			L D					-	CABLE
		DOC	FRA	AME	DETAIL						
		NOTE		(1)	(2)	(3)	(4)			(5)	(6)
FLOOR REFERENCE	DOOR NUMBER	SIZE	THICKNESS	TYPE	MATERIAL & FINISH	FRAME TYPE	MATERIAL & FINISH	HEAD	JAMB	HARDWARE GROUP	REMARKS
	101A	3'-0"X7'-0"	1 3/4"	А	А	А	А	Н2	J2	3.0	
	102A	2'-6"X7'-0"	1 3/4"	А	А	А	А	Н2	J2	1.0	
	102B	10'-0"X10'-0"	VIF	А	А	А	А	Н3	J3	7.0	
~	102C	10'-0"X10'-0"	VIF					Н3	J3	7.0	
FLOOI	102D	10'-0"X10'-0"	VIF					Н3	J3	7.0	
STF	102E	3'-0"X7'-0"	1 3/4"	А	А	А	А	Н2	J2	2.0	
	103A	3'-0"X7'-0"	1 3/4"	А	А	А	А	H1	H1	6.0	
	104A	3'-0"X7'-0"	1 3/4"	А	А	А	А	Н2	J2	4.0	
	104B	(2)2'-6"X7'-0"	1 3/4"	А	А	А	А	Н2	J2	5.0	
	105A					•					


DOOR SCHEDIILE

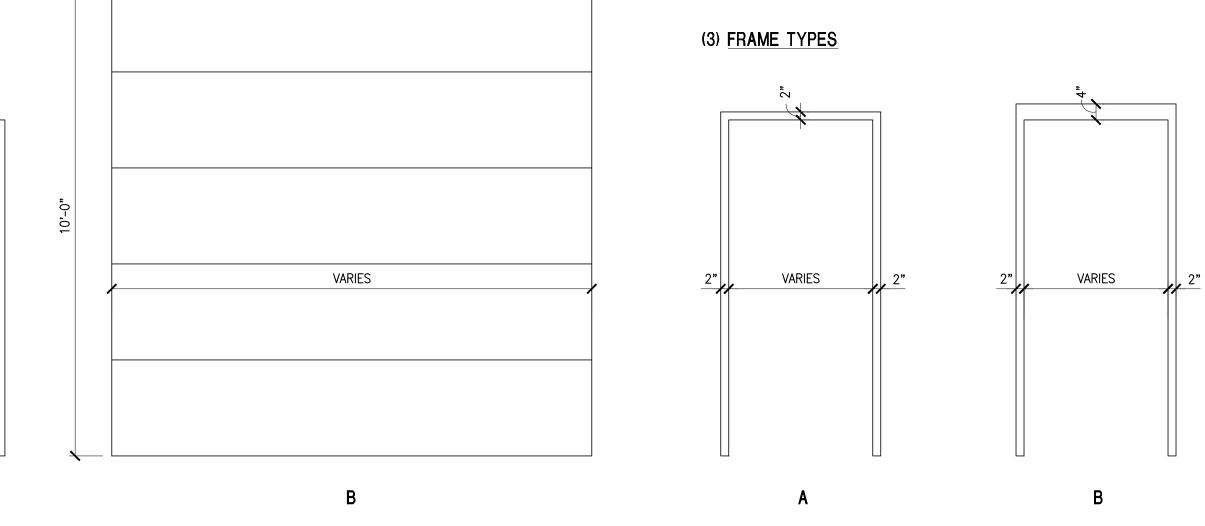

ROOM FINISH KEY NOTES:

- FLOOR
 A. EXISTING CONC TO REMAIN, SEAL
- 2. WALL A. CMU, PNT B. EXIST TO REMAIN, PNT C. 5/8" GWB, PNT
- 3. CEILING A. ARMSTRONG 2X2 FISSURED ACT W/STEEL GRID B. OPEN TO STRUCTURE ABOVE, EXISTING TO REMAIN. C. %" GWB, PNT
- 4. REMARKS A. PATCH, REPAIR, AND FINISH ANY ADJACENT CEILINGS, WALLS, OR FLOORS WHICH MAY HAVE BEEN DISTURBED DURING CONSTRUCTION. MATCH ADJACENT FINISHES. B. DEBUR, CLEAN AND PAINT ALL EXPOSED STRUCTURAL STEEL. PAINT ALL EXPOSED PLUMBING AND CONDUIT TO MATCH CEILING.

ROOM FINISH SCHEDULE - = NOT APPLICABLE										
)E		NOTE	(1)	(2)	(2)	(2)	(2)	(3)		(4)
RENCE	ER				WA	\LL				
REFE	NUMBER							(5)	H H	S
FLOOR	ROOM	ROOM NAME	FLOOR	NORTH	SOUTH	EAST	WEST	CEILING	CEILING	REMARKS
	101	SOLICITOR STORAGE	А	А	А	В	А	С	10'-0"	
OOR	102	STORAGE	А	В	В	A/B	В	В	_	В
FLO	103	RESTROOM	А	В	В/С	В	B/C	Α	8'-0"	
1ST	104	STORAGE	А	В	В	В	В	В	_	А
	105	MECHANICAL ROOM	_	_	_	_	_	_	_	

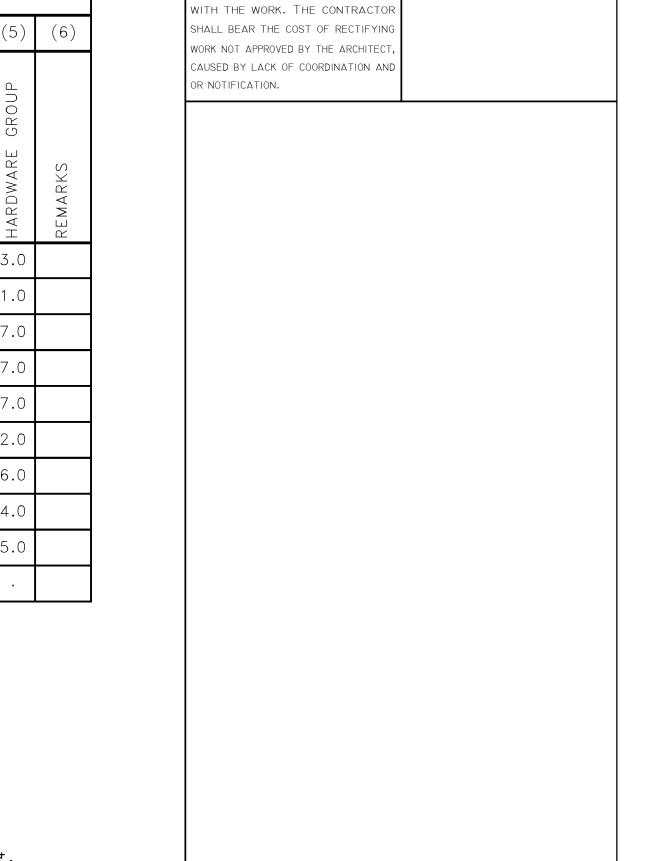

ALL DIMENSIONS, MEASUREMENTS AND STAMP

PROJECT CONDITIONS SHALL BE CHECKED AND VERIFIED IN THE FIELD BY THE

CONTRACTOR. REFER ALL DIFFERENCES, N WRITING, TO THE ARCHITECT FOR CONSIDERATION PRIOR TO PROCEEDING

REVISIONS			

KEY PLAN

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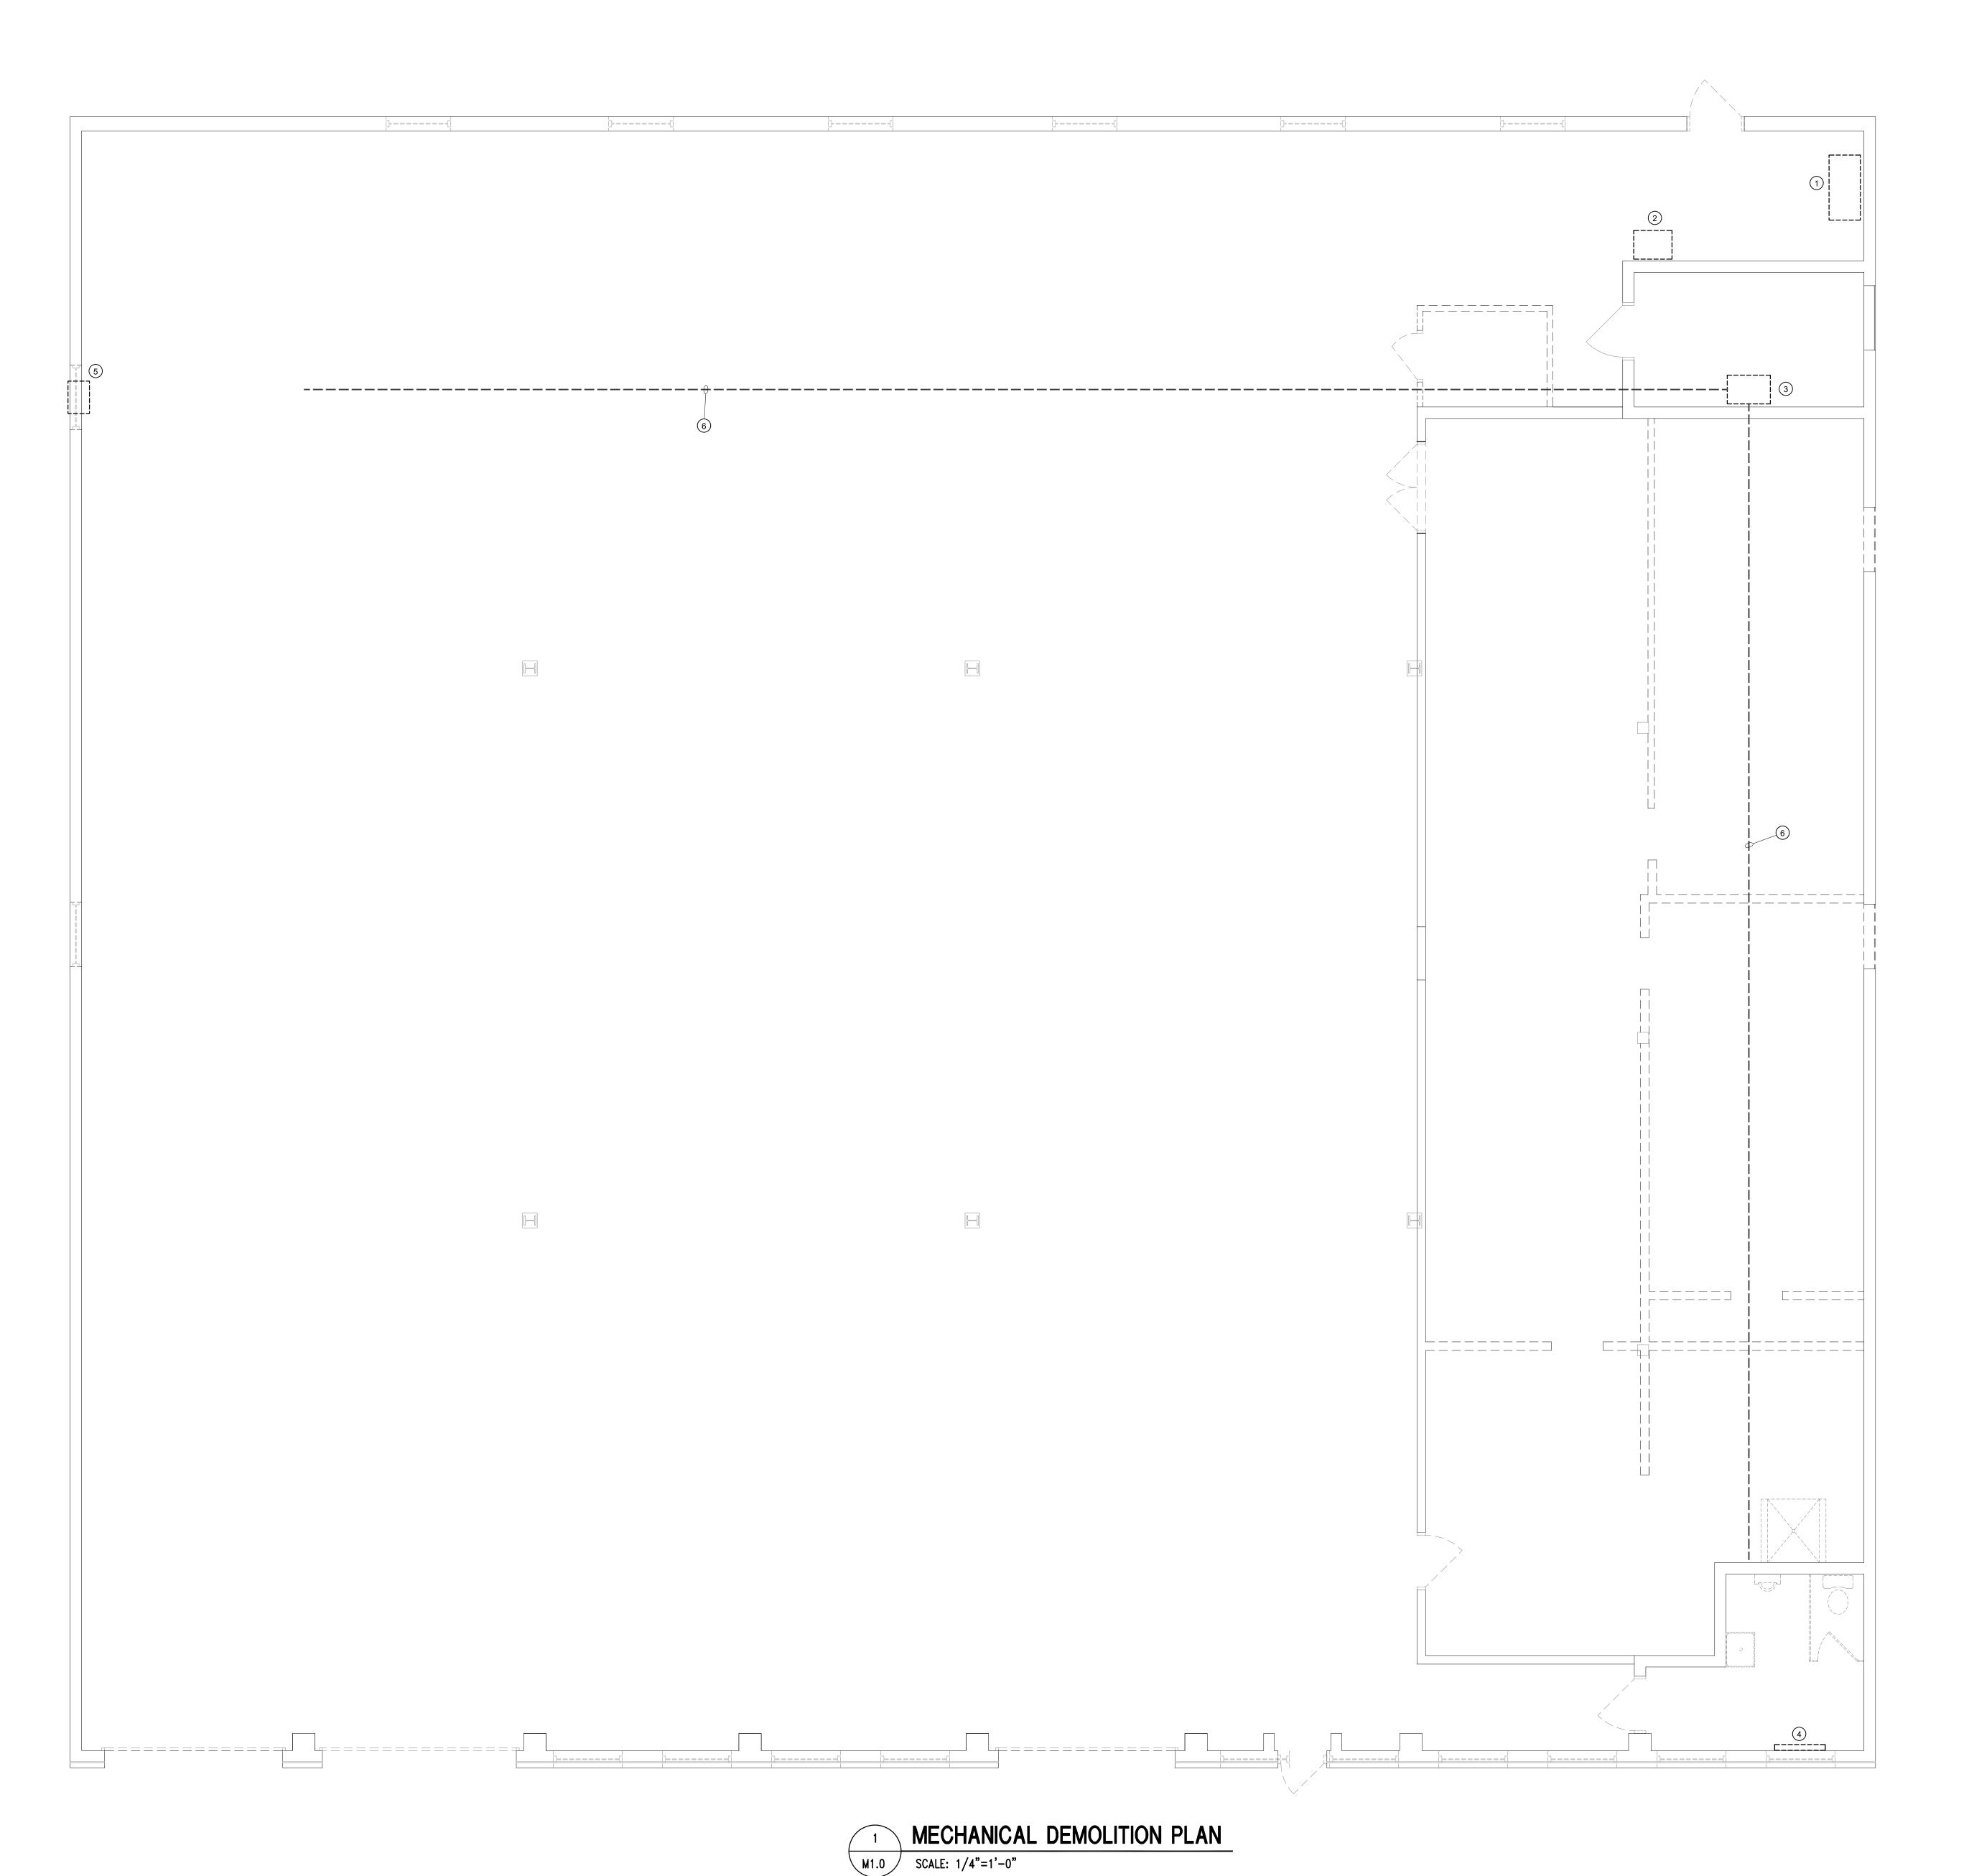
CITY OF LANCASTER

PROJECT DESCRIPTION

DEMOLITION AND ALTERATIONS FOR BEAVER STREET STORAGE FACILITY 622 BEAVER ST LANCASTER, PA

SHEET TITLE ROOM FINISH AND DOOR SCHEDULES, DOOR AND FRAME TYPES AND DETAILS

ISSUE DATE	8.15.2019	SCALE	AS NO	OTED
FILE NUMBER	1853	DRAWN BY	AJB	CHECKED BY CAD



DRAWING NOTES:

- REMOVE AND DISPOSE FUEL OIL TANK AND ASSOCIATED FUEL OIL
 DISTRIBUTION PIPING, FILL PIPE AND VENT PIPE. CONTRACTOR SHALL FILL
 AND SEAL OPENING IN EXTERIOR WALL AIR AND WATER TIGHT.
- 2. REMOVE AND DISPOSE CONDENSING UNIT AND ASSOCIATED REFRIGERANT PIPING.
- 3. REMOVE AND DISPOSE FUEL OIL FURNACE, COOLING COIL AND ASSOCIATED APPURTENANCES, INCLUDING BUT NOT LIMITED TO FUEL VENTS, OIL PIPING, CONDENSATE PIPING, DUCTWORK AND CONTROLS.
- 4. REMOVE AND DISPOSE ELECTRIC WALL HEATER.
- 5. REMOVE AND DISPOSE WALL FAN AND ASSOCIATED CONTROLS.
- 6. REMOVE ALL SUPPLY AND RETURN DUCTWORK AND ASSOCIATED DIFFUSERS, REGISTERS AND GRILLES.

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ALL DIMENSIONS, MEASUREMENTS AND STAMP

Moore Engineering Company 3637 Columbia Avenue Lancaster, PA 17603 P (717) 285-3141 F (717) 285-2443 www.mooreengineering.com

REVISIONS

KEY PLAN



HAMMEL ASSOCIATES ARCHITECTS, LLC 25 E. Grant St. | Suite 102 | Lancaster, PA 17602 | 717.393.3713 | www.hammelarch.com

CITY OF LANCASTER

PROJECT DESCRIPTION


CITY OF LANCASTER 622 BEAVER ST LANCASTER, PA

SHEET TITLE MECHANICAL DEMOLITION PLAN

ISSUE DATE 08/16/19 SCALE AS NOTED

FILE NUMBER 1853_19011 DRAWN BY DLE CHECKED BY SMB

M1.0

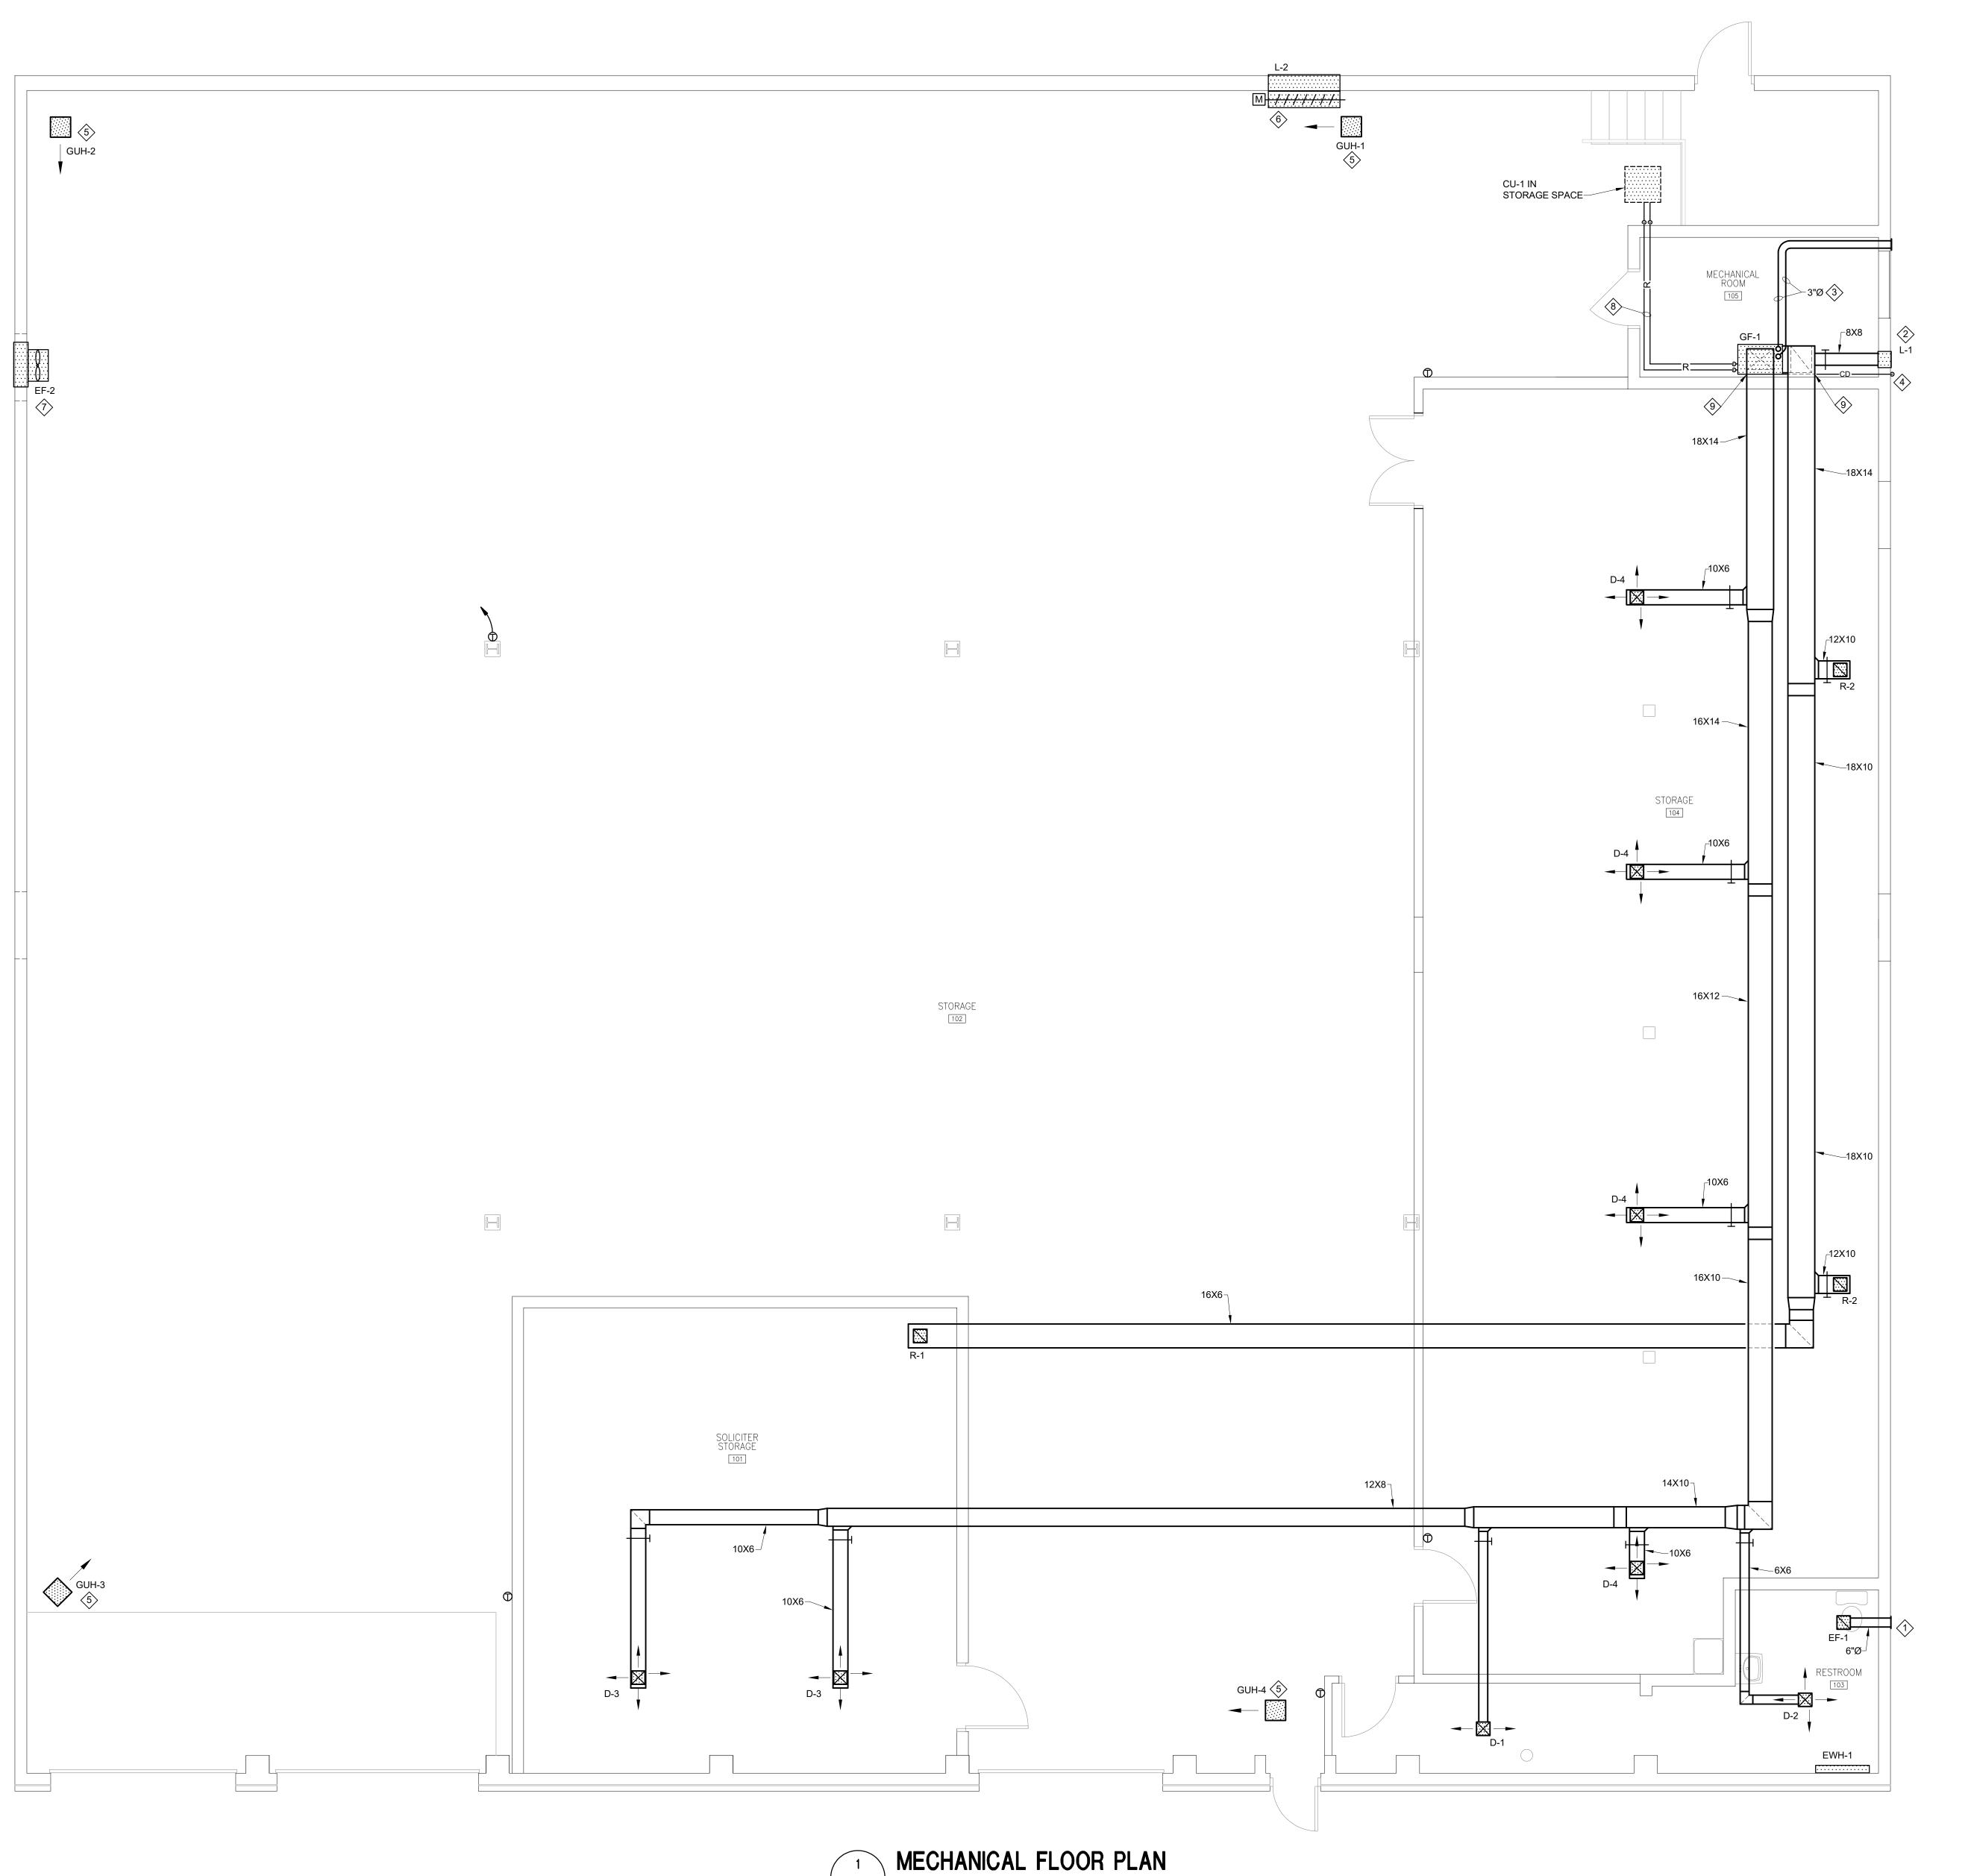

M2.0 SCALE: 1/4"=1'-0"

DRAWING NOTES:

- PROVIDE TOILET EXHAUST FAN WITH BACKDRAFT DAMPER AND WALL CAP.

 ROUTE DUCT FROM NEW LOUVER IN EXISTING WALL OPENING TO RETURN.
- ROUTE DUCT FROM NEW LOUVER IN EXISTING WALL OPENING TO RETURN DUCT. PROVIDE BACKDRAFT DAMPER AT LOUVER.
- EXTERIOR WALL IN COMPLIANCE WITH MANUFACTURER'S REQUIREMENTS.

3. PROVIDE 3" COMBUSTION AIR INTAKE AND VENT FROM FURNACE THRU

- 4. PROVIDE $\frac{3}{4}$ " CONDENSATE DRAIN FROM FURNACE AND COOLING COIL TO EXTERIOR AND SPILL HORIZONTALLY AT 18" ABOVE GRADE.
- RUN 5" VENT FROM GAS UNIT HEATER THRU ROOF. MECHANICAL CONTRACTOR SHALL BE RESPONSIBLE FOR ROOF PENETRATION, FLASHING, COUNTER FLASHING AND SEALING ROOF WATERTIGHT.
- TO OPEN WITH EF-2 FAN OPERATION. USE EXISTING WINDOW WALL OPENING FOR MOUNTING LOUVER.

6. PROVIDE INTAKE LOUVER WITH MOTOR OPERATED DAMPER INTERLOCKED

- USE DEMO'D FAN WALL OPENING FOR INSTALLATION OF NEW EXHAUST FAN.
- 8. ROUTE AND SIZE REFRIGERANT PIPING PER MANUFACTURER'S INSTALLATION INSTRUCTIONS.
- 9. SUPPLY AND RETURN DUCTS SHALL RISE TO BOTTOM OF ROOF STRUCTURE. DUCTS SHALL RUN HORIZONTALLY AT THAT ELEVATION.

ALL DIMENSIONS, MEASUREMENTS AND PROJECT CONDITIONS SHALL BE CHECKED AND VERIFIED IN THE FIELD BY THE CONTRACTOR. REFER ALL DIFFERENCES, IN WRITING, TO THE ARCHITECT FOR CONSIDERATION PRIOR TO PROCEEDING WITH THE WORK. THE CONTRACTOR SHALL BEAR THE COST OF RECTIFYING WORK NOT APPROVED BY THE ARCHITECT, CAUSED BY LACK OF COORDINATION AND OR NOTIFICATION.

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	UNIT HEATERS								
SYMBOL	INPUT MBH	OUTPUT MBH	CFM	H.P.	FAN RPM	VOLTAGE	GAS FLUE	MTG HEIGHT	BASIS OF DESIGN MANUFACTURER AND MODEL
GUH-1	125	100	2200	1/4	1140	120V/1Ø	5"	10'-0"	TRANE GHNE012A
GUH-2	125	100	2200	1/4	1140	120V/1Ø	5"	10'-0"	TRANE GHNE012A
GUH-3	125	100	2200	1/4	1140	120V/1Ø	5"	10'-0"	TRANE GHNE012A
GUH-4	125	100	2200	1/4	1140	120V/1Ø	5"	10'-0"	TRANE GHNE012A

	ELECTRIC WALL HEATER						
SYMBOL	WATTS	BTUH	VOLTAGE	AMPS	TYPE	BASIS OF DESIGN MANUFACTURER AND MODEL	
EWH-1	1500	5120	208V/1Ø	7.3	SURFACE MOUNTED	QMARK CWH1202DSAF	

FANS									
SYMBOL	CFM	E.S.P.	SONES	RPM	HP	VOLTS/PH	ROOF OPENING (IN)	BASIS OF DESIGN MANUFACTURER AND MODEL NO.	REMARKS
EF-1	125	0.25	3.5	1050	128W	120V/1Ø	N/A	GREENHECK SP-B150	
EF-2	7000	0.51	33	1750	1½	208V/1Ø	N/A	GREENHECK AER-E24C-418-A15	

LOUVERS								
SYMBOL	CFM	SIZE	REMARKS					
L-1	L-1 300 16X16							
L-2	7000	44W X 64H	INTAKE					

ME	MECHANICAL SYMBOL				
	SCHEDULE				
→ D	DIFFUSER				
† 2 −	SIDEWALL DIFFUSER				
™ R	REGISTER				
<u>~</u>	SIDEWALL REGISTER				
	BALANCING DAMPER				
	SQUARE DUCT ELBOW WITH TURNING VANES				
\bigcirc	THERMOSTAT				
<u> </u>	CONTROL SWITCH				
——CD——	CONDENSATE DRAIN PIPE				
R	REFRIGERANT PIPING				
	CONNECT NEW TO EXISTING				

	CONDENSING UNITS								
SYMBOL	CAPACITY MBH	OUTDOOR TEMP	COMP RLA	RESSORS VOLTAGE	COND HP	ENSOR FAN VOLTAGE	ELEC MCA	TRICAL MOCP	BASIS OF DESIGN MANUFACTURER AND MODEL
CU-1	48	95	16.7	208V/1Ø	1/5	208V/1Ø	24	40	TRANE 4TTR4048L1
CU-2									

	FURNACES									
SYMBOL	OUTPUT (BTUH)	INPUT (BTUH)	CFM	E.S.P.	E.S.P. INDOOR FAN VOLTAGE		MCA	МОСР	FUEL	BASIS OF DESIGN MANUFACTURER AND MODEL
GF-1	97,000	92,150	1600	0.60	3/4	115V/1Ø	12.9	20	N.G.	TRANE TUH1C100A960C

DIFFUSERS						
SYMBOL	CFM	FACE SIZE	NECK SIZE	BLOW		
D-1	100	12X12	6X6	2-WAY OPPOSITE		
D-2	100	12X12	6X6	4-WAY		
D-3	200	12X12	9X9	4-WAY		
D-4	250	12X12	9X9	4-WAY		

REGISTERS				
SYMBOL	CFM	SIZE	REMARKS	
R-1	400	14X14	RETURN	
R-2	500	16X16	RETURN	

DUCTWORK NOTES:

- 1. ALL DUCTWORK SIZES NOTED ARE FREE AREA SIZES.
- 2. TURNING VANES SHALL BE PROVIDED IN ALL DUCT ELBOWS.
- 3. SPLITTERS AND BALANCING DAMPERS SHALL BE PROVIDED AT ALL DUCT
- 4. THE MECHANICAL CONTRACTOR SHALL BE RESPONSIBLE FOR COORDINATING INSTALLATION OF NEW DIFFUSERS AND REGISTERS WITH SUSPENDED CEILING GRID AND LIGHTING FIXTURES TO BE INSTALLED BY THE GENERAL AND ELECTRICAL CONTRACTORS RESPECTIVELY.
- 5. LENGTH OF FLEXIBLE DUCT BRANCHES SHALL NOT EXCEED 8'-0"
 MAXIMUM. ANY ADDITIONAL LENGTH AS NEEDED FOR INDIVIDUAL
 CONNECTIONS SHALL BE ACCOMPLISHED WITH ROUND RIGID DUCTWORK.
- 6. FLEXIBLE DUCT WILL NOT BE ACCEPTABLE FOR EXHAUST FAN INSTALLATIONS.
- 7. PROVIDE ALL DAMPERS, SPLITTERS, AND EXTRACTORS AS REQUIRED FOR PROPER AIR DISTRIBUTION IN GENERAL ACCORDANCE WITH THE
- STANDARDS OF THE NATIONAL ENVIRONMENTAL BALANCING BUREAU.

 8. FURNISH AND INSTALL AS NECESSITATED BY EXISTING CONDITIONS

ALL SUPPORT MATERIALS TO INSURE A RIGID INSTALLATION.

9. THE MECHANICAL CONTRACTOR SHALL FURNISH AND INSTALL FLEXIBLE FABRIC CONNECTIONS BETWEEN DUCTWORK AND FANS IN ORDER TO ISOLATE EQUIPMENT AND PREVENT VIBRATION.

GENERAL NOTES:

- (THESE NOTES APPLY TO ALL MECHANICAL DRAWINGS)
- ANY PHYSICAL INSTALLATION MODIFICATIONS DUE TO FIELD CONDITIONS SHALL BE RESOLVED BY THE MECHANICAL CONTRACTOR IN ACCORDANCE WITH THE RECOMMENDATIONS OF THE MECHANICAL ENGINEER.
- 2. THE ENTIRE INSTALLATION SHALL COMPLY WITH ALL CODES, LOCAL, STATE, AND NATIONAL.
- 3. THIS CONTRACTOR SHALL PROVIDE ALL MISCELLANEOUS STEEL AND SUPPORTS TO SUSPEND DUCTWORK AND EQUIPMENT.
- 4. ALL EQUIPMENT SHALL BE INSTALLED WITH VIBRATION ISOLATORS.
- 5. THIS CONTRACTOR SHALL PROVIDE ALL LABOR, MATERIALS, AND EQUIPMENT TO ENSURE A COMPLETE SYSTEM.
- 6. THIS CONTRACTOR SHALL COORDINATE HIS WORK WITH ALL OTHER TRADES.
- 7. THE MECHANICAL CONTRACTOR SHALL SEAL ALL HIS RESPECTIVE WALL AND ROOF PENETRATIONS.
- ALL ROOF OPENINGS AND FLASHINGS SHALL BE PROVIDED BY THE
- MECHANICAL CONTRACTOR
- 9. THE MECHANICAL CONTRACTOR SHALL PAY FOR ALL FEES AND PERMITS AS NECESSARY TO COMPLETE THE INSTALLATION.

FUEL OIL TANK DEMOLITION NOTES

1. EXISTING FUEL OIL TANKS AND RESIDUAL OIL TO BE DISPOSED OF BY

- MECHANICAL CONTRACTOR IN ACCORDANCE WITH D.E.P. REQUIREMENTS.
 SUBMIT PROPER FORMS FOR VERIFICATION, WHERE REQUIRED.
- MECHANICAL CONTRACTOR SHALL TRANSPORT REMAINING FUEL LEFT IN FUEL OIL TANK OFFSITE, AND DISPOSE OF IN APPROVED MANNER.

DEMOLITION NOTES:

- RESPECTIVE CONTRACTOR IS RESPONSIBLE FOR PERFORMING ANY DEMOLITION WORK (EVEN IF NOT SHOWN ON THE PLANS)
 NECESSARY FOR COMPLETION OF PROJECT. THIS INCLUDES REMOVAL OF ANY EQUIPMENT AND MATERIALS THAT WILL NO LONGER BE UTILIZED AFTER COMPLETION OF THIS PROJECT.
- EQUIPMENT THAT IS REMOVED SHALL BE TURNED OVER TO OWNER.
 IF OWNER DOES NOT WANT EQUIPMENT, IT SHALL BE DISPOSED OF
 PROPERLY BY RESPECTIVE CONTRACTOR.

MECHANICAL NOTES:

- (THESE NOTES APPLY TO ALL MECHANICAL DRAWINGS)
- ALL REFRIGERATION PIPING SHALL BE INSTALLED IN STRICT ACCORDANCE WITH THE MANUFACTURER'S SPECIFICATIONS AND RECOMMENDATIONS, PIPE SIZES SHALL BE PER MANUFACTURER'S RECOMMENDATIONS.
- 2. ALL REFRIGERANT PIPING SHALL BE PITCHED A MINIMUM OF 1/2" IN 10' 0" IN THE DIRECTION OF THE REFRIGERANT FLOW.

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SHEET TITLE MECHANICAL SCHEDULES, NOTES AND DETAILS

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DRAWING NOTES:

- REMOVE AND DISPOSE WATER CLOSET AND ASSOCIATED WATER PIPING.
 PREPARE SANITARY PIPING FOR NEW FIXTURE.
- 2. REMOVE AND DISPOSE URINAL AND ASSOCIATED WATER PIPING. PREPARE SANITARY FOR NEW FIXTURE.
- 3. REMOVE AND DISPOSE UTILITY SINK AND ASSOCIATED WATER AND SANITARY PIPING TO WALL ON FLOOR AND CAP.
- 4. REMOVE AND DISPOSE SHOWER, SHOWER VALVE AND DRAIN AND
- ASSOCIATED WATER AND SANITARY PIPING TO WALL ON FLOOR AND CAP.
- 5. REMOVE EXISTING WATER PIPING AFTER EXISTING BACKFLOW PREVENTER TO ALL EXISTING FIXTURES.

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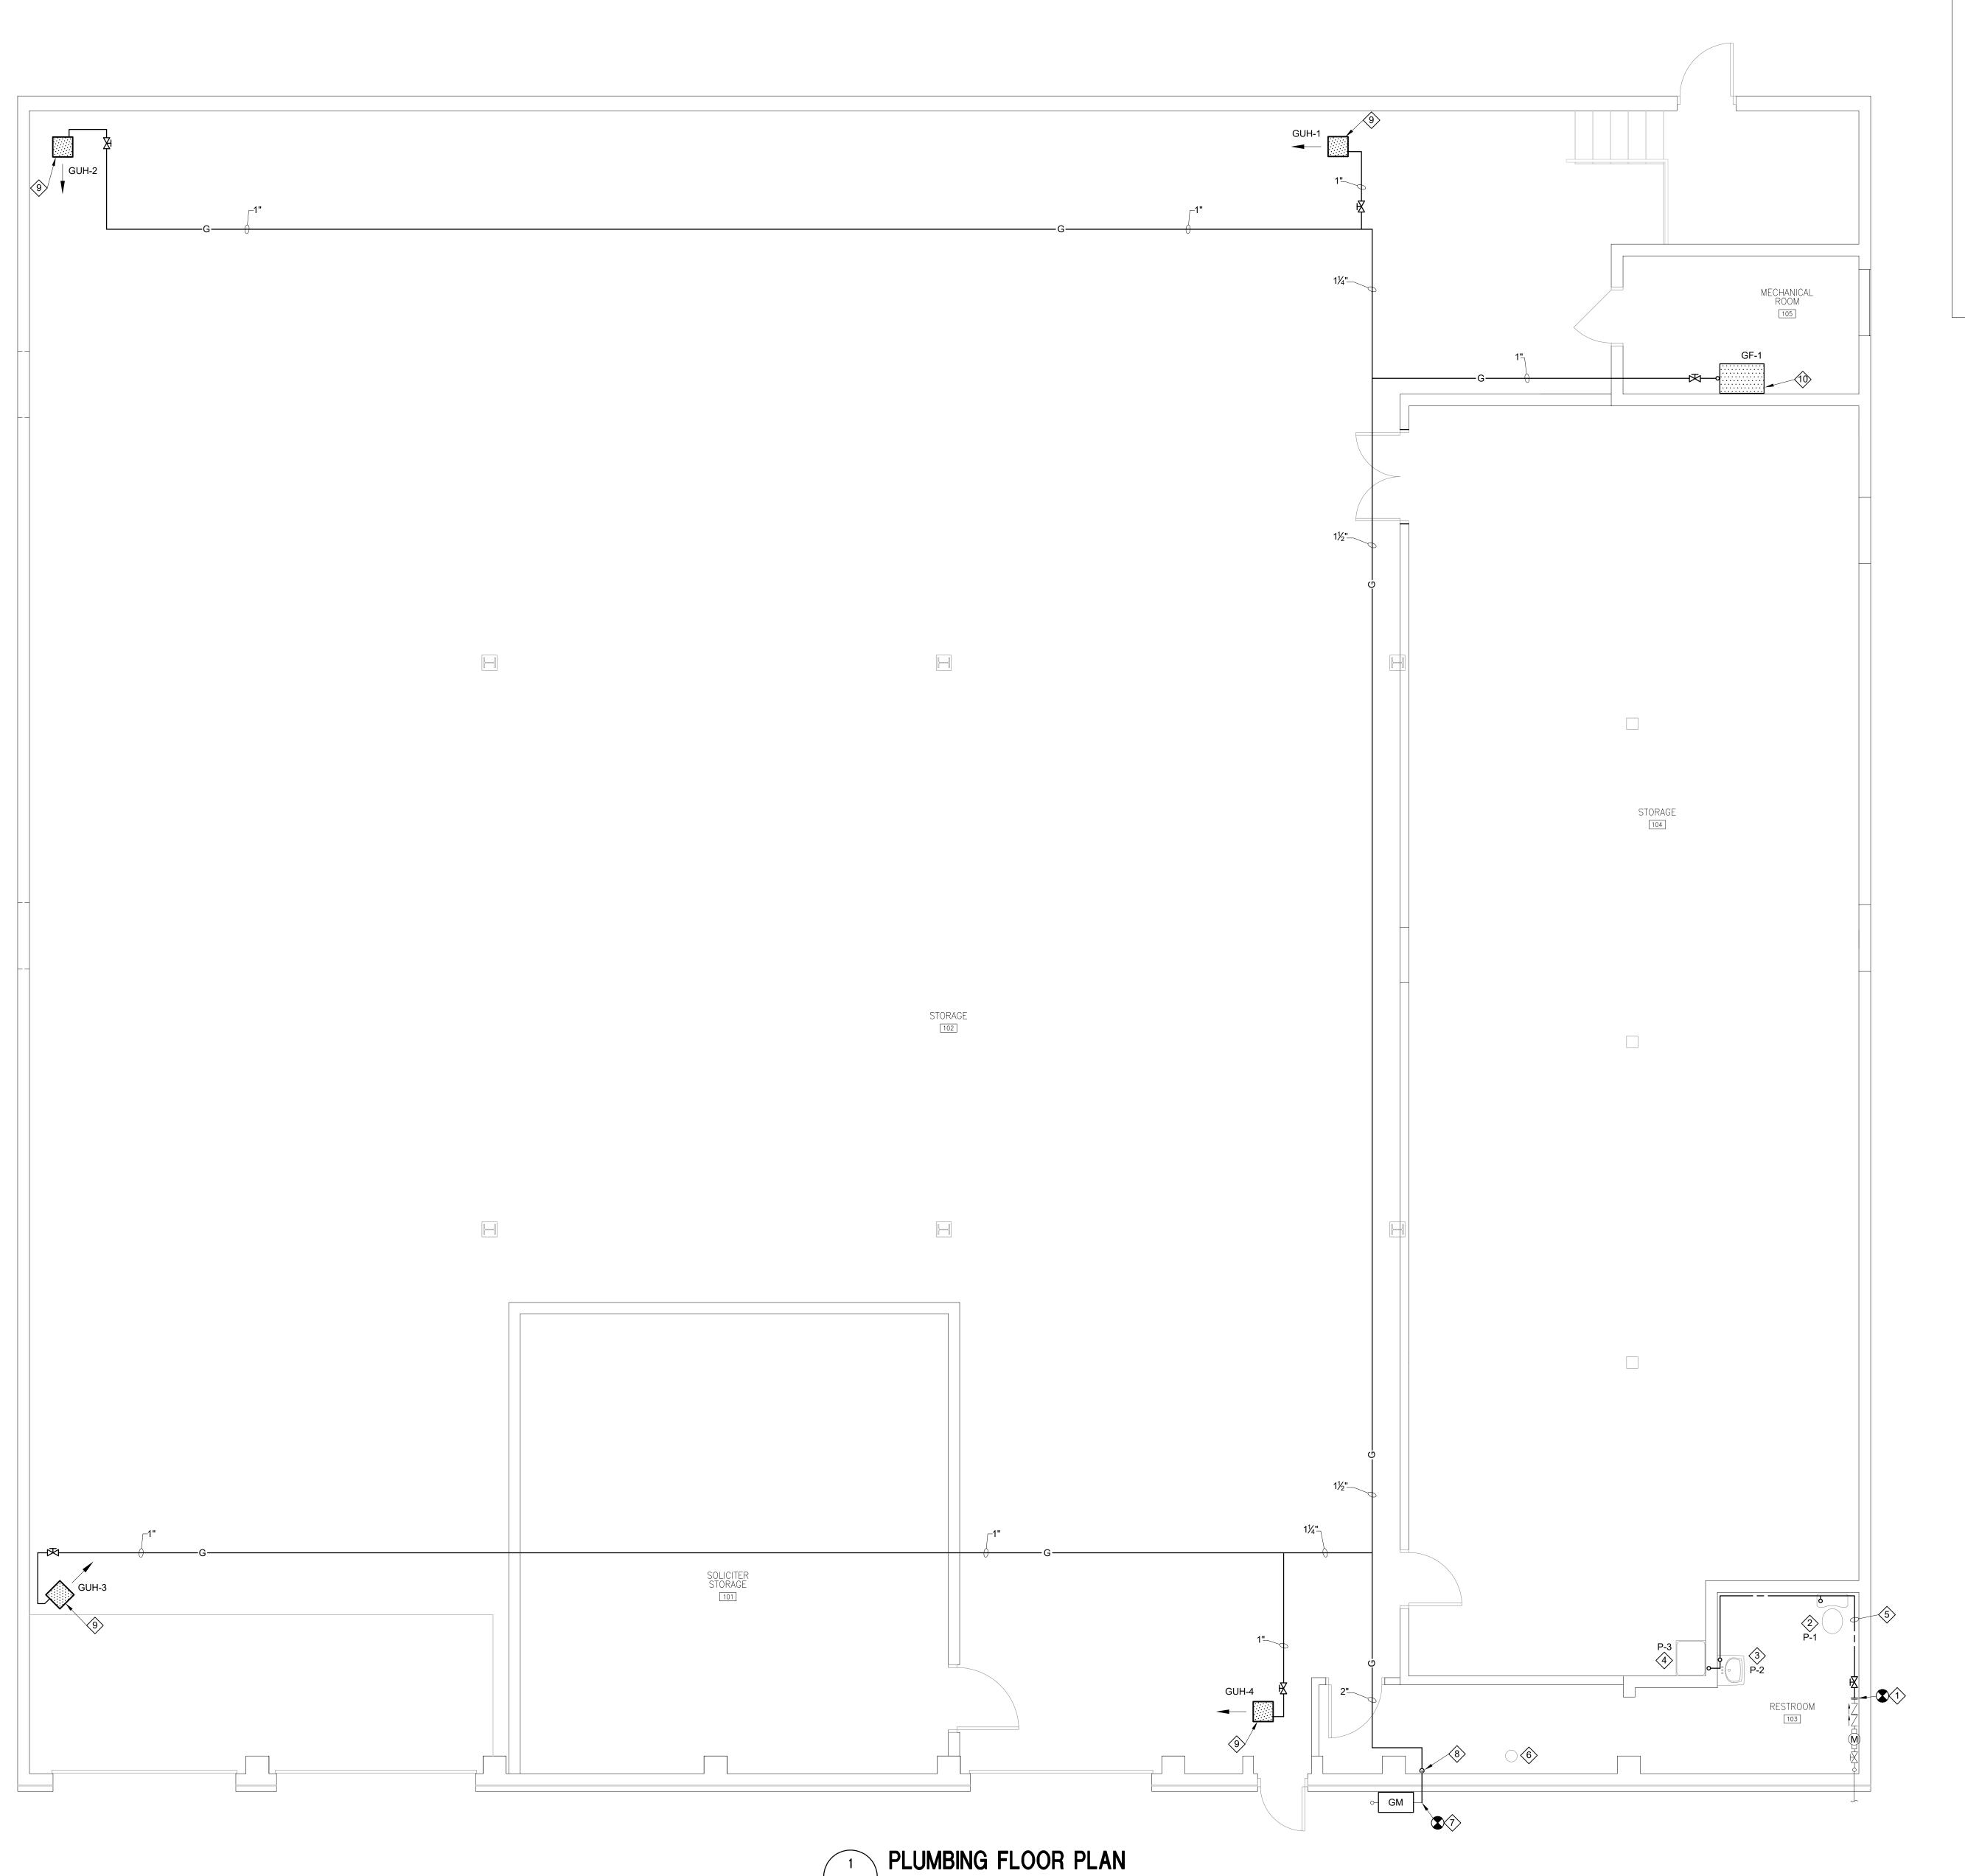
CITY OF LANCASTER 622 BEAVER ST LANCASTER, PA

SHEET TITLE PLUMBING DEMOLITION PLAN

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P2.0 SCALE: 1/4"=1'-0"

DRAWING NOTES:

- 1. CONNECT NEW $\frac{3}{4}$ " CW TO EXISTING DOMESTIC CW SERVICE.
- CONNECT NEW ½" CW TO NEW WATER CLOSET. CONNECT WATER CLOSET DRAIN TO EXISTING SANITARY DRAIN. VERIFY EXISTING DRAIN ROUGH-IN AND NEW FIXTURE ARE COMPATIBLE.
- 3. CONNECT NEW $\frac{1}{2}$ " CW TO NEW LAVATORY AND INSTANTANEOUS WATER HEATER, WH-1. CONNECT DRAIN FROM LAVATORY TO EXISTING DRAIN.
- 4. CONNECT NEW ½" CW TO NEW UTILITY SINK AND INSTANTANEOUS WATER HEATER, WH-2. CONNECT DRAIN FROM UTILITY SINK TO EXISTING DRAIN
- 5. RUN NEW $^3\!4$ " CW ALONG WALL IN RESTROOM. PROVIDE BRANCH PIPES WITH SHUTOFF VALVE TO FIXTURES.
- 6. PROVIDE CAP FOR 4-INCH TEMPORARY SERVICE.

WHICH SERVED REMOVED UTILITY SINK IN RESTROOM.

- 7. PROVIDE GAS SERVICE CONNECTION, PIPE TRANSITION AND REGULATOR, IF REQUIRED TO GAS METER PROVIDED BY UTILITY.
- 8. PROVIDE GAS PIPE RISER WITH SHUTOFF VALVE AT BUILDING ENTRANCE. EXTEND GAS PIPE UP TO BOTTOM OF STRUCTURE.
- GAS UNIT HEATER BY MECHANICAL CONTRACTOR. FINAL GAS PIPING CONNECTION BY PLUMBING CONTRACTOR.
- GAS FURNACE BY MECHANICAL CONTRACTOR. FINAL GAS PIPING CONNECTION BY PLUMBING CONTRACTOR.

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	WATER HEATER SCHEDULE							
SYMBOL	DESCRIPTION	STORAGE (GALLON)	VOLT/PH	KW	MOCP	FLOW RATE (GPM)	RECOVERY GPH @ 90°F RISE	BASIS OF DESIGN MANUFACTURER AND MODEL NO.
WH-1	INSTANTANEOUS	#-	208V/1Ø	7.2	30	0.75	44-	BOSCH US7
WH-2	MINI-TANK	7	115V/1Ø	1.44	15	11-	6.8	BOSCH ES8

	PLUMBING	FIXT	URE	SCH	HEDL	JLE
SYMBOL	DESCRIPTION	WASTE	VENT	НОТ	COLD	REMARKS
P-1	WATER CLOSET	4"	2"	#	1/2"	
P-2	LAVATORY	1½"	11/4"	1/2"	1/2"	
P-3	SERVICE SINK	2"	11/4"	1/2"	1/2"	

PLUMBING NOTES

- INDIVIDUAL FIXTURE PIPING CONNECTION SIZES SHALL BE IN ACCORDANCE WITH PLUMBING FIXTURE SCHEDULE.
 ANY PHYSICAL INSTALLATION MODIFICATIONS DUE TO FIELD CONDITIONS SHALL BE RESOLVED BY THE PLUMBING CONTRACTOR IN ACCORDANCE WITH THE RECOMMENDATIONS OF THE MECHANICAL ENGINEER AT NO ADDITIONAL EXPENSE TO THE OWNER.
- 3. ALL WASTE LINES AS SHOWN SHALL BE BELOW FLOOR UNLESS OTHERWISE NOTED. ALL VENT LINES SHALL BE CONCEALED IN WALLS OR ABOVE CEILING. ALL WATER PIPING SHALL BE CONCEALED WHERE PHYSICALLY POSSIBLE.
- 4. THE ENTIRE INSTALLATION SHALL COMPLY WITH ALL CODES, LOCAL, STATE AND NATIONAL HAVING JURISDICTION.5. THE CONTRACTOR SHALL RIGIDLY SUPPORT ALL EQUIPMENT.
- 6. THE CONTRACTOR SHALL PROVIDE ALL LABOR, MATERIALS AND EQUIPMENT TO INSURE A COMPLETE SYSTEM.7. THE CONTRACTOR SHALL THOROUGHLY COORDINATE HIS WORK WITH
- THAT OF OTHER TRADES.

 8. THE CONTRACTOR SHALL SEAL ALL RESPECTIVE WALL, FLOOR,
- CEILING OR ROOF PENETRATIONS.

 9. THE PLUMBING CONTRACTOR SHALL PAY FOR ALL FEES AND PERMITS

PLUMBIN	IG SYMBOL SCHEDULE
	DOMESTIC COLD WATER PIPING
	DOMESTIC HOT WATER PIPING
	SANITARY SEWER PIPING
	SANITARY SEWER VENT PIPING
——c—	CONDENSATE PIPING
—— G——	GAS PIPING
_	BALANCING VALVE
─ ────────	SHUT-OFF VALVE

C.O. FLOOR CLEANOUT

C.O. WALL CLEANOUT

AS NECESSARY TO COMPLETE THE INSTALLATION.

NATURAL GAS PIPING SYSTEMS NOTES:

- 1. GAS PIPE SHALL BE SCHEDULE 40 SEAMLESS STEEL PIPE.
- INSTALLATION SHALL BE ACCORDING TO LOCAL CODES AND GAS COMPANY REQUIREMENTS. AFTER INSTALLATION, PIPE SHALL BE TESTED WITH 30 LB. TEST FOR 1 HOUR WITNESSED BY LOCAL GAS COMPANY BEFORE SERVICE IS TURNED ON.
- 3. PROVIDE A SUITABLE GAS COCK AND UNIONS AT EACH CONNECTION TO EACH PIECE OF GAS FIRED EQUIPMENT.
- 4. PROVIDE SUITABLE GAS PRESSURE REGULATORS WITH VENTS TO THE ATMOSPHERE REQUIRED IN ORDER TO MAINTAIN REQUIRED PRESSURE AT EACH PIECE OF GAS CONSUMING EQUIPMENT.
- 5. EQUIPMENT SHALL BE INSTALLED IN ACCORDANCE WITH THE STANDARDS OF THE NATIONAL FIRE PROTECTION ASSOCIATION OR THE NATIONAL FUEL GAS CODE FOR GAS-FIRED UNIT HEATERS AND DUCT FURNACES, AND THESE STANDARDS SHOULD BE FOLLOWED CAREFULLY. AUTHORITIES HAVING JURISDICTION SHOULD BE CONSULTED BEFORE INSTALLATION ARE MADE TO VERIFY LOCAL CODES AND INSTALLATION
- 6. MECHANICAL CONTRACTOR SHALL COORDINATE GAS SERVICE WITH ALL OTHER TRADES TO AVOID CONFLICT.
- ALL EXPOSED PIPING SHALL BE PAINTED WITH (1) PRIME COAT AND (2) COATS OF BEST QUALITY OIL BASE PAINT.

PLUMBING CUTTING AND PATCHING NOTE:

THE CONTRACTOR SHALL BE RESPONSIBLE FOR ALL CUTTING AND PATCHING REQUIRED FOR THE INSTALLATION OF ALL WORK ON THIS PROJECT. CUTTING AND PATCHING METHODS SHALL CONFORM TO THE REQUIREMENTS OF THE OWNER AND THE ARCHITECT. PATCHES IN FIRE RATED DEMISING WALLS, CEILING OR FLOORS SHALL MAINTAIN THE FIRE RATING OF THOSE BARRIERS BY THE USE OF APPROVED MATERIALS INCLUDING SPECIAL FIRE RATED SEALING COMPOUNDS OR MATERIALS IDENTICAL TO THE BARRIER MATERIALS.

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	ES/FLOORBOXES/POWER POLES	FIRE ALARI
SYMBOL	DESCRIPTION	SYMBO -Å-
-	120V DUPLEX RECEPTACLE	Ê
⇔ ♦	120V DUPLEX RECEPTACLE - CEILING MOUNTED 120V QUAD RECEPTACLE - CEILING MOUNTED	S
# #	120V QUAD RECEPTACLE	(H)
-147 -⊖	120V SIMPLEX RECEPTACLE	© •
₽R	14-50R RANGE RECEPTACLE WITH MATCHING PLUG AND CORD	®
∌ D	14-30R DRYER RECEPTACLE WITH MATCHING PLUG AND CORD	\bigoplus_{H}
₩ 0-00	1 PHASE SIMPLEX RECEPTACLE WITH NEMA CONFIGURATION TO MATCH EQUIPMENT	© •
₩ 0-00	3 PHASE SIMPLEX RECEPTACLE WITH NEMA CONFIGURATION TO MATCH EQUIPMENT	Ĕ
Ф	120V CORDREEL HUNG FROM WALL/CEILING	8
•	FLUSH FLOOR BOX/POKE-THRU FOR MOUNTING DEVICES INDICATED	÷ E
	CONCEALED FLOOR BOX/POKE-THRU FOR MOUNTING DEVICES INDICATED	Ė
0	PEDESTAL-TYPE FLOOR BOX/POKE-THRU FOR MOUNTING DEVICES INDICATED	♦
PP	POWER POLE FOR MOUNTING DEVICES INDICATED (HEIGHT AS REQUIRED)	©
RECEPTACLE	ES - ATTRIBUTES	Ē
В	MOUNTED HORIZONTALLY IN BASEBOARD KICK SPACE	FR
GF	INTEGRAL GROUNDFAULT	KB
IG	ISOLATED GROUND	<u>IZD</u>
SI	INTEGRAL SURGE PROTECTION, ISOLATED GROUND	●PS
SP	INTEGRAL SURGE PROTECTION	●FS
TR	TAMPER RESISTANT (CHILD PROOF)	●TS
WC	DEDICATED FOR WATER COOLER	●SD
VM	DEDICATED FOR VENDING MACHINE	
MO	MICROWAVE RECEPTACLE MOUNTED IN CABINET ABOVE	WG
WP	WEATHERPROOF	PC
00"	MOUNT AT HEIGHT TO CENTER INDICATED	WP
*	MOUNT AT 8" ABOVE COUNTER	ARAI
U	INTEGRAL USB CHARGER	ARAS
SP/P	INTEGRAL SURGE PROTECTION MOUNTED AT PROJECTOR HEIGHT (VERIFY WITH OWNER)	FAC
SP/T	INTEGRAL SURGE PROTECTION MOUNTED AT TELEVISION HEIGHT (VERIFY WITH OWNER)	∏FAS
		∏FAA
WIRING		∏FAG
	DECODIDATION	∏FAV
SYMBOL	<u>DESCRIPTION</u>	_
	CONDUIT & WIRE	LIGHTING CC
	CONDUIT & WIRE UNDERFLOOR OR UNDERGROUND	SYMBO
	HOME RUN WITH PANEL & CIRCUIT NUMBER NOTED	S
	MULTIPLE SWITCHED CIRCUITS FED FROM SAME HOME RUN	S _M
——UG——	UNDERGROUND	S _{R/L}
—— OH——	OVERHEAD	
	EMERGENCY ONLY CIRCUIT	

c CONDUIT DOWN

END OF CONDUIT

O CONDUIT UP

RE ALARM	
SYMBOL	DESCRIPTION
È	WALL MOUNTED FIRE ALARM VISUAL STROBE
S	PHOTOELECTRIC SMOKE DETECTOR - CEILING MOUNTED
\bigoplus	HEAT DETECTOR
©	CARBON MONOXIDE DETECTOR - CEILING MOUNTED
B	BEAM DETECTOR
\oplus_{H}	HIGH HEAT DETECTOR - CEILING MOUNTED
	DUCT SMOKE DETECTOR
₩	MONOXIDE DETECTOR
百	WALL MOUNTED FIRE ALARM AUDIO DEVICE
8	CEILING MOUNTED FIRE ALARM AUDIO DEVICE
\$ Ē	WALL MOUNTED FIRE AUDIO/VISUAL DEVICE
È È	WALL MOUNTED FIRE ALARM VISUAL DEVICE
	CEILING MOUNTED FIRE AUDIO/VISUAL DEVICE
Ê	CEILING MOUNTED FIRE VISUAL DEVICE
E	WALL MOUNTED MANUAL PULL STATION
FR	RELAY AND/OR MONITORING DEVICE AS REQUIRED BY THE APPLICATION REQUIREMENTS
KB	KNOX BOX
■DH	MAGNETIC DOOR HOLDER
●PS	SPRINKLER PRESSURE SWITCH
●FS	SPRINKLER FLOW SWITCH
●TS	SPRINKLER TAMPER SWITCH
●SD	SMOKE DAMPER
WG	WIRE GUARD
PC	PROTECTIVE COVER
WP	WEATHERPROOF
ARAP	AREA OF RESCUE ASSISTANCE PANEL
ARAS	AREA OF RESCUE ASSISTANCE REMOTE STATION
FACP	FIRE ALARM CONTROL PANEL
FASEP	FIRE ALARM SIGNAL EXTENDER PANEL
FAAP	FIRE ALARM LCD ANNUNCIATOR
FAGP	FIRE ALARM GRAPHIC / LCD ANNUNCIATOR
FAVP	FIRE ALARM VOICE PANEL
LIGHTING CONTROLS	
SYMBOL	DESCRIPTION
S	SINGLE POLE SWITCH

OCCUPANCY SENSOR SWITCH

RAISE AND LOWER SWITCH PROVIDED WITH

EQUIPMENT UNLESS OTHERWISE NOTED

POWER DISTRIBUTION AND CONTROL

	<u> </u>
SYMBOL	DESCRIPTION
● PS	PUSH-BUTTON STATION
ΘE	EMERGENCY PUSHBUTTON
● GV	GAS VALVE SHUTOFF
	PHOTOELECTRIC CELL
ㅁ	FUSED DISCONNECT SWITCH
	CONTACTOR
	MOTOR STARTER (FURNISHED BY M.C. UNLESS OTHERWISE INDICATED)
\boxtimes_{I}	COMBINATION STARTER & DISCONNECT SWITCH (FURNISHED BY M.C. UNLESS OTHERWISE INDICATED)
\wedge	MOTOR
X	RACEWAY
-	PANELBOARD, RECESSED MOUNTED
	PANELBOARD, SURFACE MOUNTED
①	JUNCTION BOX
	CONDUCTOR
	TRANSFORMER AS SCHEDULED

CABLE TRAY

DEO SURVEILL	ANCE/ACCESS CONTROL SYSTEM
SYMBOL	DESCRIPTION
●H/C	HANDICAP (ADA) DOOR OPERATOR PUSH PAD
□ CA	ACCESS SYSTEM CARD READER
K	INTRUSION DETECTION SYSTEM KEYPAD
↓ DH	INTRUSION DETECTION SYSTEM WALL MOUNTED MOTION DETECTOR
M s	INTRUSION DETECTION SYSTEM CEILING MOUNTED MOTION DETECTOR
A	INTRUSION DETECTION SYSTEM WALL MOUNTED AUDIO ALARM
	CCTV SYSTEM CEILING M OUNTED CAMERA
-01	PARAPIT-MOUNTED EXTERIOR CAMERA PAN-TILT-ZOOM
■ES	ELECTRIC STRIKE FOR DOOR ACCESS SYSTEM
■BG	GLASS BREAK SENSOR - CEILING MOUNTED UNLESS OTHERWISE INDICATED
•DC	ACCESS CARD SYSTEM DOOR CONTACT
□ IC	INTERCOM/CAMERA STATION
□ MS	INTERCOM/CAMERA MASTER STATION

DOOR HARDWARE PACKAGE PER SPECIFICATIONS. PROVIDE 3/4" CONDUIT AND

WIRING TO ALL EQUIPMENT REQUIRED BY HARDWARE MANUFACTURER. DOOR

SHALL OPERATE AS DESCRIBED IN THE NOTES OF THE HARDWARE PACKAGE.

<u>LIGHTING</u>

LUMINAIRE WITH LAMP(S) ON UNSWITCHED NORMAL/EMERGENCY CIRCUIT LUMINAIRE WITH LAMP(S) ON UNSWITCHED NORMAL CIRCUIT LUMINAIRE - CEILING MOUNTED LUMINAIRE - CEILING MOUNTED - NORMAL & EMERGENCY WALL MOUNTED LUMINAIRE

WALL MOUNTED LUMINAIRE - NORMAL & EMERGENCY

LUMINAIRE - CEILING MOUNTED - EMERGENCY ONLY

FLOOD OR SPOT LUMINAIRE

WALL MOUNTED LUMINAIRE - EMERGENCY ONLY WALL MOUNTED FLOOD OR SPOT LUMINAIRE - EMERGENCY ONLY

REMOTE HEADS - HEADS AS SCHEDULED OR INDICATED

EMERGENCY BATTERY UNIT - HEADS AS SCHEDULED OR INDICATED

LUMINAIRE - SINGLE OR DUAL SWITCHING LUMINAIRE - NORMAL & EMERGENCY CIRCUITS

EXTERIOR LUMINAIRE


GENERAL ELECTRICAL NOTES:

- 1. THE ENTIRE ELECTRICAL INSTALLATION SHALL COMPLY WITH THE NEC AND ALL LOCAL, STATE AND NATIONAL CODES.
- 2. THE ELECTRICAL CONTRACTOR SHALL COORDINATE HIS/HER WORK WITH ALL OTHER
- 3. THE ELECTRICAL CONTRACTOR SHALL COORDINATE HIS/HER WORK WITH THE ARCHITECTURAL PHASING PLANS INCLUDING ASBESTOS ABATEMENT PLANS.
- 4. THE ELECTRICAL CONTRACTOR IS RESPONSIBLE FOR, BUT NOT LIMITED TO: ALL TEMPORARY AND PERMANENT CROSSOVER CONNECTIONS, RELOCATION OF SYSTEM EQUIPMENT AND REPROGRAMMING OF THE SYSTEM EQUIPMENT TO THE NEW AND EXISTING SYSTEMS THAT THE ELECTRICAL CONTRACTOR WILL NEED TO PROVIDE DURING THE RENOVATION/CONSTRUCTION PROJECT. THESE SYSTEMS INCLUDE BUT NOT LIMITED TO THE
- A. NORMAL POWER/LIGHTING CIRCUITS
- B. EMERGENCY POWER/LIGHTING CIRCUITS C. FIRE ALARM SYSTEMS
- D. SECURITY SYSTEMS
- E. CAMERA SYSTEMS F. INTERCOM SYSTEMS
- G. MASTER CLOCK SYSTEMS H. SOUND SYSTEMS
- I. TELEPHONE SYSTEMS J. DATA SYSTEMS
- 5. SHUTDOWNS OF ANY OF THE SYSTEMS LISTED ABOVE MUST BE COORDINATED WITH AND APPROVED BY THE ARCHITECT, OWNER AND CONSTRUCTION MANAGER.
- 6. THERE WILL BE MULTIPLE LABOR AND INDUSTRY, TOWNSHIP, OWNER, ARCHITECT AND ENGINEER INSPECTIONS THAT WILL NEED TO BE SATISFIED BY THE ELECTRICAL
- 7. THE ELECTRICAL CONTRACTOR SHALL PROVIDE ALL LABOR, MATERIALS AND EQUIPMENT, WHETHER SPECIFIED OR NOT, TO PROVIDE A COMPLETE AND OPERATIONAL SYSTEM.
- 8. THE ELECTRICAL CONTRACTOR IS RESPONSIBLE FOR ALL CONDUIT AND CABLE TRAY PENETRATIONS THROUGH CHASES, WALLS OR FLOORS WHICH ARE FIRE-RATED. THE ELECTRICAL CONTRACTOR SHALL UNDER THE DIRECTION OF THE ARCHITECT, PROPERLY SEAL ALL PENETRATIONS TO MAINTAIN FIRE PROTECTION RATING. REFER TO THE ARCHITECTURAL DRAWINGS FOR FIRE RATED PARTITIONS.

- A. NOT ALL SYMBOLS SHOWN ON THIS DRAWING ARE USED ON THIS PROJECT.
- B. ONE OR MORE ATTRIBUTES MAY BE ADDED TO A BASIC SYMBOL TO SPECIFY ADDITIONAL REQUIREMENTS FOR THE DEVICE DESCRIBED BY THE BASIC SYMBOL.
- C. REFER TO SPECIFICATIONS FOR PANELBOARD AND LUMINAIRE SCHEDULES.

POWER RISER DIAGRAM NOTES:

- CONDUCTORS BY PPL.
- 2. 3#3/0 IN 2" CONDUIT.
- 3. PROVIDE A SEPARATE #6 GROUNDING CONDUCTOR TO EACH OF THE FOLLOWING:
- FOUNDATION FOOTER REBAR - UTILITY SIDE OF WATER METER SERVICE (BEFORE WATER METER AND WITHIN 5' OF WHERE IT ENTERS THE BUILDING.)
- BUILDING STEEL - TWO 3/4" x 10' COPPER CLAD GROUND RODS SPACES 7' APART MINIMUM.

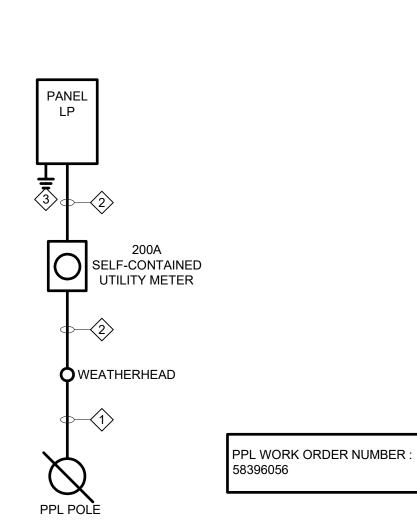

POWER RISER DIAGRAM

ALL DIMENSIONS, MEASUREMENTS AND STAMP PROJECT CONDITIONS SHALL BE CHECKED AND VERIFIED IN THE FIELD BY THE CONTRACTOR. REFER ALL DIFFERENCES, IN WRITING, TO THE ARCHITECT FOR CONSIDERATION PRIOR TO PROCEEDING WITH THE WORK. THE CONTRACTOR SHALL BEAR THE COST OF RECTIFYING WORK NOT APPROVED BY THE ARCHITECT, CAUSED BY LACK OF COORDINATION AND OR NOTIFICATION.

> Moore Engineering Company 3637 Columbia Avenue Lancaster, PA 17603 P (717) 285-3141 F (717) 285-2443 www.mooreengineering.com

HAMMEL ASSOCIATES ARCHITECTS, LLC 25 E. Grant St. | Suite 102 | Lancaster, PA 17602 | 717.393.3713 | www.hammelarch.com

CITY OF LANCASTER

PROJECT DESCRIPTION


REVISIONS

KEY PLAN

CITY OF LANCASTER 622 BEAVER ST LANCASTER, PA

SHEET TITLE SCHEDULES & RISER ISSUE DATE 08/16/19

scale AS NOTED FILE NUMBER 1853_19011 DRAWN BY TPM | CHECKED BY WMF

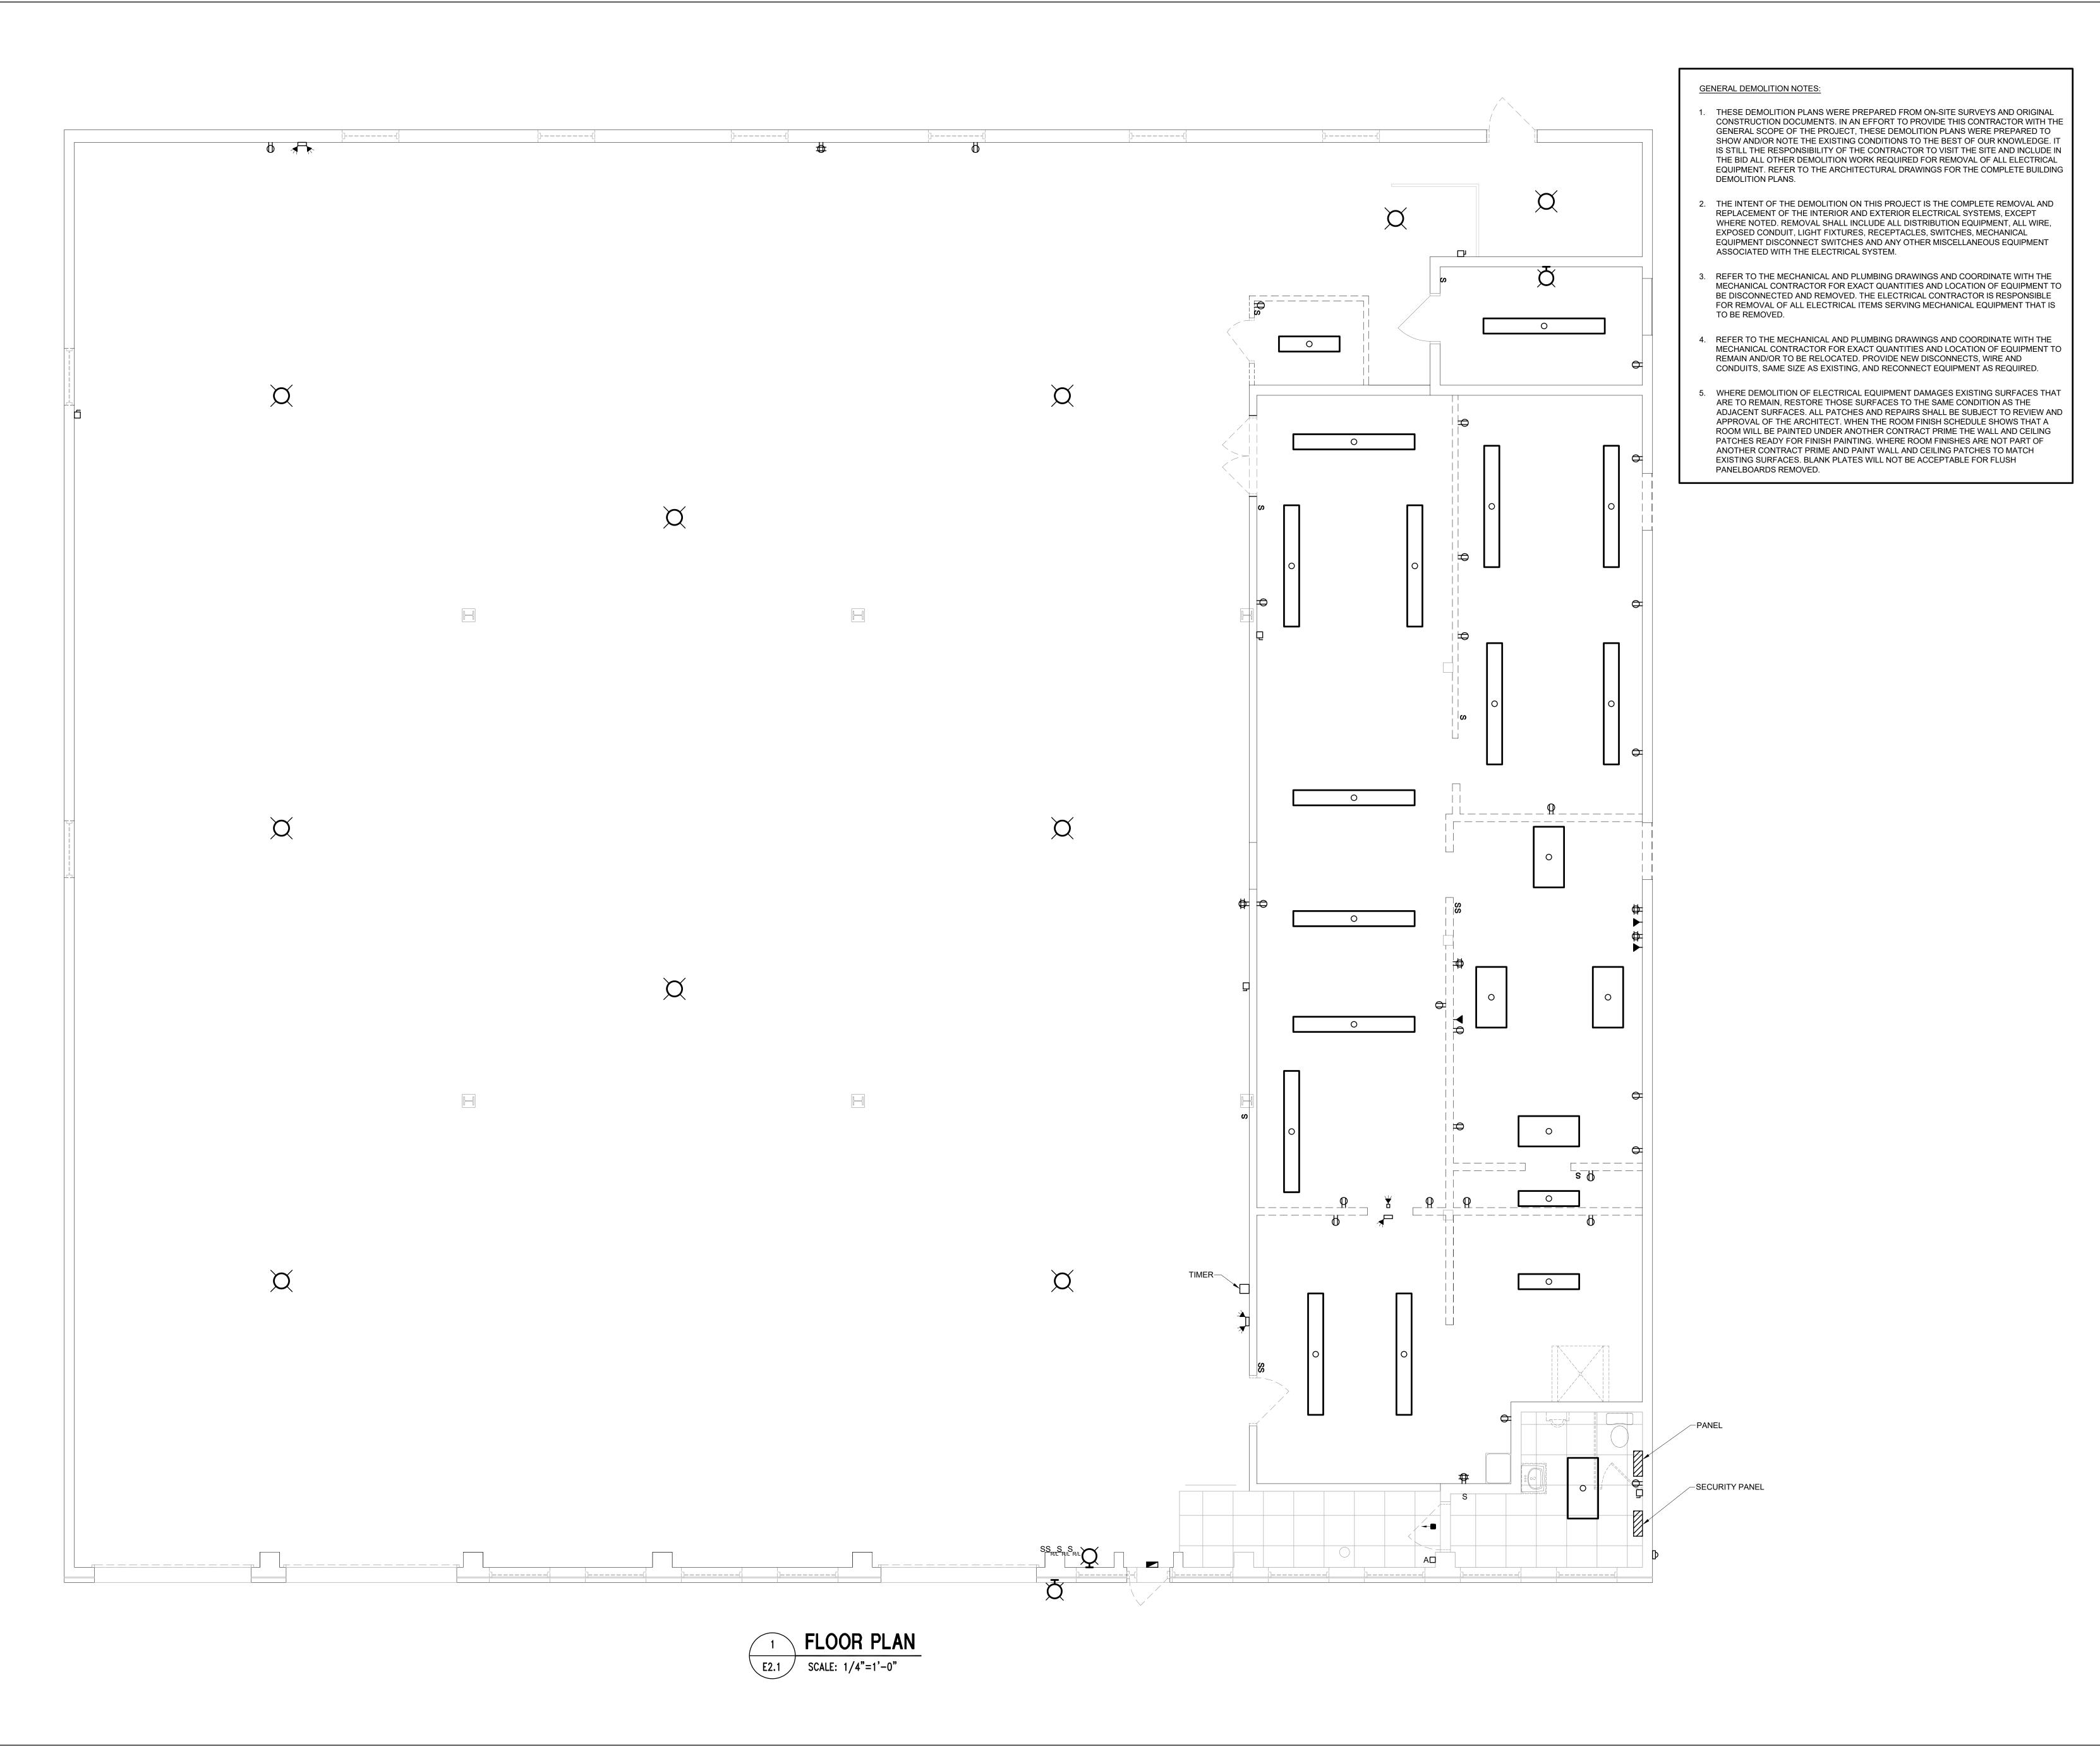

PROJECT CONDITIONS SHALL BE CHECKED AND VERIFIED IN THE FIELD BY THE CONTRACTOR. REFER ALL DIFFERENCES, IN WRITING, TO THE ARCHITECT FOR CONSIDERATION PRIOR TO PROCEEDING WITH THE WORK. THE CONTRACTOR SHALL BEAR THE COST OF RECTIFYING WORK NOT APPROVED BY THE ARCHITECT, CAUSED BY LACK OF COORDINATION AND

OR NOTIFICATION.

ALL DIMENSIONS, MEASUREMENTS AND STAMP

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CITY OF LANCASTER

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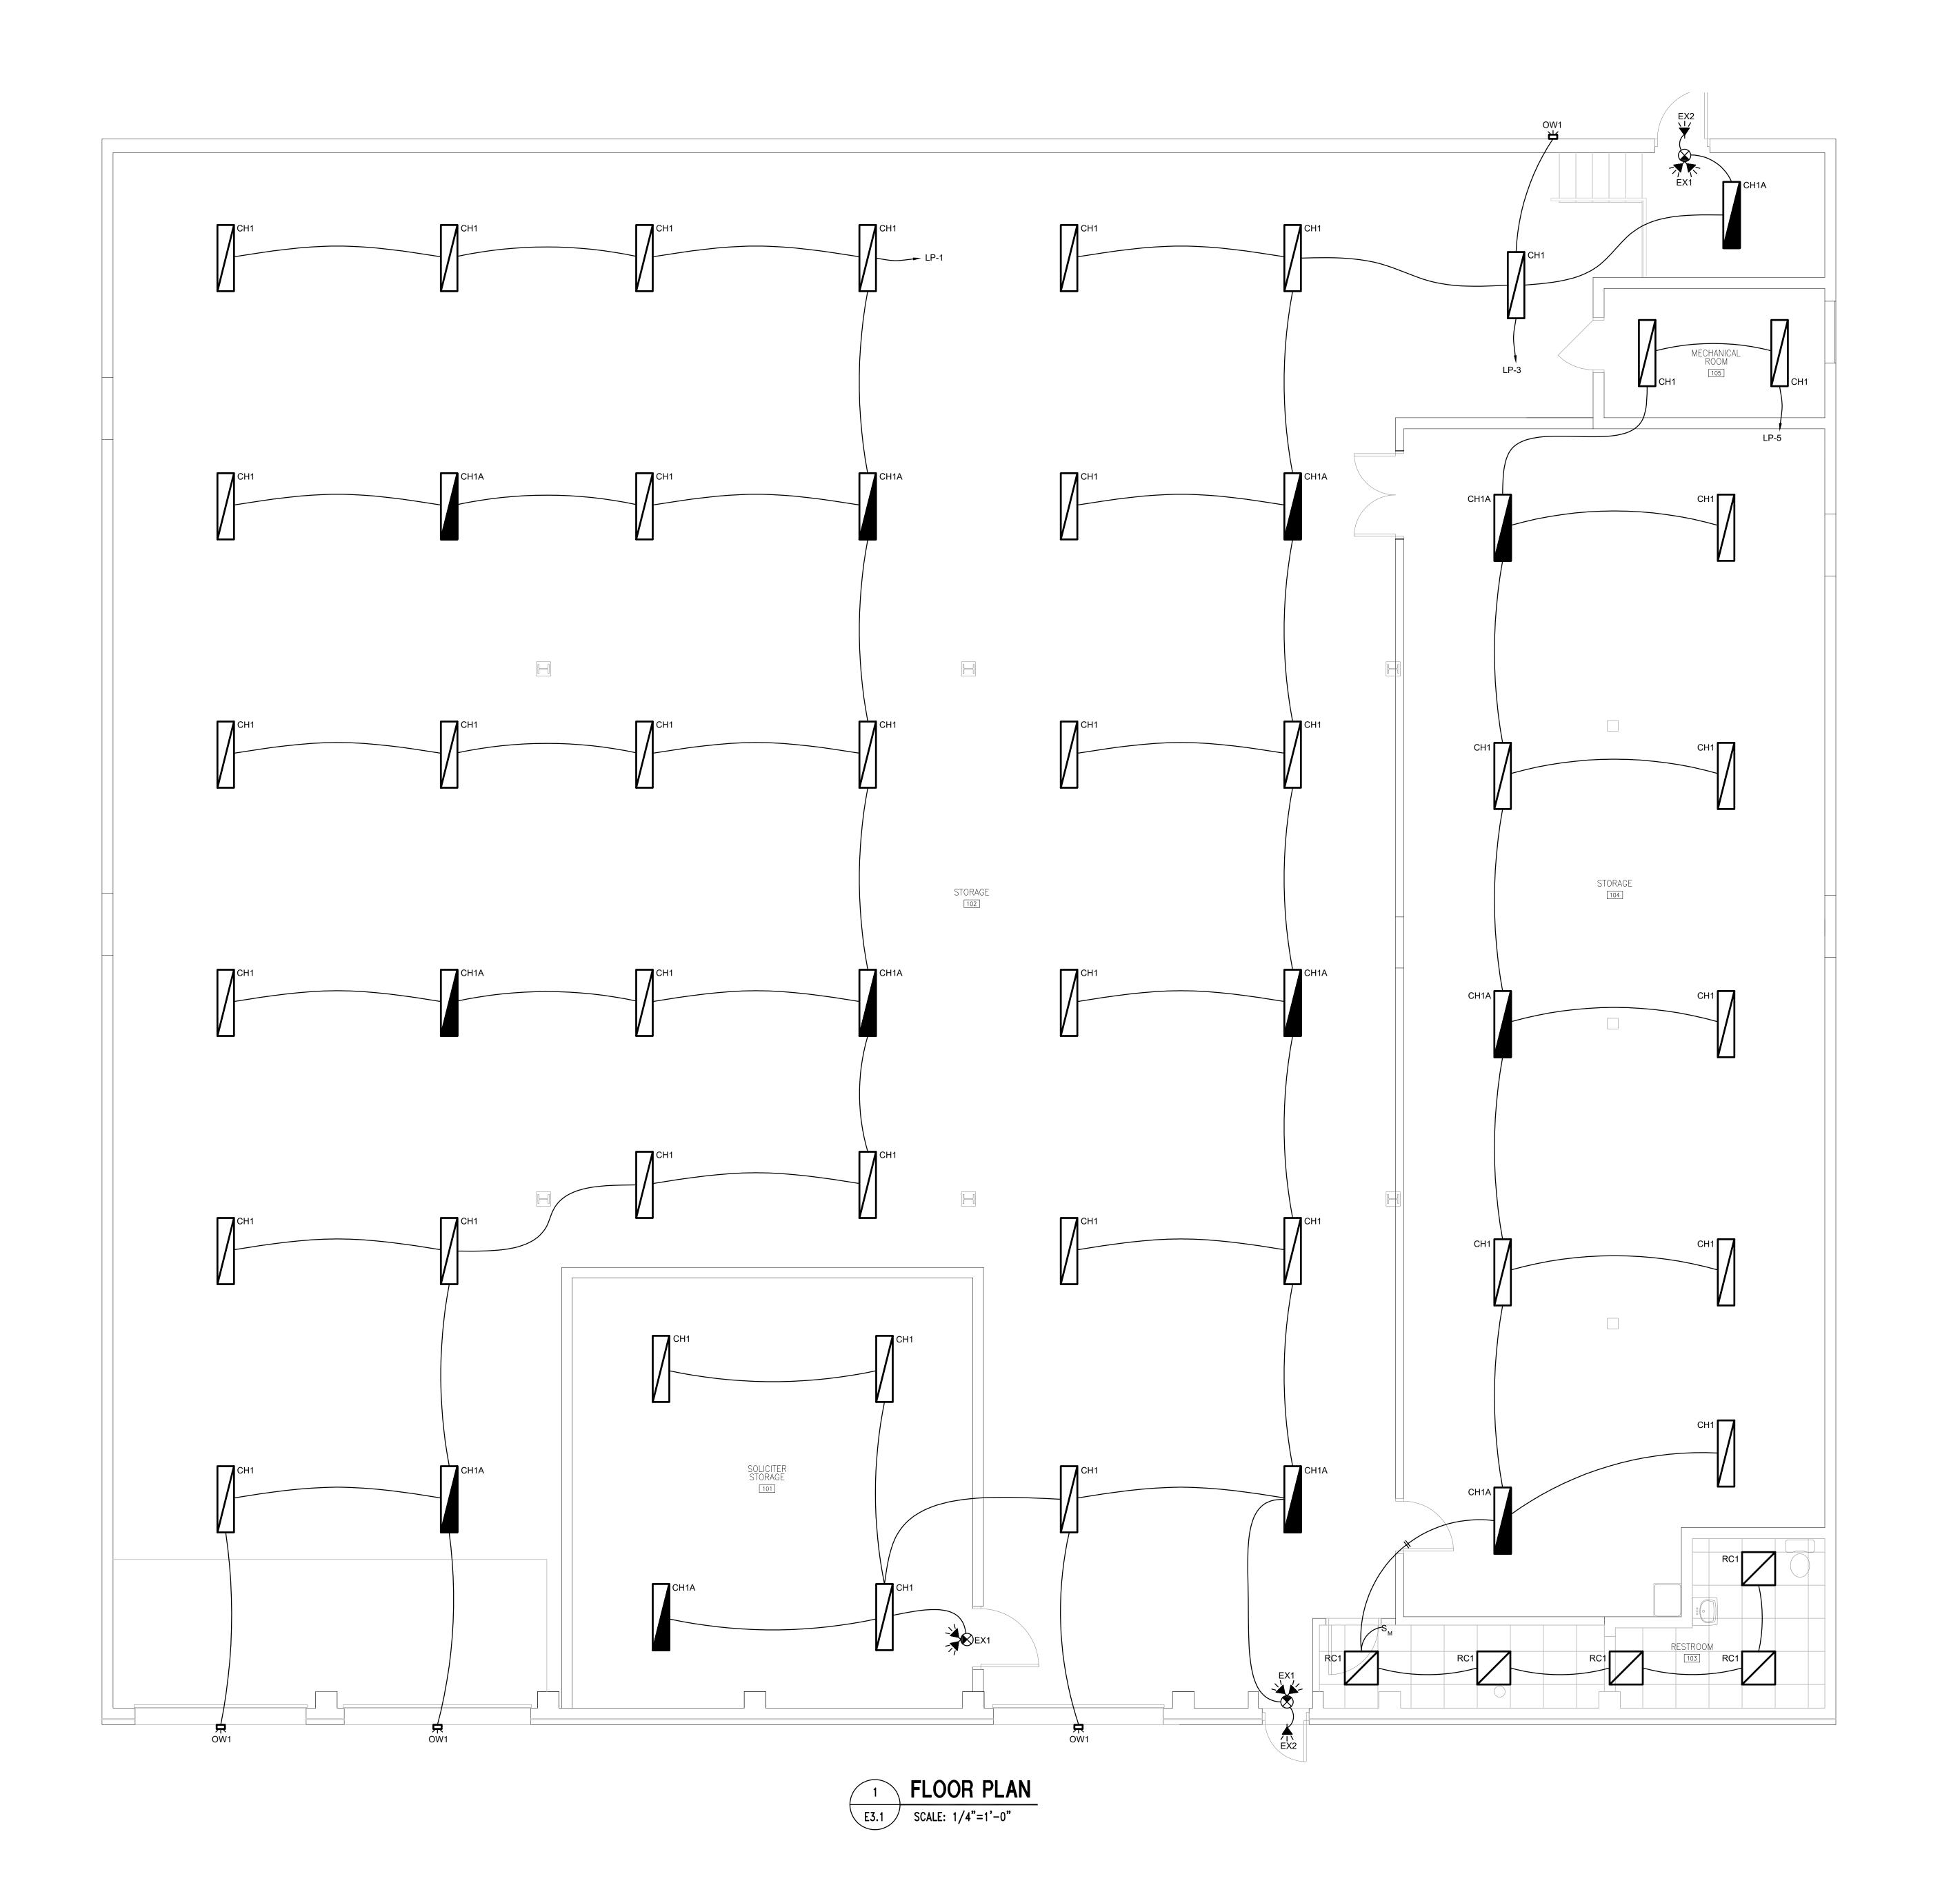
CITY OF LANCASTER 622 BEAVER ST LANCASTER, PA

SHEET TITLE ELECTRICAL DEMOLITION PLAN

ISSUE DATE 08/16/19 SCALE AS NOTED

FILE NUMBER 1853_19011 DRAWN BY TPM CHECKED BY WMF

F2.1



ALL DIMENSIONS, MEASUREMENTS AND PROJECT CONDITIONS SHALL BE CHECKED AND VERIFIED IN THE FIELD BY THE CONTRACTOR. REFER ALL DIFFERENCES, IN WRITING, TO THE ARCHITECT FOR CONSIDERATION PRIOR TO PROCEEDING WITH THE WORK. THE CONTRACTOR SHALL BEAR THE COST OF RECTIFYING WORK NOT APPROVED BY THE ARCHITECT, CAUSED BY LACK OF COORDINATION AND OR NOTIFICATION.

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REVISIONS

KEY PLAN

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CITY OF LANCASTER

PROJECT DESCRIPTION

CITY OF LANCASTER 622 BEAVER ST LANCASTER, PA

SHEET TITLE LIGHTING PLAN

ISSUE DATE 08/16/19 SCALE AS NOTED

FILE NUMBER 1853_19011 DRAWN BY TPM CHECKED BY WMF

F3.1

