

STUDIOS

ARCHITECTURE + MASTER PLANNING

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I HEREBY CERTIFY THAT THESE
DOCUMENTS WERE PREPARED OR
APPROVED BY ME, AND THAT I AM A
DULY LICENSED PROFESSIONAL
ARCHITECT UNDER THE LAWS OF THE
STATE OF PENNSYLVANIA.
LICENSE NUMBER: #RA405311
EXPIRATION DATE: 6-30-2023


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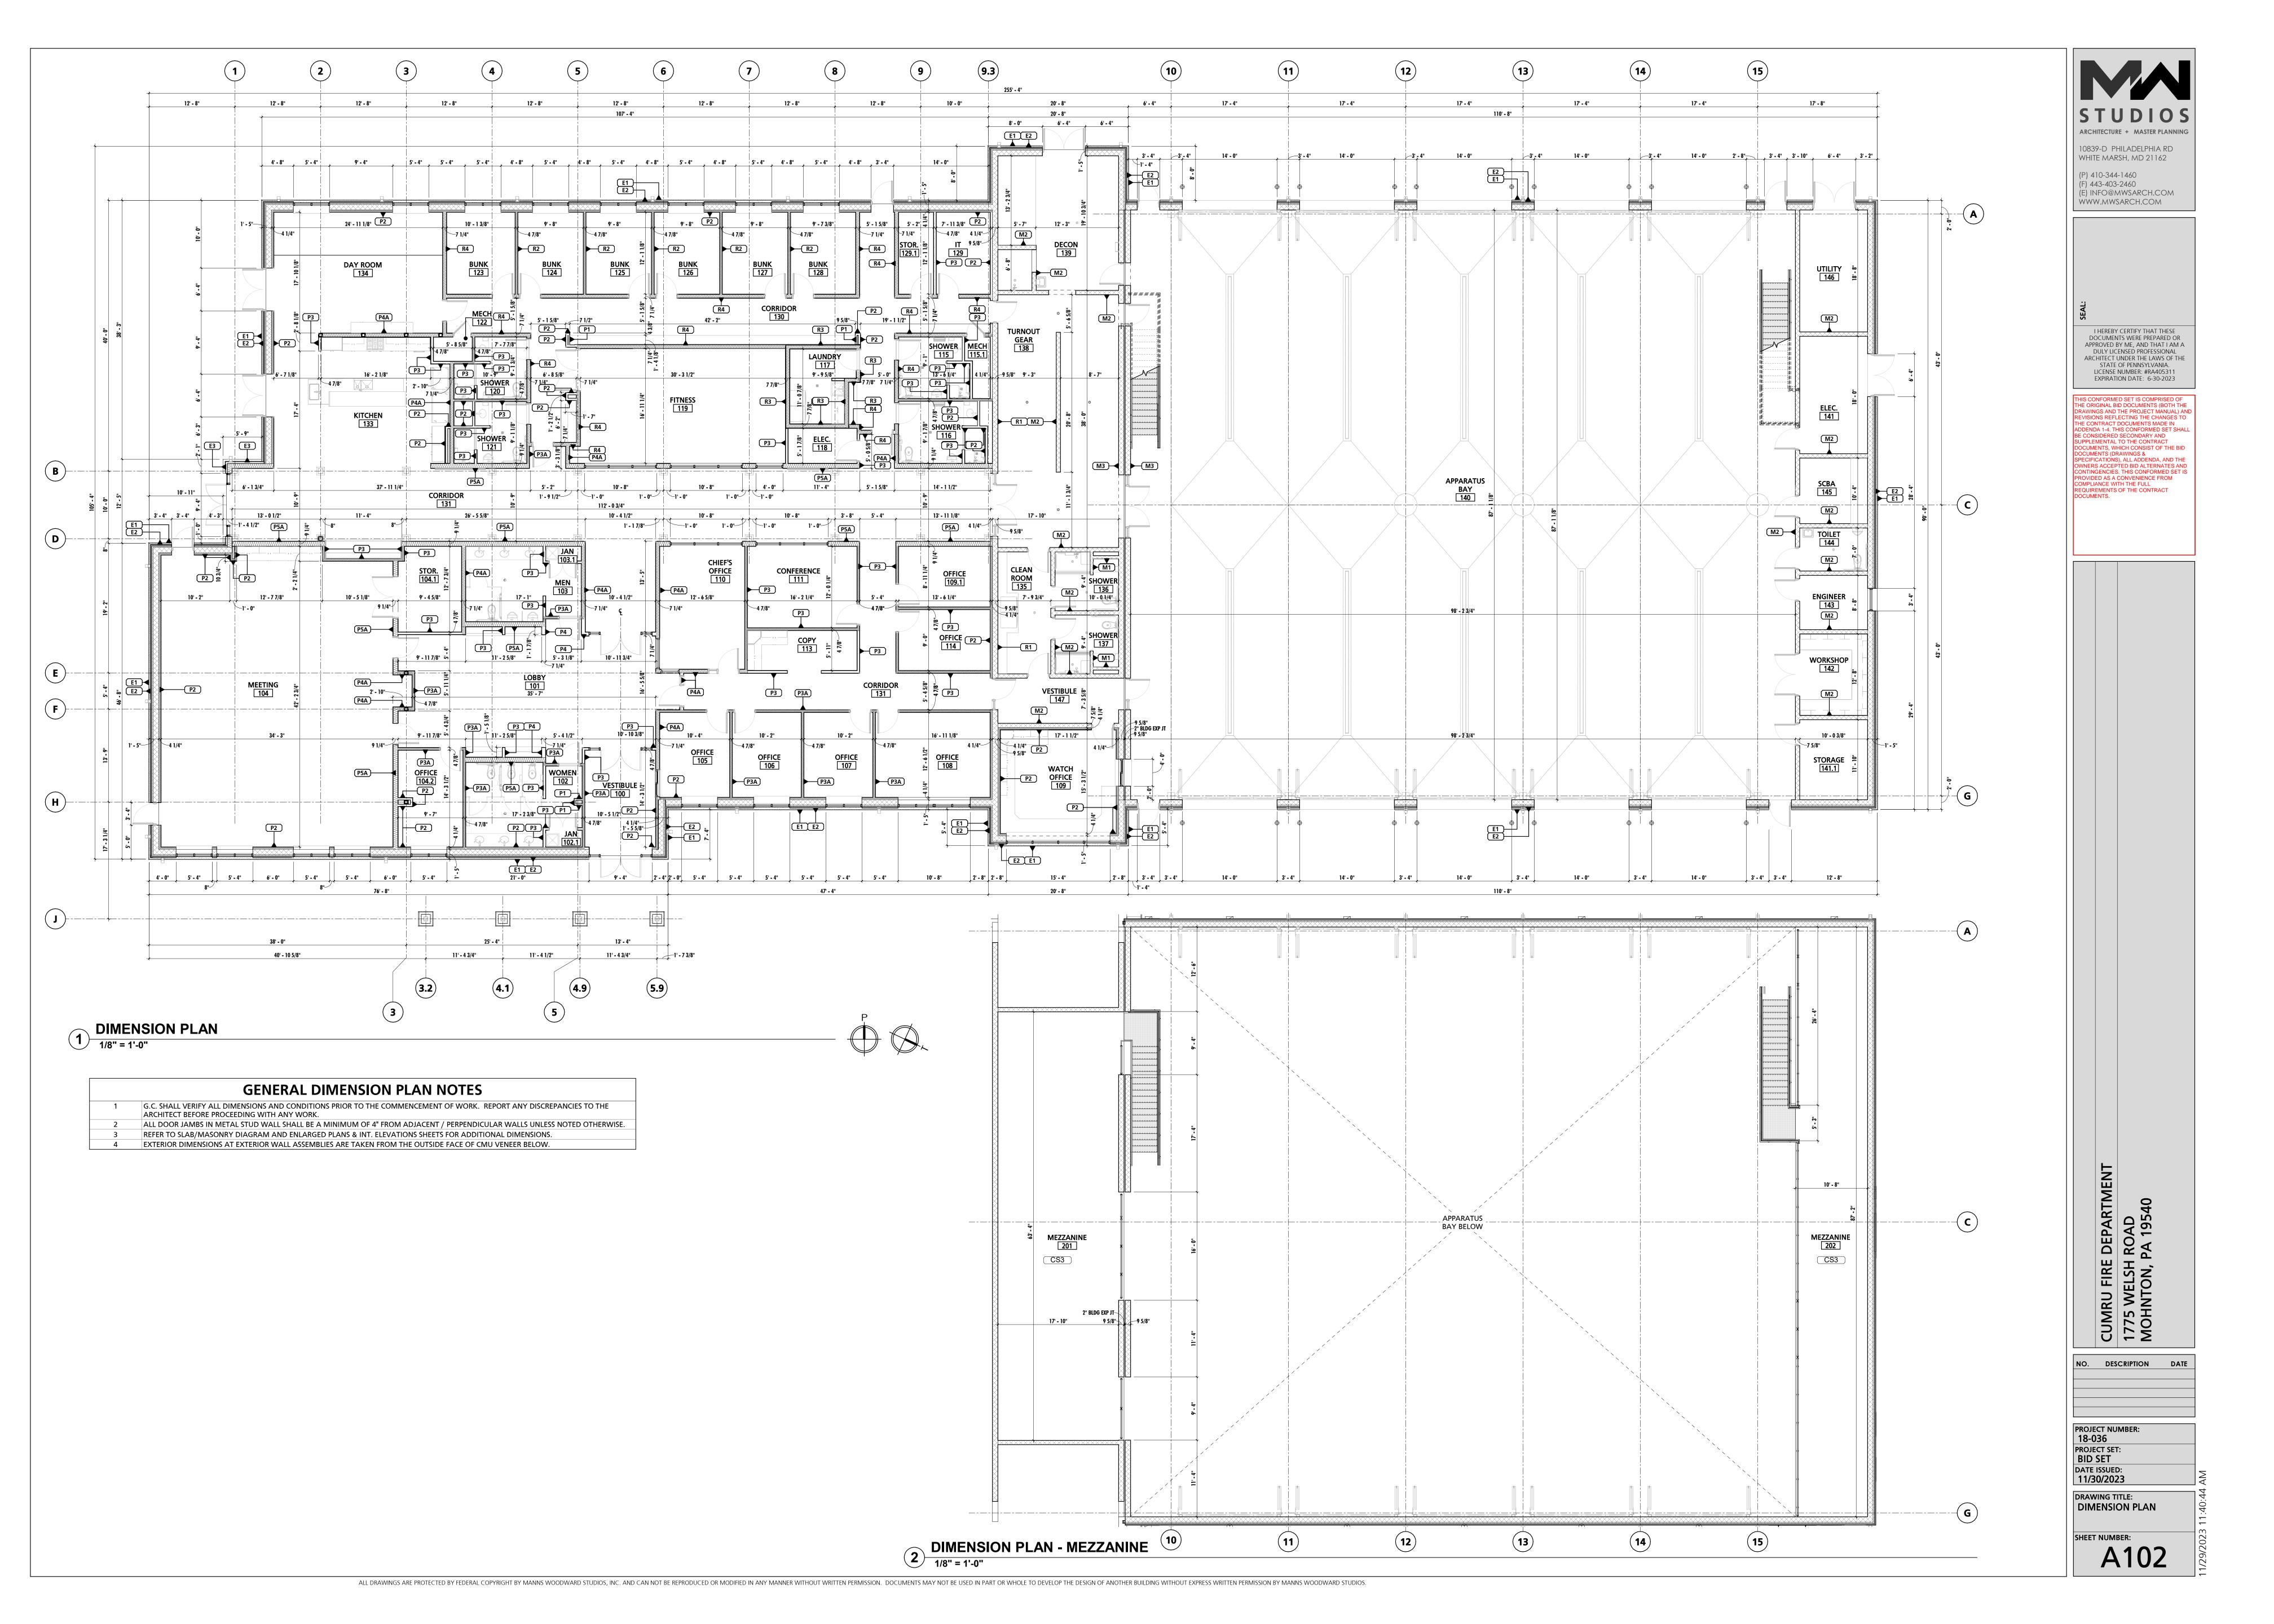
CUMRU FIRE DEPARTMENT 1775 WELSH ROAD MOHNTON, PA 19540


PROJECT NUMBER:
18-036
PROJECT SET:
BID SET
DATE ISSUED:
11/30/2023


DRAWING TITLE:
EXTERIOR SITE SLAB
DIAGRAM
SHEET NUMBER:


A100.1



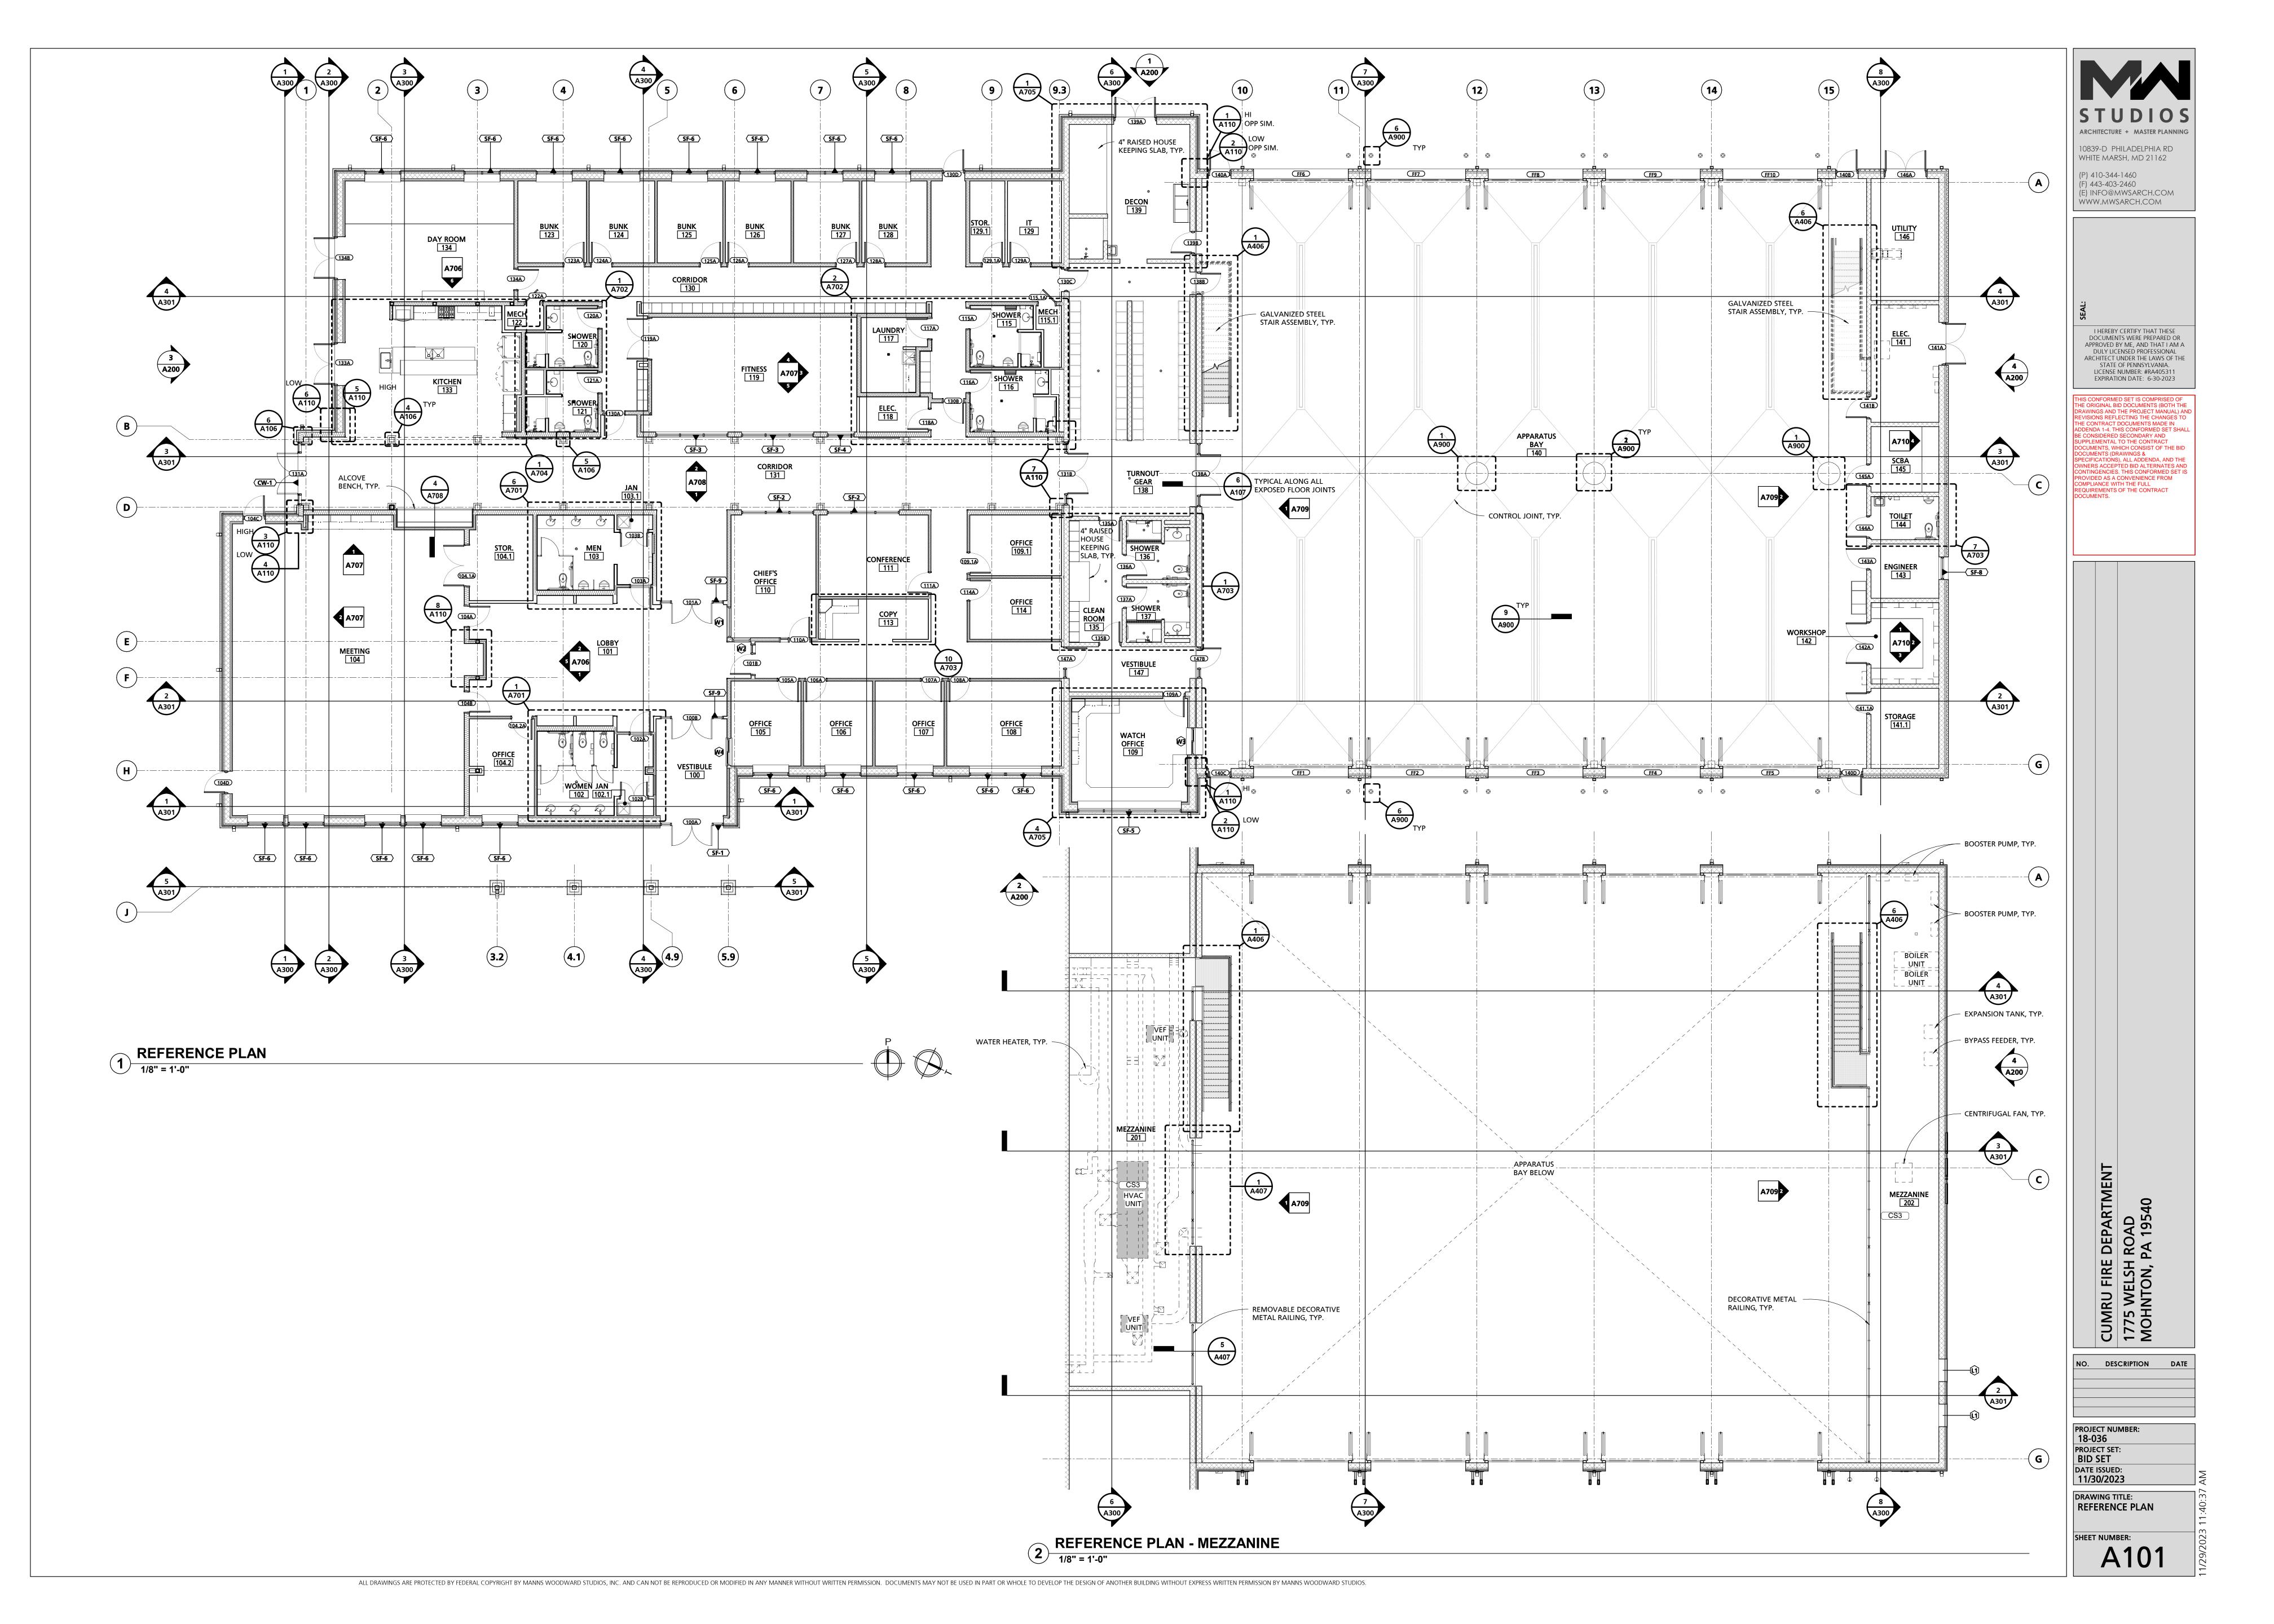

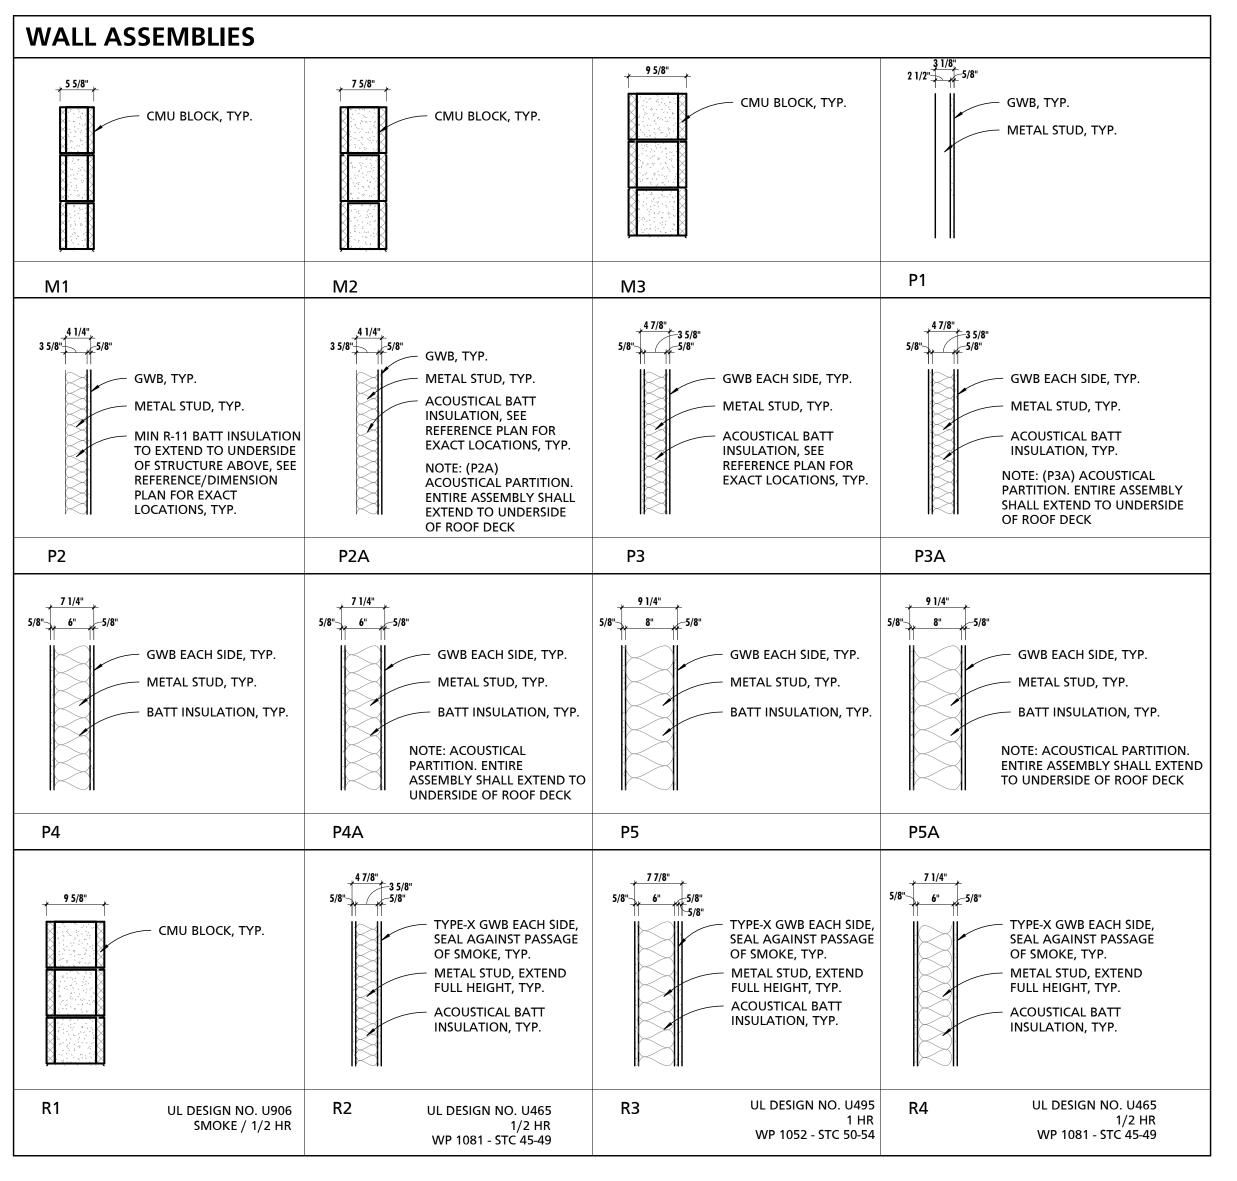

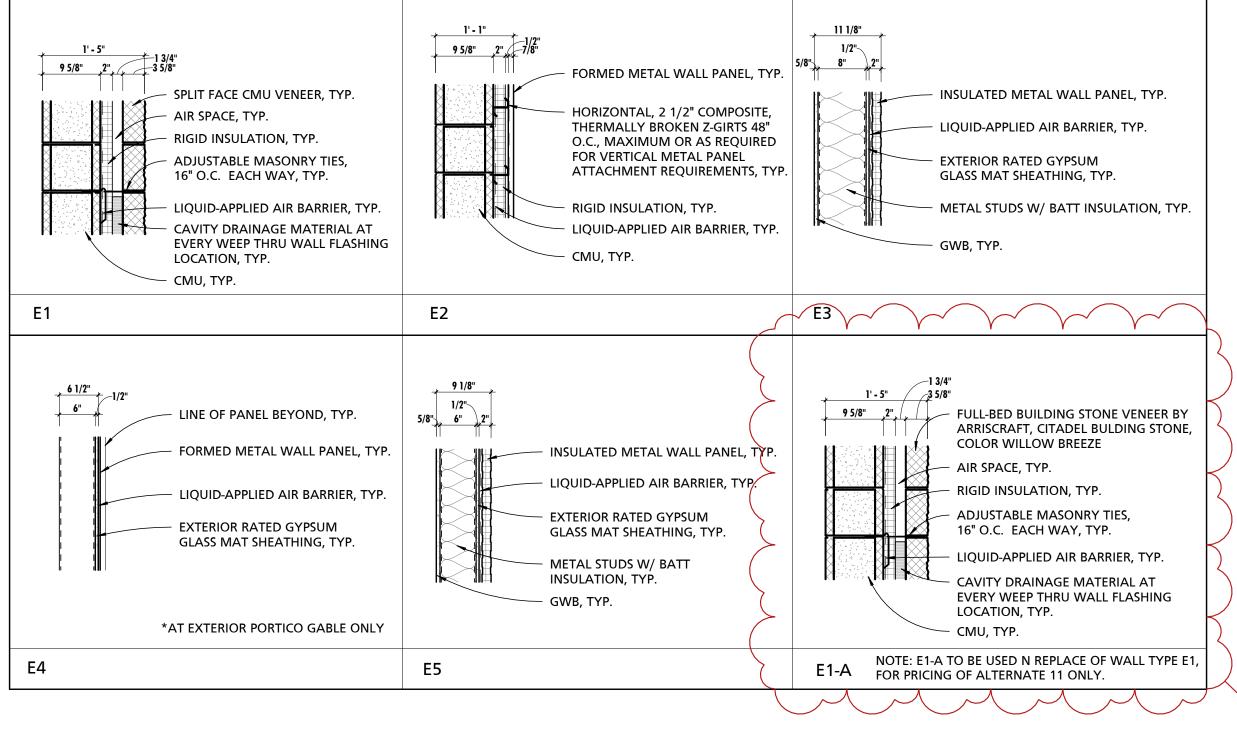

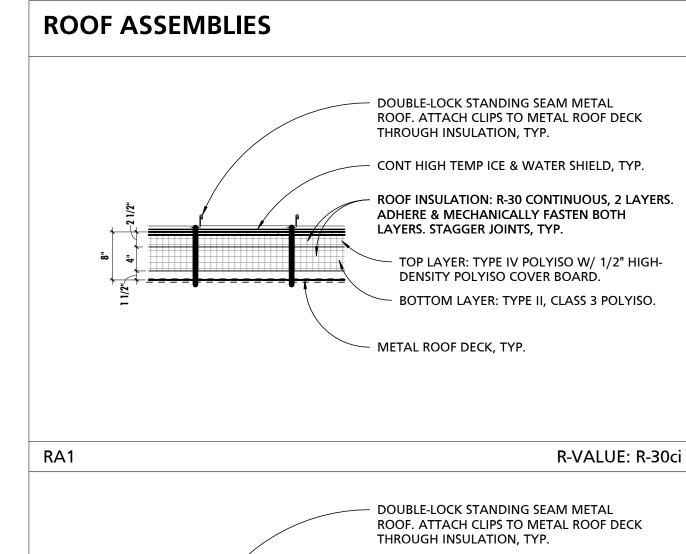

HIGH TEMP ICE & WATER SHIELD, TYP.

EXTERIOR RATED GLASS MAT GYPSUM SHEATHING, TYP.

METAL ROOF DECK, TYP.

REINFORCED CONCRETE SLAB ON GRADE, TYP.

VAPOR BARRIER, TYP.


RIGID INSULATION, TYP.

POROUS GRAVEL FILL, TYP.

SEE STRUCTURAL DWGS FOR ADDITIONAL INFORMATION

CS1

REINFORCED CONCRETE SLAB ON GRADE, TYP.

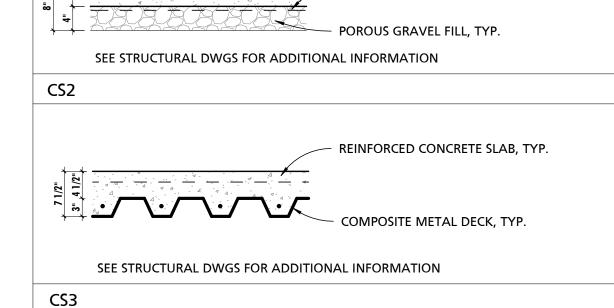

GENERAL PARTITION NOTES

ENTRY SPACES, LOBBIES, AND CORRIDORS TO RECEIVE IMPACT RESISTANT GYPSUM WALL BOARD, U.N.O.
PROVIDE FIBERGLASS REINFORCED MOISTURE RESISTANT GYPSUM WALL BOARD IN ALL EQUIPMENT ROOMS, JANITOR'S CLOSETS, RESTROOMS, KITCHENS AND OTHER WET AREAS. PROVIDE FIBERGLASS REINFORCED MOISTURE RESISTANT WALL

BOARD IN ALL OTHER AREAS WITHIN 8'-0" OF WATER SOURCE.

CONTRACTOR SHALL PROVIDE BLOCKING AND NAILERS AS REQUIRED TO SUPPORT ALL NEW WORK, INCLUDING ITEMS TO BE PROVIDED AND/OR INSTALLED BY OWNER.

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ALL CORRIDOR AND FIRE-RATED PARTITIONS SHALL BE EXTENDED TO THE UNDERSIDE OF THE STRUCTURE ABOVE, U.N.O. THE PERIMETER WALLS OF ANY SPACE NOT PROVIDED WITH A CEILING SHALL EXTEND TO THE UNDERSIDE OF DECK ABOVE.

ABOVE.
PROVIDE DEFLECTION TRACKS AT TOP OF ALL NON-LOAD BEARING STUD WALLS EXTENDING TO THE UNDERSIDE OF STRUCTURE ABOVE, U.N.O.

PROVIDE CONCRETE BACKER BOARD IN LIEU OF GYPSUM WALL BOARD WHERE TILE FINISH IS INDICATED.

ALL FIRE WALLS SHALL BE PLACARDED OR STENCILED ON BOTH SIDES WITH THE PHRASE "FIRE WALL" PER IBC SECTION 703.7.1. THE LETTERS SHALL BE RED IN COLOR, 6" INCHES HIGH AND A MIN. OF 3/4" WIDE. THE PHRASE SHALL BE WRITTEN ONCE FOR EACH 15 FEET OF HORIZONTAL WALL LENGTH. THIS SIGNAGE MAY BE LOCATED IN THE CONCEALED SPACE ABOVE A CEILING.

MOISTURE RESISTANT GYPSUM WALL BOARD SHALL BE UTILIZED IN ALL AREAS WHERE GYPSUM WALL BOARD IS TO BE DIRECTLY ADHERED TO CONCRETE OR MASONRY SURFACES IN INTERIOR APPLICATIONS. SUBSTRATE SHALL BE CLEANED AS REQUIRED AND FREE OF DUST, DEBRIS, AND MOISTURE PRIOR TO ADHESION AND FINISHING.

CONSTRUCTION OF RATED WALL ASSEMBLIES SHALL BE IN ACCORDANCE WITH UL AND GYPSUM ASSEMBLY SPECIFICATIONS. REFER TO CODE PLANS FOR ADDITIONAL INFORMATION.

PROVIDE A BULLNOSE CMU AT ALL OUTSIDE CORNERS OF INTERIOR MASONRY WALLS & SILLS.

ALL PARTITIONS LABELED P#A ARE ACOUSTICALLY RATED AND SHALL EXTEND TO UNDERSIDE OF ROOF/MEZZANINE DECK ABOVE. PROVIDE REQUIRED DEFLECTION TRACK AT TOP PLATE CONNECTION POINT.

		SCHEDULE - INTERIOR PARTITION & WALL TYPE			
		F	RE RATING	STC RATII	NG
MARK	WIDTH	DESCRIPTION RATING	ASSEMBLY REF.	ASSMEBLY REF.	RATING
M1	0' - 5 5/8"	6" CONCRETE MASONRY UNIT			
M2	0' - 7 5/8"	8" CONCRETE MASONRY UNIT			
M3	0' - 9 5/8"	10" CONCRETE MASONRY UNIT			
P1	0' - 3 1/8"	2-1/2" METAL STUD WITH 5/8" GYPSUM WALL BOARD ON ONE SIDE			
P2	0' - 4 1/4"	3-5/8" METAL STUD WITH 5/8" GYPSUM WALL BOARD ON ONE SIDE			
Р3	0' - 4 7/8"	3-5/8" METAL STUD W/ 5/8" GYPSUM WALL BOARD EACH SIDE		<varies></varies>	<varies></varies>
P3A	0' - 4 7/8"	3-5/8" METAL STUD W/ 5/8" GYPSUM WALL BOARD EACH SIDE		NGC 2018004	50
P4	0' - 7 1/4"	6" METAL STUD W/ 5/8" GYPSUM WALL BOARD EACH SIDE			
P4A	0' - 7 1/4"	6" METAL STUD W/ 5/8" GYPSUM WALL BOARD EACH SIDE		<varies></varies>	<varies></varies>
P5	0' - 9 1/4"	8" METAL STUD W/ 5/8" GYPSUM WALL BOARD EACH SIDE			
P5A	0' - 9 1/4"	8" METAL STUD W/ 5/8" GYPSUM WALL BOARD EACH SIDE			50
R1	0' - 9 5/8"	SEE CODE PLANS SMOKE	U 906		45-49
R2	0' - 4 7/8"	SEE CODE PLANS 1/2	U465		45-49
R3	0' - 7 7/8"	SEE CODE PLANS 1	UL495		50-54
R4	0' - 7 1/4"	SEE CODE PLANS 1/2	U465		45-49

	SCHEDULE - EXTERIOR WALL TYPE						
			MIN. F	R-VALUE			
MARK	WIDTH	DESCRIPTION	R	R-CI			
E1	17"	9-5/8" CMU W/ LIQUID APPLIED AIRBARRIER W/ 2" RIGID INSULATION W/ ADJUSTABLE MASONRY TIE 16" O.C. VERTICALLY & HORIZONTALLY 32" O.C. STAGGERED EACH ROW W/ 1-3/4" AIR SPACE W/ 3-5/8" SPLIT FACE CMU VENEER	N/A	R-11.4			
E2	13-3/8"	9-5/8" CMU W/ LIQUID APPLIED AIR BARRIER W/ 2" RIGID INSULATION & HORIZONTAL, 2 1/2" COMPOSITE, THERMALLY BROKEN Z-GIRTS 48" O.C. W/ PRE-FINISHED VERTICAL METAL PANEL	N/A	R-11.4			
E3	11-1/8"	5/8" GWB W/ 8" METAL STUD W/ BATT INSULATION W/ 1/2" EXTERIOR RATED GYPSUM GLASS MAT SHEATHING W/ LIQUID APPLIED AIR BARRIER W/ PRE-FINISHED HORIZONTAL INSULATED METAL WALL PANEL	R-13	R-7.5			
E4	6 -1/2"	6" METAL STUD W/ 1/2" EXTERIOR RATED GYPSUM GLASS MAT SHEATHING W/ LIQUID APPLIED AIR BARRIER W/ VERTICAL METAL PANEL	N/A	N/A			
E5	9-1/8"	5/8" GWB W/ 6" METAL STUD W/ R-19 BATT INSULATION W/ 1/2" EXTERIOR RATED GYPSUM GLASS MAT SHEATHING W/ LIQUID APPLIED AIR BARRIER W/ 2" INSULATED HORIZONTAL CORRUGATED METAL PANEL	R-13	R-7.5			

		SCHEDULE - SLAB ASSEMBLY TYPES		
			MII	N. R-VALUE
MARK	THICKNESS	DESCRIPTION	R	R-CI

SCHEDULE - ROOF TYPES

RA1 STANDING SEAM METAL ROOF PANEL OVER ICE & WATER SHIELD, 2 1/2" POLYISO COMPOSITE PANEL W/ 1/2" HIGH-DENSITY POLYISO COVER BOARD, 4" POLYISO RIGID INSULATION AND 1-1/2" METAL ROOF DECK

RA2 STANDING SEAM METAL ROOF PANEL OVER ICE & WATER SHIELD, 1/2" EXTERIOR RATED GYPSUM GLASS MAT SHEATHING AND 1-1/2" METAL ROOF DECK

1' - 3" 8" REINFORCED CONCRETE SLAB ON GRADE W/ VAPOR BARRIER W/ 1" RIGID INSULATION W/ 6" POROUS GRAVEL FILL

<0aries>4vantessforced concrete slab on grade w/ vapor barrier w/ 4" porous gravel fill

CS3 0' - 7 1/2" 4 1/2" REINFORCED CONCRETE SLAB W/ 3" COMPOSITE METAL DECK



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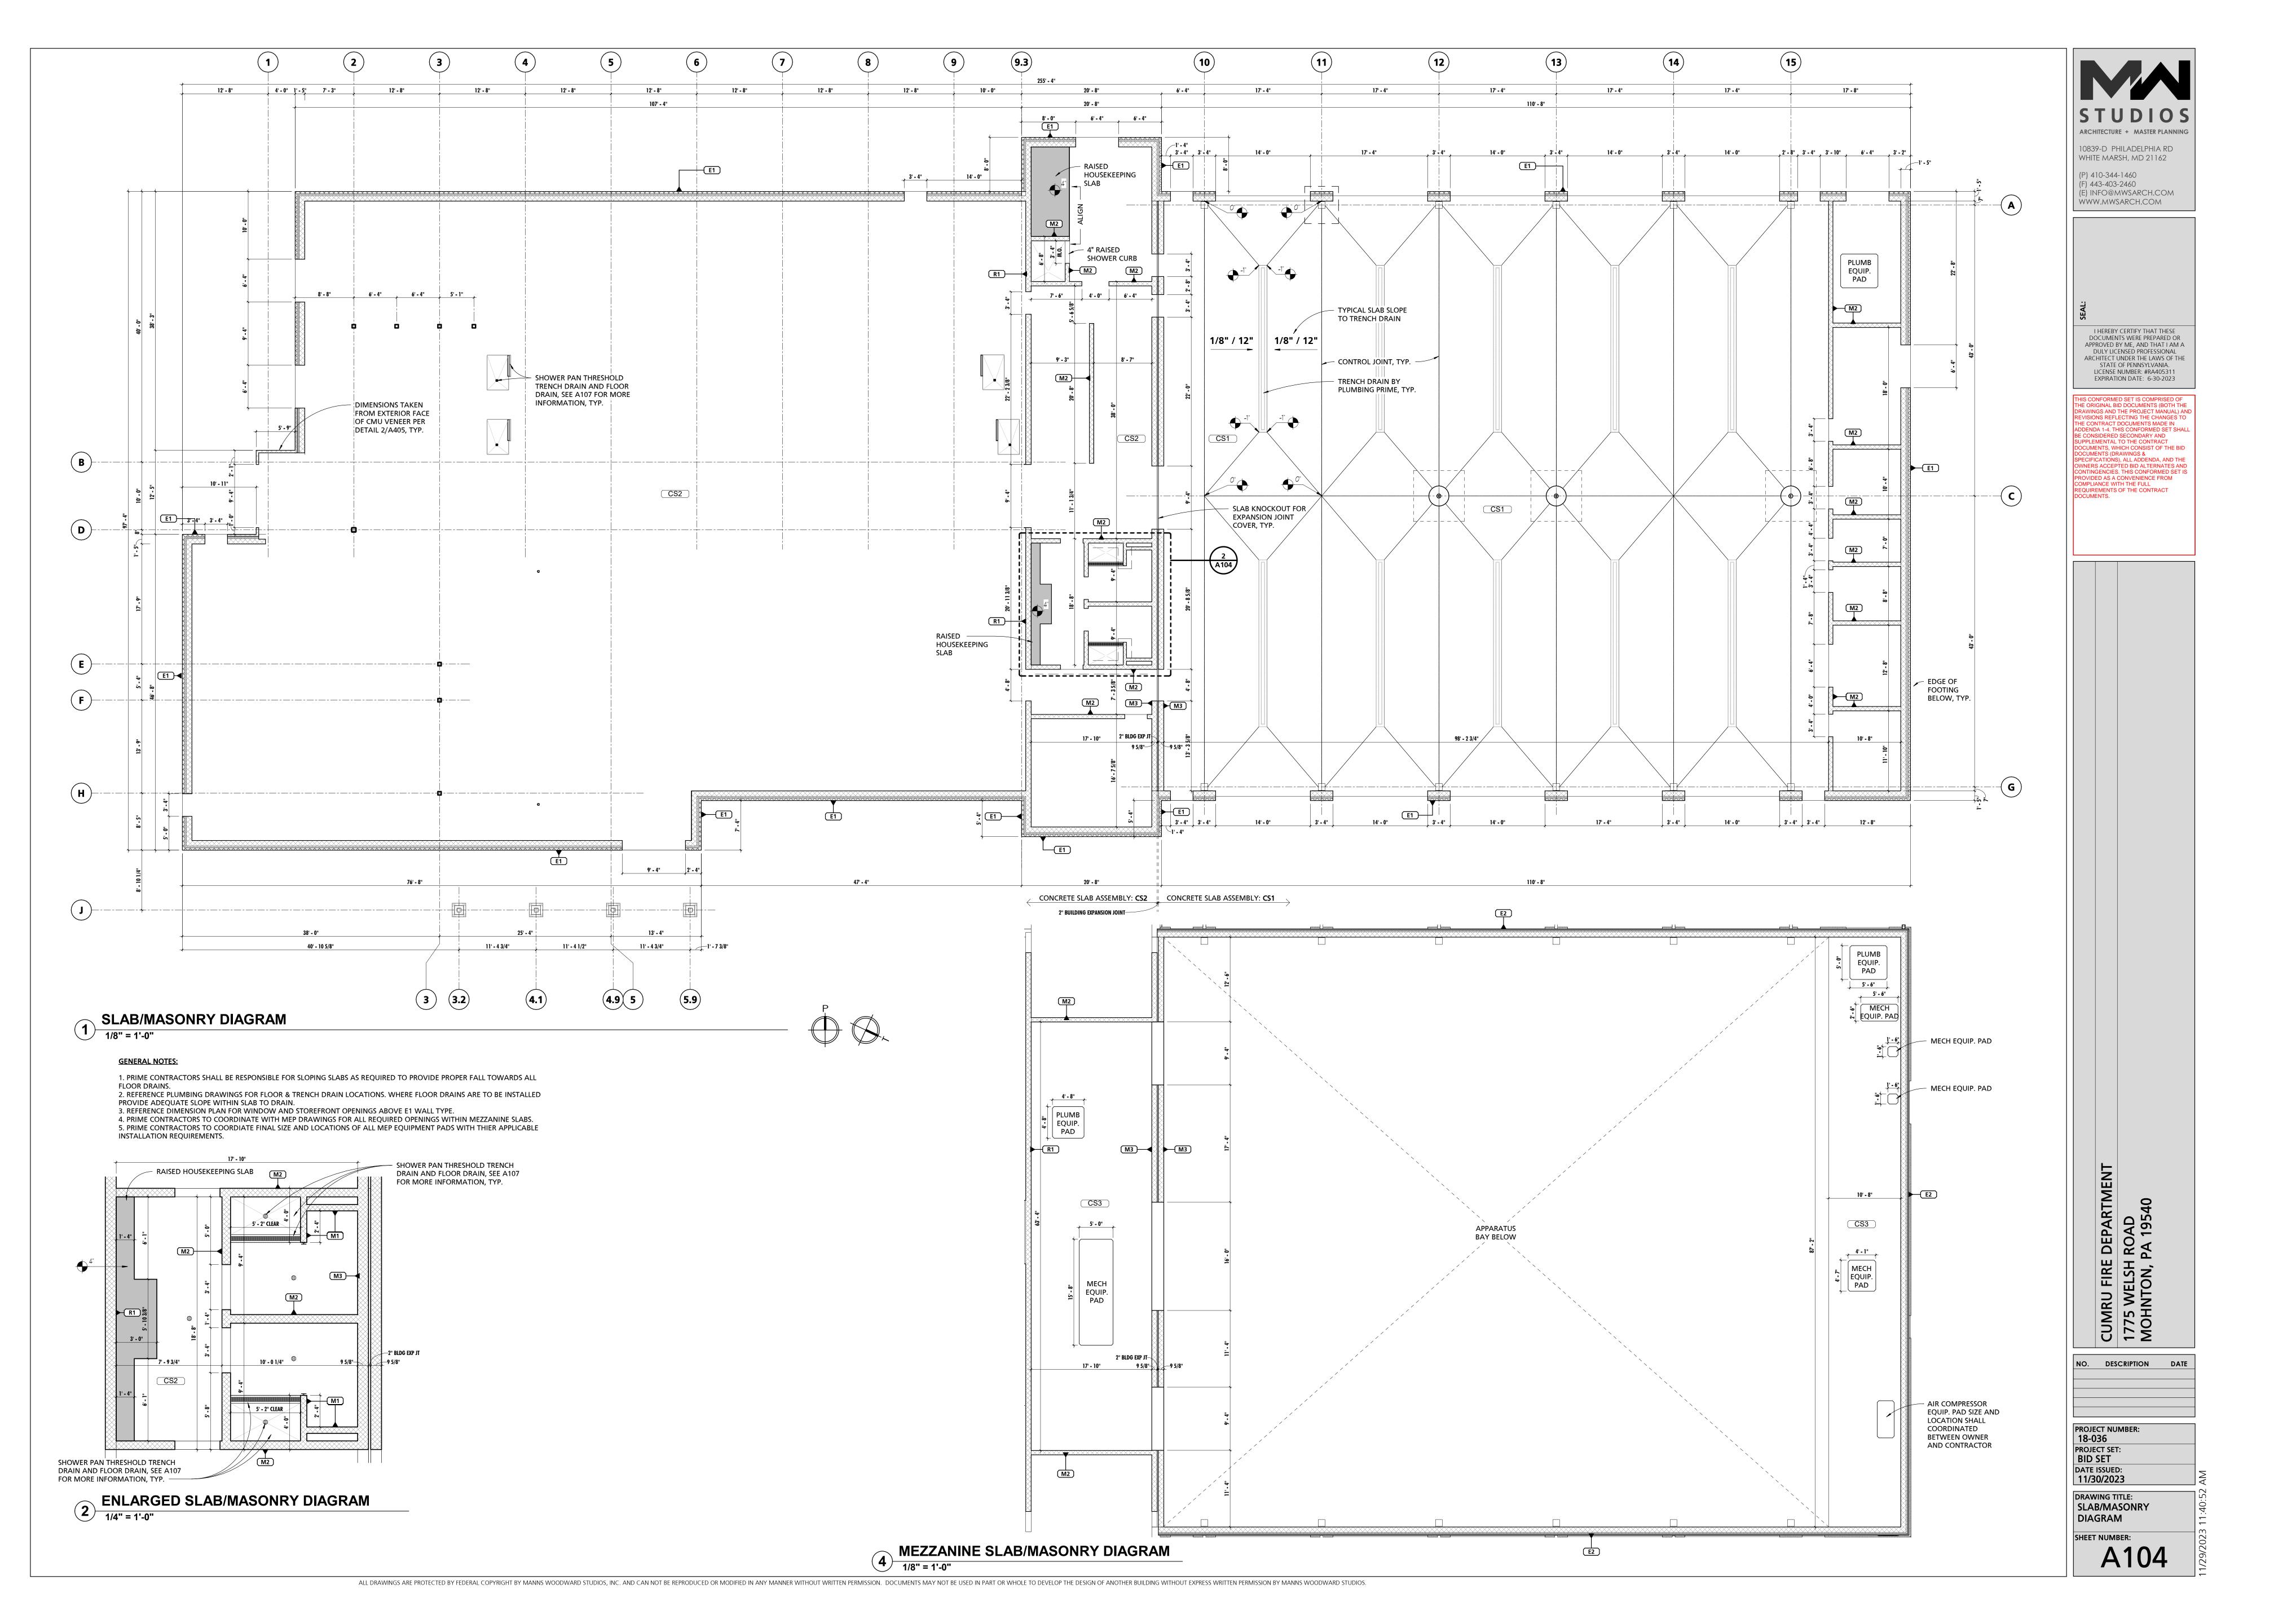
MIN. R-VALUE

R-30

CUMRU FIRE DEPARTMENT 1775 WELSH ROAD MOHNTON, PA 19540

PROJECT NUMBER:
18-036
PROJECT SET:
BID SET
DATE ISSUED:
11/30/2023

DRAWING TITLE:
CONSTRUCTION TYPES






		SCHEDULE - MA	ATERIAL FINISH K	(EY
FINISH MARK	DESCRIPTION	BOD MANUFACTURER	BOD MODEL/PRODUCT LINE	COMMENTS
BT-1	6" x 24" CERAMIC TILE	TILE AMERICA	ATLANTIC STONE	
BT-2	3" x 12" CERAMIC TILE BASE	DALTILE	LINDEN POINT	
BT-3	4" RUBBER BASE	JOHNSONITE	TRADITIONAL RUBBER BASE	
BT-4	6" RUBBER BASE	JOHNSONITE	TRADITIONAL RUBBER BASE	
CG-1	CORNER GUARD	PROTEK SYSTEMS	CG-20R	
CPT-1	24"x24" CARPET TILE	MOHAWK GROUP	963 HERITAGE	
CT-1	6"x24" & 12"x24" CERAMIC TILE	TILE AMERICA	ATLANTIC STONE	6"x24" & 12"x24" STACKED PATTERN - PATTERN B32
CT-2	12"x24" CERAMIC TILE	DALTILE	LINDEN POINT	
CT-3	2"x2" GLAZED CERAMIC MOSAIC	DALTILE	LINDEN POINT	
CT-4	12"x24" CERAMIC WALL TILE	DALTILE	LINDEN POINT	
CT-5	3"x6" CERAMIC SUBWAY WALL TILE	DALTILE	RETROSPACE	
FRP-1	FIBER REINFORCED PANELING	MARLITE	STANDARD FRP	SMOOTH TEXTURE
FRP-2	FIBER REINFORCED PANELING	MARLITE	ARTIZAN	STACKED PATTERN
HPC-1	HIGH PERFORMANCE COATING - COLOR 1	SHERWIN-WILLIAMS	TBD	
HPC-2	HIGH PERFORMANCE COATING - COLOR 2	SHERWIN-WILLIAMS	TBD	<varies></varies>
HPC-3	HIGH PERFORMANCE COATING - COLOR 3	SHERWIN-WILLIAMS	TBD	TYPICAL @ EXPOSED STEEL STRUCTURE, U.N.O.
HPC-4	HIGH PERFORMANCE COATING - COLOR 4	SHERWIN-WILLIAMS	TBD	TYPICAL @ EXPOSED METAL DECK, U.N.O.
LVT-1	LUXURY VINYL TILE	ARMSTRONG	NATURAL CREATIONS	NATURAL CREATIONS WITH DIAMOND 10 TECHNOLOGY
PL-1	PLASTIC LAMINATE	FORMICA	TBD	
PL-2	PLASTIC LAMINATE	FORMICA	TBD	
PT-1	PAINT - COLOR 1	SHERWIN-WILLIAMS	TBD	
RES-1	RESINOUS FLOORING - COLOR 1	BASF	UCRETE HP/F	
RES-2	RESINOUS FLOORING - COLOR 2	BASF	UCRETE HP/F	
RES-3	RESINOUS FLOORING - COLOR 1	BASF	UCRETE RG	RESIN WALL SYSTEM IN SHOWER STALLS 136 & 137
RT-1	RESILIENT ATHETIC FLOORING	JOHNSONITE	REPLAY COMMOTION	
SC-1	SEALED CONCRETE			
SIM-1	SIMULATED STONE	CORIAN	GRANULAR QUARTZ	
SIM-2	SIMULATED STONE	CORIAN	GRANULAR QUARTZ	
SP-1	SOUND PANEL	ARMSTRONG	SOUNDSOAK	
SP-2	SOUND PANEL	KIREI	ECHOPANEL	24mm THICK PANELS
SS-1	SOLID SURFACE COUNTERTOP	CORIAN	DUPONT	
VCT-1	STATIC-DISSIPATIVE VINYL COMPOSITE TILE	ARMSTRONG	EXCELON SDT	SEE SPECIFICATIONS FOR GROUNDING REQUIREMENTS.

TRANSITION ANNOTATIONS

TS) TRANSITION STRIP (EC) EXPANSION JOINT COVER M MARBLE THRESHOLD T ALUMINUM THRESHOLD

REFER TO SHEET (A106) FOR FLOOR TRANSITIONS DETAILS.
REFER TO SHEET (A601) & (A603) FOR INTERIOR AND EXTERIOR ALUMINUM THRESHOLDS.

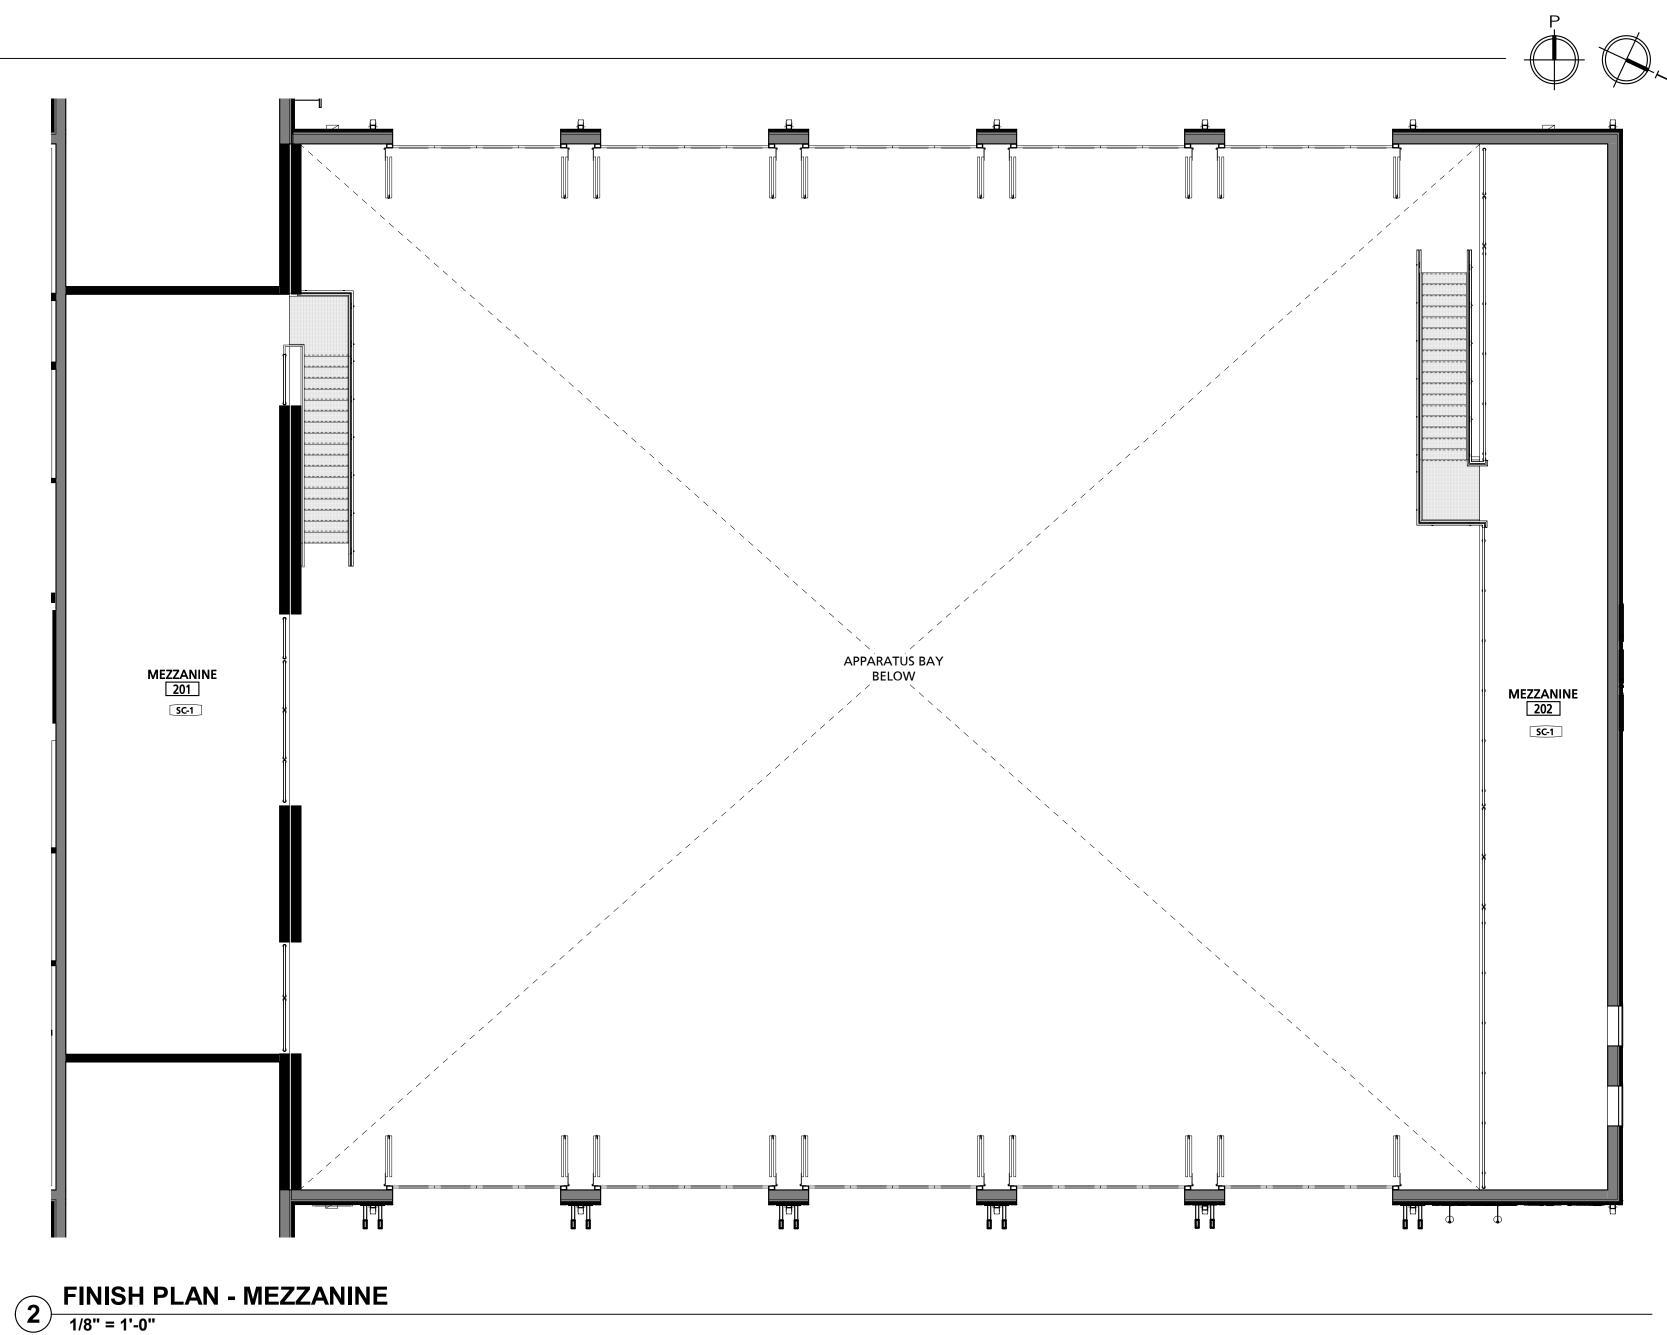

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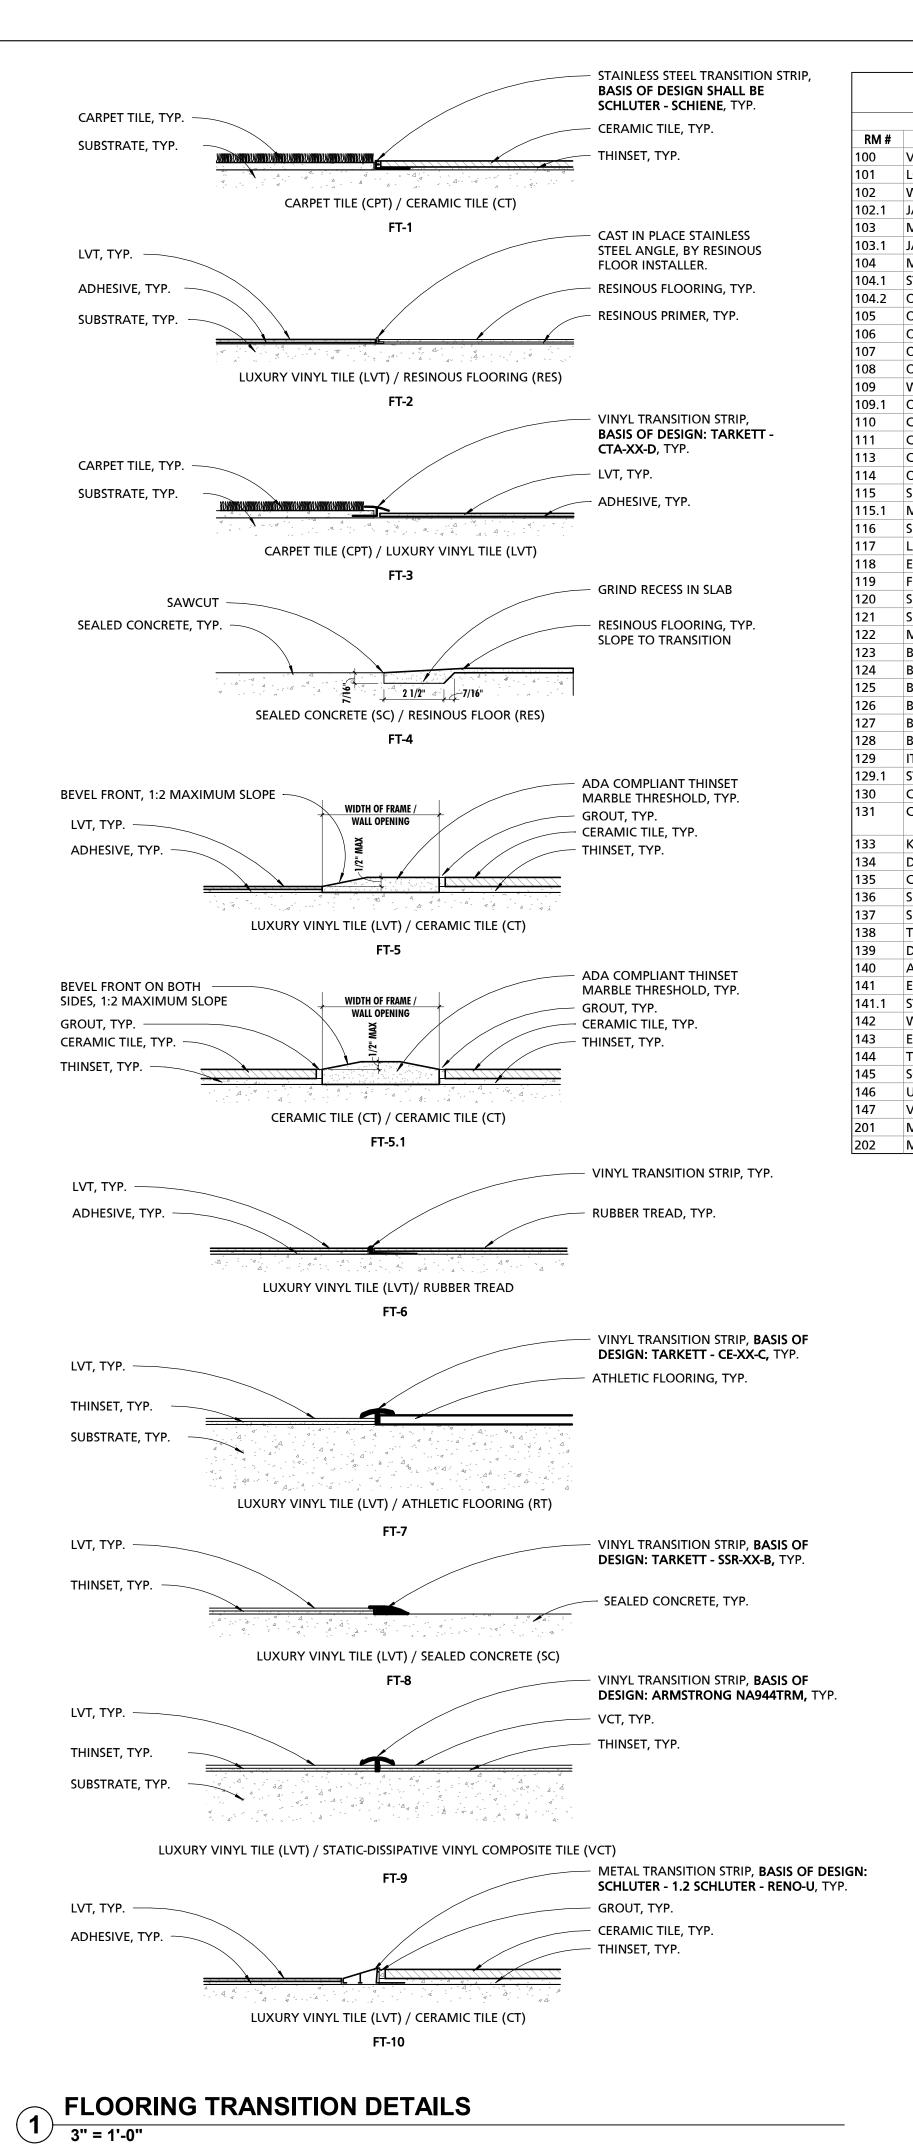
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NO. DESCRIPTION DATE PROJECT NUMBER: 18-036 PROJECT SET: **BID SET** DATE ISSUED: 11/30/2023

DRAWING TITLE:

FINISH PLAN



OUTSIDE

CORNERS

FLOOR COVE & INSIDE WALL CORNER

TILE DETAILS APPLICABLE TO ALL TILE WITHOUT SANITARY BASE OR BULLNOSE TRIM PROFILES

2 TYPICAL TILE EDGE DETAIL
3" = 1'-0"

SCHLUTER QUADEC

CORNER OR EQUAL

TILE, SEE SCHEDULE

SCHLUTER QUADEC CORNER OR EQUAL

EXPOSED TILE EDGES



						SCHEI	DULE - FI	NISHES	
RM#	ROOM INFORMATION ROOM NAME	FLOOR FINISH	BASE	NORTH	WALL SOUTH	FINISH EAST	WEST	CEILING FINISH	REMARKS
100	VESTIBULE	CT-1	BT-1	PT-1	PT-1	PT-1	PT-1	CLG-2	
101	LOBBY	CT-1	BT-1	PT-1	PT-1	PT-1	PT-1	CLG-2/3	
102	WOMEN	CT-1	N/A	CT-1	CT-1/PT-1	CT-1	CT-1	CLG-3	
102.1	JAN	CT-1	BT-1	FRP-1	FRP-1	FRP-1	FRP-1	CLG-3	
103	MEN JAN	CT-1	N/A BT-1	CT-1/PT-1	CT-1 FRP-1	CT-1 FRP-1	CT-1 FRP-1	CLG-3	
103.1 104	MEETING	CPT-1	BT-3	FRP-1 PT-1	PT-1	PT-1	PT-1	CLG-3 CLG-2/3	
104.1	STOR.	CPT-1	BT-3	PT-1	PT-1	PT-1	PT-1	CLG-2/3	
104.1	OFFICE	CPT-1	BT-3	PT-1	PT-1	PT-1	PT-1	CLG-1	
105	OFFICE	CPT-1	BT-3	PT-1	PT-1	PT-1	PT-1	CLG-1	
106	OFFICE	CPT-1	BT-3	PT-1	PT-1	PT-1	PT-1	CLG 1	
107	OFFICE	CPT-1	BT-3	PT-1	PT-1	PT-1	PT-1	CLG-1	
108	OFFICE	CPT-1	BT-3	PT-1	PT-1	PT-1	PT-1	CLG-1	
109	WATCH OFFICE	LVT-1	BT-3	PT-1	PT-1	PT-1	PT-1	CLG-1	
109.1	OFFICE	CPT-1	BT-3	PT-1	PT-1	PT-1	PT-1	CLG-1	
110	CHIEF'S OFFICE	CPT-1	BT-3	PT-1	PT-1	PT-1	PT-1	CLG-1	
111	CONFERENCE	CPT-1	BT-3	PT-1	PT-1	PT-1	PT-1	CLG-2/5	
113	COPY	CPT-1	BT-3	PT-1	PT-1	PT-1	PT-1	CLG-1	
114	OFFICE	CPT-1	BT-3	PT-1	PT-1	PT-1	PT-1	CLG-1	
115	SHOWER	CT-2/CT-3	CT-2	CT-4	CT-4	CT-4	CT-4	CLG-3	
115.1	MECH	SC-1	BT-3	PT-1	PT-1	PT-1	PT-1	CLG-1	
116	SHOWER		CT-2/4	CT-2/4	CT-2/4	CT-2/4	CT-2/4	CLG-3	
117	LAUNDRY	CT-2	BT-2	PT-1	PT-1	PT-1	PT-1	CLG-3	
118	ELEC.	SC-1	BT-3	PT-1	PT-1	PT-1	PT-1	CLG-1	
119	FITNESS	RT-1	BT-3	PT-1	PT-1	PT-1	PT-1	CLG-1	
120	SHOWER		CT-2/4	CT-2/4	CT-2/4	CT-2/4	CT-2/4	CLG-3	
121	SHOWER		CT-2/4 BT-3	CT-2/4	CT-2/4	CT-2/4 PT-1	CT-2/4	CLG-3	
122	MECH BUNK	SC-1 CPT-1	BT-3	PT-1	PT-1 PT-1	PT-1	PT-1 PT-1	CLG-1	
123 124	BUNK	CPT-1	BT-3	PT-1	PT-1	PT-1	PT-1	CLG-1	
125	BUNK	CPT-1	BT-3	PT-1	PT-1	PT-1	PT-1	CLG-1	
126	BUNK	CPT-1	BT-3	PT-1	PT-1	PT-1	PT-1	CLG-1	
127	BUNK	CPT-1	BT-3	PT-1	PT-1	PT-1	PT-1	CLG-1	
128	BUNK	CPT-1	BT-3	PT-1	PT-1	PT-1	PT-1	CLG-1	
129	IT	VCT-1	BT-3	PT-1	PT-1	PT-1	PT-1	CLG-1	
129.1	STOR.	SC-1	BT-3	PT-1	PT-1	PT-1	PT-1	CLG-1	
130	CORRIDOR	LVT-1	BT-3	PT-1	PT-1	PT-1	PT-1	CLG-1/3	
131	CORRIDOR	LVT-1	BT-3	PT-1/SP-1/2	PT-1/SP-1/2	PT-1	PT-1	CLG-1/3/4	ALL EXPOSED STEEL TO RECEIVE HPC-3 PAINT. ALL EXPOSED METAL DECK TO RECEIVE HPC-4 PAINT. RECESSED 1x4 STAINED MAPLE HARDWOOD BASE AT ALCOVE BENCH
133	KITCHEN	LVT-1	BT-3	PT-1/CT-5/FRP-2	PT-1	PT-1/FRP-2	PT-1/FRP-2	CLG-3/4	ALL EXPOSED STEEL TO RECEIVE HPC-3 PAINT. FRP-2 ONLY APPLIES AT KITCHEN ISLAND
134	DAY ROOM	CPT-1	BT-3/4	PT-1	PT-1	PT-1	PT-1	CLG-1	
135	CLEAN ROOM	RES-1	N/A	HPC-1	HPC-1	HPC-1	HPC-1	CLG-8	
136	SHOWER	RES-1	N/A	HPC-1/RES-3	HPC-1	HPC-1/RES-3	HPC-1/RES-3	CLG-8	
137	SHOWER	RES-1	N/A	HPC-1	HPC-1/RES-3	HPC-1/RES-3	HPC-1/RES-3	CLG-8	
138	TURNOUT GEAR	RES-1	N/A	HPC-1	HPC-1	HPC-1	HPC-1	CLG-7	ALL EXPOSED METAL DECK TO RECEIVE HPC-4 PAINT.
139	DECON	RES-1	N/A	HPC-1	HPC-1	HPC-1	HPC-1	CLG-7	ALL EXPOSED METAL DECK TO RECEIVE HPC-4 PAINT. SHOWER TO RECEIVE 4" RESINOUS COVE BASE.
140	APPARATUS BAY	RES-1/2	N/A	HPC-1/2	HPC-1/2	HPC-1/2	HPC-1/2	CLG-7	ALL EXPOSED STEEL TO RECEIVE HPC-3 PAINT. ALL EXPOSED METAL DECK TO RECEIVE HPC-4 PAINT.
141	ELEC.	RES-1	N/A	HPC-1	HPC-1	HPC-1	HPC-1	CLG-7	ALL EXPOSED STEEL TO RECEIVE HPC-3 PAINT. ALL EXPOSED METAL DECK TO RECEIVE HPC-4 PAINT.
141.1	STORAGE	RES-1	N/A	HPC-1	HPC-1	HPC-1	HPC-1	CLG-7	ALL EXPOSED STEEL TO RECEIVE HPC-3 PAINT. ALL EXPOSED METAL DECK TO RECEIVE HPC-4 PAINT.
142	WORKSHOP	RES-1	N/A	HPC-1	HPC-1	HPC-1	HPC-1	CLG-7	ALL EXPOSED STEEL TO RECEIVE HPC-3 PAINT. ALL EXPOSED METAL DECK TO RECEIVE HPC-4 PAINT.
143	ENGINEER	RES-1	N/A	HPC-1	HPC-1	HPC-1	HPC-1	CLG-7	ALL EXPOSED STEEL TO RECEIVE HPC-3 PAINT. ALL EXPOSED METAL DECK TO RECEIVE HPC-4 PAINT.
144 145	TOILET SCBA	RES-1	N/A N/A	H.P.C1 HPC-1	HPC-1	HPC-1	HPC-1	CLG-8 CLG-7	ALL EXPOSED STEEL TO RECEIVE HPC-3 PAINT. ALL EXPOSED METAL DECK TO RECEIVE HPC-4 PAINT.
146	UTILITY	SC-1	N/A N/A	HPC-1	HPC-1	HPC-1	HPC-1	CLG-7	ALL EXPOSED STEEL TO RECEIVE HPC-3 PAINT. ALL EXPOSED METAL DECK TO RECEIVE HPC-4 PAINT. ALL EXPOSED STEEL TO RECEIVE HPC-3 PAINT. ALL EXPOSED METAL DECK TO RECEIVE HPC-4 PAINT.
146	VESTIBULE	RES-1	N/A N/A	HPC-1	HPC-1	HPC-1	HPC-1	CLG-7 CLG-1	ALL LAPOSED STEEL TO RECEIVE HPC-3 PAINT. ALL EAPOSED WIETAL DECK TO RECEIVE HPC-4 PAINT.
201	MEZZANINE	SC-1	N/A	HPC-1	HPC-1	HPC-1	HPC-1	CLG-1	ALL EXPOSED STEEL TO RECEIVE HPC-3 PAINT. ALL EXPOSED METAL DECK TO RECEIVE HPC-4 PAINT.
202	MEZZANINE	SC-1	N/A	HPC-1	HPC-1	HPC-1	HPC-1	CLG-7	ALL EXPOSED STEEL TO RECEIVE HPC-3 PAINT. ALL EXPOSED METAL DECK TO RECEIVE HPC-4 PAINT. ALL EXPOSED STEEL TO RECEIVE HPC-3 PAINT. ALL EXPOSED METAL DECK TO RECEIVE HPC-4 PAINT.
	1716 <i>667</i> 3141146	ا حرد ا	14/7	I II S I	Jin C-1	i ii ⊆ i	1111 5-1	CEO-/	THE ENTOSED STEEL TO RECEIVE THE COTTAINST. ALE ENTOSED WILLIAE DECK TO RECEIVE TIFE TAINST.

FINISH				
MARK	DESCRIPTION	BOD MANUFACTURER	BOD MODEL/PRODUCT LINE	COMMENTS
BT-1	6" x 24" CERAMIC TILE	TILE AMERICA	ATLANTIC STONE	
BT-2	3" x 12" CERAMIC TILE BASE	DALTILE	LINDEN POINT	
BT-3	4" RUBBER BASE	JOHNSONITE	TRADITIONAL RUBBER BASE	
BT-4	6" RUBBER BASE	JOHNSONITE	TRADITIONAL RUBBER BASE	
CG-1	CORNER GUARD	PROTEK SYSTEMS	CG-20R	
CPT-1	24"x24" CARPET TILE	MOHAWK GROUP	963 HERITAGE	
CT-1	6"x24" & 12"x24" CERAMIC TILE	TILE AMERICA	ATLANTIC STONE	6"x24" & 12"x24" STACKED PATTERN - PATTERN B32
CT-2	12"x24" CERAMIC TILE	DALTILE	LINDEN POINT	
CT-3	2"x2" GLAZED CERAMIC MOSAIC	DALTILE	LINDEN POINT	
CT-4	12"x24" CERAMIC WALL TILE	DALTILE	LINDEN POINT	
CT-5	3"x6" CERAMIC SUBWAY WALL TILE	DALTILE	RETROSPACE	
FRP-1	FIBER REINFORCED PANELING	MARLITE	STANDARD FRP	SMOOTH TEXTURE
FRP-2	FIBER REINFORCED PANELING	MARLITE	ARTIZAN	STACKED PATTERN
HPC-1	HIGH PERFORMANCE COATING - COLOR 1	SHERWIN-WILLIAMS	TBD	
HPC-2	HIGH PERFORMANCE COATING - COLOR 2	SHERWIN-WILLIAMS	TBD	<varies></varies>
HPC-3	HIGH PERFORMANCE COATING - COLOR 3	SHERWIN-WILLIAMS	TBD	TYPICAL @ EXPOSED STEEL STRUCTURE, U.N.O.
HPC-4	HIGH PERFORMANCE COATING - COLOR 4	SHERWIN-WILLIAMS	TBD	TYPICAL @ EXPOSED METAL DECK, U.N.O.
LVT-1	LUXURY VINYL TILE	ARMSTRONG	NATURAL CREATIONS	NATURAL CREATIONS WITH DIAMOND 10 TECHNOLOG
PL-1	PLASTIC LAMINATE	FORMICA	TBD	
PL-2	PLASTIC LAMINATE	FORMICA	TBD	
PT-1	PAINT - COLOR 1	SHERWIN-WILLIAMS	TBD	
RES-1	RESINOUS FLOORING - COLOR 1	BASF	UCRETE HP/F	
RES-2	RESINOUS FLOORING - COLOR 2	BASF	UCRETE HP/F	
RES-3	RESINOUS FLOORING - COLOR 1	BASF	UCRETE RG	RESIN WALL SYSTEM IN SHOWER STALLS 136 & 137
RT-1	RESILIENT ATHETIC FLOORING	JOHNSONITE	REPLAY COMMOTION	
SC-1	SEALED CONCRETE			
SIM-1	SIMULATED STONE	CORIAN	GRANULAR QUARTZ	
SIM-2	SIMULATED STONE	CORIAN	GRANULAR QUARTZ	
SP-1	SOUND PANEL	ARMSTRONG	SOUNDSOAK	
SP-2	SOUND PANEL	KIREI	ECHOPANEL	24mm THICK PANELS
SS-1	SOLID SURFACE COUNTERTOP	CORIAN	DUPONT	
VCT-1	STATIC-DISSIPATIVE VINYL COMPOSITE TILE	ARMSTRONG	EXCELON SDT	SEE SPECIFICATIONS FOR GROUNDING REQUIREMENTS.

	SC	CHEDULE - CE	ILING TYPES	
MARK	DESCRIPTION	BOD MANUFACTURER	BOD MODEL	COMMENTS
CLG-1	2x2 ACOUSTICAL CEILING TILE	ARMSTRONG	ULTIMA SQUARE LAY-IN 1940	
CLG-2	2X2 ARCHITECTURAL METAL CEILING TILE	USG	PANZ	
CLG-3	5/8" GYPSUM BOARD CEILING	USG	ENSEMBLE ACOUSTICAL DRYWALL CEILING	
CLG-4	6"x96" FAUX PLANK METAL CEILING	ARMSTRONG	METALWORKS-LINEAR	PROVIDE 6" AXIOM VECTOR STRAIGHT TRIMAROUND ENTIRE PERIMETER.
CLG-5	4"x96" FAUX PLANK METAL CEILING	ARMSTRONG	METALWORKS-LINEAR-SYNCHRO	
CLG-6	HALF VENTED METAL SOFFIT	PAC-CLAD	PAC-750	
CLG-7	PAINTED EXPOSED METAL DECK	TBD	TBD	
CLG-8	2x2 ACOUSTICAL CEILING TILE	ARMSTRONG	OPTIMA HEALTH ZONE	

- STEEL COLUMN, TYP.

- FILL GAP AT MITERED

CORNERS WITH BONDO, TYP.

3"x6"x3/8" STEEL ANGLE COLUMN

BASE COVER W/ HPC-3 PAINT, SHOP

FABRICATE FOR TIGHT SLIP-FIT AND

SHOP INSTALL LOOSE ON COLUMN,

SLAB IS IN PLACE, GRIND AWAY ANY

THEN PLUG WELD TO COLUMN

AFTER STEEL ERECTION & FLOOR


WELD SPLATTER AND FINISH ALL

RECEIVING HPC-3 PAINT., TYP.

1/4" DIA. PRE-DRILLED


HOLE 2" O.C., TYP.

SIDES WITH WIRE BRUSH PRIOR TO

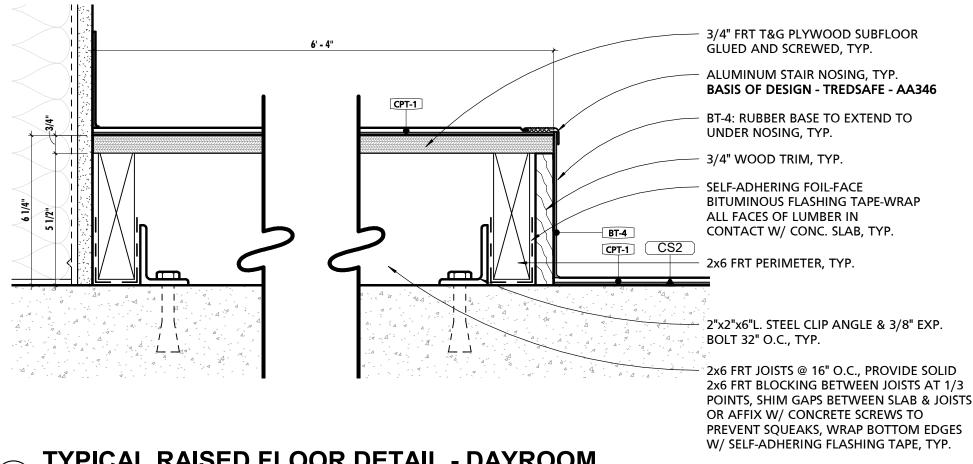


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CORRIDOR 131 TYPICAL COLUMN BASE DETAIL

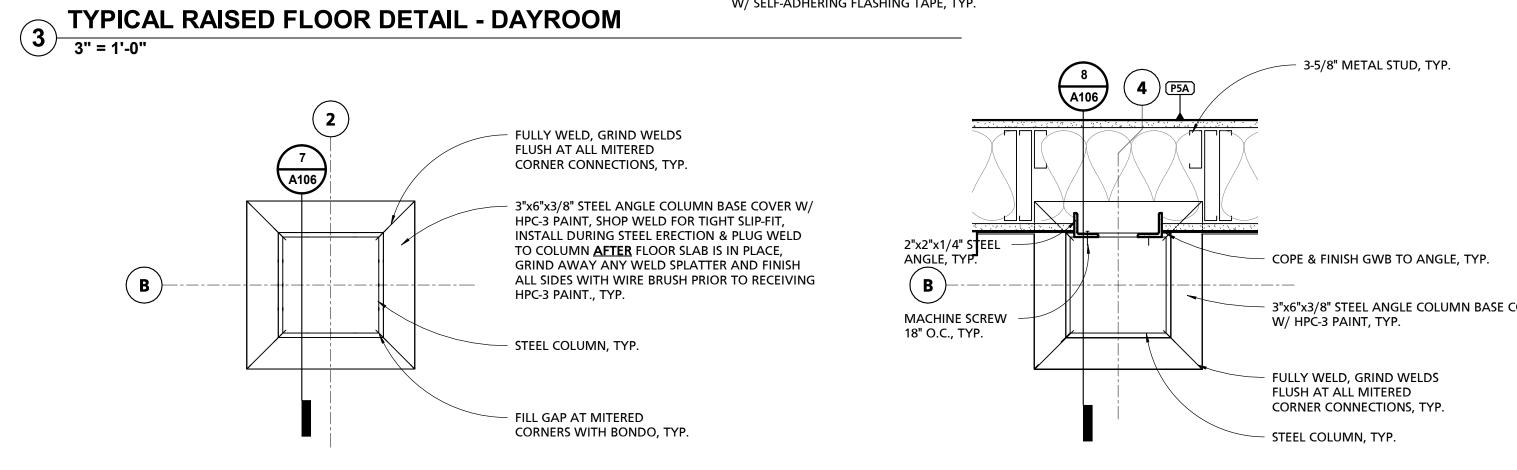


CORRIDOR 131 TYPICAL COLUMN BASE DETAIL

	COLUMN BASE COVER AXON	
ТҮР.	8 1 E3	
NGLE, TYP.	E3	 MACHINE SCREW 18" O.C., TYP. 2"x2"x1/4" STEEL ANGLE, TYP.
OLUMN BASE COVER		— COPE & FINISH GWB TO ANGLE, TYP
	B	
YP.		 FULLY WELD, GRIND WELDS FLUSH AT ALL MITERED CORNER CONNECTIONS, TYP.
		— STEEL COLUMN, TYP.



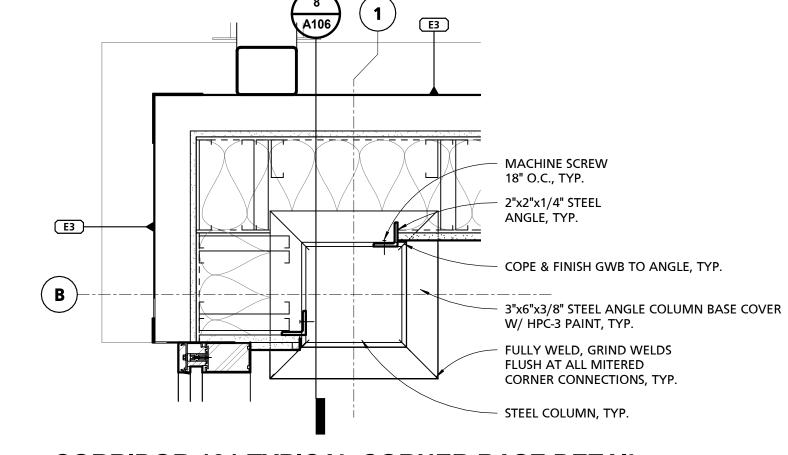

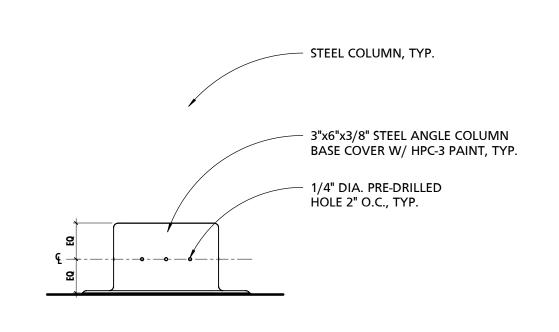

	COLUMN BASE COVER FRONT ELEVATION	
\mathcal{F}	1 1/2" = 1' 0"	_

	B 3"x6"x3/8" STEEL ANGLE COLUMN BASE COVER W/ HPC-3 PAINT, TYP.	2"x2"x1/4" STEEL ANGLE,	STEEL COLUMN, TYP.
	CONT. BEAD OF SEALANT, TYP.	COPE AROUND STEEL BASE COVER AND WELD COPED SECTION AND GRIND SMOOTH PRIOR TO RECEIVING HPC-3 PAINT, TYP.	3"x6"x3/8" STEEL ANGLE COLUMN BASE COVER W/ HPC-3 PAINT, TYP.
CS2 °	CONTINUOUS ISOLATION MATERIAL W/ SEALANT, TYP.	MACHINE SCREW 18" O.C., TYP.	CONTINUOUS ISOLATION MATERIAL W/ SEALANT, TYP.
	FIRST FLOOR 0' - 0"	72n- 4 4 4 4 4 4 4 4 4 4 4 4 4 4 4 4 4 4 4	FIRST FLOOR 0' - 0"

	CUMRU F	1775 WEI MOHNTC		
10.	DES	CRIPTION	DATE	
ROJE 18-0	CT NU	MBER:]
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ATE	ISSUED 8 <mark>0/20</mark> 2			2
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HEET	NUMI	BER:		200
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ARCHITECTURE + MASTER PLANNING

10839-D PHILADELPHIA RD

(E) INFO@MWSARCH.COM WWW.MWSARCH.COM

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EXPIRATION DATE: 6-30-2023

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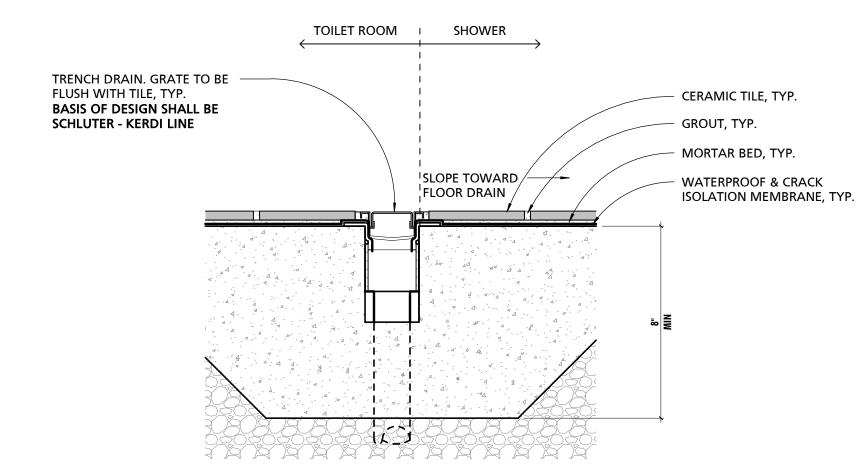
PROVIDED AS A CONVENIENCE FROM COMPLIANCE WITH THE FULL

REQUIREMENTS OF THE CONTRACT DOCUMENTS.


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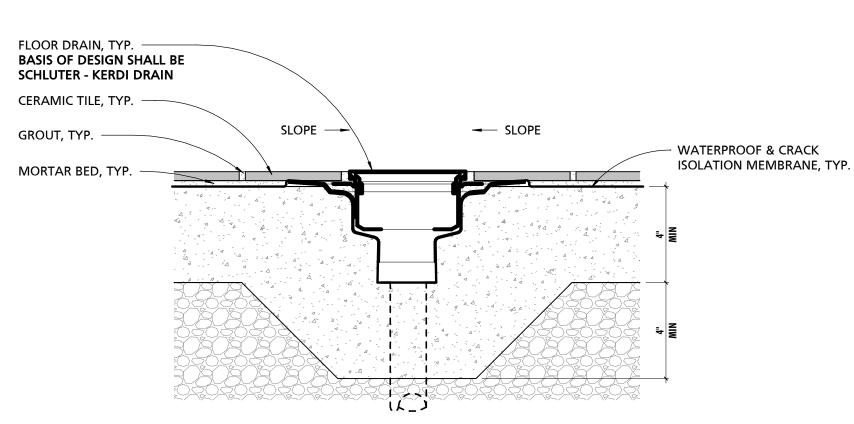
TYPICAL RESINOUS SHOWER SECTION DETAIL 3/4" = 1'-0"




4 TYPICAL TILE SHOWER TRENCH DRAIN
3" = 1'-0"



TYPICAL RESINOUS SHOWER TRENCH DRAIN

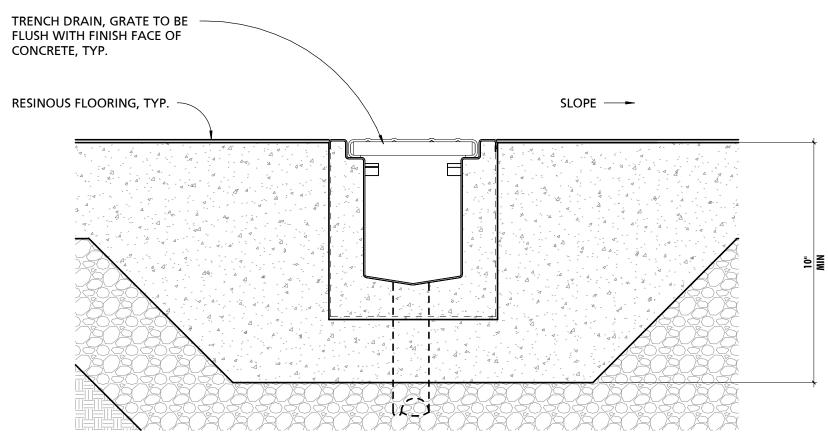


5 TYPICAL TILE SHOWER FLOOR DRAIN
3" = 1'-0"

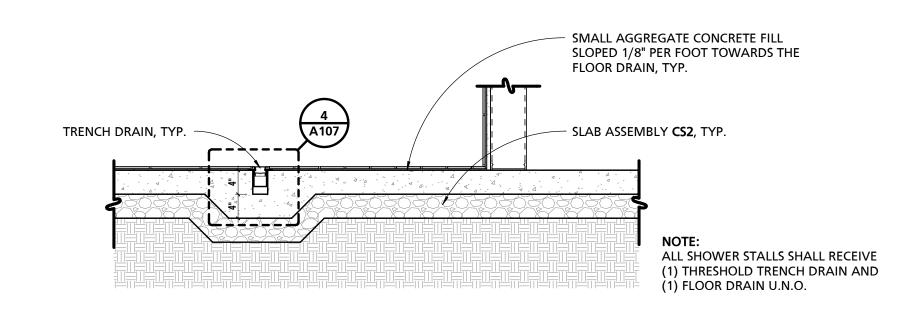

TYPICAL TILE SHOWER SECTION DETAIL

3/4" = 1'-0"

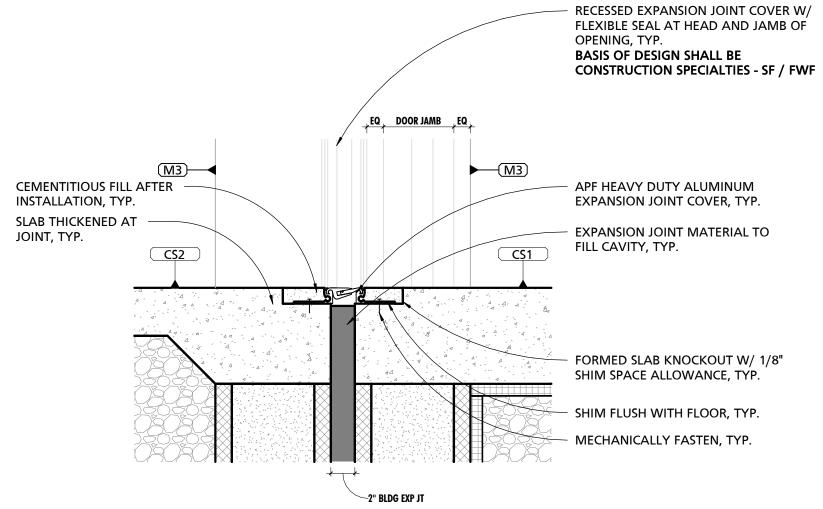

6 TYPICAL FLOOR EXPANSION JOINT COVER

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NO. DESCRIPTION DATE

PROJECT NUMBER: 18-036 PROJECT SET: **BID SET** DATE ISSUED:

11/30/2023 DRAWING TITLE: FINISH DETAILS

SHEET NUMBER: ALL DRAWINGS ARE PROTECTED BY FEDERAL COPYRIGHT BY MANNS WOODWARD STUDIOS, INC. AND CAN NOT BE REPRODUCED OR MODIFIED IN ANY MANNER WITHOUT WRITTEN PERMISSION. DOCUMENTS MAY NOT BE USED IN PART OR WHOLE TO DEVELOP THE DESIGN OF ANOTHER BUILDING WITHOUT EXPRESS WRITTEN PERMISSION BY MANNS WOODWARD STUDIOS.




SCHEDULE ABBREVIATIONS:
O.P.O.I. - OWNER PROVIDED; OWNER INSTALLED O.P.C.I - OWNER PROVIDED; CONTRACTOR INSTALLED C.P.C.I. - CONTRACTOR PROVIDED; CONTRACTOR INSTALLED

GENERAL NOTES:

1. THE PURPOSE OF THIS PLAN IS TO BE SUPPLEMENTARY IN NATURE TO ALREADY SPECIFIED COMPONENTS THAT REQUIRE BLOCKING TO BE SELF SUPPORTING.


2. BLOCKING SHALL STILL BE INCLUDED FOR ALL OTHER NECESSARY FIXTURES THAT MAY NOT BE ILLUSTRATED WITHIN THIS PLAN. FIXTURES INCLUDED BUT ARE NOT LIMITED TO CASEWORK, TOILET ACCESSORIES, RAILINGS, PLUMBING FIXTURES, ELECTRICAL FIXTURES, MECHANICAL COMPONENTS, COUNTERTOPS, AND ALL OTHER ITEMS THAT ARE REQUIRED TO BE SELF SUPPORTING.

3. 1a GENERAL PRIME CONTRACTOR TO COORDINATE LOCATIONS OF BLOCKING WITH ALL ELECTRICAL, MECHANICAL, AND PLUMBING COMPONENTS THAT SHARE WALL SPACE WITHIN PROXIMITY TO REQUIRED BLOCKING.

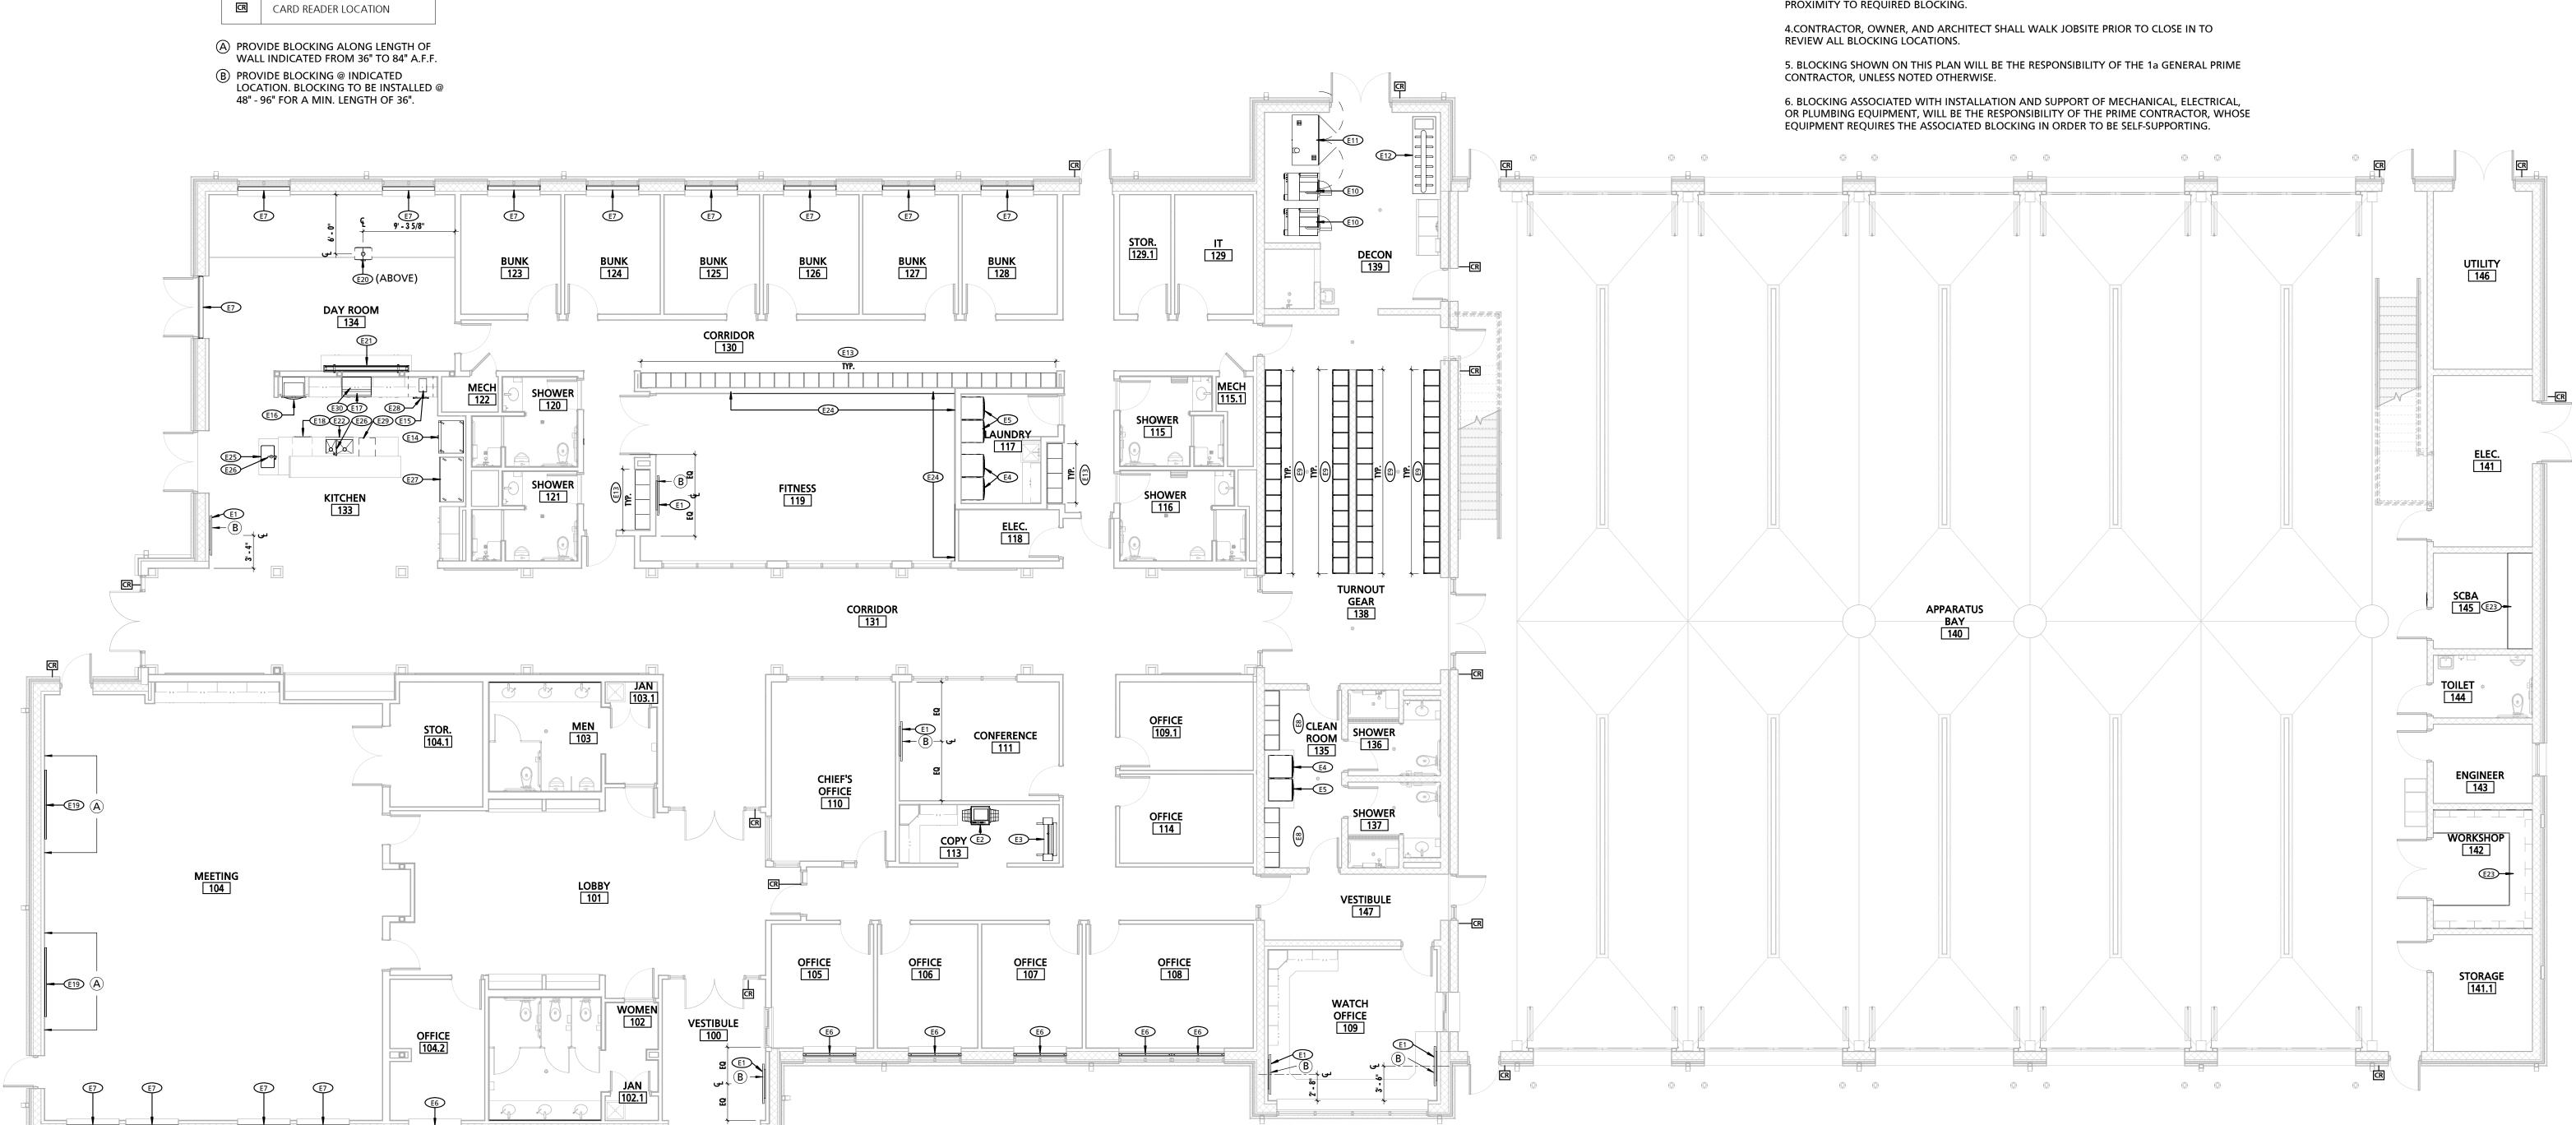

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EQUIPMENT LEGEND

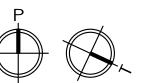

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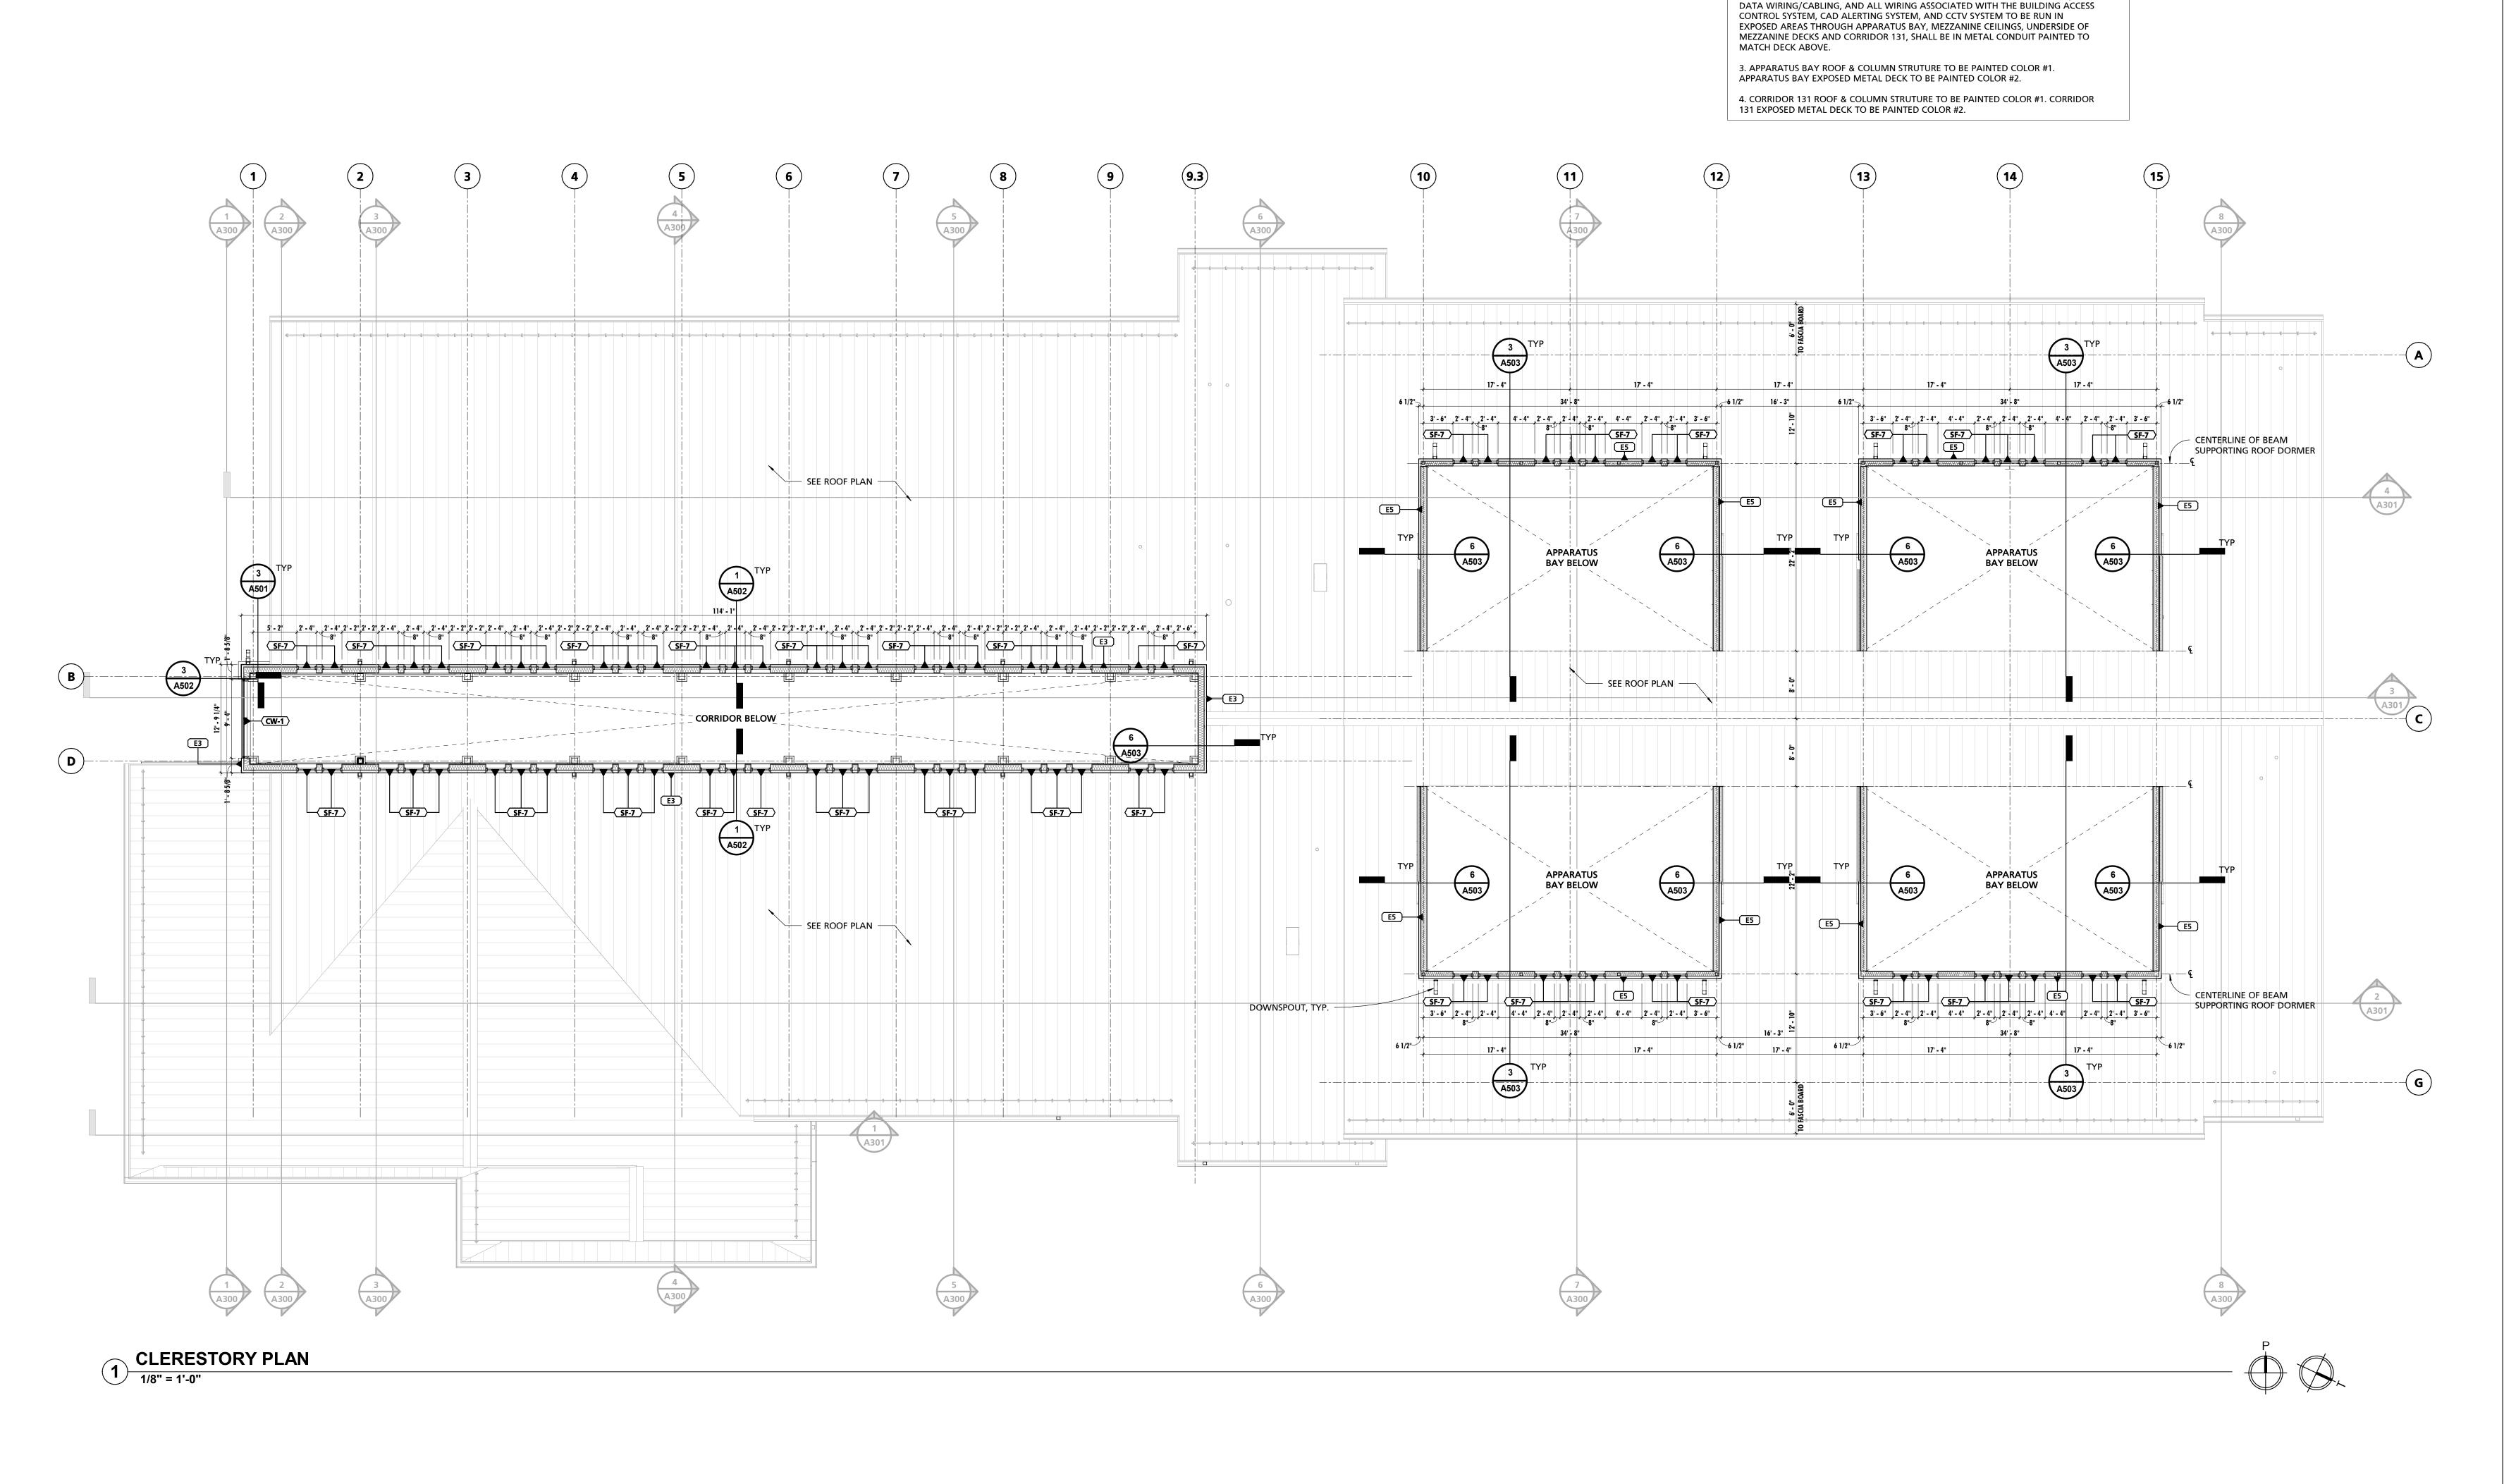
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DESCRIPTION

PROJECT SET: BID SET DATE ISSUED:

11/30/2023 **EQUIPMENT & BLOCKING**



GENERAL NOTES

WITHIN CORRIDOR 131'S AREA.

1. ALL EXPOSED UTILITIES, INCLUDING BUT NOT LIMITED TO, PIPES, DUCTS,

CONDUITS, WORK BOXES, DEVICES, AND ALL OTHER ASSOCIATED UTILITY ITEMS MOUNTED WITHIN CORRIDOR 131'S CEILING SHALL BE PAINTED TO MATCH CEILING

OR HAVE A MATCHING FACTORY FINISH. MECHANICAL, PLUMBING, ELECTRICAL, AND GENERAL CONTRACTORS SHALL PROVIDE COORDINATED SHOP DRAWINGS OF ALL

MEP RELATED ITEMS AND ASSOCIATED MOUNTING HEIGHTS THAT ARE TO OCCUR

2. ELECTRICAL PRIME TO PROVIDE ALL ELECTRICAL WIRING INCLUDING TO BUT NOT

LIMITED TO, GENERAL POWER SUPPLIES, LOW VOLTAGE COMMUNICATIONS, A/V,



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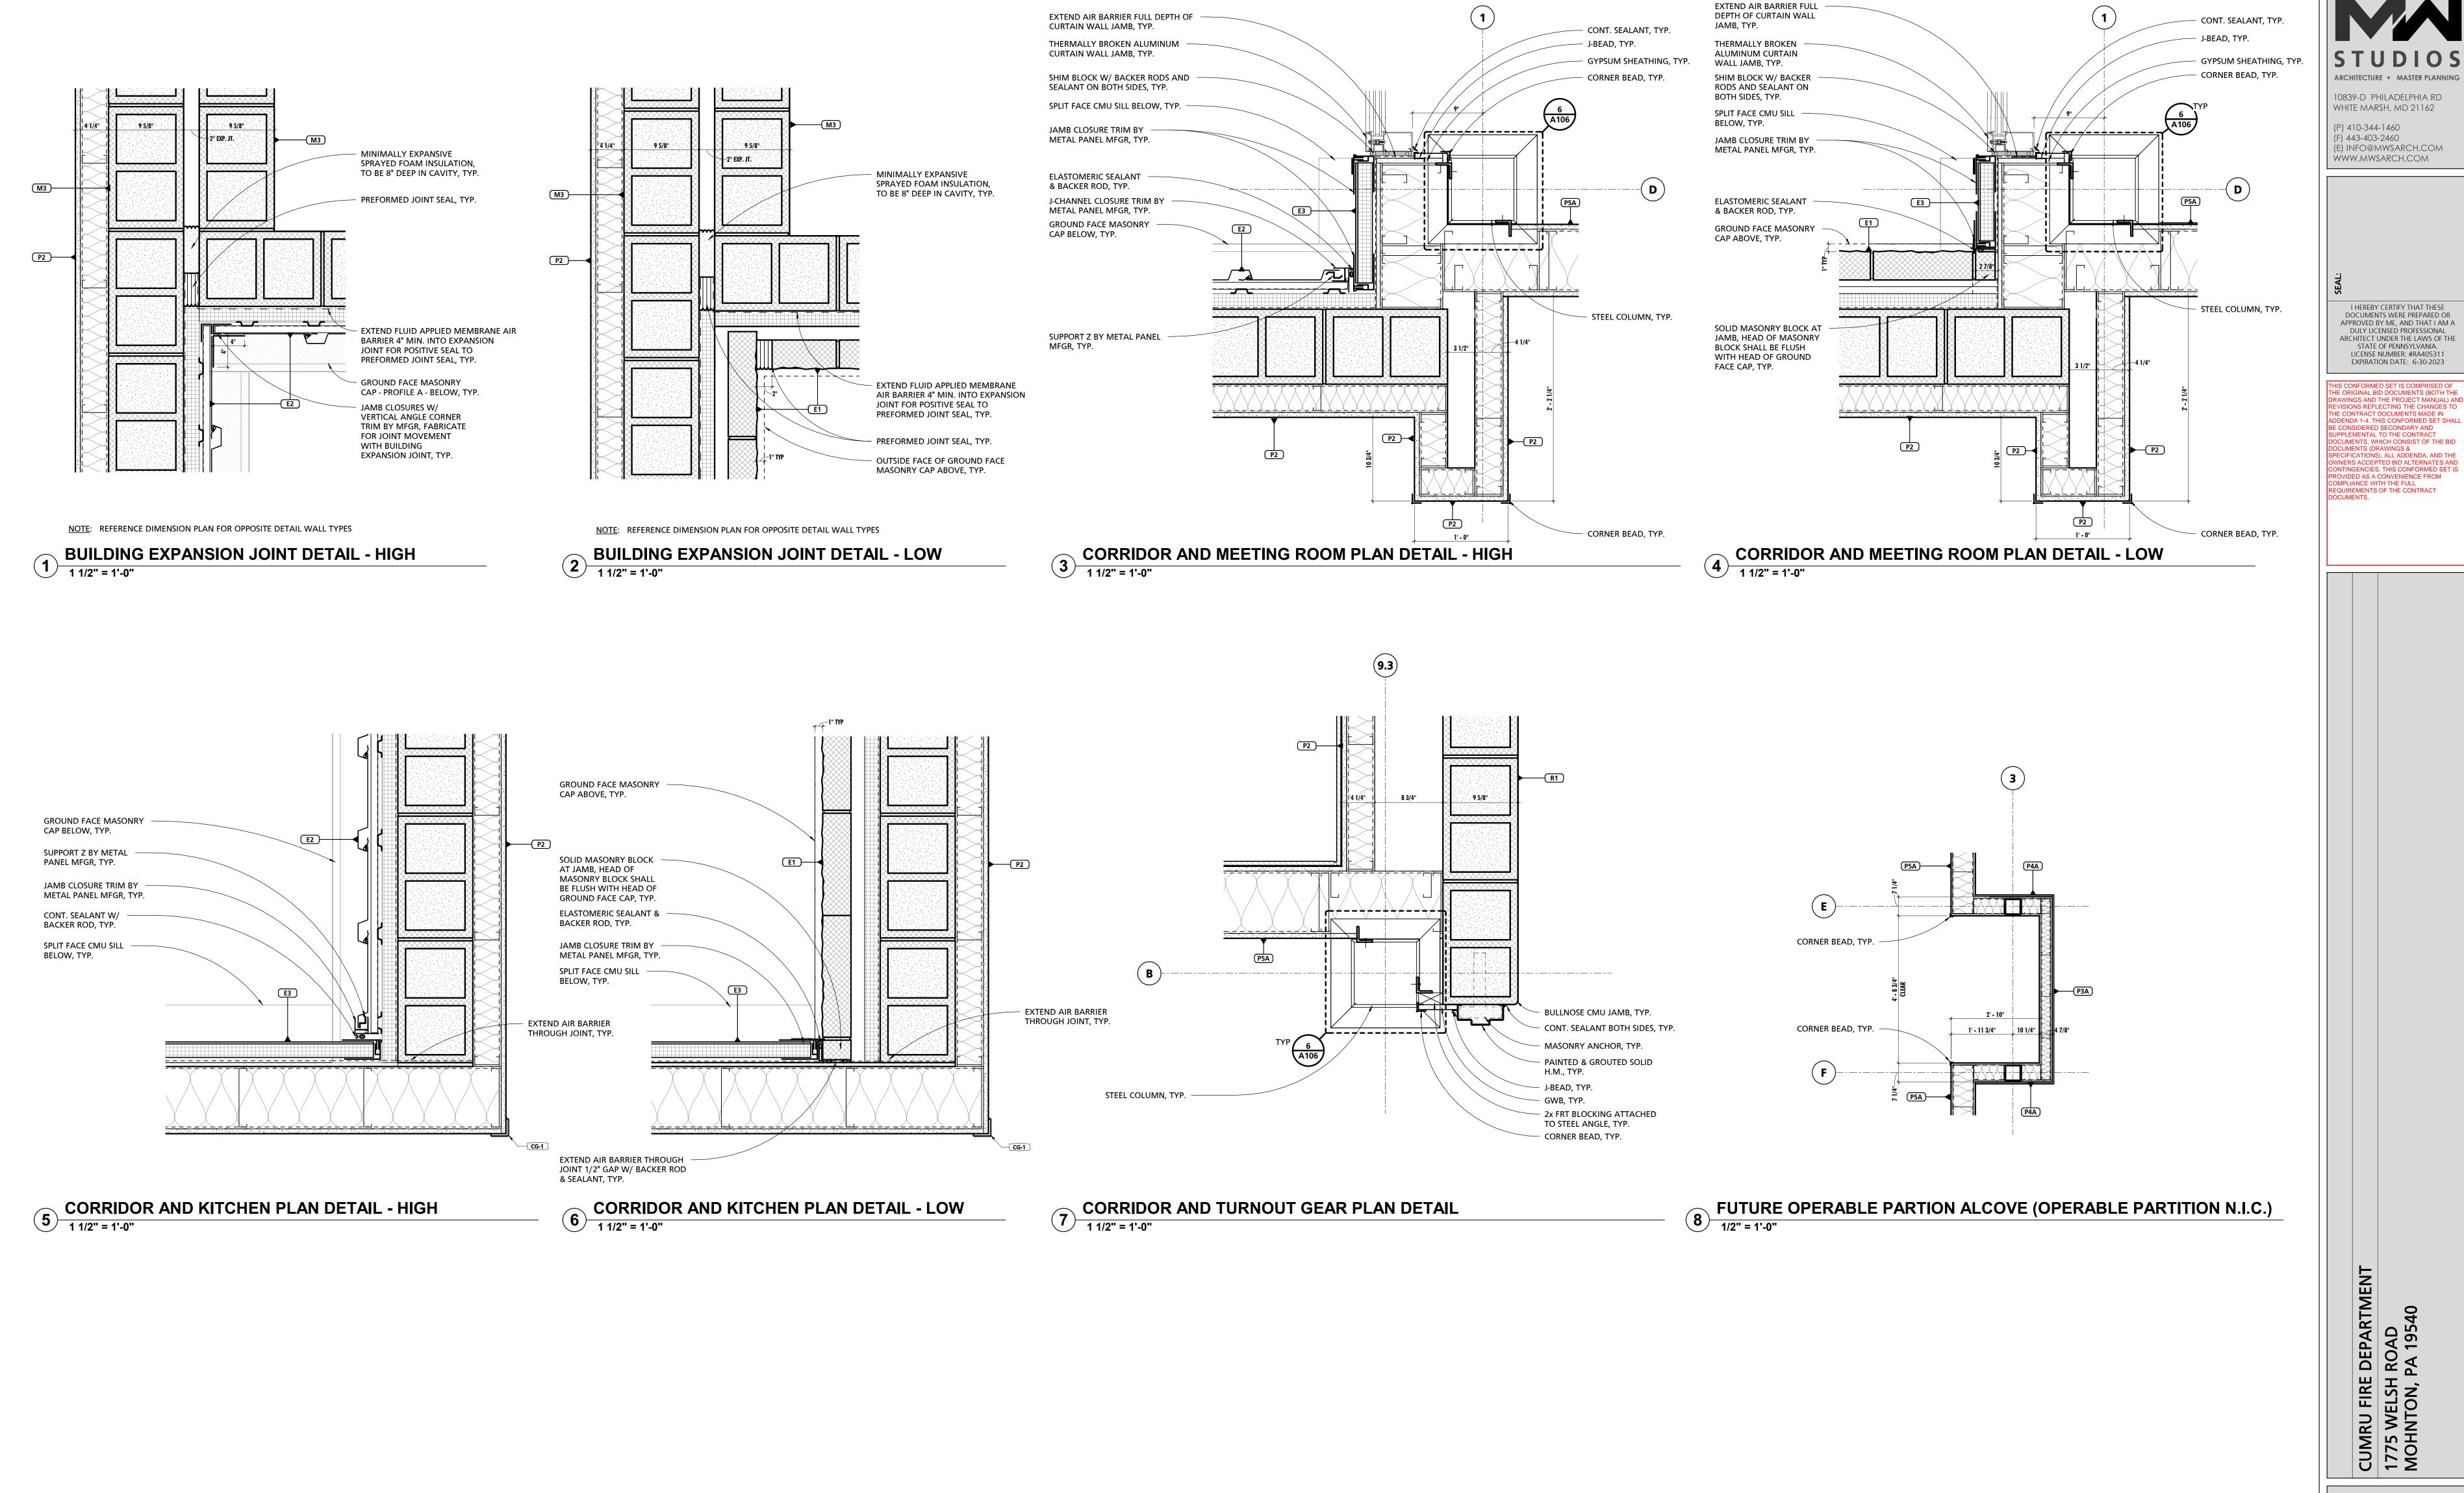
DESCRIPTION DATE

PROJECT NUMBER: 18-036 PROJECT SET:

BID SET DATE ISSUED:


11/30/2023


DRAWING TITLE: CLERESTORY PLAN




DESCRIPTION DATE

PROJECT NUMBER: PROJECT SET: BID SET DATE ISSUED: 11/30/2023 DRAWING TITLE: PLAN DETAILS

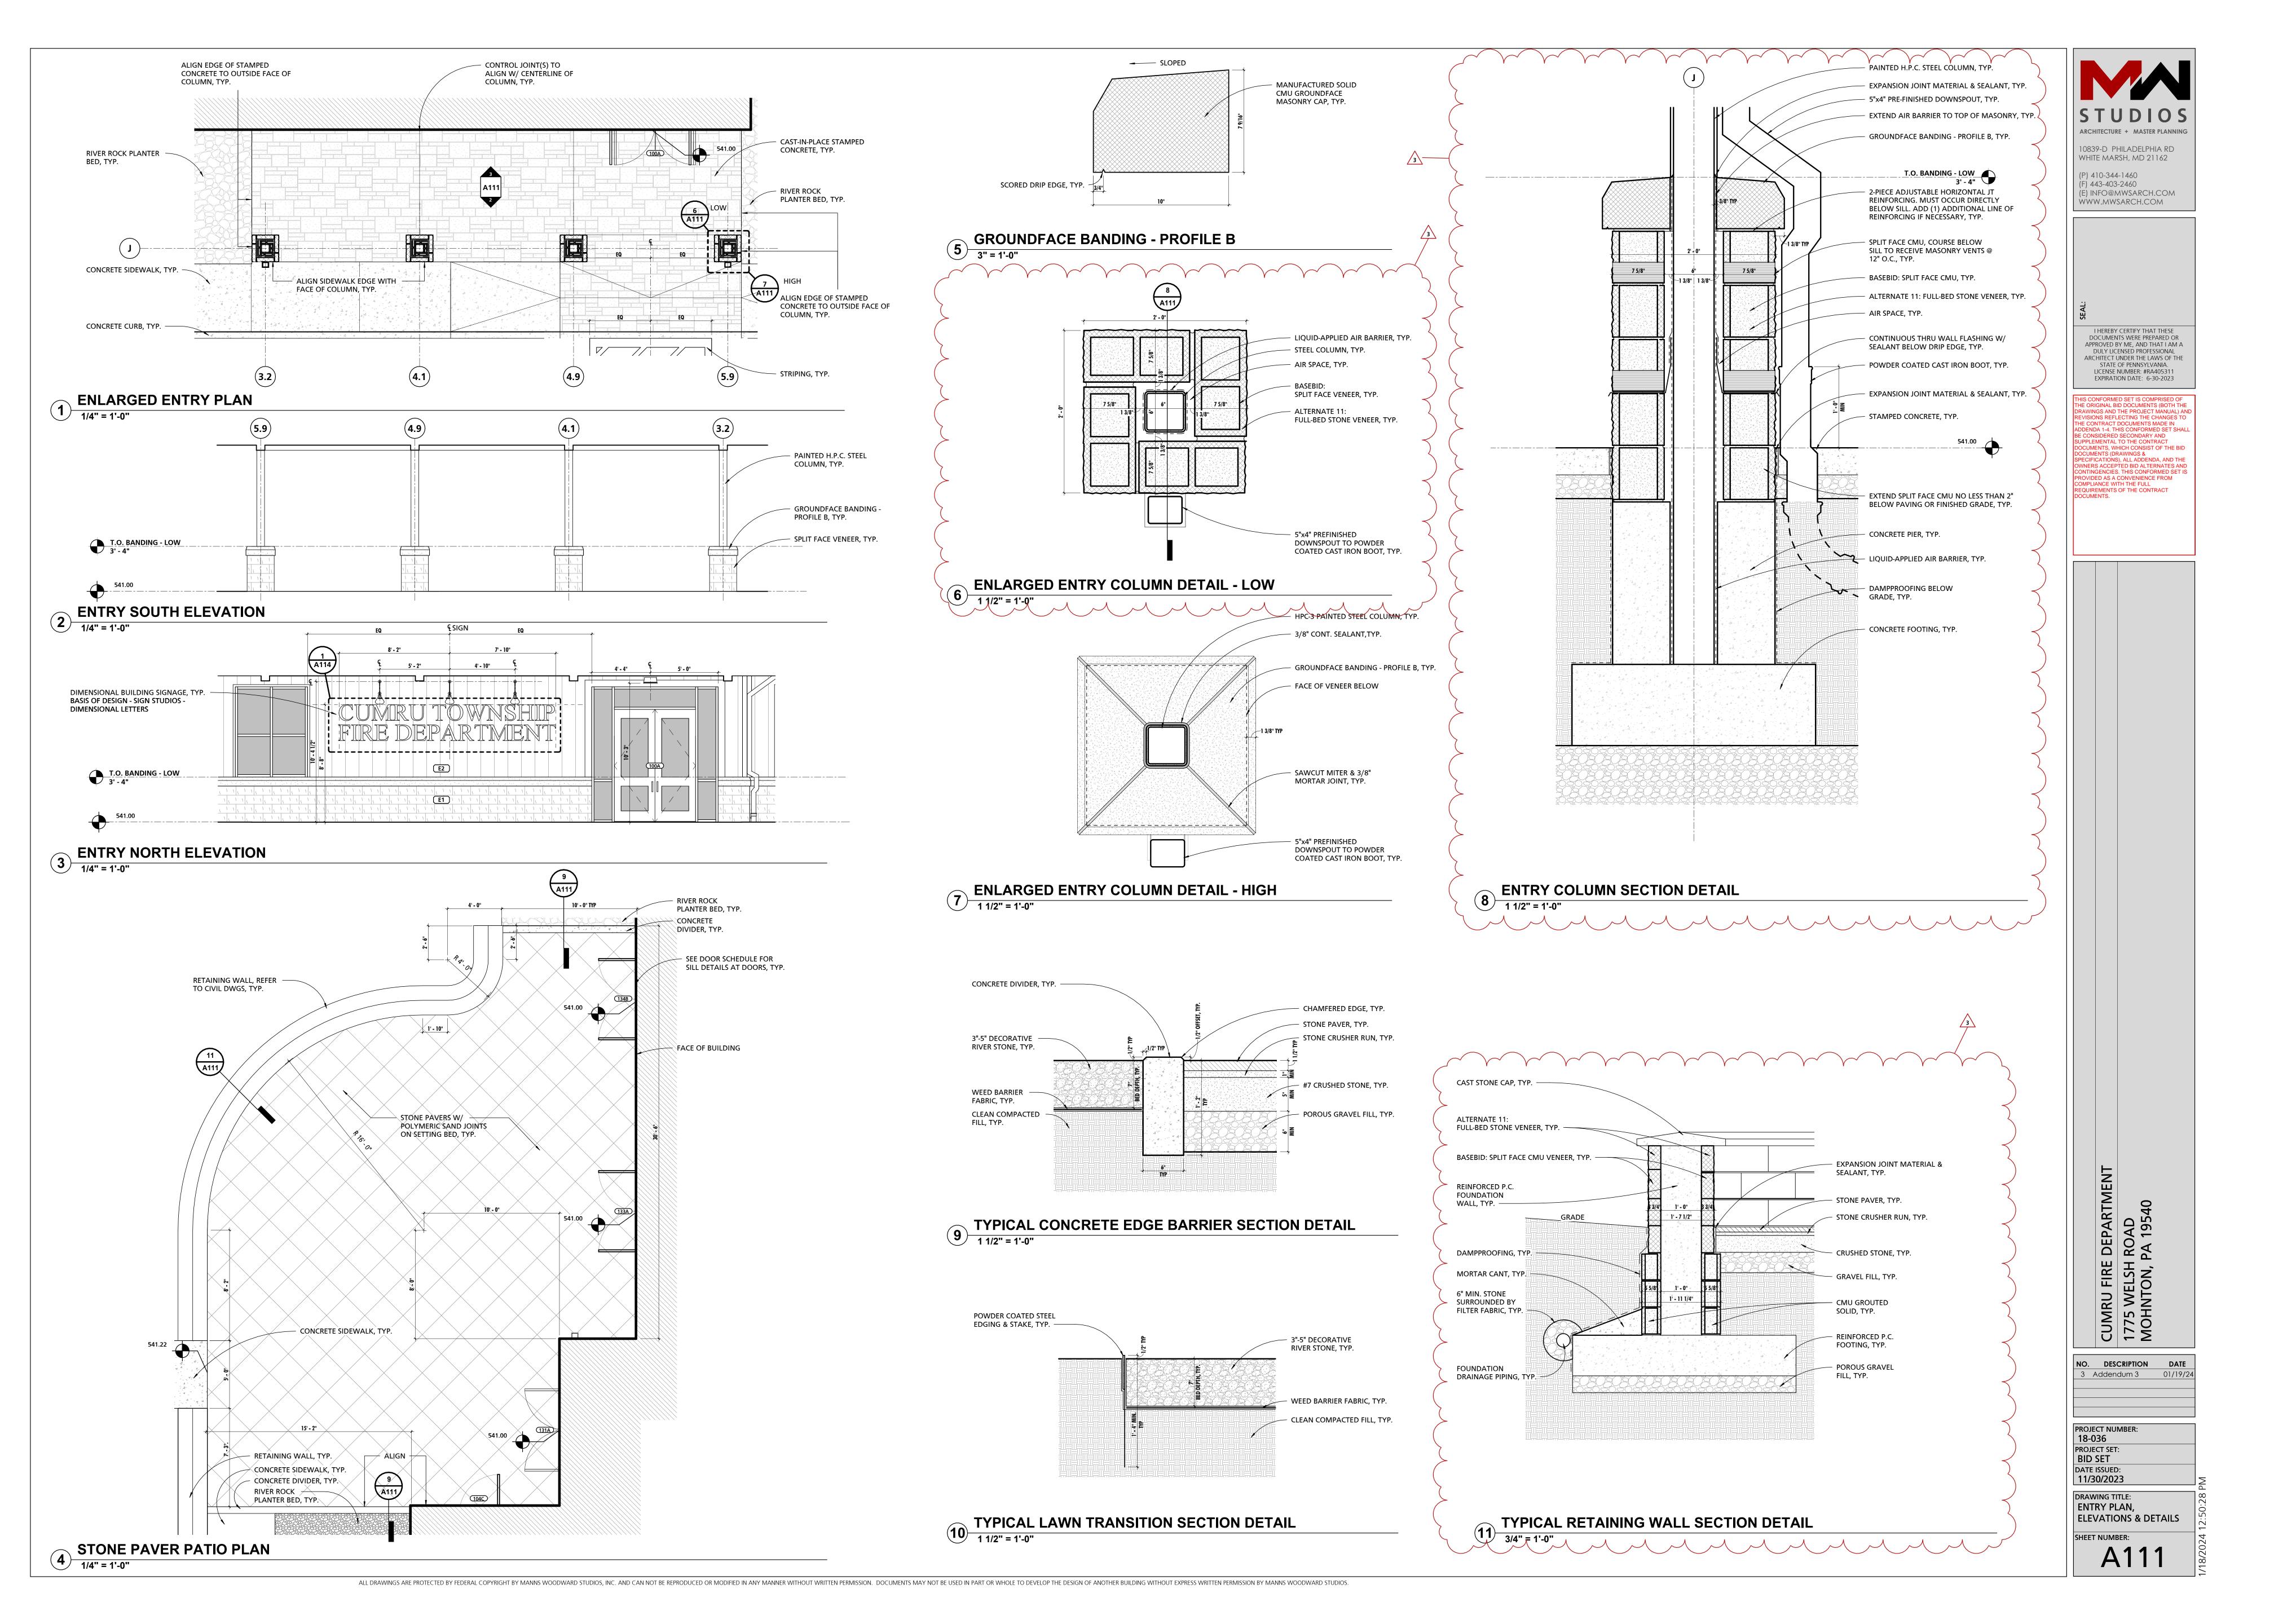


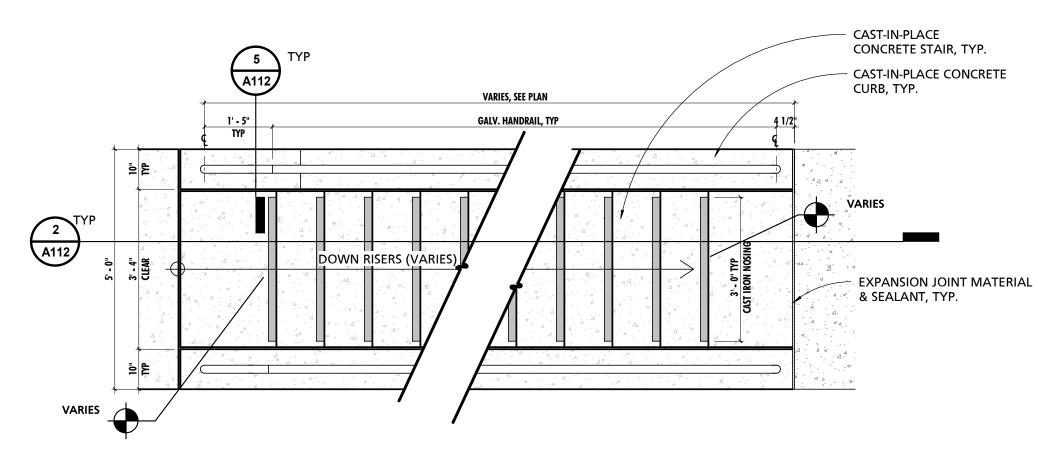

1) CONCRETE STAIR PLAN

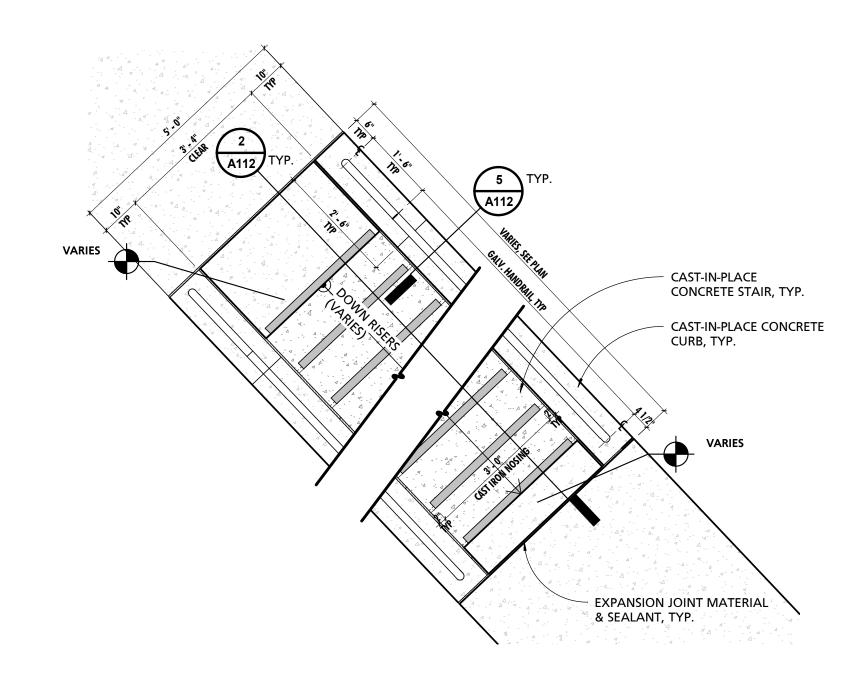

CONCRETE STAIR PLAN

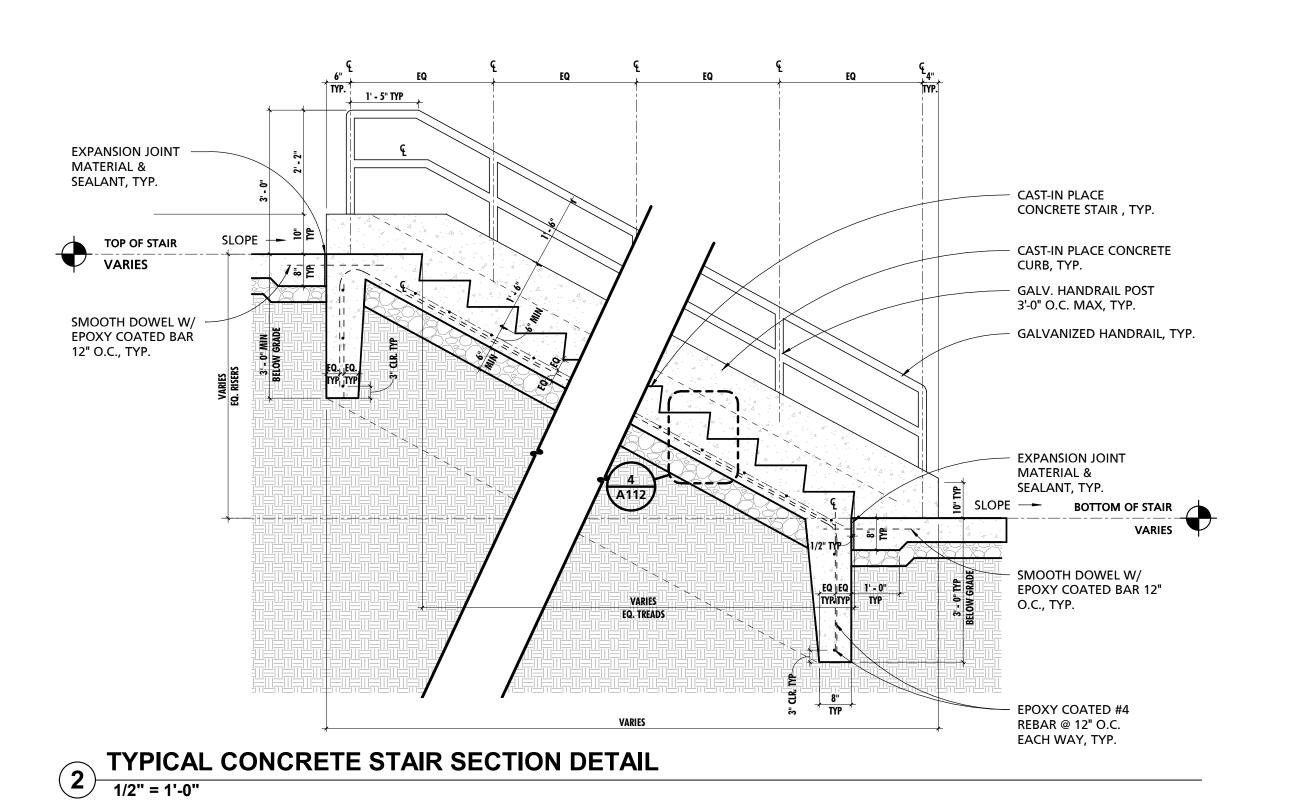

SIOPE 1/8", TYP.—

1'-0" U.M.O.

CAST-IN-PLACE CONCRETE STAIR, TYP.


CAST-IN-PLACE CAST IRON STAIR NOSING, TYP.

EPOXY COATED #4
REBAR @ 12" O.C. EACH
WAY, TYP.

POROUS GRAVEL FILL, TYP.

TYPICAL EMBEDDED STAIR NOSING SECTION DETAIL

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5 TYPICAL EXTERIOR HANDRAIL SECTION DETAIL

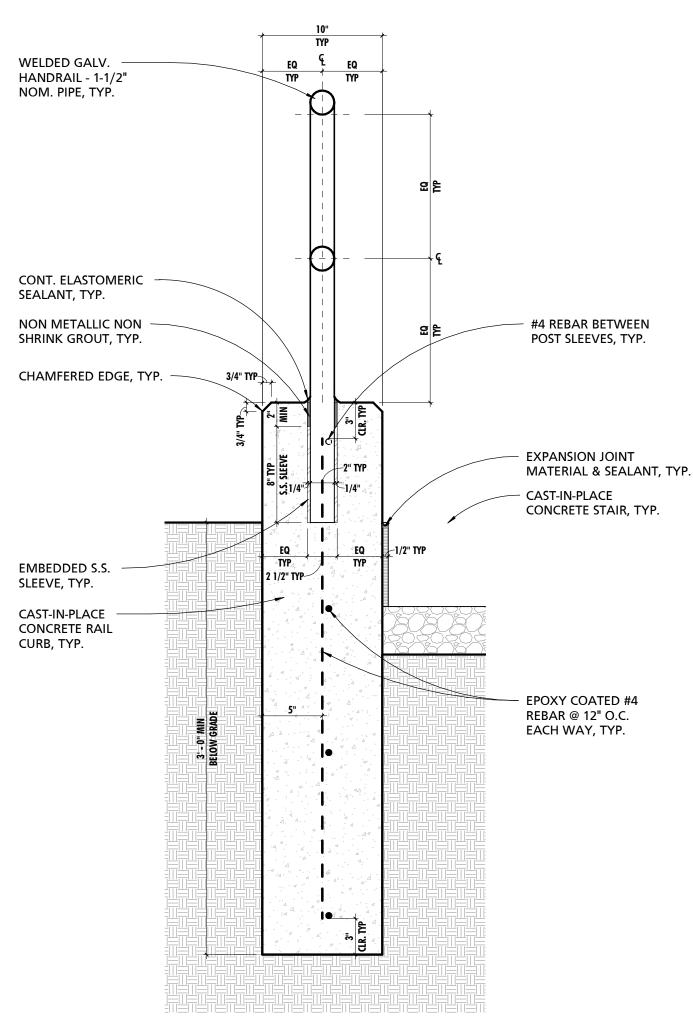STUDIOS

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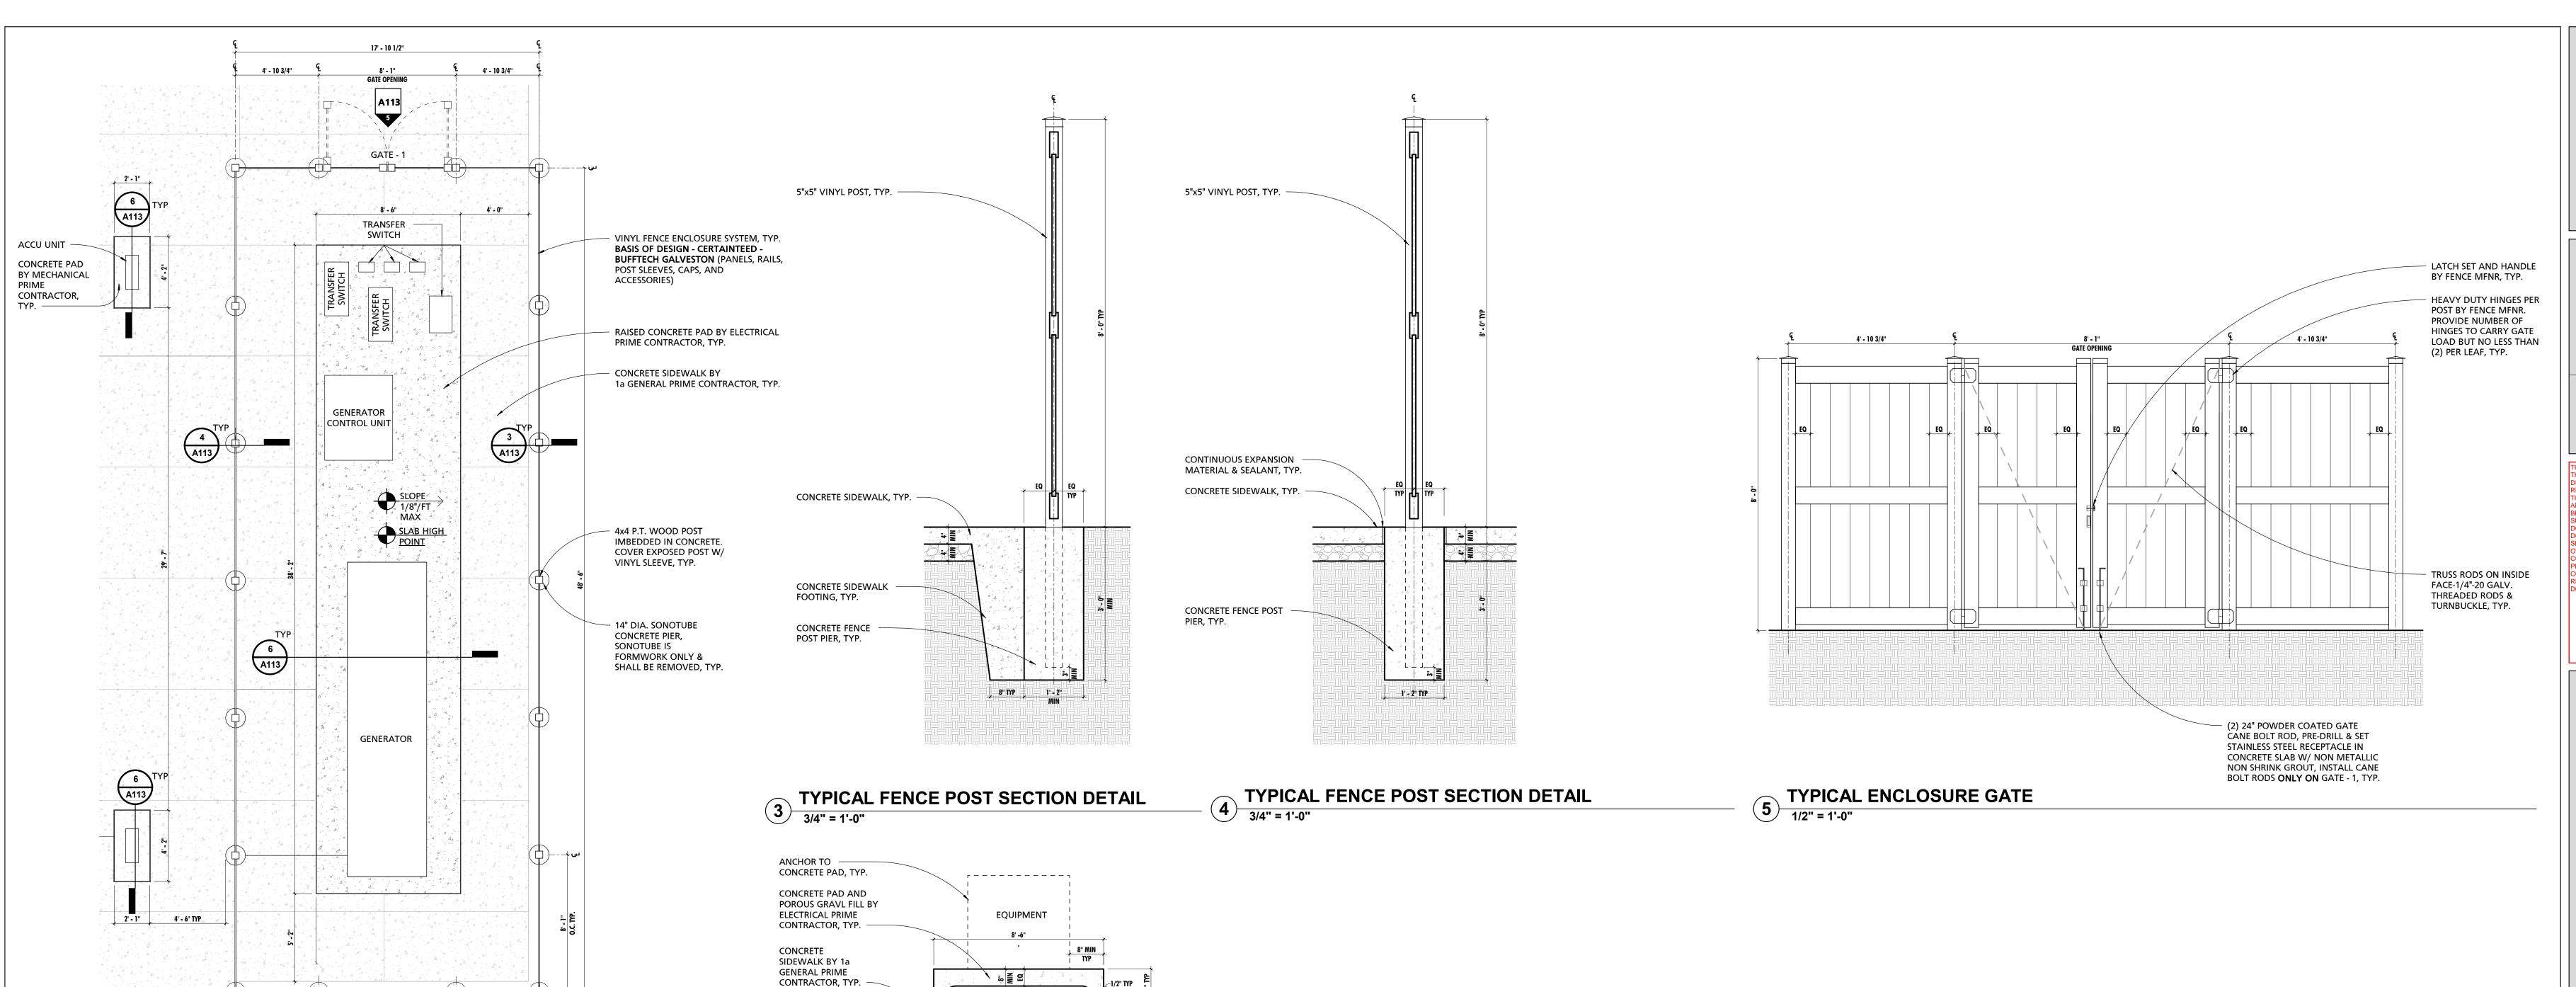
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UMRU FIRE DEPARTMENT
775 WELSH ROAD
AOHNTON, PA 19540

PROJECT NUMBER:
18-036
PROJECT SET:
BID SET

DATE ISSUED:

DRAWING TITLE:
EXTERIOR STAIR DETAILS




EQUIPMENT PAD ENCLOSURE

9' - 9"
FROM FACE OF
SPLITFACE VENEER

NOTES:

1. CONTRACTOR'S SHALL COORDINATE FINAL PAD SIZE W/ EQUIPMENT. WHERE EQUIPMENT REQUIRES LARGER PAD SIZE CONTRACTOR SUPPLYING EQUIPMENT SHALL BE RESPONSIBLE FOR ADDED COST.

2. CONTRACTOR PROVIDING CONCRETE PADS SHALL PROVIDE FLAT AREAS WHERE REQUIRED FOR EQUIPMENT INSTALLATION & WARP REMAINING SURFACE TO DRAIN WATER FROM EQUIPMENT PAD.

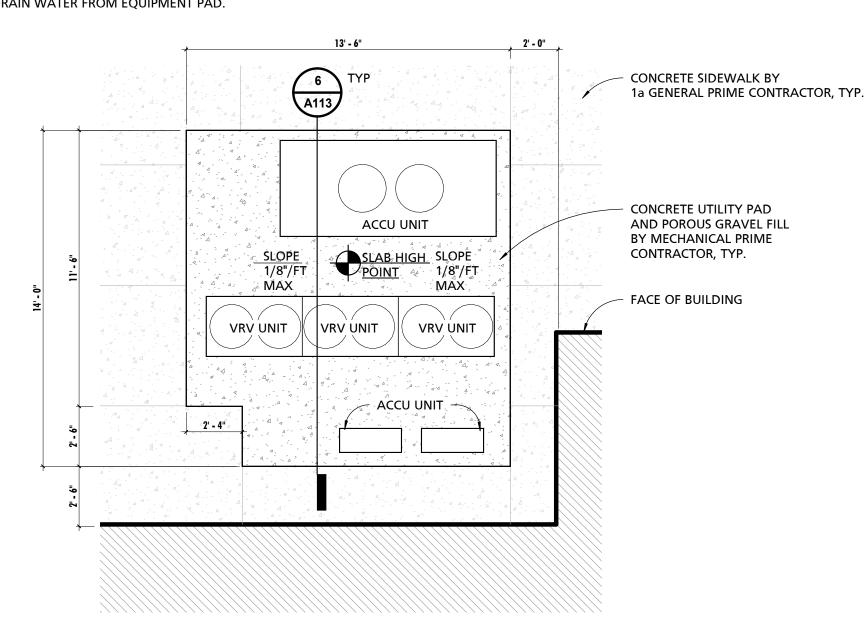

GATE - 2

2 EQUIPMENT PAD PLAN 1/4" = 1'-0"

NOTE

1. CONTRACTOR'S SHALL COORDINATE FINAL PAD SIZE W/ EQUIPMENT. WHERE EQUIPMENT REQUIRES LARGER PAD SIZE CONTRACTOR SUPPLYING EQUIPMENT SHALL BE RESPONSIBLE FOR ADDED COST.

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6 TYPICAL EQUIPMENT PAD SECTION DETAIL 3/4" = 1'-0"

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NOTE

EXPANSION JOINT MATERIAL & SEALANT, TYP.

EPOXY COATED #4

REBAR @ 12" O.C. EACH WAY, TYP.

1. CONTRACTOR'S SHALL COORDINATE FINAL PAD SIZE W/ EQUIPMENT. WHERE EQUIPMENT REQUIRES LARGER PAD SIZE CONTRACTOR SUPPLYING EQUIPMENT SHALL BE RESPONSIBLE FOR ADDED COST.

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STUDIOS

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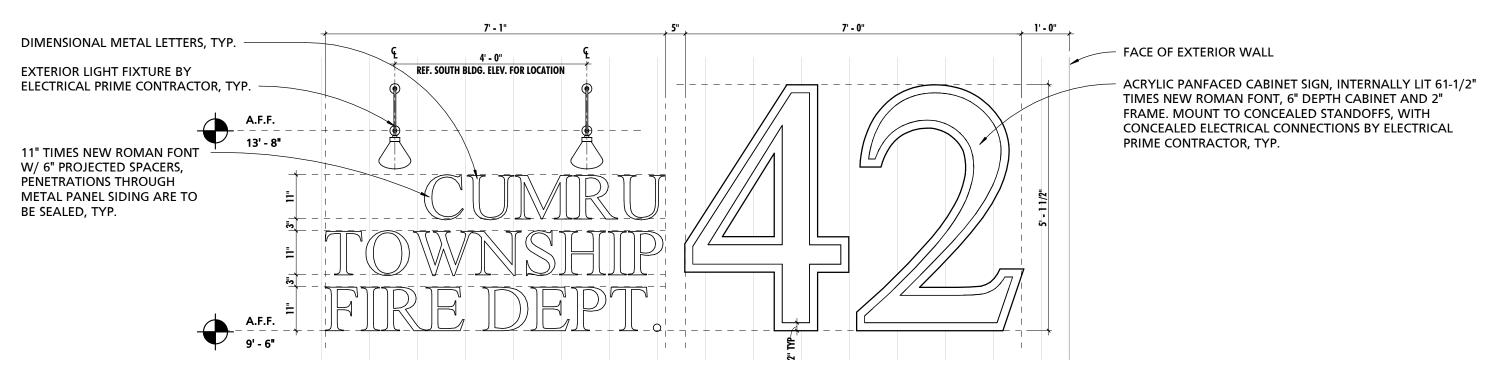
CUMRU FIRE DEPARTMENT 1775 WELSH ROAD MOHNTON, PA 19540

PROJECT NUMBER:
18-036
PROJECT SET:
BID SET
DATE ISSUED:
11/30/2023


DRAWING TITLE:
SITE DETAILS


BUILDING SIGNAGE & INTERNALLY LIT 42" CABINET SIGN

1/2" = 1'-0"



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(E) INFO@MWSARCH.COM WWW.MWSARCH.COM
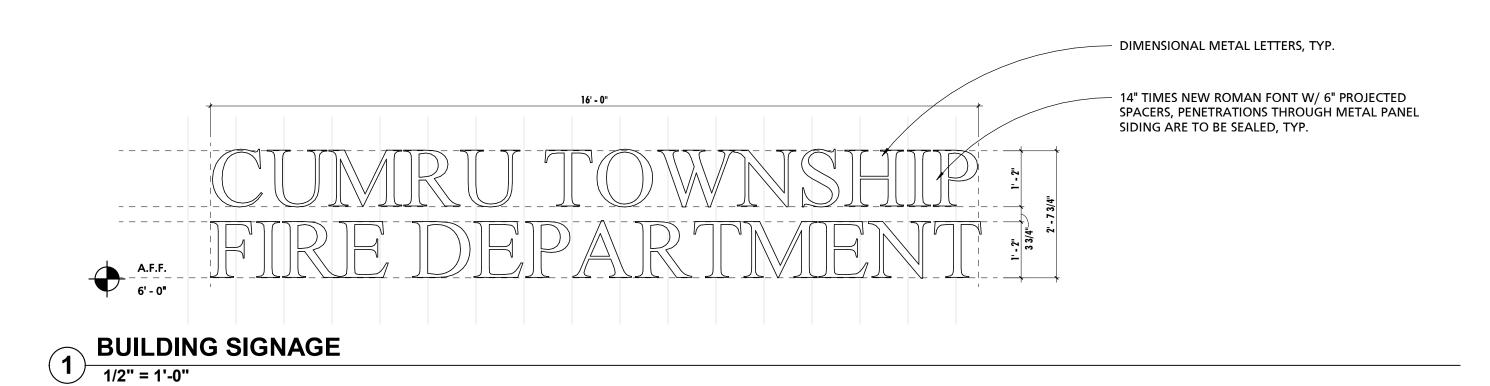
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DOCUMENTS WERE PREPARED OR
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DULY LICENSED PROFESSIONAL
ARCHITECT UNDER THE LAWS OF THE STATE OF PENNSYLVANIA. LICENSE NUMBER: #RA405311 EXPIRATION DATE: 6-30-2023

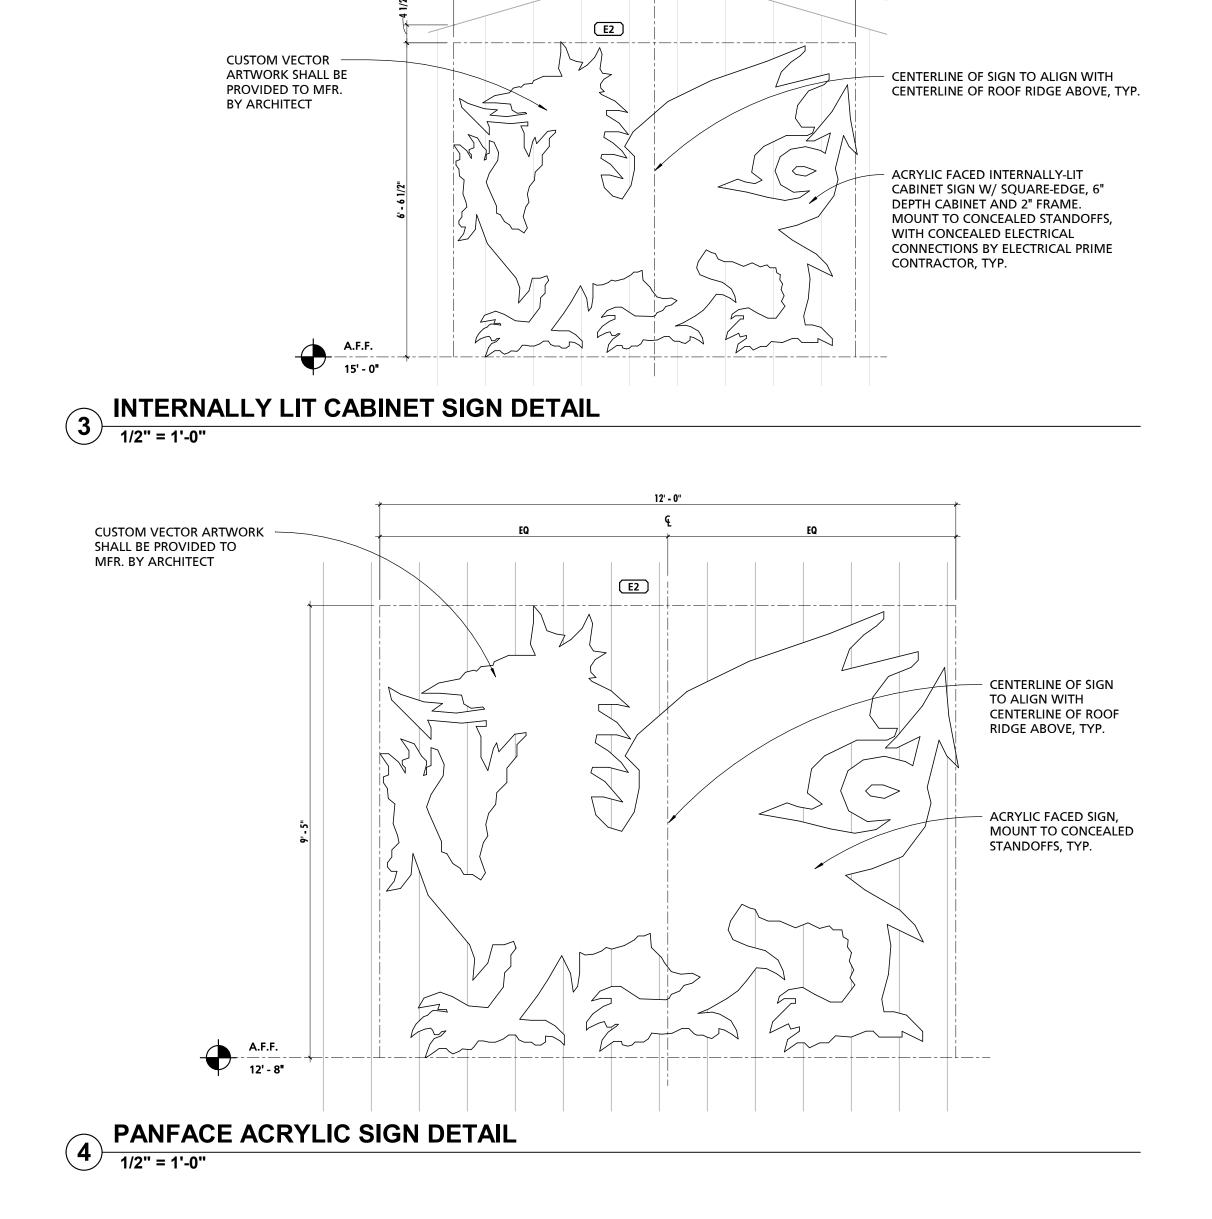
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NO. DESCRIPTION DATE

PROJECT NUMBER: 18-036 PROJECT SET: BID SET

DATE ISSUED:

11/30/2023 DRAWING TITLE: SIGNAGE DETAILS

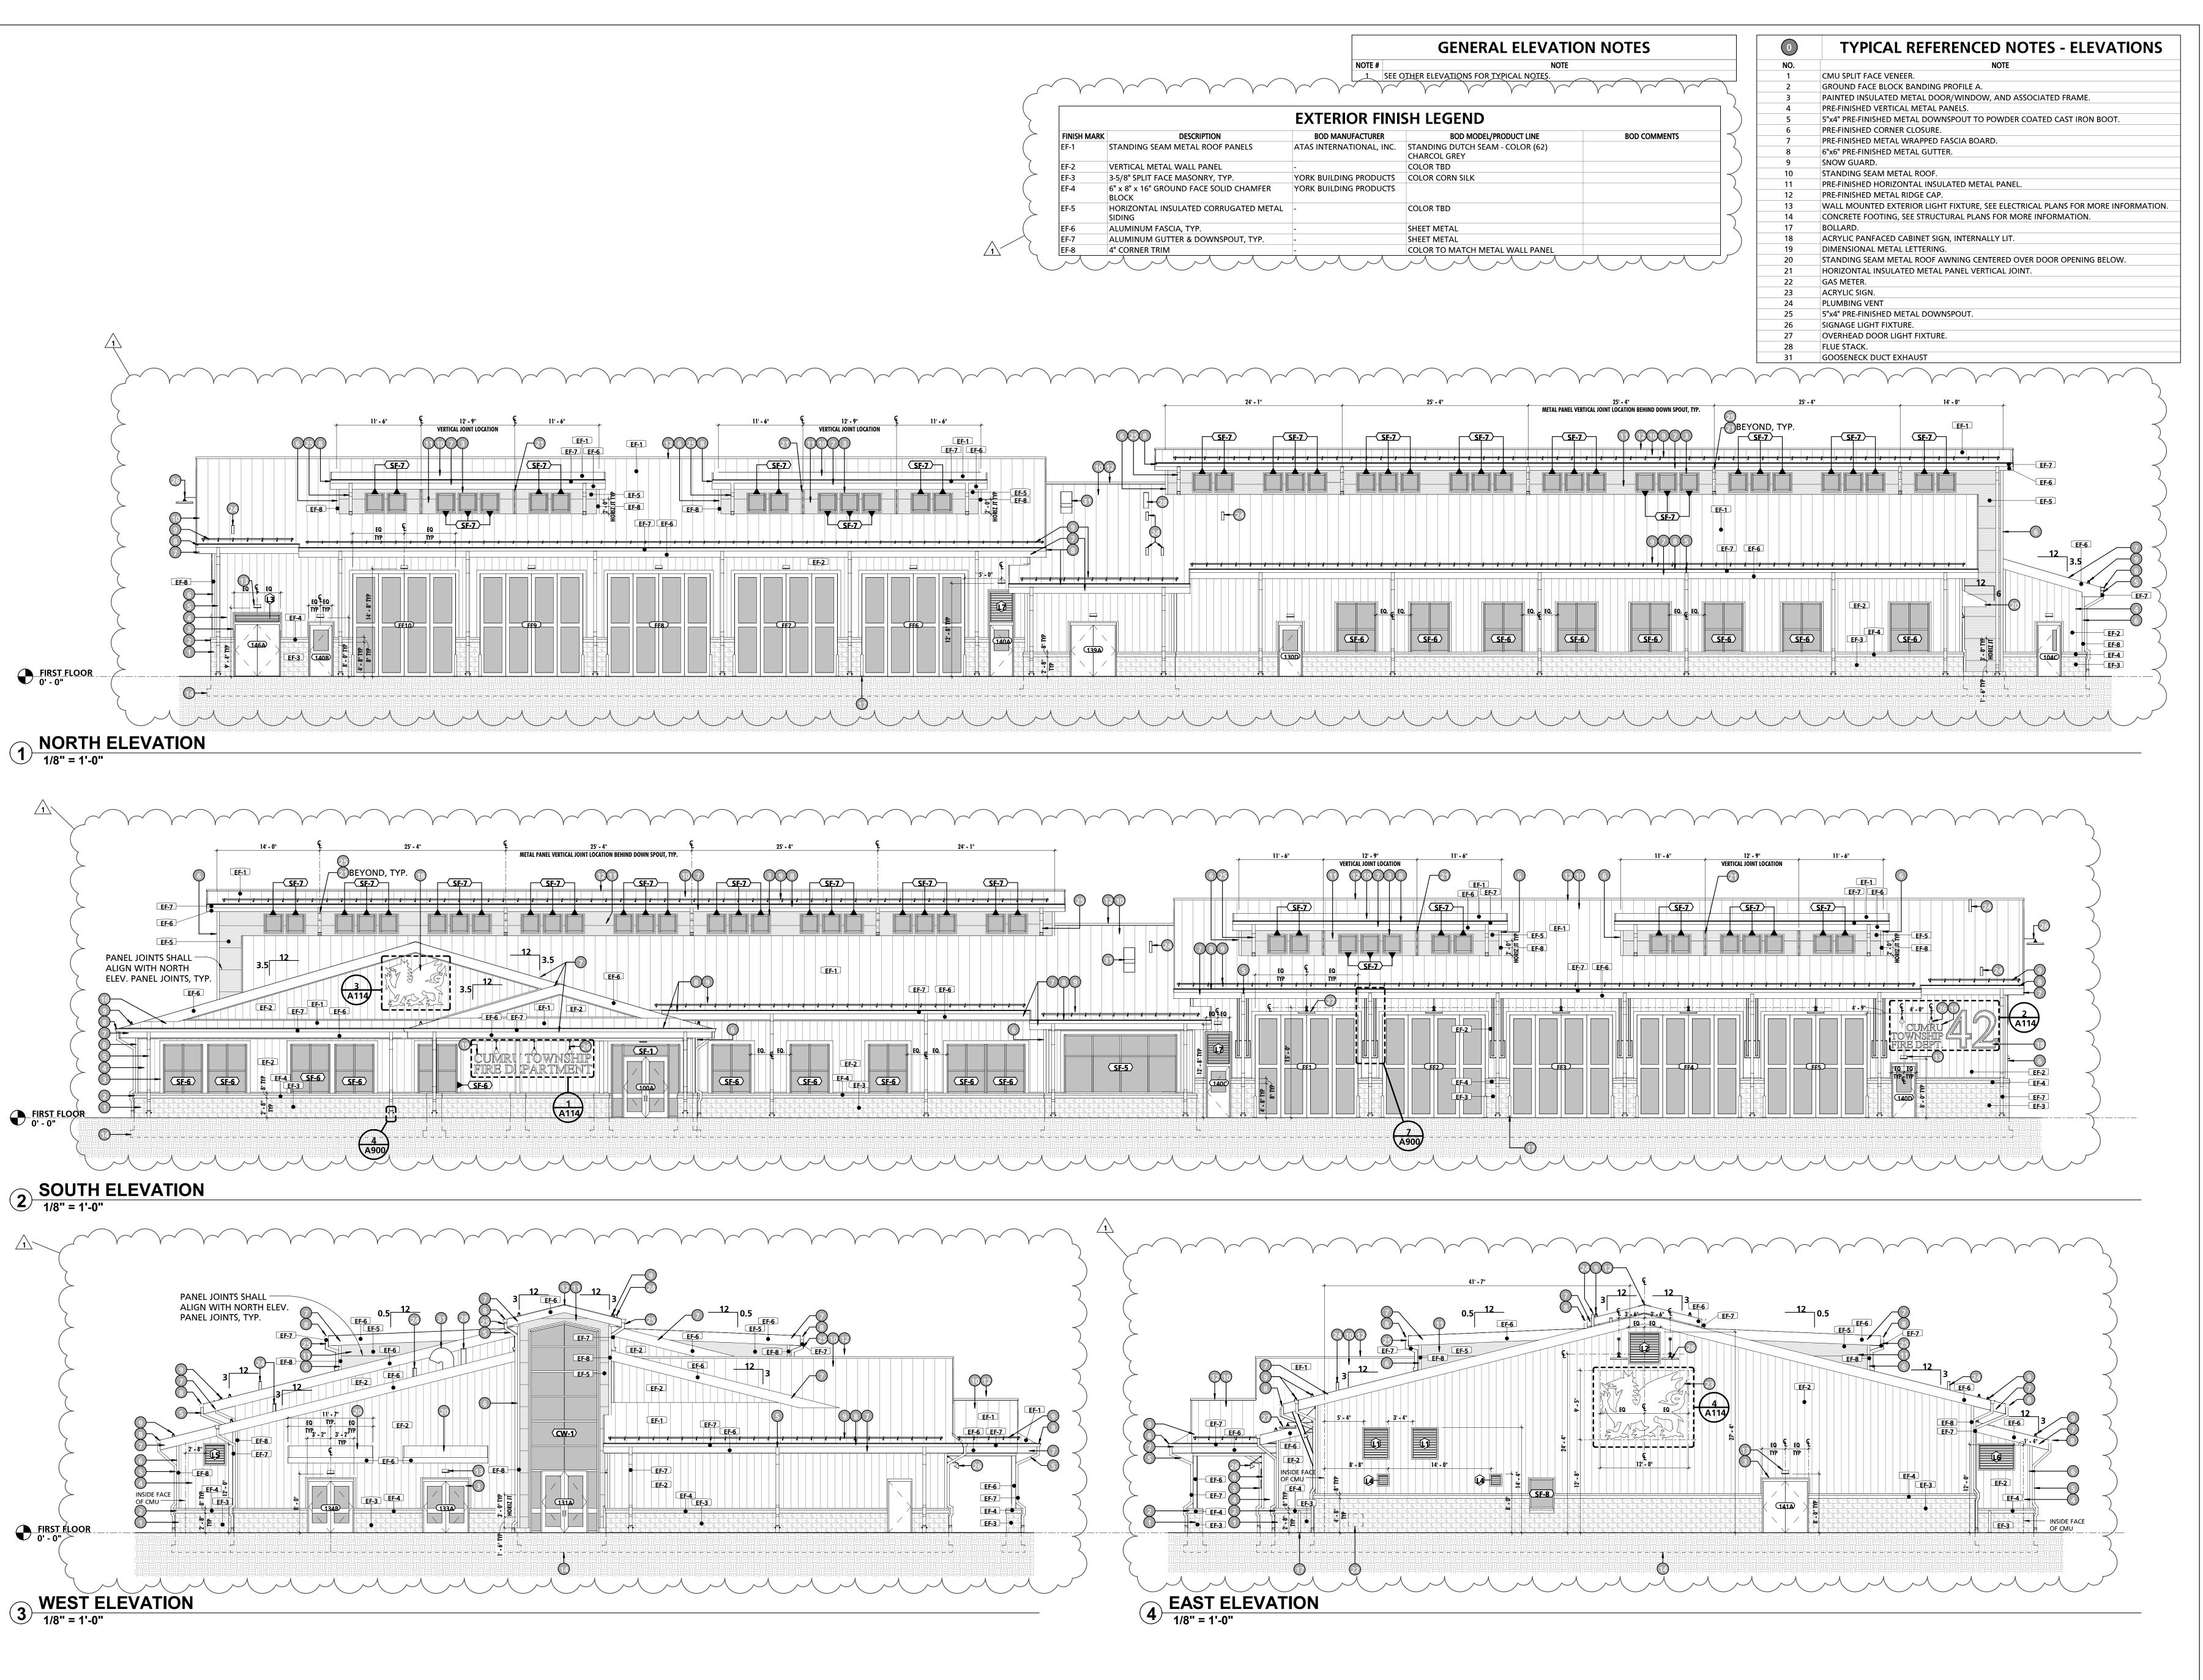

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FXPIRATION DATE: 6-30-2023

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CUMRU FIRE DEPARTMENT 1775 WELSH ROAD MOHNTON, PA 19540


NO. DESCRIPTION DATE
1 Addenedum 1 12/21/2
PROJECT NUMBER:
18-036

PROJECT SET:
BID SET
DATE ISSUED:
11/30/2023

DRAWING TITLE:

DRAWING TITLE:
BUILDING ELEVATIONS
SHEET NUMBER:

A200

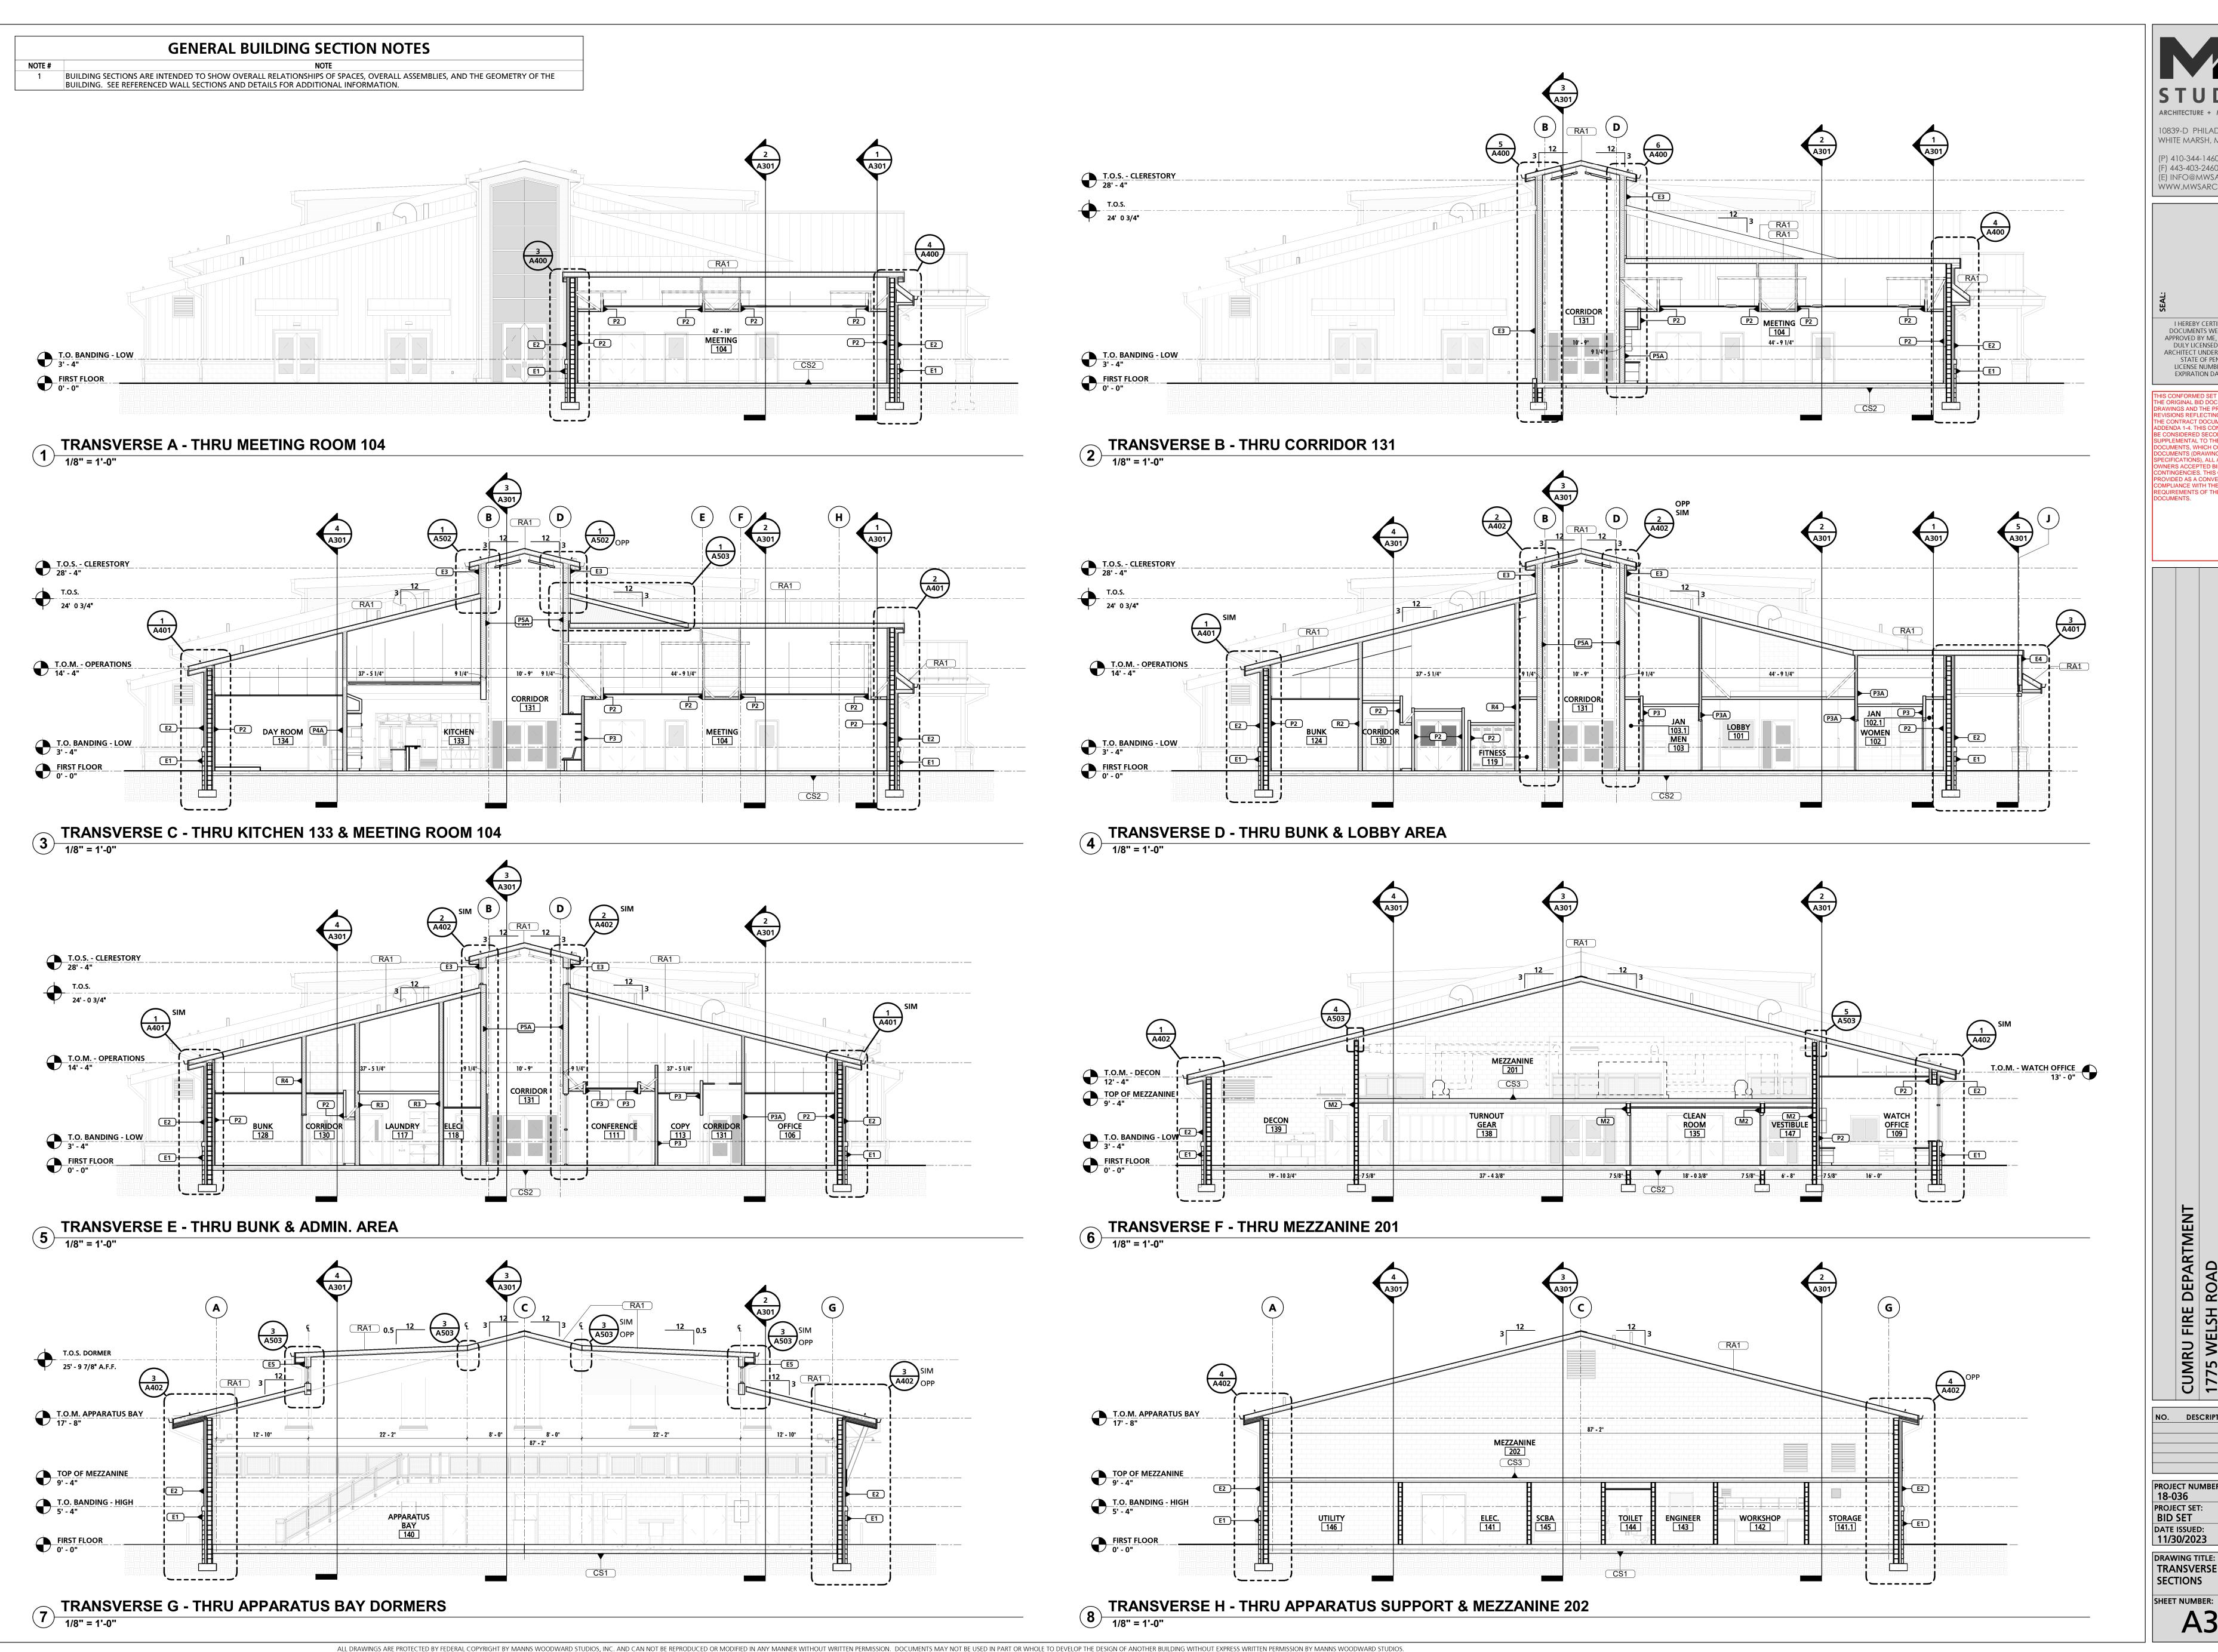

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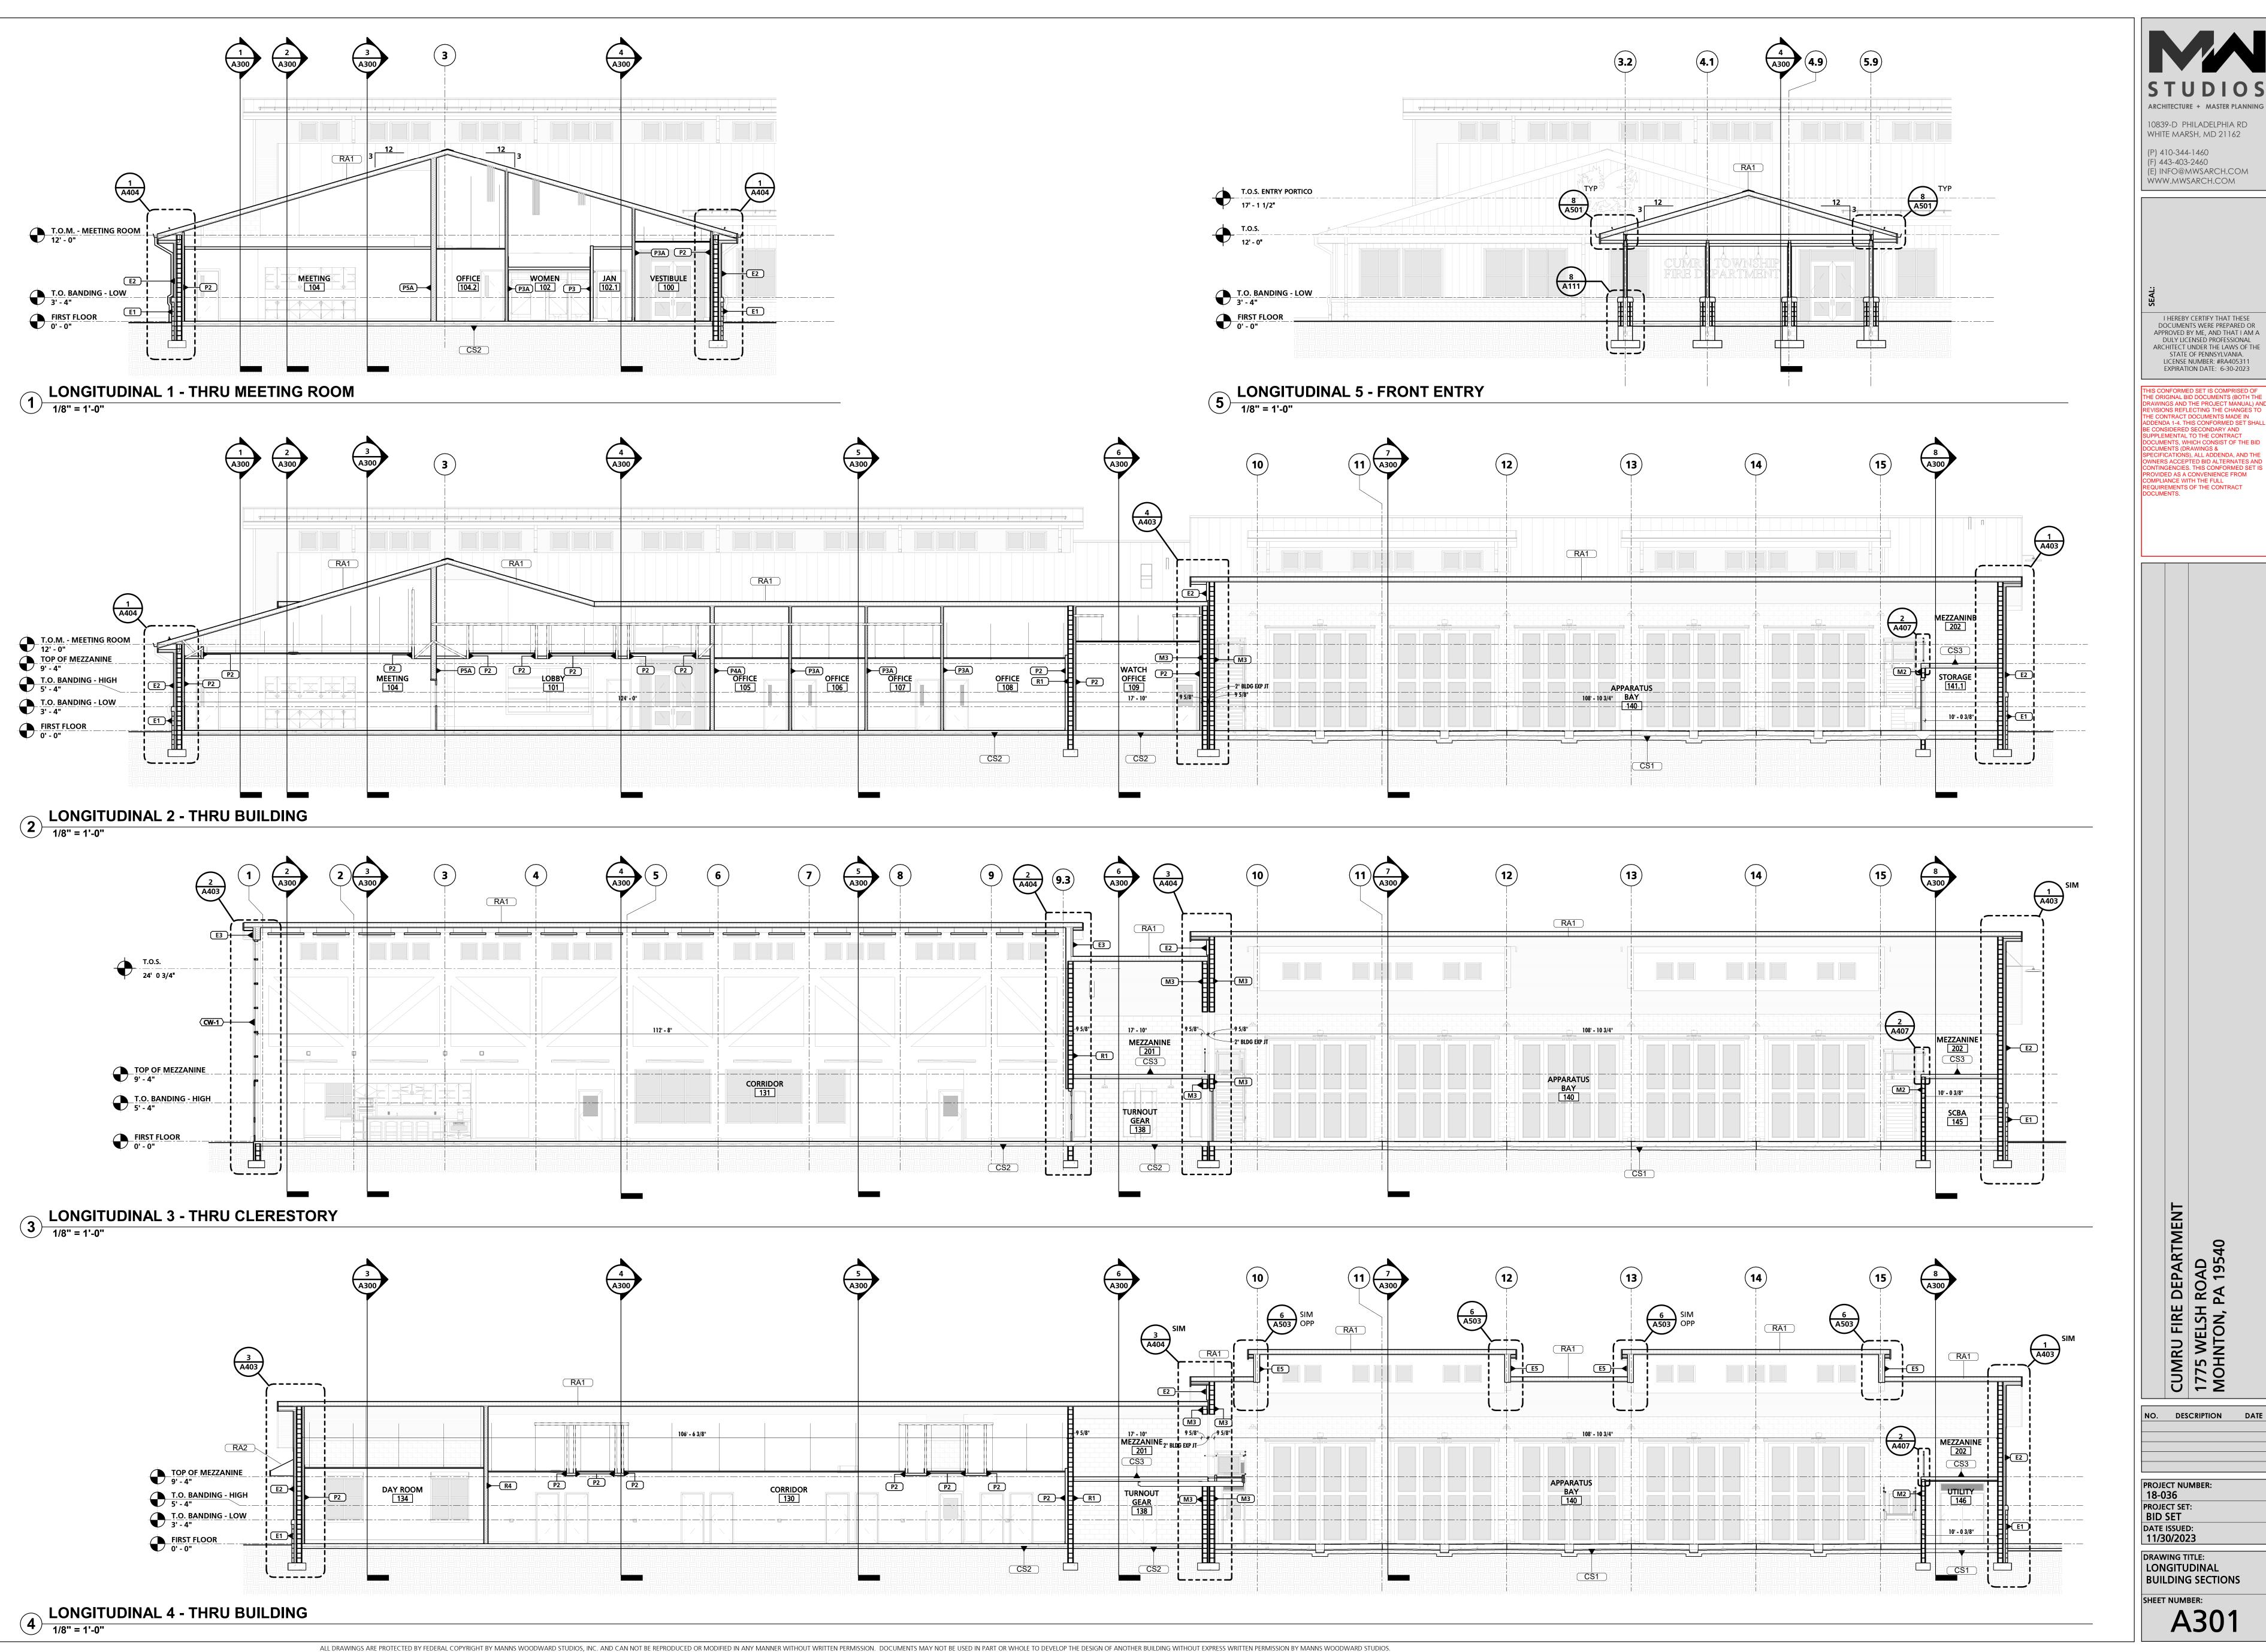
F) 443-403-2460 (E) INFO@MWSARCH.COM WWW.MWSARCH.COM

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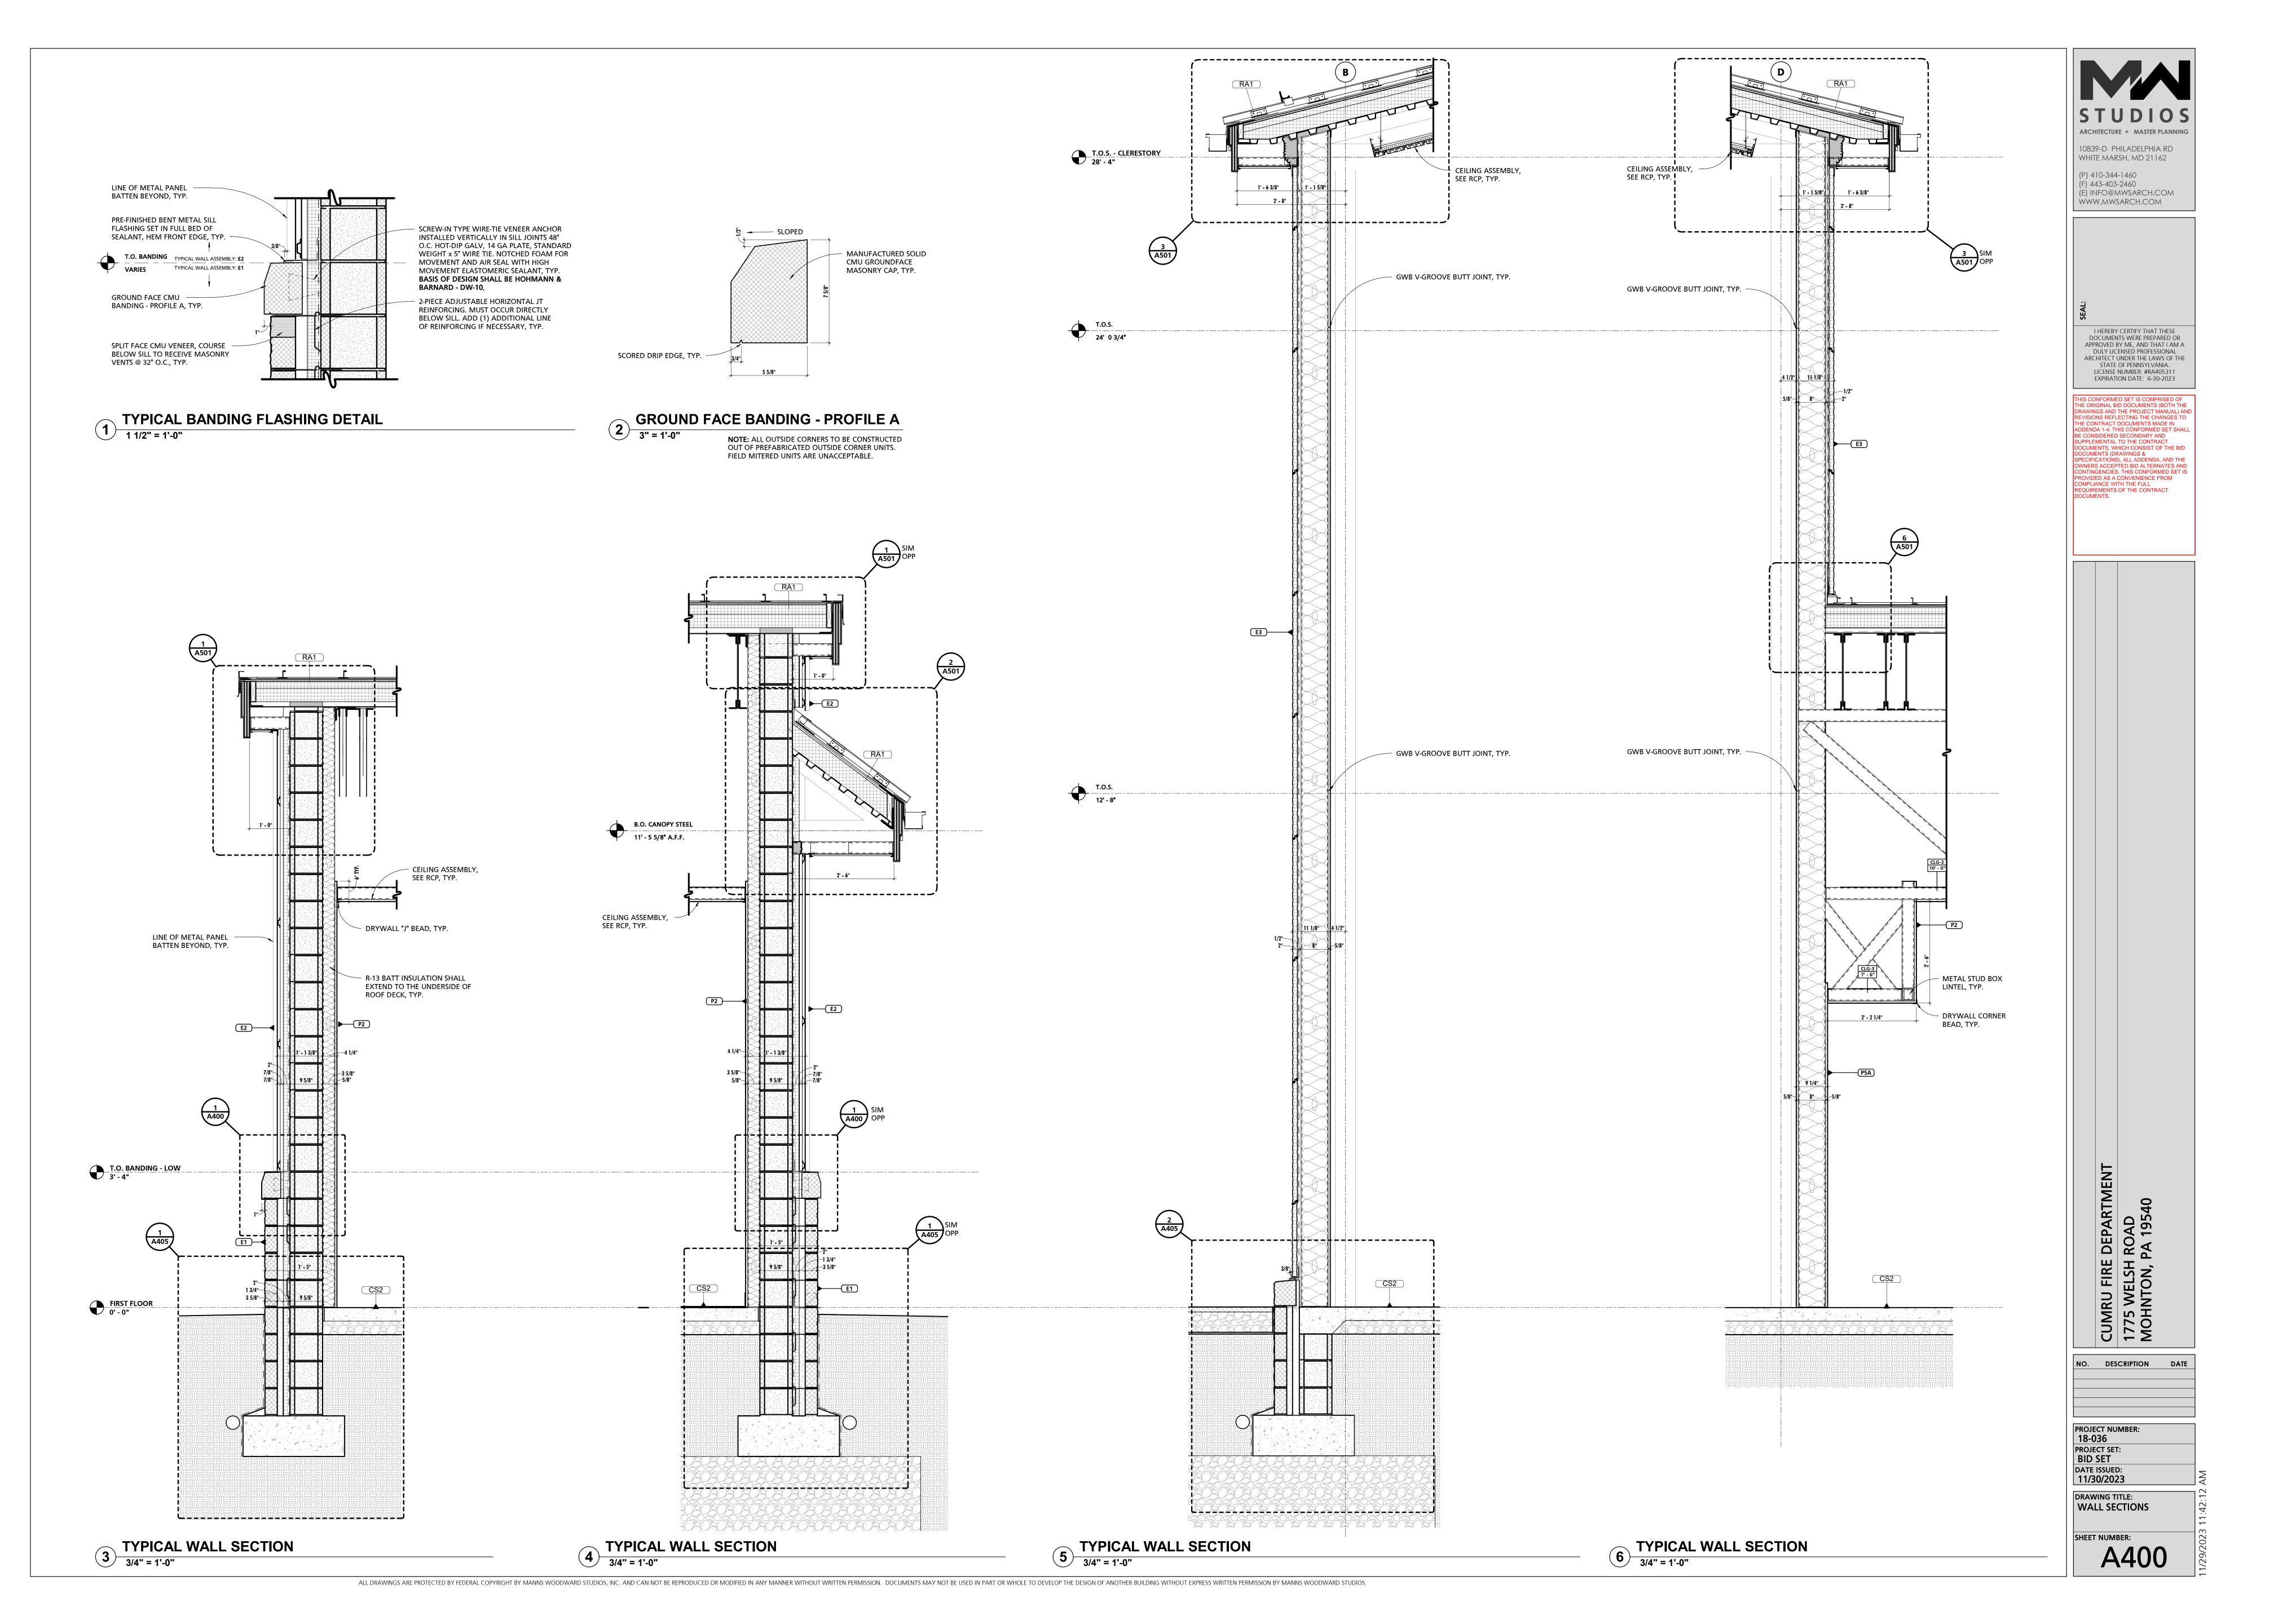
PROVIDED AS A CONVENIENCE FROM COMPLIANCE WITH THE FULL REQUIREMENTS OF THE CONTRACT DOCUMENTS.


NO. DESCRIPTION DATE PROJECT NUMBER: 18-036 DRAWING TITLE: TRANSVERSE BUILDING

A300



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SHEET NUMBER: A401

DRAWING TITLE:
WALL SECTIONS

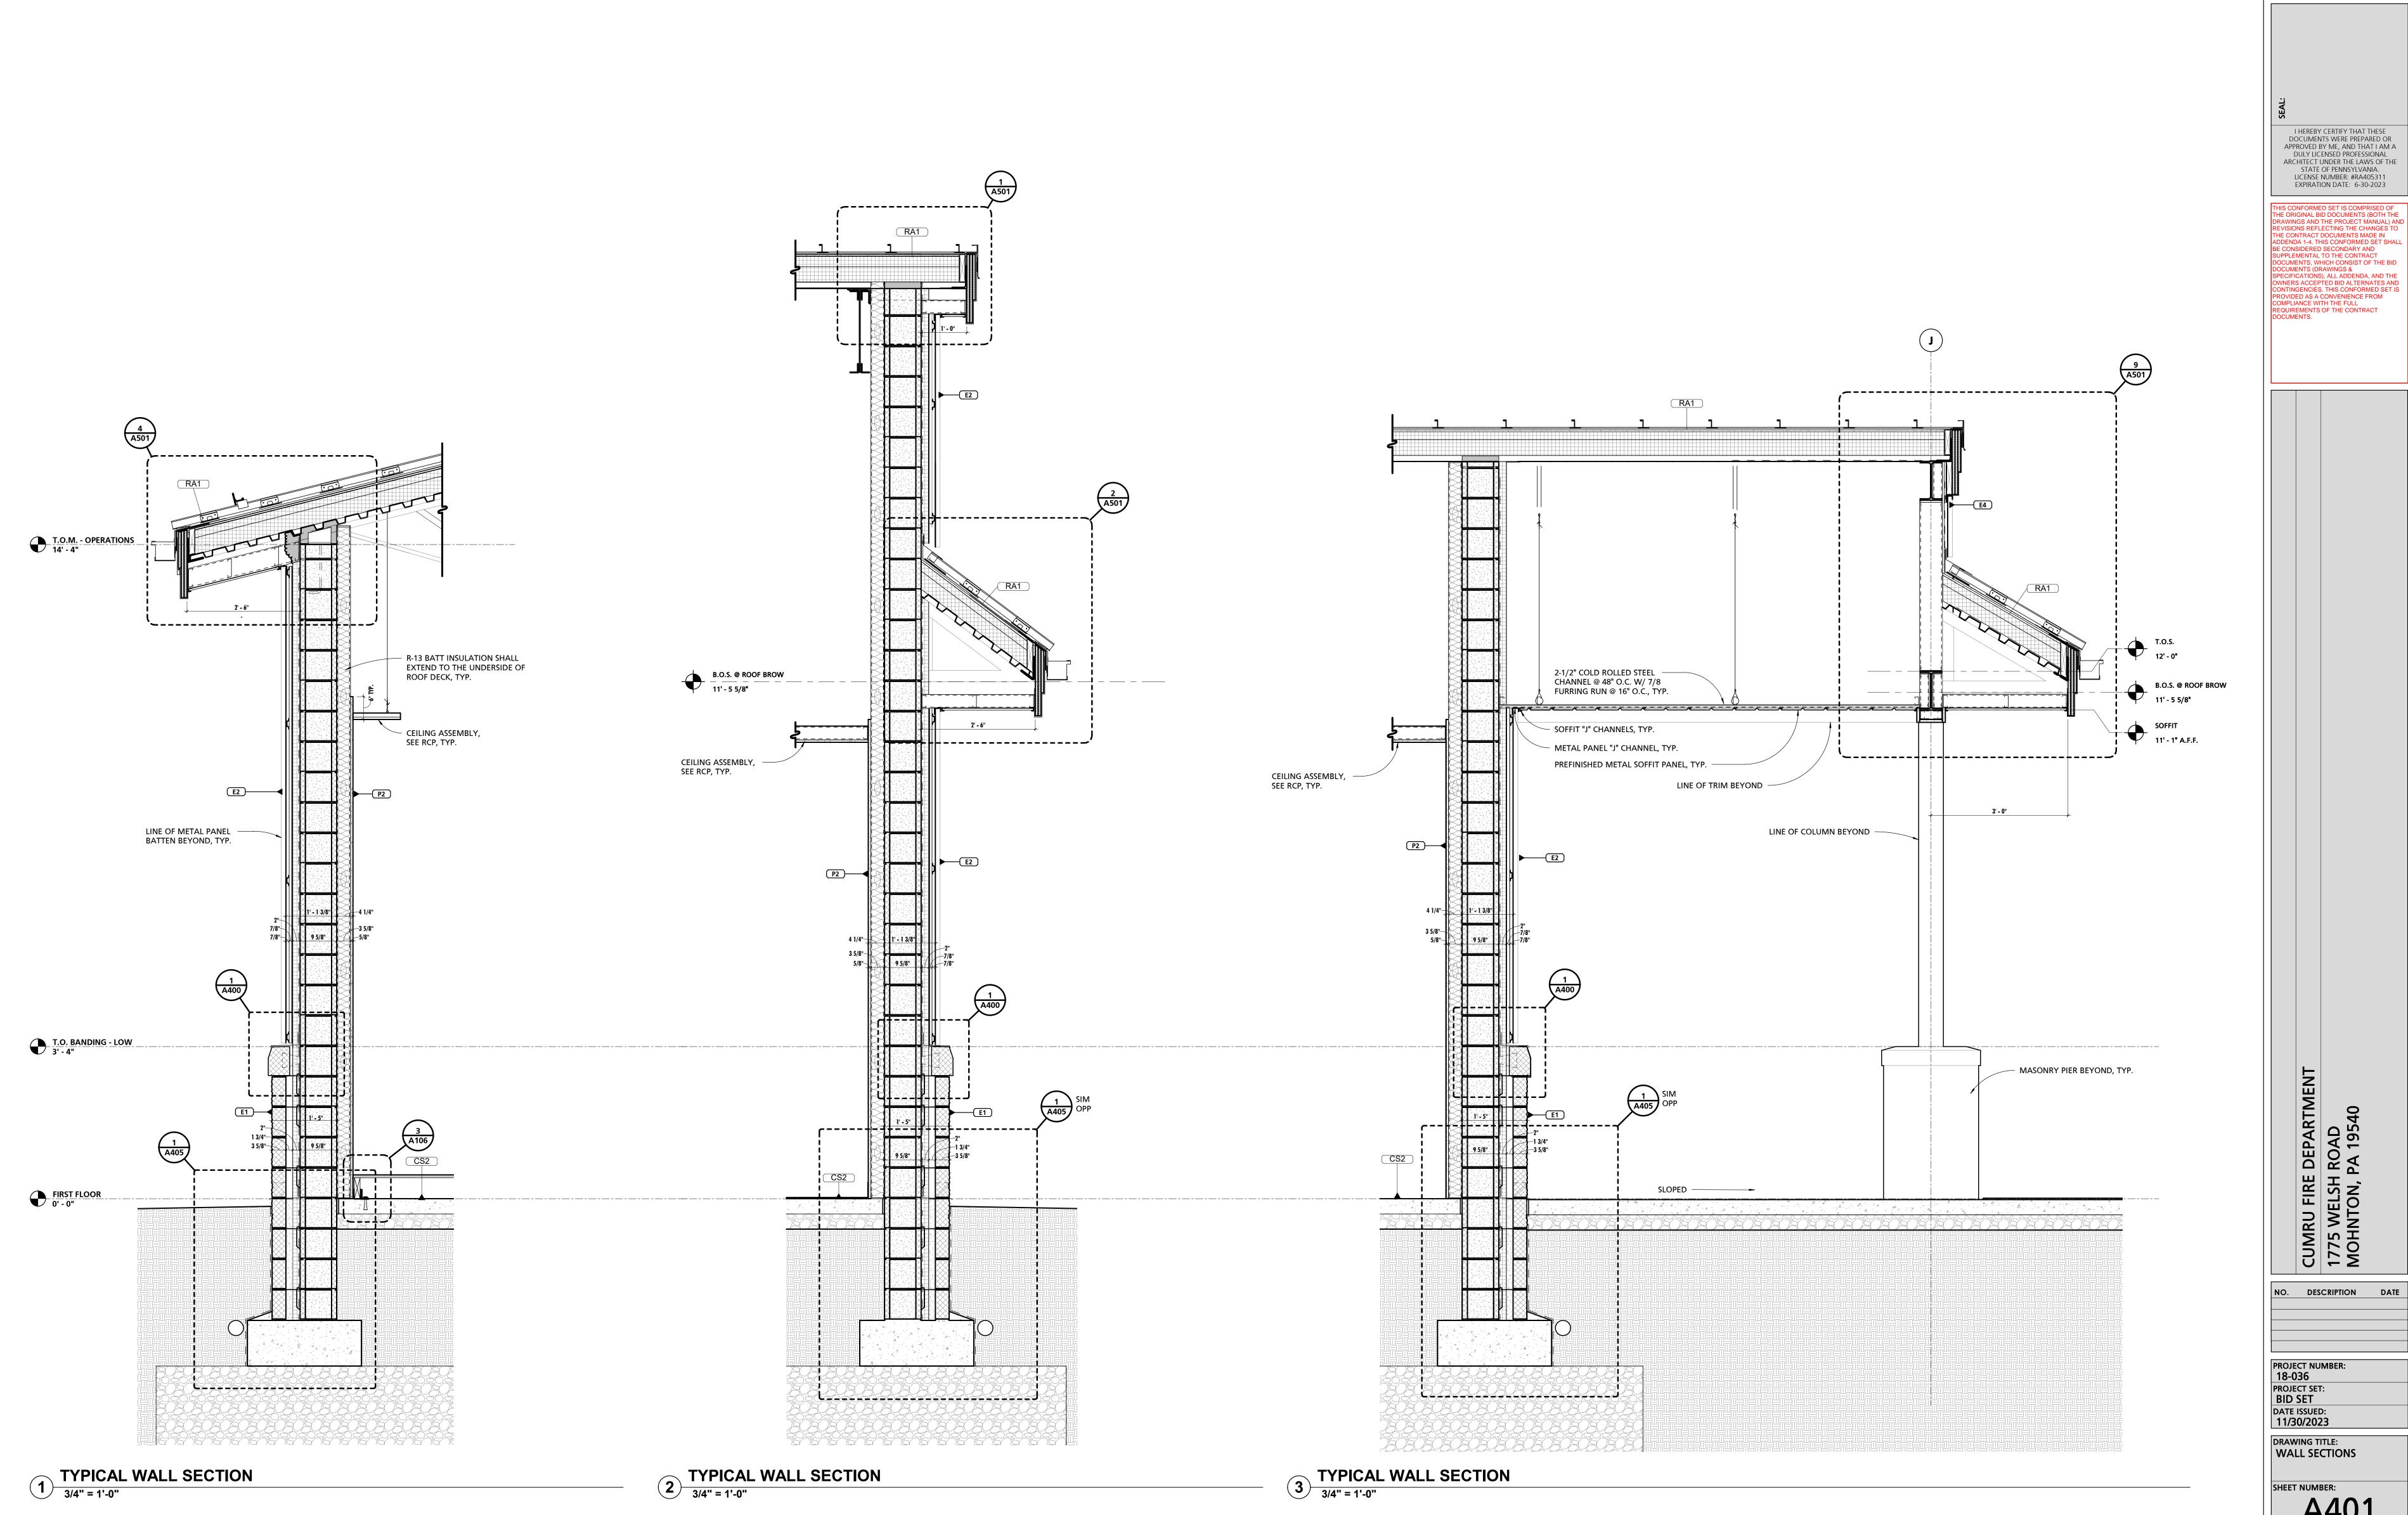11/30/2023

PROJECT NUMBER: 18-036 PROJECT SET: BID SET DATE ISSUED:

NO. DESCRIPTION DATE

STUDIOS


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(P) 410-344-1460 (F) 443-403-2460




NO. DESCRIPTION DATE PROJECT NUMBER: 18-036 PROJECT SET: BID SET DATE ISSUED: 11/30/2023 DRAWING TITLE:
WALL SECTIONS SHEET NUMBER: A402

EXPIRATION DATE: 6-30-2023 THIS CONFORMED SET IS COMPRISED OF THE ORIGINAL BID DOCUMENTS (BOTH THE DRAWINGS AND THE PROJECT MANUAL) AND REVISIONS REFLECTING THE CHANGES TO THE CONTRACT DOCUMENTS MADE IN ADDENDA 1-4. THIS CONFORMED SET SHALL BE CONSIDERED SECONDARY AND SUPPLEMENTAL TO THE CONTRACT DOCUMENTS, WHICH CONSIST OF THE BID DOCUMENTS (DRAWINGS & SPECIFICATIONS), ALL ADDENDA, AND THE OWNERS ACCEPTED BID ALTERNATES AND CONTINGENCIES. THIS CONFORMED SET IS PROVIDED AS A CONVENIENCE FROM COMPLIANCE WITH THE FULL REQUIREMENTS OF THE CONTRACT DOCUMENTS.

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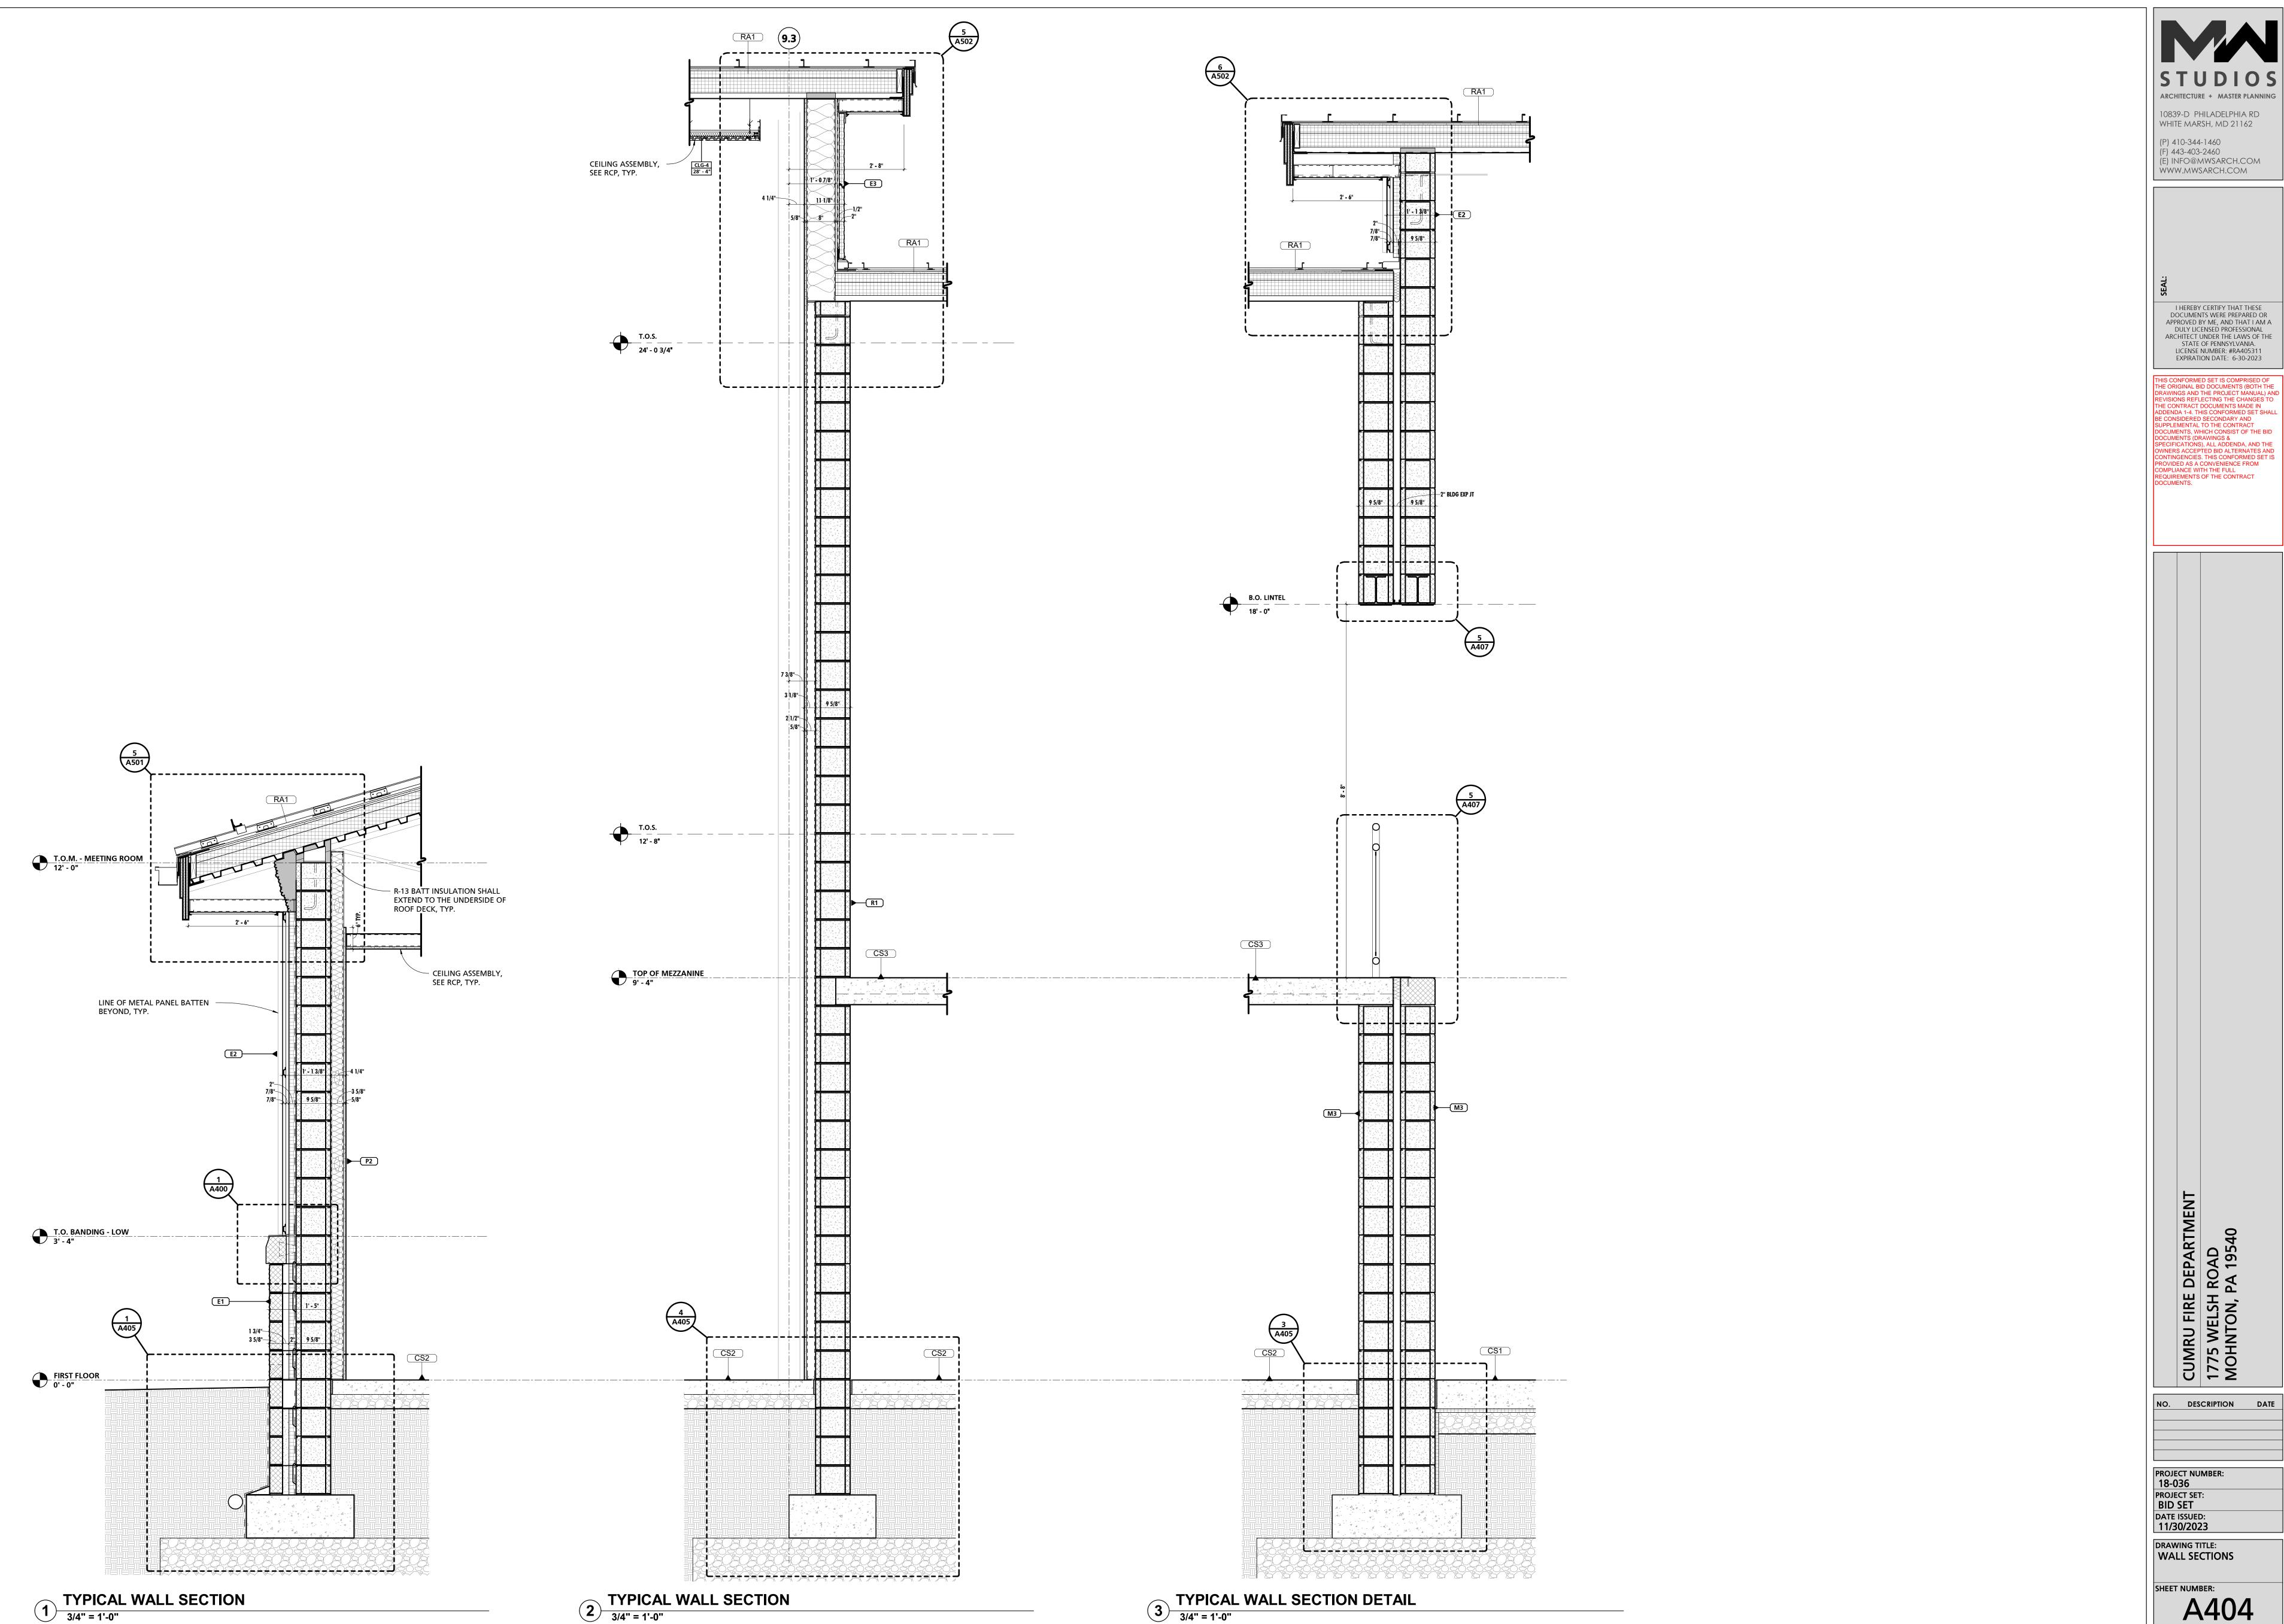
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BID SET DATE ISSUED: 11/30/2023 DRAWING TITLE: WALL SECTIONS SHEET NUMBER: A403

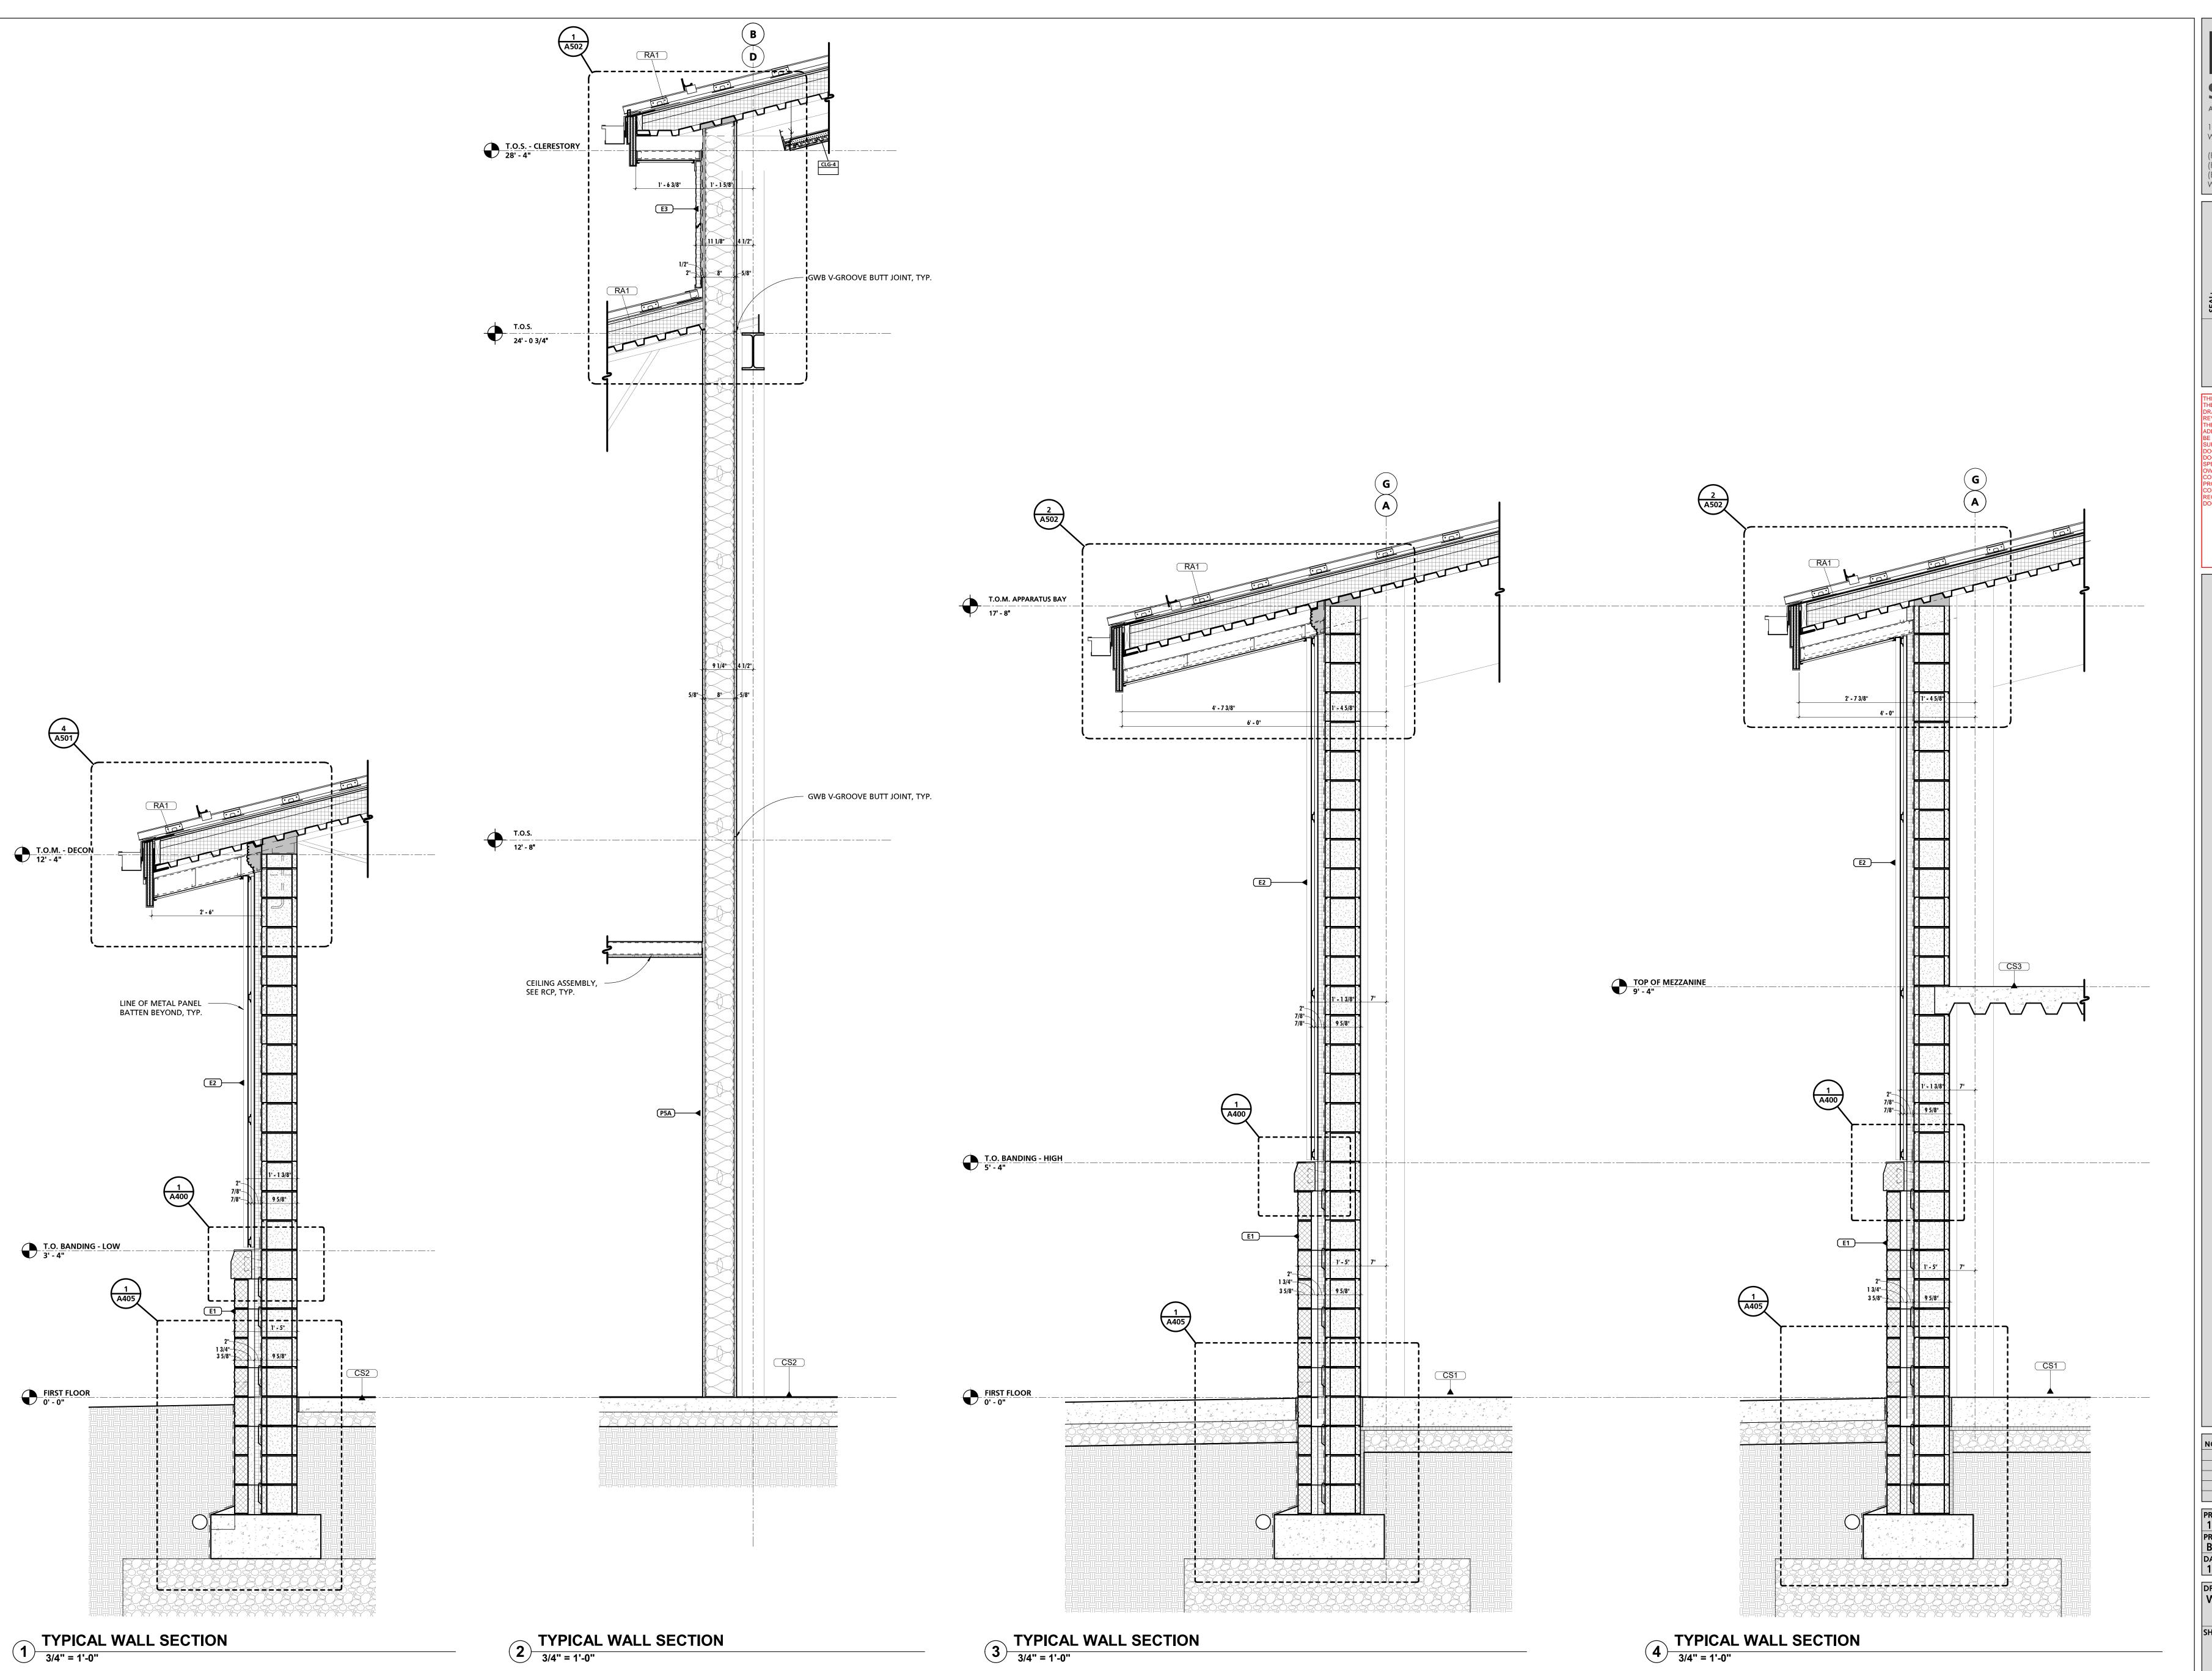STUDIOS

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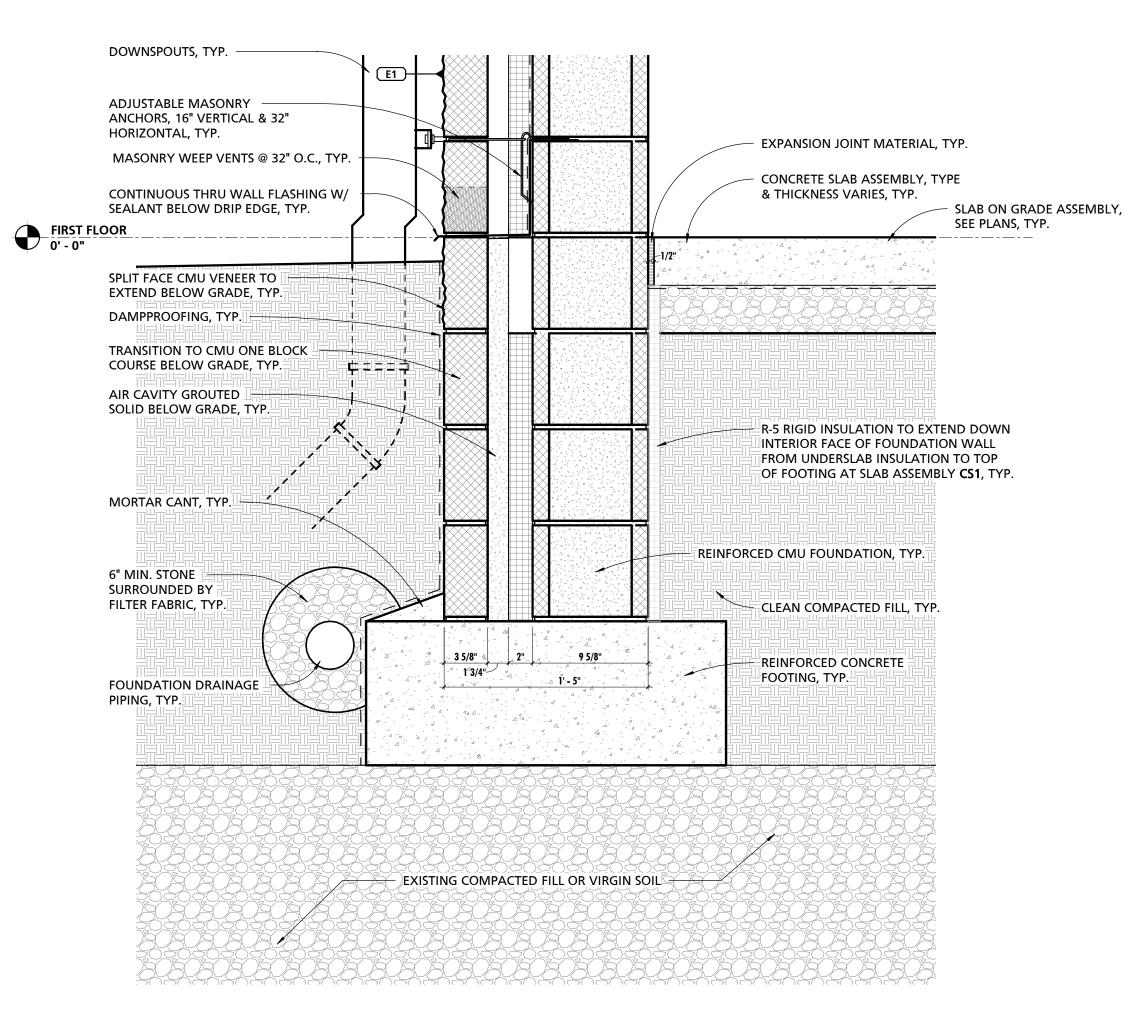
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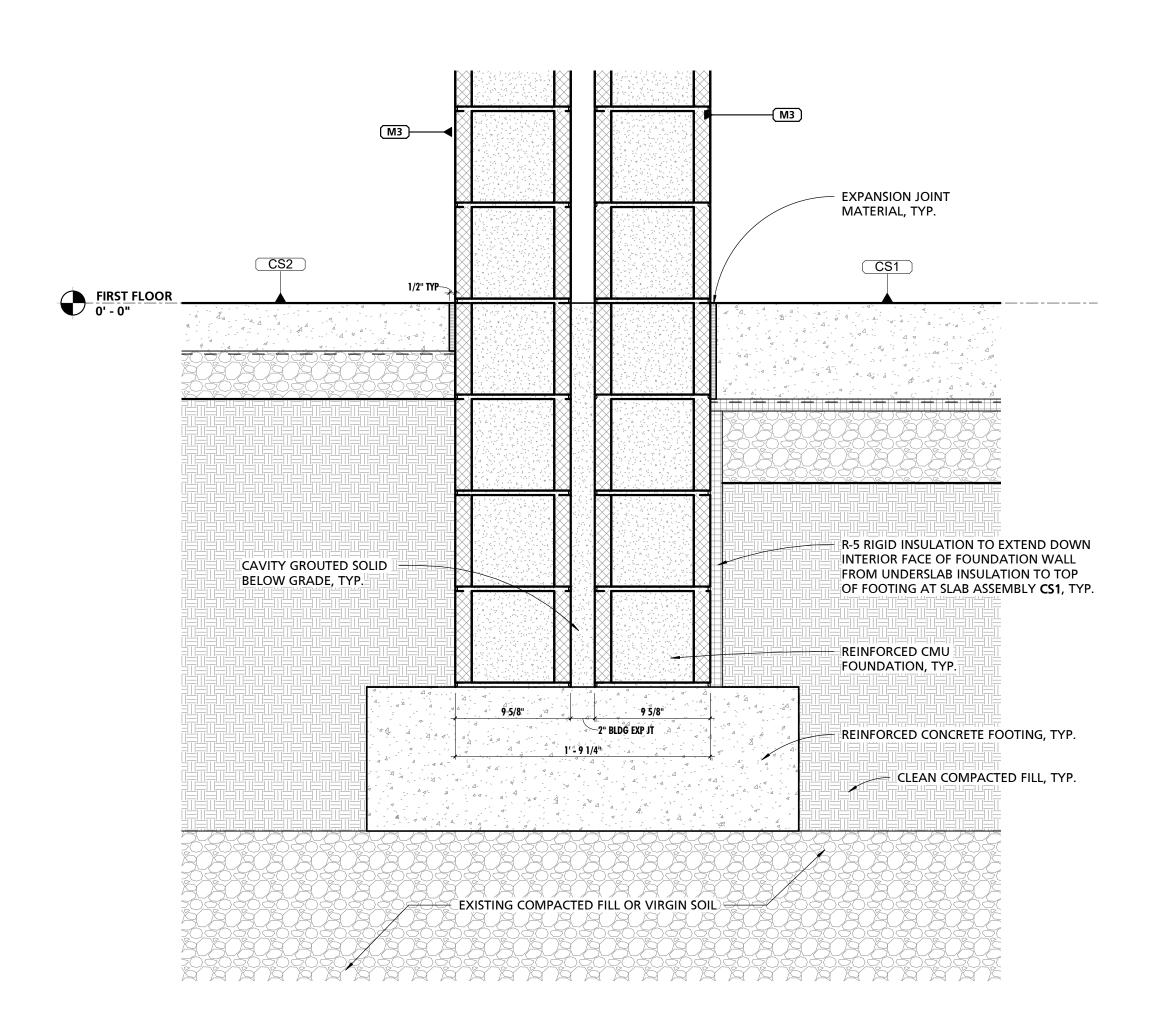


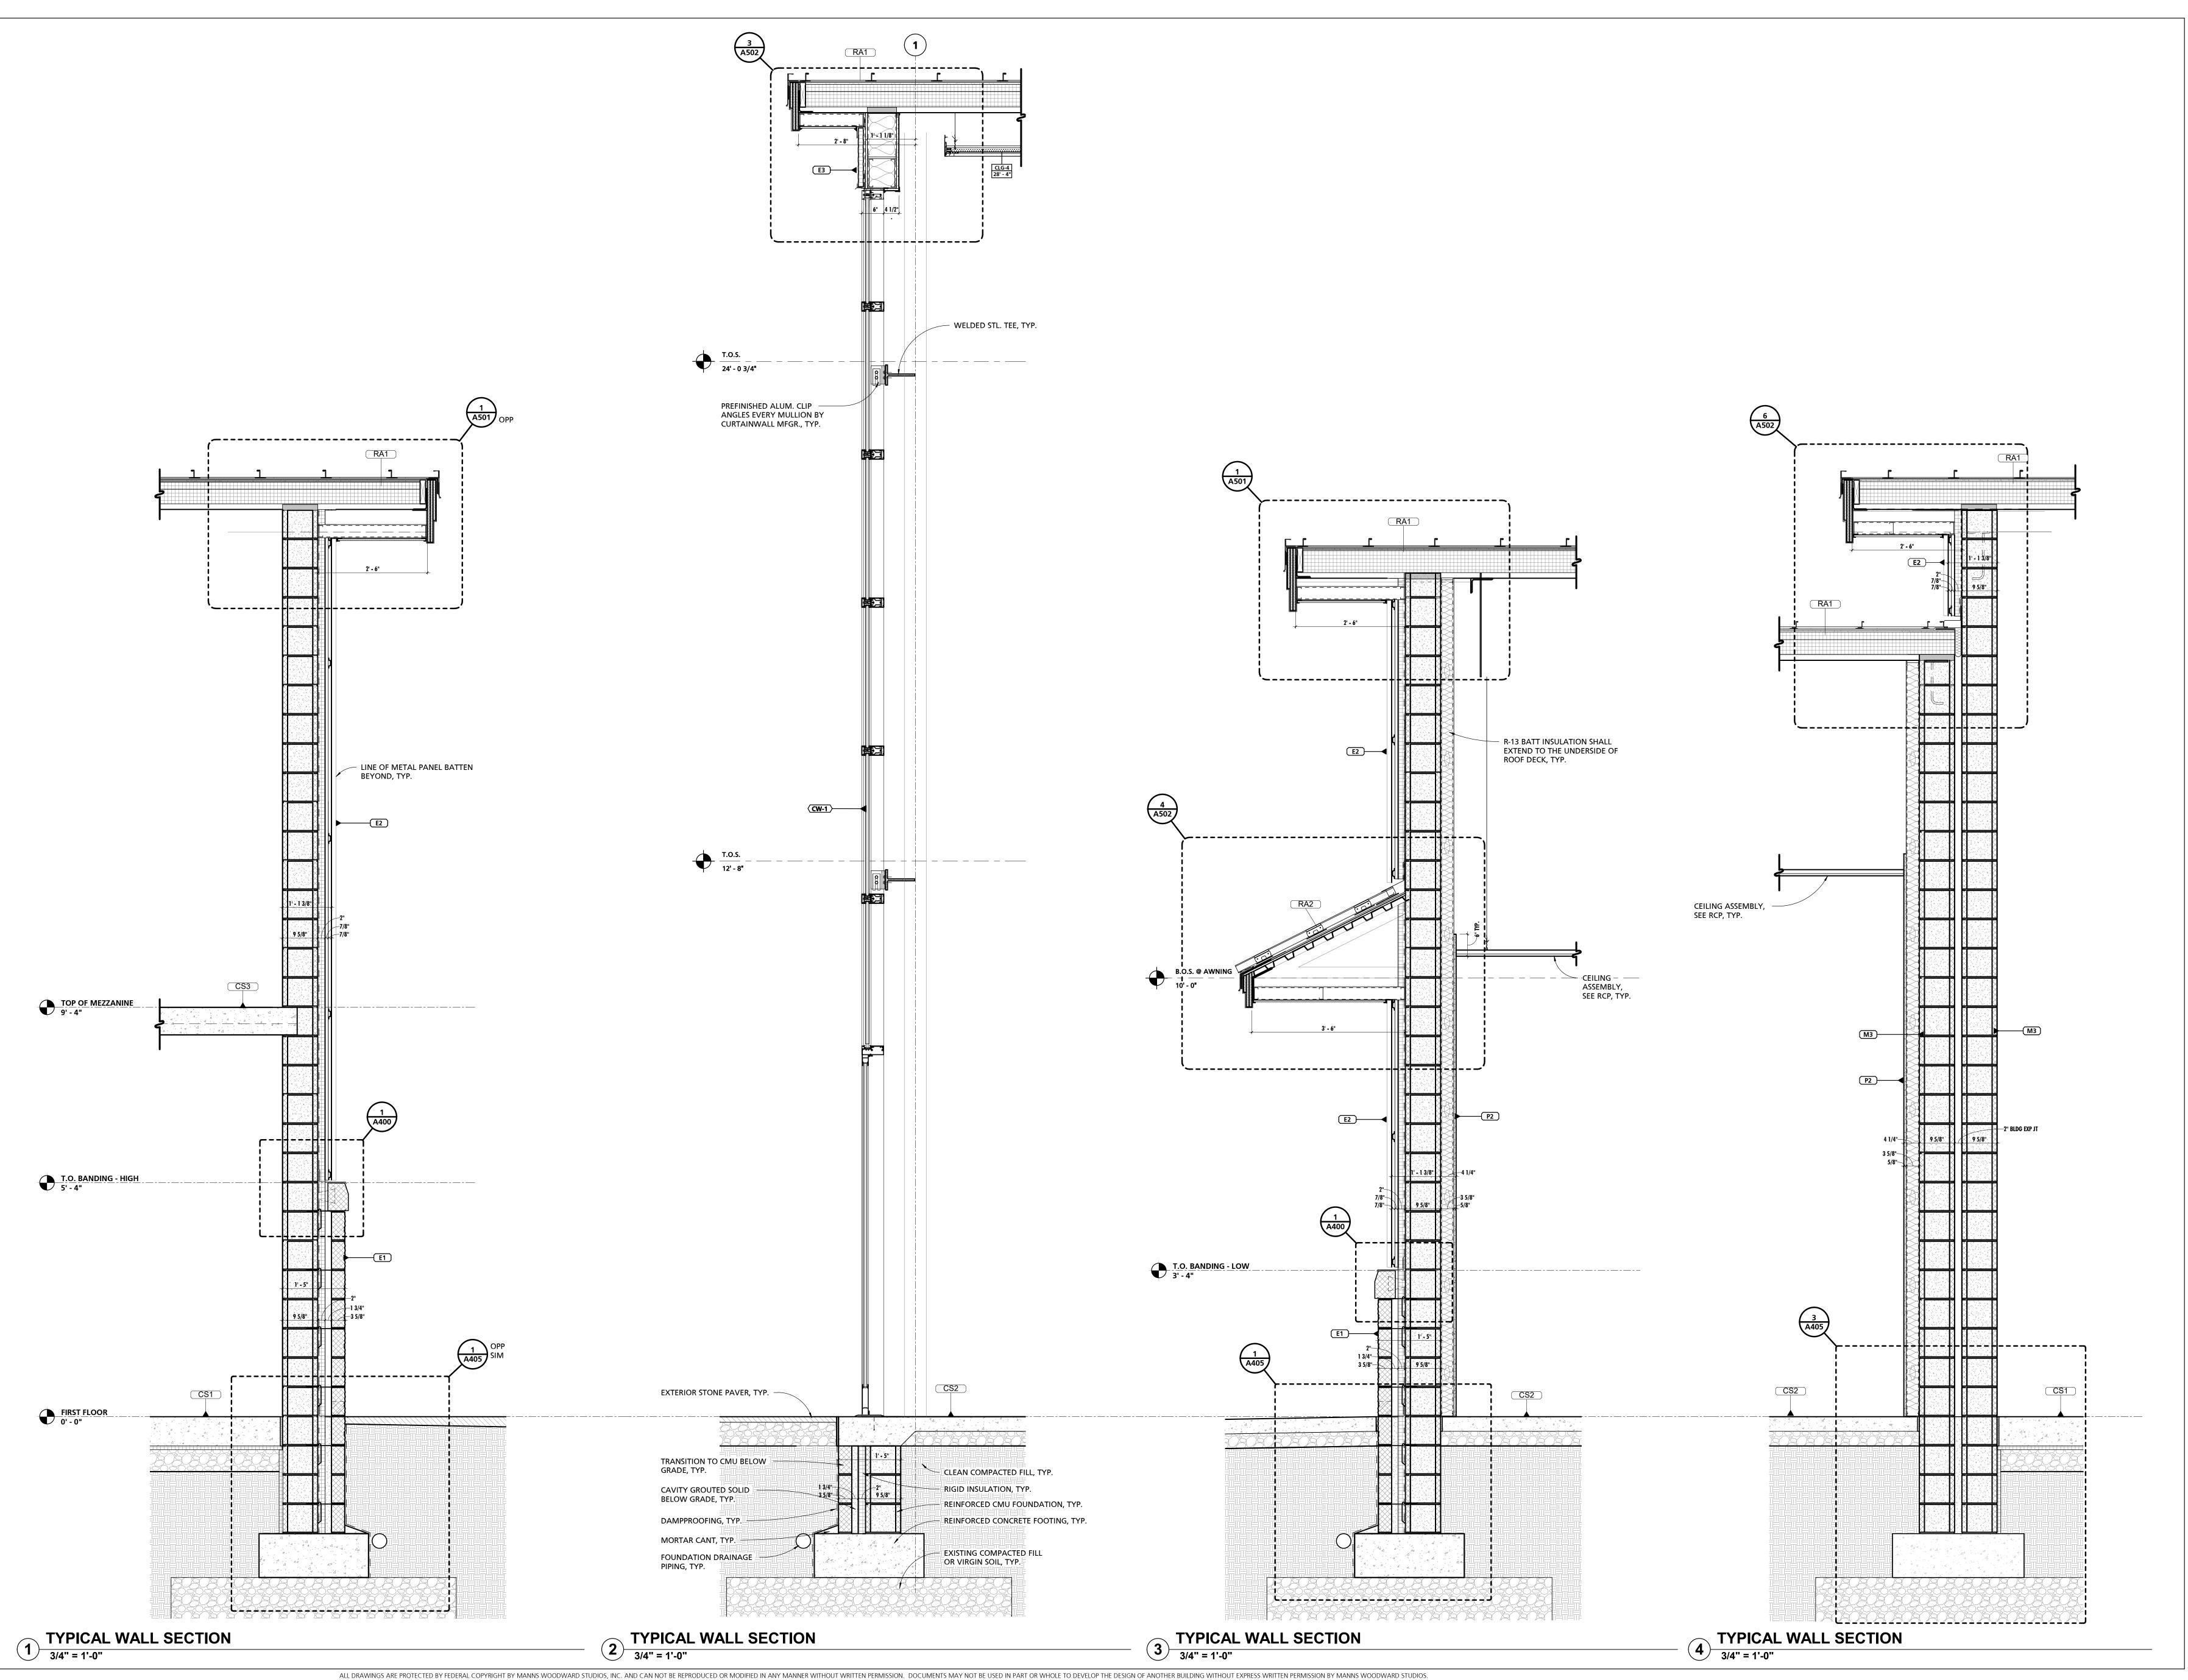SHEET NUMBER: A404

DRAWING TITLE:
WALL SECTIONS




1 TYPICAL FOUNDATION DETAIL @ WALL TYPE E1



TYPICAL FOUNDATION DETAIL @ BUILDING EXPANSION JOINT
1 1/2" = 1'-0"

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- EXPANSION JOINT MATERIAL, TYP. CONCRETE SLAB ASSEMBLY, TYPE & THICKNESS VARIES, TYP. FIRST FLOOR 0' - 0" REINFORCED CMU FOUNDATION, \square SIZE VARIES, TYP. \square CLEAN COMPACTED FILL, TYP. REINFORCED CONCRETE FOOTING, TYP. - EXISTING COMPACTED FILL OR VIRGIN SOIL

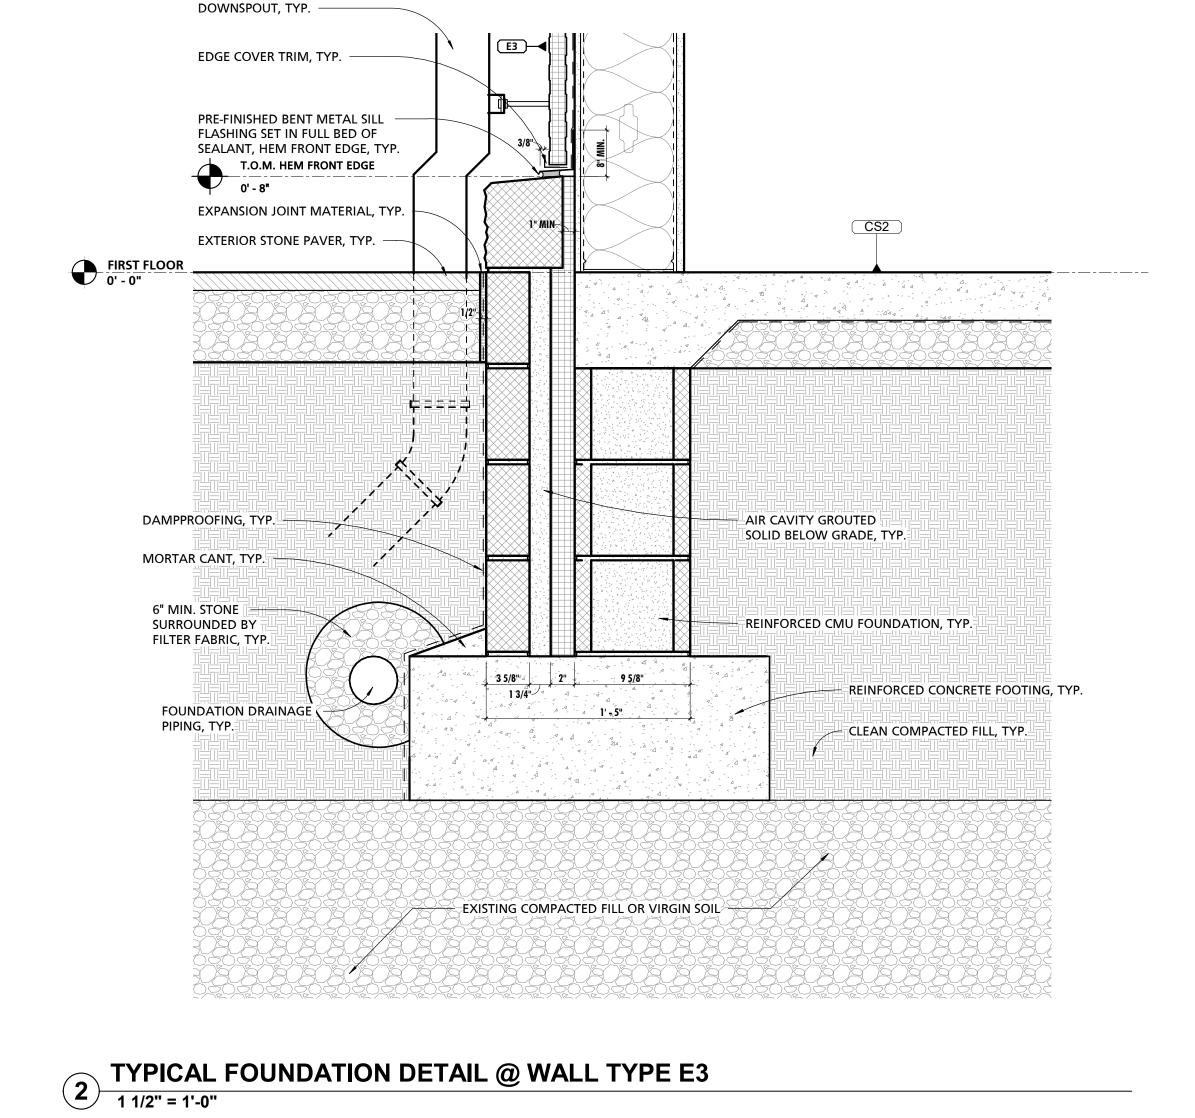4 TYPICAL INTERIOR FOUNDATION DETAIL
1 1/2" = 1'-0"


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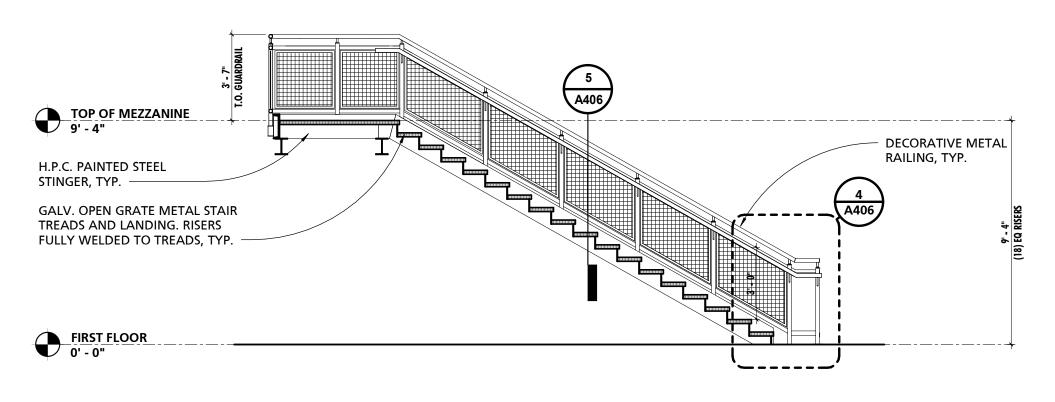
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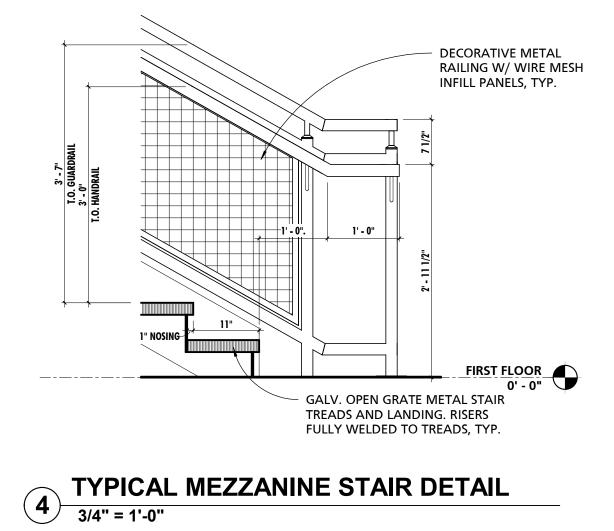
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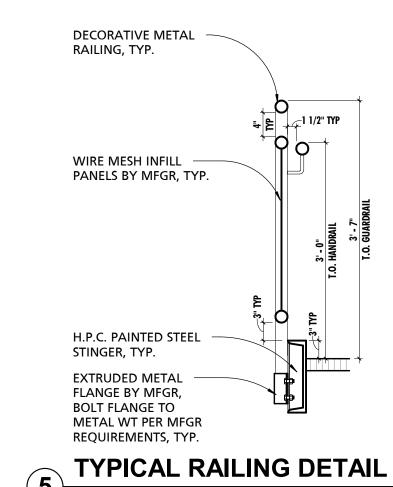
PROJECT SET: BID SET DATE ISSUED: 11/30/2023 DRAWING TITLE: TYPICAL FOUNDATION

DESCRIPTION DATE







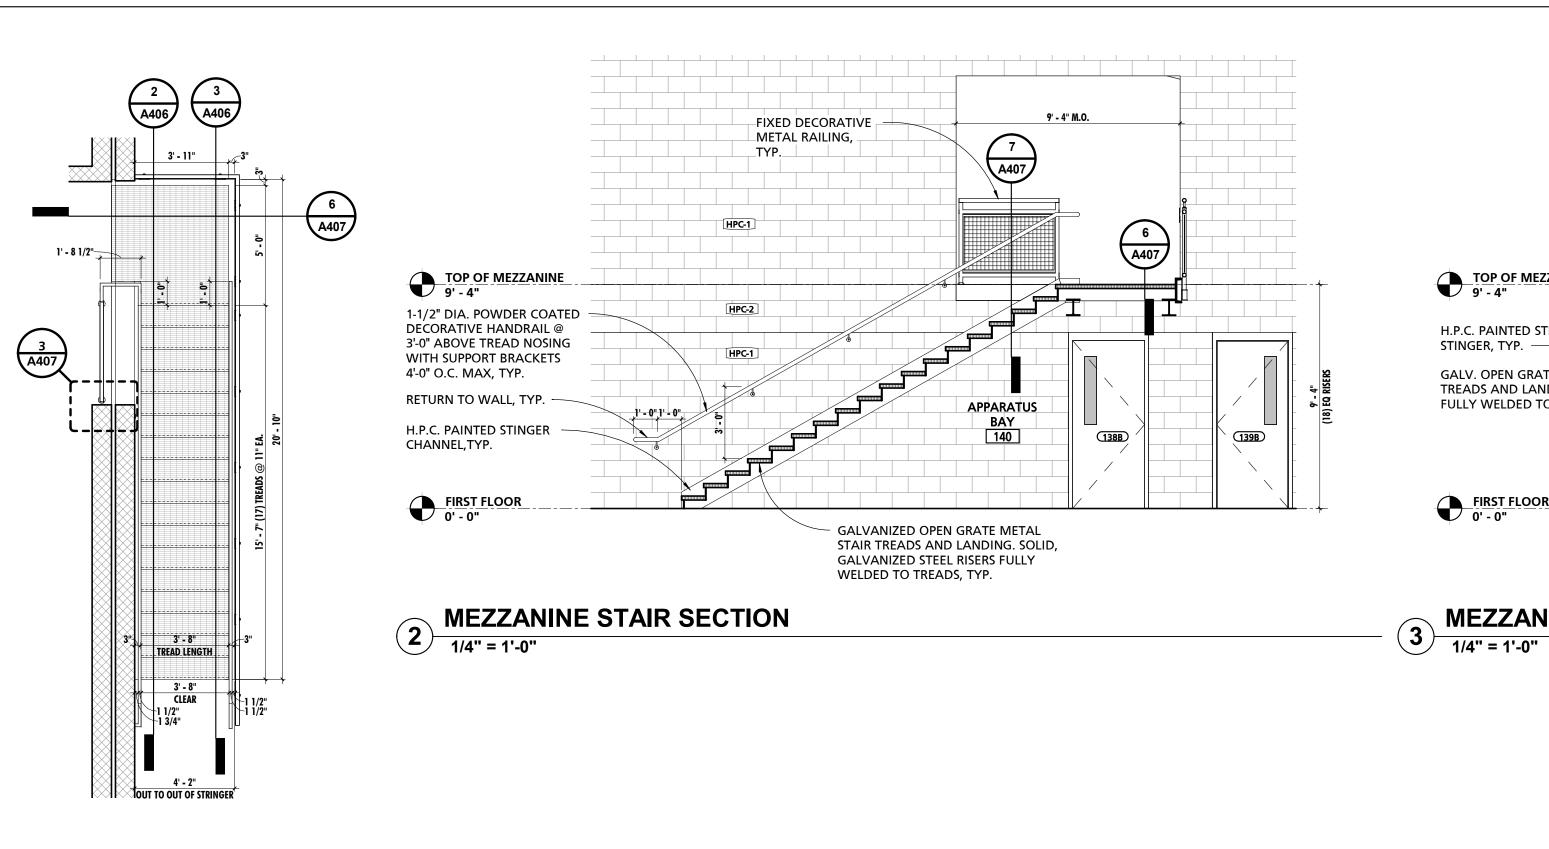

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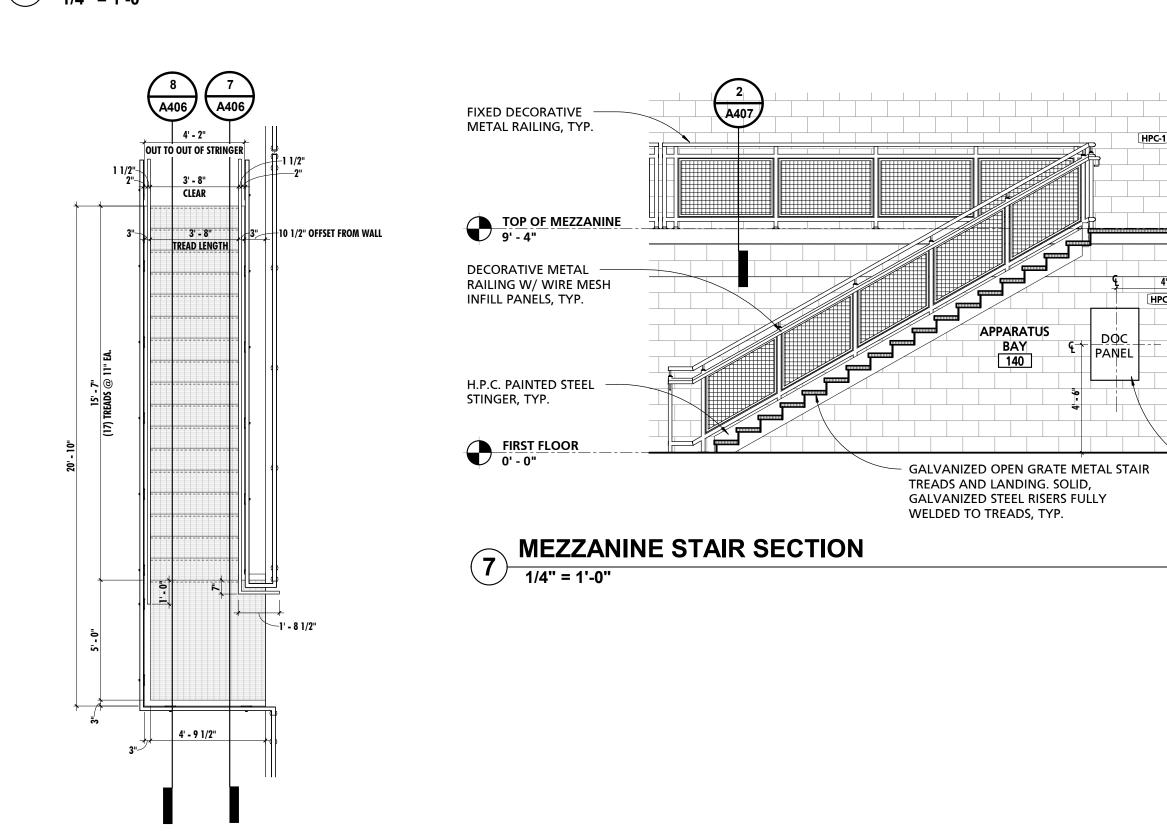
WHITE MARSH, MD 21162


(P) 410-344-1460

(F) 443-403-2460

5 | TYPICAL | 3/4" = 1'-0"

1 MEZZANINE STAIR PLAN
1/4" = 1'-0"



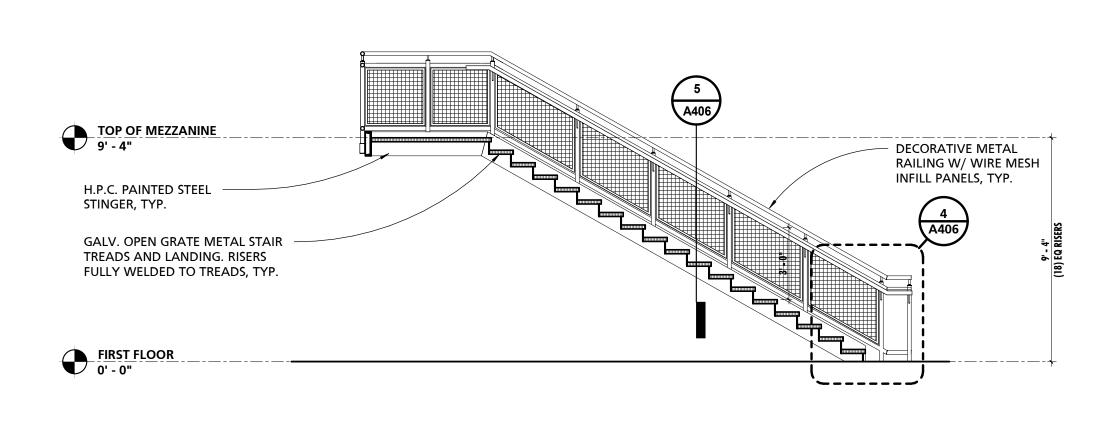

MEZZANINE STAIR SECTION 8 1/4" = 1'-0"

(141B)

ELECTRICAL PANEL

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MEZZANINE STAIR SECTION


6 MEZZANINE STAIR PLAN
1/4" = 1'-0"

CUMRU FIRE DEPARTMENT 1775 WELSH ROAD MOHNTON, PA 19540

PROJECT NUMBER: 18-036 PROJECT SET: **BID SET** DATE ISSUED:

11/30/2023 DRAWING TITLE: TYPICAL STAIR DETAILS

DESCRIPTION DATE

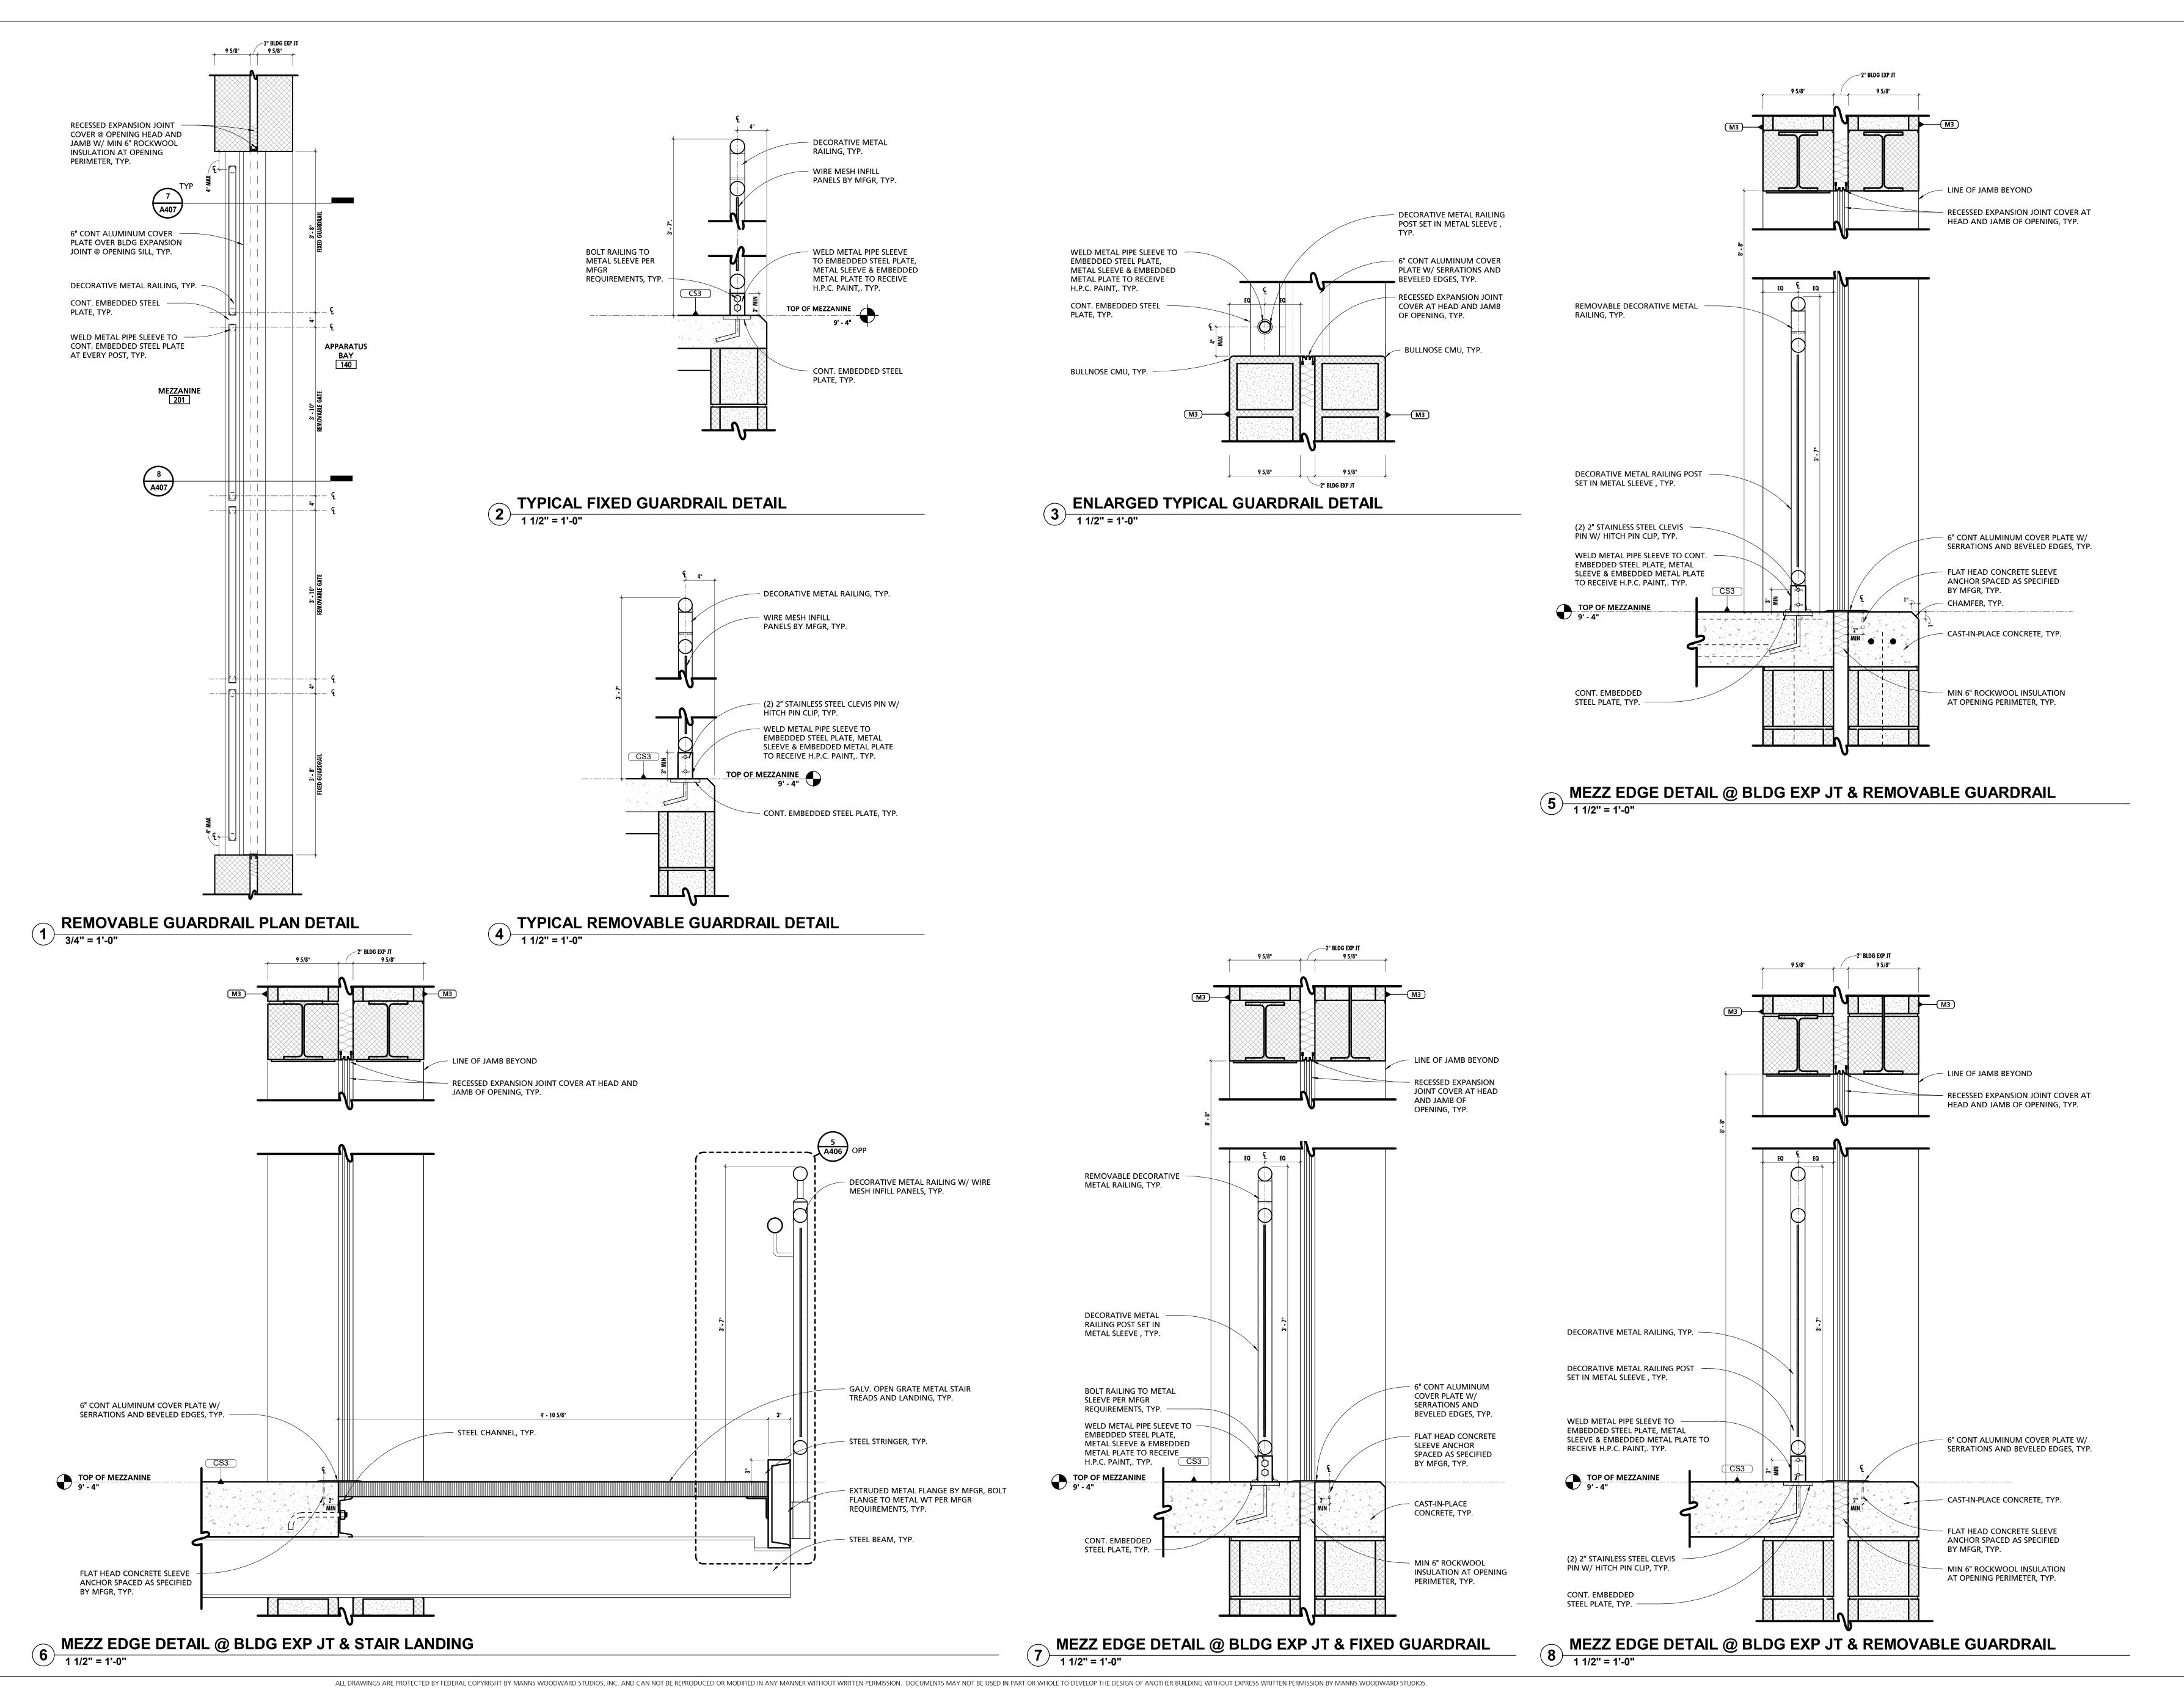

NO. DESCRIPTION DATE PROJECT NUMBER: 18-036 PROJECT SET: BID SET DATE ISSUED: 11/30/2023 DRAWING TITLE: TYPICAL GUARDRAIL DETAILS SHEET NUMBER: A407


REVISIONS REFLECTING THE CHANGES TO THE CONTRACT DOCUMENTS MADE IN ADDENDA 1-4. THIS CONFORMED SET SHALL BE CONSIDERED SECONDARY AND SUPPLEMENTAL TO THE CONTRACT DOCUMENTS, WHICH CONSIST OF THE BID DOCUMENTS (DRAWINGS & SPECIFICATIONS), ALL ADDENDA, AND THE OWNERS ACCEPTED BID ALTERNATES AND CONTINGENCIES. THIS CONFORMED SET IS PROVIDED AS A CONVENIENCE FROM COMPLIANCE WITH THE FULL REQUIREMENTS OF THE CONTRACT REQUIREMENTS OF THE CONTRACT DOCUMENTS.

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GENERAL ROOFING NOTES

BLOCKING/MISCELLANEOUS FRAMING INDICATED WITHIN THE DOCUMENTS IS SHOWN FOR THE PURPOSES OF DESIGN INTENT. IT SHALL BE THE CONTRACTORS RESPONSIBILITY, WHETHER SHOWN OR NOT SHOWN, TO PROVIDE BLOCKING/MISCELLANEOUS FRAMING AS REQUIRED TO PROPERLY SUPPORT ALL SUBSTRATES, FLASHINGS, COPINGS, BRAKE METAL, SOFFITS, INSULATIONS, CLIPS, STOPS, MISCELLANEOUS ITEMS, ROOFING MEMBRANES OR SYSTEMS AND SIMILAR ITEMS REQUIRED TO COMPLETE THE WORK. WHERE ADDITIONAL BLOCKING/MISCELLANEOUS FRAMING, INCLUDING BUT NOT LIMITED TO THE REPLACEMENT OF INDICATED SHEATHING/DECKING, IS RECOMMENDED BY ONE OF THE ASSEMBLY COMPONENTS MANUFACTURER, THE CONTRACTOR SHALL PROVIDE AND INSTALL SUCH BLOCKING/MISCELLANEOUS FRAMING TO COMPLY WITH THE MANUFACTURER'S RECOMMENDATIONS.

CONTRACTOR SHALL BE RESPONSIBLE FOR COORDINATING FINAL ROOFING SUBSTRATE REQUIREMENTS TO ENSURE SUCCESSFUL INSTALLATION OF ROOFING MATERIALS IN A MANNER THAT MAINTAINS THE FULL PRODUCT WARRANTY AND COMPLIES WITH ALL APPLICABLE BUILDING CODES OF THE AHJ.

0	REFERENCED NOTES - ROOF PLANS
NO.	NOTE
1	6"x6" PREFINISHED ALUMINUM GUTTER
2	STANDING SEAM RIDGE CAP
3	4" x 5" ALUMINUM DOWNSPOUT CONNECTED TO BOOT
4	PREFINISHED SNOW RETENTION SYSTEM BY METAL ROOF MFGR
5	GOOSENECK DUCT EXHAUST
6	FLUE STACK
7	STANDING SEAM HIP CAP FLASHING
8	STANDING SEAM VALLEY FLASHING
9	SPLASH PAN FABRICATED FROM STANDING SEAM ROOF METAL, ATTACH TO DOWNSPOUT OUTLET AT OUTFALL ONTO LOWER ROOF PAN
10	SANITARY VENT
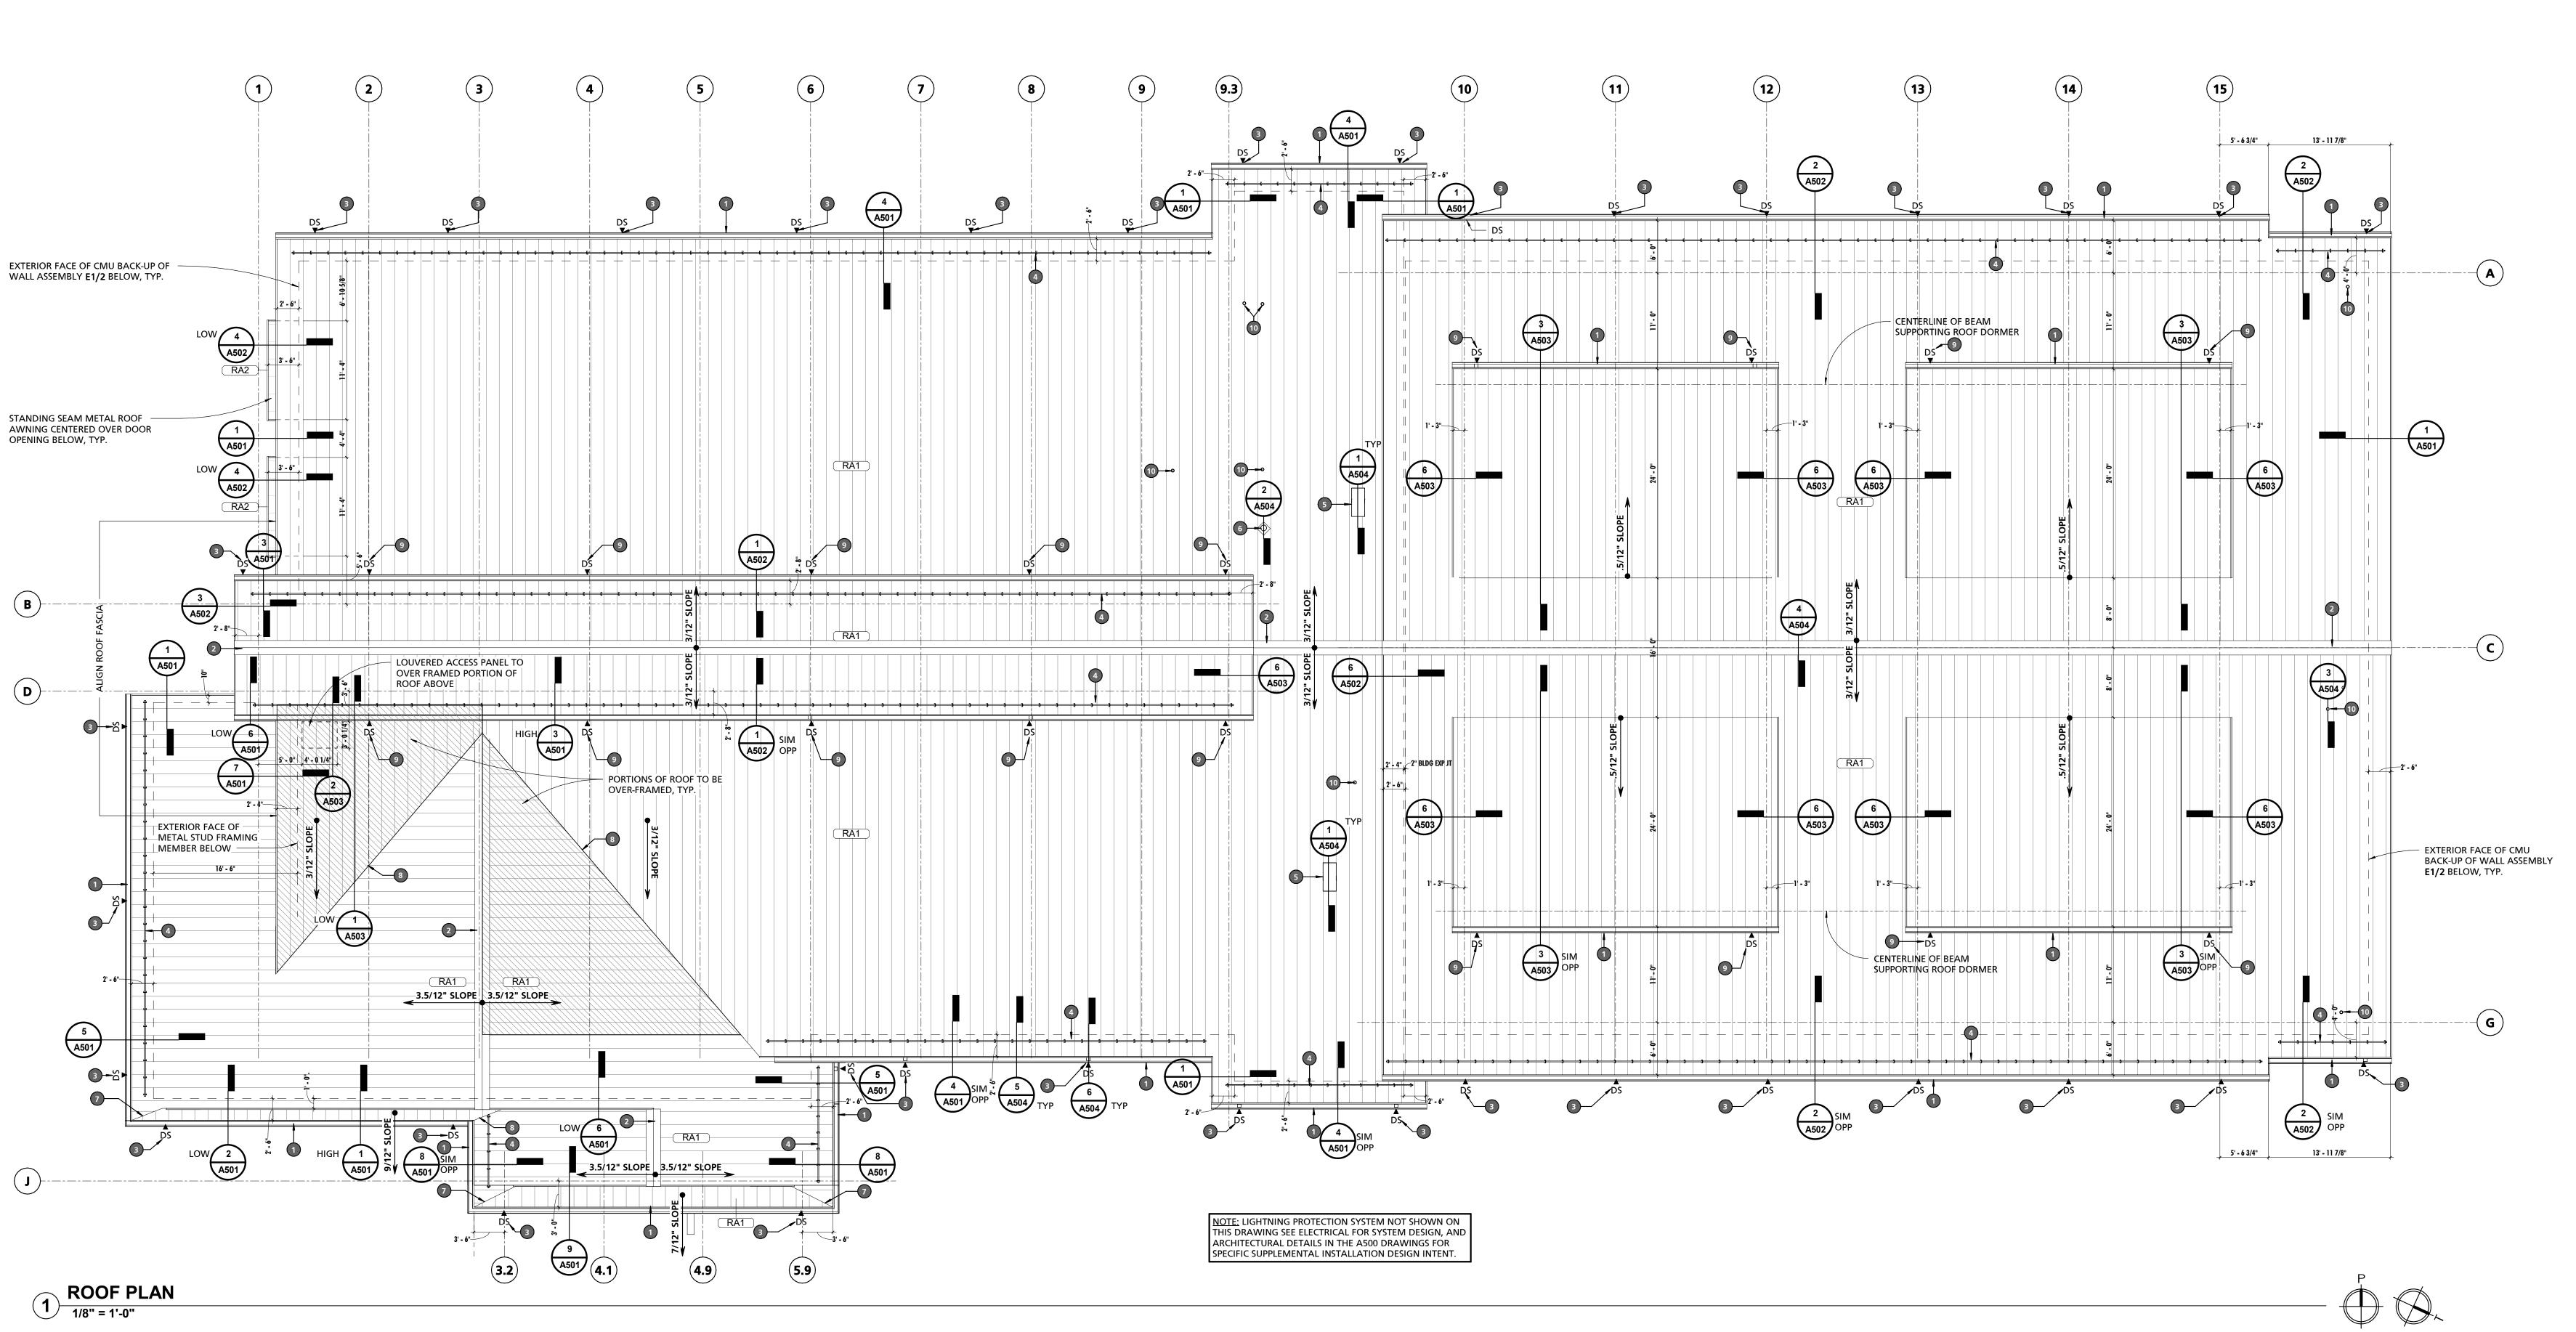
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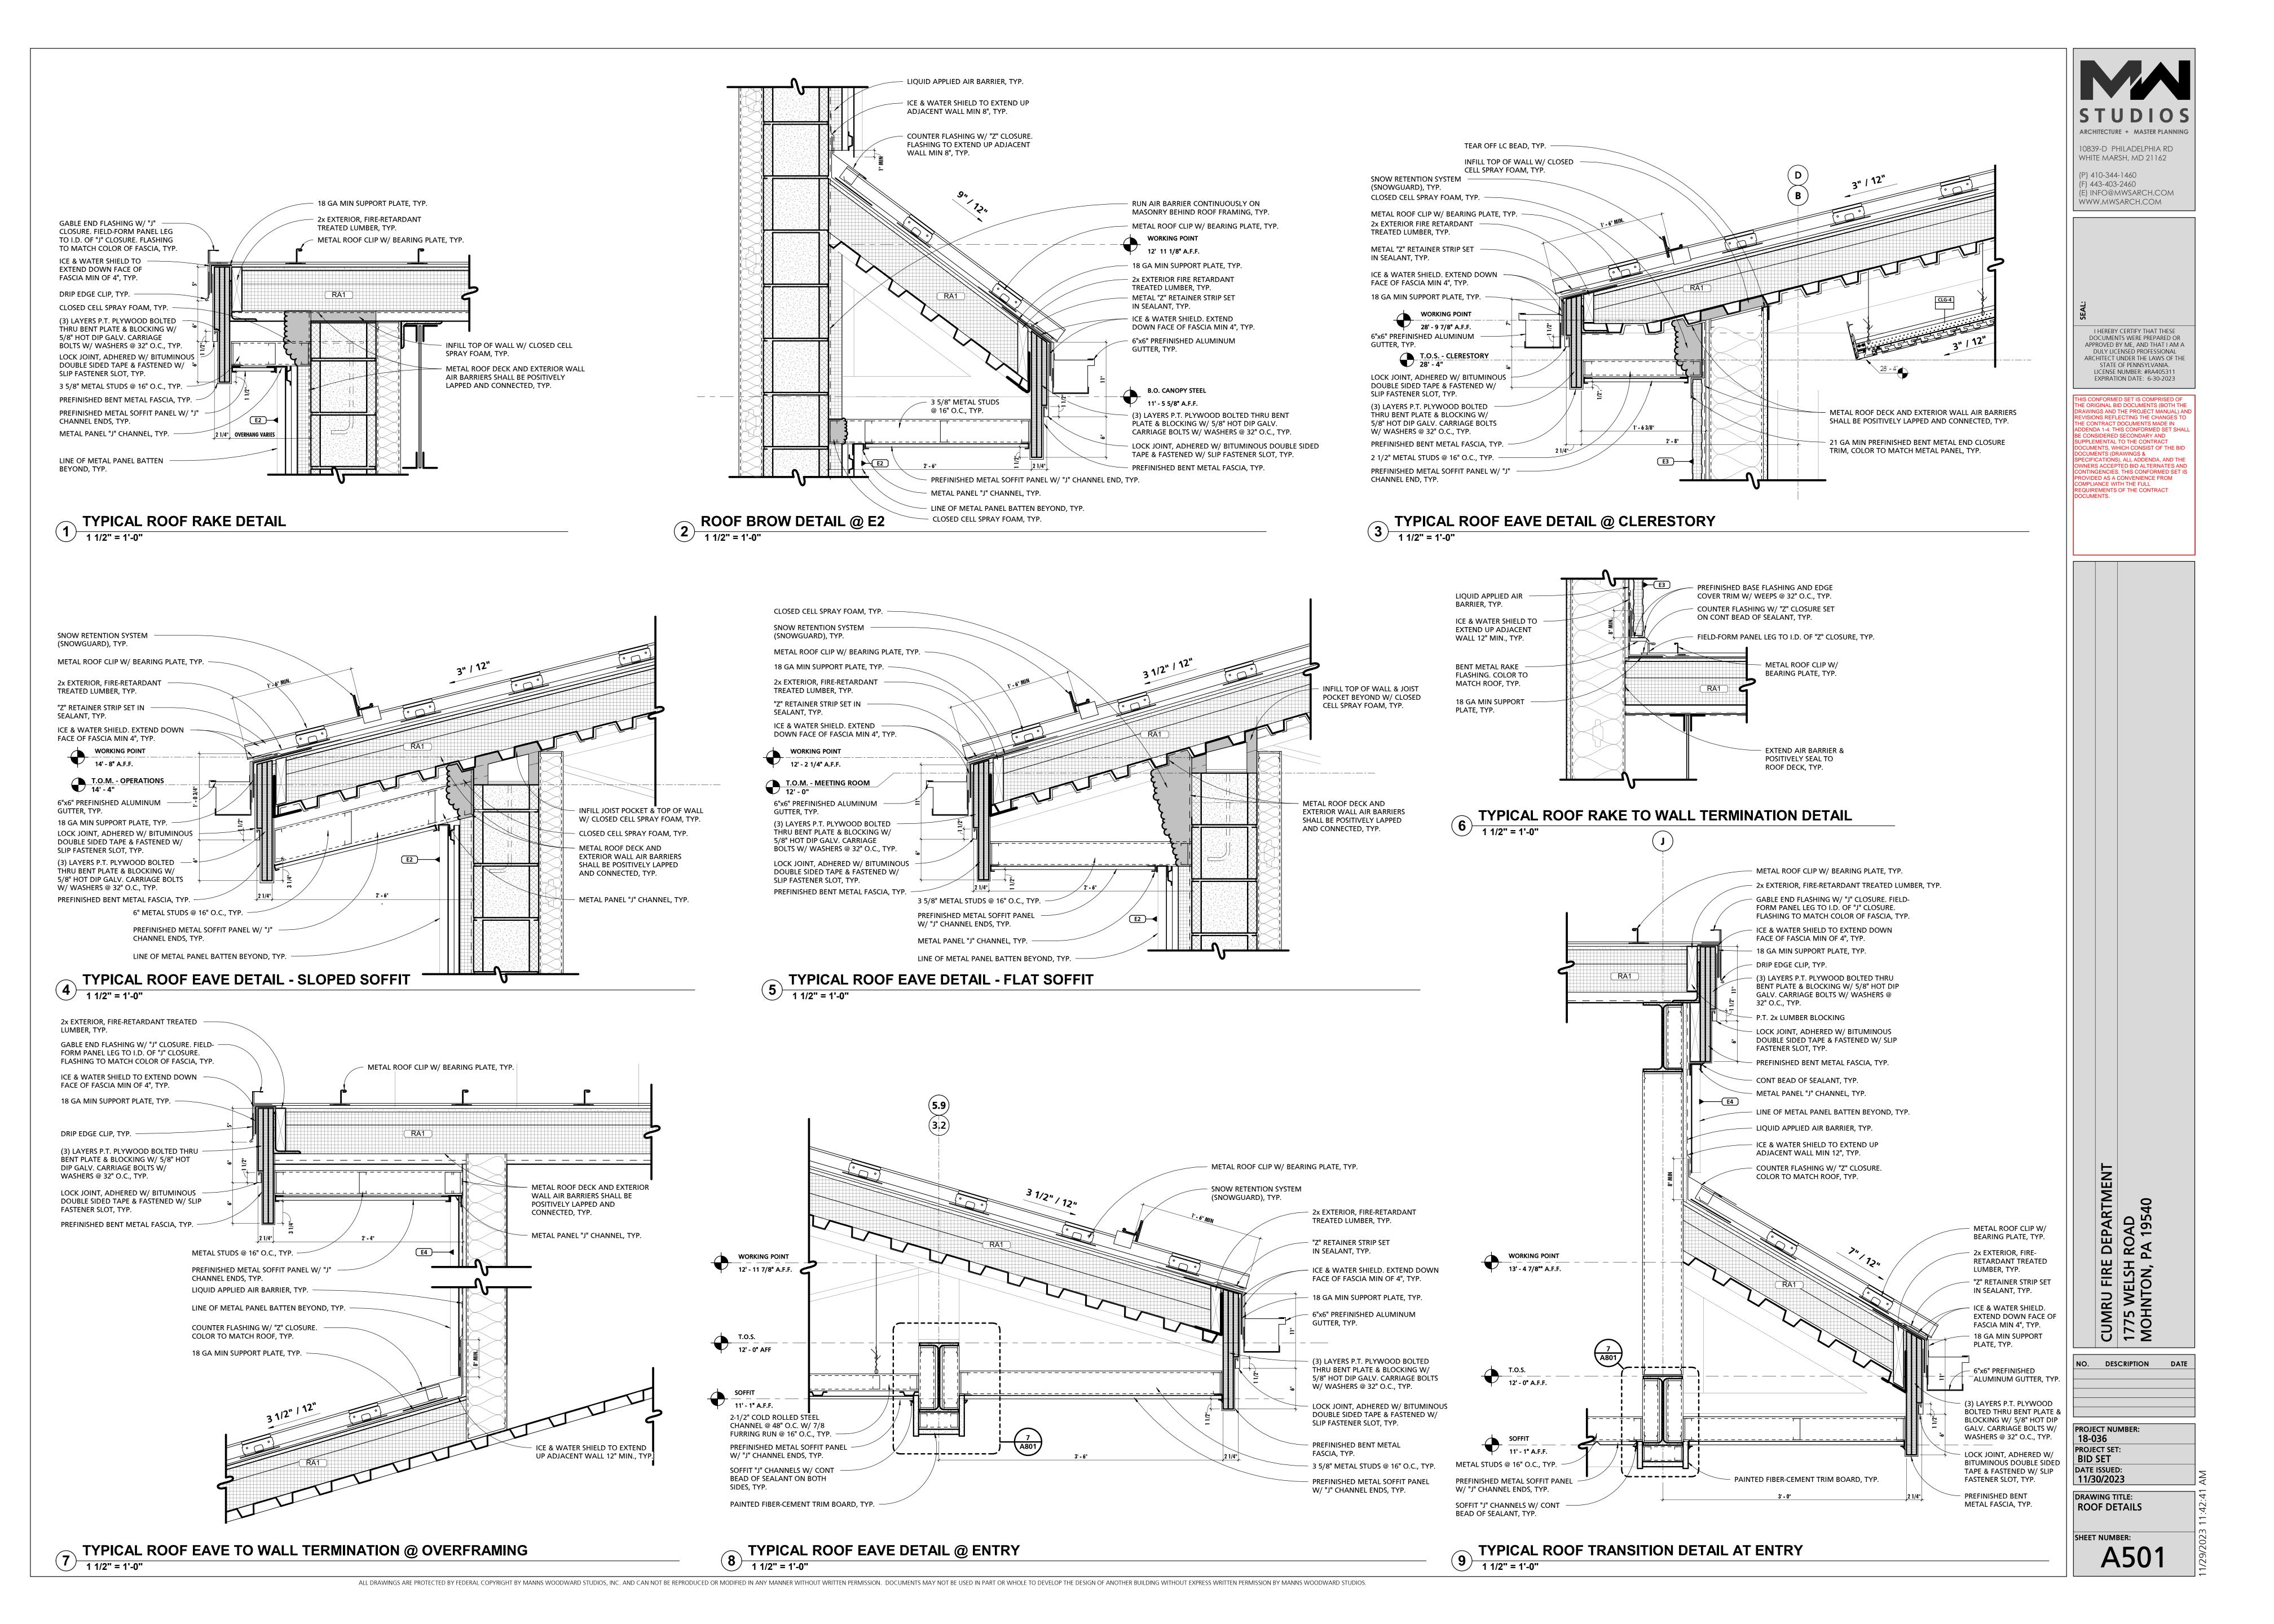
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DOCUMENTS.


CUMRU FIRE DEPARTMENT 1775 WELSH ROAD MOHNTON, PA 19540

DESCRIPTION DATE

PROJECT NUMBER: PROJECT SET: BID SET DATE ISSUED:

11/30/2023 DRAWING TITLE: ROOF PLAN



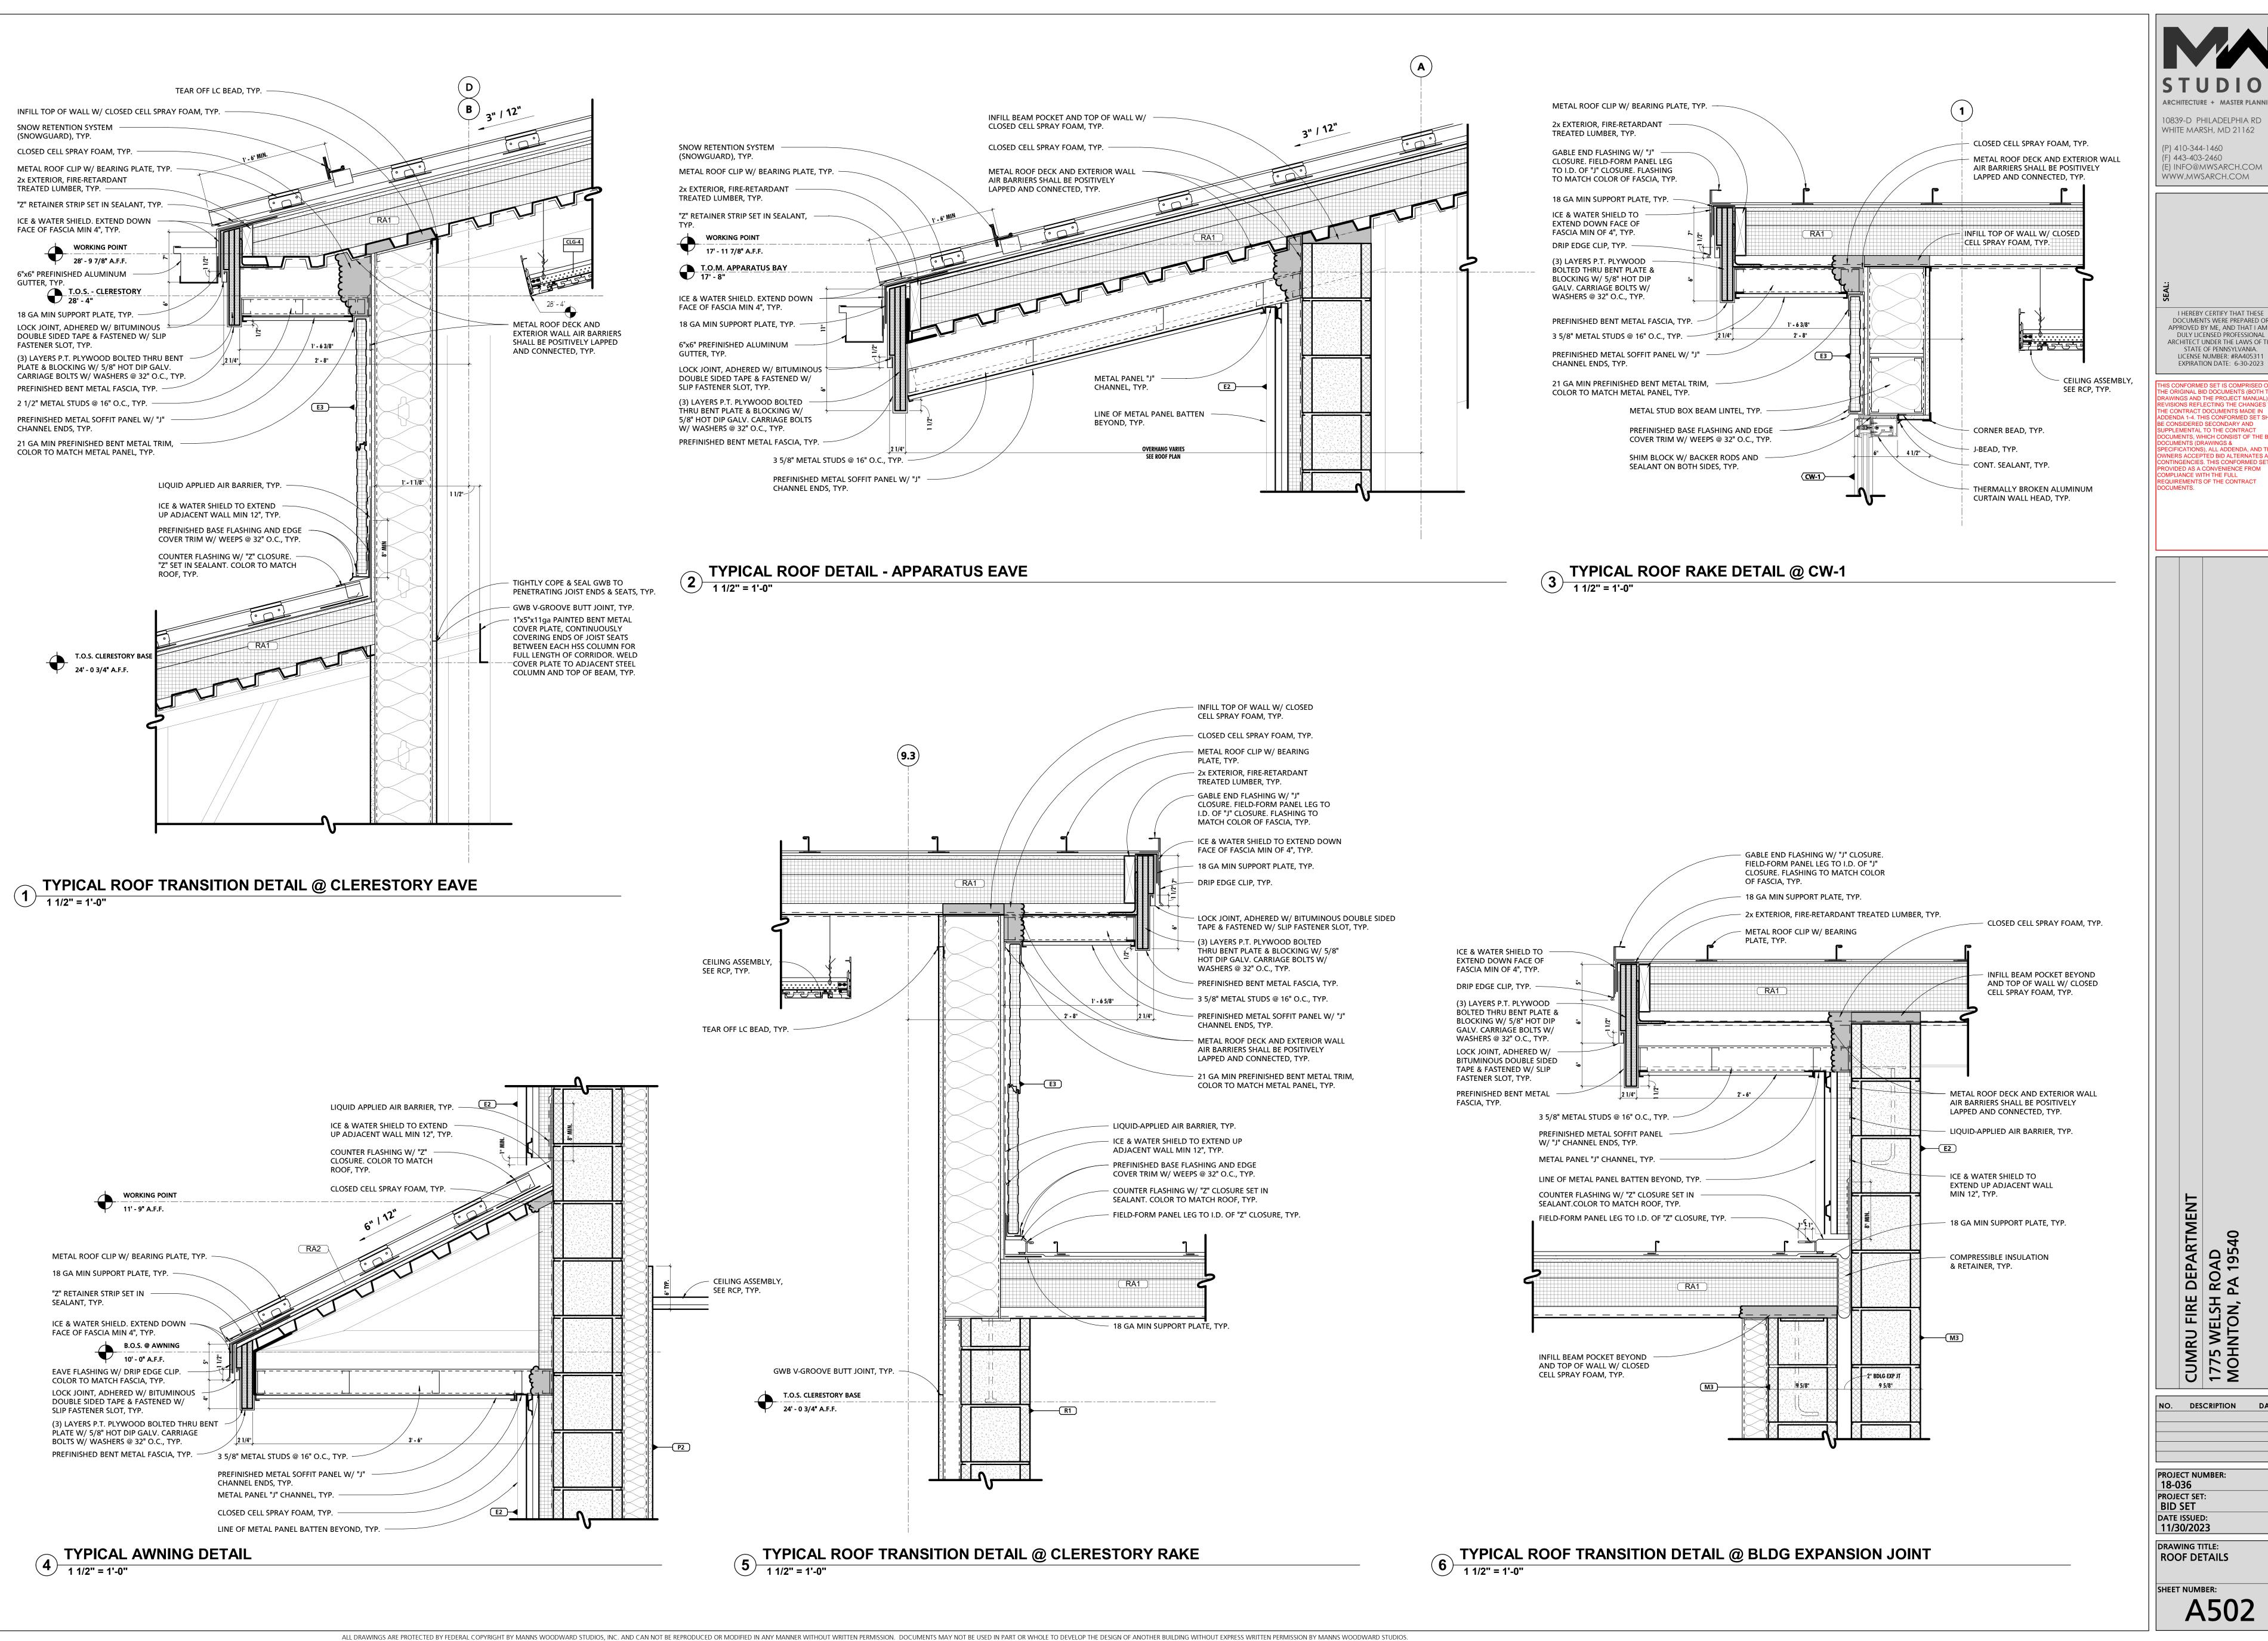



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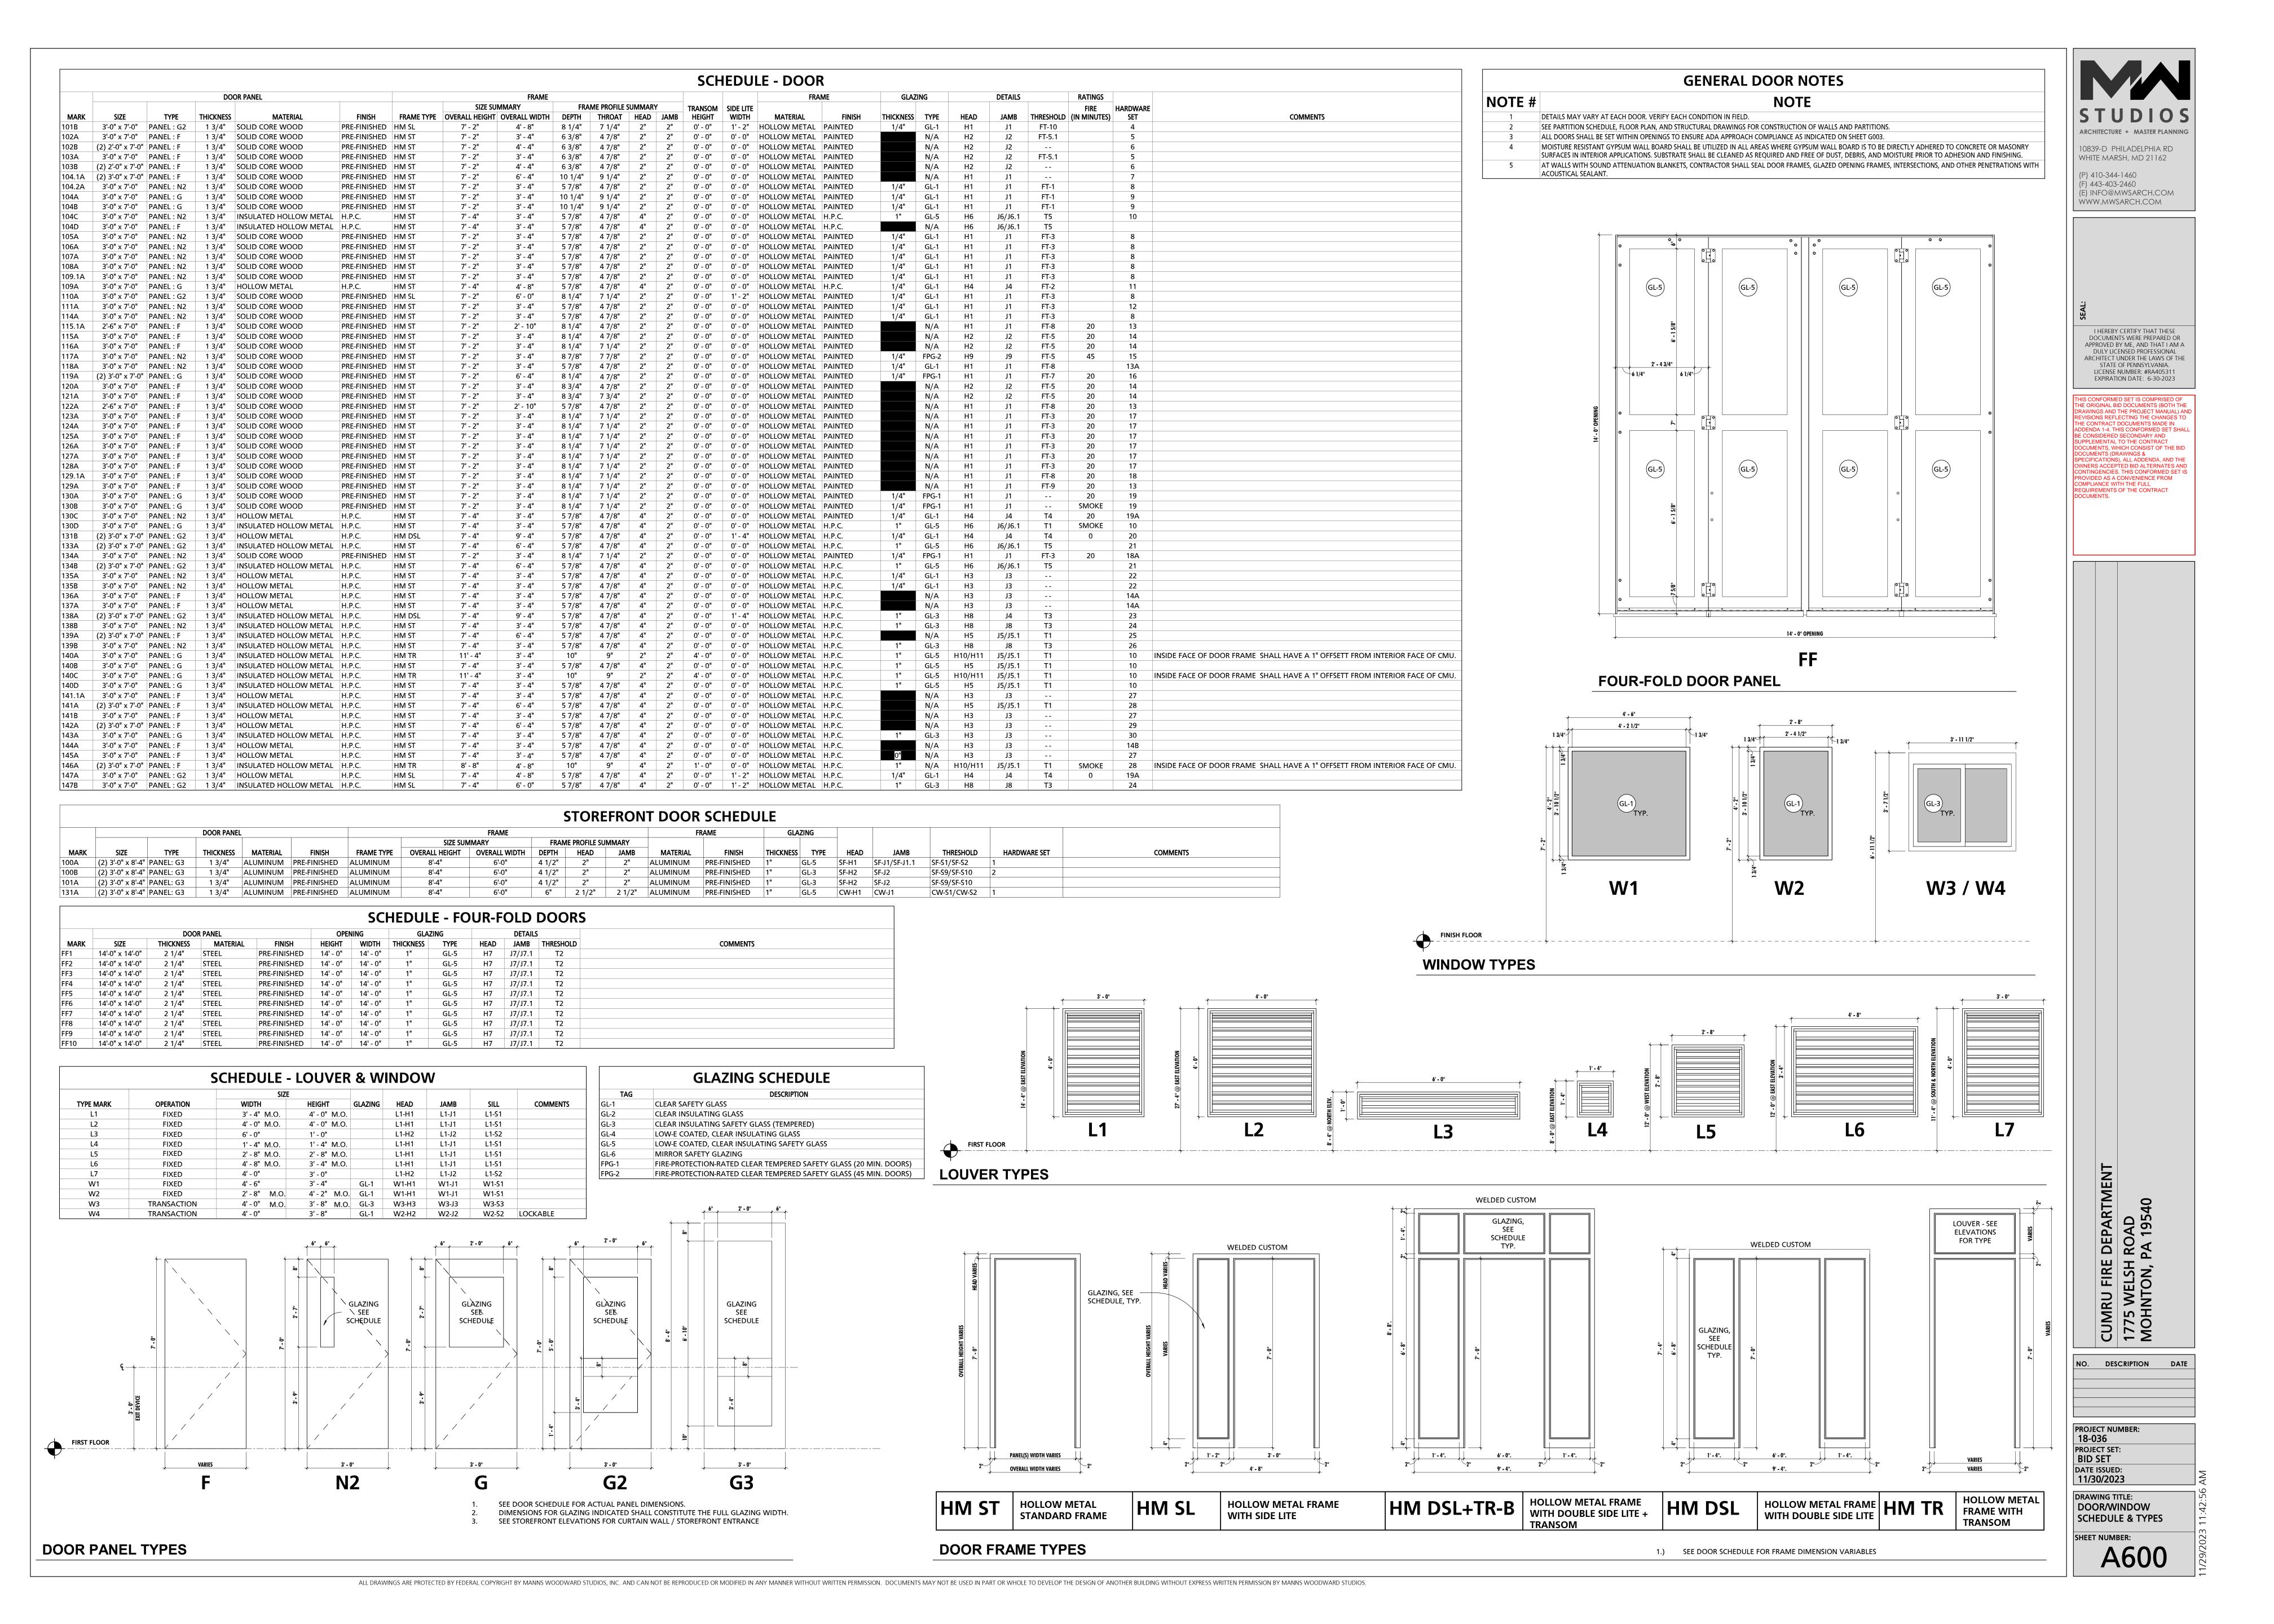
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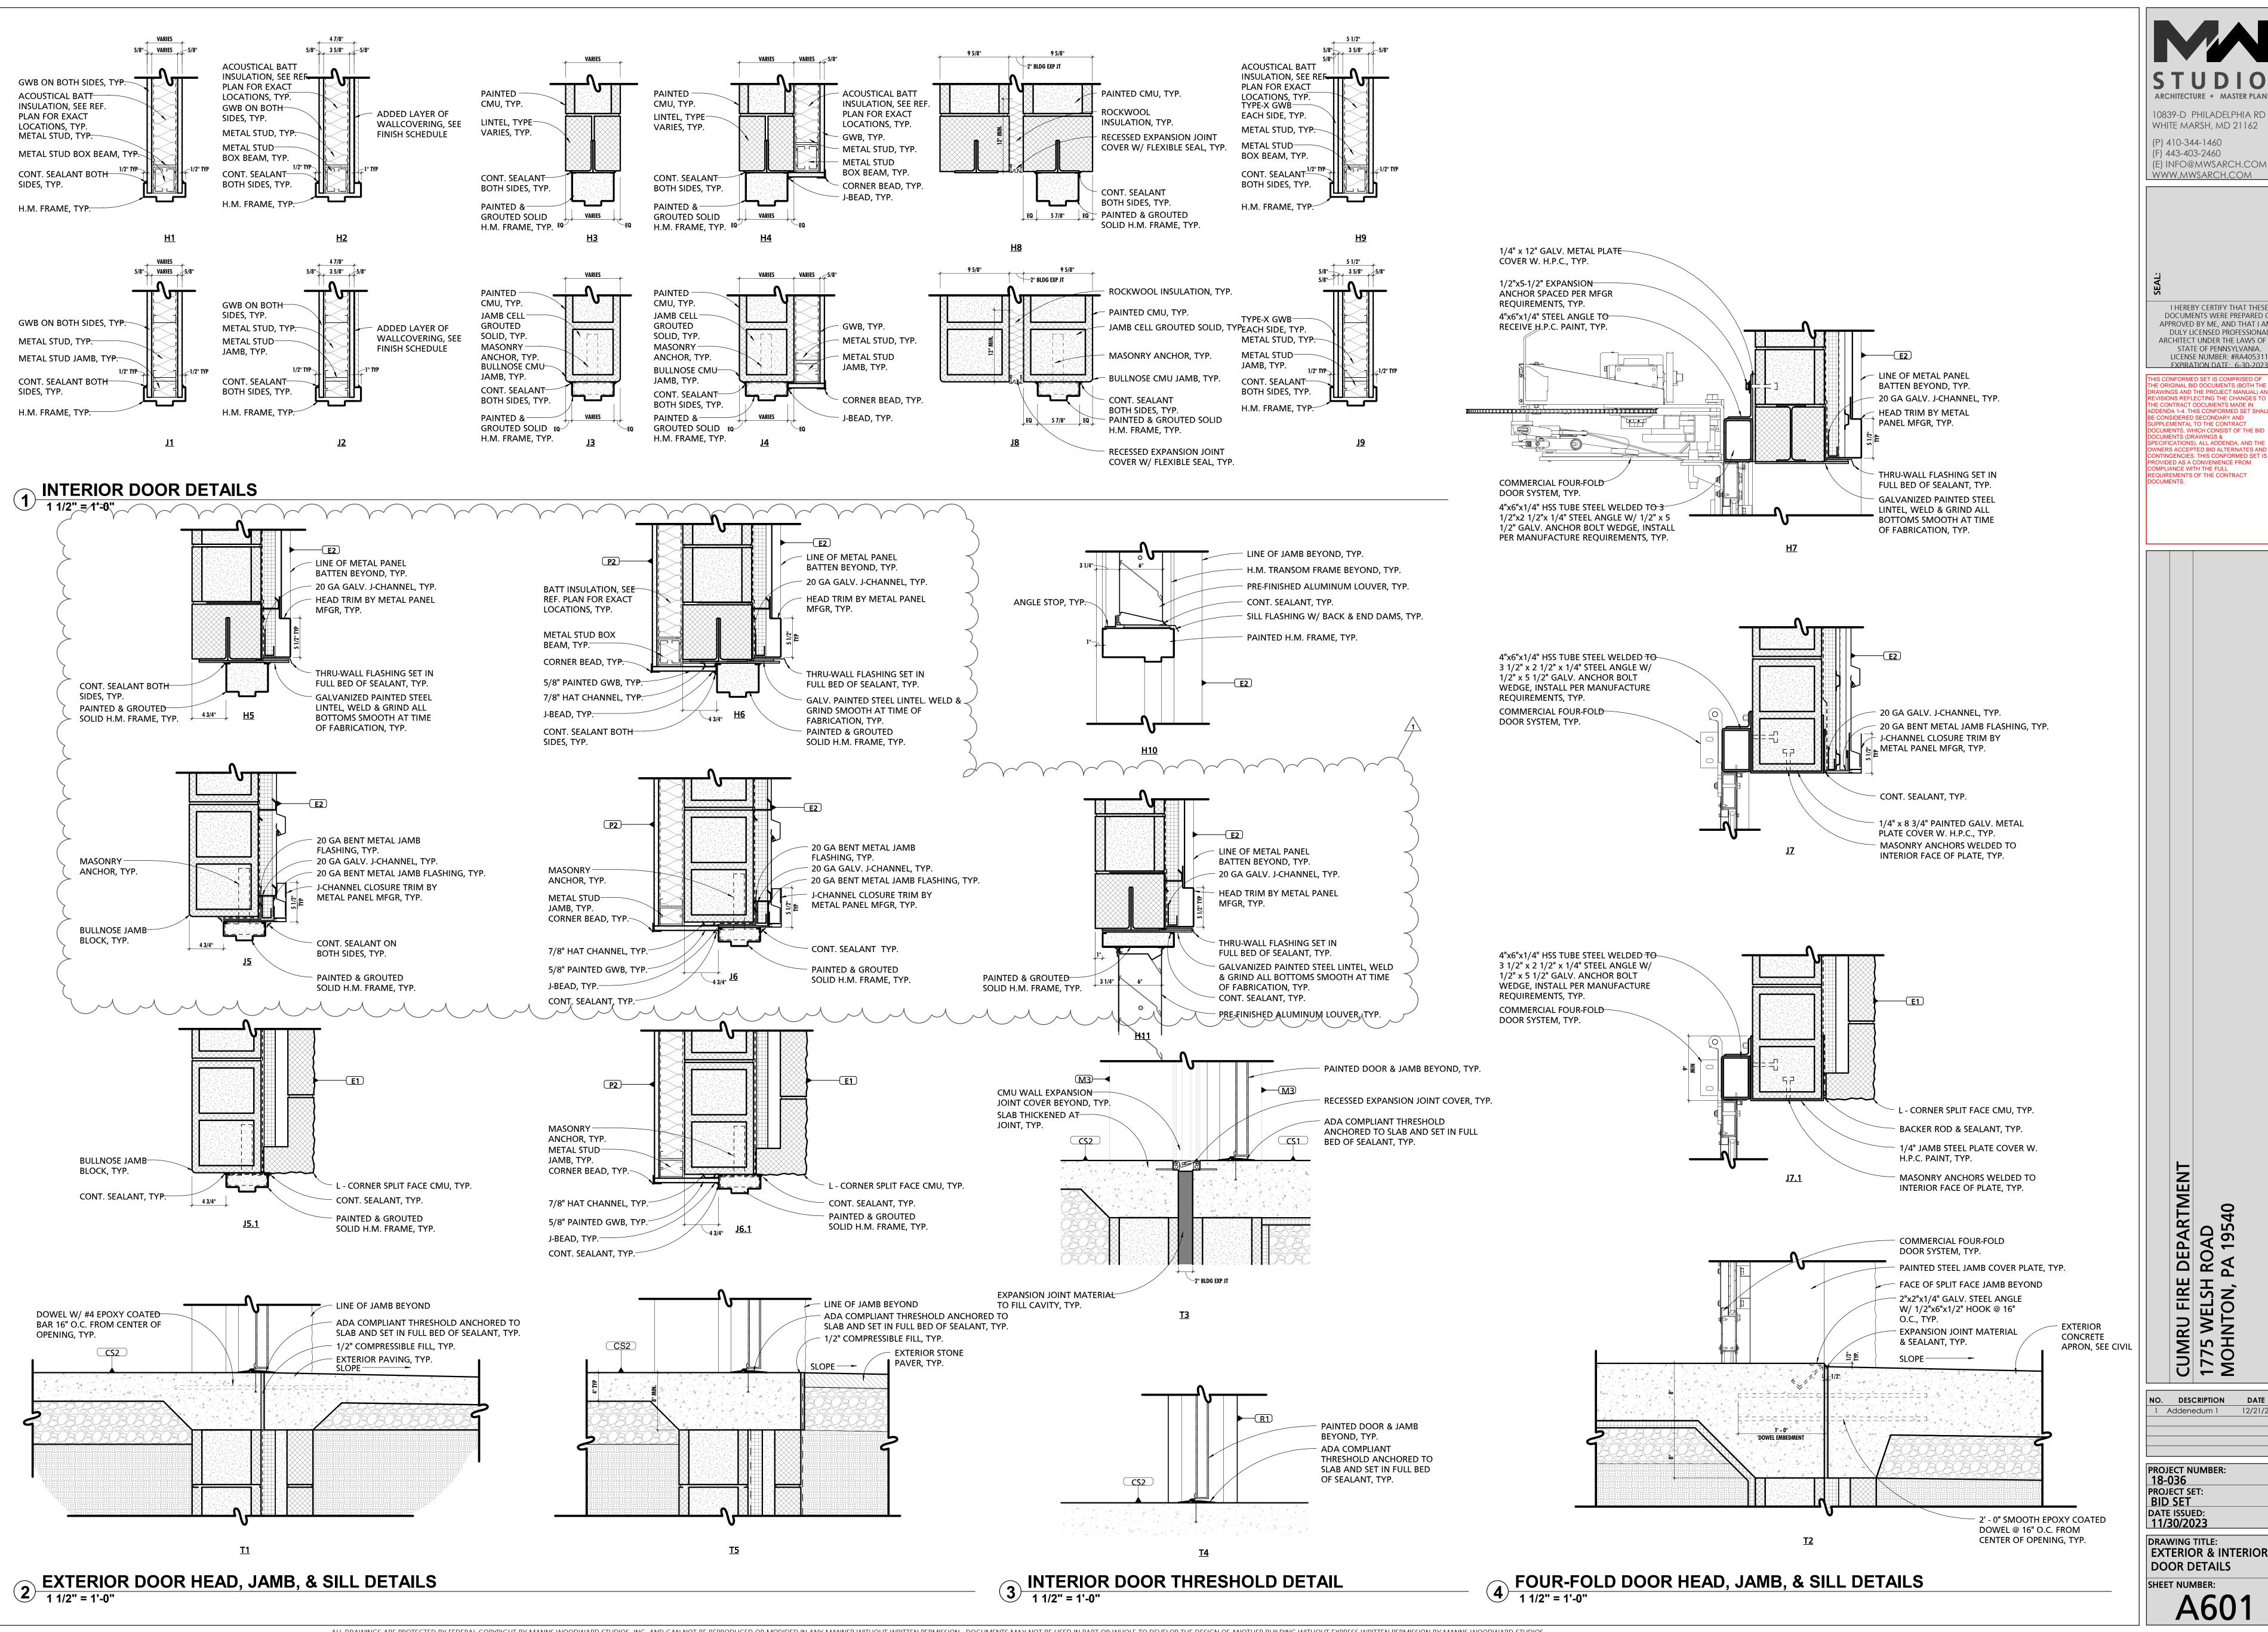
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DESCRIPTION PROJECT NUMBER: 18-036 PROJECT SET: BID SET DATE ISSUED: 11/30/2023 **DRAWING TITLE: ROOF DETAILS**









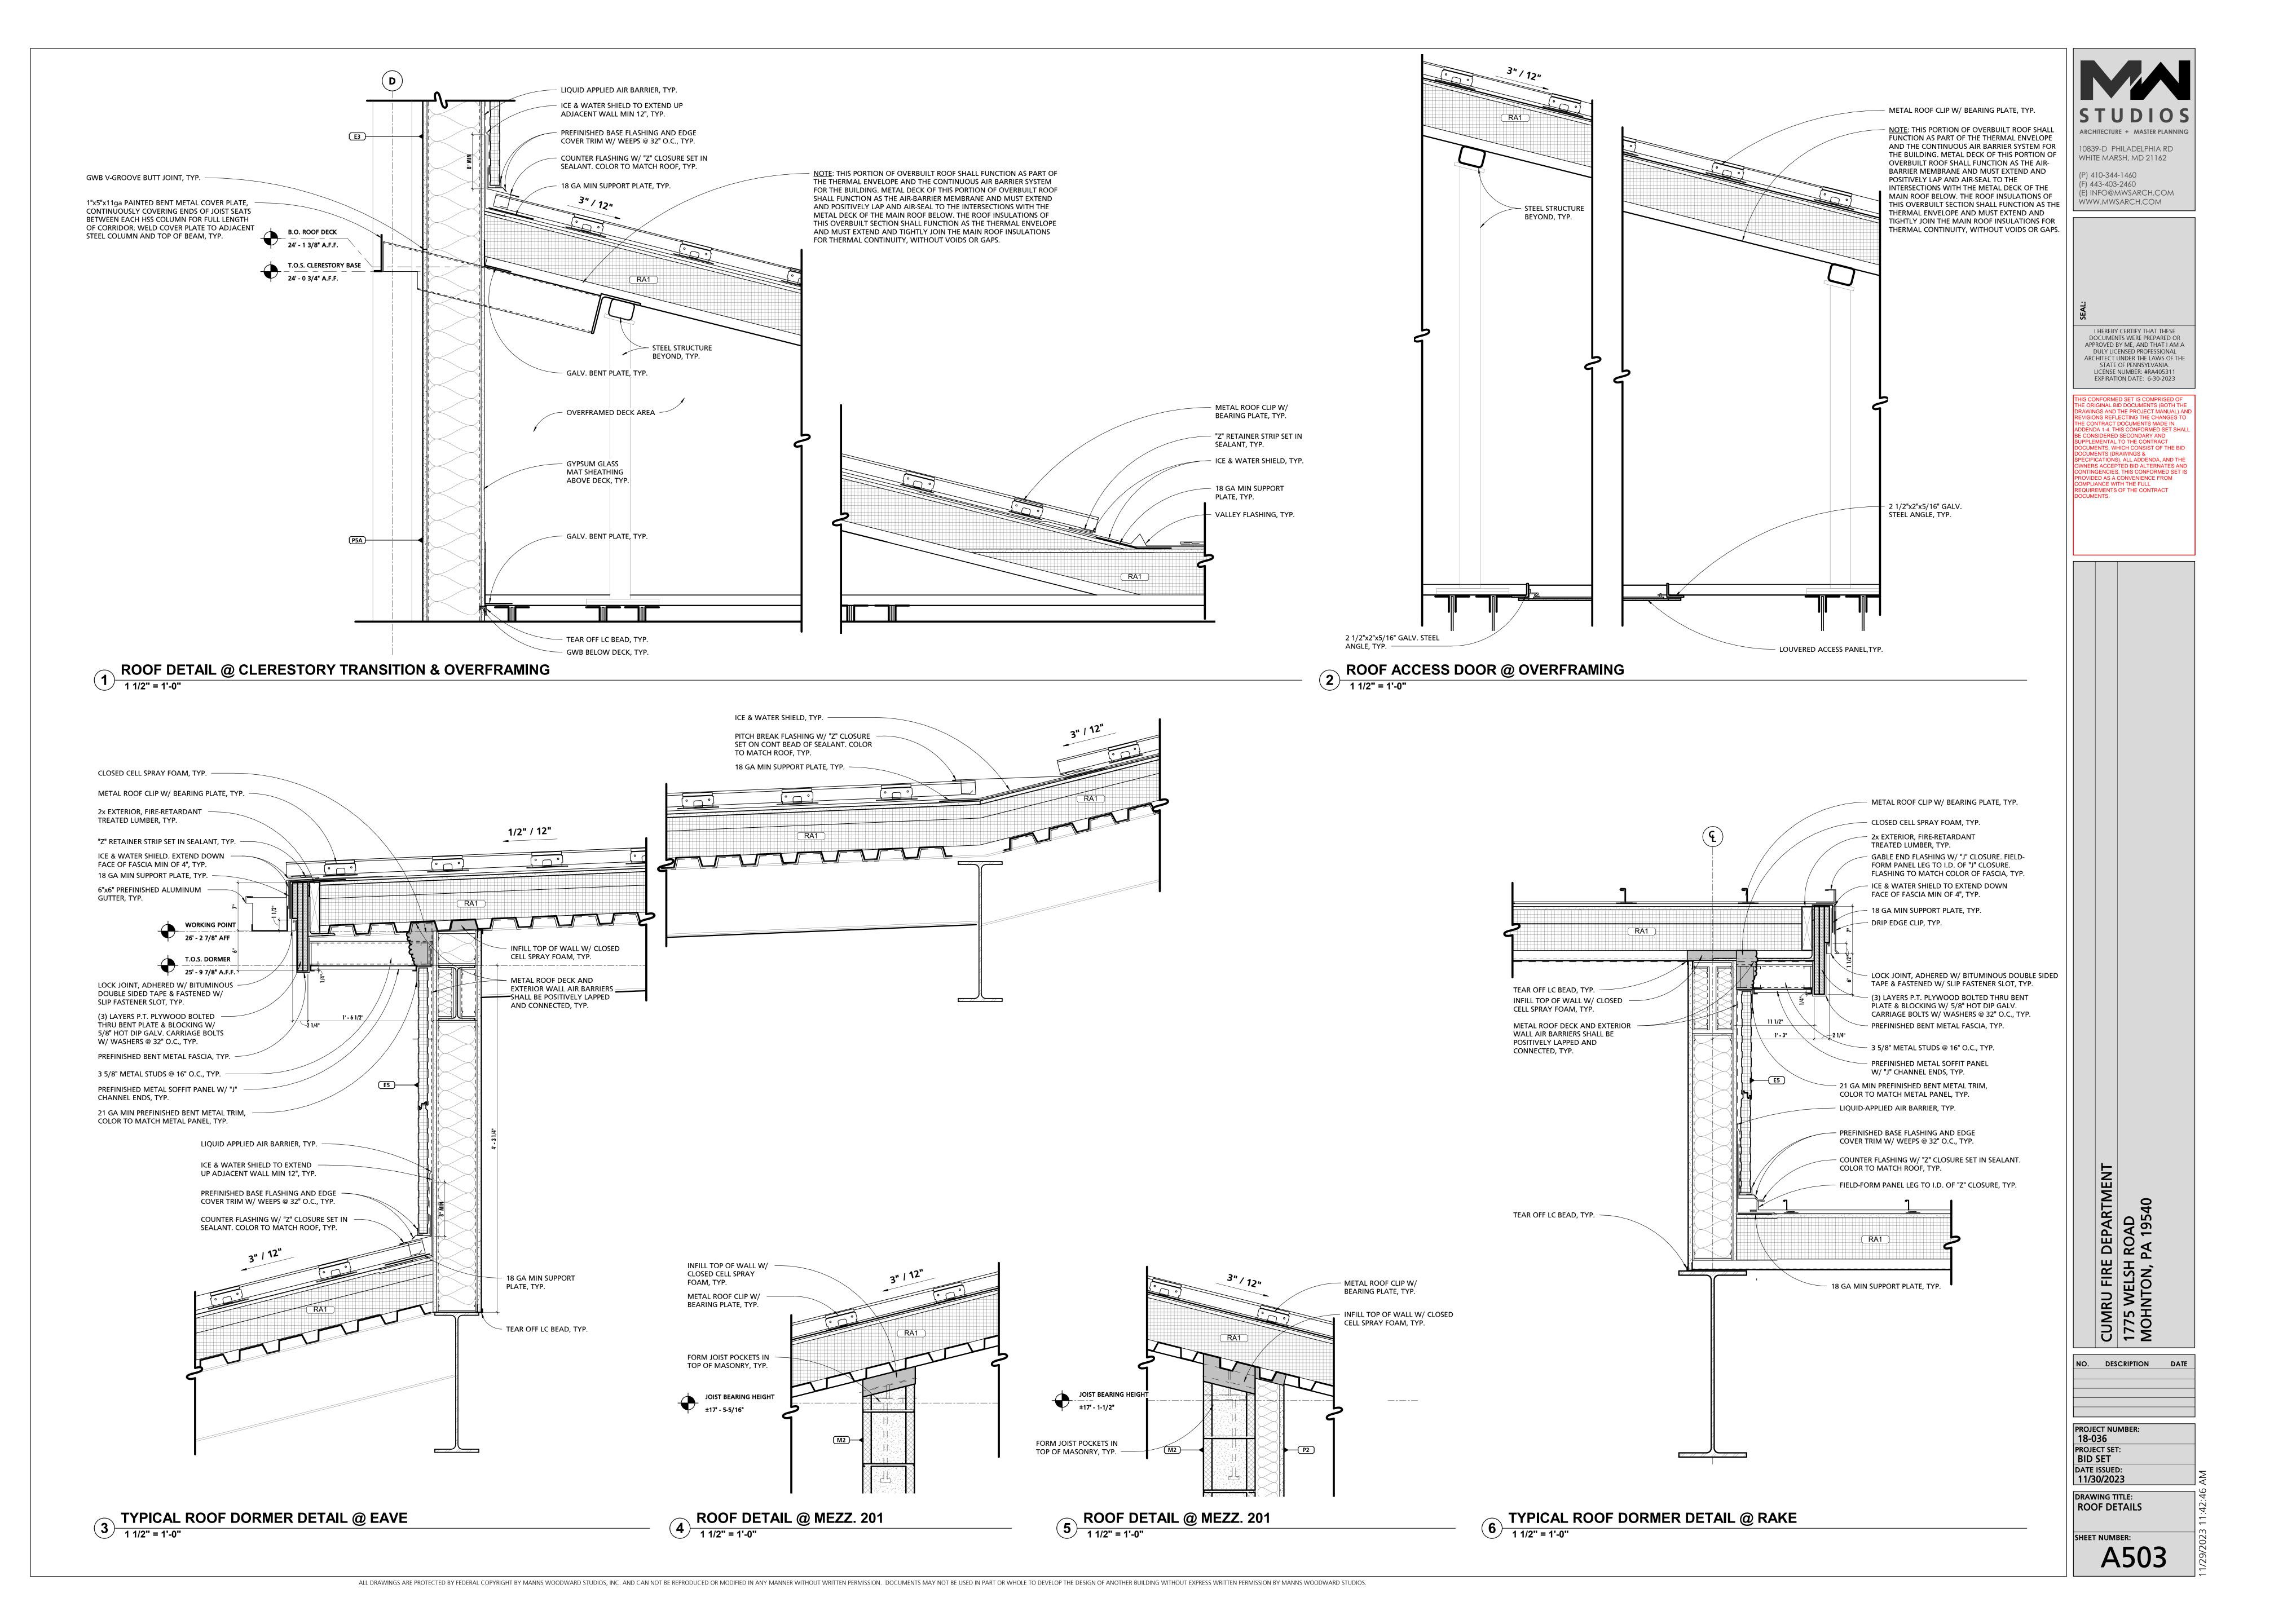
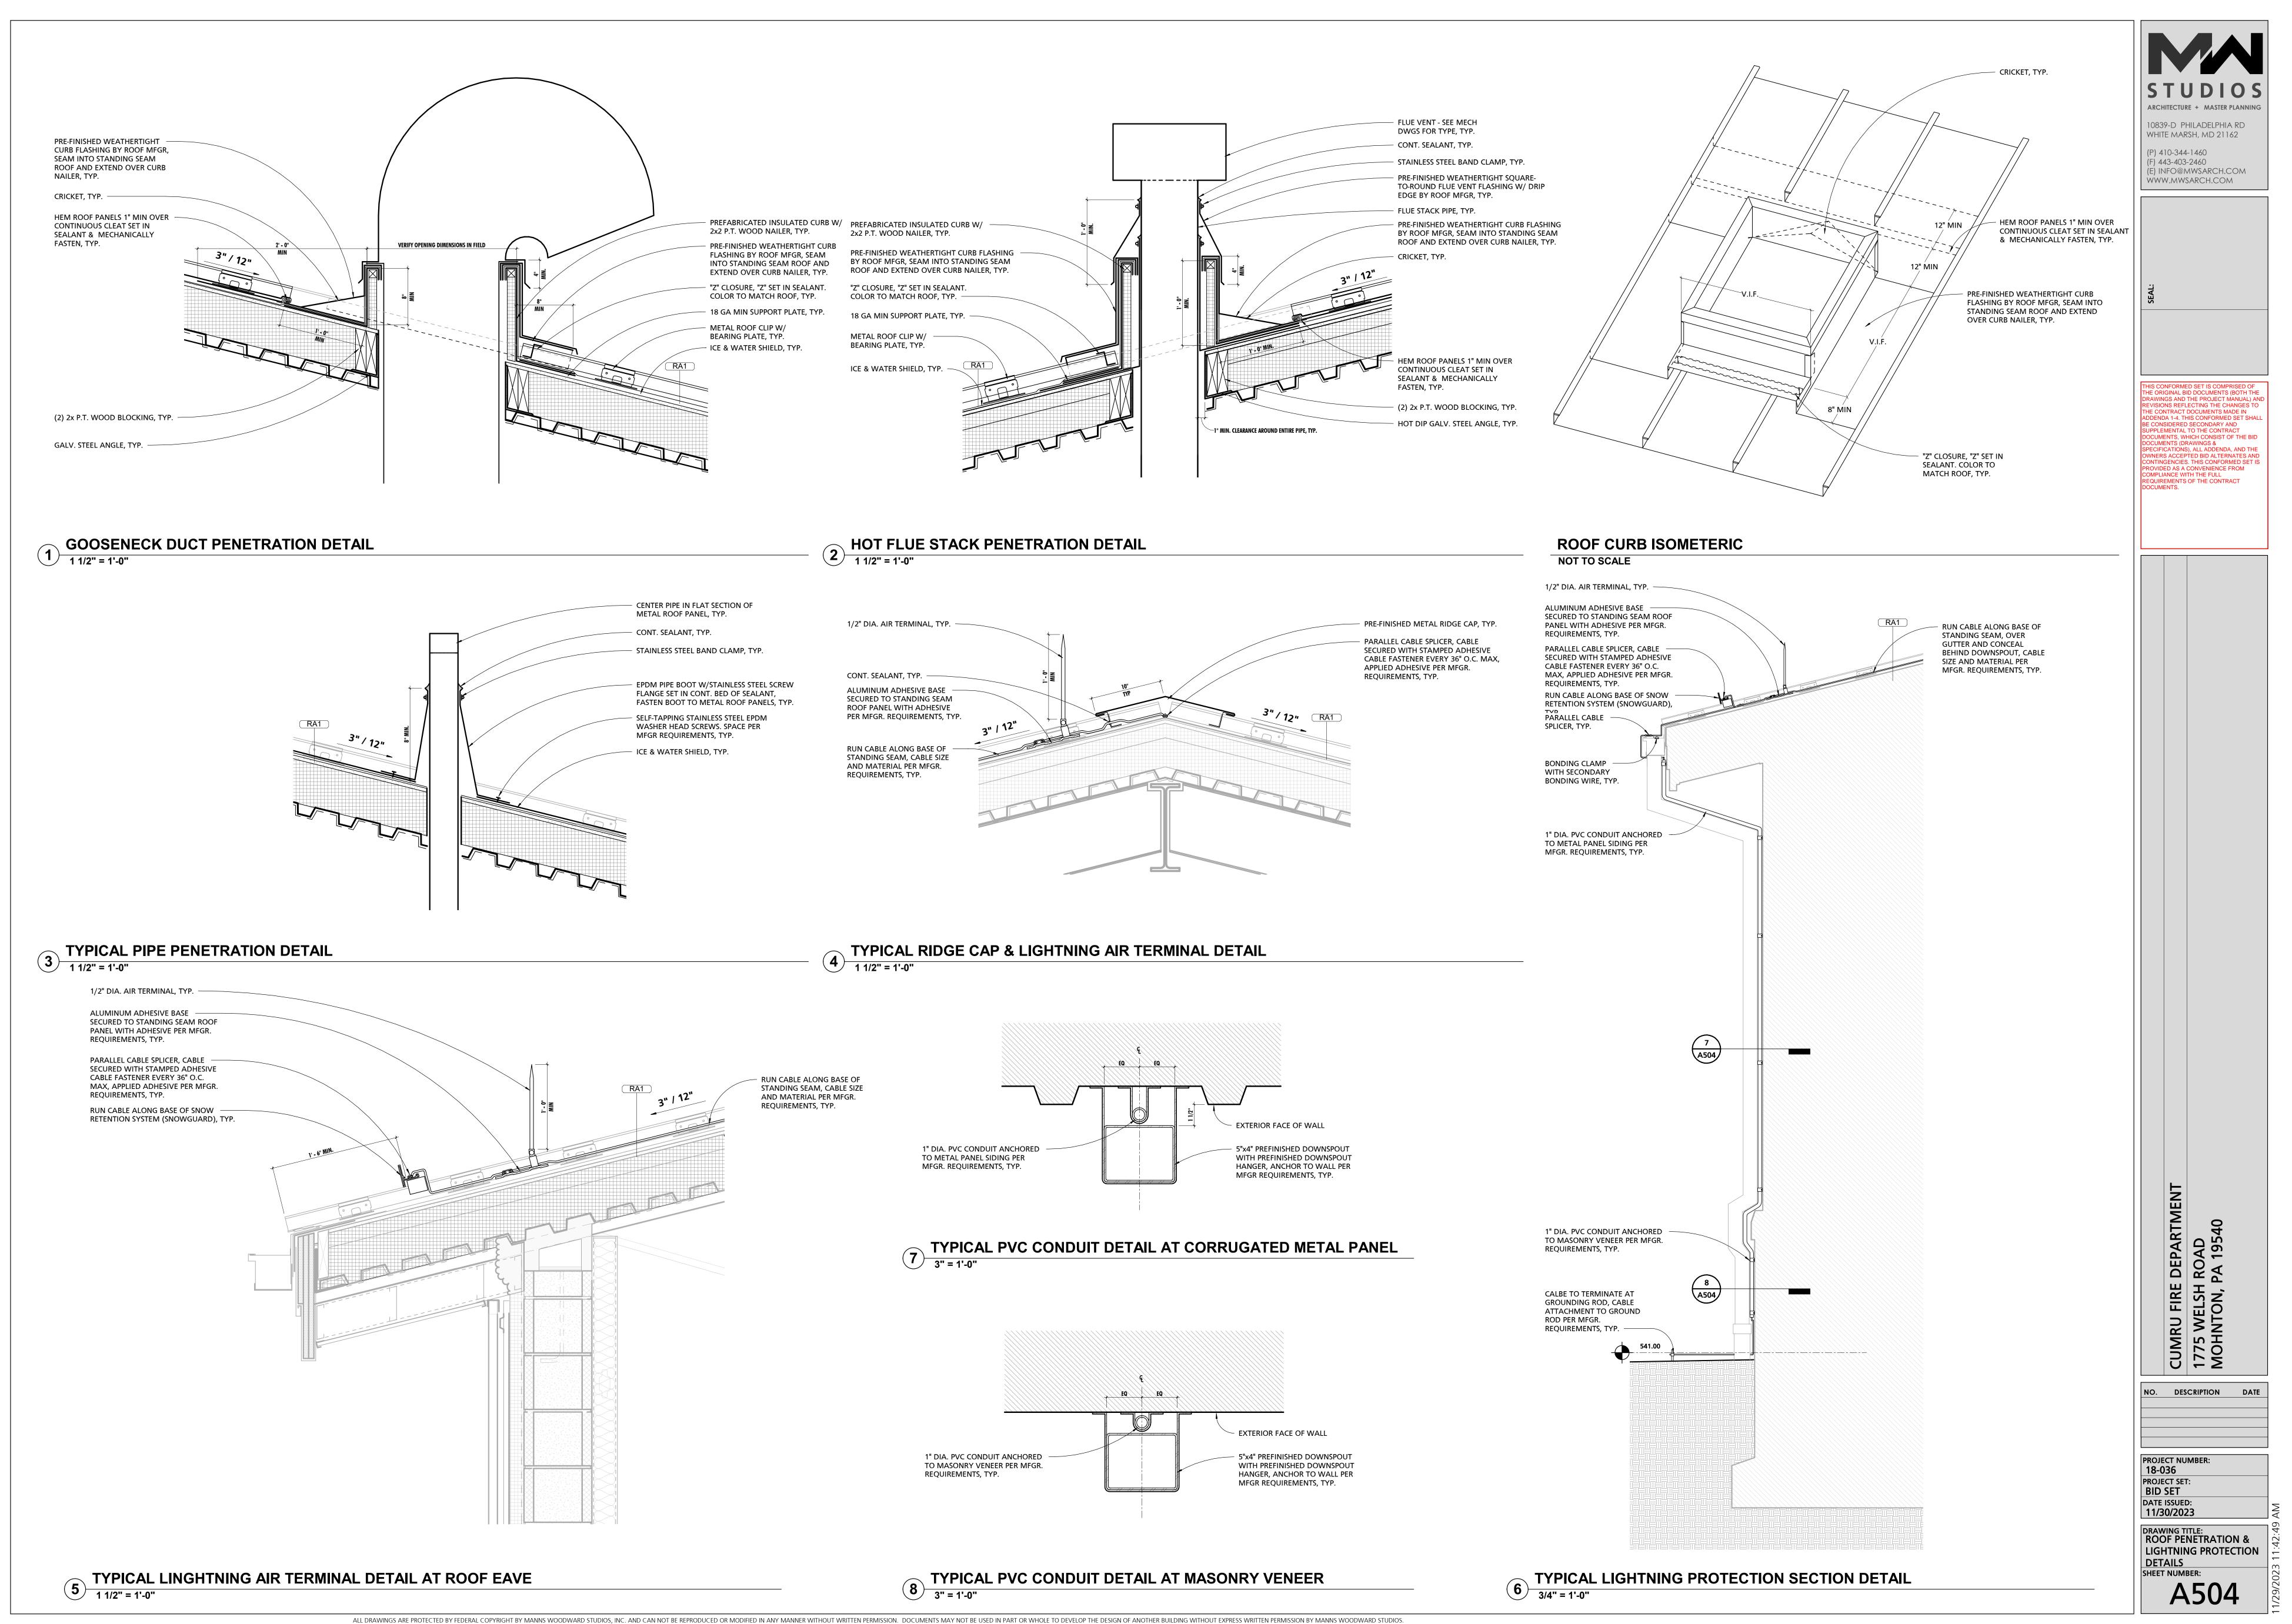
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- 20 GA BENT METAL JAMB

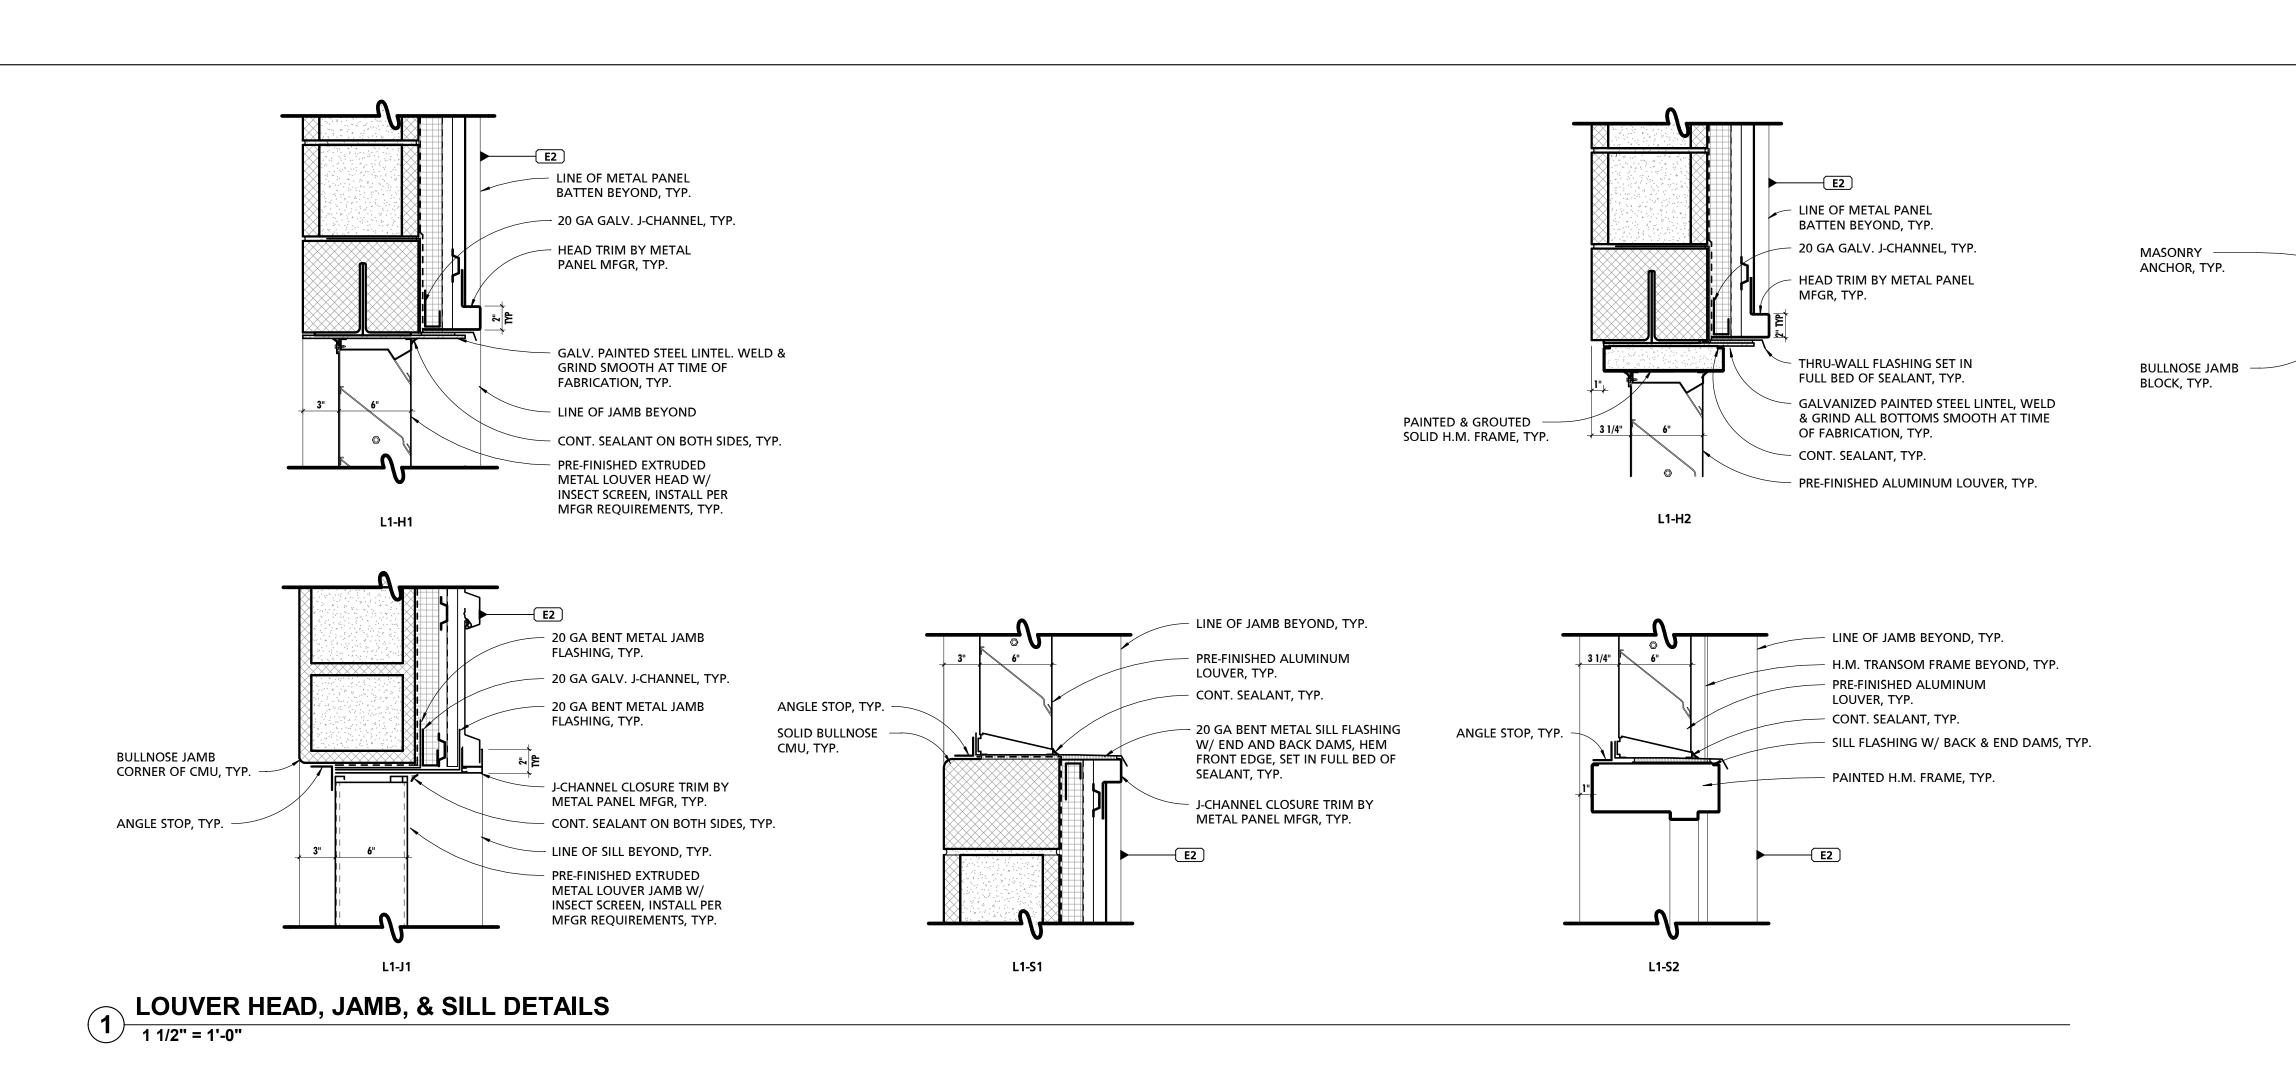– 20 GA GALV. J-CHANNEL, TYP.

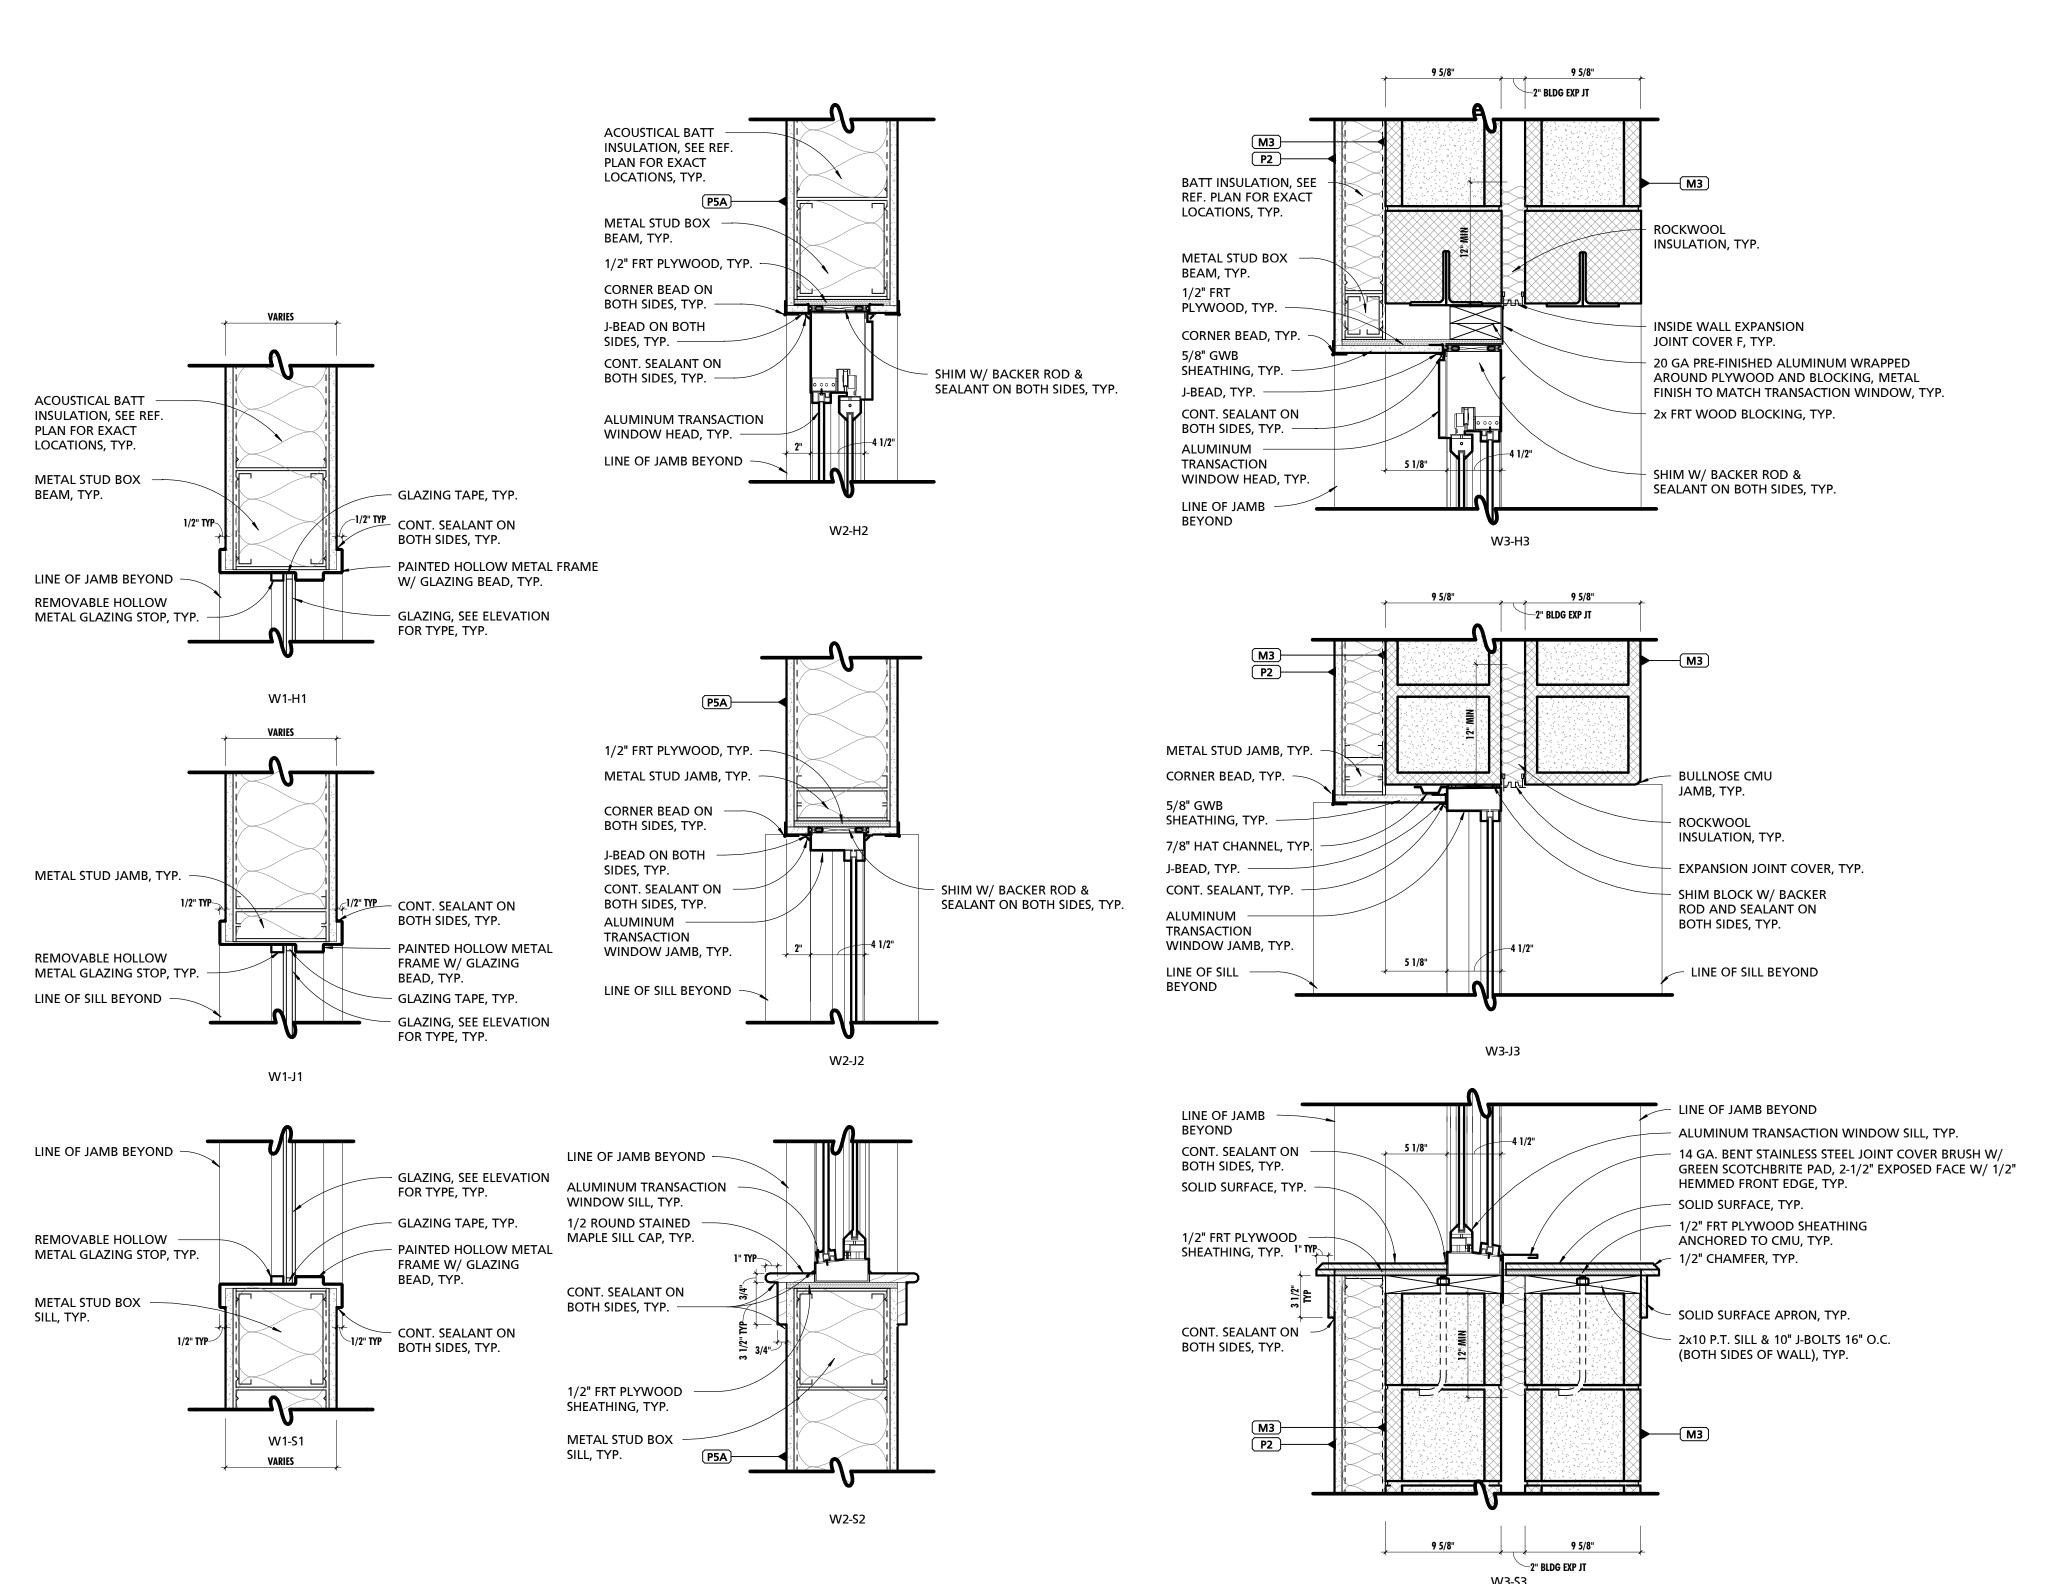J-CHANNEL CLOSURE TRIM BY

⋆ METAL PANEL MFGR, TYP.

CONT. SEALANT ON

PAINTED & GROUTED

SOLID H.M. FRAME, TYP.

BOTH SIDES, TYP.

<u>L1-J2</u>

— 20 GA BENT METAL JAMB FLASHING, TYP.

PRE-FINISHED ALUMINUM LOUVER, TYP.

FLASHING, TYP.

j Ç

I HEREBY CERTIFY THAT THESE
DOCUMENTS WERE PREPARED OR
APPROVED BY ME, AND THAT I AM A
DULY LICENSED PROFESSIONAL
ARCHITECT UNDER THE LAWS OF THE
STATE OF PENNSYLVANIA.
LICENSE NUMBER: #RA405311
EXPIRATION DATE: 6-30-2023

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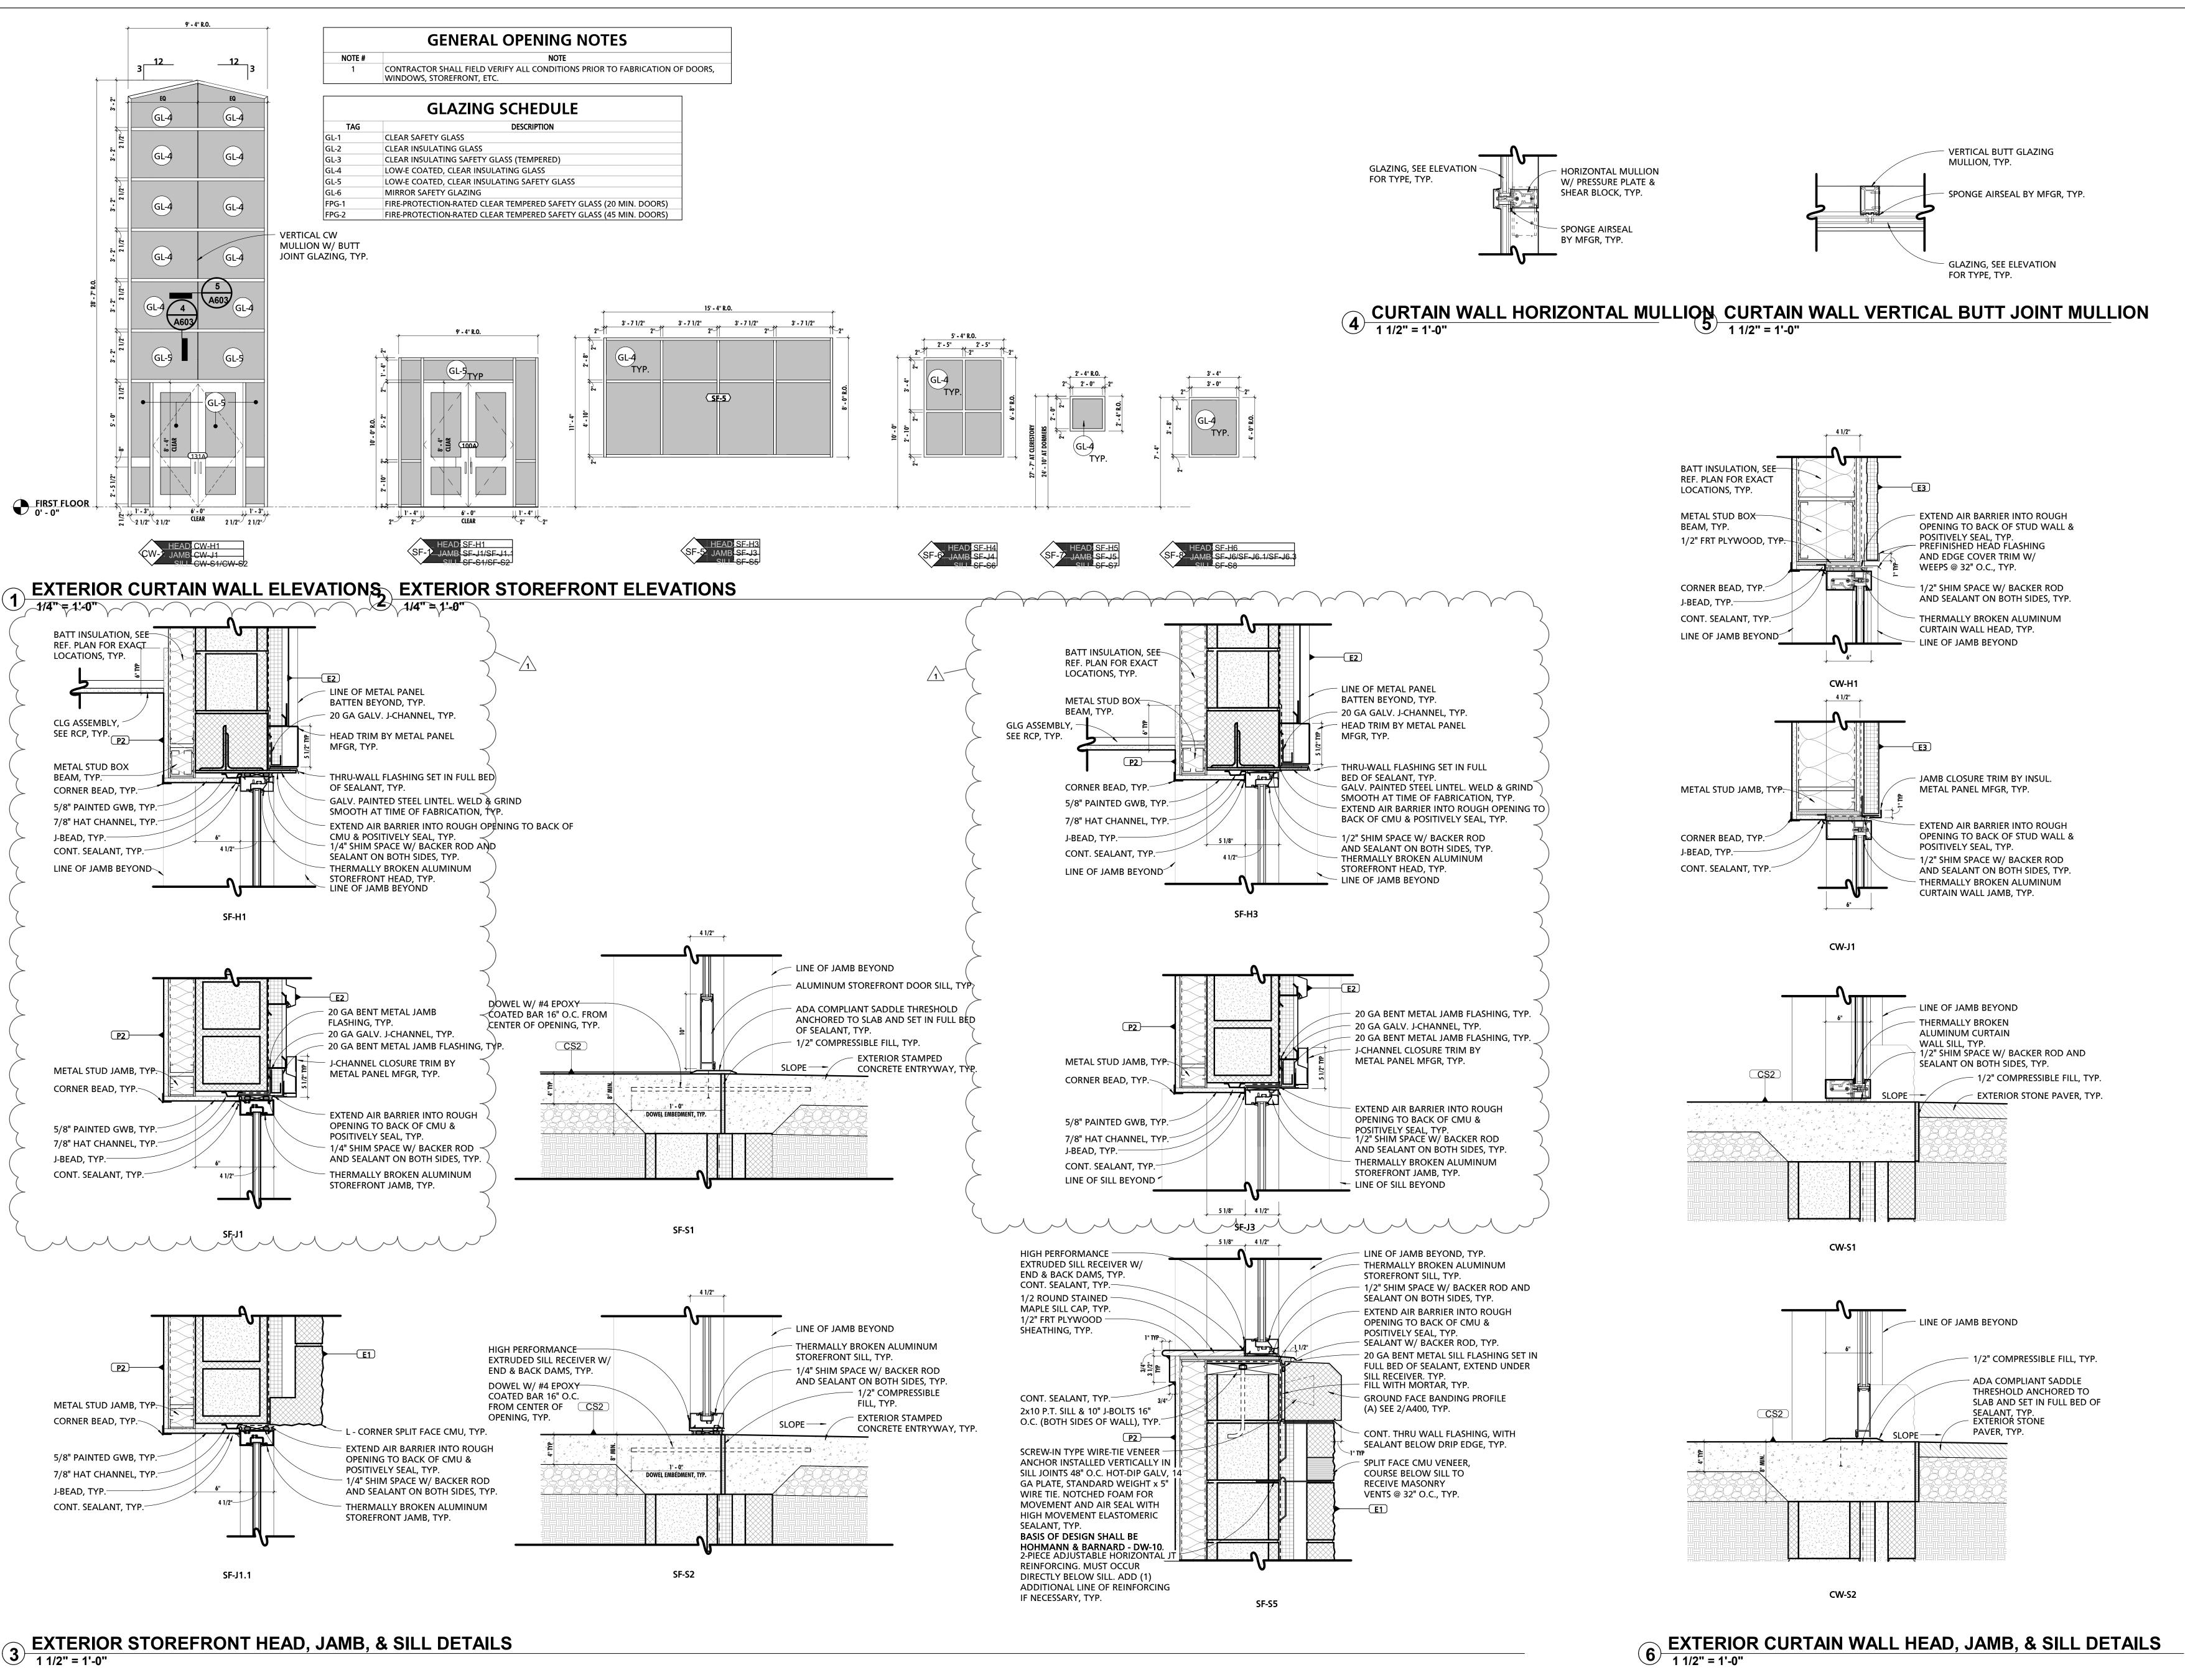
CUMRU FIRE DEPARTMENT
1775 WELSH ROAD
MOHNTON, PA 19540

PROJECT NUMBER:
18-036
PROJECT SET:
BID SET
DATE ISSUED:
11/30/2023

DRAWING TITLE:
EXTERIOR & INTERIOR
WINDOW DETAILS

SHEET NUMBER:


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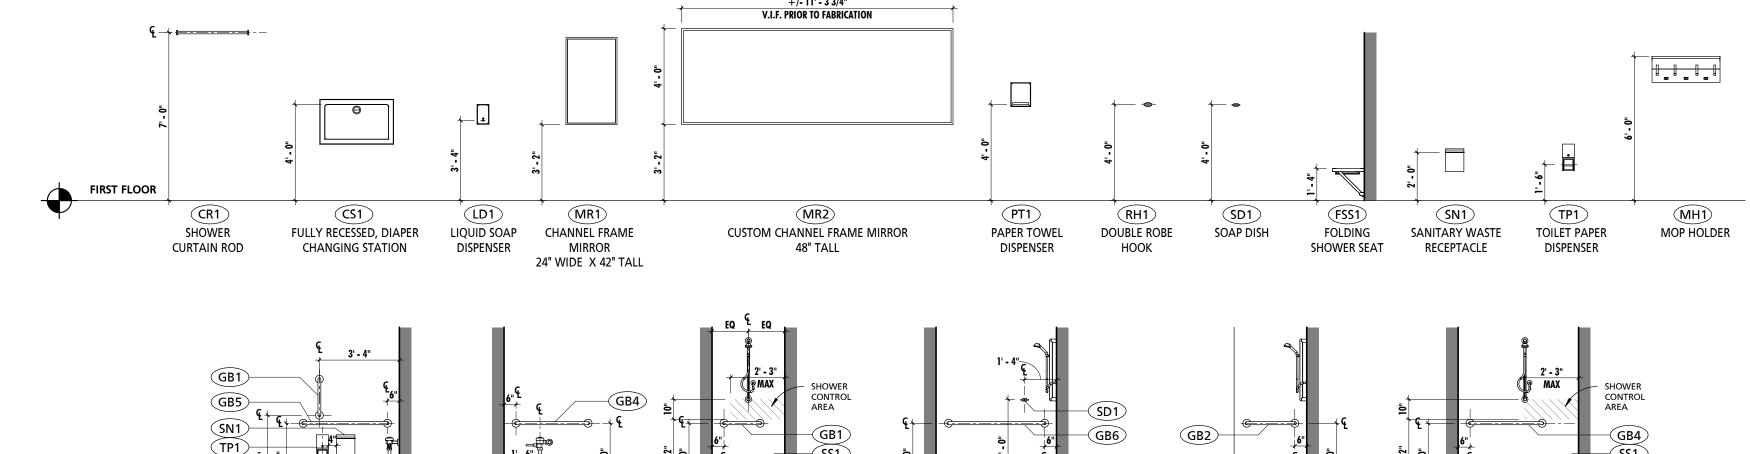
ARCHITECTURE + MASTER PLANNIN 10839-D PHILADELPHIA RD WHITE MARSH, MD 21162 (P) 410-344-1460 (F) 443-403-2460 (E) INFO@MWSARCH.COM WWW.MWSARCH.COM I HEREBY CERTIFY THAT THESE DOCUMENTS WERE PREPARED O APPROVED BY ME, AND THAT I AM DULY LICENSED PROFESSIONAL ARCHITECT UNDER THE LAWS OF T STATE OF PENNSYLVANIA. LICENSE NUMBER: #RA40531 **EXPIRATION DATE: 6-30-2023** HE ORIGINAL BID DOCUMENTS (BOTH THE RAWINGS AND THE PROJECT MANUAL) AN HE CONTRACT DOCUMENTS MADE IN DDENDA 1-4. THIS CONFORMED SET SHAI UPPLEMENTAL TO THE CONTRACT OCUMENTS, WHICH CONSIST OF THE BID OCUMENTS (DRAWINGS & ECIFICATIONS), ALL ADDENDA, AND THE

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DESCRIPTION Addenedum 1 PROJECT NUMBER: 18-036 PROJECT SET: **BID SET** DATE ISSUED: 11/30/2023 DRAWING TITLE: **EXTERIOR STOREFRONT ELEVATIONS & DETAILS** SHEET NUMBER:





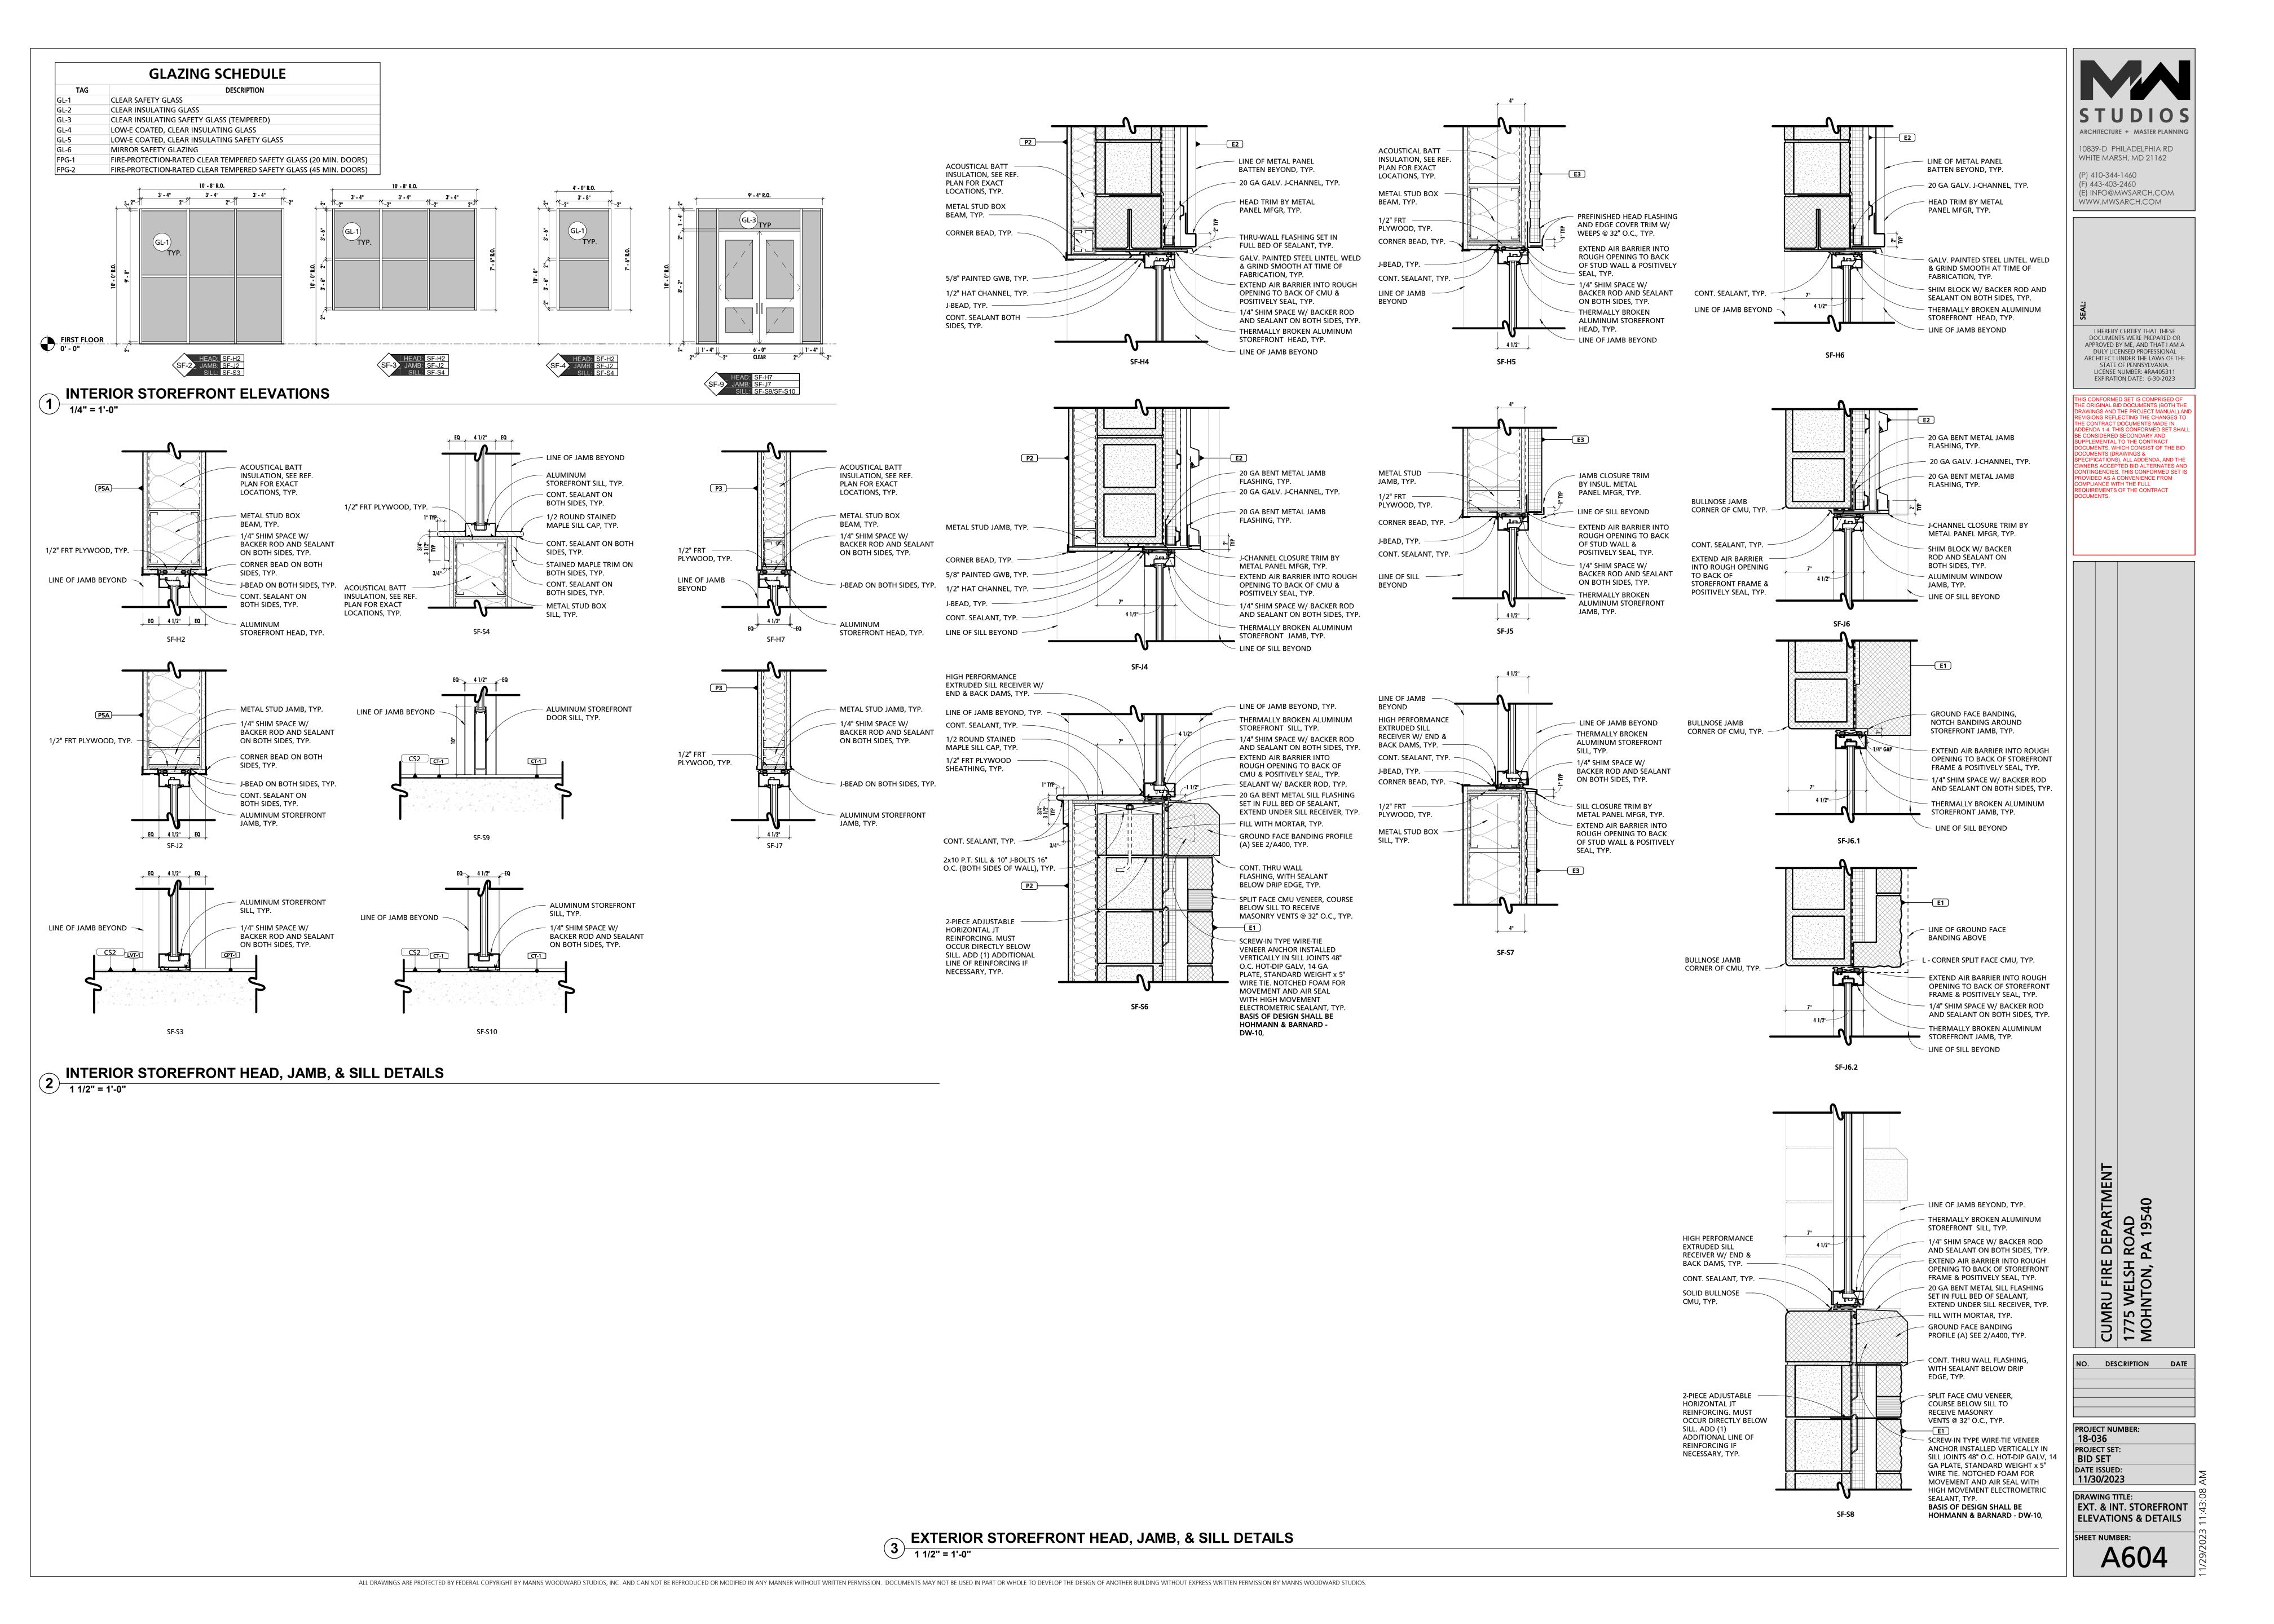

SHOWER STALL BACK WALL

ELEVATION

(SHOWER 115, 116, 120 & 121)

SIMULATED STONE COUNTERTOP

& BACKSPLASH, TYP.

PLYWOOD SUBSTRATE, TYP.

PLASTIC LAMINATE OVER

ADJUSTABLE SHELF, TYP.

& FRONT WITH 1/2" BC

2x4 LUMBER BASE, CLAD TOP

BASE MATERIAL, SEE FINISH

3/4" MDF, TYP.

PLYWOOD, TYP.

SCHEDULE, TYP.

SHOWER STALL END WALL

(SHOWER 136 & 137)

ELEVATION

SHOWER STALL END WALL

ELEVATION

(SHOWER 115, 116, 120 & 121)

TYPICAL TOILET & SHOWER STALL ACCESSORY MOUNTING HEIGHTS & LOCATIONS

TYPICAL TOILET BACK

WALL ELEVATION

CONT. BEAD OF SEALANT, TYP. SOLID SURFACE SHELF, TYP. CONCEALED SHELF BRACKET @ EVERY OTHER STUD LOCATION. PROVIDE BLOCKING AND (3) 1/4" SOLID SURFACE, TYP. A325 BOLT-THRU CONNECTIONS MOISTURE RESISTANT @ EVERY BRACKET, DRYWALL MDF CORE, TYP. AND HARDWOOD CLADDING TO BE COPED AROUND BRACKET STAINED 1x4 MAPLE PENETRATIONS, TYP. HARDWOOD, TYP. BASIS OF DESIGN - A&M HARDWARE - CFLAT9 INSTALL CONTINUOUS, VERTICAL 2x4 BLOCKING ON EACH STUD BEFORE INSTALLING SHELF SUPPORT BRACKET. BLOCKING SHALL EXTEND FROM FINISH FLOOR UP TO 12" ABOVE THE HIGHEST BRACKET.


SHOWER STALL BACK WALL

ELEVATION


(SHOWER 136 & 137)

TYPICAL SOLID SURFACE SHELF & BRACKET

1 1/2" = 1'-0"

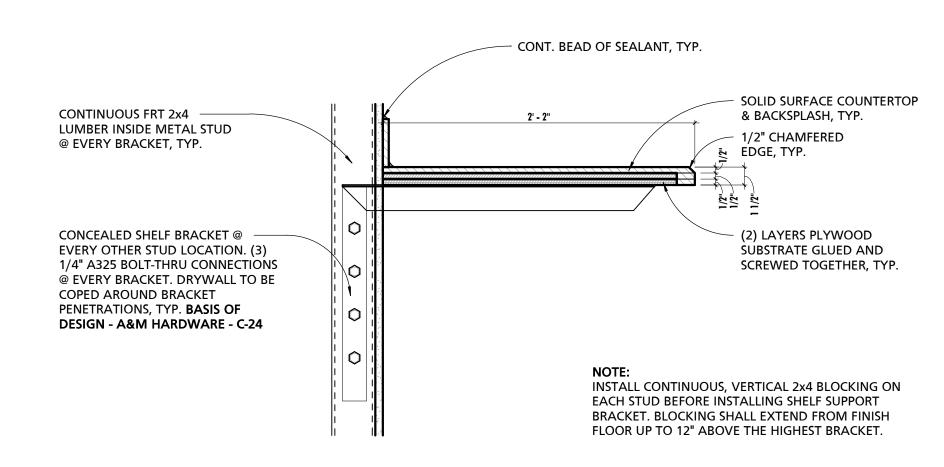

TYPICAL SOLID SURFACE COUNTERTOP & BRACKET

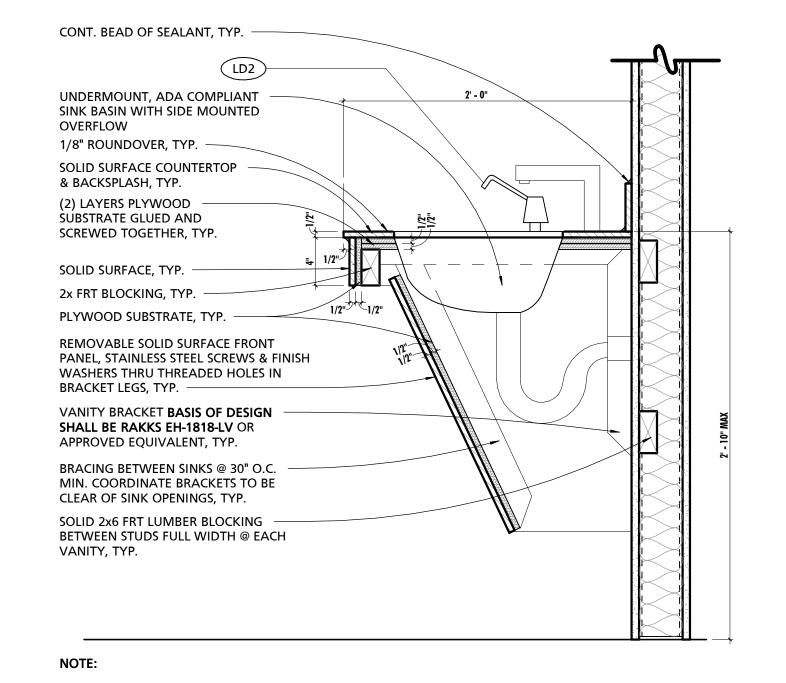


1. CONTRACTOR RESPONSIBLE FOR ENSURING ALL FABRICATED CASEWORK CONFORMS WITH ADA REQUIREMENTS. SEE ADA CODE SHEET FOR ADDITIONAL INFORMATION RELATED TO CLEARANCE

2. SEE INTERIOR ELEVATIONS FOR WALL FINISHES AND BACK SPLASH REQUIREMENTS 3. ALL COUNTERS SHALL BE SEAMLESS UNLESS NOTED OTHERWISE.

TYPICAL VANITY UNDERMOUNT SINK DETAIL

1 1/2" = 1'-0"

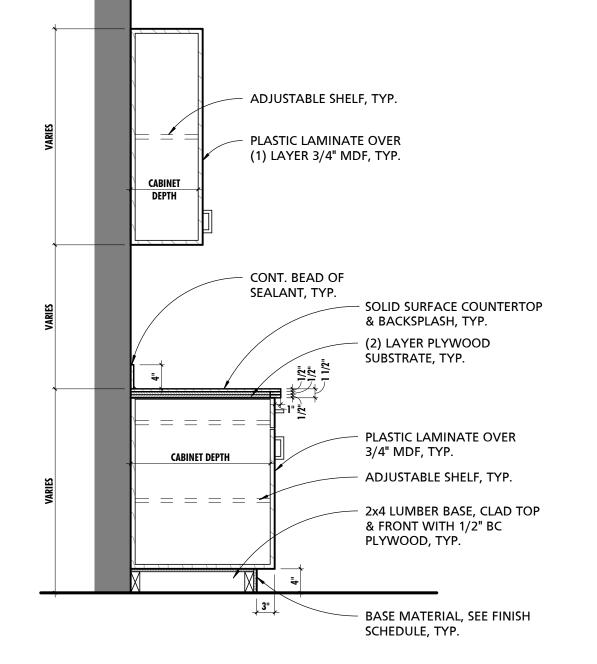

FIRST FLOOR

1/4" = 1'-0"

TYPICAL TOILET SIDE

WALL ELEVATION

TYP SOLID SURFACE COUNTERTOP & CASEWORK

2. WHERE CABINET WIDTH EXCEEDS 30" SHELVES SHALL BE 1" THICK.

1. MINIMUM WALL CABINET DEPTH SHALL BE 11". CABINET DEPTH SHALL INCREASE TO ACCOMMODATE MINIMUM INTERIOR DEPTH.

TYP SIM STONE COUNTERTOP & CASEWORK

- ADJUSTABLE SHELF, TYP.

PLASTIC LAMINATE OVER

(1) LAYER 3/4" MDF, TYP.

- CONT. BEAD OF

SEALANT, TYP.

CABINET DEPTH

= = =


E8 METAL LOCKER, TYP. — 4" RAISED CONCRETE HOUSEKEEPING PAD, TYP.

RESINOUS COVE BASE TO COVER VERTICAL

FACE OF HOUSEKEEPING PAD, TYP.

6 LOCKER DETAIL - CONCRETE BASE

1' - 4" 2"

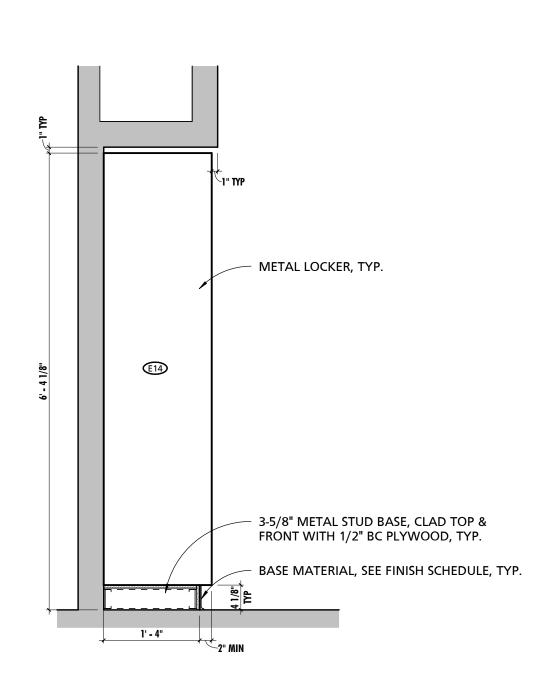

7 LOCKER DETAIL - METAL STUD BASE

3/4" = 1'-0"

ARCHITECTURE + MASTER PLANNING 10839-D PHILADELPHIA RD WHITE MARSH, MD 21162

P) 410-344-1460

F) 443-403-2460

(E) INFO@MWSARCH.COM

WWW.MWSARCH.COM

MOUNTING HEIGHTS & LOCATIONS APPLY TO BASIS OF DESIGN EQUIPMENT.

IF FINAL SELECTED EQUIPMENT DOES NOT MATCH THE BASIS OF DESIGN. G.C.

SHALL COORDINATE FINAL LOCATION OF EQUIPMENT W/ ARCHITECT PRIOR

ALL CONTROLS SHALL NOT EXTEND ABOVE 48" FOR FRONT APPROACH & 54"

FOR SIDE APPROACH. (SEE REACH RANGE DIAGRAMS.)

TO INSTALLATION.


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PROJECT NUMBER: PROJECT SET: BID SET DATE ISSUED: 11/30/2023 **TYPICAL EQUIPMENT & CASEWORK DETAILS** SHEET NUMBER:


DESCRIPTION DATE


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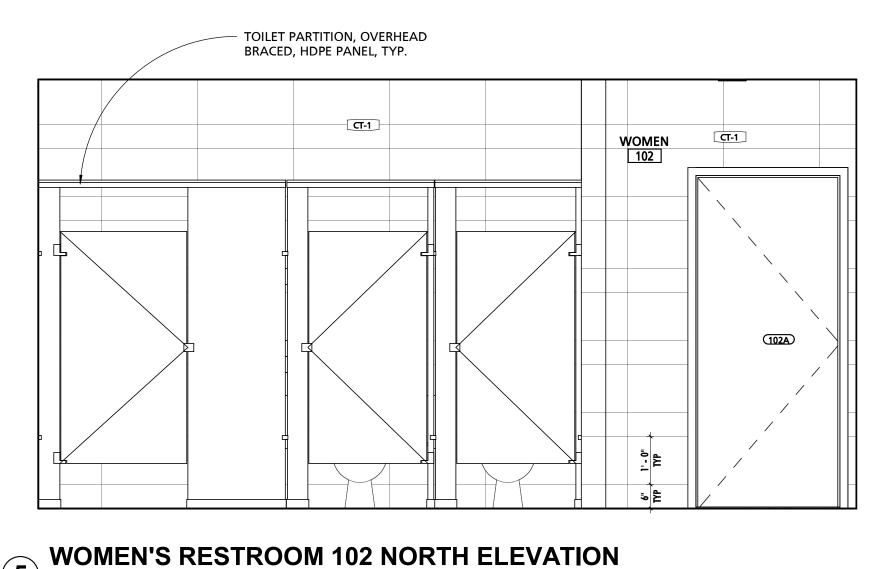






GENERAL INTERIOR ELEVATION NOTES							
NOTE #	NOTE						
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3	REFER TO SHEET A108 FOR EQUIPMENT SCHEDULE & NOTES.						
4	ALIGN BASE AND WALL TILE GROUT LINES WITH FLOOR TILE GROUT LINES U.N.O.						
5	ENLARGED PLAN DIMENSIONS SHALL BE DIMENSIONED FROM OUTSIDE FACE OF GWB UNLESS NOTED OTHERWISE.						
6	INTERIOR ELEVATION DIMENSIONS SHALL BE DIMENSIONED FROM OUTSIDE FACE OF TILE.						
7	START TILE WORKPOINT ABBREVIATION (S.T.W.)						

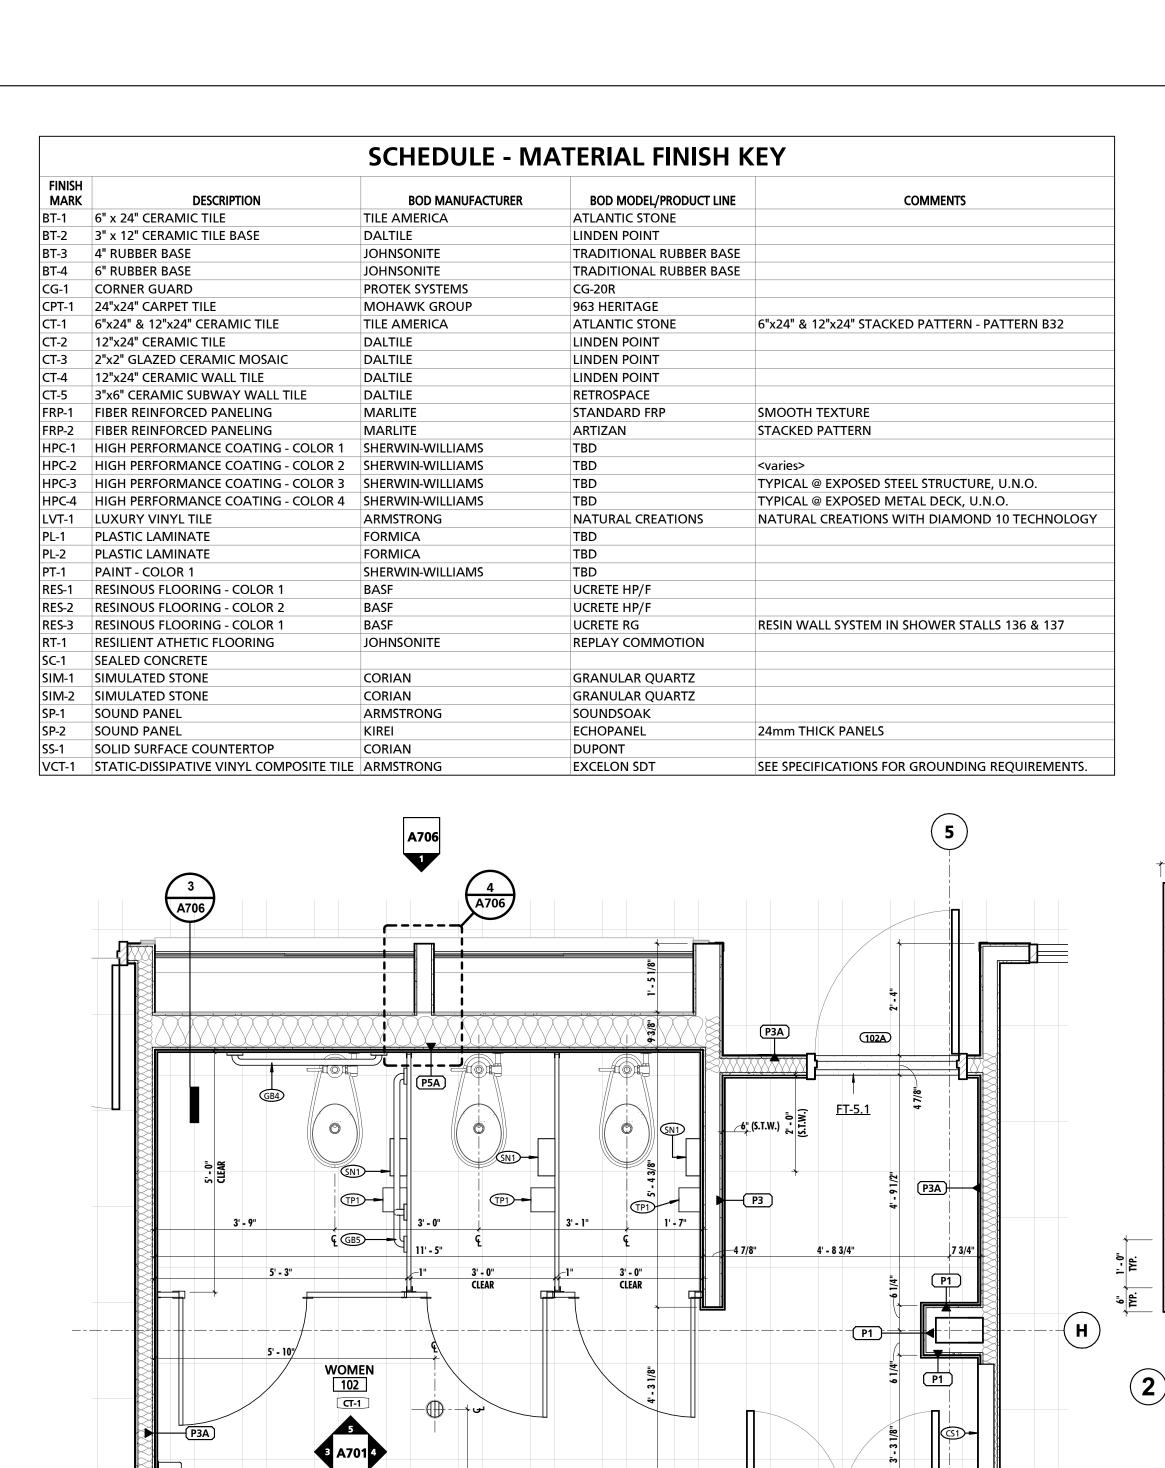

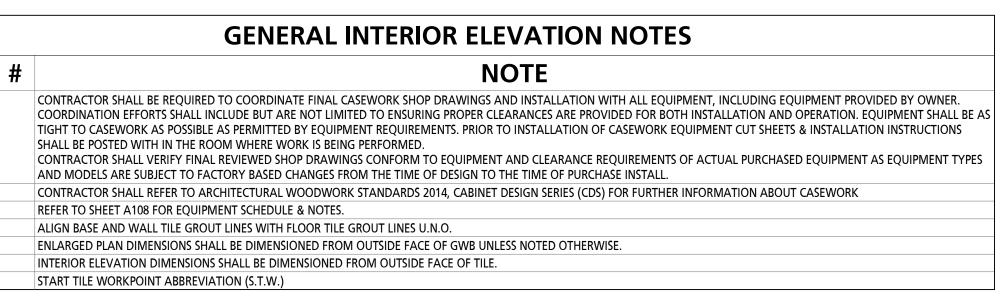

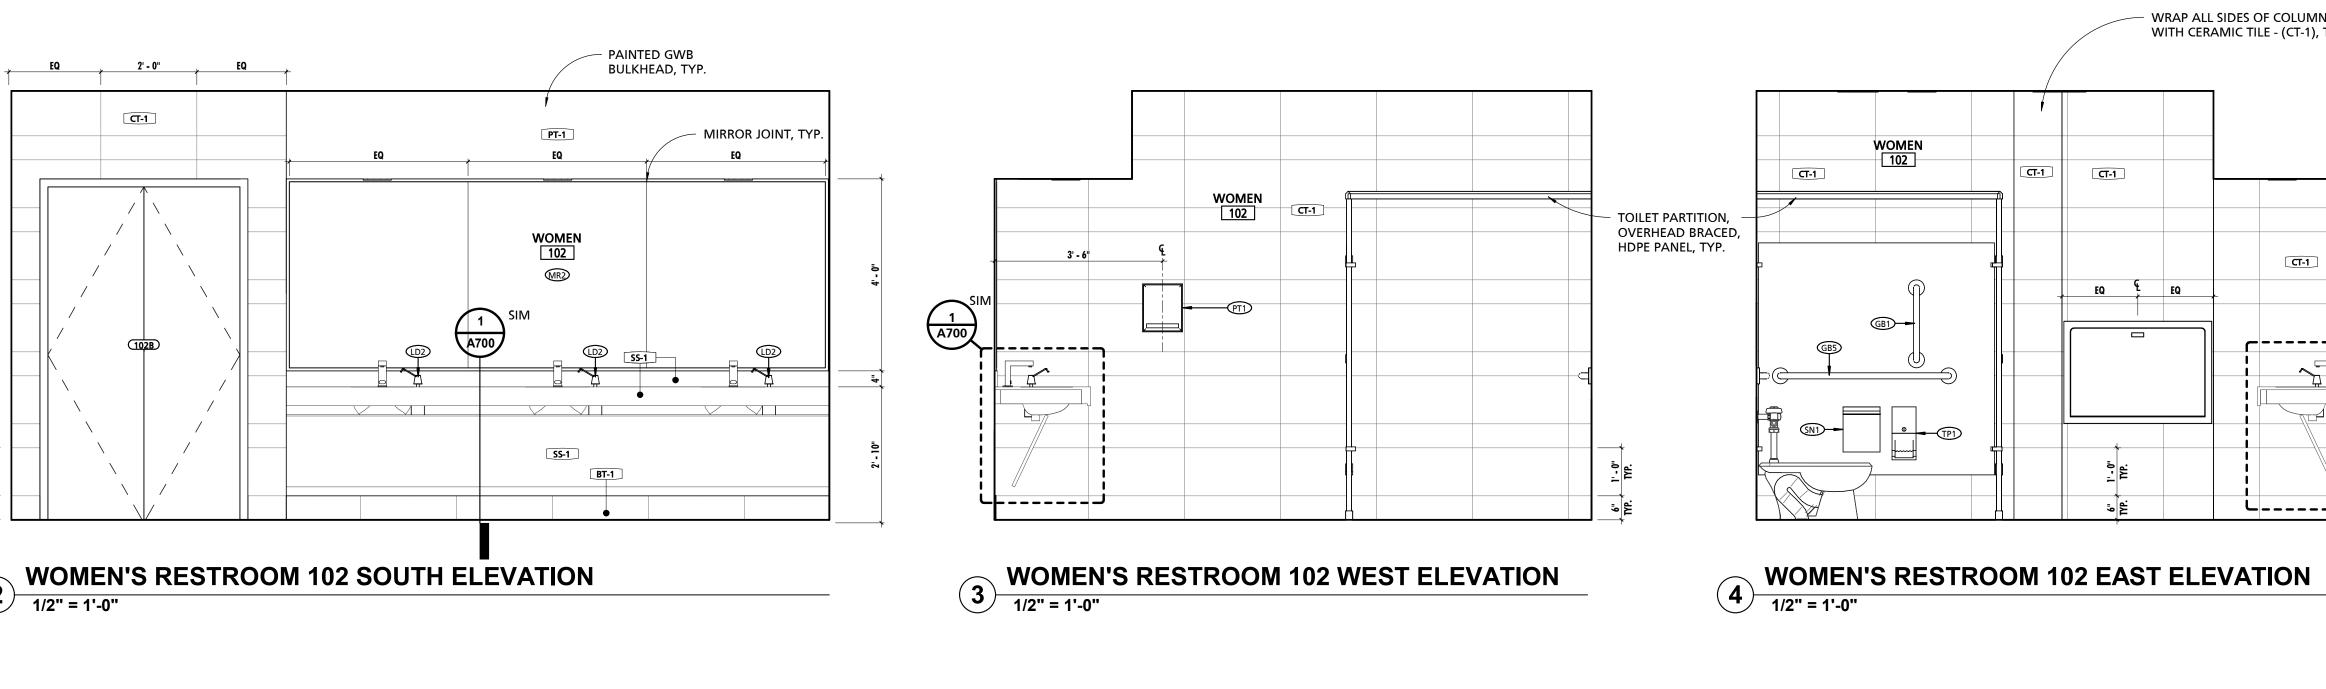

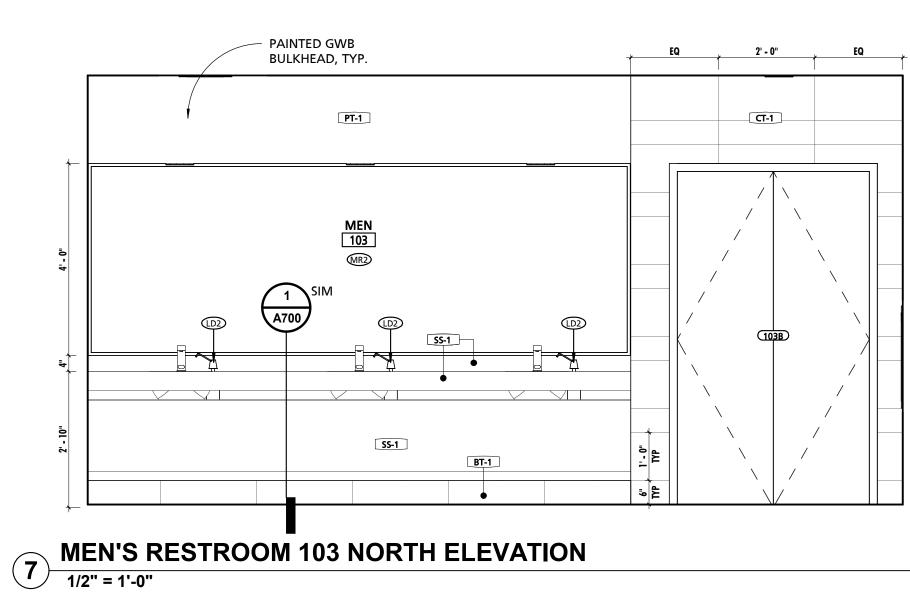

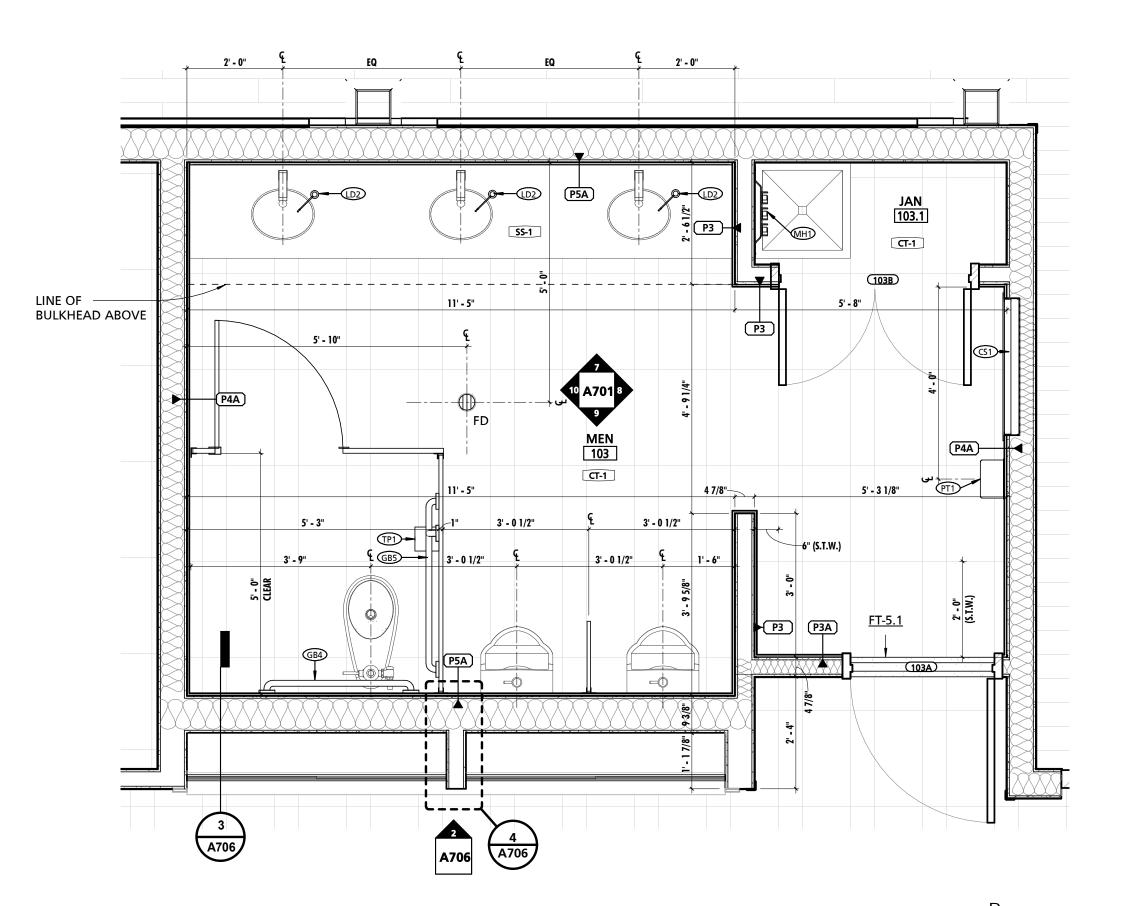


LINE OF BULKHEAD ABOVE


WOMEN'S PUBLIC RESTROOM 102


6 MEN'S PUBLIC RESTROOM 103

1/2" = 1'-0"

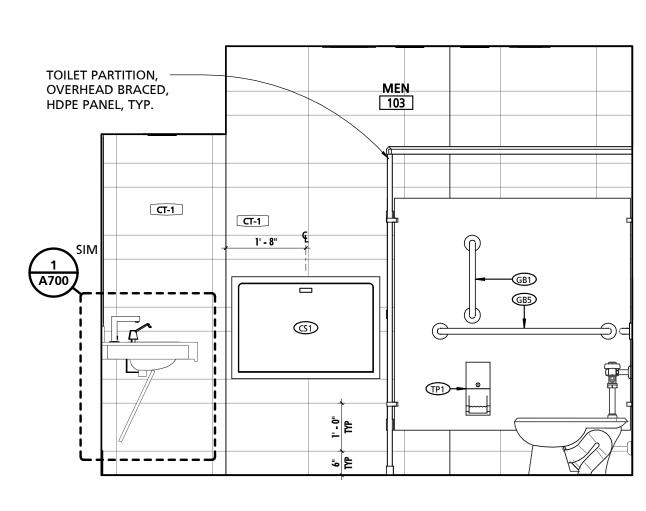

MEN'S RESTROOM 103 EAST ELEVATION

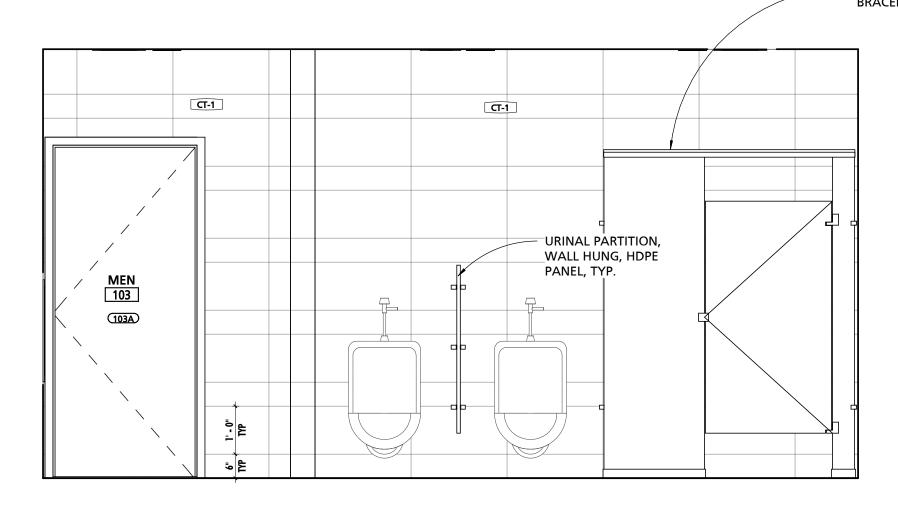

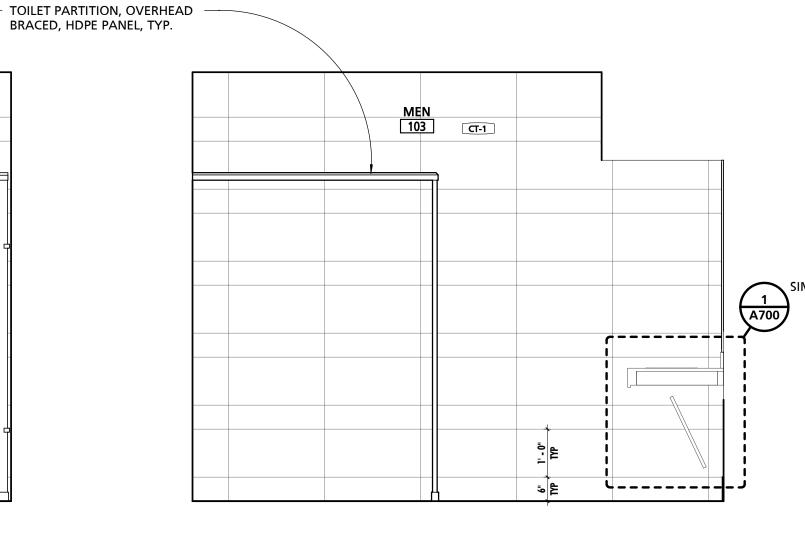

PROJECT SET: BID SET DATE ISSUED: 11/30/2023 DRAWING TITLE: **ENLARGED PLANS & INT. ELEVATIONS**

SHEET NUMBER:

MEN'S RESTROOM 103 SOUTH ELEVATION

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MEN'S RESTROOM 103 WEST ELEVATION

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WRAP ALL SIDES OF COLUMN WALL WITH CERAMIC TILE - (CT-1), TYP.

CT-1

DULY LICENSED PROFESSIONAL ARCHITECT UNDER THE LAWS OF THE

STATE OF PENNSYLVANIA.

LICENSE NUMBER: #RA405311

DESCRIPTION DATE

A701

		SCHEDULE - MA	ATERIAL FINISH K	XEY
FINISH MARK	DESCRIPTION	BOD MANUFACTURER	BOD MODEL/PRODUCT LINE	COMMENTS
3T-1	6" x 24" CERAMIC TILE	TILE AMERICA	ATLANTIC STONE	
BT-2	3" x 12" CERAMIC TILE BASE	DALTILE	LINDEN POINT	
3T-3	4" RUBBER BASE	JOHNSONITE	TRADITIONAL RUBBER BASE	
3T-4	6" RUBBER BASE	JOHNSONITE	TRADITIONAL RUBBER BASE	
CG-1	CORNER GUARD	PROTEK SYSTEMS	CG-20R	
CPT-1	24"x24" CARPET TILE	MOHAWK GROUP	963 HERITAGE	
CT-1	6"x24" & 12"x24" CERAMIC TILE	TILE AMERICA	ATLANTIC STONE	6"x24" & 12"x24" STACKED PATTERN - PATTERN B32
CT-2	12"x24" CERAMIC TILE	DALTILE	LINDEN POINT	
CT-3	2"x2" GLAZED CERAMIC MOSAIC	DALTILE	LINDEN POINT	
CT-4	12"x24" CERAMIC WALL TILE	DALTILE	LINDEN POINT	
CT-5	3"x6" CERAMIC SUBWAY WALL TILE	DALTILE	RETROSPACE	
FRP-1	FIBER REINFORCED PANELING	MARLITE	STANDARD FRP	SMOOTH TEXTURE
FRP-2	FIBER REINFORCED PANELING	MARLITE	ARTIZAN	STACKED PATTERN
HPC-1	HIGH PERFORMANCE COATING - COLOR 1	SHERWIN-WILLIAMS	TBD	
HPC-2	HIGH PERFORMANCE COATING - COLOR 2	SHERWIN-WILLIAMS	TBD	<varies></varies>
HPC-3	HIGH PERFORMANCE COATING - COLOR 3	SHERWIN-WILLIAMS	TBD	TYPICAL @ EXPOSED STEEL STRUCTURE, U.N.O.
HPC-4	HIGH PERFORMANCE COATING - COLOR 4	SHERWIN-WILLIAMS	TBD	TYPICAL @ EXPOSED METAL DECK, U.N.O.
LVT-1	LUXURY VINYL TILE	ARMSTRONG	NATURAL CREATIONS	NATURAL CREATIONS WITH DIAMOND 10 TECHNOLOGY
PL-1	PLASTIC LAMINATE	FORMICA	TBD	
PL-2	PLASTIC LAMINATE	FORMICA	TBD	
PT-1	PAINT - COLOR 1	SHERWIN-WILLIAMS	TBD	
RES-1	RESINOUS FLOORING - COLOR 1	BASF	UCRETE HP/F	
RES-2	RESINOUS FLOORING - COLOR 2	BASF	UCRETE HP/F	
RES-3	RESINOUS FLOORING - COLOR 1	BASF	UCRETE RG	RESIN WALL SYSTEM IN SHOWER STALLS 136 & 137
RT-1	RESILIENT ATHETIC FLOORING	JOHNSONITE	REPLAY COMMOTION	
SC-1	SEALED CONCRETE			
SIM-1	SIMULATED STONE	CORIAN	GRANULAR QUARTZ	
SIM-2	SIMULATED STONE	CORIAN	GRANULAR QUARTZ	
SP-1	SOUND PANEL	ARMSTRONG	SOUNDSOAK	
SP-2	SOUND PANEL	KIREI	ECHOPANEL	24mm THICK PANELS
SS-1	SOLID SURFACE COUNTERTOP	CORIAN	DUPONT	
VCT-1	STATIC-DISSIPATIVE VINYL COMPOSITE TILE	ARMSTRONG	EXCELON SDT	SEE SPECIFICATIONS FOR GROUNDING REQUIREMENTS.

MARK	DESCRIPTION	BOD MANUFACTURER	BOD MODEL	COMMENTS
CR1	HEAVY DUTY SHOWER CURTAIN ROD	AMERICAN SPECIALTIES	1214/1200-SHU	<varies></varies>
CS1	RECESSED DIAPER CHANGING STATION	AMERICAN SPECIALTIES	9013	
DTS1	DOUBLE TOWEL RACK W/ TOP SHELF	AMERICAN SPECIALTIES	7311-24	
E7	BLACKOUT ROLLER SHADE	MECHO	SEE SPECIFICATIONS	BY 1a GENERAL PRIME CONTRACTOR
FSS1	ADA FOLDING SHOWER SEAT	AMERICAN SPECIALTIES	8203	
GB1	18" LONG GRAB BAR	AMERICAN SPECIALTIES	3800	
GB2	24" LONG GRAB BAR	AMERICAN SPECIALTIES	3800	
GB4	36" LONG GRAB BAR	AMERICAN SPECIALTIES	3800	
GB5	42" LONG GRAB BAR	AMERICAN SPECIALTIES	3800	
GB6	48" LONG GRAB BAR	AMERICAN SPECIALTIES	3800	
LD1	SOAP DISPENSER	N/A	N/A	OWNER PROVIDED CONTRACTOR INSTALLED
LD2	LAVATORY LIQUID SOAP DISPENSER	N/A	N/A	OWNER PROVIDED CONTRACTOR INSTALLED
MH1	MOP & BROOM HOLDER	BOBRICK	B-239X34	
MR1	CHANNEL FRAME MIRROR - 24" WIDE x 42" TALL	AMERICAN SPECIALTIES	0620-2442	
MR2	CUSTOM CHANNEL FRAME MIRROR - 48" TALL	LANCASTER PAINT & GLASS		VERIFY MAX WIDTH IN FIELD PRIOR TO FABRICATION
PT1	WALL MOUNTED PAPER TOWEL DISPENSER	N/A	N/A	<varies></varies>
RH1	DOUBLE ROBE HOOK	AMERICAN SPECIALTIES	7345	
SDS1	SOAP DISH SHELF	AMERICAN SPECIALTIES	7380-S18	
SN1	SANITARY WASTE RECEPTACLE	N/A	N/A	OWNER PROVIDED CONTRACTOR INSTALLED
TP1	TOILET PAPER DISPENSER	N/A	N/A	OWNER PROVIDED CONTRACTOR INSTALLED


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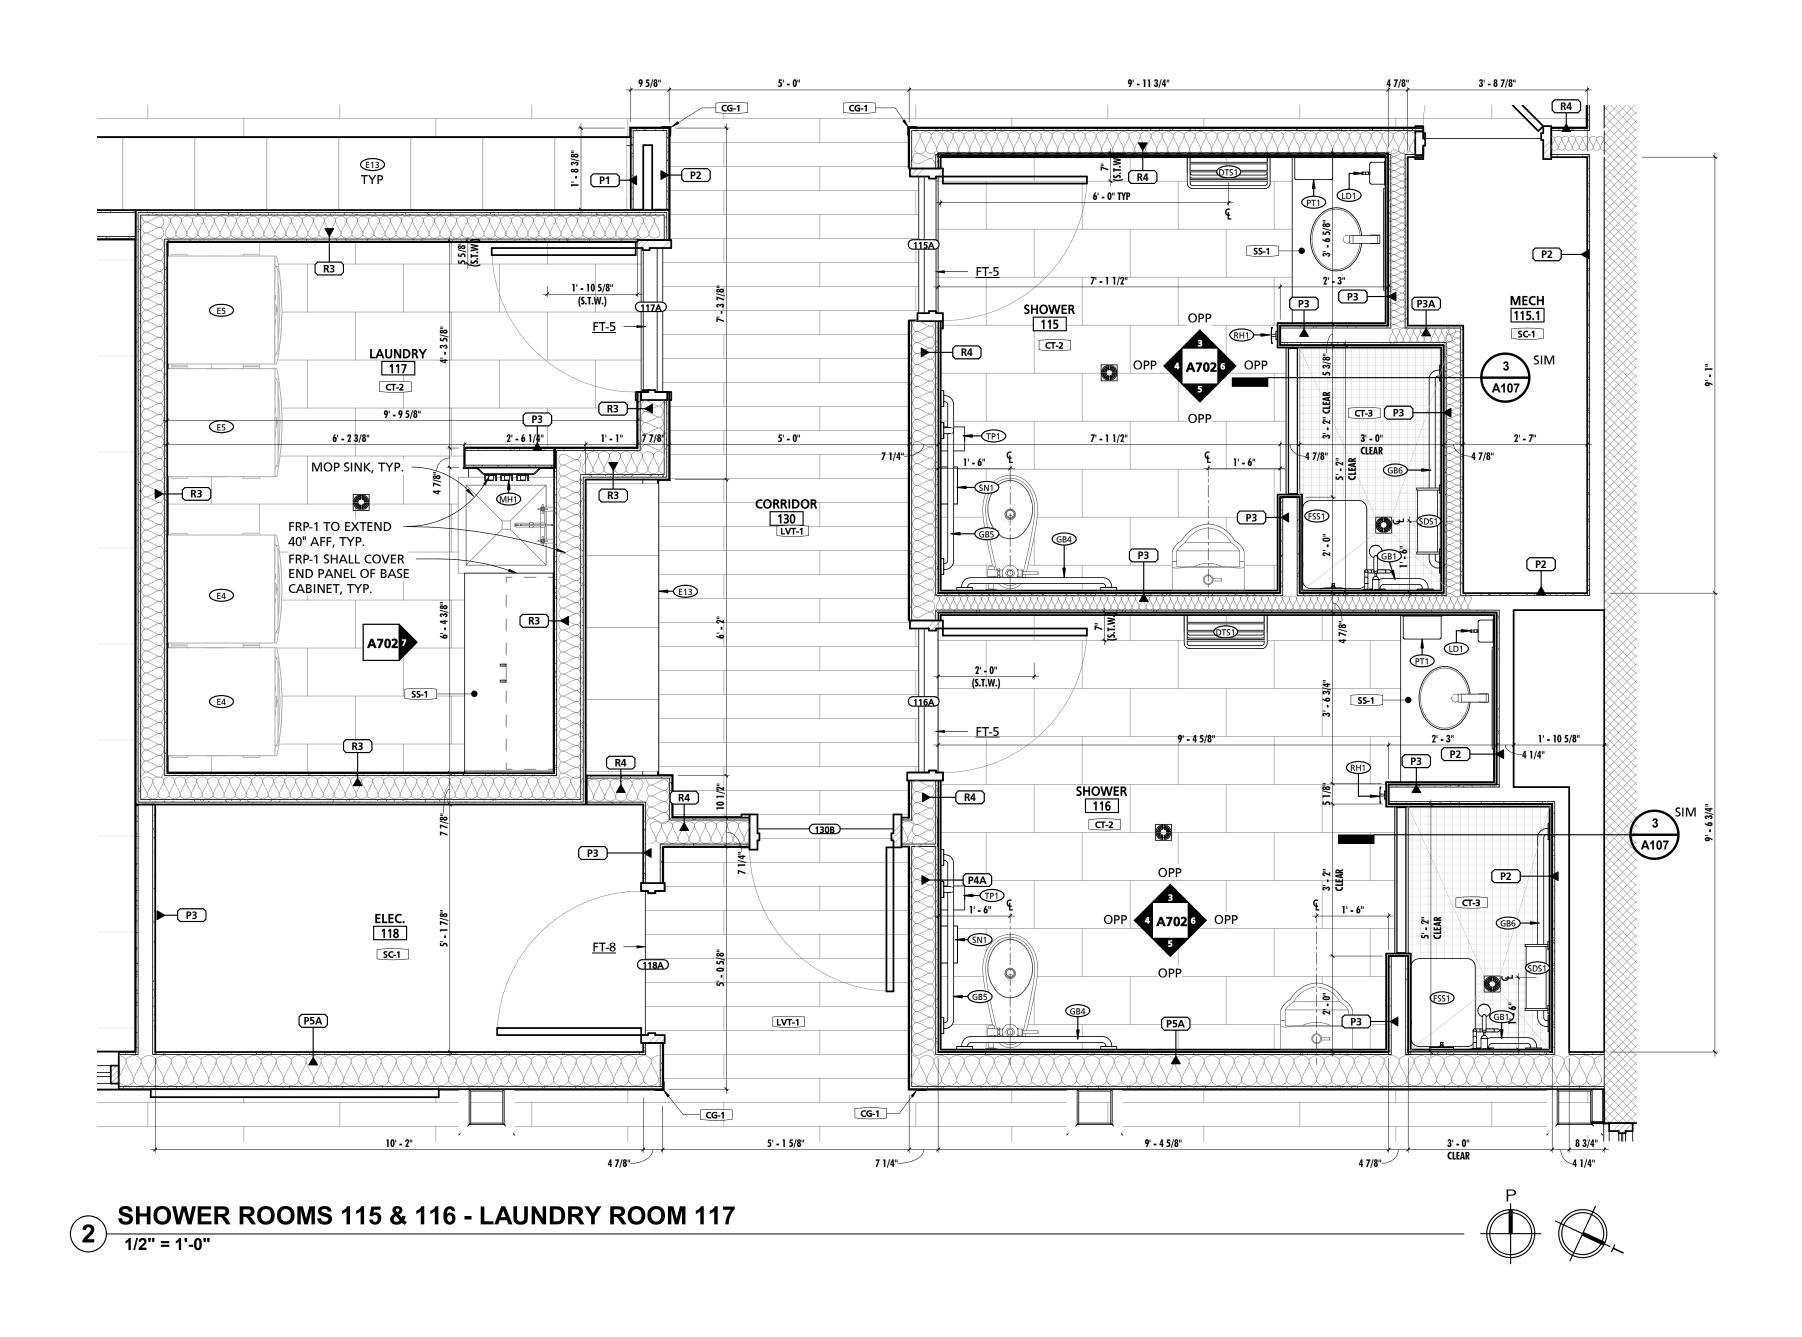



.. E


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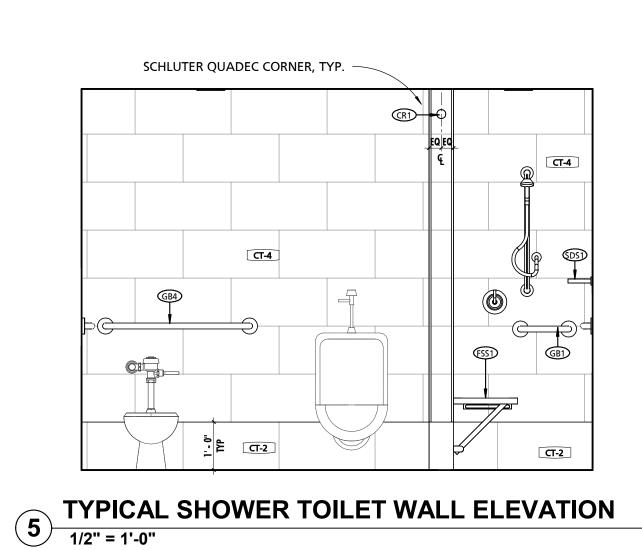
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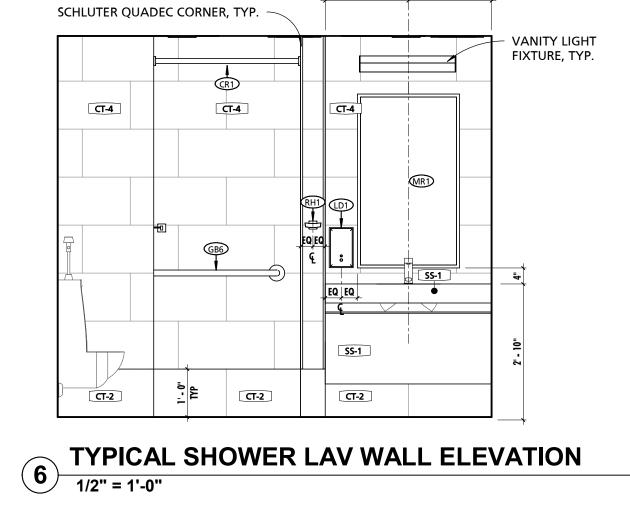







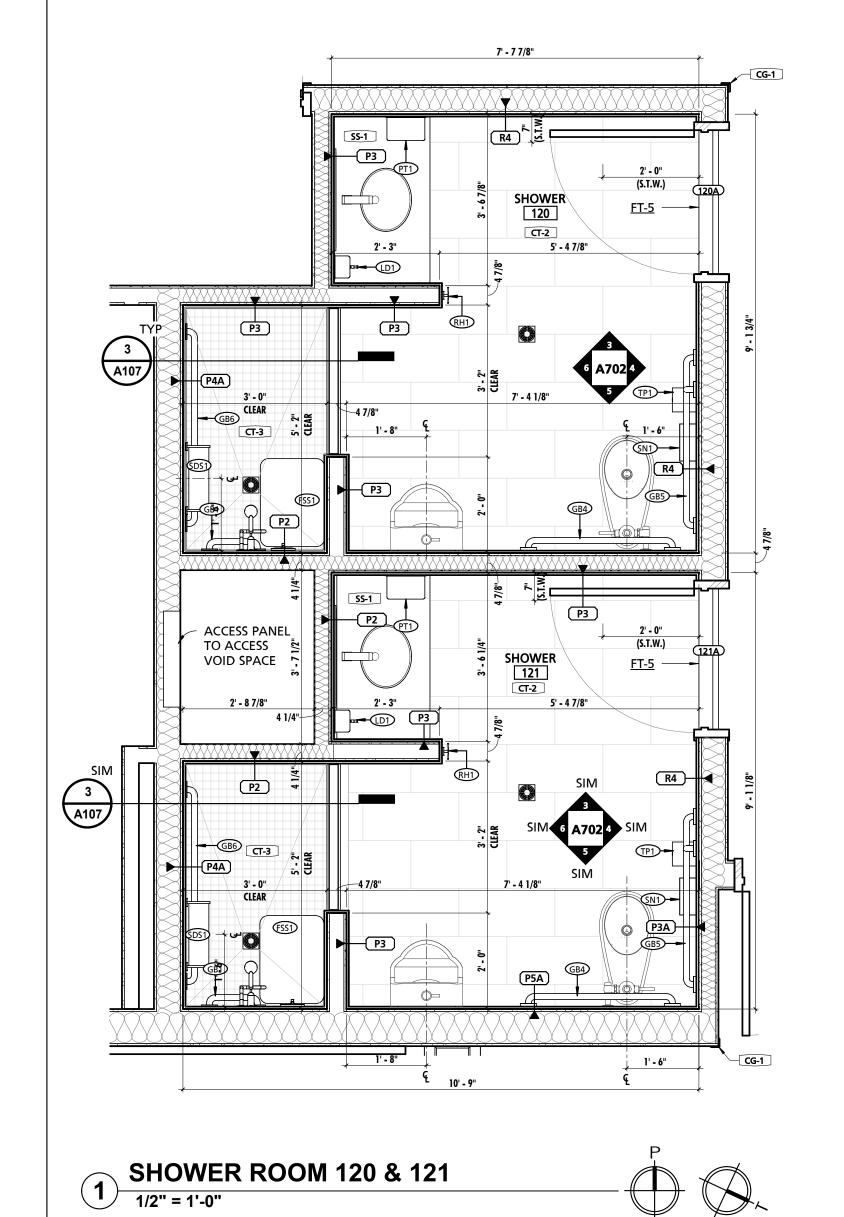

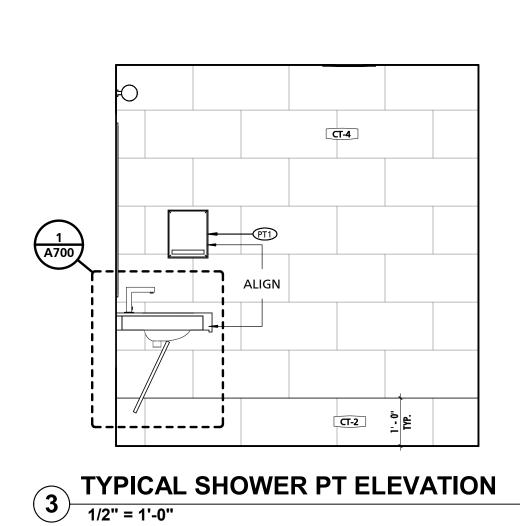

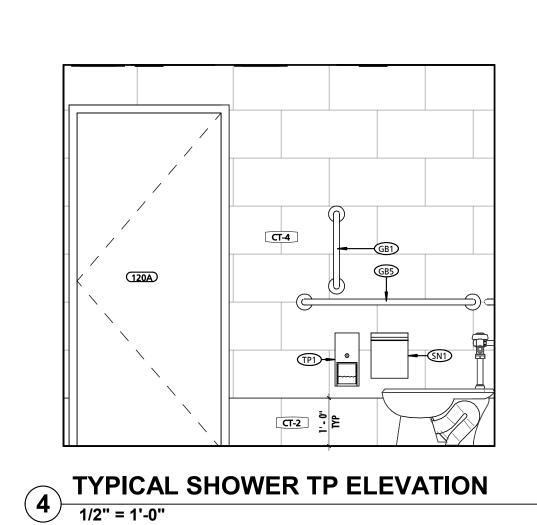

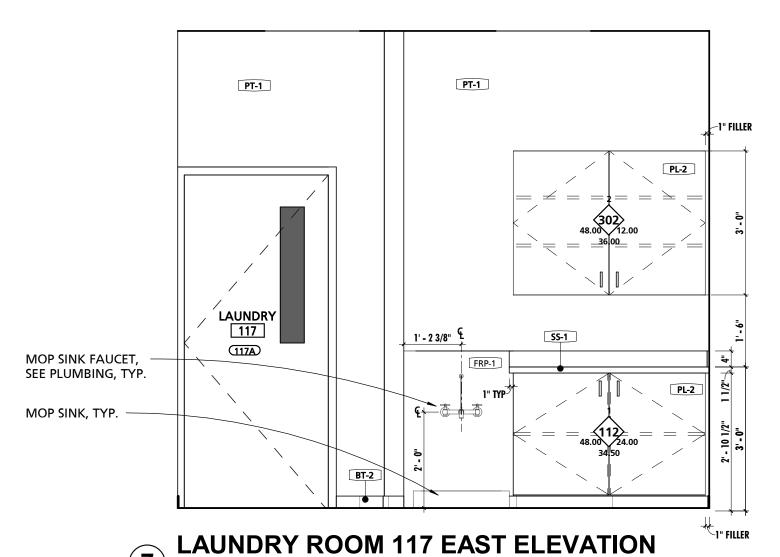

7 LAUNDRY ROOM 117 EAST ELEVATION
1/2" = 1'-0"


PROJECT NUMBER:
18-036
PROJECT SET:
BID SET
DATE ISSUED:
11/30/2023

DRAWING TITLE:
ENLARGED PLANS & INT.
ELEVATIONS

SHEET NUMBER:

A702

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LICENSE NUMBER: #RA405311
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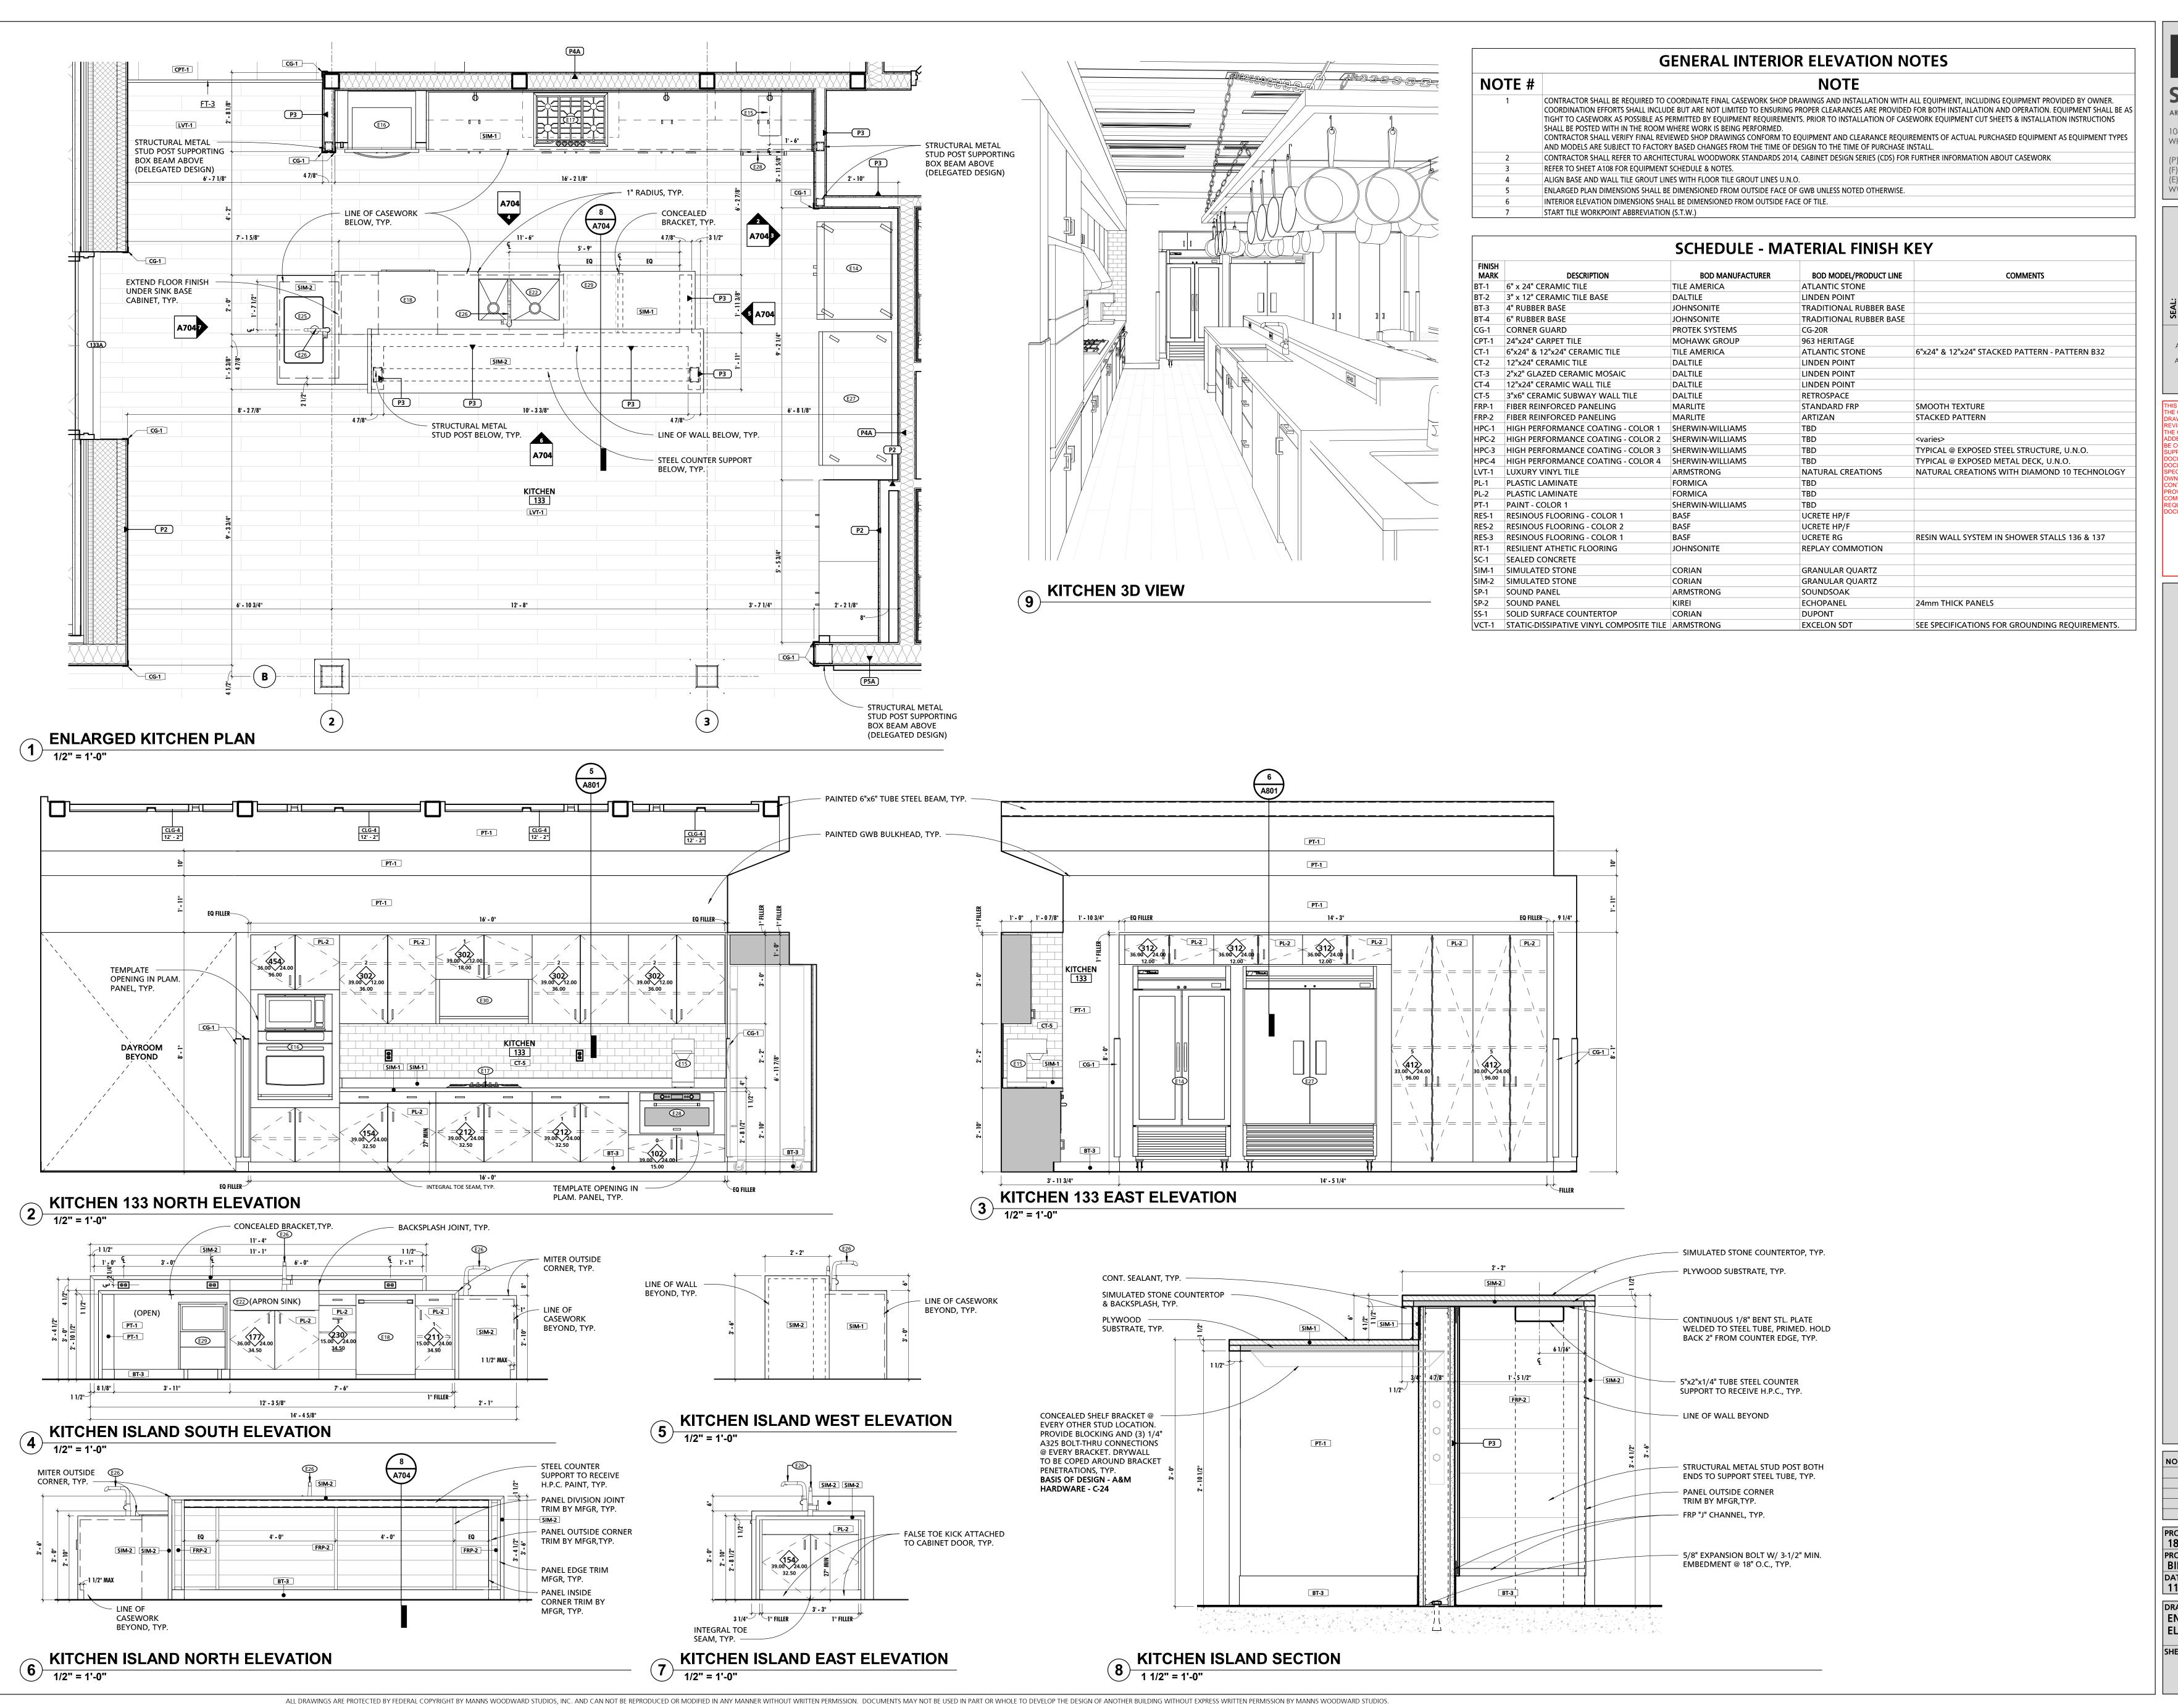
CUMRU FIRE DEPARTMENT
1775 WELSH ROAD
MOHNTON, PA 19540

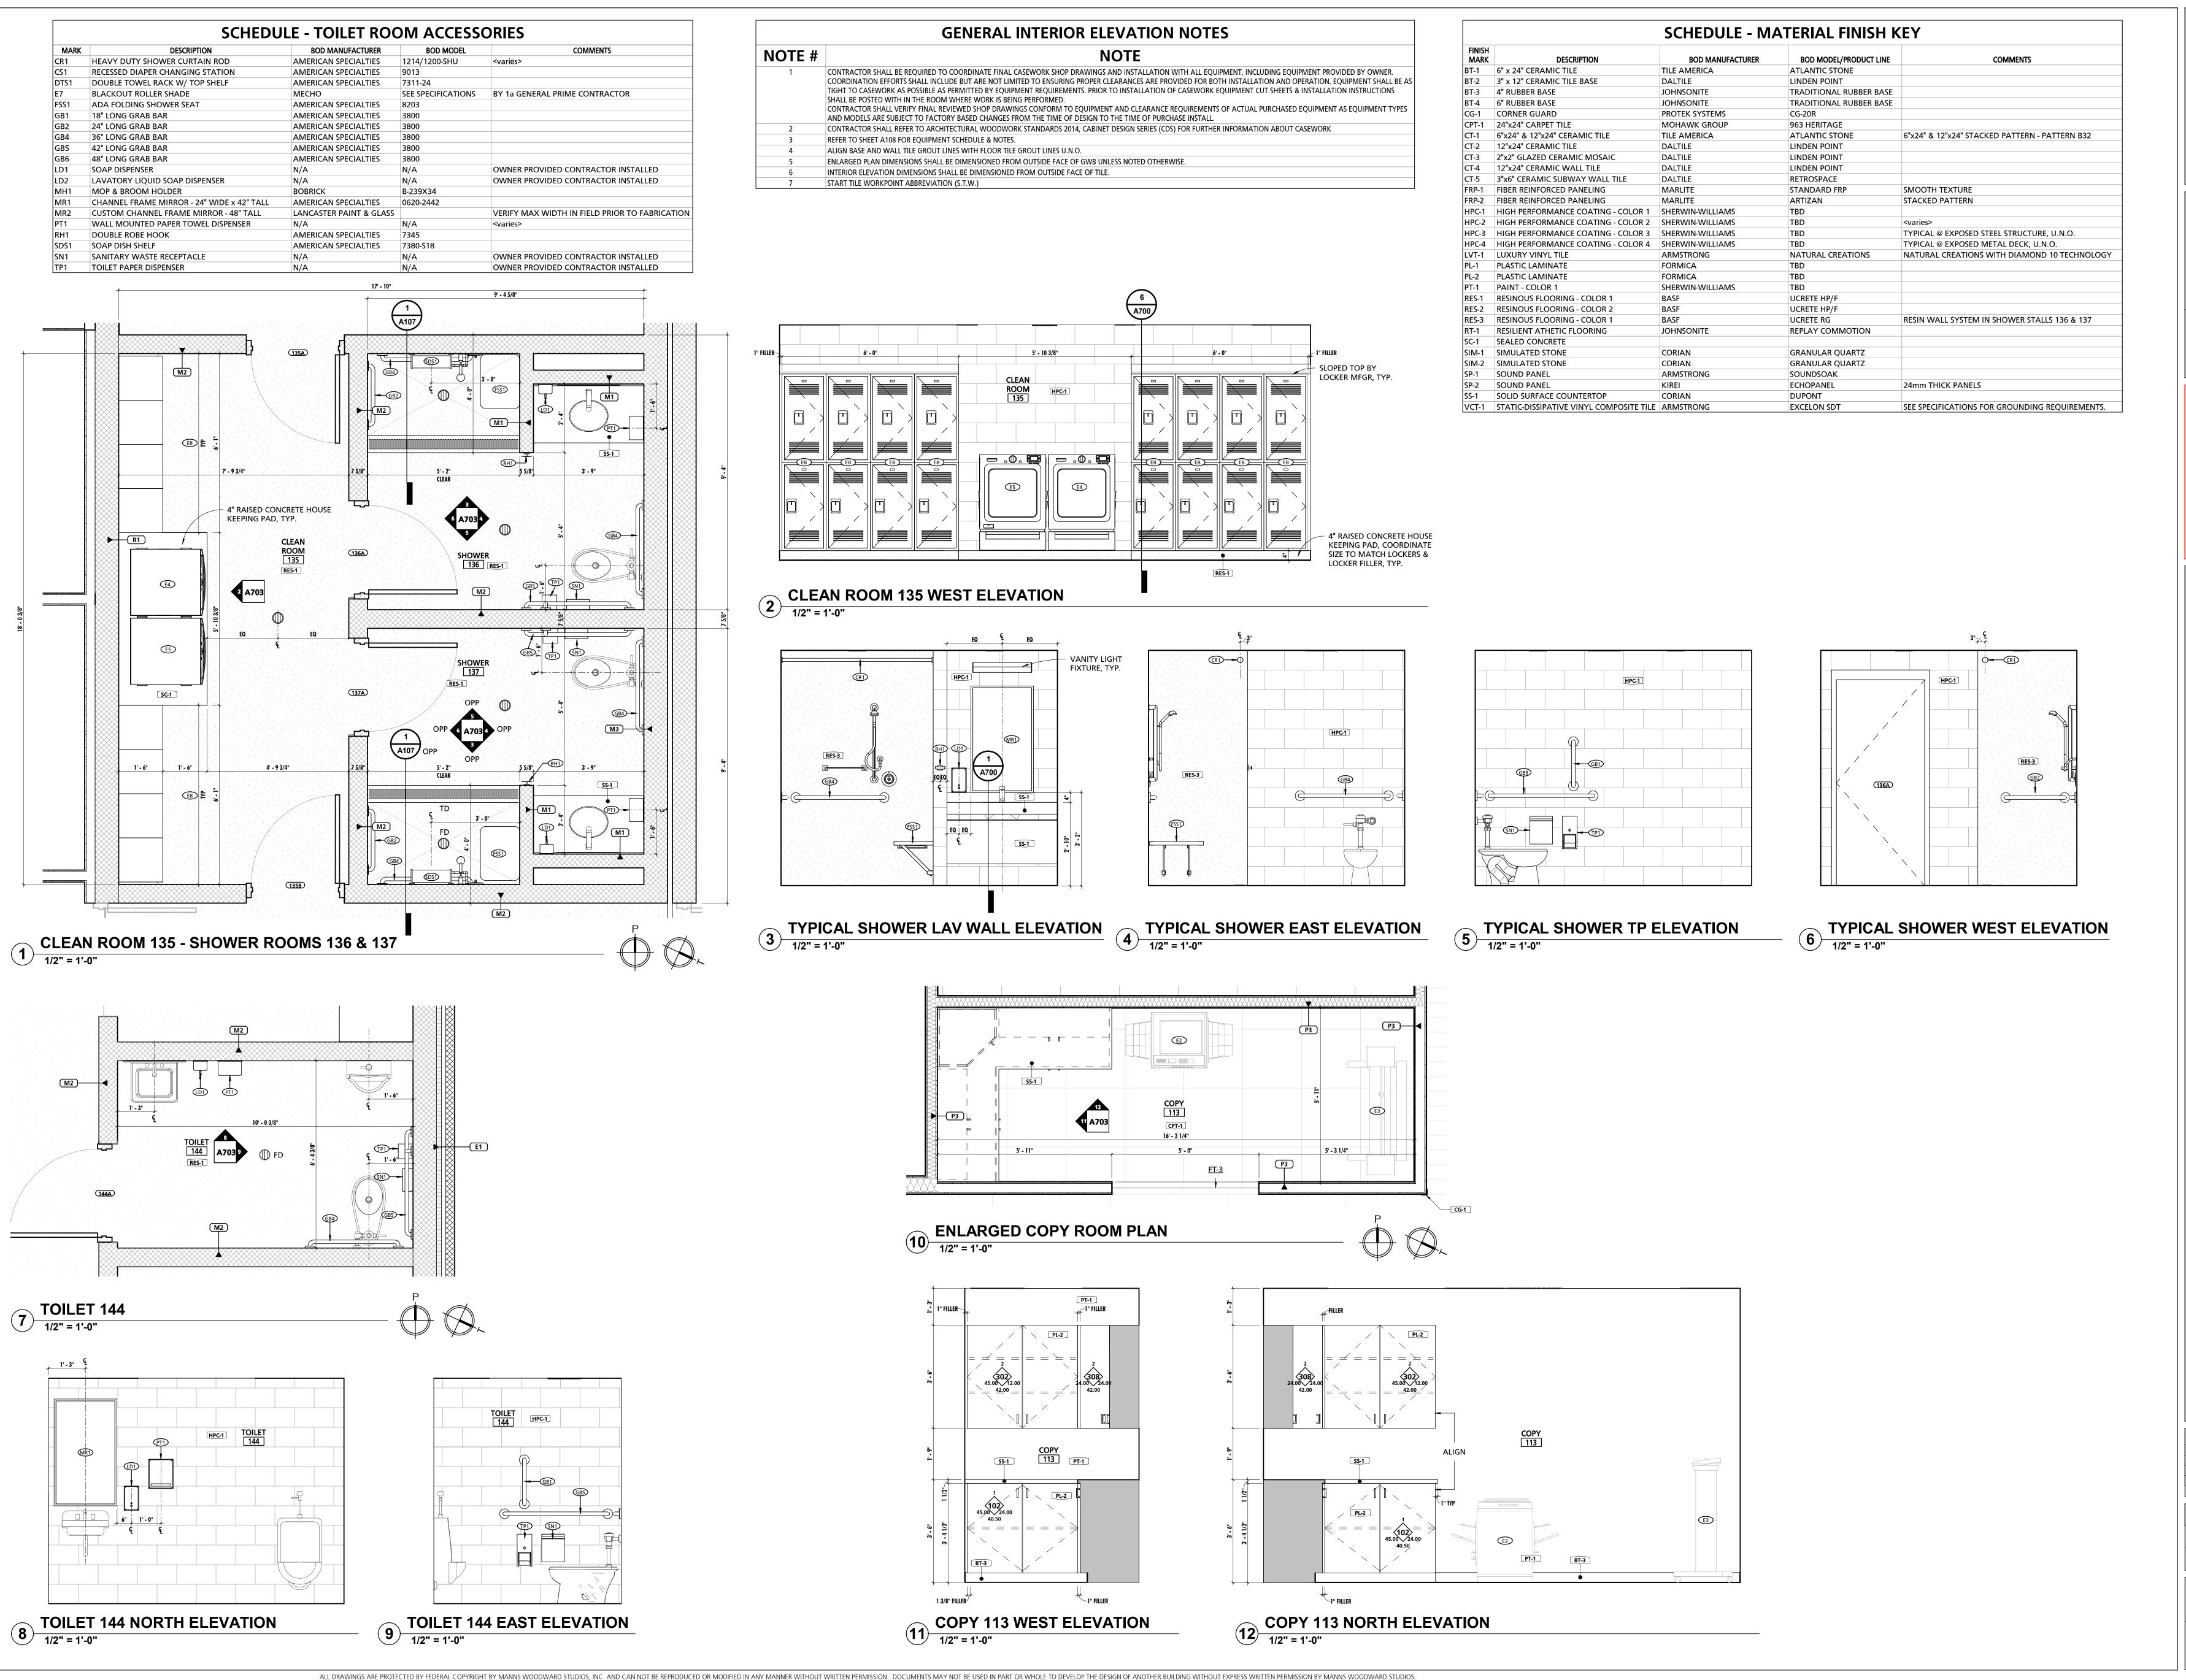PROJECT NUMBER:
18-036
PROJECT SET:
BID SET
DATE ISSUED:
11/30/2023

DRAWING TITLE:
ENLARGED PLANS & INT.
ELEVATIONS

SHEET NUMBER:

A703



STUDIOS

ARCHITECTURE + MASTER PLANNING

10839-D PHILADELPHIA RD WHITE MARSH, MD 21162

(P) 410-344-1460
(F) 443-403-2460
(E) INFO@MWSARCH.COM WWW.MWSARCH.COM

I HEREBY CERTIFY THAT THESE DOCUMENTS WERE PREPARED OR APPROVED BY ME, AND THAT I AM A DULY LICENSED PROFESSIONAL ARCHITECT UNDER THE LAWS OF THE STATE OF PENNSYLVANIA. LICENSE NUMBER: #RA405311 EXPIRATION DATE: 6-30-2023

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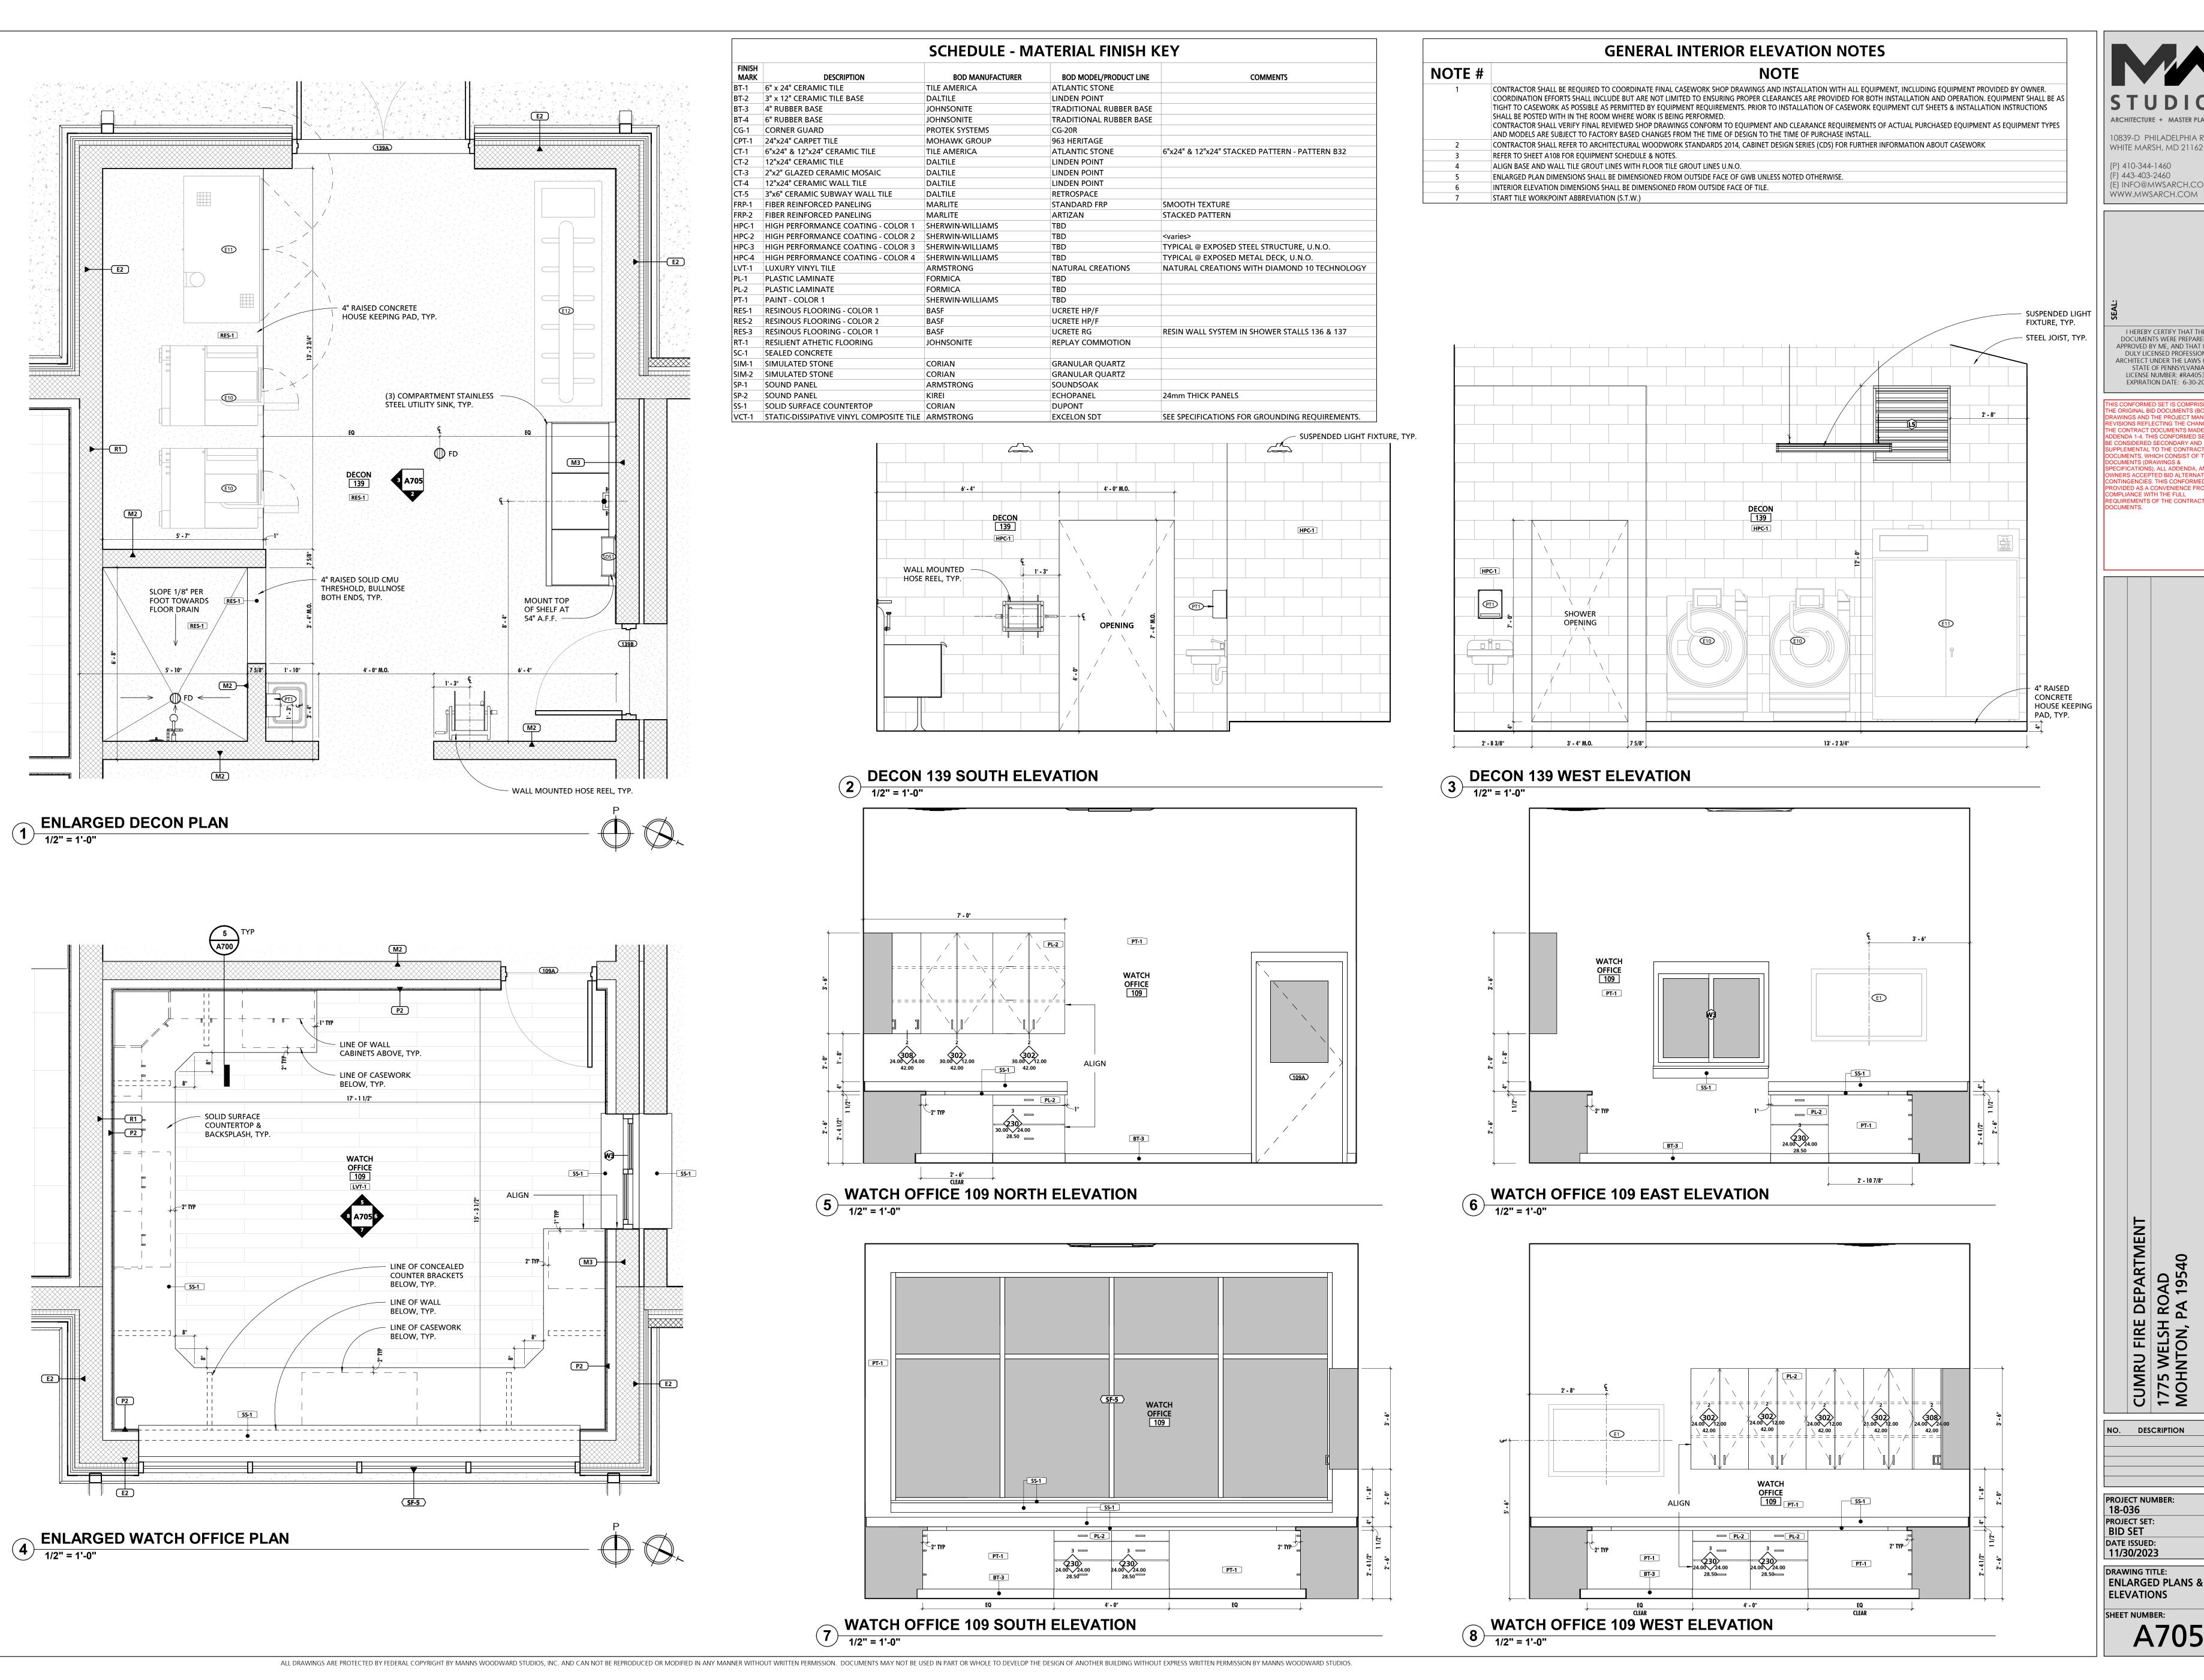
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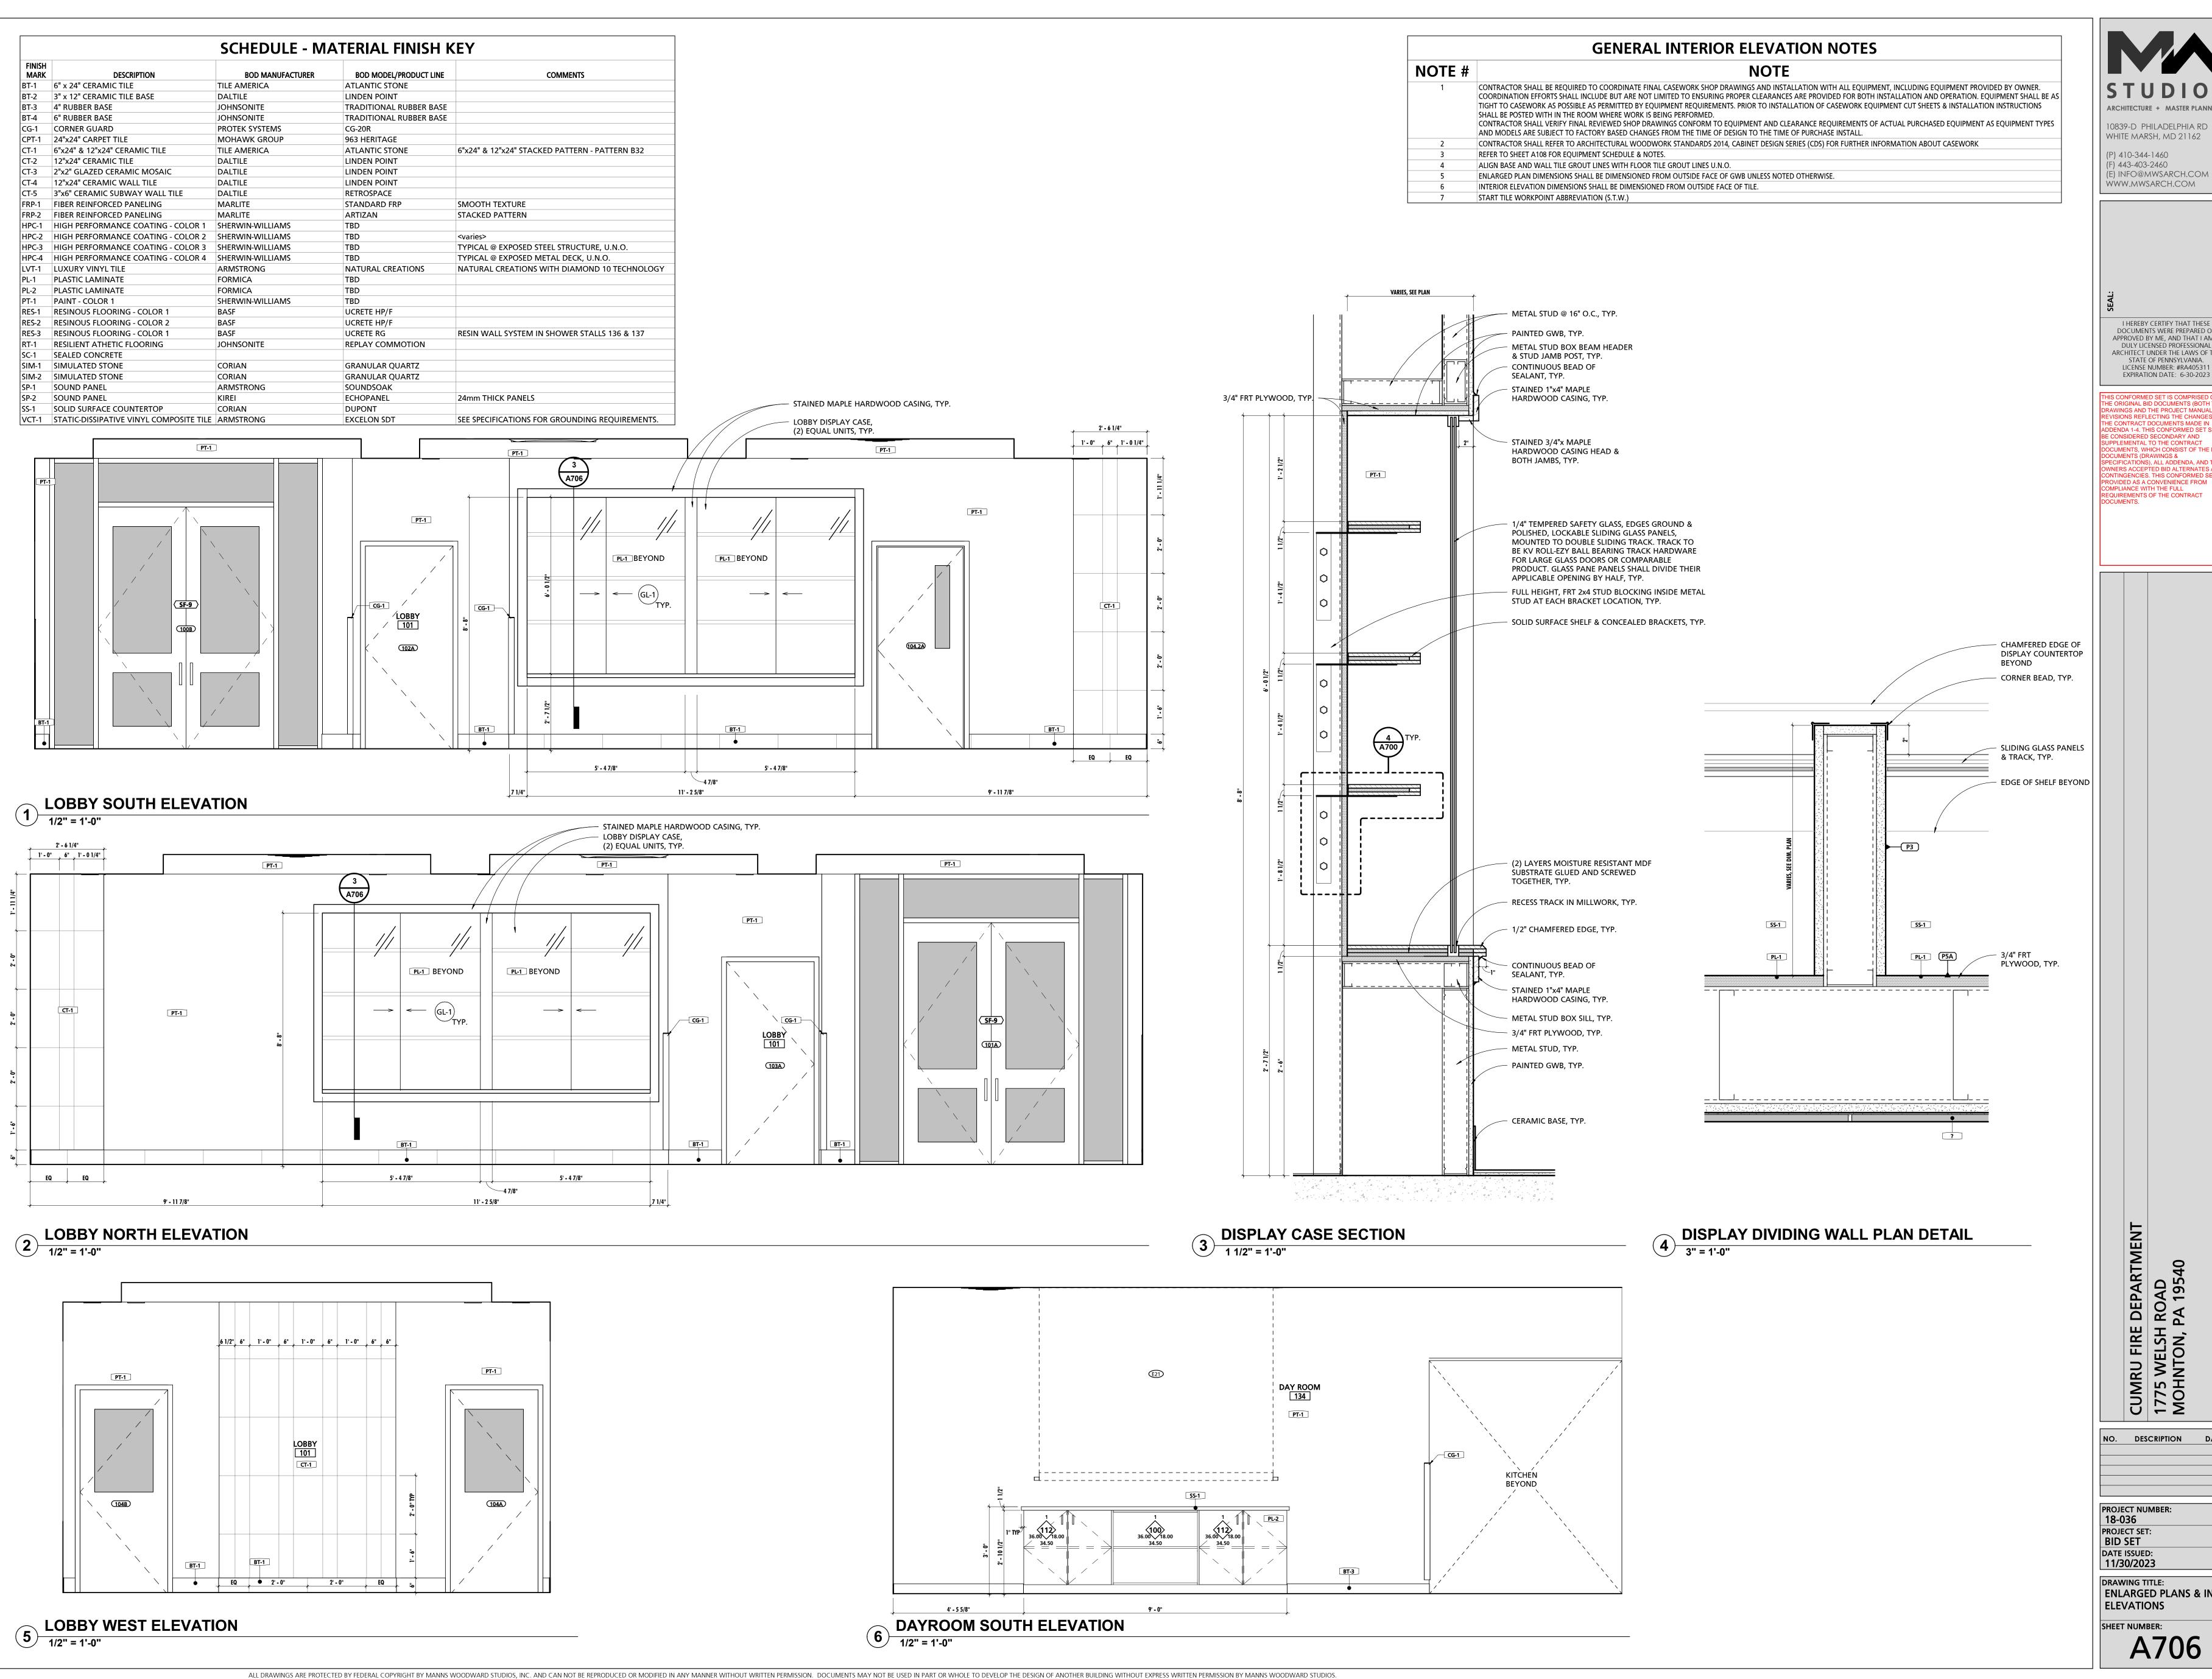
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EXPIRATION DATE: 6-30-2023

REQUIREMENTS OF THE CONTRACT DOCUMENTS.

NO. DESCRIPTION DATE BID SET DATE ISSUED: 11/30/2023 DRAWING TITLE: **ENLARGED PLANS & INT ELEVATIONS** SHEET NUMBER: A705




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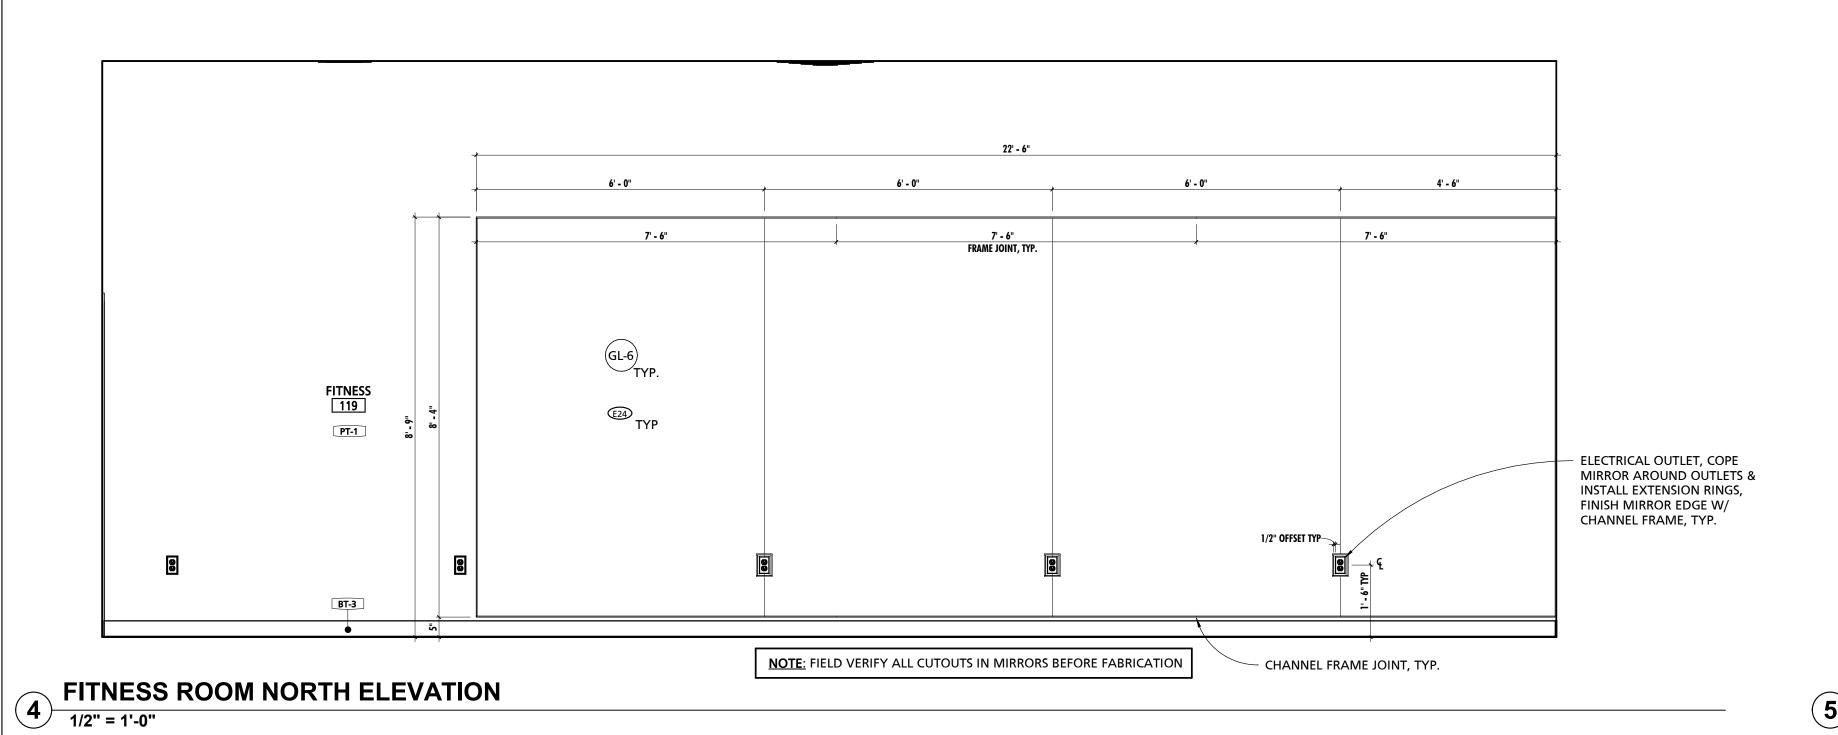
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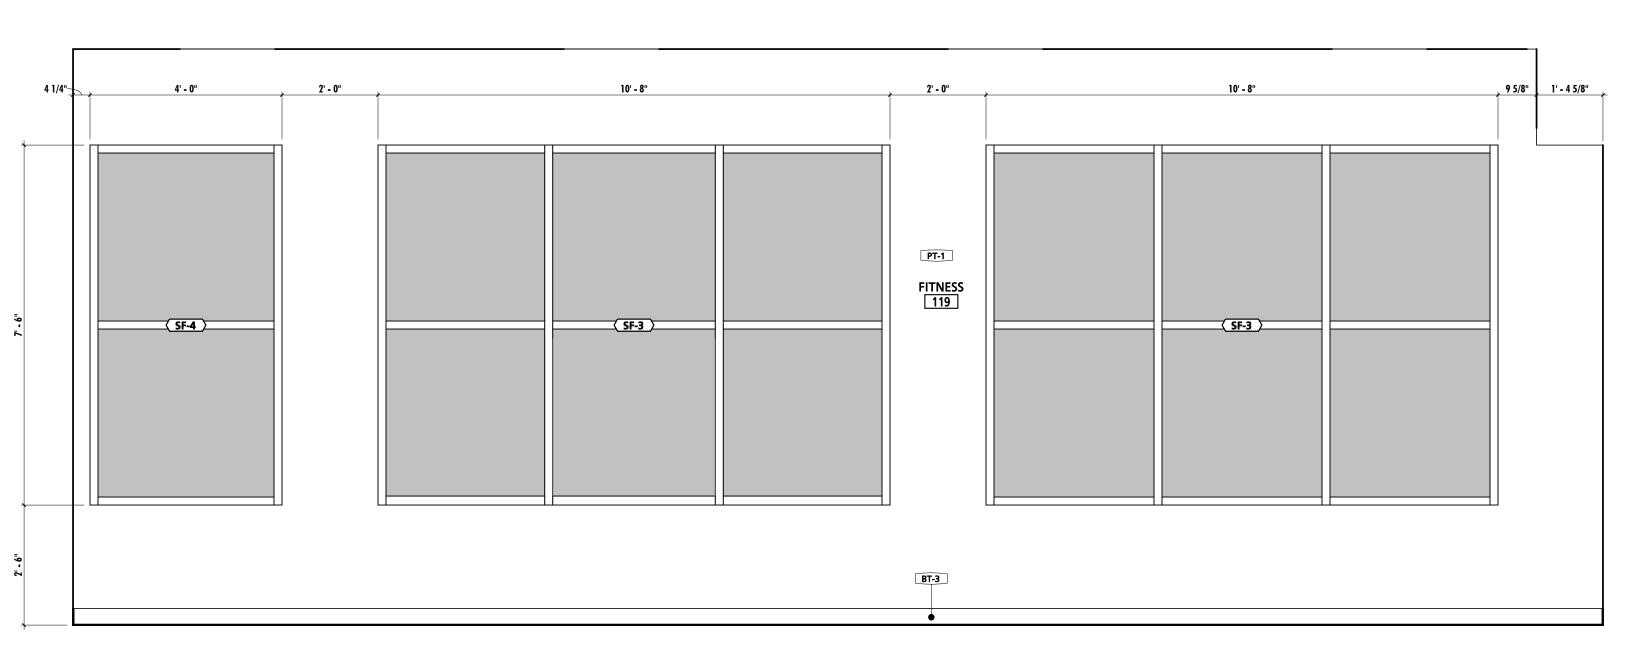
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DESCRIPTION DATE PROJECT NUMBER: PROJECT SET: BID SET DATE ISSUED: 11/30/2023 **DRAWING TITLE: ENLARGED PLANS & INT ELEVATIONS** SHEET NUMBER:



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DESCRIPTION DATE PROJECT NUMBER: 18-036 PROJECT SET: **BID SET** DATE ISSUED: 11/30/2023 DRAWING TITLE: **ENLARGED PLANS & INT ELEVATIONS**

COMMENTS

6"x24" & 12"x24" STACKED PATTERN - PATTERN B32

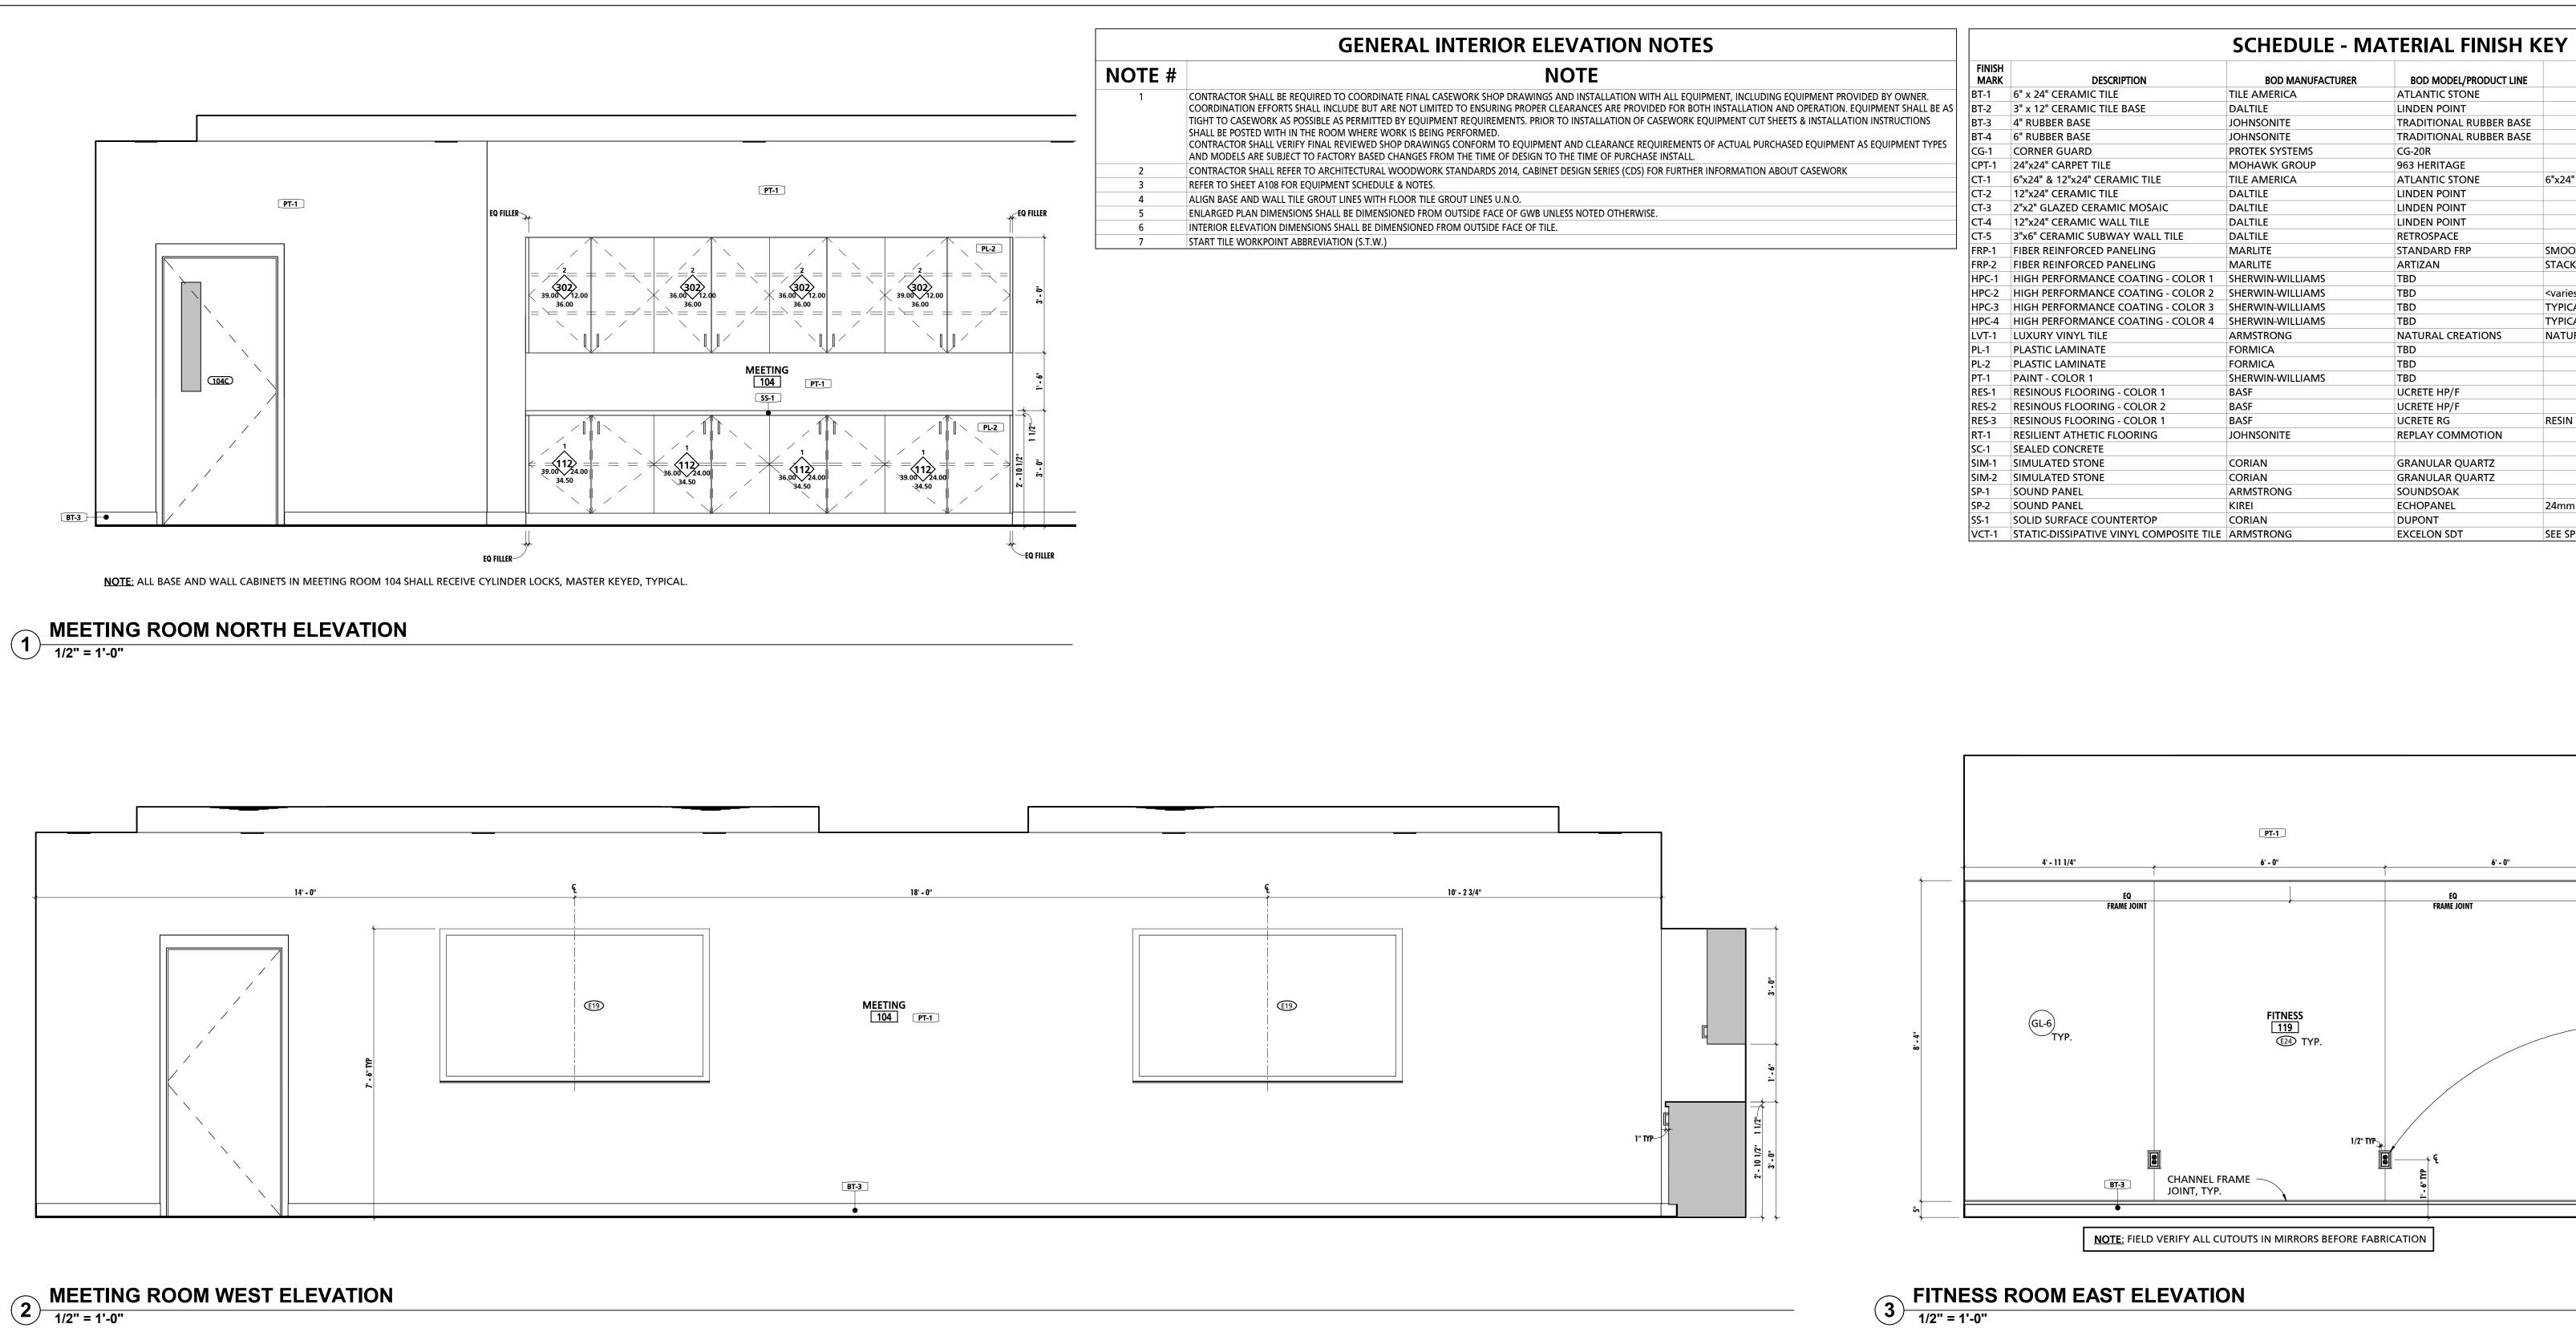TYPICAL @ EXPOSED STEEL STRUCTURE, U.N.O.

NATURAL CREATIONS WITH DIAMOND 10 TECHNOLOGY

RESIN WALL SYSTEM IN SHOWER STALLS 136 & 137

SEE SPECIFICATIONS FOR GROUNDING REQUIREMENTS.

ELECTRICAL OUTLET, COPE MIRROR AROUND OUTLETS & INSTALL EXTENSION RINGS, FINISH MIRROR

EDGE W/ CHANNEL FRAME, TYP.

TYPICAL @ EXPOSED METAL DECK, U.N.O.

SMOOTH TEXTURE

STACKED PATTERN

24mm THICK PANELS

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(E) INFO@MWSARCH.COM

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WHITE MARSH, MD 21162

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BOD MODEL/PRODUCT LINE

TRADITIONAL RUBBER BASE

TRADITIONAL RUBBER BASE

ATLANTIC STONE

LINDEN POINT

963 HERITAGE

LINDEN POINT

LINDEN POINT

LINDEN POINT

STANDARD FRP

NATURAL CREATIONS

REPLAY COMMOTION

GRANULAR QUARTZ

GRANULAR QUARTZ

RETROSPACE

ARTIZAN

TBD

UCRETE HP/F

UCRETE HP/F

SOUNDSOAK

ECHOPANEL

EXCELON SDT

DUPONT


UCRETE RG

ATLANTIC STONE

CG-20R

FITNESS ROOM SOUTH ELEVATION

1/2" = 1'-0" SHEET NUMBER: A707

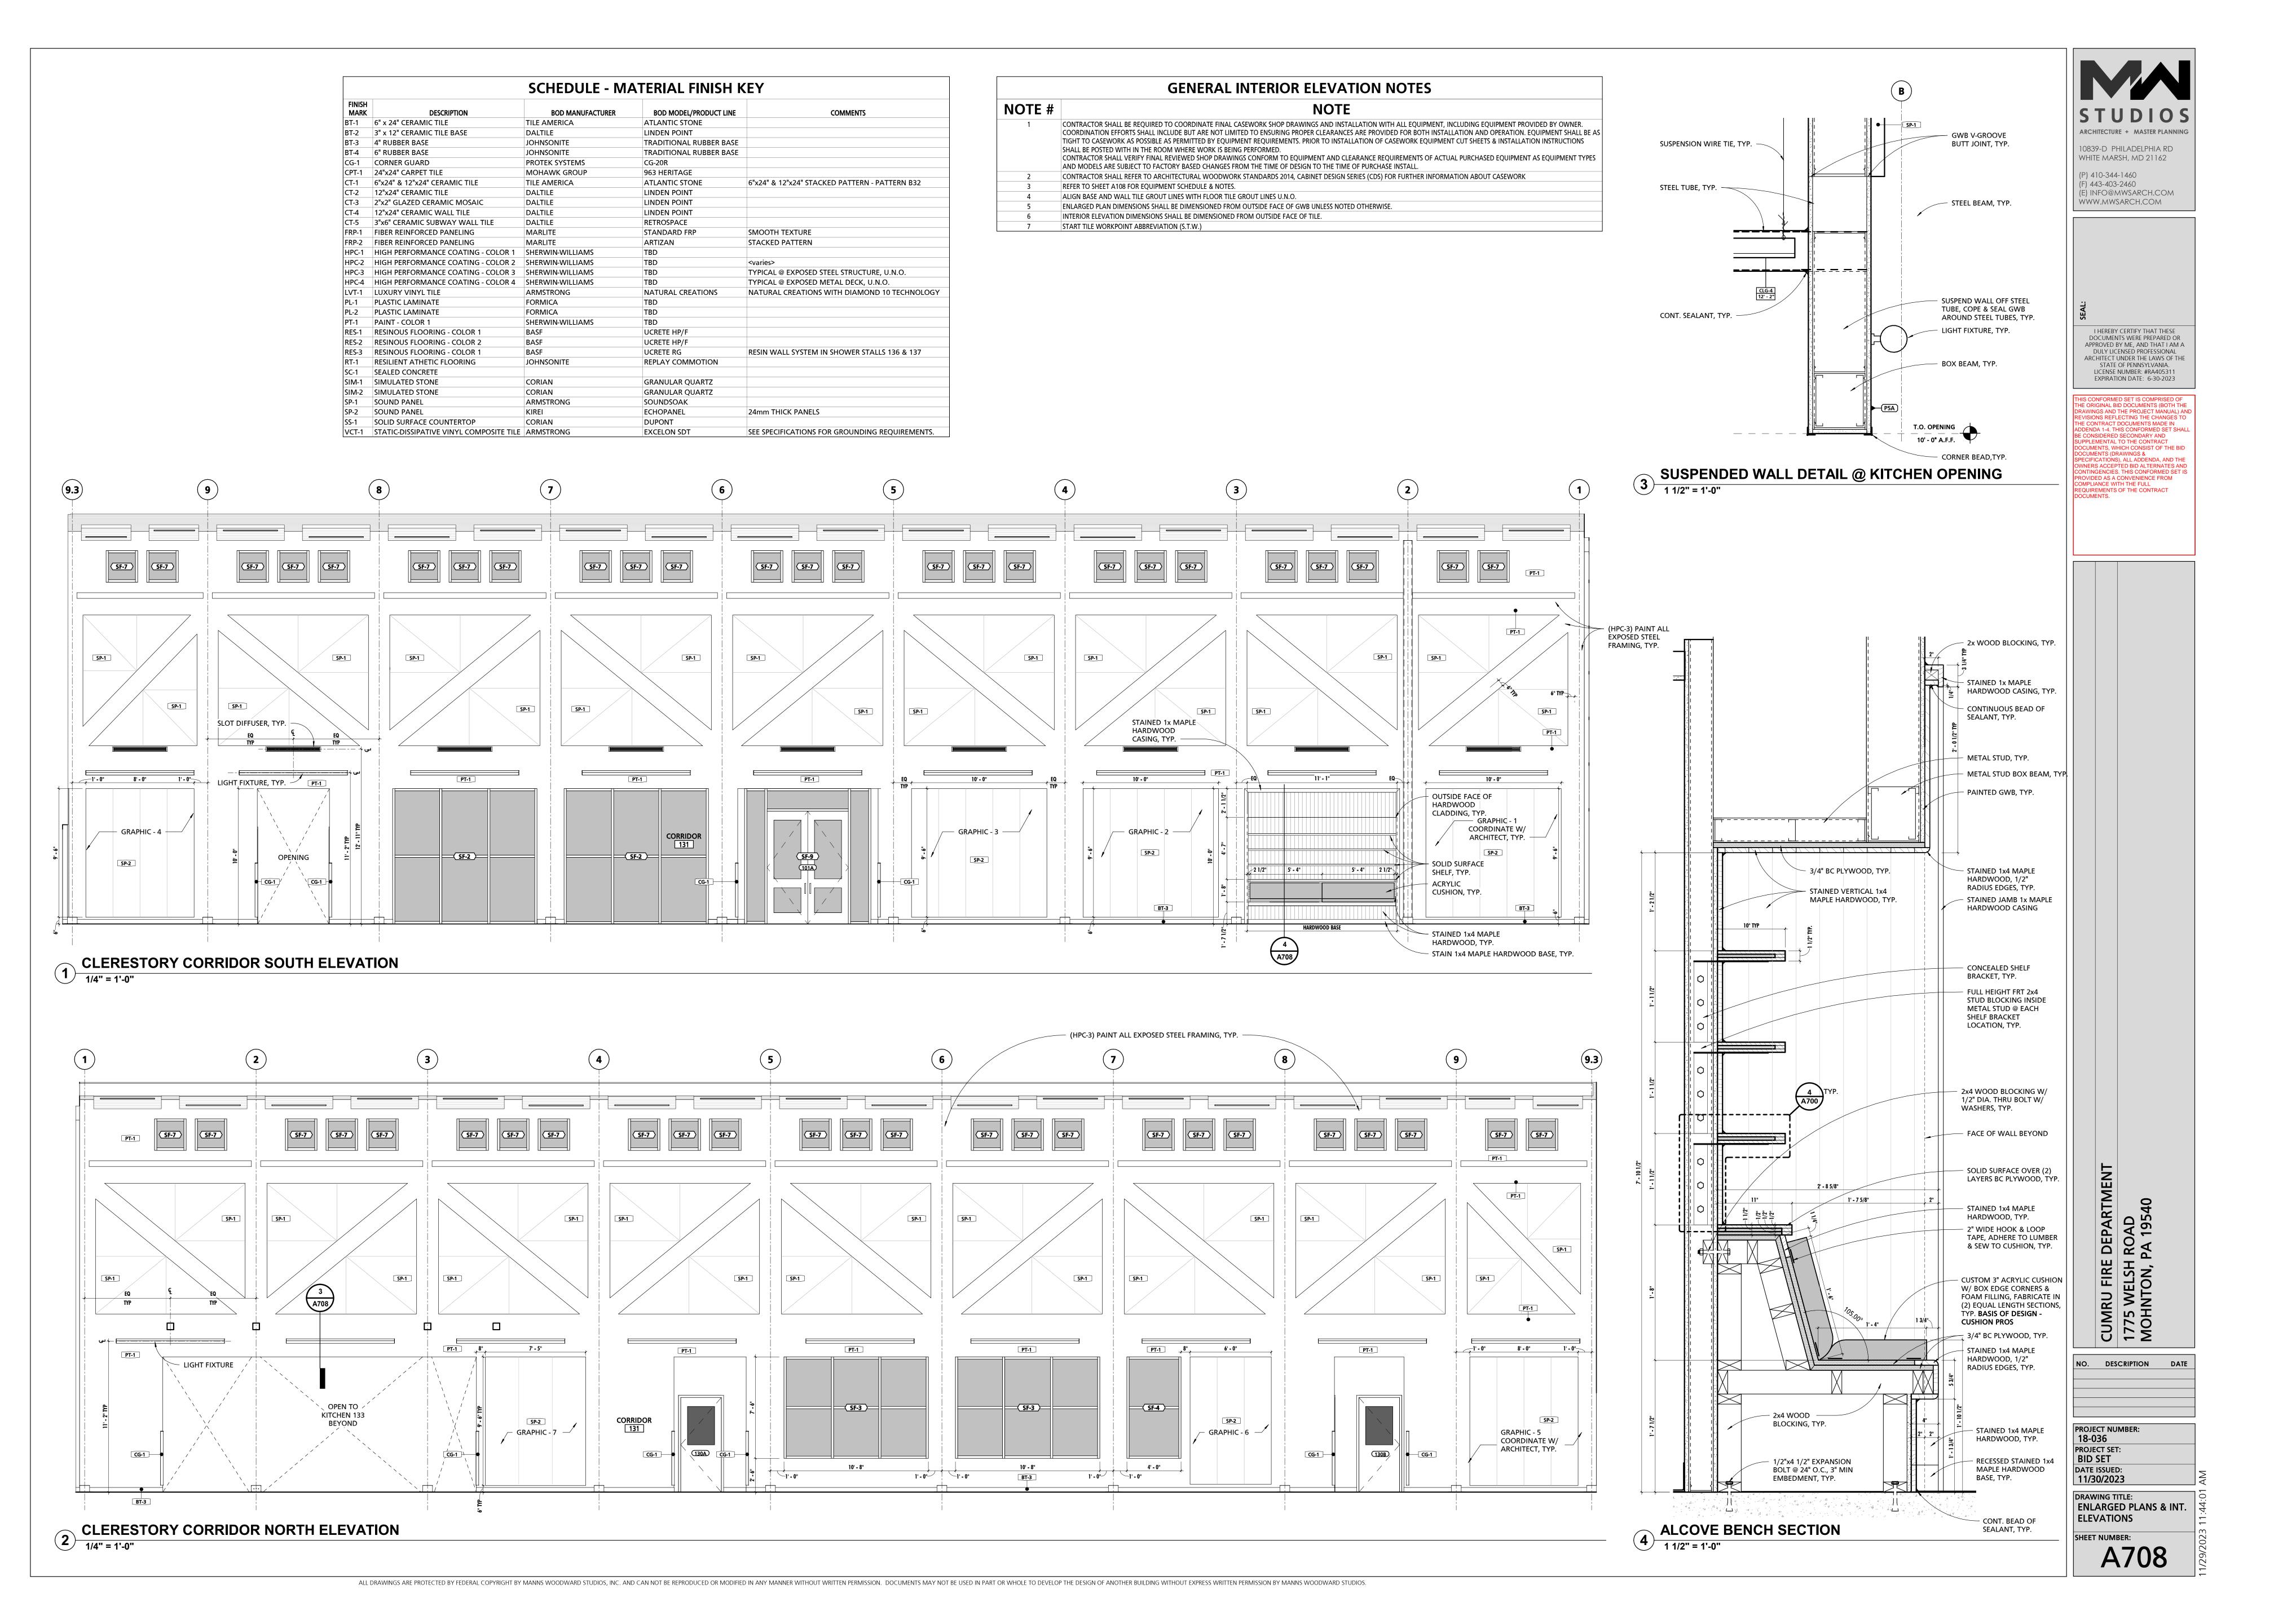

GENERAL INTERIOR ELEVATION NOTES

NOTE # **NOTE**

CONTRACTOR SHALL BE REQUIRED TO COORDINATE FINAL CASEWORK SHOP DRAWINGS AND INSTALLATION WITH ALL EQUIPMENT, INCLUDING EQUIPMENT PROVIDED BY OWNER. COORDINATION EFFORTS SHALL INCLUDE BUT ARE NOT LIMITED TO ENSURING PROPER CLEARANCES ARE PROVIDED FOR BOTH INSTALLATION AND OPERATION. EQUIPMENT SHALL BE AS TIGHT TO CASEWORK AS POSSIBLE AS PERMITTED BY EQUIPMENT REQUIREMENTS. PRIOR TO INSTALLATION OF CASEWORK EQUIPMENT CUT SHEETS & INSTALLATION INSTRUCTIONS SHALL BE POSTED WITH IN THE ROOM WHERE WORK IS BEING PERFORMED.

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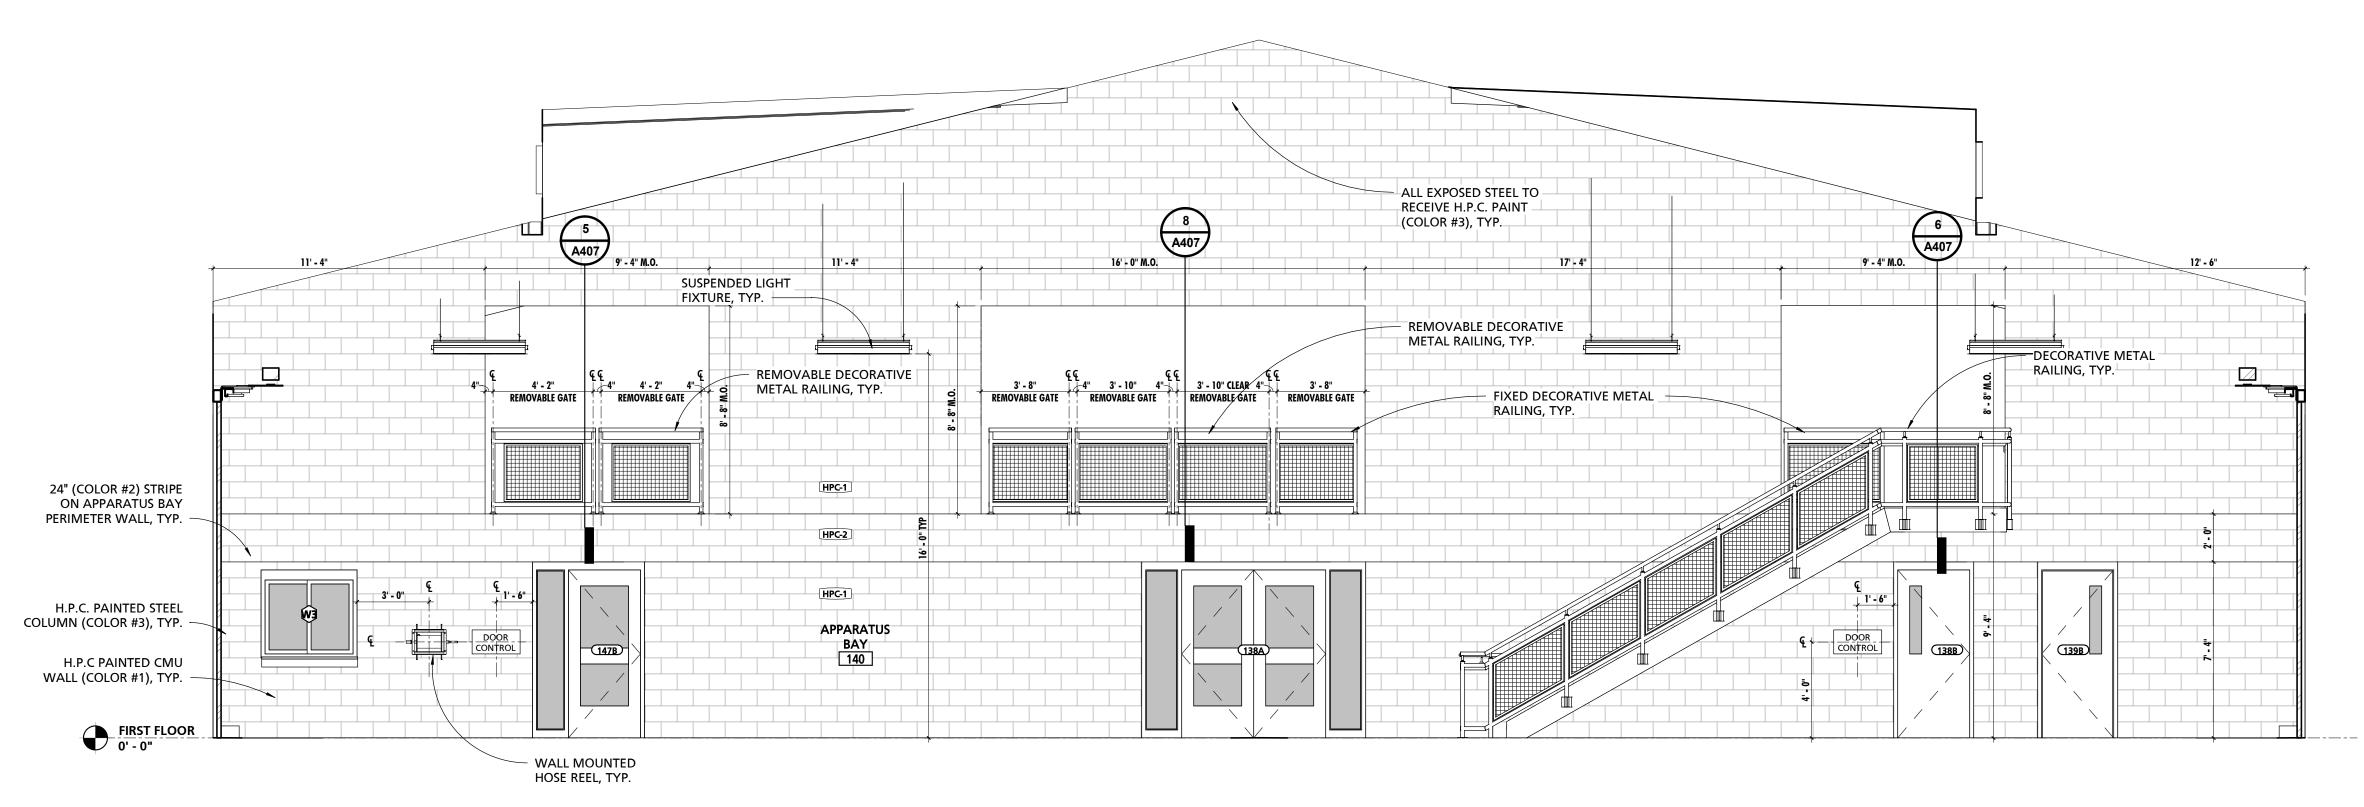
CONTRACTOR SHALL REFER TO ARCHITECTURAL WOODWORK STANDARDS 2014, CABINET DESIGN SERIES (CDS) FOR FURTHER INFORMATION ABOUT CASEWORK

REFER TO SHEET A108 FOR EQUIPMENT SCHEDULE & NOTES. ALIGN BASE AND WALL TILE GROUT LINES WITH FLOOR TILE GROUT LINES U.N.O.


ENLARGED PLAN DIMENSIONS SHALL BE DIMENSIONED FROM OUTSIDE FACE OF GWB UNLESS NOTED OTHERWISE.

INTERIOR ELEVATION DIMENSIONS SHALL BE DIMENSIONED FROM OUTSIDE FACE OF TILE. START TILE WORKPOINT ABBREVIATION (S.T.W.)

		SCHEDULE - MA	ATERIAL FINISH K	CEY
FINISH MARK	DESCRIPTION	BOD MANUFACTURER	BOD MODEL/PRODUCT LINE	COMMENTS
BT-1	6" x 24" CERAMIC TILE	TILE AMERICA	ATLANTIC STONE	
BT-2	3" x 12" CERAMIC TILE BASE	DALTILE	LINDEN POINT	
BT-3	4" RUBBER BASE	JOHNSONITE	TRADITIONAL RUBBER BASE	
BT-4	6" RUBBER BASE	JOHNSONITE	TRADITIONAL RUBBER BASE	
CG-1	CORNER GUARD	PROTEK SYSTEMS	CG-20R	
CPT-1	24"x24" CARPET TILE	MOHAWK GROUP	963 HERITAGE	
CT-1	6"x24" & 12"x24" CERAMIC TILE	TILE AMERICA	ATLANTIC STONE	6"x24" & 12"x24" STACKED PATTERN - PATTERN B32
CT-2	12"x24" CERAMIC TILE	DALTILE	LINDEN POINT	
CT-3	2"x2" GLAZED CERAMIC MOSAIC	DALTILE	LINDEN POINT	
CT-4	12"x24" CERAMIC WALL TILE	DALTILE	LINDEN POINT	
CT-5	3"x6" CERAMIC SUBWAY WALL TILE	DALTILE	RETROSPACE	
FRP-1	FIBER REINFORCED PANELING	MARLITE	STANDARD FRP	SMOOTH TEXTURE
FRP-2	FIBER REINFORCED PANELING	MARLITE	ARTIZAN	STACKED PATTERN
HPC-1	HIGH PERFORMANCE COATING - COLOR 1	SHERWIN-WILLIAMS	TBD	
HPC-2	HIGH PERFORMANCE COATING - COLOR 2	SHERWIN-WILLIAMS	TBD	<varies></varies>
HPC-3	HIGH PERFORMANCE COATING - COLOR 3	SHERWIN-WILLIAMS	TBD	TYPICAL @ EXPOSED STEEL STRUCTURE, U.N.O.
HPC-4	HIGH PERFORMANCE COATING - COLOR 4	SHERWIN-WILLIAMS	TBD	TYPICAL @ EXPOSED METAL DECK, U.N.O.
LVT-1	LUXURY VINYL TILE	ARMSTRONG	NATURAL CREATIONS	NATURAL CREATIONS WITH DIAMOND 10 TECHNOLOGY
PL-1	PLASTIC LAMINATE	FORMICA	TBD	
PL-2	PLASTIC LAMINATE	FORMICA	TBD	
PT-1	PAINT - COLOR 1	SHERWIN-WILLIAMS	TBD	
RES-1	RESINOUS FLOORING - COLOR 1	BASF	UCRETE HP/F	
RES-2	RESINOUS FLOORING - COLOR 2	BASF	UCRETE HP/F	
RES-3	RESINOUS FLOORING - COLOR 1	BASF	UCRETE RG	RESIN WALL SYSTEM IN SHOWER STALLS 136 & 137
RT-1	RESILIENT ATHETIC FLOORING	JOHNSONITE	REPLAY COMMOTION	
SC-1	SEALED CONCRETE			
SIM-1	SIMULATED STONE	CORIAN	GRANULAR QUARTZ	
SIM-2	SIMULATED STONE	CORIAN	GRANULAR QUARTZ	
SP-1	SOUND PANEL	ARMSTRONG	SOUNDSOAK	
SP-2	SOUND PANEL	KIREI	ECHOPANEL	24mm THICK PANELS
SS-1	SOLID SURFACE COUNTERTOP	CORIAN	DUPONT	
VCT-1	STATIC-DISSIPATIVE VINYL COMPOSITE TILE	ARMSTRONG	EXCELON SDT	SEE SPECIFICATIONS FOR GROUNDING REQUIREMENTS.



APPARATUS BAY WEST ELEVATION

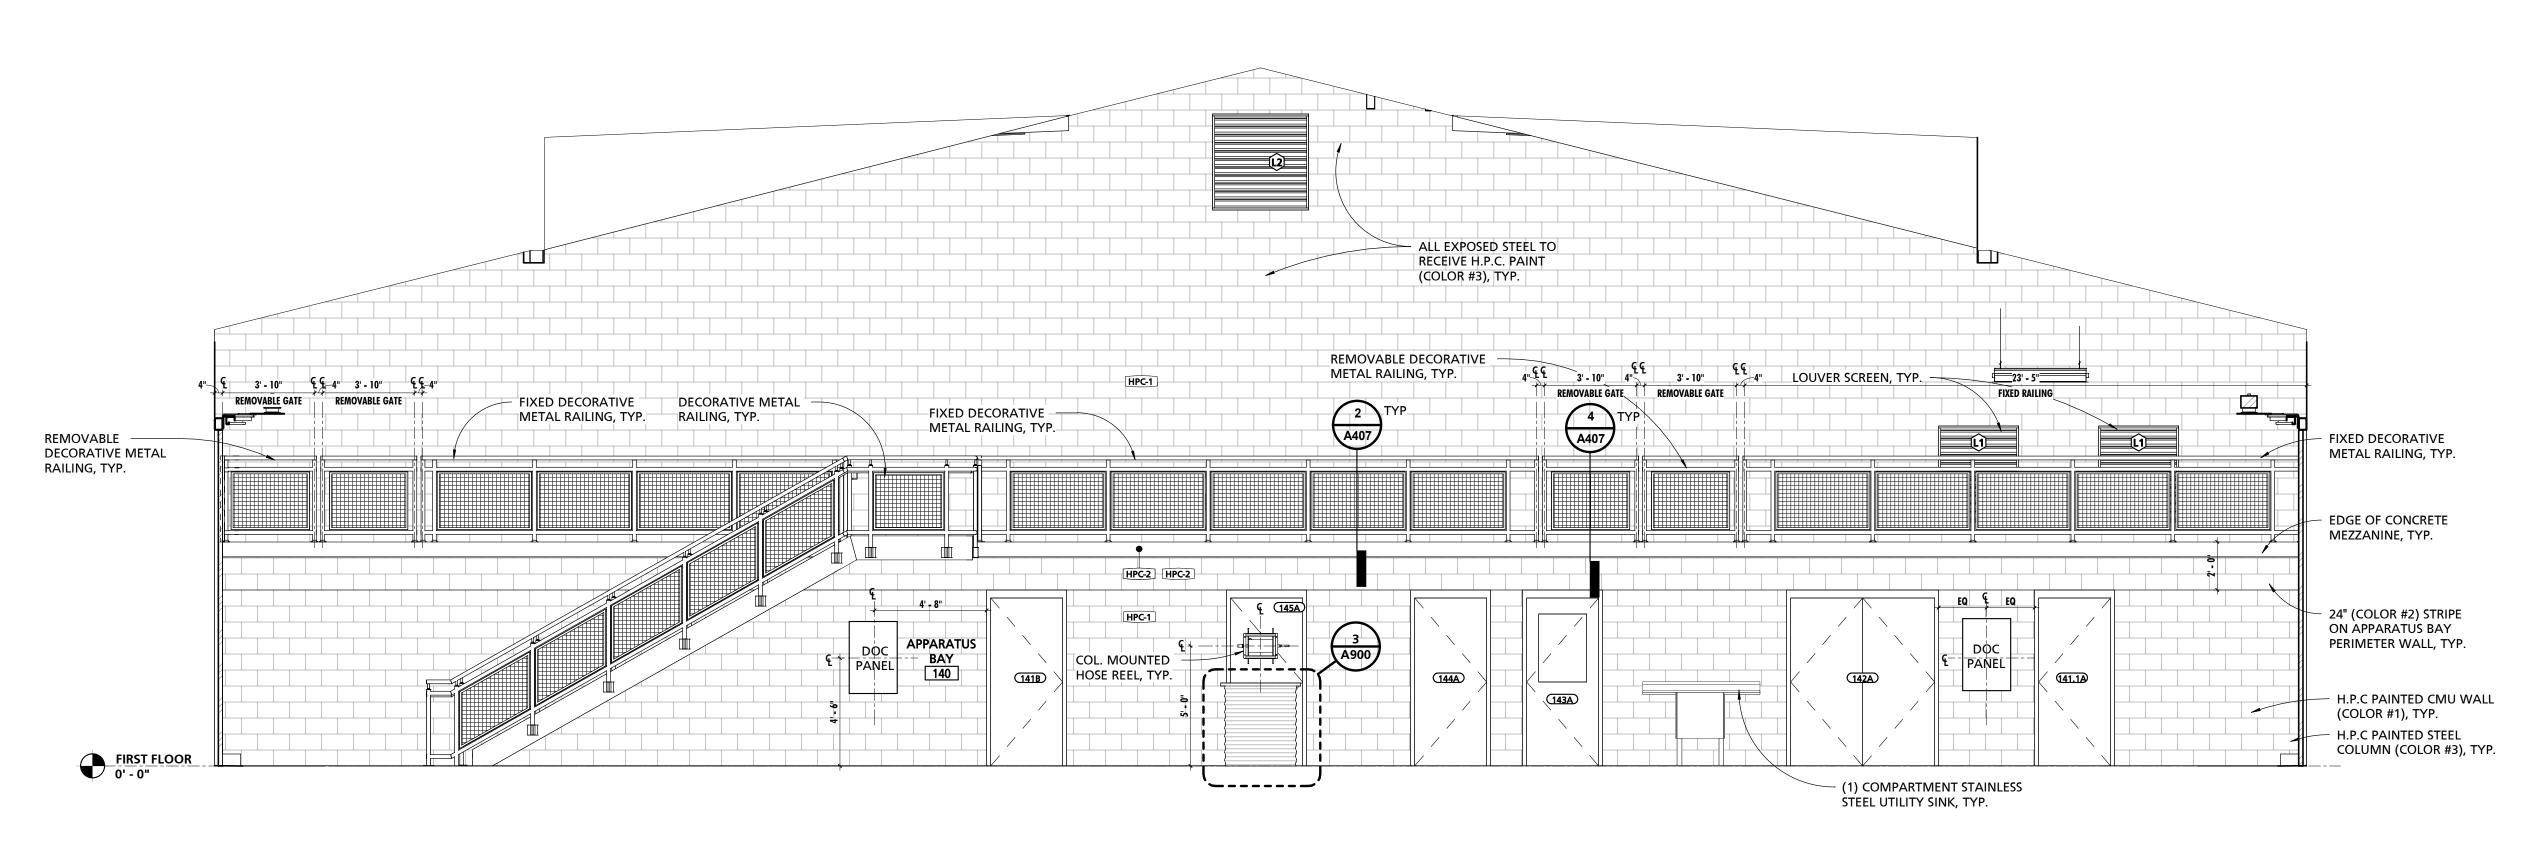

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APPARATUS BAY EAST ELEVATION

1/4" = 1'-0"

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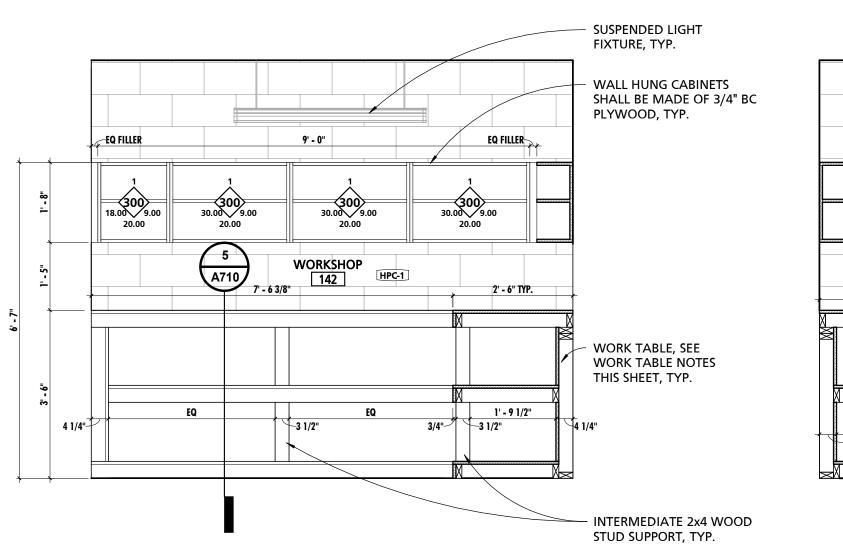
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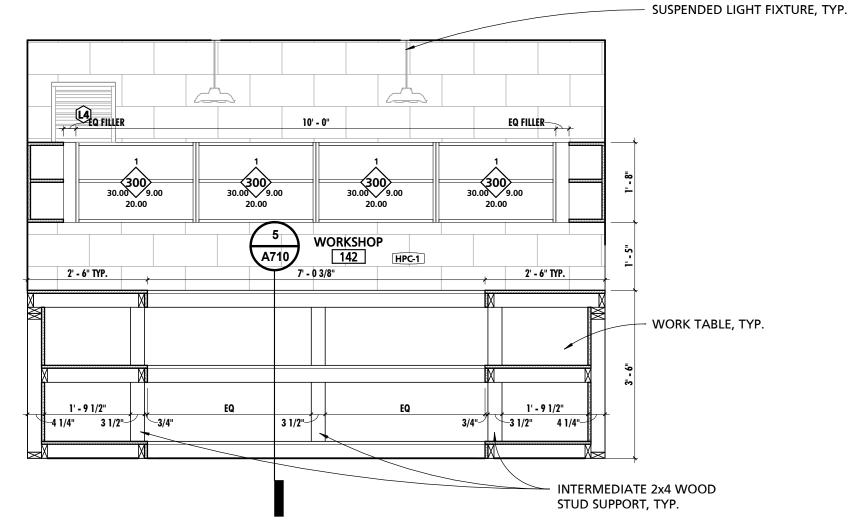
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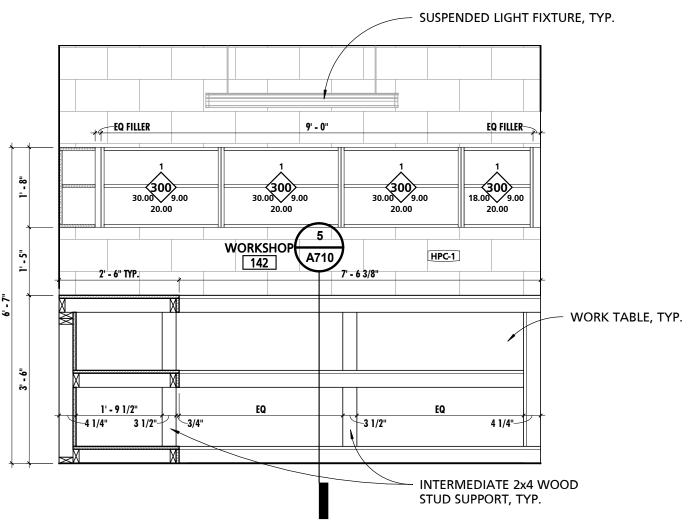
PROJECT NUMBER: 18-036 PROJECT SET: BID SET DATE ISSUED: 11/30/2023 DRAWING TITLE: **ENLARGED PLANS & INT ELEVATIONS**

NO. DESCRIPTION DATE

SHEET NUMBER:







WORKSHOP NORTH ELEVATION

1/2" = 1'-0"

WORKSHOP EAST ELEVATION

1/2" = 1'-0"


WORKSHOP SOUTH ELEVATION


1/2" = 1'-0"

TYPICAL WORK TABLE NOTES:

5. FACE APRON WITH 3/4" BC PLYWOOD.

O.C. ALONG FRONT ENDS ONLY.

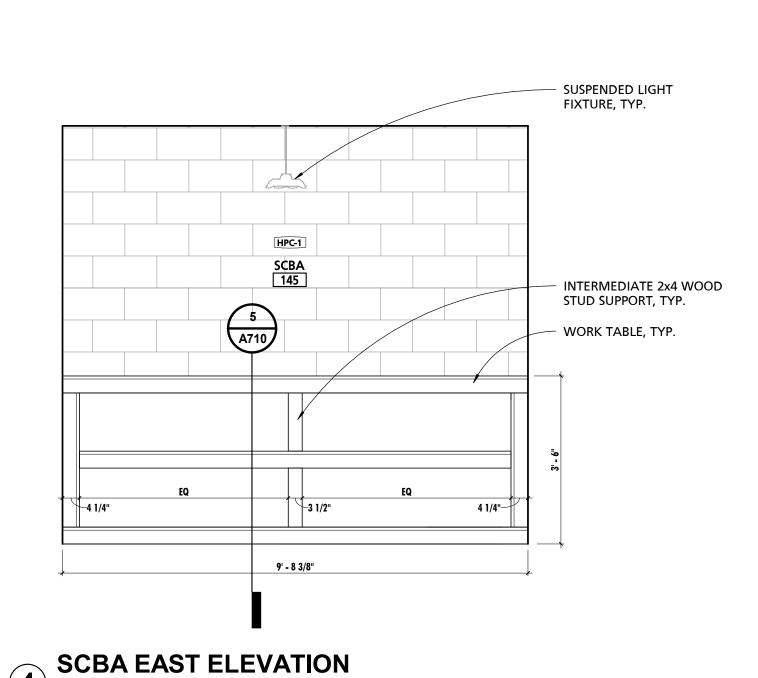

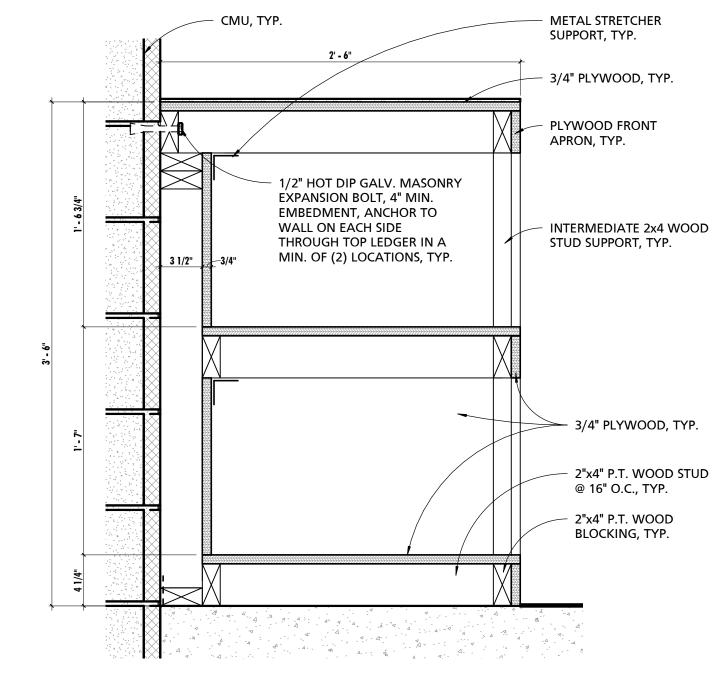

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WORK TABLE SECTION1 1/2" = 1'-0"

1. FABRICATE OF 2x4 HEM FIR SELECT STUDS & 3/4" SANDED BC PLYWOOD.

6. SHELF SURFACES AND ENTIRE BACK PANEL SHALL BE 3/4" BC PLYWOOD.

2. ASSEMBLE WITH 2-1/2"x#10 CORROSION RESISTANT CONSTRUCTION SCREWS.

3. ANCHOR TO WALL ON EACH SIDE THROUGH TOP LEDGER IN A MINIMUN OF (2) LOCATIONS.

7. USE PRESSURE TREATED 2x4 BLOCKING IN CONTACT WITH SLAB AND ISOLATE FROM SLAB.

8. ATTACH HARDWOOD TOP WITH COUNTERSUNK 1" CORROSION RESISTANT WOOD SCREWS ROUGHLY 32"

4. PROVIDE 2x STRETCHERS 24" O.C. MAX BELOW TOP AND MIDDLE SHELFS, TOE SCREW IN PLACE.

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GENERAL INTERIOR ELEVATION NOTES

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VCT-1	STATIC-DISSIPATIVE VINYL COMPOSITE TILE	ARMSTRONG	EXCELON SDT	SEE SPECIFICATIONS FOR GROUNDING REQUIREMENTS.

SCHEDULE - MATERIAL FINISH KEY



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PROJECT NUMBER: 18-036 PROJECT SET: BID SET DATE ISSUED: 11/30/2023 DRAWING TITLE: **ENLARGED PLANS & INT ELEVATIONS**

SHEET NUMBER:

GENERAL CEILING NOTES UNDERSIDE OF EXPOSED STRUCTURE, PIPING, AND DUCTWORK IN ALL ROOMS, STAIRWAYS, AND OTHER SPACES SHALL BE PAINTED UNLESS NOTED OTHERWISE. CONTRACTOR SHALL COORDINATE COLOR SELECTION WITH THE ARCHITECT PRIOR TO PAINTING OR PRIMING, TYP. CONTRACTOR SHALL COORDINATE FINAL FIELD LOCATION OF ALL EXIT SIGNS AND EMERGENCY LIGHTING WITH ARCHITECT PRIOR TO ROUGH-IN, TYP. THE CONTRACTOR SHALL PROVIDE SPRINKLER SYSTEM SHOP DRAWINGS TO THE ARCHITECT FOR APPROVAL WHERE SPRINKLERS ARE REQUIRED BY CODE (SEE CODE SHEET). DRAWINGS SHALL INDICATE HEAD LOCATIONS, HEAD TYPES, AND PIPING DISTRIBUTION. IN EXPOSED OCCUPIED AREAS MAINS SHALL BE ROUTED THROUGH AREAS WITH ACCESSIBLE FINISHED CEILINGS TO THE MAXIMUM EXTENT FEASIBLE. WHERE CEILINGS ARE FINISHED ALL HEADS SHALL BE EQUIPPED WITH CONCEALMENT COVERS. SEE SPECIFICATIONS FOR ADDITIONAL INFORMATION. 4 ***APPARATUS BAYS ONLY*** CONTRACTOR SHALL PROVIDE COORDINATION DRAWINGS WITHIN THE APPARATUS BAY AREA INDICATING, WHERE APPLICABLE, THE VEHICLE EXHAUST SYSTEMS, SPRINKLER SYSTEM, OVERHEAD DOOR TRACKS, HEATERS (INCLUDING COMBUSTIBLE CLEARANCE REQUIREMENTS), LIGHTING, RETRACTABLE DROP DOWN CORDS, INTERIOR STORMDRAIN PIPING, FANS. COORDINATION DRAWINGS AT A MINIMUM SHALL INCLUDE PLANS AND BOTH LONGITUDINAL AND TRANSVERSE SECTIONS THROUGH THE BAYS INDICATING THE LOCATION AND ELEVATION OF BAY SYSTEM COMPONENTS. SPRINKLER LOCATIONS DEPICTED HEREIN ARE DIAGRAMMATIC AND ARE SHOWN FOR DESIGN INTENT ONLY. ON ACT CEILINGS IN FIRE-RATED AREAS INSTALL HOLD DOWN CLIPS ON ACOUSTIC PANELS WEIGHING LESS THAN 1 LB. PER SQ. FT. PER SPEC. ALL MECHANICAL, ELECTRICAL, PLUMBING, AND SPRINKLER WORK TO OCCUR IN AREAS WHERE THE STRUCTURE IS EXPOSED SHALL BE EXECUTED IN A COORDINATED, NEAT AND WORKMANLIKE MANNER. AT A MINIMUM ALL WIRING SHALL BE RUN THROUGH CONDUITS, PIPE AND DUCT INSULATION SHALL BE NEATLY INSTALLED AND PAINTABLE. ALL PIPES AND DUCTS SHALL BE RUN EITHER PERPENDICULAR OR PARALLEL TO WALL CONSTRUCTION AND SHALL BE INSTALLED AT THE SAME NOMINAL ELEVATION OR SLOPE. ALL MATERIALS AND INSTALLATION METHODS SHALL COMPLY WITH APPLICABLE CODES AND STANDARDS. WHERE MECHANICAL, ELECTRICAL, AND PLUMBING DRAWINGS INDICATE OTHER REQUIREMENTS THE GREATER QUALITY SHALL PREVAIL.

8 WHERE CEILINGS ARE EXPOSED ALL TIES, CABLES, AND SUPPORTS FOR CLOUDS, ELECTRICAL, MECHNICAL EQUIPMENT AND OTHER APPURTENANCES SHALL BE

TO ENSURE THERE ARE NO STARK CONTRASTING COLORS.

COORDINATE GRID MAINS AS REQUIRED TO ACHIEVE THIS DESIGN INTENT.


INSTALLED IN A NEAT, ORGANIZED AND WORKMAN LIKE MANNER. VISIBLE TIES SHALL BE PLUMB/TRUE/SQUARE TO ELEMENTS, TIGHTLY WRAPPED, WITH EXCESS WIRE


9 CONTRACTOR SHALL COORDINATE THE COLOR AND FINISH OF ALL CEILING MOUNTED EQUIPMENT SUCH AS DIFFUSERS, RETURNS, SPEAKERS, ETC. WITH THE ARCHITECT

10 WHERE ACT GRID LAYOUT AT EDGE CONDITIONS FOR 2X2 TILES REQUIRE TILES TO BE CUT TO LESS THAN 3", UTILIZE A 2X4 TILE IN LIEU OF THE 2X2 TILE. OMIT CEILING GRID CROSS MEMBERS AS REQUIRED. NO TILE SHALL EXCEED 27" OR BE LESS THAN 3" AT PERIMETER CONDITIONS. IT IS THE CONTRACTORS RESPONSIBILITY TO

11 PROVIDE 6" THICK MINERAL WOOL ACOUSTICAL BATT INSULATION ABOVE THE CEILING IN CHIEF'S OFFICE 110, CONFERENCE 111, OFFICE 109.1, AND OFFICE 114.

	SCHEDULE - CEILING TYPES							
MARK	DESCRIPTION	BOD MANUFACTURER	BOD MODEL	COMMENTS				
CLG-1	2x2 ACOUSTICAL CEILING TILE	ARMSTRONG	ULTIMA SQUARE LAY-IN 1940					
CLG-2	2X2 ARCHITECTURAL METAL CEILING TILE	USG	PANZ					
CLG-3	5/8" GYPSUM BOARD CEILING	USG	ENSEMBLE ACOUSTICAL DRYWAL CEILING	L				
CLG-4	6"x96" FAUX PLANK METAL CEILING	ARMSTRONG	METALWORKS-LINEAR	PROVIDE 6" AXIOM VECTOR STRAIGHT TRIM AROUND ENTIRE PERIMETER.				
CLG-5	4"x96" FAUX PLANK METAL CEILING	ARMSTRONG	METALWORKS-LINEAR-SYNCHRO					
CLG-6	HALF VENTED METAL SOFFIT	PAC-CLAD	PAC-750					
CLG-7	PAINTED EXPOSED METAL DECK	TBD	TBD					
CLG-8	2x2 ACOUSTICAL CEILING TILE	ARMSTRONG	OPTIMA HEALTH ZONE					

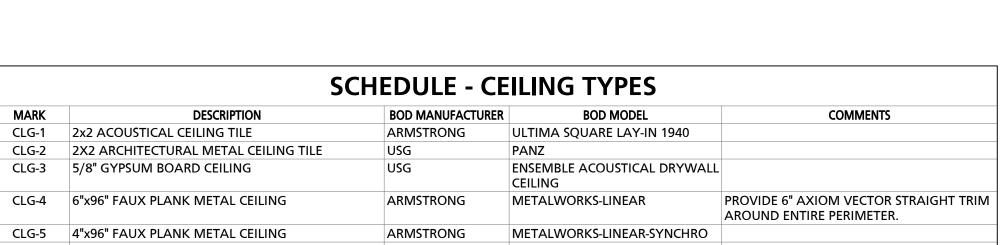

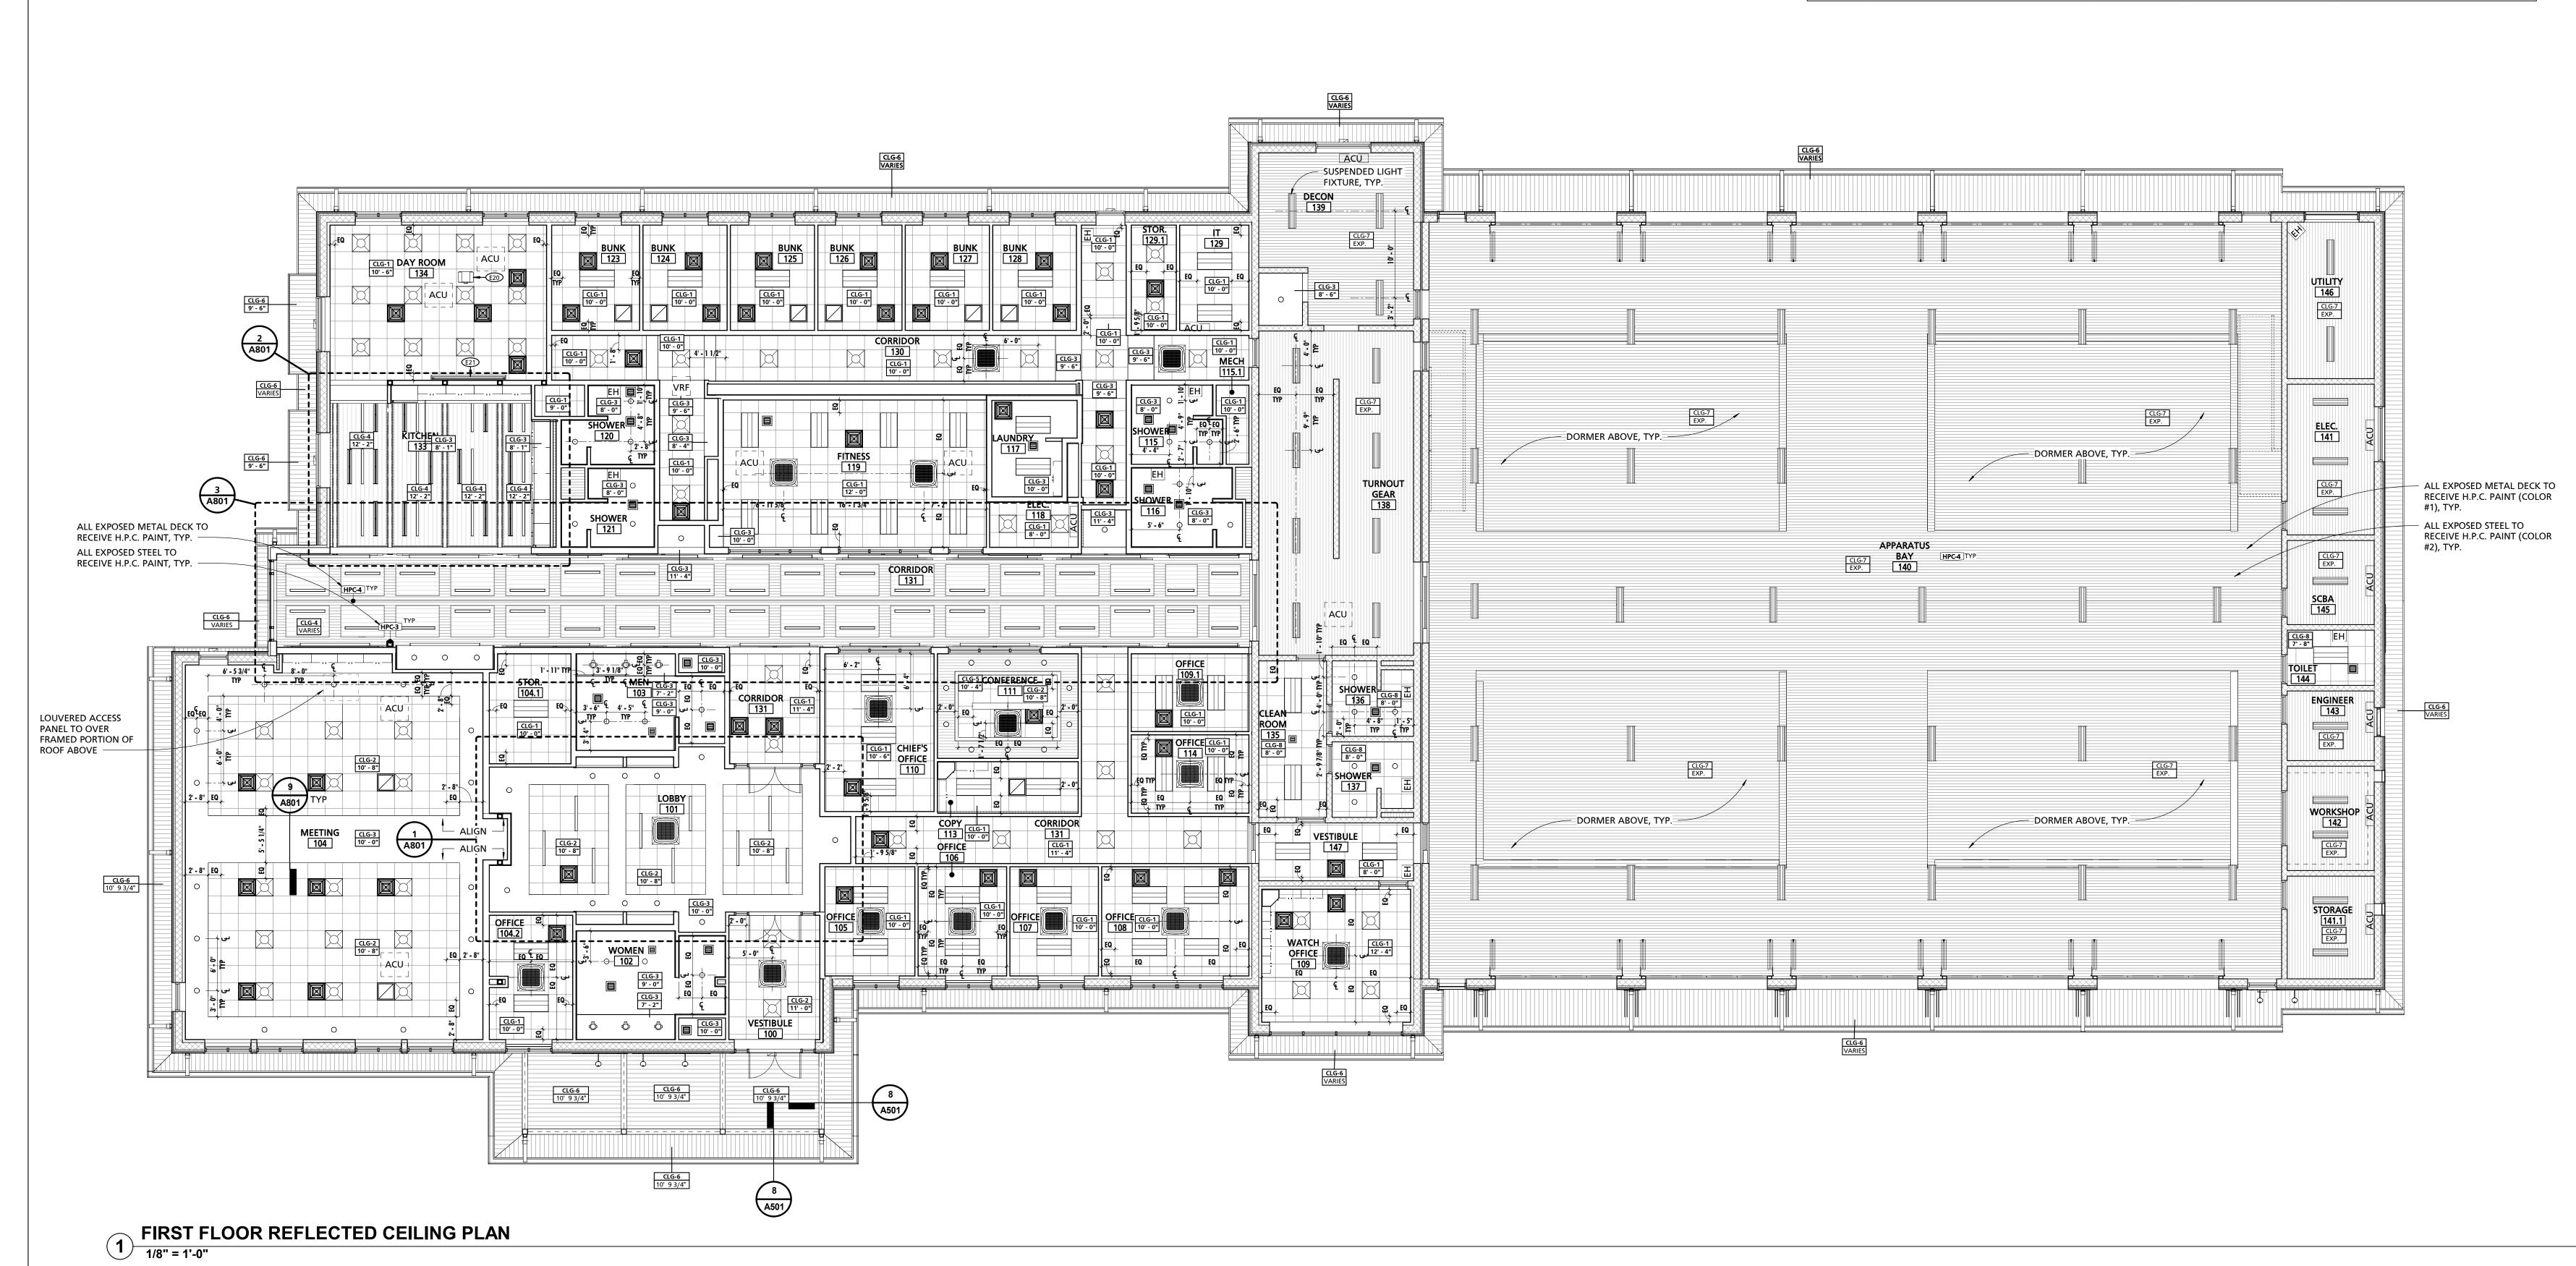

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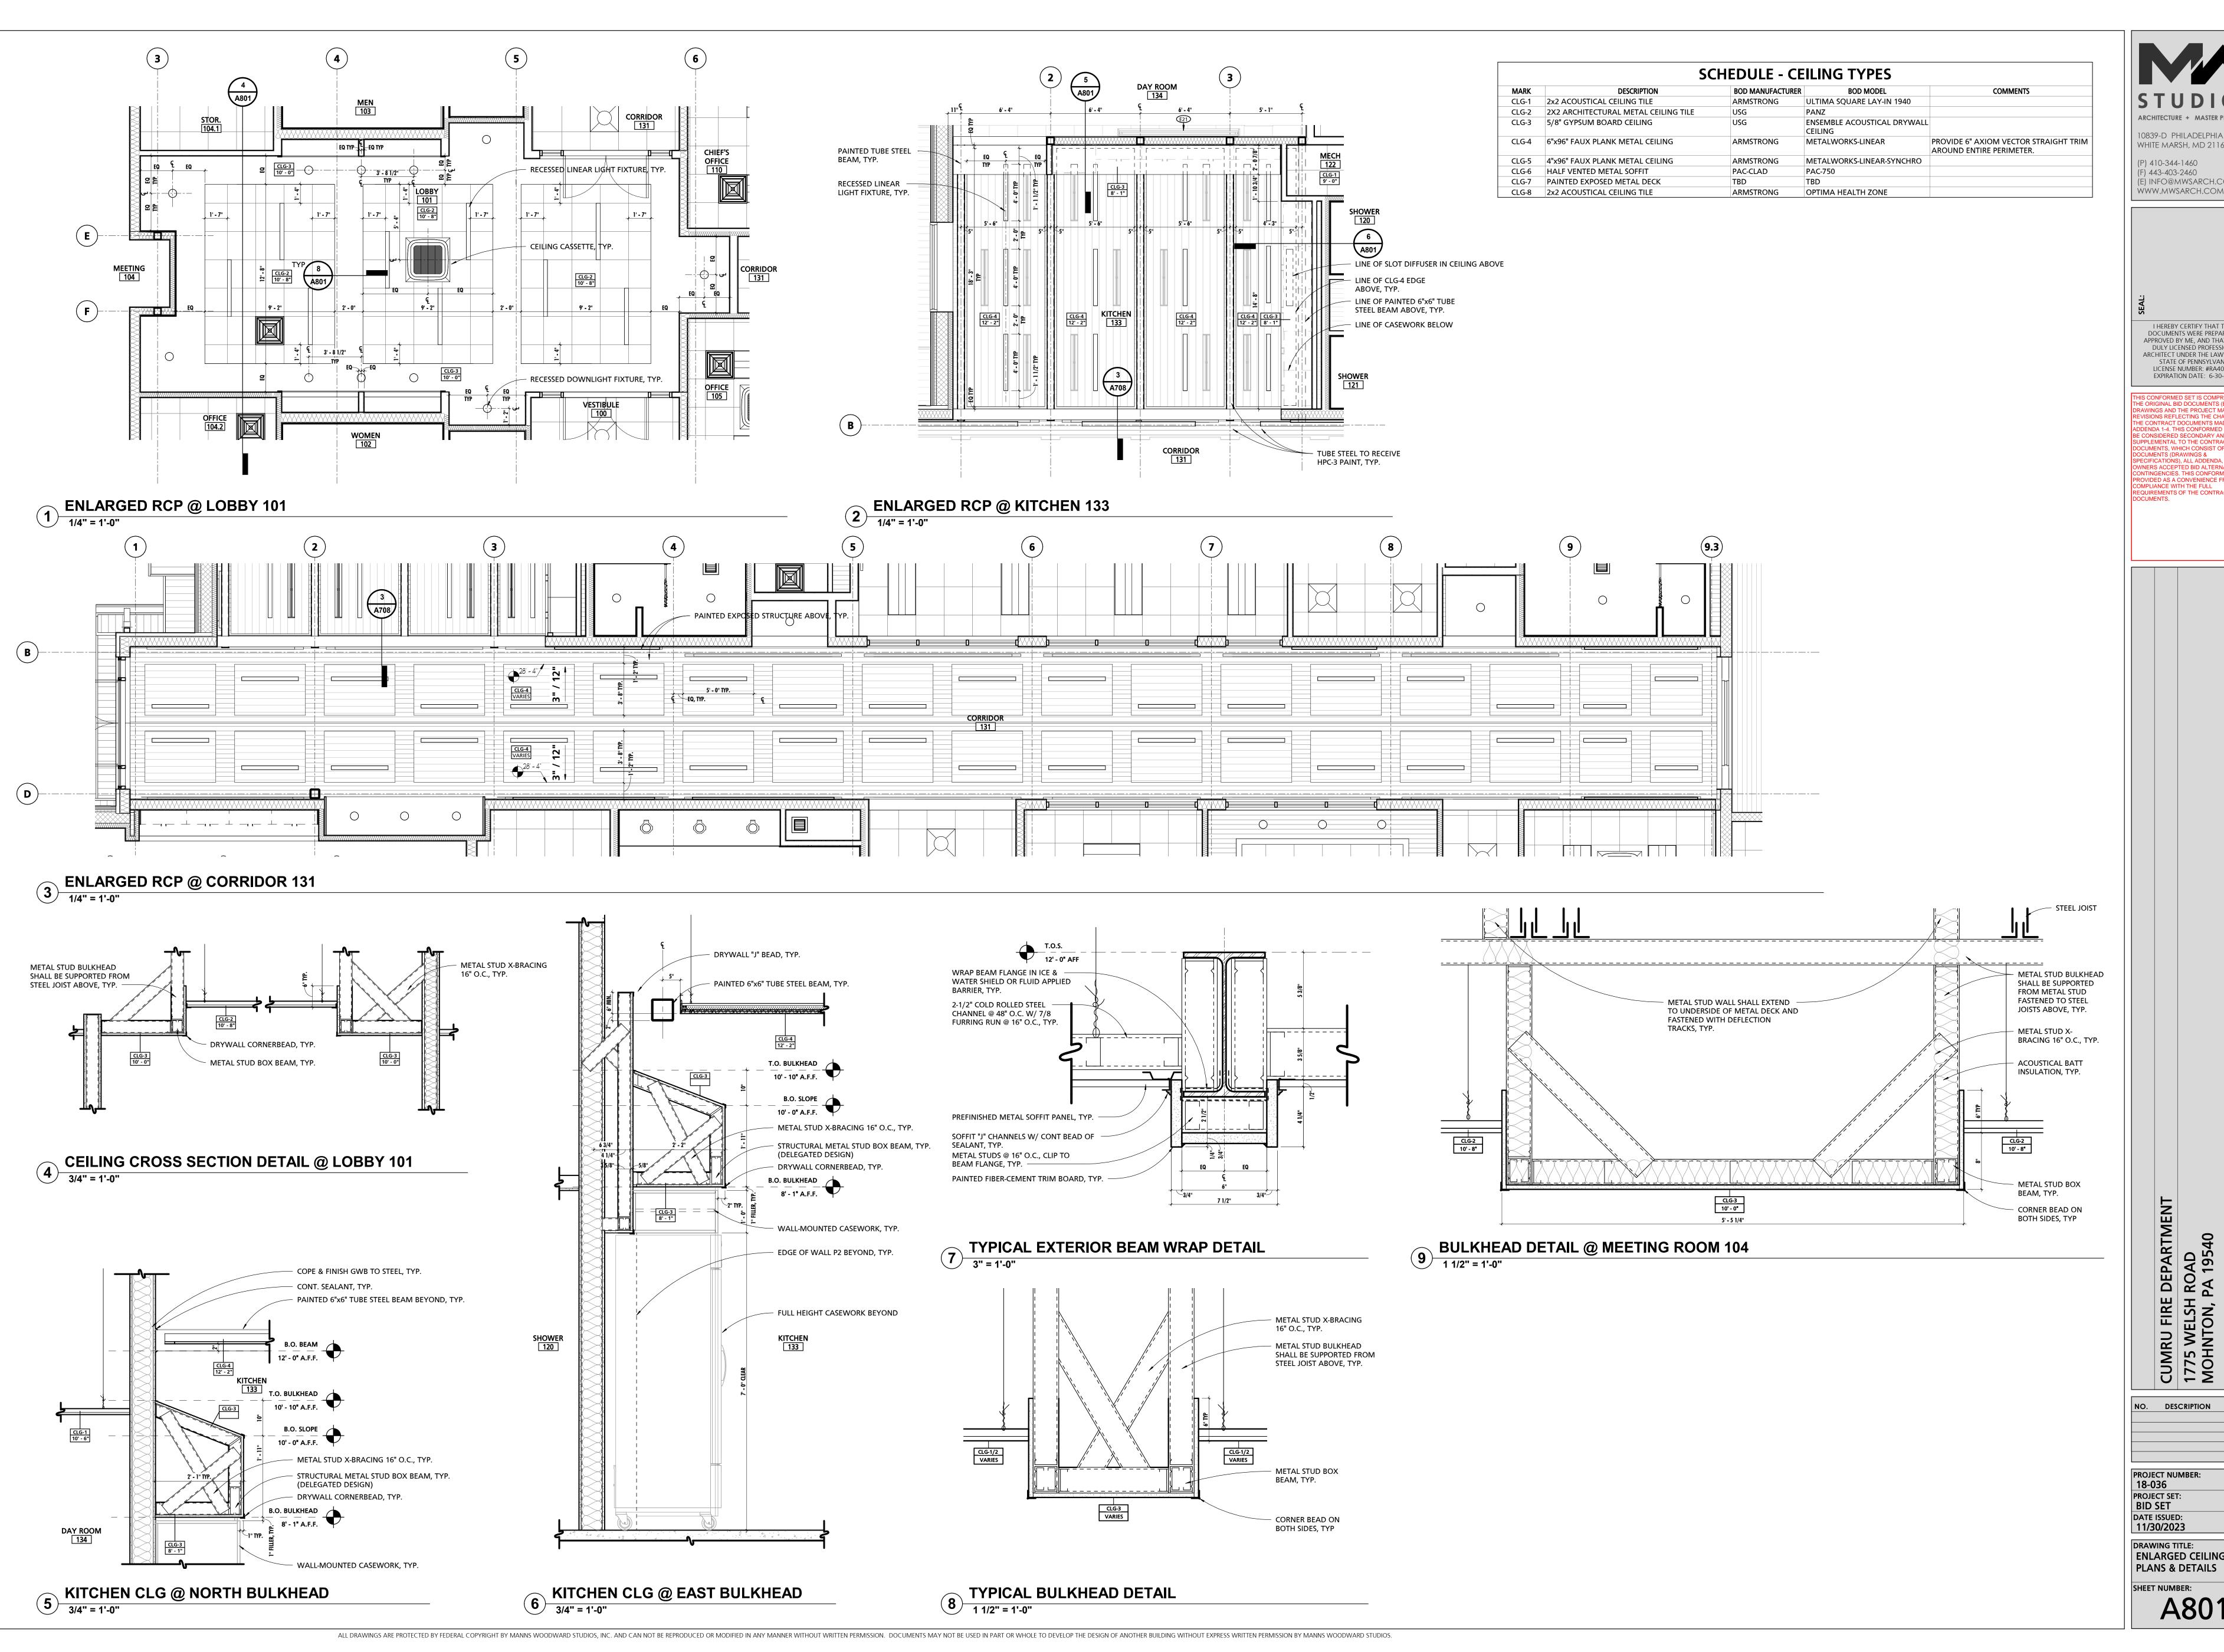
I HEREBY CERTIFY THAT THESE DOCUMENTS WERE PREPARED OR APPROVED BY ME, AND THAT I AM A DULY LICENSED PROFESSIONAL ARCHITECT UNDER THE LAWS OF THE State of Pennsylvania. LICENSE NUMBER: #RA405311 EXPIRATION DATE: 6-30-2023

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DESCRIPTION DATE

PROJECT SET: BID SET DATE ISSUED:

11/30/2023 DRAWING TITLE: REFLECTED CEILING PLAN





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DESCRIPTION PROJECT NUMBER: PROJECT SET: DATE ISSUED: 11/30/2023 DRAWING TITLE: **ENLARGED CEILING** PLANS & DETAILS SHEET NUMBER:





CO	COLUMN FOOTING SCHEDULE									
MARK	SIZE	BOTTOM REINFORCING								
F30	3'-0"x3'-0"x1'-0"	(3)-#4 x 2'-6" EACH WAY, BOTTOM								
F40	4'-0"x4'-0"x1'-0"	(4)-#5 x 3'-6" EACH WAY, BOTTOM								
F55	5'-6"x5'-6"x1'-4"	(6)-#6 x 5'-0" EACH WAY, BOTTOM								
F75	7'-6"x7'-6"x1'-6"	(7)-#7 x 7'-0" EACH WAY, BOTTOM								

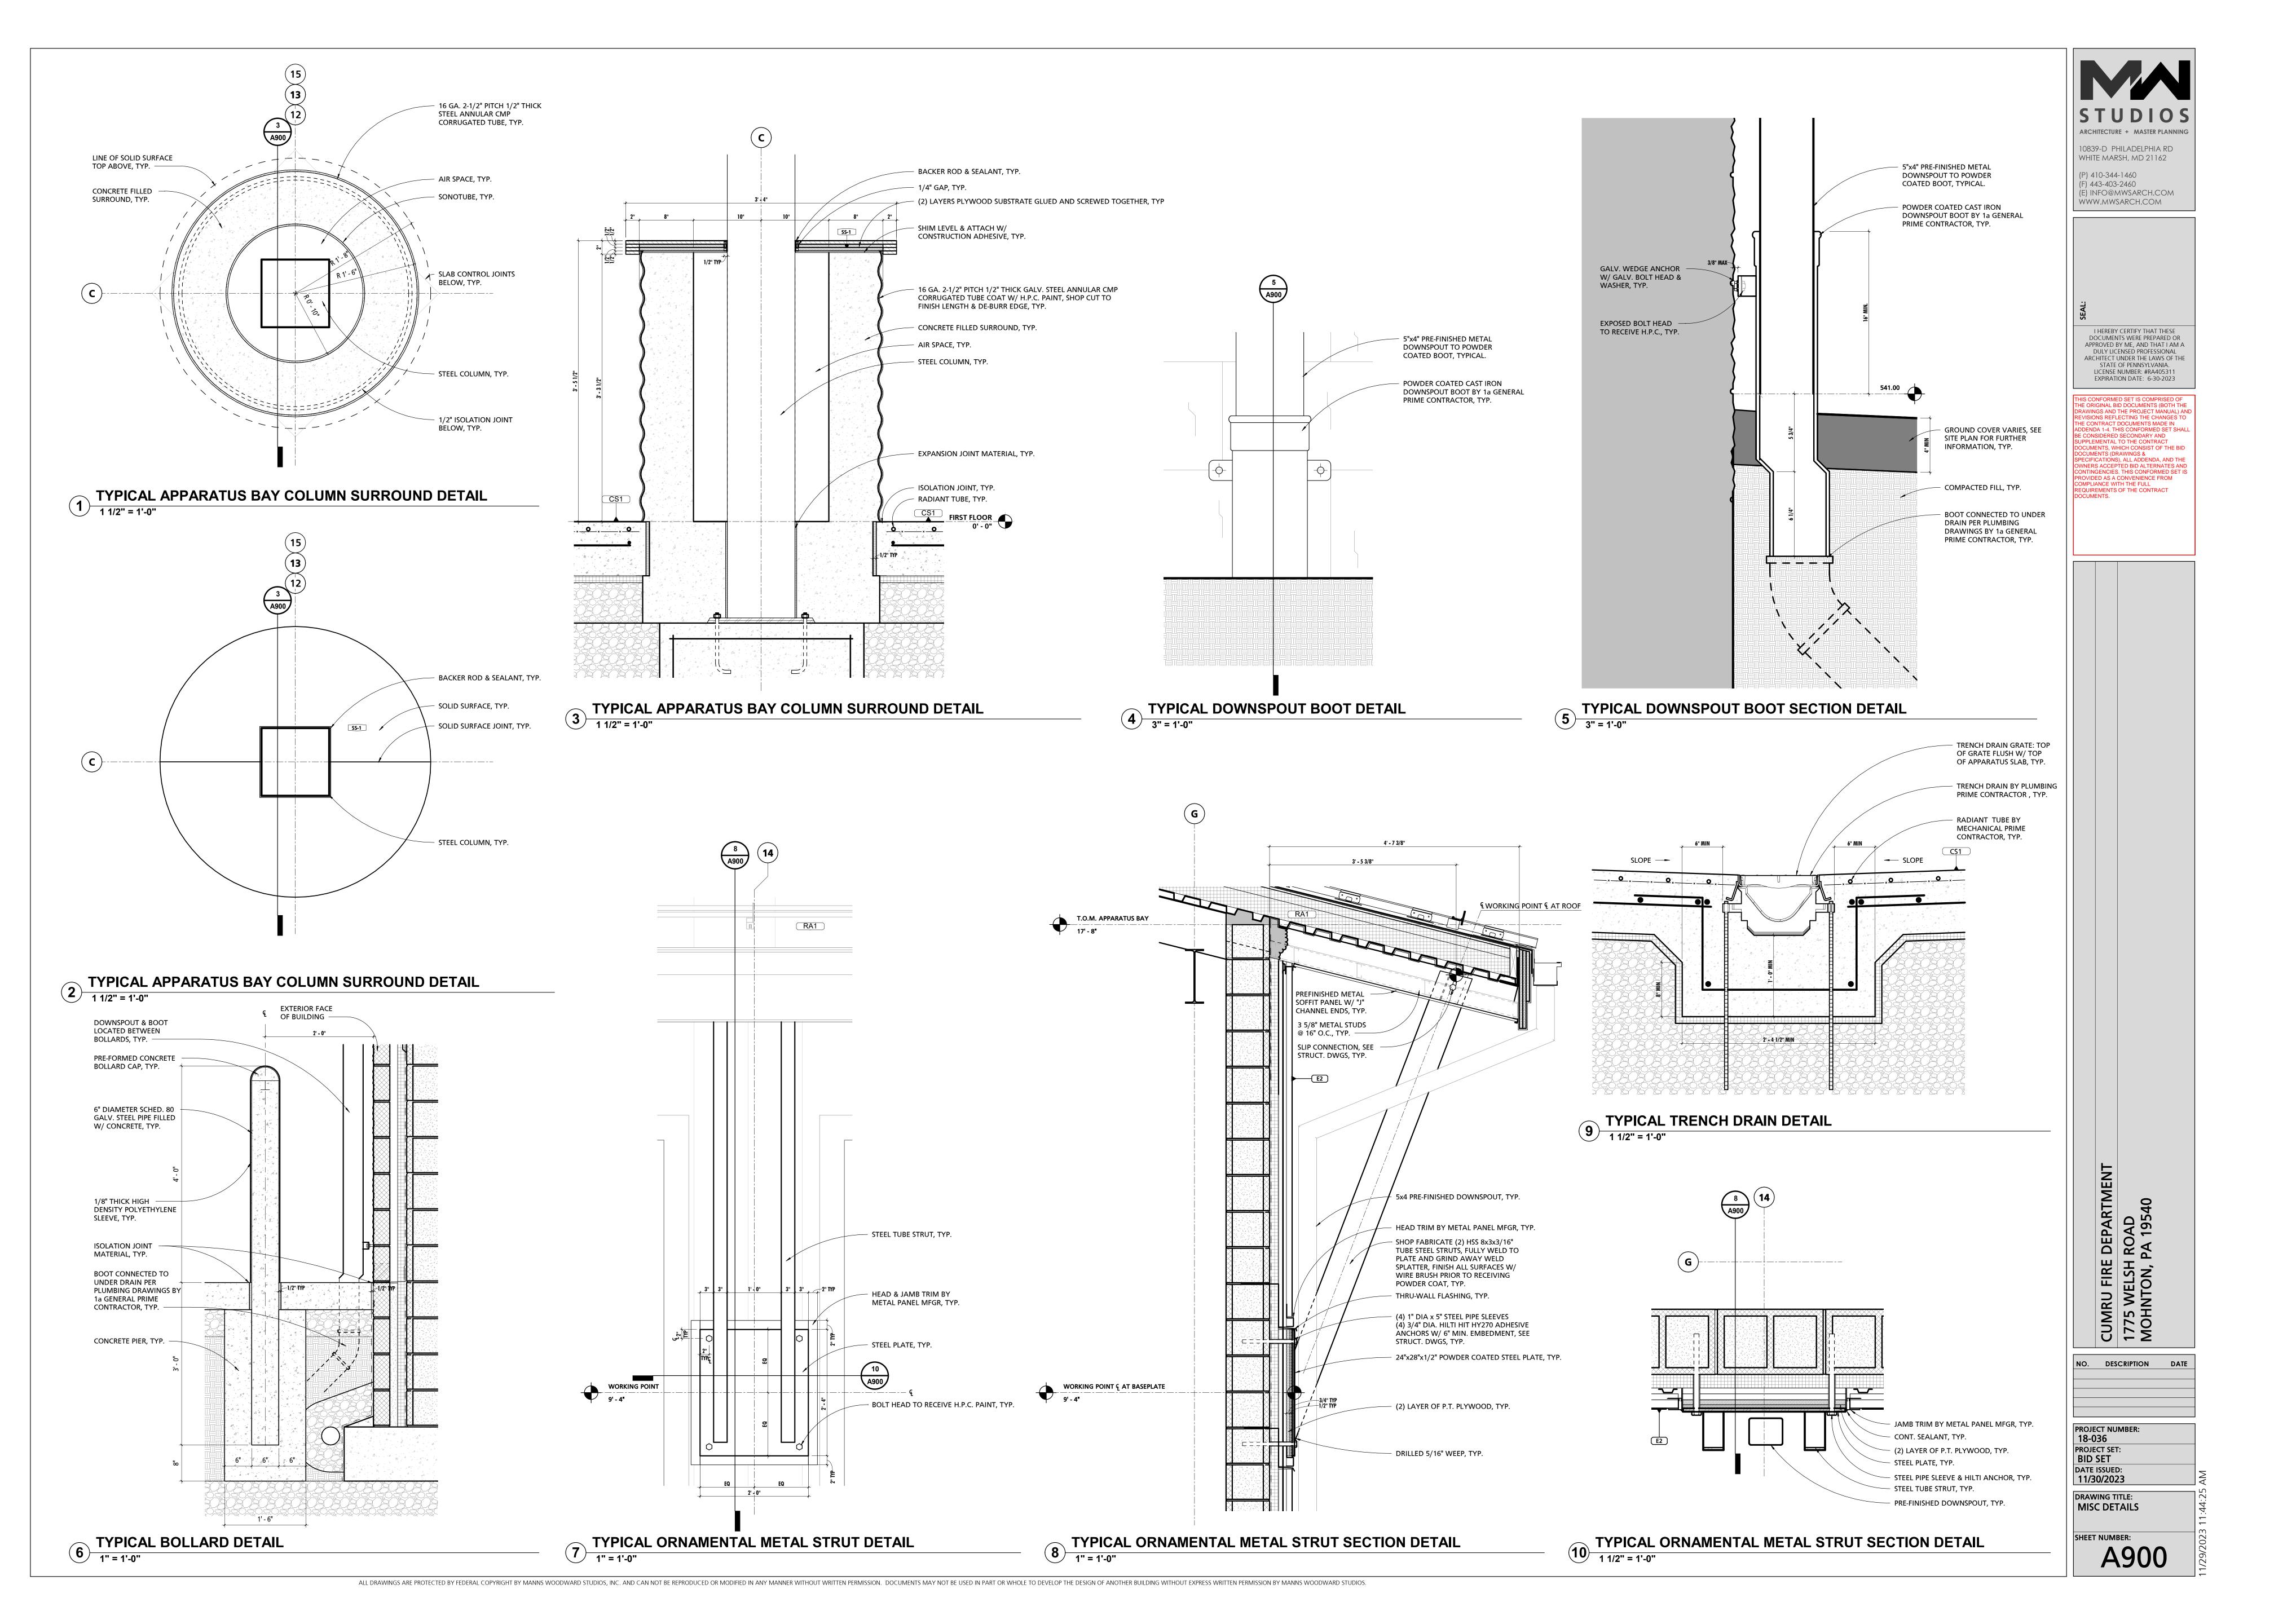
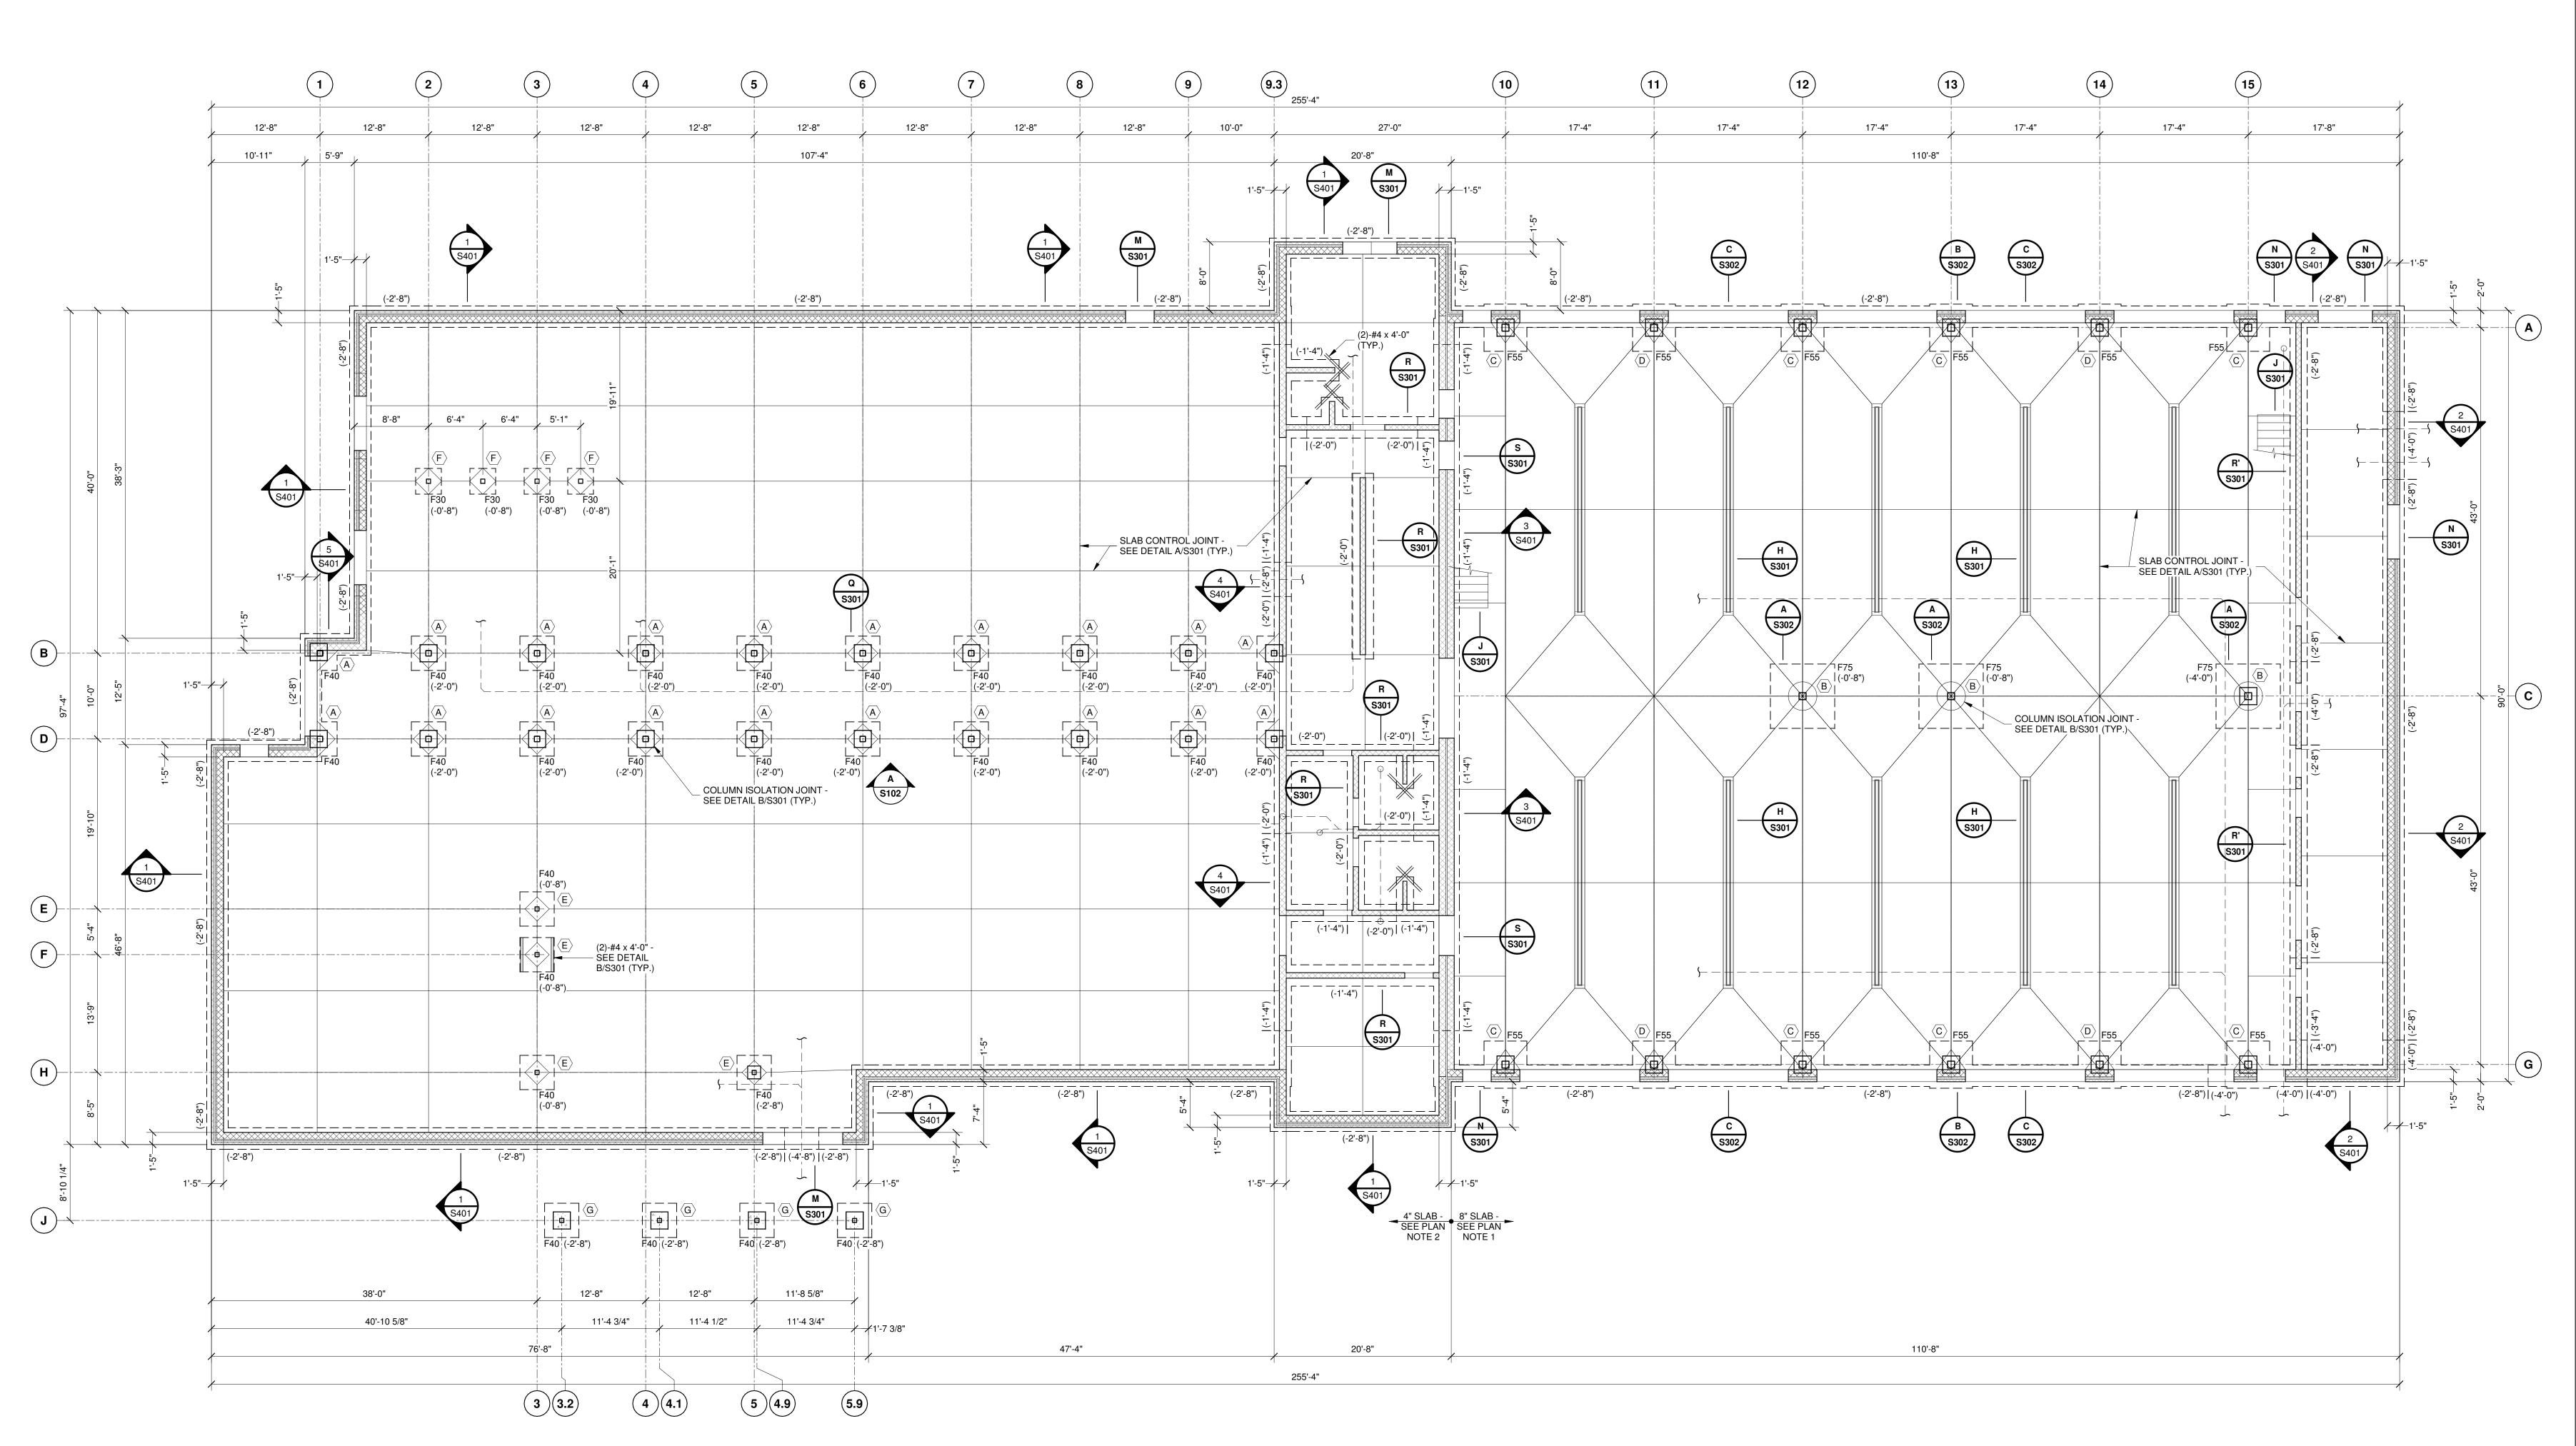
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FOUNDATION/ FIRST FLOOR PLAN

1/8" = 1'-0" 1. UNLESS OTHERWISE NOTED, SLAB-ON-GRADE TO BE 8" MINIMUM. THICK CONCRETE SLAB w/ #3 @ 12"o.c. EACH WAY, ON SEAMLESS POLYETHYLENE VAPOR BARRIER OVER 1" HIGH DENSITY, 60psi MINIMUM COMPRESSIVE STRENGTH OWENS CORNING FOAMULAR 600XPS INSULATION, OVER 6" THICK CRUSHED STONE OR WASHED GRAVEL OVER A PROPERLY PREPARED SUBGRADE. 2. UNLESS OTHERWISE NOTED, SLAB-ON-GRADE TO BE 4" MINIMUM THICK CONCRETE SLAB w/ 6x6x10/10 WWM ON SEAMLESS POLYETHYLENE VAPOR BARRIER OVER 6" THICK CRUSHED STONE OR WASHED GRAVEL OVER A PROPERLY PREPARED SUBGRADE. 3. TOP OF SLAB-ON-GRADE ELEVATION EQUALS DATUM ELEVATION 0'-0" UNLESS OTHERWISE NOTED ±X" AS REFERENCED FROM DATUM ELEVATION 0'-0".


4. TOP OF FOOTING ELEVATIONS ARE NOTED THUS (-X'-X") IN PLAN AS REFERENCED FROM DATUM ELEVATION 0'-0".


5. REFER TO DRAWING 2.1 FOR GENERAL NOTES. 6. REFER TO ARCHITECTURAL DRAWINGS FOR LAYOUT OF INTERIOR CMU WALLS, SLOPED SLABS, FLOOR DRAINS, SLAB DEPRESSIONS, ETC.
7. SEE ARCHITECTURAL DRAWINGS FOR LOCATION AND CONNECTION OF FAUX WELDED STEEL COLUMN BASE TRIM INSTALLED ON COLUMN DURING FABRICATION.

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OMPLIANCE WITH THE FULL EQUIREMENTS OF THE CONTRACT OCUMENTS.



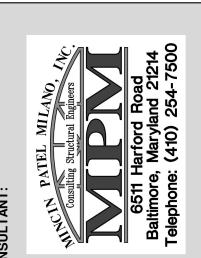


NO. DESCRIPTION DATE

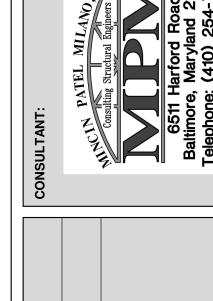18-036 BID SET

MPM #18150

11/30/2023


FOUNDATION/ FIRST FLOOR PLAN

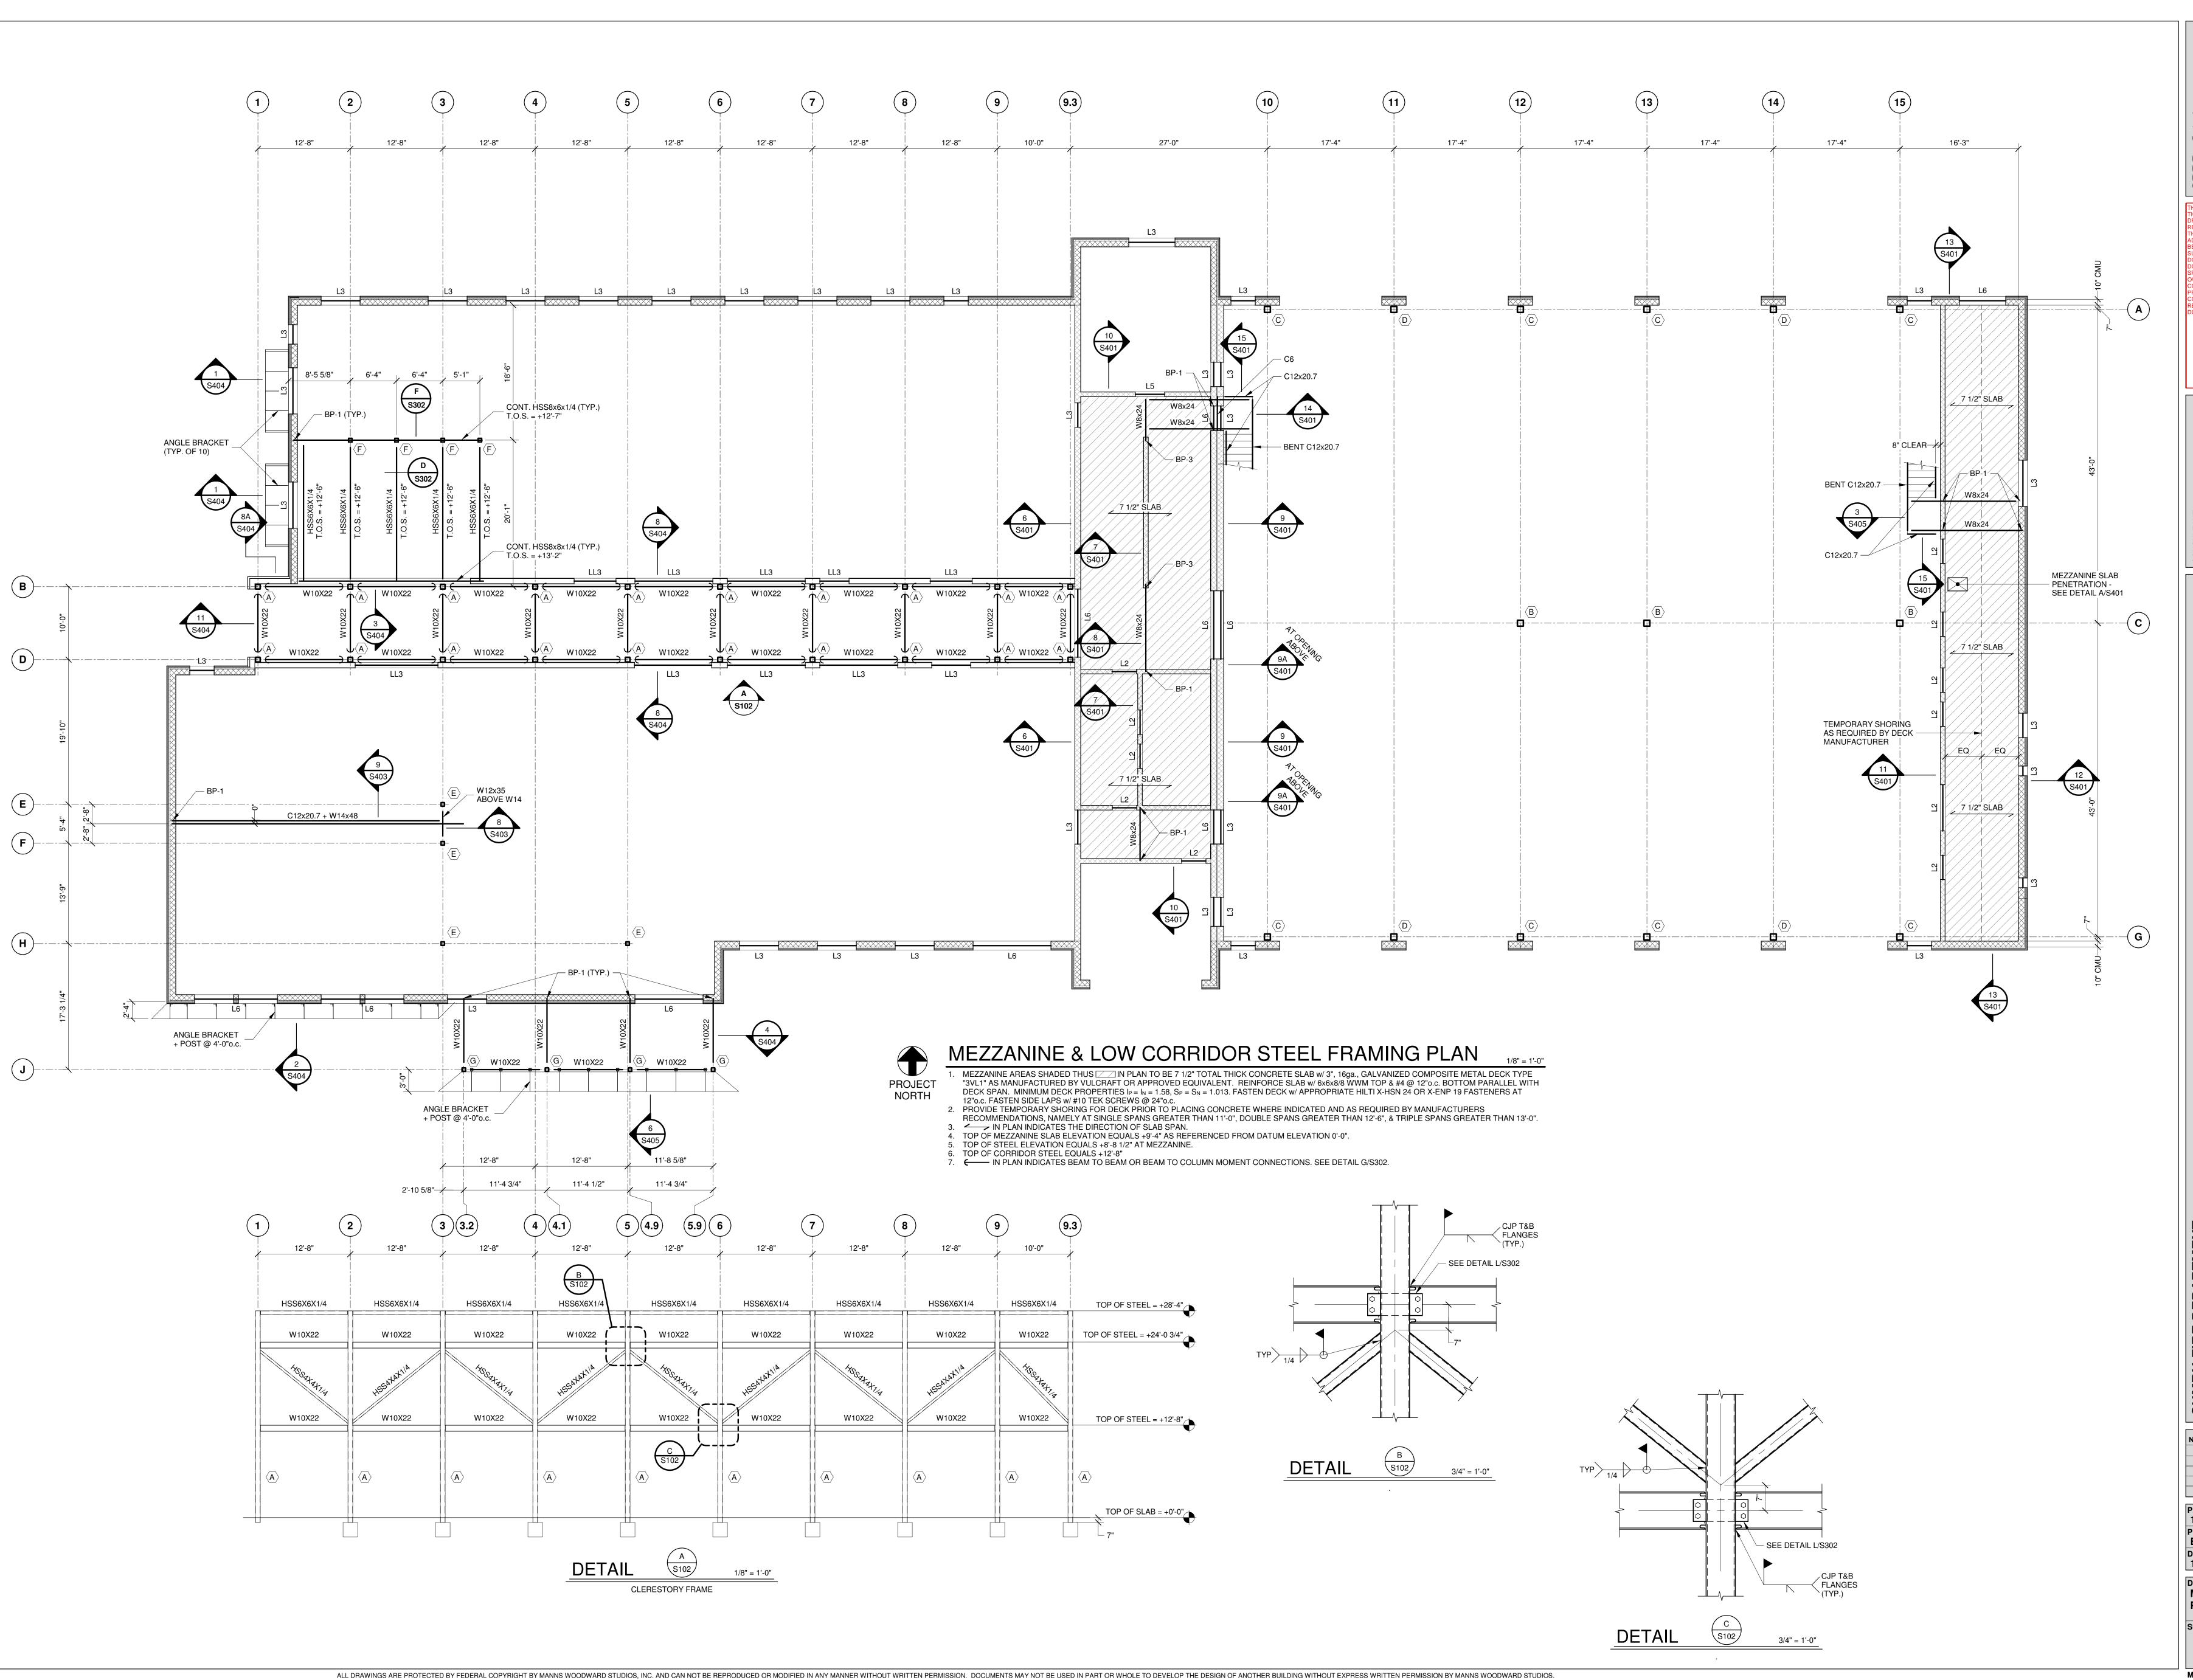



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DOCUMENTS (DRAWINGS &
BPECIFICATIONS), ALL ADDENDA, AND THE WNERS ACCEPTED BID ALTERNATES AND ONTINGENCIES. THIS CONFORMED SET IS PROVIDED AS A CONVENIENCE FROM COMPLIANCE WITH THE FULL REQUIREMENTS OF THE CONTRACT DOCUMENTS.






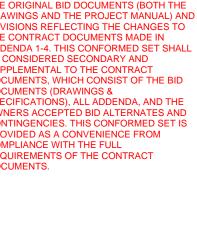

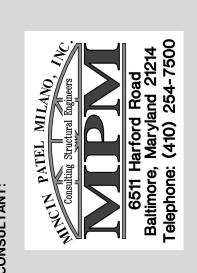NO. DESCRIPTION DATE PROJECT BID SET

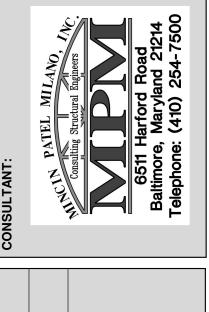DATE 11/30/2023 DRAWING
MEZZANINE FRAMING

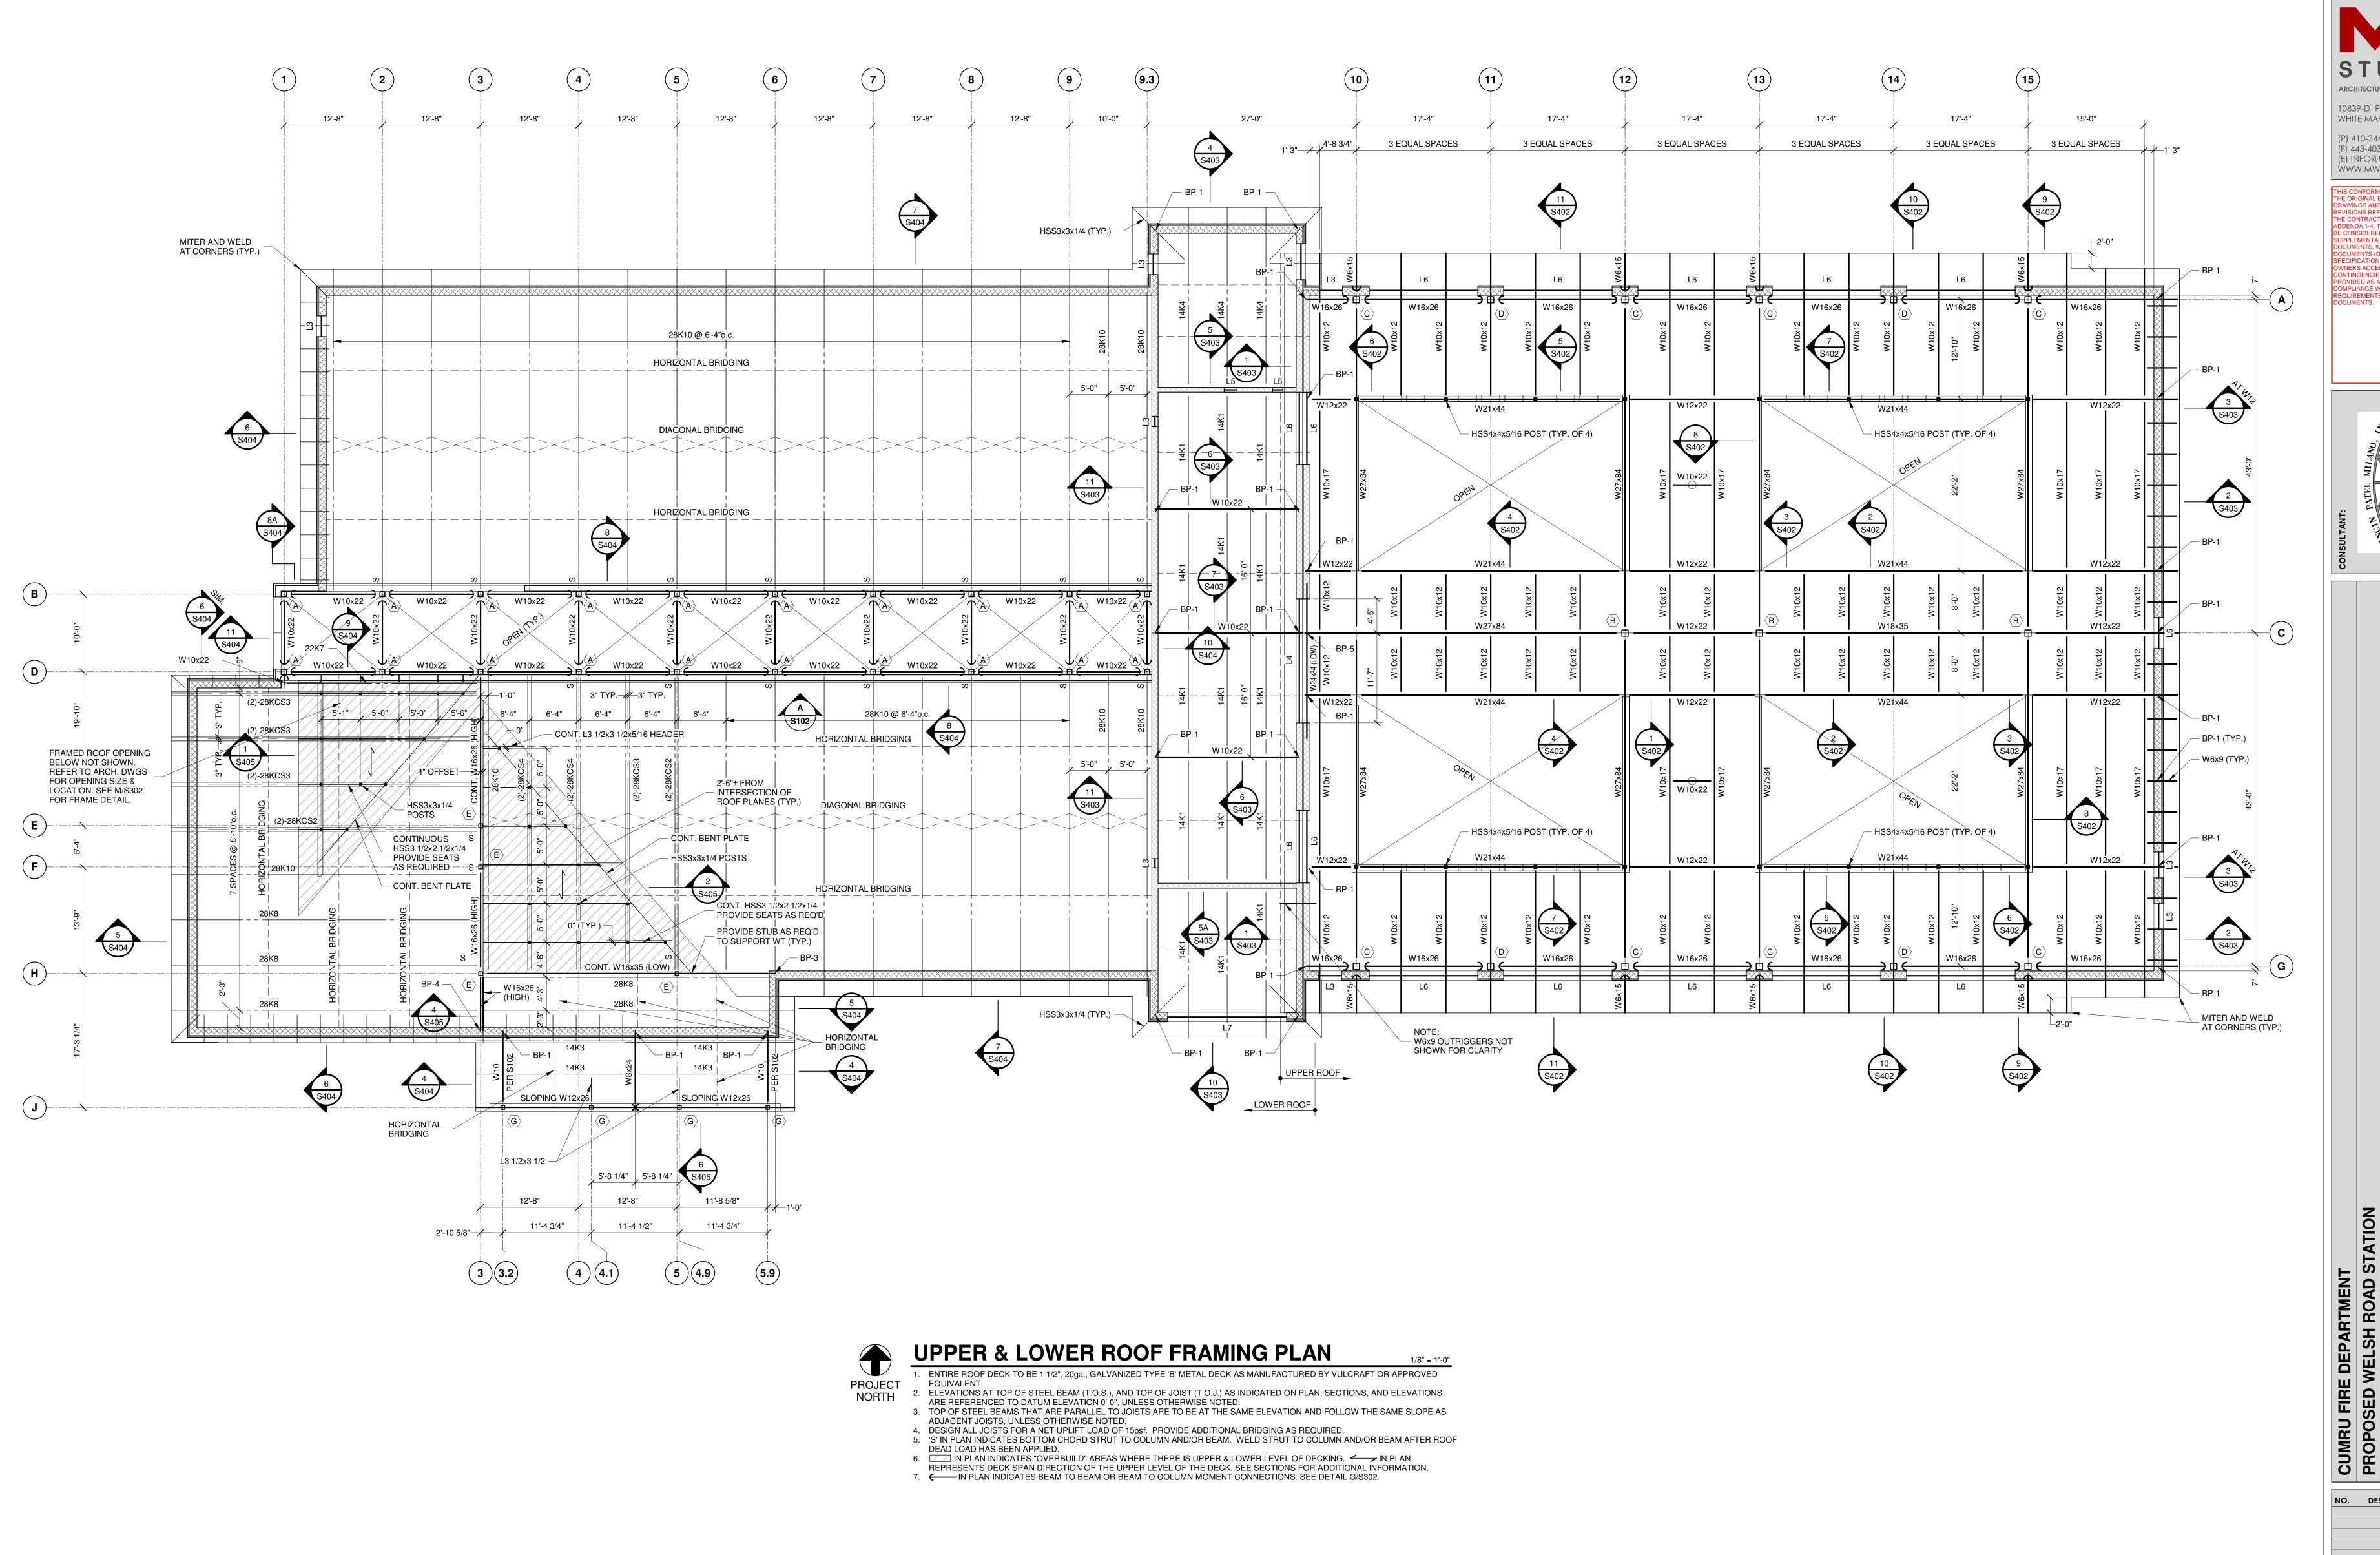

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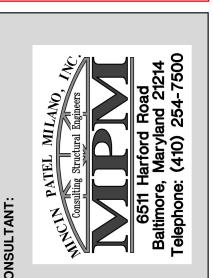
STUDIOS

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PROPOSED WELSH ROAD STATIC
1775 WELSH ROAD
MOHNTON, PA 19540


NO. DESCRIPTION DATE

PROJECT
18-036

PROJECT 18-036 PROJECT BID SET DATE 11/30/2023

DRAWING ROOF FRAMING PLAN

S103

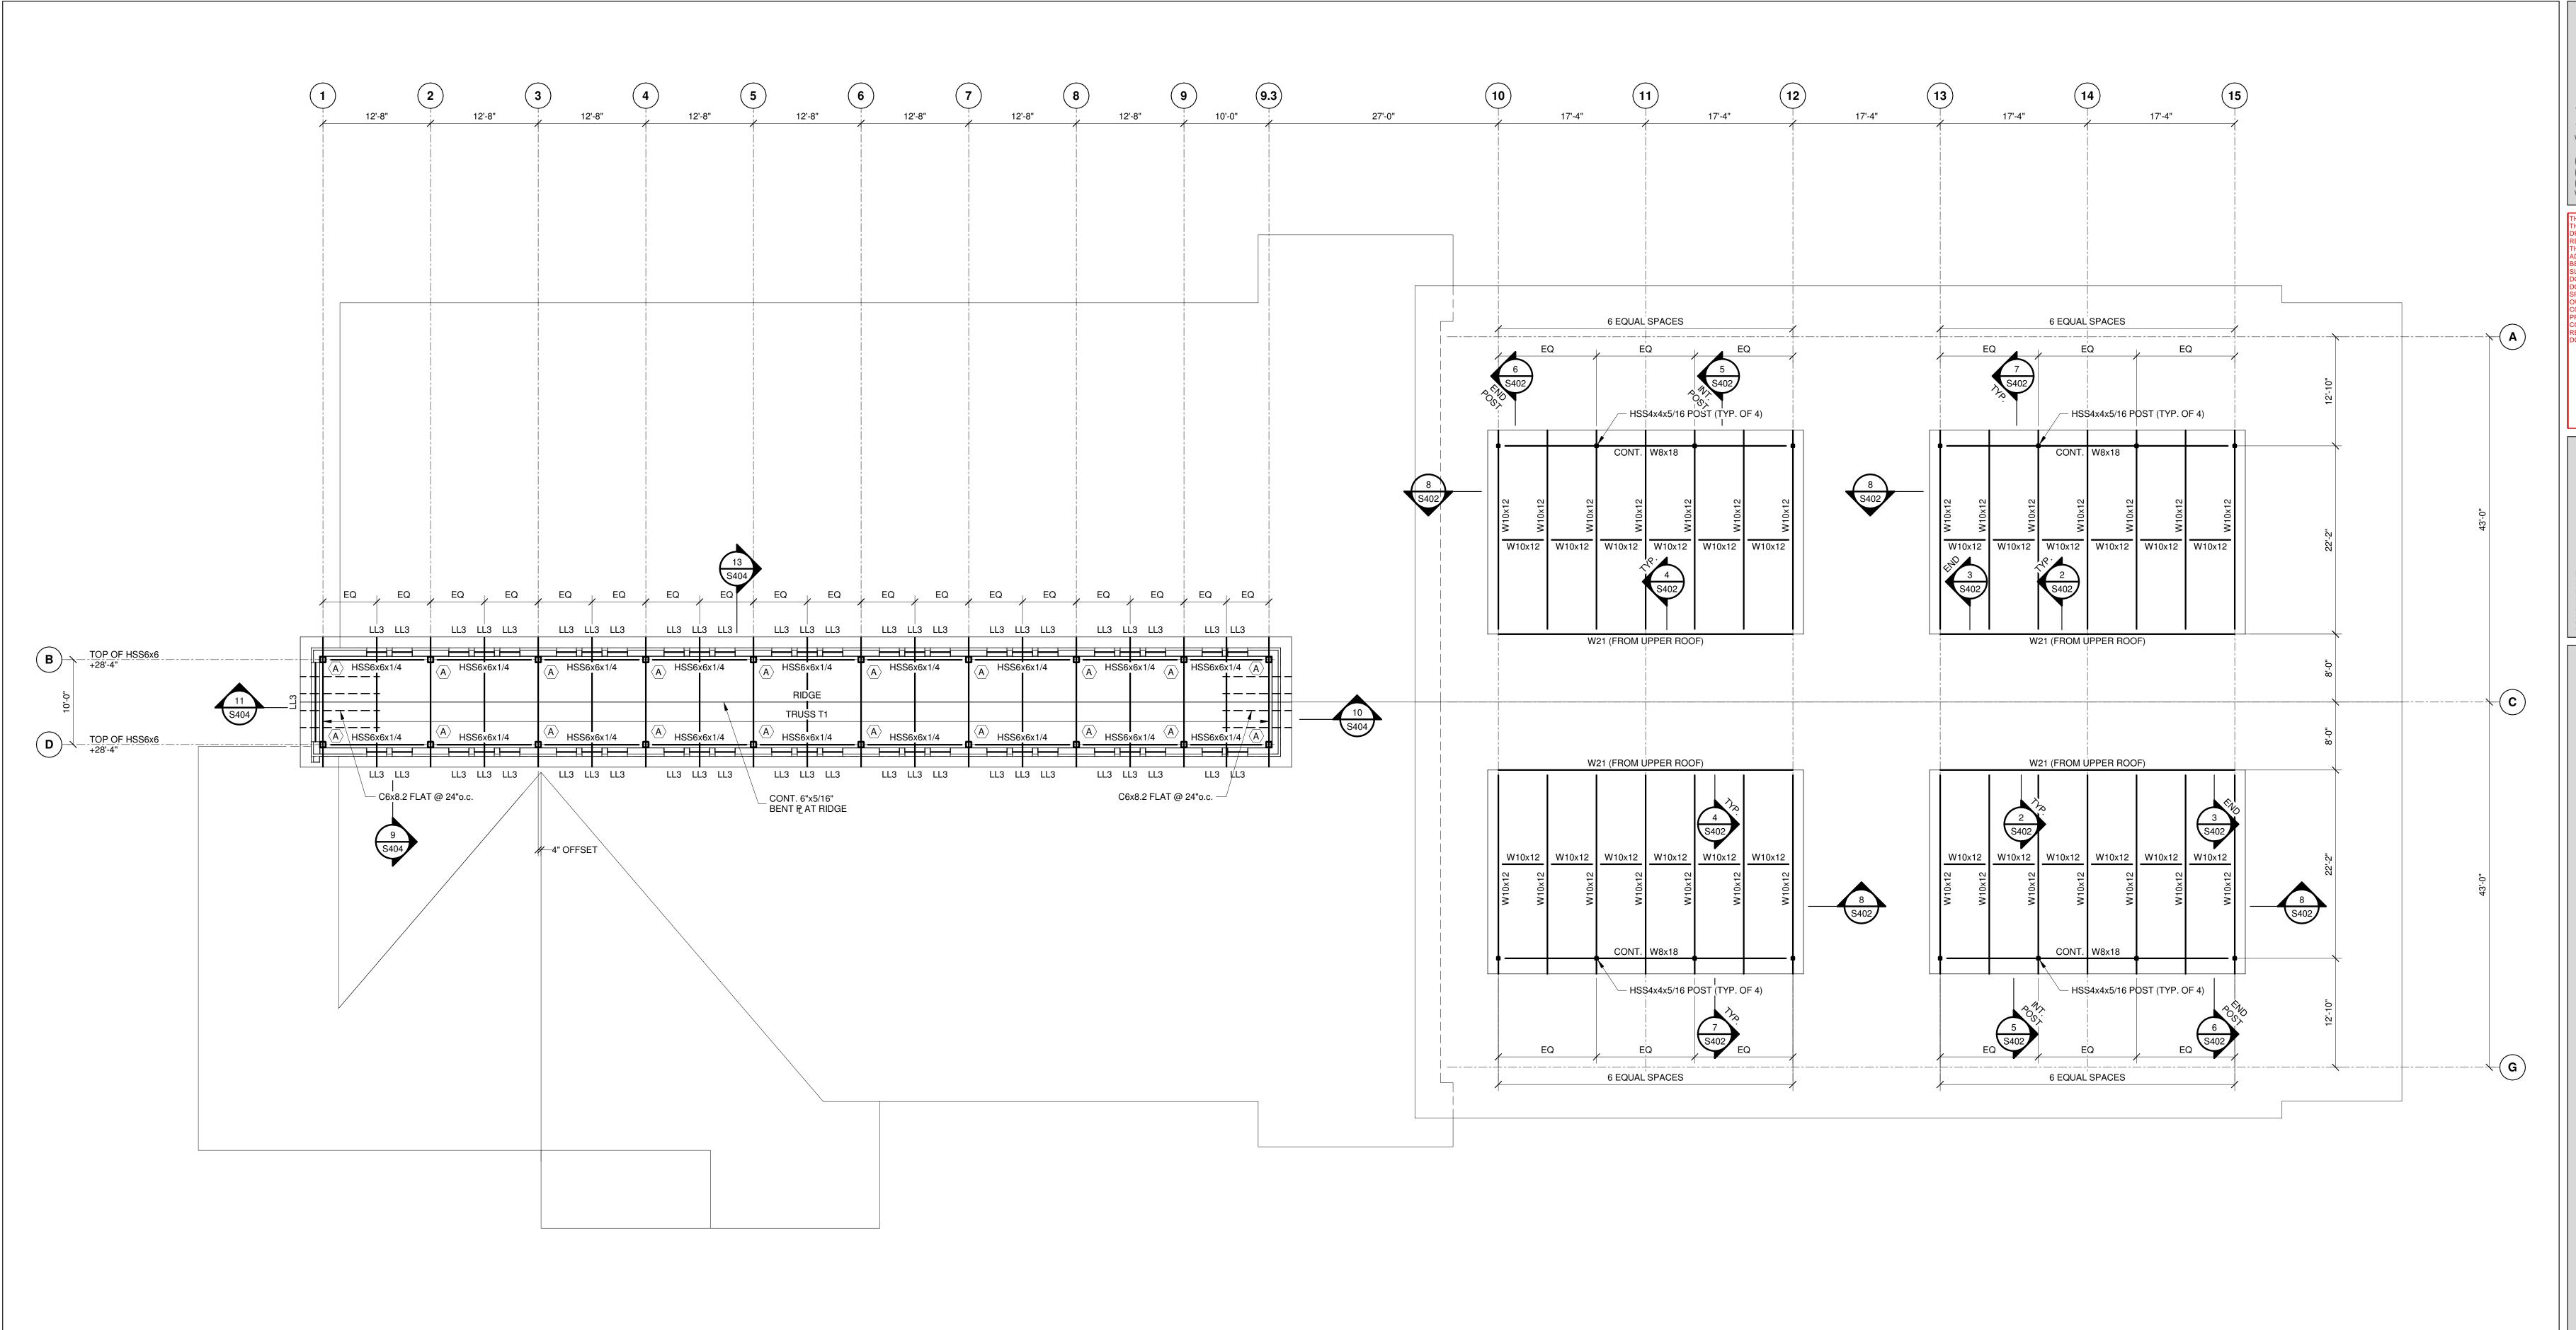



DORMER ROOF FRAMING PLAN

1. ENTIRE DORMER ROOF DECK TO BE 1 1/2", 20ga., GALVANIZED TYPE 'B' METAL DECK AS MANUFACTURED BY VULCRAFT OR

1/8" = 1'-0"


APPROVED EQUIVALENT.

2. ELEVATIONS AT TOP OF STEEL BEAM (T.O.S.) AS INDICATED ON PLAN AND/OR SECTIONS ARE REFERENCED TO DATUM ELEVATION 0'-0", UNLESS OTHERWISE NOTED.

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PROVIDED AS A CONVENIENCE FROM COMPLIANCE WITH THE FULL REQUIREMENTS OF THE CONTRACT DOCUMENTS.



NO. DESCRIPTION DATE

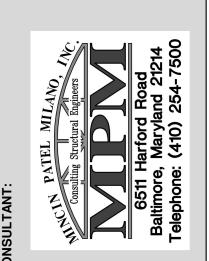11/30/2023 **HIGH ROOF**

CLERESTORY ROOF FRAMING PLAN

1/8" = 1'-0" 1. ENTIRE CLERESTORY ROOF DECK TO BE 1 1/2", 20ga., GALVANIZED TYPE 'B' METAL DECK AS MANUFACTURED BY VULCRAFT OR APPROVED EQUIVALENT.
 ELEVATIONS AT TOP OF STEEL BEAM (T.O.S.) AS INDICATED ON PLAN, SECTIONS, AND ELEVATIONS ARE REFERENCED TO DATUM ELEVATION 0'-0", UNLESS OTHERWISE NOTED. PROJECT NORTH

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A	BBREVIATIONS
&	AND
@	AT
Ø	DIAMETER
±	PLUS OR MINUS
AES AFF	ARCHITECTURALLY EXPOSED STEEL ABOVE FINISHED FLOOR
ARCH	ARCHITECTURAL
ASD	ALLOWABLE STRESS DESIGN
BM	BEAM
BOTT	BOTTOM
BP	BEARING PLATE
ВР С СМU	CENTERLINE CONCRETE MASONRY UNIT
COL	COLUMN
CONC	CONCRETE
CONT	CONTINUOUS
COORD	COORDINATE
DIA	DIAMETER
DN	DOWN
DWG	DRAWING
EL	ELEVATION
ELEV	ELEVATION
EQUIV	EQUIVALENT
EW	EACH WAY
EX	EXISTING
EXIST	EXISTING
EXT	EXTERIOR
FD'N	FOUNDATION
FT'G	FOOTING
GA	GAUGE
GALV	GALVANIZED
GC	GENERAL CONTRACTOR
GEN	GENERAL
HK	HOOK
HORIZ	HORIZONTAL
HS	HIGH STRENGTH
INSUL	INSULATION
INT	INTERIOR
INV	INVERT
L	ANGLE
LBS	POUNDS
LT GA	LIGHTGAUGE
MAS	MASONRY
MAX	MAXIMUM
MECH	MECHANICAL
MEZZ	MEZZANINE
MIN	MINIMUM
MISC	MISCELLANEOUS
MPH	MILES PER HOUR
MTL	METAL
NA	NOT APPLICABLE
NTS	NOT TO SCALE
OC	ON CENTER
OPP	OPPOSITE
PC	PRECAST CONCRETE
PERP	PERPENDICULAR
PL	PLATE
PREFAB PROJ	PREFABRICATED PROJECTION
PSF PT	POUNDS PER SQUARE FOOT PRESSURE TREATED
REINF	REINFORCED, REINFORCEMENT
REQ'D	REQUIRED
REV	REVISION
RTU	ROOFTOP UNIT
SAN	SANITARY
SD	STORM DRAIN
SIM	SIMILAR
SJ	SLAB JOINT
SOG	SLAB ON GRADE
SPEC	SPECIFICATION
SS	STAINLESS STEEL
STD	STANDARD
STRUCT T&B	TOP AND BOTTOM
TB	TRUSS BEARING
THRU	THROUGH
TOB	TOP OF BEAM
TOJ	TOP OF JOIST
TOS TOW	TOP OF SLAB TOP OF WALL
TYP	TYPICAL
UON VERT	UNLESS OTHERWISE NOTED VERTICAL
VIF	VERIFY IN FIELD
w/	WITH
WWM	WELDED WIRE MESH
	-

	LINTE	L SCHEDULE	
MARK	ТҮРЕ	CONFIGURATION	REMARKS
Р	4" WIDE x 8" HIGH PRECAST MASONRY LINTEL w/ (1)-#5 T & B FOR EACH 4" OF WALL THICKNESS.		FOR OPENINGS IN NON-BEARING INTERIOR PARTITIONS UP TO 5'-0" WIE PROVIDE 8" MINIMUM BEARING EACH END.
P6	6" WIDE x 8" HIGH PRECAST MASONRY LINTEL w/ (1)-#5 T & B.		FOR OPENINGS IN NON-BEARING INTERIOR PARTITIONS UP TO 5'-0" WII PROVIDE 8" MINIMUM BEARING EACH END.
P10	4" WIDE x 8" HIGH + 6" WIDE x 8" HIGH PRECAST MASONRY LINTEL w/ (2)-#5 TOP & BOTTOM.		FOR OPENINGS IN NON-BEARING INTERIOR PARTITIONS UP TO 5'-0" WII PROVIDE 8" MINIMUM BEARING EACH END.
L1	GALVANIZED L4x3 1/2x5/16 LLV FOR EACH 4" OF WALL THICKNESS.		FOR OPENINGS UP TO 6'-0" WIDE, UNLESS OTHERWISE NOTED. PROVIDE 8" MINIMU BEARING EACH END.
L2	GALVANIZED L6x3 1/2x5/16 LLV FOR EACH 4" OF WALL THICKNESS.		FOR OPENINGS BETWEEN 6'-0" TO 10'-0" WIDE, UNLES OTHERWISE NOTED. PROVIDE 8" MINIMUM BEARING EACH END.
L3 L6x3 1/2x5/16 LLV + L5x5x5/16 GALVANIZE ALL ANGLES		10" CMU	FOR OPENINGS IN 10" CMU WALL WHERE INDICATED. PROVIDE 8" MINIMUM BEARING EACH END.
L4	W16x46 w/ 5/16"x9" GALVANIZED BOTTOM PLATE (WELDED ASSEMBLY)	1/2"————————————————————————————————————	FOR OPENINGS IN 10" CMU WALLS WHERE INDICATED PROVIDE BP-4 EACH END.
L5	W8x21 w/ 5/16"x7" GALVANIZED BOTTOM PLATE (WELDED ASSEMBLY)	8" CMU 1/2"——1/2"	FOR OPENINGS IN 8" CMU WALLS WHERE INDICATED PROVIDE BP-2 EACH END.
L6	W8x21 w/ 5/16"x9" GALVANIZED BOTTOM PLATE (WELDED ASSEMBLY)	1/2"————————————————————————————————————	FOR OPENINGS IN 10" CMU WALLS WHERE INDICATED PROVIDE BP-2 EACH END.
L7	W12x26 w/ 5/16"x9" GALVANIZED HANGER PLATES @ 16"o.c. & 5/16"x9" GALVANIZED BOTTOM PLATE (WELDED ASSEMBLY)	10" CMU	FOR OPENINGS IN 10" CMU WALLS WHERE INDICATED. PROVIDE BP-4 EACH END.

ALL OPENINGS IN MASONRY WALLS AND IN PARTITIONS ARE TO BE PROVIDED WITH LINTELS. LINTELS SHALL BE STRUCTURAL STEEL OR PRECAST CONCRETE AS INDICTED, UNLESS OTHERWISE NOTED. ALL LINTELS SHALL HAVE 8" MINIMUM BEARING AND SHALL BE SET IN A FULL BED OF MORTAR. SHORE LINTELS AS REQUIRED TO PREVENT ROTATION DURING CONSTRUCTION. NOTE THAT ALL WALL OPENINGS MAY NOT BE SHOWN ON THE STRUCTURAL DRAWINGS. CONTRACTOR SHALL COORDINATE SIZE, TYPE, AND LOCATION OF ALL LINTELS REQUIRED WITH ARCHITECTURAL AND MECHANICAL DRAWINGS.

1/2"—

			COLUMN S	SCHEDULE			
	A	B	©	D	Œ	F	G
UPPER ROOF LOWER ROOF			HIGH ROOF EAVE	HIGH ROOF EAVE			
1 ST FLOOR	HSS8x8x3/8	HSS10x10x3/8	HSS10x10x5/16	HSS10x10x5/16	HSS6x6x5/16 (HEIGHT VARIES)	HSS6x6x1/4	HSS6x6x5/16 (HEIGHT VARIES)
BOTTOM OF BASE PLATE ELEVATION	-0'-7"	-0'-11"	-0'-11"	-0'-11"	-0'-7"	-0'-7"	-0'-7"
BASE PLATE	14"x1"x14"	16"x1"x16"	16"x1"x16"	16"x1"x16"	12"x1"x12"	12"x1"x12"	12"x1"x12"
BASE PLATE CONFIGURATION (U.O.N.)							
ANCHOR BOLTS	(4)-3/4"Øx 1'-6" + 3" HOOK w/ 4" THREADED PROJECTION	(4)-3/4"Øx 1'-0" + 3" HOOK w/ 4" THREADED PROJECTION	(4)-3/4"Øx 1'-6" + 3" HOOK w/ 4" THREADED PROJECTION				
CONCRETE PIER SIZE & REINFORCING (IF REQ'D)	20"x20" (4)-#9 VERT. & #3 TIES @ 8"o.c.	24"x24" (8)-#8 VERT. & (2)-#3 TIES @ 8"o.c.	24"x24" (8)-#8 VERT. & (2)-#3 TIES @ 8"o.c.	24"x24" (8)-#8 VERT. & (2)-#3 TIES @ 8"o.c.	18"x18" (4)-#8 VERT. & #3 TIES @ 8"o.c.		24"x24" (8)-#8 VERT. & (2)-#3 TIES @ 8"o.c.
PIER DETAIL					4.4.4		

STRUCTURAL GENERAL NOTES

THE CONTRACTOR SHALL CHECK AND VERIFY ALL DIMENSIONS AND CONDITIONS INDICATED ON THESE DRAWINGS AND SHALL NOTIFY THE ARCHITECT/ENGINEER OF ANY DISCREPANCIES OR POTENTIAL CONFLICTS PRIOR TO PROCEEDING WITH CONSTRUCTION. THE CONTRACTOR SHALL USE ARCHITECTURAL DRAWINGS FOR LAYOUT PURPOSES, COORDINATE THE LOCATION OF ALL WALLS, ETC. WITH ARCHITECTURAL DRAWINGS.

THE BUILDING IS DESIGNED TO BE SELF-SUPPORTING AND STABLE AFTER THE BUILDING IS FULLY COMPLETED. CONSTRUCTION MEANS AND METHODS ARE SOLELY THE CONTRACTOR'S RESPONSIBILITY. THE CONTRACTOR MUST DETERMINE ERECTION PROCEDURE AND SEQUENCE, WHICH WILL ENSURE THE STABILITY OF THE BUILDING, IT'S COMPONENT PARTS, AND TEMPORARY OR INCOMPLETE CONNECTIONS DURING ERECTION, INCLUDING THE ADDITION OF ANY SHORING, SHEETING, TEMPORARY GUYS, BRACING, TIEDOWNS, ETC. THAT MAY BE NECESSARY. SUCH MATERIAL AND METHODS ARE NOT SHOWN IN THE CONTRACT DRAWINGS OR SPECIFICATIONS AND ARE SOLELY THE RESPONSIBILITY OF THE CONTRACTOR. THE ENGINEER HAS NO EXPERTISE IN, AND TAKES NO RESPONSIBILITY FOR, THE CONSTRUCTION MEANS AND METHODS OR JOB SITE SAFETY DURING CONSTRUCTION. PROCESSING OR APPROVING SUBMITTALS MADE BY THE CONTRACTOR WHICH MAY CONTAIN INFORMATION RELATED TO CONSTRUCTION METHODS OR SAFETY ISSUES, OR PARTICIPATION IN MEETINGS WHERE SUCH ISSUES MIGHT BE DISCUSSED, SHALL NOT BE CONSTRUED AS VOLUNTARY ASSUMPTION BY THE ENGINEER OF ANY RESPONSIBILITY FOR CONSTRUCTION METHODS AND/OR SAFETY PROCEDURES. IT IS SOLELY THE RESPONSIBILITY OF EACH CONTRACTOR TO FOLLOW ALL APPLICABLE SAFETY PROCEDURES. IT IS SOLELY THE RESPONSIBILITY OF EACH CONTRACTOR TO FOLLOW ALL APPLICABLE SAFETY CODES AND REGULATIONS DURING ALL PHASES OF CONSTRUCTION. THE STRUCTURAL ENGINEER DOES NOT ENGAGE IN AND DOES NOT SUPERVISE CONSTRUCTION.

THE CONTRACTOR SHALL VERIFY/COORDINATE FLOOR SLOPES, ROOF, AND WALL OPENINGS, DUCT AND PIPE OPENINGS, EQUIPMENT PADS, ETC. WITH THE ARCHITECTURAL AND MECHANICAL DRAWINGS.

A SUBSURFACE EXPLORATION PROGRAM AND GEOTECHNICAL ENGINEERING EVALUATION HAS BEEN PERFORMED BY ECS MID-ATLANTIC, LLC TO ASSIST THE DESIGN TEAM IN THE PREPARATION OF THESE DOCUMENTS. THEIR REPORT, DATED JANUARY 17, 2019, IS AVAILABLE TO CONTRACTORS FOR INFORMATIONAL PURPOSES ONLY AND DOES NOT RELIEVE THE CONTRACTORS OF THEIR RESPONSIBILITIES TO CONDUCT THEIR OWN INDIVIDUAL TAILORED STUDY TO ASSESS SUBSURFACE CONDITIONS. BASED UPON THE GEOTECHNICAL ENGINEERING REPORT. THE NEW STRUCTURE MAY BE SUPPORTED ON SPREAD FOOTINGS FOUNDED UPON FIRM APPROVED NATURAL SOILS OR NEW CONTROLLED STRUCTURAL FILL. AN ALLOWABLE BEARING PRESSURE OF 2,000psf HAS BEEN USED FOR FOUNDATION DESIGN. IF SOILS OF THIS CAPACITY ARE NOT ENCOUNTERED AT ELEVATIONS INDICATED. FOOTINGS SHALL BE LOWERED OR INCREASED IN SIZE AT THE DIRECTION OF THE GEOTECHNICAL INSPECTION AGENCY AND ARCHITECT/ ENGINEER. FROST PROTECTION FOR PERIMETER WALL FOUNDATION SHALL BE CONSIDERED AS 3'-0" MINIMUM BELOW ADJACENT FINAL GRADE.

EARTHWORK OPERATIONS: ALL EARTHWORK OPERATIONS ARE TO BE MONITORED BY AN APPROVED GEOTECHNICAL INSPECTION AGENCY. STRIP CONSTRUCTION AREA PLUS 10' BEYOND OF ALL TOPSOIL, ORGANIC MATERIALS, PAVEMENT, UNSUITABLE EXISTING FILL AND/OR HIGHLY PLASTIC MATERIAL, UTILITIES, DEBRIS AND ALL OTHER DELETERIOUS NON- SOIL MATERIALS. DURING CLEARING AND STRIPPING OPERATIONS, PROVIDE POSITIVE SURFACE DRAINING AWAY FROM CONSTRUCTION AREA. AFTER CLEANING AND STRIPPING AND/OR EXCAVATING TO GRADE. THE CONSTRUCTION AREA SHOULD BE PROOFROLLED WITH A MINIMUM 10 TON PAYLOAD TRUCK OR PNEUMATIC TIRED VEHICLE OF SIMILAR SIZE AND WEIGHT. ANY UNSUITABLE MATERIAL OBSERVED DURING THE EXCAVATION AND PROOFROLLING OPERATIONS SHOULD BE DENSIFIED IN PLACE OR UNDERCUT TO A STABLE SUBGRADE AND REPLACED WITH APPROVED COMPACTED FILL. ADDITIONAL UNDERCUTTING OF EXISTING SOILS THAT ARE DISTURBED OR EXPOSED TO WATER SHOULD BE EXPECTED. COMPACTED STRUCTURAL FILL/BACKFILL SHOULD CONSIST OF EXISTING SOILS OR BORROW CLASSIFIED AS ML, CL, SM, SC, SW, SP, GW, GP, GM, GC, OR BETTER PROVIDED THEY DO NOT CONTAIN ORGANICS, CONTAIN NO PARTICLE SIZES GREATER THAN 4" IN ANY DIRECTION, AND FALL WITHIN -1 AND +3 PERCENTAGE POINTS OF OPTIMUM MOISTURE, OR BORROW MATERIAL CLASSIFIED AS ML, CL, SM, SC OR MORE GRANULAR IN ACCORDANCE WITH THE UNIFIED SOIL CLASSIFICATION SYSTEM, ASTM D-2487. ALL FILL MATERIAL SHOULD HAVE A LIQUID LIMIT LESS THAN 40 AND A PLASTICITY LESS THAN 20. CONTROLLED COMPACTED FILL/BACKFILL SHOULD BE PLACED IN HORIZONTAL LIFTS, WITH MAX. HEIGHT OF 8" LOOSE MEASURE. FILL/BACKFILL SHOULD BE COMPACTED TO AT LEAST 98% OF MAX. DRY DENSITY AS DETERMINED BY THE STANDARD PROCTOR COMPACTION TEST ASTM D698 AT -1 AND +3 PERCENTAGE POINTS OF OPTIMUM MOISTURE CONTENT.

THE REPORT INDICATES THAT EXISTING UNDOCUMENTED FILL SOILS WERE ENCOUNTERED AT BORING LOCATIONS B-10 AND B-12 AND ARE EXPECTED TO BE ENCOUNTERED IN OTHER AREAS OF THE BUILDING. FILL AT BORING B-10 EXTENDED TO 18'-0"± BELOW GRADE. EXISTING FILL WILL NEED TO BE EXCAVATED AND REMOVED AND REPLACED WITH NEW CONTROLLED STRUCTURAL FILL. THE REPORT ALSO INDICATES THAT HIGHLY PLASTIC SOILS (CH) WERE ENCOUNTERED IN SEVERAL BORING LOCATIONS. EXISTING HIGHLY PLASTIC SOILS ARE UNSUITABLE FOR DIRECT FOUNDATION SUPPORT AND MUST BE REMOVED AND REPLACED WITH CONTROLLED FILL WHERE ENCOUNTERED. ALTHOUGH AUGER REFUSAL WAS GENERALLY NOT ENCOUNTERED NEAR ANTICIPATED FOOTING SUBGRADE LEVELS. IT MAY BE POSSIBLE THAT SHALLOW ROCK MAY EXIST AT OTHER AREAS. SHOULD ROCK BE ENCOUNTERED AT FOOTING SUBGRADE LEVELS, THE ROCK SHOULD BE REMOVED TO CREATE A LEVEL BEARING SURFACE AND REPLACED WITH COMPACTED CR-6 WASHED STONE TO A DEPTH OF 6" MINIMUM BELOW FOOTING SUBGRADE.

<u>SLAB-ON-GRADE:</u>
THE REPORT INDICATES THAT ON-SITE NATURAL SOILS MAY BE SUITABLE TO SUPPORT SLAB-ON-GRADE ALTHOUGH MOISTURE CONTROL DURING EARTHWORK OPERATIONS IS EXPECTED. AREAS OF SOFT OR YIELDING SOILS SHOULD BE REMOVED AND REPLACED WITH CONTROLLED FILL. SLAB-ON-GRADE SHOULD BE SUPPORTED ON A MINIMUM OF 2'-0" NON-EXPANSIVE SOILS. IF HIGHLY PLASTIC SOILS ARE ENCOUNTERED AT SLAB SUBGRADES, THEY SHOULD BE UNDERCUT IN THEIR ENTIRETY OR TO A MINIMUM OF 2'-0" BELOW SUBGRADE ELEVATION AND REPLACED WITH APPROVED STRUCTURAL FILL. ANY EXISTING UNDOCUMENTED FILL THAT IS ENCOUNTERED AT SLAB-ON-GRADE SUBGRADE LEVELS. MUST BE THOROUGHLY EVALUATED BY THE GEOTECHNICAL ENGINEERING INSPECTION AGENCY PRIOR TO ACCEPTANCE. ALL CONCRETE SLAB-ON-GRADE TO BE PLACED ABOVE A MOISTURE BARRIER AND DRAINAGE LAYER OF WASHED GRAVEL (GP, GW).

ALL SOILS USED AS BACKFILL WITHIN THE CRITICAL ZONE BEHIND WALLS RETAINING EARTH SHOULD HAVE USCS CLASSIFICATIONS OF SM OR MORE GRANULAR WITH A MAXIMUM 35% FINES AND MINIMUM ANGLE OF INTERNAL FRICTION OF 30° WHEN COMPACTED TO 98% OF IT'S MAXIMUM DRY DENSITY PER ASTM A698. ON SITE MATERIALS SHALL NOT BE USED.

CAST IN PLACE CONCRETE AND REINFORCING ALL CONCRETE SHALL CONFORM TO ACI 301, ACI 318. ACI 315. ALL CONCRETE SHALL BE NORMAL WEIGHT CONCRETE AND HAVE THE FOLLOWING 28 DAY COMPRESSIVE STRENGTH (f'c):

SLAB-ON-GRADE: 4,000psi SLAB ON METAL FORM: 4,000psi

EXTERIOR EXPOSED CONCRETE SUBJECT TO DE-ICERS: 4.500psi GROUT FOR MASONRY FILL: 3,000psi PEA GRAVEL CONCRETE OR GROUT PER ASTM C476

ALL OTHER CONCRETE: 3,000psi CEMENTITIOUS MATERIAL SHALL BE MINIMUM 75% PORTLAND CEMENT ASTM C150, TYPE I OR TYPE II.

CALCIUM CHLORIDE IS NOT ALLOWED. REINFORCING - ASTM A 615, GRADE 60

BRACE ALL WALLS AS REQUIRED UNTIL CONSTRUCTION IS STABLE.

ALL DRAWINGS ARE PROTECTED BY FEDERAL COPYRIGHT BY MANNS WOODWARD STUDIOS, INC. AND CAN NOT BE REPRODUCED OR MODIFIED IN ANY MANNER WITHOUT WRITTEN PERMISSION. DOCUMENTS MAY NOT BE USED IN PART OR WHOLE TO DEVELOP THE DESIGN OF ANOTHER BUILDING WITHOUT EXPRESS WRITTEN PERMISSION BY MANNS WOODWARD STUDIOS.

WELDED WIRE FABRIC - ASTM A 185 SYNTHETIC MICROFIBERS SHALL BE USED IN 8" SLAB AND SHALL BE DISPENSED UNIFORMLY AT A RATE OF 1.5 LBS/CU. YD. USE CORROSIVE INHIBITING AND WATERPROOFING ADMIXTURES IN 8" SLABS, USE ADMIXTURE PER MANUFACTURERS RECOMMENDATIONS. BASIS OF DESIGN: SPG VAPOR LOCK 40/40 SPLICE LAPS FOR ALL REINFORCING SHALL BE CLASS "B" SPLICE


ALL CONCRETE OTHER THAN FOOTINGS SHALL CONTAIN A WATER-REDUCING ADMIXTURE PER MANUFACTURER'S RECOMMENDATIONS. ALL EXTERIOR CONCRETE SHALL BE AIR-ENTRAINED 4-6%. MAXIMUM SLUMP TO BE 4".

MASONRY WORK SHALL COMPLY WITH ACI530.1/ASCE 6 "SPECIFICATIONS FOR MASONRY STRUCTURES." CONCRETE MASONRY UNITS SHALL CONFORM TO ASTM C 90. CONCRETE MASONRY UNITS SHALL HAVE A MINIMUM COMPRESSIVE STRENGTH OF 1,900 PSI AND A MINIMUM PRISM STRENGTH (F'm) OF BRICK UNITS SHALL COMPLY WITH ASTM C216.

MORTAR SHALL CONFORM TO ASTM C 270, TYPE S FOR ALL CMU WALLS AND TYPE 'N' FOR VENEERS. ALL MASONRY WALLS SHALL BE CONTINUALLY REINFORCED WITH LADDER TYPE HORIZONTAL JOINT REINFORCEMENT AT 16" CENTER TO CENTER VERTICALLY MINIMUM AND ALL INTERSECTIONS OF WALLS AND CORNERS SHALL BE PROVIDED WITH PREFABRICATED 'T' AND CORNER PIECES.

VERTICAL MASONRY REINFORCEMENT SHALL BE AS NOTED ON SCHEDULE AND SECTIONS. REINFORCED WALLS SHALL HAVE CELLS FILLED SOLID WITH GROUT IN FOUR COURSE MAXIMUM LIFTS. PROVIDE HOLES IN BOTTOM OF EACH LIFT TO ENSURE WALL IS FILLED SOLID. SPLICE LAPS FOR VERTICAL WALL REINFORCING SHALL BE 48 BAR DIAMETERS, UNLESS PROVIDE CONTROL JOINTS IN ALL ABOVE GRADE MASONRY WALLS AT 30' ON CENTER, MAXIMUM, UNLESS OTHERWISE NOTED.

ALL OPENINGS IN MASONRY WALLS AND PARTITIONS ARE TO BE PROVIDED WITH LINTELS. LINTELS SHALL BE STRUCTURAL STEEL OR PRECAST CONCRETE AS INDICATED IN THE LINTEL SCHEDULE. ALL LINTELS SHALL HAVE 8" MINIMUM BEARING AND SHALL BE SET IN A FULL BED OF MORTAR. SHORE LINTELS AS REQUIRED TO PREVENT ROTATION DURING CONSTRUCTION. NOTE THAT ALL WALL OPENINGS MAY

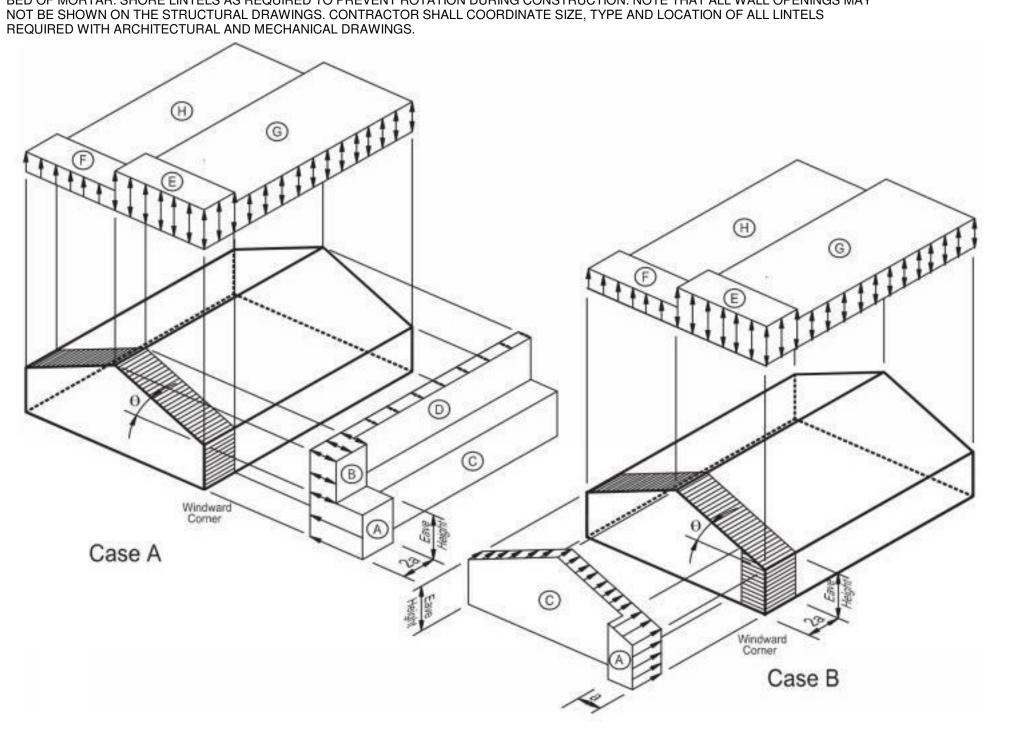

MAIN WINDFORCE RESISTING SYSTEM									
HORIZONTAL VERTICAL (DESIGN PRESSURES IN psf) (DESIGN PRESSURES IN psf)				I psf)	OVER (DESIGN PRES	HANG SSURES IN psf)			
Α	В	С	D	E F G H		Еон	G _{OH}		
29	-9	20	-5	-27	-18	-19	-14	-38	-30

3. FOR ALLOWABLE STRESS DESIGN (ASD) MULTIPLY TABULATED VALUES BY 0.6.

FABRICATION AND ERECTION OF STRUCTURAL STEEL SHALL CONFORM TO AISC SPECIFICATIONS AND AWS D1.1 ALL STRUCTURAL STEEL SHALL CONFORM TO THE FOLLOWING:

W-SHAPES: ASTM A992, GRADE 50. MISC. SHAPES: ASTM A36

TUBE STEEL: ASTM A500, GRADE B PIPES: ASTM A53, GRADE B.

WELDING ELECTRODES: E70XX HIGH STRENGTH BOLTS: ASTM A 325. ANCHOR BOLTS: ASTM F1554 GRADE 36

FABRICATION AND ERECTION OF STEEL DECK SHALL CONFORM TO STEEL DECK INSTITUTE SPECIFICATIONS.

STEEL DECK - ASTM A 653 (SQ), GRADE 33 GALVANIZING - ASTM A 924, G 90 GALVANIZED COATING. PLACE DECK IN ACCORDANCE WITH MANUFACTURER'S RECOMMENDATIONS.

FASTEN DECK TO ALL SUPPORTS PER DETAIL M/S302. FASTEN SIDE LAPS WITH #10 SCREWS AT 12" MAX.

NO LOADS SHALL BE SUSPENDED FROM METAL DECK. PROVIDE SUPPORT FRAME AT ALL OPENINGS GREATER THAN 8" IN EITHER DIRECTION.

THE DESIGN, FABRICATION, AND INSTALLATION OF ALL LIGHTGAUGE FRAMING AND THEIR CONNECTIONS SHALL BE THE RESPONSIBILITY OF THE CONTRACTOR. THE LIGHTGAUGE FRAMING COMPONENTS SHALL BE IN ACCORDANCE WITH ASTM 653. MINIMUM STUD SIZES AND GAUGES ARE INDICATED ON THE DRAWINGS, ALL LIGHTGAUGE MATERIALS SHALL BE GALVANIZED IN ACCORDANCE WITH ASTM A924 WITH A MIN. G60 COATING. THE MINIMUM YIELD STRENGTH OF THE LIGHTGAUGE METAL STUD FRAMING COMPONENTS SHALL BE AS FOLLOWS: 16 GAUGE AND HEAVIER - ASTM A653 SQ, GRADE 50

18 GAUGE AND LIGHTER - ASTM A653 SQ, GRADE 33 ALL CONNECTIONS SHALL BE WELDED, SCREWED, OR POWDER FASTENED AS INDICATED ON THESE DRAWINGS. DO NOT CUT OR SPLICE LIGHTGAUGE FRAMING MEMBERS. DO NOT BEAR OR CONNECT LIGHTGAUGE MEMBERS WITHIN TWELVE INCHES OF THE PUNCHED OPENING IN THE MEMBER WEBS. UNLESS THE MEMBERS ARE REINFORCED WITH A MINIMUM 18" LONG UNPUNCHED TRACK OR STUD AT THE PUNCH OPENING. THE TRACK OR STUD REINFORCING PIECE SHALL BE THE SAME SIZE AND GAUGE AS THE PUNCHED MEMBER. FASTEN THE REINFORCING PIECE TO THE MEMBER WITH A MINIMUM OF FOUR SCREWS. THE CONTRACTOR SHALL PROVIDE LIGHTGAUGE MEMBERS AT THE SIZE AND SPACING INDICATED ON THESE DRAWINGS. LARGER SIZES AND/OR CLOSER SPACING MAY BE SUBSTITUTED PROVIDED THE SUBSTITUTIONS ARE COORDINATED WITH THE ARCHITECTURAL DRAWINGS.

STEEL GRATING TO BE McNICHOLS BANDED 1 1/2" GALVANIZED STEEL GRATING WITH 1 1/4"x3/16" BEARING BARS @ 1 3/16"o.c. AND CROSS

RODS @ 4"o.c. CONNECT TO STEEL BEAMS BY WELDING AT 12"o.c. OR APPROXIMATELY EVERY 10TH/ BEARING BAR. STEEL STAIRS AND RAILING SYSTEMS

THE CONTRACTOR SHALL BE RESPONSIBLE FOR THE DESIGN. FABRICATION. AND ERECTION OF THE STEEL STAIRS AND RAILING SYSTEMS. STAIR AND RAILING FRAMING SHALL BE DESIGNED FOR APPLICABLE CODE REQUIREMENTS.

SHOP DRAWINGS/SUBMITTALS ORIGINAL SHOP DRAWINGS/SUBMITTALS SHALL BE SUBMITTED FOR ARCHITECT/ENGINEER'S REVIEW FOR THE FOLLOWING:

CONCRETE MIX DESIGN CONCRETE AND MASONRY REINFORCING STEEL SHOP DRAWINGS

STRUCTURAL STEEL, STEEL JOIST, AND METAL DECK SHOP DRAWINGS STEEL GRATING SHOP DRAWINGS

SHOP DRAWINGS & CALCULATIONS SIGNED & SEALED BY PROFESSIONAL ENGINEER REGISTERED IN THE STATE OF PENNSYLVANIA FOR THE COLD-FORMED METAL FRAMING

STEEL STAIRS AND RAILINGS IF A CONTRACTOR OR OWNER FAILS TO SUBMIT THE SHOP DRAWINGS, THE FIRM, MINCIN PATEL MILANO, INC. WILL NOT BE RESPONSIBLE FOR THE CONTRACTORS INTERPRETATION OF THE INTENT OF THE STRUCTURAL DRAWINGS. AT THE TIME OF THE SHOP DRAWING SUBMISSION, THE GENERAL CONTRACTOR SHALL STATE IN WRITING ANY DEVIATION OR OMISSIONS FROM THE CONTRACT DOCUMENTS. THE GENERAL CONTRACTOR SHALL REVIEW ALL SHOP DRAWINGS PRIOR TO SUBMISSION TO THE A/E AND SHALL MAKE ALL CORRECTIONS AS HE DEEMS NECESSARY.

AN INDEPENDENT INSPECTION AGENCY, PAID FOR BY THE CONTRACTOR AND APPROVED BY THE ARCHITECT/ ENGINEER, SHALL INSPECT/

MONITOR/ TEST THE FOLLOWING ITEMS: EARTHWORK OPERATIONS INCLUDING PLACEMENT OF COMPACTED FILL AND VERIFICATION OF SOIL BEARING CAPACITY CAST IN PLACE CONCRETE AND REINFORCING STEEL

STRUCTURAL STEEL, STEEL JOISTS, AND METAL DECK COLD-FORMED METAL FRAMING

STEEL STAIR AND RAILINGS STEEL GRATING COPIES OF THE INSPECTORS FINAL REPORTS CERTIFYING THAT THE ITEMS INSPECTED HAVE BEEN INSTALLED IN ACCORDANCE WITH THE REQUIREMENTS OF THE CONTRACT DOCUMENTS SHALL BE SUBMITTED TO THE ARCHITECT/ENGINEER.

THIS BUILDING HAS BEEN DESIGNED FOR THE FOLLOWING LIVE LOAD CRITERIA FROM THE 2015 INTERNATIONAL BUILDING CODE (IBC 2015):

ROOF DESIGN LIVE LOAD: SNOW LOAD: GROUND SNOW (Pg) FLAT ROOF SNOW LOAD (Pf) 30psf SNOW EXPOSURE FACTOR (Ce) 1.0 SNOW IMPORTANCE FACTOR (I) 1.2 SNOW THERMAL FACTOR 1.0 FLOOR DESIGN LIVE LOAD: 125psf MF77ANINF APPARATUS BAY 250psf OTHERS BASIC WIND SPEED WIND EXPOSURE: INTERNAL PRESSURE COEFFICIENT: ±0.18

HEIGHT & EXPOSURE ADJUSTMENT COEFFICIENT: WIND DESIGN PRESSURES: SEE TABLES RISK CATEGORY SEISMIC IMPORTANCE FACTOR I_e SEISMIC SITE CLASS MAPPED SPECTRAL RESPONSE COEFFICIENTS: $S_S = 0.207$ $S_1 = 0.054$ SITE COEFFICIENTS


 $F_a = 1.6$ $F_V = 2.4$ DESIGN SPECTRAL RESPONSE COEFFICIENTS $S_{DS} = 0.220$ $S_{DI} = 0.087$

SEISMIC RESPONSE COEFFICIENT:

DESIGN BASE SHEAR:

SEISMIC DESIGN CATEGORY: ANALYSIS PROCEDURE: EQUIVALENT LATERAL FORCE PROCEDURE ORDINARY REINFORCED MASONRY SHEAR WALLS AND STRUCTURAL STEEL SYSTEM BASIC FORCE RESISTING SYSTEM: NOT SPECIFICALLY DETAILED FOR SEISMIC RESISTANCE... RESPONSE MODIFICATION COEFFICIENT:

 $C_S = 0.165$ ADMINISTRATION AREA $V = 100^{K}$ APPARATUS BAY

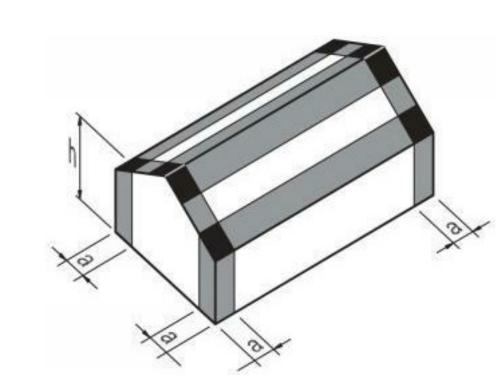

ROOFS - ZONE 1 / WALLS - ZONE 4

ROOFS - ZONE 2 / WALLS - ZONE 5

COMPONENTS AND CLADDING						
	ROOF (DESIGN PRESSURES IN psf)			WALLS (DESIGN PRESSURES IN psf)		
ZONE SF	1	2	3	4	5	
10sf	14.9 -23.7	14.9 -41.3	14.9 -61	25.9 -28.1	25.9 -34.	
20sf	13.6 -23	13.6	13.6 -57.1	24.7 -26.9	24.7	
50sf	11.9 -22.2	11.9 -33.6	11.9 -51.8	23.2 -25.4	23.2 -29.	
100sf	10.5 -21.5	10.5 -30.3	10.5 -47.9	22 -24.2	22 -26.	
500sf				19.3	19.3	

2. FOR ALLOWABLE STRESS DESIGN (ASD) MULTIPLY TABULATED VALUES BY 0.6.




WHITE MARSH, MD 21162 (P) 410-344-1460 (F) 443-403-2460

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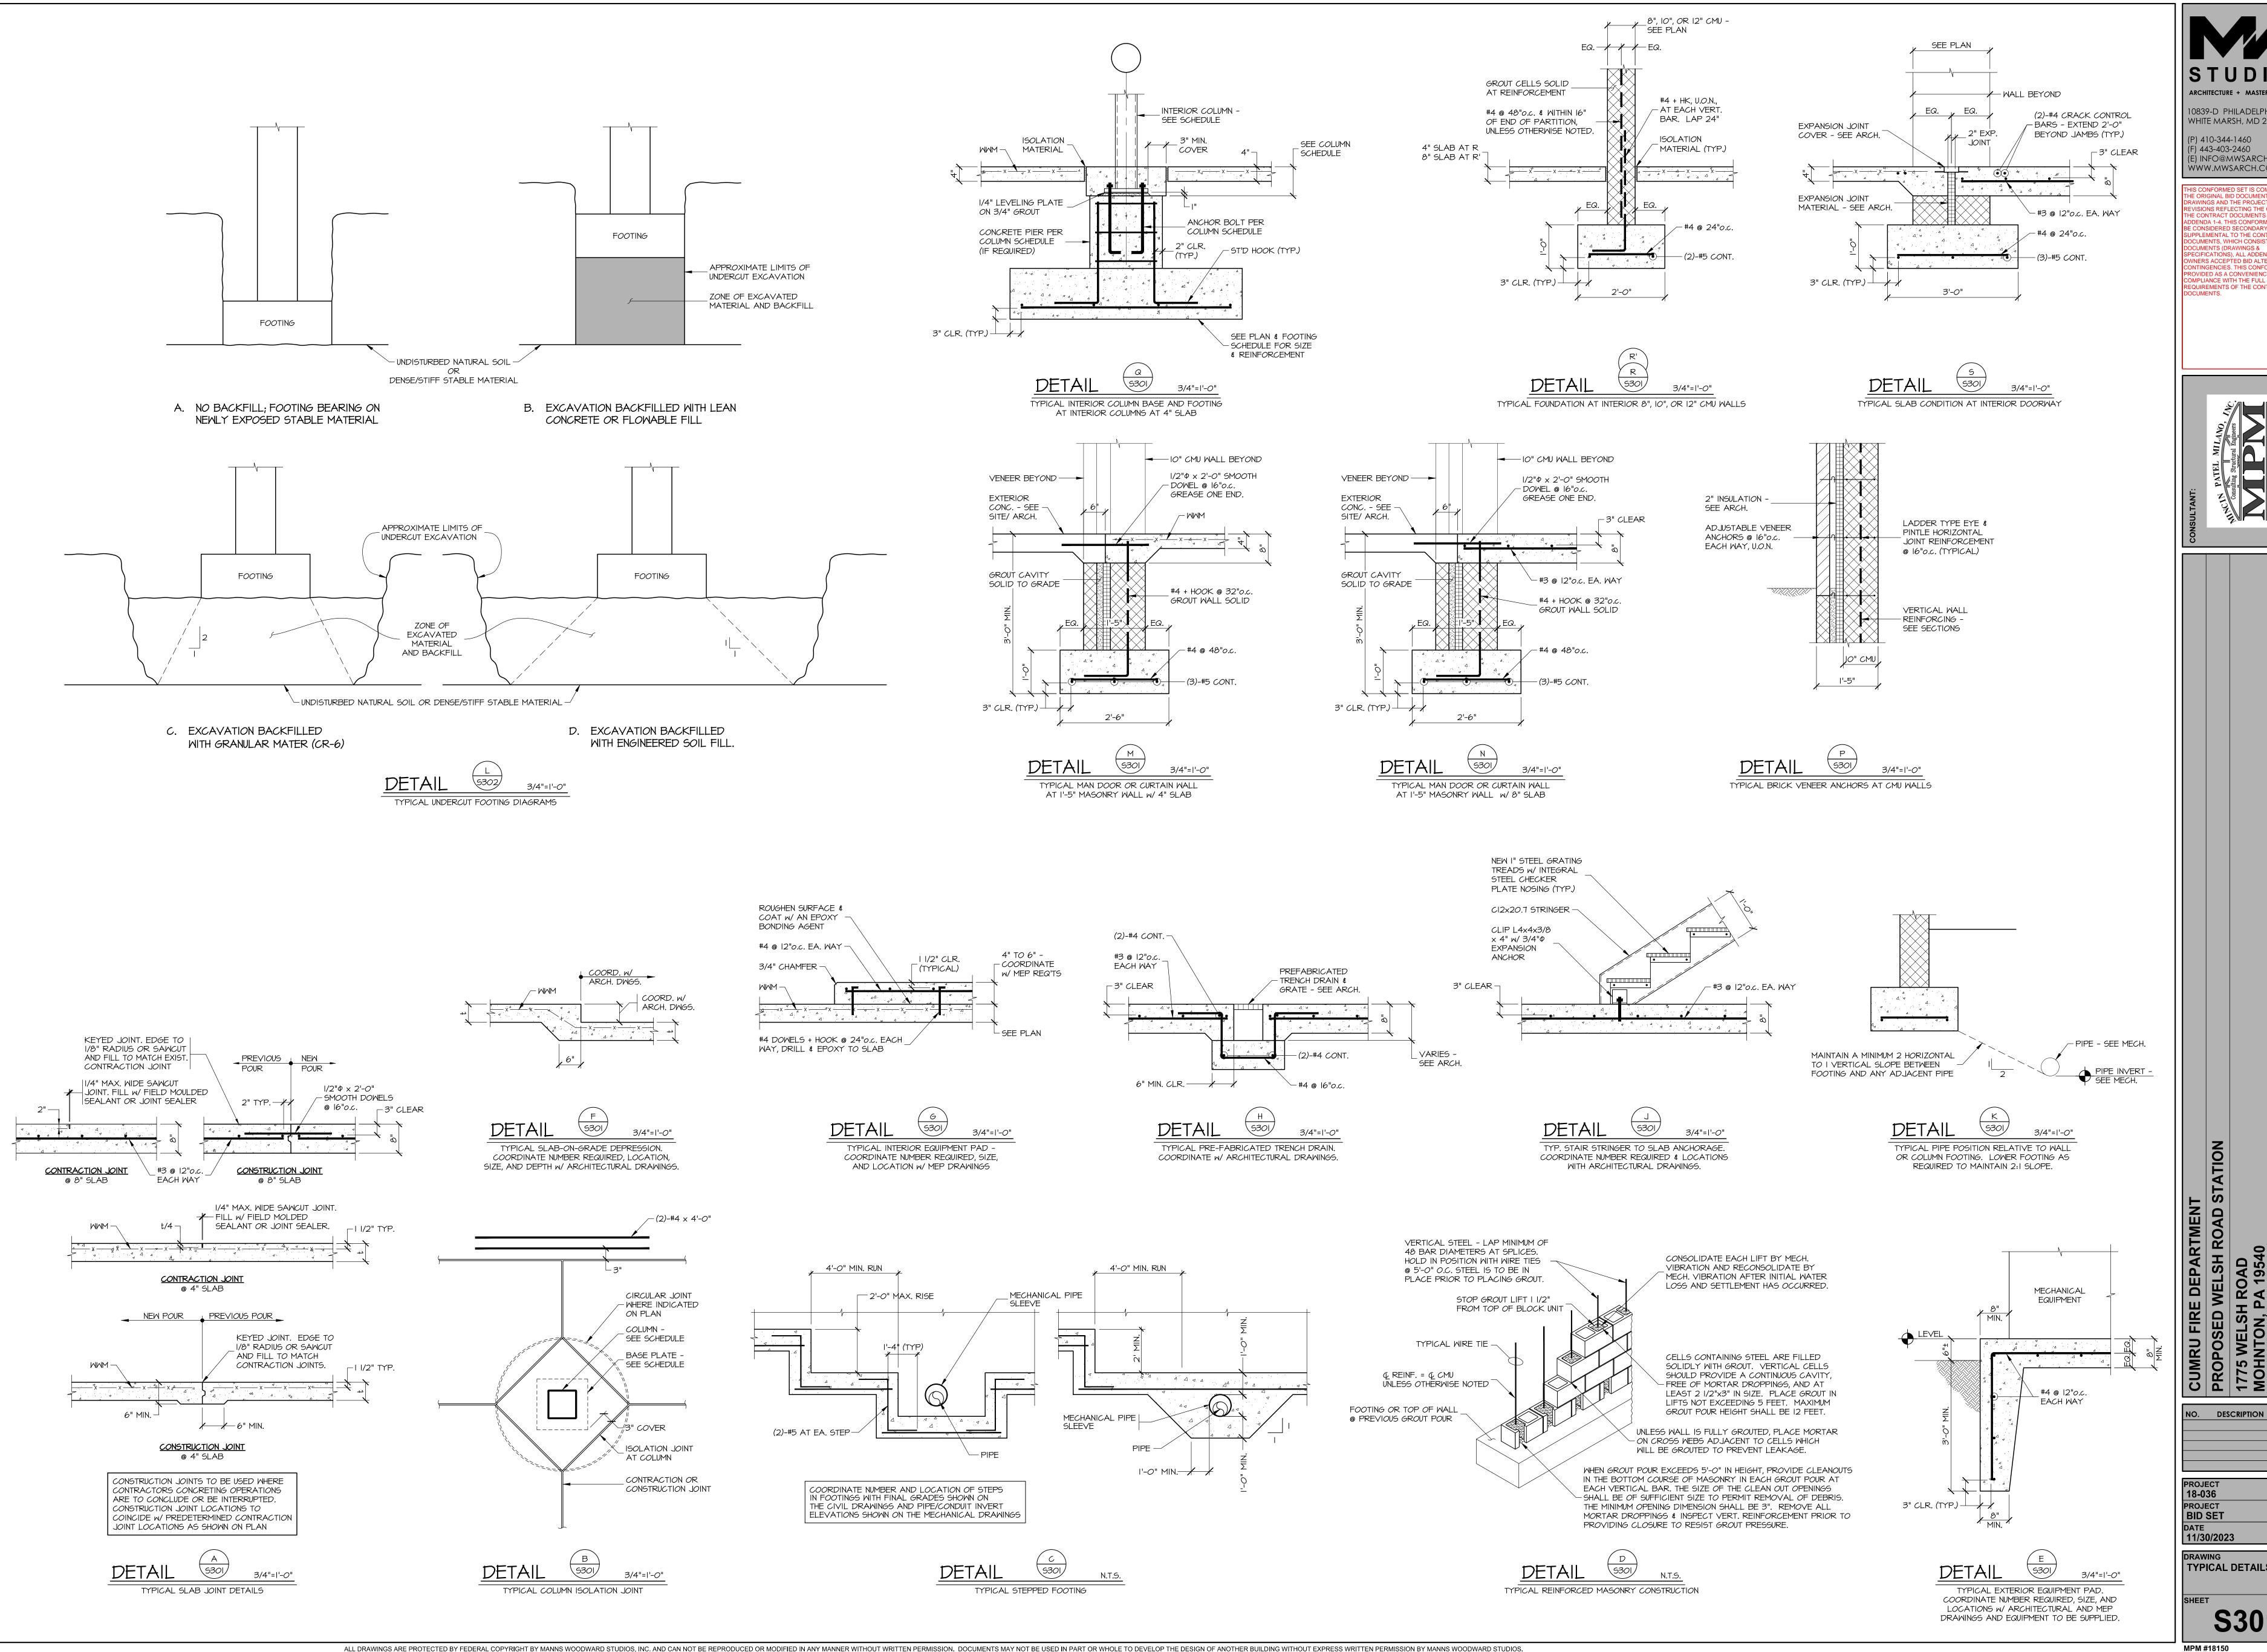
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DESCRIPTION

BID SET 11/30/2023


GENERAL NOTES & SCHEDULES

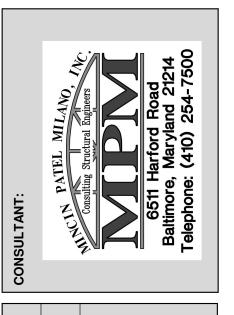

ARCHITECTURE + MASTER PLANNING 10839-D PHILADELPHIA RD WHITE MARSH, MD 21162


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NO. DESCRIPTION DATE


TYPICAL DETAILS

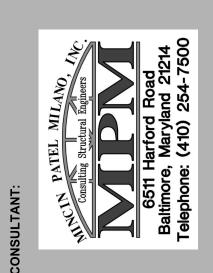

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COMPLIANCE WITH THE FULL
REQUIREMENTS OF THE CONTRACT
OCUMENTS.

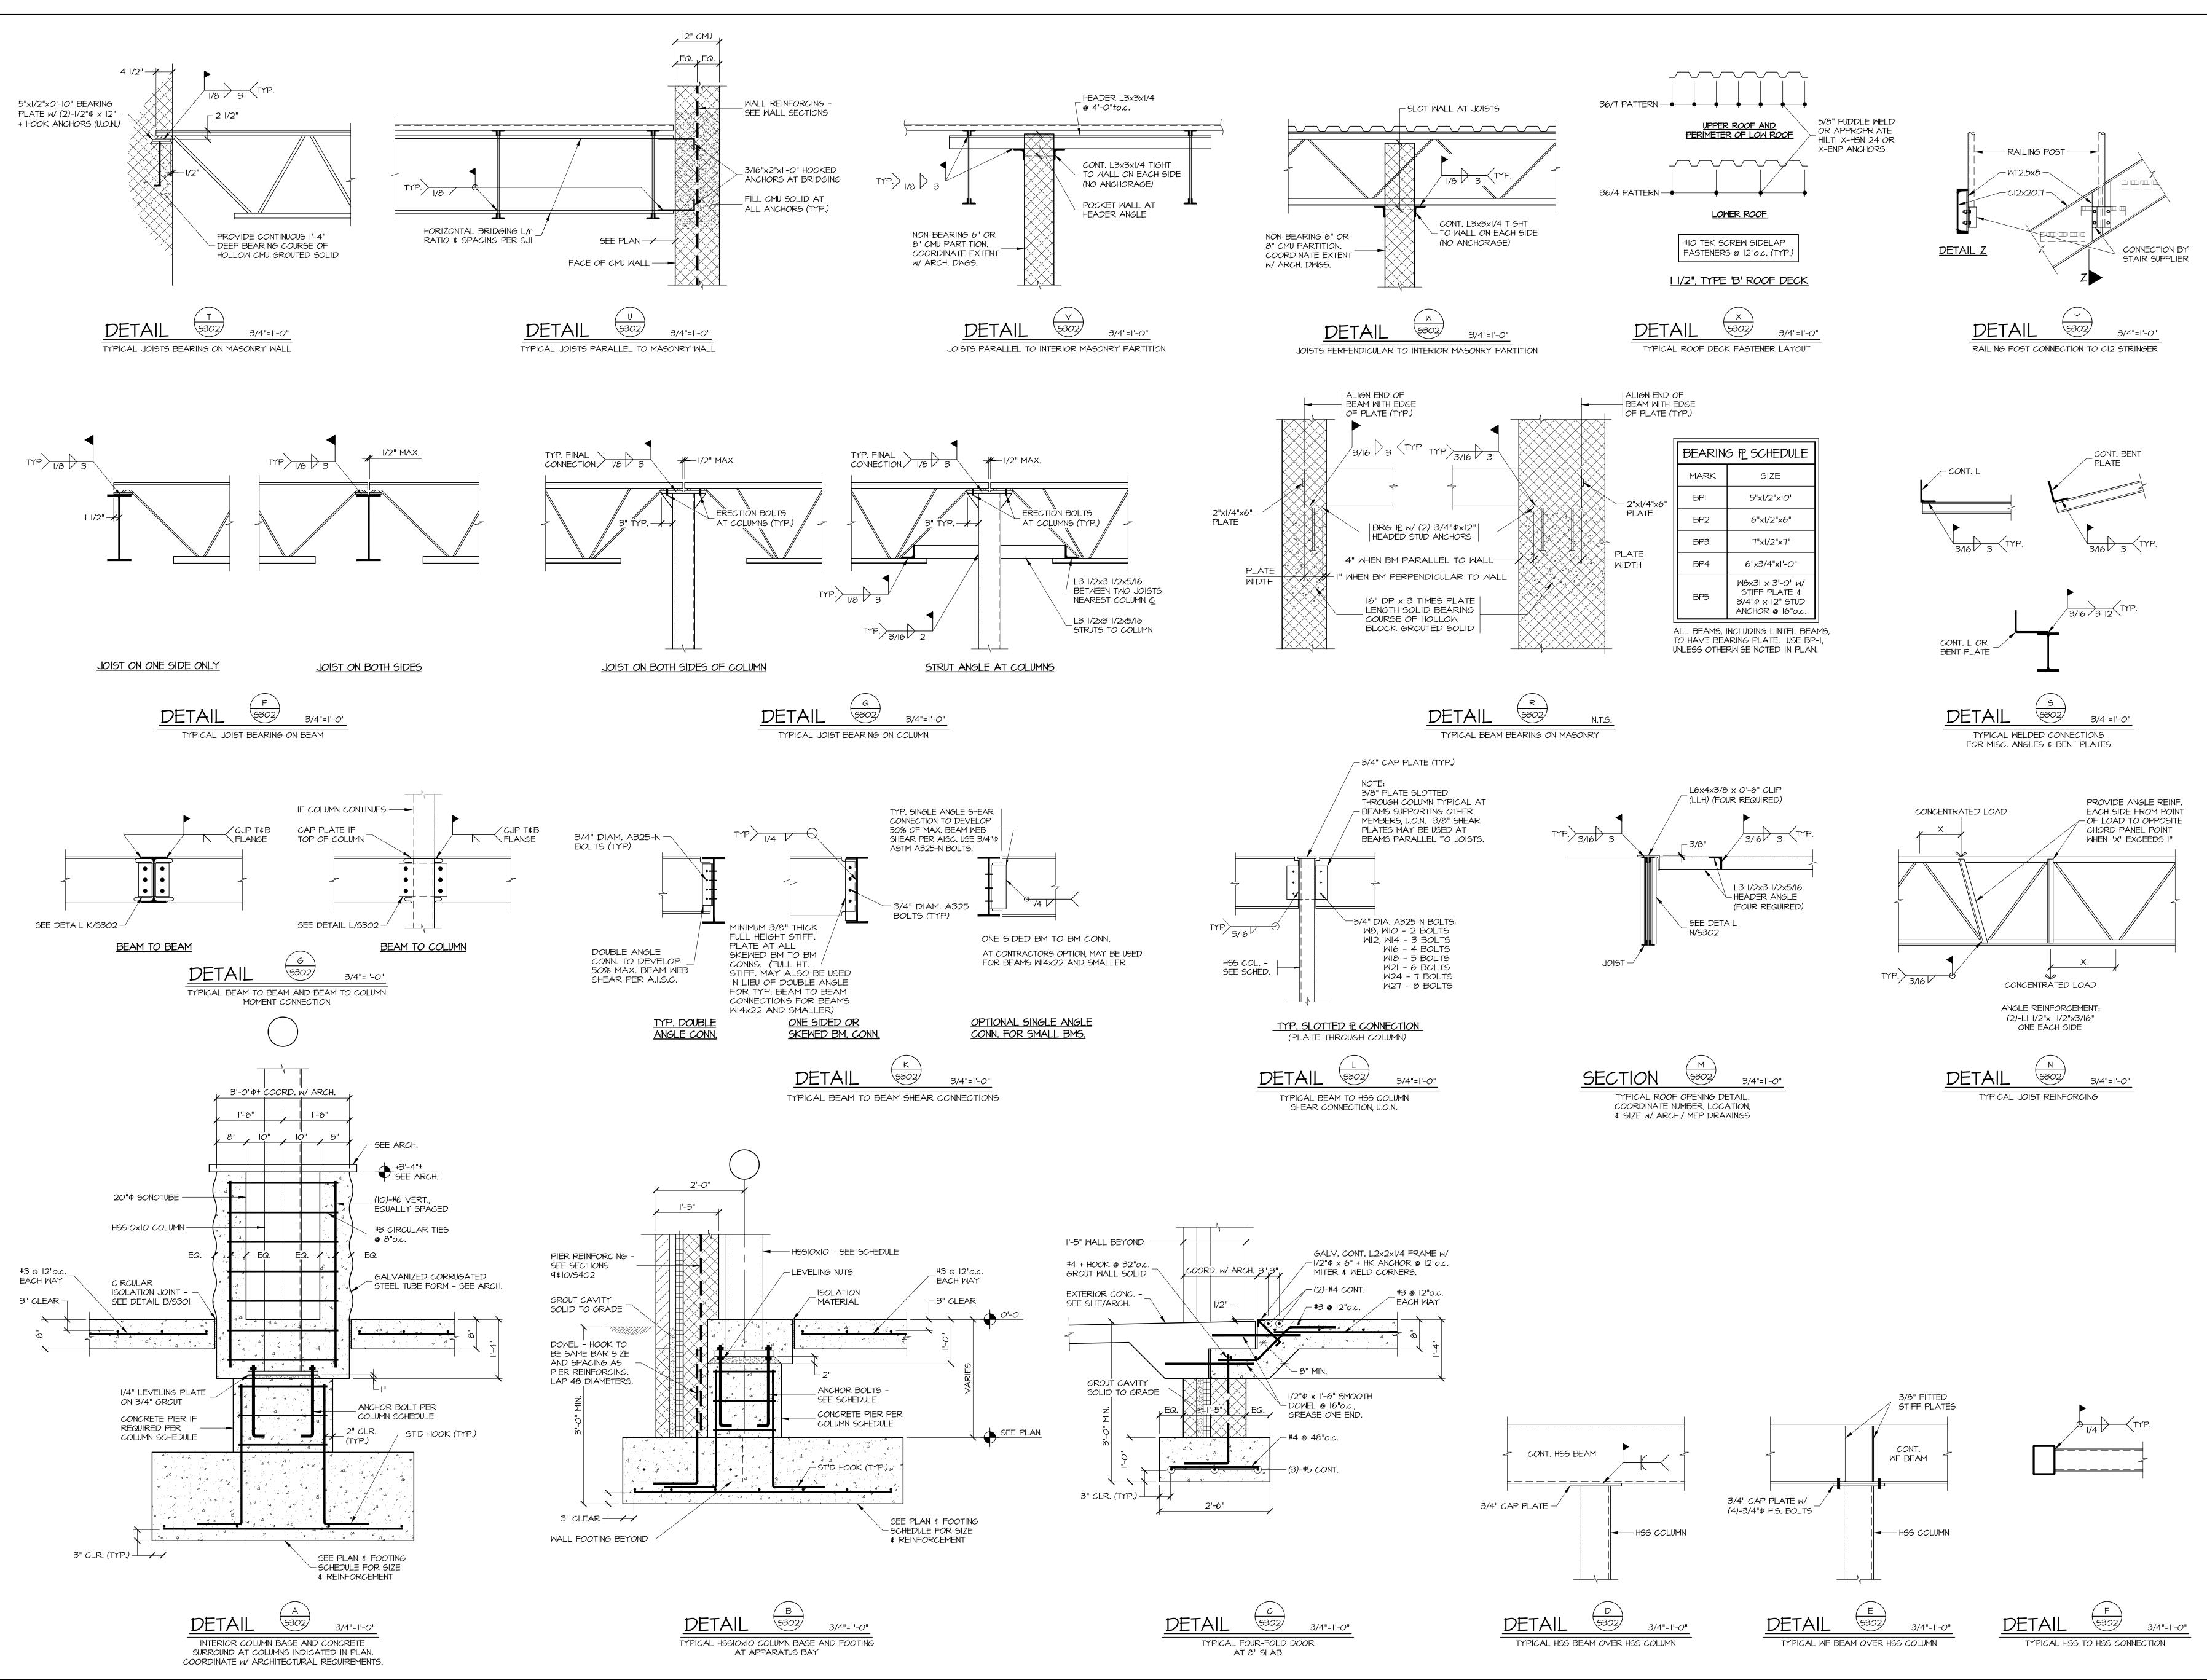

CUMRU FIRE DEPARTMENT
PROPOSED WELSH ROAD STATION
1775 WELSH ROAD
MOHNTON, PA 19540

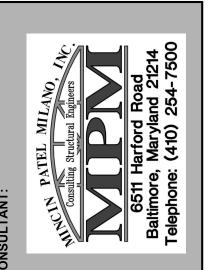NO. DESCRIPTION DATE

PROJECT 18-036 PROJECT BID SET 11/30/2023

TYPICAL DETAILS

MPM #18150