

GREAT VALLEY SCHOOL DISTRICT BOUNDARY

		CS.1	COVER SHEET	
	Architectural		Mechanical	
A001 A002 A003 AD101 A101 A121 A141 A201 A501 A502	CODE REVIEW GENERAL NOTES AND ABBREVIATION INTERIOR PARTITION TYPES FIRST FLOOR DEMOLITION PLAN FIRST FLOOR PLAN FIRST FLOOR DIMENSION PLAN FIRST FLOOR REFLECTED CEILING PLAN ROOF PLAN BUILDING ELEVATIONS & FRAME ELEVATIONS PLAN & SECTION DETAILS CEILING DETAILS	M001 MD100 MD101 M100 M101 M500 M501 M600	COVERSHEET - MECHANICAL FIRST FLOOR DEMOLITION PLAN - MECHANICAL ROOF PLAN - DEMOLITION FIRST FLOOR PLAN NEW ROOF PLAN DETAILS - MECHANICAL DETAILS - MECHANICAL SCHEDULES - MECHANICAL	P000 PD101 P001 P101 P102 P201 P301 P401 P402
A550 A551	INTERIOR DETAILS KITCHEN LAYOUT		Electrical	
A601 A602 A801 A805 A806 A807 A808 A809 A810 A841 A851 A900 A901	DOOR SCHEDULE INTERIOR FRAME ELEVATIONS ENLARGED TOILET RM PLANS, ELEVATIONS & DETAILS CORRIDOR/OPEN WORKSPACE ELEVATIONS CONFERENCE, RECEPTION, COPY ROOM TYPICAL OFFICE ENLARGED PLANS & ELEVATIONS BUSINESS SUITE, CONF & OFFICES PLANS & ELEVS ENLARGED PUBLIC & SUPERINTENDENT AREA PLANS & ELEVATIONS ENLARGED AREA PLANS & ELEVATIONS CASEWORK LEGEND & DETAILS SIGNAGE SCHEDULE AND DETAILS FINISH SCHEDULE FIRST FLOOR FINISH PLAN	E001 ED101 ED102 E101 E201 E202 E401 E402 E403 E501 E502 E503	COVERSHEET - ELECTRICAL FIRST FLOOR DEMOLITION PLAN - ELECTRICAL ROOF DEMOLITION PLAN - ELECTRICAL FIRST FLOOR PLAN - LIGHTING FIRST FLOOR PLAN - POWER ROOF PLAN - POWER FIRST FLOOR PLAN - AV SYSTEMS FIRST FLOOR PLAN - AV SYSTEMS FIRST FLOOR PLAN - ENGLARGED PLANS - AV SYSTEMS AV SYSTEM DETAILS DETAILS AND DIAGRAMS - ELECTRICAL DETAILS AND DIAGRAMS - ELECTRICAL DETAILS AND DIAGRAMS - ELECTRICAL	FP000 FPD101 FP101

E601

SCHEDULES - ELECTRICAL

# RENOVATIONS TO: **GVSD - DISTRICT ADMINISTRATION** OFFICE 100 LINDENWOOD DRIVE MALVERN, PA 19355



DISTRICT ADMINISTRATION OFFICE SITE

Sheet Index

# Plumbing


**COVERSHEET - PLUMBING** FIRST FLOOR PLAN - DEMOLITION - PLUMBING FIXTURE LIST - PLUMBING FIRST FLOOR PLAN - DRAINAGE & VENT - PLUMBING **ROOF PLAN - DRAINAGE & VENT - PLUMBING** FIRST FLOOR PLAN - SUPPLY - PLUMBING ENLARGED PLANS - PLUMBING DETAILS - PLUMBING DETAILS - PLUMBING

# Fire Protection

**COVERSHEET - FIRE PROTECTION** 101 FIRST FLOOR PLAN - DEMOLITION - FIRE PROTECTION **FIRST FLOOR PLAN - FIRE PROTECTION** 





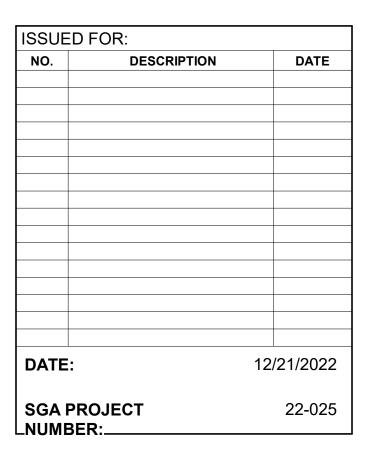

Key Plan: Drawing Title: COVER SHEET


2015 Inte 2015 Inte 2014 NE 2009 Inte Accessib Building containee	ernational Building Code w ernational Residential Cod ernational Fire Code with L ernational Plumbing Code ernational Mechanical Cod ernational Mechanical Cod ernational Fuel Gas Code ernational Energy Conserv ernational Energy Conserv ernational Property Mainte ernational Property Mainte ernational Property Mainte cernational Performance Co bility Requirements, Chapte Code (IBC) for new constr ed in the 2018 International onal Plumbing Code (IPC)	de with PA UCC An Local Amendments de with PA UCC Ame vation Code with PA g Code with PA UC enance Code I Interface Code ectrical Code ode ter 11 and Appendia ruction along with t I Existing Building (	nendments andments A UCC Amen CC Amendme C Amendme
PROJECT DESCRIPTION: THE PROJECT INCLUDES RENOVATION ON 100 LINDENWOOD DRIVE, IN MALVERN, PA. JURISDICTION: E NCLUDES INTERIOR DEMOLITION AND INTERIOR FIT-OUT FOR N FOR THE GREAT VALLEY SCHOOL DISTRICT. <b>NTERNATIONAL EXISTING BUIL</b> <u>CHAPTER 5: CLASSIFICATION OF WORK</u> <u>SECTION 505: ALTERATION LEVEL 3</u> 505.1 SCOPE LEVEL 3 ALTERATIONS APPLY WHERE THE WORK AREA EXCE <b>NTERNATIONAL BUILDING COD</b> CHAPTER 3: USE AND OCCUPANCY CLASSIFICATION	EAST WHITELAND TOWNSHIP. WORK NEW DISTRICT OPERATIONS OFFICES <b>DING CODE, 2015</b> EEDS 50 PERCENT OF THE BUILDING AREA.	SECTION 1109.2.2: WA WHERE WATE WHEELCHAIR- COMPARTMEN AMBULATORY ACCESSIBLE O SECTION 1109.5.1: MIN NO FEWER TH THE REQUIRE REQUIREMEN REQUIREMEN	R FEATURES AND FACIL ATER CLOSET COMPARTME -ACCESSIBLE COMPARTME -ACCESSIBLE COMPART NTS AND URINALS PROV ACCESSIBLE WATER CL COMPARTMENT. NIMUM NUMBER IAN TWO DRINKING FOU MENTS FOR PEOPLE WH TS FOR STANDING PERS TS FOR STANDING PERS TS FOR PEOPLE WHO U FOR TWO SEPARATE D
SECTION 302: CLASSIFICATION BUSINESS, GROUP B		SECTION 1209.3: MECI ACCESS TO M	SS TO UNOCCUPIED SP/ HANICAL APPLIANCES IECHANICAL APPLIANCE RUCTURES SHALL BE IN
CHAPTER 6: TYPES OF CONSTRUCTION TABLE 601: FIRE-RESISTANCE RATING REQUIREMENTS FOR E CONSTRUCTION TYPE IIB (ASSUMED) STRUCTURAL FRAME (COLUMNS, GIRDERS, TRUSSES): BEARING WALLS (INTERIOR, EXTERIOR): NON-BEARING WALLS (INTERIOR, EXTERIOR): FLOOR CONSTRUCTION (INCLUDING BEAMS & JOISTS): ROOF CONSTRUCTION (INCLUDING BEAMS & JOISTS):	BUILDING ELEMENTS (HOURS)		ING SYSTEMS (REFEREN TO RIGHT OF SHEET A00
CHAPTER 8: INTERIOR FINISHES SECTION 803: WALL AND CEILING FINISHES SECTION 803.1.1: INTERIOR WALL AND CEILING FINISH MATER - CLASS A: FLAME SPREAD 0-25; SMOKE-DEVELOPED - CLASS B: FLAME SPREAD 26-75; SMOKE-DEVELOPED - CLASS C: FLAME SPREAD 76-200; SMOKE-DEVELOPE TABLE 803.9: INTERIOR WALL AND CEILING FINISH REQUIREME SPRINKLERED - EXIT ENCLOSURES AND EXIT PASSAGEWAYS - CORRIDORS	0 INDEX 0-450 D INDEX 0-450 ED INDEX 0-450		
- ROOMS AND ENCLOSED SPACES <b>SECTION 804: INTERIOR FLOOR FINISH</b> SECTION 804.4.1: MINIMUM CRITICAL RADIANT FLUX INTERIOR FLOOR FINISH AND FLOOR COVERING MATE PASSAGEWAYS AND CORRIDORS SHALL NOT BE LESS 3 AND NOT LESS THAN CLASS II IN GROUPS A,B,E,H,I-4 COVERING MATERIALS SHALL COMPLY WITH THE DOO 1630). EXCEPTION: WHERE A BUILDING IS EQUIPPED THROU SYSTEM IN ACCORDANCE WITH SECTION 903.3.1.1 OR PERMITTED IN ANY AREA WHERE CLASS I MATERIALS COMPLYING WITH DOC FF-1 "PILL TEST" (CPSC 16 CFR AREA CLASS II MATERIALS ARE REQUIRED.	SS THAN CLASS I IN GROUPS I-1, I-2 AND I -4,M,R-1,R-2 AND S. IN ALL AREAS, FLOOR DC FF-1 "PILL TEST" (CPSC 16 CFR, PART UGHOUT WITH AN AUTOMATIC SPRINKLER R 903.3.1.2, CLASS II MATERIALS ARE S ARE REQUIRED AND MATERIALS		
SECTION 805: COMBUSTIBLE MATERIALS IN TYPES I AND II CO SECTION 805.1: APPLICATION COMBUSTIBLE MATERIALS INSTALLED ON OR EMBEDI OR II CONSTRUCTIONS SHALL COMPLY WITH SECTION EXCEPTION: STAGES AND PLATFORMS CONSTRUCTED AND 410.4, RESPECTIVELY. CHAPTER 9: FIRE PROTECTION SYSTEMS	DDED IN FLOORS OF BUILDINGS OF TYPE I NNS 805.1.1 THROUGH 805.1.3.		
- MAXIMUM TRAVEL DISTANCE <b>SECTION 907: FIRE ALARM AND DETECTION SYSTEMS</b> SECTION 907.2.2: GROUP B A MANUAL FIRE ALARM SYSTEM SHALL BE INSTALLED WHERE ONE OF THE FOLLOWING CONDITIONS EXISTS 1. THE COMBINED GROUP B OCCUPANT LOAD OF ALL 2. THE GROUP B OCCUPANT LOAD IS MORE THAN 100 THE LOWEST LEVEL OF EXIT DISCHARGE. 3. THE FIRE AREA CONTAINS AN AMBULATORY CARE F EXCEPTION: MANUAL FIRE ALARM BOXES ARE NOT REQUIRED EQUIPPED THROUGHOUT WITH AN AUTOMATIC SPRINKLER S' WITH SECTION 903.3.1.1 AND THE OCCUPANT NOTIFICATION A THROUGHOUT THE NOTIFICATION ZONES UPON SPRINKLER V	75 FEET D IN GROUP B OCCUPANCIES TS: L FLOORS IS 500 OR MORE. 0 PERSONS ABOVE OR BELOW E FACILITY. ED WHERE THE BUILDING IS SYSTEM INSTALLED IN ACCORDANCE APPLIANCES WILL ACTIVATE		
CHAPTER 10: MEANS OF EGRESS SECTION 1004: OCCUPANT LOAD TABLE 1004.1.1: MAXIMUM FLOOR AREA ALLOWANCES PER OG - ACCESSORY STORAGE AREAS - ASSEMBLY WITHOUT FIXED SEATS (CONCENTRATED - ASSEMBLY WITHOUT FIXED SEATS (UNCONCENTRAT SECTION 1005: EGRESS WIDTH	300 GROSS D) 7 NET		
SECTION 1005: EGRESS WIDTH SECTION 1005.1: MINIMUM REQUIRED EGRESS WIDTH THE TOTAL WIDTH OF MEANS OF EGRESS IN INCHES S OCCUPANT LOAD SERVED BY THE MEANS OF EGRESS OCCUPANT FOR STAIRWAYS AND BY 0.2 INCHES PER COMPONENTS. SECTION 1005.2: DOOR ENCROACHMENT DOORS, WHEN FULLY OPENED, AND HANDRAILS SHAL OF EGRESS WIDTH BY MORE THAN 7 INCHES.	SS MULTIPLIED BY 0.3 INCHES PER R OCCUPANT FOR OTHER EGRESS		
SECTION 1017: EXIT ACCESS TRAVEL DISTANCE SECTION 1017.1: GENERAL TRAVEL DISTANCE WITHIN THE EXIT ACCESS PORTION SHALL BE IN ACCORDANCE WITH THIS SECTION. TABLE 1016.1: EXIT ACCESS TRAVEL DISTANCE GROUP B - FULLY SPRINKLERED: 300 FEET	)N OF THE MEANS OF EGRESS SYSTEM		
SECTION 1022: NUMBER OF EXITS AND CONTINUITY SECTION 1022.1: GENERAL EXITS SHALL COMPLY WITH SECTION 1022 THROUGH OF SECTIONS 1003 THROUGH 1015. AN EXIT SHALL NC INTERFERES WITH ITS FUNCTION AS A MEANS OF EGF PROTECTION IS ACHIEVED, SUCH A LEVEL OF PROTEC ARRIVAL AT THE EXIT DISCHARGE. EXITS SHALL BE CO ENTRY INTO THE EXIT TO THE EXIT DISCHARGE.	OT BE USED FOR ANY PURPOSE THAT GRESS. ONCE A GIVEN LEVEL OF EXIT ECTION SHALL NOT BE REDUCED UNTIL		
SECTION 1028: EXIT DISCHARGE SECTION 1028.1: GENERAL EXITS SHALL DISCHARGE DIRECTLY TO THE EXTERIOF SHALL BE AT GRADE OR SHALL PROVIDE A DIRECT PA EXIT DISCHARGE SHALL NOT REENTER A BUILDING. TI 2 SHALL NOT EXCEED 50 PERCENT OF THE NUMBER A OF THE REQUIRED EXITS.	ATH OF EGRESS TRAVEL TO GRADE. THE THE COMBINED USE OF EXCEPTIONS 1 AND	Y	1 

### dments

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018 International ility provisions , the 2018

# **SYMBOL KEY**

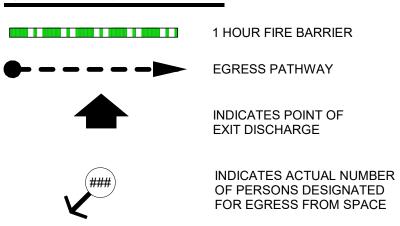

FEC

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INDICATES POINT OF

OF PERSONS DESIGNATED FOR EGRESS FROM SPACE

FIRE EXTINGUISHER CABINET

TRAVEL DISTANCE		
MARK TRAVEL DISTANCE		
1A	72' - 2"	
1B	127' - 0"	
1C	117' - 11 19/64"	

ILITIES RTMENT


MENTS ARE PROVIDED IN A TOILET ROOM OR BATHING ROOM, AT LEAST ONE RTMENT SHALL BE PROVIDED. WHERE THE COMBINED TOTAL WATER CLOSET OVIDED IN A TOILET ROOM OR BATHING ROOM IS SIX OR MORE, AT LEAST ONE R CLOSET COMPARTMENT SHALL BE PROVIDED IN ADDITION TO THE WHEELCHAIR-

OUNTAINS SHALL BE PROVIDED. ONE DRINKING FOUNTAIN SHALL COMPLY WITH WHO USE A WHEELCHAIR AND ONE DRINKING FOUNTAIN SHALL COMPLY WITH THE ERSONS. EXCEPTION: A SINGLE DRINKING FOUNTAIN THAT COMPLIES WITH THE USE WHEELCHAIRS AND STANDING PERSONS SHALL BE PERMITTED TO BE DRINKING FOUNTAINS.

### SPACES

CES INSTALLED IN UNDER-FLOOR AREAS, IN ATTIC SPACES AND ON ROOFS OR E IN ACCORDANCE WITH THE INTERNATIONAL MECHANICAL CODE.

ENCE PHILADELPHIA PLUMBING CODE, SECTION P-701.0)

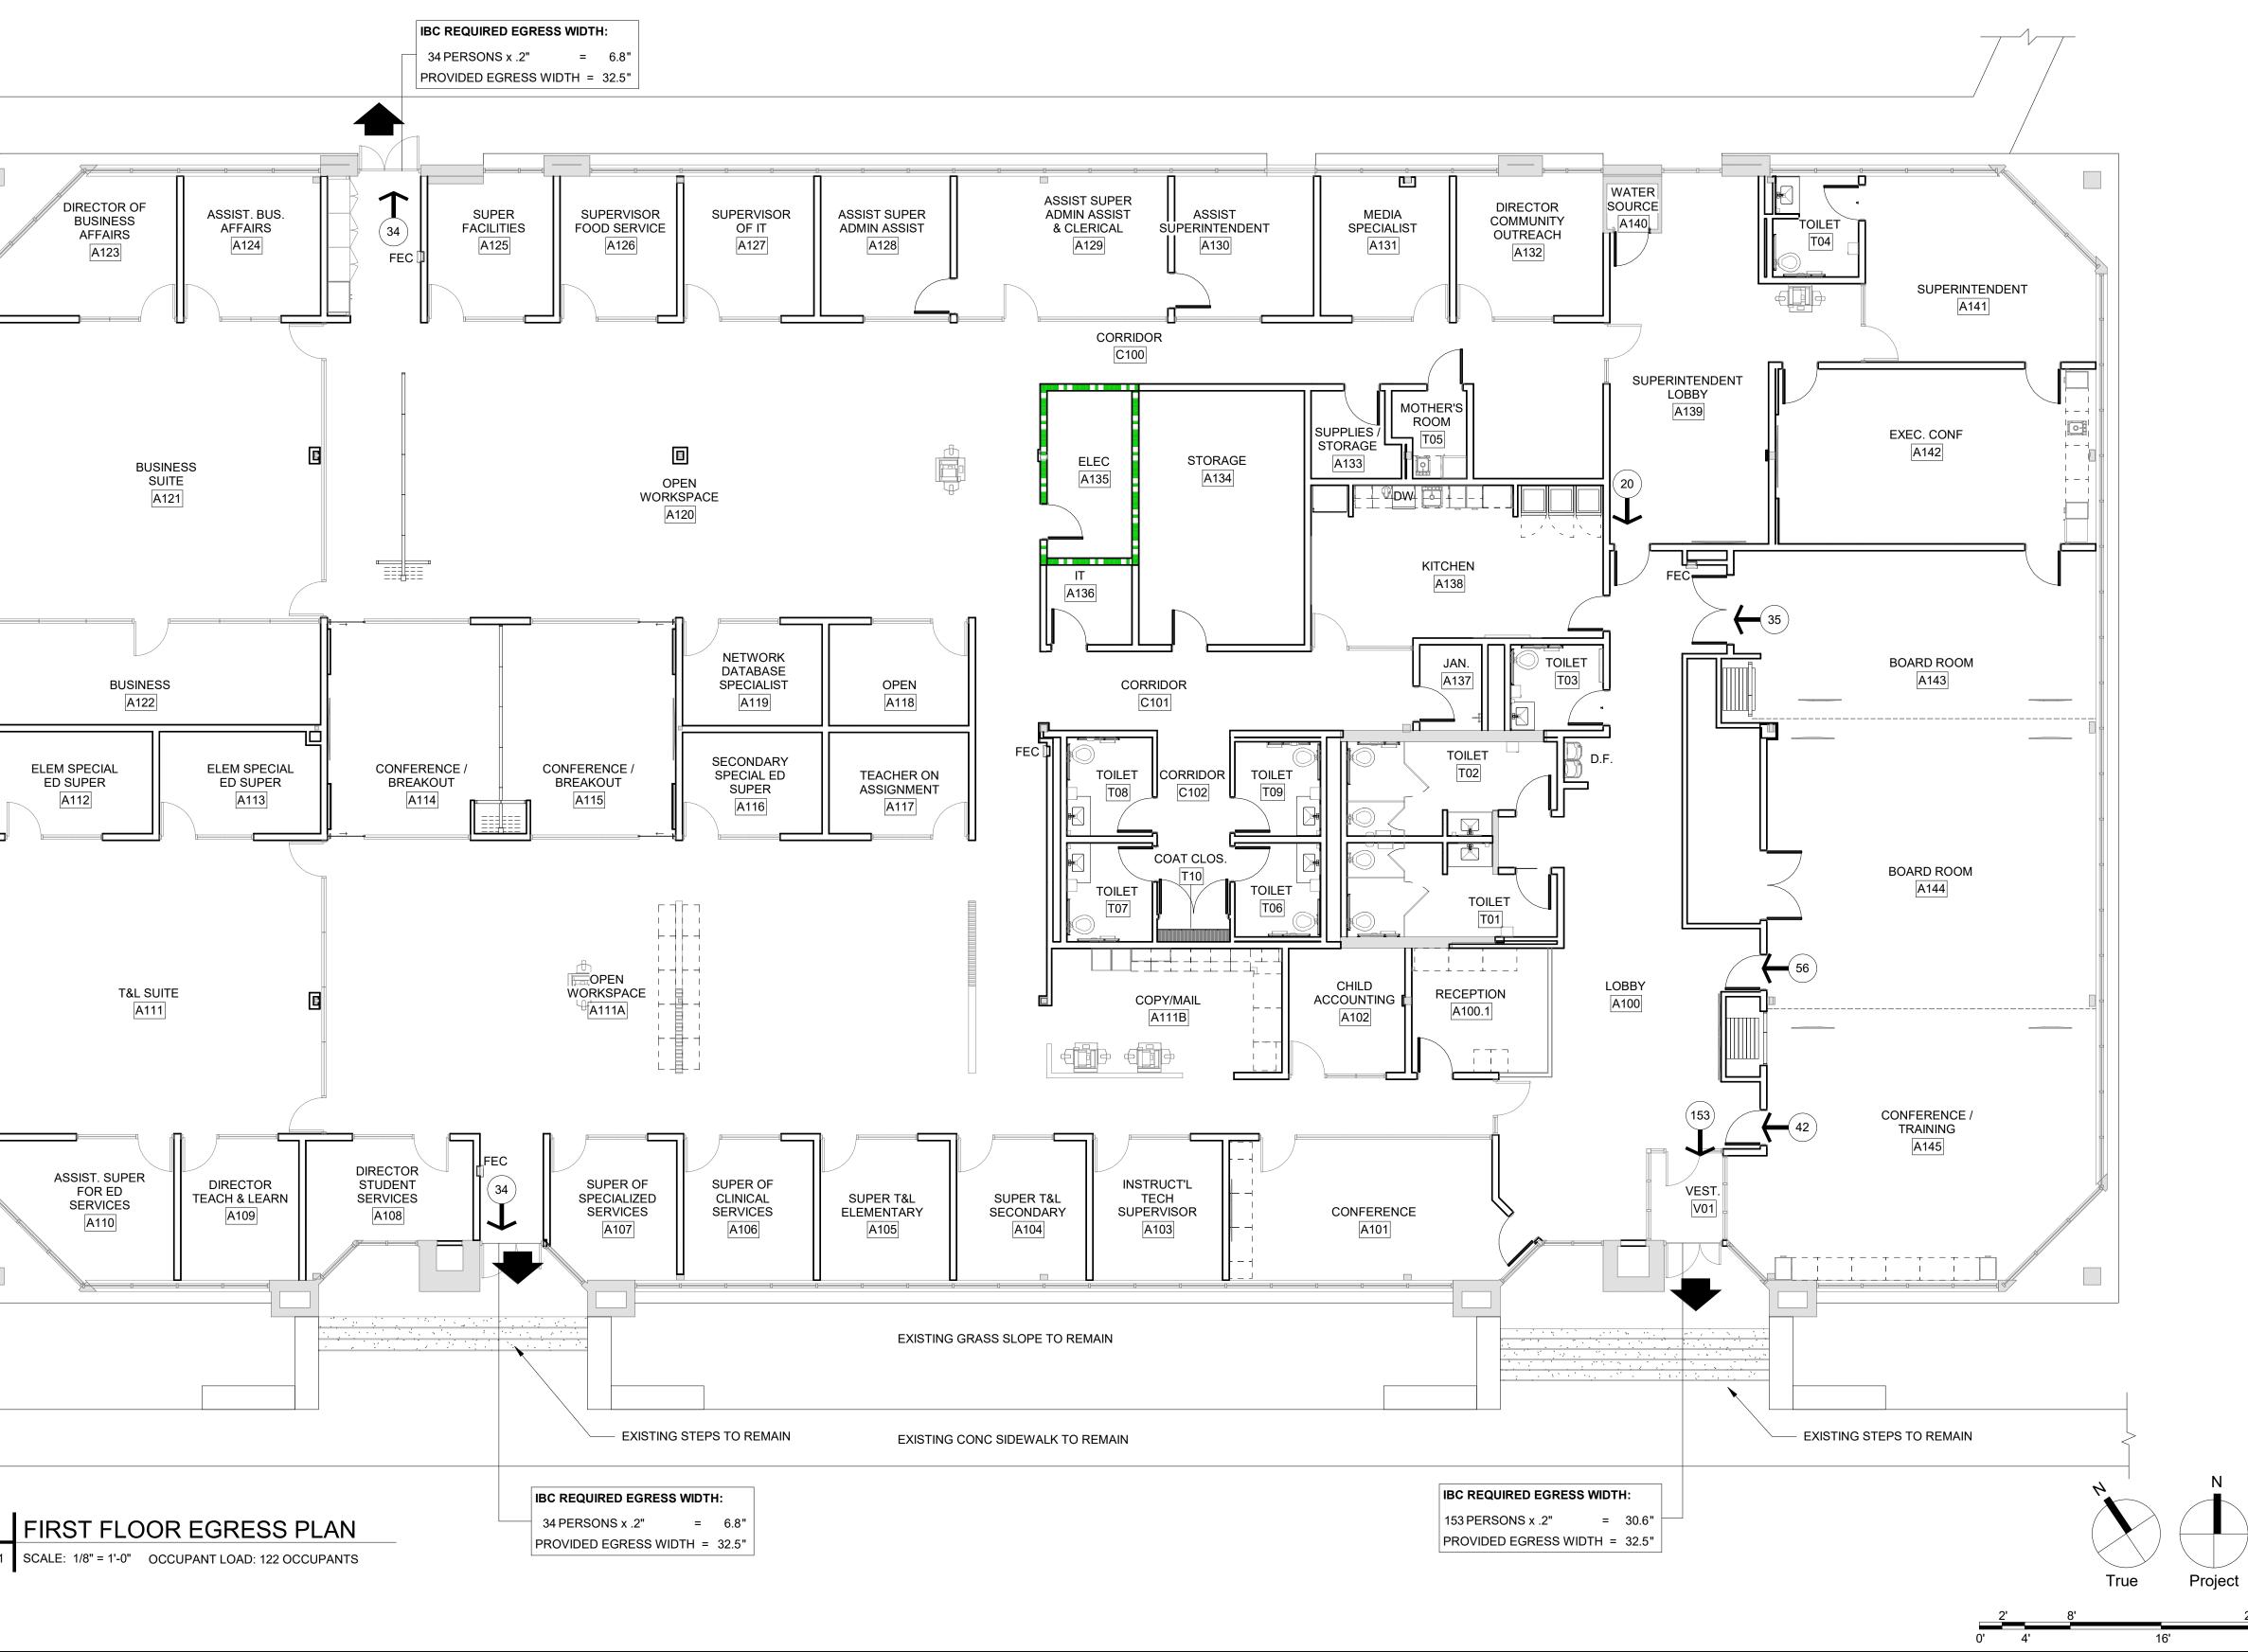



BUILDING CONSTRUCTION DATA (CHAPTER 5 OF IBC 2015)						
AREA	GROUP	CONSTRUCTION TYPE	BUILDING AREA	ALLOWABLE AREA	MAXIMUM HEIGHT	ALLOWABLE HEIGHT
FIRE AREA 1	BUSINESS - 'B'	* IIB - ANY NONCOMBUSTIBLE MATERIAL PERMITTED BY CODE	18,153 SF	** 43,500 SF	14'-8"	75 FEET, 3 STORIES


OCCUPANCY 'E'; SM = BUILDINGS TWO OR MORE STORIES ABOVE GRADE PLANE EQUIPPED THROUGHOUT WITH AN AUTOMATIC SPRINKLER SYSTEM INSTALLED IN ACCORDANCE WITH SECTION 903.3.1.1


\* EXCEPTIONS PERMITTED BY SECTION 603, COMBUSTIBLE MATERIAL IN TYPE I AND II CONSTRUCTION.


\*\* FRONTAGE INCREASE ALLOWED BY CODE, BUT NOT NEEDED FOR CONFORMANCE WITH ALLOWABLE AREA CALCULATION; THEREFORE NOT INCLUDED.

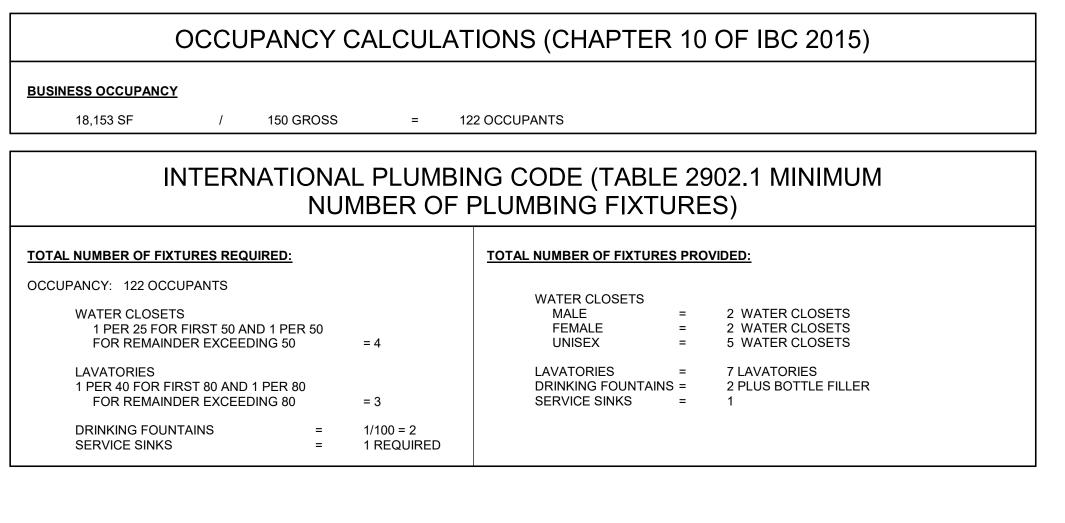

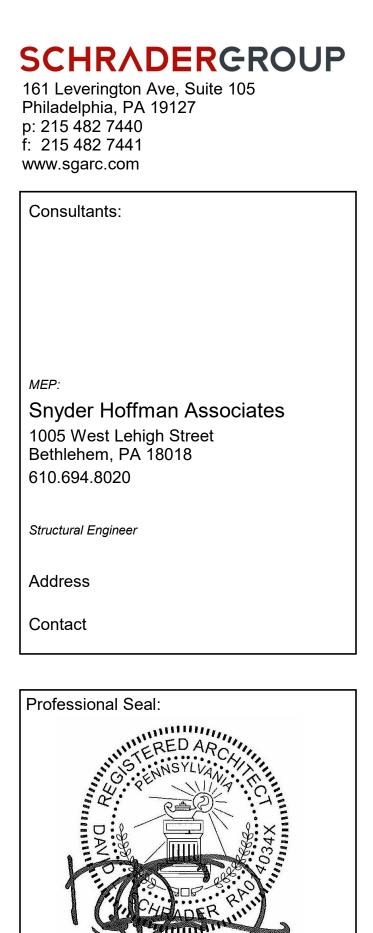

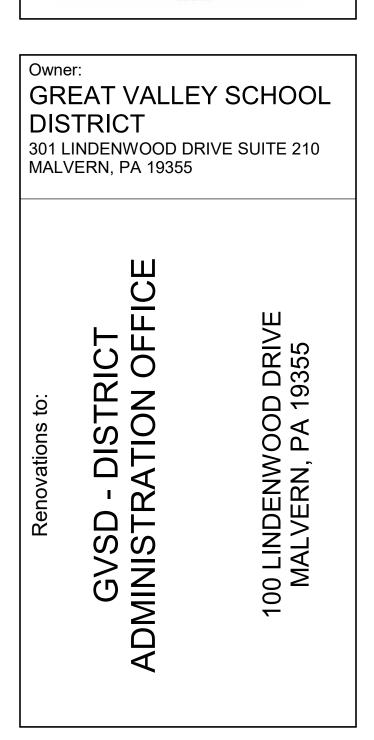

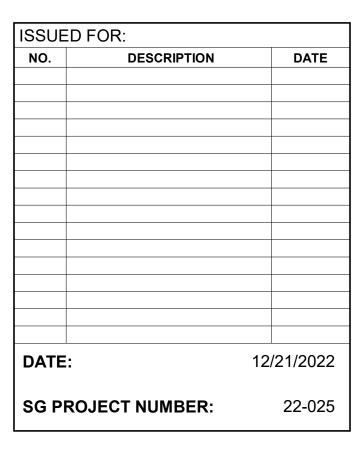

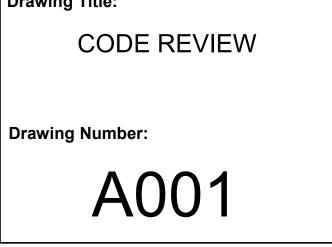

### **GENERAL NOTES**

				,,
1.	THE CONTRACTOR SHALL INVESTIGATE JOB SITE TO COMPARE CONTRACT DOCUMENTS AND EXISTING CONDITIONS. INCLUDE COST FOR ALL WORK DESCRIBED IN CONTRACT DOCUMENTS AND REQUIRED OR IMPLIED BY EXISTING	20.		TO TERMINATE A MINIMUM OF 8" BELOW FERENCE CIVIL DRAWINGS FOR PROPOSED
	CONDITIONS. NOTIFY ARCHITECT OF ANY OMISSIONS OR CONFLICTS IN THE DRAWINGS AND ANY RESTRICTIONS RELATED TO THE EXECUTION OF THE WORK.		CONTROL JOINTS IN GYPSUM BO CEILINGS SHALL BE SPACED AS F	ARD PARTITIONS AND GYPSUM BOARD FOLLOWS:
2.	THE CONTRACTOR SHALL COMPLY AND COORDINATE ALL WORK WITH BUILDING OWNER REGARDING HEAT, WATER, ELECTRICITY, DELIVERIES, ACCESS, ELEVATOR AVAILABILITY, NOISE CONTROL, TRASH AND DEBRIS REMOVAL, HOISTING, AND ANY OTHER UTILITIES OR OWNER'S RULES AND REGULATIONS CONCERNING THE PROJECT SITE.		PARTITIONS INTERIOR CEILINGS EXTERIOR CEILINGS	- 30 FT. MAXIMUM IN EITHER DIRECTION. - 30 FT. MAXIMUM IN EITHER DIRECTION. - 30 FT. MAXIMUM IN EITHER DIRECTION.
3.	THE CONTRACTOR SHALL COORDINATE SCHEDULING, PROVISIONS FOR INSTALLATION, LOCATIONS AND THE ACTUAL INSTALLATION OF ITEMS FURNISHED BY OWNER OR BY OTHERS.	22.		ATED WALLS ARE TO BE SEALED TO MAINTAIN FION AND RATING (ASTM E814 SYSTEM BY 3M,
4		23.	ALL INSULATION EXPOSED TO CE	ILING PLENUM IS TO BE FIRE AND DUST PROC
4.	THE CONTRACTOR SHALL VERIFY ALL DIMENSIONS IN THE FIELD AND IS RESPONSIBLE FOR ALL PHASES INCLUDING BIDDING, FABRICATION, COORDINATION AND CONSTRUCTION. CONTRACT DRAWINGS ARE NOT INTENDED	24.		RN GRILLES SHALL BE LOCATED IN THE CENTE ESS OTHERWISE INDICATED ON PLANS.
5.	TO REPRESENT EXACT DIMENSIONS. DO NOT SCALE DRAWINGS. DIMENSIONS GOVERN. LARGE SCALE DETAILS	25.		ITH MANUFACTURER'S INSTRUCTIONS WHEN G ANY EQUIPMENT AND FURNISHINGS.
6.	GOVERN OVER SMALL SCALE DETAILS. THE CONTRACTOR SHALL SUBMIT FOR ARCHITECT'S REVIEW PRIOR TO	26.	CONTRACTOR SHALL VERIFY EQUINSTALLATION.	UIPMENT LOCATIONS WITH OWNER PRIOR TO
	FABRICATION OR PURCHASE, SHOP DRAWINGS OR SAMPLES FOR ALL MILLWORK, CUSTOM METALWORK, CUSTOM CASEWORK, AND ALL OTHER ITEMS AS REQUESTED BY THE ARCHITECT FOR ALL ABOVE BUILDING STANDARD ITEMS.	27.	BUT NOT LIMITED TO PIPE, COND BOXES, HANGER RODS, ETC. SHA	RYWALL AND MASONRY SURFACES INCLUDING UIT, DUCTWORK, GRILLES, REGISTERS, DEVIC ALL HAVE THEIR COMMON JOINTS WITH
7.	CHANGES IN DRAWINGS OR ACTUAL WORK MUST BE ISSUED BY THE ARCHITECT.	00		ULKED TO PROVIDE AN AIR-TIGHT SEAL.
8.	PERFORM ALL WORK AND INSTALL MATERIALS IN STRICT ACCORDANCE WITH MANUFACTURER'S SPECIFICATIONS AND INSTRUCTIONS AND IN A MANNER CONSISTENT WITH INDUSTRY STANDARD OF WORKMANSHIP.	28.	DURING THE CONSTRUCTION PR FOR REMOVING ALL TEMPORARY	STRAY PAINT, DIRT, OR STAINS INCURRED OCESS. CONTRACTOR SHALL BE RESPONSIB Y EQUIPMENT COVERINGS USED DURING ALSO BE RESPONSIBLE FOR REMOVING HIS
9.	THE CONTRACTOR SHALL EXAMINE ALL SURFACES TO DETERMINE THAT THEY ARE SOUND, DRY, CLEAN AND READY TO RECEIVE FINISHES PRIOR TO INSTALLATION. START OF INSTALLATION SHALL IMPLY ACCEPTANCE OF SUBSTRATE AND SHALL NOT BE GROUNDS FOR CLAIMS AGAINST IMPROPER PERFORMANCE OF INSTALLED MATERIALS. ADVISE ARCHITECT OF ANY EXISTING CONSTRUCTION NOT LEVEL, SMOOTH AND PLUMB WITHIN INDUSTRY STANDARDS PRIOR TO START OF CONSTRUCTION.	29.	THE CONTRACTOR SHALL PERFO COMPLIANCE WITH THE PUBLISH SHALL PROVIDE FIRE WATCHES I OPERATIONS. THE TRAINING OF	ORM ALL CUTTING AND WELDING IN ED STANDARDS OF NFPA. THE CONTRACTOR FOR ALL CUTTING, GRINDING, AND WELDING THESE FIRE WATCHES AND THE USE OF THE EXTINGUISHERS IS THE RESPONSIBILITY OF TH
10.	PROTECTIVE ENCLOSURES, TEMPORARY DOORS AND PARTITIONS AND DUST BARRIERS TO PROTECT ALL OCCUPANTS AND EXISTING WORK AND FINISHES TO REMAIN. LOCATION OF SUCH PROTECTION SHALL BE VERIFIED WITH OWNER AND LOCAL CODE OFFICIALS FOR EGRESS CONFORMANCE, PRIOR TO	30.	OF UTILITY WALL PENETRATIONS	
ANE		31.	ALL FIXTURES LABELED "	NDICATE HANDICAP ACCESSIBLE FIXTURES.
	COMMENCING WORK AND IN COORDINATION WITH PROGRESSION OF WORK SCHEDULE. PERFORM WORK IN A MANNER THAT WILL AVOID HAZARDS TO PERSONS IN ADJACENT AREAS AND THAT WON'T INTERFERE WITH WORK OR		WHERE TWO DISSIMILAR METALS PAINT.	S MEET, PAINT FACE OF ONE WITH BITUMINOU
	PASSAGE TO ANY OF THESE AREAS. REPAIR AND REPLACE ANY DAMAGES CAUSED BY IMPROPER PROTECTIONS AT NO ADDITIONAL CHARGE TO OWNER.	33.	ALL EXTERIOR ENTRANCE DOOR WEATHER STRIPPING AS PER SP	S AND FRAMES TO RECEIVE PERIMETER ECIFICATIONS.
11.	WORK DAMAGED DURING CONSTRUCTION OR NOT CONFORMING TO SPECIFIED STANDARDS, TOLERANCES OR MANUFACTURER'S INSTRUCTIONS FOR INSTALLATION SHALL BE REPLACED, BY THE CONTRACTOR, AT NO ADDITIONAL CHARGE TO THE OWNER.	34.	CONTRACTOR IS TO PROVIDE ST PARTITIONS ABOVE 10'-0".	UD BRACING AS REQUIRED FOR METAL STUD
12.	THE CONTRACTOR SHALL MAINTAIN ALL EXITS, EXIT LIGHTING, FIRE PROTECTION DEVICES AND LIFE SAFETY SYSTEMS IN WORKING ORDER. CONTRACTOR TO PROVIDE TEMPORARY FIRE EXTINGUISHERS DURING THE COURSE OF	35.	WALKS, PAVEMENT MULCH, ETC.	ST BE LOCATED ABOVE GRADE, CONCRETE DO NOT COVER UNDER ANY CIRCUMSTANCE SONRY WORK IS RESPONSIBLE FOR VORK (TYPICAL).
13.	CONSTRUCTION AS REQ'D BY THE AUTHORITIES HAVING JURISDICTION . EXIT DOORS, EGRESS DOORS, AND OTHER DOORS REQUIRED FOR MEANS OF	36.		OF CONSTRUCTION DISTURBED BY OPERATION RESTORED AT THE CONTRACTORS EXPENSE
14.	EGRESS SHALL BE OPERABLE FROM THE INSIDE WITHOUT USE OF A KEY OR SPECIAL KNOWLEDGE OR EFFORT.	37.		F, CURBS AND LANDSCAPING DAMAGED DURIN AIRED BY CONTRACTOR AT NO ADDITIONAL
14.	CONTRACTOR SHALL FULLY ACQUAINT HIMSELF WITH THE CONDITIONS OF THE CONTRACT, LOCAL CONDITIONS RELATING TO LOCATION, ACCESSIBILITY AND GENERAL CHARACTER OF THE CONSTRUCTION SITE AND LOCAL LABOR CONDITIONS SO THAT HE UNDERSTANDS THE NATURE, EXTENT, DIFFICULTIES, AND RESTRICTIONS RELATED TO THE EXECUTION OF WORK. NOTIFY ARCHITECT OF ALL DISCREPANCIES PRIOR TO COMMENCING WORK.	38.	CONTRACTOR IS RESPONSIBLE F	FOR KEEPING ALL WEEP JOINTS AROUND . STORE FRONTS FREE OF CAULK.
		39.	PARTITIONS FOR ALL CABINET W	KING SHALL BE PROVIDED AT DRYWALL ORK AT TOP AND BOTTOM OF WALL MOUNTEI
15.	ALL WOOD BLOCKING IN FIRE RATED ASSEMBLIES TO BE FIRE RETARDANT.		UNITS AND UNDER COUNTER TO SHELVING UNITS SHALL HAVE CO	P LEVEL OF BASE CABINET. ALL OPEN-FACE INCEALED ANCHOR BRACKETS.
16.	ALL WOOD ON EXTERIOR WALLS AND ROOF TO BE MOISTURE RESISTANT.	40.		S, LOUVERS, VENTS, EXHAUST FANS, PIPE
17.	IN ALL INSTANCES WHERE WORK IS BEING CORRECTED OR REPAIRED, CONTRACTOR IS TO REPAINT ENTIRE WALL TO NEAREST CORNER OR BREAK- LINE WHERE WALL CHANGES DIRECTION.			PENETRATIONS THRU EXTERIOR WALLS SHAI RIMETER WITH SEALANT. (BOTH ON EXTERIOR S NOTED IN NOTE 38.
18.	CONTRACTOR TO COORDINATE WITH E.C. THE MOUNTING HEIGHT OF ALL SWITCHES AND OUTLETS AT MILLWORK, COUNTERS, SHELVING, SINKS, ETC.	41.	WITH 20 GA. MIN. STUDS AT 12" O CHANNELS AT 4'-0" O.C. (MAX.) AN	H RECEIVE CERAMIC TILE SHALL BE FRAMED C.C. W/ HORIZONTAL COLD ROLLED STIFFENER ND EXTEND FROM FINISHED FLOOR TO ONAL STUD KICKERS MUST ALSO BE INSTALLE D ABOVE CEILING.
		40		

42. FIRE EXTINGUISHER CABINETS TO BE MOUNTED 4'-0" A.F.F. TO TOP MAXIMUM IN ACCORDANCE ACCESSIBILITY REQUIREMENTS. (FIRE EXTINGUISHERS WITH GROSS WEIGHT OVER 40LBS. MUST BE MOUNTED 3'-6" MAX.). CLEARANCE BETWEEN THE BOTTOM OF THE FLOOR AND THE EXTINGUISHER MAY NOT BE LESS THAN 4".)

CONTRACTOR IS TO PROVIDE ALL MISC. FRAMING, BLOCKING, ETC. TO HANG SCREENS, BULLETIN BOARDS, RAILS, TOILET ACCESSORIES, WOODWORK, ETC. /ES TO TERMINATE A MINIMUM OF 8" BELOW REFERENCE CIVIL DRAWINGS FOR PROPOSED

19.

CEILING PLENUM IS TO BE FIRE AND DUST PROOF. TURN GRILLES SHALL BE LOCATED IN THE CENTER NLESS OTHERWISE INDICATED ON PLANS. Y WITH MANUFACTURER'S INSTRUCTIONS WHEN LING ANY EQUIPMENT AND FURNISHINGS. EQUIPMENT LOCATIONS WITH OWNER PRIOR TO

NY STRAY PAINT, DIRT, OR STAINS INCURRED PROCESS. CONTRACTOR SHALL BE RESPONSIBLE ARY EQUIPMENT COVERINGS USED DURING L ALSO BE RESPONSIBLE FOR REMOVING HIS DAILY.

S OF CONSTRUCTION DISTURBED BY OPERATIONS BE RESTORED AT THE CONTRACTORS EXPENSE. ALT, CURBS AND LANDSCAPING DAMAGED DURING

HICH RECEIVE CERAMIC TILE SHALL BE FRAMED 2" O.C. W/ HORIZONTAL COLD ROLLED STIFFENER ) AND EXTEND FROM FINISHED FLOOR TO ÁGONAL STUD KICKERS MUST ALSO BE INSTALLED TUD ABOVE CEILING.

# **TYPICAL ABBREVIATIONS:**

AP ACT AFF AHU ALUM, AL ARCH ASPH ATTCHMT BD BLDG	ACOUSTICAL PANEL ACOUSTICAL CEILING TILE ABOVE FINISHED FLOOR AIR HANDLING UNIT ALUMINUM ARCHITECTURAL ASPHALT ATTACHMENT BOARD BUILDING	FIN FL. FLSH FLUOR F.O.S. FR(G) FRTW FT FUR FVC
BLK BM B.O.S. BRG BRK BTM BYND	BLOCK(ING) BEAM BOTTOM OF SLAB BEARING BRICK BOTTOM BEYOND	GA GALV GC G.I. GL GM GR
CJ CLO. CLG CLR CMU C.O. COL CONC CONT CORR COV CPT CT/CER C.U.H. CW	CONTROL OR CONSTRUCTION JOINT CLOSET CEILING CLEAR CONCRETE MASONRY UNIT CLEAN OUT COLUMN CONCRETE CONTINUOUS CORRIDOR COVER CARPET CERAMIC TILE/CERAMIC CABINET UNIT HEATER CURTAINWALL	GWB GYP.BD / GWB H.B. H.C. "H" HDW HDWD H.M. HOR HT HTR I.D. INFO INSUL
D (or) DRN DBL DET D.F. DIA DIM DIV. STRIP DN DP DR DR DR D.S. DT D.W. DWG	DRAIN DOUBLE DETAIL DRINKING FOUNTAIN DIAMETER DIMENSION DIVIDER STRIP DOWN DAMPPROOF(ING) DOOR DOWN SPOUT DRAIN TILE DISH WASHER DRAWING	INT INV JAN JT KO LAM LAV LP LT MFGR / MANUF. MAS MATL MAX
EA EJ EJC EIFS ELEC EL ELEV ENCL EQ EQUIP EXG EXP EXT	EACH EXPANSION JOINT EXPANSION JOINT COVER EXTERIOR INSUL. FINISH SYSTEM ELECTRICAL ELEVATION ELEVATOR ENCLOSURE EQUAL EQUIPMENT EXISTING EXPANSION EXTERIOR	MBM MC MECH MEMB MEP MIN MIR MISC M.O. MOV M.T. MTL
FA FCU FD FE FEC F.F. / FIN. FL.	FRESH AIR FAN COIL UNIT FLOOR DRAIN FIRE EXTINGUISHER FIRE EXTINGUISHER CABINET FINISH FLOOR	N NIC NOM NO. NTS

# SYMBOL LEGEND

	NEW STUD WALL	TYPICAL DETAIL NUMBER SHEET NUMBER
	EXISTING WALL / CONSTRUCTION	1 <b>A</b> 800
	NEW DOOR	TYPICAL DETAIL 1 NUMBER A500 SHEET NUMBER
	EXISTING DOOR	1 A500
	EXISTING WALL / CONSTRUCTION TO BE DEMOLISHED	
	EXISTING DOOR TO BE DEMOLISHED	A500
	NEW WINDOW, STOREFRONT OR CURTAINWALL	A500
1	COLUMN GRID LINE	ROOM NAME
	ELEMENT ABOVE OR HIDDEN LINE	S6C
	CENTERLINE	
\	BREAKLINE	
+	DIMENSION (TO CENTER LINE)	$\langle \underline{1} \rangle$
	DIMENSION (TO FRAMING)	

RID	DOCU	<b>STI</b>
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FINISH FLOOR FLASHING FLUORESCENT FACE OF STUDS FRAME(ING) FIRE RATED TREATED WOOD FEET OR FOOT	O.C. OFF O.H. OPNG OPP O.S.B. OVHD
FURRING FIRE VALVE CABINET GAGE OR GAUGE GALVANIZE GENERAL CONTRACTOR GALVANIZED IRON GLASS GALVANIZED METAL	P.LAM. PTN P.C.PL P.H. PL PLAS PLUM PNL PNT
GRADE GYPSUM WALL BOARD GYPSUM BOARD HOSE BIB HOLLOW CORE HANDICAPPED ACCESSIBLE HARDWARE	POL PR PSF PSI PTS P.T. PWD
HARDWOOD HOLLOW METAL HORIZONTAL HEIGHT HEATER	Q.T. R R. VENT REF REINF
INSIDE DIAMETER INFORMATION INSULATION OR INSULATED INTERIOR INVERT JANITOR	REQ'D. RET REV RM R.O.
JOINT	RSTRM SA
KNOCKOUT LAMINATE LAVATORY LOW POINT LIGHT	SAN SAN. ST. SCR SEC SCHED
MANUFACTURER MASONRY MATERIAL MAXIMUM METAL BUILDING MANUFACTURER MECHANICAL CONTRACTOR MECHANICAL MEMBRANE MECHANICAL, ELECTRICAL, PLUMBING	SCU SF SG SHT SIM SOG SP SPLSH. BL SPEC
MINIMUM MIRROR MISCELLANEOUS MASONRY OPENING MOVABLE MARBLE THRESHOLD METAL	SPR SQ SS SSTL SSD STN STL STG/STOR STRFRNT STRUCT
	SUSP

NOT IN CONTRACT

NOMINAL NUMBERS

NOT TO SCALE

	PLASTIC LAMINATE PARTITION PORTLAND CEMENT PLASTE PAPER HOLDER PROPERTY LINE PLASTER PLUMBING PANEL PAINT POLISHED PAIR POUNDS PER SQUARE FOO POUNDS PER SQUARE INCH POINTS PRESSURE TREATED PLYWOOD
	QUARRY TILE RADIUS RANGE VENT REFERENCE REINFORCE, REINFORCED REQUIRE(D) RETURN REVISE, REVISION ROOM ROUGH OPENING RESTROOM
	SELF-ADHERED SANITARY SANITARY STACK SCREEN SECTION SCHEDULE(D) SELF-CONTAINED UNIT SQUARE FOOT (FEET) SCHRADERGROUP SHEET SIMILAR SLAB ON GRADE STANDPIPE SEL ASH PLOCK
BLK. IR T	SPLASH BLOCK SPECIFICATION SPRINKLER SQUARE SOLID SURFACE STAINLESS STEEL SEE STRUCTURAL DRAWING STAIN(ED) STEEL STORAGE STOREFRONT STRUCTURAL, STRUCTURE SUSPEND(ED)

ON CENTER

OPPOSITE HAND

ORIENTED STRAND BOARD

OFFICE

OPENING

OPPOSITE

OVERHEAD

T&B T&G TB TEMP TH THK THRU T.O.C. T.O.M. T.O.S. TPFS TRTD TYP
U.L. UNFIN U.N.O.
V VCT VENT. VERT VEST V.I.F. V.W.C. VOL
W W/ WxH WC WD WDW WH WK WP WF WSHP WT & @ '
#

TEMPERED
TOP AND BOTTOM
TONGUE AND GROOVE
TACKBOARD
TEMPORARY
THRESHOLD
THICK(NESS)
THROUGH
TOP OF CURB
TOP OF MASONRY
TOP OF
TOP OF STEEL
THROUGH-PENETRATION FIRE SAFING
TREATED

UNDERWRITERS LABORATORY UNFINISHED UNLESS NOTED OTHERWISE

TYPICAL

VENT VINYL COMPOSITION TILE VENTILATE VERTICAL VESTIBULE VERIFY IN FIELD VINYL WALL COVERING VOLUME

WIDTH WITH WIDTH x HEIGHT WHITE BOARD WATER CLOSET

WOOD WINDOW WATER HEATER WORK WORK POINT

WATERPROOF WATER SOURCE HEAT PUMP WEIGHT AND

AT FEET INCHES POUNDS

EXTERIOR ELEVATION TAG

INTERIOR ELEVATION TAG

DETAIL TAG

WALL SECTION TAG

BUILDING SECTION TAG

DETAIL CALL-OUT TAG

ROOM TAG

S6C PARTITION TAG

DOOR TAG

WINDOW TAG

DEPTH ------(1)-----

HEIGHT

FINISH

TYPE —

MOUNTING -

Height —

HEIGHT

WIDTH

48

F.E.C.

G

DEMO TAG - OBJECT(S)

D06

→ D06 →

•

DEMO TAG - EXTENTS

CEILING TAG

VISUAL DISPLAY UNIT TAG

CASEWORK TAG

LOCKER TAG


TOILET ACCESSORY TAG

ELEVATION MARKER

0'-0" SPOT ELEVATION

NEW PARTIALLY RECESSED FIRE EXTINGUISHER CABINET

DENOTES ADA ACCESSIBILITY

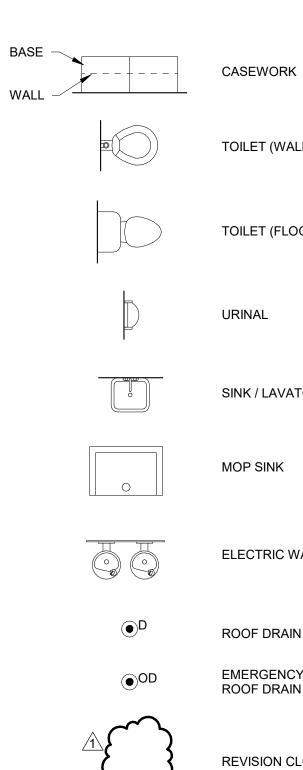

TOILET (WALL MOUNTED)
TOILET (FLOOR MOUNTED)

URINAL

SINK / LAVATORY


MOP SINK


ELECTRIC WATER COOLER


ROOF DRAIN

EMERGENCY OVERFLOW ROOF DRAIN

**REVISION CLOUD & TAG** 

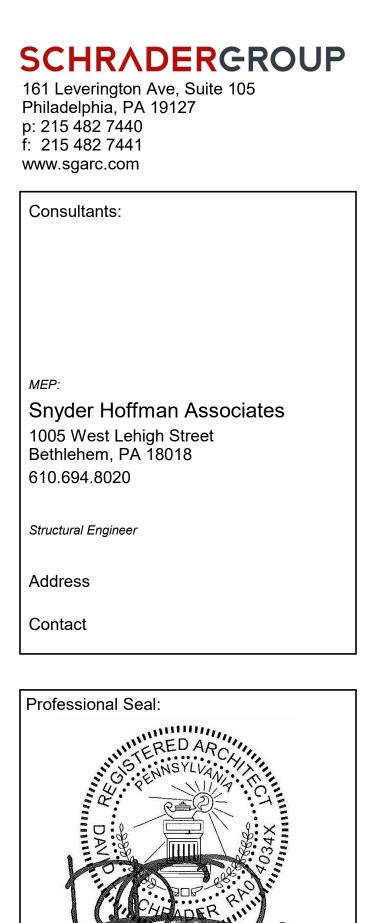

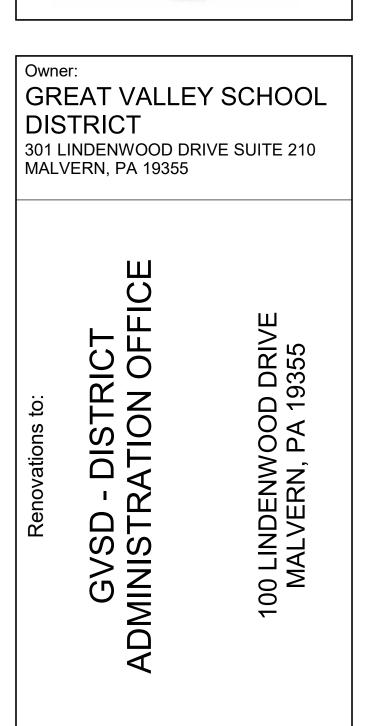

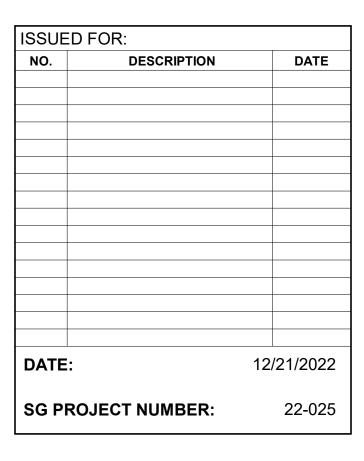


Key Plan: Drawing Title: GENERAL NOTES AND ABBREVIATION




PARTITION SCHEDULE									
WALL TYPE	WALL CONSTRUCTION	W/ TYPE	ALL FRAN	/ING SPACING	EIDE	L RATIN	G STC	WALL TYPE	
H7A	7/8" METAL HAT CHANNEL 5/8" GWB	METAL	7/8"	16" O.C.	-	-	-	S6CX	
S1A	1 5/8" METAL STUD 5/8" GWB ACOUSTICAL BATT INSULATION WALL ASSEMBLY TO UNDERSIDE OF DECK	METAL	1 5/8"	16" O.C.		-	_		
S2A	2 1/2" METAL STUD 5/8" GWB ACOUSTICAL BATT INSULATION WALL ASSEMBLY TO UNDERSIDE OF DECK	METAL	2 1/2"	16" O.C.		-	-		
S3A	3 5/8" METAL STUD 5/8" GWB ACOUSTICAL BATT INSULATION WALL ASSEMBLY TO UNDERSIDE OF DECK	METAL	3 5/8"	16" O.C.	_	-	34		
S3C	3 5/8" METAL STUD 5/8" GWB ACOUSTICAL BATT INSULATION WALL ASSEMBLY TO UNDERSIDE OF DECK	METAL	3 5/8"	16" O.C.	-	-	45		
S4A	4" METAL STUD 5/8" GWB ACOUSTICAL BATT INSULATION WALL ASSEMBLY TO UNDERSIDE OF DECK	METAL	4"	16" O.C.	_	-	34		
S4C	4" METAL STUD 5/8" GWB ACOUSTICAL BATT INSULATION WALL ASSEMBLY TO UNDERSIDE OF DECK	METAL	4"	16" O.C.	-	-	40		
S6A	6" METAL STUD 5/8" GWB ACOUSTICAL BATT INSULATION WALL ASSEMBLY TO UNDERSIDE OF DECK	METAL	6"	16" O.C.	-	-	37		
S6C	6" METAL STUD 5/8" GWB ACOUSTICAL BATT INSULATION WALL ASSEMBLY TO UNDERSIDE OF DECK	METAL	6"	16" O.C.	-	-	40		

PARTITION SCHEDULE									
	WA	ALL FRAI	MING	WAL	L RATIN	G			
WALL CONSTRUCTION	TYPE	SIZE	SPACING	FIRE RATING	UL#	STC			
6" METAL STUD 5/8" GWB, TYPE 'X' ACOUSTICAL BATT INSULATION FIRE RATED WALL ASSEMBLY TO UNDERSIDE OF DECK - PROVIDE TPFS AT ALL VOIDS AND PENETRATIONS	METAL	6"	24" O.C.	1 HR	U419	40			

WALLS ARE TO BE ACOUSTICALLY SEALED TO DECK							
ACOUSTICAL INSULATION MUST BE INSTALLED TO UNDERSIDE OF DECK AND IN BETWEEN FLUTES							
STAGGER SEAMS FOR DOUBLE							
PROVIDE ACOUSTICAL SEALANT AT ALL WALLS							
AT DOUBLE LAYERS OF GWB, PROVIDE BACKER ROD							
TYPICAL FIRE-RATED OR ACOUSTICALLY-RATED GWB PARTITION DETAIL							
MAXIMUM 1/2" JOINT BETWEEN UNDERSIDE OF DECK AND TOP OF GWB (SCALLOPED TO FIT PERPENDICULAR DECK FLUTES), FIRE-SEALED (OR ACOUSTICALLY SEALED)							
FIRE-RATED (OR ACOUSTICAL) GWB PARTITION PER FLOOR PLAN							
THIS DETAIL APPLICABLE TO ALL GWB PARTITIONS AND SHAFTWALLS THAT ARE DESIGNED TO IBC TABLE 720.1 AND/OR 'UL' DESIGN STANDARDS PER THE PRECEDING PARTITION TYPES							
PARTITION SCHEDULE NOTES:							
1. REFERENCE STRUCTURAL DRAWINGS FOR TYPICAL T.O. WALL DETAIL WHEN MASONRY PARTITION IS CONTINUOUS TO UNDERSIDE OF DECK ABOVE.							
2. IN THE EVENT OF THE ROOF STRUCTURE INTERRUPTING A PROPOSED PARTITION'S PATH TO THE UNDERSIDE OF THE DECK, CONTRACTOR IS RESPONSIBLE FOR PROVIDING CLOSURE / PARTITION OF EQUAL OR GREATE FIRE, SOUND AND RESILIENCE RATINGS TO UNDERSIDE OF DECK TO MAINTA ALL PROPOSED FIRE, SOUND AND SAFETY RATINGS AT NO ADDITIONAL COST TO THE OWNER. IN THE EVENT OF SAID CONFLICT, CONTRACTOR TO SUBMIT ALL PROPOSED PARTITION SUBSTITUTION REQUESTS DUE TO CONFLICTS WITH ROOF FRAMING TO ARCHITECT FOR APPROVAL PRIOR TO INSTALLATIO							
3. ALL WET WALLS TO RECEIVE MOISTURE RESISTANT GYPSUM WALL BOARD, REFERENCE PLANS FOR LOCATIONS,							
4. ALL WALLS UTILIZING WALL WASH LIGHT FIXTURES OR LIGHT FIXTURES LOCATED WITHIN 24" OF WALL ARE TO RECEIVE A 'LEVEL 5' FINISH.							
5. ALL FIRE WALLS, FIRE BARRIERS, FIRE PARTITIONS, SMOKE BARRIERS AND SMOKE PARTITIONS OR ANY OTHER WALL REQUIRED TO HAVE PROTECTED OPENINGS OR PENETRATIONS SHALL BE EFFECTIVELY AND PERMANENTLY IDENTIFIED WITH SIGNS OR STENCILING PER IBC 703.6'							
<ol> <li>EXTERIOR PARTITION TYPES DO NOT SHOW OR DICTATE INTERIOR FINISHES WALL CONSTRUCTION SHOWN STOPS AT WALL STRUCTURE / BACK-UP.</li> <li>ALL INTERIOR PARTITIONS WHICH RECEIVE CERAMIC TILE FINISH INSTALLED</li> </ol>							
<ol> <li>ALL INTERIOR PARTITIONS WHICH RECEIVE CERAMIC TILE FINISH INSTALLED MORE THAN 5' IN HEIGHT SHALL BE FRAMED WITH 20 GA. MIN. STUDS AT 12" O.C. W/ HORIZONTAL COLD ROLLED STIFFENER CHANNELS AT 4'-0" O.C. (MAX AND EXTEND FROM FINISHED FLOOR TO STRUCTURE ABOVE. 20 GA. DIAGON STUD KICKERS MUST ALSO BE INSTALLED AT EVERY OTHER VERTICAL STUD ABOVE CEILING.</li> </ol>							
8. ALL INTERIOR CORRIDOR PARTITIONS ARE TO RECEIVE "IMPACT RESISTANT" GYPSUM WALL BOARD UP TO A MINIMUM OF 10' A.F.F. UNLESS OTHERWISE NOTED. REFERENCE SPECIFICATIONS FOR CLASS OF IMPACT RATED DRYWALL.							
<ol> <li>PARTITION SCHEDULE LEGEND:</li> <li>PREFIX CODES (CORE TYPES)</li> </ol>							
S METAL STUD M MASONRY W WOOD STUD H FURRING / HAT CHANNEL U SHAFTWALL							
2. FINISH CODES							
<ul> <li>A (1) LAYER OF FINISH ON ONE SIDE</li> <li>B (2) LAYERS OF FINISH ON ONE SIDE</li> <li>C (1) LAYER OF FINISH ON BOTH SIDES</li> <li>D (2) LAYER OF FINISH ON BOTH SIDES</li> <li>E (1) LAYER OF FINISH ON ONE SIDE, (2) LAYERS ON THE OTHER SIDE</li> </ul>							
3. RATING CODES R BALLISTIC RESISTANT							
QACOUSTIC RATEDX1 HOUR FIRE RATEDZ2 HOUR FIRE RATED							
<ul> <li>SPECIAL CONDITION CODES</li> <li>SP SMOKE PARTITION - SEAL ALL PENETRATIONS AND TOP/BOTTOM OF PARTITION. SEE DETAIL ABOVE.</li> </ul>							
PARTITION. SEE DETAIL ABOVE. PH PARTIAL HEIGHT - FINISH TO TERMINATE 12" ABOVE FINISHED CEILING FRAMING TO CONTINUE TO DECK ABOVE MR MOISTURE RATED GYPSUM WALL BOARD							
CB 1/2" CEMENT BACKING PANEL; PROVIDE 1/2" GWB ABOVE WHERE WAI TILE STOPS IN ORDER TO PROVIDE FLUSH FINISH. PW PROVIDE 3/4" FIRE RATED TREATED PLYWOOD BEHIND FINISH							
<ul> <li>IR IMPACT RESISTANT GYPSUM WALL BOARD TO 10' ABOVE FINISHED FL</li> <li>NB BATT INSULATION IS NOT REQUIRED</li> <li>HW HALF HEIGHT WALL, REFERENCE DETAILS FOR SPECIFIC WALL HEIGH</li> <li>CT WALL RECEIVES CERAMIC TILE FINISH OVER 5', REFERENCE GENERA</li> <li>NOTE 41 ON A003.</li> </ul>							
PARTITION TAG SYMBOL LEGEND:							
NUMBER INDICATES       LETTER INDICATES         CORE SIZE       FINISH CONFIGURATION         PREEX TO       INDICATES RATING							
PREFIX TO INDICATES RATING INDICATE CORE MATERIAL IR, PH							
LOWER SECTION OF TAG INDICATES SPECIAL CONDITION. REFERENCE WALL MODIFIER CODE.							

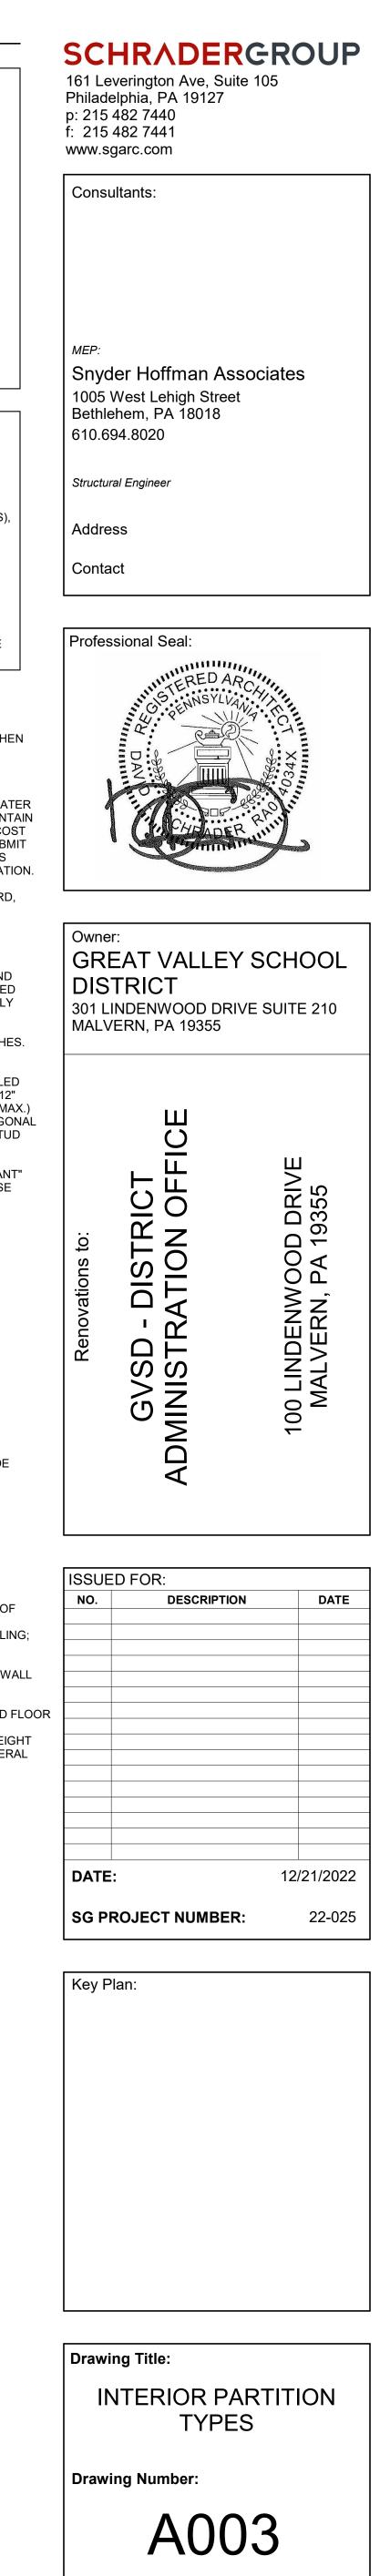

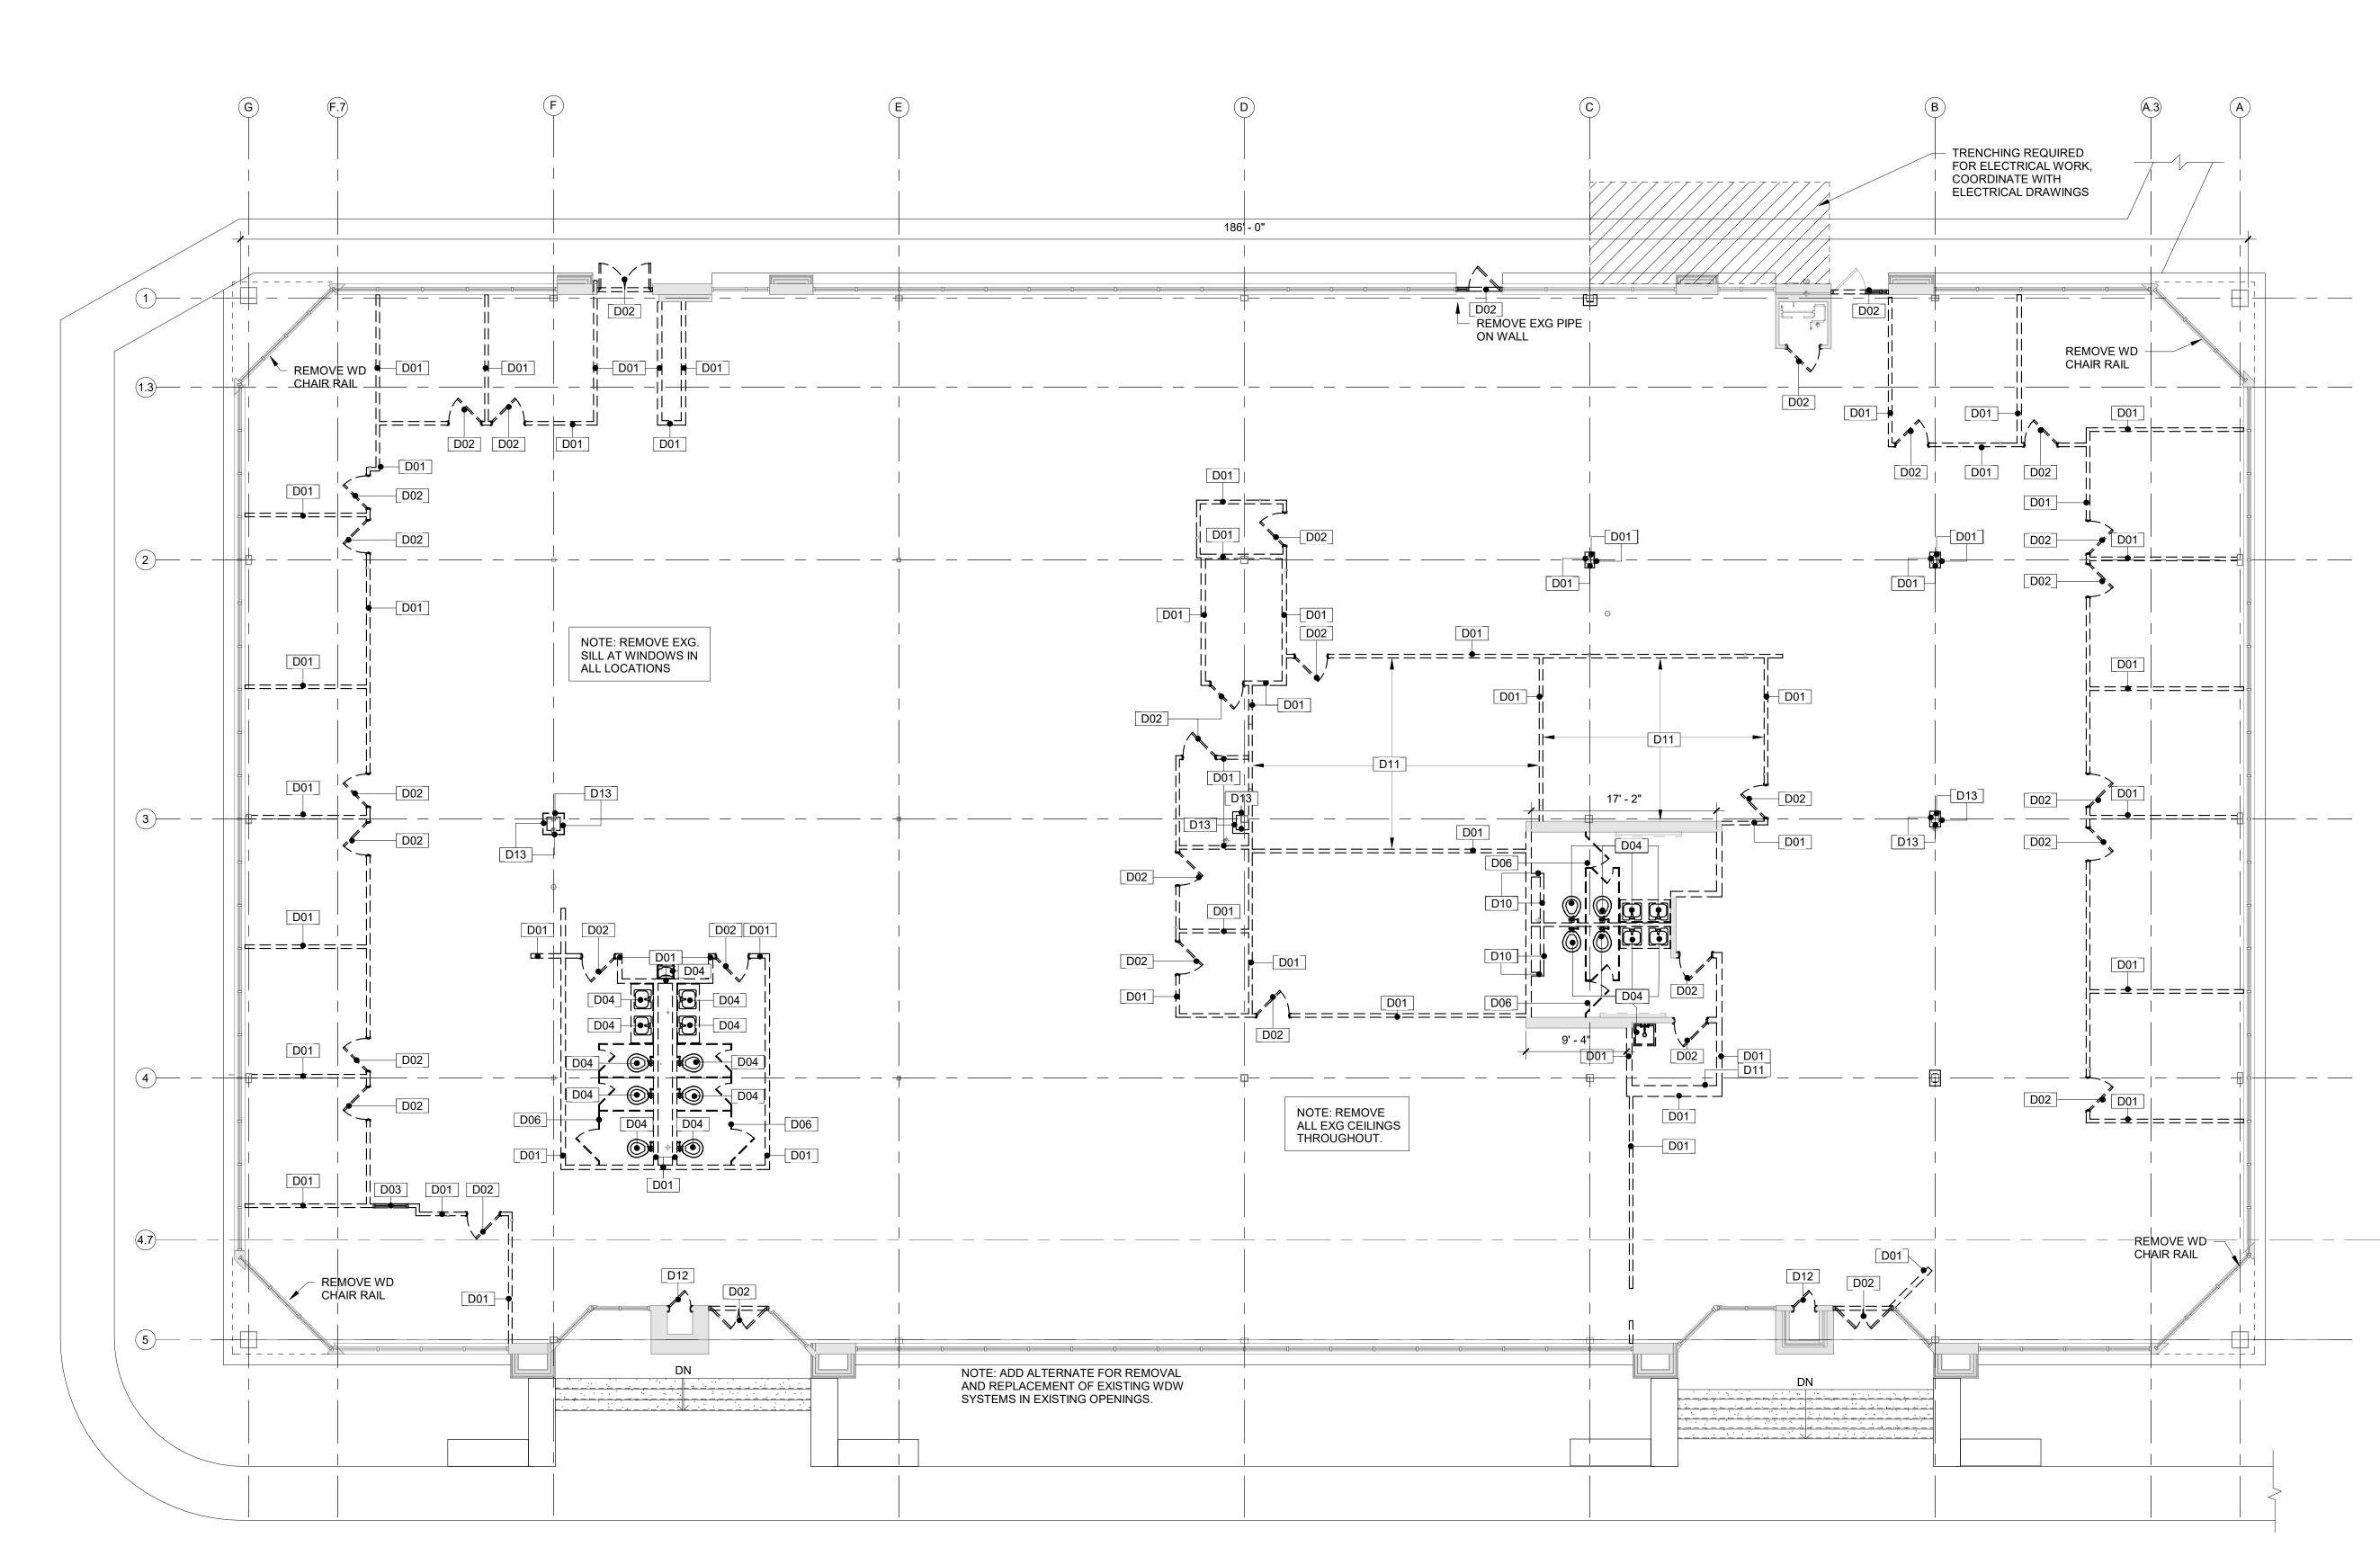

1FIRST FLOOR DEMOLITION PLANAD101SCALE: 1/8" = 1'-0"

### **DEMOLITION GENERAL NOTES**

- EXISTING BUILDING INFORMATION WAS OBTAINED FROM FLOOR PLAN PROVIDED BY "JLL | Jones Lang LaSalle Brokerage, Inc." AND BUILDING EXTERIOR RENOVATION DRAWINGS BY OTJ ARCHITECTS, AS WELL AS ON SITE SURVEY. EXISTING INFORMATION IS FOR REFERENCE ONLY. CONTRACTOR TO VERIFY ALL EXISTING CONDITIONS PRIOR TO CONSTRUCTION.
- BEFORE STARTING WORK, MAKE A THOROUGH EXAMINATION OF THOSE PORTIONS OF THE STRUCTURE IN WHICH THE WORK IS TO BE PERFORMED. CHECK ALL THE WORK ADJOINING OR AT UNDERLYING LOCATIONS. REPORT TO THE ARCHITECT ANY AND ALL CONDITIONS WHICH MAY INTERFERE WITH OR OTHERWISE AFFECT OR PREVENT THE PROPER EXECUTION AND COMPLETION OF THE WORK. DO NOT START THE WORK UNTIL SUCH CONDITIONS HAVE BEEN EXAMINED AND A COURSE OF ACTION MUTUALLY AGREED UPON.
- CONTRACTOR SHALL PERFORM ALL NECESSARY DEMOLITION AS REQUIRED FOR 3. INSTALLATION OF NEW WORK AS SHOWN ON THE DRAWINGS. ALL DEMOLITION NOT SPECIFICALLY SHOWN BUT NECESSARY TO COMPLETE THE PROJECT AS SHOWN SHALL BE THE RESPONSIBILITY OF THE CONTRACTOR.
- PRIOR TO THE START OF DEMOLITION, THE CONTRACTOR SHALL CALL TO THE 4. ATTENTION OF THE OWNER: ANY DAMAGE, CRACKS OR OTHER IMPERFECTIONS IN THE WORK ADJACENT TO DEMOLITION AREAS.
- CONTRACTORS SHALL INSPECT AND ASSESS EACH SPACE AND FULFILL THE INTENT 5. OF THE WORK REQUIRED BY THE CONTRACT DOCUMENTS. DEVIATIONS REQUIRED BY FIELD CONDITIONS SHALL BE BROUGHT TO THE ATTENTION OF THE ARCHITECT BEFORE PROCEEDING.
- ANY CUTTING AND REMOVAL INDICATED ON THE DRAWINGS ARE GENERAL 6. INDICATIONS ONLY AND DO NOT NECESSARILY SHOW THE FULL EXTENT OF CUTTING AND REMOVAL WHICH MAY BE REQUIRED BY JOB CONDITIONS.
- CONSTRUCTION AND EXISTING FINISHES SHALL REMAIN UNLESS NOTED 7. OTHERWISE. DURING DEMOLITION WORK, PROPERLY PROTECT ALL EXISTING WORK SHOWN TO REMAIN, EXERCISE CARE WHEN REMOVING ADJACENT WORK. PROPERLY REPAIR TO THE ORIGINAL CONDITIONS. ANY DAMAGE TO ITEMS SHOWN TO REMAIN, CAUSED BY DEMOLITION PROCEDURES, TO THE SATISFACTION OF, AND AT NO ADDITIONAL COST, TO THE OWNER. PATCH SURFACE FINISHES BEHIND DEMOLITION WORK (I.E. FLOORS. WALLS. CEILINGS, ETC.) TO MATCH SURROUNDING CONDITIONS.
- BEFORE STARTING DEMOLITION OPERATIONS, PROTECT ALL EXISTING EQUIPMENT NOT DESIGNATED TO BE REMOVED. PERFORM ALL WORK REQUIRED TO PROTECT THE PUBLIC AND UTILITIES.

- PERMITTED.
- ELEMENTS. EXCEPT WHERE NOTED OTHERWISE, REMOVE ALL DEMOLISHED MATERIALS

10.

- CONDITIONS FOR THE GENERAL PUBLIC AND WORKMEN.
- 12. REMOVAL OF ALL REMAINING ITEMS. 13.
- REQUIREMENTS PROVIDED BY THEM.
- 14.
- 15 REQUIREMENTS.
- 16

# **DEMOLITION DEFINITIONS**

TAKE NECESSARY PRECAUTIONS TO PREVENT DUST AND DIRT FROM RISING BY WETTING DEMOLISHED DEBRIS. EXCESSIVE USE OF WATER WILL NOT BE

CONTRACTOR SHALL BE RESPONSIBLE FOR PROVIDING ALL NECESSARY, TEMPORARY BRACING AND / OR SHORING REQUIRED TO MAINTAIN THE INTEGRITY AND STRUCTURAL STABILITY OF THE BUILDING AND ITS INDIVIDUAL

FROM THE SITE. DO NOT BURN OR BURY MATERIALS ON THE SITE. AT THE COMPLETION OF WORK FOR EACH DAY, CLEAN THE ENTIRE AREA INVOLVED AND LEAVE IT IN A NEAT CONDITION, FREE OF DEBRIS AND RUBBISH. KEEP ALL ADJOINING PUBLIC AREAS CLEAN AND FREE OF DEBRIS OR CONSTRUCTION MATERIALS DURING WORKING HOURS. AND MAKE AN EFFORT TO PROVIDE SAFE

THE OWNER WILL REMOVE ALL EXISTING ITEMS THAT THE OWNER WISHES TO SALVAGE PRIOR TO START OF DEMOLITION. CONTRACTOR IS RESPONSIBLE FOR

ARCHITECTURAL, MECHANICAL, ELECTRICAL, PLUMBING DRAWINGS, AND PROJECT SPECIFICATIONS MAY PROVIDE ADDITIONAL DEMOLITION REQUIREMENTS. THE CONTRACTOR SHALL BE RESPONSIBLE FOR BEING FAMILIAR WITH THESE DRAWINGS AND PROJECT SPECIFICATIONS AND ANY

PRIOR TO THE DEMOLITION OF THOSE ITEMS WHICH HAVE UTILITY CONNECTIONS (WATER, GAS, ELECTRICITY, STEAM, ETC. ) THE CONTRACTOR SHALL ARRANGE WITH THE OWNER TO LOCATE SHUTOFF VALVES, PANEL BOXES AND OTHER CONTROL ELEMENTS, SO THAT WATER DAMAGE AND OTHER POTENTIALLY INCONVENIENT OR DANGEROUS SITUATIONS ARE AVOIDED. REFERENCE PARTIAL DEMOLITION PLANS FOR SPECIFIC DEMOLITION

REFERENCE DIVISION 01 SPECIFICATION SECTIONS FOR SELECTIVE DEMOLITION, CUTTING, AND PATCHING. TEMPORARY FACILITIES AND CONTROLS, SITE AND BUILDING DEMOLITION, CONSTRUCTION WASTE MANAGEMENT, AND RELATED SECTIONS FOR ADDITIONAL DEMOLITION REQUIREMENTS.

WALL PARTITION SYSTEM - ALL WALL CONSTRUCTION FROM FLOOR SLAB, INCLUDING ALL ASSOCIATED STEEL, DOOR AND WINDOW SYSTEMS, BLOCKING, CORNICES, TRIM, BASE, FINISHES, TRACKS AND ALL RELATED ATTACHMENTS AND COMPONENTS. REFERENCE MEP DRAWINGS FOR ADDITIONAL REQUIREMENTS. DOES NOT INCLUDE BUILDING STRUCTURE UNLESS NOTED OTHERWISE (U.N.O.).

**DOOR SYSTEM** - ALL CONSTRUCTION RELATED TO A DOOR OPENING, INCLUDING DOOR, FRAME, TRIM, THRESHOLD, STOPS, CLOSURES, TRANSOMS, SIDELIGHTS AND ALL RELATED ATTACHMENTS AND ANCHORS, ECT., TO PROVIDE A CLEAR ROUGH OR MASONRY OPENING. THE DOOR SYSTEM DOES NOT INCLUDE STRUCTURAL LINTELS UNLESS NOTED OTHERWISE.

WINDOW SYSTEMS - ALL CONSTRUCTION RELATED TO A WINDOW OPENING, INCLUDING SASH, FRAME, TRIM, SILL, WEIGHTS, LOCKS, BLINDS, AND ALL RELATED ATTACHMENTS AND COMPONENTS TO PROVIDE A CLEAR ROUGH OR MASONRY OPENING. THE WINDOW SYSTEM DOES NOT INCLUDE STRUCTURAL LINTELS OR EXTERIOR SILLS UNLESS NOTED OTHERWISE.

FLOOR SYSTEM - THE CONCRETE SLAB, SETTING BEDS, SUBFLOOR, FINISH FLOOR MATERIALS AND ANY FINISH ATTACHED ABOVE OR CEILING SYSTEM OR ATTACHMENT SUSPENDED BELOW. THE FLOOR SYSTEM DOES NOT INCLUDE ANY STRUCTURAL STEEL MEMBERS UNLESS NOTED OTHERWISE.


**CEILING SYSTEM** - ALL SUSPENDED CONSTRUCTION OR CEILING CONSTRUCTION SUPPORTED BY A WALL SYSTEM BEING REMOVED INCLUDING ALL RELATED ATTACHMENTS AND COMPONENTS (INCLUDING BUT NOT LIMITED TO LIGHTS, SPEAKERS, EXIT SIGNS. DIFFUSERS/REGISTERS, ECT.) UP TO THE UNDERSIDE OF THE BUILDING SLAB OR SUPPORTING STRUCTURE. REFERENCE MEP DRAWINGS FOR ADDITIONAL REQUIREMENTS.

**CASEWORK SYSTEM** - INCLUDING SHELVING, COUNTERS, CABINETRY, SINKS, ECT., AND ALL RELATED HARDWARE AND ATTACHMENTS REMOVED TO THE FINISHED WALL AND FLOOR.

FLOOR FINISH SYSTEM - ALL FLOOR FINISHES, INCLUDING BASE PADDING, FILLER STRIPS, THRESHOLDS, TRANSITION STRIPS, AND SPOT LEVELING UNDERLAYMENT, (U.O.N.) TO TOP OF SUBFLOOR CONSTRUCTION. REMOVE MASTICS ONLY AS REQUIRED TO PREP FLOOR FOR NEW FINISH, U.O.N.


**STAIR SYSTEM** - ALL CONSTRUCTION RELATED TO A STAIR SYSTEM INCLUDING TREADS, RISERS, STRINGERS, SUPPORT FRAMING, FINISHES, BLOCKING, HANDRAILS, GUARD RAILS, BRACKETS, NOSINGS, PANS, AND CONCRETE.


DEMOLITION KEY						
KEY VALUE	KEYNOTE TEXT					
D01	REMOVE EXISTING WALL IN ITS ENTIRETY.					
D02	REMOVE EXISTING DOOR SYSTEM IN ITS ENTIRETY.					
D03	REMOVE EXISTING WINDOW IN ITS ENTIRETY.					
D04	REMOVE EXISTING PLUMBING FIXTURE.					
D06	REMOVE EXISTING TOILET PARTITION SYSTEM IN ITS ENTIRETY.					
D10	REMOVE EXISTING MILLWORK IN ITS ENTIRETY.					
D11	REMOVE ELECTRICAL EQUIPMENT IN THIS ROOM.					
D12	REMOVE EXISTING CLOSET DOOR AND INFILL AS REQUIRED FOR NEW CONSTRUCTION.					
D13	REMOVE COLUMN SURROUND.					

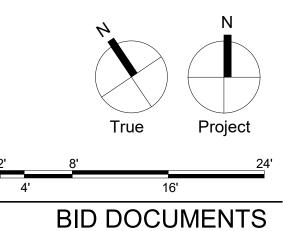






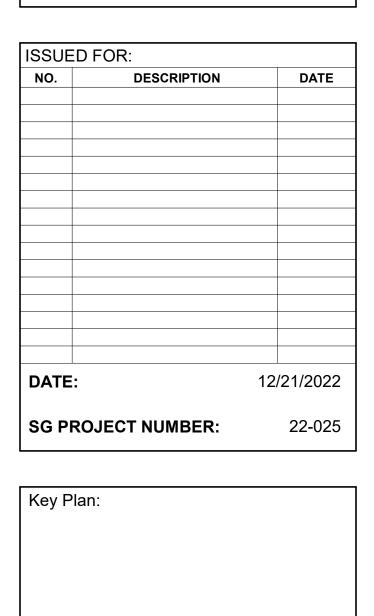

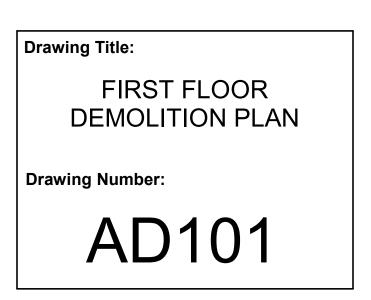

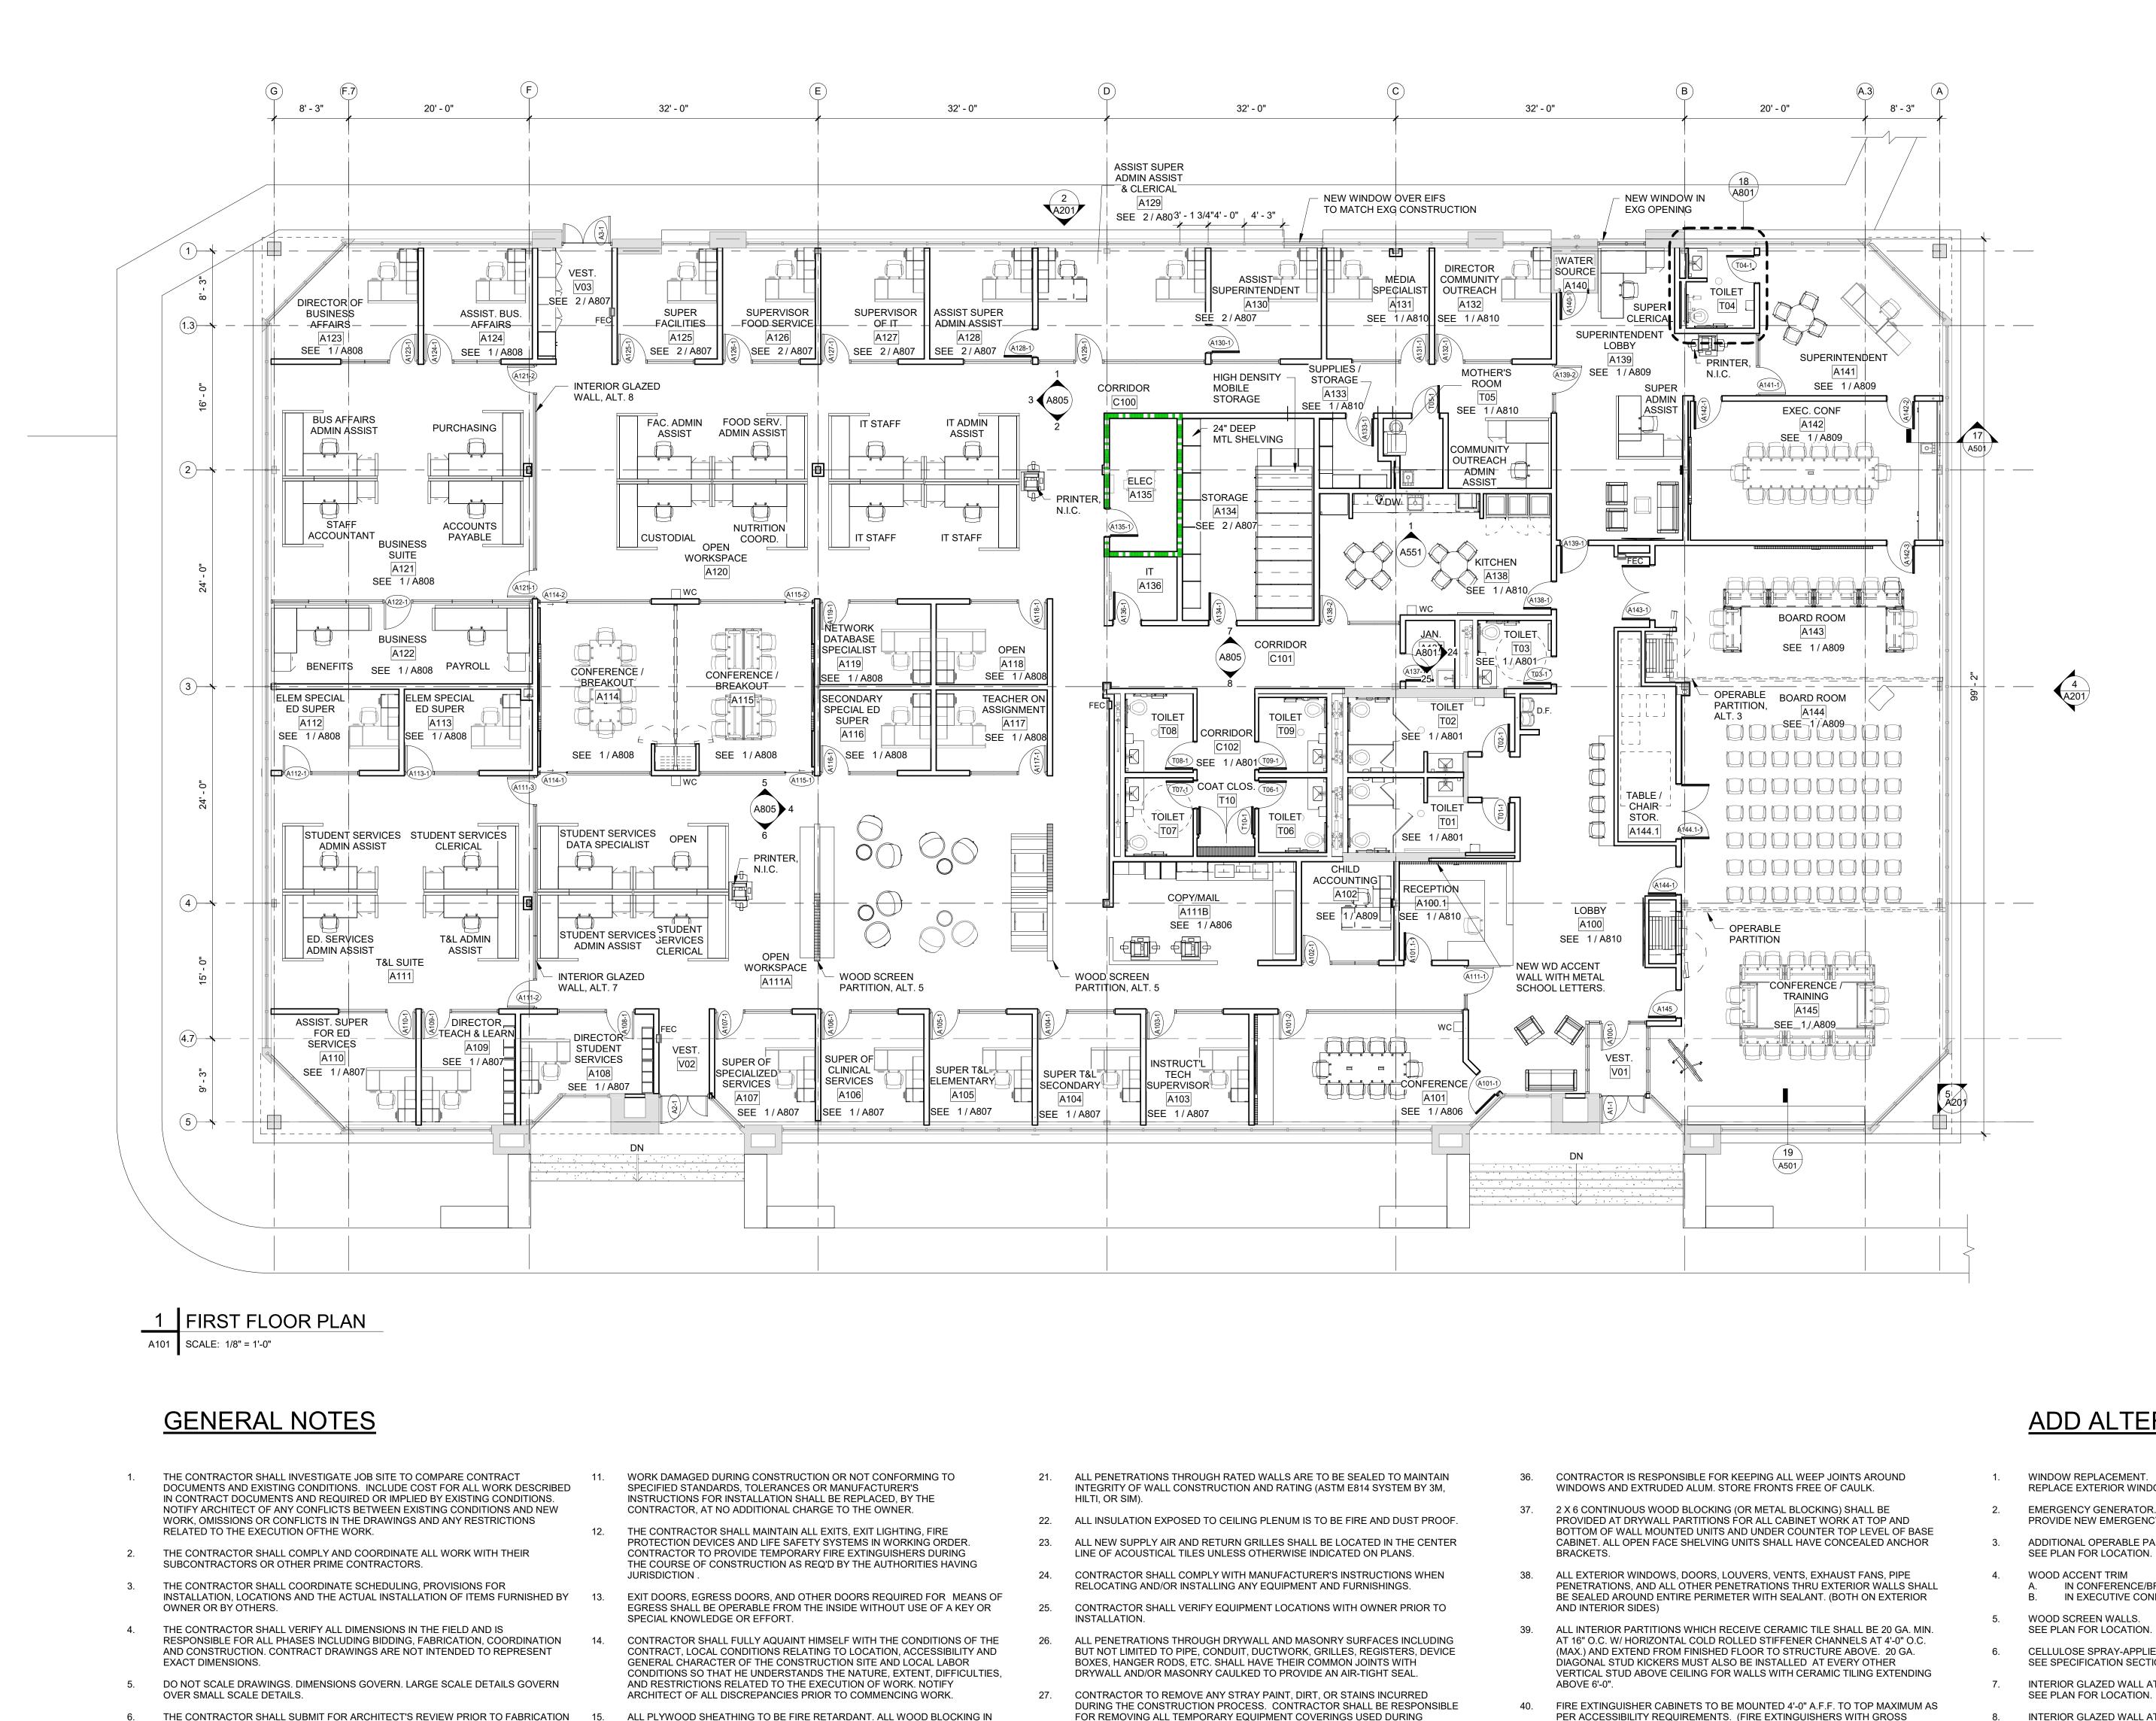

- THE CONTRACTOR SHALL SUBMIT FOR ARCHITECT'S REVIEW PRIOR TO FABRICATION OR PURCHASE, SHOP DRAWINGS OR SAMPLES FOR ALL MILLWORK, CUSTOM METALWORK, CUSTOM CASEWORK, AND ALL OTHER ITEMS AS REQUESTED BY THE ARCHITECT FOR ALL ABOVE BUILDING STANDARD ITEMS.
- CHANGES IN DRAWINGS OR ACTUAL WORK SHALL BE ISSUED BY THE ARCHITECT. 7 PERFORM ALL WORK AND INSTALL MATERIALS IN STRICT ACCORDANCE WITH 8 MANUFACTURER'S SPECIFICATIONS AND INSTRUCTIONS AND IN A MANNER CONSISTENT WITH INDUSTRY STANDARD OF WORKMANSHIP.
- THE CONTRACTOR SHALL EXAMINE ALL SURFACES TO DETERMINE THAT THEY ARE SOUND, DRY, CLEAN AND READY TO RECEIVE FINISHES PRIOR TO INSTALLATION. START OF INSTALLATION SHALL IMPLY ACCEPTANCE OF SUBSTRATE AND SHALL NOT BE GROUNDS FOR CLAIMS AGAINST IMPROPER PERFORMANCE OF INSTALLED 19. MATERIALS. ADVISE ARCHITECT OF ANY EXISTING CONSTRUCTION NOT LEVEL, SMOOTH AND PLUMB WITHIN INDUSTRY STANDARDS PRIOR TO START OF CONSTRUCTION.
- THE CONTRACTOR SHALL INSTALL AND MAINTAIN ALL NECESSARY COVERINGS, 10. PROTECTIVE ENCLOSURES, TEMPORARY DOORS AND PARTITIONS AND DUST BARRIERS TO PROTECT ALL OCCUPANTS AND EXISTING WORK AND FINISHES TO REMAIN. LOCATION OF SUCH PROTECTION SHALL BE VERIFIED WITH OWNER AND LOCAL CODE OFFICIALS FOR EGRESS CONFORMANCE, PRIOR TO COMMENCING WORK AND IN COORDINATION WITH PROGRESSION OF WORK SCHEDULE. PERFORM WORK IN A MANNER THAT WILL AVOID HAZARDS TO PERSONS IN ADJACENT AREAS AND THAT WON'T INTERFERE WITH WORK OR PASSAGE TO ANY OF THESE AREAS. REPAIR AND REPLACE ANY DAMAGES CAUSED BY IMPROPER PROTECTIONS AT NO ADDITIONAL CHARGE TO OWNER.
- TERIOR CEILINGS EXTERIOR CEILING

11.	WORK DAMAGED DURING CONSTRUCTION OR NOT CONFORMING TO SPECIFIED STANDARDS, TOLERANCES OR MANUFACTURER'S INSTRUCTIONS FOR INSTALLATION SHALL BE REPLACED, BY THE	21.	ALL PENETRATIONS THROUGH RATED WALLS ARE TO BE SEALED TO MAINTAIN INTEGRITY OF WALL CONSTRUCTION AND RATING (ASTM E814 SYSTEM BY 3M, HILTI, OR SIM).	36.	CONTRACTOR IS RES WINDOWS AND EXTR
40	CONTRACTOR, AT NO ADDITIONAL CHARGE TO THE OWNER.	22.	ALL INSULATION EXPOSED TO CEILING PLENUM IS TO BE FIRE AND DUST PROOF.	37.	2 X 6 CONTINUOUS W PROVIDED AT DRYW
12.	THE CONTRACTOR SHALL MAINTAIN ALL EXITS, EXIT LIGHTING, FIRE PROTECTION DEVICES AND LIFE SAFETY SYSTEMS IN WORKING ORDER. CONTRACTOR TO PROVIDE TEMPORARY FIRE EXTINGUISHERS DURING THE COURSE OF CONSTRUCTION AS REQ'D BY THE AUTHORITIES HAVING	23.	ALL NEW SUPPLY AIR AND RETURN GRILLES SHALL BE LOCATED IN THE CENTER LINE OF ACOUSTICAL TILES UNLESS OTHERWISE INDICATED ON PLANS.		BOTTOM OF WALL MO CABINET. ALL OPEN F BRACKETS.
	JURISDICTION .	24.	CONTRACTOR SHALL COMPLY WITH MANUFACTURER'S INSTRUCTIONS WHEN RELOCATING AND/OR INSTALLING ANY EQUIPMENT AND FURNISHINGS.	38.	ALL EXTERIOR WIND PENETRATIONS, AND
13.	EXIT DOORS, EGRESS DOORS, AND OTHER DOORS REQUIRED FOR MEANS OF EGRESS SHALL BE OPERABLE FROM THE INSIDE WITHOUT USE OF A KEY OR SPECIAL KNOWLEDGE OR EFFORT.	25.	CONTRACTOR SHALL VERIFY EQUIPMENT LOCATIONS WITH OWNER PRIOR TO INSTALLATION.		BE SEALED AROUND AND INTERIOR SIDES
14.	CONTRACTOR SHALL FULLY AQUAINT HIMSELF WITH THE CONDITIONS OF THE CONTRACT, LOCAL CONDITIONS RELATING TO LOCATION, ACCESSIBILITY AND GENERAL CHARACTER OF THE CONSTRUCTION SITE AND LOCAL LABOR CONDITIONS SO THAT HE UNDERSTANDS THE NATURE, EXTENT, DIFFICULTIES, AND RESTRICTIONS RELATED TO THE EXECUTION OF WORK. NOTIFY	26.	ALL PENETRATIONS THROUGH DRYWALL AND MASONRY SURFACES INCLUDING BUT NOT LIMITED TO PIPE, CONDUIT, DUCTWORK, GRILLES, REGISTERS, DEVICE BOXES, HANGER RODS, ETC. SHALL HAVE THEIR COMMON JOINTS WITH DRYWALL AND/OR MASONRY CAULKED TO PROVIDE AN AIR-TIGHT SEAL.	39.	ALL INTERIOR PARTIT AT 16" O.C. W/ HORIZ (MAX.) AND EXTEND F DIAGONAL STUD KICF VERTICAL STUD ABO ABOVE 6'-0".
15.	ARCHITECT OF ALL DISCREPANCIES PRIOR TO COMMENCING WORK. ALL PLYWOOD SHEATHING TO BE FIRE RETARDANT. ALL WOOD BLOCKING IN FIRE RATED ASSEMBLIES TO BE FIRE RETARDANT.	27.	CONTRACTOR TO REMOVE ANY STRAY PAINT, DIRT, OR STAINS INCURRED DURING THE CONSTRUCTION PROCESS. CONTRACTOR SHALL BE RESPONSIBLE FOR REMOVING ALL TEMPORARY EQUIPMENT COVERINGS USED DURING CONSTRUCTION AND HE SHALL ALSO BE RESPONSIBLE FOR REMOVING HIS TRASH OFF OF THE JOB SITE DAILY.	40.	FIRE EXTINGUISHER PER ACCESSIBILITY F WEIGHT OVER 40LBS THE BOTTOM OF THE
16.	ALL WOOD ON EXTERIOR WALLS AND ROOF TO BE MOISTURE RESISTANT.	28.	THE CONTRACTOR SHALL PERFORM ALL CUTTING AND WELDING IN COMPLIANCE	44	4".)
17.	IN ALL INSTANCES WHERE WORK IS BEING CORRECTED OR REPAIRED, CONTRACTOR IS TO REPAINT ENTIRE WALL TO NEAREST CORNER OR BREAKLINE WHERE WALL CHANGES DIRECTION.		WITH THE PUBLISHED STANDARDS OF NFPA. THE CONTRACTOR SHALL PROVIDE FIRE WATCHES FOR ALL CUTTING, GRINDING, AND WELDING OPERATIONS. THE TRAINING OF THESE FIRE WATCHES AND THE USE OF THE CONTRACTOR'S SUPPLIED FIRE EXTINGUISHERS IS THE RESPONSIBILITY OF THE CONTRACTOR.	41.	REPAIR AND/OR REP DEMOLISHED, AND N DAMAGED DURING TI REPAIRS, REPLACEM
18.	CONTRACTOR TO COORDINATE WITH E.C. THE MOUNTING HEIGHT OF ALL SWITCHES AND OUTLETS AT MILLWORK, COUNTERS, SHELVING, SINKS, ETC.	29.	REFER TO MECHANICAL, PLUMBING AND ELECTRICAL DRAWINGS FOR DETAILS OF UTILITY WALL PENETRATIONS.		ITEMS TO THEIR ORIO SATISFACTION OF AN
10		30.	ALL FIXTURES LABELED " 🖉 " INDICATE HANDICAP FIXTURES.		
19.	CONTRACTOR IS TO PROVIDE ALL MISC. FRAMING, BLOCKING, ETC. TO HANG SCREENS, BULLETIN BOARDS, RAILS, TOILET ACCESSORIES, WOODWORK, ETC.	31.	WHERE TWO DISSIMILAR METALS MEET, PAINT FACE OF ONE WITH BITUMINOUS PAINT.		
20.	CONTROL JOINTS IN GYPSUM BOARD PARTITIONS AND GYPSUM BOARD CEILINGS SHALL BE SPACED AS FOLLOWS:	32.	ALL EXTERIOR ENTRANCE DOORS AND FRAMES TO RECEIVE PERIMETER WEATHER STRIPPING AS PER SPECIFICATIONS.		
	PARTITIONS- 30 FT. MAXIMUM IN EITHER DIRECTION.INTERIOR CEILINGS- 30 FT. MAXIMUM IN EITHER DIRECTION.EXTERIOR CEILINGS- 30 FT. MAXIMUM IN EITHER DIRECTION.	33.	CONTRACTOR IS TO PROVIDE STUD BRACING AS REQUIRED FOR METAL STUD PARTITIONS ABOVE 10'-0".		
	EXTERIOR CEILINGS - 30 FT. MAXIMUM IN EITHER DIRECTION.	34.	ANY AREA OUTSIDE THE LIMITS OF CONSTRUCTION DISTURBED BY OPERATIONS OF THE CONTRACTOR SHALL BE RESTORED AT THE CONTRACTORS EXPENSE.		
		35.	ALL CONCRETE WALKS, ASPHALT, CURBS AND LANDSCAPING DAMAGED DURING CONSTRUCTION ARE TO BE REPAIRED BY CONTRACTOR AT NO ADDITIONAL		

COST TO THE OWNER.

# ADD ALTERNATES

REQUIREMENTS. (FIRE EXTINGUISHERS WITH GROSS S. MUST BE MOUNTED 3'-6" MAX.). CLEARANCE BETWEEN E FLOOR AND THE EXTINGUISHER MAY NOT BE LESS THAN


PLACE EXISTING ITEMS NOT SCHEDULED OR NOTED TO BE NOT SPECIFIED TO BE REMOVED, BUT WHICH BECOME THE PROGRESS OF THE WORK. MAKE ANY AND ALL SUCH MENTS AND MODIFICATIONS TO RESTORE THE DAMAGED IGINAL CONDITION AT THE TIME OF DAMAGE, TO THE ND AT NO ADDITIONAL COST TO THE OWNER.

- WINDOW REPLACEMENT. REPLACE EXTERIOR WINDOW SYSTEM
- EMERGENCY GENERATOR. PROVIDE NEW EMERGENCY GENERATOR TO FULLY BACK-UP BUILDING SYSTEMS.
- ADDITIONAL OPERABLE PARTITION IN BOARD ROOM.
- WOOD ACCENT TRIM IN CONFERENCE/BREAKOUT ROOMS. SEE PLAN.
- IN EXECUTIVE CONFERENCE ROOM. SEE PLAN.
- SEE PLAN FOR LOCATION
- CELLULOSE SPRAY-APPLIED INSULATION AT UNDERSIDE OF ROOF DECK. SEE SPECIFICATION SECTION 072129 SPRAYED INSULATION.
- INTERIOR GLAZED WALL AT TEACHING & LEARNING SUITE.
- INTERIOR GLAZED WALL AT BUSINESS SUITE.
- SEE PLAN FOR LOCATION. PUBLIC ANNOUNCEMENT SYSTEM.
- SEE ELECTRICAL DRAWINGS AND SPECIFICATIONS.


GENERAL PLAN NOTES


1 ALL DIMENSIONS ARE TO OUTSIDE FACE OF FOUNDATIONS, COLUMN LINE, OR FACE OF FRAMING UNLESS NOTED OTHERWISE. CONTRACTOR SHALL VERIFY DIMENSIONS PRIOR TO CONSTRUCTION AND NOTIFY ARCHITECT IMMEDIATELY OF ANY DISCREPANCIES.


SEE ENLARGED PLANS FOR TYPICAL INTERIOR ELEVATIONS.

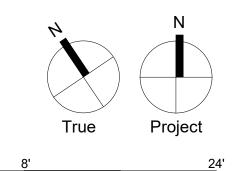



**BID DOCUMENTS** 

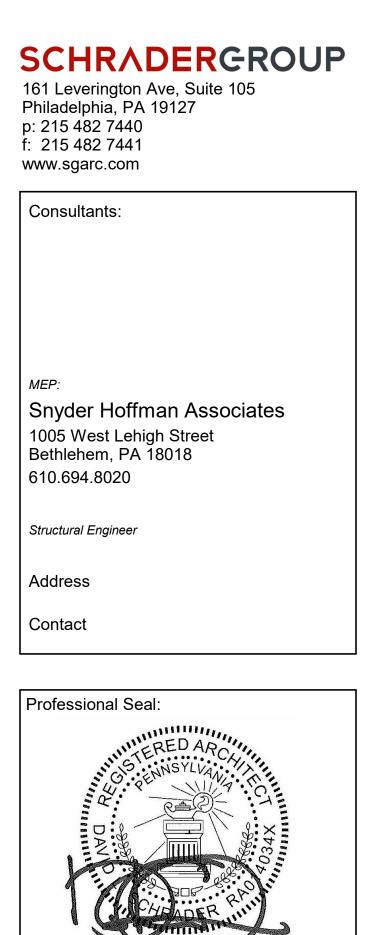

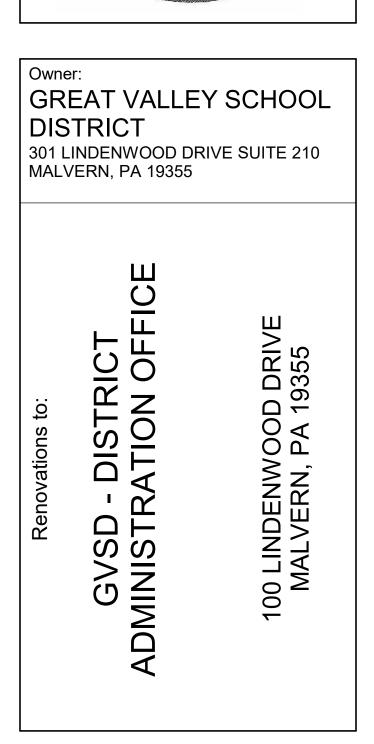

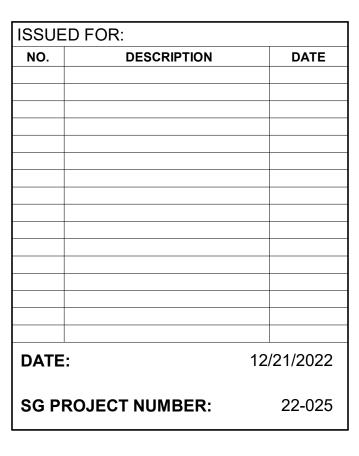


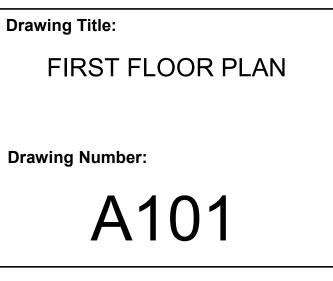


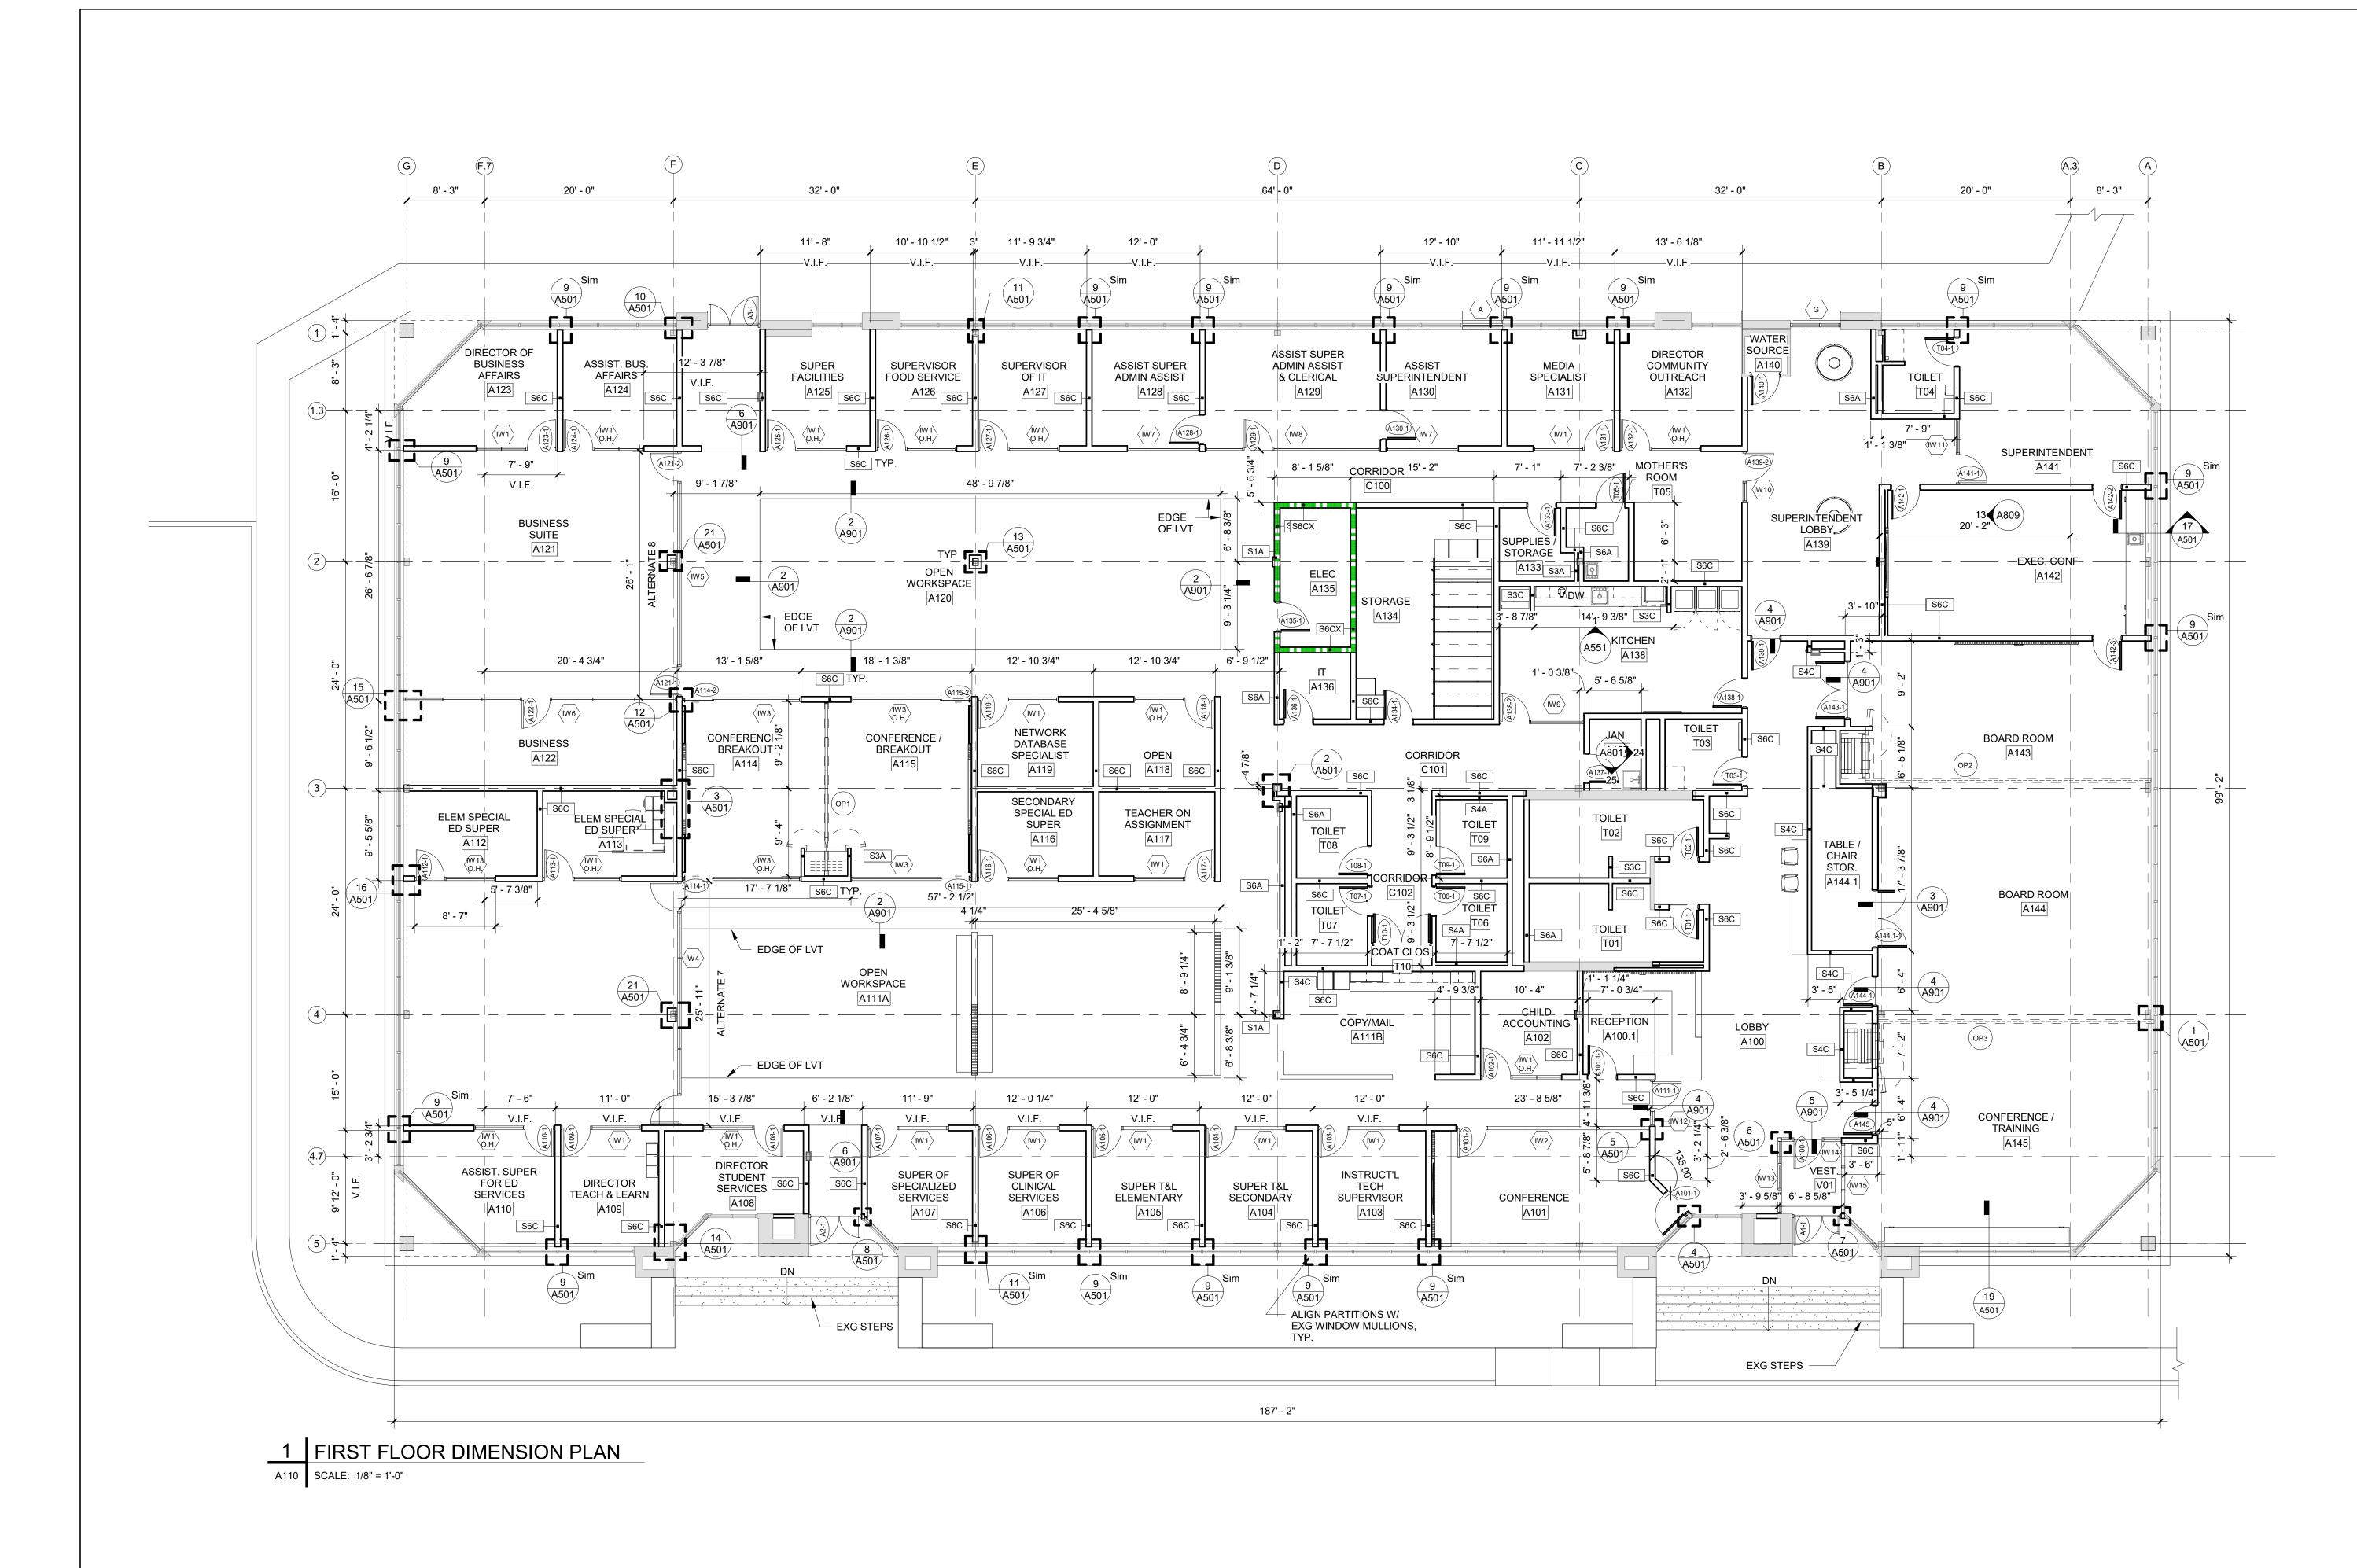


### GENERAL PLAN NOTES


- 1. ALL DIMENSIONS ARE TO OUTSIDE FACE OF FOUNDATIONS, COLUMN LINE, OR FACE OF FRAMING UNLESS NOTED OTHERWISE. CONTRACTOR SHALL VERIFY DIMENSIONS PRIOR TO CONSTRUCTION AND NOTIFY ARCHITECT IMMEDIATELY OF ANY DISCREPANCIES.
- 2. SEE ENLARGED PLANS FOR TYPICAL INTERIOR ELEVATIONS.

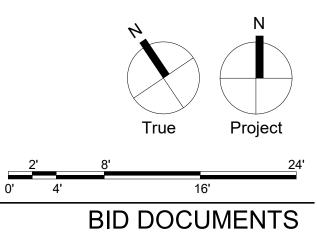


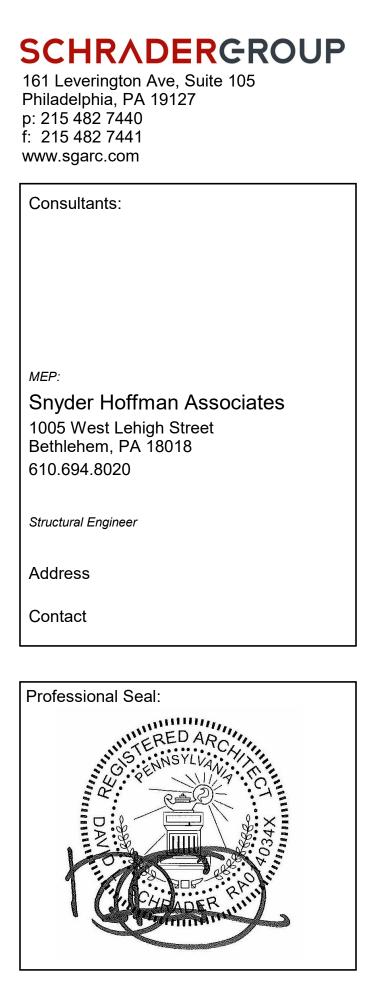



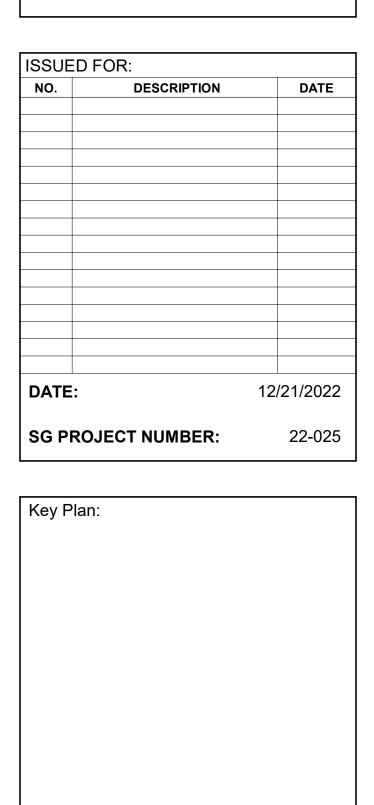

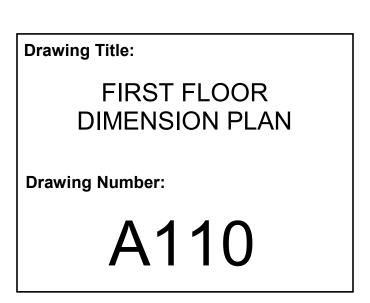


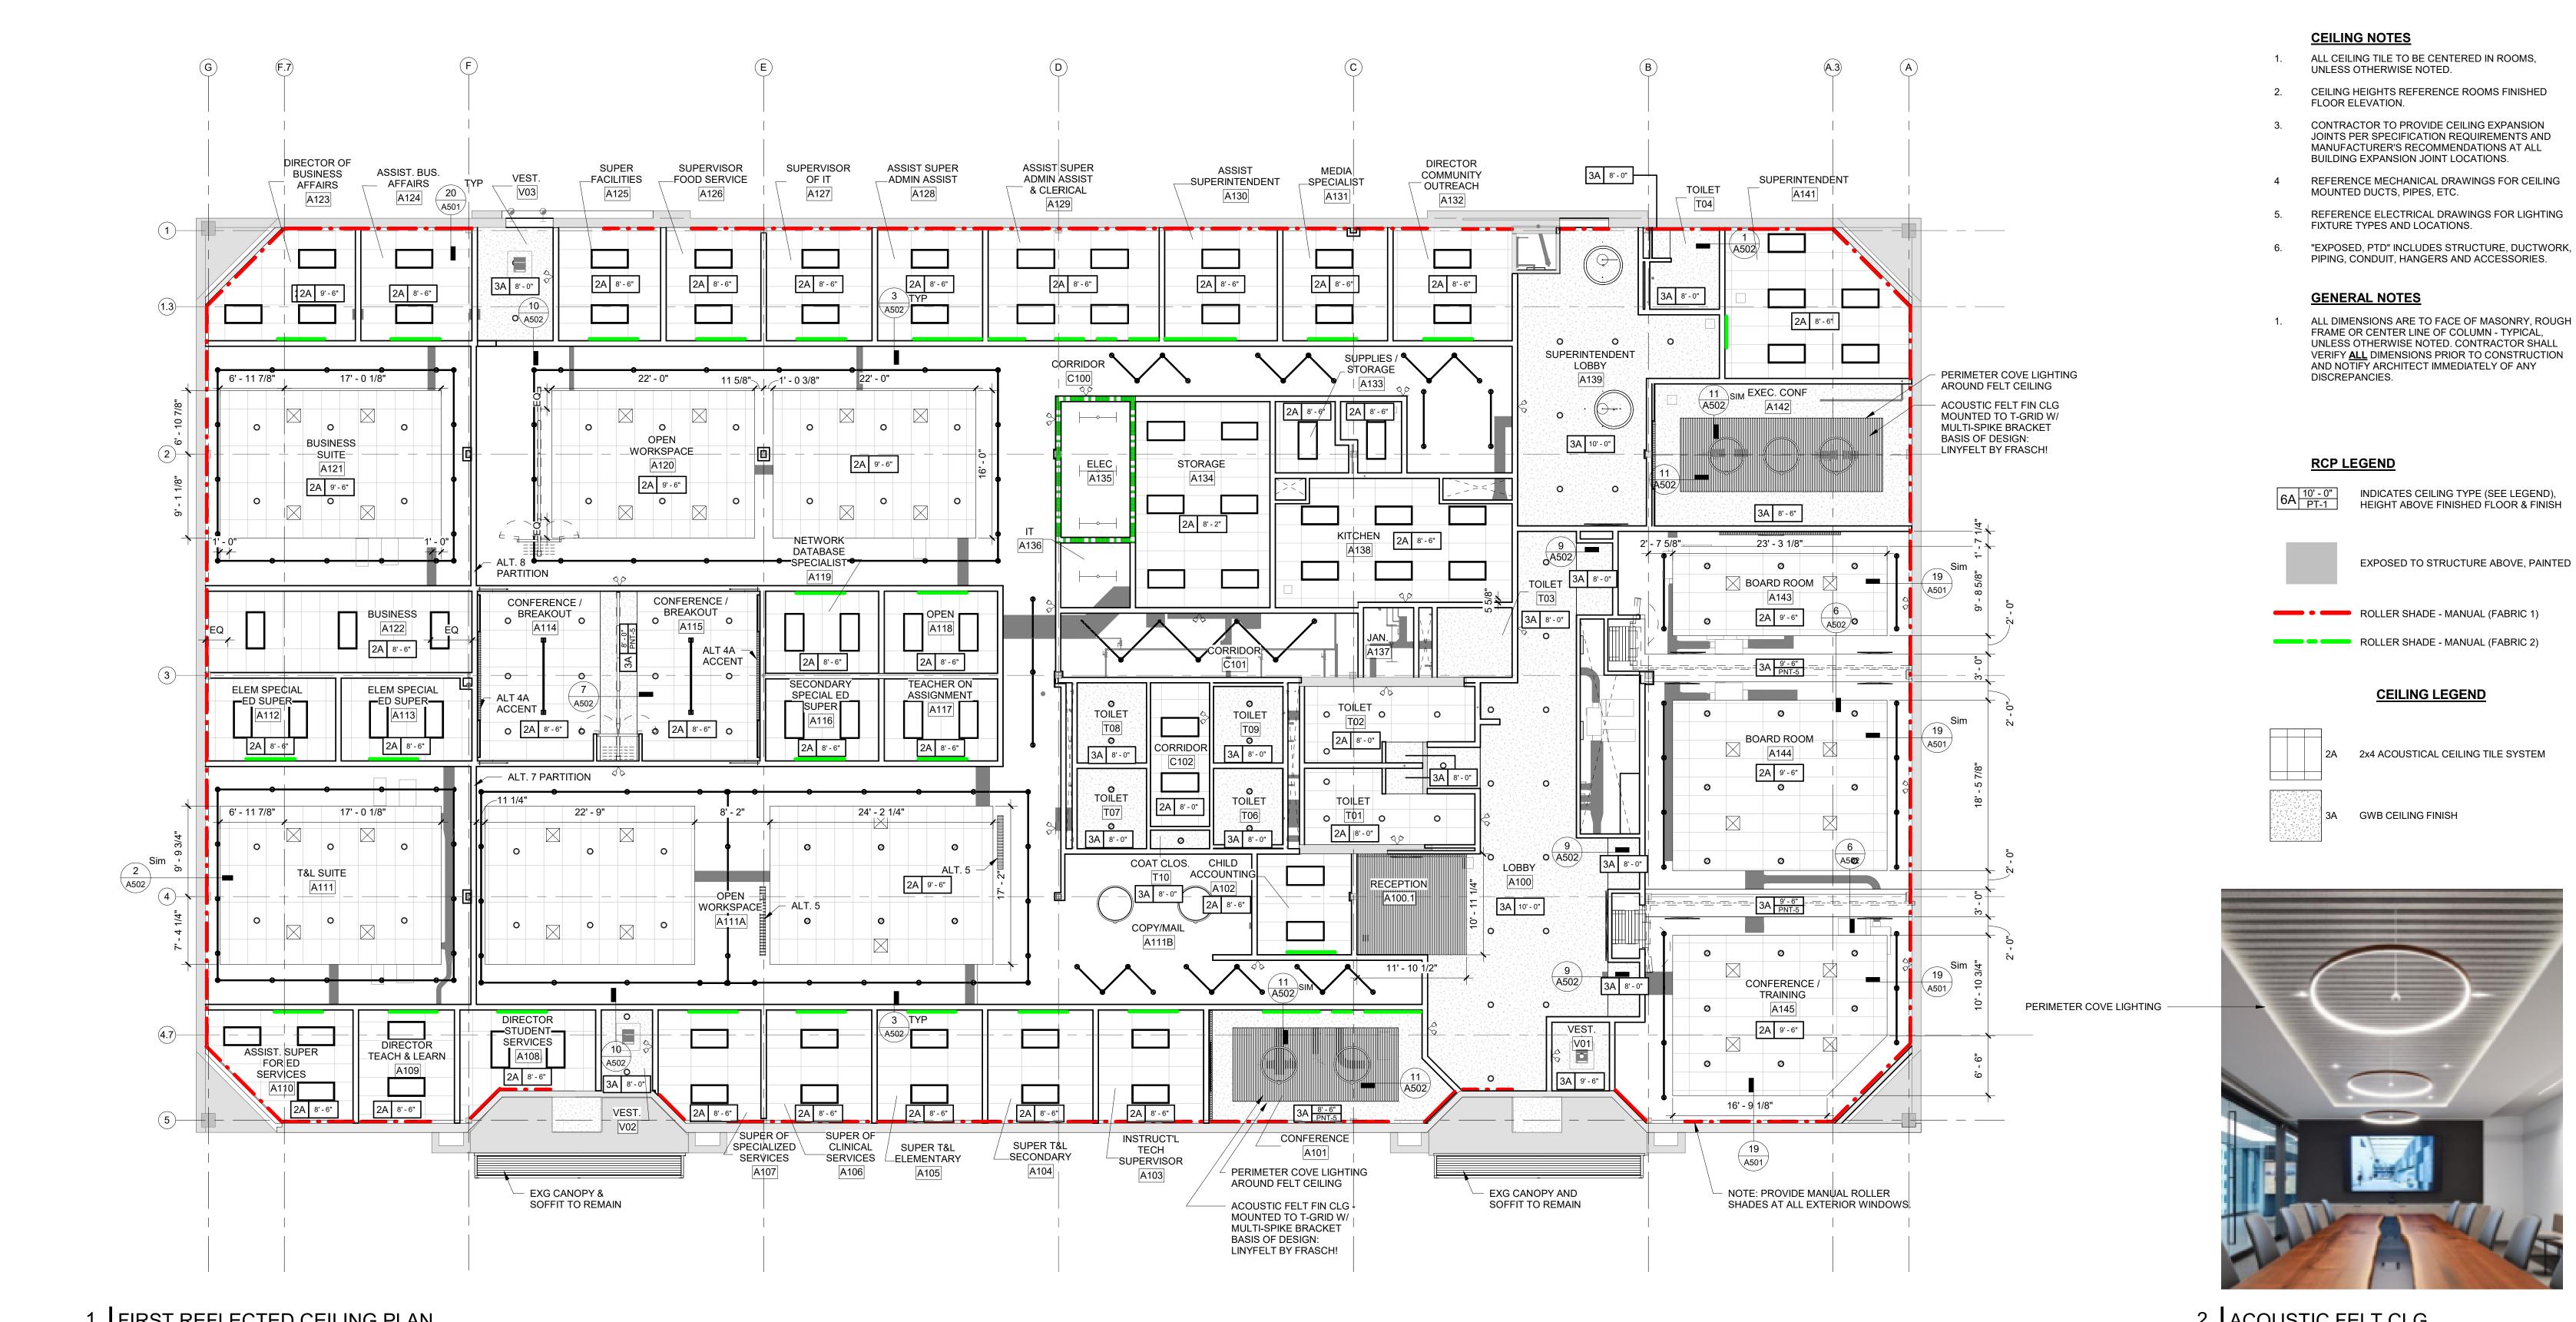


1 FIRST REFLECTED CEILING PLAN A121 SCALE: 1/8" = 1'-0"


- 2
   ACOUSTIC FELT CLG


   A121
   SCALE: 1 1/2" = 1'-0"

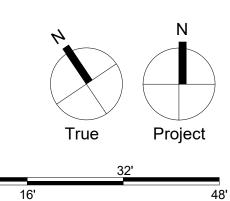

0' 4'

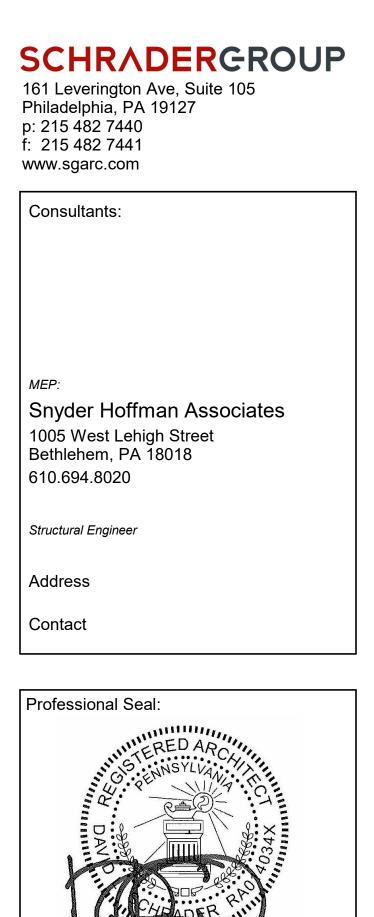

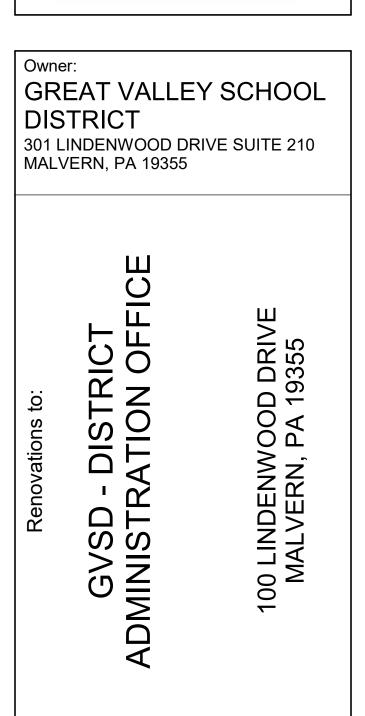


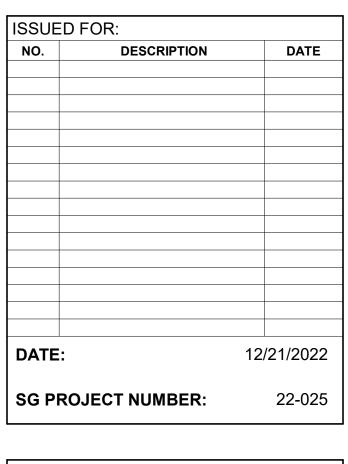


Key Plan: Drawing Title:



A121

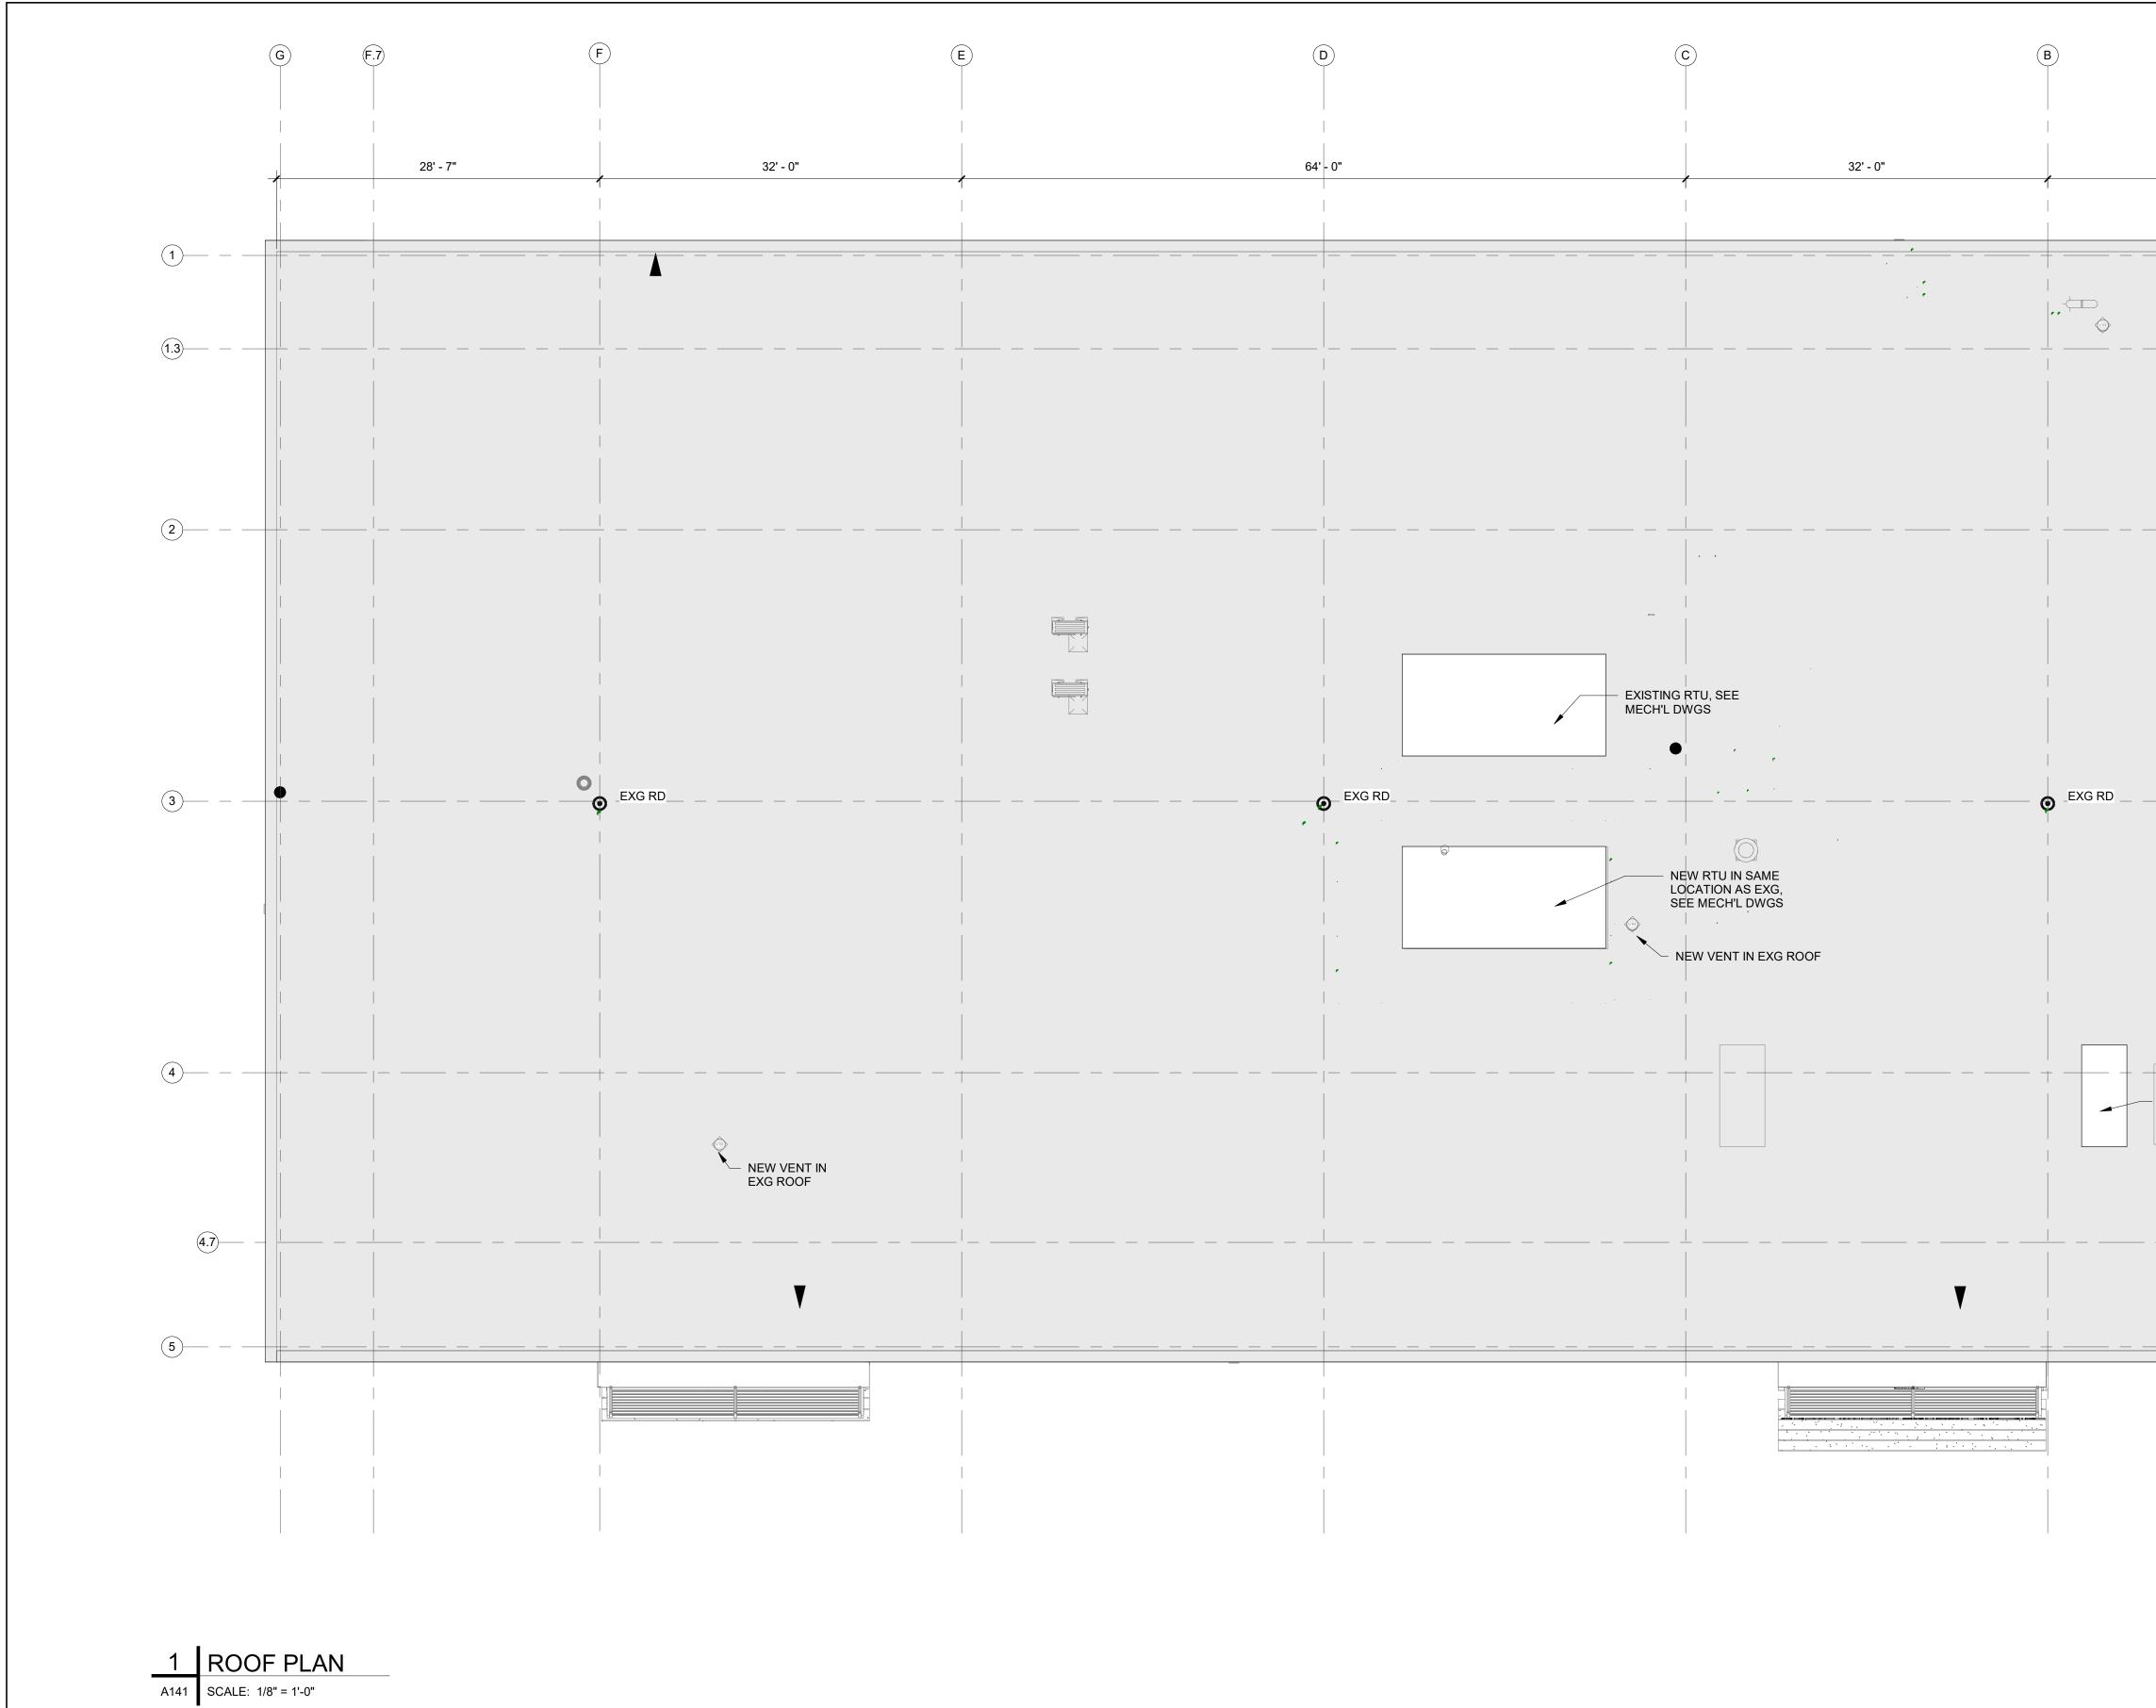

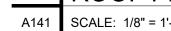



A	3	A
28' - 3"		   <del> </del> 
	· ·	
NEW RTU IN SAME LOCATION AS EXG, SEE MECH'L DWGS	 	


Project True 0' 4' 16'

BID DOCUMENTS


EXISTING ROOF STRUCTURE

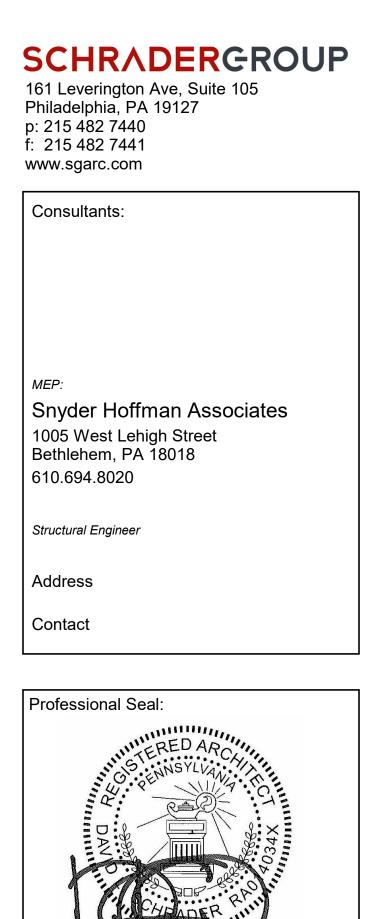

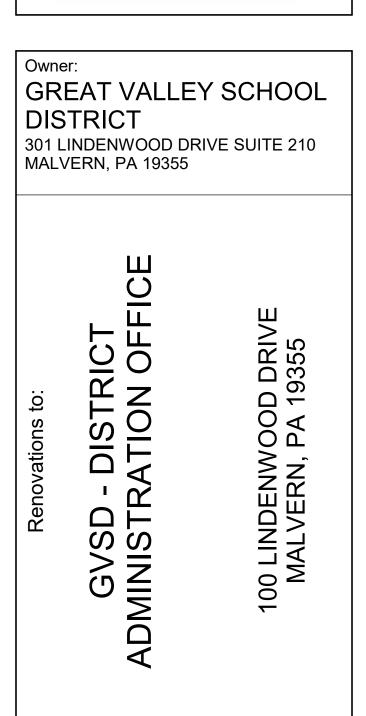

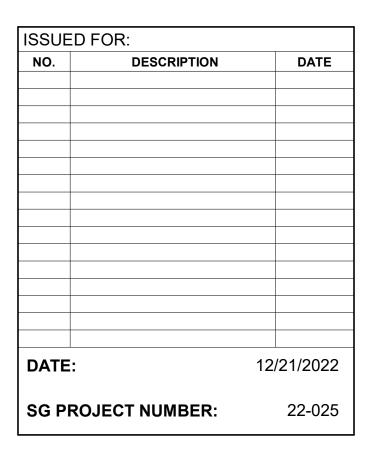



Key Plan: Drawing Title: ROOF PLAN

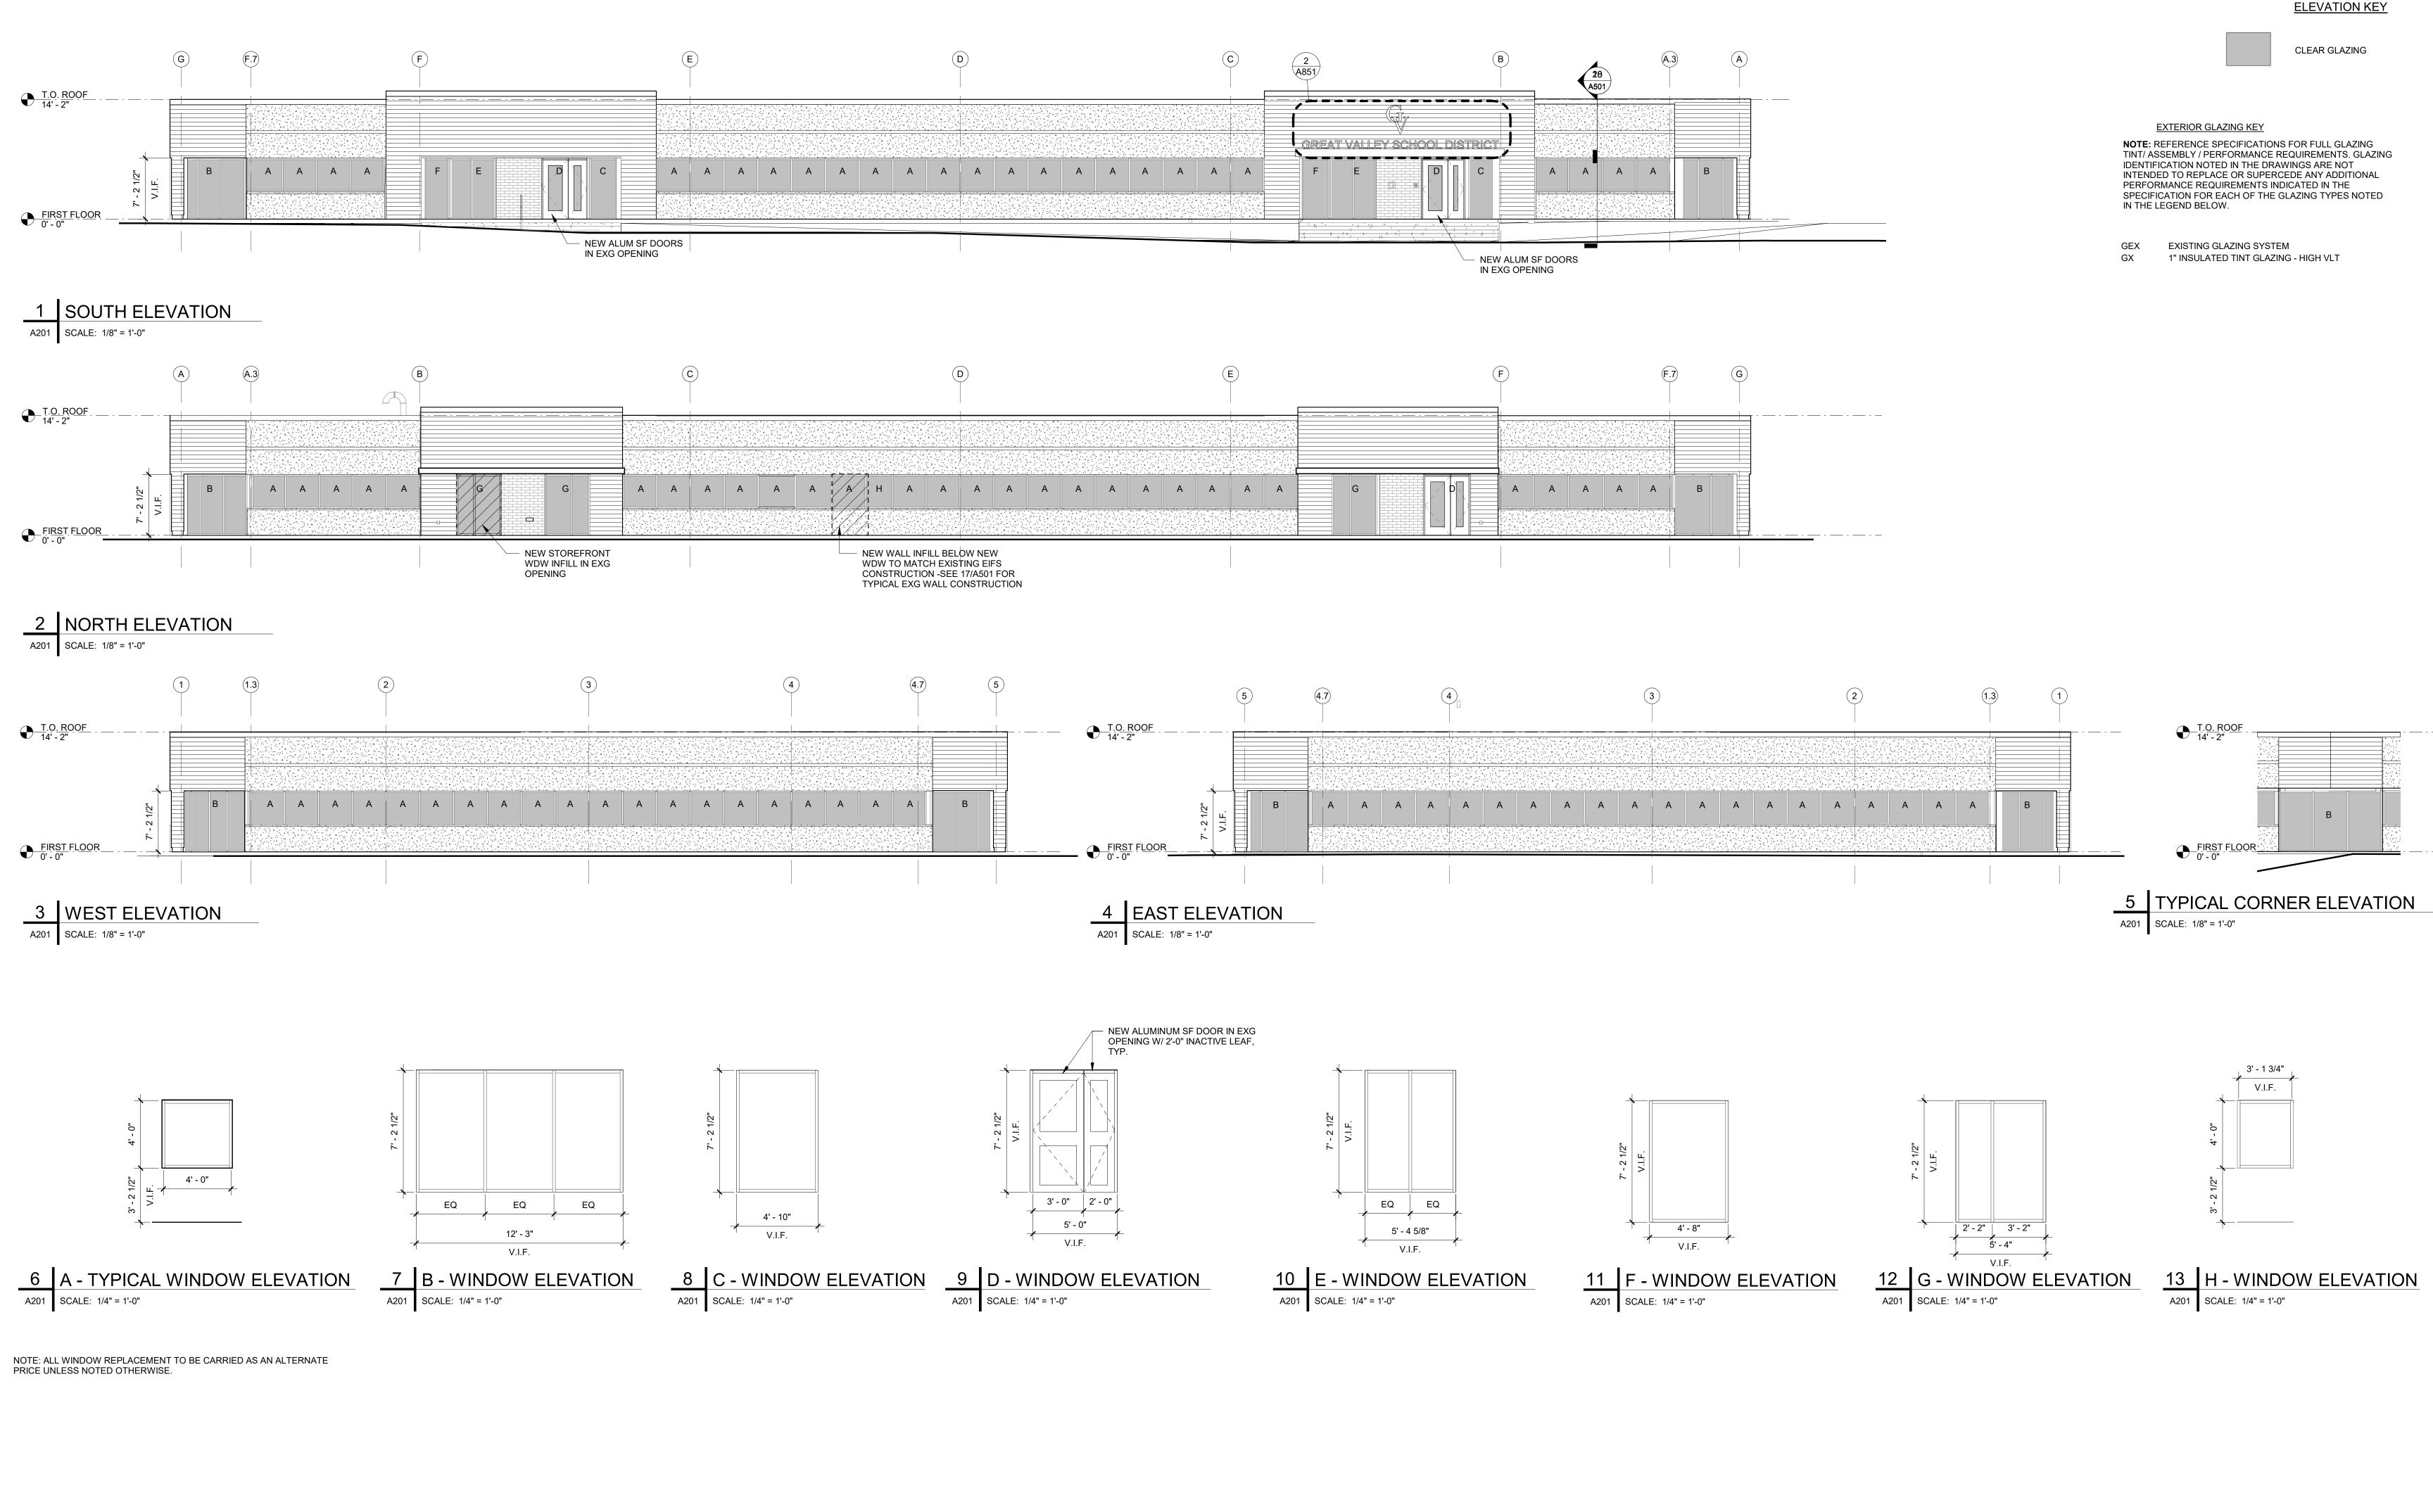





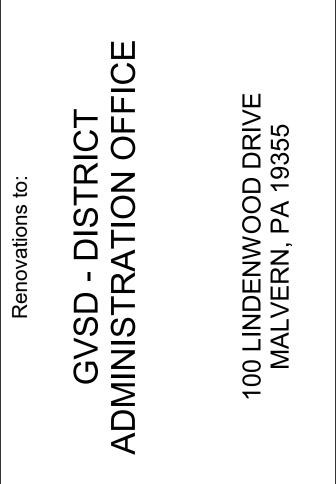


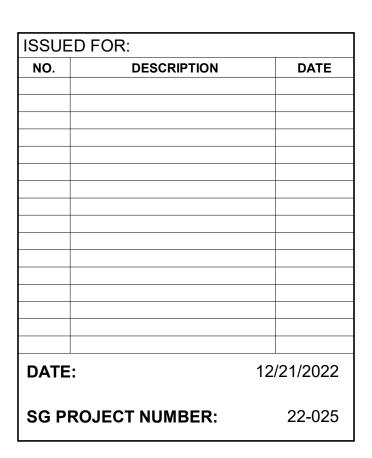

Key Plan: Drawing Title: BUILDING ELEVATIONS &

Drawing Number: A201

FRAME ELEVATIONS

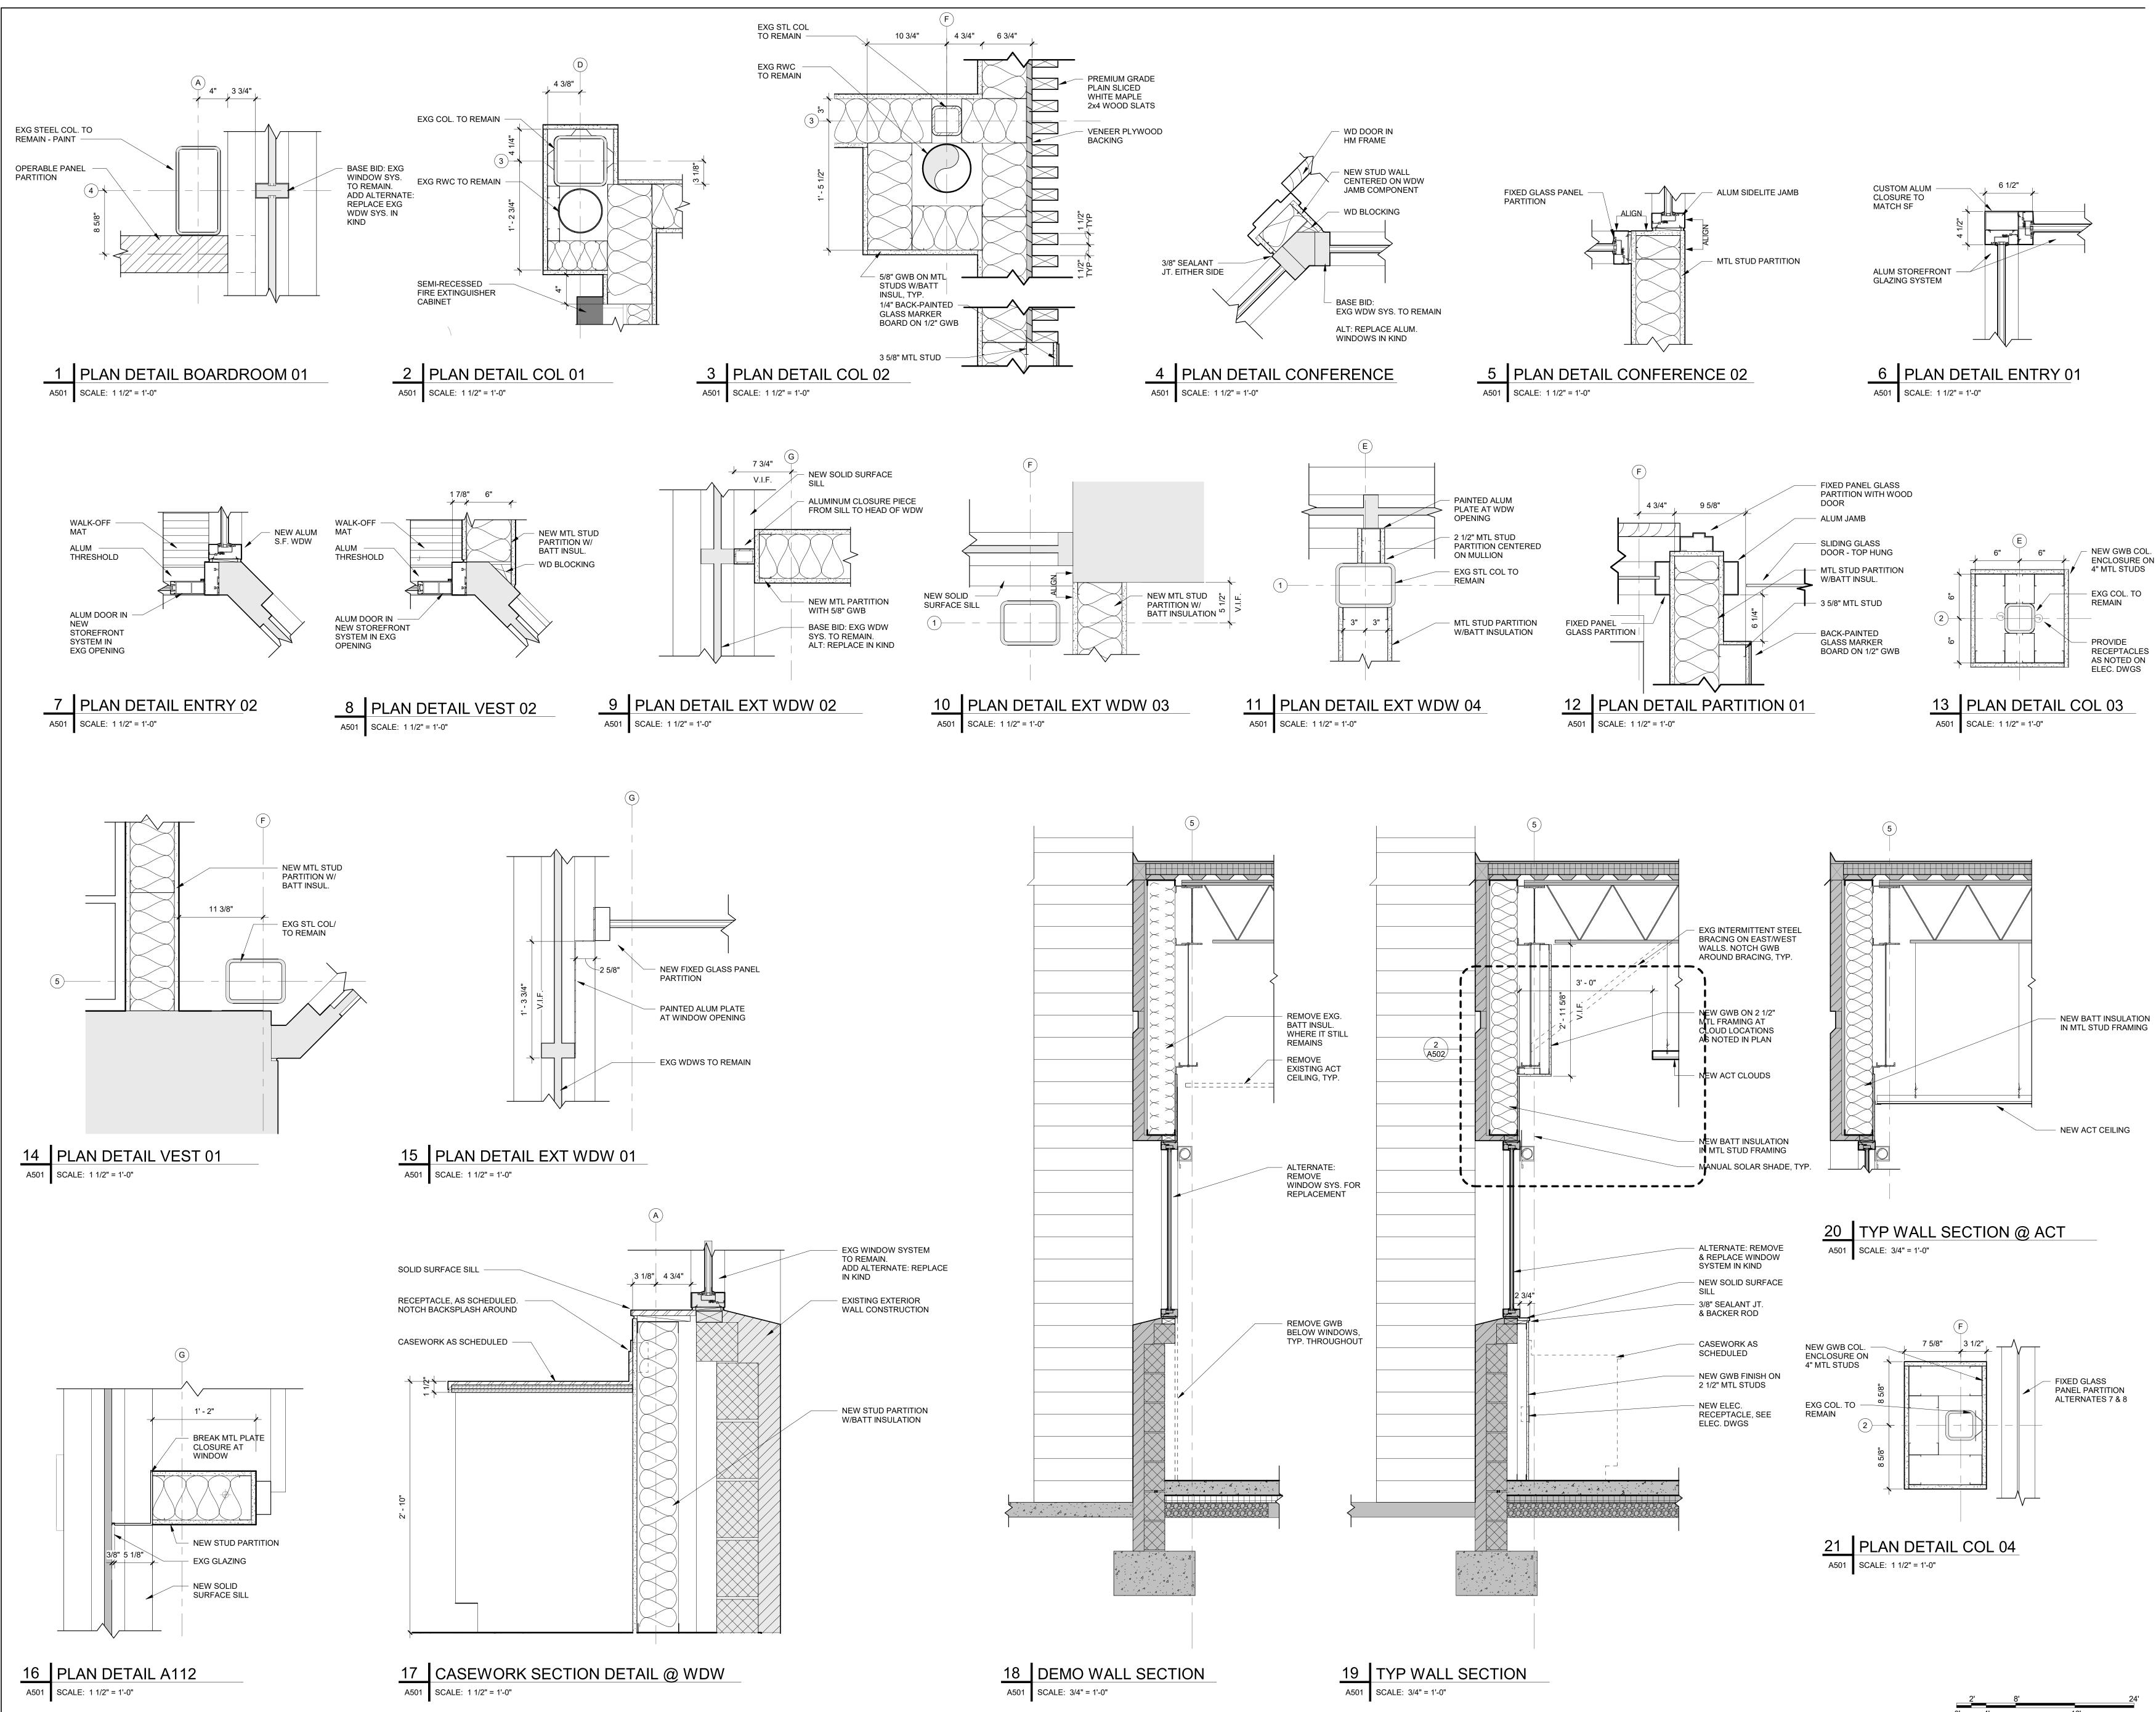



BID DOCUMENTS






DETAILS

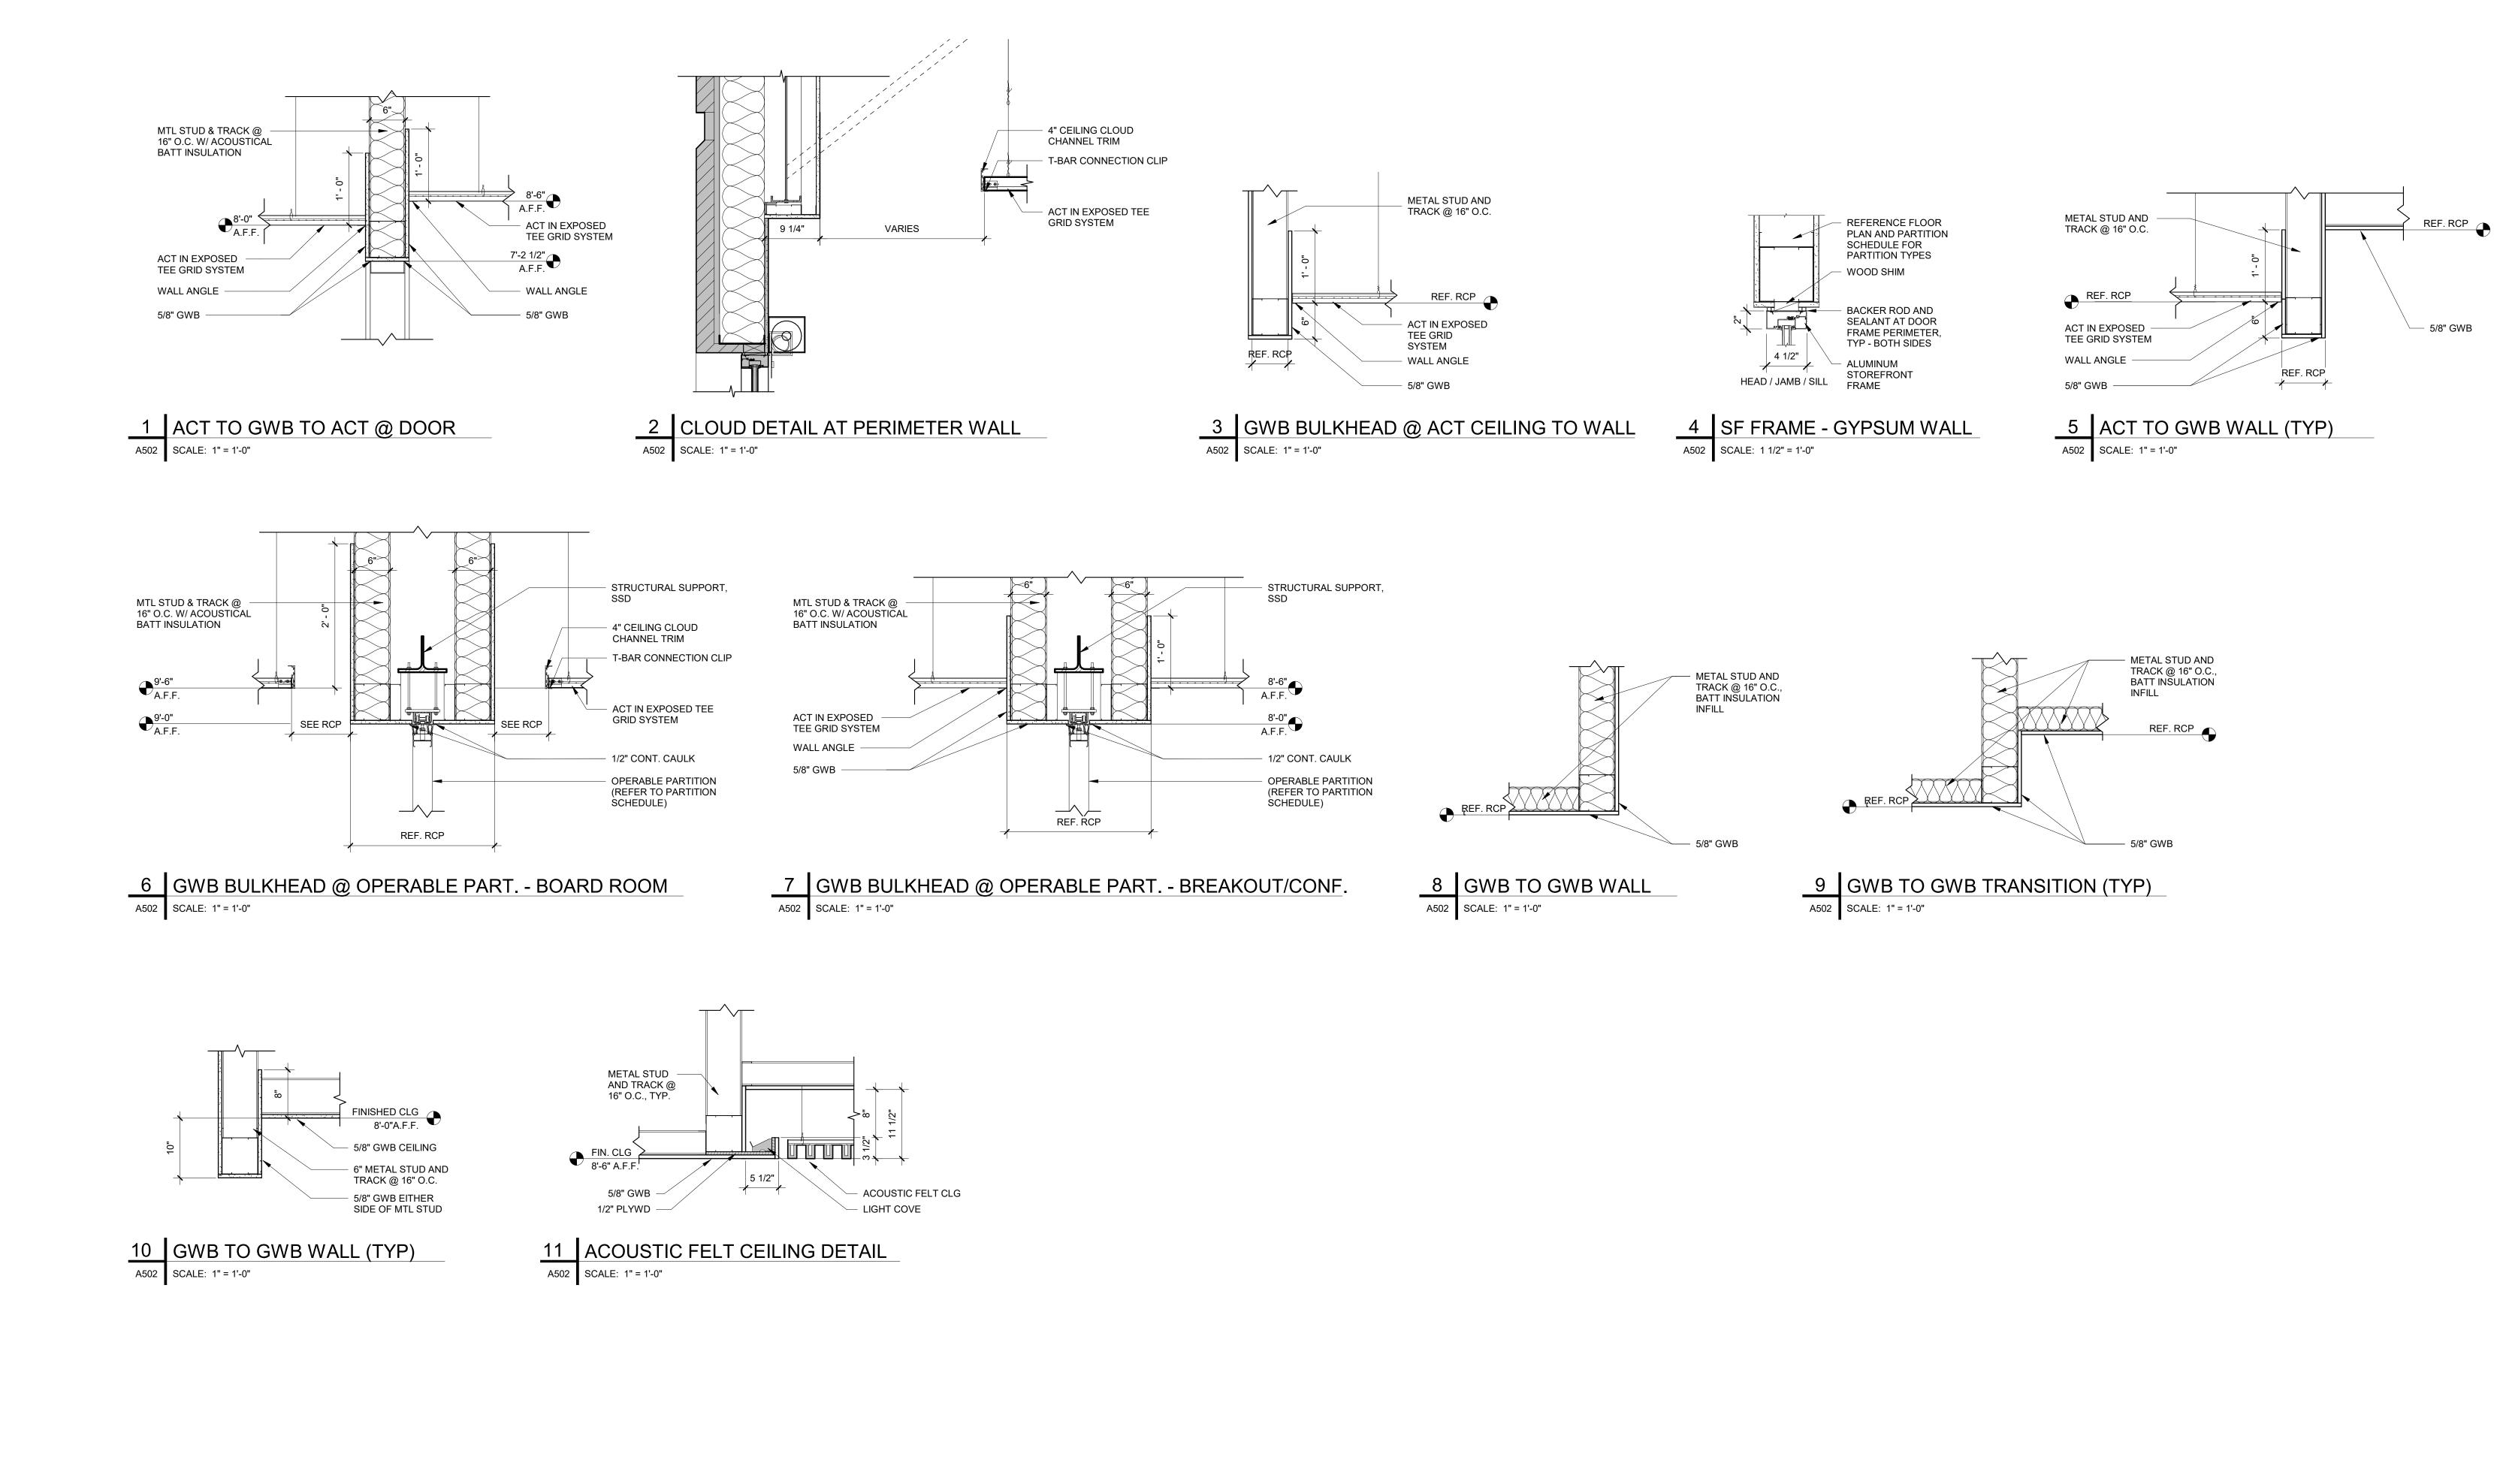

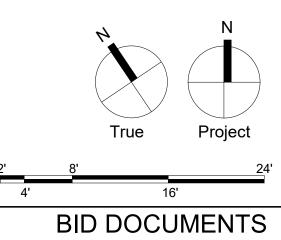

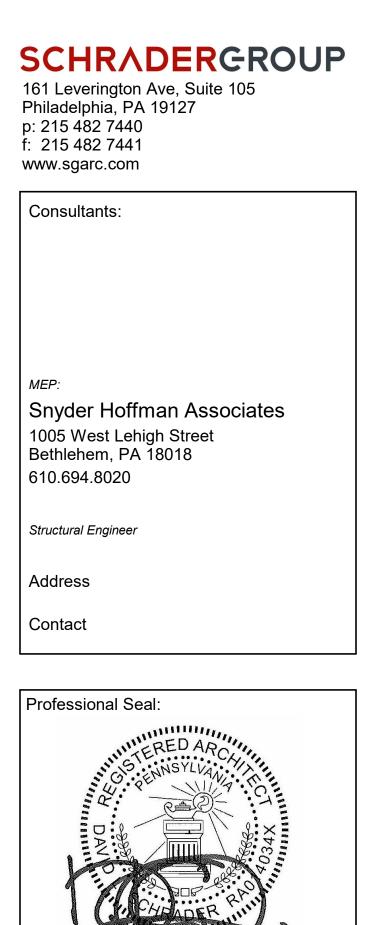






Key Plan: Drawing Title:

**CEILING DETAILS** Drawing Number: A502

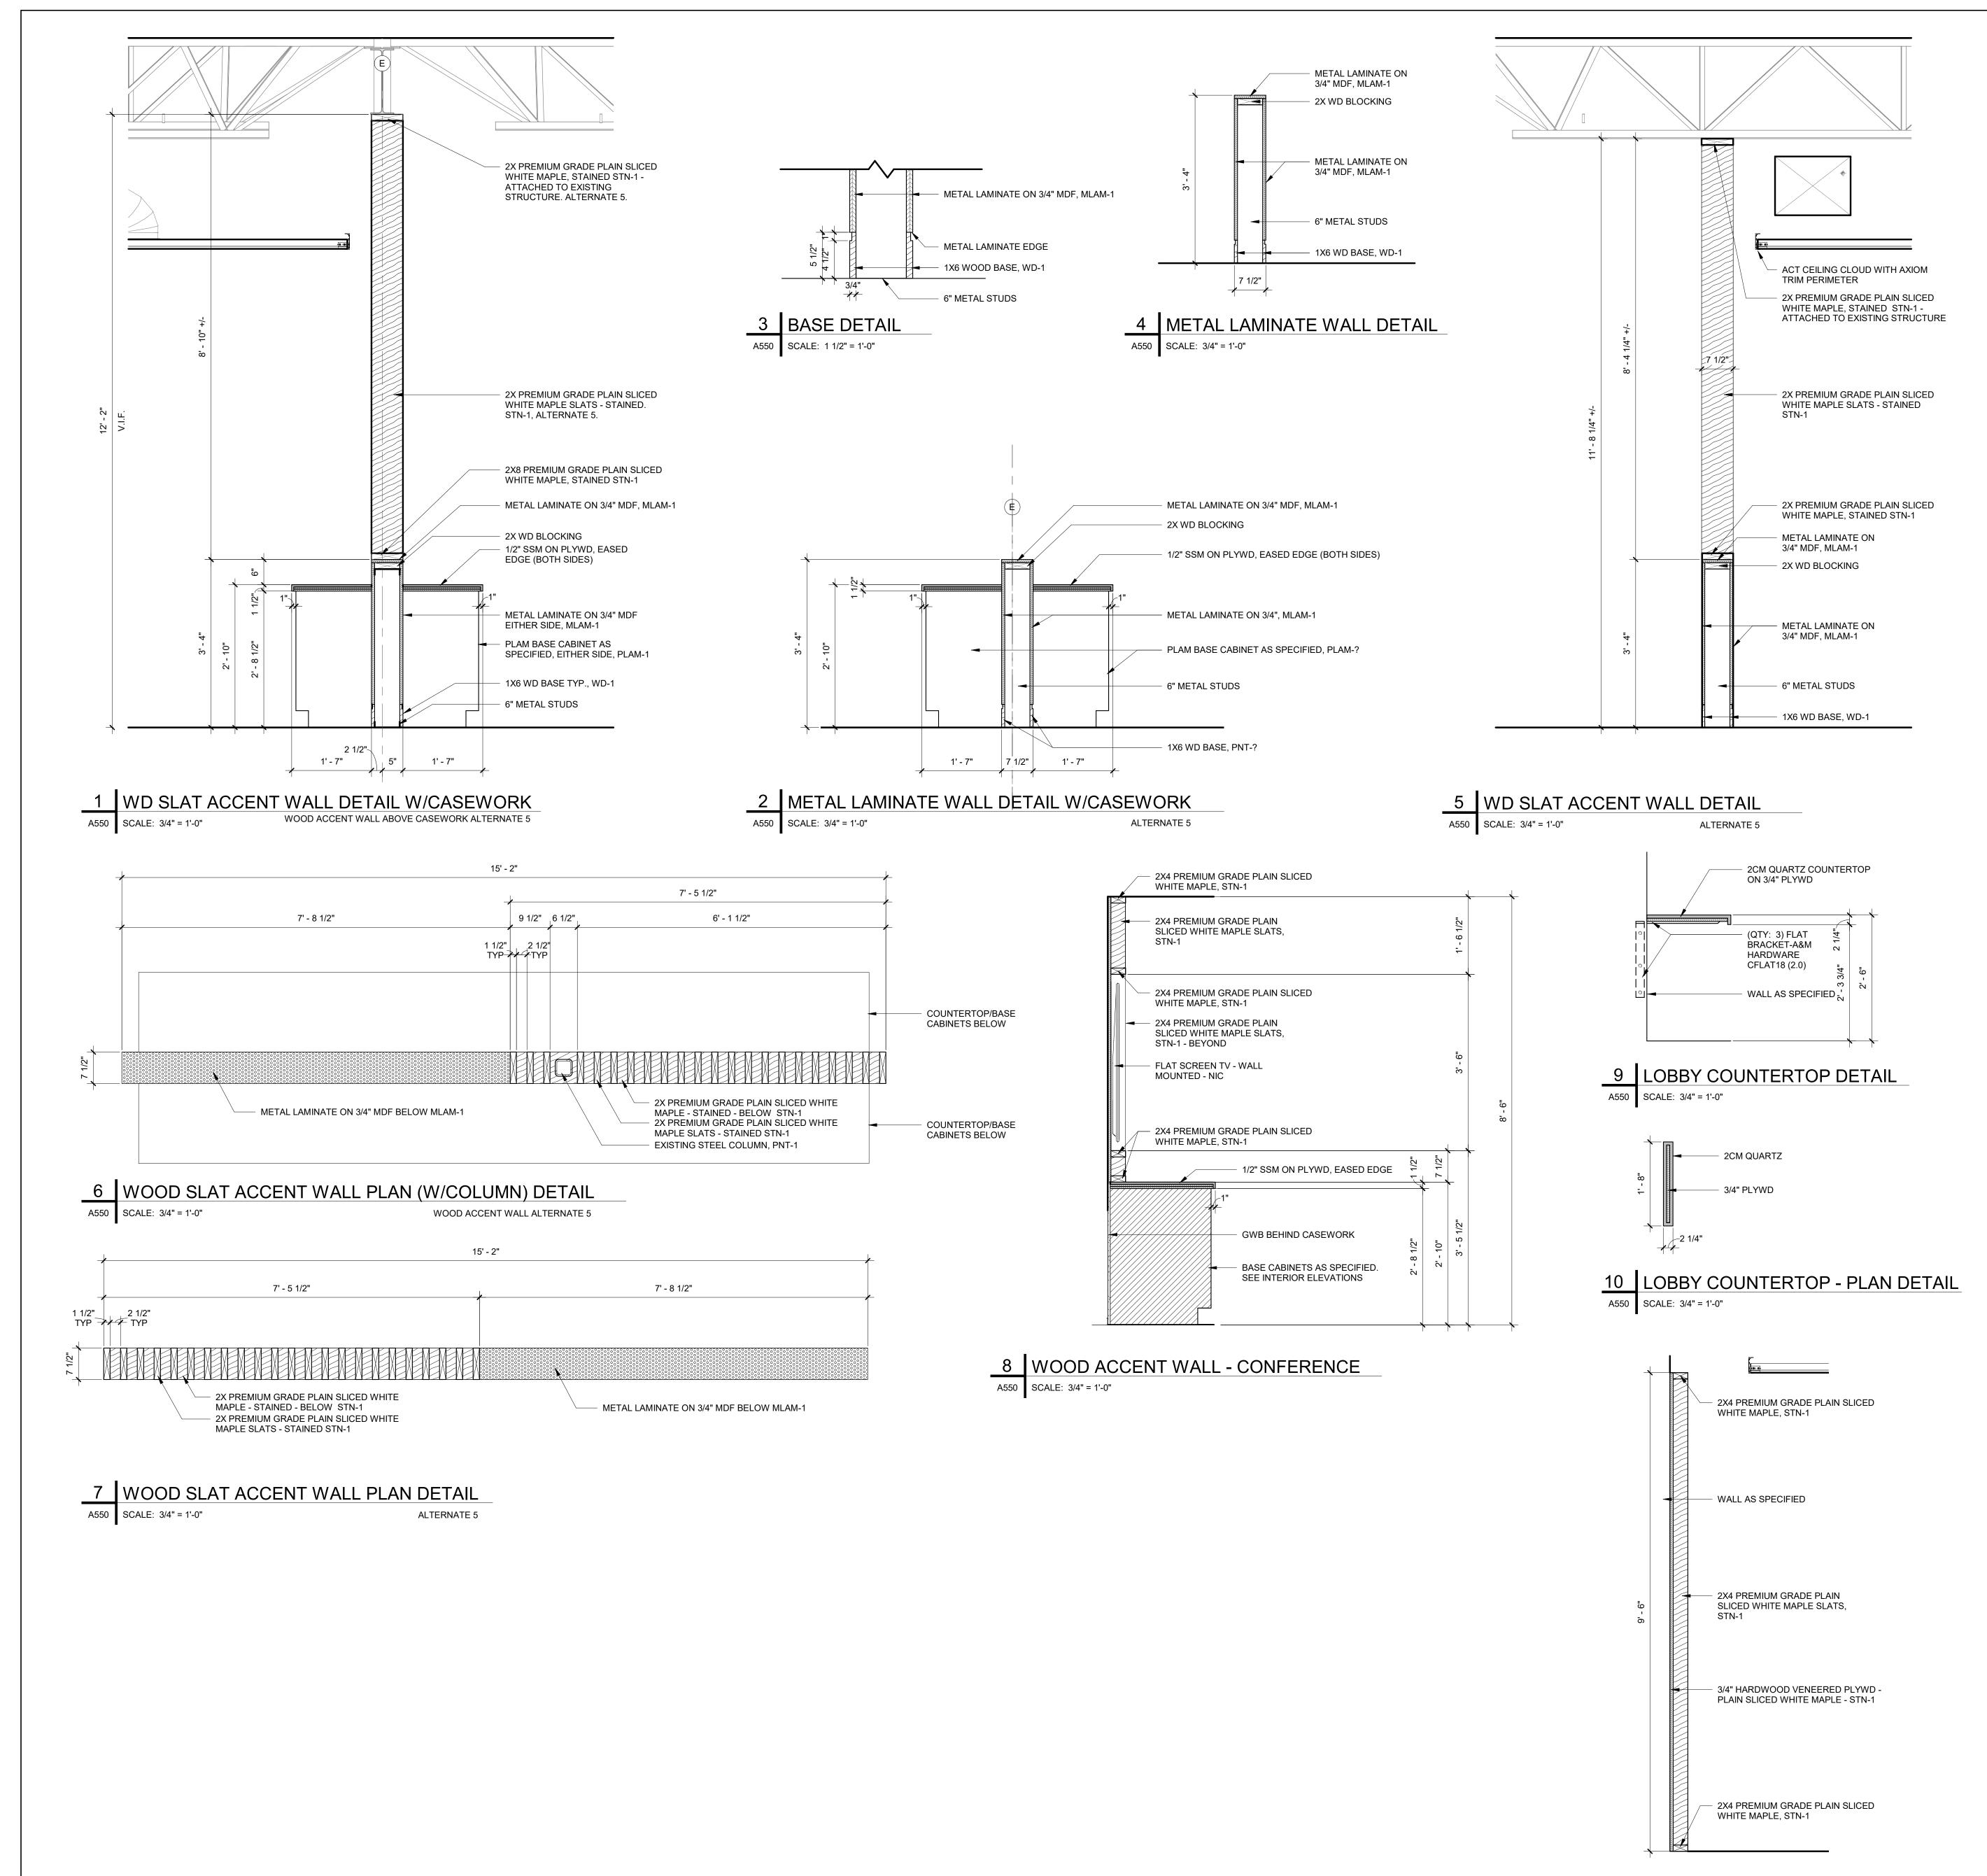




 2X4 PREMIUM GRADE PLAIN SLICED WHITE MAPLE, STN-1 -- 2X4 PREMIUM GRADE PLAIN SLICED WHITE MAPLE SLATS, STN-1 2X4 PREMIUM GRADE PLAIN SLICED WHITE MAPLE, STN-1 2X4 PREMIUM GRADE PLAIN SLICED WHITE MAPLE SLATS, STN-1 - BEYOND - FLAT SCREEN TV - WALL MOUNTED - NIC 2X4 PREMIUM GRADE PLAIN SLICED WHITE MAPLE, STN-1 – 2X4 PREMIUM GRADE PLAIN SLICED WHITE MAPLE SLATS, STN-1 3/4" HARDWOOD VENEERED PLYWD -PLAIN SLICED WHITE MAPLE - STN-1 - 2X4 PREMIUM GRADE PLAIN SLICED WHITE MAPLE, STN-1


 
 11
 WOOD ACCENT WALL - CONF/BREAKOUT


 A550
 SCALE: 3/4" = 1'-0"
 ALTERNATE 4A

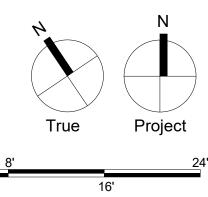


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**BID DOCUMENTS** 



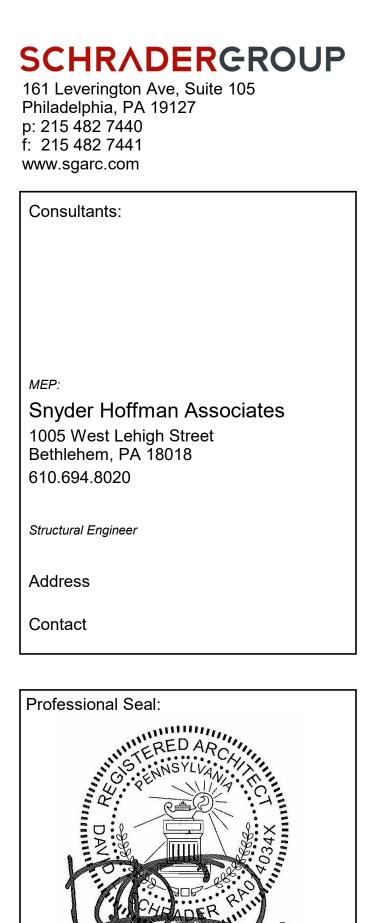


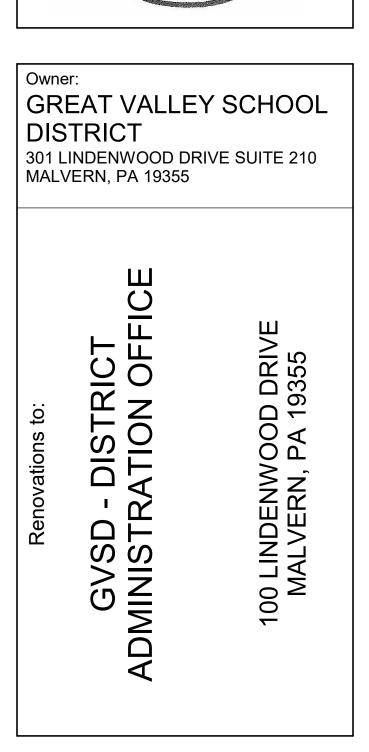

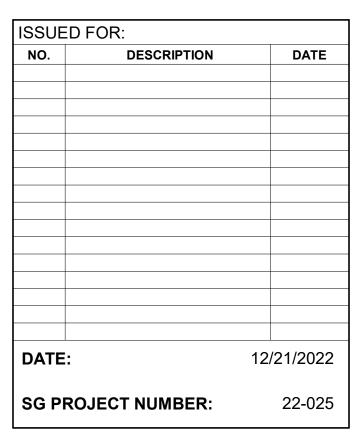Key Plan: Drawing Title:

**INTERIOR DETAILS** Drawing Number: A550


OF					LE	SCHEDU	AND FRAME	DOOR							
CEILING PC				FIRE	GLAZING		FRAME					DOOR	[		
HEIGHT D	NO. LENGTH	COMMENTS		RATING	TYPE	DEPTH	FINISH	MATERIAL	TYPE	FINISH	MATERIAL	THICKNESS	HEIGHT	WIDTH	TYPE
8' - 0"	OP1 18' - 4"			-	Т		Anodized		1	Anodized		0' - 2"	7' - 0 1/2"	2' - 11 3/4"	
9' - 6" 9' - 6"	OP2 32' - 10" OP3 32' - 10"			-	Т т		Anodized Anodized		1	Anodized Anodized		0' - 2"	7' - 0 1/2" 7' - 0 1/2"	3' - 0" 3' - 0"	
				-	T		Anodized		1	Anodized		0' - 2"	7' - 0 1/2"	3' - 0"	
				-	-	0' - 8 1/4"	Paint - Gossamer Veil		1	Stain		0' - 1 3/4"	7' - 0"	3' - 0"	A
			TRANSLUCENT GLAZING		Т		Anodized		1	Stain		0' - 1 3/4"	7' - 0 1/2"	3' - 0"	
			TRANSLUCENT GLAZING TRANSLUCENT GLAZING		- -	0' - 8 1/4"	Paint Anodized		1	Stain Stain		0' - 1 3/4" 0' - 1 3/4"	7' - 0" 7' - 0 1/2"	3' - 0" 3' - 0"	
			TRANSLUCENT GLAZING		T		Anodized		1	Stain		0' - 1 3/4"	7' - 0 1/2"	3' - 0"	
			TRANSLUCENT GLAZING		Т		Anodized		1	Stain		0' - 1 3/4"	7' - 0 1/2"	3' - 0"	
			TRANSLUCENT GLAZING		T		Anodized		1	Stain		0' - 1 3/4"	7' - 0 1/2"	3' - 0"	
			TRANSLUCENT GLAZING TRANSLUCENT GLAZING		Т		Anodized Anodized		1	Stain Stain		0' - 1 3/4" 0' - 1 3/4"	7' - 0 1/2" 7' - 0 1/2"	3' - 0" 3' - 0"	
			TRANSLUCENT GLAZING		T		Anodized		1	Stain		0' - 1 3/4"	7' - 0 1/2"	3' - 0"	
			TRANSLUCENT GLAZING		T		Anodized		1	Stain		0' - 1 3/4"	7' - 0 1/2"	3' - 0"	
			TRANSLUCENT GLAZING		Т		Anodized		1	Stain		0' - 1 3/4"	7' - 0 1/2"	3' - 0"	
			TRANSLUCENT GLAZING		T		Anodized		1	Stain		0' - 1 3/4"	7' - 0 1/2"	3' - 0" 3' - 0"	
				-	<u>г</u> Т		Anodized Anodized			Stain Stain		0' - 1 3/4" 0' - 1 3/4"	7' - 0 1/2" 7' - 0 1/2"	3' - 0"	
			TRANSLUCENT GLAZING		T		Anodized		1	Stain		0' - 1 3/4"	7' - 0 1/2"	3' - 0"	
			TRANSLUCENT GLAZING		Т		Anodized	Aluminum	1	Stain		0' - 1 3/4"	7' - 0 1/2"	3' - 0"	
			SLIDING DOOR						FRAMELESS		Glass	0' - 0 3/8"	7' - 0 1/2"	3' - 0"	
			SLIDING DOOR SLIDING DOOR						FRAMELESS FRAMELESS		Glass Glass	0' - 0 3/8" 0' - 0 3/8"	7' - 0 1/2" 7' - 0 1/2"	3' - 0" 3' - 0"	
			SLIDING DOOR						FRAMELESS		Glass	0' - 0 3/8"	7' - 0 1/2"	3' - 0"	
			TRANSLUCENT GLAZING		Т		Anodized		1	Stain		0' - 1 3/4"	7' - 0 1/2"	3' - 0"	
			TRANSLUCENT GLAZING		T		Anodized		1	Stain		0' - 1 3/4"	7' - 0 1/2"	3' - 0"	
FOLDING PARTITION	OPERABLE F		TRANSLUCENT GLAZING TRANSLUCENT GLAZING		Т		Anodized Anodized		1	Stain Stain		0' - 1 3/4" 0' - 1 3/4"	7' - 0 1/2" 7' - 0 1/2"	3' - 0" 3' - 0"	B
	0. 2. 0. 222 1			-	T		Anodized		1	Stain		0' - 1 3/4"	7' - 0 1/2"	3' - 0"	
				-	Т		Anodized	Aluminum	1	Stain		0' - 1 3/4"	7' - 0 1/2"	3' - 0"	
	<b>\</b>		TRANSLUCENT GLAZING		T		Anodized		1	Stain		0' - 1 3/4"	7' - 0 1/2"	3' - 0"	
			TRANSLUCENT GLAZING TRANSLUCENT GLAZING		<u> </u>		Anodized Anodized		1	Stain Stain		0' - 1 3/4" 0' - 1 3/4"	7' - 0 1/2" 7' - 0 1/2"	3' - 0" 3' - 0"	
,			TRANSLUCENT GLAZING		T		Anodized		1	Stain		0' - 1 3/4"	7' - 0 1/2"	3' - 0"	
,			TRANSLUCENT GLAZING	-	т		Anodized	Aluminum	1	Stain	Wood	0' - 1 3/4"	7' - 0 1/2"	3' - 0"	В
,			TRANSLUCENT GLAZING		Т		Anodized		1	Stain		0' - 1 3/4"	7' - 0 1/2"	3' - 0"	
4'-0"			TRANSLUCENT GLAZING TRANSLUCENT GLAZING		- T	0' - 8 1/4"	Paint Anodized		1	Stain Stain		0' - 1 3/4" 0' - 1 3/4"	7' - 0" 7' - 0 1/2"	3' - 0" 3' - 0"	
TYP.			TRANSLUCENT GLAZING		-	0' - 8 1/4"	Paint		1	Stain		0' - 1 3/4"	7' - 0"	3' - 0"	
,	qule		TRANSLUCENT GLAZING		Т		Anodized	Aluminum	1	Stain		0' - 1 3/4"	7' - 0 1/2"	3' - 0"	
,			TRANSLUCENT GLAZING	-	Т		Anodized	Aluminum	1	Stain		0' - 1 3/4"	7' - 0 1/2"	3' - 0"	
	8			-	-	0' - 8 1/4" 0' - 8 1/4"	Paint - Gossamer Veil Paint - Gossamer Veil		1	Stain Stain		0' - 1 3/4" 0' - 1 3/4"	7' - 0" 7' - 0"	3' - 0" 3' - 0"	
!	ŭ			45	-	0' - 8 1/4"	Paint - Gossamer Veil		1	Stain		0' - 1 3/4"	7'-0"	3' - 0"	A
-				-	-	0' - 8 1/4"	Paint - Gossamer Veil		1	Stain		0' - 1 3/4"	7' - 0"	3' - 0"	A
				-	-	0' - 8 1/4"	Paint - Gossamer Veil		1	Stain		0' - 1 3/4"	7' - 0"	3' - 0"	A
'			TRANSLUCENT GLAZING		-	0' - 8 1/4"	Paint Anodized		1	Stain Stain		0' - 1 3/4" 0' - 1 3/4"	7' - 0" 7' - 0"	3' - 0" 3' - 0"	
o.				-	-	0' - 8 1/4"	Paint		1	Stain		0' - 1 3/4"	7' - 0"	3'-0"	
5.				-	Т		Anodized		1	Stain		0' - 1 3/4"	7' - 0 1/2"	3' - 0"	
	<b>\</b>			-	-	0' - 5 1/2"	Paint - Gossamer Veil		1	Stain		0' - 1 3/4"	7' - 0"	3' - 0"	
			TRANSLUCENT GLAZING		T	0' 9 1/4"	Anodized Paint		1	Stain		0' - 1 3/4"	7' - 0 1/2"	3' - 0" 3' - 0"	
	+			-	-	0' - 8 1/4" 0' - 8 1/4"	Paint - Gossamer Veil		1	Stain Stain		0' - 1 3/4" 0' - 1 3/4"	7' - 0" 7' - 0"	3 - 0	B
				-	-	0' - 8 1/4"	Paint - Gossamer Veil		1	Stain		0' - 1 3/4"	7' - 0"	3' - 0"	
				-	-	0' - 8 1/4"	Paint		1	Stain		0' - 1 3/4"	7' - 0"	6' - 0"	
				-	-	0' - 8 1/4"	Paint		1	Stain		0' - 1 3/4"	7' - 0"	3' - 0"	
				-	-	0' - 8 1/4" 0' - 8 1/4"	Paint - Gossamer Veil Paint		1	Stain Stain		0' - 1 3/4" 0' - 1 3/4"	7' - 0" 7' - 0"	6' - 0" 3' - 0"	
	2 OPERABLE			-	-	0' - 8 1/4"	Paint - Gossamer Veil		1	Stain		0' - 1 3/4"	7' - 0"	3' - 0"	A
	A601 SCALE: 1/4" = 1'-0"			-	-	0' - 8 1/4"	Paint - Gossamer Veil	Hollow Metal	1	Stain	Wood	0' - 1 3/4"	7' - 0"	3' - 0"	A
	•			-	-	0' - 8 1/4"	Paint - Gossamer Veil		1	Stain		0' - 1 3/4"	7' - 0"	3' - 0"	
				-	-	0' - 8 1/4" 0' - 8 1/4"	Paint - Gossamer Veil Paint - Gossamer Veil		1	Stain Stain		0' - 1 3/4" 0' - 1 3/4"	7' - 0" 7' - 0"	3' - 0" 3' - 0"	
				-	-	0' - 6 3/4"	Paint - Gossamer Veil		<u> </u>	Stain		0' - 1 3/4"	7'-0"	3 - 0"	
				-	-	0' - 6 3/4"	Paint - Gossamer Veil		1	Stain		0' - 1 3/4"	7' - 0"	3' - 0"	A
				-	-	0' - 6 3/4"	Paint - Gossamer Veil		1	Stain		0' - 1 3/4"	7' - 0"	3' - 0"	
				-	-	0' - 6 3/4"	Paint - Gossamer Veil		1	Stain		0' - 1 3/4"	7' - 0"	3' - 0"	
				-	-	0' - 6 3/4"	Paint - Gossamer Veil	Hollow Metal	1	Stain	Wood	0' - 1 3/4"	7' - 0"	6' - 0"	A

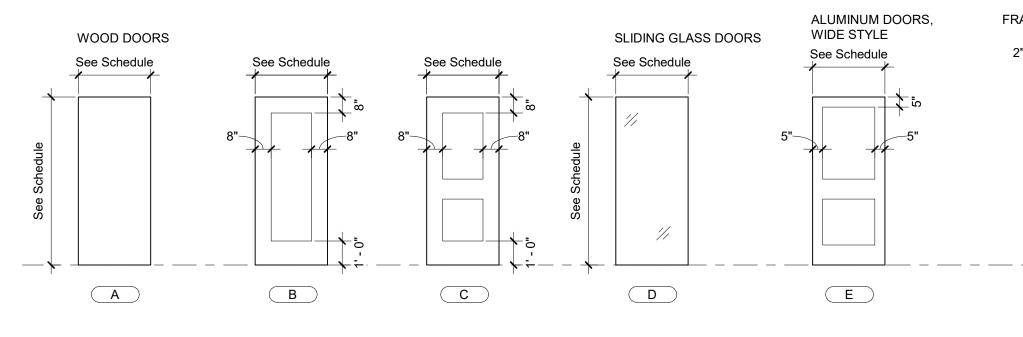



SCALE: 1/4" = 1'-0"

FRAME TYPES 2"-\_\_See Schedule\_\_\_2"

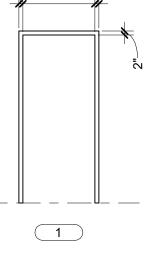


OPERABLE PARTITION SCHEDULE							
POCKET DOOR	COMMENTS						
Yes							
Yes	ALTERNATE 3; Provide Partition [with (2) Marker Boards, each side]						
Yes	Provide (2) Marker Boards, each side						

### DOOR NOTES


- 1. ALL CLOSERS TO HAVE CLOSING SPECS SET 90° 12°, 5
- SECONDS MIN.
- 2. ALL DOOR LOCKS, LATCHES, PANIC HARDWARE AND PULLS TO BET SET 34"-48" AFF. 3. ALL DOOR OPERATING DEVICES (OTHER THAN PANIC
- HARDWARE) TO BE LEVER OPERATED.
- 4. ALL THRESHOLDS TO BE 1/2" MAX. HEIGHT, BEVELED TO 1:2 SLOPE.
- 5. ALL GLASS IN DOORS AND WITHIN 24" OF A DOOR TO BE SAFETY TEMPERED GLASS (T).
- \*SEE DOOR TYPES\* DIMENSION NOTED IS FROM FINISHES FLOOR TO BOTTOM OF GLAZING.
- <u>GLAZING KEY</u>
- T TEMPERED GLAZING


NOTE: REFERENCE SPECIFICATIONS FOR FULL GLAZING TINT/ ASSEMBLY / PERFORMANCE REQUIREMENTS. GLAZING IDENTIFICATION NOTED IN THE DRAWINGS ARE NOT INTENDED TO REPLACE OR SUPERCEDE ANY ADDITIONAL PERFORMANCE REQUIREMENTS INDICATED IN THE SPECIFICATION FOR EACH OF THE GLAZING TYPES NOTED IN THE LEGEND BELOW.


GEX EXISTING GLAZING SYSTEM GX 1" INSULATED TINT GLAZING - HIGH VLT

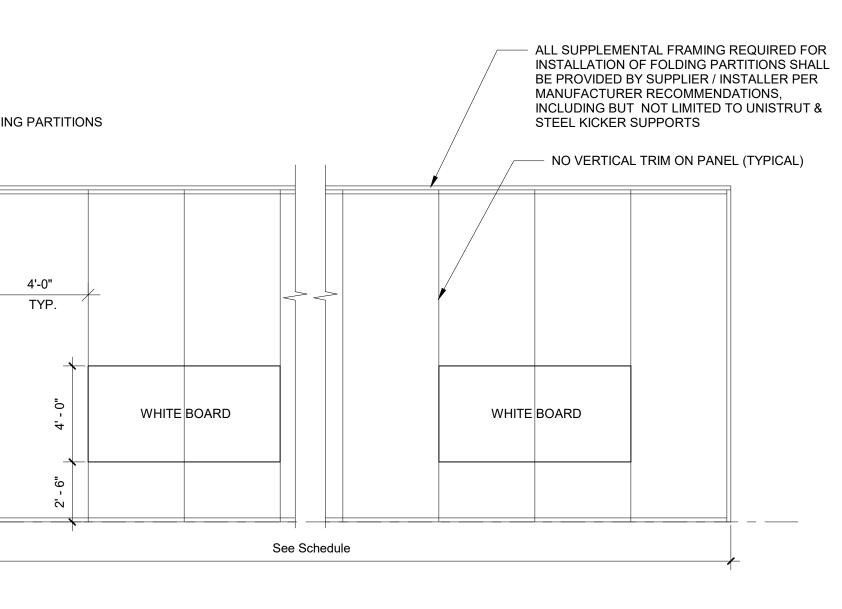

# PARTITION - TYPICAL ELEVATION

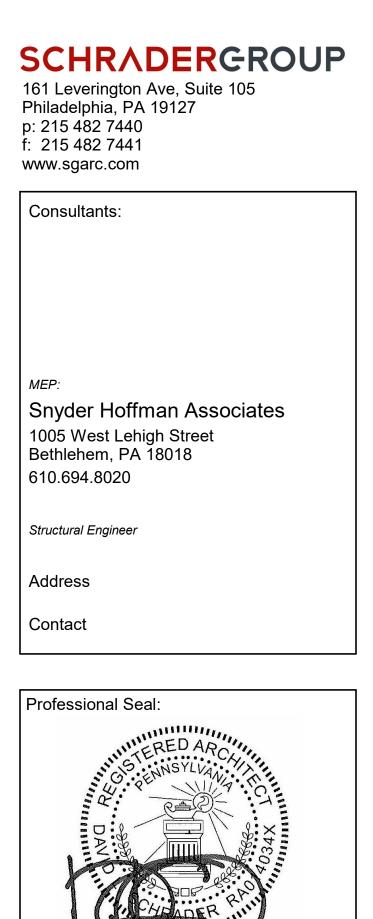

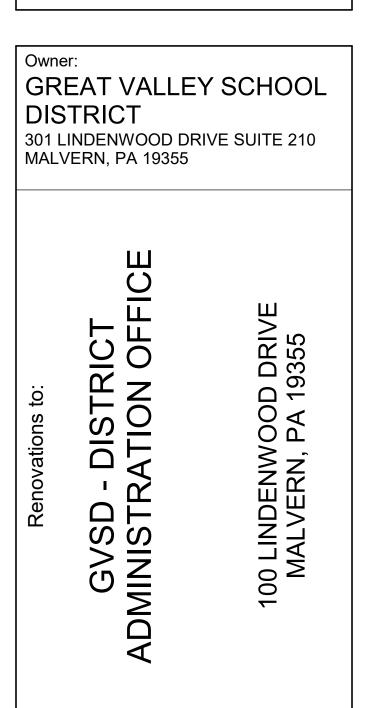


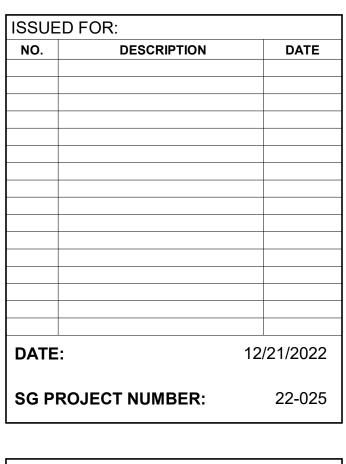



Key Plan: Drawing Title:


DOOR SCHEDULE


A601

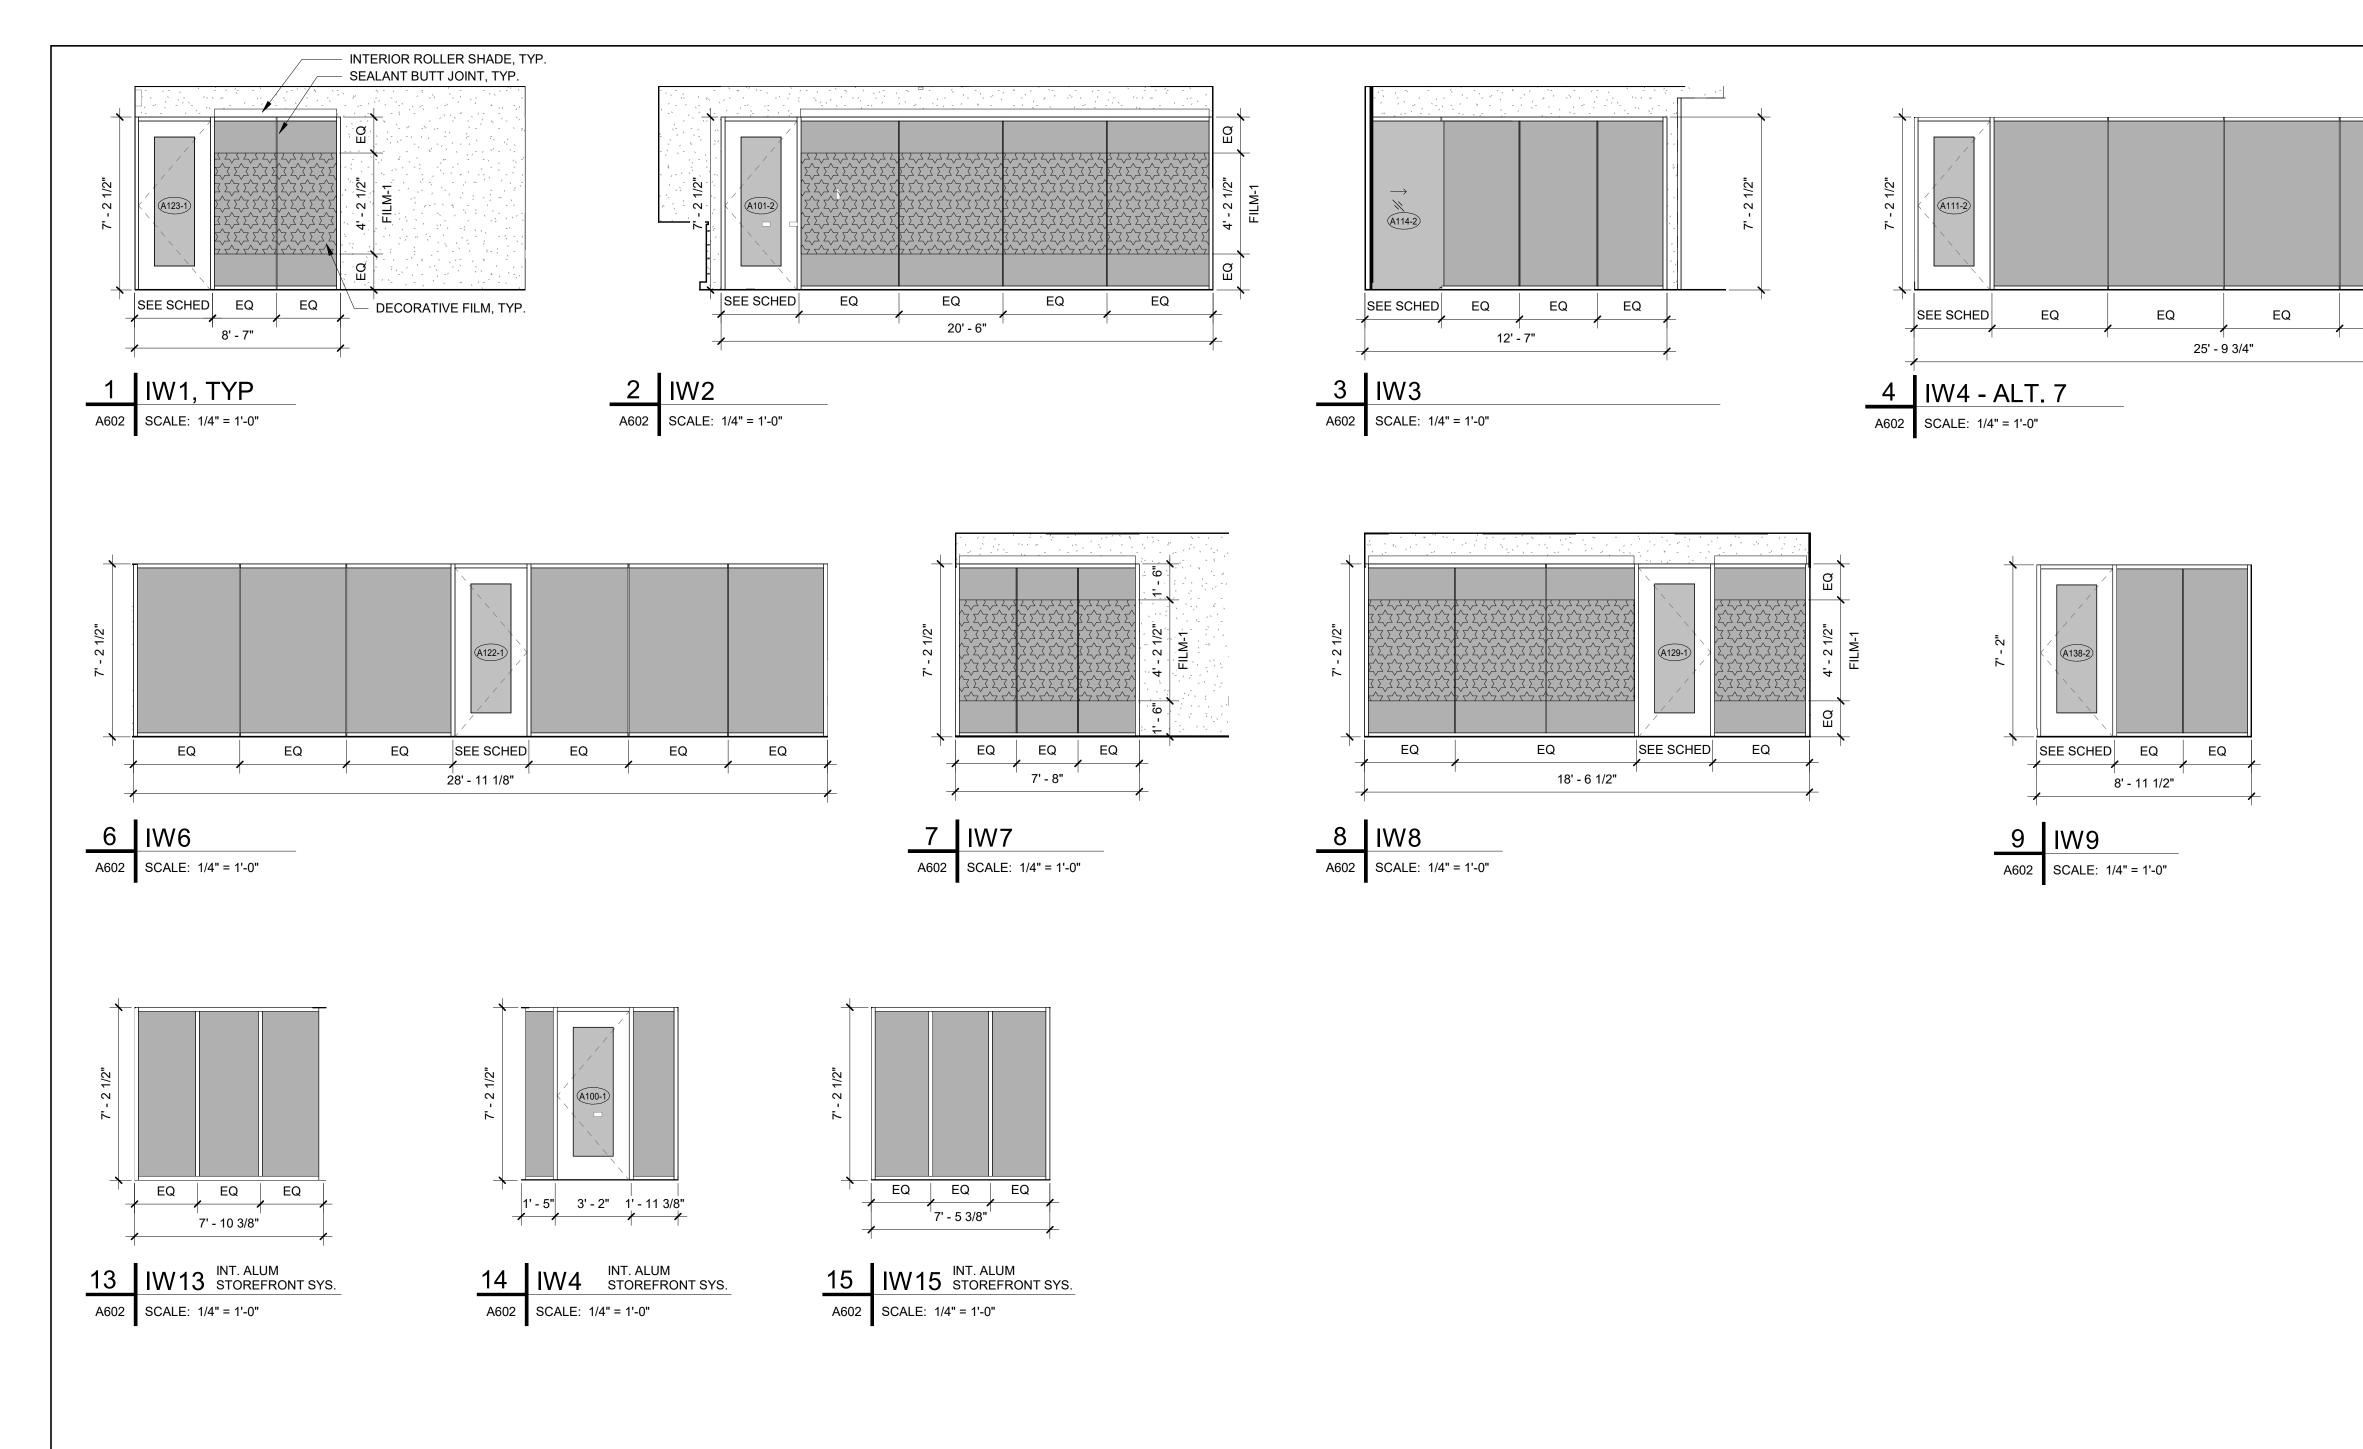


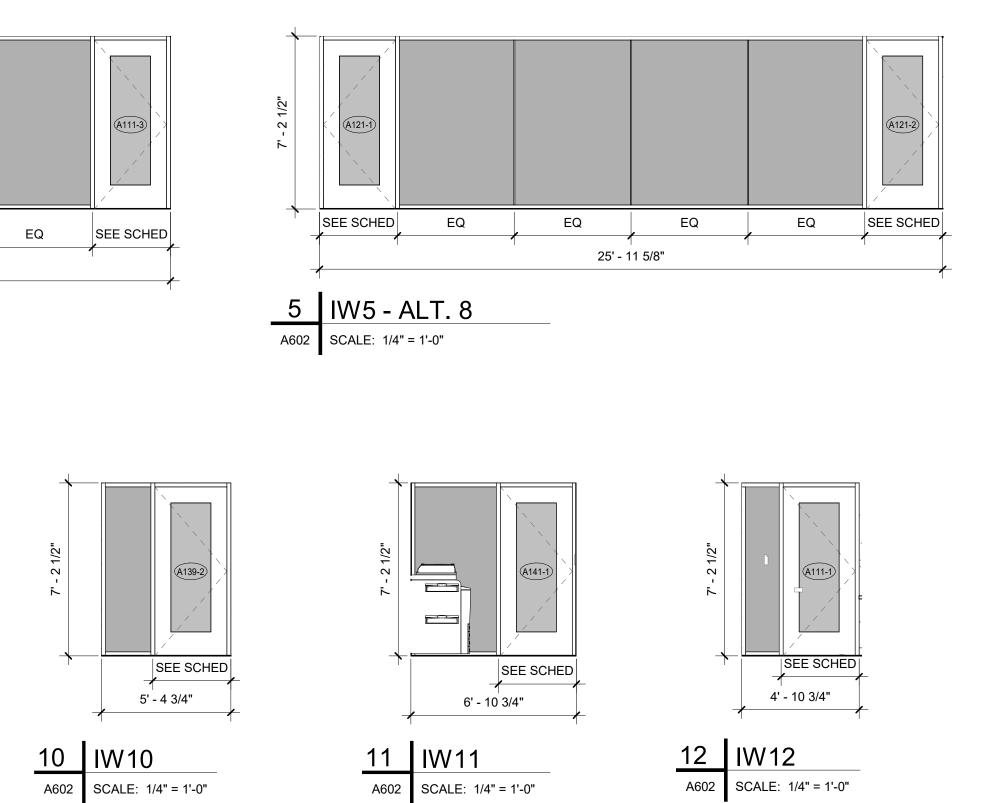

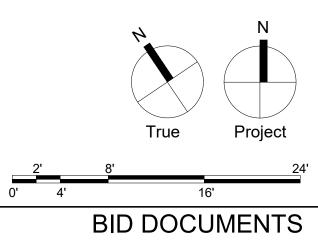

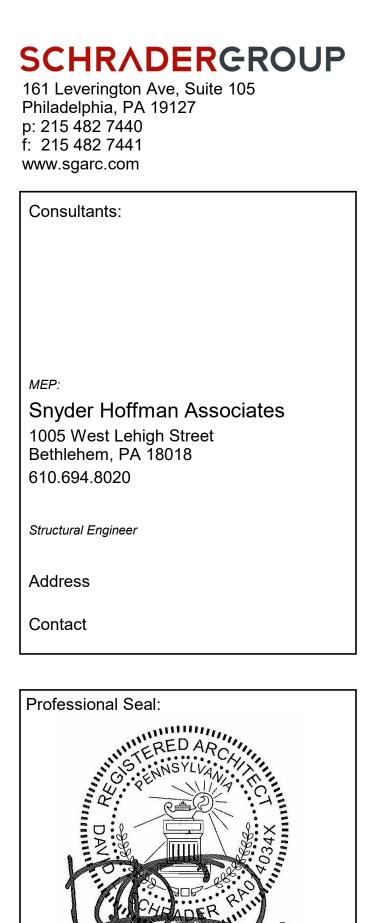


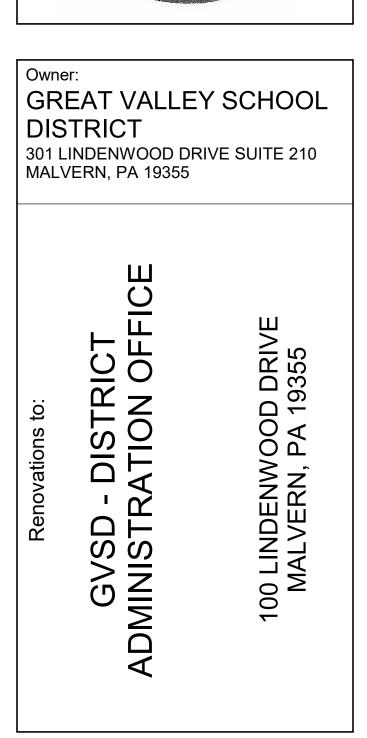


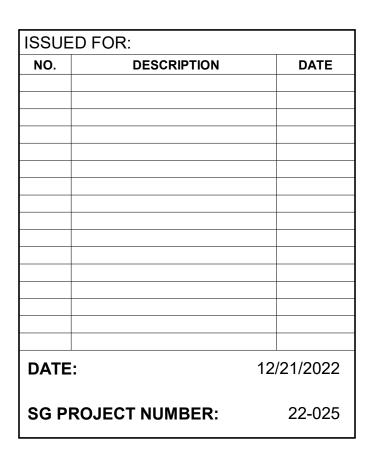


Key Plan:



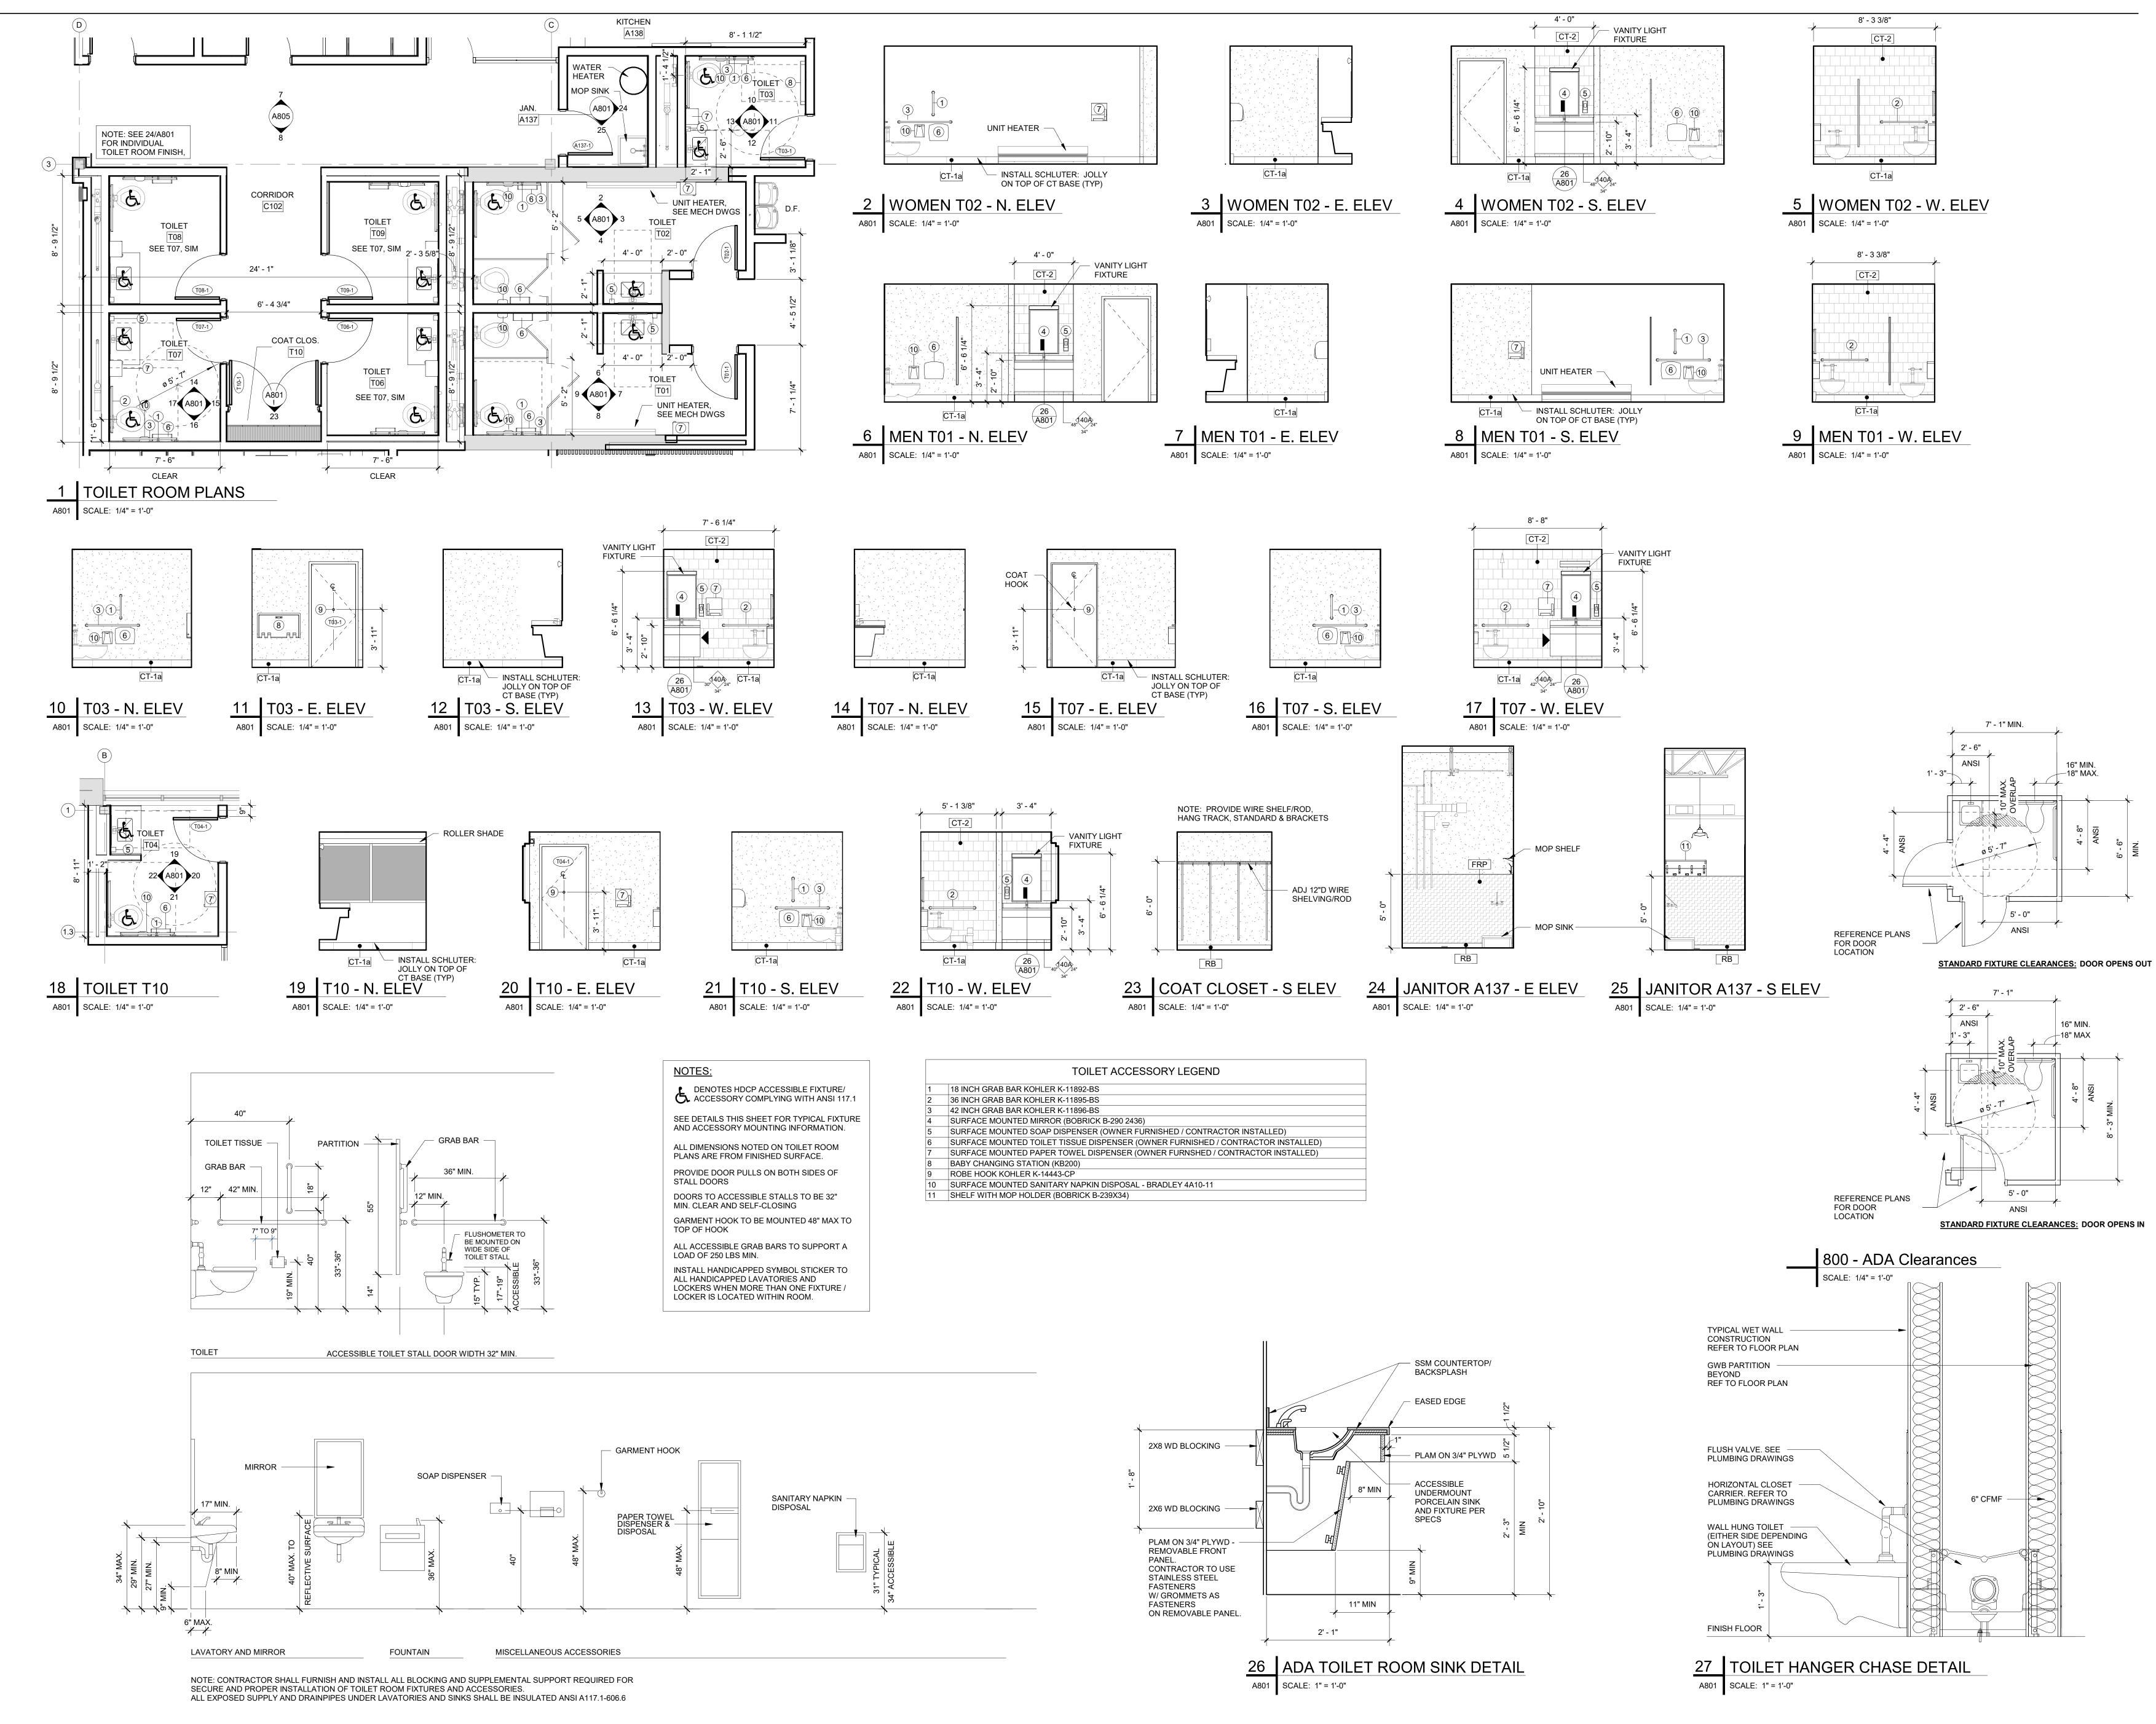


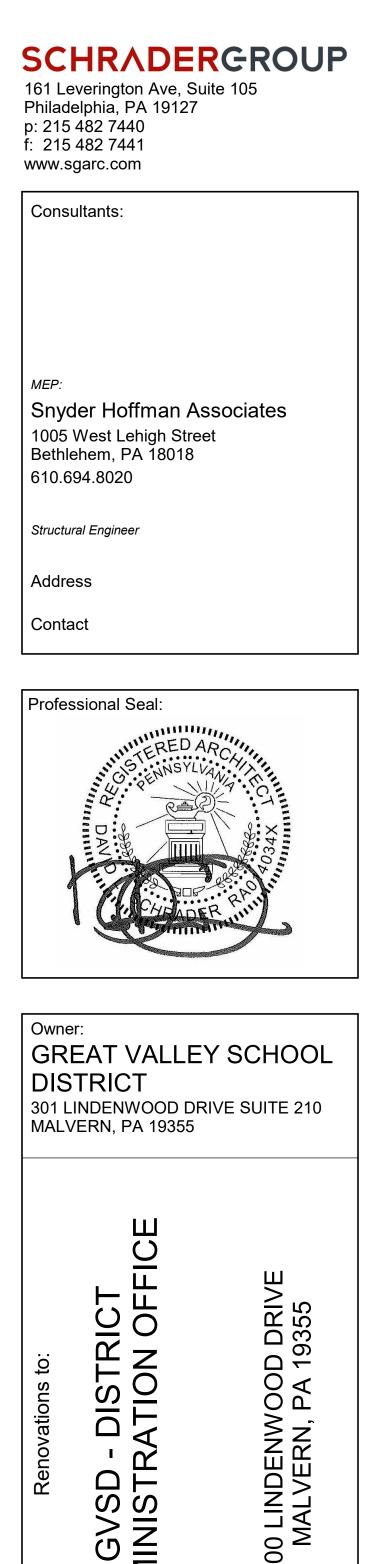

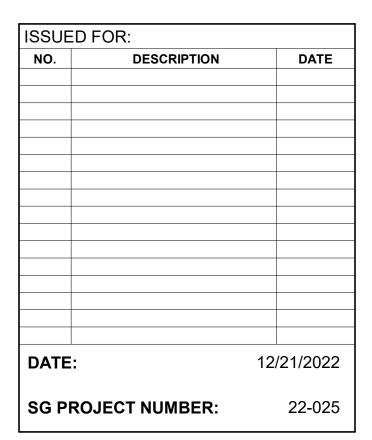


GVSD



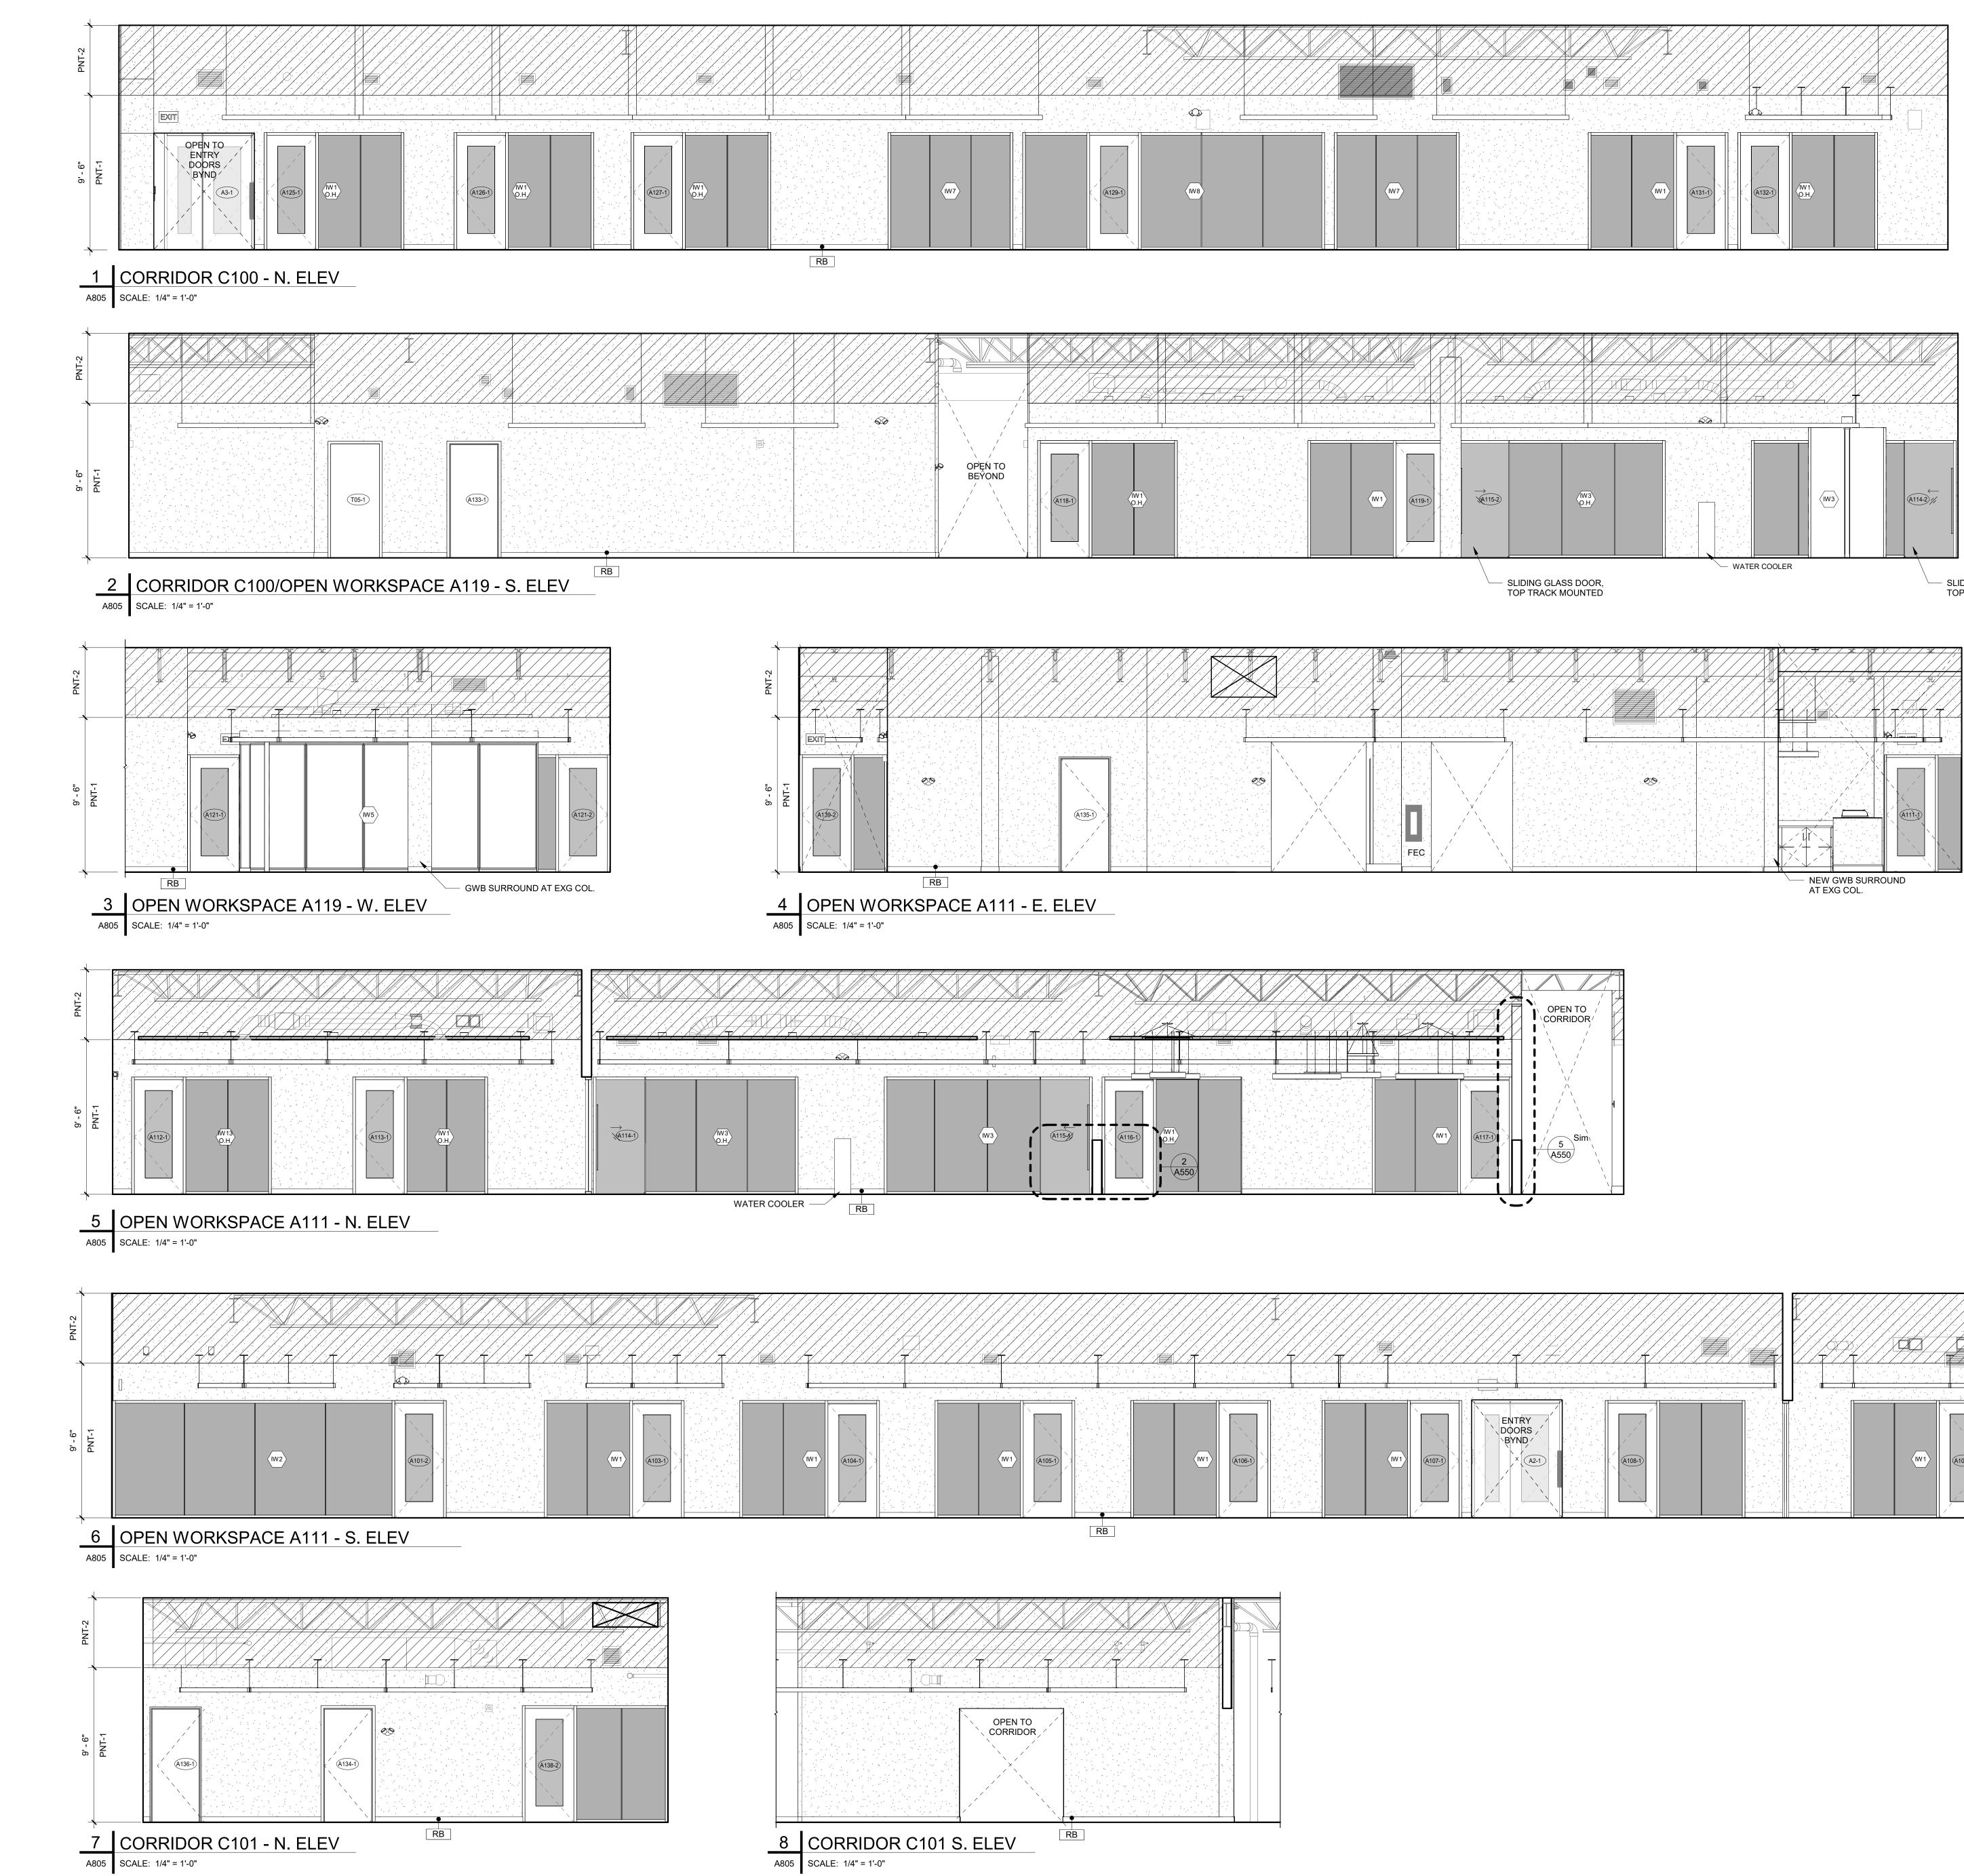

			· · · · · · ·
	(A129-1)		
RB			 


OPEN TO BEYOND	

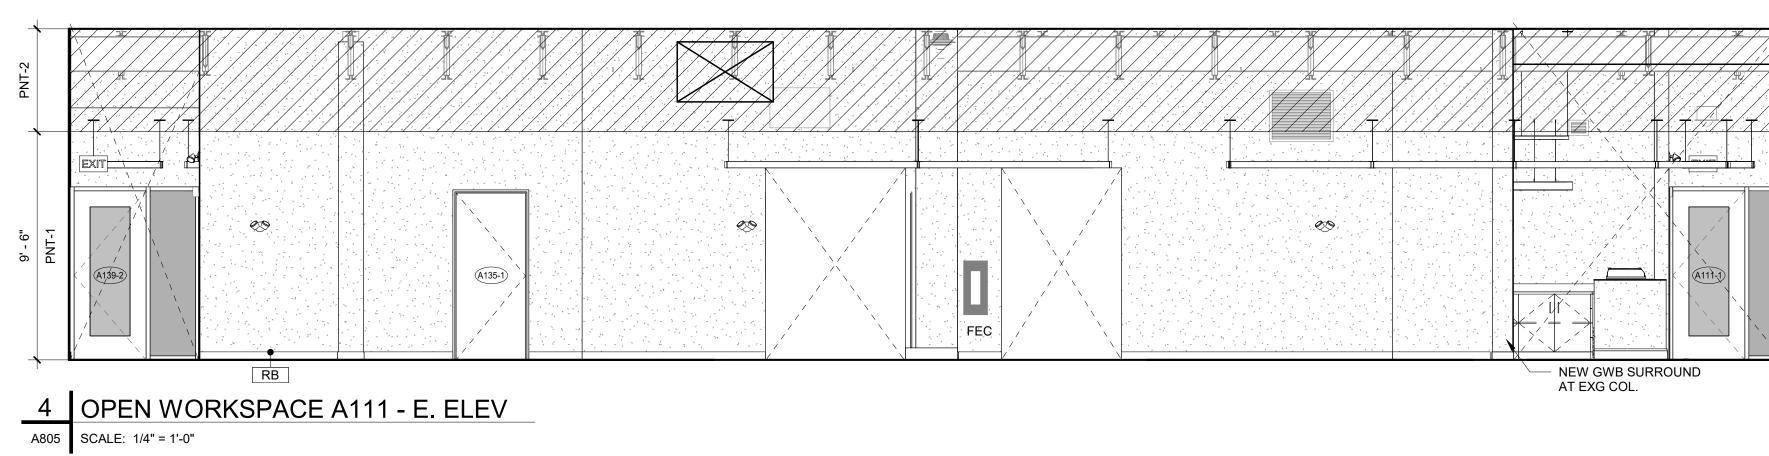

	,    ,    ,    ,   ,   ,   ,   ,   ,			
(W3) O.H		(W3)	A115-3	
WATER COOL				`_'


SLIDING GLASS DOOR, TOP TRACK MOUNTED


TRY ORS ND × (A2-1)			WT O.H	

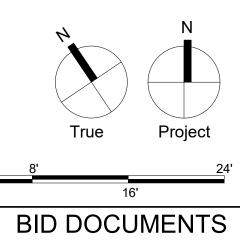







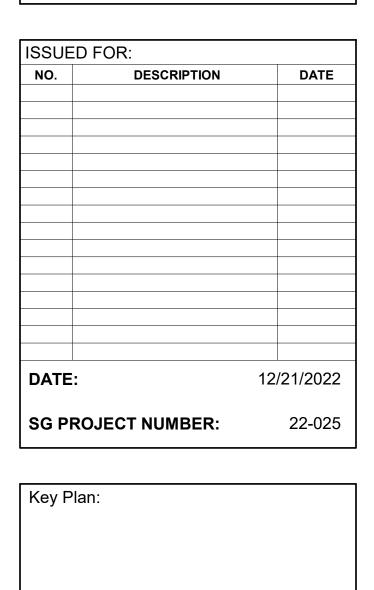

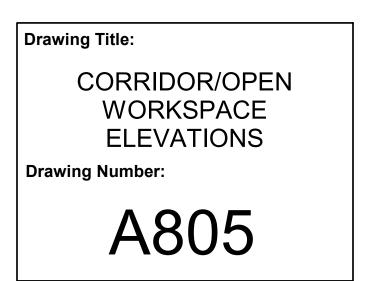

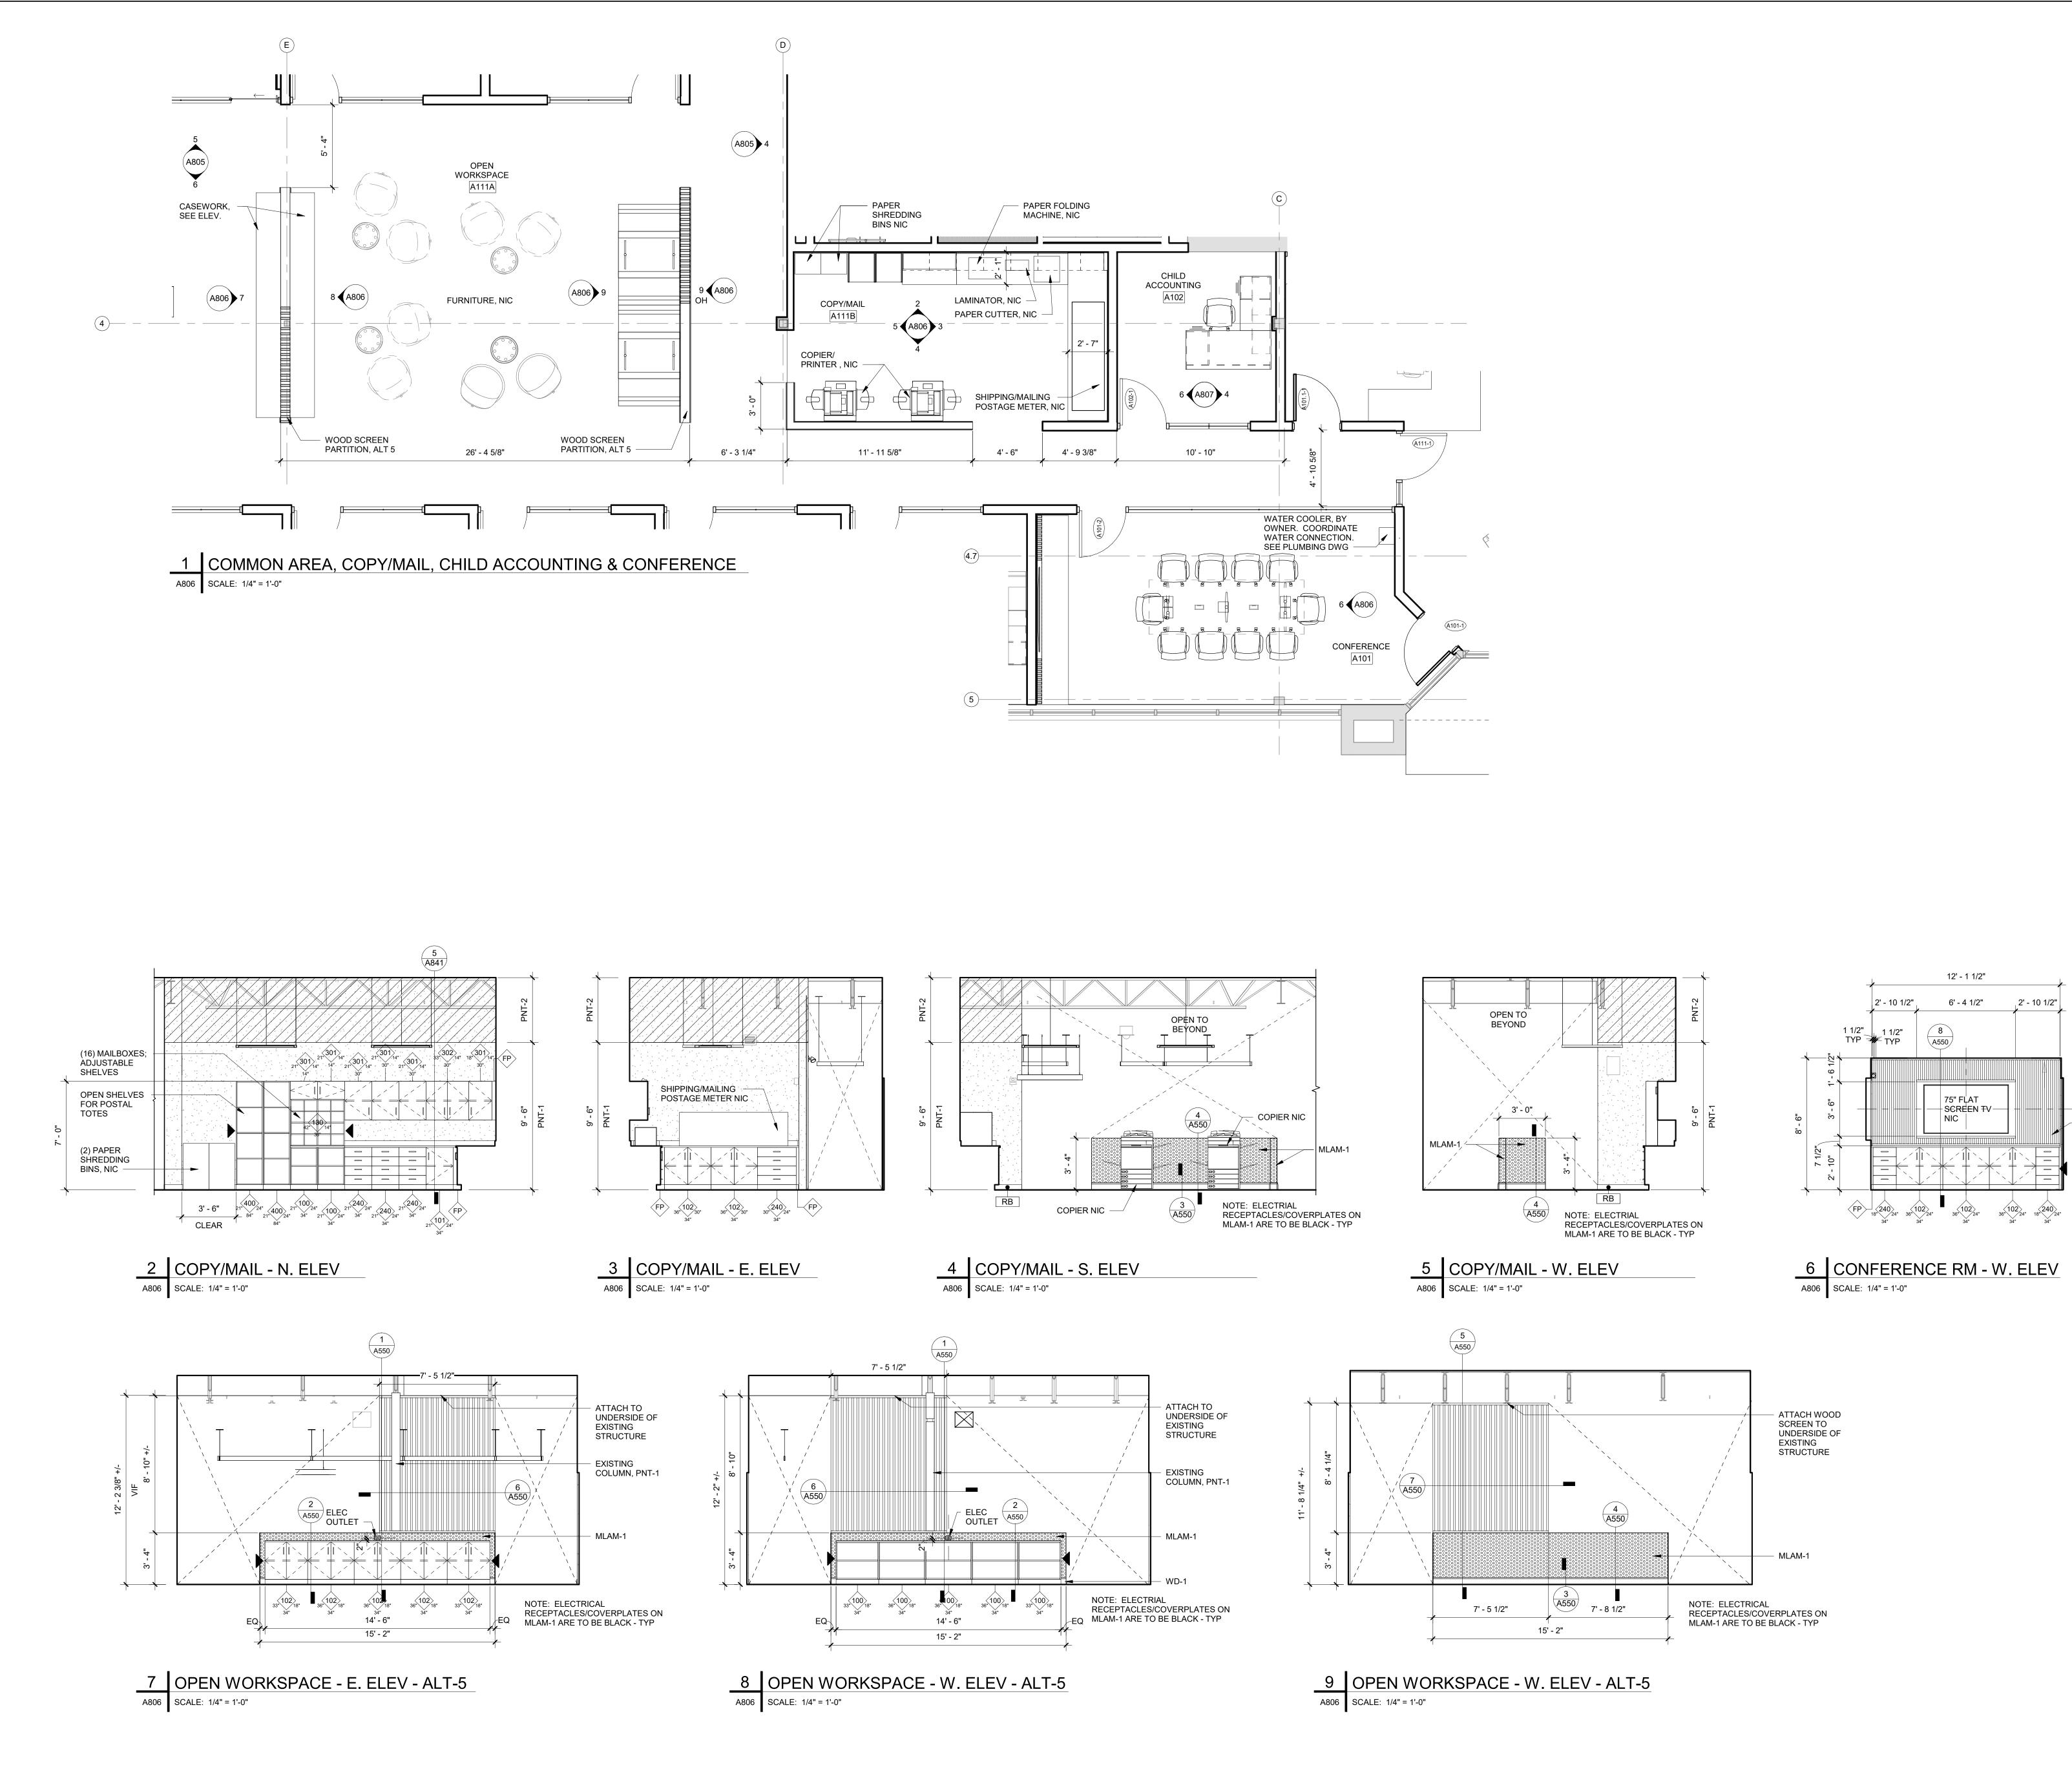

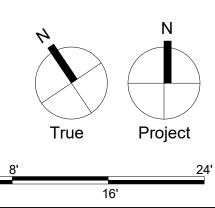

12' - 1 1/2"

6' - 4 1/2"

75" FĻAT

36" 102 34"

NIC

SCREEN TV-

A550/

2' - 10 1/2"

 $\begin{array}{c} 102\\ 36^{"} \\ 34^{"} \\ 34^{"} \\ 34^{"} \\ 34^{"} \\ 34^{"} \end{array}$ 


WD ACCENT
 WALL

2' - 10 1/2"


BID DOCUMENTS






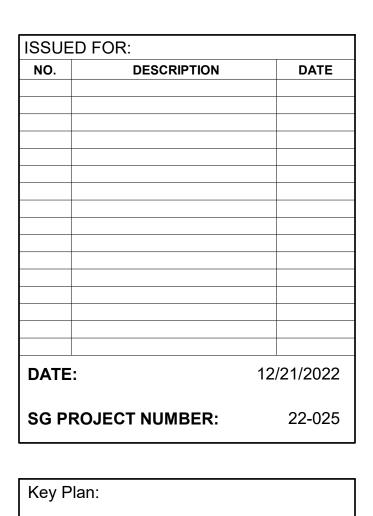




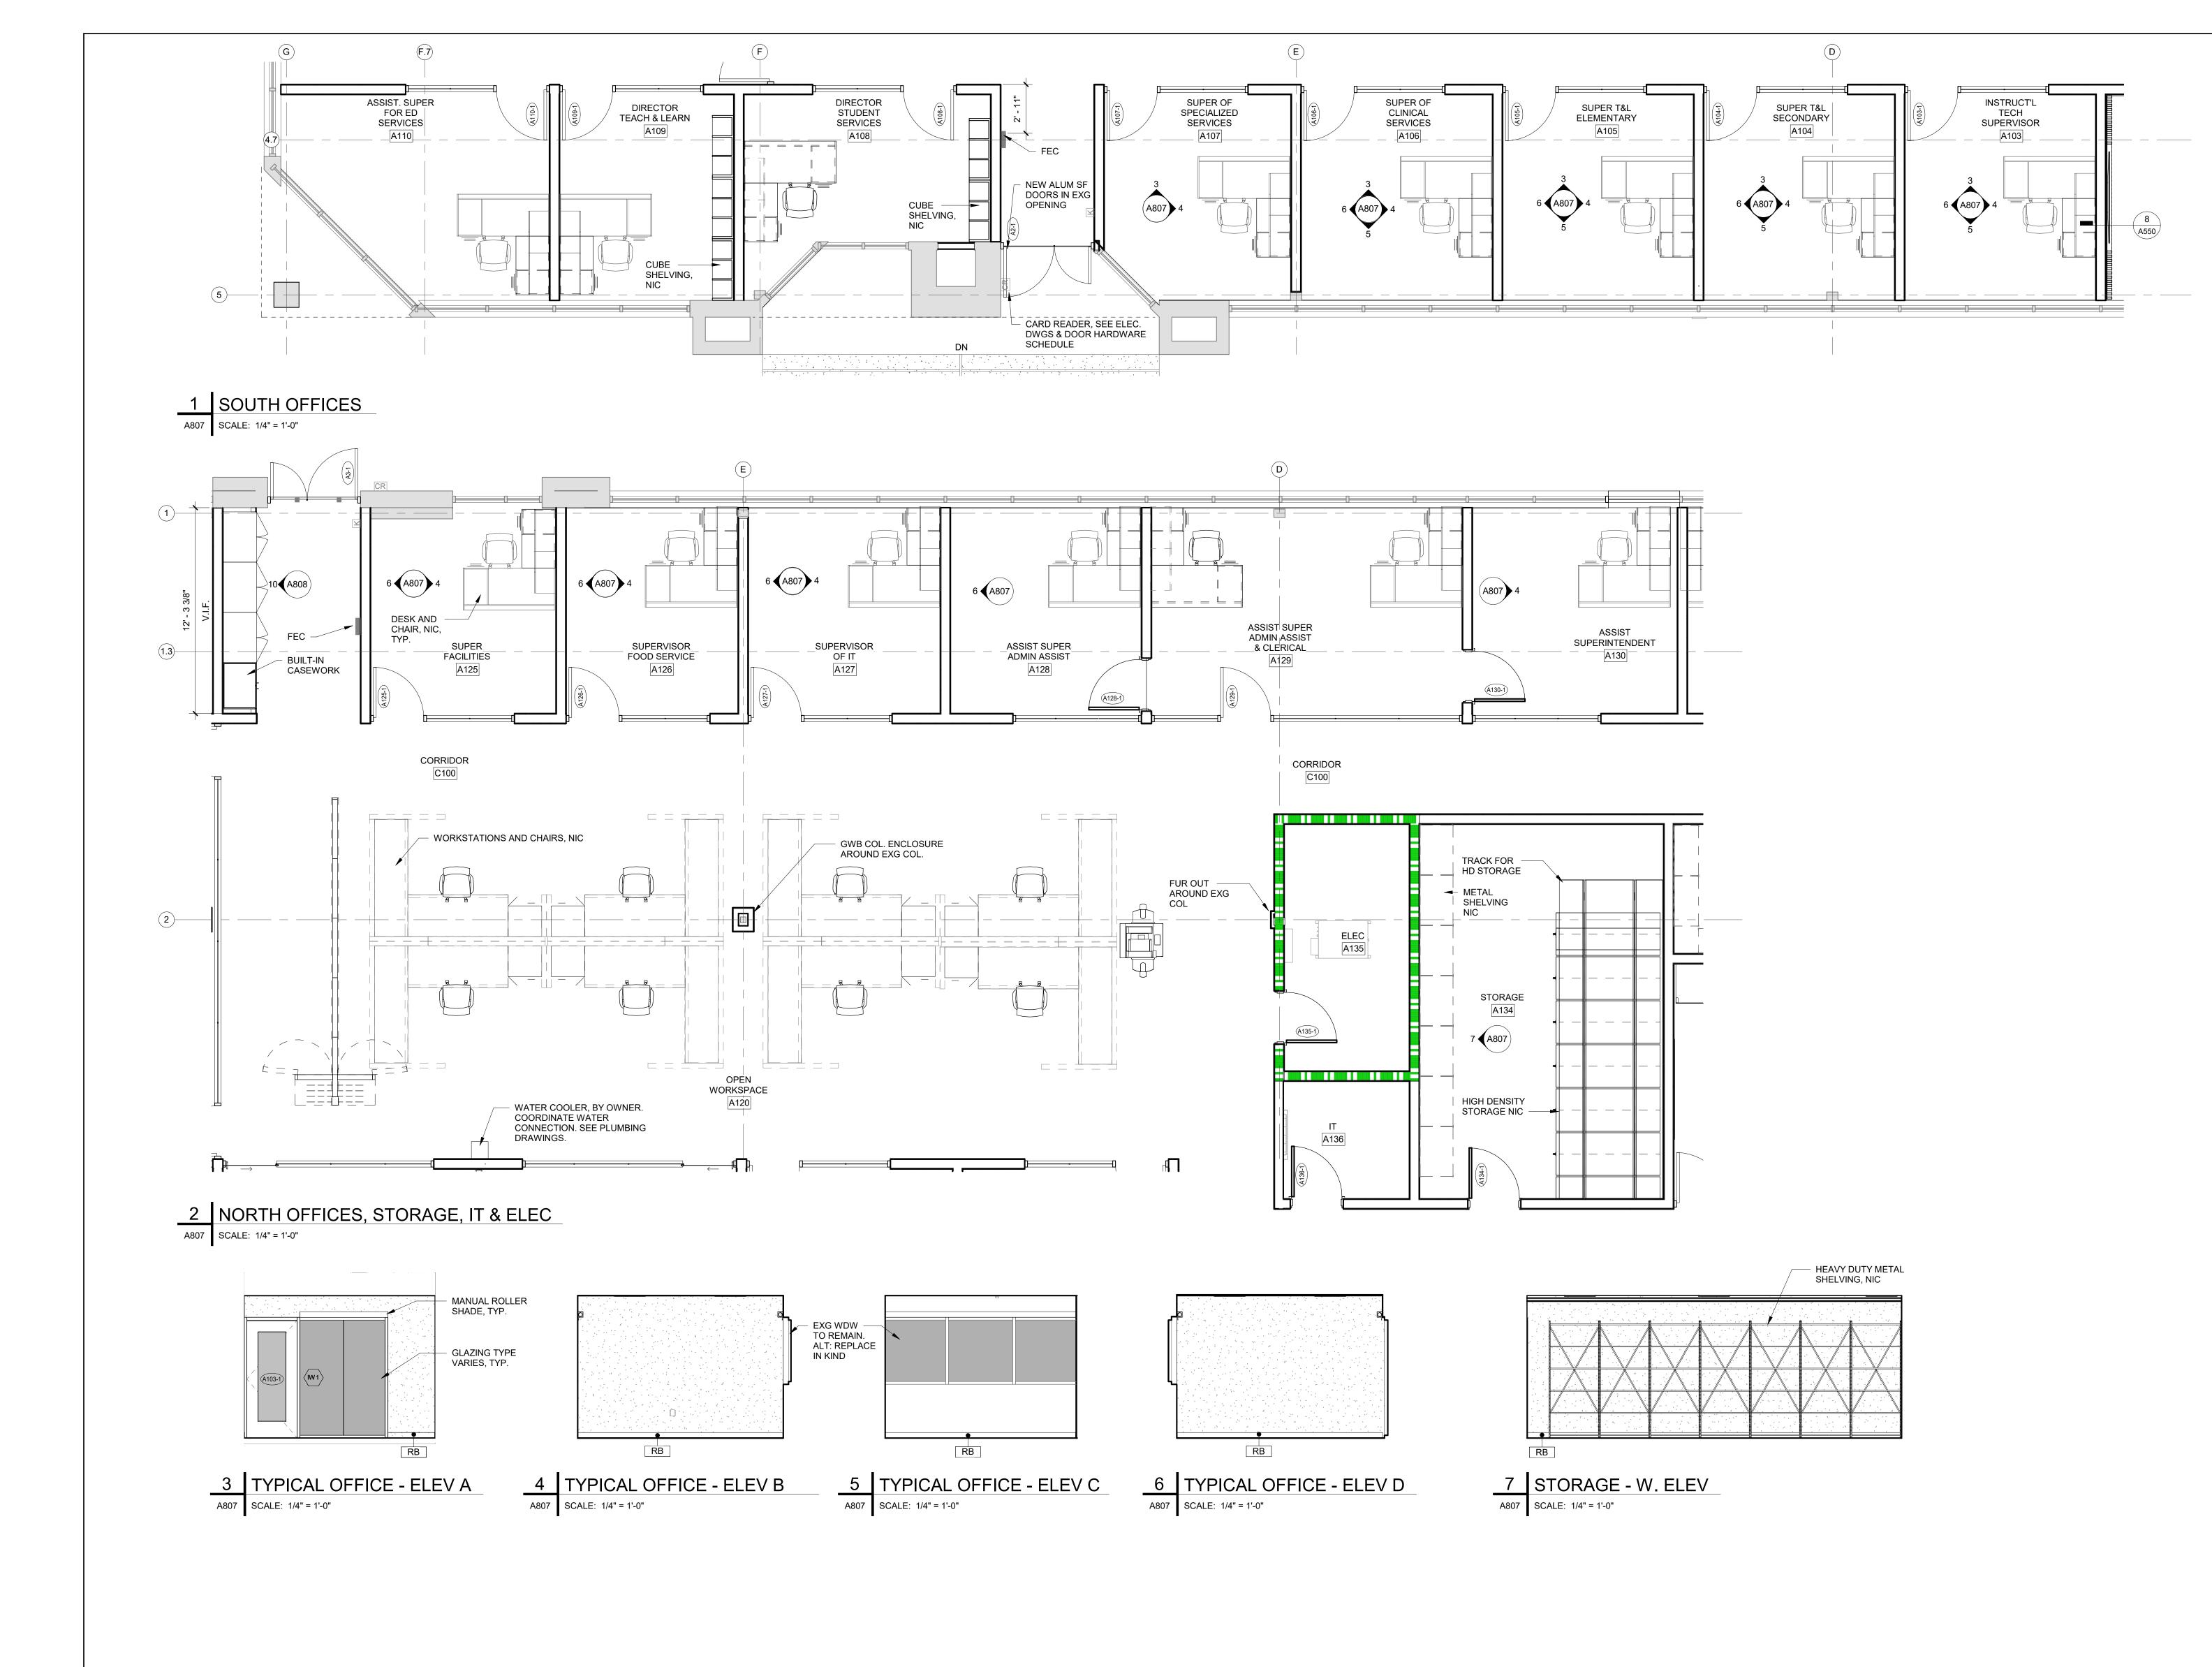

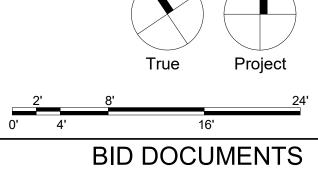






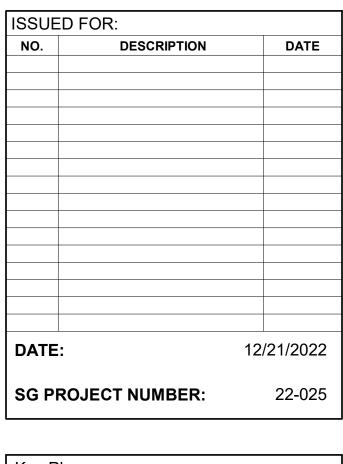


Key Plan:






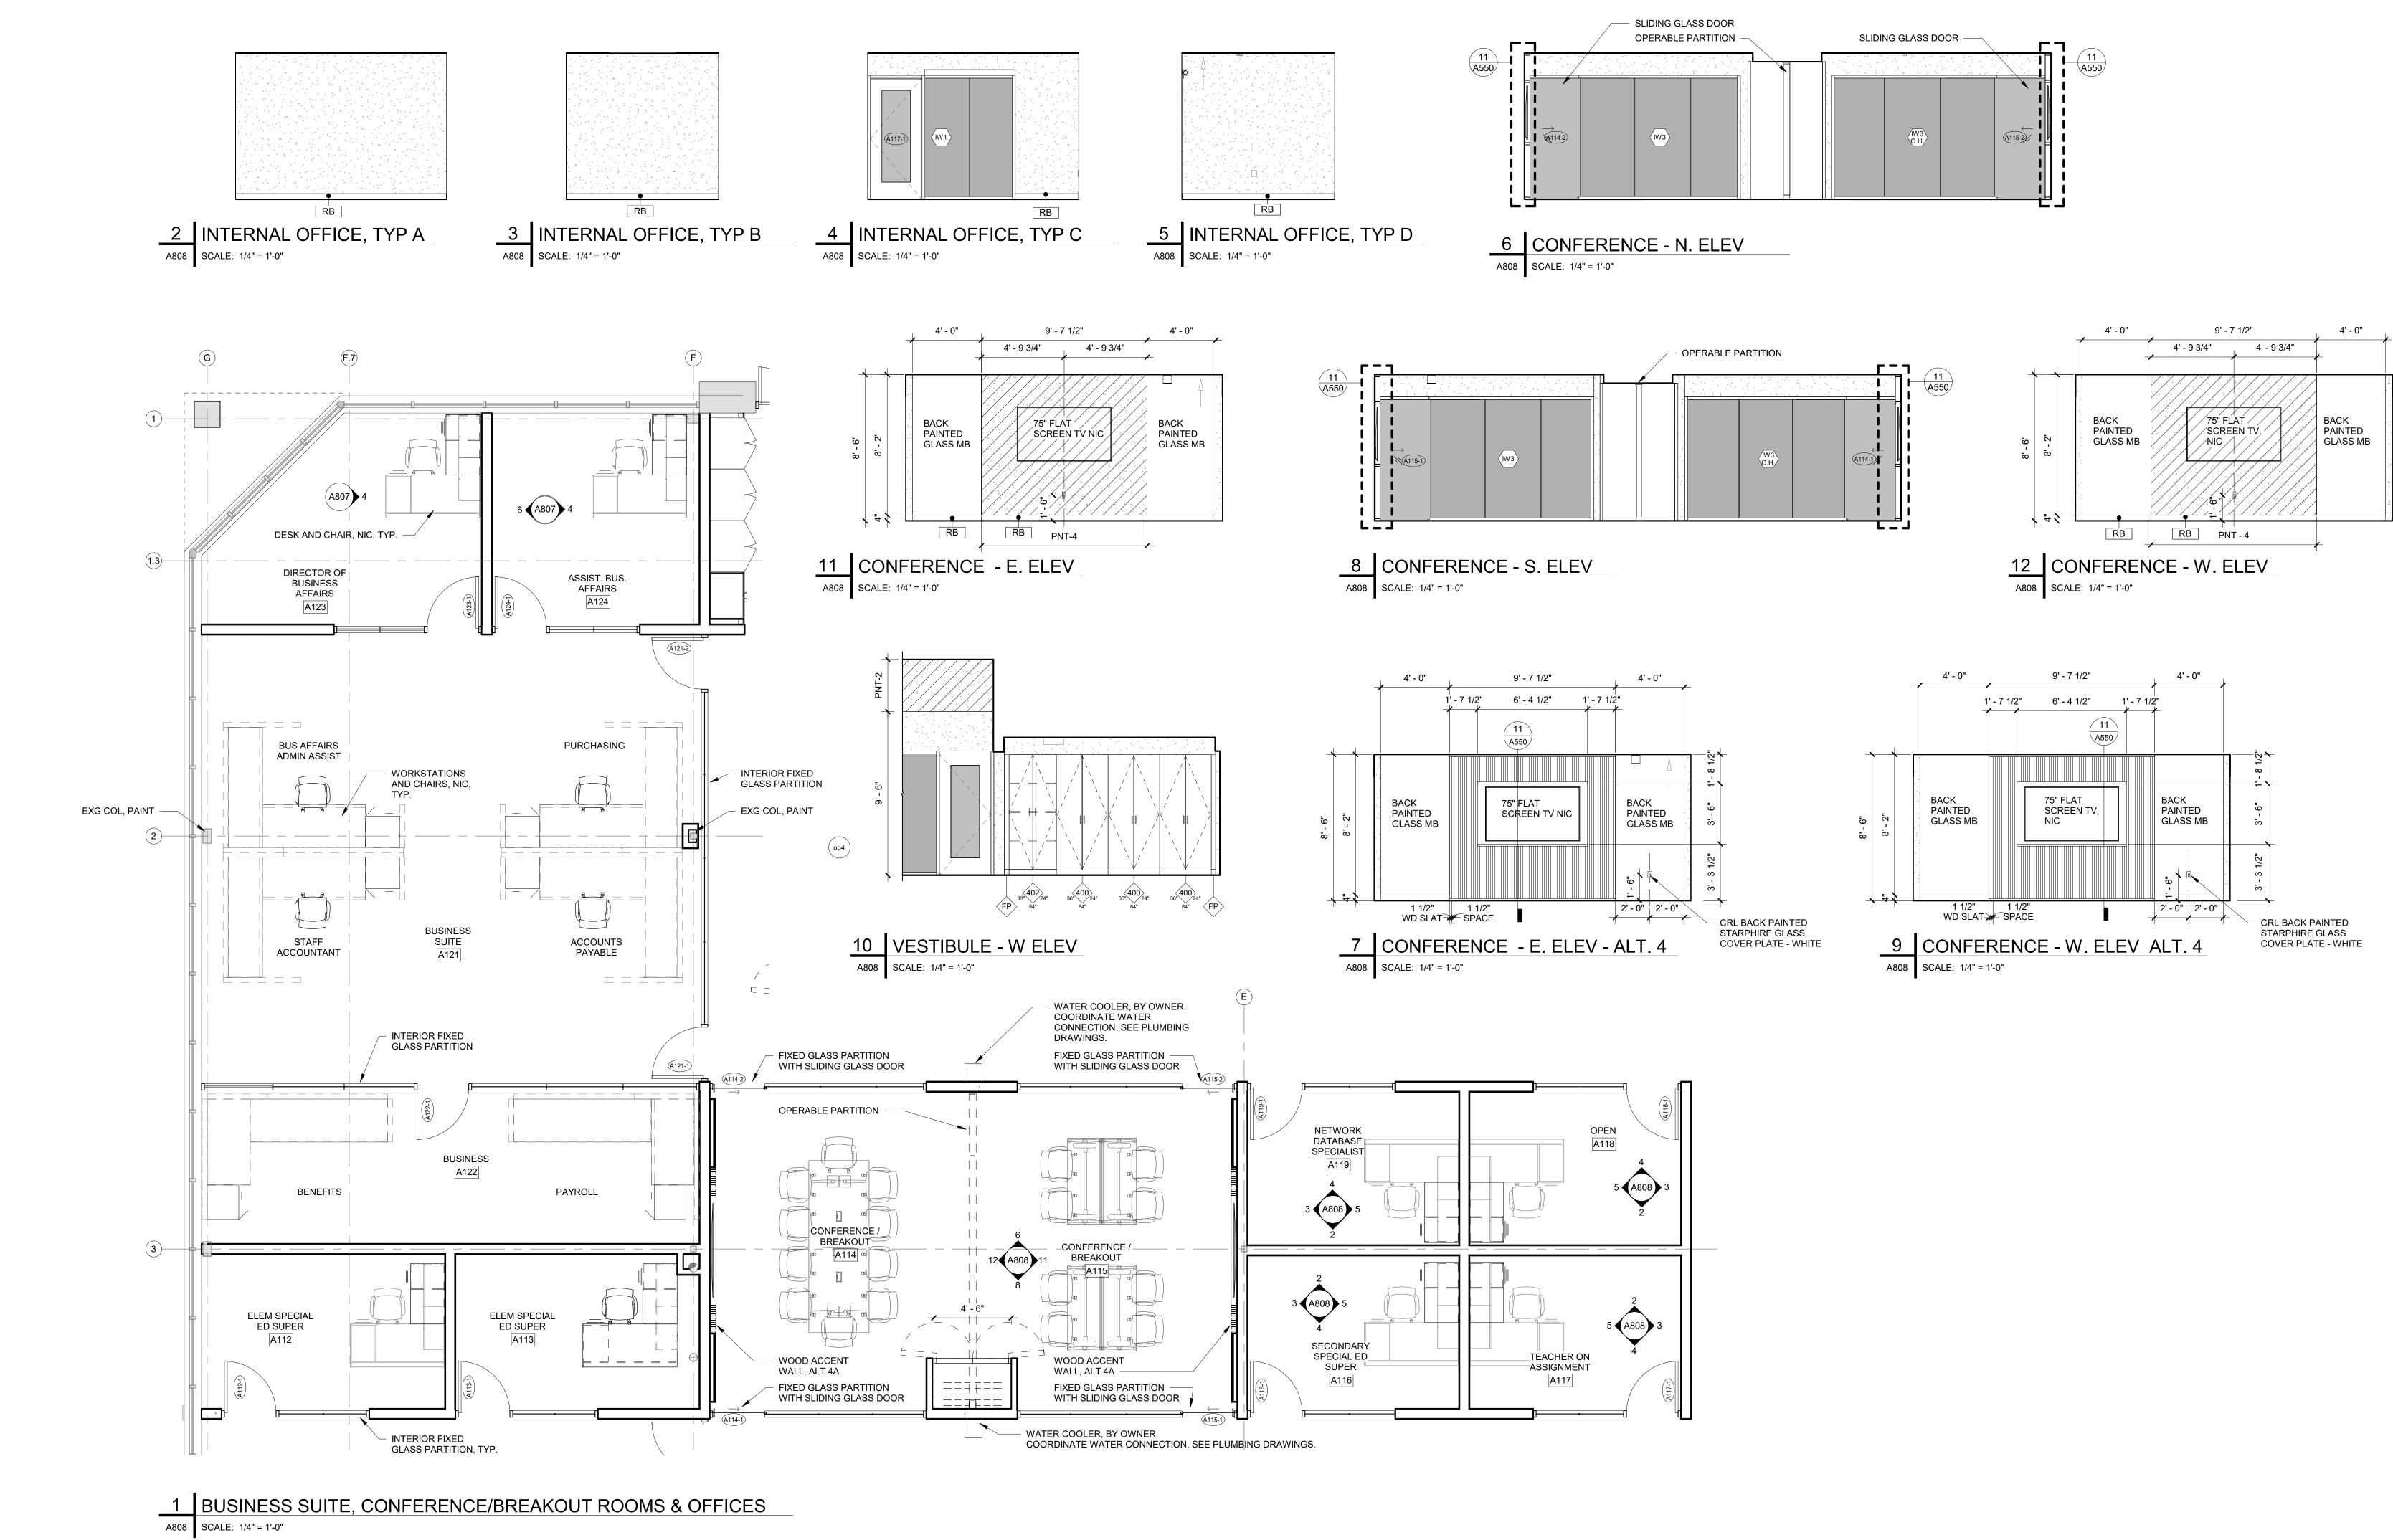


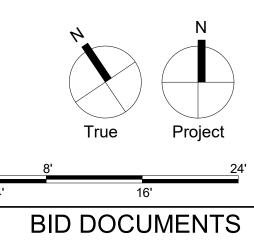







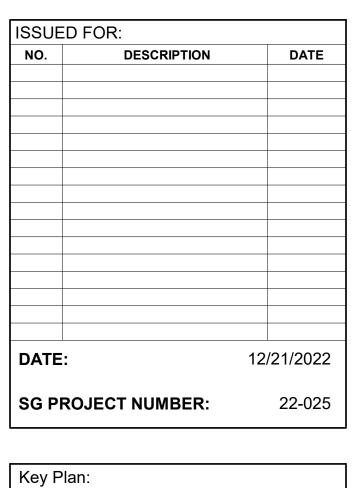


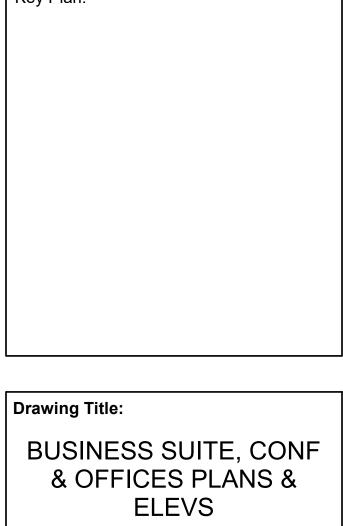




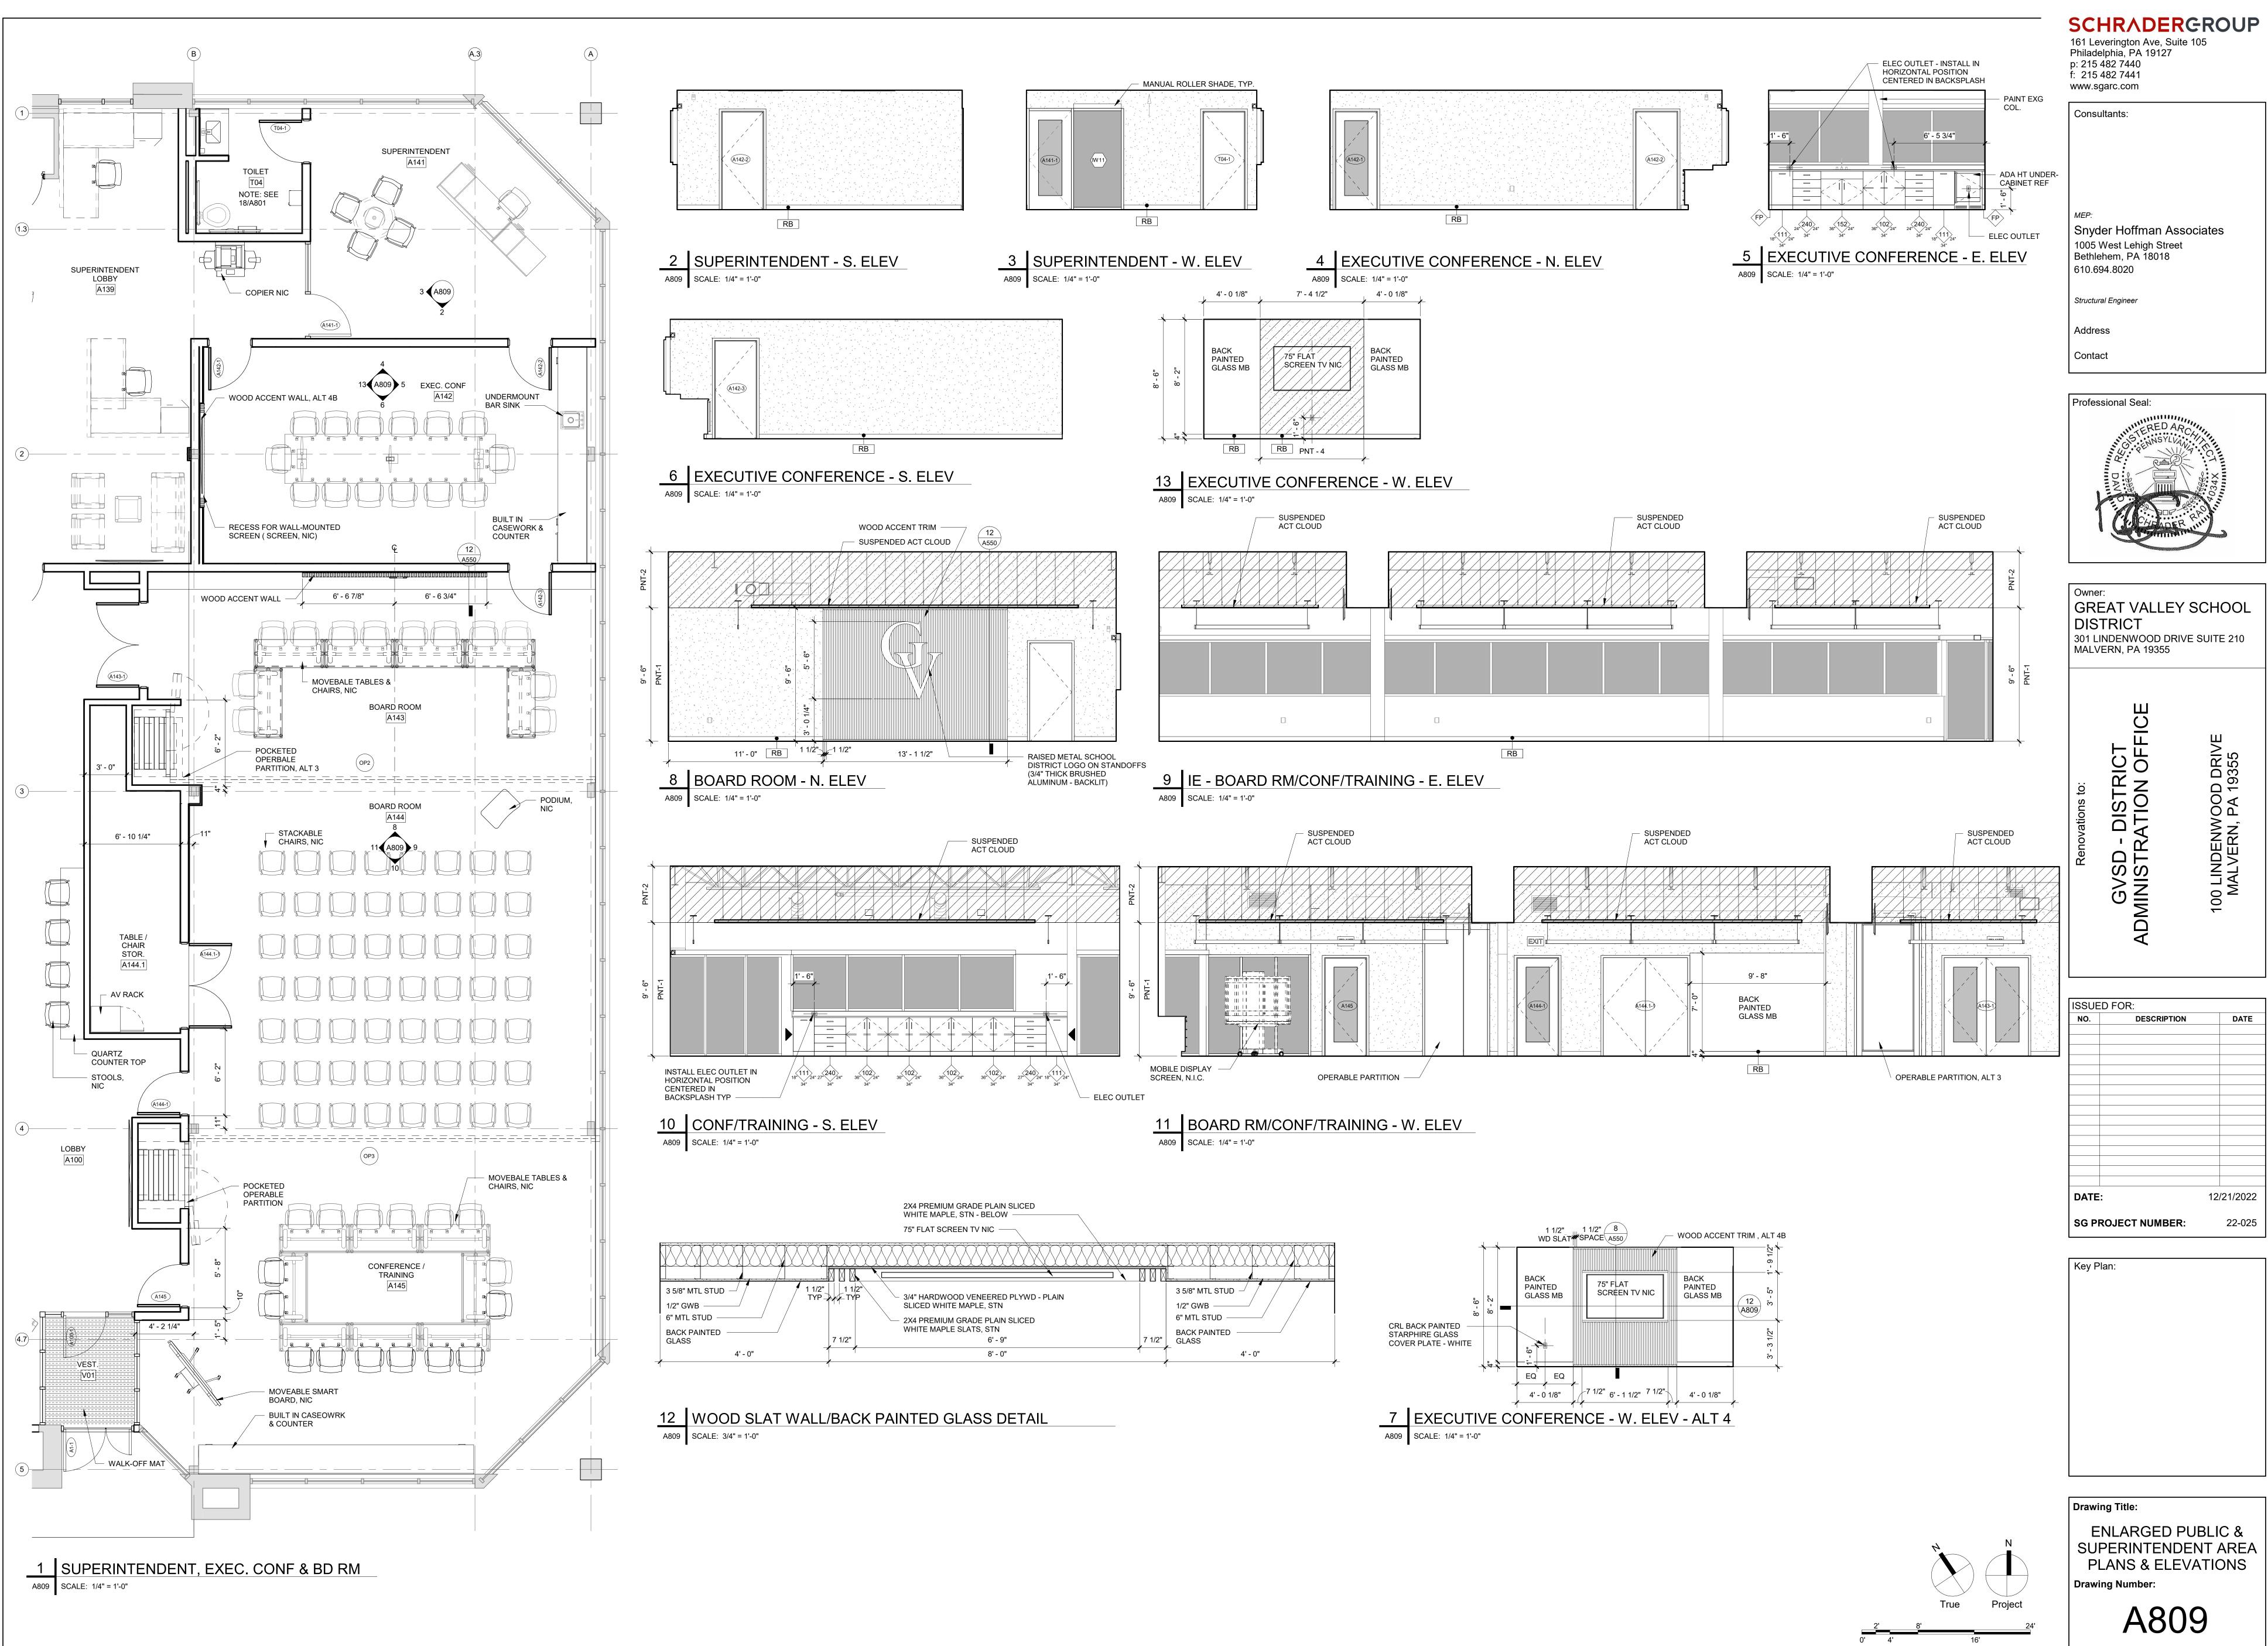

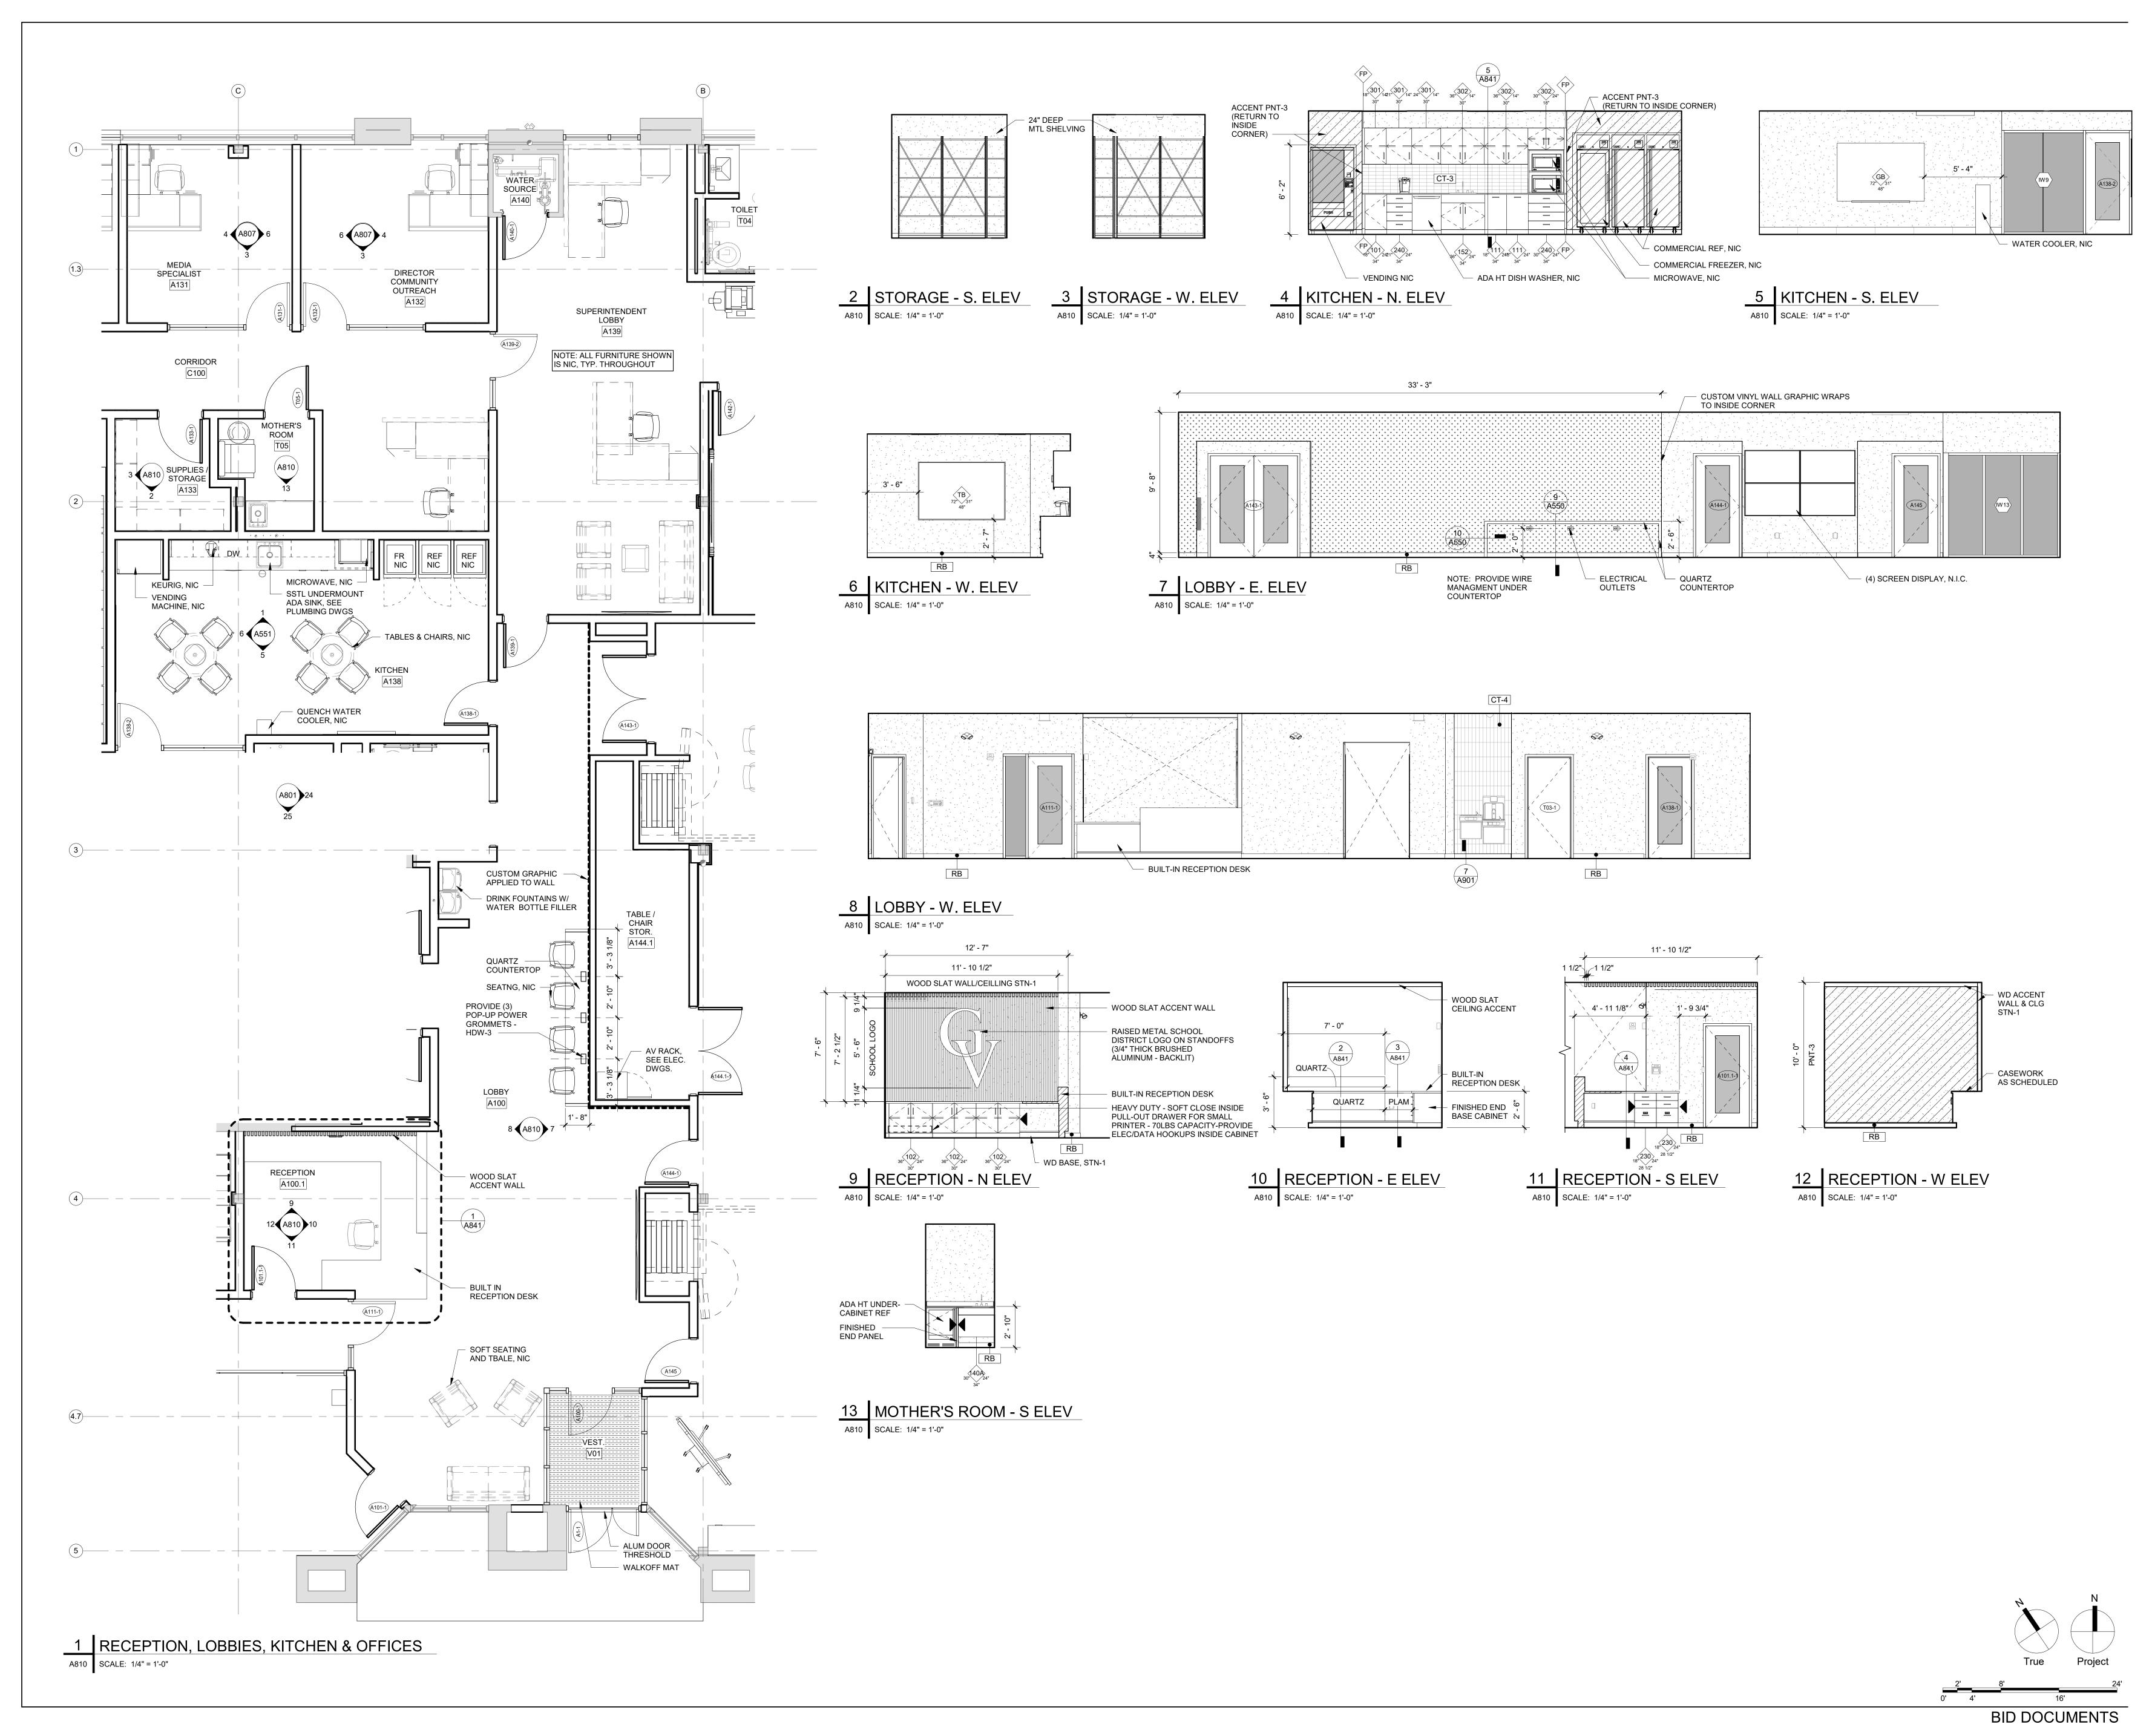

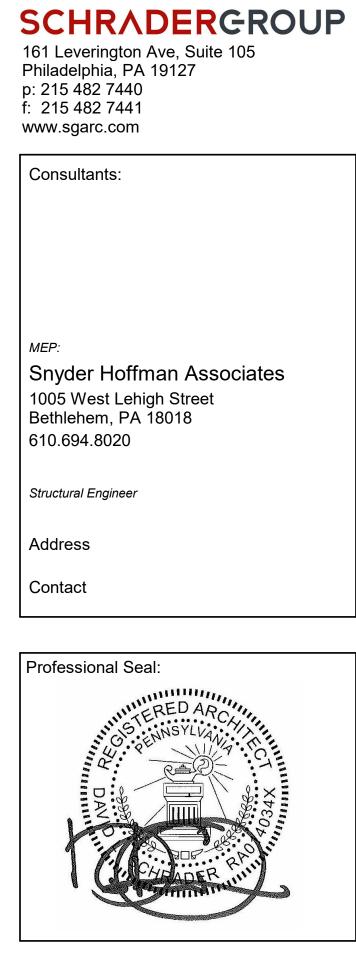




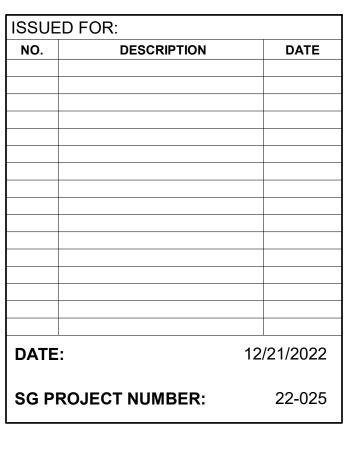


Key Plan:




A810

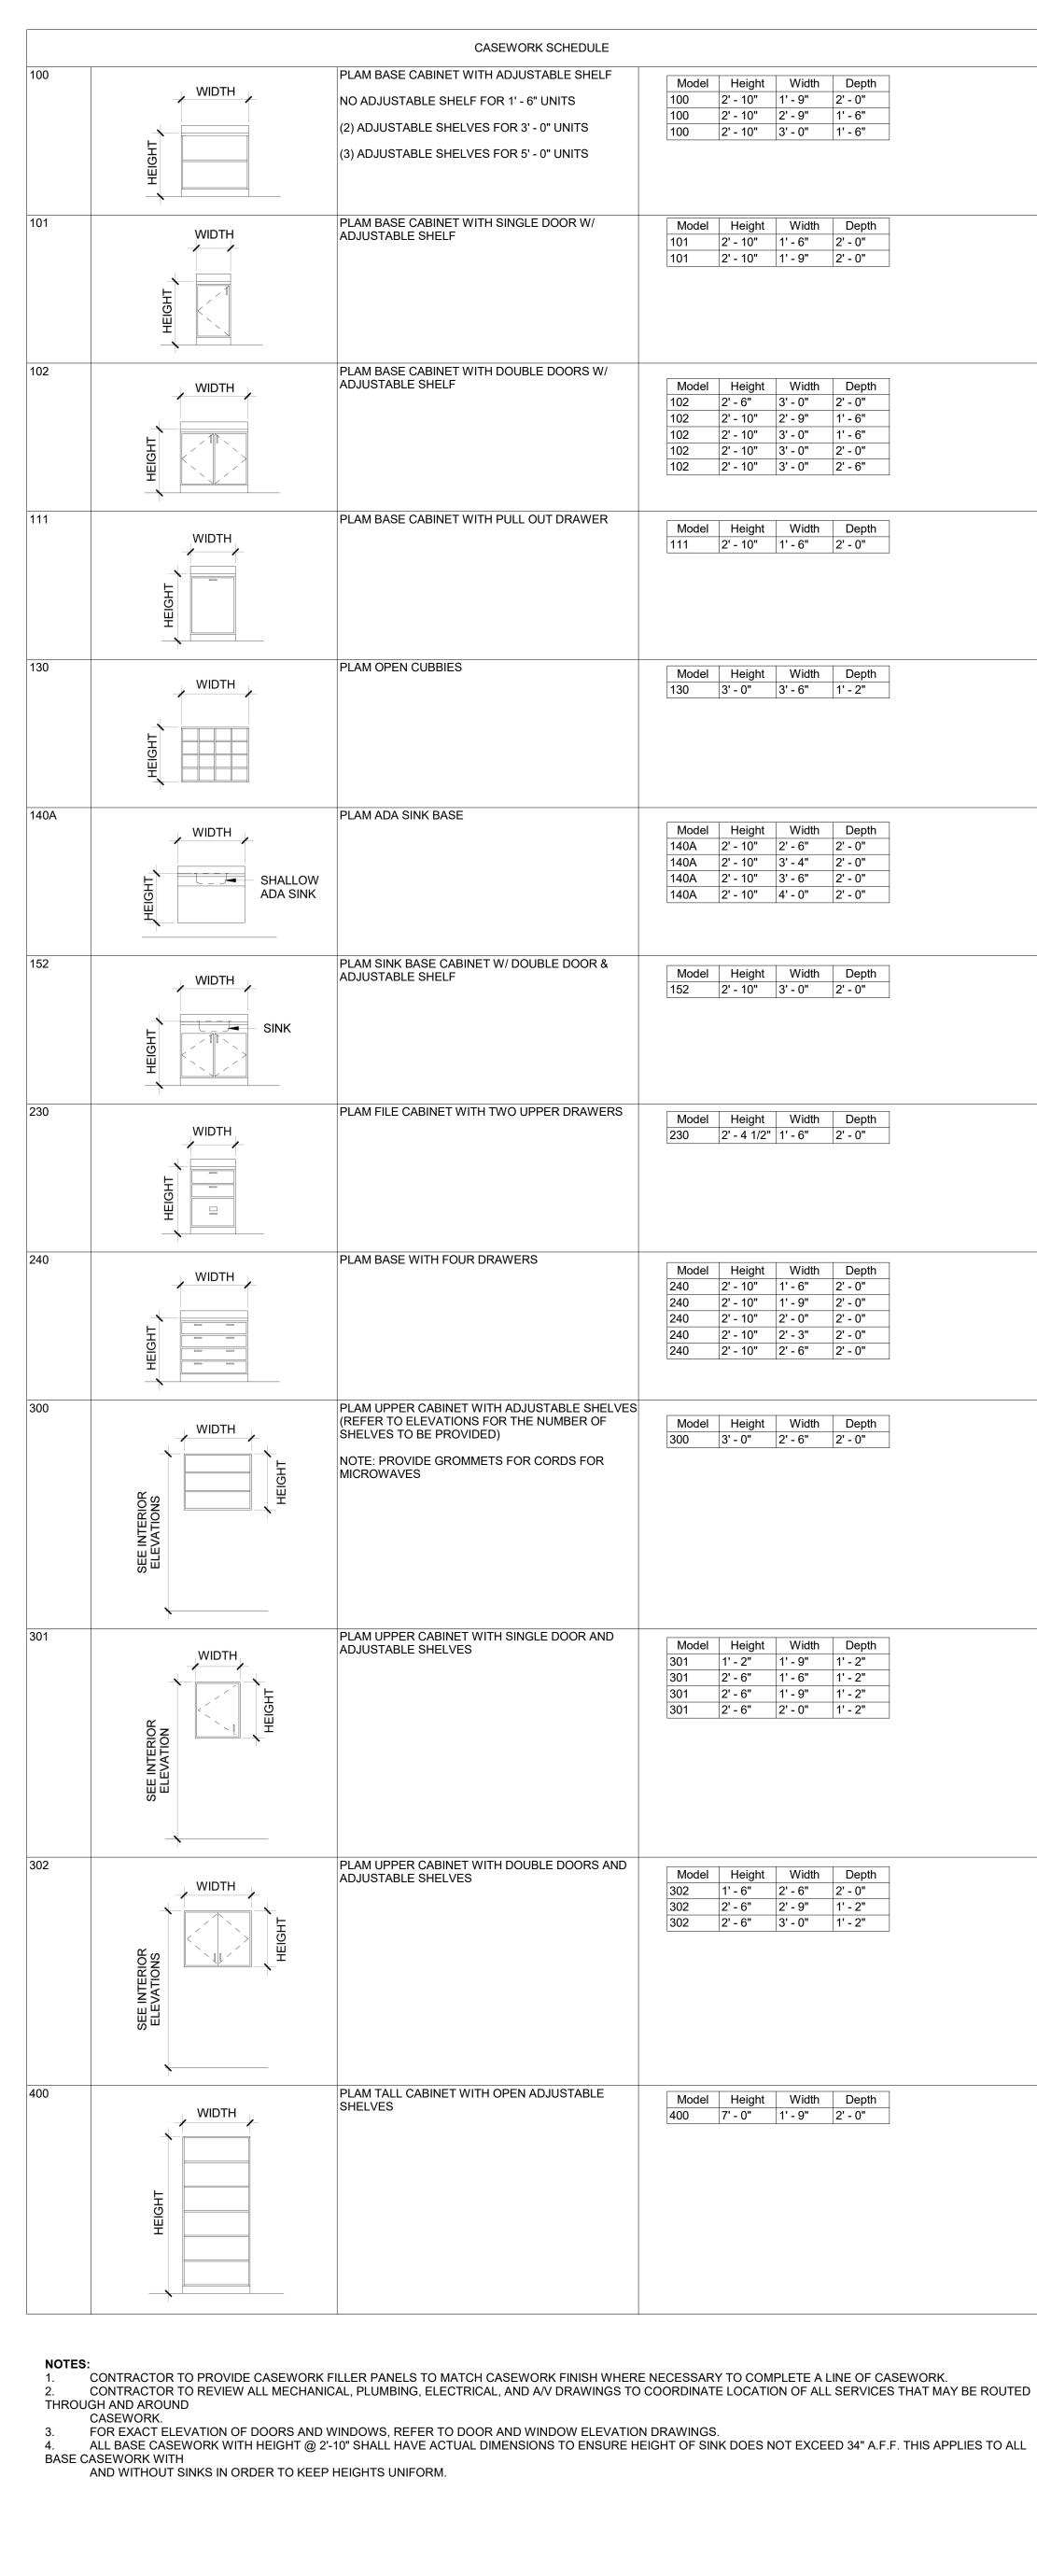


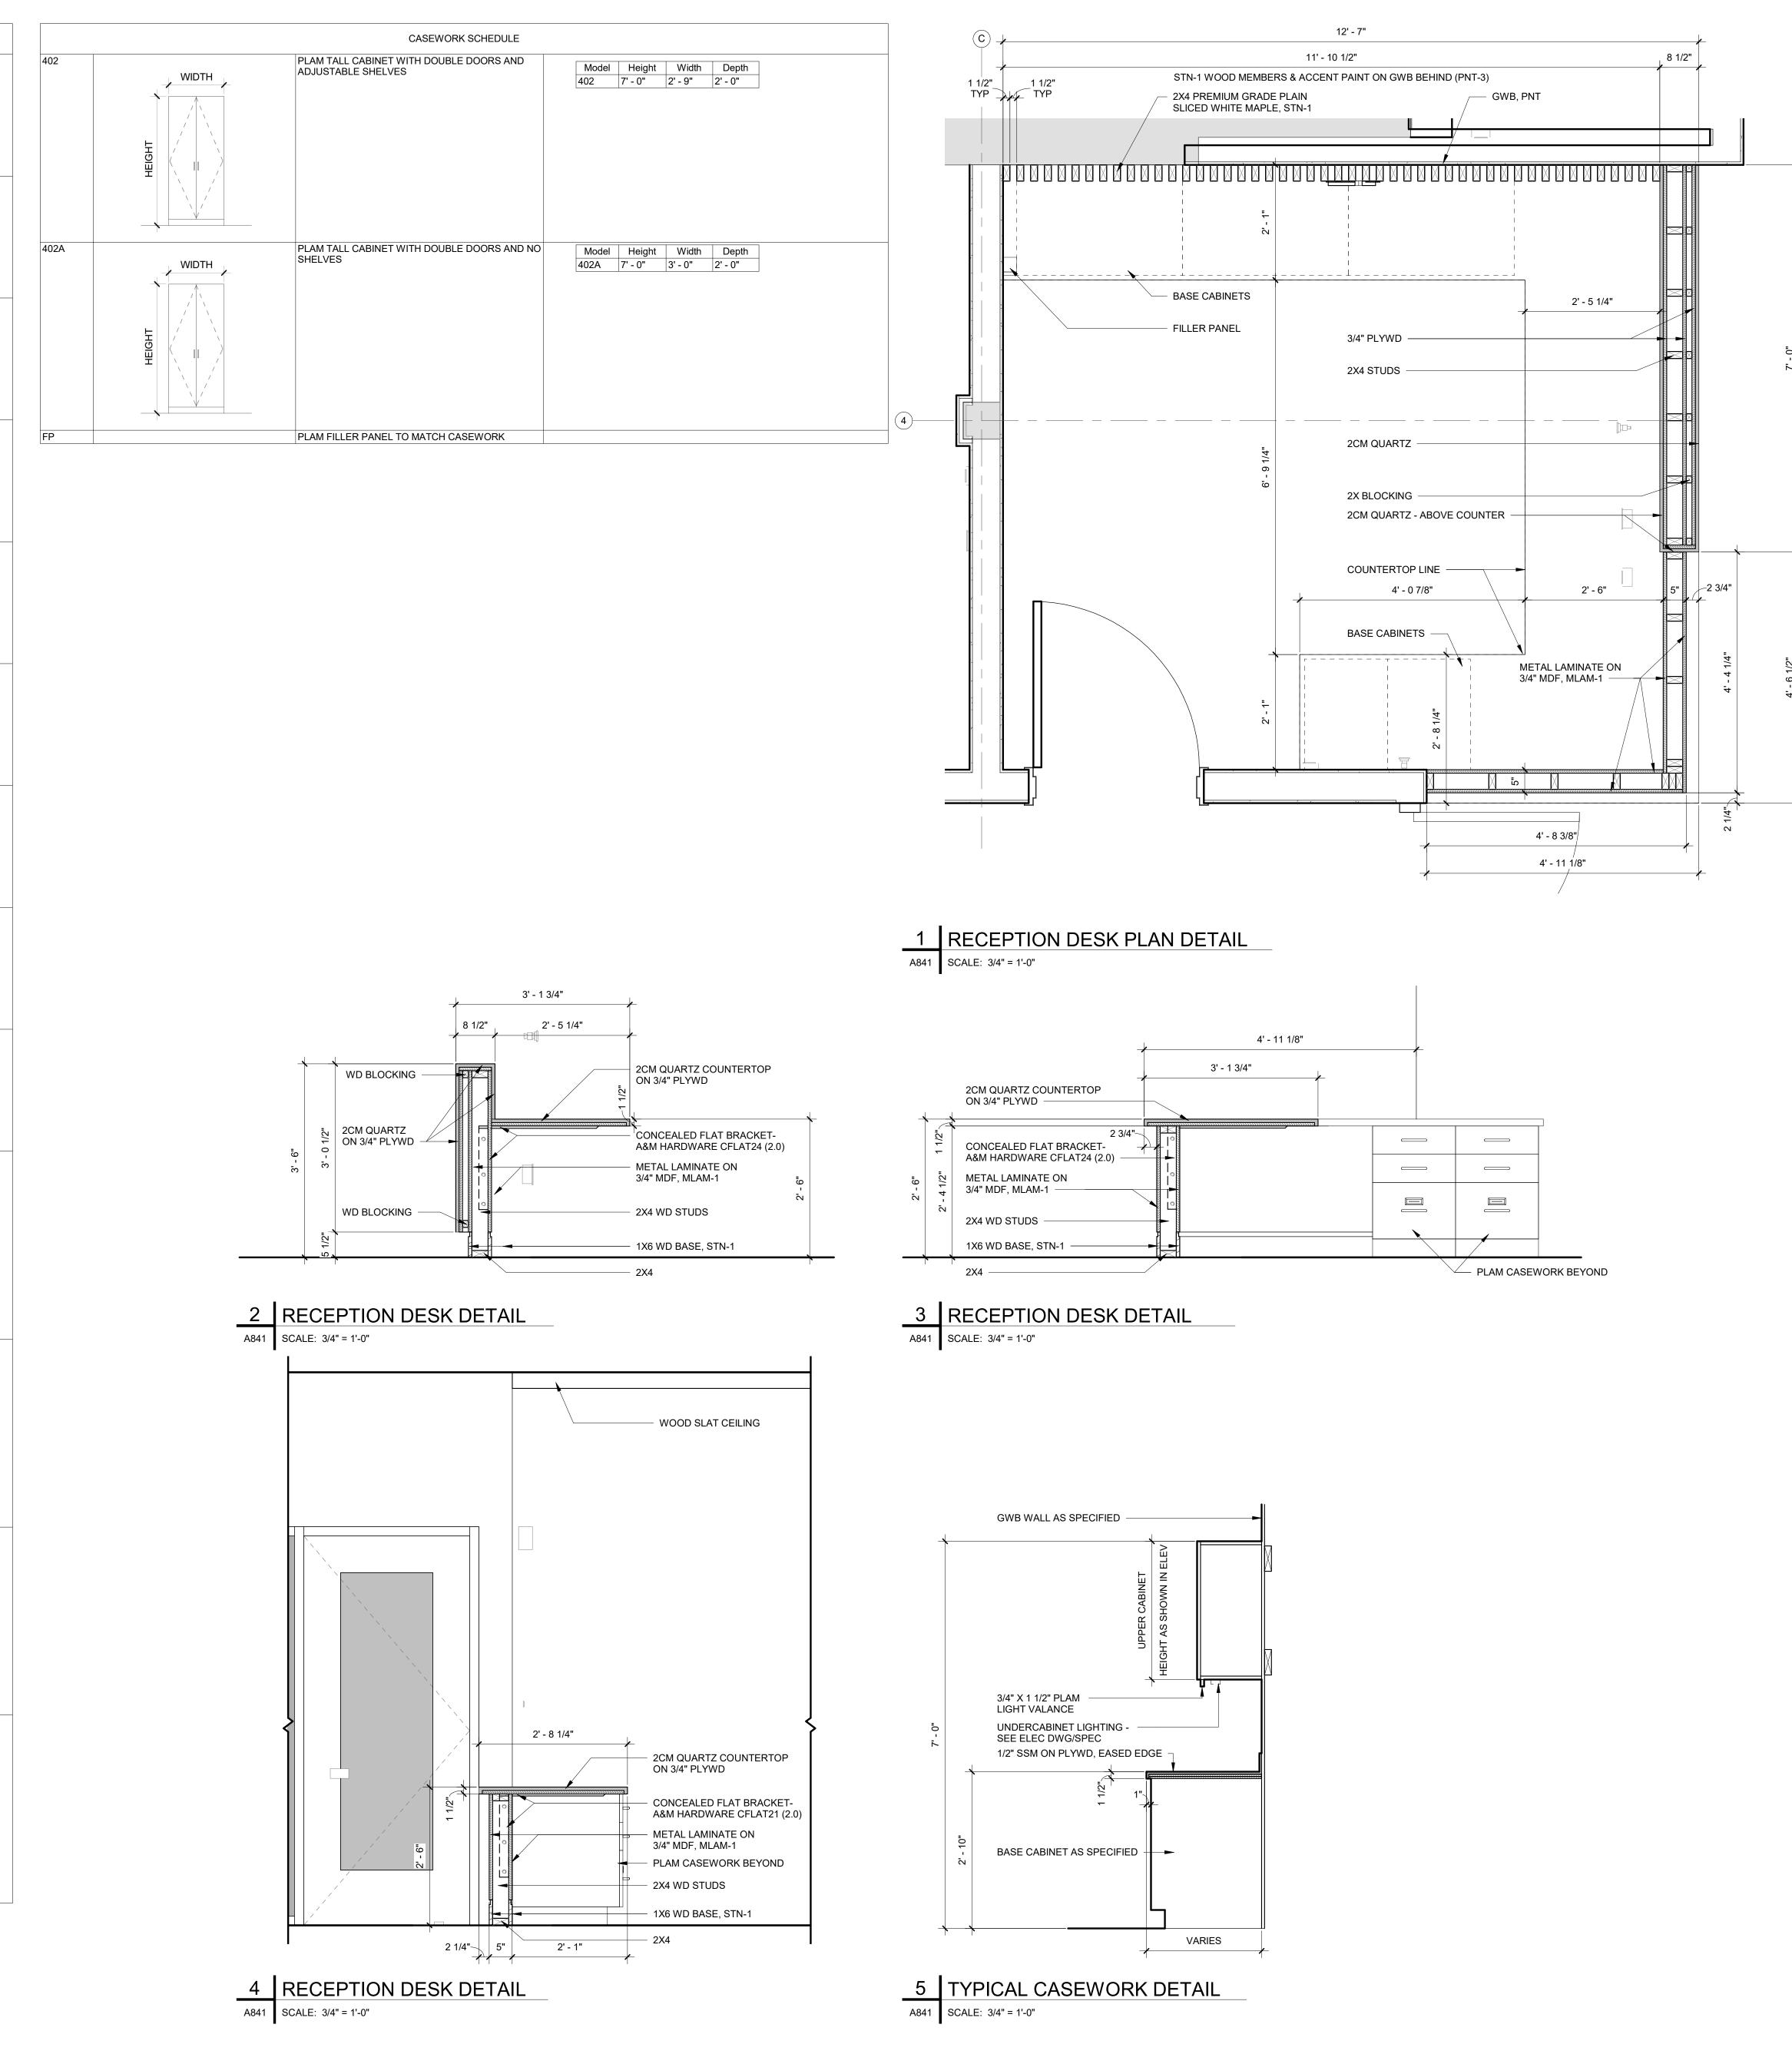






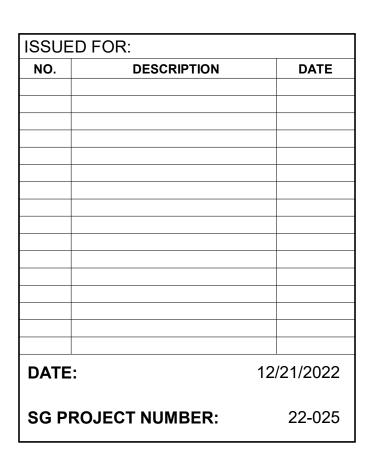


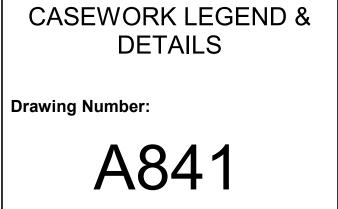



			To Drav					
DOOR NO.	From Rm: Number A145	From Rm: Name CONFERENCE / TRAINING	To Rm: Number	To Rm: Name	SIGN TYPE	NUMBER ON SIGN	TEXT ON SIGN	COMMENTS
\1-1 \2-1	V02	VEST.			-			
\3-1 \100-1	V01	VEST.	V03 A100	VEST. LOBBY	-			
A101-1 A101-2	A100 A111A	LOBBY	A101 A101	CONFERENCE	3			
		WORKSPACE			-			
101.1-1	A111A	OPEN WORKSPACE	A100.1	RECEPTION	3			
102-1	A102	CHILD ACCOUNTING	A111A	OPEN WORKSPACE	3			
103-1	A111A	OPEN WORKSPACE	A103	INSTRUCT'L TECH	3			
104-1	A111A	OPEN	A104	SUPERVISOR SUPER T&L	3			
105-1	A111A	WORKSPACE OPEN	A105	SECONDARY SUPER T&L	3			
106-1	A111A	WORKSPACE OPEN	A106	ELEMENTARY SUPER OF	3			
		WORKSPACE		CLINICAL SERVICES				
107-1	A111A	OPEN WORKSPACE	A107	SUPER OF SPECIALIZED SERVICES	3			
108-1	A108		A111A	OPEN WORKSPACE	3			
109-1	A111	SERVICES T&L SUITE	A109	DIRECTOR	3			
110-1	A110	ASSIST.	A111	TEACH & LEARN T&L SUITE	3			
		SUPER FOR ED SERVICES						
111-1	A111A	OPEN WORKSPACE	A100	LOBBY	3			
111-2	A111	T&L SUITE	A111A	OPEN WORKSPACE	3			
111-3	A111	T&L SUITE	A111A	OPEN	3			
112-1	A112	ELEM SPECIAL	A111	WORKSPACE T&L SUITE	3			
A113-1	A113	ED SUPER		T&L SUITE	3			
		ED SUPER						
A114-1	A114	CONFERENCE / BREAKOUT		OPEN WORKSPACE	3			
114-2	A120	OPEN WORKSPACE	A114	CONFERENCE / BREAKOUT				
115-1	A111A	OPEN WORKSPACE	A115	CONFERENCE / BREAKOUT	3			
115-2	A115	CONFERENCE / BREAKOUT	A120	OPEN WORKSPACE	3			
116-1	A116	SECONDARY SPECIAL ED	A111A	OPEN WORKSPACE	3			
117 1	Δ111Λ	SPECIAL ED SUPER OPEN	A117	TEACHER ON	3			
117-1	A111A	WORKSPACE	A117	ASSIGNMENT	3			
118-1	A118	OPEN	A120	OPEN WORKSPACE	3			
.119-1	A120	OPEN WORKSPACE	A119	NETWORK DATABASE SPECIALIST	3			
121-1	A121	BUSINESS SUITE	A120	OPEN WORKSPACE	3			
121-2	A121	BUSINESS	C100	CORRIDOR	3			
122-1	A122	BUSINESS	A121	BUSINESS	3			
123-1	A121	BUSINESS	A123	SUITE DIRECTOR OF	3			
		SUITE		BUSINESS AFFAIRS				
124-1	A121	BUSINESS SUITE	A124	ASSIST. BUS. AFFAIRS	3			
125-1	A125	SUPER FACILITIES	C100	CORRIDOR	3			
126-1	A126		C100	CORRIDOR	3			
127-1	A127	SUPERVISOR OF IT	C100	CORRIDOR	3			
128-1	A129	ASSIST SUPER ADMIN ASSIST &	A128	ASSIST SUPER ADMIN ASSIST	3			
129-1	C100	CLERICAL	A129	ASSIST SUPER	3			
				ADMIN ASSIST & CLERICAL	_			
130-1	A129	ASSIST SUPER ADMIN ASSIST &	A130	ASSIST SUPERINTENDE	3			
124 4	C100	CLERICAL	A 104		2			
131-1	C100	CORRIDOR	A131	MEDIA SPECIALIST	3			
132-1	A132	DIRECTOR COMMUNITY	C100	CORRIDOR	3			
133-1	C100	OUTREACH CORRIDOR	A133	SUPPLIES /	2			
134-1	C101	CORRIDOR	A134	STORAGE STORAGE	4			
135-1	A120	OPEN WORKSPACE	A135	ELEC	4			
136-1	C101	CORRIDOR	A136	IT	4			
137-1 138-1	C101 A100	CORRIDOR LOBBY	A137 A138	JAN. KITCHEN	2 3			
138-2 139-1	C101 A139	CORRIDOR SUPERINTEND	A138 A100	KITCHEN LOBBY	3			
139-2	A139	ENT LOBBY		CORRIDOR	3			
		ENT LOBBY						
.140-1	A140	WATER SOURCE	A139	SUPERINTENDE NT LOBBY				
141-1	A139	SUPERINTEND ENT LOBBY		SUPERINTENDE NT				
142-1	A142	EXEC. CONF	A139	SUPERINTENDE NT LOBBY	3			
142-2	A141	SUPERINTEND ENT	A142	EXEC. CONF	3			
142-3	A142	EXEC. CONF	A143	BOARD ROOM	3			
143-1 144-1	A143 A144	BOARD ROOM BOARD ROOM	A100	LOBBY LOBBY	3 3			
144.1-1	A144	BOARD ROOM		TABLE / CHAIR STOR.	2			
\145	A145	CONFERENCE / TRAINING	A100	LOBBY	3			
	A100	LOBBY	T01	TOILET	1B			
02-1 02-12	A100 C101	LOBBY CORRIDOR	T02 C102	TOILET CORRIDOR	1C 3			
03-1 04-1	A100 A141	LOBBY SUPERINTEND	T03 T04	TOILET TOILET	1A 1A			
-04-1 	A141 A100	ENT LOBBY	T01	TOILET	1A 1A			
04-2 105-1	A100 T05	MOTHER'S	C100	CORRIDOR	1A 4			
06-1	C102	ROOM CORRIDOR	T06	TOILET	1A			
07-1 08-1	C102 C102	CORRIDOR CORRIDOR	T07 T08	TOILET TOILET	1A 1A			
	C102	CORRIDOR	T08	TOILET	1A 1A			


NOTE: TEXT ON SIGNAGE TO BE CONFIRMED WITH SCHOOL DISTRICT DURING SUBMITTAL REVIEW.

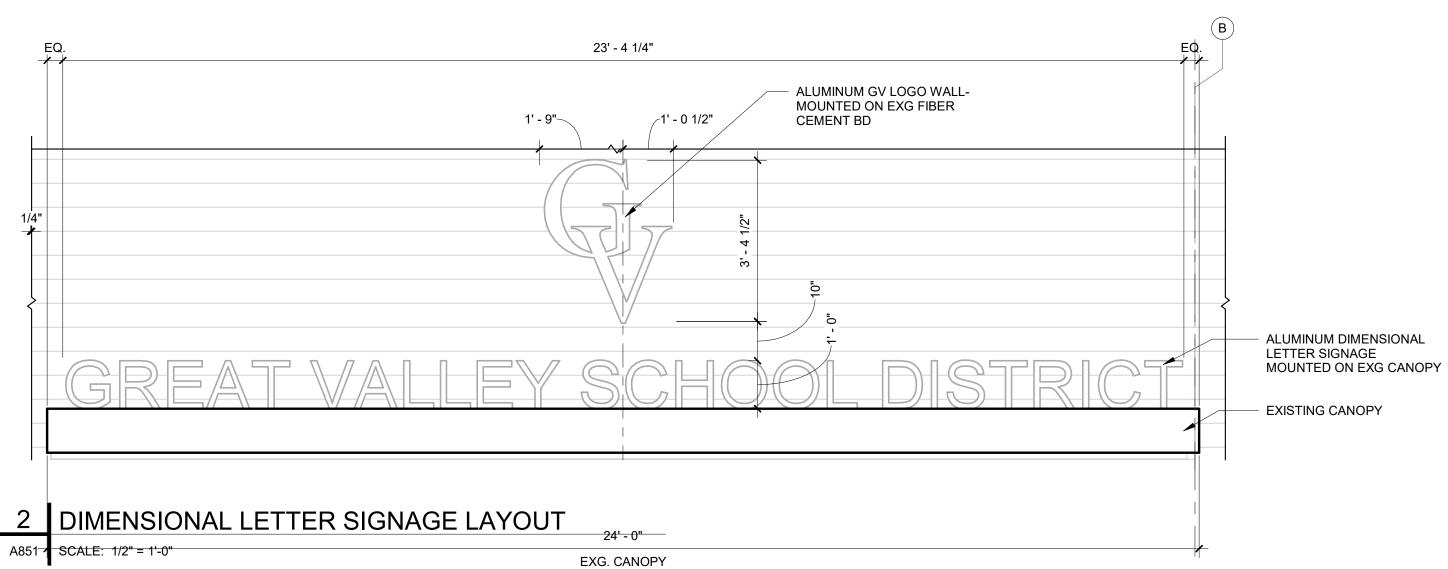

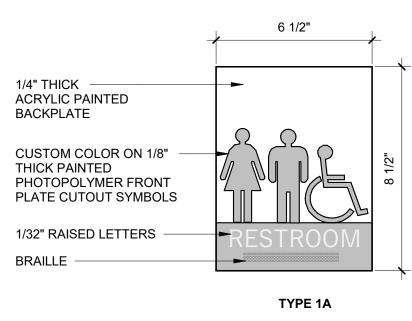

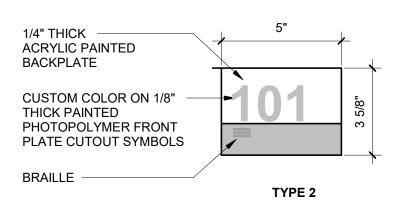

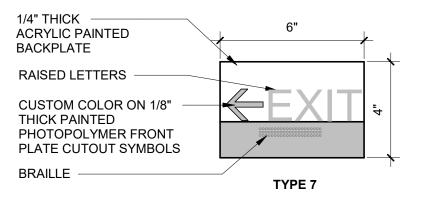

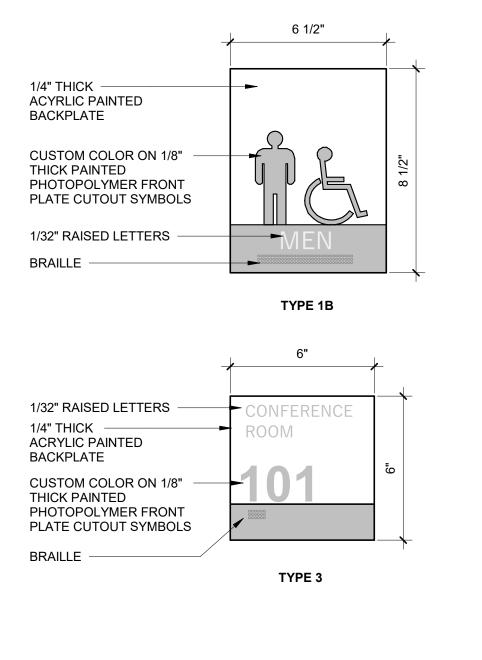





BRAILLE


NOTES: 1.SIGNAGE WILL BE MOUNTED VIA DOUBLE FACED TAPE AND SILICONE 2.FONT IS TO BE FUTURA 3.PROVIDE BACKPLATE FOR SIGNAGE MOUNTED ON GLASS

1 SIGN TYPES A851 SCALE: 3" = 1'-0"

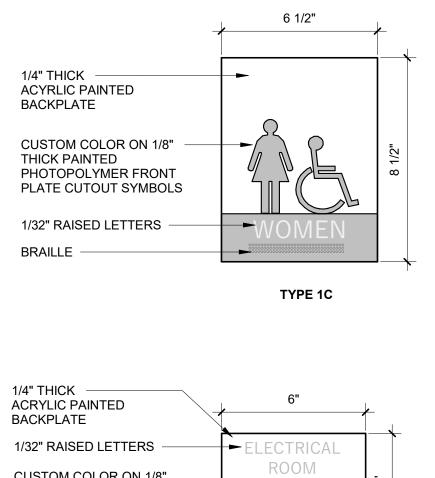


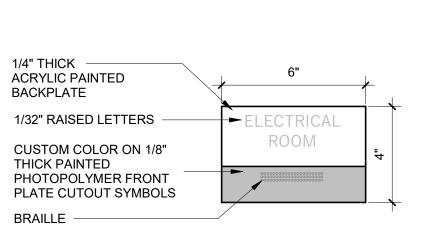





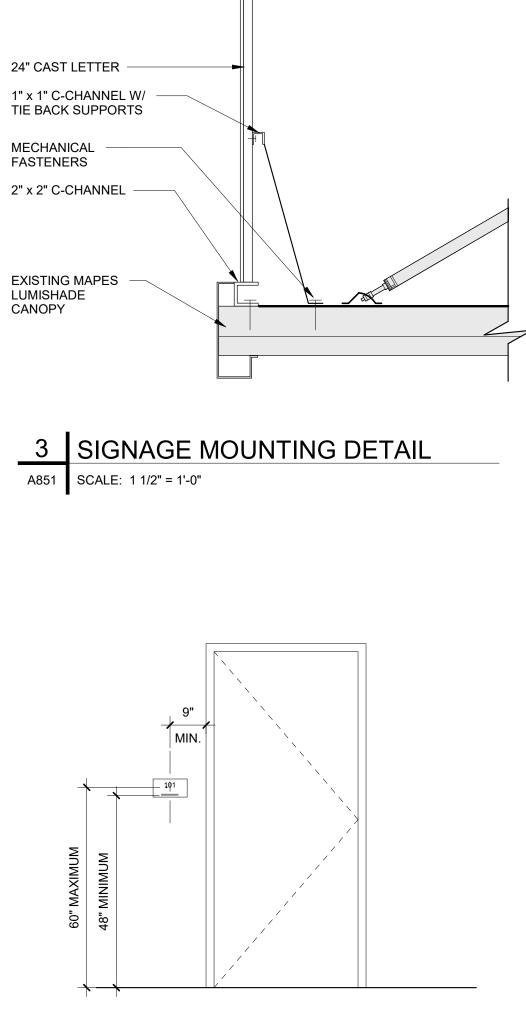

4 TYP SIGNAGE DOOR LOCATION A851 SCALE: 1/2" = 1'-0"

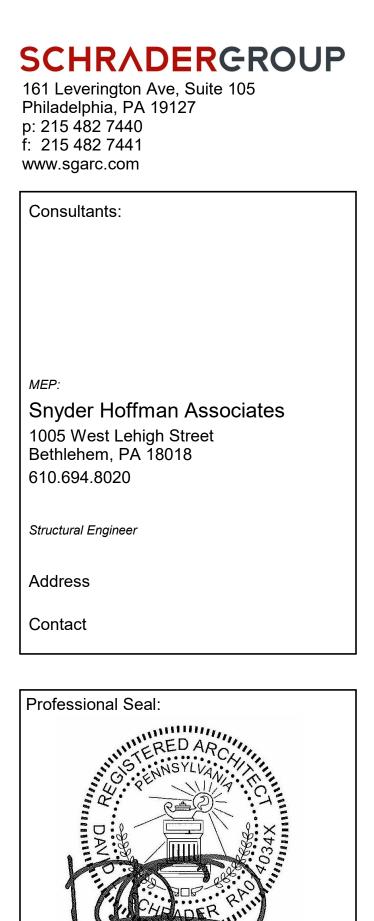

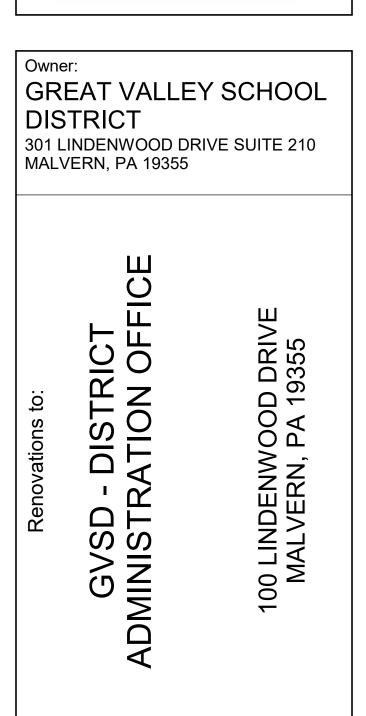

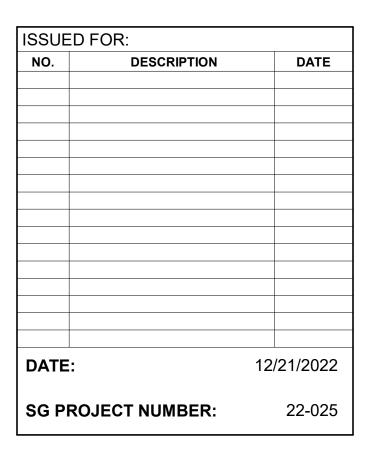




				RO	OM FINIS	H SCHEDL	JLE			
					WINDOW	CEILII	NG	CASEWOR	( FINISH	
ROOM #	Name	FLOOR FINISH		WALL FINISH	SILL FINISH	MATERIAL	FINISH	COUNTERTOP	CABINET	COMMENTS
A100 A100.1	LOBBY RECEPTION	CT-1 CPT-1	RB-1 RB/WD-1	PNT-1/CT-4/VWC-2 PNT-1/PNT-3/WD STN-1		GWB GWB/WD	PNT-5 PNT-3/STN-1	QTZ-1 QTZ-1		SEE INTERIOR ELEVATIONS SEE INTERIOR ELEVATIONS
A101	CONFERENCE	CPT-3	RB-1	PNT-1/WD	SSM-1	AB-1/GWB	-/PNT-5	SSM-1		SEE INTERIOR ELEVATIONS
	CHILD ACCOUNTING INSTRUCT'L TECH SUPERVISOR	CPT-1 CPT-1	RB-1 RB-1	PNT-1 PNT-1	- SSM-1	ACT-2A ACT-2A	-	-	-	HDW-2 HDW-2
	SUPER T&L SECONDARY	CPT-1	RB-1	PNT-1	SSM-1 SSM-1	ACT-2A	-	-		HDW-2
	SUPER T&L ELEMENTARY	CPT-1	RB-1	PNT-1	SSM-1	ACT-2A	-	-	-	HDW-2
	SUPER OF CLINICAL SERVICES SUPER OF SPECIALIZED SERVICES	CPT-1 CPT-1	RB-1 RB-1	PNT-1 PNT-1	SSM-1 SSM-1	ACT-2A ACT-2A	-	-	-	HDW-2 HDW-2
	DIRECTOR STUDENT SERVICES	CPT-1	RB-1	PNT-1	SSM-1 SSM-1	ACT-2A	-	-	-	HDW-2
		CPT-1	RB-1	PNT-1	SSM-1	ACT-2A	-	-	-	HDW-2
	ASSIST. SUPER FOR ED SERVICES T&L SUITE	CPT-1 CPT-1	RB-1 RB-1	PNT-1 PNT-1/PNT-2	SSM-1 SSM-1	ACT-2A ACT-2A/EXP	- -/PNT-2	-	-	HDW-2 SEE INTERIOR ELEVATIONS
	OPEN WORKSPACE	CPT-1/LVT-1	RB-1	PNT-1/PNT-2	-	ACT-2A/EXP	-/PNT-2	-		SEE INTERIOR ELEVATIONS & ALTERNATE 5
	COPY/MAIL	CPT-1	RB/WD-1	PNT-1/PNT-2/MLAM-1	-	EXP	PNT-2	SSM-1	PLAM-1	SEE INTERIOR ELEVATIONS
	ELEM SPECIAL ED SUPER ELEM SPECIAL ED SUPER	CPT-1 CPT-1	RB-1 RB-1	PNT-1 PNT-1	SSM-1	ACT-2A ACT-2A	-	-	-	HDW-2 HDW-2
	CONFERENCE / BREAKOUT	CPT-3	RB-1	PNT-1/PNT-4	-	ACT-2A/GWB	-/PNT-5	-		SEE INTERIOR ELEVATIONS & ALTERNATE 4
	CONFERENCE / BREAKOUT	CPT-3	RB-1	PNT-1/PNT-4	-	ACT-2A/GWB	-/PNT-5	-		SEE INTERIOR ELEVATIONS & ALTERNATE 4
	SECONDARY SPECIAL ED SUPER TEACHER ON ASSIGNMENT	CPT-1 CPT-1	RB-1 RB-1	PNT-1 PNT-1	-	ACT-2A ACT-2A	-	-	-	HDW-2 HDW-2
	OPEN	CPT-1	RB-1	PNT-1	-	ACT-2A	-	-	-	HDW-2
	NETWORK DATABASE SPECIALIST	CPT-1	RB-1	PNT-1	-	ACT-2A	-	-	-	HDW-2
	OPEN WORKSPACE BUSINESS SUITE	CPT-1/LVT-1 CPT-1	RB-1 RB-1	PNT-1/PNT-2 PNT-1/PNT-2	- SSM-1	ACT-2A/EXP ACT-2A/EXP	-/PNT-2 -/PNT-2	-	-	SEE INTERIOR ELEVATIONS
	BUSINESS	CPT-1	RB-1	PNT-1	SSM-1	ACT-2A/EAI	-/1 111-2	-	-	HDW-2
	DIRECTOR OF BUSINESS AFFAIRS	CPT-1	RB-1	PNT-1	SSM-1	ACT-2A	-	-	-	HDW-2
A124 A125	ASSIST. BUS. AFFAIRS SUPER FACILITIES	CPT-1 CPT-1	RB-1 RB-1	PNT-1 PNT-1	SSM-1 SSM-1	ACT-2A ACT-2A	-	-	-	HDW-2 HDW-2
	SUPERVISOR FOOD SERVICE	CPT-1	RB-1	PNT-1	SSM-1	ACT-2A	-	-	-	HDW-2
	SUPERVISOR OF IT	CPT-1	RB-1	PNT-1	SSM-1	ACT-2A	-	-	-	HDW-2
	ASSIST SUPER ADMIN ASSIST ASSIST SUPER ADMIN ASSIST & CLERICAL	CPT-1 CPT-1	RB-1 RB-1	PNT-1 PNT-1	SSM-1 SSM-1	ACT-2A ACT-2A	-	-	-	HDW-2 (QTY:2) HDW-2
	ASSIST SUPER ADMIN ASSIST & CLERICAL ASSIST SUPERINTENDENT	CPT-1	RB-1	PNT-1	SSM-1 SSM-1	ACT-2A ACT-2A	-	-	-	HDW-2
	MEDIA SPECIALIST	CPT-1	RB-1	PNT-1	SSM-1	ACT-2A	-	-	-	HDW-2
	DIRECTOR COMMUNITY OUTREACH SUPPLIES / STORAGE	CPT-1 CONC-1	RB-1 RB-1	PNT-1 PNT-1	SSM-1	ACT-2A ACT-2A	-	-	-	HDW-2 METAL SHELVING
	STORAGE	CPT-1	RB-1	PNT-1		ACT-2A	-	-		METAL SHELVING METAL SHELVING & HIGH DENSITY STORAGE
	ELEC	CONC-1	RB-1	PNT-1	-	EXP	PNT-1	-	-	
	IT JAN.	CONC-1 CONC-1	RB-1 RB-1	PNT-1 FRP-1/PNT-1	-	EXP EXP	PNT-1 PNT-1	-	-	SEE INTERIOR ELEVATIONS
	KITCHEN	LVT-1	RB-1	PNT-1/PNT-3/CT-3	-	ACT-2A	-	 SSM-1		SEE INTERIOR ELEVATIONS
	SUPERINTENDENT LOBBY	CPT-1	RB-1	PNT-1	SSM-1	GWB	PNT-5	-	-	
	WATER SOURCE SUPERINTENDENT	CONC-1 CPT-1	RB-1 RB-1	PNT-1 PNT-1	- SSM-1	EXP ACT-2A	PNT-1 -	-	-	
	EXEC. CONF	CPT-3	RB-1	PNT-1/PNT-4	SSM-1	AB-1/GWB	-/PNT-5	SSM-1		SEE INTERIOR ELEVATIONS & ALTERNATE 4
	BOARD ROOM	CPT-2	RB-1	PNT-1/PNT-2/WD	SSM-1	ACT-2A/EXP/GWB		-	-	SEE INTERIOR ELEVATIONS
A144 A144.1	BOARD ROOM TABLE / CHAIR STOR.	CPT-2 CONC-1	RB-1 RB-1	PNT-1/PNT-2 PNT-1	SSM-1	ACT-2A/EXP/GWB EXP	-/PNT-2/PNT-5 PNT-1	-	-	SEE INTERIOR ELEVATIONS
	CONFERENCE / TRAINING	CPT-2	RB-1	PNT-1/PNT-2	SSM-1	ACT-2A/EXP/GWB		SSM-1		SEE INTERIOR ELEVATIONS
	CORRIDOR	CPT-1	RB-1	PNT-1/PNT-2	-	EXP	PNT-2	-	-	SEE INTERIOR ELEVATIONS
	CORRIDOR	CPT-1 CPT-1	RB-1 RB-1	PNT-1/PNT-2 PNT-1	-	EXP ACT-2A	PNT-2	-	-	
	TOILET	CT-1	CT-1A	CT-2/VWC-1	-	ACT-2A/GWB	-/PNT-5	SSM-1	PLAM-1	TP-1; SEE INTERIOR ELEVATIONS
	TOILET	CT-1	CT-1A	CT-2/VWC-1	-	ACT-2A/GWB	-/PNT-5	SSM-1	PLAM-1	TP-1; SEE INTERIOR ELEVATIONS
	TOILET	CT-1 CT-1	CT-1A CT-1A	CT-2/VWC-1 CT-2/VWC-1	 	GWB GWB	PNT-5 PNT-5	SSM-1 SSM-1		SEE INTERIOR ELEVATIONS SEE INTERIOR ELEVATIONS
	MOTHER'S ROOM	CPT-1	RB-1	PNT-1	-	ACT-2A	-	SSM-1		SEE INTERIOR ELEVATIONS
	TOILET	CT-1	CT-1A	CT-2/VWC-1	-	GWB	PNT-5	SSM-1		SEE INTERIOR ELEVATIONS
	TOILET	CT-1 CT-1	CT-1A CT-1A	CT-2/VWC-1 CT-2/VWC-1		GWB GWB	PNT-5 PNT-5	SSM-1 SSM-1		SEE INTERIOR ELEVATIONS SEE INTERIOR ELEVATIONS
T08	TOILET	CT-1	CT-1A	CT-2/VWC-1		GWB	PNT-5 PNT-5	SSM-1		SEE INTERIOR ELEVATIONS
	TOILET	CT-1	CT-1A	CT-2/VWC-1	-	GWB	PNT-5	SSM-1		SEE INTERIOR ELEVATIONS
	COAT CLOS. VEST.	CPT-1 WOM-1	RB-1 RB-1	PNT-1 PNT-1		GWB GWB	PNT-5 PNT-5	-	-	SEE INTERIOR ELEVATIONS
	VEST.	WOM-1	RB-1	PNT-1	-	GWB	PNT-5 PNT-5	-	-	
V03	VEST.	WOM-1	RB-1	PNT-1	-	GWB	PNT-5	-	PLAM-1	SEE INTERIOR ELEVATIONS

				FINISH SPECIFICATIO	NS		
			BASIS OF DESIGN				
TAG	MATERIAL	MANUFACTURER	PRODUCT	COLOR	SIZE	INSTALLATION METHOD	COMMENTS
LOOR							
CONC-1 SEALE		SHERWIN WILLIAMS INTERFACE	HEAVY SHIELD SUITE SERENITY COLLECTION: DIAMOND DREAM	SW 7655 STAMPED CONCRETE 106661 BLISS	25CM X 1M	ASHLAR	
CPT 2 CARPE		INTERFACE	NIGHT LIGHTS COLLECTION: GLISTEN	107232 NICKEL	25CM X 1M	ASHLAR	
CPT-3 CARPE		FLOR (INTERFACE)	TUXEDO POCKET	INDIGO/GOLD			
CT-1 CERAM		GARDEN STATE TILE	ARDOSIA - NATURAL FINISH	ELEPHANT GREY	32"X32"	STACK; GROUT SIZE: 2MM	EPOXY GROUT COLOR: MAPEI KERAPOXY CQ - 107 IRON
LVT-1 LUXUR	Y VINYL TILE	INTERFACE	LEVEL SET COLLECTION: NATURAL WOODGRAINS	A00210 TEAK	25CM X 1M	ASHLAR	
WOM-1 WALK-	OFF TILE	MATS INC	SUPER NOP 52	CHARCOAL	19.68" X 19.68" X 1/2"		
WALL							
	IIC TILE (TLT ROOM)	GARDEN STATE TILE	MATERIC - MATTE FINISH	BIANCO MACRO	8X8	BRICK PATTERN LAYOUT; GROUT SIZE: 3/16"	EPOXY GROUT COLOR: MAPEI KERAPOXY CQ - 93 WARM GRAY
	IIC TILE (BREAKROOM)	GARDEN STATE TILE	UPTOWN MATTE	CANVAS WHITE	3X6	STACK; GROUT SIZE: 1/8"	EPOXY GROUT COLOR: MAPEI KERAPOXY CQ - 38 AVALANCHE
	IIC TILE (DRINKING FOUNTAIN ACCENT TILE		CHROMA	BLU BRICK	3X12	STACK; GROUT SIZE: 1/8"	EPOXY GROUT COLOR: MAPEI KERAPOXY CQ - 93 WARM GRAY
FRP-1 FIBERC	GLASS REINFORCED PANELS	MARLITE	STANDARD FRP PANELS - PEBBLED FINISH	P199 BRIGHT WHITE			
PNT-1 PAINT		SHERWIN WILLIAMS	TYPICAL WALL PAINT/HOLLOW METAL TRIM	SW 9165 GOSSAMER VEIL			
PNT-2 PAINT		SHERWIN WILLIAMS	WALL/CEILING PAINT	SW 7068 GRIZZLE GRAY			
PNT-3 PAINT		SHERWIN WILLIAMS		SW 7655 STAMPED CONCRETE			
PNT-4 PAINT	WALLCOVERING	WOLF GORDON WOLF GORDON	SCUFFMASTER - SOLID METAL - METALLIC ACCENT WALL PAINT INKED LINEN - 20 OZ	GOH 33072237 FOG	54"	REVERSE HANG, RANDOM MATCH	
	VALLCOVERING	MDC STUDIO	DIGITAL SOLUTIONS S1188357 - TYPE II WALLCOVERING	CUSTOM IMAGES/WALL GRAPHICS ON	54		
				DIGISMOOTH BASE			
CEILING		554000					
	TIC BAFFLE SYSTEM	FRASCH! ARMSTRONG		34 PURE GRAY WHITE	95" X 22.5" X 2.25"		EDGE PROFILE: SQUARE LAY-IN; GRID: 15/16" PRELUDE BLIZZARD WHITE
PNT-2 PAINT		SHERWIN WILLIAMS	ULTIMA 1913 - 15/16" SQUARE LAY-IN EXPOSED CEILING PAINT	SW 7068 GRIZZLE GRAY	24"X24"X3/4"		EDGE PROFILE: SQUARE LAT-IN; GRID: 15/10 PRELODE BLIZZARD WHITE
PNT-3 PAINT		SHERWIN WILLIAMS	CEILING	SW 7000 GRIZZLE GRAT			
PNT-5 PAINT		SHERWIN WILLIAMS	CEILING	HIGH REFLECTIVE WHITE			
BASE							
CT-1a CERAM	IIC TILE	GARDEN STATE TILE	ARDOSIA	ELEPHANT GREY	6"X32"	INSTALL SCHLUTER STRIP: JOLLY ON TOP OF BASE - BRUSHED STAINLESS STEEL	
RB-1 RUBBE	R BASE	TARKETT/JOHNSONITE	COVE BASE	20 CHARCOAL	<u> </u>	BRUSHED STAINLESS STEEL	
	BASE TRIM			SHERWIN-WILLIAMS SW 6258 TRICORN	4		
				BLACK			
CABINETRY							
	ARE (CASEWORK DRAWER PULLS)	MOCKETT	ROD DRAWER PULL	STAINLESS STEEL	7 9/16"		
MLAM-1 METAL PLAM-1 PLAST		CHEMETAL WILSONART		606 BLACKENED ALUMINUM HARVEST MAPLE 7953-38			3MM EDGEBANDING COLOR: DOLKEN 3301 MATCHING HARVEST MAPLE
		WIESONART		TARVEST WAFEL 7855-50			LAMINATE
QTZ-1 QUART	Z (COUNTERTOP)	CAMBRIA	JEWEL COLLECTION	WHITNEY	2CM		
SSM-1 SOLID	SURFACE MATERIAL (COUNTERTOP & SILLS	i) CORIAN		CARBON CONCRETE	1/2" THICK	EASED EDGES	
		MECHO SHADE	E SCREEN - 3% OPENNESS (EXTERIOR WINDOWS)	CHARCOAL/GREY 30.01			
	R SHADE (MANUAL) R SHADE (MANUAL)	MECHO SHADE	E SCREEN - 3% OPENNESS (EXTERIOR WINDOWS)	CHARCOAL/GREY 30.01			
NO-Z NOLLL		MECHOSIADE		CHARGOAL/GILL 1 30.01			
MISC.							
DECOF	ATIVE LIGHT FIXTURE	OCL ARCHITECTURAL LIGHTING		GLP GOLDTASTIC METALLIC POWDER COA	г		
	DOORS			PAINT & SDG SHADOW GRAY			
DR-1 WOOD	DOORS	GRAHAM - MASONITE ARCHITECTURAL	PLAIN SLICED WHITE MAPLE - SS1 (STAIN GROUP)	#300			
FILM-1 DECOF	ATIVE WINDOW FILM	3M	CUSTOM LOGO DESIGN - TBD				
	PAINTED GLASS BOARD	GENERAL GLASS (GGI)	MAX GLASSBOARDS - MAGNETIZED - BACK PAINTED GLASS MARKERBOARDS	WHITE	SINGLE SIDED: 1/4" THICK	Z-CLIP SYSTEM	
HDW-2 HARDV	ARE (TYPICAL OFFICE COAT HOOK)	CRAIGHILL	HITCH WALL HOOK - DOUBLE	STAINLESS STEEL	3.3" X 2" X 3/4"	MOUNT 5'-0" AFF	
	ARE	MOCKETT	MEDIUM POP-UP POWER GROMMET (2) POWER, (1) DATA, DUAL USB	ALUMINUM FINISH	8 5/16" X 4 7/16"		
HDW-3 HARWA			CHARGER				
				COLOR TO MATCH WILSONART HARVEST MAPLE 7953-38			
STN-1 STAIN	PARTITION	BOBRICK	COMPACT LAMINATE DURALINE SERIES - 1080 SERIES				

FINISH SPECIFICATIONS


### FINISH ABBREVIATIONS


ACT	ACOUSTICAL CEILING PANEL
AWC	ACOUSTICAL WALL COVERING
CAB	CABINETS
CC	CUBLICLE CURTAIN
CG	CORNER GUARDS
CM	CULTURED MARBLE
CPT	CARPET
CT	CERAMIC TILE
EP	EPOXY PAINT
FARF	FLUID APPLIED RESIN FLOOR
HDW	DECORATIVE HARDWARE
IRWC	IMPACT-RESISTANT WALL COVERING
LC	LOCKER COLOR
LF	LAMINATE FLOOR
LIN	LINOLEUM
LVT	LUXURY VINYL TILE
MIR	MIRROR
MSV	MANUFACTURED STONE VENEER
NS	NATURAL STONE
PC	PAINTED CONCRETE
PF	PANEL FABRICE
PLAM	PLASTIC LAMINATE
PNT	PAINT
QT	QUARRY TILE
QTZ	QUARTZ
RB	RUBBER BASE
RF	RUBBER FLOOR
RP	RESIN PANELS
SC	SEALED CONCRETE
SSM	SOLID SURFACE MATERIAL
STN	STAIN
SV	SHEET VINYL
QTZ	QUARTZ
SSM	SOLID SURFACE MATERIAL
STN	STAIN
SV	SHEET VINYL
TA	TOILET ACCESSORIES
TP	TOILET PARTITION
TWC	TEXTILE WALL COVERING
VB	VINYL BASE
VCT	VINYL COMPOSITE TILE
VET	VINYL ENHANCED TILE
VWC	VINYL WALL COVERING
WC	WALL COVERING
WF	WOOD FLOOR
WOM	WALK-OF MAT

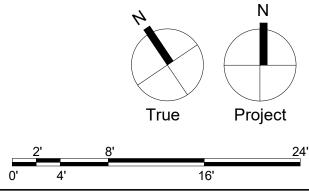

BID DOCUMENTS



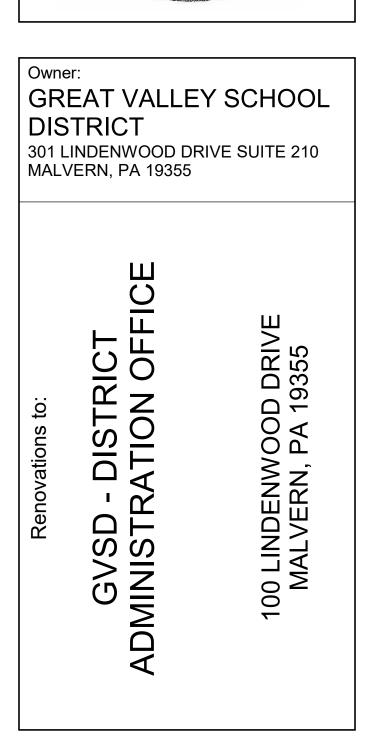

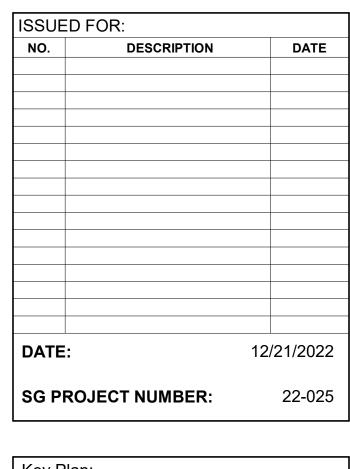





### **FINISH EXTENTS NOTES**

- WALL DESIGNATION REFERS TO NORTH NOTED ON THE KEY PLAN.
- IN ALL CASES WHERE EXPOSED CEILINGS ARE TO BE PAINTED ALL DUCTWORK AND OTHER EXPOSED MECHANICAL, ELECTRICAL AND PLUMBING EQUIPMENT TO BE PAINTED AS WELL.
- PROVIDE 3/4" AC FIRE RATED PLYWOOD FROM FINISH FLOOR TO 8'-0" A.F.F. BEHIND TELECOM EQUIPMENT. COORDINATE WITH TELECOM REQUIREMENTS. PROVIDE PAINT FINISH TO MATCH ADJACENT

CONSTRUCTION PRIOR TO PLACEMENT OF EQUIPMENT.

FLOOR FINISHES TO BE CONTINUOUS UNDER ALL CASEWORK, MILLWORK, CABINETRY, PLUMBING AND

FLOOR FIXTURES UNLESS OTHERWISE NOTED.

- PAINT EXTENT DESIGNATION INDICATED ON FINISH SCHEDULE ONLY APPLIES TO WALLS AND CEILINGS. DO NOT PAINT INTERIOR BRICK VENEER, GROUND FACED MASONRY SURFACES, GLAZING, DOOR AND WINDOW
- REFER TO PARTITION TYPES AND INTERIOR ELEVATIONS FOR EXTENT OF PAINTING. REFER TO WINDOW AND DOOR SCHEDULES FOR APPLICABLE FINISHES.

FRAMES UNLESS OTHERWISE NOTED.

- REFER TO REFLECTED CEILING PLANS FOR CEILING TYPES, MATERIALS, FINISHES AND HEIGHTS.
- PROVIDE ADA / ANSI COMPLIANT METAL THRESHOLDS / TRANSITION STRIPS BETWEEN ALL DISSIMILAR FLOORING MATERIALS. SUBMIT SAMPLES TO ARCHITECT FOR REVIEW VIA SHOP DRAWING / SAMPLE SUBMITTAL PROCESS.
- SEE "A800" SERIES INTERIOR ELEVATIONS FOR ADDITIONAL INFORMATION ON WALL PAINT LOCATIONS.

### **ROOM FINISH TAG**

ASSROC	M 🗕 —	ROOM NAME
B112	<b></b>	ROOM NUMBER
PNT-01		CEILING FINISH
PNT-02	-	WALL FINISH
CPT-01		FLOOR FINISH
RB-03	<b></b>	BASE MATERIAL
	B112 PNT-01 PNT-02 CPT-01	PNT-01 PNT-02 CPT-01

### FINISH EXTENTS LEGEND

CARPET TILE
CERAMIC TILE
LVT
SEALED CONCRETE

WALK OFF MAT

