

STEEL COLUMN SCHEDULE			
MARK	SIZE	BASE PLATE (WHERE REQUIRED)	REMARKS
C2	HSS44x48"	3'x7'x2'-11"	UPPER LEVEL
C1	HSS54x54"	3'x7'x2'-11"	LOWER LEVEL

UNLESS NOTED OTHERWISE:
 1. PROVIDE 4-3/4x1-1/2" ANCHOR RODS W/ DOUBLE NUT, EXTEND 1'-0" INTO PIER.
 2. PROVIDE 1" NON-SHRINK GROUT BELOW BASE PLATE.
 3. STEEL COLUMNS SHALL EXTEND FROM PIER TO FLOOR BEARING ELEVATION. USE 1/4" COLUMN CAP PLATE AT TOP U.N.O.

FOOTING SCHEDULE				COMMENTS
MARK	FOOTING SIZE	REINFORCEMENT		
F1	(6) 15 BOT	(3) 15 x CONT. (3) 4 x CONT. (4) 4 x 24" TRANS.		TYPICAL EXT. WALL
F2	2'-0" x 12' x CONT.	(8) 14 x CONT.		ELEVATED PATIO PIERS
F3	4'-0" x 4'-0" x 12"	(8) 15 BOT. E.W.		
F4	2'-0" x 12' x 12"	(3) 14 BOT. E.W.		
F5	11'-0" x 8'-6" x 8"	45 # 17' O.C. TOP (4) BOT. E.W.		ELEVATOR
F6	5'-0" x 8'-0" x 14"	(7) 15 BOT. E.W.		INTERIOR COLUMN
F7	4'-0" x 4'-0" x 14"	(6) 15 BOT. E.W.		INTERIOR COLUMN
F8	3'-0" x 3'-0" x 12"	(4) 15 BOT. E.W.		STEEL COLUMN
F9	4'-0" x 4'-0" x 18"	(6) 15 BOT. E.W.		
F10	3'-6" x 3'-6" x 12"	(5) 15 BOT. E.W.		

BOTTOM OF FOOTING (B.O.F.) ELEVATION +3'-0" (U.N.O.) RELATIVE TO EXTERIOR GRADE

PIER SCHEDULE				REMARKS
MARK	SIZE	CONC.	REINFORCING	
P1	15"x6"	X	(6) 15 VERTICAL	
P2	24"x24"	X	(8) 15 VERTICAL	

TOP OF PIER ELEVATION +0'-0" (U.N.O.) RELATIVE TO DATUM

1 FOUNDATION PLAN
 SCALE 1/4" = 1'-0"

FOUNDATION NOTES:
 1. SEE SHEET 50.0 FOR STRUCTURAL NOTES, ABBREVIATIONS AND SYMBOLS.
 2. SEE SHEET 55.0 FOR TYPICAL FOOTING AND FOUNDATION DETAILS.
 3. TOP OF SLAB ELEVATION +0'-0".
 4. BOTTOM OF EXTERIOR FOOTING ELEVATION (B.O.F.) AT WALL +3'-0".
 5. LAP REINFORCING AS FOLLOWS:
 #4-24
 PROVIDE #5 DOUELS FROM FOOTING INTO MASONRY WALLS. EXTEND DOUELS TO 3" CLEAR BOTTOM OF FOOTING.
 HOOK DOUELS AT BOTTOM OF FOOTING.
 6. FOOTINGS FOR WALLS NOT NOTED SHALL BE 12" THICK WITH A FINISH PROJECTION OF 4" EACH SIDE. REINFORCING W/ 2#5 CONTINUOUS, AND L#5 CONTINUOUS FOR EACH 6' WIDTH OVER 24". SEE SLO FOR DOUELS INTO PIERS.
 7. REFER TO ARCHITECTURAL DRAWINGS FOR ADDITIONAL INFORMATION AND DIMENSIONS.
 8. REFER TO ARCHITECTURAL DRAWINGS FOR LOCATIONS OF RAFTERS AND PARTITION WALLS.
 9. REFER TO ARCHITECTURAL DRAWINGS FOR ADDITIONAL INFORMATION AND DIMENSIONS.

DESIGN DEVELOPMENT - FOR REVIEW ONLY

DRAWING NAME: FOUNDATION PLAN
 LOCATION: WOODLANDS AT GREYSTONE
 SCUL THORPE DR. WEST GOSHEN TOWNSHIP
 CHESTER COUNTY, PA

Project number: SFA-1905	Drawn by: RCH
Date: 2019-10-03	CHK'd by: RCH
Scale: AS NOTED	Approv. by: MHE
Sheet no.:	

S1.0

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CONNECTION TYPE		NAILING PATTERN U.O.C. IN SECTIONS	
1.	JOIST TO SILL OR GIRDER, TOENAIL	(3/8D)	(3/8D)
2.	BRIDGING TO JOIST, TOENAIL EACH END	(3/8D)	(3/8D)
3.	7/8" SUBFLOOR TO JOIST, FACE NAIL	(3/8D)	(3/8D)
4.	WEEKER THAN 7/8" SUBFLOOR TO JOIST, FACE NAIL	(3/8D)	(3/8D)
5.	2" SUBFLOOR TO GIRDER, BLIND AND FACE NAIL	(3/8D)	(3/8D)
6.	SOLE PLATE TO JOIST OR BRIDGING, TYPICAL FACE NAIL	(3/8D)	(3/8D)
7.	SOLE PLATE TO JOIST OR BRIDGING, AT BRACED W. PANELS	(3/8D)	(3/8D)
8.	TOP PLATE TO STUD, END NAIL	(3/8D)	(3/8D)
9.	STUD TO SOLE PLATE	(3/8D)	(3/8D)
10.	DOUBLE STUDS, FACE NAIL	(3/8D)	(3/8D)
11.	DOUBLE TOP PLATES, TYPICAL FACE NAIL	(3/8D)	(3/8D)
12.	DOUBLE TOP PLATES, LAP SPICE	(3/8D)	(3/8D)
13.	BLOCKING BETWEEN JOISTS OR RAFTERS TO TOP PLATE, TOENAIL	(3/8D)	(3/8D)
14.	RIP JOIST TO TOP PLATE, TOENAIL	(3/8D)	(3/8D)
15.	TOP PLATES LAP AND INTERSECTIONS, FACE NAIL	(3/8D)	(3/8D)
16.	CONTINUOUS HEADER, TUD PIECE	(3/8D)	(3/8D)
17.	CONTINUOUS HEADER TO STUD, TOENAIL	(3/8D)	(3/8D)
18.	CEILING JOISTS LAP OVER PARTITIONS, FACE NAIL	(3/8D)	(3/8D)
19.	CEILING JOISTS TO PARALLEL RAFTERS, FACE NAIL	(3/8D)	(3/8D)
20.	RAFTER TO PLATE, TOENAIL	(3/8D)	(3/8D)
21.	7" BRACE TO EACH STUD AND PLATE, FACE NAIL	(3/8D)	(3/8D)
22.	7/8" SHEATHING OR LESS TO EACH BEARING, FACE NAIL	(3/8D)	(3/8D)
23.	WEEKER THAN 7/8" SHEATHING TO EACH BEARING, FACE NAIL	(3/8D)	(3/8D)
24.	7" PLANKS	(3/8D)	(3/8D)
25.	BUILT-UP CORNER STUDS	(3/8D)	(3/8D)
26.	2x6 BOX BEAM / HEADER	(3/8D)	(3/8D)
27.	BUILT-UP GIRDER AND BEAMS	(3/8D)	(3/8D)
28.	BUILT-UP GIRDER AND BEAMS	(3/8D)	(3/8D)

WOOD BEARING WALL SCHEDULE						
FLOOR LEVEL	TYPICAL EXTERIOR WALL			TYPICAL INTERIOR BEARING WALLS		
	STUD SIZE & SPACING	STUD GRADE	PLATE GRADE	STUD SIZE & SPACING	STUD GRADE	PLATE GRADE
0	2x6 @ 16" O.C.	HEF-HR NO. 2	HEF-HR NO. 2	2x4 @ 16" O.C.	HEF-HR NO. 2	HEF-HR NO. 2
1	2x6 @ 16" O.C.	HEF-HR NO. 2	HEF-HR NO. 2	2x4 @ 16" O.C.	HEF-HR NO. 2	HEF-HR NO. 2



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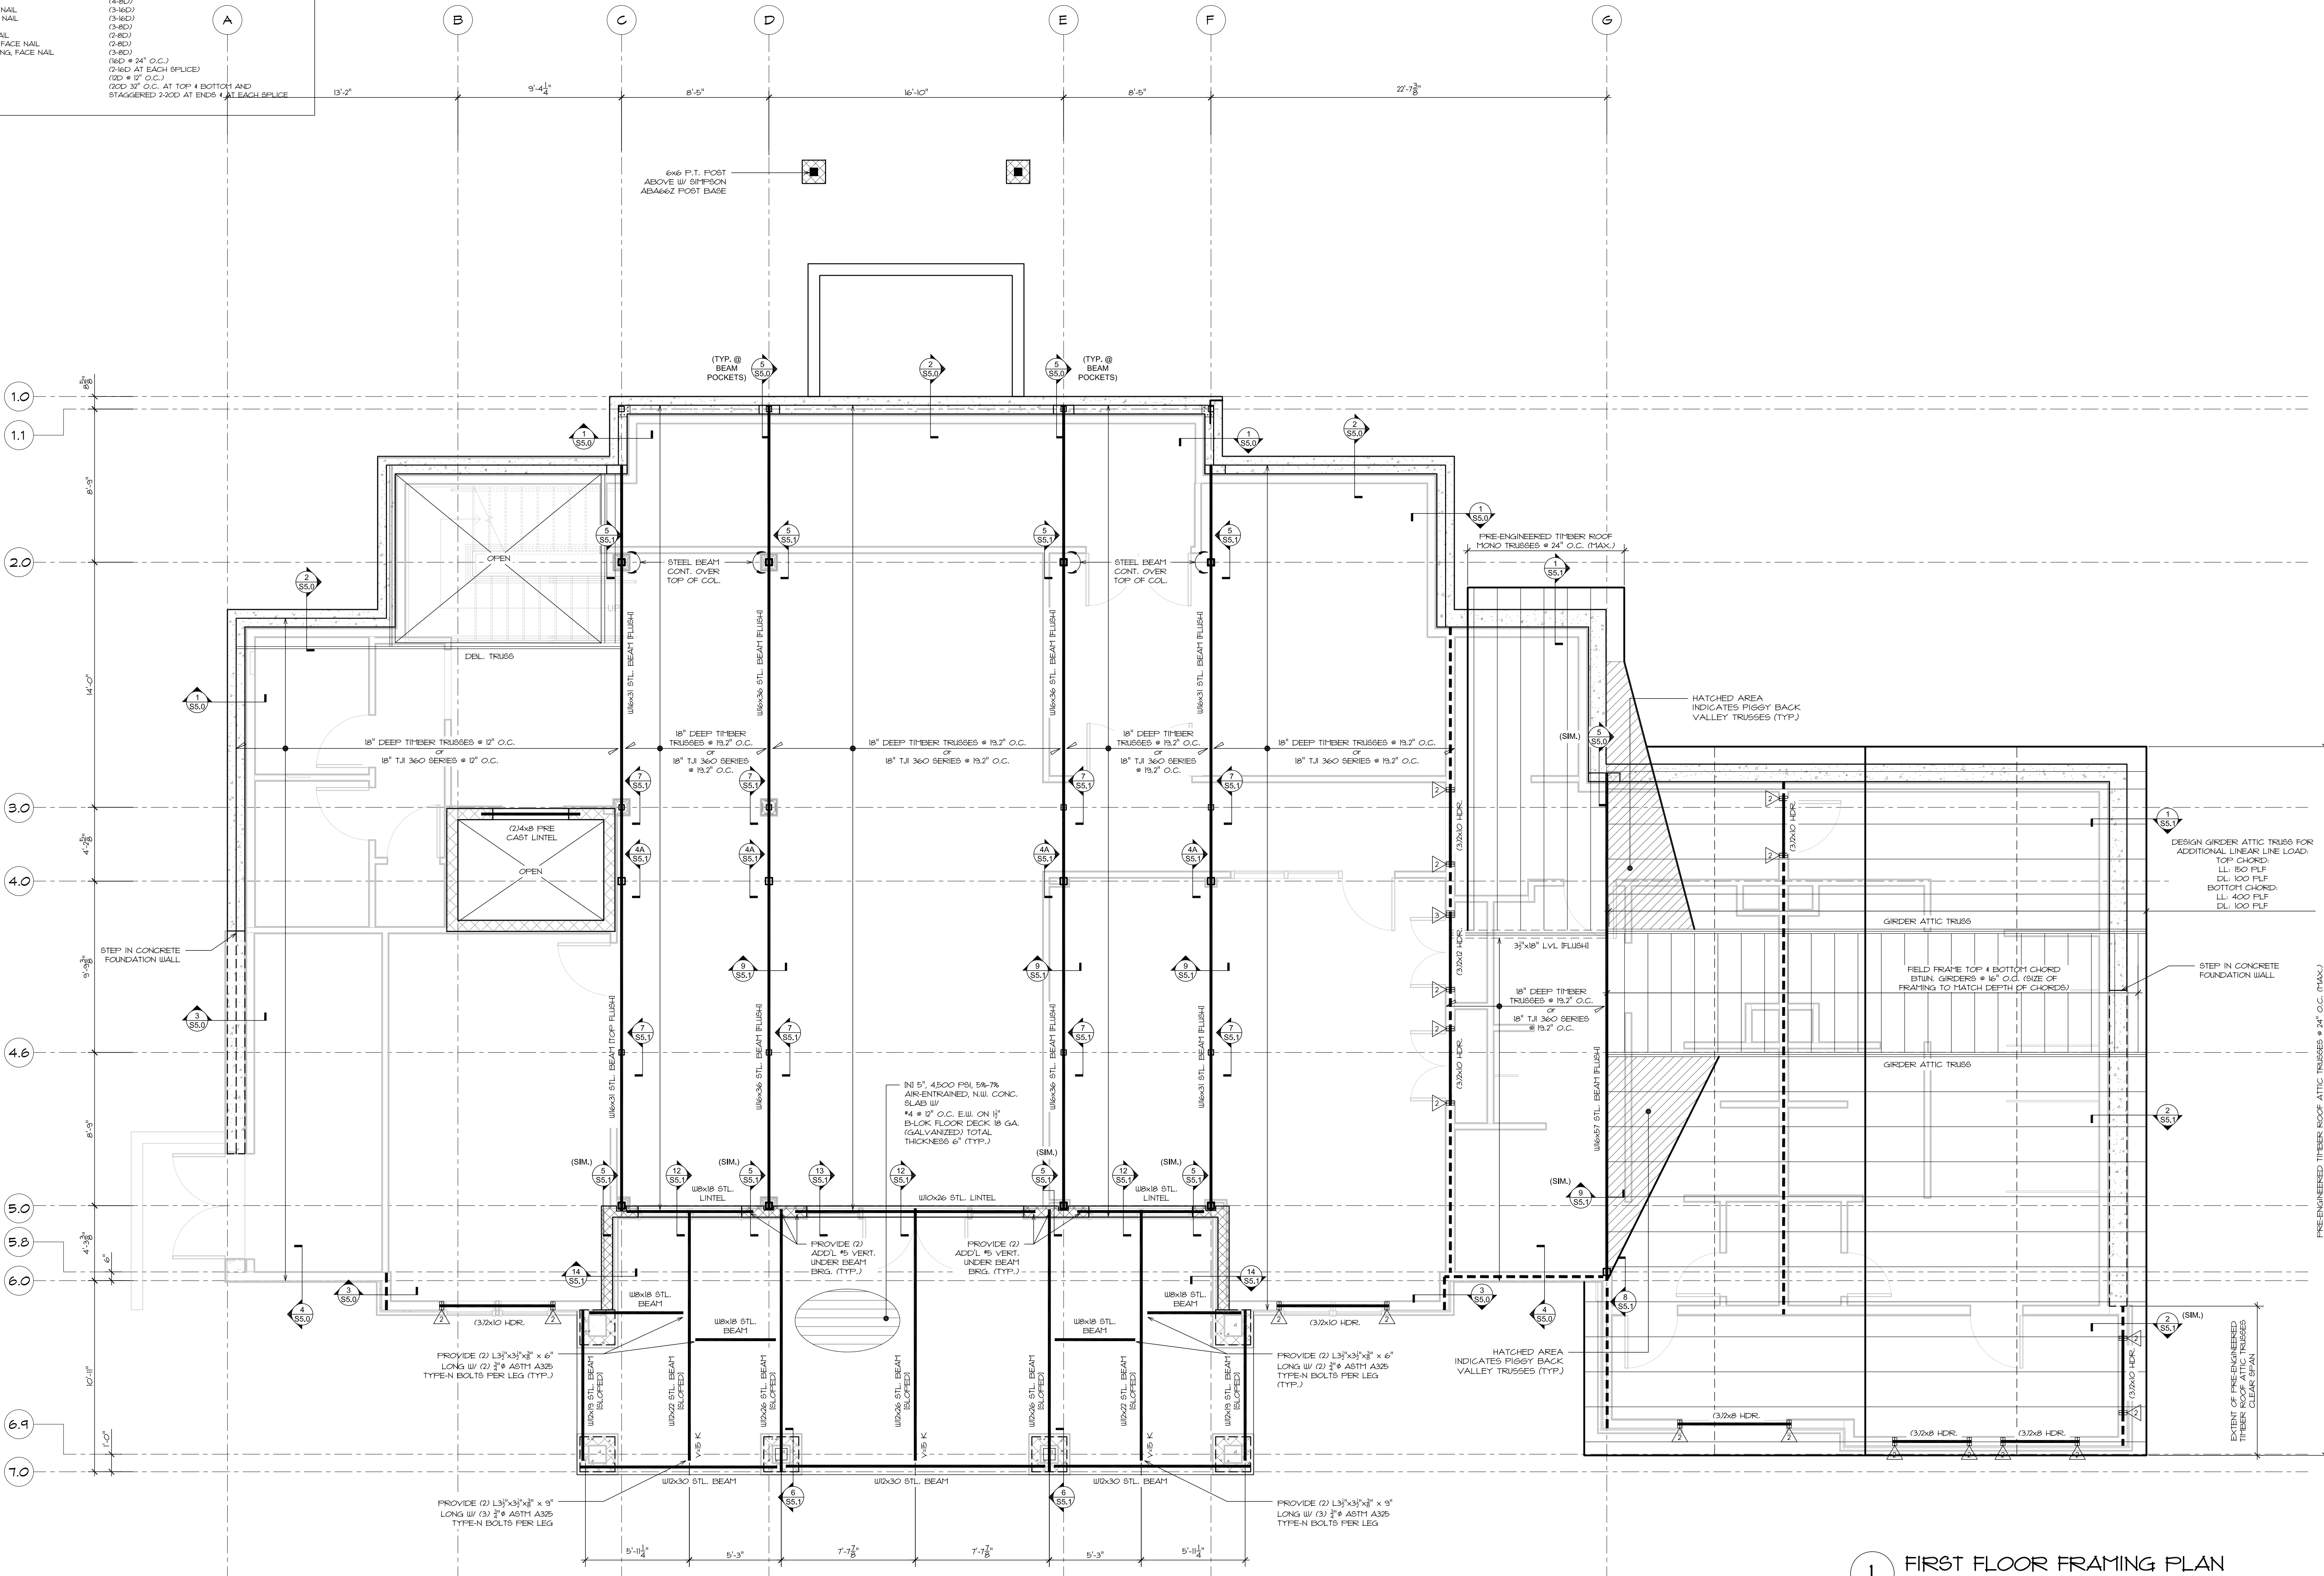
REVISIONS	Date	No.	Description

DESIGN DEVELOPMENT - FOR REVIEW ONLY

WOODLANDS AT GREYSTONE
SCUL THORPE DR. WEST GOSHEN TOWNSHIP
CHESTER COUNTY, PA


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date: 2019-10-03
scale: AS NOTED
sheet no. S1.1

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STEEL COLUMN SCHEDULE			
MARK	SIZE	BASE PLATE (WHERE REQUIRED)	REMARKS
C2	HSS44x43x8	1'x7'x2" 1"	UPPER LEVEL
C1	HSS65x55x8	1'x2'x2" 1"	LOWER LEVEL

- UNLESS NOTED OTHERWISE:
- PROVIDE 4-3/4x 1-1/2" ANCHOR BOLDS W/ DOUBLE NUT, EXTEND 1'-0" INTO PIER.
 - PROVIDE 1" NON-SHRINKING GROUT BELOW BASE PLATE.
 - STEEL COLUMNS SHALL EXTEND FROM FLOOR FOOTING TO FLOOR BEARING ELEVATION. USE 1/4" COLUMN CAP PLATE AT TOP U.N.O.



1 FIRST FLOOR FRAMING PLAN
SCALE 1/4" = 1'-0"

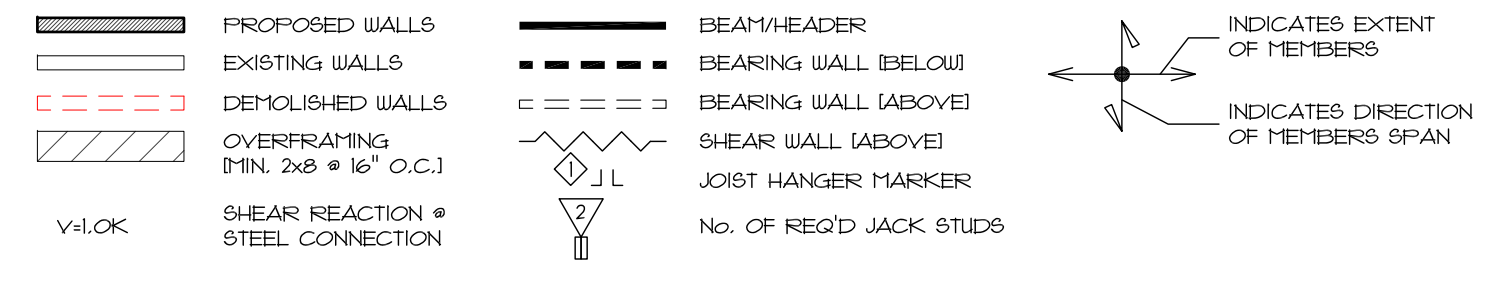FLOOR FRAMING NOTES:
 1. SEE SHEET 5007 FOR STRUCTURAL NOTES, ABBREVIATIONS AND SYMBOLS.
 2. TOP OF FLOOR JOIST ELEVATION = +0'-00"
 3. TOP OF STEEL ELEVATION = +0'-00"
 4. REFER TO ARCHITECTURAL DRAWINGS FOR LOCATIONS OF PARTS AND PARTITION WALLS.
 5. REFER TO ARCHITECTURAL DRAWINGS FOR ADDITIONAL INFORMATION AND DIMENSIONS.

DESIGN DEVELOPMENT - FOR REVIEW ONLY

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3

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CONNECTION TYPE	NAILING PATTERN U.N.O. IN SECTIONS
1. JOIST TO SILL OR GIRDER, TOENAIL	(3x6D)
2. BRIDGING TO JOIST, TOENAIL EACH END	(3x6D)
3. 1"x6" SUBFLOOR TO JOIST, FACE NAIL	(3x6D)
4. WIDER THAN 1"x6" SUBFLOOR TO JOIST, FACE NAIL	(3x6D)
5. 2" SUBFLOOR TO GIRDER, BLIND AND FACE NAIL	(3x6D)
6. SOLE PLATE TO JOIST OR BLOCKING, TYPICAL FACE NAIL	(6D @ 16" O.C.)
7. SOLE PLATE TO JOIST OR BLOCKING, AT BRACED W. PANELS	(3x6D PEN 16")
8. TOP PLATE TO STUD, END NAIL	(3x6D END NAIL)
9. STUD TO SOLE PLATE	(6D @ 24" O.C.)
10. DOUBLE STUDS, FACE NAIL	(6D @ 16" O.C.)
11. DOUBLE TOP PLATE, TYPICAL FACE NAIL	(3x6D)
12. DOUBLE TOP PLATE, LAP SPLICE	(3x6D)
13. BLOCKING BETWEEN JOISTS OR RAFTERS TO TOP PLATE, TOENAIL	(3x6D)
14. RFT JOIST TO TOP PLATE, TOENAIL	(6D @ 16" O.C.)
15. TOP PLATES LAP AND INTERSECTIONS, FACE NAIL	(3x6D)
16. CONTINUOUS HEADER, TUD PIECE	(6D @ 16" O.C. ALONG EDGE)
17. CEILING JOISTS TO PLATE, TOENAIL	(3x6D)
18. CONTINUOUS HEADER TO STUD, TOENAIL	(3x6D)
19. CEILING JOISTS LAP OVER PARTITIONS, FACE NAIL	(3x6D)
20. CEILING JOISTS TO PARALLEL RAFTERS, FACE NAIL	(3x6D)
21. RAFTER TO PLATE, TOENAIL	(3x6D)
22. 1" BRACE TO EACH STUD AND PLATE, FACE NAIL	(3x6D)
23. 1"x6" SHEATHING OR LESS TO EACH BEARING, FACE NAIL	(3x6D)
24. WIDER THAN 1"x6" SHEATHING TO EACH BEARING, FACE NAIL	(3x6D)
25. BUILT-UP CORNER STUDS	(6D @ 24" O.C.)
26. 7" PLANKS	(6D AT EACH SPLICE)
27. 2x6 BOX BEAM / HEADER	(3D @ 17" O.C.)
28. BUILT-UP GIRDER AND BEAMS	(3D @ 17" O.C. AT TOP 4 BOTTOM AND STAGGERED 2'00" AT ENDS 4 AT EACH SPLICE)

FLOOR LEVEL	TYPICAL EXTERIOR WALL			TYPICAL INTERIOR BEARING WALLS		
	STUD SIZE & SPACING	STUD GRADE	PLATE GRADE	STUD SIZE & SPACING	STUD GRADE	PLATE GRADE
0	2x6 @ 16" O.C.	HE-FIR NO. 2	HE-FIR NO. 2	2x4 @ 16" O.C.	HE-FIR NO. 2	HE-FIR NO. 2
1	2x6 @ 16" O.C.	HE-FIR NO. 2	HE-FIR NO. 2	2x4 @ 16" O.C.	HE-FIR NO. 2	HE-FIR NO. 2

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A

B


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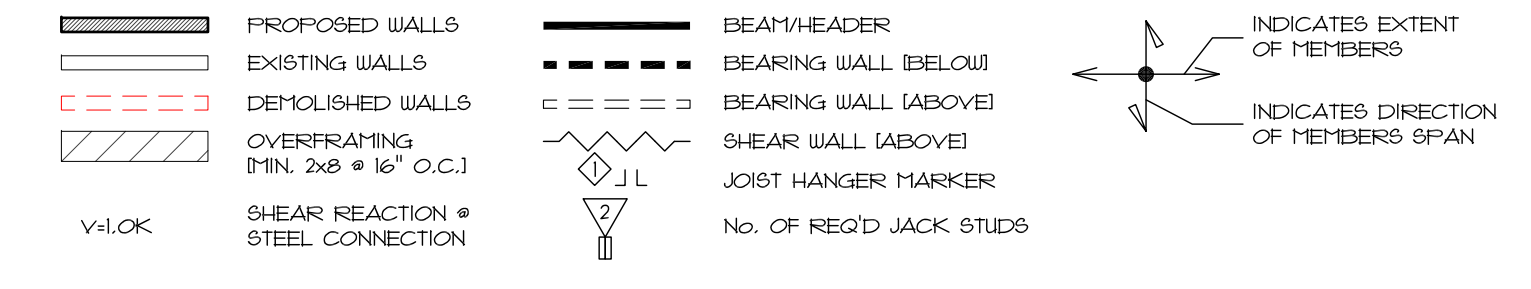
REVISIONS	Date	No.	Description

SEAL:

DRAWING NAME: **CEILING FRAMING PLAN**
WOODLANDS AT GREYSTONE
 SCUL THORPE DR. WEST GOSHEN TOWNSHIP
 CHESTER COUNTY, PA

Project number: SFA-1905
 date: 2019-10-03
 scale: AS NOTED
 sheet no. S1.2

1 CEILING FRAMING PLAN
 SCALE 1/4" = 1'-0"
 ROOF FRAMING NOTES
 1. SEE "SHEET 302" FOR STRUCTURAL NOTES, ABBREVIATIONS AND SYMBOLS.
 2. REFER TO ARCHITECTURAL DRAWINGS FOR LOCATIONS OF RAFTERS AND PARTITIONS WALLS.
 3. REFER TO ARCHITECTURAL DRAWINGS FOR ADDITIONAL INFORMATION AND DIMENSIONS.


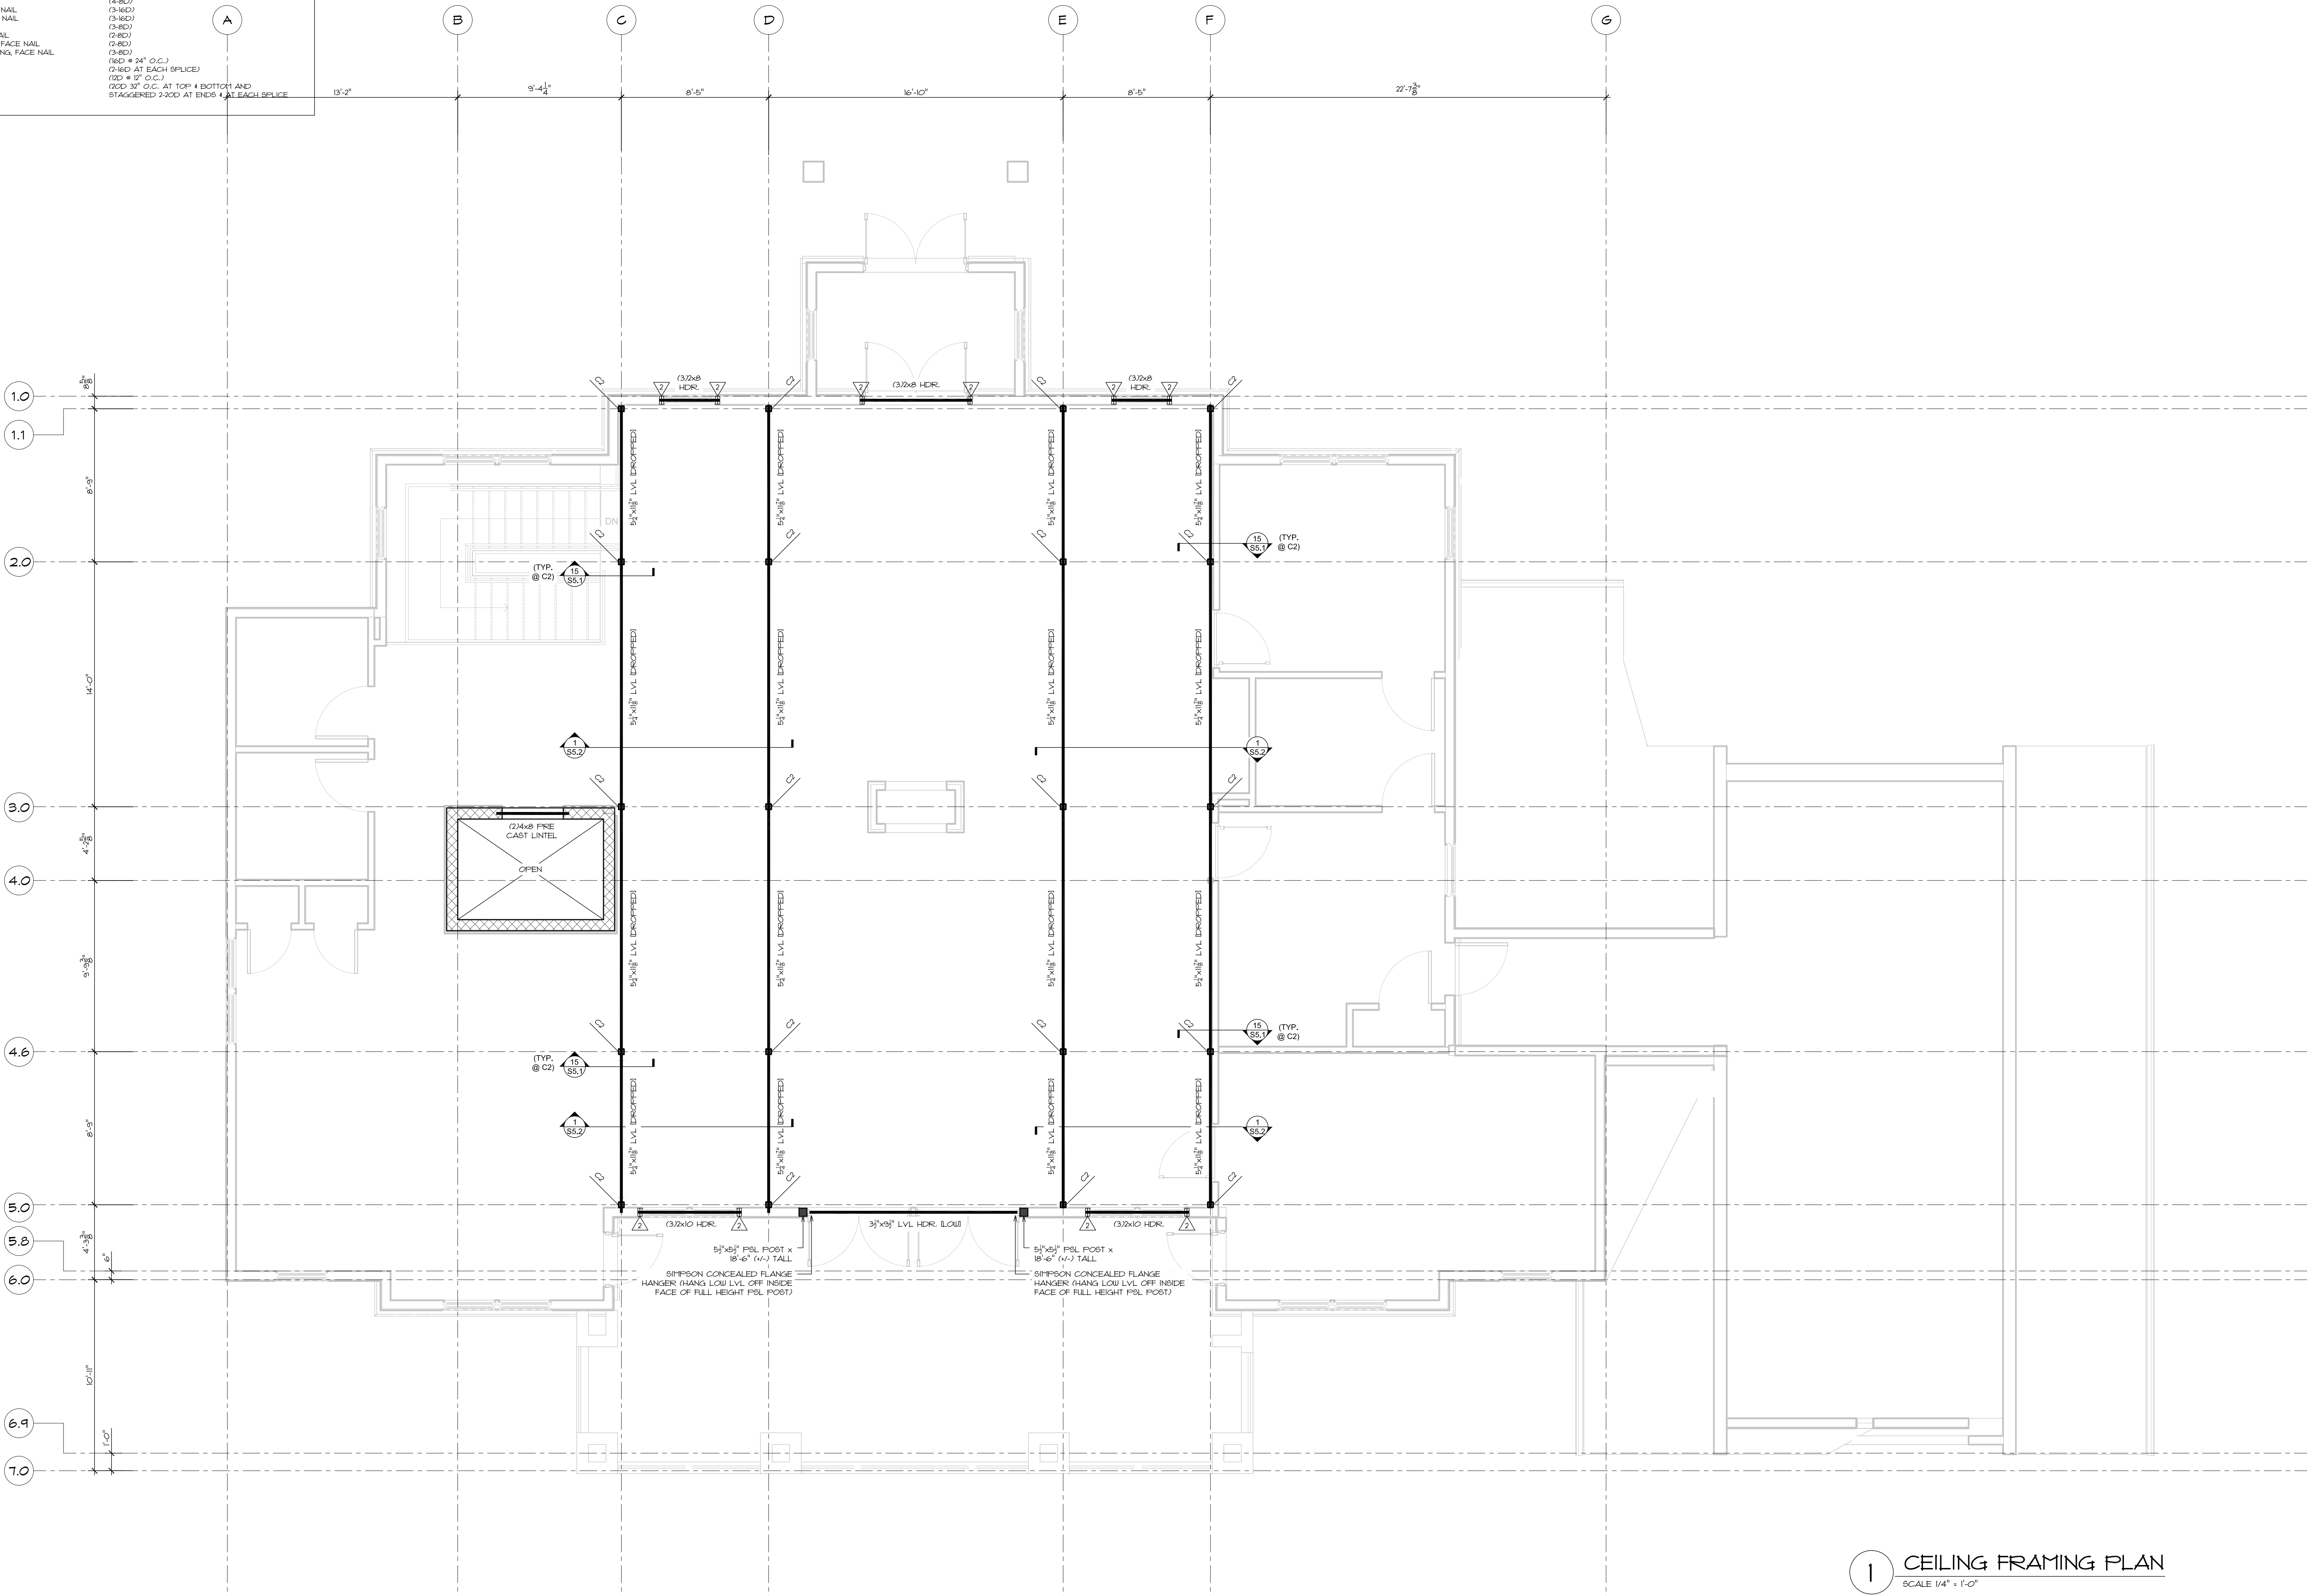


DESIGN DEVELOPMENT - FOR REVIEW ONLY

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CONNECTION TYPE	NAILING PATTERN (N.O.G. IN SECTIONS)
1. JOIST TO SILL OR GIRDER, TOENAIL	(3/8D)
2. ENDING TO JOIST, TOENAIL EACH END	(3/8D)
3. 1"x6" SUBFLOOR TO JOIST, FACE NAIL	(3/8D)
4. WIDER THAN 1"x6" SUBFLOOR TO JOIST, FACE NAIL	(3/8D)
5. 2" SUBFLOOR TO GIRDER, BLIND AND FACE NAIL	(3/8D)
6. SOLE PLATE TO JOIST OR BLOORING, TYPICAL FACE NAIL	(6D # 16" O.C.)
7. SOLE PLATE TO JOIST OR BLOORING, AT BRACED W. PANELS	(3/8D PEN 16")
8. TOP PLATE TO STUD, END NAIL	(2/4D)
9. STUD TO SOLE PLATE	(2/4D END NAIL)
10. DOUBLE STUDS, FACE NAIL	(6D # 24" O.C.)
11. DOUBLE TOP PLATE, TYPICAL FACE NAIL	(6D # 16" O.C.)
12. DOUBLE TOP PLATE, LAP SPLICE	(9/8D)
13. BLOCKING BETWEEN JOISTS OR RAFTERS TO TOP PLATE, TOENAIL	(3/8D)
14. RFT JOIST TO TOP PLATE, TOENAIL	(6D # 16" O.C.)
15. TOP PLATES LAP AND INTERSECTIONS, FACE NAIL	(3/8D)
16. CONTINUOUS HEADER, TWO PIECES	(6D # 16" O.C. ALONG EDGE)
17. CEILING JOISTS TO PLATE, TOENAIL	(3/8D)
18. CONTINUOUS HEADER TO STUD, TOENAIL	(4/8D)
19. CEILING JOISTS LAP OVER PARTITIONS, FACE NAIL	(3/8D)
20. CEILING JOISTS TO PARALLEL RAFTERS, FACE NAIL	(3/8D)
21. RAFTER TO PLATE, TOENAIL	(3/8D)
22. 1" BRACE TO EACH STUD AND PLATE, FACE NAIL	(2/8D)
23. 1"x6" SHEATHING OR LESS TO EACH BEARING, FACE NAIL	(3/8D)
24. WIDER THAN 1"x6" SHEATHING TO EACH BEARING, FACE NAIL	(3/8D)
25. BUILT-UP CORNER STUDS	(6D # 24" O.C.)
26. 7" PLANKS	(2/4D AT EACH SPLICE)
27. 2x6 BOX BEAM / HEADER	(2D # 17" O.C.)
28. BUILT-UP GIRDER AND BEAMS	(2D # 17" O.C. AT TOP 4 BOTTOM AND STAGGERED 2'0D AT ENDS 4 AT EACH SPLICE)

WOOD BEARING WALL SCHEDULE						
FLOOR LEVEL	TYPICAL EXTERIOR WALL			TYPICAL INTERIOR BEARING WALLS		
	STUD SIZE & SPACING	STUD GRADE	PLATE GRADE	STUD SIZE & SPACING	STUD GRADE	PLATE GRADE
0	2x6 @ 16" O.C.	HE-FHR NO. 2	HE-FHR NO. 2	2x4 @ 16" O.C.	HE-FHR NO. 2	HE-FHR NO. 2
1	2x6 @ 16" O.C.	HE-FHR NO. 2	HE-FHR NO. 2	2x4 @ 16" O.C.	HE-FHR NO. 2	HE-FHR NO. 2

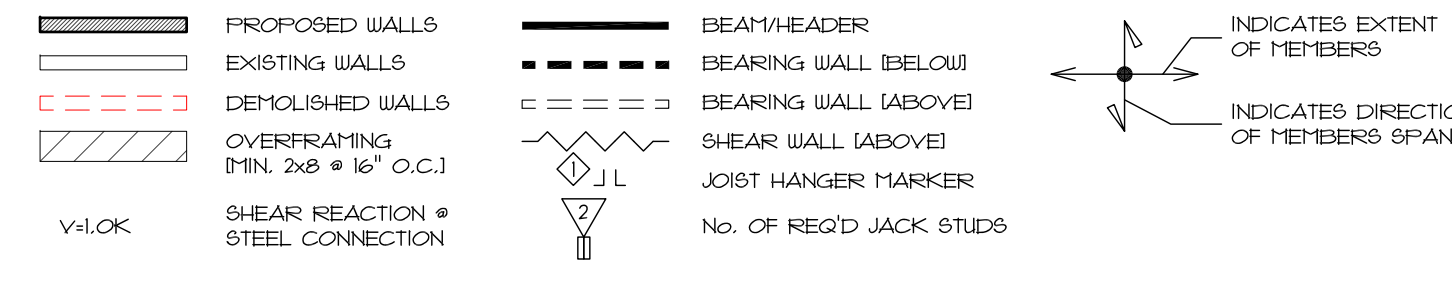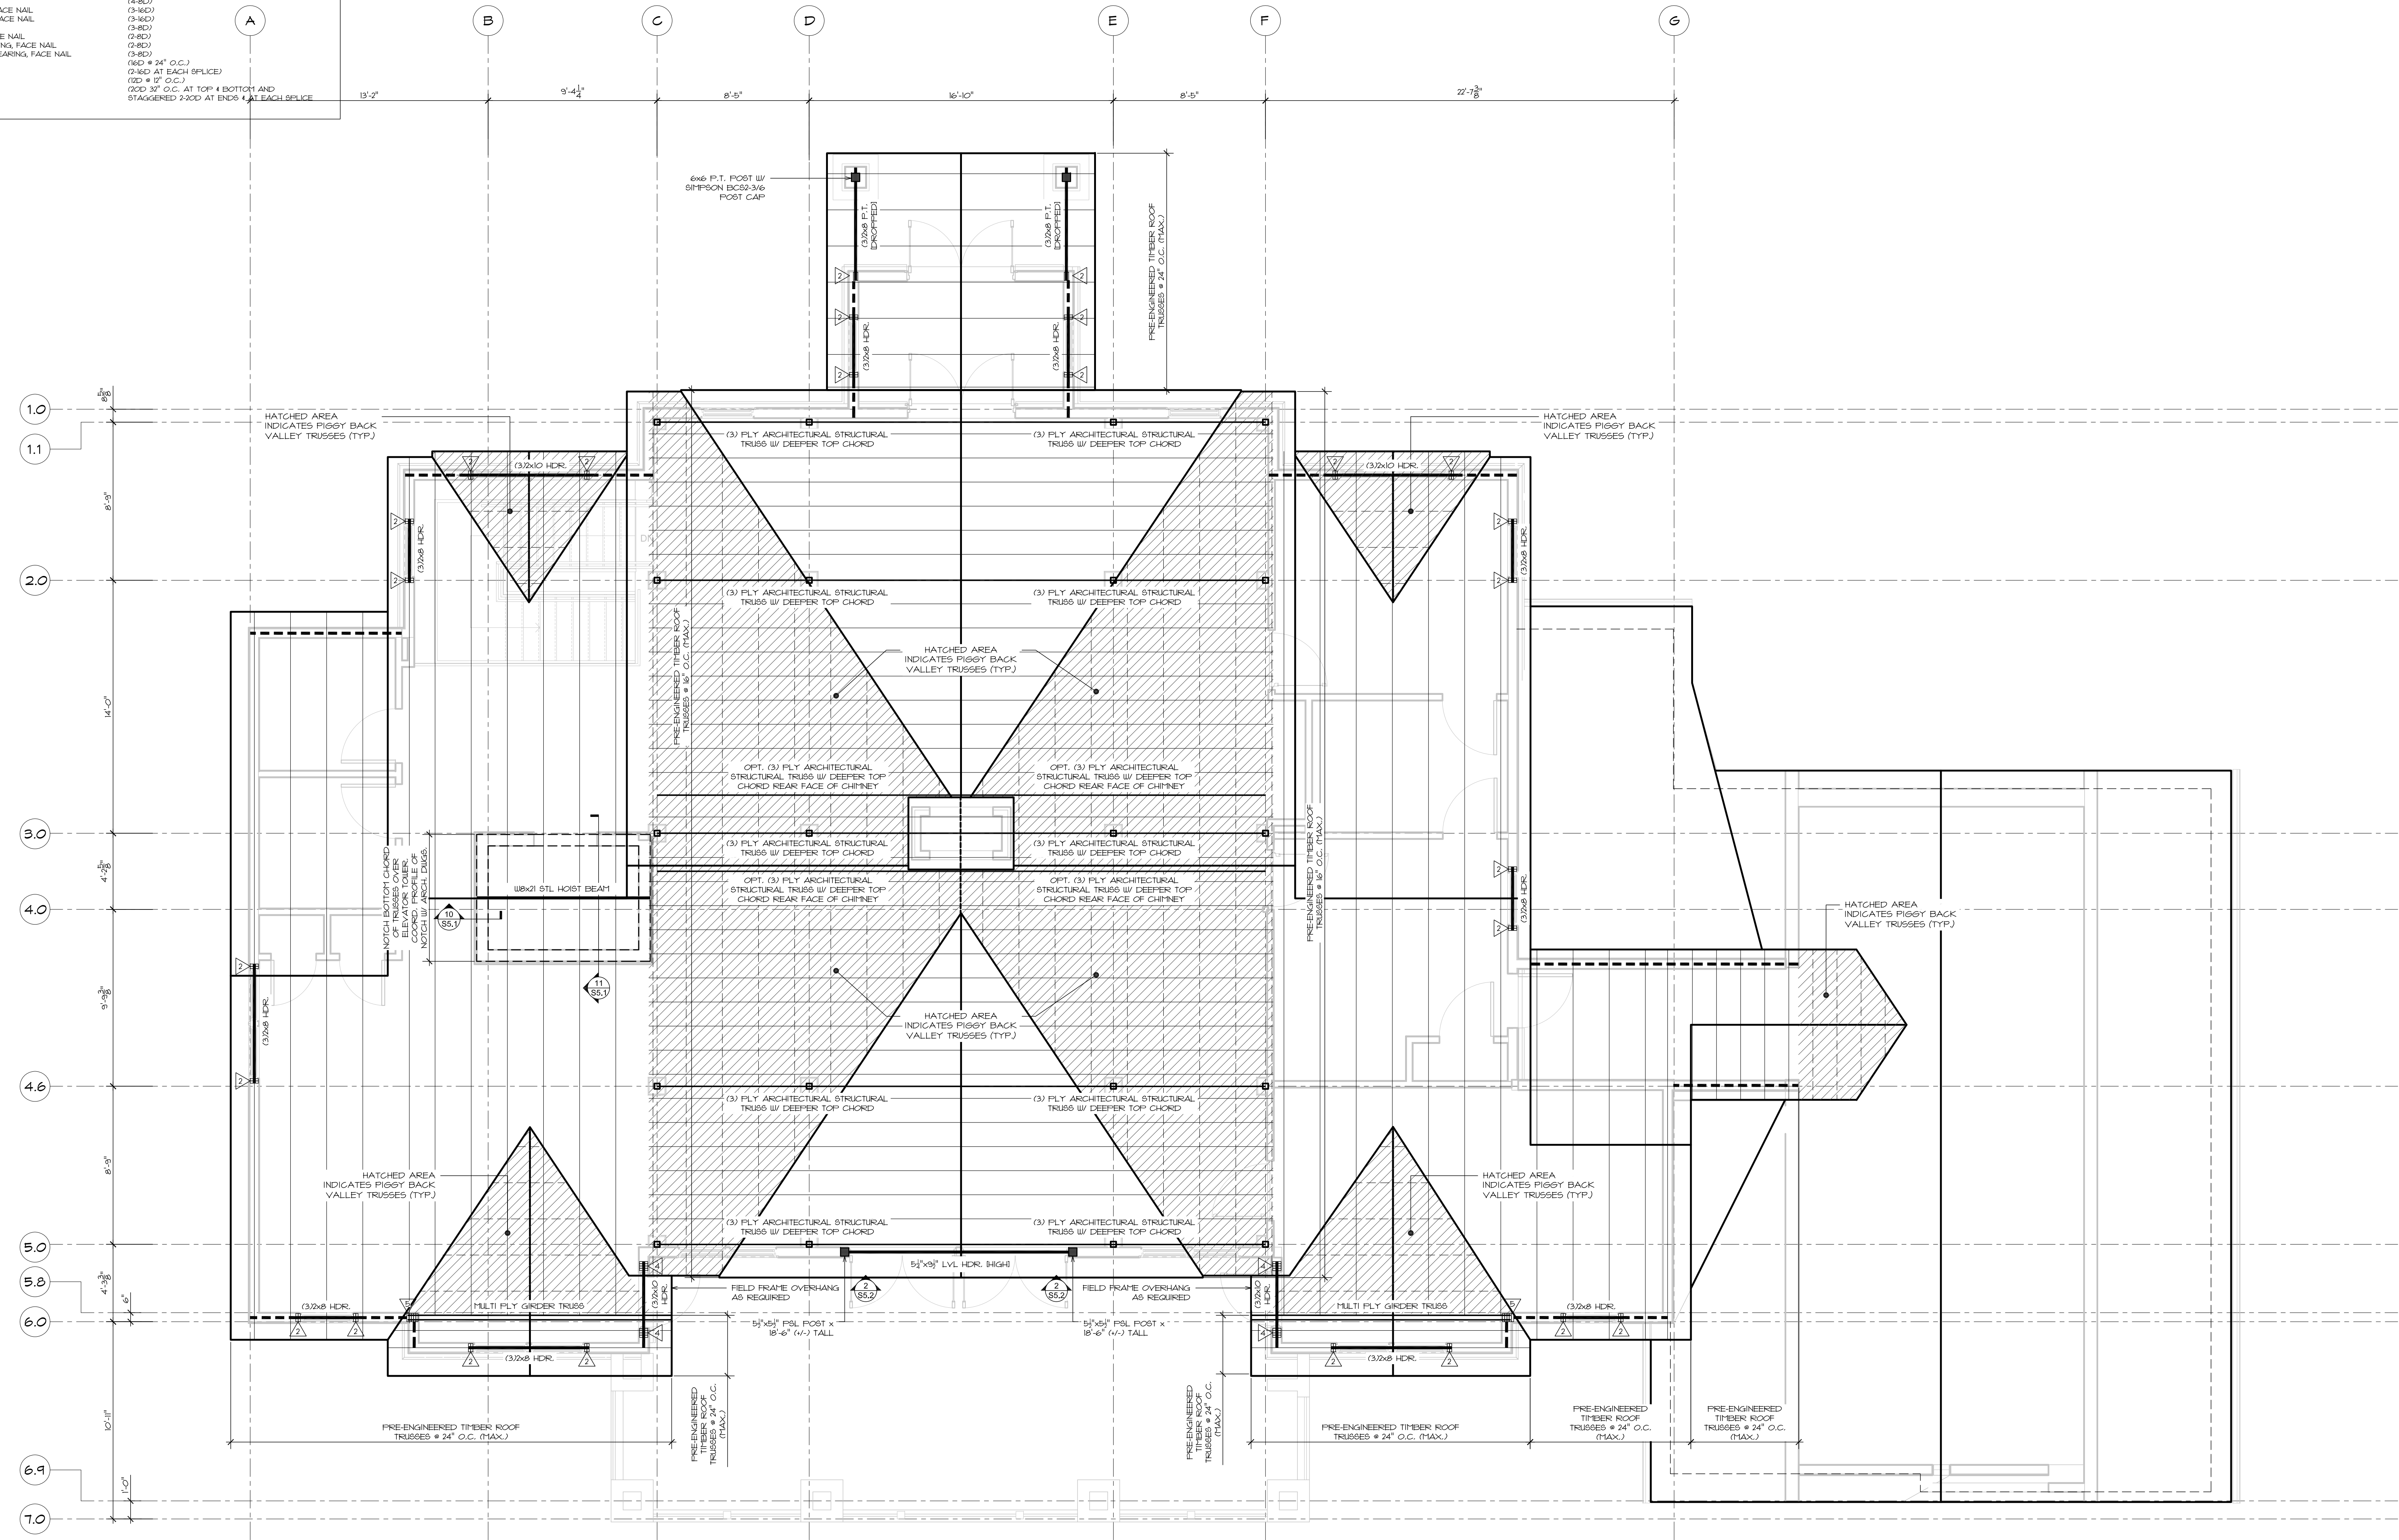

ROOF FRAMING NOTES
 SHEATHING: 1/2" CDX PL. FLOOR SHEATHING, APA SPAN RATED 24" O.C. OR EQ., PLACED AT RIGHT ANGLES TO RAFTERS, STAGGER JOINTS, NAIL W/ 8d @ 6" @ EDGE AND 17" O.C. WITHIN 6' OF EAVES AND RIDGES (HPS) NAIL W/ 8d @ 4" O.C. EDGE AND 17" O.C. FIELD.
 TRUSSES: MAX. SPACING 24" O.C.
 PROVIDE 114" 1x6 HURRICANE TIE (OR APPROVED EQUAL) @ EA. END OF TRUSSES (TYP.)
 CONSULT ARCH. FOR ROOF AND CEILING PROFILES.
 TRUSS MANUFACTURER (TM) TO DETERMINE SPACING BASED ON LOADING, OPENINGS, ETC.
 TR1 TO SPECIFY REQUIRED BRACING, HANGERS AND CONNECTORS (H.V.G.).

TRUSSES TO BE DESIGNED FOR THE FOLLOWING:
 FINISH LOADS (M) TO VERIFY ANY ADDITIONAL LOAD CASES):
 TOP CHORD
 DEAD LOAD
 LIVE LOAD
 SNOW LOAD
 BOTTOM CHORD
 DEAD LOAD
 LIVE LOAD

2 PSF - ACTUAL DL FOR ANY OVER FRAMING
 20 PSF
 30 PSF
 15 PSF
 100 PSF MECHANICAL ATTIC SPACE







1 ROOF FRAMING PLAN
 SCALE 1/4" = 1'-0"

ROOF FRAMING NOTES
 1. SEE SHEET 802 FOR STRUCTURAL NOTES, ABBREVIATIONS AND SYMBOLS.
 2. ROOF TRUSS BEARING ELEVATION: +3'-0".
 3. REFER TO ARCHITECTURAL DRAWINGS FOR LOCATIONS OF RAFTERS AND PARTITION WALLS.
 4. REFER TO ARCHITECTURAL DRAWINGS FOR ADDITIONAL INFORMATION AND DIMENSIONS.

DESIGN DEVELOPMENT - FOR REVIEW ONLY
 ROOF FRAMING PLAN

S1.3

1 2 3 4 5 6 7 8

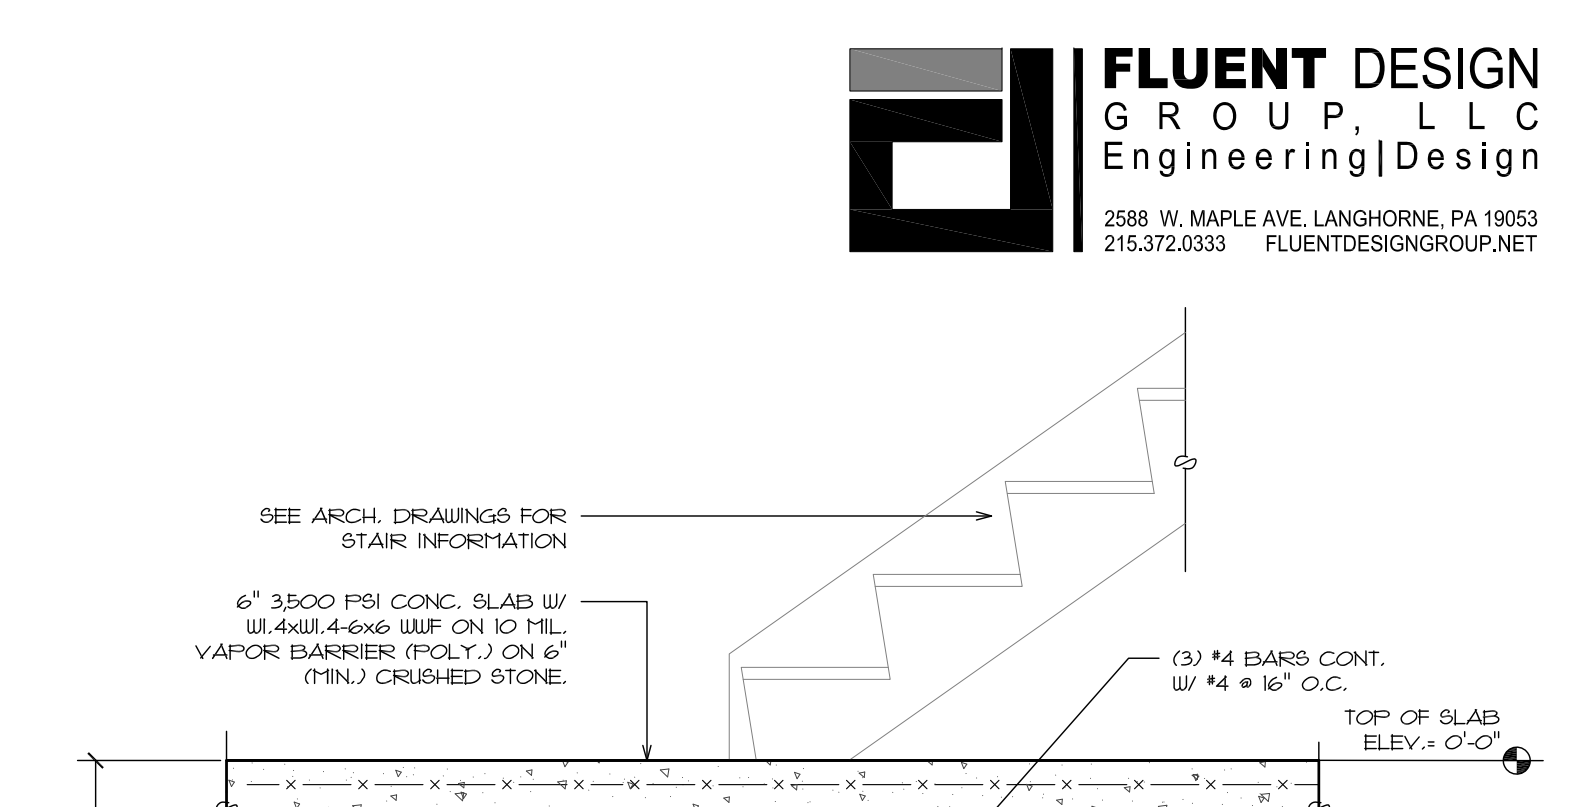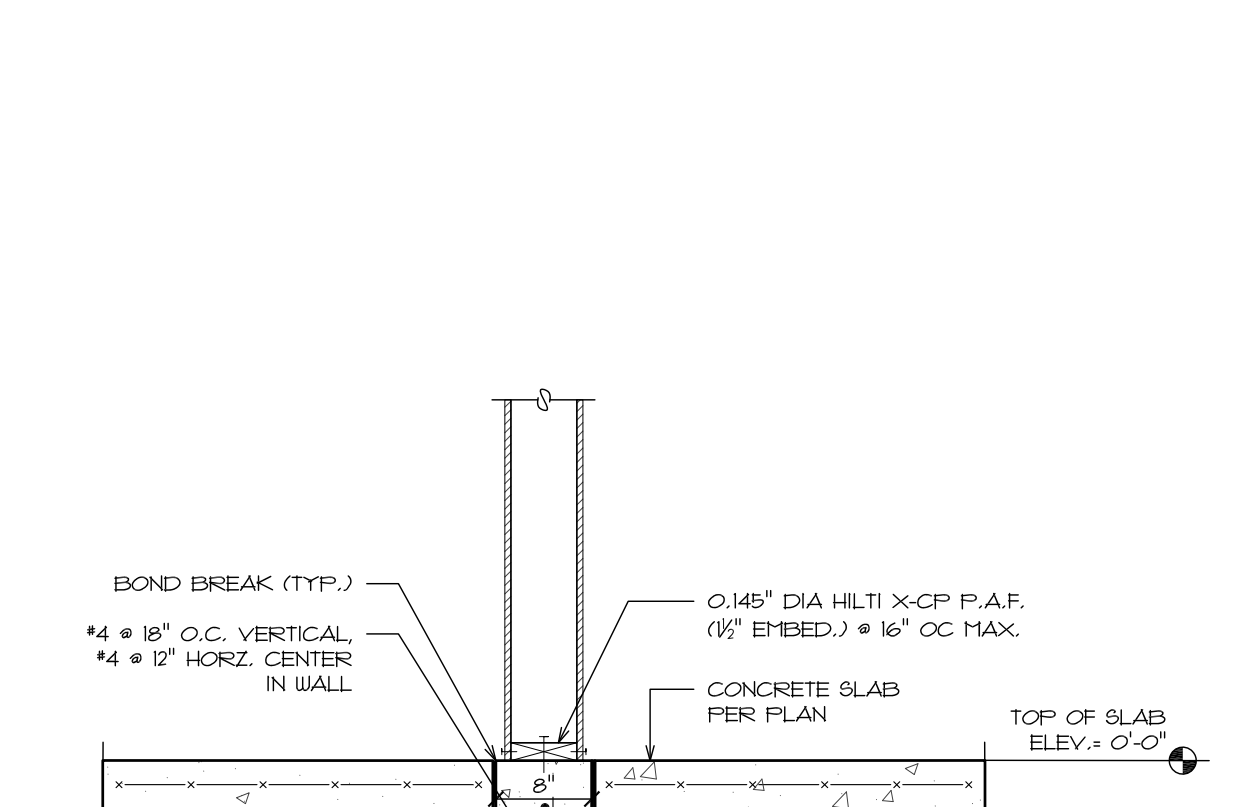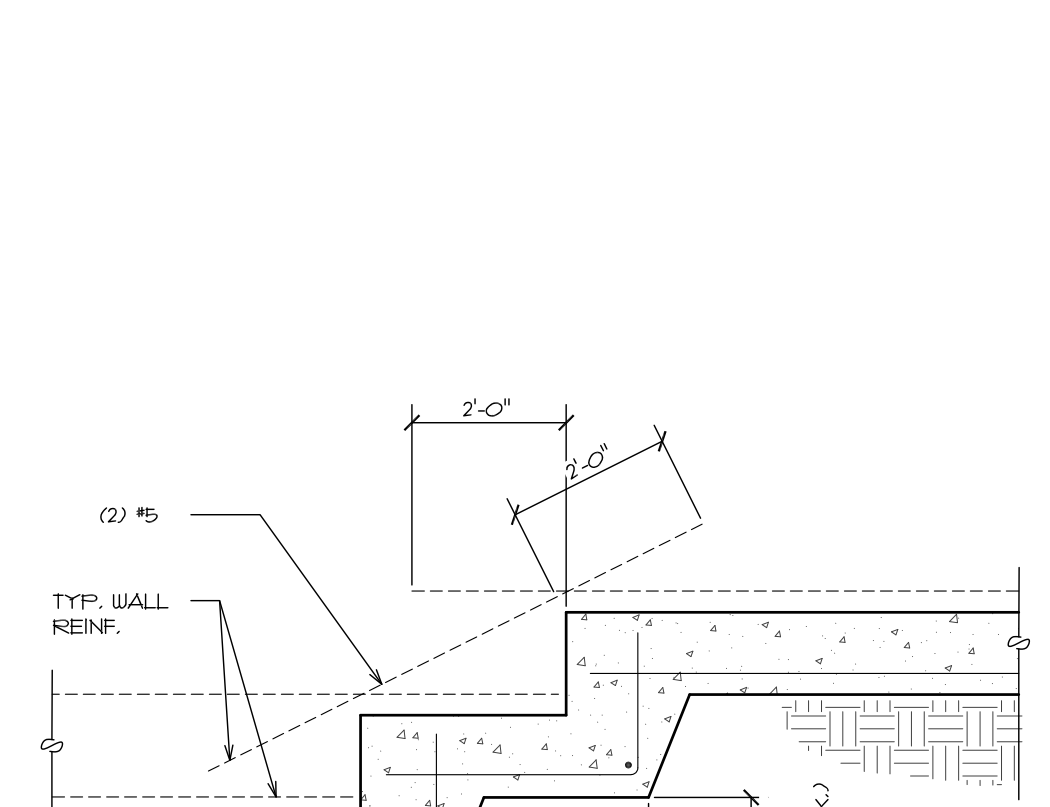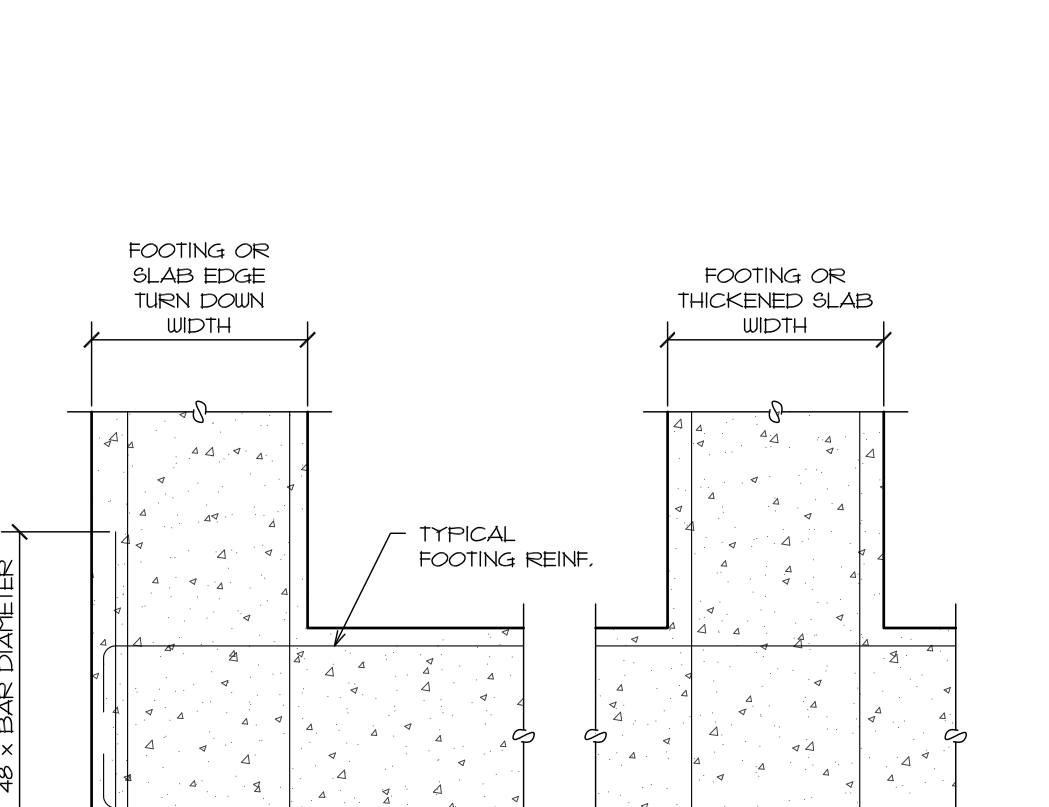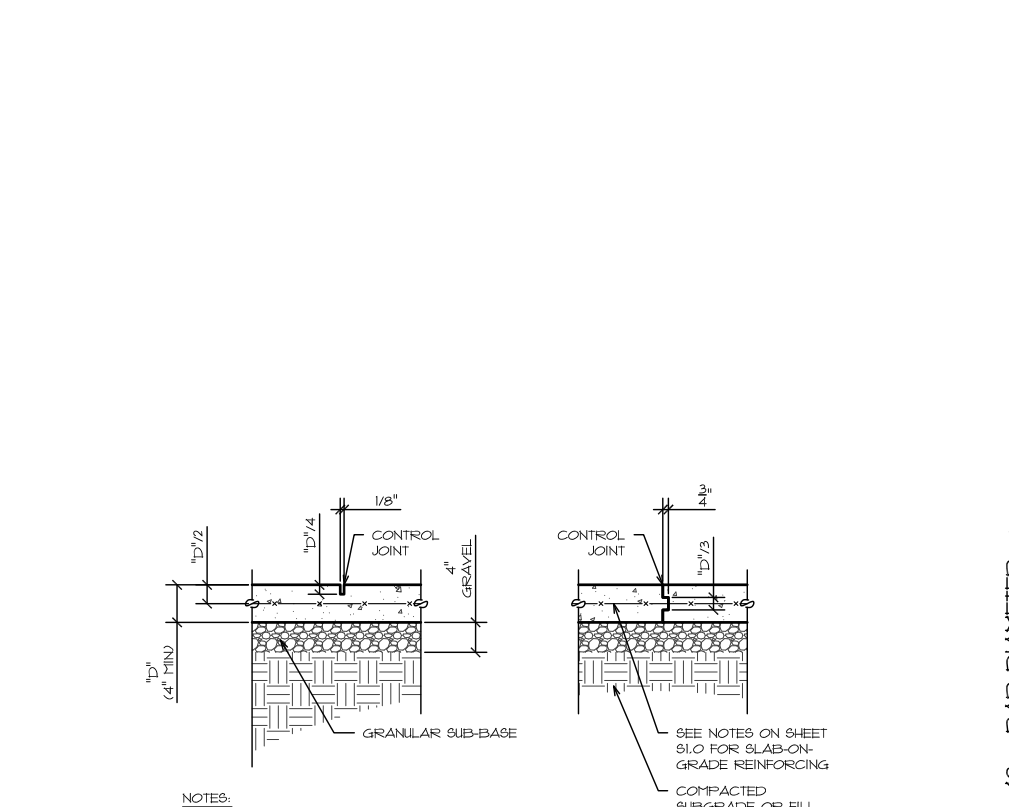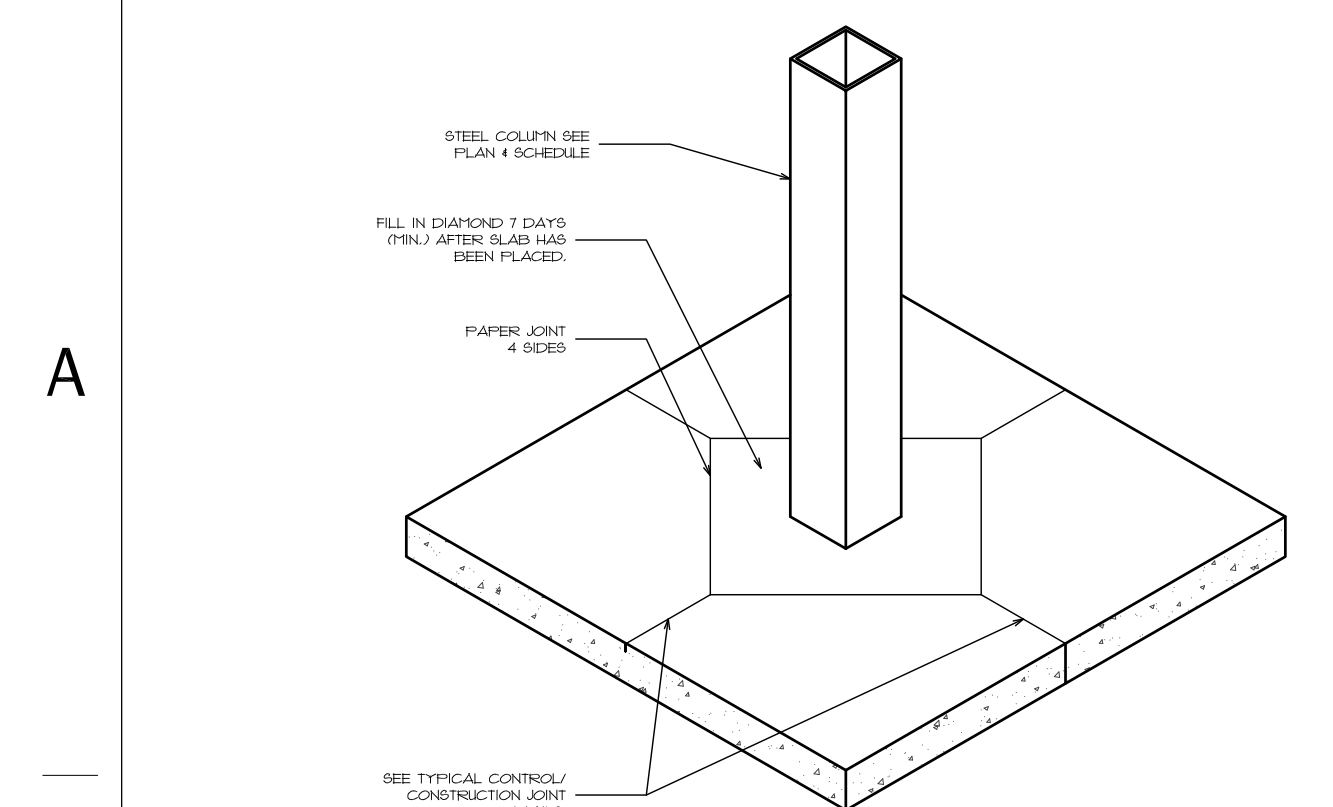

ISOMETRIC STEEL COLUMN DETAIL
SCALE 1/2" = 1'-0"












CONSTRUCTION JOINT & CONTROL JOINT DETAIL
SCALE 3/4" = 1'-0"

FOOTING INTERSECTION PLAN DETAIL
SCALE 3/4" = 1'-0"

STEPPED FOOTING DETAIL
SCALE 3/4" = 1'-0"

INTERIOR BEARING WALL FOUNDATION DETAIL
SCALE 3/4" = 1'-0"

STAIR FOUNDATION DETAIL
SCALE 3/4" = 1'-0"

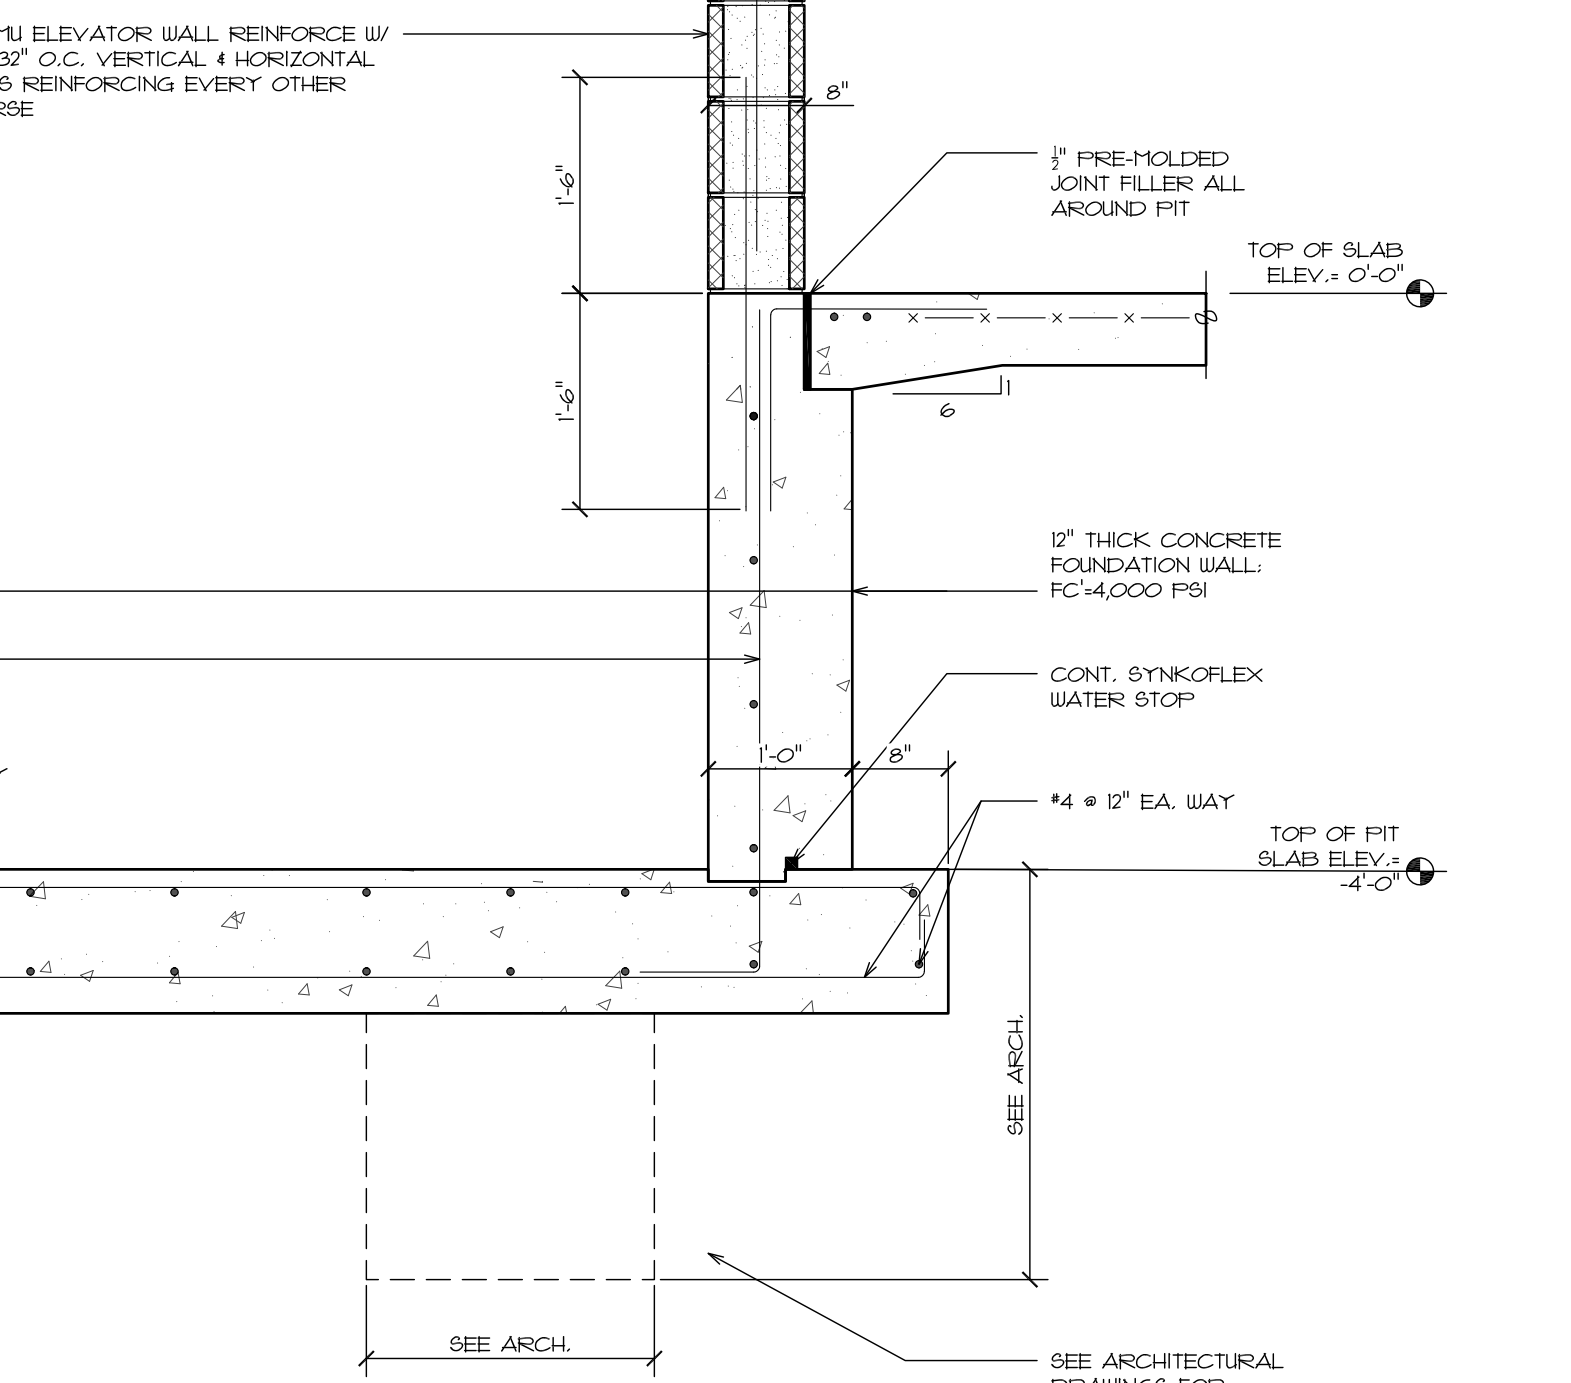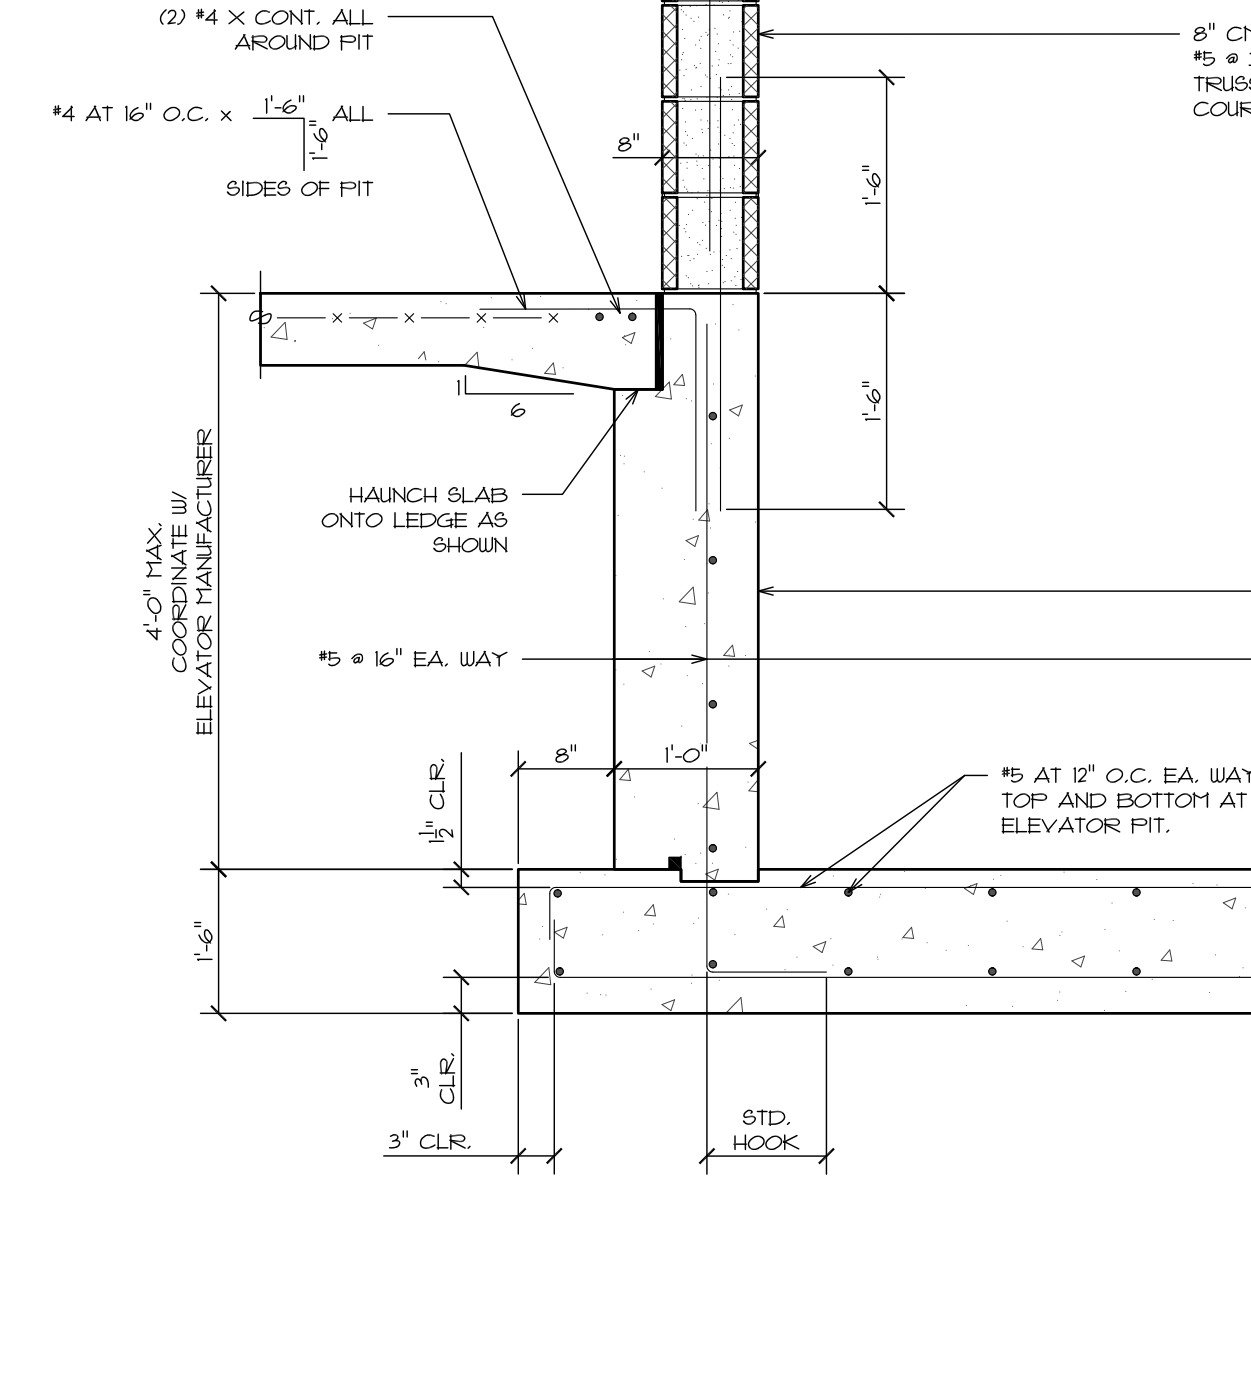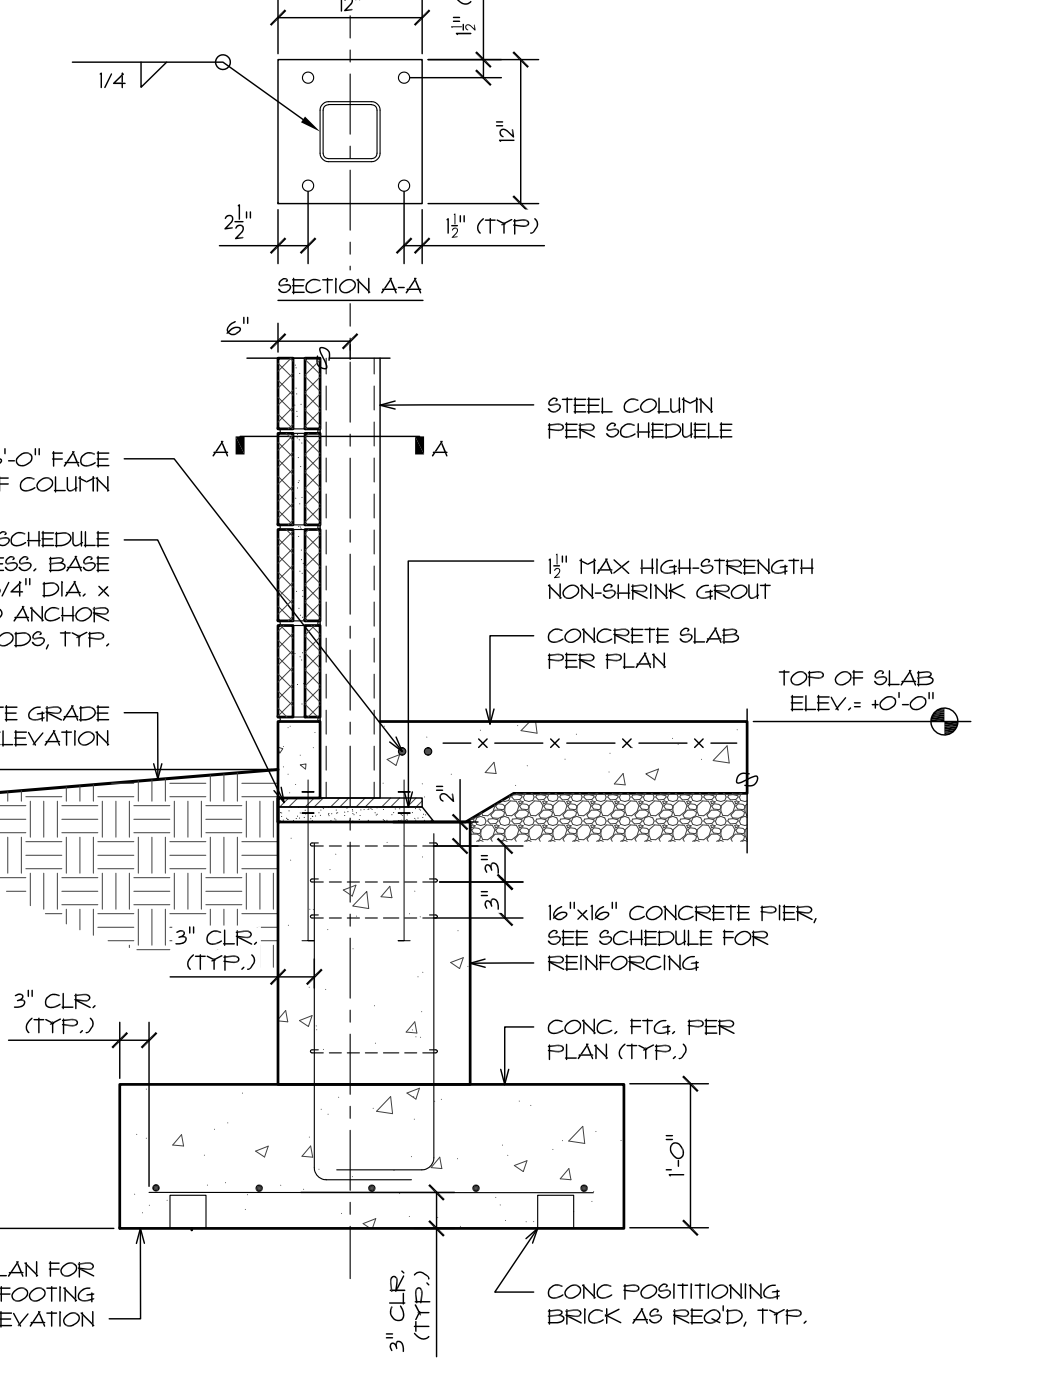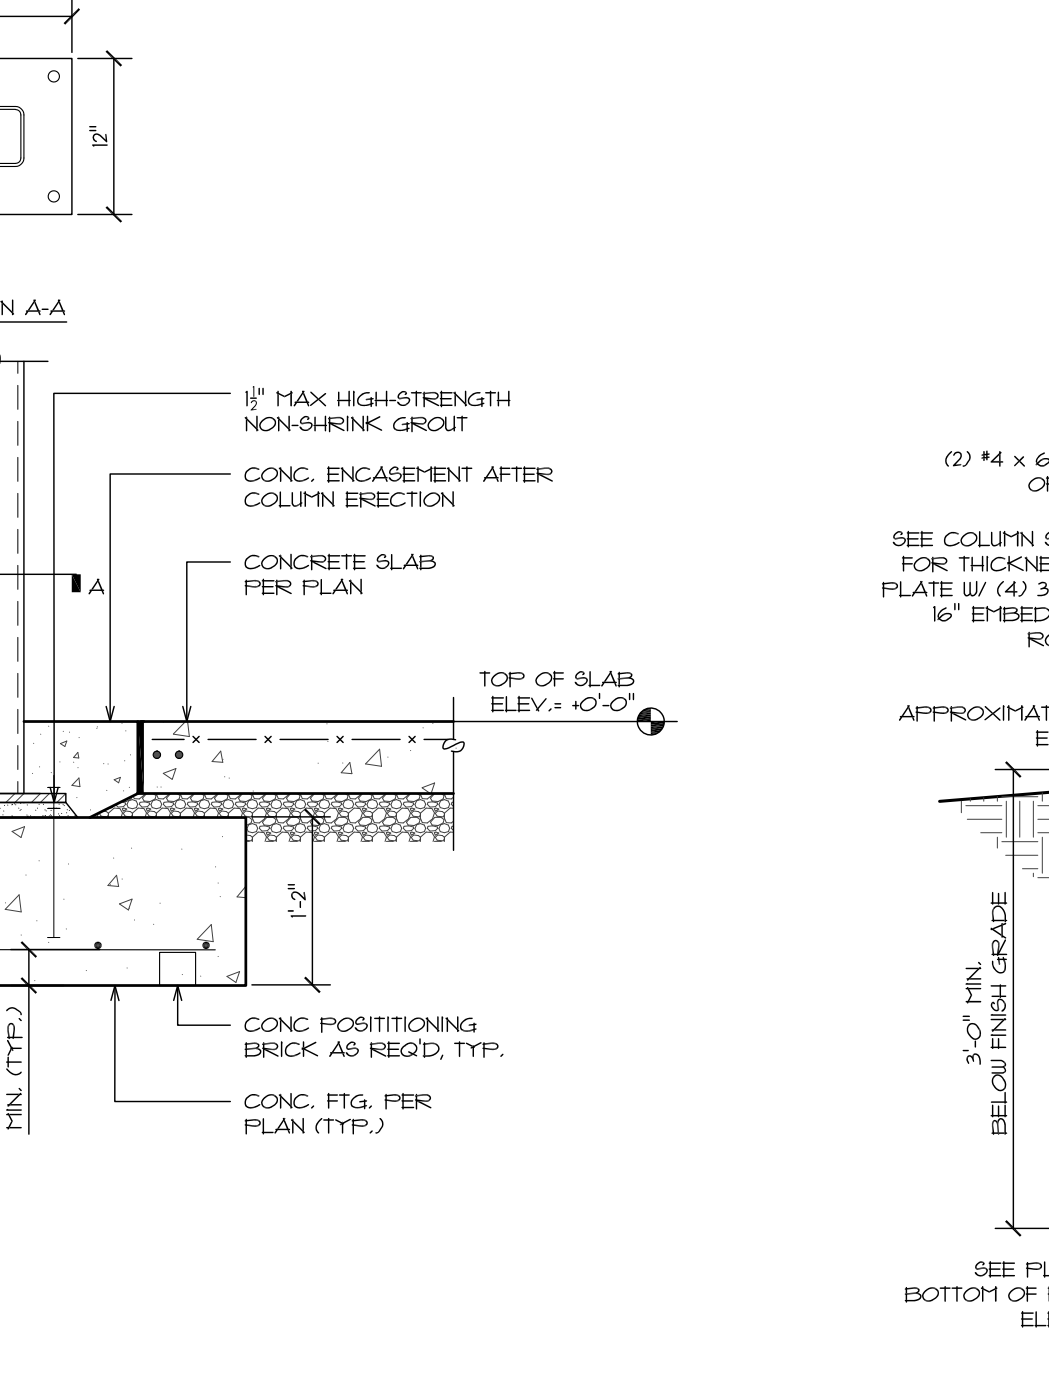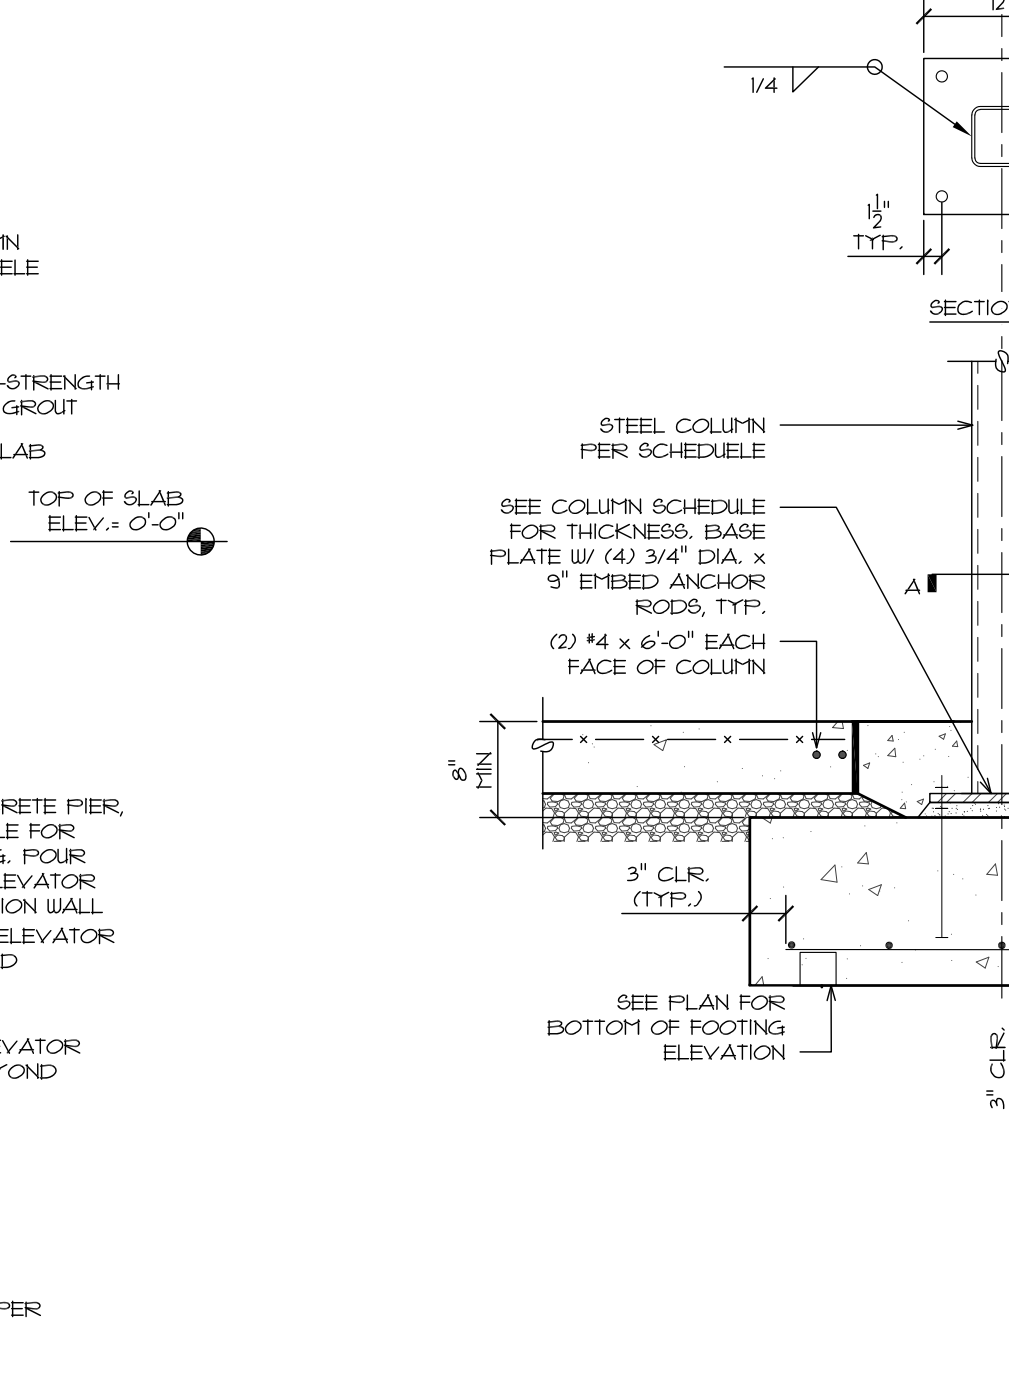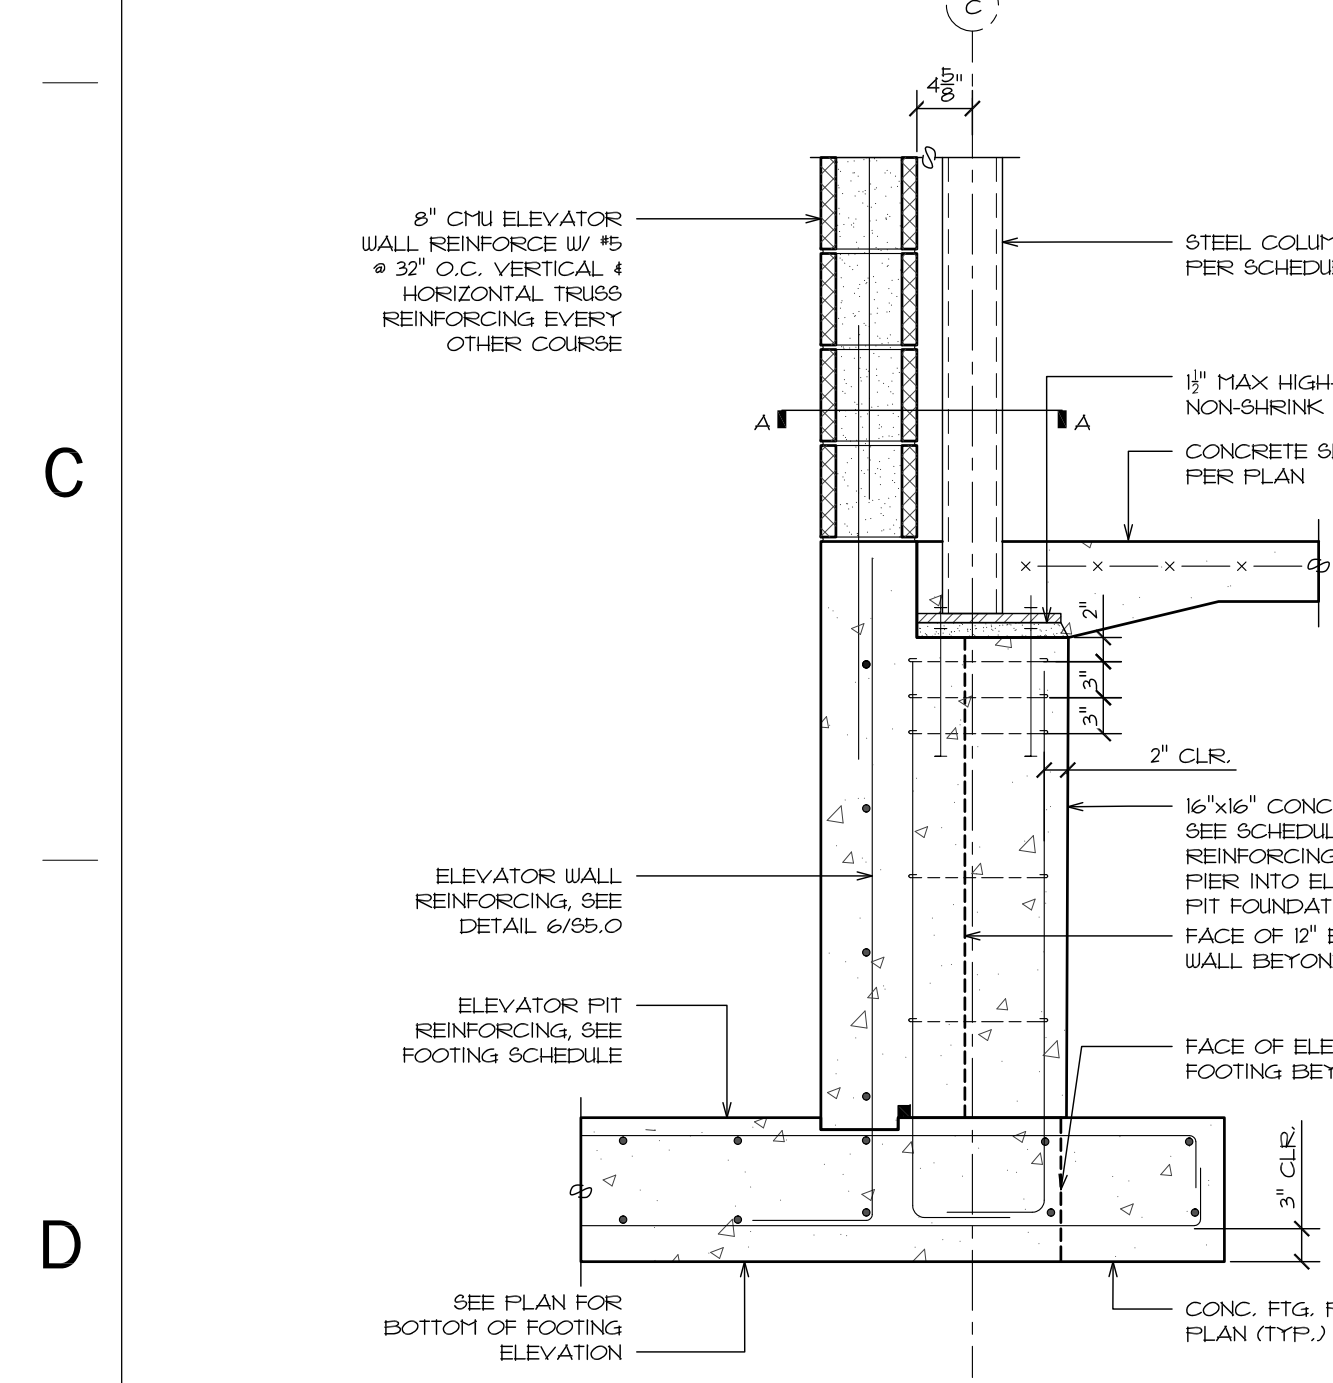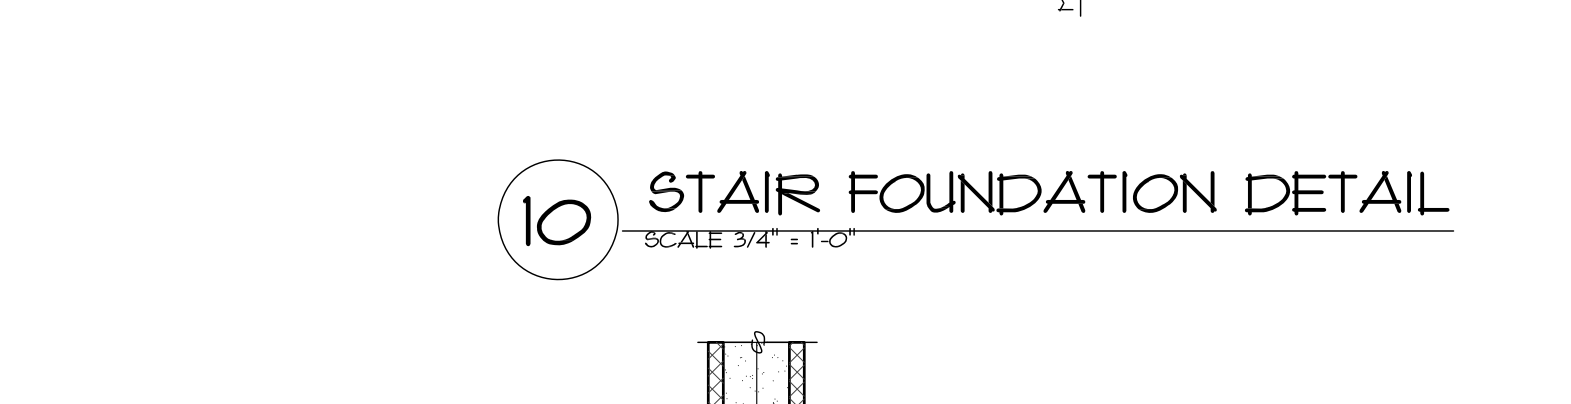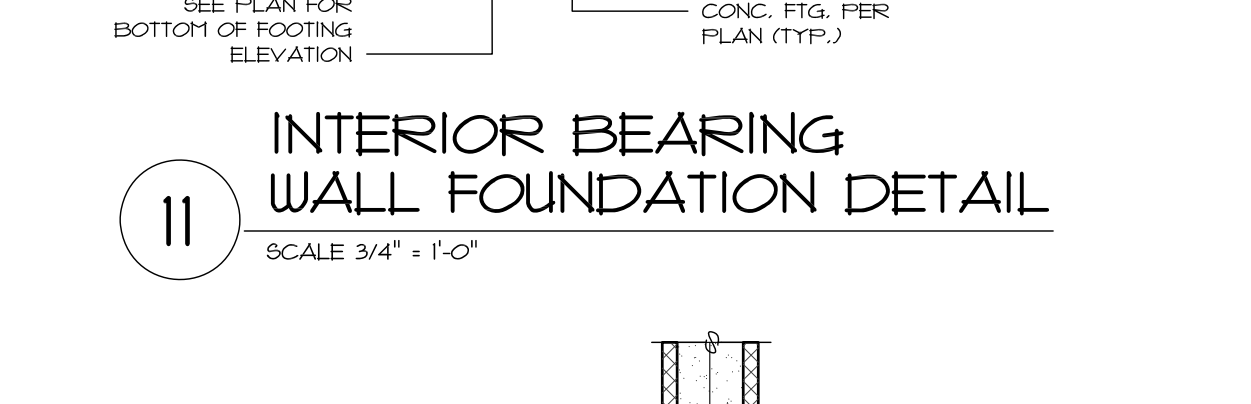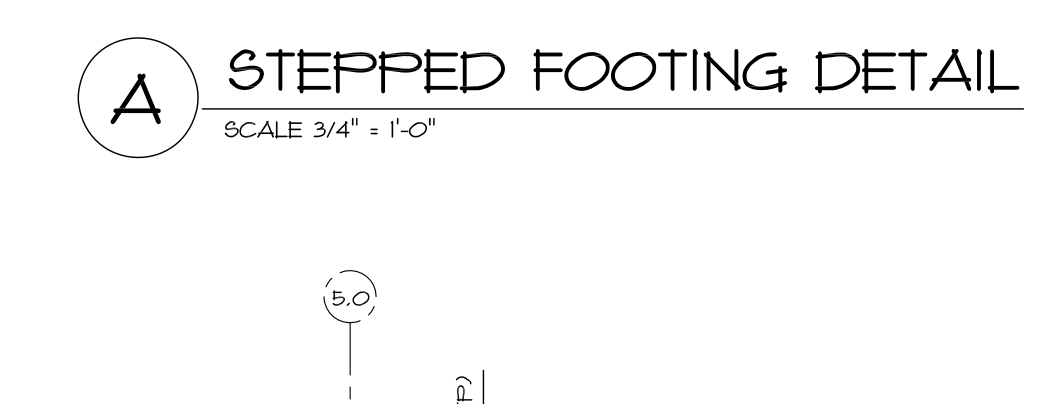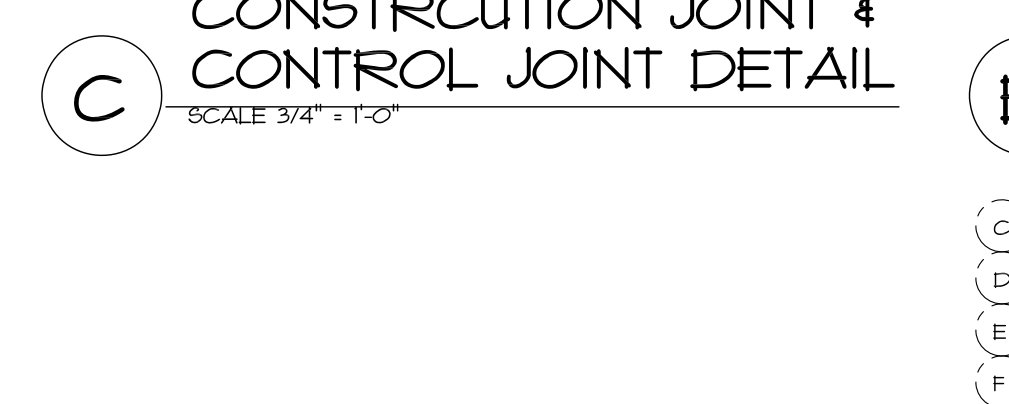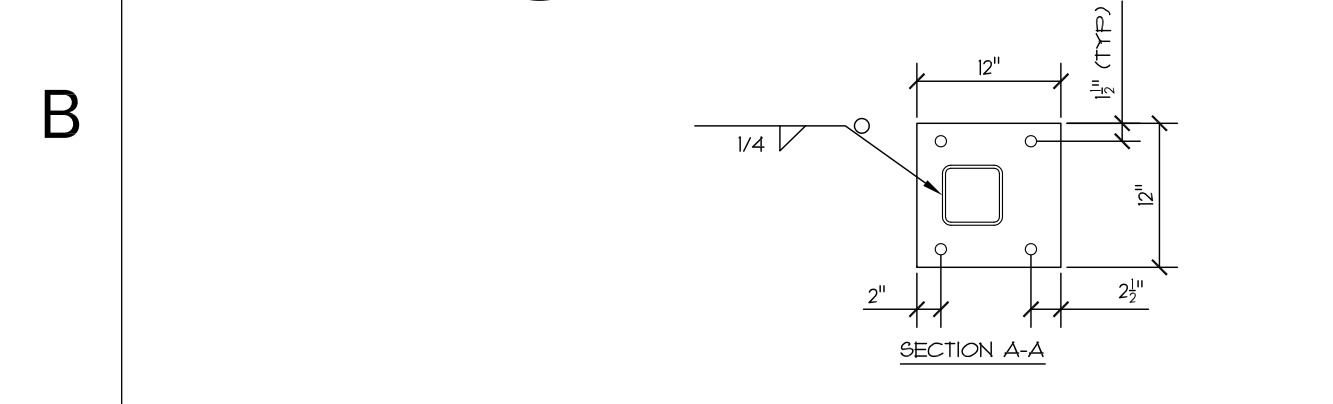

INTERIOR STL. COL. FOUNDATION DETAIL
SCALE 3/4" = 1'-0"







INTERIOR STL. COL. FOUNDATION DETAIL
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EXTERIOR STL. COL. FOUNDATION DETAIL
SCALE 3/4" = 1'-0"

EXTERIOR STL. COL. FOUNDATION DETAIL
SCALE 3/4" = 1'-0"

ELEVATOR FOUNDATION DETAIL
SCALE 3/4" = 1'-0"

ELEVATOR FOUNDATION DETAIL
SCALE 3/4" = 1'-0"

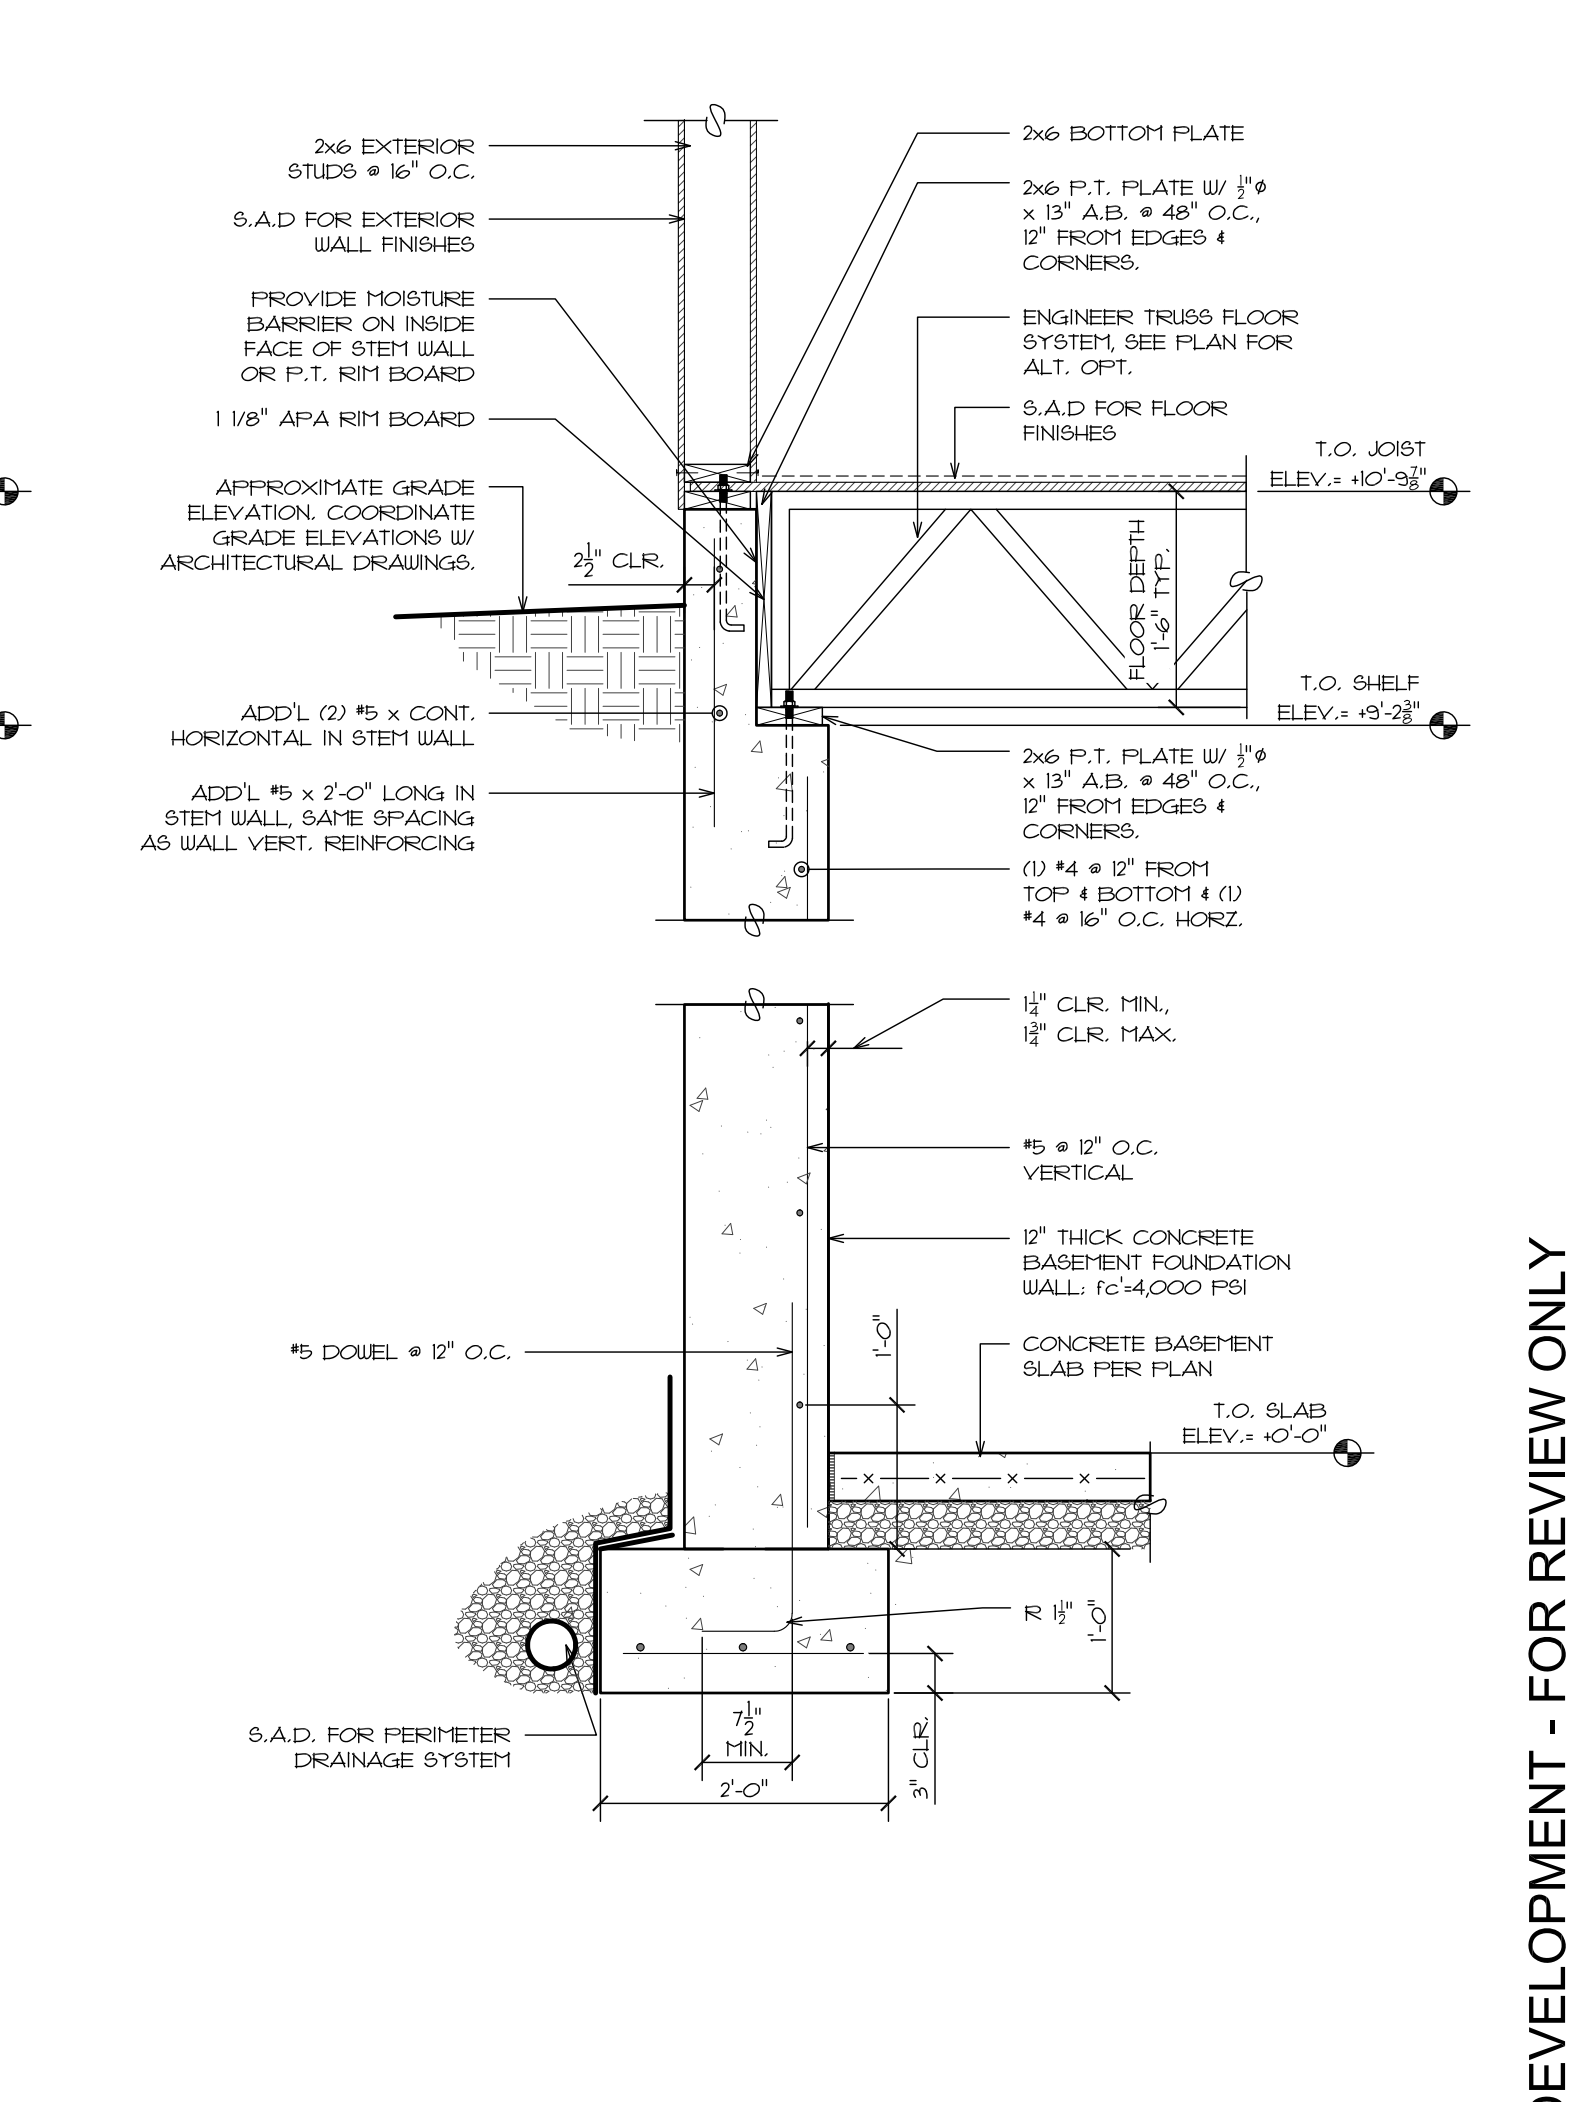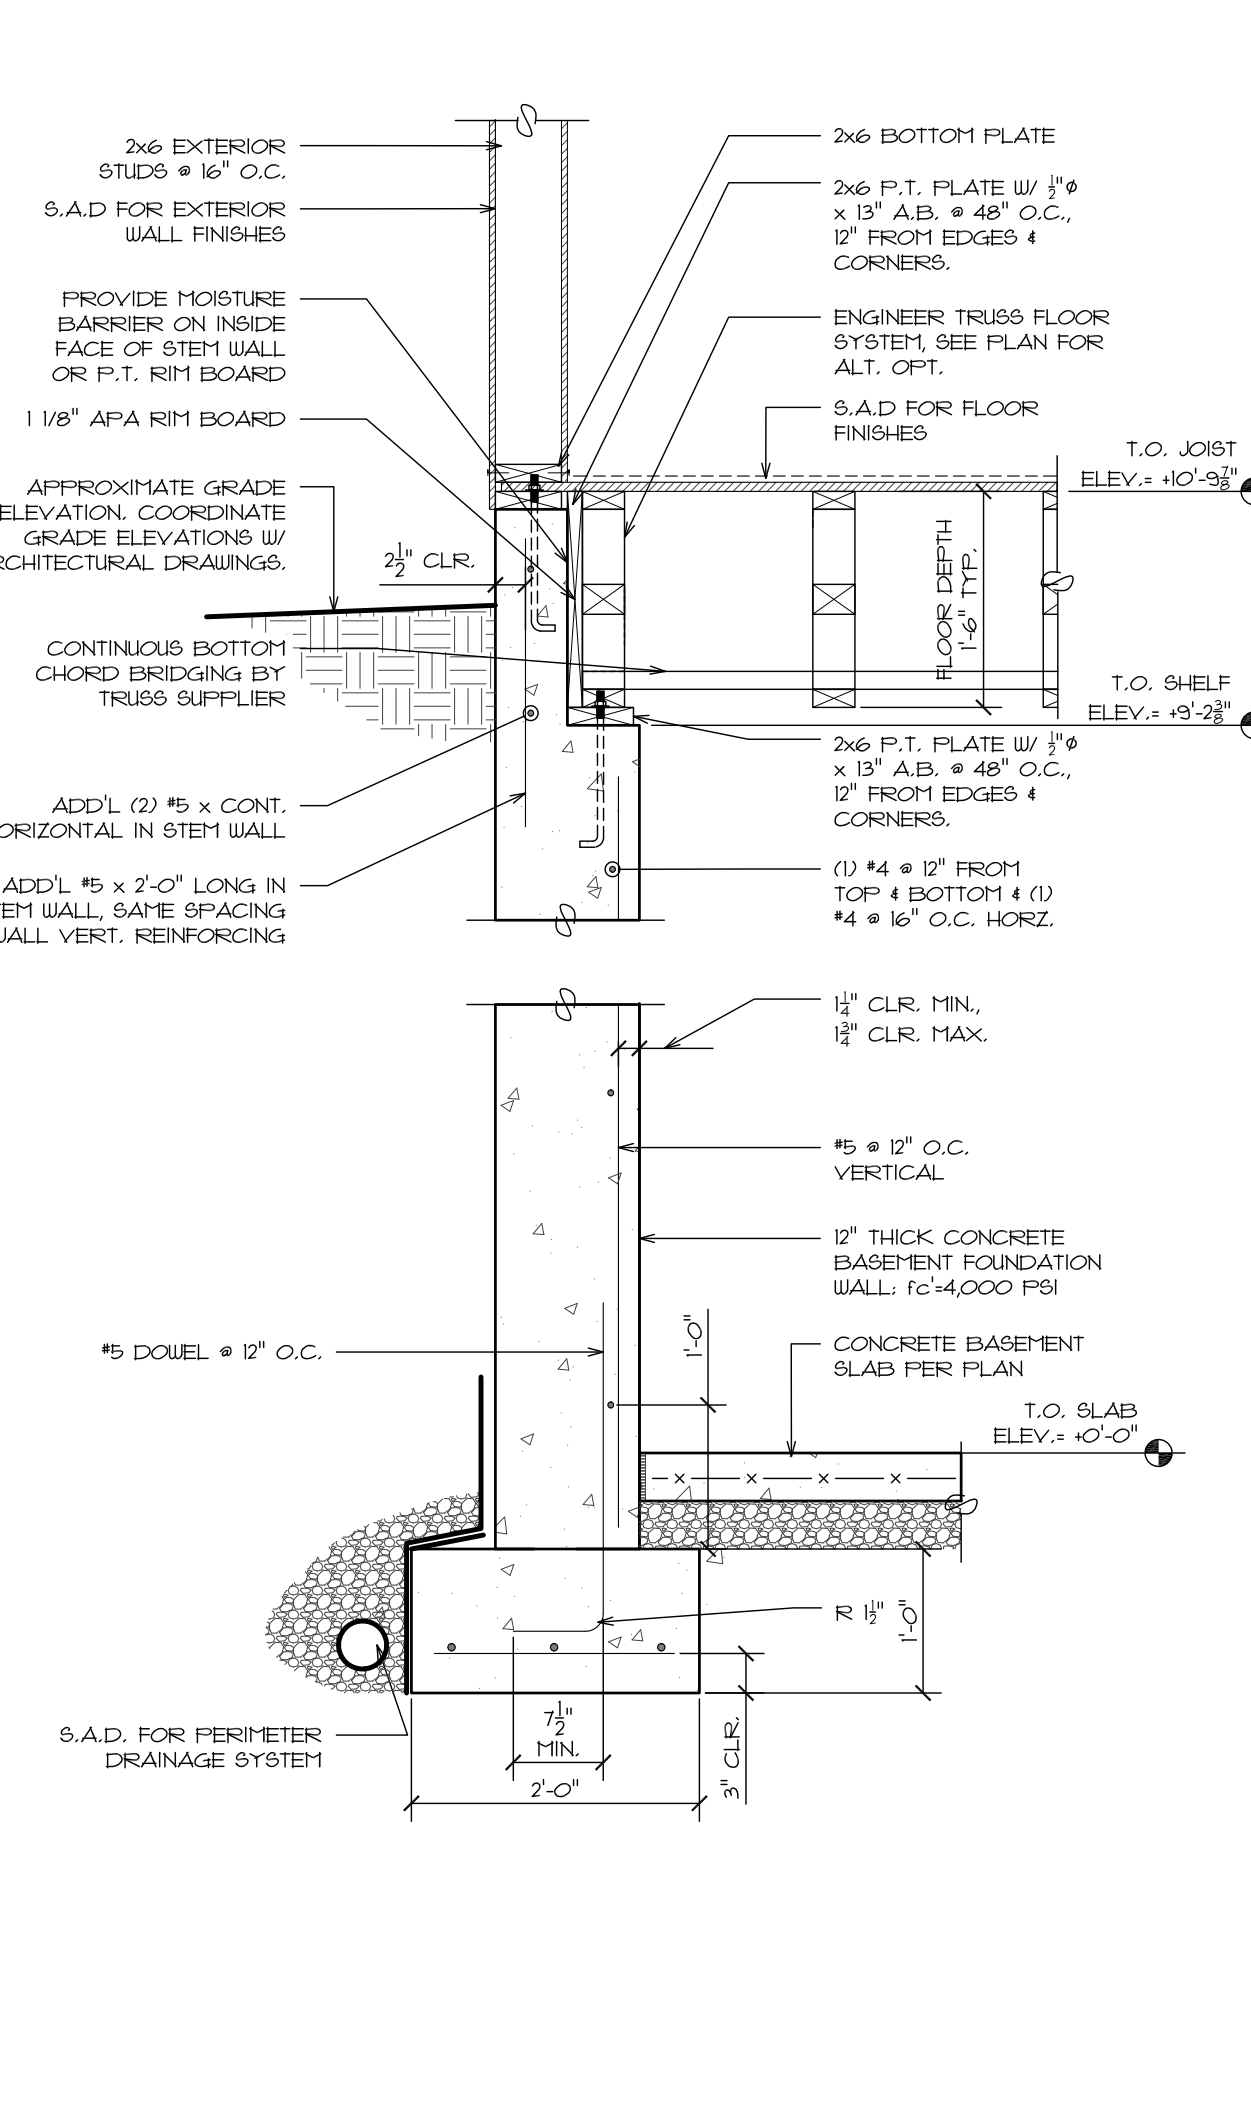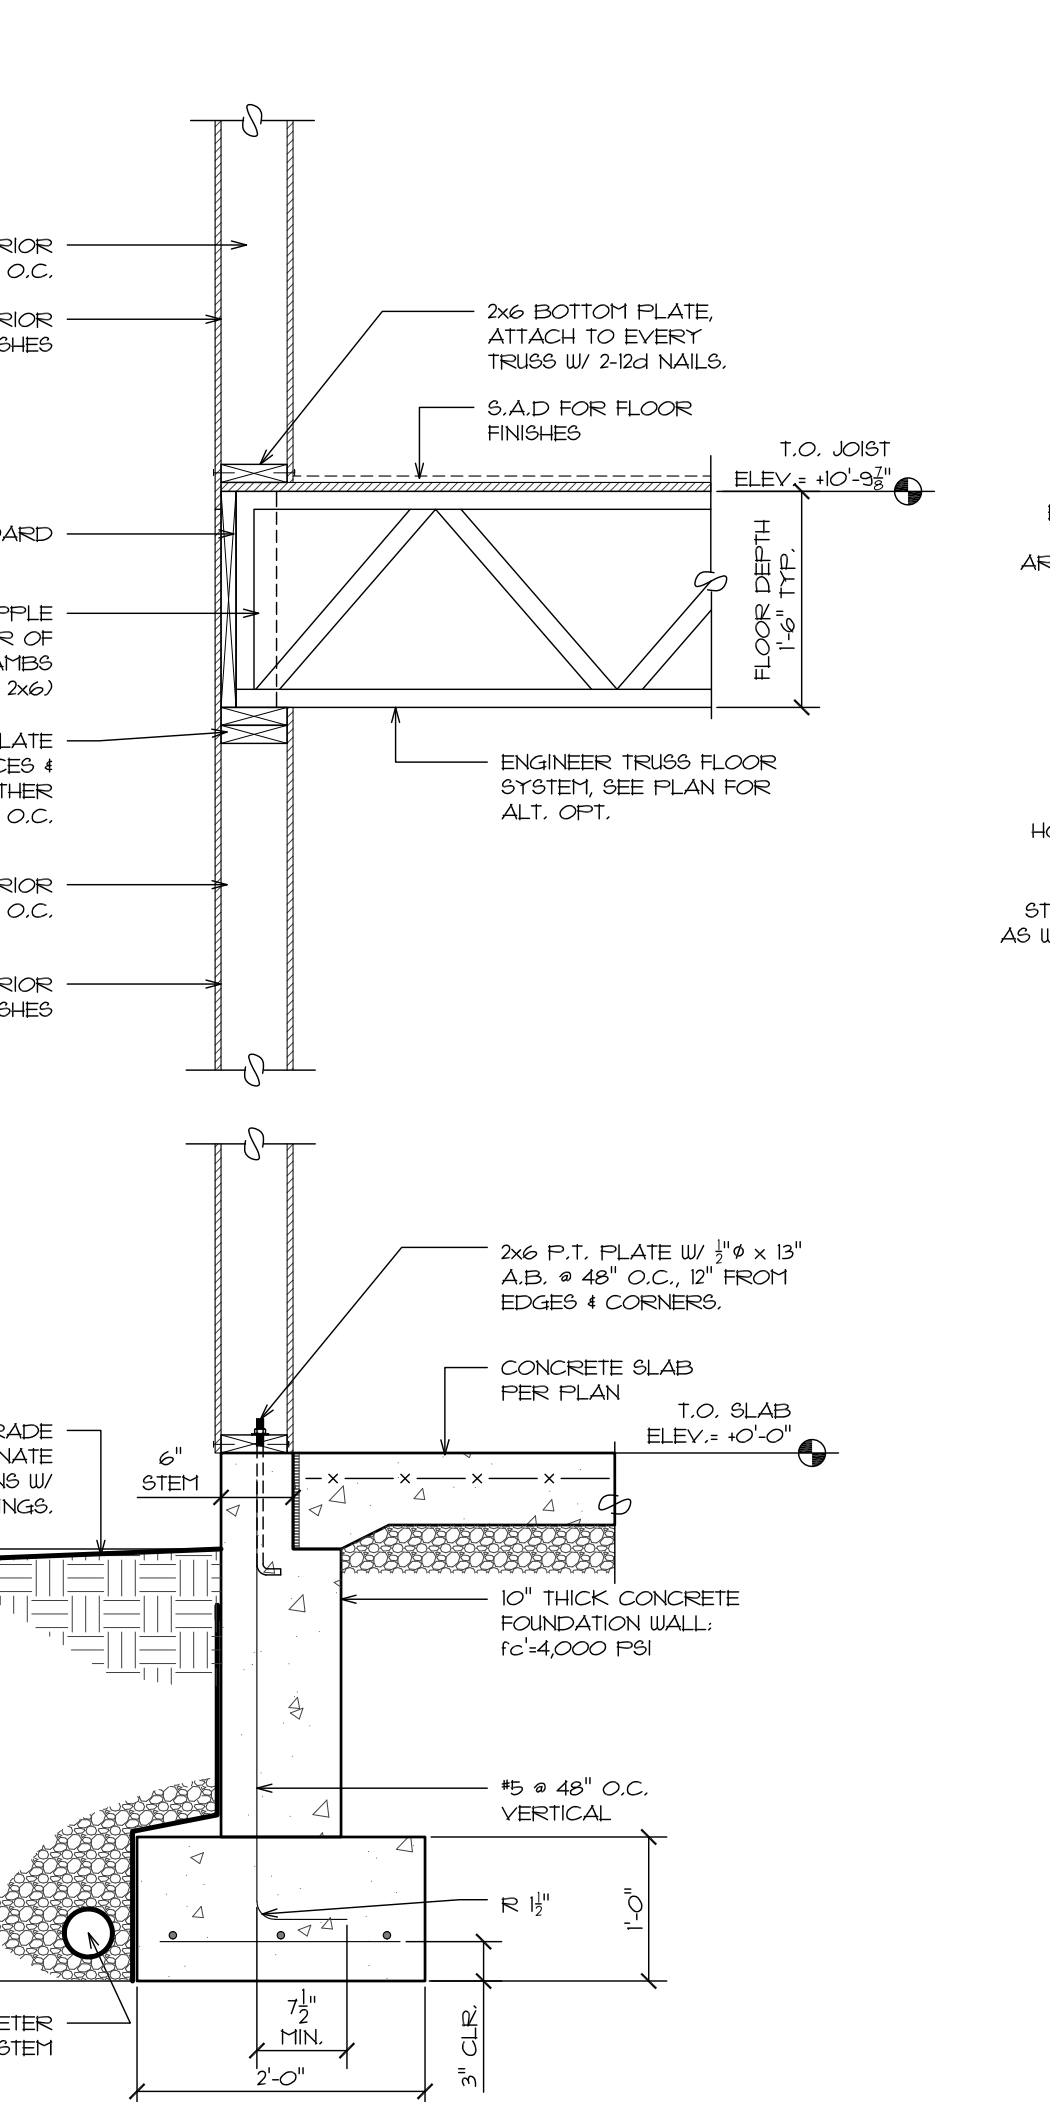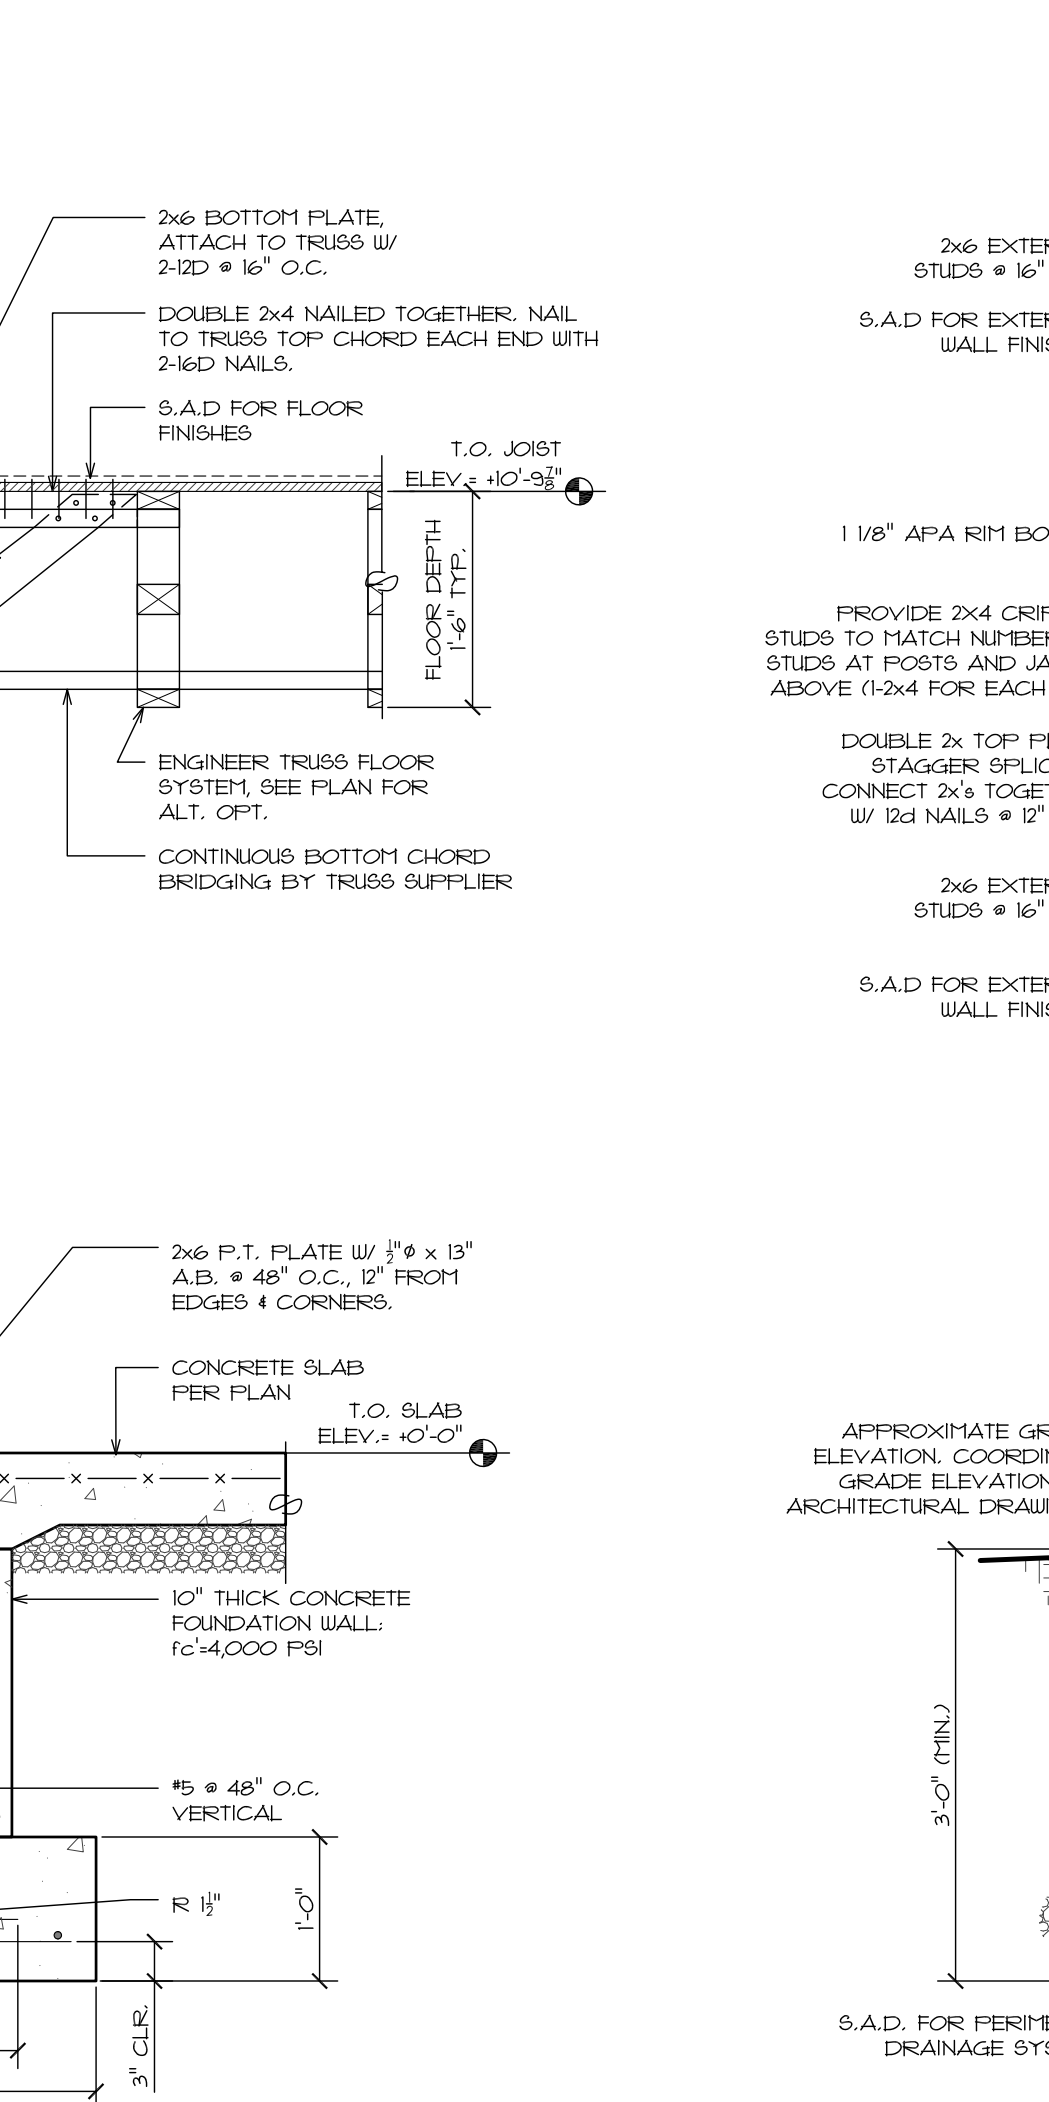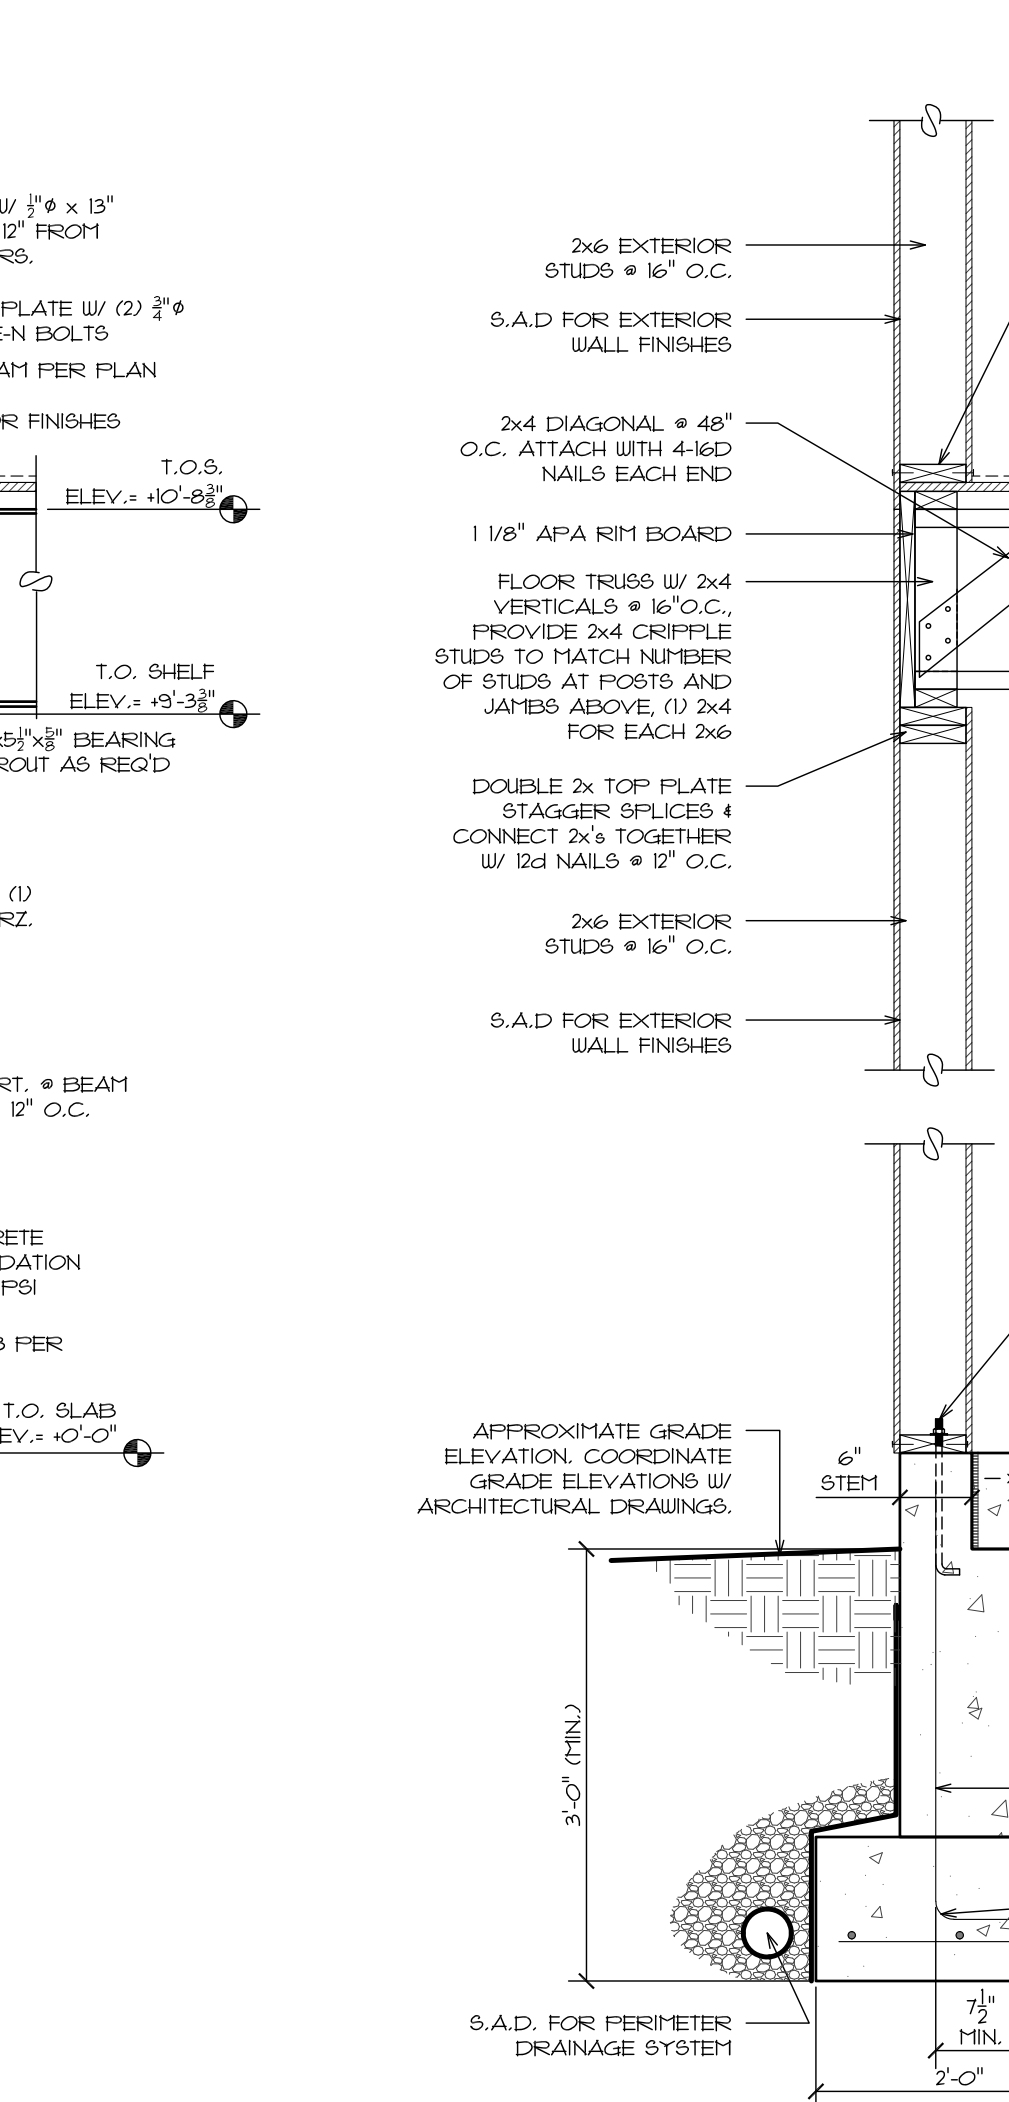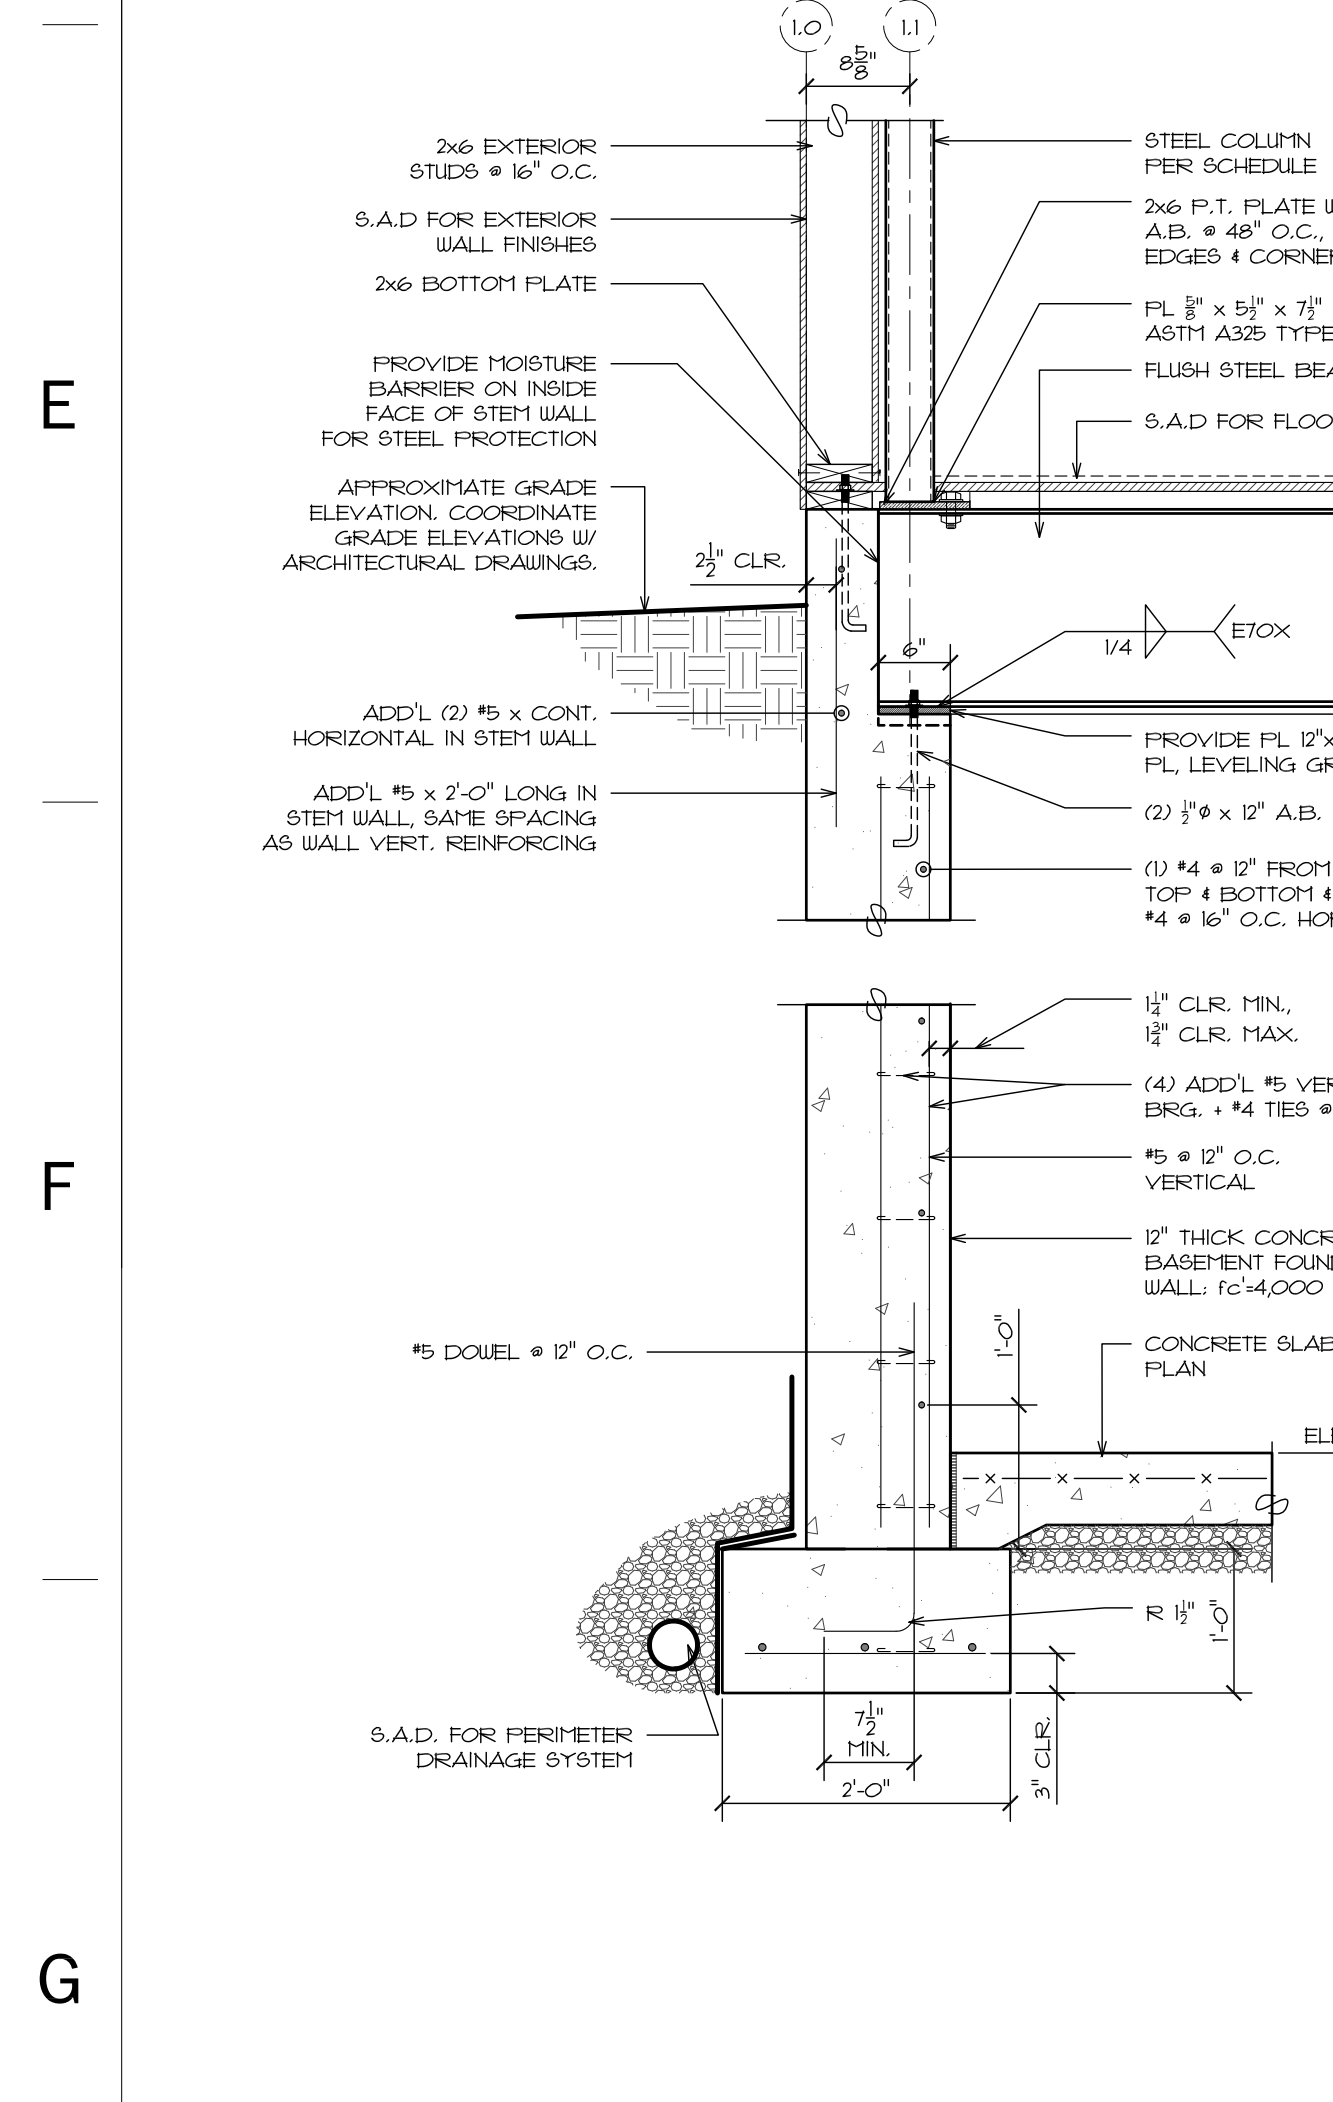

FOUNDATION DETAIL
SCALE 3/4" = 1'-0"

FOUNDATION DETAIL
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FOUNDATION DETAIL
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FOUNDATION DETAIL
SCALE 3/4" = 1'-0"

FOUNDATION DETAIL
SCALE 3/4" = 1'-0"

FOUNDATION DETAIL
SCALE 3/4" = 1'-0"

REVISIONS	Description	Date	No.

SEAL:

WOODLANDS AT GREYSTONE
SCUL THORPE DR. WEST GOSHEN TOWNSHIP
CHESTER COUNTY, PA


Project number: SFA-1905
date: 2019-10-03
scale: AS NOTED
sheet no.

Drawn by: RCH
chk'd by: RCH
approved by: MHB

S5.0

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DESIGN DEVELOPMENT - FOR REVIEW ONLY

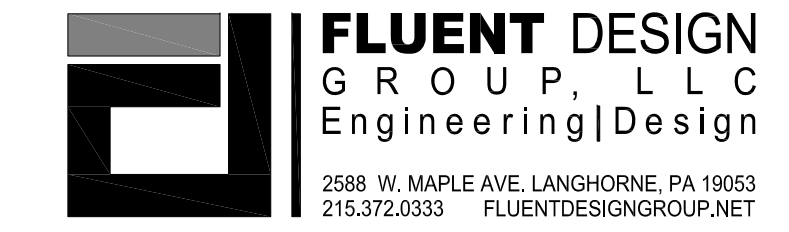

Stampfl Associates architecture + planning
711 Hyde Park Doylestown, PA 19002
215.345.4609 p 215.345.4610 f
www.stampflassociates.com



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Table with 2 columns: Date, No. and 2 columns: Description, chkd by

WOODLANDS AT GREYSTONE
SCUL THORPE DR. WEST GOSHEN TOWNSHIP
CHESTER COUNTY, PA
Project number: SFA-1905
date: 2019-10-03
scale: AS NOTED
sheet no.

Table A - End Support
Table B - Intermediate or Cantilever Support
Table C - Intermediate or Cantilever Support



NAILING SCHEDULE
LOCATION ROOF FLOOR
DIAPHRAGM BOUNDARY 10d # 6" o.c. 10d # 6" o.c.

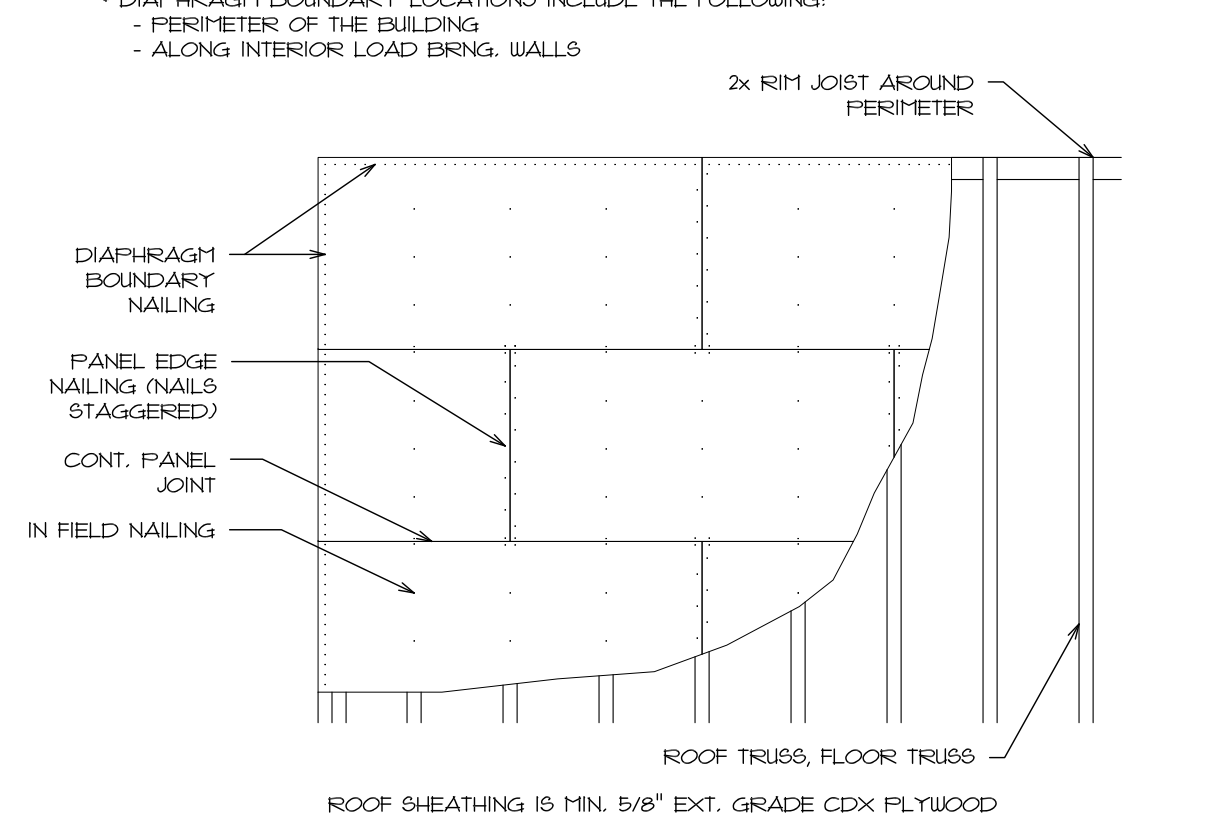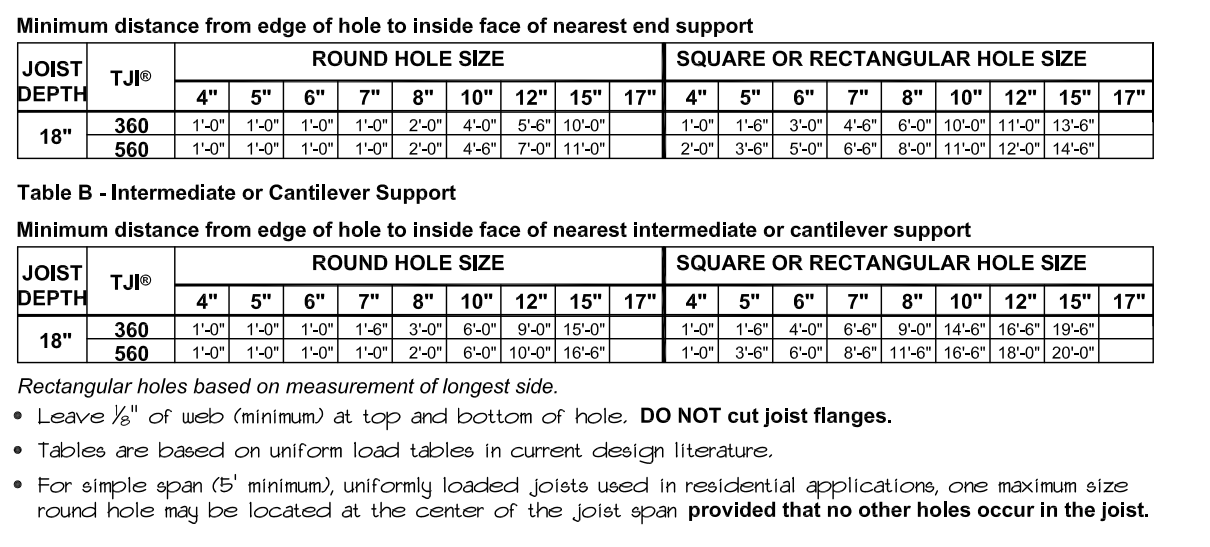

A STEEL DETAIL
SCALE 1" = 1'-0"



B ROOF SHEATHING ATTACHMENT
SCALE 1/2" = 1'-0"

C TJI ALLOWABLE HOLE DIAGRAM
SCALE N.T.S.

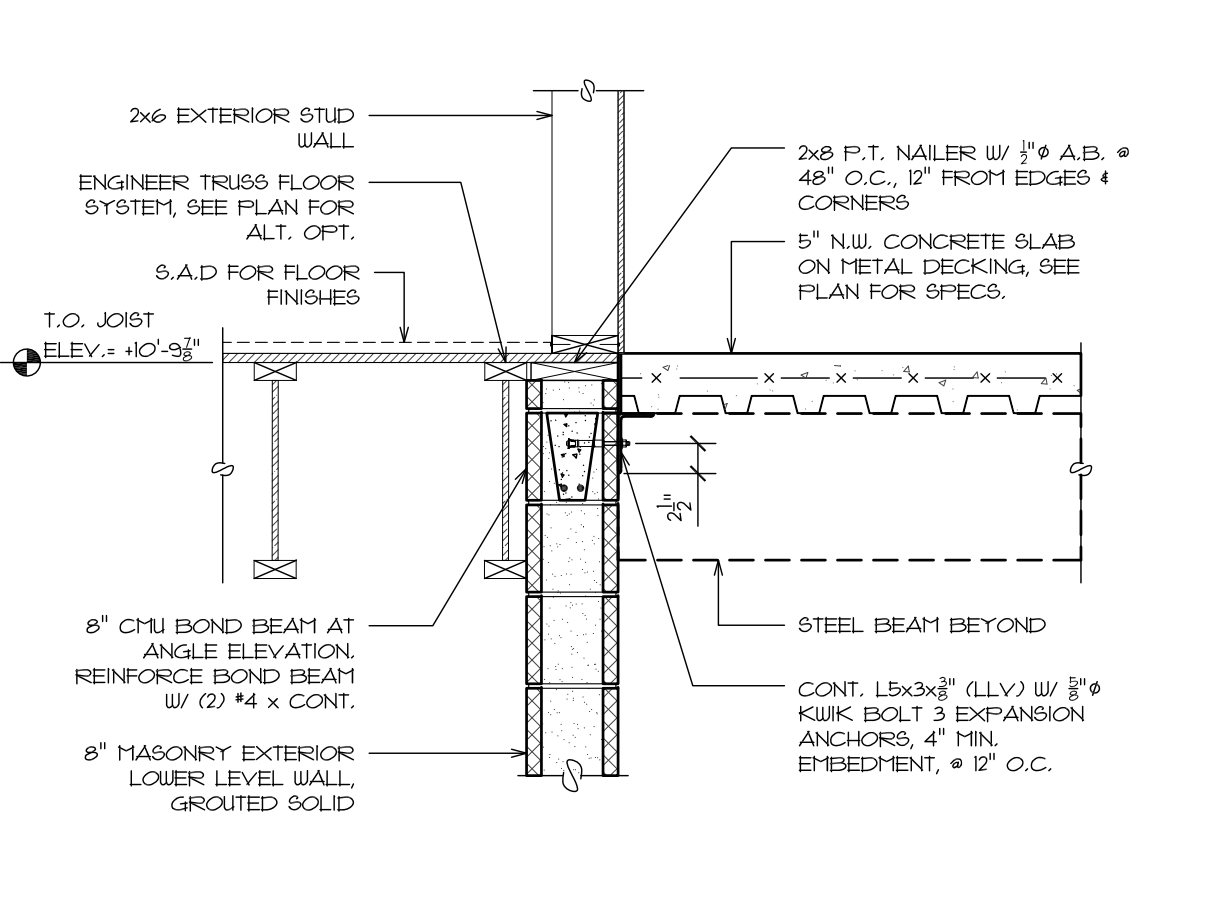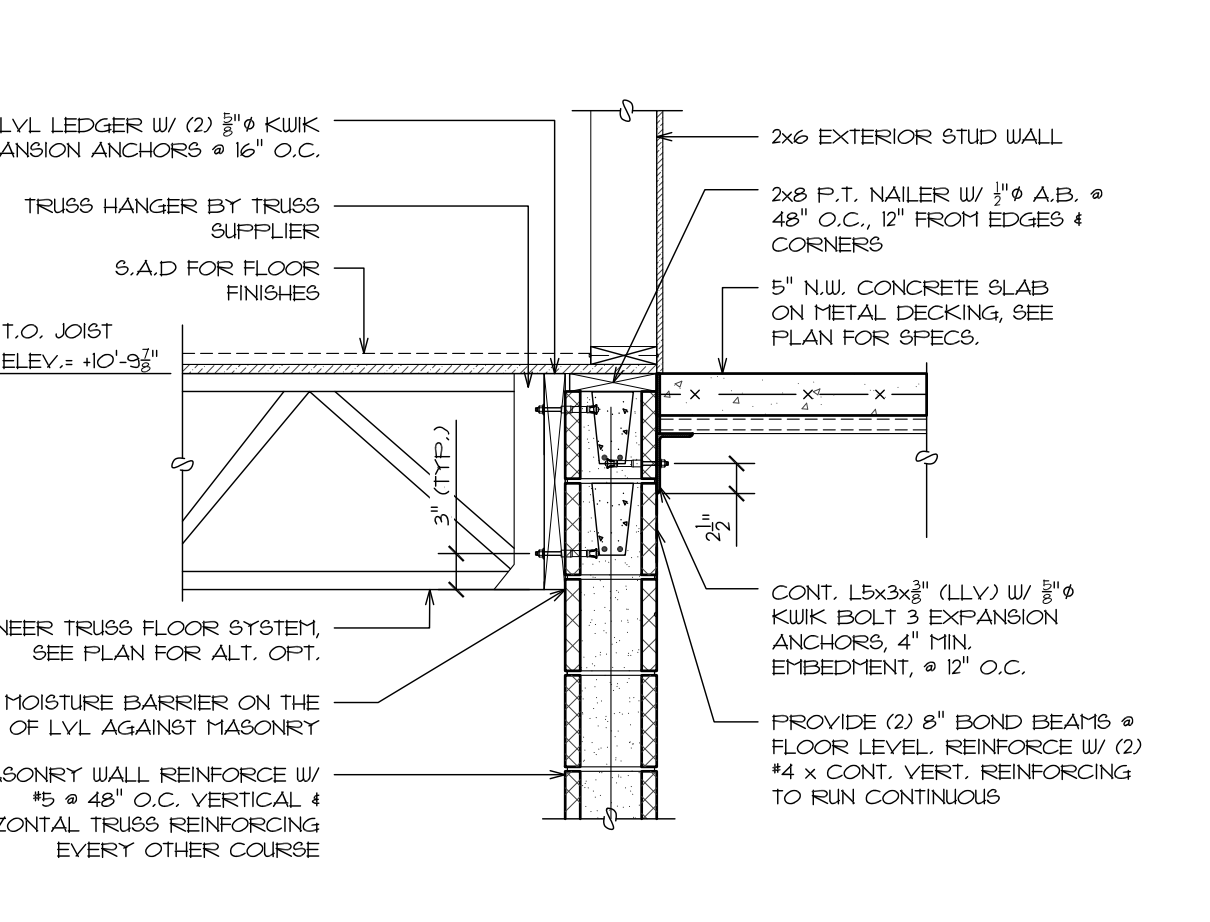

14 ELEVATED DECK SLAB FRAMING DETAIL
SCALE 3/4" = 1'-0"


12 ELEVATED DECK SLAB EDGE SUPPORT DETAIL
SCALE 3/4" = 1'-0"

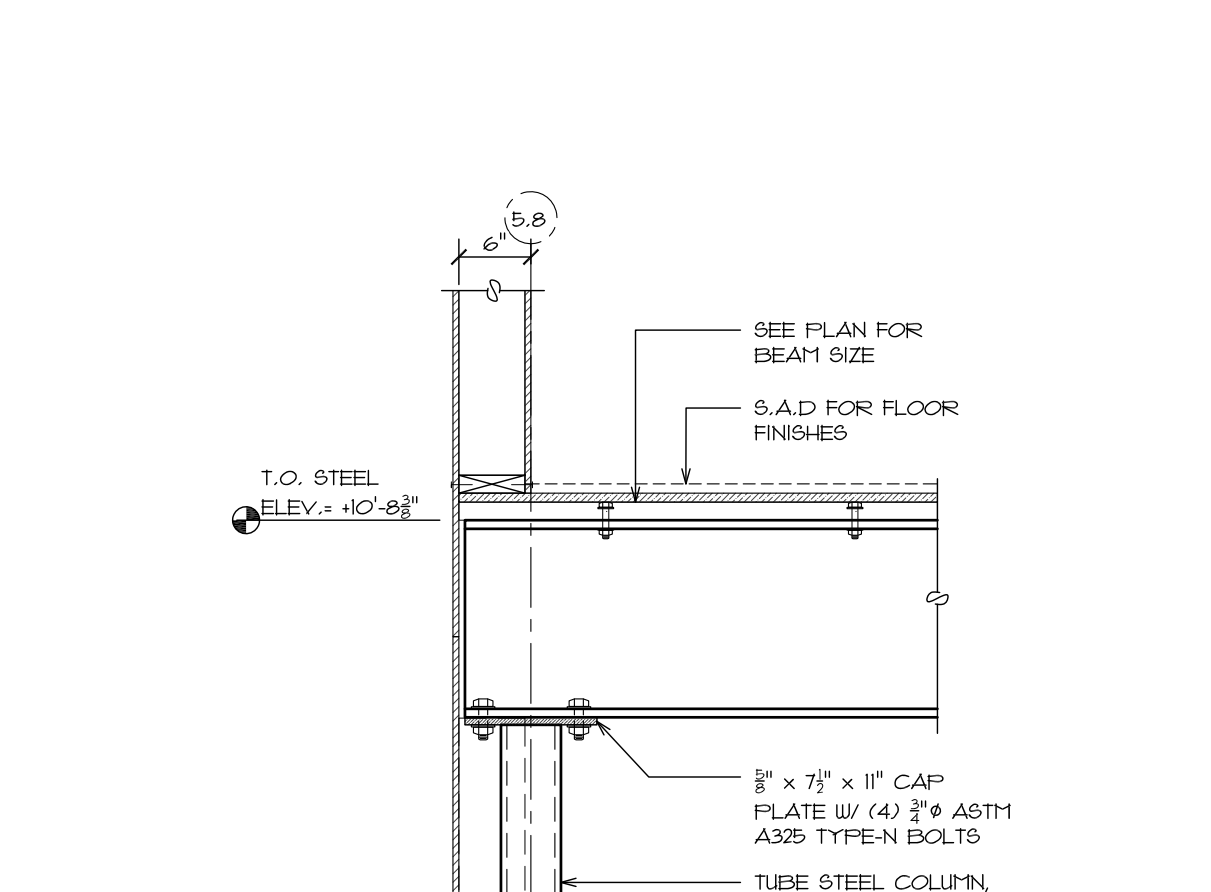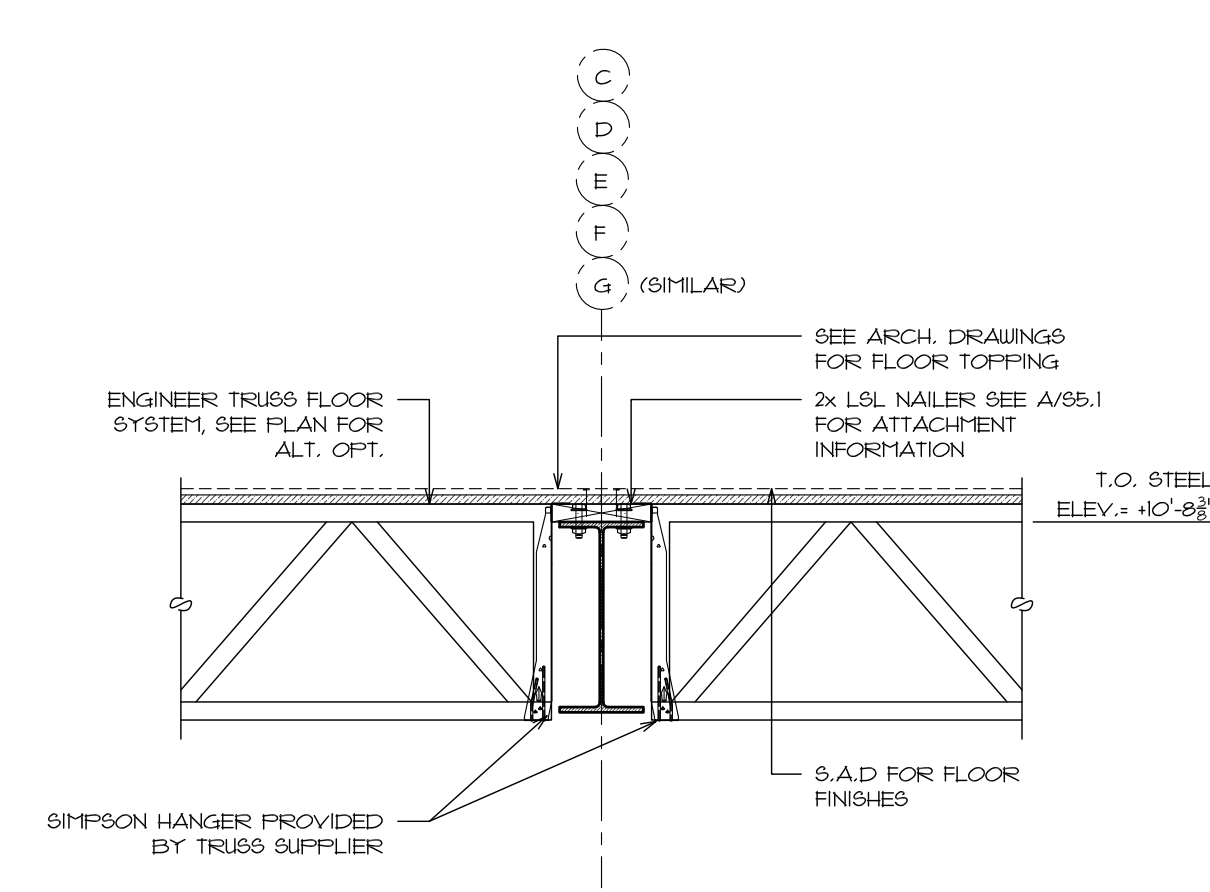


9 STEEL FRAMING DETAIL
SCALE 3/4" = 1'-0"

13 ELEVATED DECK SLAB EDGE SUPPORT DETAIL
SCALE 3/4" = 1'-0"

4A STEEL DETAIL - BEAM SPLICE @ COL.
SCALE 3/4" = 1'-0"


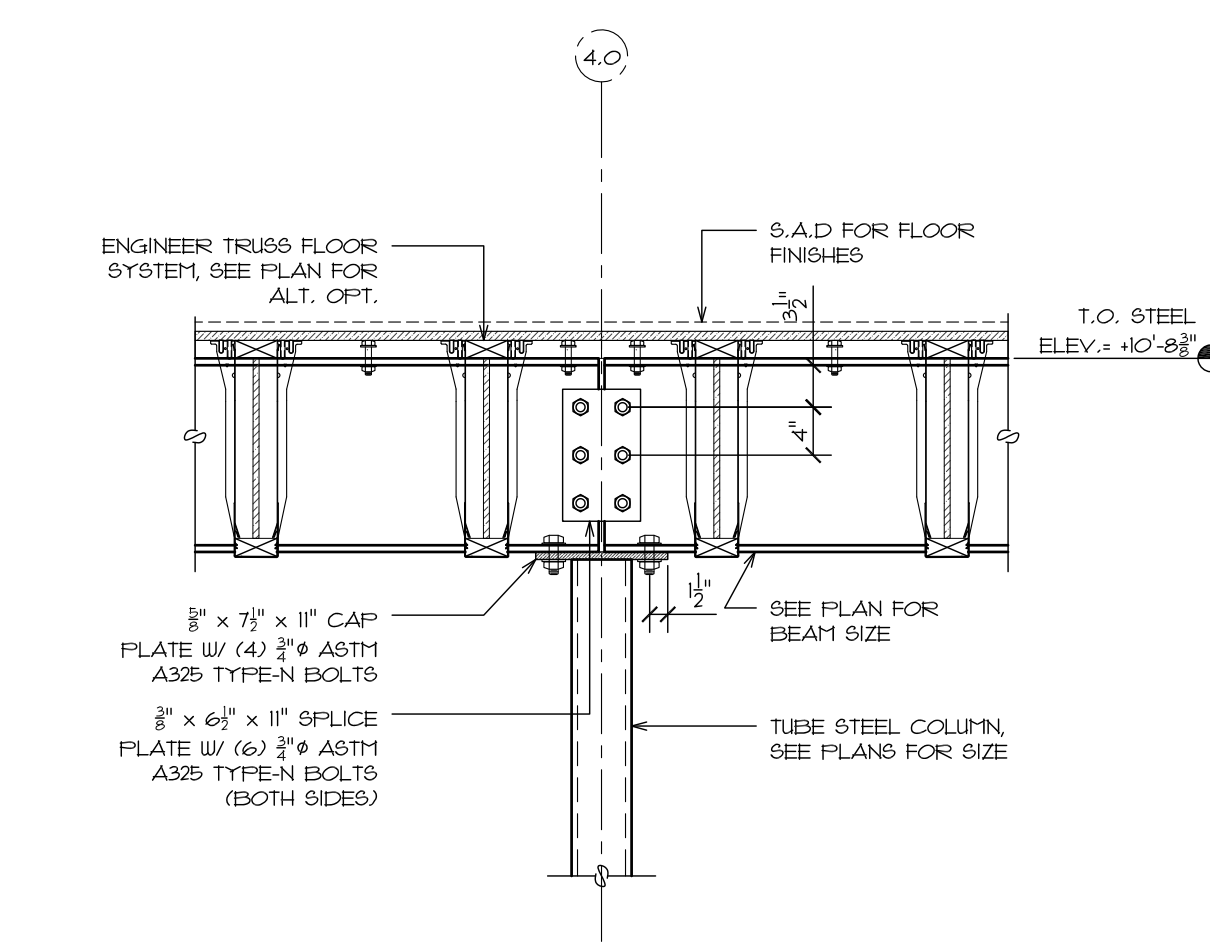


8 ELEVATOR LEDGER DETAIL
SCALE 3/4" = 1'-0"

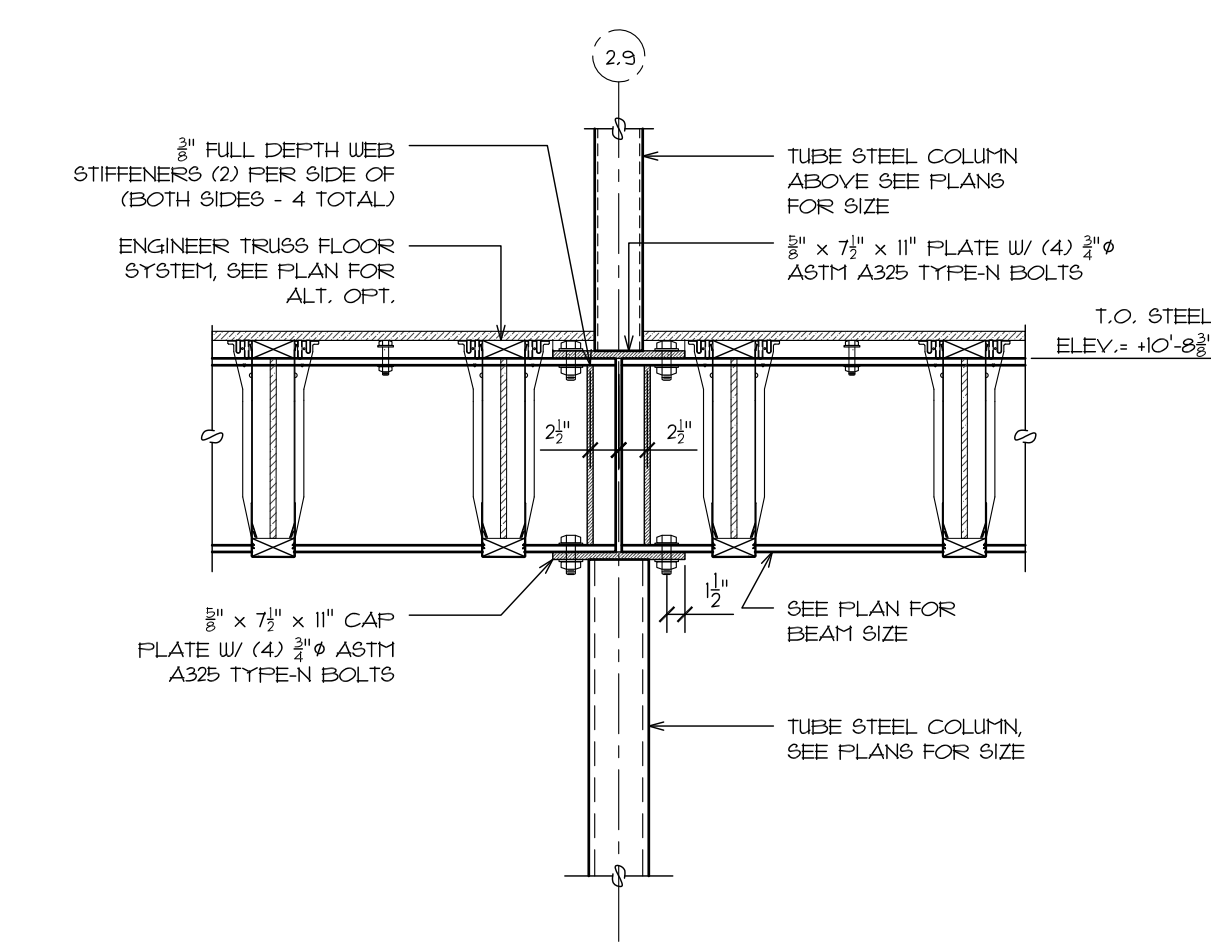


4 STEEL DETAIL - COLUMN ABOVE
SCALE 3/4" = 1'-0"


4A STEEL DETAIL - BEAM SPLICE @ COL.
SCALE 3/4" = 1'-0"

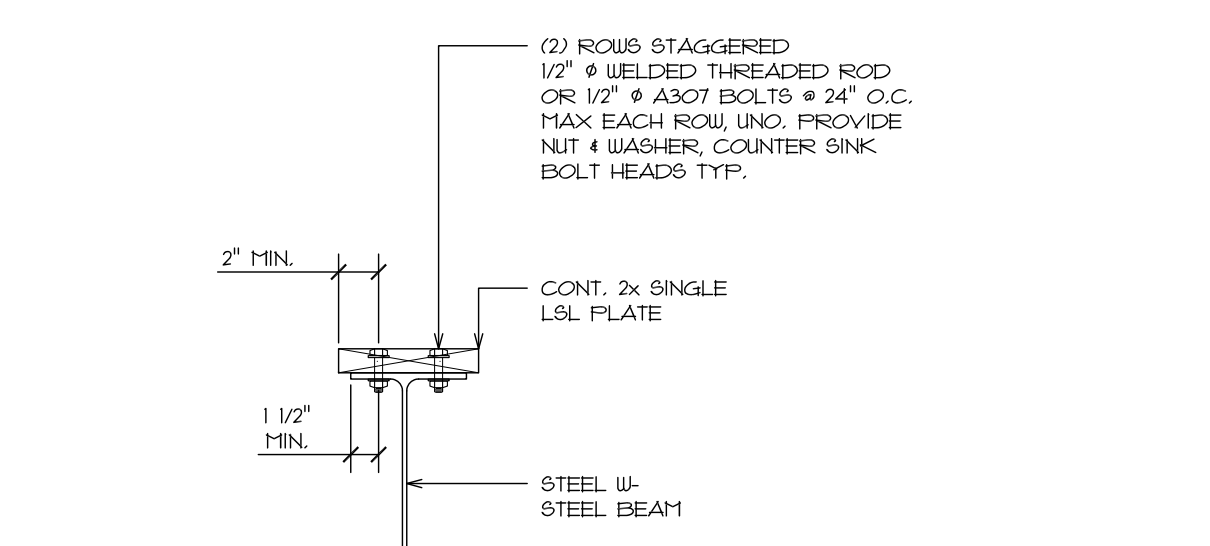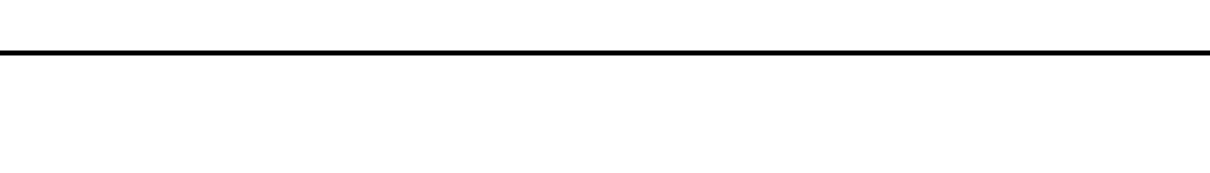


7 EXTERIOR STL. STEEL DETAIL - COL. ABOVE
SCALE 3/4" = 1'-0"

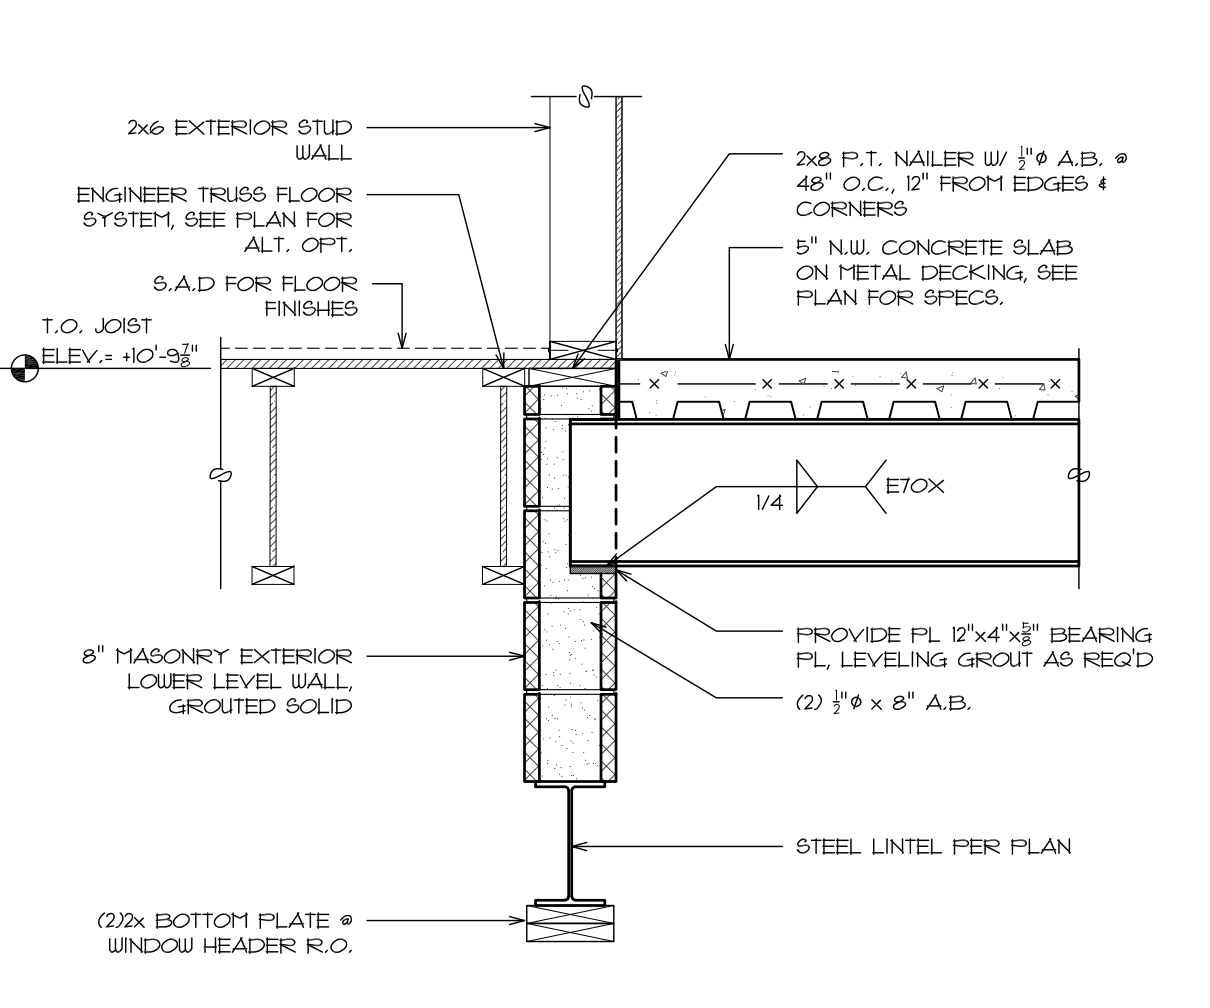


11 HOIST BEAM BRG. DETAIL
SCALE 3/4" = 1'-0"

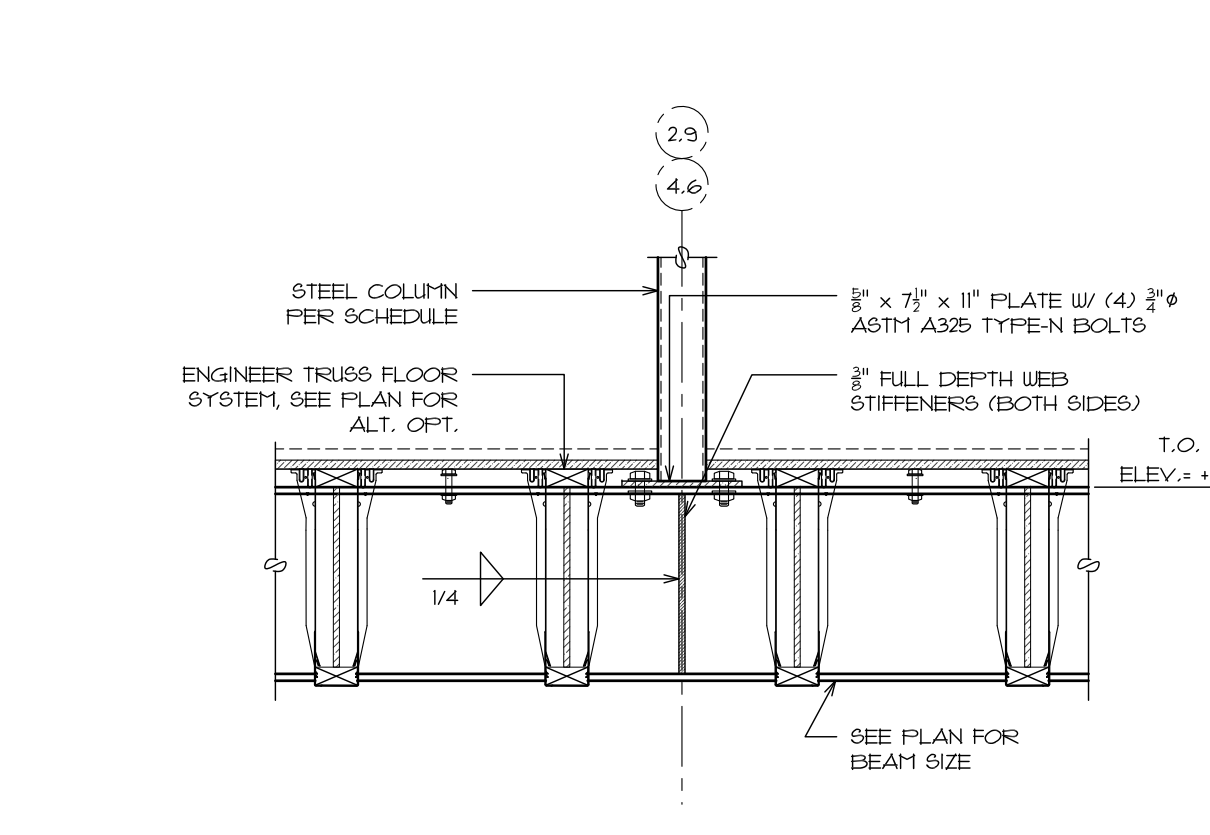

10 HOIST BEAM DETAIL
SCALE 3/4" = 1'-0"


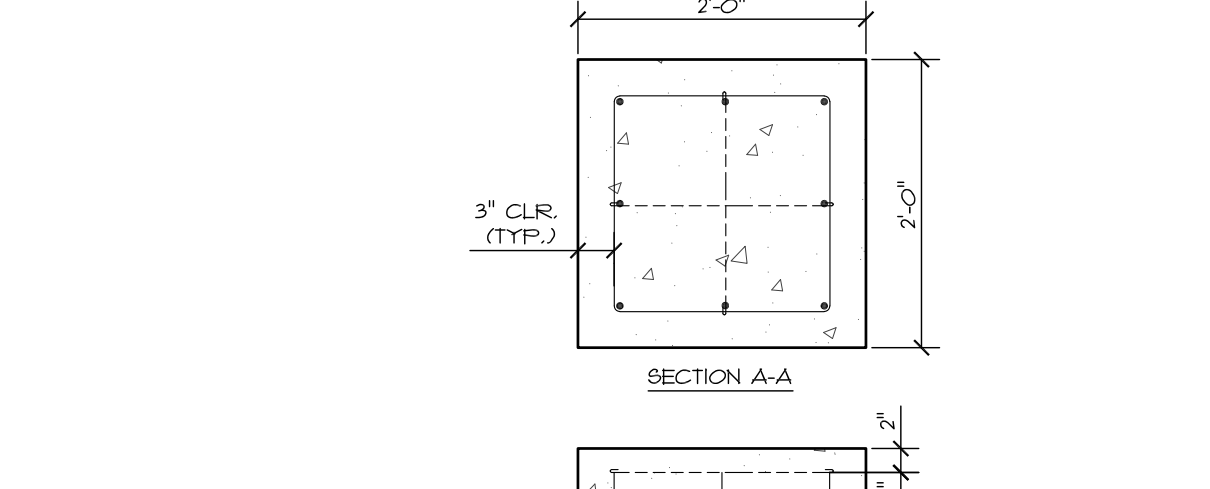


6 STEEL DETAIL - ELEVATOR PILASTER
SCALE 3/4" = 1'-0"

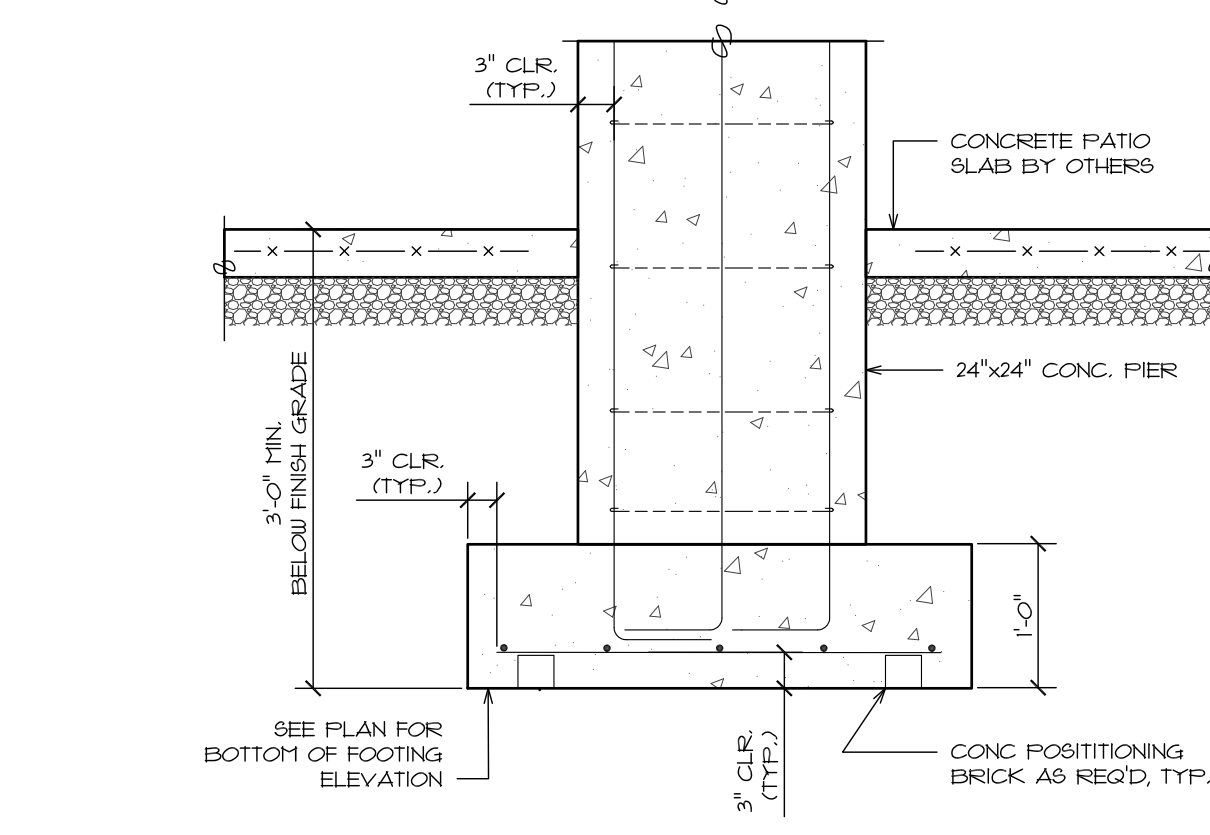


5 STEEL DETAIL - BEAM CONT. @ COL.
SCALE 3/4" = 1'-0"


5 STEEL DETAIL - BEAM CONT. @ COL.
SCALE 3/4" = 1'-0"

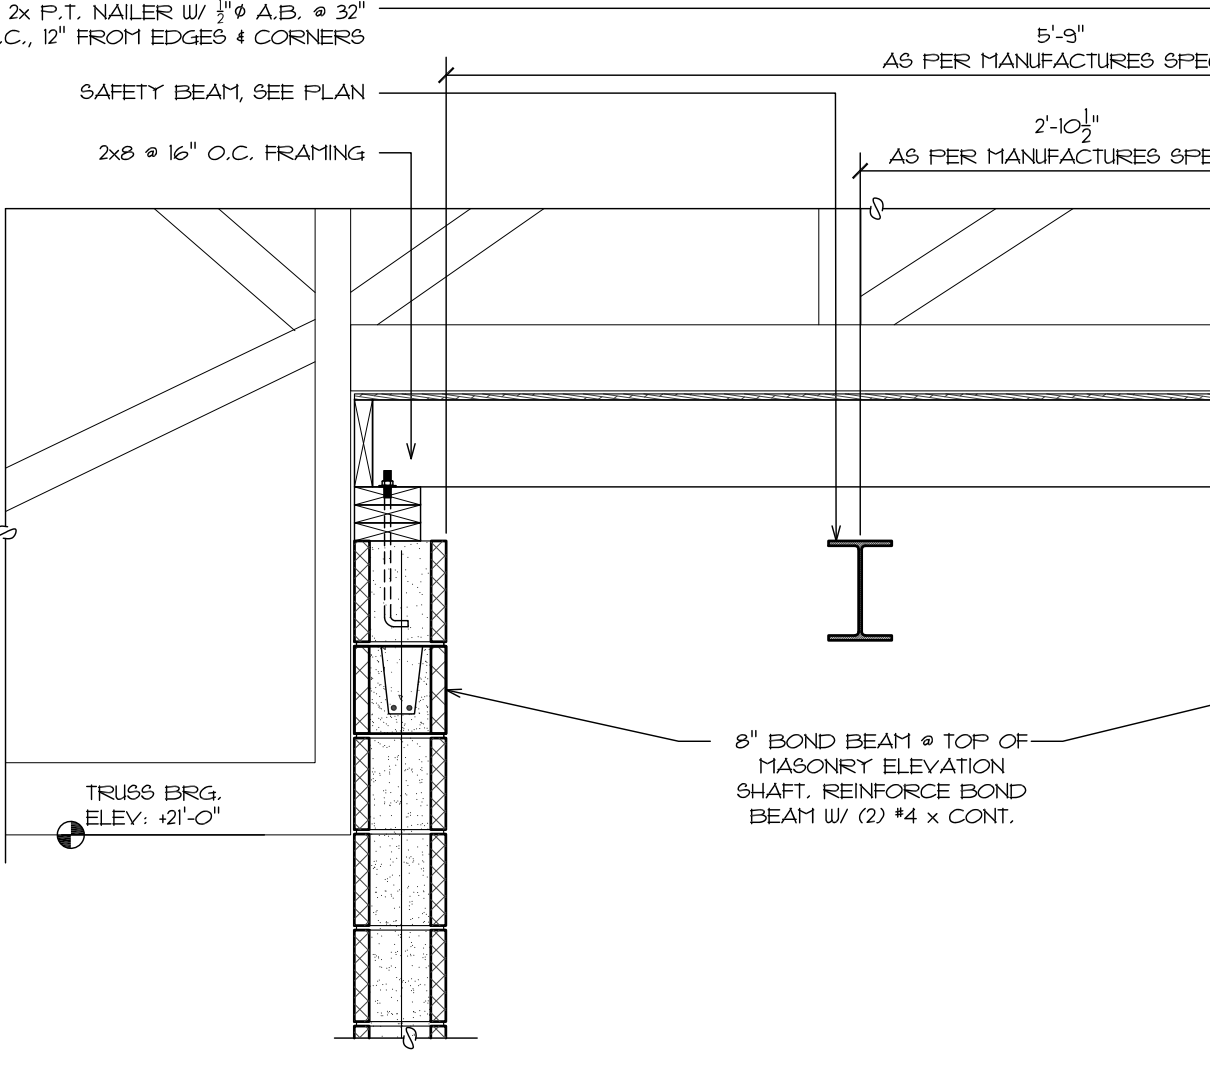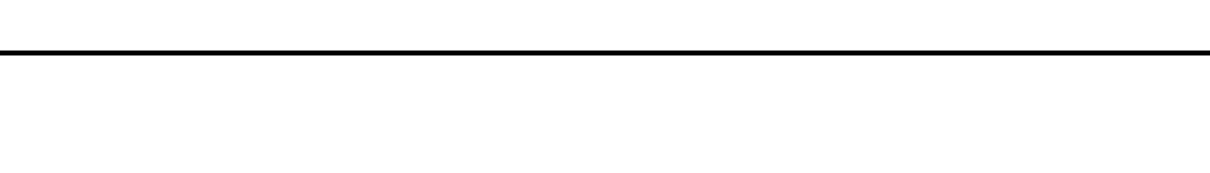


15 SADDLE BRACKET DETAIL
SCALE 3/4" = 1'-0"

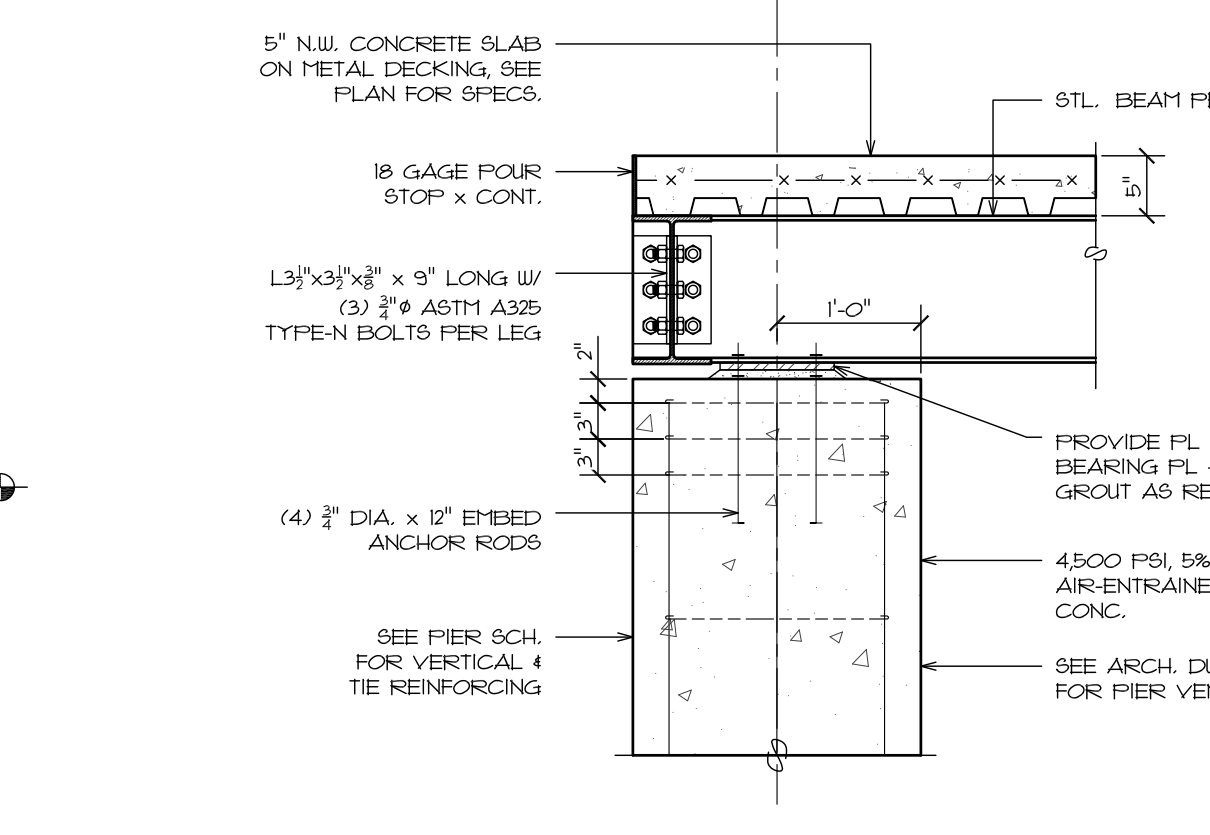

12 ELEVATED DECK STEEL DETAIL
SCALE 3/4" = 1'-0"


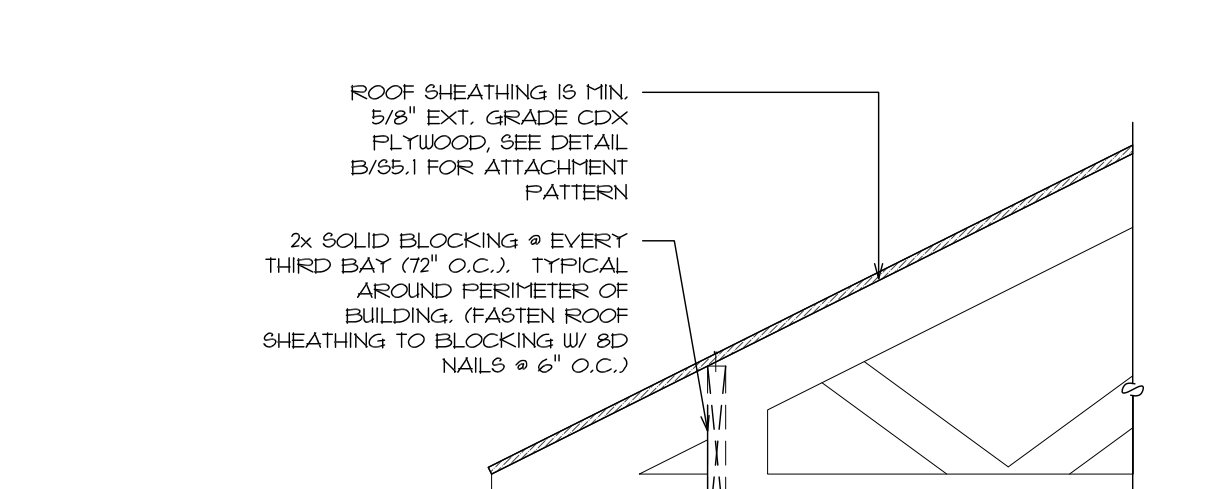


7 EXTERIOR STL. STEEL DETAIL - COL. ABOVE
SCALE 3/4" = 1'-0"

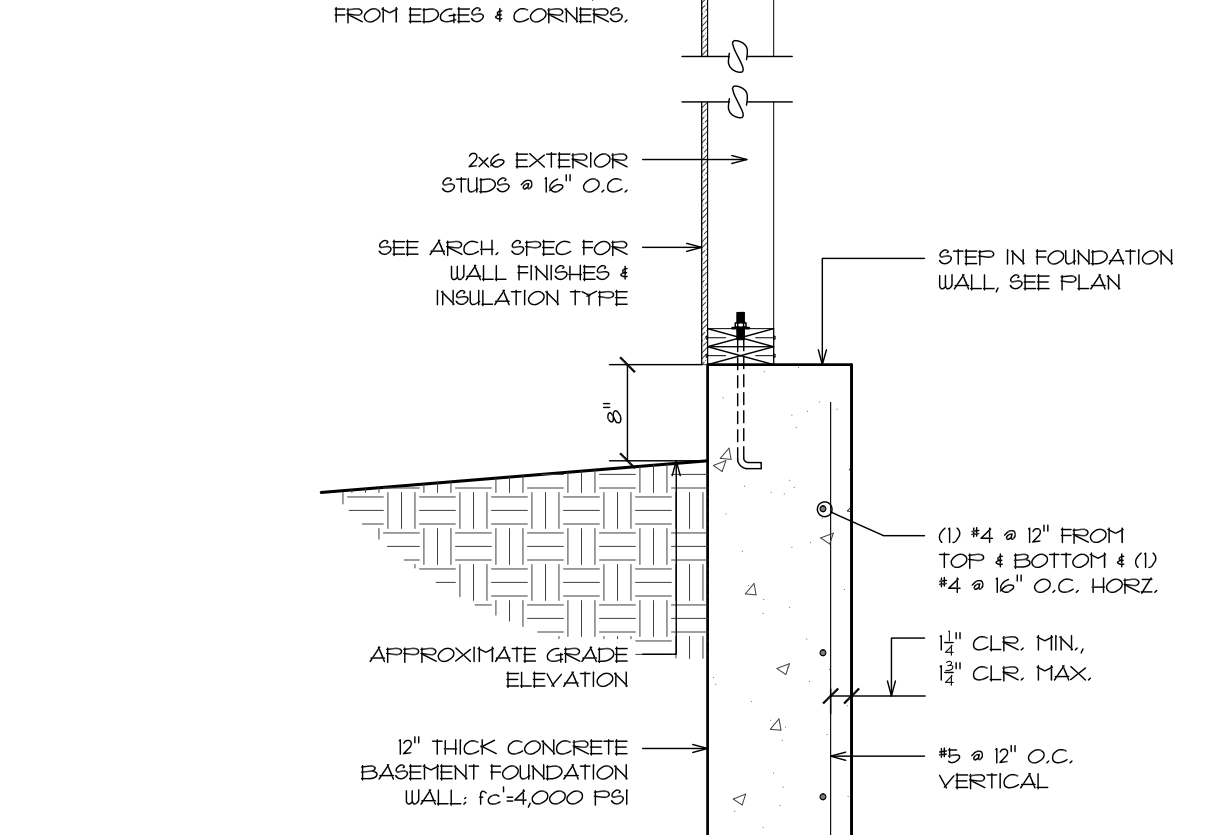


6 STEEL DETAIL - ELEVATOR PILASTER
SCALE 3/4" = 1'-0"


6 STEEL DETAIL - ELEVATOR PILASTER
SCALE 3/4" = 1'-0"

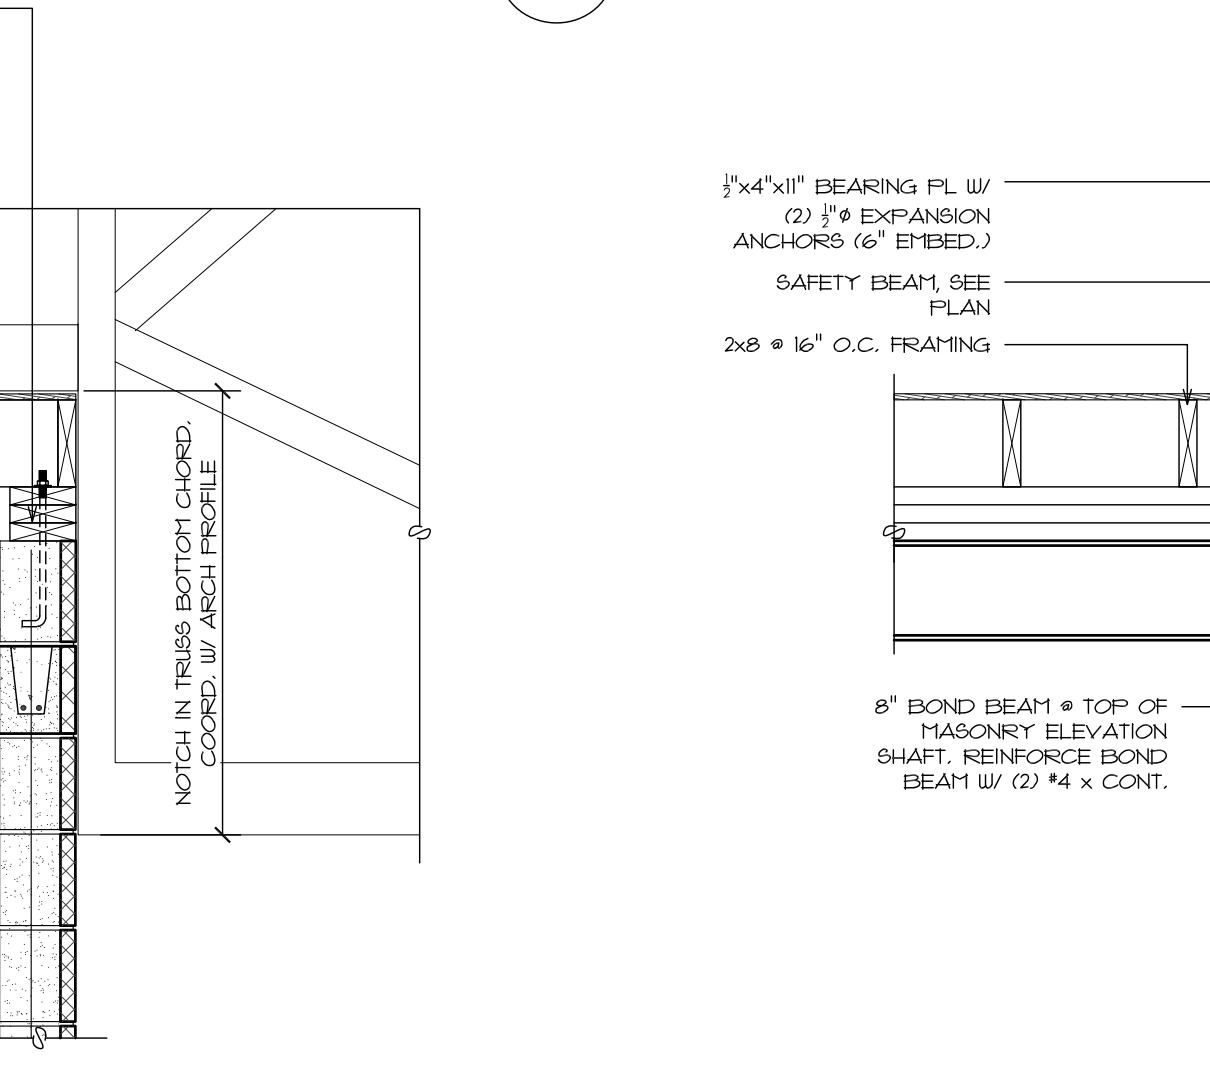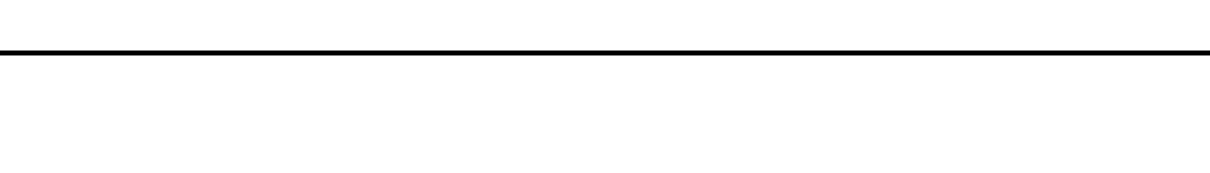


11 HOIST BEAM BRG. DETAIL
SCALE 3/4" = 1'-0"

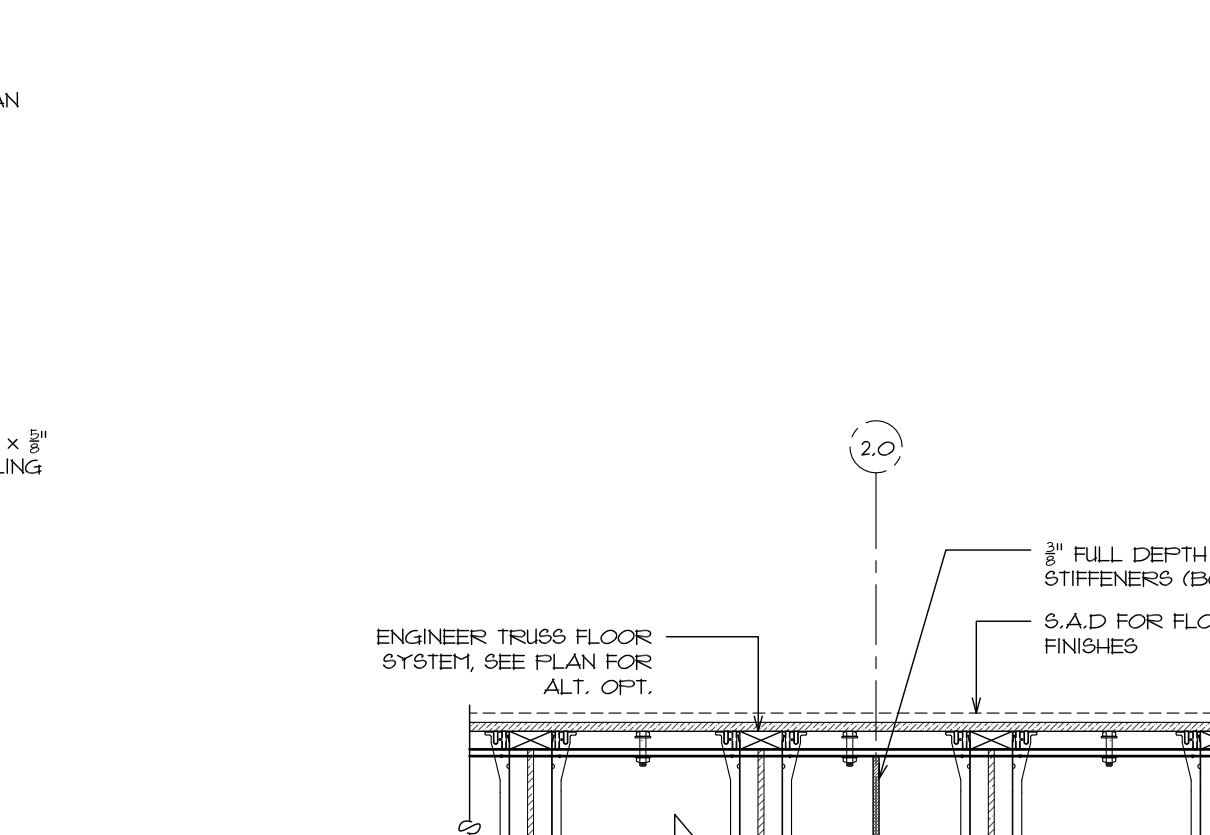

10 HOIST BEAM DETAIL
SCALE 3/4" = 1'-0"


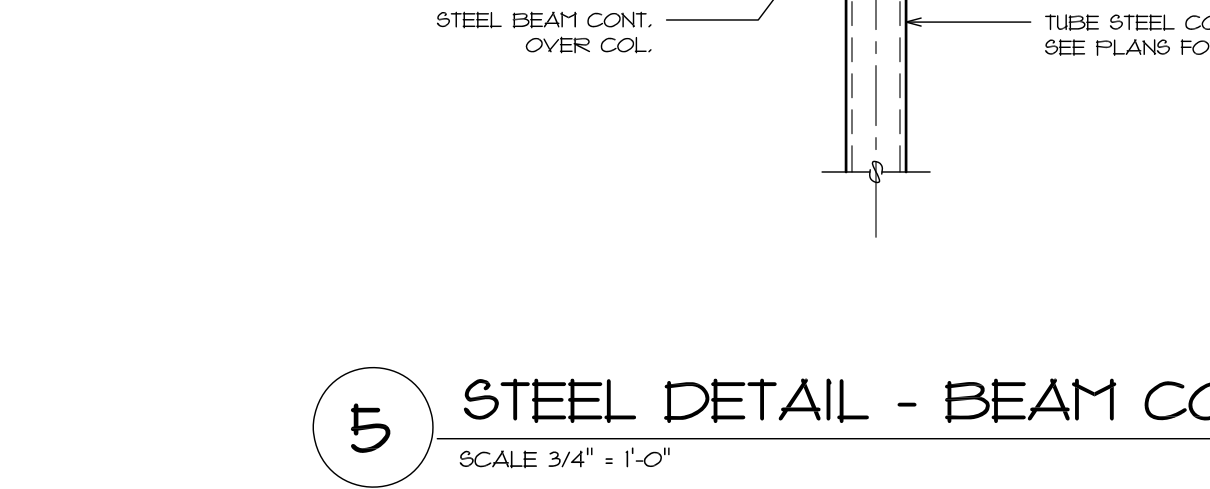


6 STEEL DETAIL - ELEVATOR PILASTER
SCALE 3/4" = 1'-0"

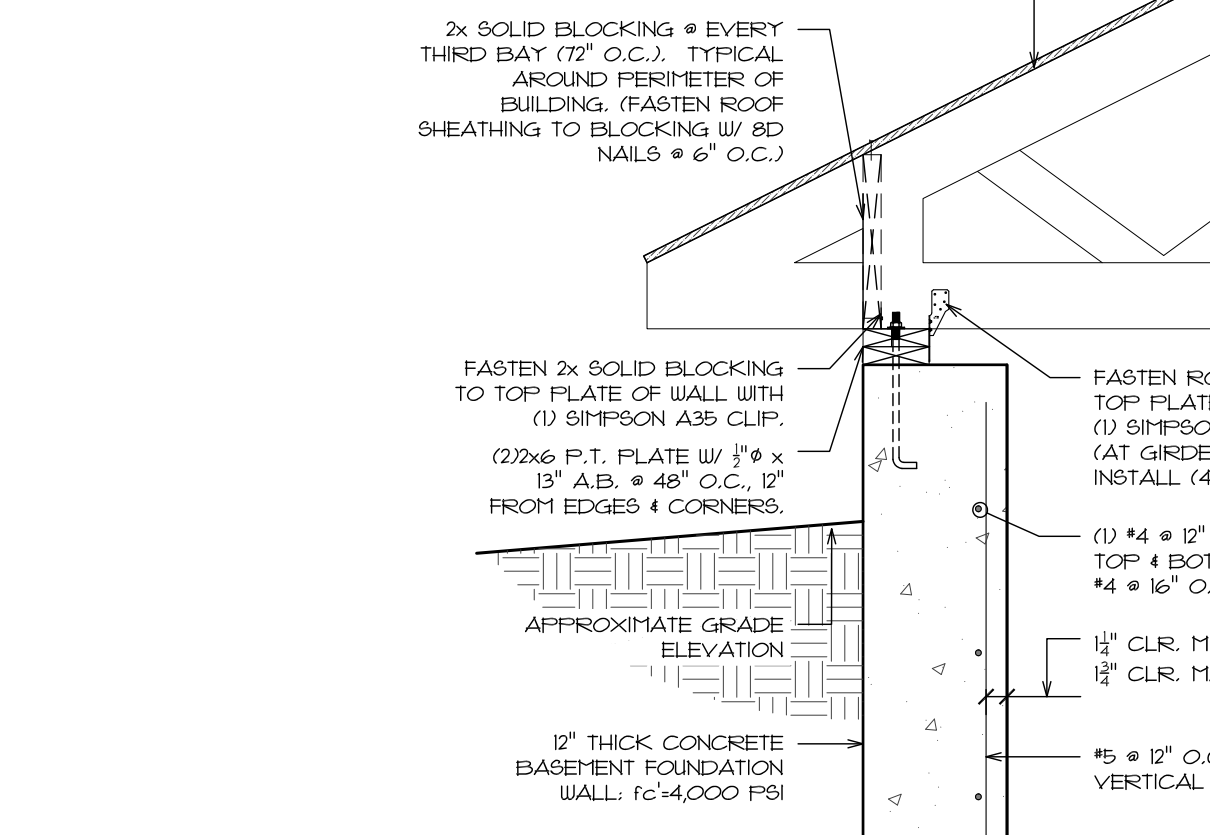


5 STEEL DETAIL - BEAM CONT. @ COL.
SCALE 3/4" = 1'-0"


5 STEEL DETAIL - BEAM CONT. @ COL.
SCALE 3/4" = 1'-0"

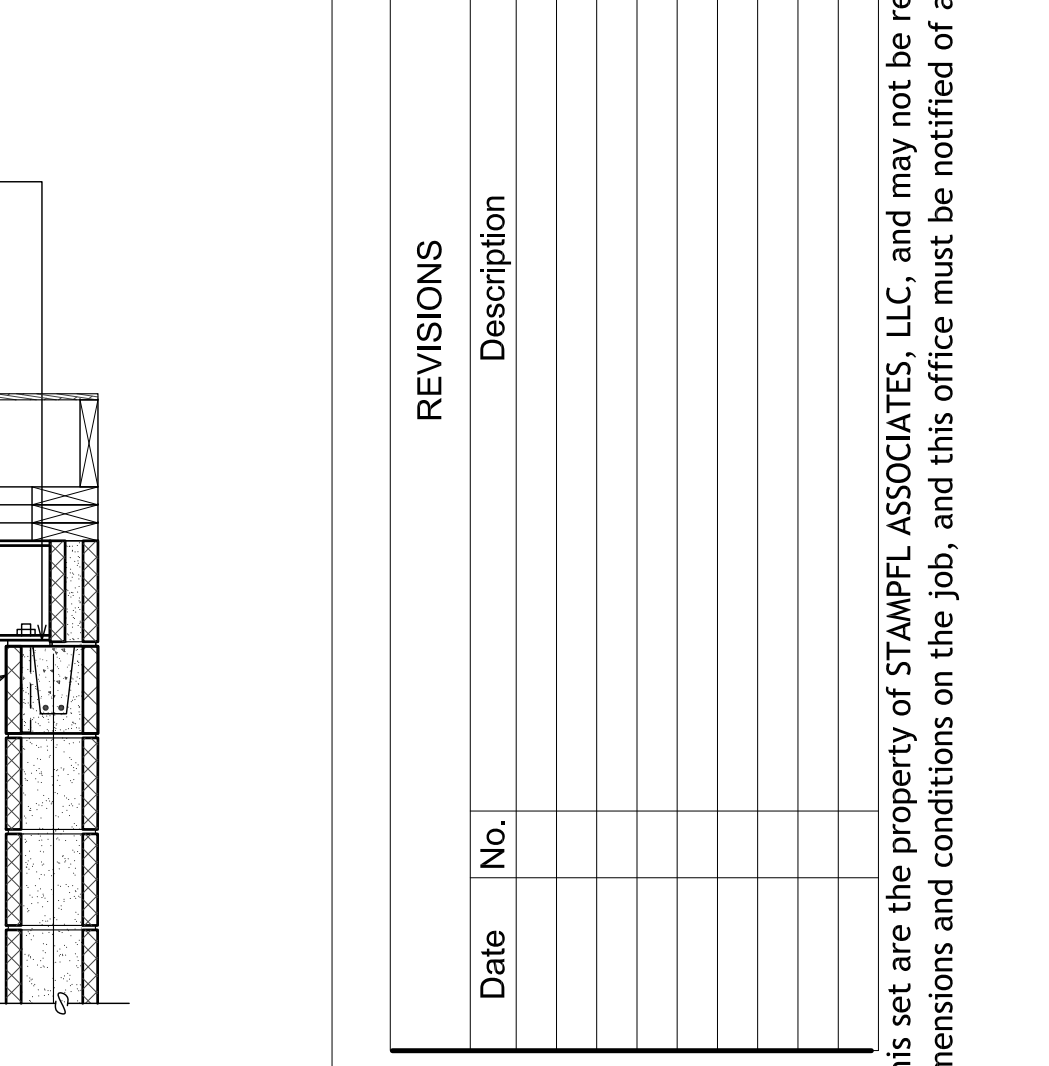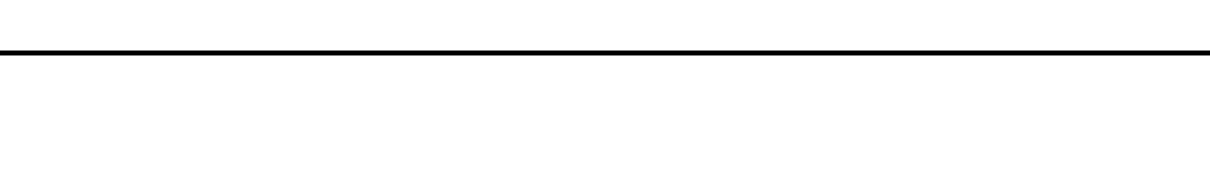


15 SADDLE BRACKET DETAIL
SCALE 3/4" = 1'-0"

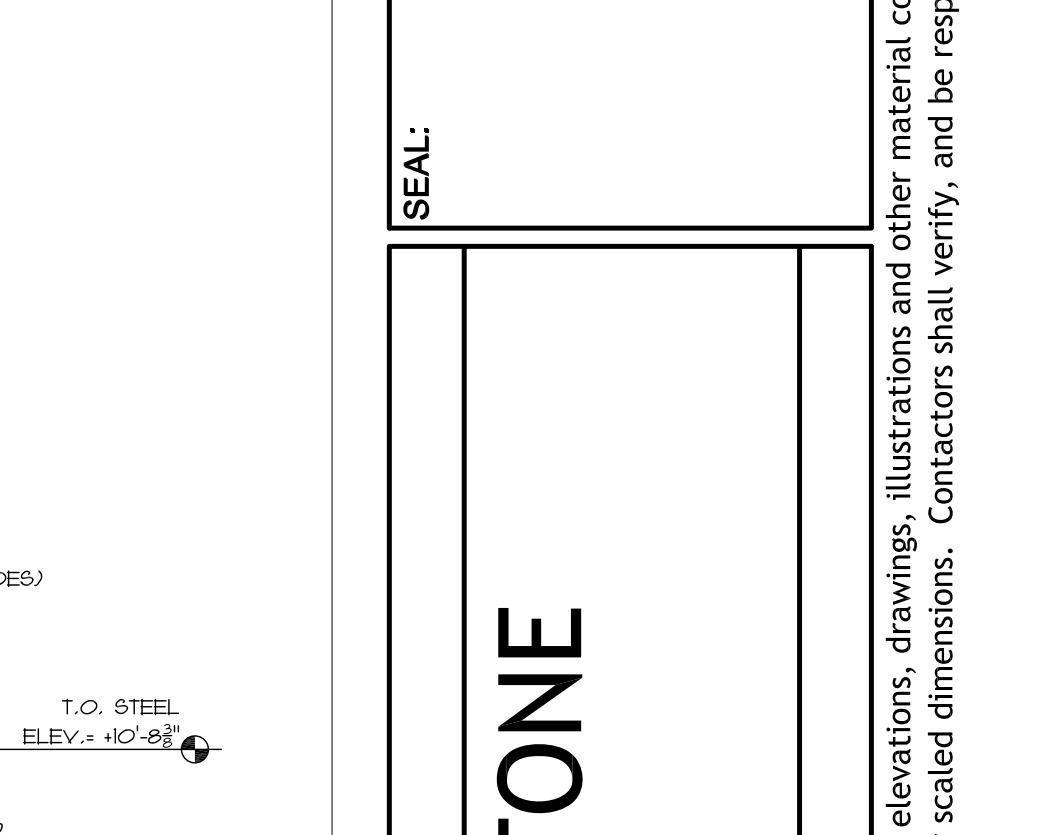

12 ELEVATED DECK STEEL DETAIL
SCALE 3/4" = 1'-0"

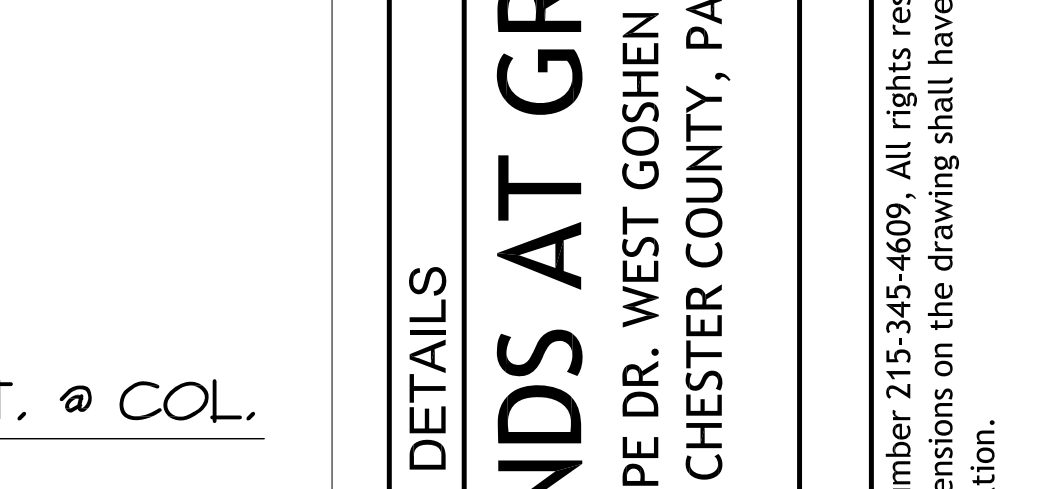


7 EXTERIOR STL. STEEL DETAIL - COL. ABOVE
SCALE 3/4" = 1'-0"

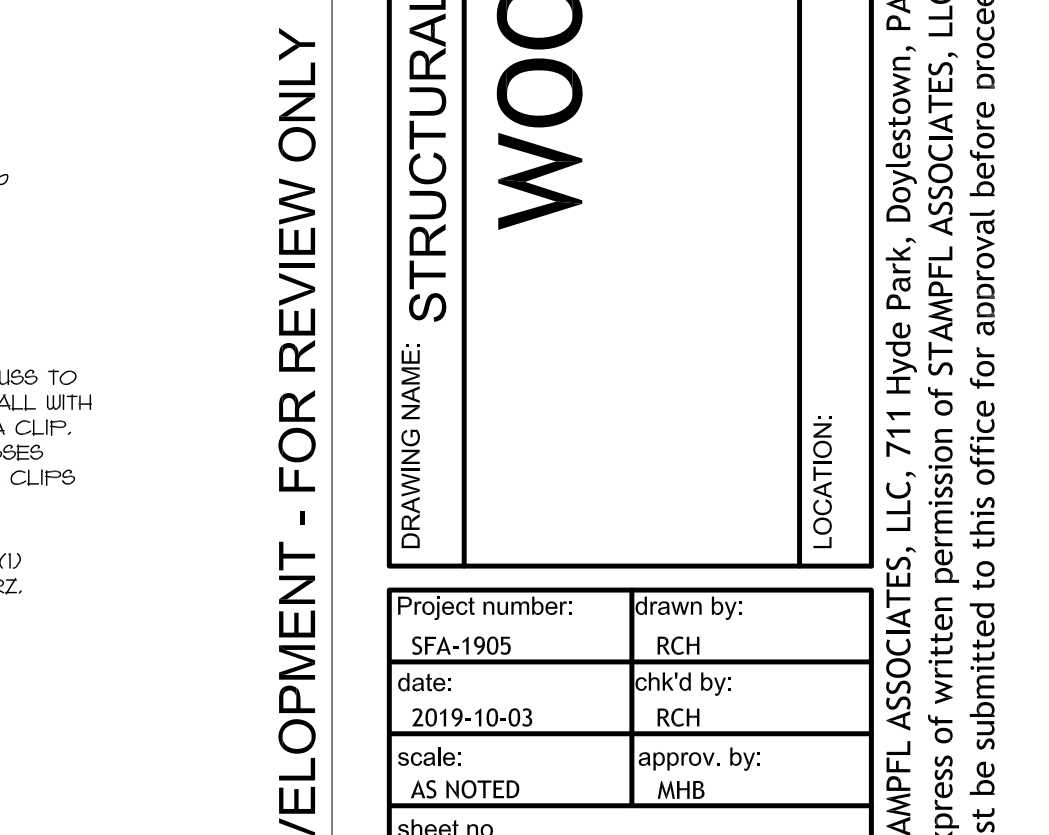


6 STEEL DETAIL - ELEVATOR PILASTER
SCALE 3/4" = 1'-0"



6 STEEL DETAIL - ELEVATOR PILASTER
SCALE 3/4" = 1'-0"

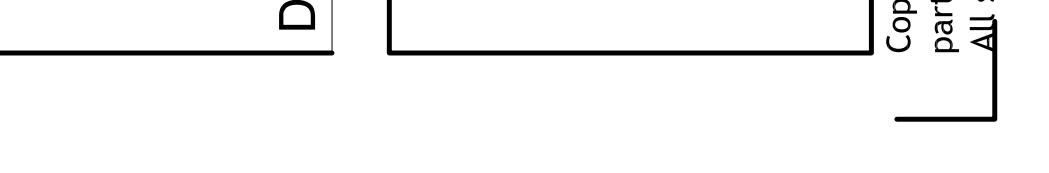

DESIGN DEVELOPMENT - FOR REVIEW ONLY

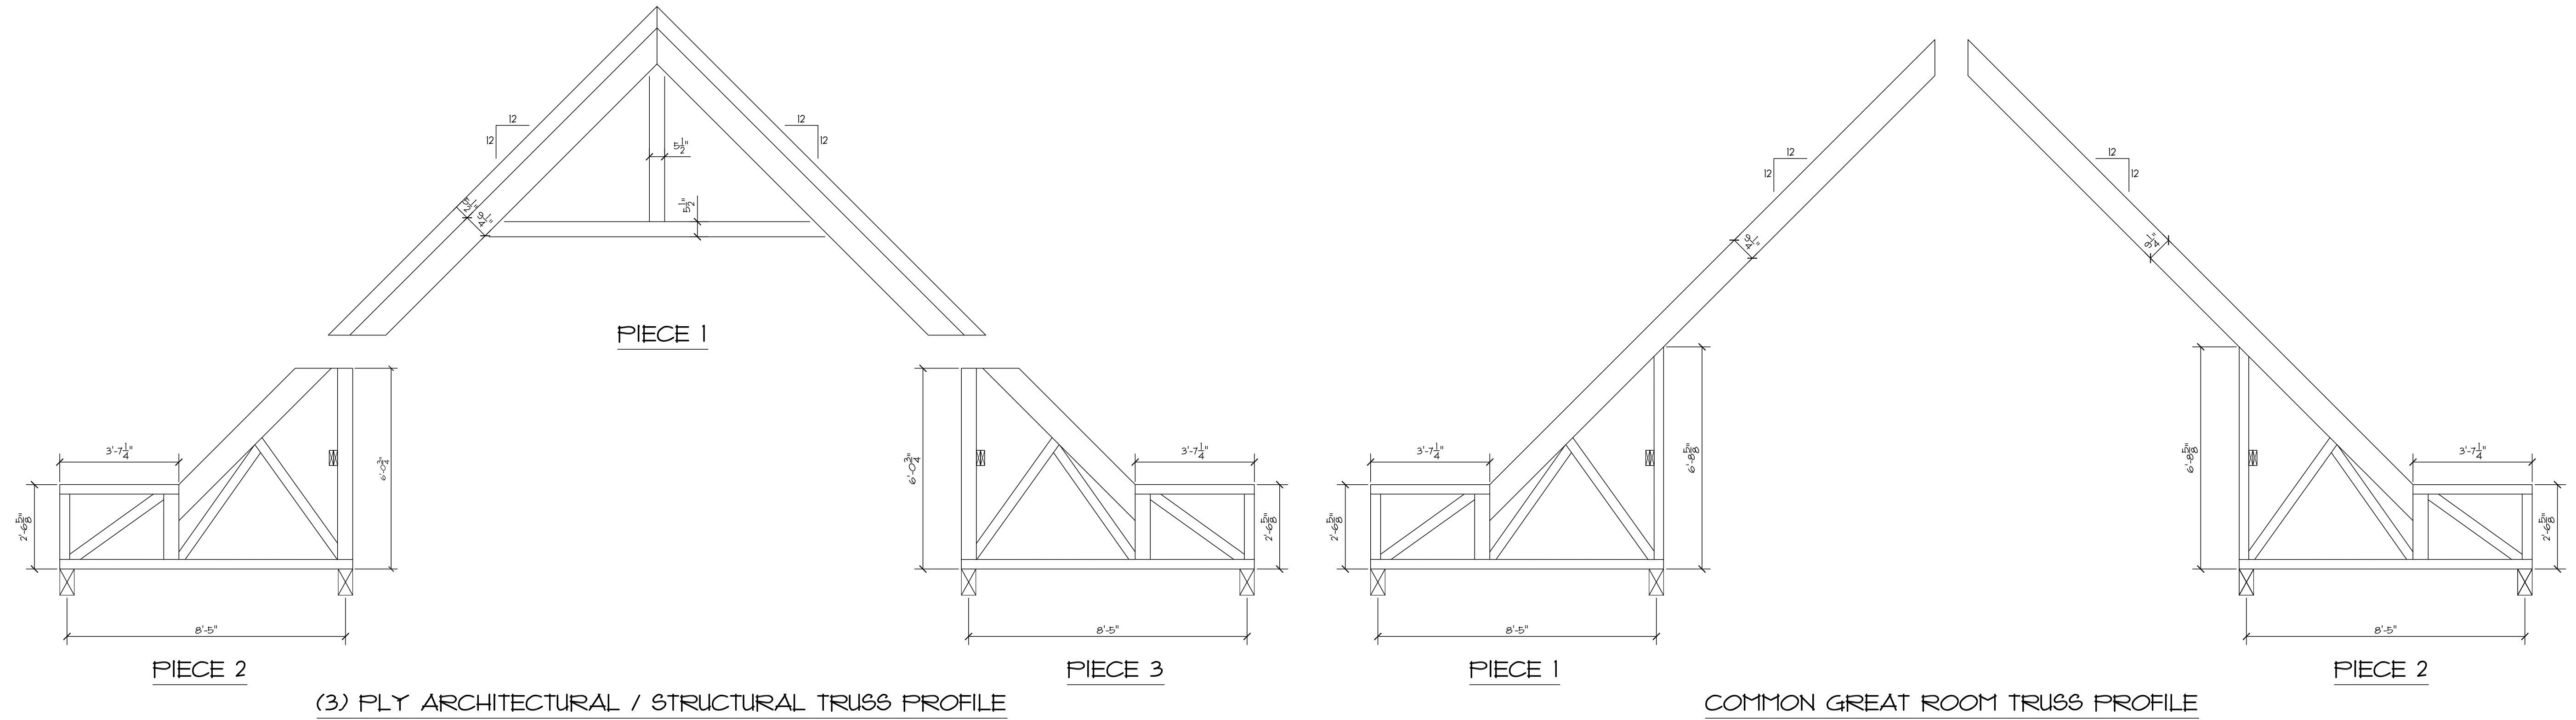

A GREAT ROOM TRUSS PROFILES
 SCALE 3/8" = 1'-0"

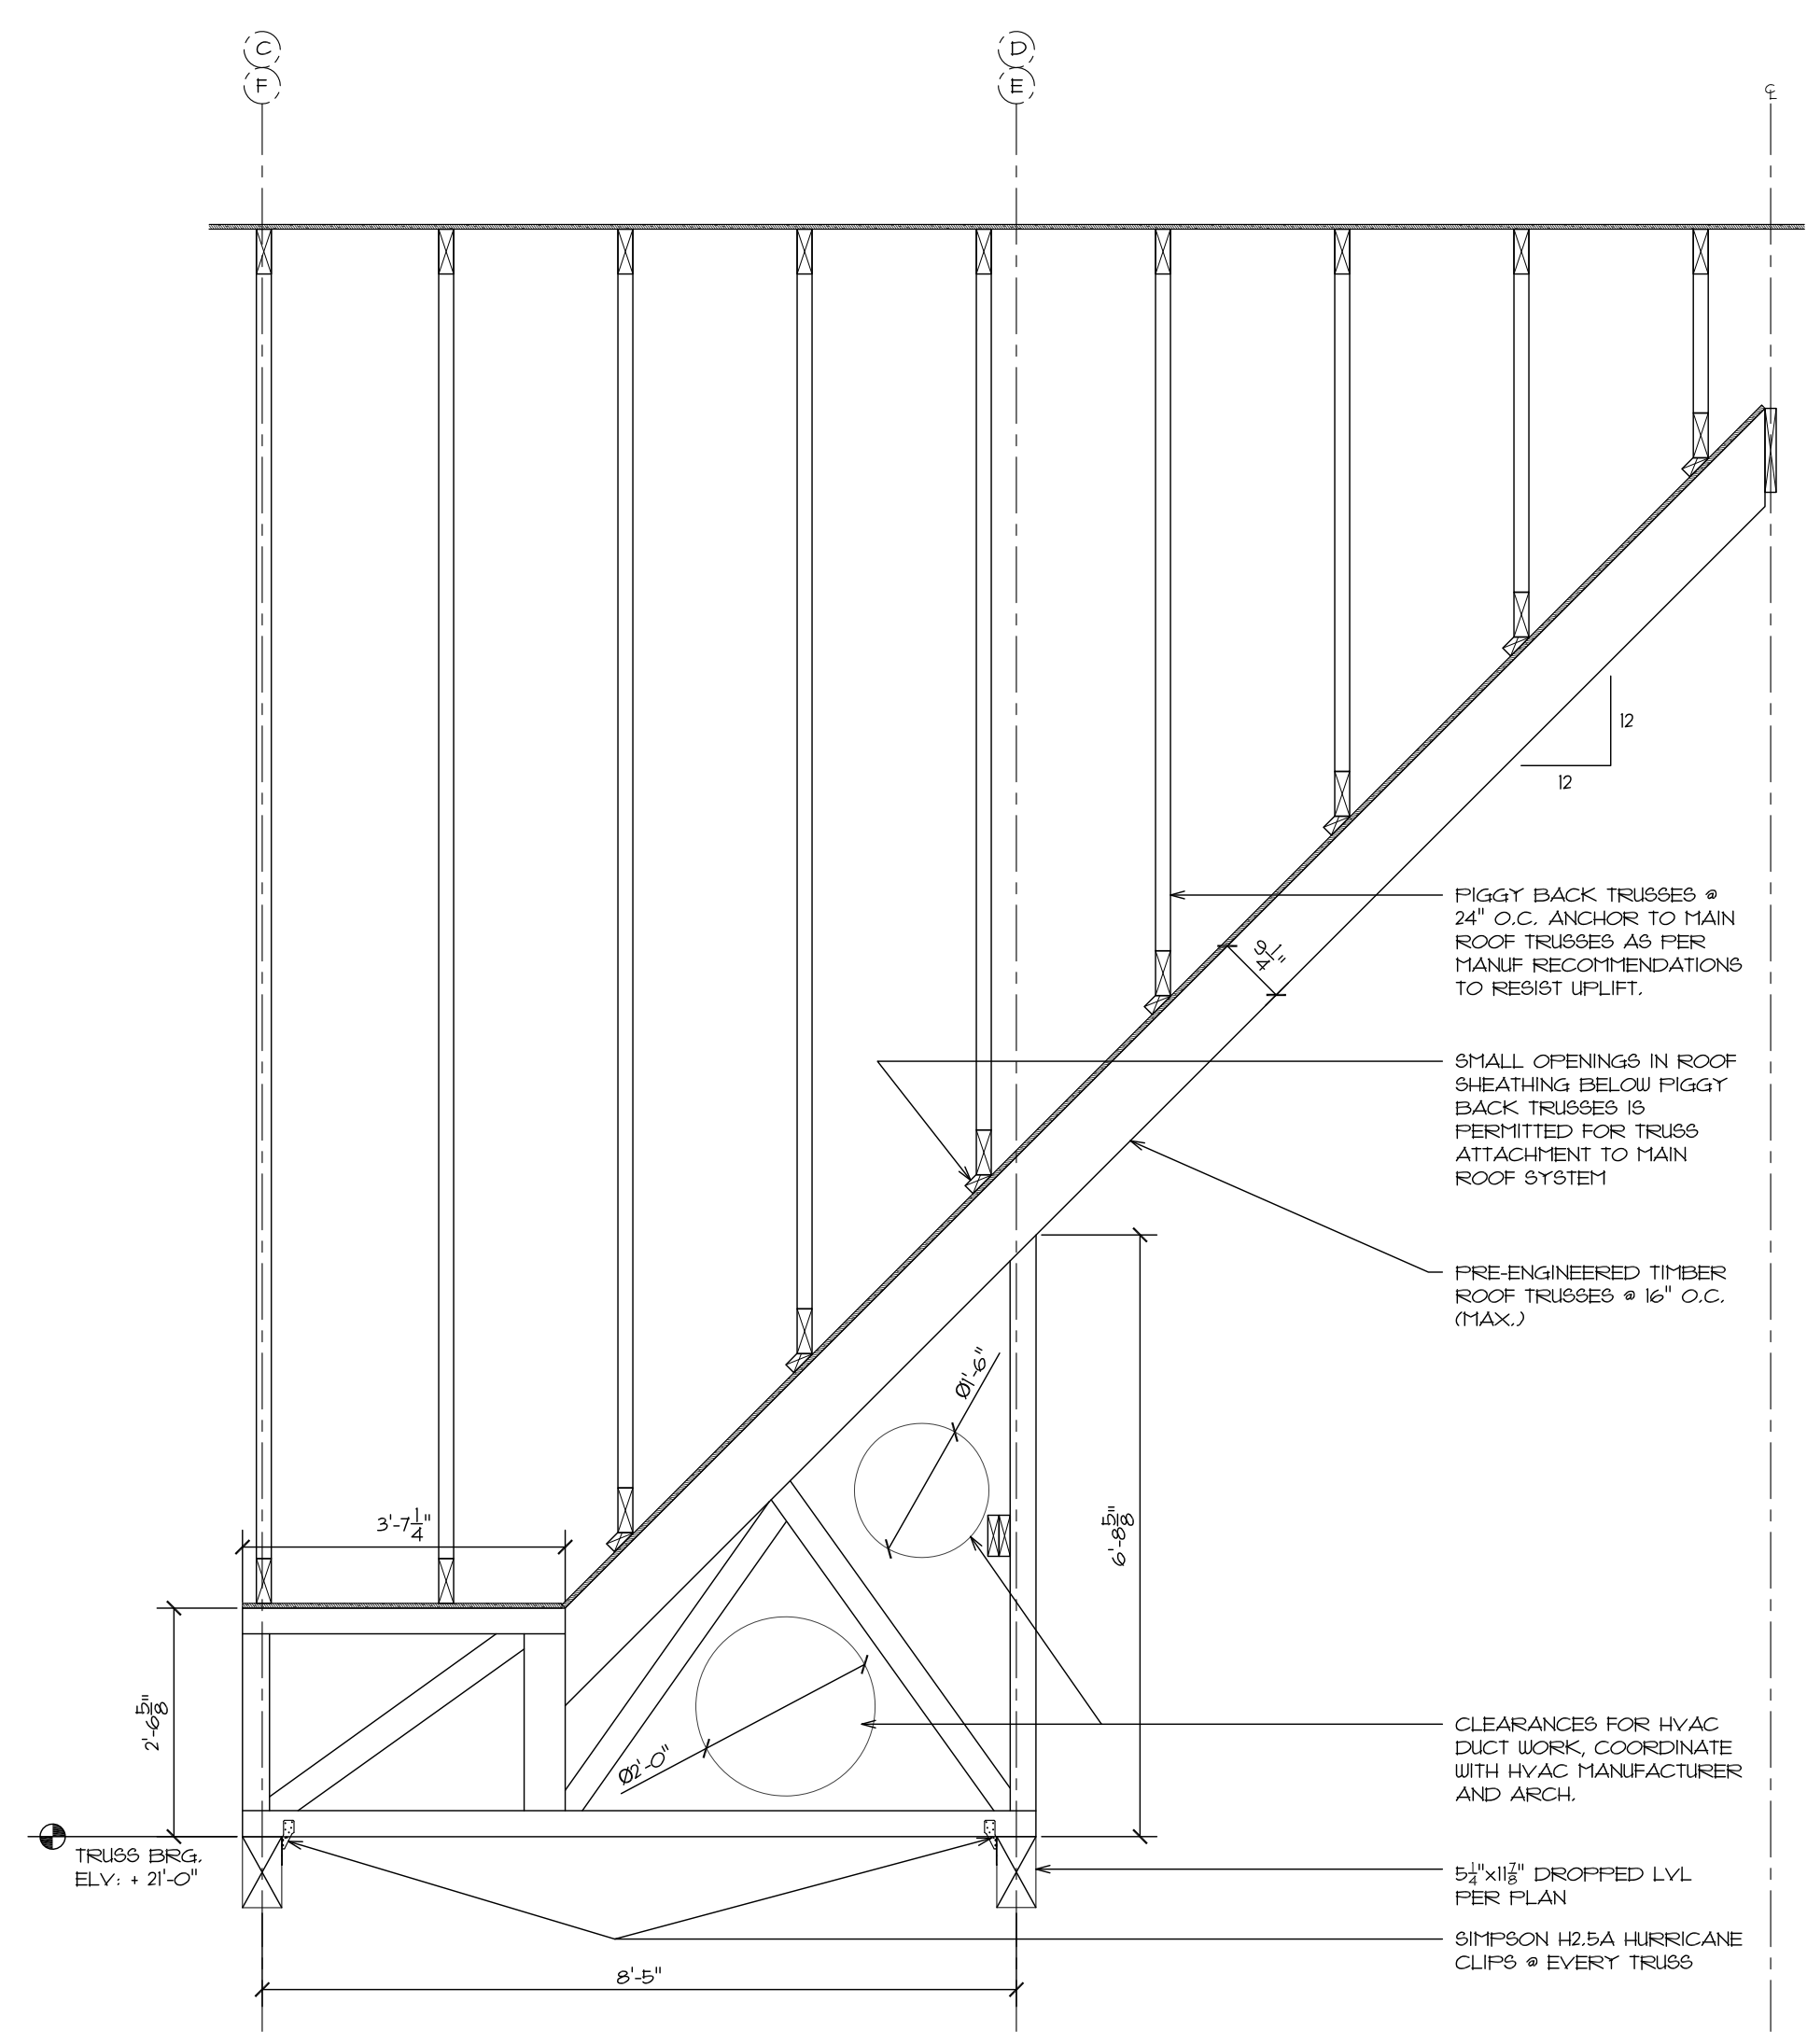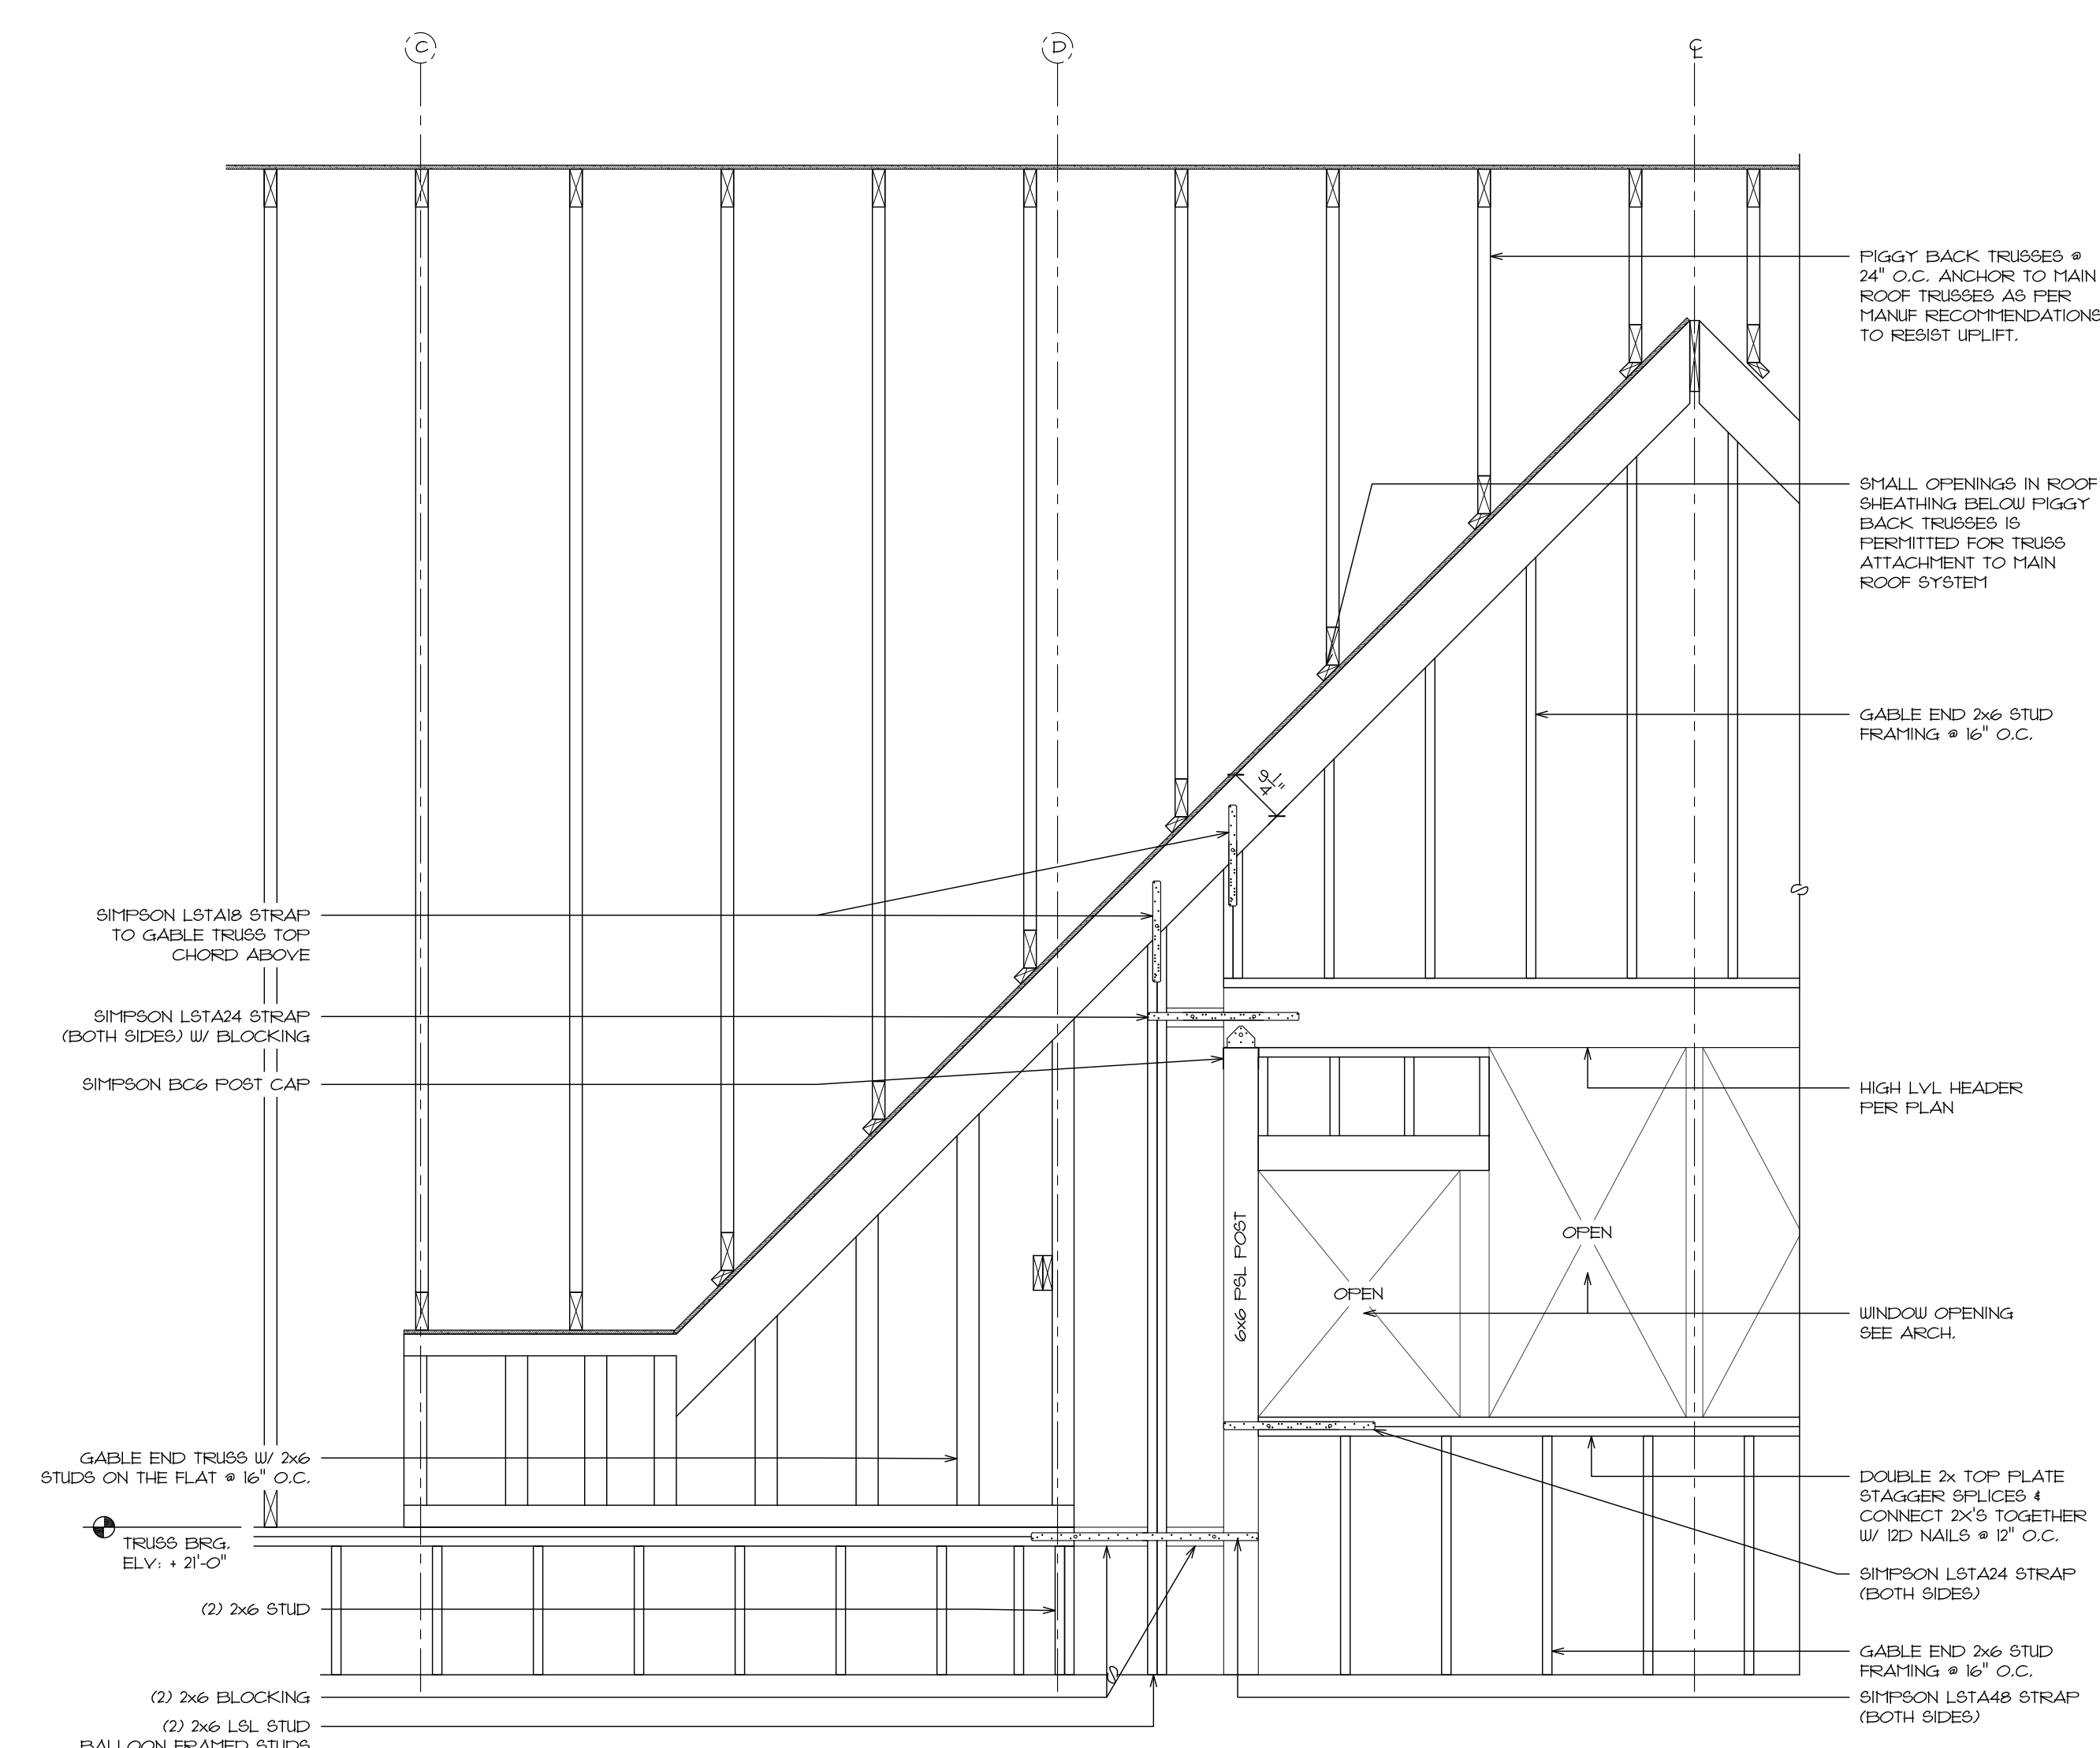

REVISIONS	Date	No.	Description	chk'd by

SEAL:

WOODLANDS AT GREYSTONE
 SCUL THORPE DR. WEST GOSHEN TOWNSHIP
 CHESTER COUNTY, PA

DRAWING NAME: TRUSS FRAMING DETAILS & PROFILES

PROJECT NUMBER: SFA-1905
 DATE: 2019-10-03
 SCALE: AS NOTED

DRAWN BY: RCH
 CHECKED BY: RCH
 APPROVED BY: MHB

LOCATION:

DESIGN DEVELOPMENT - FOR REVIEW ONLY

S5.2

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