
Methacton SCHOOL DISTRICT

2020 HIGH SCHOOL FRONT ENTRY REPLACEMENT PROJECT 1005 KRIEBEL MILL ROAD EAGLEVILLE, PA. MSD PROJECT #20.7.8

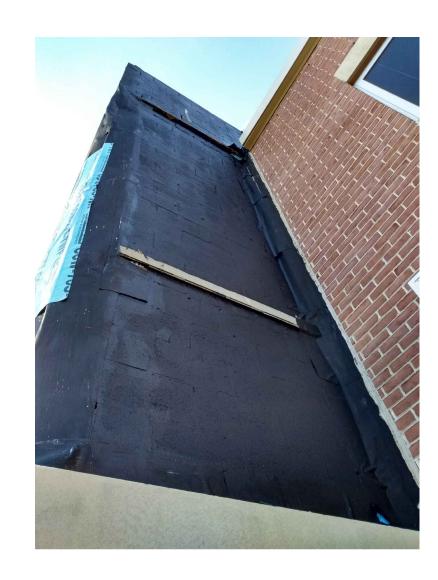





PROPOSED ENTRANCE

GENERAL CONSTRUCTION WORK

GENERAL

- TYPICAL SECTIONS AND DETAILS ALL SECTIONS, DETAILS AND NOTES ARE INTENDED TO BE TYPICAL UNLESS OTHERWISE DETAILED. SHOP AND ERECTION DRAWINGS SUBMITTED BY THE CONTRACTOR SHALL SHOW APPLICATION OF TYPICAL SECTIONS AND DETAILS FOR SIMILAR
- OPENINGS AND EMBEDDED ITEMS ALL CURBED AND OTHER OPENINGS, EQUIPMENT BASES. DEPRESSIONS, FRAMES, CASTINGS, PIPE SLEEVES, CONDUITS, INSERTS, EDGE PROTECTION. ANCHOR BOLTS AND SIMILAR ITEMS SHALL BE PROVIDED, LOCATED AND INSTALLED AS SHOWN ON APPROVED SHOP DRAWINGS FOR MANUFACTURED ITEMS AND OTHER TRADES. VERIFY EXISTING UTILITIES. INFORM AND OBTAIN REQUIRED PERMITS FROM OWNERS OF

SUCH UTILITIES BEFORE STARTING ANY WORK.

GIVEN AGE OF BUILDING, THE EXISTENCE OF HAZARDOUS MATERIALS IS POSSIBLE. THE OWNER SHALL PROVIDE A HAZARDOUS MATERIAL REPORT BY A THIRD PARTY CONTRACTOR FOR ALL ASBESTOS TESTING. CONTRACTOR TO INCLUDE LEAD PAINT TESTING ON THE STUCCO OF AREAS TO BE RE-COATED PRIOR TO RE-COATING WORK AS PART OF THE BASE SCOPE OF WORK.

STRUCTURAL DESIGN CRITERIA

GOVERNING CODES: MINIMUM DESIGN LOADS FOR BUILDINGS AND OTHER STRUCTURES (ASCE7) INTERNATIONAL BUILDING CODE (IBC)


EXISTING CONDITIONS

ALL DIMENSIONS, ELEVATIONS AND PHYSICAL CONDITIONS SHOWN ON THE DRAWINGS FOR EXISTING STRUCTURES ARE BASED UPON LIMITED FIELD INSPECTIONS AND OTHER AVAILABLE SOURCES. SUCH DEPICTIONS OF EXISTING CONSTRUCTION ARE INTENDED TO BE GENERAL, APPROXIMATE AND LIMITED TO THOSE AREAS FOR WHICH WORK IS REQUIRED, AND ARE PROVIDED ONLY FOR THE CONVENIENCE OF THE CONTRACTOR. PRIOR TO BIDDING, AND/OR CONSTRUCTION, CONDUCT A CAREFUL EXAMINATION OF EXISTING CONDITIONS AT THE SITE APPLICABLE TO THE WORK

- EXACT EXTENT OF THE CONSTRUCTION WORK CANNOT BE NECESSARILY OR ACCURATELY DETERMINED PRIOR TO COMMENCEMENT OF WORK. ACTUAL FIELD CONDITIONS MAY REQUIRE MODIFICATIONS TO THE CONSTRUCTION DETAILS, MATERIAL QUANTITIES AND EXTENT OF THE MODIFICATION WORK SHOWN ON CONTRACT DRAWINGS. PERFORM THE WORK TO MEET FIELD CONDITIONS
- EXAMINE AND FIELD VERIFY ALL EXISTING AND GIVEN DIMENSIONS AND CONDITIONS PRIOR TO COMMENCEMENT OF THE WORK AND FABRICATION OF CONSTRUCTION MATERIALS. REPORT VARIANCES FROM THE DRAWINGS AND SPECIFICATIONS AND POTENTIAL INTERFERENCES PROMPTLY TO THE ENGINEER. INCORPORATE ACTUAL FIELD CONDITIONS AND DIMENSIONS IN THE WORK AND INDICATE CHANGES AND ADJUSTMENTS ON DRAWINGS SUBMITTED FOR APPROVAL.


CONSTRUCTION OPERATIONS

- ASSUME AN ABSOLUTE OBLIGATION TO PROTECT EXISTING STRUCTURES AND EQUIPMENT, NEW WORK, PERSONNEL, STUDENTS, AND THE GENERAL PUBLIC FROM DAMAGE, LOSS OR INJURY RESULTING FROM THE CONTRACTOR'S OPERATIONS. IN THE EVENT OF SUCH DAMAGE OR LOSS, PROMPTLY REPLACE OR RESTORE THE WORK TO AN EQUIVALENT QUALITY TO THE SATISFACTION OF THE ENGINEER AND AT NO EXPENSE TO THE OWNER.
- REMOVE TO THE EXTENT INDICATED AND PROPERLY DISPOSE OF EXISTING STRUCTURES AND MATERIALS TO BE DEMOLISHED IN ACCORDANCE WITH THE
- EXCAVATIONS WHICH MAY UNDERMINE EXISTING STRUCTURES TO REMAIN SHALL BE BRACED BY A SUITABLE EXCAVATION SUPPORT SYSTEM DESIGNED IN ACCORDANCE WITH THE SPECIFICATIONS AND APPROVED BY THE ENGINEER. DESIGN SHALL BE PERFORMED BY A QUALIFIED PROFESSIONAL ENGINEER CURRENTLY REGISTERED IN THE COMMONWEALTH OF PENNSYLVANIA.
- THE CONTRACTOR SHALL BE RESPONSIBLE FOR THE STRUCTURAL INTEGRITY OF THE NEW AND EXISTING CONSTRUCTION AT ALL TIMES DURING THE WORK. ANY CONDITION ENCOUNTERED BY THE CONTRACTOR WHICH COULD IMPAIR THE STRUCTURAL INTEGRITY SHALL BE REPORTED IMMEDIATELY TO THE ENGINEER.
- THE CONTRACTOR SHALL IDENTIFY ALL OVERHEAD UTILITY LINES AND COMPLY WITH CORRESPONDING CLEARANCE REQUIREMENTS. THE CONTRACTOR SHALL COORDINATE, MAINTAIN, SUPPORT, PROTECT AND
- RESTORE EXISTING PUBLIC AND PRIVATE UTILITIES AFFECTED BY CONSTRUCTION. THE CONTRACTOR SHALL COMPLY WITH UTILITY COMPANY REQUIREMENTS FOR THE PROTECTION OF EXISTING UTILITIES.
- ALL DISCARDED, DEMOLISHED OR EXCAVATED MATERIAL SHALL BECOME THE PROPERTY OF THE CONTRACTOR UNLESS OTHERWISE NOTED, MATERIALS SHALL BE PROPERLY DISPOSED OF OFF SITE, IN ACCORDANCE WITH ALL APPLICABLE STATUTORY REQUIREMENTS.
- THE CONTRACTOR IS ADVISED THAT THE WORK SCHEDULE SHALL CONFORM STRICTLY TO THE OPERATIONAL REQUIREMENTS SPECIFIED UNDER VARIOUS SECTIONS OF THE SPECIFICATIONS WITH RESPECT TO PROTECTION, SCHEDULING, AND COORDINATION REQUIREMENTS.
- THE CONTRACTOR SHALL EXECUTE CONSTRUCTION OPERATIONS IN A MANNER TO MINIMIZE NOISE IN ACCORDANCE WITH THE PROVISIONS OF THE SPECIFICATIONS.

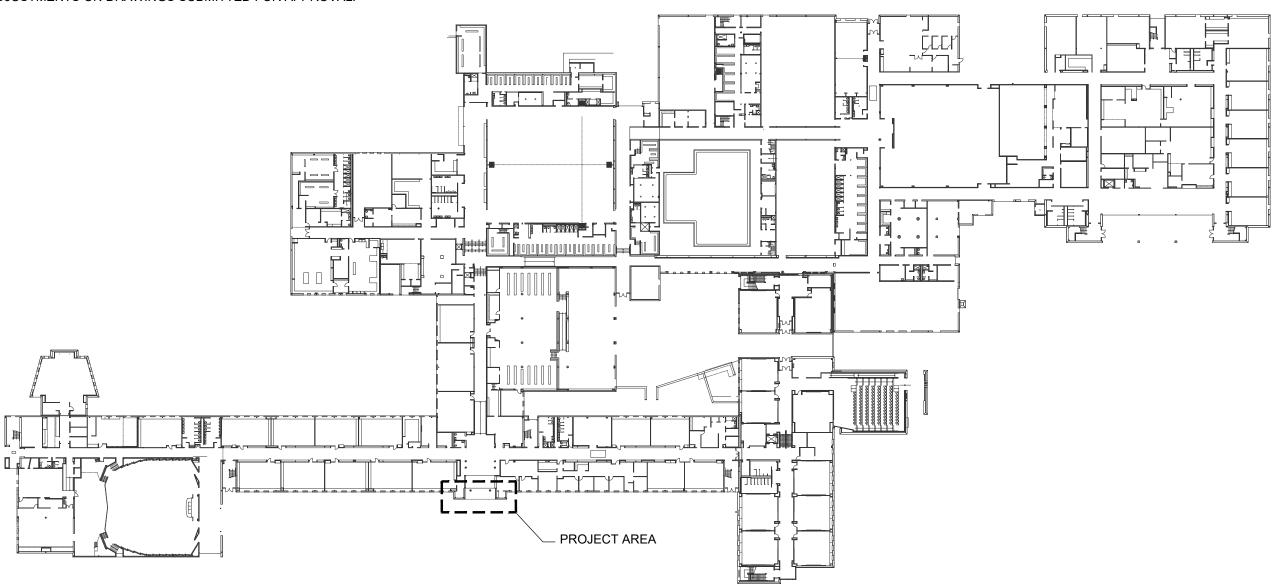

FLOOR PLAN

CROSS REFERENCING:

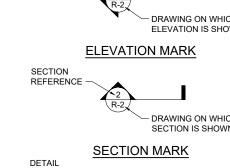

— QUANTITY OF TASK 15 SF


S.S. STAINLESS STEEL
N.I.C. NOT IN CONTRACT WATERSTOP EXPANSION JOINT CONTROL JOINT N.T.S. NOT TO SCALE CENTER LINE TYP. TYPICAL CENTER TO CENTER U.N.O. UNLESS NOTED OTHERWISE V.I.F. VERIFY IN FIELD

SHEET INDEX

ON CENTER

COVER SHEET REFERENCE PLAN AND DEMOLITION **ELEVATIONS**

SECTIONS **DETAILS ALTERNATES** STRUCTURAL DETAILS

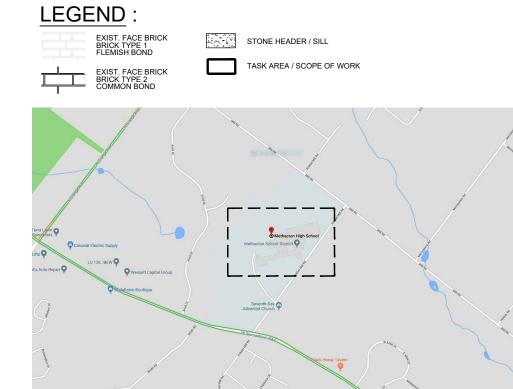



LOCATION MAP


Shephard Restoration Engineers,


Project No. 2019.020 Date 1/7/2020AJG/WJG Drawn Checked TPS



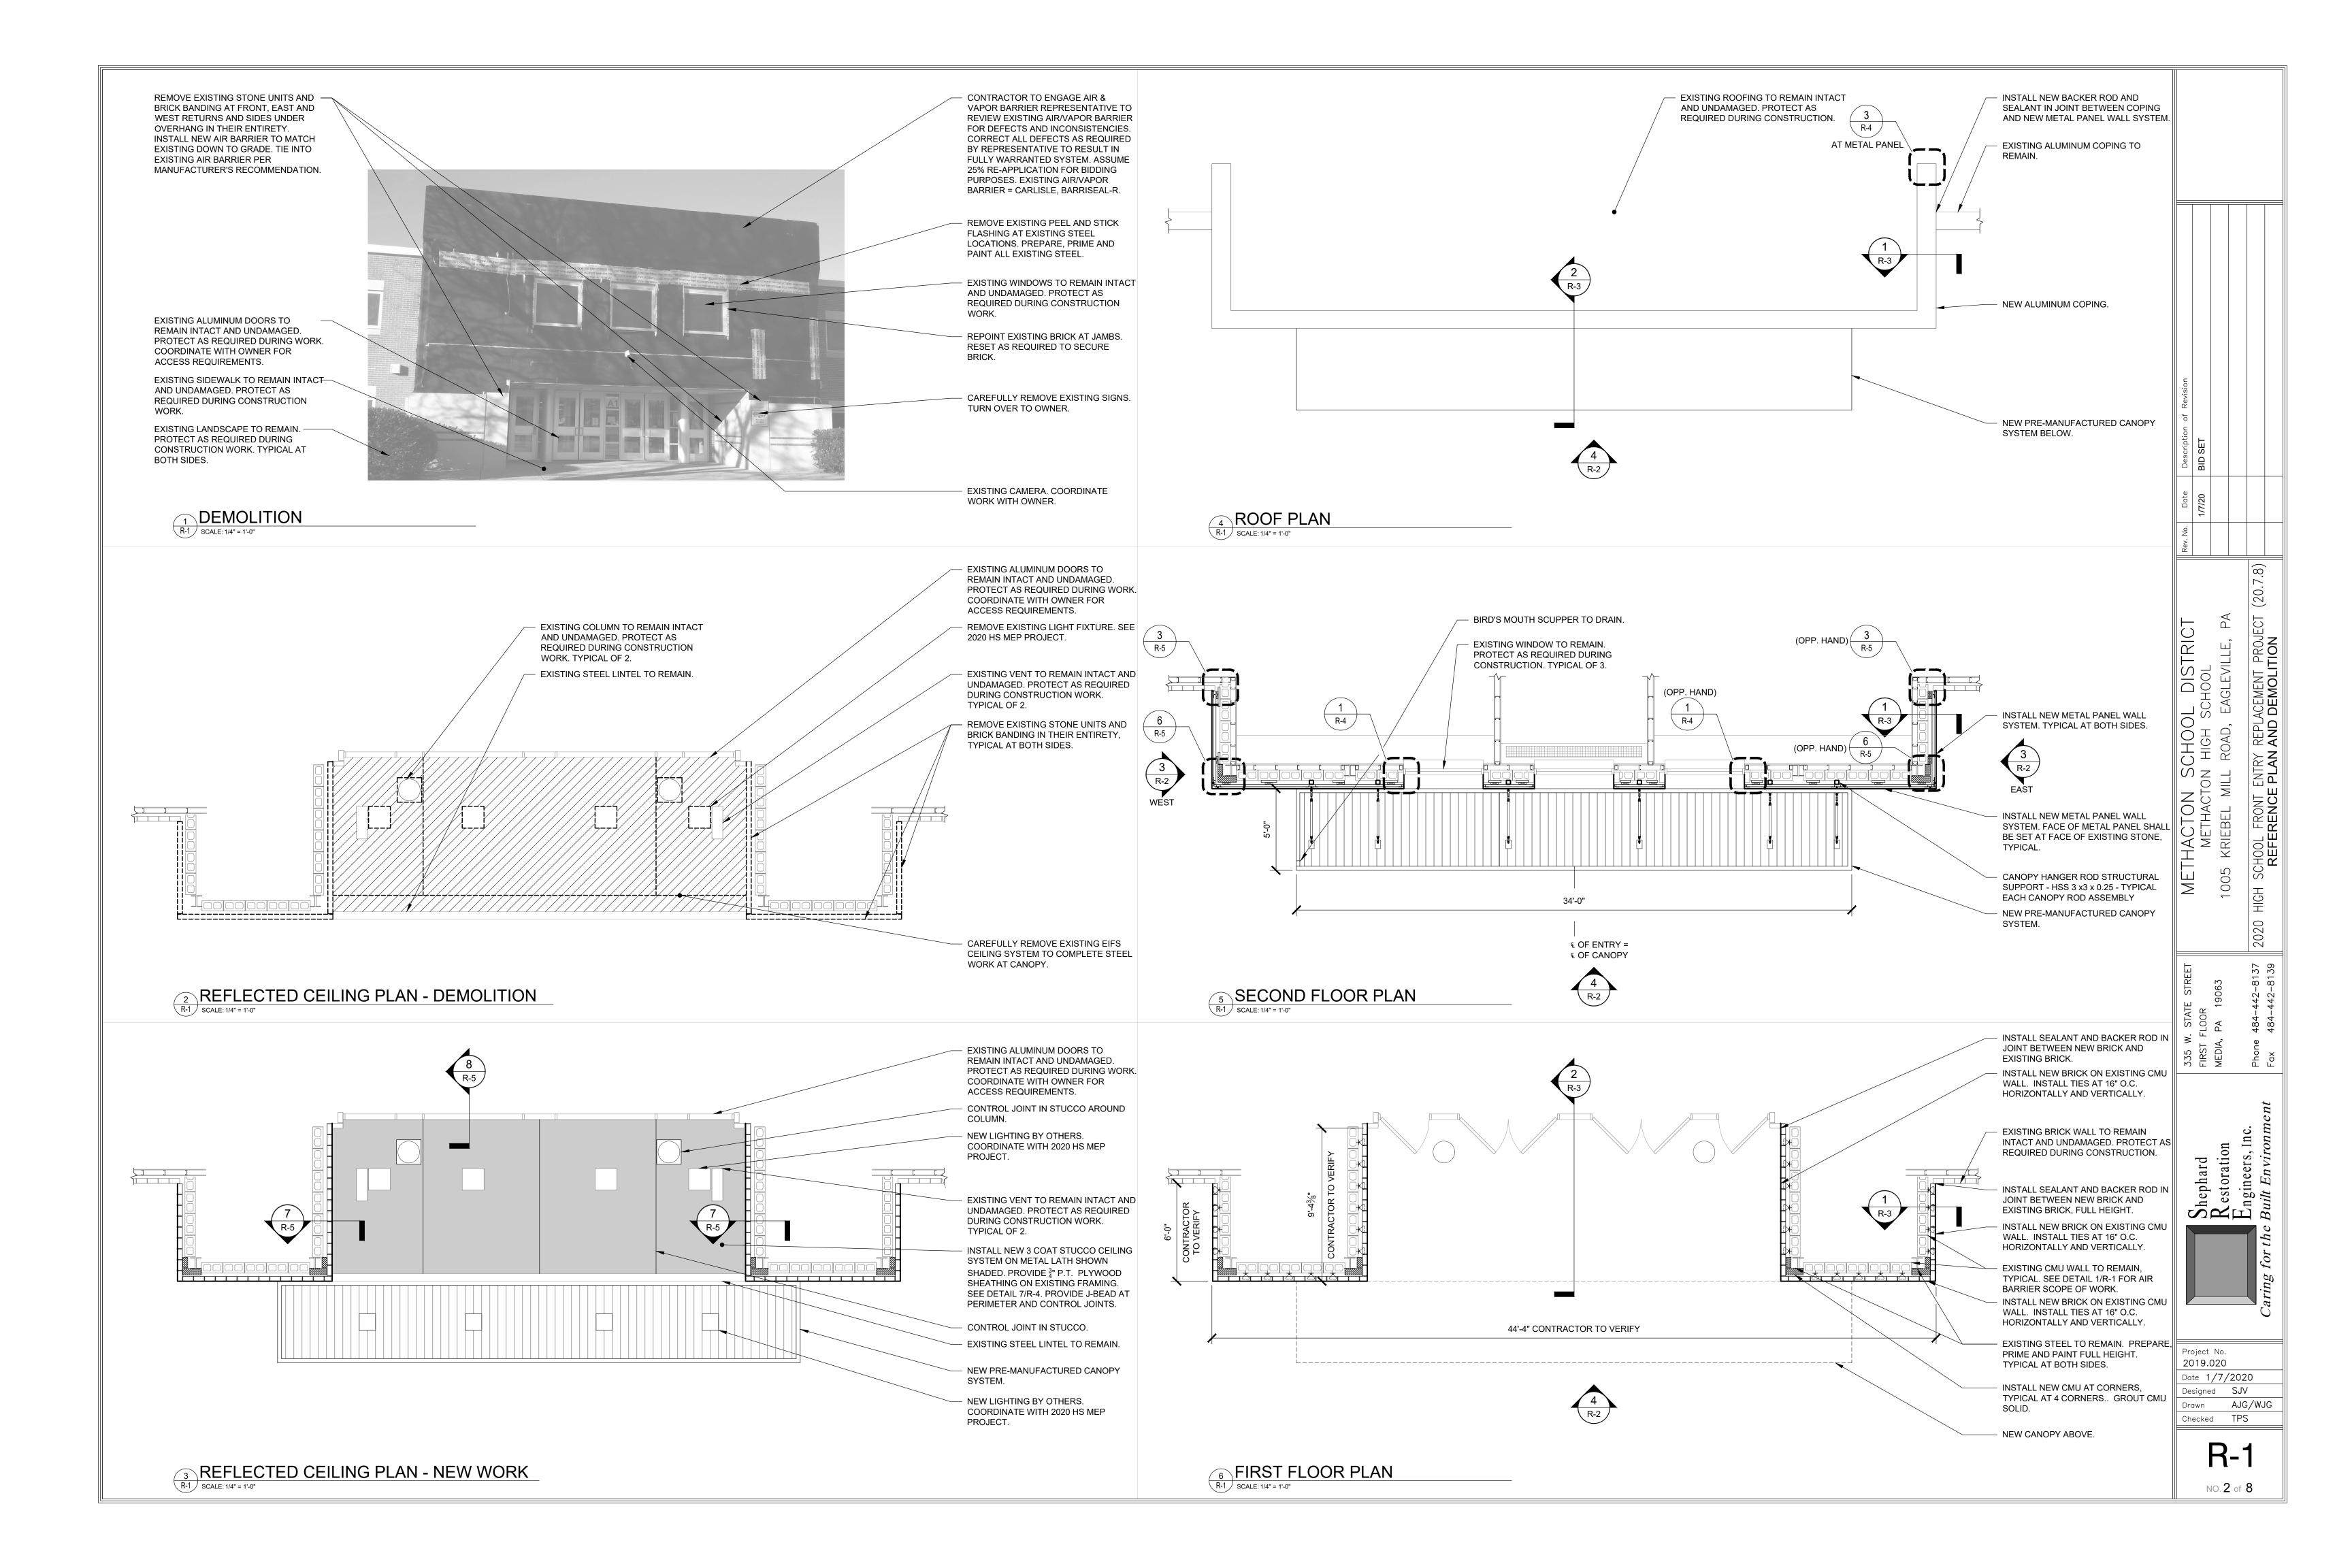

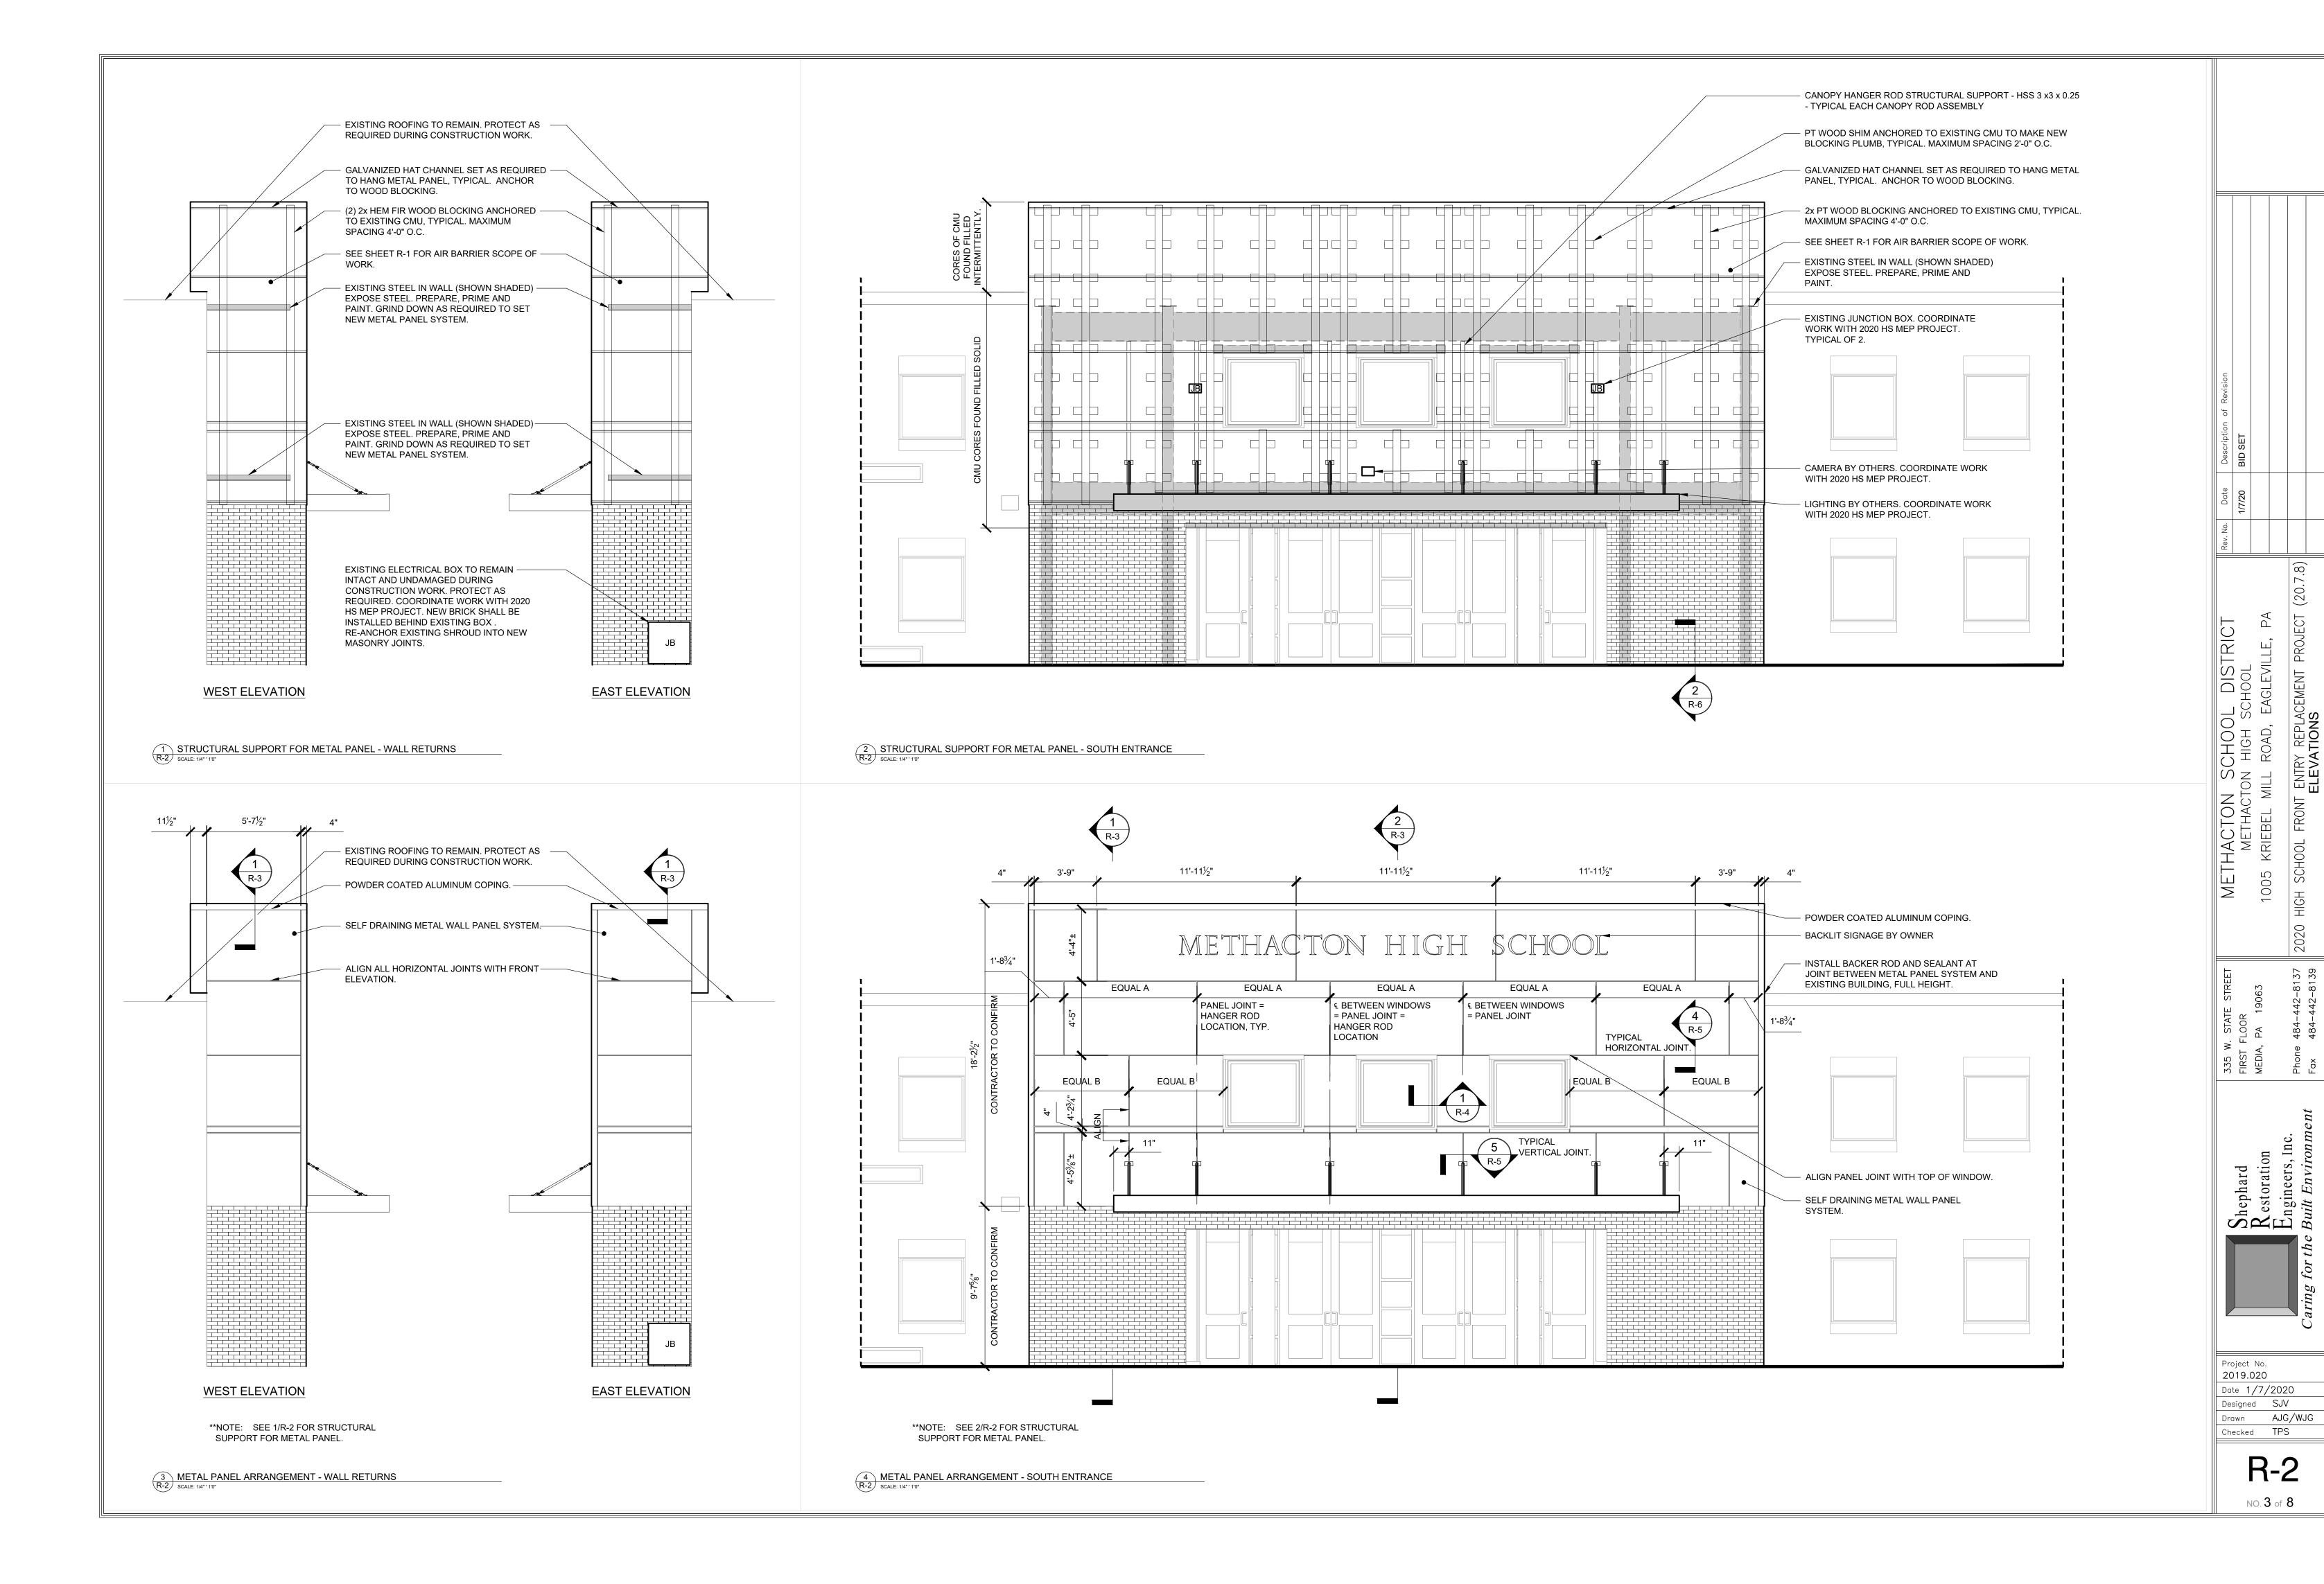

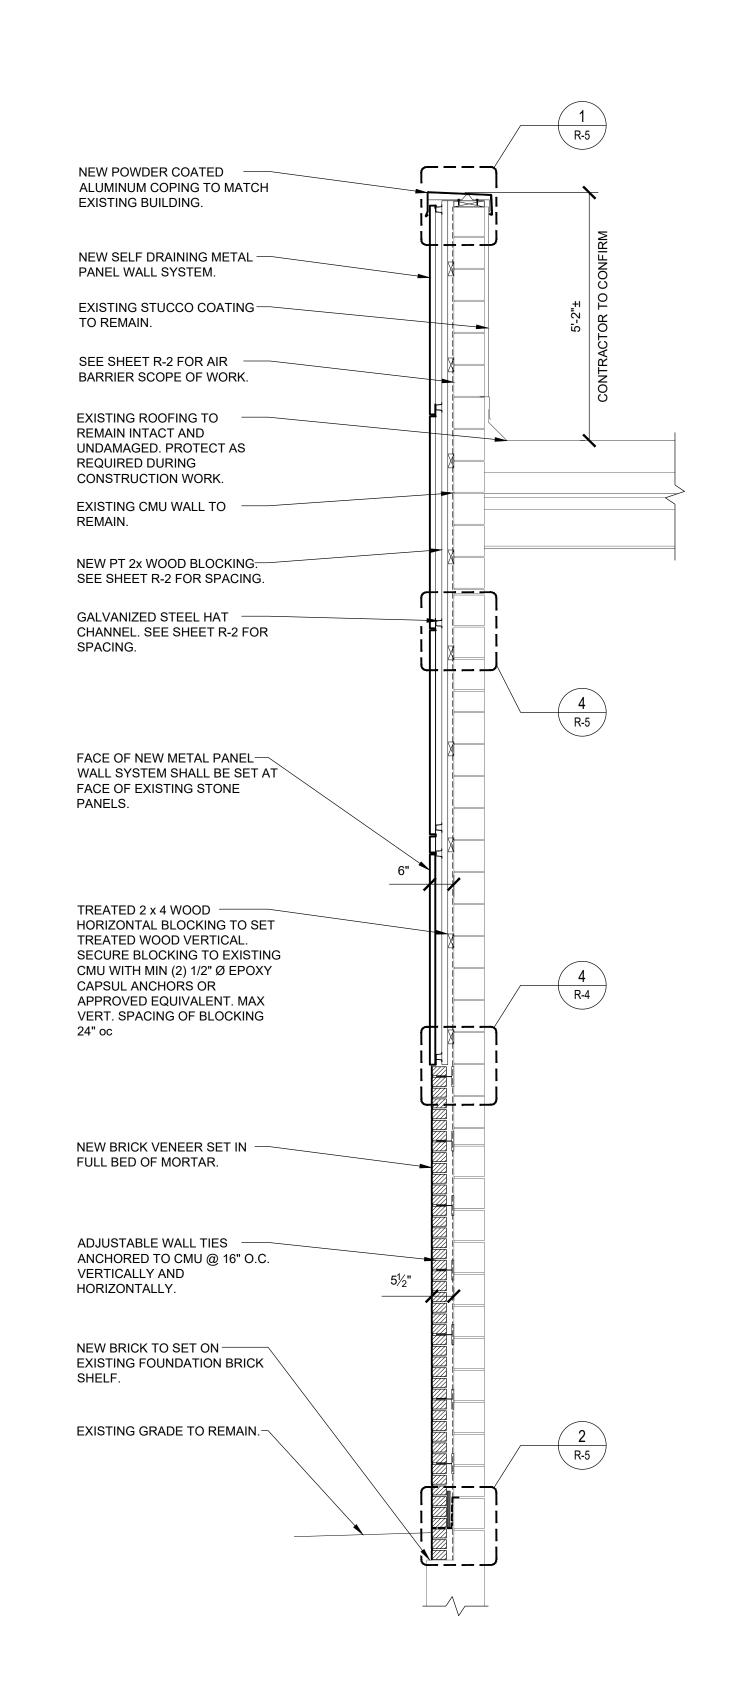

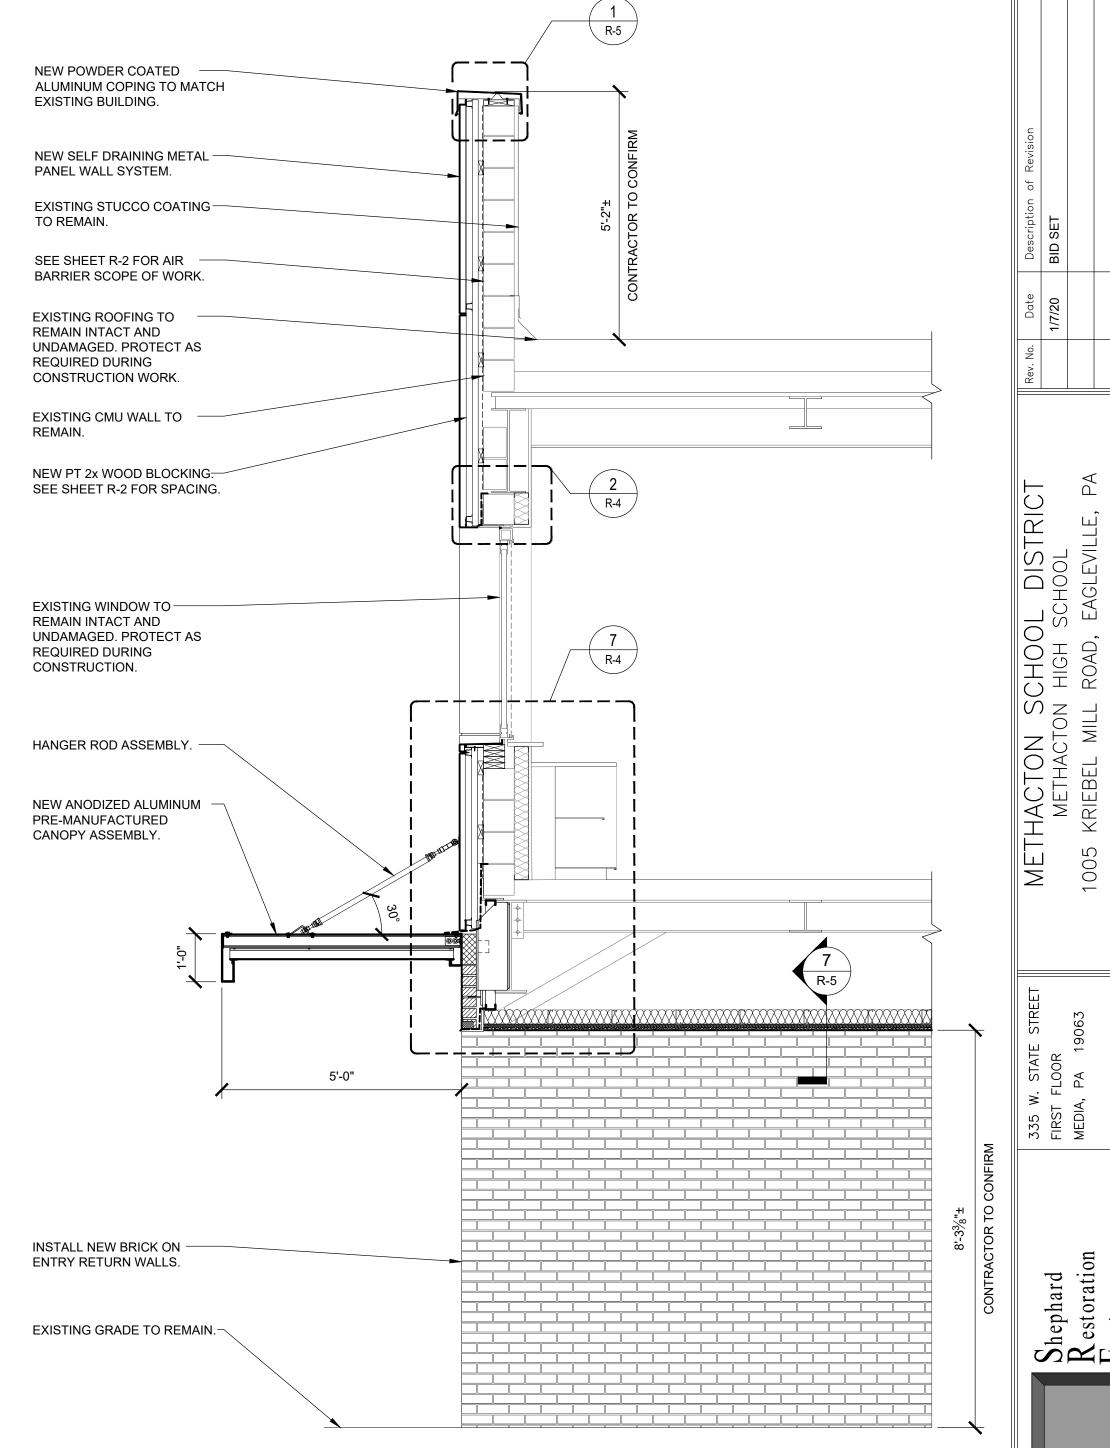

2 WALL SECTION
R-3 SCALE: 1/2" = 1'-0"

Shephard Restoratio Engineers,

Project No. 2019.020 Date 1/7/2020 Designed SJV Drawn AJG/WJG Checked TPS

NO.4 of 8

NALL SECTION
SCALE: 1/2" = 1'-0"

