

Learning Bridge Charter School 1400 East 13th Street - Ely, Nevada - APN 02-271-11

Owner Learning Bridge B of D 1400 East 13th Street Ely, Nevada 89301 775-289-3500 contact: mjury@elylearningbridge.org

Architect R6 Studio 421 Railroad Street ste 208 Elko, Nevada 89801 775-738-7829 contact: Catherine Wines catherine@r6studio.com

General Contractor

MP&E Engineer 2920 South Jones Blvd #100 Las Vegas, Nevada 89146 702-221-5160 contact: Dyan Martinez dyanm@dgkock.com

Mech Contractor

Elec Contractor T.B.D.

Sheet Index

General

Cover Sheet, Vicinity Map, Sheet Index General Notes & Project Scope of Work

Code Analysis, Accessibility Notes & Exit Plan

Architectural

Architectural Site Plan

a2.1 Overall Building Floor & Demolition Plan

a2.2 Enlarged Floor Plan Interior Elevations

Reflected Ceiling Plan

Wall Section

Schedules

Specifications

Mechanical

m0.1 Legend, Index, Calcs

m2.1 Demolition Floor Plan HVAC

m2.2 Enlarged Floor Plan HVAC

Electrical


e0.1 Legend, Index, Abbreviations

e0.2 Specifications Single Lines, Schedules

e0.4 Details e2.1 Demolition Floor Lighting Plan

e2.2 Enlarged Floor Lighting Plan e3.1 Demolition Floor Power Plan

e3.2 Enlarged Floor Power Plan

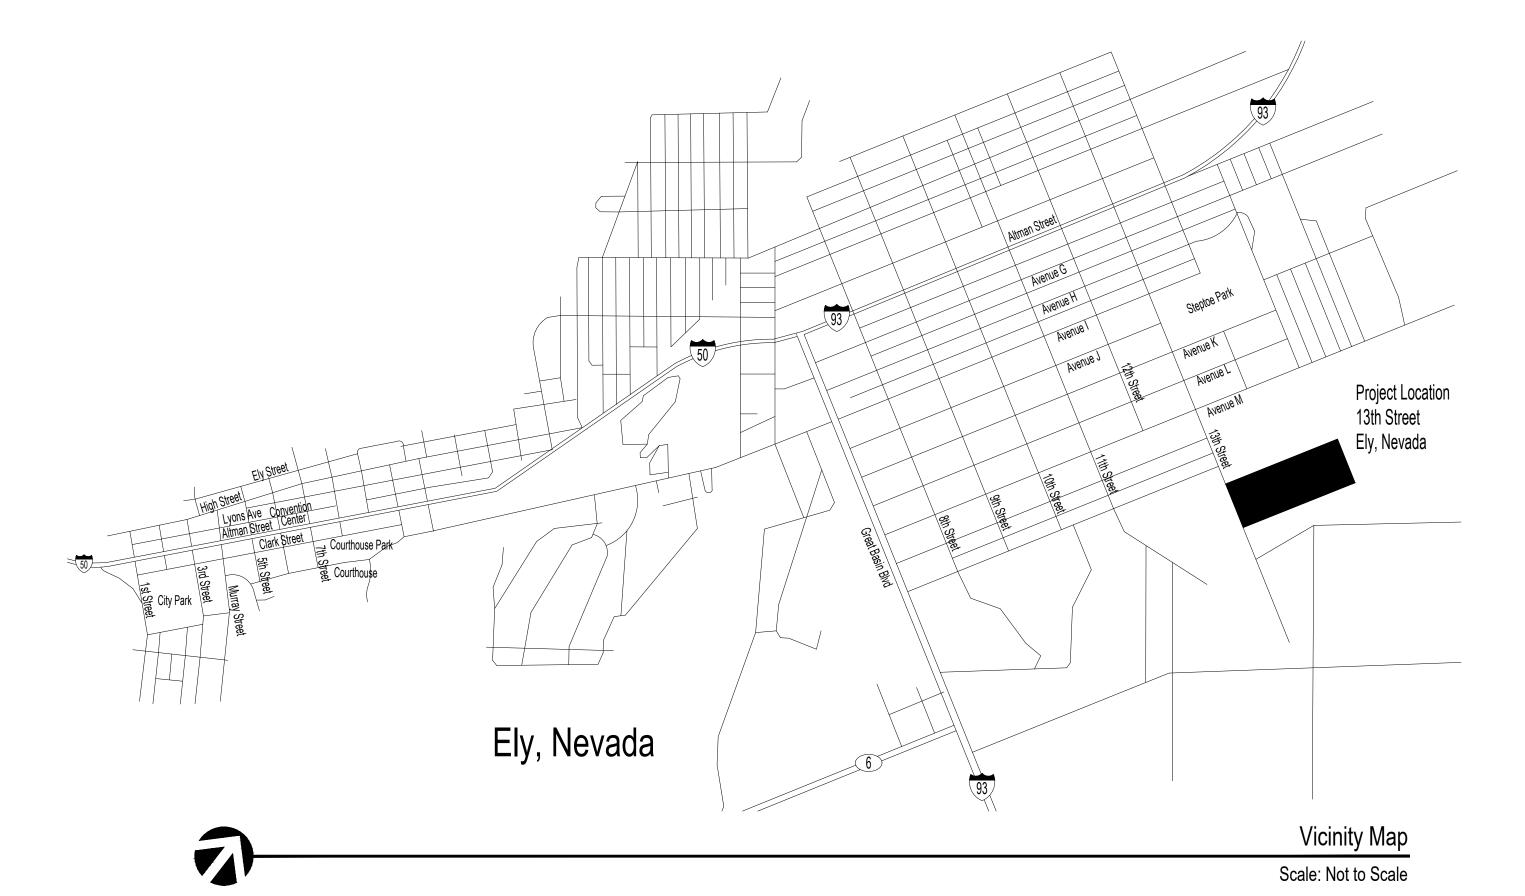

421 RAILROAD STREET STE 208 ELKO, NEVADA 89801 p775.738.7829 f775.738.7817 www.R6STUDIO.com



PROJECT NAME

SHEET NAME

Vicinity Map Sheet index Cover Sheet

REVISIONS

DATE

1.7.2025

SHEET NUMBER

a0.1

Drawing Abbreviations

Not to scale	n.t.s.
Not in contract	n.i.c.
Unless noted otherwise	u.n.o.
Above finish floor	a.f.f.
Pounds per square foot	p.s.f.
Pounds per square inch	p.s.i.
Square Feet	s.f.
Gypsum wall board	gyp. bd.
Diameter	dia.
Typical to all locations	typ.

Applicable Codes

- 2012 International Building Code
- 2012 Uniform Mechanical Code
- 2012 Uniform Plumbing Code
- 2012 International Fire Code
- National Electrical Code 2012 International Fuel Gas Code
- 2012 International Energy Conservation Code

Deferred Submittals

To be submitted separately to the governing official

- All exterior signage
- Automatic fire sprinkler system renovation

Drawing Symbols

- North Arrow
- Window Symbol
- Room Occupants
- Room Name & Number
- Detail
- Elevation (single sided sim.)
- Room signage
- Fire Extinguisher

Project Scope of Work

- 1- This drawing package represents a remodel of the entrance and office area at a pre-manufactured metal building that is currently occupied by a K-8 Charter School with an 'E' occupancy.
- 2- Verify existing conditions correspond with what is represented in this drawing set, at the Learning Bridge site on 13th Street in Ely, Nevada.
- 3- It is the contractors responsibility to keep the building secure during the duration of the
- 4- The entire building is to be compliant with the Americans with Disabilities Act of 1990 and the ADA Amendments act of 2010 requirements and laws.
- 5- Learning Bridge Chart School has verified no hazardous materials exist at the building site. or hazardous materials are at a low enough level that is acceptable for all construction to be performed without specific remediation of these materials. A testing report is available upon request.

General Notes

1- Drawings represent the desired result of construction. The methods of construction and the risks involved during the construction are the responsibility of the contractor. The contractor shall maintain the buildings structural integrity at all stages of construction.

2- Contractor responsible for all demolition required to perform work.

3- All construction shall comply with requirements of the 2018 International Building Code along with other listed codes and all city, county, state and federal agencies having jurisdiction with a modified order of understanding with the Building Department of the City of Ely.

4- The contractor shall verify all dimensions and elevations prior to the commencement of work. Discrepancies in the dimensions which may be found shall be brought to the attention of the the architect for a decision before proceeding with work. Do not scale drawings.

5- All construction and finish materials proposed by the contractor and or dictated by construction documents shall be reviewed for general compliance by the Architect through a formal submittal process prior to commencing work and shall be approved by the Architect prior to commencing work.

6- As a minimum standard all work performed and materials installed shall be in accordance with all applicable codes, regulations and ordinances having jurisdiction.

7- Install all manufacturers items, materials and equipment in strict accordance with manufacturers recommendations unless otherwise specifically noted by the Architect.

8- Dimensions on plans are to the face of the studs or structural columns unless noted otherwise. Dimensions on large scale drawings govern over dimensions on small drawings or details.

9- Contractor to follow provided dimensions on drawings, if a necessary dimension is missing the contractor shall notify the architect for clarification before proceeding. Do not scale drawings.

10- Size, placement and orientation of structural framing members on structural drawings override members shown on architectural drawings.

11- Sprinkler, Plumbing, Mechanical, Electrical, or any other contractors shall not penetrate or cut any structural members without prior written apporval of the Architect and the Structural Engineer.

12- The General Contractor shall maintain a complete current set of drawings at the construction site during all phases of construction for use by all trades.

13- The General Contractor shall coordinate with the owner the locations for construction traffic and waste disposal during the construction phase.

14- The General Contractor is responsible for obtaining all permits required to perform all work included in these documents.

15- A seperate permit is required for all exterior sign installation.

16- The General Contractor is responsible for obtaining temporary power and all costs associated with

17- Contractor to provide all owners manuals and warranties prior to final payment. All equipment and finish materials to be new and of the highest available commercial grade quality. All products are to be approved by the Architect prior to installation.

18- 'UL numbers listed in these documents are based on the most current issue of Underwritters Laboratories Inc. Fire Resistance Directory.

19- The General Contractor is responsible for protecting all existing site features and fixtures that are to remain. Any damage to these areas will be repaired or replaced at the expense of the contractor.

20- All work in these drawings and specifications consists of furnishing all labor, equipment and materials necessary for and reasonably incidental to the complete construction of the building. These including but are not limited to minor details not specifically mentioned or shown that are necessary to complete the construction, subject to the terms and conditions of the contract.

21- All work in this project shall be done in accordance with the best modern construction practice using high grade new equipment and materials. Workmanship and all construction practices must be a neat appearance and will be inspected at the same level of scrutiny as the performance of the entire building.

22- All applicable portions of Division 1 GENERAL REQUIREMENTS shall be included and strictly adheared to, any conflict noted in the drawings shall be immediately brought to the attention of the Architect for written

23- The contractor is to provide the Architect with complete construction submittals for all finish materials and shop drawings for all construction areas requiring specialty construction, including structural plans and procedures, with a 7 day turn around time for the Architect and the Architect's consultants.

24- Prior to final acceptance the contractor is to clean the entire premises with a professional, deep cleaning service that will leave the building in a new, clean, move-in ready, and useable state.

25- The contractor is to notify the owner, Architect and Engineer of any conflict in the drawings and shall not proceed until they have received written clarification executed by all parties, including the owner.

26- These drawings are the property of the Architect and to be used solely with respect to this project. These documents shall not be reused or reproduced in any form without the written permission of the



421 RAILROAD STREET STE 208 ELKO, NEVADA 89801 p775.738.7829 f775.738.7817 www.R6STUDIO.com



Documents are instruments of service for use solely with respect to this project. Copyright (c) 2008 by Catherine Wines, Architect Elko, Nevada. Unauthorized use is subject to prosecution. All rights reserved.

PROJECT NAME

earning Bridge Charter.

SHEET NAME

General Notes

REVISIONS

DATE

1.7.2025

SHEET NUMBER

Code Analysis

Governing Design Factors D2 Earthquake Zone 90 m.p.h. Wind Speed Frost Depth 36" Loads Roof dead load 15 p.s.f. Roof live load or snow load 30 p.s.f. 20 p.s.f. Floor dead load 50 p.s.f. Floor live load 60 p.s.f. Ground snow load 1,500 psi Soil bearing

Occupancy Classification

Area		Size	Occupant Load
В	Building (w/o multi-purpose room)	16,542 s.f. gross	
	Occupied Areas	11,258 s.f. net	562 (20 net)
	Multi-Purpose Room	2,448 s.f. (net)	163 (15 net)
	Modular One	1,539 s.f. (net)	30 (50)
	Modular Two	1,539 s.f. (net)	30 (50)
	Total for O.C.	16,985 s.f.	785 total occupants

18,991 s.f.

Soil report may over ride typical bearing pressure

Building Classification

Type of construction	Type V - B
Allowable area	9,500 s.f.
with fire sprinkler system throughout	18,500 s.f.
Actual area (net useable space)	13,737 s.f.
Allowable height (stories)	1
with fire sprinkler system throughout	2
Actual height (stories)	1

Total Building SF

Fire Resistance

Fire sprinklers provided through-out	Yes
Fire alarm system with visual sensors, audio alarm	
and fire monitoring provided	Yes
Fire alarm system with audio warning system	Yes
Fire walls required	No
Install fire extinguishers at all required areas as per IFC 906	
All fire extinguishers are to be placed in lockable cabinets and recess	ed into the wall.

Exits required (.2" per occupant on main level)
Main building - 145"

	Modular 1 - 33"	(1) w/36" door
	Modular 2 - 33"	(1) w/36" door
	exits must also be provided so an occupant is not m distance of the building from an accessible exit	nore than $\frac{1}{2}$ the diagonal
Exits pro	vided	
	Main building	(9) w/36" door
	Modular 1	(2) w/36" door

(4) w/36" door

(2) w/36" door

Modular 1 Modular 2

Exit doors from the Multi-Purpose Room and exterior gates (near modulars) are to have approved egress hardware, exit signs, and egress pathway illumination.

Plumbing

Fixtures required (for entire building)

1 per 50 (women) and 50 (men) based on total occupancy 7 women's and 7 men's required,

single ocupancy unisex can substitute any gender specific fixture

Fixtures provided 6 women (2 accessible)

6 men (2 accessible)

8 unisex, single occupancy fixtures


Drinking fountain 1 per 100 - 7 required


2 accommodate handi-cap


Faculty Lounge to have chilled, water cooler to satisfy one fixture requirement

Mop sink 1 required -2 provided in janitor's closet

Landscaping Not applicable

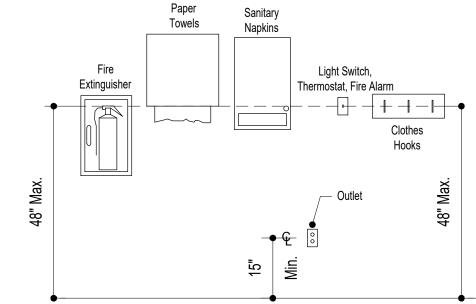

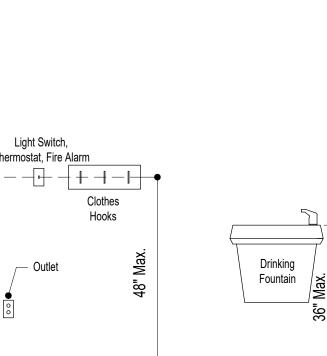

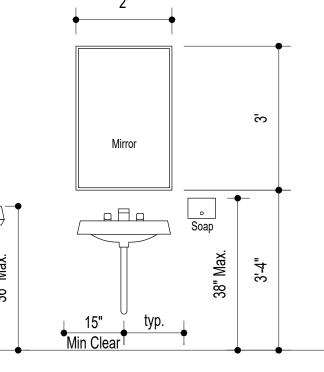


17" Min. Depth 8" Min. Knee Clearance

6" Max.

Toe Clearance

39"-41" 42" Min. - Protruding 24" min. 42" max.

421 RAILROAD STREET STE 208 ELKO, NEVADA 89801 p775.738.7829 f775.738.7817 www.R6STUDIO.com

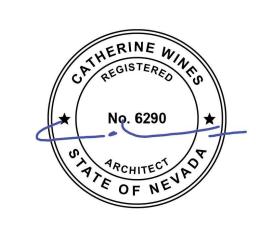

Documents are instruments of service for use solely with respect to this project. Copyright (c) 2008 by Catherine Wines, Architect Elko, Nevada. Unauthorized use is subject to prosecution. All rights reserved.

PROJECT NAME



earning Bridge Charter Entrance Rer 13th Street E Ely, Nevada

SHEET NAME

Accessibility Notes Code Analysis Exit Plan

REVISIONS

DATE

1.7.2025

SHEET NUMBER

Exit Plan Notes

Number of occupants to exit at this location 1- The greatest diagonal distance in the building is 230', there is no location in the building that is greater than 115' from an exit.

Exit Plan Legend

5- Walks, sidewalks and pedestrian ways shall be free of gratings whenever possible. For gratings located in the surface of any of these areas, grid openings in gratings shall be limited to $\frac{1}{2}$ inch in the 6- Abrupt changes in level along any accessible route shall not exceed $\frac{1}{2}$ inch. When changes in level do occur, they shall be beveled with a slope no greater than 1:2 except that level changes not exceeding $\frac{1}{2}$

inch may be vertical. 7- Floors at landings shall not be more than $\frac{1}{2}$ " lower than the threshold of the doorway. When changes in levels greater than $\frac{1}{2}$ " are necessary, they shall comply with the requirements for curb ramps.

8- All accessible entrances shall be identified with at least one standard sign and with additional directional signs, as required, visible from approaching pedestrian ways.

1- All construction shall comply with the accessibility requirements of the federal Americans with

2- Walks and sidewalks subject to these regulations shall have a continuous common surface, not

interrupted by steps or by abrupt changes in level exceeding $\frac{1}{2}$ inch and shall be a minimum of 48 inches

3- Surfaces with a slope of less than 6 percent gradient shall be at least as slip resistant as that described

Accessibility Notes

as medium salted finish.

Disabilities Act of 1990 and the ADA Amendments act of 2010.

Surface cross slopes shall not exceed ½ inch per foot.

4- Surfaces with a slope of 6 percent gradient or greater shall be slip-resistant.

9- Every required entrance or passage doorway shall be of a size as to permit the installation of a door not less than 3 feet in width and not less than 6 feet, 8 inches in height. Doors shall be capable of opening at least 90 degrees and shall be so mounted that the clear width of the doorway is not less than 32 inches.

10- Latching and locking doors that are hand activated and which are in a path of travel shall be operable with a single effort by lever type hardware, panic bars, push-pull activating bars, or other hardware designed to provide passage without requiring the ability to grasp the opening hardware.

11- Hand activated door opening hardware shall be centered between 30 inches and 44 inches above the

12- Door hardware shall be openable from the inside without use of a key or special knowledge or effort.

13- Bathroom accessories, such as grab bars, towel bars, soap dishes, etc., on or within walls shall be sealed against moisture.

14- Above floor flush valves shall be mounted on the wide side of toilet area and within 40 inches of the floor. The force required to activate the controls shall not exceed 5 pounds.

15- Hot water and drain pipes under accessible lavatories shall be insulated or otherwise covered. There shall be no sharp or abrasive surfaces under lavatories. Faucet controls shall be operable with one hand and shall not require tight grasping, pinching, or twisting of the wrist. The force required to activate the controls shall not exceed 5 pounds. Lever-operated, push-type and electronically controlled mechanisms are acceptable.

16- All exit doors are to swing in the direction of travel.

Multi-Purpose Room Maximum Occupancy Must be posted prominently Using 15 net occupant load factor for un-concentrated with unfixed table and chair use Learning Center Learning Center egress travel distance 58'-2" egress travel distance 46'-10" Classroom egress travel distance 69'-1" egress travel distance 69'-1" egress travel < distance 167'-2" distance 167'-2" Vocational Classroom Vocational Classroom Modular classroom buildings to be Modular classroom buildings to be submitted under a seperate deferred submittal submitted under a seperate deferred submittal

2- There are 5 exit paths of travel out of the main building not including a

seperate exit for the mechanical room.

3- All exits are ADA compliant.

Typical Required Mounting Heights

Scale: NTS

Exit & Area Plan

Scale: NTS

421 RAILROAD STREET STE 208 ELKO, NEVADA 89801 p775.738.7829 f775.738.7817 www.R6STUDIO.com



Documents are instruments of service for use solely with respect to this project. Copyright (c) 2008 by Catherine Wines, Architect Elko, Nevada. Unauthorized use is subject to prosecution. All rights reserved.

PROJECT NAME

Learning Bridge Charter School Entrance Remodel 13th Street East Ely, Nevada

SHEET NAME

Architectural Site Plan

REVISIONS

DATE


1.7.2025

SHEET NUMBER

a1.1


File number 24-010 - Learning Bridge, Ely City

Note: For reference only, entire exterior improvemnts are existing, to remain

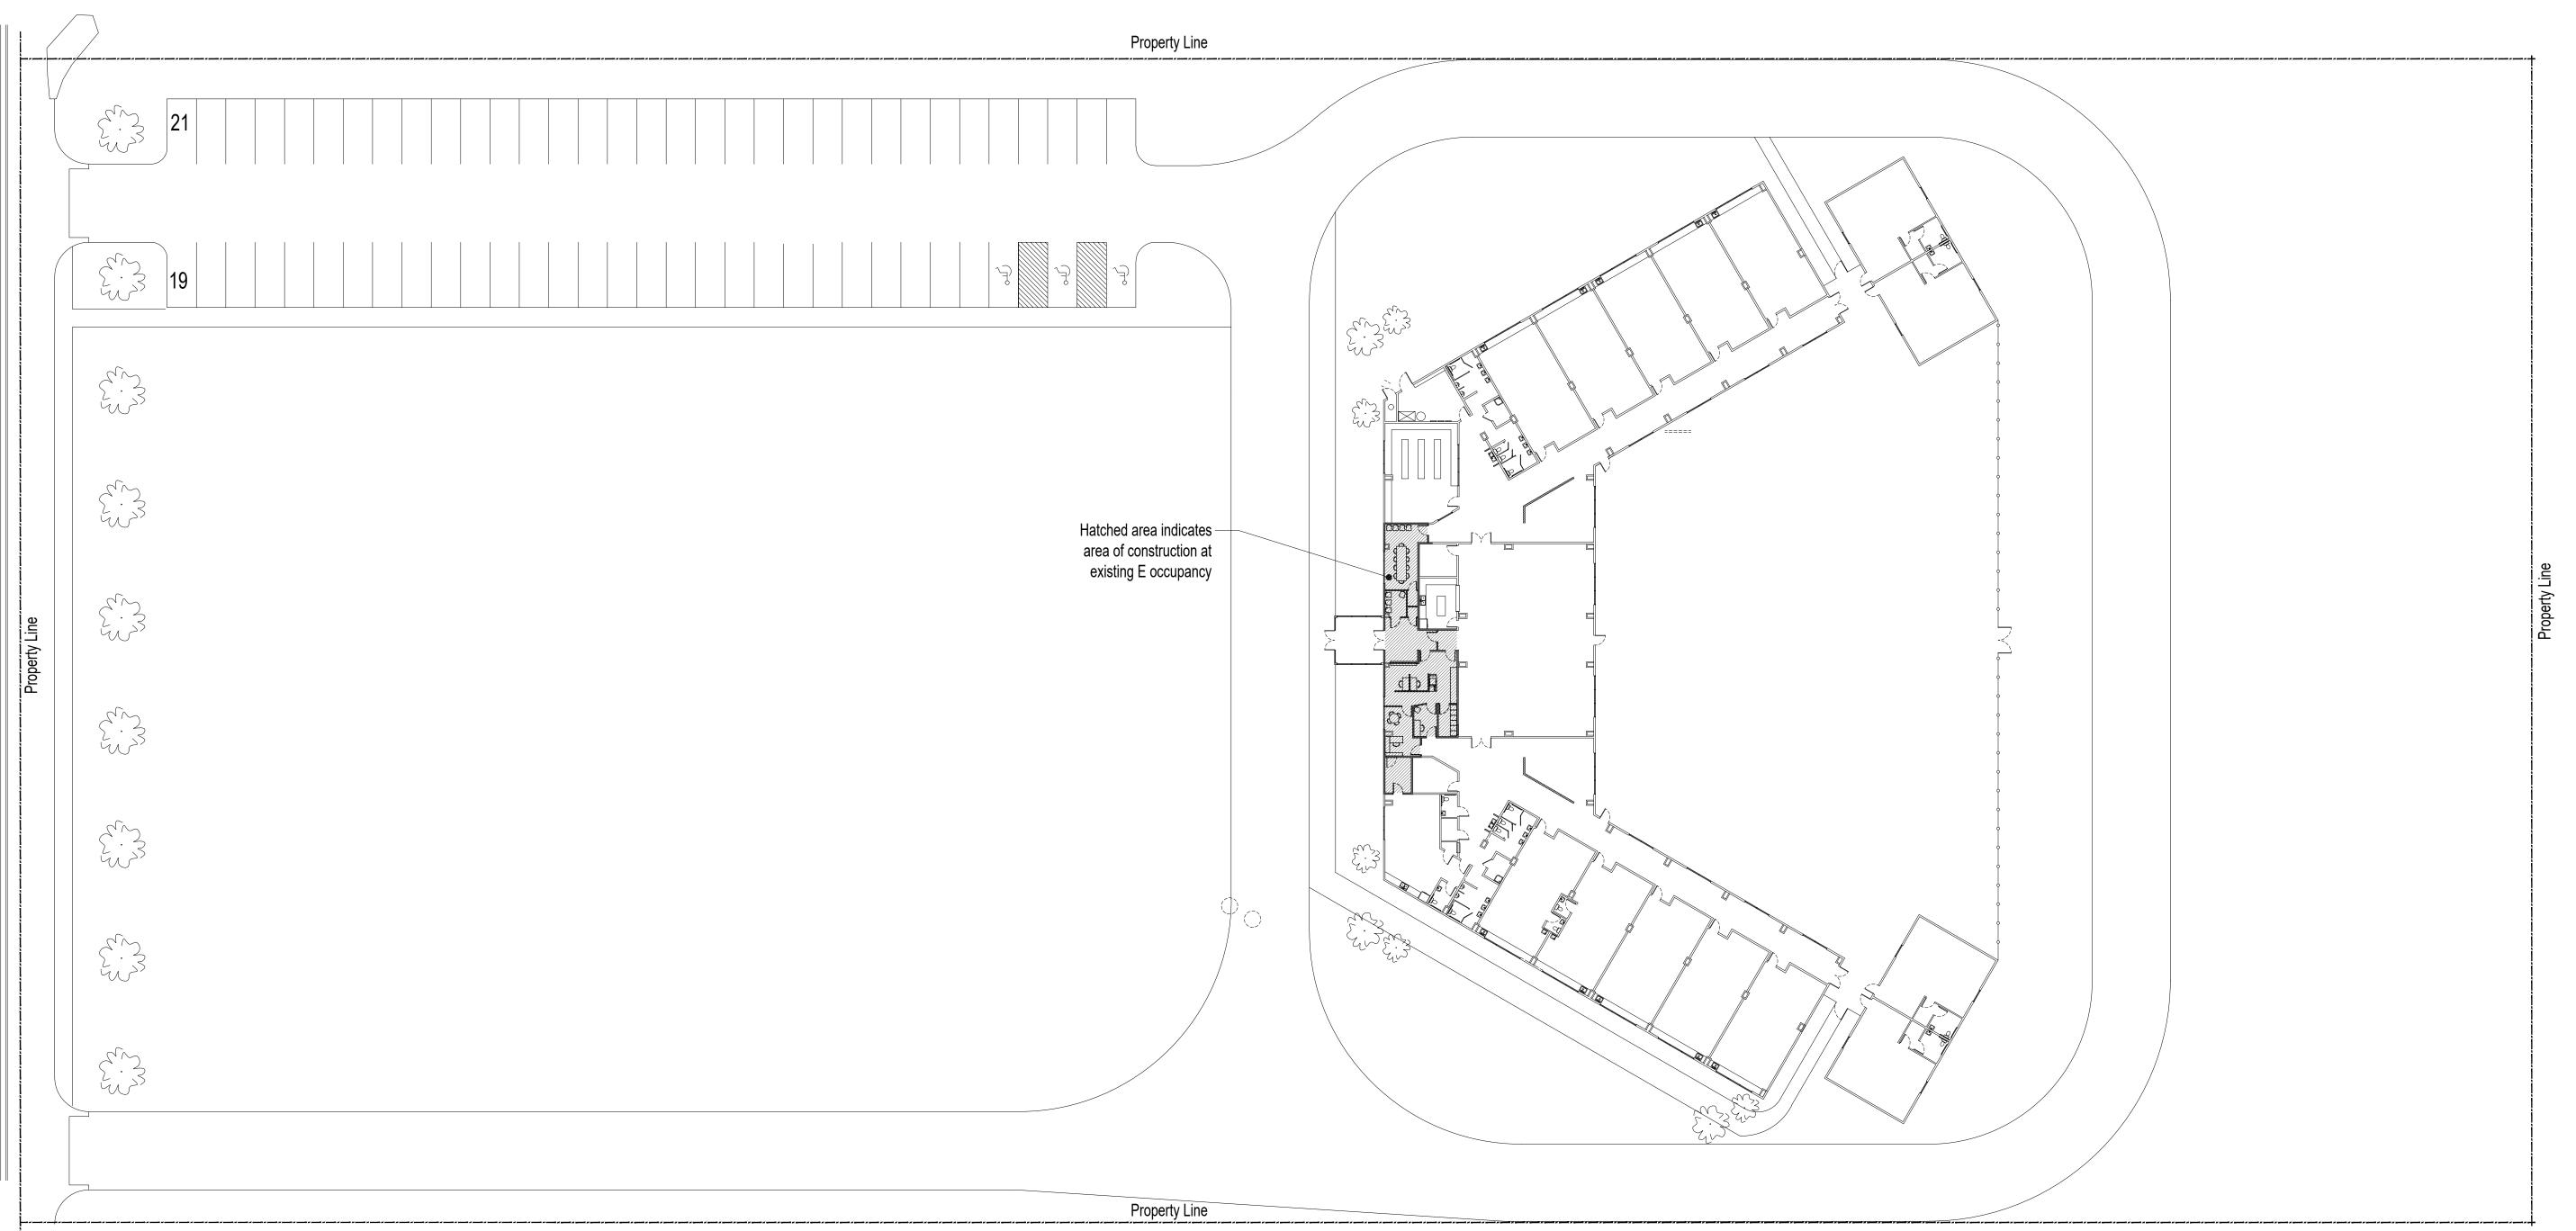

13th Street

Architectural Site Plan Scale: NTS Do Not Scale Drawings

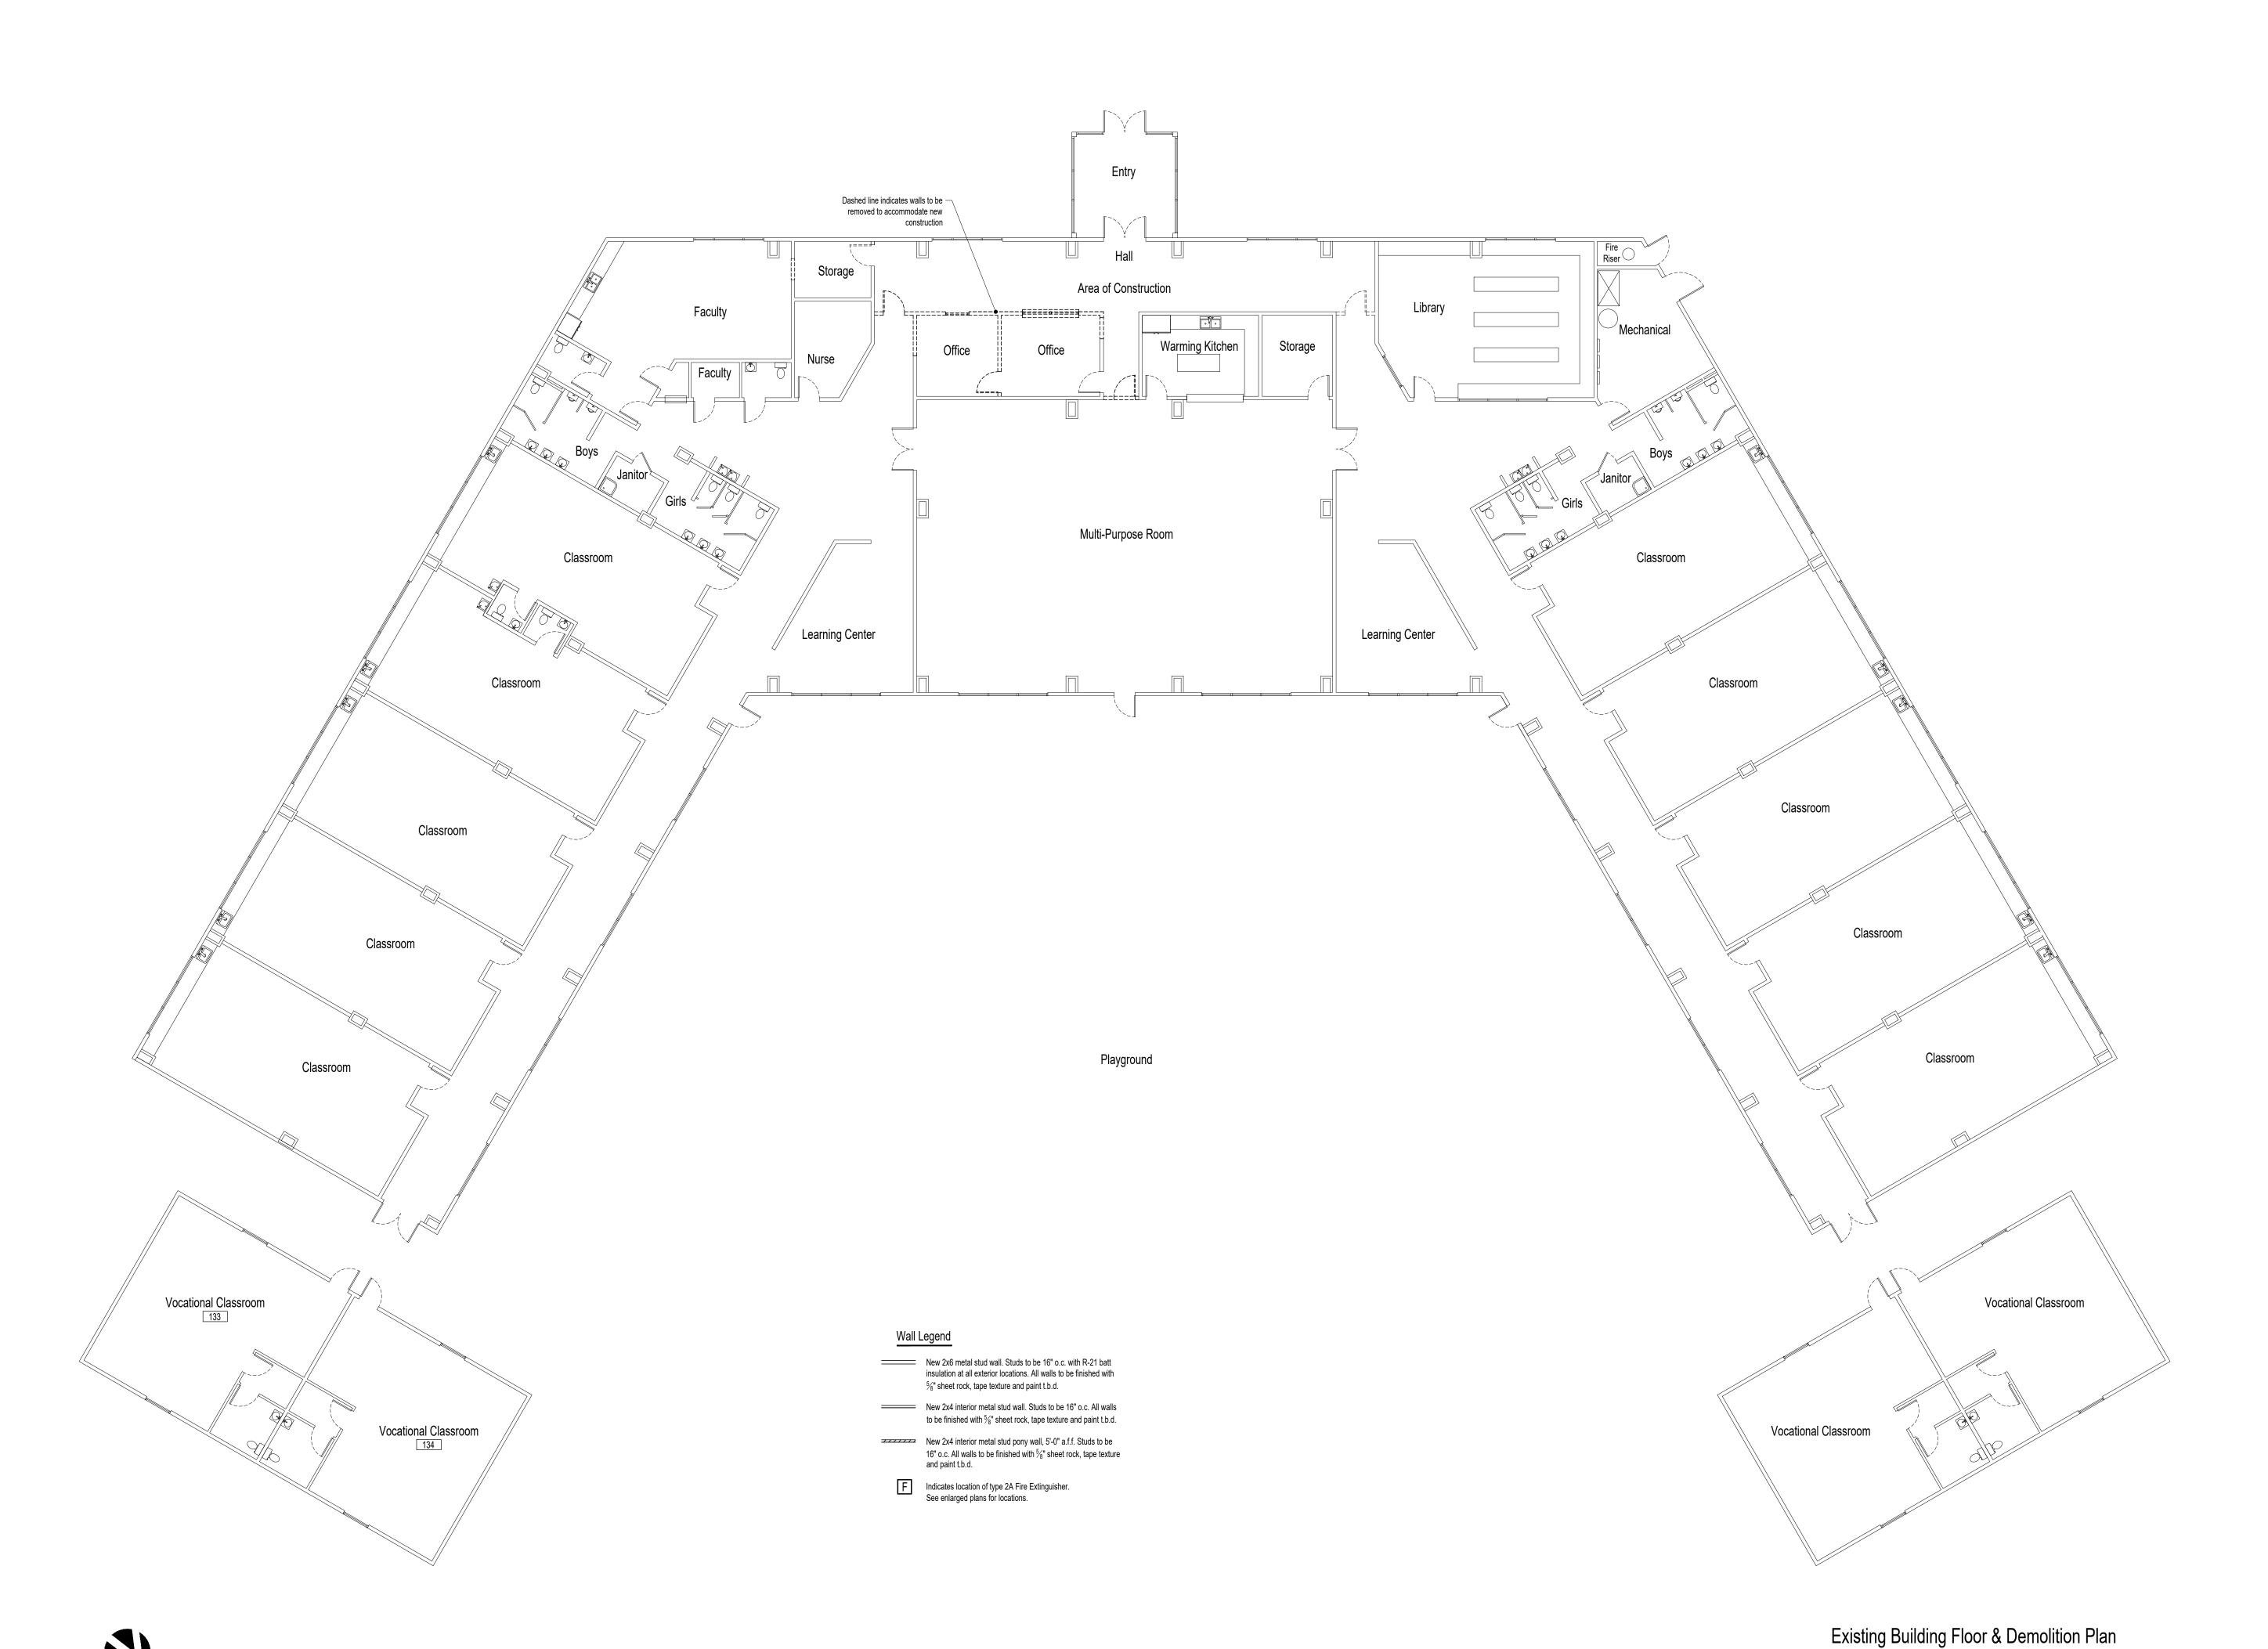



421 RAILROAD STREET STE 208 ELKO, NEVADA 89801 p775.738.7829 f775.738.7817 www.R6STUDIO.com



Documents are instruments of service for use solely with respect to this project. Copyright (c) 2008 by Catherine Wines, Architect Elko, Nevada. Unauthorized use is subject to prosecution. All rights reserved.

PROJECT NAME

Learning Bridge Charter School
Entrance Remodel
13th Street East

SHEET NAME

Overall Floor Plan Demolition Plan

REVISIONS


DATE

Scale: 1/16" = 1'-0" Do Not Scale Drawings

1.7.2025

SHEET NUMBER

a2.1

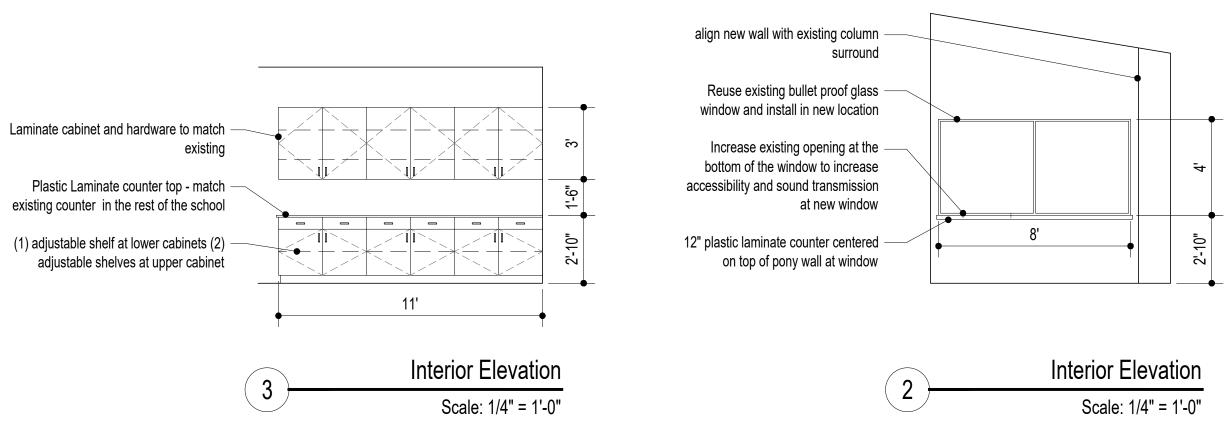

Floor Plan Notes

1- All insulation whether concealed or exposed shall have a flame spread index of not more than 25 and a smoke spread index of not more than 450.

2- All exterior wall insulation to be R-21.

3- All roof insulation to be R-38.

4- All interior finish materials to be Class B or better to comply with the requirements of atriums in IBC 404.8.

5- A class II hose pipe connection to be installed near new fire riser location, coordinate with the Ely Fire Dept.

6- Occupant Load signs to be posted in each assembly space near the exits to comply with IBC 1004.3.

7- All building signage must be highly visible and easily read and comply with all code and ADA requirements. All interior and exterior signage to be a deferred submittal.

8- 2-A portable fire extinguishers for 'ordinary' or 'moderate' Class A fire hazards shall be located within 75 feet of any location in the building or one for every 11,250 s.f. of occupiable floor space. Coordinate with architect locations prior to installation. All fire extinguishers are to be located in a recessed lockable cabinet. All portable fire extinguishers to comply with IBC section 906.

9- All plumbing walls to be 6" with sound attenuation batt insulation. All wet walls to be tiled up to 5'-0" a.f.f.

Wall Legend

===== Existing wall to demolish

Existing wall to remain

New 2x wood stud wall, colled rolled metal studs are acceptable. Studs to be 16" o.c. with R-21 batt insulation at all exterior locations. All walls to be finished with 5/8" sheet rock, tape texture and paint t.b.d.

New 2x4 interior metal stud pony wall, 5'-0" a.f.f. Studs to be 16" o.c. All walls to be finished with $\frac{5}{8}$ " sheet rock, tape texture and paint t.b.d.

New 2x4 interior metal stud pony wall, 4'-0" a.f.f. Studs to be 16" o.c. All walls to be finished with $\frac{5}{8}$ " sheet rock, tape texture and paint t.b.d.

Indicates location of type 2A Fire Extinguisher

RESTUDIO CATHERINE WINES, ARCHITECT

421 RAILROAD STREET STE 208 ELKO, NEVADA 89801 p775.738.7829 f775.738.7817 www.R6STUDIO.com



Documents are instruments of service for use solely with respect to this project. Copyright (c) 2008 by Catherine Wines, Architect Elko, Nevada. Unauthorized use is subject to prosecution. All rights reserved.

PROJECT NAME

odel st

Entrance Remodel 13th Street East

SHEET NAME

earning Bridge Charter School

Enlarged Floor Plans


REVISIONS

DATE

1.7.2025

SHEET NUMBER

a2.2

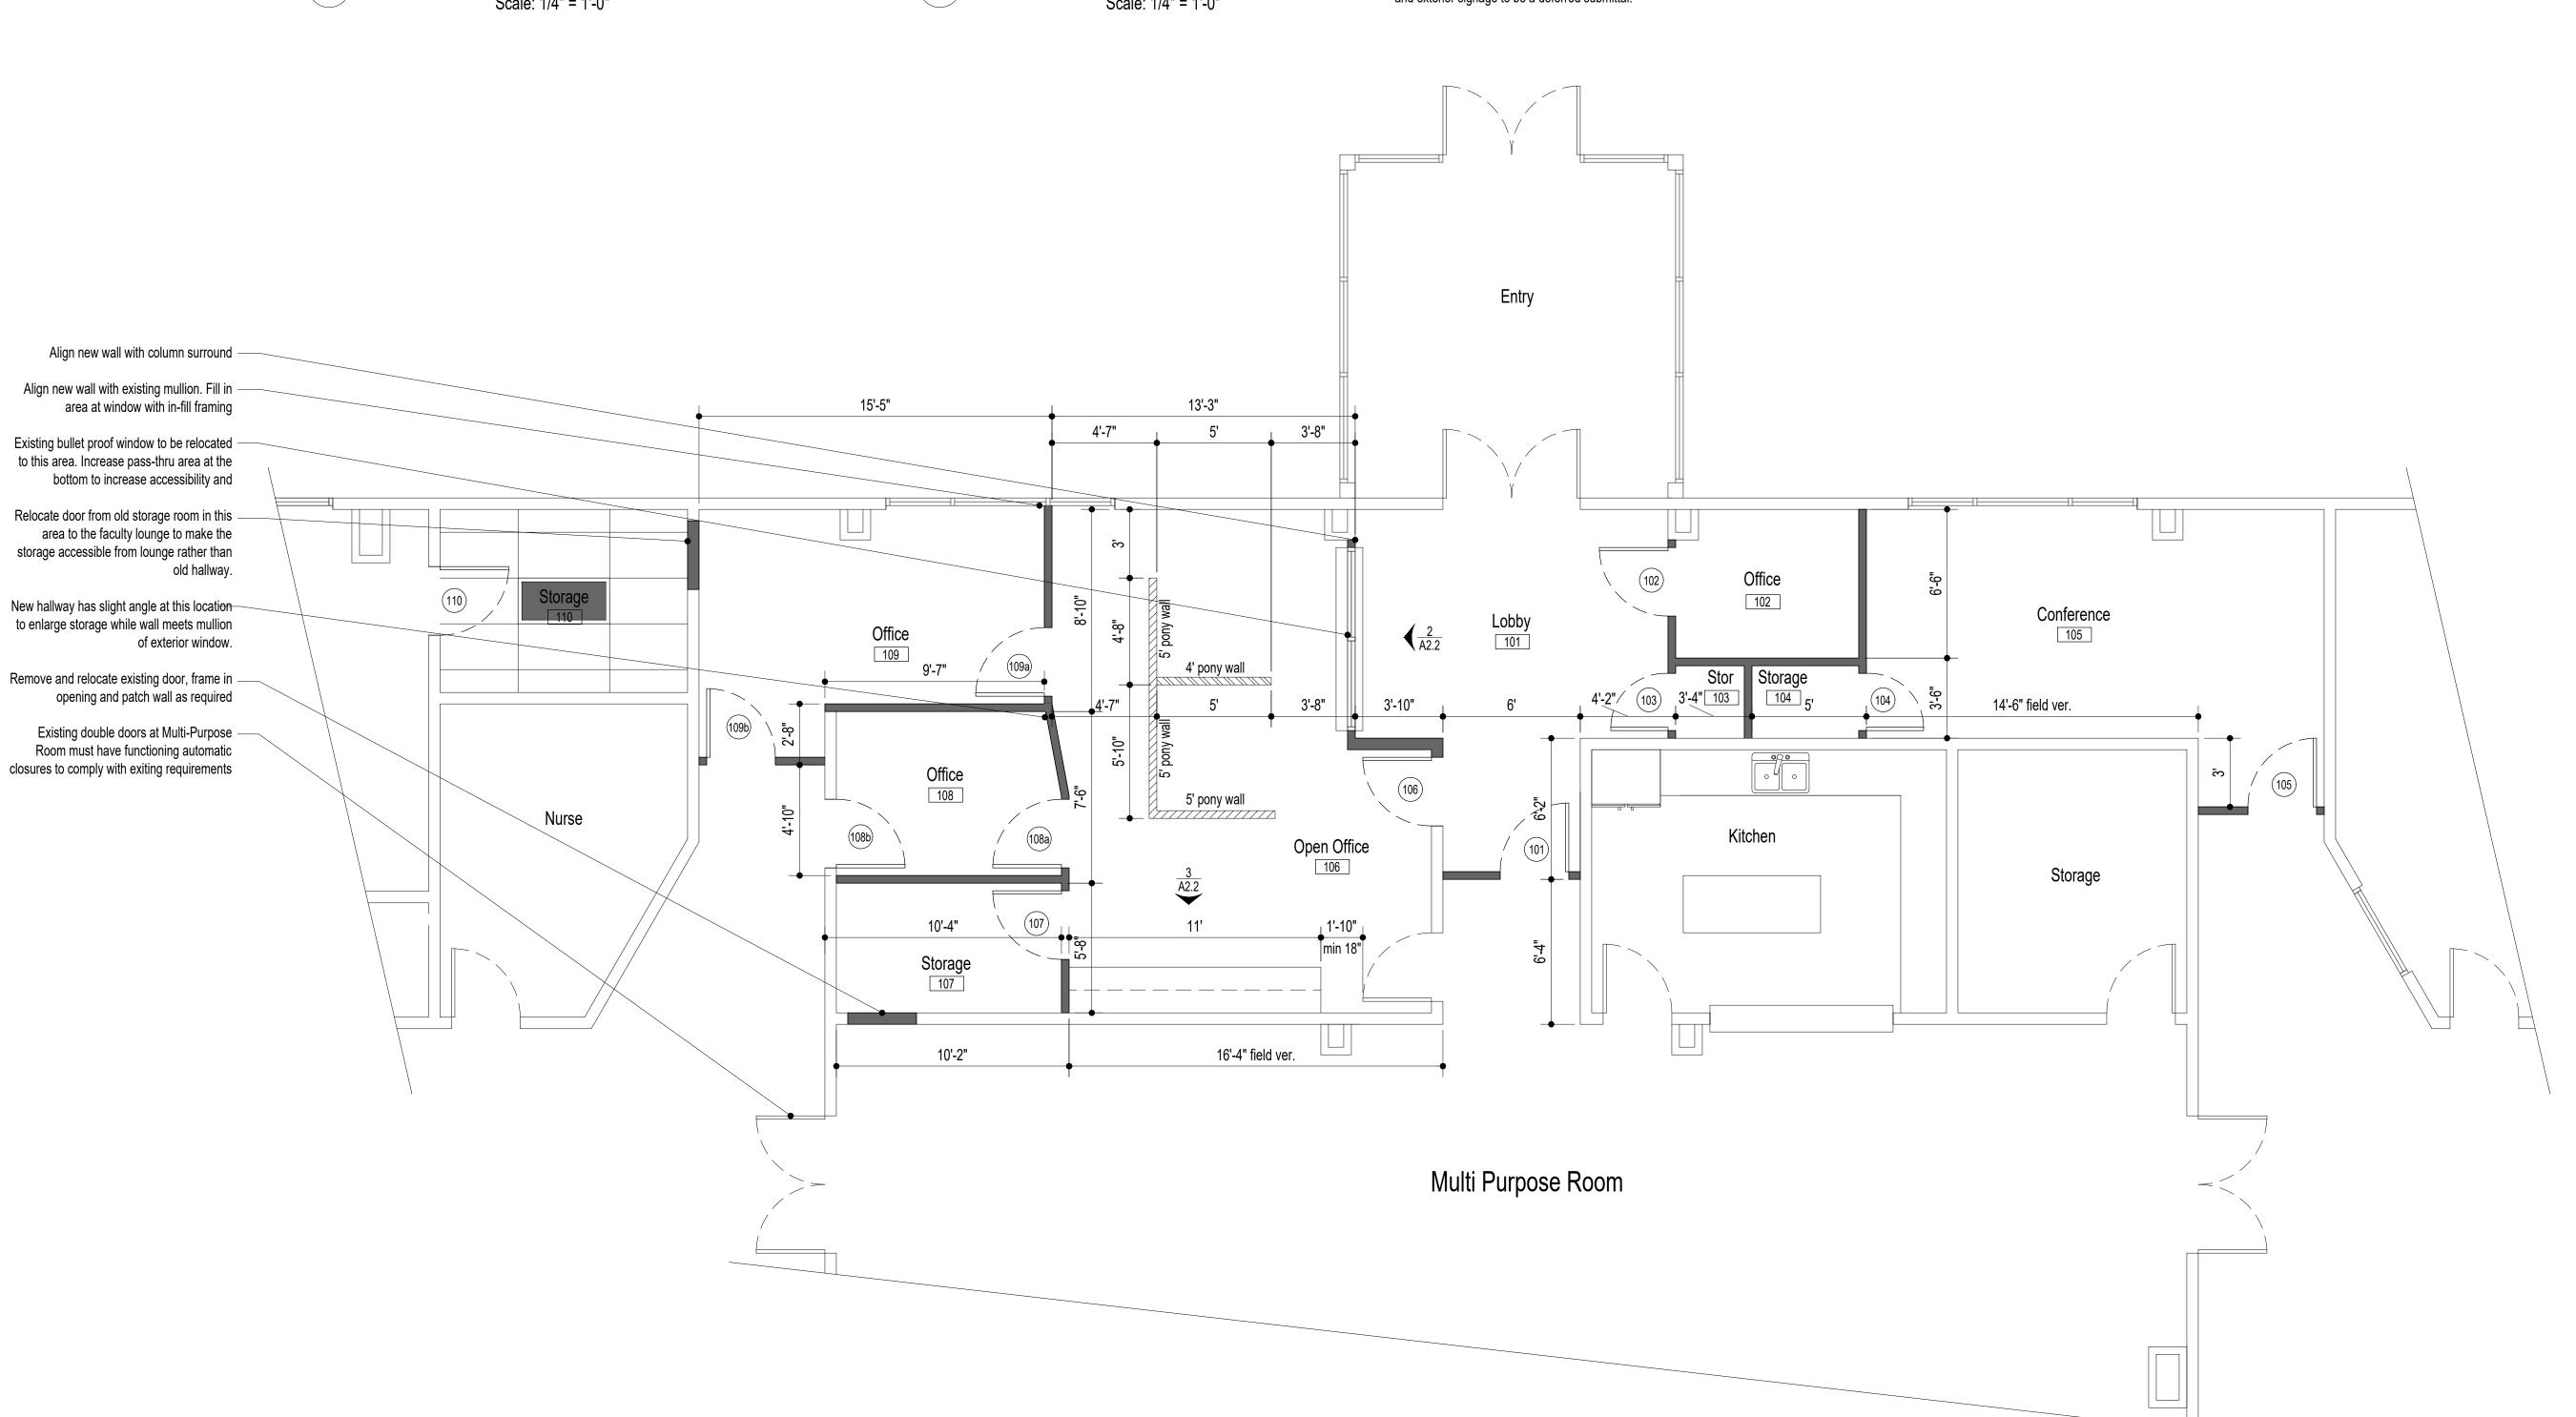

1- New ceiling to be installed to match the existing ceiling as much as possible.

2- Seismic rails at room edges can be reused as much as

3- Acoustic tiles to match existing as much a possible Existing school has left over tiles from the original construction but it will not be acceptable to use all the tiles and leave them with no routine replacement tiles for future use.

4- All interior finish materials to be Class B or better to comply with the requirements of atriums in IBC 404.8.

5- Reuse existing light fixtures as much as possible, to save money, see electrical.

Wall Legend

==== Existing wall to demolish

Existing wall to remain

New 2x wood stud wall, colled rolled metal studs are acceptable. Studs to be 16" o.c. with R-21 batt insulation at all exterior locations. All walls to be finished with 5/8" sheet rock, tape texture and paint t.b.d.

New 2x4 interior metal stud pony wall, 5'-0" a.f.f. Studs to be 16" o.c. All walls to be finished with $\frac{5}{8}$ " sheet rock, tape texture and paint t.b.d.

New 2x4 interior metal stud pony wall, 4'-0" a.f.f. Studs to be 16" o.c. All walls to be finished with $\frac{5}{8}$ " sheet rock, tape texture and paint t.b.d.

Indicates location of type 2A Fire Extinguisher

421 RAILROAD STREET STE 208 ELKO, NEVADA 89801 p775.738.7829 f775.738.7817 www.R6STUDIO.com



Documents are instruments of service for use solely with respect to this project. Copyright (c) 2008 by Catherine Wines, Architect Elko, Nevada. Unauthorized use is subject to prosecution. All rights reserved.

PROJECT NAME

Entrance Remodel 13th Street East Ely, Nevada

Learning Bridge Charter School

SHEET NAME


Reflected Ceiling Plan


REVISIONS

DATE

1.7.2025

SHEET NUMBER

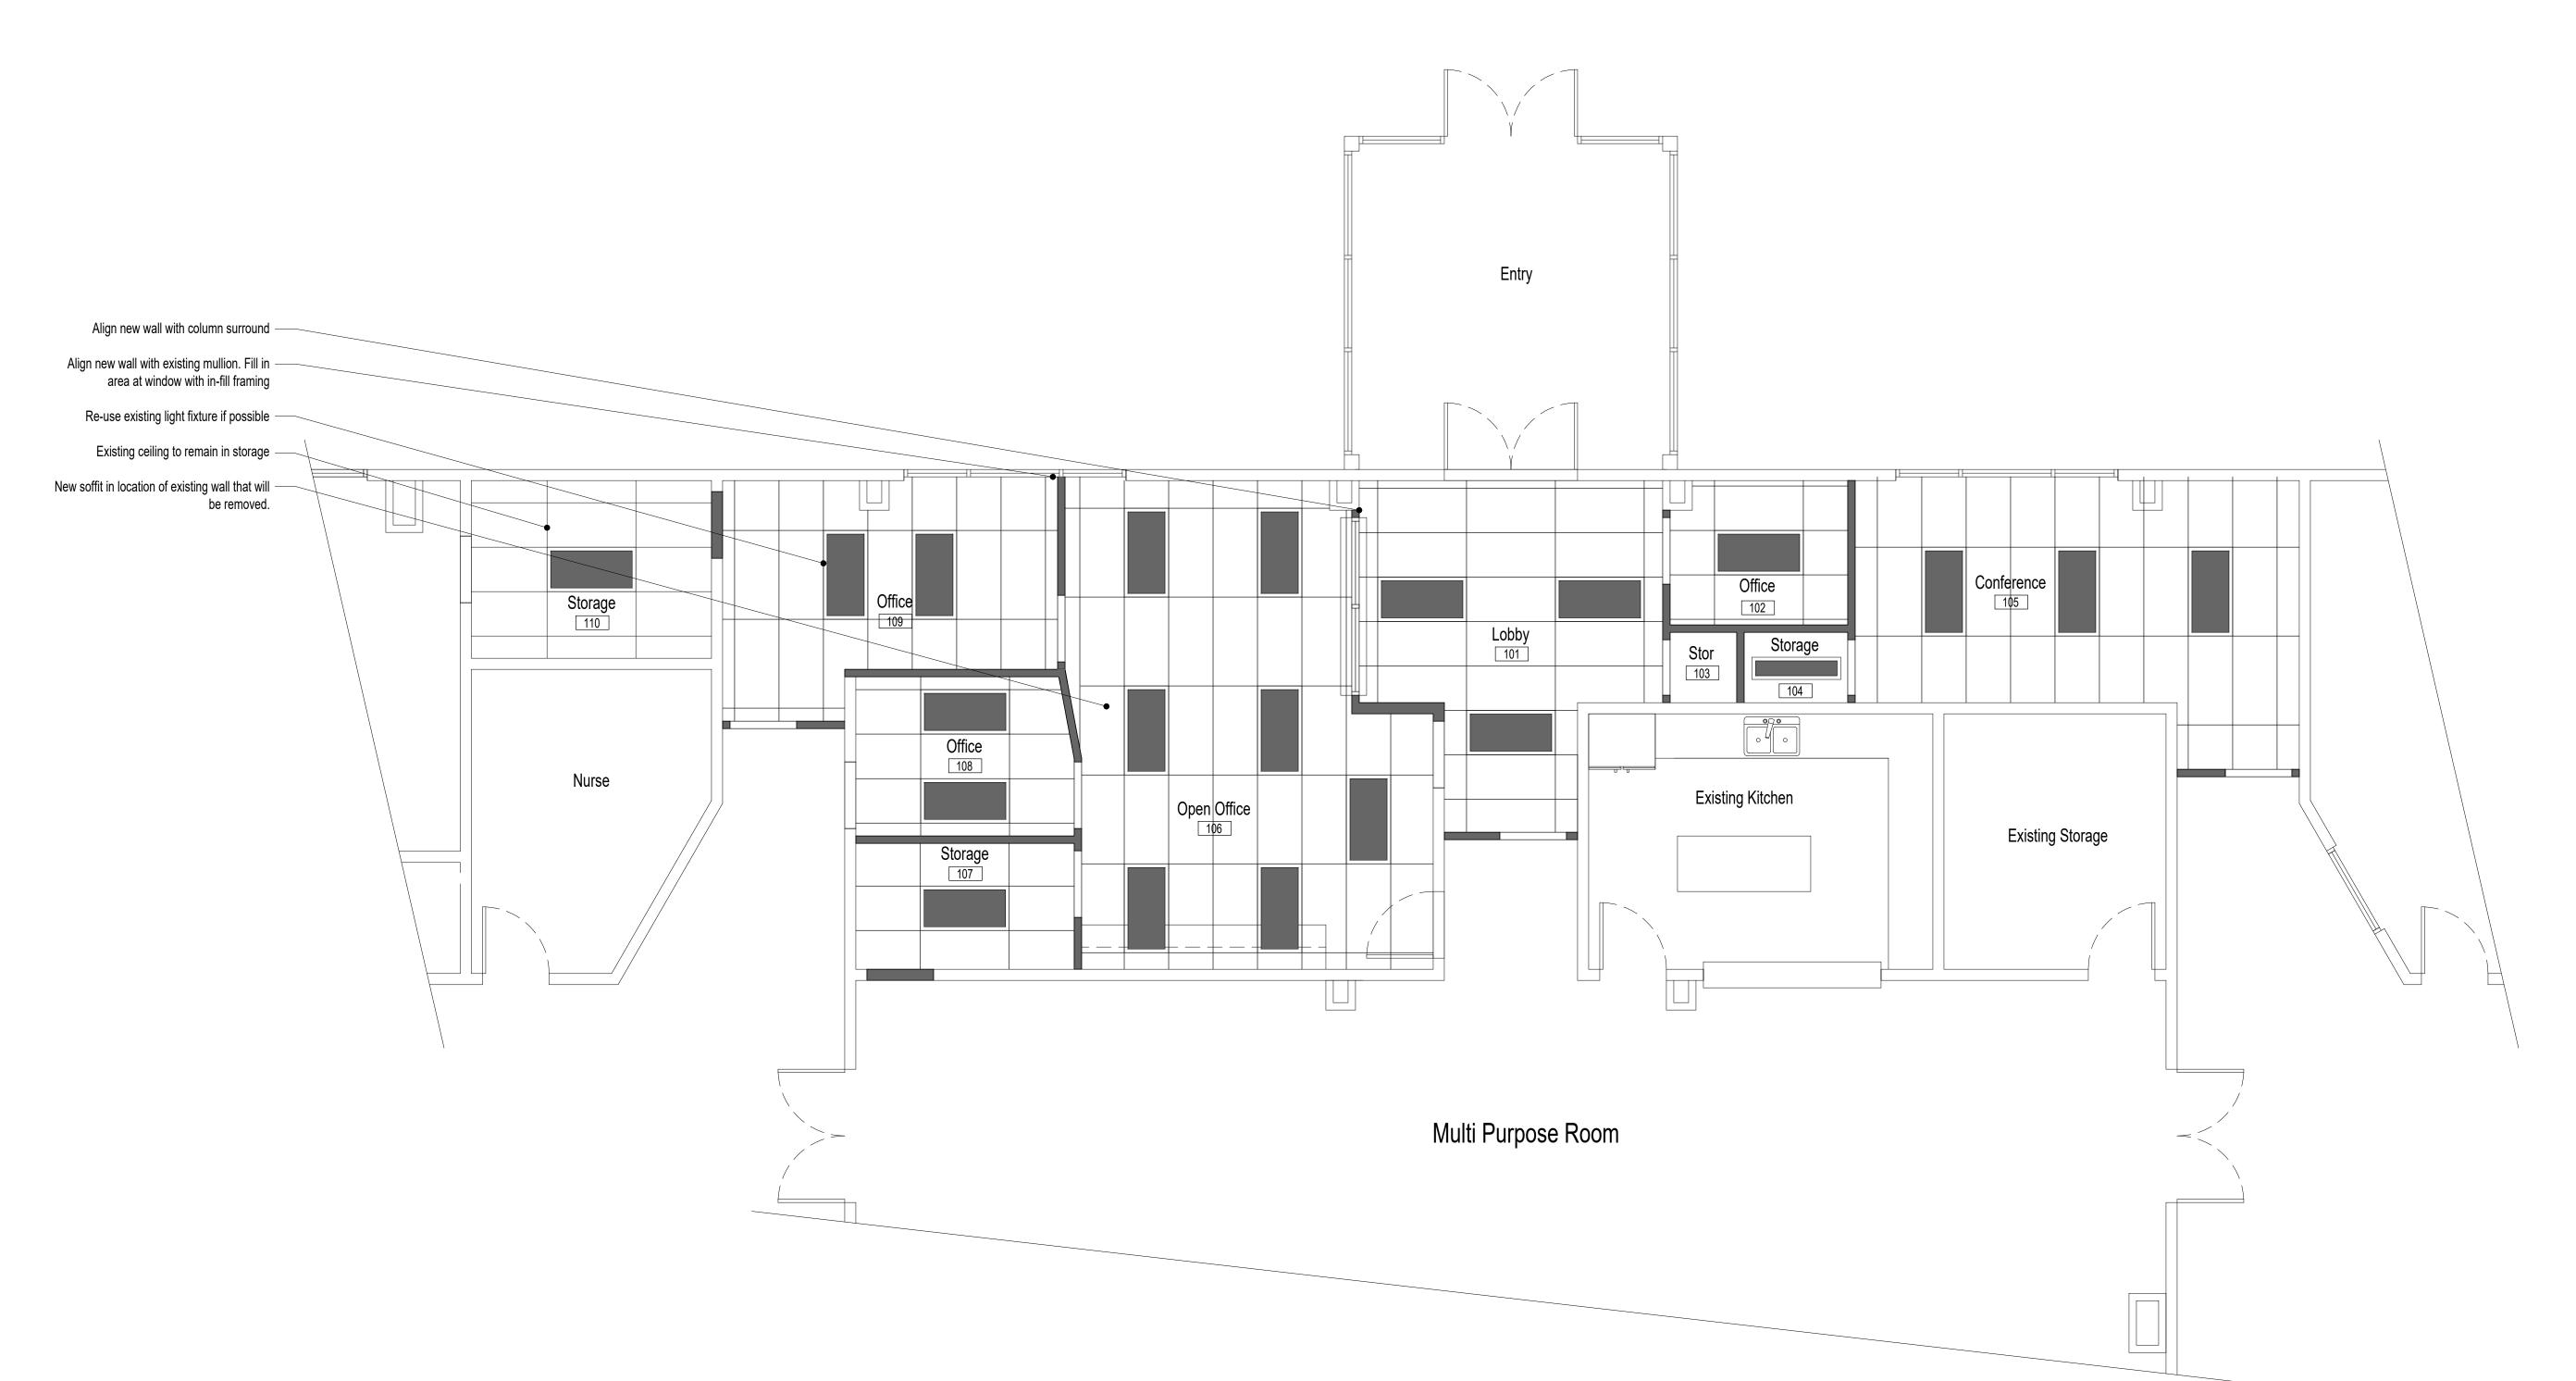

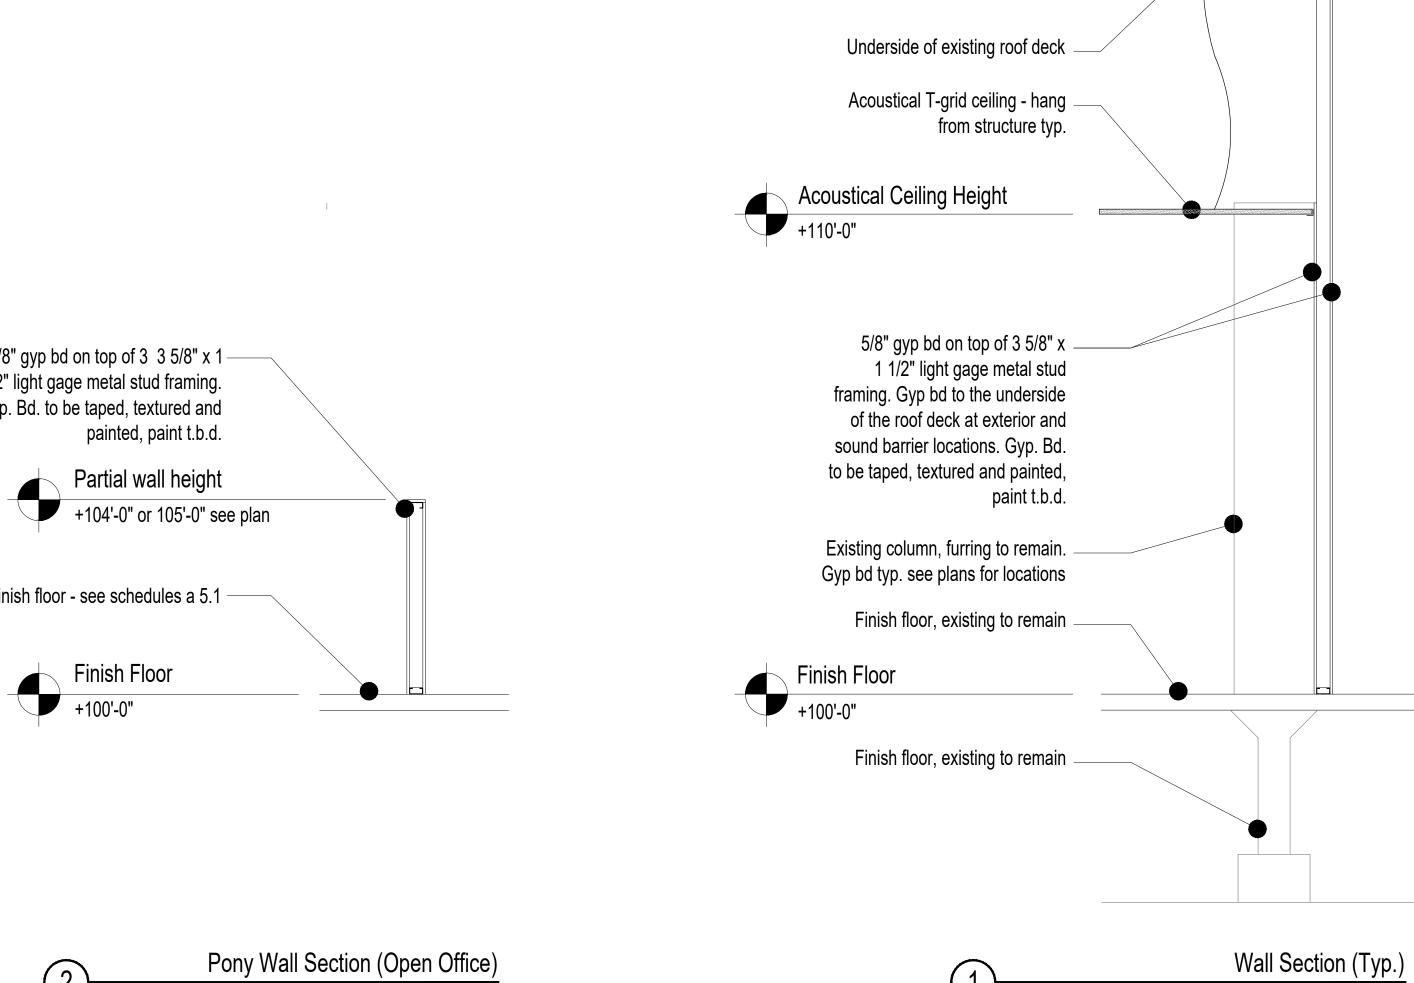



421 RAILROAD STREET STE 208 ELKO, NEVADA 89801 p775.738.7829 f775.738.7817 www.R6STUDIO.com



Documents are instruments of service for use solely with respect to this project. Copyright (c) 2008 by Catherine Wines, Architect Elko, Nevada. Unauthorized use is subject to prosecution. All rights reserved.

PROJECT NAME

Learning Bridge Charter Entrance Remodel 13th Street East Ely, Nevada

SHEET NAME

Wall Sections

REVISIONS

DATE


Scale: 1/4" = 1'-0"

1.7.2025

SHEET NUMBER

a4.1

File number 24-010 - Learning Bridge, Ely City

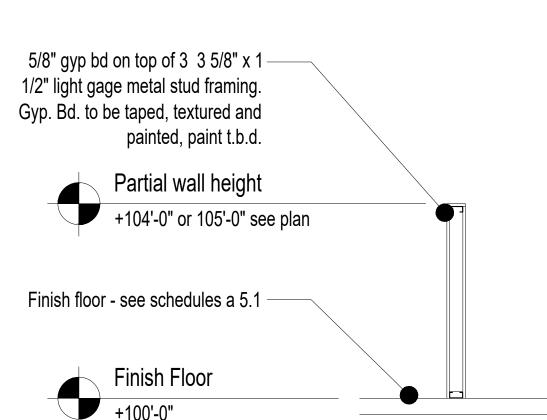

Pony Wall Section (Open Office)

Scale: 1/4" = 1'-0"

Signage Schedule										
Sign Symbol	Location	Total # of Signs	Size	Color	Braille	Mount Height	Viewing Distance	Character Height	Comments	
First F	loor					•				
SG - 1	Conference (105)	1	8"x6"	matched existing		40"-70"	>6'	min 5/8"		
SG - 2	Storage (103, 104)	2	8"x4"	matched existing		40"-70"	>6'	min 5/8"		
SG - 3	Open Office, Storage (106, 107, 110)	4	8"x4"	matched existing	yes	40"-70"	>6'	min 5/8"		
SG - 4	Office (102, 108, 109)	5	8"x6"	matched existing	yes	40"-70"	>6'	min 5/8"		
SG - 5	Multi Purpose	1	8"x8"	matched existing	yes	40"-70"	>6'	min 5/8"		

??? CONFERENCE SG - 1

??? **OFFICE** ..4%... SG - 4

STORAGE NO PUBLIC ACCESS SG - 2

??? ??? SG - 5

STAFF ONLY

SG - 3

Signage Notes

- 1- All directional, informational and pictogram signs to comply with ANSI A117.2009 Chapter 7.
- 2- Visual characters shall be uppercase, lower case or a combination and in conventional form, characters shall not be italic, oblique, script, or highly decorative.
- 3- Uppercase letter 'I' shall be used to determine the allowable height and stroke width of all characters. The letter 'O' shall be used to determine allowable character width.
- 4- Character spacing shall be measured between the two closest points of adjacency with-in the message.
- 5- Line spacing between baselines shall be 135% min and 170% max of character height,
- 6- Visual characters shall be 40" min above the floor measured to baseline of character.
- 7- Characters and their background shall have a non-glare finish and characters shall contrast with their background.
- 8- Raised characters shall be raised $\frac{1}{32}$ " min above the background.
- 9- Braille shall be below the corresponding text, with dots that have a round or domed shape.
- 10- Braille shall be separated $\frac{3}{8}$ " min from any other raised character.
- 11- Braille shall be min 48" a.f.f. and max 60" a.f.f.
- 12- Pictograms shall have a field min 6" and characters or braille shall not be located in the pictogram field.
- 13- Coordinate color of signs with tenant and architect prior to installation.

Door Hardware Sets

1 - Interior Door (single) - Finish t.b.d. Best Lock, no equal -1 Lever style knob to be ADA compliant Thumb lock on pull side

Keyed on push side

Thumb lock on push side

Keyed on pull side

- -3 Hinges -1 Wall stop
- 2 Interior Door (single) Finish t.b.d. Best Lock, no equal -1 Lever style knob to be ADA compliant
- -3 Hinges -1 Wall stop

-1 Wall stop

- 3 Interior Door (single) Finish t.b.d. Best Lock, no equal
- -1 Lever style knob to be ADA compliant Keyed on pull side -Panic Bar at push side -3 Hinges
- Door Hardware Schedule to be completed by material supplier and general contractor, coordinate with architect and owner prior to installation

					[D o	o r	Sch	edule	<u>}</u>			
		Door						Frame	Э				
				sate				Deta	ails		•		
Symbol	Room Name	Size	Туре	Existing to Relocate	Glazing	Door Material	Frame Material	Head	Jamb	Fire Rating	Hardware Group	Self Closure	Comments
101	Multi Purpose Room	3'-0" x 7'-0"	В	yes	yes	W	М	a / a5.1	b / a5.1	no	3	ves	
102	Office	3'-0" x 7'-0"	В	yos	yes	W	M	a / a5.1	b / a5.1	no	2	ycs	
103	Storage	3'-0" x 7'-0"	A		you	W	M	a / a5.1	b / a5.1	no	2		
104	Storage	3'-0" x 7'-0"	A			W	М	a / a5.1	b / a5.1	no	2		
105	Conference Room	3'-0" x 7'-0"	В		yes	W	М	a / a5.1	b / a5.1	no	1	yes	
106A	Open Office	3'-0" x 7'-0"	В		yes	W	М	a / a5.1	b / a5.1	no	1	yes	
106B	Open Office	3'-0" x 7'-0"	Α	yes		W	М	a / a5.1	b / a5.1	no	1	yes	
107	Storage	3'-0" x 7'-0"	Α			W	М	a / a5.1	b / a5.1	no	1		
108A	Office	3'-0" x 7'-0"	В		yes	W	М	a / a5.1	b / a5.1	no	1		
108B	Office	3'-0" x 7'-0"	В		yes	W	М	a / a5.1	b / a5.1	no	1		
109A	Office	3'-0" x 7'-0"	В	yes	yes	W	М	a / a5.1	b / a5.1	no	1		
109B	Office	3'-0" x 7'-0"	В		yes	W	М	a / a5.1	b / a5.1	no	1		
110	Storage	3'-0" x 7'-0"	В	yes	yes	W	M	a / a5.1	b / a5.1	no	1		

Door Types

Door Notes

- 1- Due to multiple use some door details are
- 3- All locksets on doors shall be ADA lever type.
- 4- All openings larger than 1/4" in exterior wall to use backer rod and commercial grade caulk for
- 5- Interior doors to have knock down metal frames,
- 6- Exterior metal doors to have welded paint grade
- 7- not used
- 8- All stops to be industrial grade stainless steel,
- 9- All door hardware to be mounted at 36" a.f.f.
- 10- All doors and entrances are to be accessible based on requirements of the Americans with
- 11- All panic hardware shall be listed in accordance UL 10C and UL 305.
- 12- The actuating portion of the releasing device shall extend at least one-half of the door leaf width of any fire rated door.
- 13- The maximum unlatching force shall not exceed 15 lbs on any door with-in the path of travel of a

- reversed from direction shown.
- 2- Interior doors to be installed to clear finish floor material by $\frac{1}{2}$ "
- dust control.
- color t.b.d.
- metal frame.
- either pedestal or wall stops.
- u.n.o.
- Disabilities Act.
- with UL 305, fire exit hardware shall be listed with
- designated exit.

SHEET NAME

Schedules

Learning Bridge Charter

Entrance Remodel 13th Street East Ely, Nevada

421 RAILROAD STREET STE 208 ELKO, NEVADA 89801

p775.738.7829 f775.738.7817

www.R6STUDIO.com

Documents are instruments of service for use solely

Catherine Wines, Architect Elko, Nevada. Unauthorized

with respect to this project. Copyright (c) 2008 by

use is subject to prosecution. All rights reserved.

PROJECT NAME

Interior Finish Notes

- 1- Floor tile to match existing, there is a significant amount of left over flooring from the original construction, that is available to use. It will be enough to patch all places that need new flooring installed, no new flooring will need to be purchased. Coordinate with owner.
- 2- All wall texture to be orange peel.
- 3- All paint sheen to be semi-gloss.
- 4- All flooring and base to be installed per manufacturer's specifications.
- 5- Sound attenuation insulation to be placed at all new walls in new offices. It is not necessary to place insulation in existing walls that will remain.
- 6- not used
- 7- All fire extinguishers to be placed in recessed stainless steel cabinets.


DATE

REVISIONS

1.7.2025

SHEET NUMBER

File number 24-010 - Learning Bridge, Ely City

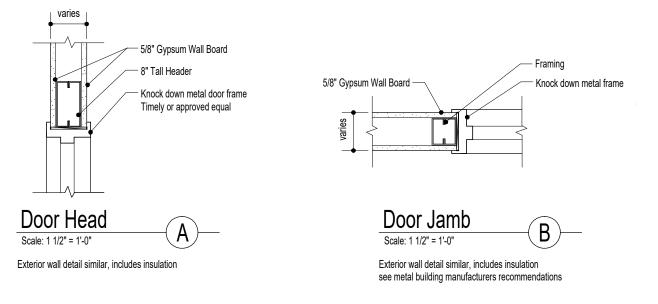

Honey Company	Room Name First Floor	JOOL F-1	B-1	North Wall	East Wall	South Wall	West Wall	Ceiling	Specialty	Comments	Ceiling Height								
102 Office 103 Storag		F-1	L D 1	1 14/4			I												
102 Office 103 Storag	у	F-1	D 1	147.4					First Floor										
103 Storag	•		ו-ט ן	W-1	W-1	W-1	W-1	C-1			9'-0"								
	е	F-1	B-1	W-1	W-1	W-1	W-1	C-1			9'-0"								
104 Storag	age	F-1	B-1	W-1	W-1	W-1	W-1	C-1			9'-0"								
	age	F-1	B-1	W-1	W-1	W-1	W-1	C-1			9'-0"								
105 Confe	erence Room	F-1	B-1	W-1	W-1	W-1	W-1	C-1			9'-0"								
106 Open	n Office	F-1	B-1	W-1	W-1	W-1	W-1	C-1			9'-0"								
107 Storaç	age	F-1	B-1	W-1	W-1	W-1	W-1	C-1			9'-0"								
108 Office	е	F-1	B-1	W-1	W-1	W-1	W-1	C-1		sound attenuation insulation	9'-0"								
109 Office	е	F-1	B-1	W-1	W-1	W-1	W-1	C-1		sound attenuation insulation	9'-0"								
110 Storaç	age	F-1	B-1	W-1	W-1	W-1	W-1	C-1			9'-0"								

Floor

Solid Wood Door

With metal frame

Solid Core Wood Door

With metal frame

F-1 12" VCT tile - color t.b.d.

Base

B-1 6" Vinyl cove base - color t.b.d.

Ceiling

C-1 2x4 acoustic grid ceilng

W-1 5/8" gyp bd. attached to framing, screw drywall as required by code, tape, texture and paint with base color, t.b.d.

Specialty

S-1 Not used

Where manufacturers have been sp	pecifically named, any alternate shal	ll be approved in writing by the a	architect / owner prior to the come	ensment of worl
Excavation				
Bearing soil, type NA, all existing	exterior build—out to remain			
Foundation				
Footings - concrete mix NA				
Foundation wall material <u>NA</u> nterior foundation wall material <u>NA</u>				
Columns NA				
Girders NA	Sills			
Basement enterance NA	Basement wind	lows		
Waterproofing NA				
Termite protection NA Additional foundation notes				
Exterior Walls				
Framing material NA existing to re	main			
Paper or felt NA		ing		
Sheathing <u>NA</u>			spacing	
Exterior finish NA				
Exterior veneer <u>NA</u>			Lintole	
Door sills NA Flashing	VVIITUOW SIIIS	Fvt	Linters erior Finish	
Gable walls same as walls _	other	LX		
Additional exterior wall notes				
Mezzanine floor framing NA Additional floors framing NA Additional floor notes		spacing _NA	anch	nors <u>NA</u>
Sub Flooring @ Mezzar				
Material <u>NA</u> Material <u>NA</u>		SIZENA	type _ NA	
			typeNA	
Partition Framing				
Studs 4" cold rolled metal studs Plumbing studs NA	size & spacing 16" o.c.		_ other	
Plumbing studs NA	size & spacing]	other	
Additional partition notes all walls to	extend to the underside of the re	oot deck		
O - 11: Fu 1 0 O - 11:				
I VIIINA FRANCISA A	•		u · · ·	
Ceiling Framing & Ceilin	ating cizo & enacing 2'v4' Arm	istrong or approved equal		
Material acoustical grid, match exis			1 (* * 1 11	
Material <u>acoustical grid, match exi</u>	headers separating ceiling areas to	be wood frame, finish to mate	ch finish walls	
Material <u>acoustical grid, match existed</u> Additional ceiling framing notes <u>All</u> All building columns and exposed		be wood frame, finish to mate	ch finish walls	
Material <u>acoustical grid, match exi</u>	headers separating ceiling areas to	be wood frame, finish to mate	ch finish walls	
Material acoustical grid, match exist Additional ceiling framing notes All All building columns and exposed Roof Framing Rafters NA	headers separating ceiling areas to beams to be furred out with gyp I 	be wood frame, finish to mate bd		
Material acoustical grid, match exist Additional ceiling framing notes All All building columns and exposed Roof Framing Rafters NA Spacing NA	headers separating ceiling areas to beams to be furred out with gyp Trusses anchors	be wood frame, finish to mate		
Material acoustical grid, match exist Additional ceiling framing notes All All building columns and exposed Roof Framing Rafters NA	headers separating ceiling areas to beams to be furred out with gyp Trusses anchors	be wood frame, finish to mate		
Material acoustical grid, match exist Additional ceiling framing notes All All building columns and exposed Roof Framing Rafters NA Spacing NA	headers separating ceiling areas to beams to be furred out with gyp Trusses anchors	be wood frame, finish to mate		
Material acoustical grid, match exist Additional ceiling framing notes All All building columns and exposed Roof Framing Rafters NA Spacing NA Additional roof framing notes	headers separating ceiling areas to beams to be furred out with gyp I Trusses anchors	be wood frame, finish to mate		
Material <u>acoustical grid, match existed</u> Additional ceiling framing notes <u>All</u> All building columns and exposed Roof Framing Rafters NA Spacing NA Additional roof framing notes Roofing Sheathing NA Roofing NA	headers separating ceiling areas to beams to be furred out with gyp l Trusses anchors Space	be wood frame, finish to mate		
Material acoustical grid, match exist Additional ceiling framing notes All All building columns and exposed Roof Framing Rafters NA Spacing NA Additional roof framing notes Roofing NA Roofing NA Roofing NA Roofing NA Fastening NA	headers separating ceiling areas to beams to be furred out with gyp l Trusses anchorsSpace	be wood frame, finish to mate	Size	
Material acoustical grid, match exist Additional ceiling framing notes All All building columns and exposed Roof Framing Rafters NA Spacing NA Additional roof framing notes Roofing NA Roofing NA Roofing NA Roofing NA Space NA Roofing	headers separating ceiling areas to beams to be furred out with gyp l Trusses anchorsSpace	be wood frame, finish to mate bd cing Style	SizeNailing	
Material acoustical grid, match exist Additional ceiling framing notes All All building columns and exposed Roof Framing Rafters NA Spacing NA Additional roof framing notes Roofing NA Roofing NA Roofing NA Juderlay NA HA Juderlay NA HA	headers separating ceiling areas to beams to be furred out with gyp lands and the furred out with gyp lands and gy	cing Style	Size Nailingt	
Material acoustical grid, match exist Additional ceiling framing notes All All building columns and exposed Roof Framing Rafters NA Spacing NA Additional roof framing notes	headers separating ceiling areas to beams to be furred out with gyp lands and the furred out with gyp lands and gyp lands	cing Style kness Gage or weightshield	Size Nailingt	
Material acoustical grid, match exist Additional ceiling framing notes All All building columns and exposed Roof Framing Rafters NA Spacing NA Additional roof framing notes	headers separating ceiling areas to beams to be furred out with gyp lands and the furred out with gyp lands and gy	cing Style kness Gage or weightshield Down spo	Size Nailingt	

_ weight or thickness NA_

_ weight or thickness _ _ weight or thickness _

Location Office, conference, lobby, storage

__ **Finish** _orange peel

Location

Location

Ceiling finish material acoustical grid

Joint treatment 2 layers drywall tape

Additional wall finish notes match existing at all locations

Wet wall locations NA

Fire wall locations NA

Flooring 1 VCT tile 12x12

Flooring 2 NA
Flooring 3 NA
Additional Flooring Notes____

10- Flooring

__Subfloor_slab on grade

__ _Subfloor_

__ _Subfloor_

11- Stairs					
Tread / Size Location NA	Riser / Size	Strings / Size	Handrail / Size	Balasters	
Location NA Location NA Disappearing Garage Stai	r N A				
	I IVA				
13- Insulation					
Location	Thickness		Туре	R-value	Vapor Barrie
Roof Exterior Walls	NA NA				
Floor Bathroom walls	NA NA				
Additional insulation notes	S				
14- Plumbing	Nimbar		Mala	0:	Oalan
Fixture see plumbing plans for	Number Locate fixture schedule	lions	Make	Size	Color
				Heating capacity	
	NA				
Breakroom Accessories _					
Additional plumbing fixture	e notes				
	NA				
	NA			exposed shelving lineal fee exposed shelving lineal fee	
1 Bathroom cabinet materia Conference room cabinet	l material		lineal feetlineal feet	exposed shelving lineal fee exposed shelving lineal fee	
Other cabinet locations m	natch existing — AWI pr materia natch existing — AWI premium	grade quality cabinets	lineal feet see a2.1	exposed shelving lineal fee	see a2.2
Counter top material	NA NA	Bathro	om counter top Material	Soit close diawers	NA
Additional cabinet notes <u>\</u>	IA	same	see a3.2		
	table at lower cabinet, (2) adj tic laminate w/integrated 4" b		et N	yes A	
rolled plastic	c laminate plastic laminate to be Wilsonar	t standard color and fi	standard finish t.I	o.d.	
pull style hardware at ed	ach drawer and door, standard	stock, t.b.d.			
46 Caplara Caulki		fin a			
·	ng, and Weatherproo larger to be caulked with com	•	approved equal Use back	ver rod at all joints larger tha	n 1/4"
	ork to be caulked at entire po	<u>_</u>		ter roa at an jointe larger tha	
17- Fire Protection					
Provide commercial grad	de fire extinguishers in lockable		- 	 	
Automatic fire sprinkler	system is in place, remodel e	xisting system to acco	modate new floor plan lay	out	
18- Garage Special	Instructions				
NA					
19- Patio & Porch S	Special Instruction				
NA	.,,,,,,,,,,,,,,,,,,,,,,,,,,,,,,,,,,,,,,				
20- Terraces & Balo	conies Special Instru	ction			
21- Walks & Drivew	/ays				
see civil dwgs	-				
22- Other On-site Ir	nprovements				
Area to be landscaped inc	licted on site plan				
Topsoil thic			s	High shrubs	
234e diamets caping	mto be dete	Low shrubs		Ground cover	
Additional landscaping no					

R6ST	
CATHERINE WINE	S, ARCHITECT

421 RAILROAD STREET STE 208 ELKO, NEVADA 89801 p775.738.7829 f775.738.7817 www.R6STUDIO.com



Documents are instruments of service for use solely with respect to this project. Copyright (c) 2008 by Catherine Wines, Architect Elko, Nevada. Unauthorized use is subject to prosecution. All rights reserved.

PROJECT NAME

Learning Bridge Charter

SHEET NAME

REVISIONS

DATE

1.7.2025

SHEET NUMBER

