

1 SOUTH - FRONT ELEVATION


A-1 SCALE: 1/8"= 1'-0" Note: field verify all dimensions




RETAIL - INTERIOR RENOVATION FOR:

1-800-FLOWERS


2365 Windy Hill Road, Marietta, Georgia 30368 Cobb County -- Bldg. Permit # 2012-001703

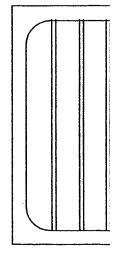


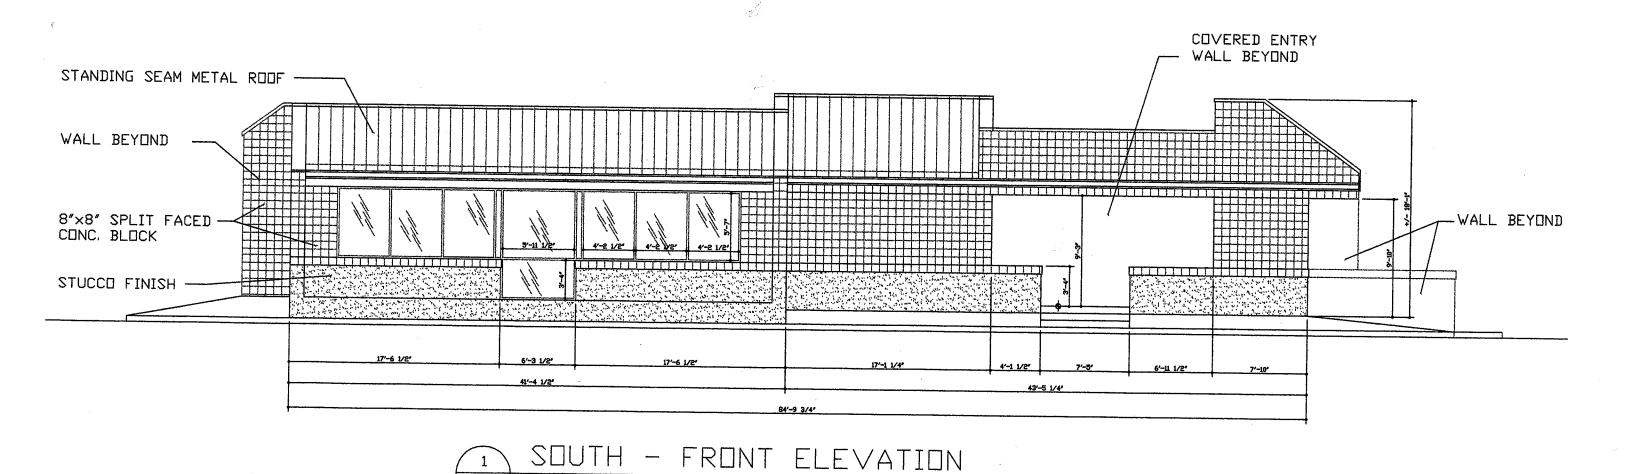


Note: field verify all dimensions

SCALE: 1/8"= 1'-0"

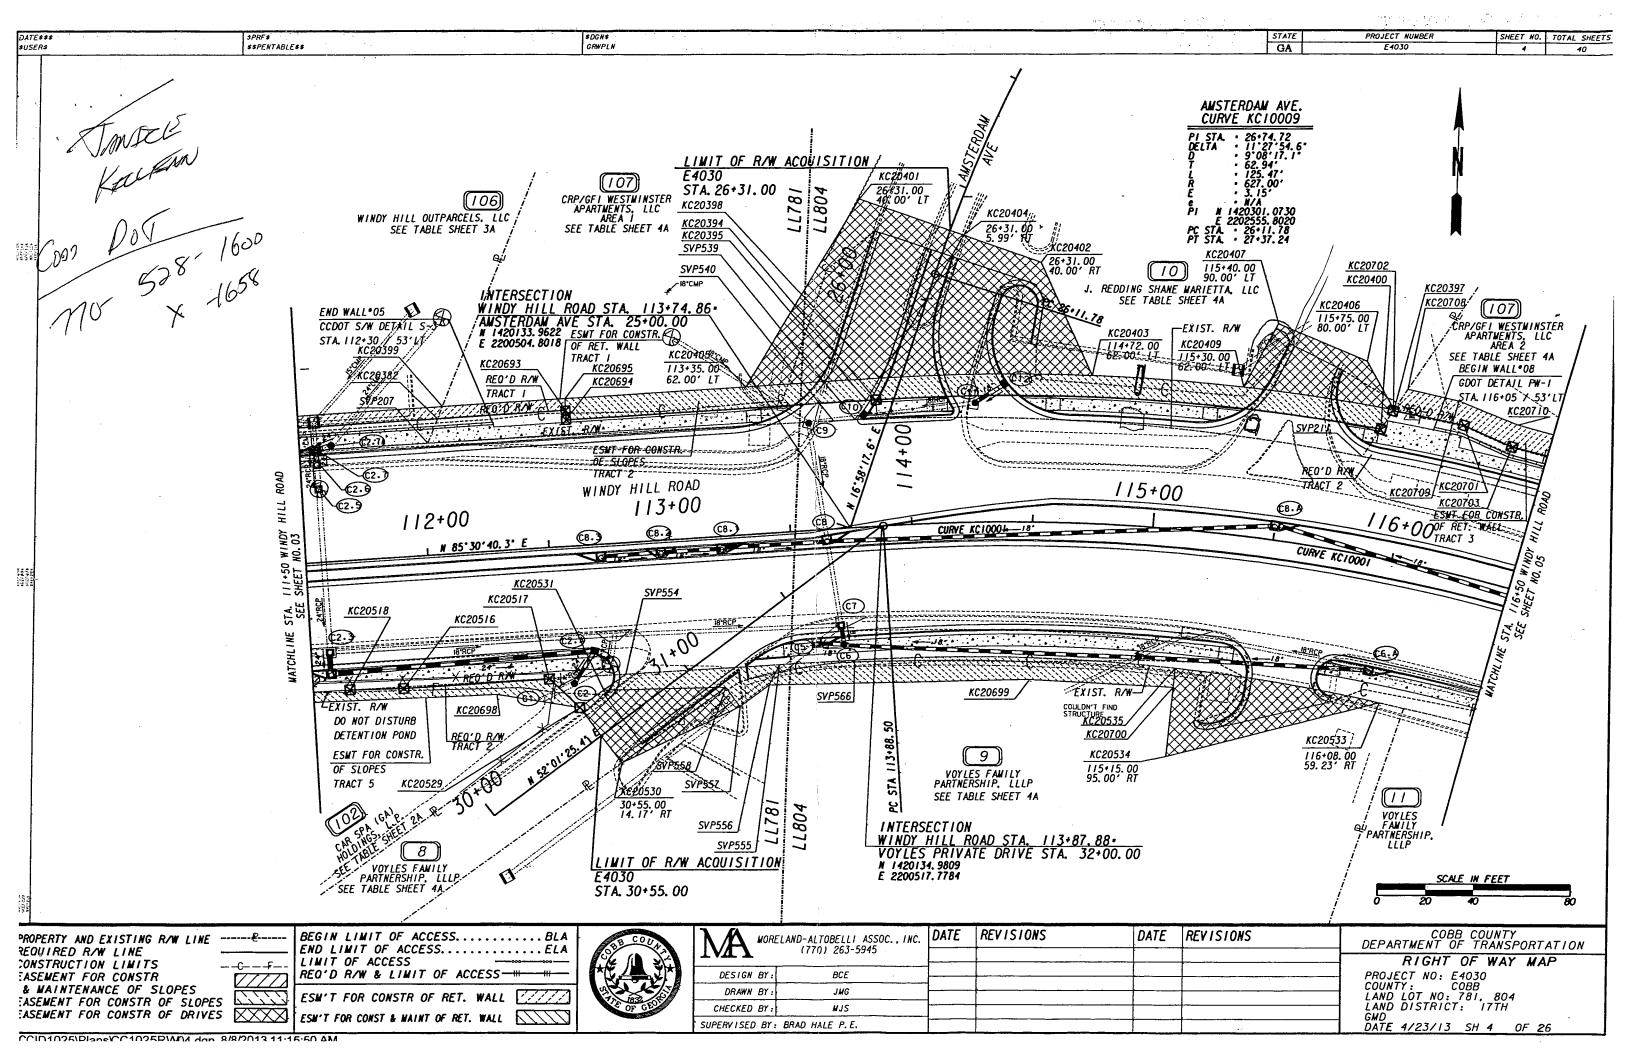

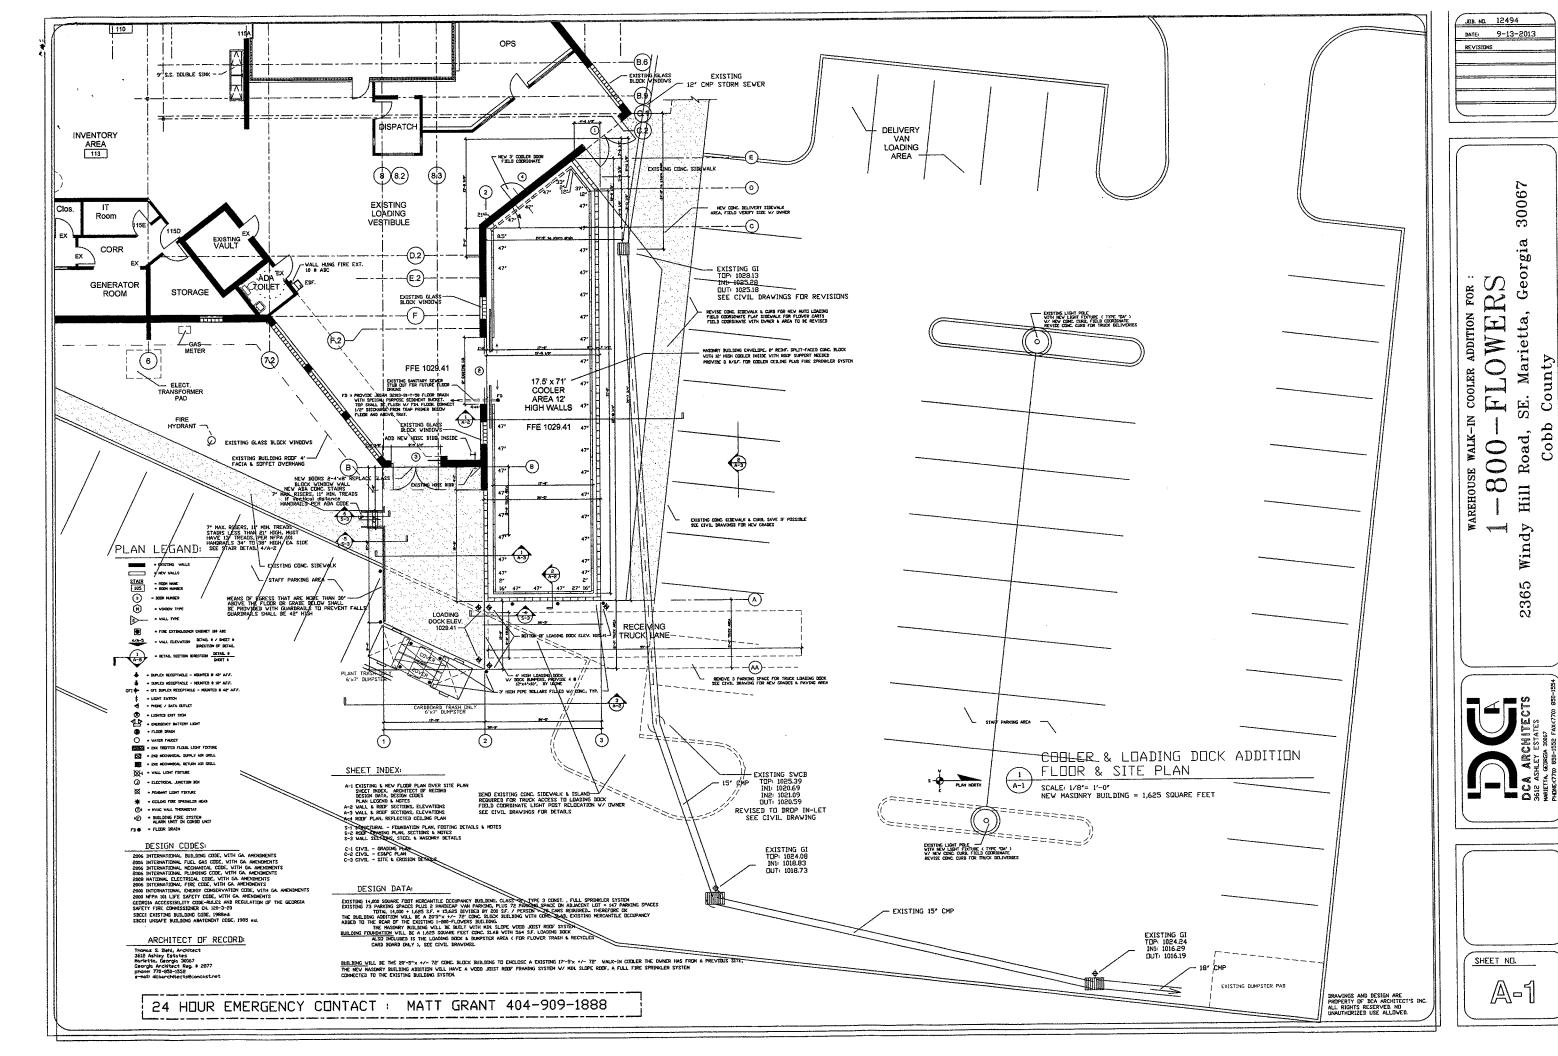

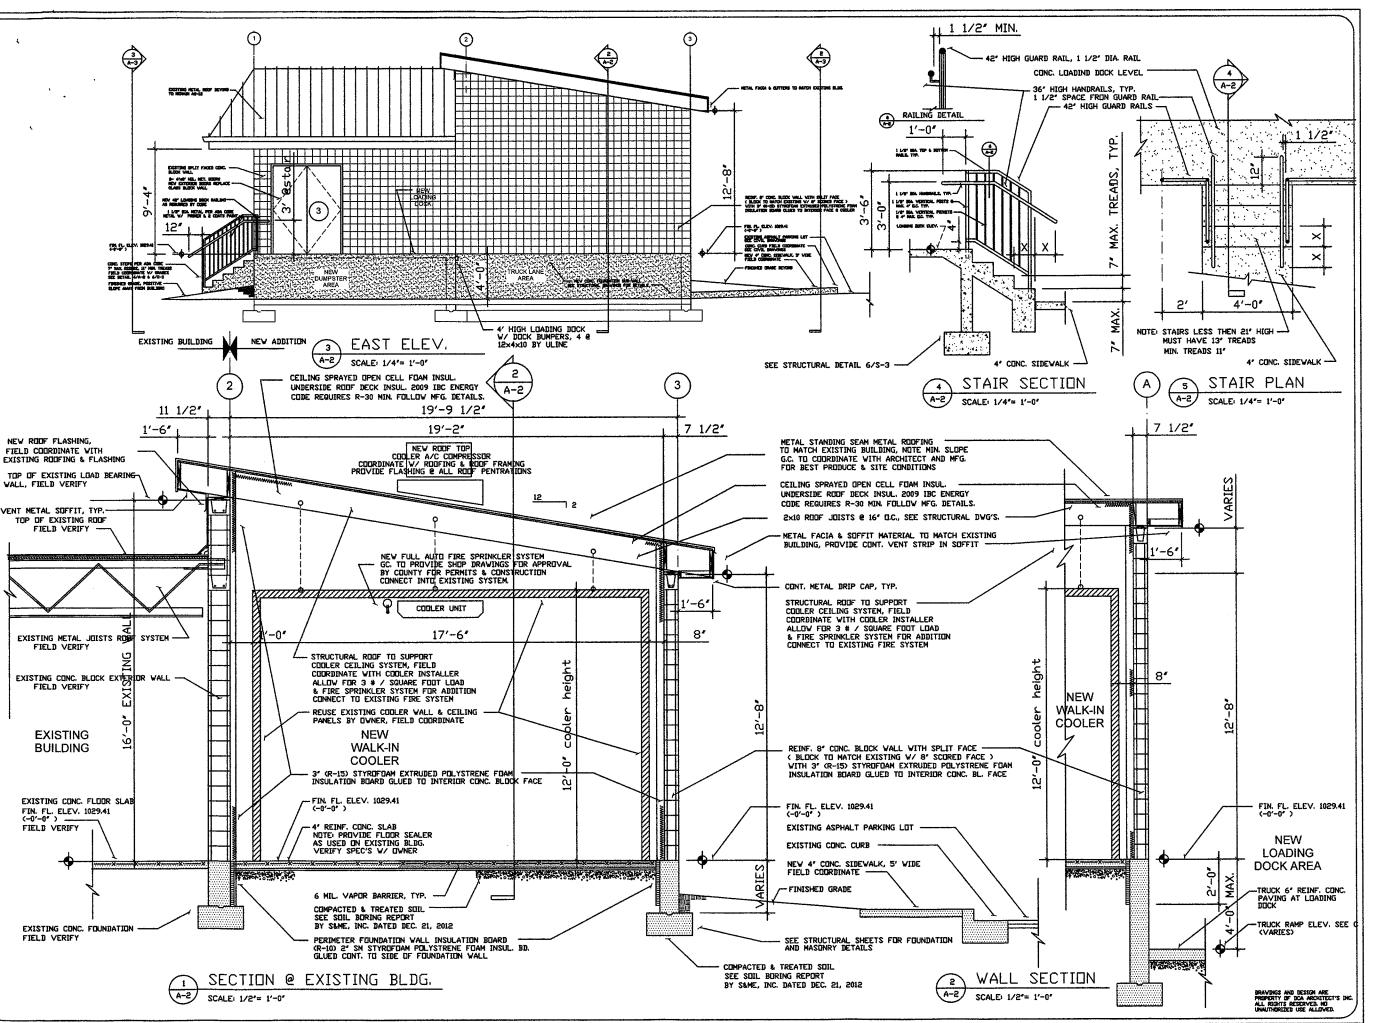

JOB. NO. 12494

BATE 9-13-2013


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\$\frac{3}{1}\text{TAR RAILING DTL}}
\$\frac{3}{2}\text{TAR RAILING DTL}}
\$\frac{1}{2}\text{-2}\text{-2013}

walk-in cooler addition for : $1-800-FLOWERS \\ 2365 \ \mbox{Windy Hill Road, SE. Marietta, Georgia 30067}$

County

Cobb



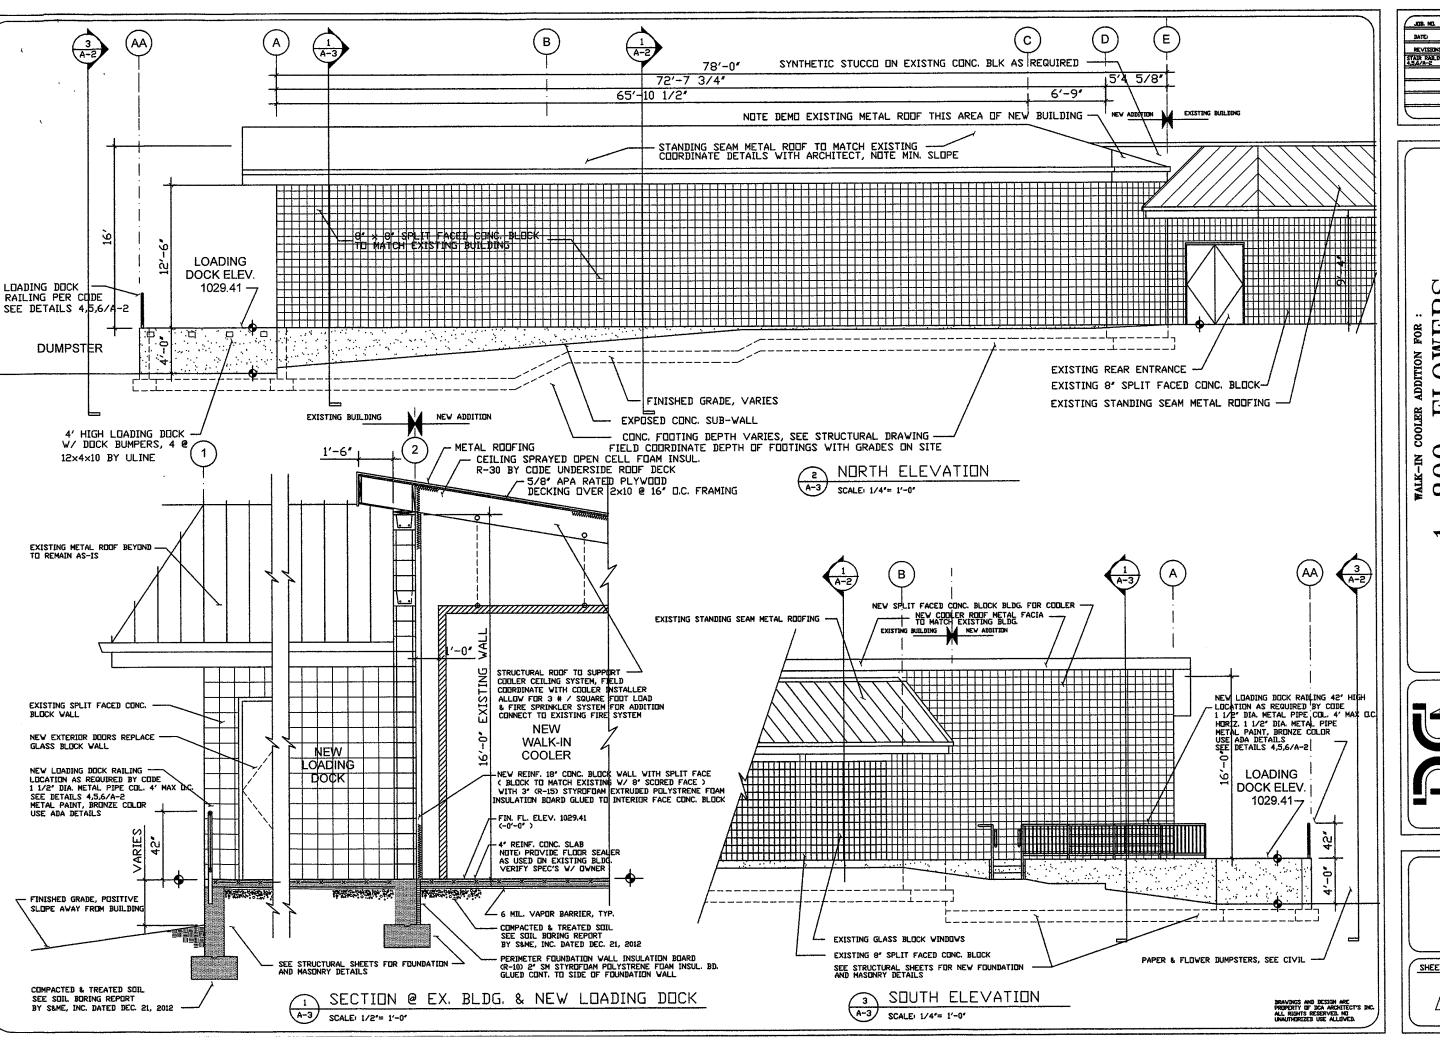

JOB. NO. 12494

BATE 9-13-2013

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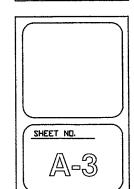
STAIR RABBING BET. 12-2-2013


1-800-FLOWERS
2365 Windy Hill Road, SE. Marietta, Georgia

County

Copp

DCA ARCHITECTS
SEE ASHETS
WHETTA CENTRO 850-1554



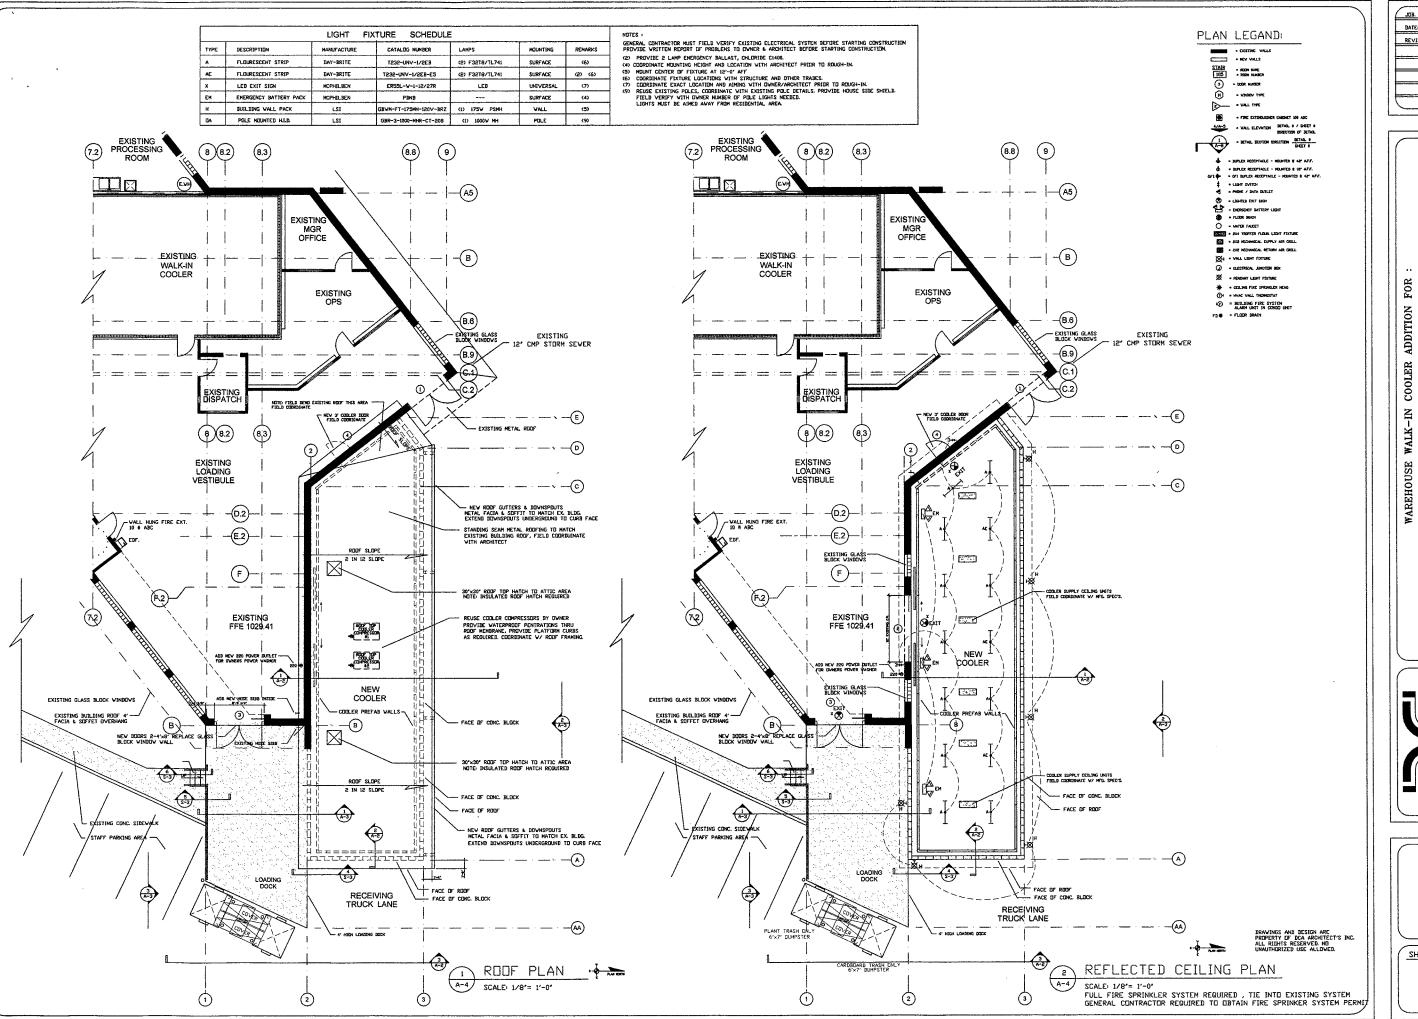

| JOB. NO. | 12494 |
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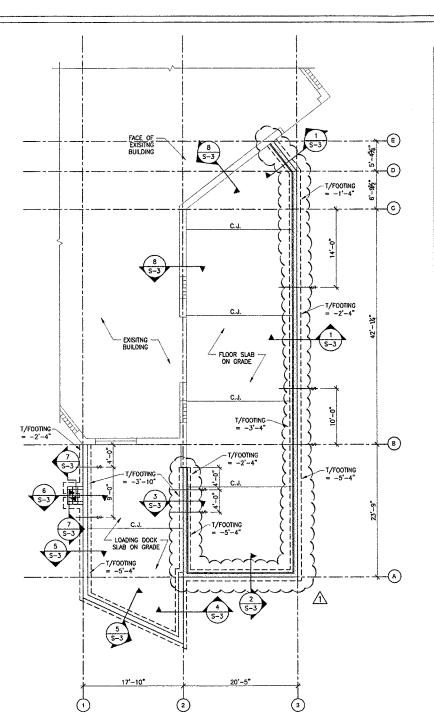
1-800-FLOWERS
2365 Windy Hill Road, SE. Marietta, Georgia 30067

County

Cobb

DCA ARCHITECTS
3612 ASHEY ESTATES
WHEITH, GENERA 3067.
PROMETTY, GENERA 3067.

SHEET NO.



- Australia

FOUNDATION PLAN S-1 SCALE: 18"=1'-0"

FOUNDATION PLAN NOTES:

- VERIFY ALL DIMENSIONS AND ELEVATIONS WITH ARCHITECTURAL DRAWINGS BEFORE COMMERCING CONSTRUCTION. ALL DISOREFANCIES SHALL BE BROUGHT TO THE ATTENTION OF THE ARCHITECT AND THE STRUCTURAL ENGINEER, FOR ADDITIONAL INFORMATION SEE ARCHITECTURAL DRAWINGS.
- 2. TOP OF CONCRETE SLAB ELEVATION = $+0^{\circ}-0^{\circ}$. CORRESPONDING TO AN ACTUAL ELEVATION = 1029.41° . ALL OTHER DIMENSIONS ARE MEASURED FROM THIS DATUM.
- 3. SLAB ON GRADE SHALL BE 4" NORMAL WEIGHT CONCRETE, REINFORCED WITH 6x6 W1.4xW1.4 W.W.F. LOCATED 11/2" BELOW THE TOP OF SLAB, UNO.
- 4. C.J. INDICATES CONTROL JOINT, SEE 2/S-1.
- SEE ARCHITECTURAL DRAWINGS FOR ANY SLOPES, DEPRESSIONS, TRENCHES, ECT. IN SLAB ON GRADE.
- TOP OF FOOTING ELEVATION VARIES, SEE PLAN. CONFIRM TOP OF FOOTING ELEVATIONS SHOWN WITH FINISHED GRADE ELEVATIONS. TOP OF FOOTING SHOULD BE A MINIMUM OF 1'-0' BELOW FINISHED GRADE.
- 7. ---- INDICATES STEP IN FOOTING ELEVATION, SEE 4/S-1.

NOTES:

THIS STRUCTURE WAS DESIGNED IN ACCORDANCE WITH THE 2006 INTERNATIONAL BUILDING CODE WITH GEORGIA AMENDMENTS AND ASCE 7. THE FOLLOWING CRITERIA APPLY:

GROUND SNOW LOAD, Pg = 5 psf BASIC WIND SPEED 90 mph
WIND IMPORTANCE FACTOR, IW = 1.0
WIND EXPOSURE CATEGORY: B

INTERNAL PRESSURE COEFFICIENT: ±0.18
COMPONENTS & CLADDING: ZONE A-10 A-20 A-50 A-100 ZONE 1 +10.0 +10.0 +10.0 +10.0 -13.3 -13.0 -12.5 -12.1 ZONE 2 +10.0 +10.0 +10.0 -23.2 -21.4 -18.9 -17.0 ZONE 3 +10.0 +10.0 +10.0 -34.3 -12.1 -28.1 -28.9 ZONE 4 +14.6 +13.9 +13.0 +12.4 -15.8 -15.1 -14.3 -13.6

ZONE 5 +14.6 +13.9 +13.0 +12.4 -19.5 -18.2 -16.5 -15.1 (A = EFFECTIVE WIND AREA, σ = 3"-0", ADJUSTMENT FACTOR = 1.00. SEE FIG. 6-3, ASCE 7-05 FOR ZONE LAYOUT AND ADD. INFO.)

SEISMIC FORCE RESISTING STATEM.
ORDINARY REINFORCED MASORRY
SHEAR WALLS
DESIGN BASE SHEAR TO 10.4 KIPS
SEISMIC RESPONSE COEFFICIENT, Cs = 0.133
RESPONSE MODIFICATION FACTOR, R = 2.0
ANALYSIS PROCEDURE: E.L.F. PROCEDURE

ALLOWABLE SOIL BEARING IS 2500 paf ON PROPERLY PREPARED SUBGRADE PER RECOMMENDATIONS IN GEOTECHNICAL REPORT GEOTECHNICAL REPORT # 1801-12-405 BY S&ME, INC., DATED DECEMBER 21, 2012

SAFE FLOOR LOADS SHALL BE POSTED IN CONSPICUOUS PLACES.

GENERAL:

STRUCTURAL DRAWINGS INDICATE TYPICAL AND CERTAIN SPECIFIC CONDITIONS ONLY.
SHOP DRAWINGS SHALL DETAIL ALL CONDITIONS IN ACCORDANCE WITH SPECIFIED STANDARDS
AND THE SPECIFIC REQUIREMENTS OF THIS PROLECT.
CONTRACTOR SHALL PROVIDE TEMPORARY SHORING AND BRACING FOR ALL STRUCTURAL
ELEMENTS DURING CONSTRUCTION.
J. CONTRACTOR IS TO VERIFY ALL DIMENSIONS AND CONDITIONS BEFORE EXECUTING ANY WORK.

EXISTING CONDITIONS:

I WHERE EXSTING CONDITIONS ARE SHOWN THEY HAVE BEEN DERIVED FROM AVAILABLE DRAWINGS AND REPRESENT THE ENGINEER'S BEST ESTIMATE OF ACTUAL CONDITIONS DEPICTED EXISTING CONDITIONS MAY NOT, IN ALL CASES, BE CORROBORATED BY FIELD INVESTIGATIONS.

2. ALL DIMENSIONS AND DETAILS OF EXISTING WORK INDICATED ON THE DRAWINGS SHALL BE FIELD MEASURED AND VERTILE BEFORE PROCEDING WITH WORK, ANY DISCREPANICES SHALL BE IMMEDIATELY REPORTED TO THE ENGINEER.

3. NECSSABAY PRECAUTIONS SHALL BE TAKEN NOT TO DISTURBO OR UNDERMINE ANY EXISTING BUILDING FOUNDATIONS OR STRUCTURE AND SHORING SHALL BE PROVIDED AS REQUIRED.

CONCRETE:

- CONORE IE:

 CONORETE FOR ALL STRUCTURAL ELEMENTS SHALL HAVE A MINIMUM 28 DAY COMPRESSIVE
 STRUCTH OF 3,000 DIA AND SHALL BE NORMAL WEIGHT.

 SHESS NOTED CHECKNEE, SLABS ON GRADE SHALL BE A MINIMUM OF FOUR INCHES THICK,
 SHALL BE REINFORCED WITH 650-WIT 4,WIT 4, WIF. AND PLACED OVER A MINIMUM 4" THICK
 LAYER OF FREE-FRAINING MATERIAL SUCH AS CRUSHED STONE.

 3. ALL CONCRETE EXPOSED TO WEATHER SHALL HAVE A MINIMUM WATER/CEWENT RATIO OF 0.45
 AND SHALL BE ARE RITAINED 357 +/-1.

 4. ALL STRUCTURAL CONCRETE SHALL BE FABRICATED AND ERECTED IN ACCORDANCE WITH THE
 "ACI BUILDING COOR FEQUIPMENTS FOR REINFORCED CONCRETE", LATEST EDITION.

 5. CONCRETE TEST REPORTS SHALL BE AVAILABLE AT THE JOB SITE.

REINFORCING:

- REINFORCING STEEL SHALL BE ASTM 615, GRADE 60, EXCEPT TIES AND STIRRUPS SHALL BE GRADE 40 OR 60. LAP SPLICE LENGTH IS NO LESS THAN 43" FOR #6 BARS, 36" FOR #5 BARS, AND 29" FOR #4 BARS. PROMDE BENT CORNER BARS.
- WELDED WIRE FABRIC SHALL COMPLY WITH ASTM A185. LAP ALL W.W.F. A MINIMUM OF ONE SPACE AT ALL SIDES AND SPLICES.

MASONRY

- STEENGTH OF ALL MASONRY SHALL BE TYPE "S" WITH A COMPRESSIVE STEENGTH OF NOT LESS THAN 1800 pei AT 28 DAYS, AND SHALL COMFORM TO ASTM CZY.

 2. WHERE MASONRY IS REINFORCED, CELLS ARE TO BE GROUTED SOLID WITH A GROUT OF 3.000 pai STERICHEN AT 26 DAYS. SEE ASTM C476.

 3. MASONRY SHALL HAVE A MINIMUM NET AREA COMPRESSIVE STRENGTH (f'm) OF 1500 pai AT 28 DAYS AND SHALL CONFORM TO ASTM C500.

 4. VERTICAL REINFORCING BARS SHALL BE CENTERED IN GROUT FILLED BLOCK CELLS AT CORNERS, INTERSECTIONS, EACH SIDE OF OPENINGS OVER 2 FEET WIDE AND AS SHOWN ON PLANS.

I. STRUCTURAL WOOD COMPONENTS (BEAMS, JOISTS, RAFTERS, ETC.) SHALL HAVE THE FOLLOWING MINIMUM ALLOWARILE FIBER STRESSES OF NO. 2 SOUTHERN PINE CONFORMING TO THE LATEST EDITION OF MOS, AS FOLLOWS UNLESS MOTED OTHERWOODS:

SHEAR Y = SO SPORTS
BENDING 2X5 Fb = 1,250 psi.
BENDING 2X6 Fb = 1,250 psi.
BENDING 2X10 Fb = 1,250 psi.
BENDING 2X11 Fb = 975 psi.


2. WOOD IN CONTACT WITH CONCERTE OR MASONRY, AND AT OTHER LOCATIONS AS SHOWN ON STRUCTURAL DRAWINGS, SHALL BE PROTECTED OR PRESSURE TREATED IN ACCORDANCE WITH AMERICAN WOOD — PRESEMERS' ASSOCIATION STRUCTURAL DRAWINGS, STRUCTURAL PROMINERS SHOWN ARE NOMINAL UNLESS NOTED OTHERWISE.

ASSOCIATION STANDARDS. MEMBER SIZES SHOWN ARE NOMINAL UNLESS NOTICE OTHERWISE.


3. PLYWOOD FLOOR, WALL AND ROOF SHEATHING ARE DESIGNED AS DIAPHRAGINS AND SHALL COMPLY WITH APPLICABLE PROVISIONS OF CHAPTER 23 OF THE BUILDING CODE. UNLESS SHOWN OTHERWISE, SPAIN ARED PANILS SHALL BE FASTENED TO NOMINAL 2X SOUTHERN PINE FRAMING SPACED UP TO 24" O/C. IN ACCORDANCE WITH THE FOLLOWING:
PANELS UP TO 1/2" THICK: 8d NAILS AT 6" O/C. EDGE, 12" O/C. ELSEWHERE.
PANELS UP TO 5/8" THICK: 10d NAILS AT 6" O/C. EDGE, 12" O/C. ELSEWHERE.

O/C. ELSEWHERE.


PANELS UP TO 3/4" THICK: 12d NAILS AT 6" O/C. EDGE, 12"
O/C. ELSEWHERE.

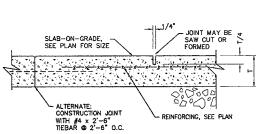

2 CONTROL S-1 SCALE: */*=1'-0" JOINT

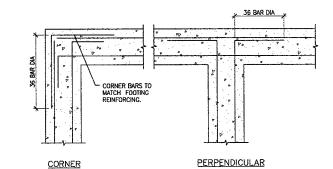

3 TYP. FOOTING INTERSECTION DETAIL
S-1 SCALE: **=1'-0"

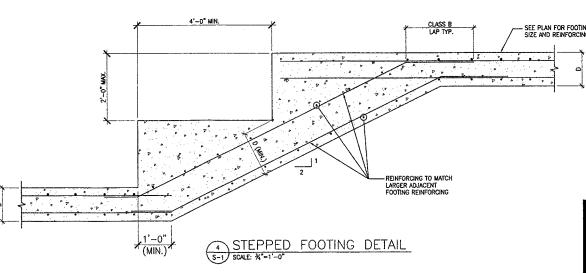



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Georg FOR ADDITION Marietta, COOLER SE. NI-Road, WAREHOUSE \odot Windy 2365

JOB. NO. 12494 DATE:

REVISIONS

09-13-2013

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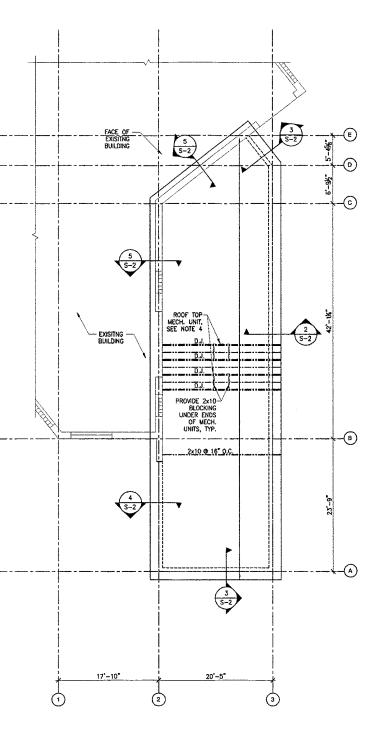
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S-1








ROOF FRAMING PLAN


ROOF FRAMING PLAN NOTES:

- VERIFY ALL DIMENSIONS AND ELEVATIONS WITH ARCHITECTURAL DRAWINGS BEFORE COMMENCING CONSTRUCTION, ALL DISCREPANCIES SHALL BE BROUGHT TO THE ATTENTION OF THE ARCHITECT AND THE STRUCTURAL ENGINEER. FOR ADDITIONAL INFORMATION SEE ARCHITECTURAL DRAWINGS.
- SEE ARCHITECTURE FOR TOP OF FINISHED ROOF ELEVATIONS, ROOF SLOPES AND ROOF DRAIN LOCATIONS.
- COORDINATE SIZE AND LOCATION OF ALL OPENINGS IN ROOF WITH ARCH, MECH, AND PLUMBING DRAWINGS.
- D.J. INDICATES DOUBLE 2x10 ROOF JOISTS SUPPORTING SIDES OF ROOF TOP MECHANICAL UNITS. COORDINATE LOCATION OF MECHANICAL UNITS WITH ARCHITECTURAL AND MECHANICAL DRAWINGS.

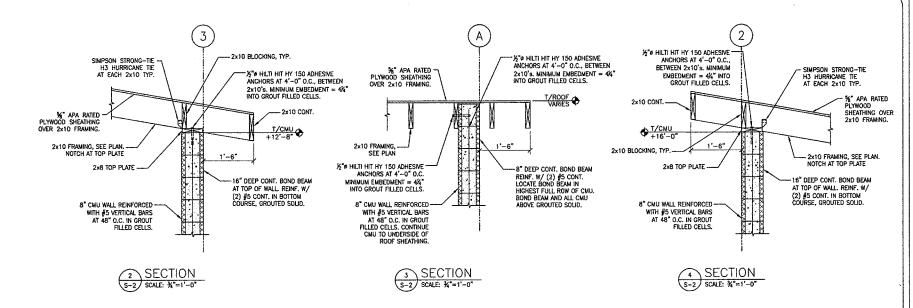


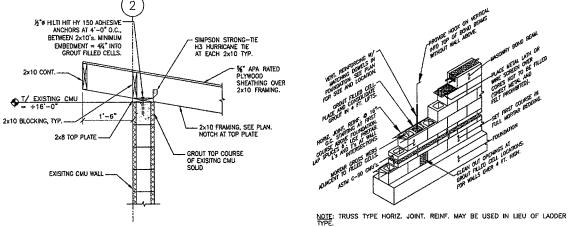

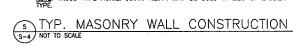


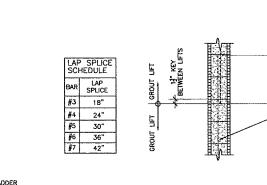

TYP. CMU LAP SPLICE

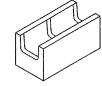

5 SECTION S-2 SCALE: ¾"=1'-0"

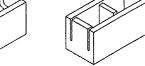


Depressed Web Bond Beam Unit

NOTES:

1. BOND BEAMS SHALL BE 8" DEEP, REINFORCED WITH
(2) #5 CONTINUOUS AT BEAM MID-DEPTH, U.N.O.
PROVIDE (2) #5 × 2"-6" CORNER BARS AT ALL
CORNERS AND INTERSECTIONS.

2. BOND BEAMS SHALL BE LOCATED AT THE TOP OF ALL MASONRY WALLS AND AS INDICATED IN SECTIONS AND DETAILS, U.N.O.

7 TYP. MASONRY BOND BEAM S-4 NOT TO SCALE

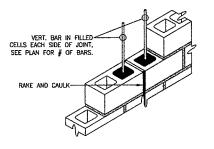


8 TYP. MASONRY CONTROL JOINT S-4 NOT TO SCALE



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VERTICAL REINF. AS REQUIRED

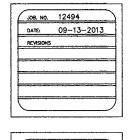



30067 Georgia ERS ADDITION Marietta, COOLER SE. WALK-IN Road, Ō WAREHOUSE ∞ Windy 2365

County

Cobb

DCA ARCHITECTS
3612 ASHLEY ESTATES
MARETA, GEON-1525 PAK(770) 850-1554

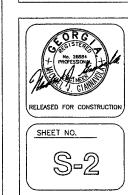

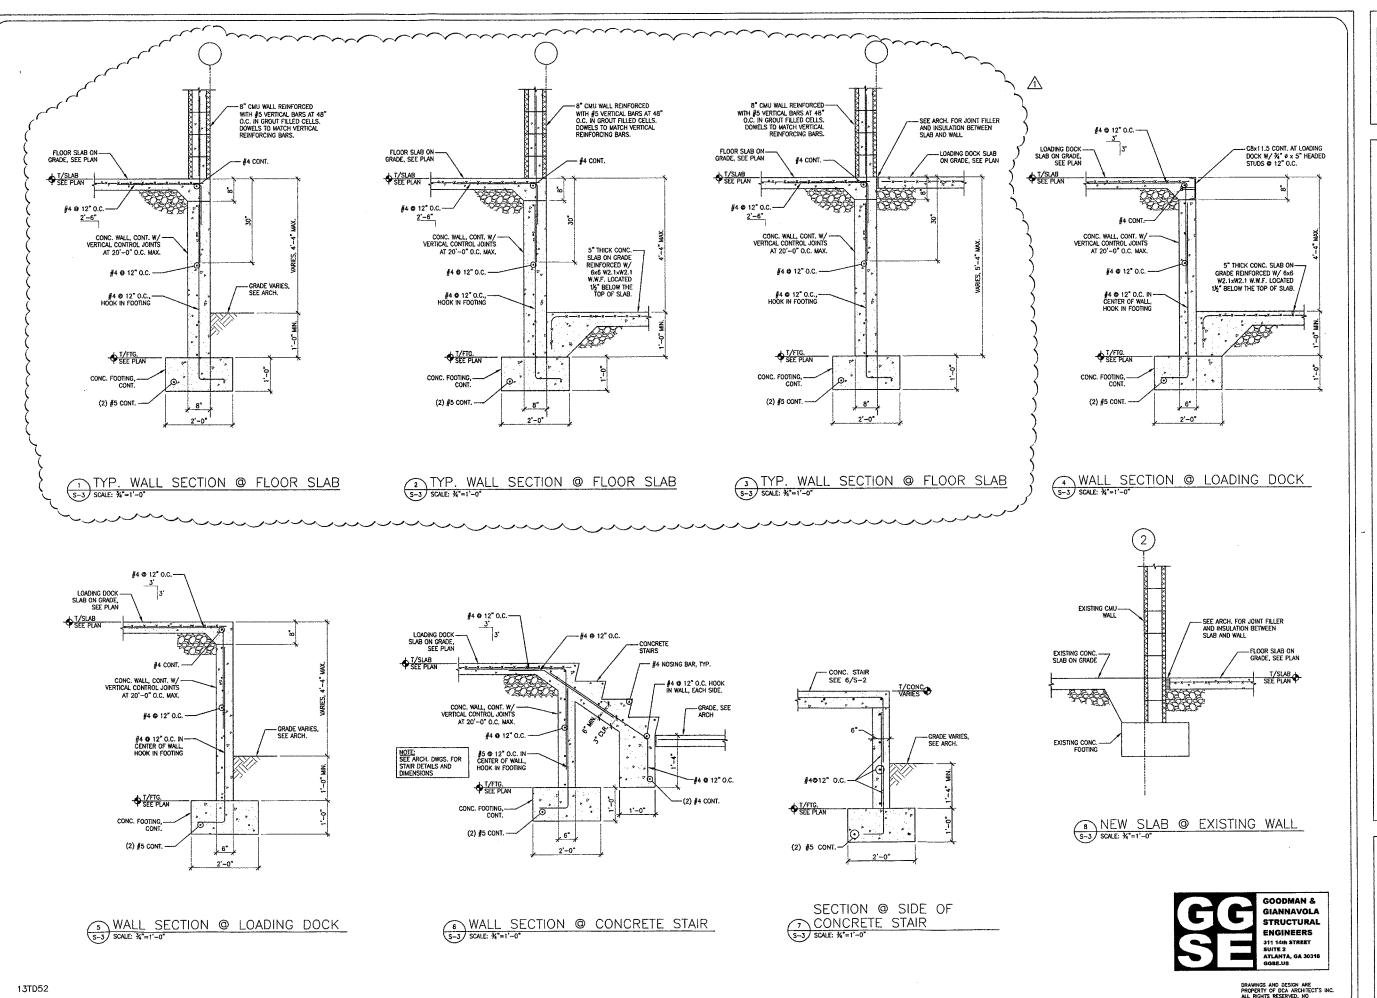

JOB, NO. 12494

DATE: 09-13-2013

REVISIONS

1 12-04-2013

BOO-FLOWERS
Road, SE. Marietta, Georgia 30067
Cobb County

Windy

2365

DCA ARCHITECTS
3612 ASHEY ESTATES
MARKETIN, GROUND SOUTHWAND SOUTH







Location Map

FEMA Map

Site Notes:

- The SITE CONTAINS: 2.26 ACRES SEE ARCHITECTURAL DRAWINGS FOR OVERALL PLAN AND SURVEY PROPERLY TOTAL DISTURBED ACREAGE: 0.11 ACRES TOTAL INCREASE IN INFERMOUS ACREAGE: 0.658 SF
- SITE ADDRESS: 2365 WINDY HILL ROAD, MARKETTA, GA 30067 PARCEL ID NUMBER: 17080100290

- THE POSTION IN THE PLANS ARE SHOWN FOR THE CONTRACTOR'S CONNENENCE. THE PROVINCE ASSULES NO RESPONSIBILITY FOR THE LOCATION OF ALL UNITIES SHOWN ON THE PLANS ARE SHOWN FOR THE CONTRACTOR'S CONNENENCE. THE PROVINCE ASSULES NO RESPONSIBILITY FOR THE LOCATION OF ALL UNITIES SHOWN ON THE PLANS AND REPORT ANY DISCREPANCES TO THE UNITIES WHICH MAY EAST ON THE SHE BUT ARE NOT SHOWN. THE CONTRACTOR SHALL HAVE THE RESPONSIBILITY ON VERBEY THE LOCATION OF ALL UNITIES SHOWN ON THE PLANS AND REPORT THAT YES SHOWN ON THE LOCATION OF THE PLANS AND REPORT THAT YES SHOWN ON THE PLANS AND REPORT THAT YES SHOWN ON

- CONTRACTOR SHALL CONTRACT THE UTILITY LOCATOR AS REQUIRED BY GEORGA LAW AND HAVE ALL UTILITIES MARKED PRIOR TO ANY CONSTRUCTION ACTIVITY. CONTRACTOR WILL HAVE A PRIVATE UTILITY LOCATOR LOCATE ALL UTILITIES WITHIN THE CONSTRUCTION MURITS NOT COVERED BY THE UTILITY PROTECTION GENTER.
- THE CONTRACTOR SHALL IMMEDIATELY NOTIFY THE ENGINEER OF ANY DISCREPANCES OR ERRORS THAT HE MAY DISCOVER IN THESE PLANS

Grading Notes:

- RK MUST ACHIEVE 95% STD COMPACTION RATE

- CONTRACTOR SHALL FOLLOW ALL APPLICABLE SAFETY AND CONSTRUCTION PROCEDURES, ORDINANCES, CODES, AND STANDARDS
- MANIMUM, GRADED SLOPES ALLOWED 24-14


 CONTRACTOR SHALL BE RESPONSIBLE FOR PROTECTING ALL EARTHWORK AND GRADING OPERATIONS FROM GRADING, SEDMENTATION, OR DAMAGE DURING CONSTRUCTION. REPAIR OR REPLACEMENT OF EARTHWORK SHALL BE THE CONTRACTOR'S RESPONSIBILITY AT NO ADDITIONAL COST TO THE OWNER. REMOVING AND CLEANING UP SEDMENT ACCUMULATIONS SHALL BE AT NO ADDITIONAL COST TO THE OWNER.
- 10. CONTRACTOR SHALL PROVIDE ALL EXCAVATING, FILLING, BACKFILLING, IMPORTING, EXPORTING, AND GRADING REQUIRED TO BRING ENTIRE PROJECT TO THE FINAL GRADES AND ELEVATIONS SHOW




TOTAL SITE ACRES = 2.26 ACRES TOTAL LIMITS OF DISTURBANCE = 0.11 ACRES

Tree Protection Note:

1. NO TREES WILL BE DISTURBED AS A PART OF THIS PROJECT.

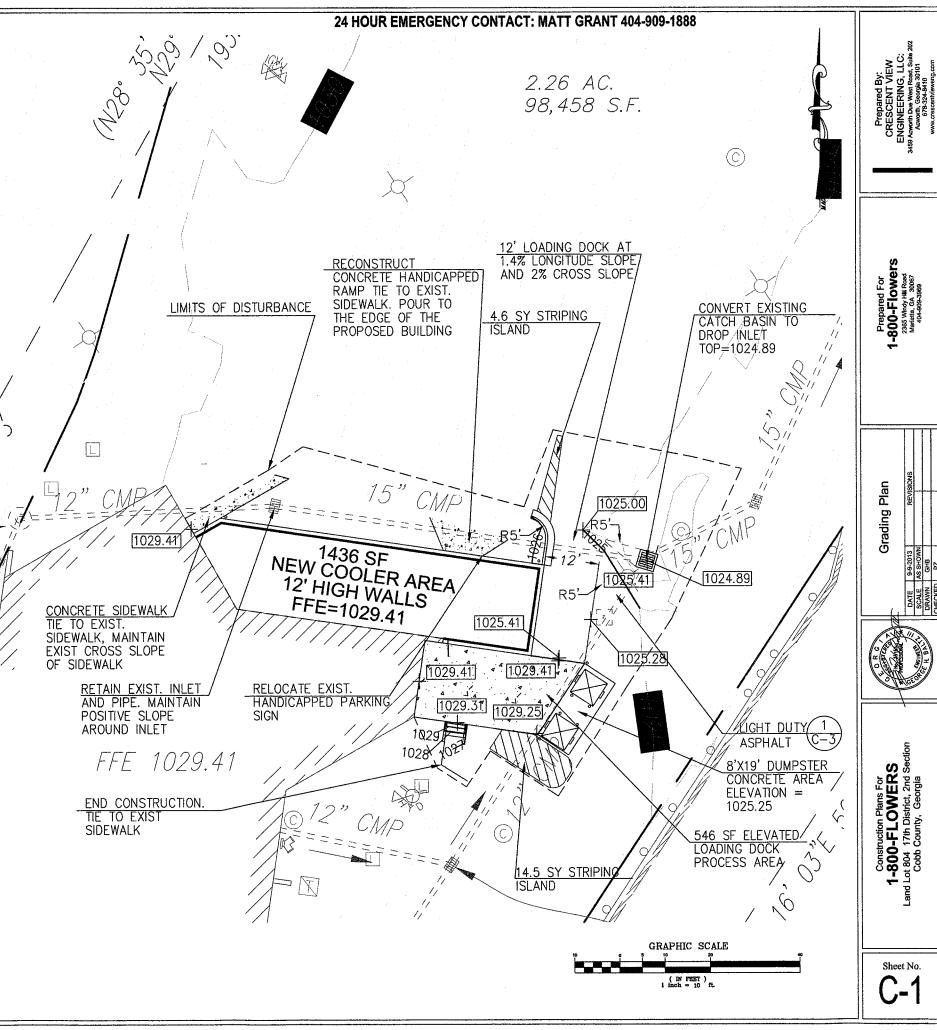

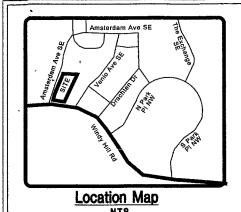

Basin Sediment Calculations

DRAINAGE AREA = 0.33 ACRES: DISTURBED AREA =0.11 ACRES DRAINAGE AREA STORAGE REQUIRED = 0.33 X 67 = 22.11 CY COMPOSITE FILTER SOCK PROVIDED = 199 LINEAR FEET (0.04 CU YO PER LF) TYPE C SILT FENCE PROVIDED = 67 LINEAR FEET (0.045 CU YD PER LF) INLET SEDIMENT TRAP TYPE F PROVIDED = 1 EA (14.02 CU YD PER EA)* INLET SEDIMENT TRAP TYPE P PROVIDED = 2 EA (1.34 CU YD PER EA)

* ONE INLET SEDIMENT TRAP WILL BE EXCAVATED TO PROVIDE ADDITIONAL ONSITE SEDIEMNT STORAGE SEE DETAILS ON SHEET C-2

TOTAL STORAGE PROVIDED = 199 X 0.04 + 67 X 0.045 + 1 X 14.02 + 2 X 1.34 = 27.68 CY > 22.11 CY REQUIRED.

ES&PC Notes:

- 1. THE CONSTRUCTION PAD SHALL BE MAINTAINED IN A CONDITION WHICH WILL PREVENT TRACKING OR FLOW OF MUD ONTO PUBLIC STREETS.
- 2 SAND BAG BARRIERS SHALL BE CLEANED OR REPLACED AND MAINTAINED IN FUNCTIONAL CONDITION UNTIL PERMANENT EROSION CONTROL MEASURES ARE ESTABLISHED
- 3. ALL GRASSING SHALL BE IN ACCORDANCE WITH CHAPTER 6, SECTION IN "VEGETATIVE PRACTICES" OF THE MANUAL FOR EROSION AND SEDIMENT CONTROL IN GEORGIA.
- 5. EROSON CONTROL DEWCES WILL BE IN PLACE BEFORE SITE DISTURBANCE AND WILL BE PERIODICALLY INSPECTED AND REPAIRED OR RESTORED AS NEEDED TO FUNCTION PROPERLY UNTIL PERMANENT MEASURES ARE ESTABLISHED AND PROJECT IS COMPLETE, I.E.: CONSTRUCTION FORTS AND SLIT FERICES SHALL BE RE-TOPPED OR CLEANED AS SLIT REDUCES THEIR EFFECTIVENESS.
- 6. ANY ADDITIONAL CONSTRUCTION OTHER THAN SHOWN ON THIS PLAN WILL REQUIRE SEPARATE AND ADDITIONAL EROSION AND SEDIMENT CONTROL MEASURES
- 7. TEMPORARY VEGETATION AND/OR HEAVY MULCH WILL BE USED TO STABILIZE AREAS. IN NO CASE SHALL A SITE BE LEFT BARE FOR MORE THAN TWO WEEKS
- 8. ALL DISTURBED AREAS WILL BE PERMANENTLY LANDSCAPED AND GRASSED AS SOON AS CONSTRUCTION PHASES PERMIT
- 9. ALL WORK SHALL BE PERFORMED IN ACCORDANCE WITH THE SPECIFICATION OF THE MANUAL FOR EROSION AND SEDIMENT CONTROL IN GEORGIA
- 10. ADDITIONAL MEASURES MAY BE REQUIRED TO CONTROL FROSION AS DETERMINED NECESSARY BY COBB COUNTY INSPECTORS.
- 11. PERSON RESPONSIBLE FOR EROSION CONTROL MEASURES IS: 24 HOUR EMERGENCY CONTACT: JOE AMSZYNSIG 770-616-7391
- 12. SEDIMENTATION & EROSION CONTROL MEASURES TO BE INSPECTED DAILY.
- 13. EROSION CONTROL MEASURES WILL BE MAINTAINED AT ALL TIMES. IF FULL IMPLEMENTATION OF THE APPROVED PLAN DOES NOT PROVIDE FOR EFFECTIVE EROSION CONTROL, ADDITIONAL EROSION AND SEDIMENT CONTROL MEASURES SHALL BE MAPLEMENTED TO CONTROL OR TREAT THE SEDIMENT SOURCE.

Cobb ES&PC Notes:

- 2. IN CONCENTRATED FLOW AREAS, ALL SLOPES STEEPER THAN 2.5:1 AND WITH A HEIGHT TEN FEET OR GREATER, AND CUTS AND FILLS WITHIN STREAM BUFFERS, SHALL BE STABILIZED WITH THE APPROPRIATE EROSION CONTROL MATTING OR PLANNET.

- ADDITIONAL ERGSION CONTROL DEVICES TO BE USED AS REQUIRED BY COBB COUNTY.
- 11. IF STREAMS ARE ON YOUR SITE, COSO COUNTY WILL REQUIRE THAT THE STREAM BUFFERS BE LEFT UNDISTURBED AND A CONSERVATION EASEMENT OR A RESTRICTINE COMEMINE OF PLACED ON THAT PROPERTY. FOR MORE INFORMATION, PLEASE FEEL FREE TO CONTACT DAMA, CONNISON WITH THE PLANNING DIVISION © 770-528-2199 OR DAMA_CONSCIONECOMETY.CRG.

THE ESCAPE OF SEDIMENT FROM THE SITE SHALL BE PREVENTED BY THE INSTALLATION OF EROSION AND SEDIMENT CONTROL MEASURES AND PRACTICES PRIOR TO, OR CONCURRENT WITH, LAND-DISTURBING ACTIVITIES.

EROSION CONTROL MEASURES WILL BE MAINTAINED AT ALL TIMES. IF FULL IMPLEMENTATION OF THE APPROVED PLAN DOES NOT PROVIDE FOR EFFECTIVE EROSION CONTROL, ADDITIONAL EROSION AND SEDIMENT CONTROL MEASURES SHALL BE PROVIDED BY THE CONTRACTOR FOR EFFECTIVE EROSION IMPLEMENTED TO CONTROL OR TREAT THE SEDIMENT SOURCE.

ANY DISTURBED AREAS LEFT EXPOSED FOR A PERIOD GREATER THAN 14 DAYS SHALL BE STABILIZED WITH MULCH OR TEMPORARY SEEDING.

ANY DISTURBED AREAS REMAINING IDLE FOR 30 DAYS SHALL BE STABILIZED WITH PERMANENT VEGETATION.

Construction Activity Schedule

INSTALLATION OF INITIAL EROSION CONTROL MEASURES CONSTRUCT SD2-HB INSTALL NEW BUILDING AND LOADING DOCK

MAINTENANCE OF EROSION AND SEDIMENT CONTROL MEASURES FINAL LANDSCAPING, GRASSING, ETC (IF REQUIRED). BMP REMOVAL



Vegetation Plan:

- DISTURBED AREA STABILIZATION METHODS & SAMPLES

 DISTURBED AREA STABILIZATION METHODS & SAMPLES

 TO SOIL SURFACE FOR A PERIOD OF (6) MONTHS OR LESS WHEN SEEDING IS NOT PRACTICAL. ON OR BEFORE THE 14TH DAY (OR Ds.2)

 DISTURBED AREA STABILISH A TEMPORARY VECETATIVE COVER W/FAST GROWING SEEDS APPLIED TO ROUGH CRADED AREAS THAT WILL BE EXPOSED FOR LESS THAN 6 MONTHS. (THEN Ds.3)

 DISTURBED AREA STABILISH AT THE (30) DAYS ESTABLISH PERMANENT VECETATIVE COVER SUCH AS TREES, SHRUBS, WINES, GRASSES, SOD OR LEGISTATIVE (ADM 70 Dc.4)

- DS4 SOD FOR HIGHLY ERODIBLE OR CRITICALLY ERODED LANDS-ALLOWS IMMEDIATE GROUND COVER REDUCING RUNOFF, EROSION, DUST & SEDIMENT.


| FERTILIZE | r requirements f | OR PERMANEN | VEGETATION | (Us3) |
|-------------------------------------|--------------------------------|--------------------------------|---------------------|------------------------------------|
| TYPES OF SPECIES | PLANTING YEAR | FERIFLIZER (N-P-K) | (foe./scre) | R TOP DRESSING RATE (fbs./ocre) |
| COOL SEASON GRASSES | FIRST SECOND MAINTENANCE | 6-12-12 6-12-12 10-10-10 | 1500 1000 400 | 0-50 |
| COOL SEASON GRASSES & LEGUMES | FIRST SECOND NAINTENANCE | 6-12-12 0-10-10 0-10-10 | 1500 1000 400 | 50-100 50-100 30 |
| WARM SEASON GRASSES | FIRST SECOND MAINTENANCE | 6-12-12 6-12-12 10-10-10 | 1500 800 400 | 50 |
| WARM SEASON CRASSES A LECKMES | FIRST SECOND MAINTENANCE | 6-12-12 0-10-10 0-10-10 | 1500 1000 400 | 50100 30 |


State Waters Statement:

NO WATERS OF THE STATE EXIST ON OR WITHIN 200 FEET OF THE PROJECT SITE (ONSITE POND IS MAN MADE WITH PERMANENT POOL PIPED TO POND), PROJECT RECEIVING WATERS ARE THE CHATTAHOOCHEE RIVER.

Soil Legend:

Ubp -- URBAN LAND AND BORROW PITS

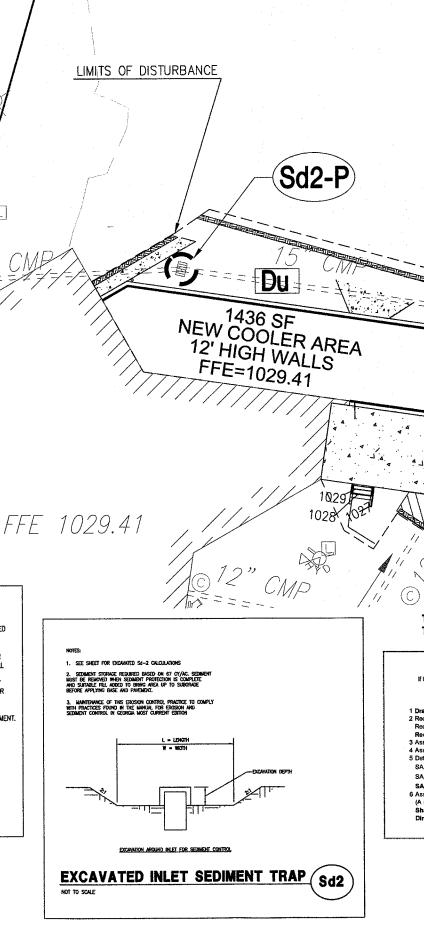

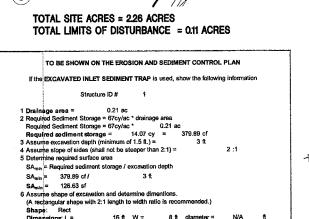

24 HOUR EMERGENCY CONTACT: MATT GRANT 404-909-1888

S



Sd2-P

Sd1-C

0

Sd1-Cfs

GPS COORD OF CO

Sd2-F

EXCAVATED #1


33D \$4" 16.52" 84D 28" 57.28"

Construction Plans For 1-800-FLOWERS In Lot 804 17th District, 2nd Sect Cobb County, Georgia

Prepared For -800-Flower: 2365 Windy Hill Road Mariette. GA 30067 404-909-3969

ES&PC I

Sheet No.

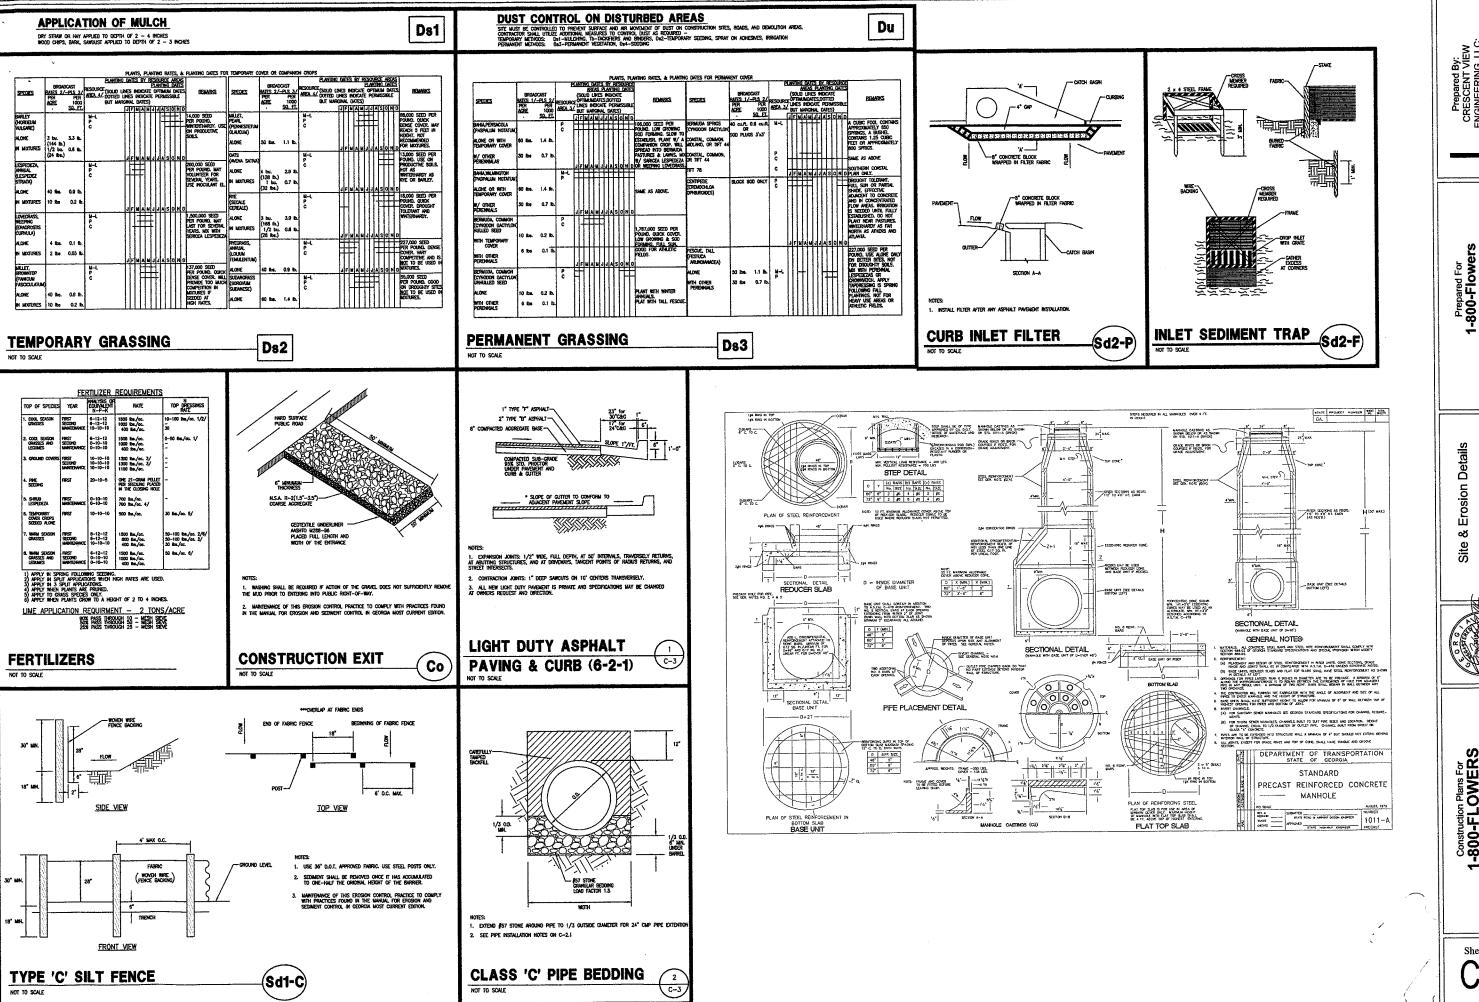

1-800-Flowers 2365 Windy-Hill Road Marlette, GA 30067 404-909-3969

1-800-FLOWERS id Lot 804 17th District, 2nd Secti Cobb County, Georgia

Sheet No.