

WATER PIPING PLAN SCALE: 1/4"= 1'-0"

San. pipes 3" & above- slopes @ 1/8"/ lin. ft. San. pipes 2" & below- slopes @ 1/4"/ lin. ft.

WATER PIPING NOTES:


- ALL WATER PIPING SHALL BE INSTALLED IN ACCORDANCE WITH THE 2020 FLORIDA BUILDING PLUMBING CODE, AND LOCAL ORDINANCES. 2. PLUMBING CONTRACTOR SHALL PAY ALL FEES, INSPECTION AND CONNECTION CHARGES REQUIRED.
- 3. PLUMBING CONTRACTOR SHALL GUARANTEE ALL WORK FREE OF DEFECTS IN MATERIAL AND WORKMANSHIP FOR A PERIOD OF ONE YEAR FROM DATE OF ACCEPTANCE.
- 4. SUBMIT SHOP DRAWINGS TO ARCHITECT FOR APPROVAL OF ALL EQUIPMENT, MATERIALS AND LAYOUTS PRIOR TO INSTALLATION.
- 5. OFFSET PIPING AS REQUIRED TO CLEAR BUILDING STRUCTURE, DUCTWORK, ETC. AS REQUIRED BY FIELD CONDITIONS. COORDINATE WITH ALL EXISTING AND NEW WORK.
- 6. PLUMBING CONTRACTOR SHALL VERIFY ALL SPACE CONDITIONS AND DIMENSIONS AT JOB SITE PRIOR TO FABRICATION AND INSTALLATION OF MATERIALS AND EQUIPMENT.
- 7. COORDINATE WORK WITH OTHER TRADES.
- 8. FURNISH AND INSTALL ALL PLUMBING FIXTURES.
- 9. EACH PLUMBING FIXTURE SHALL BE PROVIDED WITH AIR CHAMBERS AS PER F.B.C.
- 10. WHEREVER DISSIMILAR METALS ARE TO BE JOINED, A DIELECTRIC
- FITTING SHALL BE PROVIDED TO CONNECT BOTH TYPES OF PIPES. 11. PROVIDE ALL WATER PIPING
- 12. HOT & COLD WATER PIPING ABOVE FLOOR OR BELOW SLAB WITHIN BUILDING WALLS SHALL BE TYPE "L" COPPER TUBING, HARD DRAWN ABOVE GROUND, SOFT ANNEALED BELOW GROUND, ALL WATER PIPING BELOW GROUND, SO'T ANNIALED BELOW GROUND, ALL WATER FIFING
 BELOW GROUND UNDER CONCRETE SLAB SHALL BE ENCASED IN A 4"
 PVC SCHEDULE 40 PIPE CASING AS PER "SFBC" REQUIREMENTS.
 JOINTS SHALL BE MADE ON ALL COPPER PIPE ABOVE GROUND WITH
 95/5 SOLDER. COLD WATER PIPES OUTSIDE THE BUILDING SHALL BE
 TYPE "L" COPPER PIPE HARD DRAWN. AT OWNER'S OPTION ALL WATER
 PIPING & FITTINGS COULD BE SUBSTITUTED FOR PVC SCHEDULE 40
 WEIGHT BUILDING STITLINGS AND LISTED IN ACCORDANCE WITH THE "TERG" WEIGHT PIPING & FITTINGS AND USED IN ACCORDANCE WITH THE "FBC". TYPE "L" COPPER FOR 2" AND UNDER, TYPE "K" COPPER FOR 2" & ABOVE. NO FITTINGS SHALL BE INSTALLED IN ALL UNDERGROUND WATER PIPING.

WAT	WATER LEGEND		
SYMBOL	DESCRIPTION		
	COLD WATER PIPE HOT WATER PIPE GATE VALVE		
U. G.	AIR CHAMBER Underground		
	T & P TEMP. & PRESSURE RELIEF VALVE		

COLD WATER SUPPLY & PLUMBING FIXTURE SCHEDULE					
DESCRIPTION	WASTE	CW	HW	FU	
1-W.C.	3"	1/2"	•	4	
1-LAVS	1-1/2"	1/2"	1/2"	1	
1-TUB	2"	1/2"	1/2"	2	
TOTAL F.U.				7 F.U. AT ADDITION	

Note:

- A) HORIZONTAL RUN OF H&CW SERVICE PIPE SHALL BE TRENCHED UNDER PAVED AREA & SHALL BE ENCASED IN SCHEDULE 40 PVC PIPE WITH MIN. 24" COVER. ENDS OF ENCASEMENT PIPE SHALL BE SEALED TO PREVENT EROSION.
- B) PROVIDE SAND ENVELOPE 6" BELOW & ABOVE PIPE THE FULL WIDTH OF TRENCH.

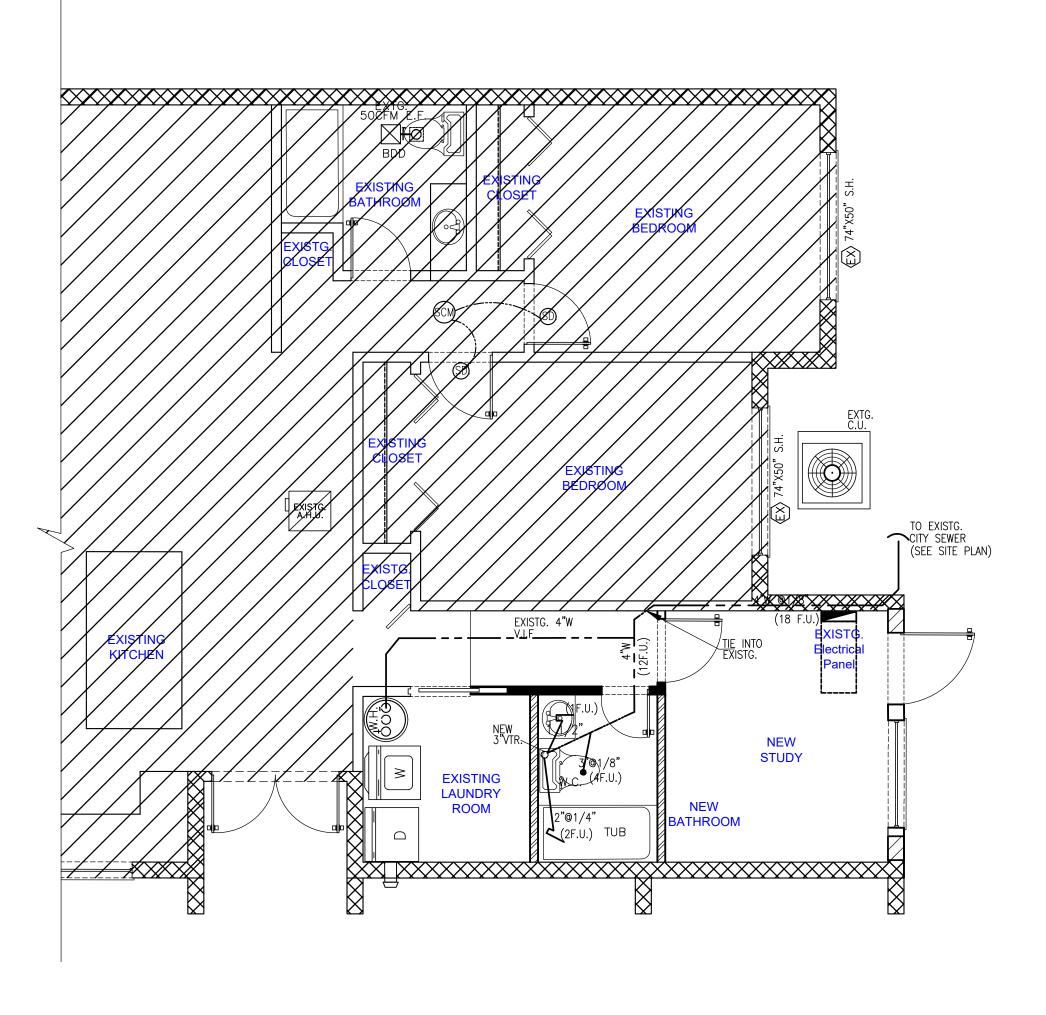

SANITARY PLUMBING PLAN
SCALE: 1/4"= 1'-0"

SANITARY PIPING NOTES:

- 1. ALL SANITARY PIPING SHALL BE INSTALLED IN ACCORDANCE WITH THE 2020 FLORIDA BUILDING CODE, STATE AND LOCAL ORDINANCES. 2. PLUMBING CONTRACTOR SHALL PAY ALL FEES, INSPECTION AND CONNECTION CHARGES REQUIRED.
- 3. PLUMBING CONTRACTOR SHALL GUARANTEE ALL WORK FREE OF DEFECTS IN MATERIAL AND WORKMANSHIP FOR A PERIOD OF ONE YEAR FROM DATE OF ACCEPTANCE.
- 4. SUBMIT SHOP DRAWINGS TO ARCHITECT FOR APPROVAL OF ALL EQUIPMENT, MATERIALS AND LAYOUTS PRIOR TO INSTALLATION.

5. OFFSET PIPING AS REQUIRED TO CLEAR BUILDING STRUCTURE,

- DUCTWORK, ETC. AS REQUIRED BY FIELD CONDITIONS. COORDINATE WITH ALL EXISTING AND NEW WORK. 6. PLUMBING CONTRACTOR SHALL VERIFY ALL SPACE CONDITIONS AND
- DIMENSIONS AT JOB SITE PRIOR TO FABRICATION AND INSTALLATION OF MATERIALS AND EQUIPMENT.
- 7. COORDINATE WORK WITH OTHER TRADES. 8. FURNISH AND INSTALL PLUMBING FIXTURES.
- 9. PROVIDE STOP VALVES FOR EACH FIXTURE.
- 10. WHEREVER DISSIMILAR METALS ARE TO BE JOINED, A DIELECTRIC FITTING SHALL BE PROVIDED TO CONNECT BOTH TYPES OF PIPES. 11. PROVIDE SANITARY PIPING.
- 12. SANITARY SOIL PIPE & FITTINGS BELOW GRADE OR FLOOR SLAB ON FILL CAN BE STANDARD WEIGHT BELL & SPIGOT CAST IRON, COATED WITH TAR PITCH WITH LEAD & OKUM JOINTS OR NEOPRENE SEALS, OR CAST IRON NO HUB PIPE & FITTINGS OR PVC SCHEDULE 40 PIPE & FITTINGS. IN ACCORDANCE WITH THE "FBC". SANITARY & VENT PIPING ABOVE FLOOR SLAB WITHIN BUILDING WALLS CAN BE CAST IRON NO HUB PIPING & FITTINGS OR PVC SCHEDULE 40 PIPING & FITTINGS. IN ACCORDDANCE WITH THE "FBC".

PLUMBING LEGEND

DESCRIPTION SYMBOL SANITARY PIPE VENT PIPE _____ P TRAP WALL CLEANOUT - \otimes FLUSH CLEANOUT _ | _ _ VENT THRU ROOF UNDERGROUND

> TABLE 604.4 MAXIMUM FLOW RATES AND CONSUMPTION FOR PLUMBING FIXTURES AND FIXTURE FITTINGS.

PLUMBING FIXTURE OR FIXTURE FITTING	MAXIMUM FLOW RATE OR QUANTITY	
Lavatory,private	1.5 gpm at 60 psi	
Lavatory,public (other than metering)	0.5 gpm at 60 psi	
Shower head ^a	1.5 gpm at 80 psi	
Sink faucet	1.5 gpm at psi	
Urinal	1.0 gallon per flushing cycle	
Water closet	1.28 gallons per flushing cycle	

PLUMBING CONTRACTOR TO FOLLOW TABLE 604.4 FOR COMPLYING WITH REQUIREMENTS FOR NEW FIXTURES

A WATER HAMMER ARRESTOR SHALL BE INSTALED WHERE QUICK CLOSING VALVES ARE USED. WATER HAMMER ARRESTOR SHALL BE INSTALLED IN ACCORDANCE WITH MANUFACTURERS SPECS AND SHALL CONFORM TO ASSE 1010.

DATE:

DRAWN BY: S. DELINCE Hollywd Florida 33024 PHONE: 786-606-5531 EMAIL: mduclosdesign01

@aol.com 10/15/21 1/4" = 1'-0"

OWNER: Nachum Caplan & Alyssa Cohen PROJECT : Garage enclosure to Bath & Study Addition

