

ADDENDUM #02

PROJECT: ISSUE DATE: **RENOVATIONS TO PALMERTON WEIGHT ROOM** Tuesday, March 5th 2024

The following clarifications, amendments, additions, deletions, revisions and modifications in this Addendum forms a part of the Contract Documents and modifies the original Bidding Documents as noted below. This addendum must be acknowledged in the form of proposal in the space provided for this purpose. Failure to so acknowledge this addendum may subject the Bidder to disqualifications.

GENERAL

- Existing original drawings of weight room provided by Palmerton Area School District for reference.
- List of bidders as of March 1st, 2024.
- The following items were discussed during the non-mandatory pre-bid meeting on February 28th, 2024.
 - Mechanical, scope of work is contracted as an ESCO project through McClure Co. There is no mechanical work included in the scope of this project. M1.1 has been provided for the contractor's reference. Any references to mechanical work in the specifications shall be removed.
 - o Bid forms will be included via an addendum closer to the bid opening date.
 - RFI Cut-Off date is the end of day, March 8th, 2024. RFIs must be submitted in writing.
- Where floor mounted plumbing fixtures, floor drains, or floor piping are to be removed, GC shall open floor. PC will be responsible to remove any additional concrete to reach plumbing needed below floor and the GC will replace concrete floor and finish as per specifications. Refer to MEP drawings.
- The only utility services to be impacted outside of the building will be the water and sanitary. Interceptions should be planned as close to the building as possible. PC shall be responsible for outside work related to water and sanitary (including any excavation) and the GC shall patch asphalt or grass as necessary.
- All forms (including but not limited to bid, performance, and payment bond forms) are to be acquired by the bidder as per the specifications.

DRAWINGS

ADDED STRUCTURAL:

S.1 – PALMERTON WEIGHT ROOM TYPICAL STRUCTURAL DRAWING

REVISED ARCHITECTURAL:

- G0.00 COVER SHEET
 - \circ Updated sheets
- A0.01 DEMOLITION PLAN LEVEL 01
 - Updated concrete slab information.
 - \circ Updated coordination notes.
- A1.01 REFERENCE PLAN LEVEL 01 (SHEET NOT PROVIDED)
 - Remove language for civil and food service from general plan notes, typical. No civil or food service drawings to be included in this project.

A4.00 – WALL SECTIONS

• Updated concrete slab information.

RENOVATIONS TO PALMERTON HIGH SCHOOL WEIGHT ROOM **3525 FIRELINE ROAD** PALMERTON, PA 18071

PALMERTON AREA SCHOOL DISTRICT 680 FOURTH STREET PALMERTON, PA 18071

GENERAL CONDITIONS

- THIS CONSTRUCTION PROJECT PROVIDE APPROPRIATE SAFETY MEASU
- 3. QUALITY OF MATERIALS AND WORKMANSHIP SHALL BE IN ACCORDANCE WITH THE BEST STANDARDS AND PRACTICE OF THE TRADES INVOLVED
- THE CONTRACTOR SHALL FILE ALL REQUIRED INSURANCE CERTIFICATES AND OBTAIN ALL REQUIRED BUILDING PERMITS PRIOR TO COMMENCEMENT OF THE WORK. COSTS OF PERMITS TO BE PAID BY BUILDER, APPROVED PERMIT TO BE POSTED.
- 5. A COMPLETE SET OF PROJECT DOCUMENTS, INCLUDING AN ORIGINAL STAMPED SET OF DRAWINGS AND ALL SUBSEQUENT CHANGES AND CLARIFICATIONS SHALL BE KEPT ON SITE AT ALL TIMES. ALL PROPOSED CHANGES TO ORIGINAL PROJECT DOCUMENT BID SET ARE TO BE SUBMITTED BY CONTRACTOR IN THE FORM OF CHANGE ORDERS, INCLUDING ALL BACKUP INFORMATION, FOR APPROVAL BY OWNER/ARCHITECT.
- 6. PRIOR TO COMMENCEMENT OF WORK, CONTRACTOR, OWNER, AND ARCHITECT SHALL HOLD A PRE-CONSTRUCTION CONFERENCE TO CONFIRM SITE ACCESS ROUTE, SCHEDULE, AND SEQUENCE OF WORK. 7. THE CONTRACTOR SHALL BE RESPONSIBLE FOR THE SECURITY AND PROTECTION OF ALL CONDITIONS AND MATERIALS WITHIN THE PROPOSED CONSTRUCTION AREA. THE CONTRACTOR SHALL HAVE SOLE RESPONSIBILITY FOR ANY
- DAMAGE OR INJURY CAUSED BY OR DURING THE EXECUTION OF WORK. 8. SECTIONS AND DETAILS SHOWN, WHILE DRAWN FOR SPECIFIC LOCATIONS, ARE INTENDED TO ESTABLISH THE GENERAL TYPES OF DETAILS TO BE USED THROUGHOUT. WORK NOT INDICATED ON A PART OF THE DRAWINGS BUT REASONABLY IMPLIED TO BE SIMILAR TO THAT SHOWN AT CORRESPONDING PLACES, SHALL BE REPEATED. MINOR DETAILS NOT USUALLY SHOWN OR SPECIFIED, BUT REQUIRED FOR PROPER CONSTRUCTION OF ANY PART OF THE WORK SHALL BE INCLUDED AS IF THEY WERE INDICATED IN THE DRAWINGS.
- 9. CONTRACTOR TO VERIFY AND/OR ESTABLISH ALL EXISTING CONDITIONS AND DIMENSIONS AT THE SITE AND TO NOTIFY THE OWNER/ARCHITECT OF ANY DISCREPANCIES AND/OR DEVIATIONS FROM DRAWINGS. PROPOSED REMEDIES, IF REQUIRING ADDITIONAL WORK, ARE TO BE SUBMITTED FOR APPROVAL IN THE FORM OF WRITTEN CHANGE ORDERS TO THE OWNER IN ACCORDANCE WITH THE TERMS OF THE CONTRACT BEFORE ORDERING MATERIAL OR COMMENCING WITH WORK.
- 10. CONTRACTOR TO VERIFY LOCATION OF ALL BELOW GRADE UTILITIES AND STORM WATER SYSTEMS PRIOR TO EXCAVATION. NOTIFY ARCHITECT OF ANY CONFLICTS WITH PROPOSED CONSTRUCTION.
- 11. ARCHITECT/ENGINEER IS NOT RESPONSIBLE FOR WORK THAT THE ARCHITECT/ENGINEER'S DOES NOT REVIEW AND/OR WORK NOT COMPLETED IN ACCORDANCE WITH ARCHITECT/ENGINEER'S PLAN AND/OR INSTRUCTIONS. NO DEVIATION FROM DESIGN DRAWINGS IS PERMITTED WITHOUT WRITTEN APPROVAL.
- 12. PROVIDE DAILY CLEAN-UP OF AREAS ADJACENT TO CONSTRUCTION AS WELL AS PERIODIC CLEAN-UP OF CONSTRUCTION AREAS 13. AT JOB COMPLETION, BESIDES FINAL GENERAL CLEANING, REMOVE ALL STAINS AND PAINT FROM ALL NEW GLASS,
- TILE, AND OTHER FINISHES AND WASH AND POLISH STONE.

GENERAL DRAWING NOTES

- . WRITTEN DIMENSIONS HAVE PRECEDENCE OVER SCALED DIMENSIONS. 2. ITEMS NOT NOTED AS EXISTING ARE NEW. DOORS AND WINDOWS NOT NUMBERED ON THE FLOOR PLAN OR
- ELEVATIONS ARE EXISTING TO REMAIN, UNLESS NOTED OTHERWISE.
- 3. ALL DIMENSIONS TO EXISTING SURFACES ARE TO FINISH, AND ALL DIMENSIONS TO NEW CONSTRUCTION ARE TO ROUGH FRAMING, UNLESS NOTED OTHERWISE.
- 4. MECHANICAL, ELECTRICAL, PLUMBING & FIRE PROTECTION SYSTEMS INDICATED ON ARCHITECTURAL DRAWINGS ARE
- FOR REFERENCE ONLY. COORDINATE WITH MEPF DRAWINGS 5. ENCLOSED ACCESSIBLE SPACE UNDER STAIRS SHALL HAVE WALLS AND SOFFITS PROTECTED BY 5/8" FIRE RATED GWB UNLESS NOTED OTHERWISE.

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MATERIALS		<u>SYMBOLS</u>				
	GYPSUM WALLBOARD	XX	KEYED NOTE IDENTIFIER	NO.	CEILING HEIGHT & MATERIAL IDENTIFIER	
	FOAM INSULATION		KEYED NOTE (DEMOLITION)	MATL GL-NO>	GLAZING PANEL IDENTIFIER	
	BATT INSULATION			NO.	FURNITURE IDENTIFIER	
	RIGID INSULATION	\sim	CASEWORK/MILLWORK IDENTIFIER			
	LOOSE FILL INSULATION		REVISION IDENTIFIER	FLOOR FINISH WALL FINISH	Floor Finish Plan - Floor/Wall/Base Finish identifier	
	WOOD BLOCKING		COLUMN LINE OR	BASE MATL		
	ROUGH WOOD	(NO.)	GRID IDENTIFIER	EL NO.	SPOT ELEVATION INDICATOR	
JUNNINI,	FINISH WOOD	(NO.)				
	PLYWOOD/SHEATHING	NO. SIM			NORTH INDICATOR	
マ・ケインダ、クマーズ・ダン・ダン・ フィップ・デリン マンド・フィント ア・ダン・マーズ クレマンレーズ	MDO/MDF	DWG	DETAIL INDICATOR	\square	NORTHINDIOATON	
	ORIENTED STRAND BOARD (0SB)	SIM				
	CORK	NO. DWG	SECTION INDICATOR		LEVEL INDICATOR	
	GLASS	SIM				
	BRICK	NO. DWG	EXTERIOR ELEVATION INDICATOR	NO. NO.	SLOPE INDICATOR	
	CONCRETE	XX				
	CONCRETE UNIT MASONRY	XX DWG XX	INTERIOR ELEVATION INDICATOR	0" - 0"	DIMENSION STRING	
	STONE	xx		7 7		
	TILE	ROOM NAME	ROOM IDENTIFIER			
	TERRAZZO	NO.			EXISTING DOOR TO REMAIN (SWING @ 45 DEGREES)	
	EARTH	(DOOR NO.)	DOOR & RATING IDENTIFIER			
030303	GRAVEL	DR NO.) 1HR			DOOR TO BE DEMOLISHED	
	CLAY	NO.>	WINDOW / GLAZING IDENTIFIER		DOUT TO DE DEMOLISTED	
	STEEL	$\langle NO. \rangle$	PARTITION TYPE IDENTIFIER			
	ALUMINUM	(NO.)	ACCESSORIES IDENTIFIER		NEW DOOR AS SCHEDULED (SWING @ 90 DEGREES)	

LINE I TPES

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EXISTING CONSTRUCTION ITEM / WALL TO BE DEMOLISHED NEW CONSTRUCTION HIDDEN ITEM ITEM ABOVE ↔ Centerline GRID LINE

BREAK LINE VIEW NO. / SHEET NO. MATCH LINE VIEW NO. / SHEET NO. — - — - — - — - — - — MOISTURE / VAPOR BARRIER ---- DAMPROOFING / WATER PROOFING 1 HR FIRE-RATED WALL 2 HR FIRE-RATED WALL 3 HR FIRE-RATED WALL

- PATH OF EGRESS

SITE LOCATION MAP



DRAWING INDEX

SHEET NAME	
COVER SHEET	
GENERAL INFORMATION	
LIKE SAFE/TY PLAN	
Y Y Y Y Y Y Y Y	
PALMERTON WEIGHT ROOM TYPICAL STRUCTURAL DWG	2
	\sim
DEMOLITION PLAN - LEVEL 01	
REFERENCE PLAN - LEVEL 01	
FLOOR PLAN - LEVEL 01	
REFLECTED CEILING PLAN - LEVEL 01	
FINISH PLAN & SCHEDULE - LEVEL 01	
WALL SECTIONS	
DOOR SCHEDULE & DETAILS	
FIRST FLOOR PLAN - MECHANICAL (FOR COORDINATION PURPOSES ONLY)	
COVER SHEET - PLUMBING	
DEMOLITION PLAN - PLUMBING	
FLOOR PLANS - PLUMBING	
ENLARGED FLOOR PLANS - PLUMBING	
DETAILS - PLUMBING	
DETAILS - PLUMBING	
SPECIFICATIONS - PLUMBING	
COVER SHEET - ELECTRICAL	
DEMOLITION PLAN - LEVEL 01 - ELECTRICAL	
FLOOR PLAN - LEVEL 01 - LIGHTING	
FLOOR PLAN - LEVEL 02 - POWER	
DETAILS & DIAGRAMS - ELECTRICAL	
SPECIFICATIONS - ELECTRICAL	

RENOVATIONS TO PALMERTON HIG SCHOOL WEIGHT ROO

3525 FIRELINE ROAD PALMERTON PA 1807

PALMERTON AREA SCHOOL DISTRIC

680 FOURTH STREET PALMERTON, PA 1807

PROJECT TEA

<u>Structura</u>


PANY & LENTZ

ENGINEERING


ALLOY5 ARCHITECTURE

> SNYDER HOFFMAN & McCLURE COMPANY

		<u> 30011113310113.</u>
NO.	ISSUE DESCRIPTION	DATE
1	100% DD REVIEW	01/12/24
2	100% CD REVIEW	02/09/24
3	BID SET	02/16/24
4	ADDENDUM 02	03/05/24

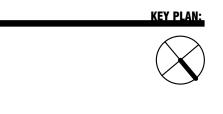





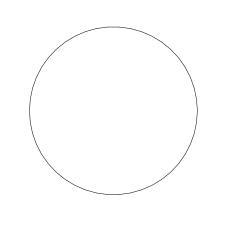


HEET TITLE: **COVER SHEET**


DATE:	02/16/2024
SCALE: As	indicated
DRAWN BY:	MC
CHECKED BY:	RG
PROJ NO:	22-0073

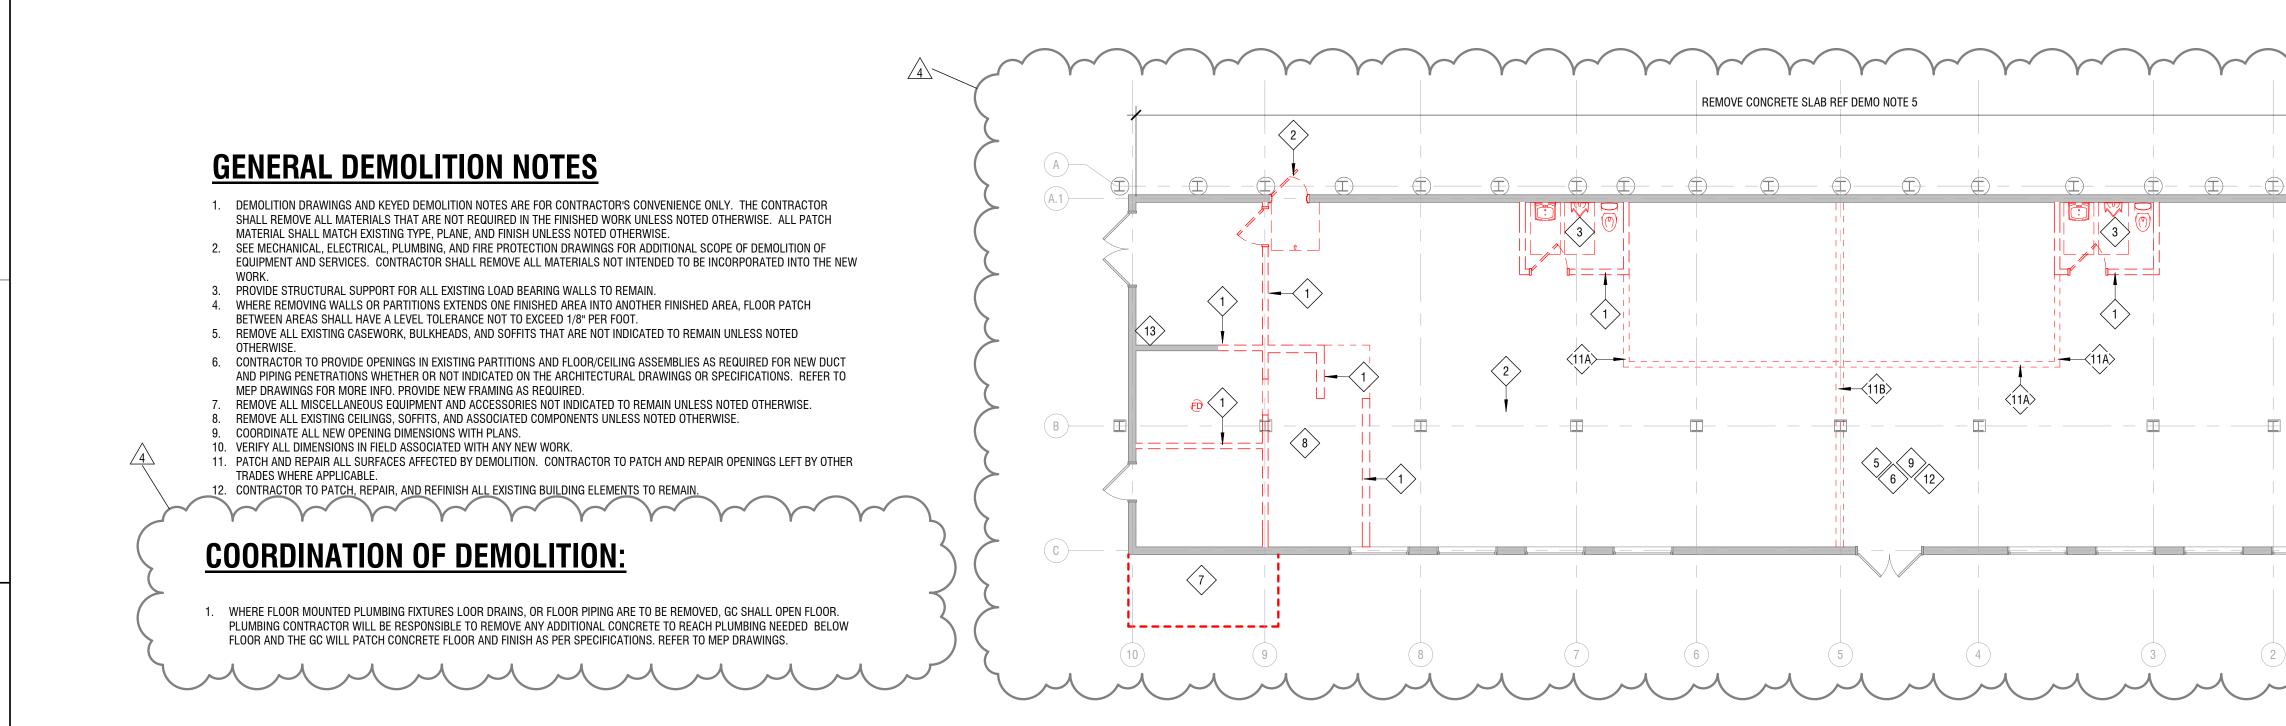


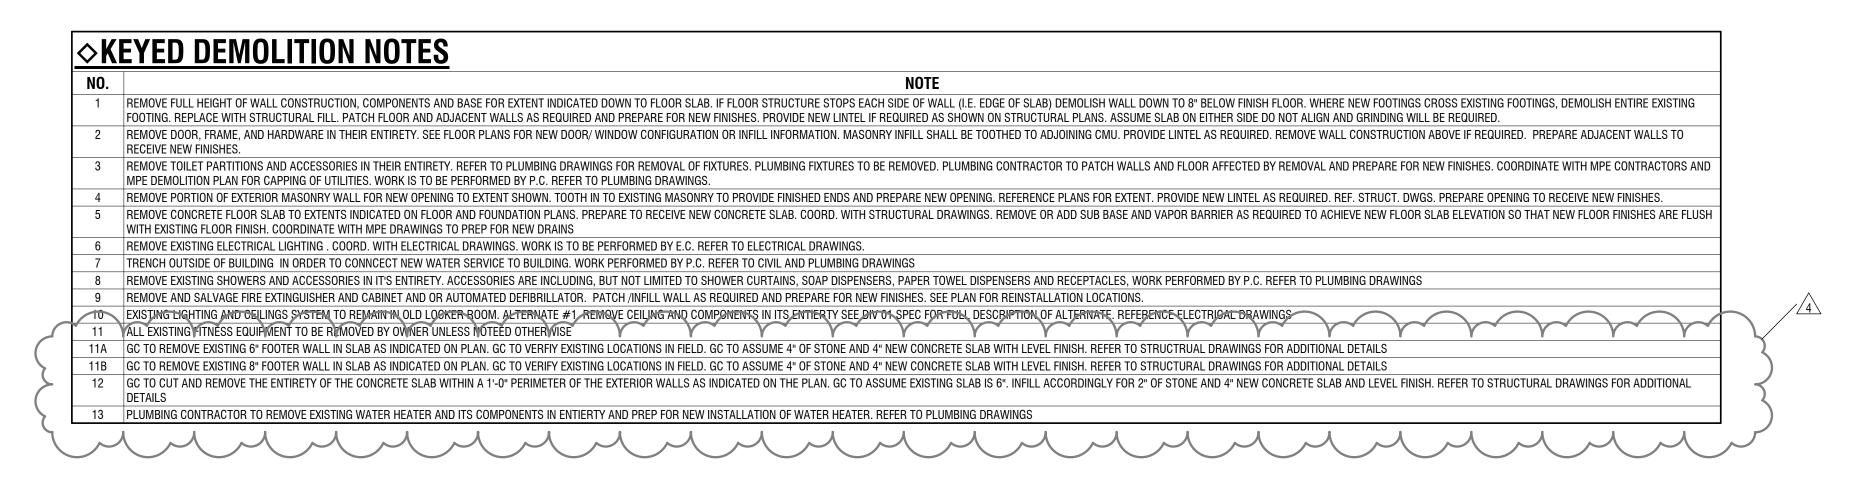

1 **LEVEL 01- DEMOLITION PLAN** 1/8" = 1'-0"

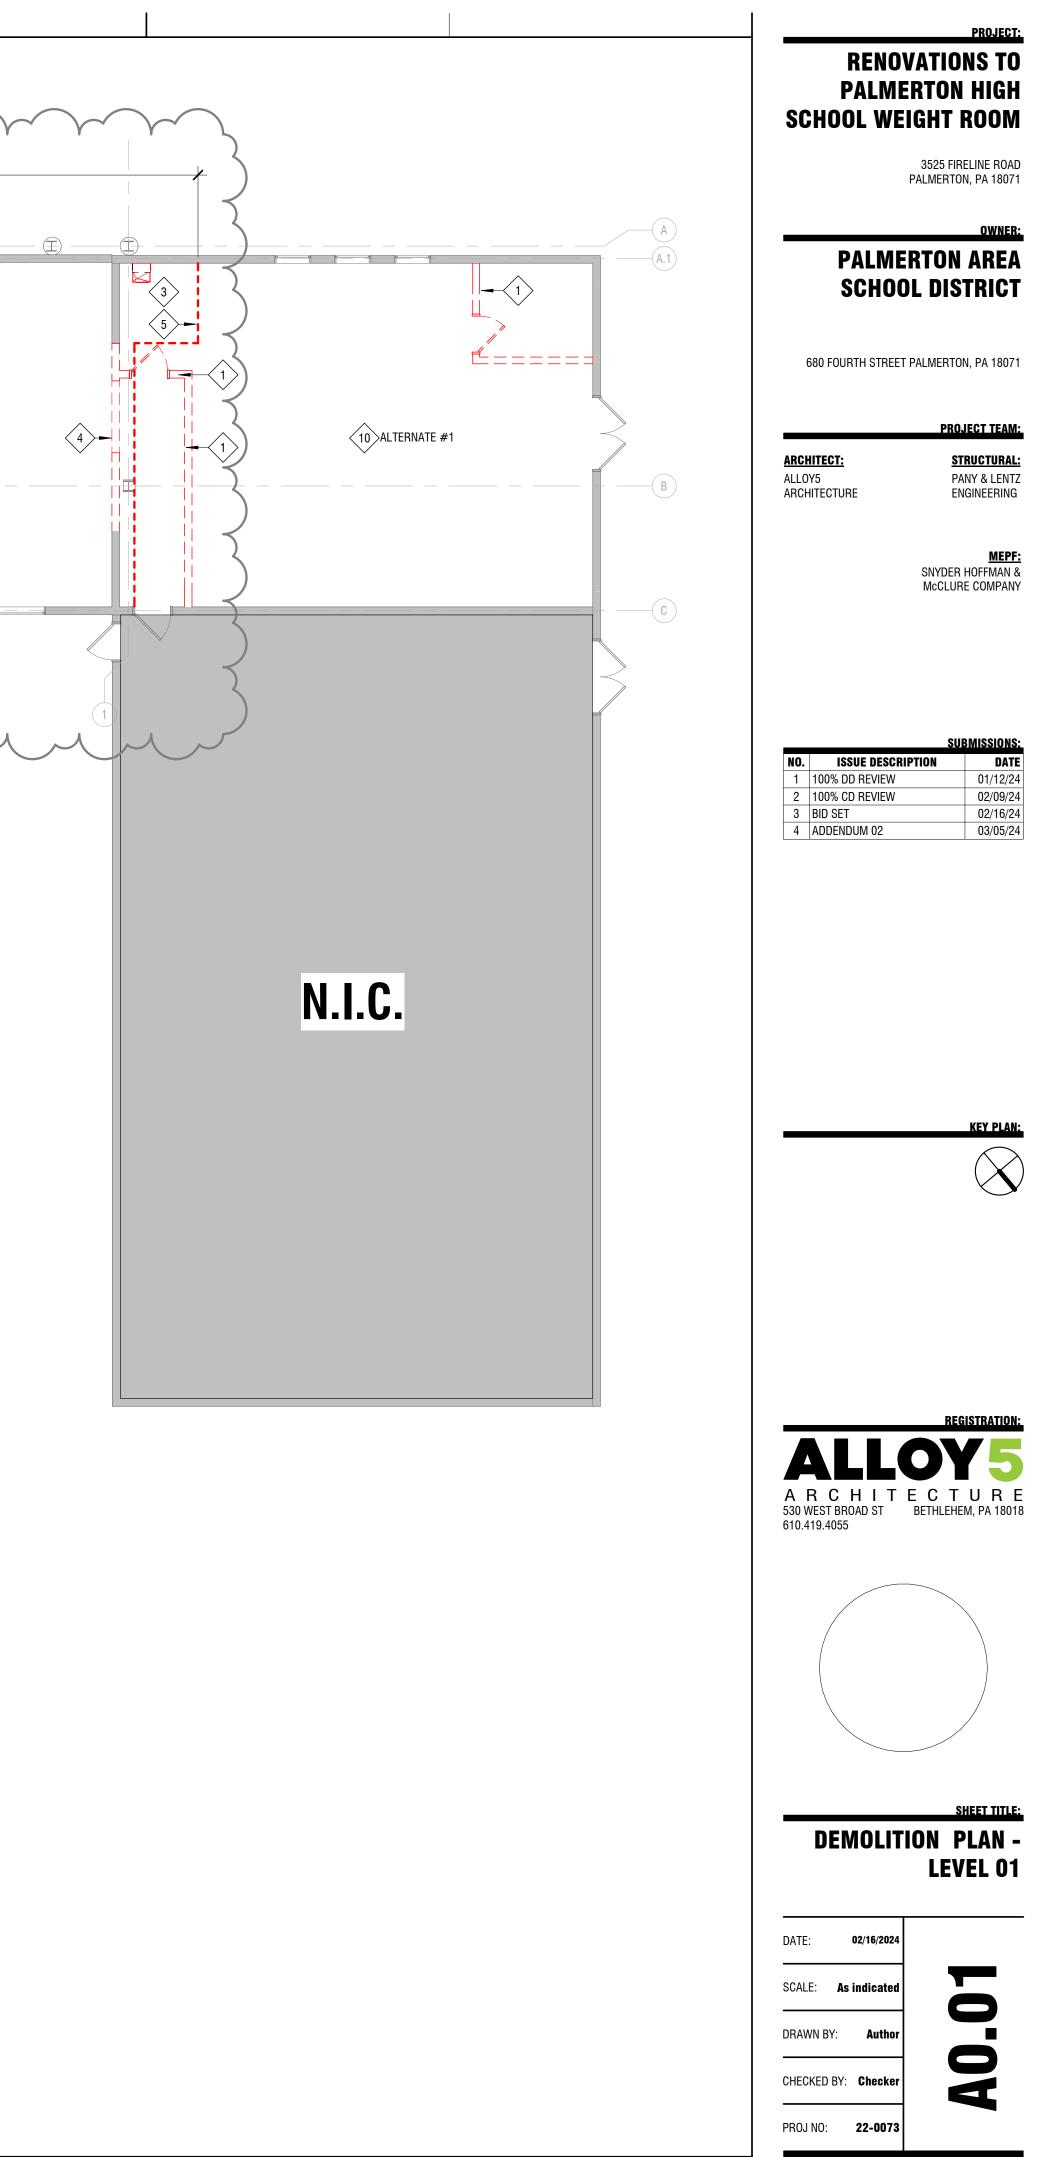

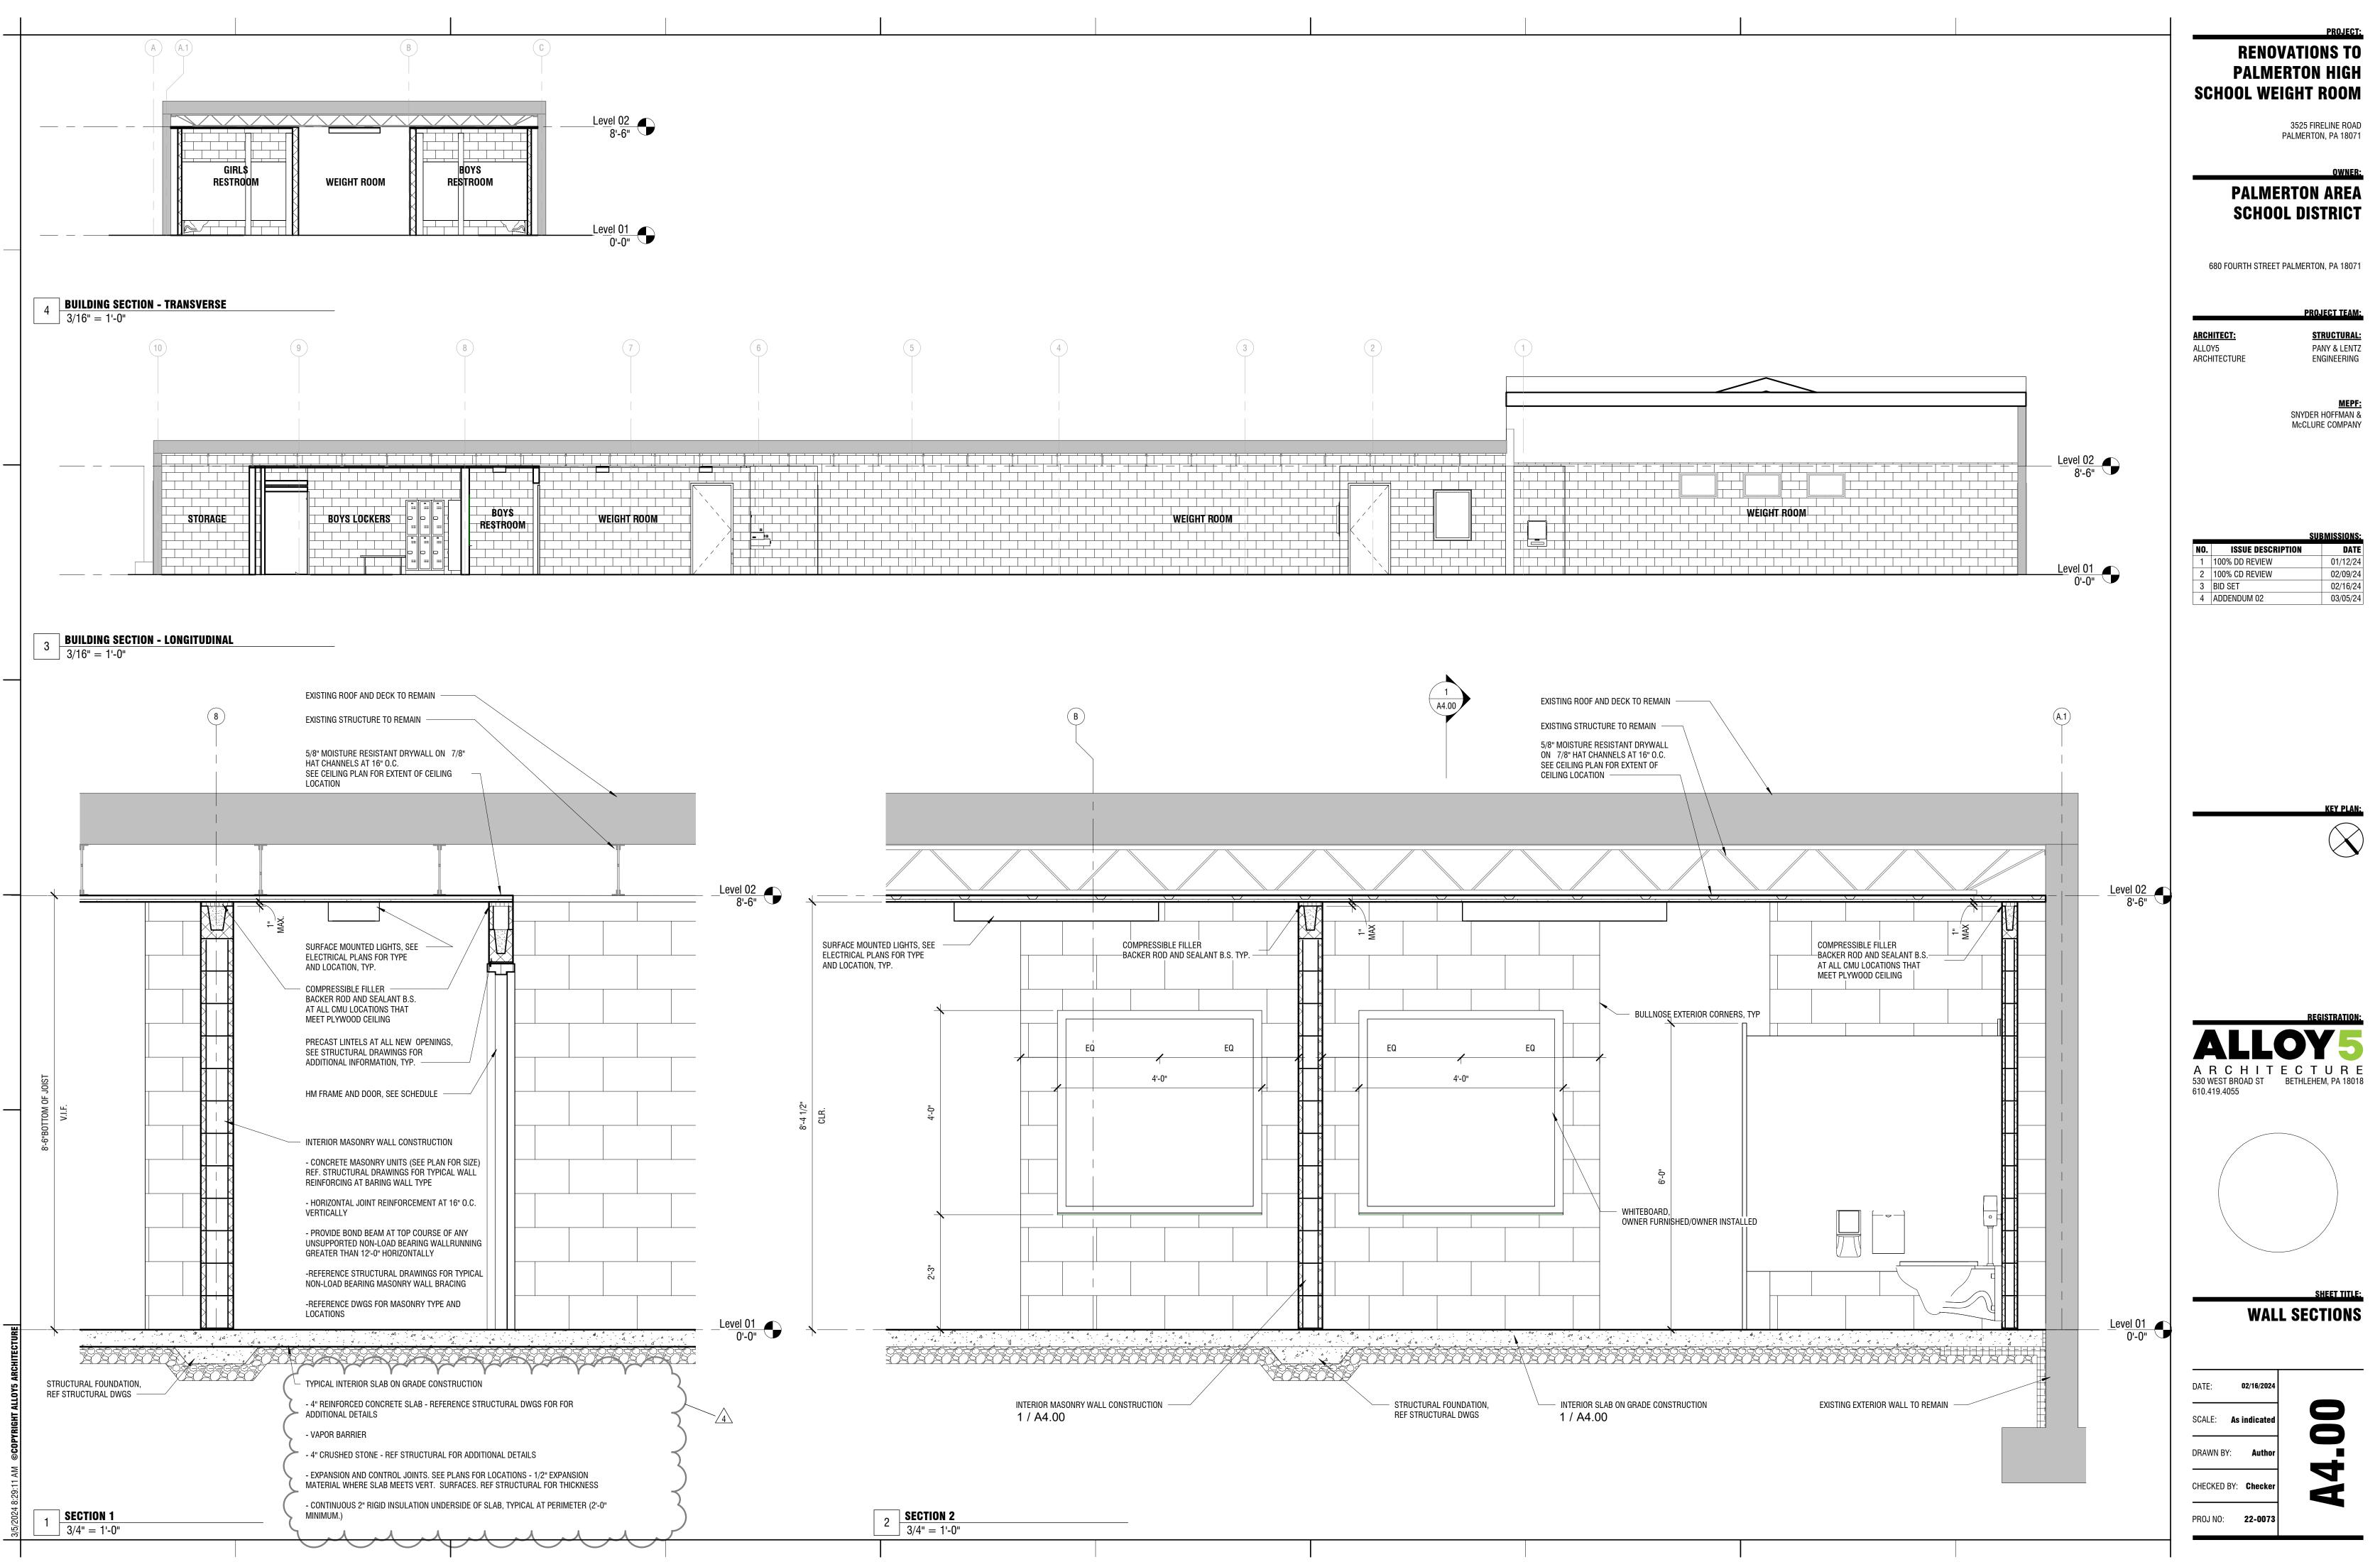

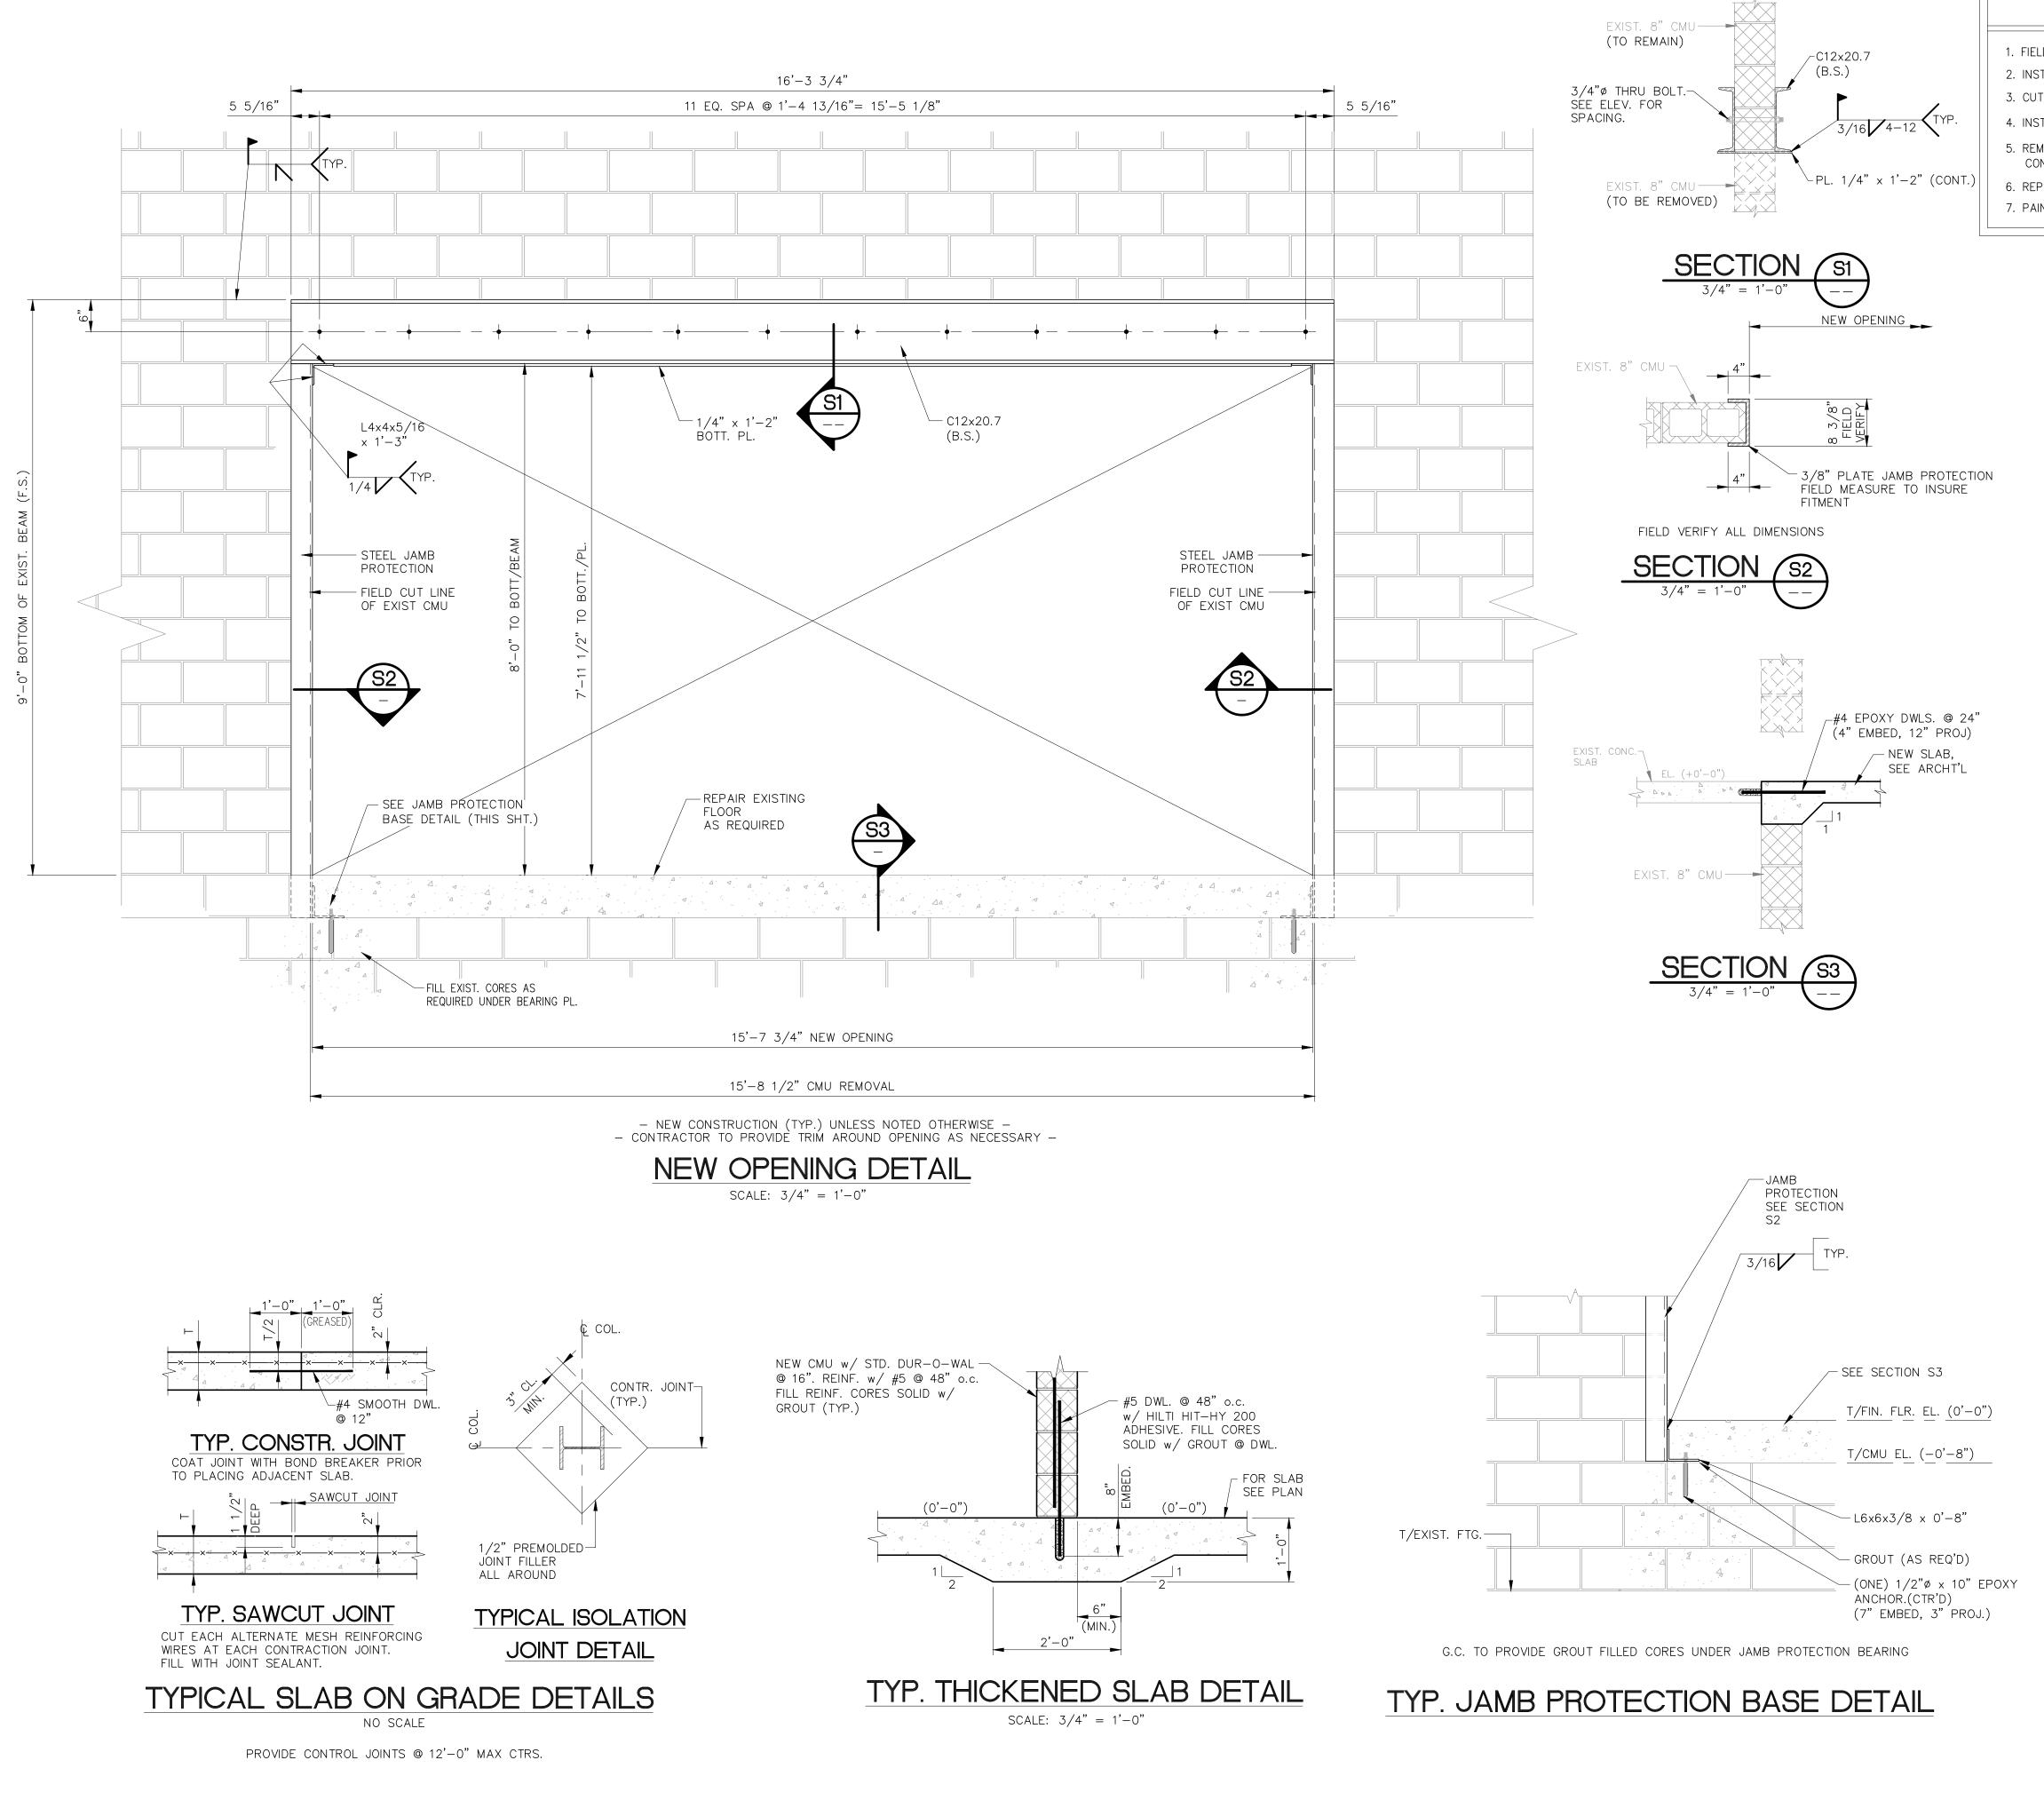

	FIELD LOC	ATE WHERE NEW C12 CHANNELS WILL BE INSTALLED. NOTE ANY	N SEQUENCE / INTERFERENCES.		
3. (CUT AND	IEW C12'S ON EACH SIDE OF WALL TO CREATE NEEDLE BEAM. F MINIMALLY REMOVE EXIST LINTEL, CMU AS REQUIRED TO INSTAL IEW JAMB PROTECTION ON BOTH SIDES OF NEW OPENING	FULLY TIGHTEN ALL THRU-BOLTS		
		DOOR FRAME, EXIST. LINTEL AND CMU IN 6' MAX SECTIONS AND REMOVING CMU AND INSTALLING PLATES IN 6' MAX SECTIONS			FHM ВY
6. F	REPAIR E	KISTING FLOOR AS REQUIRED REQUIRED			2/7/24 F
		NERAL NOTES			COMMENT
	1.	All Contractors and Subcontractors are responsible for ad specified in these notes. All parties must carefully study may pertain to their trades. Failure to read these notes to deviate from their requirements. Any questions will b	y all notes for items which s does not permit the Contractor		AND
	2.	Contractors and Subcontractors shall verify all conditions, responsible for same.	, check all measurements and be		REVIEW A
	3.	All work shall be done in accordance with the current bui authorities.	ilding code of all governing		FOR
	4.	All walls shall be adequately braced until the entire struc and is structurally sound/stable.	tural frame has been installed		SSUED
	5.	All Contractors and Subcontractors on this project shall b performance of their work, coordination with other trades on the job site.			N A 10
	6.	Acceptance of deviations from any of the requirements o sole discretion of the Engineer. Acceptance of a deviation not be construed as permitting any other deviation.			
	7.	Construction materials shall be provided free from defect of to the limits set forth on the drawings by experienced tr		COMPANY	18101 -163(
	<u>CC</u>	NCRETE All slab on grade concrete shall be 4000 psi.		MO	PA 433.
	1. 2.	Welded wire fabric shall conform to ASTM A185 and ASTM	A A497, latest edition.	\smile	
	3.	Welded wire fabric must lap one full mesh at side and er together.	nd laps, and must be wired	FING	$ \geq 2$
	4.	All concrete shall contain an approved water reducing ad	mixture.	ERI	<i>ENGI</i> , Hanical • Allen† Fax:
	5.	All pours shall be terminated by forms. Provide keys, as between adjacent pours.	s directed by Engineer,		<i>IG ENG</i> Mechanical ● Aller 4 ● F g X:
	6.	Provide clearances from faces of concrete to reinforcemen		NGINEE	71/ RAL • 5 e t 6 3 4
		Cast against and permanently exposed to earth Exposed to earth or weather		Ш	SUL SUL Stre 3-1
		#5 or smaller #6 or larger	1-1/2" 2"		1 0 V 1 + 3 1
		Not exposed to weather or in contact with earth Slabs, walls, joists Beams, girders, columns (principal reinf., ties, stirrups or spirals)	,		Hamilto
	7.	All concrete shall be formed, unless otherwise approved be poured unformed provided the trench/hole is excavate sides.			609 Office
	8.	Concrete Contractor shall provide all high chairs, spacers, proper placement of reinforcing steel.	, supports, etc., necessary for	SEAL	
	9.	Curing of concrete is to start as soon as finishes will no permissible to delay the curing until the morning after th			
	STE	RUCTURAL STEEL			
	1. 2.	Material, fabrication and erection shall conform to the lat Specification. The Steel Contractor is responsible for confirming and co			
		dimensions, selecting fabrication processes and technique connections, coordinating his work with that of all other work is a safe and satisfactory manner.	es of construction, adequacy of trades and performing his		
	3.	All wide flange structural steel shall conform with ASTM A unless noted otherwise. All channels, angles, plates and misc. steel shall conform			L L
		unless noted otherwise.		Σ	STRIC
	5.	Provide bearing plates and anchor bolts, studs and/or wo beams and/or wall bearing joists, as approved by the En		MERTON WEIGHT ROOM	SCHOOL DISTRICT INE ROAD M, PA 18017
	6. 7	All welding electrodes to be E70XX.	of the "Structural Welding		100L [ROAD A 18017
	7.	All welding shall be in accordance with the latest edition Code" as published by the American Welding Society.			, SCHO LINE R EM, PA
	8.	All welding, shop and field, shall be performed by welders qualified according to American Welding Society standards.			
		<u>DP DRAWINGS</u>	w Shop drawing	ERTC	n are/ 6 city Thlehi
YXC	1. 2.	Submit a PDF of all Erection and shop drawings for review must be checked by the detailer prior to submission; fai cause for rejection. Details must be on sheets of at lea combinations of similar type members. If it is desired to detailing, approval must be requested at the time of bid Contract Drawings or any portion thereof used for shop cause for rejection, unless prior approval is made during Detailer must use column and lintel designations as show	ilure to do so will be ast 24" x 36" in size with to use other than this type of Iding. Reproductions of the drawing preparation will be the bidding process.	PALME	Palmerton Af 2156 CI Bethle
	3.	Detailer is responsible for determination of required web o			
	4.	beams and columns. All revisions to shop drawings after the first submission r	must be so identified on	DESIGNED DRAWN	MJB FHM
	5.	subsequent submissions. Review of shop drawings shall not relieve the Contractor		CHECKED	
	6.	even if such items are not shown on the shop drawings. Any changes, proposed by the detailer, must be clearly ic		JOB. NO. SCALE	2024130 3/4" = 1'-0"
7.		and, upon request of the Engineer, substantiated by submission of the calculations used to design such change. All subcontractors must work with a full set of drawings.			2/6/24
	8.	Contractors shall submit shop drawings for review at leas the required date for return from review.	Pany & Lentz Engineering Company accepts no responsibility for	SHEET NO.	S.1
			unauthorized use of this document. Reproduction of this drawing or any portion thereof is prohibited without the written consent of Pany & Lentz Engineering Company. Only final construction documents signed and sealed by the Engineer of Record are valid.	OF 1	SHEETS REV.

