
# Lighthouse Christian Academy

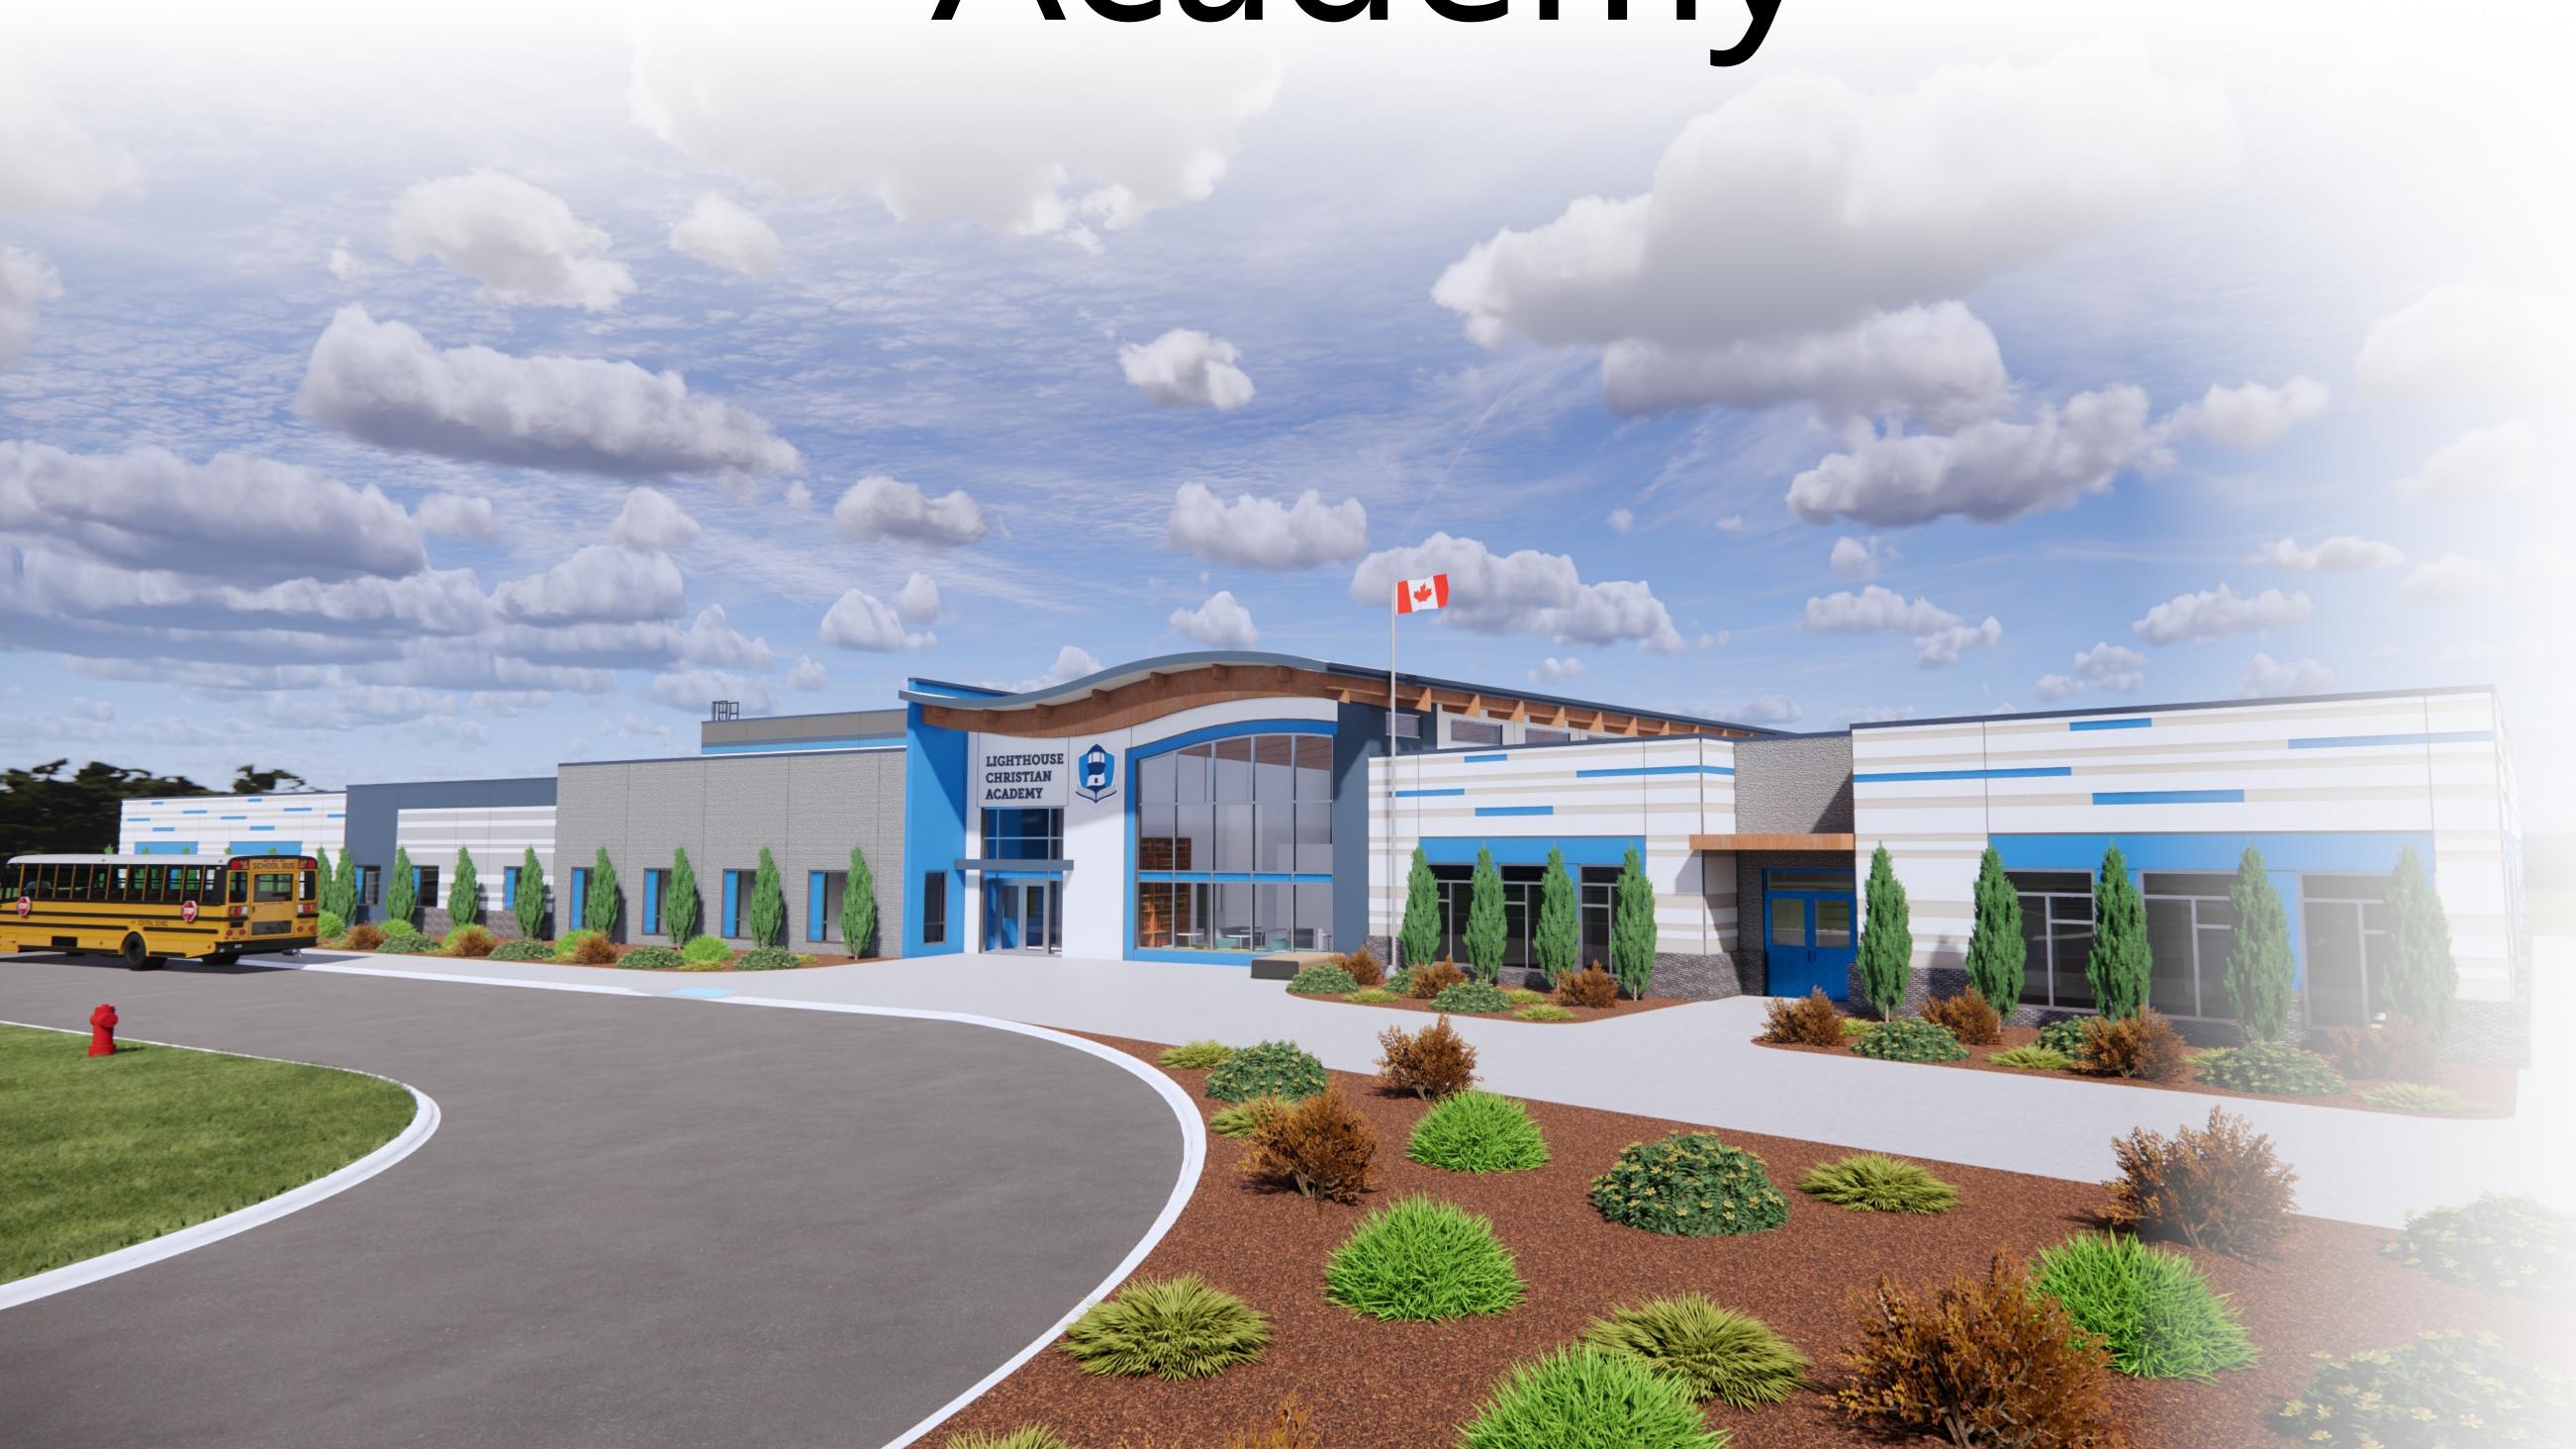

Lacombe County, AB

School Building

DO NOT SCALE DRAWING - VERIFY ALL DIMENSIONS. DATUMS AND LEVELS PRIOR TO COMMENCEMENT OF WORK, REPORT ANY OTHER GOVERNING AUTHORITIES, THIS IS A COPYRIGHT DRAWING AND SHALL NOT BE REPRODUCED OR REVISED WITHOUT THE WRITTEN CONSENT OF THE CONSULTAN



**PRELIMINARY** 

**NOT FOR CONSTRUCTION** 





SYMBOL LEGEND

1 Floor Plan

**DRAWING INDEX** 

DRAWING NUMBER

CONSTRUCTION TAC

**EXTERIOR FINISH TAG** 

**ELEVATION CALLOUT** 

WINDOW TAG

2025-07-04 4:49:53 PM Drawn by: Checked by:

Sheet Name:

## **BUILDING INFORMATION & BUILDING CODE ANALYSIS**

### **BUILDING A**

BUILDING USE & CLASSIFICATION:

A-2 - ASSEMBLY

**BUILDING DESIGN:** NATIONAL BUILDING CODE - 2023 ALBERTA EDITION - 3.2.2.25 (NON-SPRINKLERED)

(COMBUSTIBLE)(NON-COMBUSTIBLE) NO STANDPIPE SYSTEM REQUIRED AS PER 3.2.5.8 BUILDING AREA:

PROVIDED AREA: 1,268.92 m<sup>2</sup> - 13,658.59 ft<sup>2</sup> MAX: 1,600 m<sup>2</sup> - (17,222 ft<sup>2</sup>)

BUILDING HEIGHT: 1 STOREY(S)

**BUILDING ACCESS:** 1 STREET(S)

FIRE SEPARATIONS AND RATINGS: FLOOR ASSEMBLIES SHALL BE FIRE SEPARATIONS AND,

IF OF COMBUSTIBLE CONSTRUCTION, SHALL HAVE A FIRE-RESISTANCE RATING NOT LESS THAN 45 MIN, MEZZANINES SHALL HAVE, IF OF COMBUSTIBLE CONSTRUCTION, A FIRE-RESISTANCE RATING NOT LESS THAN 45 MIN, ROOF ASSEMBLIES SHALL HAVE, IF OF COMBUSTIBLE CONSTRUCTION, A FIRE-RESISTANCE RATING NOT LESS THAN 45 MIN, EXCEPT THAT IN A BUILDING NOT MORE THAN I STOREY IN BUILDING HEIGHT, THE

FIRE-RESISTANCE RATING IS PERMITTED TO BE WAIVED PROVIDED THE ROOF ASSEMBLY IS CONSTRUCTED AS A FIRE-RETARDANT-TREATED WOOD ROOF SYSTEM CONFORMING TO

ARTICLE 3.1.14.1., AND THE BUILDING AREA IS NOT MORE THAN I) 800 m<sup>2</sup> IF FACING ONE STREET, II) 1 000 m<sup>2</sup> IF FACING 2 STREETS, OR

III) 1 200 m<sup>2</sup> IF FACING 3 STREETS, AND LOADBEARING WALLS, COLUMNS AND ARCHES SUPPORTING AN ASSEMBLY REQUIRED TO HAVE A FIRE-RESISTANCE RATING SHALL

I) HAVE A FIRE-RESISTANCE RATING NOT LESS THAN 45 MIN, OR II) BE OF NONCOMBUSTIBLE CONSTRUCTION.

**BUILDINGS EXITS:** 

3.4.2.5. MAX. TRAVEL DISTANCE FOR EXITS = 30 m

### **BUILDING B**

BUILDING USE & CLASSIFICATION: A-2 - ASSEMBLY

**BUILDING DESIGN:** 

NATIONAL BUILDING CODE - 2023 ALBERTA EDITION - 3.2.2.25 (NON-SPRINKLERED)

(COMBUSTIBLE)(NON-COMBUSTIBLE) NO STANDPIPE SYSTEM REQUIRED AS PER 3.2.5.8 **BUILDING AREA:** PROVIDED AREA: 1,597.95 m<sup>2</sup> - 17,200.16 ft<sup>2</sup>

MAX: 1,600 m<sup>2</sup> - (17,222 ft<sup>2</sup>) **BUILDING HEIGHT:** 

1 STOREY(S) **BUILDING ACCESS:** 

1 STREET(S)

FIRE SEPARATIONS AND RATINGS: FLOOR ASSEMBLIES SHALL BE FIRE SEPARATIONS AND, IF OF COMBUSTIBLE CONSTRUCTION, SHALL HAVE A FIRE-RESISTANCE RATING NOT LESS THAN 45 MIN, MEZZANINES SHALL HAVE, IF OF COMBUSTIBLE CONSTRUCTION, A FIRE-RESISTANCE RATING NOT LESS THAN 45 MIN, ROOF ASSEMBLIES SHALL HAVE, IF OF COMBUSTIBLE CONSTRUCTION,

A FIRE-RESISTANCE RATING NOT LESS THAN 45 MIN, EXCEPT THAT IN A BUILDING NOT MORE THAN 1 STOREY IN BUILDING HEIGHT, THE FIRE-RESISTANCE RATING IS PERMITTED TO BE WAIVED PROVIDED THE ROOF ASSEMBLY IS CONSTRUCTED AS A FIRE-RETARDANT-TREATED WOOD ROOF SYSTEM CONFORMING TO

ARTICLE 3.1.14.1., AND THE BUILDING AREA IS NOT MORE THAN I) 800 m<sup>2</sup> IF FACING ONE STREET, II) 1 000 m<sup>2</sup> IF FACING 2 STREETS, OR

LOADBEARING WALLS, COLUMNS AND ARCHES SUPPORTING AN ASSEMBLY REQUIRED TO HAVE A FIRE-RESISTANCE RATING SHALL I) HAVE A FIRE-RESISTANCE RATING NOT LESS THAN 45 MIN, OR II) BE OF NONCOMBUSTIBLE CONSTRUCTION.

**BUILDINGS EXITS:** 

3.4.2.5. MAX. TRAVEL DISTANCE FOR EXITS = 30 m

III) 1 200 m<sup>2</sup> IF FACING 3 STREETS, AND

### LIMITING DISTANCE REQUIREMENTS: 3.2.3.

NORTH BUILDING FACE:

- PLANS INDICATE DEFICIT OF FEMALE SPECIFIC WATER CLOSETS COMPARED TO REQUIREMENT.

LIMITING DISTANCE = >9m ALLOWABLE OPENINGS = 100% REQUIRED RATING: N/A SOUTH BUILDING FACE: LIMITING DISTANCE = >9m ALLOWABLE OPENINGS = 100% REQUIRED RATING: N/A EAST BUILDING FACE: LIMITING DISTANCE = >9m ALLOWABLE OPENINGS = 100% REQUIRED RATING: N/A WEST BUILDING FACE: LIMITING DISTANCE = >9m

ALLOWABLE OPENINGS = 100%

REQUIRED RATING: N/A

FIRE HYDRANT REQUIRED WITHIN 90 m OF PRINCIPAL ENTRANCE


### FIXTURE COUNT

HEALTH / WATER CLOSETS / LAVATORIES (3.7.2.2.-A)

USE: ASSEMBLY OCCUPANT LOAD: 250 PERSONS WATER CLOSETS REQUIRED: 5 MALE, 5 FEMALE PROVIDED: 10 MALE, 10 FEMALE, 5 UNIVERSAL WATER SUPPLY WATER SUPPLY REQUIREMENTS AS PER 3.2.5.7.

BUILDING B VOLUME = 8,435.15m<sup>3</sup> WATER SUPPLY COEFFICIENT = 10 WATER SUPPLY COEFFICIENT (w/ HEAVY TIMBER) = 19 SPATIAL COEFFICIENT = 1.5

 CALCULATION - 8,435.15m³x10x1.5 = 126,527.2 LITRES CALCULATION (w/ HEAVY TIMBER) - 8,435.15m3x19x1.5 = 240,401.78 LITRES GLULAM ROOF TBC. HEAVY TIMBER CALCULATION IS TO BE USED IF CONFIRMED TO BE REVIEWED AT BP PHASE

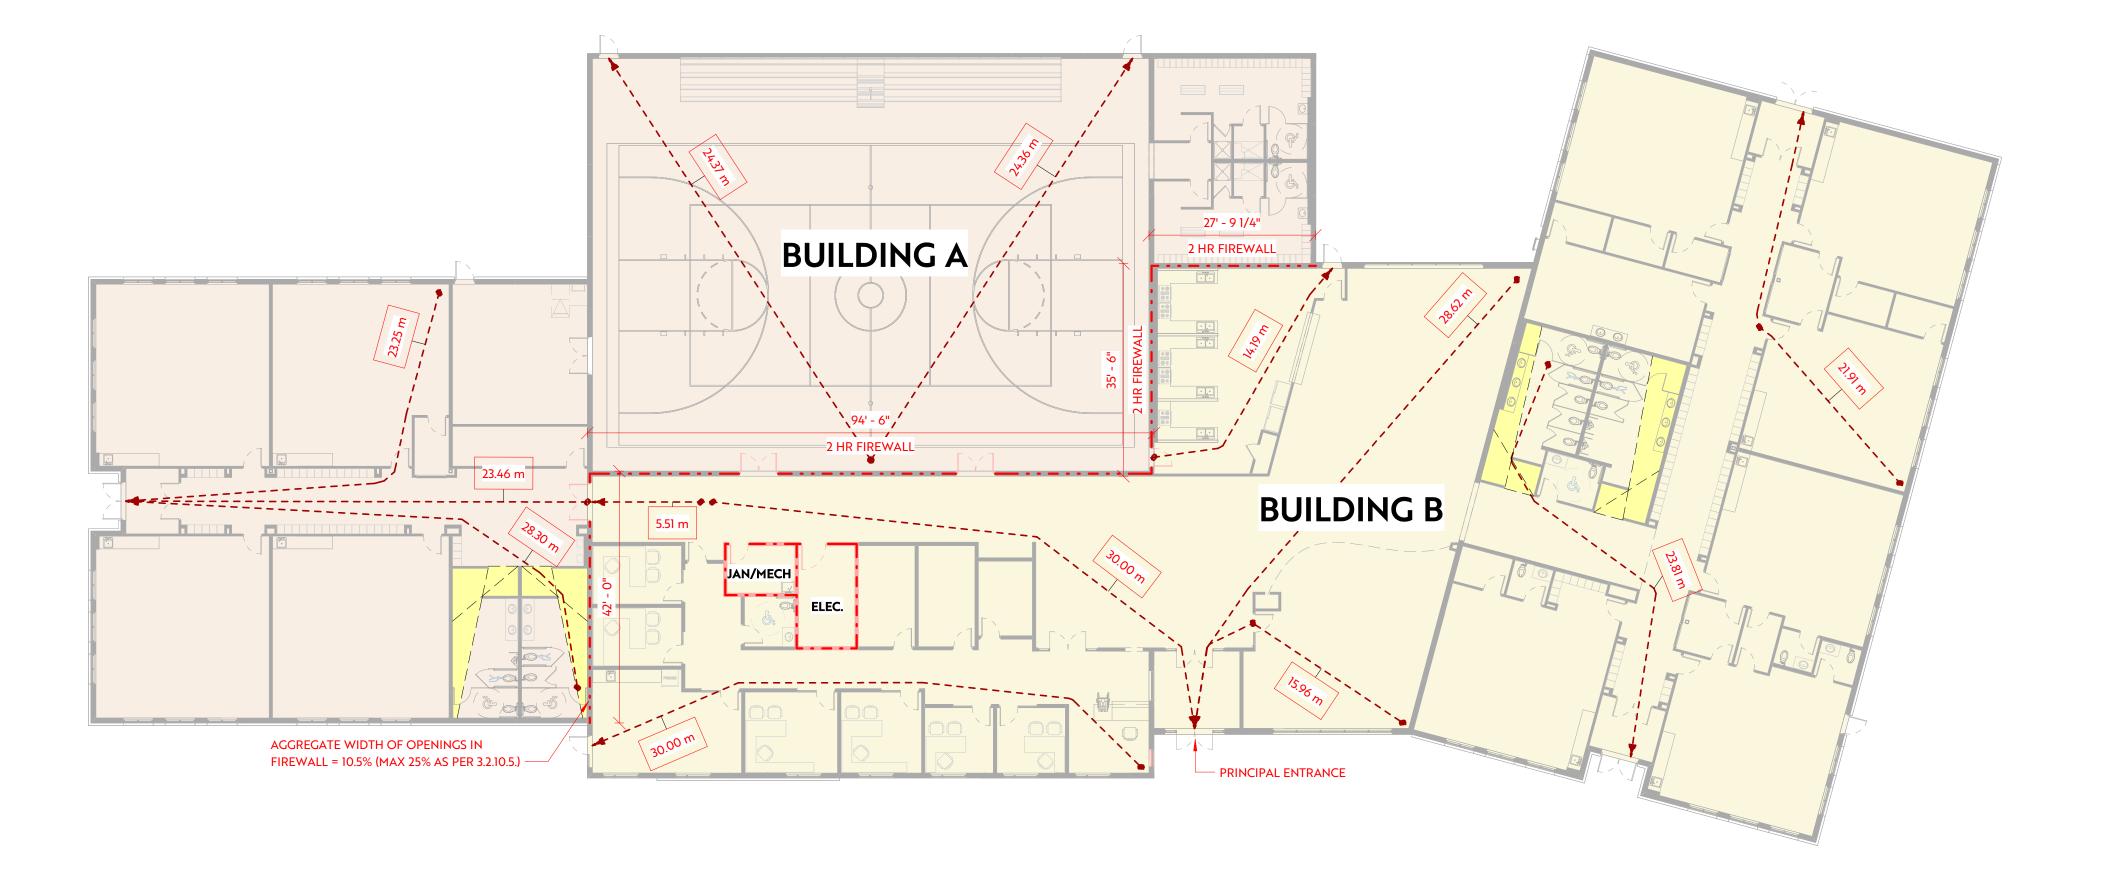

Occupant Load as per A.B.C. 3.1.17.1. Occupancy Area per Occupant Area (ft²) Type Person (m²) Load Assembly 1,380.49 m<sup>2</sup> 14,859.51 ft<sup>2</sup> Classroom 866.66 m<sup>2</sup> 9,328.7 ft<sup>2</sup> 1.85 475 Library 86.54 m<sup>2</sup> 931.47 ft<sup>2</sup> 1.85 47 Offices 246.03 m<sup>2</sup> 2,648.29 ft<sup>2</sup> 9.3 Storage / 286.99 m² 3,089.17 ft<sup>2</sup> Utilities 2,866.72 m<sup>2</sup> 30,857.14 ft<sup>2</sup> 560

**NOTE:** A PERMANENT SIGN INDICATING A MAXIMUM OCCUPANT LOAD OF 250 PEOPLE SHALL BE POSTED IN A CONSPICUOUS LOCATION

### NOTES

2. ADD BLOCKING BETWEEN STUDS AS REQUIRED

3. FIRE SEPARATION AS SHOWN:

ENTRANCE OF ROOM -DEMONSTRATES COMPLIANCE W/ A.B.C. 3.7.2.2.(15) (b)

**NOT FOR CONSTRUCTION** 

1. RATED WALLS SHALL BE FRAMED TO UNDERSIDE OF RATED FLOOR ASSEMBLY OR ROOF ASSEMBLY


TO SUPPORT ALL EDGES OF 1/2" TYPE 'X' GYPSUM

0 HR • • • • • • • • 3/4 HR 1 HR 2 HR 4 HR

REPRESENTS LINE OF SIGHT FROM

\ Life Safety Plan

DO NOT SCALE DRAWING - VERIFY ALL DIMENSIONS, DATUMS AND LEVELS PRIOR TO COMMENCEMENT OF WORK, REPORT ANY DISCREPANCIES OR OMISSIONS TO THE APPLICABLE BUILDING CODE AND ANY OTHER GOVERNING AUTHORITIES. THIS IS A COPYRIGHT DRAWING AND SHALL NOT BE REPRODUCED OR REVISED WITHOUT THE WRITTEN CONSENT OF THE CONSULTANT.

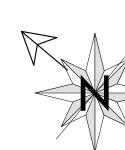

**PLANWORKS** Stamp:

**PRELIMINARY** 







Joor

2025-07-04 3:14:11 PM Date: KL, KS Drawn by: ြုံ Checked by: LB, AB Sheet Name:

**Code Review** 

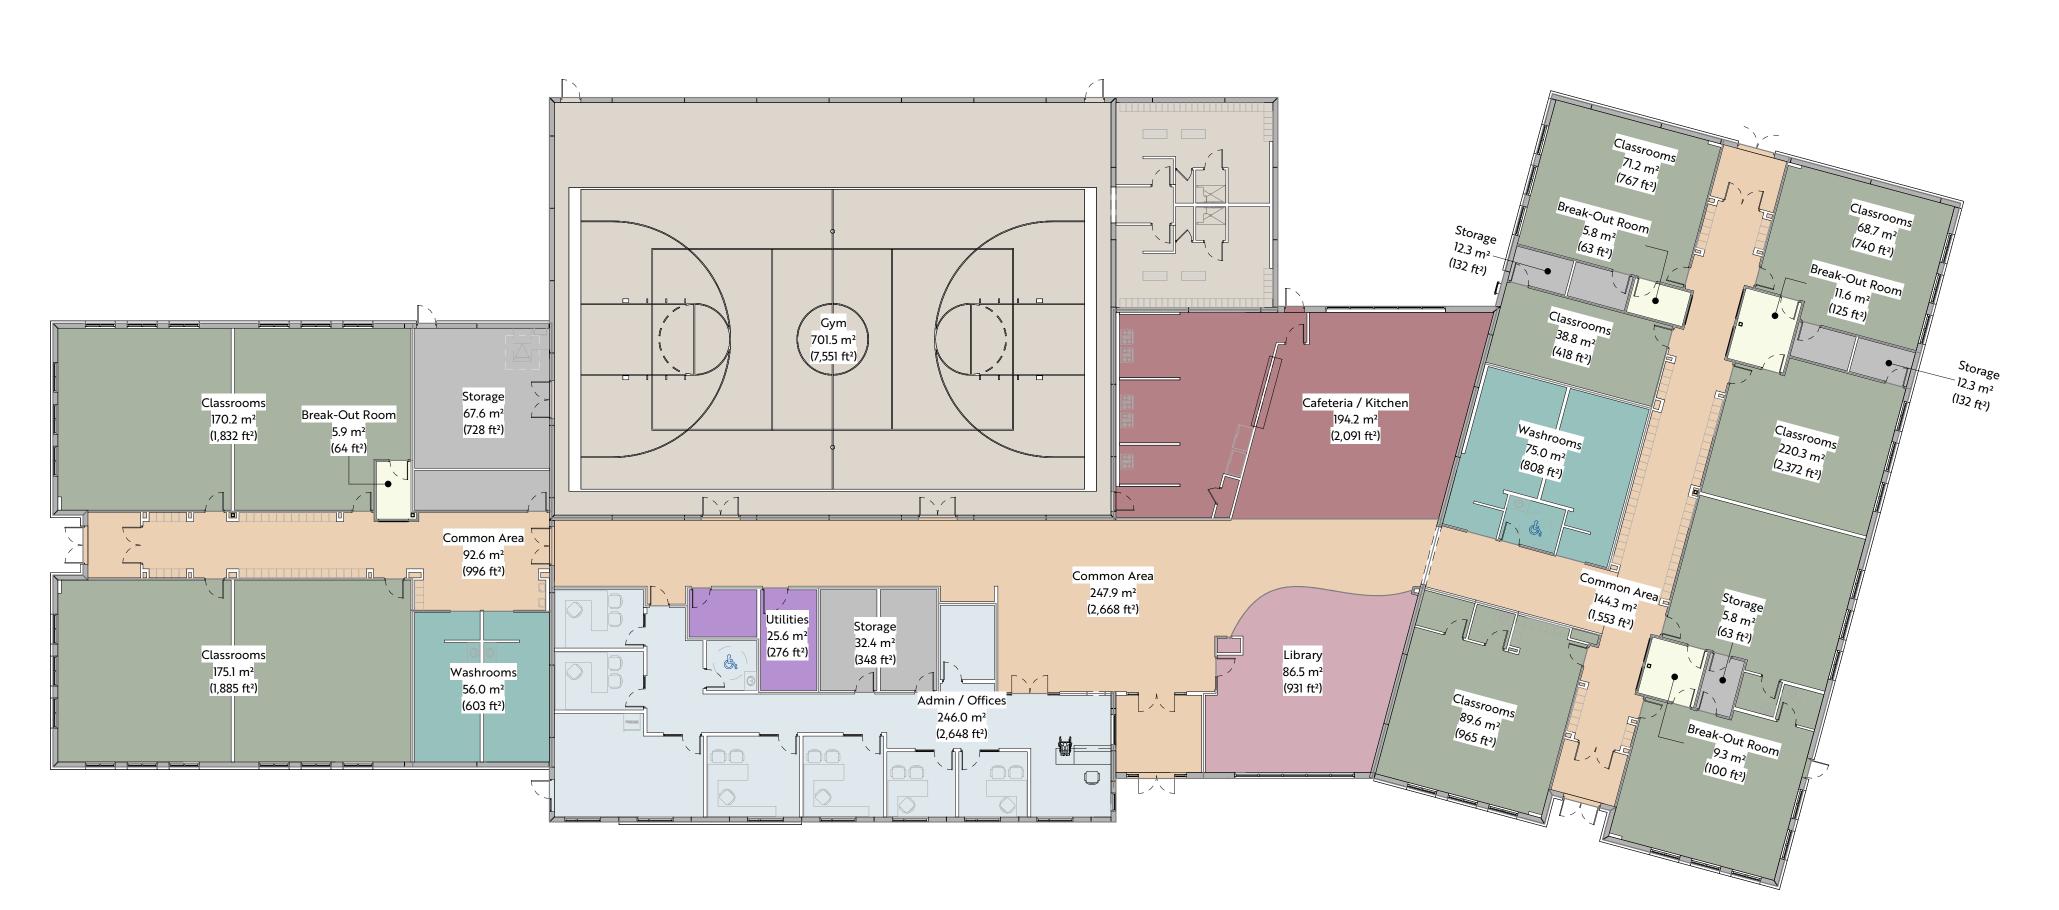

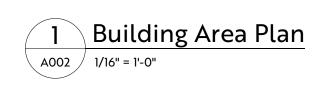


DO NOT SCALE DRAWING - VERIFY ALL DIMENSIONS, DATUMS AND LEVELS PRIOR TO COMMENCEMENT OF WORK. REPORT ANY DISCREPANCIES OR OMISSIONS TO THE APPLICABLE BUILDING CODE AND ANY OTHER GOVERNING AUTHORITIES. THIS IS A COPYRIGHT DRAWING AND SHALL NOT BE REPRODUCED OR REVISED WITHOUT THE WRITTEN CONSENT OF THE CONSULTANT.



Flo	oor Areas	
Admin / Offices	246.03 m <sup>2</sup>	7
Break-Out Room	32.63 m²	
Cafeteria / Kitchen	194.23 m²	2
Classrooms	834.03 m²	;
Common Area	484.74 m²	
Gym	701.53 m²	
Library	86.54 m²	
Storage	130.34 m²	
Utilities	25.6 m <sup>2</sup>	
Washrooms	131.05 m <sup>2</sup>	
	2,866.72 m <sup>2</sup>	3
Grand total	2,866.72 m <sup>2</sup>	3



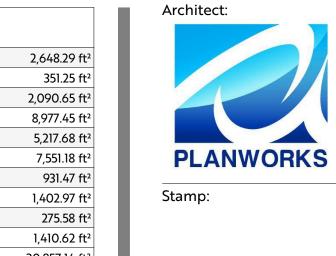

**PRELIMINARY** 

NOT FOR CONSTRUCTION

aggregate design studio ltd.







istian


Building


Lighthouse (School Build)


	ıng.n	_	_	_	<u> </u>	<u> </u>	<u> </u>			
	NO.	٧	В	U		ш	ш	U		
										_
	۶ Pro	oje	ct N	10:					A244	8
	Pro Pro Da	te:		2	025	5-07	7-0	4 3:	14:13 F	וי
	Dr	awı	n b	y:					KL, I	K
	E Ch	ecl	кec	l by	<b>/</b> :				LB, A	4
	Drace Childrenge Childrenge Sh	eet	. Na	am	e:					


**Building Areas** 



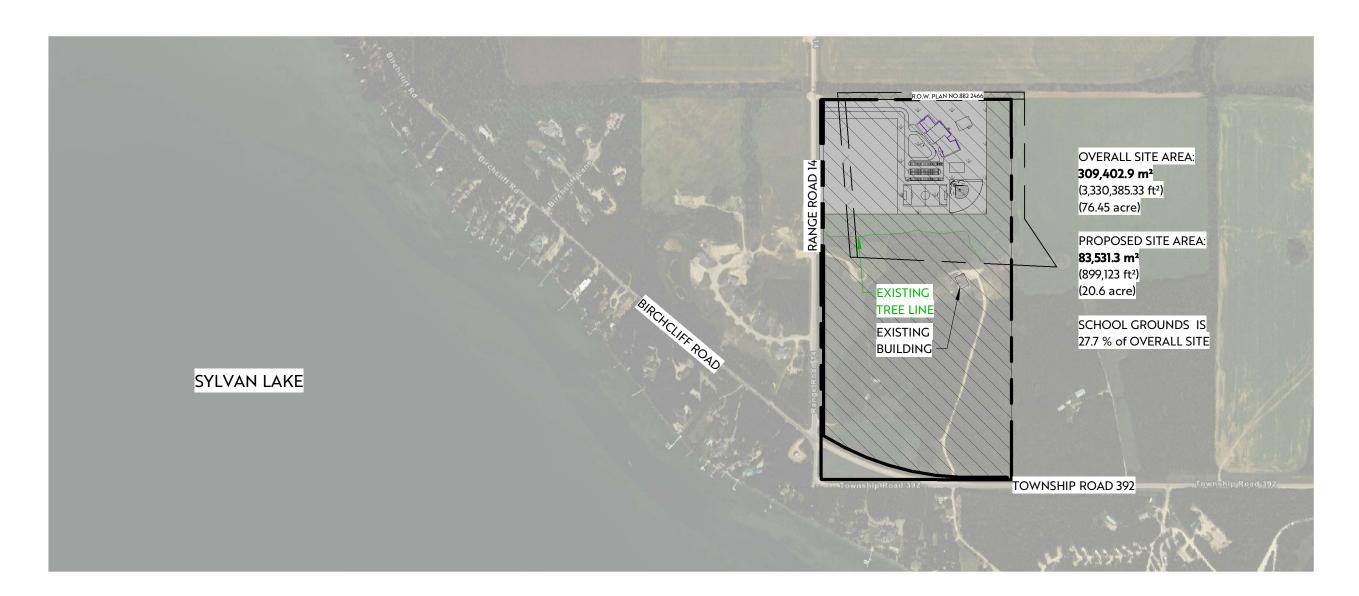

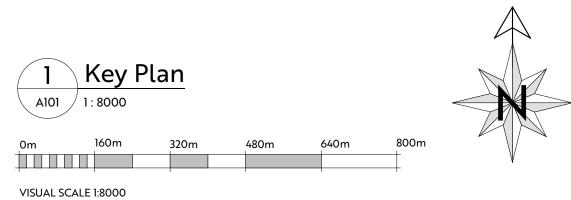

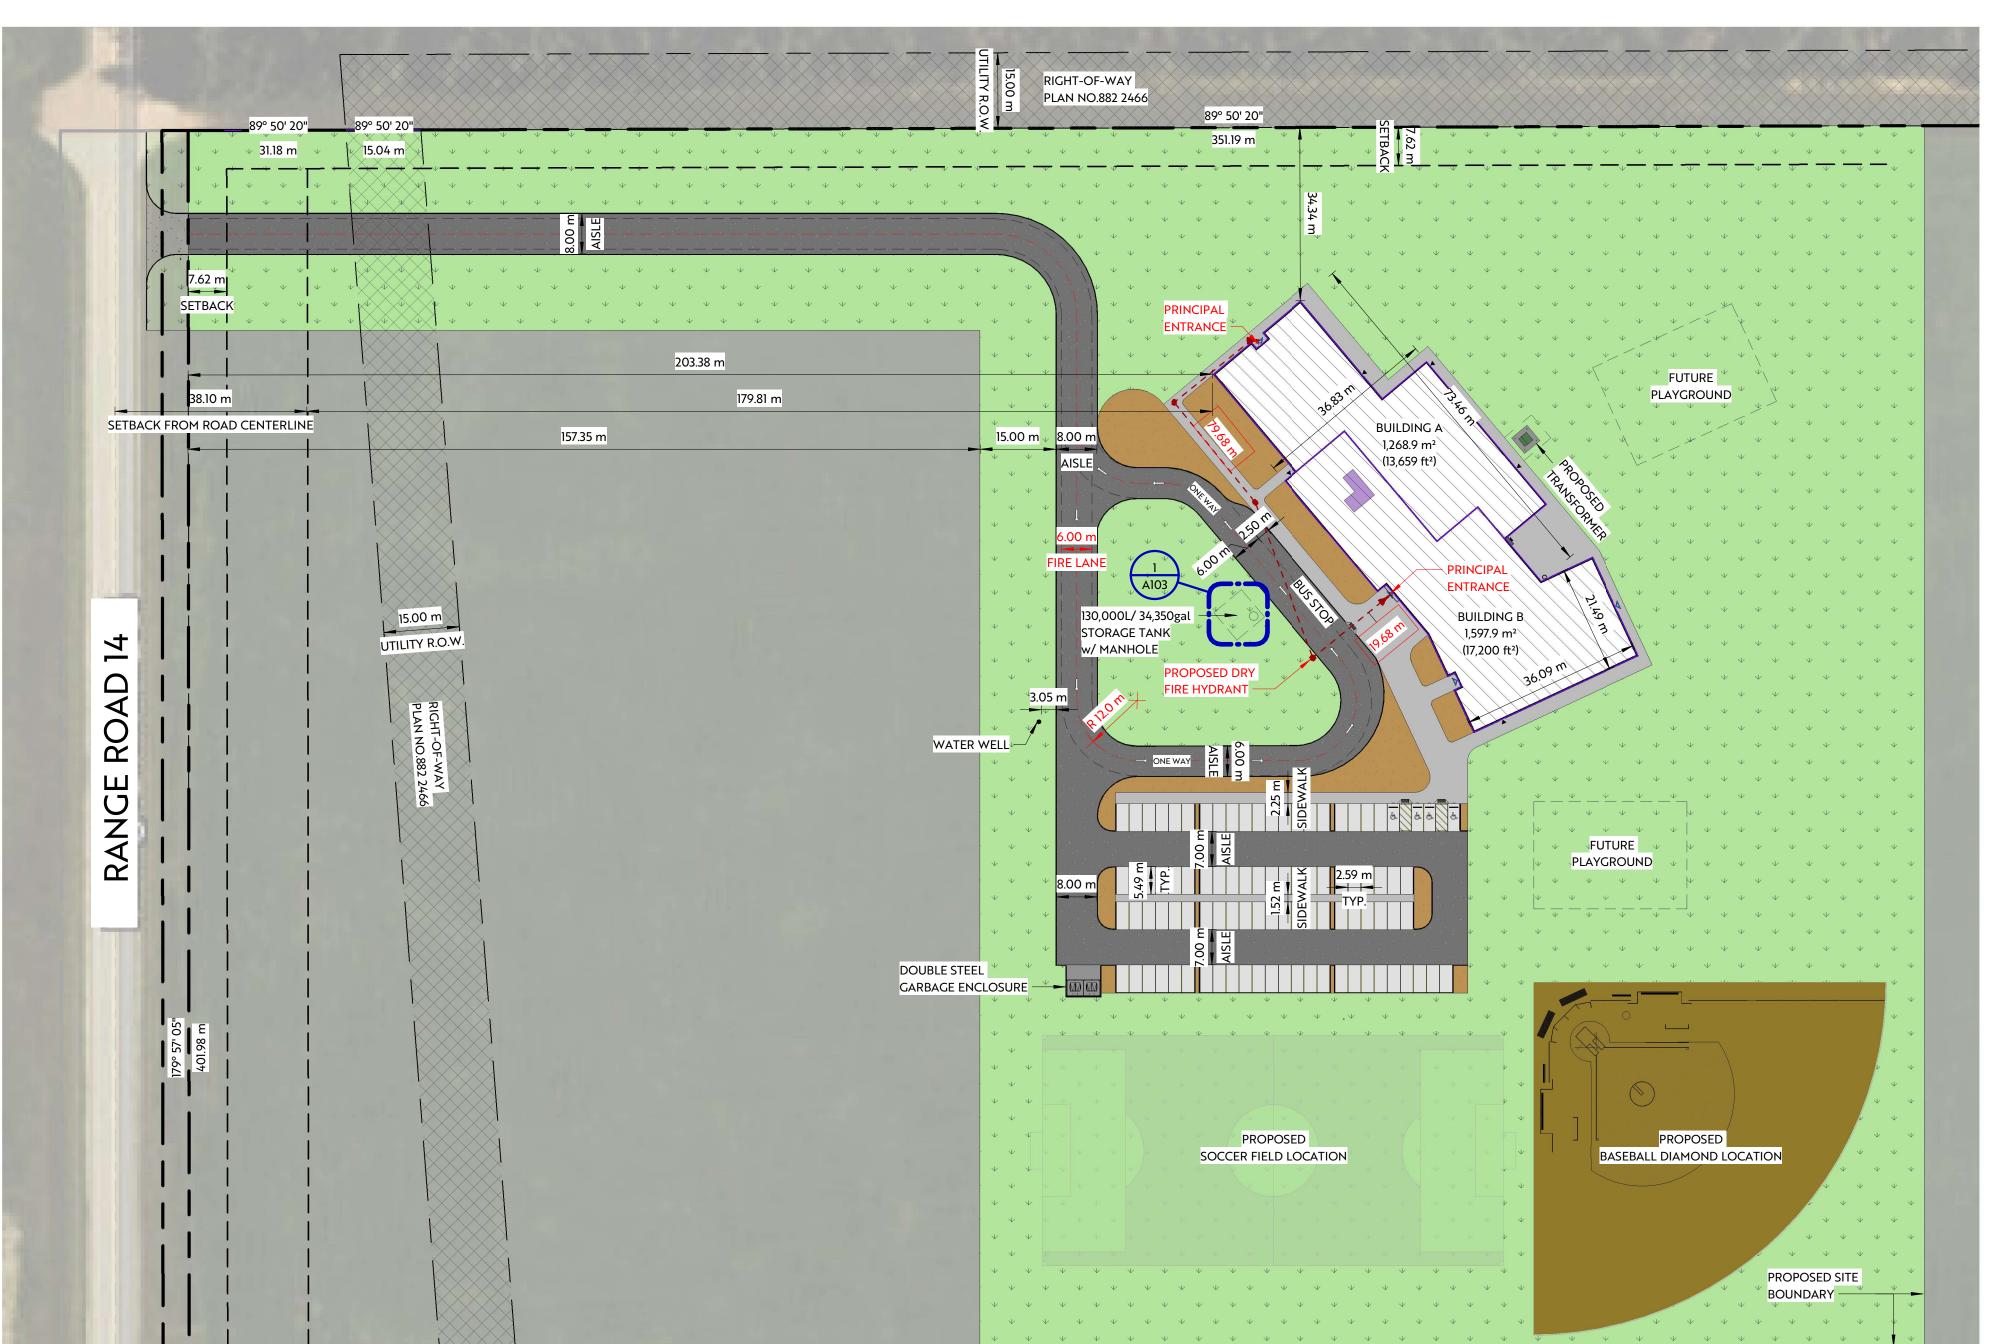

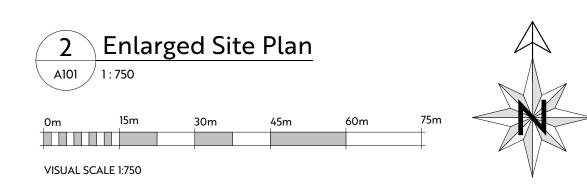

### NOTES CONCERNING BUILDING LOCATION

- ENGINEER IS TO BE ADVISED BEFORE START OF CONSTRUCTION OF ANY UN-KNOWN FEATURES ON THIS OR THE ADJACENT SITES THAT MIGHT IMPACT ON THE PROJECT EITHER DURING CONSTRUCTION OR FUTURE USE.
- 2. THE "NORTH" ORIENTATION REFERS TO NOMINAL NORTH RATHER THAN TRUE OR MAGNETIC NORTH.
- 3. ANY DIMENSIONS THAT SHOW THE LOCATION OF EXISTING FEATURES ARE APPROXIMATE ONLY, AND ARE TO BE CONFIRMED BEFORE CONSTRUCTION START AS REQUIRED BY A CERTIFIED LAND SURVEYOR.
- 4. LANDSCAPING IS SUBJECT TO CHANGE.

Parking Sc	Parking Schedule			
Stall Type	Count	Required		
BARRIER FREE PARKING	4			
PARKING	89	1.		
TOTAL STALLS	93	N		

SITE PLAN LEGEN	D
PROPERTY LINE	
SETBACK LINE	
RIGHT OF WAY LINE	
RIGHT OF WAY HATCH	
PROPOSED BUILDING	
SERVICE ROOM	
FENCE	
MAN DOOR	▼
OVERHEAD DOOR	
BARRIER FREE	<u> </u>
ENTRANCE	V

### SITE MATERIAL LEGEND

APRON		GRAVEL
SIDEWALK	\psi \psi \psi \psi \psi \psi \psi \psi	LANDSCAPING
LIGHT DUTY ASPHALT		HARD LANDSCAPINC
HEAVY DUTY ASPHALT	\-\(\)\\\\\\\\\\\\\\\\\\\\\\\\\\\\\\\\\	MULCH

Site Schedule ON SITE						
HEAVY DUTY ASPHALT	4,630.7 m <sup>2</sup>	49,844.76 f				
LANDSCAPING	32,061.1 m <sup>2</sup>	345,102.93 f				
LIGHT DUTY ASPHALT	1,344.5 m²	14,472.55 f				
MULCH	1,234.4 m²	13,286.87 f				
SIDEWALK	1,358.4 m²	14,621.85 f				
	40,687.3 m²	437,954.45 f				
OFF SITE						
HEAVY DUTY ASPHALT - BOULEVARD	81.7 m²	879.74 f				
LANDSCAPING - BOULEVARD	248.9 m²	2,679.32 f				
	330.6 m²	3,559.06 f				
Grand total	41,017.9 m <sup>2</sup>	441,513.51 f				

### BYLAW INFORMATION LACOMBE COUNTY LAND USE BYLAW

7.1 AGRICULTURAL DISTRICT (A) **▼ TBC IF NEEDS REZONING** 

**SETBACKS** FRONT YARD (NE): REQUIRED: 7.62 m (25 ft) REAR YARD (SW):

REQUIRED: 7.62 m (25 ft) SIDE YARD (NW): REQUIRED: 7.62 m (25 ft)

83,531.3 m<sup>2</sup> (899,123 ft<sup>2</sup>)(20.6 acre)

SIDE YARD (SE): REQUIRED: 7.62 m (25 ft) SITE SIZE:

SITE COVERAGE: PROVIDED: 3.45% MAX: N/A BUILDING HEIGHT: PROVIDED: 9.14m (30 ft)

MAX: N/A PARKING: PARKING REQUIREMENTS: PLACES OF PUBLIC ASSEMBLY

1 STALL/ 99.96 m<sup>2</sup> 1,385 m<sup>2</sup> / 99.96 m<sup>2</sup> 13.8 ≈ 14 STALLS STALLS REQUIRED = 14

UNIVERSAL STALLS REQUIRED = 2

Stamp:

**PLANWORKS** 

**PRELIMINARY** 

NOT FOR CONSTRUCTION





chool

9 4 0 0 1 1 1 0 ್ಲ್ Project No: Date: 2025-07-04 4:49:55 PM g Drawn by: KL, KS LB, AB EChecked by: Sheet Name:

Site Plan

DO NOT SCALE DRAWING - VERIFY ALL DIMENSIONS, DATUMS AND LEVELS PRIOR TO COMMENCEMENT OF WORK. REPORT ANY OTHER GOVERNING AUTHORITIES. THIS IS A COPYRIGHT DRAWING AND SHALL NOT BE REPRODUCED OR REVISED WITHOUT THE WRITTEN CONSENT OF THE CONSULTANT.





6.14(5a) PROVIDE YEAR ROUND COLOUR AND INTEREST, A TREE MIX OF APPROX. 50% CONIFEROUS AND 50% DECIDUOUS


6.14(5g-i) ONE TREE FOR EVERY 3.05m (10ft) AND ONE SHRUB FOR EACH 1.83m (6ft) OF LINEAR FRONTAGE ABUTTING THE RIGHT-OF-WAY **SHALL** BE REQUIRED 6.14(5g-ii) ONE TREE FOR EVERY 3.05m (10ft) AND ONE SHRUB FOR EACH 1.83m (6ft) OF VARIANCE REQUIRED DUE TO 8 LINEAR SIDE OR REAR YARD **MAY** BE REQUIRED

50% OF DECIDUOUS TREES SHALL BE AT LEAST 65mm (2.5in) CALIPER AND 50% SHALL BE A MINIMUM OF 76mm (3in) CALIPER. 75% OF CONIFEROUS TREES SHALL BE A MINIMUM OF 2.5m (8.2ft) IN HEIGHT AND 25% SHALL BE A MINIMUM OF 3.5m (11.5ft) IN HEIGHT.


REQUIRED TREES FROM FRONTAGE = 80 TREES REQUIRED SHRUBS FROM FRONTAGE = 133 SHRUBS

REQUIRED TREES FROM SIDE AND REAR YARD (IF APPLICABLE) = 308 TREES REQUIRED SHRUBS FROM SIDE AND REAR YARD (IF APPLICABLE) = 513 SHRUBS

SITE M	ATERIAL LEGEND		
	APRON		GRAVEL
	SIDEWALK	\ \ \ \ \ \ \ \ \ \ \ \ \ \ \ \ \ \ \	LANDSCAPING
	LIGHT DUTY ASPHALT		HARD LANDSCAPING
	HEAVY DUTY ASPHALT	, - (, )	MULCH

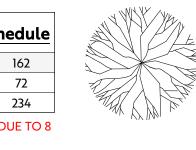


TREE DEFICIT

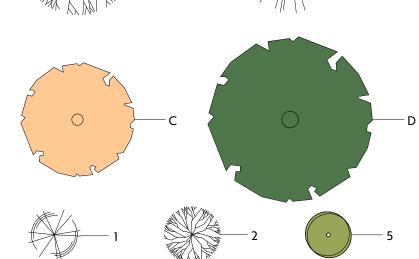

Grand total



Type	Botanical Name	Label	Size (Mature)	Caliper	Min. Height/Spread	Provided
Shrub						•
Coniferous						
Rocky Mountain Juniper	Juniperus scopulorum	1	3-4.6m (10-15ft)	26mm (1.0in)	450mm (1.5ft) Spread	32
Mugo Pine	Pinus Mugo	2	0.8m-3.7m (2.5-12ft)	26mm (1.0in)	450mm (1.5ft) Spread	7
Calgary Carpet Juniper	Juniperus Horizontalis	3	0.3m (1.0ft)	-	450mm (1.5ft) Spread	33
						72
Deciduous						
Shrubby Potentilla	Dasiphora Fruticosa	4	1.2m (4.0ft)	-	450mm (1.5ft)	34
Purple Leaf Sand Cherry	Prunus X Cistena	5	3.0m (10.0ft)	-	450mm (1.5ft)	56
						90
Tree						
Coniferous						
White Spruce	Picea Glauca	Α	15-30m (50-100ft)	60mm (2.4in)	2.5m (8.2ft)	16
Colorado Spruce	Picea Pungens	В	-	-	3.5m (11.5ft)	20
						36
Deciduous						
2 0 0 . 0 . 0 . 0 . 0		_	12 25 (20 (00)	(5)	2 5 (0 24)	10
Green Ash	Fraxinus Pennsylvanica	С	12-25m (39-40ft)	65mm (2.5in)	2.5m (8.2ft)	18

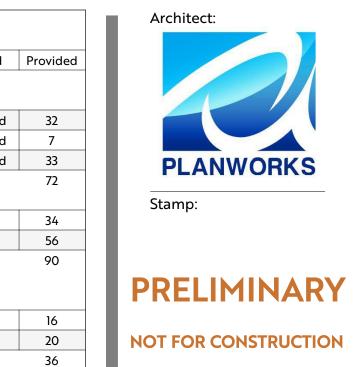







Lighthouse School Build

질 Project No: ੈਂ Date: 2025-07-04 4:49:58 PM KL, KS g Drawn by: LB, AB


ြာ Checked by: ္င္ဒီ Sheet Name:


Landscaping

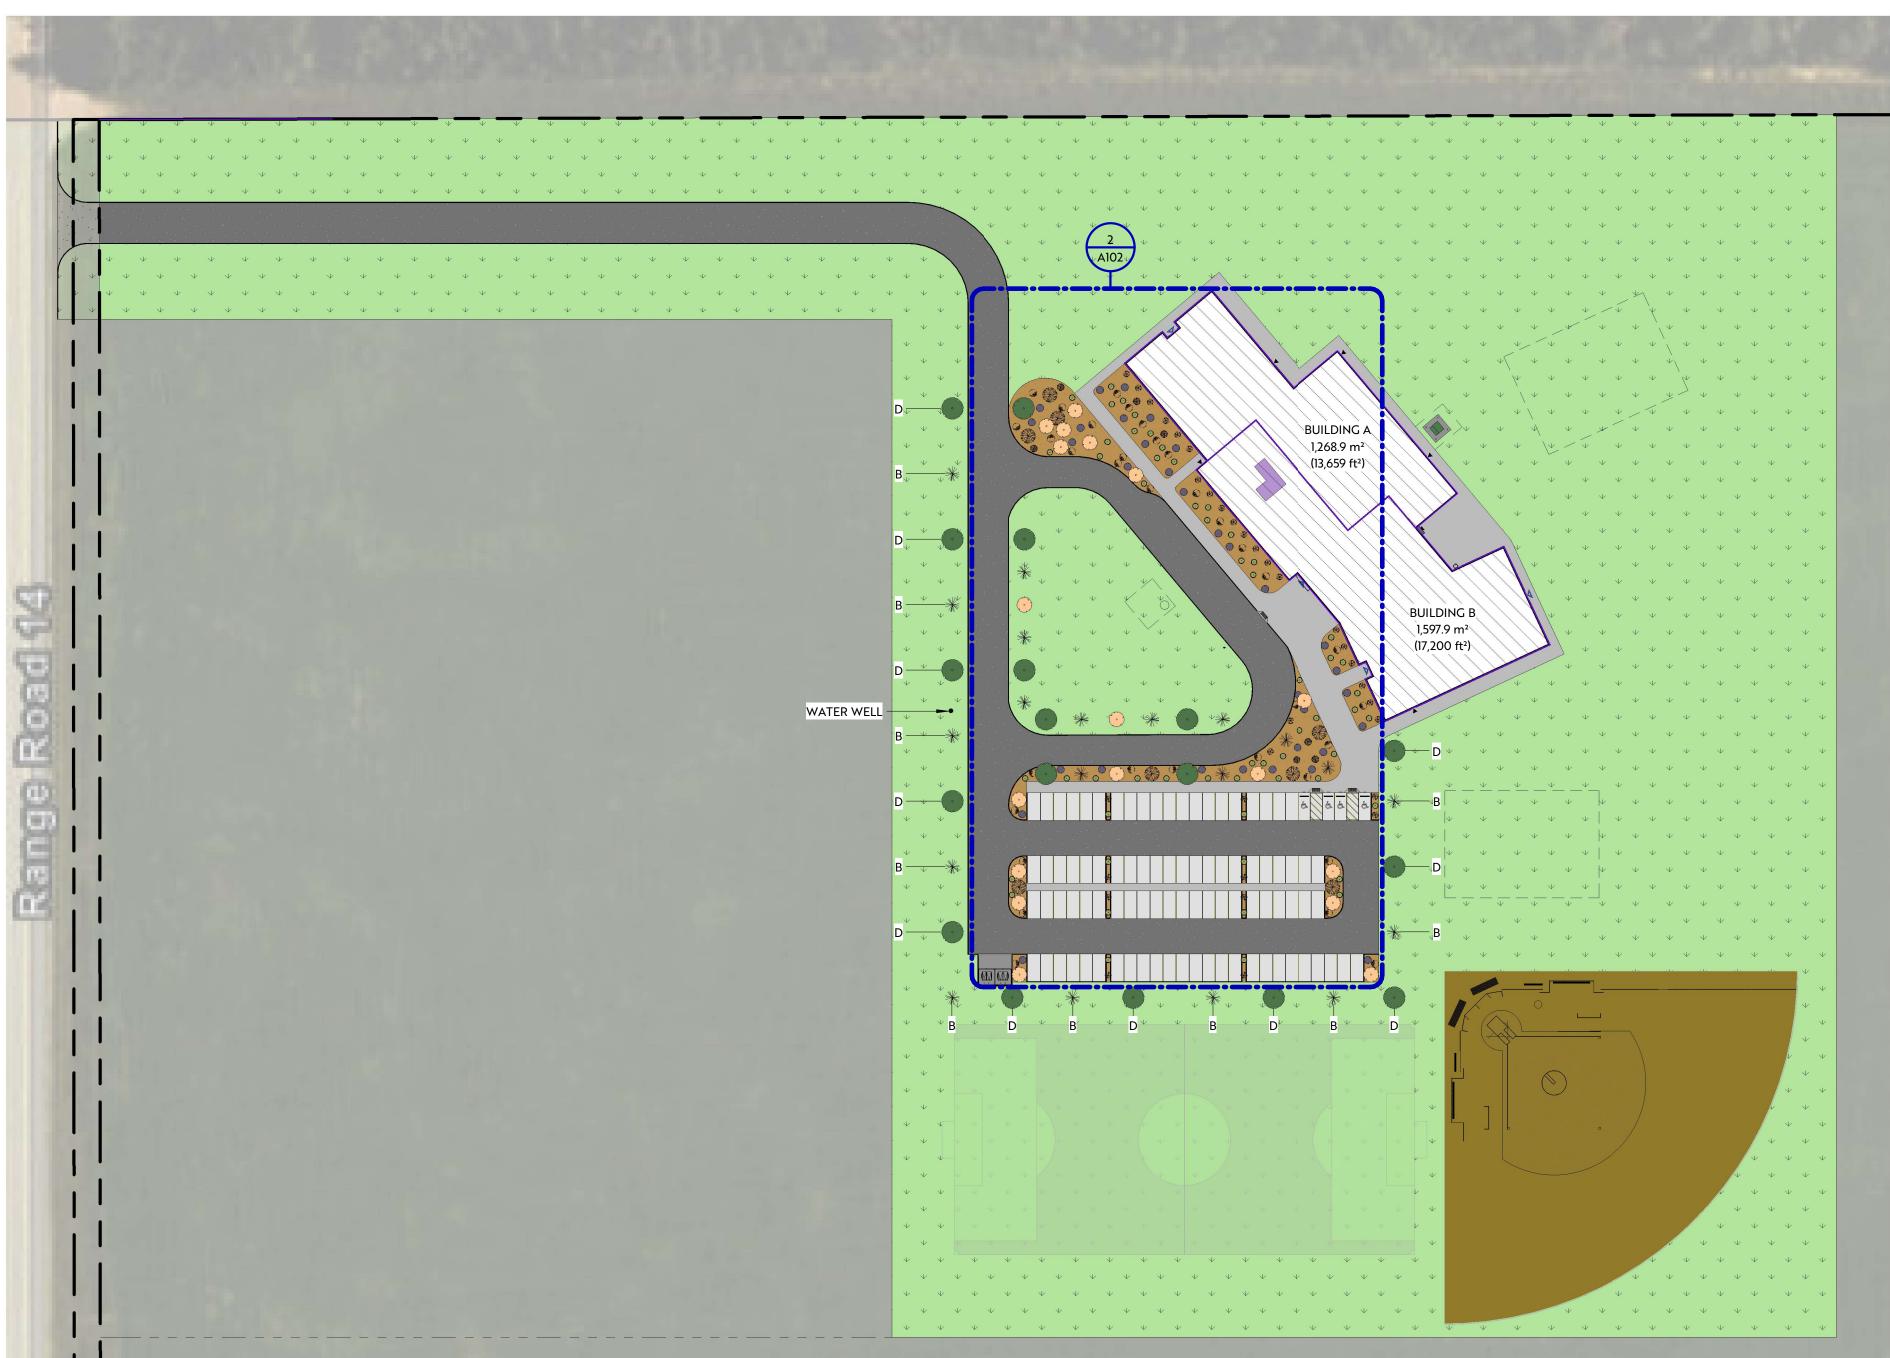

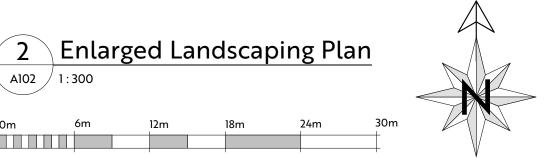

VISUAL SCALE 1:300

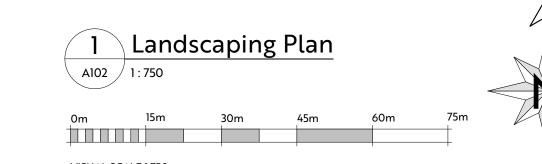

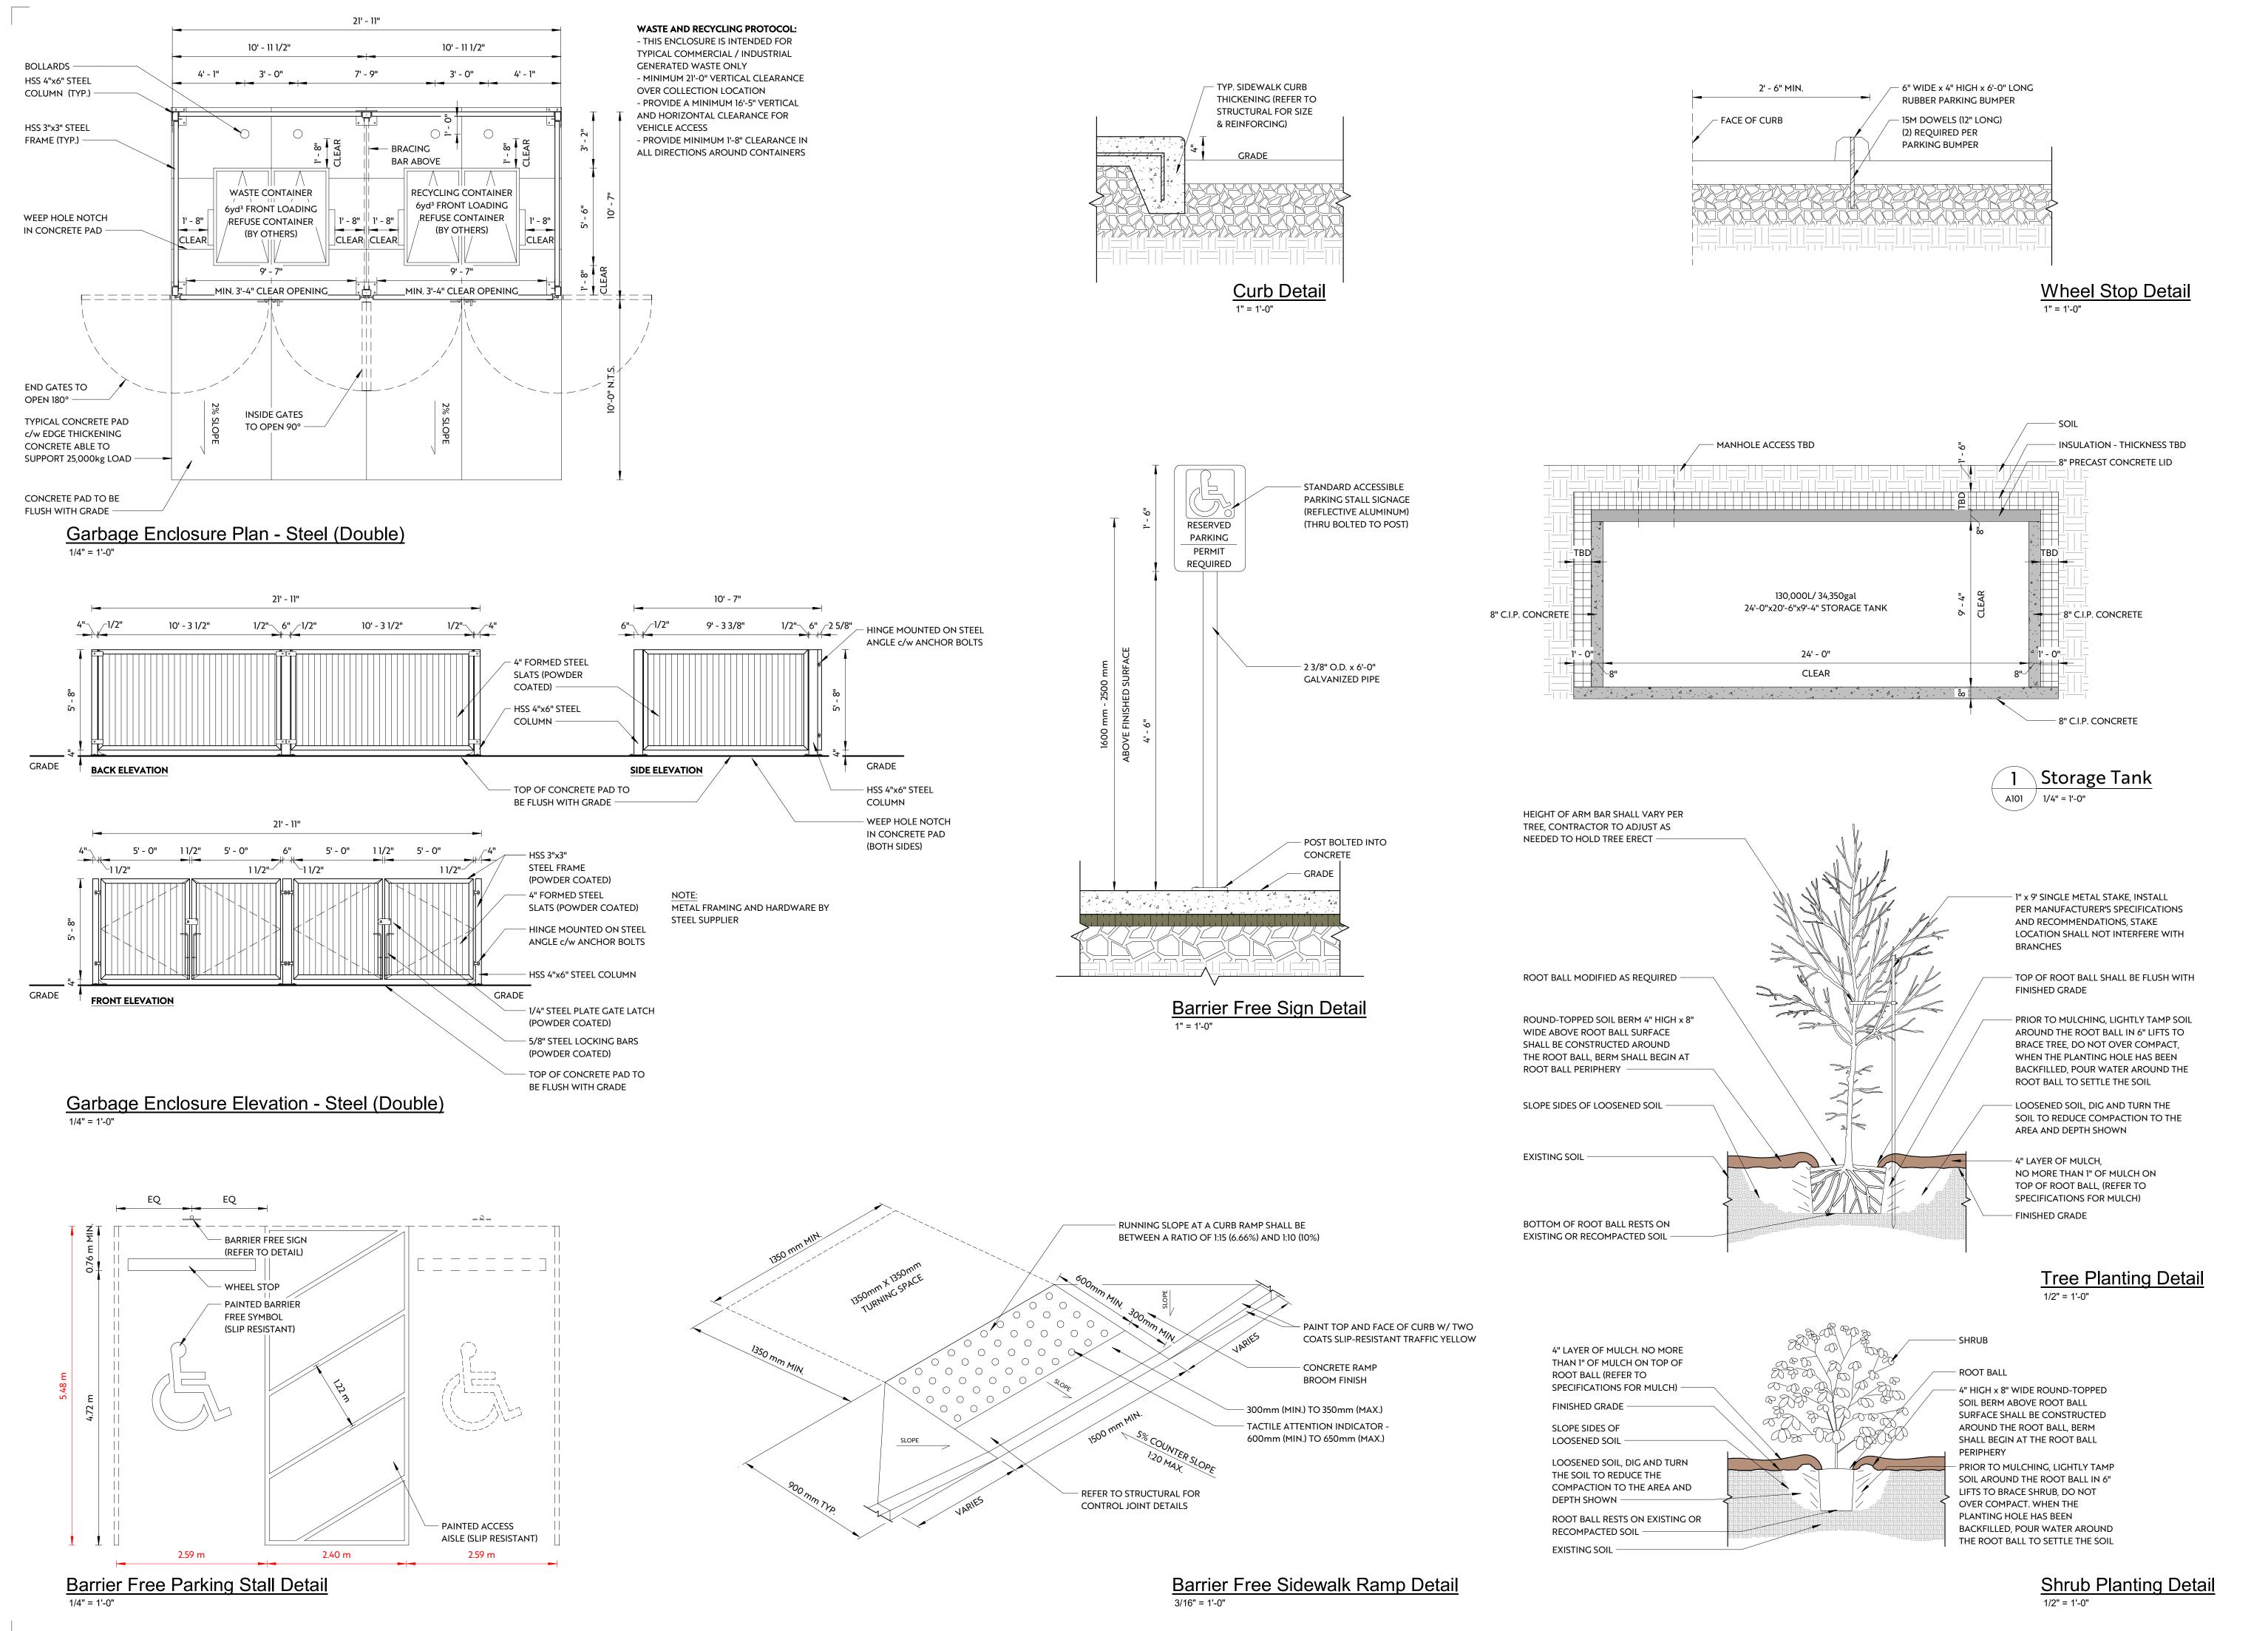

Stamp:

**PRELIMINARY NOT FOR CONSTRUCTION** 

design studio Itd.





Building

o 9

Sheet Name:

ತ್ತ Project No: Date: 2025-07-04 4:50:00 PM KL, KS Drawn by: Checked by: LB, AB

Site Details

DO NOT SCALE DRAWING - VERIFY ALL DIMENSIONS, DATUMS AND LEVELS PRIOR TO COMMENCEMENT OF WORK. REPORT ANY DISCREPANCIES OR OMISSIONS TO THE APPLICABLE BUILDING CODE AND ANY OTHER GOVERNING AUTHORITIES. THIS IS A COPYRIGHT DRAWING AND SHALL NOT BE REPRODUCED OR REVISED WITHOUT THE WRITTEN CONSENT OF THE CONSULTANT.

NEW PRECAST WALL EXISTING WALL \_\_\_\_\_ \_\_ \_ \_ \_ DEMOLISHED WALL **NEW DOOR** EXISTING DOOR

NOTE:

1. RATED WALLS SHALL BE FRAMED TO UNDERSIDE OF RATED FLOOR ASSEMBLY OR ROOF ASSEMBLY

2. ADD BLOCKING BETWEEN STUDS AS REQUIRED TO SUPPORT ALL EDGES OF 1/2" TYPE 'X' GYPSUM BOARD

3. FIRE SEPARATION AS SHOWN:

0 HR - - - - - - - -3/4 HR — — — — — — — — 1HR -----2 HR 4 HR

4. ALL WASHROOMS AND JANITOR ROOMS TO RECEIVE IMPERVIOUS DURABLE FLOOR AND WALL FINISH UP TO 5'-0" A.F.F.

5. ALL TILED WALLS ADJACENT TO PRECAST WALLS TO BE CONSTRUCTED AS:

1" GAP 1 5/8" STEEL STUDS @ 24" O/C 1/2" GYPSUM BOARD

7. MILLWORK BY MILLWORK SUPPLIER

6. FURNITURE NOT INCLUDED

8. ALL FLOOR SUPPORTING STRUCTURES TO MAINTAIN FLOOR F.R.R., AND BE RATED THROUGH THE USE OF: SPRAY APPLIED FIRE PROOFING, INTUMESCENT PAINT, FRAMED ASSEMBLIES, OR

**EQUIVALENT THICKNESS CALCULATIONS** 

WAREHOUSE/SHOP AREAS THE SEAM JOINTS OF THE POLY VAPOUR BARRIER DO NOT REQUIRE SEAL OR TAPING. PLACE THE LOOSE END AT A SEAM JOINT ON TOP OF THE ADJACENT

MEMBRANE WITH A MINIMUM OVERLAP OF 1'-0". FLOOR PENETRATIONS DO NOT REQUIRE SEAL OR TAPING. WHERE MEMBRANES HAVE BEEN CUT TO ACCOMMODATE PENETRATIONS, IT IS RECOMMENDED A MEMBRANE PATCH BE PLACED AROUND THE PENETRATION AREA AND ALONG THE CUT SEAM WITH A MINIMUM 1'-0" OVERLAP TO MINIMIZE ANY SUBGRADE MOISTURE STATIC

PRESSURE EXPOSURE. PLACE THE VAPOUR BARRIER TIGHT AROUND THE PERIMETER OF WALLS, TRENCH DRAINS, AND DOCK LEVELERS.

OFFICE SPACE (WITH RADON PROVISIONS)

THE JOINTS BETWEEN ADJACENT POLY VAPOUR BARRIERS SHALL BE TAPED WITH AN APPROPRIATE TAPE PRODUCT TO ADEQUATELY SEAL THE MEMBRANE AT JOINTS.

SEAL/TAPE ALL MEMBRANE FLOOR PENETRATIONS WITH AN APPROPRIATE TAPE PRODUCT TO ADEQUATELY SEAL THE MEMBRANE AT PENETRATIONS.

THE VAPOUR BARRIER MEMBRANE IS REQUIRED TO BE BROUGHT UP TO THE EDGE OF FOUNDATION WALL AND LAP ONTO FACE OF FOUNDATION WALL, BUT NOT MORE THAN THE DEPTH OF CONCRETE SLAB SPECIFIED. SEAL THE MEMBRANE TO THE FOUNDATION WALL WITH ACOUSTIC SEALANT OR OTHER SIMILAR MEANS OF ADEQUATE ADHESION.

**PRELIMINARY NOT FOR CONSTRUCTION** 

design studio Itd.









o 0


Project No: 2025-07-04 3:14:16 PM Date: KL, KS Drawn by: Checked by: LB, AB

> Floor Plan Overall

DO NOT SCALE DRAWING - VERIFY ALL DIMENSIONS, DATUMS AND LEVELS PRIOR TO COMMENCEMENT OF WORK. REPORT ANY DISCREPANCIES OR OMISSIONS TO THE APPLICABLE BUILDING CODE AND ANY OTHER GOVERNING AUTHORITIES. THIS IS A COPYRIGHT DRAWING AND SHALL NOT BE REPRODUCED OR REVISED WITHOUT THE WRITTEN CONSENT OF THE CONSULTANT.

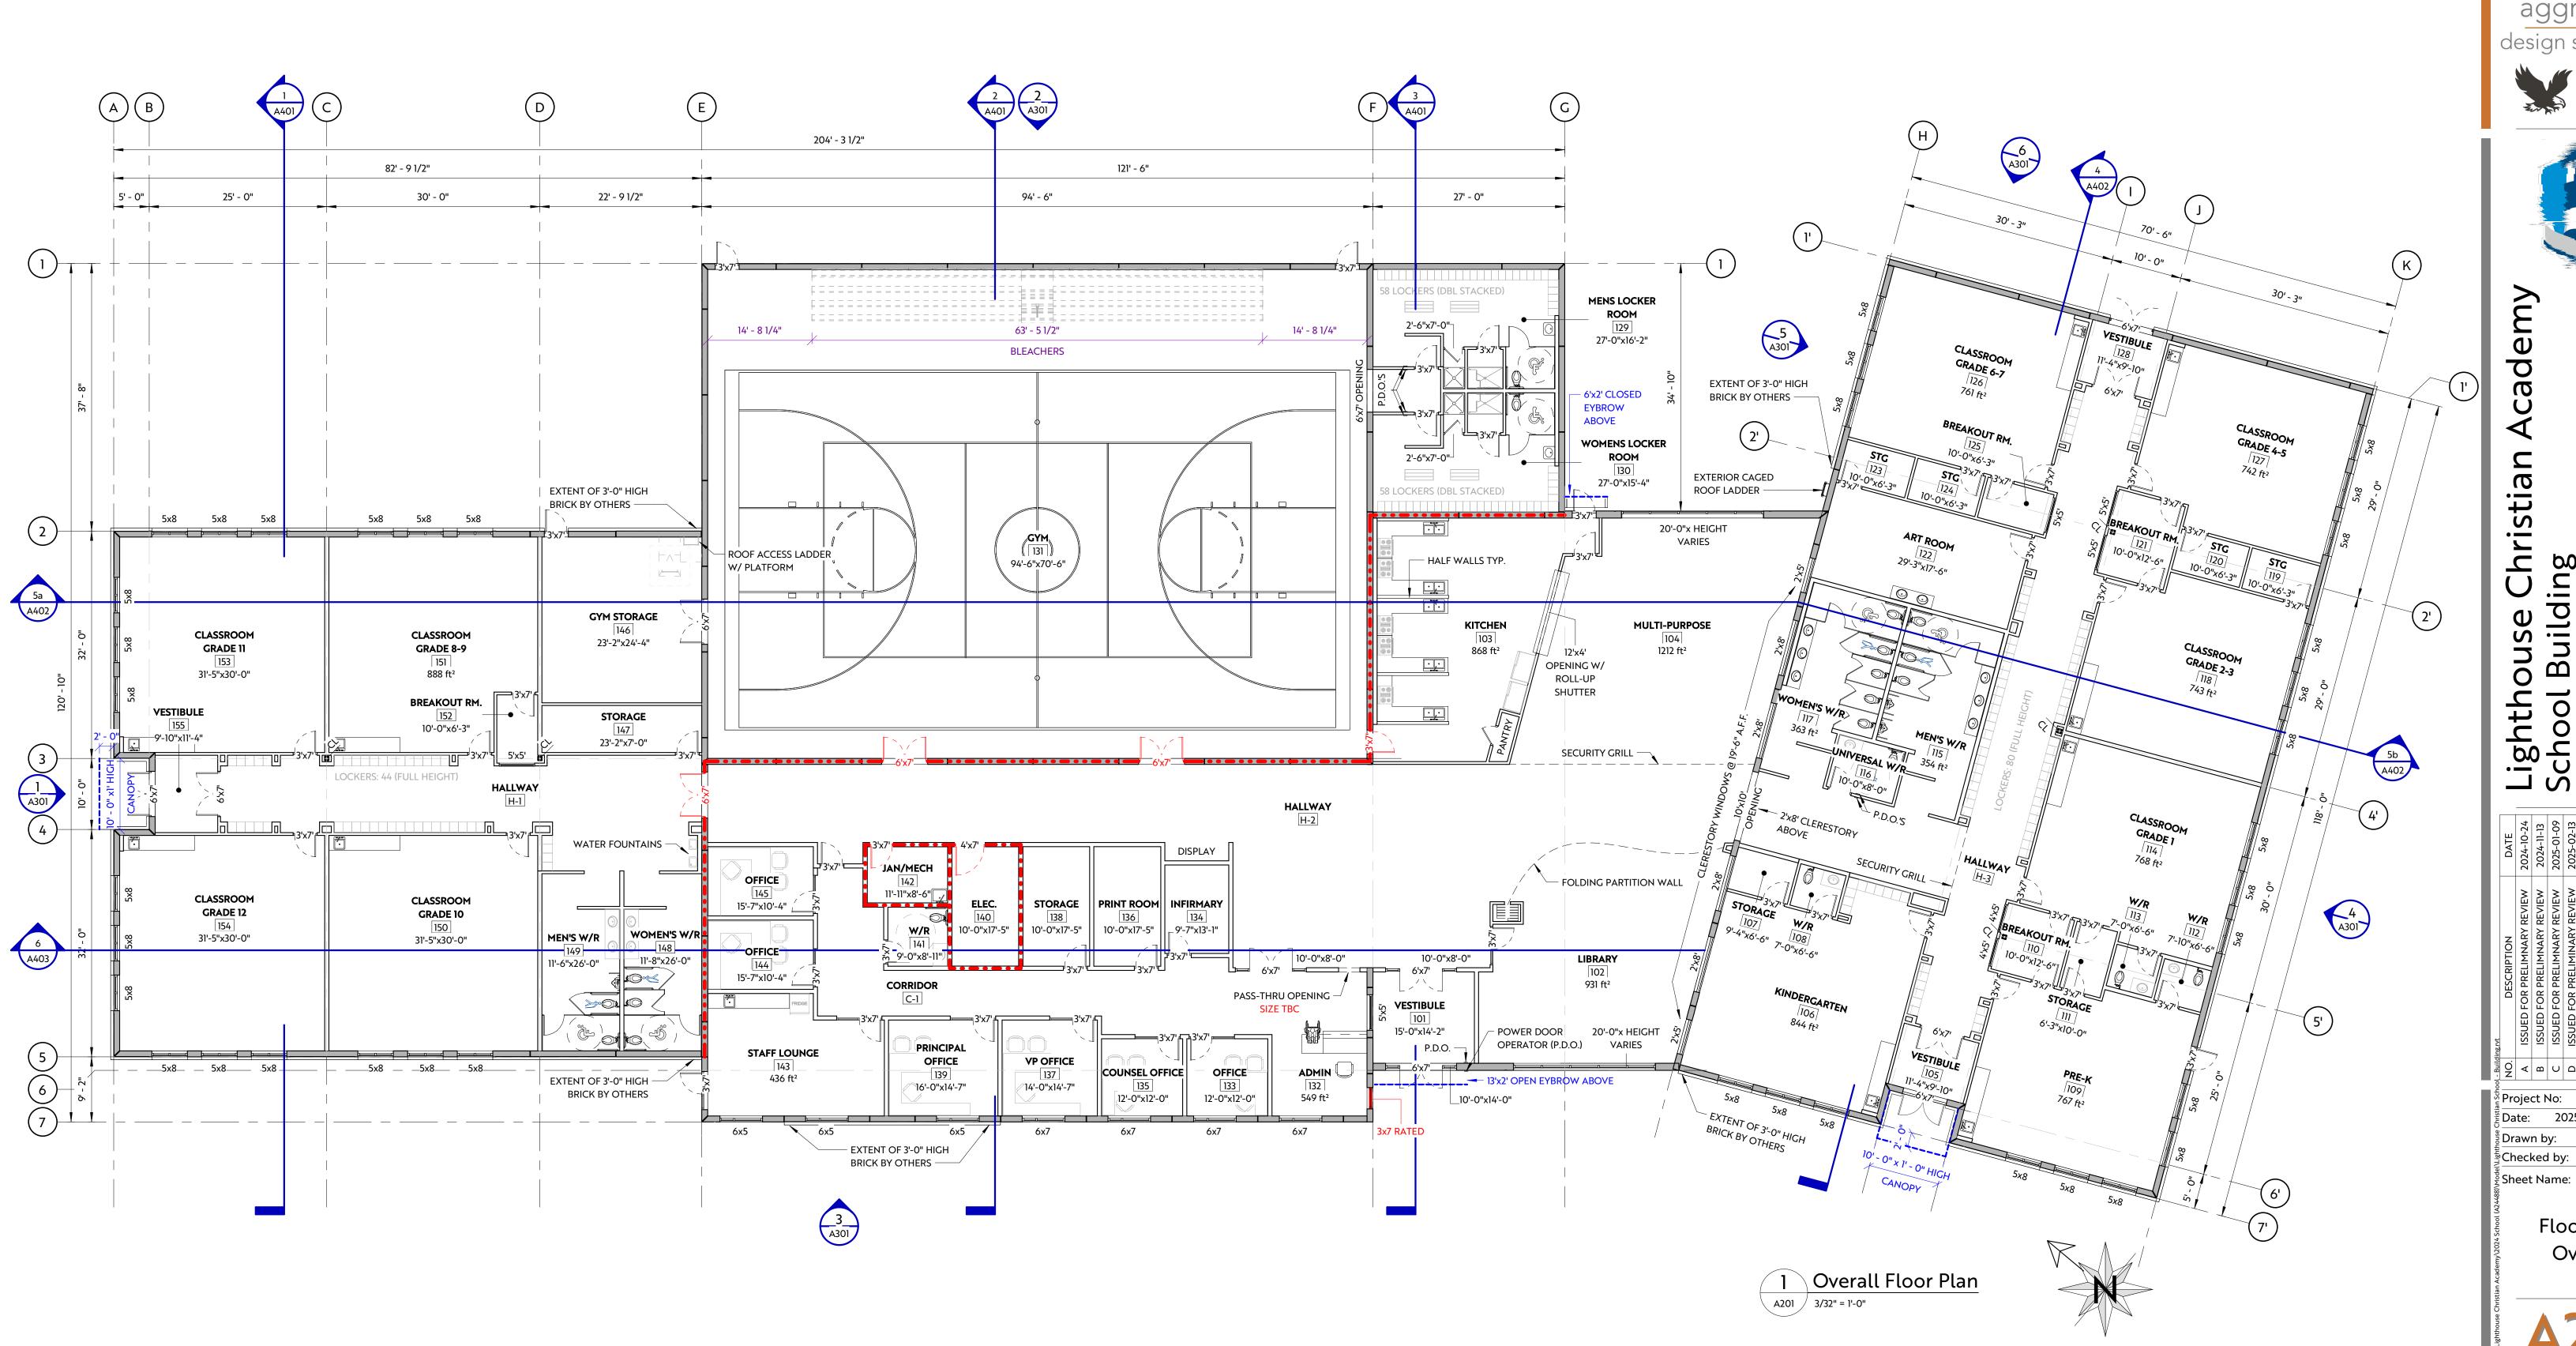

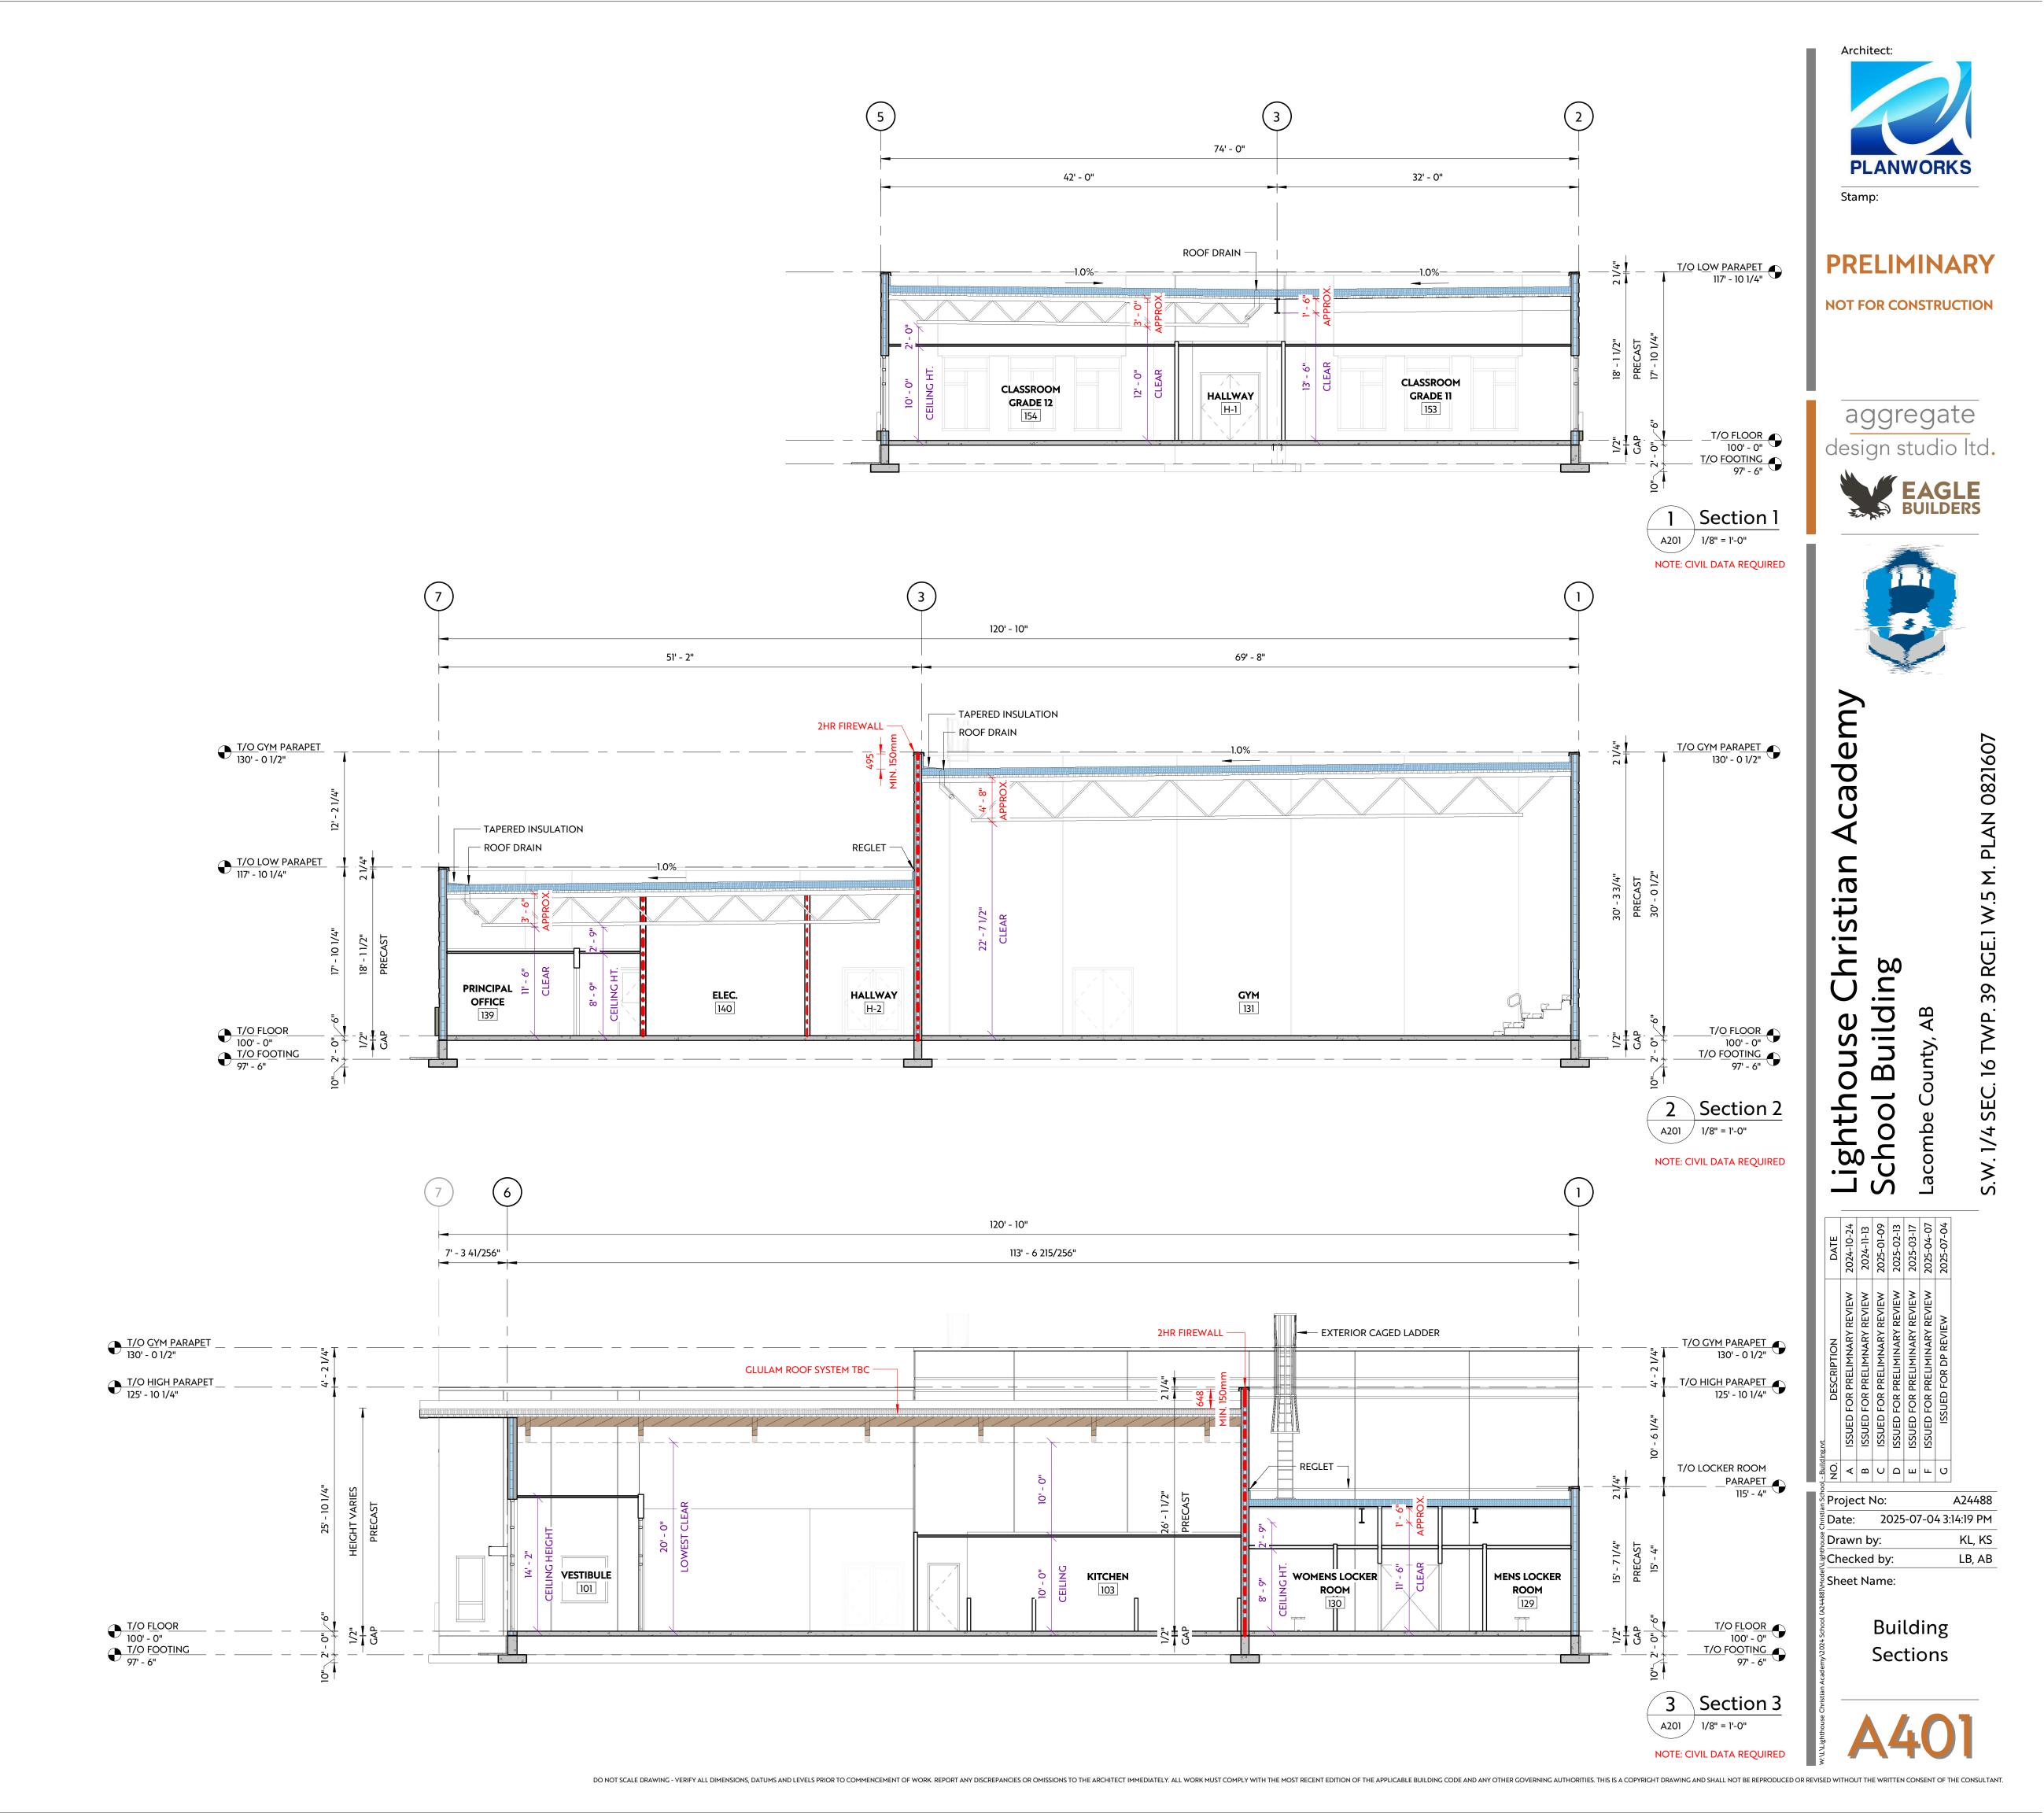

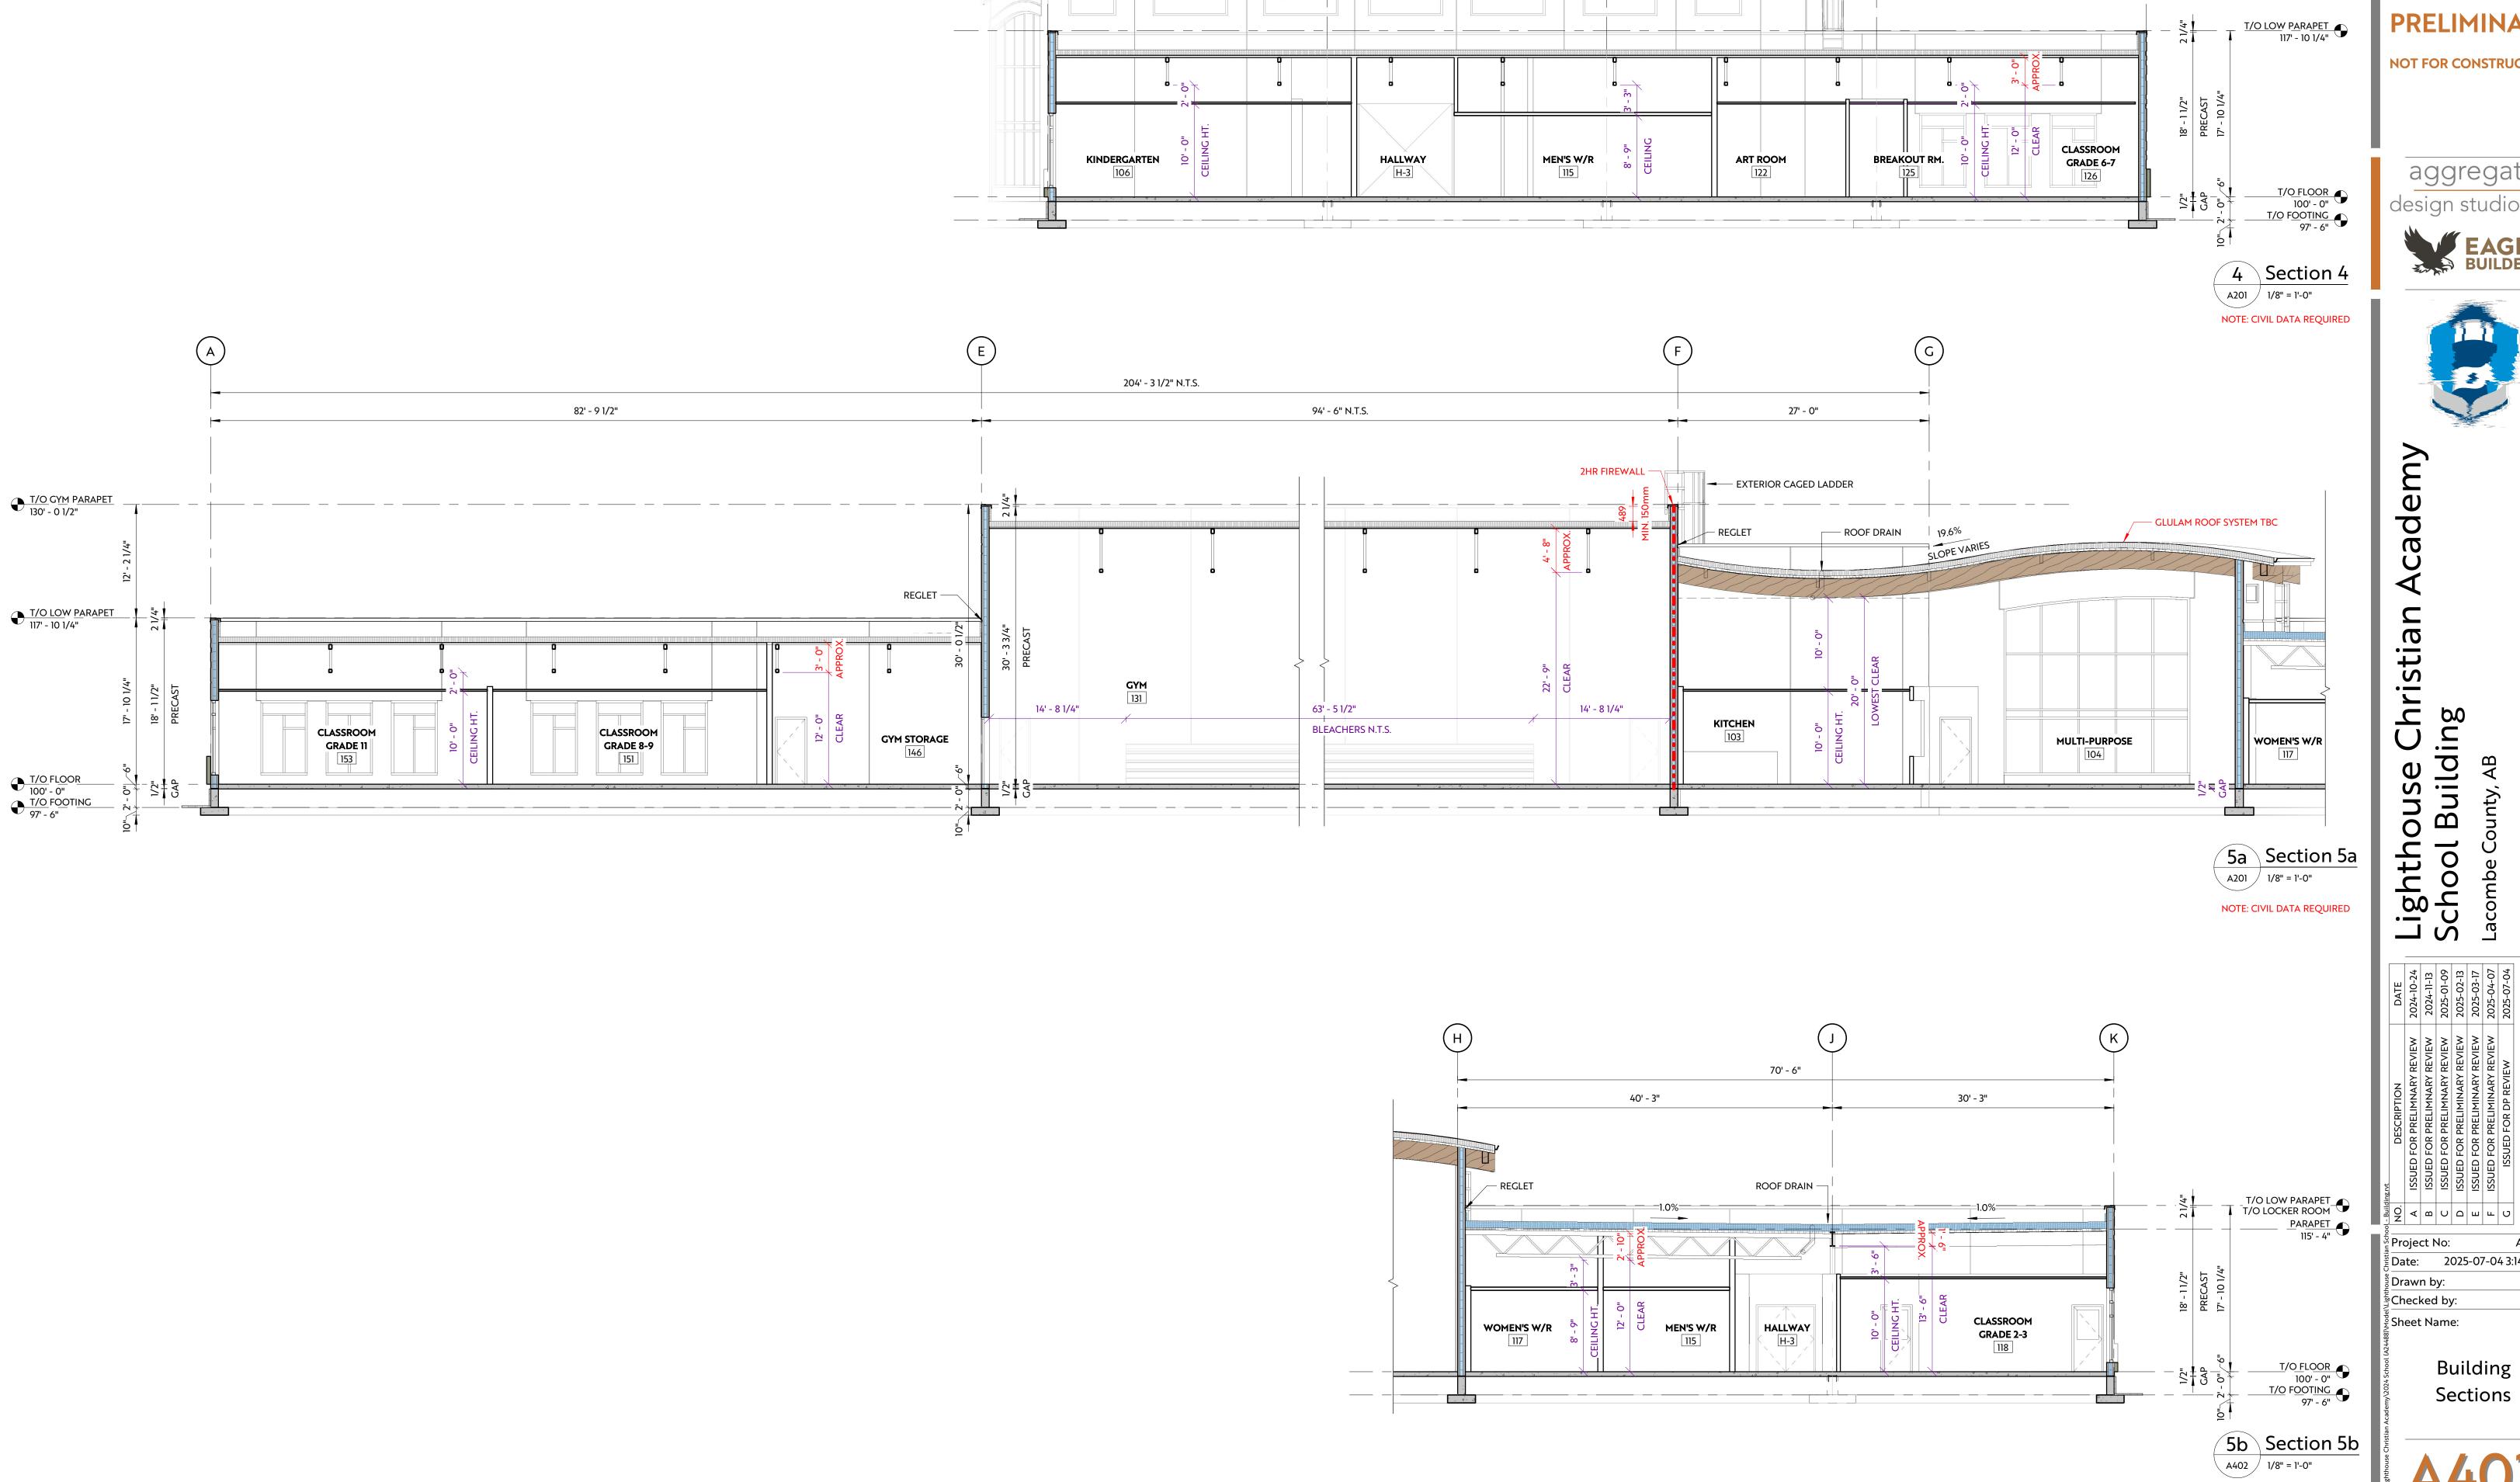

30' - 0"

118' - 0"

30' - 0"

29' - 0"

29' - 0"

Stamp:

**PRELIMINARY** 

NOT FOR CONSTRUCTION

design studio ltd.










A24488 2025-07-04 3:14:21 PM KL, KS LB, AB

> Building Sections

NOTE: CIVIL DATA REQUIRED

DO NOT SCALE DRAWING - VERIFY ALL DIMENSIONS, DATUMS AND LEVELS PRIOR TO COMMENCEMENT OF WORK. REPORT ANY DISCREPANCIES OR OMISSIONS TO THE ARCHITECT IMMEDIATELY. ALL WORK MUST COMPLY WITH THE WOST RECENT EDITION OF THE APPLICABLE BUILDING CODE AND ANY OTHER GOVERNING AUTHORITIES. THIS IS A COPYRIGHT DRAWING AND SHALL NOT BE REPRODUCED OR REVISED WITHOUT THE WRITTEN CONSENT OF THE CONSULTANT.

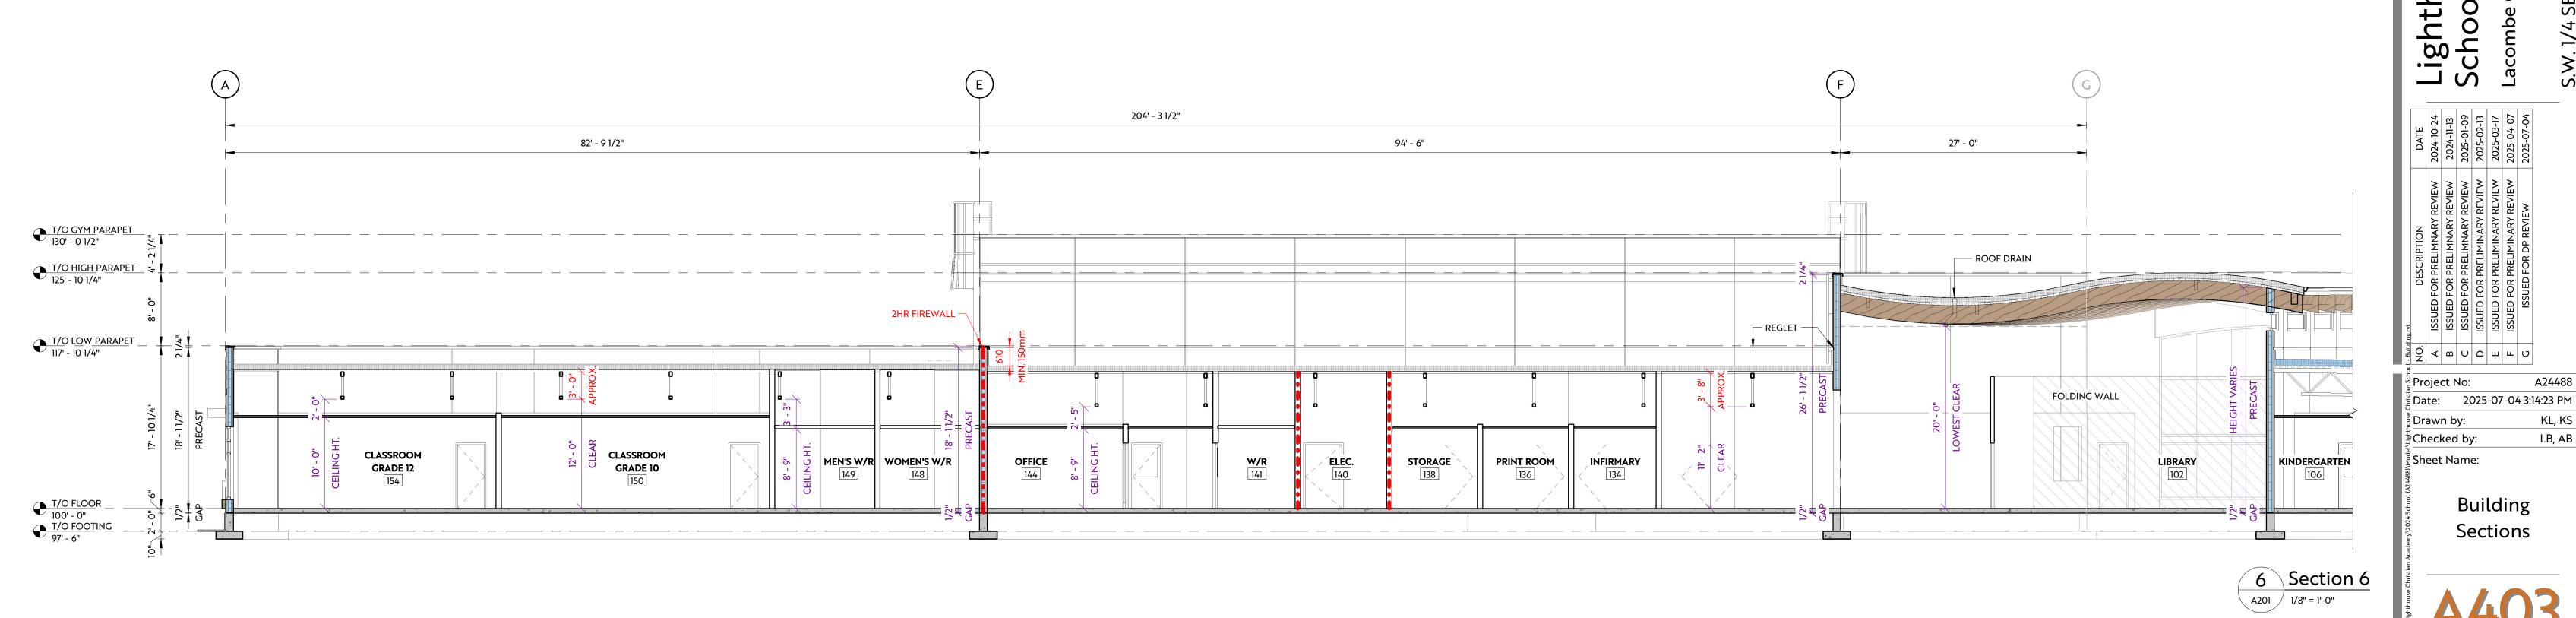

ouse Chri Building Lighthouse ( School Buildi

KL, KS

LB, AB

Building

Sections

NOTE: CIVIL DATA REQUIRED

DO NOT SCALE DRAWING - VERIFY ALL DIMENSIONS, DATUMS AND LEVELS PRIOR TO COMMENCEMENT OF WORK. REPORT ANY DISCREPANCIES OR OMISSIONS TO THE APPLICABLE BUILDING CODE AND ANY OTHER GOVERNING AUTHORITIES. THIS IS A COPYRIGHT DRAWING AND SHALL NOT BE REPRODUCED OR REVISED WITHOUT THE WRITTEN CONSENT OF THE CONSULTANT.

**PRELIMINARY** NOT FOR CONSTRUCTION

aggregate design studio ltd.









불 Date: 2025-07-04 3:14:26 PM KL, KS g Drawn by: LB, AB ြာ Checked by:

္ခ်ီ Sheet Name:


Isometric

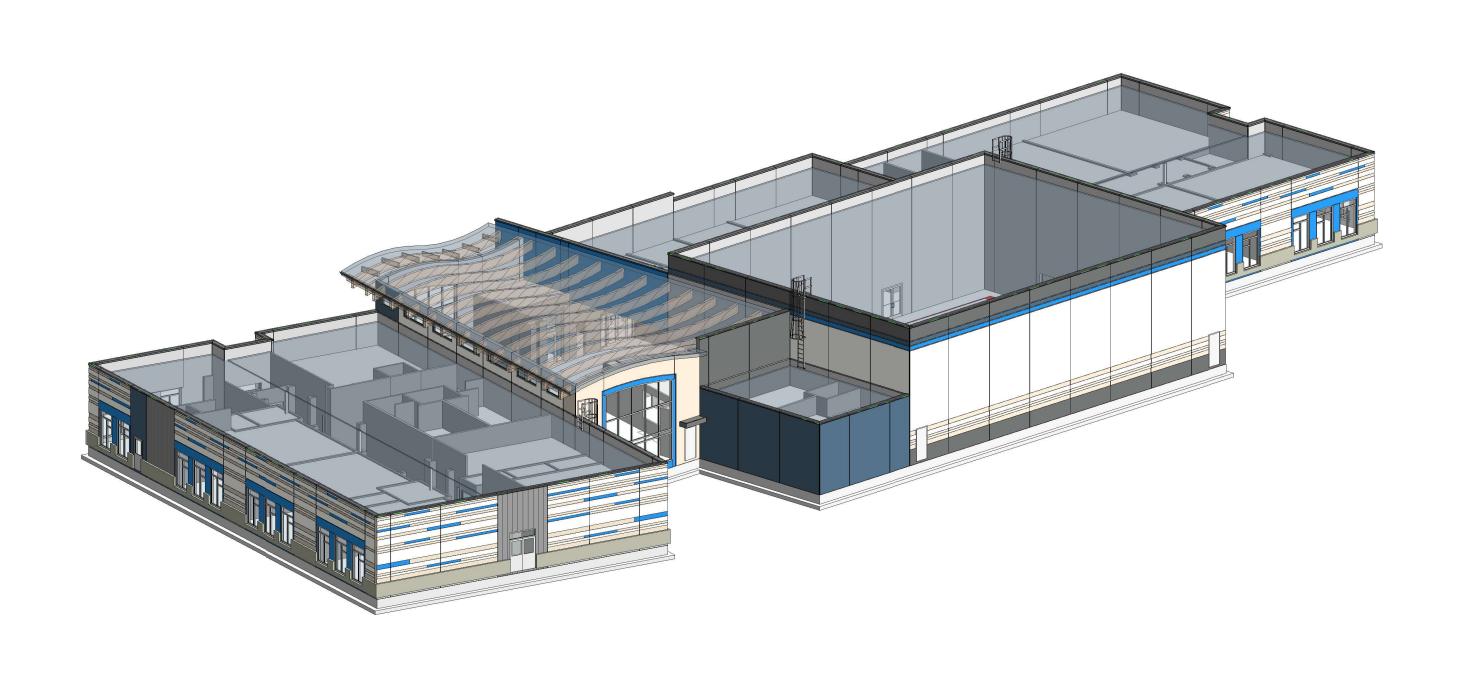

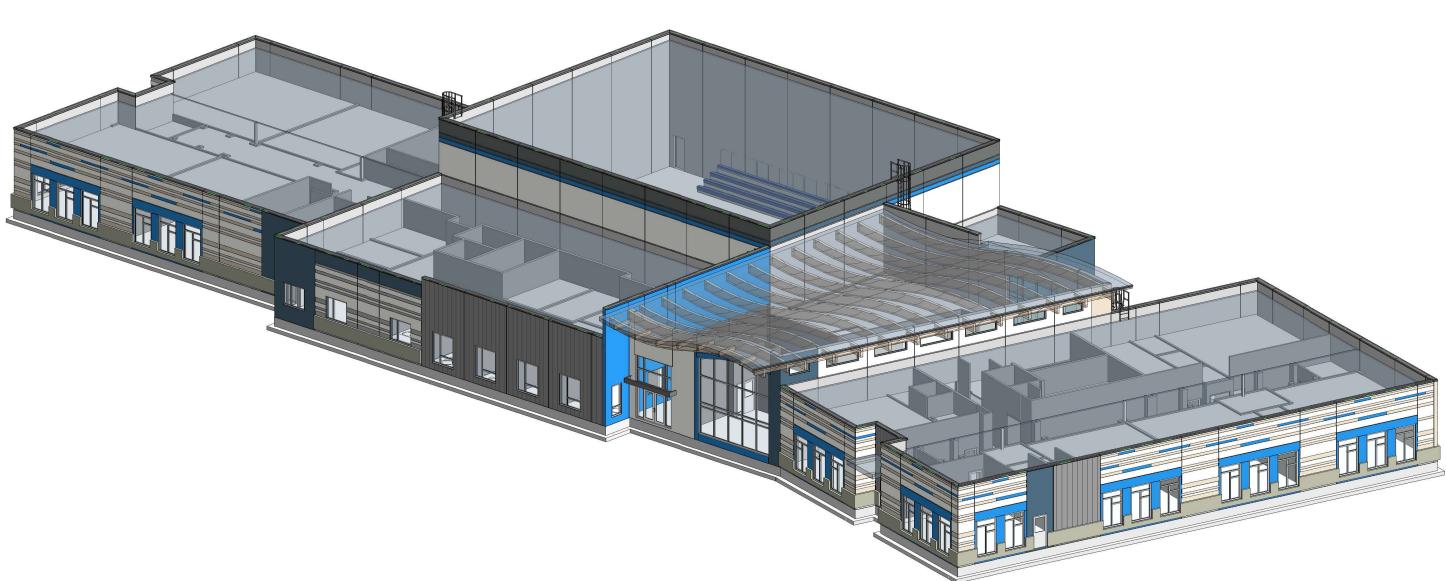


Arch 3D - Southeast

2 Arch 3D - Southwest

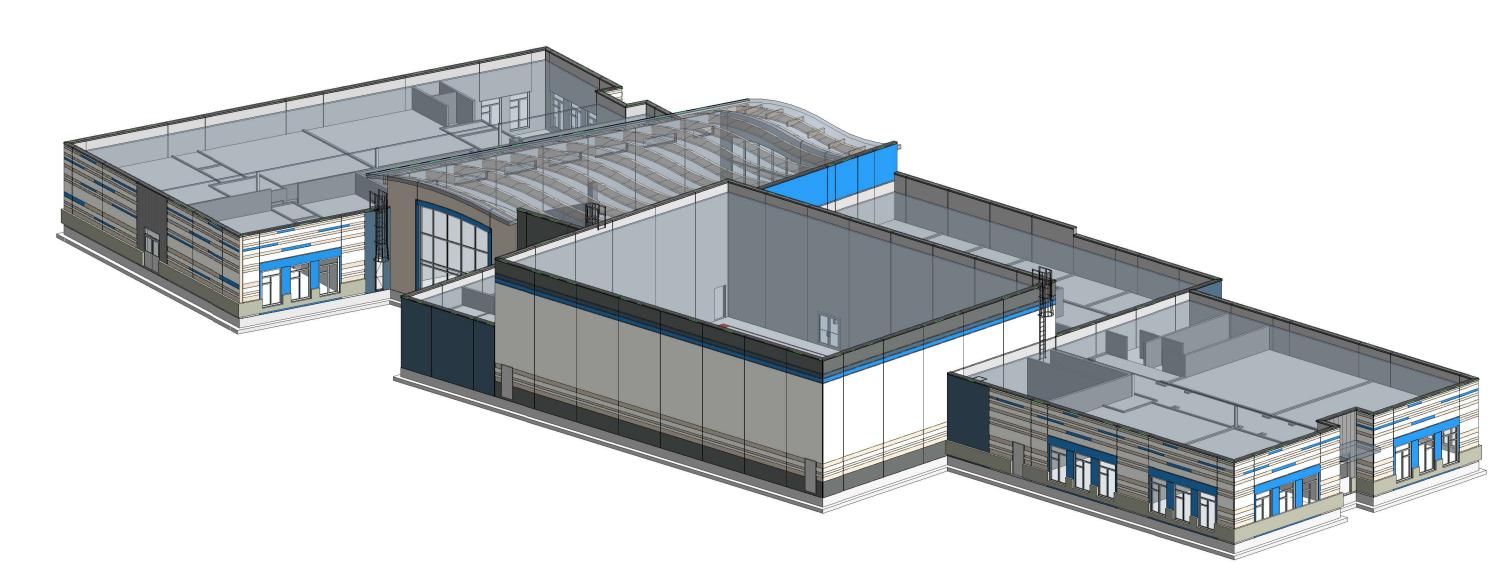

3 Arch 3D - Northeast

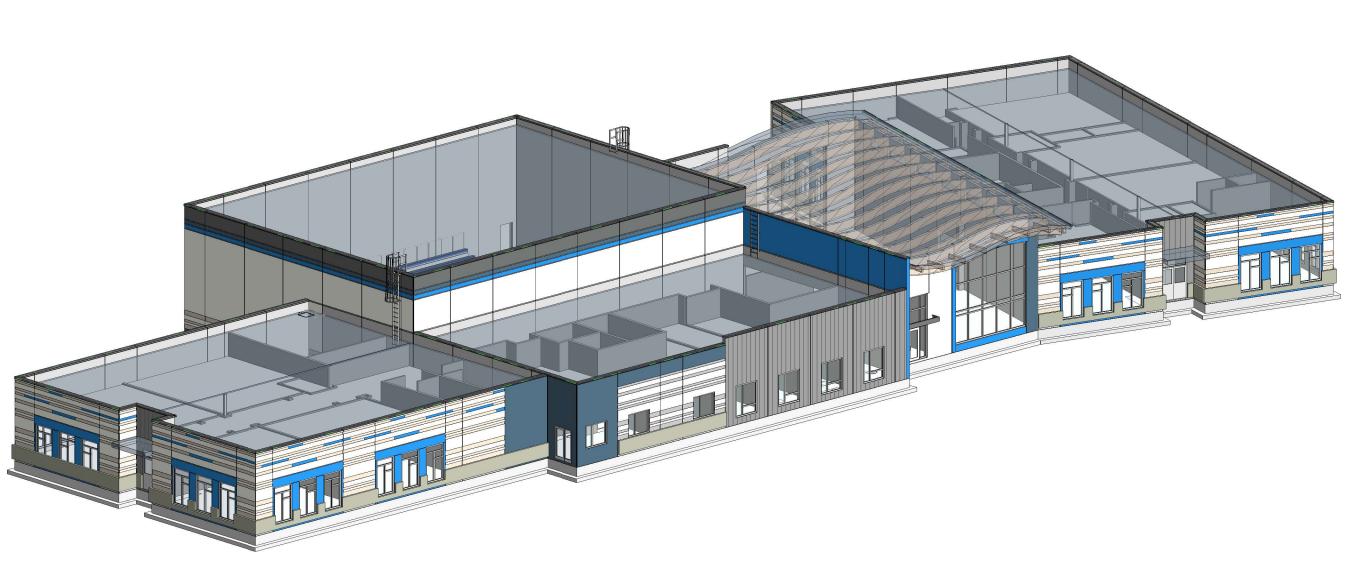

4 Arch 3D - Northwest

DO NOT SCALE DRAWING - VERIFY ALL DIMENSIONS, DATUMS AND LEVELS PRIOR TO COMMENCEMENT OF WORK. REPORT ANY DISCREPANCIES OR OMISSIONS TO THE APPLICABLE BUILDING CODE AND ANY OTHER GOVERNING AUTHORITIES. THIS IS A COPYRIGHT DRAWING AND SHALL NOT BE REPRODUCED OR REVISED WITHOUT THE WRITTEN CONSENT OF THE CONSULTANT.



Formliner Area m² Reckli 2/106 B Amur 135.23 m<sup>2</sup> 1,455.60 ft<sup>2</sup>

DO NOT SCALE DRAWING - VERIFY ALL DIMENSIONS, DATUMS AND LEVELS PRIOR TO COMMENCEMENT OF WORK. REPORT ANY DISCREPANCIES OR OMISSIONS TO THE ARCHITECT IMMEDIATELY. ALL WORK MUST COMPLY WITH THE WRITTEN CONSENT OF THE CONSULTANT.



# **PRELIMINARY**

NOT FOR CONSTRUCTION

aggregate design studio ltd.







chool

9 4 0 0 1 1 1 0

g Drawn by:

Checked by:

္ခ်ီ Sheet Name:

Date: 2025-07-04 4:50:01 PM

Exterior


Render

KL, KS

LB, AB

**Formliner** Area m² Area ft² Reckli 2/106 B Amur 135.23 m<sup>2</sup> 1,455.60 ft<sup>2</sup>

DO NOT SCALE DRAWING - VERIFY ALL DIMENSIONS, DATUMS AND LEVELS PRIOR TO COMMENCEMENT OF THE APPLICABLE BUILDING CODE AND ANY OTHER GOVERNING AUTHORITIES. THIS IS A COPYRIGHT DRAWING AND SHALL NOT BE REPRODUCED OR REVISED WITHOUT THE WRITTEN CONSENT OF THE CONSULTANT.

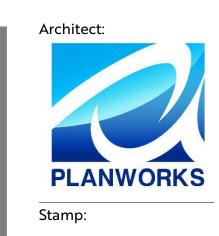

# **PRELIMINARY**

NOT FOR CONSTRUCTION

aggregate design studio ltd.





School

ੈ Date: 2025-07-04 4:50:01 PM KL, KS ្ទី Drawn by: LB, AB ြာ Checked by: ္ခ်ီ Sheet Name:

> Exterior Render