FINAL ENGINEERING PLANS FOR

SOLACE AT CORNER LAKE / CORNER LAKE GARDENS PD

(23-S-293) (PSP-22-12-362)

SECTION 9, TOWNSHIP 22 SOUTH, RANGE 32 EAST ORANGE COUNTY, FLORIDA

> PARCEL ID NO.: 09 - 22 - 32 - 0000 - 00 - 006

OWNER

MI HOMES OF ORLANDO 400 INTERNATIONAL PARKWAY, SUITE 470 LAKE MARY, FL 32746 PH: (407) 531-5176

MADDEN MOORHEAD & STOKES, LLC

MAITLAND, FLORIDA 32751 PHONE (407) 629-8330 FAX (407) 629-8336

UTILITY PROVIDERS WATER SERVICE: ORANGE COUNTY UTILITIES 9150 CURRY FORD ROAD, ORLANDO, FL 32825 PHONE: (407) 254-9900 ELECTRICITY DUKE ENERGY OPERATIONS CENTER CHARTER COMMUNICATIONS 2801 W SR 426 3767 ALL AMERICAN BLVD. OVIEDO, FLORIDA 32765 ORLANDO, FL 32810 DEFUDT@DUKE-ENERGY.COM PHONE: (407) 532-8511 **TELEPHONE** TECO ENERGY 450 N. GOLDENROD ROAD 600 WEST ROBINSON ST. ORLANDO, FLORIDA 32807 ORLANDO, FL 32801

THIS APPROVAL IS SUBJECT TO EXISTING 05.30.2024

VERNON D. LEEMING E.I. FOR THE ORANGE COUNTY ENGINEER

PLANS EXPIRE

Paola Talavera FOR THE MANAGER, **ENGINEERING DIVISION** ORANGE COUNTY UTILITIES DEPARTMENT OF ORANGE COUNTY UTILITIES DIVISION STANDARDS

INDEX OF SHEETS

THE LAND REFERRED TO HEREIN BELOW IS SITUATED IN THE COUNTY OF

COUNTY, FLORIDA. LESS THE NORTH 350 FEET OF THE WEST 300 FEET

THE SOUTHEAST 1/4 OF THE SOUTHWEST 1/4, LYING IN SECTION 9

TOTAL SITE ACREAGE: 74.19

ENGINEERS CERTIFICATION:

REGULATIONS AND SPECIFICATIONS.

NOTE:

1 THE DESIGN IS BASE ON OCU MANUAL 2021.

TOWNSHIP 22 SOUTH, RANGE 32 EAST, PUBLIC RECORDS OF ORANGE COUNTY, FLORIDA. LESS THE NORTH 30' ROAD RIGHT-OF-WAY AND LESS ROAD RIGHT-OF-WAY FOR CR-419 AND LESS THE PART LYING EAST OF

CONSTRUCTION PLANS WERE PREPARED IN ACCORDANCE WITH THE MANUAL OF UNIFORM STANDARDS FOR DESIGN, CONSTRUCTION, AND MAINTENANCE FOR STREETS AND HIGHWAYS, FDOT GREEN BOOK, AND ORANGE COUNTY

ORANGE, STATE OF FLORIDA, AND IS DESCRIBED AS FOLLOWS:

C001	COVER SHEET
C003	SYMBOLS AND ABBREVIATIONS
C004	GENERAL NOTES
C005	EXISTING CONDITIONS PLAN
C006	TRACT PLAN
C100	OVERALL SITE PLAN
C101	SIGN PLAN
C201 - C202	UTILITY PLAN
C301	DRAINAGE PLAN
C401 - C404	GRADING PLANS
C601 - C605	PLAN AND PROFILES
C700	EROSION CONTROL PLANS
C801	FIRE TRUCK CIRCULATION PLAN
C901 - C905	CONSTRUCTION DETAILS
C911 - C912	COUNTY DETAILS
	ALTA/NSPS LAND TITLE BOUNDARY, TOPOGRAPHIC, AND TREE SURVEY
H201 - H203	LANDSCAPE PLANS
A101 - A102	ARBOR PLANS

5/29/2025

APPROVED 5/29/2024

Digitally signed by Paola Paola Talavera Date: 2023.06.01 14:18:38

THIS APPROVAL IS SUBJECT TO EXISTING REQUIREMENTS

PHONE: (407) 654-5355

DAVE BROWN

DEVELOPER/OWNER:

MI HOMES OF ORLANDO LLC 400 INTERNATIONAL PARKWAY 470

LAKE MARY, FLORIDA 32746

EMAIL: dbrown@mihomes.com 1

PHONE: (407) 531-5177

CIVIL ENGINEERS 431 E. HORATIO AVENUE, SUITE 260

PROJECT TEAM MEMBERS CIVIL ENGINEER: **ENVIRONMENTAL:** MADDEN, MOORHEAD, & STOKES, LLC. BIO-TECH CONSULTING 431 E HORATIO AVE, STE 260 3025 EAST SOUTH ST. MAITLAND, FL 32751 ORLANDO, FL 32803 PHONE: (407) 629-8330 PHONE: (407) 894-5969 SURVEYOR: LANDSCAPE ARCHITECT ALLEN & COMPANY DALY DESIGN GROUP 16 EAST PLANT STREET 913 N PENNSYLVANIA AVE, WINTER GARDEN, FLORIDA 34787 WINTER PARK, FL 32789


PHONE: (407) 740-7373

PHONE: (407) 282-8335


RA8627@ATT.COM

PHONE: (407) 420-6663

Digitally signed by,, Benjamin S Beckham Date: 2024 05 28 × 10:28:58 -04 00¹² **VICINITY MAP**

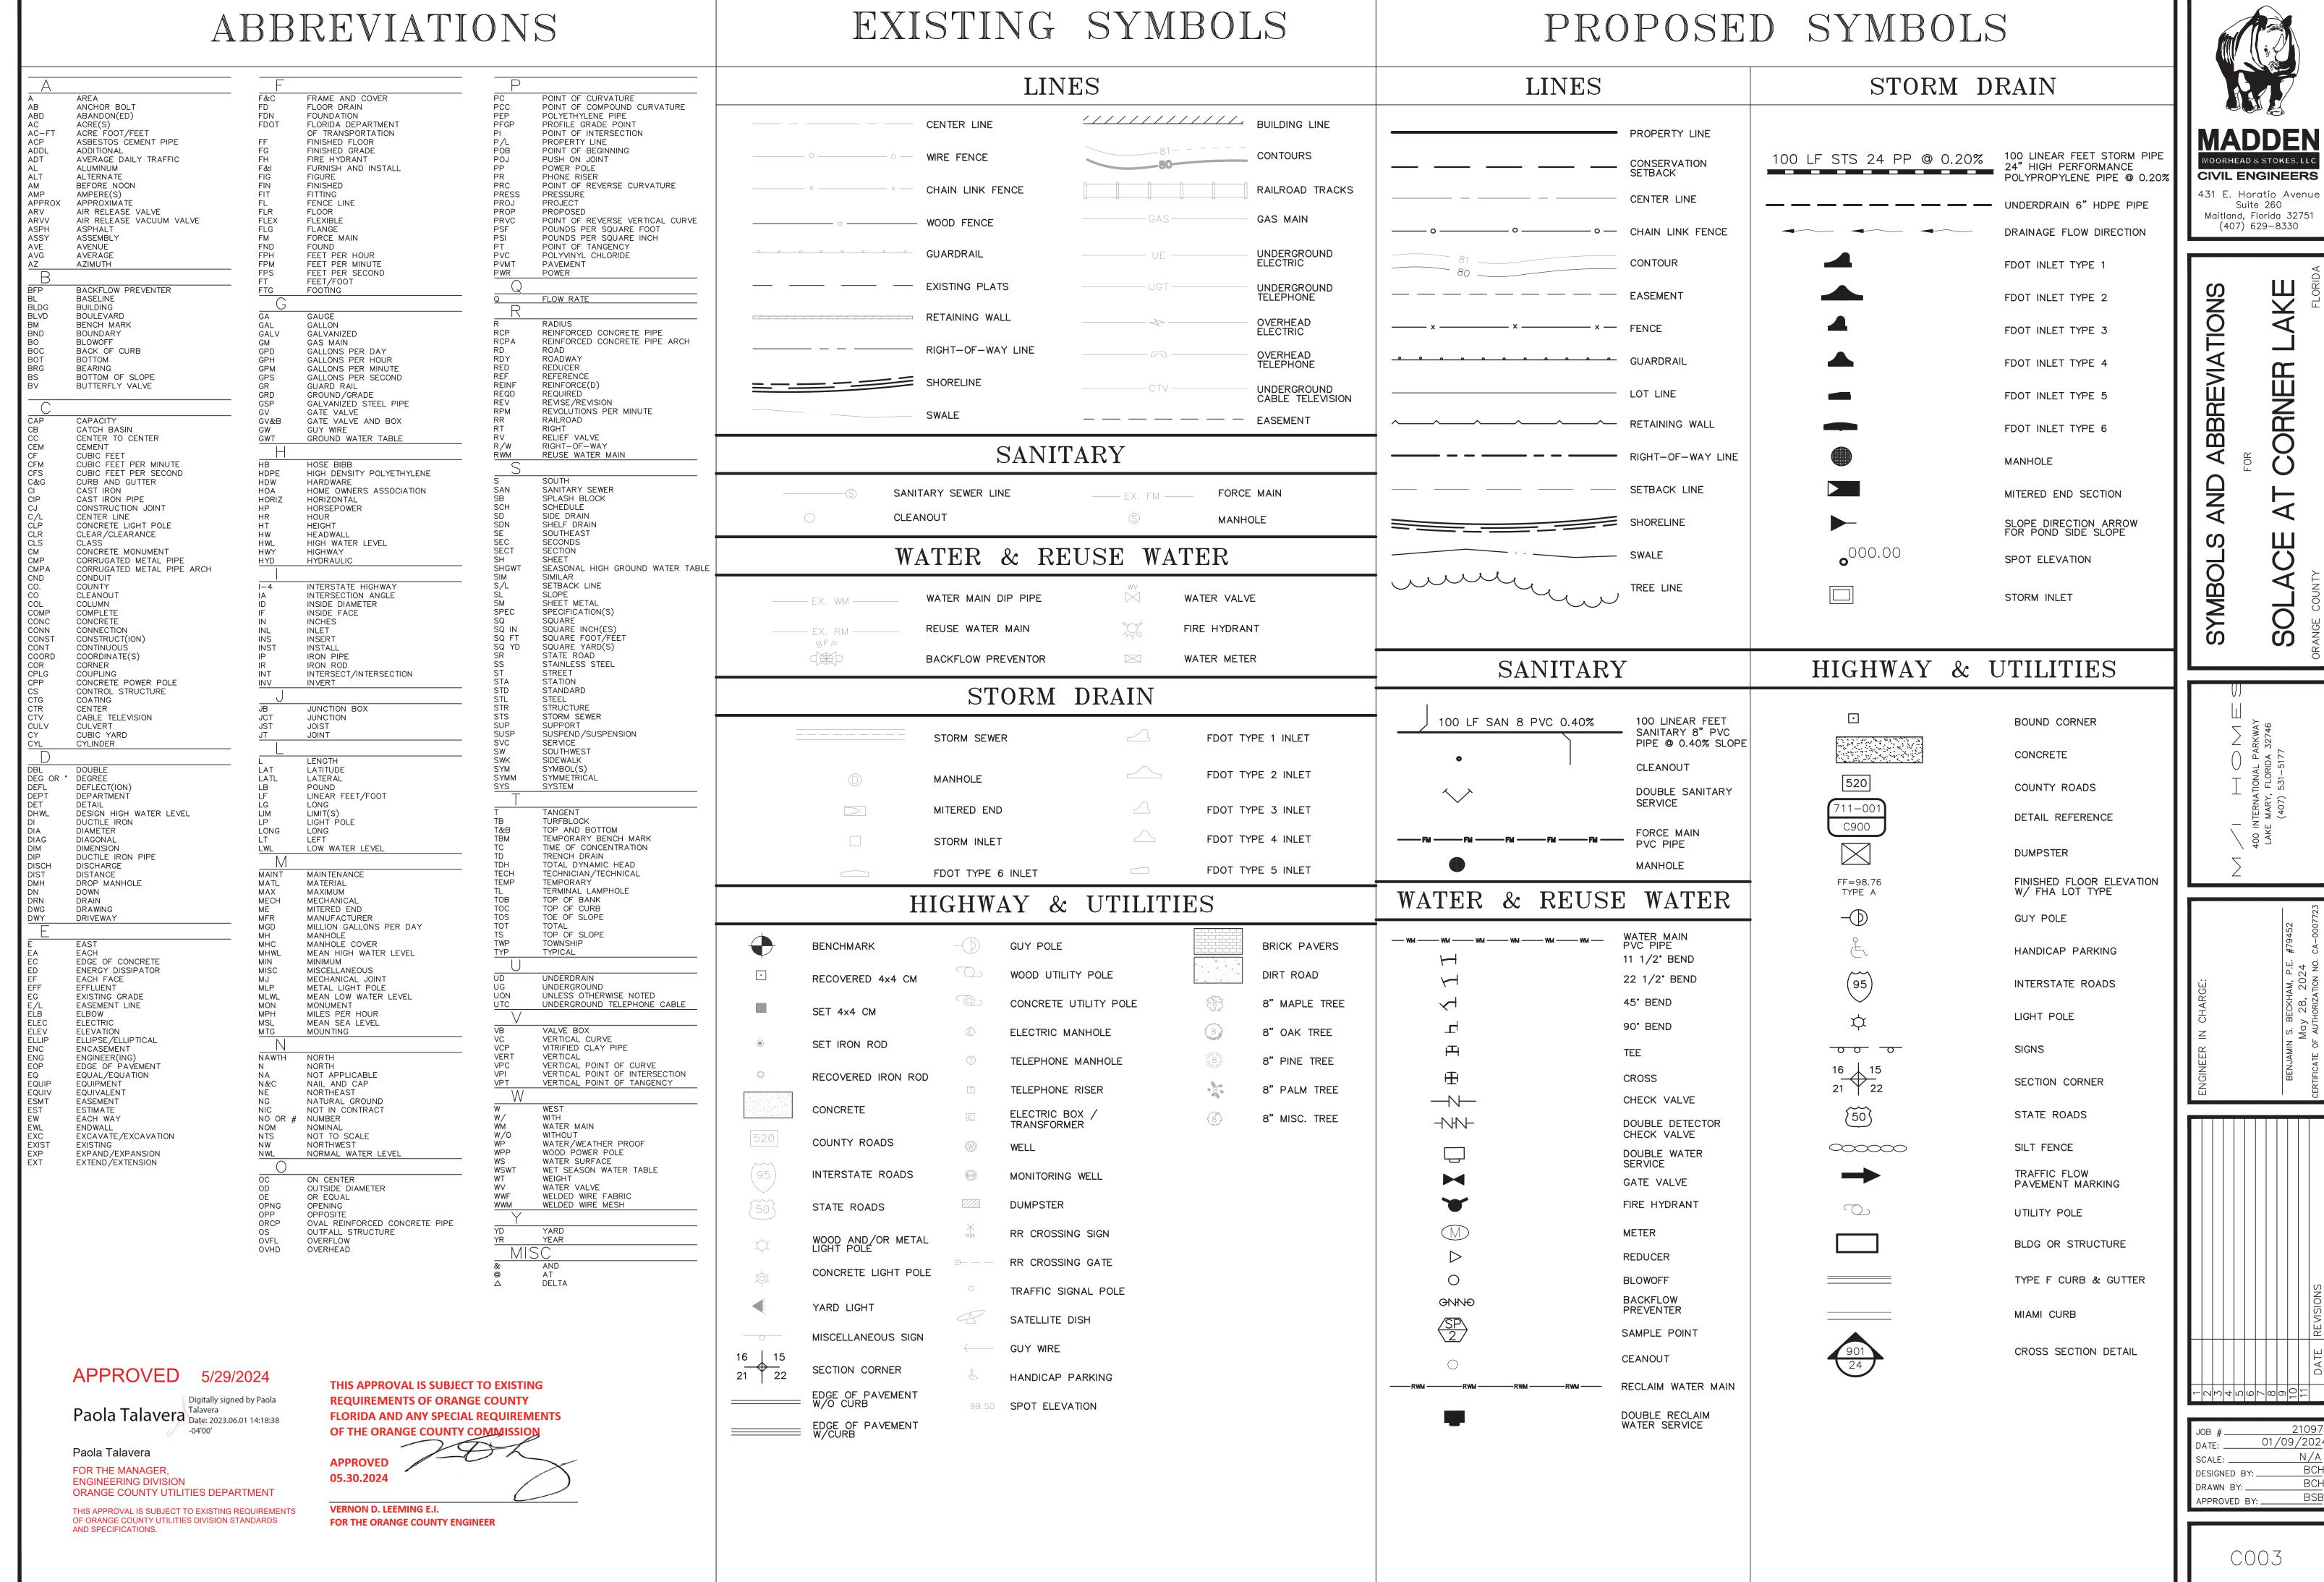



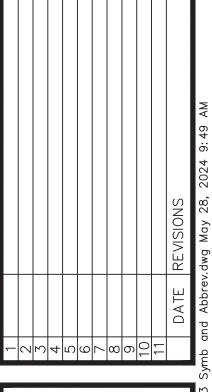

INCONSISTENCY.

PRELIMINARY SUBDIVISION PLAN DATED "RECEIVED *," THE CONDITION OF APPROVAL SHALL CONTROL TO THE EXTENT OF SUCH CONFLICT OR

2. THIS PROJECT SHALL COMPLY WITH, ADHERE TO, AND NOT DEVIATE FROM OR OTHERWISE CONFLICT WITH ANY VERBAL OR WRITTEN PROMISE OR REPRESENTATION MADE BY THE APPLICANT (OR AUTHORIZED AGENT) TO THE BOARD OF COUNTY COMMISSIONERS ("BOARD") AT THE PUBLIC HEARING WHERE THIS DEVELOPMENT RECEIVED FINAL APPROVAL, WHERE SUCH PROMISE OR REPRESENTATION, WHETHER ORAL OR WRITTEN, WAS RELIED UPON BY THE BOARD IN APPROVING THE DEVELOPMENT, COULD HAVE REASONABLY BEEN EXPECTED TO HAVE BEEN RELIED UPON BY THE BOARD IN APPROVING THE DEVELOPMENT, OR COULD HAVE REASONABLY INDUCED OR OTHERWISE INFLUENCED THE BOARD TO APPROVE THE DEVELOPMENT. IN THE EVENT ANY SUCH PROMISE OR REPRESENTATION IS NOT COMPLIED WITH OR ADHERED TO, OR THE PROJECT DEVIATES FROM OR OTHERWISE CONFLICTS WITH SUCH PROMISE OR REPRESENTATION. THE COUNTY MAY WITHHOLD (OR POSTPONE ISSUANCE OF) DEVELOPMENT PERMITS AND / OR POSTPONE THE RECORDING OF (OR REFUSE TO RECORD) THE PLAT FOR THE PROJECT. FOR PURPOSES OF THIS CONDITION, A "PROMISE" OR "REPRESENTATION" SHALL BE DEEMED TO HAVE BEEN MADE TO THE BOARD BY THE APPLICANT (OR AUTHORIZED AGENT) IF IT WAS EXPRESSLY MADE TO THE BOARD AT A PUBLIC HEARING WHERE THE DEVELOPMENT WAS CONSIDERED AND APPROVED.

PURSUANT TO SECTION 125.022. FLORIDA STATUTES, ISSUANCE OF THIS DEVELOPMENT PERMIT BY THE COUNTY DOES NOT IN ANY WAY CREATE ANY RIGHTS ON THE PART OF THE APPLICANT TO OBTAIN A PERMIT FROM A STATE OR FEDERAL AGENCY AND DOES NOT CREATE ANY LIABILITY ON THE PART OF THE COUNTY FOR ISSUANCE OF THE PERMIT, OR ANY OTHER DEVELOPMENT ORDER, IF THE APPLICANT FAILS TO OBTAIN REQUISITE APPROVALS OR FULFILL THE OBLIGATIONS IMPOSED BY A STATE OR FEDERAL AGENCY OR UNDERTAKES ACTIONS THAT RESULT IN A VIOLATION OF STATE OR FEDERAL LAW. PURSUANT TO SECTION 125.022, THE APPLICANT SHALL OBTAIN ALL OTHER APPLICABLE STATE OR

FEDERAL PERMITS BEFORE COMMENCEMENT OF DEVELOPMENT. 4. DEVELOPER / APPLICANT HAS A CONTINUING OBLIGATION AND RESPONSIBILITY FROM THE DATE OF APPROVAL OF THIS PRELIMINARY SUBDIVISION PLAN TO PROMPTLY DISCLOSE TO THE COUNTY ANY CHANGES IN OWNERSHIP, ENCUMBRANCES, OR OTHER MATTERS OF RECORD AFFECTING THE PROPERTY THAT IS SUBJECT TO THE PLAN. AND TO RESOLVE ANY ISSUES THAT MAY BE IDENTIFIED BY THE COUNTY AS A RESULT OF ANY SUCH CHANGES. DEVELOPER / APPLICANT ACKNOWLEDGES AND UNDERSTANDS THAT ANY SUCH CHANGES ARE SOLELY THE DEVELOPER'S / APPLICANT'S OBLIGATION AND RESPONSIBILITY TO DISCLOSE AND RESOLVE, AND THAT THE DEVELOPER'S / APPLICANT'S FAILURE TO DISCLOSE AND RESOLVE ANY SUCH CHANGES TO THE SATISFACTION OF THE COUNTY MAY RESULT IN THE COUNTY NOT ISSUING (OR DELAYING ISSUANCE OF) DEVELOPMENT PERMITS, NOT RECORDING (OR DELAYING RECORDING OF) A PLAT FOR THE PROPERTY, OR BOTH. 5. PROPERTY THAT IS REQUIRED TO BE DEDICATED OR OTHERWISE CONVEYED TO ORANGE COUNTY (BY PLAT OR OTHER MEANS) SHALL BE FREE AND CLEAR OF ALL ENCUMBRANCES, EXCEPT AS MAY BE ACCEPTABLE TO COUNTY AND CONSISTENT WITH THE ANTICIPATED USE. OWNER / DEVELOPER SHALL PROVIDE, AT NO COST TO COUNTY, ANY AND ALL EASEMENTS REQUIRED FOR APPROVAL OF A PROJECT OR NECESSARY FOR RELOCATION OF EXISTING EASEMENTS, INCLUDING ANY EXISTING FACILITIES, AND SHALL BE RESPONSIBLE FOR THE FULL COSTS OF ANY SUCH RELOCATION PRIOR TO ORANGE COUNTY'S ACCEPTANCE OF THE CONVEYANCE. ANY ENCUMBRANCES THAT ARE DISCOVERED AFTER APPROVAL OF A PD LAND USE PLAN SHALL BE THE RESPONSIBILITY OF OWNER / DEVELOPER TO RELEASE AND RELOCATE, AT NO COST TO COUNTY, PRIOR TO COUNTY'S ACCEPTANCE OF CONVEYANCE, AS PART OF THE REVIEW PROCESS FOR CONSTRUCTION PLAN APPROVAL(S), ANY REQUIRED OFF-SITE EASEMENTS IDENTIFIED BY COUNTY MUST BE CONVEYED TO COUNTY PRIOR TO ANY SUCH APPROVAL, OR AT A LATER DATE AS DETERMINED BY COUNTY, ANY FAILURE TO COMPLY WITH THIS CONDITION MAY RESULT IN THE WITHHOLDING OF DEVELOPMENT PERMITS AND PLAT APPROVAL(S). IF APPLICABLE. AN ACKNOWLEDGEMENT OF CONTIGUOUS SUSTAINABLE AGRICULTURAL LAND PURSUANT TO SECTION 163,3163. FLORIDA STATUTES, MUST BE EXECUTED AND RECORDED IN THE PUBLIC RECORDS OF ORANGE COUNTY, FLORIDA, PRIOR TO FINAL APPROVAL OF THIS PLAN AND A COPY OF SUCH ACKNOWLEDGMENT SHALL BE SUBMITTED WITH ALL FUTURE PERMIT APPLICATIONS FOR THIS PROJECT. THIS PROJECT SHALL BE A GATED COMMUNITY SUBJECT TO AND GOVERNED BY ARTICLE VIII, CHAPTER 34, AS IT MAY BE AMENDED FROM TIME TO TIME (THE "GATED COMMUNITIES ORDINANCE") AND THE INFRASTRUCTURE, OTHER THAN PUBLIC UTILITIES, SHALL BE PRIVATELY OWNED AND MAINTAINED. THE DEVELOPER, AS THAT TERM IS DEFINED BY THE GATED COMMUNITIES ORDINANCE, INCLUDING ITS SUCCESSORS AND ASSIGNS SHALL FULLY COMPLY WITH THE GATED COMMUNITIES ORDINANCE. TO THAT END, THE DEVELOPER ACKNOWLEDGES AND AGREES THAT, PURSUANT TO THE GATED COMMUNITIES ORDINANCE, A GATED COMMUNITY IS A PRIVILEGE AND NOT A RIGHT, AND, AS SUCH, APPROVAL OF THIS PROJECT AS A GATED COMMUNITY BY THE BOARD CONSTITUTES A CONTRACT BETWEEN THE DEVELOPER AND THE BOARD, THE CONSIDERATION FOR WHICH

ORDINANCE TO HELP ENSURE THE FINANCIAL ABILITY OF ITS SUCCESSORS AND ASSIGNS TO MAINTAIN THE INFRASTRUCTURE AFTER THE TURNOVER OF THE INFRASTRUCTURE. FURTHERMORE, PRIOR TO OR CONCURRENT WITH SUBMITTAL OF THE PLAT, THE DEVELOPER SHALL ENTER INTO AN AGREEMENT WITH THE COUNTY CONFIRMING ITS OBLIGATIONS UNDER THE GATED COMMUNITIES ORDINANCE. 8. IN ACCORDANCE WITH FEMA REQUIREMENTS, A LETTER OF MAP CHANGE (LOMC) MAY BE REQUIRED FROM THE OWNER/ENGINEER. NEW DEVELOPMENT WITHIN THE 100-YEAR FLOODPLAIN WHERE NO ESTABLISHED BASE FLOOD ELEVATIONS (BFE) HAVE BEEN IDENTIFIED MUST PERFORM A STUDY TO ESTABLISH THE BFE PRIOR TO CONSTRUCTION PLAN REVIEW AND APPROVAL. COMPENSATION STORAGE MUST BE PROVIDED FOR ALL FLOODWATER DISPLACED BY DEVELOPMENT WITHIN 100-YEAR FLOODPLAIN IN ACCORDANCE WITH ORANGE COUNTY ORDINANCE 2021-37, AND AS

IS THE DEVELOPER'S UNDERSTANDING AND ACKNOWLEDGMENT THAT THE DEVELOPER SHALL CREATE AND MAINTAIN THE RESERVE ACCOUNTS AS

SET FORTH IN, AND IN ACCORDANCE WITH, THE GATED COMMUNITIES ORDINANCE, INCLUDING, NOTWITHSTANDING SECTION 720.303(6)(I), FLORIDA

STATUTES. THE REQUIREMENT THAT THE DEVELOPER MAKE THE INITIAL CONTRIBUTIONS UNDER SECTION 34-291(C)(6) OF THE GATED COMMUNITIES

9. PRIOR TO ANY SITE CONSTRUCTION PLAN APPROVAL AND ANY FILLING WITHIN THE 100-YEAR FLOOD ZONE, THE APPLICANT MUST OBTAIN THE REQUIRED PERMIT(S) AND APPROVAL(S) FROM THE ORANGE COUNTY FLOODPLAIN ADMINISTRATOR AUTHORIZING ANY FILL PURSUANT TO CHAPTER 19, ORANGE COUNTY CODE. REVIEW AND APPROVAL OF COMPENSATING STORAGE CALCULATIONS MUST ACCOMPANY THE ABOVE PERMIT AS PROVIDED FOR IN CHAPTER 19-107.

10. A CURRENT PHASE ONE ENVIRONMENTAL SITE ASSESSMENT (ESA) AND CURRENT TITLE OPINION SHALL BE SUBMITTED TO THE COUNTY FOR REVIEW AS PART OF ANY CONSTRUCTION PLAN SUBMITTAL AND MUST BE APPROVED PRIOR TO CONSTRUCTION PLAN APPROVAL FOR ANY STREETS AND/OR TRACTS ANTICIPATED TO BE DEDICATED TO THE COUNTY AND/OR TO THE PERPETUAL USE OF THE PUBLIC 11. A MANDATORY PRE-APPLICATION/SUFFICIENCY REVIEW MEETING FOR THE PLAT SHALL BE REQUIRED PRIOR TO PLAT SUBMITTAL, BUT AFTER APPROVAL OF THE SITE CONSTRUCTION PLANS. THE APPLICANT SHALL RESOLVE, TO THE COUNTY'S SATISFACTION, ALL ITEMS IDENTIFIED IN THE PRE-APPLICATION / SUFFICIENCY REVIEW MEETING PRIOR TO FORMAL SUBMITTAL OF THE PLAT TO THE COUNTY. 12. ASSOCIATED OFFSITE INFRASTRUCTURE INCLUDING, BUT NOT LIMITED TO, TURNING LANE(S), ROADWAY IMPROVEMENTS, AND PUBLIC UTILITIES,

MUST BE SUBMITTED AS AN E-PLAN AND HAVE A CERTIFICATE OF COMPLETION PRIOR TO PLATTING. 13. IN ACCORDANCE WITH ORANGE COUNTY CODE CHAPTER 30, ARTICLE VIII, DIVISION 2, SECTION 30-280(E) OF THE ORANGE COUNTY SITE DEVELOPMENT ORDINANCE AND CHAPTER 34, ARTICLE VIII, DIVISION 2, SECTION 34-290(H)(10) OF THE ORANGE COUNTY GATED COMMUNITIES ORDINANCE, THE O&M PLAN SHALL CONTAIN, AT A MINIMUM, THE FOLLOWING INFORMATION: 1) A SCHEDULE FOR MOWING STORMWATER PONDS, INCLUDING AROUND STRUCTURES,

 A SCHEDULE FOR ALGAE CONTROL FOR WET BOTTOM PONDS, A SCHEDULE FOR DISKING DRY PONDS.

4) A SCHEDULE FOR INSPECTION OF PIPES, UNDERDRAINS, CONTROL STRUCTURES, POND SLOPES, AND ANY OTHER PERMITTED STORMWATER MANAGEMENT CONTROL OR CONVEYANCE STRUCTURE

5) A METHOD FOR IDENTIFYING AND REPAIRING OR REPLACING DAMAGED STRUCTURES OR ERODED POND BANKS, ADDITIONAL REQUIREMENTS AS NECESSARY TO ADDRESS SPECIFIC SITE CONDITIONS RELATED TO LAND USE, SOIL CONDITIONS, WATER TABLE, ANNUAL RAINFALL, AND THE AGE OF THE SYSTEM, AND, 7) AN ASSESSMENT AND PERFORMANCE EVALUATION (APE) REPORT CERTIFIED BY A PROFESSIONAL ENGINEER (PE) LICENSED IN THE STATE OF FLORIDA TO BE SUBMITTED EVERY THREE YEARS. ADDITIONAL MAINTENANCE REQUIREMENTS MAY BE ESTABLISHED BY THE PE PERFORMING THE

EVALUATION REPORT. 14. PRIOR TO ISSUANCE OF ANY CERTIFICATE OF COMPLETION, ALL STORM DRAIN INLETS SHALL HAVE METAL MEDALLION INLET MARKERS INSTALLED. TEXT ON THE MARKER SHALL READ 'NO DUMPING, ONLY RAIN IN THE DRAIN." SPECIFICATION DETAIL WILL BE PROVIDED WITHIN ALL PLAN SETS. CONTACT THE NATIONAL POLLUTANT DISCHARGE ELIMINATION SYSTEM (NPDES) SUPERVISOR AT THE ORANGE COUNTY ENVIRONMENTAL

15. PRIOR TO COMMENCEMENT OF ANY EARTH WORK OR CONSTRUCTION, IF ONE ACRE OR MORE OF LAND WILL BE DISTURBED. THE DEVELOPER SHALL PROVIDE A COPY OF THE COMPLETED NATIONAL POLLUTANT DISCHARGE ELIMINATION SYSTEM (NPDES) NOTICE OF INTENT (NOI) FORM FOR STORMWATER DISCHARGE FROM CONSTRUCTION ACTIVITIES TO THE ORANGE COUNTY ENVIRONMENTAL PROTECTION DIVISION, NPDES ADMINISTRATOR. I'HE ORIGINAL NOI FORM SHALL BE SENT TO THE FLORIDA DEPARTMENT OF ENVIRONMENTAL PROTECTION BY THE DEVELOPER. 16. APPROVAL OF THIS PLAN DOES NOT CONSTITUTE APPROVAL OF A PERMIT FOR THE CONSTRUCTION OF A BOAT RAMP, ANY PERSON DESIRING TO CONSTRUCT A BOAT RAMP SHALL APPLY TO THE ORANGE COUNTY ENVIRONMENTAL PROTECTION DIVISION AS SPECIFIED IN ORANGE COUNTY CODE CHAPTER 15 ENVIRONMENTAL CONTROL, ARTICLE XV BOAT RAMPS, PRIOR TO INSTALLATION, FOR AN ORANGE COUNTY BOAT RAMP FACILITY PERMIT, AS WELL AS TO ANY OTHER ORANGE COUNTY DIVISION(S) FOR ANY OTHER APPLICABLE PERMITS.

17. APPROVAL OF THIS PLAN DOES NOT CONSTITUTE APPROVAL OF A PERMIT FOR THE CONSTRUCTION OF A BOAT DOCK, BOARDWALK, OBSERVATION PIER, FISHING PIER, COMMUNITY PIER OR OTHER SIMILAR PERMANENTLY FIXED OR FLOATING STRUCTURES. ANY PERSON DESIRING TO CONSTRUCT ANY OF THESE STRUCTURES SHALL APPLY TO THE ORANGE COUNTY ENVIRONMENTAL PROTECTION DIVISION, AS SPECIFIED IN ORANGE COUNTY CODE CHAPTER 15 ENVIRONMENTAL CONTROL, ARTICLE IX DOCK CONSTRUCTION, PRIOR TO INSTALLATION, FOR AN ORANGE COUNTY DOCK CONSTRUCTION PERMIT, AS WELL AS TO ANY OTHER ORANGE COUNTY DIVISION(S) FOR ANY OTHER APPLICABLE PERMITS. 18. PRIOR TO MASS GRADING, CLEARING, GRUBBING OR CONSTRUCTION, THE APPLICANT IS HEREBY NOTICED THAT THIS SITE MUST COMPLY WITH HABITAT PROTECTION REGULATIONS OF THE U.S. FISH AND WILDLIFE SERVICE (USFWS) AND THE FLORIDA FISH & WILDLIFE CONSERVATION

19. UNLESS A CONSERVATION AREA IMPACT (CAI) PERMIT IS APPROVED BY ORANGE COUNTY CONSISTENT WITH ORANGE COUNTY CODE CHAPTER 15, ARTICLE X, "WETLAND CONSERVATION AREAS", PRIOR TO CONSTRUCTION PLAN APPROVAL, NO CONSERVATION AREA OR BUFFER ENCROACHMENTS SHALL BE PERMITTED. APPROVAL OF THIS PLAN DOES NOT AUTHORIZE ANY DIRECT OR INDIRECT CONSERVATION AREA IMPACTS. 20. IN LIEU OF CONVENTIONAL (NON-NITROGEN-REDUCING) ONSITE SEWAGE TREATMENT AND DISPOSAL SYSTEMS (OSTDS), ALSO REFERRED TO AS SEPTIC SYSTEMS, THE DEVELOPMENT SHALL IMPLEMENT ADVANCED NITROGEN REDUCING SEPTIC SYSTEMS APPROVED BY THE FLORIDA DEPARTMENT

THE OWNER SHALL DONATE RIGHT-OF-WAY ON LAKE PICKETT ROAD AT NO COST TO THE COUNTY. THE RIGHT-OF-WAY SHALL BE CONVEYED PRIOR TO OR CONCURRENT WITH FIRST PLAT APPROVAL. 23. PURSUANT TO ARTICLE XII, CHAPTER 30, ORANGE COUNTY CODE, UNLESS DOCUMENTATION TO THE COUNTY'S SATISFACTION HAS BEEN PROVIDED PROVING THAT A PROPERTY IS EXEMPT OR VESTED, EACH PROPERTY MUST APPLY FOR AND OBTAIN CONCURRENCY. UNLESS REQUIRED AT A DIFFERENT TIME (BY AGREEMENT. CONDITION OF APPROVAL, ETC.), RESIDENTIAL PROPERTIES MUST OBTAIN CONCURRENCY PRIOR TO APPROVAL OF THE PLAT; NON-RESIDENTIAL PROPERTIES THAT ARE REQUIRED TO PLAT MUST OBTAIN CONCURRENCY FOR ANY LOT WITH AN ASSIGNED USE PRIOR TO APPROVAL OF THE PLAT (LOTS WITHOUT AN ASSIGNED USE SHALL BE LABELED AS "FUTURE DEVELOPMENT") AND NON-RESIDENTIAL PROPERTIES THAT ARE NOT REQUIRED TO PLAT MUST OBTAIN CONCURRENCY PRIOR TO OBTAINING THE FIRST BUILDING PERMI CONCURRENCY MAY BE OBTAINED EARLIER THAN PLAT OR BUILDING PERMIT, BUT IT IS ULTIMATELY THE RESPONSIBILITY OF THE APPLICANT TO OBTAIN CONCURRENCY, INCLUDING ANY PROPORTIONATE SHARE AGREEMENT, AS APPLICABLE, IN A TIMELY FASHION. SHOULD AN APPLICANT WAIT TO OBTAIN CONCURRENCY UNTIL LATER IN THE DEVELOPMENT PROCESS, THE COUNTY WILL NOT BE RESPONSIBLE FOR ANY DELAYS CAUSED BY

THE APPLICANT'S FAILURE TO OBTAIN CONCURRENCY IN A TIMELY FASHION. 24. A MASTER UTILITY PLAN (MUP) FOR THE PD SHALL BE SUBMITTED TO ORANGE COUNTY UTILITIES AT LEAST THIRTY (30) DAYS PRIOR TO SUBMITTAL OF THE FIRST SET OF CONSTRUCTION PLANS. CONSTRUCTION PLANS WITHIN THIS PD SHALL BE CONSISTENT WITH AN APPROVED AND UP-TO-DATE MASTER UTILITY PLAN (MUP). MUP UPDATES SHALL BE SUBMITTED TO ORANGE COUNTY UTILITIES AT LEAST THIRTY (30) DAYS PRIOR TO THE CORRESPONDING CONSTRUCTION PLAN SUBMITTAL. THE MUP AND UPDATES MUST BE APPROVED PRIOR TO CONSTRUCTION PLAN 25. POLE SIGNS AND BILLBOARDS SHALL BE PROHIBITED. ALL OTHER SIGNAGE SHALL COMPLY WITH CHAPTER 31.5 OF THE ORANGE COUNTY

26. SHORT TERM/TRANSIENT RENTAL IS PROHIBITED. LENGTH OF STAY SHALL BE FOR 180 CONSECUTIVE DAYS OR GREATER. 27. UNLESS OTHERWISE SPECIFIED TO THE COUNTY'S SATISFACTION IN THE PSP, A DEVELOPMENT PLAN, IN CONFORMANCE WITH THE REQUIREMENTS OF SECTION 34-131(B) (20), INCLUDING THE APPROPRIATE GROUP TYPE, IS REQUIRED FOR THE PARK / RECREATION TRACT(S) WITHIN THIS PRELIMINARY SUBDIVISION PLAN (PSP), OR PHASE THEREOF, AS APPROPRIATE. REGARDLESS OF WHETHER THE PARK / RECREATION TRACT IS INCLUDED IN THE PSP OR APPROVED VIA A SEPARATE DEVELOPMENT PLAN, THE PARK / RECREATION AREA TRACT(S) SHALL BE CONSTRUCTED IN CONJUNCTION WITH THE SUBDIVISION INFRASTRUCTURE AND COMPLETED PRIOR TO ISSUANCE OF THE CERTIFICATE OF COMPLETION (C OF C) FOR THE INFRASTRUCTURE FOR THE PHASE IN WHICH THE PARK / RECREATION TRACT(S) IS LOCATED. 28. NEW STREETS THAT ARE EXTENSIONS OF OR IN ALIGNMENT WITH EXISTING STREETS SHALL BEAR THE SAME NAMES AS THOSE BORNE BY

SUCH EXISTING STREETS. UNLESS ALTERNATIVE APPROVED BY ORANGE COUNTY ISS/911 ADMINISTRATIVE DEPARTMENT 29. THE DECLARATION OF COVENANTS, CONDITIONS, AND RESTRICTIONS (CC&RS) SHALL PROVIDE THAT FOR THE HOA IS RESPONSIBLE FOR THE 1/29/20 REPAIR OR REPLACEMENT OF ANY DECORATIVE ENHANCEMENTS (E.G., PAVERS) REMOVED OR DAMAGED AS A RESULT OF OPERATIONS AND MAINTENANCE ACTIVITIES PERFORMED BY ORANGE COUNTY WITHIN TRACT A-1 AS SHOWN ON THE PSP AND ALL UTILITY EASEMENTS.

> THIS APPROVAL IS SUBJECT TO EXISTING REQUIREMENTS OF ORANGE COUNTY FLORIDA AND ANY SPECIAL REQUIREMENTS OF THE ORANGE COUNTY COMMISSION

05.30.2024

Digitally signed by Paola

IVISION STANDARDS

Paola Talavera Date: 2023.06.01 14:18:38

ORANGE COUNTY UTILITIES DEPARTMENT

THIS APPROVAL IS SUBJECT TO EXISTING REQUIREMENTS.

Paola Talavera

FOR THE MANAGER.

ENGINEERING DIVISION

OF ORANGE COUNTY UTILITIE

AND SPECIFICATIONS.

COMMUNITY BOAT RAMPS AND SEMI-PRIVATE DOCKS ARE PROHIBITED ON CORNER LAKE

VERNON D. LEEMING E.I. FOR THE ORANGE COUNTY ENGINEER GENERAL NOTES

- ALL CONSTRUCTION WORK SHALL BE IN ACCORDANCE WITH THE LATEST LOCAL AGENCY DETAILS, THE FDOT "STANDARD SPECIFICATIONS FOR ROAD AND BRIDGE CONSTRUCTION" ADOPTED IN 1991 BY THE STATE OF FLORIDA, AND ALL SUPPLEMENTS THERETO, AND THE FDOT "STANDARD PLANS", WHICHEVER IS MORE STRINGENT.
- ALL FDOT DESIGN INDICES ARE HEREBY INCORPORATED AS PLAN REFERENCES HEREIN. CONTRACTOR IS RESPONSIBLE FOR OBTAINING COMPLETE COPIES OF ALL APPLICABLE INDEX DRAWINGS AND CONSTRUCTING ALL WORKS IN CONFORMANCE WITH THE FDOT STANDARD PLANS, LATEST EDITION.
- THE LOCATIONS OF EXISTING UTILITIES SUCH AS WATER MAINS, SEWER MAINS, GAS LINES, ETC., AS SHOWN ON THE PLANS, WITH THE EXCEPTION OF THE LOCATIONS OF EXISTING UTILITIES AT ALI POINTS OF CONNECTION TO AND AT ALL AREAS OF CONFLICT WITH UTILITY PROVIDER MAINS, WHICH HAVE BEEN FIELD VERIFIED, HAVE BEEN DETERMINED FROM THE BEST AVAILABLE INFORMATION AND ARE PROVIDED FOR THE CONVENIENCE OF THE CONTRACTOR. HOWEVER. THE ENGINEER AND OWNER DO NOT ASSUME RESPONSIBILITY FOR THE SIZES AND LOCATIONS SHOWN. THE CONTRACTOR SHALL BE RESPONSIBLE FOR FIELD VERIFICATION OF THE SIZE AND LOCATION OF ALL EXISTING UTILITIES SHOWN AND NOT SHOWN ON THESE PLANS.
- CONTRACTOR, INCLUDING ANY SUB-CONTRACTORS, IS RESPONSIBLE TO ENSURE THAT ALL REQUIRED PERMITS ARE OBTAINED AND ARE IN HAND AT THE JOB SITE PRIOR TO THE COMMENCEMENT OF CONSTRUCTION. CONTRACTOR SHALL ABIDE BY ALL CONDITIONS CONTAINED THEREIN. PERMITS INCLUDED (BUT NOT NECESSARILY LIMITED TO) ARE:
- ACOE NATIONWIDE OR INDIVIDUAL DREDGE AND FILL FDEP WATER DISTRIBUTION
- FDEP SANITARY SEWER COLLECTION AND TRANSMISSION FDEP REUSE - FDEP DREDGE AND FILL
- FDEP NPDES GENERIC PERMIT FOR STORMWATERDISCHARGE FROM LARGE AND SMALL CONSTRUCTION ACTIVITIES FDOT DRIVEWAY CONNECTION FDOT UTILITY
- FDOT STORMWATER DISCHARGE CONNECTION - FLORIDA FISH AND WILDLIFE CONSERVATION COMMISSION PERMIT
- FOR IMPACTS TO PROTECTED SPECIES LOCAL RIGHT OF WAY USE
- LOCAL UNDERGROUND UTILITIES WATER MANAGEMENT DISTRICT CONSUMPTIVE USE FOR
- CONSTRUCTION DEWATERING (CUP) WATER MANAGEMENT DISTRICT ENVIRONMENTAL RESOURCE PERMIT (ERP)
- CONTRACTOR IS RESPONSIBLE FOR VERIFYING ALL SETBACKS AND EASEMENTS BEFORE BEGINNING CONSTRUCTION.
- 6. BENCHMARKS AND OTHER REFERENCE POINTS SHALL BE CAREFULLY MAINTAINED THROUGHOUT THE CONSTRUCTION PERIOD. IF DISTURBED OR DESTROYED, THESE POINTS SHALL BE REPLACED BY A LICENSED FLORIDA PROFESSIONAL LAND SURVEYOR (P.L.S.) AT CONTRACTOR'S
- DIFFERING SITE CONDITIONS FROM THAT WHICH IS REPRESENTED HEREON, WHETHER ABOVE, ON, OR BELOW THE SURFACE OF THE GROUND, SHALL BE BROUGHT TO THE IMMEDIATE ATTENTION OF THE ENGINEER AND OWNER IN WRITING. NO CLAIM FOR EXPENSES INCURRED BY THE CONTRACTOR DUE TO DIFFERING SITE CONDITIONS WILL BE ALLOWED IF CONTRACTOR FAILS TO PROVIDE THE REQUIRED WRITTEN NOTIFICATION OF SUCH CONDITIONS TO THE ENGINEER AND
- THE CONTRACTOR SHALL BE RESPONSIBLE FOR DEMOLITION AND REMOVAL OF ALL EXISTING STRUCTURES, ETC., UNLESS OTHERWISE NOTED. ALL SOIL STRIPPINGS AND ANY UNSUITABLE MATERIAL SHALL BE REMOVED FROM THE SITE AND DISPOSED OF BY THE CONTRACTOR UNLESS OTHERWISE DIRECTED BY THE OWNER.
- THE CONTRACTOR SHALL PROTECT ALL EXISTING STRUCTURES AND UTILITIES NOTED TO REMAIN FROM DAMAGE OR DISPLACEMENT DURING CONSTRUCTION. IN THE EVENT OBSTRUCTIONS ARE ENCOUNTERED, THE CONTRACTOR SHALL PROMPTLY NOTIFY THE ENGINEER AND THE UTILITY COMPANY. THE CONTRACTOR WILL BE RESPONSIBLE FOR ALL COSTS INCURRED TO REPAIR DAMAGE OR CORRECT DISPLACEMENT.
- 10. CONTRACTOR SHALL BE EXTREMELY CAUTIOUS WHEN WORKING NEAR TREES WHICH ARE TO BE SAVED, WHETHER SHOWN IN THE PLANS OR DESIGNATED IN THE FIELD. CONTRACTOR SHALL BECOME FAMILIAR WITH AND CONFORM WITH ALL TREE PROTECTION/PRESERVATION PROVISIONS OF THE PRELIMINARY SUBDIVISION PLAN / DEVELOPMENT PLAN AND LOCAL GOVERNMENT. CONTRACTOR SHALL BE RESPONSIBLE FOR REPLACEMENT AND MITIGATION COSTS FOR ANY TREES REMOVED THAT WERE DESIGNATED TO BE PRESERVED.
- 11. WHEN DETAILS ARE PROVIDED, CONTRACTOR SHALL CONSTRUCT JOB PER SPECIFIC DETAILS, AND NOT BY SCALING FROM THESE PLANS.
- 12. IT IS THE RESPONSIBILITY OF THE CONTRACTOR TO PROVIDE ANY REQUIRED TRAFFIC CONTROL PLANS. ALL WORK SHALL BE EXECUTED UNDER THE ESTABLISHED PLAN AND FDOT, AND LOCAL AGENCY APPROVED PROCEDURES.
- 13. THE CONTRACTOR SHALL RESTORE OFF SITE CONSTRUCTION AREAS TO EQUAL OR BETTER CONDITION THAN EXISTED PRIOR TO COMMENCEMENT OF CONSTRUCTION.
- 14. AS-BUILT DRAWINGS SHALL BE KEPT BY THE CONTRACTOR AND SUBMITTED TO THE PROJECT ENGINEER UPON PROJECT COMPLETION.
- 15. CONTRACTOR SHALL COMPLY WITH ALL LOCAL AGENCY REQUIREMENTS FOR INSPECTION AND TESTING.
- 16. ALL NEW UTILITIES AND UPGRADED UTILITIES PROVIDED TO OR ON THE SITE MUST BE INSTALLED UNDERGROUND.
- 17. THE CONTRACTOR SHALL BE RESPONSIBLE FOR THE RESTORATION OF ANY TRAFFIC SIGNAL EQUIPMENT INCLUDING BUT NOT LIMITED TO FIBER LOOP SENSORS PULL BOXES, CONDUIT TRAFFIC SIGNALS, AND CABINETS. ANY ITEMS DAMAGED BY THE CONTRACTOR WILL BE RESTORED TO THEIR ORIGINAL CONDITIONS UNLESS OTHERWISE AGREED UPON BY THE COUNTY TRAFFIC ENGINEER.
- 18. ALL CONSTRUCTION MUST BE IN ACCORDANCE WITH UTILITY PROVIDER'S STANDARDS AND CONSTRUCTION SPECIFICATIONS, LATEST EDITION.
- 19. CONTRACTOR SHALL NOTIFY ALL APPROPRIATE UTILITY COMPANIES OF PROPOSED START OF WORK IN ACCORDANCE WITH THEIR STANDARD REQUIREMENTS; INCLUDING BUT NOT LIMITED TO, WATER, RECLAIMED WATER, SEWER, POWER, TELEPHONE, GAS AND CABLE TV
- 20. PRIOR TO COMMENCEMENT. CONTRACTOR SHALL PROVIDE ENGINEER WITH CONSTRUCTION SCHEDULE FOR VARIOUS SITE WORK ELEMENTS SO THAT PERIODIC SITE VISITS MAY BE COORDINATED TO ENSURE TIMELY CERTIFICATION OF COMPLETION TO AGENCIES AND AVOID DELAYS IN ISSUANCE OF CERTIFICATES OF OCCUPANCY/COMPLETION.
- 21. ALL RECOMMENDATIONS AND REQUIREMENTS OF INSPECTION PERSONNEL OTHER THAN OWNER/OWNER'S REPRESENTATIVE SHALL BE REPORTED TO ENGINEER/OWNER/OWNER'S REPRESENTATIVE PRIOR TO IMPLEMENTATION, COMPENSATION WILL NOT BE ALLOWED FOR WORK THAT IS NOT AUTHORIZED BY ENGINEER/OWNER/OWNER'S REPRESENTATIVE.
- 22. CONTRACTOR SHALL CONFIRM COMPATIBILITY OF PIPE SLOPES AND INVERTS DURING SHOP DRAWING AND MATERIALS ORDERING PHASE OF PROJECT AND ADVISE ENGINEER OF ANY DISCREPANCIES.
- 23. NO EXISTING MATERIAL SHALL BE USED IN NEW CONSTRUCTION UNLESS APPROVED DURING THE SHOP DRAWING APPROVAL PROCESS BY ENGINEER/OWNER/OWNER'S REPRESENTATIVE IN WRITING.
- 24. CONTRACTOR SHALL STAKE ALL IMPROVEMENTS USING THE PLAT(S), ROAD CENTERLINE GEOMETRY, AND BUILDING COORDINATES PROVIDED IN THESE PLANS. CONTRACTOR SHALL CONFIRM WITH THE ENGINEER THAT THE PLAT IS CURRENT PRIOR TO CONSTRUCTION.
- 25. CONTRACTOR SHALL CONFIRM THE BUILDING DIMENSIONS SHOWN HEREIN WITH THOSE IN THE FINAL ARCHITECTURAL DRAWINGS PRIOR TO STAKEOUT. IT IS THE CONTRACTOR'S SOLE RESPONSIBILITY TO COMPLETELY STAKE AND CHECK ALL IMPROVEMENTS TO ENSURE ADEQUATE POSITIONING, BOTH HORIZONTAL AND VERTICAL, INCLUDING MINIMUM BUILDING SETBACKS PRIOR TO THE INSTALLATION OF ANY IMPROVEMENT.

PAVING AND DRAINAGE

- 1. THE CONTRACTOR SHALL CONSTRUCT PAVEMENT IN ACCORDANCE WITH TYPICAL PAVEMENT SECTIONS AND LOCAL AGENCY SPECIFICATIONS. THE FINISHED PAVEMENT GRADES SHALL CONFORM TO THOSE SPECIFIED ON THE GRADING PLAN.
- 2. FLORIDA LAW (F.S. 553.851) PROTECTION OF UNDERGROUND PIPELINES MANDATES THAT "NO EXCAVATOR SHALL COMMENCE OR PERFORM ANY EXCAVATION IN ANY PUBLIC OR PRIVATE STREET, ALLEY, RIGHT-OF-WAY DEDICATED TO THE PUBLIC USE, OR GAS UTILITY FASEMENT WITHOUT FIRST OBTAINING INFORMATION CONCERNING THE POSSIBLE LOCATION OF GAS PIPELINES IN THE AREA OF THE PROPOSED EXCAVATION." THIS INCLUDES ANY OPERATION UTILIZING HAND TOOLS OR POWER TOOLS WHICH MOVES OR REMOVES ANY STRUCTURE, EARTH, ROCK, OR OTHER MASS OF MATERIAL BY SUCH METHODS AS DIGGING, BACKFILLING, DEMOLITION, GRADING, DITCHING, DRILLING, BORING AND CABLE PLOWING. THE EXCAVATOR MUST NOTIFY THE GAS UTILITY A MINIMUM OF 48 HOURS AND A MAXIMUM OF 5 DAYS PRIOR TO EXCAVATING (EXCLUDING SATURDAYS, SUNDAYS, AND LEGAL HOLIDAYS).
- 3. EXCAVATION, PAVING, AND STORM SEWER WORK SHALL BE DONE IN ACCORDANCE WITH FDOT "STANDARD SPECIFICATION FOR ROAD AND BRIDGE CONSTRUCTION", LATEST EDITION, AND LOCAL AGENCY SPECIFICATIONS.
- 4. UNLESS OTHERWISE NOTED, GRADE TO MEET EXISTING ELEVATIONS AT PROPERTY LINES. CONTRACTOR SHALL PROVIDE POSITIVE DRAINAGE OF THE SITE TO THE RETENTION PONDS AS SHOWN BY PROPOSED GRADES AND FLOW ARROWS.
- 5. DURING CONSTRUCTION, THE CONTRACTOR SHALL PROVIDE ADEQUATE DRAINAGE AND PROPER SOIL EROSION CONTROL MEASURES FOR PROTECTION OF ALL DRAINAGE AND SEWER STRUCTURES AND AT ALL ADJACENT LANDS AND ROADS.
- 6. THE CONTRACTOR IS RESPONSIBLE FOR OBTAINING ANY AND ALL GEOTECHNICAL REPORTS PREPARED FOR THE SITE. GEOTECHNICAL RECOMMENDATIONS ARE NOT THE RESPONSIBILITY OF ENGINEER. ENGINEER HAS RELIED ON THE GEOTECHNICAL REPORT(S) IN PREPARATION OF THE DRAWINGS. ANY CONFLICT BETWEEN INFORMATION WITHIN THE REPORT AND THESE DRAWINGS SHALL BE REPORTED TO ENGINEER/OWNER /OWNER'S REPRESENTATIVE. ENGINEER ASSUMES NO RESPONSIBILITY FOR THE CORRECTNESS, COMPLETENESS, OR ACCURACY OF GEOTECHNICAL INFORMATION.
- 7. THE SITE SHALL BE CLEARED OF ALL TREES EXCEPT THOSE WHICH ARE DESIGNATED TO BE SAVED OR RELOCATED. BEFORE CONSTRUCTION, THE CONTRACTOR SHALL MEET AT THE SITE WITH THE OWNER. AT THIS TIME, ANY TREES TO BE SAVED SHALL BE POINTED OUT AND TAGGED. THESE TREES SHALL BE PROTECTED FROM DAMAGE.
- 8. THE CONTRACTOR SHALL IMMEDIATELY NOTIFY THE SUPERVISING ENGINEER IF A PAVEMENT OR FOUNDATION STAKE IS DISTURBED.
- 9. THE CONTRACTOR SHALL INSTALL, AS PART OF THE INFRASTRUCTURE AND BEFORE CERTIFICATE OF COMPLETION, DROP CURBS AND HANDICAP RAMPS AT ALL INTERSECTIONS OF THE SIDEWALK WITH THE PROPOSED PAVEMENT TO MEET ORANGE COUNTY AND A.D.A. SPECIFICATIONS.
- 10. FOR HORIZONTAL AND VERTICAL CLEARANCES BETWEEN STORM PIPES AND WATER MAINS/SERVICES, SEE WATER NOTES ON THIS SHEET AND FDEP SEPARATION TABLE ON UTILITY PLAN.
- 11. ALL PUBLIC STORM PIPE MATERIALS SHALL BE REINFORCED CONCRETE PIPE (RCP) ASTM C-76 CLASS III, UNLESS OTHERWISE SPECIFIED. LIFTING HOLES ARE PROHIBITED.
- 12. ALL PRIVATE STORM PIPE MATERIALS SHALL BE AS FOLLOWS: 12.1. DIAMETERS LESS THAN OR EQUAL TO 12-INCH SHALL BE HIGH DENSITY POLYETHYLENE (HDPE) PIPE 12.2. DIAMETERS GREATER THAN OR EQUAL TO 15-INCH SHALL BE
- 13. MINIMUM COVER OVER ALL PIPE SHALL BE 36-INCHES FROM TOP OF PIPE TO FINISHED GRADE, UNLESS OTHERWISE NOTED.
- 14. ALL STORM SYSTEM MANHOLE AND INLET STRUCTURES SHALL BE
- 15. THE CONTRACTOR SHALL USE CONCRETE WITH A MINIMUM 28 DAY

POLYPROPYLENE (PP) PIPE.

- 16. ALL SIDEWALK WIDTHS SHALL BE AS NOTED ON THE SITE PLAN AND SHALL HAVE 1-INCH DEEP CONTRACTION JOINTS EVERY 5-FEET AND AN EXPANSION JOINT EVERY 20-FEET (MINIMUM). MAXIMUM SIDEWALK CROSS SLOPES SHALL BE 2.00% AND MAXIMUM SIDEWALK RUNNING SLOPES SHALL BE 5.00% EXCEPT AT RAMP LOCATIONS. MAXIMUM RAMP SLOPES SHALL BE 8.33%.
- 17. PROVIDE FDOT TYPE III SILT FENCE ALONG THE PROPERTY LINES AND PHASE LINES AS WELL AS ANY CONSTRUCTION WITHIN THE OTHER PHASES THAT IS DEEMED NECESSARY.
- 18. ALL TEST REPORTS GENERATED BY A TESTING FIRM ARE TO HAVE COPIES SENT DIRECTLY TO THE LOCAL AGENCY AS SOON AS THEY ARE GENERATED. CLEARANCE FROM THE LOCAL AGENCY SHALL BE RECEIVED PRIOR TO PAVING.
- 19. THE BASE COURSE SHALL NOT BE CONSTRUCTED UNTIL AFTER SUBGRADE CONSTRUCTION HAS BEEN COMPLETED AND REQUIRED SUBGRADE TEST RESULTS HAVE BEEN SUBMITTED TO AND APPROVED BY THE LOCAL AGENCY'S ENGINEER.
- 20. THE FINISHED BASE COURSE SHALL BE PRIMED WITHOUT DELAY. PROTECTED FROM HEAVY TRAFFIC, AND CONTINUOUSLY MAINTAINED FREE OF DAMAGE UNTIL THE WEARING SURFACE IS APPLIED. ALL BAD AREAS SHALL BE CUT OUT AND REPLACED PRIOR TO APPLYING WEARING SURFACE.
- 21. ASSUMING ACCEPTABLE CURING, THE WEARING SURFACE SHALL BE APPLIED NO SOONER THAN SEVEN (7) DAYS AND NO LATER THAN THIRTY (30) DAYS AFTER BASE COMPLETION.
- 22. ALL CONCRETE PIPE JOINTS SHALL BE WRAPPED IN FILTER FABRIC. 23. ROADWAY MARKING, STRIPING, SIGNS, AND OTHER TRAFFIC CONTROL
- BY THE USDOT FEDERAL HIGHWAY ADMINISTRATION AS WELL AS FDOT AND LOCAL AGENCY STANDARDS AND SPECIFICATIONS. 24. ALL OFFSITE ROADWAY MARKING/STRIPING MATERIAL SHALL BE

DEVICES SHALL BE IN ACCORDANCE WITH THE "MANUAL ON UNIFORM

TRAFFIC CONTROL DEVICES FOR STREETS AND HIGHWAYS" (MUTCD),

INCLUDING SUBSEQUENT REVISIONS AND ADDENDUMS. AS PUBLISHED

- THERMOPLASTIC UNLESS OTHERWISE SPECIFIED.
- 25. ALL ONSITE ROADWAY MARKING/STRIPING MATERIAL SHALL BE PAINT UNLESS OTHERWISE SPECIFIED. 26. REGULATORY SIGNS AND MARKINGS SHALL BE IN PLACE PRIOR TO FINAL INSPECTION OF PAVING AND DRAINAGE IMPROVEMENTS.
- PAVEMENT UNLESS OTHERWISE NOTED. 28. POND SLOPES AND BERMS SHALL BE SODDED TO TWO (2) FEET BELOW THE NORMAL WATER LINE (N.W.L.). IN THE CASE OF DRY

27. PAVEMENT RETURN RADII SHALL BE MEASURED TO THE EDGE OF

OTHERWISE SPECIFIED. 29. ALL PRECAST DRAINAGE STRUCTURES TO HAVE STEEL FRAME. ALL STRUCTURES IN PAVED AREAS TO HAVE STEEL RECTILINEAR GRATES

BOTTOM PONDS, THE BOTTOM WILL BE SEEDED AND MULCHED UNLESS

- 30. CONTRACTOR SHALL NOT COMPACT, STABILIZE, OR CONSTRUCT BASE COURSE WITHIN LANDSCAPE ISLANDS, TRACTS OR MEDIANS. WHERE SUCH TREATMENT DOES OCCUR. IT SHALL BE REMOVED AND REPLACED WITH SUITABLE PLANTING SOILS ACCEPTABLE TO LANDSCAPE ARCHITECT.
- 31. YARD DRAINS SHALL BE NYOPLAST INLINE DRAINS AND DRAIN BASINS, OR APPROVED EQUAL, WITH CAST IRON GRATES AND WATERTIGHT ADAPTER CONNECTIONS. DOMED GRATES SHALL BE PROVIDED IN NON-SODDED AREAS.

WITH H-20 LOADING.

32. ALL FIRE HYDRANT LOCATIONS SHALL BE MARKED BY PLACING BLUE REFLECTIVE PAVEMENT MARKERS IN THE CENTER OF THE NEAREST

33. MINIMUM LONGITUDINAL SLOPE OF CURB SHALL BE 0.30% UNLESS SPECIFIED OTHERWISE.

PAVING AND DRAINAGE (CONTINUED)

- 34. FINISHED FLOOR ELEVATION IS TYPICALLY 8" INCHES ABOVE DESIGN FINISHED GRADE AT OUTSIDE PERIMETER OF BUILDINGS EXCEPT AT ENTRIES AND WHERE OTHERWISE SHOWN.
- 35. CONTRACTOR SHALL REMOVE ALL MUCK DEPOSITS IN CONSTRUCTION AREAS AND AREAS TO BE FILLED. SEE GEOTECHNICAL REPORT.
- 36. DRAINAGE MANHOLES AND INLETS (NOT INCLUDING CONTROL STRUCTURES) IN THE PLANS ARE IDENTIFIED BY TOP TYPE ONLY. CONTRACTOR SHALL PROVIDE STANDARD DITCH BOTTOM INLET TOPS AND TYPE 'J' OR 'P' STRUCTURE BOTTOMS, SIZED AS REQUIRED TO ACCOMMODATE PIPE SIZES AND ORIENTATIONS SHOWN, SHOP DRAWINGS SHALL BE SUBMITTED WHICH CLEARLY REPRESENT SUCH
- 37. CONTRACTOR SHALL STABILIZE AND PROTECT ALL END WALL MITERED END SECTION, FLARED END SECTION, ETC. STRUCTURES THROUGHOUT THE PROJECT UNTIL THE BANK SLOPES OF THE RECEIVING WATER BODY ARE STABILIZED AND ACCEPTED BY OWNER

- ALL MATERIALS AND CONSTRUCTION REQUIREMENTS FOR THE FIRE SERVICE, WATER LINES, CHECK VALVES, BACKFLOW PREVENTERS, GATE VALVES, ETC., SHALL BE IN ACCORDANCE WITH LOCAL AGENCY STANDARD DETAILS AND CONSTRUCTION SPECIFICATIONS.
- ALL CONSTRUCTION AND MATERIALS SHALL BE IN COMPLIANCE WITH AWWA STANDARDS AND IN ACCORDANCE WITH LOCAL AGENCY STANDARDS.
- ALL PUBLIC WATER SYSTEM COMPONENTS, EXCLUDING FIRE HYDRANTS, THAT WILL BE INSTALLED UNDER THIS PROJECT AND THAT WILL COME INTO CONTACT WITH DRINKING WATER WILL CONFORM TO NSF INTERNATIONAL STANDARD 61 AND WILL BE MARKED WITH THE NSF SEAL OF APPROVAL
- 4. CONTRACTOR SHALL VERIFY SIZE AND TYPE OF EXISTING MAIN PRIOR TO ORDERING TAPPING MATERIALS FOR TIE-INS.
- SITE CONTRACTOR SHALL COORDINATE AND VERIFY ALL UTILITY SERVICES WITH FINAL ARCHITECTURAL DRAWINGS AND BUILDING CONTRACTOR.
- SITE UTILITY WORK SHALL TERMINATE 5-FEET FROM BUILDINGS UNLESS OTHERWISE STATED. MINIMUM COVER OVER ALL PIPE SHALL BE 36-INCHES FROM TOP OF
- PIPE TO FINISHED GRADE, UNLESS OTHERWISE NOTED. 8. THE WATER MAIN SHALL BE LOCATED ABOVE THE STORMWATER AND

SANITARY MAINS AT CONFLICTS, WHERE POSSIBLE.

- VERTICAL SEPARATION BETWEEN UNDERGROUND POTABLE WATER MAINS AND SANITARY OR STORM SEWERS, WASTEWATER OR STORMWATER FORCE MAINS, AND RECLAIMED WATER PIPELINES:
- 9.1. NEW OR RELOCATED, UNDERGROUND WATER MAINS CROSSING ANY EXISTING OR PROPOSED GRAVITY- OR VACUUM-TYPE SANITARY SEWER OR STORM SEWER SHALL BE LAID SO THE OUTSIDE OF THE WATER MAIN IS AT LEAST 12 INCHES ABOVE OR BELOW THE OUTSIDE OF THE OTHER PIPELINE. HOWEVER, IT IS PREFERABLE TO LAY THE WATER MAIN ABOVE THE OTHER PIPELINE. 9.2. NEW OR RELOCATED, UNDERGROUND WATER MAINS CROSSING ANY
- EXISTING OR PROPOSED PRESSURE-TYPE SANITARY SEWER, WASTEWATER OR STORMWATER FORCE MAIN, OR PIPELINE CONVEYING RECLAIMED WATER SHALL BE LAID SO THE OUTSIDE OF THE WATER MAIN IS AT LEAST 12 INCHES ABOVE OR BELOW THE OUTSIDE OF THE OTHER PIPELINE. HOWEVER, IT IS PREFERABLE TO LAY THE WATER MAIN ABOVE THE OTHER PIPELINE.
- 10. HORIZONTAL SEPARATION BETWEEN UNDERGROUND WATER MAINS AND SANITARY OR STORM SEWERS, WASTEWATER OR STORMWATER FORCE MAINS, RECLAIMED WATER PIPELINES, AND ON-SITE SEWAGE TREATMENT AND DISPOSAL SYSTEMS:
- 10.1. NEW OR RELOCATED, UNDERGROUND WATER MAINS SHALL BE LAID TO PROVIDE A HORIZONTAL DISTANCE OF AT LEAST THREE FEET BETWEEN THE OUTSIDE OF THE WATER MAIN AND THE OUTSIDE OF ANY EXISTING OR PROPOSED STORM SEWER. STORMWATER FORCE MAIN, OR PIPELINE CONVEYING RECLAIMED WATER REGULATED UNDER PART III OF CHAPTER 62-610, F.A.C.
- 10.2. NEW OR RELOCATED, UNDERGROUND WATER MAINS SHALL BE LAID TO PROVIDE A HORIZONTAL DISTANCE OF AT LEAST THREE FEET, AND PREFERABLY TEN FEET, BETWEEN THE OUTSIDE OF THE WATER MAIN AND THE OUTSIDE OF ANY EXISTING OR PROPOSED VACUUM-TYPE SANITARY SEWER.
- 10.3. NEW OR RELOCATED, UNDERGROUND WATER MAINS SHALL BE LAID TO PROVIDE A HORIZONTAL DISTANCE OF AT LEAST SIX FEET, AND PREFERABLY TEN FEET, BETWEEN THE OUTSIDE OF THE WATER MAIN AND THE OUTSIDE OF ANY EXISTING OR PROPOSED GRAVITY- OR PRESSURE-TYPE SANITARY SEWER. WASTEWATER FORCE MAIN, OR PIPELINE CONVEYING RECLAIMED WATER NOT REGULATED UNDER PART III OF CHAPTER 62-610, F.A.C. THE MINIMUM HORIZONTAL SEPARATION DISTANCE BETWEEN WATER MAINS AND GRAVITY-TYPE SANITARY SEWERS SHALL BE REDUCED TO THREE FEET WHERE THE BOTTOM OF THE WATER MAIN IS LAID AT LEAST SIX INCHES ABOVE THE TOP OF THE SEWER.
- 10.4. NEW OR RELOCATED, UNDERGROUND WATER MAINS SHALL BE LAID TO PROVIDE A HORIZONTAL DISTANCE OF AT LEAST TEN FEET BETWEEN THE OUTSIDE OF THE WATER MAIN AND ALL PARTS OF ANY EXISTING OR PROPOSED "ON-SITE SEWAGE TREATMENT AND DISPOSAL SYSTEM" AS DEFINED IN SECTION 381.0065(2), F.S., AND RULE 64E-6.002, F.A.C.
- AT THE UTILITY CROSSINGS DESCRIBED IN NOTES 8 AND 9 ABOVE, ONE FULL LENGTH OF WATER MAIN PIPE SHALL BE CENTERED ABOVE OR BELOW THE OTHER PIPELINE SO THE WATER MAIN JOINTS WILL BE AS FAR AS POSSIBLE FROM THE OTHER PIPELINE. ALTERNATIVELY, AT SUCH CROSSING, THE PIPES SHALL BE ARRANGED SO THAT ALL WATER MAIN JOINTS ARE AT LEAST THREE FEET FROM ALL JOINTS IN VACUUM-TYPE SANITARY SEWERS. STORM SEWERS, STORMWATER FORCE MAINS, OR PIPELINES CONVEYING RECLAIMED WATER REGULATED UNDER PART III OF CHAPTER 62-610, F.A.C., AND AT LEAST SIX FEET FROM ALL JOINTS IN GRAVITY-OR PRESSURE-TYPE SANITARY SEWERS, WASTEWATER FORCE MAINS. OR PIPELINES CONVEYING RECLAIMED WATER NOT REGULATED UNDER PART III OF CHAPTER 62-610, F.A.C.
- 12. WATER LINES 2-INCHES, OR LESS, IN DIAMETER SHALL BE POLYETHYLENE
- 13. WATER LINES 4-INCH TO 12-INCH IN DIAMETER SHALL BE NSF LOGO PVC PIPE CONFORMING TO AWWA C-900 AND BE DR-18.
- 14. ALL FITTINGS SHALL BE DUCTILE IRON (D.I.) OR GRAY IRON MECHANICAL JOINTS WITH A MINIMUM PRESSURE RATING OF 250 P.S.I. CONFORMING TO ANSI A-21.10 / AWWA C-110, OR D.I. COMPACT FITTINGS FOR DIAMETERS 4-INCH TO 12-INCH CONFORMING TO ANSI A-21.53 / AWWA C-153.
- 15. FROM THE POINT OF SERVICE (P.O.S.) FORWARD AS DESIGNATED BY F.S. 633, FIRE SUPPLY PIPE SHALL BE DR-14 AND TESTED AT 200 PSI FOR TWO HOURS.
- 16. GATE VALVES SHALL CONFORM TO AWWA C-509-87, WITH WRENCH NUT EXTENSION STEMS AND OTHER APPURTENANCES AS REQUIRED AND SHALL BE IRON BODY, FULL BRONZE MOUNTED, DOUBLE DISK, PARALLEL SEAT, NON-RISING STEM VALVES WITH O-RING SEALS AND END CONNECTIONS AS CALLED FOR ON THE PLANS. ALL TEES, CAPS, PLUGS, BENDS, VALVES, ETC., SHALL BE PROVIDED WITH GRIP RING RESTRAINTS.
- 17. ALL NON-METALLIC WATER MAINS SHALL BE INSTALLED WITH A CONTINUOUS. INSULATED 10 GAUGE COPPER WIRE INSTALLED DIRECTLY ON TOP OF THE PIPE FOR LOCATION PURPOSES. IN ADDITION, ALL PVC WATER MAINS SHALL BE A SOLID BLUE COLOR. ALL LETTERING SHALL APPEAR LEGIBLY ON PIPE AND SHALL RUN THE ENTIRE LENGTH OF THE PIPE. LETTERING SHALL READ AS IS ACCEPTABLE FOR THE INTENDED USE.
- 18. SERVICE MAINS FOR FIRE HYDRANTS SHALL BE INSTALLED IN ACCORDANCE WITH NFPA 24, LATEST EDITION.
- 19. NEW FIRE HYDRANTS SHALL BE INSTALLED SO THAT 5-1/4" INCH PORT IS FACING THE ROADWAY BY WHICH IT IS ACCESSED. HYDRANTS SHALL BE POSITIONED NOT MORE THAN 5 FEET AWAY FROM THE CURB OR BERM OF

WATER (CONTINUED)

CONSTRUCTION SPECIFICATIONS.

- HYDROSTATIC TESTING AND THE DISINFECTION OF THE WATER DISTRIBUTION SYSTEM SHALL BE DONE IN ACCORDANCE WITH AWWA STANDARDS. HYDROSTATIC TESTING TO BE DONE IN ACCORDANCE WITH AWWA C-600 FOR DUCTILE IRON PIPE AND C-605 FOR PVC PIPE. DISINFECTING AND BACTERIOLOGICAL EVALUATION TO BE DONE IN ACCORDANCE WITH AWWA C-651 AND RULE 62-555.340 F.A.C.
- 21. THE CONTRACTOR SHALL SUPPLY COMPLETE AS-BUILT INFORMATION RELATIVE TO LOCATION AND ELEVATION OF ALL WATER LINES AND SERVICES. THE INFORMATION SHALL BE SUBMITTED ON LEGIBLY MARKED-UP PRINTS TO THE ENGINEER WITHIN TWO (2) WEEKS OF THE COMPLETION OF THE WATER LINE CONSTRUCTION.
- 22. CONTRACTOR SHALL COORDINATE ALL UTILITIES SYSTEMS TEST SCHEDULING TO ALLOW ENGINEER'S ATTENDANCE PROVIDING MINIMUM NOTICE OF FIVE (5) WORKING DAYS. CONTRACTOR'S FAILURE TO PROPERLY NOTIFY ENGINEER MAY RESULT IN RETESTING AT ENGINEER'S OPTION AND AT
- CONTRACTOR'S EXPENSE. 23. NEW HYDRANTS SHALL BE TESTED AND IN PROPER WORKING ORDER WITH DOCUMENTATION SUPPLIED TO THE FIRE MARSHAL PRIOR TO ANY
- COMBUSTIBLE CONSTRUCTION. (I.E. FIRE FLOW TEST SHALL BE PERFORMED) DEFLECTIONS AT PIPE JOINTS SHALL NOT EXCEED THE LESSOR OF THOSE RECOMMENDED BY THE PIPE MANUFACTURER OR UTILITY PROVIDER'S
- 25. ALL PIPE AND PIPE FITTINGS INSTALLED UNDER THIS PROJECT SHALL BE COLOR CODED IN ACCORDANCE WITH SUB PARAGRAPH 62-555.320(21)(B)3, F.A.C. USING BLUE AS A PREDOMINANT COLOR. ALL DUCTILE IRON WATER MAINS SHALL BE MARKED WITH A CONTINUOUS STRIPE LOCATED WITHIN THE TOP 90 DEGREES OF THE PIPE. SAID STRIPE SHALL BE A MINIMUM 2 INCHES IN WIDTH AND SHALL BE BLUE IN COLOR. BACKFILL SHALL NOT BE PLACED FOR 30 MINUTES FOLLOWING PAINT APPLICATION. FOR PIPE WITH AN INTERNAL DIAMETER OF 24" OR GREATER. TAPE OR PAINT SHALL BE APPLIED IN CONTINUOUS LINES A LONG EACH SIDE OF THE PIPE AS WELL AS ALONG THE TOP OF THE PIPE.
- 26. MARK RESIDENTIAL SERVICES WITH 6-FOOT HIGH PIECE OF 2"X4" PLANK PAINTED BLUE WITH LOT NUMBER CLEARLY MARKED AND A 'W IMPRESSED IN THE CURB. IT IS THE INTENT THAT EVERY LOT IS PROVIDED WITH A WATER SERVICE; THEREFORE IT IS THE CONTRACTOR'S RESPONSIBILITY TO INSTALL A WATER SERVICE TO EACH LOT.
- PIPE MATERIALS: PVC MAINS - ALL PIPE, PIPE FITTINGS, PIPE JOINT PACKING AND JOINTING MATERIALS, VALVES, FIRE HYDRANTS, AND METERS INSTALLED UNDER THIS PROJECT SHALL CONFORM TO APPLICABLE AWWA STANDARDS AND SHALL BE MANUFACTURED IN ACCORDANCE WITH AWWA STANDARD C900, LATEST EDITION, PVC SHALL BE MANUFACTURED IN ACCORDANCE WITH AWWA STANDARD C900. THE PVC SHALL HAVE A MINIMUM WORKING PRESSURE OF 150 P.S.I. AND SHALL HAVE A DIMENSION RATIO (DR) OF 18. PIPE SHALL BE THE SAME O.D. AS DUCTILE IRON PIPE PVC JOINTS - SHALL BE IN ACCORDANCE WITH ASTM D3139. DUCTILE IRON MAINS - SHALL CONFORM TO ANSI/AWWA C150/C151. A MINIMUM OF CLASS 50 PIPE SHALL BE SUPPLIED. DUCTILE IRON JOINTS - SHALL BE IN ACCORDANCE WITH ANSI A21.11 AND SERVICES - SHALL BE IN ACCORDANCE WITH AWWA C901/C800
- WATER MAIN CONNECTION SHALL BE MADE UNDER THE SUPERVISION OF THE UTILITY PROVIDER. ALL VALVES SHALL BE OPERATED BY UTILITY PROVIDER PERSONNEL ONLY.

STANDARDS FOR POLYETHYLENE TUBING, CLASS 160.

- 29. ALL PIPE AND PIPE FITTINGS INSTALLED UNDER THIS PROJECT SHALL CONTAIN NO MORE THAN 8.0% LEAD, AND ANY SOLDER OR FLUX USED IN THIS PROJECT SHALL CONTAIN NO MORE THAN 0.2% LEAD.
- 30. NEW OR ALTERED FIRE HYDRANT LEADS SHALL HAVE A MINIMUM INSIDE DIAMETER OF 6-INCH AND SHALL INCLUDE AN AUXILIARY VALVE.
- A CONTINUOUS AND UNIFORM BEDDING WILL BE PROVIDED IN TRENCHES FOR UNDERGROUND PIPE INSTALLED UNDER THIS PROJECT; BACKFILL MATERIAL WILL BE TAMPED IN LAYERS AROUND UNDERGROUND PIPE INSTALLED UNDER THIS PROJECT AND TO A SUFFICIENT HEIGHT ABOVE THE PIPE TO ADEQUATELY SUPPORT AND PROTECT THE PIPE; AND UNSUITABLY SIZED STONES (AS DESCRIBED IN APPLICABLE AWWA STANDARDS OR MANUFACTURERS' RECOMMENDED INSTALLATION PROCEDURES) FOUND IN TRENCHES WILL BE REMOVED FOR A DEPTH OF A LEAST SIX INCHES BELOW THE BOTTOM OF UNDERGROUND PIPE INSTALLED UNDER THIS
- 32. CONTRACTOR SHALL NOT ACTIVATE WATER SERVICE UNTIL FDEP HAS CLEARED THE SYSTEM FOR USE AND THE CLEARANCE LETTER HAS BEEN RECEIVED BY THE OWNER.
- ENGINEER RESERVES THE RIGHT TO WITHHOLD AUTHORIZATION OF PAYMENT FOR ANY PORTION OF THE UTILITIES PIPE WORK WHICH HAS NOT BEEN TESTED, OBSERVED BY ENGINEER, AND REPORTED TO CONFORM TO PROJECT SPECIFICATIONS.

THE 7TH EDITION OF THE FLORIDA FIRE PREVENTION CODE IS HEREBY INCORPORATED NFPA 1, 2018 EDITION

NFPA 13, 2016 EDITION NFPA 14, 2016 EDITION NFPA 24, 2016 EDITION NFPA 101, 2018 EDITION

DEMOLITION NOTES

EXISTING UNDERGROUND UTILITIES, UNLESS OTHERWISE NOTED, MAY BE CAPPED/PLUGGED AND ABANDONED IN PLACE EXCEPT WITHIN 30 FT. OF BUILDING. CAPPED AND PLUGGED PIPE ENDS SHALL BE ENCASED IN CONCRETE, 6" MINIMUM THICKNESS AROUND PIPE. MANHOLE BASES MAY BE LEFT IN PLACE PROVIDED THAT PIPE OPENINGS ARE PLUGGED AND REMAINING BASES ARE FILLED WITH CONCRETE 6" MINIMUM ABOVE HIGHEST INVERT.

CONTRACTOR SHALL BE KNOWLEDGEABLE OF THE CONSTRUCTION

- DOCUMENTS AND BE RESPONSIBLE FOR PROTECTING ANY EXISTING FACILITY SO DESIGNATED OR DESIGNATED TO BE UTILIZED IN THE CONTRACTOR SHALL REMOVE ALL FOUNDATIONS, CONCRETE SLABS,
- AND UNDERGROUND STRUCTURES EXISTING ON THE SITE AT THE TIME OF BIDDING UNLESS OTHERWISE DIRECTED. CONTRACTOR SHALL COORDINATE WITH APPLICABLE UTILITY

COMPANIES AND BE RESPONSIBLE FOR THE TERMINATION,

CAPPING-OFF AND REMOVAL OF ALL UNDERGROUND AND

ABOVE-GROUND UTILITY SERVICES EXISTING AT THE TIME OF BIDDING

UNLESS DIRECTED TO BID OTHERWISE. CONTRACTOR IS RESPONSIBLE FOR IDENTIFYING AND DISPOSING ALL WASTE MATERIALS CONSISTENT WITH ALL RULES AND REGULATIONS

APPLICABLE TO THE SPECIFIC MATERIAL FOUND.

SPECIAL PURPOSE

THE EXISTENCE AND LOCATION OF ANY OVERHEAD OR UNDERGROUND UTILITY LINES. PIPES. OR STRUCTURES SHOWN ON THESE PLANS ARE OBTAINED BY A RESEARCH OF THE AVAILABLE RECORDS. THE CONTRACTOR SHALL TAKE ALL NECESSARY PRECAUTIONS TO AVOID DAMAGE TO SAME. THE CONTRACTOR SHALL USE EXTREME CAUTION WHEN WORKING NEAR OVERHEAD UTILITIES SO AS TO SAFELY PROTECT ALL PERSONNEL AND EQUIPMENT AND SHALL BE RESPONSIBLE FOR ALL COST AND LIABILITY IN CONNECTION THEREWITH.

SANITARY SERVICE


SANITARY SERVICE TO BE PROVIDED AND PERMITTED INDIVIDUALLY BY SEPTIC ON EACH INDIVIDUAL LOT.


DORHEAD & STOKES, LI

CIVIL ENGINEERS 431 E. Horatio Avenue Suite 260 Maitland, Florida 32751 (407) 629-8330

01/09/2 N/A DESIGNED BY: DRAWN BY:.

APPROVED BY: __

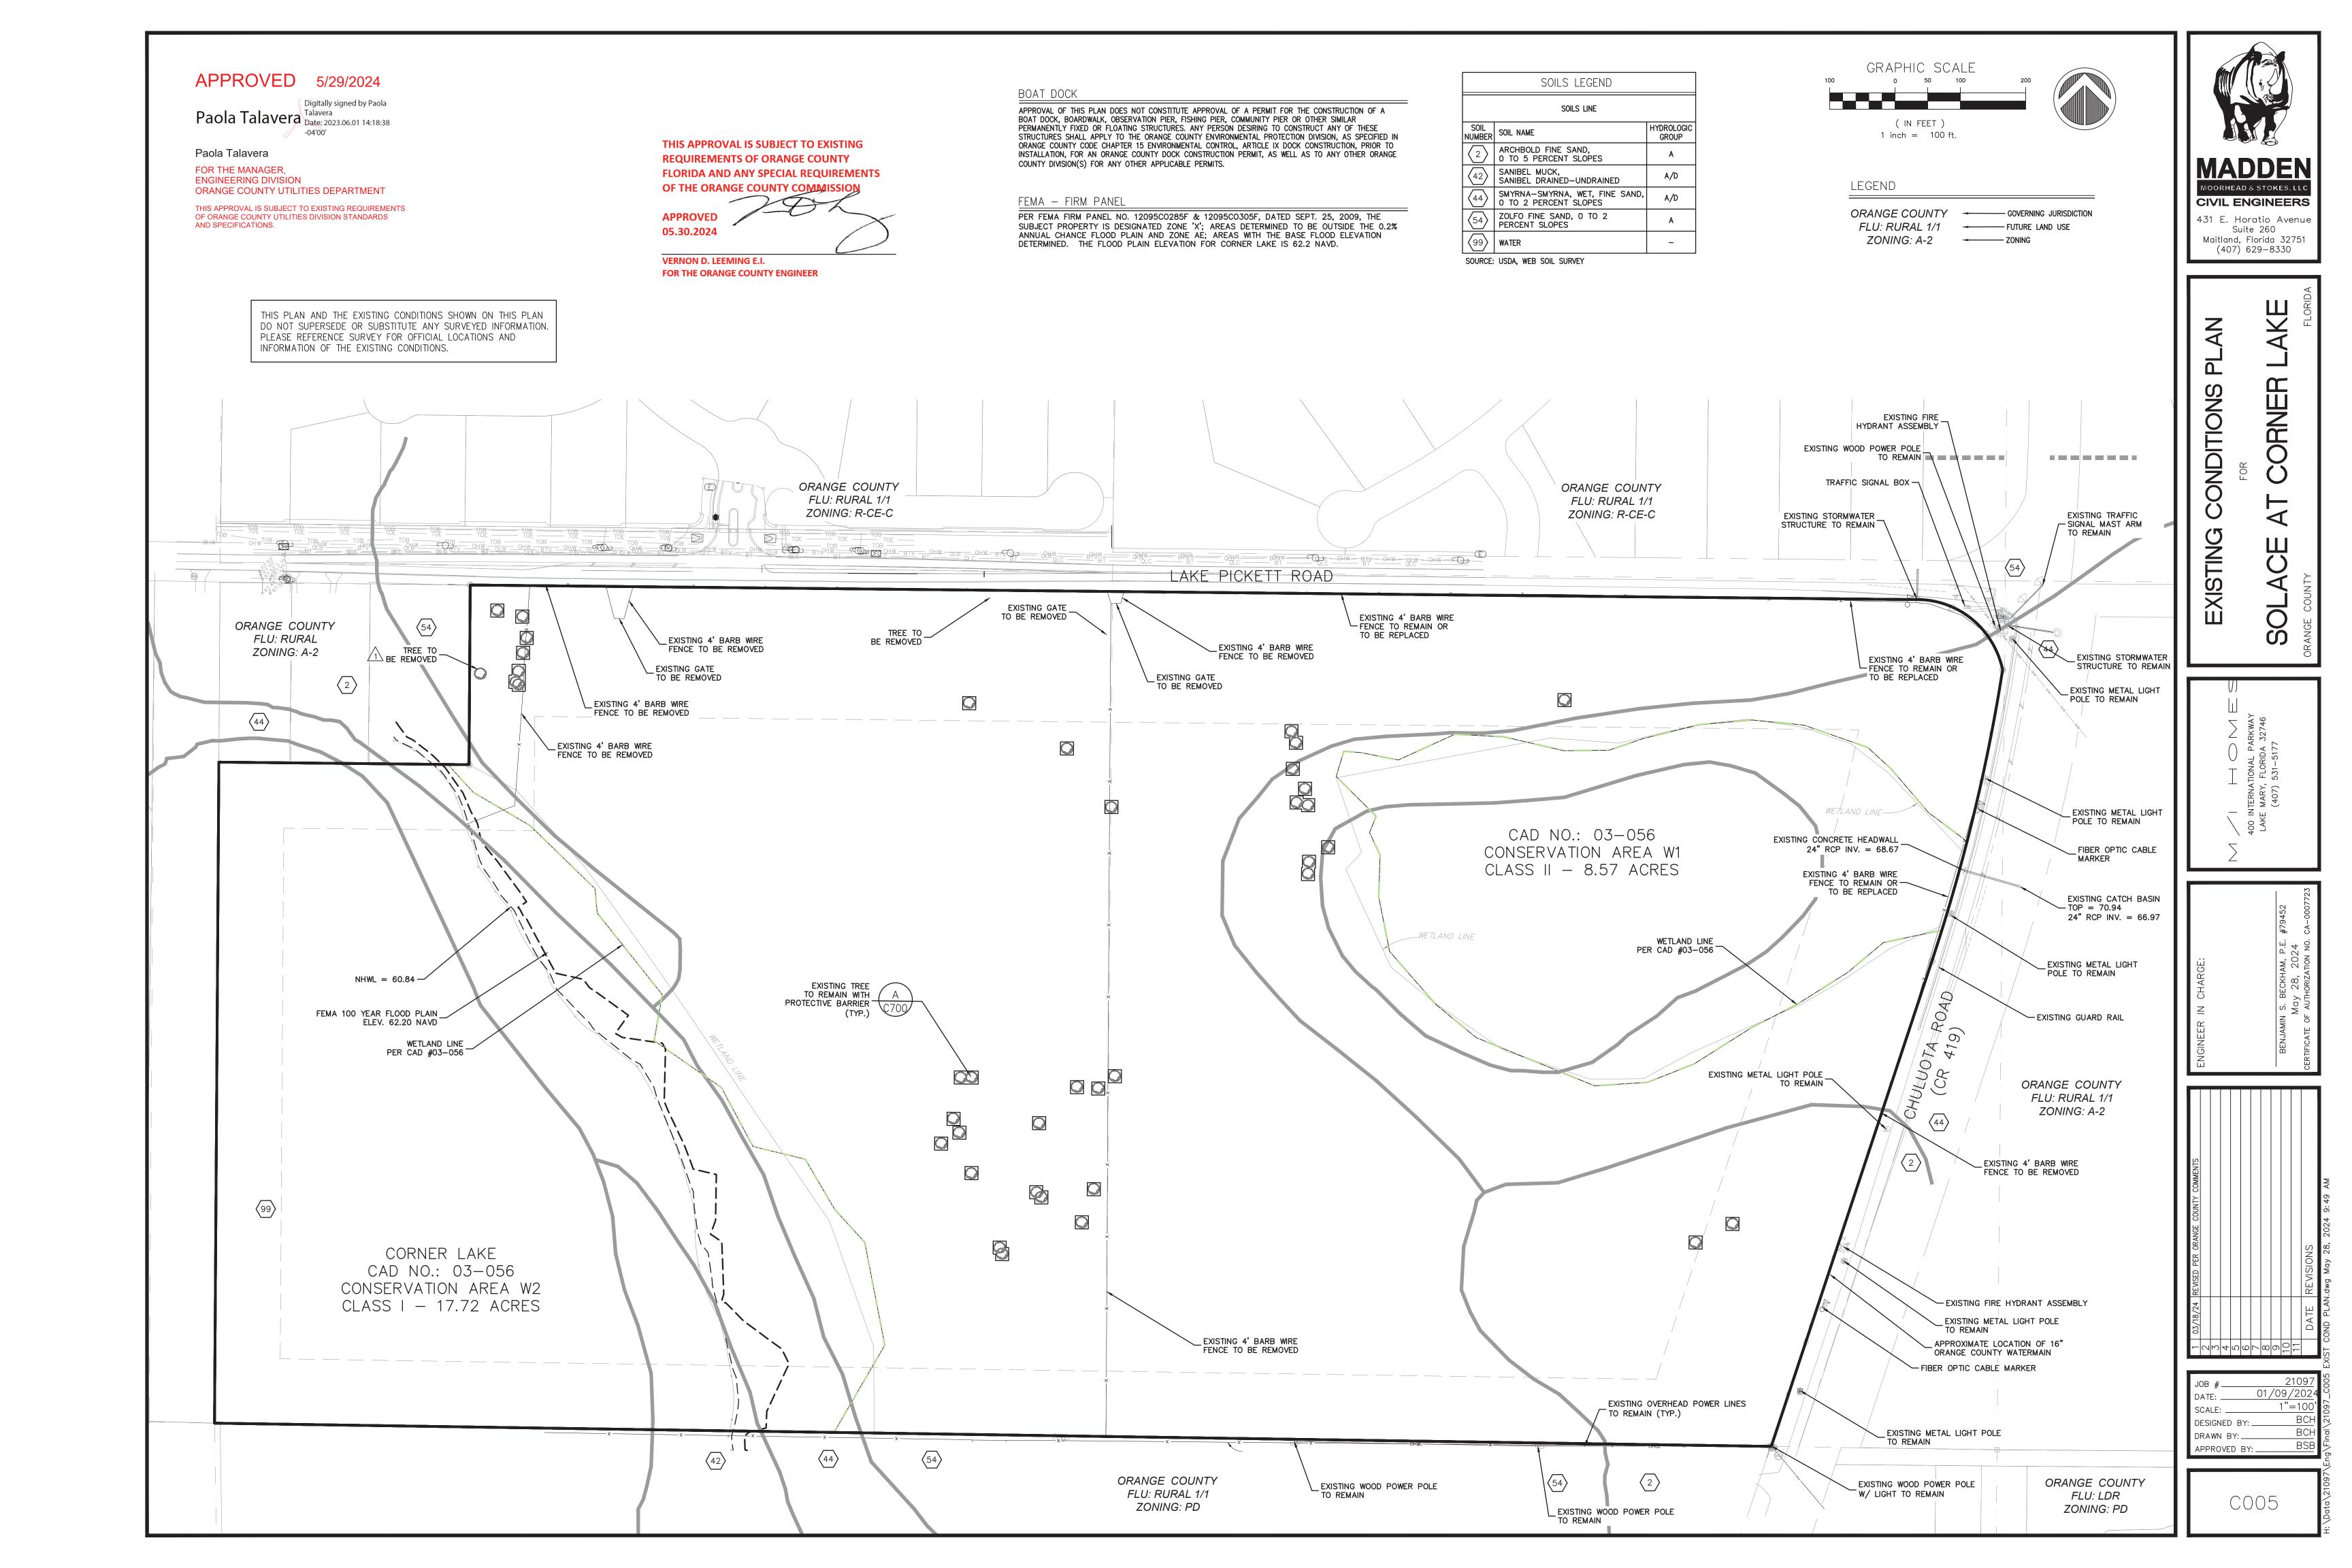


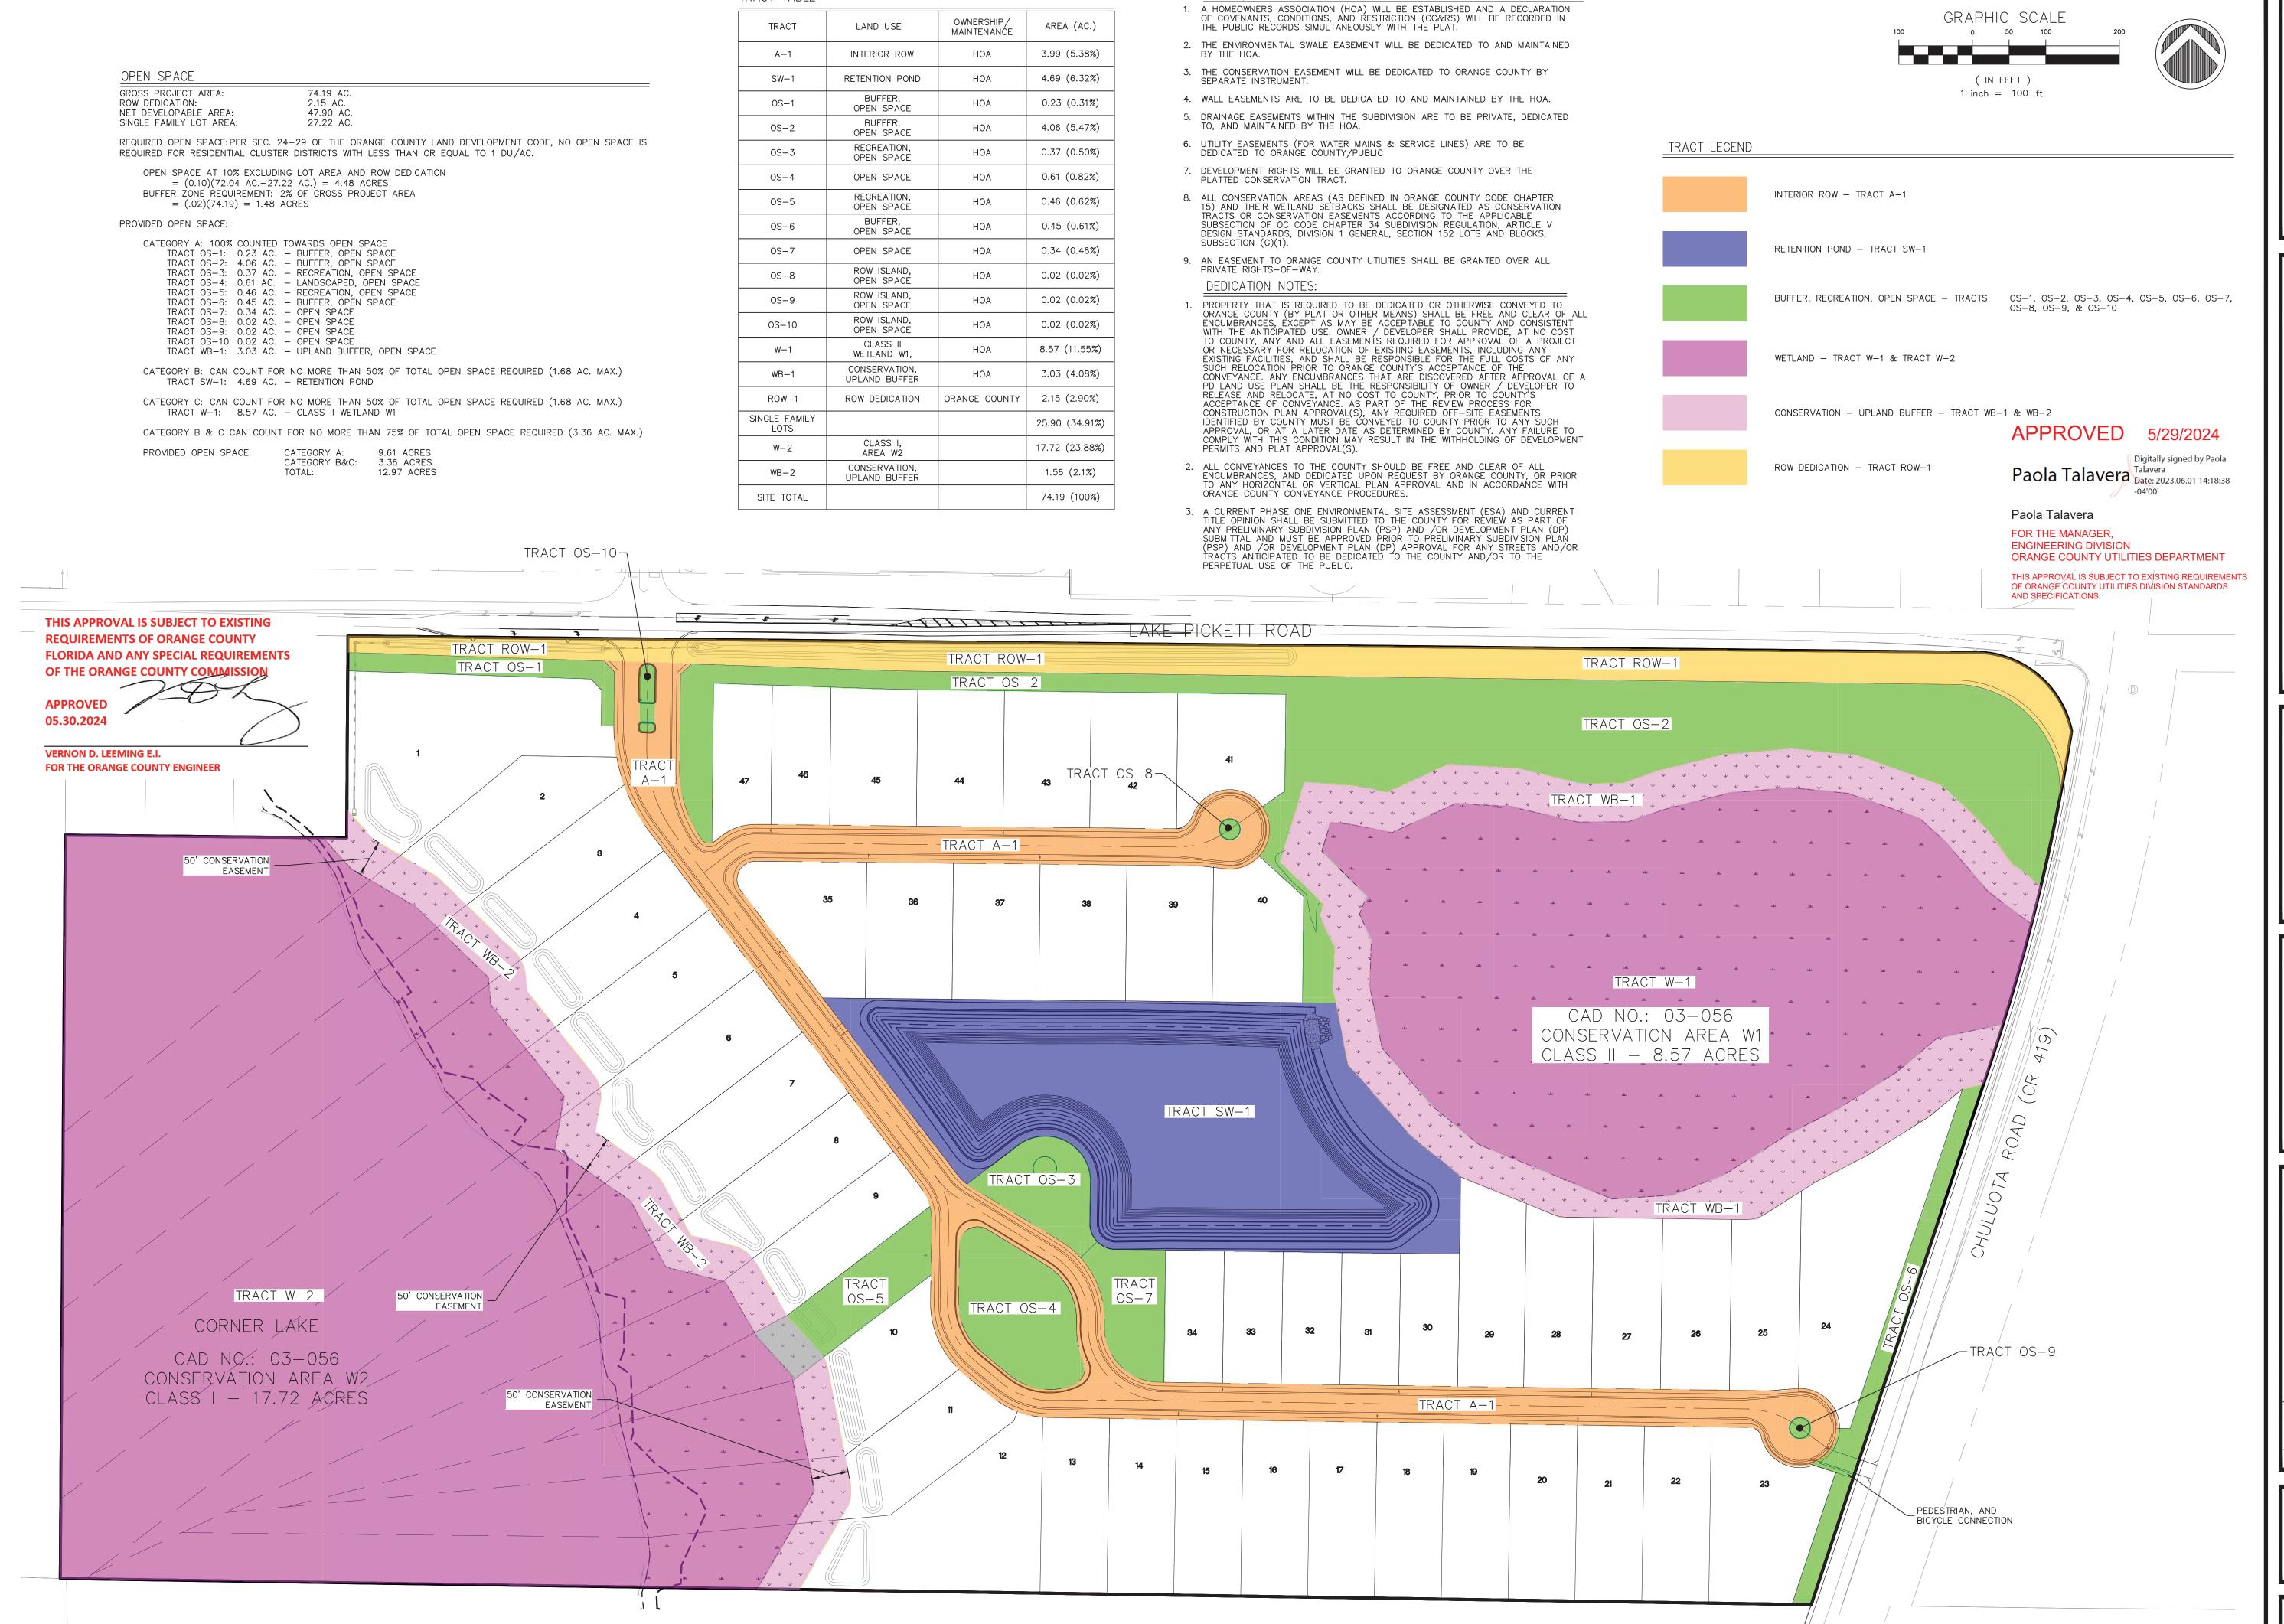

<u>TRACT/EASEMENT NOTES:</u>

TRACT TABLE


OWNERSHIP/

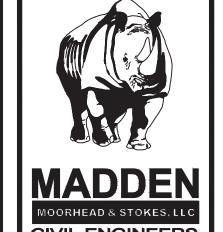

GRAPHIC SCALE

CIVIL ENGINEERS 431 E. Horatio Avenue Suite 260 Maitland, Florida 32751 (407) 629-8330

DESIGNED BY: DRAWN BY: APPROVED BY: .

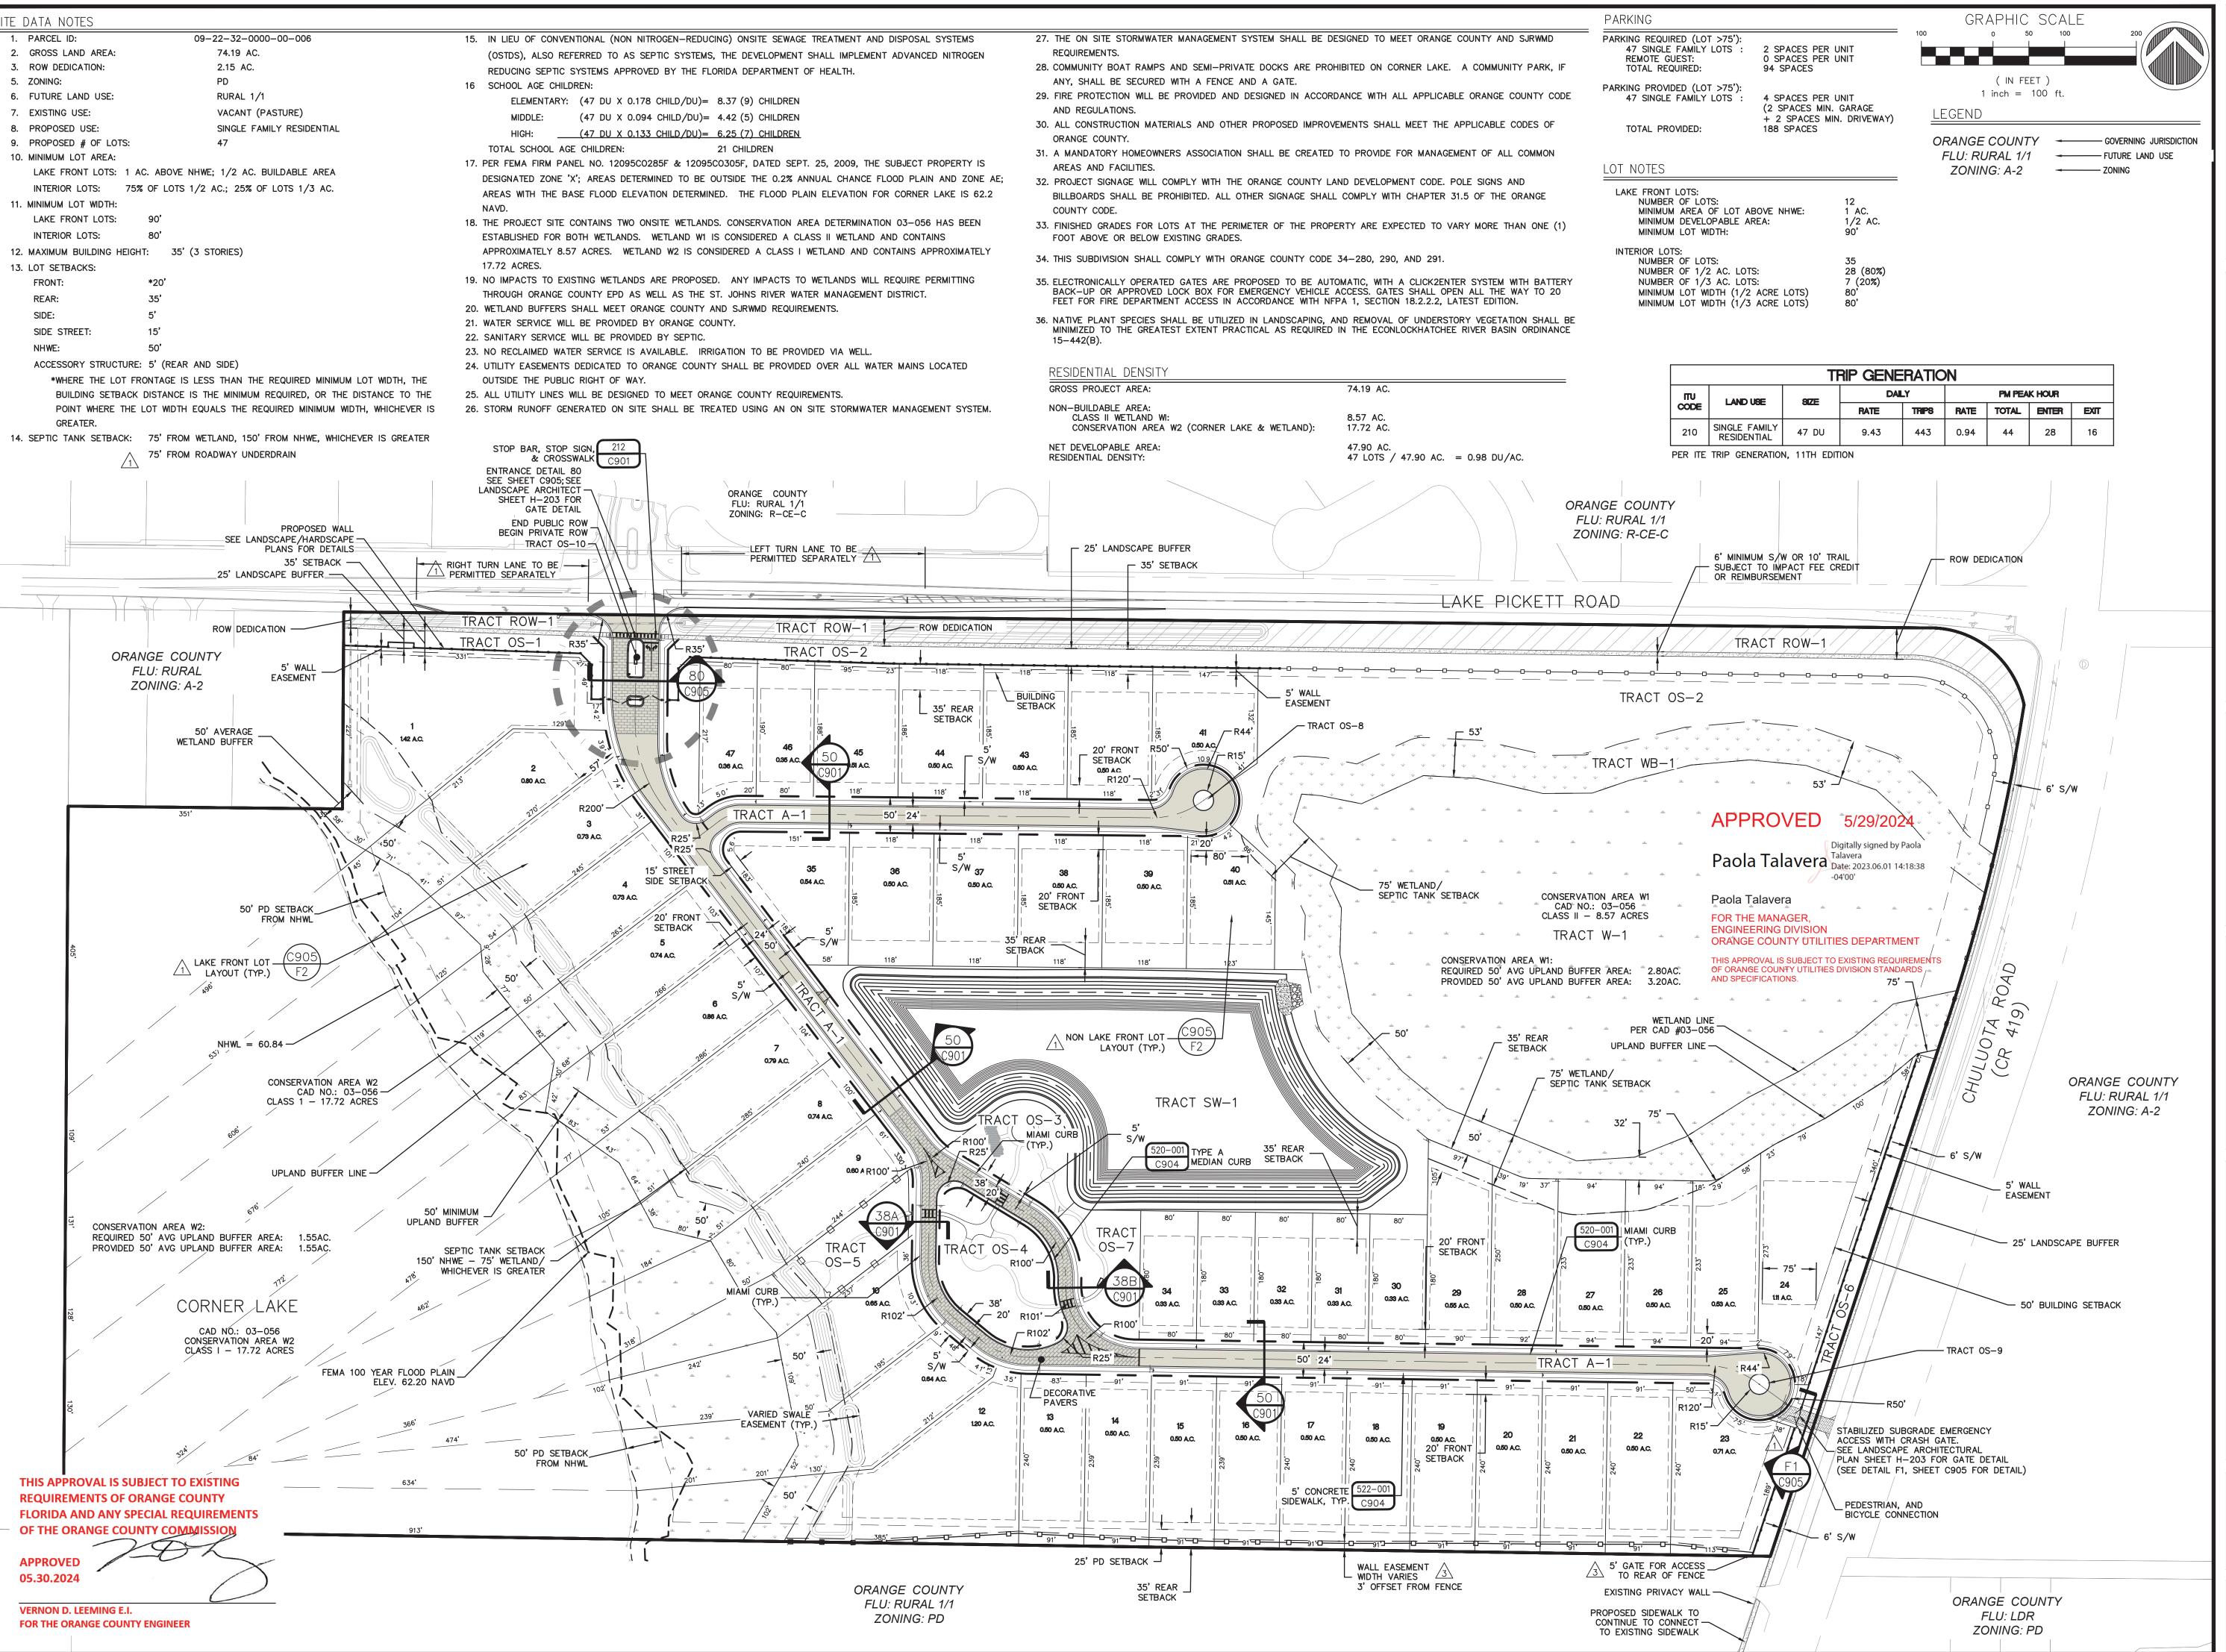



Fivil ENGINEERS

431 E. Horatio Avenue
Suite 260

Maitland, Florida 32751
(407) 629-8330

ERALL SITE PLAN
FOR

AT CORNER LAKE

M / I H C M E S
400 INTERNATIONAL PARKWAY
LAKE MARY, FLORIDA 32746
(407) 531-5177

24 REVISED PER ORANGE COUNTY COMMENTS

24 REVISED PER ORANGE COUNTY COMMENTS

E REVISIONS

CERT

 JOB #
 21097


 DATE:
 01/09/2024


 SCALE:
 1"=100'

 DESIGNED BY:
 BCH

 DRAWN BY:
 BCH

 APPROVED BY:
 BSB

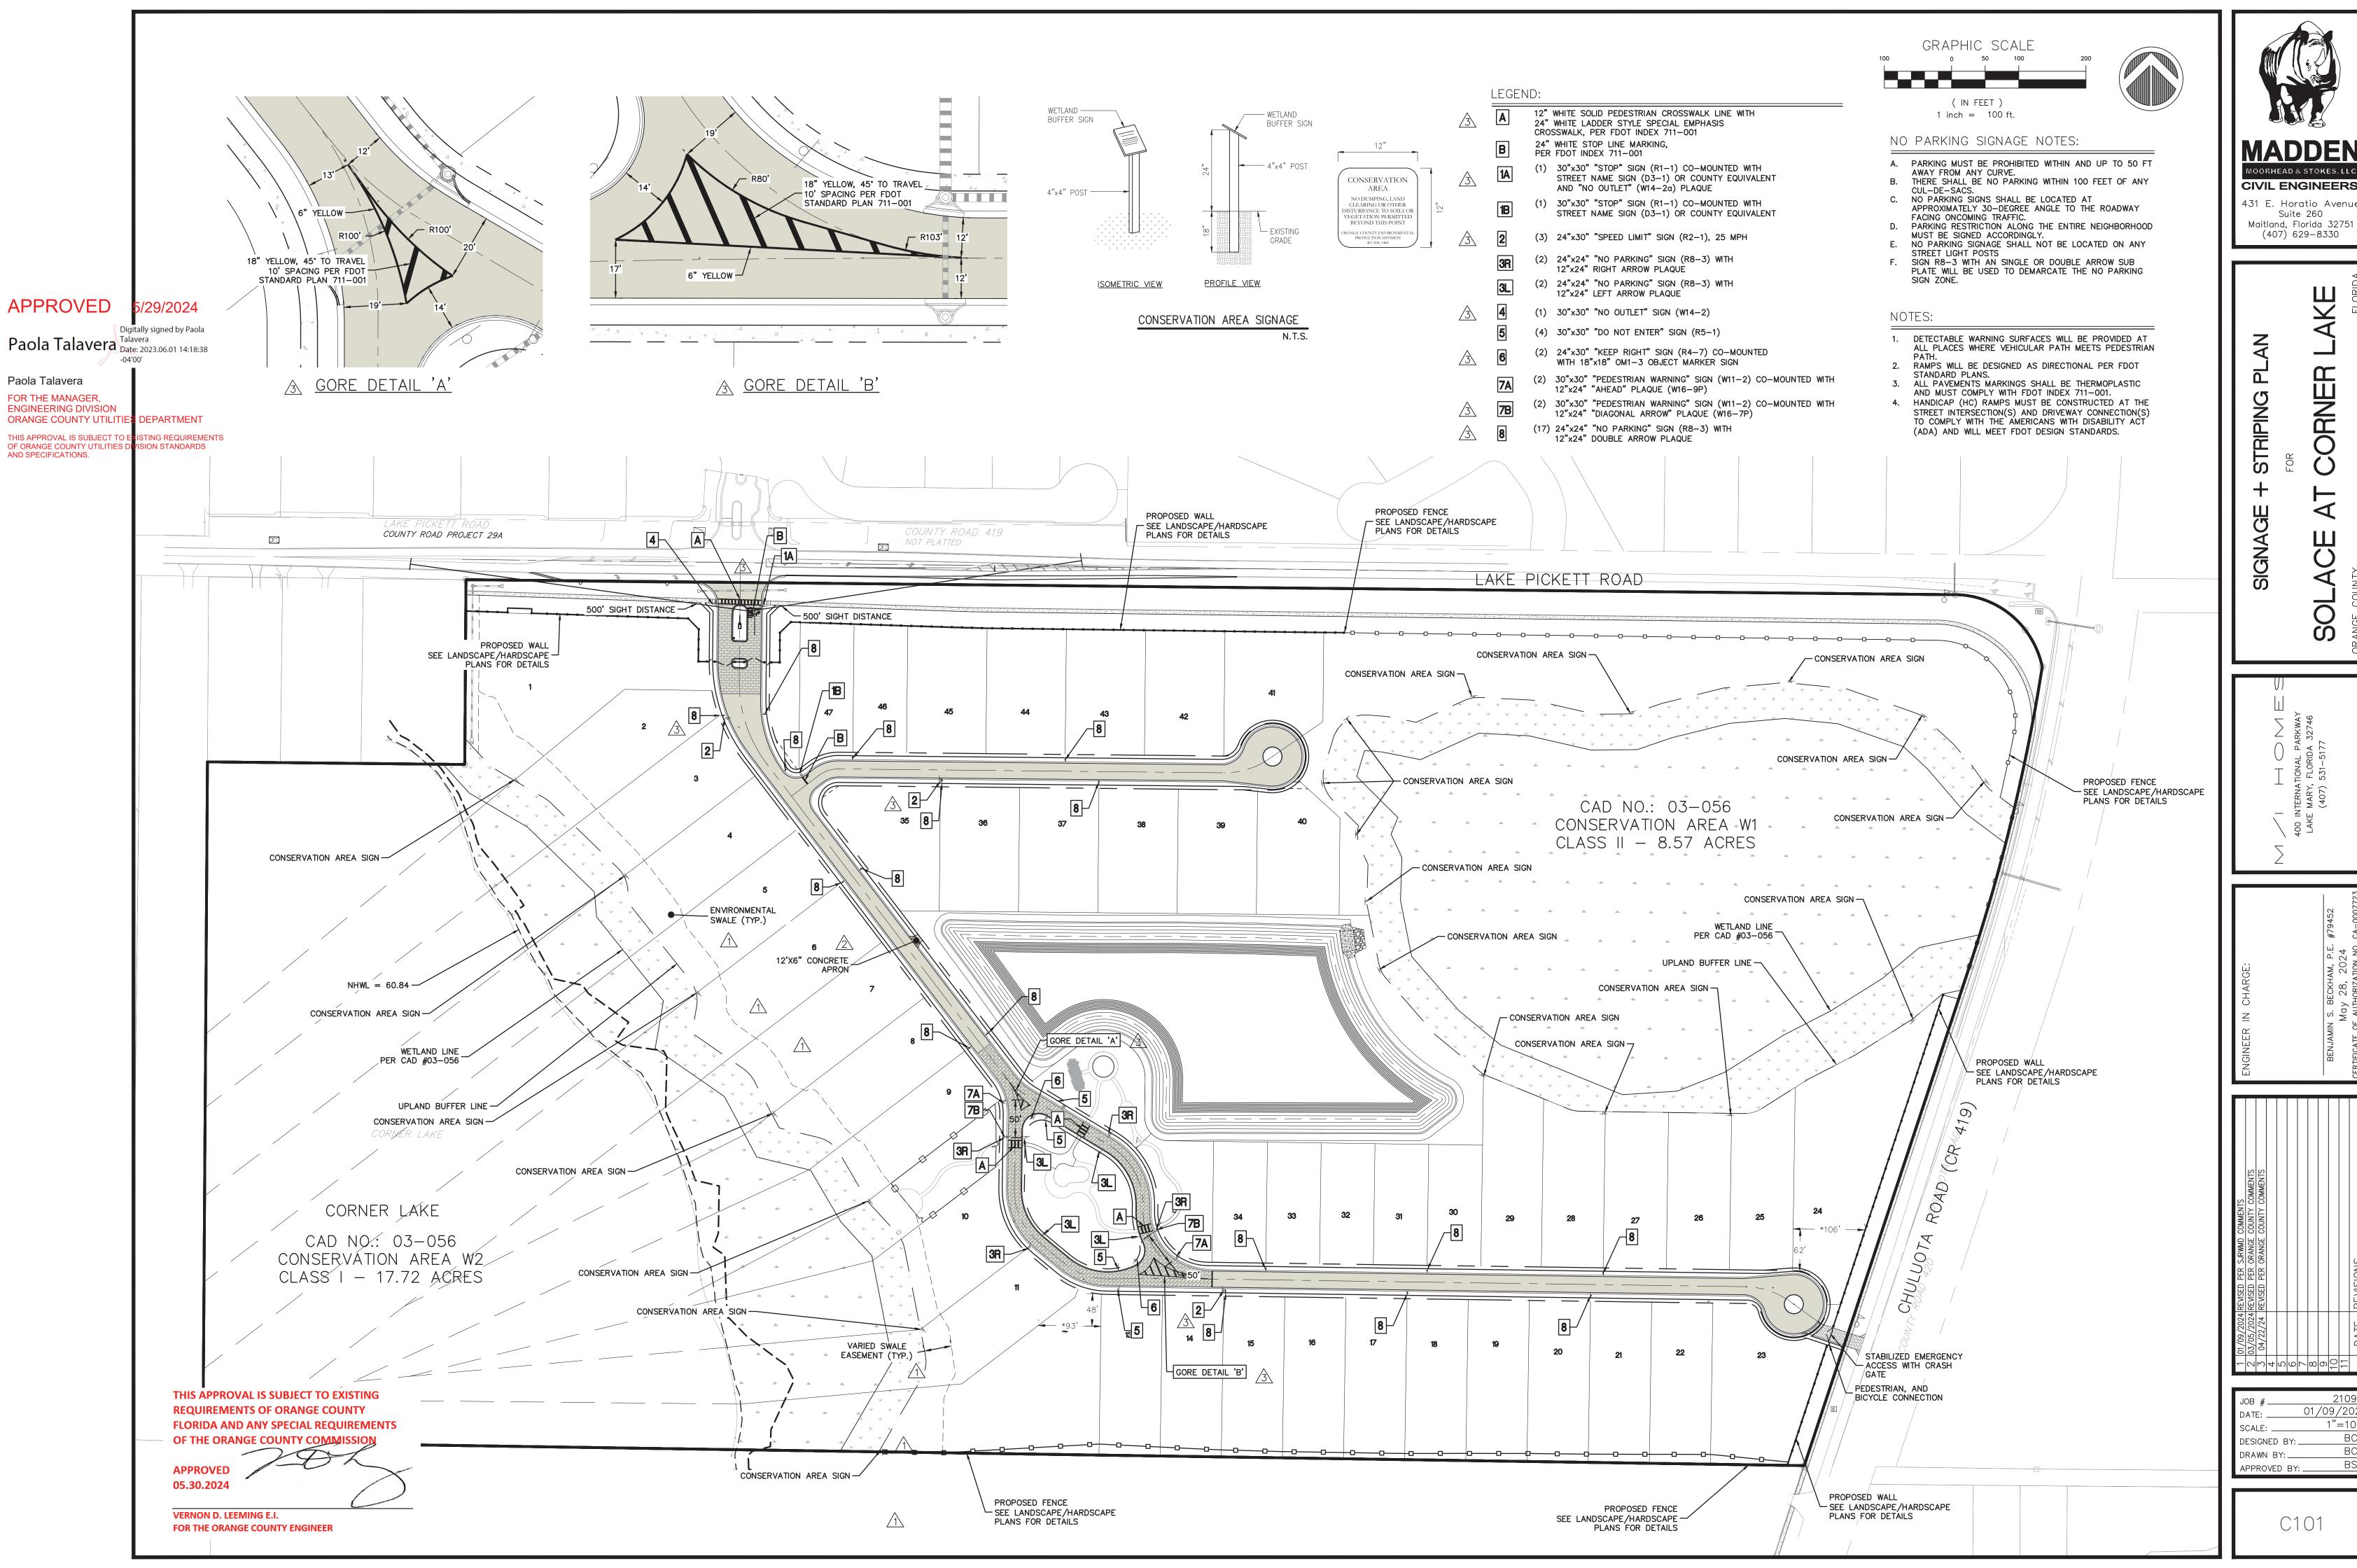

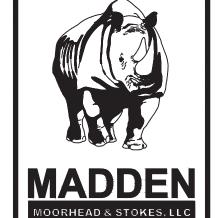


431 E. Horatio Avenue Suite 260 Maitland, Florida 32751 (407) 629-8330

(C)

DESIGNED BY: DRAWN BY: _ APPROVED BY: _

FDEP SEPARATION I	REQUIREMENTS UNDER 62-555.314	4 EFFECTIVE 8-	-28-2003	
HAZARD	HORIZONTAL SEPARATION	VERTICAL :	SEPARATION	JOINT
HAZARD	HORIZONTAL SEPARATION	WATER ABOVE	WATER BELOW	SPACING
STORM SEWER	3FT MIN	12IN PREF, 6IN MIN	12IN MIN	3FT MIN
STORM FORCE MAIN	3FT MIN	12IN MIN	12IN MIN	3FT MIN
RECLAIMED WATER IF REGULATED UNDER 62-610	3FT MIN	12IN MIN	12IN MIN	3FT MIN
RECLAIMED WATER IF NOT REGULATED UNDER 62-610	10FT PREF, 6FT MIN	12IN MIN	12IN MIN	6FT MIN
VACUUM SANITARY SEWER	10FT PREF, 3FT MIN	12IN PREF, 6IN MIN	12IN MIN	3FT MIN
GRAVITY SANITARY SEWER	10FT PREF, 6FT MIN, 3FT MIN IF WATER MAIN IS	12IN PREF, 6IN MIN	12IN MIN	6FT MIN
	6IN ABOVE GRAVITY SANITARY SEWER.			
SANITARY SEWER FORCE MAIN	10FT PREF, 6FT MIN	12IN MIN	12IN MIN	6FT MIN
SEWAGE TREATMENT & DISPOSAL SYSTEM	10FT MIN	NONE	NONE	NONE

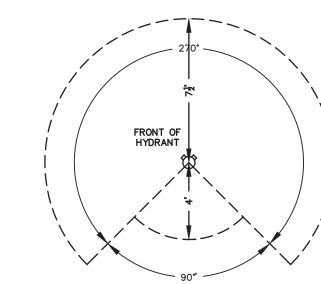

FIRE HYDRANT CLEARANCE DETAIL

THE NEEDED FIRE FLOW PER NFPA 1, CHAPTER 18.4.5.1.1 IS 1,000 GPM FOR 1 HOUR (PROPOSED UNITS ARE LESS THAN 5,000 SF)

HOMES 5,000 SQUARE FEET OR LESS SHALL PROVIDE 1,000 GPM; HOMES EXCEEDING 5,000 SQUARE FEET SHALL PROVIDE FIRE FLOW IN ACCORDANCE WITH TABLE 18.4.5.1.2 OF NFPA 1 (FFPC, 7th EDITION).

NEEDED FIRE FLOW DETERMINED AT 1,022.8 GPM. SEE UTILITY REPORT FOR DEMAND.

NOTES:

- 1. FIRE DEPARTMENT ACCESS ROADS PROVIDED AT THE START OF A PROJECT AND SHALL BE MAINTAINED THROUGHOUT CONSTRUCTION. (NFPA 1, 16.1.4).
- 2. A WATER SUPPLY FOR FIRE PROTECTION, EITHER TEMPORARY OR PERMANENT, SHALL BE MADE AVAILABLE AS SOON AS COMBUSTIBLE MATERIAL ACCUMULATES. THIS APPLIES TO BOTH COMMERCIAL AND RESIDENTIAL DEVELOPMENTS. (NFPA 1, 16.4.3.1).
- WHERE UNDERGROUND WATER MAINS AND HYDRANTS ARE TO BE PROVIDED, THEY SHALL BE INSTALLED, COMPLETED, AND IN SERVICE PRIOR TO CONSTRUCTION WORK. (NFPA 1, 16.4.3.1.3).
- FIRE FLOW TESTING SHALL BE PERFORMED IN ACCORDANCE WITH NFPA 291, RECOMMENDED PRACTICE FOR FIRE FLOW TESTING.
- HYDRANT SHALL BE MARKED WITH A BLUE REFLECTOR THAT IS PLACED 6" IN THE ROADWAY IN
- ACCORDANCE WITH NFPA 1, CHAPTER 18.5.10. 6. THE FOLLOWING IS REQUIRED FOR ACCESS SIGNAGE FOR NEW CONSTRUCTION SITES:
- A. SIGNAGE SHALL READ 'FIRE DEPARTMENT ACCESS' AND SHALL INCLUDE SITE ADDRESS, OR RANGE OF ADDRESSES, FOR ALL COMMERCIAL SITES AND RESIDENTIAL MODEL HOMES. SIZE: THE TWO-SIDED SIGN PLATE SHALL BE A MINIMUM OF 4X4 FEET
- COLOR: THE SIGN SHALL HAVE A RED BACKGROUND WITH A WHITE LEGEND. LETTERING FOR THE SIGN SHALL BE FOUR INCH.
- ADDRESS ON SIGN SHALL BE TWO AND ONE HALF INCH. LOCATION: SIGN SHALL BE INSTALLED AT EACH POINT OF ENTRY.
- BOTTOM OF SIGN SHALL BE SIX FEET ABOVE GRADE ON POSTS.

ELECTRONICALLY OPERATED GATES ARE PROPOSED TO BE AUTOMATIC, WITH A CLICK2ENTER SYSTEM WITH BATTERY BACK-UP OR APPROVED LOCK BOX FOR EMERGENCY VEHICLE ACCESS. GATES SHALL OPEN ALL THE WAY TO 20 FEET FOR FIRE DEPARTMENT ACCESS IN ACCORDANCE WITH NFPA 1, SECTION 18.2.2.2, LATEST EDITION.

8. PLANS SHALL BE IN ACCORDANCE WITH THE FLORIDA FIRE PREVENTION CODE, 7th EDITION.

9. ALL FIRE DEPARTMENT ACCESS ROADS SHALL BE DESIGNED TO WITHSTAND A LOAD OF 43 TONS. (NFPA 1, 18.2.3.5.2)

11. UNLESS NOTED OTHERWISE, IRRIGATION TO BE BY WELL, TO BE PERMITTED SEPARATELY.

10. ALL EXISTING UTILITIES HAVE BEEN FIELD VERIFIED (VERTICALLY AND HORIZONTALLY) AT ALL POINTS OF

CONNECTION AND AT ALL AREAS OF CONFLICT WITH OCU INFRASTRUCTURE.

GRAPHIC SCALE

(IN FEET)

0 50 100

APPROVED 5/29/2024


Digitally signed by Paola

Paola Talavera Date: 2023.06.01 14:18:38 -04'00'

Paola Talavera


FOR THE MANAGER, **ENGINEERING DIVISION** ORANGE COUNTY UTILITIES DEPARTMENT

THIS APPROVAL IS SUBJECT TO EXISTING REQUIREMENTS OF ORANGE COUNTY UTILITIES DIVISION STANDARDS AND SPECIFICATIONS.

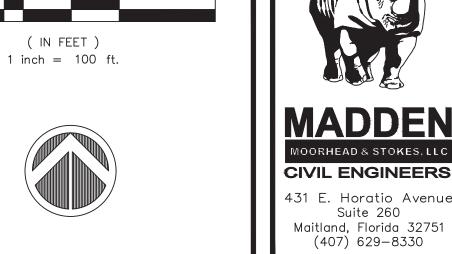


7770007007

JOB #	21097
DATE:	01/09/2024
SCALE:	1"=100'
DESIGNED BY:	BCH
DRAWN BY:	BCH
APPROVED BY:	BSB

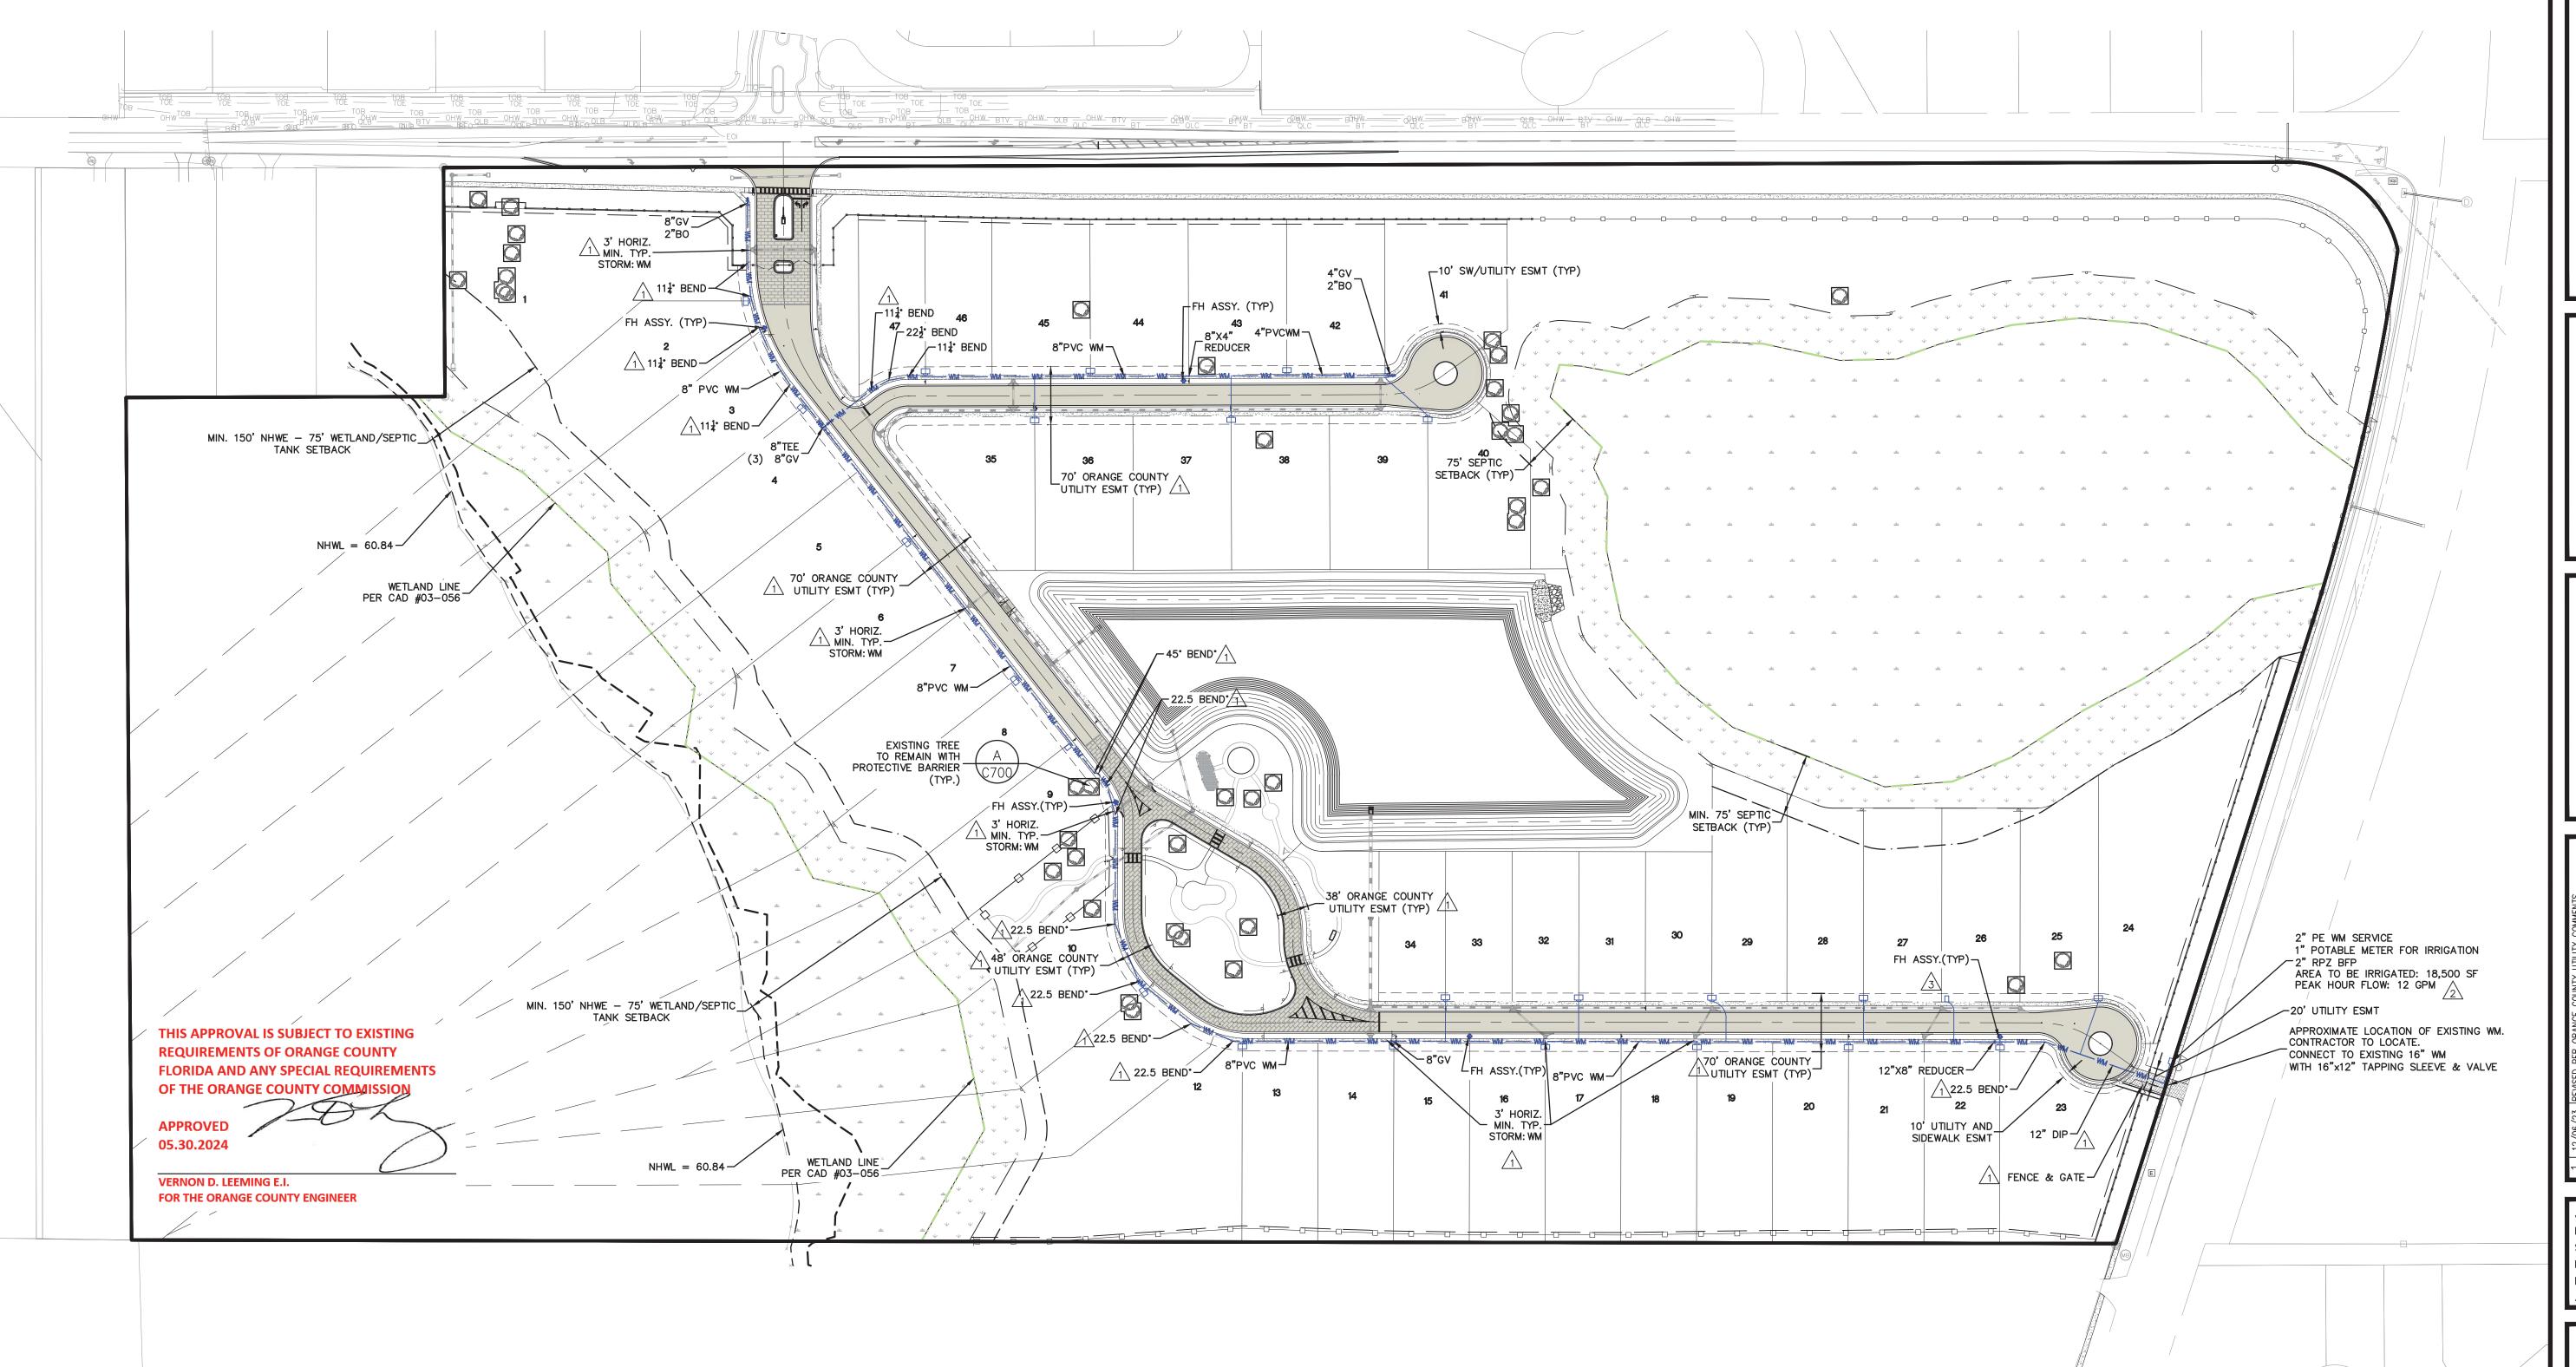

PIPES	DIAN CLIT #	FASTING	NORTHING	ELEVATION.	MAIN TYPE	TYPE OF SHOT	CONSTRUCTION METHOD	MATERIAL	DDESCRIPE OF ASS	MANI IFACTI IDED	COMMENTS
TO NOMBER	TENT OIL F	LAGIII O			WANT THE	THE GO SHOT	CONTROL METHOD	WATER VIOLE	THEODORE OFFICE	manor Actoriza	COMMENTO

\$	PLAN SHT # EASTING	NORTHING	ELEVATION	MAIN TYPE	FITTING TYPE	COMMENTS
	_					
	_					
	+					
	_					
	_					
H						
<u> </u>						

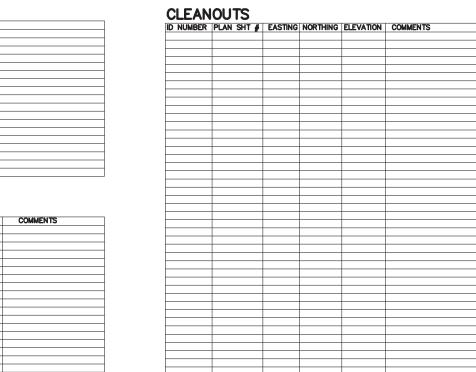

IFT STA	NOITA													
ID NUMBER	PLAN SHT #	EASTING	NORTHING	RIM ELEV.	INVERT ELV N	INVERT ELV NE	INVERT ELV E	INVERT ELV SE	INVERT ELV S	INVERT ELV SW	INVERT ELV W	INVERT ELV NW	MANUFACTURER	COMMENTS
ANHOL		FAORNO	NORTHNO	BW FI FW		IKKERT FLV KIF		W. 1 1. 1	III.	INVEST FIX ON			MANUEL ON IDED	0011171170
		EASTING	NORTHING	RIM ELEV.	INVERT ELV N	INVERT ELV NE	INVERT ELV E	INVERT ELV SE	INVERT ELV S	INVERT ELV SW	INVERT ELV W	INVERT ELV NW	MANUFACTURER	COMMENTS
		EASTING	NORTHING	RIM ELEV.	INVERT ELV N	INVERT ELV NE	INVERT ELV E	INVERT ELV SE	INVERT ELV S	INVERT ELV SW	INVERT ELV W	INVERT ELV NW	MANUFACTURER	COMMENTS
		EASTING	NORTHING	RIM ELEV.	INVERT ELV N	INVERT ELV NE	INVERT ELV E	INVERT ELV SE	INVERT ELV S	INVERT ELV SW	INVERT ELV W	INVERT ELV NW	MANUFACTURER	COMMENTS
		EASTING	NORTHING	RIM ELEV.	INVERT ELV N	INVERT ELV NE	invert elv e	INVERT ELV SE	INVERT ELV S	INVERT ELV SW	INVERT ELV W	INVERT ELV NW	MANUFACTURER	COMMENTS
		EASTING	NORTHING	RIM ELEV.	INVERT ELV N	INVERT ELV NE	INVERT ELV E	invert elv se	INVERT ELV S	INVERT ELV SW	INVERT ELV W	INVERT ELV NW	MANUFACTURER	COMMENTS
		EASTING	NORTHING	RIM ELEV.	INVERT ELV N	INVERT ELV NE	INVERT ELV E	INVERT ELV SE	INVERT ELV S	INVERT ELV SW	INVERT ELV W	INVERT ELV NW	MANUFACTURER	COMMENTS
		EASTING	NORTHING	RIM ELEV.	INVERT ELV N	INVERT ELV NE	INVERT ELV E	INVERT ELV SE	INVERT ELV S	INVERT ELV SW	INVERT ELV W	INVERT ELV NW	MANUFACTURER	COMMENTS
		EASTING	NORTHING	RIM ELEV.	INVERT ELV N	INVERT ELV NE	INVERT ELV E	INVERT ELV SE	INVERT ELV S	INVERT ELV SW	INVERT ELV W	INVERT ELV NW	MANUFACTURER	COMMENTS
		EASTING	NORTHING	RIM ELEV.	INVERT ELV N	INVERT ELV NE	INVERT ELV E	INVERT ELV SE	INVERT ELV S	INVERT ELV SW	INVERT ELV W	INVERT ELV NW	MANUFACTURER	COMMENTS
		EASTING	NORTHING	RIM ELEV.	INVERT ELV N	INVERT ELV NE	INVERT ELV E	INVERT ELV SE	INVERT ELV S	INVERT ELV SW	INVERT ELV W	INVERT ELV NW	MANUFACTURER	COMMENTS

THIS APPROVAL IS SUBJECT TO EXISTING REQUIREMENTS OF ORANGE COUNTY FLORIDA AND ANY SPECIAL REQUIREMENTS OF THE ORANGE COUNTY COMMISSION

05.30.2024

VERNON D. LEEMING E.I. FOR THE ORANGE COUNTY ENGINEER

APPROVED 5/29/2024

Paola Talavera

Digitally signed by Paola
Talavera
Date: 2023.06.01 14:18:38

-04'00' Paola Talavera FOR THE MANAGER, ENGINEERING DIVISION
ORANGE COUNTY UTILITIES DEPARTMENT


THIS APPROVAL IS SUBJECT TO EXISTING REQUIREMENTS OF ORANGE COUNTY UTILITIES DIVISION STANDARDS AND SPECIFICATIONS.

CIVIL ENGINEERS 431 E. Horatio Avenue Suite 260 Maitland, Florida 32751 (407) 629-8330


ORNER

											DATE REVISIONS	L.dwg May 28, 2024 9:50 AM
											DATE	May 28,
-	7	3	4	2	9	7	∞	6	10	11		L.dwg


1"=50 SCALE: ___ DESIGNED BY: ___ DRAWN BY: ____ APPROVED BY: __

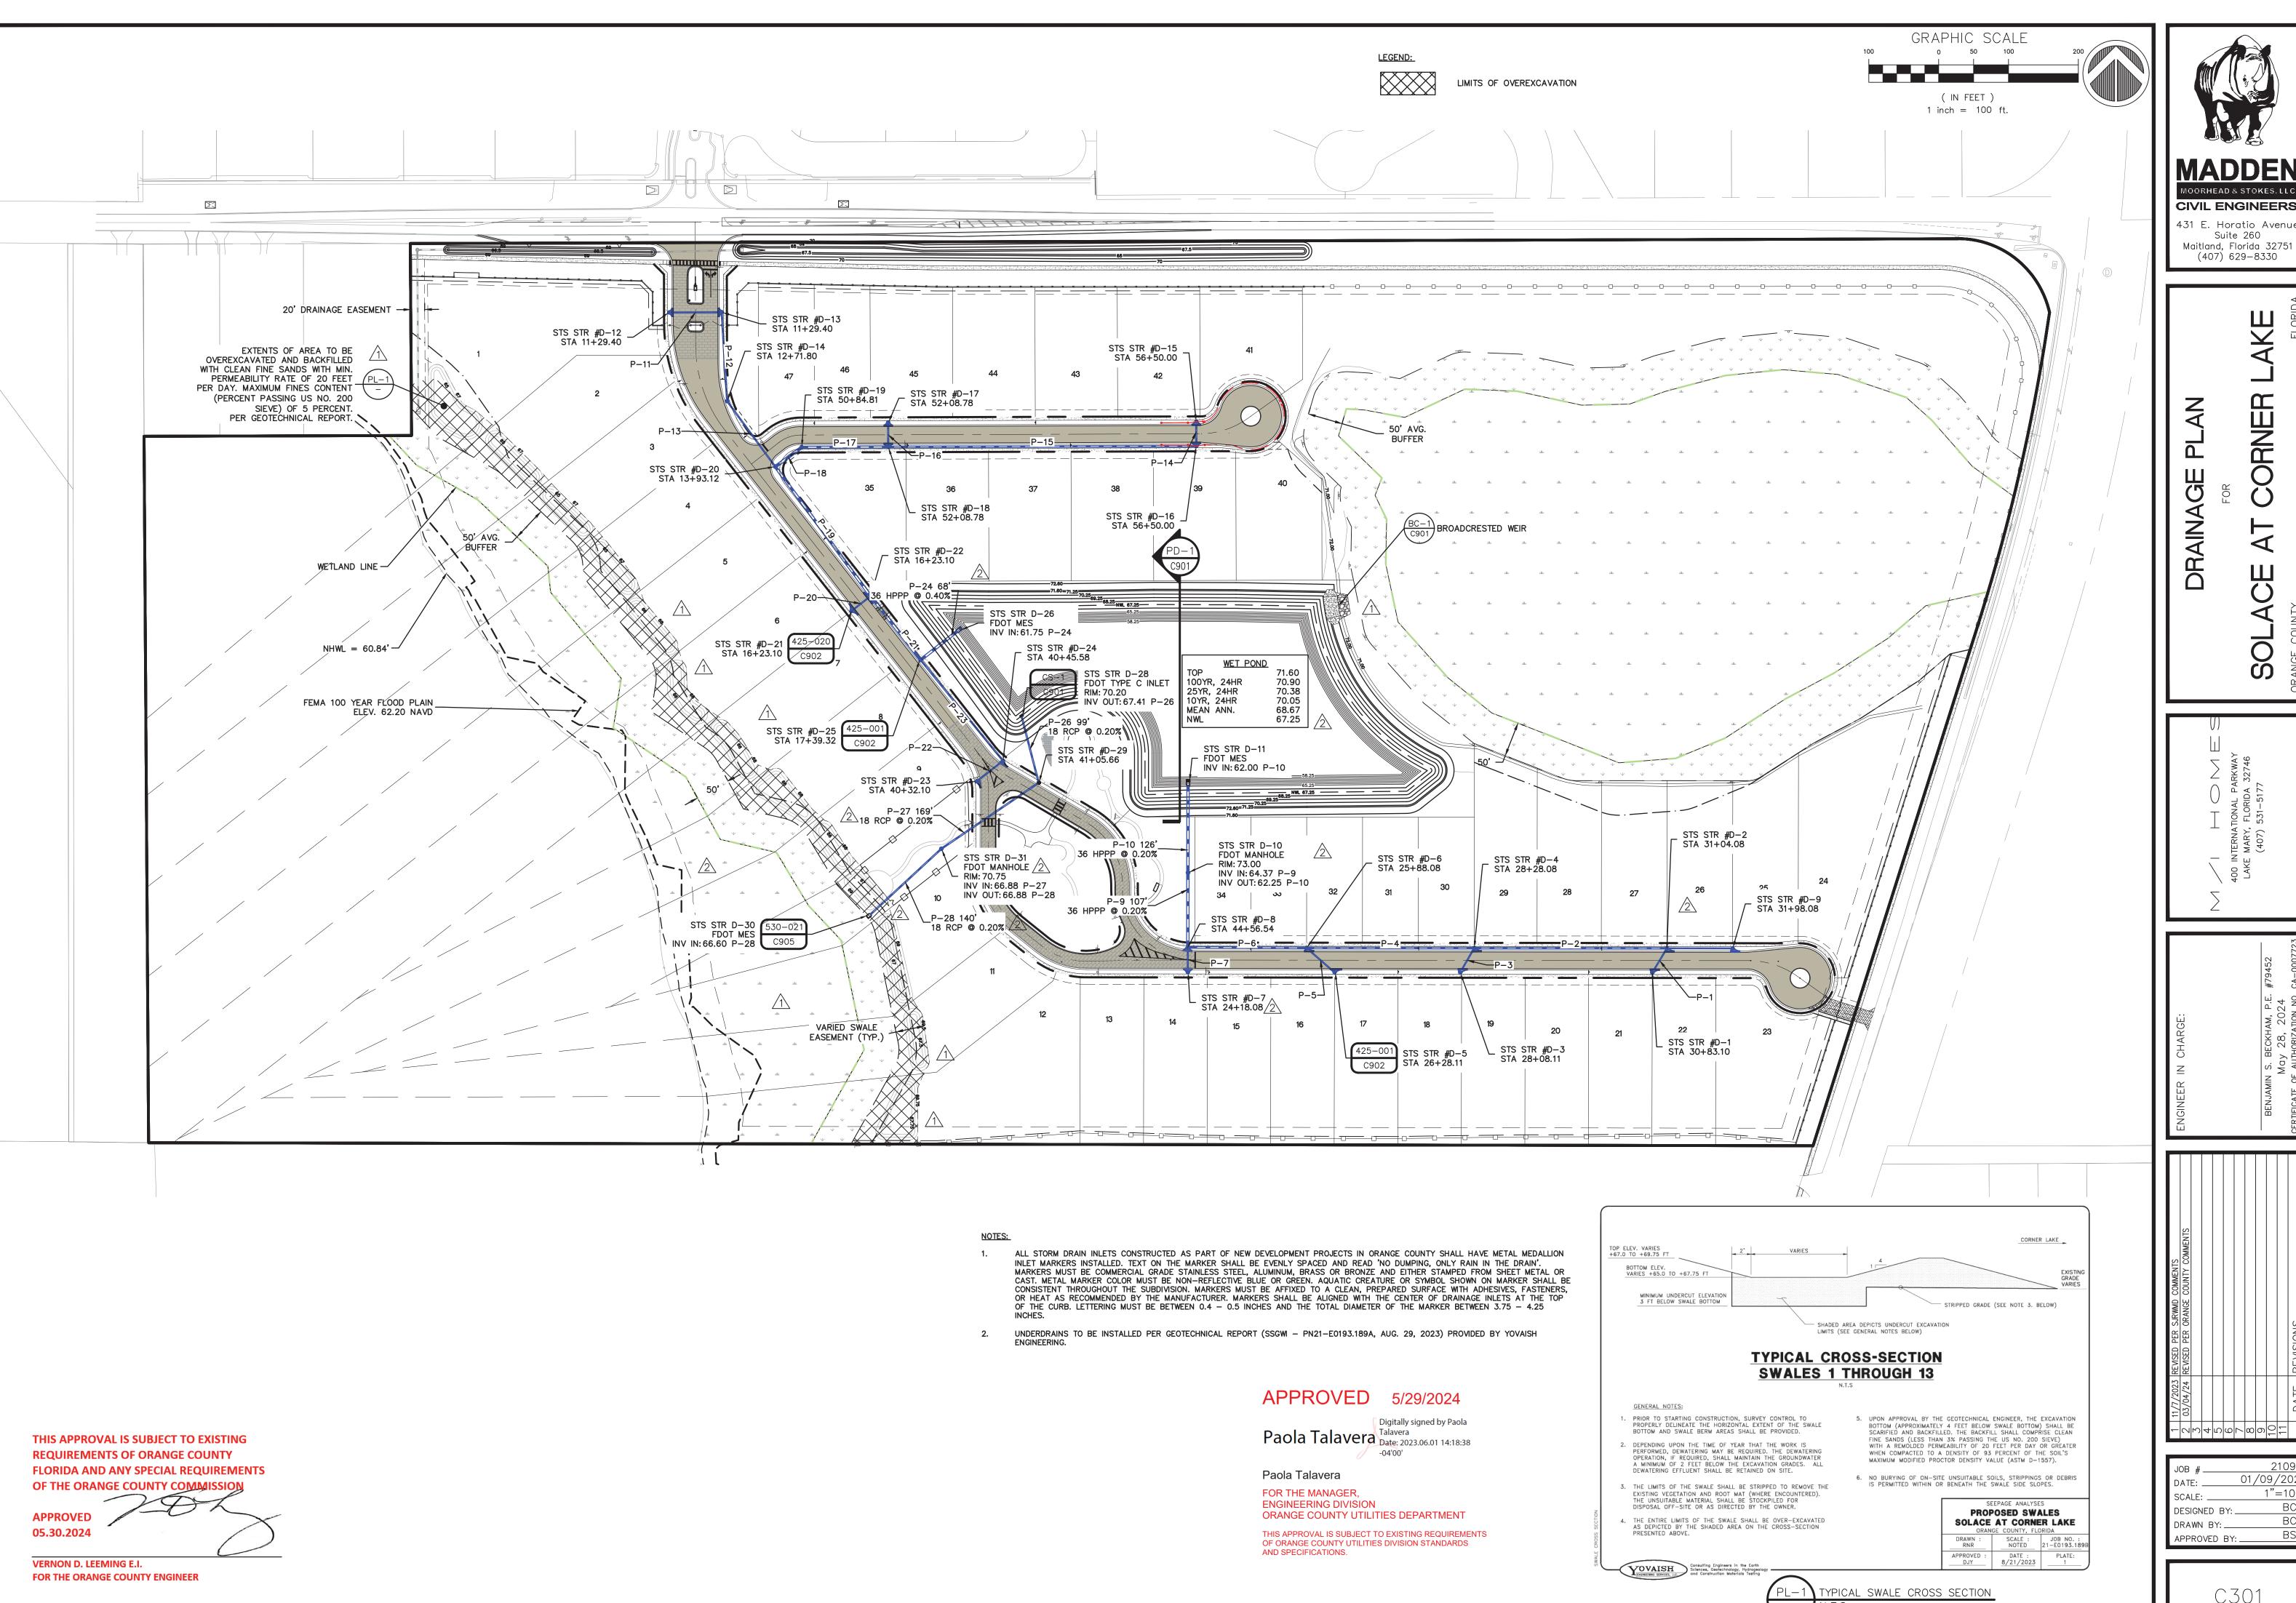


431 E. Horatio Avenue Suite 260 Maitland, Florida 32751 (407) 629-8330

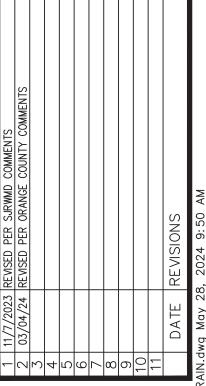

01/09/2 1"=10 SCALE: DESIGNED BY: . DRAWN BY: _ APPROVED BY: _

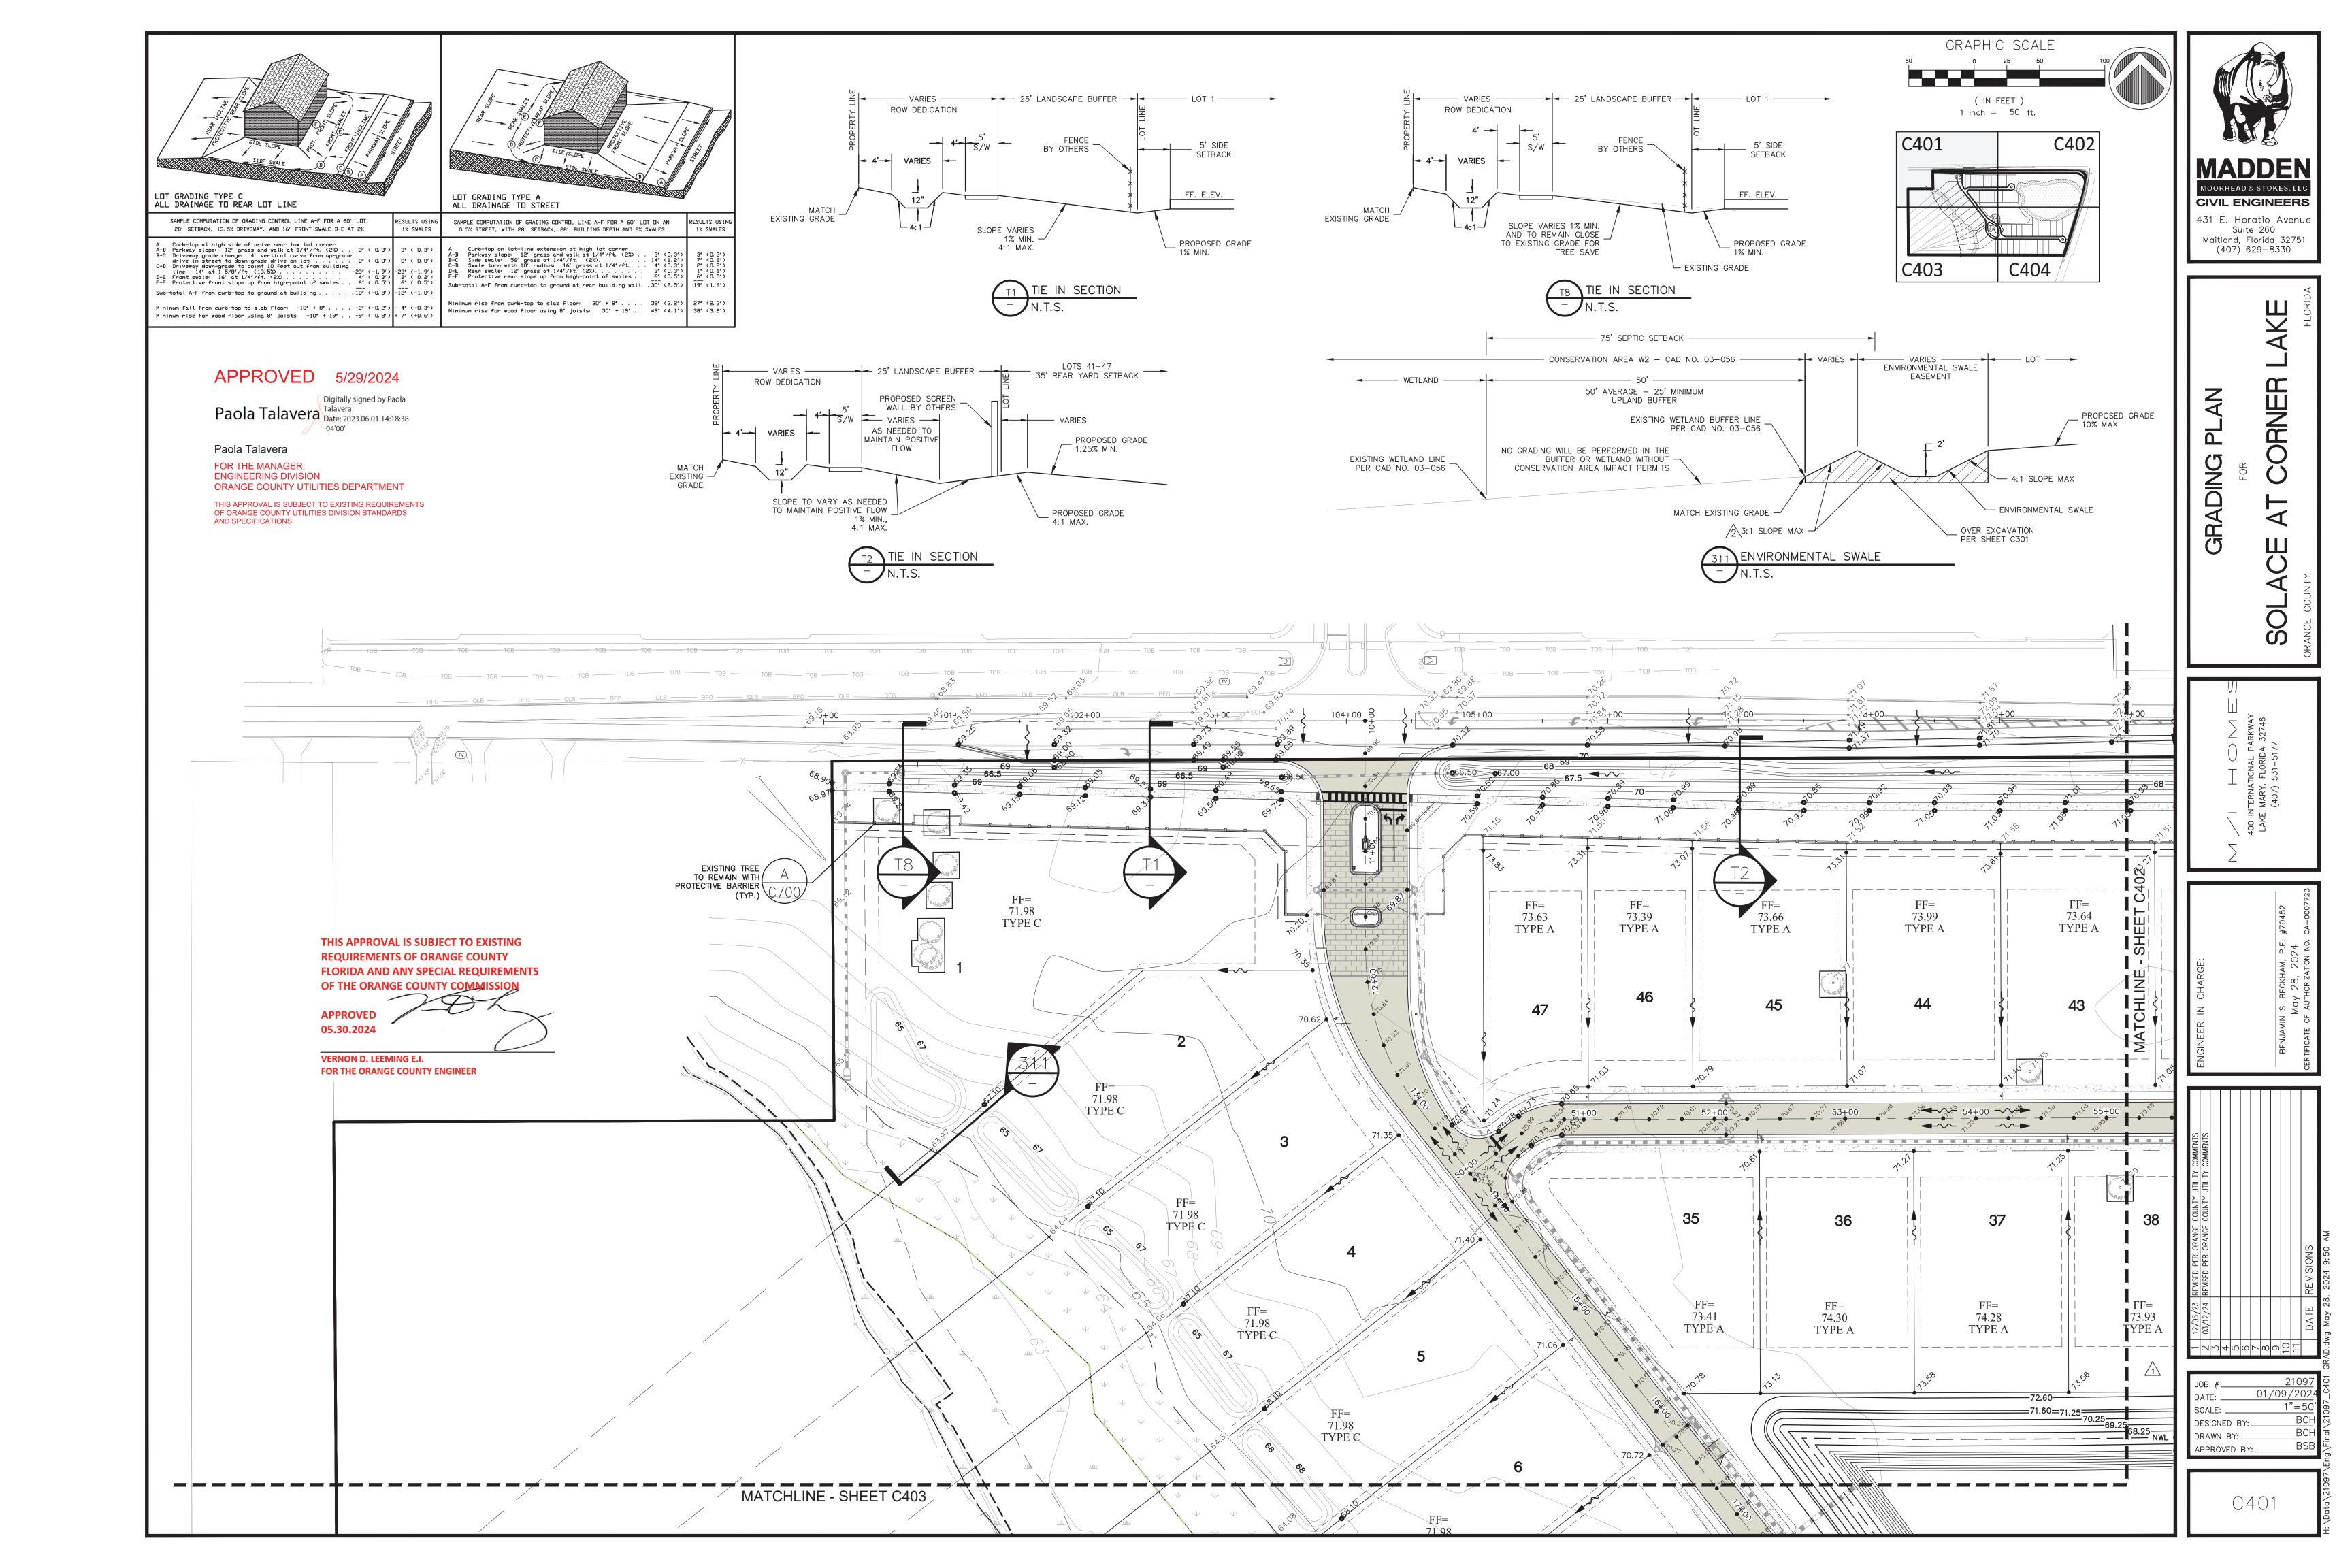

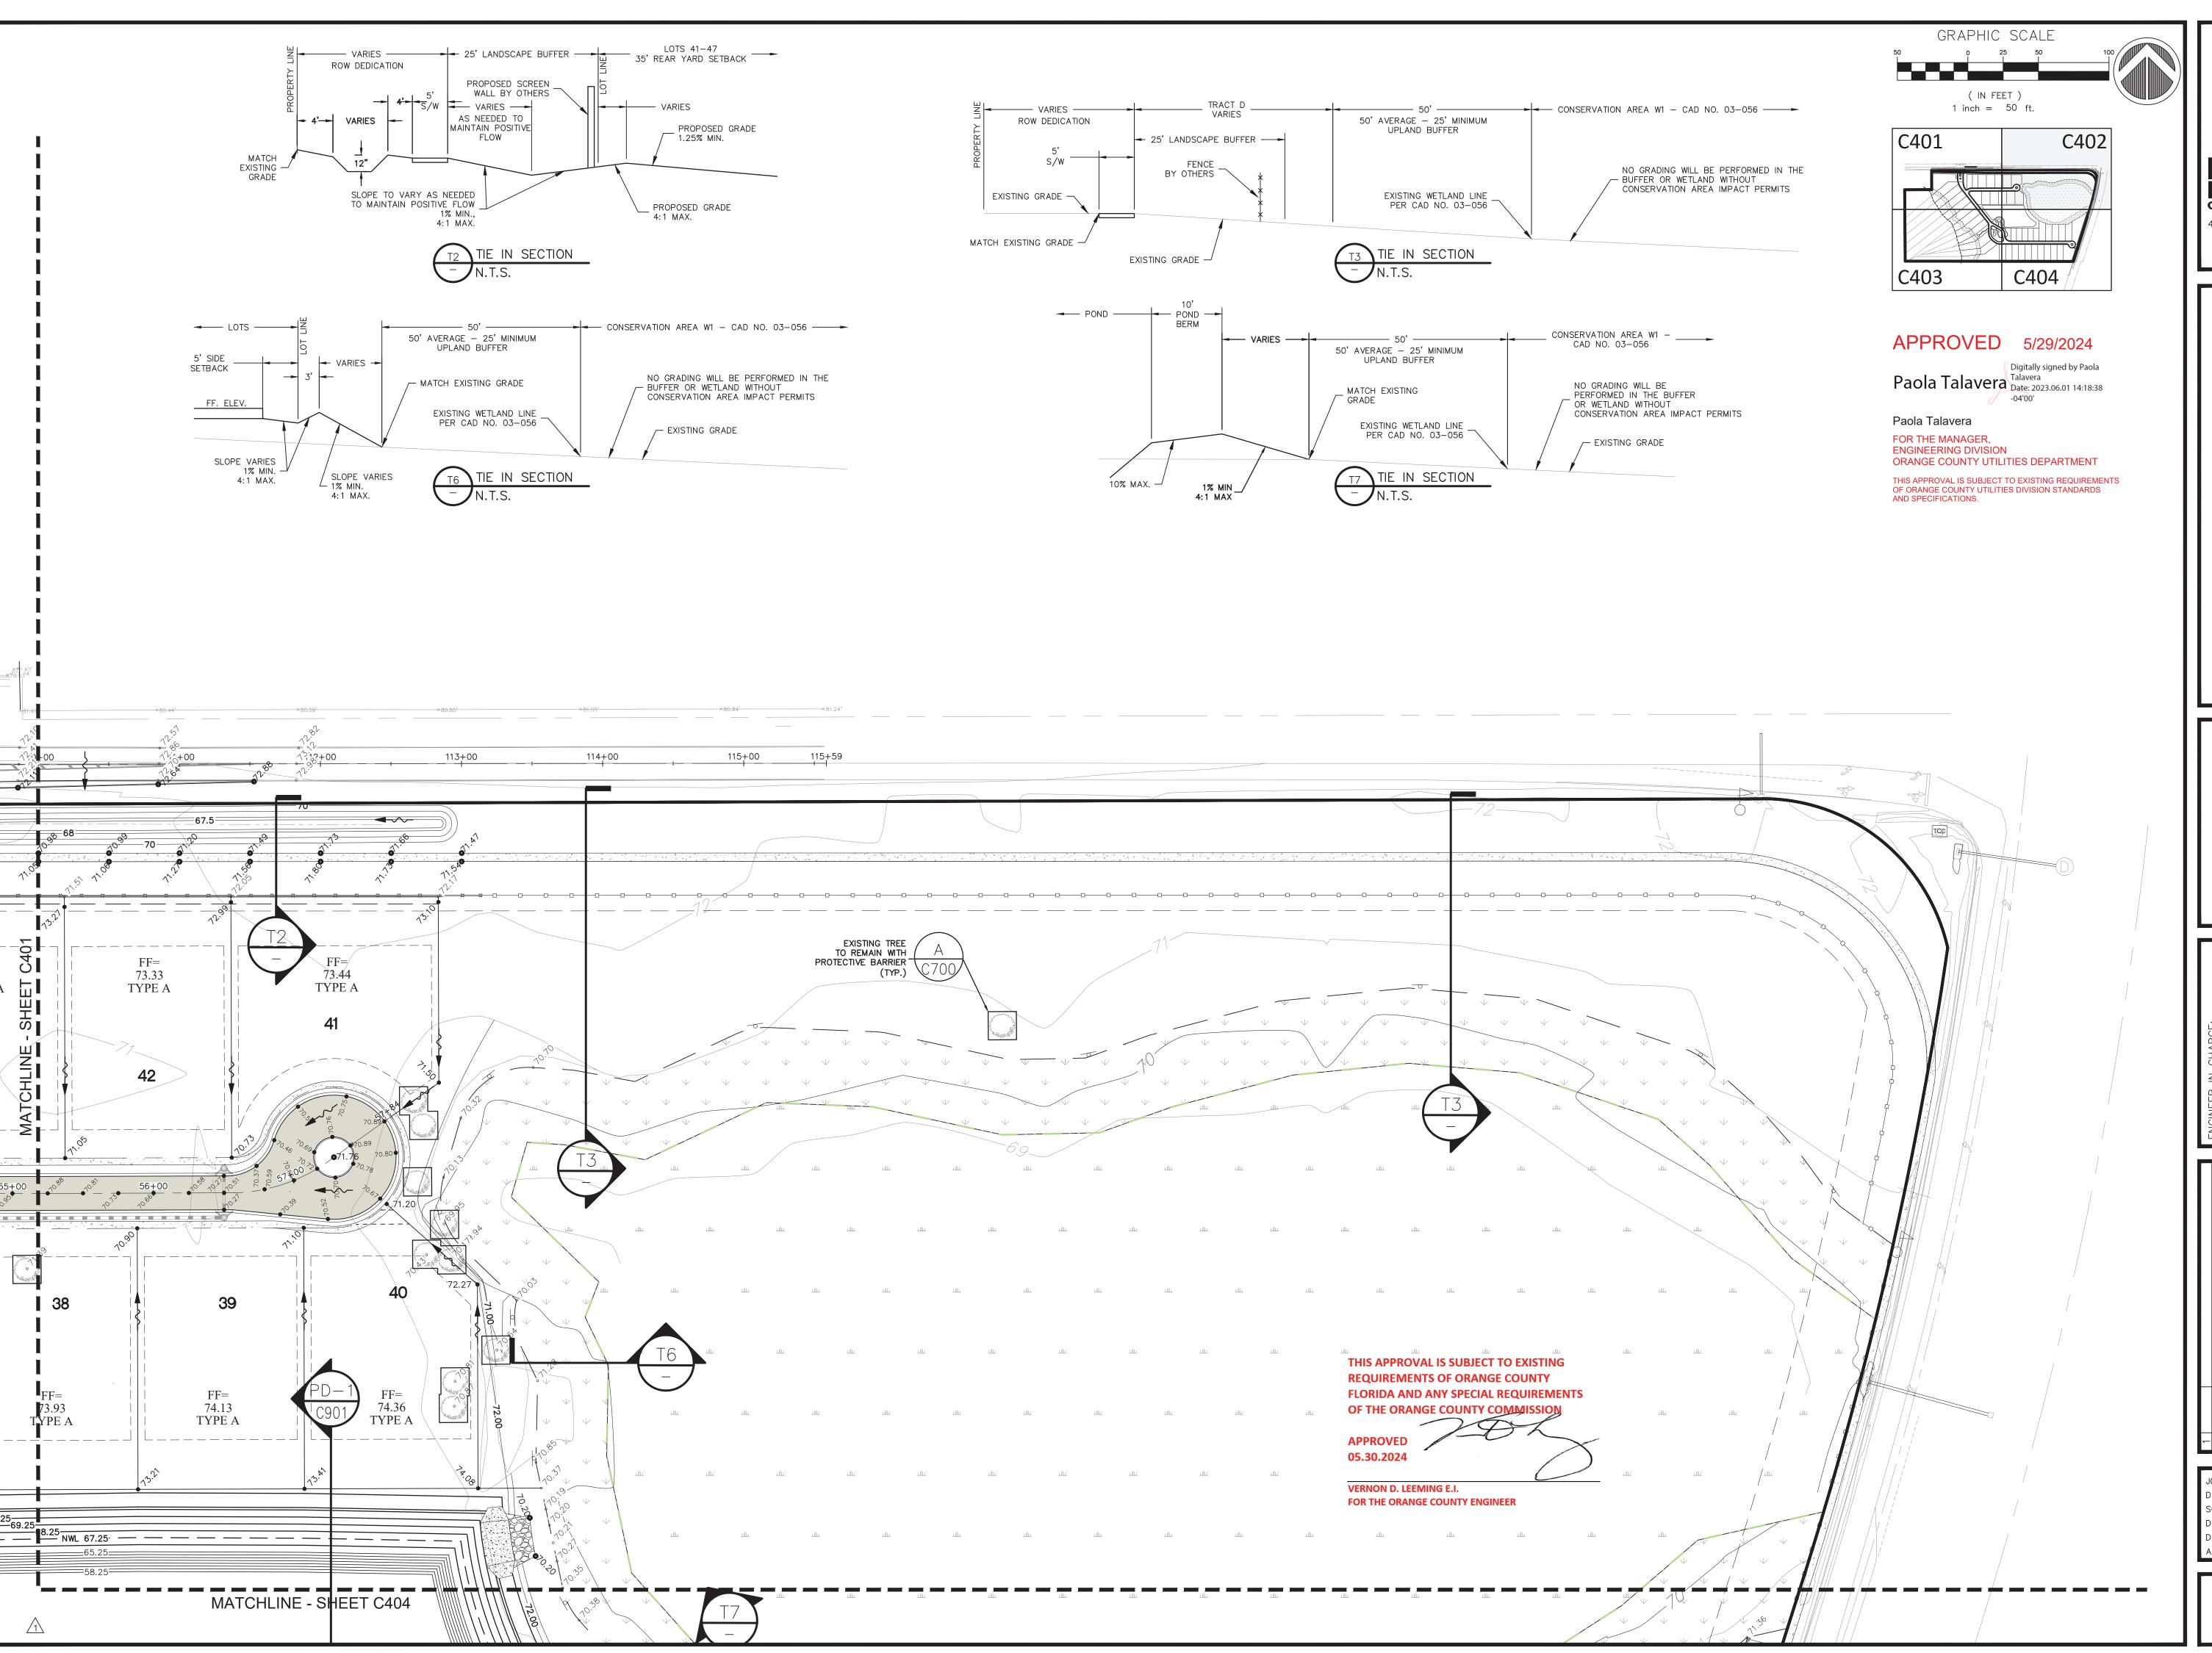




Suite 260 Maitland, Florida 32751 (407) 629-8330


GRADING PLAN
FOR AT CODNIED 1 AVI


400 INTERNATIONAL PARKWAY
LAKE MARY, FLORIDA 32746
(407) 531–5177

SIONS

CERTIFICATE OF A
1 9:50 AM

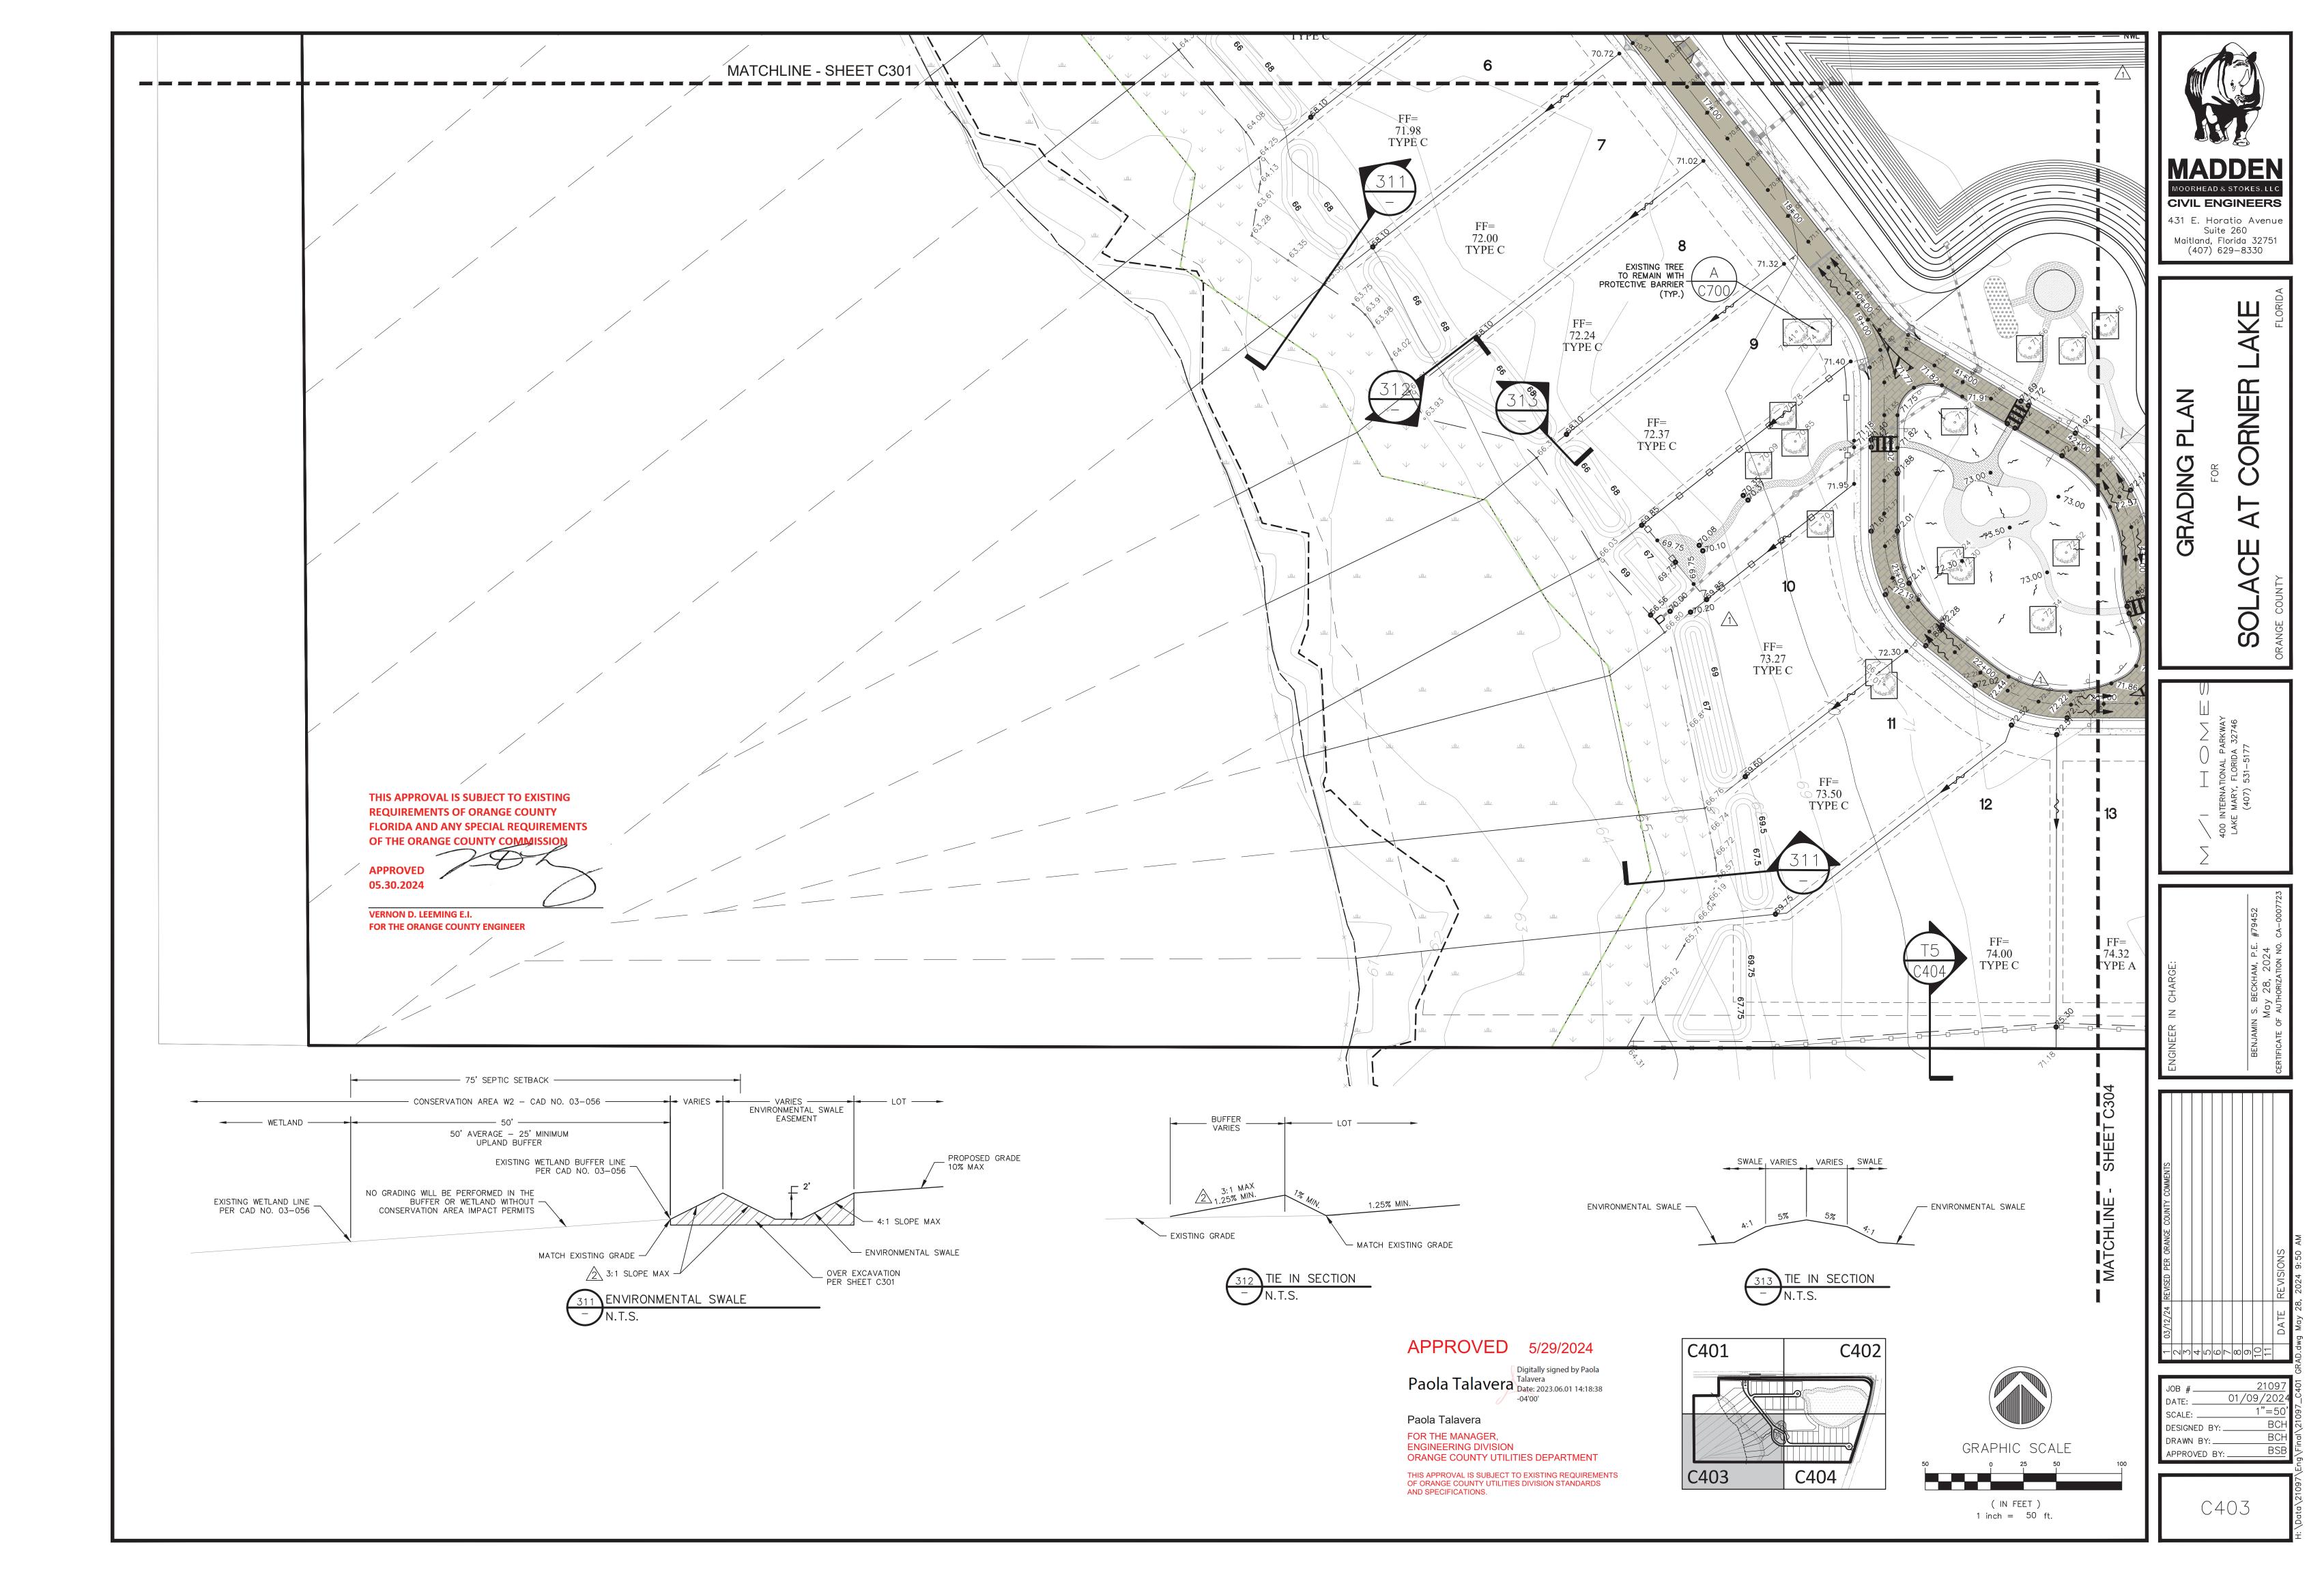

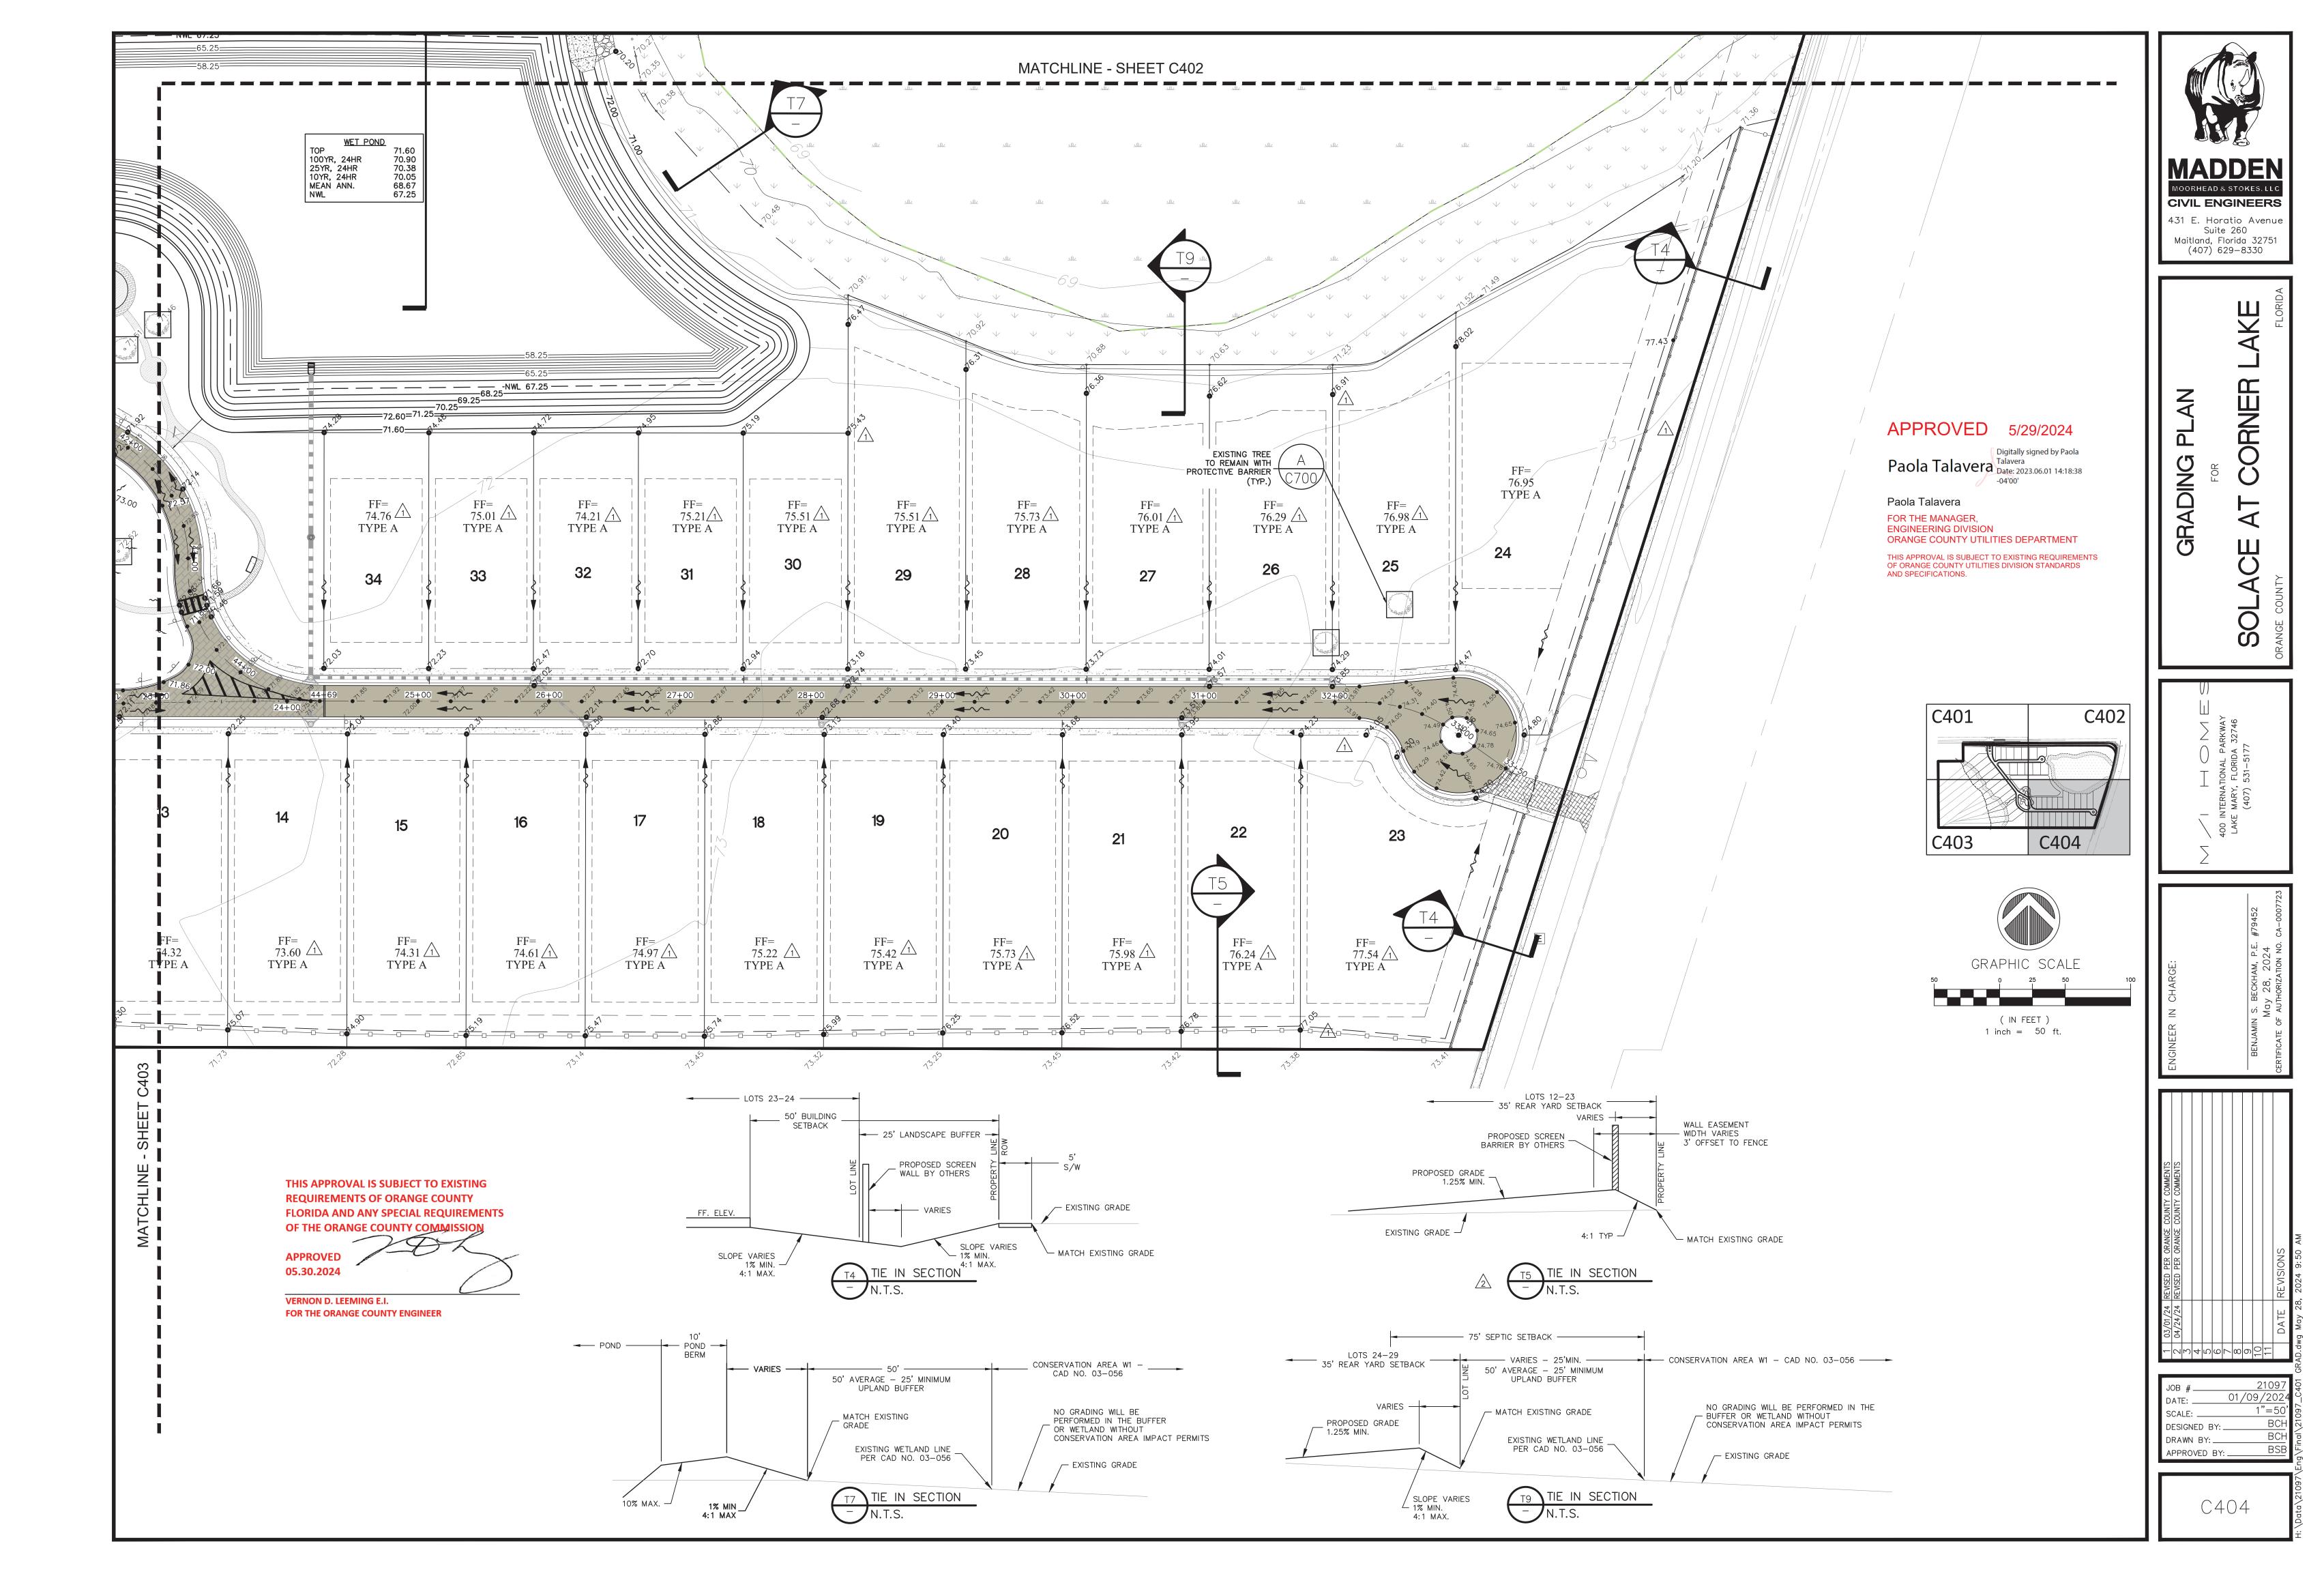

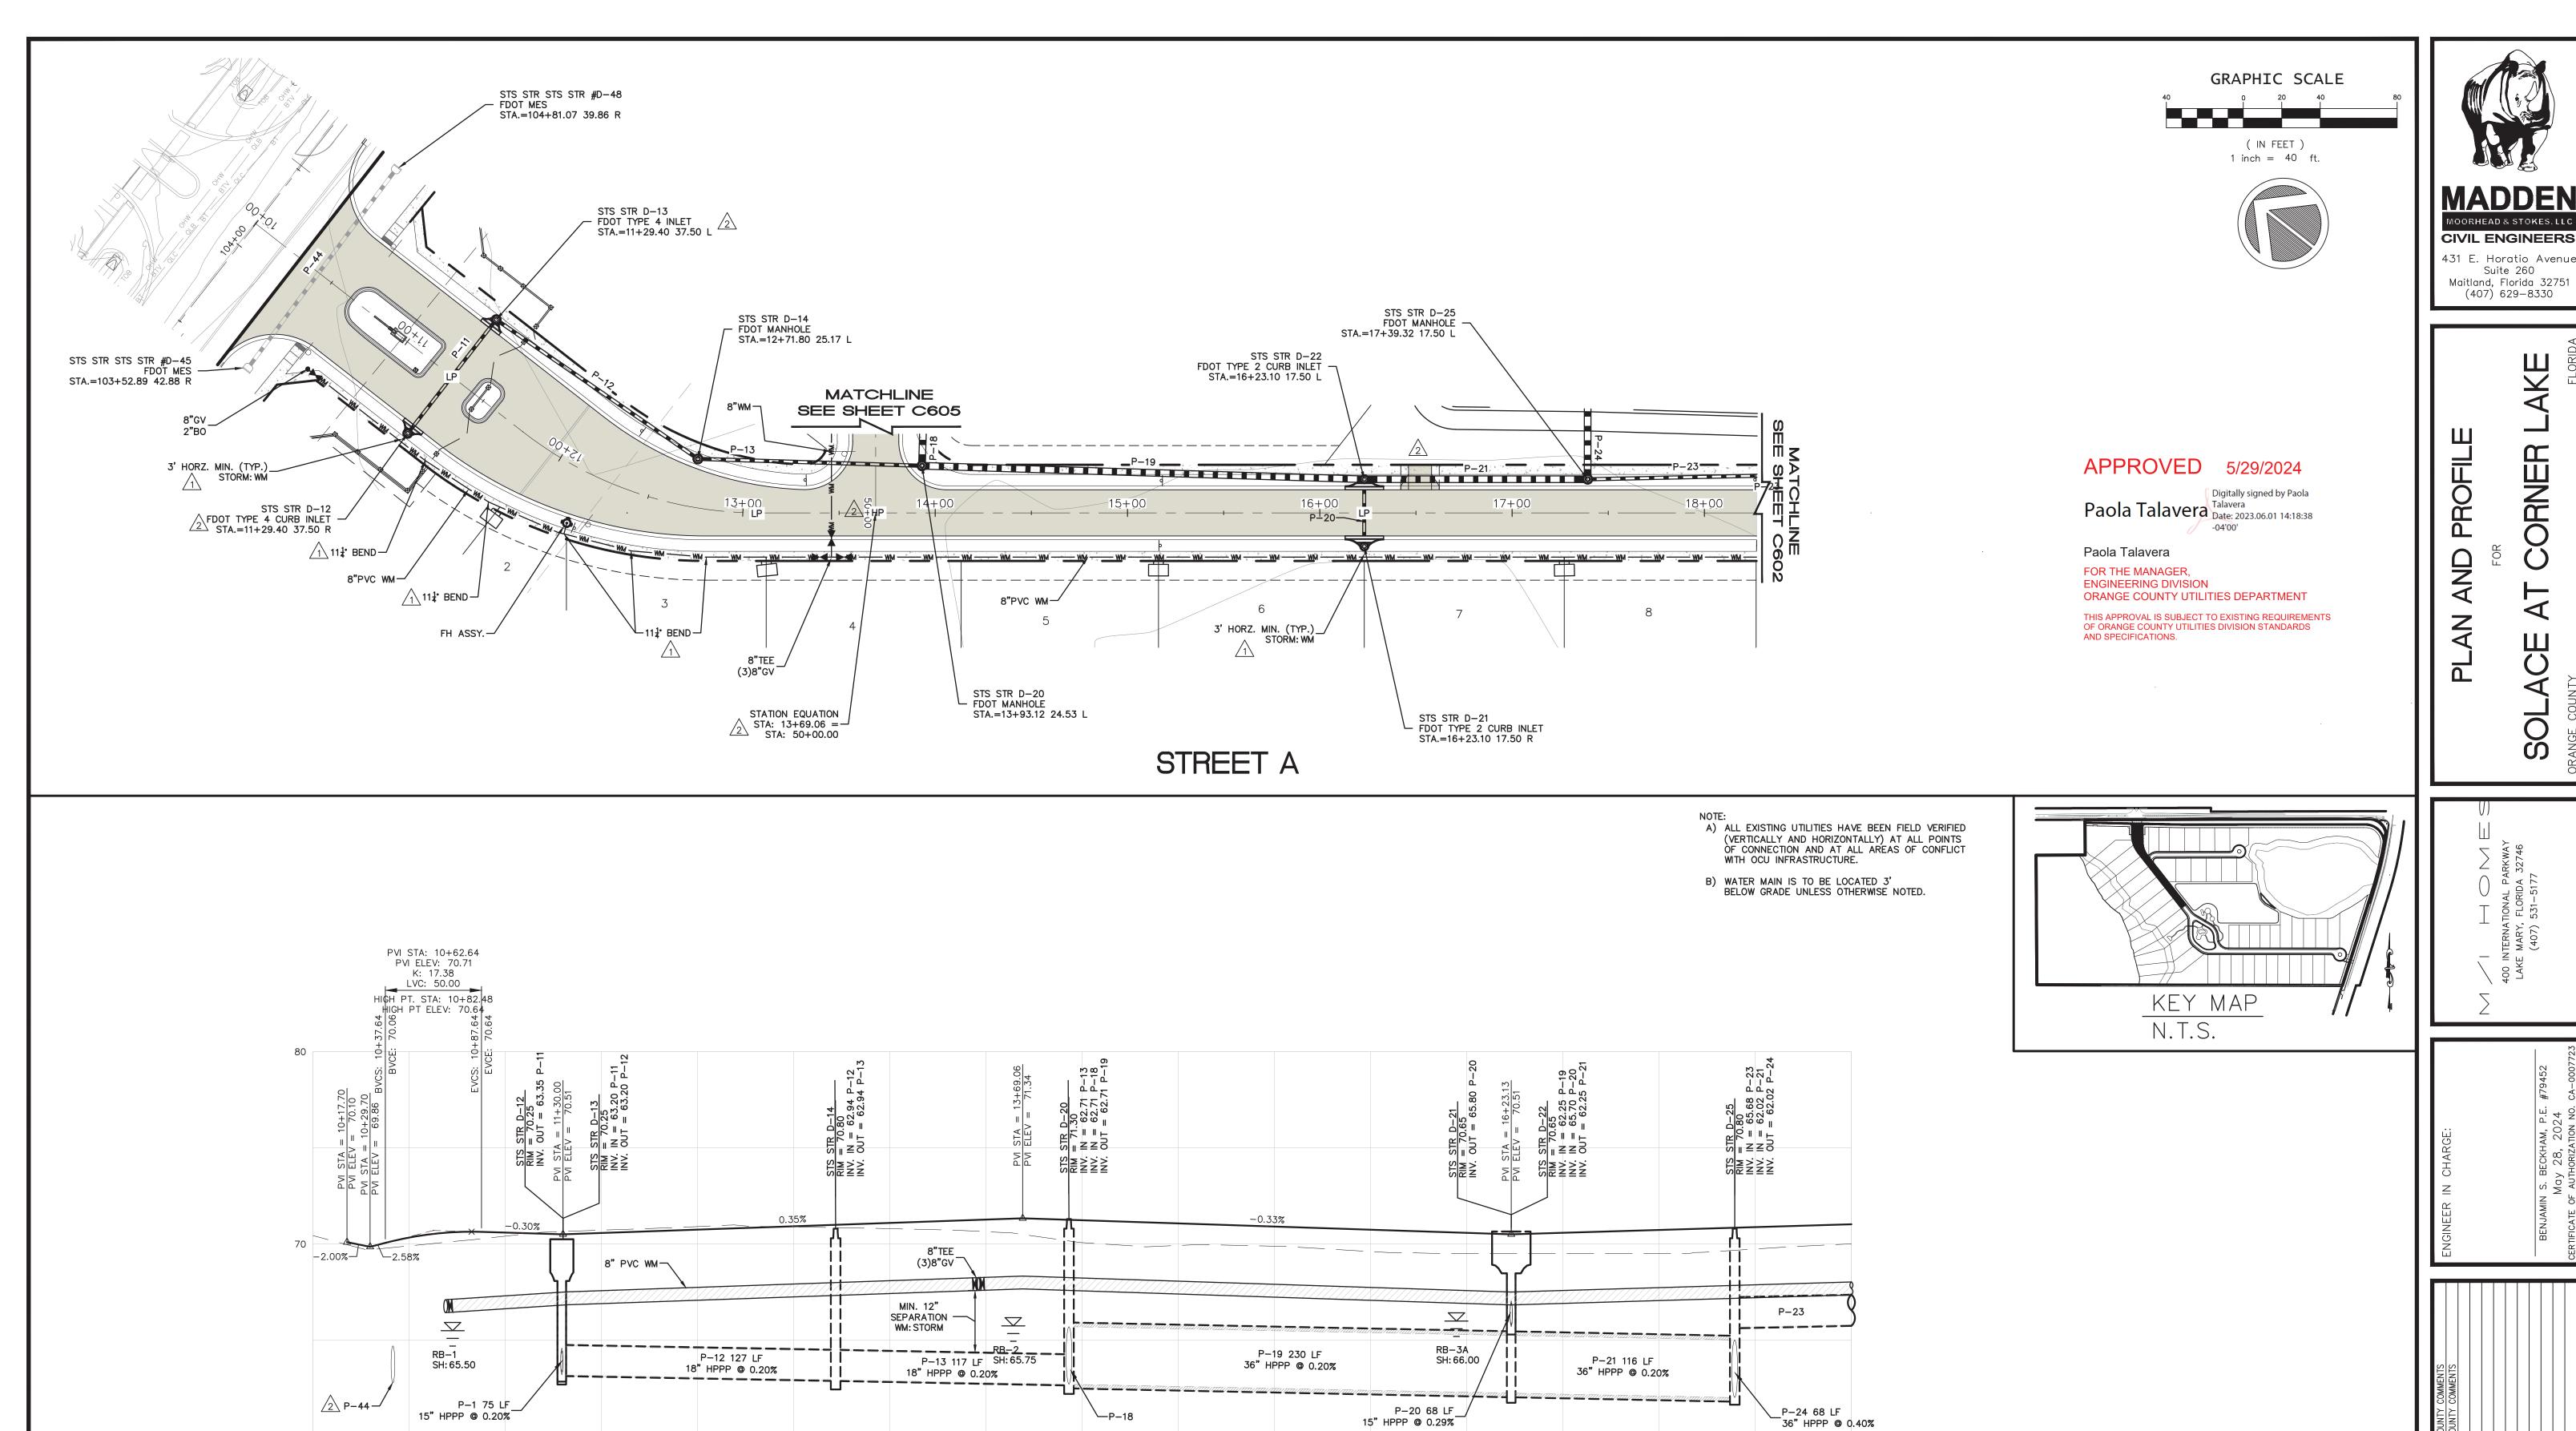

15+00

17+00

16+00

18+00

10+00

11+00

12+00

13+00

14+00


THIS APPROVAL IS SUBJECT TO EXISTING **REQUIREMENTS OF ORANGE COUNTY** FLORIDA AND ANY SPECIAL REQUIREMENTS


05.30.2024

VERNON D. LEEMING E.I. FOR THE ORANGE COUNTY ENGINEER

JOB #	21097
DATE: 01/	09/2024
SCALE: H: 1"=40'	
DESIGNED BY:	BCH_
DRAWN BY:	BCH
APPROVED BY:	BSB

-22420287027

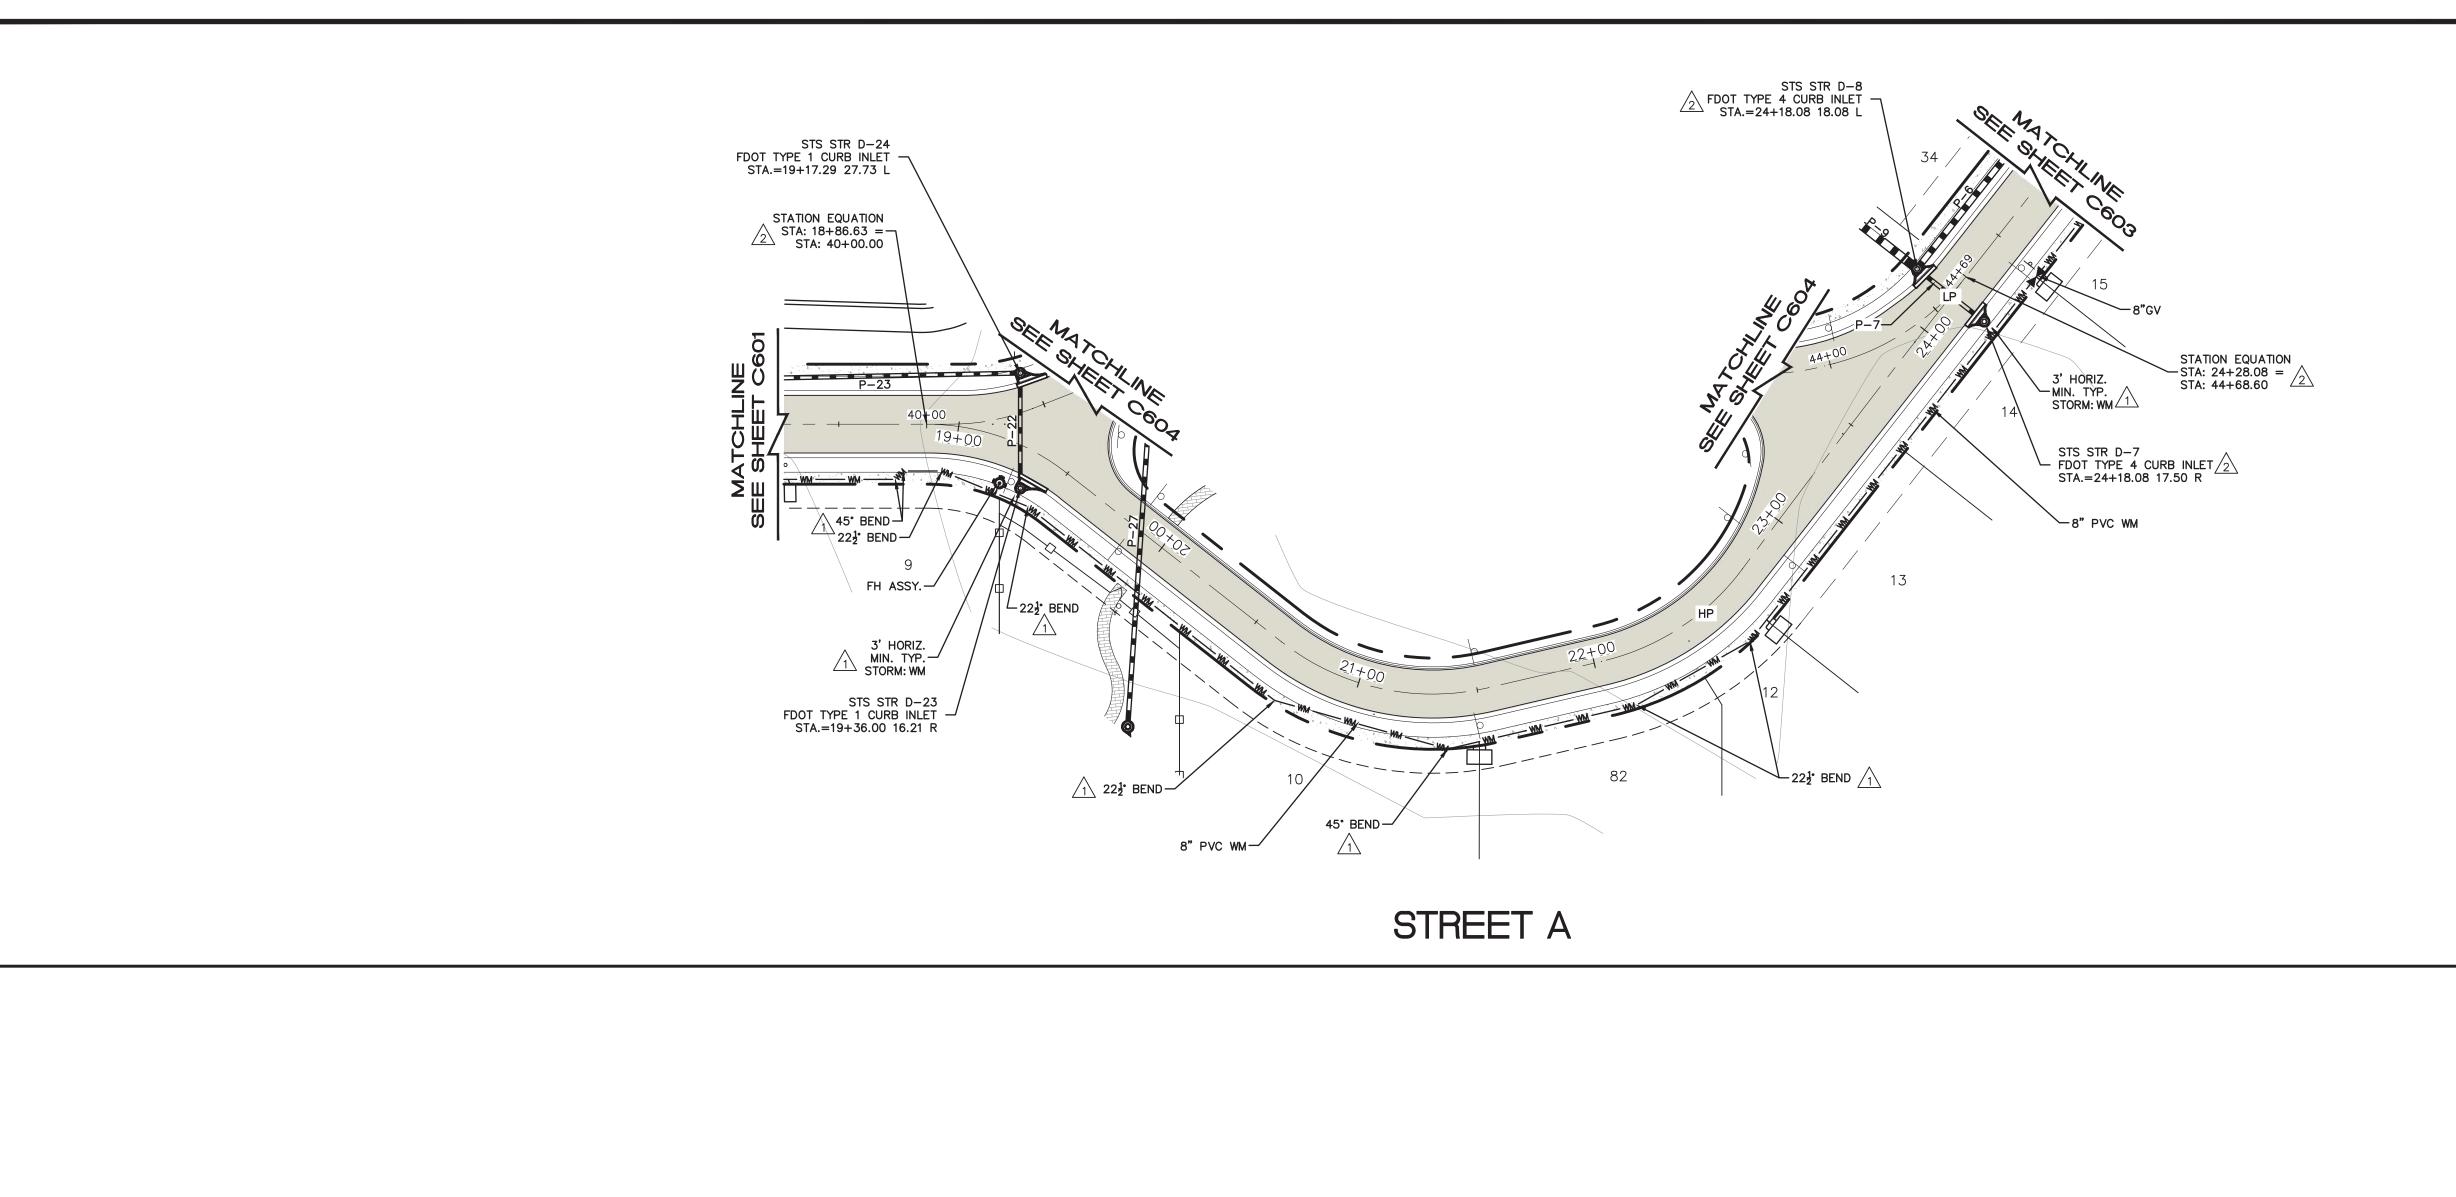

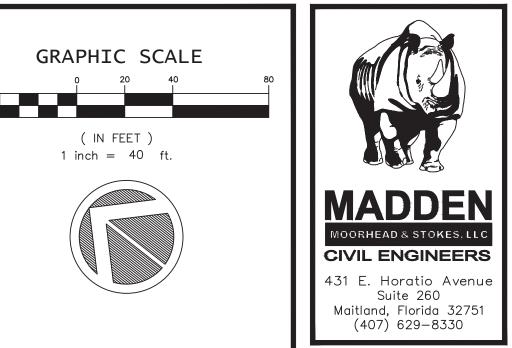

PLAN AND PROFILE

CORNER LAKE

M / I H O M E S
400 INTERNATIONAL PARKWAY
LAKE MARY, FLORIDA 32746
(407) 531–5177

BENJAMIN S. BECKHAM, P.E. #79452

May 28, 2024

CERTIFICATE OF AUTHORIZATION NO. CA-0007723

THIS APPROVAL IS SUBJECT TO EXISTING REQUIREMENTS OF ORANGE COUNTY FLORIDA AND ANY SPECIAL REQUIREMENTS OF THE ORANGE COUNTY COMMISSION

APPROVED 5/29/2024

Paola Talavera Date: 2023.06.01 14:18:38

FOR THE MANAGER, ENGINEERING DIVISION ORANGE COUNTY UTILITIES DEPARTMENT

KEY MAP

N.T.S.

NOTE:

A) ALL EXISTING UTILITIES HAVE BEEN FIELD VERIFIED

(VERTICALLY AND HORIZONTALLY) AT ALL POINTS OF

CONNECTION AND AT ALL AREAS OF CONFLICT WITH

OCU INFRASTRUCTURE.

B) WATER MAIN IS TO BE LOCATED 3' BELOW GRADE UNLESS OTHERWISE NOTED.

THIS APPROVAL IS SUBJECT TO EXISTING REQUIREMENTS OF ORANGE COUNTY UTILITIES DIVISION STANDARDS AND SPECIFICATIONS.


Paola Talavera


-04'00'

Digitally signed by Paola

APPROVED 05.30.2024

VERNON D. LEEMING E.I.
FOR THE ORANGE COUNTY ENGINEER

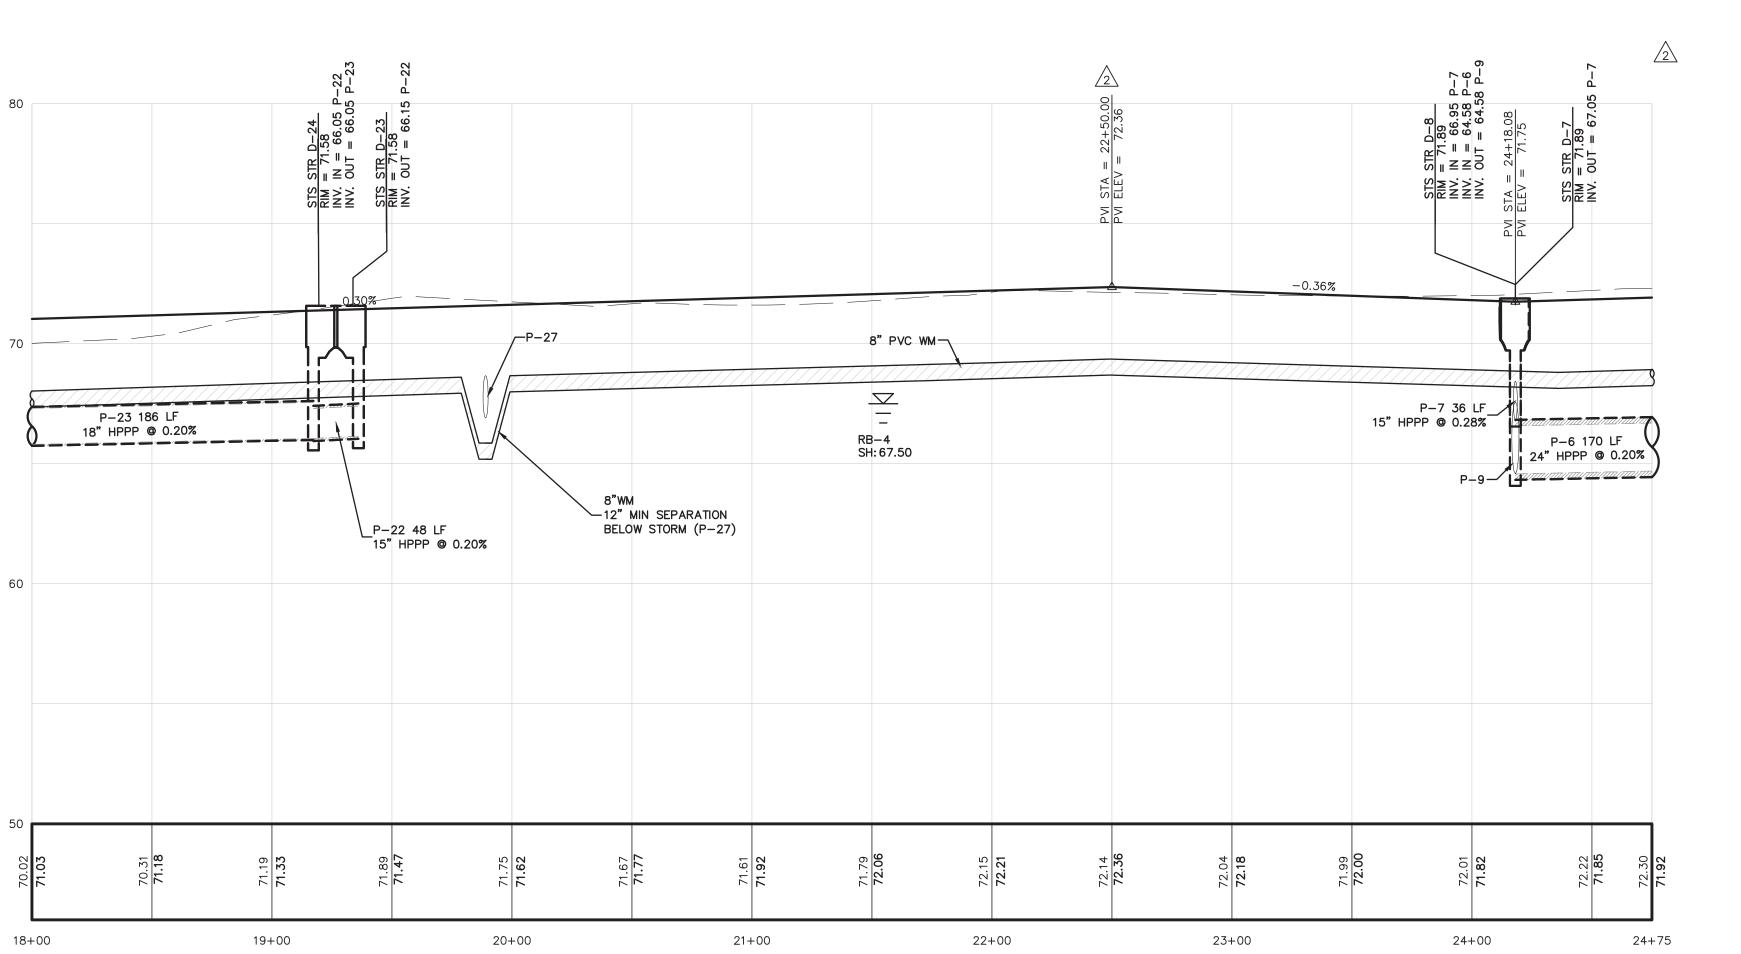

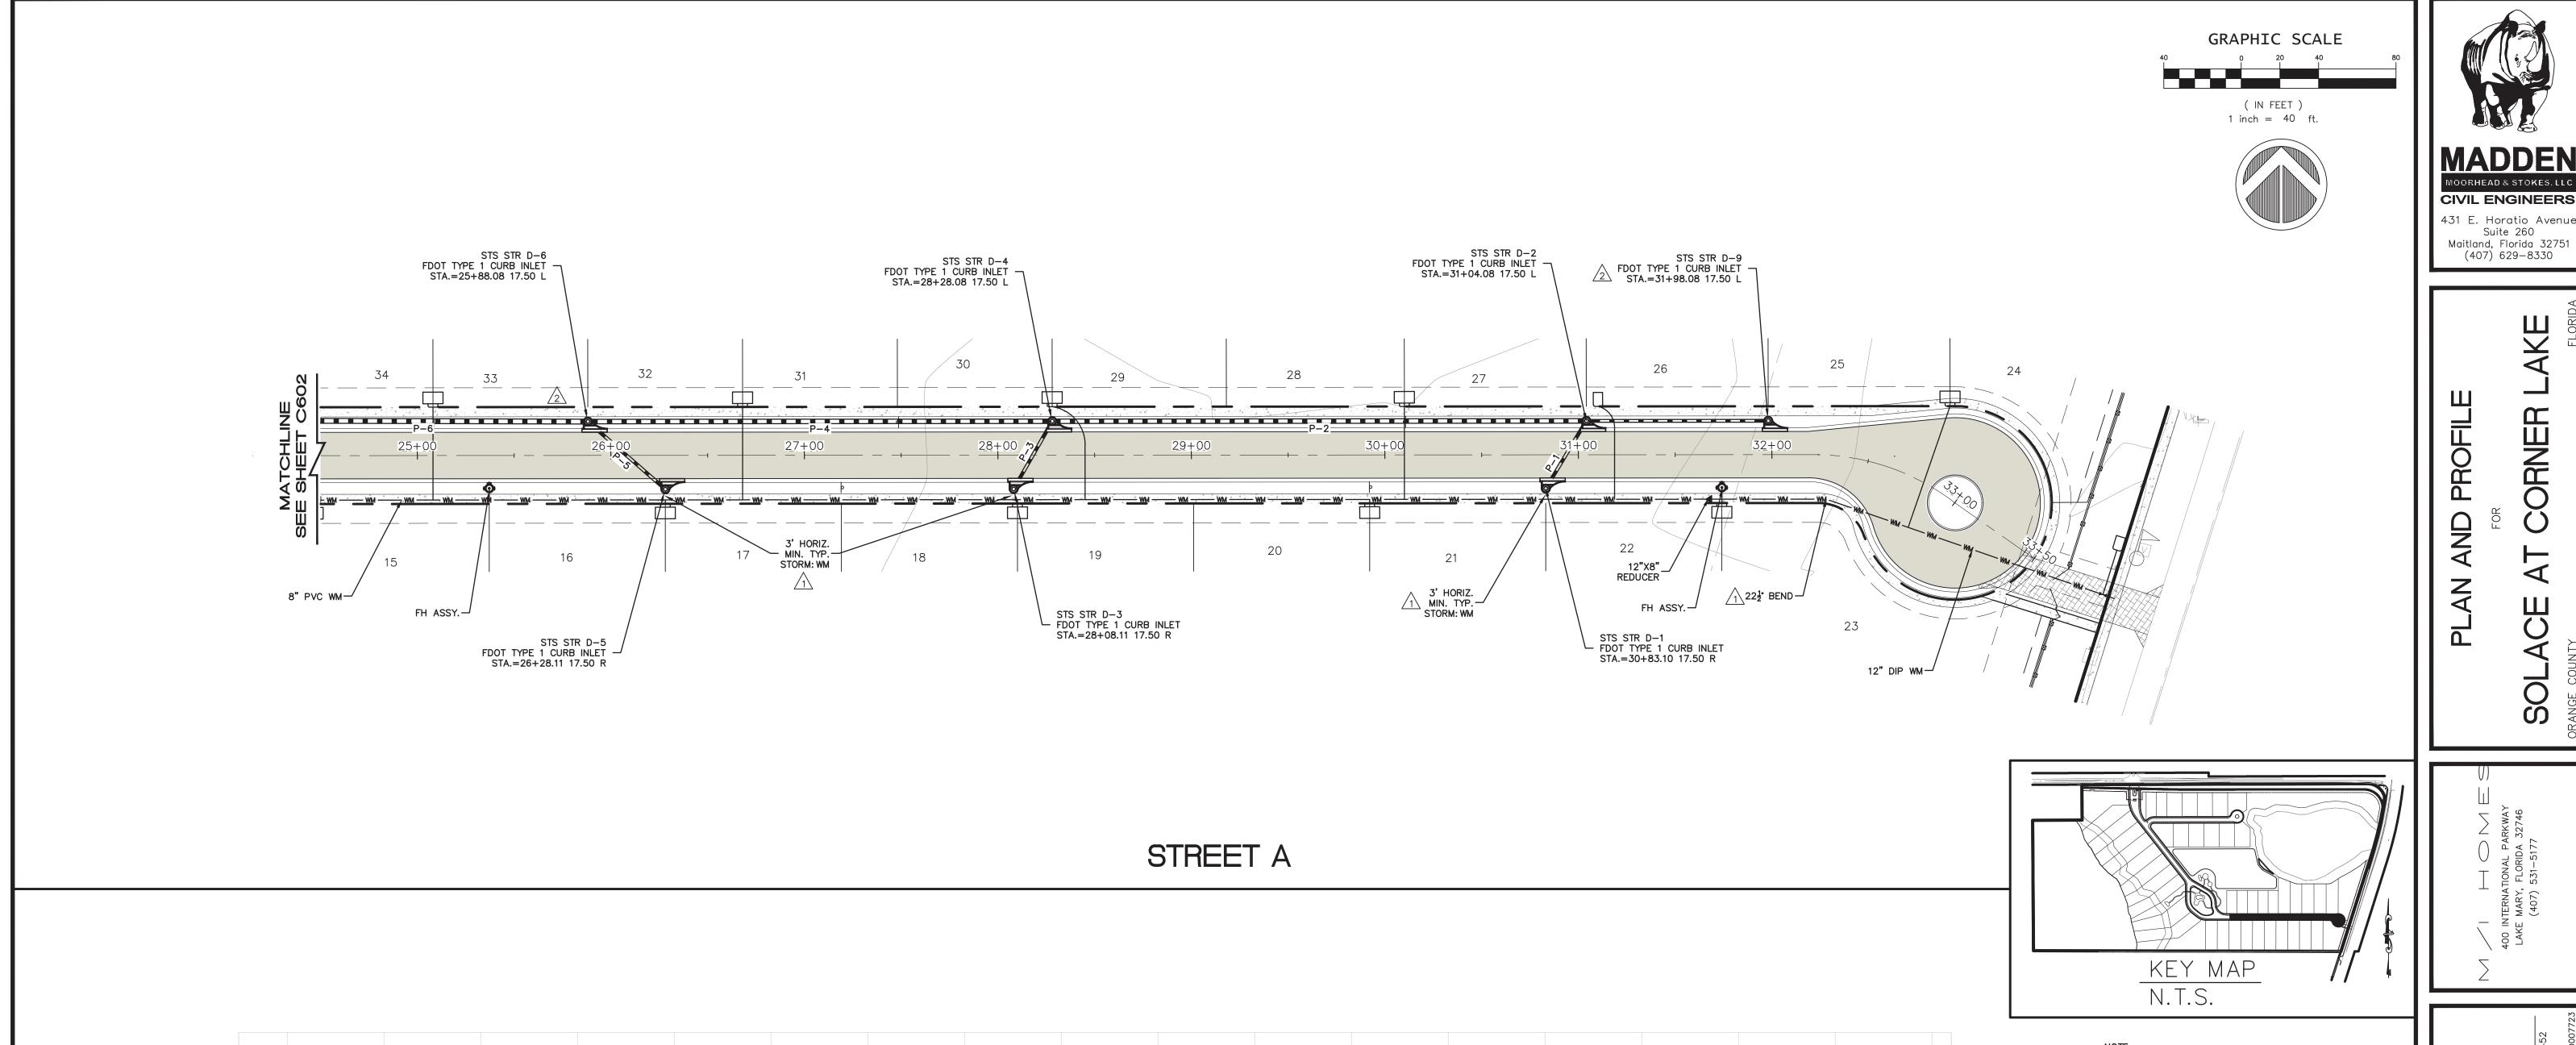

STR D-6 = 72.40 IN = 64.92 IN = 67.65 IN = 67.65 IOUT = 64.92

26+00

P-5 53 LF_ 15" HPPP @ 0.28%

P-6 170 LF 24" HPPP @ 0.20%

24+75 25+00

P-3 40'_ 15 HPPP @ 0.25%

24" HPPP @ 0.20%

27+00

SII: 70.00

| Part | Pa

28+00

STR D-2 = 73.95 IN = 69.00 P-1 IN = 66.38 P-25 OUT = 66.38 P-2

31 + 00

P-1 41 LF 15" HPPP @ 0.25%

30+00

29+00

__12"X8" /__REDUCER

32+00

| | P-25 94' 15 HPPP @ 0.20% /2

A) ALL EXISTING UTILITIES HAVE BEEN FIELD VERIFIED

(VERTICALLY AND HORIZONTALLY) AT ALL POINTS OF

CONNECTION AND AT ALL AREAS OF CONFLICT WITH

OCU INFRASTRUCTURE.

B) WATER MAIN IS TO BE LOCATED 3' BELOW GRADE UNLESS OTHERWISE NOTED.

THIS APPROVAL IS SUBJECT TO EXISTING **REQUIREMENTS OF ORANGE COUNTY** FLORIDA AND ANY SPECIAL REQUIREMENTS

05.30.2024

0.48%

33+00

33+60

VERNON D. LEEMING E.I. FOR THE ORANGE COUNTY ENGINEER

APPROVED 5/29/2024

Paola Talavera
Digitally signed by Paola
Talavera
Date: 2023.06.01 14:18:38

Paola Talavera FOR THE MANAGER, ENGINEERING DIVISION
ORANGE COUNTY UTILITIES DEPARTMENT THIS APPROVAL IS SUBJECT TO EXISTING REQUIREMENTS OF ORANGE COUNTY UTILITIES DIVISION STANDARDS AND SPECIFICATIONS.


-04'00'


Suite 260

ORNER

-2245070021

01/09/2 SCALE: H: 1"=50' V: 1"= DESIGNED BY: __ DRAWN BY:___ APPROVED BY: ___

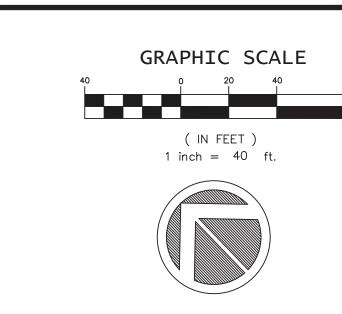

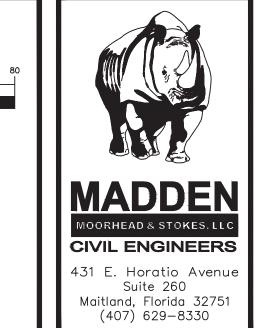

PROFILE
ORNER LAKE

PLAN AND PROFILE

400 INTERNATIONAL PARKWAY
LAKE MARY, FLORIDA 32746
(407) 531–5177


BENJAMIN S. BECKHAM, P.E. #79452 May 28, 2024 CERTIFICATE OF AUTHORIZATION NO. CA-0007723

1/24 REVISED PER ORANGE COUNTY COMMENTS


TE REVISIONS


C604

APPROVED BY: __

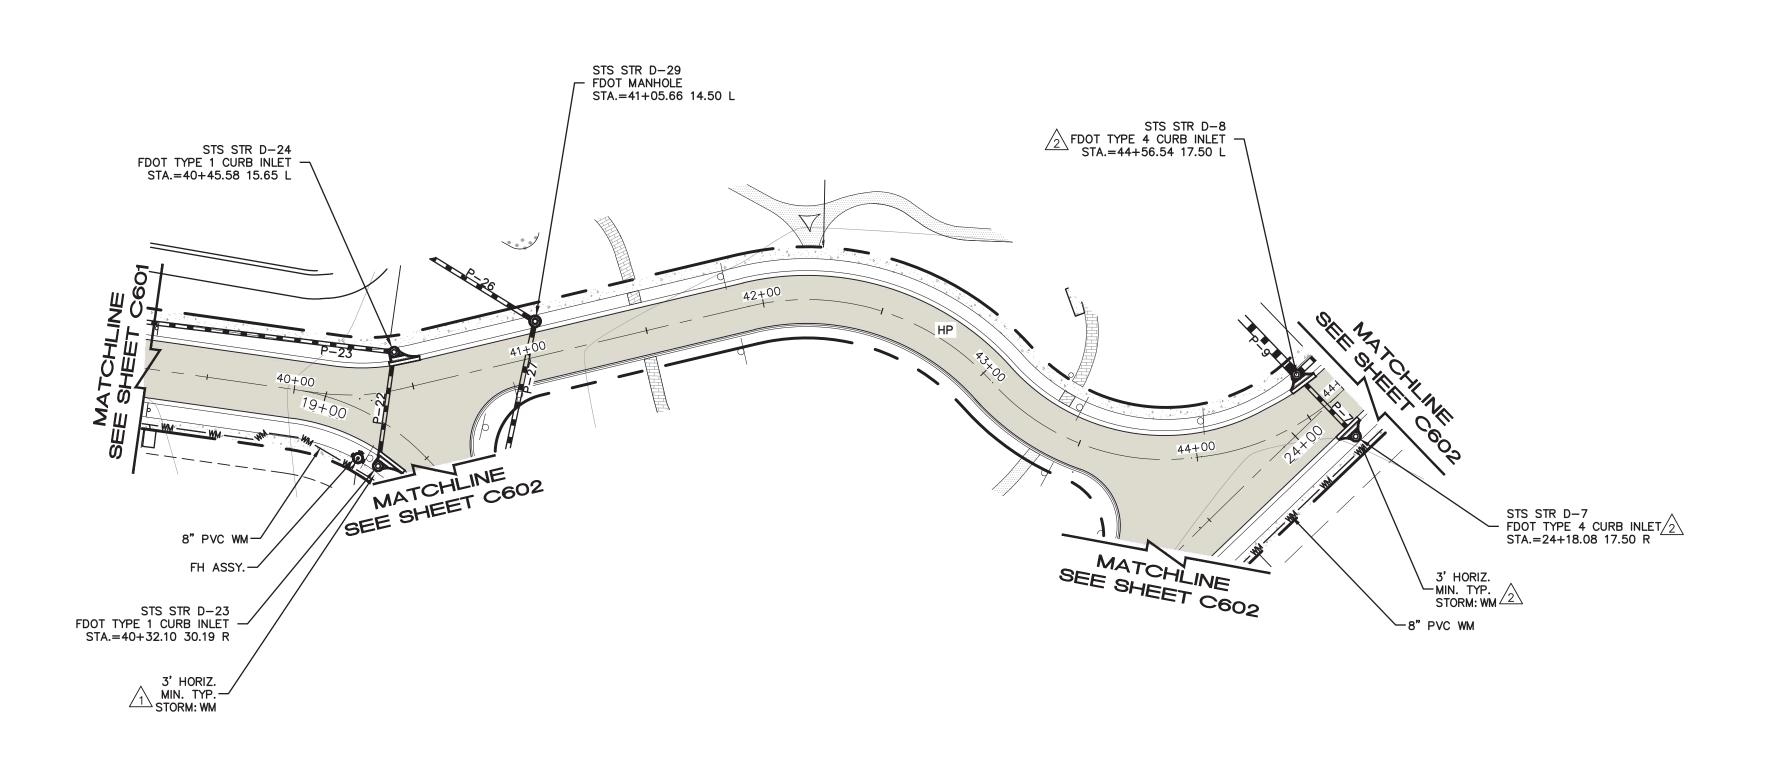

STREET A2

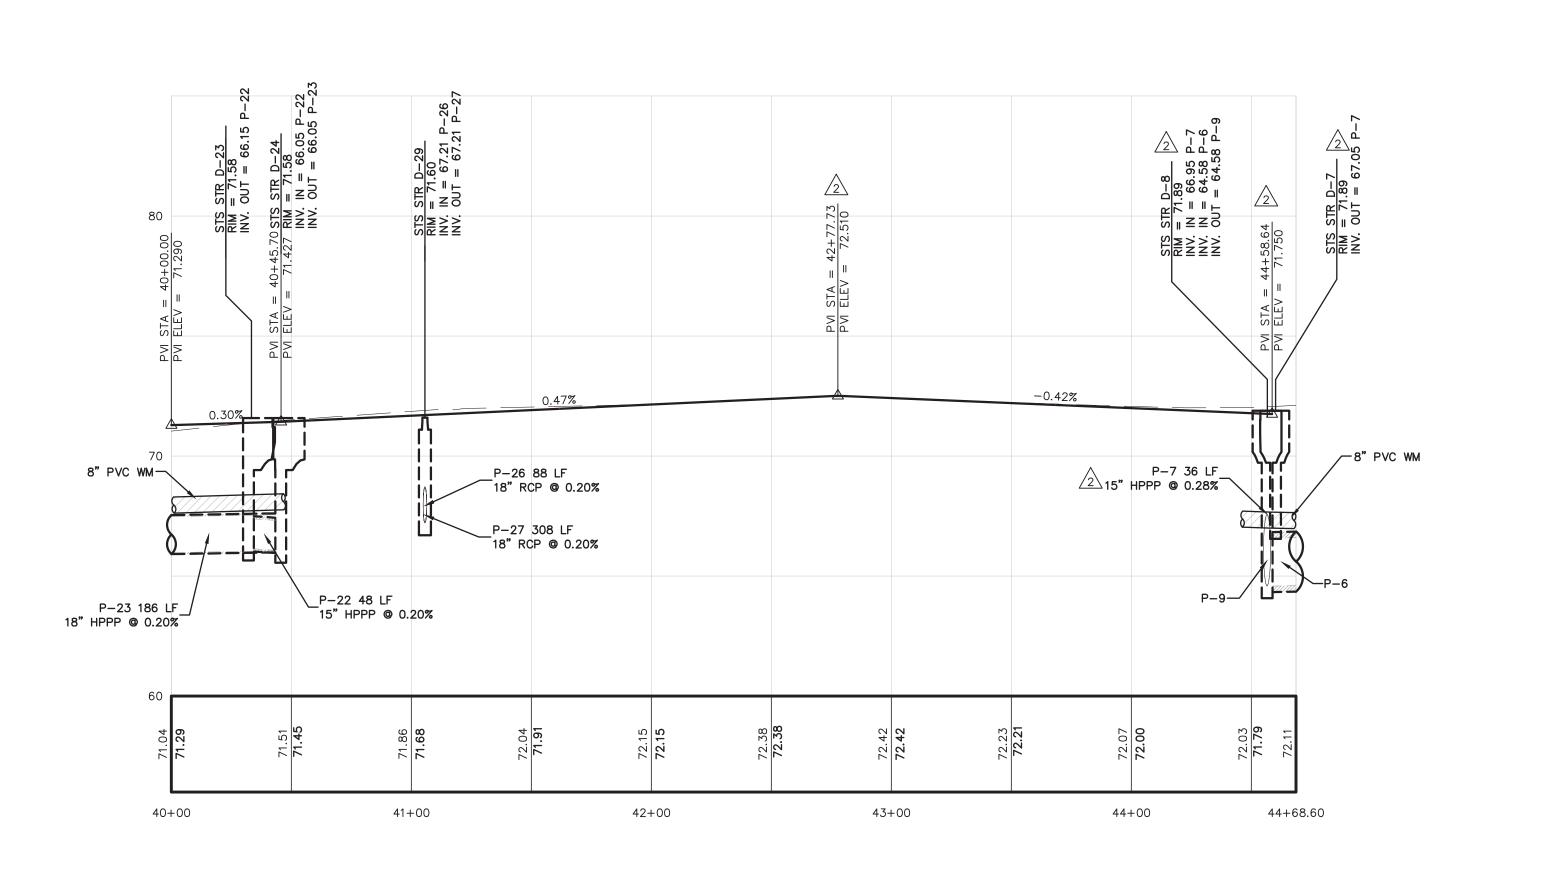

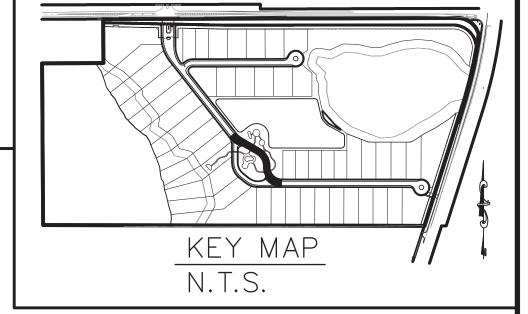

NOTE:

A) ALL EXISTING UTILITIES HAVE BEEN FIELD VERIFIED

(VERTICALLY AND HORIZONTALLY) AT ALL POINTS OF

CONNECTION AND AT ALL AREAS OF CONFLICT WITH

OCU INFRASTRUCTURE.

B) WATER MAIN IS TO BE LOCATED 3' BELOW GRADE UNLESS OTHERWISE NOTED.

THIS APPROVAL IS SUBJECT TO EXISTING REQUIREMENTS OF ORANGE COUNTY FLORIDA AND ANY SPECIAL REQUIREMENTS OF THE ORANGE COUNTY COMMISSION

APPROVED 05.30.2024


VERNON D. LEEMING E.I.
FOR THE ORANGE COUNTY ENGINEER


APPROVED 5/29/2024

Paola Talavera
Digitally signed by Paola
Talavera
Date: 2023.06.01 14:18:38
-04'00'

Paola Talavera
FOR THE MANAGE

FOR THE MANAGER,
ENGINEERING DIVISION
ORANGE COUNTY UTILITIES DEPARTMENT
THIS APPROVAL IS SUBJECT TO EXISTING REQUIREMENTS
OF ORANGE COUNTY UTILITIES DIVISION STANDARDS
AND SPECIFICATIONS.

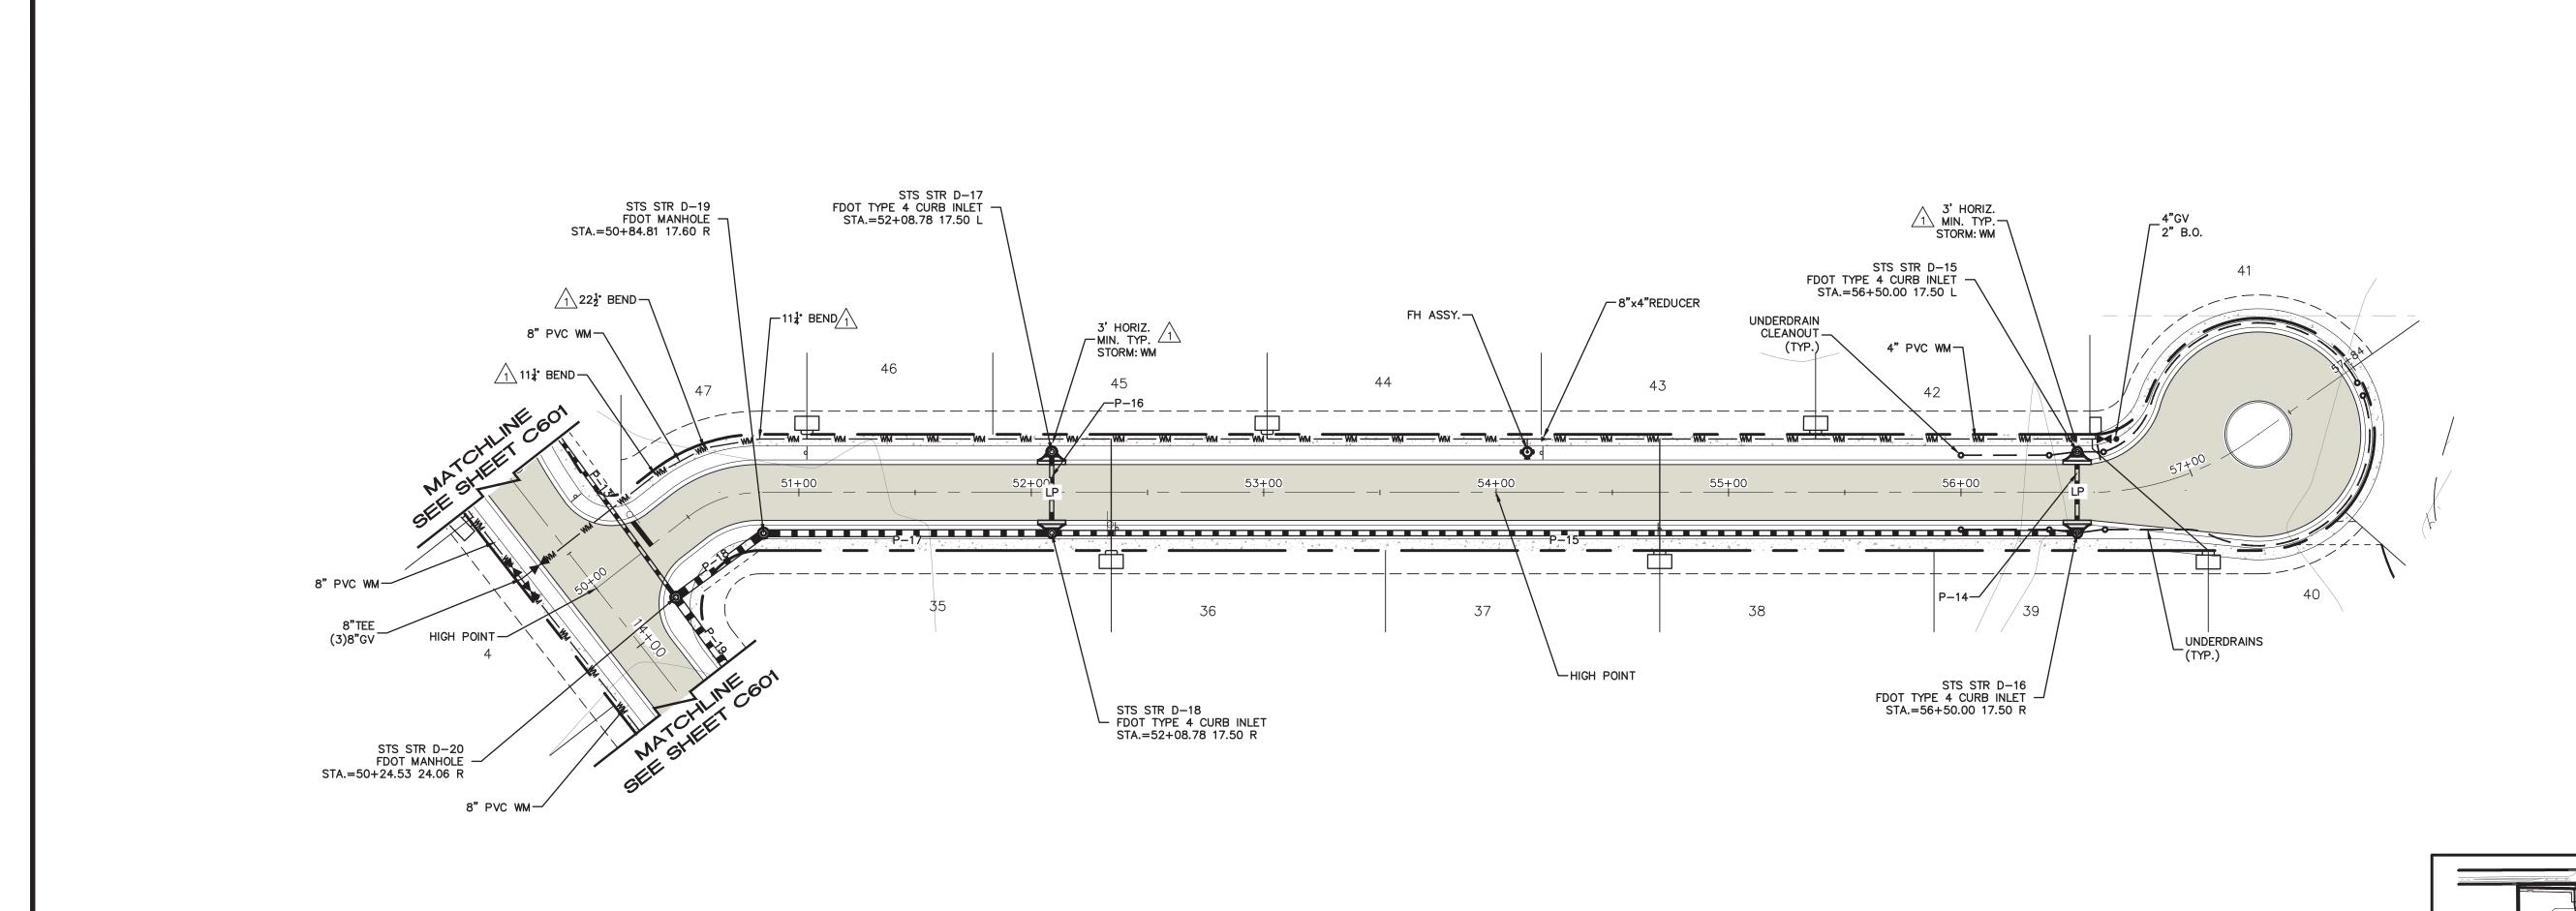

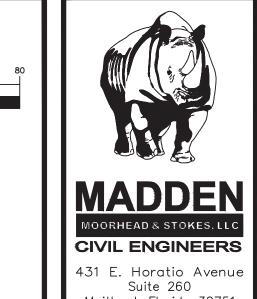

GRAPHIC SCALE

(IN FEET) 1 inch = 40 ft.

KEY MAP

A) ALL EXISTING UTILITIES HAVE BEEN FIELD VERIFIED

UNDERDRAINS TO BE INSTALLED PER GEOTECHNICAL REPORT PROVIDED BY YOVAISH ENGINEERING.

EXTENTS OF ROAD SECTION TO BE UNDERDRAINED

Digitally signed by Paola

B) WATER MAIN IS TO BE LOCATED 3' BELOW GRADE UNLESS OTHERWISE NOTED.

APPROVED 5/29/2024

Paola Talavera Date: 2023.06.01 14:18:38

ORANGE COUNTY UTILITIES DEPARTMENT

THIS APPROVAL IS SUBJECT TO EXISTING REQUIREMENTS OF ORANGE COUNTY UTILITIES DIVISION STANDARDS AND SPECIFICATIONS.

Paola Talavera FOR THE MANAGER,

ENGINEERING DIVISION

-04'00'

LEGEND:


(VERTICALLY AND HORIZONTALLY) AT ALL POINTS OF CONNECTION AND AT ALL AREAS OF CONFLICT WITH OCU INFRASTRUCTURE.

Maitland, Florida 32751 (407) 629-8330

- 724430 - 801


SCALE: H: 1"=40' V: 1"=4 DESIGNED BY: _ DRAWN BY: ___ APPROVED BY: __

STREET B

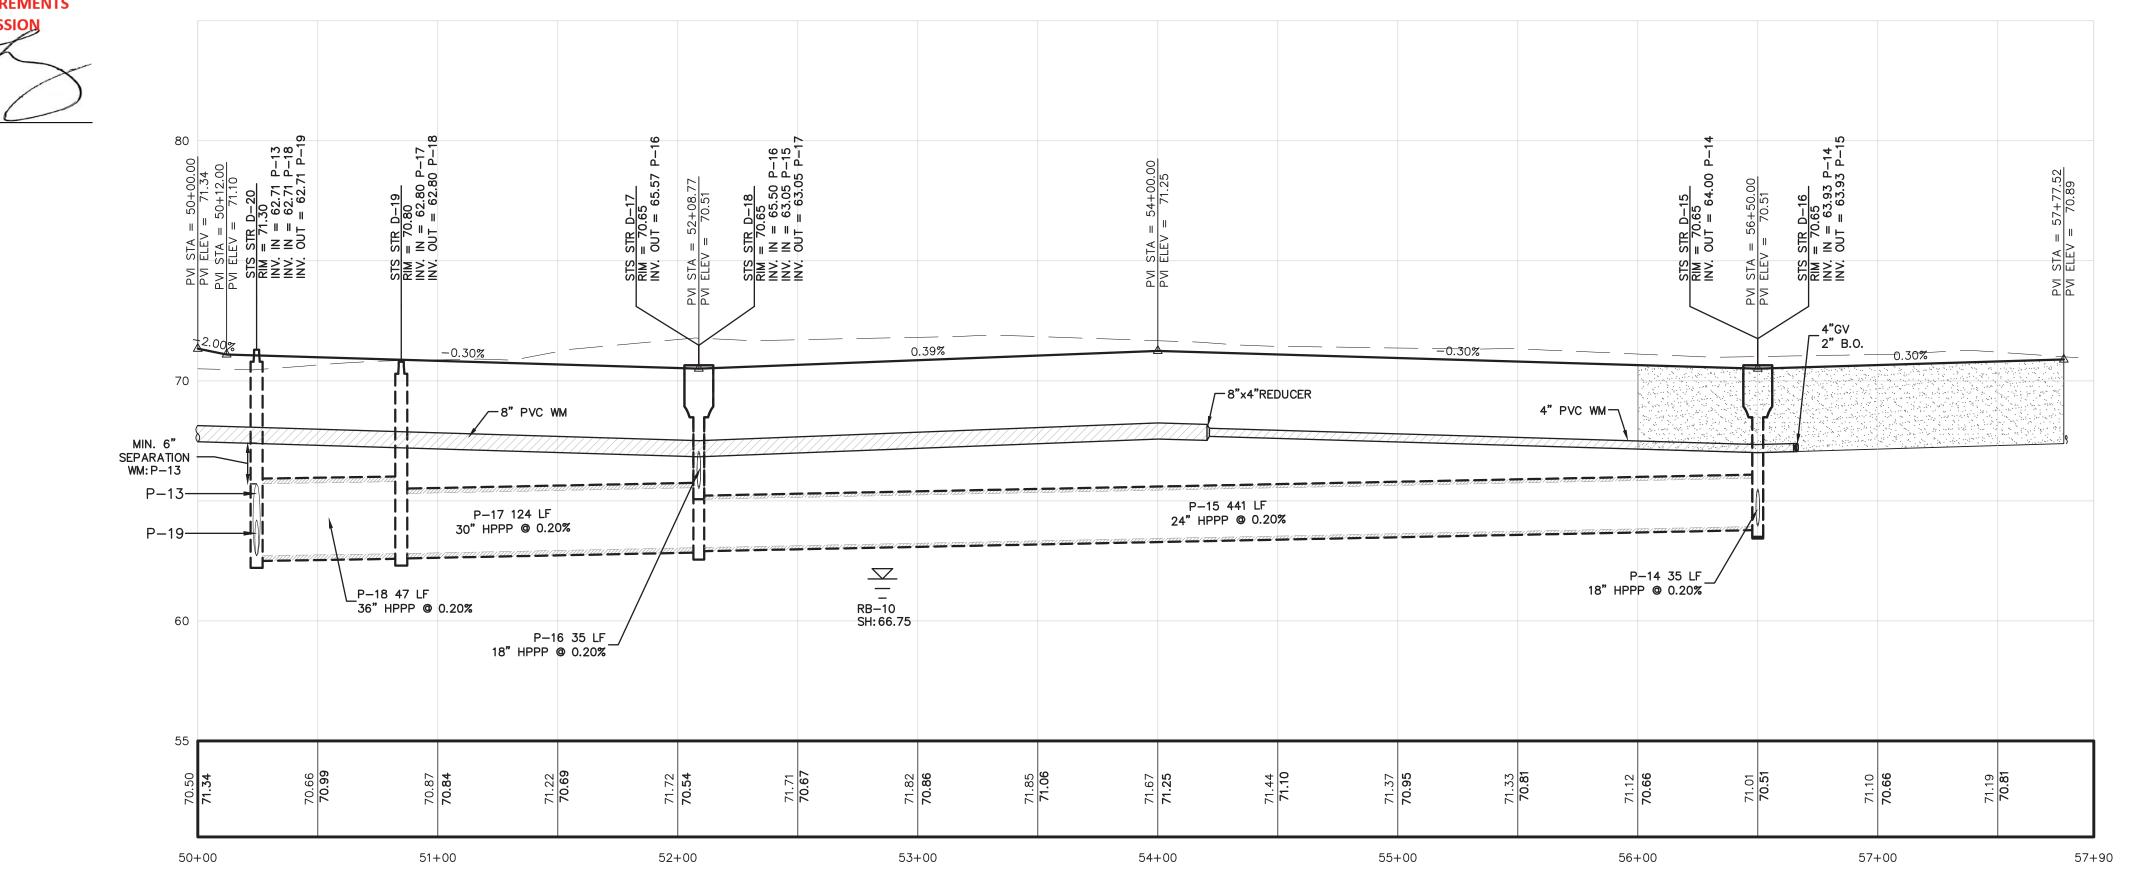

THIS APPROVAL IS SUBJECT TO EXISTING REQUIREMENTS OF ORANGE COUNTY FLORIDA AND ANY SPECIAL REQUIREMENTS OF THE ORANGE COUNTY COMMISSION 05.30.2024

VERNON D. LEEMING E.I. FOR THE ORANGE COUNTY ENGINEER

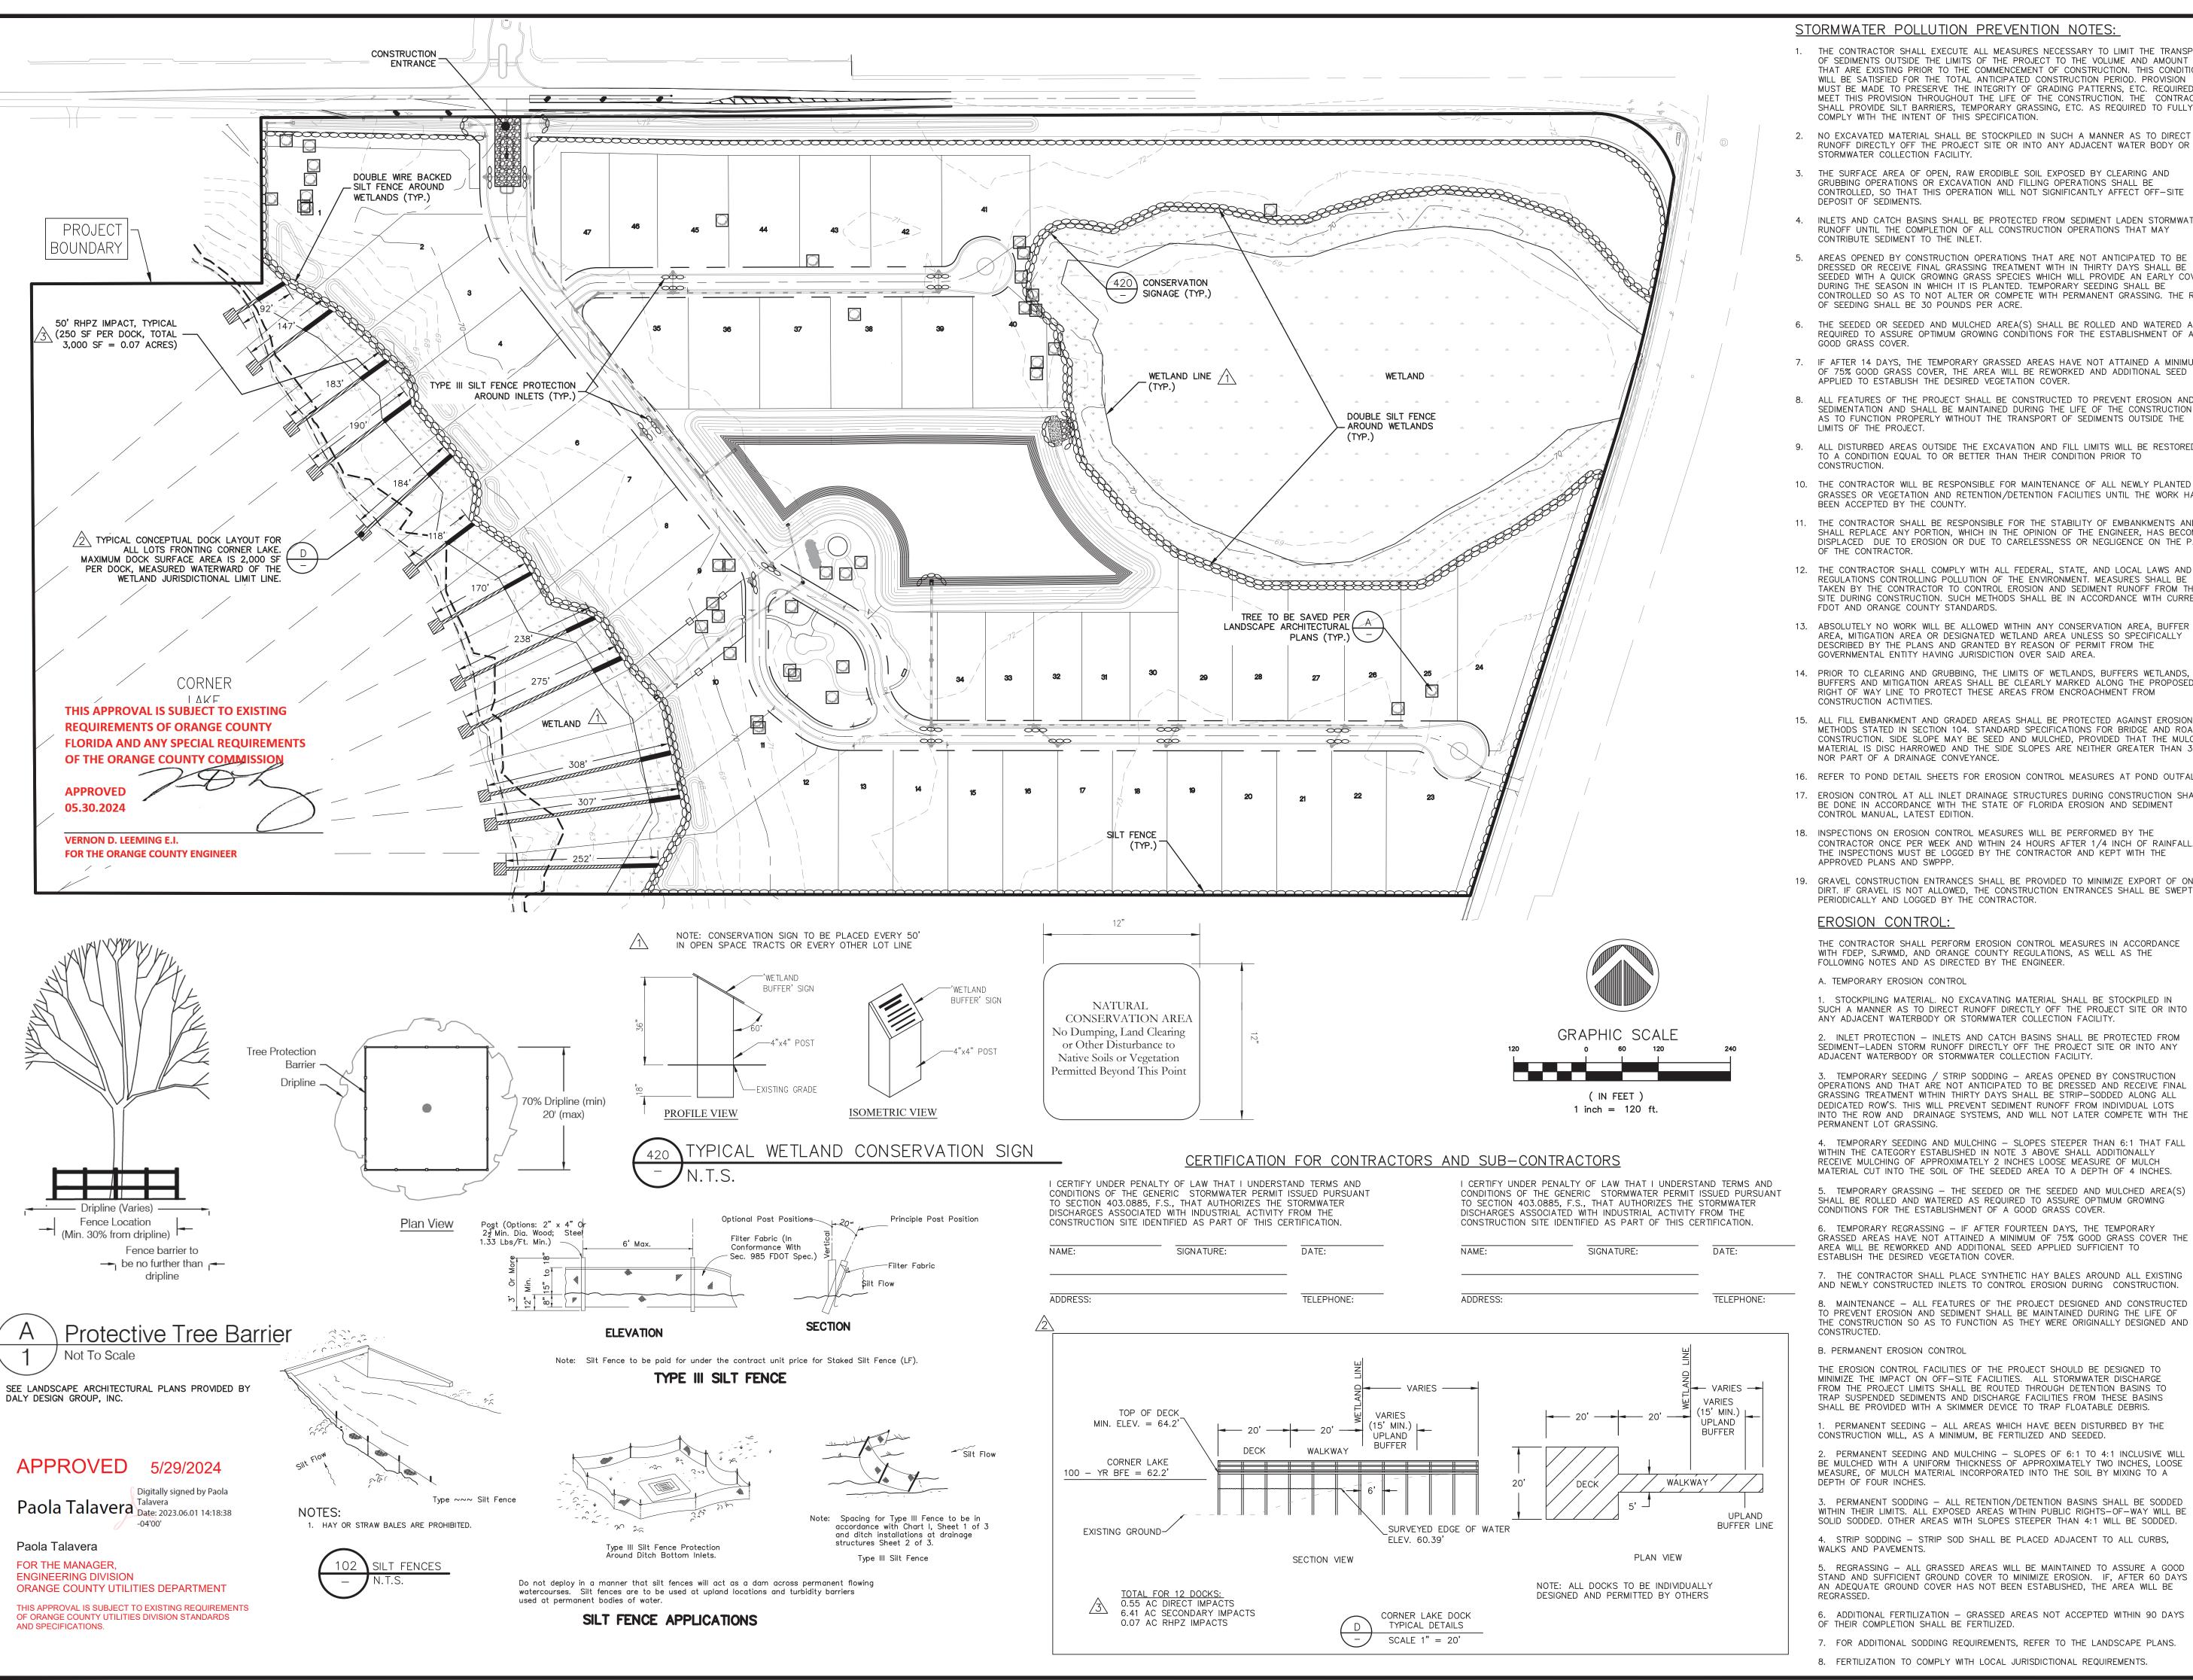

STORMWATER POLLUTION PREVENTION NOTES:

- THE CONTRACTOR SHALL EXECUTE ALL MEASURES NECESSARY TO LIMIT THE TRANSPORT OF SEDIMENTS OUTSIDE THE LIMITS OF THE PROJECT TO THE VOLUME AND AMOUNT THAT ARE EXISTING PRIOR TO THE COMMENCEMENT OF CONSTRUCTION. THIS CONDITION WILL BE SATISFIED FOR THE TOTAL ANTICIPATED CONSTRUCTION PERIOD. PROVISION MUST BE MADE TO PRESERVE THE INTEGRITY OF GRADING PATTERNS, ETC. REQUIRED TO MEET THIS PROVISION THROUGHOUT THE LIFE OF THE CONSTRUCTION. THE CONTRACTOR SHALL PROVIDE SILT BARRIERS, TEMPORARY GRASSING, ETC. AS REQUIRED TO FULLY COMPLY WITH THE INTENT OF THIS SPECIFICATION.
- NO EXCAVATED MATERIAL SHALL BE STOCKPILED IN SUCH A MANNER AS TO DIRECT RUNOFF DIRECTLY OFF THE PROJECT SITE OR INTO ANY ADJACENT WATER BODY OR STORMWATER COLLECTION FACILITY.
- 3. THE SURFACE AREA OF OPEN, RAW ERODIBLE SOIL EXPOSED BY CLEARING AND GRUBBING OPERATIONS OR EXCAVATION AND FILLING OPERATIONS SHALL BE CONTROLLED, SO THAT THIS OPERATION WILL NOT SIGNIFICANTLY AFFECT OFF-SITE DEPOSIT OF SEDIMENTS
- 4. INLETS AND CATCH BASINS SHALL BE PROTECTED FROM SEDIMENT LADEN STORMWATER RUNOFF UNTIL THE COMPLETION OF ALL CONSTRUCTION OPERATIONS THAT MAY CONTRIBUTE SEDIMENT TO THE INLET.
- AREAS OPENED BY CONSTRUCTION OPERATIONS THAT ARE NOT ANTICIPATED TO BE DRESSED OR RECEIVE FINAL GRASSING TREATMENT WITH IN THIRTY DAYS SHALL BE SEEDED WITH A QUICK GROWING GRASS SPECIES WHICH WILL PROVIDE AN EARLY COVER, DURING THE SEASON IN WHICH IT IS PLANTED. TEMPORARY SEEDING SHALL BE CONTROLLED SO AS TO NOT ALTER OR COMPETE WITH PERMANENT GRASSING, THE RATE OF SEEDING SHALL BE 30 POUNDS PER ACRE.
- THE SEEDED OR SEEDED AND MULCHED AREA(S) SHALL BE ROLLED AND WATERED AS REQUIRED TO ASSURE OPTIMUM GROWING CONDITIONS FOR THE ESTABLISHMENT OF A GOOD GRASS COVER.
- 7. IF AFTER 14 DAYS, THE TEMPORARY GRASSED AREAS HAVE NOT ATTAINED A MINIMUM OF 75% GOOD GRASS COVER, THE AREA WILL BE REWORKED AND ADDITIONAL SEED APPLIED TO ESTABLISH THE DESIRED VEGETATION COVER.
- 8. ALL FEATURES OF THE PROJECT SHALL BE CONSTRUCTED TO PREVENT EROSION AND SEDIMENTATION AND SHALL BE MAINTAINED DURING THE LIFE OF THE CONSTRUCTION SO AS TO FUNCTION PROPERLY WITHOUT THE TRANSPORT OF SEDIMENTS OUTSIDE THE
- 9. ALL DISTURBED AREAS OUTSIDE THE EXCAVATION AND FILL LIMITS WILL BE RESTORED TO A CONDITION EQUAL TO OR BETTER THAN THEIR CONDITION PRIOR TO CONSTRUCTION.
- 10. THE CONTRACTOR WILL BE RESPONSIBLE FOR MAINTENANCE OF ALL NEWLY PLANTED GRASSES OR VEGETATION AND RETENTION/DETENTION FACILITIES UNTIL THE WORK HAS BEEN ACCEPTED BY THE COUNTY.
- 11. THE CONTRACTOR SHALL BE RESPONSIBLE FOR THE STABILITY OF EMBANKMENTS AND SHALL REPLACE ANY PORTION, WHICH IN THE OPINION OF THE ENGINEER, HAS BECOME DISPLACED DUE TO EROSION OR DUE TO CARELESSNESS OR NEGLIGENCE ON THE PART OF THE CONTRACTOR.
- 12. THE CONTRACTOR SHALL COMPLY WITH ALL FEDERAL, STATE, AND LOCAL LAWS AND REGULATIONS CONTROLLING POLLUTION OF THE ENVIRONMENT. MEASURES SHALL BE FAKEN BY THE CONTRACTOR TO CONTROL EROSION AND SEDIMENT RUNOFF FROM THE SITE DURING CONSTRUCTION. SUCH METHODS SHALL BE IN ACCORDANCE WITH CURRENT FDOT AND ORANGE COUNTY STANDARDS.
- 13. ABSOLUTELY NO WORK WILL BE ALLOWED WITHIN ANY CONSERVATION AREA, BUFFER AREA, MITIGATION AREA OR DESIGNATED WETLAND AREA UNLESS SO SPECIFICALLY DESCRIBED BY THE PLANS AND GRANTED BY REASON OF PERMIT FROM THE GOVERNMENTAL ENTITY HAVING JURISDICTION OVER SAID AREA.
- 14. PRIOR TO CLEARING AND GRUBBING, THE LIMITS OF WETLANDS, BUFFERS WETLANDS, BUFFERS AND MITIGATION AREAS SHALL BE CLEARLY MARKED ALONG THE PROPOSED RIGHT OF WAY LINE TO PROTECT THESE AREAS FROM ENCROACHMENT FROM CONSTRUCTION ACTIVITIES.
- 15. ALL FILL EMBANKMENT AND GRADED AREAS SHALL BE PROTECTED AGAINST EROSION BY METHODS STATED IN SECTION 104. STANDARD SPECIFICATIONS FOR BRIDGE AND ROAD CONSTRUCTION. SIDE SLOPE MAY BE SEED AND MULCHED, PROVIDED THAT THE MULCH MATERIAL IS DISC HARROWED AND THE SIDE SLOPES ARE NEITHER GREATER THAN 3:1 NOR PART OF A DRAINAGE CONVEYANCE.
- 16. REFER TO POND DETAIL SHEETS FOR EROSION CONTROL MEASURES AT POND OUTFALLS
- 17. EROSION CONTROL AT ALL INLET DRAINAGE STRUCTURES DURING CONSTRUCTION SHALL BE DONE IN ACCORDANCE WITH THE STATE OF FLORIDA EROSION AND SEDIMENT CONTROL MANUAL, LATEST EDITION.
- 18. INSPECTIONS ON EROSION CONTROL MEASURES WILL BE PERFORMED BY THE CONTRACTOR ONCE PER WEEK AND WITHIN 24 HOURS AFTER 1/4 INCH OF RAINFALL. THE INSPECTIONS MUST BE LOGGED BY THE CONTRACTOR AND KEPT WITH THE APPROVED PLANS AND SWPPP.
- 19 GRAVEL CONSTRUCTION ENTRANCES SHALL BE PROVIDED TO MINIMIZE EXPORT OF ONSITE DIRT. IF GRAVEL IS NOT ALLOWED, THE CONSTRUCTION ENTRANCES SHALL BE SWEPT PERIODICALLY AND LOGGED BY THE CONTRACTOR.

EROSION CONTROL:

THE CONTRACTOR SHALL PERFORM EROSION CONTROL MEASURES IN ACCORDANCE WITH FDEP, SJRWMD, AND ORANGE COUNTY REGULATIONS, AS WELL AS THE FOLLOWING NOTES AND AS DIRECTED BY THE ENGINEER.

A. TEMPORARY EROSION CONTROL

1. STOCKPILING MATERIAL. NO EXCAVATING MATERIAL SHALL BE STOCKPILED IN SUCH A MANNER AS TO DIRECT RUNOFF DIRECTLY OFF THE PROJECT SITE OR INTO

ANY ADJACENT WATERBODY OR STORMWATER COLLECTION FACILITY. 2. INLET PROTECTION — INLETS AND CATCH BASINS SHALL BE PROTECTED FROM SEDIMENT-LADEN STORM RUNOFF DIRECTLY OFF THE PROJECT SITE OR INTO ANY ADJACENT WATERBODY OR STORMWATER COLLECTION FACILITY.

TEMPORARY SEEDING / STRIP SODDING - AREAS OPENED BY CONSTRUCTION OPERATIONS AND THAT ARE NOT ANTICIPATED TO BE DRESSED AND RECEIVE FINAL GRASSING TREATMENT WITHIN THIRTY DAYS SHALL BE STRIP-SODDED ALONG ALL DEDICATED ROW'S. THIS WILL PREVENT SEDIMENT RUNOFF FROM INDIVIDUAL LOTS INTO THE ROW AND DRAINAGE SYSTEMS, AND WILL NOT LATER COMPETE WITH THE PERMANENT LOT GRASSING.

4. TEMPORARY SEEDING AND MULCHING - SLOPES STEEPER THAN 6:1 THAT FALL WITHIN THE CATEGORY ESTABLISHED IN NOTE 3 ABOVE SHALL ADDITIONALLY RECEIVE MULCHING OF APPROXIMATELY 2 INCHES LOOSE MEASURE OF MULCH MATERIAL CUT INTO THE SOIL OF THE SEEDED AREA TO A DEPTH OF 4 INCHES.

TEMPORARY GRASSING - THE SEEDED OR THE SEEDED AND MULCHED AREA(S) SHALL BE ROLLED AND WATERED AS REQUIRED TO ASSURE OPTIMUM GROWING

CONDITIONS FOR THE ESTABLISHMENT OF A GOOD GRASS COVER. 6. TEMPORARY REGRASSING - IF AFTER FOURTEEN DAYS, THE TEMPORARY GRASSED AREAS HAVE NOT ATTAINED A MINIMUM OF 75% GOOD GRASS COVER THE

7. THE CONTRACTOR SHALL PLACE SYNTHETIC HAY BALES AROUND ALL EXISTING AND NEWLY CONSTRUCTED INLETS TO CONTROL EROSION DURING CONSTRUCTION. MAINTENANCE - ALL FEATURES OF THE PROJECT DESIGNED AND CONSTRUCTED

B. PERMANENT EROSION CONTROL

THE EROSION CONTROL FACILITIES OF THE PROJECT SHOULD BE DESIGNED TO MINIMIZE THE IMPACT ON OFF-SITE FACILITIES. ALL STORMWATER DISCHARGE FROM THE PROJECT LIMITS SHALL BE ROUTED THROUGH DETENTION BASINS TO TRAP SUSPENDED SEDIMENTS AND DISCHARGE FACILITIES FROM THESE BASINS SHALL BE PROVIDED WITH A SKIMMER DEVICE TO TRAP FLOATABLE DEBRIS.

PERMANENT SEEDING - ALL AREAS WHICH HAVE BEEN DISTURBED BY THE CONSTRUCTION WILL, AS A MINIMUM, BE FERTILIZED AND SEEDED.

PERMANENT SEEDING AND MULCHING - SLOPES OF 6:1 TO 4:1 INCLUSIVE WILL BE MULCHED WITH A UNIFORM THICKNESS OF APPROXIMATELY TWO INCHES, LOOSE MEASURE, OF MULCH MATERIAL INCORPORATED INTO THE SOIL BY MIXING TO A DEPTH OF FOUR INCHES.


. PERMANENT SODDING - ALL RETENTION/DETENTION BASINS SHALL BE SODDED WITHIN THEIR LIMITS. ALL EXPOSED AREAS WITHIN PUBLIC RIGHTS-OF-WAY WILL BE SOLID SODDED. OTHER AREAS WITH SLOPES STEEPER THAN 4:1 WILL BE SODDED. 4. STRIP SODDING - STRIP SOD SHALL BE PLACED ADJACENT TO ALL CURBS,

5. REGRASSING - ALL GRASSED AREAS WILL BE MAINTAINED TO ASSURE A GOOD STAND AND SUFFICIENT GROUND COVER TO MINIMIZE EROSION. IF, AFTER 60 DAYS AN ADEQUATE GROUND COVER HAS NOT BEEN ESTABLISHED, THE AREA WILL BE

ADDITIONAL FERTILIZATION - GRASSED AREAS NOT ACCEPTED WITHIN 90 DAYS OF THEIR COMPLETION SHALL BE FERTILIZED.


7. FOR ADDITIONAL SODDING REQUIREMENTS, REFER TO THE LANDSCAPE PLANS.


8. FERTILIZATION TO COMPLY WITH LOCAL JURISDICTIONAL REQUIREMENTS.

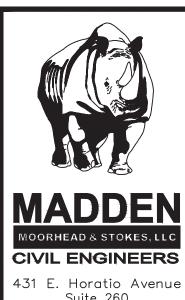

Suite 260 Maitland, Florida 32751 (407) 629-8330

1"=12 SCALE: DESIGNED BY: DRAWN BY: APPROVED BY: __

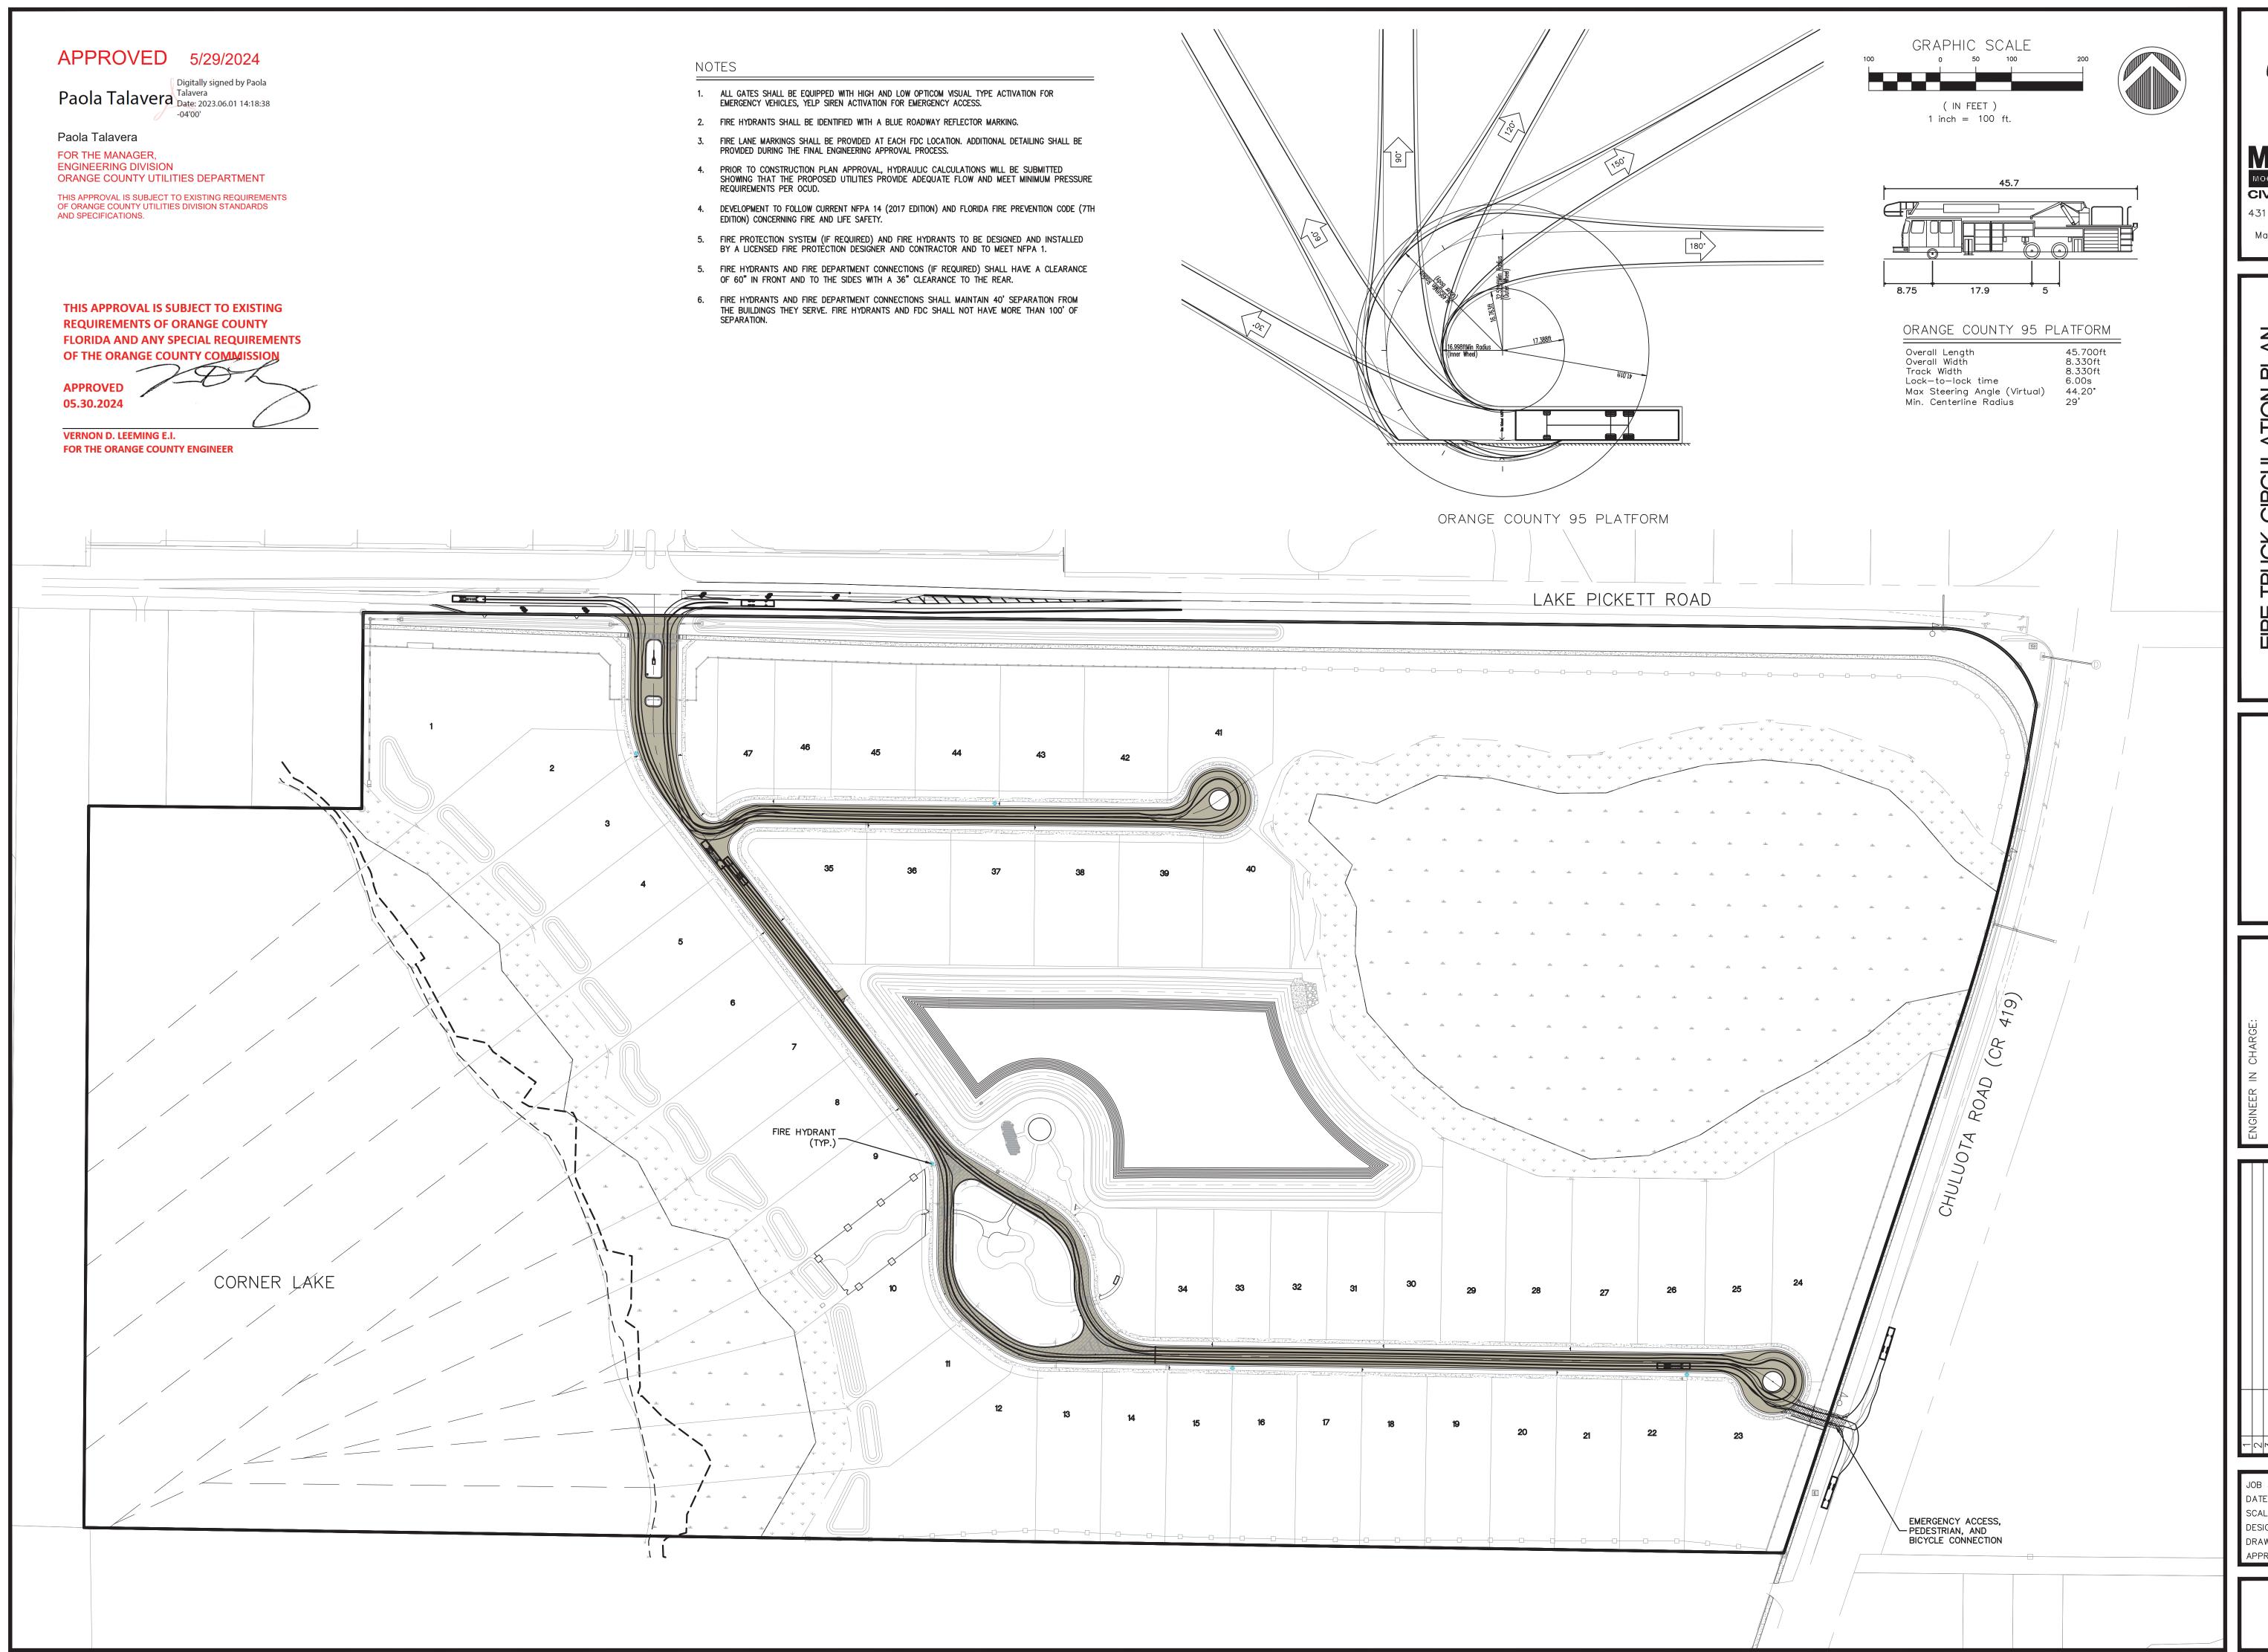

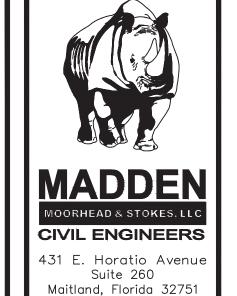

(407) 629-8330

WE ARE TO THE TOTAL TO THE TOTAL TOTAL

SLACE AT CORNER LA


400 INTERNATIONAL PARKWAY
LAKE MARY, FLORIDA 32746
(407) 531–5177


BENJAMIN S. BECKHAM, P.E. #79452


May 28, 2024

CERTIFICATE OF AUTHORIZATION NO. CA-00077


5 6 7 8 9 10 11 DATE REVISIONS FIRE TRUCK.dwg May 28, 2024 9:51 AM

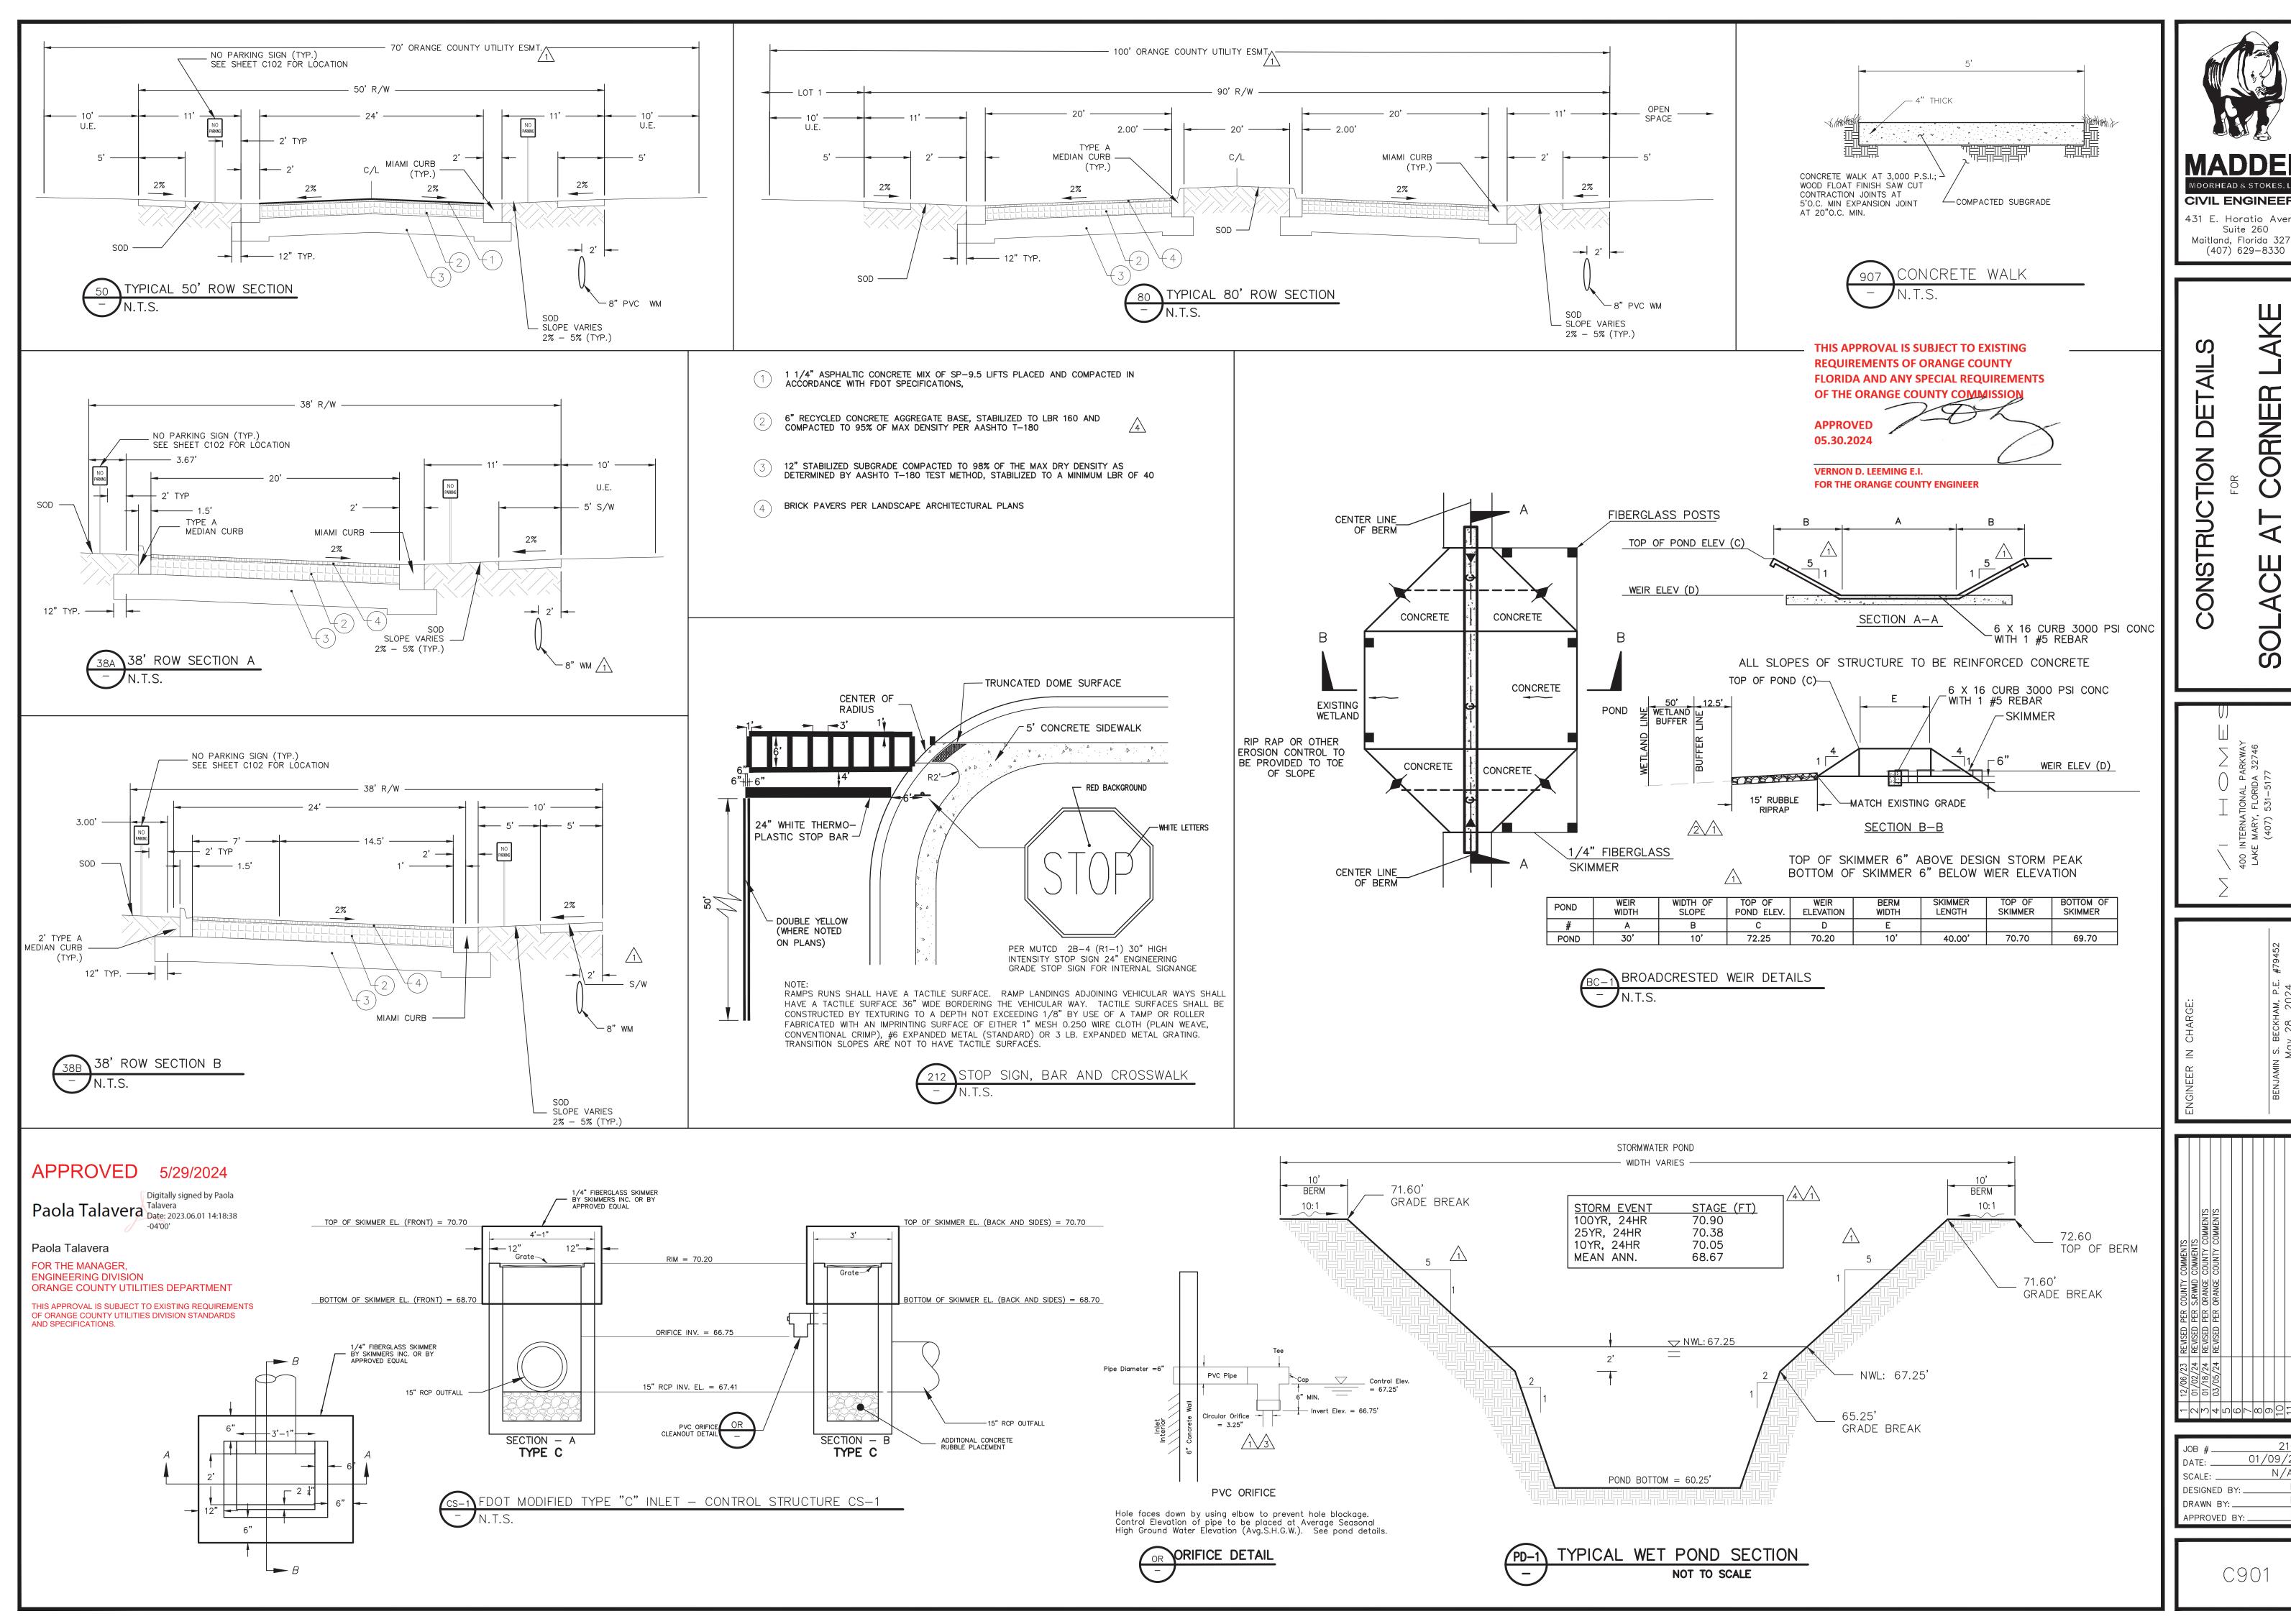

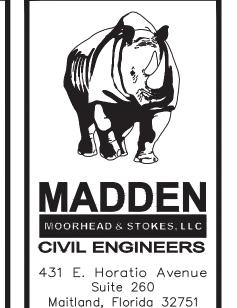

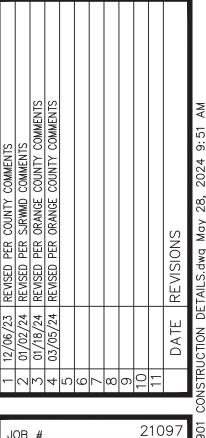

01/09/20 N/A DESIGNED BY: _ DRAWN BY: _ APPROVED BY: __

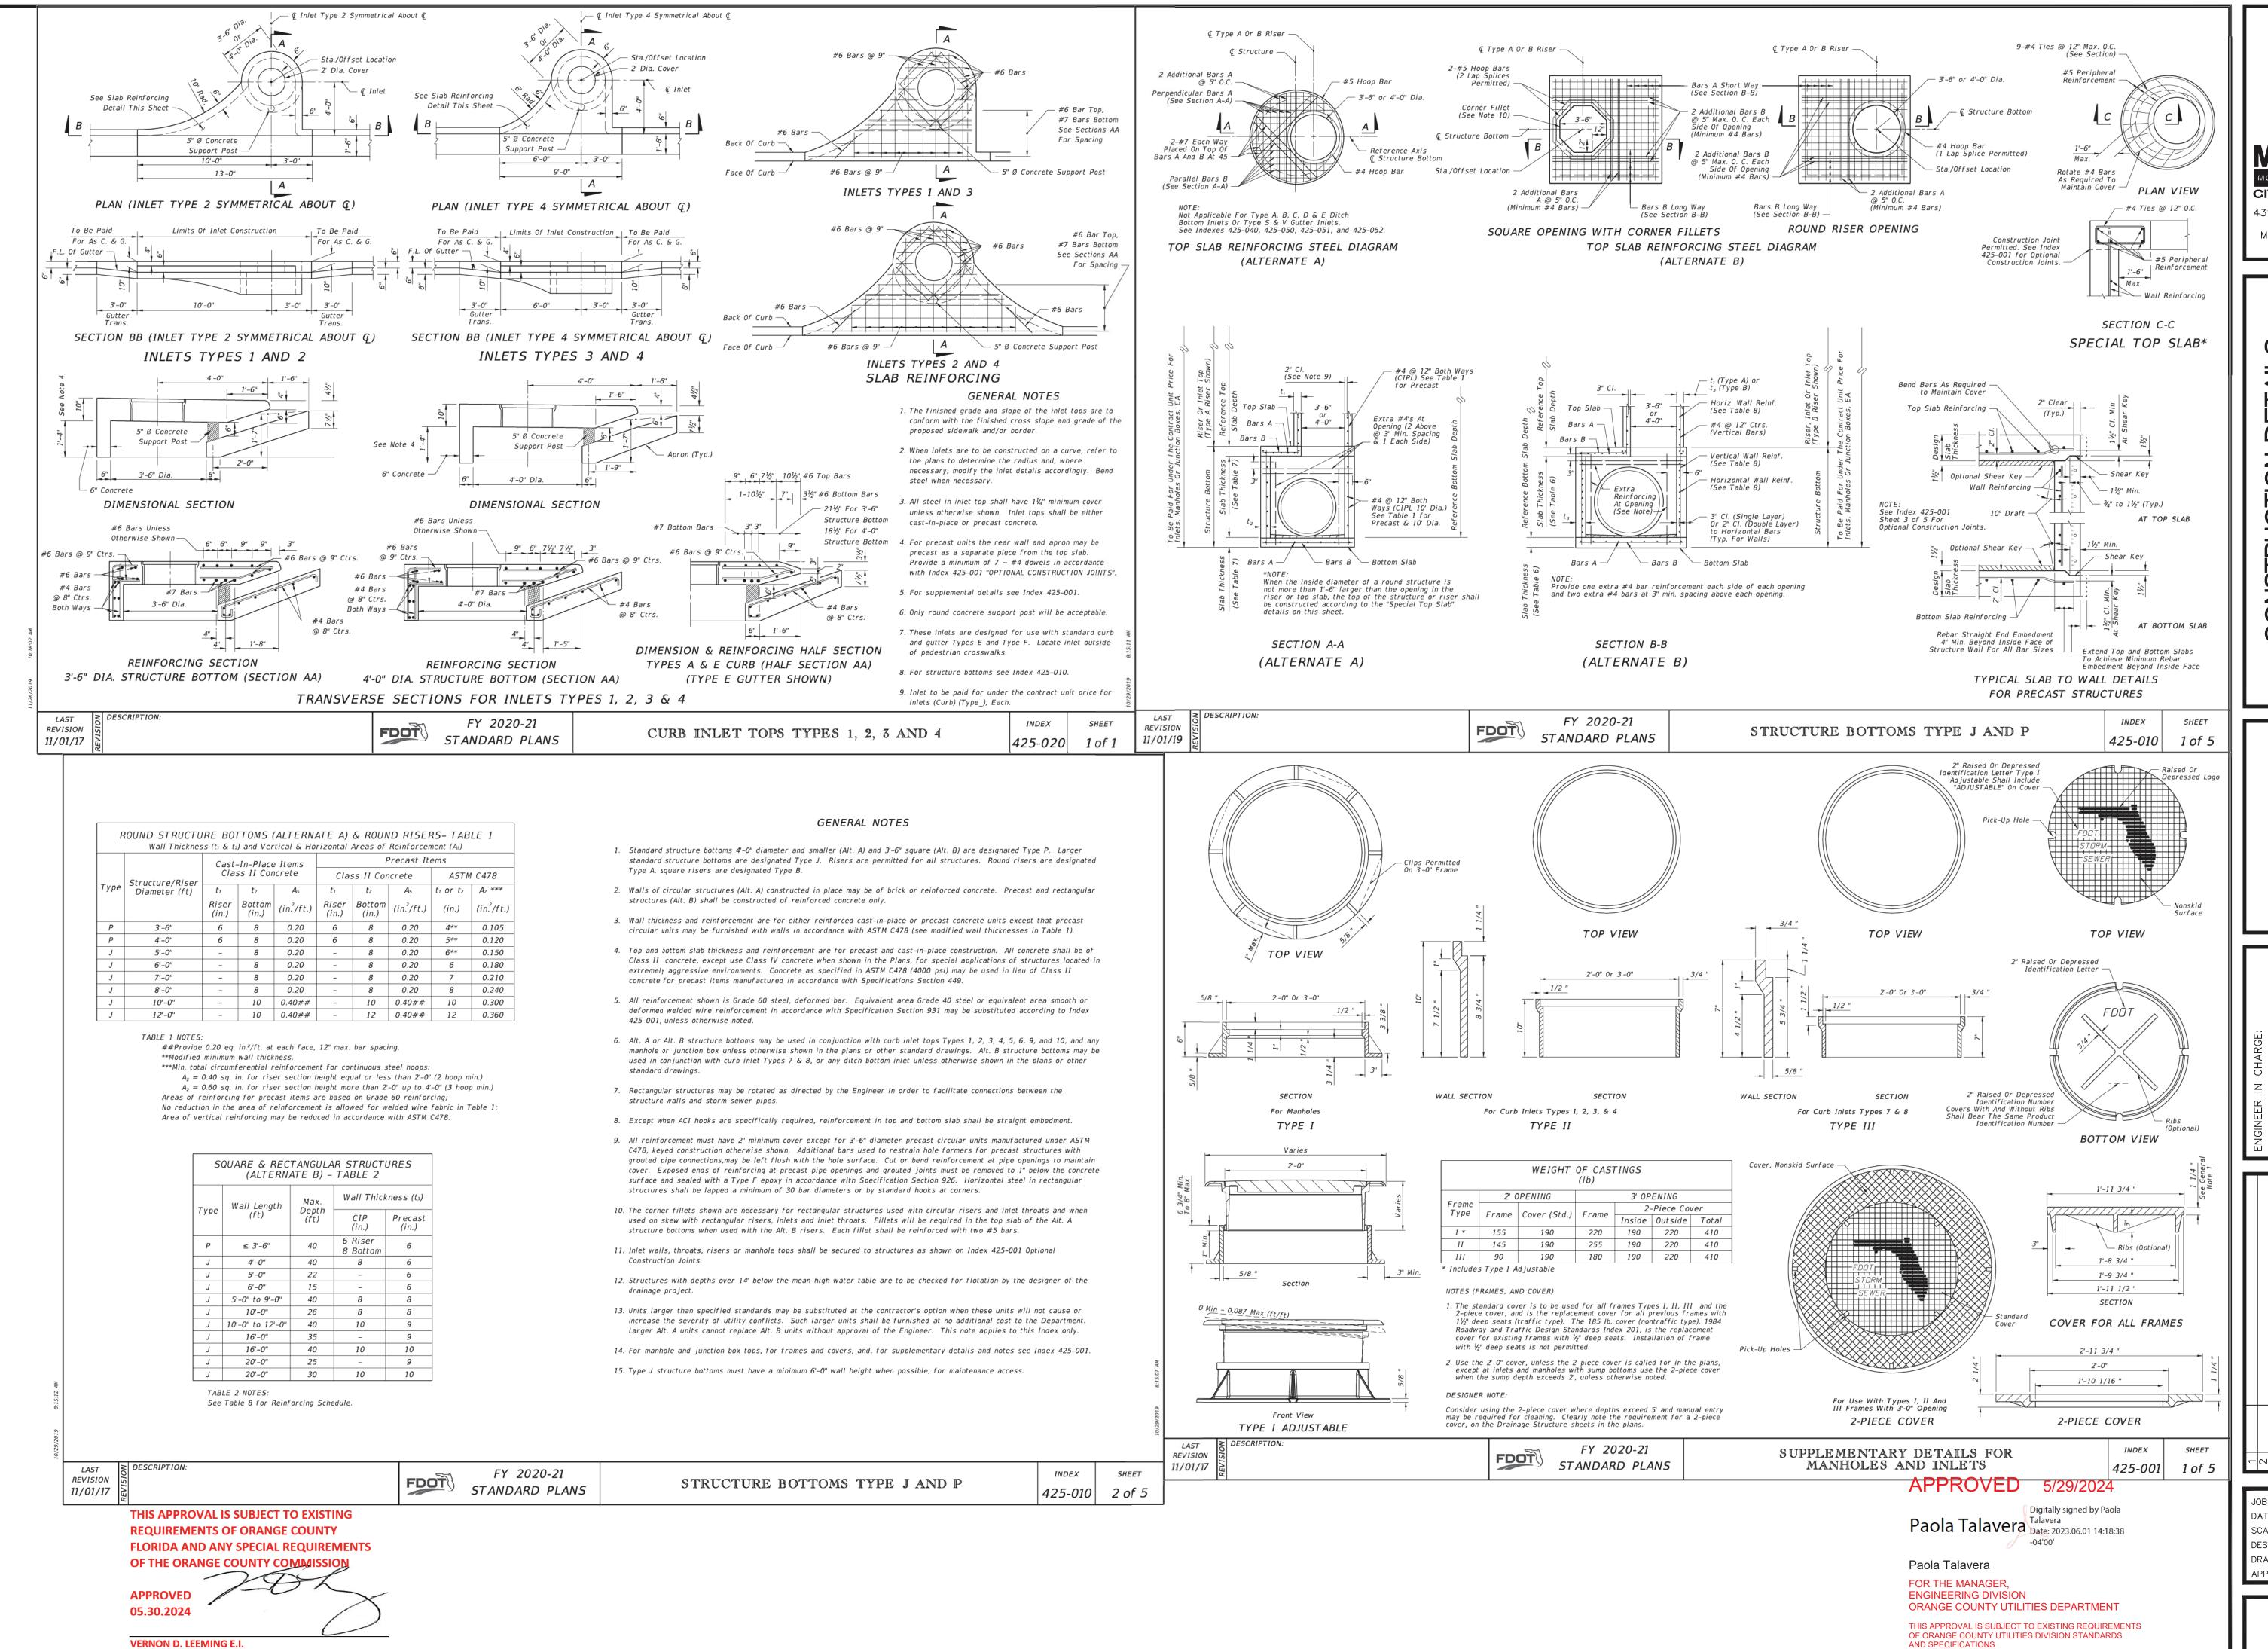

FOR THE ORANGE COUNTY ENGINEER

MADDEN
MOORHEAD & STOKES, LLC
CIVIL ENGINEERS
431 E. Horatio Avenue

Suite 260
Maitland, Florida 32751
(407) 629-8330

CONSTRUCTION DETAILS

400 INTERNATIONAL PARKWAY
LAKE MARY, FLORIDA 32746
(407) 531-5177

BENJAMIN S. BECKHAM, P.E. #79452

May 28, 2024

CERTIFICATE OF AUTHORIZATION NO. CA-000772