List of Drawings

Cover

ARCHITECTURAL

- AR.0 Architectural Reference Information
- LS0.1 Building and Code Information and First Floor Composite Life Safety Plan
- A1.1 First Floor Demolition Plan
- A1.1A First Floor Demolition Reflected Ceiling Plan
- A2.1 First Floor New Work Plan A2.2 Roof New Work Plan
- A3.01 Lower Level Reflected Ceiling Plan
- A3.1 First Floor Reflected Ceiling Plan
- A3.2 Enlarged Board Room Reflected Ceiling Plan A6.1 Enlarged Toilet Room and Vestibule Plans, Elevations,
- Sections and Details
- A6.2 Lobby Millwork Plan, Elevations and Details
- A8.1 Interior Elevations A9.1 Color Code, Room Finish, Door & Window Shade Schedules
- and Details
- A9.2 Partition Types A9.3 Interior Sections and Details
- A9.4 Interior Sections and Details
- A9.5 Ceiling Sections and Details
- A10.1 First Floor Finish Plan F2.1 First Floor Furniture Plan

MECHANICAL MR.0 Mechanical Reference Information

- M1.01 Basement Demolition Plan
- M1.1 First Floor Demolition Plan
- M2.1 First Floor Sheet Metal Plan
- M3.01 Basement Plumbing & HVAC Piping Plan M3.1 First Floor Plumbing, HVAC Piping & Fire Protection Plan
- M6.1 Details & Schedules
- M8.1 Mechanical Systems Controls



R Frankenmuth INSURANCE **Executive Suite Renovation**

ELECTRICAL

- ER.0 Electrical Reference Information
- E0.01 Basement Composite Plan
- E0.1 First Floor Composite Plan
- E1.1 Partial Technology and Electrical Demolition Plans E2.1 Partial First Floor Lighting Plan
- E3.1 Partial First Floor Power & Auxiliary Systems Plan
- E6.1 Panel Schedules & Partial One-Line Diagram
- E7.1 Details
- E8.1 Lighting Fixture Schedule & Lighting Controls Risers
- TR.0 Technology Reference Information T3.1 Partial First Floor Technology Systems Plan
- T5.1 Technology Risers
- T5.2 Technology Details

1 Mutual Avenue Frankenmuth, MI 48787

Site Map					Ref	er to Drawing LS0.1	for Code Information
ä			Gas	St. Lorenz Lutheran Church and School	Bavarian Veterinary H P G G G G G G G G G G G G G G G G G G	Pine Grove Dr	
Junction Rd	W Genesee St	W Genesee St	W Genesee St	W Genesee St FRANKENMUTH	W Genesee St	W Genesee St	W Genesee St
		Oppenheimer & Co. Inc.	Pran Diversified Fitness Club	INSURANCE		Heine St.	Rei f St

Signature

Date

Signature

Date

Registration Seal

Date

Signature




INTEGRATED design solutions architecture engineering interiors & technology 1441 west long lake, suite 200 troy, michigan 48098 5211 cascade road SE, suite 300 grand rapids, michigan 49546 248.823.2100 www.ids-michigan.com

Issued for	Issue Date
Design Development Quality Management Review Bids	02-26-2021 04-21-2021 07-15-2021

 \odot 2021 INTEGRATED $ext{design}$ solutions, LLC īD≗ Project Number




ABBREVIATIONS

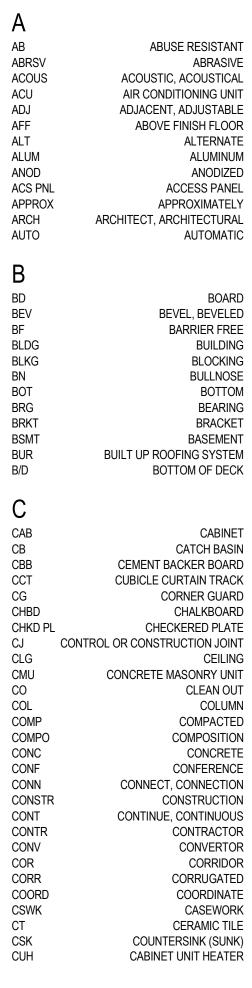


MATERIAL LEGEND


SOIL
GRANULAR FILL
GRAVEL
CONCRETE
CONCRETE MASC
BRICK
GLAZED CMU

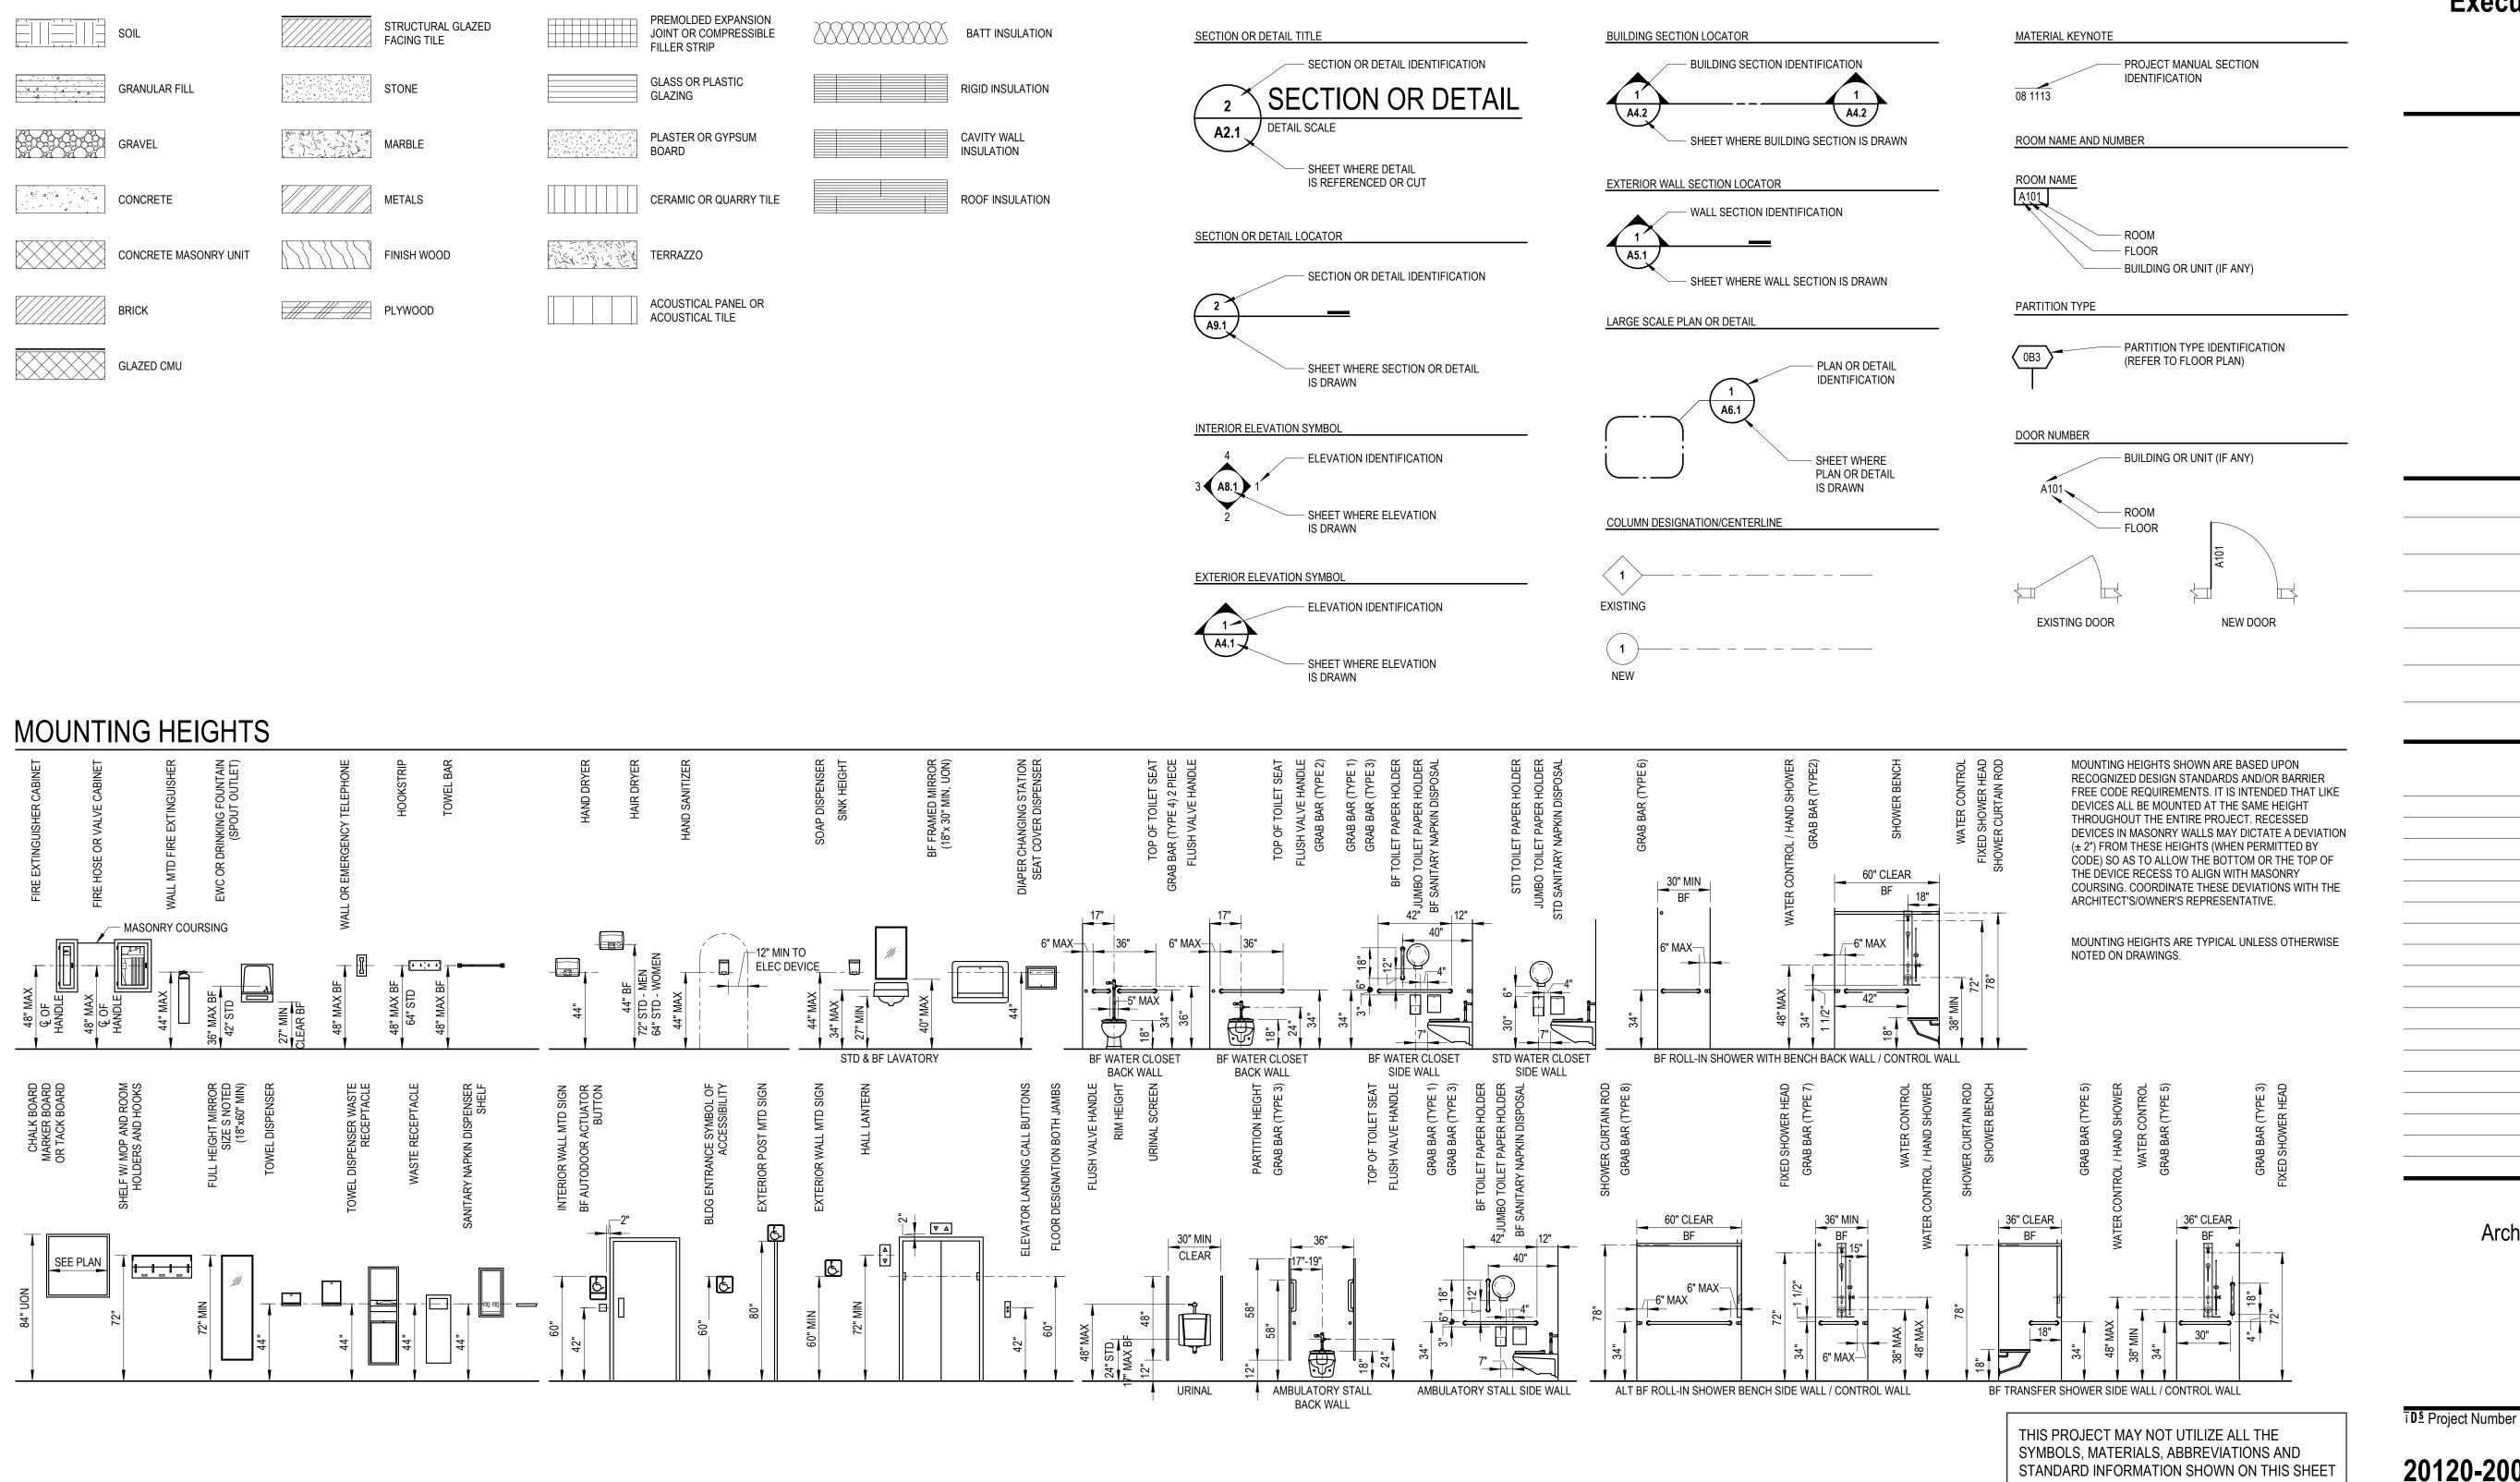


F (CONT) D K FHC KD DEPTH FIRE HOSE CABINET KNOCK DOWN DOUBLE FHR FIRE HOSE RACK KIT KITCHEN DBL DUMBWAITER FIN FINISH, FINISHED FLASH DUTCH DOOR FLASHING DEMOLISH, DEMOLITION FLR FLOOR FPRFG FIREPROOFING LONG, LENGTH DEPRESSED FR DEPARTMENT FRAME LABORATORY LAB FRGM FRP DETAIL FIRE RATED GLAZING MARKINGS LAMINATE, LAMINATED LAM FIBERGLASS REINFORCED PANEL DRINKING FOUNTAIN LAVATORY LA DIAMETER FT FEET, FOOT LBI LABEL DIAGONAL FTG FOOTING LBS POUNDS FTR DIFFUSER FIN TUBE RADIATION LINEAR FOOT FVC DIMENSION LEFT HAND FIRE VALVE CABINET LH FWC DIRECTORY FABRIC WALL COVERING LEFT HAND REVERSE LHR LOCKER DIRECT APPLIED EXT FINISH SYSTEM LKR DAMPPROOFING SYSTEM LONG LEG HORIZONTAL LLH G DEMOUNTABLE LONG LEG VERTICAL LLV DOWN GA GAGE, GAUGE LOUVER OPENING LO DOOR OPENING GALV GALVANIZED LP LOW POINT DOOR GRFC GLASS FIBER REINFORCED CONCRETE LPRF LIGHT PROOF DRAWING DRAIN TILE LT WT GRFG GLASS FIBER REINFORCED GYPSUM LIGHT WEIGHT GALVANIZED IRON DOWEL DRAWER GLASS Μ GRADE GR GRG MAINT MAINTENANCE GLASS REINFORCED GYPSUM GRL MATL GRILLE MATERIAL GYP BD GYPSUM BOARD MAX MAXIMUM EACH MCC MULTI COLOR COATING EXHAUST FAN MDS METAL DIVING STRIP EXTERIOR INSULATION FINISH SYSTEM MECH MECHANICAL HIGH, HEIGHT MET EXPANSION JOINT Н METAL OR METALLIC ELEVATION HOSE BIBB METAL THRESHOLD HB MT ELECTRIC, ELECTRICAL HC HOLLOW CORE MEZZ MEZZANINE ELEVATOR HDWD HARDWOOD MFR MANUFACTURER HDWE ENCLOSURE HARDWARE MANHOLE MH HM ENTRANCE, ENTRY HOLLOW METAL MIN MINIMUM HORIZ ELECTRICAL PANEL HORIZONTAL, HORIZONTALLY MISCELLANEOUS MISC HORIZB HP HORIZONTAL BLINDS MKBD EQUAL MARKERBOARD MLDG EQUIPMENT HIGH POINT MOULDING EACH WAY HOUR HR MO MASONRY OPENING ELECTRICAL WATER COOLER MRT MARBLE THRESHOLD EXISTING MTD MOUNTED EXPANDED, EXPANSION MULL MULLION INSIDE DIAMETER EXPANSION BOLT EXTERIOR INVERT ELEVATION Ν INCLUDE, INCLUDING INCL NIC NOT IN CONTRACT INFO INFORMATION IN INCH, INCHES NO NUMBER INSUL IR FACTORY NOM NOMINAL INSULATE, INSULATION FIRE ALARM CONTROL PANEL NRC NOICE REDUCTION COEFFICIENT IMPACT RESISTANT INT NTS FLOOR DRAIN INTERIOR NOT TO SCALE

SYMBOL LEGEND

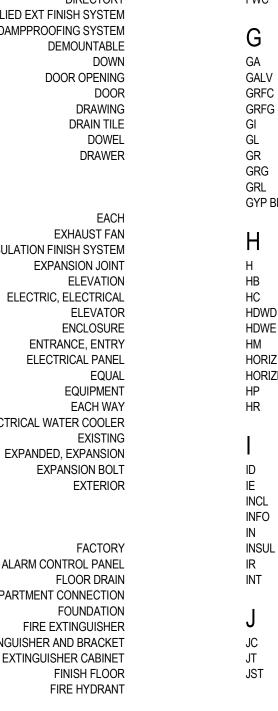

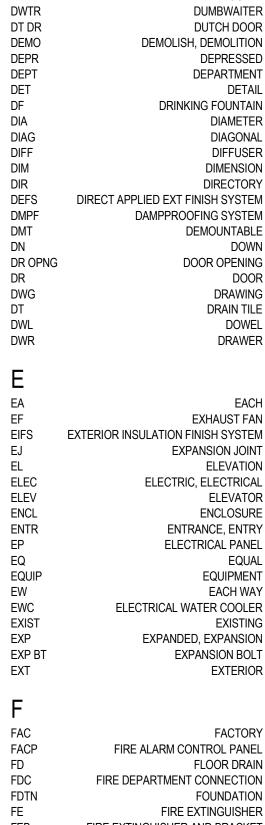


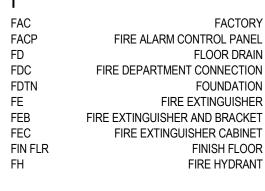






STRUCTURAL GLAZED FACING TILE	
STONE	
MARBLE	
METALS	
FINISH WOOD	
PLYWOOD	

JOINT OR COMPRESSIBLE FILLER STRIP
GLASS OR PLASTIC GLAZING
PLASTER OR GYPSUM BOARD
CERAMIC OR QUARRY TILE

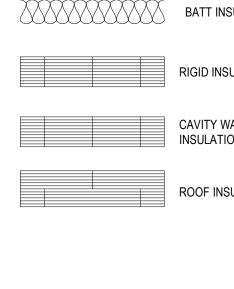


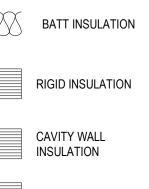


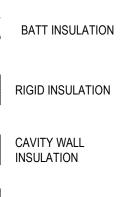

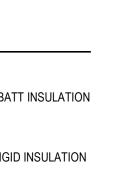




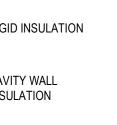

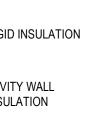




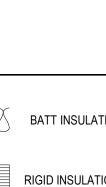









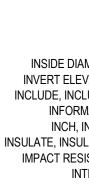




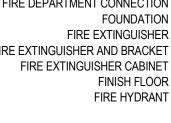




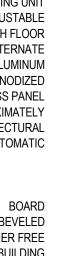


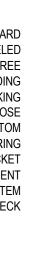



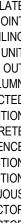



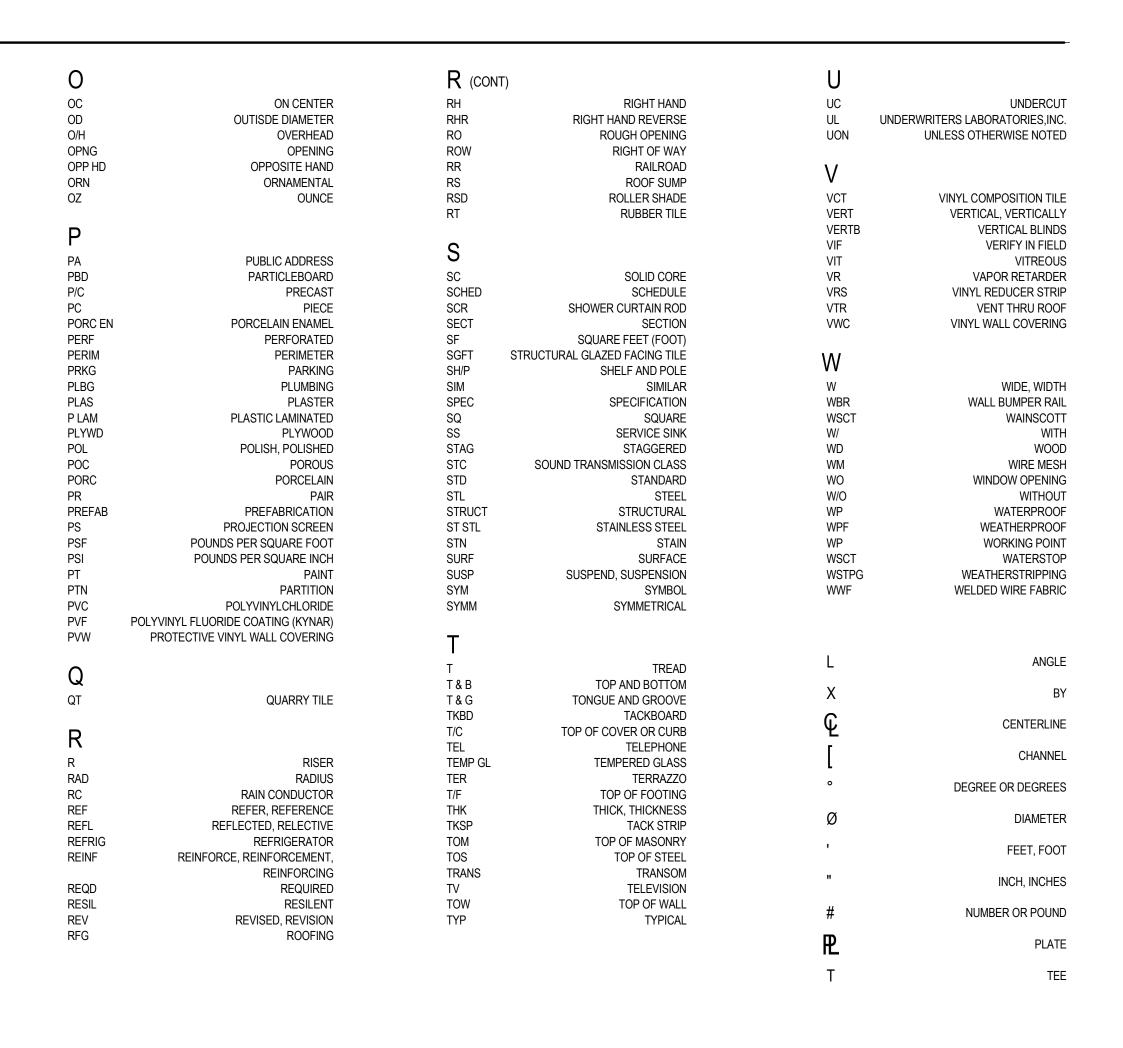



Drawing Number

AR.0

Architectural Reference Information

 \odot 2021 Integrated ${
m d}$ n solutions, LL IDS Drawing Title

Pr	oject Administrator
	Administrator
	Project Designer
K. Litwi	in/T. Easthope
Project A	Architect / Engineer
	K. Marshall
	Drawn By
	K. Marshall
	Q.M. Review
	N. LaForest
	Approved
	B. Sundberg
	Drawing Scale
	As Noted
Issued for	Issue Date
Design Development	02-26-2021
Quality Management Review	04-21-2021
Bids	07-15-2021
	<u> </u>


1 Mutual Avenue Frankenmuth, MI 48787 Key Plan

Executive Suite Renovation



architecture engineering interiors & technology 1441 west long lake, suite 200 troy, michigan 48098 5211 cascade road SE, suite 300 grand rapids, michigan 49546 248.823.2100 www.ids-michigan.com




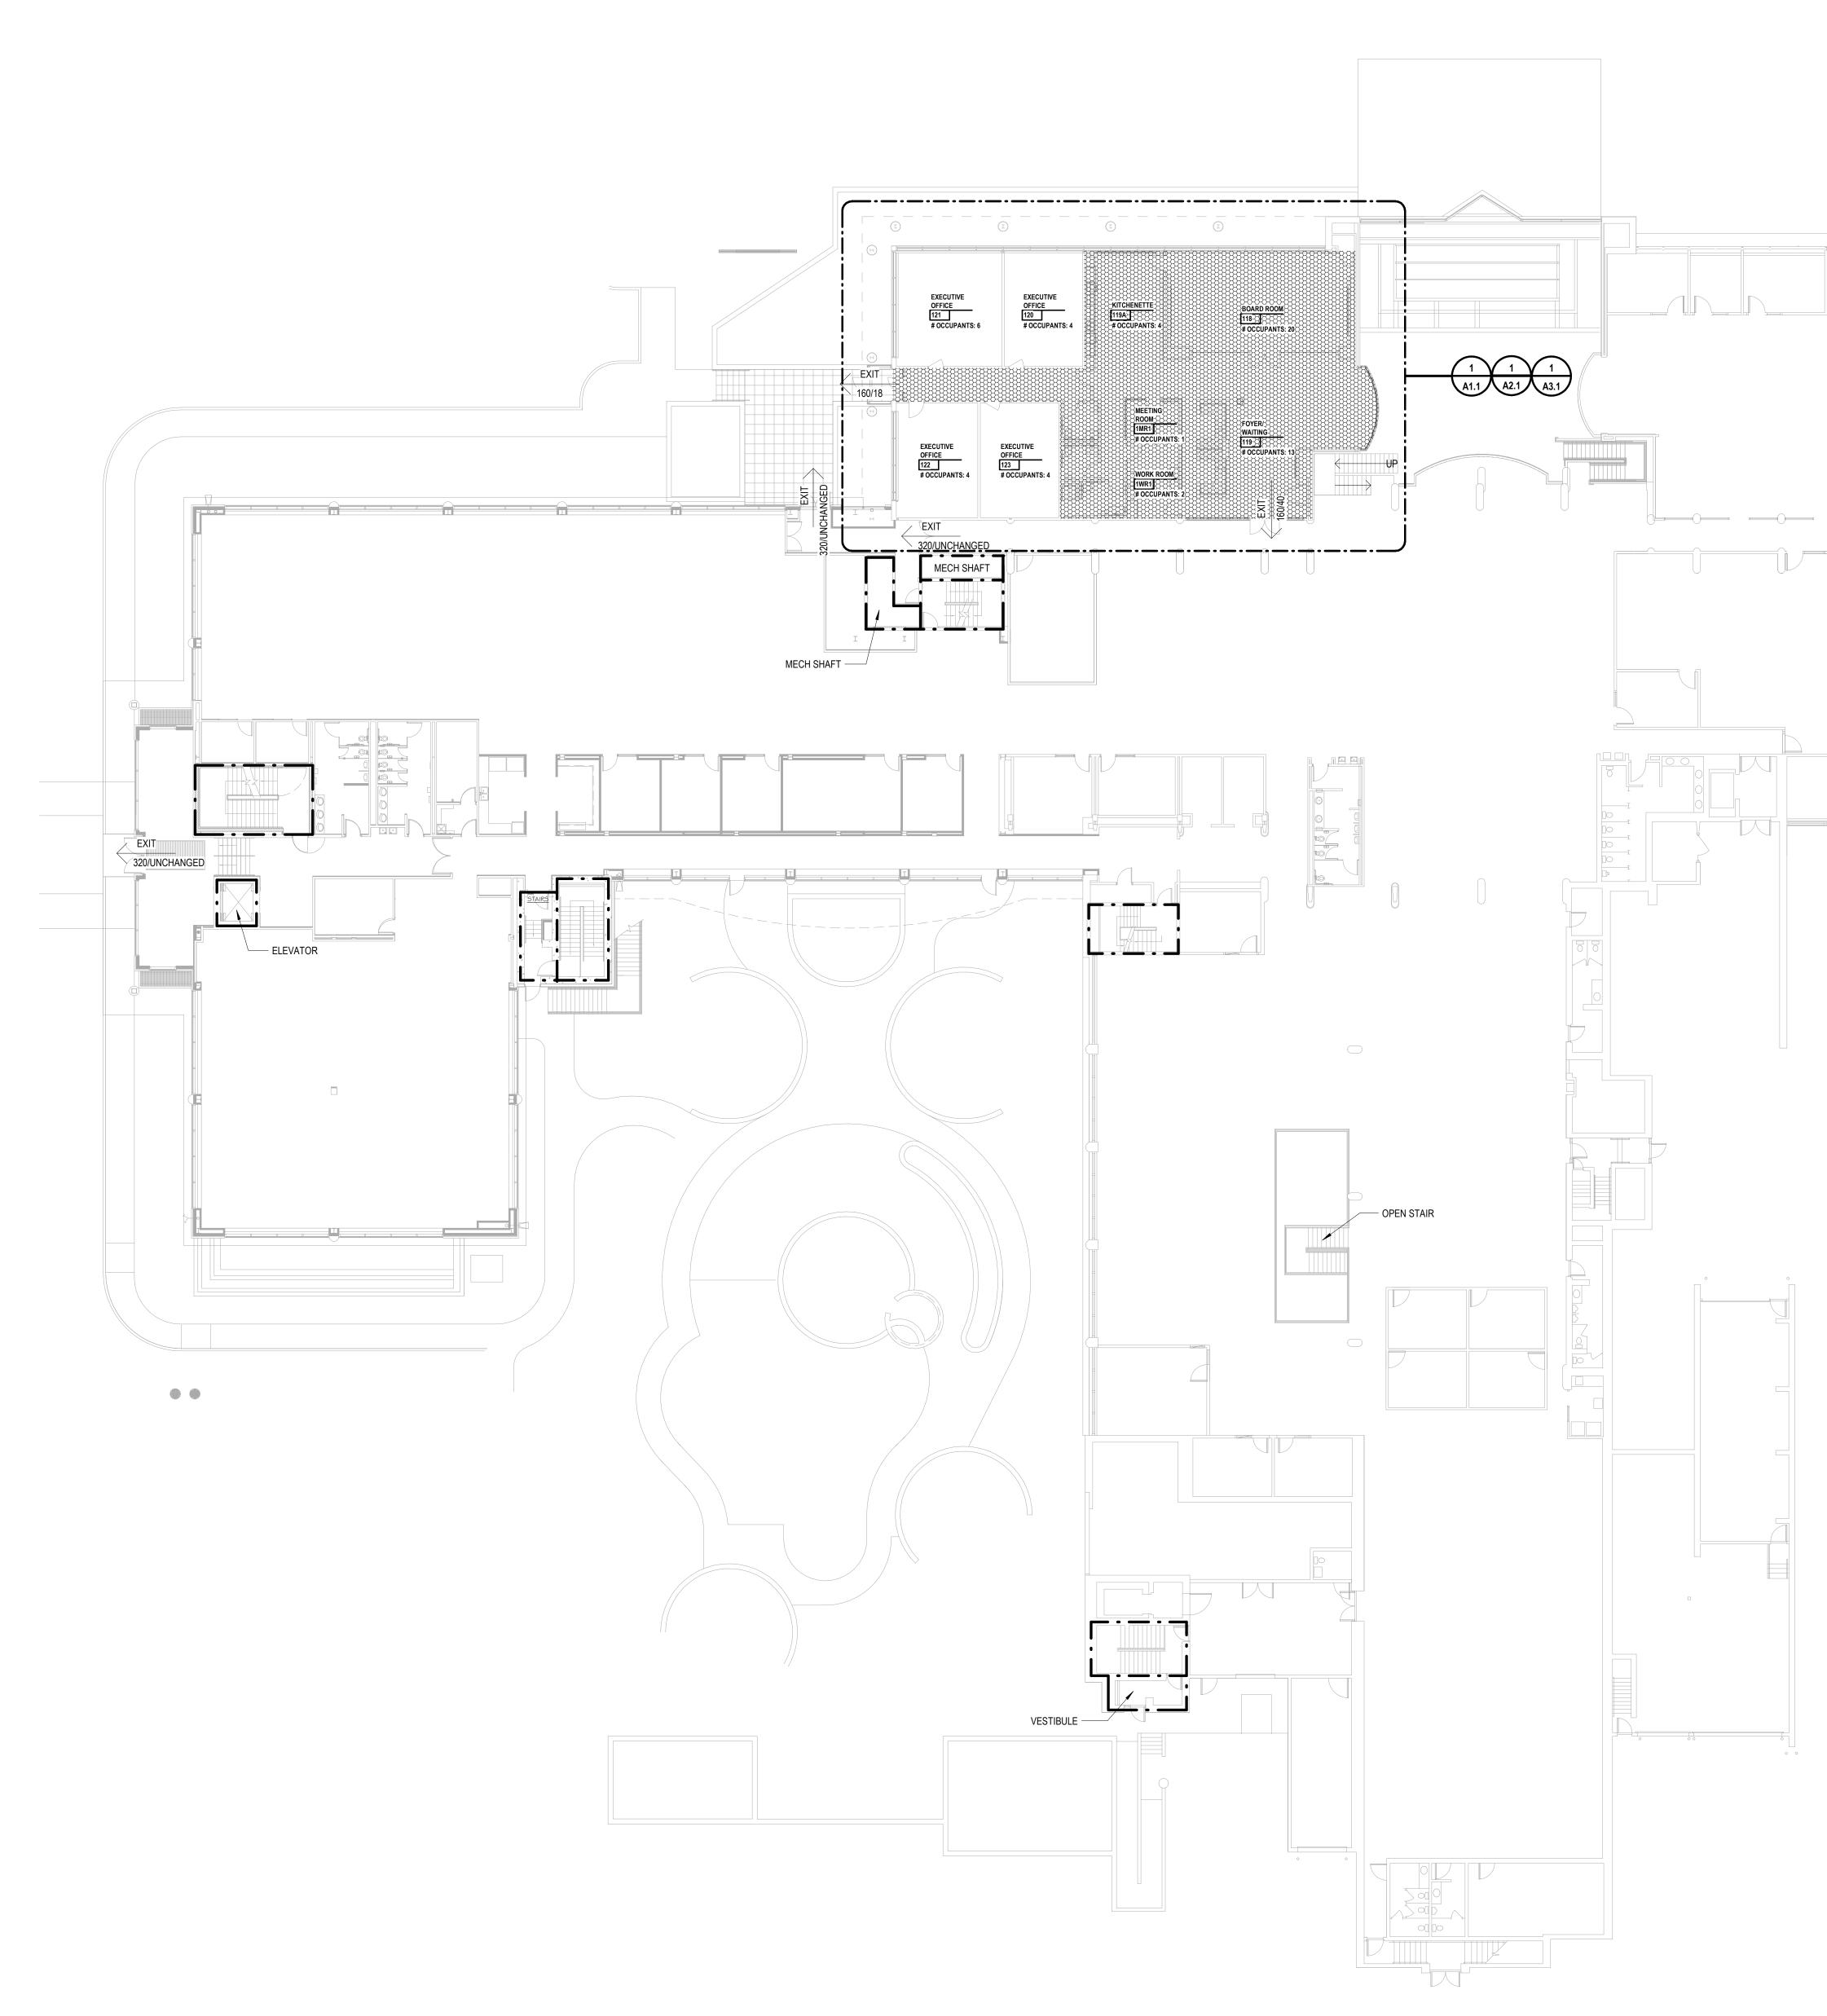




APPLICABLE CC	INSTRUCTION CODES AND STANDARDS
Building:	Michigan Department of Licensing and Regulatory Affairs, Bureau of Construction Codes, 2015 Michigan Building Code, Incorporating the 2015 Edition of the International Building Code as referenced by the 2015 Michigan Rehabilitation Code for Existing Buildings
	Michigan Department of Licensing and Regulatory Affairs, Bureau of Construction Codes, 2015 Michigan Rehabilitation Code for Existing Buildings, Incorporating the 2015 Edition of the International Existing Building Code
Barrier Free:	Michigan Department of Licensing and Regulatory Affairs, Bureau of Construction Codes, 2015 Michigan Building Code, Incorporating the 2015 Edition of the International Building Code
	Michigan Department of Licensing and Regulatory Affairs, Bureau of Construction Codes, 2009 ICC A117.1 - Accessible and Usable Buildings and Facilities
	U.S. Department of Justice and Architecture and Transportation Barriers Compliance Board, American with Disabilities Act (ADA) 2010 - Standards for Accessible Design
Energy:	Michigan Department of Licensing and Regulatory Affairs, Bureau of Construction Codes, Part 10a - Michigan Energy Code for Buildings and Structures, Not Including Residential Buildings, Incorporating the 2013 Edition of the ANSI/ASHRAE/IESNA Standard 90.1
Structural:	Michigan Department of Licensing and Regulatory Affairs, Bureau of Construction Codes, 2015 Michigan Building Code, Incorporating the 2015 Edition of the International Building Code
Mechanical:	Michigan Department of Licensing and Regulatory Affairs, Bureau of Construction Codes, Mechanical Division, 2015 Michigan Mechanical Code, Incorporating the 2015 Edition of the International Mechanical Code
Plumbing:	Michigan Department of Licensing and Regulatory Affairs, Bureau of Construction Codes, Plumbing Division, 2015 Michigan Plumbing Code, Incorporating the 2015 Edition of the International Plumbing Code
Fire Protection:	Michigan Department of Licensing and Regulatory Affairs, Bureau of Construction Codes, 2015 Michigan Building Code, Incorporating the 2013 Edition of NFPA 13 - Installation of Sprinkler Systems
Electrical:	Michigan Department of Licensing and Regulatory Affairs, Bureau of Construction Codes, Electrical Division, 2017 Michigan Electrical Code, Incorporating the 2017 Edition of the National Electrical Code
Fire Alarm:	Michigan Department of Licensing and Regulatory Affairs, Bureau of Construction Codes, Electrical Division, Incorporating the 2013 Edition of NFPA 72 - National Fire Alarm and Signaling Code

BUILDING INFORMATION

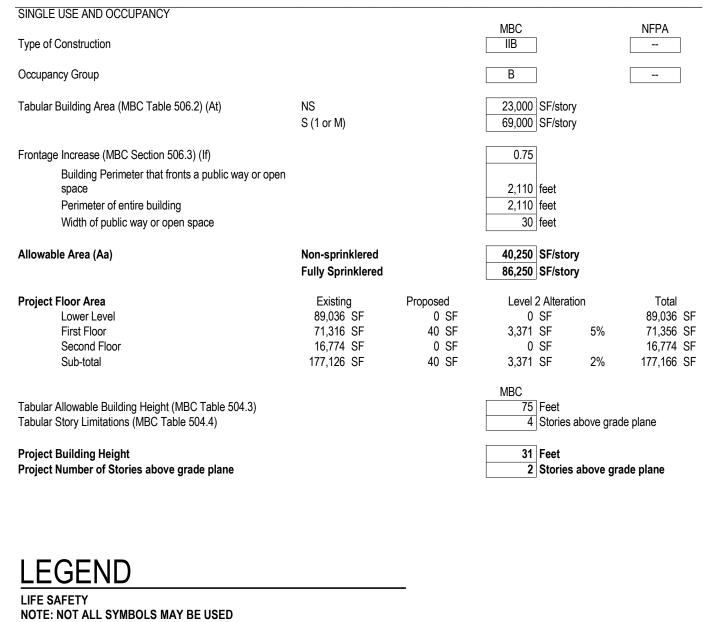


AREA OF LEVEL 2 ALTERATION

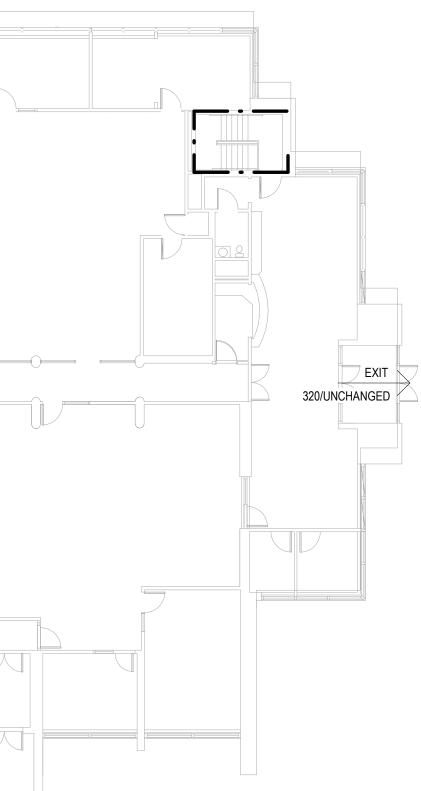

LIFE SAFETY NOTE: NOT ALL SYMBOLS	MAY BE USED
EXIT 000/000	EXIT CAPACITY / TABULAR OCCUPANT LOAD
	1-HR FIRE-RATED PARTITION
 • • 	2-HR FIRE-RATED PARTITION
 	3-HR FIRE-RATED PARTITION
	SMOKE TIGHT PARTITION

888888

ī**D**≗ Project Number

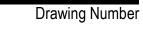

LS0.1

20120-2000

IDS Drawing Title Building and Code Information and First Floor Composite Life Safety Plan


 $f{c}$ 2021 integrated $f{d}$ ${
m m}$ solutions, LLC

P	roject Administrator
	Administrator
	Project Designer
K. Litw	vin/T. Easthope
Project	Architect / Engineer
	K. Marshall
	Drawn By
	K. Marshall
	Q.M. Review
	N. LaForest
	Approved
	B. Sundberg
	Drawing Scale
	1/16" = 1'-0"
Issued for	Issue Date
Design Development	02-26-2021
Quality Management Review	04-21-2021
Bids	07-15-2021

	1 Mutual Avenue Frankenmuth, MI 48787
NORTH	Key Plan

Executive Suite Renovation




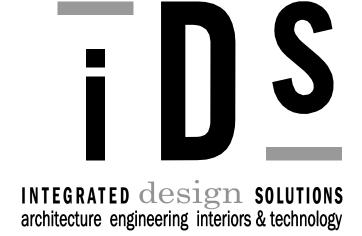

1441 west long lake, suite 200 troy, michigan 48098

5211 cascade road SE, suite 300 grand rapids, michigan 49546

248.823.2100 www.ids-michigan.com

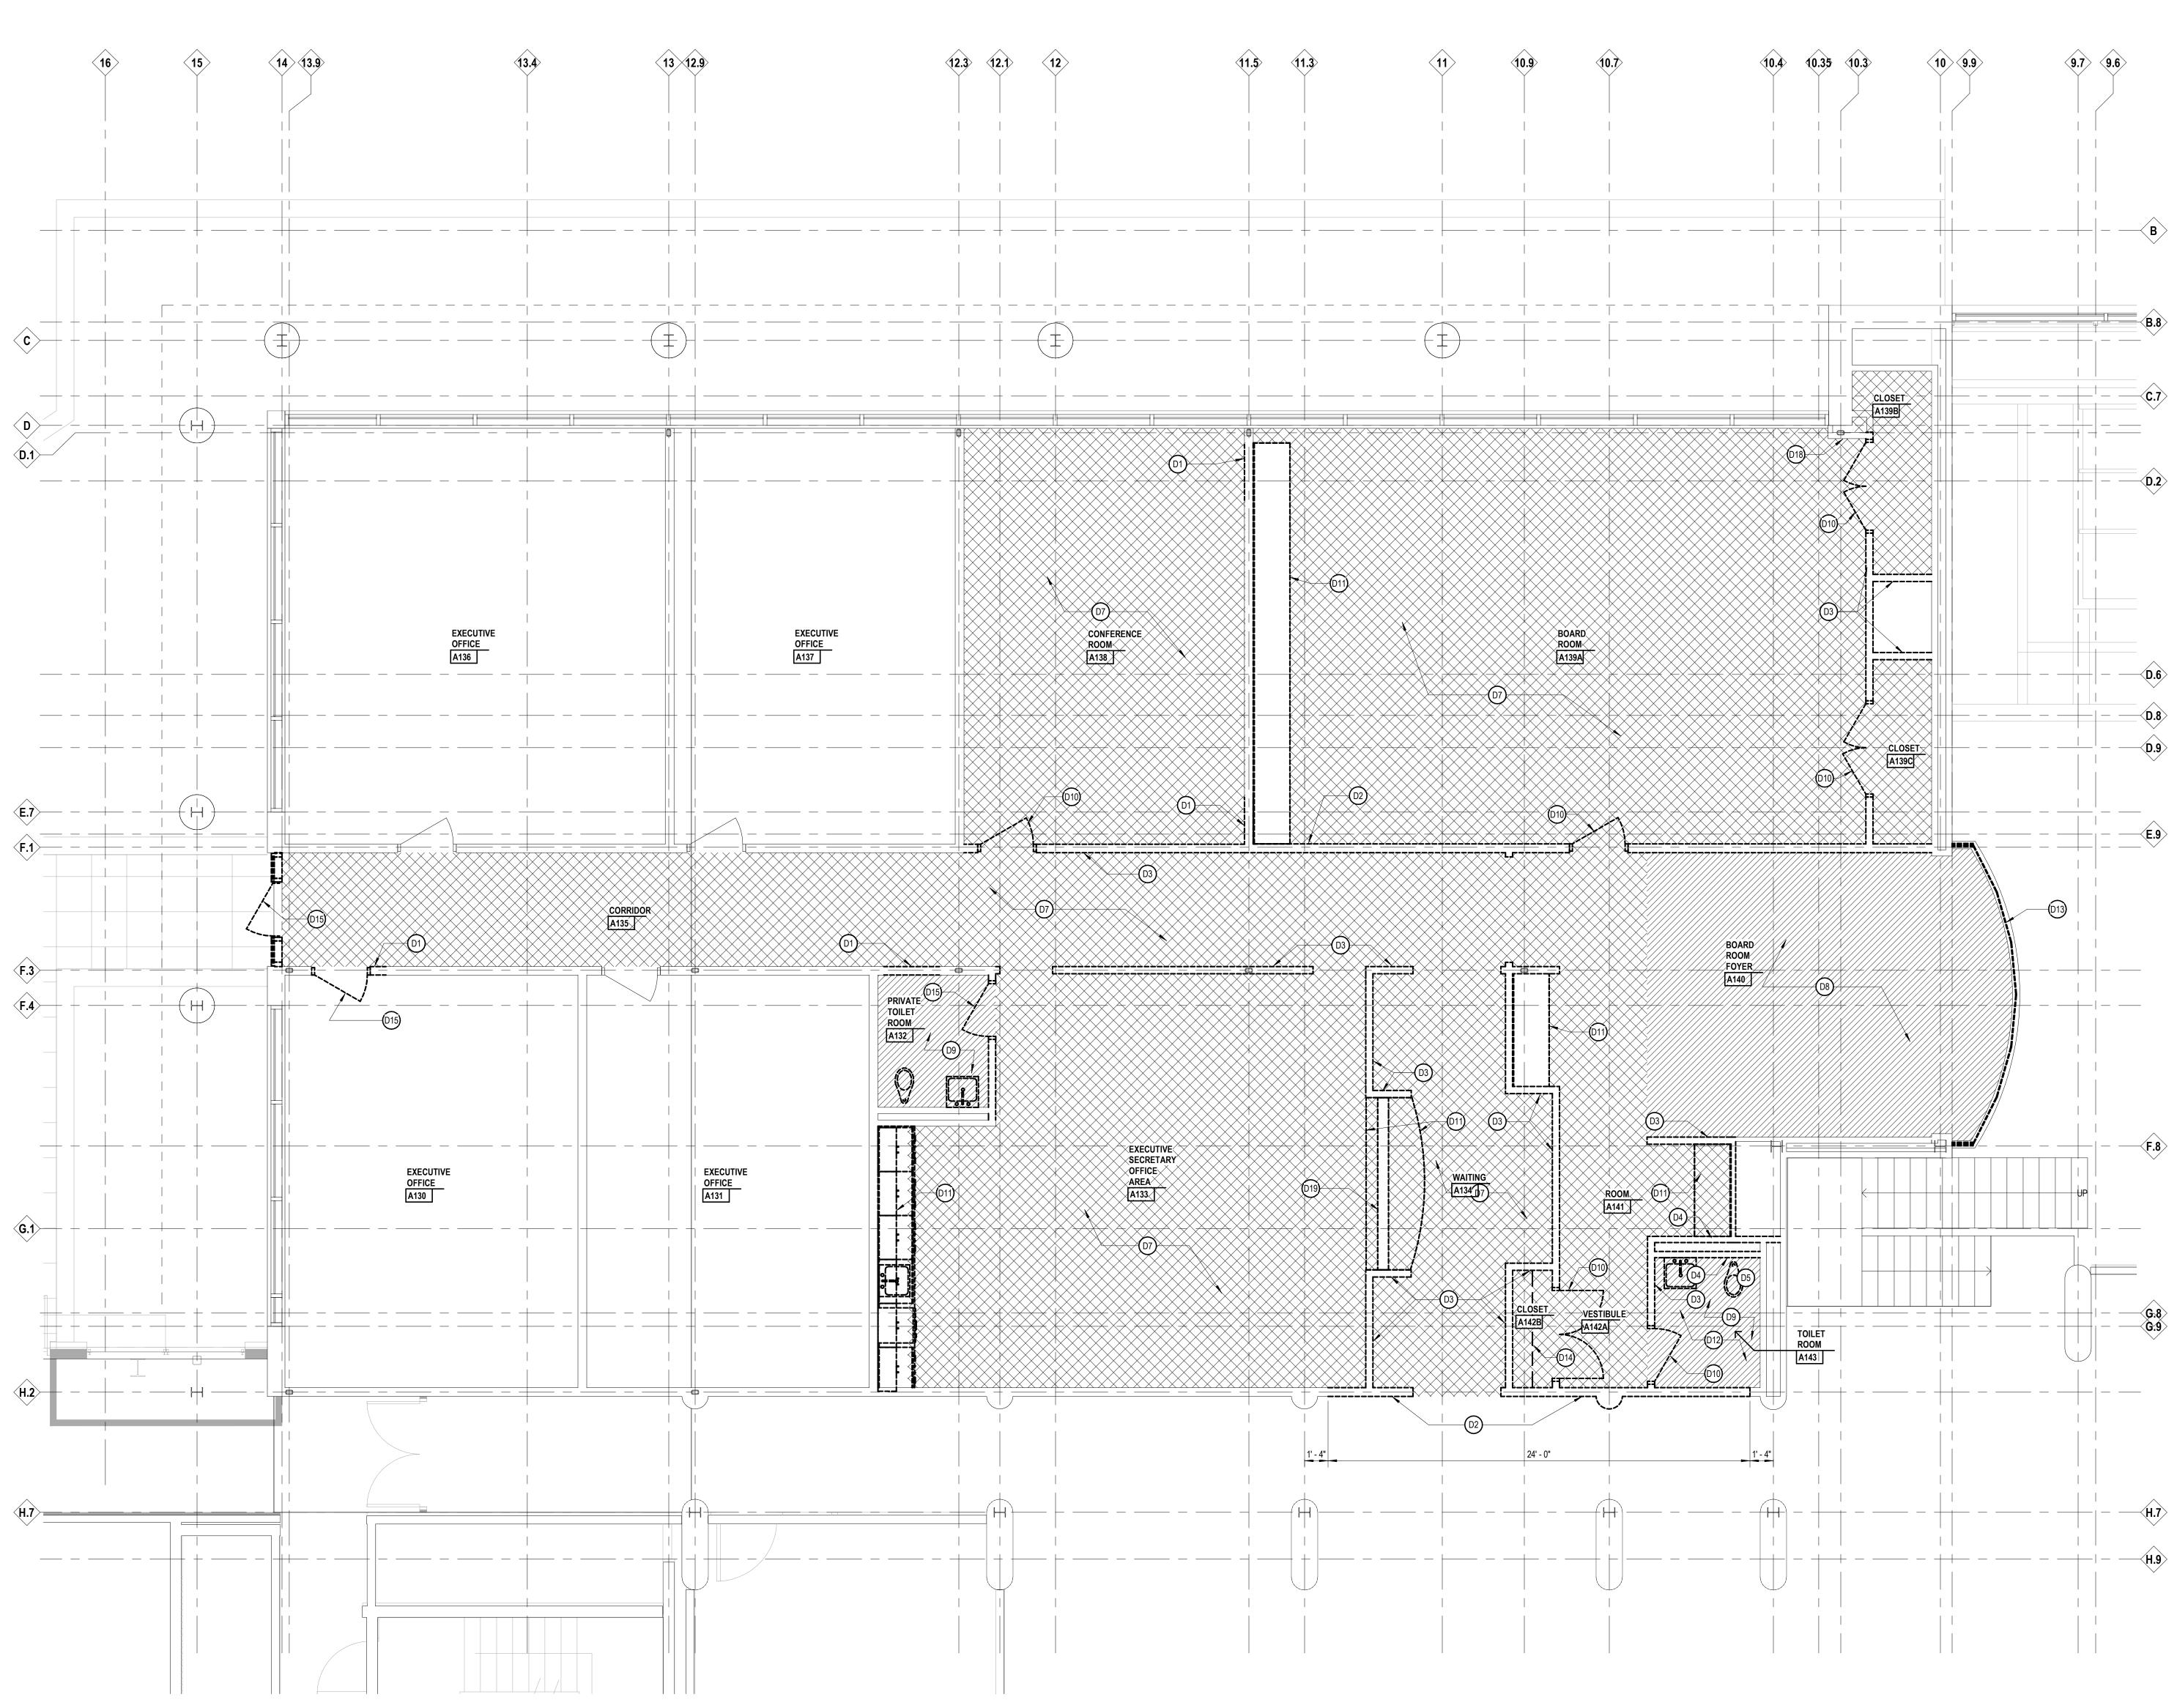

- DEMOLITION PLAN A. ALL DEMOLITION WORK REQUIRED IS NOT NECESSARILY LIMITED TO WHAT IS SHOWN ON THE DEMOLITION PLAN. THE INTENT IS TO REMOVE ALL MECHANICAL, ELECTRICAL, AND ARCHITECTURAL ITEMS AS REQUIRED TO FACILITATE NEW CONSTRUCTION.
- B. CONTRACTOR SHALL PROVIDE TEMPORARY DUSTPROOF PARTITIONS WITH DOORS AT LOCATIONS INDICATED AND/OR AS REQUIRED TO ADEQUATELY SEPARATE OCCUPIED AREAS FROM CONSTRUCTION HAZARDS, NOISE AND/OR DUST. REFER TO SPECIFICATIONS FOR ADDITIONAL INFORMATION. COORDINATE ALL LOCATIONS WITH ARCHITECT'S/OWNER'S REPRESENTATIVE.
- C. CONTRACTOR SHALL PROVIDE DUST MATS AT ALL CONSTRUCTION AREA ENTRANCES AND EXIT LOCATIONS. COORDINATE ALL LOCATION'S WITH ARCHITECT'S/OWNER'S REPRESENTATIVES.
- D. CONTRACTOR SHALL CONTINUOUSLY MAINTAIN ALL MEANS OF EGRESS AND ALL FIRE PROTECTION FEATURES FOR PORTIONS OF THE BUILDING THAT REMAIN OCCUPIED DURING CONSTRUCTION.
- E. COORDINATE SCOPE AND EXTENT OF DEMOLITION WITH NEW WORK PLANS AND DETAILS.
- F. REFER TO MECHANICAL AND ELECTRICAL DEMOLITION SHEETS FOR ADDITIONAL INFORMATION.

	EXISTING TO REMAIN			
	EXISTING ACOUSTIC LAY-IN CEILING TO BE REMOVED AS NOTED BY KEYNOTE			
	EXISTING FLOOR/FINISH TO BE REMOVED AS NOTED BY KEYNOTE			
	EXISTING CARPETING/FINISH TO BE REMOVED AS NOTED BY KEYNOTE			
KEYNOTE	S			
EMOLITION PLAN				
HADED ITEMS HAVE BEEN REVISED FROM PREVIOUS				
OTE: NOT ALL KEYNOTE	S MAY BE USED	IOTE: NOT ALL KEYNOTES MAY BE USED		

EXISTING TO BE REMOVED

LEGEND SYMBOL INDICATOR

LEGEND

DEMOLITION PLAN

_ _ _

NOTE: NOT ALL SYMBOLS MAY BE USED

- D1 REMOVE PORTION OF GYPSUM BOARD / METAL STUD PARTITION. COORDINATE WITH NEW WORK PLANS
- D2 REMOVE GYPSUM BOARD / METAL STUD PARTITION TO UNDERSIDE OF STRUCTURE (2+1 LAYERS OF GYPSUM BOARD)
- D3 REMOVE GYPSUM BOARD / METAL STUD PARTITION TO UNDERSIDE OF STRUCTURE (1+1 LAYERS OF GYPSUM BOARD)
- D4 REMOVE GYPSUM BOARD / METAL STUD PARTITION TO UNDERSIDE OF STRUCTURE (1 LAYER OF GYPSUM BOARD)
- D5 REMOVE ACOUSTICAL CEILING PANELS, GRID AND SUSPENSION
- SYSTEM
- D6 REMOVE GYPSUM BOARD / METAL STUD CEILING AND/OR CEILING DROP AND SUSPENSION SYSTEM
- D7 REMOVE CARPET, BASE AND ADHESIVE DOWN TO STRUCTURAL SLAB
- D8 REMOVE WOOD FLOORING, BASE AND ADHESIVE DOWN TO STRUCTURAL SLAB
- D9 REMOVE CERAMIC TILE, TILE BASE, MARBLE SILL AND THIN SET TO TOP OF STRUCTURAL SLAB
- D10 REMOVE DOOR AND FRAME IN ITS ENTIRETY
- D11 REMOVE COUNTER, BASE CABINETS AND / OR WALL MOUNTED CABINETS IN THEIR ENTIRETY
- D12 REMOVE TOILET ACCESSORIES: MIRROR, SOAP DISPENSER, PAPER TOWEL DISPENSER, TOILET PAPER HOLDER, GRAB BARS, SHELVES, DOORSTOPS, ETC
- D13 REMOVE GLASS RAILING PANELS AND TOP CAP IN THEIR ENTIRETY -RAILING BASE TO REMAIN. COORDINATE WITH NEW WORK PLANS
- D14 REMOVE SHELVING AND COAT ROD IN ITS ENTIRETY
- D15 SALVAGE DOOR, FRAME AND HARDWARE FOR REINSTALLATION D17 REMOVE PORTION OF CEMENT PLASTER SOFFIT TO NEAREST CONTROL
- JOINT. REMAINING SOFFIT TO BE PROTECTED FROM DAMAGE.
- D18 REMOVE GYPSUM BOARD FROM METAL FRAMING (FRAMING TO REMAIN) AS REQUIRED TO INSTALL NEW FINISHES COORDINATE WITH NEW WORK PLAN
- D19 REMOVE PARTIAL HEIGHT GYPSUM BOARD AND METAL FRAMING PARTITION IN ITS ENTIRETY
- D20 REMOVE RAISED LIGHT COVE AND GRILL IN ITS ENTIRETY



ī **D**^s Project Number

Drawing Number

A1.1

IDS Drawing Title First Floor Demolition Plan

 $^{
m c}$ 2021 integrated ${
m d}$ sign solutions, LL

Pr	oject Administrator
	Administrator
	Project Designer
K. Litwi	n/T. Easthope
Project A	Architect / Engineer
	K. Marshall
	Drawn By
	K. Marshall
	Q.M. Review
	N. LaForest
	Approved
	B. Sundberg
	Drawing Scale
	1/4" = 1'-0"
Issued for	Issue Date
Design Development	02-26-2021
Quality Management Review	04-21-2021
Bids	07-15-2021


1 Mutual Avenue Frankenmuth, MI 48787 Key Plar

Executive Suite Renovation



INTEGRATED design solutions architecture engineering interiors & technology 1441 west long lake, suite 200 troy, michigan 48098 5211 cascade road SE, suite 300 grand rapids, michigan 49546 248.823.2100



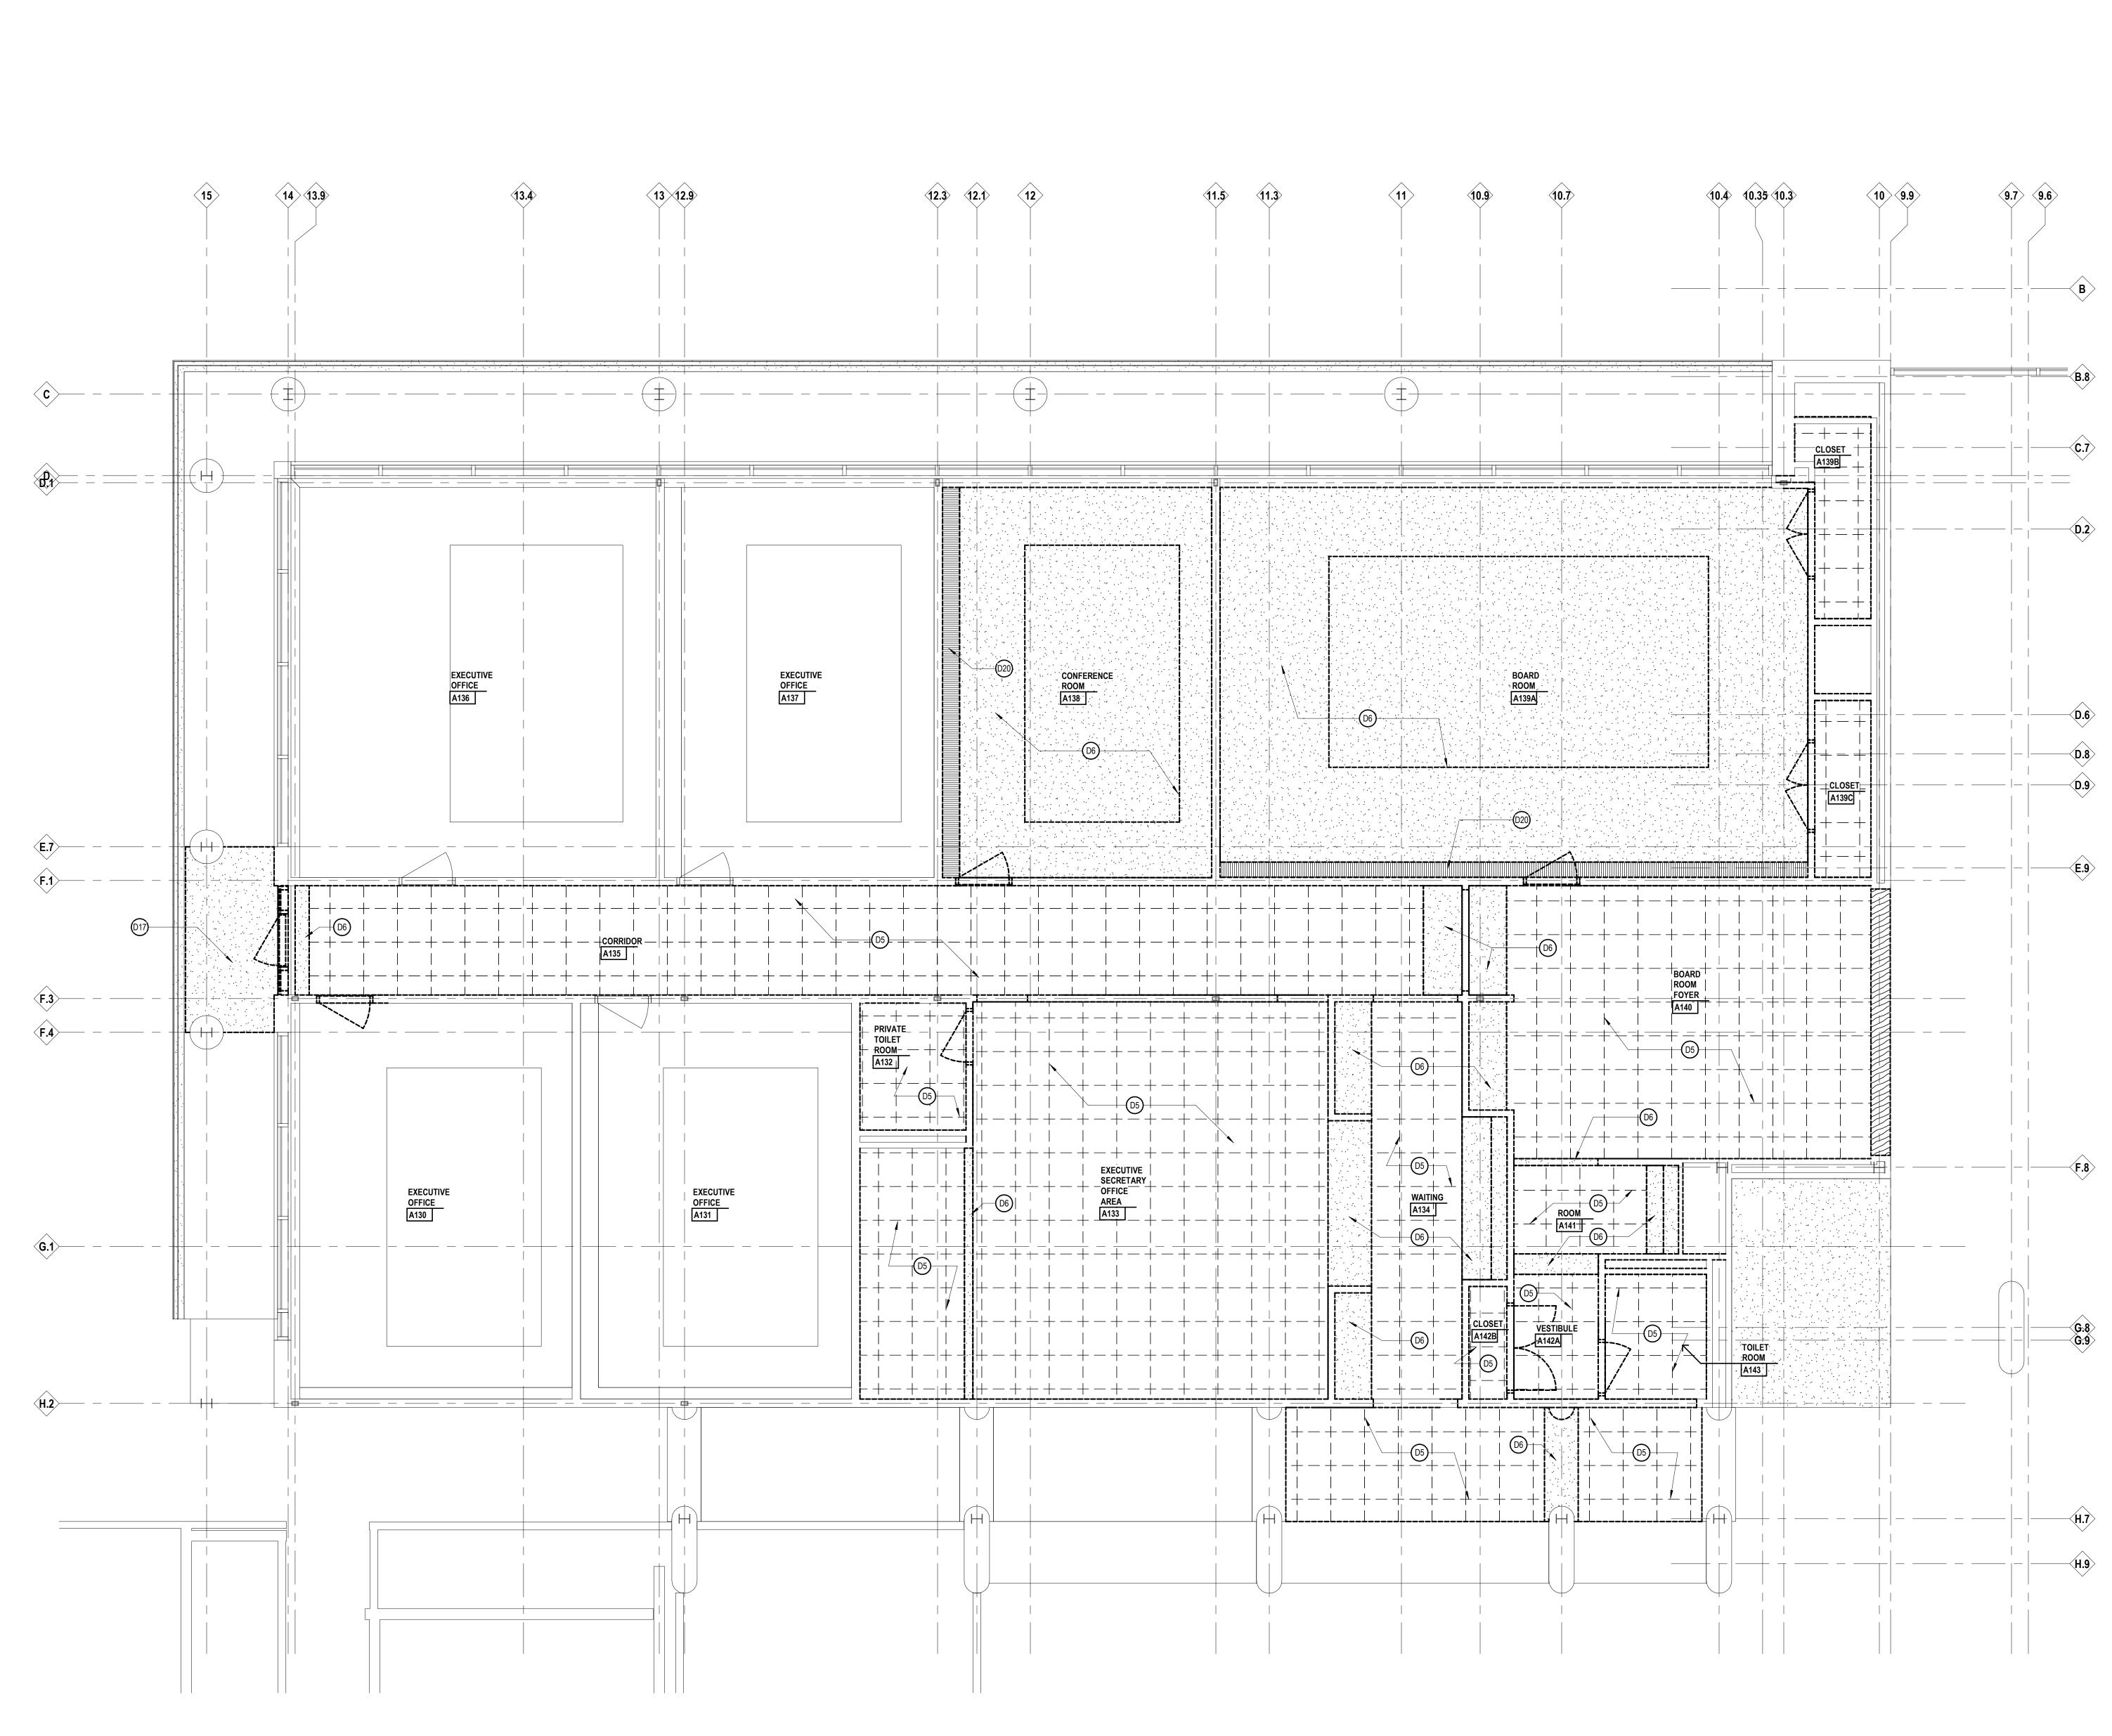

- DEMOLITION PLAN A. ALL DEMOLITION WORK REQUIRED IS NOT NECESSARILY LIMITED TO WHAT IS SHOWN ON THE DEMOLITION PLAN. THE INTENT IS TO REMOVE ALL MECHANICAL, ELECTRICAL, AND ARCHITECTURAL ITEMS AS REQUIRED TO FACILITATE NEW CONSTRUCTION.
- B. CONTRACTOR SHALL PROVIDE TEMPORARY DUSTPROOF PARTITIONS WITH DOORS AT LOCATIONS INDICATED AND/OR AS REQUIRED TO ADEQUATELY SEPARATE OCCUPIED AREAS FROM CONSTRUCTION HAZARDS, NOISE AND/OR DUST. REFER TO SPECIFICATIONS FOR ADDITIONAL INFORMATION. COORDINATE ALL LOCATIONS WITH ARCHITECT'S/OWNER'S REPRESENTATIVE.
- C. CONTRACTOR SHALL PROVIDE DUST MATS AT ALL CONSTRUCTION AREA ENTRANCES AND EXIT LOCATIONS. COORDINATE ALL LOCATION'S WITH ARCHITECT'S/OWNER'S REPRESENTATIVES.
- D. CONTRACTOR SHALL CONTINUOUSLY MAINTAIN ALL MEANS OF EGRESS AND ALL FIRE PROTECTION FEATURES FOR PORTIONS OF THE BUILDING THAT REMAIN OCCUPIED DURING CONSTRUCTION.
- E. COORDINATE SCOPE AND EXTENT OF DEMOLITION WITH NEW WORK PLANS AND DETAILS.
- F. REFER TO MECHANICAL AND ELECTRICAL DEMOLITION SHEETS FOR ADDITIONAL INFORMATION.

LEGEND DEMOLITION PLAN NOTE: NOT ALL SYMBOLS MAY BE USED EXISTING TO BE REMOVED _ _ _ EXISTING TO REMAIN -----EXISTING ACOUSTIC LAY-IN CEILING TO BE REMOVED AS

	NOTED BY KEYNOTE
	EXISTING FLOOR/FINISH TO BE REMOVED AS NOTED BY KEYNOTE
	EXISTING CARPETING/FINISH TO BE REMOVED AS NOTED BY KEYNOTE
<u>KEYNOTE</u>	S
EMOLITION PLAN	

SHADED ITEMS HAVE BEEN REVISED FROM PREVIOUS NOTE: NOT ALL KEYNOTES MAY BE USED

LEGEND SYMBOL INDICATOR

- D1 REMOVE PORTION OF GYPSUM BOARD / METAL STUD PARTITION. COORDINATE WITH NEW WORK PLANS
- D2 REMOVE GYPSUM BOARD / METAL STUD PARTITION TO UNDERSIDE OF STRUCTURE (2+1 LAYERS OF GYPSUM BOARD)
- D3 REMOVE GYPSUM BOARD / METAL STUD PARTITION TO UNDERSIDE OF STRUCTURE (1+1 LAYERS OF GYPSUM BOARD)
- D4 REMOVE GYPSUM BOARD / METAL STUD PARTITION TO UNDERSIDE OF STRUCTURE (1 LAYER OF GYPSUM BOARD)
- D5 REMOVE ACOUSTICAL CEILING PANELS, GRID AND SUSPENSION
- SYSTEM D6 REMOVE GYPSUM BOARD / METAL STUD CEILING AND/OR CEILING DROP
- AND SUSPENSION SYSTEM
- D7 REMOVE CARPET, BASE AND ADHESIVE DOWN TO STRUCTURAL SLAB D8 REMOVE WOOD FLOORING, BASE AND ADHESIVE DOWN TO
- STRUCTURAL SLAB D9 REMOVE CERAMIC TILE, TILE BASE, MARBLE SILL AND THIN SET TO TOP OF STRUCTURAL SLAB
- D10 REMOVE DOOR AND FRAME IN ITS ENTIRETY
- D11 REMOVE COUNTER, BASE CABINETS AND / OR WALL MOUNTED CABINETS IN THEIR ENTIRETY
- D12 REMOVE TOILET ACCESSORIES: MIRROR, SOAP DISPENSER, PAPER TOWEL DISPENSER, TOILET PAPER HOLDER, GRAB BARS, SHELVES, DOORSTOPS, ETC
- D13 REMOVE GLASS RAILING PANELS AND TOP CAP IN THEIR ENTIRETY -RAILING BASE TO REMAIN. COORDINATE WITH NEW WORK PLANS
- D14 REMOVE SHELVING AND COAT ROD IN ITS ENTIRETY

WORK PLAN

- D15 SALVAGE DOOR, FRAME AND HARDWARE FOR REINSTALLATION D17 REMOVE PORTION OF CEMENT PLASTER SOFFIT TO NEAREST CONTROL
- JOINT. REMAINING SOFFIT TO BE PROTECTED FROM DAMAGE. D18 REMOVE GYPSUM BOARD FROM METAL FRAMING (FRAMING TO REMAIN) AS REQUIRED TO INSTALL NEW FINISHES - COORDINATE WITH NEW
- D19 REMOVE PARTIAL HEIGHT GYPSUM BOARD AND METAL FRAMING PARTITION IN ITS ENTIRETY
- D20 REMOVE RAISED LIGHT COVE AND GRILL IN ITS ENTIRETY



ī **D**^s Project Number

Drawing Number

A1.1A

First Floor Demolition Reflected Ceiling Plan

 \odot 2021 integrated ${
m d}$ Sign Solutions, LL IDS Drawing Title

Pr	oject Administrator
	Administrator
	Project Designer
K. Litw	in/T. Easthope
Project A	Architect / Engineer
	K. Marshall
	Drawn By
	K. Marshall
	Q.M. Review
	N. LaForest
	Approved
	B. Sundberg
	Drawing Scale
	1/4" = 1'-0"
Issued for	Issue Date
Design Development	02-26-2021
Quality Management Review	04-21-2021
Bids	07-15-2021

1 Mutual Avenue Frankenmuth, MI 48787 Key Plan


Executive Suite Renovation



INTEGRATED design solutions architecture engineering interiors & technology 1441 west long lake, suite 200 troy, michigan 48098 5211 cascade road SE, suite 300 grand rapids, michigan 49546

248.823.2100



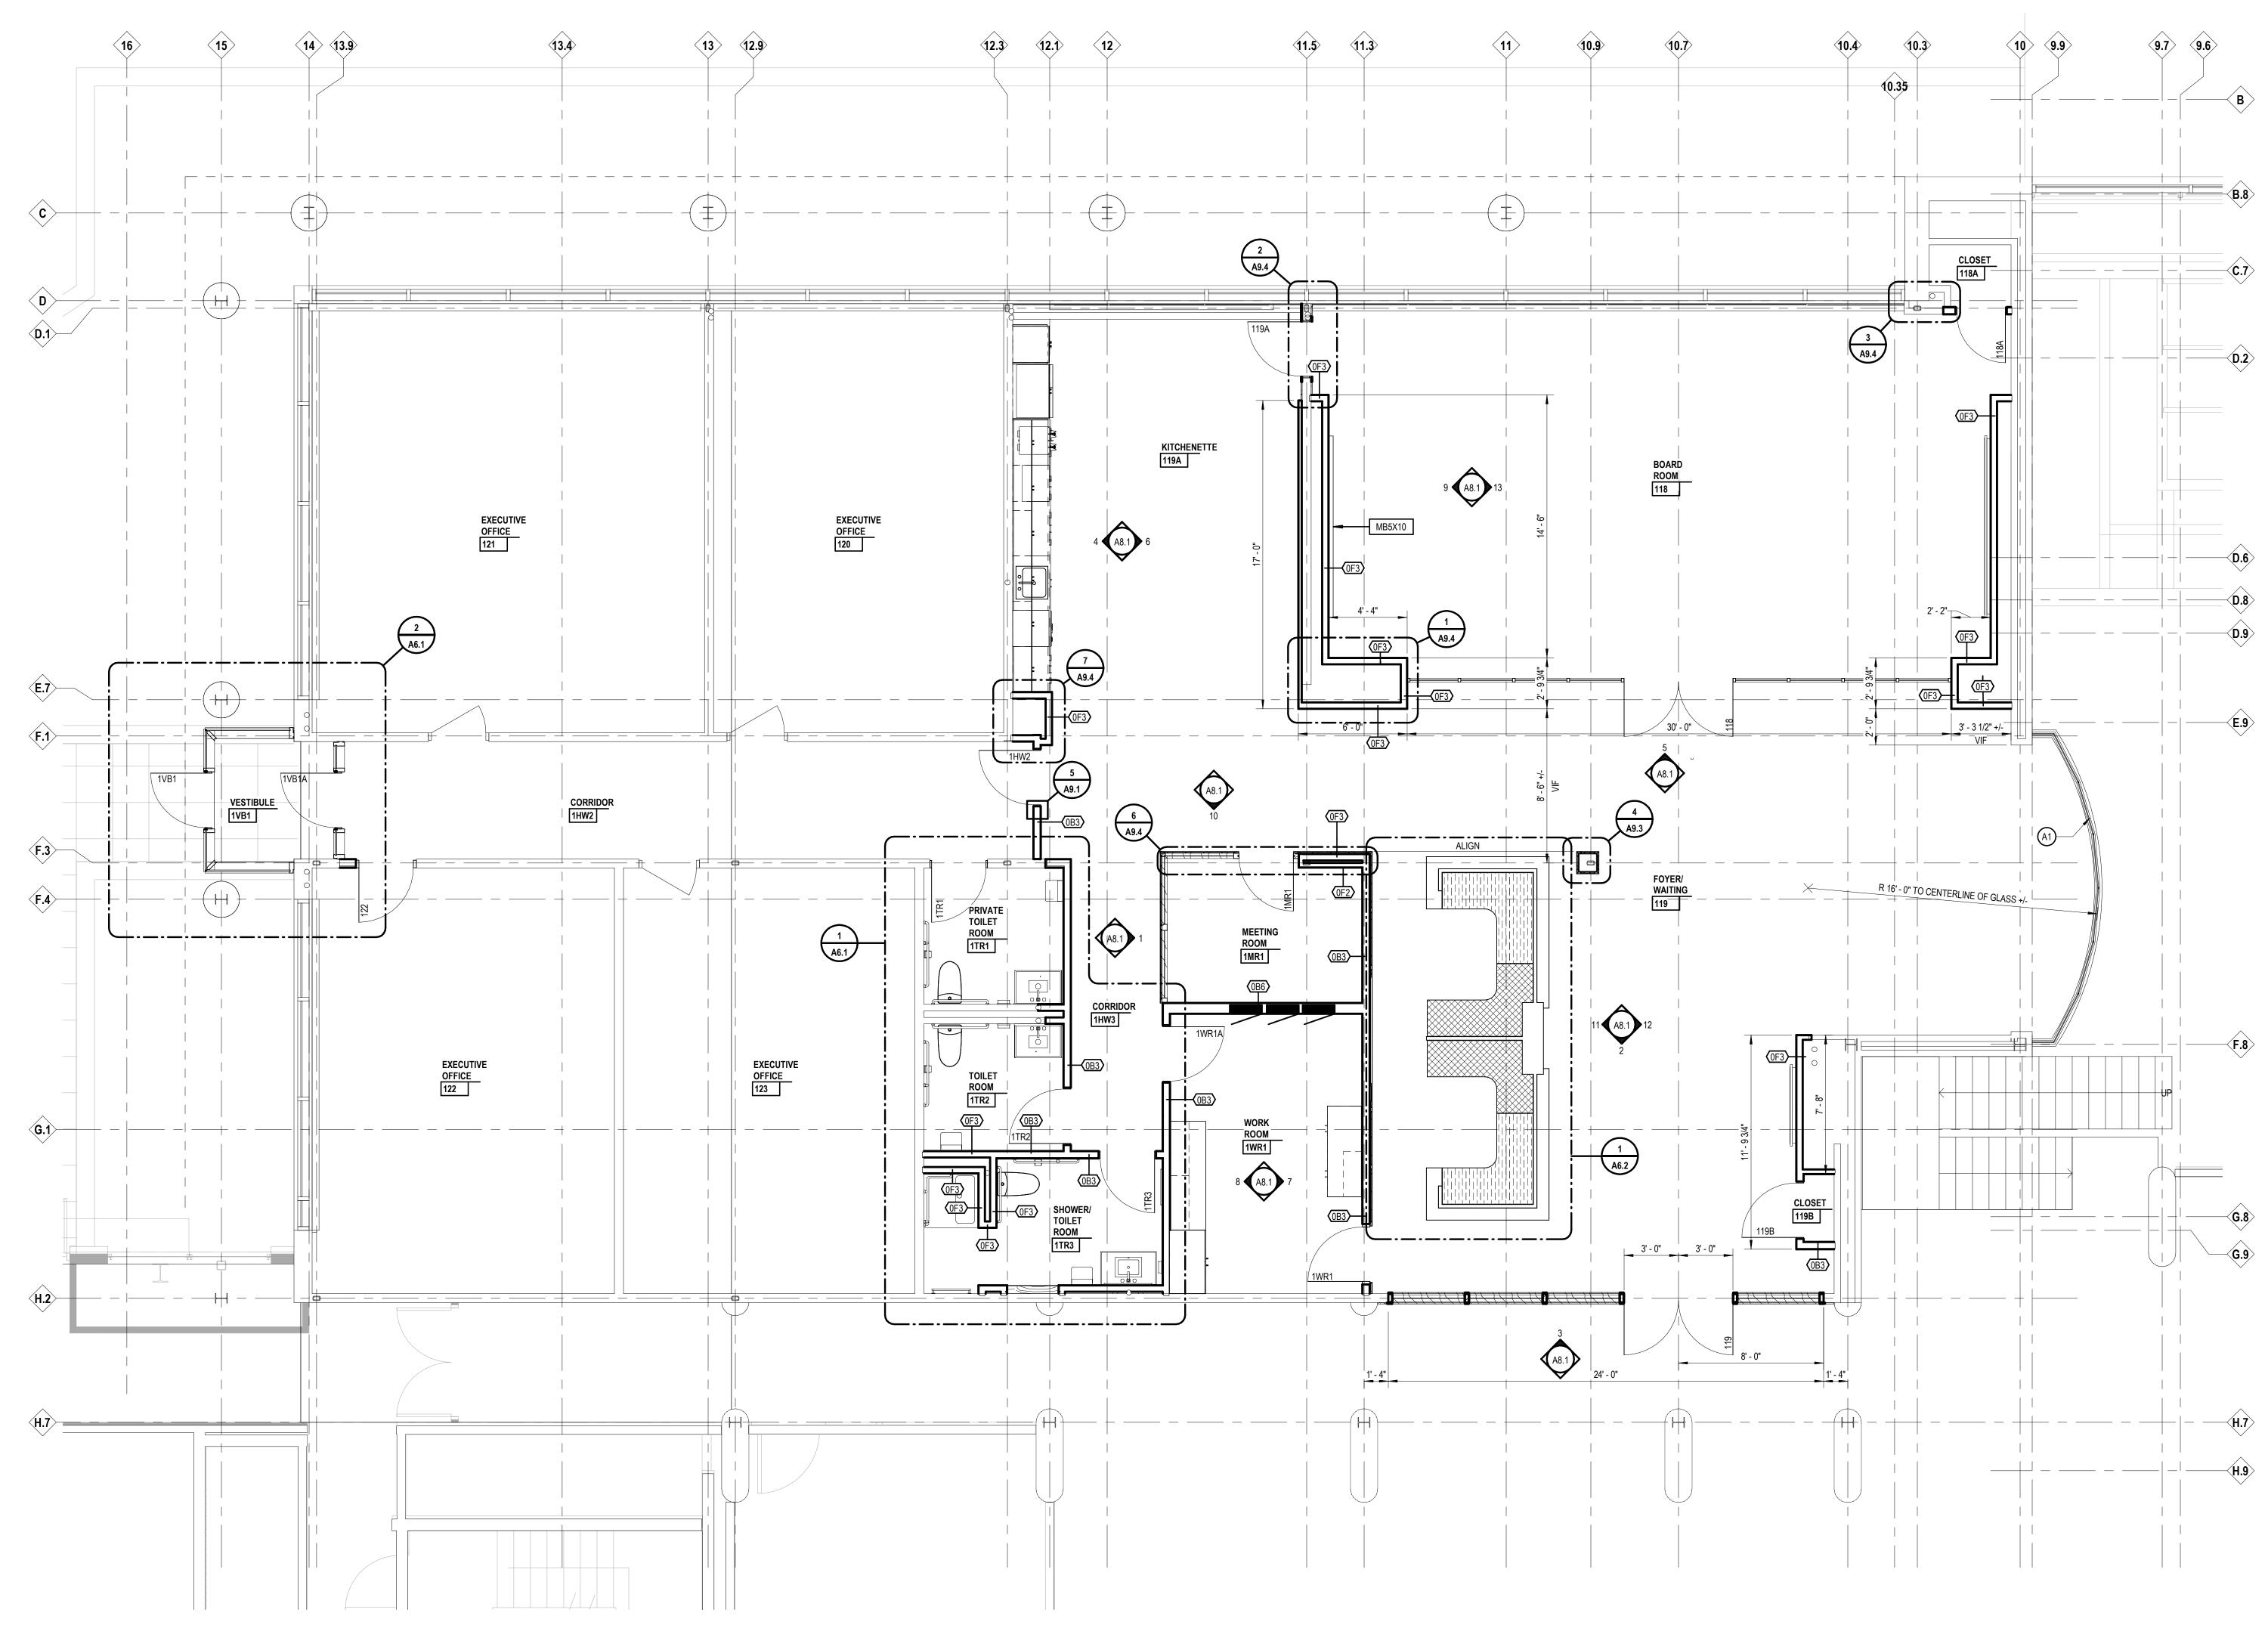

- NEW WORK PLAN
- A. REFER TO SHEET A9.1 FOR DOOR SCHEDULE AND COLORS.
- B. REFER TO SHEET A9.1 FOR FINISH SCHEDULE AND COLORS. C. REFER TO LIFE SAFETY PLANS FOR PARTITION RATINGS.
- D. PARTIAL WALL POCHEING IS SHOWN THROUGHOUT THIS PLAN AND THE TERMINATION OF SAME SHALL NOT BE CONSTRUED TO REPRESENT A CHANGE IN WALL MATERIAL. VERIFY WALL MATERIALS WITH PARTITION TYPES AND SCHEDULES.
- E. PATCH AND/OR REPAIR ALL EXISTING FLOOR, WALL AND OR CEILING FINISHES AS REQUIRED TO MATCH EXISTING OR TO ACCEPT NEW FINISHES AS SCHEDULED AT ALL AREAS AFFECTED BY THE DEMOLITION WORK. REFER TO MECHANICAL AND ELECTRICAL SHEETS FOR ADDITIONAL SCOPE OF WORK.
- F. INFILL ALL OPENINGS IN EXISTING WALLS ABOVE CEILINGS THAT ARE THE RESULT OF MECHANICAL OR ELECTRICAL DEMOLITION. OPENINGS IN MASONRY WALLS SHALL BE FILLED WITH MASONRY OF SIMILAR TYPES AND THICKNESS AS EXISTING. OPENINGS IN OTHER TYPES OF WALL CONSTRUCTION SHALL MATCH EXISTING MATERIALS, FINISHES AND WALL THICKNESS. REFER TO MECHANICAL AND ELECTRICAL SHEETS FOR SCOPE OF WORK.
- G. PROVIDE POSITIVE SLOPE TO ALL FLOOR DRAINS WHILE KEEPING FLOOR LEVEL AT WALL BASE.
- H. COORDINATE SIZE AND LOCATION OF ALL ACCESS DOORS WITH TRADES REQUIRING SAME. QUANTITIES SHOWN DO NOT NECESSARILY REPRESENT ALL ACCESS DOORS REQUIRED FOR ACCESSIBILITY.

LEGEND

NEW WORK PLAN NOTE: NOT ALL SYMBOLS MAY BE USED

NOTE. NOT ALL ST	WDOLS WAT DE USED
	EXISTING CONSTRUCTION
	NEW CONSTRUCTION
	PARTITION TYPE - REFER TO PARTITION DETAILS SHEET A9.2
G	SHALL COMPLY WITH BARRIER FREE REQUIREMENTS
XXXX	CASEWORK/ MILLWORK TAG
XXXX	SIGN NUMBER - REFER TO SCHEDULE SHEET A9.1
L	CORNER GUARD
	NEW CONSTRUCTION
L	

KEYNOTES

NEW WORK FLOOR PLAN SHADED ITEMS HAVE BEEN REVISED FROM PREVIOUS

NOTE: NOT ALL KEYNOTES MAY BE USED


(#) LEGEND SYMBOL INDICATOR

A1 08 8000 1/2" TEMPERED, CURVED GLASS SET IN EXISTING CURVED TRACK AT BASE AND FRAMED INTO SOFFIT ABOVE





ī**D**≗ Project Number

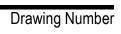

A2.1

IDS Drawing Title First Floor New Work Plan

 $^{\odot}$ 2021 integrated ${
m d}$ sign solutions, LLC

Pr	oject Administrator
	Administrator
	Project Designer
K. Litw	in/T. Easthope
Project A	Architect / Engineer
	K. Marshall
	Drawn By
	K. Marshall
	Q.M. Review
	N. LaForest
	Approved
	B. Sundberg
	Drawing Scale
	1/4" = 1'-0"
Issued for	Issue Date
Design Development	02-26-2021
Quality Management Review	04-21-2021
Bids	07-15-2021

1 Mutual Avenue Frankenmuth, MI 48787 Key Plar

Executive Suite Renovation



INTEGRATED design solutions architecture engineering interiors & technology 1441 west long lake, suite 200 troy, michigan 48098 5211 cascade road SE, suite 300 grand rapids, michigan 49546

248.823.2100

www.ids-michigan.com



<u>KEYNOTES</u> NEW WORK ROOF PLAN

SHADED ITEMS HAVE BEEN REVISED FROM PREVIOUS NOTE: NOT ALL KEYNOTES MAY BE USED

- (#) LEGEND SYMBOL INDICATOR
- R1 PATCH AND REPAIR EFIS WALL SURFACE UPON REMOVAL OF EF#20
- R2 EXISTING EXHAUST FAN OUTLETS EF#7, EF#8 AND EF#9 TO REMAIN REPAIR ANY DAMAGE TO EFIS SURFACE UPON COMPLETION OF MECHANICAL WORK IN CEILING PLENUM BEYOND
- R3 NEW EXHAUST FAN OUTLET FOR EF#1 CREATE NEW OPENING IN EFIS WALL FOR OUTLET LOUVER



Drawing Number


A2.2



Roof New Work Plan

 $oldsymbol{ iny c}$ 2021 integrated d ${
m gn}$ solutions, LL IDS Drawing Title

		Administrator
ŀ	K. Litwir	Project Designer n/T. Easthope
		chitect / Engineer K. Marshall
		Drawn By K. Marshall
		Q.M. Review N. LaForest
		Approved B. Sundberg
		Drawing Scale As Noted
Issued for		Issue Date
	Bids	07-15-2021

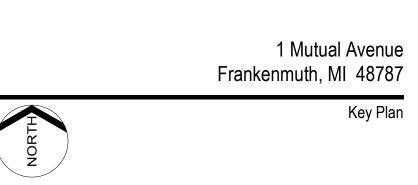

Executive Suite Renovation






5211 cascade road SE, suite 300 grand rapids, michigan 49546

248.823.2100 www.ids-michigan.com


Project Title

Project Administrator

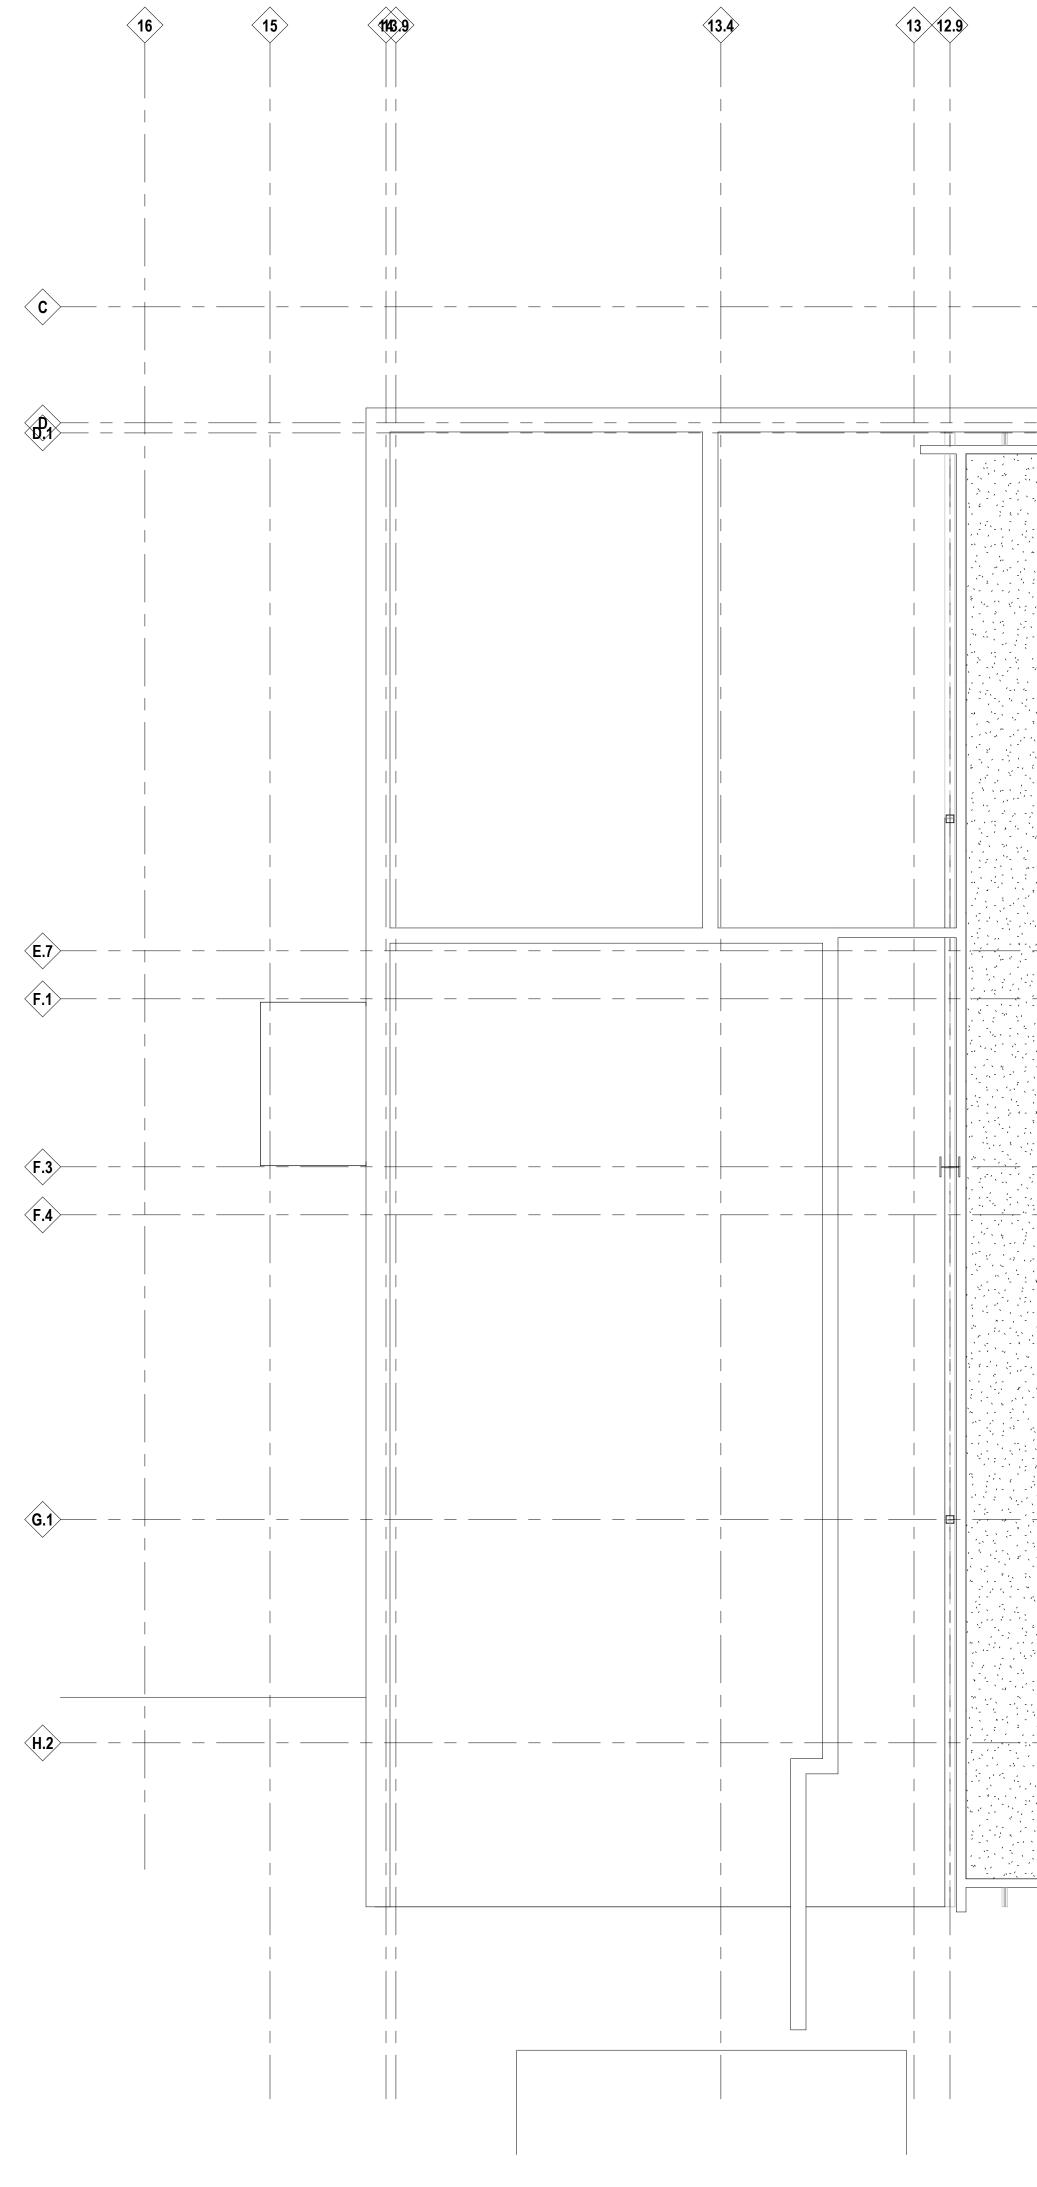

- REFLECTED CEILING PLAN A. CEILING HEIGHT 10'-0" AFF UNLESS OTHERWISE NOTED.
- B. ACOUSTICAL CEILING PANELS AND/OR TILES SHALL BE CENTERED
- WITHIN THE ROOM OR BORDER UNLESS OTHERWISE NOTED.
- C. REFER TO FLOOR PLANS FOR PARTITION TYPE DESIGNATION.
- D. COORDINATE CEILING SUSPENSION SYSTEMS WITH OTHER CEILING SPACE EQUIPMENT SUPPORTING DEVICES.
- E. UNLESS OTHERWISE NOTED LOCATION OF ITEMS SHOWN IN AREAS WITHOUT FINISH CEILINGS IS APPROXIMATE. COORDINATE EXACT LOCATION BETWEEN TRADES.
- F. COORDINATE SIZE AND LOCATION OF ALL ACCESS DOORS WITH TRADES REQUIRING SAME. QUANTITIES SHOWN DO NOT NECESSARILY REPRESENT ALL ACCESS DOORS REQUIRED FOR

		LEGEND REFLECTED CEILING PLAN NOTE: NOT ALL SYMBOLS	
			LAY-IN CEILING
			EXISTING LAY-IN CEILING
9.6>			GYPSUM BOARD CEILING
			06 4023 HARDWOOD VENEEF PLYWOOD CEILING
			AREA OF EXISTING CEILING TO BE REMOVED AND REPLACED - COORD WITH MECH AND ELEC RECESSED DOWNLIGHT
	D 0		RECESSED LINEAR LIGHT FIXTURE
	B.8	0 ()	PENDANT LIGHT FIXTURE
	C. 7		LIGHT FIXTURES
	U. <i>I</i>		LINEAR RETURN DIFFUSER
. 			LINEAR SUPPLY DIFFUSER
			EXHAUST AIR DIFFUSER
	D.2		RETURN AIR REGISTER/GRILLS
	\checkmark		SUPPLY AIR REGISTER/GRILLS
			ACCESS PANEL (24X24 UON
			RADIANT CEILING PANEL
		•	SPRINKLER HEAD
		U ® ©	SENSORS
		6 Ed	FIRE ALARM DEVICES
		S 5	SPEAKERS
	\wedge	\odot	MICROPHONE
	— D.6	& § Š	EXIT SIGNS
	\wedge	0	JUNCTION BO
	D.8	₽ Ø	RECEPTACLES
	—(D.9)	∇	WIRELESS ACCESS POIN
	\sim	©	CAMER/
	E.9		FLAT PANEL MONITOF
	\checkmark		
		<u>KEYNOTES</u>	5
		REFLECTED CEILING PLAN SHADED ITEMS HAVE BEEN	REVISED FROM PREVIOUS
		(#) LEGEND SYMBOL INI C1 08 3113 10"X10" SOFF	IT/WALL ACCESS PANEL - PAINT 09 9100 (PT-04)
		C2 09 9100 PAINT (PT-04	
		·	
		C3 09 9100 PAINT (PT-02	
		C4 09 2400 CEMENT PLA	STER SOFFIT TO MATCH EXISTING ADJACENT
		C5 EXISTING GYPSUM B	OARD CEILING TO REMAIN - NO WORK
			ARD SOFFIT - COORDINATE LIMITS WITH UPPER
		C6 09 2900 GYPSUM BO/ CABINETS	
	F.8	CABINETS	NG ACCESS PANEL - PAINT TO MATCH
	F.8	CABINETS C7 08 3113 24"X24" CEILI	
	F.8	CABINETS C7 08 3113 24"X24" CEILI	
	F.8	CABINETS C7 08 3113 24"X24" CEILI	
	F.8	CABINETS C7 08 3113 24"X24" CEILI	
	F.8	CABINETS C7 08 3113 24"X24" CEILI	
	F.8	CABINETS C7 08 3113 24"X24" CEILI	
		CABINETS C7 08 3113 24"X24" CEILI	
	=	CABINETS C7 08 3113 24"X24" CEILI	
		CABINETS C7 08 3113 24"X24" CEILI	
		CABINETS C7 08 3113 24"X24" CEILI	

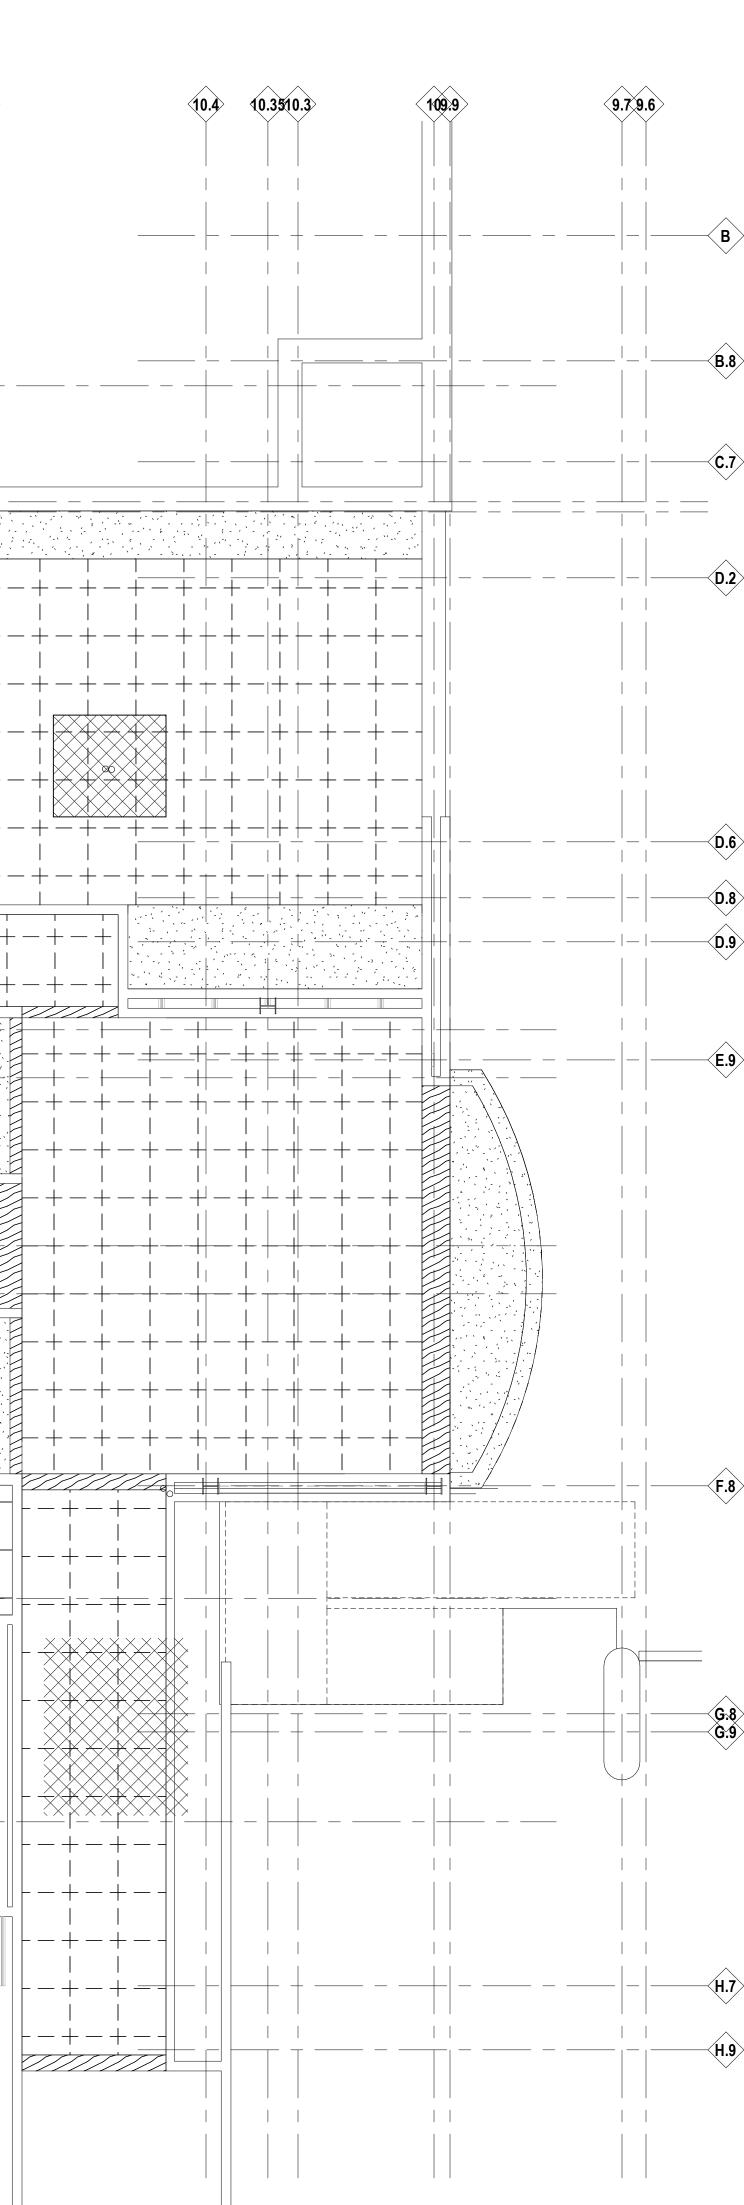



ī **D** Project Number


Drawing Number

A3.01

IDS Drawing Title Lower Level Reflected Ceiling Plan

 \circ 2021 integrated ${
m de}$ sign solutions, LL

Pr	oject Administrator
	Administrator
	Project Designer
K. Litwi	in/T. Easthope
Project A	Architect / Engineer
	K. Marshall
	Drawn By
	K. Marshall
	Q.M. Review
	N. LaForest
	Approved
	B. Sundberg
	Drawing Scale
	As Noted
Issued for	Issue Date
Design Development	02-26-2021
Quality Management Review	04-21-2021
Bids	07-15-2021

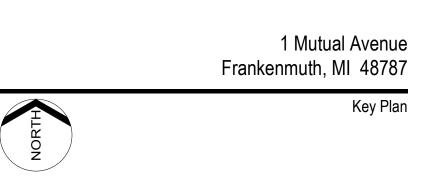

Executive Suite Renovation






5211 cascade road SE, suite 300

grand rapids, michigan 49546

248.823.2100

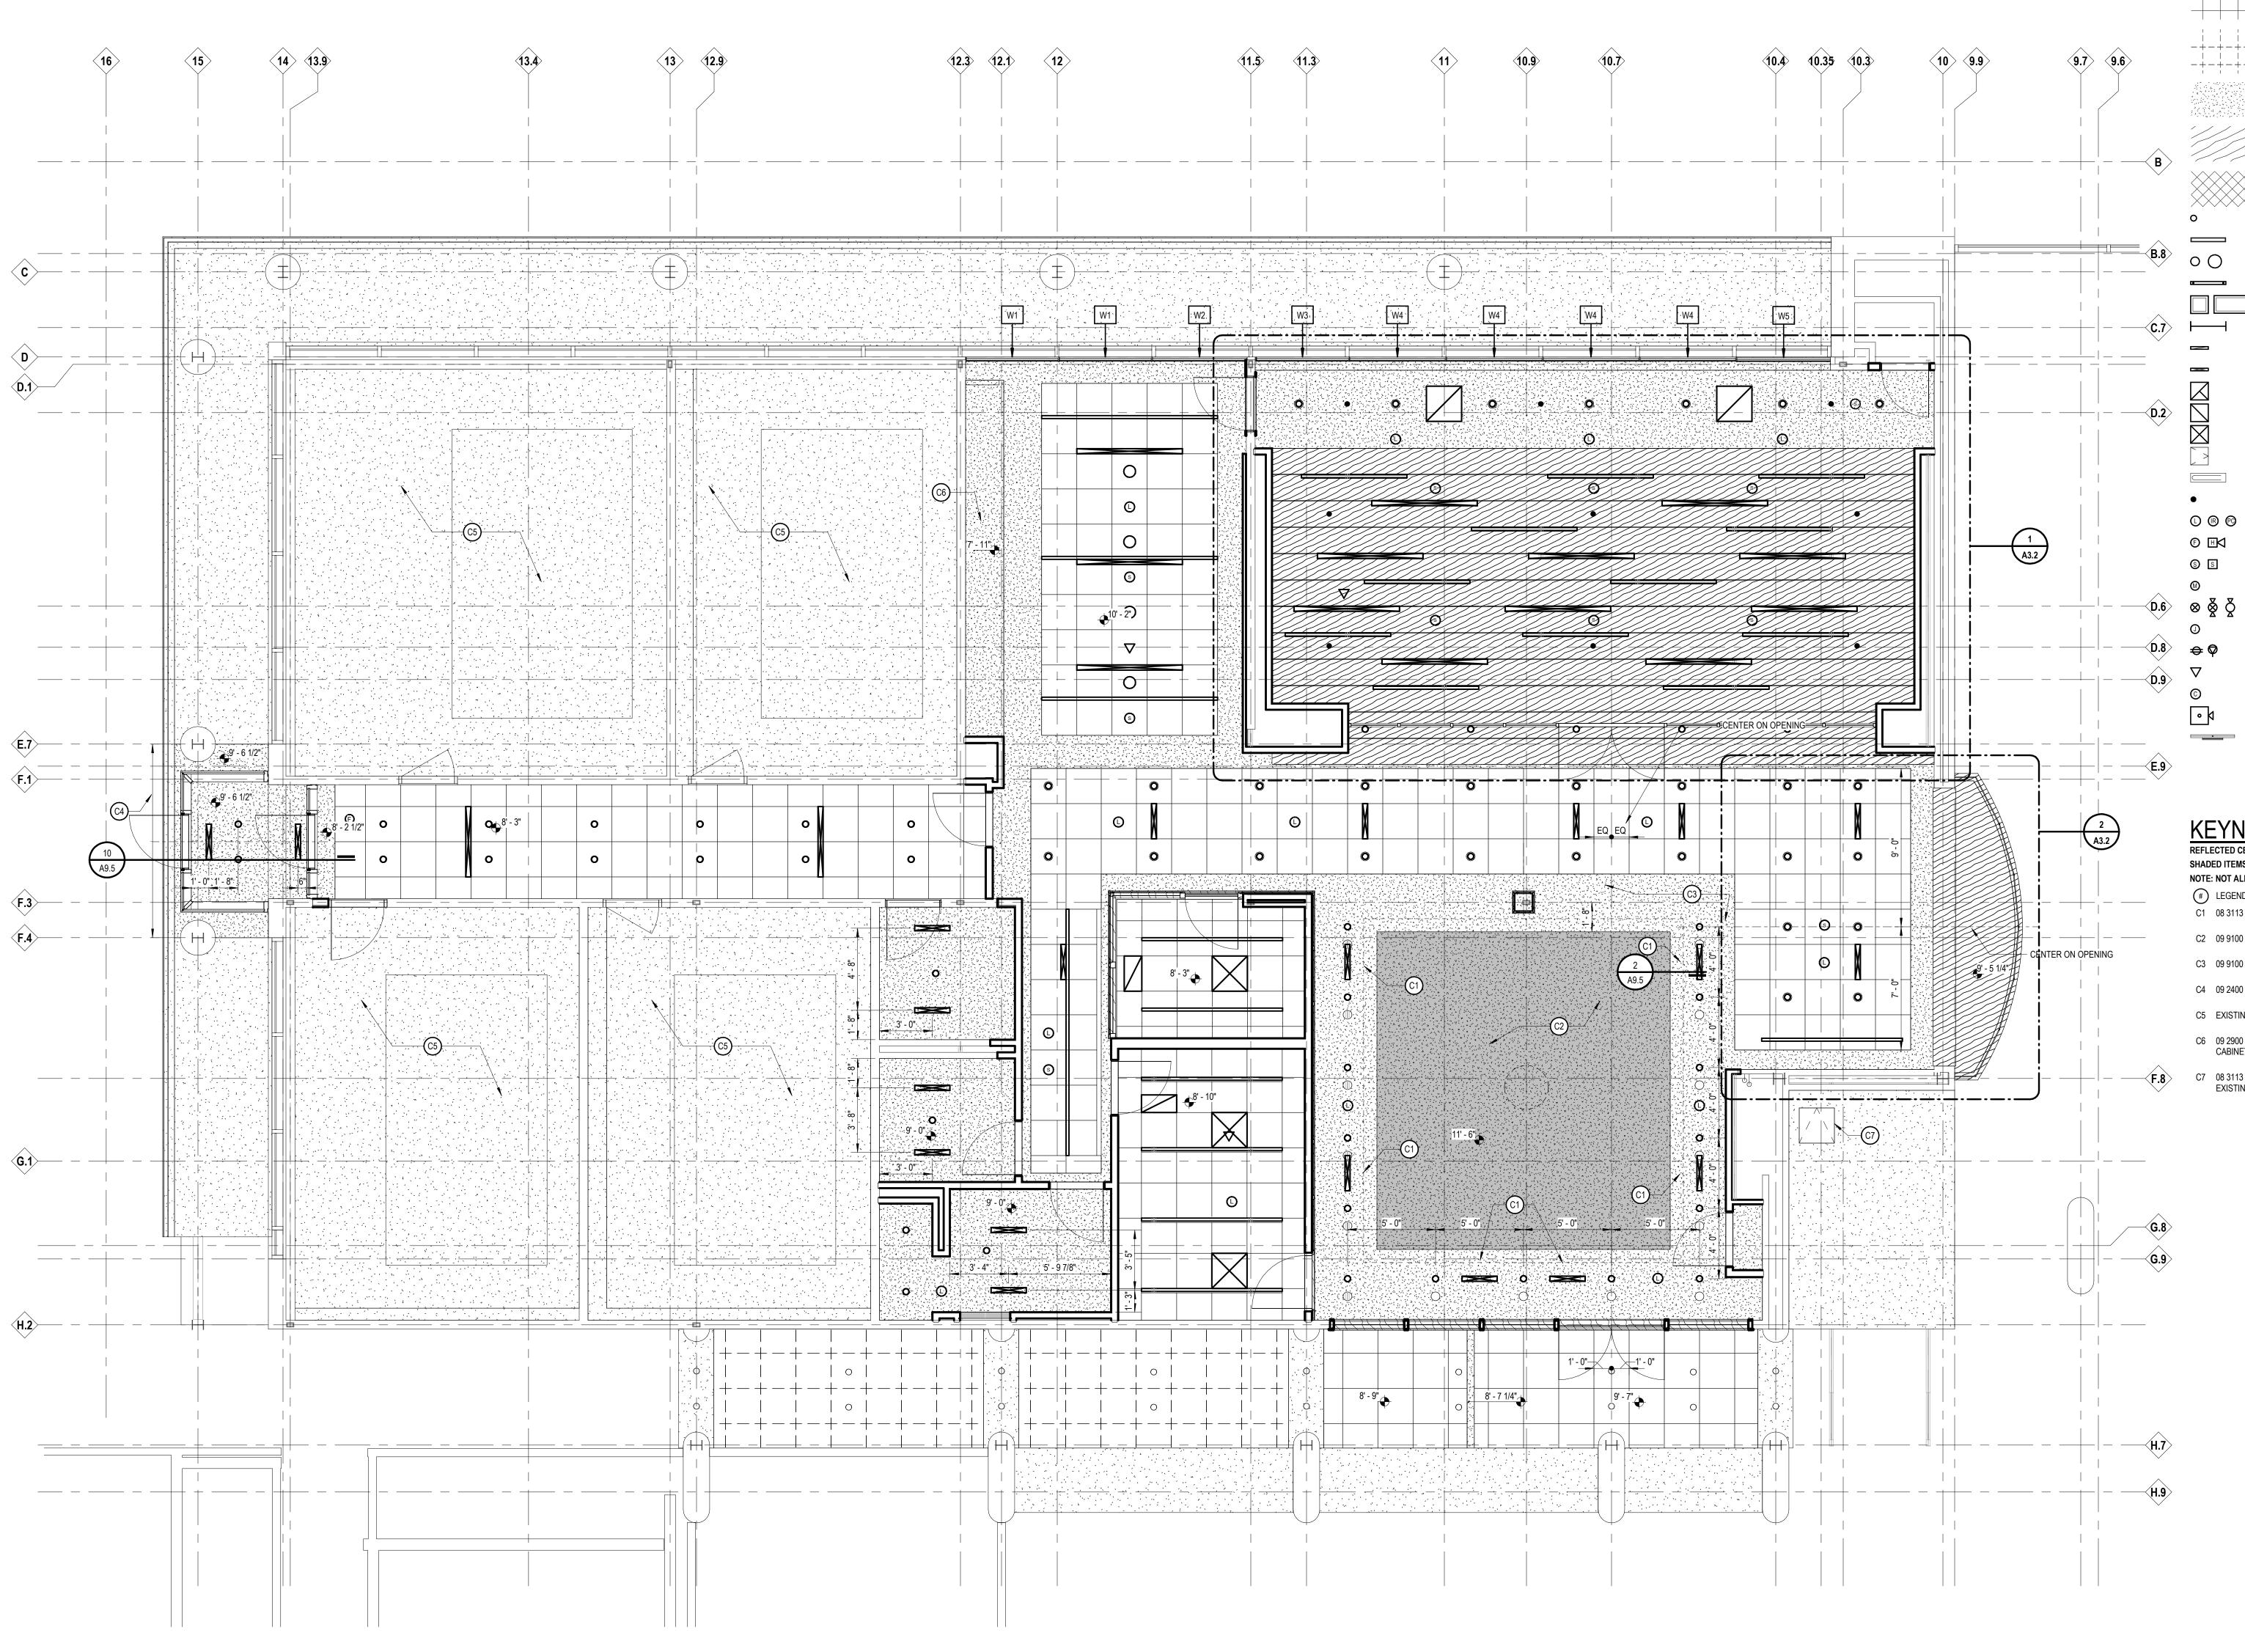

- REFLECTED CEILING PLAN
- A. CEILING HEIGHT 10'-0" AFF UNLESS OTHERWISE NOTED.
- B. ACOUSTICAL CEILING PANELS AND/OR TILES SHALL BE CENTERED WITHIN THE ROOM OR BORDER UNLESS OTHERWISE NOTED.
- C. REFER TO FLOOR PLANS FOR PARTITION TYPE DESIGNATION.
- D. COORDINATE CEILING SUSPENSION SYSTEMS WITH OTHER CEILING SPACE EQUIPMENT SUPPORTING DEVICES.
- E. UNLESS OTHERWISE NOTED LOCATION OF ITEMS SHOWN IN AREAS WITHOUT FINISH CEILINGS IS APPROXIMATE. COORDINATE EXACT
- LOCATION BETWEEN TRADES. F. COORDINATE SIZE AND LOCATION OF ALL ACCESS DOORS WITH TRADES REQUIRING SAME. QUANTITIES SHOWN DO NOT NECESSARILY REPRESENT ALL ACCESS DOORS REQUIRED FOR ACCESSIBILITY.


LEGEND

0


X

۲

| • k

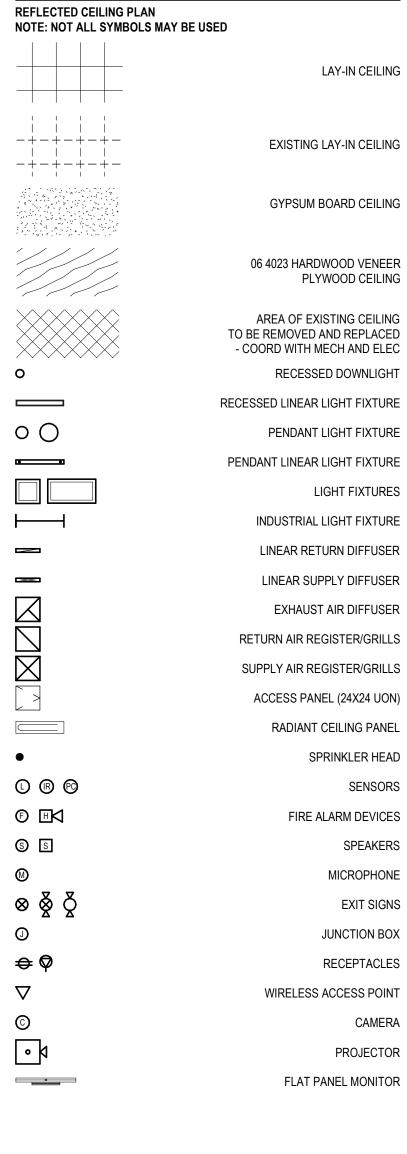


KE	EYNOTES
REFLE	ECTED CEILING PLAN
-	ED ITEMS HAVE BEEN REVISED FROM PREVIOUS
(#)	
C1	08 3113 10"X10" SOFFIT/WALL ACCESS PANEL - PAINT 09 9100 (PT-04)
C2	09 9100 PAINT (PT-04)
C3	09 9100 PAINT (PT-02)
C4	09 2400 CEMENT PLASTER SOFFIT TO MATCH EXISTING ADJACENT
C5	EXISTING GYPSUM BOARD CEILING TO REMAIN - NO WORK
C6	09 2900 GYPSUM BOARD SOFFIT - COORDINATE LIMITS WITH UPPER CABINETS
C7	08 3113 24"X24" CEILING ACCESS PANEL - PAINT TO MATCH EXISTING CEILING

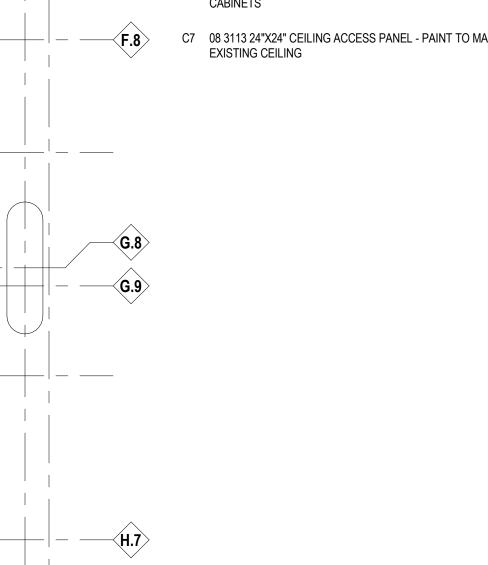

- (H.9)



ī Ds Project Number

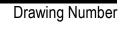

A3.1

IDS Drawing Title First Floor Reflected Ceiling Plan

 \circ 2021 integrated $ext{design}$ solutions, LL

Pr	oject Administrator
	Administrator
	Project Designer
K. Litwi	n/T. Easthope
Project A	rchitect / Engineer
	K. Marshall
	Drawn By
	K. Marshall
	Q.M. Review
	N. LaForest
	Approved
	B. Sundberg
	Drawing Scale
	1/4" = 1'-0"
Issued for	Issue Date
Design Development	02-26-2021
Quality Management Review	04-21-2021
Bids	07-15-2021

	1 Mutual Avenue Frankenmuth, MI 48787
NORTH	Key Plan


Executive Suite Renovation




INTEGRATED design solutions architecture engineering interiors & technology 1441 west long lake, suite 200 troy, michigan 48098 5211 cascade road SE, suite 300 grand rapids, michigan 49546


248.823.2100




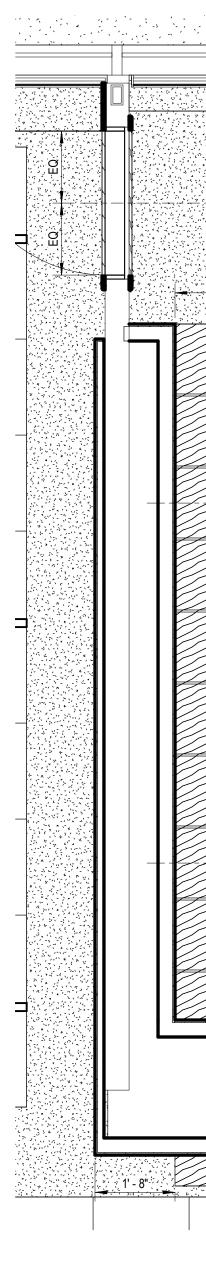

1 A3.1 ENLARGED BOARD ROOM REFLECTED CEILING PLAN

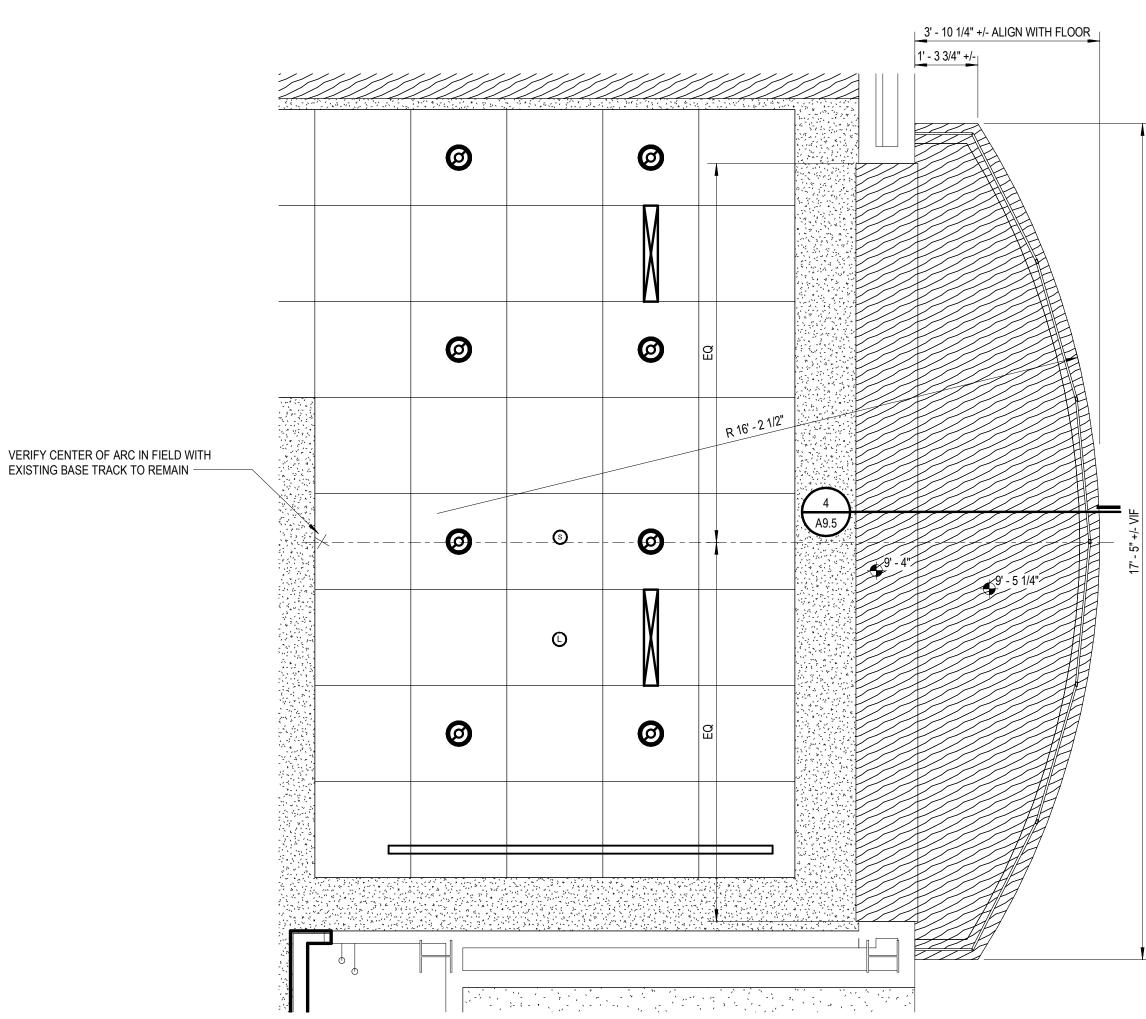

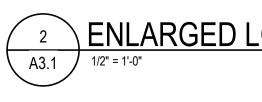

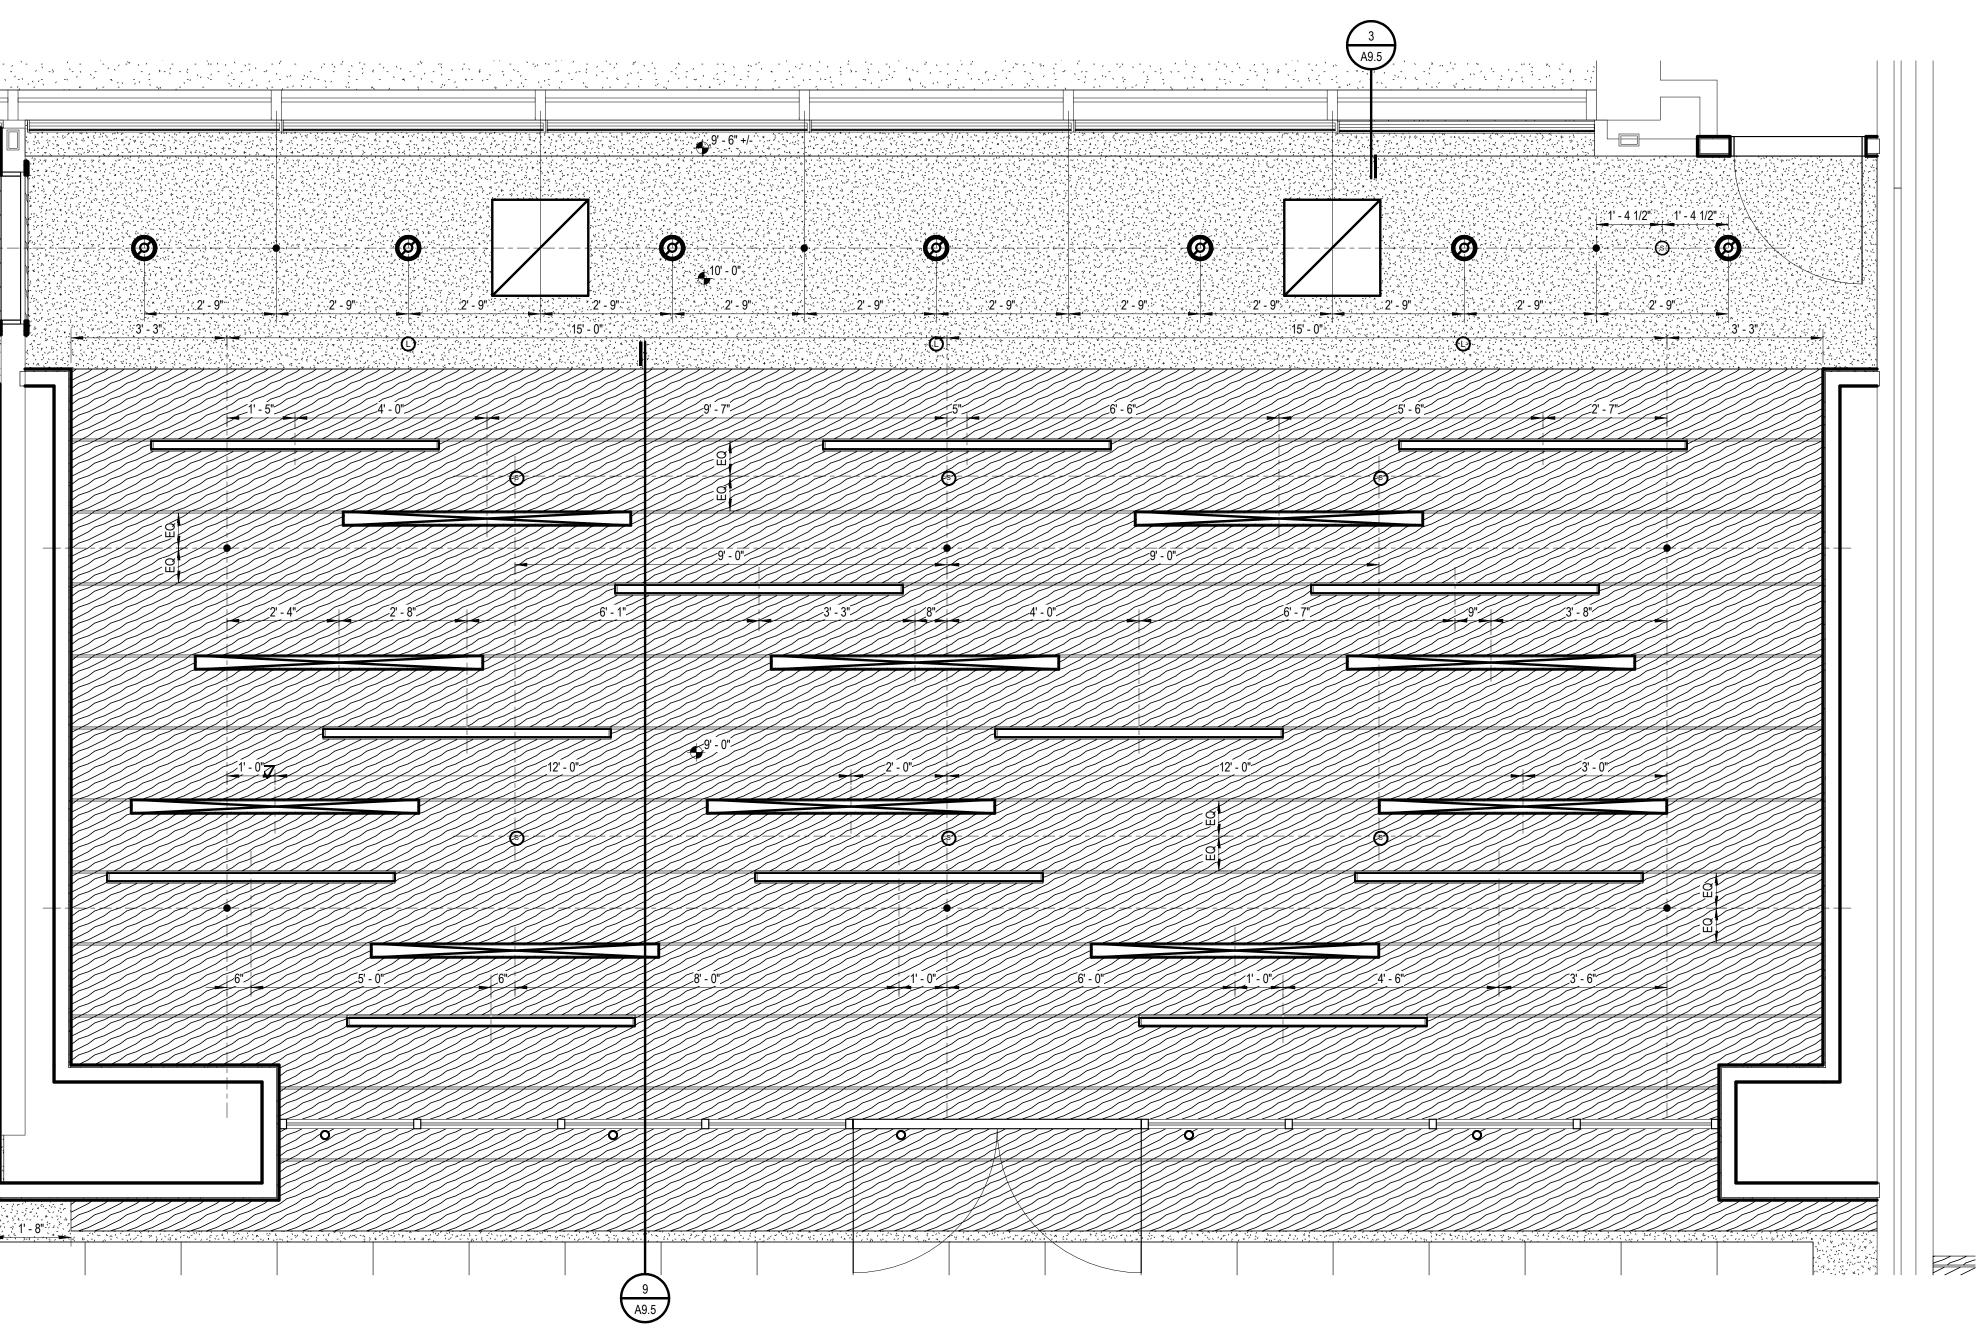

2 A3.1 ENLARGED LOBBY BALCONY REFLECTED CEILING PLAN

GENERAL NOTES

- REFLECTED CEILING PLAN A. CEILING HEIGHT 10'-0" AFF UNLESS OTHERWISE NOTED.
- B. ACOUSTICAL CEILING PANELS AND/OR TILES SHALL BE CENTERED WITHIN THE ROOM OR BORDER UNLESS OTHERWISE NOTED.
- C. REFER TO FLOOR PLANS FOR PARTITION TYPE DESIGNATION.
- D. COORDINATE CEILING SUSPENSION SYSTEMS WITH OTHER CEILING SPACE EQUIPMENT SUPPORTING DEVICES.
- E. UNLESS OTHERWISE NOTED LOCATION OF ITEMS SHOWN IN AREAS WITHOUT FINISH CEILINGS IS APPROXIMATE. COORDINATE EXACT LOCATION BETWEEN TRADES.
- F. COORDINATE SIZE AND LOCATION OF ALL ACCESS DOORS WITH TRADES REQUIRING SAME. QUANTITIES SHOWN DO NOT NECESSARILY REPRESENT ALL ACCESS DOORS REQUIRED FOR ACCESSIBILITY.


LEGEND REFLECTED CEILING PLAN

NOTE: NOT ALL SYMBOLS MA	Y BE USED
	LAY-IN CEILING
-+-+-+-	EXISTING LAY-IN CEILING
	GYPSUM BOARD CEILING
	06 4023 HARDWOOD VENEER PLYWOOD CEILING
	AREA OF EXISTING CEILING TO BE REMOVED AND REPLACED - COORD WITH MECH AND ELEC
)	RECESSED DOWNLIGHT
	RECESSED LINEAR LIGHT FIXTURE
$\circ \circ$	PENDANT LIGHT FIXTURE
	PENDANT LINEAR LIGHT FIXTURE
	LIGHT FIXTURES
——	INDUSTRIAL LIGHT FIXTURE
	LINEAR RETURN DIFFUSER
	LINEAR SUPPLY DIFFUSER
4	EXHAUST AIR DIFFUSER
	RETURN AIR REGISTER/GRILLS
X	SUPPLY AIR REGISTER/GRILLS
<u></u>	ACCESS PANEL (24X24 UON)
	RADIANT CEILING PANEL
	SPRINKLER HEAD
	SENSORS
	FIRE ALARM DEVICES
	SPEAKERS
≥ &	EXIT SIGNS
2 X X	JUNCTION BOX
چ Ø	RECEPTACLES
- Ψ 7	WIRELESS ACCESS POINT
> D	CAMERA
	PROJECTOR
	FLAT PANEL MONITOR

KEYNOTES

	ECTED CEILING PLAN
•••••	ED ITEMS HAVE BEEN REVISED FROM PREVIOUS NOT ALL KEYNOTES MAY BE USED
\sim	
(#)	LEGEND SYMBOL INDICATOR
C1	08 3113 10"X10" SOFFIT/WALL ACCESS PANEL - PAINT 09 9100 (PT-04)
C2	09 9100 PAINT (PT-04)
C3	09 9100 PAINT (PT-02)
04	
C4	09 2400 CEMENT PLASTER SOFFIT TO MATCH EXISTING ADJACENT
C5	EXISTING GYPSUM BOARD CEILING TO REMAIN - NO WORK
00	
C6	09 2900 GYPSUM BOARD SOFFIT - COORDINATE LIMITS WITH UPPER
	CABINETS

C7 08 3113 24"X24" CEILING ACCESS PANEL - PAINT TO MATCH EXISTING CEILING

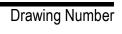

A3.2

20120-2000

© 2021 INTE	EGRATED design solutions, LLC
	IDS Drawing Title
Enlarged Board Roo	om Reflected Ceiling Plan

Pr	oject Administrator
	Administrator
	Project Designer
K. Litwi	n/T. Easthope
Project A	rchitect / Engineer
	K. Marshall
	Drawn By
	K. Marshall
	Q.M. Review
	N. LaForest
	Approved
	B. Sundberg
	Drawing Scale
	As Noted
Issued for	Issue Date
Quality Management Review	04-21-2021
Bids	07-15-2021

1 Mutual Avenue Frankenmuth, MI 48787 Key Plan


Executive Suite Renovation





INTEGRATED design solutions architecture engineering interiors & technology 1441 west long lake, suite 200 troy, michigan 48098 5211 cascade road SE, suite 300 grand rapids, michigan 49546

248.823.2100



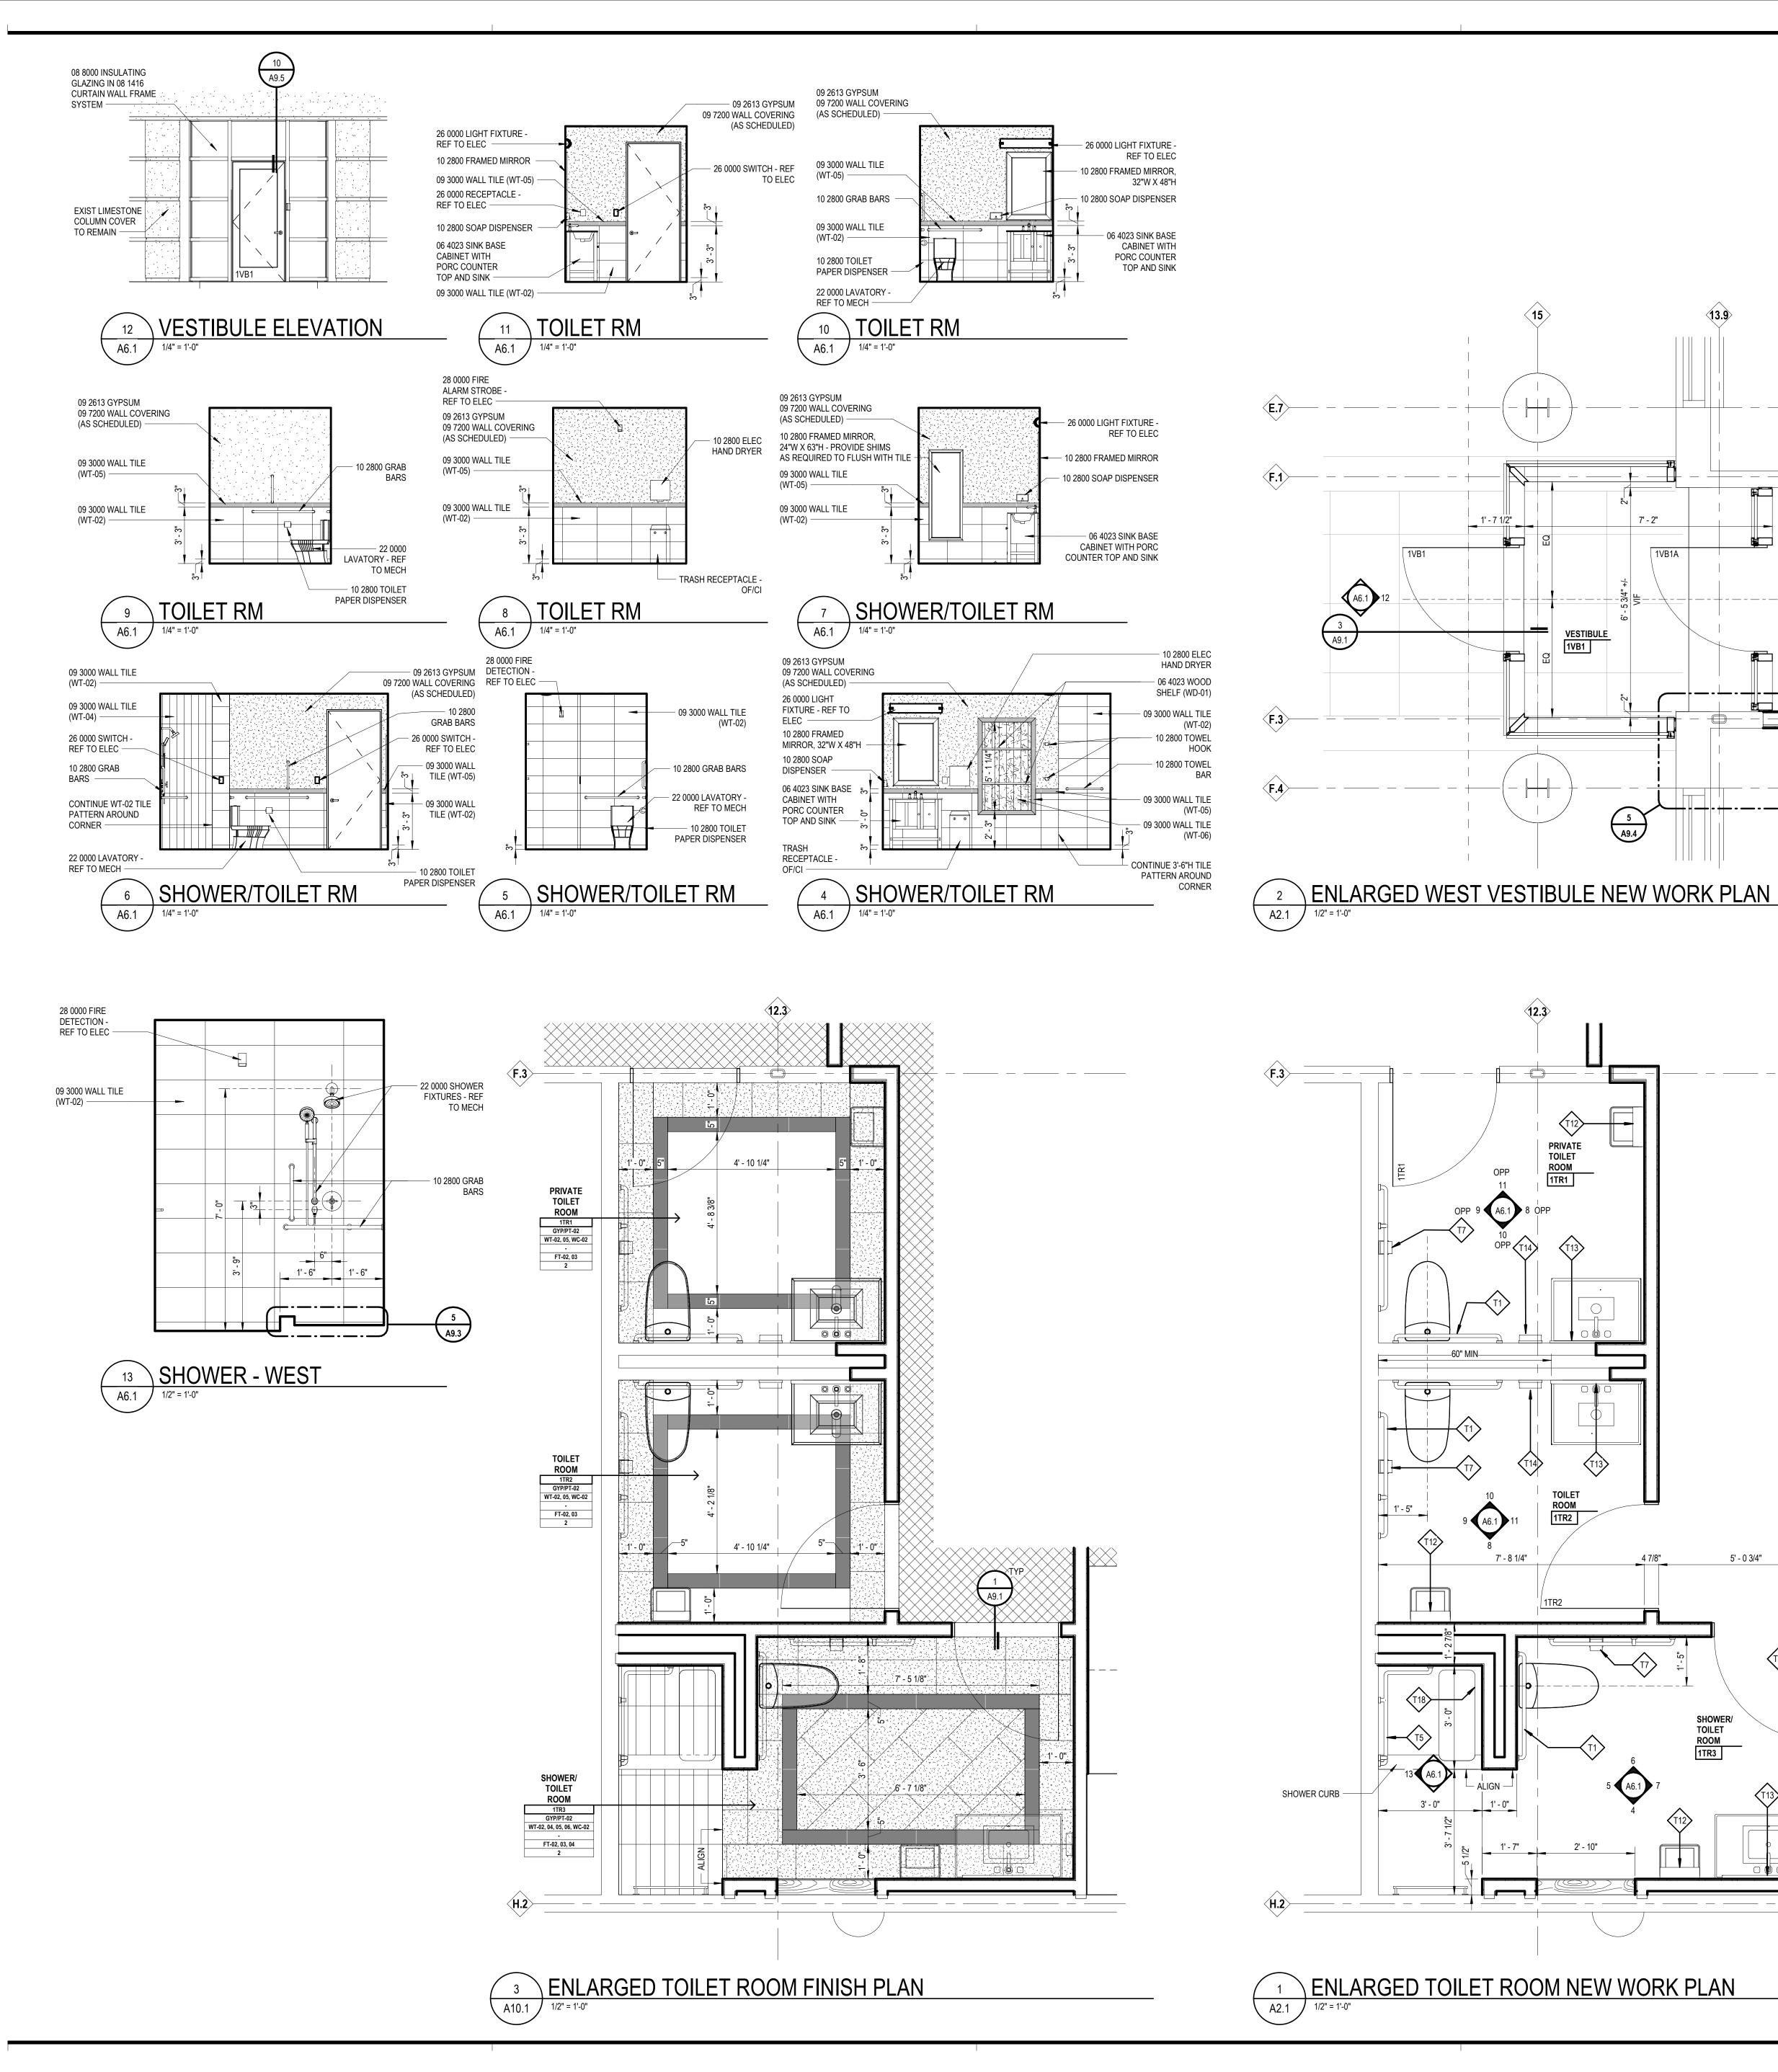

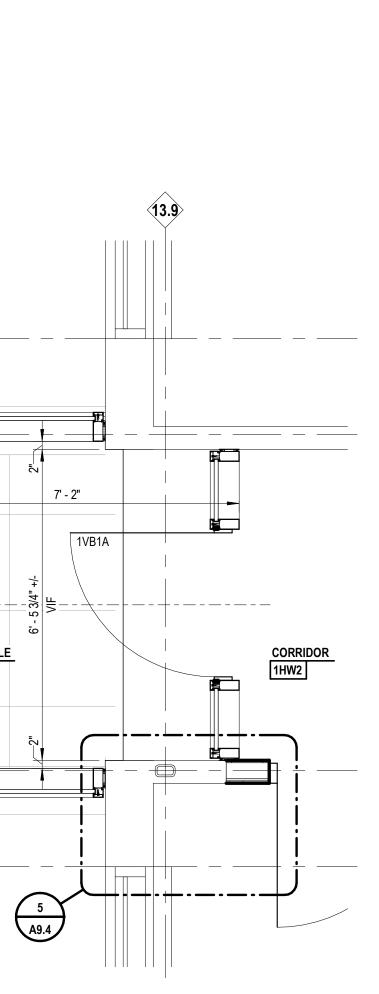

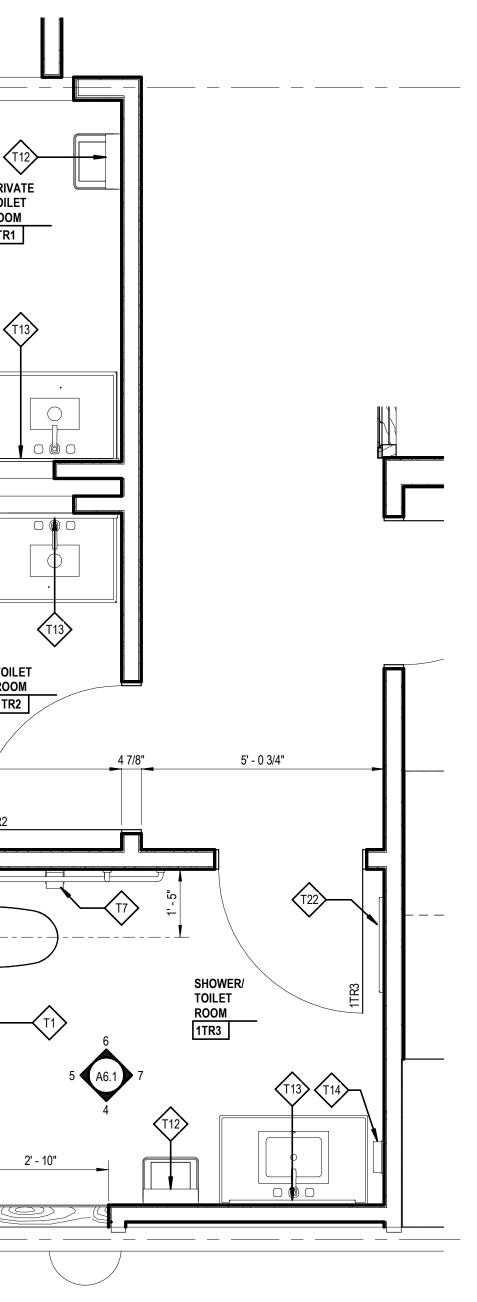

LEGEND ELEVATION MATERIALS NOTE: NOT ALL SYMBOLS MA	Y BE USED
	WOOD WD-01
	WALL TILE WT-01
	WALL TILE WT-02
	WALL TILE WT-03
	WALL TILE WT-04
	WALL TILE WT-05
	WALL TILE WT-06

LEGEND

TOILET ACCESSORIES

SHADED ITEMS HAVE BEEN REVISED FROM PREVIOUS

NOTE: NOT ALL KEYNOTES MAY BE USED


T1 GRAB BA GRAB BA T5 GRAB BA T7 TOILET F T12 ELECTRI T13 MIRROR T14 SOAP DIS	SPENSER 5 SHOWER SEAT - TRANSFER SHOWER HOOK - 63" H x 24" W
FINISH PLAN NOTE: NOT ALI	SYMBOLS MAY BE USED
ROOM NAME ROOM # CEILING WALL BASE	NOTE: FINISHES INDICATED IN ROOM FINISH TAG ARE GENERAL OVERALL FINISHES FOR ROO UNLESS OTHERWISE INDICATED BY NOTE, REMAR DETAIL AND/OR ELEVATIO
FLOOR REMARKS	ROOM SPECIFIC FINISH REMARK REFER TO REMARKS LEGEND FO ADDITIONAL INFORMATIO
	FLOOR TILE FT-
	CARPET TILE CPT-
	CARPET TILE CPT-
	CARPET TILE CPT-
	SHEET CARPET (AREA RUG) CPT-
	CARPET TILE CPT-
×××	FLOOR MATERIAL TRANSITION TA REFER TO A9.1 FOR TRANSITION/ SILL DETAI
XX-XX FLO	OR COLOR CODE TAG - REFER TO ROOM FINISH SCHEDU SHEET AS
<i>∽</i>	FLOORING INSTALATION DIRECTION
(XX-XX)	ACCENT MATERIAL, REFER TO COLOR COD
	09 6813 TILE CARPETING INSTALLATION METHOD - ASHL/
$\begin{array}{c c} \uparrow & \uparrow \\ \hline \uparrow & \uparrow \end{array}$	13 TILE CARPETING INSTALLATION METHOD - MONOLITH
09 6813	TILE CARPETING INSTALLATION METHOD - QUARTER TUP

GENERAL NOTES

FINISH PLAN A. REFER TO ROOM FINISH SCHEDULE AND COLOR CODES FOR MORE INFORMATION.

GENERAL NOTES

- INTERIOR ELEVATIONS A. ALL DIMENSIONS ARE TO FACE OF GYP BOARD UON.
- B. COORDINATE THE INTERFACING OF ALL TRADES WITH RESPECT TO DELIVERY AND INSTALLATION OF ALL FIXTURES AND EQUIPMENT
- C. CONTRACTOR TO FIELD VERIFY EXISTING CONDITIONS BEFORE INSTALLATION. CONSULT ARCHITECT WHEN ACTUAL FIELD CONDITIONS VARY FROM THOSE SHOWN ON CONSTRUCTION DOCUMENTS.
- D. COORDINATE LOCATIONS OF ALL REQUIRED UTILITIES WITH THE TRADE PROVIDING THE SAME. REFER TO MECHANICAL AND ELECTRICAL SHEETS FOR ADDITIONAL INFORMATION.
- E. FASTEN ALL TALL CASES TO THE ADJOINING WALL THROUGH THE BACK OR SIDE OF THE UNIT.
- F. ALL COUNTERTOPS INSTALLED ALONG A WALL OR EQUIPMENT ARE TO HAVE 4" BACKSPLASH AND SIDE SPLASH UON.
- G. FINISH ALL EXPOSED ENDS AND BACKS OF FREESTANDING CASEWORK/ MILLWORK.
- H. PROVIDE LOCKS ON ALL CABINET DOORS AND DRAWERS UON. ALL LOCKS SHOULD BE KEYED ALIKE BY ROOM, PROVIDE MASTER KEYING.
- I. REFER TO A9.1 ROOM FINISH SCHEDULE FOR COLORS AND FINISHES OF MATERIALS
- J. REFER TO PLANS, SECTIONS AND DETAILS FOR CASEWORK DEPTH.
- K. PROVIDE CABINET FILLERS AS NEEDED.
- L. FURNITURE AND SPECIALTY EQUIPMENT BY OTHERS SHOWN FOR REFERENCE ONLY
- M. FURNITURE SHOWN AT HALFTONE BY OWNER
- N. PROVIDE PARTITION REINFORCEMENT AT LOCATIONS OF WALL MOUNTED EQUIPMENT. REFER TO DETAIL 5/A8.1 FOR TYPICAL REQUIREMENTS AT NEW CONSTRUCTION. CONDITIONS MAY VARY AT EXISTING PARTITIONS.
- O. NOT ALL SIGN LOCATIONS ARE ELEVATED
- P. COORDINATE LOCATIONS OF ALL REQUIRED UTILITY CONNECTIONS AND/OR REQUIREMENTS WITH THE TRADE PROVIDING THE SAME

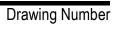

A6.1

i D^s Project Number 20120-2000

IDS Drawing Title Enlarged Toilet Room and Vestibule Plans Elevations, Sections and Details

 \odot 2021 Integrated ${
m d}$ n solutions, LL

	Diawii Dy
T. Easthor	be, K. Marshall
	Q.M. Review
	N. LaForest
	Approved
	B. Sundberg
	Drawing Scale
	1/2" = 1'-0"
Issued for	Issue Date
Design Development	02-26-2021
Quality Management Review	04-21-2021
Bids	07-15-2021

Frankenmuth, MI 48787 Key Plan

1 Mutual Avenue

Project Administrator

K. Litwin/T. Easthope Project Architect / Engineer

Administrator

Project Designer

K. Marshall

Drawn By

Executive Suite Renovation



INTEGRATED design SOLUTIONS architecture engineering interiors & technology 1441 west long lake, suite 200 troy, michigan 48098 5211 cascade road SE, suite 300


grand rapids, michigan 49546


www.ids-michigan.com


248.823.2100






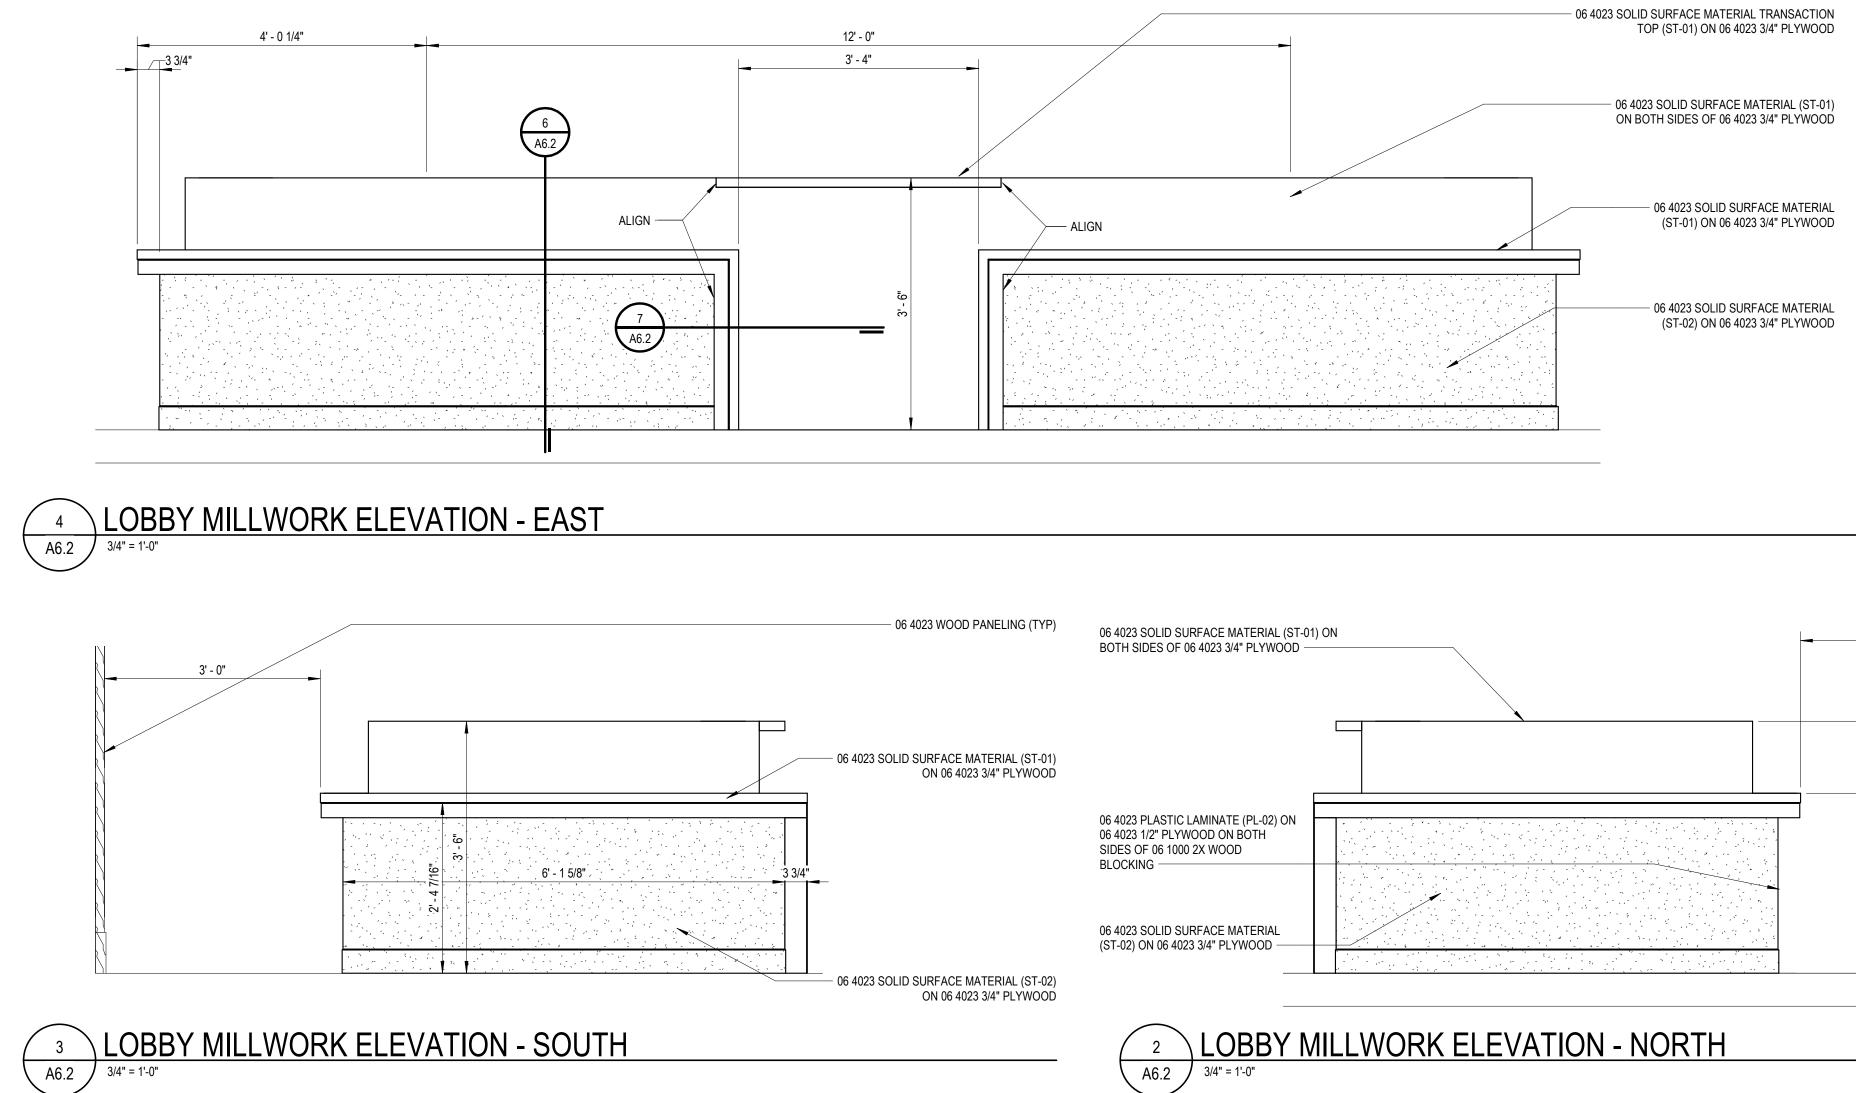

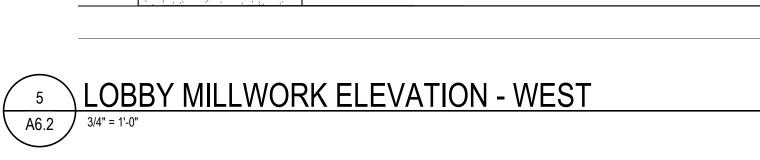

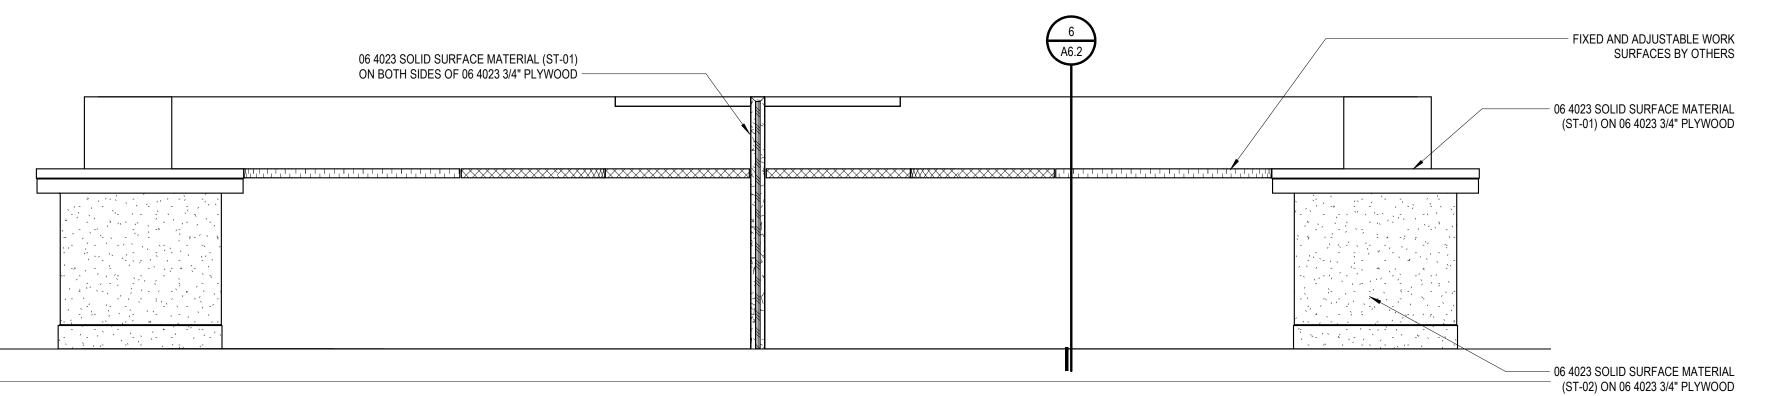





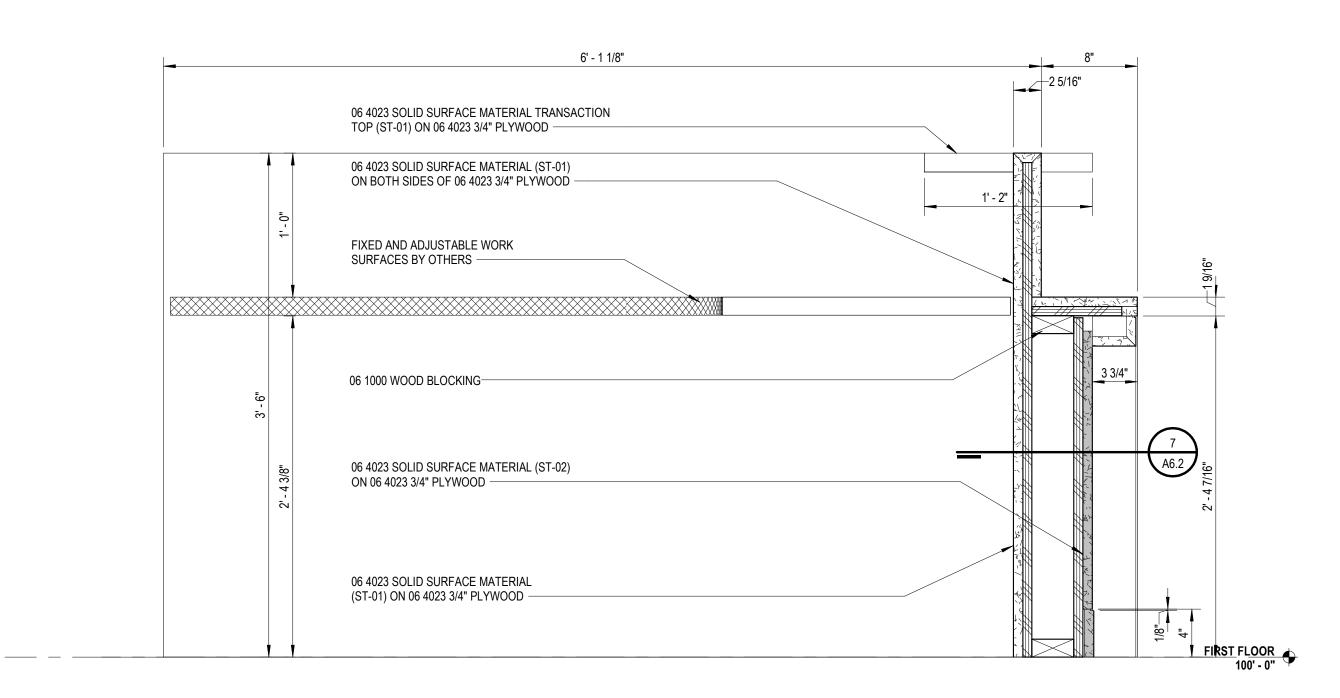

PANELING (TYP)	06 4023 SOLID SURFACE MATERIAL (ST-01 BOTH SIDES OF 06 4023 3/4" PLYWOOD —) ON	3' - 0"
IATERIAL (ST-01) 33 3/4" PLYWOOD			1- 0"
3 3/4 TETWOOD	06 4023 PLASTIC LAMINATE (PL-02) ON 06 4023 1/2" PLYWOOD ON BOTH SIDES OF 06 1000 2X WOOD BLOCKING —		¥
	06 4023 SOLID SURFACE MATERIAL (ST-02) ON 06 4023 3/4" PLYWOOD		2 - 6
IATERIAL (ST-02)			ţ



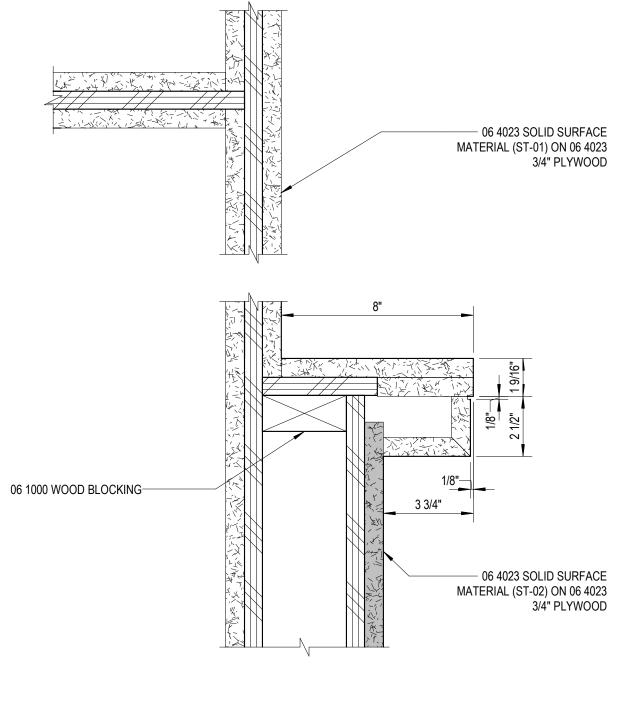

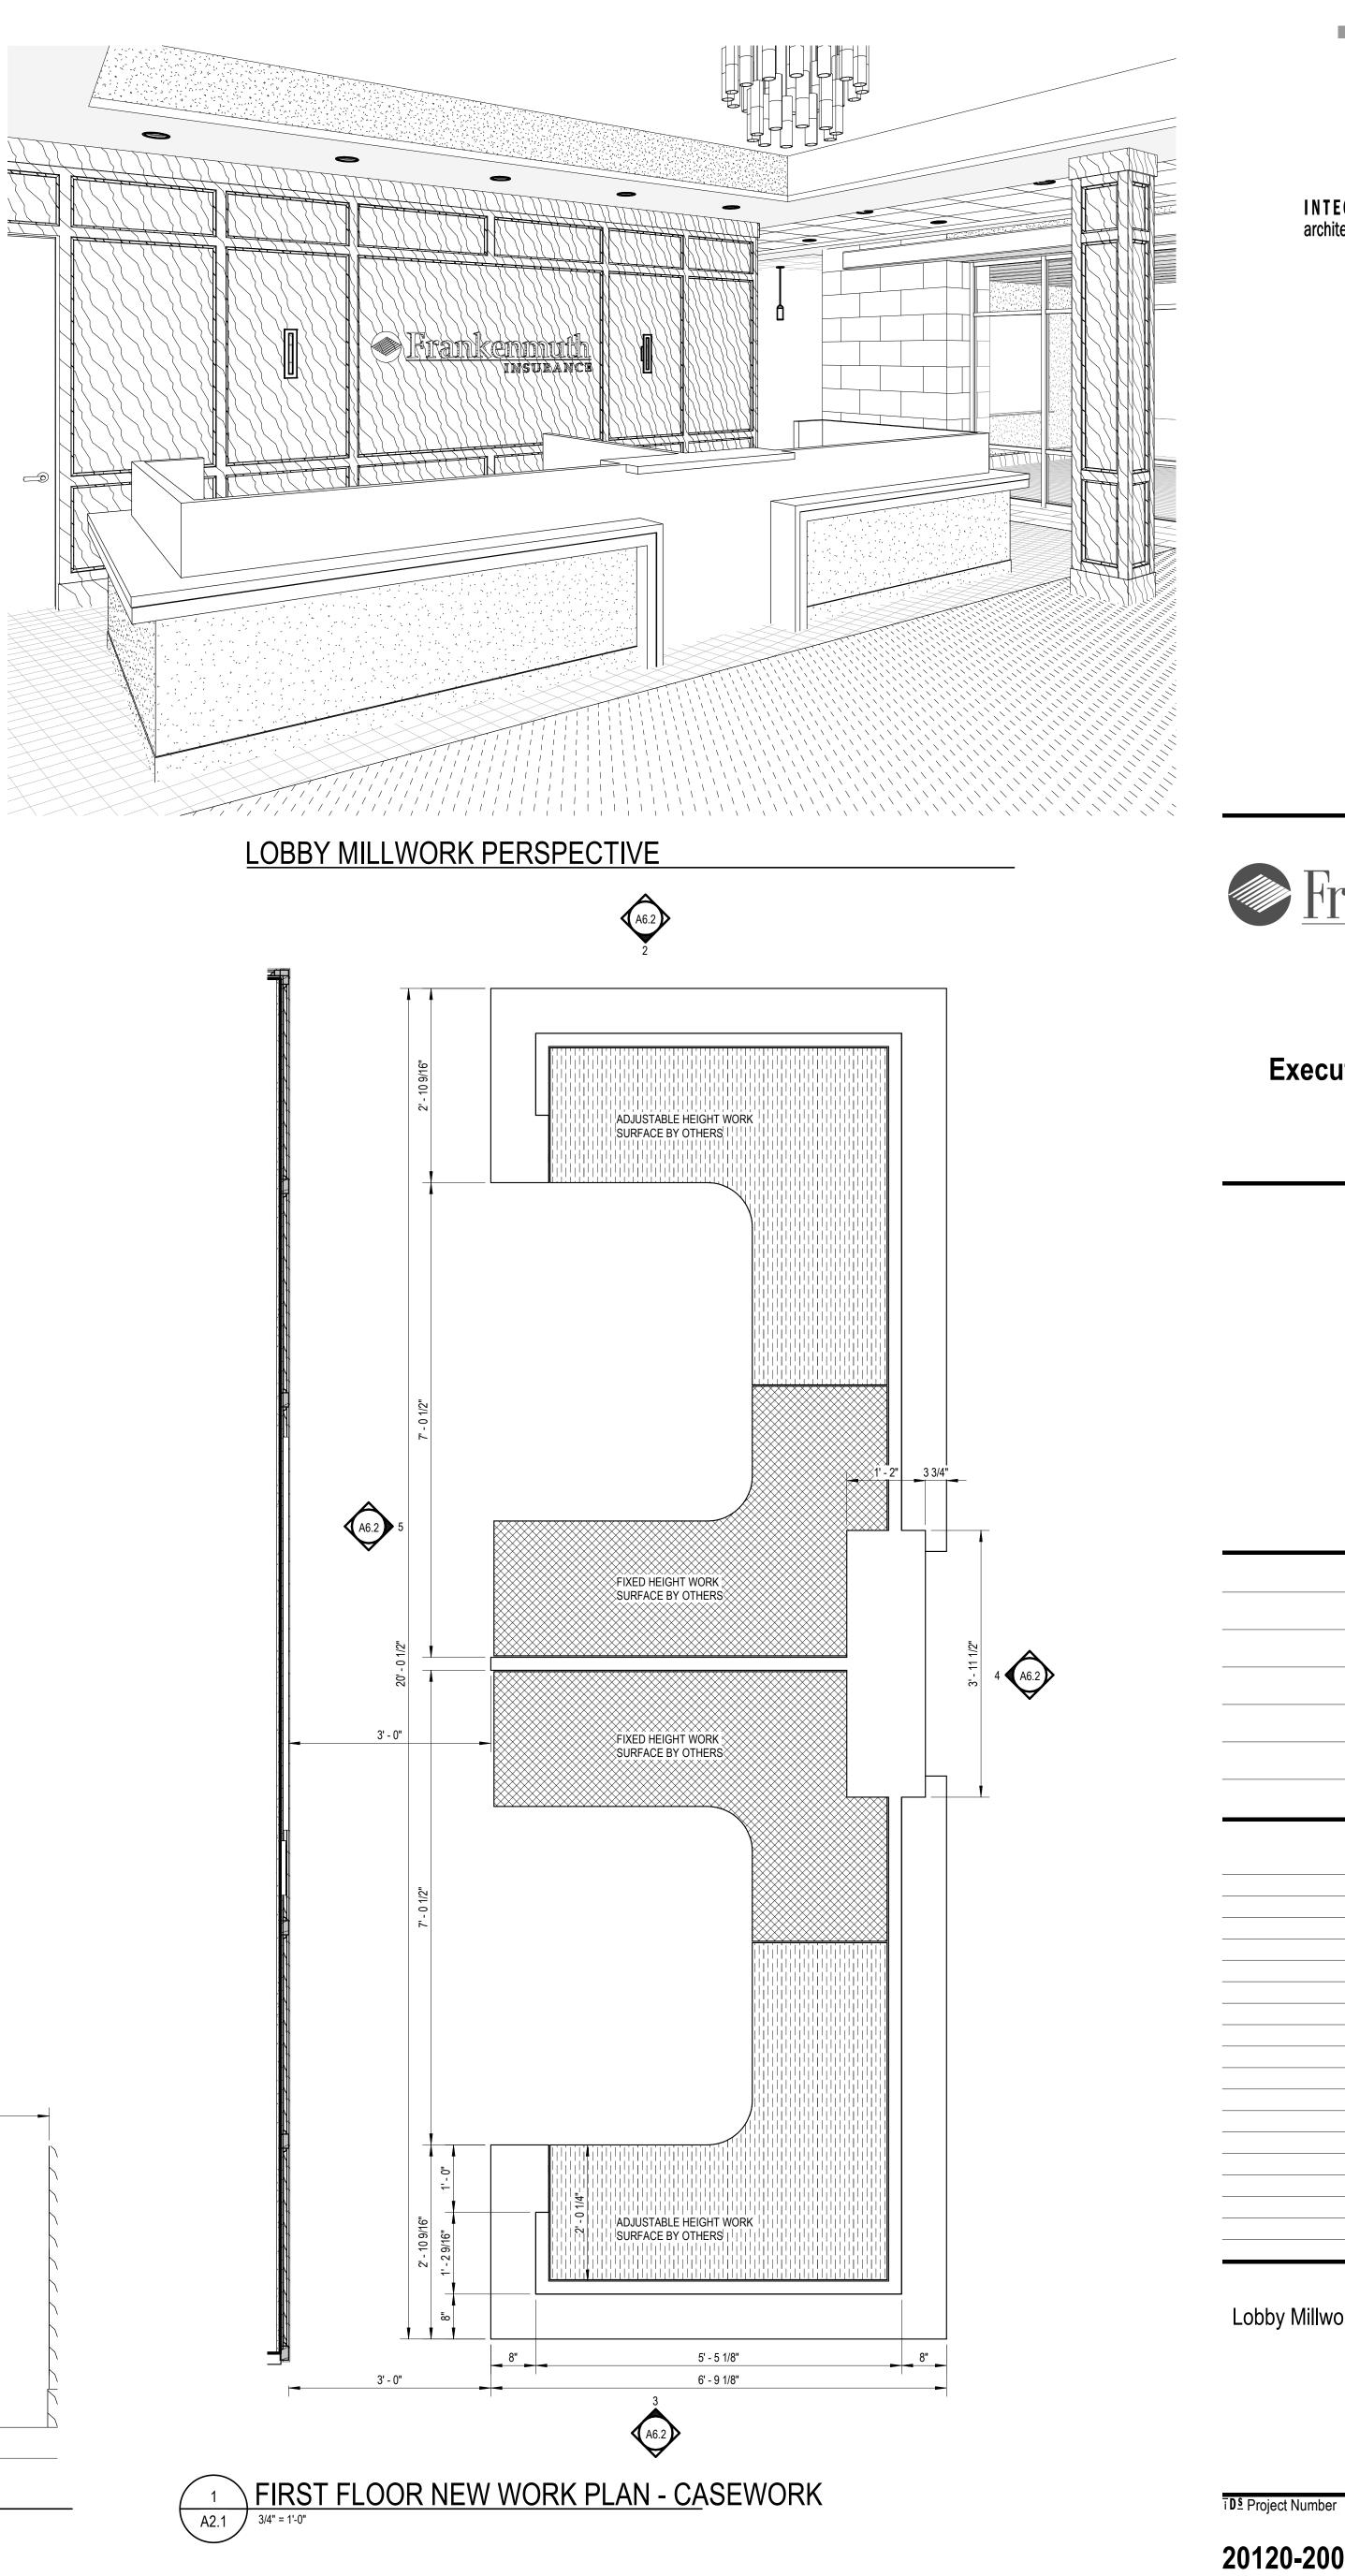



Drawing Number

A6.2

n solutions, LL IDS Drawing Title Lobby Millwork Plan, Elevations and Details

 \odot 2021 Integrated ${
m d}$

Project Administrator Administrator Project Designer K. Litwin/T. Easthope Project Architect / Engineer K. Marshall Drawn By K. Marshall Q.M. Review N. LaForest Approved B. Sundberg Drawing Scale As Noted Issue Date Issued for Quality Management Review 04-21-2021 Bids 07-15-2021


1 Mutual Avenue Frankenmuth, MI 48787 Key Plan

Executive Suite Renovation



INTEGRATED design solutions architecture engineering interiors & technology 1441 west long lake, suite 200 troy, michigan 48098 5211 cascade road SE, suite 300 grand rapids, michigan 49546 248.823.2100



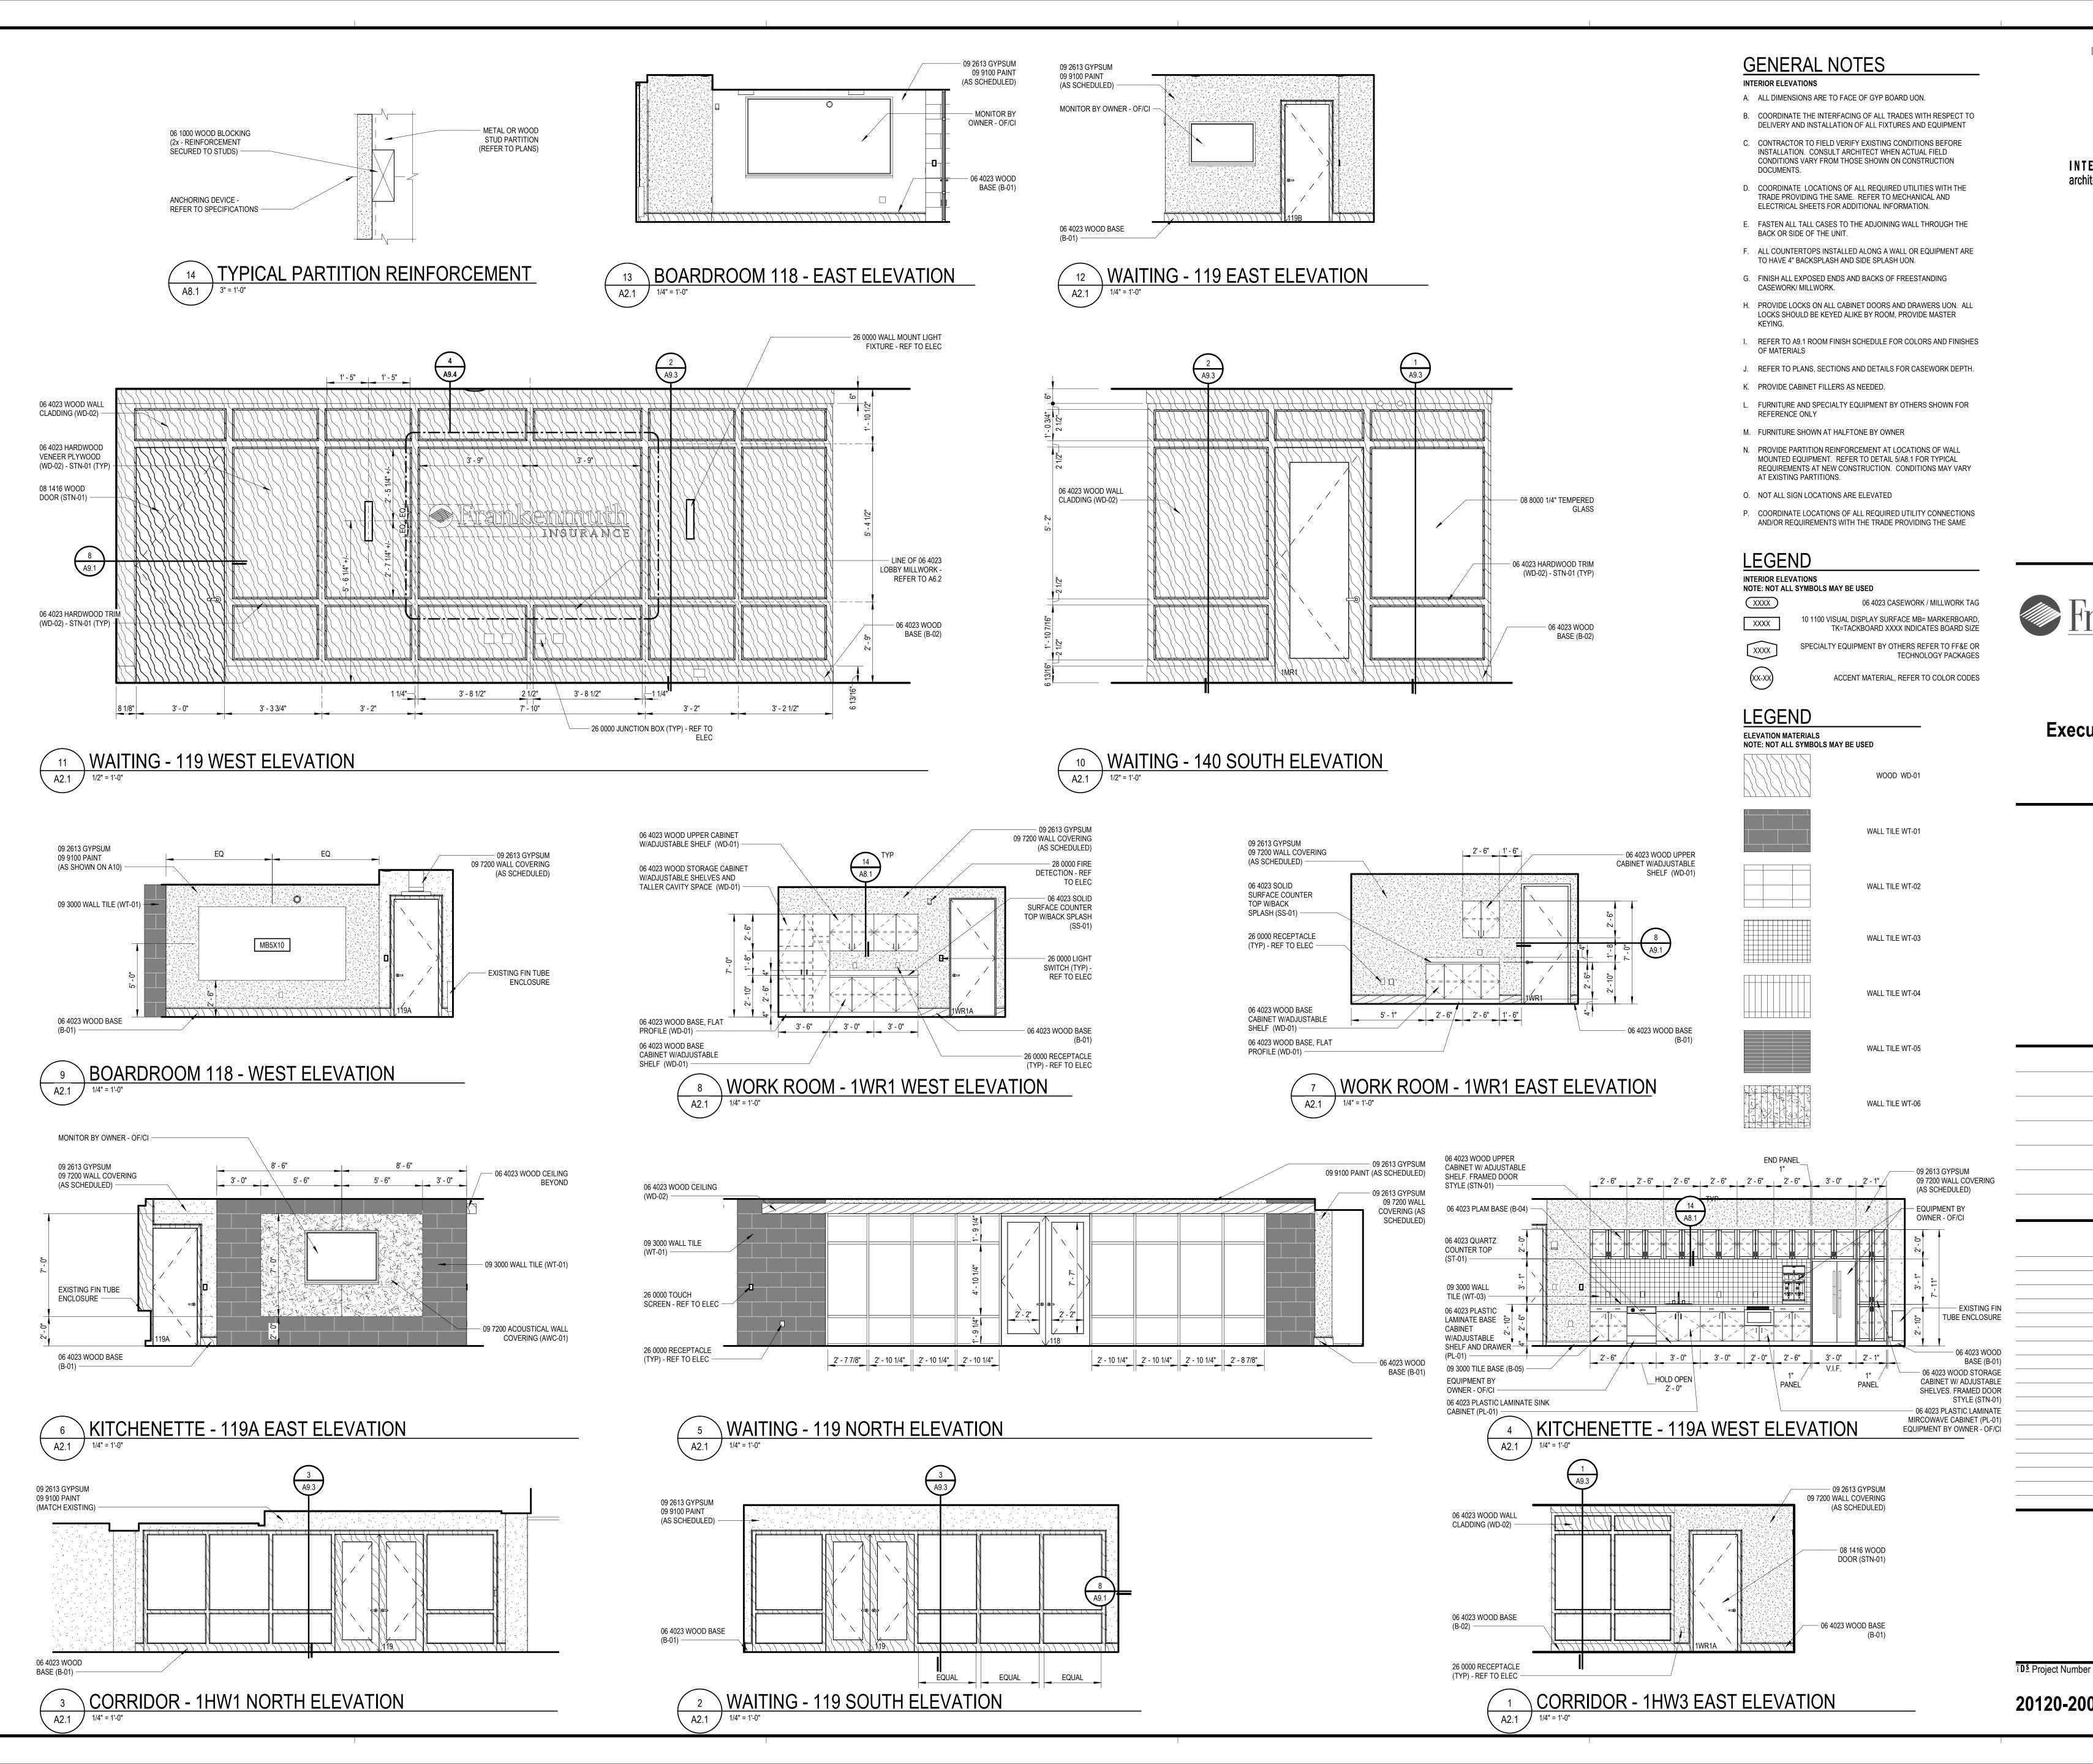



Drawing Number

A8.1



Interior Elevations

IDS Drawing Title

© 2021	INTEGRATED design solutions, LLC

Pr	oject Administrator
	Administrator
	Project Designer
K. Litw	in/T. Easthope
Project A	Architect / Engineer
	K. Marshall
	Drawn By
T. Easthop	be, K. Marshall
	Q.M. Review
	N. LaForest
	Approved
	B. Sundberg
	Drawing Scale
	As Noted
Issued for	Issue Date
Design Development	02-26-2021
Quality Management Review	04-21-2021
Bids	07-15-2021

1 Mutual Avenue Frankenmuth, MI 48787 Key Plan

Executive Suite Renovation



INSURANCE



1441 west long lake, suite 200

5211 cascade road SE, suite 300


grand rapids, michigan 49546

troy, michigan 48098

www.ids-michigan.com

248.823.2100

Project Title

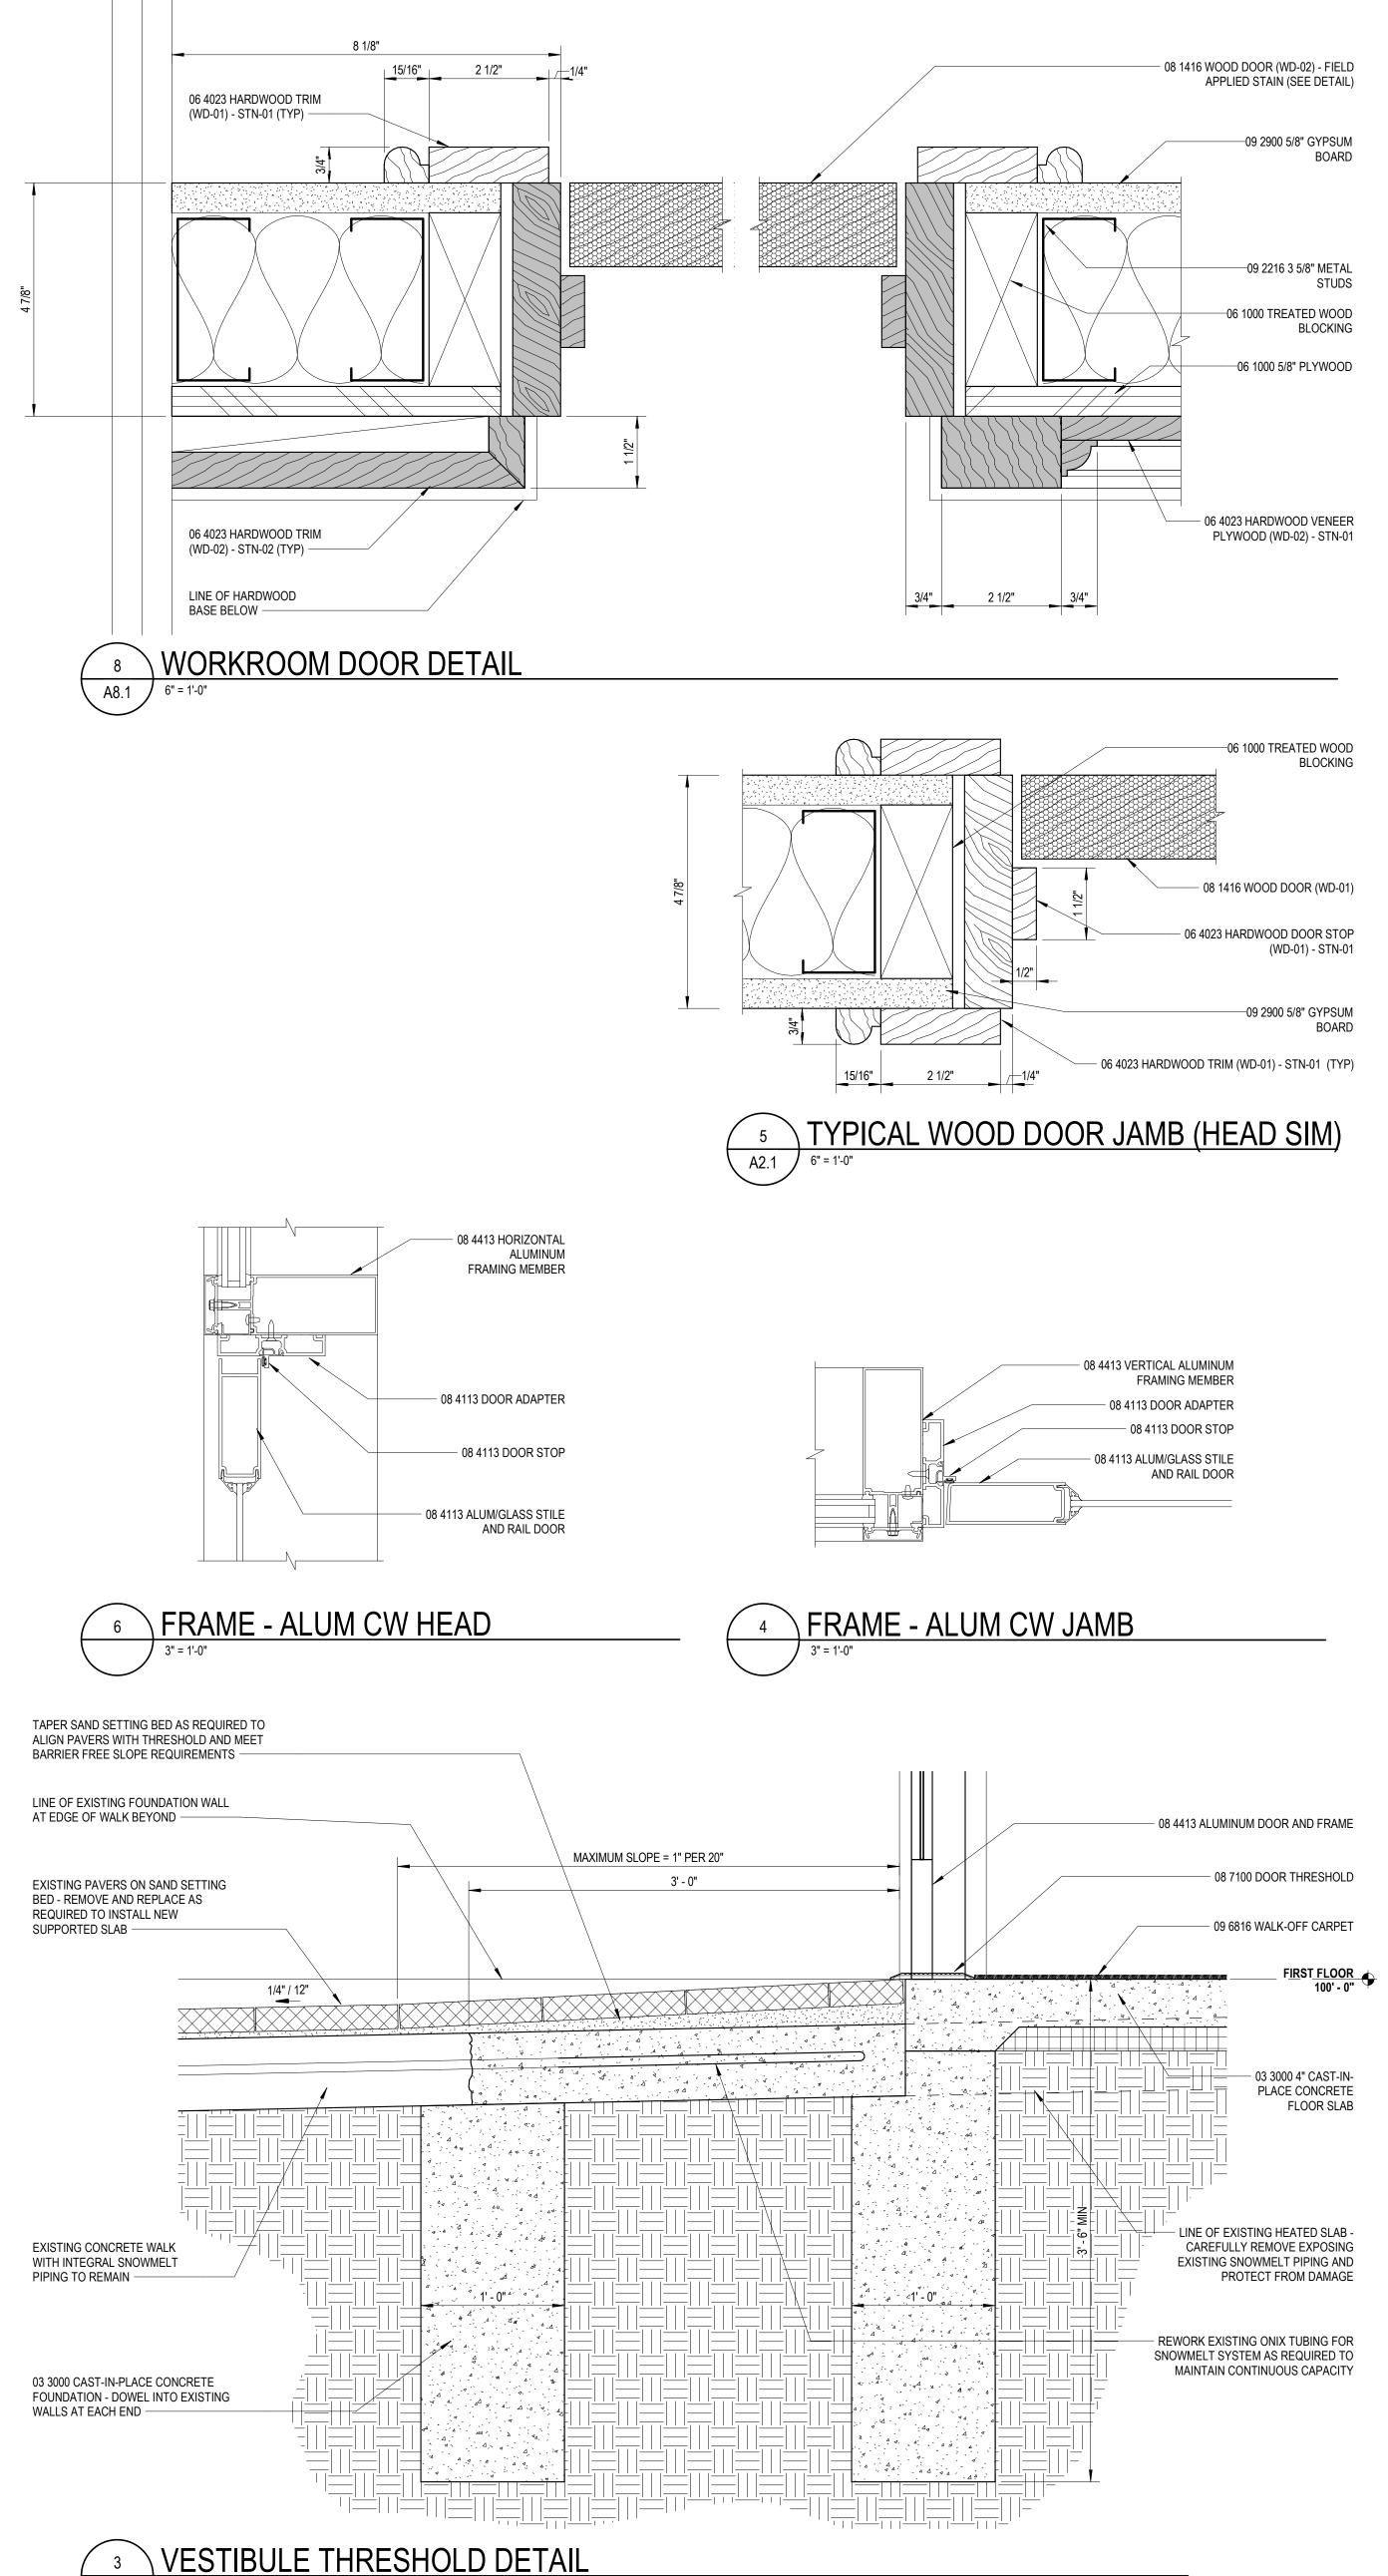

A6.1 / 1 1/2" = 1'-0"


		S	CHEDULE -	ROOM FINISH	1	
NUMBER	NAME	FLOOR	BASE	WALL	CEILING	REMARKS
1HW1	CORRIDOR	(E)	B-01	PT-05	GYP/PT-05, AC-01	
1HW2	CORRIDOR	CPT-02	B-01	WC-01	AC-01	
1HW3	CORRIDOR	CPT-02	B-01, 02	WD-01, WC-01	GYP/PT-02, AC-01	
1MR1	MEETING ROOM	CPT-03	B-01	PT-03	AC-01	
1TR1	PRIVATE TOILET ROOM	FT-02, 03	-	WT-02, 05, WC-02	GYP/PT-02	2
1TR2	TOILET ROOM	FT-02, 03	-	WT-02, 05, WC-02	GYP/PT-02	2
1TR3	SHOWER/ TOILET ROOM	FT-02, 03, 04	-	WT-02, 04, 05, 06, WC-02	GYP/PT-02	2
1VB1	VESTIBULE	CPT-05	B-03	PT-01	GYP/PT-02	
1WR1	WORK ROOM	CPT-02	B-01	WC-01	AC-01	
118	BOARD ROOM	CPT-03, FT-01	B-01	PT-03, WC-01, WT-01	GYP-01, WD-03	
118A	CLOSET	FT-01	B-01	PT-01	EXP	
119	FOYER/ WAITING	CPT-01, 02, 03, 04, FT-01	B-01, 02	PT-04, WC-01, WT-01	GYP/PT-02, 04, AC-01	
119A	KITCHENETTE	FT-01	B-01, 04, 05	WC-01, WT-01	GYP/PT-02, AC-01	1
119B	CLOSET	CPT-01	B-01	PT-01	GYP/PT-02	
122	EXECUTIVE OFFICE	(E)	(E)	(E), WC-01	(E)	


SCHEDULE - COLOR CODES


			SCHEDULE - COL	UR CODES			
COLOR CODES	PRODUCT / MATERIAL	MANUFACTURER	PRODUCT NAME / NUMBER	COLOR NAME / NUMBER	SIZE	FINISH	NOTES
AC-01	ACOUSTICAL CEILING TILE	USG	ASTRO FIRE CODE/8722		24" X 24"		USG FINELINE 1/8 DXFF 9/16" GRID
AWC-01	ACOUSTICAL WALL COVERING	FILZFELT	5MM WOOL DESIGN FELT	WEI 150	ROLL		KITCHEN
B-01	WOOD BASE			STAIN TO MATCH EXISTING			MATCH EXISTING, STN-01
B-02	WOOD BASE			STAIN TO MATCH WD-02			WOOD WALL INTEGRATED BASE
B-03	RESIL BASE	TARKETT	TRADITIONAL	MOONROCK / 29	4"H		VESTIBULE ONLY
B-04	PLASTIC LAMINATE BASE	FORMICA		NEUTRAL WHITE	4"H		KITCHEN LOWER CASEWORK
B-05	TILE BASE	ERGON	STONE PROJECT	WHITE/ FALDA	3" X 24"		RECTIFIED BULLNOSE
CPT-01	CARPET TILE	MILLIKEN	COUNTERCULTURE / FREETHINKER	DIVERGENCE / 218 FTR79	20" X 20"		INSTALL ASHLAR
CPT-02	CARPET TILE	MILLIKEN	COUNTERCULTURE / PHENOM	DIVERGENCE / 218 PHN79	20" X 20"		INSTALL ASHLAR
CPT-03	CARPET TILE	PATCRAFT	URBAN RELIEF / SUBURBAN ABSTRACT	TRANSIT / 00450	24" X 24"		INSTALL MONOLITHIC
CPT-04	SHEET CARPET	SHAW CONTRACT	RIBBONS / 5A266	SHINE / 66155	15'-0" X 12'-0"		INSTALL AS AREA RUG
CPT-05	CARPET TILE	MILLIKEN	OBEX ENTRANCE FLOORING/CUT	FIZZ / GREY	19.7" X 19.7"		WALK OFF CARPET, INSTALL MONOLITHIC
EXP	EXPOSED						
FT-01	FLOOR TILE	ERGON	STONE PROJECT	WHITE/ FALDA	12" X 24"		REF TO FINISH PLANS AND ELEVATIONS FOR INSTALL DIRECTION
FT-02	FLOOR TILE	CAESAR	JOIN	LEVITY	12" X 24"		REF TO FINISH PLANS AND ELEVATIONS FOR INSTALL DIRECTION
FT-03	FLOOR TILE	CAESAR	JOIN	INK	5" X 24"		REF TO FINISH PLANS AND ELEVATIONS FOR INSTALL DIRECTION
FT-04	FLOOR TILE	CAESAR	JOIN	LEVITY	5" X 24"		REF TO FINISH PLANS AND ELEVATIONS FOR INSTALL DIRECTION
GR-01	GROUT	TEC	INCOLOR	STERLING 909			INSTALL W/ FT-01
GR-02	GROUT	TEC	INCOLOR	MIST 939			INSTALL IN TOILET ROOMS
GR-03	GROUT	TEC	INCOLOR	DOVE GRAY 908			INSTALL W/ WT-01
GR-03	GROUT	TEC	INCOLOR	RAVEN 941			INSTALL W/ WT-03
GYP	GYP BOARD CEILING						
PL-01	PLASTIC LAMINATE	FORMICA		NEUTRAL WHITE			KITCHEN LOWER CASEWORK
PL-02	PLASTIC LAMINATE	FORMICA		GRAYSTONE			INTERIOR OF MILLWORK DESK
PT-01	PAINT	SHERWIN WILLIAMS		PEARLY WHITE / SW 7009			GENERAL
PT-02	PAINT	SHERWIN WILLIAMS		WHITE			CEILING
PT-03	PAINT	SHERWIN WILLIAMS		SMOKY BLUE / SW 7604			ACCENT BLUE
PT-04	PAINT	SHERWIN WILLIAMS		SHIITAKE / SW 9173			ACCENT NEUTRAL
PT-05	PAINT	SHERWIN WILLIAMS		MATCH EXISTING			MATCH EXISTING, FIELD VERIFY
SC-01	SHADE CLOTH	DRAPER	SHEERWEAVE - BASIC 3%	WHITE			ACOUSTICAL FABRIC
SS-01	SOLID SURFACE	LG HAUSYS	HI-MACS	BIRCH BARK NR G714			KITCHEN COUNTER
ST-01	QUARTZ	LG HAUSYS	VIATERA	ROCOCO			MILLWORK DESK
ST-02	QUARTZ	LG HAUSYS	VIATERA	MICA			MILLWORK DESK
STN-01	WOOD STAIN			MATCH EXISTING			GENERAL
WC-01	WALL COVERING	MAHARAM	ERA / 300062	POETIC / 001			GENERAL
WC-02	WALL COVERING	ARCCOM	INTUITION / ACW-53518	MIDNIGHT BLUE #8			TOILET ROOMS
WD-01	WOOD			STAIN TO MATCH EXISTING			REF TO SPECIFICATIONS
WD-02	WOOD			STAIN TO MATCH EXISTING			REF TO SPECIFICATIONS
WD-03	WOOD CEILING						CEILING IN BOARD ROOM, REF TO SPECIFICATIONS
WT-01	WALL TILE	ERGON	STONE PROJECT	GREIGE / FALDA	12" X 24"		REF TO FINISH PLANS AND ELEVATIONS FOR INSTALL DIRECTION
WT-02	WALL TILE	CAESAR	JOIN	LEVITY	12" X 24"		REF TO FINISH PLANS AND ELEVATIONS FOR INSTALL DIRECTION
WT-03	WALL TILE	MARAZZI	ZELLIGE	CHINA	4" X 4"		REF TO FINISH PLANS AND ELEVATIONS FOR INSTALL DIRECTION
WT-04	WALL TILE	CAESAR	JOIN	LEVITY	5" X 24"		REF TO FINISH PLANS AND ELEVATIONS FOR INSTALL DIRECTION
WT-05	WALL TILE	CAESAR	JOIN	LEVITY	3" X 24"		REF TO FINISH PLANS AND ELEVATIONS FOR INSTALL DIRECTION
WT-06	WALL TILE	CAESAR	JOIN	INK	5" X 24"		REF TO FINISH PLANS AND ELEVATIONS FOR INSTALL DIRECTION

TYPE	LENGTH	WIDTH	HOUSING	MANUFACTURER	MATERIAL	MECHANISM	MOUNTING
W1	7' - 6 1/2"	5' - 3 1/2"	0"	DRAPER	SC-01	MOTORIZED- SINGLE ROLLER	TOP MOUNT, SMALL HEAD BOX
W1: 2							
N2	7' - 6 1/2"	5' - 5"	0"	DRAPER	SC-01	MOTORIZED- SINGLE ROLLER	TOP MOUNT, SMALL HEAD BOX
N2: 1							
W3	7' - 6 1/2"	5' - 3 1/2"	0"	DRAPER	SC-01	MOTORIZED- SINGLE ROLLER	TOP MOUNT, SMALL HEAD BOX
N3: 1							
N4	7' - 6 1/2"	5' - 6"	0"	DRAPER	SC-01	MOTORIZED- SINGLE ROLLER	TOP MOUNT, SMALL HEAD BOX
N4: 4							
N5	7' - 6 1/2"	5' - 4 3/4"	0"	DRAPER	SC-01	MOTORIZED- SINGLE ROLLER	TOP MOUNT, SMALL HEAD BOX

									Ľ)00F	SCHE	DULE							
		DOOR				FRAME			DETAILS				DOOR						
DOOR NUMBER	WIDTH	-	SIZE	HEIGHT	TYPE	MATERIAL	FINISH/ CC	FRGM	TYPE	MATERIAL	FINISH / CC	FRGM	HEAD	JAMB	SILL	HARDWARE SET		WALL RATING	REMARKS
1HW2	3' - 0"	3' - 0"		8' - 0"	Ν	WD	STN-01		Α	WD	STN-01		5/A9.1 SIM	5/A9.1		1			1
1MR1	3' - 0"	3' - 0"		8' - 0"	FG	WD	STN-01		A	WD	STN-01		1/A9.3 SIM	12/A9.4		2			
1TR1	3' - 0"	3' - 0"		8' - 0"	F	WD	STN-01		Α	WD	STN-01		5/A9.1 SIM	5/A9.1	1/A9.1	3			
1TR2	3' - 0"	3' - 0"		8' - 0"	F	WD	STN-01		Α	WD	STN-01		5/A9.1 SIM	5/A9.1	1/A9.1	3			
1TR3	3' - 0"	3' - 0"		8' - 0"	F	WD	STN-01		A	WD	STN-01		5/A9.1 SIM	5/A9.1	1/A9.1	3			
1VB1	3' - 0"	3' - 0"		6' - 11 1/8"	FGW	AL	PVF-01		SEE ELEV.	AL	PVF-01		6/A9.1	4/A9.1	3/A9.1	4			1
1VB1A	3' - 0"	3' - 0"		6' - 11 1/8"	(E)	AL	(E)		(E)	AL	(E)		6/A9.1	4/A9.1		5			1,4
1WR1	3' - 0"	3' - 0"		8' - 0"	F	WD	STN-01		A	WD	STN-01		8/A9.1 SIM	8/A9.1		6			
1WR1A	3' - 0"	3' - 0"		8' - 0"	F	WD	STN-01		A	WD			5/A9.1 SIM	5/A9.1		7			
118	6' - 0"	3' - 0"	3' - 0"	8' - 10"	FGW	AL	ANOD-01		SEE ELEV.	AL	ANOD-01					8			6
118A	2' - 8"	2' - 8"		8' - 0"	F	WD	STN-01		Α	WD			5/A9.1 SIM	3/A9.4		7			
119	6' - 0"	3' - 0"	3' - 0"	8' - 0"	FG	WD	STN-01		SEE ELEV.	WD	STN-01					9			1
119A	3' - 0"	3' - 0"		8' - 0"	F	WD	STN-01		Α	WD	STN-01			5/A9.4		10			
119B	3' - 0"	3' - 0"		8' - 0"	F	WD	STN-01		A	WD	STN-01		5/A9.1 SIM	5/A9.1		2			
122	3' - 0"	3' - 0"		8' - 0"	(E)	WD	(E)		(E)	WD	(E)		5/A9.1 SIM	11/A9.4		5			4

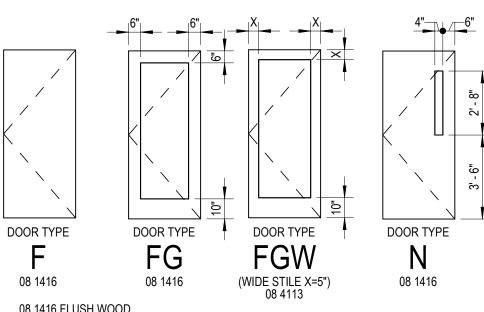

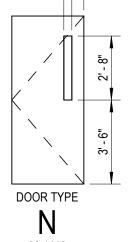


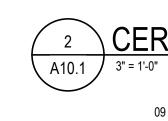


1

08 1416 FLUSH WOOD 08 4113 ALUMINUM AND GLASS STILE & RAIL

DOOR TYPES NOTE: ALL GLASS TO BE 1/4" SAFETY GLASS, UON

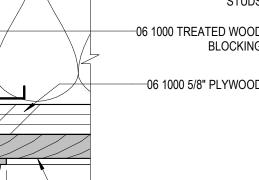


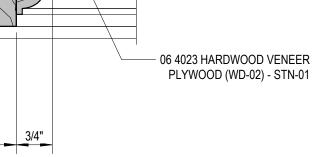

08 4113 DOOR ADAPTER
08 4113 ALUM/GLASS STILE AND RAIL DOOR

09 3000 METAL


EDGE STRIP -09 3000 CERAMIC TILE (THINSET) -

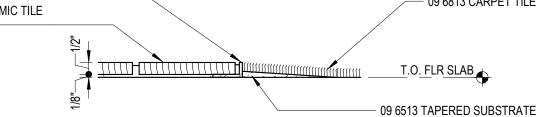

CERAMIC TILE/CARPET TRANSITION

09 3000 MARBLE THRESHOLD (W/ 1:2 BEVEL - TYP) -

09 6813 CARPET TILE -

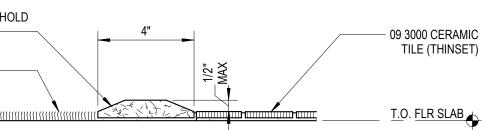

- 09 6813 CARPET TILE

TRANSITION STRIPS

ABBREVIATIONS **ROOM FINISH SCHEDULE**

ROOM FINISH SCHEDULE	
AC PANEL	ACOUSTICAL PANEL
AC TILE	ACOUSTICAL TILE
AC WP	ACOUSTICAL WALL PANEL
CC	COLOR CODE
CMU	CONCRETE MASONRY UNIT
СТ	CERAMIC TILE
CEM PLAS	CEMENT PLASTER
CONC	CONCRETE
DEFS	DIRECT APPLIED EXTERIOR FINISH SYSTEM
(E)	EXISTING FINISH
EIFS	EXTERIOR INSULATION FINISH SYSTEM
EPT	EPOXY PAINTED
ETERR	EPOXY TERRAZZO
ENTR MAT	ENTRY MAT SYSTEM
EXP CONST	EXPOSED CONSTRUCTION
FWC	FABRIC WALL COVERING
	GROUND FACE CONCRETE MASONRY UNIT
GF CMU GL CMU	GLAZED CONCRETE MASONRY UNIT
GYP BD	GYPSUM BOARD
HD/SLR	HARDENER/ SEALER
IR GYP BD	IMPACT RESISTANT GYPSUM BOARD
LIMEST	LIMESTONE
LIN MET	LINEAR METAL
LINO	LINOLEUM
MCC	MULTI-COLORED COATING
MET PANEL	METAL PANEL
P'LAM	PLASTIC LAMINATE
PAVER T	PAVER TILE
PLAS	PLASTER
POL CONC	POLISHED CONCRETE
PORC T	PORCELAIN TILE
PT	PAINT
QT	QUARRY TILE
RT	RUBBER TILE
RESIN FLR	RESINOUS FLOORING
RESIL	RESILIENT
SGFT	STRUCTURAL GLAZED FACING TILE
SHT V	SHEET VINYL
SLD SURF	SOLID SURFACE MATERIAL
SS	STAINLESS STEEL
STN	STAIN
TC	TRAFFIC COATING
TERR	TERRAZZO
VCT	VINYL COMPOSITION TILE
VWC	VINYL WALLCOVERING
VEN PLAS	VENEER PLASTER
WD	WOOD
	1008

GENERAL NOTES

- ROOM FINISH SCHEDULE
- * REFER TO ABBREVIATIONS LIST FOR MATERIAL CODE DESCRIPTIONS A. "ROOM NUMBER AND ROOM NAME" CORRESPOND TO THE NUMBER
- AND NAMES INDICATED ON THE SHEETS. B. "MATERIAL/FINISH" INDICATE THE SPECIFIC MATERIALS AND FINISHES
- TO BE USED TO CONSTRUCT AND FINISH THE FLOORS, BASE, WALLS AND CEILINGS.
- C. "CC" INDICATES THE COLOR CODE FOR EACH MATERIAL AND/OR FINISH, REFER TO "COLOR CODES".
- D. "REMARKS" INDICATES ANY SPECIAL REQUIREMENTS FOR THE MATERIAL AND FINISH IN A ROOM - SEE "ROOM FINISH SCHEDULE REMARKS".
- E. "CEILING" IS THE MATERIAL AND FINISH AT THE UNDERSIDE OF THE FLOOR OR ROOF ABOVE. "SOFFIT" IS THE MATERIAL AND FINISH AT THE UNDERSIDE OF THE STAIR RUN.
- F. REFER TO A10 SERIES FOR FLOOR TILE PATTERNS AND MATERIALS.
- G. REFER TO A8 SERIES FOR INTERIOR ELEVATIONS.
- H. "E" PREFIX TO THE "PT" CODE REFER TO EPOXY PAINT MATERIAL (E PT-XX).

REMARKS ROOM FINISH SCHEDULE

CABINETS ONLY

- 1. PLASTIC LAMINATE BASE (B-04) TO BE INSTALLED AT KITCHEN
- 2. INCLUDE (1) ROBE HOOK ON BACK OF DOOR


GENERAL NOTES

- DOOR SCHEDULE
- A. REFER TO THE DRAWINGS FOR DOOR LOCATIONS
- B. "DOOR NUMBER" CORRESPONDS TO THE DOOR NUMBER INDICATED ON THE DRAWINGS. NOTE: AT EXISTING WALL OPENINGS, FIELD VERIFY SIZE OF DOORS AND FRAMES.
- C. (DOOR) "SIZE" INDICATES THE NOMINAL WIDTH AND HEIGHT OF THE DOOR IN FEET AND INCHES. ALL DOORS ARE 1 3/4" THICK UNLESS OTHERWISE NOTED.
- D. "DOOR AND FRAME TYPE/MATL/FINISH" INDICATES THE CODES FOR TYPE (INDICATED ON THE DRAWINGS), MATERIAL AND FINISH.
- E. "CC" INDICATES THE COLOR CODE FOR FINISHES OF DOORS AND FRAMES, SEE "SCHEDULE - COLOR CODES".
- F. "DETAILS HEAD- JAMB-SILL" INDICATES THE DETAIL NUMBER INDICATED ON THE DRAWINGS.
- G. "HARDWARE SET" INDICATES HARDWARE SET NUMBERS SPECIFIED IN 08 7100 - DOOR HARDWARE.
- H. "DOOR ASSEMBLY RATING" INDICATES THE MINIMUM FIRE
- RESISTANCE RATING FOR FIRE DOORS AND/OR SIDELITES.
- I. "WALL RATING" INDICATES THE FIRE RESISTANCE RATING OF THE WALL CONTAINING THE DOOR.
- J. "FRGM" INDICATES FIRE-RATED GLAZING MARKINGS.
- K. "REMARKS" INDICATES ANY SPECIAL REQUIREMENTS FOR A DOOR AND FRAME - SEE "DOOR SCHEDULE - REMARKS".

REMARKS DOOR SCHEDULE


- 1. ACCESS CONTROL SYSTEM
- 2. REMOVABLE MULLION 3. LOW ENERGY POWER OPERATED DOOR 4. DOOR, FRAME AND HARDWARE SALVAGED FROM EXISTING - SEE DEMOLITION PLAN
- 5. HOLLOW METAL ASTRAGAL 6. 08 7100 FLOOR STOPS MOUNTED TO WOOD CEILING

CARPET TO TILE TRANSITION W/ THRESHOLD (THINSET) A6.1 / 3" = 1'-0"

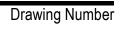

A9.1

īDs Project Number 20120-2000

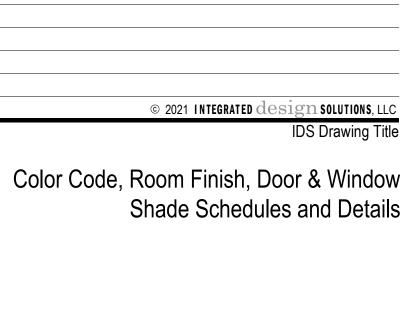

Р	roject Administrator Administrator
K. Litw	Project Designer vin/T. Easthope
Project <i>i</i>	Architect / Engineer K. Marshall
	Drawn By T. Easthope
	Q.M. Review
	N. LaForest
	Approved B. Sundberg
	Drawing Scale
	As Noted
Issued for	Issue Date
Design Development	02-26-2021
Quality Management Review	04-21-2021
Bids	07-15-2021

1 Mutual Avenue Frankenmuth, MI 48787 Key Plan

Executive Suite Renovation



INTEGRATED design SOLUTIONS architecture engineering interiors & technology 1441 west long lake, suite 200 troy, michigan 48098 5211 cascade road SE, suite 300 grand rapids, michigan 49546

248.823.2100



07 8413 HEAD OF WALL FIRE RESISTIVE JOINT SYSTEM AT RATED PARTITIONS -

CONSTRUCTION AT VOIDS OF STEEL DECK ONLY -09 2116 METAL J RUNNER (SECURED TO DECK) -DO NOT SECURE STUDS OR GYPSUM BOARD TO J RUNNER -

09 2900 SOUND ATTENUATION INSULATION TO DECK ABOVE -

09 2116 1" GYPSUM CORE BOARD -----

09 2116 C-H STUDS -

09 2116 METAL J RUNNER (SECURED TO FLOOR) -

PARTITION SERIES 'G'

FACE OF WALL CONSTR

REFER TO PLAN -

CEILING AS SCHEDULED

09 2216 METAL STUDS -

09 2216 METAL RUNNER CHANNEL

(SECURED TO FLOOR) -BASE AS SCHEDULED -09 2900 ACOUSTICAL SEALANT (CONT) -

PARTITION SERIES 'F'

CONSTRUCTION AT VOIDS OF STEEL DECK ONLY 09 2216 SLOTTED DEFLECTION TRACK (SECURED TO DECK) -


09 2900 5/8" GYPSUM BOARD (CROSS BRACES @ 3RD POINTS VERTICALLY) ———

09 2900 5/8" GYPSUM BOARD -

09 2216 METAL STUDS -09 2216 METAL RUNNER CHANNEL (SECURED TO FLOOR) -

09 2900 ACOUSTICAL SEALANT (CONT BOTH SIDES) -

PARTITION SERIES 'E'

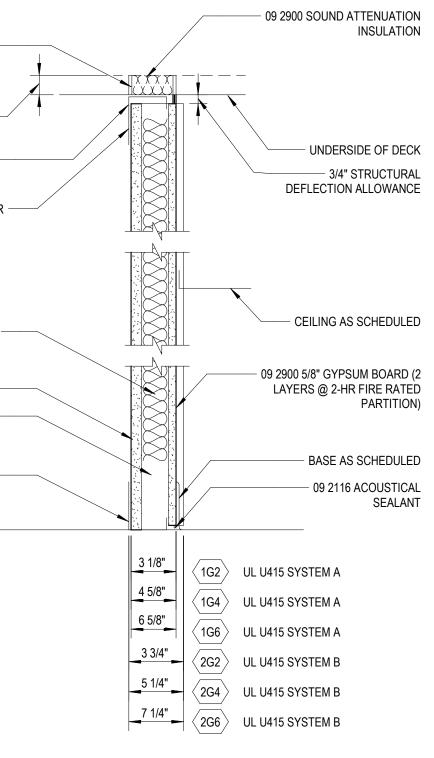

GENERAL NOTES INTERIOR PARTITIONS

- "WALL" AND "PARTITION" ARE USED TO DENOTE EITHER WALLS OR PARTITIONS INTERCHANGEABLY.
- 2. REFER TO SHEET AR.0 ARCHITECTURAL REFERENCE INFORMATION
- FOR ABBREVIATIONS, SYMBOLS, AND GRAPHIC INDICATIONS. 3. REFER TO COMPOSITE LIFE SAFETY PLANS FOR PARTITION FIRE
- RATINGS. 4. REFER TO ROOM FINISH SCHEDULE FOR WALL FINISHES AND WALL

PARTITION TYPE GRAPHIC TAG

ASSEMBLY RATING -S = SMOKE PARTITION

0 = NON-RATED

BASE.


- SIZE DESIGNATOR


- PARTITION SERIES


(SEE TABLE BELOW)

MATERIAL	DESIGNATION SIZE	ACTUAL SIZE	SPACING
MASONRY	4 6 8 12	3 5/8 " 5 5/8 " 7 5/8 " 11 5/8 "	N/A
STEEL STUDS	1 2 3 4 6	1 5/8 " 2 1/2 " 3 5/8 " 4" 6"	16" OC
FURRING	0 1 2 3	7/8 " 1 5/8 " 2 1/2 " 3 5/8 "	16" OC
SHAFTWALL C-H STUDS	2 4 6	2 1/2 " 4" 6"	24" OC

- SUBSTITUTE 09 2900 TILE BACKING BOARD AT LOCATIONS TO RECEIVE A TILE WALL FINISH.
- 6. ALL NON-LOAD BEARING METAL WALL FRAMING SHALL BE BASED ON TOTAL STUD HEIGHT. REFER TO SPECIFICATION SECTIONS 05 4000 -COLD-FORMED METAL FRAMING, 09 2116 - GYPSUM BOARD SHAFT WALL ASSEMBLIES AND 09 2216 - NON-STRUCTURAL METAL FRAMING FOR ADDITIONAL REQUIREMENTS.
- 7. WHERE ROOMS WITH DIFFERENT PARTITION REQUIREMENTS ARE ADJACENT, THE PARTITION WITH THE GREATER FIRE-RATING AND/OR STC SHALL BE USED BETWEEN THEM.
- 8. AT INTERSECTIONS OF DIS-SIMILAR PARTITON TYPES, THE HIGHEST RATED PARTITION IS TO RUN THROUGH THE INTERSECTION TO MAINTAIN ENCLOSURE. MAINTAIN RATING OF RATED PARTITION AT INTERSECTION WITH COLUMN ENCLOSURES BY EXTENDING RATED CLOSURE AS REQUIRED.
- 9. FIRE-RATED PARTITIONS SHALL BE CONSTRUCTED ACCORDING TO THE FIRE TEST INDICATED. NO SUBSTITUTIONS OF MATERIALS OR DEVIATIONS FROM CONSTRUCTION ARE ALLOWED. ADDITIONAL LAYERS MAY BE REQUIRED FOR ACOUSTICAL OR OTHER REASONS AND MUST BE EXECUTED AS SHOWN.
- 10. STC RATINGS ARE MINIMUM ACOUSTICAL PERFORMANCE REQUIREMENT. SPECIFIC ACOUSTICAL TESTS ARE GIVEN FOR REFERENCE ONLY. SOUND ATTENUATION BLANKET THICKNESS SHALL BE AS FOLLOWS:
- A. 1 1/2 " FOR PARTITIONS WITH 1 5/8 " AND 2 1/2 " STUDS (INCLUDING SHAFTWALLS).
- B. 3" FOR PARTITIONS WITH 3 5/8 ", 4" OR 6" STUDS. C. 3" FOR SHAFTWALLS WITH 4" OR 6" STUDS UNO. D. AS REQUIRED FOR FIRE RATING.
- 11. DETAILS ARE DIAGRAMMATIC PRECISE REQUIREMENTS OF TESTS ASSEMBLIES SHALL GOVERN.

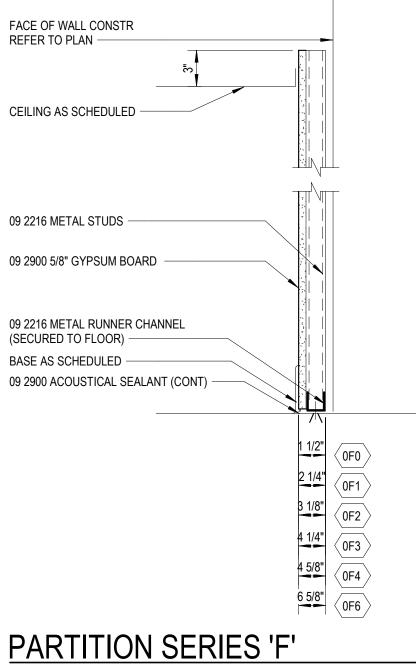

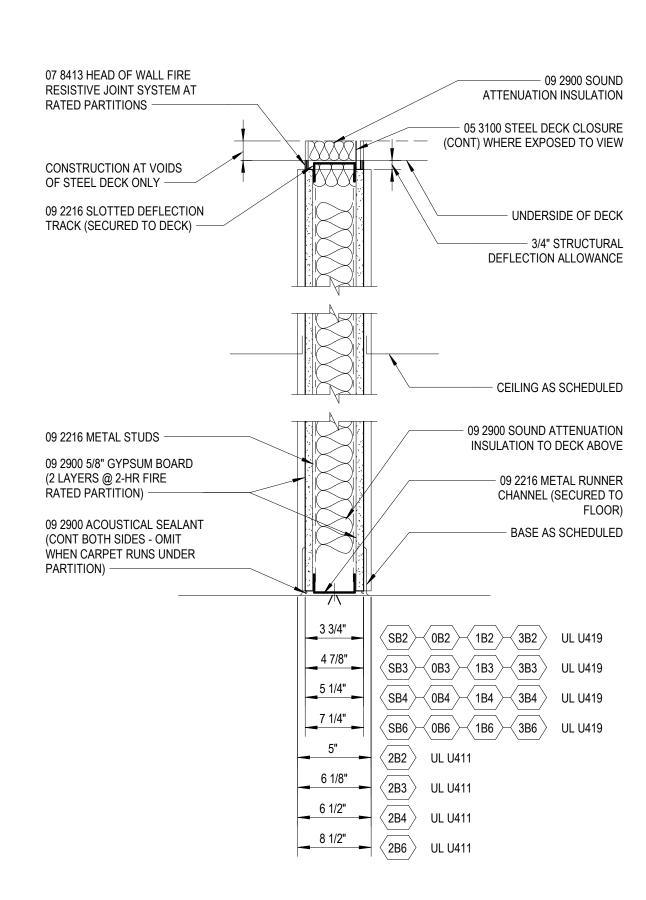

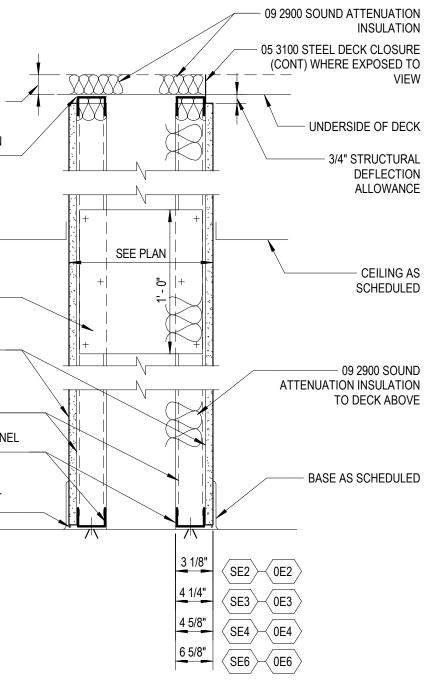

PARTITION SERIES 'B'





Drawing Number

ī**D**≗ Project Number

Partition Types

 ${
m gn}$ solutions, LLC $f{c}$ 2021 integrated $f{d}$ IDS Drawing Title

Project Administrator Administrator Project Designer K. Litwin/T. Easthope Project Architect / Engineer K. Marshall Drawn By K. Marshall Q.M. Review N. LaForest Approved B. Sundberg Drawing Scale As Noted Issued for Issue Date Design Development 02-26-2021 Quality Management Review 04-21-2021 Bids 07-15-2021		
Project Designer K. Litwin/T. Easthope Project Architect / Engineer K. Marshall Drawn By K. Marshall Q.M. Review N. LaForest Approved B. Sundberg Drawing Scale As Noted Issued for Issue Date Design Development 02-26-2021 Quality Management Review 04-21-2021	Pr	oject Administrator
K. Litwin/T. Easthope Project Architect / Engineer K. Marshall Drawn By K. Marshall Q.M. Review N. LaForest Approved B. Sundberg Drawing Scale As Noted Issued for Issue Date Design Development 02-26-2021 Quality Management Review 04-21-2021		Administrator
Project Architect / Engineer K. Marshall Drawn By K. Marshall Q.M. Review N. LaForest Approved B. Sundberg Drawing Scale As Noted Issued for Issue Date Design Development 02-26-2021 Quality Management Review 04-21-2021		
K. Marshall Drawn By K. Marshall Q.M. Review N. LaForest Approved B. Sundberg Drawing Scale As Noted Issued for Issue Date Design Development 02-26-2021 Quality Management Review 04-21-2021	K. Litwi	n/T. Easthope
Drawn By K. Marshall Q.M. Review N. LaForest Approved B. Sundberg Drawing Scale As Noted Issued for Issue Date Design Development 02-26-2021 Quality Management Review 04-21-2021	Project A	-
K. Marshall Q.M. Review N. LaForest Approved B. Sundberg Drawing Scale As Noted Issued for Issue Date Design Development 02-26-2021 Quality Management Review 04-21-2021		K. Marshall
Q.M. Review N. LaForest Approved B. Sundberg Drawing Scale As Noted Issued for Issue Date Design Development 02-26-2021 Quality Management Review 04-21-2021		,
N. LaForest Approved B. Sundberg Drawing Scale As Noted Issued for Issue Date Design Development 02-26-2021 Quality Management Review 04-21-2021		
Approved B. Sundberg Drawing Scale As Noted Issued for Issue Date Design Development 02-26-2021 Quality Management Review 04-21-2021		
B. Sundberg Drawing Scale As Noted Issued for Issue Date Design Development 02-26-2021 Quality Management Review 04-21-2021		
Drawing Scale As Noted Issued for Issue Date Design Development 02-26-2021 Quality Management Review 04-21-2021		••
As Noted Issued for Issue Date Design Development 02-26-2021 Quality Management Review 04-21-2021		
Issued forIssue DateDesign Development02-26-2021Quality Management Review04-21-2021		-
Design Development02-26-2021Quality Management Review04-21-2021		AS NOted
Quality Management Review 04-21-2021	Issued for	Issue Date
	Design Development	02-26-2021
Bids 07-15-2021	Quality Management Review	04-21-2021
	Bids	07-15-2021

1 Mutual Avenue Frankenmuth, MI 48787 Key Plan


Executive Suite Renovation




INTEGRATED design solutions architecture engineering interiors & technology 1441 west long lake, suite 200 troy, michigan 48098 5211 cascade road SE, suite 300 grand rapids, michigan 49546 248.823.2100





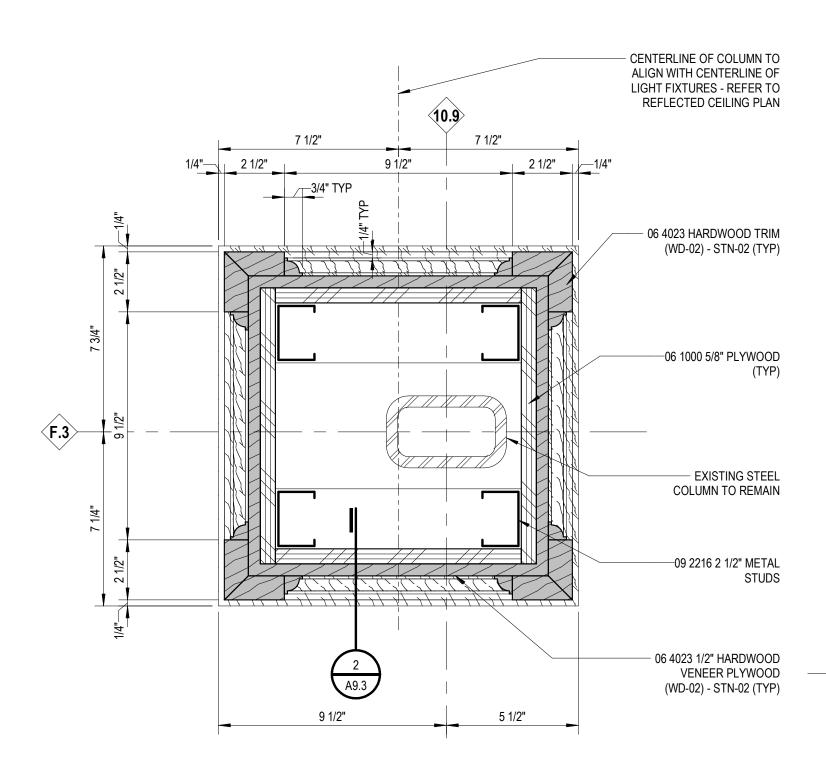



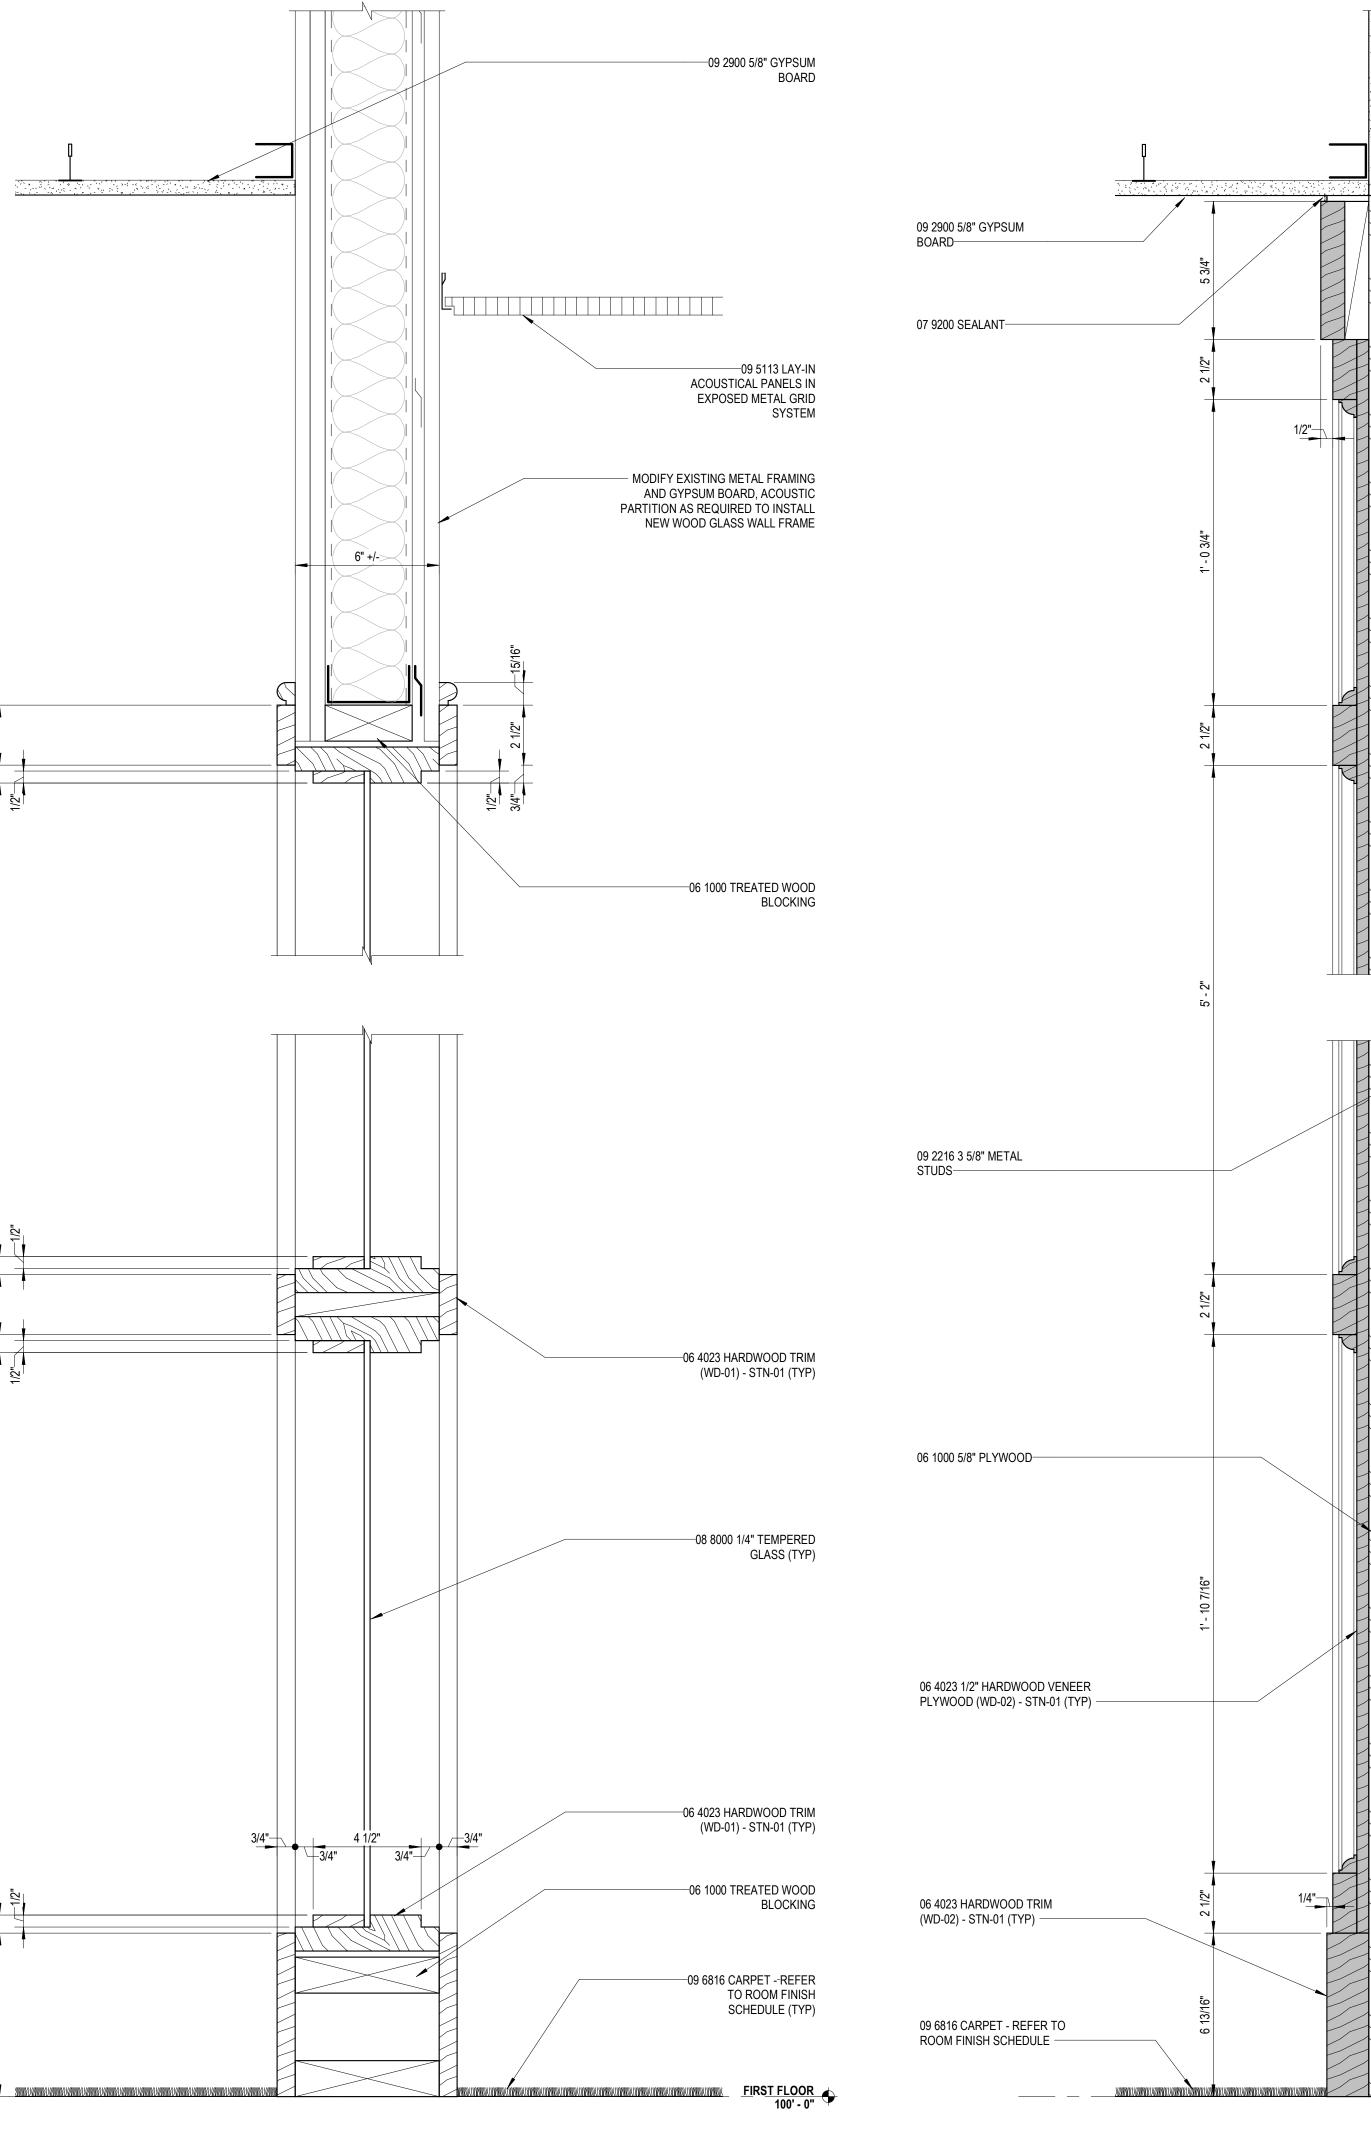

WING ENTRANCE INTERIOR WALL SECTION A8.1 3" = 1'-0"






FIRST FLOOR 100' - 0"

1/4"-

1 MEETING ROOM INTERIOR WALL SECTION A8.1 3" = 1'-0"

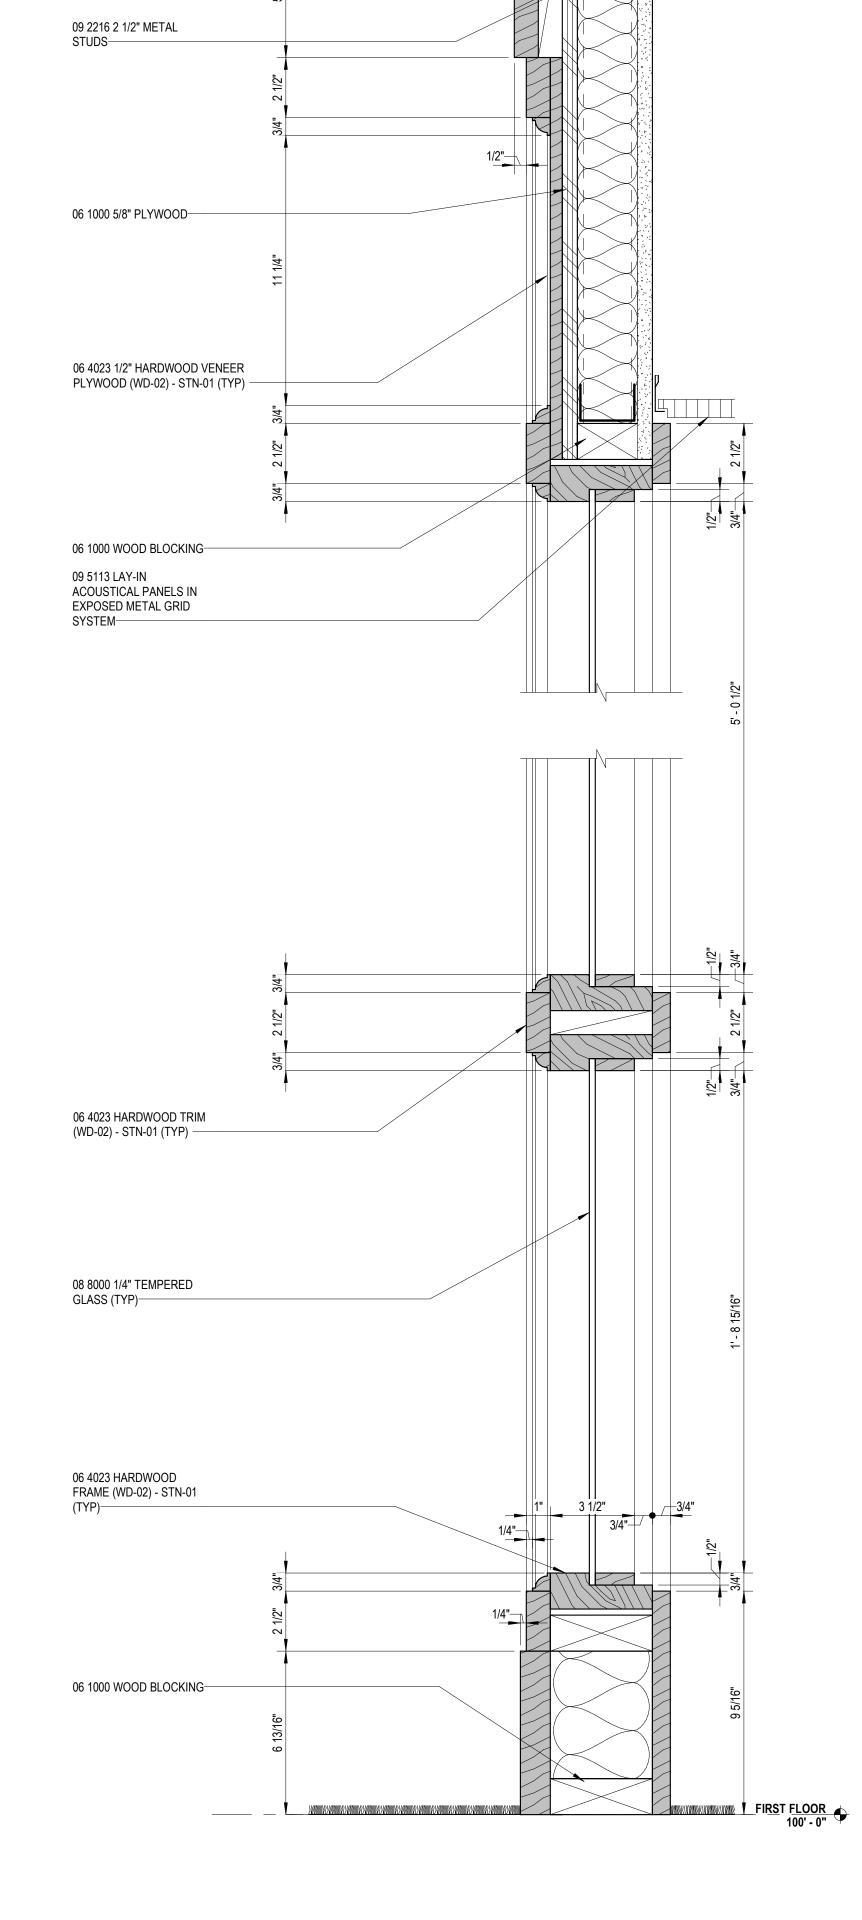

5 SHOWER BASE DETAIL A6.1


3 7 7 7 7 7 7

09 2900 5/8" GYPSUM BOARD

07 9200 SEALANT-

1/2"____

06 4023 HARDWOOD TRIM (WD-02) - STN-01 (TYP) ——

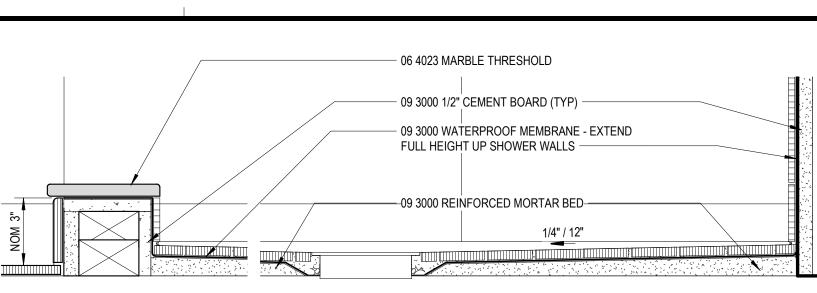



ī**D**≗ Project Number

Drawing Number

A9.3

Interior Sections and Details

M SOLUTIONS, LLC IDS Drawing Title

 $^{
m c}$ 2021 integrated ${
m d}$

Pr	oject Administrator
	Administrator
	Project Designer
K. Litwi	in/T. Easthope
Project A	Architect / Engineer
	K. Marshall
	Drawn By
	K. Marshall
	Q.M. Review
	N. LaForest
	Approved
	B. Sundberg
	Drawing Scale
	As Noted
Issued for	Issue Date
Design Development	02-26-2021
Quality Management Review	04-21-2021
Bids	07-15-2021

1 Mutual Avenue Frankenmuth, MI 48787 Key Plan


Executive Suite Renovation



INTEGRATED design solutions architecture engineering interiors & technology 1441 west long lake, suite 200 troy, michigan 48098 5211 cascade road SE, suite 300 grand rapids, michigan 49546

248.823.2100



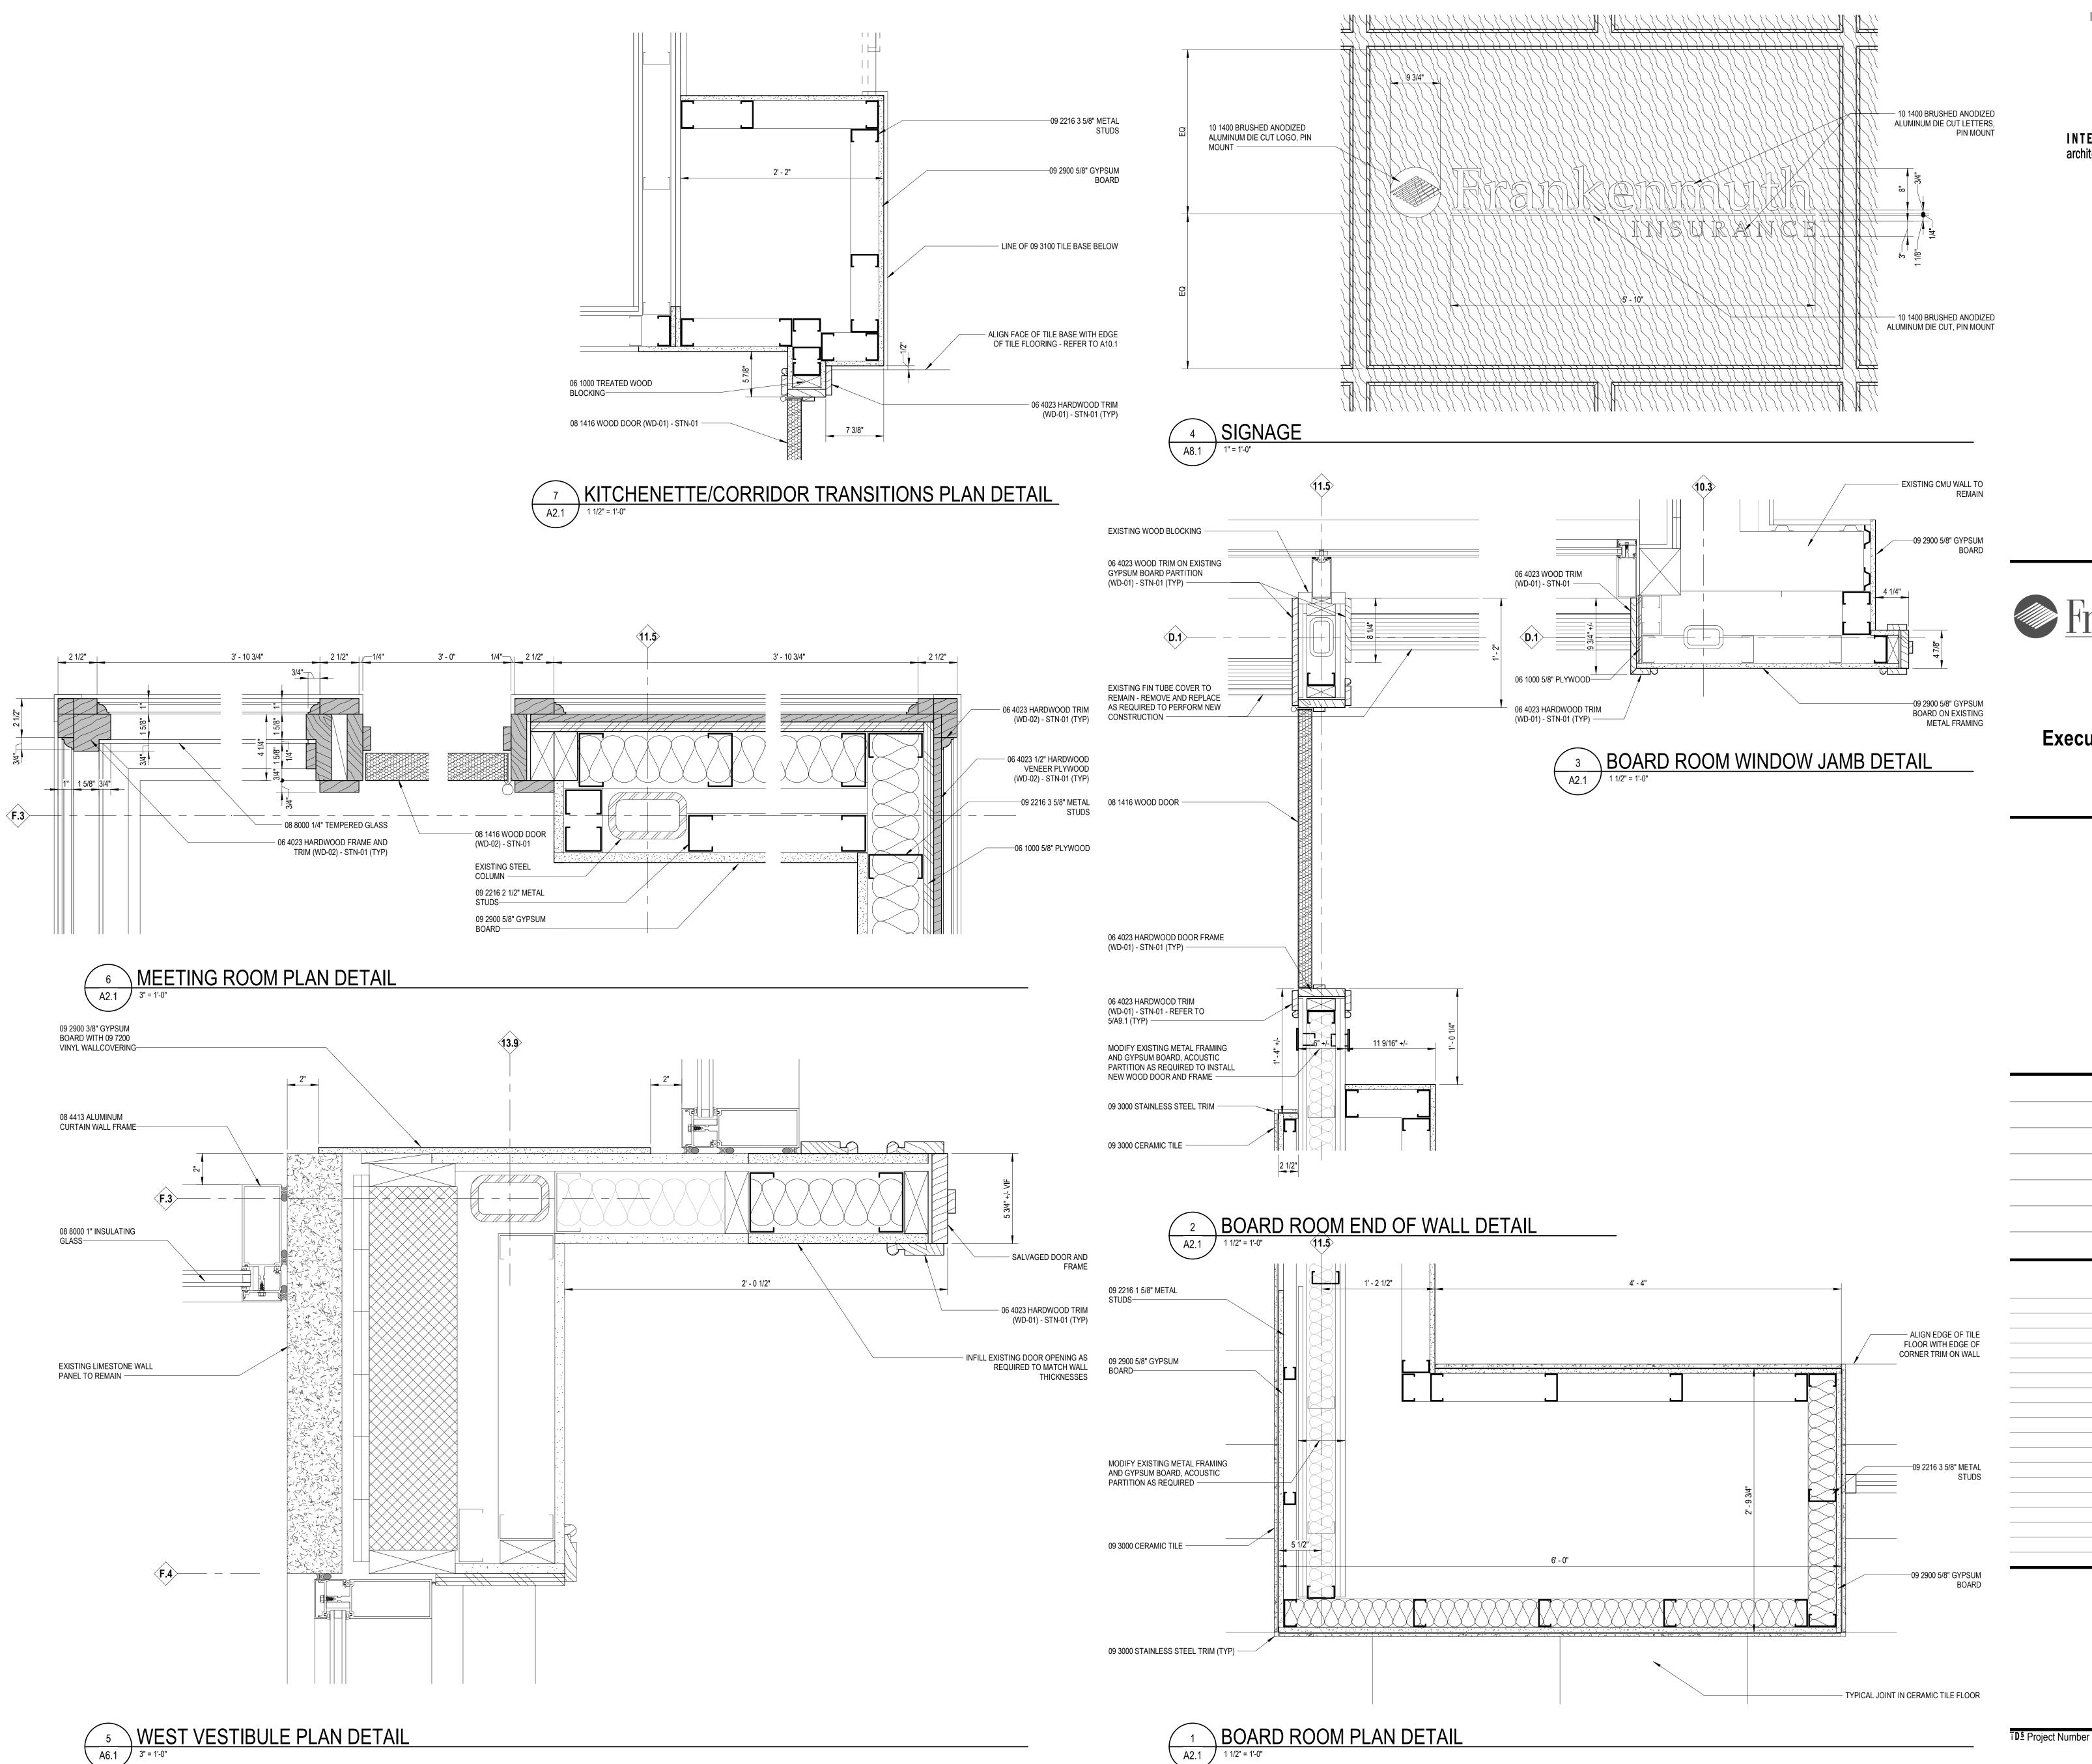



Drawing Number

A9.4

Interior Sections and Details

n solutions, LL IDS Drawing Title

 \odot 2021 integrated ${
m d}$

Pr	oject Administrator
	Administrator
	Project Designer
K. Litwi	n/T. Easthope
Project A	rchitect / Engineer
	K. Marshall
	Drawn By
	K. Marshall
	Q.M. Review
	N. LaForest
	Approved
	B. Sundberg
	Drawing Scale
	As Noted
Issued for	Issue Date
Design Development	02-26-2021
Quality Management Review	04-21-2021
Bids	07-15-2021

1 Mutual Avenue Frankenmuth, MI 48787 Key Plan

Executive Suite Renovation




INTEGRATED design solutions architecture engineering interiors & technology 1441 west long lake, suite 200 troy, michigan 48098



5211 cascade road SE, suite 300 grand rapids, michigan 49546

248.823.2100

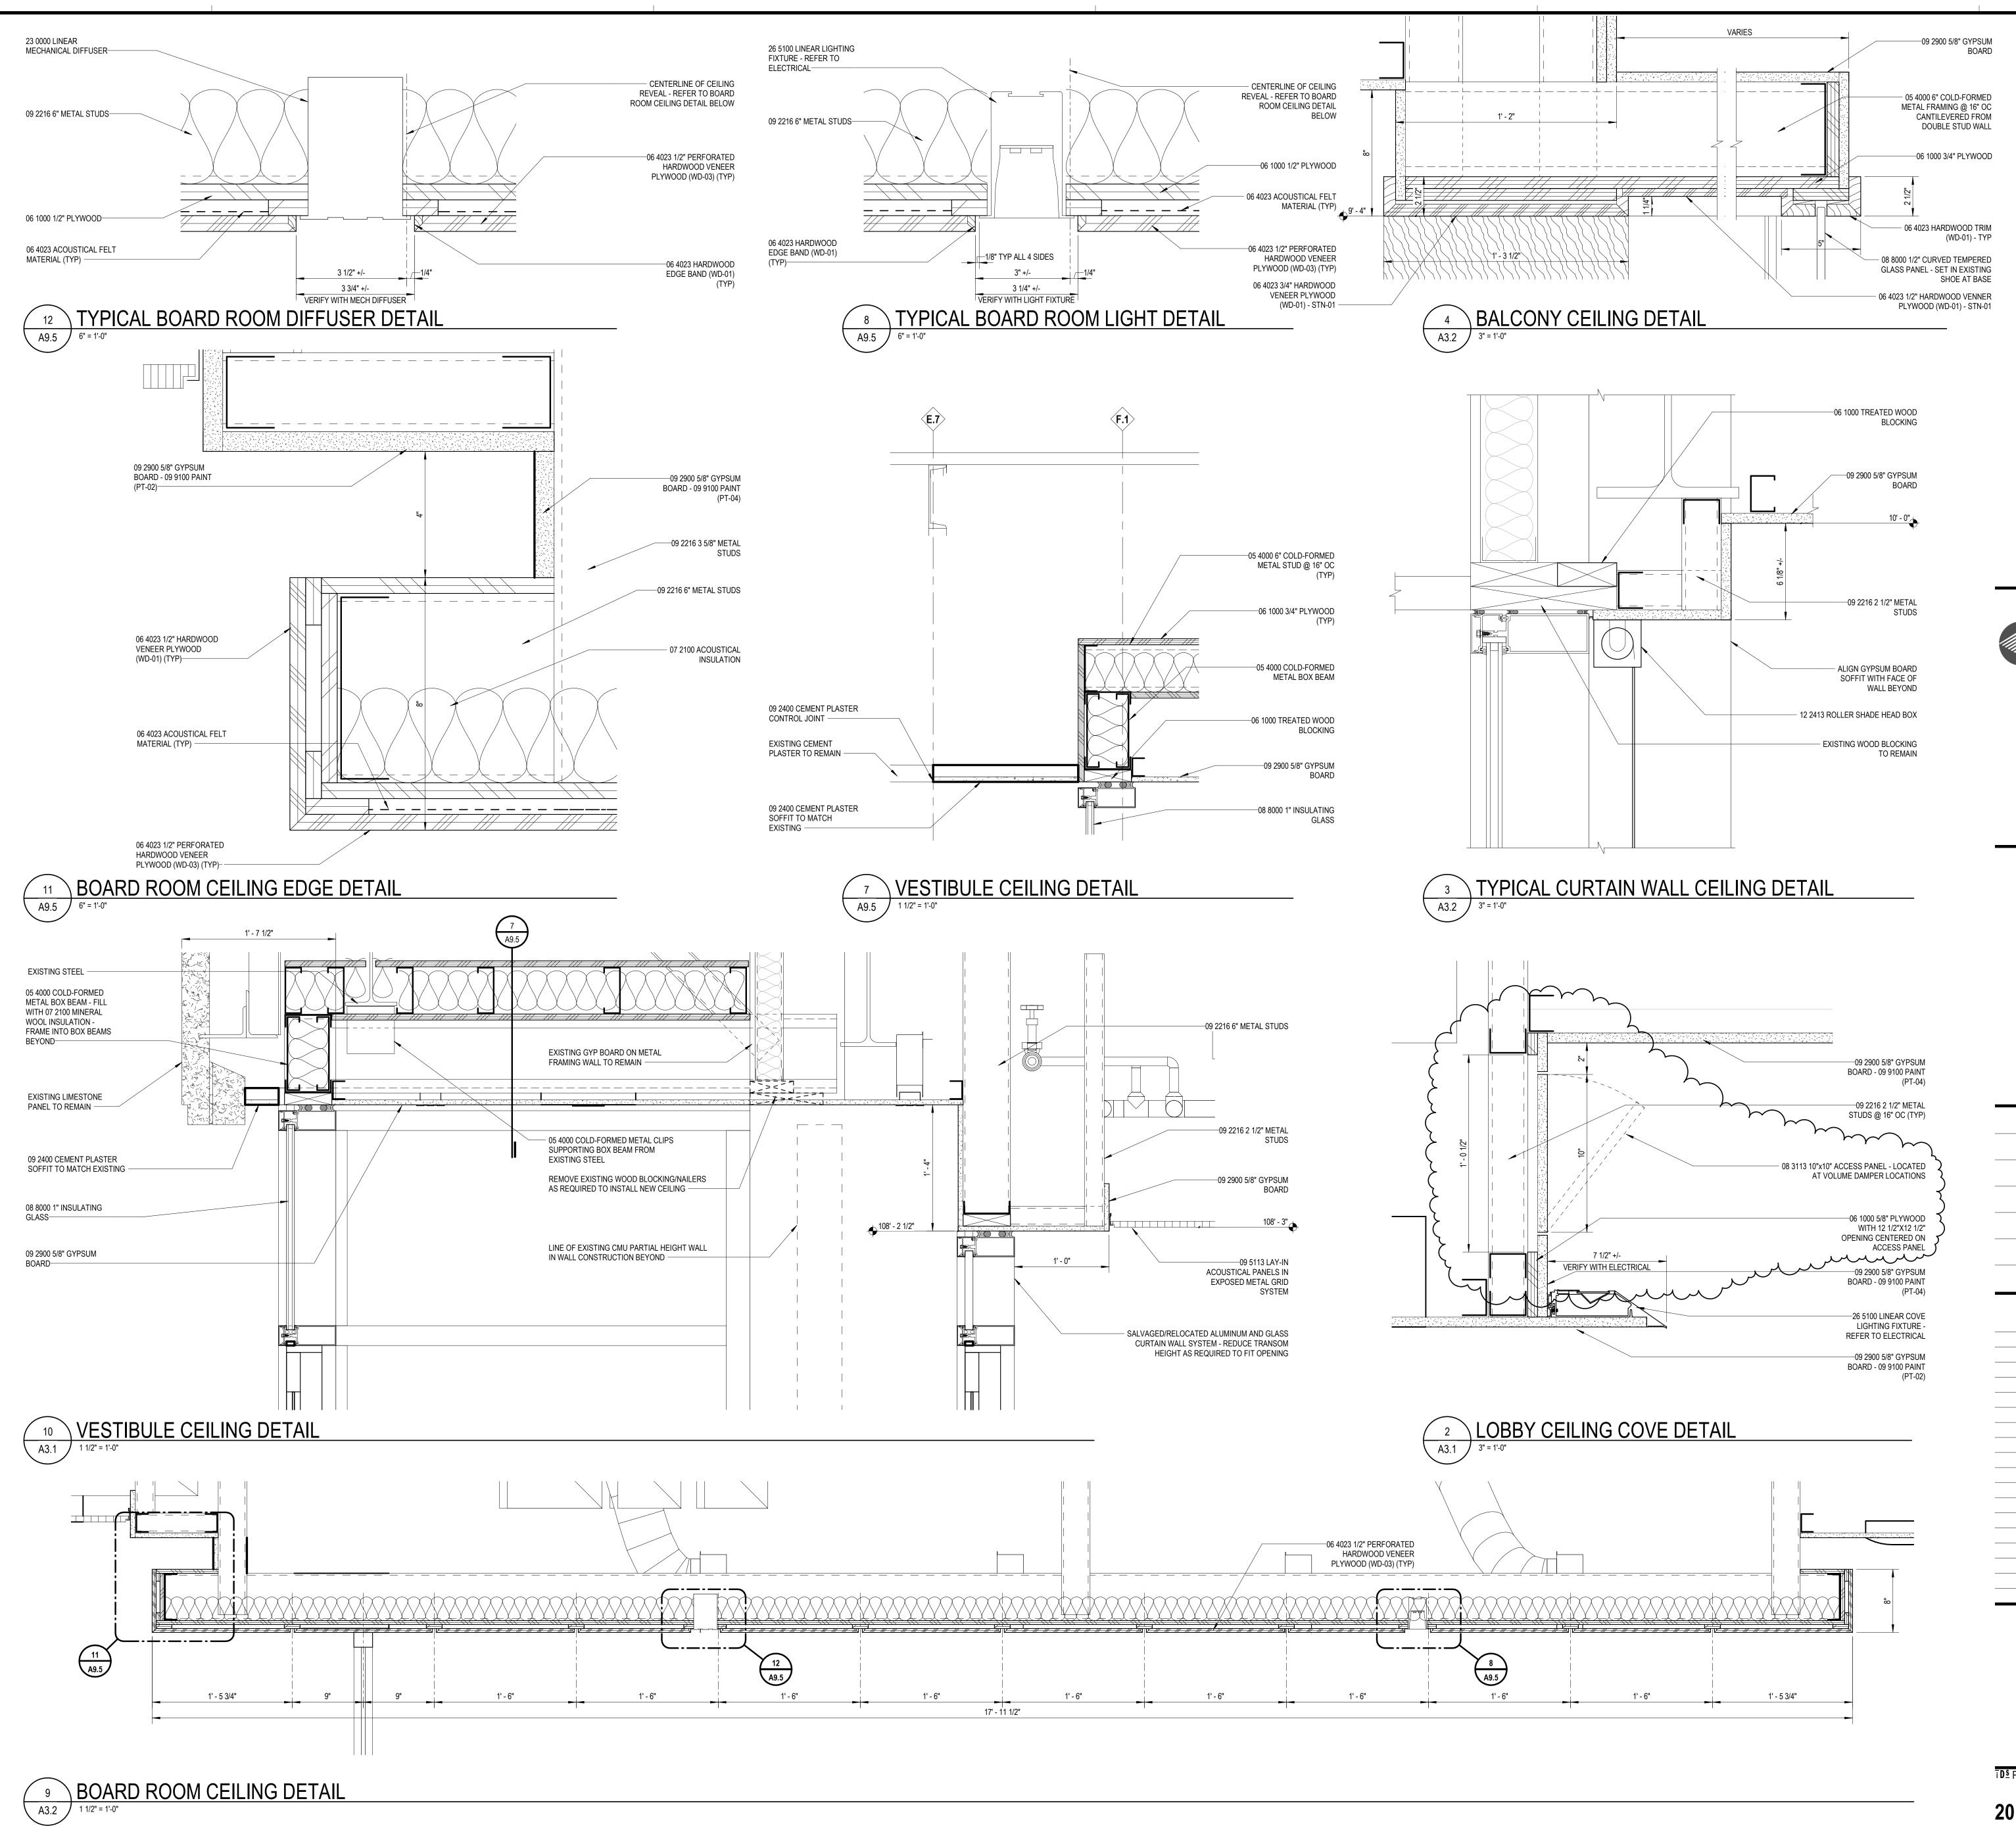

īD^s Project Number



Drawing Number

A9.5

Ceiling Sections and Details

 \odot 2021 integrated $ext{design}$ solutions, LL IDS Drawing Tit

I	Project Administrator Administrator
	Project Designer
K. Litv	win/T. Easthope
Project	Architect / Engineer
	K. Marshall
	Drawn By
	K. Marshall
	Q.M. Review
	N. LaForest
	Approved
	B. Sundberg
	Drawing Scale
	As Noted
Issued for	Issue Date
Design Development	02-26-2021
Quality Management Review	
Bids	


1 Mutual Avenue Frankenmuth, MI 48787 Key Plan

Executive Suite Renovation



INTEGRATED design solutions architecture engineering interiors & technology 1441 west long lake, suite 200 troy, michigan 48098 5211 cascade road SE, suite 300 grand rapids, michigan 49546 248.823.2100 www.ids-michigan.com



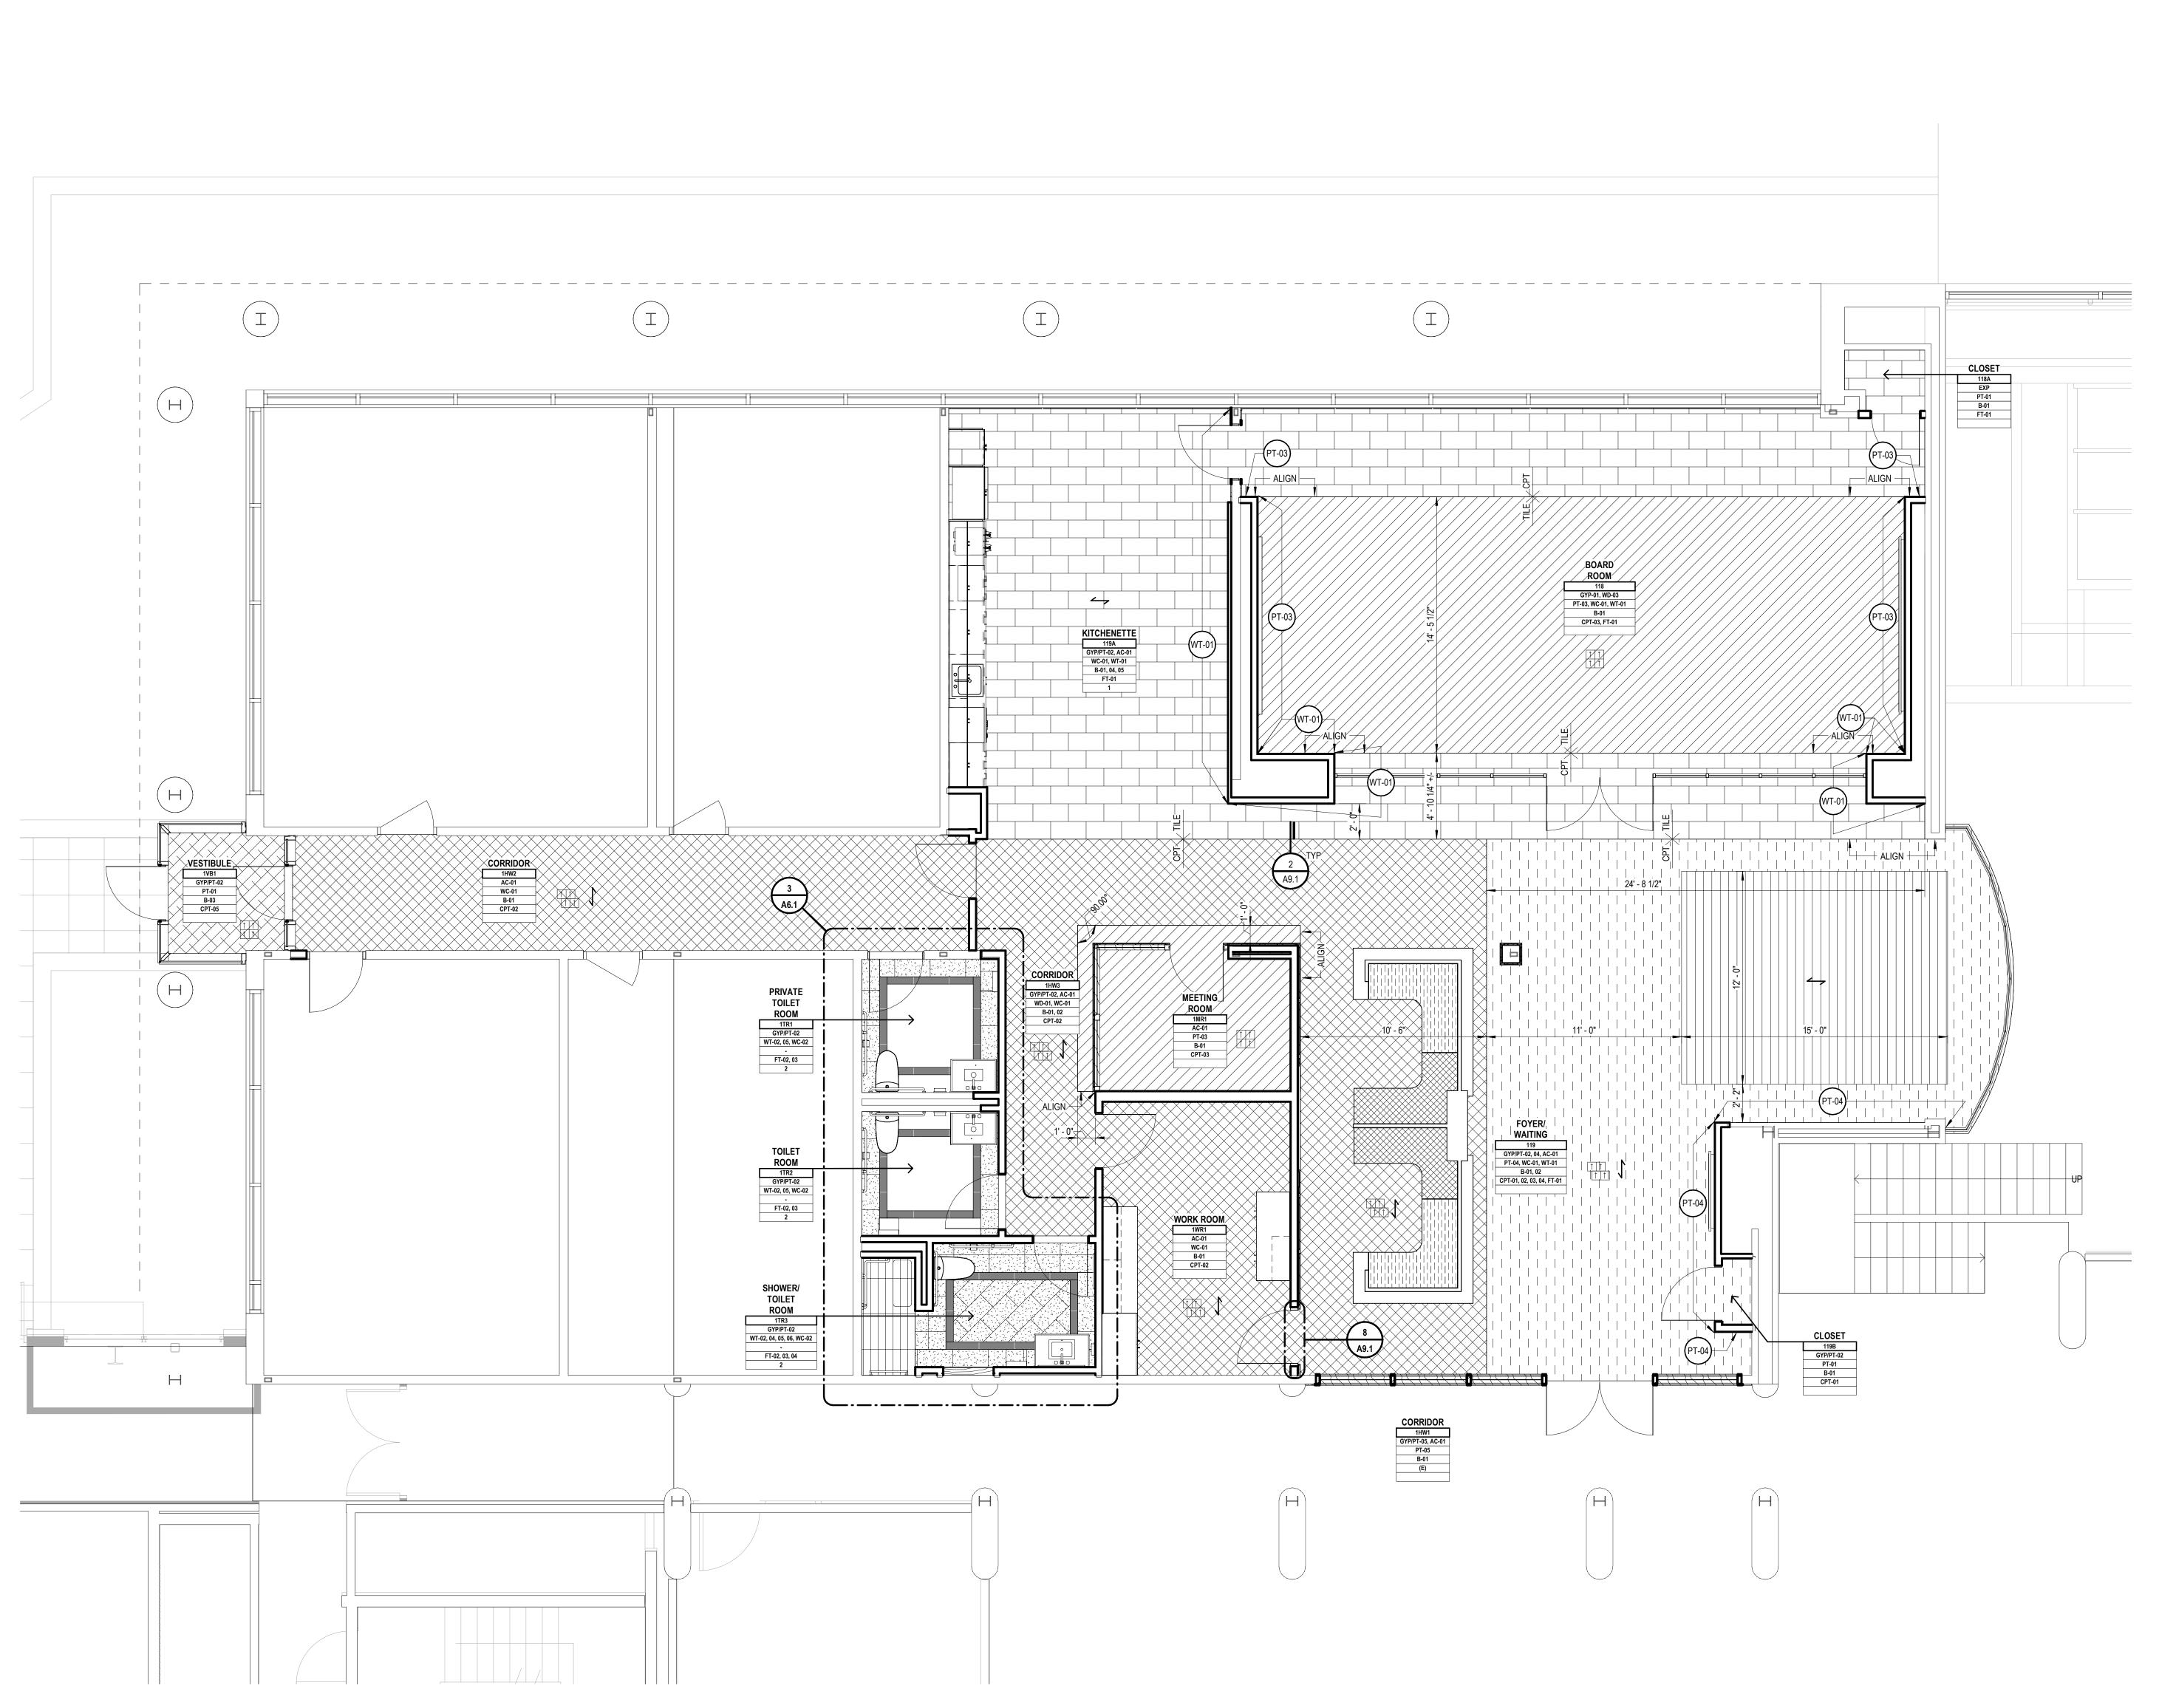

GENERAL NOTES FINISH PLAN

A. REFER TO ROOM FINISH SCHEDULE AND COLOR CODES FOR MORE INFORMATION.

LEGENI FINISH PLAN NOTE: NOT ALL SY	MBOLS MAY BE USED
ROOM NAME ROOM # CEILING WALL BASE	NOTE: FINISHES INDICATED IN ROOM FINISH TAGS ARE GENERAL OVERALL FINISHES FOR ROOM UNLESS OTHERWISE INDICATED BY NOTE, REMARK, DETAIL AND/OR ELEVATION.
FLOOR REMARKS	ROOM SPECIFIC FINISH REMARKS, REFER TO REMARKS LEGEND FOR ADDITIONAL INFORMATION
	FLOOR TILE FT-01
	FLOOR TILE FT-02
	FLOOR TILE FT-03
	FLOOR TILE FT-04
	CARPET TILE CPT-01
	CARPET TILE CPT-02
	CARPET TILE CPT-03
	SHEET CARPET (AREA RUG) CPT-04
	CARPET TILE CPT-05
<u> </u>	FLOOR MATERIAL TRANSITION TAG REFER TO A9.1 FOR TRANSITION/ SILL DETAILS
XX-XX FLOOR C	COLOR CODE TAG - REFER TO ROOM FINISH SCHEDULE SHEET A9.1
\sim	FLOORING INSTALATION DIRECTION
(XX-XX)	ACCENT MATERIAL, REFER TO COLOR CODES
	813 TILE CARPETING INSTALLATION METHOD - ASHLAR
	CARPETING INSTALLATION METHOD - QUARTER TURN
	09 6813 TILE CARPETING INSTALLATION METHOD - NON-DIRECTIONAL




Drawing Number

A10.1

First Floor - Finish Plan

 \odot 2021 integrated ${
m de}$ esign solutions, LLC IDS Drawing Title

Pr	oject Administrator
	Administrator
	Project Designer
K. Litwi	in/T. Easthope
Project A	Architect / Engineer
	K. Marshall
	Drawn By
	T. Easthope
	Q.M. Review
	N. LaForest
	Approved
	B. Sundberg
	Drawing Scale
	1/4" = 1'-0"
Issued for	Issue Date
Design Development	02-26-2021
Quality Management Review	04-21-2021
Bids	07-15-2021

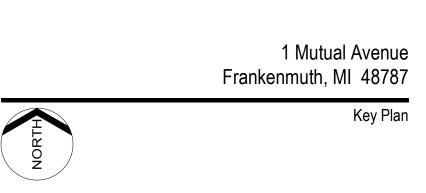


Executive Suite Renovation



INTEGRATED design SOLUTIONS architecture engineering interiors & technology 1441 west long lake, suite 200 troy, michigan 48098 5211 cascade road SE, suite 300 grand rapids, michigan 49546



248.823.2100 www.ids-michigan.com

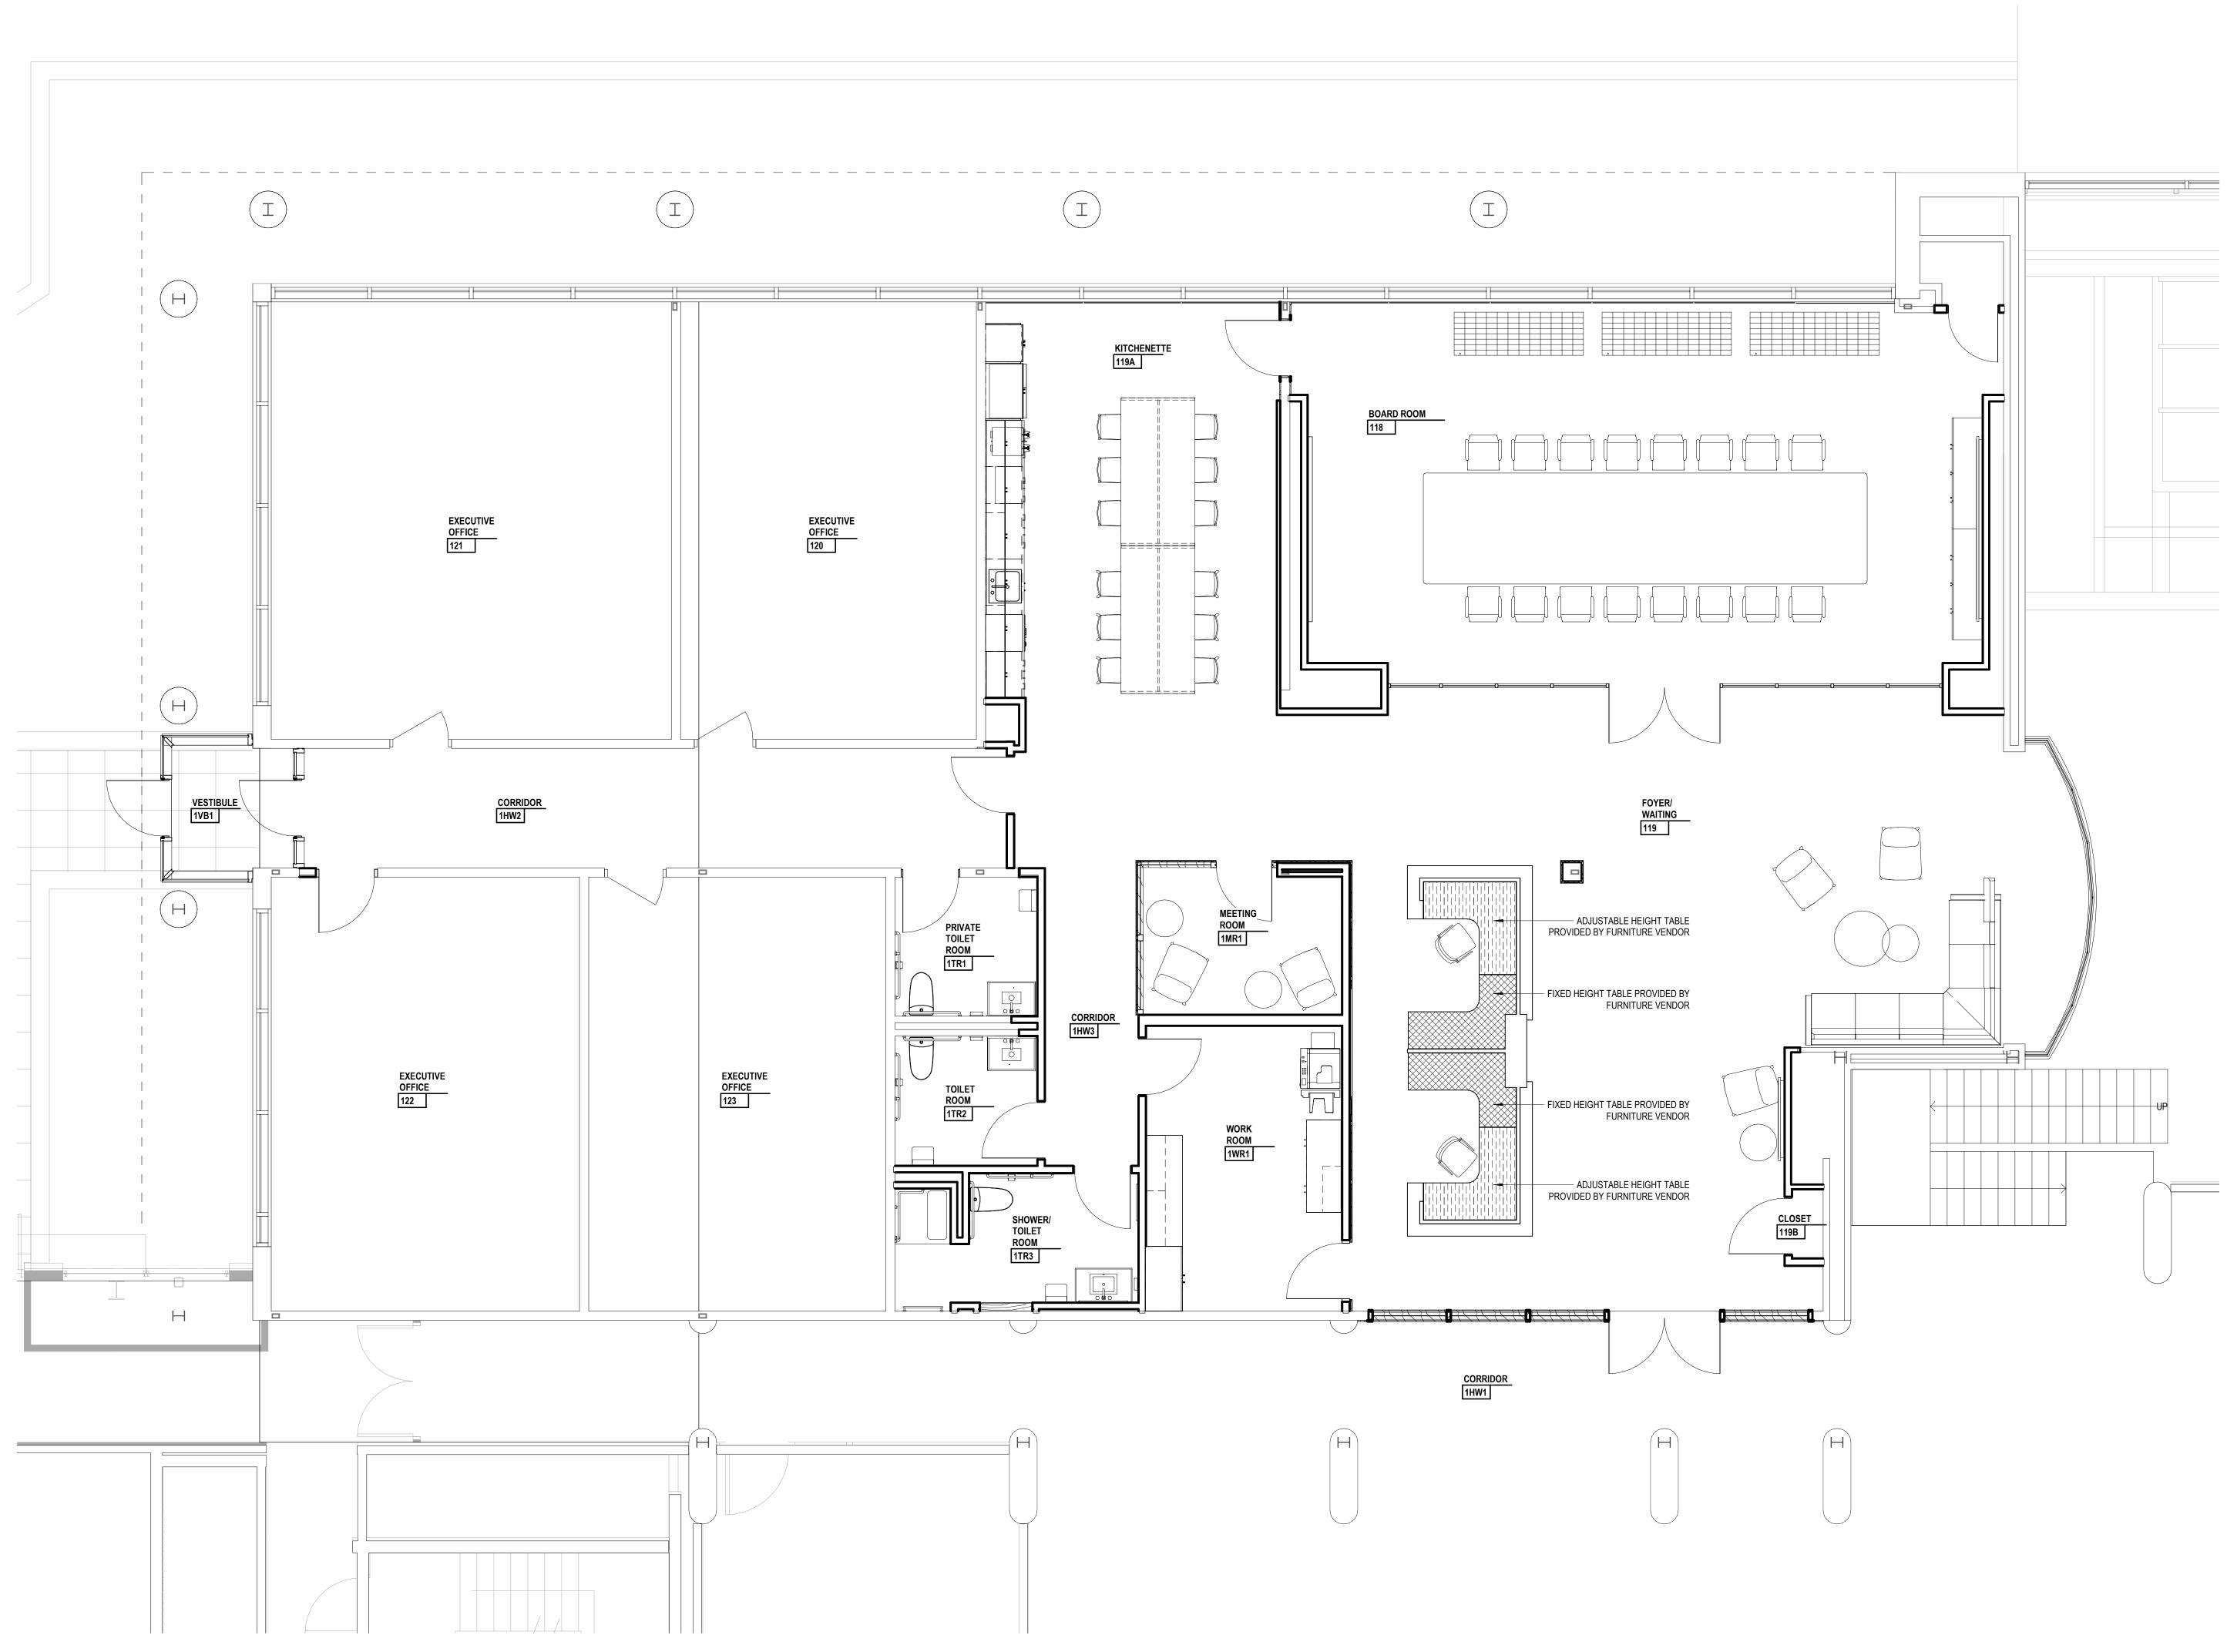

GENERAL NOTES FURNITURE FIXTURE AND EQUIPMENT PLAN

- A. ITEMS SHOWN IN GRAYSCALE ARE FOR REFERENCE ONLY.
- B. COORDINATE THE INTERFACING OF ALL TRADES WITH RESPECT TO DELIVERY AND INSTALLATION OF ALL FURNITURE, FIXTURES AND EQUIPMENT
- C. CONTRACTOR TO FIELD VERIFY EXISTING CONDITIONS BEFORE INSTALLATION. CONSULT ARCHITECT WHEN ACTUAL FIELD CONDITIONS VARY FROM THOSE SHOWN ON CONSTRUCTION DOCUMENTS.
- D. COORDINATE LOCATIONS OF ALL REQUIRED UTILITIES WITH THE TRADE PROVIDING THE SAME. REFER TO MECHANICAL AND ELECTRICAL SHEETS FOR ADDITIONAL INFORMATION.

ī**D**≗ Project Number






Drawing Number

For Reference Only

First Floor Furniture Plan

sign SOLUTIONS, LLC IDS Drawing Title $oldsymbol{ iny c}$ 2021 integrated d

P	roject Administrator
	Administrator
	Project Designer
K. Litw	in/T. Easthope
Project /	Architect / Engineer
	K. Marshall
	Drawn By
	T. Easthope
	Q.M. Review
	N. LaForest
	Approved
	B. Sundberg
	Drawing Scale
	As Noted
Issued for	Issue Date
Design Development	02-26-2021
Quality Management Review	04-21-2021
Bids	07-15-2021

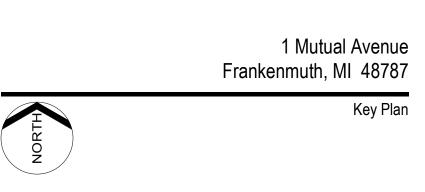

Executive Suite Renovation




INTEGRATED design solutions architecture engineering interiors & technology

1441 west long lake, suite 200 troy, michigan 48098

5211 cascade road SE, suite 300 grand rapids, michigan 49546


248.823.2100

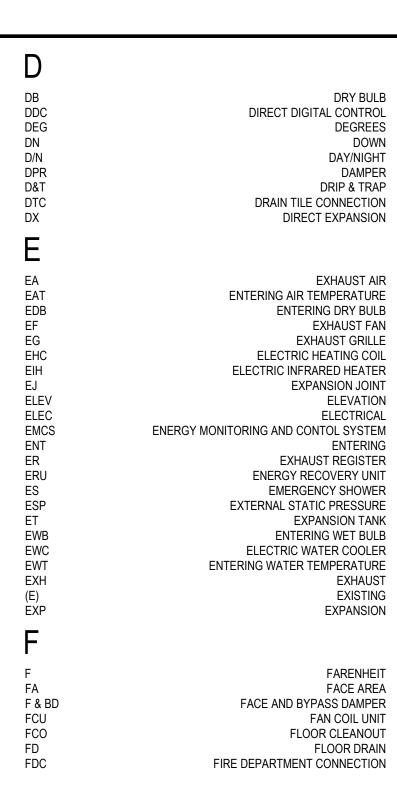


	EXPANSION COMPENSATOR/EXPANSION JOINT
•• _{SH}	SPRING HANGER
FCO O	FLOOR CLEANOUT
wco	WALL CLEANOUT
O_{MH}	MANHOLE
0	FLOOR DRAIN
СВ	CATCH BASIN
•	PENDANT SP HD (FLUSH MOUNTED TYPE)
-\$	SIAMESE CONNECTION
-≮ ₽	PRESSURE INDICATOR
φ	TEMPERATURE INDICATOR
φ	THERMOMETER
Р	MANUAL AIR VENT
	FLOW MEASURING DEVICE
₽₽	FLOW ELEMENT (ORIFICE PLATE)
$\mathbf{\Theta}$	POINT OF NEW CONNECTION
- \///// -	TO BE DEMOLISHED AND REMOVED
\bigcirc	PLUMBING RISER TAG
MGS	MASTER GAS SHUT-OFF VALVE
PRV	PRESSURE REDUCING STATION
RPBP	REDUCED PRESSURE BACKFLOW PREVENTER
— F —	FIRE PROTECTION PIPING
— CW —	DOMESTIC COLD WATER PIPING
— HPCW —	HIGH PRESSURE COLD WATER
<u> </u>	DOMESTIC HOT WATER PIPING
— HWR —	DOMESTIC HOT WATER RETURN PIPING
— NPW —	NON-POTABLE WATER PIPING
<u> </u>	DISTILLED WATER

ABBREVIATIONS		
А		
AAV AC ACCU AD AE AFF AFT AHU APD AL APPROX ARCH ASR	AIR ADMITTANCE VALVE AIR COMPRESSOR AIR COOLED CONDENSING UNIT ACCESS DOOR AIR EXTRACTOR ABOVE FINISHED FLOOR AIR FLOW TRANSMITTED AIR HANDLING UNIT AIR PRESSURE DROP ACTIVE LENGTH APPROXIMATELY ARCHITECTURAL AUTOMATIC SPRINKLER RISER	
В		
BAS BBD BF BFP BHP BP BTU BWV	BUILDING AUTOMATION SYSTEM BOILER BLOWDOWN BARRIER FREE BOILER FEEDWATER PUMP BRAKE HORSEPOWER BACKFLOW PREVENTER BRITISH THERMAL UNIT BACKWATER VALVE	
С		
CAP CC CD CFH CFM CI CLG CO COND COND CONN CONT CONT CONT CONT CONT CONT CONT	CAPACITY COILING COIL COLD DECK CUBIC FEET PER HOUR CUBIC FEET PER MINUTE CAST IRON CEILING CLEANOUT CONDENSATE (COOLING) CONNECTION CONTINUATION CONTINUATION CONTRACTOR CONVECTOR CENTRAL PROCESSING UNIT CONDENSATE RETURN (STEAM) COOLING TOWER CABINET UNIT HEATER CONTROL VALVE COLD WATER	
SYMBOLS		

SMOKE DAMPER	
SMOKE DAMPER AND FIRE DAMPER	
VOLUME DAMPER WITH REMOTE OPERATOR	
FLEXIBLE DUCT	
CUH OR CONVECTOR (SURFACE)	
FINNED TUBE RADIATION	
TERMINAL VOLUME BOX (W/O HEATING COIL)	
TERMINAL VOLUME BOX (W/ HEATING COIL)	
FLEXIBLE PIPE CONNECTION	
INDICATES FLAT OVAL DUCT SIZE	
INDICATES RECTANGULAR DUCT SIZE	
INDICATES ROUND DUCT SIZE	
ANGLE RELIEF VALVE	
ANGLED STOP CHECK VALVE	
BALANCE VALVE	
BUTTERFLY VALVE (SEE SPECIFICATION FOR TYPE)	
BALL, GAS, GATE, GLOBE, PLUG VALVE	
CHECK VALVE W/ ARROW INDICATING FLOW	
CONTROL VALVE	
LINEAR STOP CHECK VALVE	
MIXING VALVE	
PRESSURE REDUCING VALVE	
PRESSURE RELIEF VALVE	
STRAINER	
UNION	
PIPE ANCHOR	
PIPE GUIDE	
	VOLUME DAMPER WITH REMOTE OPERATOR FLEXIBLE DUCT CUH OR CONVECTOR (SURFACE) FINNED TUBE RADIATION FINNED TUBE RADIATION TERMINAL VOLUME BOX (W/ HEATING COIL) TERMINAL VOLUME BOX (W/ HEATING COIL) FLEXIBLE PIPE CONNECTION INDICATES FLAT OVAL DUCT SIZE INDICATES RECTANGULAR DUCT SIZE INDICATES RECTANGULAR DUCT SIZE INDICATES ROUND DUCT SIZE ANGLE RELIEF VALVE BALANCE VALVE BALANCE VALVE SUTTERFLY VALVE (SEE SPECIFICATION FOR TYPE) BALL, GAS, GATE, GLOBE, PLUG VALVE (SEE SPECIFICATION FOR TYPE) BALL, GAS, GATE, GLOBE, PLUG VALVE (SEE SPECIFICATION FOR TYPE) BALL, GAS, GATE, GLOBE, PLUG VALVE (SEE SPECIFICATION FOR TYPE) CHECK VALVE W/ ARROW INDICATING FLOW CONTROL VALVE INEAR STOP CHECK VALVE MIXING VALVE PRESSURE REDUCING VALVE STRAINER UNION

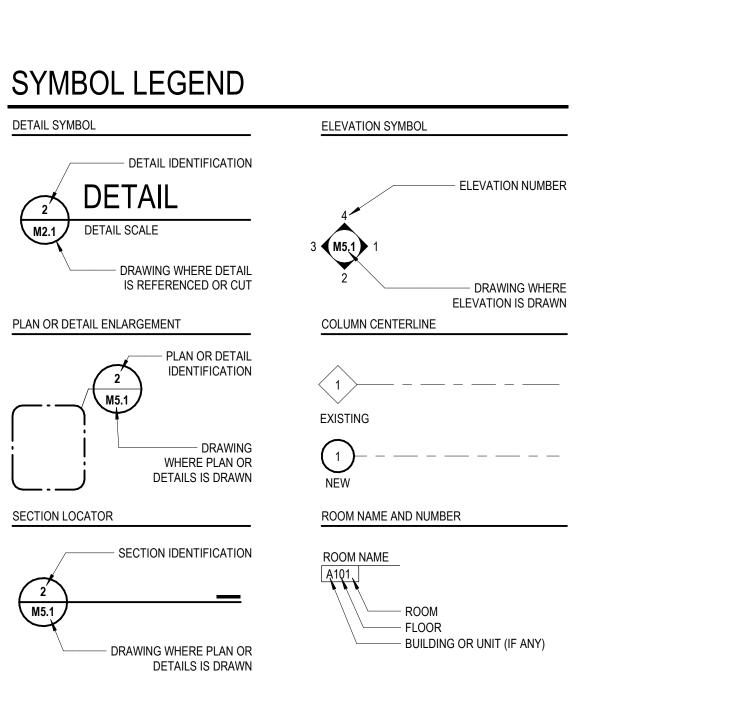

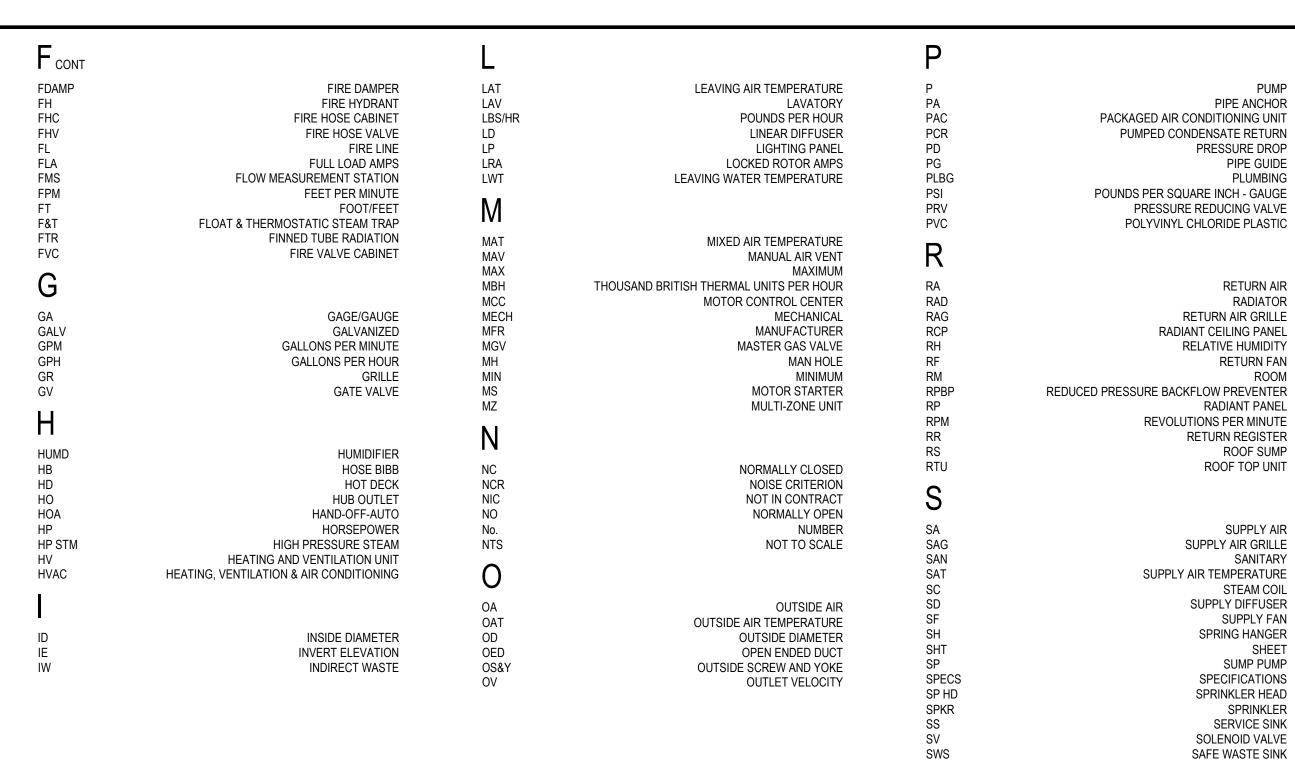

- PCWS -

— PCWR —

- COND -

— HPCR —

— HWHS —

— HWHR —

— HPWS —

— HPWR —

- HTHWS -

– HTHWR –

— HRR —

— HRS —

— STM —

– STM(#) –

— VRF —

(H)

нD

PC

HPC

SP

С

Н

	THERMOSTAT WITH GUARD
	TEMPERATURE SENSOR - DUCT MOUNTED AVERAGING ELEMENT
	TEMPERATURE SENSOR W/ SUNSHIELD
Ţ┝━━	TEMPERATURE SENSOR - DUCT MOUNTED RIGID FLEMENT
	TEMPERATURE SENSOR - IMMERSION TYPE ELEMENT
\mathbf{E}_{SD}	AREA SMOKE DETECTOR
F	DUCT SMOKE DETECTOR
F	FIRE STAT - DUCT MOUNTED
FZ	FREEZE STAT - DUCT MOUNTED
FM	FLOW METER
AQ	AQUASTAT (STRAP ON)
AFS	AIR FLOW SENSOR
LPI	LOOP POWER INDICATOR
\mathbb{D}/\mathbb{N}	DAY/NIGHT MAIN AIR SWITCH
0	MANOMETER
CR	CONTROL RELAY
CS	CURRENT SWITCH
М	MOTORIZED DAMPER MOTOR
0000	DAMPER (PARALLEL BLADE)
8888	DAMPER (OPPOSED BLADE)
EP	ELECTRIC - PNEUMATIC RELAY
S/S	START STOP (MOTOR CONTROL)
R	RELAY (ELECTRICAL)
TT	TWIST TIMER
VC	VELOCITY CONTROLLER
	MOTOR DISCONNECT SWITCH
\square	MOTOR STARTER, W/O HOA SWITCH
\boxtimes	MOTOR STARTER, W/ HOA SWITCH

CONDENSATE DRAIN PIPING (COOLING)
HIGH PRESSURE CONDENSATE RETURN PIPING
HOT WATER HEATING SUPPLY PIPING
HOT WATER HEATING RETURN PIPING
HEAT PUMP WATER SUPPLY
HEAT PUMP WATER RETURN
HIGH TEMPERATURE HOT WATER SUPPLY PIPING
HIGH TEMPERATURE HOT WATER RETURN PIPING
HEAT RECOVERY RETURN PIPING
HEAT RECOVERY SUPPLY PIPING
LOW PRESSURE STEAM
STEAM PIPING PRESSURE INDICATED
VRF SYSTEM REFRIGERANT PIPING
TEMPERATURE INDICATOR GAUGE TYPE
DIFFERNTIAL PRESSURE GAUGE
HUMIDISTAT (ROOM)
CARBON MONOXIDE SENSOR
HUMIDISTAT
THERMOSTAT
OCCUPANCY SENSOR - CEILING MOUNTED
OCCUPANCY SENSOR - WALL MOUNTED
PHOTOELECTRIC SWITCH - CEILING MOUNTED
PHOTOELECTRIC SWITCH - WALL MOUNTED
STATIC PRESSURE SENSOR
CARBON DIOXIDE SENSOR - DUCT MOUNTED

PROCESS COOLING WATER SUPPLY

PROCESS COOLING WATER RETURN

CARBON DIOXIDE SENSOR - DUCT MOUNTED
HUMIDITY SENSOR - DUCT MOUNTED

— DI —	DEIONIZED WATER SUPPLY	
— TW —	TEMPERED WATER	
— G —	NATURAL GAS PIPING	
— G(EPS) —	NATURAL GAS PIPING (EMERGENCY POWER SUPPLY)	
— NIT-OX —	NITROUS OXIDE PIPING	
— OXY —	OXYGEN PIPING	
— CA —	COMPRESSED AIR	
— CA(#) —	COMPRESSED AIR PIPING PRESSURE INDICATED	
— CO2 —	CARBON DIOXIDE GAS	
—FOR—	FUEL OIL RETURN	
— FOS —	FUEL OIL SUPPLY	
— SAN —	SANITARY SEWER	
PSAN	PUMPED SANITARY SEWER	
— v —	VENT PIPING	
—— AV ——	ACID VENT PIPING	
— VAC —	VACUUM PIPING	
— AW —	ACID WASTE	
— ST —	STORM SEWER	
— OST —	OVERFLOW STORM	
PST	PUMPED STORM WATER	
DT	DRAIN TILE	
— CHWS —	CHILLED WATER SUPPLY PIPING	
— CHWR —	CHILLED WATER RETURN PIPING	
— CWS—	CONDENSER WATER SUPPLY PIPING	
— CWR—	CONDENSER WATER RETURN PIPING	
- PCR -	PUMPED CONDENSATE RETURN PIPING	
— CR —	CONDENSATE RETURN PIPING (GRAVITY)	


REVERSE OSMOSIS WATER

— RO —

GENERAL NOTES

- AND ACTUAL FIELD CONDITIONS.
- 2. COORDINATE ALL WORK WITH APPROPRIATE TRADES.

- 8. MAXIMUM LENGTH ON FLEXIBLE DUCT SHALL BE 5'-0".
- 10. ALL HOT WATER FIN TUBE RADIATION COVERS SHALL RUN WALL TO WALL (OR COLUMN).

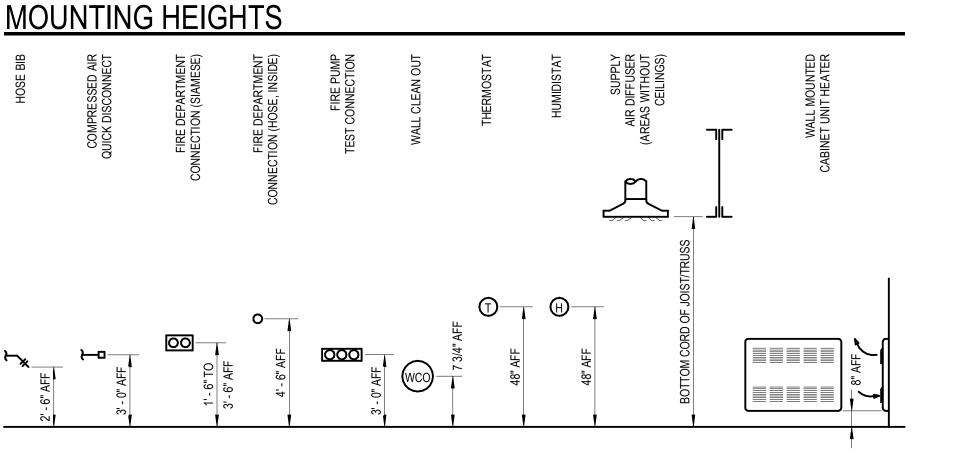

NOTATION METHODS

SUPPLY DIFFUSER, TYPE 'A', 10" NECK, 350 CFM

SIDEWALL SUPPLY REGISTER, TYPE 'A', 350 CFM

FLEXIBLE DUCT CONNECTION (TWO WAY THROW)

SUPPLY DIFFUSER (3-WAY)

RETURN REGISTER, TYPE 'A', 350 CFM

EXHAUST REGISTER, TYPE 'A', 350 CFM

SUPPLY AIR DIFFUSER, TYPE 'A' WITH

BELL MOUTH AIR INLET AREA SHALL

BE EQUAL TO '2' TIMES DUCT AREA

SUPPLY AIR BRANCH CONNECTION

RETURN AIR/EXHAUST AIR BRANCH

CONNECTION WITH VOLUME DAMPER

TYPE 'A', 5'-0" ELEMENT, 5.7 TOTAL MBH

TERMINAL VARIABLE OR CONSTANT VOLUME BOX AHU OR RTU SERVIING THE VAV OR CAV. ROOM NUMBER.

A,B,C, ETC. IF MULTIPLE COILS SERVE THE SAME SPACE

AHU OR RTU SERVIING THE VAV OR CAV. ROOM NUMBER.

A,B,C, ETC. IF MULTIPLE COILS SERVE THE SAME SPACE

(NO HEATING COIL, REFER TO EQUIPMENT SCHEDULES)

A,B,C, ETC. IF MULTIPLE COILS SERVE THE SAME SPACE

POINT WHERE CHANGE IN DUCT SIZE OR PIPE PITCH TAKES PLACE

POINT WHERE DEMOLITION ENDS/POINT OF NEW CONSTRUCTION

(HEATING COIL, REFER TO EQUIPMENT SCHEDULES)

TERMINAL VARIABLE OR CONSTANT VOLUME BOX

DUAL DUCT CONSTANT VOLUME MIXING BOX

(REFER TO EQUIPMENT SCHEDULES)

(REFER TO EQUIPMENT SCHEDULES)

REHEAT COIL, ROOM NUMBER

NEW MECHANICAL

EXISTING MECHANICAL

(REFER TO EQUIPMENT SCHEDULES)

CABINET UNIT HEATER, TYPE 'A'

SOUNT TRAP (ATTENUATOR)

FINNED TUBE RADIATION

CONVECTOR, TYPE 'A'

SPIN-IN FITTING WITH VOLUME DAMPER

AIR HANDLING UNIT No. 1

EXHAUST FAN No. 1

SD-A 10" DIA 350 CFM SD-A 10" DIA 350 CFM

RR-A 350 CFM ER-A 350 CFM

SD-A 350 CFM

SD-A S 350 CFM بمحر ~~

EF 1

5' - 0" AL С-С-5.7 МВН 0.6 GPM \mathbf{A} /CONV

VAV 2.1100.A 2.1100.A

A3 1000.A

I – – I ∽

MECHANICAL DRAWING INDEX

MR.0	Mechanical Reference Information
M1.01	Basement Demolition Plan
M1.1	First Floor Demolition Plan
M2.1	First Floor Sheet Metal Plan
M3.01	Basement Plumbing & HVAC Piping Plan
M3.1	First Floor Plumbing, HVAC Piping & Fire Protection Plan
M6.1	Details & Schedules
M8.1	Mechanical Systems Controls

STORM STEAM

TEMPERATURE CONTROL TRENCH DRAIN TURNING VANES TEMPERED WATER TYPICAL

UNIT HEATER UNDERWRITERS LABORATORY URINAL UNIT VENTILATOR

VARIABLE AIR VOLUME VOLUME DAMPER VIBRATION ISOLATOR VARIABLE REFRIGERANT FLOW VENT STACK VENT THROUGH ROOF

WASTE WASTE AND VENT WET BULB WATER CLOSET WALL CLEANOUT WATER GAUGE WALL HYDRANT (FREEZE PROTECTED) WASTE STACK

STM тс ΤV ΤW TYP UH UR UV

 \mathbf{N}

VAV

VD

VRF

VTR

VV

W&V

WB

WCO

WG

WH

WS

WC

 S_{CONT}

ST

RETURN AIR RADIATOR RETURN AIR GRILLE RADIANT CEILING PANEL RELATIVE HUMIDITY RETURN FAN ROOM RADIANT PANEL REVOLUTIONS PER MINUTE RETURN REGISTER ROOF SUMP ROOF TOP UNIT SUPPLY AIR

PUMP

PIPE ANCHOR

PIPE GUIDE

PLUMBING

PRESSURE DROP

SUPPLY AIR GRILLE SANITARY SUPPLY AIR TEMPERATURE STEAM COIL SUPPLY DIFFUSER SUPPLY FAN SPRING HANGER SHEET SUMP PUMP SPECIFICATIONS SPRINKLER HEAD SPRINKLER SERVICE SINK SOLENOID VALVE SAFE WASTE SINK

END SWITCH	ES	THERMOSTAT WITH GUARD
FLOW SWITCH - INLINE	FM	JRE SENSOR - DUCT MOUNTED AVERAGING ELEMENT
DIFFERENTIAL PRESSURE SWITCH	DPS	ATURE SENSOR W/ SUNSHIELD
PRESSURE SWITCH	PS	JRE SENSOR - DUCT MOUNTED RIGID ELEMENT
MAIN AIR SUPPLY (MECHANICAL CONTROLS)	M	RATURE SENSOR - IMMERSION TYPE ELEMENT
PNEUMATIC LINE	t,	AREA SMOKE DETECTOR
SOLENOID VALVE		DUCT SMOKE DETECTOR
PRESSURE GAUGE		FIRE STAT - DUCT MOUNTED
VALVE - TWO WAY PNEUMATIC CONTROLLED	R	REEZE STAT - DUCT MOUNTED
VALVE - THREE WAY PNEUMATIC CONTROLLED	密	FLOW METER
TWO WAY MOTORIZED VALVE	员	AQUASTAT (STRAP ON)
THREE WAY MOTORIZED VALVE	品	AIR FLOW SENSOR
ANALOG INPUT	Al	LOOP POWER INDICATOR
ANALOG OUTPUT	(AO)	DAY/NIGHT MAIN AIR SWITCH
DIGITAL INPUT	D	MANOMETER
DIGITAL OUTPUT		CONTROL RELAY
DIFFERENTIAL PRESSURE TRANSMITTER	DPT	CURRENT SWITCH
PRESSURE TRANSMITTER	PT	MOTORIZED DAMPER MOTOR
ELECTRICAL LINE DESIGNATION ON		DAMPER (PARALLEL BLADE)
CONTROL DIAGRAMS AND FLOOR PLANS		DAMPER (OPPOSED BLADE)
ELECTRICAL LINE DESIGNATION ON WIRING DIAGRAMS (VOLTAGE AS NOTED)		ELECTRIC - PNEUMATIC RELAY
SWITCH	00	TART STOP (MOTOR CONTROL)
FUSE		RELAY (ELECTRICAL)
TRANSFORMER	u.u mm	TWIST TIMER
THERMAL OVERLOAD	ş	VELOCITY CONTROLLER
RELAY CONTACT	ہ ⊣ ا	MOTOR DISCONNECT SWITCH
RELAY COIL	-0-	DR STARTER, W/O HOA SWITCH
	- -	

1. VERIFY ALL CONDITIONS IN FIELD BEFORE START OF CONSTRUCTION. NOTIFY ARCHITECT/ENGINEER OF DISCREPANCIES BETWEEN DRAWINGS

SYSTEM OR EQUIPMENT GROUND

3. COORDINATE ANY REQUIRED SHUTDOWN OF SERVICES OR EQUIPMENT WITH OWNER'S REPRESENTATIVE.

4. PROVIDE ALL MISC. STEEL AND ITEMS REQUIRED FOR THE PROPER INSTALLATION OF ALL PIPE, SHEET METAL AND EQUIPMENT

5. COORDINATE FLOOR, WALL & ROOF PENETRATIONS ETC. WITH ARCHITECTURAL TRADES.

6. INSTALL ALL DUCTWORK AS HIGH AS POSSIBLE IN AREA WITHOUT A CEILING UNLESS INDICATED OTHERWISE. 7. DUCT CONNECTED TO EQUIPMENT SHALL EQUAL EQUIPMENT CONNECTION SIZE UNLESS NOTED OTHERWISE.

9. REFER TO ARCHITECTURAL REFLECTED CEILING PLANS FOR EXACT DIFFUSER LOCATIONS IN AREAS WITH A CEILING.

11. DO NOT RUN ANY PIPING OR DUCTWORK INTO AN ELECTRICAL ROOM THAT DOES NOT SERVE THAT ROOM.

ī**D** Project Number



Drawing Number MR.0

Mechanical Reference Information

n solutions, LL IDS Drawing Title

 $^{\odot}$ 2021 integrated ${
m d}$

Pr	oject Administrator C. Azar
	Project Designer P. Carmella
Project A	rchitect / Engineer B. Partak
	Drawn By P. Carmella
	Q.M. Review M. Perez
	Approved J. Schwartz
	Drawing Scale No Scale
Issued for	Issue Date
Design Development	02-19-2021
Quality Management Review	04-21-2021
Bids	07-15-2021

THIS PROJECT MAY NOT UTILIZE ALL THE SYMBOLS, MATERIALS, ABBREVIATIONS AND STANDARD INFORMATION SHOWN ON THIS SHEET.



Executive Suite Renovation

1 Mutual Avenue

Key Plar

Frankenmuth, MI 48787

INTEGRATED design solutions

architecture engineering interiors & technology

1441 west long lake, suite 200


5211 cascade road SE, suite 300

grand rapids, michigan 49546

troy, michigan 48098

www.ids-michigan.com

248.823.2100

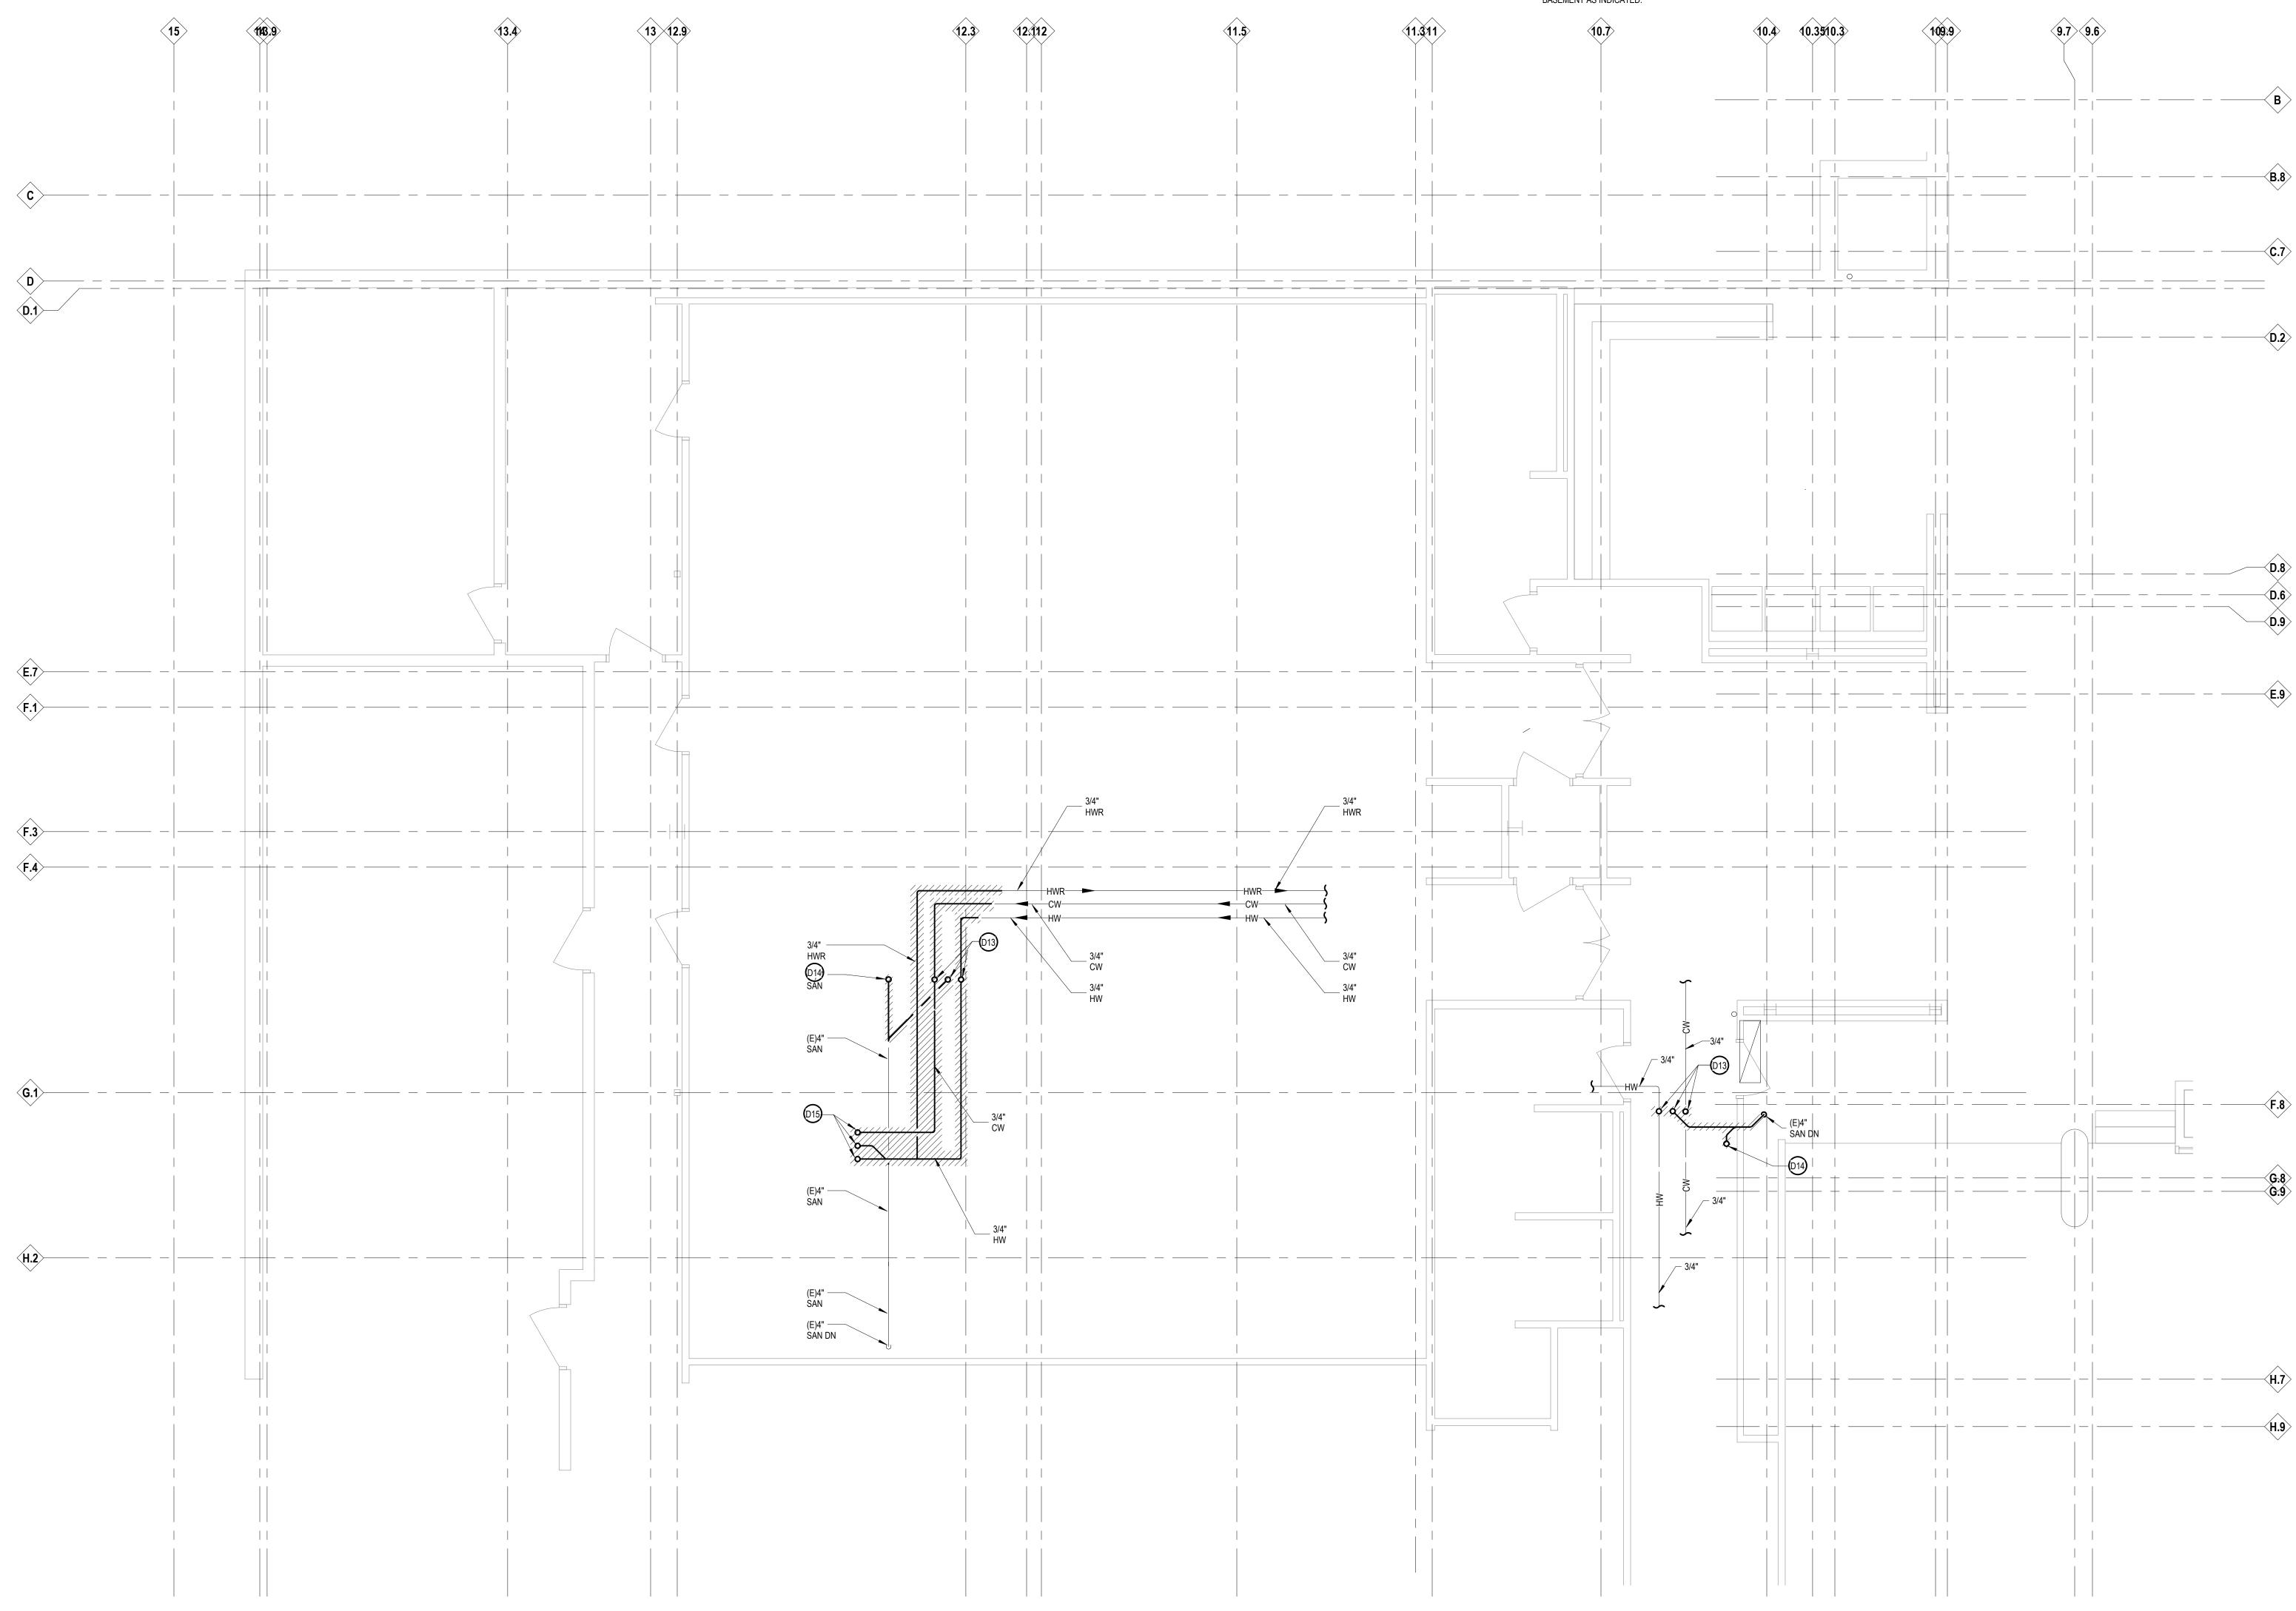

KEYNOTES DEMOLITION

NOTE: NOT ALL KEYNOTES MAY BE USED # LEGEND SYMBOL INDICATOR BACK TO MAINS AND CAP

- INDICATED.
- NEW CONTROLS AND VALVING.
- FIN-TUBE RADIATION AS INDICATED..
- ASSOCIATED DUCTWORK BACK TO MAIN AND CAP AS REQUIRED BY CORRIDOR CEILING REPLACEMENT.
- DRAWING M2.1.
- COMPLETELY, INCLUDING ALL CONTROLS, INLET AND OUTLET DUCTWORK AND EXHAUST GRILLES.
- COMPLETELY, INCLUDING ALL SANITARY, AND CW FROM BASEMENT AS INDICATED.

- D1 REMOVE VAV BOX, INCLUDING ALL CONTROLS, HWHS & R PIPING
- D2 REMOVE EXISTING DUCTWORK, INCLUDING DIFFUSERS AS
- D3 REMOVE VAV BOX, INCLUDING ALL CONTROLS, HWHS & R PIPING AND DUCTWORK AS REQUIRED TO REPLACE VAV BOX, PROVIDE
- D4 REMOVE EXISTING VALVING ABOVE CEILING SERVING EXISTING
- D5 REMOVE EXISTING LINEAR SUPPLY AIR DIFFUSER AND
- D6 REMOVE EXISTING IN-LINE EXHAUST FANS EF # 7, 8 & 9 AS REQUIRED FOR RE-INSTALLATION, REFER TO NEW WORK ON
- D7 REMOVE EXISTING IN-LINE EXHAUST FANS EF #20 & 21
- D8 REMOVE EXISTING FLOOR MOUNTED WATER CLOSET

- D9 REMOVE EXISTING LAVATORY COMPLETELY, INCLUDING ALL H & CW AND SANITARY PIPING FROM BASEMENT AND VENT PIPING UP TO ABOVE CEILING AS INDICATED.
- D10 REMOVE EXISTING KITCHEN SINK COMPLETELY, INCLUDING DISHWASHER ADJACENT INCLUDING SANITATY, H & CW FROM BASEMENT BELOW ABD VENT PIPING UP TO ABOVE CEILING ABOVE AS INDICATED.
- D11 REMOVE PORTION OF EXISTING 4" HWHS & R LINES WITH SHUT OFF VALVES, REFER TO NEW WORK.
- D12 REMOVE FIRE PROTECTION SPRINKLER HEADS IN AREAS OF CEILING DEMOLITION, REFER TO ARCH. DRAWINGS.
- D13 REMOVE EXISTING 3/4" H & CW, 2" SANITARY PIPING UP TO LAVATORY ABOVE CAP PIPING AS INDICATED. D14 REMOVE EXISTING 4" SANITARY PIPING UP TO WATER CLOSET ABOVE, CAP 4" SANITARY PIPING AS INDICATED.
- D15 REMOVE EXISTING 3/4" H & CW, 2" SANITARY PIPING UP TO KITCHEN SINK ABOVE, CAP PIPING AS INDICATED.



ī **D** Project Number



Basement Demolition Plan

 $^{\odot}$ 2021 integrated ${
m de}$ sign solutions, LL IDS Drawing Title

	Project Administrator
	C. Azar
	Project Designer
	P. Carmella
Proje	ct Architect / Engineer
	B. Partak
	Drawn By
	P. Carmella
	Q.M. Review
	M. Perez
	Approved
	J. Schwartz
	Drawing Scale
	As Noted
Issued for	Issue Date
Quality Management Review	v 04-21-2021
Bid	-


1 Mutual Avenue Frankenmuth, MI 48787

Executive Suite Renovation



INTEGRATED design solutions architecture engineering interiors & technology 1441 west long lake, suite 200 troy, michigan 48098 5211 cascade road SE, suite 300 grand rapids, michigan 49546 248.823.2100 www.ids-michigan.com



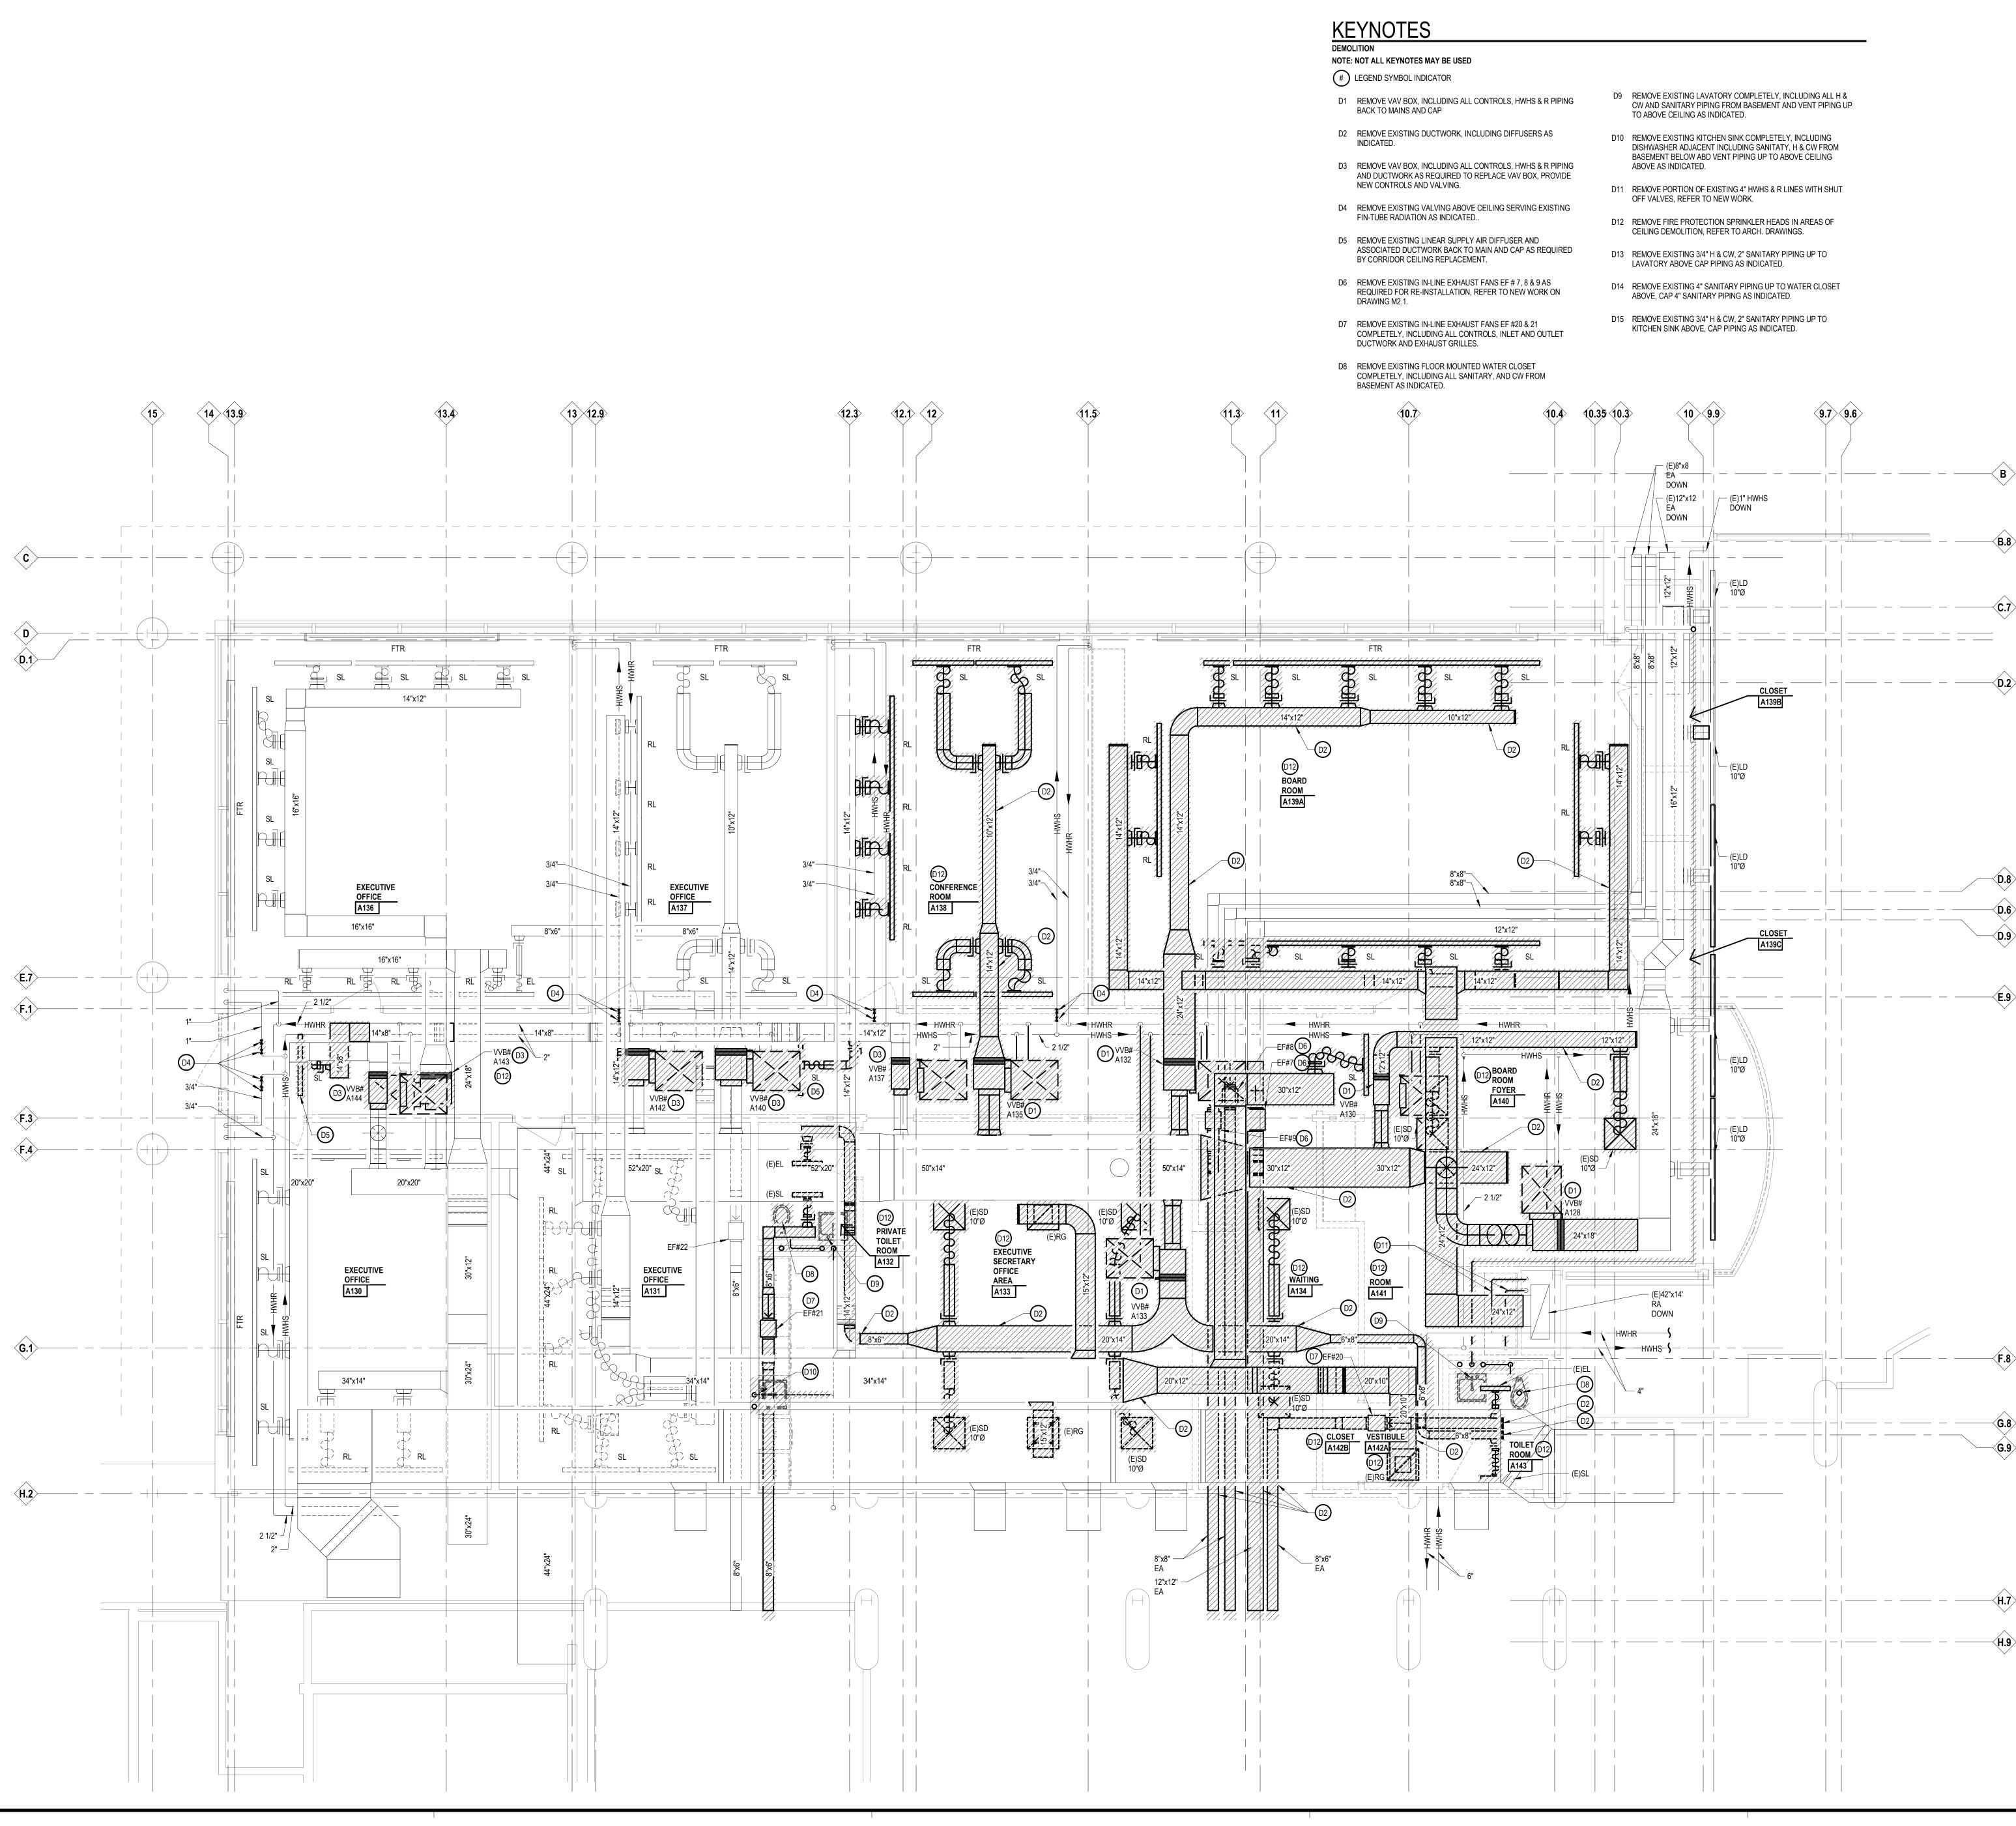



ī**D**^s Project Number




Drawing Number

First Floor Demolition Plan

 \odot 2021 integrated ${
m d}$ Sign Solutions, LL IDS Drawing Title

Pr	oject Administrator
	C. Azar
	Project Designer
	P. Carmella
Project A	Architect / Engineer
	B. Partak
	Drawn By
	P. Carmella
	Q.M. Review
	M. Perez
	Approved
	J. Schwartz
	Drawing Scale
	1/4" = 1'-0"
Issued for	Issue Date
Design Development	02-19-2021
Quality Management Review	04-21-2021
Bids	07-15-2021

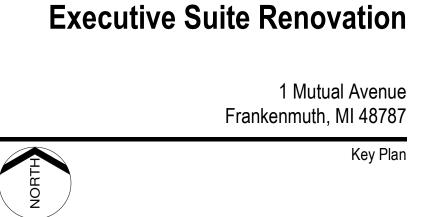





INTEGRATED design solutions

architecture engineering interiors & technology

1441 west long lake, suite 200

5211 cascade road SE, suite 300


grand rapids, michigan 49546

troy, michigan 48098

www.ids-michigan.com

248.823.2100

Project Title

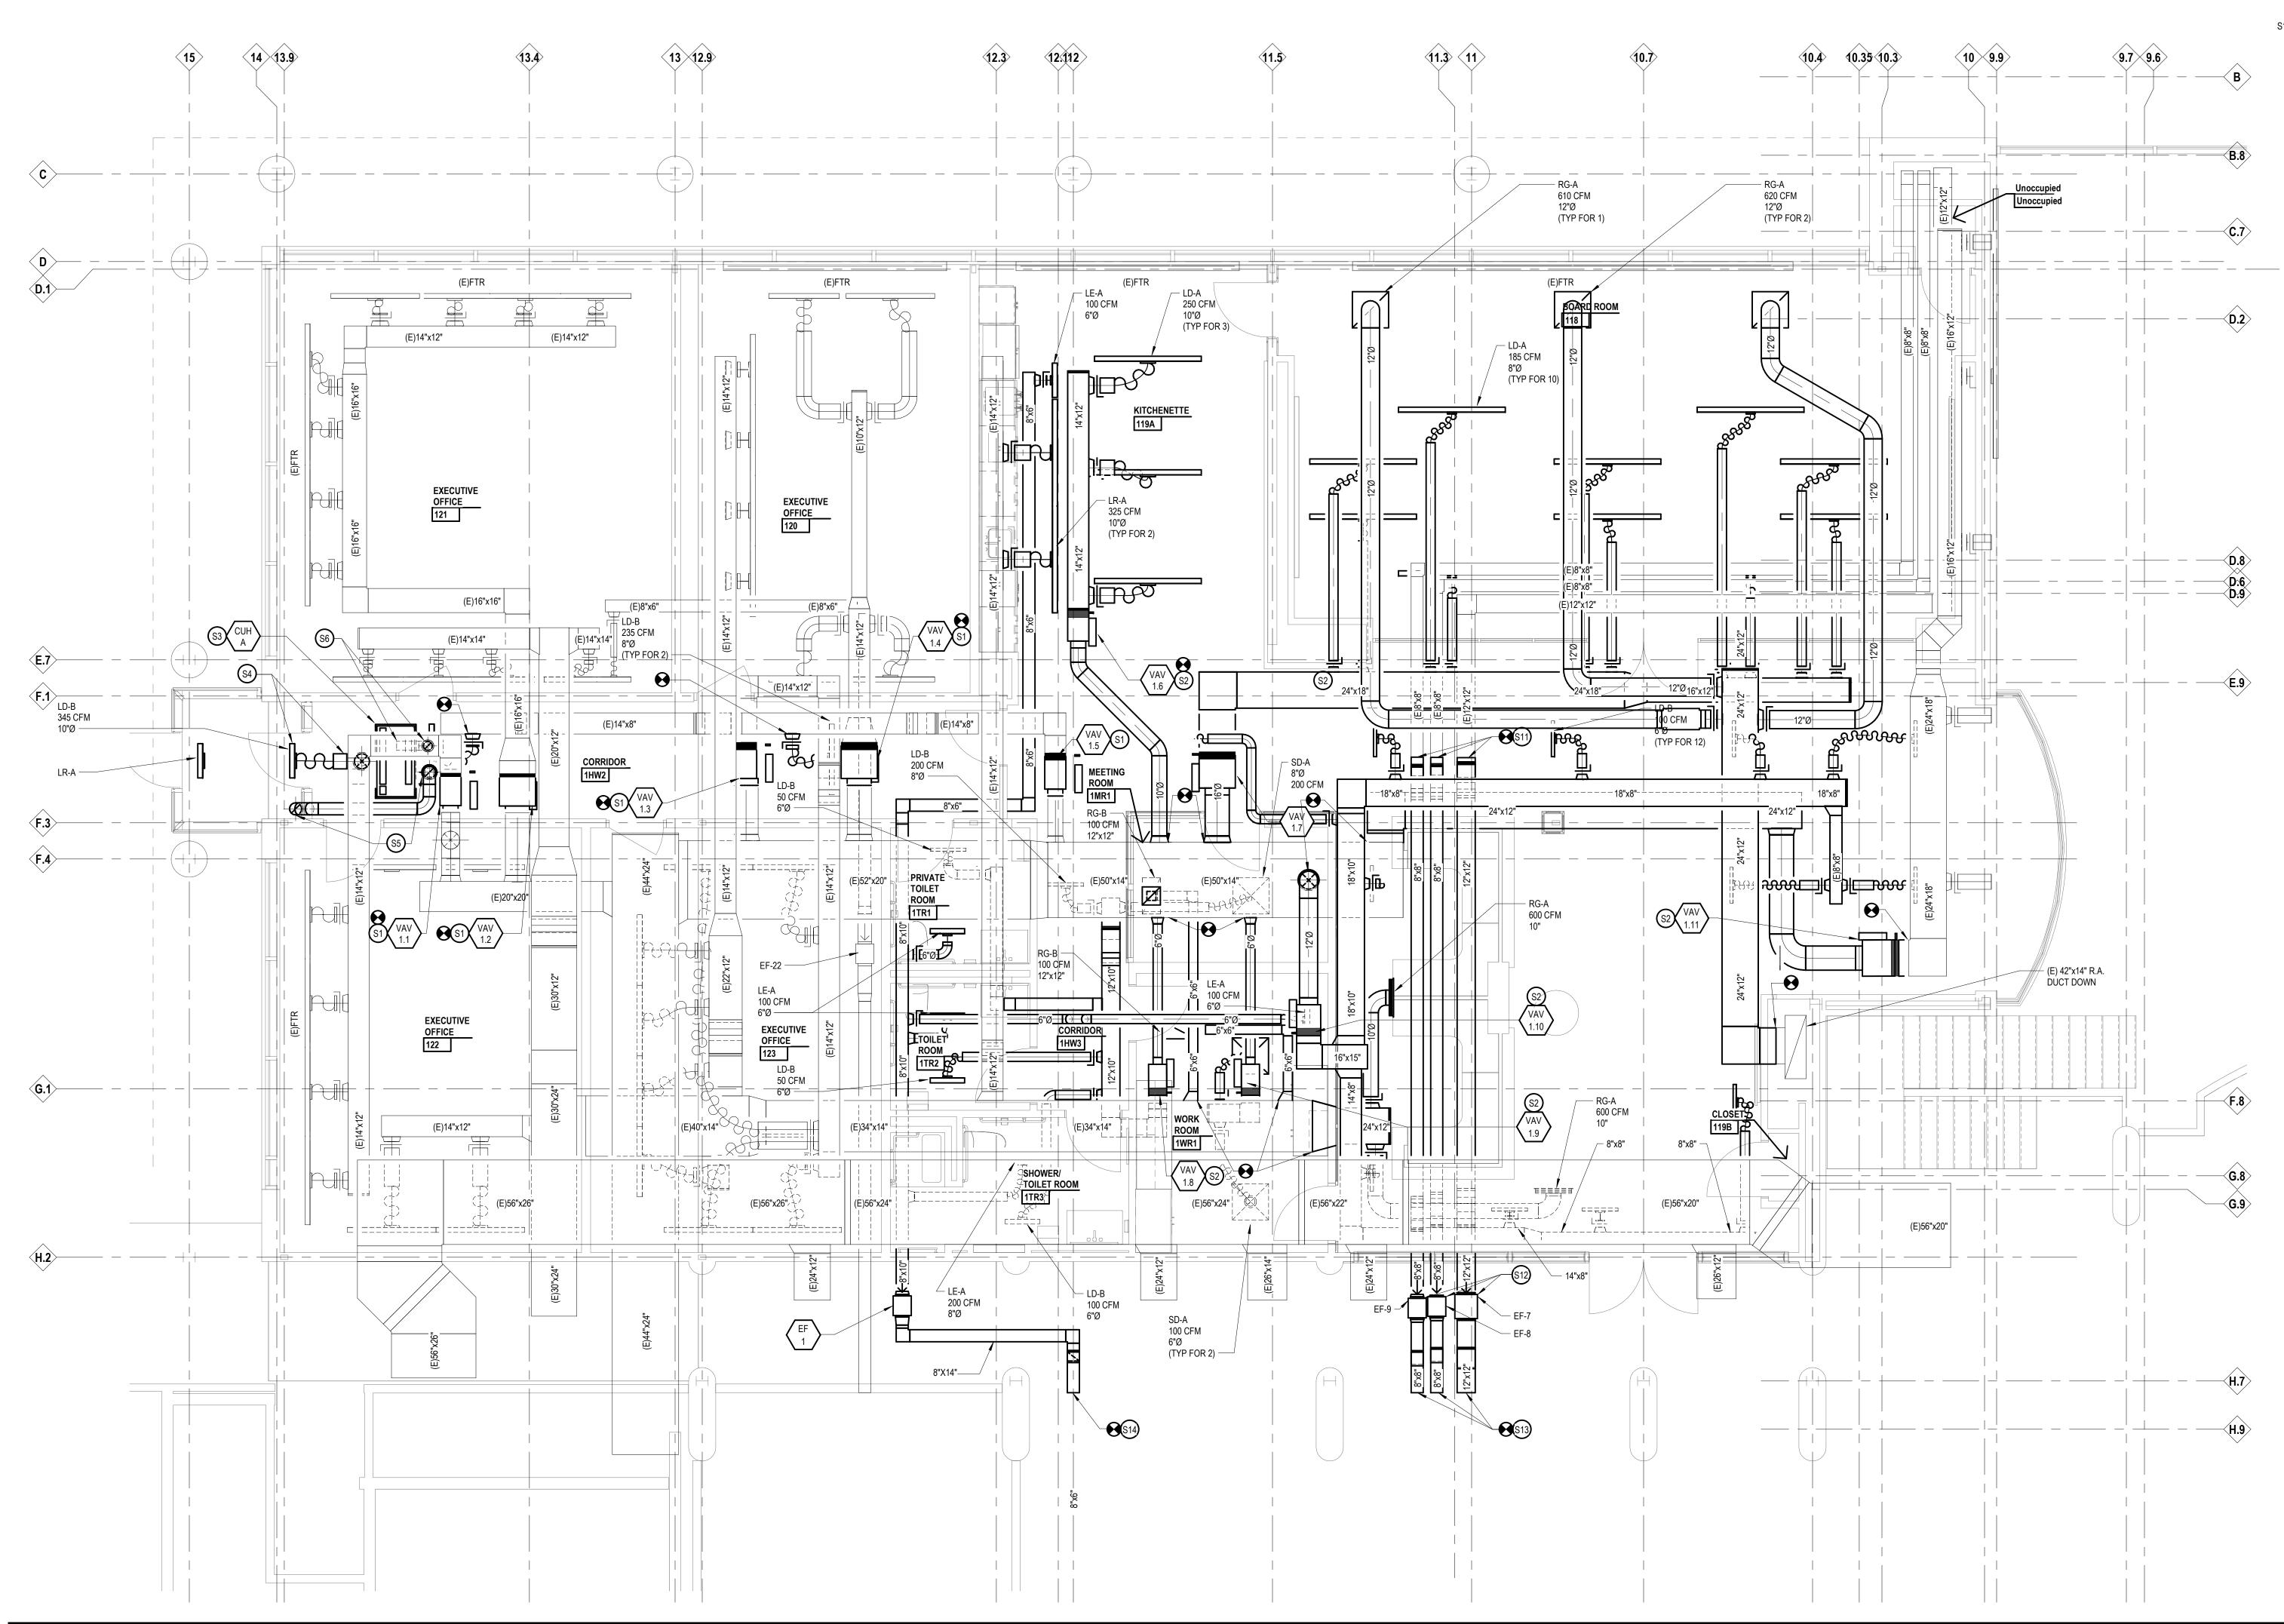

KEYNOTES

SHEET METAL NOTE: NOT ALL KEYNOTES MAY BE USED

245 CFM.

LEGEND SYMBOL INDICATOR

- S1 NEW VAV BOX IN SAME LOCATION AS PREVIOUSLY REMOVED, PROVIDE DUCT TRANSITIONS AS REQUIRED TO RECONNECT TO EXISTING DUCTWORK.
- S2 NEW VAV BOX IN NEW LOCATION, PROVIDE NEW INLET/OUTLET DUCTWORK AS INDICATED.
- S3 NEW CUH-A RECESSED ABOVE CEILING PROVIDE 30"x4" S.A. & R.A. DISCHARGE/INLET AIR PLENUM CONNECTIONS.
- S4 10" DIA. S.A. DUCT FROM 30"x4" S.A. PLENUM TO LD-B.
- S5 10" DIA. R.A. DUCT FROM 30"x4" R.A. PLENUM PENETRATE VESTIBULE CEILING BALANCE OPEN ENDED 10" DIA. R.A. DUCT TO
- S6 6" DIA. R.A. DUCT FROM 30"x4" R.A. PLENUM IN CORRIDOR CEILING BALANCE OPEN ENDED 6" DIA. R.A. DUCT TO 100 CFM.
- S11 CONNECT NEW (2) 8"x8" AND (1) 12"x12" TO EXISTING (2) 8"x8" AND (1) 12"x12" EXISTING EXHAUST AIR DUCTS , OFFSET NEW DUCTWORK UP AND OVER NEW CEILING COVE BY ARCHITECTURAL TRADES, REFER TO ARCHITECTURAL REFLECTED CEILING PLAN.
- S12 RE-INSTALL RELOCATED IN-LINE EXHAUST FAN EF-9, 8 AND 7 AS INDICATED IN NEW EXHAUST AIR DUCTWORK, EXTEND EXISTING CONTROLS AS REQUIRED.
- S13 RECONNECT (2) 8"x8" AND (1) 12"x12" NEW EXHAUST AIR DUCTS TO EXISTING SIDEWALL EXHAUST GRILLE AT LOW ROOF SIDEWALL EXHAUST.
- S14 CONNECT NEW 8"x14" EXHAUST AIR DISCHARGE DUCT FROM NEW EF-1 TO EXISTING SIDEWALL EXHAUST GRILLE AT LOW ROOF SIDEWALL EXHAUST.




ī **D**^s Project Number



First Floor Sheet Metal Plan

 \odot 2021 integrated ${
m d}$ Sign Solutions, LL IDS Drawing Tit

Р	roject Administrator
	C. Azar
	Project Designer
	P. Carmella
Project	Architect / Engineer
	B. Partak
	Drawn By
	P. Carmella
	Q.M. Review
	M. Perez
	Approved
	J. Schwartz
	Drawing Scale
	1/4" = 1'-0"
Issued for	Issue Date
Design Development	02-19-2021
Quality Management Review	04-21-2021
Bids	07-15-2021

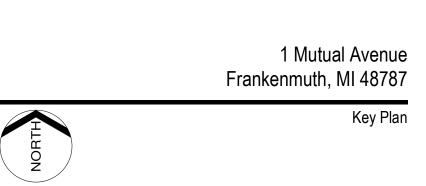


Executive Suite Renovation



INTEGRATED design solutions architecture engineering interiors & technology 1441 west long lake, suite 200 troy, michigan 48098 5211 cascade road SE, suite 300 grand rapids, michigan 49546 248.823.2100



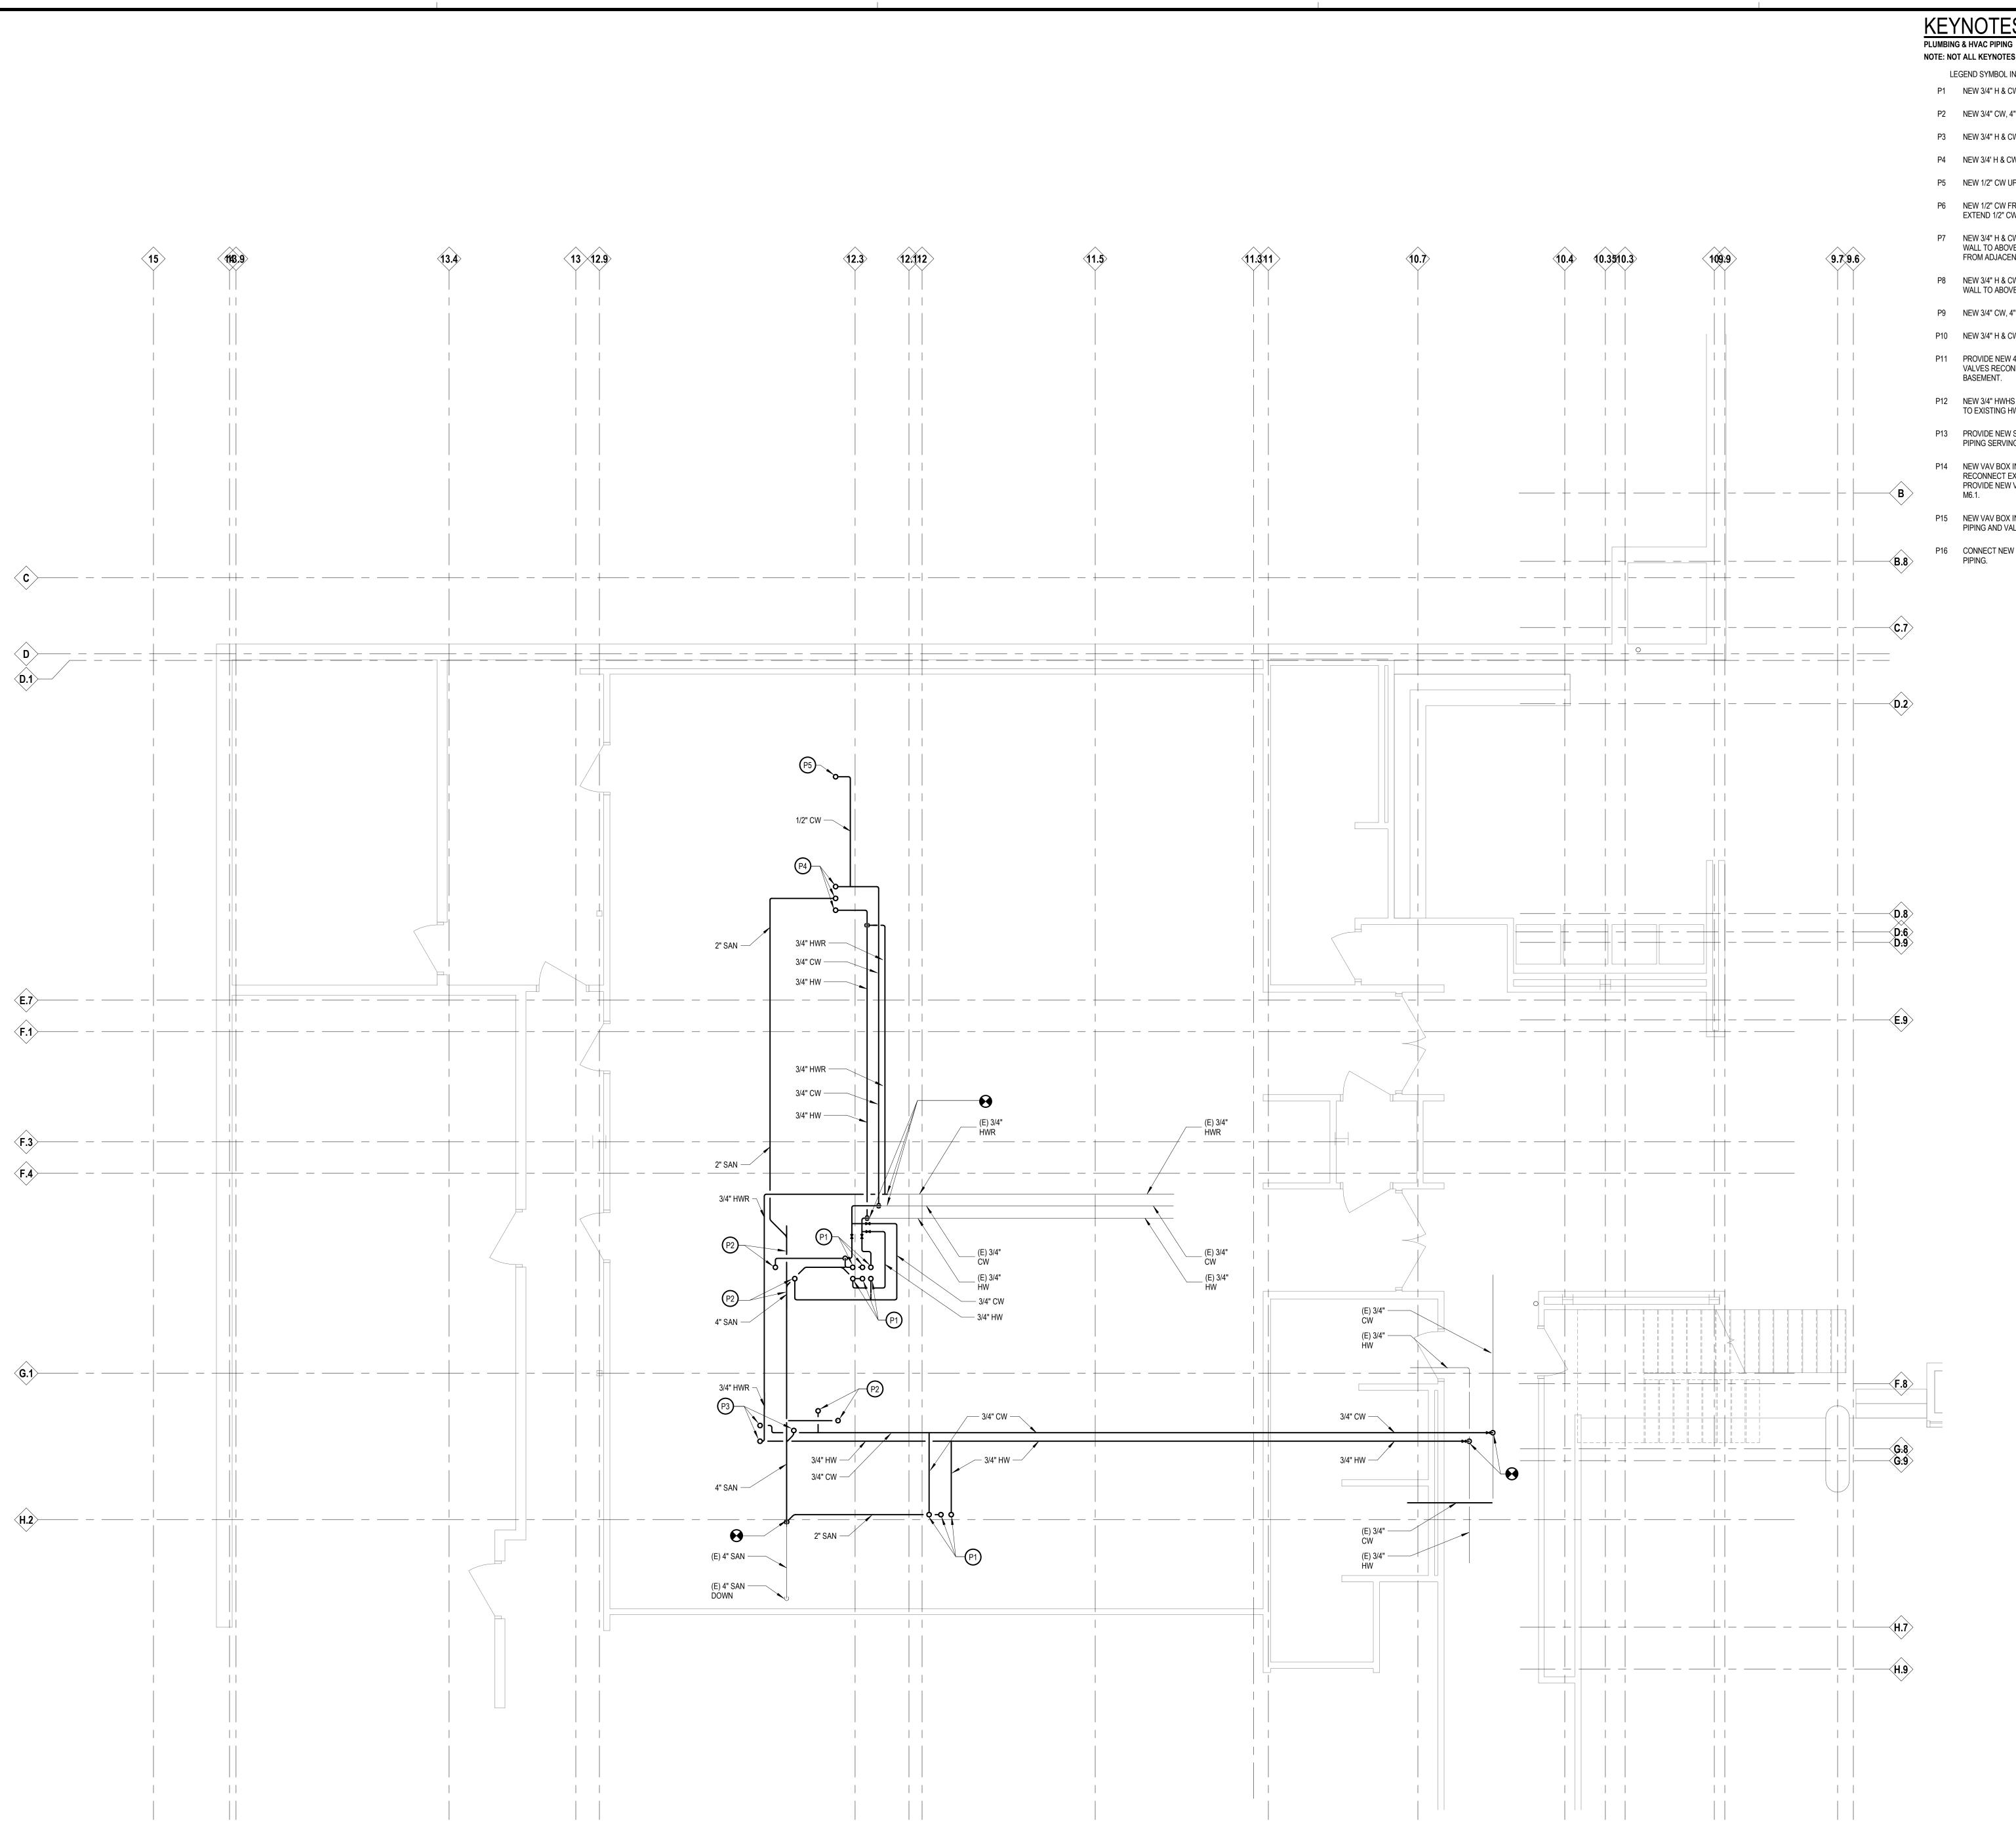

KEYNOTES

NOTE: NOT ALL KEYNOTES MAY BE USED

- LEGEND SYMBOL INDICATOR P1 NEW 3/4" H & CW, 2" SANITARY PIPING UP TO LAV-1 ABOVE.
- P2 NEW 3/4" CW, 4" SANITARY PIPING UP TO WC-1 ABOVE.
- P3 NEW 3/4" H & CW, 2" SANITARY PIPING UP TO SH-1 ABOVE
- P4 NEW 3/4' H & CW, 2' SANITARY PIPING UP TO KS-1 ABOVE
- P5 NEW 1/2" CW UP TO COFFEE MAKER ABOVE.
- P6 NEW 1/2" CW FROM BELOW CONNECT TO NEW COFFEE MAKER, EXTEND 1/2" CW TO ADJACENT REFRIGERATOR WITH ICE MAKER.
- P7 NEW 3/4" H & CW, 2" SANITARY FROM BELOW WITH 2" VENT UP IN WALL TO ABOVE CEILING FROM KS-1, EXTEND 3/4" HW AND DRAIN FROM ADJACENT DISHWASHER.
- P8 NEW 3/4" H & CW, 2" SANITARY FROM BELOW WITH A 2" VENT UP IN WALL TO ABOVE CEILING FROM LAV-1.
- P9 NEW 3/4" CW, 4" SANITARY FROM BELOW TO WC-1. .
- P10 NEW 3/4" H & CW, 2" SANITARY FROM BELOW TO SH-1. P11 PROVIDE NEW 4" HWHS & R PIPING IN STAIRS WITH SHUT OFF VALVES RECONNECT TO EXISTING 4" HWHS & R PIPING DOWN TO
- BASEMENT.
- P12 NEW 3/4" HWHS & R PIPING CONNECT TO NEW CUH-A, CONNECT TO EXISTING HWHS & R PIPING.
- P13 PROVIDE NEW SHUT OFF AND CONTROL VALVE IN EXISTING HWHS PIPING SERVING EXISTING FTR SIZED AS INDICATED.
- P14 NEW VAV BOX IN SAME LOCATION AS PREVIOUSLY REMOVED, RECONNECT EXISTING HWHS & R PIPING TO NEW VAV BOX, PROVIDE NEW VALVING AS INDICATED ON DETAIL ON DRAWING M6.1.
- P15 NEW VAV BOX IN NEW LOCATION PROVIDE NEW 3/4" HWHS & R PIPING AND VALVING AS INDICATED ON DETAIL ON DRAWING M6.1.
- P16 CONNECT NEW 3/4" HWHS & R PIPING TO EXISTING HWHS & R PIPING.

20120-1000


ī**D**≗ Project Number



Basement Plumbing & HVAC Piping Plan

@ 2021 Integrated design solutions, LLC IDS Drawing Title


	Project Administrator C. Azar
	Project Designer
	P. Carmella
Projec	t Architect / Engineer B. Partak
	Drawn By P. Carmella
	Q.M. Review
	M. Perez
	Approved J. Schwartz
	Drawing Scale
	As Noted
Issued for	Issue Date
Quality Management Review	04-21-2021
Bide	

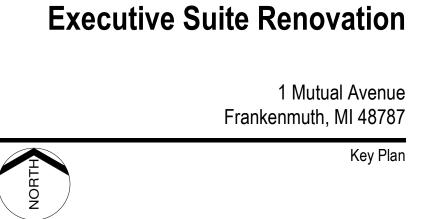



INTEGRATED design solutions architecture engineering interiors & technology 1441 west long lake, suite 200 troy, michigan 48098 5211 cascade road SE, suite 300 grand rapids, michigan 49546 248.823.2100



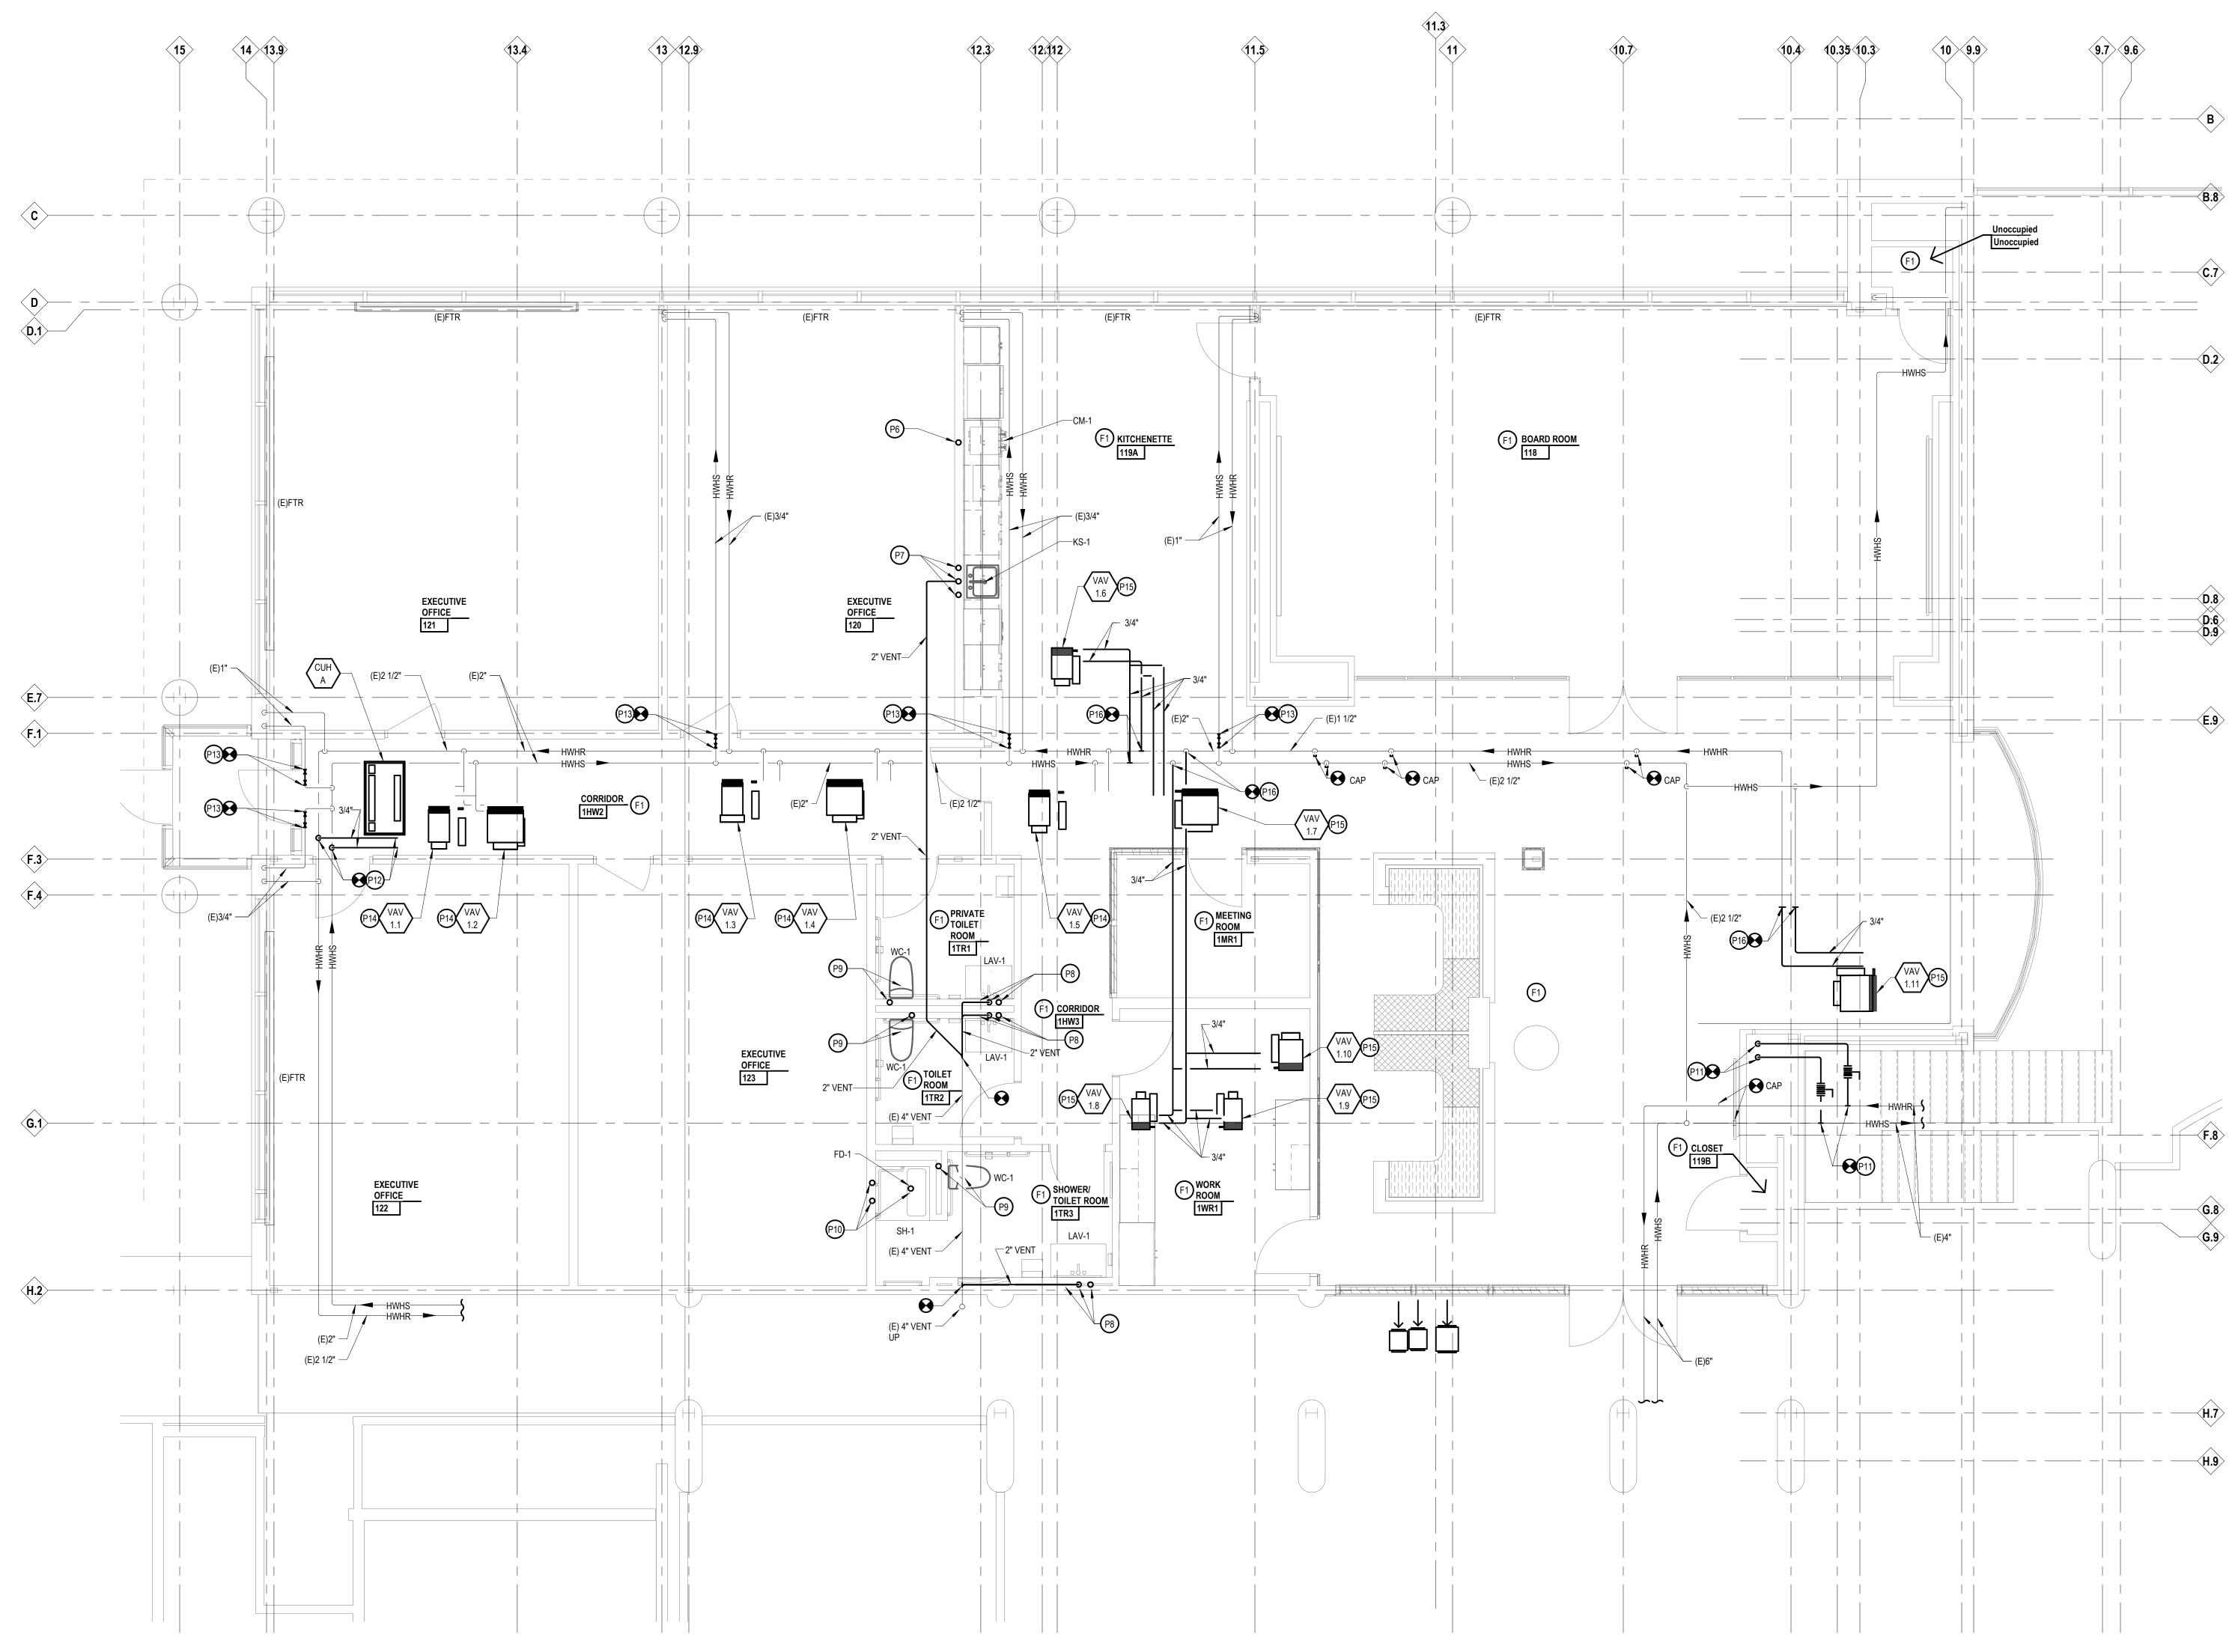

- FIRE PROTECTION 1. ALL MATERIAL AND WORKMANSHIP SHALL CONFIRM TO ALL LOCAL
- REGULATIONS 2. ALL EQUIPMENT SHALL BE INSTALLED IN STRICT ACCORDANCE WITH THE EQUIPMENT MANUFACTURERS RECOMMENDATIONS AND APPROPRIATE CODES, PROVIDE ALL FITTINGS, TRANSITIONS, VALVES,
- MISC. STEEL AND OTHER DEVICES REQUIRED FOR A COMPLETE WORKABLE INSTALLATION.
- 3. MARKABLE LABELS SHALL BE AFFIXED TO ALL FIRE PROTECTION EQUIPMENT AND A MAINTENENCE MANUAL SHALL BE PROVIDED TO THE OWNER.
- REFER TO SPECIFICATIONS FOR ADDITIONAL REQUIREMENTS.
 COORDINATE ANY REQUIRED SHUTDOWN OF SERVICES OR
- EQUIPMENT WITH THE OWNER'S REPRESENTATIVE.

(F1)

KEYNOTES FIRE PROTECTION

- NOTE: NOT ALL KEYNOTES MAY BE USED LEGEND SYMBOL INDICATOR
- F1 PROVIDE WET SPRINKLER FIRE PROTECTION COVERAGE TO ALL ROOMS WITH NEW CEILING, REFER TO ARCHITECTURAL
- REFLECTED CEILING PLANS. SEE ADDITIONAL FIRE PROTECTION NOTES ON THIS DRAWING.

KEYNOTES

PLUMBING & HVAC PIPING NOTE: NOT ALL KEYNOTES MAY BE USED

- LEGEND SYMBOL INDICATOR
- P1 NEW 3/4" H & CW, 2" SANITARY PIPING UP TO LAV-1 ABOVE.
- P2 NEW 3/4" CW, 4" SANITARY PIPING UP TO WC-1 ABOVE.
- P3 NEW 3/4" H & CW, 2" SANITARY PIPING UP TO SH-1 ABOVE
- P4 NEW 3/4' H & CW, 2' SANITARY PIPING UP TO KS-1 ABOVE P5 NEW 1/2" CW UP TO COFFEE MAKER ABOVE.
- P6 NEW 1/2" CW FROM BELOW CONNECT TO NEW COFFEE MAKER, EXTEND 1/2" CW TO ADJACENT REFRIGERATOR WITH ICE MAKER.
- P7 NEW 3/4" H & CW, 2" SANITARY FROM BELOW WITH 2" VENT UP IN
- WALL TO ABOVE CEILING FROM KS-1, EXTEND 3/4" HW AND DRAIN FROM ADJACENT DISHWASHER.
- P8 NEW 3/4" H & CW, 2" SANITARY FROM BELOW WITH A 2" VENT UP IN WALL TO ABOVE CEILING FROM LAV-1.
- P9 NEW 3/4" CW, 4" SANITARY FROM BELOW TO WC-1. .
- P10 NEW 3/4" H & CW, 2" SANITARY FROM BELOW TO SH-1.
- P11 PROVIDE NEW 4" HWHS & R PIPING IN STAIRS WITH SHUT OFF VALVES RECONNECT TO EXISTING 4" HWHS & R PIPING DOWN TO BASEMENT.
- P12 NEW 3/4" HWHS & R PIPING CONNECT TO NEW CUH-A, CONNECT TO EXISTING HWHS & R PIPING.
- P13 PROVIDE NEW SHUT OFF AND CONTROL VALVE IN EXISTING HWHS PIPING SERVING EXISTING FTR SIZED AS INDICATED.
- P14 NEW VAV BOX IN SAME LOCATION AS PREVIOUSLY REMOVED, RECONNECT EXISTING HWHS & R PIPING TO NEW VAV BOX, PROVIDE NEW VALVING AS INDICATED ON DETAIL ON DRAWING M6.1.
- P15 NEW VAV BOX IN NEW LOCATION PROVIDE NEW 3/4" HWHS & R
- PIPING AND VALVING AS INDICATED ON DETAIL ON DRAWING M6.1. P16 CONNECT NEW 3/4" HWHS & R PIPING TO EXISTING HWHS & R

PIPING.



ī**D**≗ Project Number




Drawing Number

IDS Drawing Title First Floor Plumbing, HVAC Piping & Fire Protection Plan

 $^{\odot}$ 2021 integrated ${
m d}$ sign solutions, LLC

Pr	oject Administrator
	C. Azar
	Project Designer
	P. Carmella
Project A	Architect / Engineer
	B. Partak
	Drawn By
	P. Carmella
	Q.M. Review
	M. Perez
	Approved
	J. Schwartz
	Drawing Scale
	1/4" = 1'-0"
Issued for	Issue Date
Design Development	02-19-2021
Quality Management Review	04-21-2021
Bids	07-15-2021

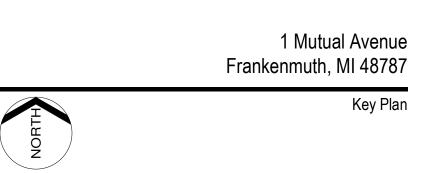



Executive Suite Renovation




INTEGRATED design solutions architecture engineering interiors & technology 1441 west long lake, suite 200 troy, michigan 48098 5211 cascade road SE, suite 300 grand rapids, michigan 49546 248.823.2100



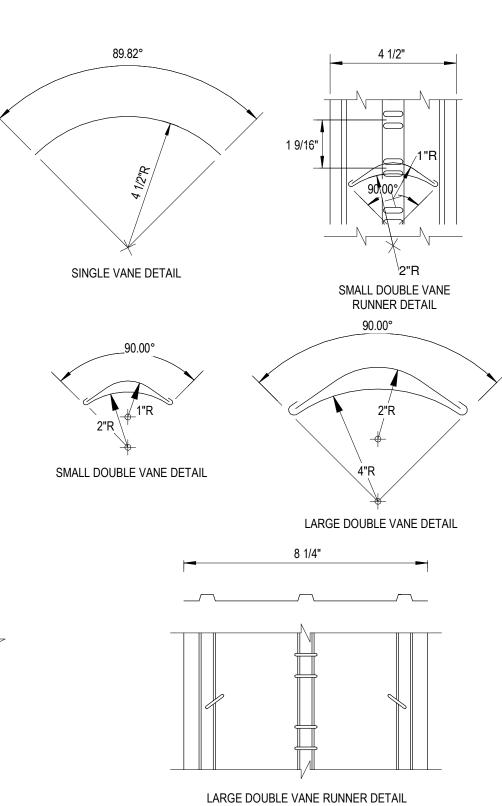


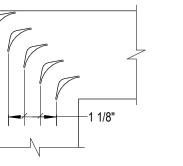


SMALL DOUBLE VANE SQUARE ELBOW UP TO 36" IN WIDTH

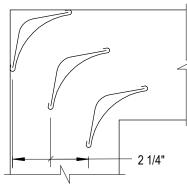


LARGE DOUBLE VANE SQUARE ELBOW MORE THAN 36" IN WIDTH

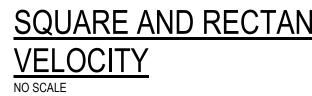

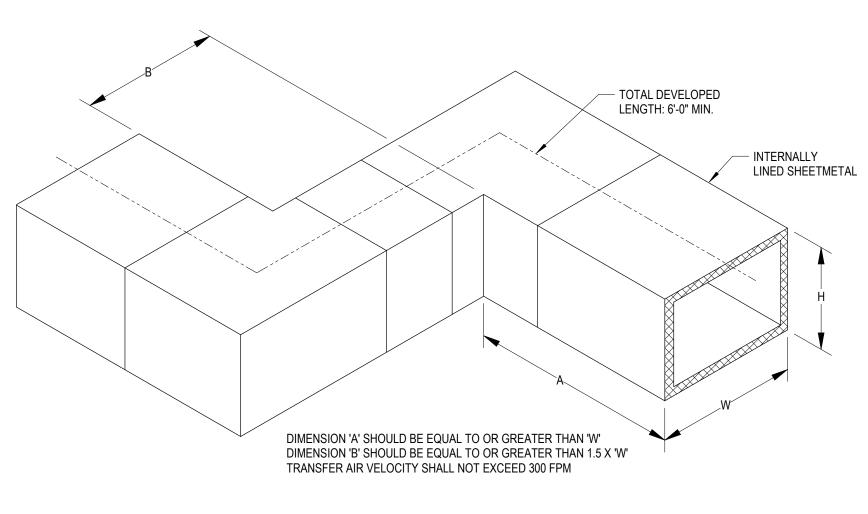



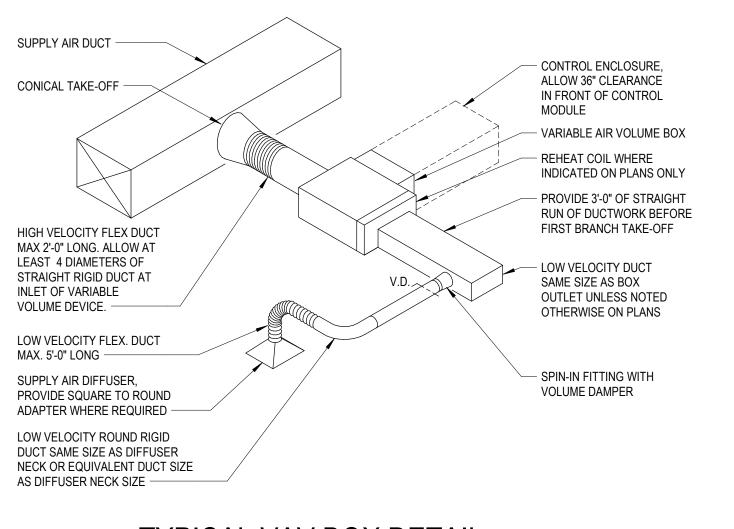

SQUARE AND RECTANGULAR ELBOWS - LOW

	FAN SCHEDULE																						
MARK	LOCATION	AREA SERVED	DESIGN AIRFLOW	INITIAL CONN.	EXTERNAL STATIC		FAN		FAN		MOTOR DATA		ELECTRICAL	63	125	INLET 250	SOUND F	POWER L	EVEL 2K	4K	8K	"GREENHECK"	REMARKS
			(CFM)	AIRFLOW (CFM)	PRESSURE (IN. WG.)	TYPE	TYPE DRIVE	FAN CLASS	FAN RPM	HP	BHP	RPM	V/PH/HZ	HZ	HZ	HZ	HZ	HZ	HZ	HZ	HZ	MODEL No.	
EF-1	INLINE ABOVE CEILING	TOILETS, WORK RM, KITCHENETTE	600	600	0.50	INLINE	DIRECT		1696	1/6	0.13	1725	115/1/60	80	79	74	67	61	51	42	40	SQ 95-VG	WEIGHT= 59 LBS.

NOTES: 1. PROVIDE ALL FANS WITH FACTORY MOUNTED AND WIRED DISCONNECT.

MARK			ROOM	MAX	MAX	·								HOT WATER T	EMPERING CO	L				
	HVAC SYSTEM	No.	NAME	COOLING AIRFLOW (CFM)	HEATING AIRFLOW (CFM)	MIN AIRFLOW (CFM)	INLET SIZE	OUTLET DUCT SIZE	MIN SP TO OPER. BOX	MAX NC	FLOW (GPM)	CAPACITY (MBH)	EWT (°F)	LWT (°F)	EAT (°F)	LAT (°F)	MAX PD (FT HD)	COIL RUNOUT (IN.)	"PRICE" MODEL NO.	REMARKS
VAV - 1.1	1	122	EXECUTIVE OFFICE	1,140	570	570	12"	16"x15"	0.26	28	0.9	18.5	180	140	55	85	3	1/2	SDV	
VAV - 1.2	1	121	EXECUTIVE OFFICE	1,705	855	855	16"	24"x18"	0.20	32	1.4	27.7	180	140	55	85	3	3/4	SDV	
VAV - 1.3	1	123	EXECUTIVE OFFICE	915	460	460	10"	14"x12.5"	0.25	25	0.7	14.9	180	140	55	85	3	1/2	SDV	
VAV - 1.4	1	120	EXECUTIVE OFFICE	915	460	460	10"	14"x12.5"	0.25	25	0.7	14.9	180	140	55	85	3	1/2	SDV	
VAV - 1.5	1	1HW2	CORRIDOR	470	235	235	8"	12"x10"	0.25	27	0.5	7.6	180	140	55	85	3	1/2	SDV	
VAV - 1.6	1	119A	KITCHENETTE	750	375	375	10"	14"x12.5"	0.25	25	0.6	12.2	180	140	55	85	3	1/2	SDV	
VAV - 1.7	1	118	BOARD ROOM	1,850	925	925	16"	24"x18"	0.20	32	1.5	30.0	180	140	55	85	3	3/4	SDV	
VAV - 1.8	1	1MR1	MEETING ROOM	600	600	600	8"	12"x10"	0.25	27	1.0	19.4	180	140	55	85	3	1/2	SDV	
VAV - 1.9	1	1WR1	WORK ROOM	200	100	100	6"	12"x8"	0.25	25	0.5	3.2	180	140	55	85	3	1/2	SDV	
VAV - 1.10	1	119	FOYER/WAITING	1,200	600	600	12"	16"x15"	0.26	28	1.0	19.4	180	140	55	85	3	1/2	SDV	
VAV - 1.11	1		EXIST 2 STORY AREA	1,975	990	990	16"	24"x18"	0.20	32	1.6	32.1	180	140	55	85	3	3/4	SDV	


NOTES:

1. MAX NC LEVEL BASED ON 1.5" INLET SP WITH NO ALLOWANCE FOR EXTERNAL ATTENUATION.


2. PROVIDE A 24"x24" CEILING MOUNTED ACCESS DOOR FOR ALL VARIABLE BOXES MOUNTED ABOVE INACCESSIBLE CEILINGS.


	HOT WATER CABINET UNIT HEATER SCHEDULE															
МАРИ	HEATING FLUID EW MARK CAPACITY FLOW (197					LAT	FAN			FIL	TER	ENCLOSURE	ENCLOSURE ELECTRICAL		"MANUFACTURER"	REMARKS
MARK	MARK CAPACITY (MBH)	(GPM)	(°F)	(°F)	(°F)	(°F)	CFM	HP	RPM	TYPE	AREA (SF)	L x D x H (IN.)	V/PH/Hz	AMPS	MODEL No.	KEIVIAKKS
CUH-A	29.8	2.0	180	150	65	95	345	1/10	1050	PERM	1.9	47"x9 1/2"x25"	120/1/60	1.40	STERLING RC-1200 SIZE 04	

NOTES: 1. PROVIDE WITH FACTORY MOUNTED AND WIRED DISCONNECT. 2. PROVIDE WITH INTEGRAL RETURN AIR THERMOSTAT.

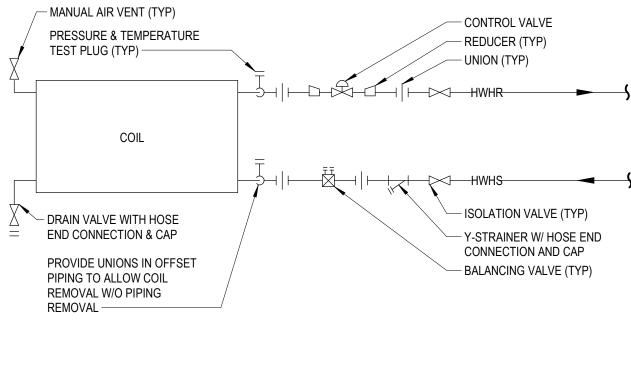



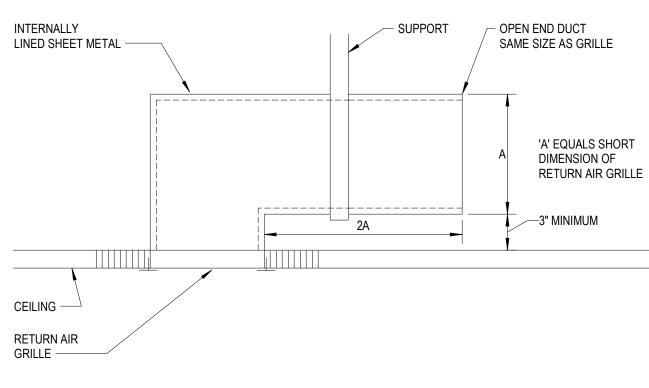

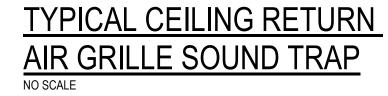

TYPICAL VAV BOX DETAIL

NO SCALE

	GRILLE, REGISTER AND DIFFUSER SCHEDULE													
MARK	CORE STYLE	BORDER FRAME TYPE	MODULE SIZE	FINISH	ACCESSORY	CONSTRUCTION	"TITUS" MODEL No.	REMARKS						
SD-A	PANEL	NOTE 1	24"x24"	WHITE	NONE	STEEL	OMNI							
RG-A	LOUVER	PLASTER FRAMES	24"x24"	BY ARCH.	NONE	STEEL	350RL							
RG-B	LOUVER	NOTE 1	24"x12"	WHITE	NONE	STEEL	350RL							
LD-A	LINEAR SLOT	NOTE 1	72" LONG	BLACK FOR BOARDROOM	MPI-39 PLENUM INSULATED	ALUMINUM	ML-39 1" SLOTS	(2) SLOTS						
LD-B	LINEAR SLOT	NOTE 1	24" LONG	WHITE	MPI-39 PLENUM INSULATED	ALUMINUM	ML-39 1" SLOTS	(2) SLOTS						
LR-A	LINEAR SLOT	NOTE 1	72" LONG OR 24" LONG	WHITE	MP-39 PLENUM UNINSULATED	ALUMINUM	MLR-39 1" SLOTS	(2) SLOTS						
LE-A	LINEAR SLOT	NOTE 1	24" LONG	WHITE	MP-39 PLENUM UNINSULATED	ALUMINUM	MLR-39 1" SLOTS	(2) SLOTS						

NOTES:

1. COORDINATE MOUNTING FRAMES WITH REFLECTED CEILING PLANS.

2. ALL WALL AND DUCT MOUNTED GRILLES SHALL HAVE COUNTER-SUNK SCREWS.

3. COORDINATE LENGTH OF ALL LINEAR SUPPLIES AND RETURNS WITH ARCHITECTURAL FLOOR PLANS AND REFLECTED CEILING PLANS. 4. LD-A FOR NON BOARDROOM AREAS SHALL BE WHITE.

5. RG-A FOR FOYER AREA SHALL BE PAINTED BY ARCH. TRADES



ī **D** Project Number



Drawing Number

Details & Schedules

 ${
m \circ}\,$ 2021 integrated ${
m d}\,$ **n solutions**, LLC IDS Drawing Title


P	roject Administrator C. Azar
	Project Designer P. Carmella
Project /	Architect / Engineer B. Partak
	Drawn By P. Carmella
	Q.M. Review
	M. Perez
	Approved J. Schwartz
	Drawing Scale
	No Scale
Issued for	Issue Date
Design Development	02-19-2021
Quality Management Review	04-21-2021
Bids	07-15-2021

1 Mutual Avenue Frankenmuth, MI 48787 Key Plan


Executive Suite Renovation





5211 cascade road SE, suite 300 grand rapids, michigan 49546 248.823.2100 www.ids-michigan.com

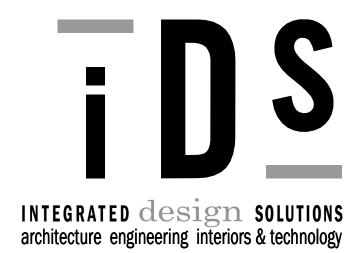


1441 west long lake, suite 200 troy, michigan 48098

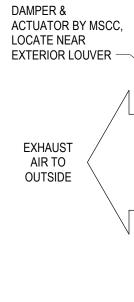

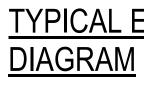

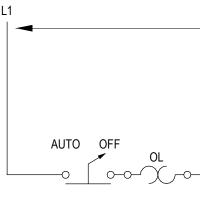

DETAIL

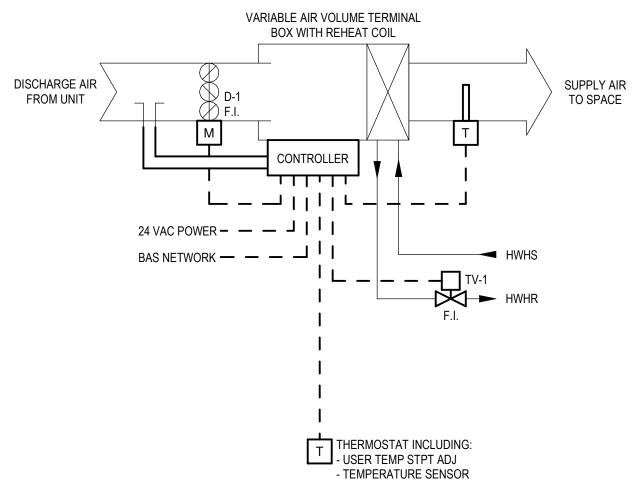

VAV TERMINAL BOX WITH REHEAT COIL **CONTROL DIAGRAM**


SEQUENCE OF OPERATION

- GENERAL 1. THE OPERATING MODE OF THE TERMINAL BOX SHALL BE AUTOMATICALLY CYCLED BETWEEN OCCUPIED AND UNOCCUPIED MODE BASED ON THE ASSOCIATED CENTRAL UNIT OCCUPANCY
- SCHEDULE. 2. REHEAT COIL CONTROL SHALL BE LIMITED SUCH THAT THE REHEAT COIL LEAVING AIR TEMPERATURE DOES NOT EXCEED 20°F GREATER THAN THE SPACE TEMPERATURE SETPOINT.

OCCUPIED MODE OPERATION

- 1. THE UNIT SHALL CONTROL HEATING AND COOLING TO MAINTAIN THE SPACE TEMPERATURE WITHIN +/- 1°F OF THE USER SET TEMPERATURE SETPOINT. 2. UPON NO DEMAND FOR HEATING OR COOLING, THE DAMPER SHALL CONTROL AIRFLOW TO
- THE MINIMUM AIRFLOW CFM SETPOINT. 3. UPON A DEMAND FOR COOLING, THE DAMPER SHALL CONTROL TOWARDS THE MAXIMUM
- COOLING AIRFLOW CFM SETPOINT. 4. UPON A DEMAND FOR HEATING, FIRST THE REHEAT CONTROL VALVE SHALL INCREASE HEATING TOWARDS MAXIMUM. UPON A FURTHER DEMAND FOR HEATING, THE DAMPER SHALL CONTROL AIRFLOW TOWARDS THE MAXIMUM HEATING AIRFLOW CFM SETPOINT.

UNOCCUPIED MODE OPERATION 1. THE REHEAT COIL CONTROL VALVE SHALL CLOSE.

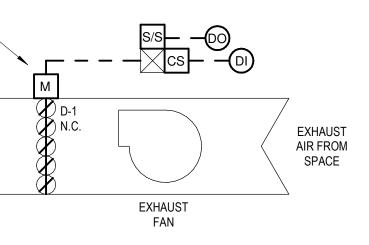


TYPICAL EXHAUST FAN CONTROL

NOTES 1. DIAGRAM IS APPLICABLE TO EXHAUST FAN EF-1, 7, 8, AND 9.

SEQUENCE OF OPERATION 1. THE EF SHALL BE SET TO ACTIVATE AND DEACTIVATE ACCORDING TO THE SET OPERATION TIME SCHEDULE FOR OCCUPIED AND UNOCCUPIED TIME PERIODS.

208 VAC POWER

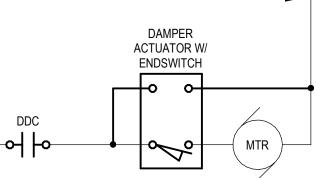


TYPICAL EXHAUST FAN WIRING


HWH VALVE BY MSCC MTR STR ∽- -
 Image: state of the state o FAN INTEGRAL T-STAT BY MFR

TYPICAL CABINET UNIT HEATER CONTROL DIAGRAM

- SEQUENCE OF OPERATION 1. THE CABINET UNIT HEATER FAN AND VALVE SHALL CYCLE TO MAINTAIN THE INTEGRAL THERMOSTAT TEMPERATURE SETPOINT.
- APPLICABLE TO UNITS LOCATED IN BUILDING VESTIBULES OR NEAR EXTERIOR DOORS, WHEN THE OUTSIDE AIR TEMPERATURE IS GREATER THAN 45°F (ADJ), THE BAS SHALL DISABLE THE UNIT.

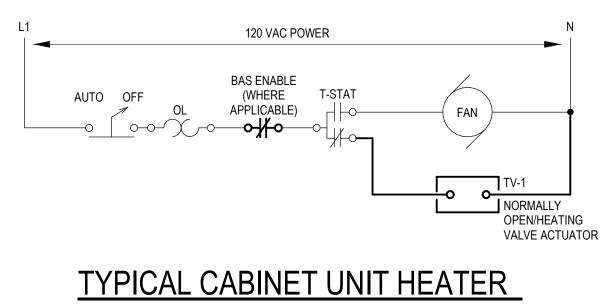

WIRING DETAIL

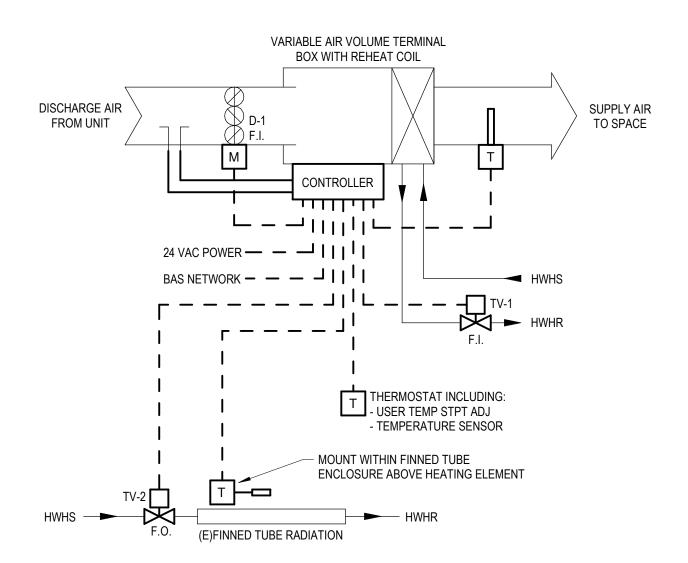

VAV TERMINAL BOX WITH REHEAT COIL & FINNED TUBE RADIATION CONTROL DIAGRAM


SEQUENCE OF OPERATION

GENERAL 1. THE OPERATING MODE OF THE TERMINAL BOX SHALL BE AUTOMATICALLY CYCLED BETWEEN OCCUPIED AND UNOCCUPIED MODE BASED ON THE ASSOCIATED CENTRAL UNIT OCCUPANCY

- SCHEDULE. 2. REHEAT COIL CONTROL SHALL BE LIMITED SUCH THAT THE REHEAT COIL LEAVING AIR TEMPERATURE DOES NOT EXCEED 20°F GREATER THAN THE SPACE TEMPERATURE SETPOINT. 3. THE FINNED TUBE RADIATION CONTROL VALVE SHALL BE REMAIN CLOSED WHEN THE OUTSIDE AIR TEMPERATURE IS GREATER THAN 65°F.
- OCCUPIED MODE OPERATION 1. THE UNIT SHALL CONTROL HEATING AND COOLING TO MAINTAIN THE SPACE TEMPERATURE
- WITHIN +/- 1°F OF THE USER SET TEMPERATURE SETPOINT. 2. UPON NO DEMAND FOR HEATING OR COOLING, THE DAMPER SHALL CONTROL AIRFLOW TO
- THE MINIMUM AIRFLOW CFM SETPOINT. UPON A DEMAND FOR COOLING, THE DAMPER SHALL CONTROL TOWARDS THE MAXIMUM
- COOLING AIRFLOW CFM SETPOINT.UPON A DEMAND FOR HEATING, FIRST THE REHEAT CONTROL VALVE AND FINNED TUBE RADIATION CONTROL VALVE SHALL INCREASE HEATING TOGETHER TOWARDS MAXIMUM. UPON A FURTHER DEMAND FOR HEATING, THE DAMPER SHALL CONTROL AIRFLOW TOWARDS THE MAXIMUM HEATING AIRFLOW CFM SETPOINT.

UNOCCUPIED MODE OPERATION 1. THE REHEAT COIL CONTROL VALVE SHALL CLOSE.

2. THE FINNED TUBE RADATION CONTROL VALVE SHALL CONTROL TO MAINTAIN THE UNOCCUPIED HEATING TEMPERATURE SETPOINT (60°F),

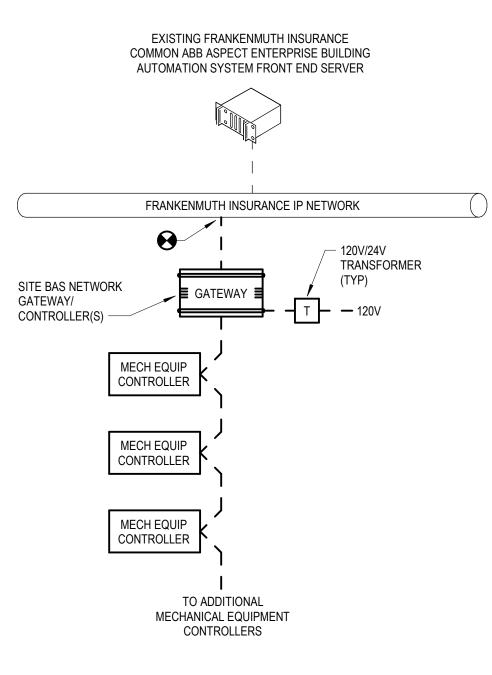

BUILDING AUTOMATION SYSTEM NETWORK RISER DIAGRAM

- NOTES
 1. THE MECHANICAL SYSTEMS CONTROLS CONTRACTOR (MSCC) SHALL PROVIDE A NEW BUILDING AUTOMATION SYSTEM (BAS) CONTROLLER/GATEWAY DEVICE OR DEVICES, POWER SUPPLIES, AND NEMA 1 ENCLOSURES AS NECESSARY TO INTEGRATE ALL IDENTIFIED FIELD DEVICES AND DEVICE NETWORKS TO THE EXISTING COMMON FRANKENMUTH INSURANCE BAS FRONT END SERVER. 2. MSCC SHALL PROVIDE ETHERNET IP DATA CONNECTION(S) AS NECESSARY AND
- SHALL LOCATE DEVICE(S) IN COORDINATION WITH OWNER.



D Project Number



Drawing Number

IDS Drawing Title Mechanical Systems Controls

 \odot 2021 Integrated ${
m d}$ n solutions, llo

	Pro	oject Administrator
		C. Azar
		Project Designer
		C. Murphy
	Project A	rchitect / Engineer
		B. Partak
		Drawn By
		C. Murphy
		Q.M. Review
		M. Perez
		Approved
		J. Schwartz
		Drawing Scale
		As Noted
	Issued for	Issue Date
Quality	Management Review	04-21-2021
	Bids	07-15-2021
	Didd	
-		

1 Mutual Avenue Frankenmuth, MI 48787 Key Plan

Executive Suite Renovation





troy, michigan 48098 5211 cascade road SE, suite 300 grand rapids, michigan 49546 248.823.2100 www.ids-michigan.com

INTEGRATED design solutions architecture engineering interiors & technology

1441 west long lake, suite 200



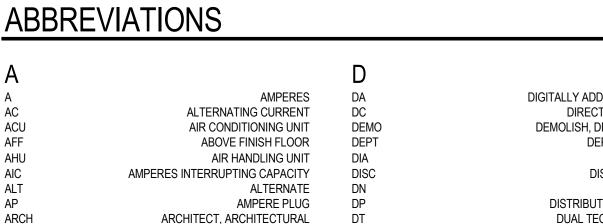

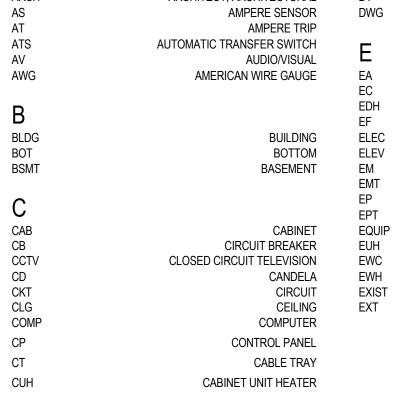


DETAIL SYMBOL


E9.1

4

o≪1

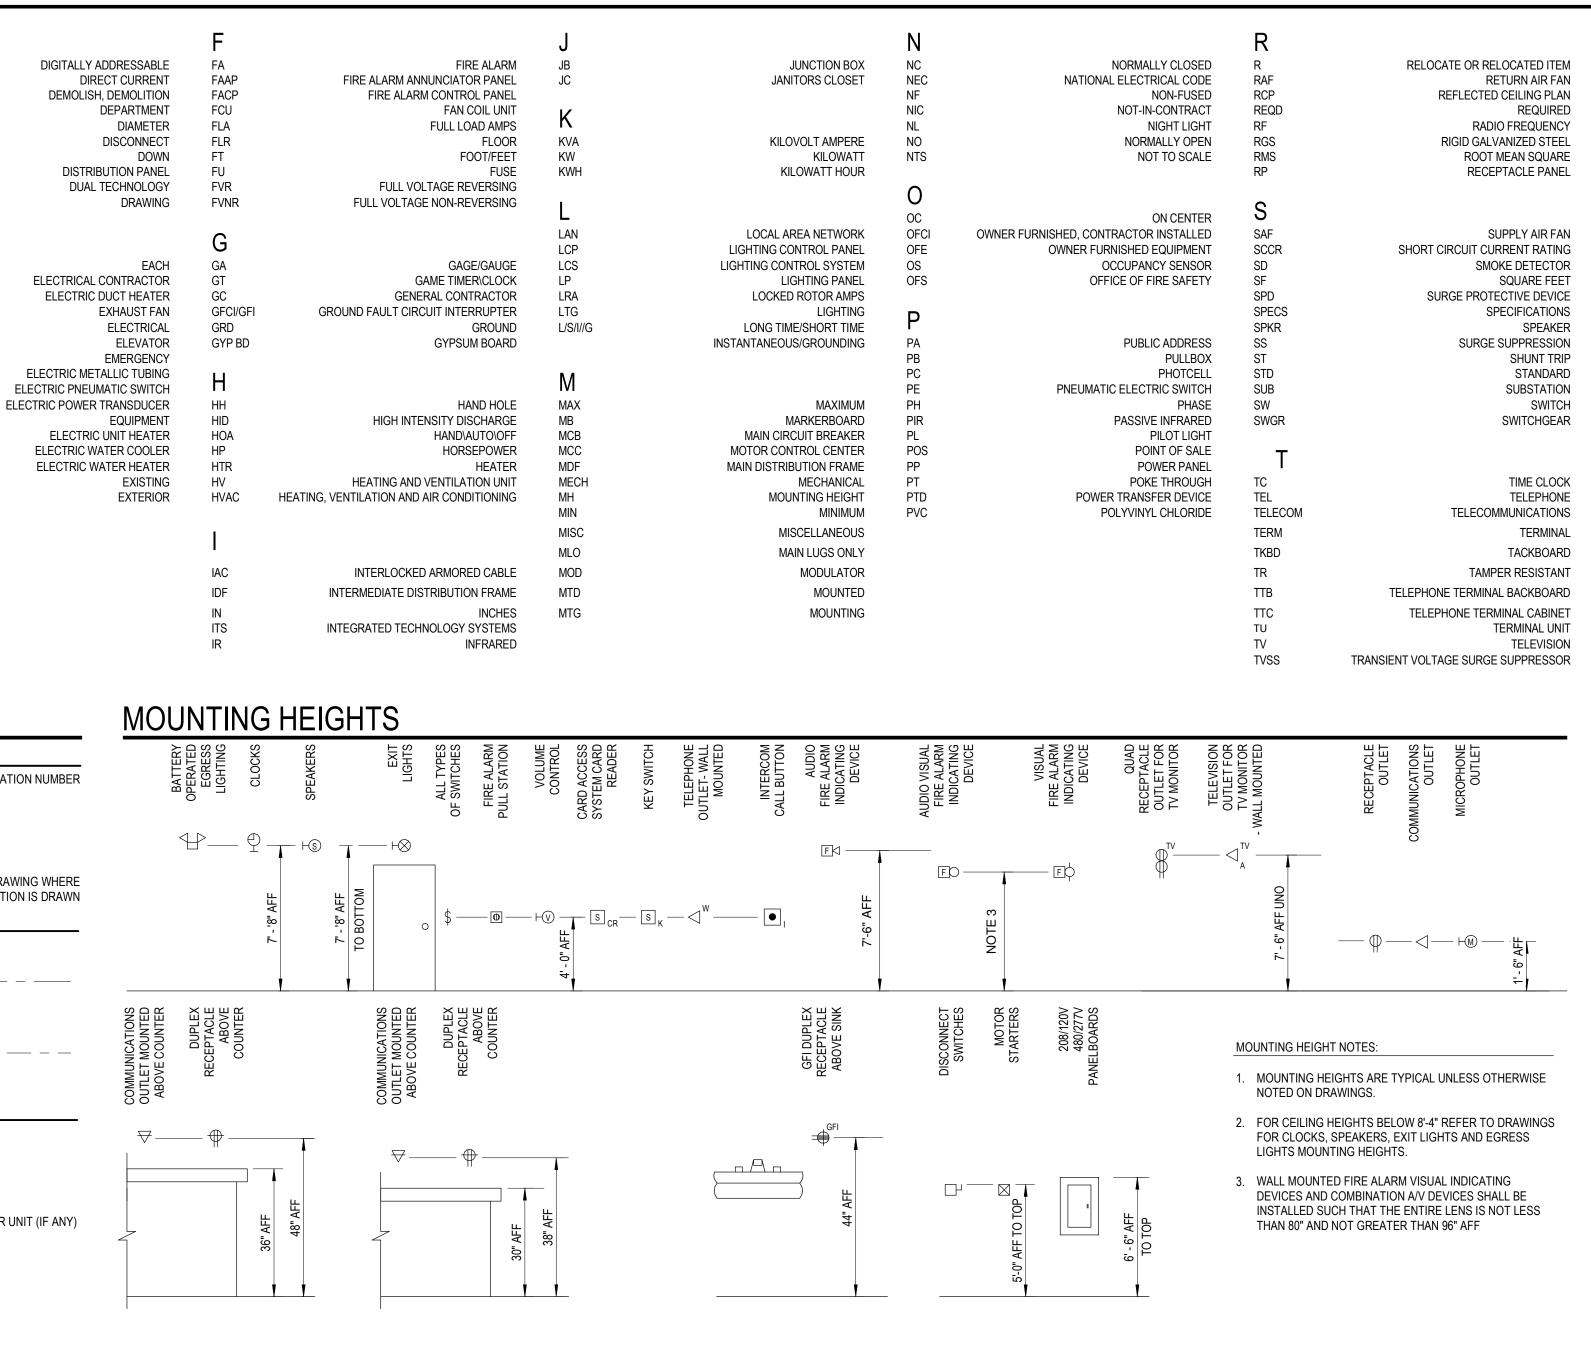

GROUND FAULT CIRCUIT INTERRUPTER PROTECTION DEVICE

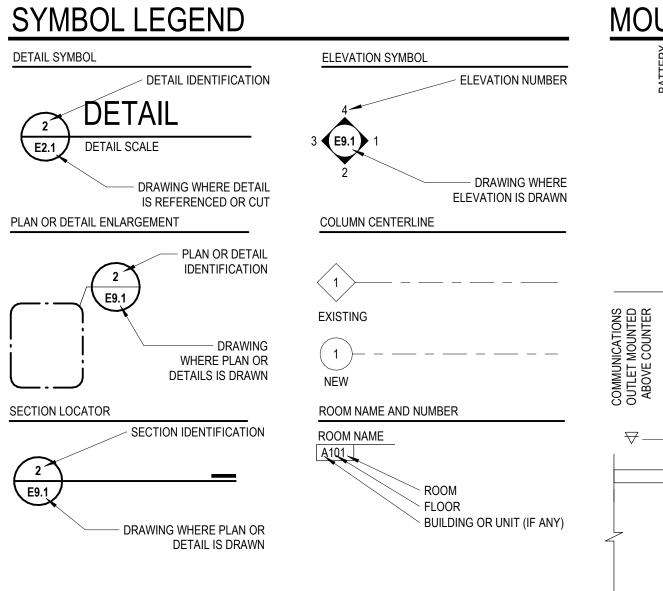

SYMBO				
	LIGHTING			▲ X
	LIGHTING FIXTURE; RECESSED OR SURFACE MOUNTED	\$	LINE VOLTAGE SINGLE POLE SWITCH	₽ ×
XX	LIGHTING FIXTURE; RECESSED OR SURFACE MOUNTED	\$ 2	LINE VOLTAGE DOUBLE POLE SWITCH	
	ON NIGHT LIGHT OR EMERGENCY CIRCUIT	\$ 3	LINE VOLTAGE THREE WAY SWITCH	G FI X
• • **	LIGHTING FIXTURE; PENDANT MOUNTED	\$ 4	LINE VOLTAGE FOUR WAY SWITCH	
XX	LIGHTING FIXTURE; PENDANT MOUNTED ON NIGHT	\$ κ	LINE VOLTAGE KEY OPERATED SWITCH	
NL	LIGHT OR EMERGENCY CIRCUIT	\$ _D	LINE VOLTAGE 'WALL BOX' DIMMER SWITCH	S S
	STRIP LIGHTING FIXTURE	\$ ∟	LINE VOLTAGE LIGHTING OCCUPANCY SENSOR WITH INTEGRAL ON/OFF SWITCH - WALL MOUNTED	€ss
XX NL	STRIP LIGHTING FIXTURE ON NIGHT LIGHT OR EMERGENCY CIRCUIT	\$ LD	LINE VOLTAGE LIGHTING OCCUPANCY SENSOR WITH INTEGRAL DIMMING - WALL MOUNTED	
or 🏠 XX	LIGHTING FIXTURE; RECESSED AIMABLE OR WALL WASH	\$L2	LINE VOLTAGE LIGHTING OCCUPANCY SENSOR WITH INTEGRAL DUAL ZONE ON/OFF SWITCH - WALL MOUNTED	- 🗢 IG - 😂
or \square^{XX}	LIGHTING FIXTURE; RECESSED OR PENDANT MTD	\$ ₽	LINE VOLTAGE SWITCH WITH PILOT LIGHT	
or \square_{XX}^{NL}	LIGHTING FIXTURE; RECESSED OR PENDANT MTD	\$ _T	LINE VOLTAGE SWITCH WITH TIMER	
×××	ON NIGHT LIGHT OR EMERGENCY CIRCUIT LIGHTING FIXTURE; SURFACE MOUNTED	\$ a \$ b	LINE VOLTAGE SINGLE POLE SWITCHES FOR DUAL LEVEL LIGHTING CONTROL	ss ss -Ø _x
×××	LIGHTING FIXTURE; SURFACE MOUNTED ON NIGHT LIGHT OR EMERGENCY CIRCUIT	\$ ^{3a} \$ ^{3b}	LINE VOLTAGE THREE WAY SWITCHES FOR DUAL LEVEL LIGHTING CONTROL	
$\overline{\nabla}$ $\overline{\nabla}$ $\overline{\nabla}$		\$ _{LVX}	LOW VOLTAGE PUSH BUTTON STATION	
	TRACK LIGHTING	D _x	CEILING MTD OCCUPANCY SENSOR	U
or 🖵	LIGHTING FIXTURE; WALL MOUNTED	юx	WALL MTD LIGHTING OCCUPANCY SENSOR	\mathbf{O}_{PT}^{X}
	LIGHTING FIXTURE; WALL MOUNTED			
OR P ^{XX} _{NL}	ON NIGHT LIGHT OR EMERGENCY CIRCUIT		WALL MTD LINE VOLTAGE LIGHTING OCCUPANCY SENSOR	0
	LIGHTING FIXTURE; UNDERCABINET MOUNTED	LC	LIGHTING CONTACTOR	
	LIGHTING FIXTURE; COVE MOUNTED	TS	TIME SWITCH	• E
	EXIT LIGHTING FIXTURE SINGLE OR DOUBLE FACE WITH			00000
×.	DIRECTIONAL ARROWS - CEILING OR PENDANT MOUNTED	-	PHOTOELECTRIC SWITCH\PHOTOCELL - CEILING MOUNTED	
H⊗	WALL MOUNTED EXIT LIGHTING FIXTURE WITH DIRECTIONAL ARROWS	Ю	PHOTOELECTRIC SWITCH/PHOTOCELL - WALL MOUNTED	
	CEILING MOUNTED SELF-CONTAINED EMERGENCY	PTD	EMERGENCY POWER TRANSFER DEVICE	XXXXXXXXXXXXXXXXXXXXXXXXXXXXXXXXXXXXXXX
	LIGHTING UNIT WALL MOUNTED SELF-CONTAINED EMERGENCY LIGHTING UNIT	• _{TS-}		
	POLE MOUNTED AREA LIGHTING FIXTURE; QUANTITY	~	POWER	
	OF LUMINARIES AS INDICATED	- Ф _х	SINGLE RECEPTACLE OUTLET	X
¤	SITE LIGHTING; BOLLARD	-9 _x	DUPLEX RECEPTACLE OUTLET	×Q.
¥	POST TOP POLE MOUNTED AREA LIGHTING FIXTURE	æ	DUPLEX RECEPTACLE OUTLET FLUSH MOUNTED IN CEILING	
${\clubsuit}$	SITE LIGHTING FIXTURE; ADJUSTABLE FLOOD	æ ×	FLUSH MOUNTED POWER ONLY FLOOR BOX	X ² _{30/30A}
-				

scutive Suite Renovation-E20.rvt
FI Exe
s/20120
orate Office
Corp
BIM 360://Frankenmuth Insurance (
7/14/2021 6:18:20 PM

DUPLEX RECEPTACLE OUTLET MOUNTED		NON-FUSED DISCONNECT SWITCH	Þ۹	CEILING MOUNTED HORN SPEAKER	N _{DS}	NURSE CALL DUTY STATION	
ABOVE COUNTER		-SWITCH SIZE	S _{CR}	SECURITY SYSTEM CARD READER	N _E	NURSE CALL EMERGENCY STATION	
DUPLEX RECEPTACLE OUTLET WITH INTEGRAL GROUND FAULT CIRCUIT INTERRUPTER PROTECTION	Z4 _{30/3}	FUSED DISCONNECT SWITCH -SWITCH SIZE/FUSE SIZE	SC	SECURITY SYSTEM DOOR CONTACT	N _{MS}	NURSE CALL MASTER STATION	-
UPLEX RECEPTACLE OUTLET CONNECTED TO UPSTREAM	CB 30A		S _{ES}	SECURITY SYSTEM ELECTRIC STRIKE	N _{PS}	NURSE CALL POWER SUPPLY	
OUND FAULT CIRCUIT INTERRUPTER PROTECTION DEVICE	CB - JUA	-CB RATING	sĸ	SECURITY SYSTEM KEY SWITCH	N _{SS}	NURSE CALL STAFF STATION	
DUPLEX RECEPTACLE OUTLET WITH INTEGRAL SURGE SUPPRESSION	VFC	VARIABLE FREQUENCY CONTROLLER	s _{MD}	SECURITY SYSTEM MOTION DETECTOR	H>	NURSE CALL WALL MOUNTED DOME LIGHT	o
DUPLEX RECEPTACLE OUTLET CONNECTED TO		MAGNETIC CONTACTOR	©	CEILING MOUNTED SECURITY CAMERA	₽c	NURSE CALL CEILING MOUNTED DOME LIGHT	•
UPSTREAM SURGE SUPPRESSION DEVICE DUPLEX RECEPTACLE OUTLET SPLIT WIRED	\$ _M	MANUAL MOTOR STARTER	Ю	WALL MOUNTED SECURITY CAMERA	₽	NURSE CALL WALL MOUNTED DOME LIGHT WITH CODE BLUE	X
DUPLEX RECEPTACLE OUTLET WITH ISOLATED GROUND	\$ _H	HORSEPOWER RATED SWITCH	F	FIRE ALARM PULL STATION	↓ c	NURSE CALL CEILING MOUNTED DOME LIGHT WITH CODE BLUE	
QUAD RECEPTACLE OUTLET		PACKAGED EQUIPMENT WITH INTEGRALLY	ED	WALL MOUNTED A/V FIRE ALARM INDICATING DEVICE	$\mathbf{A}_{\mathbf{x}}$	WALL MOUNTED COMMUNICATIONS OUTLET	
QUAD RECEPTACLE OUTLET MOUNTED ABOVE COUNTER		MOUNTED PREWIRED CONTROL PANEL	© _{AV}	CEILING MOUNTED A/V FIRE ALARM INDICATING DEVICE	⋪ҳ	ABOVE COUNTER COMMUNICATIONS OUTLET	— P —
QUAD RECEPTACLE OUTLET WITH ONE (1) INTEGRAL	*	FURNISHED AS INTEGRAL PART OF EQUIPMENT, OR AS INDICATED	E¢-	WALL MOUNTED VISUAL FIRE ALARM INDICATING DEVICE		CEILING MOUNTED COMMUNICATIONS OUTLET	—HP— I
SURGE SUPPRESSION TYPE RECEPTACLE AND ONE (1)	Т	TRANSFORMER	\mathbf{E}_{v}	CEILING MOUNTED VISUAL FIRE ALARM INDICATING DEVICE	$\mathbf{\nabla}_{\mathbf{x}}$	COMMUNICATIONS FLOORBOX	—c—
SURGE SUPPRESSION PROTECTED RECEPTACLE SPECIAL RECEPTACLE AS INDICATED	۲	GROUND ROD	₽J	WALL MOUNTED AUDIO FIRE ALARM INDICATING DEVICE	$\Phi \Delta$	MULTI-SYSTEM FLOORBOX	—HC—
POWER/COMMUNICATIONS POLE	×	LIGHTNING PROTECTION AIR TERMINAL	© _A	CEILING MOUNTED AUDIO FIRE ALARM INDICATING DEVICE		INTERCOM CALL BUTTON	
SPECIAL POWER CONNECTION	⊢G ⊣	GROUND BUS BAR AS INDICATED	∎¢-	WALL MOUNTED VISUAL EMERGENCY MASS NOTIFICATION	• IP	INTERCOM CALL BUTTON WITH PRIVACY	
CORD DROP			ĒY			ONE-LINE	НН х
		AUXILIARY SYSTEMS	\mathbf{E}_{v}	CEILING MOUNTED VISUAL EMERGENCY MASS NOTIFICATION INDICATING DEVICE		ANALOG AMPERE\VOLT METER	
POKE THROUGH ASSEMBLY LETTERS INDICATE TYPE (TYP)	Θ	CEILING MOUNTED SINGLE FACED CLOCK	F _{sd}	WALL MOUNTED AREA SMOKE DETECTOR	M	ANALOG ENERGY USAGE METER	<u> </u>
JUNCTION BOX - CEILING MOUNTED	œ	CEILING MOUNTED DOUBLE FACED CLOCK	© _{SD}	CEILING MOUNTED AREA SMOKE DETECTOR	MM	DIGITAL MULTI-FUNCTION METER	F0
JUNCTION BOX - WALL MOUNTED	Ð	WALL MOUNTED SINGLE FACED CLOCK		CEILING MOUNTED COMBINATION AREA SMOKE\CO DETECTOR	К	KIRK KEY INTERLOCK	
PUSHBUTTON STATION - EMERGENCY	ഇ	WALL MOUNTED DOUBLE FACED CLOCK	CD CD	CEILING MOUNTED TEMPERATURE DETECTOR	$\hat{}$	CIRCUIT BREAKER	— L —
POWER SHUTDOWN	ଙ୍କ	COMBINATION WALL MOUNTED SPEAKER/CLOCK	E DD	DUCT SMOKE DETECTOR	00	SWITCH	СВ
HORIZONTALLY MOUNTED MULTI-OUTLET RACEWAY	C S CI	EILING MOUNTED COMBINATION SPEAKER/CLOCK				FUSE	Ŭ
VERTICALLY MOUNTED MULTI-OUTLET RACEWAY	DIG	WALL MOUNTED DIGITAL CLOCK		WATER FLOW SWITCH	<u> </u>	TRANSFORMER	
BUS DUCT	S	CEILING MOUNTED SPEAKER	E _{ts}		7	TRANSFER SWITCH	
EQUIPMENT MOUNTING BACKBOARD	D©d	CEILING MOUNTED SPEAKER CLUSTER	⊡ _{TS}	FIRE FIGHTER TELEPHONE JACK	ᠳᡗᡂ	THERMAL OVERLOAD	
208/120V PANELBOARD	ю	WALL MOUNTED SPEAKER	FACP	FIRE ALARM CONTROL PANEL	+	CONTACTS	
480/277V PANELBOARD	\blacksquare	CEILING MOUNTED MICROPHONE OUTLET	FSCP	FIRE SUPPRESSION SYSTEM CONTROL PANEL	XXXNG	INDICATES WIRE SIZE AND CONDUIT SIZE	
DISTRIBUTION OR POWER PANELBOARD	Ю	WALL MOUNTED MICROPHONE OUTLET	FAAP	FIRE ALARM REMOTE ANNUNCIATOR PANEL	৻৻৽৽৽৽	DRAWOUT CIRCUIT BREAKER	
SINGLE PHASE MOTOR	Ю	WALL MOUNTED AUXILIARY OUTLET		SINGLE BED STATION - NURSE CALL	< ← <u>52</u> →>	AIR-MAG / VACUUM CIRCUIT BREAKER	
THREE PHASE MOTOR	Ю	WALL MOUNTED VOLUME CONTROL		DOUBLE BED STATION - NURSE CALL	@ _@		
MAGNETIC MOTOR STARTER	BO	WALL MOUNTED BELL	N _{BB}				
COMBINATION MAGNETIC MOTOR STARTER & FUSED		WALL MOUNTED CHIME	BB N _{BC}	BATHROOM STATION PULL CORD - NURSE CALL	Ŧ	SYSTEM OR EQUIPMENT GROUND	
DISCONNECT SWITCH - SWITCH SIZE / FUSE SIZE	H۵	WALL MOUNTED HORN SPEAKER	BC CB	CODE BLUE PUSHBUTTON - NURSE CALL			
			00				

ELECTRICAL DRAWING INDEX

ER.0 Electrical Reference Information E0.01 Basement Composite Plan E0.1 First Floor Composite Plan E1.1 Partial Technology and Electrical Demolition Plans E2.1 Partial First Floor Lighting Plan E3.1 Partial First Floor Power & Auxiliary Systems Plan E6.1 Panel Schedules & Partial One-Line Diagram Details

E7.1 E8.1 Lighting Fixture Schedule & Lighting Controls Risers

PROJECT GENERAL NOTES

- 1. ALL ITEMS SHOWN AS HATCHED SHALL BE DISCONNECTED AND REMOVED. LIGHT LINE WEIGHT INDICATES EXISTING EQUIPMENT TO REMAIN. HEAVY LINE WEIGHT INDICATED NEWS WORK.
- 2. ITEMS DENOTED BY THE LETTER "R" INDICATE EXISTING EQUIPMENT TO BE RELOCATED. THESE ITEMS SHALL BE DISCONNECTED, REMOVED AND STORED FOR REINSTALLATION IN NEW LOCATIONS AS INDICATED ON NEW WORK PLANS.
- 3. WHERE APPLICABLE AND NOT SPECIFICALLY INDICATED OTHERWISE, EXISTING IN PLACE CONDUITS, JUNCTION BOXES, PULL BOXES AND HANGERS MAY BE REUSED FOR NEW WORK PROVIDING THAT THE INSTALLATION IS IN ACCORDANCE WITH THE PROJECT SPECIFICATIONS.
- 4. WHERE CONDUITS ARE ROUTED CONCEALED IN WALL CAVITIES FOR ELECTRICAL EQUIPMENT INDICATED TO BE REMOVED, ABANDON THE CONDUIT CONCEALED IN THE WALL CAVITY, REMOVE THE CONDUIT EXITING THE WALL CAVITY INTO THE CEILING SPACE BEYOND THE FIRST FITTING OR JUNCTION BOX. REMOVE ALL SURFACE MOUNTED OUTLET BOXES ASSOCIATED WITH THE CONDUIT SYSTEM. ABANDON ALL FLUSH MOUNTED OUTLET BOXES ASSOCIATED WITH THE CONDUIT SYSTEM IN PLACE AND PROVIDE NEW BLANK COVER PLATES.
- 5. DISCONNECT AND REMOVE ALL ELECTRICAL EQUIPMENT AS INDICATED INCLUDING HANGERS. PULL BOXES. JUNCTION BOXES, CONDUIT AND WIRING FROM THE POWER SOURCE TO THE UTILIZATION EQUIPMENT.
- 6. WHERE REMOVAL OF CONDUIT AND WIRING AFFECTS THE OPERATION OF "UPSTREAM" AND/OR "DOWNSTREAM" UTILIZATION EQUIPMENT WHICH WAS NOT INDICATED TO BE REMOVED. PROVIDE ADDITIONAL CONDUIT AND WIRING TO RESTORE THE "UPSTREAM" AND "DOWNSTREAM" UTILIZATION EQUIPMENT TO ITS NORMAL OPERATION.
- 7. FURNISH ALL LABOR, MATERIALS, EQUIPMENT, AND SUPERVISION REQUIRED TO COMPLETE ALL DEMOLITION OF EXISTING ELECTRICAL EQUIPMENT AS SPECIFIED OR INDICATED. DISCONNECT, REMOVE AND RELOCATE ALL ITEMS AS REQUIRED TO FACILITATE THE NEW CONSTRUCTION. COORDINATE THE DEMOLITION REQUIREMENTS WITH ALL OTHER TRADES AND THE NEW WORK PLANS.
- 8. CONNECT EXIT LIGHTING TO THE SAME LIGHTING BRANCH CIRCUIT SERVING THE NORMAL LIGHTING IN THE AREA AHEAD OF ANY LOCAL SWITCHING DEVICES.
- 9. ALL 120 VOLT, 20 AMPERE BRANCH CIRCUITS EXCEEDING 100'-0" IN LENGTH SHALL BE INSTALLED USING #10 AWG CONDUCTORS.
- 10. NEW FIRE ALARM DEVICES SHALL BE COMPATABLE WITH EXISTING FIRE ALARM SYSTEM. EXISTING FIRE ALARM SYSTEM IS MANUFACTURED BY SIMPLEX. COORDINATE ALL SYSTEMS REQUIREMENTS WITH MANUFACTURER. FOR ALL FIRE ALARM WORK CONTACT: MIKE PLUMER
- HEALEY FIRE PROTECTION 248-373-7800 FOR ALL FIRE ALARM ASSOCIATED WORK. PROVIDE ALL NECESSARY COMPONENTS (EXPANSION CARDS, CONTROL PANELS, WIRING, ETC) AS REQUIRED TO COMPLETE WORK AS INDICATED.
- 11. ALL NEW LIGHTING SWITCH LEGS SERVING 0-10V DIMMABLE LIGHT FIXTURES SHALL CONSIST OF 2#12 AWG,1#12 AWG GRD. (LINE VOLTAGE) AND MIN 2#18 AWG, VIOLET AND GREY (0-10 VOLT CONTROL WIRING) WITH 600 VOLT INSTALLATION WITHIN THE SAME RACEWAY FROM DIMMER SWITCH TO NEW LED LIGHTING FIXTURES.
- 12. ALL ELECTRICAL CONDUITS ASSOCIATED WITH OUTDOOR MECHANICAL EQUIPMENT SHALL BE ROUTED WITH THE ASSOCIATED EQUIPMENT PIPING, MOUNTED ON COMMON SUPPORTS, ON GRADE, VERTICALLY ON WALLS AND ON ROOF.
- 13. EXISTING PANEL CIRCUITING; A. THE CIRCUIT NUMBERS INDICATED ON THE PLANS ARE SHOWN FOR DESIGN INTENT ONLY. ACTUAL CIRCUITS SHALL BE VERIFIED, COMBINED IF NECESSARY AND TESTED FOR ADEQUATE CAPACITY PRIOR TO CONNECTION OF ELECTRICAL DEVICES.
- B. 120 VOLT, 20A-1P BRANCH CIRCUITS SHALL NOT BE LOADED IN EXCESS OF 1500VA.
- 14. ALL WORK AND EQUIPMENT SHALL CONFORM TO THE NEC. THE MEANS AND METHODS USED BY THIS CONTRACTOR SHALL CONFORM TO NEC SECTION 110.3 (A, B & C).
- 15. FIRE ALARM SHOP DRAWINGS SHALL BE SUBMITTED TO THE FIRE MARSHAL FOR APPROVAL PRIOR TO SUBMITTING FOR ENGINEER APPROVAL.
- 16. CONTACT MCMI FOR ALL ACCESS CONTROLS WORK; A. JOE TOCCO; 586-726-7500

UNIT HEATER UNDERWRITERS LABORATORIES, INC. UNLESS OTHERWISE NOTED UNINTERRUPTIBLE POWER SUPPLY UNIVERSAL SERIAL BUS ULTRAVIOLET

UH

UON

UPS

USB

UV

WAN

WAP

WG

WP

XΡ

MISC

VARIABLE FREQUENCY CONTROLLER VERIFY IN FIELD VAPOR PROOF

> WIDE AREA NETWORK WIRELESS ACCESS POINT WIRE GUARD WEATHER PROOF

> > EXPLOSION PROOF

NEMA 3R NEMA 4X BY DEGREES DIAMETER FOOT, FEET

INCH, INCHES

EXOTHERMIC WELD OR BRAZED CONNECTION CONDUIT IN OR BELOW FLOOR SLAB OR BELOW GRADE

MISC

RACEWAY TURNED UP RACEWAY TURNED DOWN SEAL-OFF - CONDUIT SEAL CABLE TRAY

UNDERFLOOR DUCT - POWER — P — -HP- UNDERFLOOR HEADER DUCT - POWER UNDERFLOOR DUCT - COMM —c— -HC- UNDERFLOOR HEADER DUCT - COMM

SITE

FLUSH IN-GRADE HAND HOLE UNDERGROUND ELECTRICAL UNDERGROUND FIBER OPTIC COMMUNICATIONS UNDERGROUND LIGHTING

CB EMERGENCY "CODE BLUE" BOLLARD

REFER TO SHEET E8.2 FOR ADDITIONAL SYMBOLS.



īD^s Project Number

Drawing Number **ER.0**

Electrical Reference Information

© 2021 INTEGRATED C **n** solutions, LL DS Drawing Title

	C. Azaı
	Project Designer
	N. Furgasor
Proje	ct Architect / Engineer
	N. Furgasor
	Drawn By
	N. Furgasor
	Q.M. Review
	T. Carror
	Approved
	T. Carror
	Drawing Scale
	As Noted
Issued for	Issue Date
Design Developmer	nt 02-26-2021
Quality Management Review	
Bid	
	<u> </u>

THIS PROJECT MAY NOT UTILIZE ALL THE SYMBOLS, MATERIALS, ABBREVIATIONS AND STANDARDS INFORMATION SHOWN ON THIS SHEET

I N S U R A N C E **Executive Suite Renovation**

1 Mutual Avenue

Key Plan


Project Administrator

Frankenmuth, MI 48787



INTEGRATED design SOLUTIONS architecture engineering interiors & technology 1441 west long lake, suite 200 troy, michigan 48098 5211 cascade road SE, suite 300 grand rapids, michigan 49546 248.823.2100



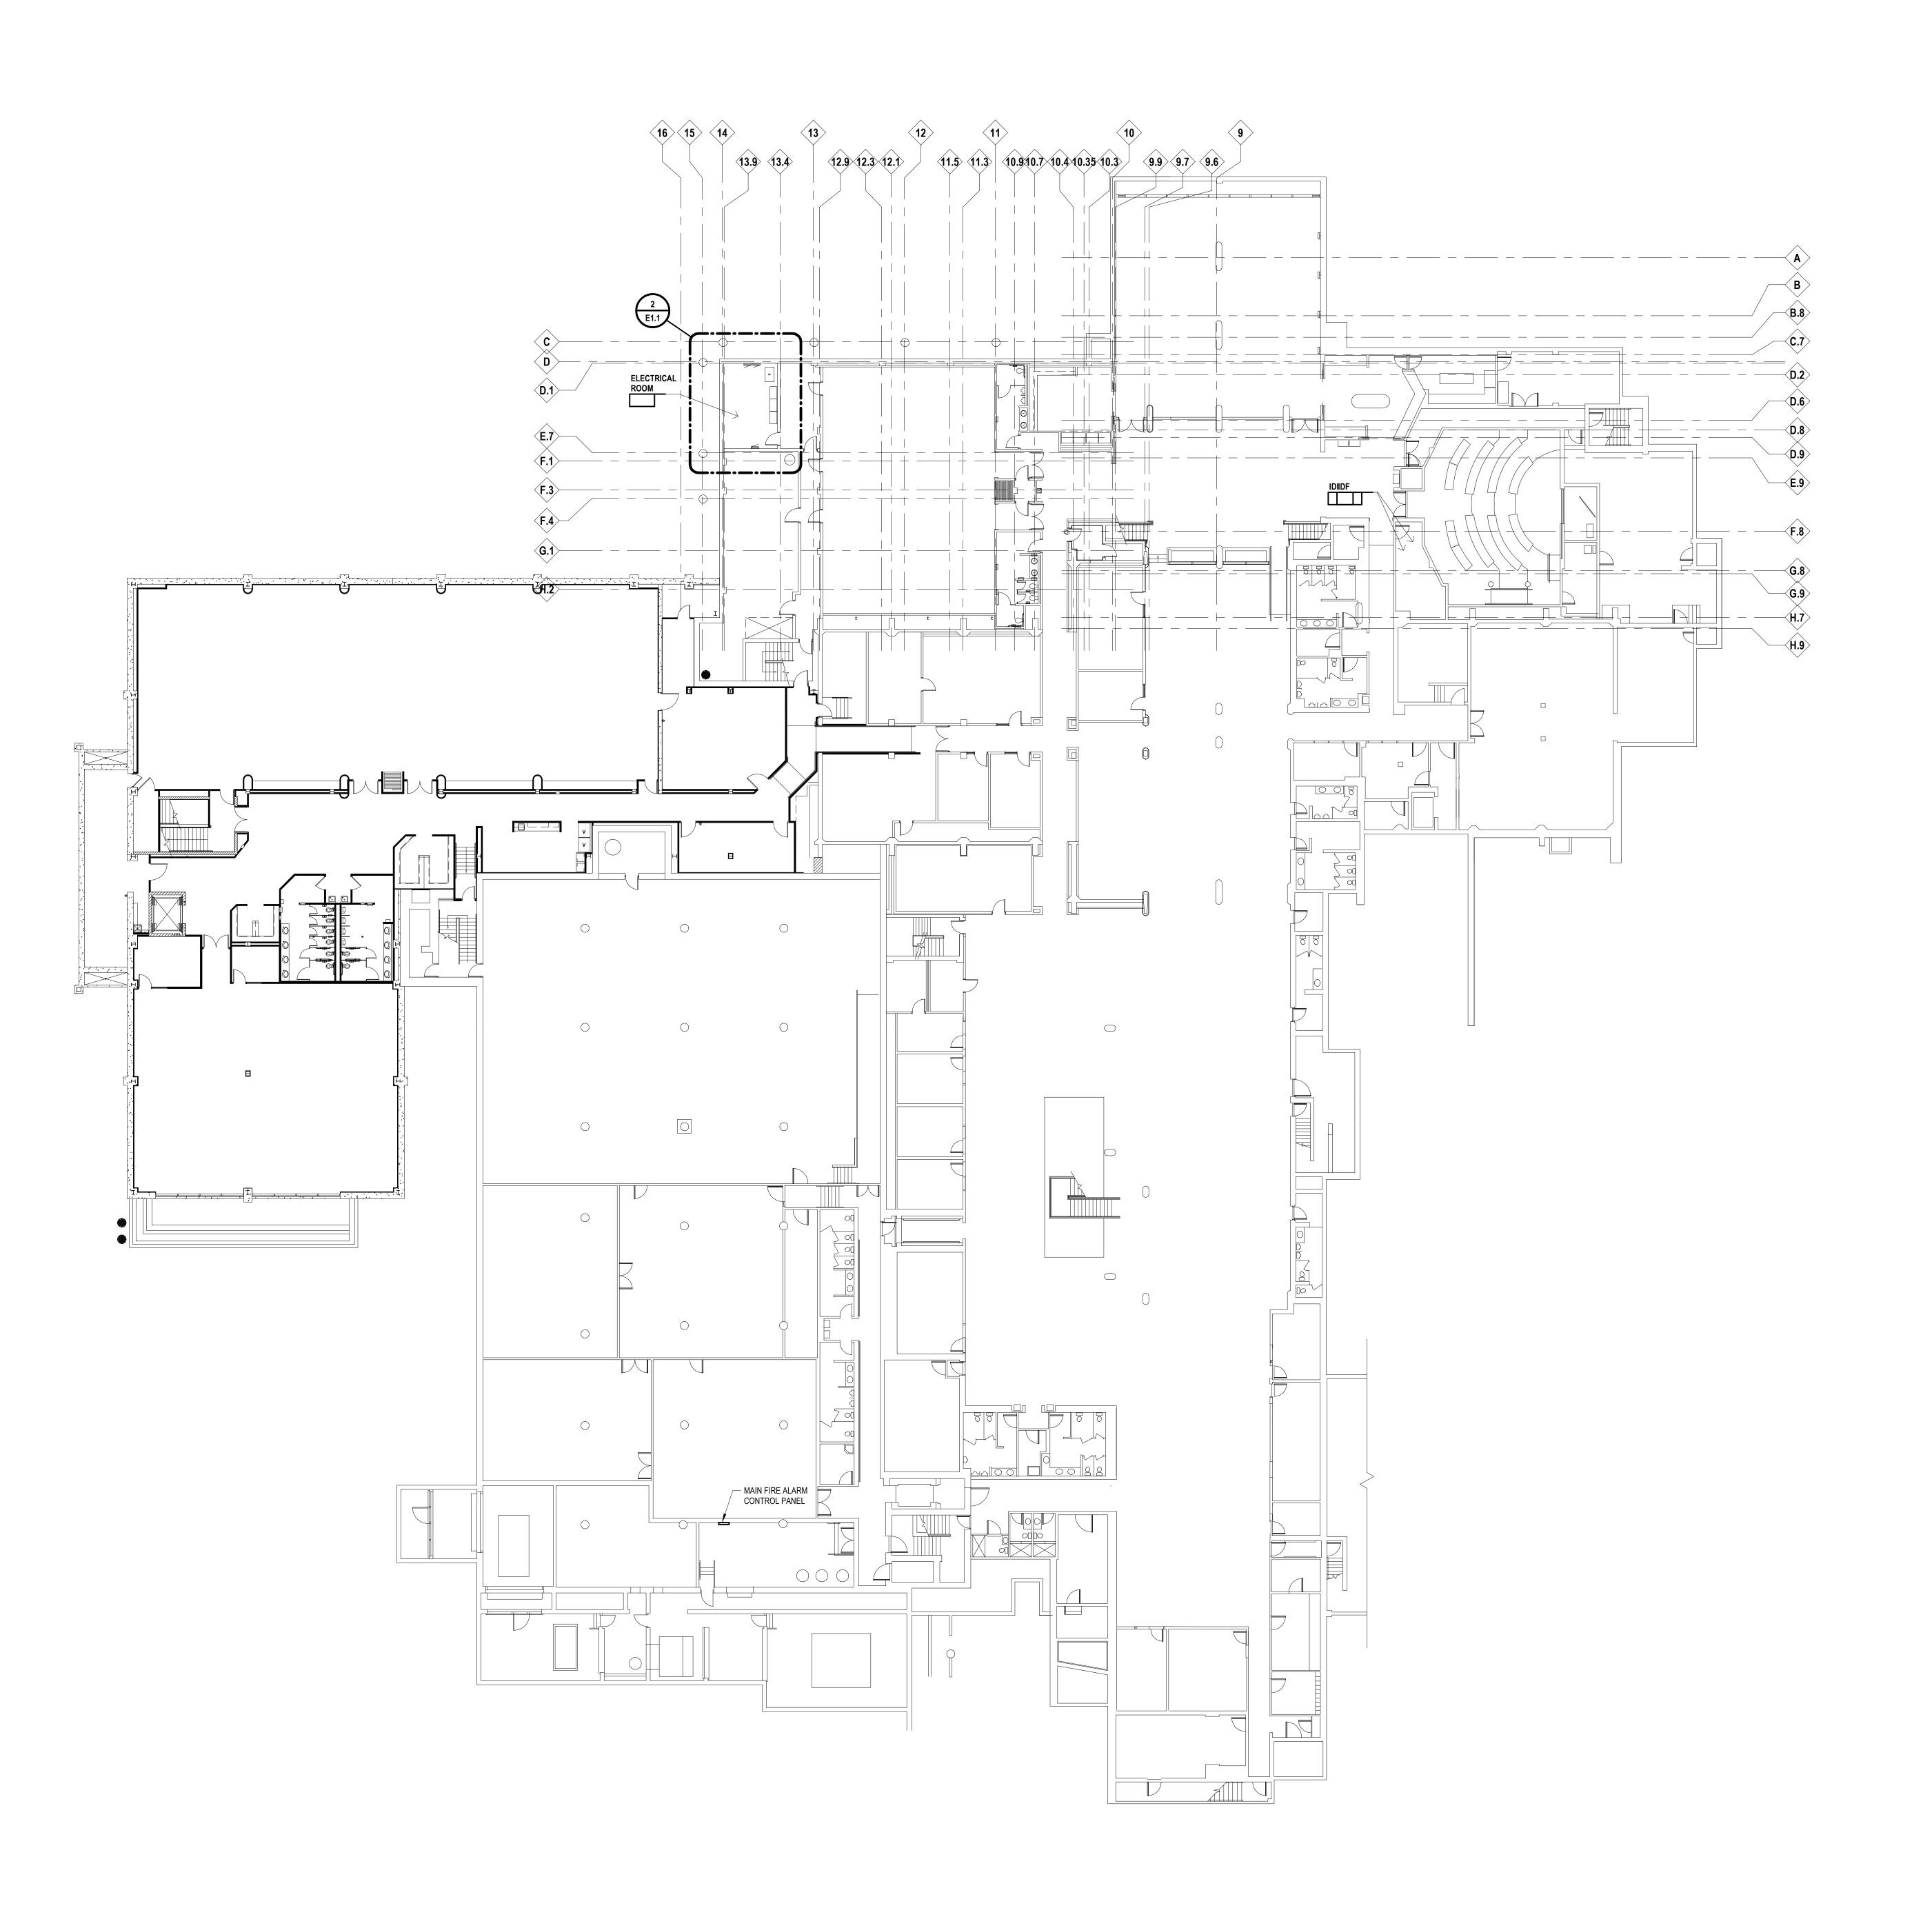




ī**D**≗ Project Number



Basement Composite Plan

 \odot 2021 integrated ${
m d}$ sign solutions, LLC IDS Drawing Title

Р	roject Administrator
	C. Azar
	Project Designer
	N. Furgason
Project	Architect / Engineer
	N. Furgason
	Drawn By
	N. Furgason
	Q.M. Review
	T. Carron
	Approved
	T. Carron
	Drawing Scale
	1/16" = 1'-0"
Issued for	Issue Date
Design Development	02-26-2021
Quality Management Review	04-21-2021
Bids	07-15-2021

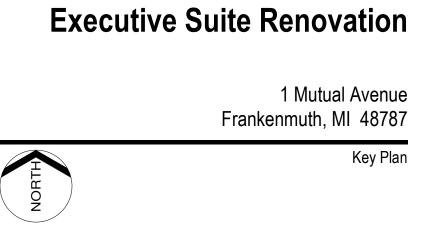






5211 cascade road SE, suite 300 grand rapids, michigan 49546

248.823.2100 www.ids-michigan.com

 \rightarrow ______,**___**____ • •

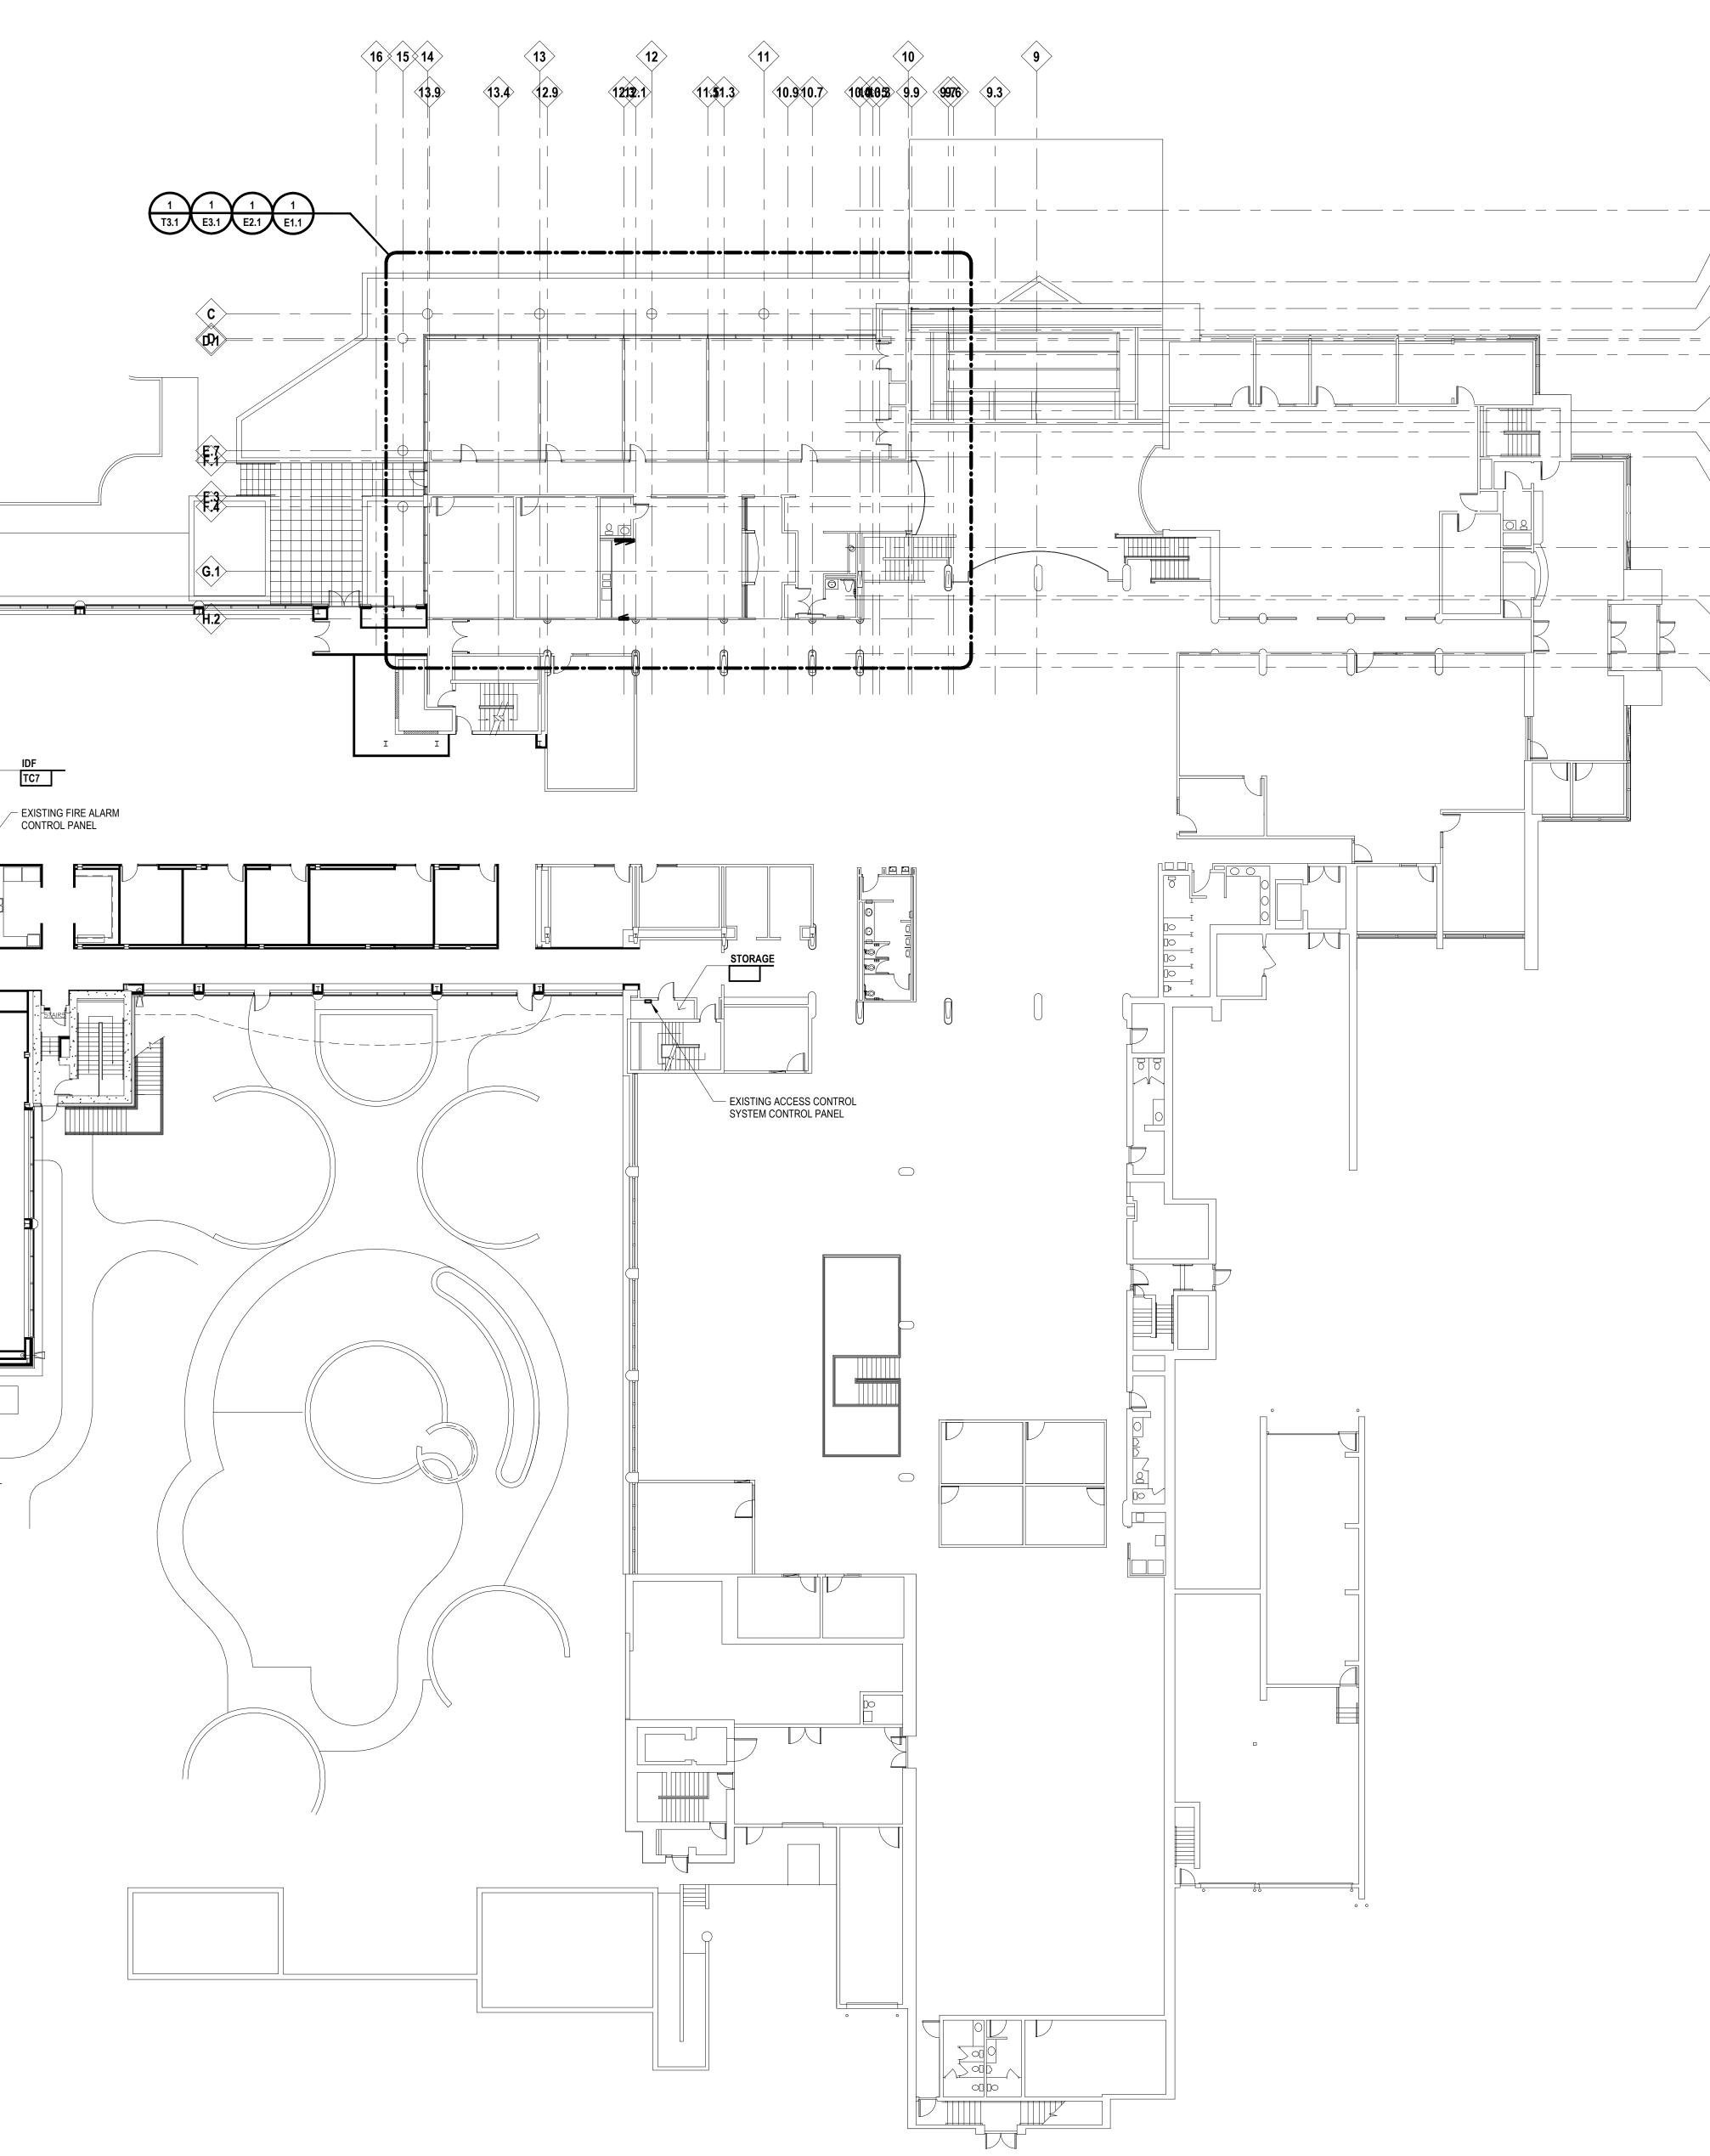




ī**D**≗ Project Number

Drawing Number E0.1

IDS Drawing Title First Floor Composite Plan

 \odot 2021 integrated ${
m d}$ ign solutions, LLC

Pi	roject Administrator
	C. Azar
	Project Designer
	N. Furgason
Project A	Architect / Engineer
	N. Furgason
	Drawn By
	N. Furgason
	Q.M. Review
	T. Carron
	Approved
	T. Carron
	Drawing Scale
	1/16" = 1'-0"
Issued for	Issue Date
Design Development	02-26-2021
Quality Management Review	04-21-2021
Bids	07-15-2021

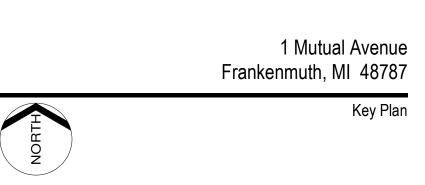

Executive Suite Renovation



INTEGRATED design SOLUTIONS architecture engineering interiors & technology 1441 west long lake, suite 200 troy, michigan 48098 5211 cascade road SE, suite 300 grand rapids, michigan 49546

(**R 8**)


⟨C.7⟩


-∕D 8

<H.9

248.823.2100 www.ids-michigan.com



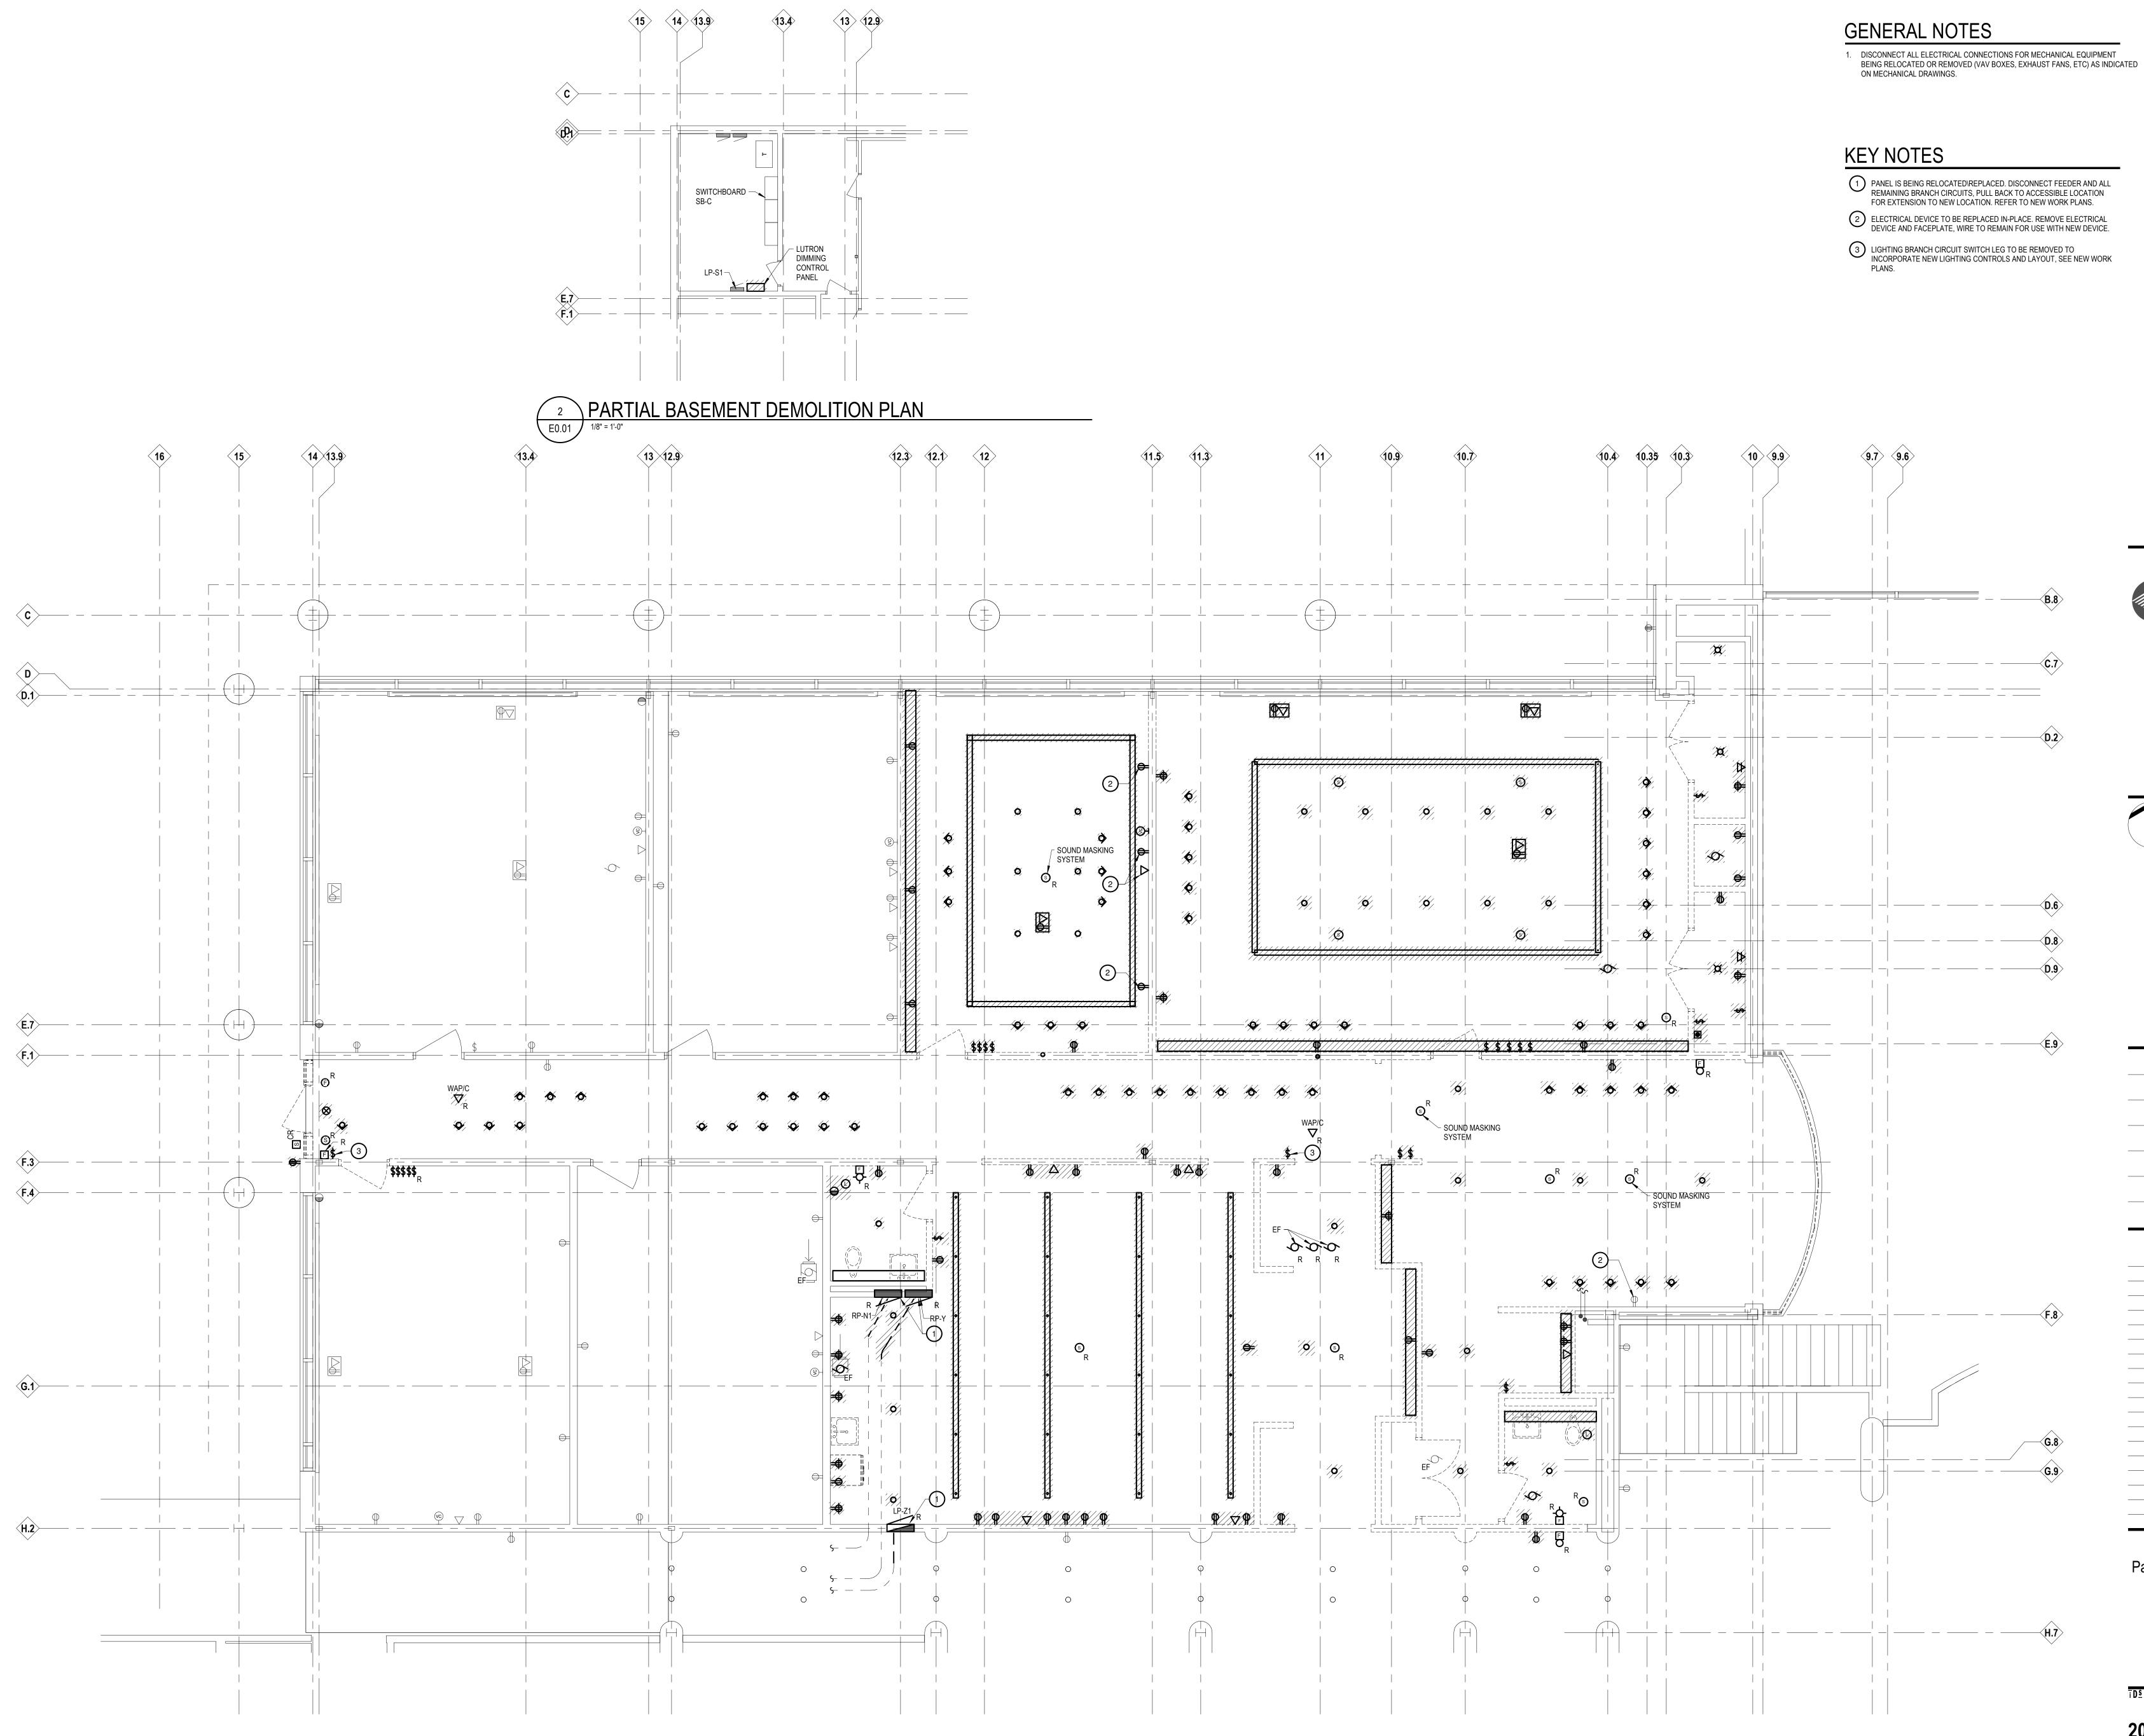

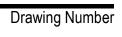

E1.1

ī**D**≗ Project Number 20120-1000

5	e
Partial Technology and Electrical Demolition Plans	

 $^{\circ}$ 2021 integrated $ext{design}$ solutions, LL

Р	roject Administrator
	C. Azar
	Project Designer
	N. Furgason
Project	Architect / Engineer
	N. Furgason
	Drawn By
	N. Furgason
	Q.M. Review
	T. Carron
	Approved
	T. Carron
	Drawing Scale
	1/4" = 1'-0"
Issued for	Issue Date
Design Development	02-26-2021
Quality Management Review	04-21-2021
Bids	07-15-2021
2.00	

	1 Mutual Avenue Frankenmuth, MI 48787
THE STATE	Key Plan
NORTH	

Executive Suite Renovation




INTEGRATED design solutions architecture engineering interiors & technology

1441 west long lake, suite 200 troy, michigan 48098

5211 cascade road SE, suite 300 grand rapids, michigan 49546

248.823.2100


www.ids-michigan.com

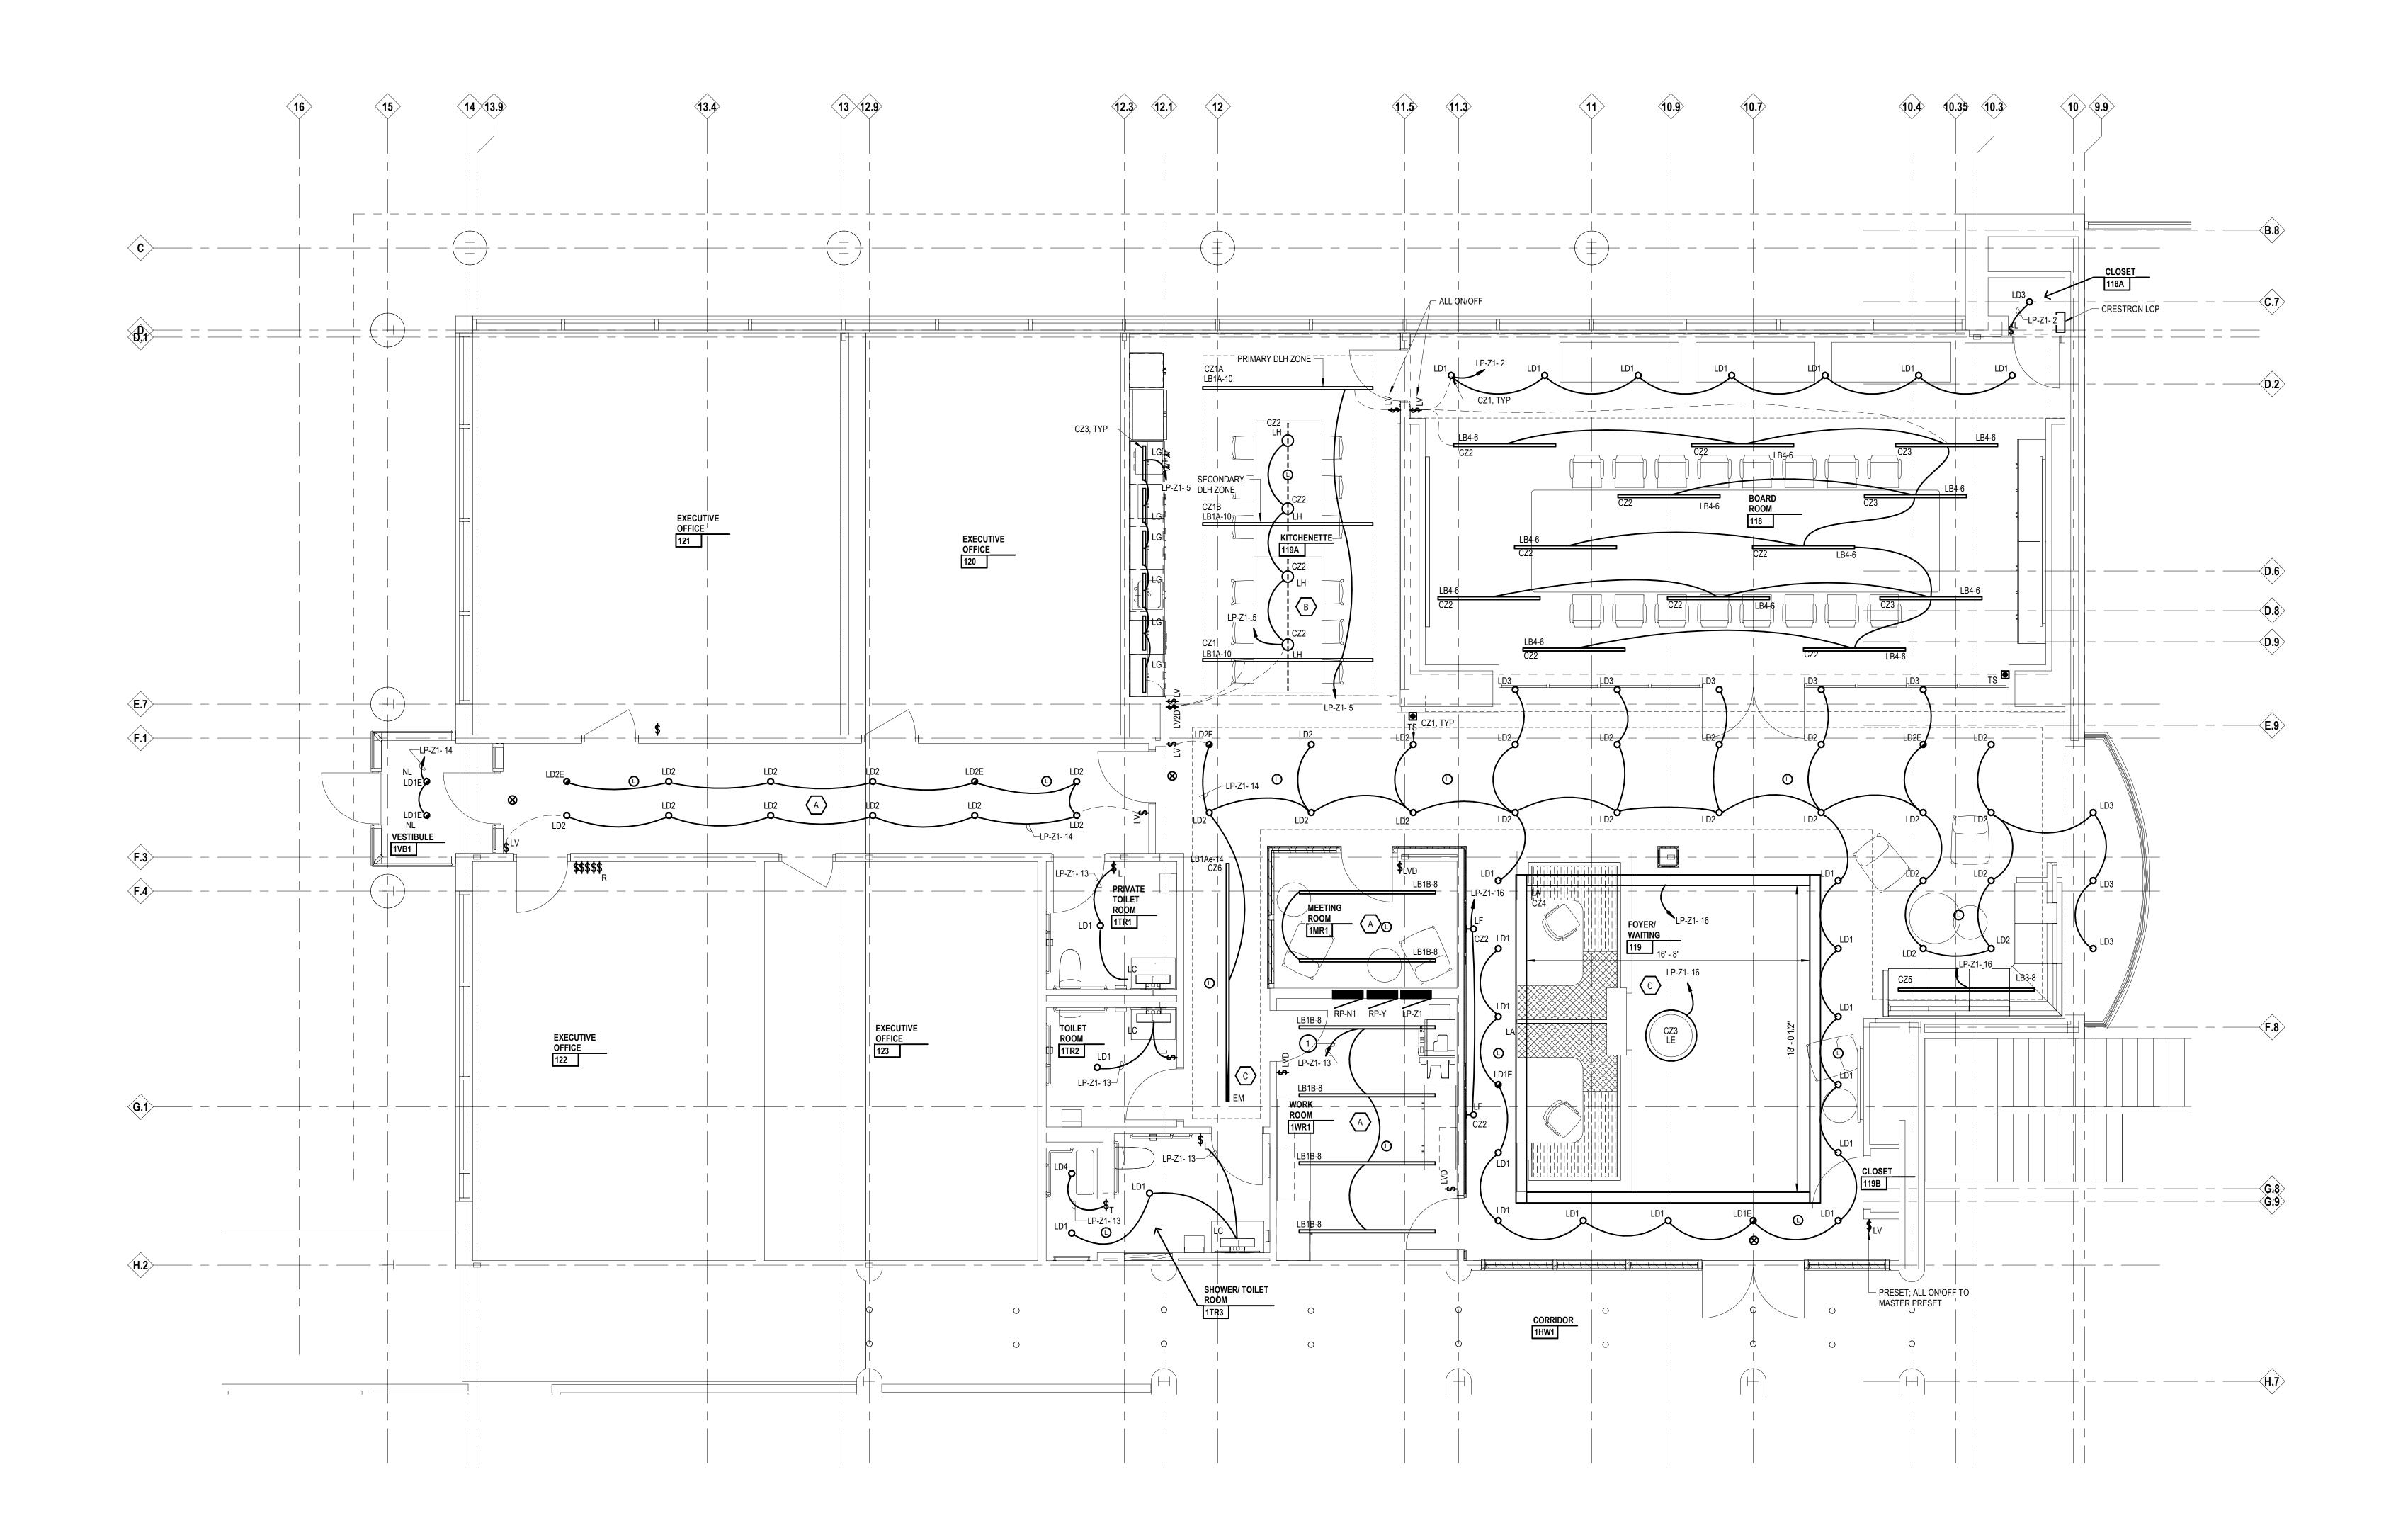

- 1. MODIFY AND EXTEND EXISTING LOCAL BRANCH LIGHTING CIRCUIT AS REQUIRED FOR NEW LIGHTING CONTROLS AND LAYOUT. CIRCUIT NUMBERS SHOWN ARE INTENDED TO COMMUNICATE DESIGN INTENT ONLY AND ARE BASED ON OWNER PROVIDED RECORD DRAWINGS. EC TO FIELD VERIFY EXISTING CIRCUITING AND ADJUST ACCORDINGLY.
- 2. ALL EXIT SIGNS ARE TYPE X1, UON, AND SHALL BE CIRCUITED TO THE UNSWITCHED SIDE OF THE LOCAL BRANCH LIGHTING CIRCUIT.
- 3. ALL EMERGENCY LIGHTING FIXTURES CONTAIN AN EMERGENCY BATTERY PACK THAT REQUIRES AN UNSWITCHED 'HOT' TO THE LOCAL BRANCH LIGHTING CIRCUIT FOR VOLTAGE SENSING. WIRE ACCORDING TO MANUFACTURER'S RECOMMENDATIONS.
- 4. COORDINATE LIGHTING FIXTURES TRIMS AND INSTALLATION WITH ARCHITECTURAL DETAILS.




ī**D**^s Project Number

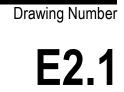

IDS Drawing Title Partial First Floor Lighting Plan

 ${
m \circ}$ 2021 integrated ${
m design}$ solutions, LLC


P	
•••	roject Administrator
	C. Azar
	Project Designer
	N. Furgason
Project /	Architect / Engineer
	N. Furgason
	Drawn By
	N. Furgason
	Q.M. Review
	T. Carron
	Approved
	T. Carron
	Drawing Scale
	1/4" = 1'-0"
Issued for	Issue Date
Issued for Design Development	Issue Date 02-26-2021
Design Development	02-26-2021
Design Development Quality Management Review	02-26-2021 04-21-2021

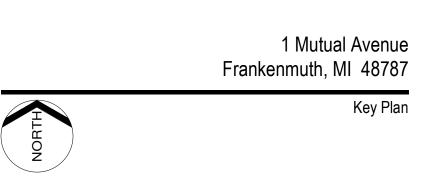

Executive Suite Renovation



INTEGRATED design solutions architecture engineering interiors & technology 1441 west long lake, suite 200 troy, michigan 48098 5211 cascade road SE, suite 300 grand rapids, michigan 49546 248.823.2100

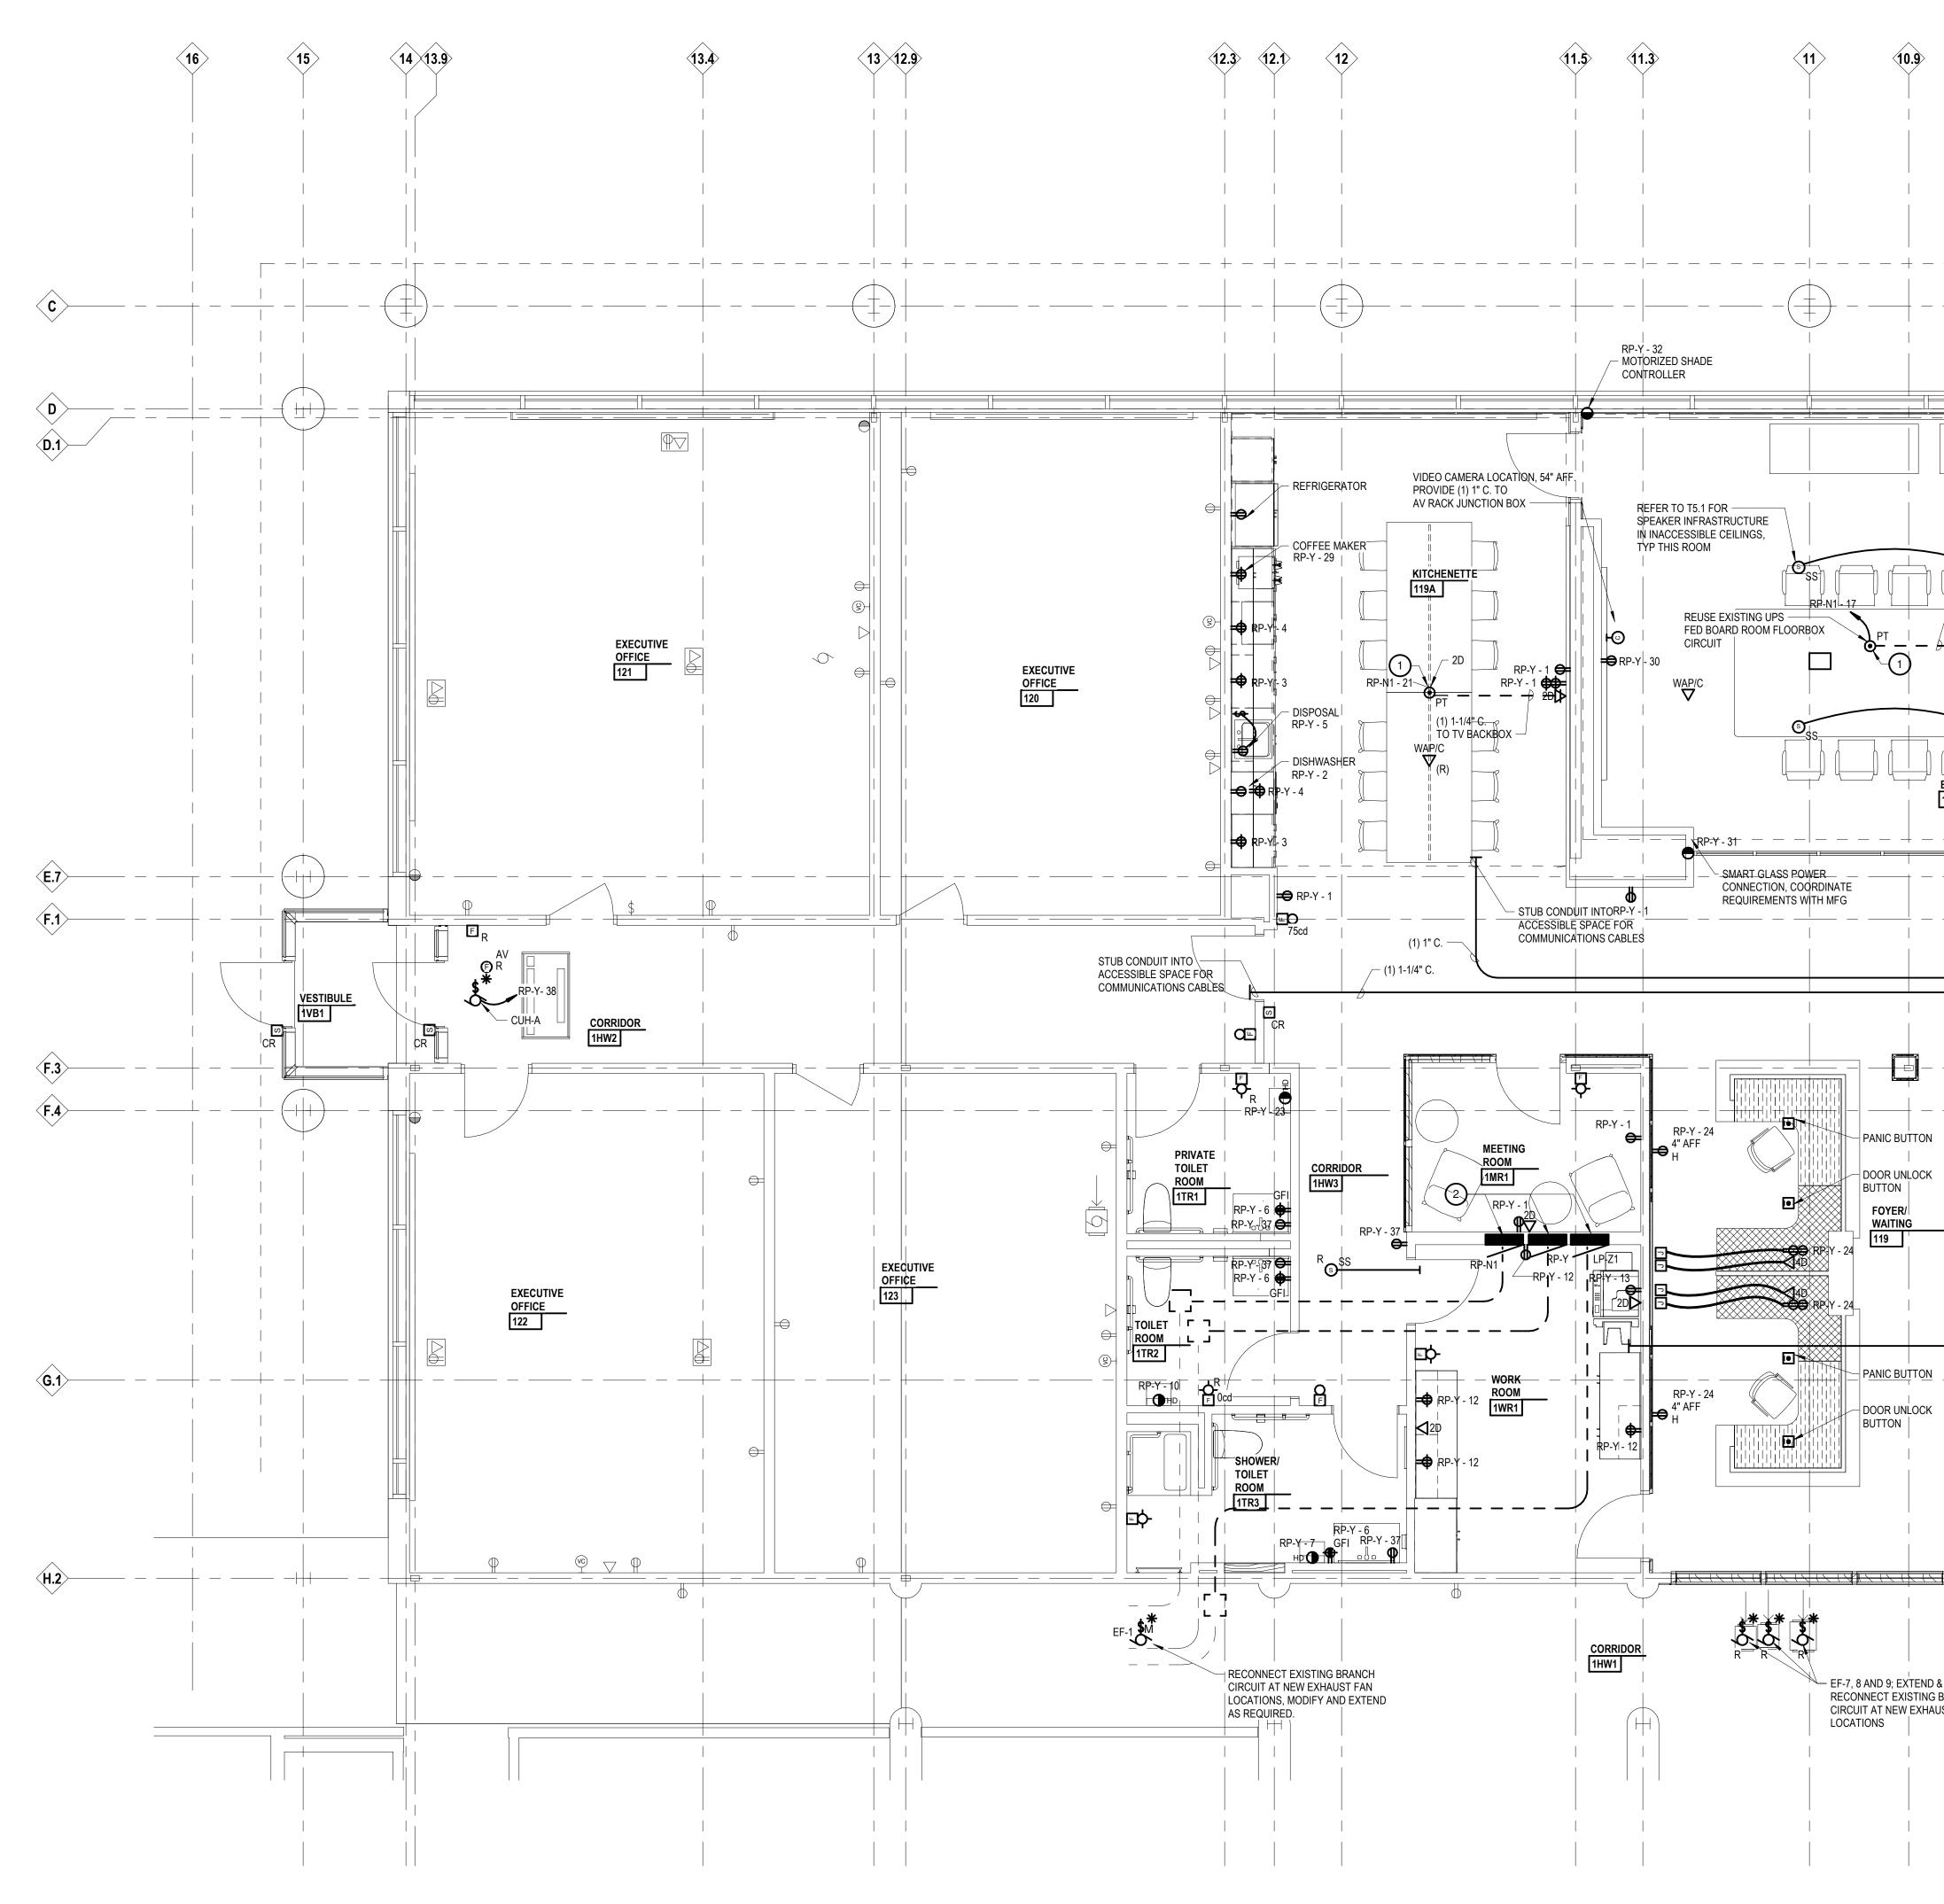




 INSTALL NEW 6" MULTI-SERVICE POKE THROUGH IN EXISTING CONCRETE AND METAL DECK FLOOR. COORINATE EXACT LOCATION WITH BOARD ROOM TABLE LEG LOCATIONS AND STRUCTURE BELOW.
 RELOCATE EXISTING SALVAGED RECEPTACLE AND LIGHTING PANELS. MODIFY AND EXTEND EXISTING FEEDERS TO NEW LOCATIONS. MODIFY AND EXTEND EXISTING REMAINING BRANCH CIRCUITS TO NEW PANEL

LOCATIONS. FIELD VERIFY EXACT WIRE SIZE AND OVERCURRENT PROTECTION.

9.7 9.6 (10.4) **10.35 10.3** <10><9.9> **<10.** (10.9) **≺B.8**> _____ ____ _ _ ___ | __ ___ _____ __ __ ____ CLOSET CRESTRON LCP CRESTRON LCP CRESTRON LCP 1/2" C. -_____ _ _ _ _ _ _ _ _ _ _ _ _ D.2 RP-Y - 30 75cd -1/2" C. TO A/V RACK J-BOX VIDEO CAMERA LOCATION, 54" ÅFF.
 PROVIDE (1) 1" C. TO
 AV RACK JUNCTION BOX - COORDINATE EXACT POWER CONNECTIONS FOR LED MONITOR WALL WITH MANUFACTURER (1) 1" C. FOR COMMUNICATIONS 1 RP-N1/- 6 (1) 1-1/4" C. - — — - -— PROVIDE (1) 1-1/4" C. TO AV RACK JUNCTION BOX (1)— (1) 1-1/4" C. FOR ¢о́мм **™**1-20 - 12"X12"X4" DEEP JUNCTION BOX FOR A/V RACK \prec D.6>RP-N1 -4 😂 TP 🚺 -′(ĭ1) 1-1/4" C. — <D.9> _ _ _ + _ _ _ _ _ SMART GLASS POWER ______ CONNECTION, COORDINATE ______ REQUIREMENTS WITH MFG ______ -<E.9> PANIC BUTTON DOOR UNLOCK COMMUNICATIONS PULL BOX ABOVE CEILING ACCESS PANEL TIE EXISTING COMM CONDUITS INTO PULL BOX, COORDINATE SIZE WITH COMM CONTRACTOR BUTTON FOYER/ WAITING **∕F.8**〉 PANIC BUTTON DOOR UNLOCK BUTTON CLOSET 119B Œ 75cd - STUB CONDUIT INTO ACCESSIBLE SPACE FOR COMMUNICATIONS CABLES EF-7, 8 AND 9; EXTEND & RECONNECT EXISTING BRANCH CIRCUIT AT NEW EXHAUST FAN -<`H.7> ______ (| ++) _____+ _____ _____ - |----- (H.9) _____ + !____+ _____ __ ___ |__ _____

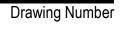

E3.1

ī **D**^s Project Number 20120-1000

IDS Drawing Title Partial First Floor Power & Auxiliary Systems Plan

© 2021 Integrated design solutions, LLC

Р	roject Administrator
	C. Azar
	Project Designer
	N. Furgason
Project /	Architect / Engineer
	N. Furgason
	Drawn By
	N. Furgason
	Q.M. Review
	T. Carron
	Approved
	T. Carron
	Drawing Scale
	1/4" = 1'-0"
Issued for	Issue Date
Design Development	02-26-2021
Quality Management Review	04-21-2021
Bids	07-15-2021

	1 Mutual Avenue Frankenmuth, MI 48787
NORTH	Key Plan

Executive Suite Renovation





INTEGRATED design solutions

architecture engineering interiors & technology

1441 west long lake, suite 200


5211 cascade road SE, suite 300 grand rapids, michigan 49546


troy, michigan 48098

www.ids-michigan.com

248.823.2100


PARTIAL ONE LINE DIAGRAM

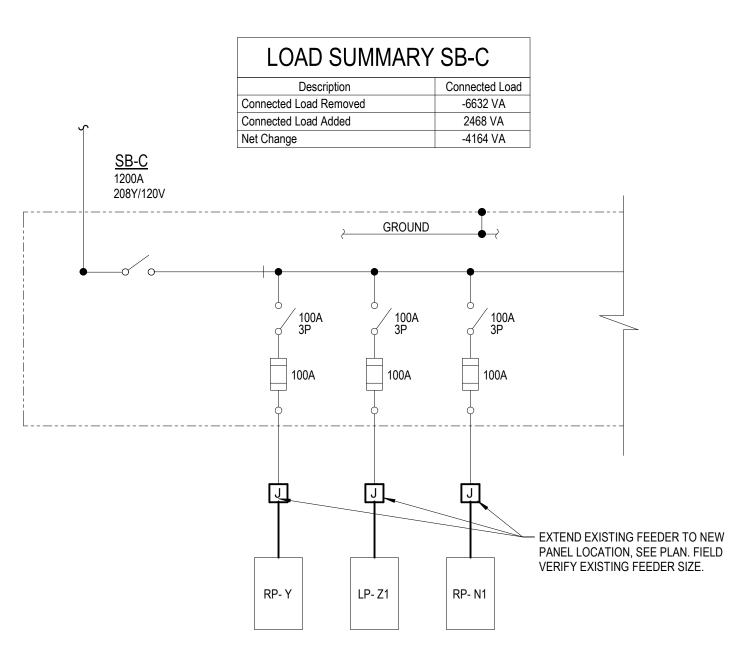

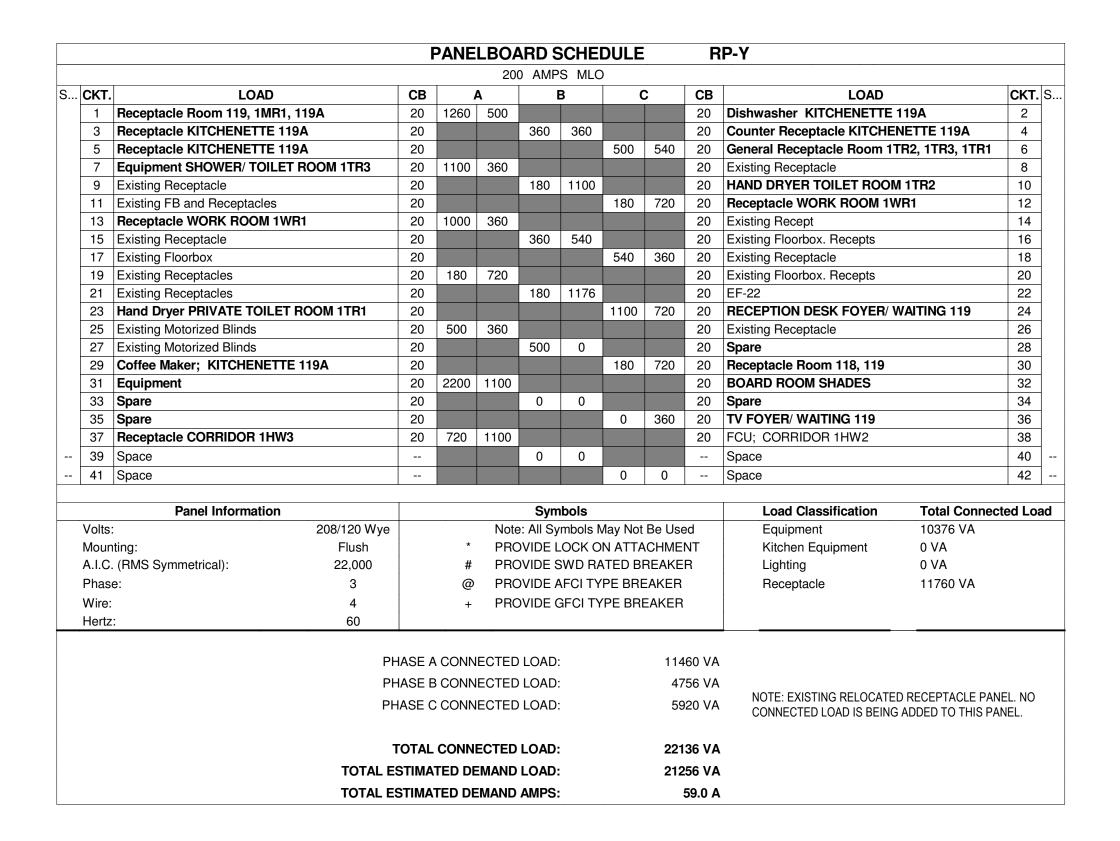

1 tv; BOARD ROOM 118 20 500 540 20 Existing Recept 130, 136, 137 22 3 Existing Recept 131 20 180 1000 20 AV RACK BOARD ROOM 118 4 5 Existing PT 20 20 360 500 20 tv; BOARD ROOM 118 4 7 Spare 20 0 360 500 20 tv; BOARD ROOM 118 6 7 Spare 20 0 360 360 20 Existing PT Open Office 8 9 Existing PT Open Office 20 360 360 20 Existing PT Open Office 10 11 Existing PT Open Office 20 360 360 20 Existing PT Open Office 10 13 Existing PT Open Office 20 360 360 20 Existing PT Open Office 14 15 Existing PT Open Office 20 360 360 20 Existing PT Open Office 16 19 Spare <th></th> <th></th> <th></th> <th></th> <th>F</th> <th>PANE</th> <th>LBOA</th> <th>ARD S</th> <th>CHE</th> <th>DULE</th> <th></th> <th>R</th> <th>P-N1</th> <th></th>					F	PANE	LBOA	ARD S	CHE	DULE		R	P-N1	
1 tv; BOARD ROOM 118 20 500 540 20 Existing Recept 130, 136, 137 22 3 Existing PT 20 180 100 20 AV RACK BOARD ROOM 118 4 5 Existing PT 20 360 500 20 AV RACK BOARD ROOM 118 4 5 Existing PT 20 360 360 500 20 Existing PT Open Office 8 9 Existing PT Open Office 20 360 360 360 20 Existing PT Open Office 11 11 Existing PT Open Office 20 360 360 360 20 Existing PT Open Office 14 15 Existing PT Open Office 20 360 360 360 20 Existing PT Open Office 14 16 Existing PT Open Office 20 500 500 20 Existing PT Open Office 14 17 Conference Table; BOARD ROOM 118 20 500 500 20 Existing PT Open Office 14				,			10	0 AMP	S MLC					
3 Existing Recept 131 20 180 1000 20 AV RACK BOARD ROOM 118 4 5 Existing PT 20 360 500 20 tv; BOARD ROOM 118 6 7 Spare 20 360 360 500 20 Existing PT Open Office 18 9 Existing PT Open Office 20 360 360 360 20 Existing PT Open Office 11 11 Existing PT Open Office 20 360 360 360 20 Existing PT Open Office 11 15 Existing PT Open Office 20 360 360 20 Existing PT Open Office 14 16 Existing PT Open Office 20 360 360 20 Existing PT Open Office 14 17 Conference Table; BOARD ROOM 118 20 360 360 20 Existing PT Open Office 14 19 Spare 20 0 500 20 Existing PT Open Office 14 21	C							I	3	(2			СКТ
5 Existing PT 20 360 500 20 tv; BOARD ROOM 118 6 7 Spare 20 0 360 360 20 Existing PT Open Office 8 9 Existing PT Open Office 20 360 360 360 20 Existing PT Open Office 10 11 Existing PT Open Office 20 360 360 360 20 Existing PT Open Office 11 13 Existing PT Open Office 20 360 360 360 20 Existing PT Open Office 11 15 Existing PT Open Office 20 360 360 20 Existing PT Open Office 14 16 Existing PT Open Office 20 360 360 20 Existing PT Open Office 14 17 Conference Table; BOARD ROOM 118 20 360 360 20 Existing PT Open Office 14 21 Space 20 0 500 20 Existing PT Open Office 14 <t< td=""><td></td><td></td><td></td><td></td><td></td><td>500</td><td>540</td><td></td><td></td><td></td><td></td><td></td><td></td><td>2</td></t<>						500	540							2
7 Spare 20 0 360 360 20 Existing PT Open Office 8 9 Existing PT Open Office 20 360 360 360 20 Existing PT Open Office 11 11 Existing PT Open Office 20 360 360 360 20 Existing PT Open Office 11 13 Existing PT Open Office 20 360 360 20 Existing PT Open Office 11 15 Existing PT Open Office 20 360 360 20 Existing PT Open Office 11 15 Existing PT Open Office 20 360 360 20 Existing PT Open Office 11 15 Existing PT Open Office 20 500 20 Existing PT Open Office 11 17 Conference Table; BOARD ROOM 118 20 500 20 Existing PT Open Office 12 21 PT; KITCHENETTE 119A 20 0 500 20 Existing PT Open Office 22 23								180	1000					4
9 Existing PT Open Office 20 360 360 360 20 Existing PT Open Office 10 11 Existing PT Open Office 20 360 360 360 20 Existing PT Open Office 11 13 Existing PT Open Office 20 360 360 360 20 Existing PT Open Office 14 15 Existing PT Open Office 20 360 360 20 Existing PT Open Office 14 15 Existing PT Open Office 20 360 360 20 Existing PT Open Office 16 17 Conference Table; BOARD ROOM 118 20 720 360 20 Existing PT Open Office 16 19 Spare 20 500 720 360 20 Existing PT Open Office 16 21 PT; KITCHENETTE 119A 20 360 50 20 Existing PT Open Office 22 22 Space - 0 0 0 - Space 24										360	500		· ·	6
11 Existing PT Open Office 20 360 360 360 20 Existing PT Open Office 11 13 Existing PT Open Office 20 360 360 360 20 Existing PT Open Office 14 15 Existing PT Open Office 20 360 360 360 20 Existing PT Open Office 14 16 Existing PT Open Office 20 Existing PT Open Office 14 14 14 15 Existing PT Open Office 14 14 17 Conference Table; BOARD ROOM 118 20 360 360 50 20 Existing Recept; Conf Room 106 14 19 Spare 20 0 500 20 Existing Recept; Conf Room 106 18 22 21 PT; KITCHENETTE 119A 20 360 50 20 Equipment; Crestron LCP 22 23 Space 0 0 Space 24 29 Space 0 0			•			0	360							8
13 Existing PT Open Office 20 360 360 360 20 Existing PT Open Office 14 15 Existing PT Open Office 20 360 360 360 20 Existing PT Open Office 14 15 Existing PT Open Office 20 360 360 360 20 Existing PT Open Office 14 17 Conference Table; BOARD ROOM 118 20 720 360 20 Existing Recept; Conf Room 106 18 19 Spare 20 0 500 20 Equipment; Crestron LCP 22 23 Space 0 0 Space 24 25 Space 0 0 Space 24 29 Space 0 0 Space 24 29 Space 0 0 Space 24 1050 VA Montring: Flush * PROVIDE LOCK ON ATTACHMENT			. .					360	360				v 1	10
15 Existing PT Open Office 20 360 360 20 Existing PT Open Office 16 17 Conference Table; BOARD ROOM 118 20 720 360 20 Existing Recept; Conf Room 106 18 19 Spare 20 0 500 20 Existing Recept; Conf Room 106 18 21 PT; KITCHENETTE 119A 20 360 50 20 Equipment; Crestron LCP 22 23 Space 0 0 Space 22 25 Space 0 0 0 Space 24 29 Space 0 0 0 Space 24 29 Space 0 0 0 Space 24 29 Space 0 0 0 Space 24 Volts: 208/120 Wye Note: All Symbols May Not Be Used Equipment										360	360			12
17 Conference Table; BOARD ROOM 118 20 720 360 20 Existing Recept; Conf Room 106 14 19 Spare 20 0 500 20 Existing Recept; Conf Room 106 14 21 PT; KITCHENETTE 119A 20 360 50 20 Equipment; Crestron LCP 22 23 Space 0 0 0 Space 24 25 Space 0 0 0 Space 24 27 Space 0 0 0 Space 24 29 Space 0 0 0 Space 24 Volts: 208/120 Wye Note: All Symbols May Not Be Used Equipment 1050 VA Mounting: Flush * PROVIDE LOCK ON ATTACHMENT Kitchen Equipment 0 VA Phase: 3 @ PROVIDE SWD RAFED BREAKER Receptacle 3300 VA Wire: 4 <t< td=""><td></td><td></td><td>. .</td><td></td><td></td><td>360</td><td>360</td><td></td><td></td><td></td><td></td><td></td><td>v 1</td><td>14</td></t<>			. .			360	360						v 1	14
19 Spare 20 0 500 20 tv; BOARD ROOM 118 20 21 PT; KITCHENETTE 119A 20 360 50 20 Equipment; Crestron LCP 22 23 Space 0 0 0 Space 24 25 Space 0 0 0 Space 24 27 Space 0 0 0 Space 24 29 Space 0 0 0 Space 24 29 Space 0 0 0 Space 24 29 Space 0 0 0 Space 24 Volts: 208/120 Wye Note: All Symbols May Not Be Used Equipment 1050 VA Kitchen Equipment 0 VA A.I.C. (RMS Symmetrical): 22,000 # PROVIDE SWD RATED BREAKER Receptacle 3300								360	360					16
21 PT; KITCHENETTE 119A 20 360 50 20 Equipment; Crestron LCP 22 23 Space 0 0 Space 24 25 Space 0 0 Space 24 27 Space 0 0 Space 24 29 Space 0 0 0 Space 34 Volts: 208/120 Wye Note: All Symbols May Not Be Used Equipment 1050 VA VA A.I.C. (RMS Symmetrical): 22,000 # PROVIDE SWD RATED BREAKER Lighting 0 VA Phase: 3 @ PROVIDE GFCI TYPE BREAKER Receptacle 3300 VA Wire: 4 + <td></td> <td></td> <td>-</td> <td>18</td> <td></td> <td></td> <td></td> <td></td> <td></td> <td>720</td> <td>360</td> <td></td> <td>÷ .</td> <td>18</td>			-	18						720	360		÷ .	18
23 Space 0 0 Space 24 25 Space 0 0 Space 26 27 Space 0 0 0 Space 26 29 Space 0 0 0 Space 26 29 Space 0 0 0 Space 26 Volts: 208/120 Wye Note: All Symbols May Not Be Used Equipment 1050 VA Mounting: Flush * PROVIDE LOCK ON ATTACHMENT Kitchen Equipment 0 VA Phase: 3 @ PROVIDE SWD RATED BREAKER Receptacle 3300 VA Wire: 4 + PROVIDE GFCI TYPE BREAKER Receptacle 3300 VA PHASE A CONNECTED LOAD: 2620 VA NOTE: EXISTING RELOCATED RECEPTACLE PANEL. PHASE B CONNECTED LOAD: 3030 VA NOTE: EXISTING RELOCATED RECEPTACLE PANEL.			•			0	500						· ·	20
25 Space 0 0 0 0 Space 24 27 Space 0 0 0 Space 24 29 Space 0 0 0 Space 24 Volts: Colspan="4">Colspan="4">Symbols Load Classification Total Connected L Volts: 208/120 Wye Note: All Symbols May Not Be Used Equipment 1050 VA Mounting: Flush * PROVIDE LOCK ON ATTACHMENT Kitchen Equipment 0 VA A.I.C. (RMS Symmetrical): 22,000 # PROVIDE SWD RATED BREAKER Receptacle 3300 VA Phase: 3 @ PROVIDE GFCI TYPE BREAKER Receptacle 3300 VA Wire: 4 + PROVIDE GFCI TYPE BREAKER NOTE: EXISTING RELOCATED RECEPTACLE PANEL. PHASE A CONNECTED LOAD: 3030 VA NOTE: EXISTING RELOCATED RECEPTACLE PANEL. CONNECTED LOAD IS BEING ADDED TO THIS PANEL.			-		20			360	50				• • •	22
27 Space 0 0 Space 24 Space 24 Space 36 Panel Information Symbols Load Classification Total Connected L Volts: 208/120 Wye Note: All Symbols May Not Be Used Equipment 1050 VA Mounting: Flush * PROVIDE LOCK ON ATTACHMENT Kitchen Equipment 0 VA A.I.C. (RMS Symmetrical): 22,000 # PROVIDE SWD RATED BREAKER Lighting 0 VA Phase: 3 @ PROVIDE GFCI TYPE BREAKER Receptacle 3300 VA Wire: 4 + PROVIDE GFCI TYPE BREAKER NOTE: EXISTING RELOCATED RECEPTACLE PANEL. PHASE A CONNECTED LOAD: 3030 VA NOTE: EXISTING RELOCATED RECEPTACLE PANEL. CONNECTED LOAD I: 3030 VA										0	0		•	24
29 Space 0 0 Space 30 Panel Information Symbols Load Classification Total Connected L Volts: 208/120 Wye Note: All Symbols May Not Be Used Equipment 1050 VA Mounting: Flush * PROVIDE LOCK ON ATTACHMENT Kitchen Equipment 0 VA A.I.C. (RMS Symmetrical): 22,000 # PROVIDE SWD RATED BREAKER Receptacle 3300 VA Phase: 3 @ PROVIDE GFCI TYPE BREAKER Receptacle 3300 VA Wire: 4 + PROVIDE GFCI TYPE BREAKER NOTE: EXISTING RELOCATED RECEPTACLE PANEL. PHASE A CONNECTED LOAD: 2620 VA NOTE: EXISTING RELOCATED RECEPTACLE PANEL. NOTE: EXISTING RELOCATED RECEPTACLE PANEL.			•			0	0						•	26
Panel Information Symbols Load Classification Total Connected L Volts: 208/120 Wye Note: All Symbols May Not Be Used Equipment 1050 VA Mounting: Flush * PROVIDE LOCK ON ATTACHMENT Kitchen Equipment 0 VA A.I.C. (RMS Symmetrical): 22,000 # PROVIDE SWD RATED BREAKER Lighting 0 VA Phase: 3 @ PROVIDE AFCI TYPE BREAKER Receptacle 3300 VA Wire: 4 + PROVIDE GFCI TYPE BREAKER Receptacle 3300 VA Hertz: 60 PHASE A CONNECTED LOAD: 2620 VA NOTE: EXISTING RELOCATED RECEPTACLE PANEL. N CONNECTED LOAD IS BEING ADDED TO THIS PANEL.			•					0	0					
Volts: 208/120 Wye Note: All Symbols May Not Be Used Equipment 1050 VA Mounting: Flush * PROVIDE LOCK ON ATTACHMENT Kitchen Equipment 0 VA A.I.C. (RMS Symmetrical): 22,000 # PROVIDE SWD RATED BREAKER Lighting 0 VA Phase: 3 @ PROVIDE AFCI TYPE BREAKER Receptacle 3300 VA Wire: 4 + PROVIDE GFCI TYPE BREAKER Receptacle 3300 VA Hertz: 60 PHASE A CONNECTED LOAD: 2620 VA NOTE: EXISTING RELOCATED RECEPTACLE PANEL. N CONNECTED LOAD:		29	Space							0	0		Space	30
Volts: 208/120 Wye Note: All Symbols May Not Be Used Equipment 1050 VA Mounting: Flush * PROVIDE LOCK ON ATTACHMENT Kitchen Equipment 0 VA A.I.C. (RMS Symmetrical): 22,000 # PROVIDE SWD RATED BREAKER Lighting 0 VA Phase: 3 @ PROVIDE AFCI TYPE BREAKER Receptacle 3300 VA Wire: 4 + PROVIDE GFCI TYPE BREAKER Receptacle 3300 VA Hertz: 60 PHASE A CONNECTED LOAD: 2620 VA NOTE: EXISTING RELOCATED RECEPTACLE PANEL. N CONNECTED LOAD:			Panel Information					Svm	bols				Load Classification Total Conn	ected Lo
A.I.C. (RMS Symmetrical): 22,000 # PROVIDE SWD RATED BREAKER Lighting 0 VA Phase: 3 @ PROVIDE AFCI TYPE BREAKER Receptacle 3300 VA Wire: 4 + PROVIDE GFCI TYPE BREAKER PHASE A CONNECTED LOAD: 2620 VA PHASE A CONNECTED LOAD: 2620 VA NOTE: EXISTING RELOCATED RECEPTACLE PANEL. N CONNECTED LOAD IS BEING ADDED TO THIS PANEL.	V	olts:	20	8/120 Wye			Note			/lay Not	Be Use	d		
Phase: 3 @ PROVIDE AFCI TYPE BREAKER Receptacle 3300 VA Wire: 4 + PROVIDE GFCI TYPE BREAKER Provide GFCI TYPE BREAKER	Ν	lour	iting:	Flush		*	PRC	VIDE L	оск о	N ATTA	CHME	ΝT	Kitchen Equipment 0 VA	
Wire: 4 + PROVIDE GFCI TYPE BREAKER Hertz: 60 2620 VA PHASE A CONNECTED LOAD: 2620 VA NOTE: EXISTING RELOCATED RECEPTACLE PANEL. N PHASE B CONNECTED LOAD: 3030 VA	A	.I.C.	(RMS Symmetrical):	22,000		#	PRC	OVIDE S	WD RA	TED BI	REAKE	R	Lighting 0 VA	
Hertz: 60 PHASE A CONNECTED LOAD: 2620 VA PHASE B CONNECTED LOAD: 3030 VA NOTE: EXISTING RELOCATED RECEPTACLE PANEL. N CONNECTED LOAD: 3030 VA	Ρ	has	e:	3		@	PRC		FCI TY	PE BRE	EAKER		Receptacle 3300 VA	
Hertz: 60 PHASE A CONNECTED LOAD: 2620 VA PHASE B CONNECTED LOAD: 3030 VA NOTE: EXISTING RELOCATED RECEPTACLE PANEL. N CONNECTED LOAD: 3030 VA	٧	Vire:		4		+	PRC		SECLTY	PE BRI	EAKER			
PHASE A CONNECTED LOAD: 2620 VA PHASE B CONNECTED LOAD: 3030 VA NOTE: EXISTING RELOCATED RECEPTACLE PANEL. N CONNECTED LOAD IS BEING ADDED TO THIS PANEL.		-		60										
	A P V	A.I.C. Phas Vire:	. (RMS Symmetrical): e:	22,000 3 4 60 PH PH	ASE B	(CONN) LOAD:	SWD RA NFCI TY SFCI TY	TED BI	REAKER EAKER EAKER 26: 30:	R 20 VA 30 VA	Lighting 0 VA Receptacle 3300 VA	
				т	OTAL	CONN	ECTED	LOAD:			83	10 VA		
TOTAL CONNECTED LOAD: 8310 VA				TOTAL ES	TIMA	TED DE	EMAND	LOAD:			83	10 VA		
TOTAL CONNECTED LOAD:8310 VATOTAL ESTIMATED DEMAND LOAD:8310 VA				TOTAL ES		TED DE		AMPS			2	23.1 A		

											P-Z1		
СКТ.	LOAD		100 AMPS MLO				LOAD		СКТ				
	Ltg; Existing Room A130		20	800	732				,	20	Lighting; Board Room		2
3	Ltg; Existing Exit Signs		20	000	752	150	600			20	Ltg; Existing NL		4
	Lighting Room Ktichenette	r 119Δ	20			100	000	253	600	20	Ltg; Existing Room A137, 138		6
	Ltg; Existing Room A137		20	1248	1120			200	000	20	Ltg; Existing Room A136		8
9	Ltg; Existing Room A136		20	1210	1120	800	1120			20	Ltg; Existing Room A130		10
-	Ltg; Existing Room A130, 131	1	20			000	1120	1056	920	20	Ltg; Existing Room A131		12
	Ltg;1TR1,1TR2,1TR3,1WR1		20	512	641					20	Lighting CORRIDOR		14
	Ltg; Existing Corr 127	,	20			640	604			20	Lighting FOYER/ WAITING 11	9	16
	Ltg; Existing Ltg		20					500	500	20	Ltg; Existing Room A06 Conference		18
	Ltg; Existing Ltg		20	500	500					20	Ltg; Existing Ltg		20
	Ltg; Existing Ltg		20			500	500			20	Ltg; Existing Ltg		22
	Space							0	0		Space		24
	Space			0	0						Space		26
	Space					0	0		Space			28	
29	Space							0	0		Space		30
													•
	Panel Information					Sym	nbols				Load Classification	Total Conne	cted Lo
Volts:		208/120 Wye				-	mbols N	-			Equipment	0 VA	
Moun	-	Flush		*			OCK O				Kitchen Equipment	0 VA	
A.I.C.	(RMS Symmetrical):	22,000		#	PRC	OVIDE S	SWD RA	ATED BI	REAKE	R	Lighting	2742 VA	
Phase	9:	3		@	PRC	OVIDE A	AFCI TY	PE BRE	EAKER		Receptacle	0 VA	
Wire:		4		+	PRC	OVIDE (GFCI TY	'PE BRI	EAKER				
Hertz:	:	60											
		DL			IECTED				60	53 VA	NOTE: EXISTING RELOCATED		
											CONNECTED LOAD IS BEING		
					IECTED					14 VA	EXISTING CONNECTED LOAD	D IS BEING REDUC	ED.
		PH	ASE C	CONN	IECTED	LOAD	:		38	829 VA			
		г	OTAL	CONN	ECTED	LOAD	:		147	'96 VA			
		TOTAL ES								'96 VA			
		TOTAL ES	STIMA	TED DF		AMPS				41.1 A			

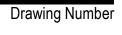

E6.1

20120-1000

IDS Drawing Title Panel Schedules & Partial One-Line Diagram

 ${
m \circ}\,$ 2021 integrated ${
m d}\,$ ${
m m}$ solutions, LLC

	Project Administrator
	C. Azar
	Project Designer
	N. Furgason
Proje	ct Architect / Engineer
	N. Furgason
	Drawn By
	N. Furgason
	Q.M. Review
	T. Carron
	Approved
	T. Carron
	Drawing Scale
	As Noted
Issued for	Issue Date
Design Developmen	t 02-26-2021
Quality Management Review	v 04-21-2021
Bid	

1 Mutual Avenue Frankenmuth, MI 48787 Key Plan

Executive Suite Renovation




1441 west long lake, suite 200 troy, michigan 48098 5211 cascade road SE, suite 300 grand rapids, michigan 49546 248.823.2100 www.ids-michigan.com

architecture engineering interiors & technology







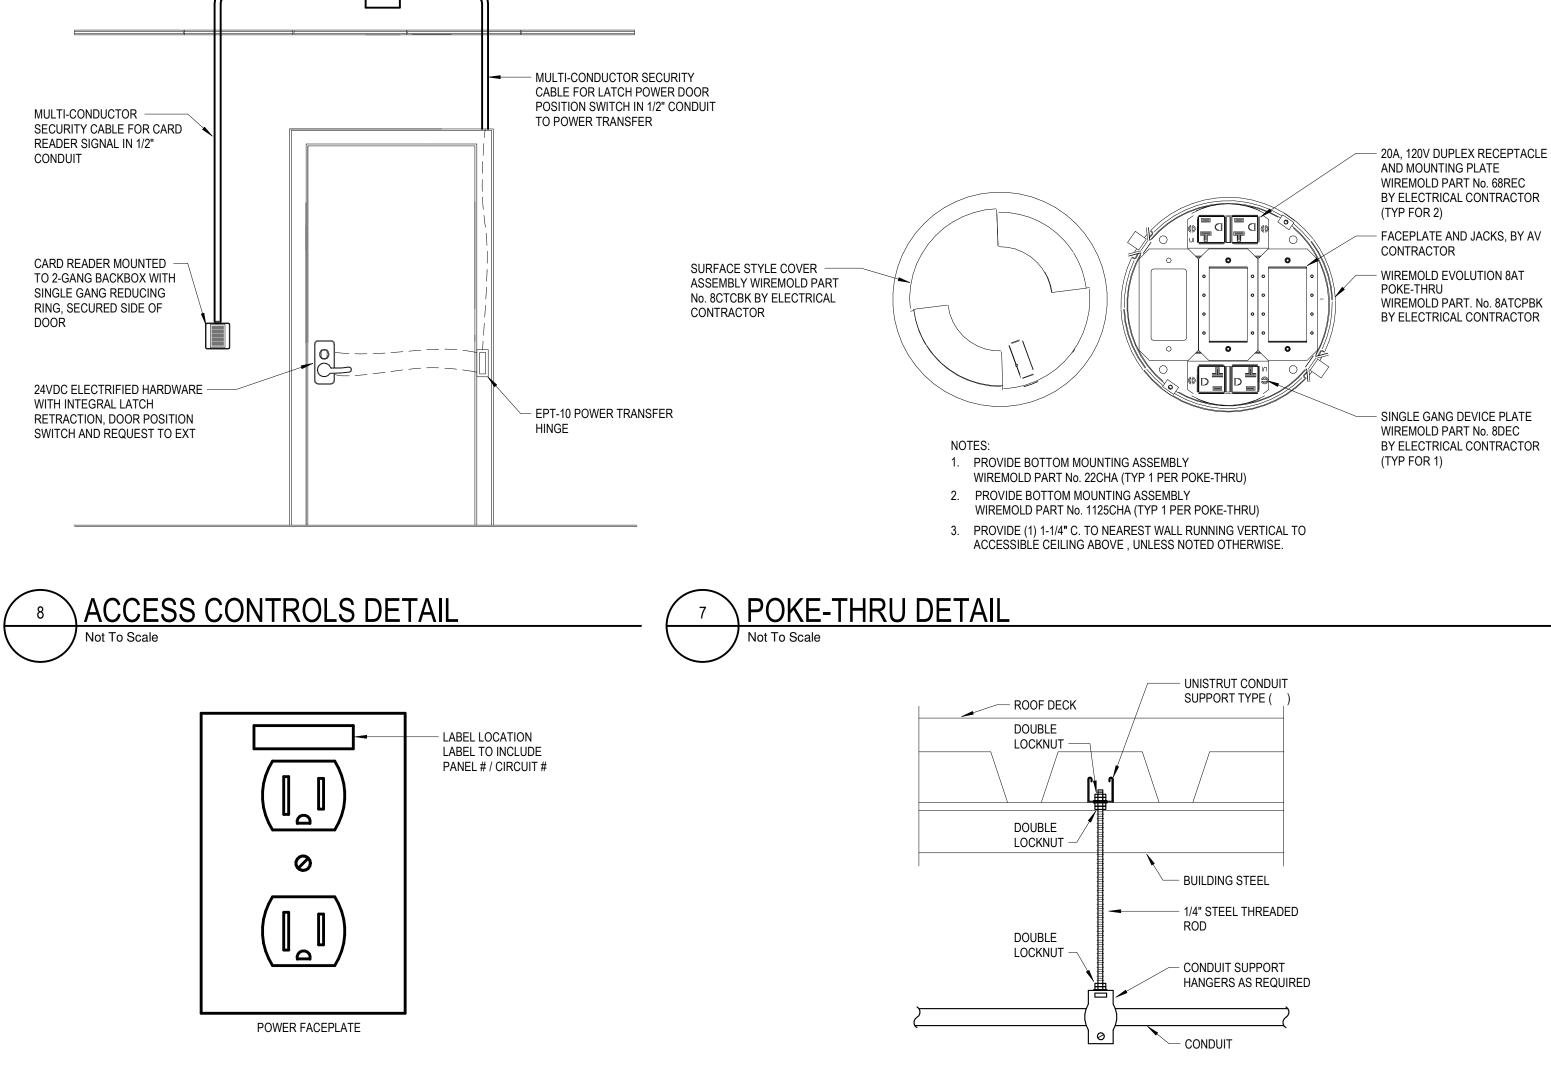

— MULTI-CONDUCTOR SECURITY

CONTROL PANEL


JUNCTION BOX ABOVE CEILING FOR -

MULTI-CABLE CONDUCTOR

SEPARATION POINT

CABLE IN 1/2" CONDUIT TO ACCESS CONTROL POWER SUPPLY AND

DETAIL TYPICAL CONDUIT HANGER DETAIL CONDUITS UP TO

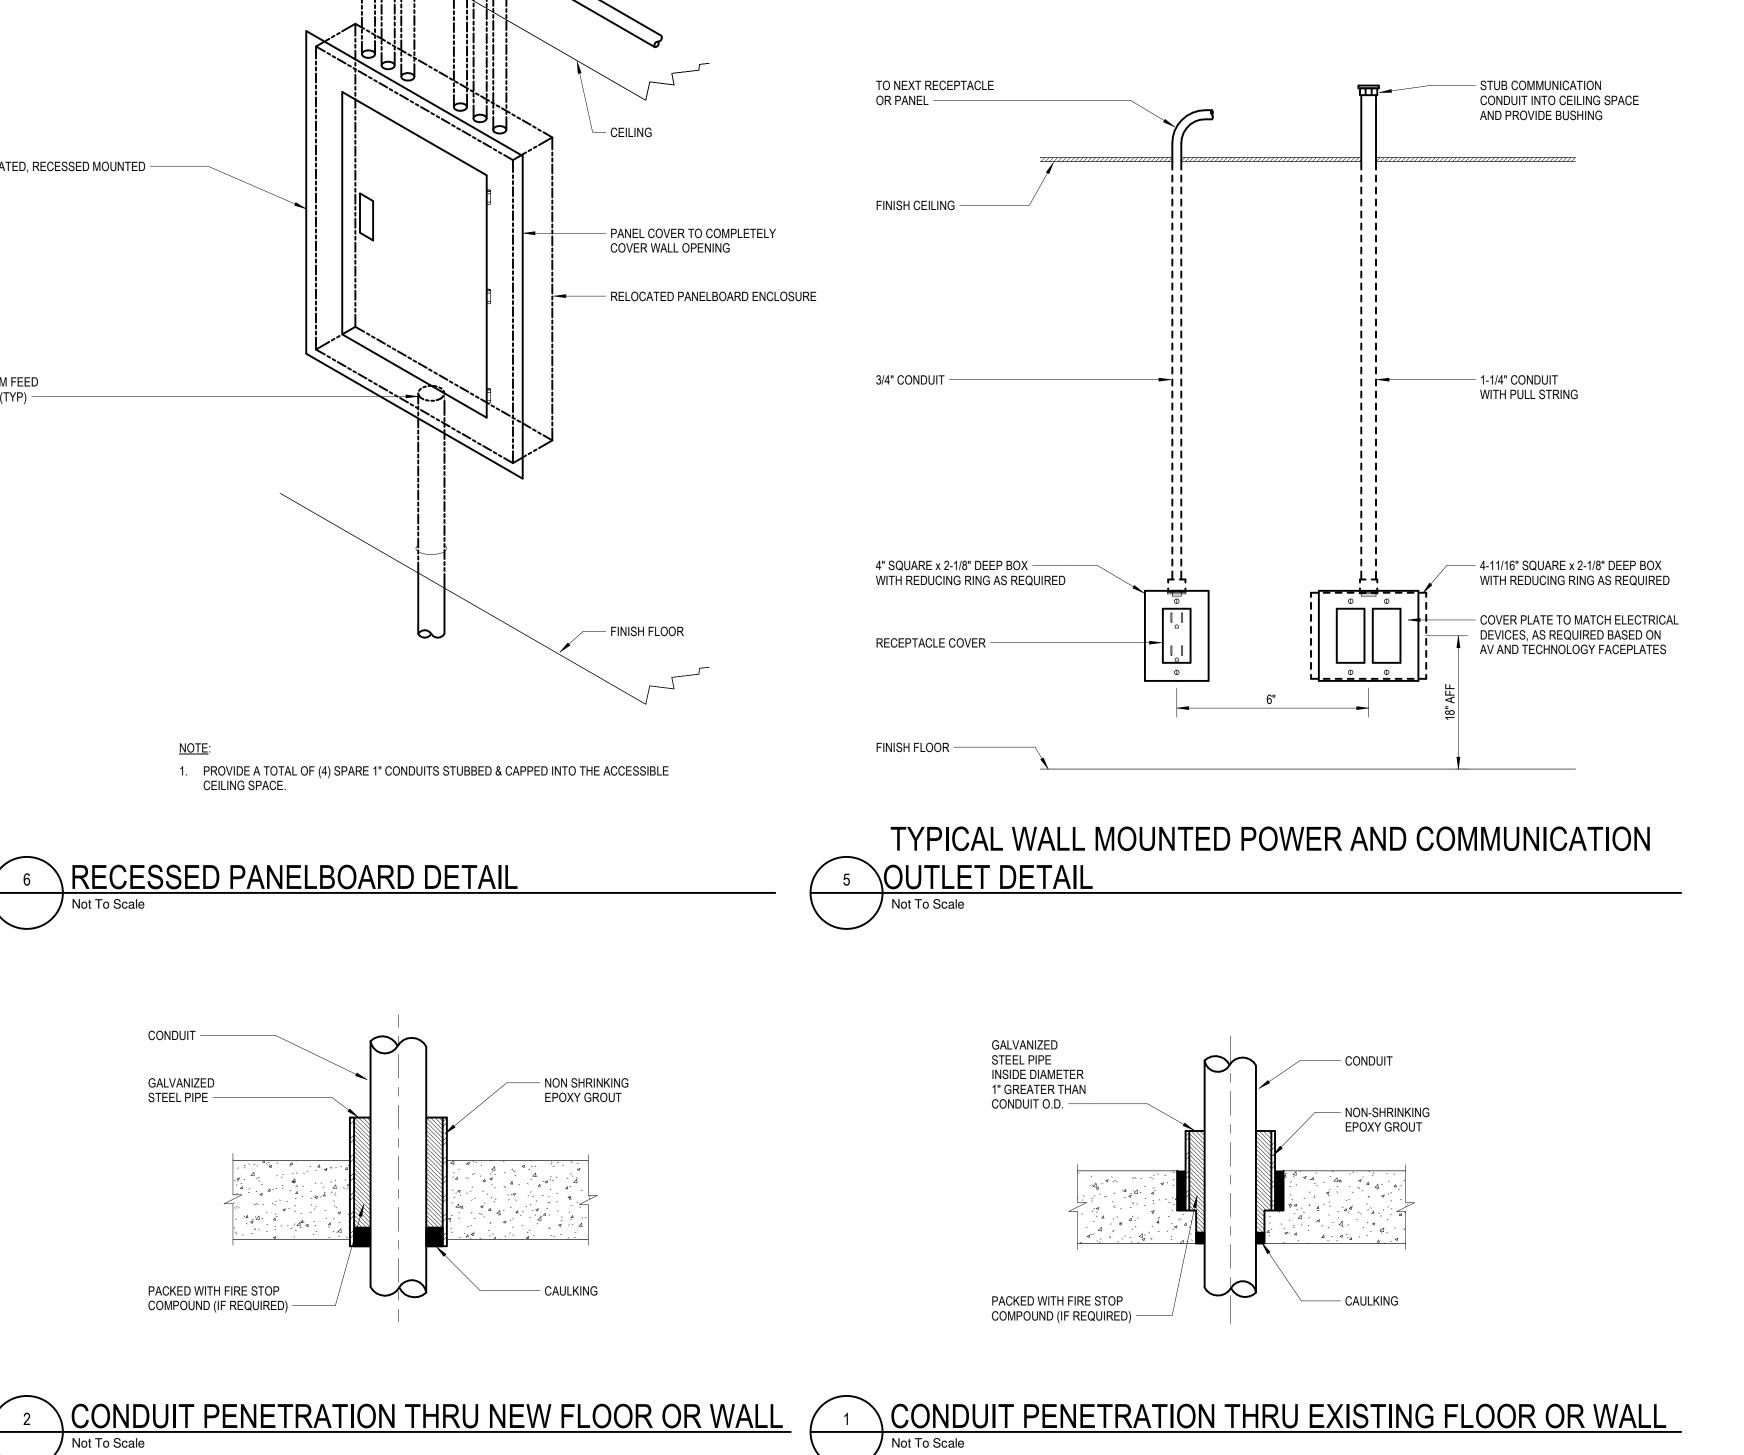

WIREMOLD PART. No. 8ATCPBK BY ELECTRICAL CONTRACTOR


 20A, 120V DUPLEX RECEPTACLE AND MOUNTING PLATE WIREMOLD PART No. 68REC BY ELECTRICAL CONTRACTOR (TYP FOR 2) - FACEPLATE AND JACKS, BY AV CONTRACTOR - WIREMOLD EVOLUTION 8AT POKE-THRU

BOTTOM FEED

PANEL (TYP) -

RELOCATED, RECESSED MOUNTED --PANEL

SPARE 1" CONDUITS SEE NOTE 1 -

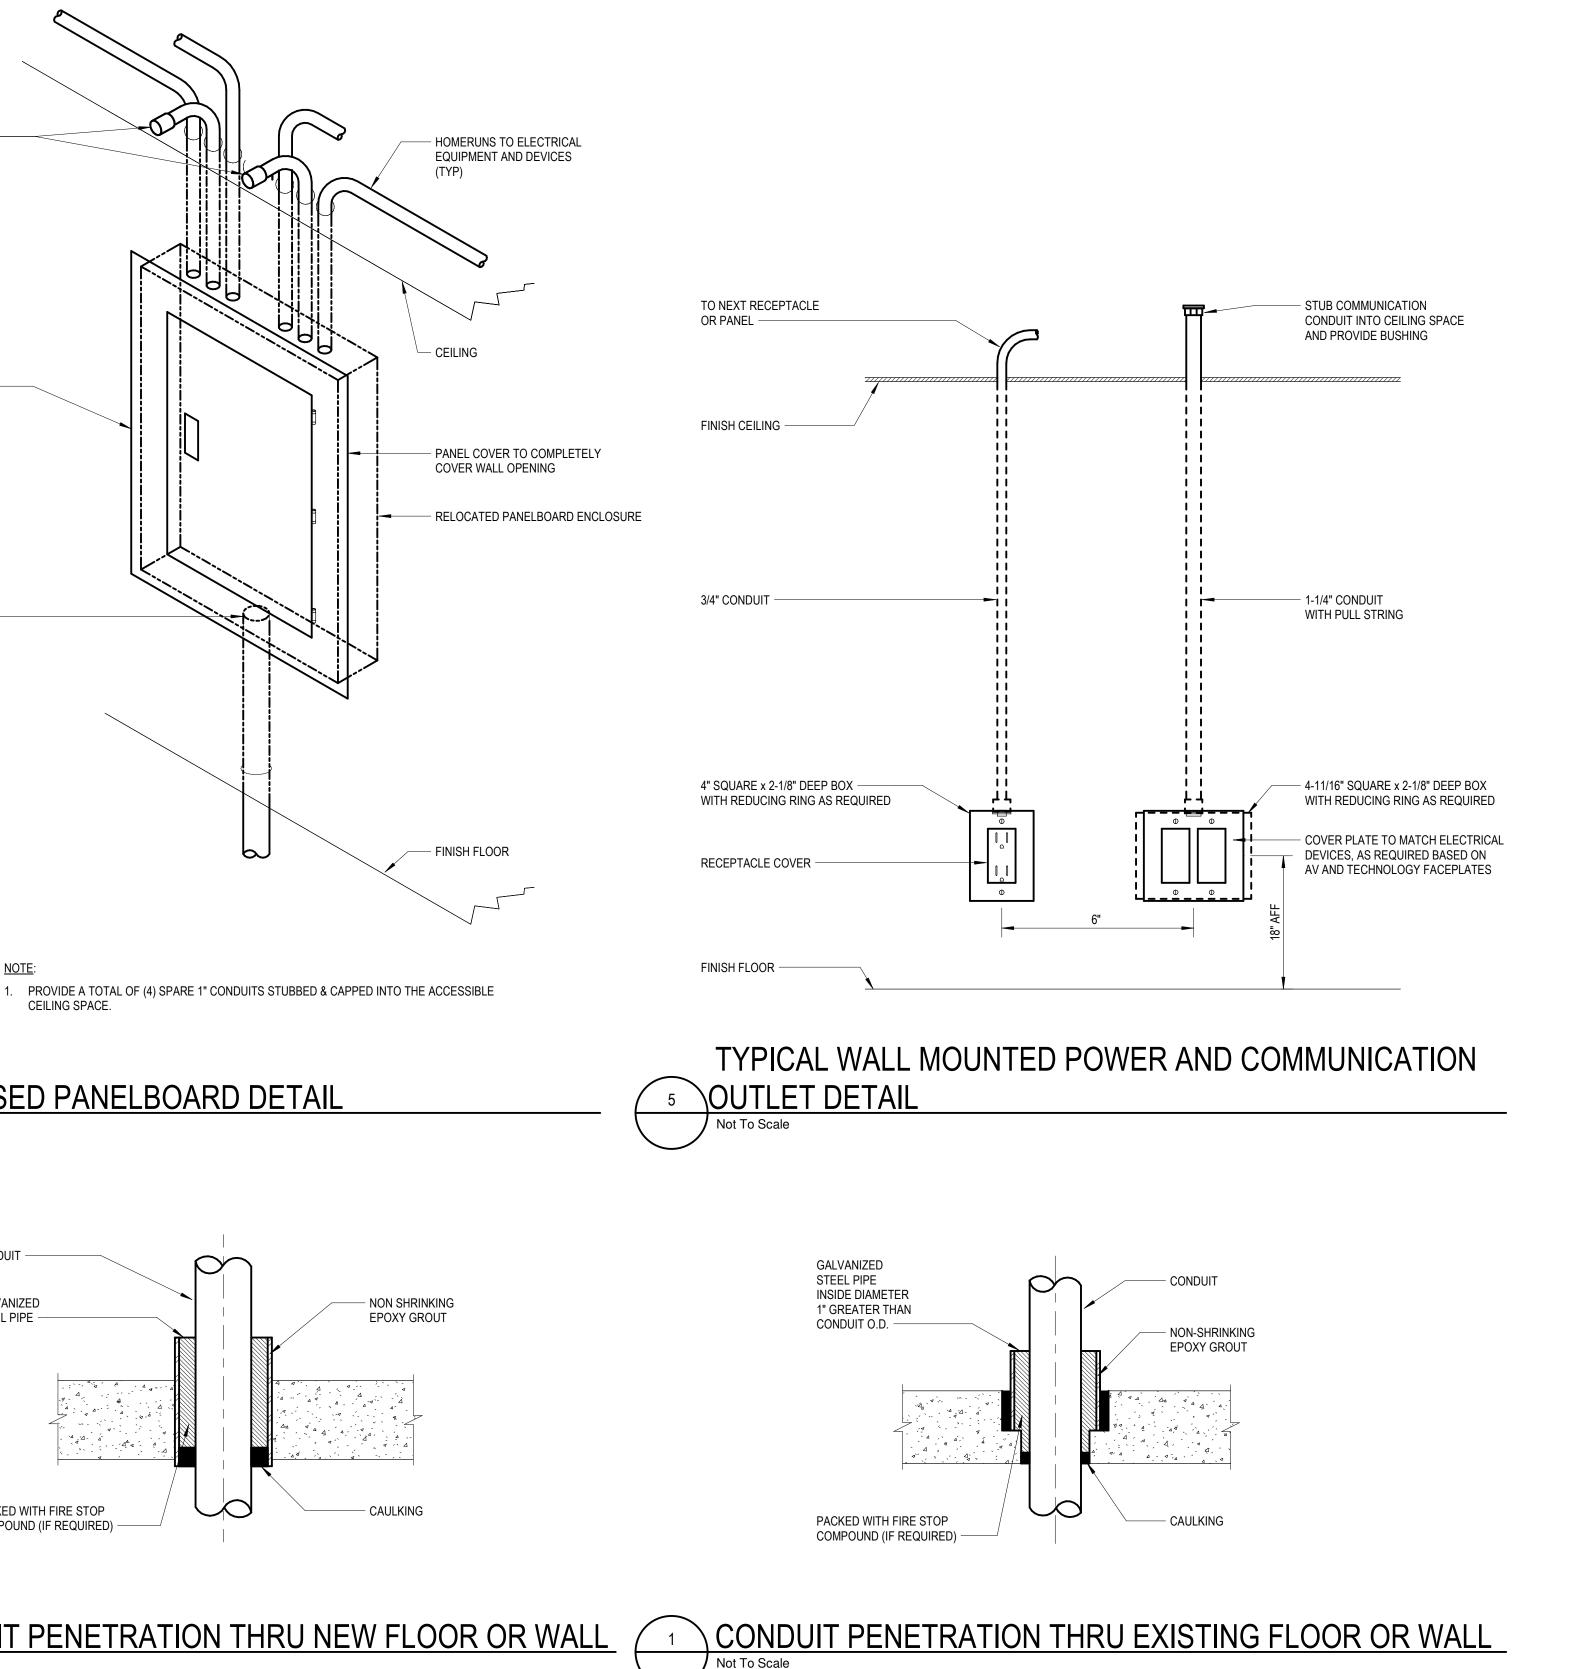

Project Administrator C. Azar Project Designer Designer Project Architect / Engineer N. Furgason Drawn By Author Q.M. Review T. Carron Approved T. Carron Drawing Scale As Noted Issue Date Issued for Quality Management Review 04-21-2021 Bids 07-15-2021

 \odot 2021 Integrated ${
m d}$

ī Ds Project Number



Drawing Number E7.1

Details

n solutions, LL IDS Drawing Title

1 Mutual Avenue Frankenmuth, MI 48787 Key Plan

Executive Suite Renovation



INTEGRATED design SOLUTIONS architecture engineering interiors & technology 1441 west long lake, suite 200 troy, michigan 48098




5211 cascade road SE, suite 300 grand rapids, michigan 49546

248.823.2100

LIGHTING CONTROL SYSTEM GENERAL NOTES

- RENOVATED AREA LIGHTING CONTROLS SYSTEMS CONSIST OF LOCALLY NETWORKED 1 DIGITAL LOW VOLTAGE LIGHTING CONTROLS. THE LOCALLY NETWORKED DISTRIBUTED LIGHTING CONTROL SYSTEM SHALL BE
- PROVIDED WITH DUAL TECHNOLOGY OCCUPANCY SENSORS, LOW-VOLTAGE PUSHBUTTONS, DIMMERS, AND SWITCHING RELAYS; DEVICES ARE CONNECTED BY GREEN CAT5 CABLING FOR A COMPLETE, FULLY PROGRAMMABLE SYSTEM. ACUITY BRANDS nLIGHT OR SPECIFIED EQUAL.
- ALL LIGHTING CONTROL SYSTEM POWER PACKS, ROOM CONTROLLERS, ETC SHALL BE LOCATED IN AN ACCESSIBLE SPACE. WHERE POSSIBLE, LOCATE WITHIN CEILING SPACE ABOVE AREA SERVED. REFER TO REFLECTED CEILING PLANS FOR ACCESS PANEL LOCATIONS.
- THE LIGHTING CONTROLS SYSTEM SHALL BE FINAL PROGRAMMED WITH THE ASSISTANCE OF THE SYSTEM MANUFACTURERS REPRESENTATIVE. THE BASIC CONTROLS SETUP AND INITIAL SEQUENCE OF OPERATIONS SHALL BE AS INDICATED WITHIN THE SPECIFICATION AND AS NOTED ON DRAWINGS.
- OCCUPANCY SENSORS SHALL BE PROVIDED FOR 100% FULL COVERAGE OF SPACES SHOWN WITH OCCUPANCY SENSORS. QUANTITIES SHOWN ON PLAN ARE FOR REFERENCE ONLY. FINAL LOCATIONS (ADHERING TO PLACEMENT QUIDELINES) AND QUANTITIES TO BE DETERMINED BY PRODUCT MANUFACTURER AND/OR VENDOR.

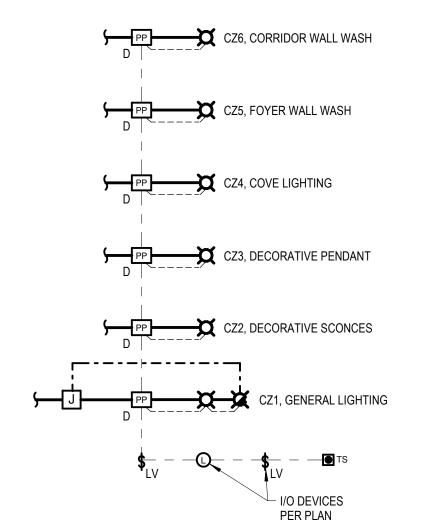


FOYER\WAITING LIGHTING CONTROLS RISER\SEQUENCE

- MULTIPLE ZONES, DIMMING, EMERGENCY SEQUENCE OF OPERATIONS:
- 1. MULTI-ZONE CONTINUOUS DIMMING TO 1% OR 10 % PER FIXTURE SCHEDULE. 2. OCCUPANCY SENSOR IN VACANCY MODE, MANUAL ON\AUTO OFF FOR ALL ZONES
- 15 MINUTES AFTER NO MOTION DETECTED. 3. PRIMARY AND SECONDARY DAYLIGHT HARVESTING ZONES TO AUTOMATICALLY MAINTAIN 50FC AT TASK HEIGHT. DAYLIGHT HARVESTING SHALL ONLY BE APPLIED
- TO CZ1 FIXTURES. 4. CZ1 - GENERAL DOWNLIGHT LIGHTING
- CZ2 WALL SCONCES CZ3 - DECORATIVE PENDANT CZ4 - COVE LIGHTING
- CZ5 LOBBY WALL WASH CZ6 - CORRIDOR WALL WASH

- ALL EMERGENCY LIGHTING WITHIN A SPACE SHALL BE CONTROLLED IN TAN NORMAL LIGHTING IN THE SAME SPACE. UPON LOSS OF NORMAL POWER, A LIGHTING SHALL COME TO FULL BRIGHTNESS. EMERGENCY CONTROL DEVI UL924 LISTED.
- ALL LIGHTING FIXTURES PROVIDED WITH POWER SUPPLIES, DRIVER OR BAL DIMMING CAPABILITES, SHALL BE WIRED WITH\AND CONNECTED TO DIMMIN POWER PACKS, ETC.
- ALL OCCUPANCY SENSORS SHALL BE PROVIDED WITH AN ISOLATED RELAY MECHANICAL CONTROLS CONTRACTOR.
- ALL LOW VOLTAGE LIGHTING CONTROLS CABLES SHALL BE IN CONDUIT IN I CONSTRUCTION AREAS. IN WALLS AND ABOVE INACCESSIBLE CEILINGS, AB ACCESSIBLE CEILINGS, UTILIZE J-HOOKS, BRIDAL RINGS AND CABLE TRAY 1 AND ROUTE CABLING. ALL PENETRATIONS THROUGH WALL CONSTRUCTION THROUGH CONDUIT SLEEVES.
- 10. ALL AUTOMATIC DIMMING TRANSITIONS SHALL OCCUR OVER A 3 SECOND F DOWN.
- 11. RISER DIAGRAMS ARE FOR REFERENCE ONLY AND ARE INCLUDED TO CONV INTENT ONLY. NOT ALL PARTS AND PIECES ARE SHOWN. ACTUAL RISERS, C

AND CONNECTIONS ARE MANUFACTURER DEPENDANT.

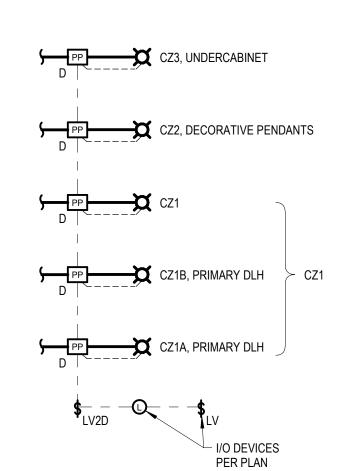


KITCHENETTE LIGHTING CONTROLS RISER\SEQUENCE \land SINGLE ZONE LIGHTING CONTROLS RISER\SEQUENCE

- MULTIPLE ZONES, DIMMING, DAYLIGHT HARVESTING PER PLAN SEQUENCE OF OPERATIONS:
- . MULTI-ZONE CONTINUOUS DIMMING TO 1% OR 10 % PER FIXTURE SCHEDULE. 2. OCCUPANCY SENSOR IN VACANCY MODE, MANUAL ON\AUTO OFF FOR ALL ZONES
- 15 MINUTES AFTER NO MOTION DETECTED. 3. PRIMARY AND SECONDARY DAYLIGHT HARVESTING ZONES TO AUTOMATICALLY
- TO CZ1 FIXTURES. 4. CZ1x - GENERAL LIGHTING CZ2 - DECORATIVE PENDANTS

CZ3 - UNDERCABINET LIGHTING

LIGHTING CONTROL SYSTEM LEGEND

ANDEM WITH , ALL EMERGENCY		LINE VOLTAGE EMERGENCY POWER SENSING CIRCUIT
VICES SHALL BE		LINE VOLTAGE
BALLASTS, WITH		LOW VOLTAGE CABLING (PER MANUFACTURER)
IING CAPABLE	\$ _{LVD}	LOW VOLTAGE CONTROL STATION WITH SINGLE-ZONE DIMMING CONTROL
AY FOR USE BY	TS	GRAPHIC TOUCHSCREEN CONTROL PANEL
N EXPOSED ABOVE	\$ _{PX}	LOW VOLTAGE PRESET STATION
Y TO SUPPORTS ON SHALL BE	D PP	POWER PACK\POWER HANDLING EQUIPMENT(CONTACTOR WITH DIMMING FUNCTIONALITY, ETC).
FADE UP OR	J	JUNCTION BOX
	ØØ	LIGHT FIXTURE (NORMAL OR EMERGENCY, REFER TO PLANS)
NVEY DESIGN , COMPONENTS	C	OCCUPANCY SENSOR

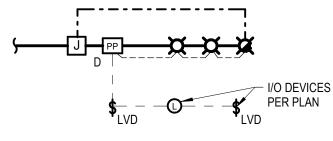


SINGLE PRIMARY ZONE, DIMMING, EMERGENCY (PER PLAN) SEQUENCE OF OPERATIONS:

1. MULTI-ZONE CONTINUOUS DIMMING TO 1% OR 10 % PER FIXTURE SCHEDULE. 2. OCCUPANCY SENSOR IN VACANCY MODE, MANUAL ON\AUTO OFF 15 MINUTES AFTER NO MOTION DETECTED.

MAINTAIN 50FC AT TASK HEIGHT. DAYLIGHT HARVESTING SHALL ONLY BE APPLIED

LIGHTING CONTROLS SCHEDULE

ROOM NUMBER NAME		CONTROLS
NAME	TYPE	SEQUENCE
CORRIDOR	NON-NETWORKED	A
CORRIDOR	NON-NETWORKED	С
MEETING ROOM	NON-NETWORKED	A
PRIVATE TOILET ROOM	LINE VOLTAGE	N/A
TOILET ROOM	LINE VOLTAGE	N/A
SHOWER/ TOILET ROOM	LINE VOLTAGE	N/A
VESTIBULE	NON-NETWORKED	A
WORK ROOM	NON-NETWORKED	A
BOARD ROOM	CRESTON	N/A
CLOSET	LINE VOLTAGE	N/A
FOYER/ WAITING	NON-NETWORKED	С
KITCHENETTE	NON-NETWORKED	В
CLOSET	N/A	N/A
	NAME CORRIDOR CORRIDOR MEETING ROOM PRIVATE TOILET ROOM TOILET ROOM SHOWER/ TOILET ROOM VESTIBULE WORK ROOM BOARD ROOM CLOSET FOYER/ WAITING KITCHENETTE	NAMETYPECORRIDORNON-NETWORKEDCORRIDORNON-NETWORKEDMEETING ROOMNON-NETWORKEDPRIVATE TOILETLINE VOLTAGEROOMLINE VOLTAGESHOWER/ TOILETLINE VOLTAGESHOWER/ TOILETLINE VOLTAGEWORK ROOMNON-NETWORKEDWORK ROOMCRESTONCLOSETLINE VOLTAGEFOYER/ WAITINGNON-NETWORKEDKITCHENETTENON-NETWORKED

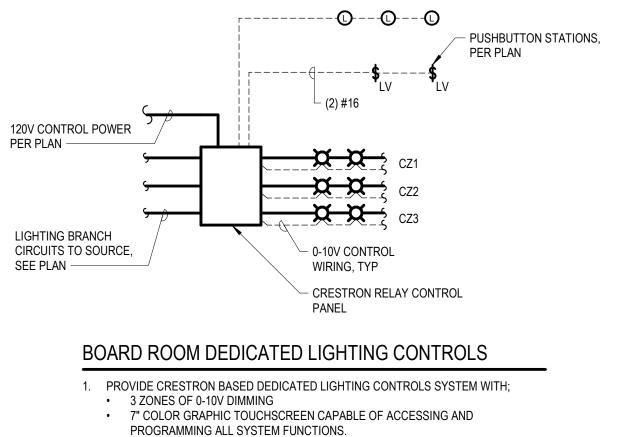

- AV SYSTEM INTEGRATION WITH CRESTON AV SYSTEM.
- REMOTE PUSHBUTTON STATION CONTACT DENNIS WALKER OF MLS-EAST; 734-732-2552
- ZONE 1 PERIMETER DOWNLIGHTS
- ZONE 2 GENERAL LINEAR LIGHTING ZONE 3 - TV WALL LINEAR LIGHTING

LIGHTING FIXTURE SCHEDULE

LA

LINEAR ASYMETRIC KNIFE-EDGE COVE LED LUMINAIRE WITH; NOMINAL 7" WIDE x

LA	CUSTON 650 LUMEN/FT	IIFE-EDGE COVE LED LUMINAIRE WITH; NOMINAL 7" WIDE x 2.5 [LED PACKAGE, ASYMETRIC DISTRIBUTION WITH ADJUSTABL SH, INTEGRAL WIRING COMPARTMENT, UL LISTING AND FIELD
	SUPPLY WITH THERMA	L AND SURGE PROTECTION. FIXTURE SHALL BE PROVIDED W AN DRAWINGS. HOUSING SHALL BE MANUFACTURED OR FIEL
	MANUFACTURERS;	LF ILLUMINATION; EN6K-C SERIES WITH EF600
	LIGHT SOURCE;	650 DELIVERED LUMEN/FT, 80 CRI MIN, 3500K CCT
	MAX INPUT WATTS; LOCATION:	432 TOTAL WATTS FOYER/WAITING COVE CEILING
LB1A-X	OPTIC, CONTINUOUS F WHITE POWDER COATI EXTERNAL TO DRIVER, DIMMABLE (TO 1%) PO	RE, RECESSED LINEAR LED LUMINAIRE WITH: EXTRUDED ALU LUSH FROST WHITE SNAP-IN DOWNLIGHT DIFFUSER, HIGH RE ED FINISH, INSTALLATION HARDWARE FOR FLUSH MOUNTING , INTEGRAL DRIVER SURGE PROTECTION, INTEGRAL DRIVER D WER SUPPLY. CONTINUOUS ROW MOUNTED FIXTURE SHALL ITERNAL JOINER SYSTEM AND WIRED TOGETHER WITH FACTO
	MANUFACTURER:	FINELITE: HP-2 R CORONET LTG; LSR2 LED AXIS LIGHTING; BRLED LUX ILLUMINAIRE; EOS 2.0R SERIES
	SOURCE:	MINIMUM 80 CRI, 650 LUMENS/FT MIN, 3500K CCT
	MAX INPUT WATTS: LOCATION:	8 WATTS/FT MAX KITCHENETTE
LB1Ae-X	SAME AS LB1A-X, EXCE MANUFACTURER:	EPT; PROVIDE 24" SECTION WITH 1600 LUMEN EMERGENCY BA FINELITE: HP-2 R CORONET LTG; LSR2 LED AXIS LIGHTING; BRLED LUX ILLUMINAIRE; EOS 2.0R SERIES
	SOURCE:	MINIMUM 80 CRI, 650 LUMENS/FT MIN, 3500K CCT
LB1B-X		8 WATTS/FT MAX KITCHENETTE T; 825 NOMINAL LUMENS\FT LUMEN PACKAGE
	MANUFACTURER:	FINELITE: HP-2 R CORONET LTG; LSR2 LED AXIS LIGHTING; BRLED LUX ILLUMINAIRE; EOS 2.0R SERIES
	SOURCE:	MINIMUM 80 CRI, 825 NOMINAL LUMENS\FT LUMENS, 3500K C
	MAX INPUT WATTS: LOCATION:	10 WATTS\FT MAX MEETING ROOM, WORK ROOM
LB3-8	SAME AS LB1A, EXCEP	T; 8'-0" LONG, TRIM FOR FLANGELESS MUD-IN INSTALLATION I
	MANUFACTURER:	FINELITE: HP-2 R CORONET LTG; LSR2 LED AXIS LIGHTING; BRLED LUX ILLUMINAIRE; EOS 2.0R SERIES
	SOURCE:	MINIMUM 80 CRI, 650 LUMENS/FT MIN, 3500K CCT
	MAX INPUT WATTS:	8 WATTS/FT MAX
LB4-X	SAME AS LB1B, EXCEP	T; TRIM FOR FLUSH INSTALLATION IN A WOOD CEILING.
	MANUFACTURER:	FINELITE: HP-2 R CORONET LTG; LSR2 LED AXIS LIGHTING; BRLED LUX ILLUMINAIRE; EOS 2.0R SERIES
	SOURCE:	MINIMUM 80 CRI, 825 NOMINAL LUMENS\FT LUMENS, 3500K C
	MAX INPUT WATTS:	10 WATTS\FT MAX
LC		IEAR WALL MOUNTED DECORATIVE LED LIGHT FIXTURE WITH; NS, SILVER METTALIC FINISH, DIE-CAST ALUMINUM END CAPS;
	MANUFACTURER:	OCL; H01-S1SA-24-MW-SMP-LED1-35K-UNV-DM1
	SOURCE:	MINIMUM 80 CRI, 2000 LUMEN, 3500K CCT
	INPUT WATTS:	45 WATTS
LD1	REFLECTOR FINISH, 50 ACCOMMODATIONS FC ELECTRONIC POWER S	PERTURE, RECESSED ARCHITECTURAL LED DOWNLIGHT LUN DEGREE WIDE DISTRIBUTION, REGRESSED DIFFUSE LENS, T OR CEILING THICKNESS TO 1-1/2", LEDS AND POWER SUPPLY S SUPPLY WIRED FOR DIMMING, OVERLOAD AND SHORT CIRCUI THE DRIVER, ENERGY STAR CERTIFIED, UL LISTING FOR DAM
	MANUFACTURER:	USAI LIGHTING; B4RDL SERIES

MANUFACTURER:	USAI LIGHTING; B4RDL SERIES
SOURCE:	MIN 80 CRI, 775 DELIVERED LUMENS, 3500K CCT
MAX INPUT WATTS:	9W
SAME AS LD1, EXCEPT;	PROVIDE INTEGRAL EM BATTERY PACK WITH INTEGRAL TES
MANUFACTURER:	USAI LIGHTING; B4RDL SERIES
SOURCE:	MIN 80 CRI, 775 DELIVERED LUMENS, 3500K CCT
MAX INPUT WATTS:	9W
SAME AS LD1, EXCEPT	WHITE PAINTED FLANGE\TRIM FOR INSTALLATION IN A LAY-II
MANUFACTURER:	USAI LIGHTING; B4RDF
SAME AS LD2, EXCEPT;	PROVIDE INTEGRAL EM BATTERY PACK WITH INTEGRAL TES
MANUFACTURER:	USAI LIGHTING; B4RDF SERIES
SOURCE:	MIN 80 CRI, 775 DELIVERED LUMENS, 3500K CCT
MAX INPUT WATTS:	9W
SAME AS LD1, EXCEPT	BLACK PAINTED REFLECTOR AND TRIMLESS MILLWORK INST
MANUFACTURER:	USAI LIGHITNG; B4RDM
SOURCE:	MIN 80 CRI, 775 DELIVERED LUMENS, 3500K CCT
MAX INPUT WATTS:	9W
BODY AND TRIM, FLUSH ELECTRONIC POWER S	PERTURE, RECESSED LED DOWNLIGHT LUMINAIRE WITH; 7-1 1 ACRYLIC FROSTED LENS, LEDS AND POWER SUPPLY SERV UPPLY WIRED FOR DIMMING, OVERLOAD AND SHORT CIRCU THE DRIVER, ENERGY STAR CERTIFIED, UL LISTING , IP65 RA
MANUFACTURER:	SPECTRUM LIGHTING; SGDF6LEDFX SERIES VANTAGE LED; A6VOFLED COOPER; HALO PD6 SERIES HE WILLIAMS; 6DR-IP SERIES
SOURCE:	MIN 80 CRI, 1500 DELIVERED LUMENS, 3500K CCT
MAX INPUT WATTS:	21
FIXTURE MOUNTING HE	TIVE BOWL PENDANT WITH; (3) EQUALY SPACED ANGLED AIF EIGHT ON PLAN, 2 TRIM RINGS AT TOP EDGE OF BOWL, MATT UMEN INTEGRAL LED PACKAGE, UNIVERSAL VOLTAGE 0-10V
MANUFACTURER:	OCL LIGHTING; REFLECTION SERIES RF1-P1ED-33-MW-SMP-
SOURCE:	MIN 80 CRI, 4500 DELIVERED LUMENS, 3500K CCT

LD1E

LD2

LD2E

LD3

LD4

LE

MAX INPUT WATTS: 50

x 2.5" DEEP EXTUDED ALUMINUM HOUSING, NOMINAL 6W/FT AND FABLE OPTICS AND DIFFUSE LENS, MUD-IN STYLE FLANGE, WHITE IELD REPLACEABLE INTEGRAL 0-10V DIMMABLE 120V POWER ED WITH CONTINUOUS RUNS AND 90 DEGREE CORNERS FOR FIELD CUT\ADJUSTED TO MATCH ACTUAL FIELD DIMENSION OF	LF	24" HIGH, 6.7" WIDE DECORATIVE WALL SCONCE WITH; SOLID ALUMINUM DIE-CAST DOMED TOP END CAPS, 1/8" THK EXTRUDED ALUMINUM BACK CHANNEL, DECORATIVE CAST ALUMINUM HORIZONTAL BARS, MATTE WHITE ACRYLIC LENS, HINGED FROM FACE, SILVER METALLIC POWDER COATED FINISH, 1600 LUMEN INTEGRAL LED PACKAGE AND UNIVERSAL VOLTAGE 0-10V DIMMABLE LED POWER SUPPLY.		
FIELD CUTADJUSTED TO MATCH ACTUAL FIELD DIMENSION OF		MANUFACTURER:	OCL LIGHTING; ALLURE SERIES AU1-S1SA-24-MW-SMP-LED1-35K-UNV-DM1	
		SOURCE:	MIN 80 CRI, 1600 DELIVERED LUMENS, 3500K CCT	
		MAX INPUT WATTS:	30	
	LG		IOUNTED LED UNDERCABINET LIGHT FIXTURE WITH; LOW PROFILE WHITE STEEL HOUSING, ACRYLIC WHITE DIFFUSER AND R SUPPLY. PROVIDE DIRECT-WIRED CONNECTION CONCEALED UNDER CABINET.	
ALUMINUM BODY, 650 NOMINAL LUMENS/FT DIRECT SYMMETRIC		MANUFACTURER:	ACUITY; JUNO UCES SERIES	
IH REFLECTANCE WHITE POWDER COATED STEEL REFLECTOR, TING IN A 15/16" T-GRID LAY-IN CEILING, INTEGRAL FUSING /ER DISCONNECT, UL LISTING AND REPLACEABLE 120V 0-10V IALL BE PROVIDED WITH MAXIMUM LENGTH LENSES AND JOINED ACTORY INSTALLED WIRING HARNESSES.		SOURCE:	MIN 80 CRI, 736 DELIVERED LUMENS, 3500K CCT	
		MAX INPUT WATTS:	10.6	
	LH		R DECORATIVE PENDANT LIGHT FIXTURE WITH; SCREW-IN LED REPLACEMENT LAMP, PENDANT MOUNT FINISHED TO IN NICKEL FINISH, 120V WIRING AND OPAL WHITE ACRYLIC DIFFUSER	
		MANUFACTURER:	TMS LIGHTING; 3009PH-LED-CR12-SN-120-OP	
		SOURCE:	3500K CCT SCREW-IN LAMP	
		MAX INPUT WATTS:	4.5W	

BATTERY PACK AS INDICATED ON PLAN.

< CCT

I IN A DRYWALL CEILING AND WALL WASH ASYMETRIC ...

K CCT

TH; EXTRUDED ALUMINUM HOUSING, ROUNDED PROFILE PS, INTEGRAL 120V 0-10V DIMMABLE (TO 10%) POWER SUPPLY

JMINAIRE WITH; 6" MAXIMUM HOUSING DEPTH, MATTE WHITE TRIM FOR MUD-IN FLANGLESS INSTALLATION, SERVICEABLE FROM BELOW, 0-10V DIMMABLE (TO 10%) UIT PROTECTION, INTEGRAL DRIVER DISCONNECT, INTEGRAL

AMP LOCATIONS; 120 VOLT OPERATION.

TEST SWITCH PROVIDING 575 LUMENS FOR 90 MINUTES

Y-IN CEILING.

EST SWITCH PROVIDING 575 LUMENS FOR 90 MINUTES

ISTALLATION HARWARE FOR INSTALLATION IN A WOOD CEILING

7-1/2" MAXIMUM HOUSING DEPTH, DEAD FRONT SHOWER LIGHT RVICEABLE FROM BELOW, 0-10V DIMMABLE (TO 10%)


CUIT PROTECTION, INTEGRAL DRIVER DISCONNECT, INTEGRAL RATING, 120 VOLT OPERATION.

AIRCRAFT CABLES, SINGLE CENTER STEM WITH LENGTH FOR

TTE WHITE ACRYLIC DIFFUSER, SILVER METALLIC POWDER / DIMMABLE POWER SUPPLY AND UL LISTING

P-LED1-35K-UNV-XX-DM1

īD^s Project Number

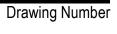

E8.1

20120-1000

Lighting Fixture Schedule & Lighting **Controls Risers**

 \odot 2021 integrated ${
m d}$ n solutions, llo IDS Drawing Title

Pr	roject Administrator C. Azar
	Project Designer
	N. Furgason
Project #	Architect / Engineer
	N. Furgason
	Drawn By
	N. Furgason
	Q.M. Review
	T. Carron
	Approved
	T. Carron
	Drawing Scale
	As Noted
Issued for	Issue Date
Design Development	02-26-2021
Quality Management Review	04-21-2021
Bids	07-15-2021

1 Mutual Avenue Frankenmuth, MI 48787 Key Plan

Executive Suite Renovation



INTEGRATED design solutions architecture engineering interiors & technology 1441 west long lake, suite 200 troy, michigan 48098 5211 cascade road SE, suite 300


grand rapids, michigan 49546


www.ids-michigan.com

248.823.2100



ABBREVIATIONS

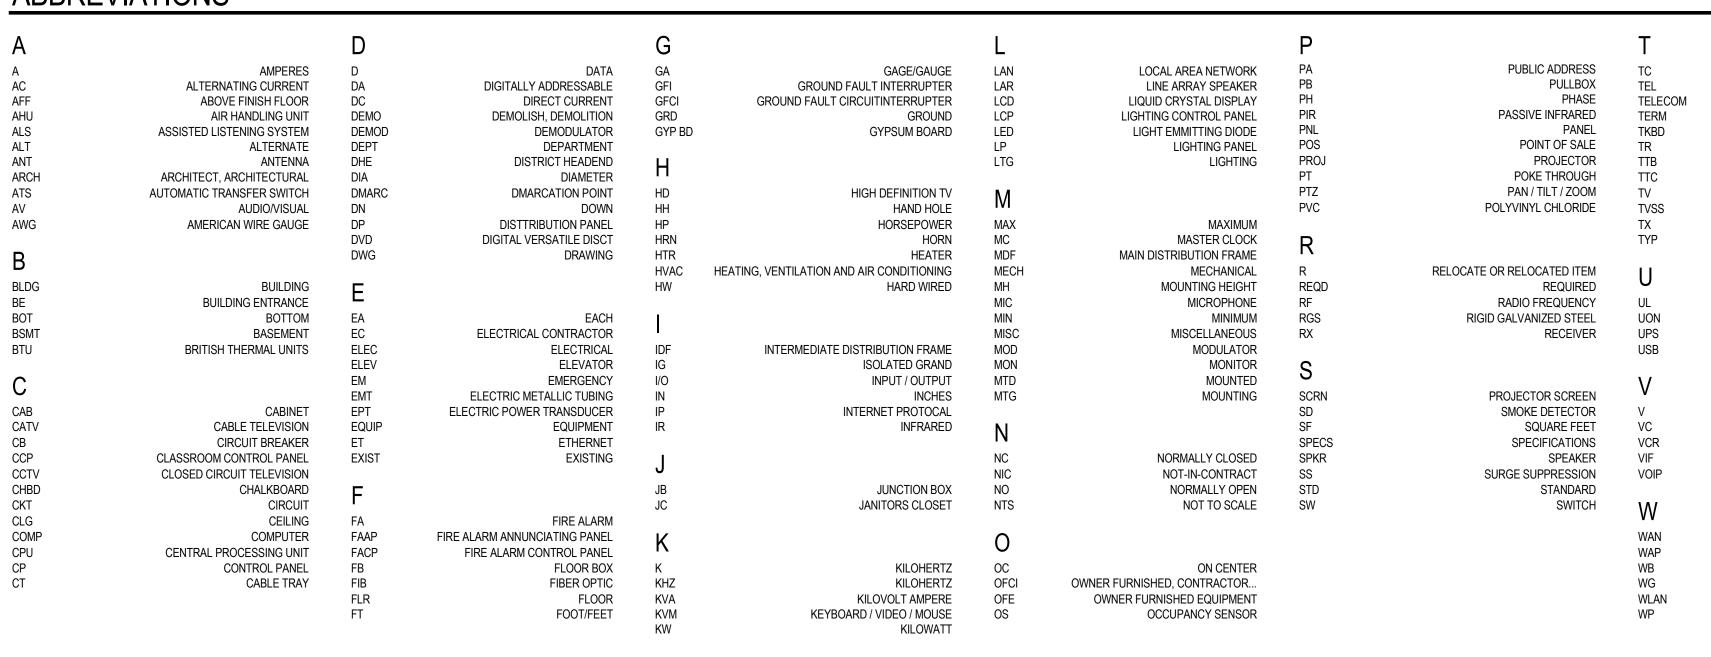

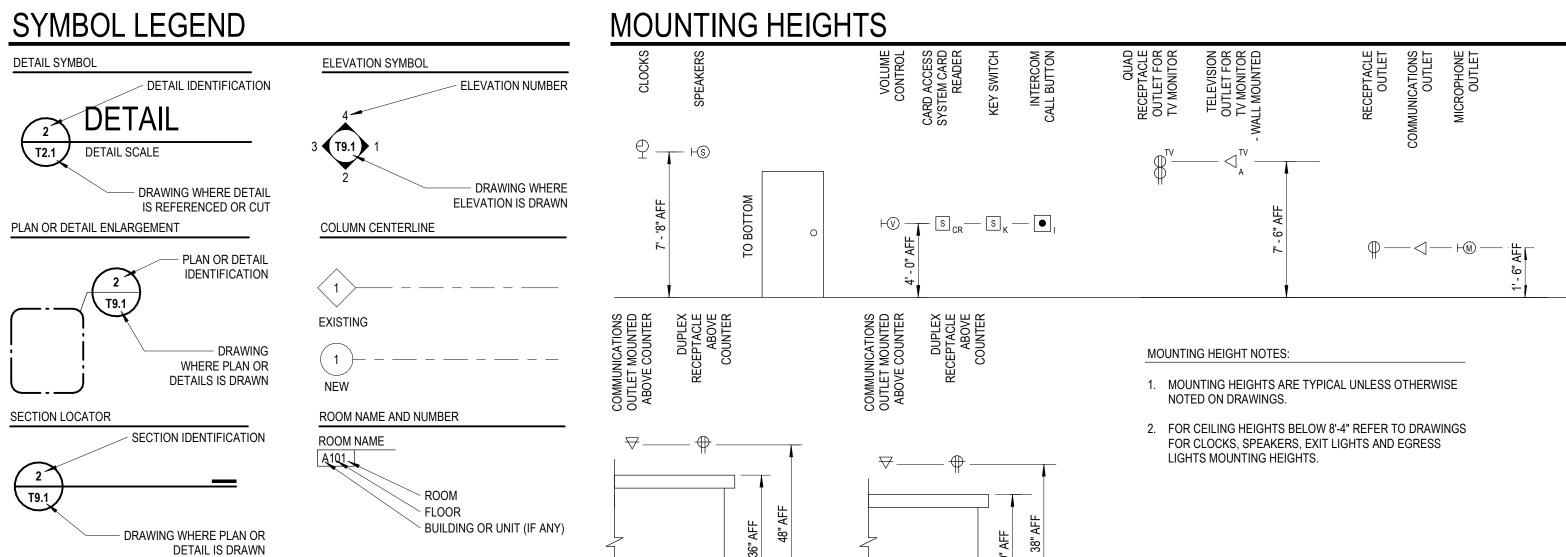

SYMBOLS (LETTERS (X) INDICATE TYPE, TYPICAL) POWER SINGLE RECEPTACLE OUTLET DUPLEX RECEPTACLE OUTLET 🔨 DUPLEX RECEPTACLE OUTLET FLUSH MOUNTED IN CEILING Ð FLUSH MOUNTED POWER ONLY FLOOR BOX DUPLEX RECEPTACLE OUTLET MOUNTED ABOVE COUNTER DUPLEX RECEPTACLE OUTLET WITH INTEGRAL GROUND FAULT PROTECTION DUPLEX RECEPTACLE OUTLET CONNECTED TO UPSTREAM GROUND FAULT PROTECTION DEVICE DUPLEX RECEPTACLE OUTLET WITH INTEGRAL SURGE SUPPRESSION DUPLEX RECEPTACLE OUTLET CONNECTED TO UPSTREAM SURGE SUPPRESSION DEVICE DUPLEX RECEPTACLE OUTLET SPLIT WIRED DUPLEX RECEPTACLE OUTLET WITH ISOLATED GROUND ΟυλΟ ΒΕΘΕΡΤΑΟΙ Ε ΟΠΤΙ ΕΤ INTER GRAL JE (1) TACLE ATED **POLE** CTION OROP MBI Y TYP) NTFD

-	QUAD RECEPTACLE OUTLET
-\$\$	QUAD RECEPTACLE OUTLET MOUNTED ABOVE COUNTER
SS SS	QUAD RECEPTACLE OUTLET WITH ONE (1) INTEGRAL SURGE SUPPRESSION TYPE RECEPTACLE AND ONE (1) SURGE SUPPRESSION PROTECTED RECEPTACLE
-O _x	SPECIAL RECEPTACLE AS INDICATED
	POWER/COMMUNICATIONS POLE
•	SPECIAL POWER CONNECTION
	CORD DROP
	POKE THROUGH ASSEMBLY LETTERS INDICATE TYPE (TYP)
O	JUNCTION BOX - CEILING MOUNTED
J	JUNCTION BOX - WALL MOUNTED
● _E	PUSHBUTTON STATION - EMERGENCY POWER SHUTDOWN
	INTERCOM CALL BUTTON
• IP	INTERCOM CALL BUTTON WITH PRIVACY
0 0 0 0	HORIZONTALLY MOUNTED MULTI-OUTLET RACEWAY
×	VERTICALLY MOUNTED MULTI-OUTLET RACEWAY
	BUS DUCT
	EQUIPMENT MOUNTING BACKBOARD

6

208/120V PANELBOARD 480/277V PANELBOARD *[]]]]*]

 \mathbf{X}

XJ_{30/30A}

D4_{30A}

ZJ_{30/30A}

СВ 30А

M

Т

×

HG-

IXILIARY			
CEILING MOUNTED SINGLE FACED CLOCK	■ CB	CODE BLUE PUSHBUTTON - NURSE CALL	Ť
CEILING MOUNTED DOUBLE FACED CLOCK	N _{DS}	NURSE CALL DUTY STATION	_
WALL MOUNTED SINGLE FACED CLOCK		NURSE CALL EMERGENCY STATION	
WALL MOUNTED DOUBLE FACED CLOCK	N _{MS}	NURSE CALL MASTER STATION	o
MBINATION WALL MOUNTED SPEAKER/CLOCK	N _{PS}	NURSE CALL POWER SUPPLY	•
IG MOUNTED COMBINATION SPEAKER/CLOCK	N _{SS}	NURSE CALL STAFF STATION	
WALL MOUNTED DIGITAL CLOCK	Ъ	NURSE CALL WALL MOUNTED DOME LIGHT	— P —
CEILING MOUNTED SPEAKER	₽c	NURSE CALL CEILING MOUNTED DOME LIGHT	— HP —
BIDIRECTIONAL WALL MOUNTED SPEAKER	÷	NURSE CALL WALL MOUNTED DOME LIGHT WITH CODE BLUE	—c—
BIDIRECTIONAL CEILING MOUNTED SPEAKER	↓ ⊂	NURSE CALL CEILING MOUNTED DOME LIGHT WITH CODE BLUE	—нс—
CEILING MOUNTED SPEAKER CLUSTER WALL MOUNTED SPEAKER	\triangleleft_{x}	WALL MOUNTED COMMUNICATIONS OUTLET -LETTER INDICATES FACEPLATE TYPE	
CEILING MOUNTED MICROPHONE OUTLET	⊲ x	ABOVE COUNTER COMMUNICATIONS OUTLET -LETTER INDICATES FACEPLATE TYPE	
WALL MOUNTED MICROPHONE OUTLET		CEILING MOUNTED COMMUNICATIONS OUTLET	
WALL MOUNTED VOLUME CONTROL		-LETTER INDICATES FACEPLATE TYPE	HH x
WALL MOUNTED BELL	$\mathbf{\nabla}_{x}$	COMMUNICATIONS FLOORBOX -LETTER INDICATES FACEPLATE TYPE	— E —
WALL MOUNTED CHIME WALL MOUNTED HORN SPEAKER	₽₽ _×	MULTI-SYSTEM FLOORBOX -LETTER INDICATES FACEPLATE TYPE	—c—
CEILING MOUNTED HORN SPEAKER		WALL MOUNTED PROJETION SYSTEM	— F0 —
SECURITY SYSTEM ELECTRIC LATCH	 ● 1	CEILING MOUNTED PROJETION SYSTEM	<u> </u>
SECURITY SYSTEM CARD READER		SHORT THROW PROJETION SYSTEM	
SECURITY SYSTEM DOOR CONTACT			
SECURITY SYSTEM KEY SWITCH			
SECURITY SYSTEM MOTION DETECTOR			

WALL MOUNTED SINGLE FACED CLOCK	
WALL MOUNTED DOUBLE FACED CLOCK	
COMBINATION WALL MOUNTED SPEAKER/CLOCK	
CEILING MOUNTED COMBINATION SPEAKER/CLOCK	
WALL MOUNTED DIGITAL CLOCK	
CEILING MOUNTED SPEAKER	
BIDIRECTIONAL WALL MOUNTED SPEAKER	
BIDIRECTIONAL CEILING MOUNTED SPEAKER	
CEILING MOUNTED SPEAKER CLUSTER	
WALL MOUNTED SPEAKER	
CEILING MOUNTED MICROPHONE OUTLET	
WALL MOUNTED MICROPHONE OUTLET	
WALL MOUNTED VOLUME CONTROL	
WALL MOUNTED BELL	
WALL MOUNTED CHIME	
WALL MOUNTED HORN SPEAKER	
CEILING MOUNTED HORN SPEAKER	
SECURITY SYSTEM ELECTRIC LATCH	
SECURITY SYSTEM CARD READER	
SECURITY SYSTEM DOOR CONTACT	
SECURITY SYSTEM KEY SWITCH	
SECURITY SYSTEM MOTION DETECTOR	
CEILING MOUNTED SECURITY CAMERA	
-ARROWS INDICATE FIELD OF VIEW WALL MOUNTED SECURITY CAMERA	
-ARROWS INDICATE FIELD OF VIEW	
FIRE ALARM CONTROL PANEL	
FIRE SUPRESSION SYSTEM CONTROL PANEL	
FIRE ALARM REMOTE ANNUNCIATOR PANEL	
SINGLE BED STATION - NURSE CALL	
DOUBLE BED STATION - NURSE CALL	

AUXILIARY

BATHROOM STATION - NURSE CALL BATHROOM STATION PULL CORD - NURSE CALL

DISTRIBUTION OR POWER PANELBOARD SINGLE PHASE MOTOR THREE PHASE MOTOR

G

æ

G

ĊS

DIG

S

SS

SS

DSX

н

CO

_ €

S

S _{CF}

s _c

S

S M

N _{BE}

N _{BC}

- MAGNETIC MOTOR STARTER COMBINATION MAGNETIC MOTOR STARTER - SWITCH SIZE / FUSE SIZE NON-FUSED DISCONNECT SWITCH -SWITCH SIZE
 - FUSED DISCONNECT SWITCH -SWITCH SIZE/FUSE SIZE ENCLOSED CIRCUIT BREAKER
 - -CB RATING
 - MAGNETIC CONTACTOR MANUAL MOTOR STARTER
 - HORSEPOWER RATED SWITCH
- PACKAGED EQUIPMENT WITH INTEGRALLY MOUNTED PREWIRED CONTROL PANEL
- FURNISHED AS INTEGRAL PART OF EQUIPMENT TRANSFORMER
 - GROUND ROD
 - LIGHTNING PROTECTION AIR TERMINAL GROUND BUS BAR AS INDICATED

TECHNOLOGY DRAWING INDEX

TR.0 Technology Reference Information T3.1 Partial First Floor Technology Systems Plan T5.1 Technology Risers T5.2 Technology Details

GENERAL NOTES

- 1. LIGHT LINE WEIGHT INDICATES EXISTING EQUIPMENT TO REMAIN OR EQUIPMENT PROVIDED BY OTHERS. HEAVY LINE WEIGHT INDICATES NEW EQUIPMENT.
- NETWORK DEVICE PLATES AND THE CABLING FOR THESE AREAS SHALL BE PROVIDED BY THE TECHNOLOGY CONTRACTOR.
- 3. TECHNOLOGY CONTRACTOR SHALL COORDINATE DEVICE OUTLET LOCATIONS WITH THE ARCHITECTURAL AND CASEWORK DRAWINGS PRIOR TO ROUGH-IN. REPORT ANY CONFLICTS TO THE CONSTRUCTION MANAGER FOR RESOLUTION.
- 4. TECHNOLOGY CONTRACTOR SHALL COORDINATE CLOSET ROOM EQUIPMENT/DEVICE LOCATIONS WITH THE GENERAL TRADES.
- 5. TECHNOLOGY CONTRACTOR SHALL NOT PLACE ANY DISTRIBUTION CABLING ALONGSIDE POWERLINES, OR SHARE THE SAME CONDUIT, CHANNEL OR SLEEVE WITH ELECTRICAL APPARATUS.
- 6. ALL CABLES SHALL BE INSTALLED IN "J" HOOKS, CONDUITS, CABLE TRAY OR AN APPROVED RACEWAY SYSTEM. WHERE CABLE TRAY IS NOT AVAILABLE. SUPPORT HORIZONTAL CABLE EVERY FIVE FEET WITH "J" HOOKS SUFFICIENT IN SIZE TO HANDLE ALL BUNDLED CABLES WHILE MINIMIZING CRUSHING. IF CABLE SLACK EXCEEDS TWELVE (12) INCHES BETWEEN SUPPORTS, ADDITIONAL SUPPORTS SHALL BE INSTALLED TO TAKE UP SLACK AND RELIEVE CABLE STRESS. ALL CABLES SHALL BE RUN PARALLEL AND PERPENDICULAR TO BUILDING STEEL. ALL COMMUNICATIONS CABLES SHALL BE LOCATED AND FASTENED TO GUARANTEE THERE SHALL BE NO INTERFERENCE FROM MAGNETIC FIELDS GENERATED FROM FIXTURE BALLASTS, MOTORS OR SIMILAR ELECTRICAL LOADS.
- 7. INSTALL ALL CABLES MAINTAINING CABLE MANUFACTURES RADIUS OF CURVATURE AND PROTECT AT BENDS AND CORNERS. MAINTAIN MINIMUM BEND RADUIS AND TENSION LIMITATIONS AS SPECIFIED BY EIA/TIA FOR ALL COMMUNICATION CABLES.
- 8. LOOSELY BUNDLE CABLES WITH VELCRO TIES SUITABLE FOR PLENUM ENVIRONMENTS, EVERY TWENTY FEET.
- 9. THE TECHNOLOGY CONTRACTOR SHALL ASSURE THAT THE COMPLETION OF CABLE INSTALLATION. CABLES ARE FREE FROM TWISTS, KINKS, SHARP BENDS, CUTS, GOUGES OR ANY OTHER PHYSICAL DAMAGE.
- 10. THESE DRAWINGS ARE DIAGRAMMATIC AND INDICATE THE GENERAL EXTENT OF WORK. THE TECHNOLOGY CONTRACTOR SHALL PROVIDE ALL INCIDENTAL MATERIALS AND LABOR OR A COMPLETE, FULLY FUNCTIONAL SYSTEM AND VERIFING FIELD RACEWAYS.
- 11. NOTIFY CM OF ANY CONFLICTS BETWEEN EQUIPMENT SUBMITTALS AND TECHNOLOGY DRAWINGS.
- 12. ALL WORK AND EQUIPMENT SHALL CONFORM TO NEC. THE MEANS AND METHODS USED BY TECHNOLOGY CONTRACTOR SHALL CONFORM TO NEW SECTION 110-3 (A AND B).
- 13. SECURITY CAMERAS AND WIRELESS ACCESS POINT LOCATIONS INDICATED ARE FOR NETWORK CABLING ONLY.
- 14. WIRELESS ACCESS POINTS ARE PROVIDED BY OWNER AND INSTALLED BY THIS CONTRACTOR. THIS CONTRACTOR IS TO PROVIDE 10' PATCH CORDS FOR EACH WIRELESS ACCESS POINT.
- 15. SECURITY CAMERAS ARE BY OTHERS. THIS CONTRACTOR IS TO PROVIDE 10' PATCH CORDS FOR EACH SECURITY CAMERA.
- 16. REMOVE ALL UNUSED (ABANDONED) LOW VOLTAGE CABLING. ALL EXISTING CABLING INTERFERING WITH NEW CONSTRUCTION (IE.. NEW CEILINGS AT A HIGHER LEVEL THAN EXISTING) SHALL BE PULLED BACK AND REROUTED THROUGH NEW CONSTRUCTION IN COMPLIANCE WITH THESE DOCUMENTS. THIS INCLUDES, BUT IS NOT LIMITED TO SOUND MASKING SYSTEMS CABLING, PA AND SOUND SYSTEM SPEAKER CABLING, COMMUNICATIONS CABLING AND SPEAKER CALBING.

NEMA 3R NEMA 4X BY CENTERLINE DEGREES FOOT, FEET INCH, INCHES NUMBER PHASE PERCENT, PERCENTAGE

MISC TIME CLOCK 3R TELEPHONE 4X Х

TELECOMMUNICATIONS TERMINAL €OR C TACKBOARD TAMPER RESISTANT PH %

TELEPHONE TERMINAL BACKBOARD TELEPHONE TERMINAL CABINET TELEVISION TRANSIENT VOLTAGE SURGE SUPPRESSOR TRANSMITTER TYPICAL

> UNDERWRITERS LABORATORIES, INC. UNLESS OTHERWISE NOTED UNINTERRUPTIBAL POWER SUPPLY UNIVERSAL SERIAL BUS

VOICE VOLUME CONTROL VIDEO CASSETTE RECORDER VERIFY IN FIELD VOICE OVER INTERNATE PROTOCOL

WIDE AREA NETWORK WIRELESS ACCESS POINT WHITEBOARD WIRE GUARD WIRELESS LOCAL AREA NETWORK WEATHER PROOF

ONE-LINE SYSTEM OR EQUIPMENT GROUND EXOTHERMIC WELD OR BRAZED CONNECTION CONDUIT IN OR BELOW FLOOR SLAB OR BELOW GRADE

RACEWAY TURNED UP RACEWAY TURNED DOWN CABLE TRAY UNDERFLOOR DUCT - POWER UNDERFLOOR HEADER DUCT - POWER UNDERFLOOR DUCT - COMM UNDERFLOOR HEADER DUCT - COMM

SITE

FLUSH IN-GRADE HAND HOLE UNDERGROUND ELECTRICAL UNDERGOUND COMMUNICATIONS UNDERGROUND FIBER OPTIC

COMMUNICATIONS UNDERGROUND LIGHTING



ī**D**^s Project Number



Drawing Number

Technology Reference Information

 \odot 2021 Integrated ${
m d}$ n solutions, llo IDS Drawing Title

F	Project Administrator C. Azar
	Project Designer
	Designer
Project	Architect / Engineer
	N. Furgason
	Drawn By
	N. Furgason
	Q.M. Review
	T. Carron
	Approved
	T. Carron
	Drawing Scale
	As Noted
Issued for	Issue Date
Quality Management Review	04-21-2021
Bids	07-15-2021

THIS PROJECT MAY NOT UTILIZE ALL THE SYMBOLS. MATERIALS, ABBREVIATIONS AND STANDARDS INFORMATION SHOWN ON THIS SHEET

INSURANCE

Executive Suite Renovation

1 Mutual Avenue


Key Plan

Frankenmuth, MI 48787



INTEGRATED design SOLUTIONS architecture engineering interiors & technology 1441 west long lake, suite 200 troy, michigan 48098 5211 cascade road SE, suite 300 grand rapids, michigan 49546 248.823.2100



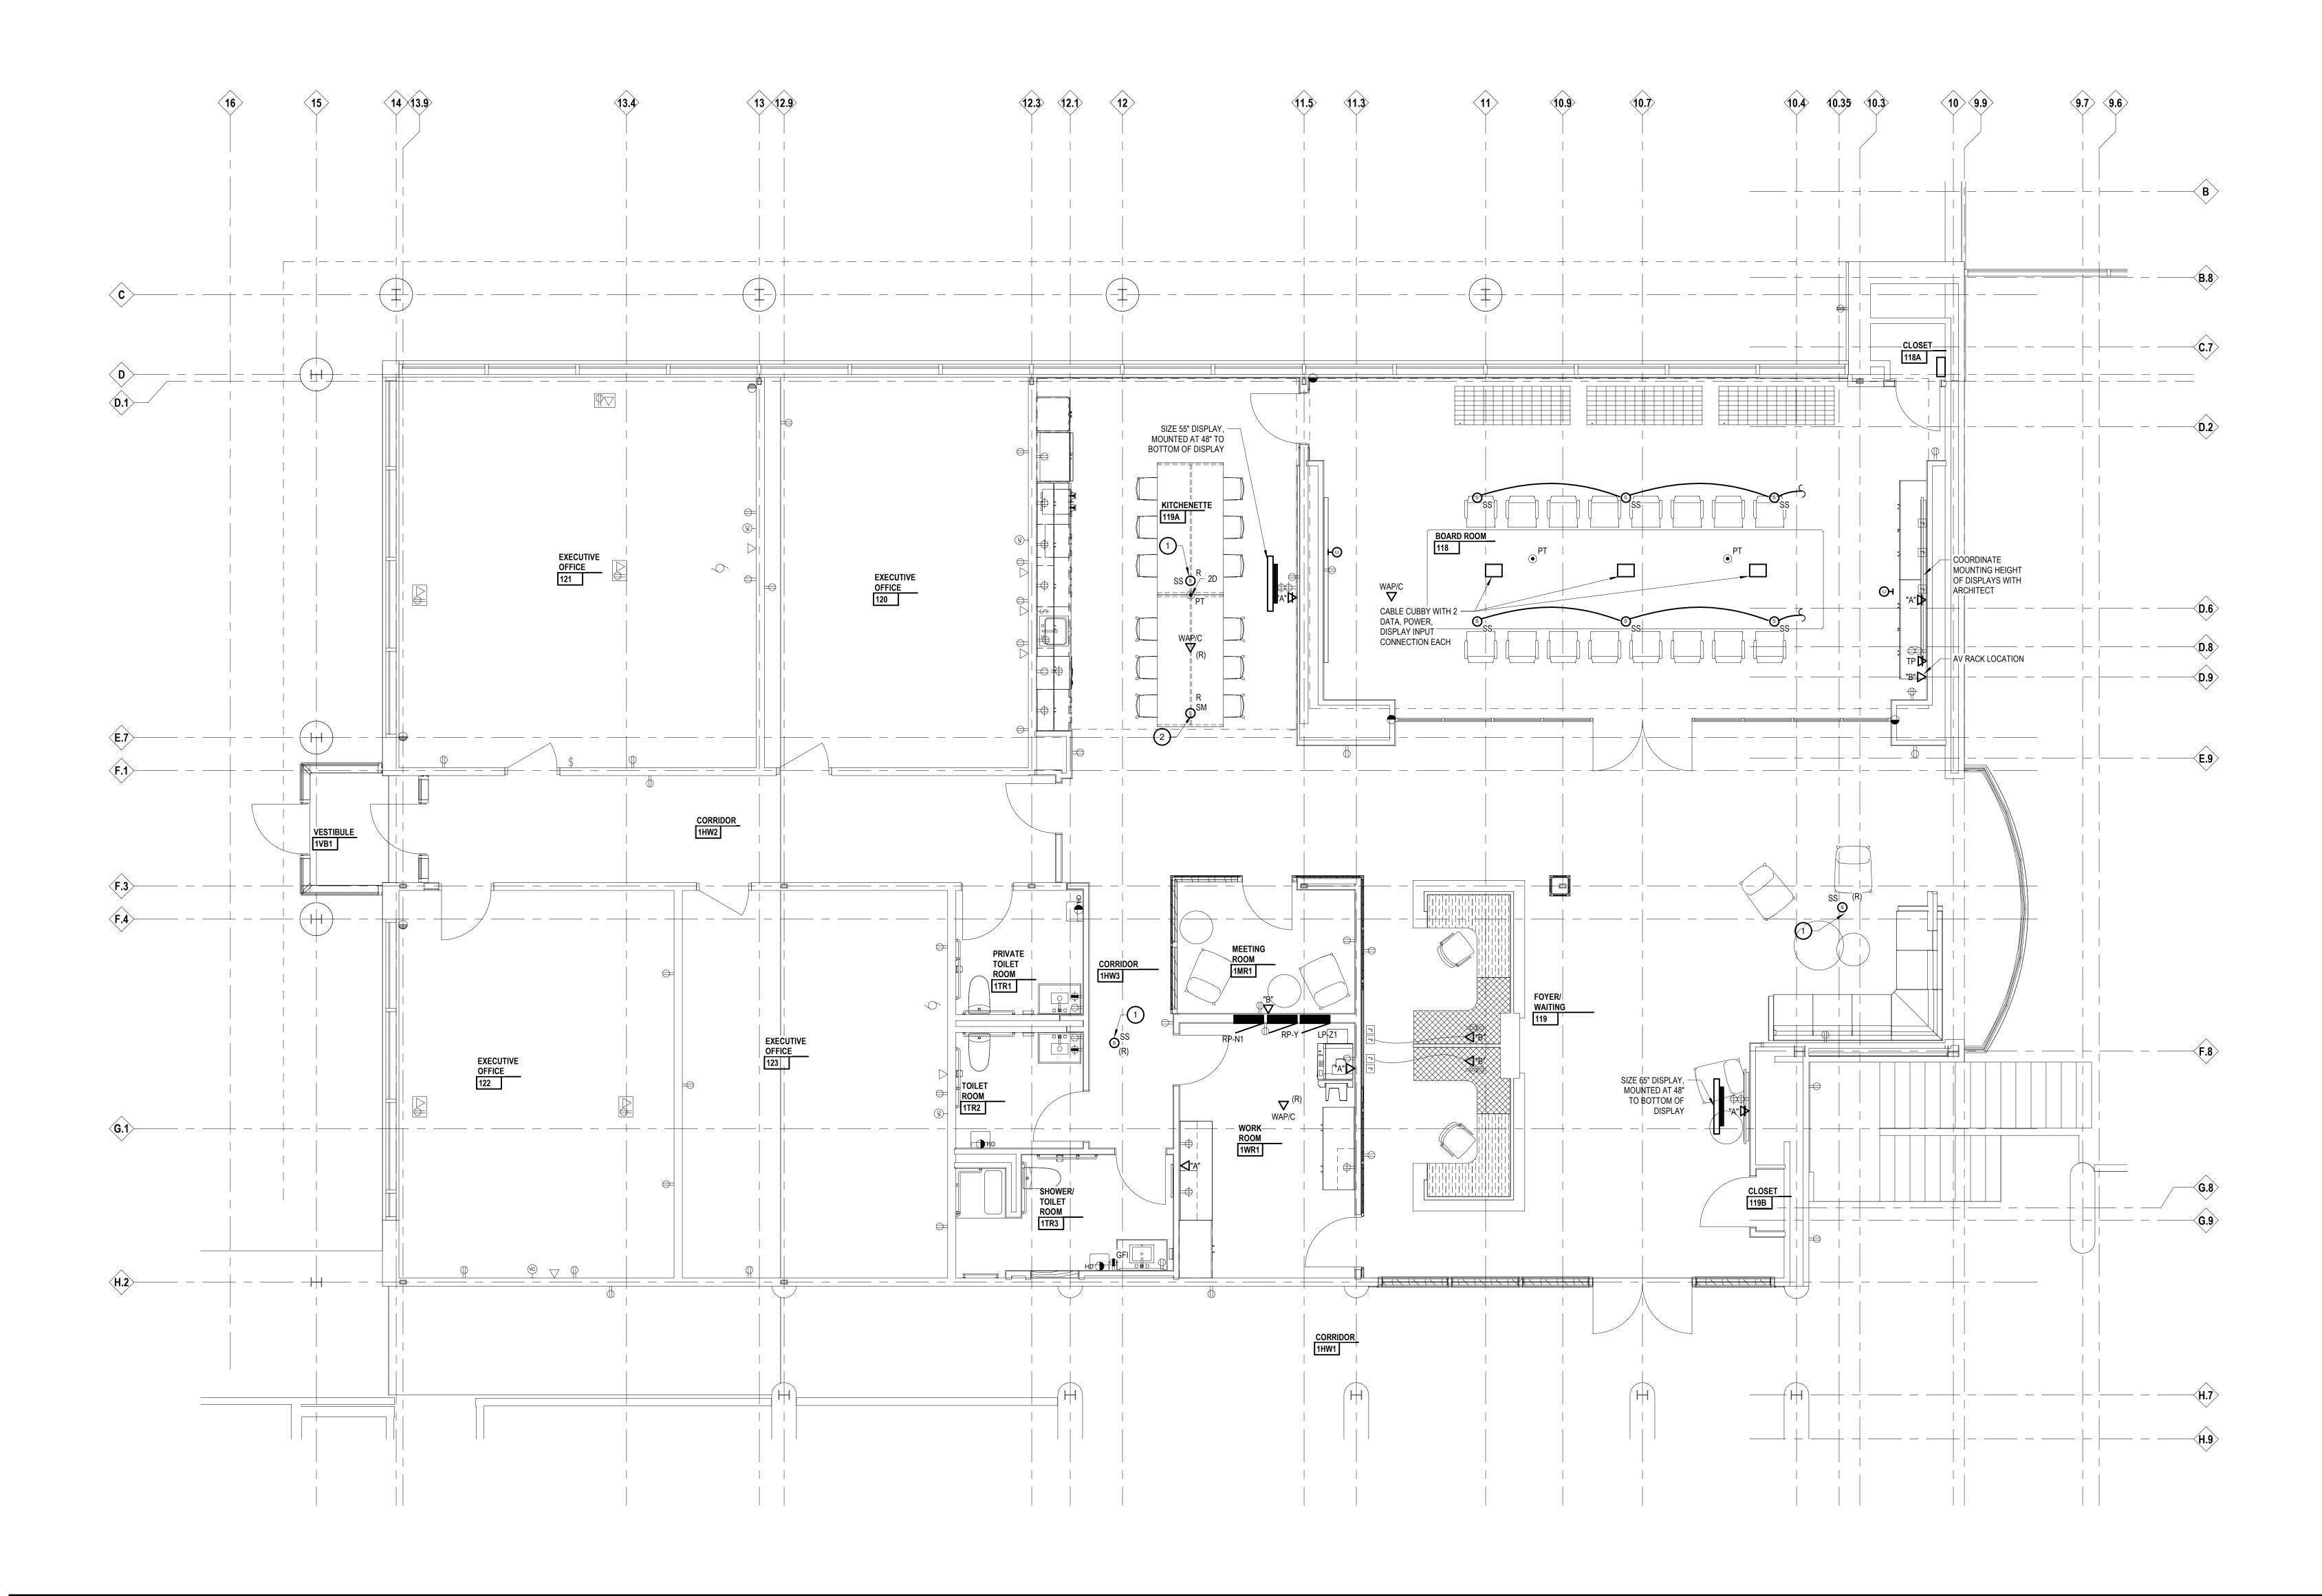

 REFER TO PROJECT ELECTRICAL DRAWINGS FOR ADDITIONAL INFORMATION AND DETAILS INCLUDING PATHWAYS AND INFRASTRUCTURE BEING PROVIDED FOR TECHNOLOGY CABLING. COORDINATE ADDITIONAL REQUIREMENTS WITH EC.

KEY NOTES

REINSTALL SALVAGED BUILDING SOUND SYSTEM MUSIC SPEAKER AT NEW LOCATION. MODIFY AND EXTEND EXISTING SPEAKER CABLING AS REQUIRED.

2 REINSTALL SALVAGED SOUND MASKING SYSTEM SPEAKER AT NEW LOCATION ABOVE ACCESSIBLE CEILING. MODIFY AND EXTEND EXISTING SPEAKER CABLING AS REQUIRED.



ī**D**^s Project Number



Drawing Number

IDS Drawing Title Partial First Floor Technology Systems Plan

 \odot 2021 INTEGRATED design solutions, LLC IDS Drawing Title

	Р	roject Administrator
		C. Azar
		Project Designer
		S. Robinson
	Project /	Architect / Engineer
		N. Furgason
		Drawn By
		N. Furgason
		Q.M. Review
		T. Carron
		Approved
		T. Carron
		Drawing Scale
		As Noted
	Issued for	Issue Date
Quali	ty Management Review	04-21-2021
· · · · · · · · · · · · · · · · · · ·	Bids	07-15-2021


1 Mutual Avenue Frankenmuth, MI 48787 Key Plan


Executive Suite Renovation



INTEGRATED design SOLUTIONS architecture engineering interiors & technology 1441 west long lake, suite 200 troy, michigan 48098 5211 cascade road SE, suite 300 grand rapids, michigan 49546 248.823.2100 www.ids-michigan.com

i D S

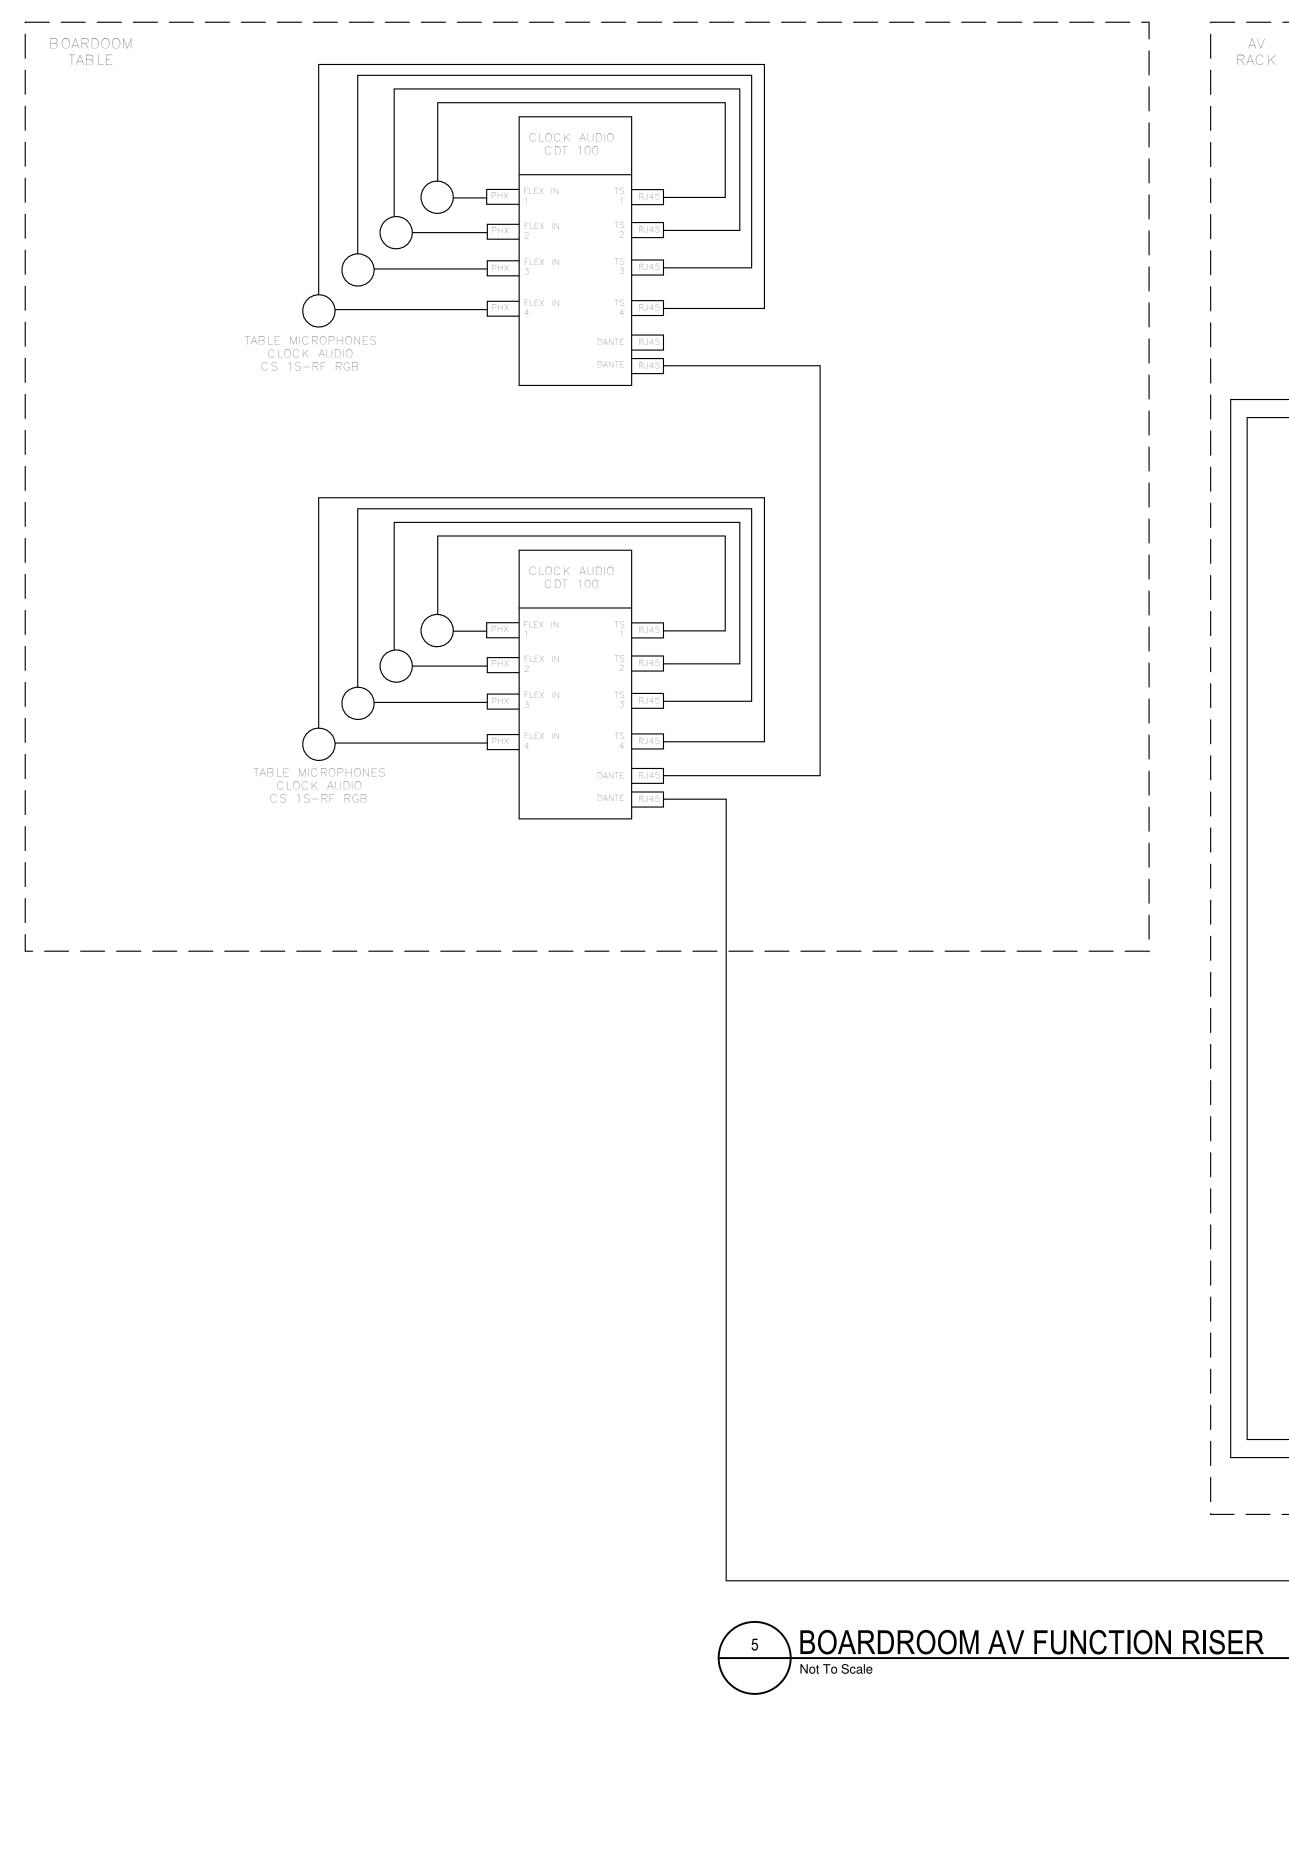

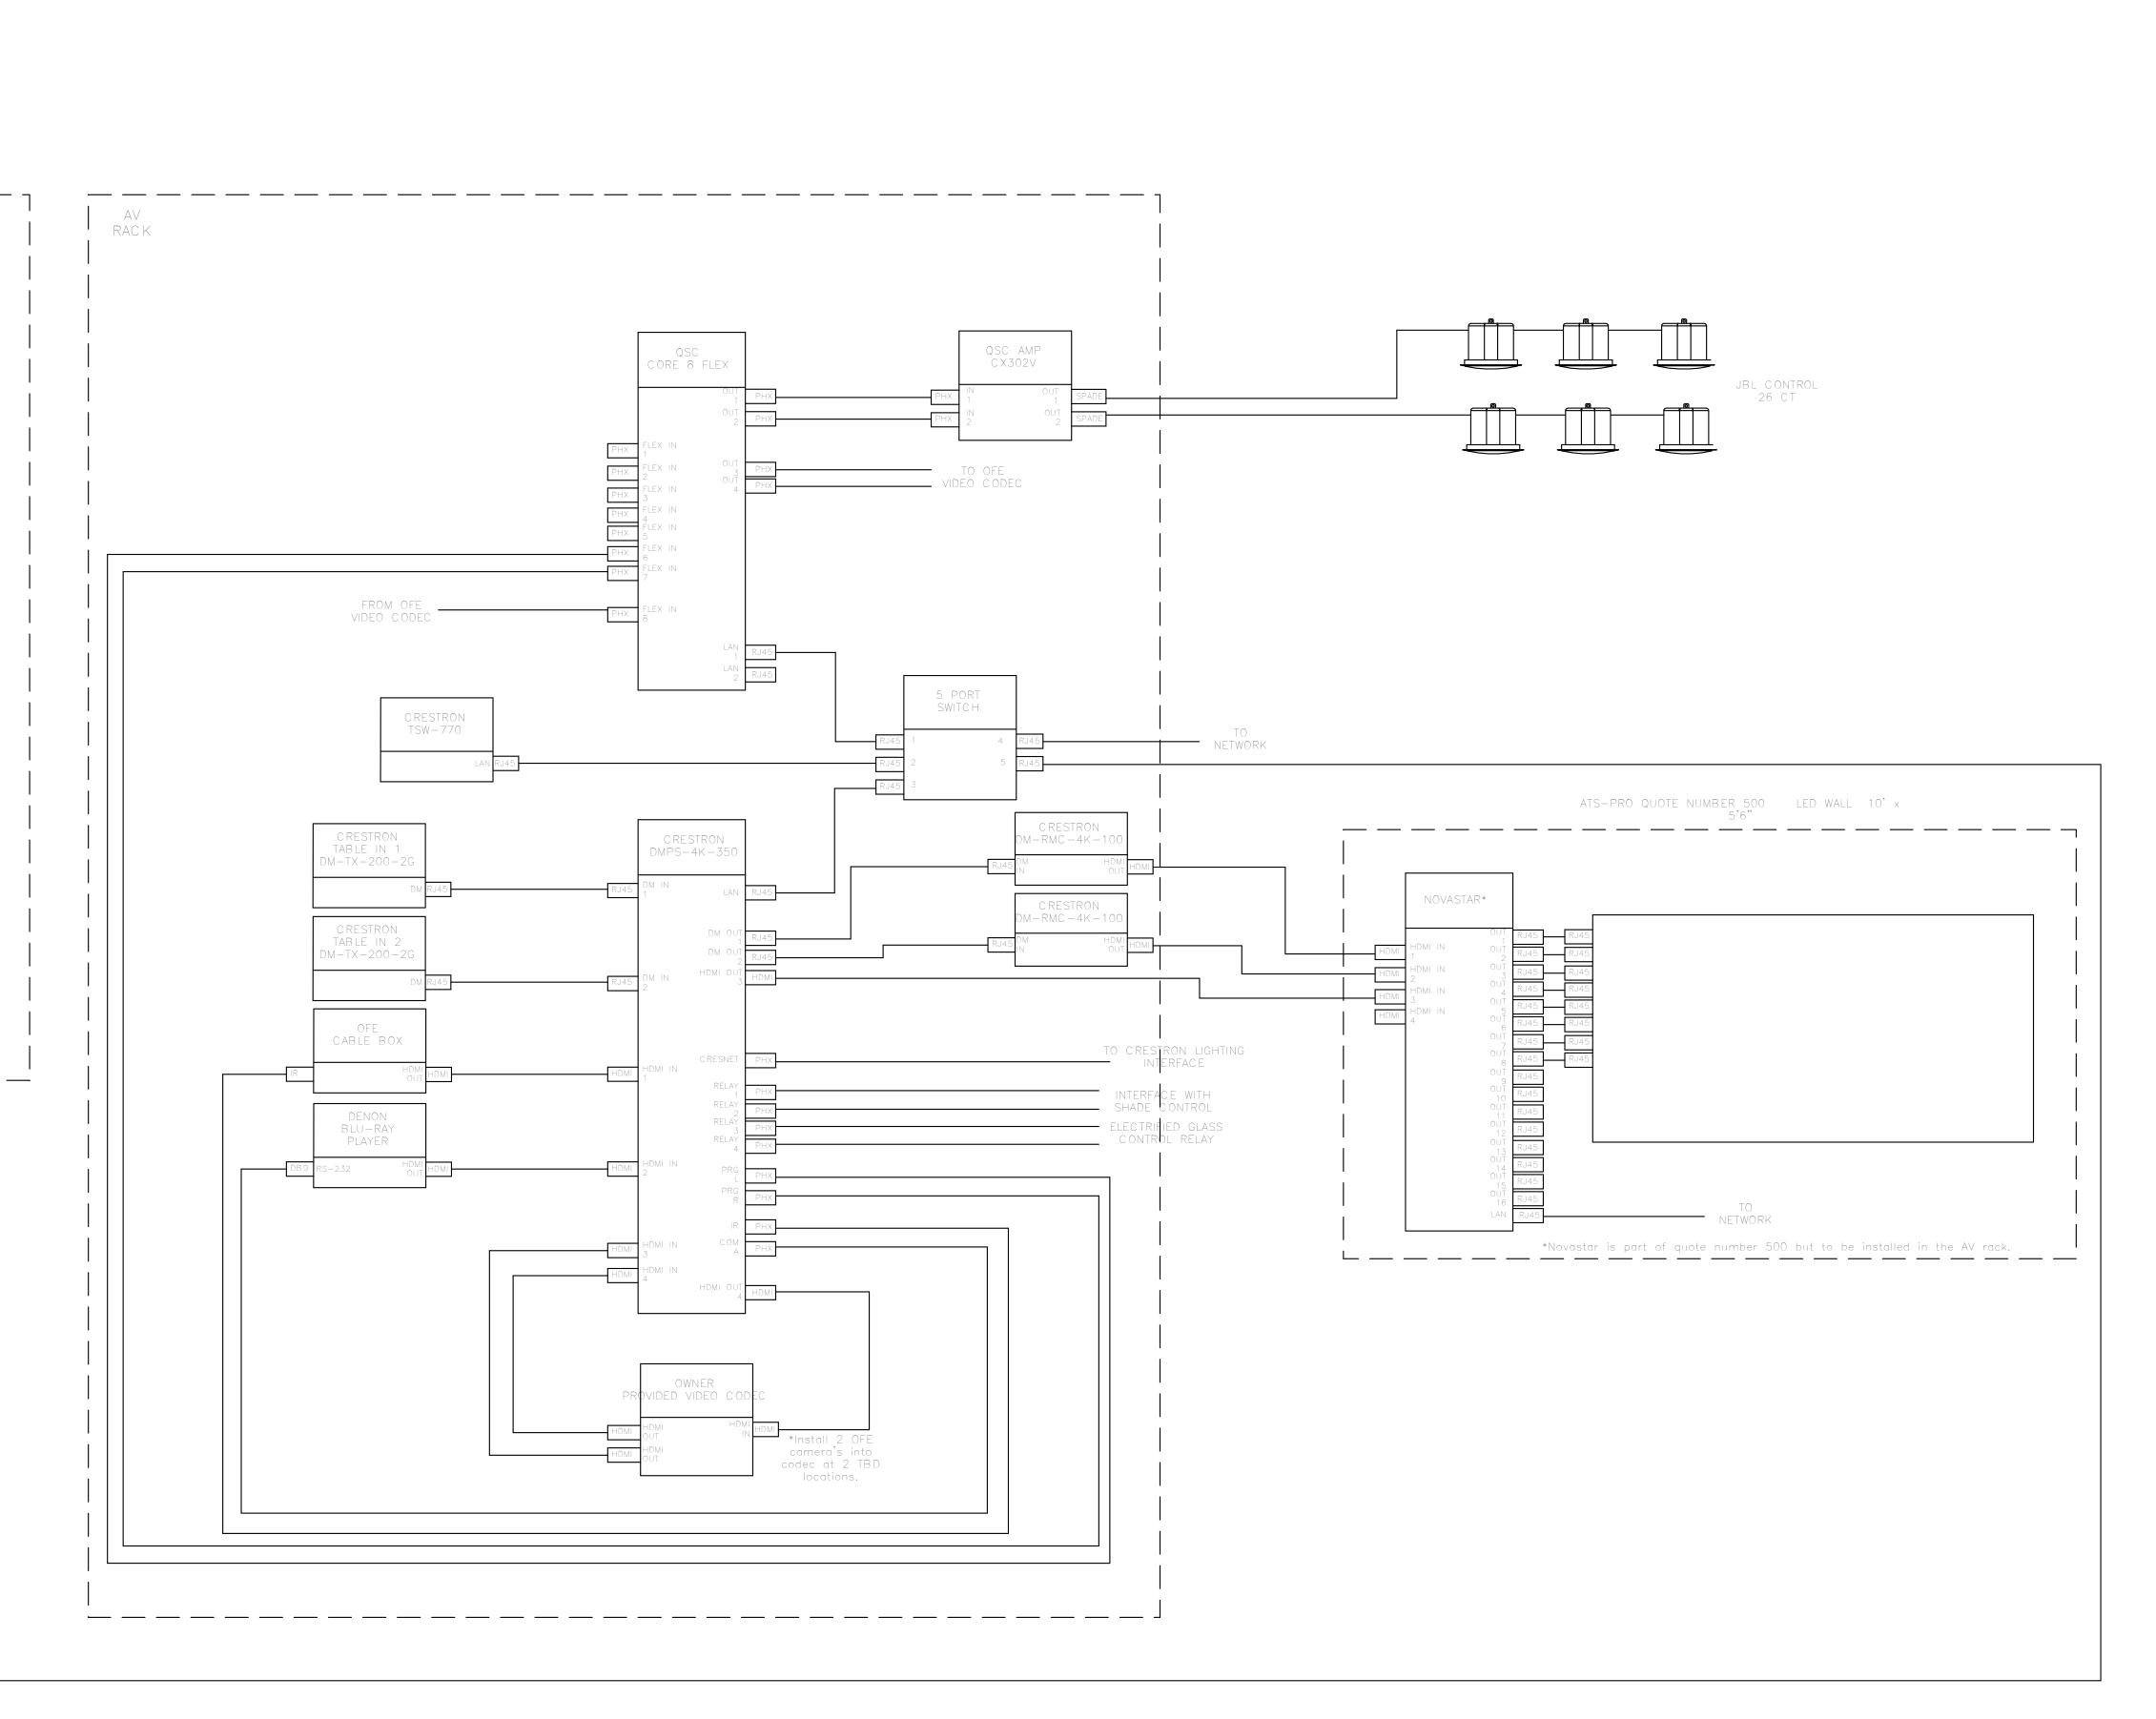



ī**D**≗ Project Number



Drawing Number

Technology Risers

 ${
m \circ}$ 2021 integrated ${
m d}$ \mathbf{n} solutions, LLC IDS Drawing Title

F	roject Administrator
	C. Azar
	Project Designer
	N. Furgason
Project	Architect / Engineer
	N. Furgason
	Drawn By
	N. Furgason
	Q.M. Review
	T. Carron
	Approved
	T. Carron
	Drawing Scale
	As Noted
Issued for	Issue Date
Design Development	02-26-2021
Quality Management Review	04-21-2021
Bids	07-15-2021

1 Mutual Avenue Frankenmuth, MI 48787 Key Plan


Executive Suite Renovation




INTEGRATED design SOLUTIONS architecture engineering interiors & technology 1441 west long lake, suite 200 troy, michigan 48098 5211 cascade road SE, suite 300 grand rapids, michigan 49546

248.823.2100 www.ids-michigan.com




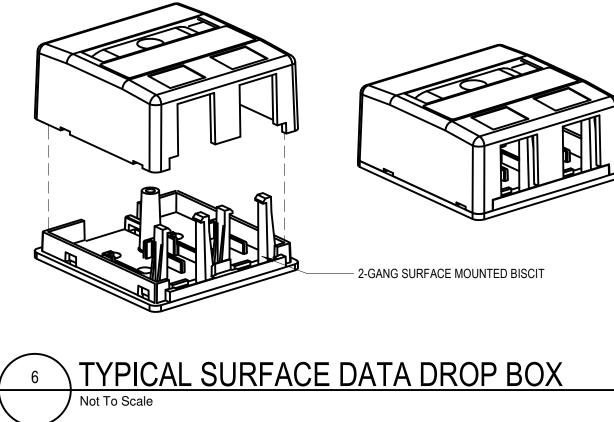


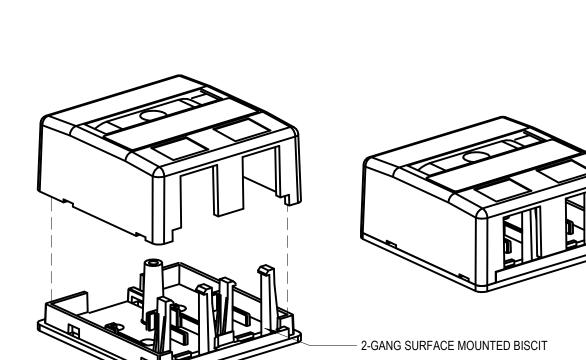







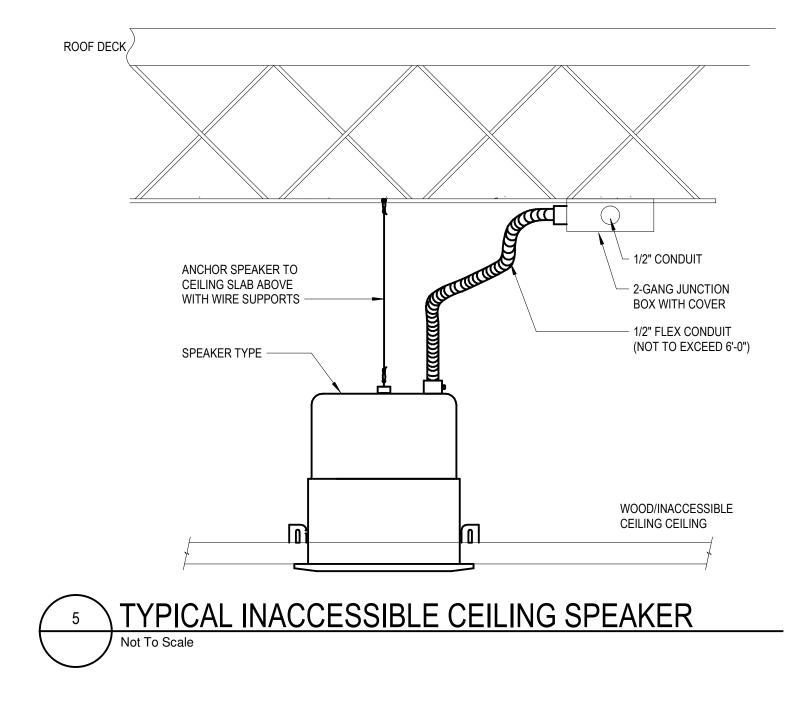


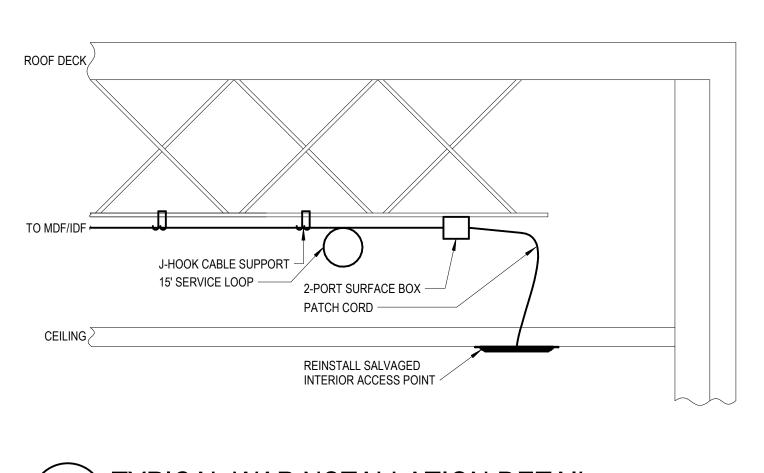




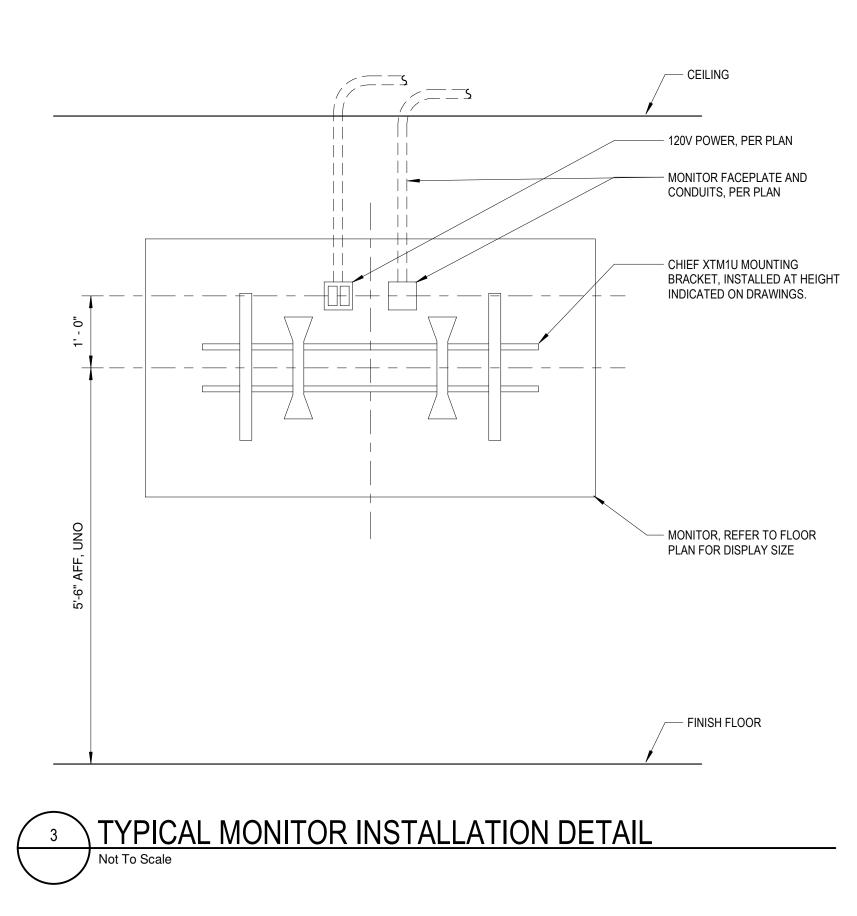

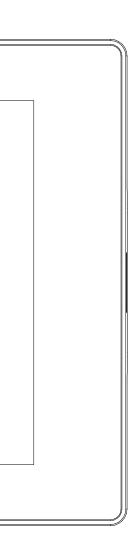

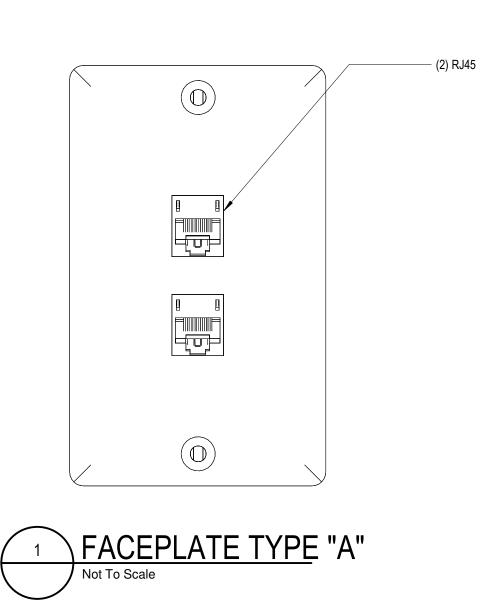

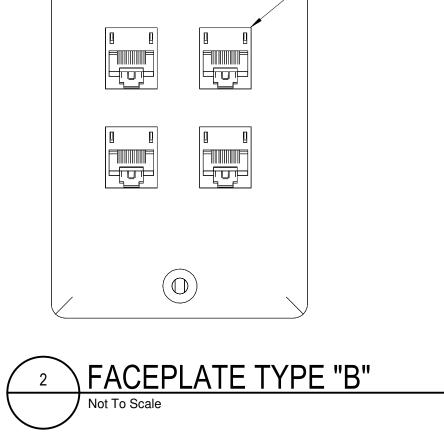

 \bigcirc (4) RJ45



Drawing Number T5.2

ī**D**≗ Project Number

Technology Details

 ${
m \circ}$ 2021 integrated ${
m d}$ **n solutions**, llo IDS Drawing Title

Pr	oject Administrator
	C. Azar
	Project Designer
	Designer
Project A	rchitect / Engineer
	N. Furgason
	Drawn By
	Author
	Q.M. Review
	T. Carron
	Approved
	T. Carron
	Drawing Scale
	As Noted
Issued for	Issue Date
Bids	07-15-2021

1 Mutual Avenue Frankenmuth, MI 48787 Key Plan

Executive Suite Renovation



INTEGRATED design SOLUTIONS architecture engineering interiors & technology 1441 west long lake, suite 200 troy, michigan 48098 5211 cascade road SE, suite 300 grand rapids, michigan 49546 248.823.2100 www.ids-michigan.com

