

Proposal Request

PR No. 02

Project:	National Weather Service TI 2242 West North Temple Street Salt Lake City, UT 84116	Date: 11/4/2024 Contract For: General Construction
Owner:	Salt Lake City International Airport Erik Groethe P.O. Box 145550 Salt Lake City, UT	
Contractor: Attn:	Saunders Construction Inc. Craig Saunders 1601 North 750 West Harrisville, UT 84404	Issued by: MHTN Architects, Inc. Project No.: 2023573 PM: James Knight

This is NOT a Change Order nor a directive to proceed with the Work described herein. Please submit an itemized quotation for changes in the Contract Sum and/or Contract Time incidental to proposed modifications to the Contract Documents described herein. Submit proposal within seven days, or notify the Architect in writing of the date on which you anticipate submitting your proposal.

Description

The owner requested the following Additions and Changes


- 1. Add Picnic table canopy in the back at the northwest corner
- 2. Add a covered bike rack near the north entry door.
- 3. Add a swing gate to access the back at the northwest corner.
- 4. Add concrete pads for the canopies and concrete sidewalks to connect the existing west sidewalk to the gate slab, canopy slabs and existing north entry slab.
- 5. Add power and data pathways for office wall monitors.
- 6. Add backing in wall for monitors.
- 7. Revise drawings to show removal of MEP for the storage room.


Attachments

C000 - DEMOLTION PLAN 'A' C000 - DEMOLITION PLAN 'B' C100 - SITE PLAN C200 - GRADING & DRAINAGE PLAN 'A' C201 - GRADING & DRAINAGE PLAN 'B' C500 - DETAIL SHEET AS100 - ARCHITECTUAL SITE PLAN A101A - FIRST FLOOR PLAN AREA A


A101B - FIRST FLOOR PLAN AREA B A410 - INTERIOR ELEVATIONS A413 - INTERIOR ELEVATIONS A415 - INTERIOR ELEVATIONS A416 - INTERIOR ELEVATIONS A419 - INTERIOR ELEVATIONS MD101 - MECHANICAL DEMOLITION PLAN M101 - MECHANICAL FLOOR PLAN M401 - ENLARGED MECHANICAL PLAN M501 - MECHANICAL SCHEDULES M601 - MECHANICAL DETAILS PD101 - PLUMBING DEMOLITION PLAN P101 - PLUMBING FLOOR PLAN P401 - ENLARGED PLUMBING PLAN P501 - PLUMBING SCHEDULES & DETAILS


EP101 - FLOOR PLAN - POWER AND SYSTEMS

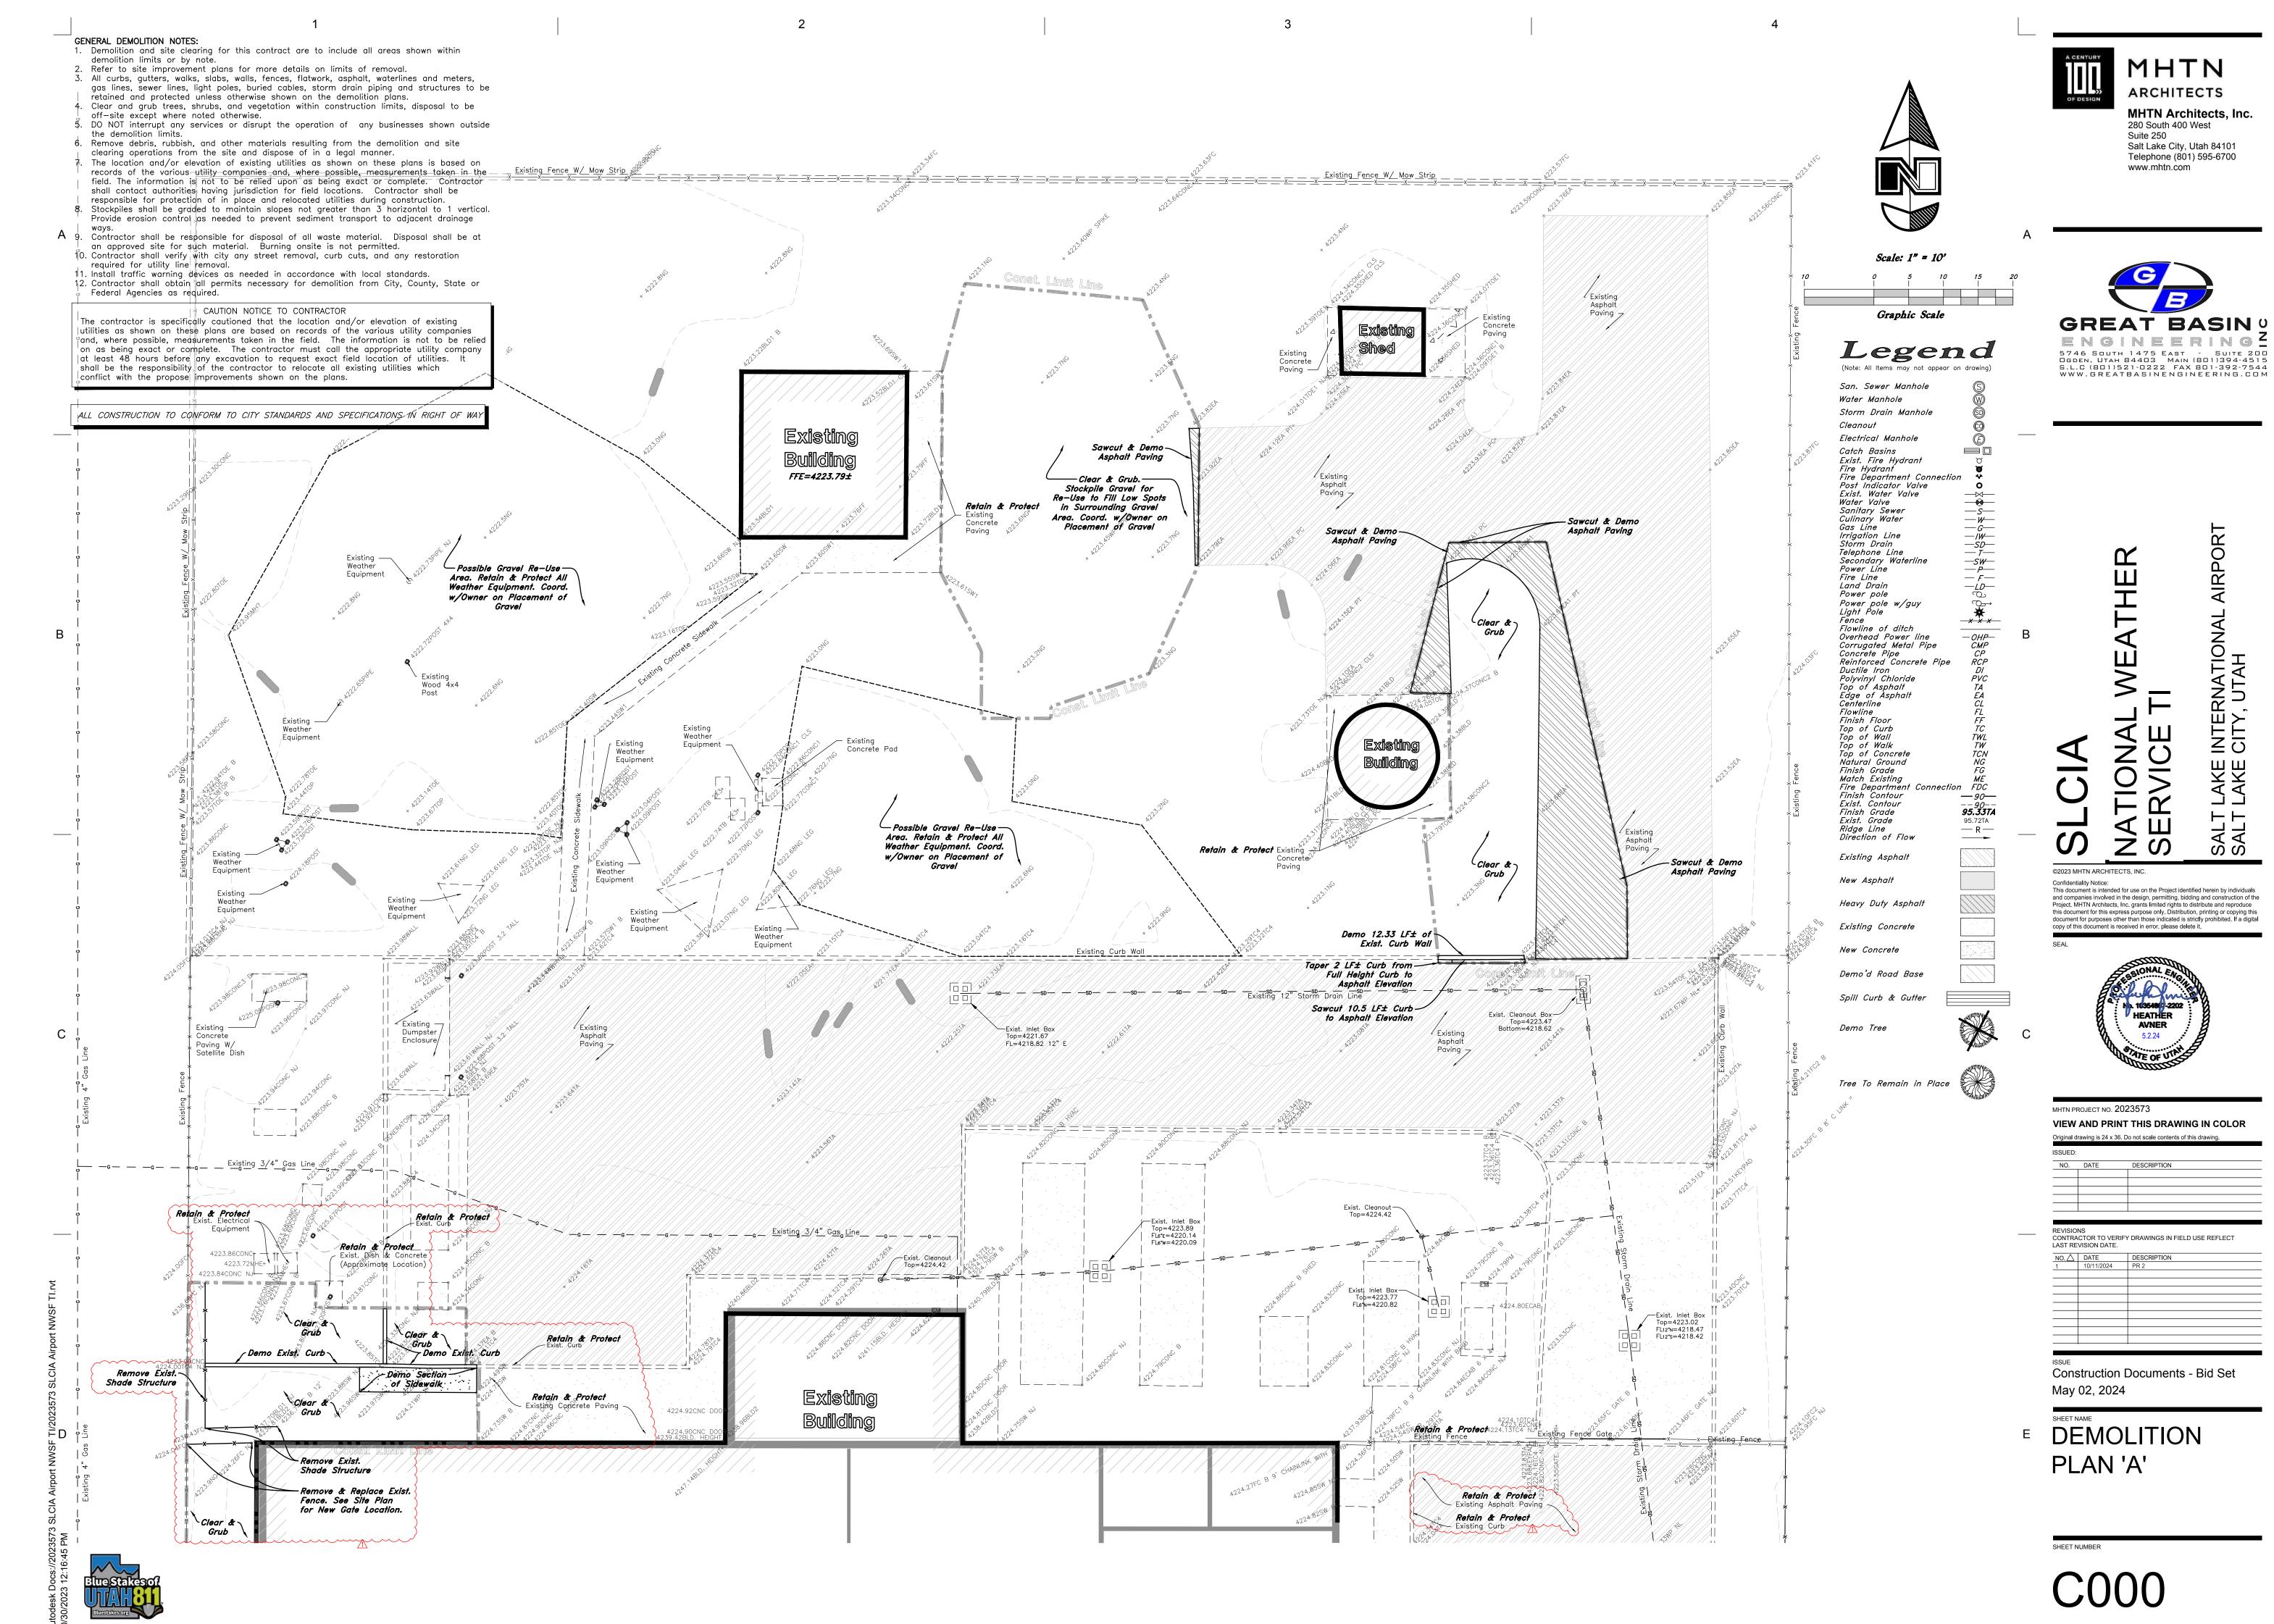


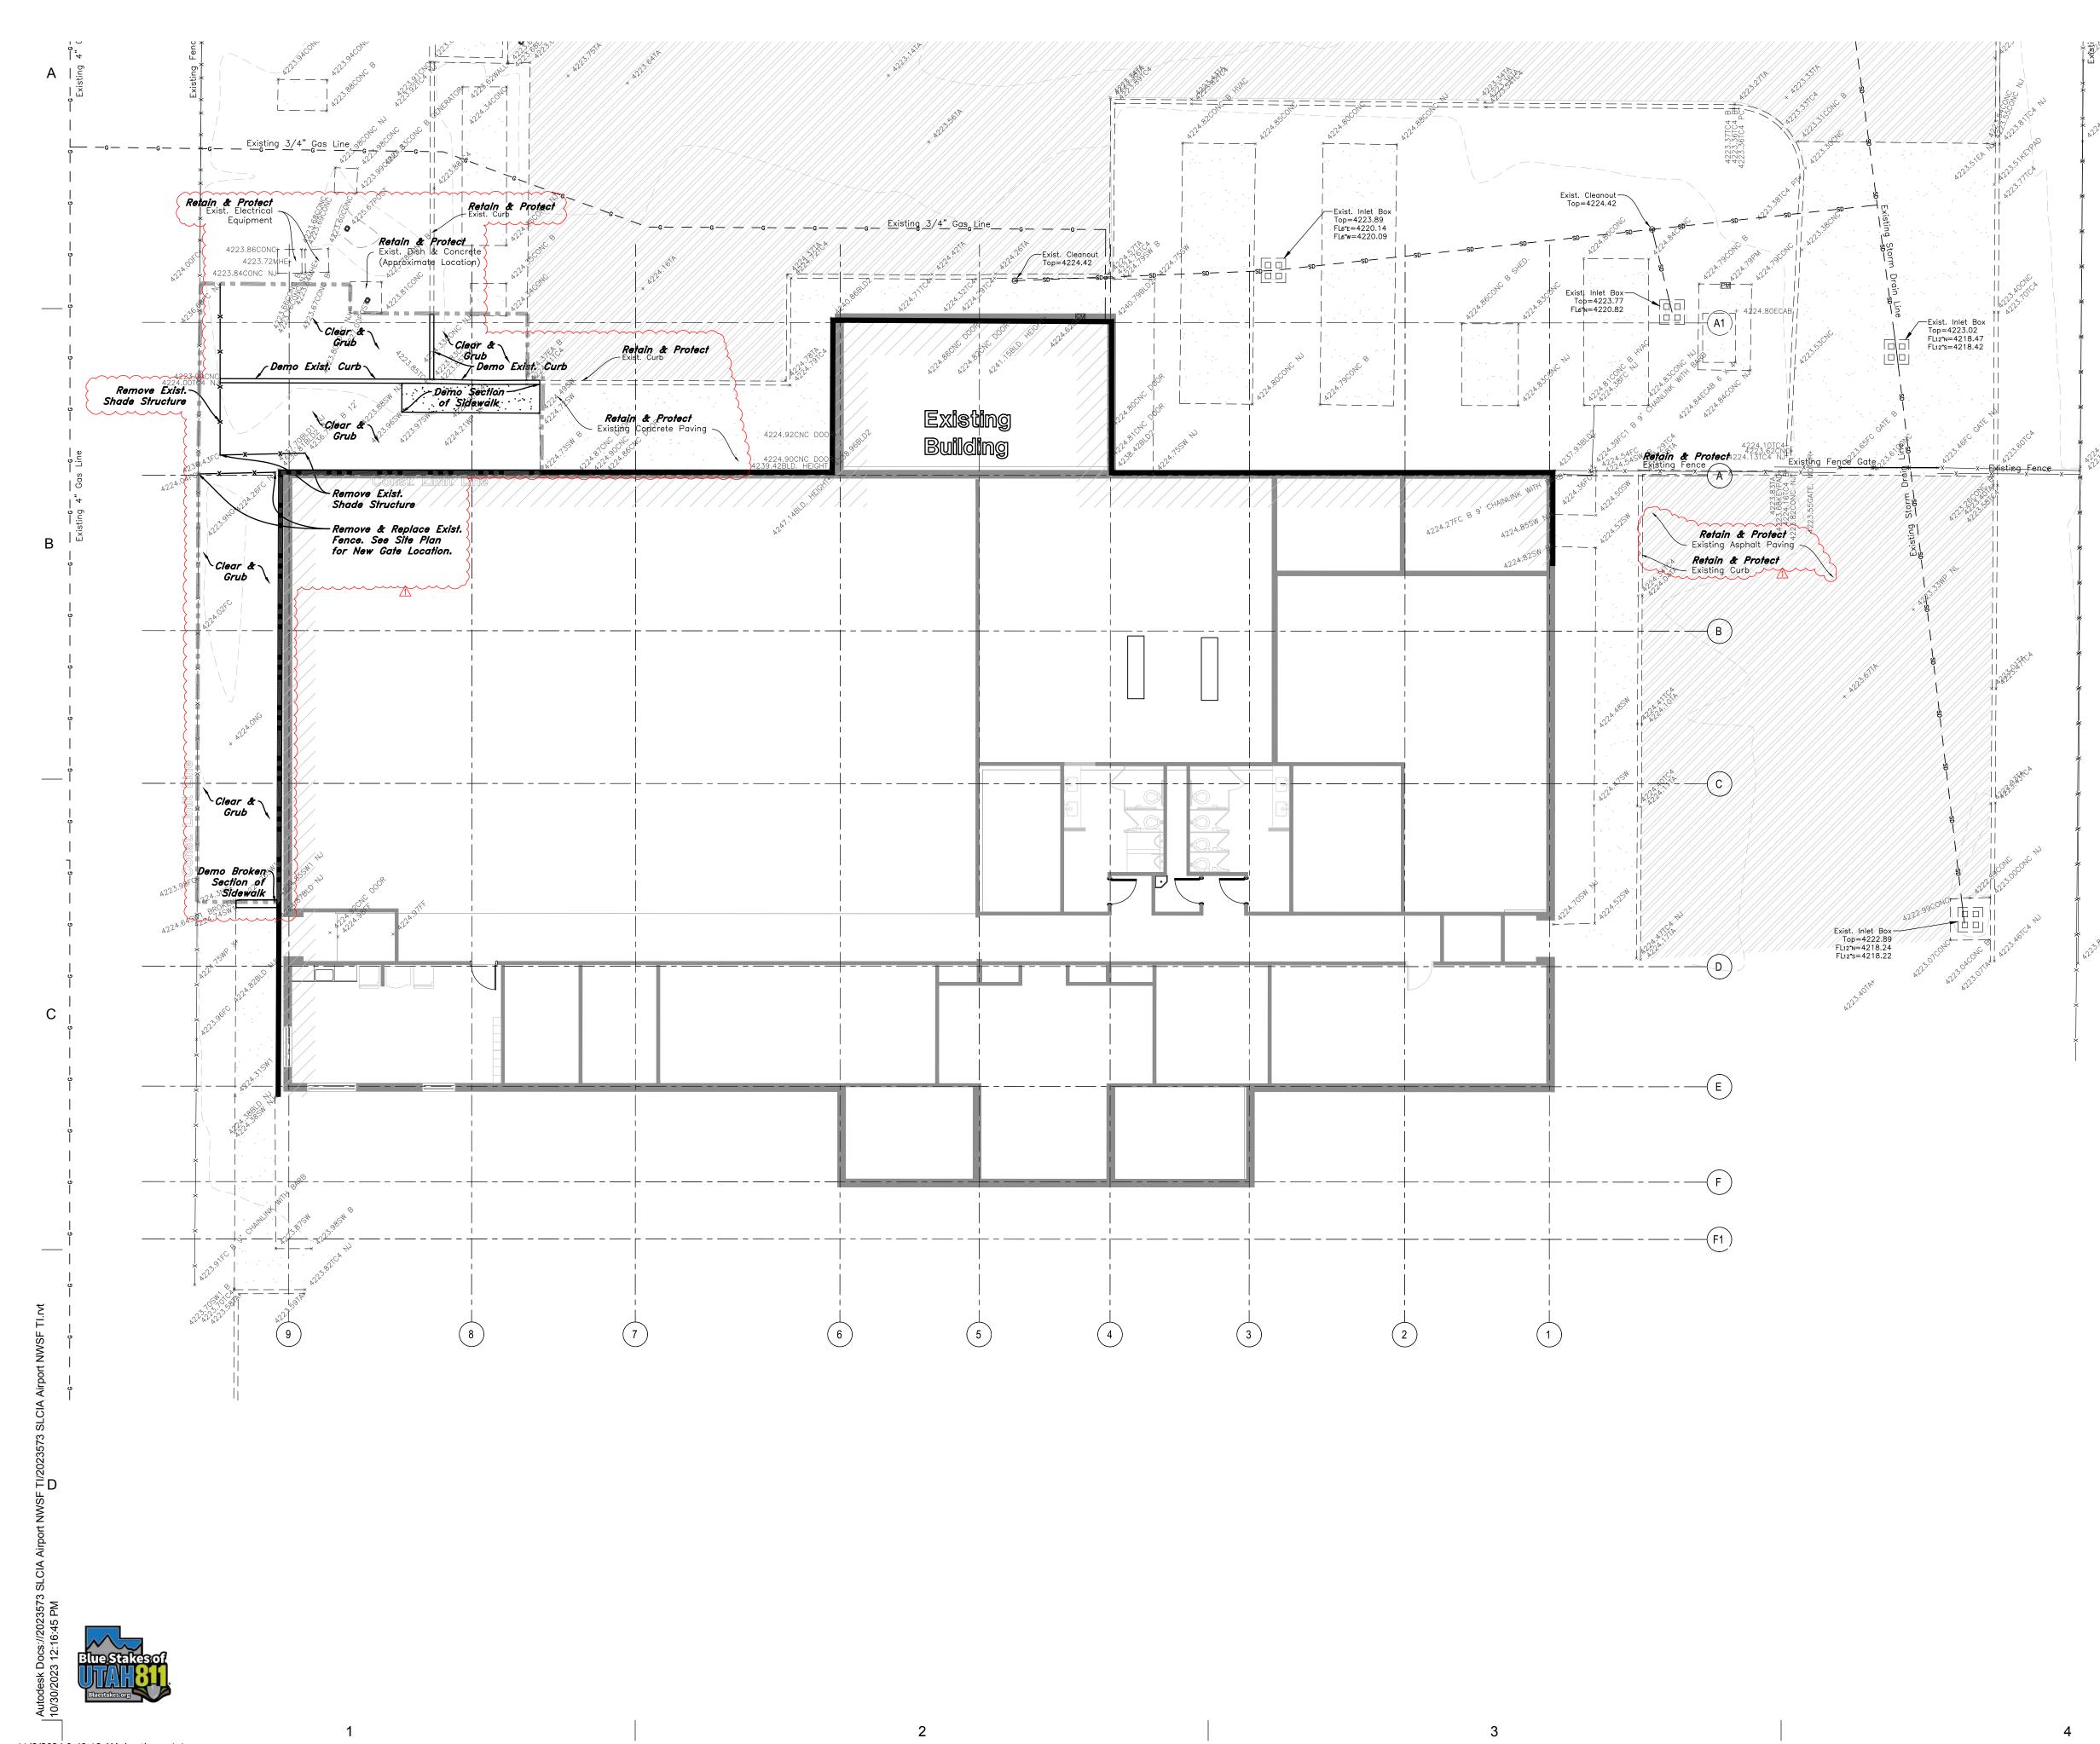



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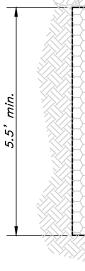


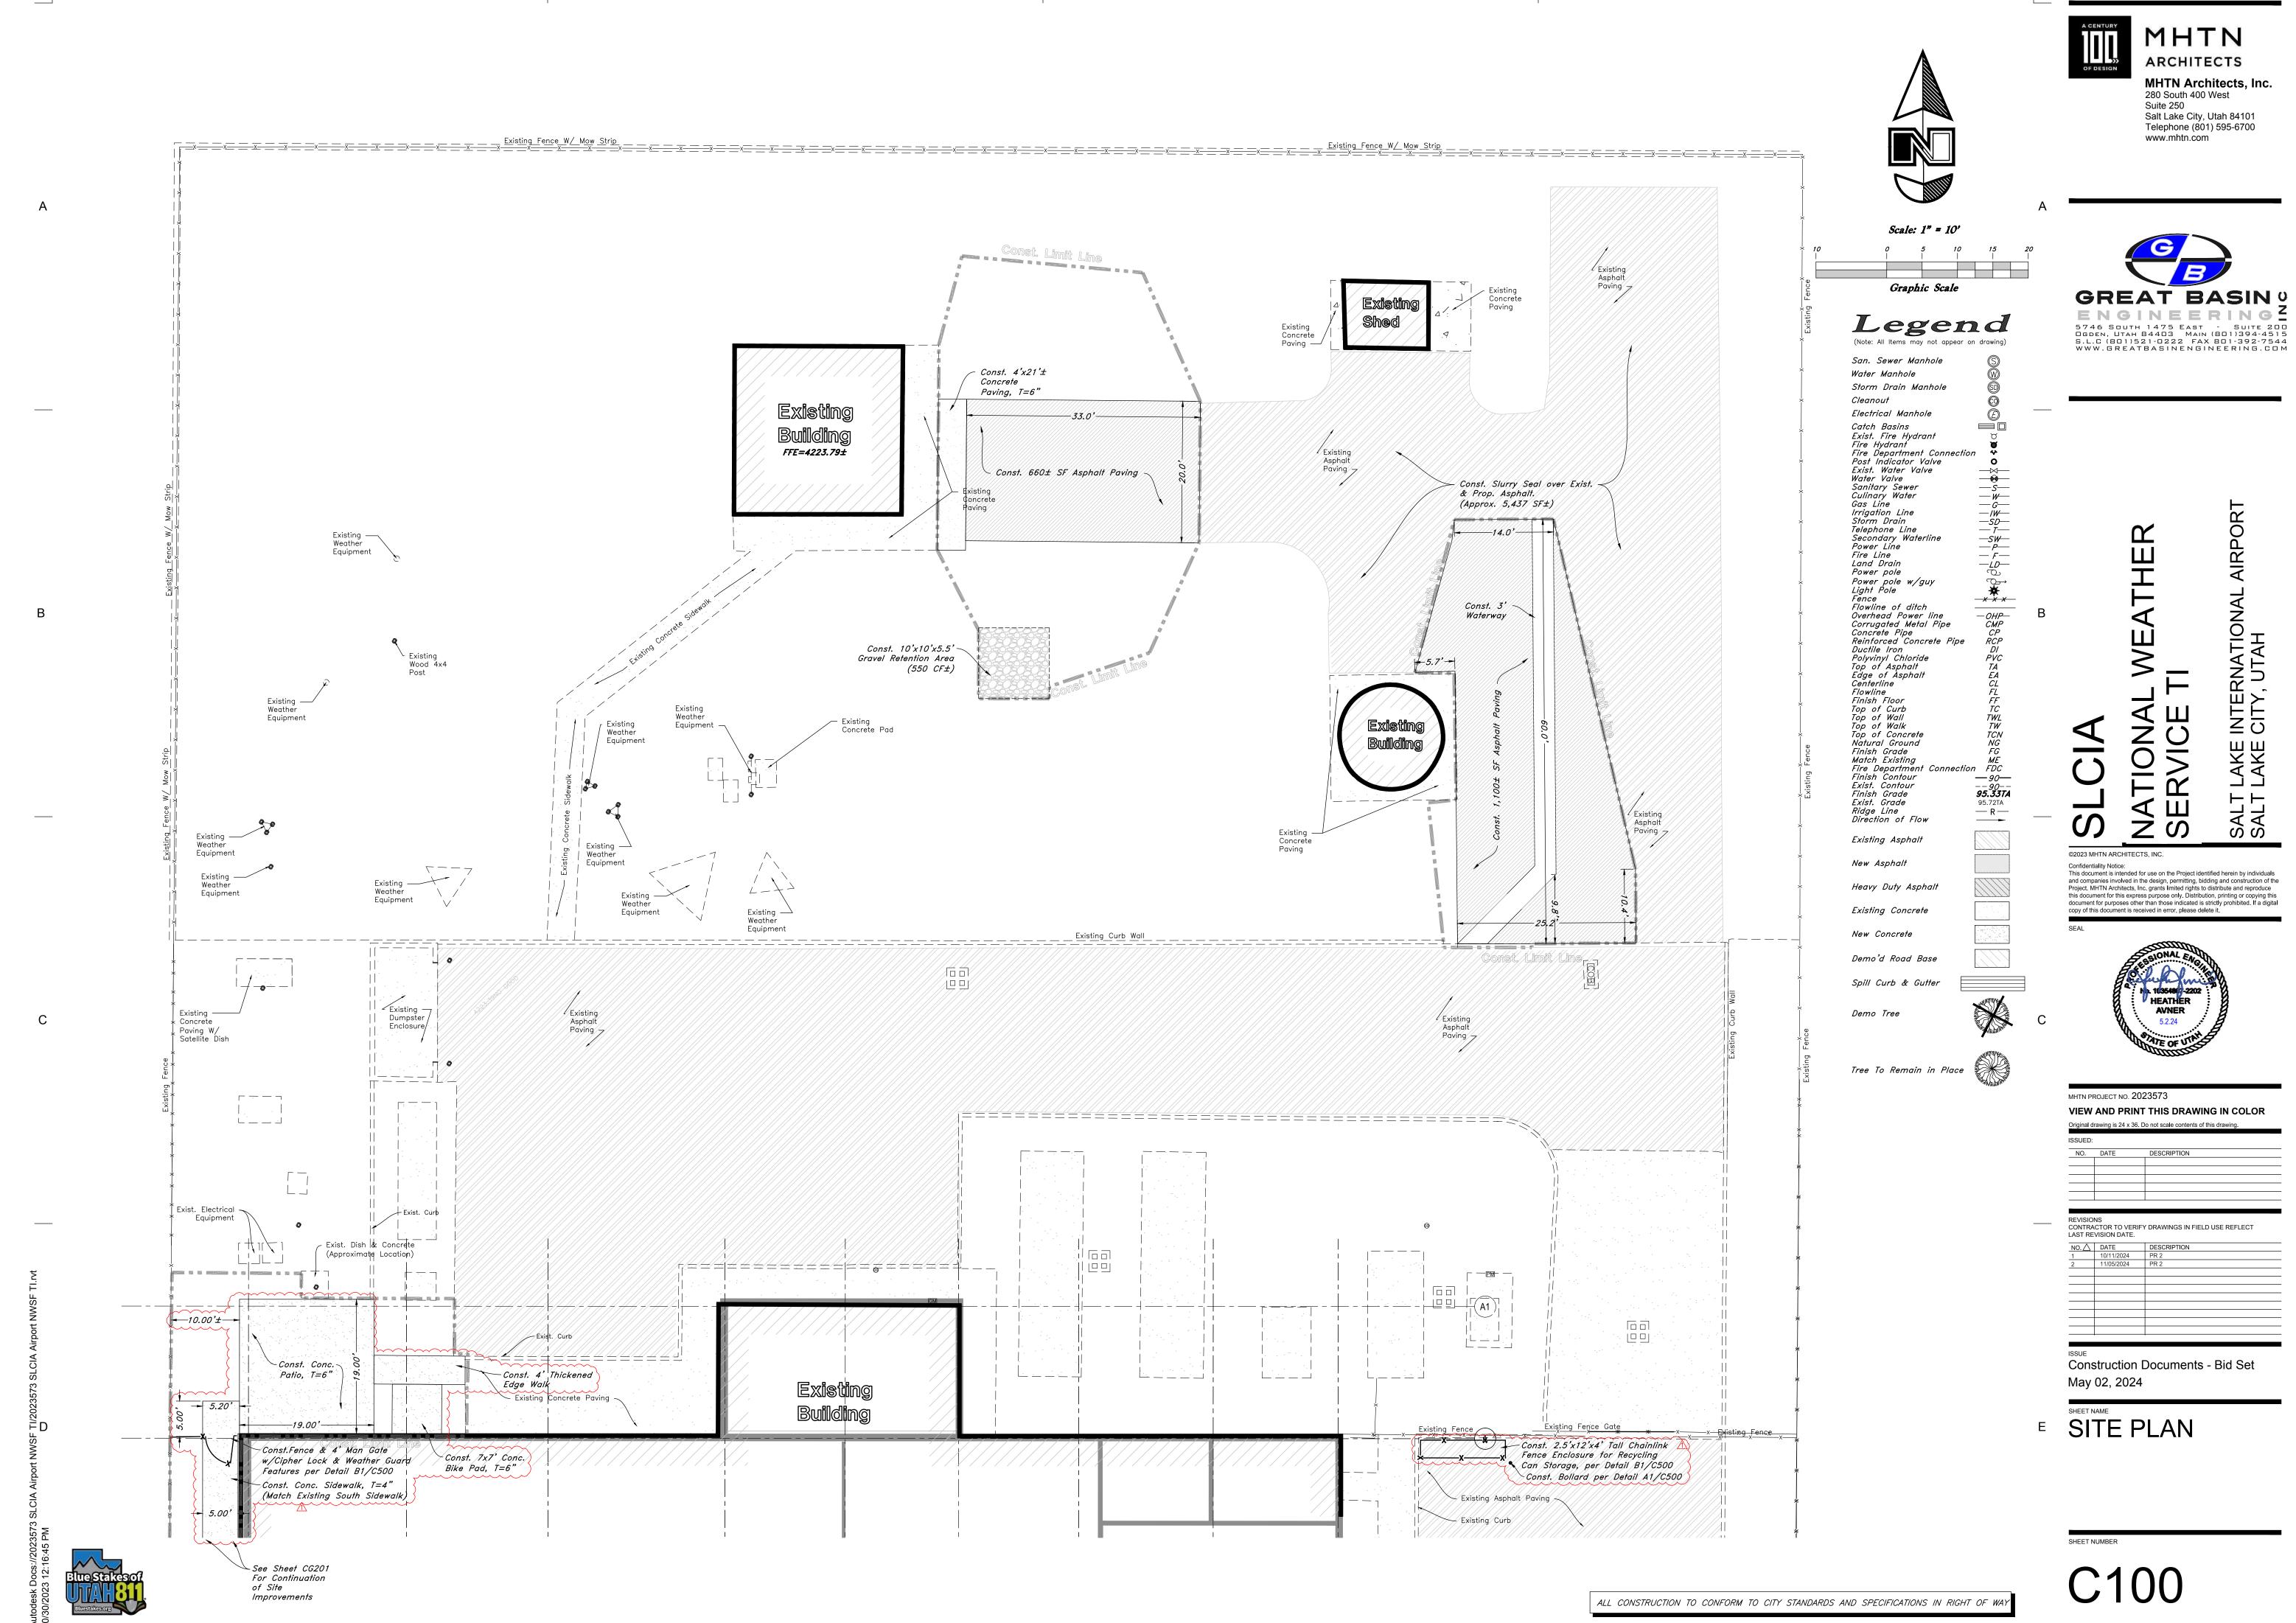

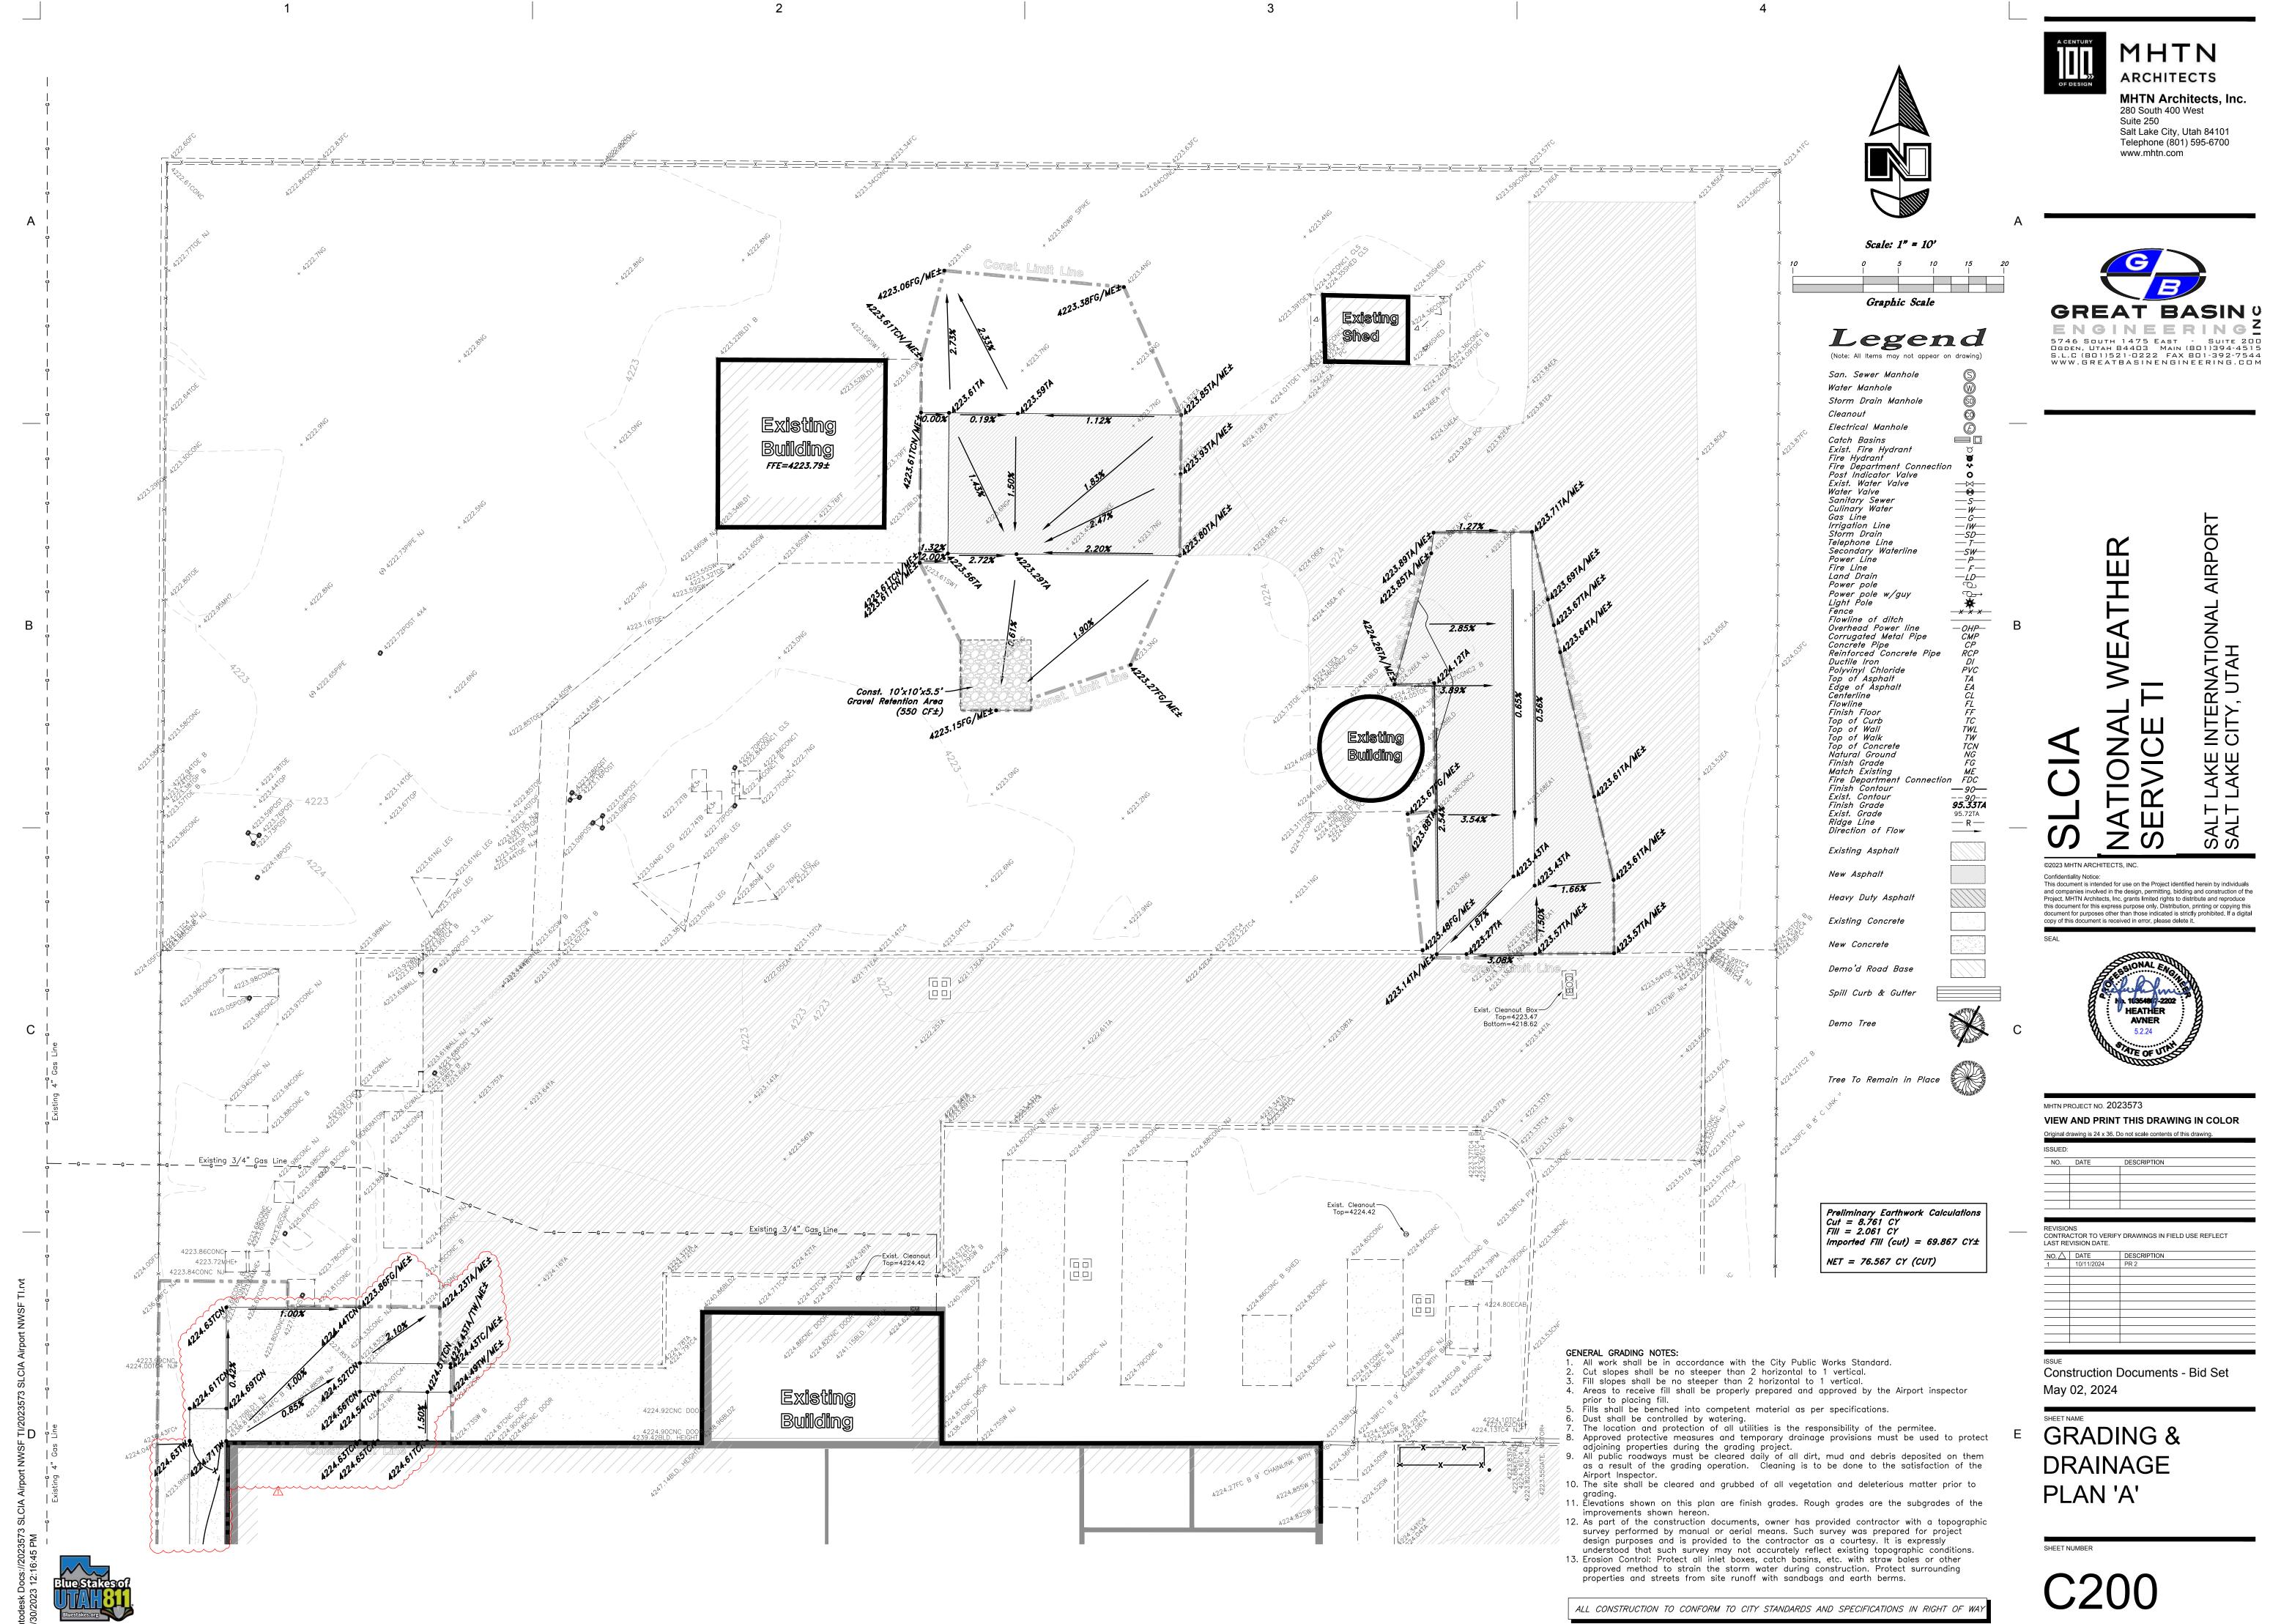

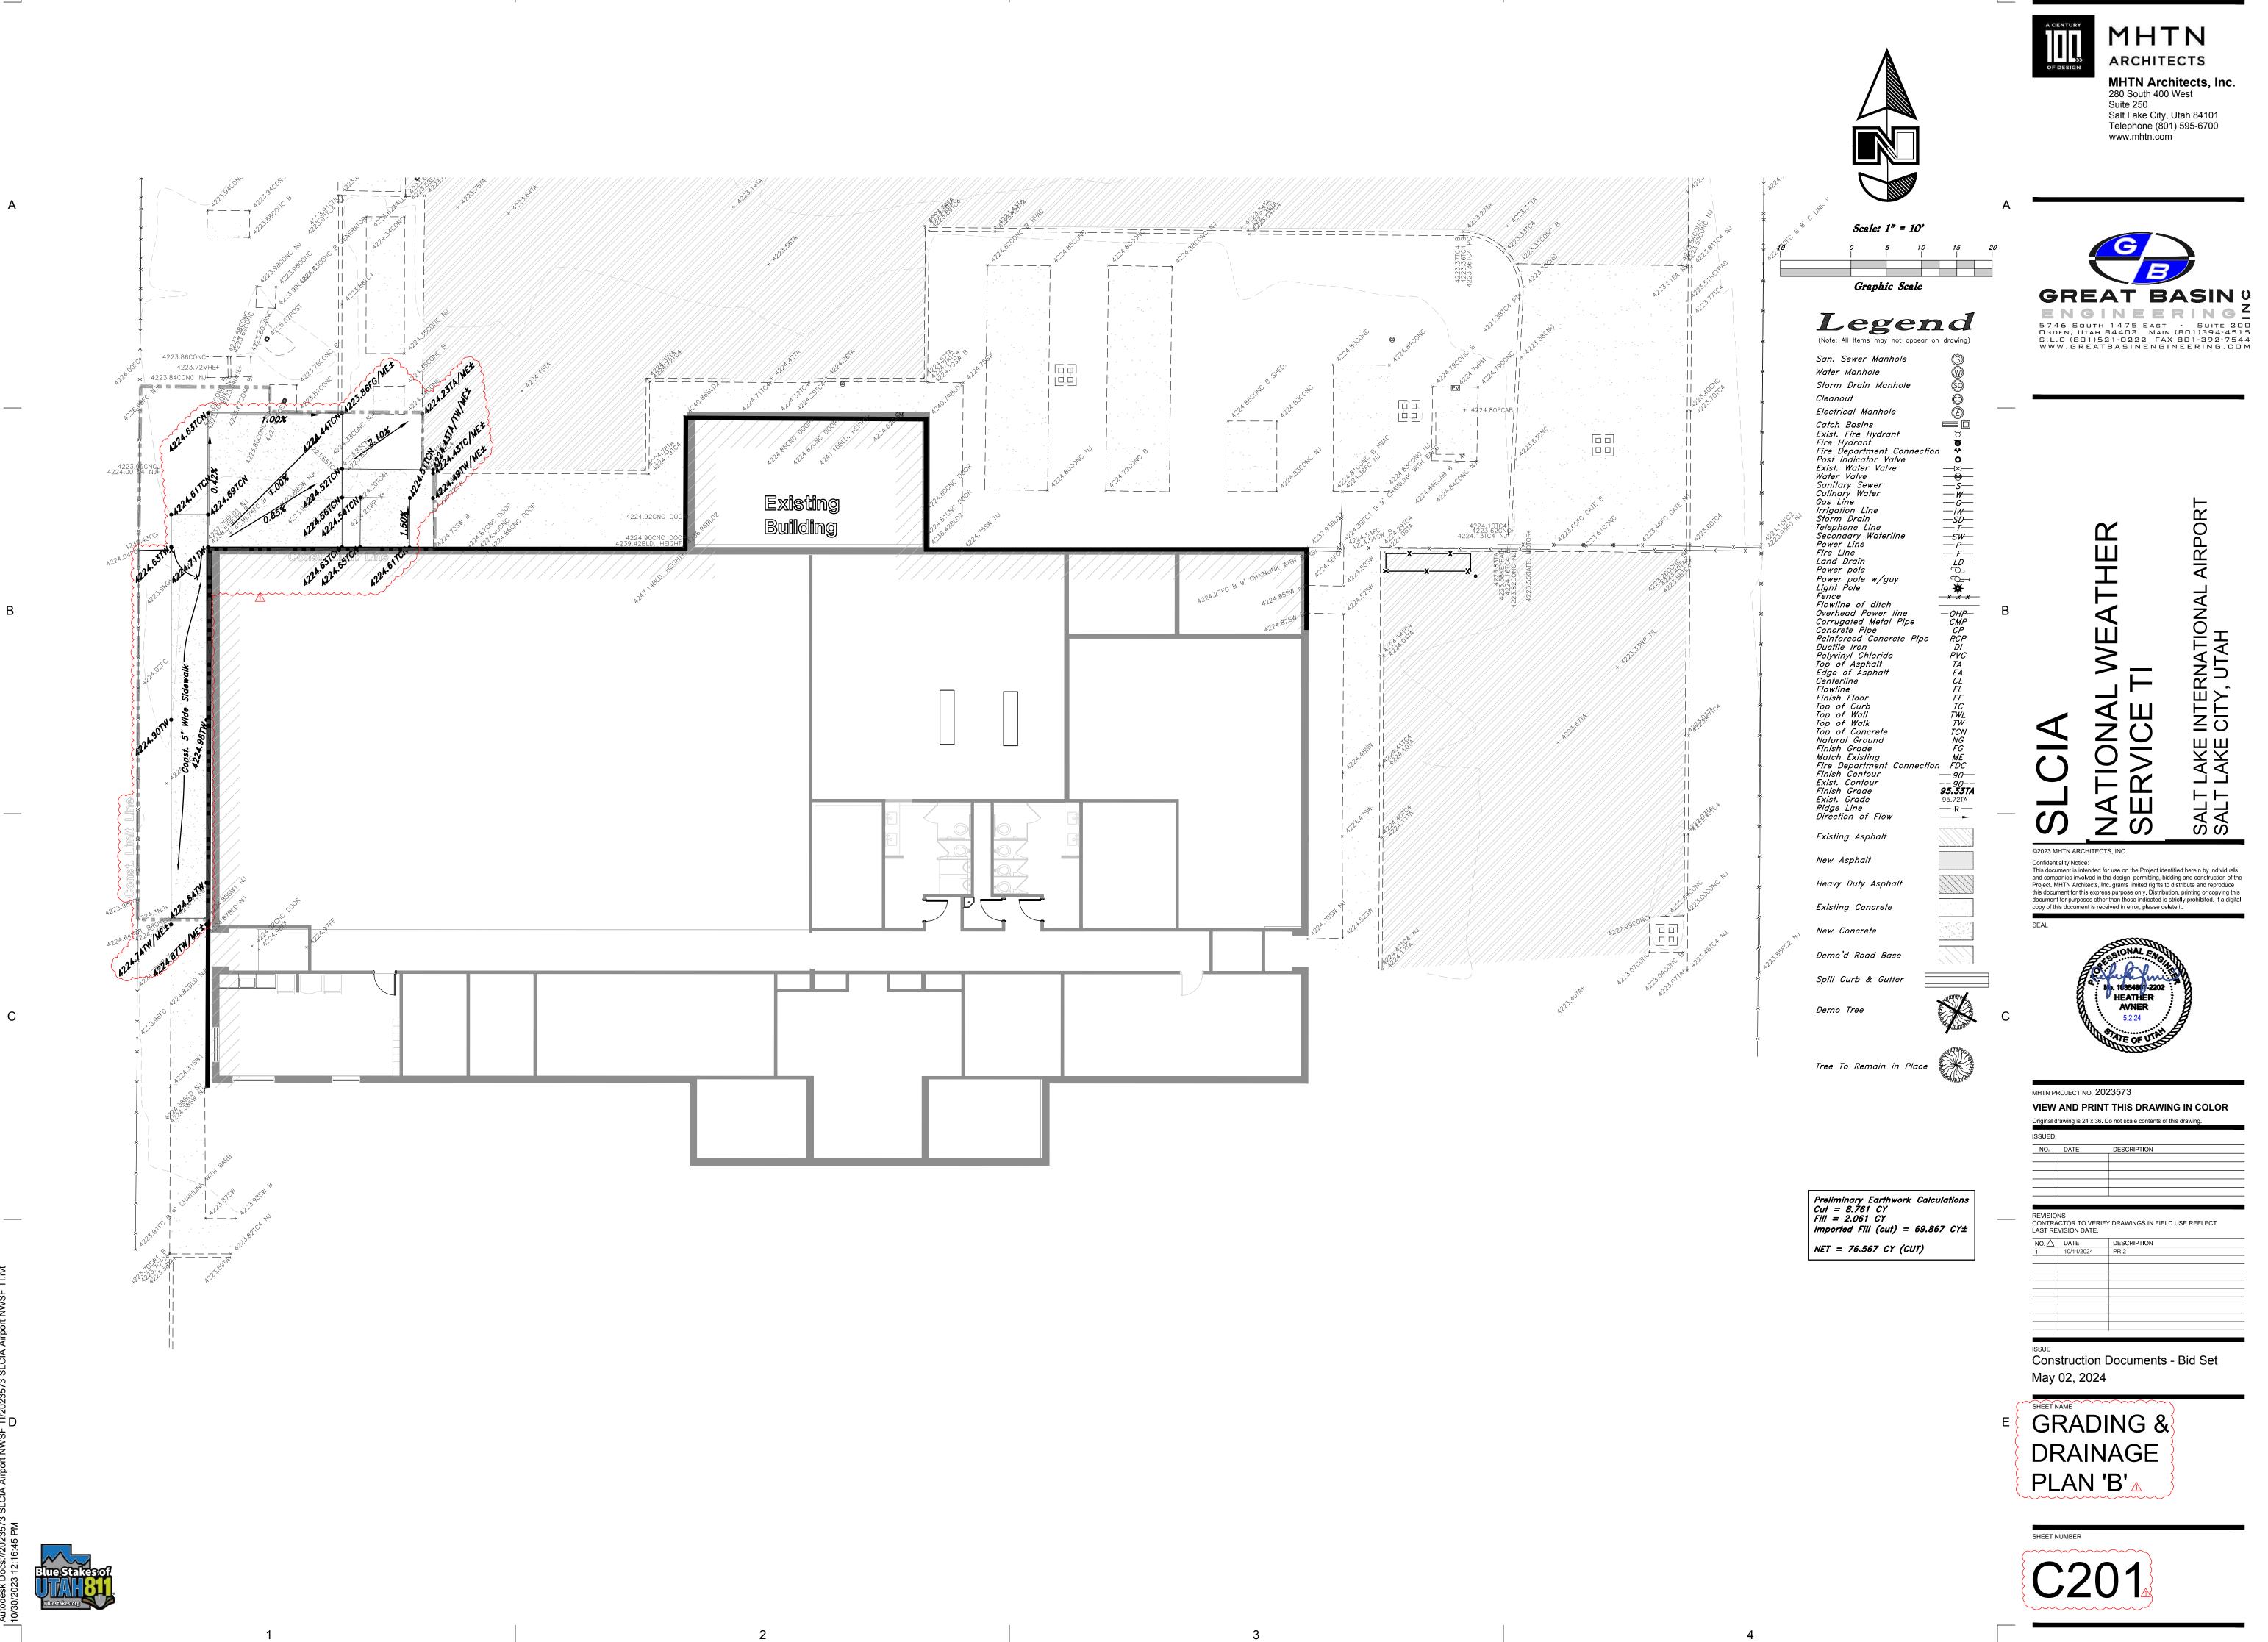

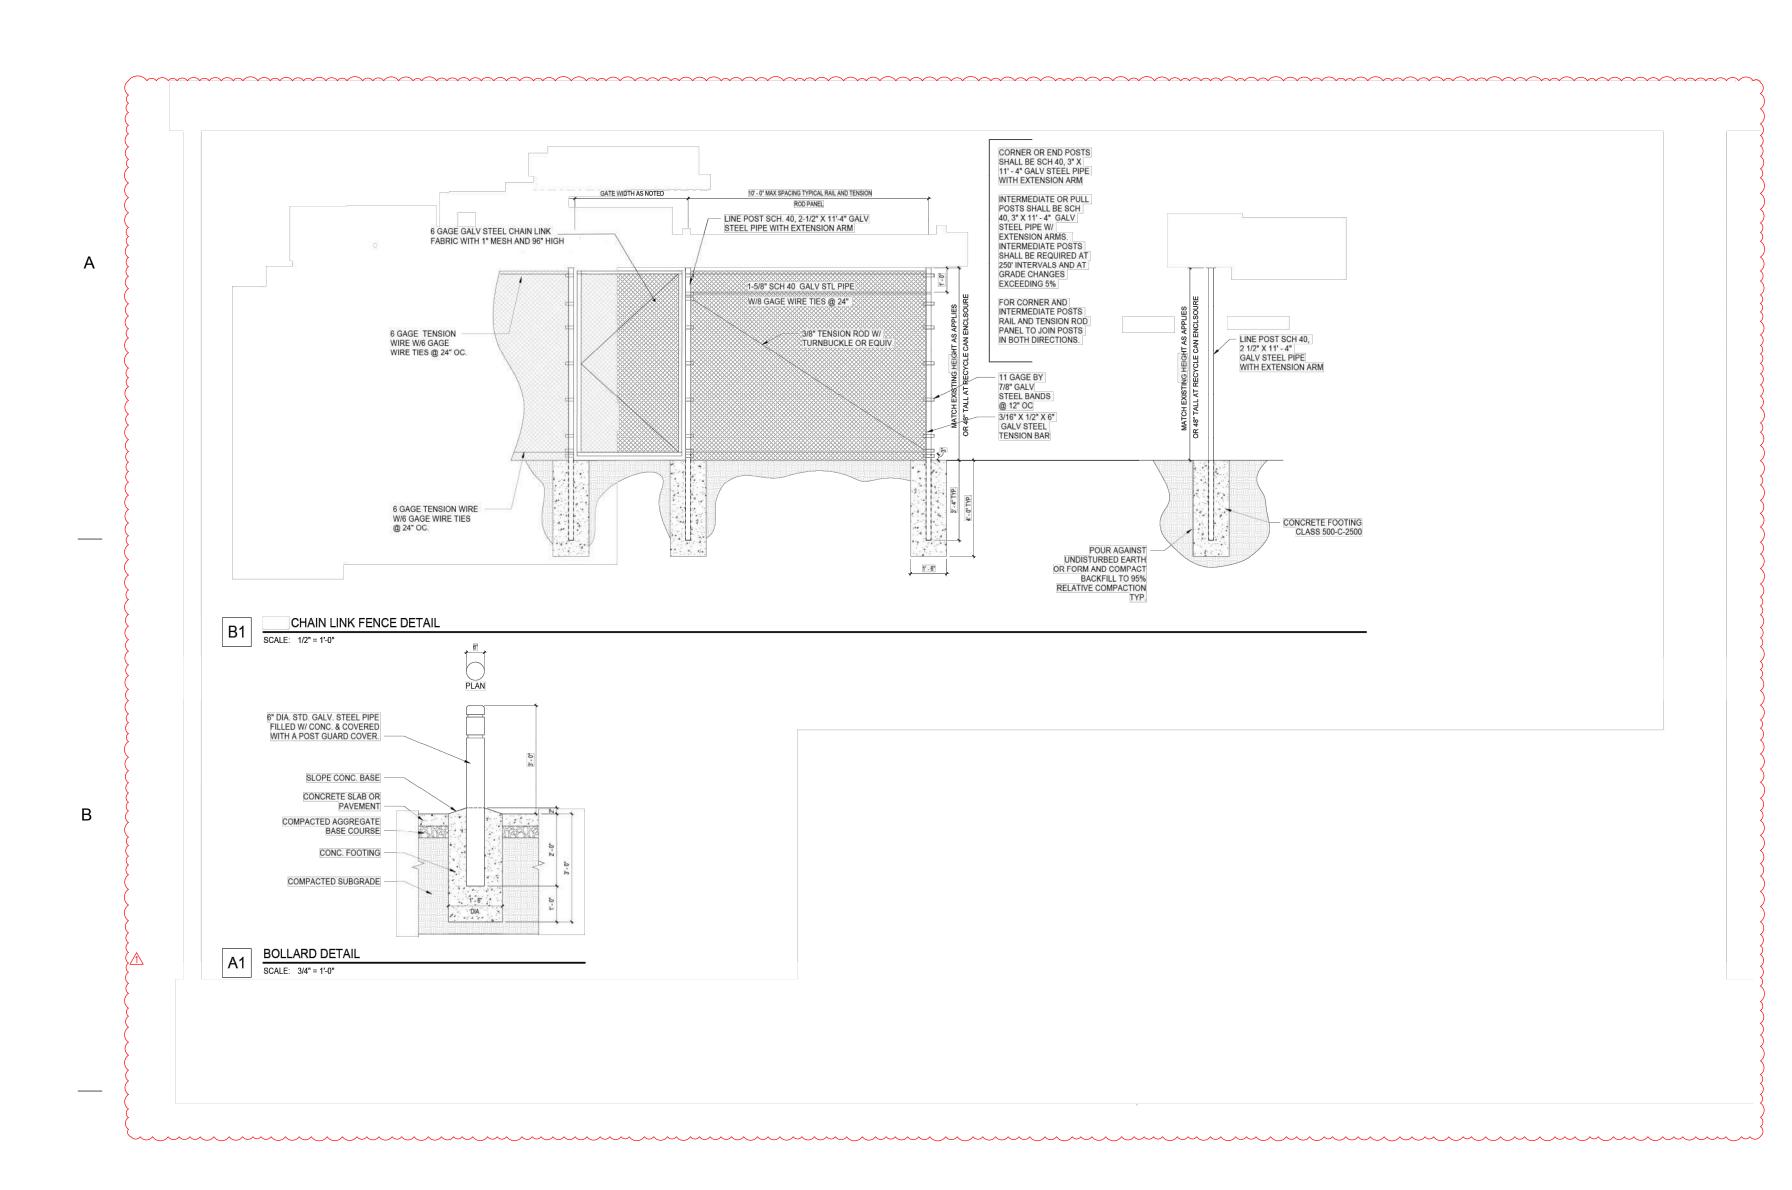


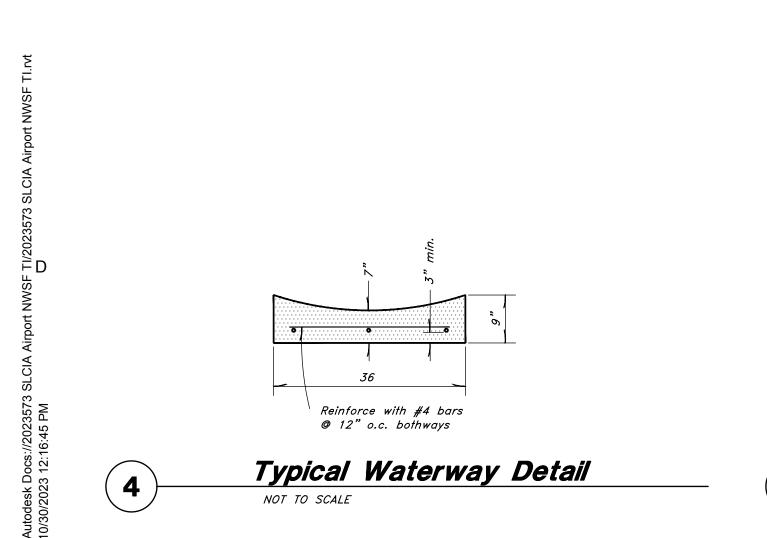

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Drive & Parking Areas

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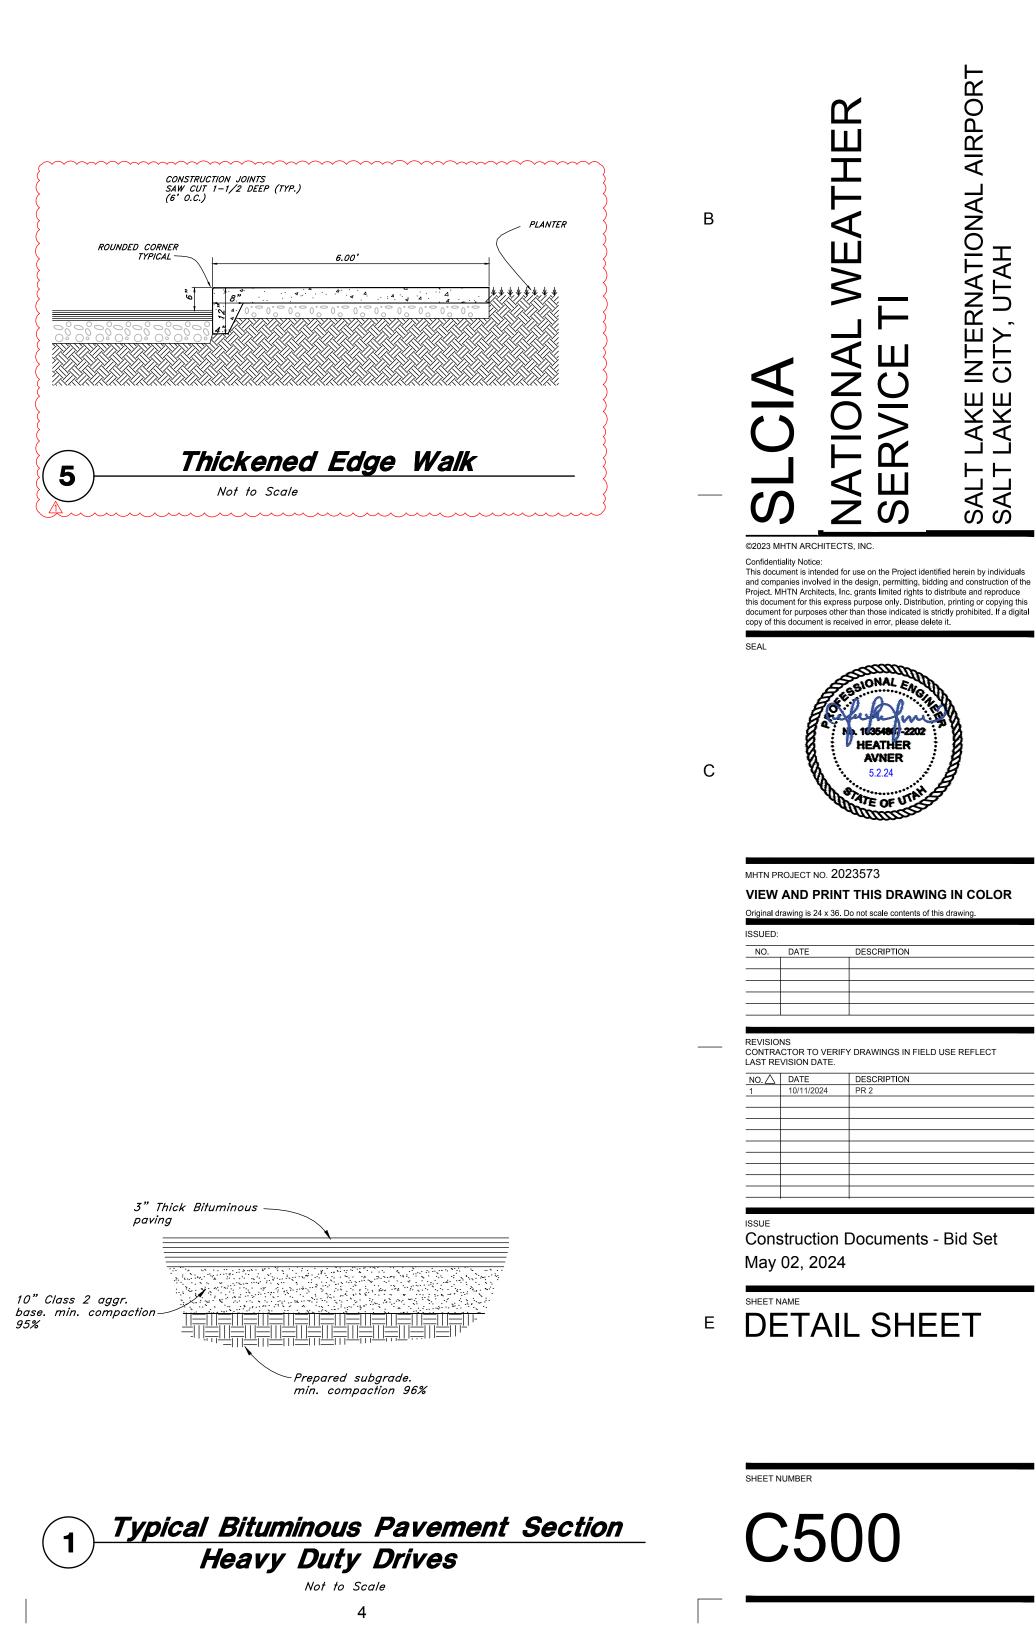
Gravel Retention Section NOT TO SCALE


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GENERAL NOTES

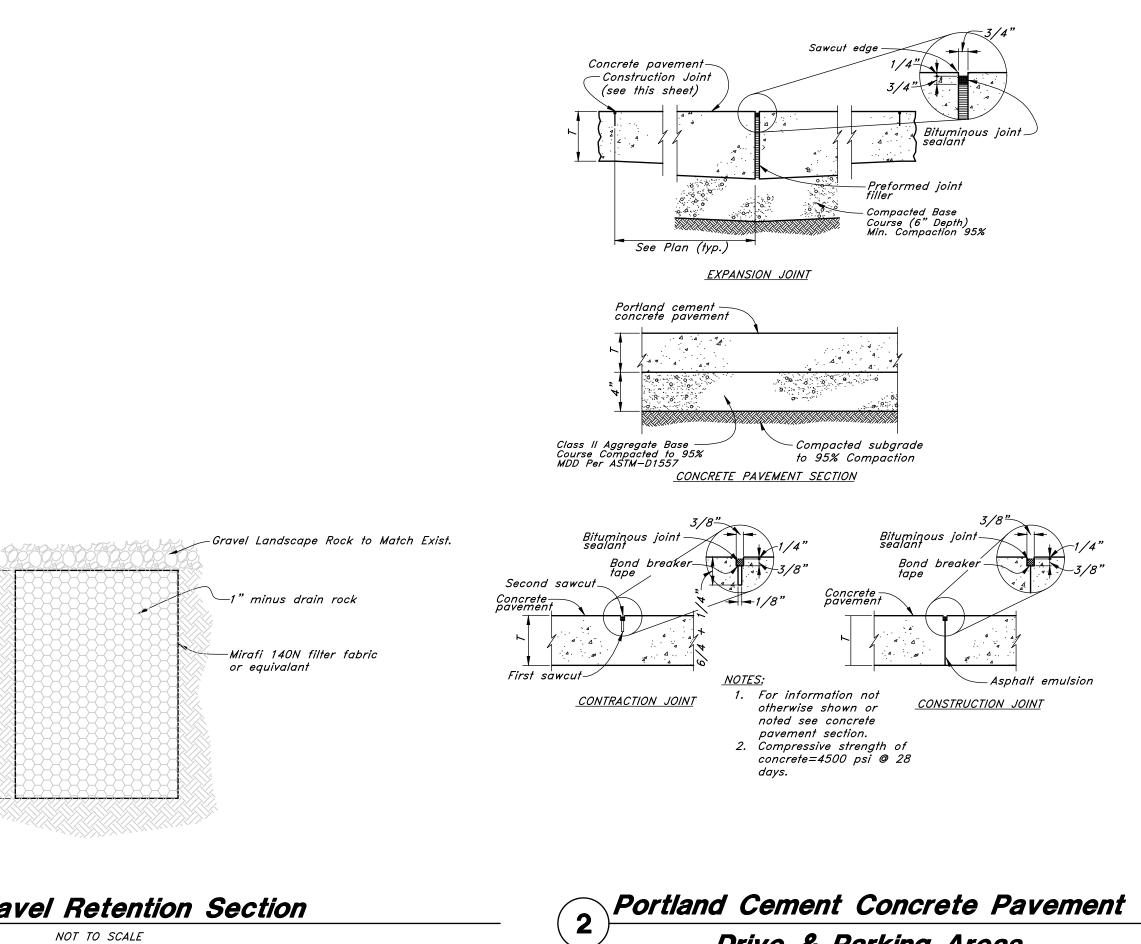- CONSTRUCT ALL SCORE JOINTS FROM THE ARCHITECTURAL SITE PLAN. SCORE JOINTS SHOWN ON THE CIVIL DRAWINGS ARE FOR
- CONTRACTOR SHALL REVIEW ALL EXPANSION JOINT LOCATIONS WITH ARCHITECT PRIOR TO INSTALLATION. SEE CIVIL DRAWINGS FOR
- INSTALL EXPANSION JOINTS @ 30'-0" O.C. MAX.
- 4. SCORE JOINTS IN PAVING ARE TO MATCH THE PAVING WIDTH TYPICAL, UNLESS NOTED OR SHOWN OTHERWISE.
- COORDINATE ALL SITE LIGHTING FIXTURE LOCATIONS WITH THE LANDSCAPE DRAWINGS. ALL SUCH LIGHTING SHALL BE STAKED FOR APPROVAL BY THE ARCHITECT PRIOR TO
- CONTRACTOR SHALL BE RESPONSIBLE FOR DAMAGE TO ANY ITEMS OR UTILITIES NOT NOTED TO BE REMOVED AND SHALL BEAR THE COST OF REPAIR TO ORIGINAL CONDITION.
- CONTRACTOR SHALL PROTECT ALL EXISTING UTILITIES NOT NOTED TO BE REMOVED AND REPAIR TO EXISTING CONDITION AT NO ADDITIONAL COST TO THE OWNER.
- ALL CONSTRUCTION OPERATIONS SHALL NOT INTERFERE WITH OPERATIONS OF OR ACCESS TO FACILITIES UNLESS AGREED TO BY OWNER. NOR RESTRICT ACCESS ON THE PUBLIC R.O.W. TEMPORARY ENTRY CLOSURE TO BE APPROVED IN WRITING BY THE OWNER AND LOCAL JURISDICTION. COORDINATE ALL DEMOLITION WORK AND TIMES WITH THE OWNER.
- STOCKPILE TOPSOIL FROM AFFECTED AREAS FOR RE INSTALLATION. CONTRACTOR SHALL BE RESPONSIBLE FOR STOCKPILING AN ADEQUATE AMOUNT OF TOPSOILTO COMPLETE LANDSCAPE OPERATIONS OR FOR PROVIDING THE SAME AS A PART OF THIS CONTRACT.
- 10. THIS CONTRACTOR SHALL BE RESPONSIBLE TO PROTECT ALL EXISTING PLANT MATERIAL AND LANDSCAPE NOT SHOWN TO BE REMOVED. INSTALL A TEMPORARY FENCE AROUND THE DRIP LINE OF ALL TREES WHEN REQUIRED.
- MAINTAIN AND PROTECT AS MUCH OF THE EXISTING IRRIGATION SYSTEM AS POSSIBLE AND FEASIBLE AND STILL PROVIDE FOR FULL COVERAGE OF THE ENTIRE AREA. KEEP ALL LAWN AREA HEADS ON A SEPARATE CIRCUIT FROM SHRUB AREA HEADS.
- 12. THE EXISTING IRRIGATION SYSTEM TO REMAIN IN USE SHALL BE PATCHED AND REPAIRED AS NECESSARY. MAINTAIN OPERATION OF THE EXISTING SYSTEM AS REQUIRED TO PROTECT EXISTING PLANT MATERIAL.
- 13. SEE CIVIL DRAWINGS FOR SITE HORIZONTAL


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REFE	RENC	E NOTES SC	HEDULE	Ξ
SYMBOL	CODE	DESCRIPTION	DETAIL	RELATED DETAILS
01 PAVEMENT	S, RAMPS, CU	RBS		
	01-03	CONCRETE PAVING		321300
SYMBOL	CODE	DESCRIPTION	DETAIL	
05 SITE FURN	ISHINGS		J	
	05-01	SHADE STRUCTURE - BASIS OF DESIGN CLASSIC RECREATION - 16'X16' ORLANDO	3	
	05-02	<i>COVERED BIKE SHELTER - BASIS OF DESIGN CYCLE SAFE - CYCLE 2-TOP ASSEMBLY W-SHELTER</i>	1	
	05-03	<i>BIKE RACKS - BASIS OF DESIGN CYCLE SAFE - (4) W-RACK</i>	3	
06 RAILINGS, I	BARRIERS, FEI	NCING	2	
	06-01	FENCE	1	
	06-02	GATE	く	
REFERENCE	NOTES	mm		
, <u> </u>	E-100	EXISTING CONCRETE PAVING - SEE CIVIL		
	E-101	EXISTING GAS LINE - SEE CIVIL		

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MHTN PROJECT NO. 2023573 VIEW AND PRINT THIS DRAWING IN COLOR Original drawing is 24 x 36. Do not scale contents of this drawing. DESCRIPTIC

REVISIONS CONTRACTOR TO VERIFY DRAWINGS IN FIELD USE REFLECT LAST REVISION DATE. NO. DATE DESCRIPTION

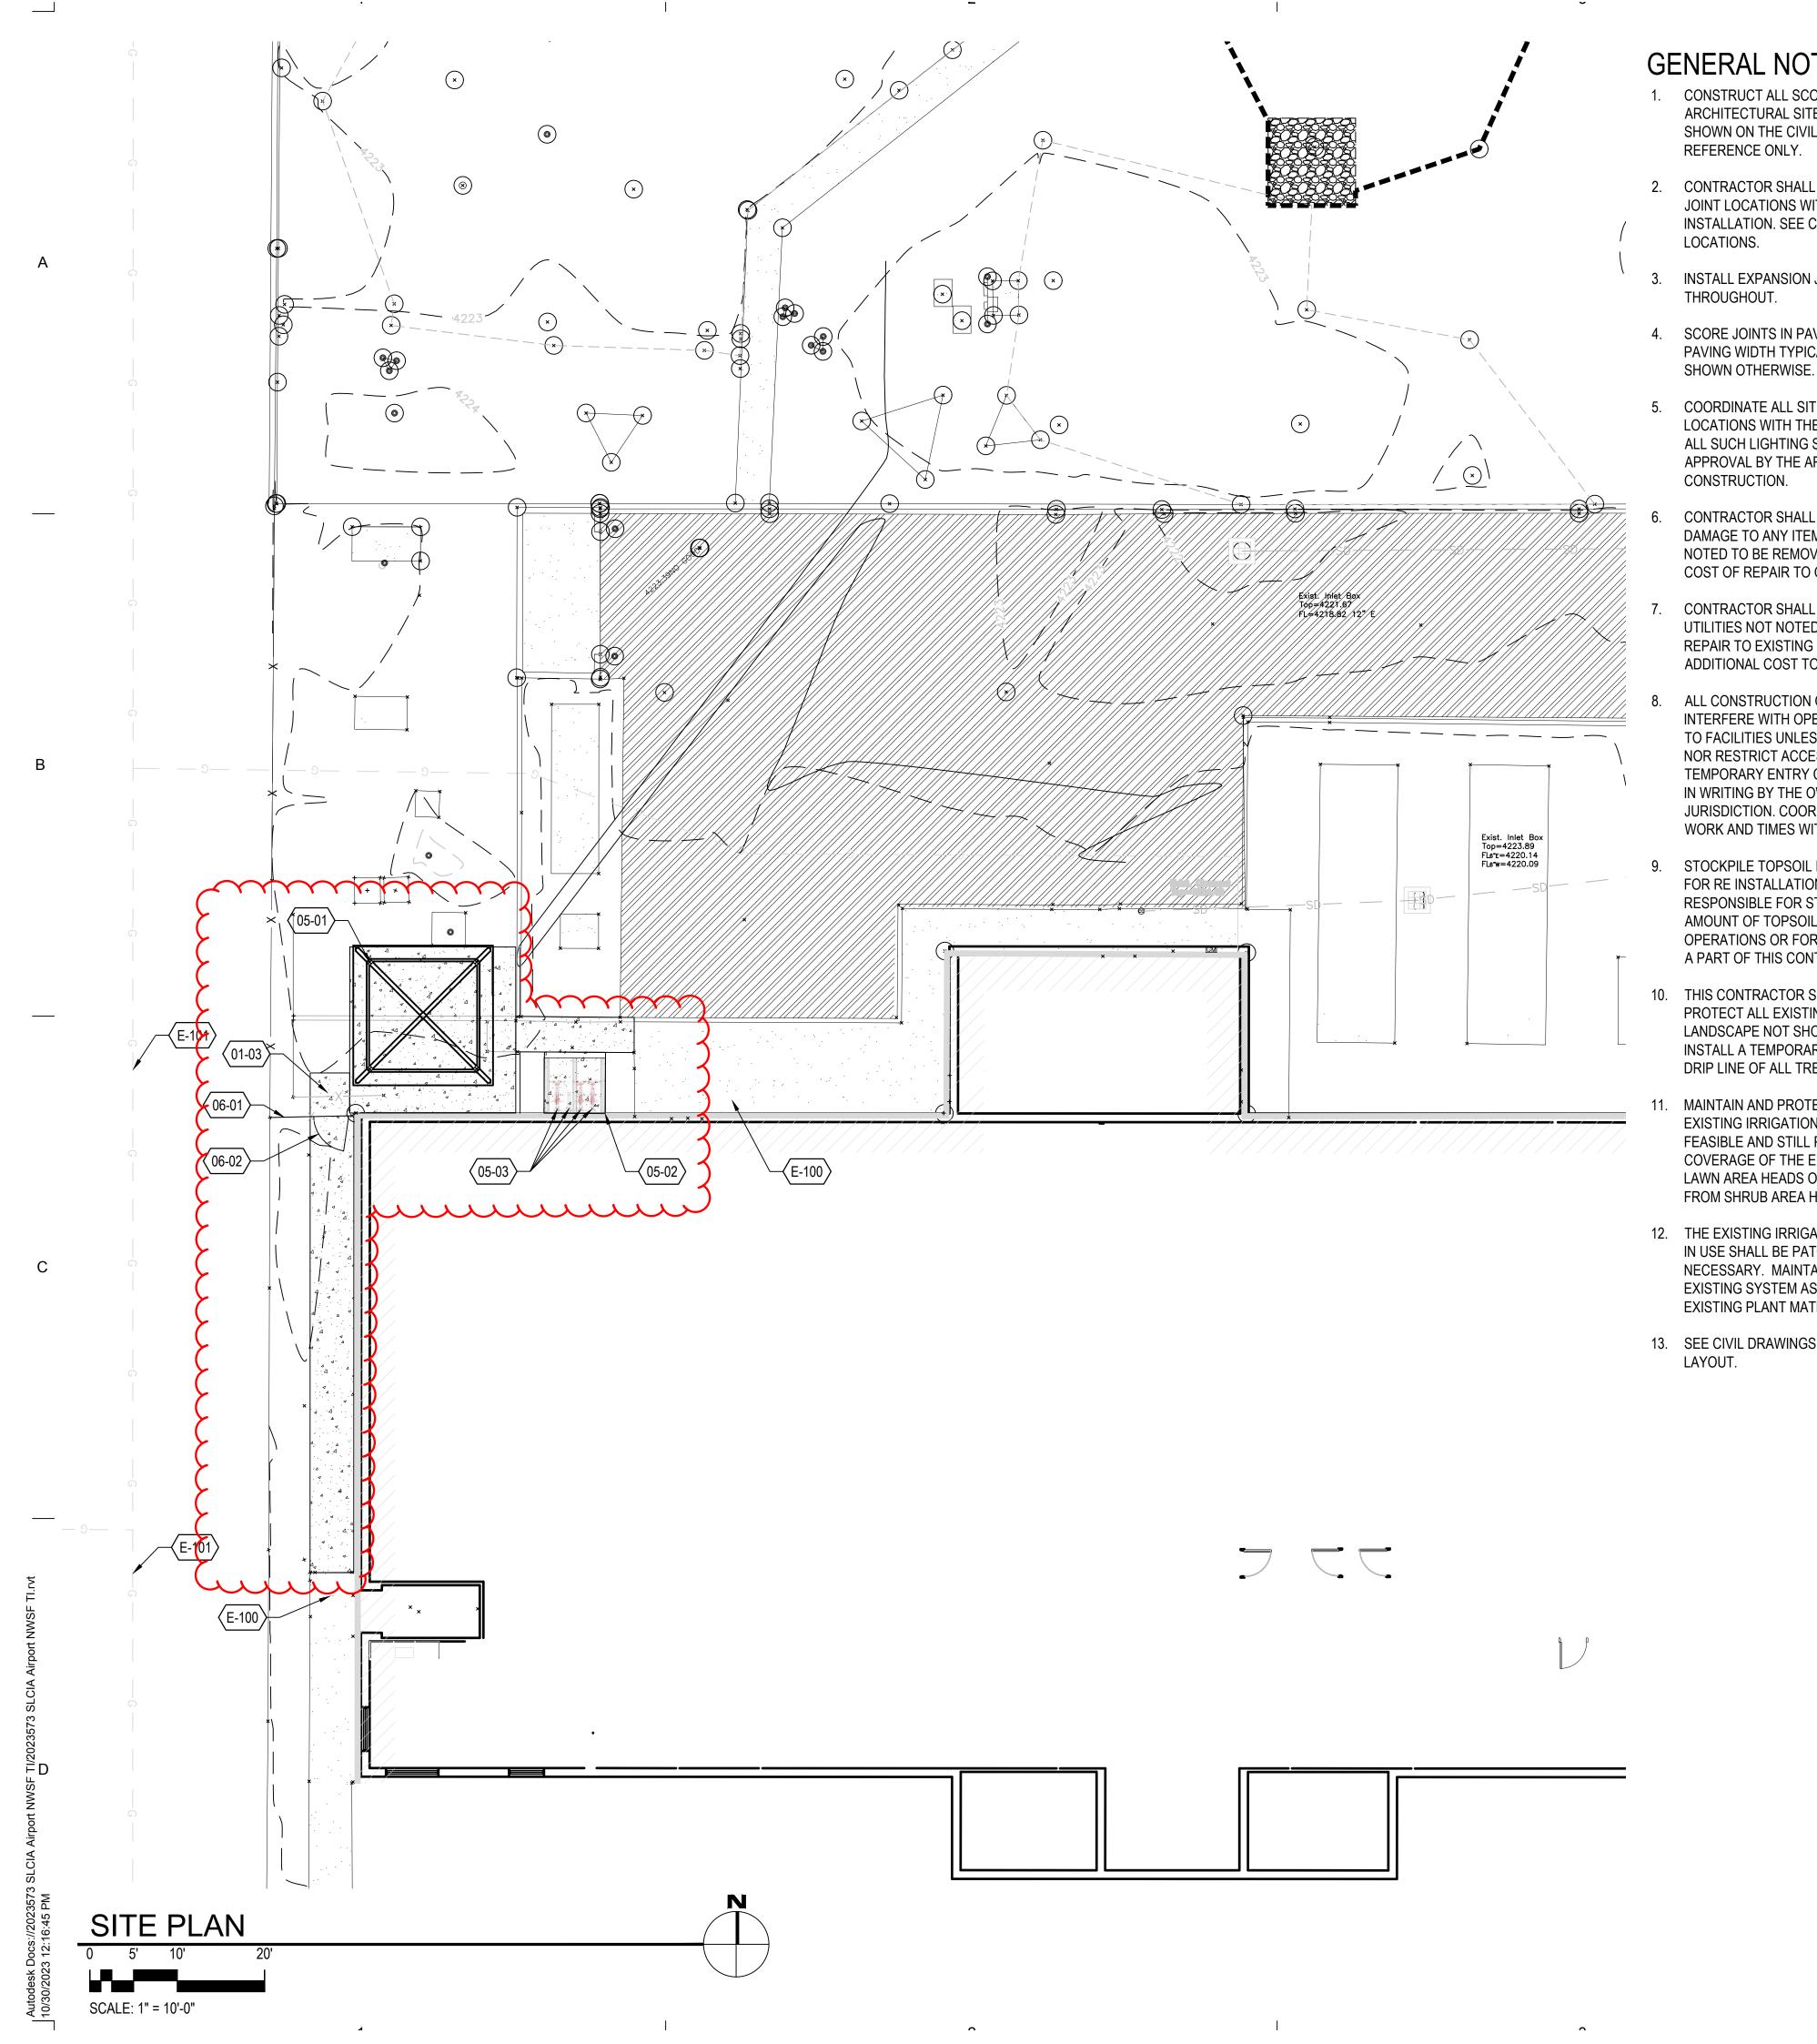Construction Documents - Bid Set May 02, 2024


SHEET NAME SITE PLAN Е

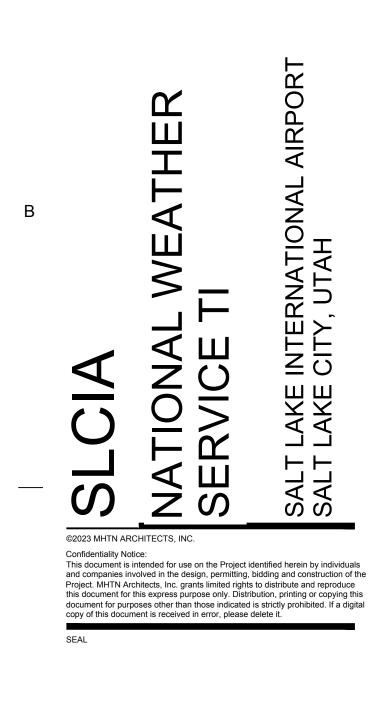SHEET NUMBER

AS100


		INT	FERIOR W	ALL TYPE S	CHEDULE					
TAG		FIRE RESISTANCE		ACOUSTICAL						
MARK	DESCRIPTION	WIDTH	TERMINATION	LIMITING HEIGHT	HEAD DETAIL	BASE DETAIL	FIRE RATING	STANDARD	SOUND BATT	STC
S3A	5/8" GB + 3 5/8" MTL STUD + 5/8" GB	4 7/8"	TO DECK	16'-6"					Yes	40
S3B	5/8" GB + 3 5/8" MTL STUD + 5/8" GB	4 7/8"	TO DECK	16'-6"					No	37
S3BX	5/8" GB + 3 5/8" MTL STUD	4 1/4"	TO DECK	15'-6"					No	

	DOOR AND FRAME SCHEDULE												
			DOOR			FR	AME						
DOOR #	ТҮРЕ	WIDTH	HEIGHT	THICKNESS	MATERIAL	ТҮРЕ	MATERIAL	REMARKS					
104	F	3'-0"	7'-0"	1 3/4"		1	TME	RELOCATED DOOR & FRAME, CLOSER, HARDWARE TME					
127	F	3'-0"	7'-0"	1 3/4"		1	TME	NEW DOOR, CLOSER, HARDWARE TME W/ NEW VACANCY					
128	F	3'-0"	7'-0"	1 3/4"		1	TME	NEW DOOR, CLOSER, HARDWARE TME					
129	F	3'-0"	7'-0"	1 3/4"		1	TME	DOOR AND HARDWARE RELOCATED FROM CORRIDOR 10					
Grand tot	al: 4												

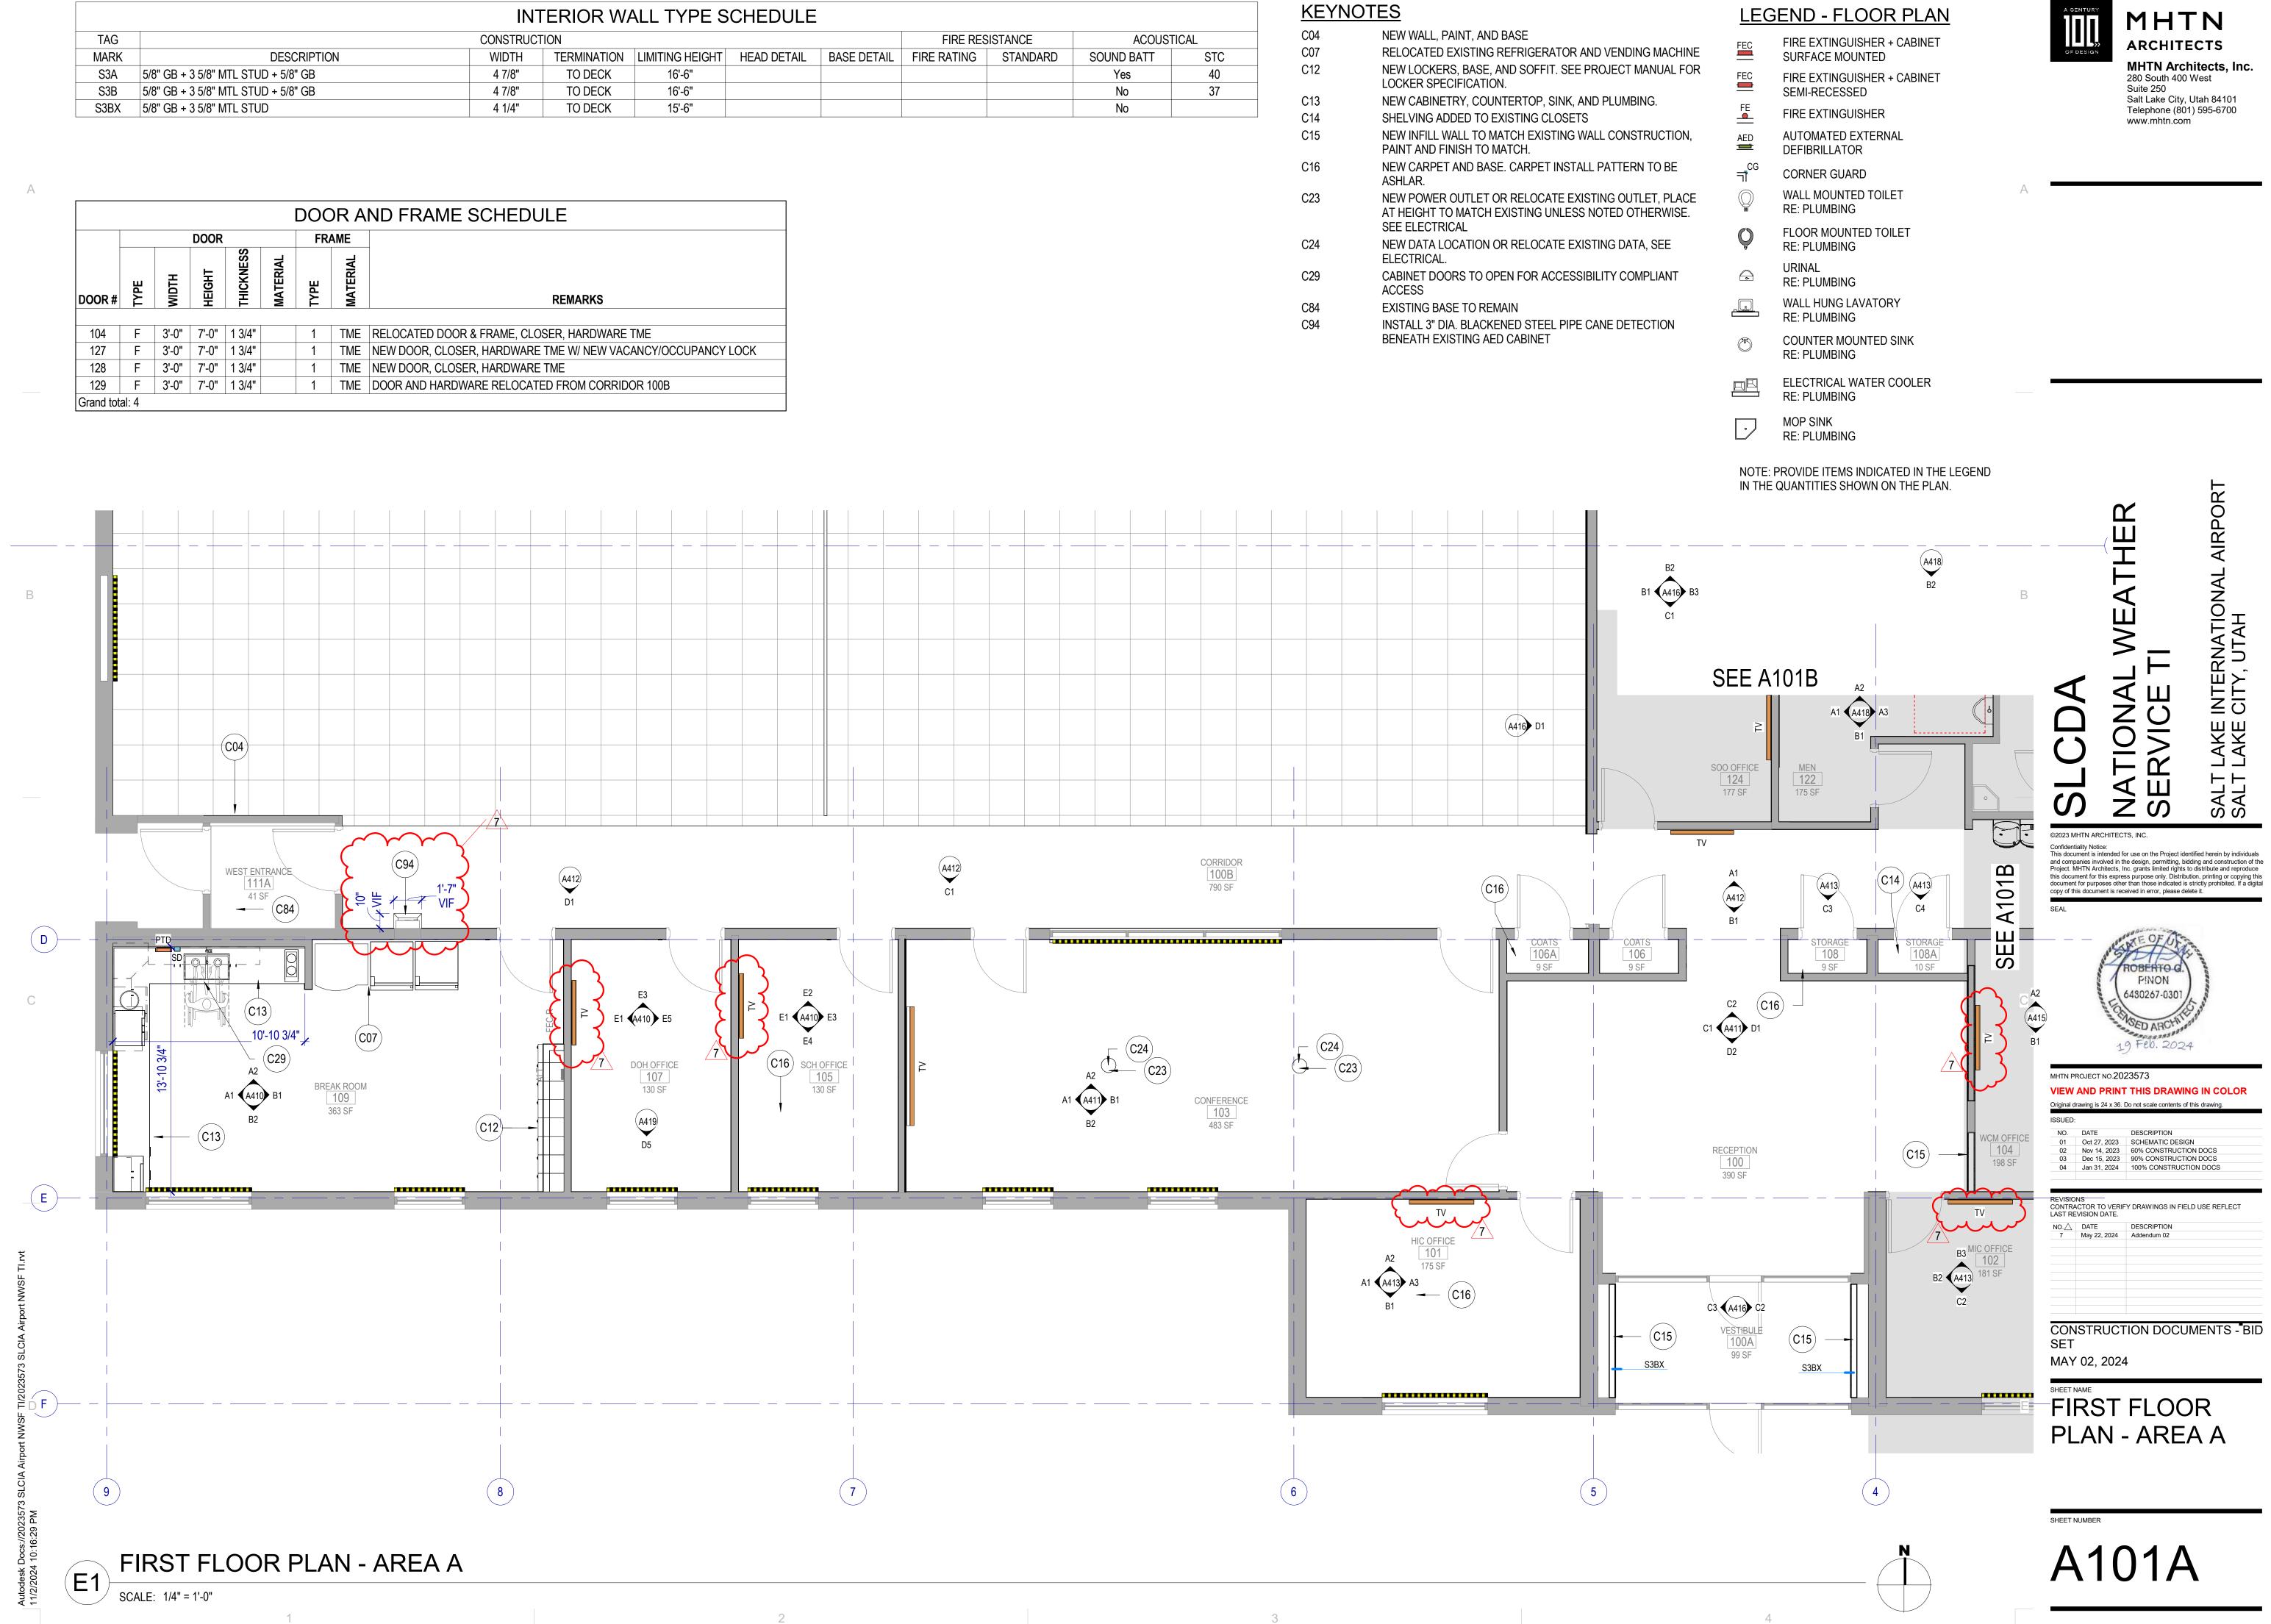

<u>NE INU I</u>	<u>L3</u>
C04	NEW WALL, PAINT, AND BASE
C07	RELOCATED EXISTING REFRIGEF
C12	NEW LOCKERS, BASE, AND SOFF LOCKER SPECIFICATION.
C13	NEW CABINETRY, COUNTERTOP,
C14	SHELVING ADDED TO EXISTING C
C15	NEW INFILL WALL TO MATCH EXIS PAINT AND FINISH TO MATCH.
C16	NEW CARPET AND BASE. CARPE ASHLAR.
C23	NEW POWER OUTLET OR RELOCA AT HEIGHT TO MATCH EXISTING SEE ELECTRICAL
C24	NEW DATA LOCATION OR RELOC. ELECTRICAL.
C29	CABINET DOORS TO OPEN FOR A ACCESS
C84	EXISTING BASE TO REMAIN
C94	INSTALL 3" DIA. BLACKENED STEI



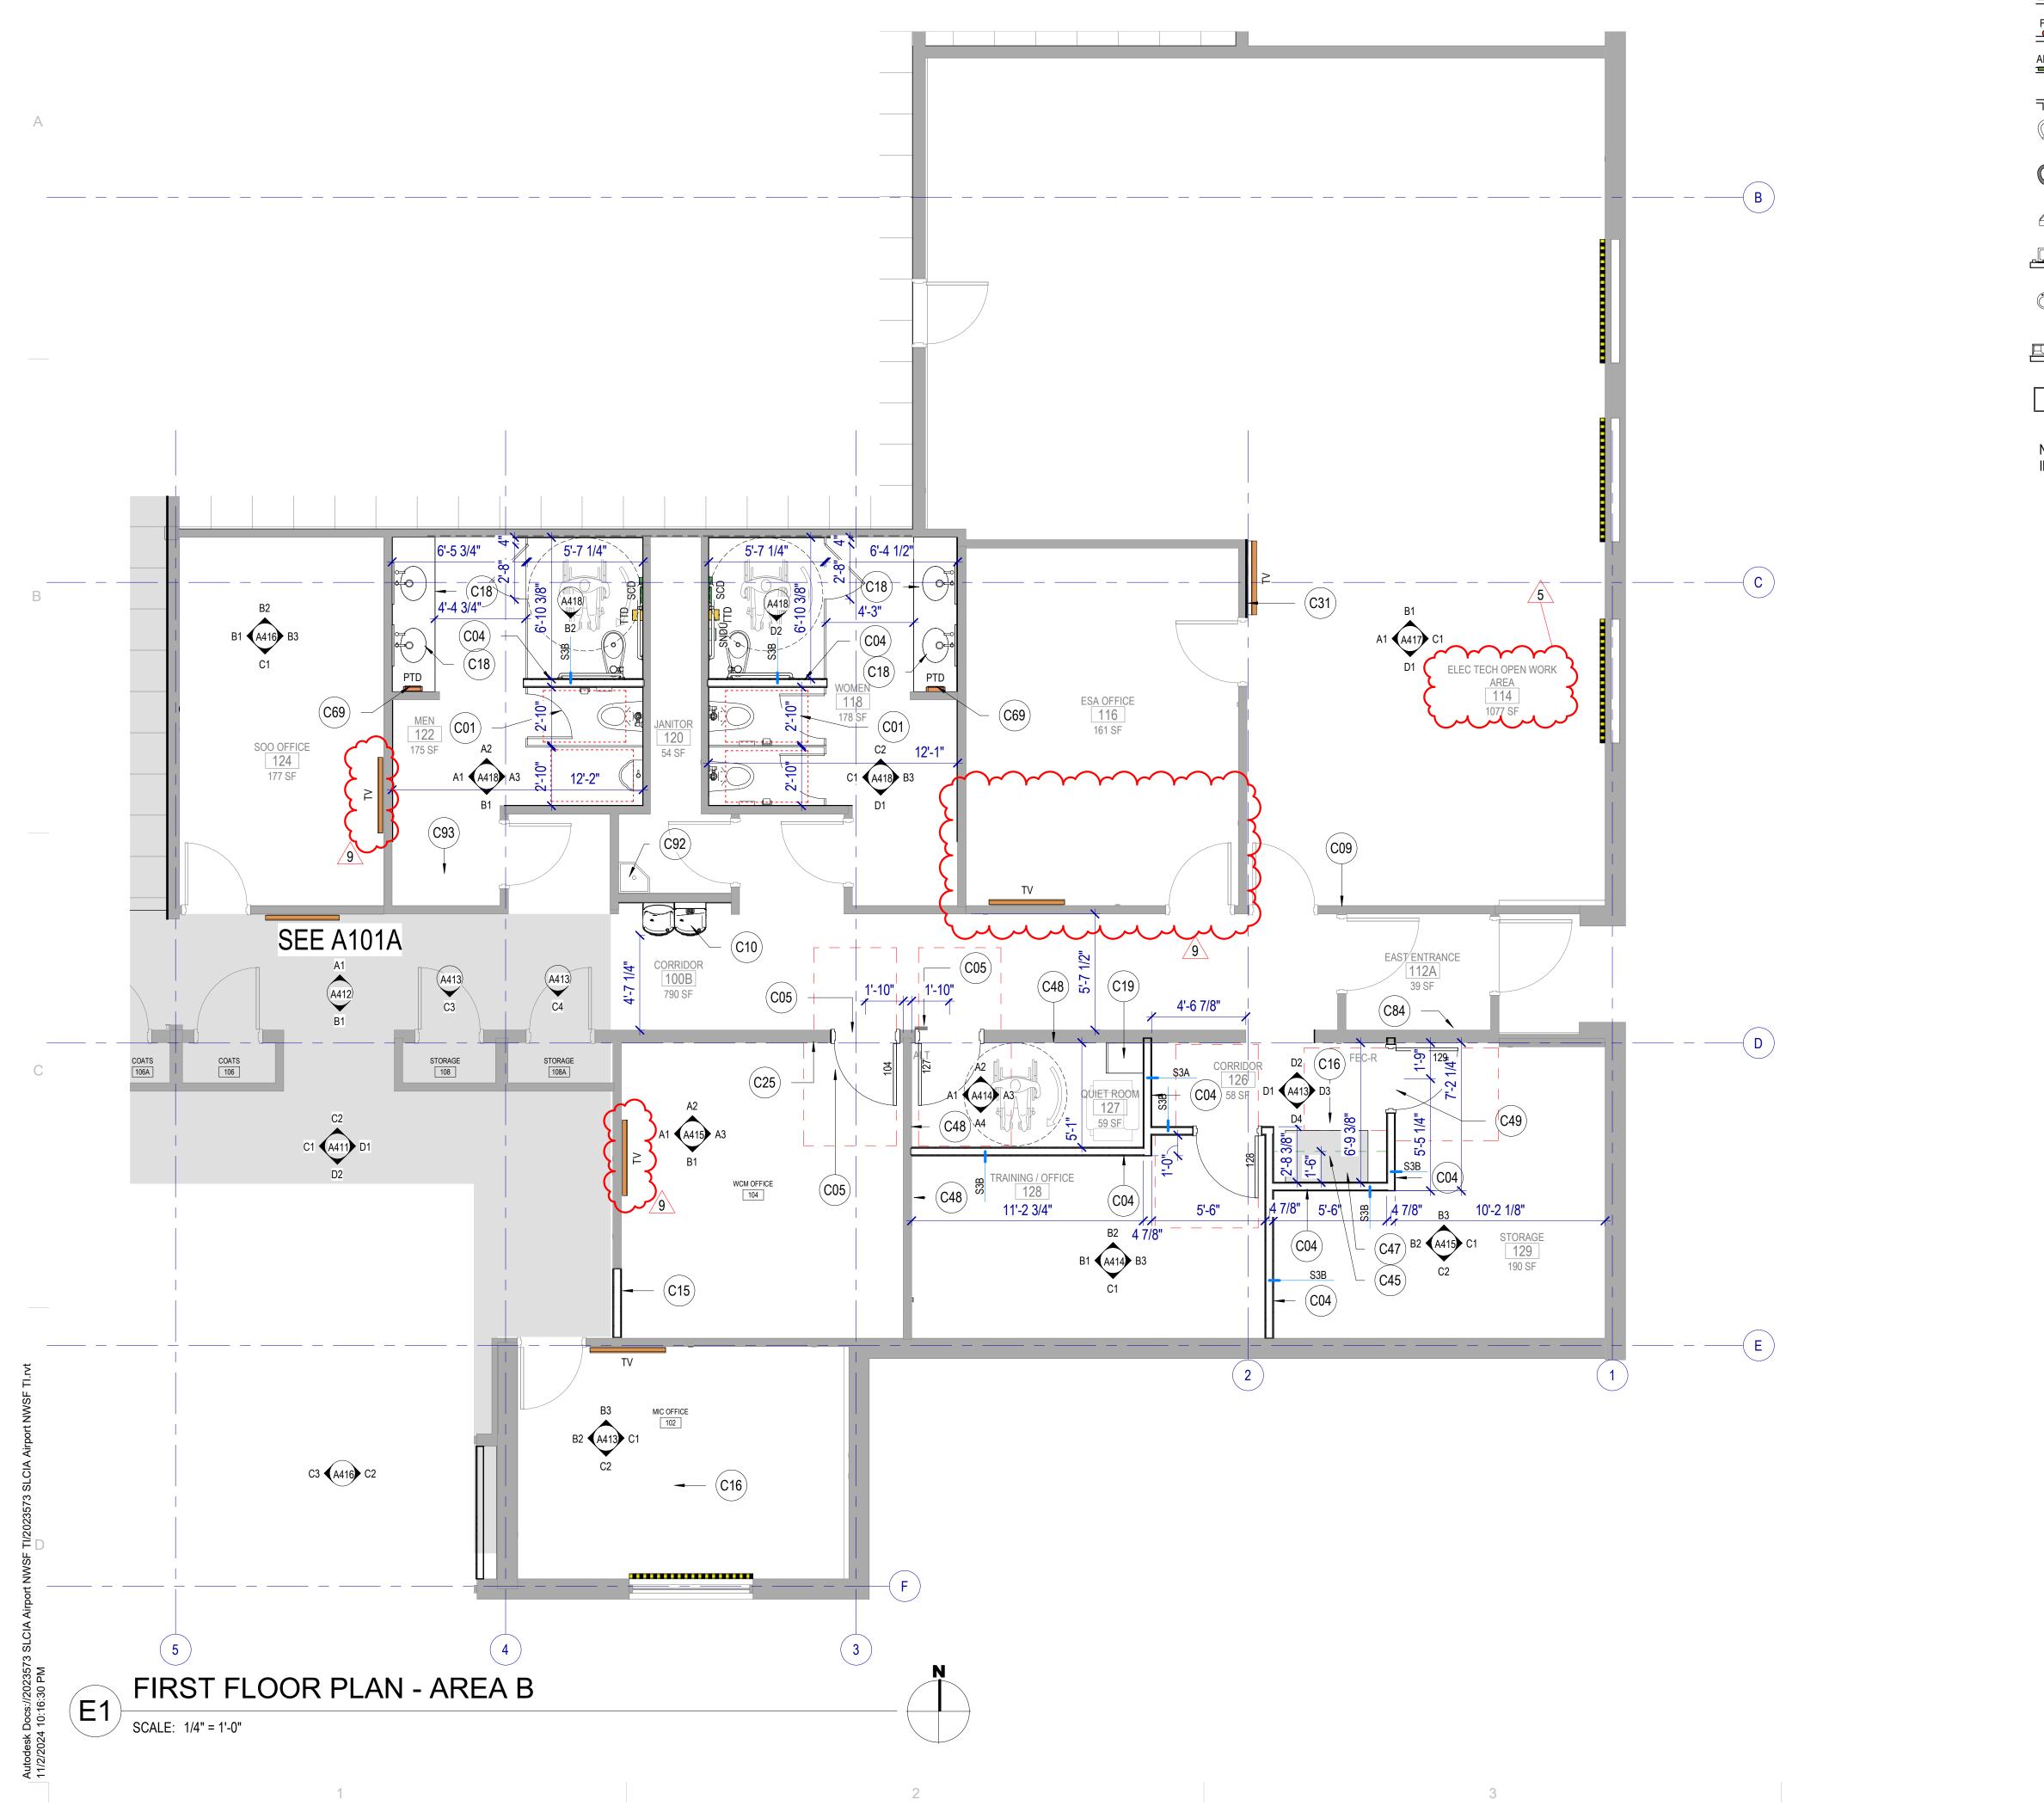

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LEGEND - FLOOR PLAN FIRE EXTINGUISHER + CABINET FEC SURFACE MOUNTED FEC FIRE EXTINGUISHER + CABINET SEMI-RECESSED FIRE EXTINGUISHER AUTOMATED EXTERNAL AED DEFIBRILLATOR CORNER GUARD **_** WALL MOUNTED TOILET RE: PLUMBING FLOOR MOUNTED TOILET Q RE: PLUMBING URINAL \bigcirc RE: PLUMBING WALL HUNG LAVATORY RE: PLUMBING COUNTER MOUNTED SINK RE: PLUMBING ELECTRICAL WATER COOLER RE: PLUMBING MOP SINK $\overline{\cdot}$ RE: PLUMBING

4

NOTE: PROVIDE ITEMS INDICATED IN THE LEGEND IN THE QUANTITIES SHOWN ON THE PLAN.

KEYNOTES

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KEYNOT	<u>KEYNOTES</u>								
C01	NEW RESTROOM FIXTURES AND STALLS, FLOOR MOUNT OR WALL MOUNT TOILETS AS SHOWN ON DRAWINGS, FIXTURES TO BE ADA / B								
	ABAAS COMPLIANT.								
C04	NEW WALL, PAINT, AND BASE								
C05	NEW DOOR AND FRAME TO MATCH EXISTING								
C09	RELOCATED THERMOSTAT, TERMINATE WIRING AND REPLACE WITH BLANK COVER.								
C10	NEW DRINKING FOUNTAINS WITH BOTTLE FILLER								
C15	NEW INFILL WALL TO MATCH EXISTING WALL CONSTRUCTION, PAINT AND FINISH TO MATCH.								
C16	NEW CARPET AND BASE. CARPET INSTALL PATTERN TO BE ASHLAR.								
C18	NEW COUNTER, SINKS, FAUCETS, MIRRORS. FIXTURES TO BE ADA / ABAAS COMPLIANT.								
C19	NEW LOW REFRIDGERATOR AND ELECTRICAL, FRIDGE NOT IN CONTRACT.								
C25	NEW LIGHT SWITCH OR RELOCATE EXISTING SWITCH								
C31	PATCH AND REPAIR GYPSUM BOARD, NEW PAINT								
C45	NEW SHELVING ABOVE EXISTING FURNITURE, ADJUSTABLE WITH BRACKETS, FULL CLOSET DEPTH.								
C47	EXISTING FURNITURE TO BE RELOCATED TO THIS LOCATION.								
C48	EXISTING WALL AT NEW CONSTRUCTION, ADD 5/8" GYPSUM BOARD ABOVE CEILING TILE TO DECK, TAPE AND MUD ABOVE ACOUSTIC CEILING								
C49	EXISTING DOOR AND FRAME RELOCATED FROM CORRIDOR, PROTECT FROM DAMAGE AND REPAIR / REPAINT AS NECESSARY.								
C69	PAPER TOWEL DISPENSER								
C84	EXISTING BASE TO REMAIN								
C92	EXISTING JANITOR SINK TO REMAIN.								
C93	NEW EPOXY FLOORING AND BASE								



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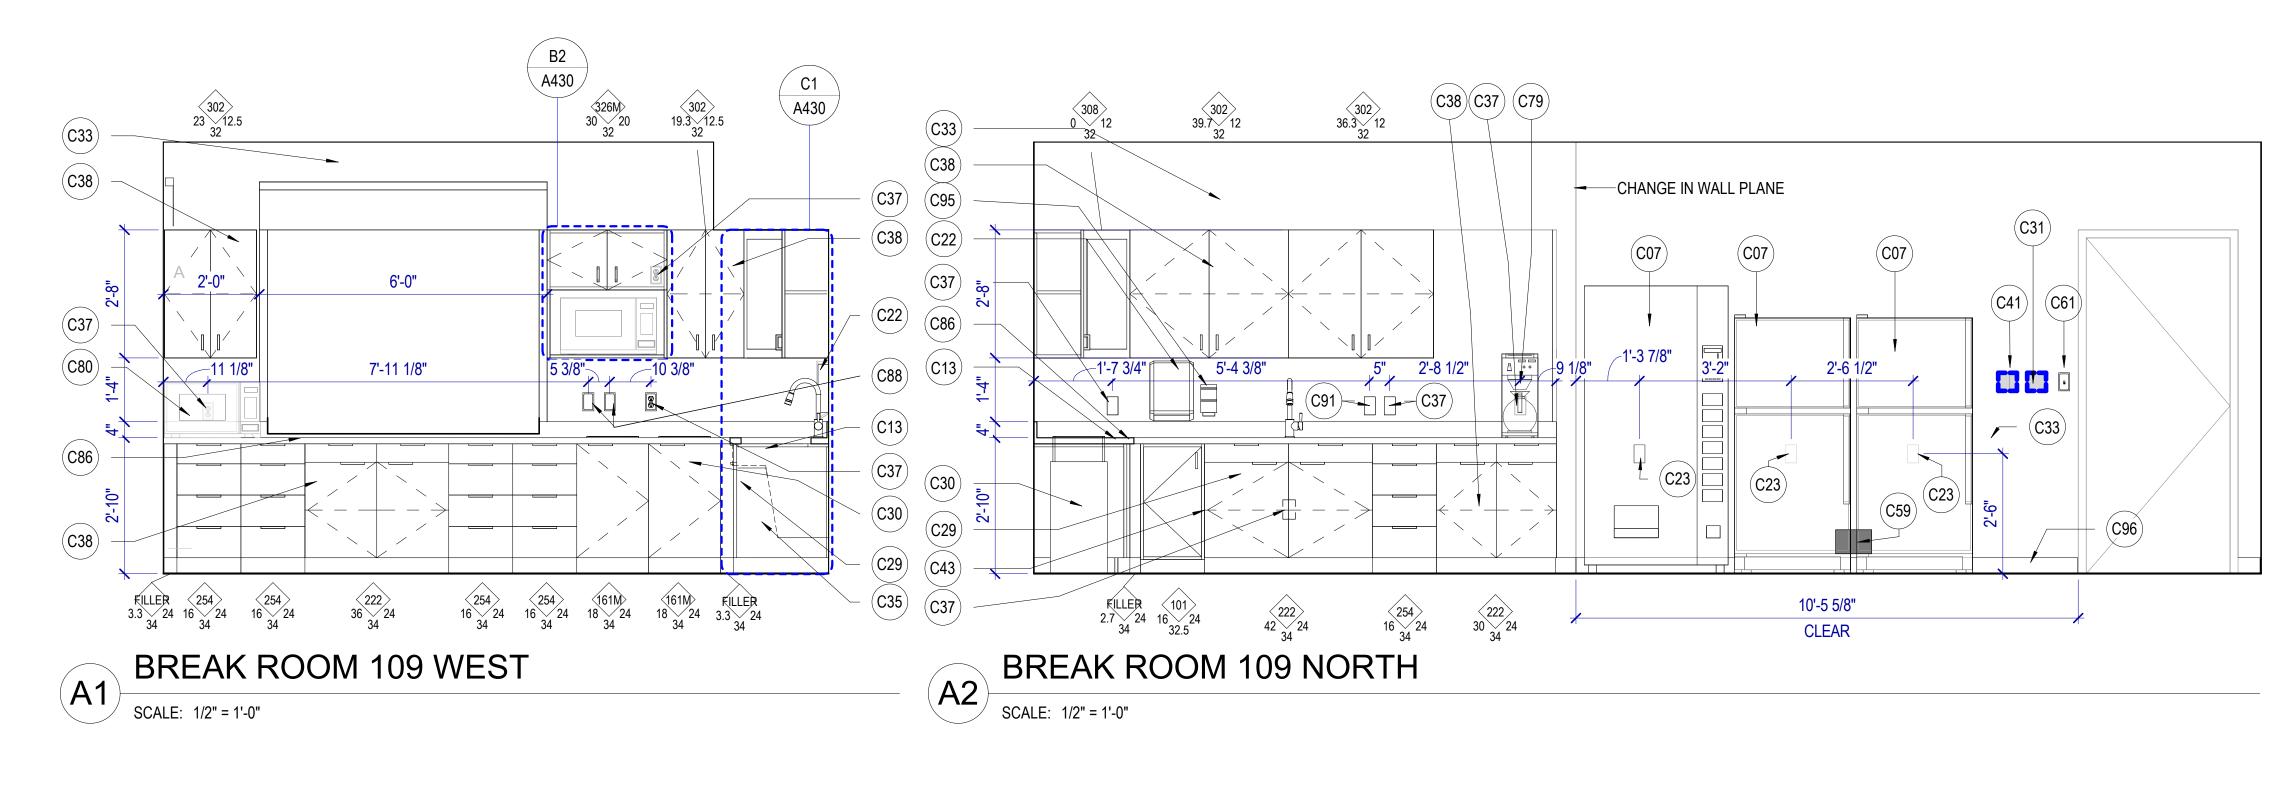
CONSTRUCTION DOCUMENTS - BID SET


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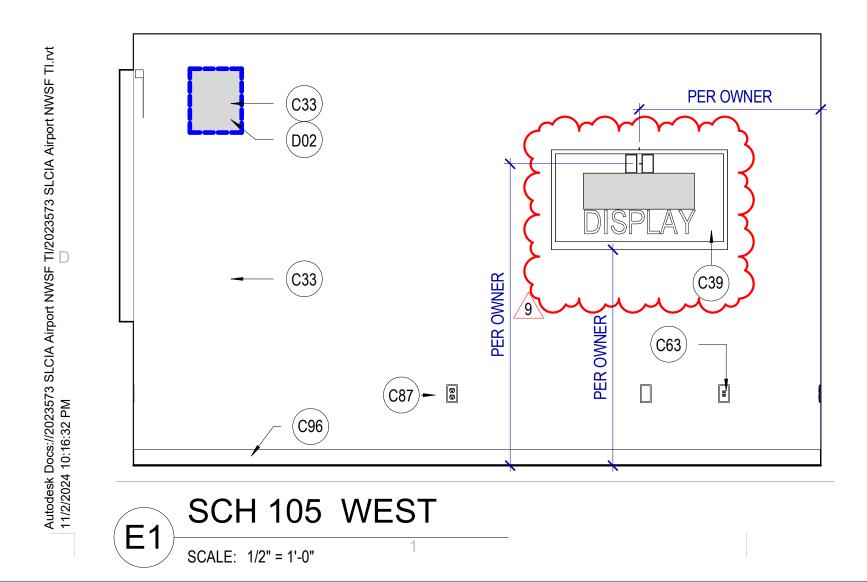
SHEET NAME FIRST FLOOR PLAN - AREA B

SHEET NUMBER


A101B





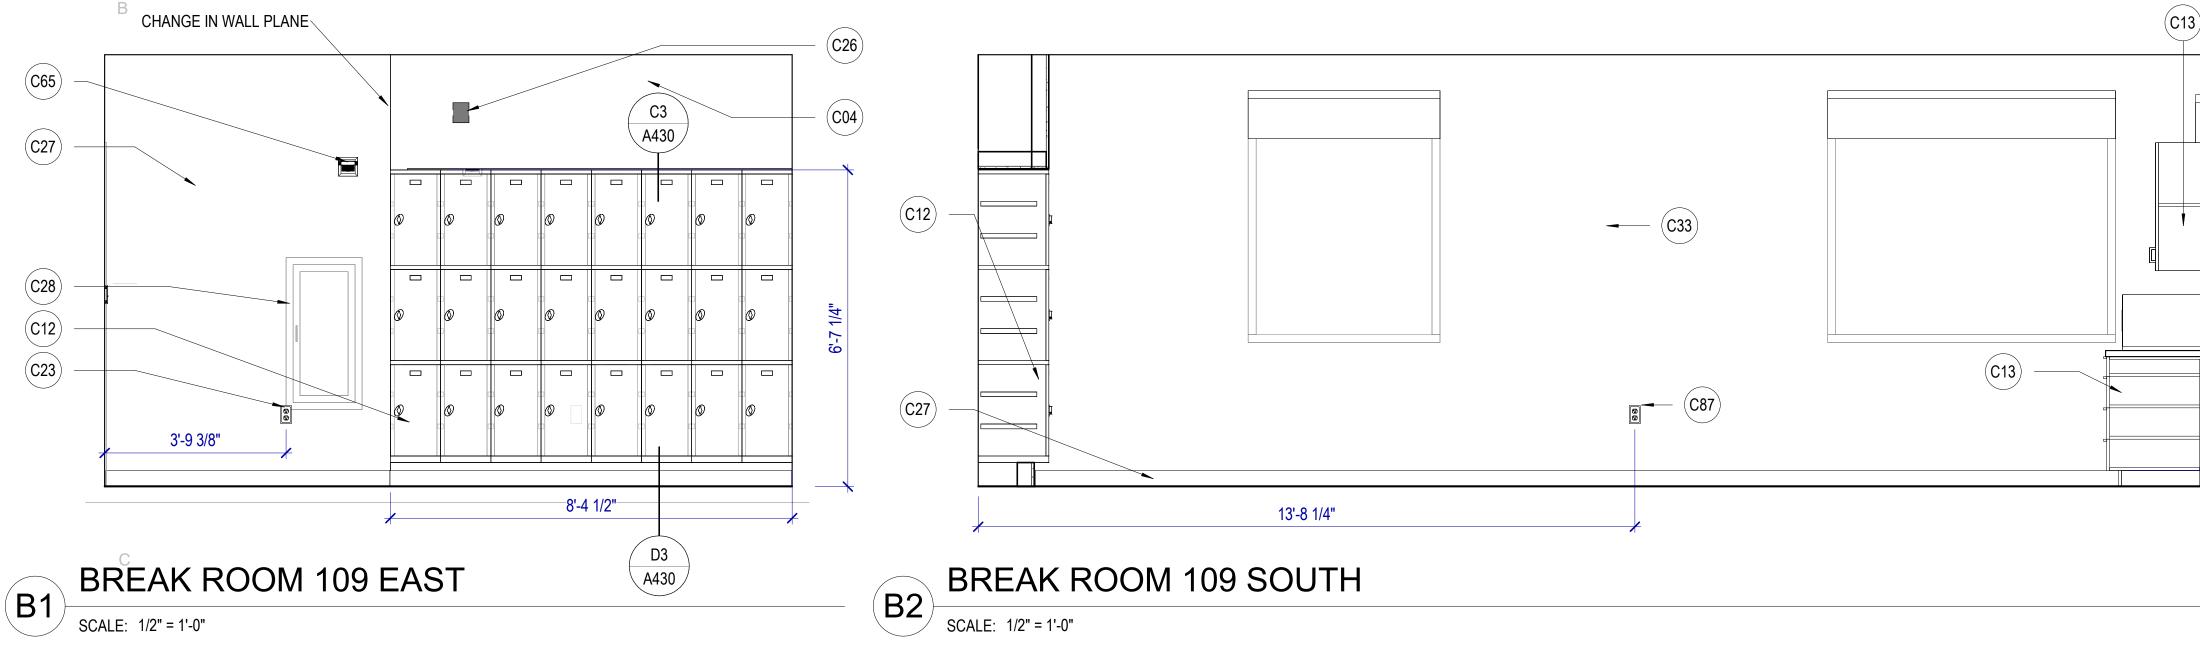

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INTERIOR ELEVA⁻⁴IONS GENERAL

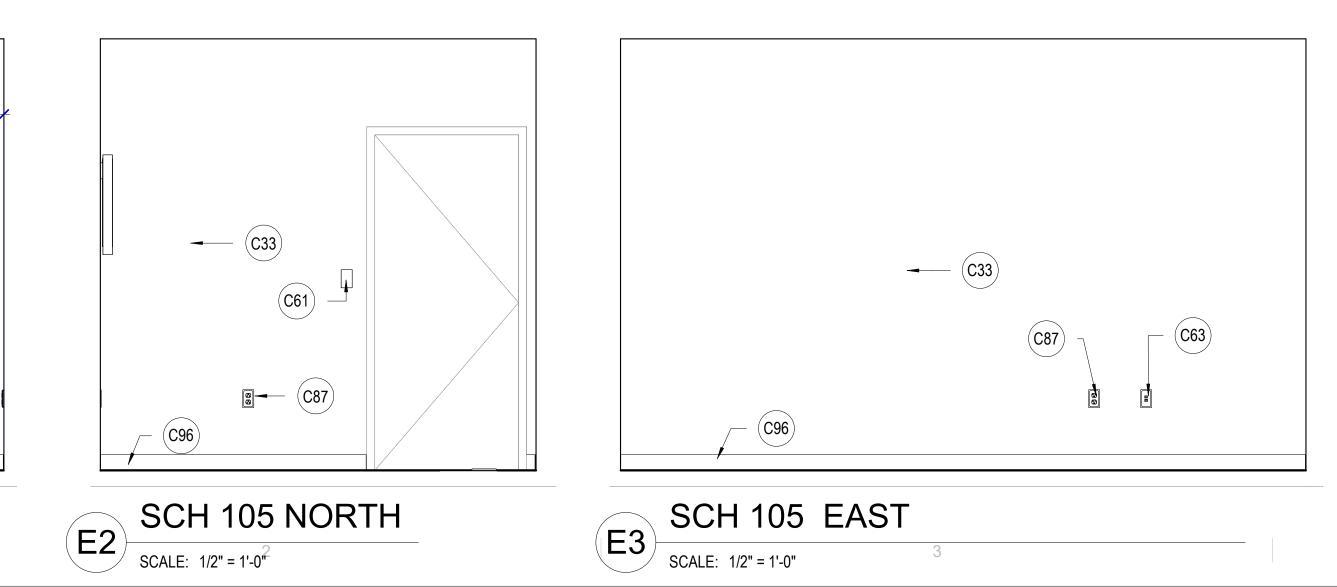NOTES

RE: North American Architectural Woodwork Standards v3.0 (NAAWS), Cabinet Design Series for cabinet types.

RE: A101A for Interior Wall Types.

RE: A101A and A101B for the Finish Schedule.

Dimensions shown to walls or casework are to finished face of wall or cabinet, UNO.

Loose kitchen appliances (mircowaves, coffee maker, refrigerator, vending machines) are N.I.C.

Equipment indicated by dashed lines is a general representation and shown for coordinationA purposes only.

Mechanical, electrical, plumbing and telecom rough-in locations are shown for general coordination purposes only. Refer to mechanical, electrical, plumbing and telecom drawings.

All unused telephone jacks / data outlets to be removed, wires safed off, and blank plates installed or patch wall. Confirm wall patches locations with Owner.

Countertops: 25" deep with 4" high backsplash, UNO. Provide sidesplashes at walls, tall cabinets or similar transitions.

Blocking: Provide fire retardant plywood blocking in walls at cabinets, wall-mounted accessories, equipment, display boards and similar items.

Finishes: Finishes are required on all exposed and semi-exposed surfaces, UNO. Wall elevations are not shown for walls where the Finish Schedule is deemed adequate to convey the intent.

Cabinet Locks: Provide locks on cabinet drawers and doors, keyed alike by room, UNO.


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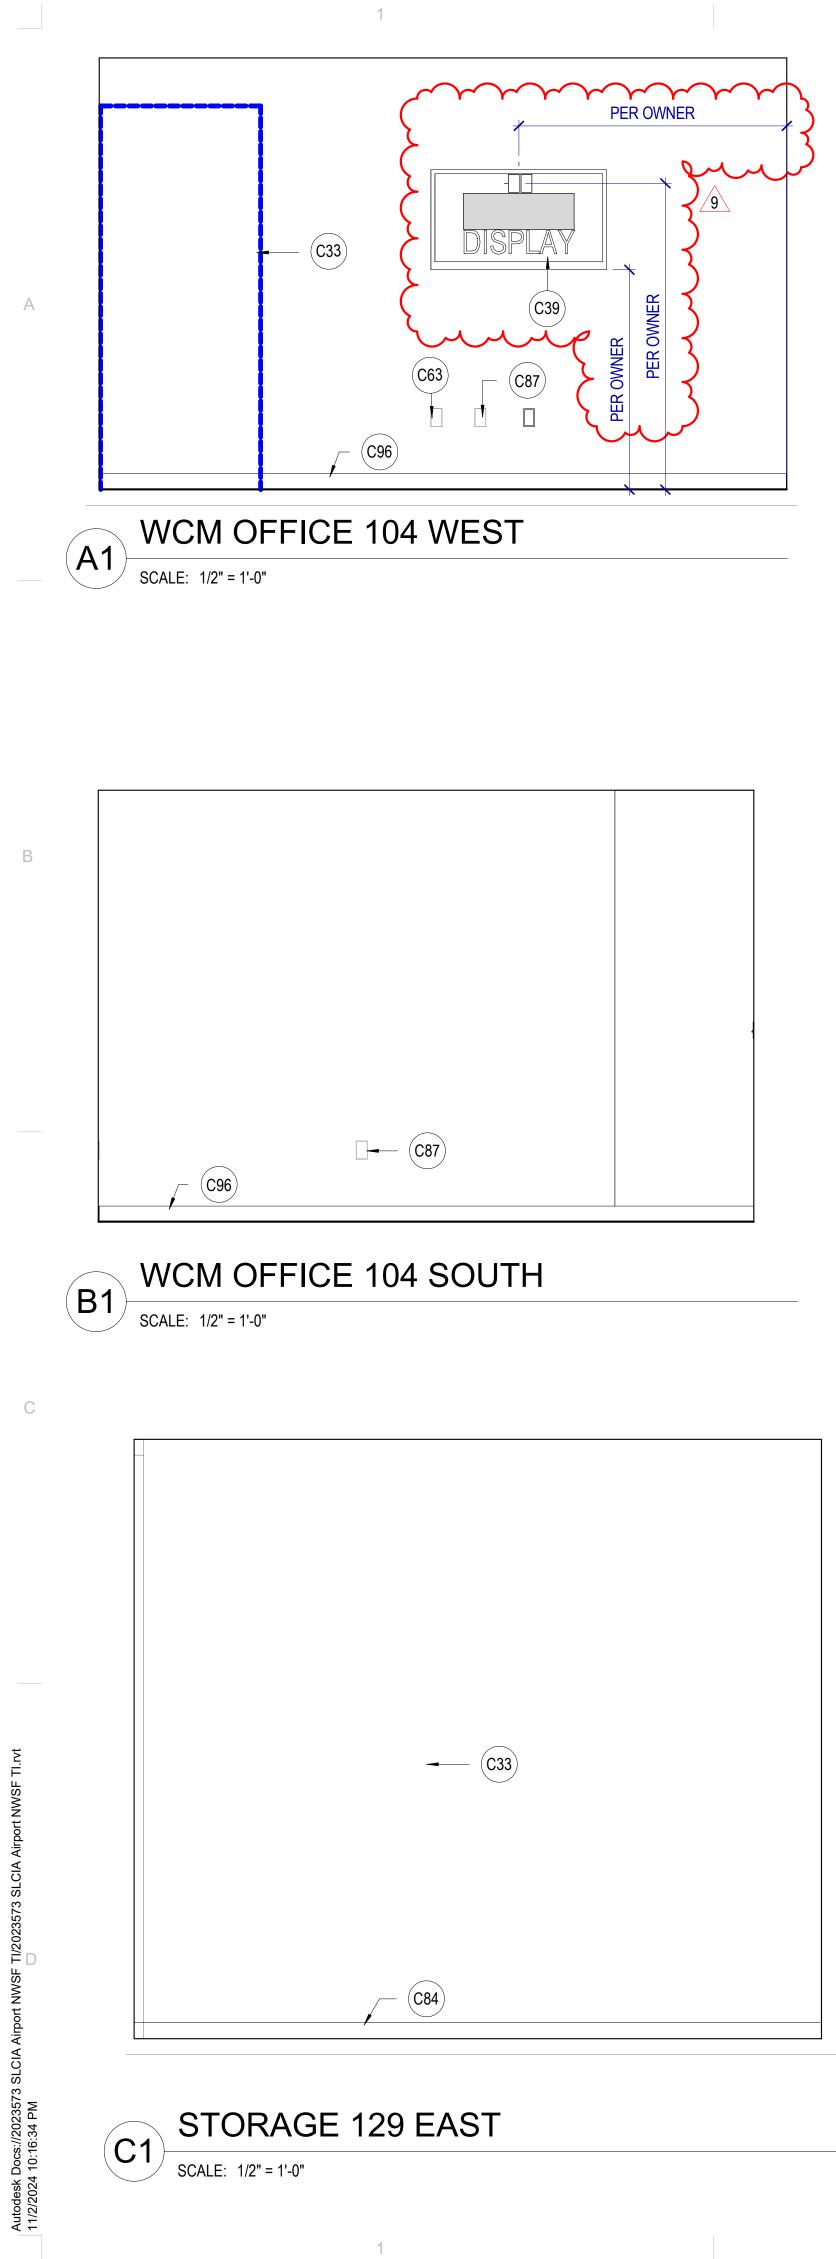
rec spe	sework Finishes: Provide laminate finishes on all exposed and semi-exposed surfaces as juired by the specifications. Provide laminate finishes on concealed surfaces if required by the ecifications. Refer to NAAWS Section 10.4.4 for definitions of exposed, semi-exposed and ncealed surfaces.		Ř	RPORT
	YNOTES		· 뿌	R R
			_ <u>+</u>	
C04	NEW WALL, PAINT, AND BASE			IAI
C07	RELOCATED EXISTING REFRIGERATOR AND VENDING MACHINE		\triangleleft	Z
C12	NEW LOCKERS, BASE, AND SOFFIT. SEE PROJECT MANUAL FOR LOCKER SPECIFICATION.			은포
C13	NEW CABINETRY, COUNTERTOP, SINK, AND PLUMBING.		>	IA I
C22	EXISTING PAPER TOWEL DESPENSOR TO REMAIN, REPOSITION ADJACENT TO SINK		> _	Z S
C23	NEW POWER OUTLET OR RELOCATE EXISTING OUTLET, PLACE AT HEIGHT TO			
*	MATCH EXISTING UNLESS NOTED OTHERWISE. SEE ELECTRICAL		√ III	ΪĹ
C26	RELOCATE EXISTING FIRE BEACON	$\overline{\mathbf{C}}$	えい	ΔΩ
C27	NEW PAINT AND BASE		$\leq \Theta$	ЩЩ
C28	EXISTING FIRE CABINET TO REMAIN	()	Θ >	XX
C29	CABINET DOORS TO OPEN FOR ACCESSIBILITY COMPLIANT ACCESS	<u> </u>	T A	
C30	NEW CABINET RECYCLE AND WASTE RECEPTICALS			нн
C31	PATCH AND REPAIR GYPSUM BOARD, NEW PAINT	$(\cap$		AL
C33	NEW PAINT	U)	≥ 0	S S S
C35	ACCESSIBILITY OBSTRUCTION FREE ZONE	©2023 MHTN A	RCHITECTS, INC.	
C37	NEW GFCI OUTLET OR RELOCATED GFCI	Confidentiality No This document is	tice: intended for use on the Project ide wolved in the design, permitting, bio	ntified herein by individuals
C38		Project. MHTN A	rchitects, Inc. grants limited rights t rthis express purpose only. Distribu	to distribute and reproduce
C39	NEW TV & MOUNTING HARDWARE TO PROJECT NO MORE THAN 4" ONTO WALKING SURFACE, PROVIDE PAINTED FR PLYWOOD BACKING ATTACHED TO WALL, SIZE TO	ocument for pur	poses other than those indicated is ment is received in error, please de	strictly prohibited. If a digital
5	BE 2" SMALLER THAN TV. PER THE AIRPORT AHJ, DO NOT PAINT OVER THE	SEAL		
کر _م	FIRE-RETARDANT DESIGNATION ON THE PLYWOOD.	ר ר	ABSINGSOD	
C41	REMOVE EXISTING TELEPHONE AND / OR CONNECTION PLATE, TERMINATE WIRING		ARANE OF OF	860
C43	AND INSTALL BLANK COVER. DOUBLE DOOR CABINET HOUSING FOR SINK DISPOSAL AND PLUMBING AS		ROBERTO G.	5680000
050	REQUIRED TO MAINTAIN ACCESSIBILITY AT SINK.		6480267-0301	See.
C59	NEW WATER SUPPLY FLUSH BOX WITH DOUBLE VALVE.		Second Res	5.000
C61 C63	EXISTING LIGHT SWITCH, LOCATION APPROXIMATE EXISTING DATA TO REMAIN, LOCATION APPROXIMATE.		SED ARCH	Da.
C65	NEW FIRE BEACON, SEE ELECTRICAL		19 Feb. 202-	4
C79	COFFEE MAKER NOT IN CONTRACT			
C80	MICROWAVE NOT IN CONTRACT		TNO.2023573 PRINT THIS DRAWIN	
C86	NEW COUNTERTOP WITH ROUNDED EDGES, AND BACKSPLASH. CAULK		s 24 x 36. Do not scale contents of	
	BACKSPLASH AT WALL.	ISSUED:		
C87	EXISTING POWER OUTLET TO REMAIN		27, 2023 SCHEMATIC DESIG	
C88	NEW BLANK FACE GFCI	03 Dec	14, 2023 60% CONSTRUCTIOn 15, 2023 90% CONSTRUCTION	ON DOCS
C91	NEW SWITCH FOR GARBAGE DISPOSAL	04 Jan 3	31, 2024 100% CONSTRUCT	ION DOCS
C95	MANUAL SOAP DISPENSER	REVISIONS		
C96			TO VERIFY DRAWINGS IN FIEI N DATE.	LD USE REFLECT
D02	REMOVE EXISTING HEATER AND ELECTRICAL. PATCH AND REPAIR WALL.	NO. DATE 9 Oct 1	DESCRIPTION 1, 2024 PR 02	
		CONST	RUCTION DOCU	
		SET		
		MAY 02,	, 2024	
		SHEET NAME		
	E	IINIE	ERIOR	
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	(C96)	SHEET NUMBE	R	
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	SCALE: 1/2" = 1'-0"	_		_




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STORAGE 129 SOUTH C2 STORAG SCALE: 1/2" = 1'-0"

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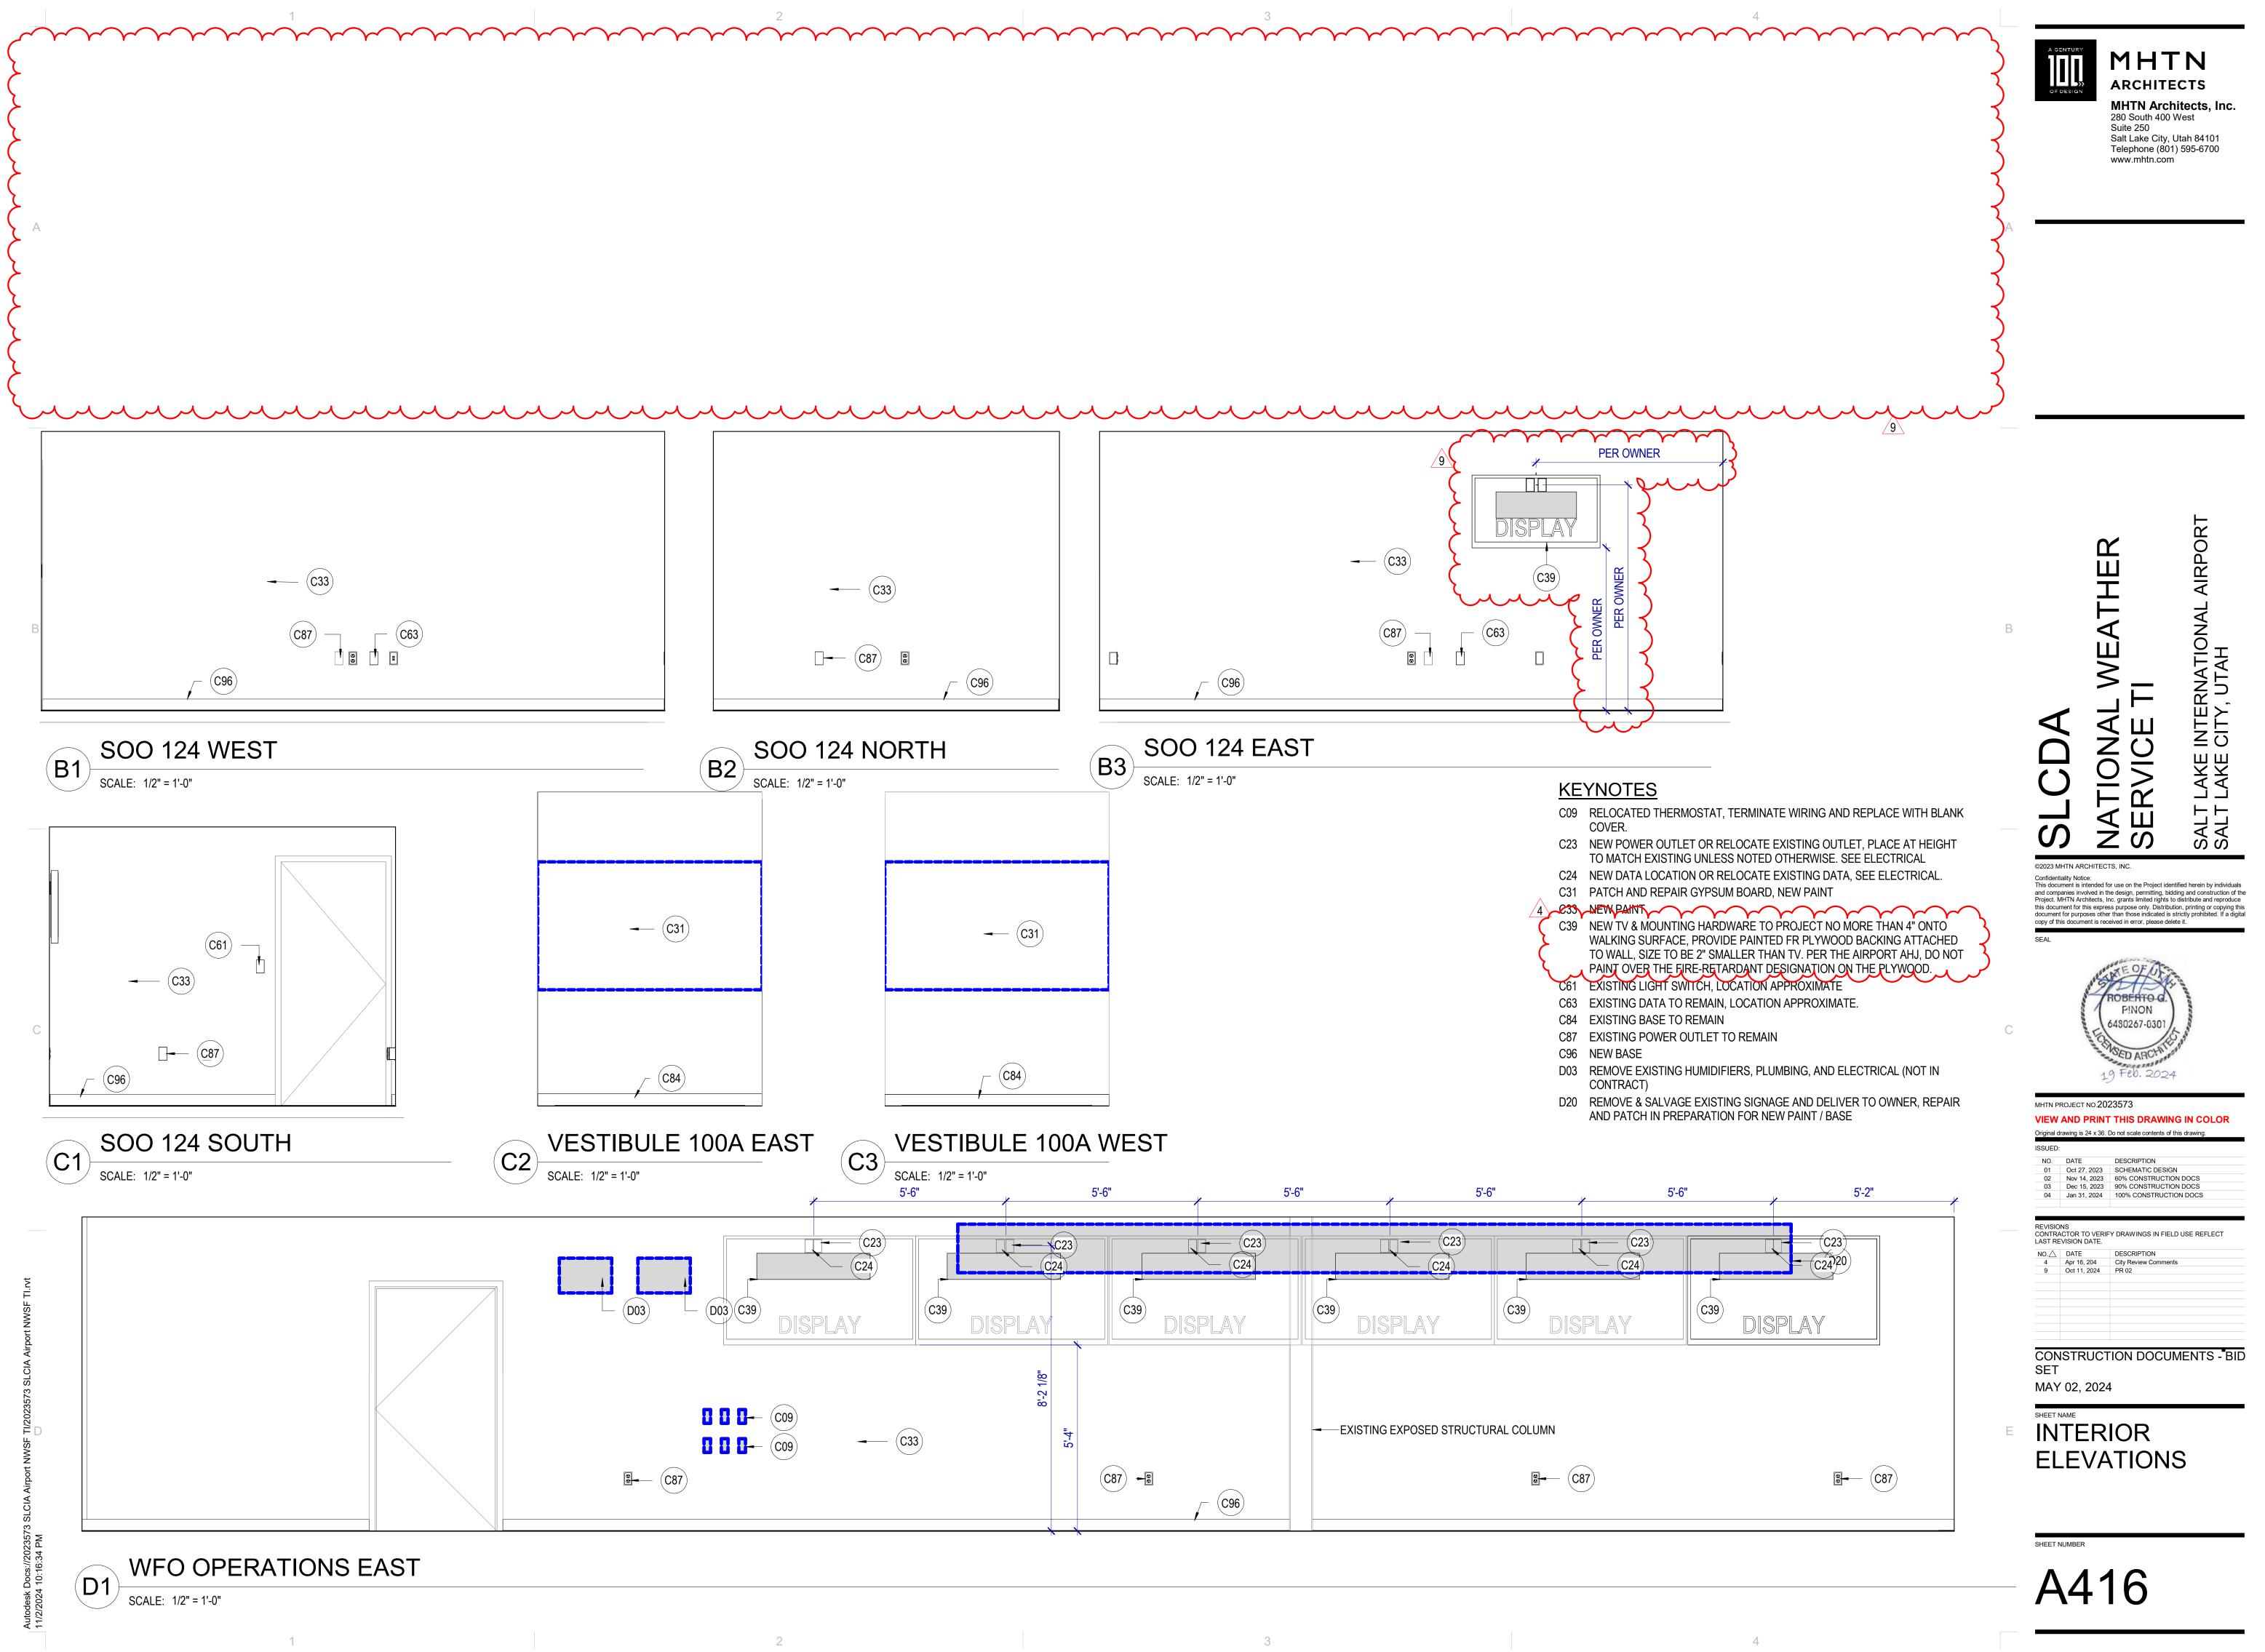



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В	SLCDA	NATIONAL WEATHER SERVICE TI	SALT LAKE INTERNATIONAL AIRPORT SALT LAKE CITY, UTAH
С	Confidentiality Not This document is and companies in Project. MHTN Ar this document for purp copy of this docur SEAL SEAL MHTN PROJEC VIEW AND Original drawing is ISSUED: NO. DATE 01 Oct 2 02 Nov 1 03 Dec 1	intended for use on the Project volved in the design, permitting rchitects, Inc. grants limited rig this express purpose only. Dis boses other than those indicate ment is received in error, please ROBERTO PINON 6490267-030 D ARCH 19 Feb. 20 T NO.2023573 PRINT THIS DRAV is 24 x 36. Do not scale content	24 VING IN COLOR ts of this drawing.
E	CONSTR SET MAY 02,	DESCRIPTION 1, 2024 PR 02	CUMENTS - BID

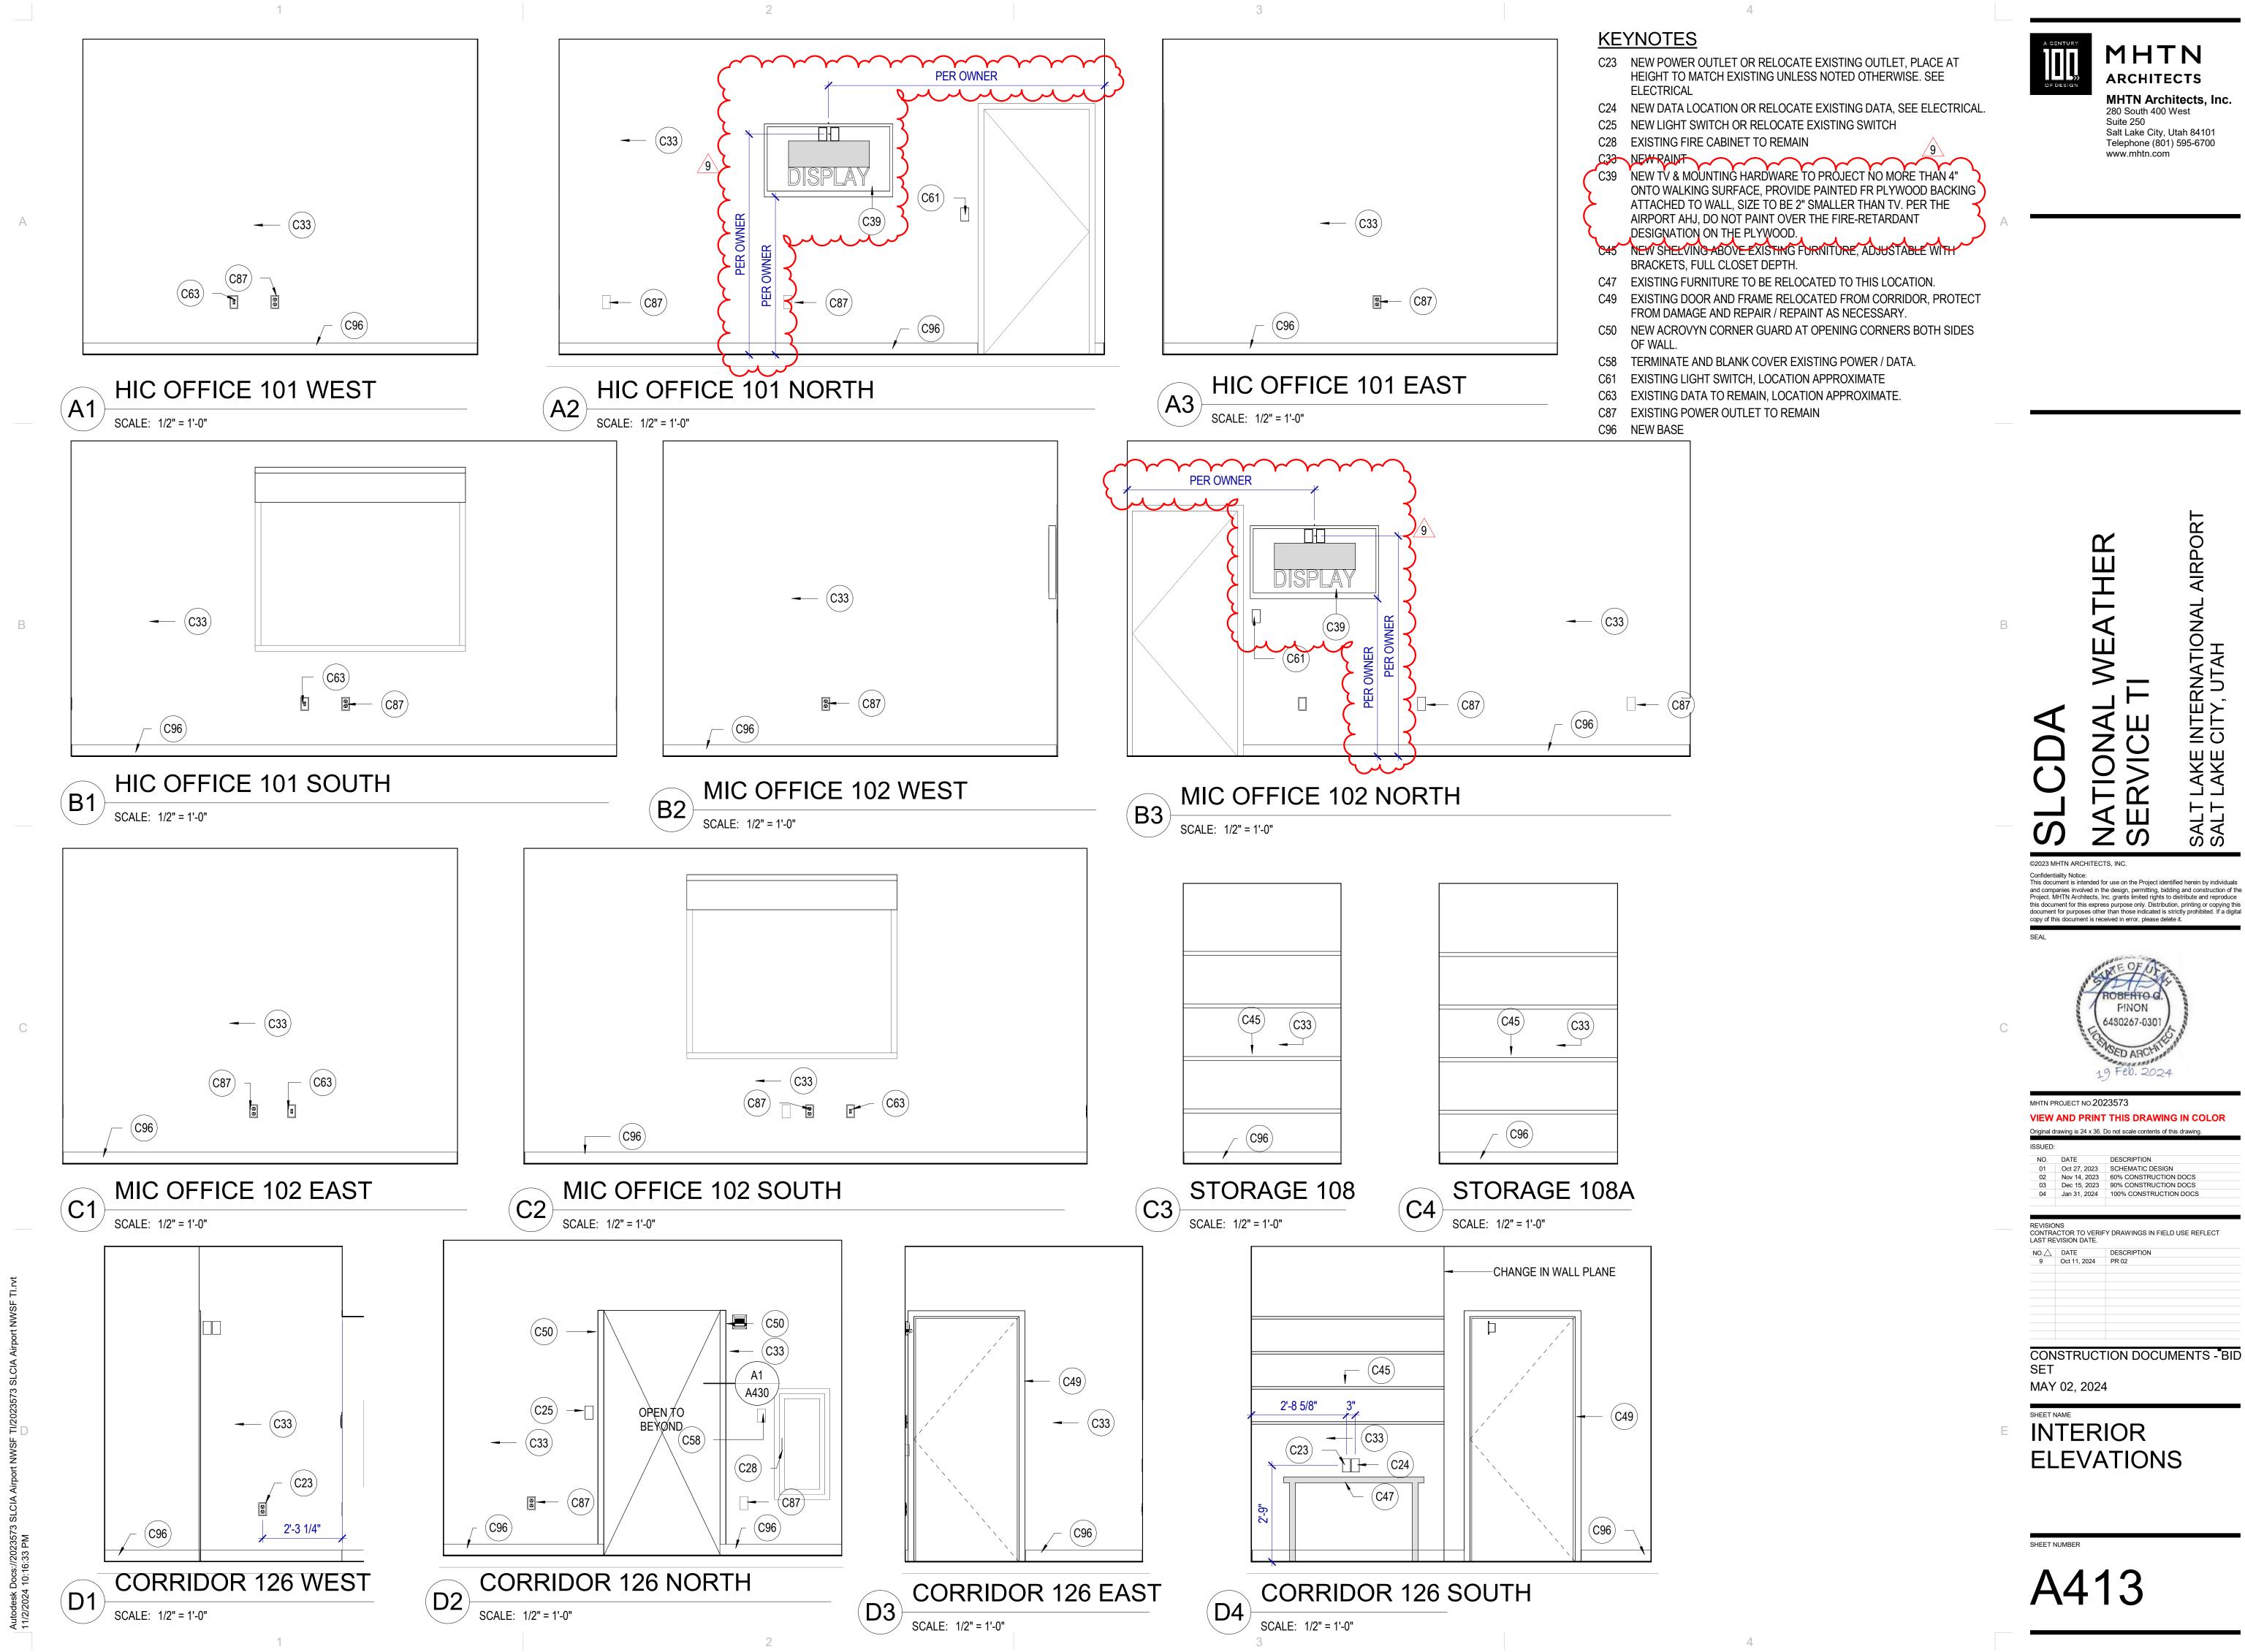SHEET NUMBER

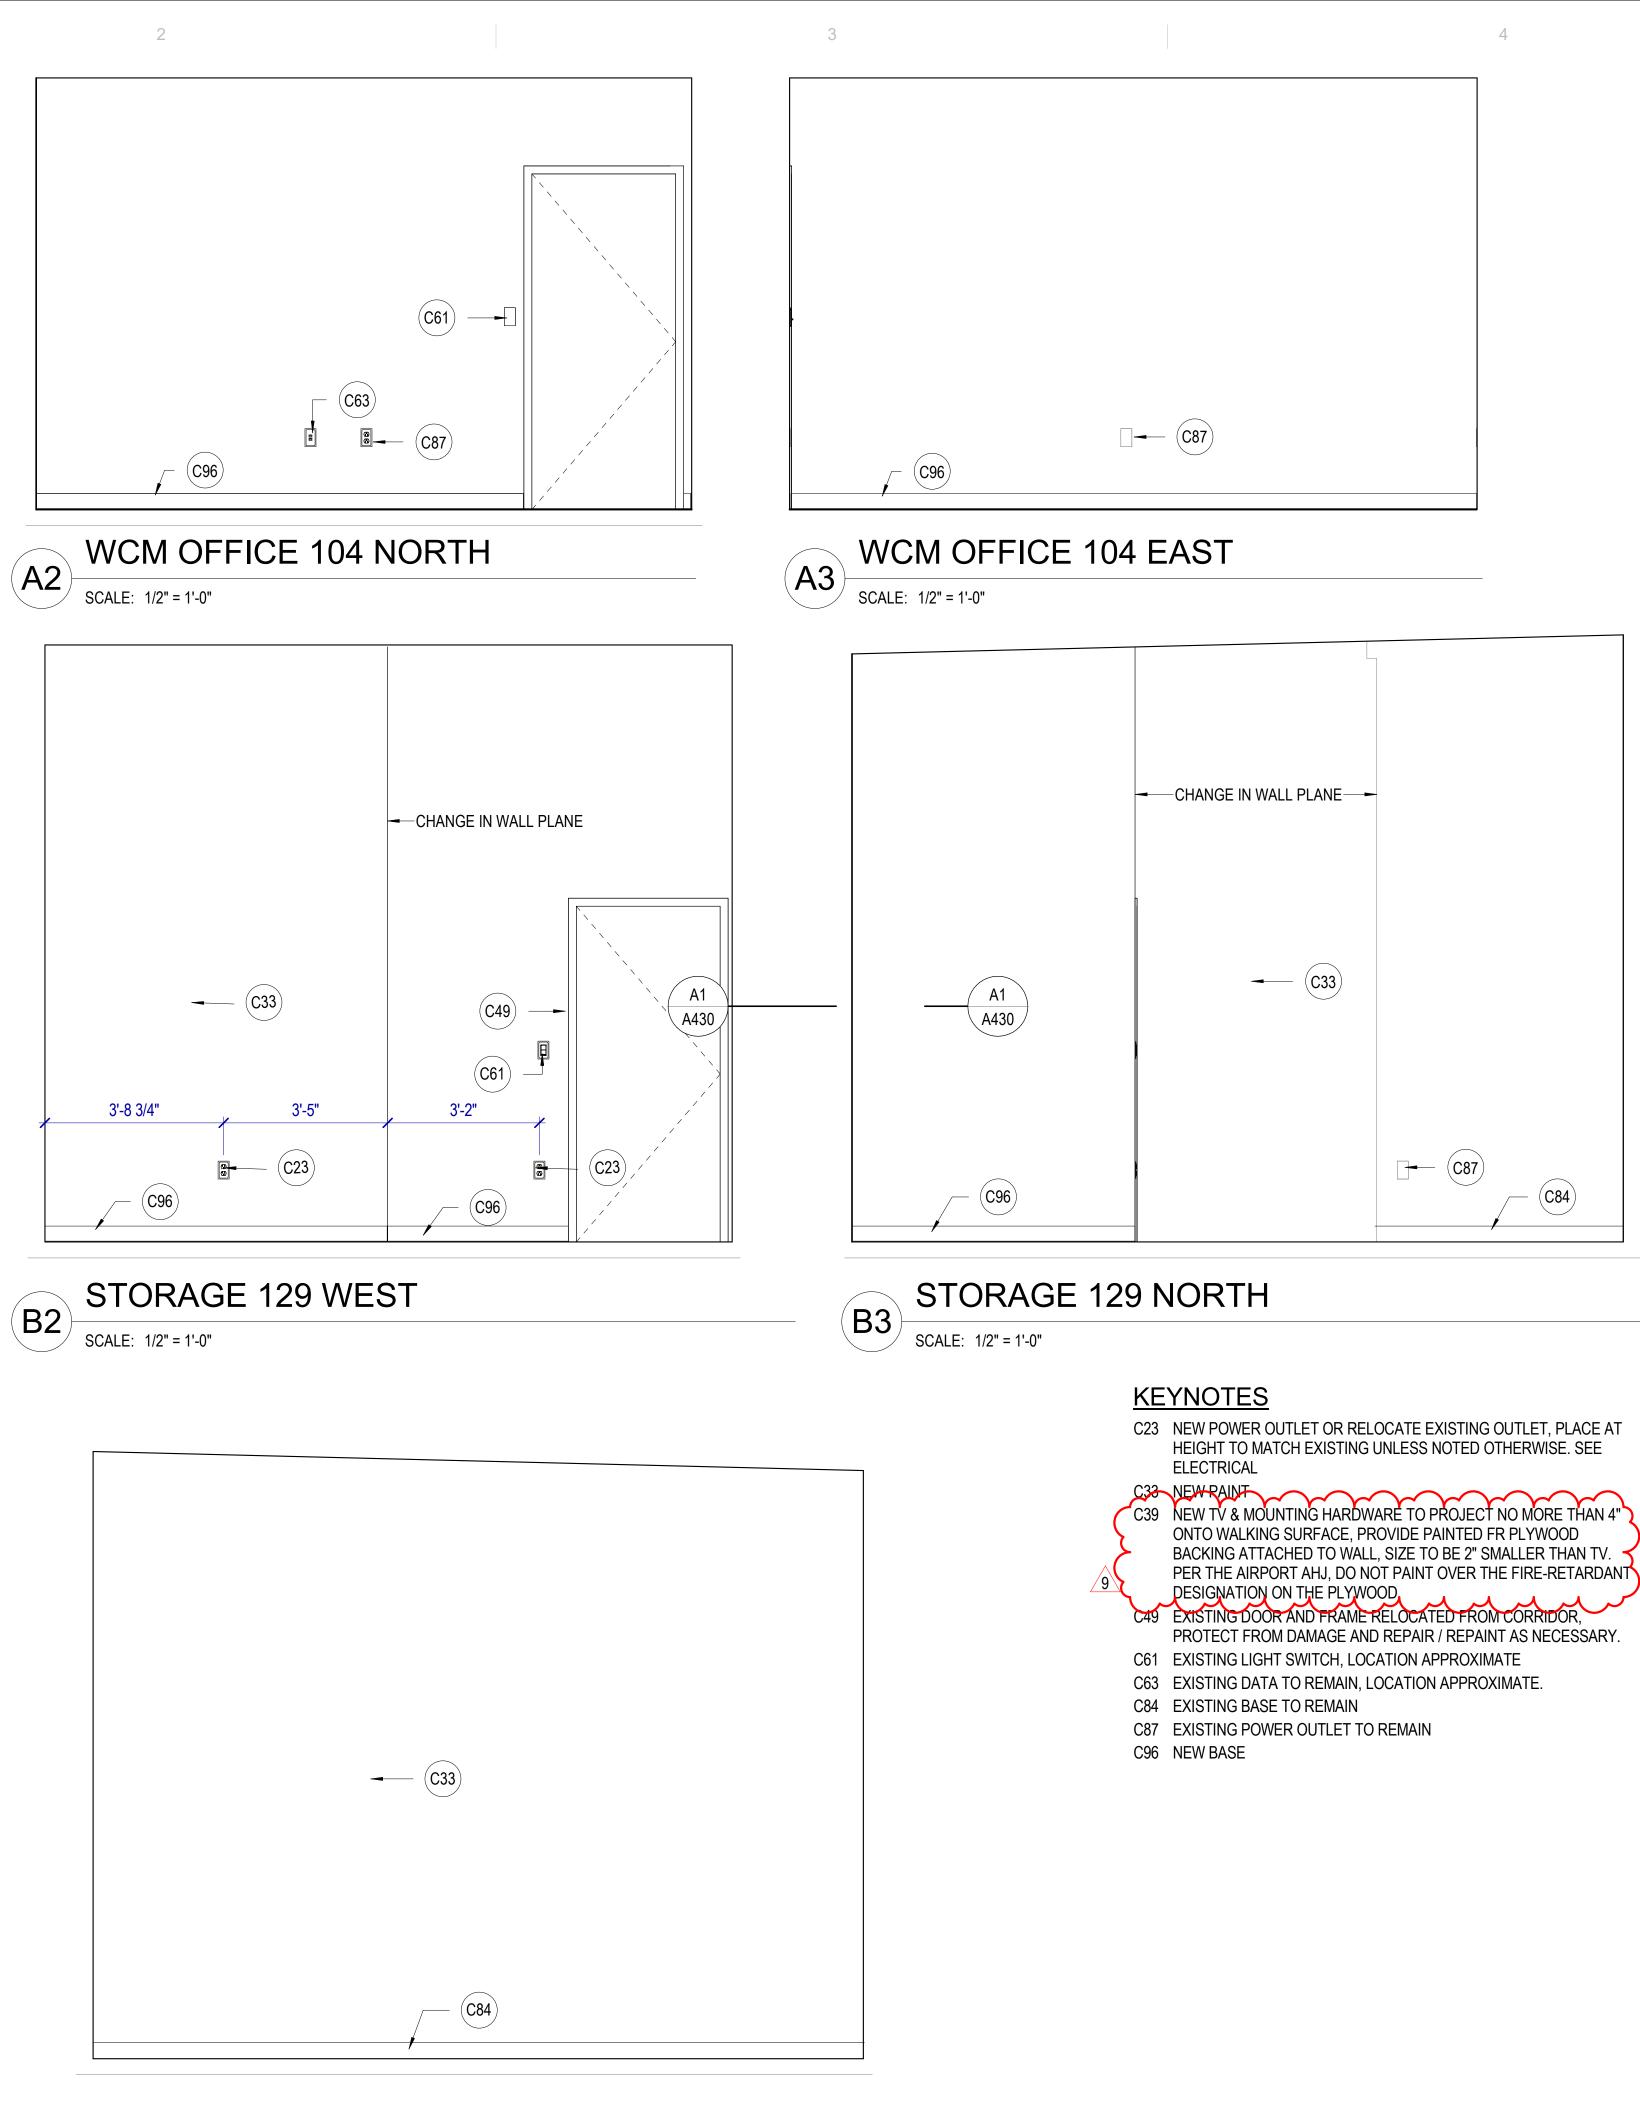A415






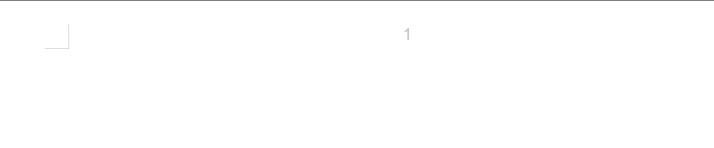





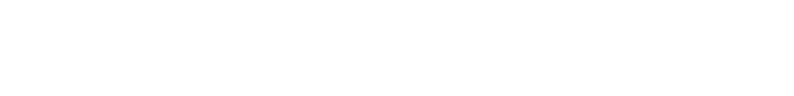














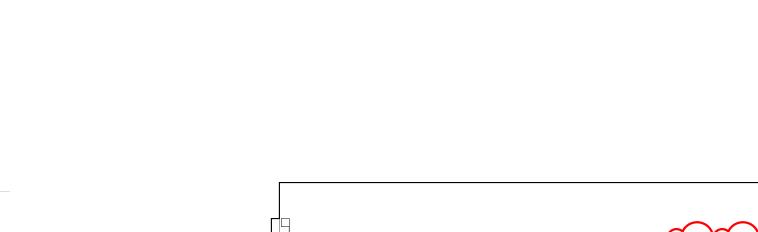

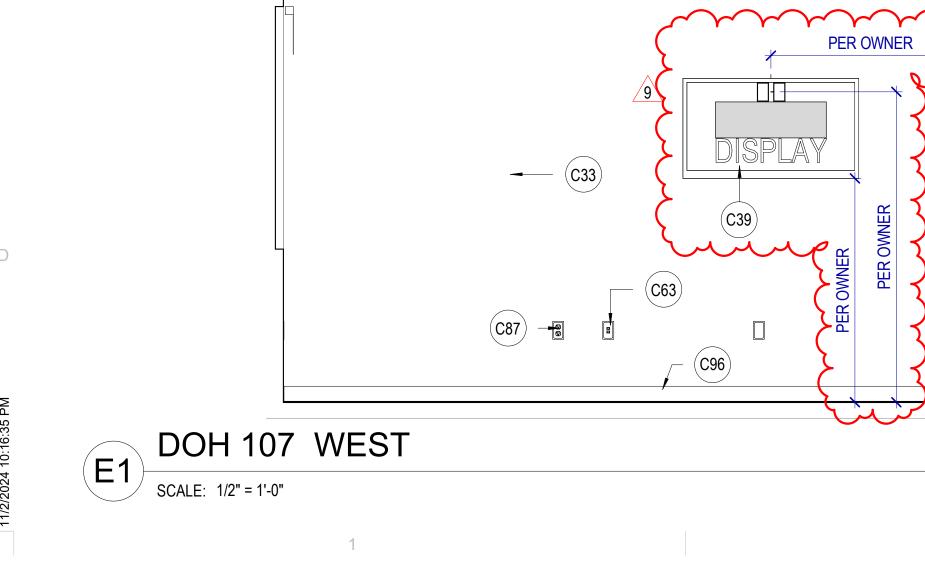

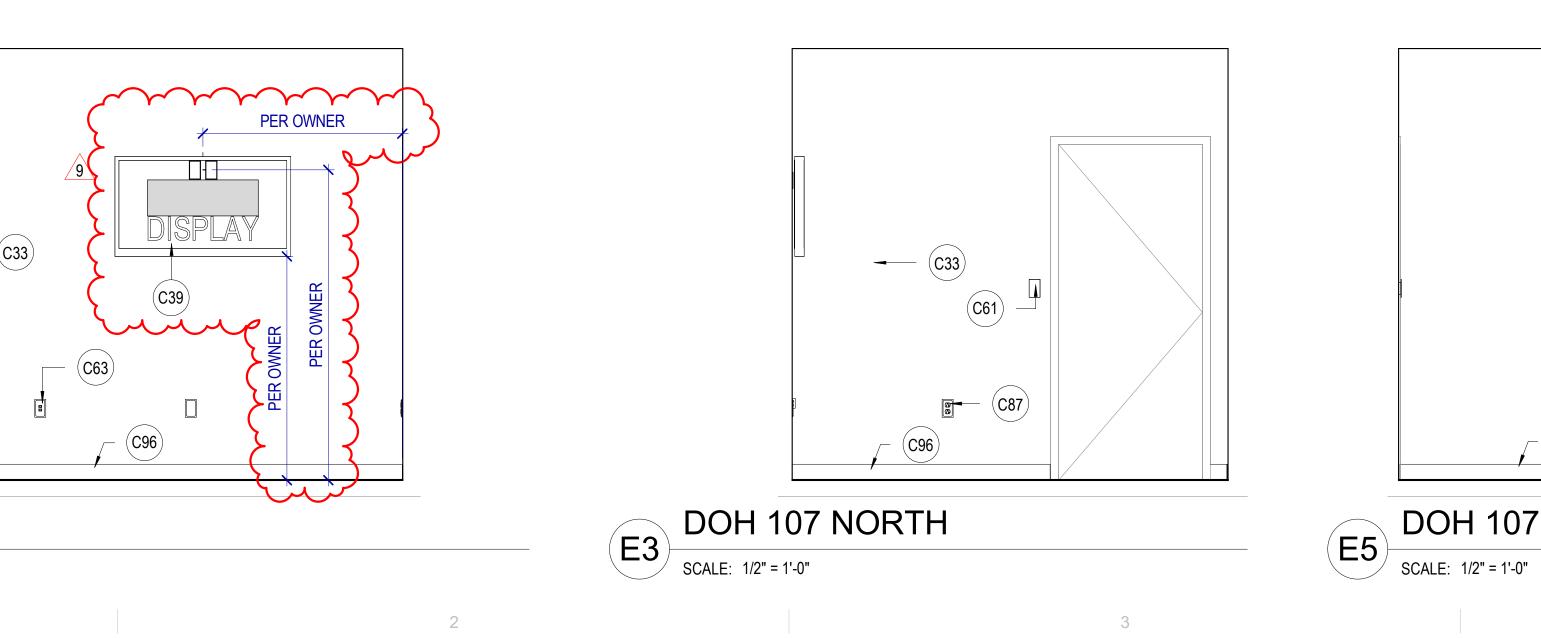

<u>KEYNOTES</u>

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C33 NEW RAINT C39 NEW TV & MOUNTING HARDWARE TO PROJECT NO MORE THAN 4" ONTO WALKING SURFACE, PROVIDE PAINTED FR PLYWOOD BACKING ATTACHED TO WALL, SIZE TO BE 2" SMALLER THAN TV. PER THE AIRPORT AHJ, DO NOT PAINT OVER THE FIRE-RETARDANT DESIGNATION ON THE PLYWOOD. C61 EXISTING LIGHT SWITCH, LOCATION APPROXIMATE


C63 EXISTING DATA TO REMAIN, LOCATION APPROXIMATE.

4

- C87 EXISTING POWER OUTLET TO REMAIN C96 NEW BASE




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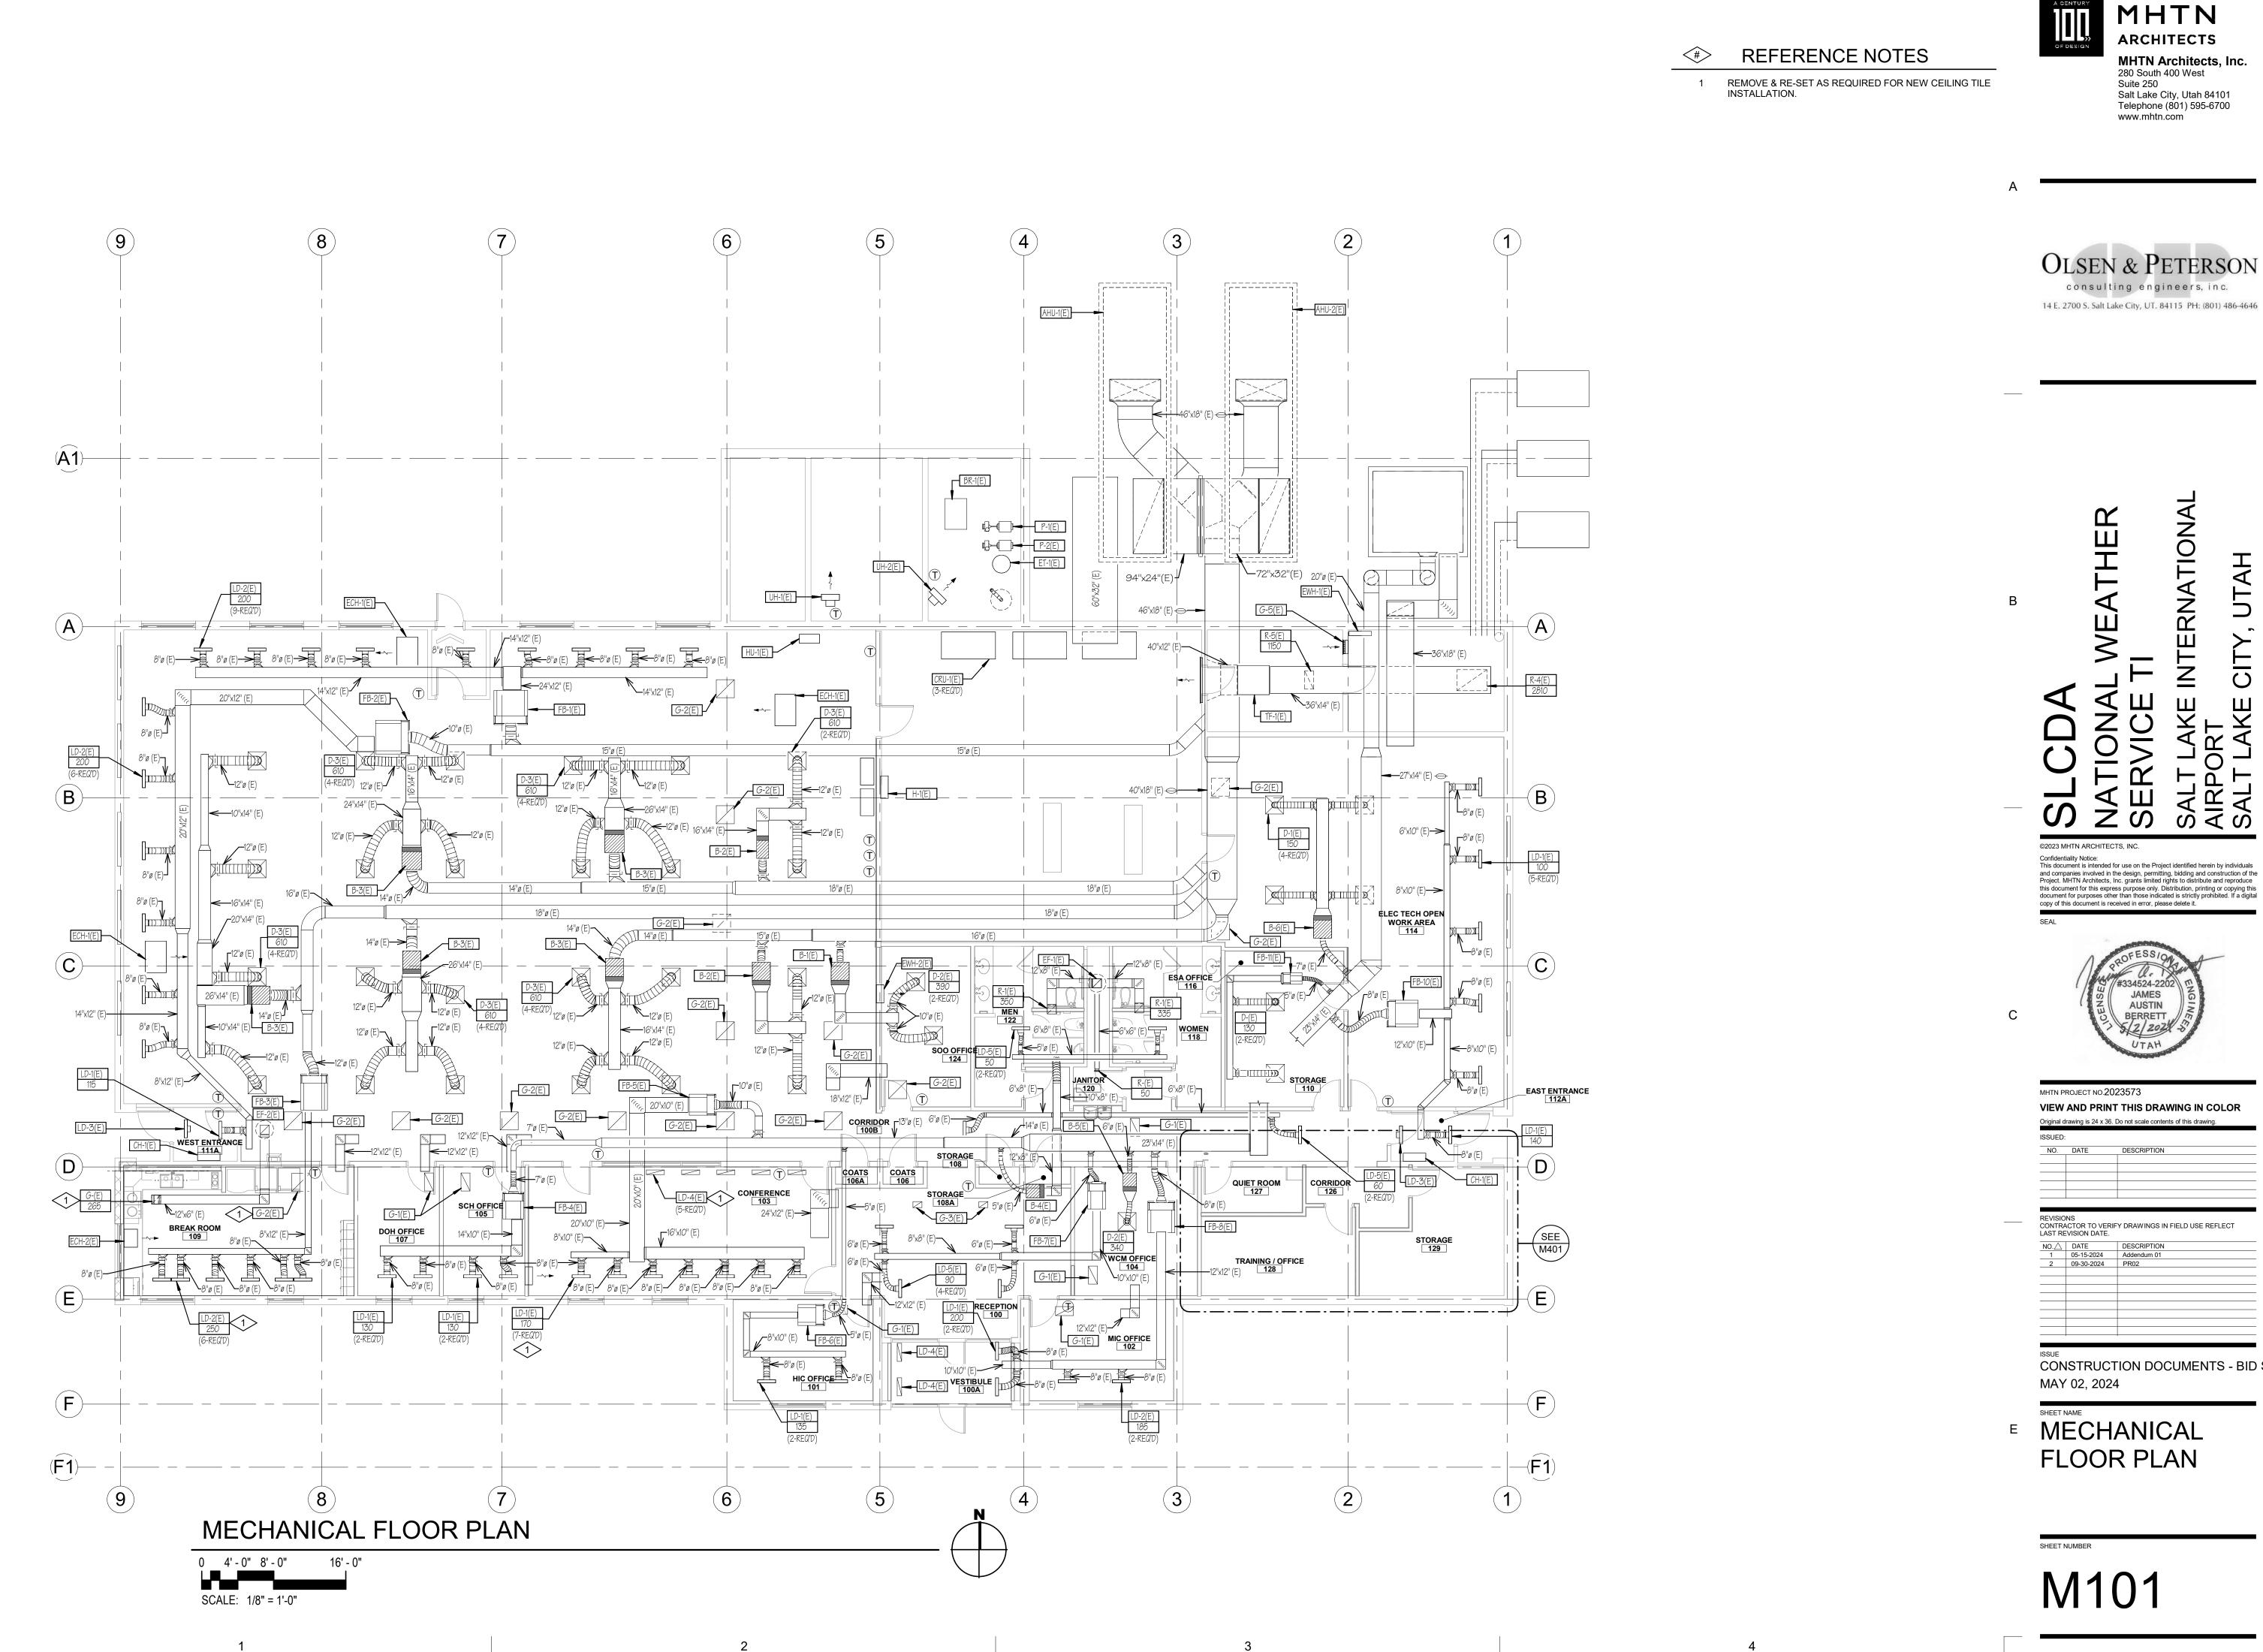

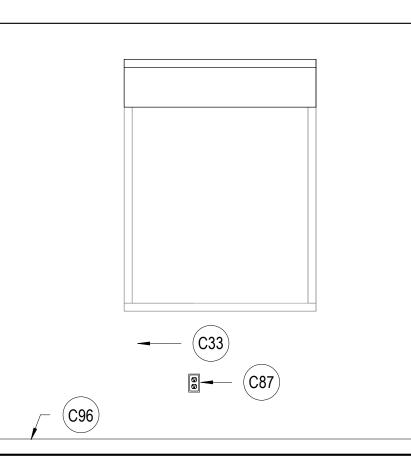
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- C33 **8**- (C87) **(C96)** DOH 107 EAST

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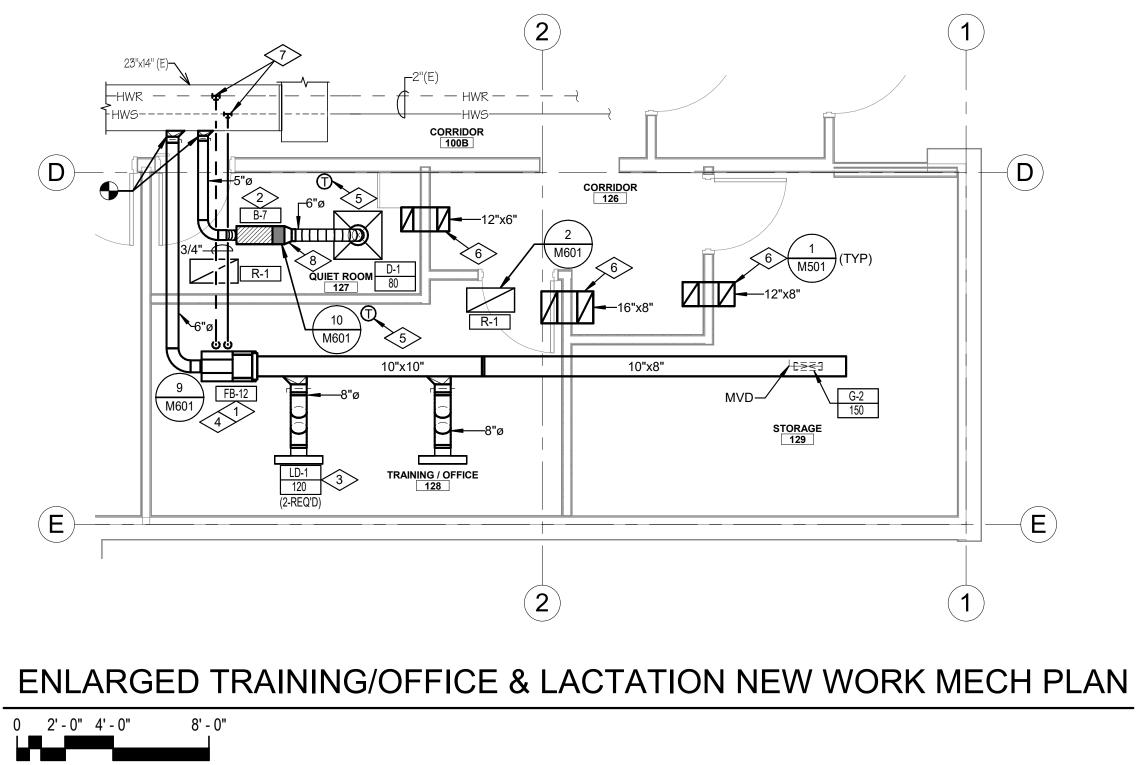
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SCALE: 1/4" = 1'-0"



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REFERENCE NOTES
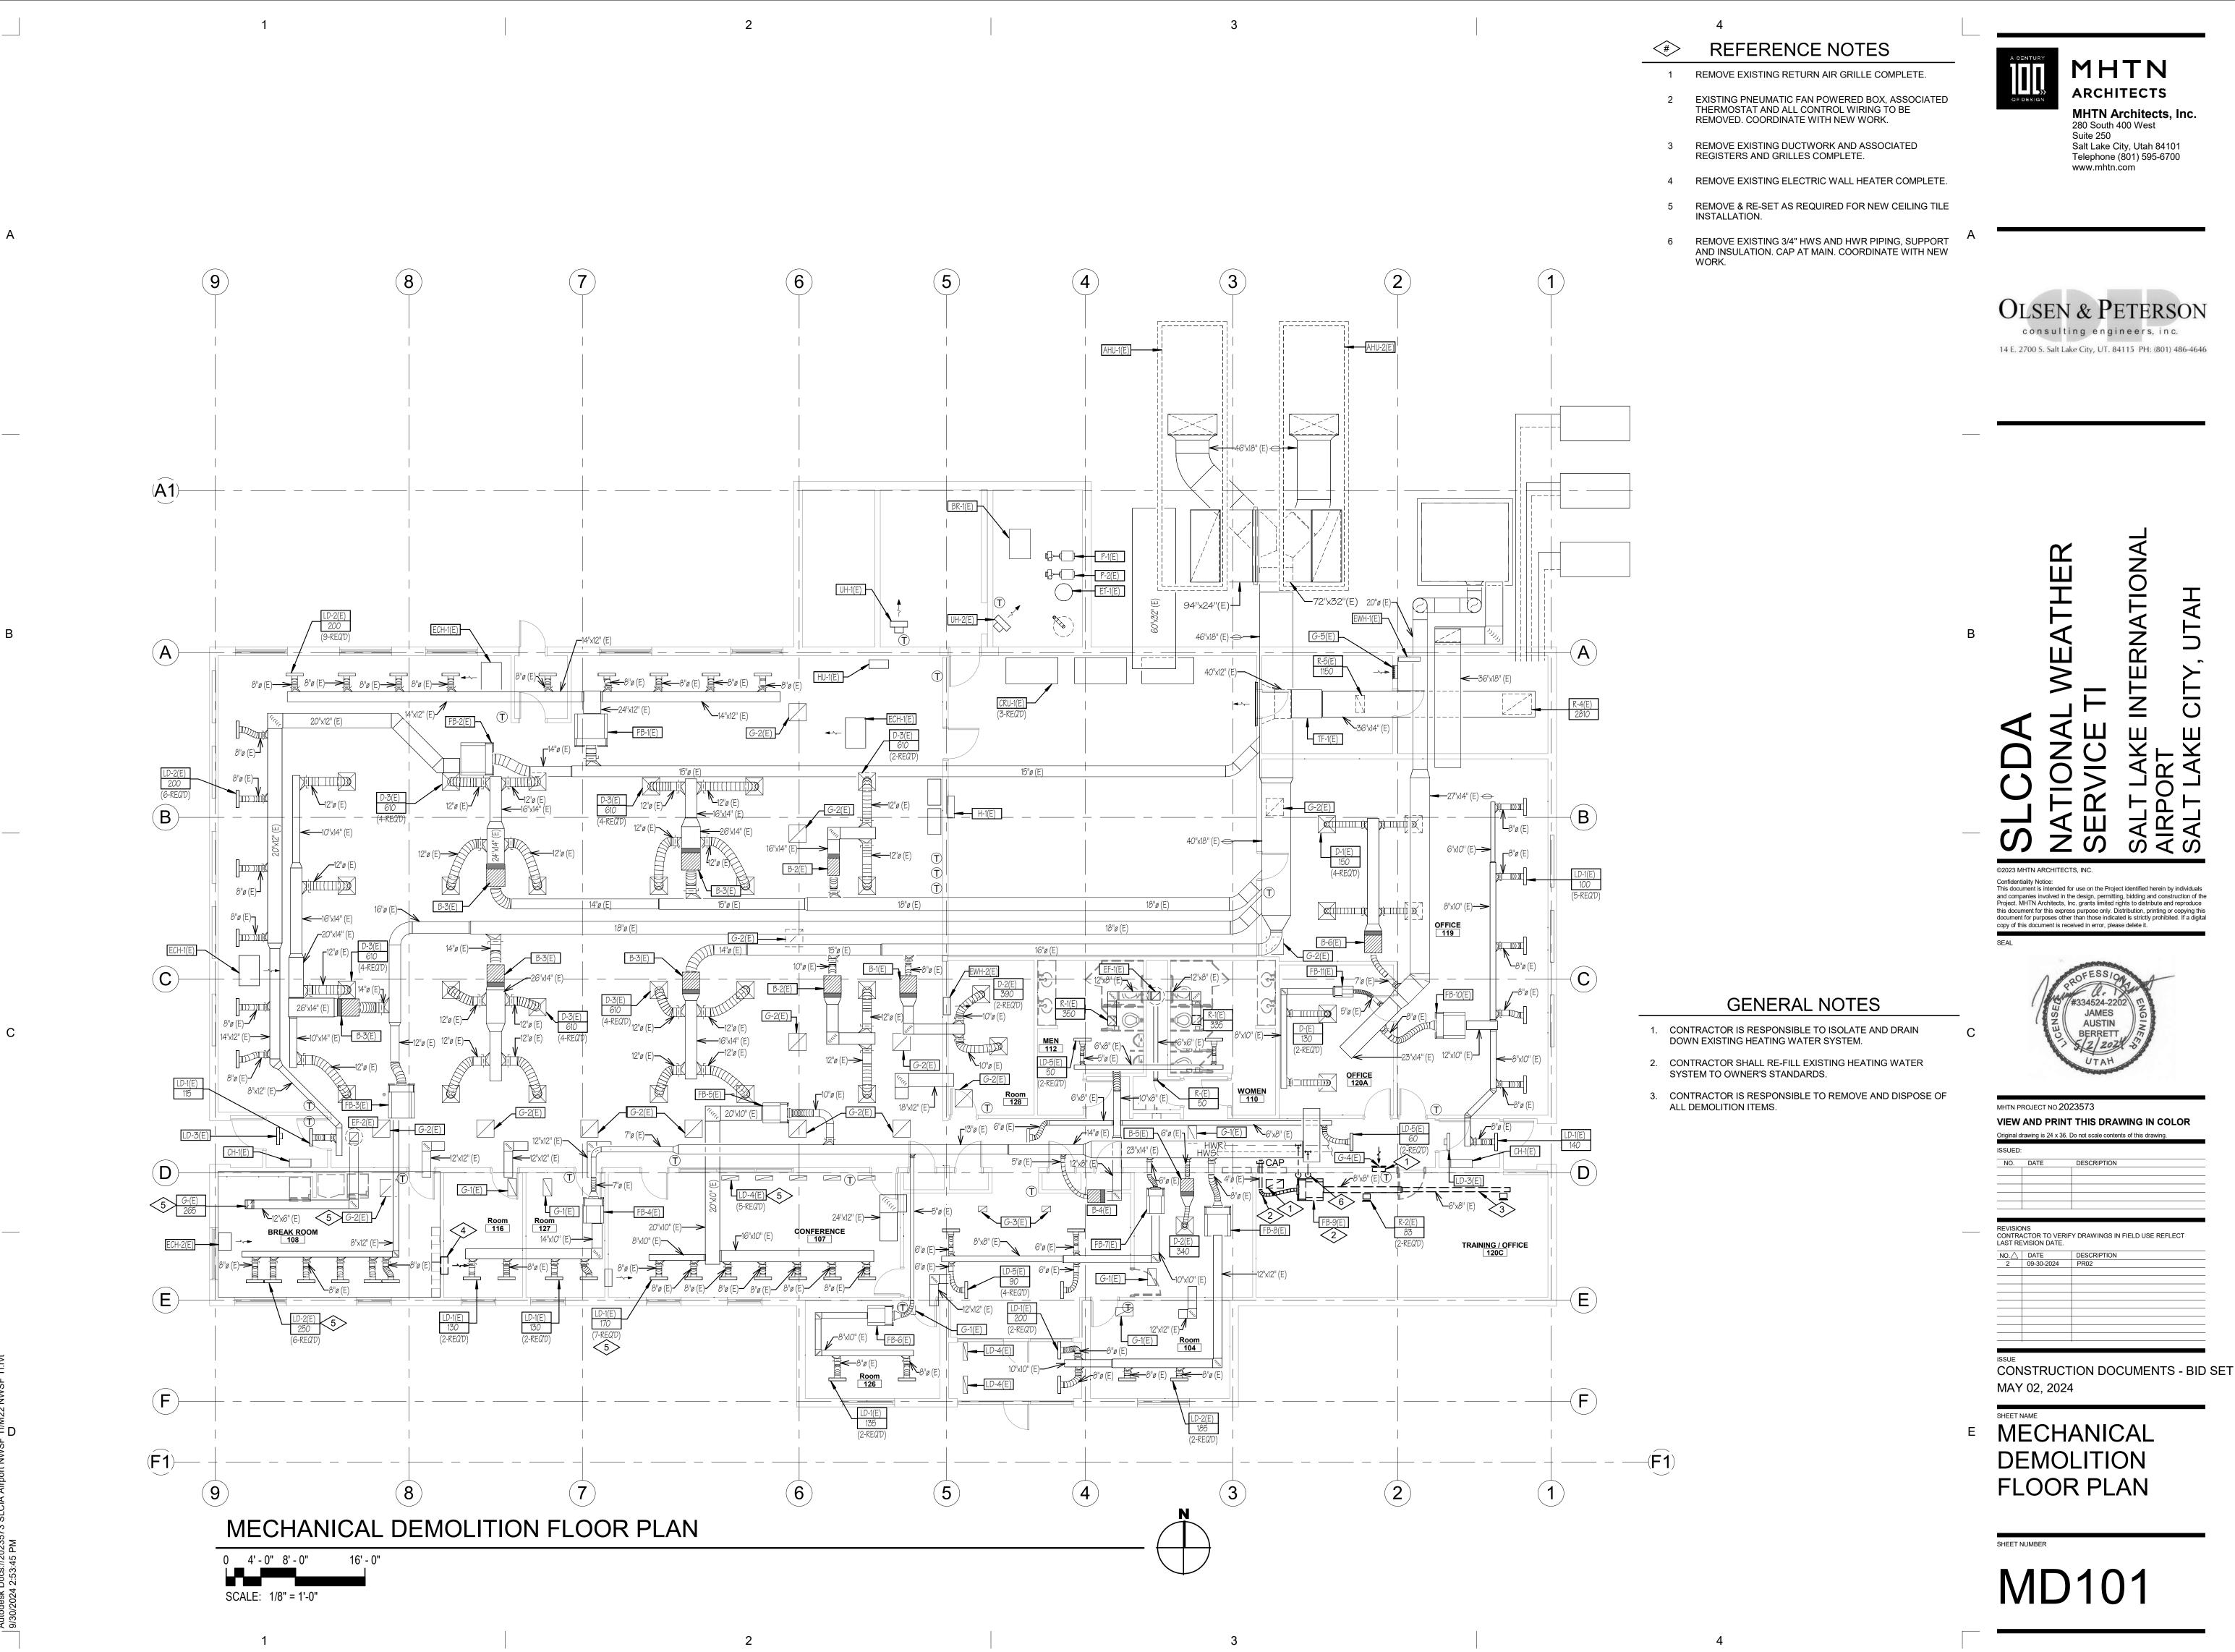
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- PROVIDE NEW FAN POWERED BOX AND ASSOCIATED DUCTWORK AND CONTROLS. 1
- 2 PROVIDE NEW VAV BOX AND ASSOCIATED DUCTWORK AND CONTROLS.
- PROVIDE NEW LINEAR SLOT DIFFUSER. COORDINATE WITH OTHER PROJECT FOR CONNECTIONS SIZES. 3
- 4 PROVIDE NEW HWS & HWR PIPING AS REQUIRED. PROVIDE NEW HW VALVE.
- 5 NEW DIGITAL HEATING/COOLING THERMOSTAT.
- TRANSFER AIR DUCT; PROVIDE OPENINGS AT EACH END ON TOP FOR SOUND ATTENUATION. 6
- 7 CONNECT NEW HWS AND HWR PIPING TO EXISTING AT APPROXIMATELY THIS LOCATION. REPAIR PIPE INSULATION AT TIE-IN.
- 8 HET FITTING WITH MANUAL BALANCING DAMPER.

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 1
 05-15-2024
 Addendum 01

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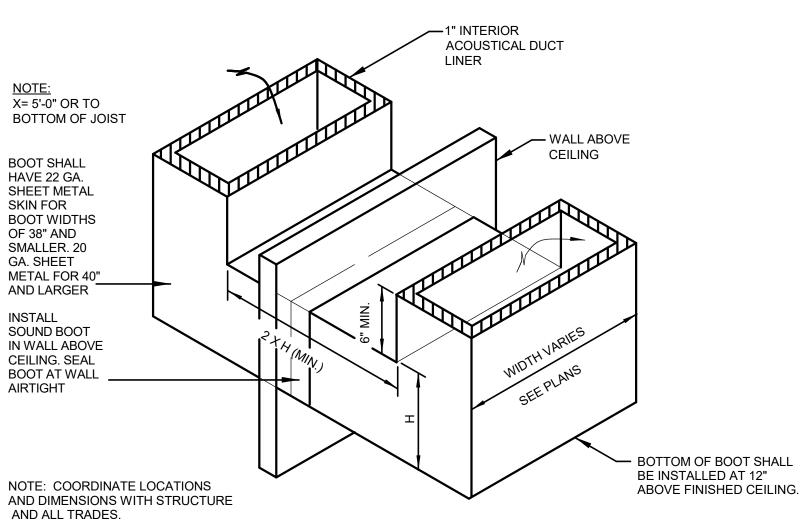
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NOTE: COORDINATE LOCATIONS AND DIMENSIONS WITH STRUCTURE AND ALL TRADES.

RETURN AIR SOUND BOOT DETAIL

M501

ſ				% (4)			% (5)		R	RE-HEAT	COIL	(2)	(6)	(1)(2)(3)
	SYMBOL	COOLING CFM	HEATING CFM	MIN. CFM	INLET SIZE	A.P.D.	HEAT. CFM	MBH	GPM	ROWS	W.P.D.	COIL SIZE	MOTOR	MAKE & MODEL
ľ	FB-12	390	220	30	6" DIA.	.33"	60	10.7	1.1	2	.06 FT.	14" x 12 1/2"	1/8 H.P. 1.1 AMPS 277/1/60	PRICE FDV5-2006

NOTES:


FOR RIGHT OR LEFT HAND COIL CONNECTIONS. COORDINATE WITH INSTALLING CONTRACTOR. (2) CAPACITIES BASED ON 55 DEG.F. ENTERING AIR TEMP., 180 DEG.F. ENTERING WATER TEMP WITH 20 DEG.F. WATER TEMP. DROP. & WATER SOLUTION

(3) COORDINATE CONTROL MOUNTING WITH ATC CONTRACTOR.

(4) MINIMUM CFM SHALL BE SET FOR 30 PERCENT OF THE TOTAL CFM FOR EACH VAV BOX.

(5) MAXIMUM HEATING CFM SHALL BE SET FOR 60 PERCENT OF THE TOTAL CFM FOR EACH VAV BOX. (6) MOTORS TO BE 277/1/60.

> SYMBOL DESIG B-7 NOTES: (1) COORDINATE CONTROL MOUNTING WITH ATC CONTRACTOR.

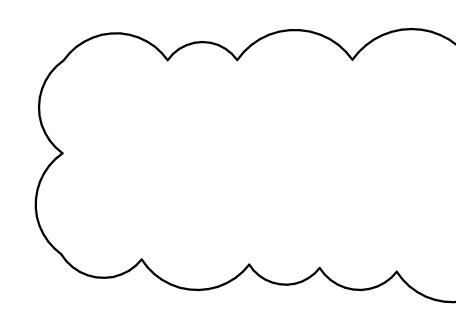

		REGISTE
SYMBOL	SIZE	LOCATION
G-1	12" x 12"	CEILING
G-2	14" X 4"	DUCT
R-1	24" x 12"	CEILING

NOTES:

SHALL COORDINATE WITH REFLECTED CEILING PLANS TO DETERMINE PROPER FRAMES.

(1) COLOR AND FINISH TO MATCH CEILING GRID, COORDINATE WITH ARCHITECT. SUPPLIER OF REGISTERS AND GRILLES (2) ALL REGISTERS TO BE C/W OPPOSED BLADE VOLUME CONTROL DAMPER.

(3) COORDINATE EXACT LOCATION WITH ARCHITECT PRIOR TO INSTALLATION.

LINEAR DIFFUSER SCHEDULE						
SYMBOL	SLOT WIDTH	# OF SLOTS	DIFFUSER LENGTH	PATTERN	CEILING	(1)(2)(3)(4) MAKE & MODEL
LD-1 CFM	3/4"	2	24"	2-WAY	LAY IN	PRICE SDS75

NOTES:

(1) COLOR & FINISH TO MATCH CEILING OR CEILING GRID. COORDINATE WITH ARCHITECT.

(2) INTERIOR DEFLECTOR OF DIFFUSER SHALL BE FLAT BLACK.

(3) MAXIMUM NC OF 35 AT DESIGN CFM.

(4) ALL LINEAR DIFFUSERS MUST BE SUPPORTED FROM OVERHEAD CONSTRUCTION INDEPENDENT OF CEILING WITH A MINIMUM OF (2) 12-GAUGE WIRES.

			DIFFU	ISER SCHI	EDULE	
SYMBOL	TYPE	DIFFUSER SIZE	NECK SIZE	LOCATION	AIR PATTERN	MAKE & MODEL
D-1 CFM	SUPPLY AIR	24"x24"	6"Ø	CEILING	4-WAY	(1)(2) PRICE SCD
D-2 CFM	SUPPLY AIR	12"x12"	6"Ø	CEILING	4-WAY	(1)(2) PRICE ASCD

NOTES:

(1) DIFFUSERS SHALL HAVE BRIGHT-WHITE FINISH.

(2) COORDINATE WITH ARCHITECTURAL CEILING PLAN FOR CEILING TYPE.

FAN POWERED VAV REHEAT BOX SCHEDULE

(1) VAV AND COIL CONTROL SHALL BE ACCESSED FROM SAME SIDE OF BOX. SEE PLAN

	VAV BOX SCHEDULE					
GN CFM	% (2) MIN. CFM	INLET SIZE	A.P.D.	% (3) HEAT. CFM	(1) MAKE & MODEL	
)	30	5" DIA.	.33"	60	PRICE SDV	

(2) MINIMUM CFM SHALL BE SET FOR 30 PERCENT OF THE TOTAL CFM FOR EACH VAV BOX. (3) MAXIMUM HEATING CFM SHALL BE SET FOR 60 PERCENT OF THE TOTAL CFM FOR EACH VAV BOX.

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	TYPE	MAKE & MODEL (1)	
	EXHAUST	PRICE 535	
	SUPPLY	PRICE 510	
	RETURN	PRICE 535	

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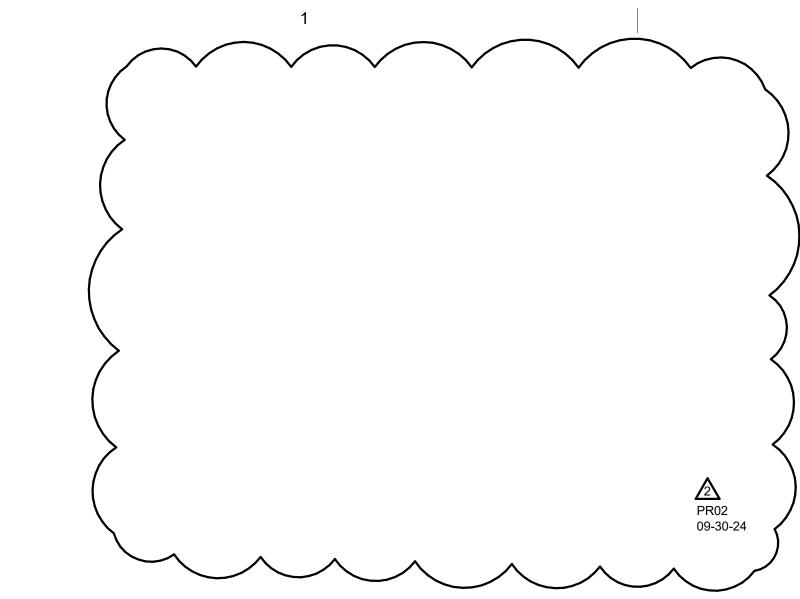
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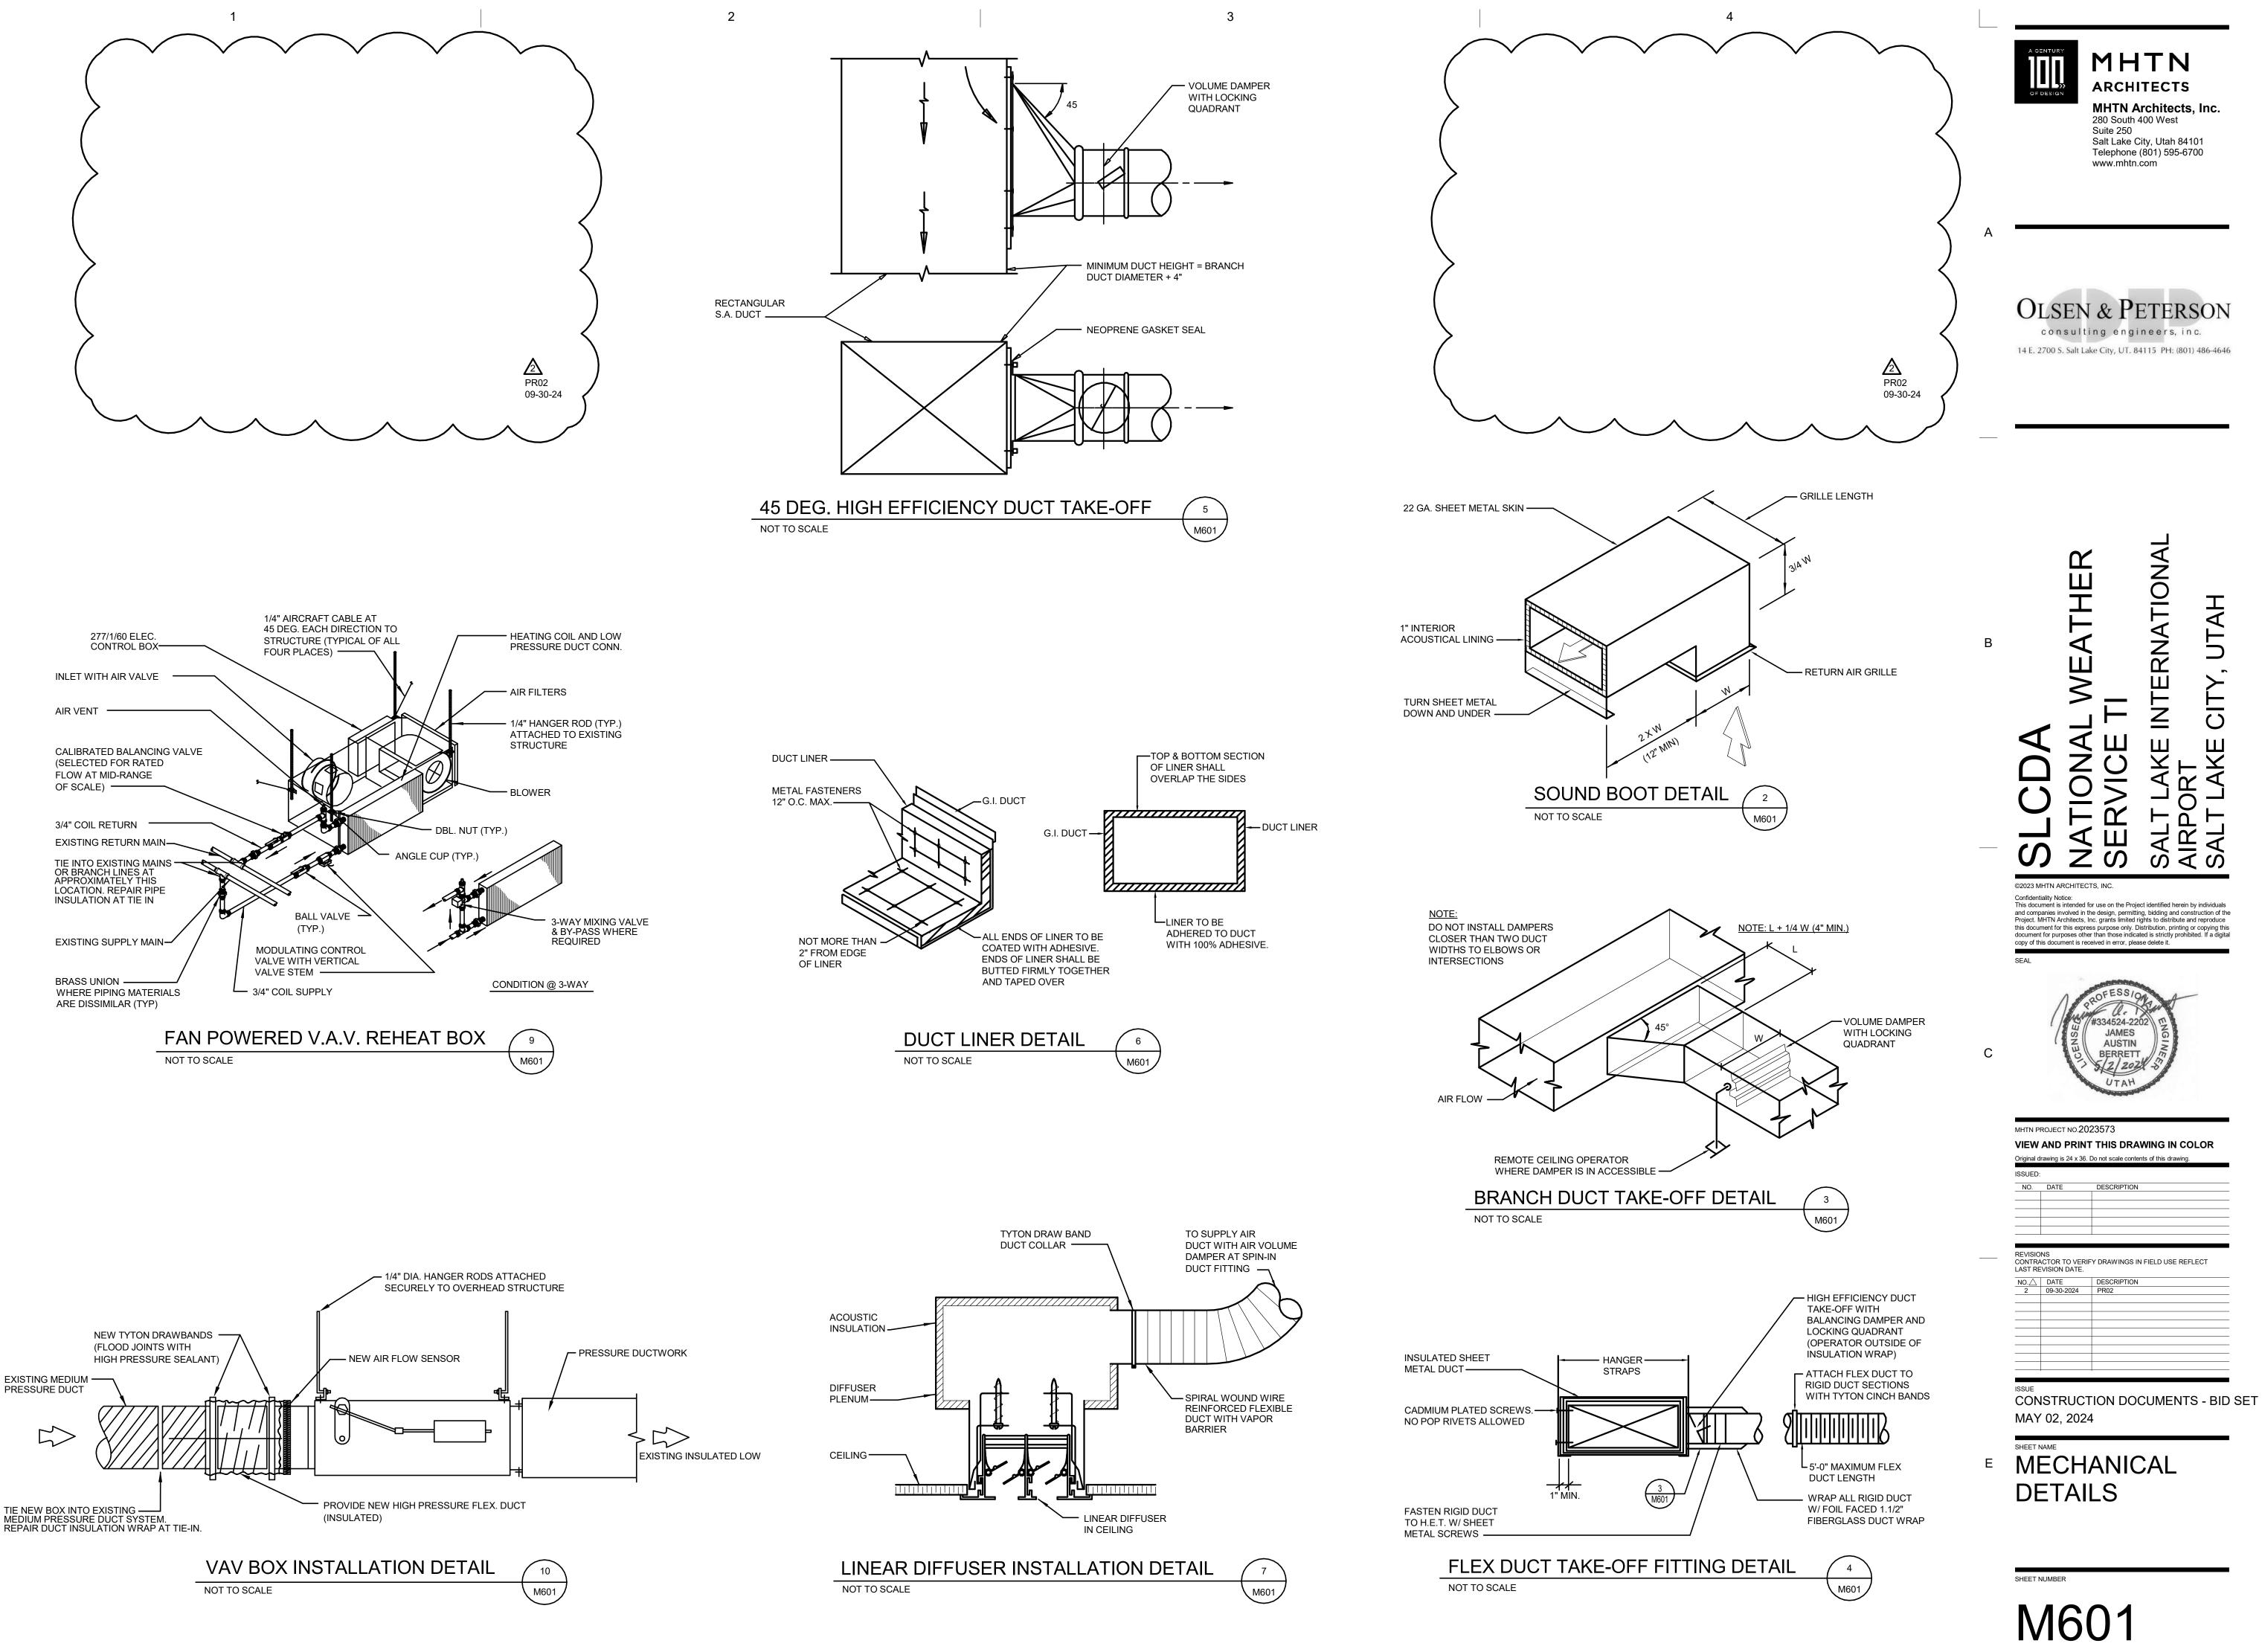
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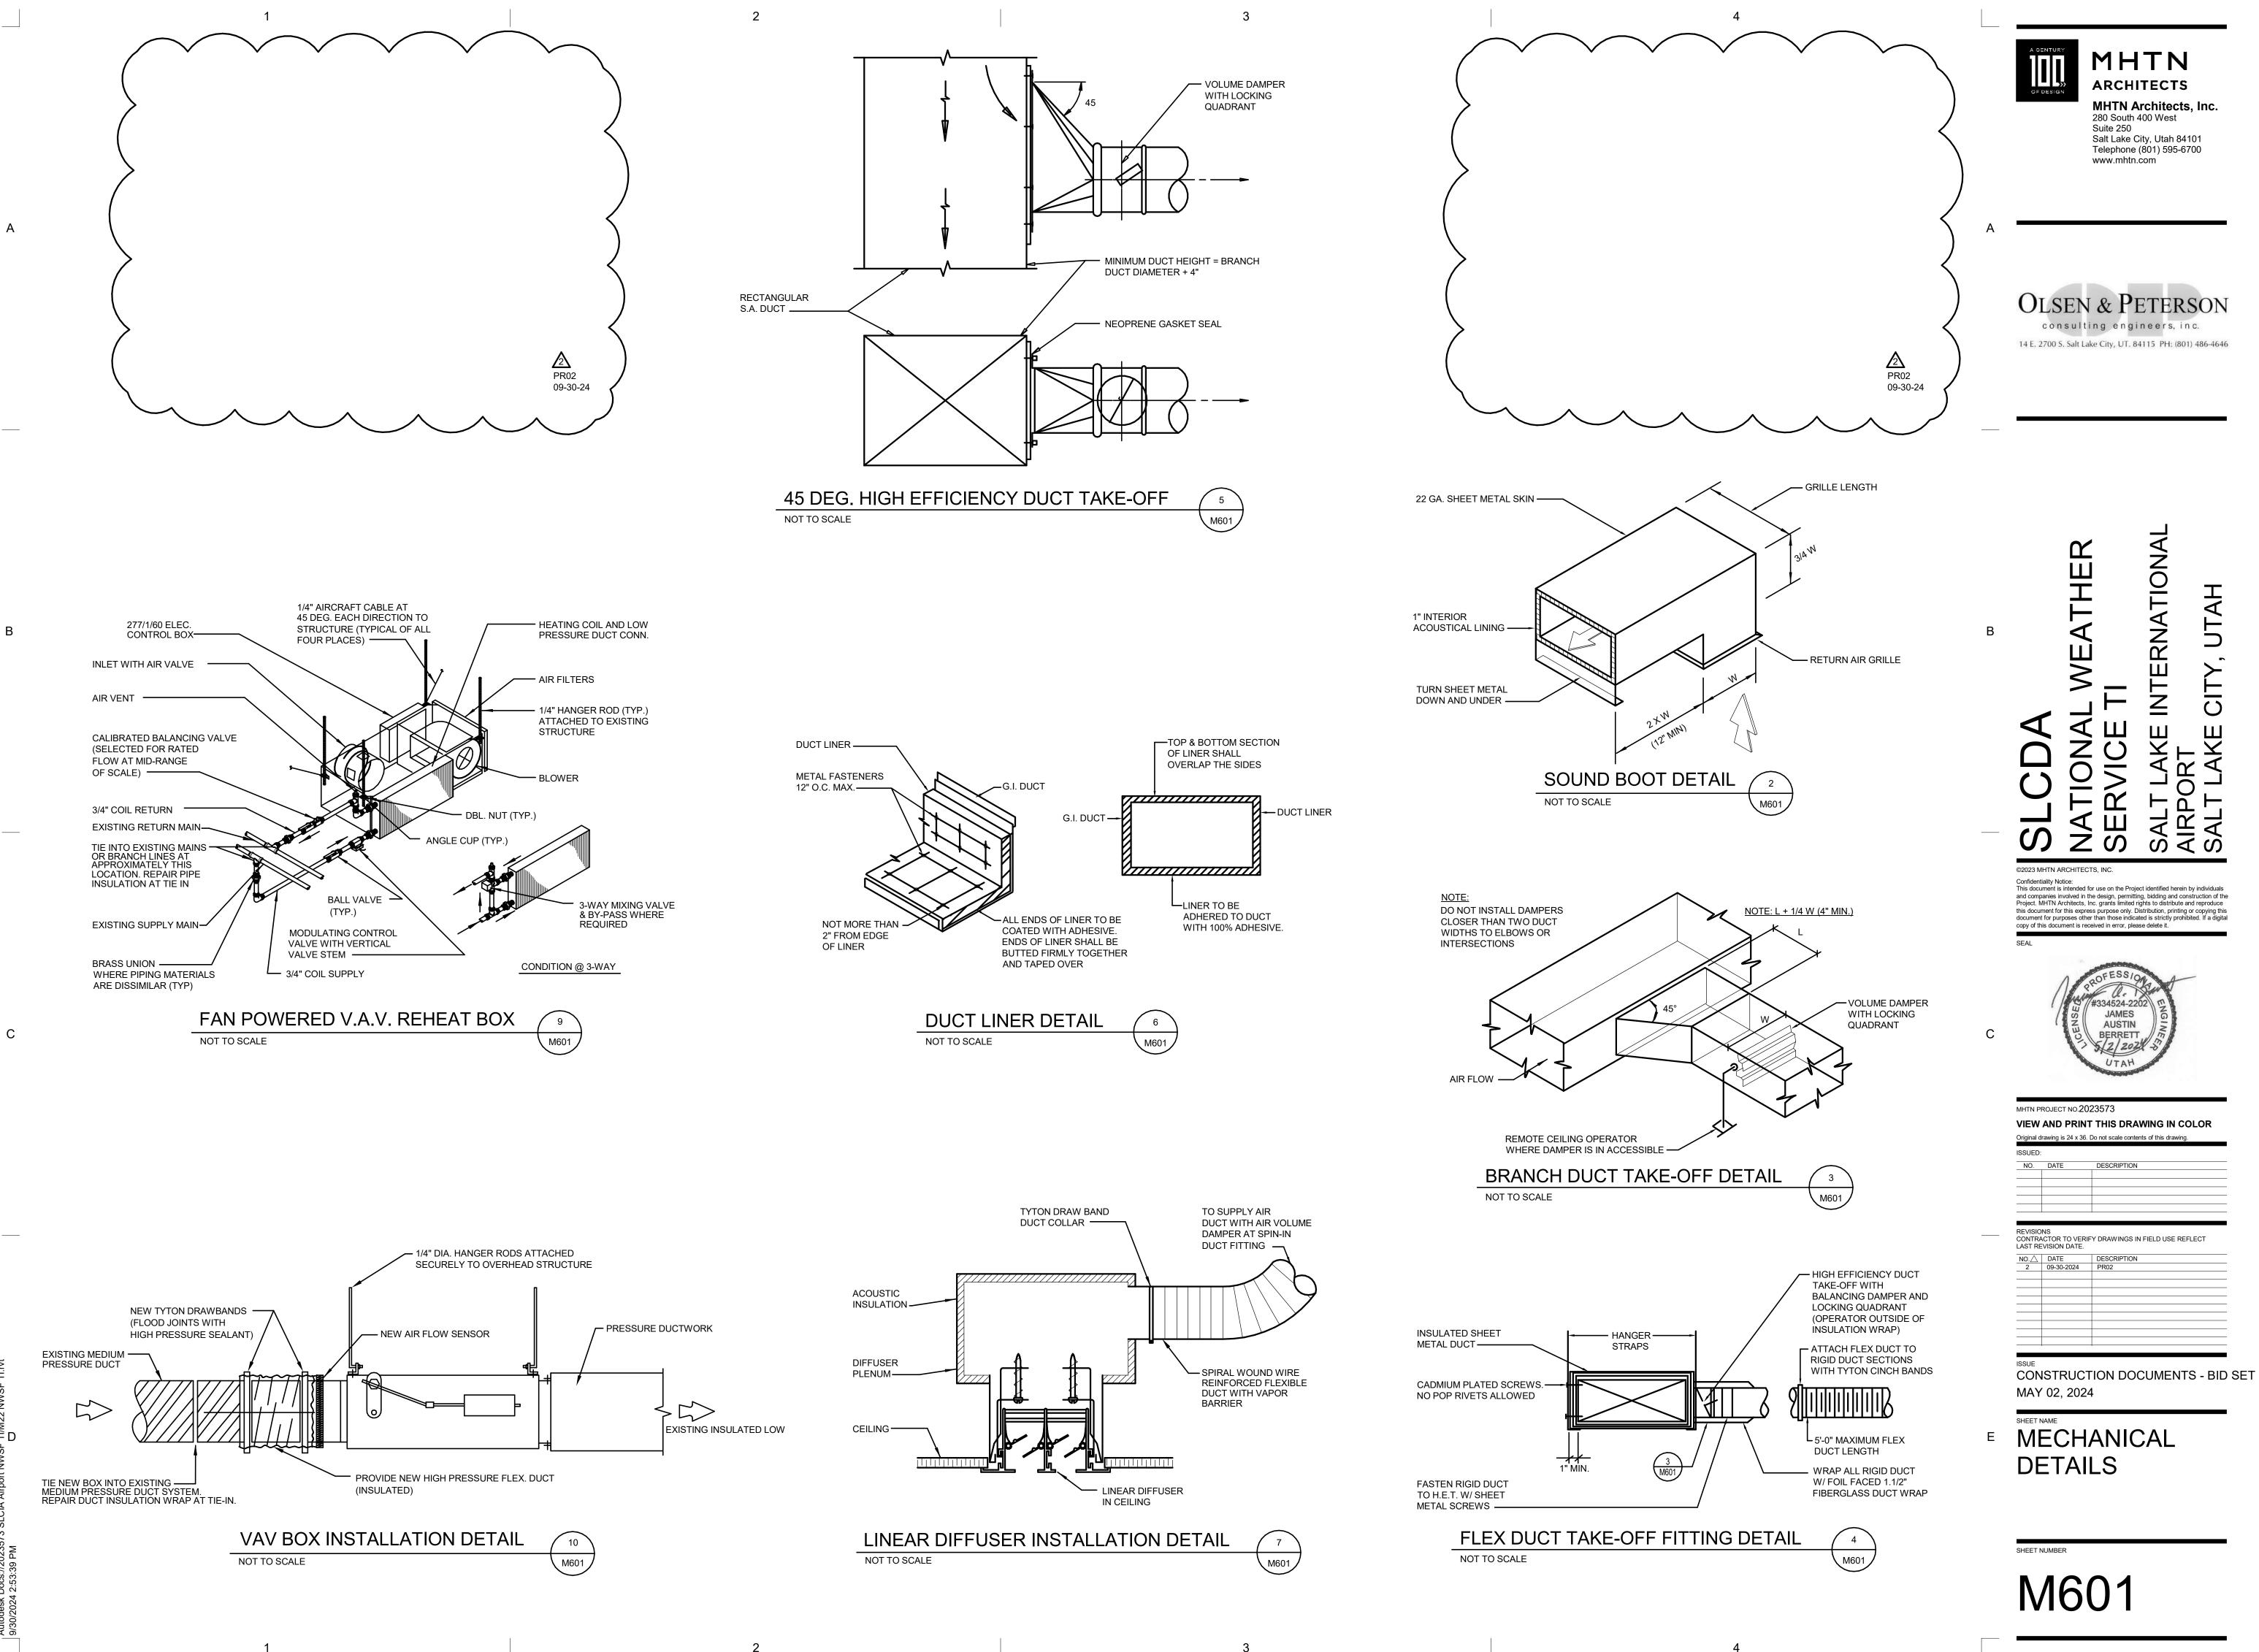
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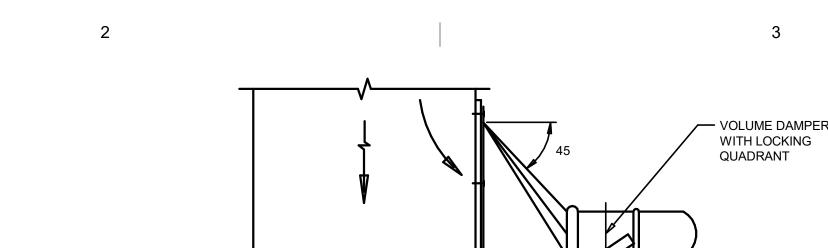
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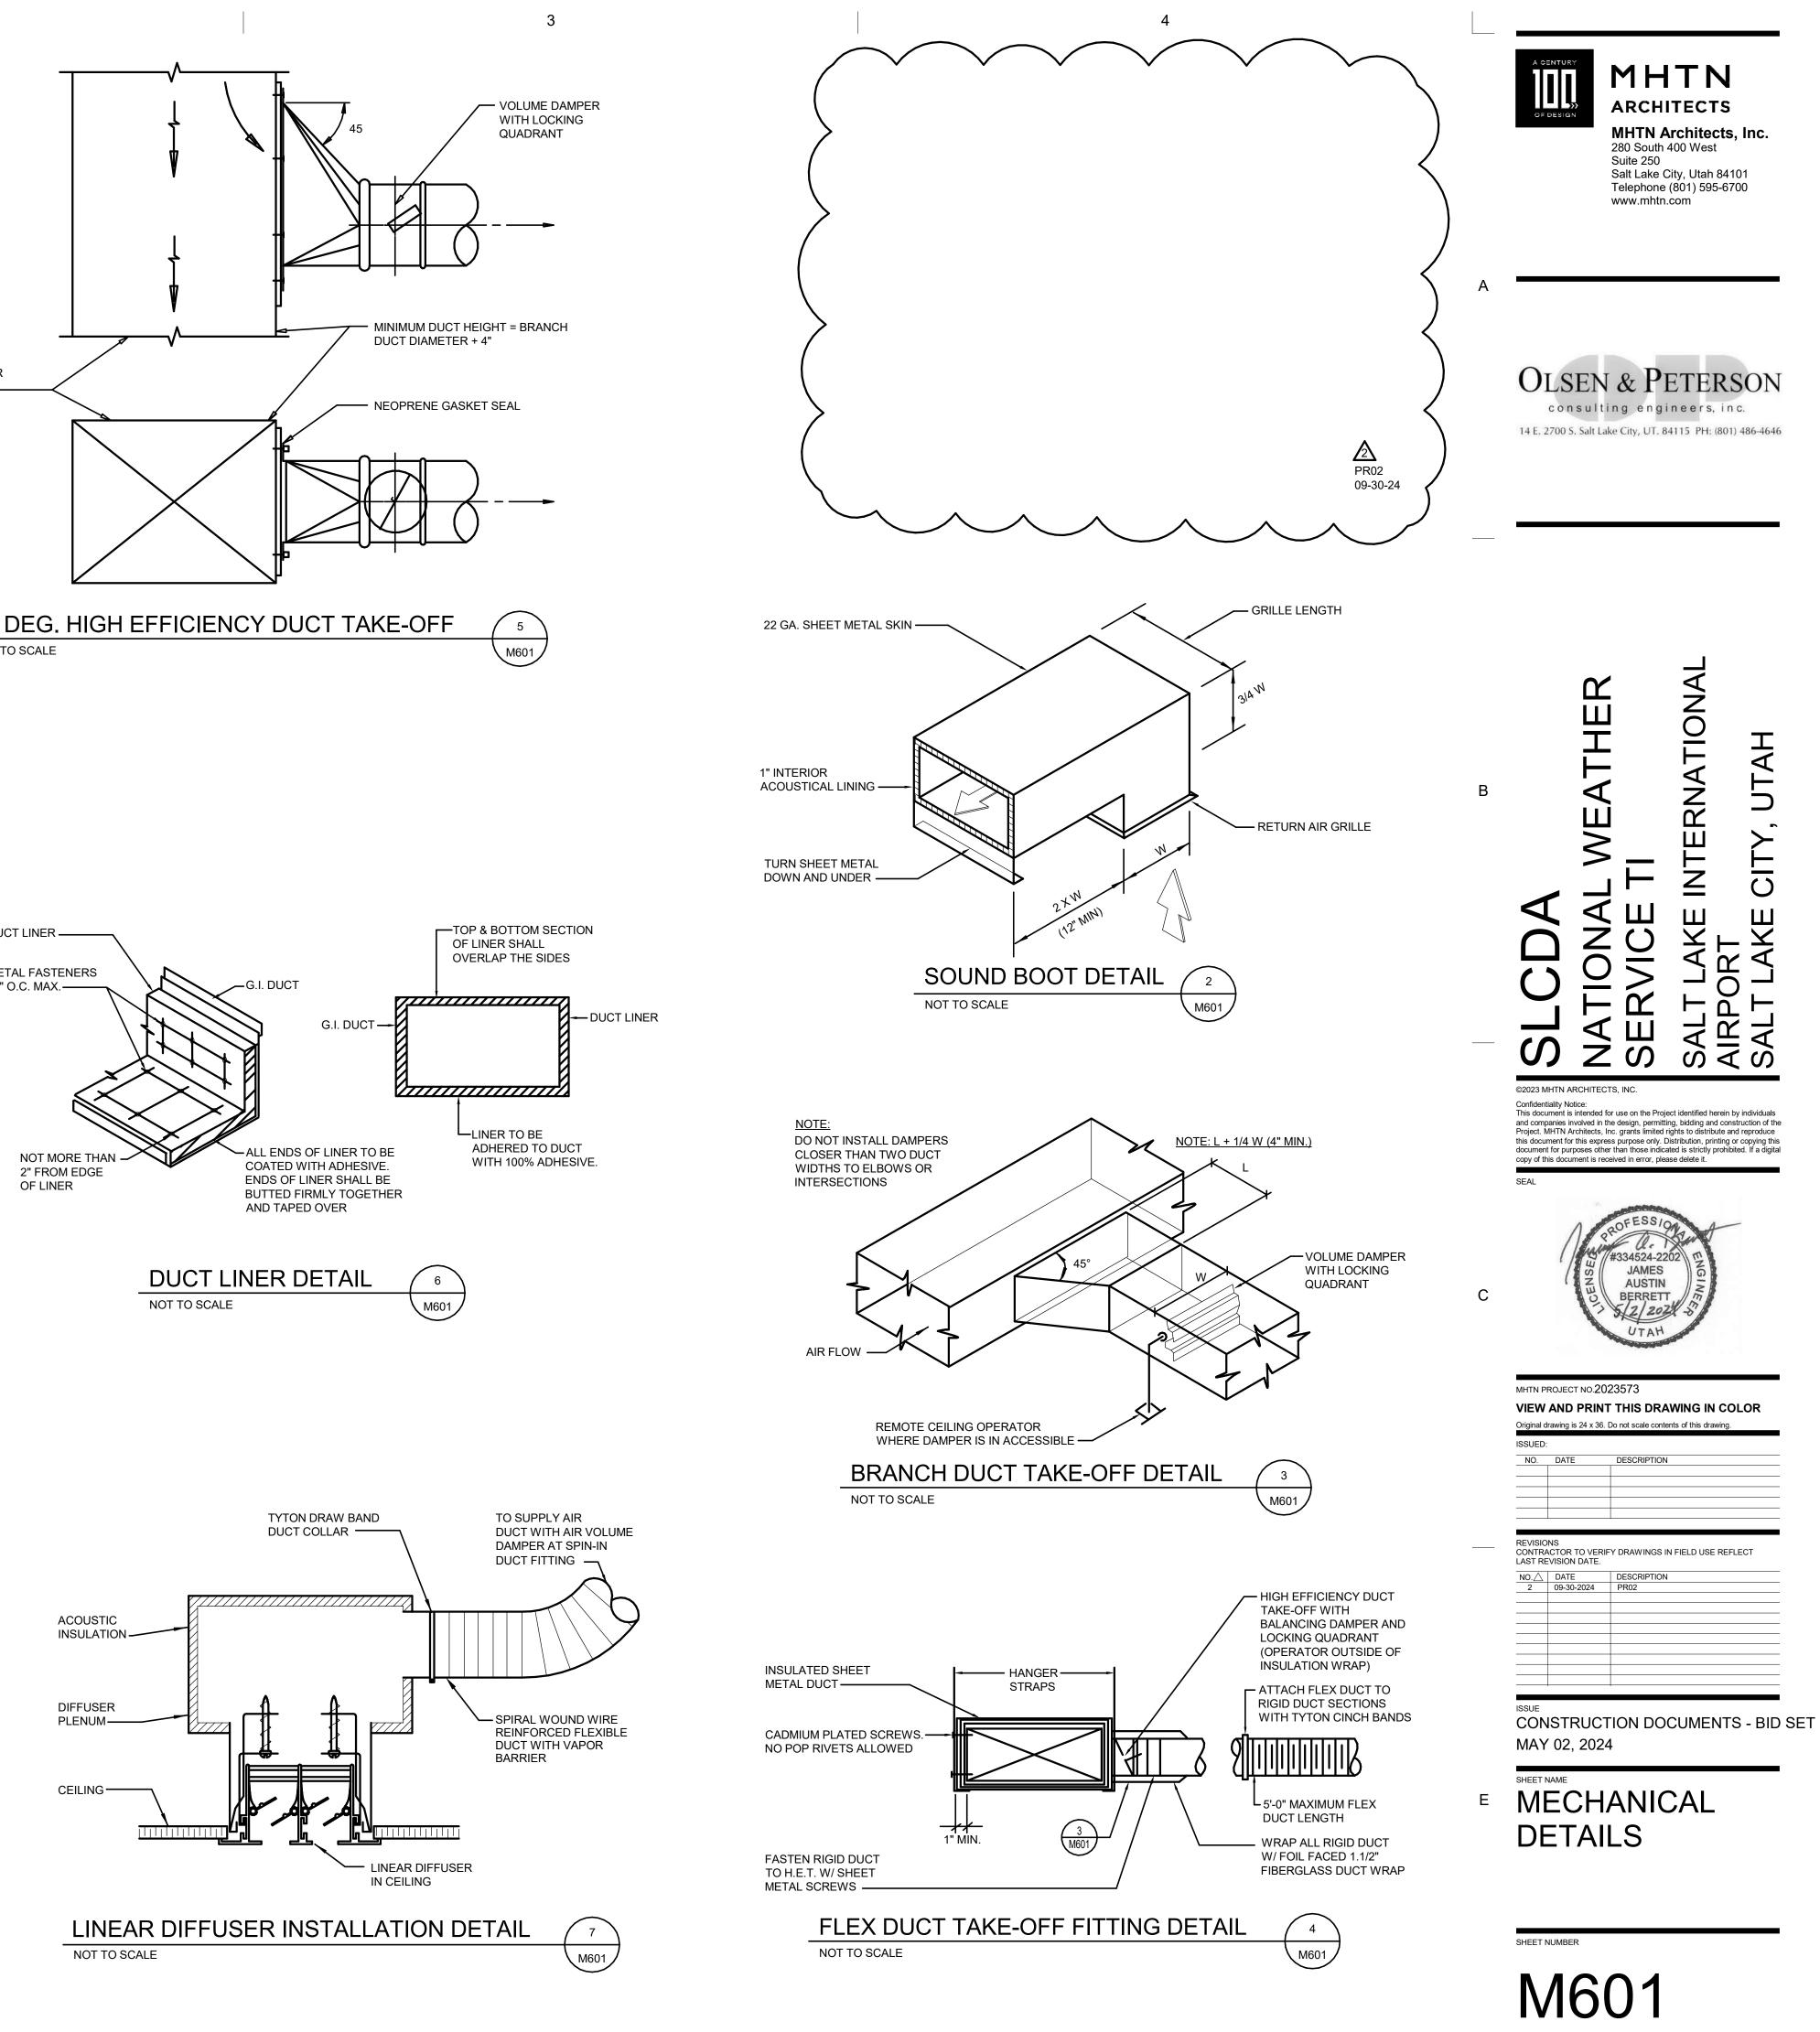
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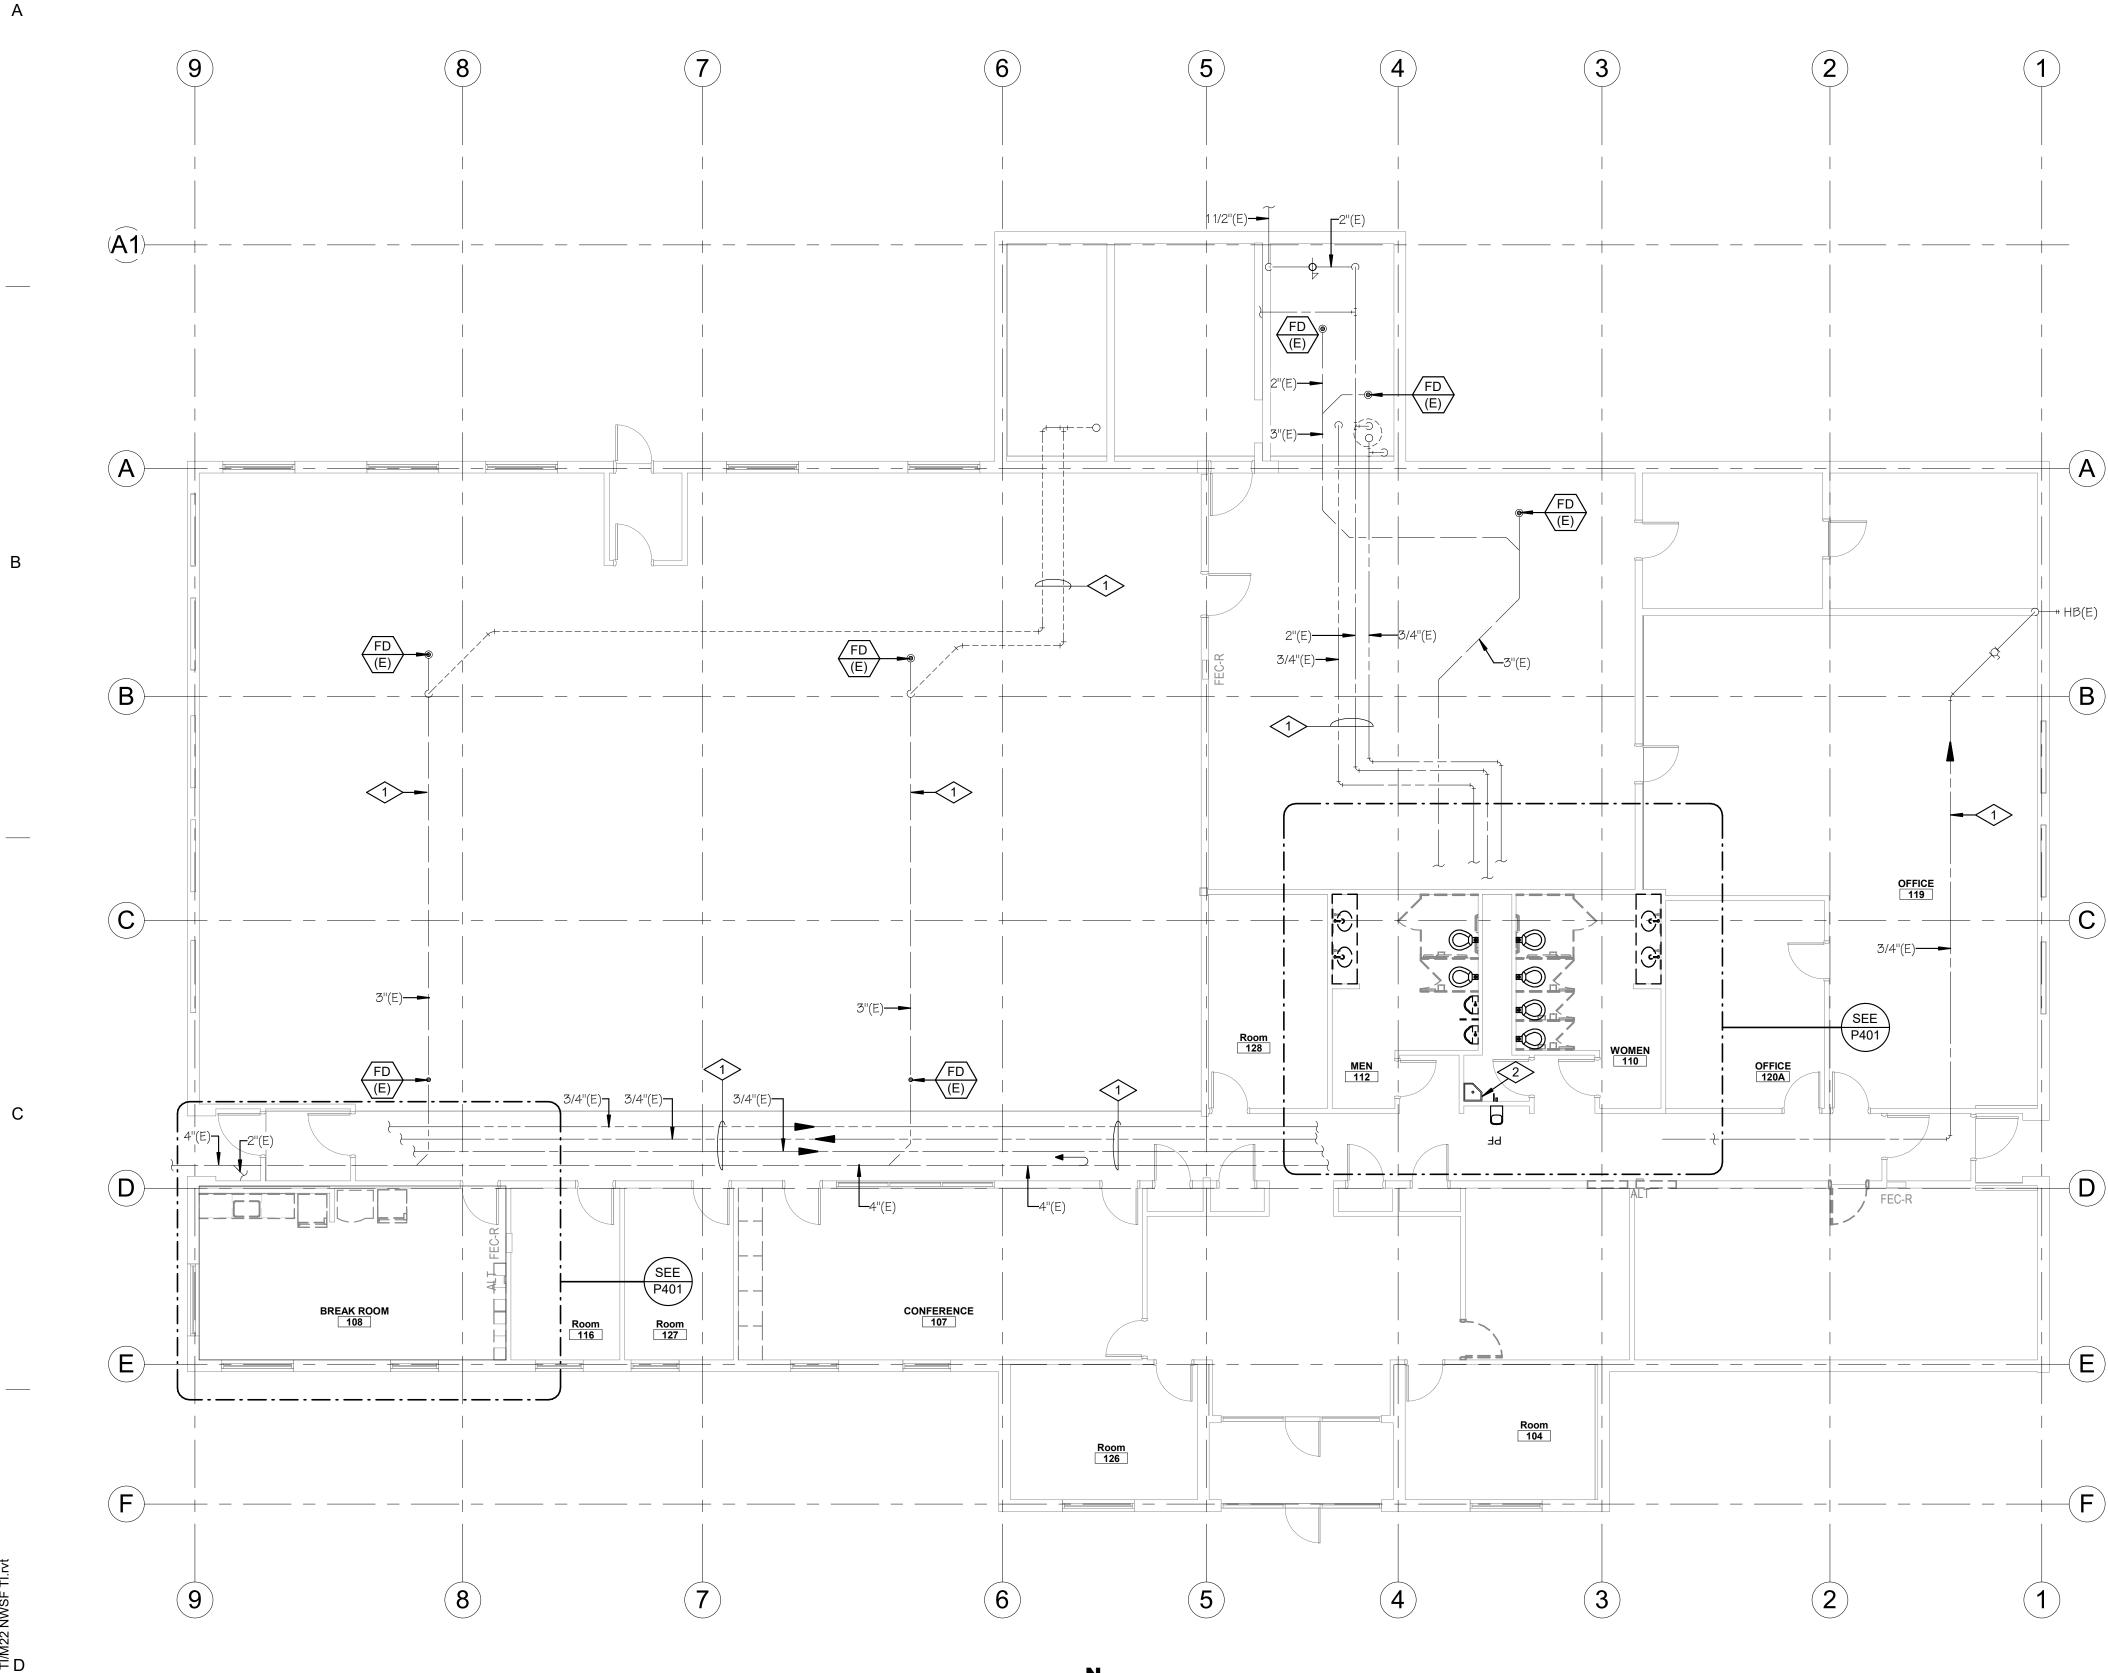












PLUMBING DEMOLITION FLOOR PLAN

0 4' - 0" 8' - 0" 16' - 0"

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SCALE: 1/8" = 1'-0"

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E PLUMBING DEMOLITION FLOOR PLAN

SHEET NUMBER

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SEAL #334524-22 JAMES AUSTIN BERRETT

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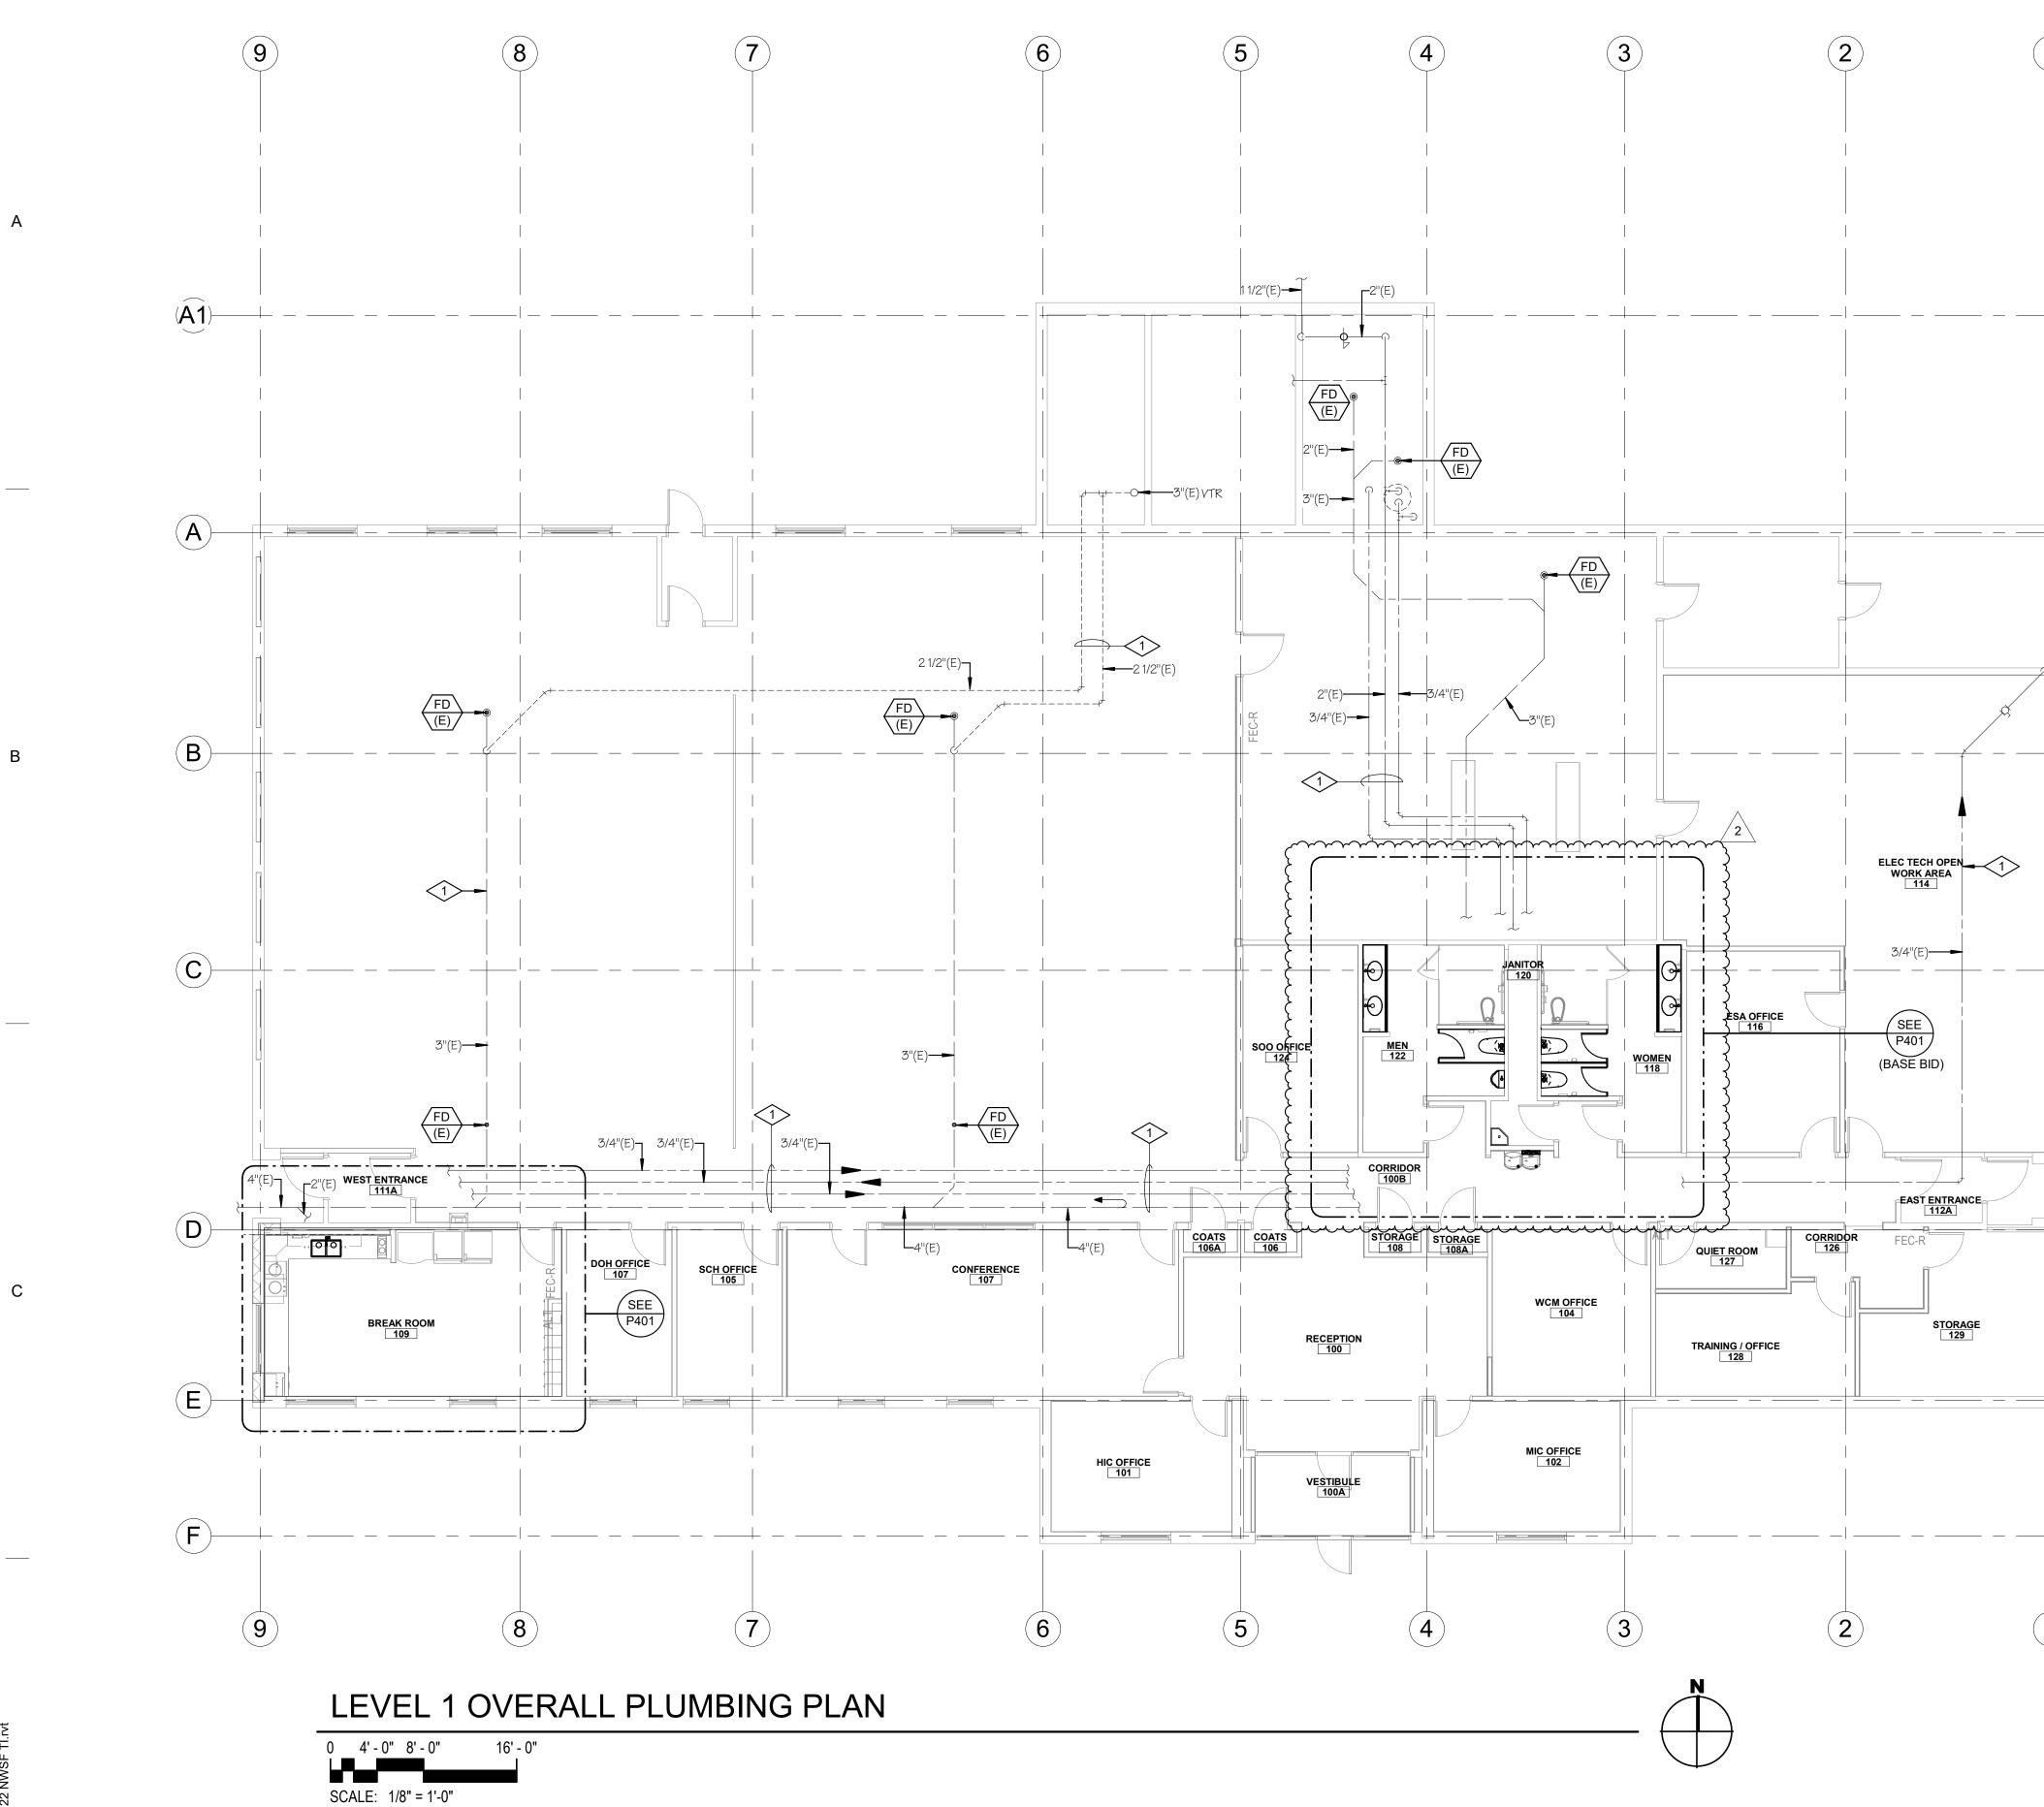
2 EXISTING JANITOR'S SERVICE SINK TO REMAIN.





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E PLUMBING FLOOR PLAN

MAY 02, 2024

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1 EXISTING PLUMBING TO REMAIN.

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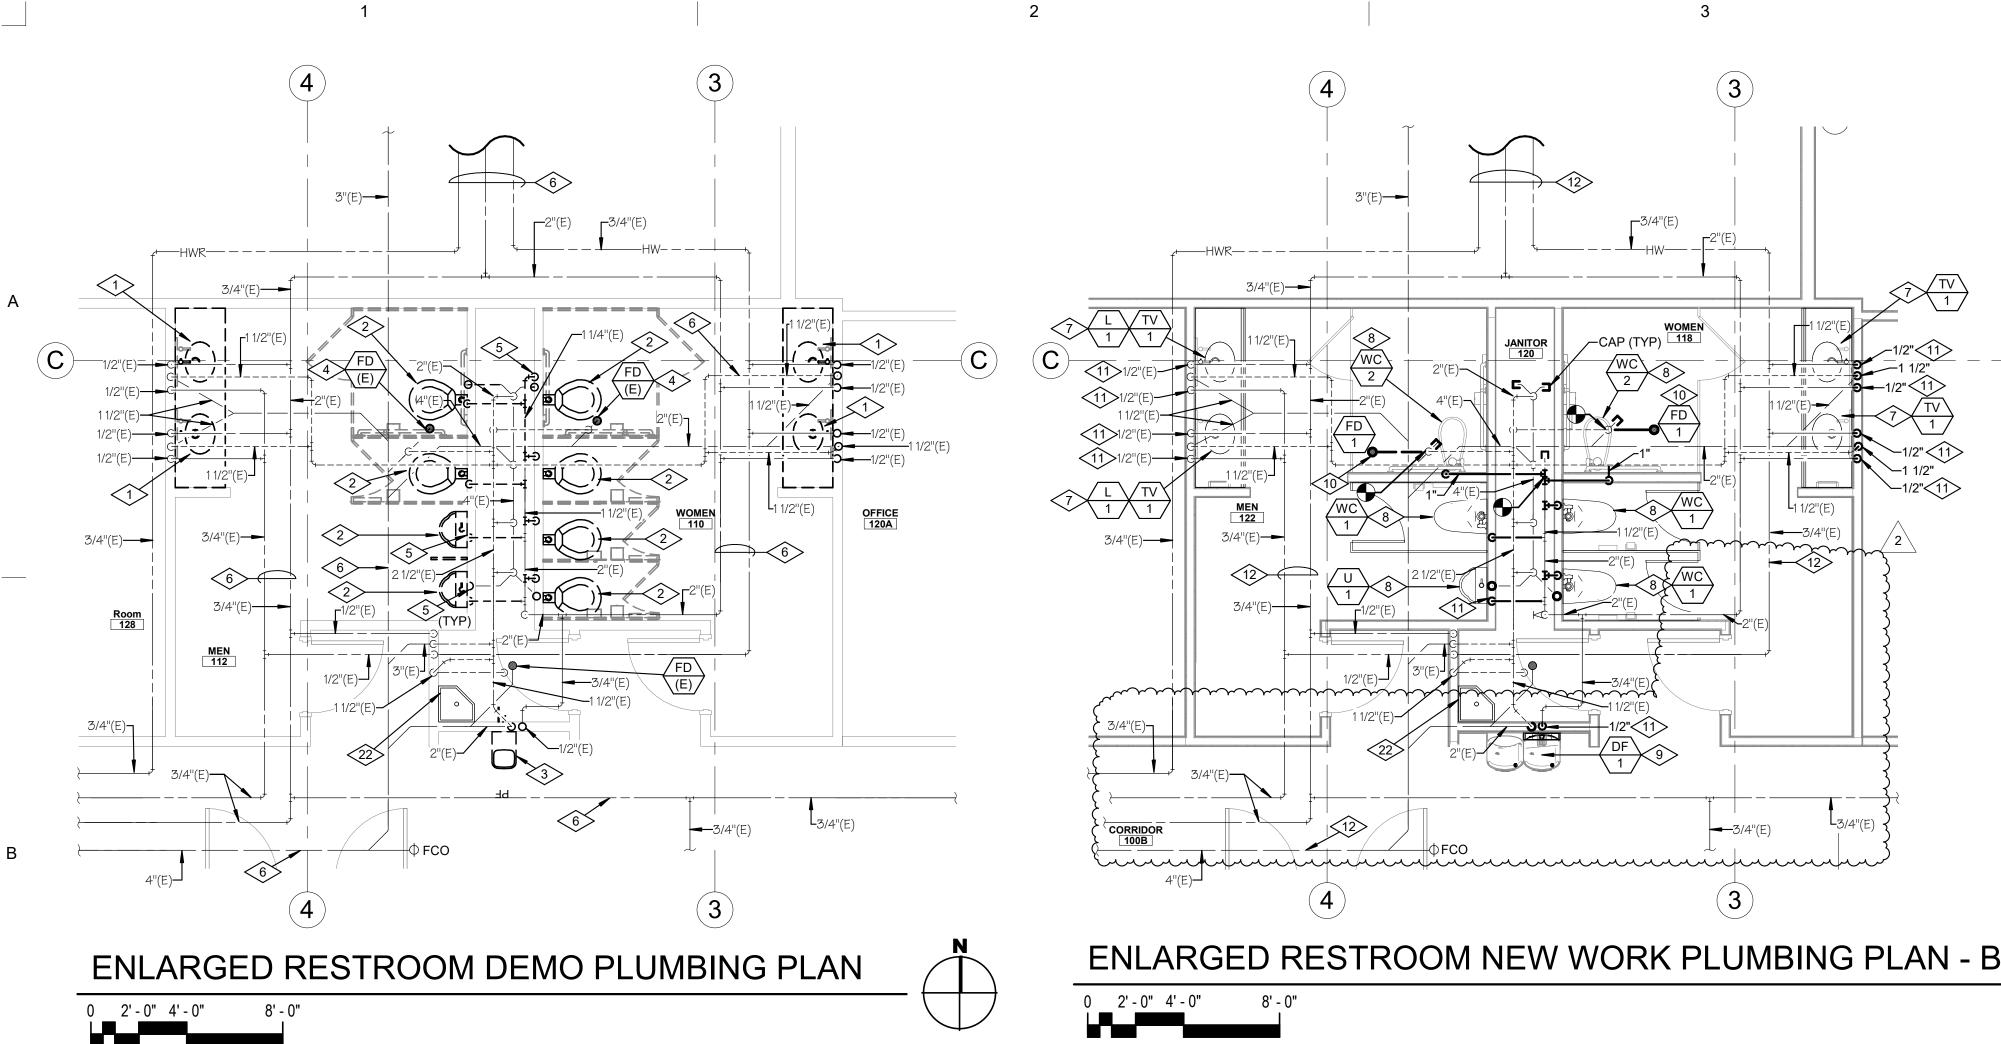
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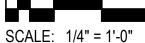
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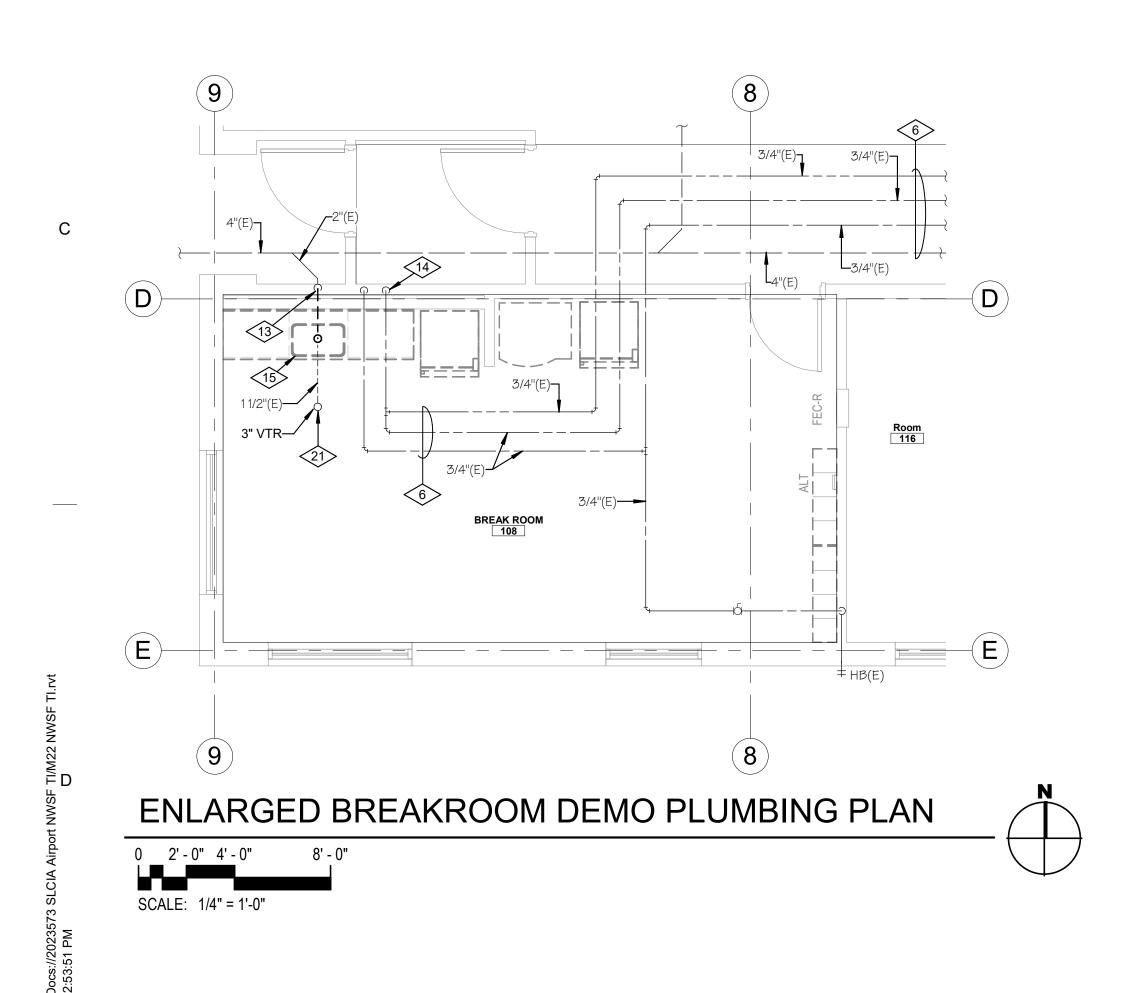
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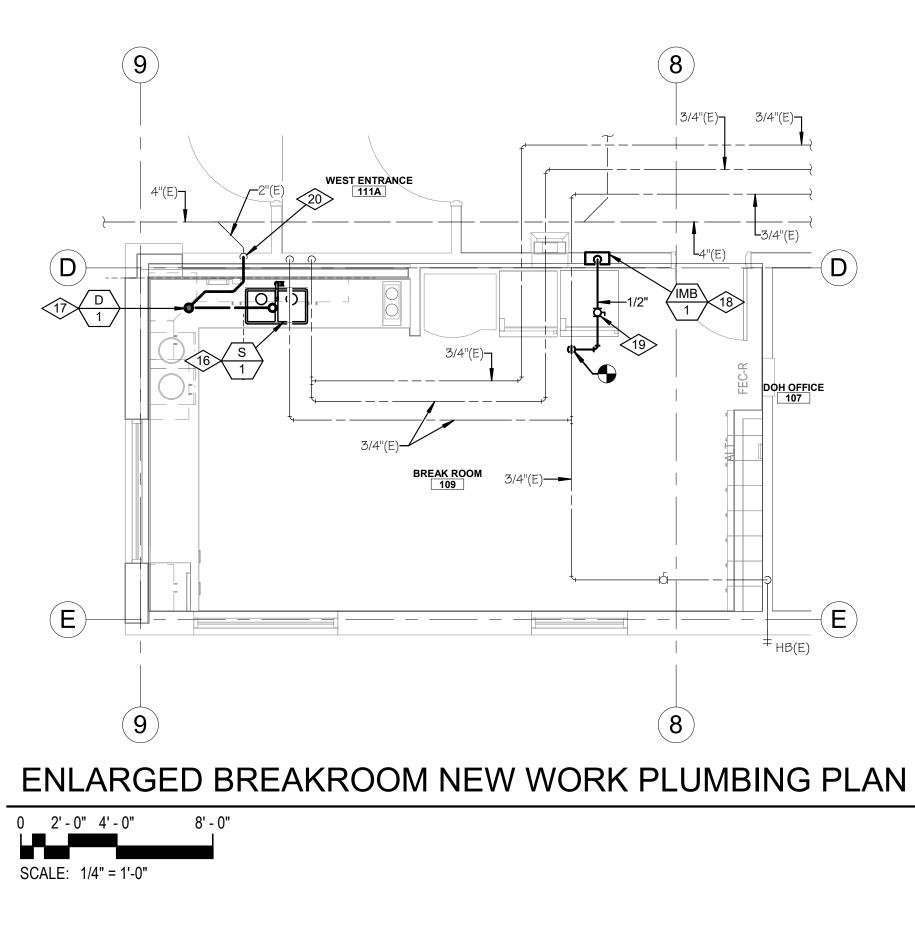
REFERENCE NOTES







ENLARGED RESTROOM NEW WORK PLUMBING PLAN - BASE SCALE: 1/4" = 1'-0"



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- REMOVE EXISTING SINK COMPLETE. REMOVE WATER LINES BACK TO WALL AND COORDINATE WITH NEW WORK FOR CONNECTION OF EXISTING TO NEW.
- REMOVE ALL EXISTING PLUMBING FIXTURES AS HIGHLIGHTED ON PLAN. REMOVE EXISTING WATER, WASTE AND VENT CONNECTIONS: CAP EXISTING LINES THAT ARE NOT RE-USED, AND COORDINATE WITH NEW WORK FOR EXTENT OF DEMOLITION FOR CONNECTION TO NEW.
- REMOVE EXISTING WATER FOUNTAIN; REMOVE EXISTING WATER AND WASTE CONNECTIONS; COORDINATE WITH NEW WORK FOR EXTENT OF DEMOLITION FOR CONNECTION TO NEW.
- REMOVE FLOOR DRAINS DOWN TO TRAP; CAP EXISTING 4 WASTE LINE BELOW FLOOR. COORDINATE WITH NEW WORK FOR EXTENT OF DEMOLITION FOR CONNECTION TO NEW.
- REMOVE EXISTING WATER LINES AND DROPS WHERE 5 SHOWN; COORDINATE CONNECTION OF NEW TO EXISTING; TYPICAL ALL WATER CLOSETS AND URINALS.
- 6 EXISTING WATER LINES, VENT LINES AND WASTE LINES TO REMAIN.
- 7 NEW SINK, UNDER COUNTER MOUNT. CONNECT NEW WATER LINES BACK TO WALL AND RECONNECT TO EXISTING. PROVIDE NEW 1/4 STOPS.
- PROVIDE NEW WATER CLOSETS AND URINALS. CONNECT NEW WATER, WASTE AND VENT CONNECTIONS TO EXISTING; CONTRACTOR TO SAW CUT WHERE REQUIRED TO INSTALL NEW WASTE LINES BELOW SLAB FOR FLOOR MOUNT WATER CLOSETS. PROVIDE NEW 2" VENT RISER FROM EACH NEW FIXTURE AND TIE INTO EXISTING IN CHASE.
- 9 PROVIDE NEW DUAL WATER FOUNTAIN WITH BOTTLE FILLER; TIE NEW WATER, WASTE AND VENT CONNECTIONS TO EXISTING.
- PROVIDE NEW FLOOR DRAINS WHERE SHOWN; 2" WASTE 10 LINE TO BE ROUTED BACK TO EXISTING. COORDINATE NEW WORK WITH ARCHITECTURAL PLANS FOR FLOOR SLOPING TO FLOOR DRAIN. CONTRACTOR TO PROVIDE SAW CUTS FOR INSTALLATION OF NEW FLOOR DRAINS TO EXISTING WASTE LINE.
- 11 PROVIDE NEW WATER LINES AND DROPS WHERE SHOWN; 1" CW DROPS TO EACH WATER CLOSET AND URINAL
- 12 EXISTING WATER LINES, VENT LINES AND WASTE LINES TO REMAIN.
- 13 REMOVE WASTE LINE UNDER COUNTER BACK TO SINK SIDE OF WALL; COORDINATE WITH NEW WORK FOR **RE-CONNECTION.**
- 14 REMOVE WATER LINES TO SINK UNDER CABINET BACK TO CABINET PENETRATION AT INSIDE OF CABINET; COORDINATE WITH NEW WORK FOR RE-CONNECTION.
- 15 REMOVE EXISTING SINK AND DISPOSER COMPLETE. COORDINATE WITH ARCHITECTURAL DEMOLITION PLANS.
- 16 RE-CONNECT NEW SINK TO EXISTING CW AND HW LINES BELOW SINK CABINET; COORDINATE WITH ARCHITECTURAL PLANS FOR CABINET STYLE. PROVIDE NEW 1/4 STOPS.
- DISPOSAL BELOW CABINET IN CORNER; PIPE NEW 17 WASTE LINES TO/FROM THE NEW SINK TO DISPOSAL AND SLOPE BACK TO EXISTING WASTE LINE CONNECTION BELOW CABINET. COORDINATE CLEARANCES AND REQUIREMENTS FOR PIPING PRIOR TO COMMENCEMENT OF WORK. DISPOSER TO BE LOCATED TO THE WEST WALL TO ALLOW INSTALLATION OF ADA SKIRT AT SINK. ACCESS WILL BE PROVIDED IN THE MILLWORK.
- ICE MAKER BOX IN WALL TO SERVE (2) REFRIGERATORS. 18 PROVIDE 1/4" COPPER PIPING TO BOTH REFRIGERATORS. MOUNT AT 48" A.F.F. PLUMBING CONTRACTOR TO PROVIDE 3/8" BRAIDED WATER CONNECTION LINES FROM IMB-1 TO EXISTING REFRIGERATORS. FIELD COORDINATE REQUIREMENTS.
- 19 LINE SIZE BALL VALVES; PROVIDE ACCESS PANEL IN ACCESSIBLE LOCATION NEW VALVES FOR ADJUSTMENT.
- 20 PROVIDE NEW 2" WASTE LINE CONNECTION AND 1-1/2" VENT TO EXISTING; COORDINATE WITH DEMOLITION PRIOR TO COMMENCEMENT OF WORK.
- 21 EXISTING 1-1/2" VENT TO 3" VTR TO REMAIN.
- 22 EXISTING SERVICE SINK AND RELATING PIPING TO REMAIN.



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NO.	DATE	DESCRIPTION
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2	09-30-2024	PR02

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CONSTRUCTION DOCUMENTS - BID SET MAY 02, 2024

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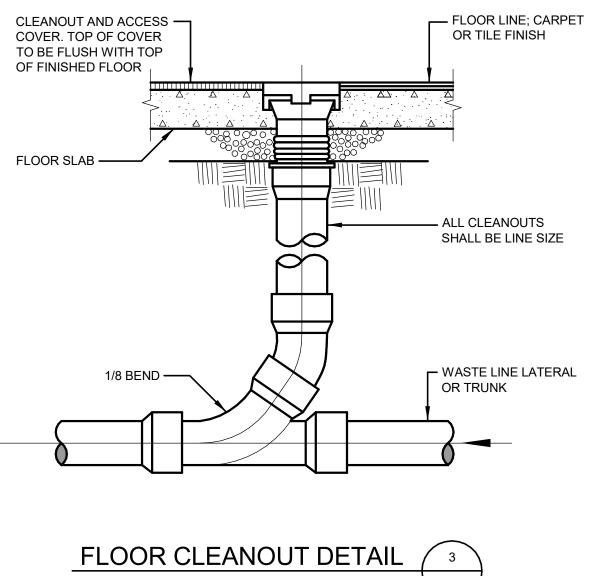
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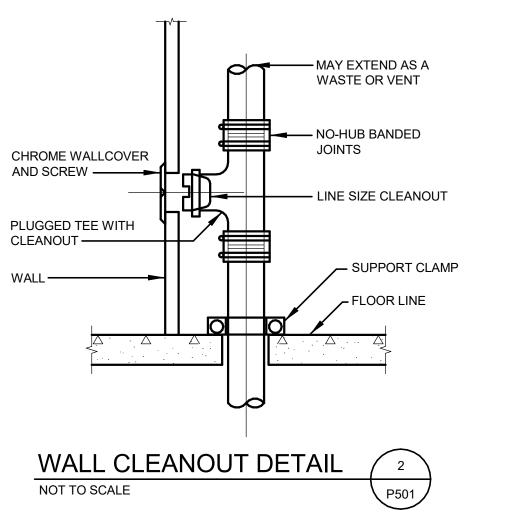
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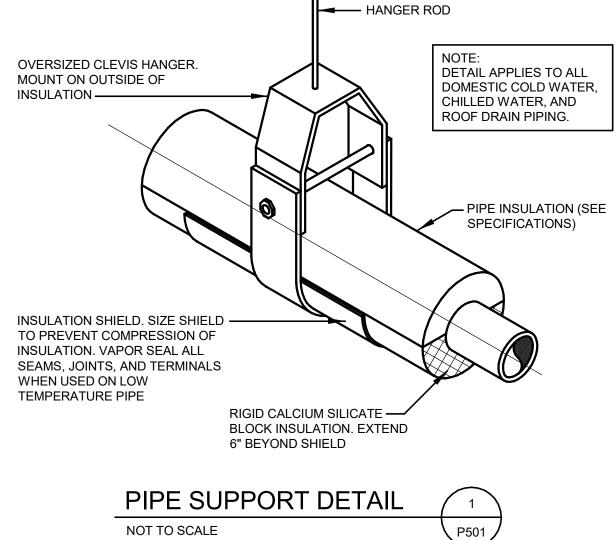


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	BRA	NCH V	VATER	LINES	SCHED	ULE	
FIXTURE	FIXTURE			FIXTURES S	-		-
	UNITS	1/2"	3/4"	1"	1 1/4"	1-1/2"	2"
WATER CLOSET	10			1	2	3	8
URINAL	5		1	2	3	6	20
LAVATORY	2	1	3	5	7	15	50
SINK	2	1	3	5	7	15	50
KITCHEN SINK	2	1	3	5	7	15	50
DRINKING FOUNTAIN	1	2	6	10	15	30	
TOTAL FIXTURE UNITS SERVED BY PIPE SIZE		2	6	10	15	30	100



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SYMBOL	FIXTURE	WASTE	VENT	C.W.	H.W.	TEMP. W.	
WC 1	WATER CLOSET	4"	2"	1"			WALL MOU
$\frac{\text{WC}}{2}$	WATER CLOSET	4"	2"	1"			FLOOR MOL
$\left\langle \begin{array}{c} U \\ 1 \end{array} \right\rangle$	URINAL	3"	2"	1"			WALL M
$\begin{pmatrix} L \\ 1 \end{pmatrix}$	LAVATORY	1-1/2"	1-1/2"	1/2"	1/2"	1/2"	UNDERCO FAUC
$\left\langle \begin{array}{c} S \\ 1 \end{array} \right\rangle$	SINK	1-1/2"	1-1/2"	1/2"	1/2"		DBL COMP
$\left\langle \begin{array}{c} D\\ 1 \end{array} \right\rangle$	DISPOSER	1-1/2"	1-1/2"	1/2"			SINK S-
	DRINKING FOUNTAIN	1-1/2"	1-1/2"	1/2"			WALL MOUI FILLE
(IMB)	ICE MAKER BOX	-	-	1/2"	-		SERV
$\left\langle \begin{array}{c} TV \\ 1 \end{array} \right\rangle$	TEMPERING VALVE			1/2"	1/2"	1/2"	SII MOL
FD 1	FLOOR DRAIN	2"	1-1/2"	-	-		AN
NOTES	<u>:</u>						

(2) 120 VOLT SENSOR

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VENT	C.W.	H.W.	TEMP. W.	NOTES (1)(2)
2"	1"			(2) WALL MOUNTED - SENSOR FLUSH VALVE
2"	1"			FLOOR MOUNTED - SENSOR FLUSH VALVE ⁽²⁾ (ADA)
2"	1"			(2) WALL MOUNTED - SENSOR FLUSH
1-1/2"	1/2"	1/2"	1/2"	UNDERCOUNTER MOUNTED W/ SENSOR ⁽²⁾ FAUCET - (ADA) W/ ASSE TV-1
1-1/2"	1/2"	1/2"		DBL COMP. SS WITH STANDARD FAUCET
1-1/2"	1/2"	-		SINK S-1 L.H. SIDE 3/4 H.P. 120/1/60
1-1/2"	1/2"			WALL MOUNTED - BI-LEVEL WITH BOTTLE FILLER ON LOW SIDE 120/1/60
-	1/2"	-		SERVES (2) REFRIGERATORS
	1/2"	1/2"	1/2"	SINGLE LAV. ASSE 1070 MOUNT UNDER LAVATORY
1-1/2"				W/DEEP SEAL TRAP AND ASSE TRAP GUARD

4

(1) CONTRACTOR SHALL VERIFY EXACT LOCATION OF ALL PLUMBING FIXTURES AND DRAINS WITH ARCHITECTURAL DRAWINGS PRIOR TO ROUGH-IN OR INSTALLATION.

PR02 09-30-24

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SEAL



MHTN PROJECT NO.2023573

VIEW AND PRINT THIS DRAWING IN COLOR Original drawing is 24 x 36. Do not scale contents of this drawing. ISSUED:

NO.	DATE	DESCRIPTION
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REVISIONS CONTRACTOR TO VERIFY DRAWINGS IN FIELD USE REFLECT LAST REVISION DATE. _____


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CONSTRUCTION DOCUMENTS - BID SET MAY 02, 2024

E PLUMBING SCHEDULES & DETAILS

SHEET NUMBER

P501

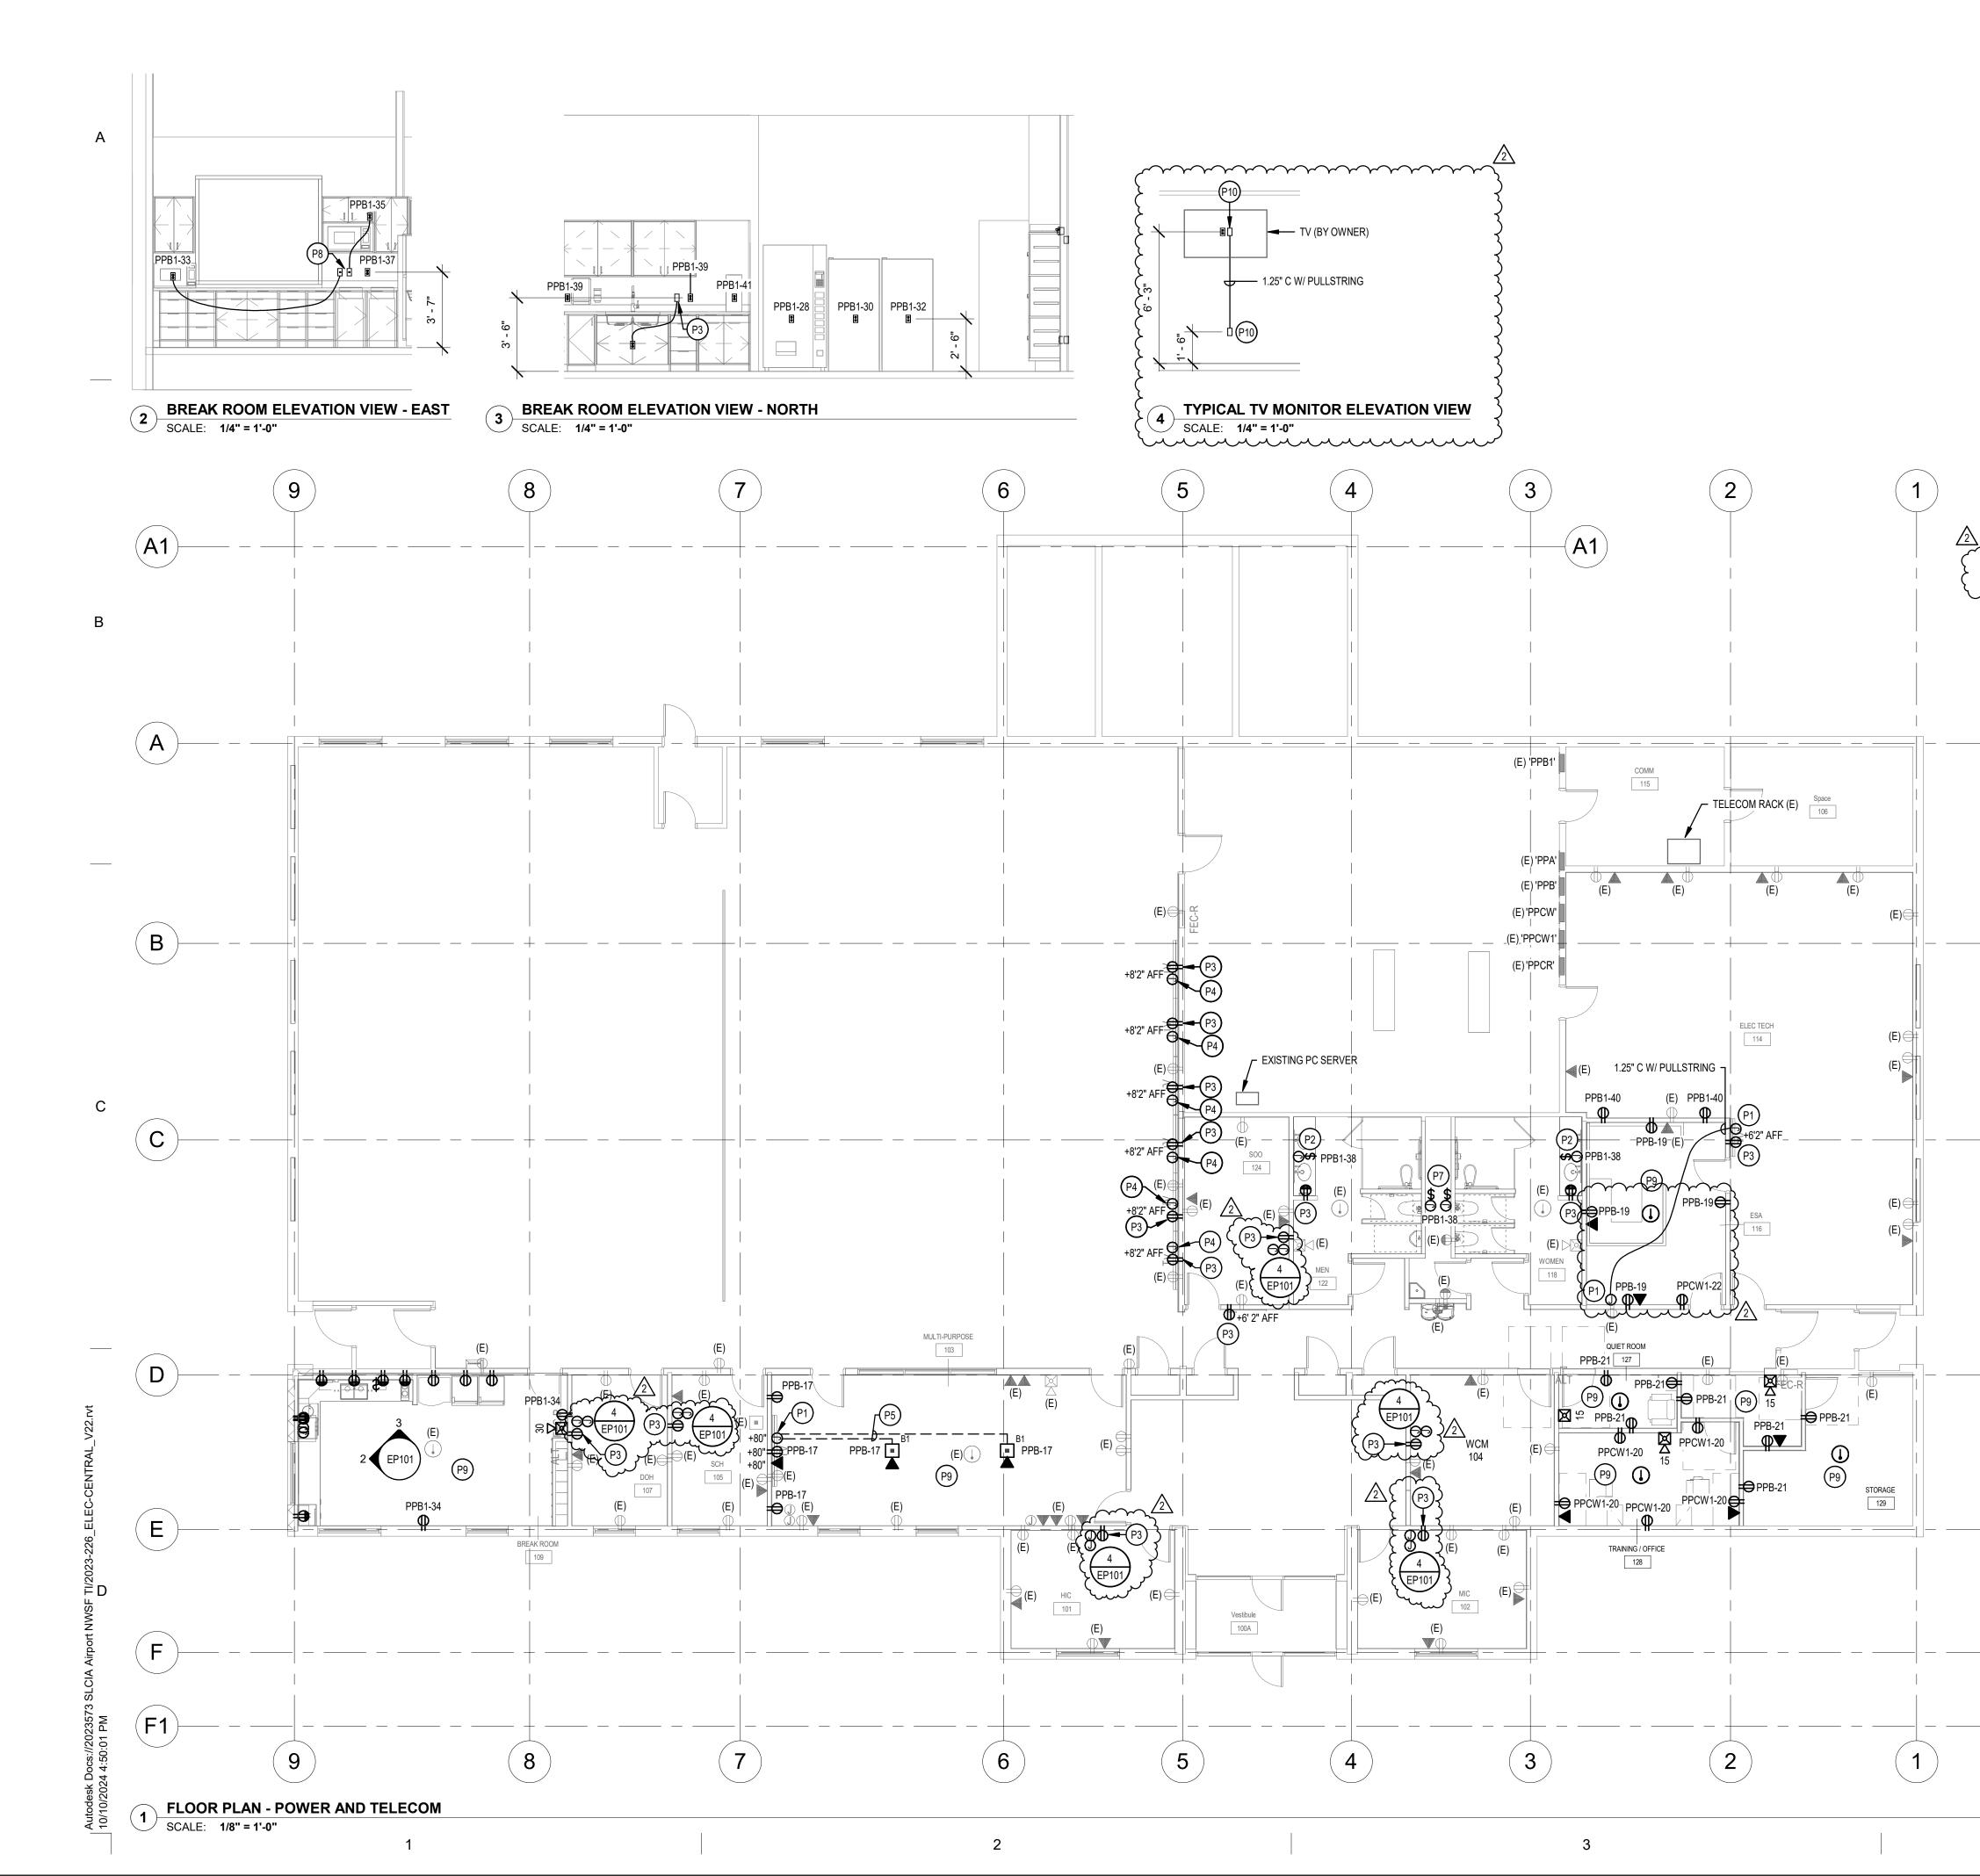

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1	ALL 120V, 20AMP OUTLETS THAT ARE WITHIN 6' OF ANY SINK SHALL BE
1.	GFCI.
2.	THE DIVISION 26 CONTRACTOR SHALL DETERMINE THE EXACT ROUTING OF ALL CONDUITS IN THE FIELD. THIS PLAN REPRESENTS A SCHEMATIC REPRESENTATION OF DEVICE LOCATIONS AND CONDUIT RUNS.
KEY	ED NOTES (#)
P1	PROVIDE JUNCTION BOX WITH SINGLE MUD RING AND COVER PLATE WITH 2" RUBBER GROMMET. SIZE BOX PER NEC.
P2	PROVIDE JUNCTION BOX AND TOGGLE SWITCH (EQUIVALENT TO HUBBELL HBL1221L, 20A, 1-POLE, 120V) FOR AUTO SINK FAUCET. PROVIDE JUNCTION BOX TO SINK LOCATION. PLUMBING CONTRACTOR SHALL PROVIDE TRANSFORMER AND LOW VOLTAGE WIRING.
P3	TIE TO EXISTING CIRCUIT. EXTEND CONDUIT AND CONDUCTORS AS REQUIRED.
P4	PROVIDE JUNCTION BOX WITH SINGLE MUD RING AND COVER PLATE WITH 2" RUBBER GROMMET EXTEND 1" CONDUIT WITH PULLSTRING FROM JUNCTION BOX TO EXISTING TELECOM RACK.
P5	EXTEND 1.25" CONDUIT WITH PULLSTRING FROM FLOOR BOX TO WALL MOUNTED JUNCTION BOX FOR TV CABLING. SAWCUT EXISTING SLAB AS REQUIRED, REFER TO ARCHITECTURAL PLANS FOR MORE INFORMATION.
P7	PROVIDE JUNCTION BOX AND TOGGLE SWITCH (EQUIVALENT TO HUBBELL HBL1221L, 20A, 1-POLE, 120V) FOR AUTO URINALS AND WATER CLOSETS. PROVIDE JUNCTION BOX IN THE LOCATION SHOWN. PLUMBING CONTRACTOR SHALL PROVIDE TRANSFORMER AND LOW VOLTAGE WIRING.
P8	PROVIDE BLANK FACE GFCI FOR PROTECTING MICROWAVE RECEPTACLE. PROVIDE LABEL "MW GFCI".
P9	RE-USE EXISTING CONDUIT AND CONDUCTORS WHEREVER POSSIBLE IN THE SPACE. EXTEND NEW CONDUIT AND BRANCH CIRCUIT WIRING AS REQUIRED.
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P10	PROVIDE 1 GANG BOX WITH CABLE ACCESS BRUSH STRAP WALL PLATE LEGRAND WP1014 (OR APPROVED EQUAL).



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240 E. MORRIS AVE. SUITE 200 SALT LAKE CITY, UT 84115 P (801) 534-1130 F (801) 534-1080

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SHEET NUMBER

E FLOOR PLAN -POWER AND SYSTEMS

EP101

MAY 02, 2024

CONSTRUCTION DOCUMENTS - BID SET

 NO.∆
 DATE
 DESCRIPTION

 1
 05/17/2024
 ADDENDUM 1

 2
 10/11/2024
 PR 02

REVISIONS CONTRACTOR TO VERIFY DRAWINGS IN FIELD USE REFLECT LAST REVISION DATE.

DESCRIPTION

NO. DATE

ISSUED:

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02/19/2024

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