


# HILLCREST 1, 2 RE-ROOF & STRUCTURAL UPGRADES LOGAN UTAH EAST STAKE

875 NORTH 1500 EAST  
LOGAN, UTAH 84321  
PROP NO. 5016495

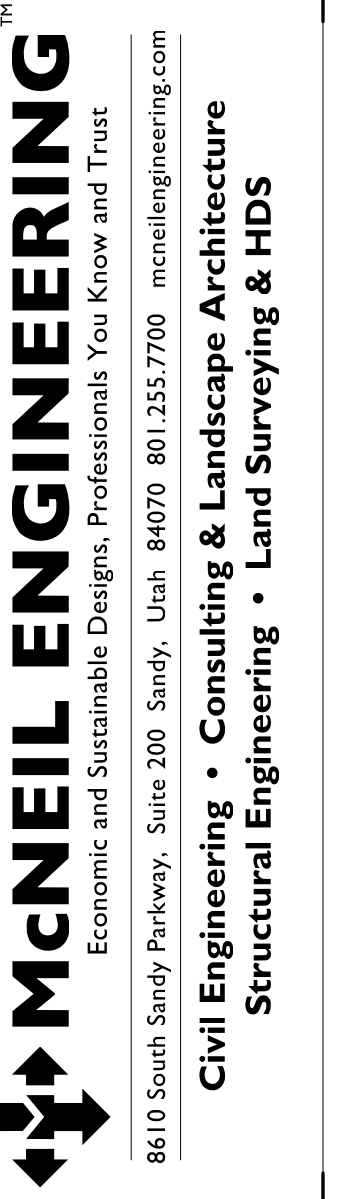

**HILLCREST 1, 2 RE-ROOF**  
The Church of Jesus Christ of Latter-Day Saints  
LOGAN UTAH EAST STAKE  
875 NORTH 1500 EAST  
LOGAN, UTAH 84321



REVISIONS	
DATE	DESCRIPTION

PROJECT NO.	19294
DRAWN BY	AJV/BV
CHECKED BY	CEG
DATE	11 APRIL 2022
PROP. NO.	5016495

COVER SHEET

**G1.00**

**APRIL 2022**

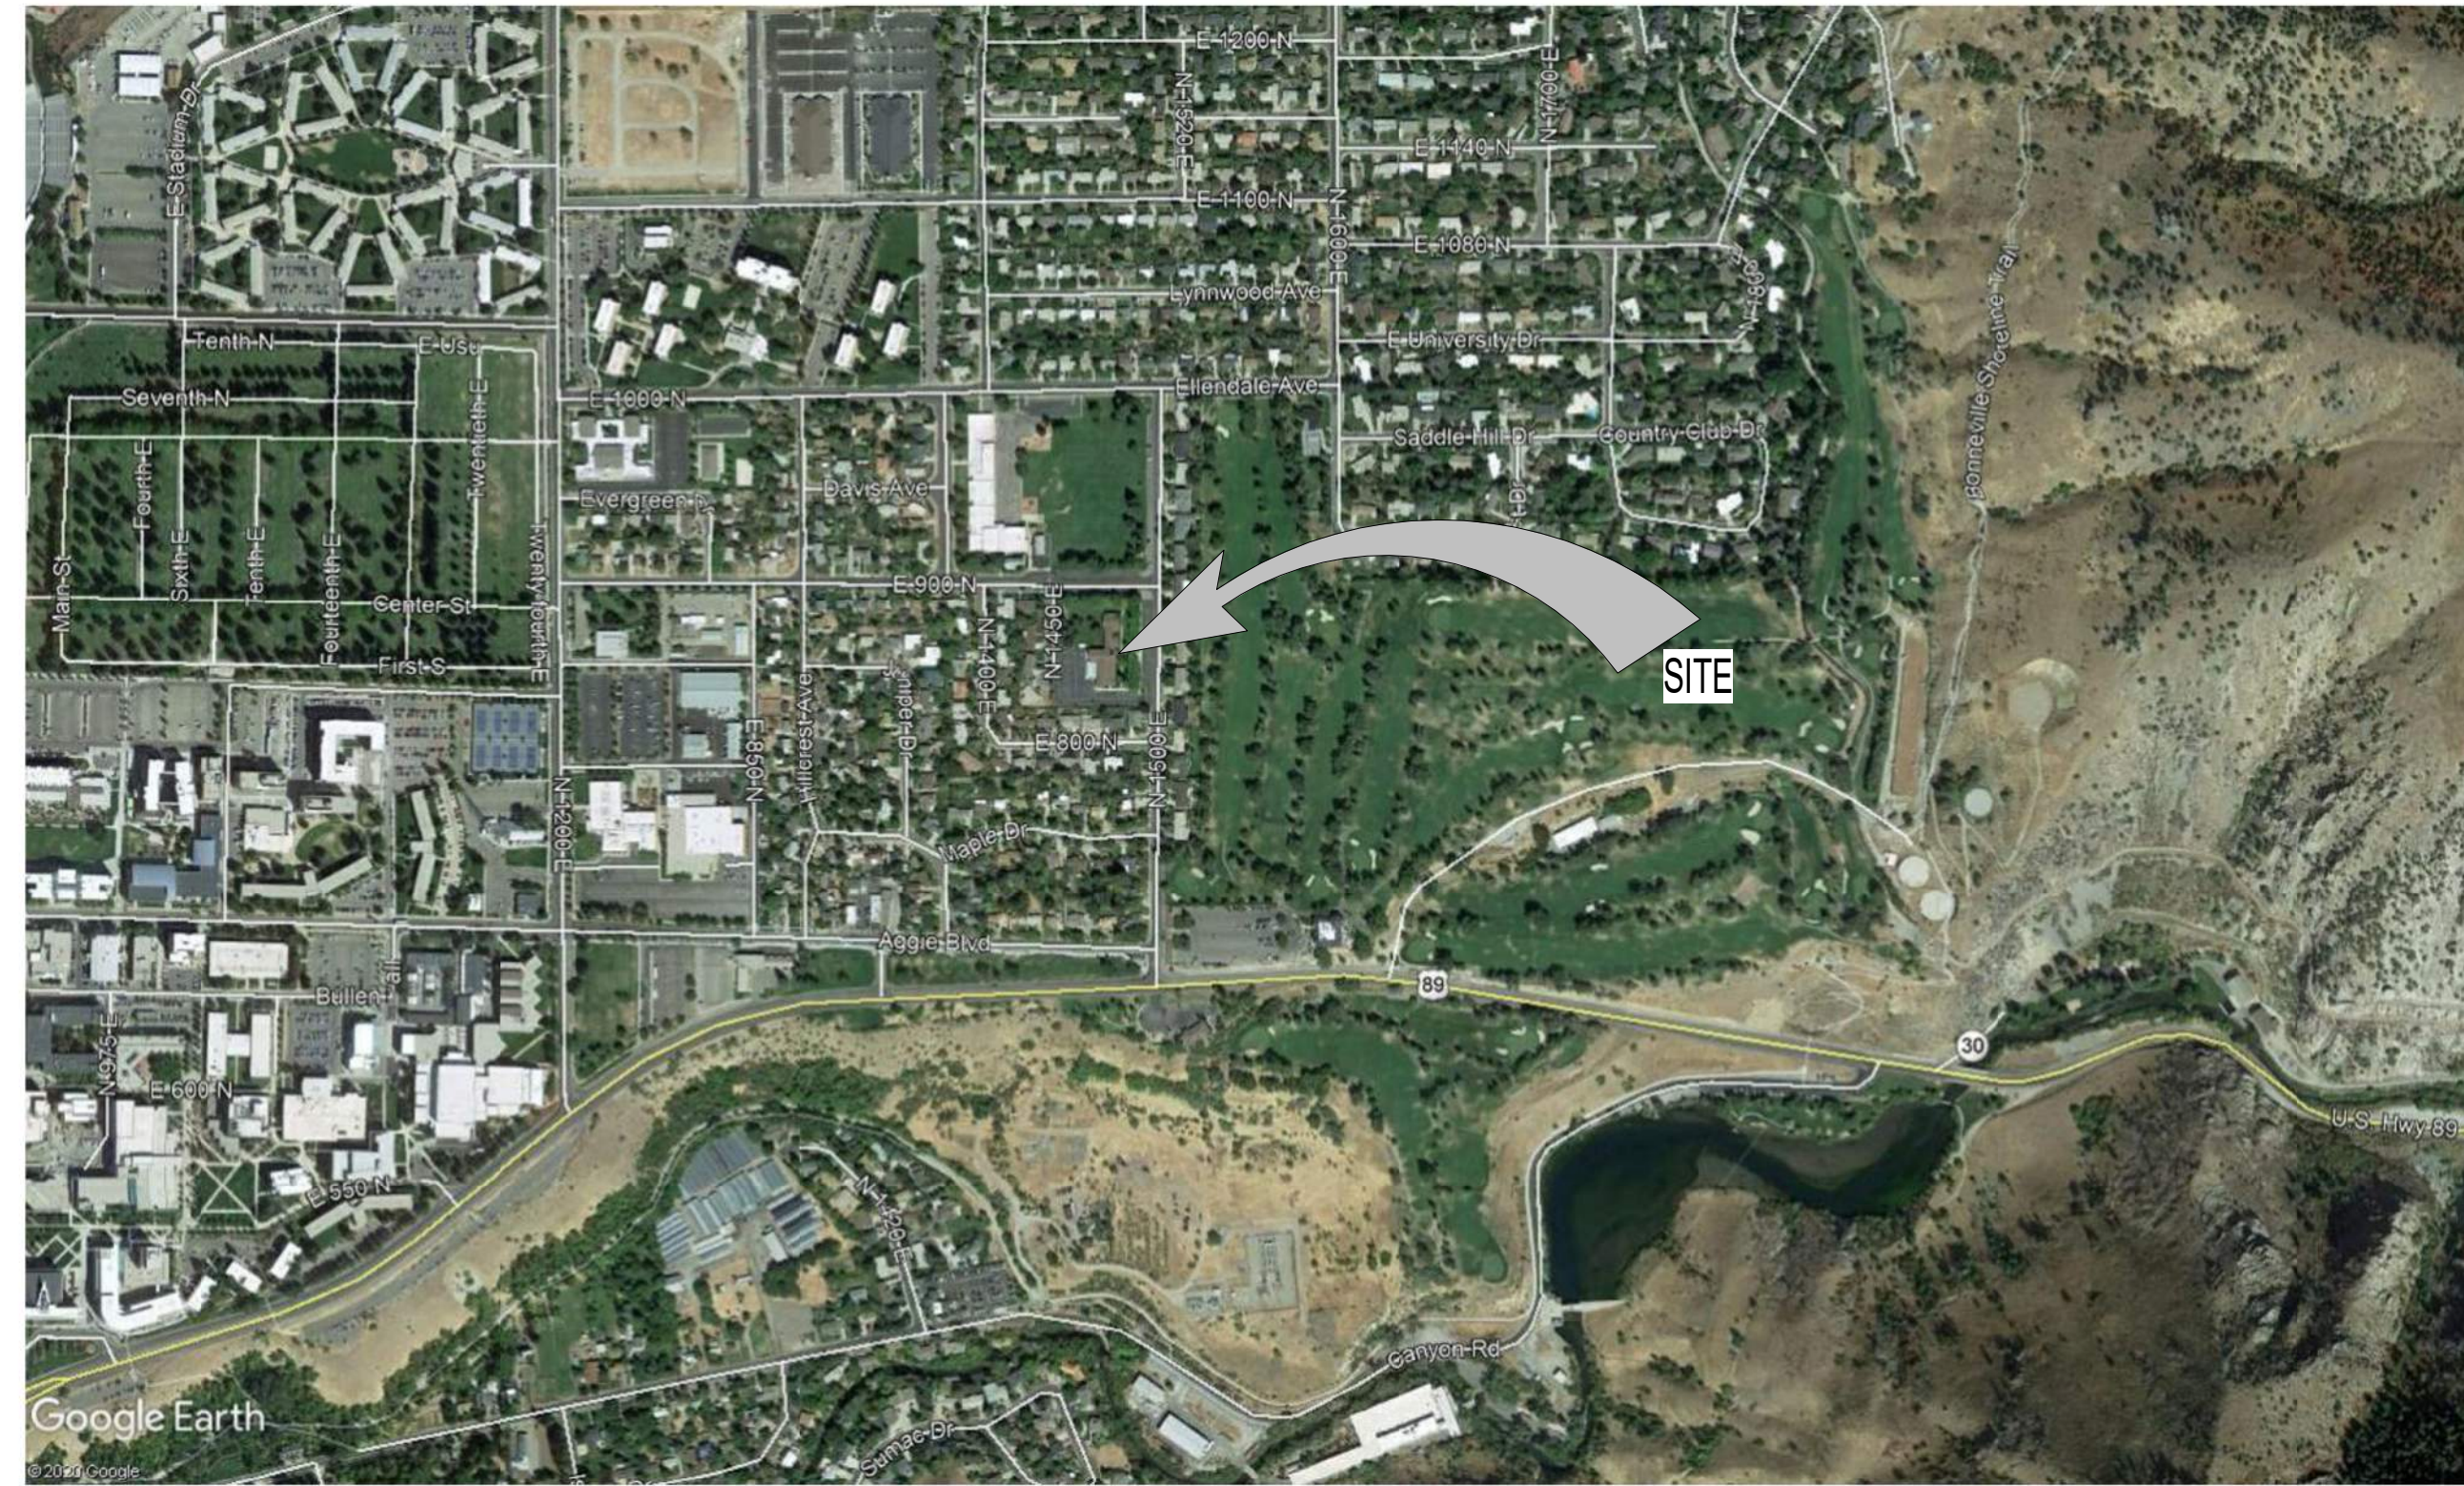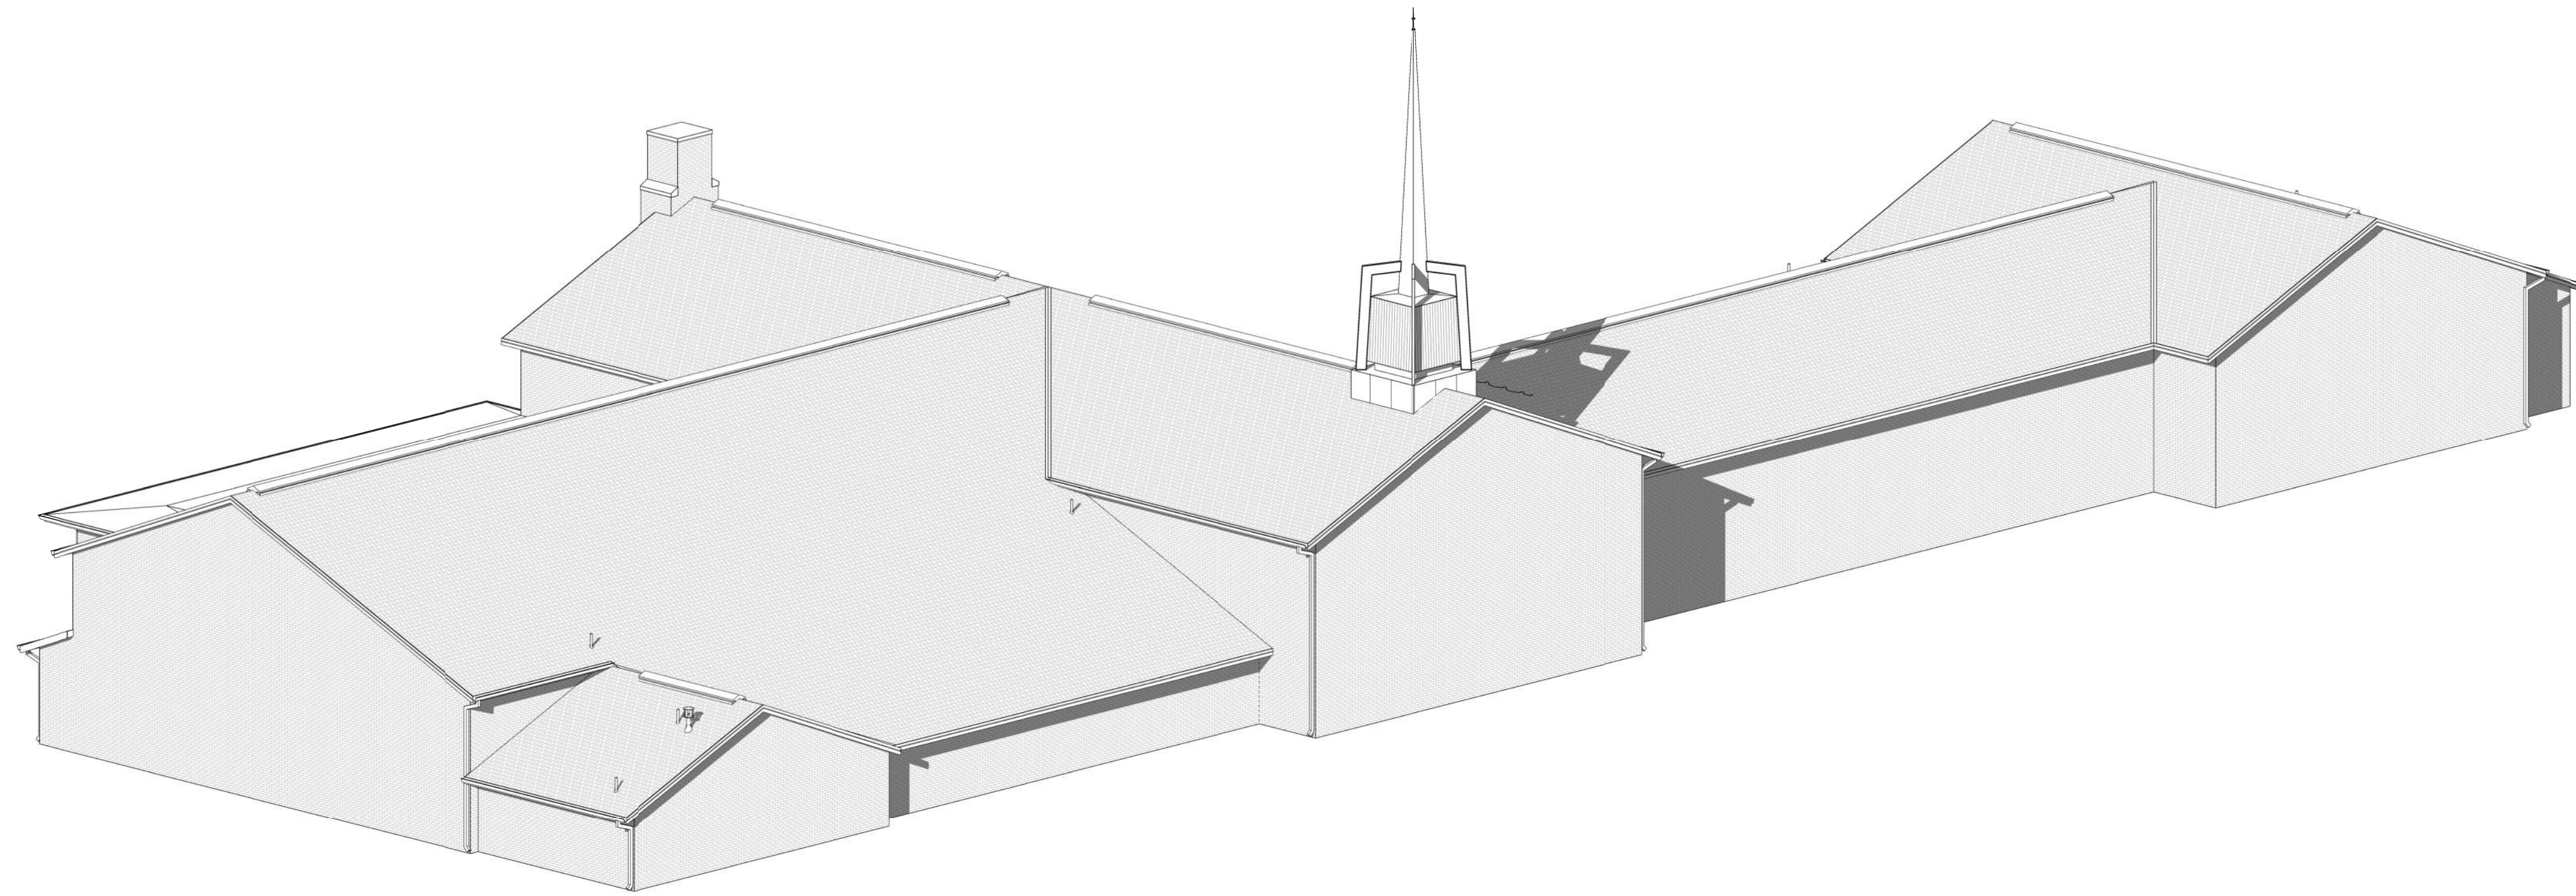

VICINITY MAP

**GENERAL NOTES:**

1. CONTRACTOR MUST VISIT THE SITE SO AS TO BE FAMILIAR WITH ALL EXISTING CONDITIONS BEFORE SUBMITTING BID. BRING ANY QUESTIONS OR CONCERNS TO THE ATTENTION OF THE ENGINEER FOR CLARIFICATION. FOR ADDENDUM PRIOR TO BID OPENING. NO ALLOWANCES WILL BE MADE FOR CONDITIONS THAT ARE CLEARLY VISIBLE.
2. CONTRACTOR SHALL WORK WITH LOCAL REPRESENTATIVE ON SCHEDULING TO INSURE CONTINUED USE OF THE BUILDING. NEITHER THE CONTRACTOR NOR ANY OF HIS PEOPLE SHALL HAVE ACCESS TO THE BUILDING WITHOUT PRIOR AUTHORIZATION.
3. ALL SAFETY STANDARDS AND REQUIREMENTS ARE THE RESPONSIBILITY OF THE CONTRACTOR.
4. EXISTING ROOF PENETRATIONS WILL BE FLASHED AND PAINTED.
5. ALL EXISTING ROOF VENTS, MECHANICAL UNITS, ROOF HATCHES, ETC. WILL BE A MINIMUM OF 10' ABOVE THE FINISHED ROOF.
6. ALL NEW METAL WILL BE GALVANIZED OR PRE-FINISHED. CAULKING WILL BE SAME COLOR AS METAL.
7. BEFORE FABRICATION OF ANY SHEET METAL WORK, SUBMIT SHOP DRAWINGS TO ENGINEER FOR REVIEW AND APPROVAL. ALL WORK TO CONFORM TO NRCA OR SMACNA DETAILS AND REQUIREMENTS WHERE NOT SPECIFICALLY DETAILED OTHERWISE.
8. COMPLY WITH ALL MANUFACTURER'S SPECIFICATIONS AND RECOMMENDATIONS.
9. CONTRACTOR RESPONSIBLE TO KEEP BUILDING WATERTIGHT AT ALL TIMES. STARTING FROM NOTICE TO PROCEED TO SUBSTANTIAL COMPLETION ANY DAMAGE TO THE BUILDING OR ITS CONTENTS WILL BE THE RESPONSIBILITY OF THE CONTRACTOR.
10. CONTRACTOR TO CHECK ALL MECHANICAL EQUIPMENT BEFORE DISCONNECTING TO MAKE SURE THEY ARE OPERATING PROPERLY. CONTRACTOR IS ALSO RESPONSIBLE FOR UNITS TO BE IN COMPLETE OPERATING CONDITION AT THE COMPLETION OF THE PROJECT. COORDINATE SHUTDOWN WITH USERS.
11. RAIN GUTTERS & DOWNSPOUTS HEADS:
  - a. RIVETS & SCREWS TO BE PAINTED SAME COLOR (NO SPRAY PAINT)
  - b. USE POP RIVETS AT ALL CONNECTIONS FROM GUTTERS TO DOWNSPOUTS.
  - c. DOWNSPOUTS TO CONNECT TO EXISTING SUB-GRADE DRAINAGE SYSTEM WHERE THERE IS EXISTING DRAINAGE SYSTEM. PROVIDE NEW CONNECTION FITTING.
  - d. DOWNSPOUTS NOT CONNECTED TO DRAINAGE SYSTEM WILL EMPTY ONTO A NEW 12"x30" PRE-CAST SPLASH BLOCK.
  - e. ALL JOINTS TO BE SEALED WATER TIGHT.
12. BEFORE ORDERING ANY MATERIALS, VERIFY ALL EXISTING CONDITIONS AND DIMENSIONS. **DO NOT SCALE DRAWINGS FOR QUANTITIES.**
13. BEFORE INSTALLATION OF ALL NEW PIPE JACKS AND PIPE FLASHINGS VERIFY THAT ALL MECHANICAL FLUES AND VENTS ARE STRAPPED TO PREVENT ANY SETTLEMENT OR SHIFTING INTO ROOF. PRIOR TO COMPLETION OF WORK, CONTRACTOR TO VERIFY THAT MECHANICAL EQUIPMENT VENTING TO HAVE POSITIVE RELEASE FLOW TO ROOF VENT AND FLUE IS SECURED TO ORIGINAL HEIGHT AND ALL CONNECTIONS ARE TIGHT AND SECURE.
14. ANY SIDING, FASCIA, ETC. THAT NEEDS TO BE REMOVED TO COMPLETE THIS JOB IS TO BE PART OF THE CONTRACT. CARE MUST BE TAKEN TO ENSURE THAT ALL ITEMS TO BE REINSTALLED ARE NOT DAMAGED DURING REMOVAL AND/OR INSTALLATION. ALL PIECES THAT ARE DAMAGED WILL BE REPLACED BY CONTRACTOR.
15. AT THE END OF CONSTRUCTION, CONTRACTOR IS TO CLEAN OUT AND FLUSH ALL RAIN GUTTERS & DOWNSPOUTS TO MAKE SURE THEY ARE NOT PLUGGED AND ARE IN WORKING CONDITION.
16. CONTRACTOR TO SUPPLY AN ON SITE PORTABLE RESTROOM. FACILITY RESTROOMS ARE NOT TO BE USED BY CONTRACTOR OR CONTRACTOR'S EMPLOYEES. LOCATION OF PORTABLE RESTROOM TO BE DETERMINED DURING PRE-CONSTRUCTION MEETING.

**SHEET INDEX**

SHEET NO.	SHEET TITLE
G1.00	COVER SHEET
G1.01	GENERAL NOTES & ABBREVIATIONS
A1.01	ROOF PLAN
A2.01	EXTERIOR ELEVATIONS
A2.02	EXTERIOR ELEVATIONS
A5.01	ROOF DETAILS
A5.02	ROOF DETAILS
A5.03	ROOF DETAILS
S0.00	GENERAL STRUCTURAL NOTES
S1.00	ROOF FRAMING PLAN
S5.00	STRUCTURAL DETAILS

**COMMON SYMBOLS & ABBREVIATIONS**

SYMBOLS	ABBREVIATIONS
ROOM FINISH KEYNOTE	A.F.F. = ABOVE FINISHED FLOOR W.H. = WATER HEATER SEC. = SECTION
GENERAL KEYNOTE	ALUM. = ALUMINUM LT. = LIGHT SECT. = SECTION
WALL CALLOUT	BD. = BOARD MAX. = MAXIMUM SIM. = SIMILAR
WINDOW CALLOUT	CONC. = CONCRETE MECH. = MECHANICAL T&G = TUNG & GROOVE
DOOR CALLOUT	DIA. = DIAMETER MFR. = MANUFACTURER T.O. = TOP OF
SECTION CALLOUT	EA. = EACH MH = MANHOLE TYP. = TYPICAL
ELEVATION CALLOUT	FD = FLOOR DRAIN MIN. = MINIMUM U.N.O. = UNLESS NOTED OTHERWISE
DETAIL CALLOUT	FURN. = FURNACE NO. = NUMBER WT. = WEIGHT
ELEVATION MARKER	GA. = GAUGE N.T.S. = NOT TO SCALE VIF = VERIFY IN FIELD
	GALV. = GALVANIZED O.C. = ON CENTER
	GPF = GALLONS PER FLUSH O.H. = OVERHANG
	GYP. = GYPSUM PR. = PAIR
	HB = HOSE BIB RCP = REFLECTED CEILING PLAN
	H.C. = HANDI-CAP RE. = REFERENCE


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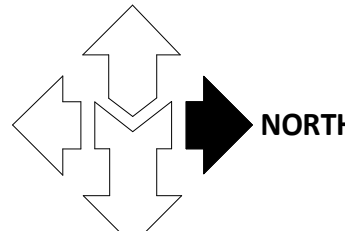
GENERAL NOTES & ABBREVIATIONS

**G1.01**


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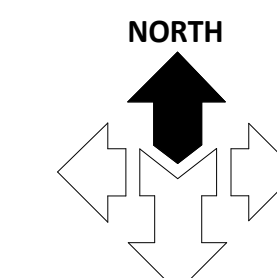
**ROOF PLAN**  
SCALE: 1/8" = 1'-0"



SCOPE OF WORK - ROOF PLAN	
#	DESCRIPTION
1	PRIOR TO COMMENCING WORK, CONTRACTOR IS TO READ & COMPLY WITH ALL APPLICABLE GENERAL NOTES FOUND ON SHEET G1.01
2	PRIOR TO REMOVAL OF ROOFING MATERIAL, INSTALL NEW STRAP ON ALL WATER HEATER FLUES AND VENT PIPE FLUES FROM FURNACES. SEE GENERAL NOTE 13/G1.01
3	DISCONNECT AND REMOVE ALL SNOW MELT CABLES. DISPOSE.
4	REMOVE EXISTING ASPHALT SHINGLE ROOFING, DRIP EDGE, PENETRATION FLASHING, FELTS, ETC. DOWN TO WOOD DECK. AFTER REMOVAL & PRIOR TO ANY NEW INSTALLATION, VISUALLY INSPECT EXISTING DECKING FOR ANY IRREGULARITIES, DRY ROT, DEFORMATIONS, ETC. BRING ANY DEFICIENCIES TO THE ATTENTION OF CONSULTANT BEFORE PROCEEDING. DISPOSE OF ALL WASTE MATERIALS LAWFULLY. PROVIDE IN BASE BID COSTS TO REMOVE AND REPLACE 800 SQ. FT. OF DAMAGED ROOF DECKING NOT OTHERWISE NOTED. MATCH THICKNESS OF EXISTING ROOF DECKING.
5	REMOVE & RECYCLE EXISTING METAL RAIN GUTTERS, DOWNSPOUTS, FLASHING, COUNTER FLASHING, DRIP EDGE & FASCIA
6	REMOVE EXISTING TURTLE VENTS. REPAIR ALL OPENINGS IN ROOF DECK. SEE DETAILS 1 & 2/A5.03
7	REMOVE EXISTING METAL VENT CAP AND CURB. EXTEND EXISTING VENT TO A POINT 30" MIN. ABOVE FINISHED ROOF. FLASH VENT PER DETAIL 8/A5.02
8	REMOVE EXISTING BUR MEMBRANE ROOFING SYSTEM DOWN TO WOOD DECK & DISPOSE. INSPECT ROOF DECK FOR DAMAGED PANELS. PROVIDE ALLOWANCE TO REPLACE 100 SQ. FT WITH NEW.
9	PROVIDE ADDITIONAL NAILING OF EXIST. ROOF DECK PER STRUCTURAL ENGINEER. SEE SHEETS S101, S102, S201 & S202. BID AS IF ONLY HALF OF THE REQUIRED NAILS ARE EXISTING
10	PERFORM SEISMIC AND STRUCTURAL UPGRADES TO ROOF AND WALL CONNECTIONS AND TRUSSES PER STRUCTURAL ENGINEER. SEE SHEETS S001, S101, S102, S201 & S202.
11	BOX OUT BELOW OVERHANGS. WRAP WITH ICE & WATER MEMBRANE AND COVER WITH 24 ga. PRE-FINISHED METAL PANEL, TO MATCH FASCIA AND FLASHING METAL. SEE DETAIL 7/A5.02
12	REMOVE & RECYCLE METAL SIDING ON BASE OF STEEPLE. PROVIDE STRUCTURAL IMPROVEMENTS TO SHEATHING PER ENGINEER. WRAP ENTIRE WOOD ASSEMBLY WITH GRACE "ICE & WATER SHIELD" AND INSTALL NEW METAL PANELS AND VERTICAL SIDING. SEE SHEET A5.03
13	INSTALL NEW SECONDARY UNDERLAYMENT PER PLAN AND SPECIFICATION
14	INSTALL NEW 24 ga. PRE-FINISHED METAL VALLEY METAL OVER SECONDARY UNDERLAYMENT PER PLAN AND SPECIFICATION. SEE DETAIL 10/A5.01
15	INSTALL NEW 24 ga. PRE-FINISHED METAL FASCIA. SEE DETAILS 2, 3, 4, 5, 6, 7, & 8/A5.01
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17	INSTALL NEW 24 ga. PRE-FINISHED METAL RAIN GUTTERS PER PLAN AND SPECIFICATIONS. SEE DETAILS 3, 4, 8, 12, & 13/A5.01
18	INSTALL NEW PRE-FINISHED METAL RIDGE VENT PER PLAN. PROVIDE NET FREE AREA AS REQUIRED PER SPECIFICATION. INSTALL PER DETAILS 1, 2, & 3/A5.02
19	INSTALL NEW ULTIMATE PIPE JACK FLASHINGS AT ALL MECHANICAL VENT PENETRATIONS PER SPECIFICATION AND DETAIL 11/A5.01 & 8/A5.02. CONTRACTOR MAY USE GALVANIZED METAL IN PLACE OF ULTIMATE FLASHINGS PROVIDED ALL JOINTS ARE SOLDERED SOLID.
19b	PROVIDE MANUFACTURER'S ONE PIECE PIPE FLASHING AT VENT PENETRATIONS
20	INSTALL NEW 40 YEAR ARCHITECTURAL PROFILE, COMPOSITION SHINGLE SYSTEM PER MANUFACTURER'S LATEST INSTRUCTIONS AND PER SPECIFICATIONS. INSTALL SYSTEM WITH ALL ASSOCIATED SHINGLES, UNDERLAYMENTS, FLASHINGS, ETC. AS REQUIRED FOR MANUFACTURER'S WARRANTY
21	INSTALL NEW 80mil PVC MEMBRANE ROOFING SYSTEM OVER 1/2" COVERBOARD. SEE DETAIL 8/A5.02.
22	INSTALL NEW 24 ga. PRE-FINISHED METAL DOWNSPOUTS. SEE DETAIL 12 & 13/A5.01. PROVIDE NEW PRE-CAST CONCRETE SPLASH BLOCK AT ALL LOCATIONS.
23	INSTALL NEW SNOW MELT CABLES PER PLAN AND SPECIFICATION. EXTEND CABLES FROM EAVE EDGE TO A MIN. 24" TO THE WARM SIDE OF THE EXTERIOR WALLS. PROVIDE NEW CLIPS AND FASTENERS PER CABLE MANUFACTURER'S LATEST RECOMMENDATION. PRIOR TO INSTALLATION, VERIFY THAT EXISTING CIRCUITS MEET SPECIFIED STANDARDS. SEE DETAIL 3/A5.03
24	REMOVE EXISTING ROOF SYSTEM AT SHED DOWN TO PLYWOOD SHEATHING. INSTALL NEW 80mil PVC MEMBRANE ROOFING SYSTEM OVER 1/2" COVERBOARD & TAPERED INSULATION. SEE DETAILS 9/A5.01

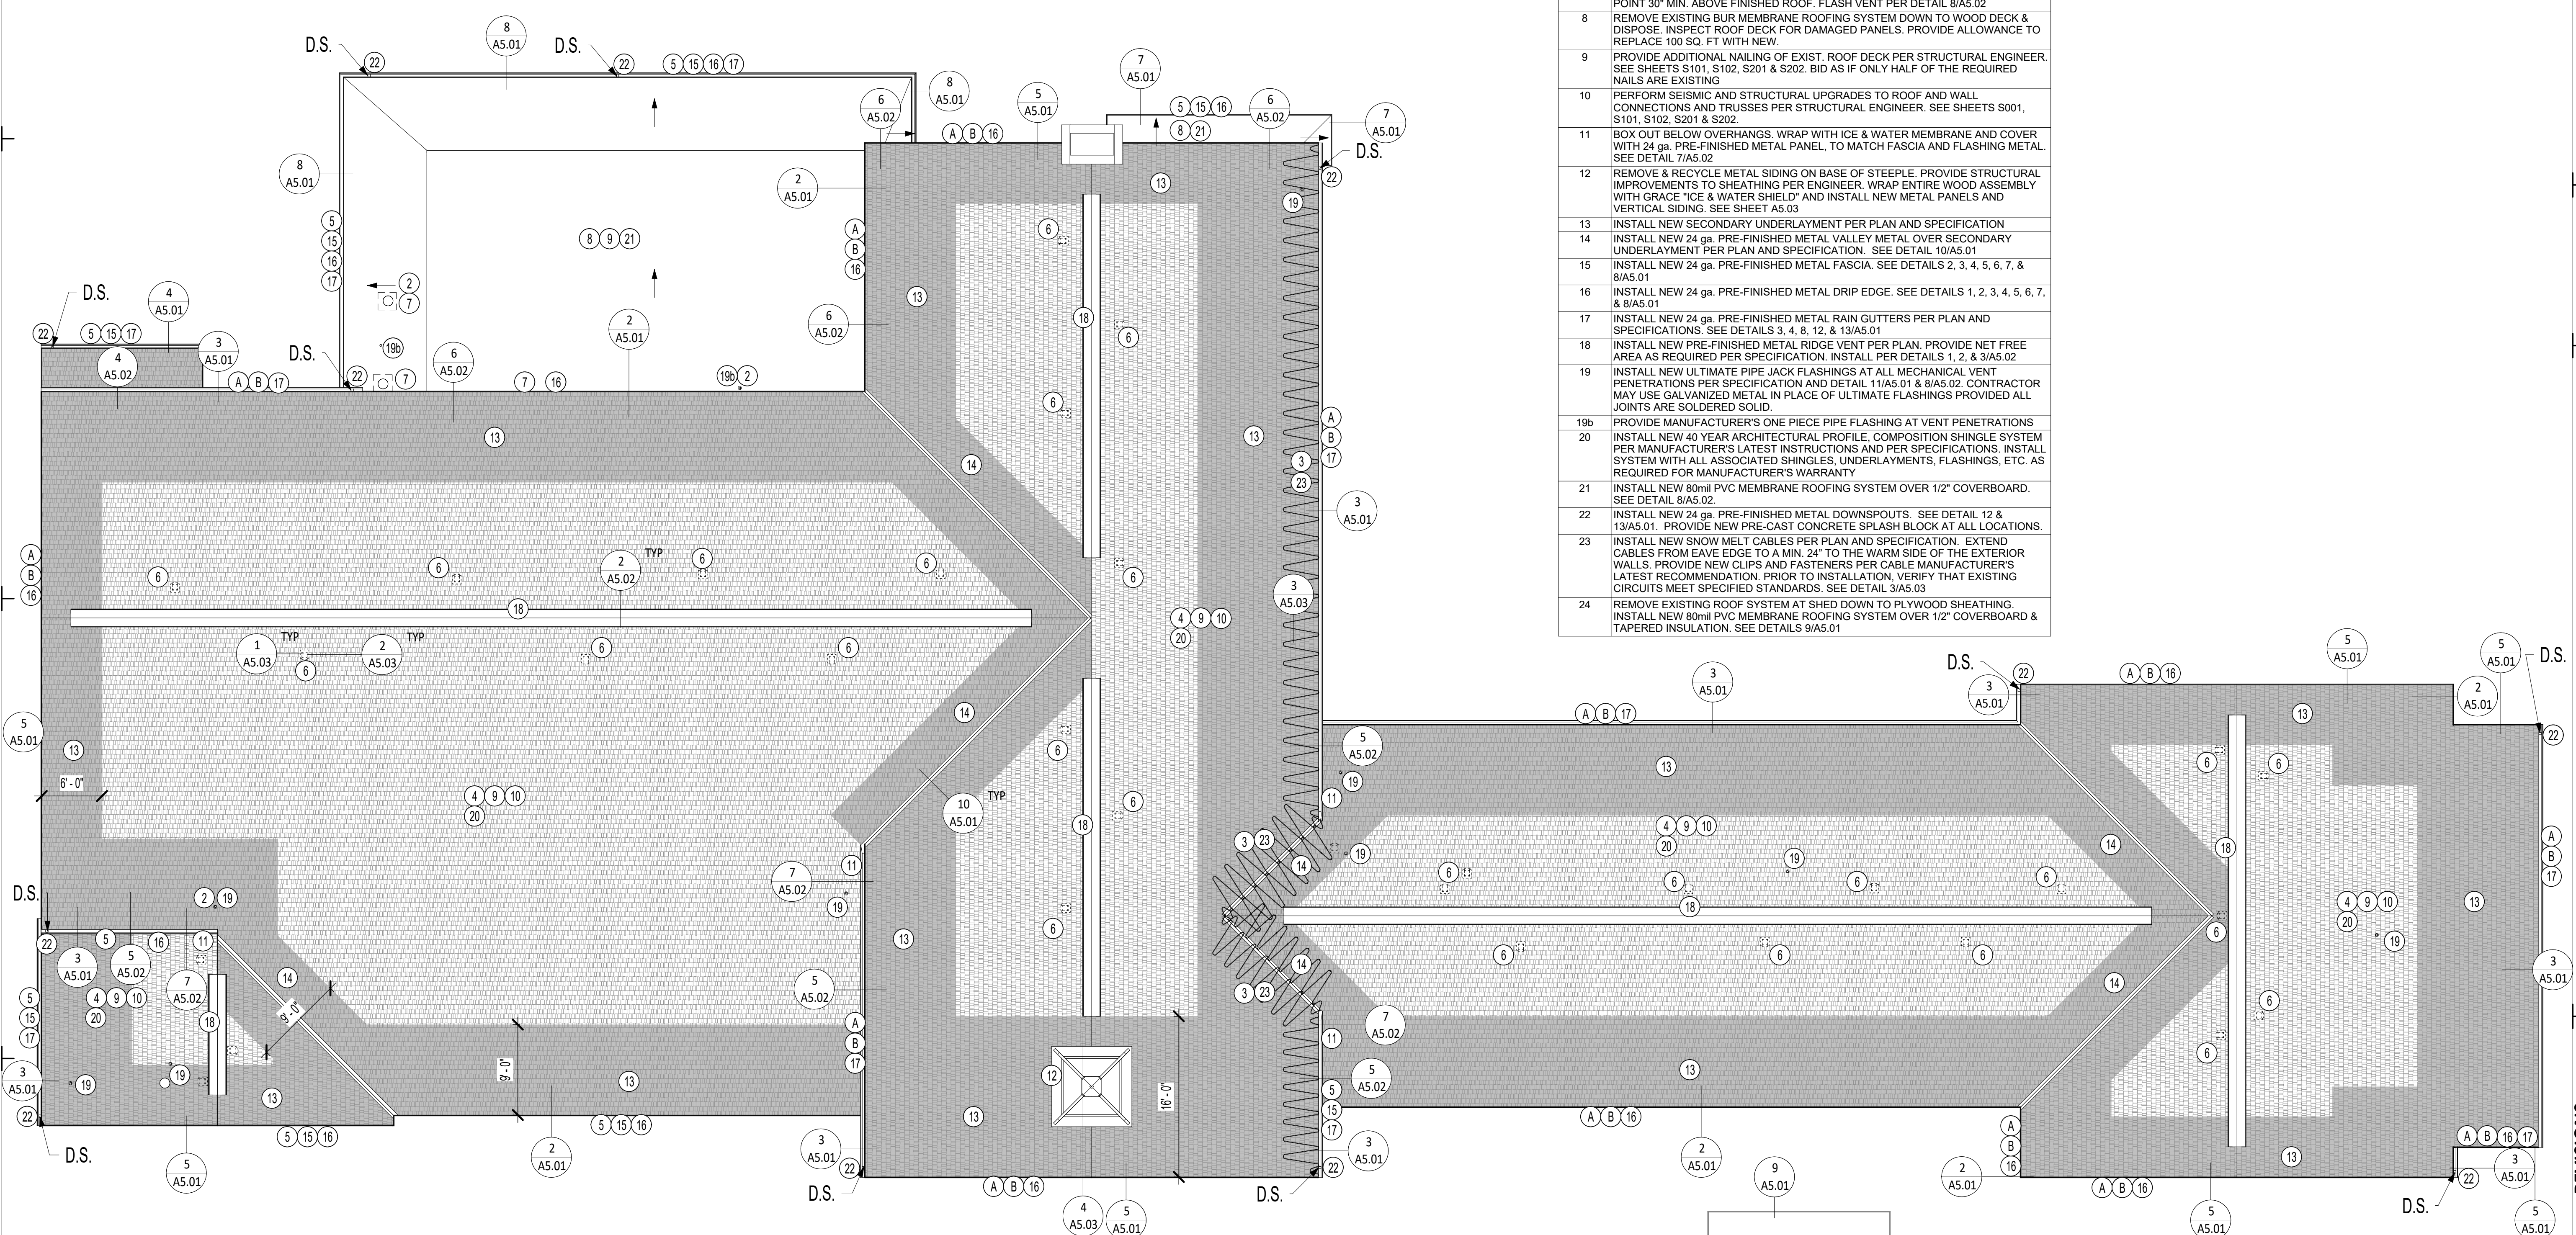

**SHED**  
SCALE: 1/8" = 1'-0"

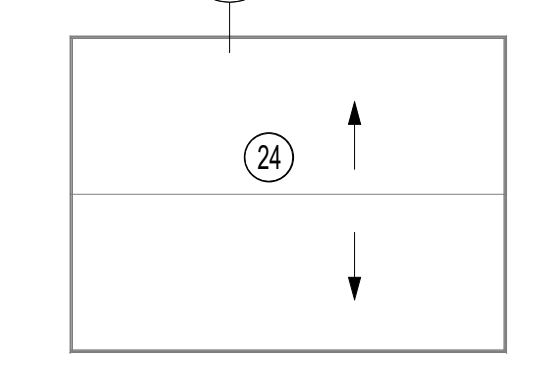


SCOPE OF WORK - ADD ALTERNATE	
#	DESCRIPTION
A	REMOVE AND RECYCLE EXISTING FASCIA METAL FROM UPPER ROOF EAVE EDGES.
B	INSTALL NEW PREFINISHED METAL FASCIA ON UPPER ROOF EAVE EDGES. SEE DETAILS 2, 3, 4, 5, 6, 9, & 10/A5.01

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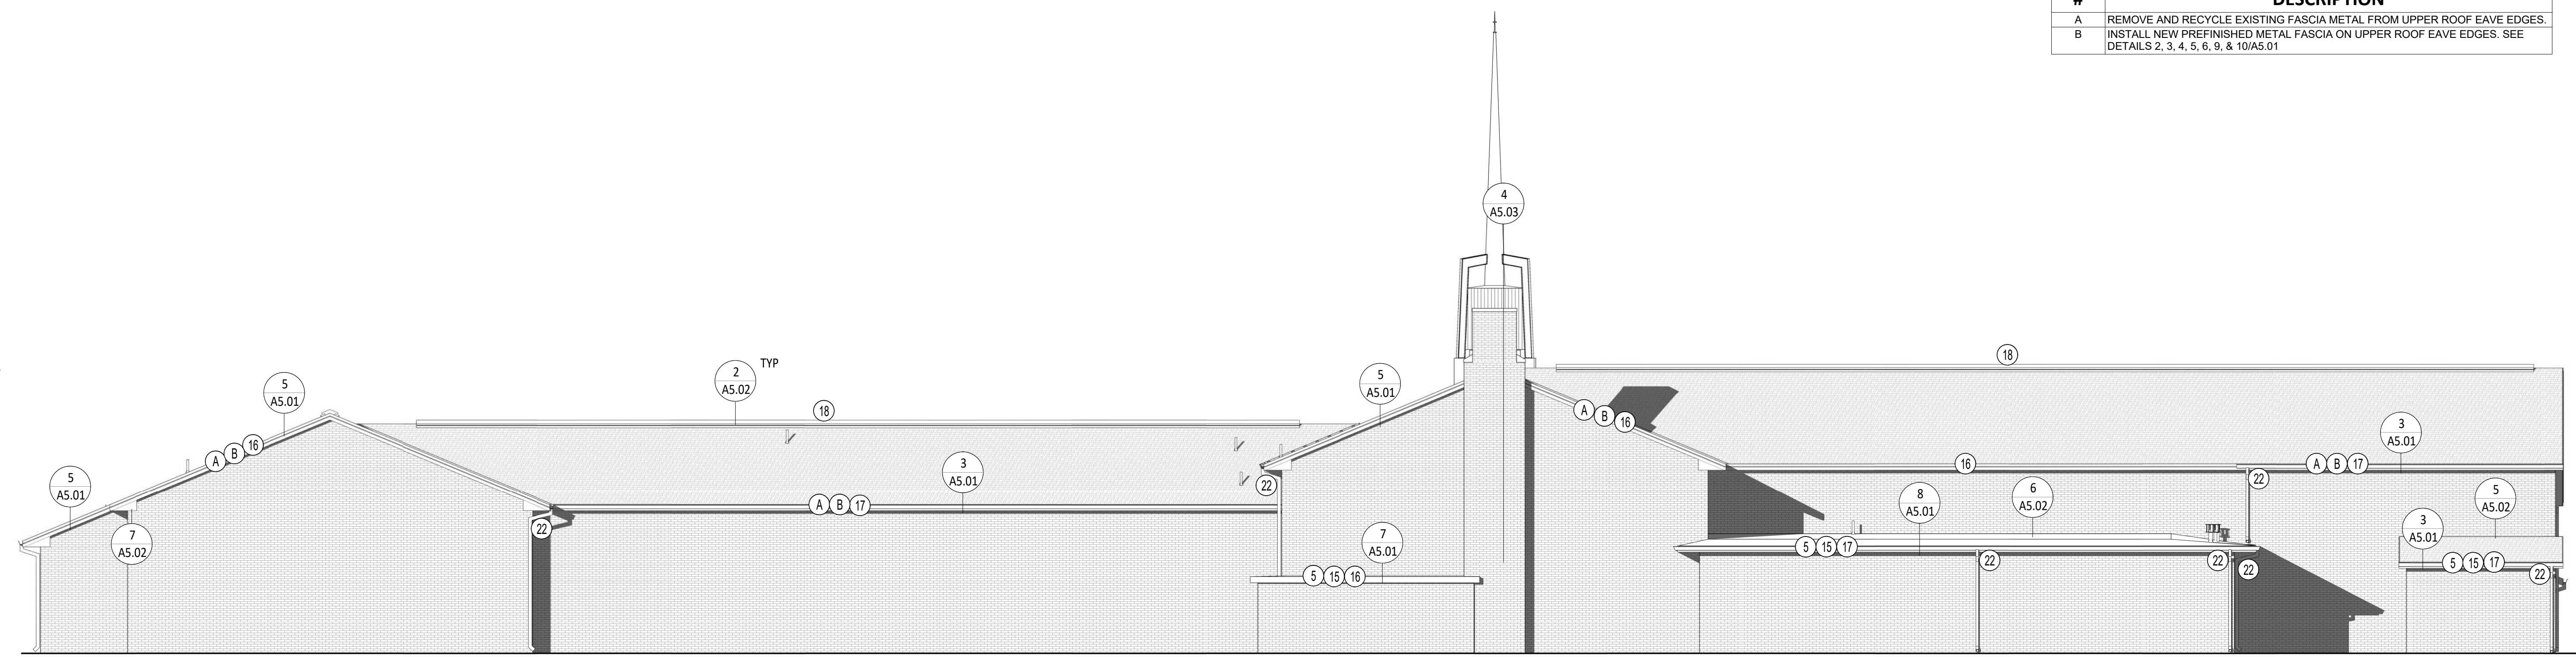
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REVISIONS	DATE	DESCRIPTION

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DRAWN BY AJV/BV  
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**EAST ELEVATION**  
SCALE: 1/8" = 1'-0"



**NORTH ELEVATION**  
SCALE: 1/8" = 1'-0"

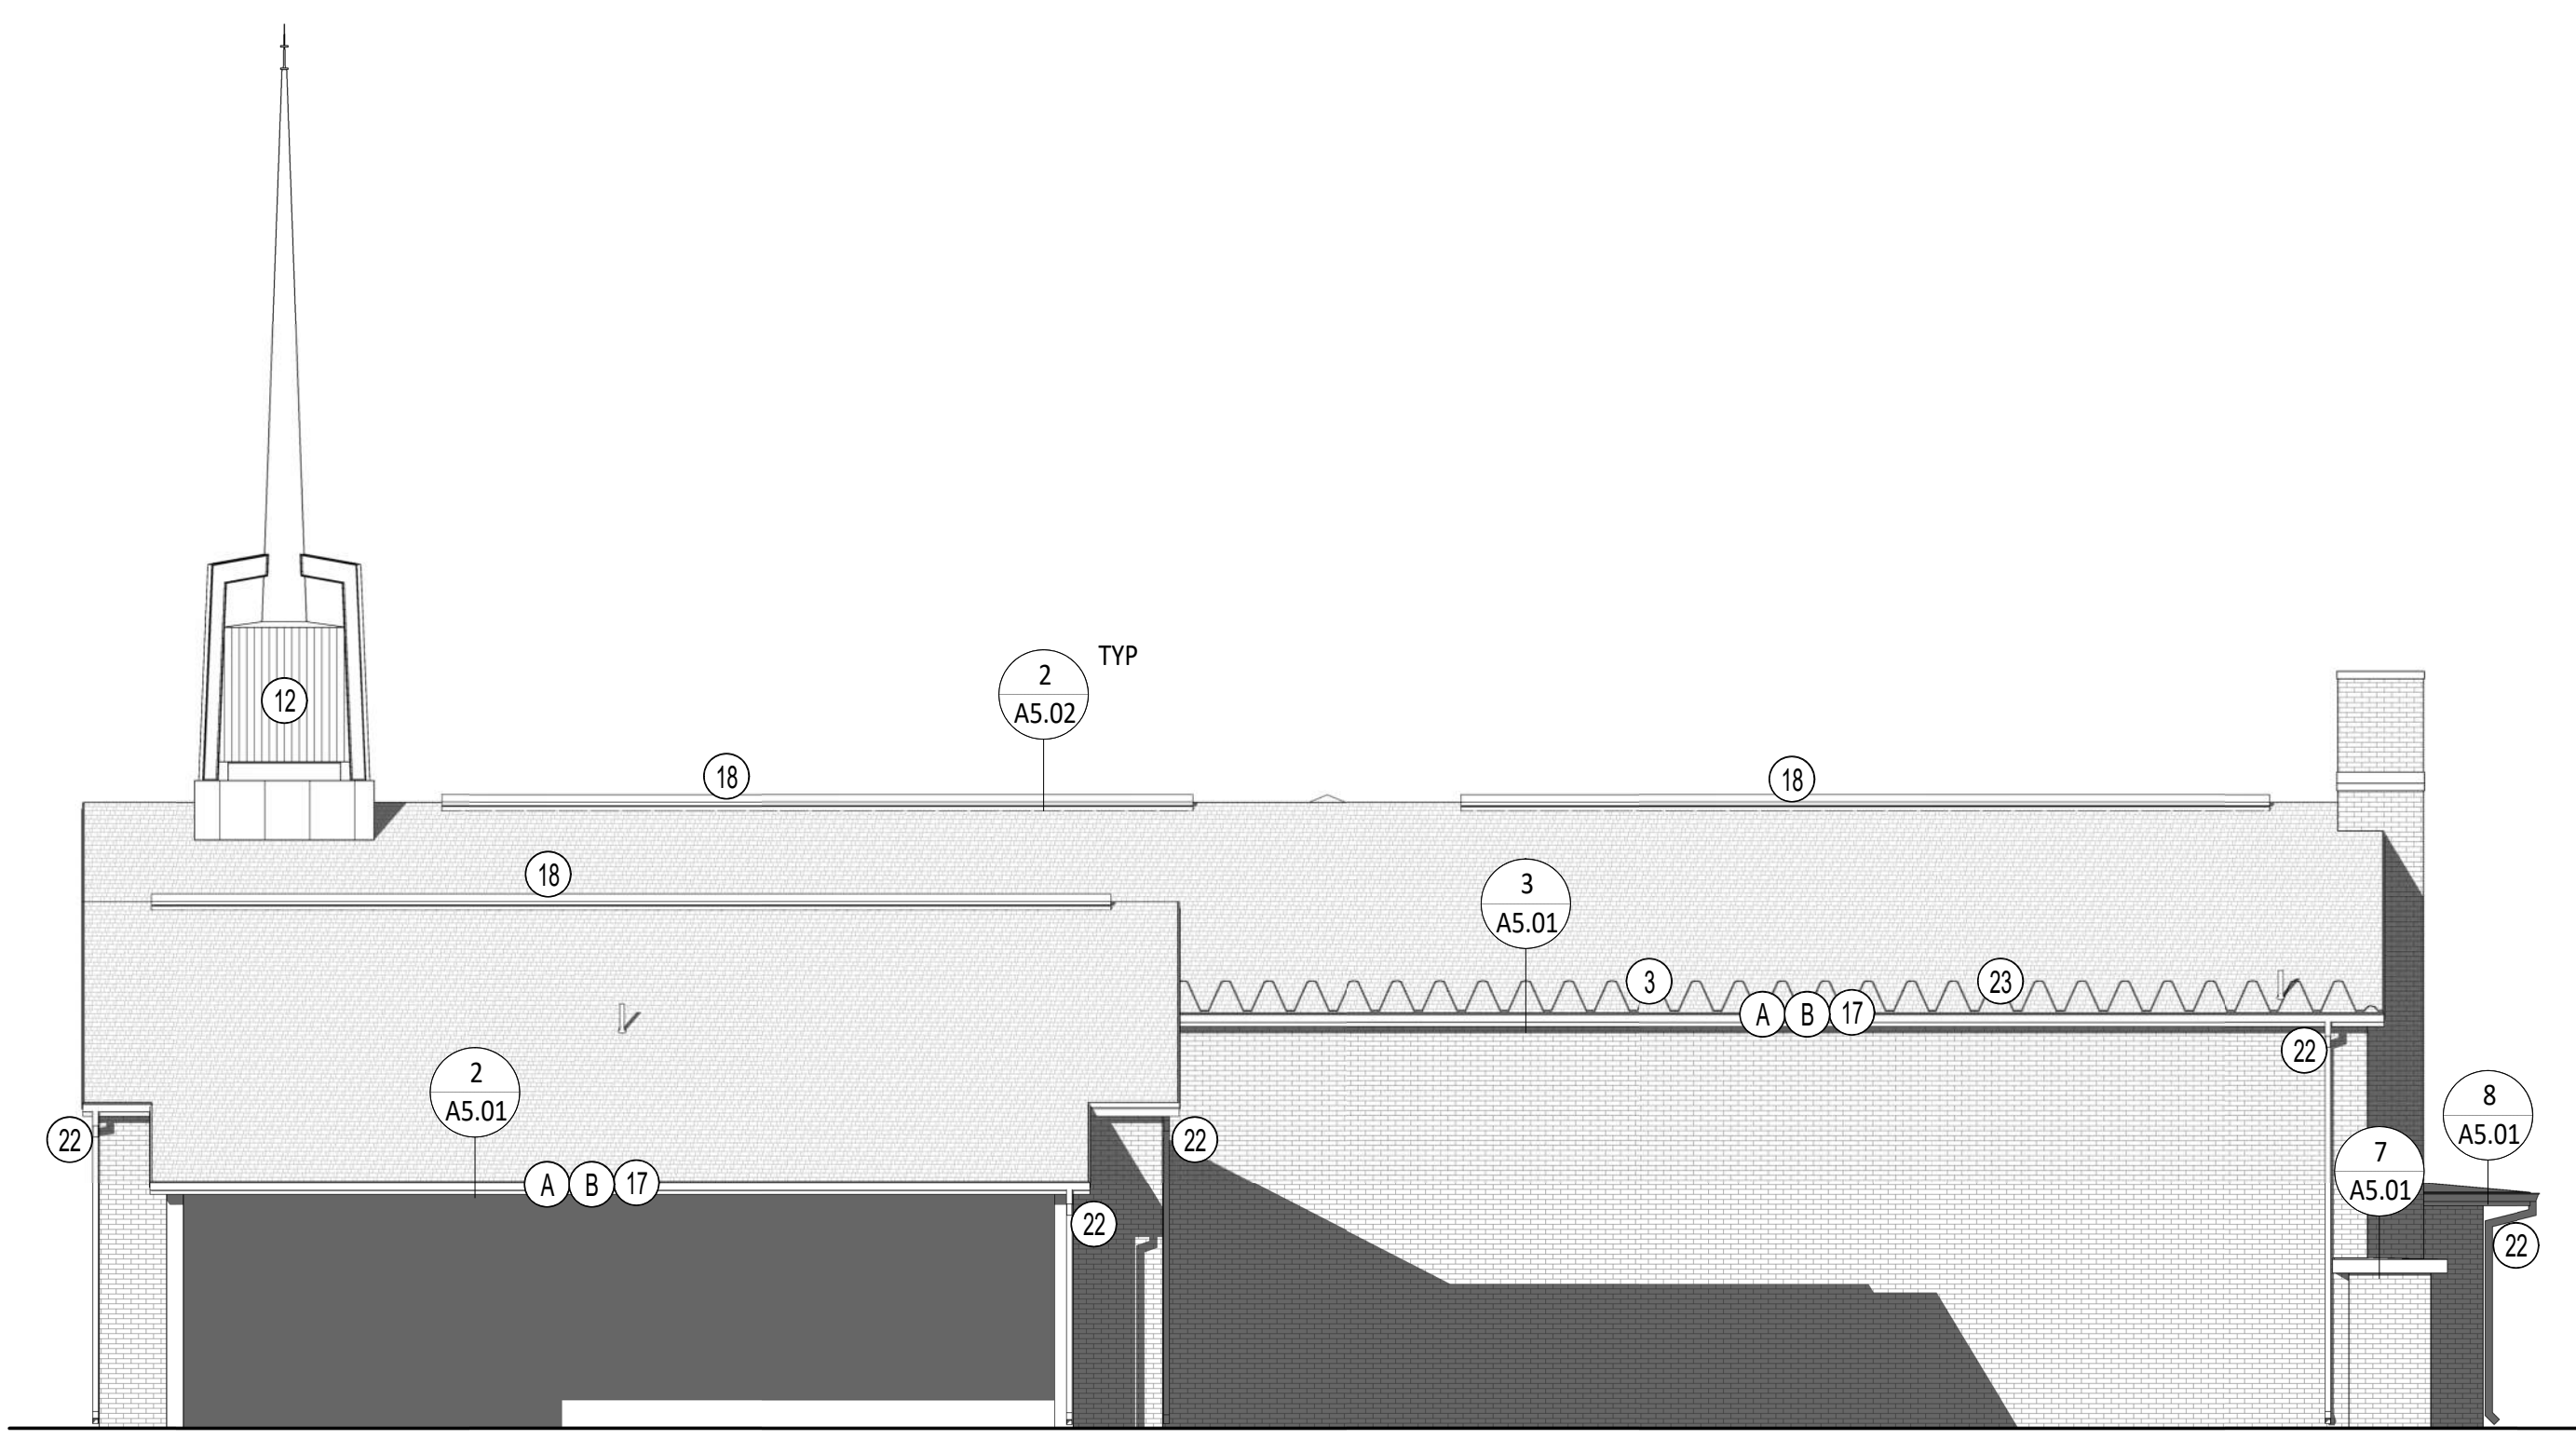SCOPE OF WORK - ROOF PLAN	
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SCOPE OF WORK - ADD ALTERNATE	
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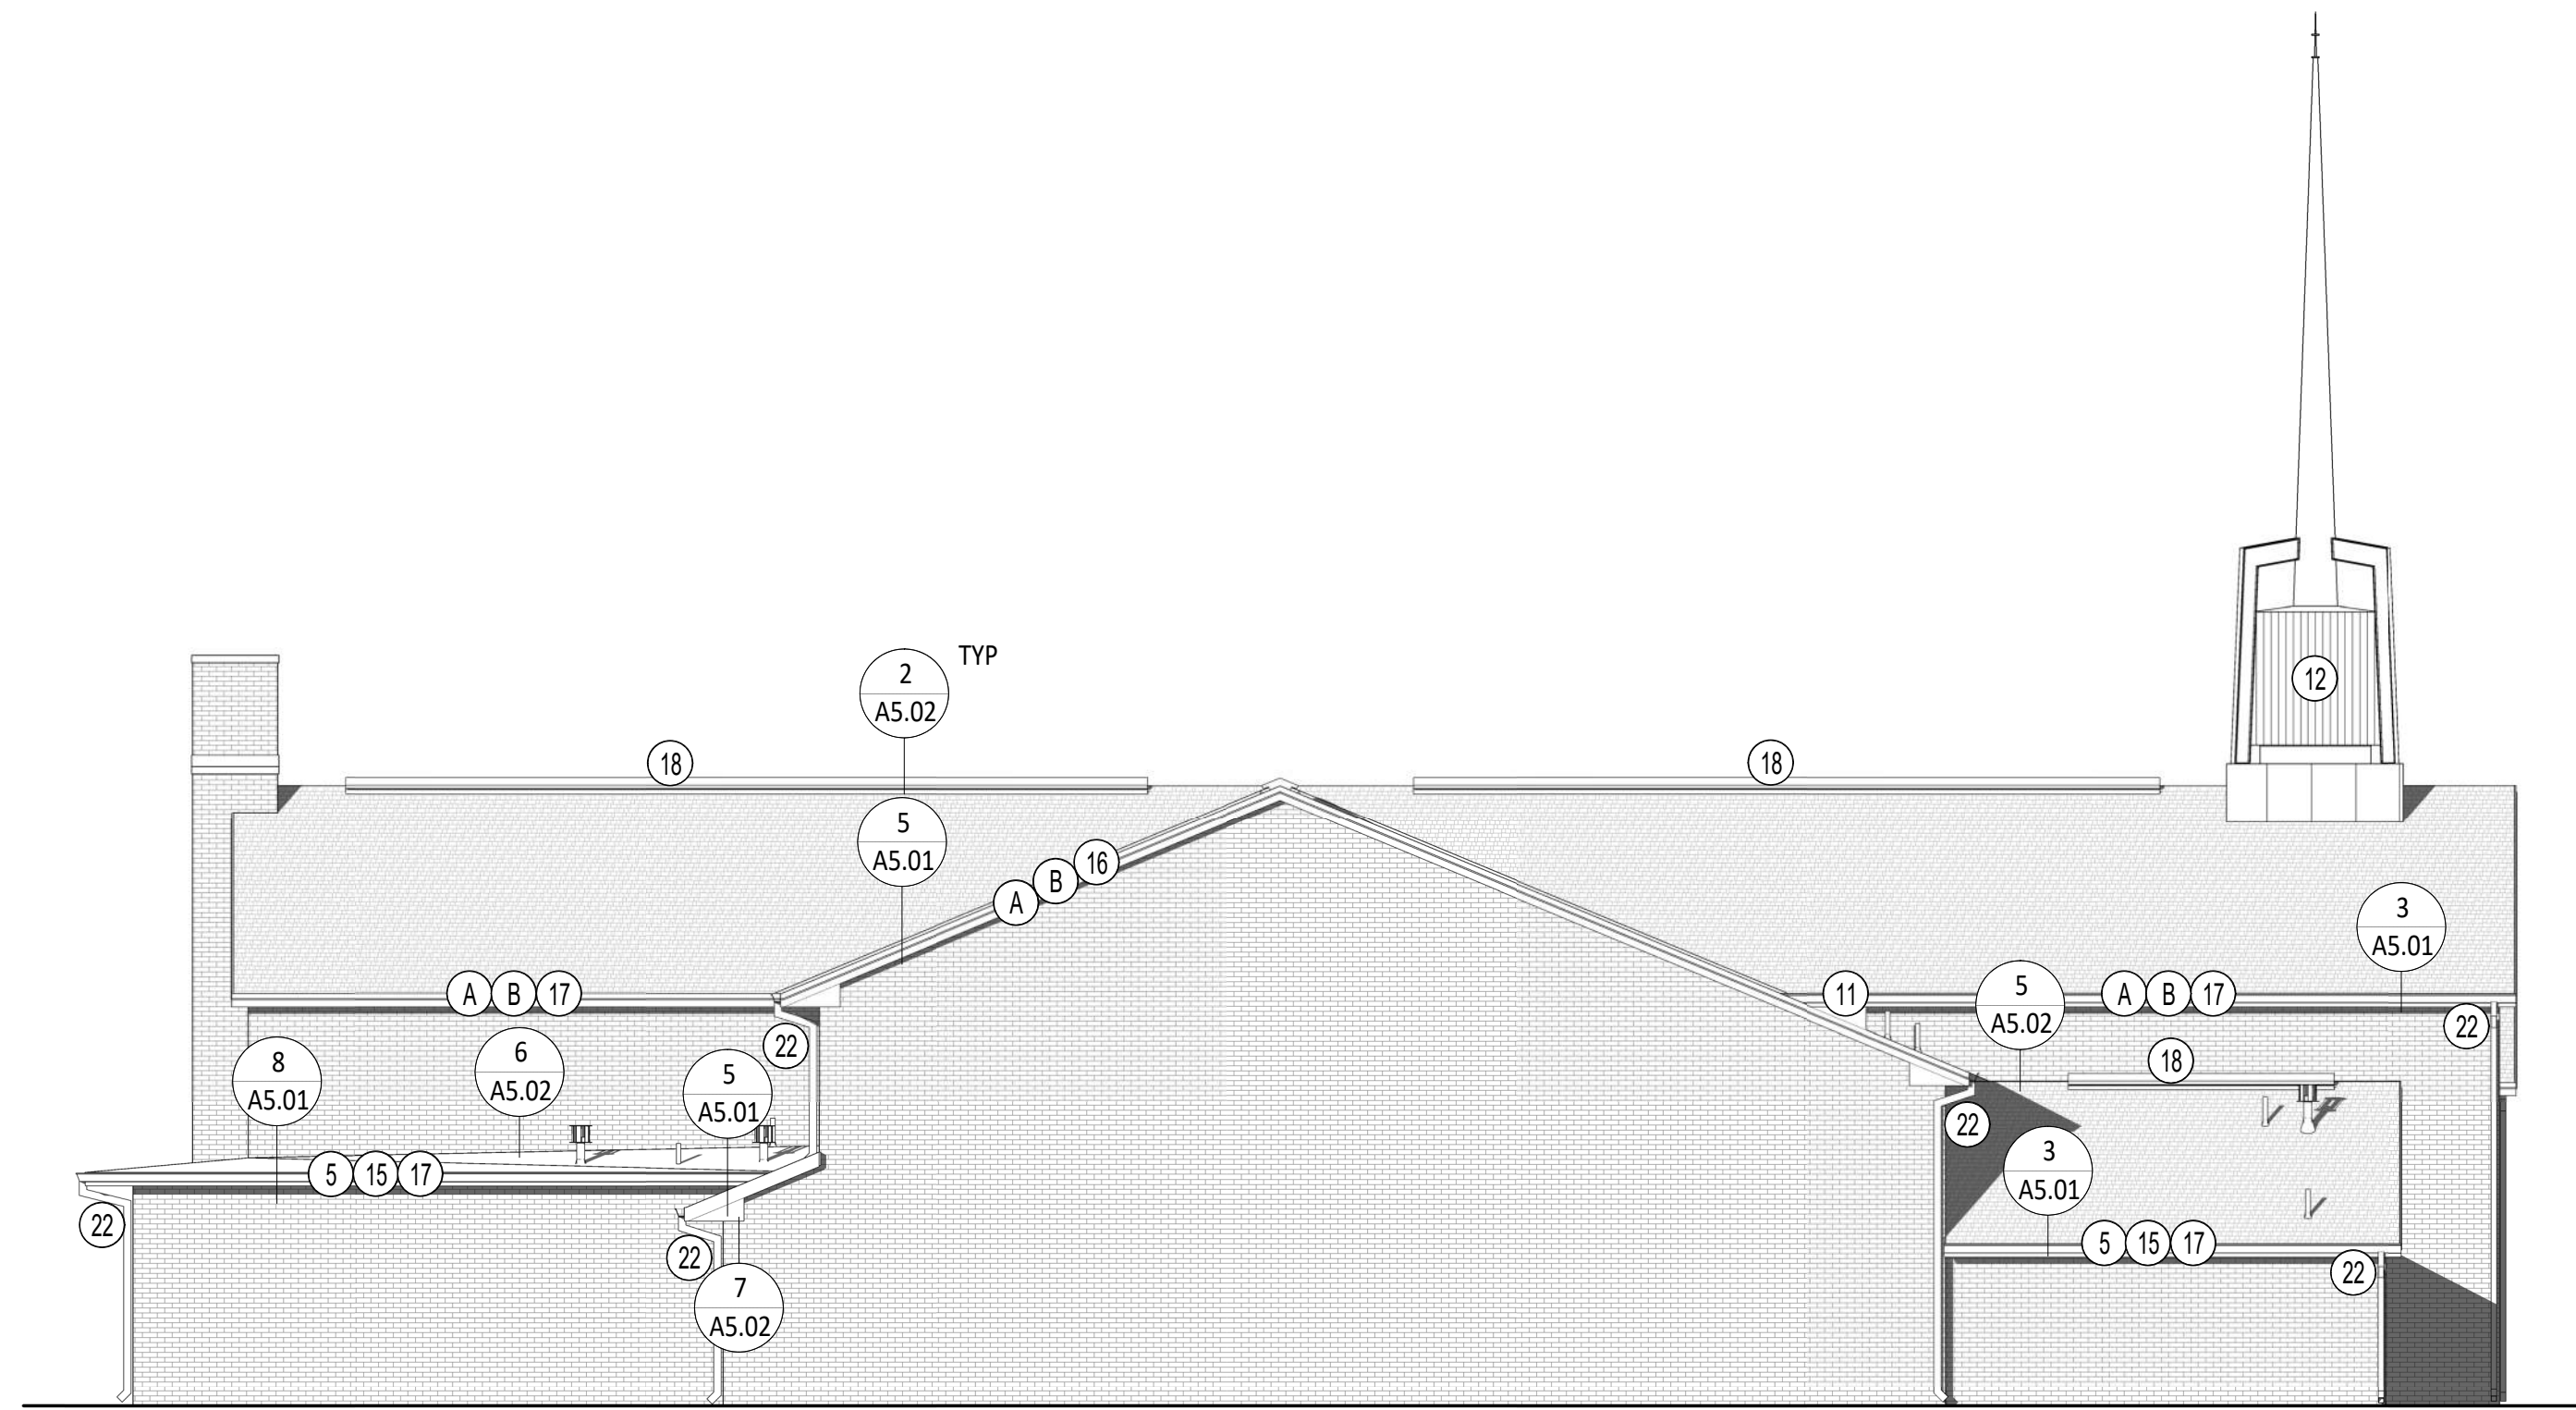
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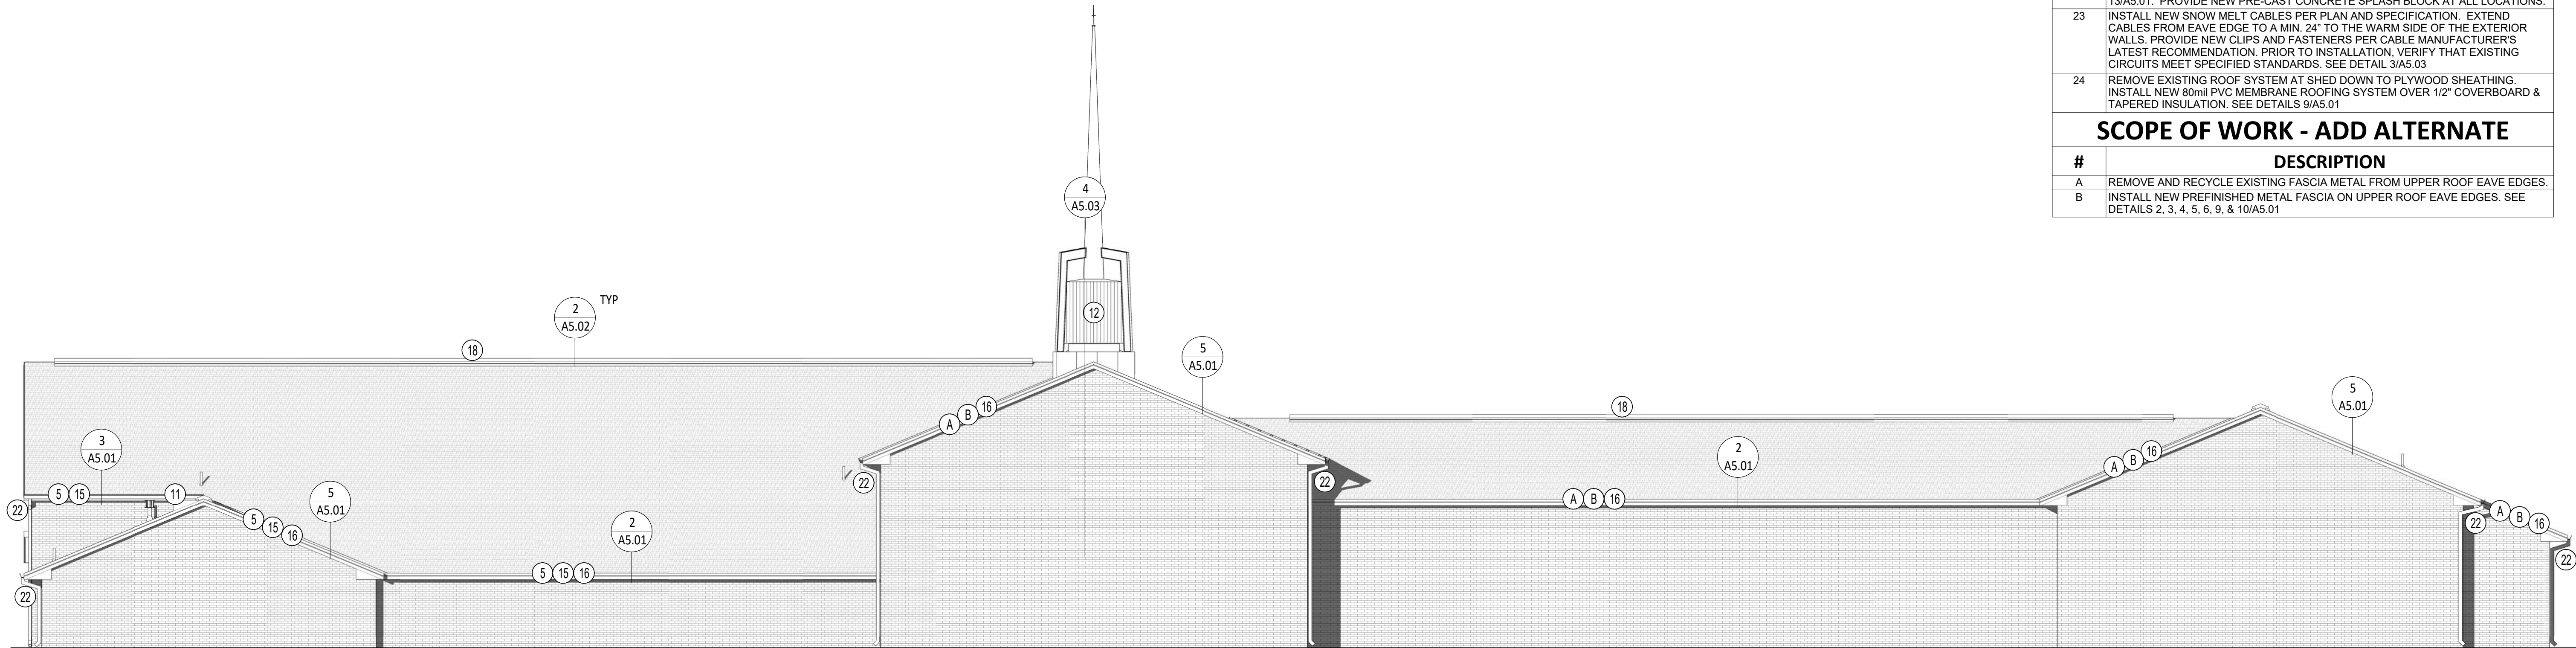
EXTERIOR ELEVATIONS  
**A2.01**

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**WEST ELEVATION**

SCALE: 1/8" = 1'-0"



**SOUTH ELEVATION**

SCALE: 1/8" = 1'-0"

**SCOPE OF WORK - ROOF PLAN**

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21	INSTALL NEW 80mil PVC MEMBRANE ROOFING SYSTEM OVER 1/2" COVERBOARD. SEE DETAIL 8/A5.02.
22	INSTALL NEW 24 ga. PRE-FINISHED METAL DOWNSPOUTS. SEE DETAIL 12 & 15/A5.01. PROVIDE NEW PRE-CAST CONCRETE SPLASH BLOCK AT ALL LOCATIONS.
23	INSTALL NEW SNOW MELT CABLES PER PLAN AND SPECIFICATION. EXTEND CABLES FROM EAVE EDGE TO A MIN. 24' TO THE WARM SIDE OF THE EXTERIOR WALLS. PROVIDE NEW CLIPS AND FASTENERS PER CABLE MANUFACTURER'S LATEST RECOMMENDATION. PRIOR TO INSTALLATION, VERIFY THAT EXISTING CIRCUITS MEET SPECIFIED STANDARDS. SEE DETAIL 3/A5.03
24	REMOVE EXISTING ROOF SYSTEM AT SHED DOWN TO PLYWOOD SHEATHING. INSTALL NEW 80mil PVC MEMBRANE ROOFING SYSTEM OVER 1/2" COVERBOARD & TAPERED INSULATION. SEE DETAILS 9/A5.01

**SCOPE OF WORK - ADD ALTERNATE**


#	DESCRIPTION
A	REMOVE AND RECYCLE EXISTING FASCIA METAL FROM UPPER ROOF EAVE EDGES.
B	INSTALL NEW PREFINISHED METAL FASCIA ON UPPER ROOF EAVE EDGES. SEE DETAILS 2, 3, 4, 5, 6, 9, & 10/A5.01

REVISIONS	DATE	DESCRIPTION


PROJECT NO.	19294
DRAWN BY	AJV/BV
CHECKED BY	CEG
DATE	11 APRIL 2022
PROP. NO.	5016495

EXTERIOR ELEVATIONS


**A2.02**

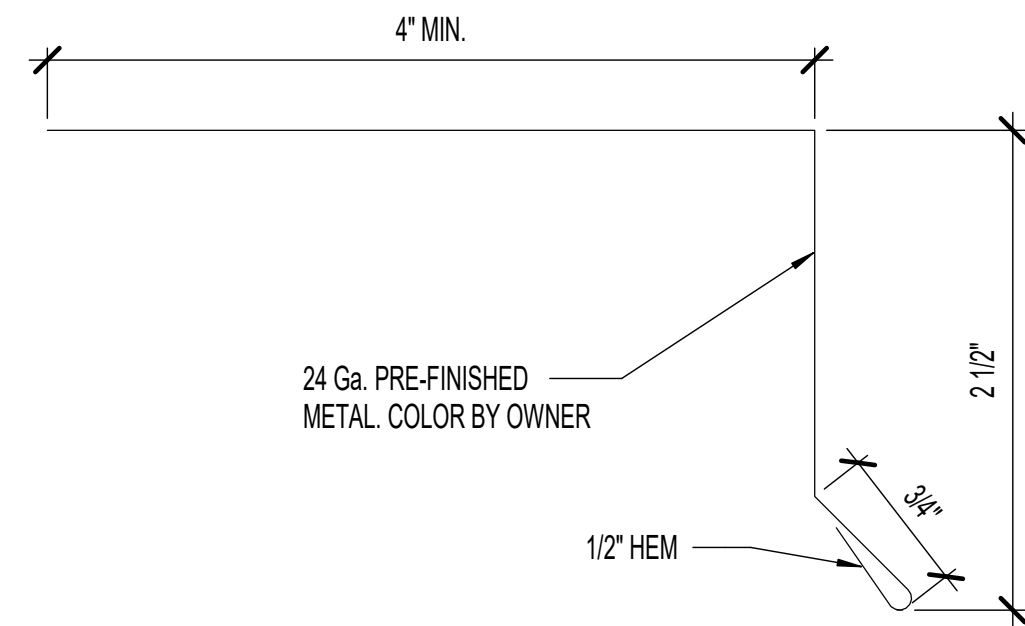


**1 STANDARD DRIP EDGE DETAIL**  
SCALE: 12" = 1'-0"

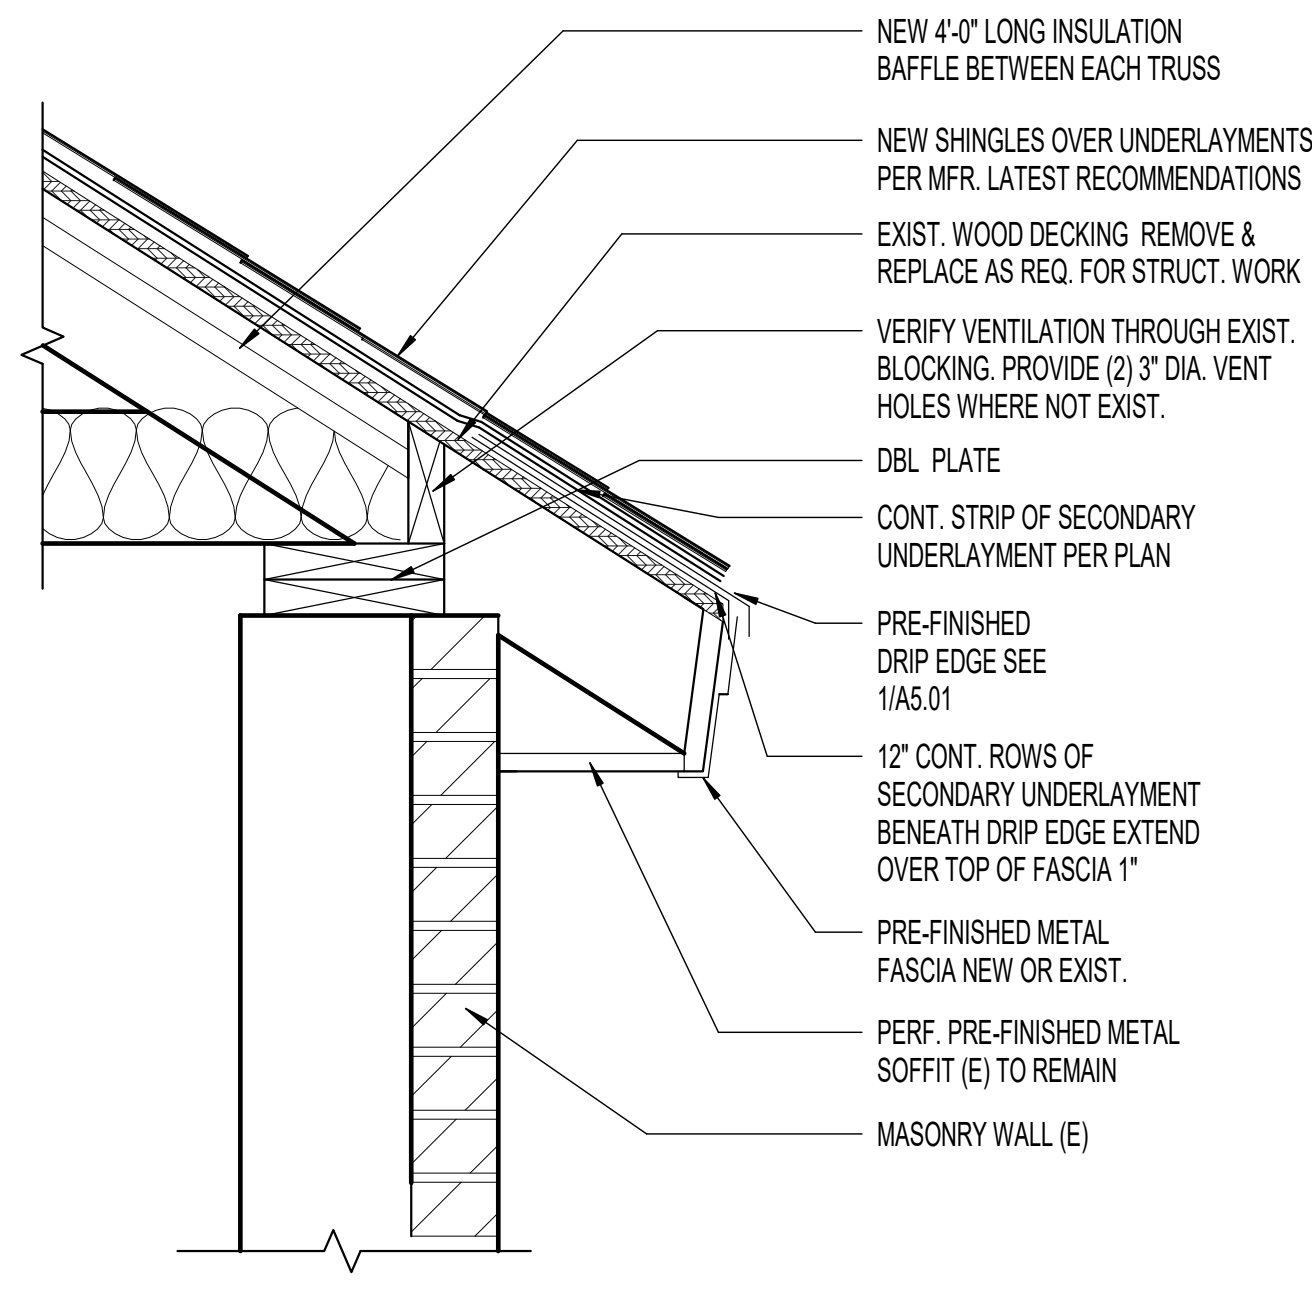


**2 EAVE DETAIL**  
SCALE: 1 1/2" = 1'-0"

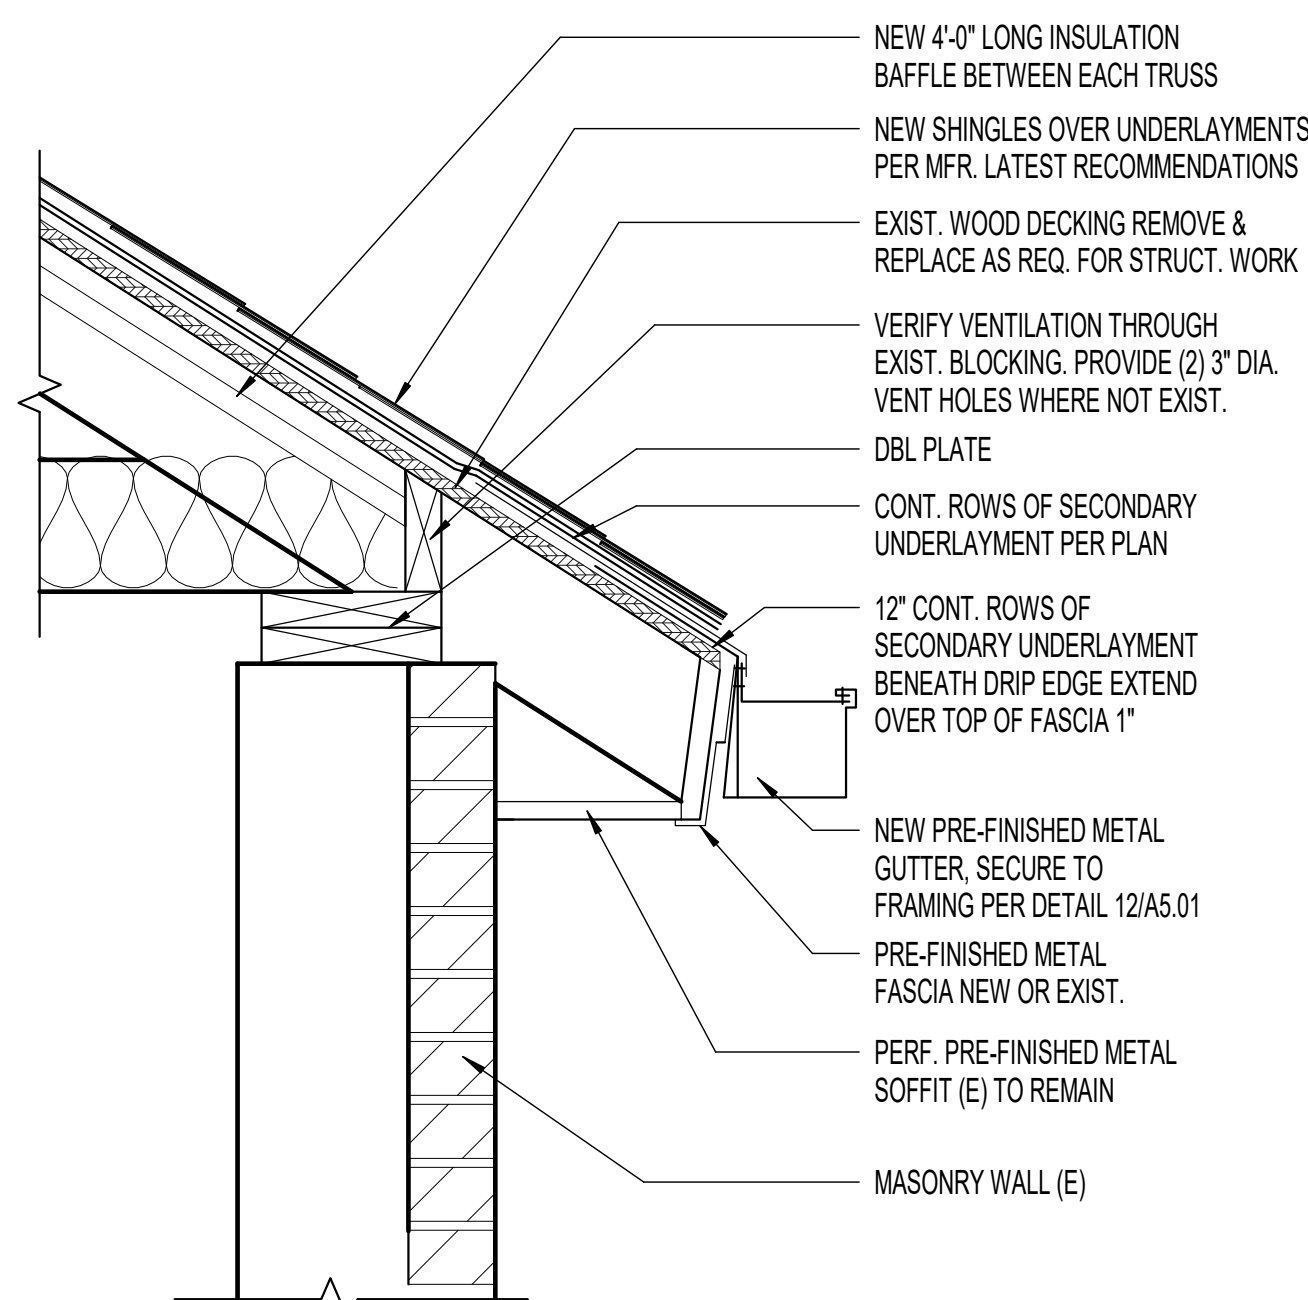


**3 EAVE DETAIL w/GUTTER**  
SCALE: 1 1/2" = 1'-0"

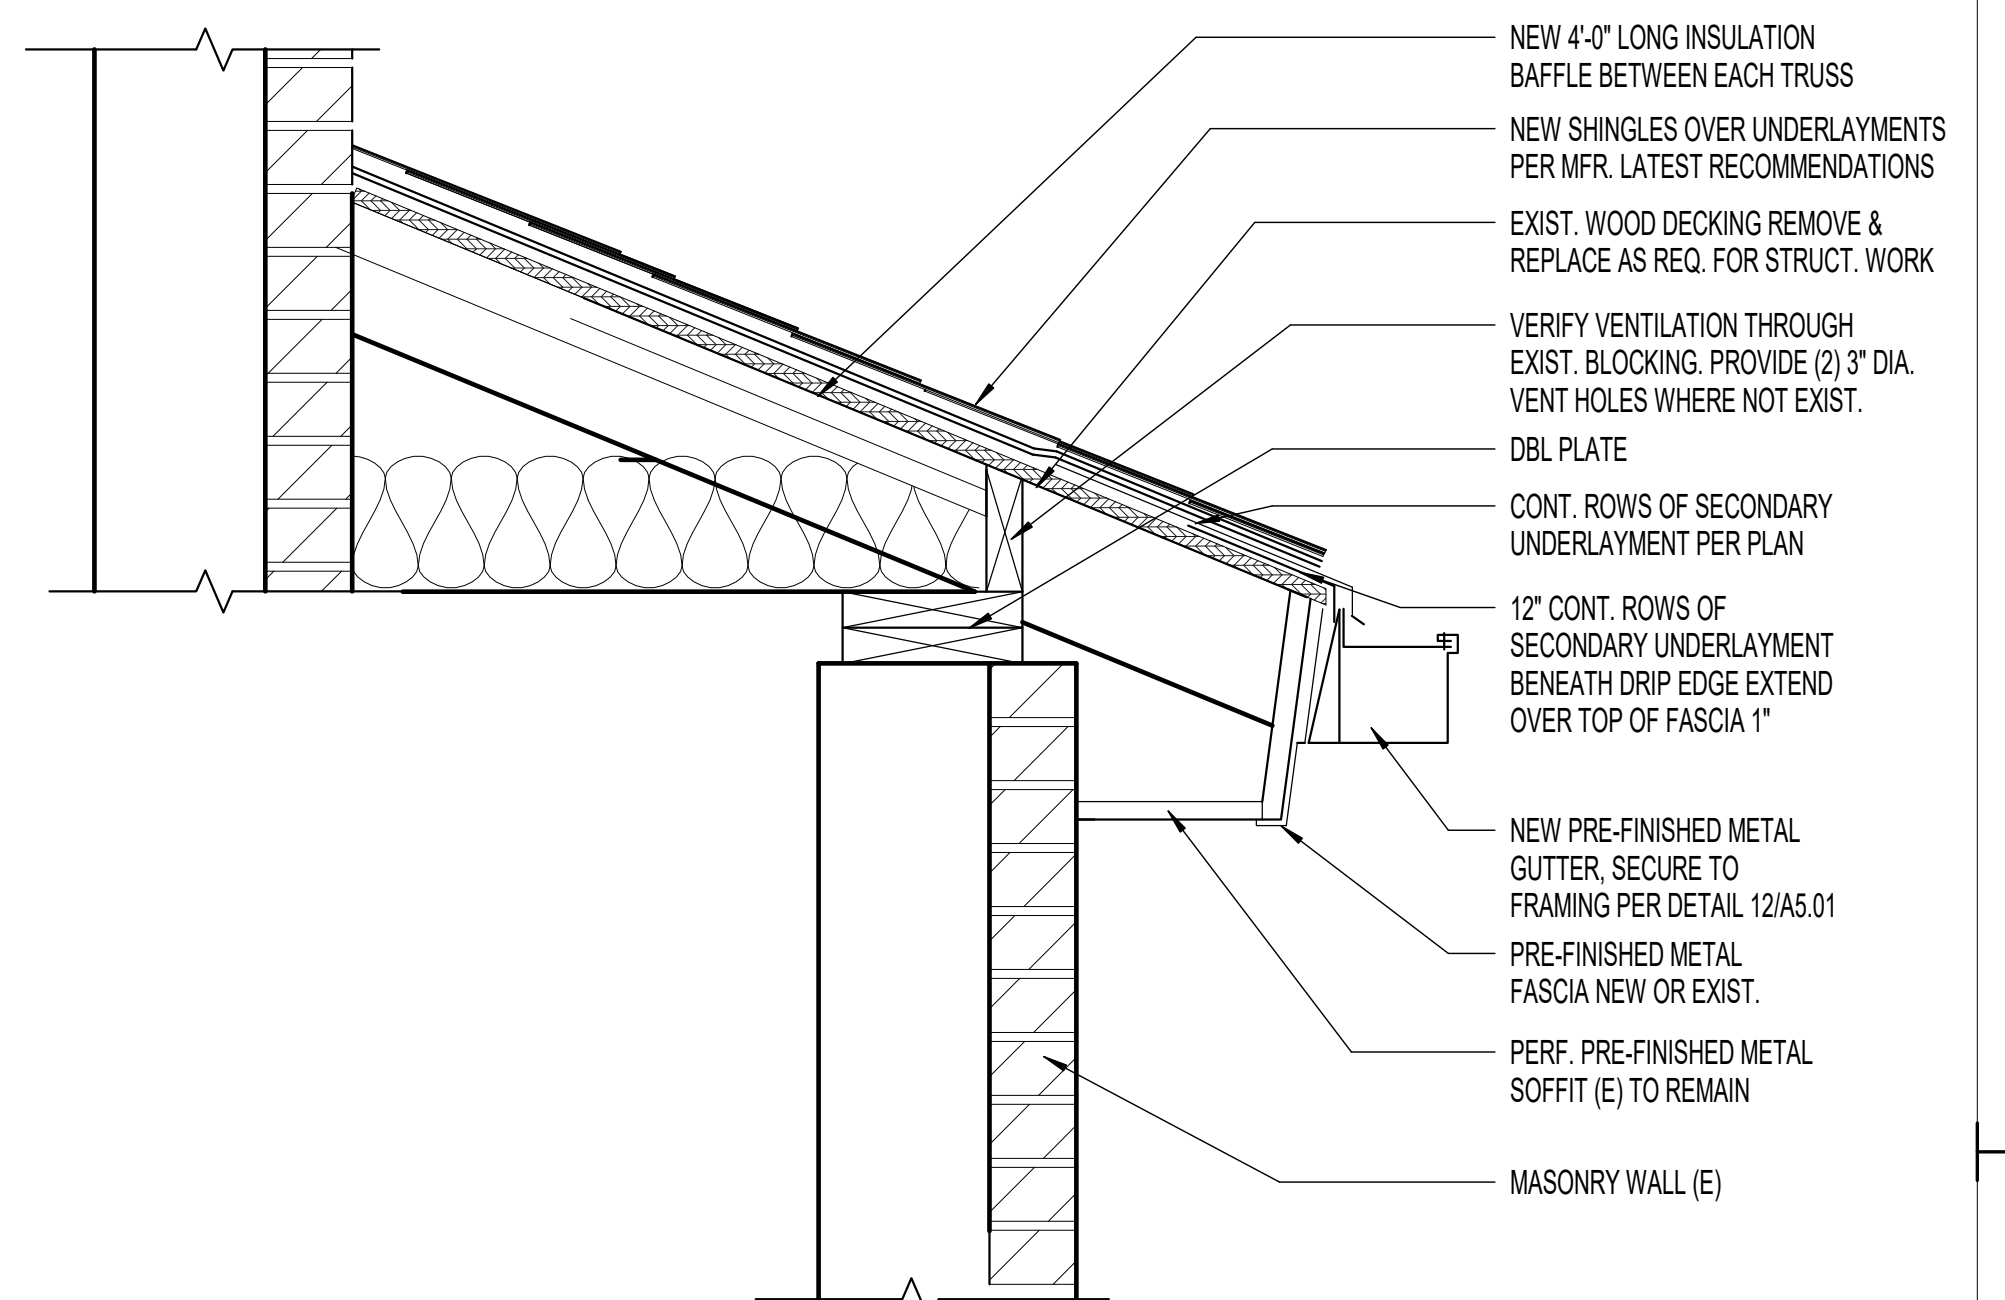


**4 EAVE DETAIL w/GUTTER LOWER**  
SCALE: 1 1/2" = 1'-0"

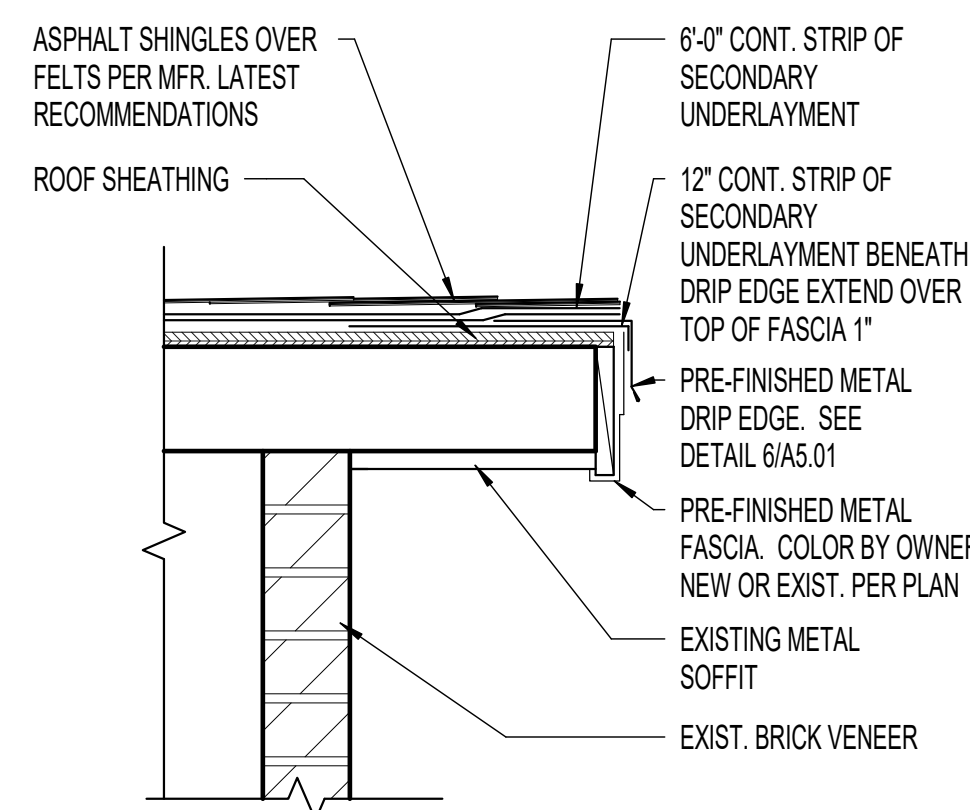


**5 TYP. FASCIA DETAIL- RAKE**  
SCALE: 1 1/2" = 1'-0"

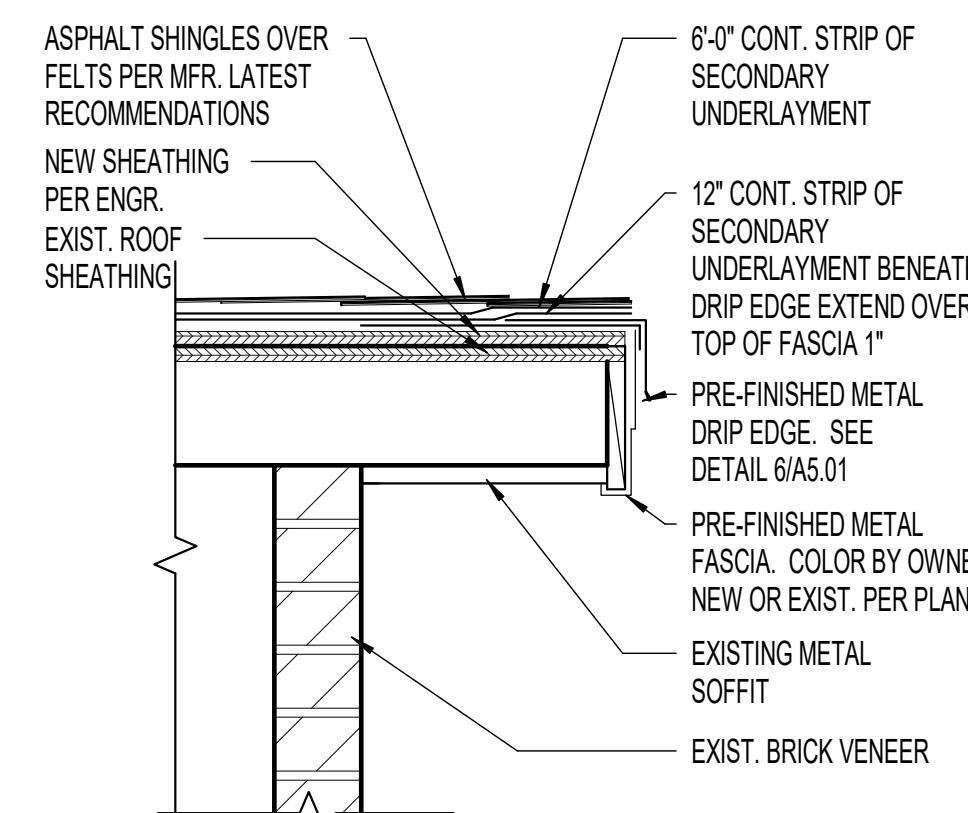


**6 TYP. FASCIA DETAIL- RAKE w/NEW SHEATHING**  
SCALE: 1 1/2" = 1'-0"

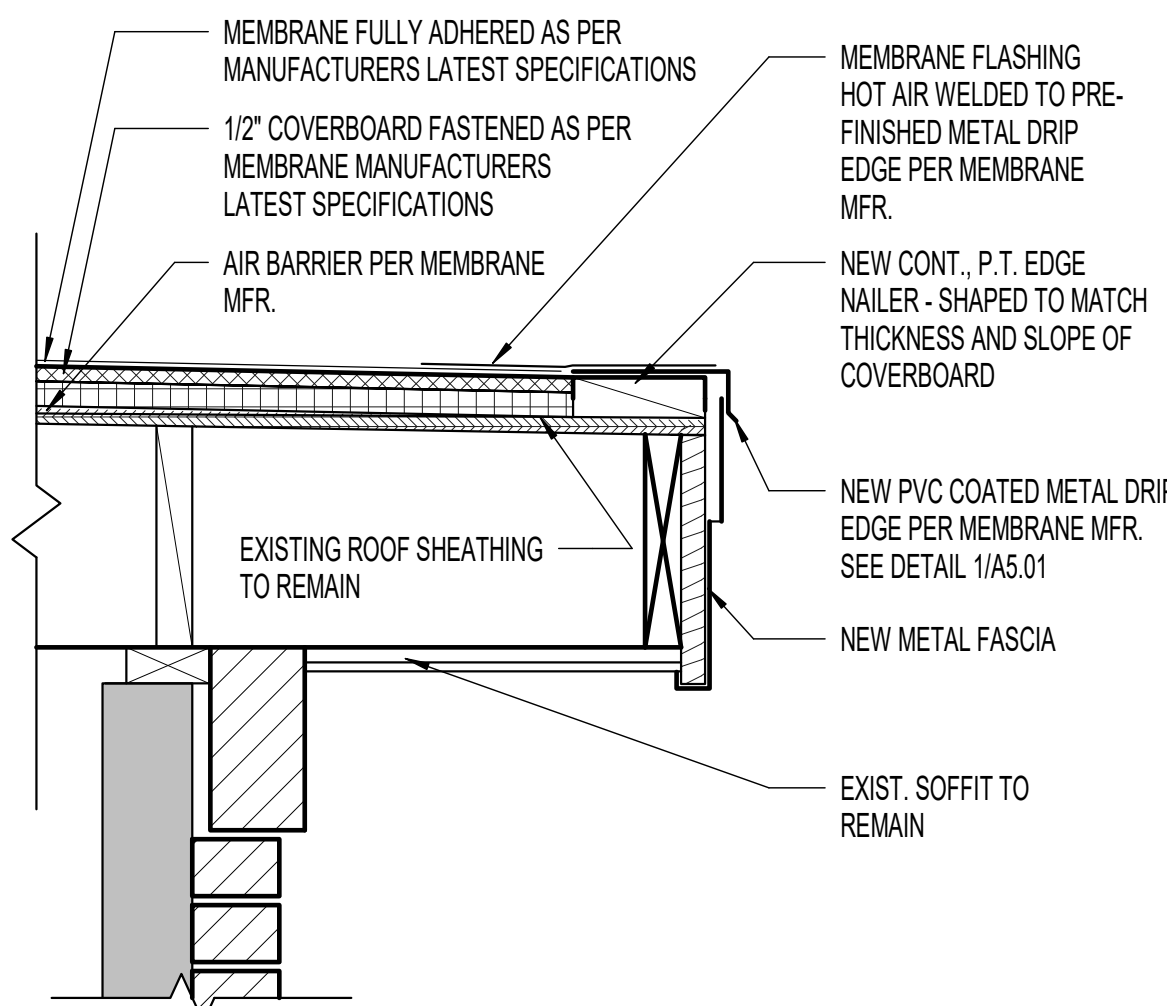


**7 LOW SLOPE EDGE DETAIL**  
SCALE: 1 1/2" = 1'-0"

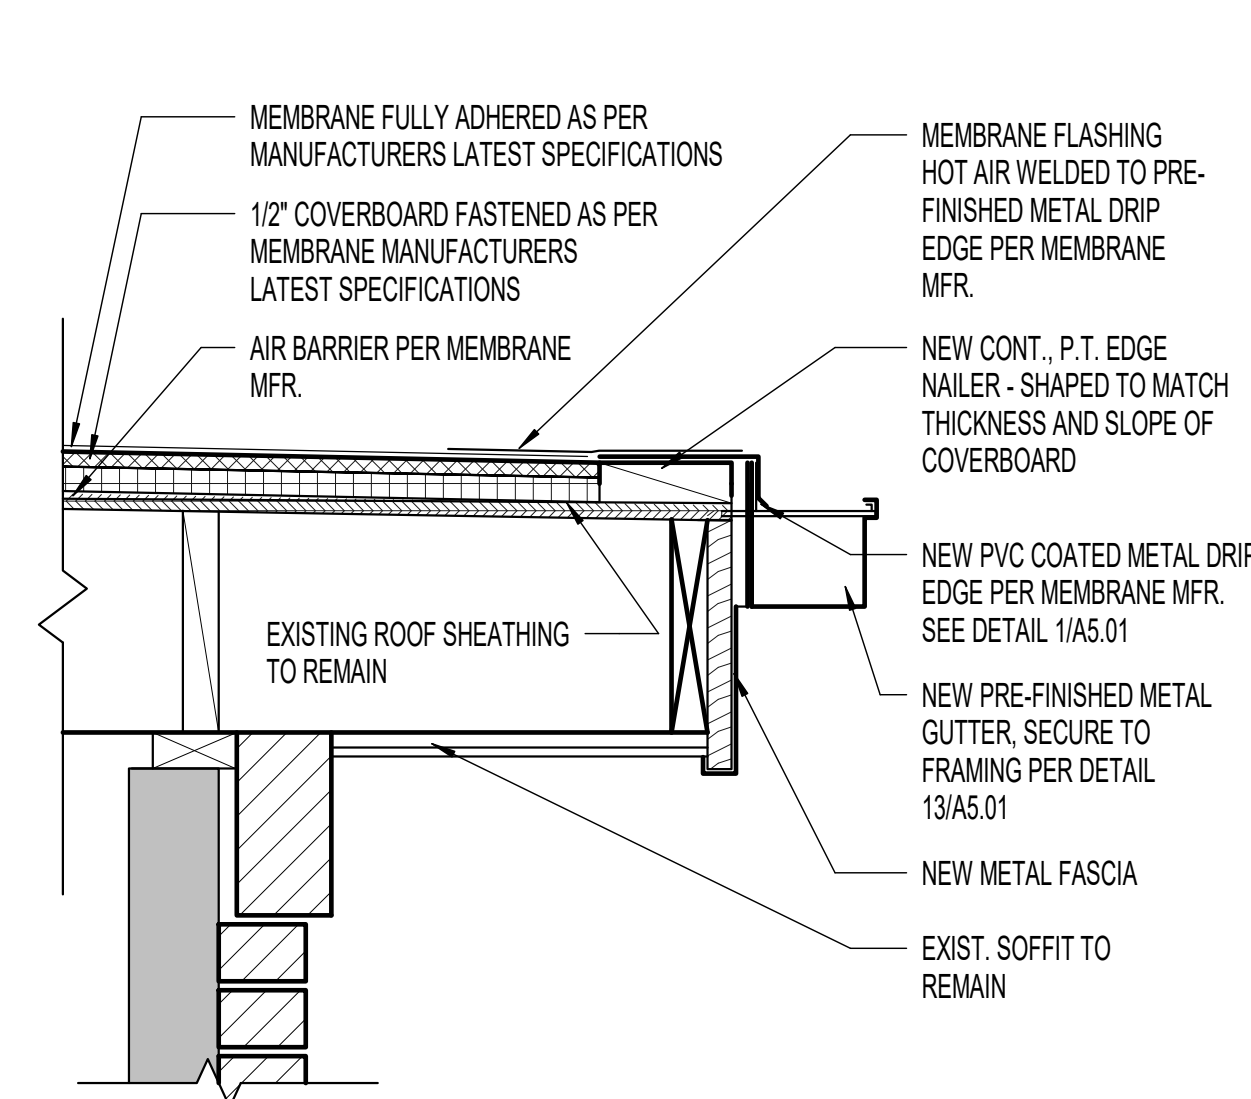


**8 LOW SLOPE EDGE w/ GUTTER**  
SCALE: 1 1/2" = 1'-0"

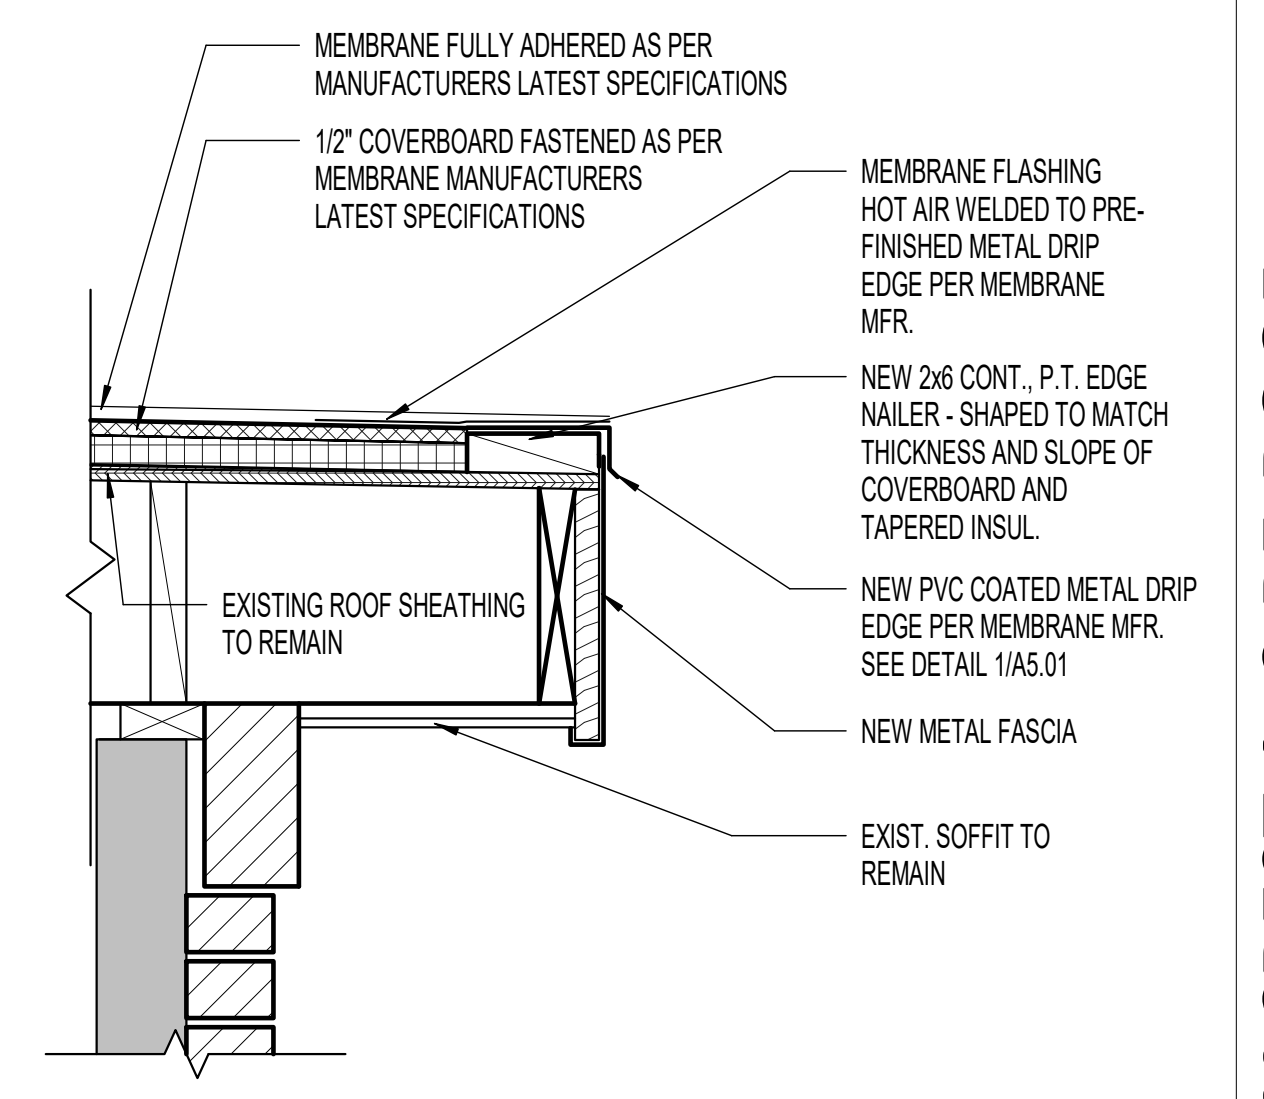

**9 EAVE DETAIL - SHED**  
SCALE: 1 1/2" = 1'-0"

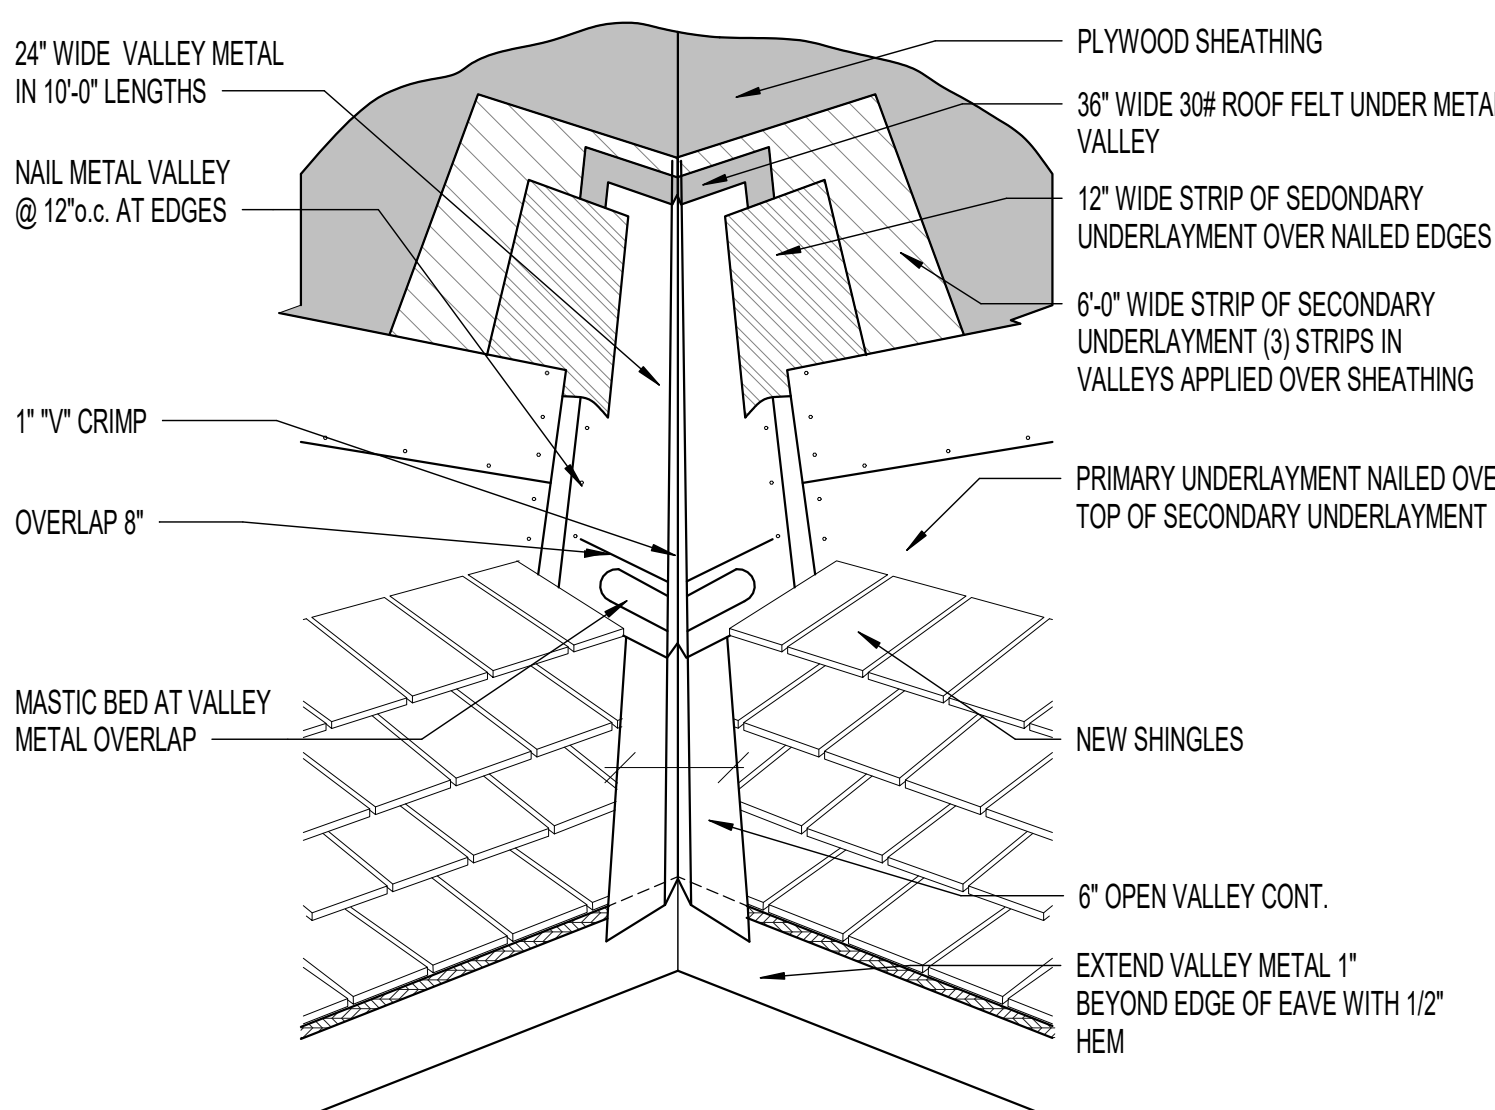


**10 VALLEY FLASHING DETAIL**  
SCALE: 1" = 1'-0"

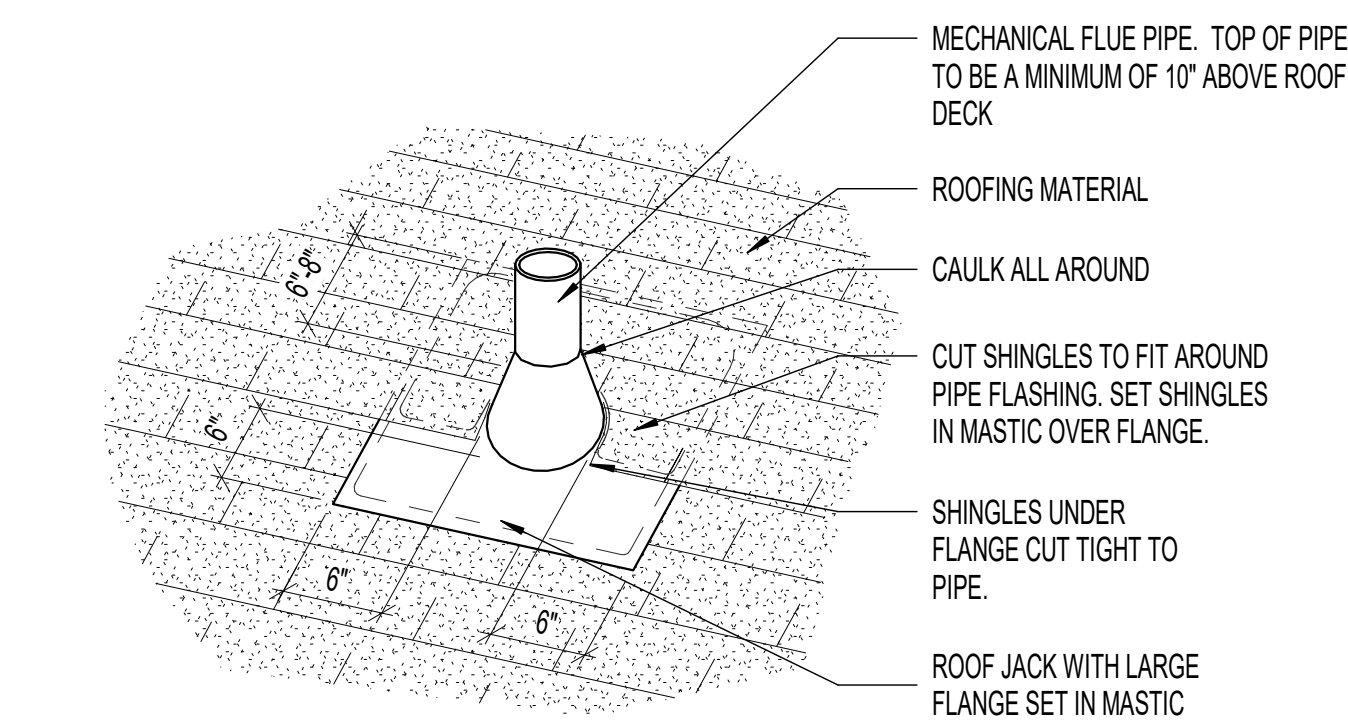


NOTE: ROOF JACKS FOR MECH. CAST IRON VENT PIPES TO BE 24 GA. GALVANIZED METAL. SOLDER ALL JOINTS. 'ULTIMATE PIPE FLASHING' FOR ALL OTHERS.

**11 PIPE JACK FLASHING - SHINGLE**  
SCALE: 12" = 1'-0"

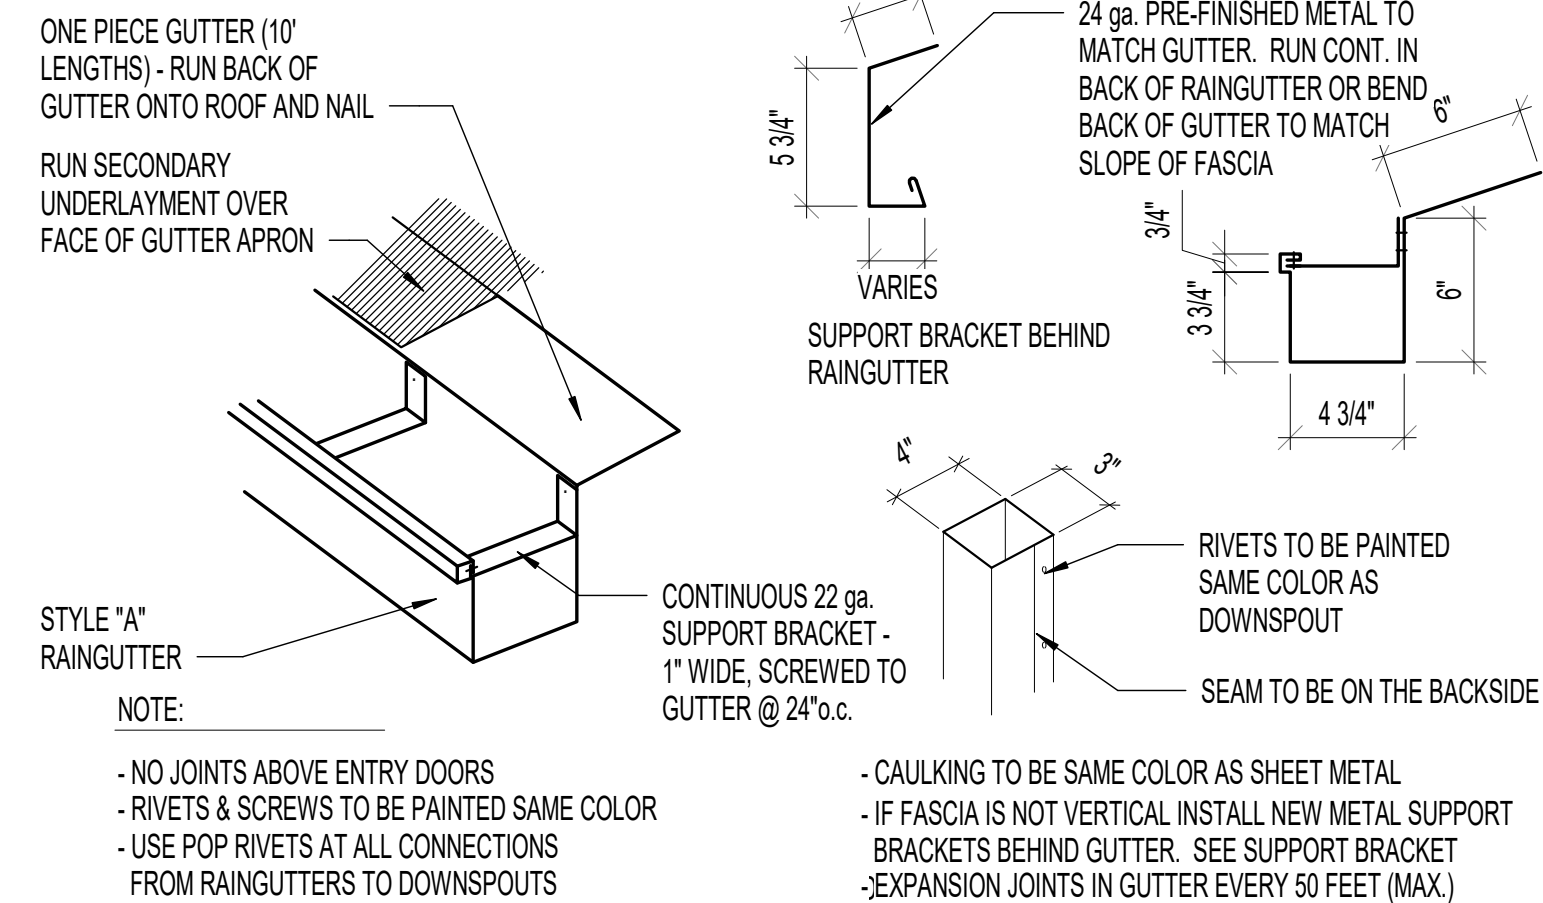

NOTE:  
- NO JOINTS ABOVE ENTRY DOORS  
- RIVETS & SCREWS TO BE PAINTED SAME COLOR  
- USE POP RIVETS AT ALL CONNECTIONS FROM RAINGUTTERS TO DOWNSPOUTS  
- CAULKING TO BE SAME COLOR AS SHEET METAL  
- IF FASCIA IS NOT VERTICAL, INSTALL NEW METAL SUPPORT BRACKETS BEHIND GUTTER. SEE SUPPORT BRACKET  
- EXPANSION JOINTS IN GUTTER EVERY 50 FEET (MAX.)

**12 GUTTER & DOWNSPOUT DETAIL**  
SCALE: 1 1/2" = 1'-0"

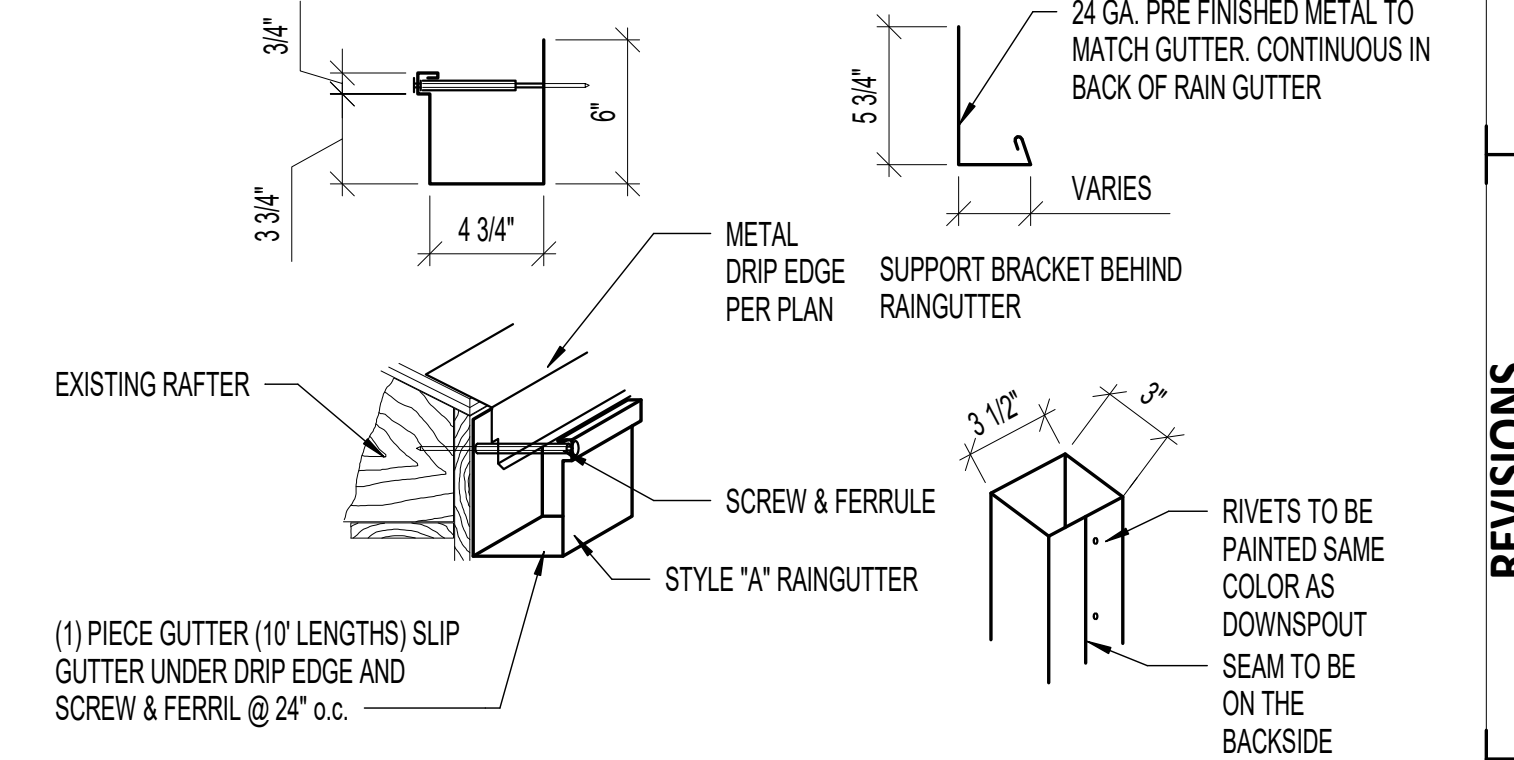


NOTE:  
- NO JOINTS ABOVE ENTRY DOORS.  
- RIVETS & SCREWS TO BE PAINTED SAME COLOR.  
- USE POP RIVETS AT ALL CONNECTIONS FROM RAIN GUTTERS TO DOWN SPOUTS  
- SPLASH BLOCKS TO BE UNDER EVERY DOWN SPOUT. VERIFY LOCATIONS AT EXISTING SITE.  
- CAULKING TO BE SAME COLOR AS SHEET METAL  
- IF FASCIA IS NOT VERTICAL, INSTALL METAL SUPPORT BRACKETS BEHIND GUTTER.


**13 GUTTER & DOWNSPOUT DETAIL- SCREW & FERRULE**  
SCALE: 1 1/2" = 1'-0"

REVISIONS	DATE	DESCRIPTION


PROJECT NO. 19294  
DRAWN BY AJV/BV  
CHECKED BY CEG  
DATE 11 APRIL 2022  
PROP. NO. 5016495

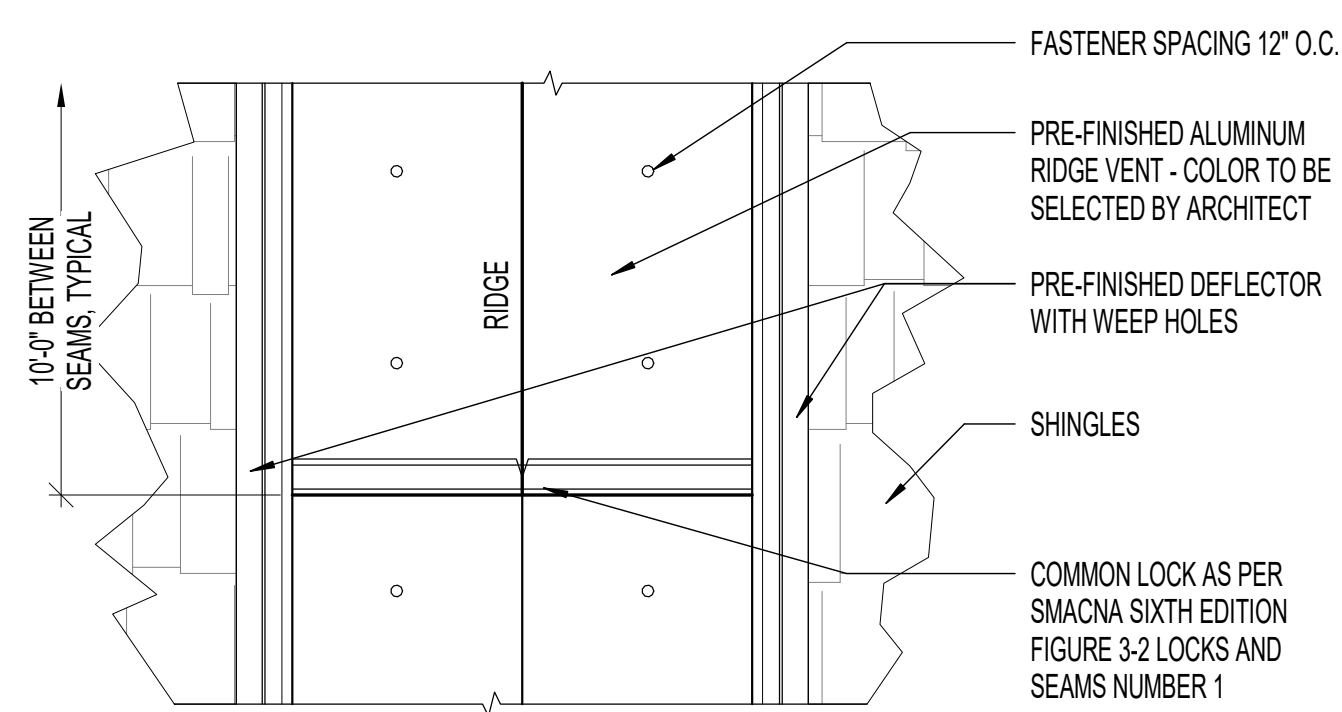


**1 RIDGE VENT PLAN**  
SCALE: 1 1/2" = 1'-0"

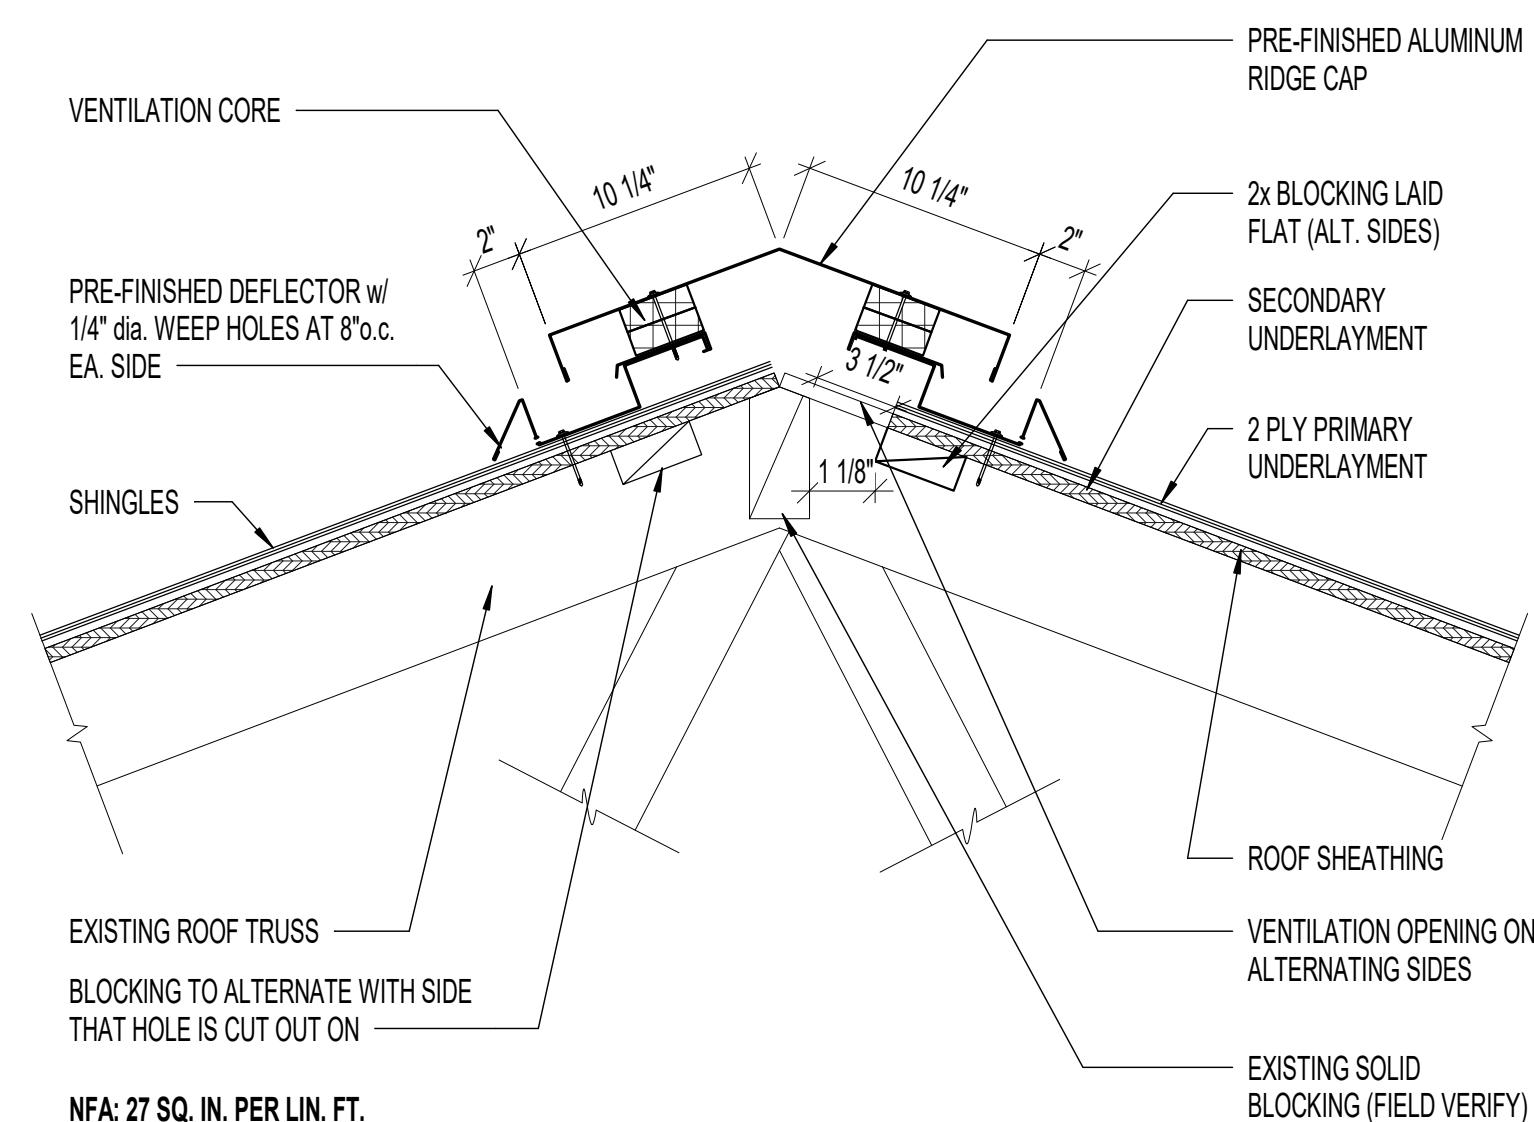


**2 RIDGE VENT SECTION**  
SCALE: 1 1/2" = 1'-0"

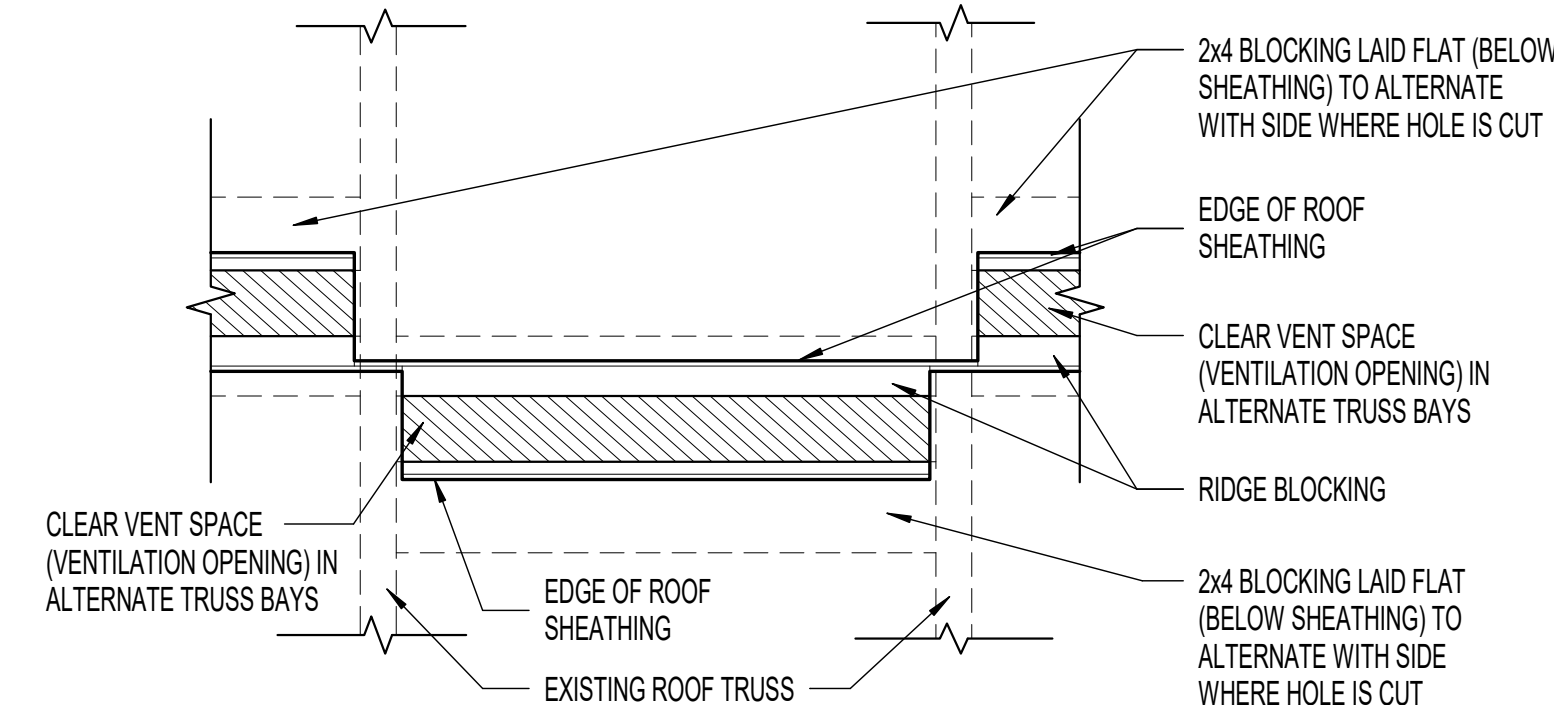


**3 RIDGE VENT PLAN (BELOW CAP)**  
SCALE: 1 1/2" = 1'-0"

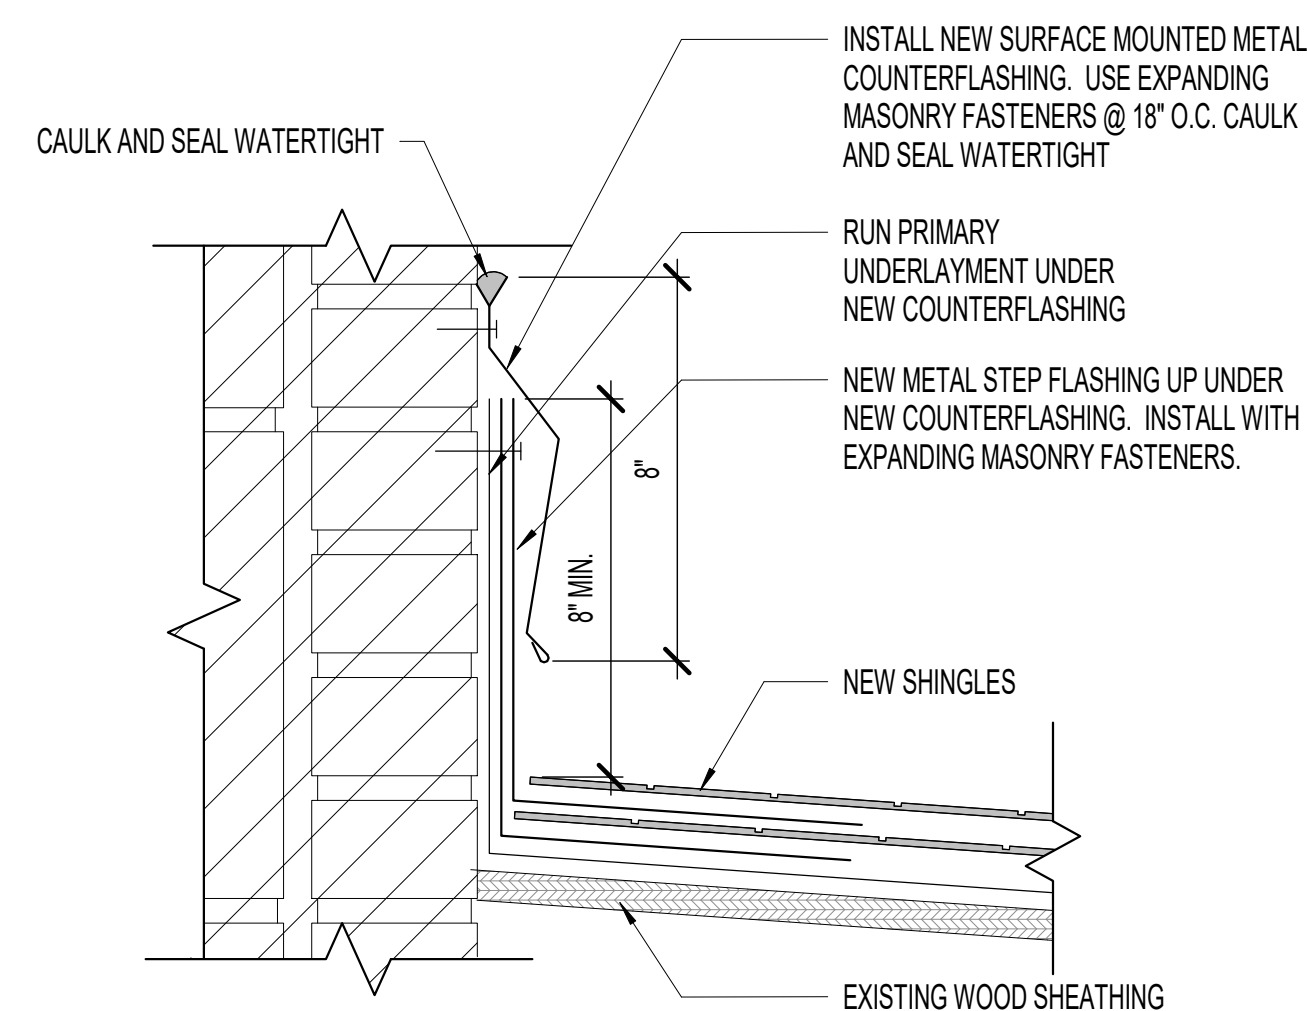


**4 STEP FLASHING DETAIL - SLOPED**  
SCALE: 3" = 1'-0"

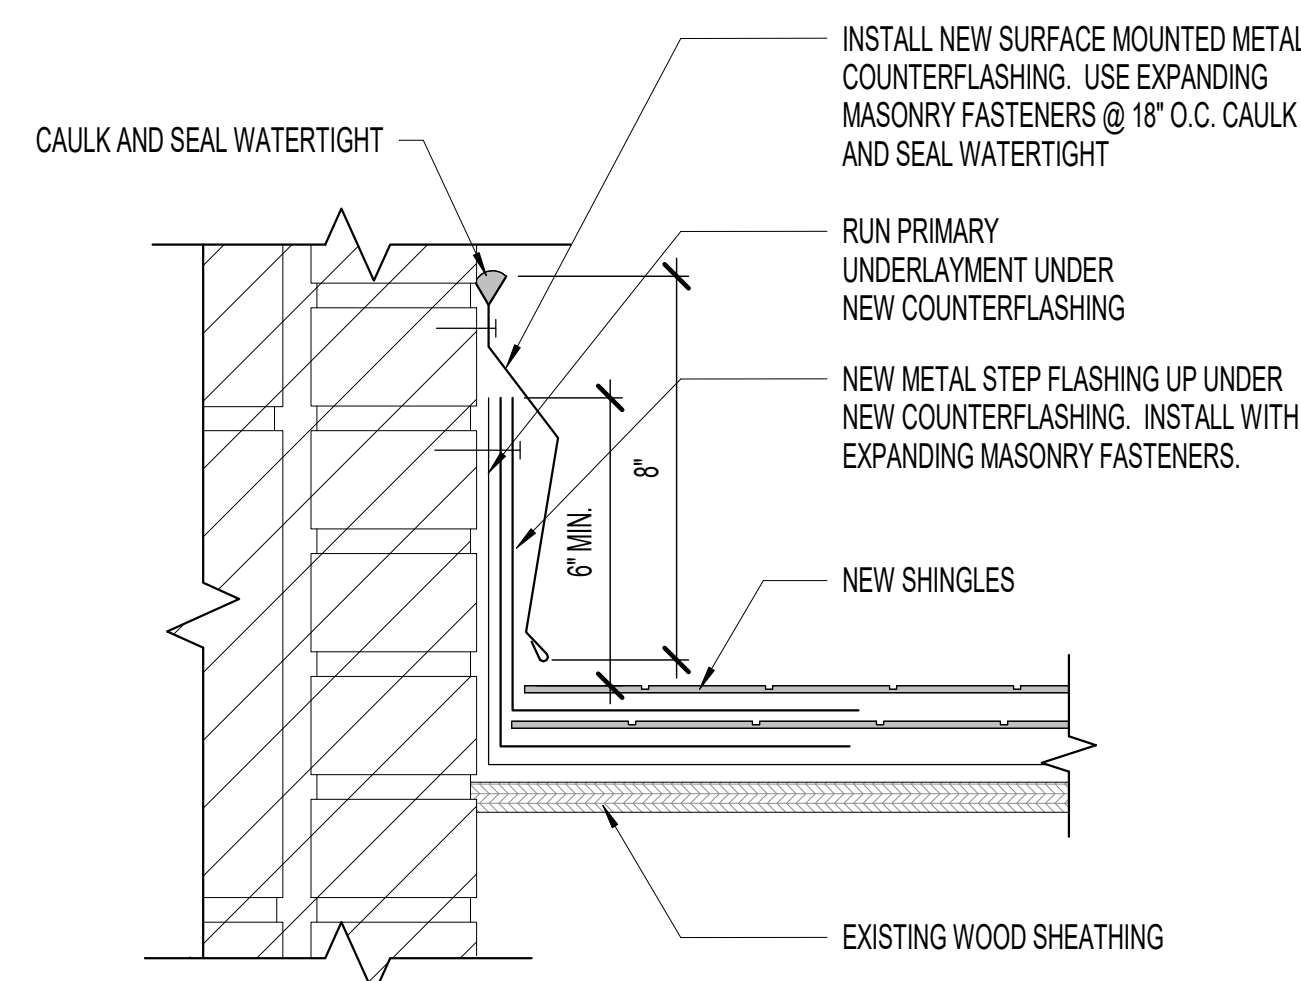


**5 STEP FLASHING DETAIL**  
SCALE: 3" = 1'-0"

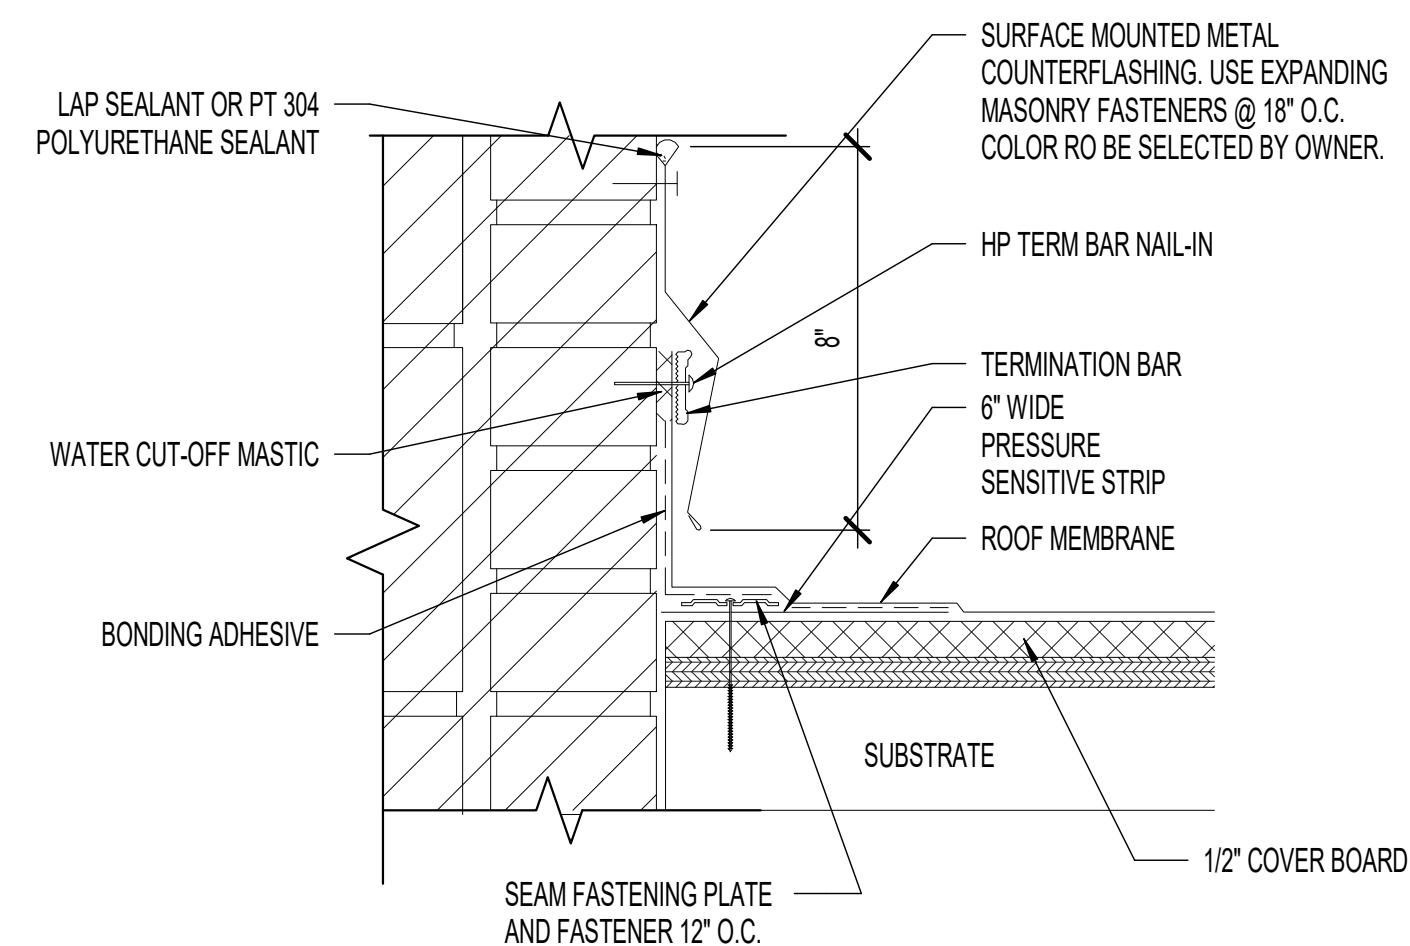


**6 COUNTER FLASHING DETAIL**  
SCALE: 3" = 1'-0"

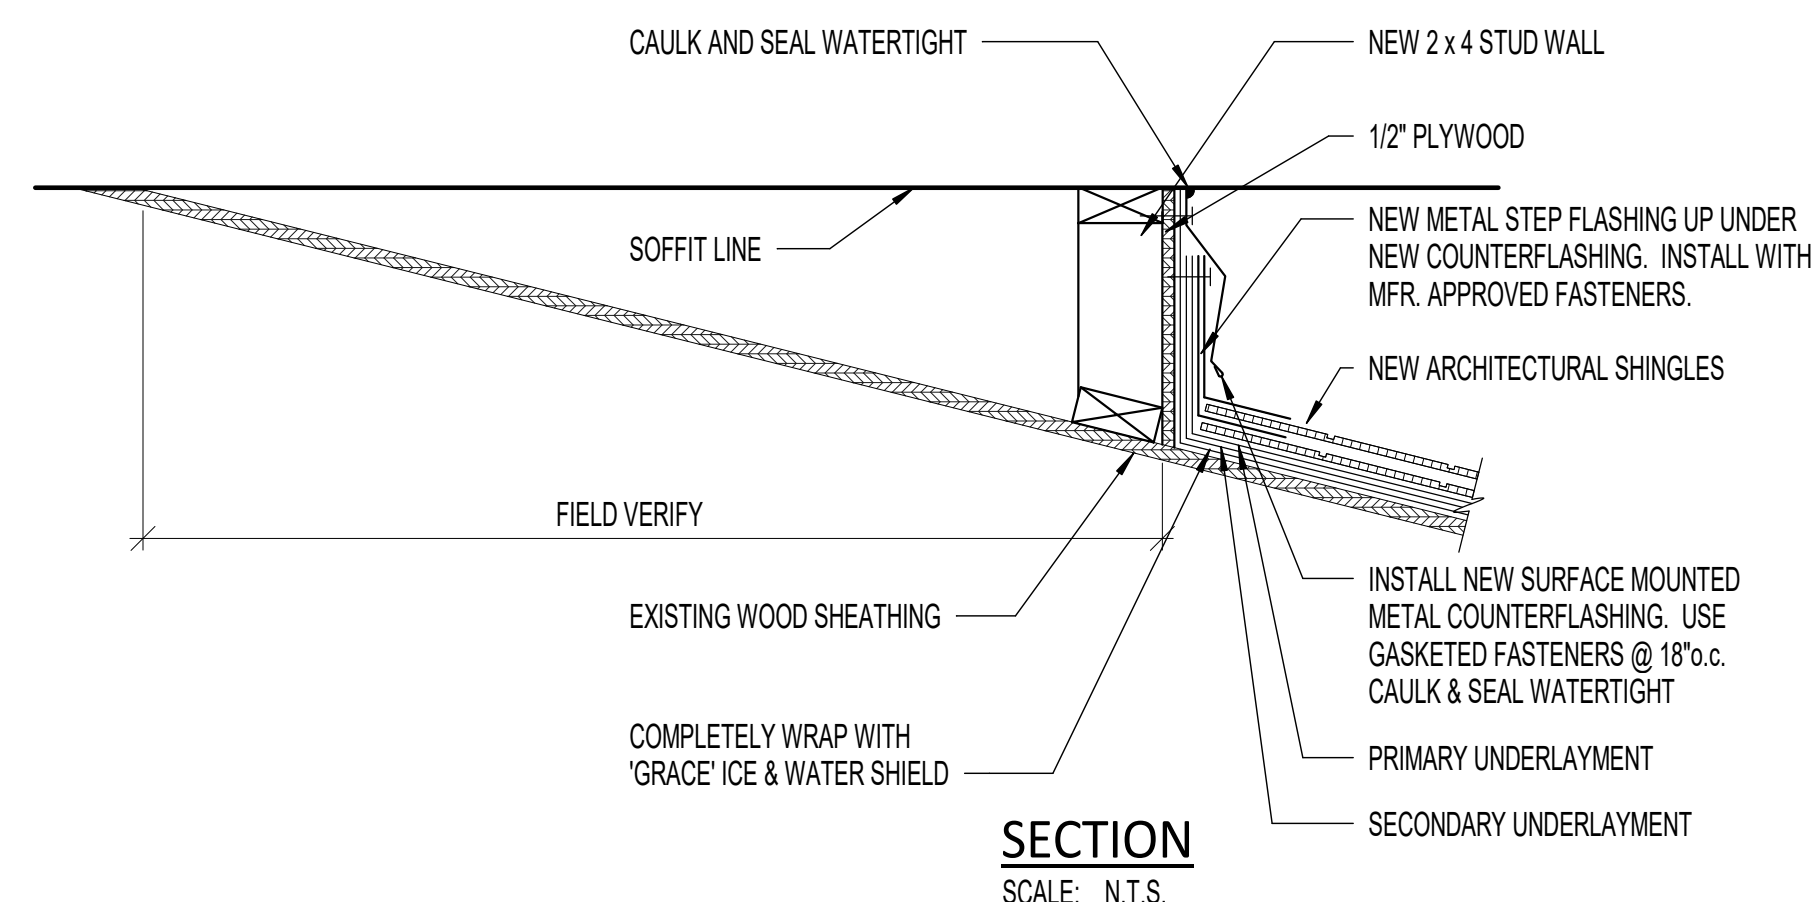

**7 BUILD-OUT FRAMING DETAIL**  
SCALE: 3/4" = 1'-0"

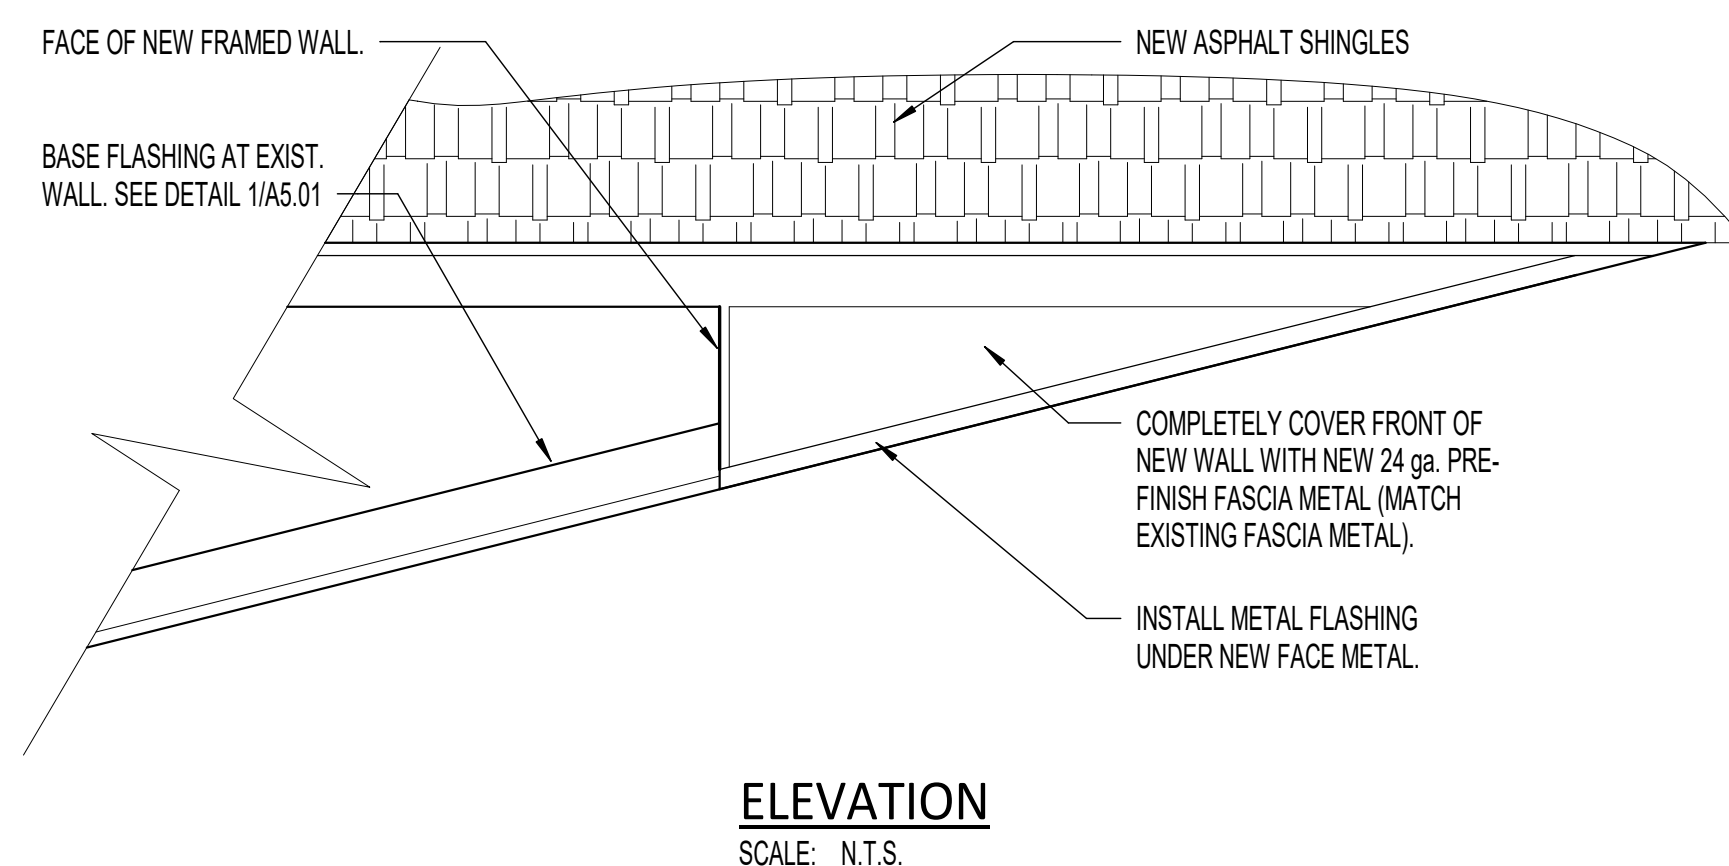

**ELEVATION**  
SCALE: N.T.S.

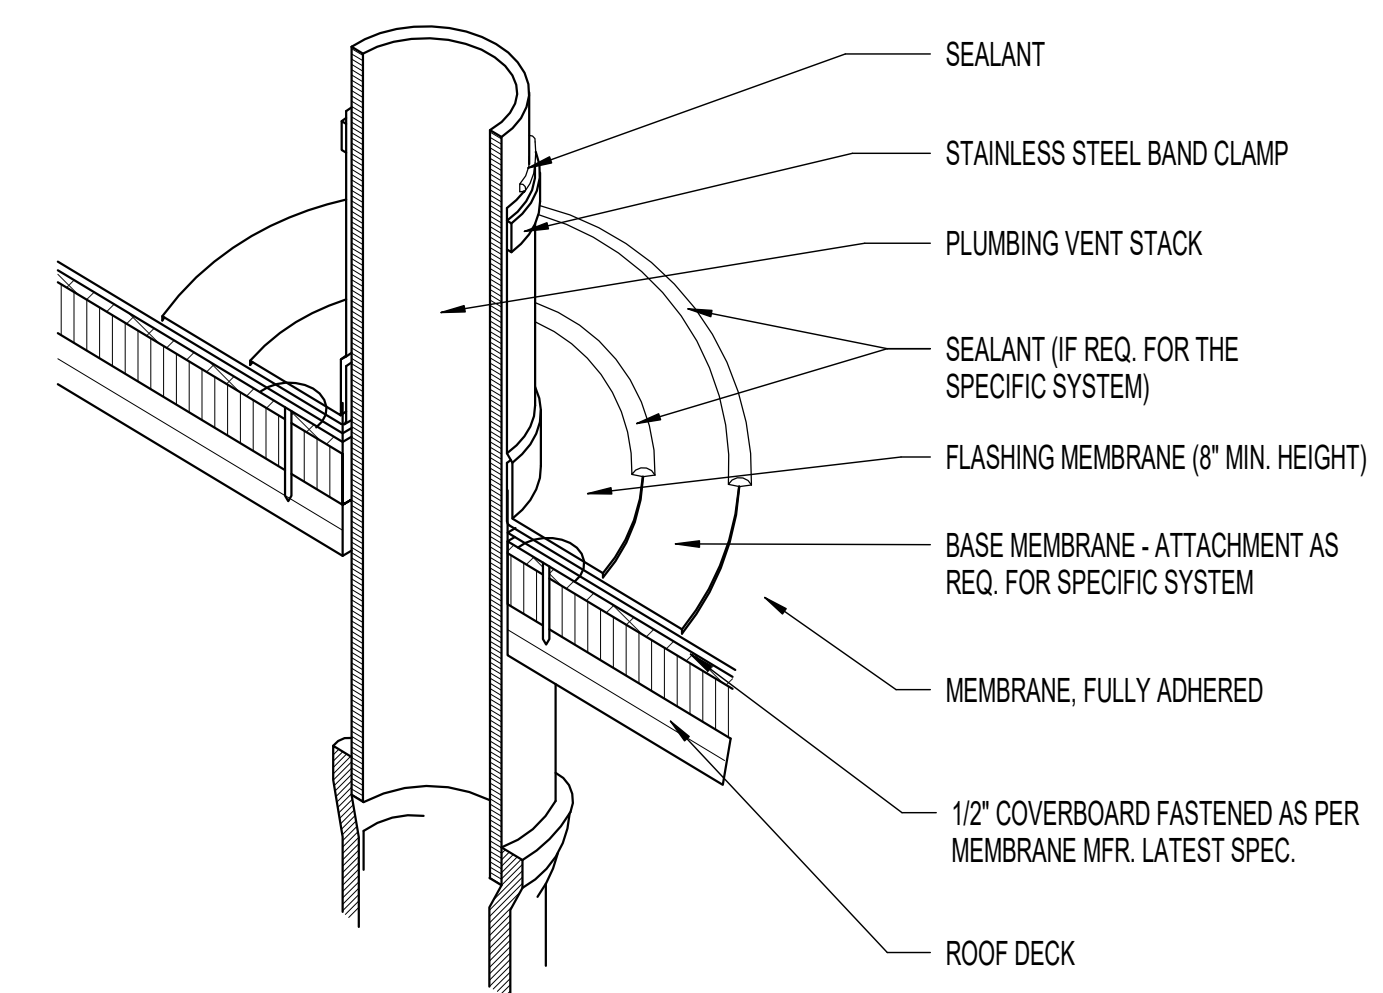


**8 PLUMBING VENT FLASHING - MEMBRANE**  
SCALE: 1 1/2" = 1'-0"


REVISIONS	DESCRIPTION

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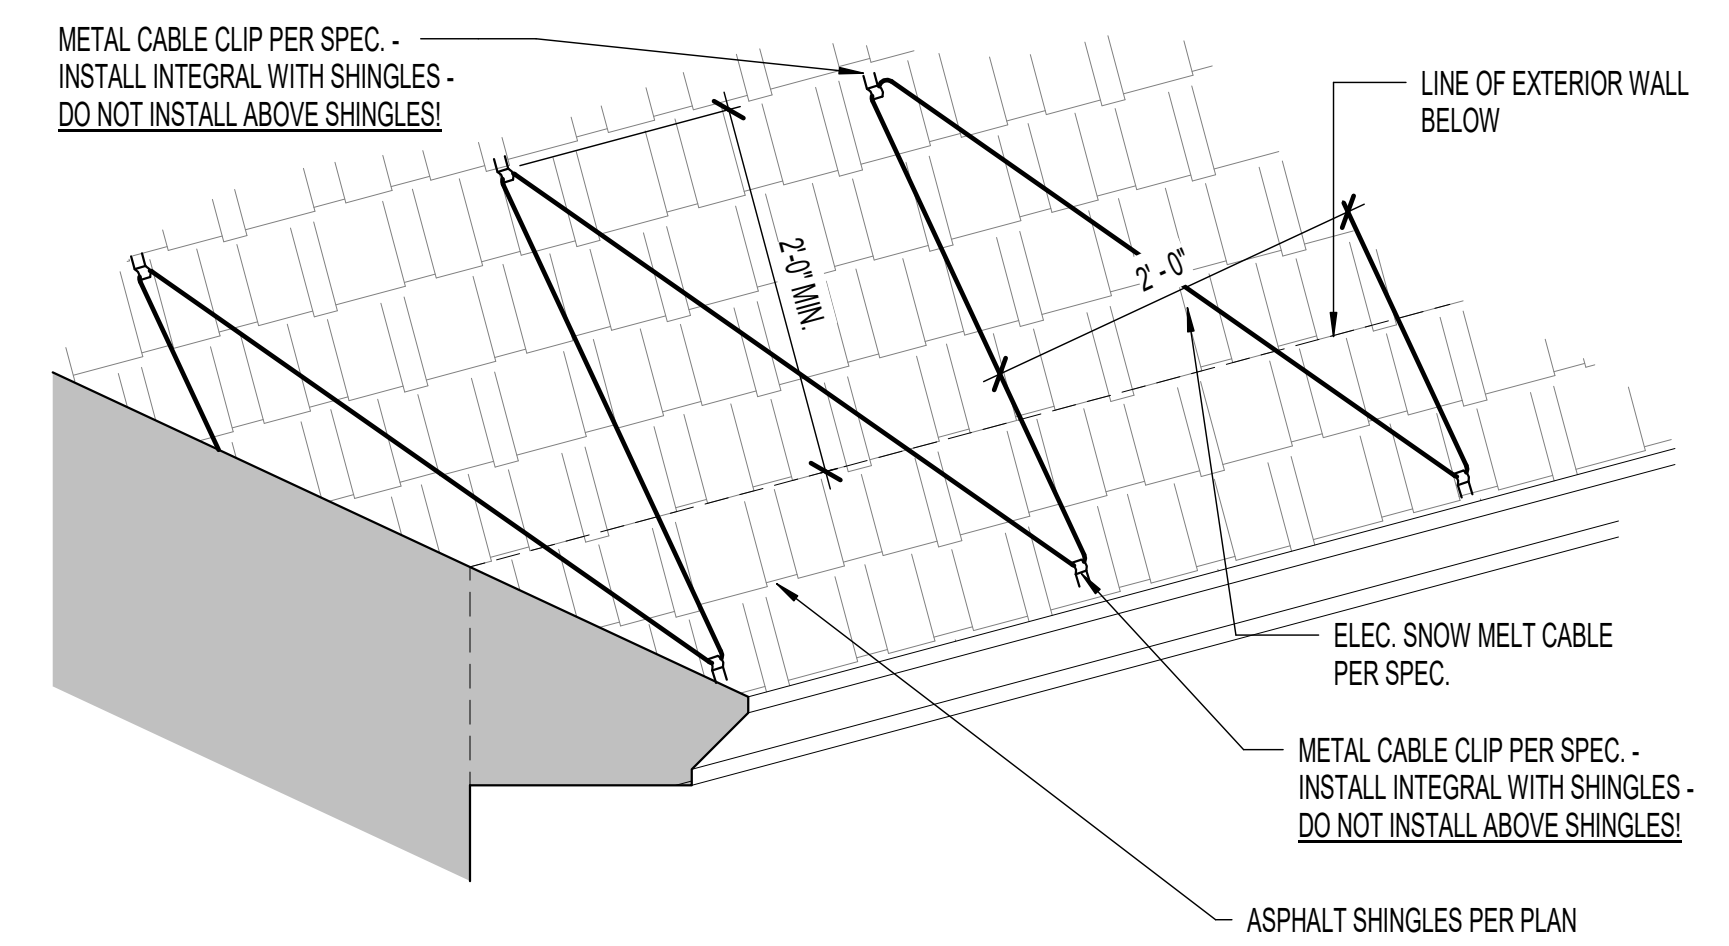
S:\2019\Files\19294\Consulting\Prod Dwg\19294 - Hillcrest 1, 2.rvt

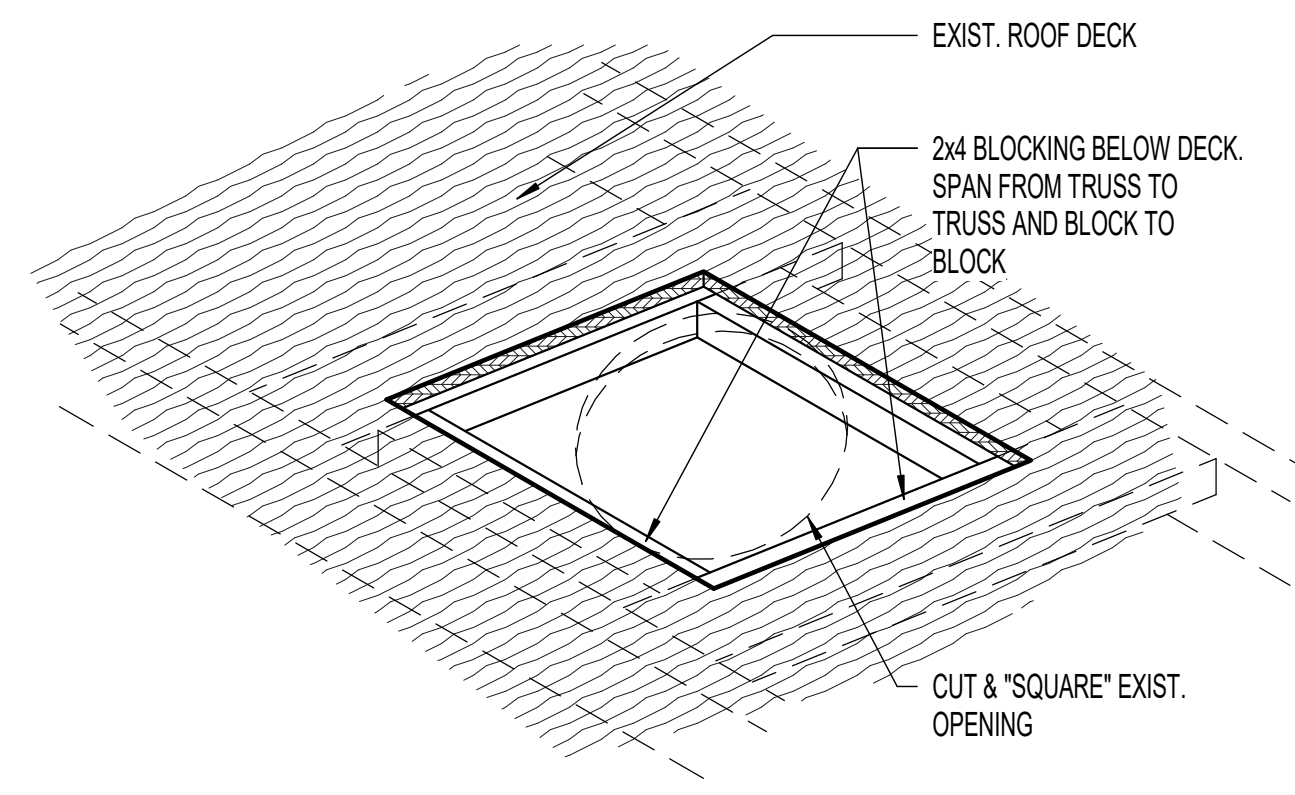


**1 PENETRATION REPAIR**  
SCALE: 1 1/2" = 1'-0"

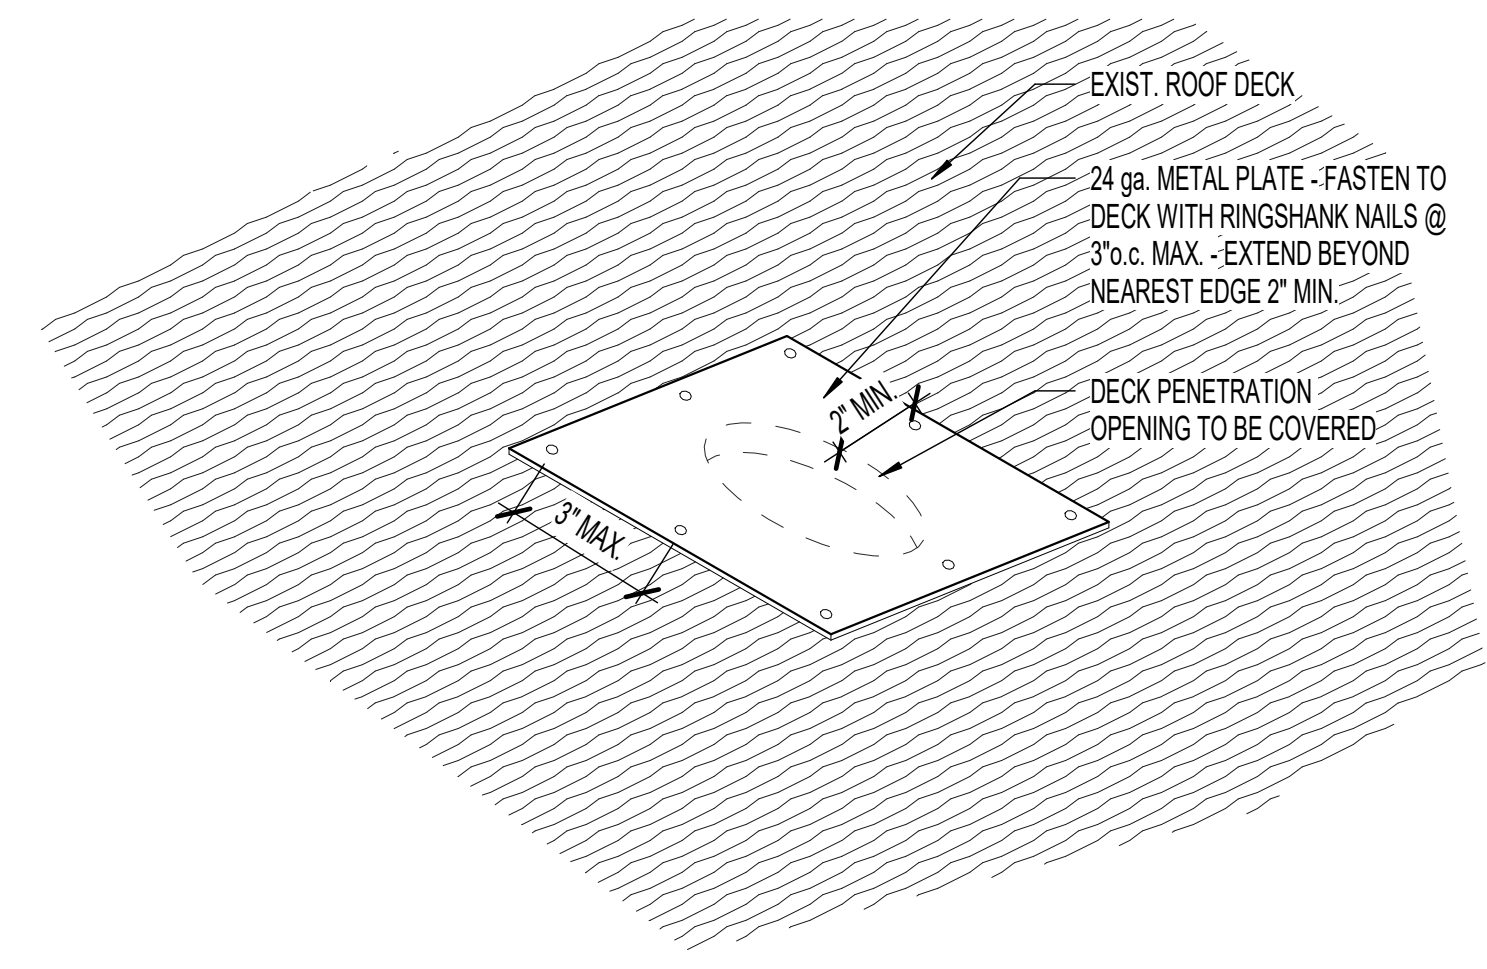


**2 PENETRATION COVER - 12" OR LESS**  
SCALE: 3" = 1'-0"




**3 SNOW MELT CABLES**  
SCALE: 1" = 1'-0"

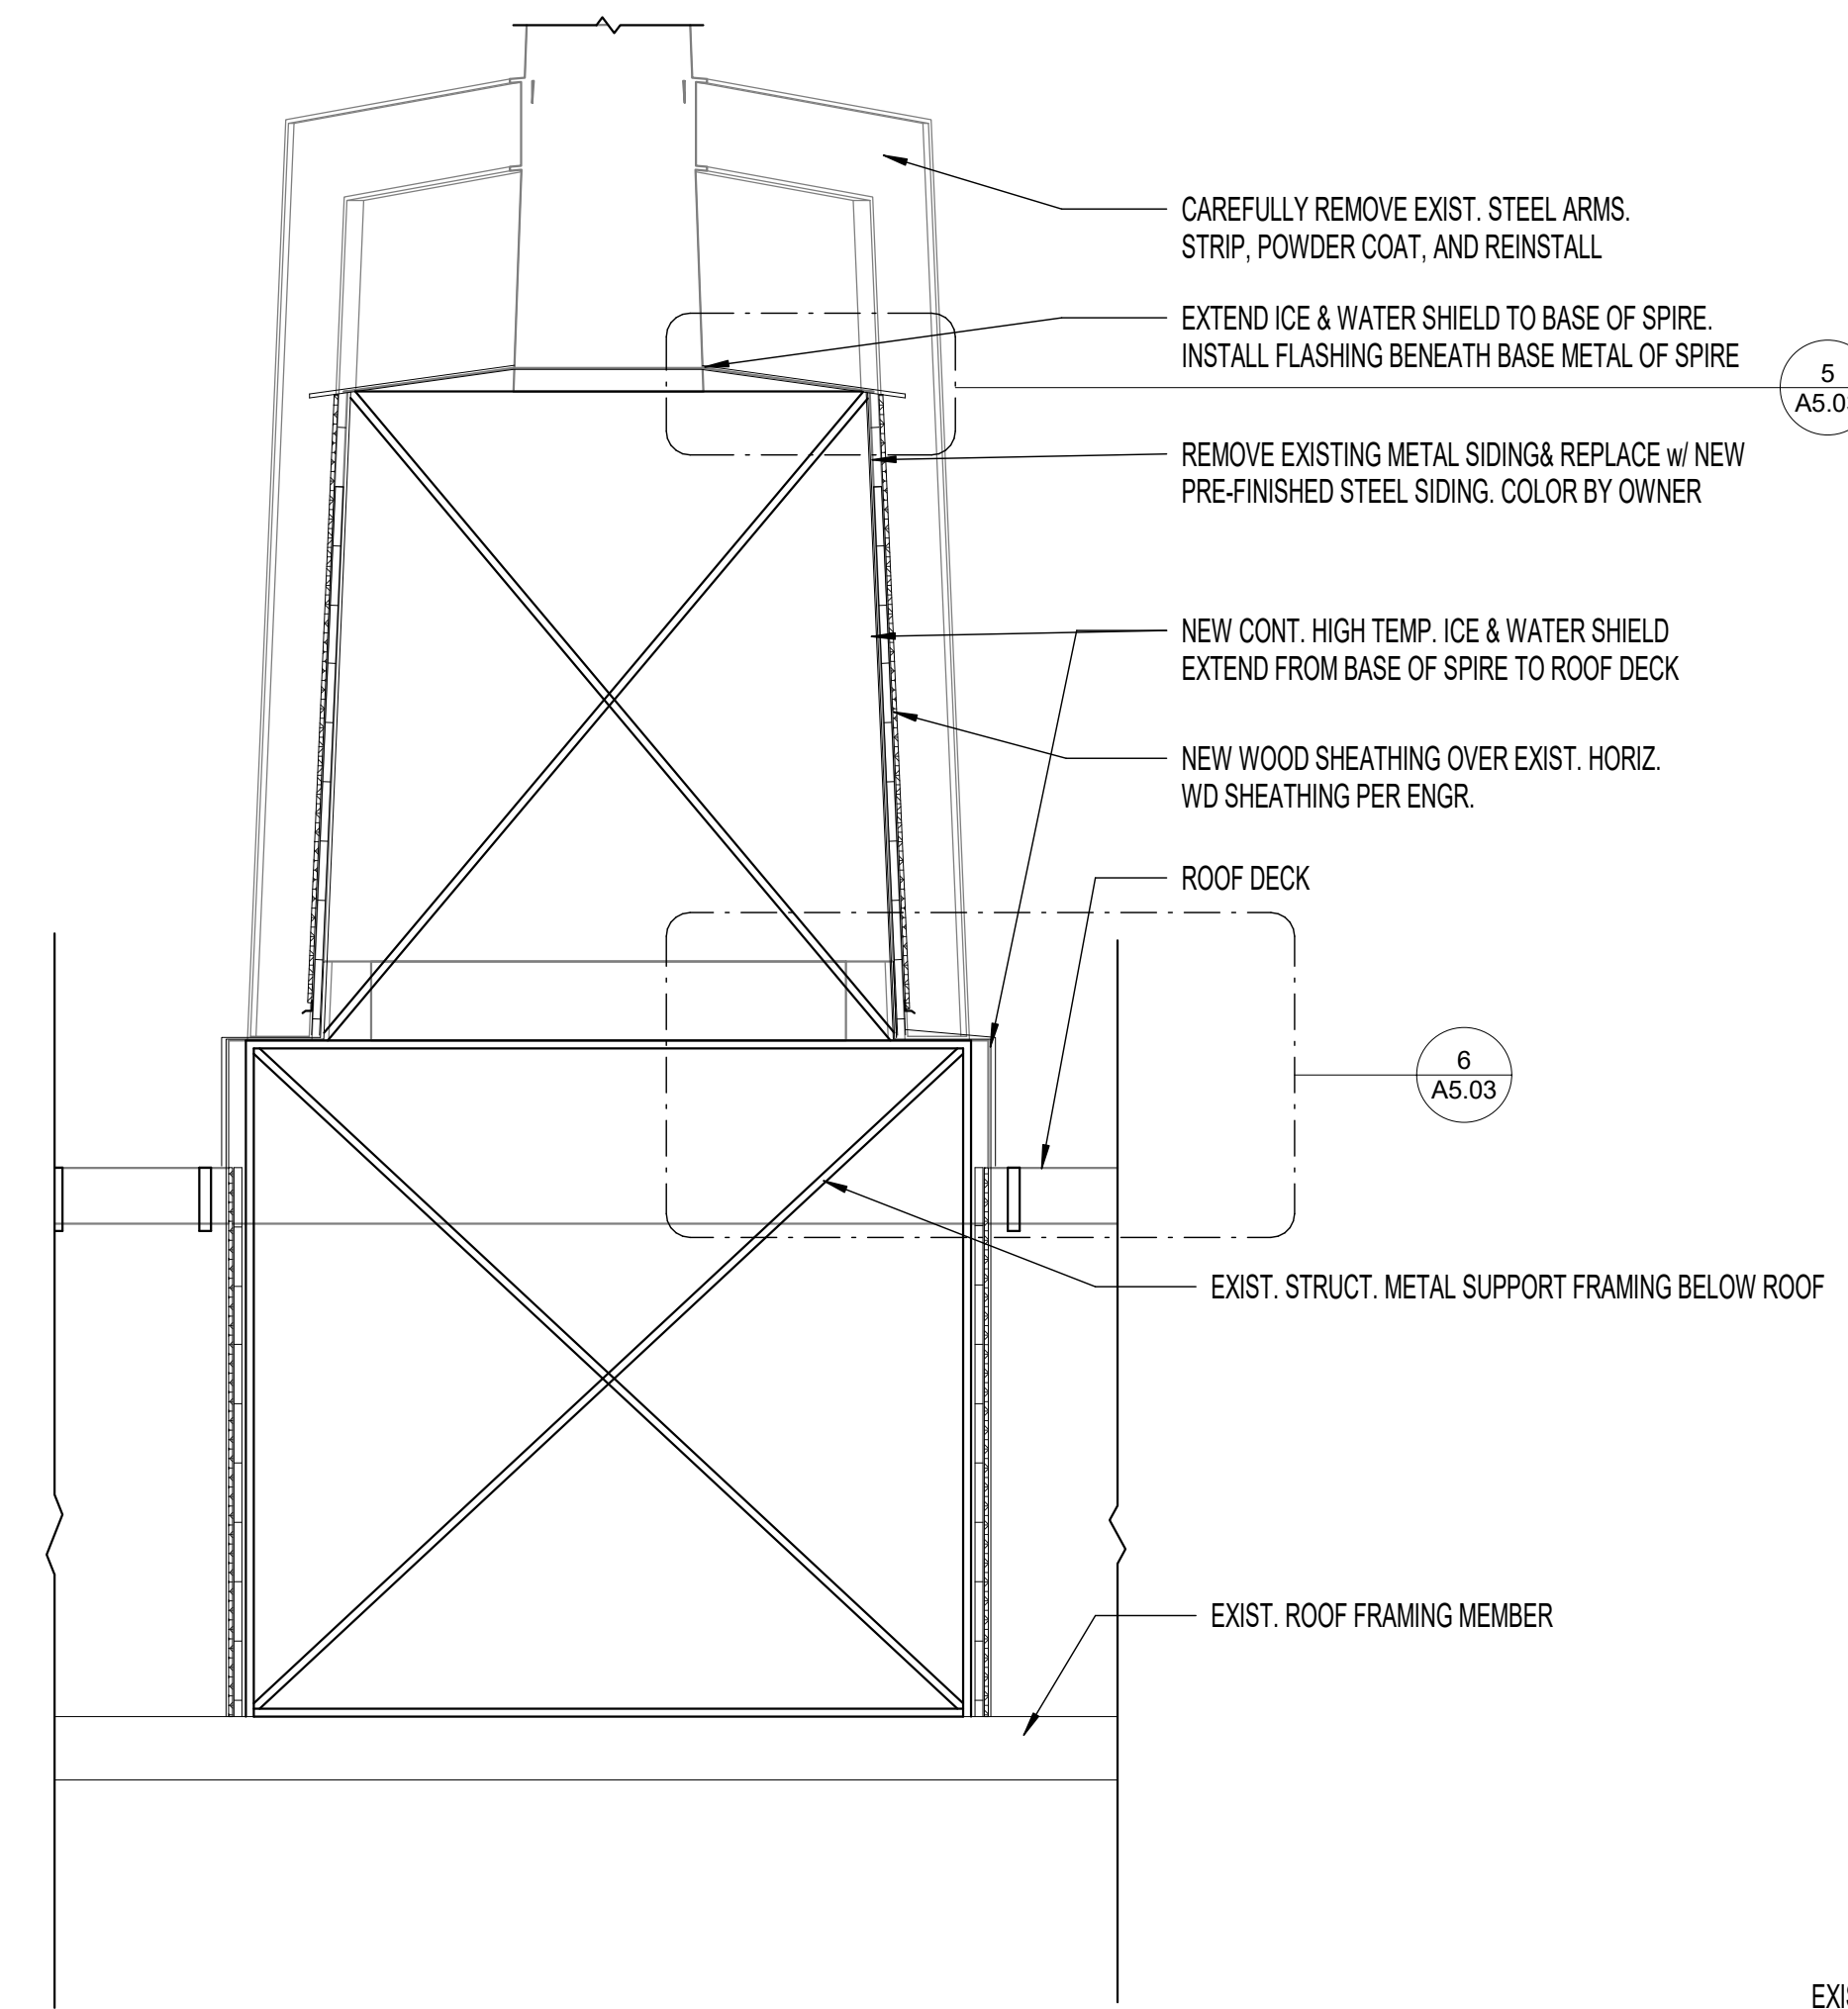


**4 STEEPLE SECTION**  
SCALE: 1/2" = 1'-0"

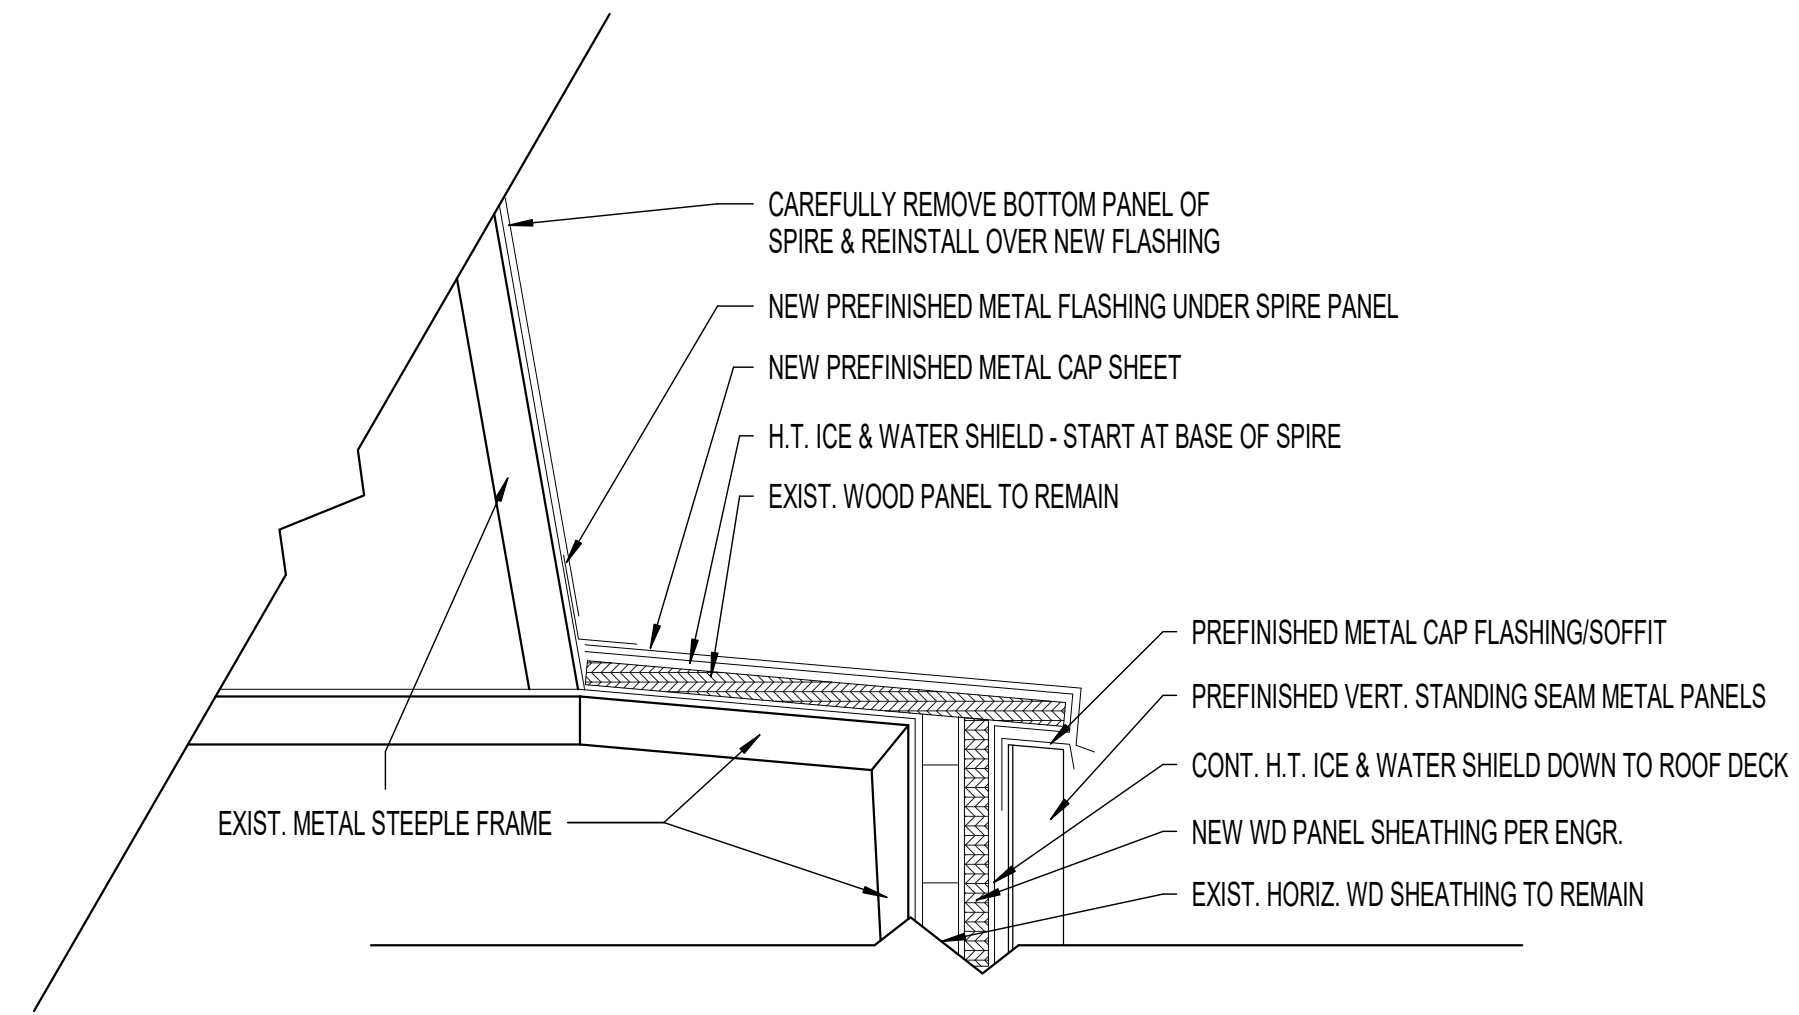

**5 DETAIL A**  
SCALE: 3" = 1'-0"

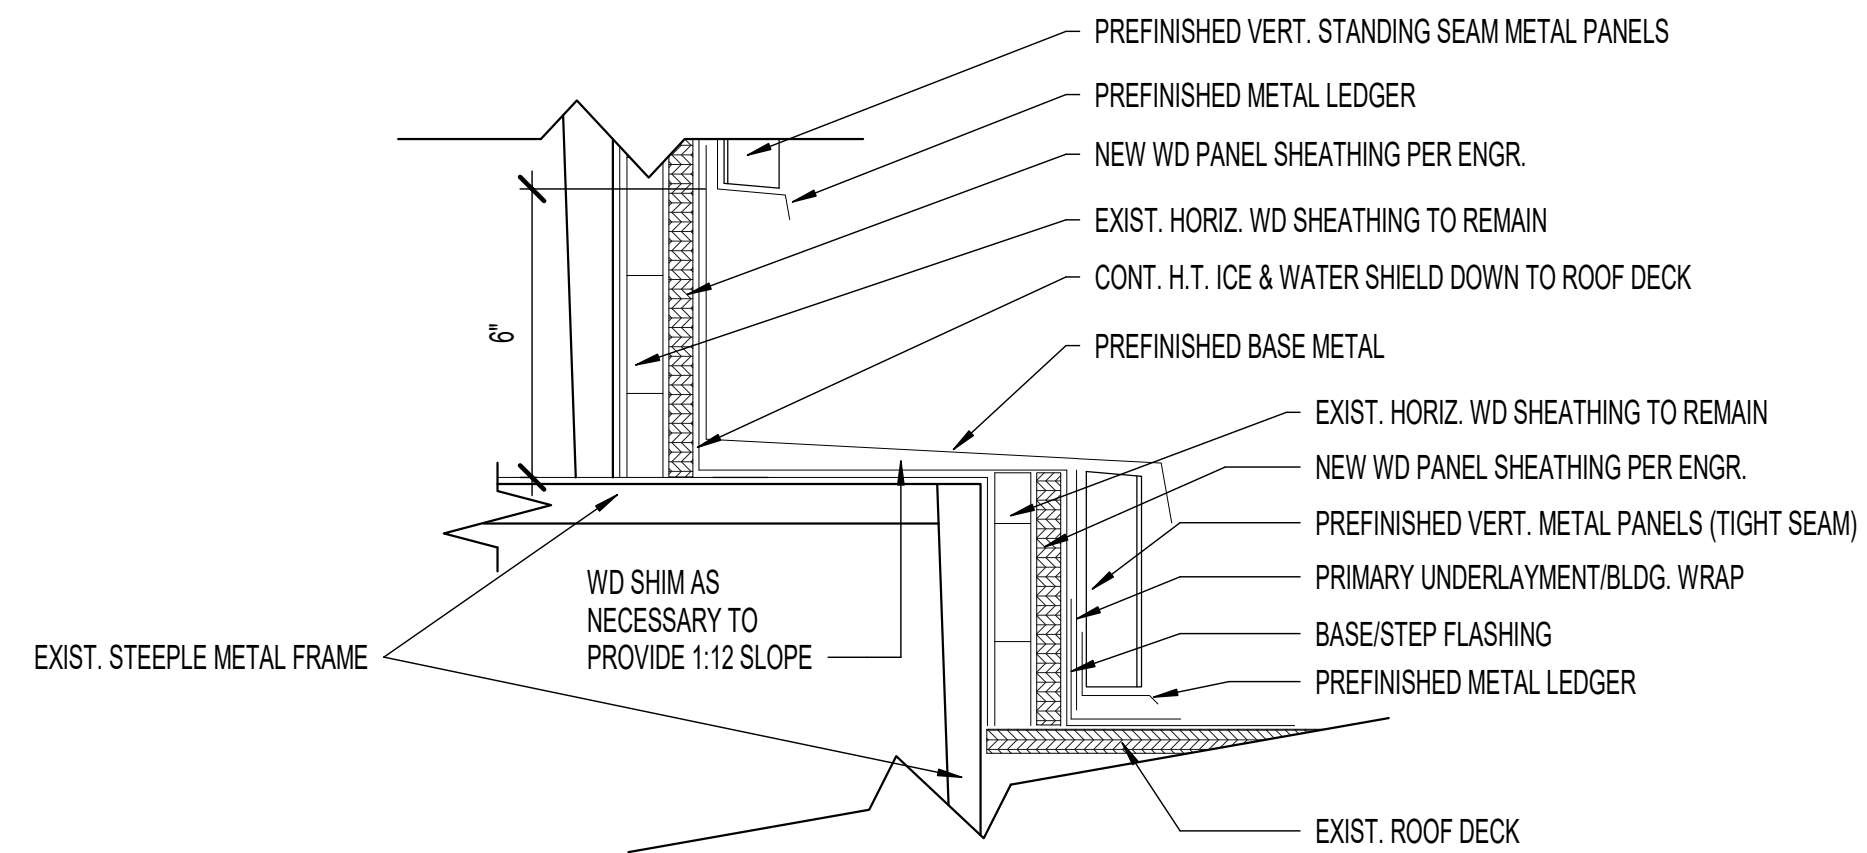

**6 DETAIL B**  
SCALE: 3" = 1'-0"

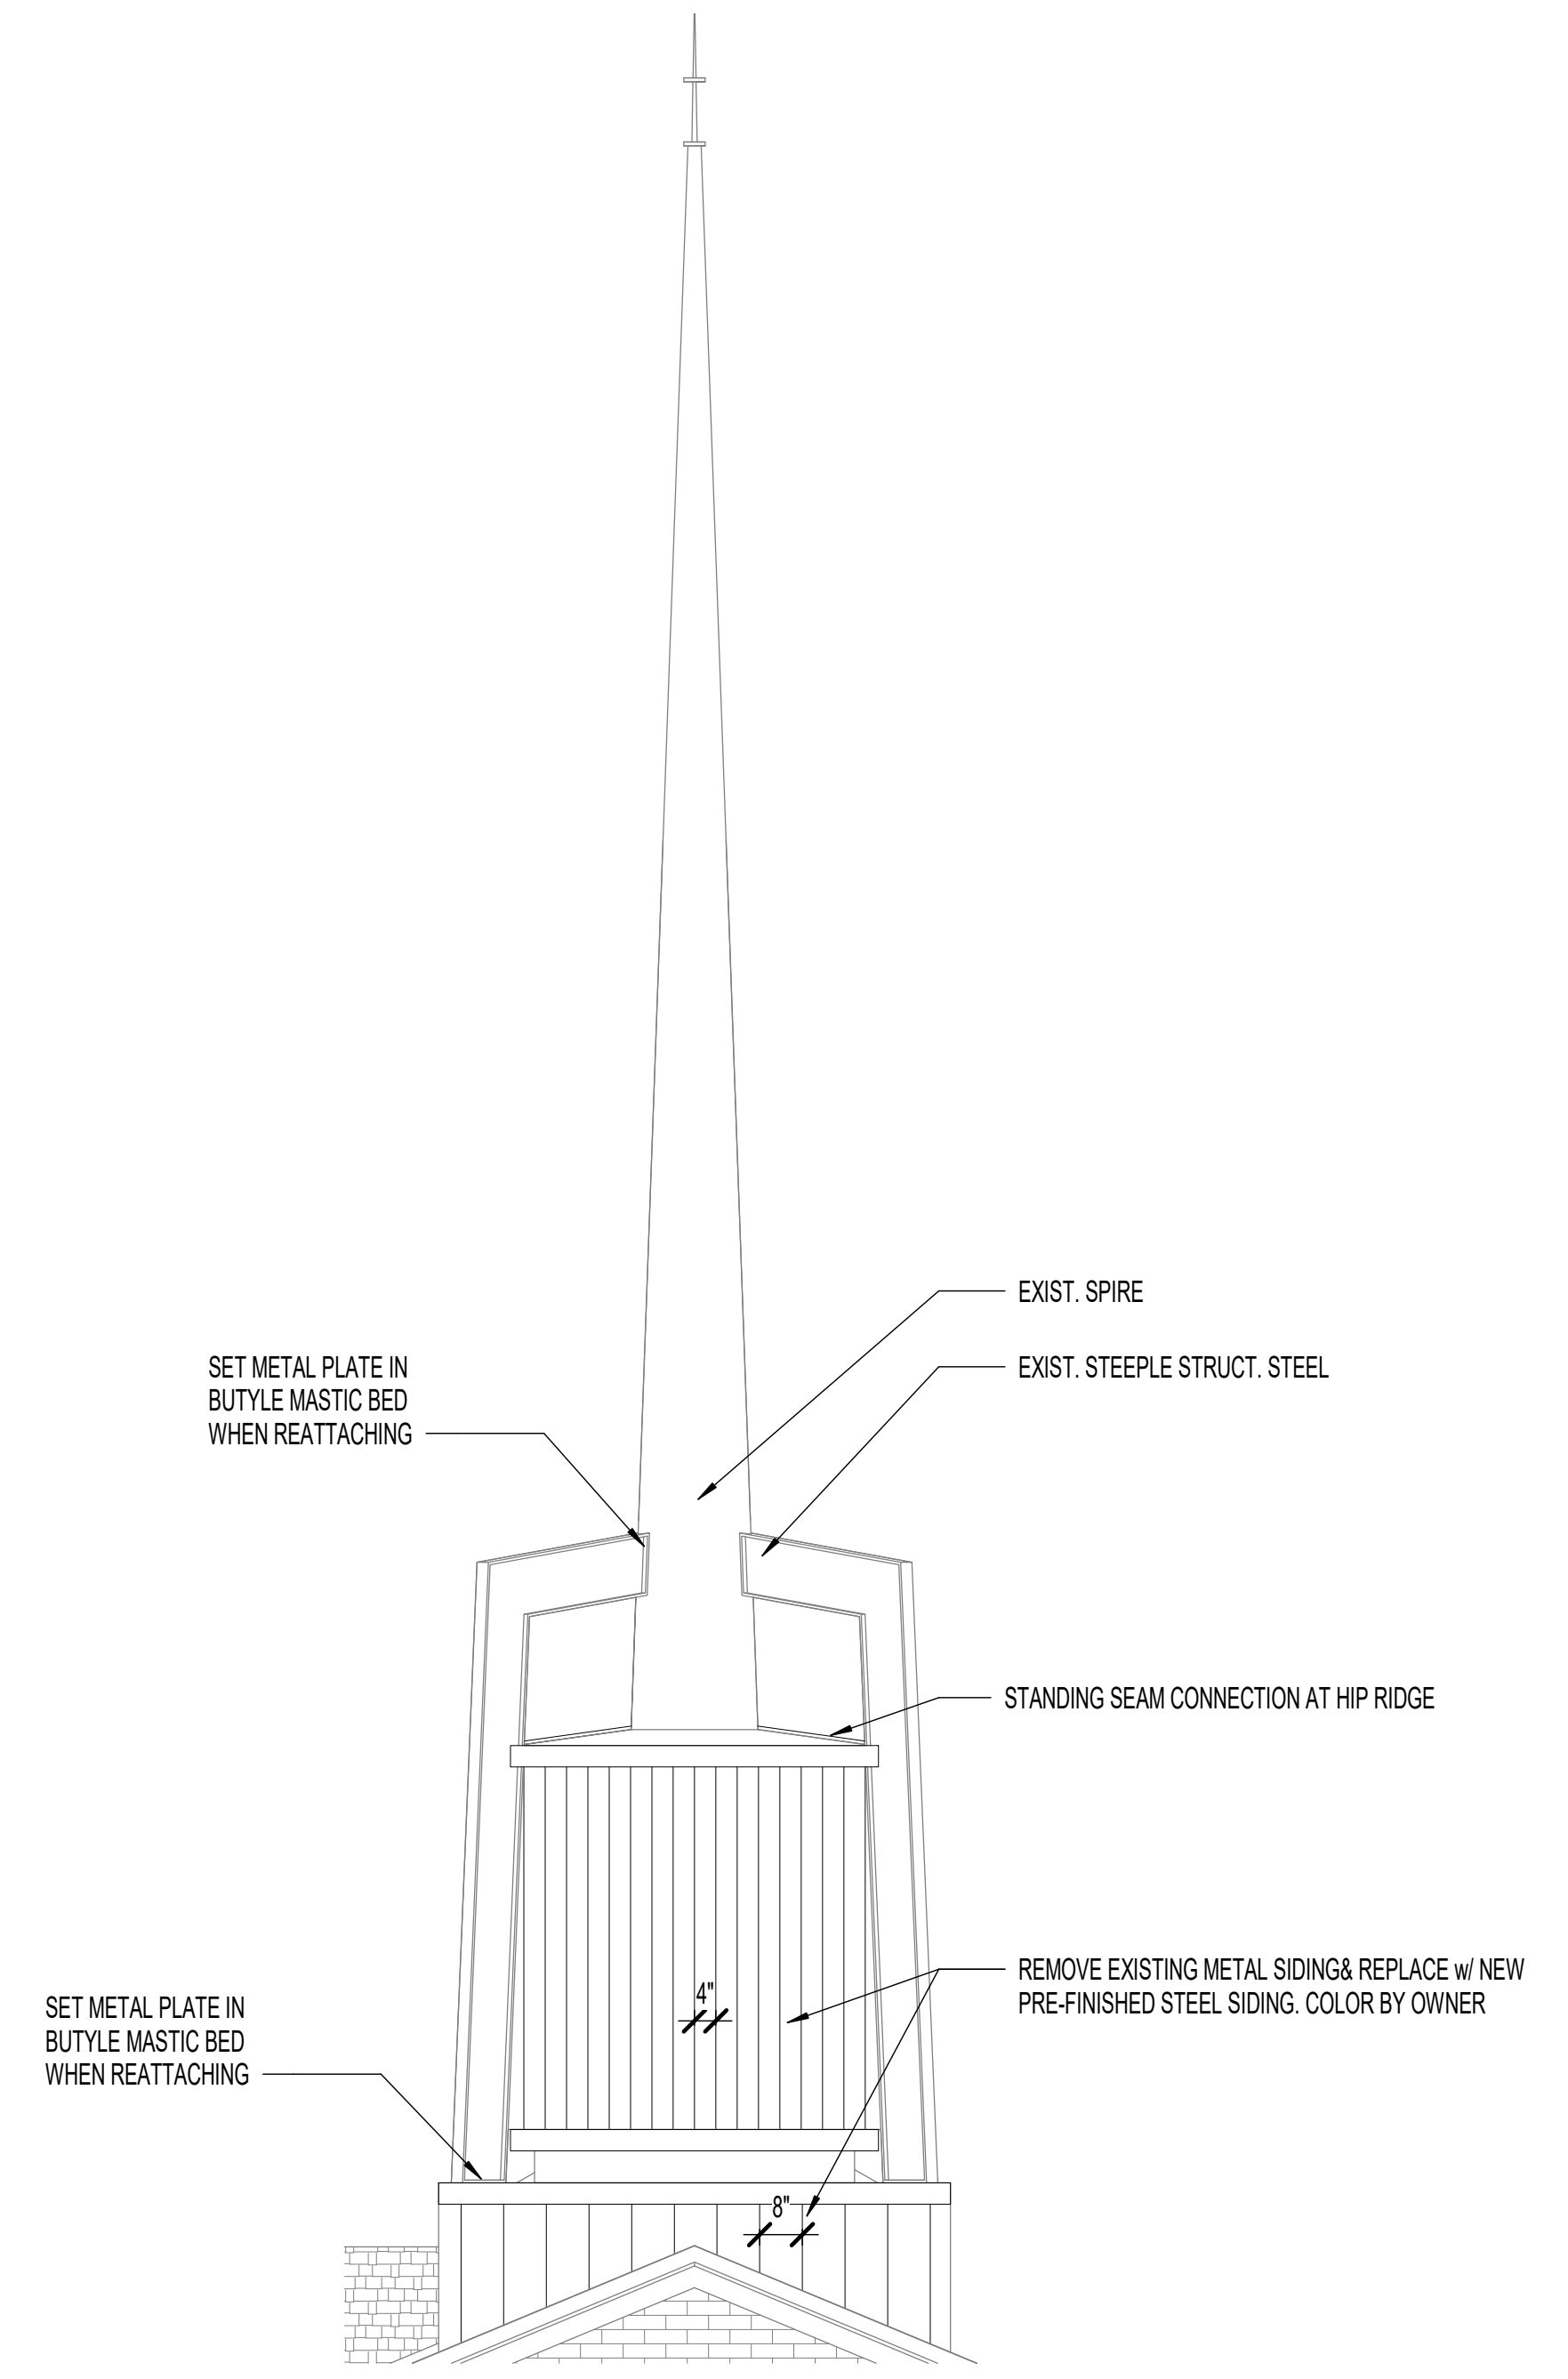

**7 STEEPLE ELEVATION**  
SCALE: 3/8" = 1'-0"

REVISIONS	DATE	DESCRIPTION

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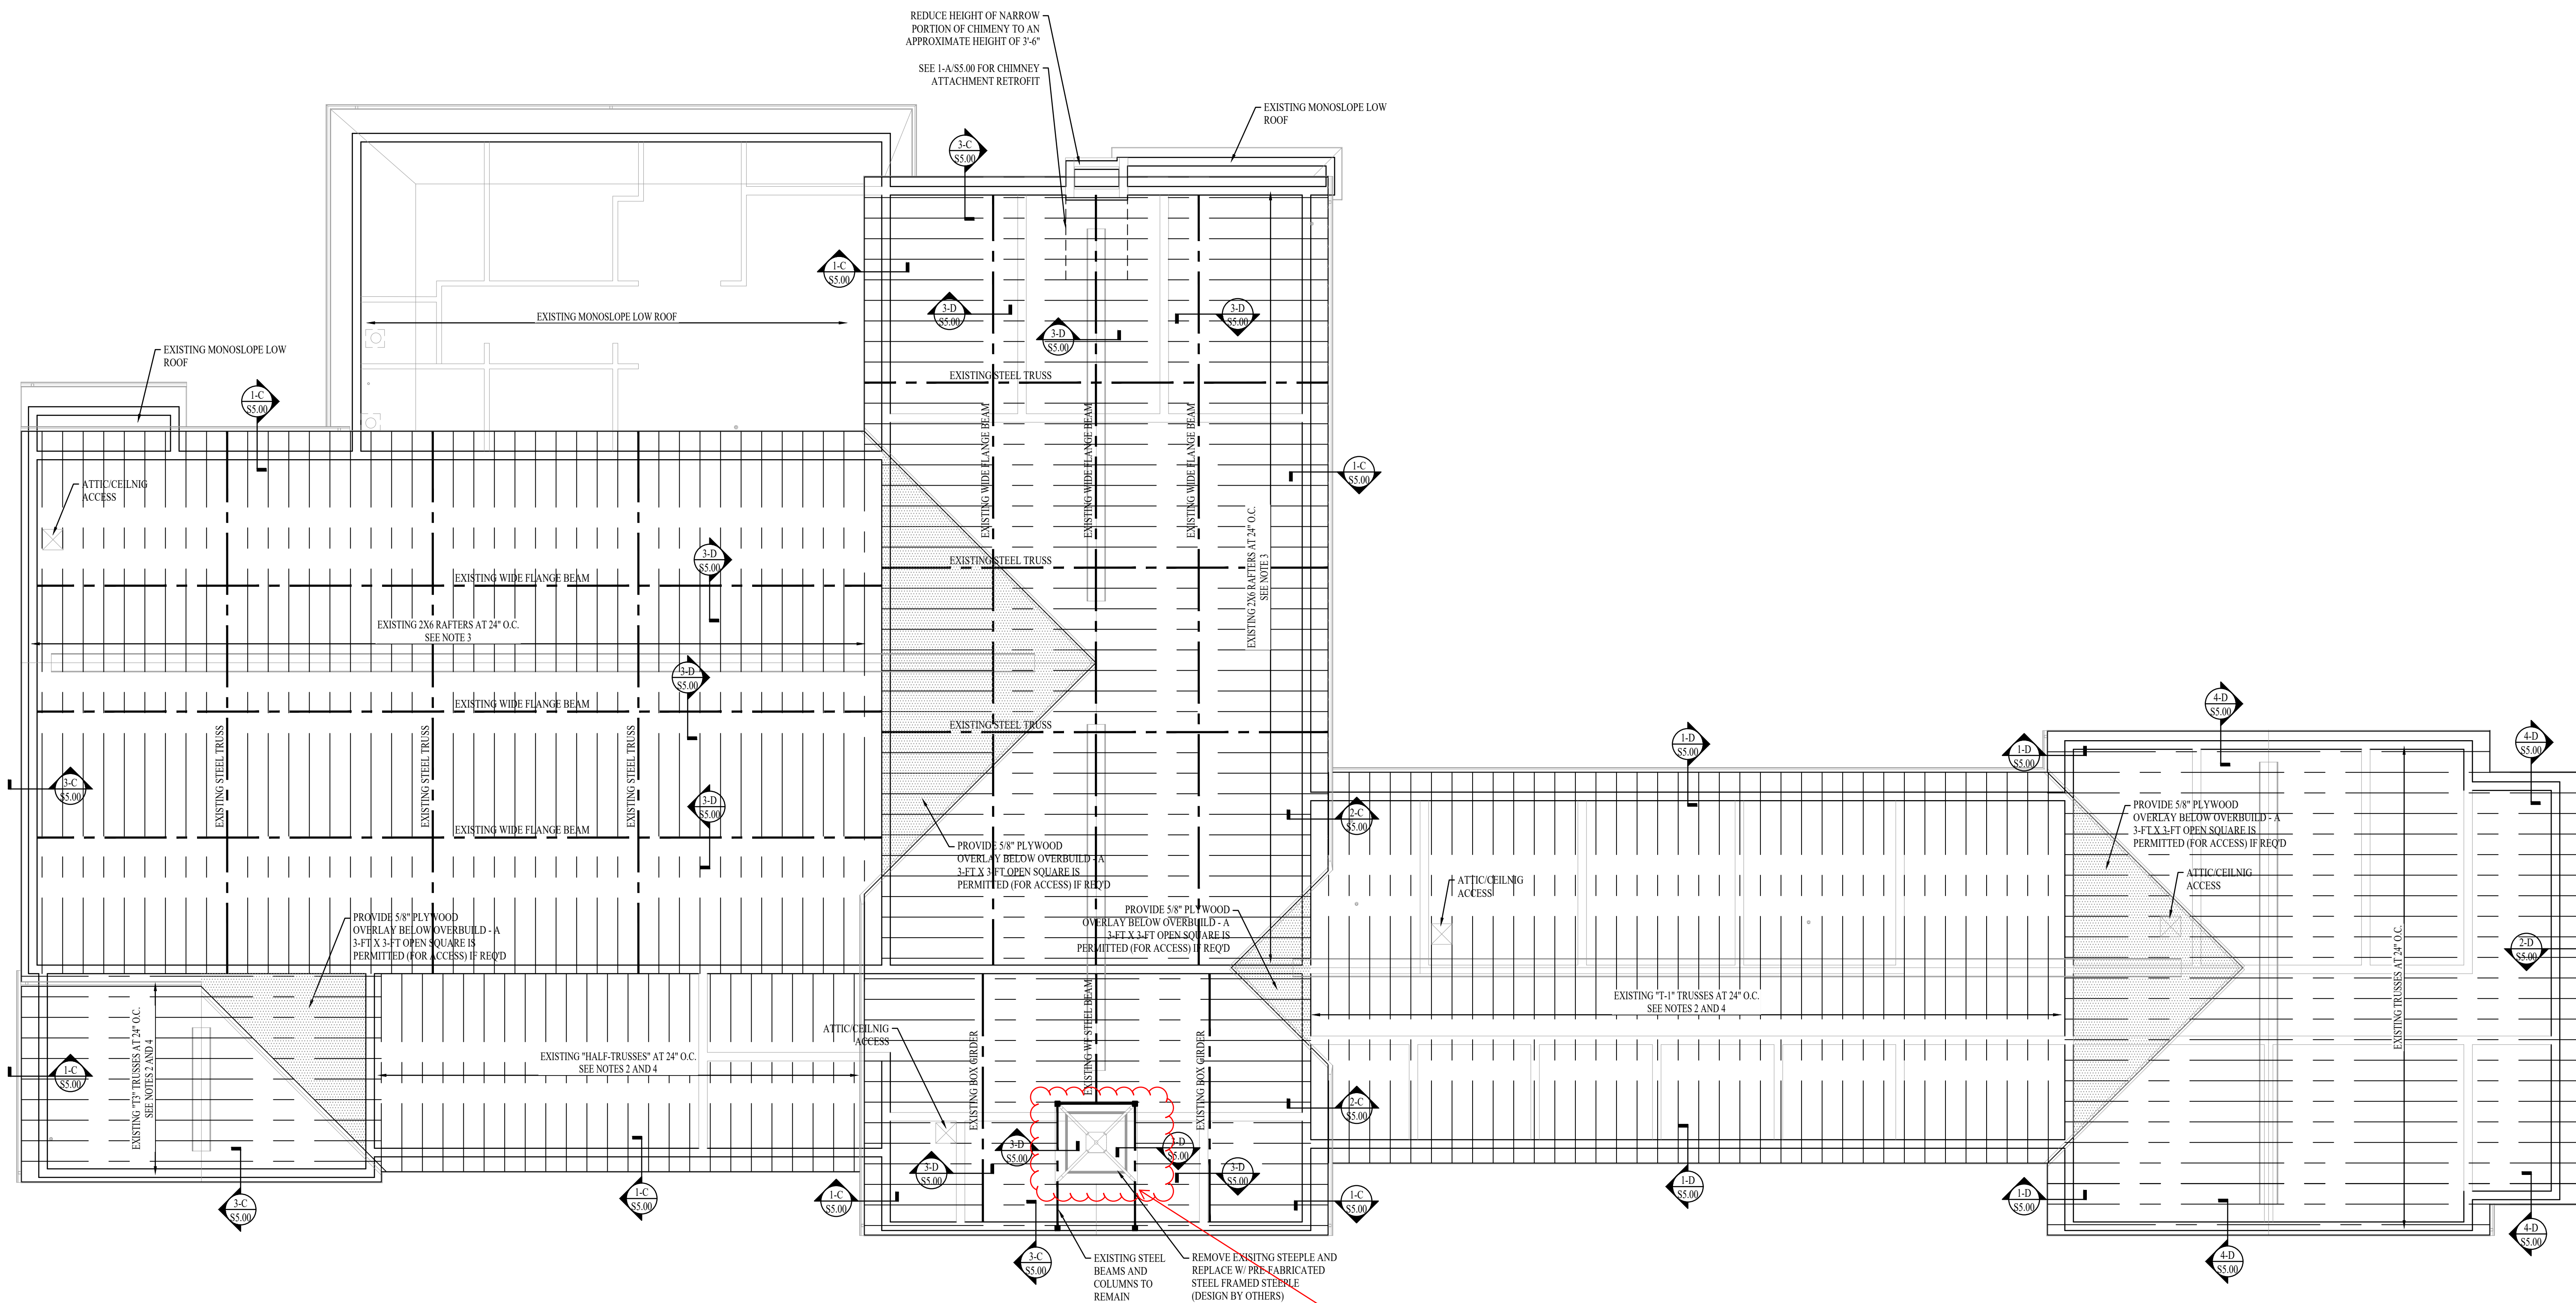


FRAMING NOTES

1	PROVIDE MIN OF 16d NAILS AT 4" O.C. AT ALL HIGH ROOF AND LOW ROOF DIAPHRAGM BOUNDARY ELEMENTS. PROVIDE MIN. 16d NAILS AT 6" O.C. FIELD NAILING
2	STRENGTHEN NAILED CONNECTIONS OF BOTTOM CHORD MEMBERS IN T1, T3, AND HALF TRUSSES - SEE DETAILS 3-A OR 3-B/S5.00, RESPECTIVELY
3	SISTER NEW 2X6 JOISTS TO EXISTING W/ (2) ROWS 16d NAILS AT 12" O.C.
4	UPGRADE DEFICIENT CHORDS OF T1, T3, AND HALF TRUSSES WITH SISTERED MEMBERS - SEE DETAILS 3-A OR 3-B/S5.00, RESPECTIVELY.

FOR CLIENT REVIEW - NOT FOR CONSTRUCTION

HILLCREST 1, 2 RE-ROOF  
 LOGAN UATH EAST STAKE  
 875 NORTH 1500 EAST, LOGAN, UT



REV	DATE	DESCRIPTION


PROJECT NO:	19294
DRAWN BY:	ARN
CHECKED BY:	CRP
DATE:	03/28/22
SHEET:	02 OF 03

ROOF FRAMING PLAN


\$1.00

**ROOF FRAMING PLAN**  
 SCALE: 1/4"=1'-0"  
 0' 1' 2' 4' 6' 10' 20'  
 NOTE: DO NOT SCALE PLAN. USE AS REFERENCE ONLY  
 VERIFY ALL DIMENSIONS ON ARCHITECTURAL PLANS


OSB OVERLAY ON STEEPLE?

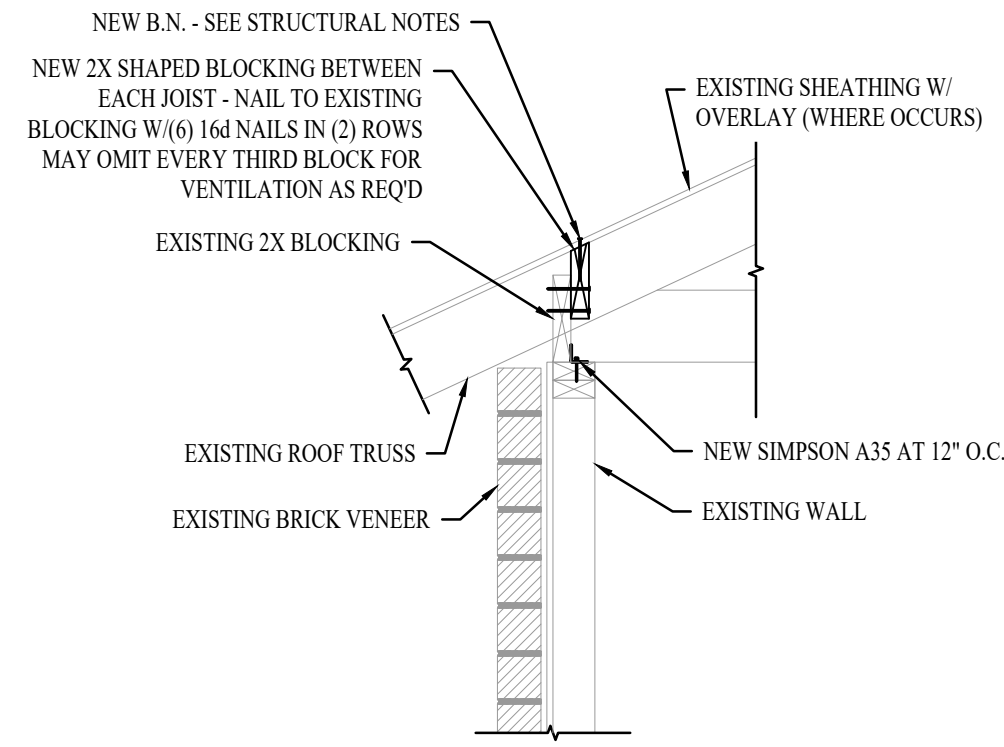


1-D  
3/4"=1'-0"

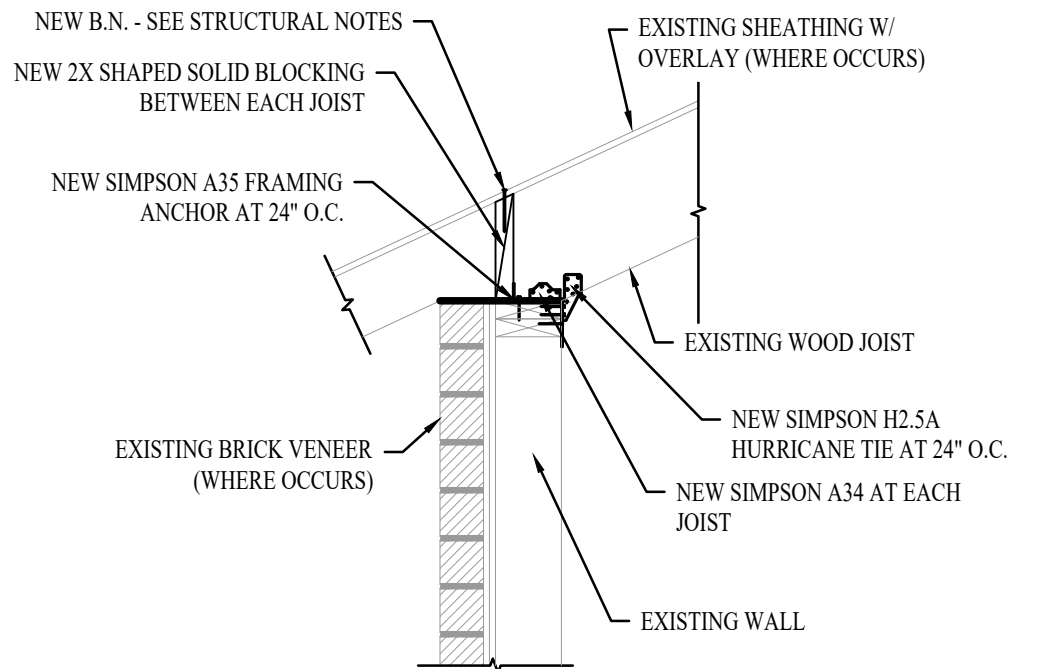


2-D  
3/4"=1'-0"

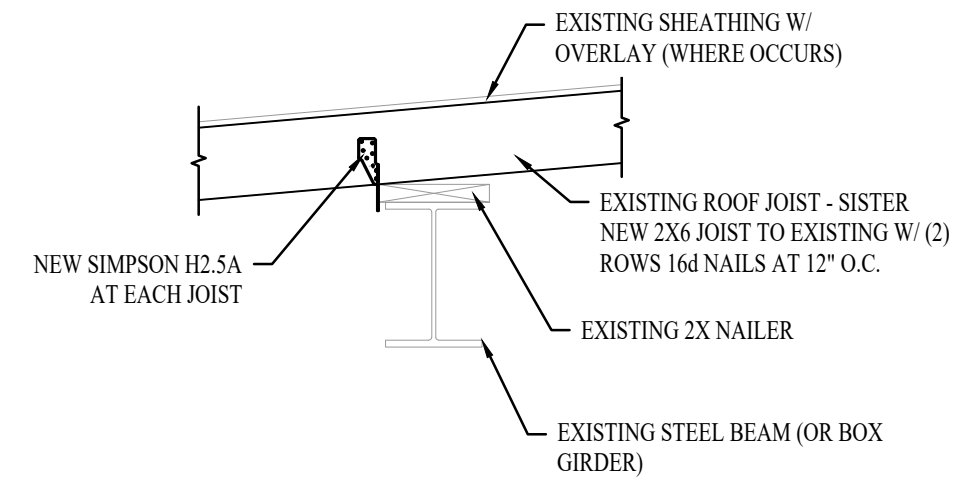


3-D  
3/4"=1'-0"

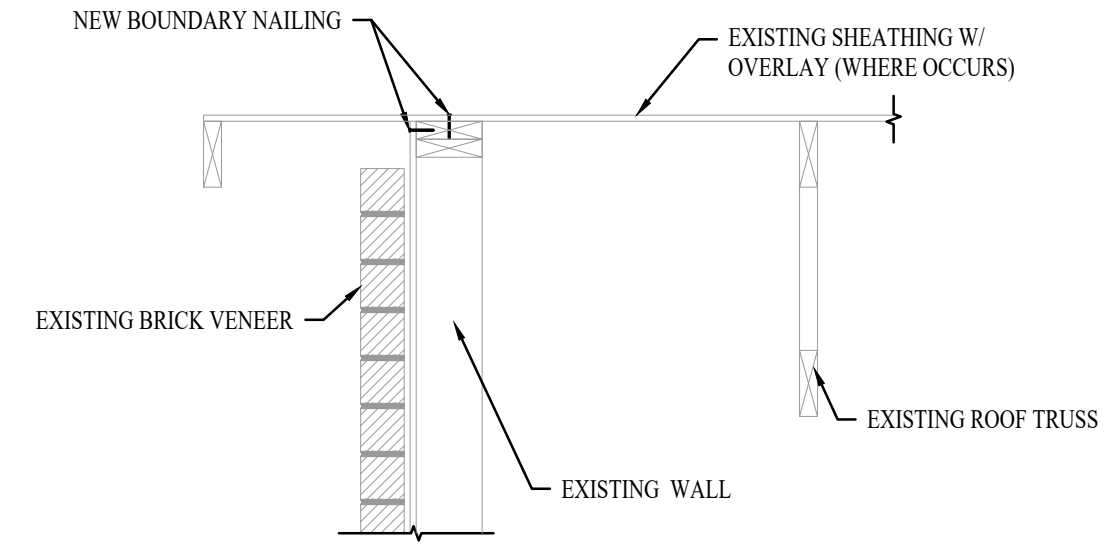


4-D  
3/4"=1'-0"

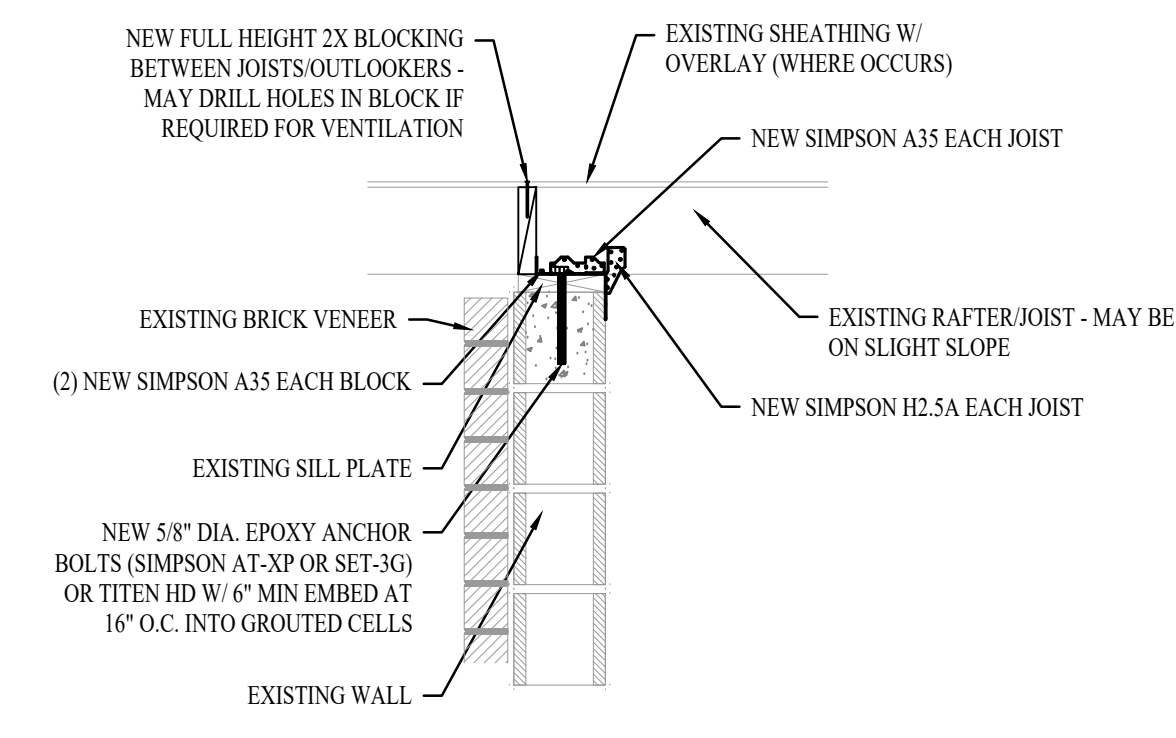

1-C  
3/4"=1'-0"

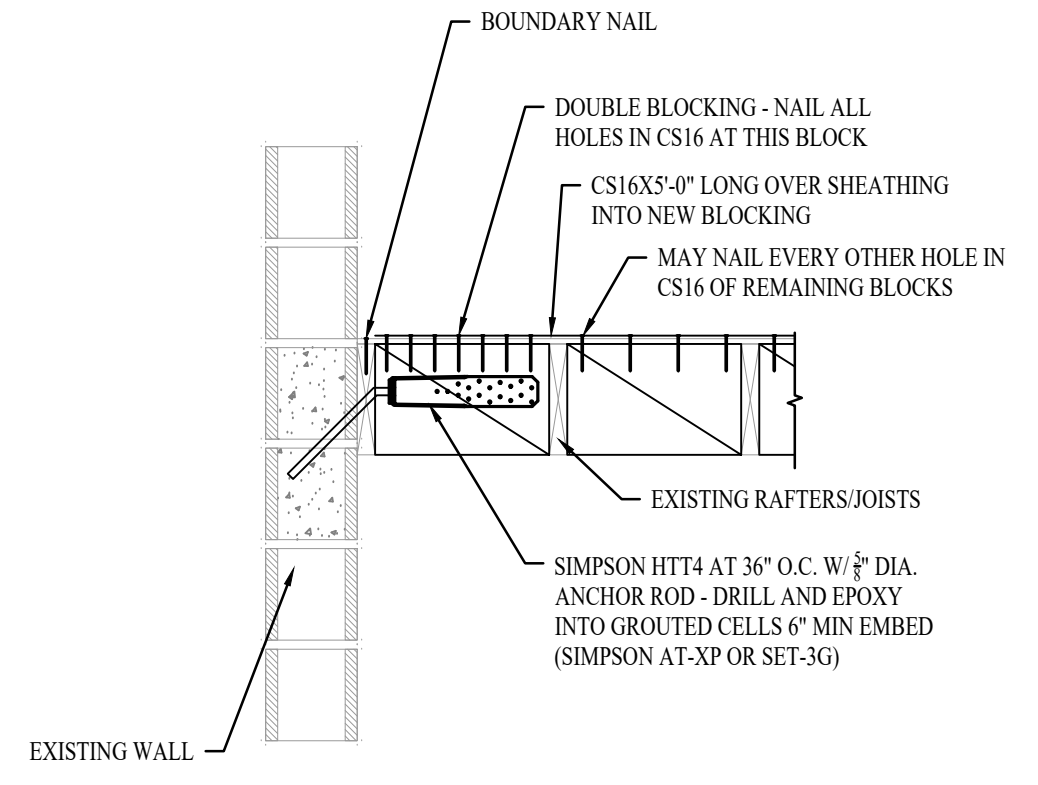


2-C  
3/4"=1'-0"

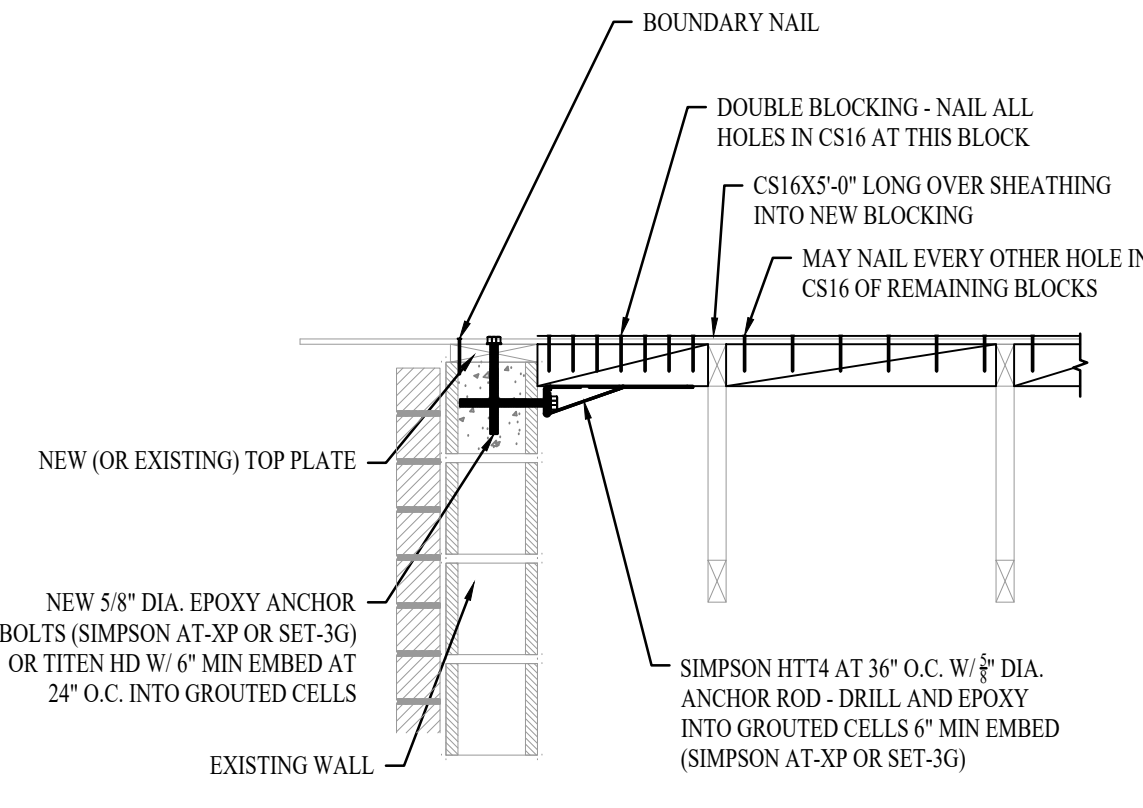


3-C  
3/4"=1'-0"


4-C  
NOT USED  
3/4"=1'-0"

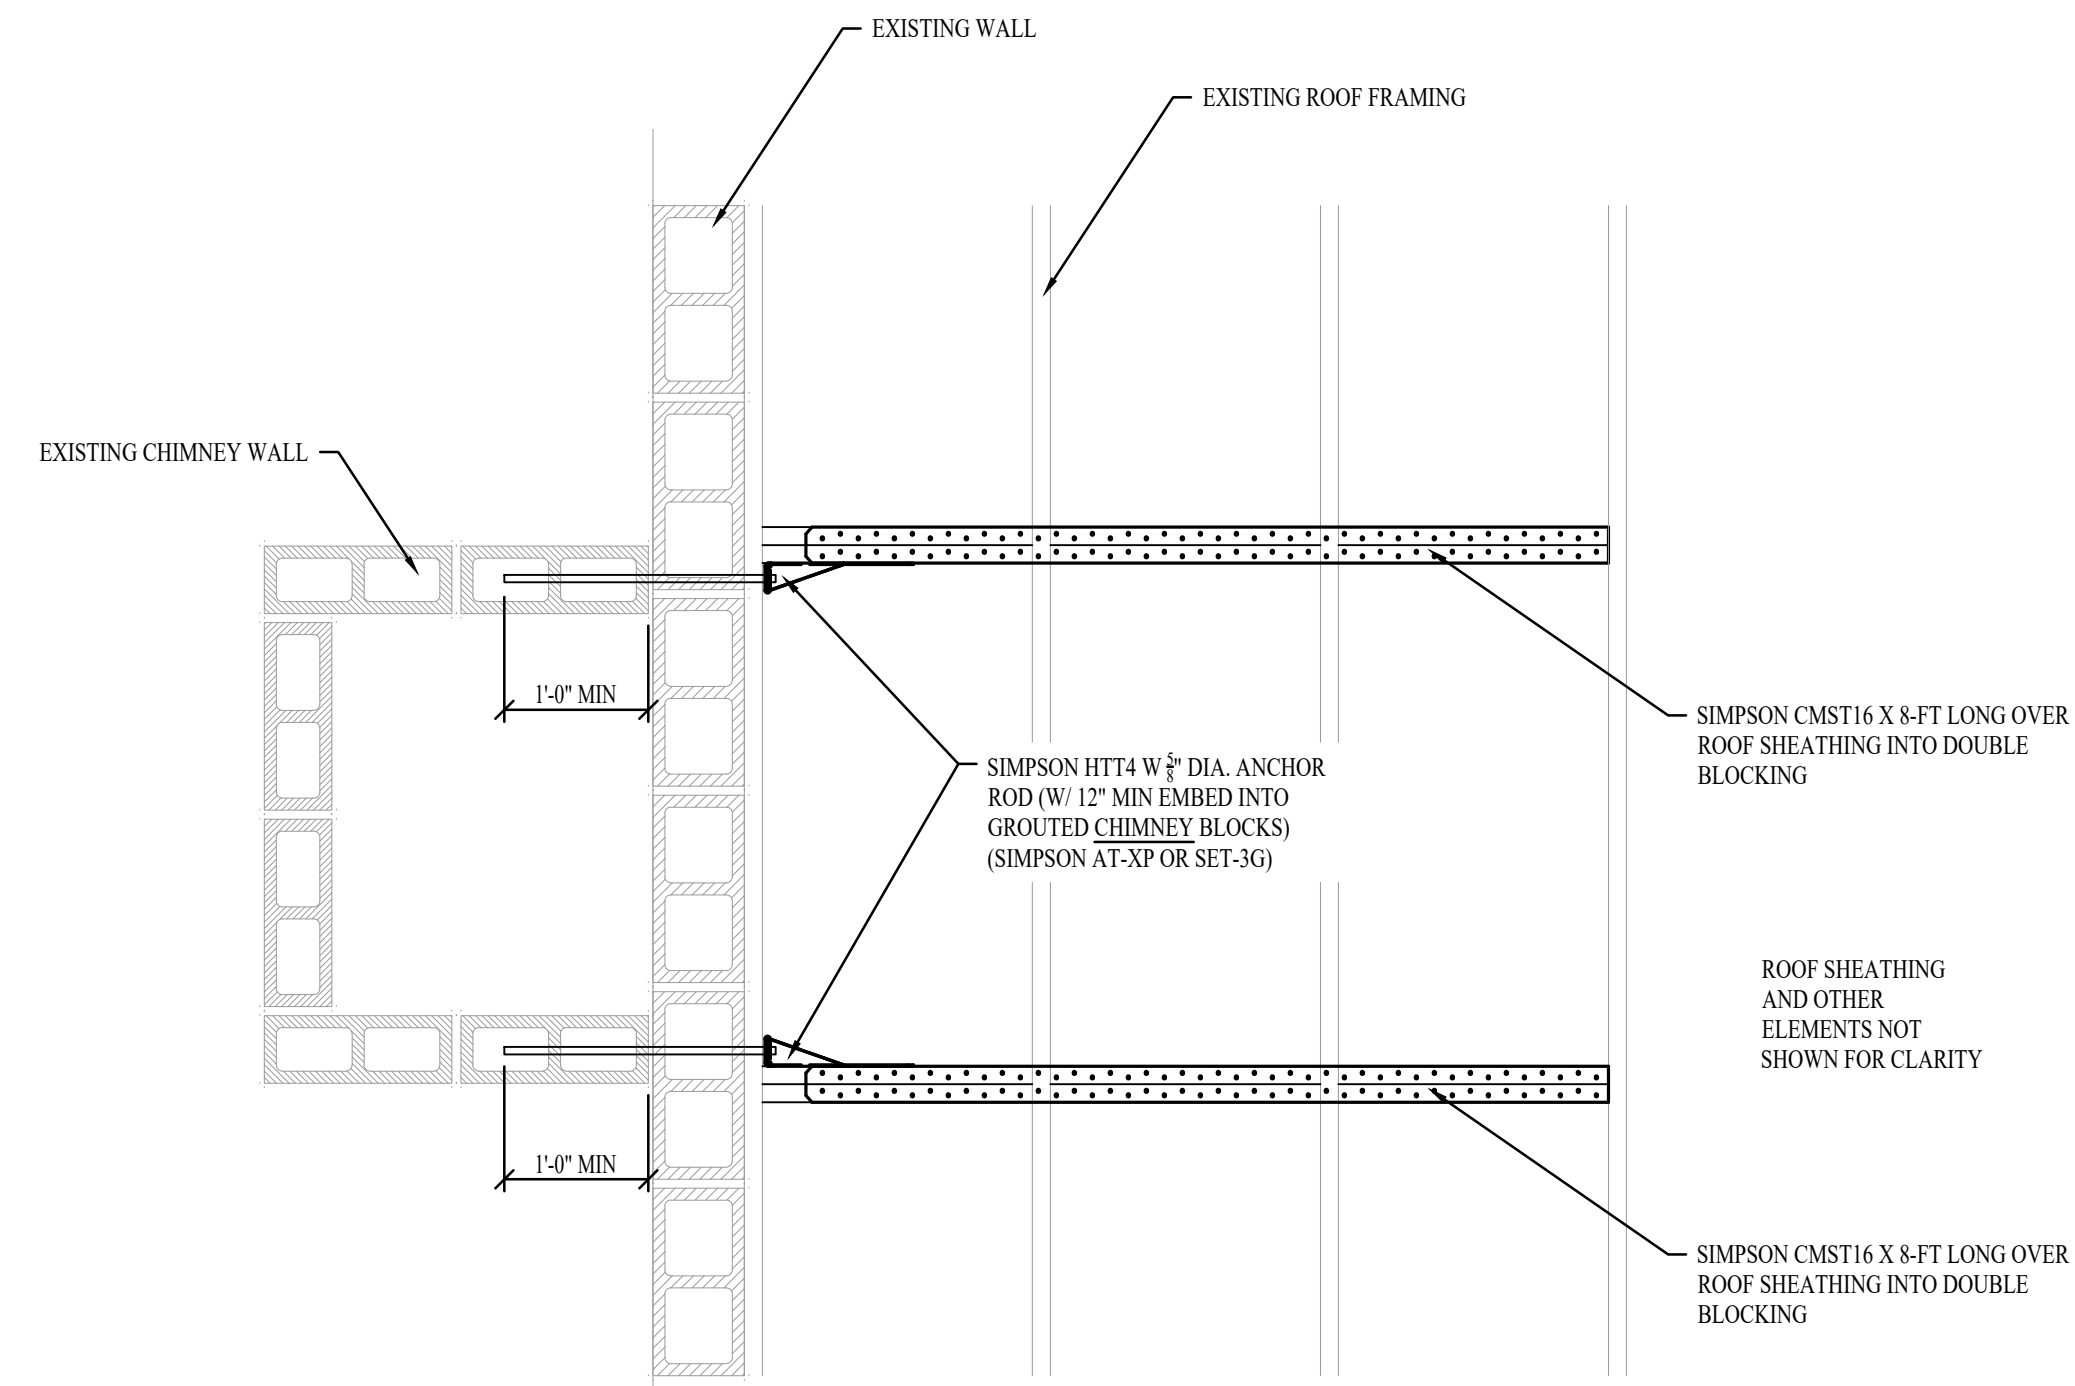

1-A  
3/4"=1'-0"

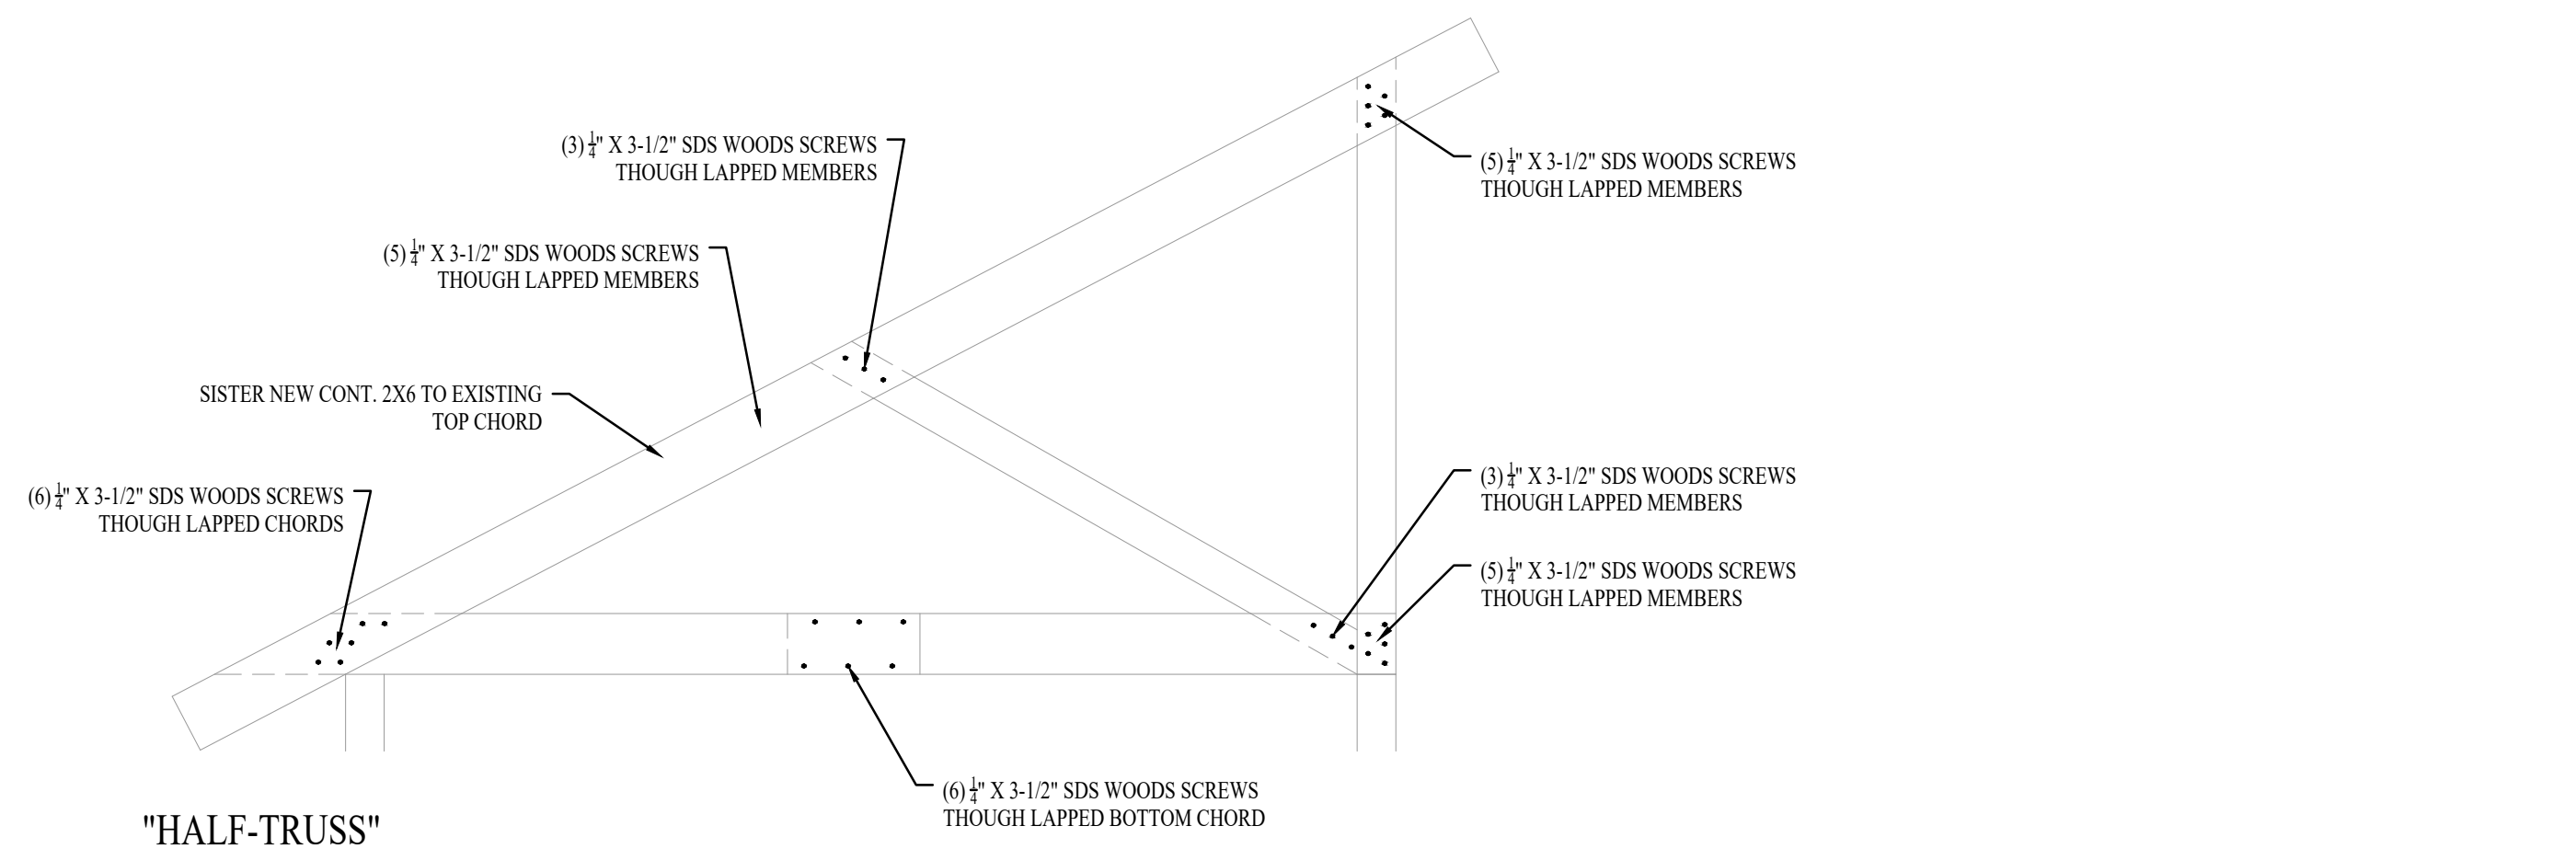

3-B  
3/4"=1'-0"

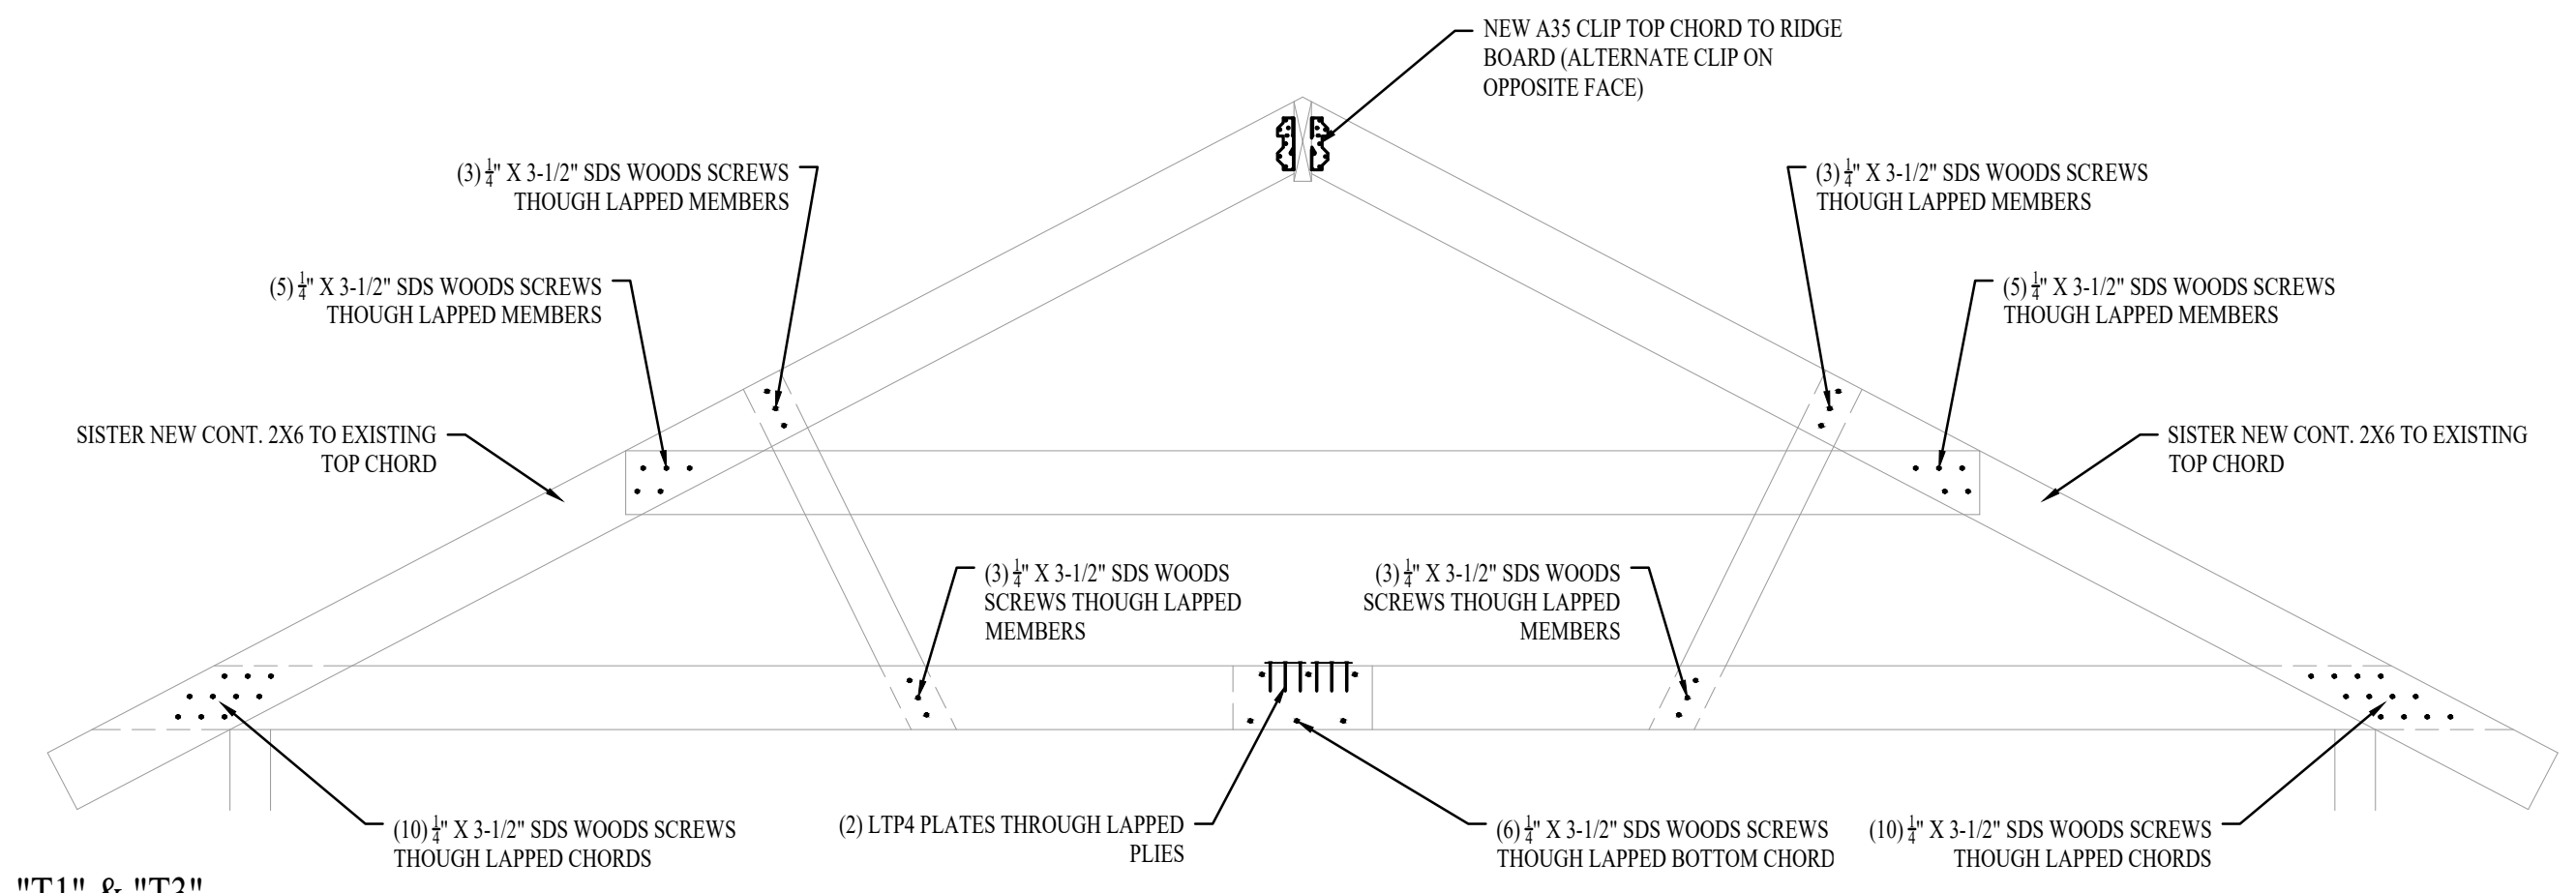

3-A  
3/4"=1'-0"

FOR CLIENT REVIEW - NOT FOR CONSTRUCTION

**HILLCREST 1, 2 RE-ROOF**  
**LOGAN UATH EAST STAKE**  
**875 NORTH 1500 EAST, LOGAN, UT**

REV	DATE	DESCRIPTION

PROJECT NO: 19294  
DRAWN BY: ARN  
CHECKED BY: CRP  
DATE: 03/28/22  
SHEET: 03 OF 03

**STRUCTURAL DETAILS**

**\$5.00**