
March 24, 1999

F Rating — 2 Hr

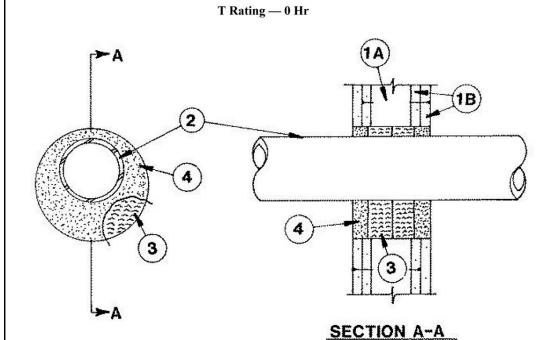

1. Wall Assembly — The fire rated gypsum wallboard/stud wall assembly shall be constructed of the materials and in the manner specified in the individual U300 or U400 Series Wall and Partition Designs in the UL Fire Resistance Directory and shall include the following construction

A. Studs — Wall framing may consist of either wood studs or steel channel studs. Wood studs to consist of nom 2 by 4 in. lumber spaced 16 in. OC. Steel studs to be min 2-1/2 in. wide and spaced max 24 in. OC.

B. Gypsum Board* — One or more layers of gypsum wallboard providing a min total thickness of 1 in. per side of wall. The gypsum wallboard type, thickness, number of layers and orientation shall be as specified in the individual Wall and Partition Design. Max diam of opening is 9-1/4 in.

2. **Through Penetrants** — One metallic pipe, conduit or tubing to be installed within opening. Pipe or conduit to be rigidly supported on both sides of wall assembly. The following types and

annular space shall be min 1/4 in. to max 2-1/4 in.

- sizes of metallic pipes, conduit or tubing may be used: A. Steel Pipe — Nom 4 in. diam (or smaller) Schedule 10 (or heavier) steel pipe. The
 - B. Conduit Nom 4 in. diam (or smaller) steel electrical metallic tubing or steel conduit. The annular space shall be min 1/4 in. to max 2-1/4 in.
- C. Copper Tubing Nom 6 in. diam (or smaller) Type M (or heavier) copper tubing. The annular space shall be min 1 in. to max 1-5/8 in.

D. Steel Pipe — Nom 6 in. diam (or smaller) Schedule 10 (or heavier) steel pipe. The annular space shall be a min 1 in. to max 1-5/8 in.

3. Forming Material — Min 2-1/2 in. thickness of min 3.5 pcf mineral fiber insulation firmly packed into opening as a permanent form. Forming material to be recessed from both surfaces of wall as required to accommodate the required thickness of fill material.

THERMAFIBER INC — Type SAF


4. Fill, Void or Cavity Material* — Sealant — Min 1 in. thickness of fill material applied within the annulus, flush with both surfaces of wall. Dry mix material mixed with water at a rate of 2.1 parts dry mix to 1 part water by weight in accordance with the accompanying installation instructions.

UNITED STATES GYPSUM CO — Type FC

*Bearing the UL Classification Mark

UL ASSEMBLY NO. W-L-5029 2 HR. / 1 HR. WALL PENETRATIONS - METAL PIPE W/ INSULATION ≤ 12"Ø STL. - ≤ 6"Ø COPPER - 2" INSUL.

> System No. W-L-5029 F Ratings — 1 and 2 Hr (See Item 1) T Ratings — 1/2, 3/4, 1, 1-1/2 and 1-3/4 Hr (See Item 3) L Rating At Ambient — 4 CFM/Sq Ft L Rating At 400 F — Less Than 1 CFM/Sq Ft

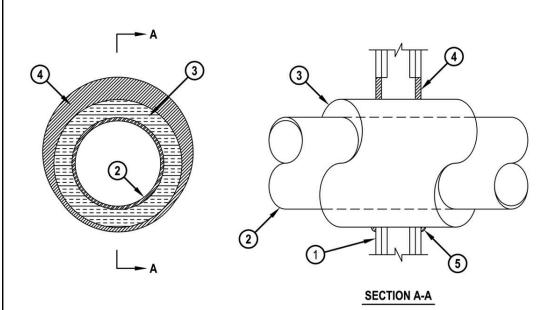

. Wall Assembly — The 1 or 2 hr fire-rated gypsum board/stud wall assembly shall be constructed of the materials and in the manner specified in the individual U300 or U400 Series Wall and Partition Designs in the UL Fire Resistance Directory and shall include the following construction

- A. Studs Wall framing may consist of either wood studs or steel channel studs. Wood studs to consist of nom 2 by 4 in. lumber spaced 16 in. OC. Steel studs to be min 2-1/2 in. wide and spaced max 24 in. OC. B. Gypsum Board* — 5/8 in. thick, 4 ft wide, with square or tapered edges. The gypsum board type, thickness, number of layers, fastener type
- and sheet orientation shall be as specified in the individual Wall and Partition Design. Max diam of opening is 18-5/8 in. The hourly F Rating of the firestop system is equal to the hourly fire rating of the wall assembly in which it is installed. Through Penetrants — One metallic pipe or tubing to be centered within the firestop system. Pipe or tubing to be rigidly supported on both sides
- of wall assembly. The following types and sizes of metallic pipes or tubing may be used: A. Steel Pipe — Nom 12 in. diam (or smaller) Schedule 10 (or heavier) steel pipe.
- B. Iron Pine Nom 12 in. diam (or smaller) cast or ductile iron pine. C. Copper Tubing — Nom 6 in. diam (or smaller) Type L (or heavier) copper tubing D. Copper Pipe — Nom 6 in. diam (or smaller) Regular (or heavier) copper pipe.
- 3. Pipe Covering* Nom 1, 1-1/2 or 2 in. thick hollow cylindrical heavy density (min 3.5 pcf) glass fiber units jacketed on the outside with an all service jacket. Longitudinal joints sealed with metal fasteners or factory-applied self-sealing lap tape. Transverse joints secured with metal fasteners or with butt tape supplied with the product.

See Pipe and Equipment Covering — Materials (BRGU) category in the Building Material Directory for the names of manufacturers. Any pipe covering material meeting the above specifications and bearing the UL Classification Marking with a Flame Spread Index of 25 or less and a Smoke Developed Index of 50 or less may be used.

The hourly T Rating of the firestop system is dependent on the hourly fire rating of the wall assembly in which it is installed, the size and type of through penetrant and the pipe covering thickness, as shown in the table below:

Wall Assembly			Pipe Covering	Annular Space		T Dating Us
Rating Hr			Thkns In.	Min In.	Max In.	T Rating Hr
1	Α	4	1	0	1-1/2	1/2
1	B or C	2	1 or 1-1/2	0	1-1/2	1/2
1	Α	4	1-1/2	0	1-1/2	1
1	Α	12	2	0	1-7/8	3/4
1	B or C	6	2	0	1-7/8	1
2	Α	4	1	0	1-1/2	1
2	B or C	4	1 or 1-1/2	0	1-1/2	1
2	B or C	6	2	0	1-7/8	1
2	Α	4	1-1/2	0	1-1/2	1-3/4
2	Α	12	2	0	1-7/8	1-1/2
2	B or C	6	2	0	1-7/8	1

+Indicates penetrant type as itemized in Item 2. A. Pipe Covering* — (Not Shown) — As an alternate to Item 3, max 2 in. thick cylindrical calcium silicate (min 14 pcf) units sized to the outside diam of the pipe or tube may be used. Pipe insulation secured with stainless steel bands or min 8 AWG stainless steel wire spaced max 12 in. OC. When the alternate pipe covering is used, the T Rating shall be determined from the table above.

See Pipe and Equipment Covering — Materials (BRGU) category in the Building Materials Directory for names of manufacturers. Any pipe covering material meeting the above specifications and bearing the UL Classification Marking with a Flame Spread Index of 25 or less and a Smoke Developed Index of 50 or less may be used. Fill. Void or Cavity Material* — Sealant — Min 5/8 in thickness of fill material applied within the annulus, flush with both surfaces of wall. At the point contact location between pipe covering and gypsum board, a min 1/2 in. diam bead of fill material shall be applied at the pipe


covering/gypsum board interface on both surfaces of wall. HILTI CONSTRUCTION CHEMICALS, DIV OF HILTI INC — FS-One Sealant *Bearing the UL Classification Mark



February 08, 2006



UL ASSEMBLY NO. C-AJ-1291 2 HR. FLOOR PENETRATION METAL PIPE UP TO 30"Ø - SCHEDULE 10

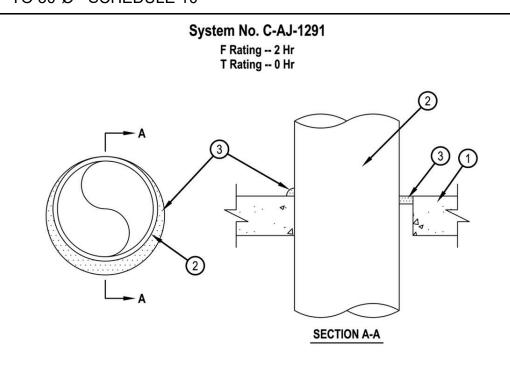

Floor or Wall Assembly -- Min 2-1/2 in. thick reinforced lightweight or normal weight (100-150 pcf) concrete. Wall may also be constructed of any UL Classified Concrete Blocks*. Max diam of opening is 30-7/8 in.

- See Concrete Blocks (CAZT) category in the Fire Resistance Directory for names of manufacturers. Through-Penetrant -- One metallic pipe or conduit to be installed either concentrically or eccentrically within the firestop system. The annular space between pipe or conduit and periphery of opening shall be min 0 in. to max 7/8 in. Pipe or conduit to be rigidly supported on both sides of
- floor or wall assembly. The following types and sizes of metallic pipes or conduits may be used: A. Steel Pipe -- Nom 30 in. diam (or smaller) Schedule 10 (or heavier) steel pipe. B. Iron Pipe -- Nom 30 in. diam (or smaller) cast or ductile iron pipe.
- C. Copper Pipe -- Nom 6 in. diam (or smaller) Regular (or heavier) copper pipe
- D. Copper Tubing -- Nom 6 in. diam (or smaller) Type L (or heavier) copper tubing E. Conduit -- Nom 6 in, diam (or smaller) steel conduit.
- F. Conduit -- Nom 4 in. diam (or smaller) steel electrical metallic tubing (EMT) 3. Fill, Void or Cavity Material* -- Sealant -- Min 1/2 in, thickness of fill material applied within the annulus, flush with top surface of floor or with both surfaces of wall. At the point contact location between pipe and concrete, a min 1/4 in. diam bead of fill material shall be applied at the
- concrete/pipe interface on the top surface of floor and on both surfaces of wall. HILTI CONSTRUCTION CHEMICALS DIV OF HILTLING -- ES -- ONE Sealant *Bearing the UL Classification Mark




Reproduced by HILTI, Inc. Courtesy of Underwriters Laboratories, Inc. December 04, 2001



UL ASSEMBLY NO. W-L-7039 2 HR. / 1 HR. WALL PENETRATION METAL DUCT. 8" X 8" MAX. 16"Ø MAX.

Through-penetration Firestop Systems Certified for Canada

System No. W-L-7039 September 24, 2010 F Rating — 1 and 2 Hr (See Item 1) T Rating — 0 Hr L Rating at Ambient - Less Than 1 CFM/sq ft

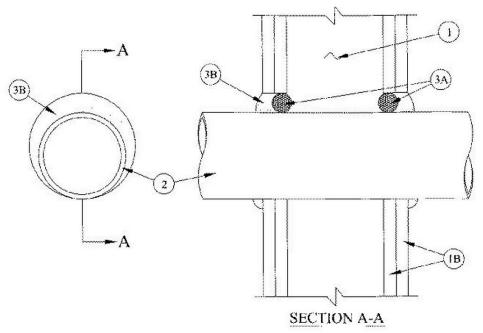

1. Wall Assembly — The 1 or 2 hr fire-rated gypsum board/stud wall assembly shall be constructed of the materials and in the manner specified in the individual U300, U400 or V400 Series Wall and Partition Designs in the UL Fire Resistance Directory and shall include the following construction features:

A. Studs — Wall framing may consist of either wood studs or steel channel studs. Wood studs to consist of nom 2 by 4 in. (51 by 102 mm) lumber spaced 16 in. (406 mm) OC. Steel studs to be min 2-1/2 in. (64 mm) wide and spaced max 24 in. (610 mm) OC.

B. Gypsum Board* — One or two layers of nom 1/2 or 5/8 in. (13 or 16 mm) thick gypsum board as specified in the individual Wall and Partition Design. Max diam of opening is 17 in. (432 mm). Max area of rectangular opening is 81 in². (523 cm²) with max dimension of 9 in. (229 mm).

The hourly F Rating of the firestop system is equal to the hourly fire rating of the wall assembly in which it is installed.

2. Steel Duct — One duct to be installed within the firestop system. The annular space shall be as specified in the Table below. Duct to be rigidly supported on both sides of wall assembly. The following types and sizes of duct may be used.

- A. Max 16 in. (406 mm) diam No. 24 gauge (or heavier) galv steel vent duct.
- B. Max 16 in. (406 mm) diam No. 24 gauge (or heavier) spiral wound galv steel duct.
- C. Max 8 in. by 8 in. (203 by 203 mm) No. 26 gauge (or heavier) galv steel duct.

Type of Duct	Max Duct Size	Annular Space
Round	16 in. (406 mm) diam	Min 0 in. (point contact) to max 1 in. (25 mm)
Rectangular	8 by 8 in. (203 by 203 mm)	Nom 1/2 in. (13 mm)

3. Firestop System — The firestop system shall consist of the following

A. Packing Material — (Optional) — Foam backer rod firmly packed into the opening as a permanent form. Packing material to be recessed from both surfaces of wall as required to accommodate the required thickness of fill material.

B. Fill, Void or Cavity Material* — (Caulk) — Min 1/2 in. (13 mm) thickness of fill material applied within the annulus, flush with both surfaces of wall. When annular space exceeds 1/2 in., min thickness of fill material is 5/8 in. (16 mm). For round ducts, additional fill material to be installed such that a min 3/8 in. crown is formed around the

TREMCO INC — TREMstop Intumescent Acrylic, FyreCaulk or TREMstop

*Bearing the UL Classification Mark

UL ASSEMBLY NO. C-AJ-1020 3 HR. FLOOR PENETRATION METAL PIPE < 6"Ø


Through-penetration Firestop Systems

System No. C-AJ-1020

December 02, 2010

F Rating — 2 and 3 Hr (See Item 3) T Rating — 0, 3/4 and 1 Hr (See Item 3)

L Rating at Ambient — Less than 1 CFM/sq ft

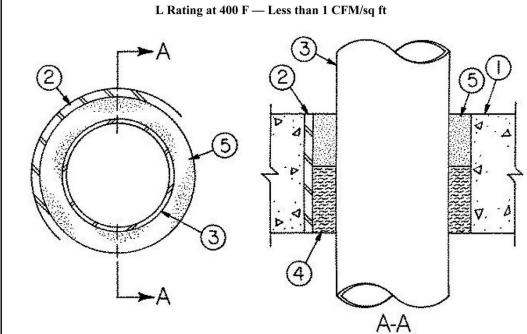

1. Floor or Wall Assembly — Reinforced lightweight or normal weight (100-150 pcf) concrete having a min thickness as specified in the table below (Item 3). Wall may also be constructed of any UL Classified Concrete Blocks*. Max diam of opening is 8 in.

See Concrete Block (CAZT) category in the Fire Resistance Directory for names

2. Metallic Sleeve — (Optional) — Nom 8 in. diam (or smaller) Schedule 40 (or heavier) steel sleeve cast or grouted into wall or floor assembly, flush with floor

or wall surfaces. 3. **Through Penetrants** — One metallic pipe, conduit or tubing to be installed either concentrically or eccentrically within the firestop system. Pipe, conduit or tubing to be rigidly supported on both sides of floor or wall assembly. The annular space shall be as specified in the table below. The following types and

sizes of metallic pipes, conduits or tubing may be used: A. Steel Pipe — Nom 6 in. diam (or smaller) Schedule 10 (or heavier) steel pipe.

B. Conduit — Nom 4 in. diam (or smaller) steel electrical metallic

C. Conduit — Nom 6 in. diam (or smaller) rigid galv steel

The F and T rating of the system is dependent upon the diam of the pipe or conduit and annular space between the pipe or conduit and the periphery of the opening as shown in the table below:

Floo r or Wall	Min Floor or Wall Thkn s In.	Max Diam of Steel Pipe or Condui t In.	Min Annula r Space In.	Max Annula r Space In.	Min Fill Mtl Thkn s In.	Min Formin g Mtl Thkns In.	F Ratin g Hr	T Ratin g Hr
F	3-3/4	1-1/2	3/8	2-1/8	1	2-3/4	2	0
F	3-3/4	6	3/8	3/4	1	2-3/4	2	0
F	3-3/4	6	3/8	1	2	1-3/4	2	0
F	4-1/2	1-1/2	3/8	2-1/8	1	3-1/2	3	3/4
F	4-1/2	6	3/8	3/4	1	3-1/2	3	0
F	4-1/2	6	3/8	1	2	2-1/2	3	0
W	5-1/2	1-1/2	3/8	2-1/8	1	3-1/2	3	3/4
W	5-1/2	6	3/8	3/4	1	3-1/2	3	0
W	6-1/2	1-1/2	3/8	2-1/8	2	2-1/2	3	1
W	6-1/2	6	3/8	1	2	2-1/2	3	0

into opening as a permanent form at the min thickness specified in the above table (Item 3). Forming material to be recessed from top surface of floor or from both surfaces of wall as required to accommodate the required thickness of fill

THERMAFIBER INC — Type SAF

5. Fill, Void or Cavity Material* — Caulk — Min thickness of fill material as specified in the above table (Item 3) applied within the annulus, flush with top surface of floor or with both surfaces of wall.

UNITED STATES GYPSUM CO — Type AS

*Bearing the UL Classification Mark

NOTE: THROUGH PENETRATION FIRE STOPPING FOR NEW PENETRATIONS IN EXISTING RATED ASSEMBLIES AS WELL AS THROUGH NEW SMOKE SMOKE PARTITIONS TO BE INCLUDED IN CONTRACT. 2 HOUR FIRE RATED CONSTRUCTION IS EXISTING. THROUGH PENETRATION FIRE STOPPING FOR EXISTING FOUND PENETRATIONS TO BE BY ALLOWANCE AMOUNT. SEE SPECIFICATIONS.

UL ASSEMBLY NO. C-AJ-5093 2 HR. FLOOR PENETRATION METAL PIPE / INSULATED UP TO 12"Ø

System No. C-AJ-5091

L Rating At Ambient — 4 CFM/Sg Ft

F Rating — 2 Hr T Ratings — 0 and 1 Hr (See Items 2 and 4)

L Rating At 400 F — Less Than 1 CFM/Sq Ft **SECTION A-A**

1. Floor or Wall Assembly — Min 4-1/2 in. (114 mm) thick reinforced lightweight or normal weight (100-150 pcf or 1600-2400 kg/m3) concrete. Wall may also be constructed of any UL Classified Concrete Blocks*. Max diam of opening is 19-1/2 in. (495 mm). See Concrete Blocks (CAZT) category in the Fire Resistance directory for names of manufacturers.

2. Metallic Sleeve — (Optional) — Nom 20 in. (508 mm) diam (or smaller) Schedule 10 (or heavier) steel sleeve cast or grouted into floor or wall assembly, flush with floor or wall surfaces or extending a max of 3 in. (76 mm) above floor or beyond both surfaces of wall. If the steel sleeve extends beyond the top surface of the floor or both surfaces of the wall, the T Rating of the firestop system is 0 hr.

The sleeve is to be cast in place flush with bottom surface of floor and may extend a max of 1 in. (25 mm) above the top surface of the floor. 2B. Sheet Metal Sleeve — (Optional) - Max 12 in. (305 mm) diam, min 24 ga galv steel provided with a 24 ga galv steel square flange spot welded to the sleeve at approximately mid-height, or flush with bottom of sleeve in floors, and sized to be a min of 2 in, (51 mm) larger than the sleeve diam. The sleeve is to be cast in place flush with bottom surface of floor and may extend a max of 1 in. (25 mm) above the top surface of the floor. 3. Through Penetrants — One metallic pipe or tubing to be installed either concentrically or eccentrically within the firestop system. Pipe or tubing to

be rigidly supported on both sides of floor or wall assembly. The following types and sizes of metallic pipes or tubing may be used: A Steel Pine — Nom 12 in (305 mm) diam (or smaller) Schedule 10 (or heavier) steel pine B. Iron Pipe — Nom 12 in. (305 mm) diam (or smaller) cast or ductile iron pipe.

C. Copper Pipe — Nom 6 in. (152 mm) diam (or smaller) Regular (or heavier) copper pipe D. Copper Tubing — Nom 6 in. (152 mm) diam (or smaller) Type L (or heavier) copper tubing.

4. Pipe Covering — Min 1/2 in. (13 mm) to max 2 in. (51 mm) thick hollow cylindrical heavy density (min 3.5 pcf or 56 kg/m3) glass fiber units jacketed on the outside with an all-service jacket. Longitudinal joints sealed with metal fasteners or factory-applied, self-sealing lap tape.

See Pipe Equipment Covering — Materials — (BRGU) category in the Building Materials Directory for names of manufacturers. Any pipe covering material meeting the above specifications and bearing the UL Classification Marking with a Flame Spread Index of 25 or less and a Smoke

4A. Pipe Covering — (Not Shown) — As an alternate to Item 4, max 2 in. (51 mm) thick cylindrical calcium silicate (min 14 pcf) units sized to the outside diam of the pipe or tube may be used. Pipe insulation secured with stainless steel bands or min 8 AWG stainless steel wire spaced max 12 in. (305 mm) OC. The annular space shall be min 1/2 in. (13 mm) to max 2-1/4 in. (57 mm).

A. Packing Material — Min 4 in. (102 mm) thickness of min 4 pcf (64 kg/m3) mineral wool batt insulation firmly packed into opening as a permanent form. Packing material to be recessed from top surface of floor or from both surfaces of wall as required to accommodate the required thickness of fill material


B. Fill, Void or Cavity Material* — Sealant — Min 1/2 in. (13 mm) thickness of fill material applied within the annulus, flush with top surface of floor or with both surfaces of wall.

HILTI CONSTRUCTION CHEMICALS, DIV OF HILTI INC — FS-One Sealant *Bearing the UL Classification Mark





System No. W-L-1054 F Ratings - 1 and 2 Hr (See Items 1 and 3) T Rating — 0 Hr L Rating At Ambient - Less Than 1 CFM/Sq Ft

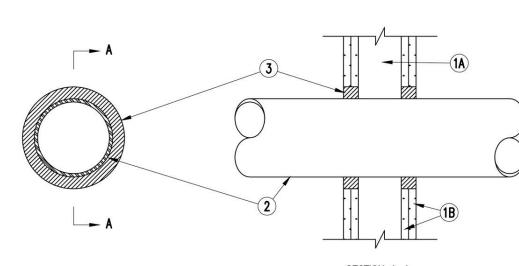

1. Wall Assembly -- The 1 or 2 hr fire-rated gypsum wallboard/stud wall assembly shall be constructed of the materials and in the manner specified in the individual U300 or U400 Series Wall and Partition Designs in the UL Fire Resistance Directory and shall include the following construction features: A. Studs -- Wall framing may consist of either wood studs or steel channel studs. Wood studs to

consist of nom 2 by 4 in. lumber spaced 16 in. OC. Steel studs to be min 2-1/2 in. wide and spaced max 24 in. OC. When steel studs are used and the diam of opening exceeds the width of stud cavity, the opening shall be framed on all sides using lengths of steel stud installed between the vertical study and screw-attached to the steel study at each end. The framed opening in the wall shall be 4 to 6 in, wider and 4 to 6 in, higher than the diam of the penetrating item such that when the penetrating item is installed in the opening, a 2 to 3 in. clearance is present between the

B. Gypsum Board* -- 5/8 in. thick, 4 ft wide with square or tapered edges. The gypsum board type, thickness, number of layers, fastener type and sheet orientation shall be as specified in the individual U300 or U400 Series Design in the UL Fire Resistance Directory. Max diam of opening is 32-1/4 in. for steel stud walls. Max diam of opening is 14-1/2 in. for wood stud walls. The F Rating of the firestop system is equal to the fire rating of the wall assembly. 2. Through-Penetrants -- One metallic pipe, conduit or tubing to be installed either concentrically or

than 45 degrees from perpendicular. Pipe, conduit or tubing to be rigidly supported on both sides of wall assembly. The following types and sizes of metallic pipes, conduits or tubing may be used: A. Steel Pipe -- Nom 30 in diam (or smaller) Schedule 10 (or heavier) steel pipe. B. Iron Pipe -- Nom 30 in. diam (or smaller) cast or ductile iron pipe.

3. Fill, Void or Cavity Material* -- Sealant -- Min 5/8 in. thickness of fill material applied within the annulus, flush with both surfaces of wall. At the point or continuous contact locations between pipe and wall, a min 1/2 in. diam bead of fill material shall be applied at the pipe wall interface on both surfaces

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December 4, 2002



ajc architects

703 east 1700 south salt lake city, ut 84105 ajcarchitects.com



ARCHITECT / CONSULTANT

AUTHORITY HAVING JURISDICTION

PROJECT DESCRIPTION

HEALTHCARE LEVEL 09 TI

KEY PRIVATE BANK CITY CREEK CENTER 36 SOUTH STATE STREET SALT LAKE CITY, UT 84111

SHEET NAME:

JL RATED PENETRATION **ASSEMBLIES**

REVISIONS

MARK DATE DESCRIPTION

DRAWN BY: KL & SR CHECKED BY: K. RIGBY

SHEET NUMBER:

penetrating item and the framing on all four sides.

C. Conduit -- Nom 4 in diam (or smaller) steel electrical metallic tubing or 6 in. diam steel conduit. D. Copper Tubing -- Nom 6 in. diam (or smaller) Type L (or heavier) copper tubing. E. Copper Pipe -- Nom 6 in. diam (or smaller) regular (or heavier) copper pipe.

INTERMOUNTAIN

ISSUE DATE: 03/26/2020 **CD PERMIT SET** ISSUE TYPE:

PROJECT#: 1953

2A. Sheet Metal Sleeve — (Optional) - Max 6 in. (152 mm) diam, min 26 ga galv steel provided with a 26 ga galv steel square flange spot welded to the sleeve at approximately mid- height, or flush with bottom of sleeve in floors, and sized to be a min of 2 in. (51 mm) larger than the sleeve diam.

Transverse joints secured with metal fasteners or with butt tape supplied with the product. The annular space between the insulated pipe and the edge of the periphery of the opening shall be min 1/2 in. (13 mm) to a max 2-1/4 in. (57 mm). When thickness of pipe covering is less than 2 in. (51 mm), the T Rating for the firestop system is 0 hr.

5. Firestop System — The firestop system shall consist of the following:


eproduced by HILTI, Inc. Courtesy of Underwriters Laboratories, Inc. May 29, 2008

UL ASSEMBLY NO. W-L-1054 2 HR. / 1 HR. WALL PENETRATION ≤ 30"Ø SCH. 10 PIPE

L Rating At 400 F - 4 CFM/Sq Ft


eccentrically within the firestop system. The annular space shall be min 0 in. to max 2-1/4 in. Pipe may be installed with continuous point contact. Pipe, conduit or tubing may be installed at an angle not greater

HILTI CONSTRUCTION CHEMICALS, DIV OF HILTI INC -- FS-One Sealant
*Bearing the UL Classification Mark

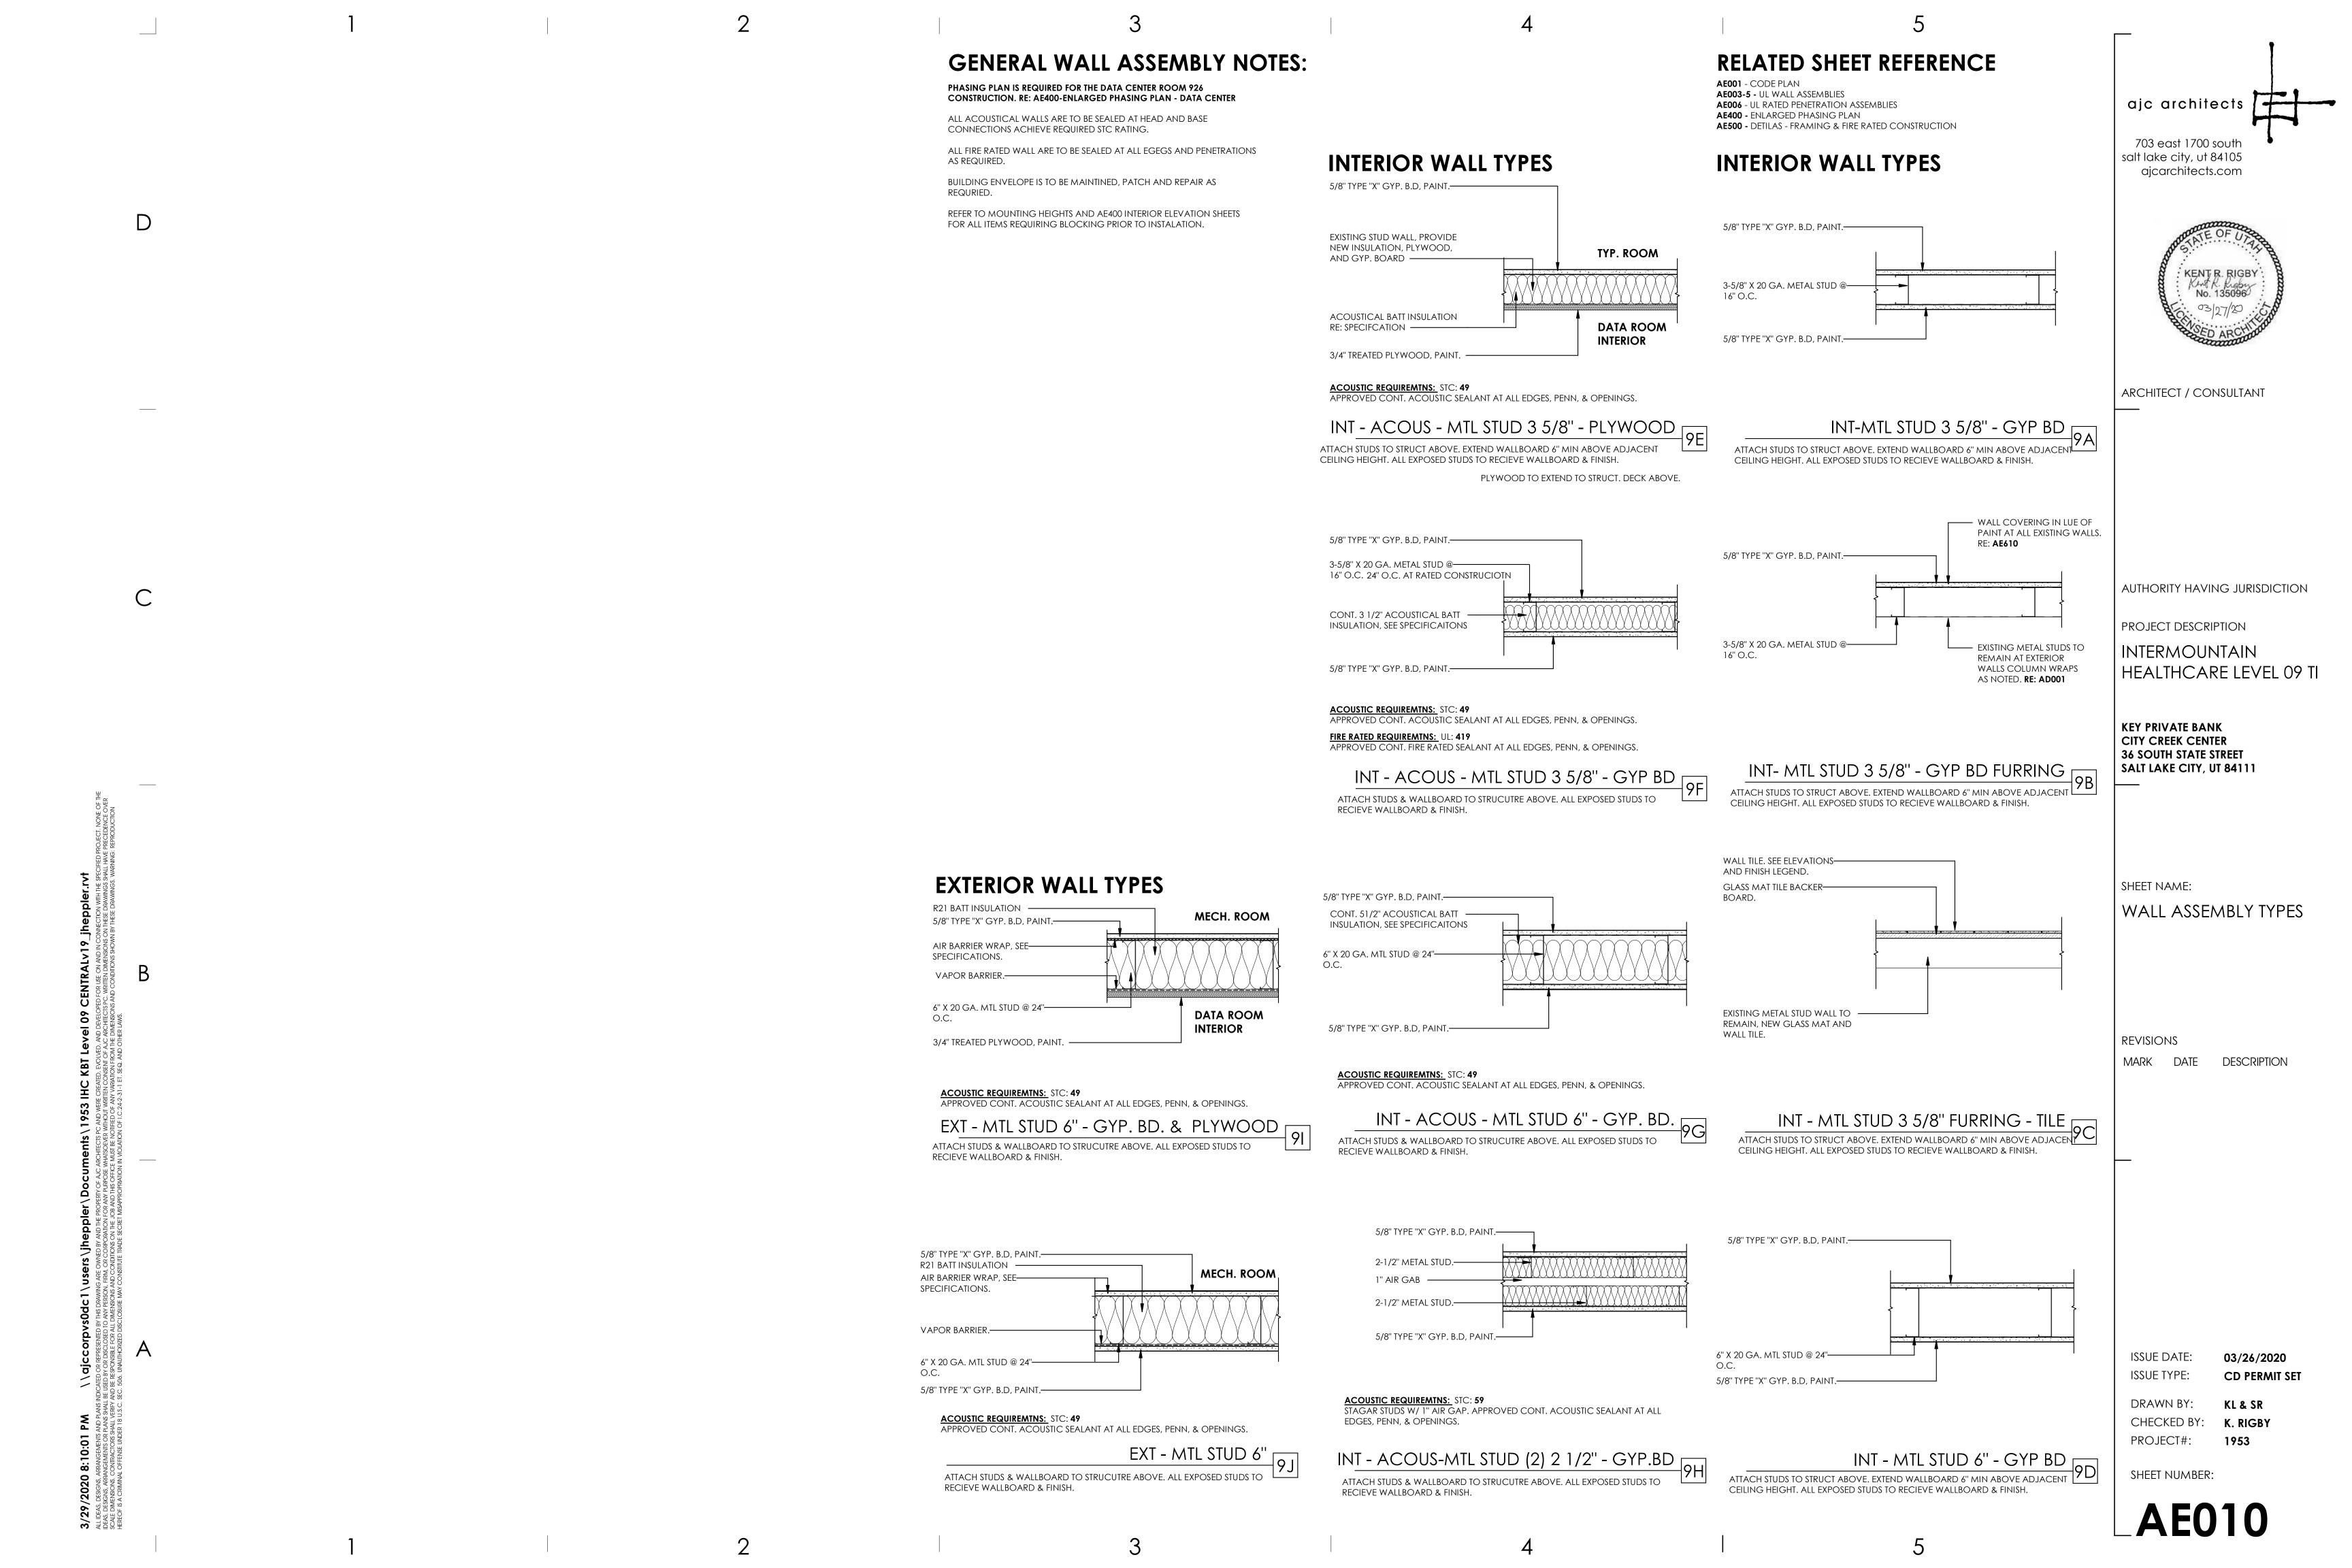

KEYED NOTES: GENERAL NOTES: PATCH & REPAIR WALLBOARD FOR SMOOTH FINISH AT ALL DEMO CASEWORK PATCH & REPAIR WALLBOARD FOR SMOOTH FINISH AT ALL DEMO WALL RELATED SHEET REFERENCE: GENERAL SHEET REFERENCE LOCATONS, AD001 LOCATONS. MAINTAIN FIRE RATING. AD001 AE010 ajc architects **AE400** - ENLARGED PHASING PLAN - DATA CENTER GI001 DRAWING INDEX COLUMN, STUDS, AND WALL BOARD TO REMAIN. GENERAL PATCH & REPAIR CONCRETE FLOOR AS REQUIR'D FOR SMOOTH **AE500** - WALL FRAMING & FIRE RATED CONST. GI002 GENERAL NOTES FINISH. REFER TO SPECIFCATION FOR ALLOWANCE. FINISH NEW GYP. BD. WALL SURFACE FLUSH WITH ADJACENT EXISTING WALL TO AE001 CODE PLAN **AE600** - DOOR & WINDOW LEGEND ADD, PATCH & REPAIR WALLBOARD AS REQUIRED FOR FLUSH & SMOOTH **AE003-5** UL WALL ASSEMBLIES **AE610** - INTERIOR FINISH LEGEND FINISH AT COLUMN WRAP LOCATIONS AD001 COORDINATE WITH ELECTRICAL PLAN FOR LOCATION TO PRESERVE AND 703 east 1700 south **AE006** UL RATED PENETARTIONS PROTECT CONDUIT AND JUNCTION BOX. REMOVE ALL MILLWORK AND FURNISHINGS. salt lake city, ut 84105 BUILDING RISER WITH COPPER AND FIBER. COORDINATE WITH ELECTRICAL PATCH & REPAIR TILE WALL AS REQUIRD FOR ALL NEW COUNTERTOPS, DO NOT SCALE DRAWINGS. ajcarchitects.com PLANS FOR LOCATION. PRESERVE AND PROTECT DURING DEMO AND PARTITIONS, ACCESSORIES, & SUPPORTS. PATCH & REPAIR TILE FLOORING AS REQUIRD FOR ALL NEW PARTITIONS, CONTRACTOR / SUBCONTRACTOR SHALL VERIFY ALL DIMENSIONS AND SUPPORTS, PLUMBING FIXTURES & CONNNECTIONS. 2" CND WITH FIBER TO DEMARC IN BASEMENT. COORDINATE WITH ELECTRICAL CONDITIONS BEFORE BEGINNING WORK, AND SHALL REPORT TO THE PLANS. PRESERVE AND PROTECT DURING DEMOLITION AND CONSTRUCTION. DATA ROOM REQUIRED TO HAVE PHASED CONSTRUCTION, REVIEW PHASING ARCHITECT OF ANY ERRORS, INCONSISTENCIES OR OMISSIONS BEFORE BUILDING CORE WITH COPPER AND FIBER. COORDINATE WITH ELECTRICAL BEGINNING WORK. SEE GENERAL NOTES AND SPECIFICATIONS. PLAN PRIOR TO BEINGING CONSTRUCTION. AE400 PLANS FOR LOCATION. PRESERVE AND PROTECT DURING DEMO AND PATCH & REPAIR CONCRETE FLOORING AT DEMO'D PLUMBING CONNECTION. CONSTRUCTION. ALL EXISTING GYP. BD. WALL SURFACES TO BE PATCHED AND REPAIRED TO MAINTAIN FIRE RATING, AE006 AD001 ATTAIN A LEVEL 5 FINISH. ALL NEW GYP. BD. WALL SURFACES TO BE FINISHED PRESERVE AND PROTECT DURING DEMO AND CONSTRUCTION. GENERAL PATCH & REPAIR WALLBOARD FOR SMOOTH FINISH AT ALL EXIST. TO A LEVEL 5 FINISH. PATCH AND REPAIR AREAS WHERE ITEMS HAVE BEEN DEMOLISHED. WALL LOCATIONS. MAINTIAN FIRE RATED CONSTRUCITON. REFERE TO SPECFICAITON FOR ALLOWANCE. AD001 AE003-AE006 AE010 AE500 PATCH & REPAIR CONCRETE FLOORING AT ALL DEMO WALL LOCATONS. ALL EXPOSED SURFACES TO RECIEVE FINISH. ANY SURFACE WITHOUT A FINISH SKIM COAT AND PREPARE ALL EXISTING GYP. BD. WALL SURFACES ON EXISTING MAINTAIN FIRE RATING. AE006 AD001 No. 135096 DESIGNATION TO RECIEVE GENERAL FINISH FROM FINISH LEGEND. BUILDING CORE WALLS TO REMAIN TO ACHIEVE A LEVEL 5 FINISH; PAINT. SEE FINISH PLAN AND FINISH LEGEND. CONTRACTOR IS REQUIRED TO MAINTAIN ALL EXISITNG FIRE RATED CONSTURCTION AND IS RESPONSIBLE TO PATCH & REPAIR OR REPLACE EXISTING FIRE RATED ASSEMBLIES AS REQUIRED. PROVIDE BLOCKING FOR ALL CASEWORK, COUNTERTOPS, SHELVING & WALL HUNG ACESSORIES AS REQUIRED. RE: **AE530** - DETAILS CENTER FLOOR BOXES IN ROOMS U.N.O ARCHITECT / CONSULTANT REFER TO ENLARGED PLANS FOR MORE DETAIL. REFER TO LOCATIONS OF HORIZONTAL LOUVERS AND ROLLER SHADES ARE SHOWN ON THE RCP. **AE402 AUTHORITY HAVING JURISDICTION** 30'-0'' 30'-0'' 30'-0" 30'-0" 30'-0" PROJECT DESCRIPTION INTERMOUNTAIN HEALTHCARE LEVEL 09 TI 920 AE402 $\square \mathsf{FB}$ □FB **KEY PRIVATE BANK** CITY CREEK CENTER 36 SOUTH STATE STREET TV 915 SALT LAKE CITY, UT 84111 □FB 925 HATCH & LINETYPE: AREA NOT IN CONTRACT 922 919 **NEW CONSTRUCTION** RATED CONSTRUCTION - AE001 SHEET NAME: **SYMBOLS:** ANNOTATED FLOOR WB PLAN SYMBOL DESCRIPTION / REFERENCE DATA ADA OPERATOR ADA CHASE ROOM 916 AD019 CARD READER CR ▽ ELECTRICAL AD019 REVISIONS **COFFEE BREWER** C2 PLUMBING DESCRIPTION MARK DATE ₹ AE403 ► AD010 DRINKING FOUNTAIN W/ BOTTLE FILLER (SINGLE FIXTURE ELEC. COOLED) (12.4)— 3 FLOOR BOX DUPLEX (12.6)-ELECTIRCAL COLLAB.

| FB | 908 903 $\square \mathsf{FB}$ FLOOR BOX DUPLEX COLLAB. □FB 904 ELECTIRCAL 913 COLLAB. 906 915B FLOOR COPIER $\langle C \rangle$ **★** (H) $\langle D \rangle$ C3 AE403 FLOOR DRAIN C2 14 PLUMBING AE401 AE401 COMMUNICATIONS 909 AE520 TRAVEL & FLEET
914 ICE PLUMBING 907 AE520 ▶ ₹ MICROWAVE MW ISSUE DATE: 03/26/2020 REFRIGERATOR ISSUE TYPE: **CD PERMIT SET** REF. (13.6) PLUMBING DRAWN BY: KL & SR SECURITY CAMERA K. RIGBY CHECKED BY: 30'-0'' 30'-0" 30'-0'' 30'-0" 30'-0'' 30'-0" ELECTRICAL 1953 PROJECT#: PLUMBING FLOOR PLAN - ANNOTATED SHEET NUMBER: TELEVISION ELECTRICAL SCALE: 1/8'' = 1'-0''

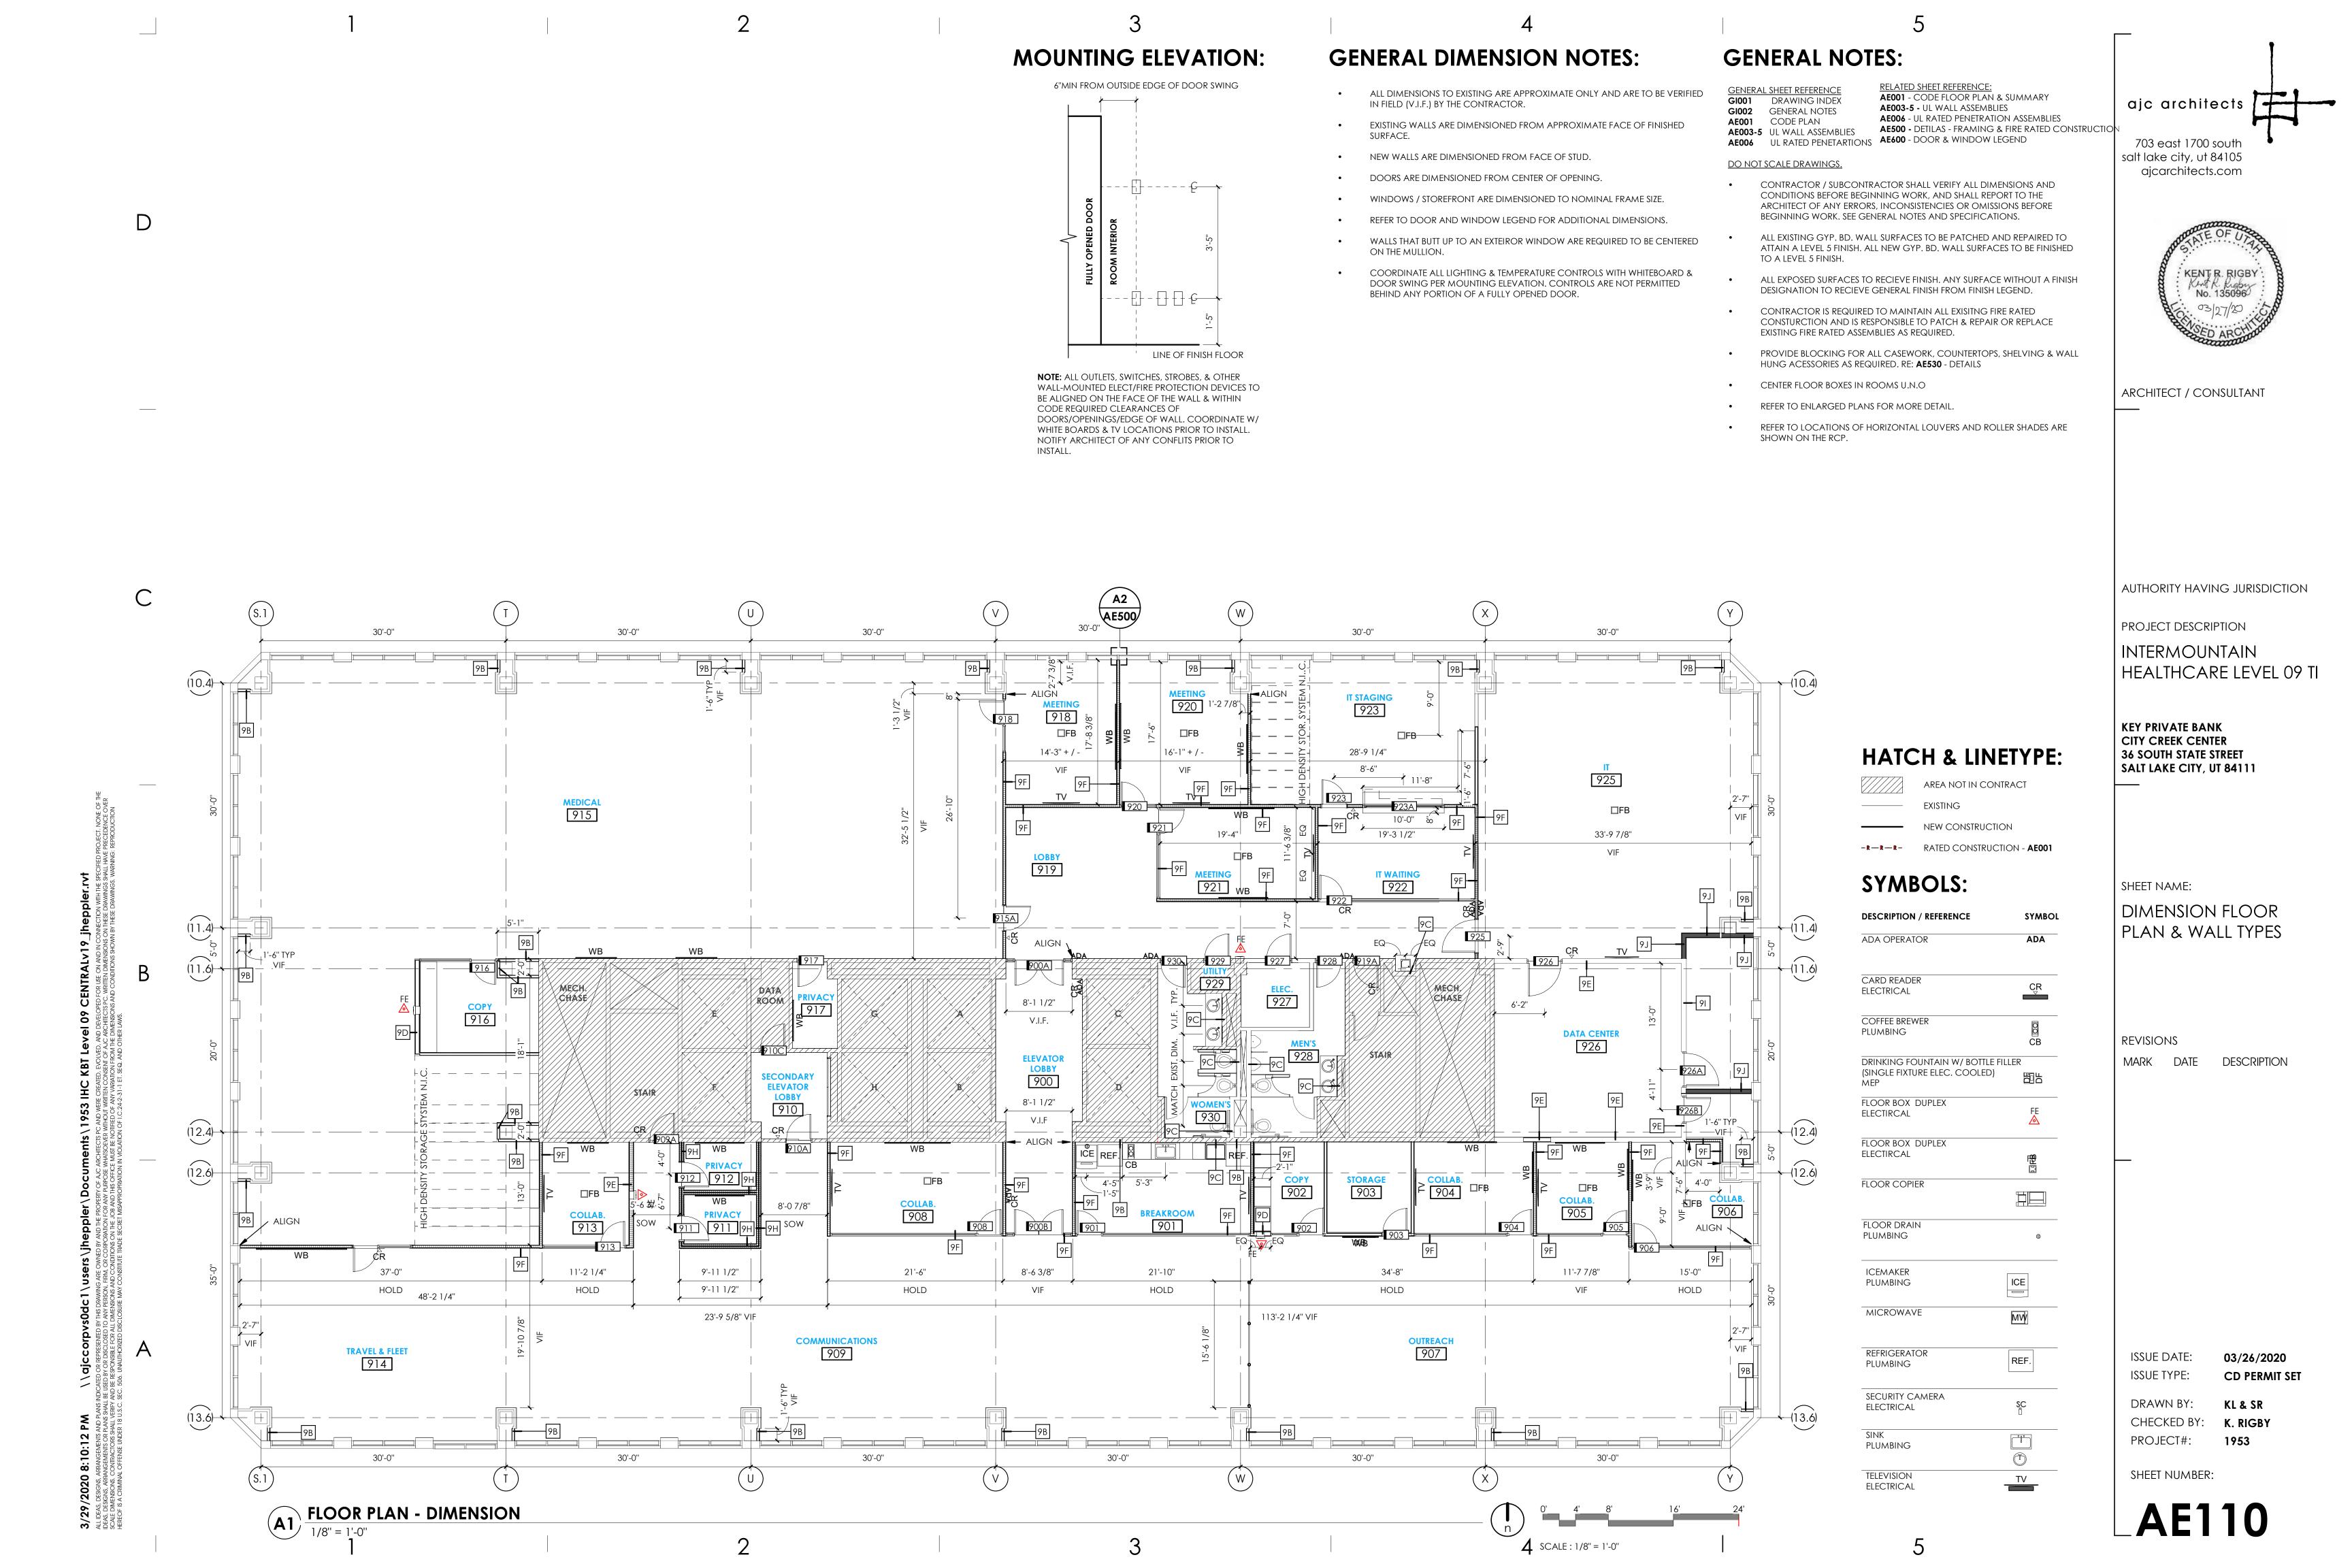

KEYED NOTES: FINISH NOTES: **GENERAL NOTES:** GI001 DRAWING INDEX WALL, FLOOR, BASE AND CEILING KEYNOTE: THIS SYMBOL, WHEN SEE INTERIOR ELEVATION SHEETS FOR ALL WALL TILE PATTERNS -CONTROL JOINT GI002 GENERAL NOTES ATTACHED TO A WALL, SHALL INDICATE THIS FINISH FOR THE ENTIRE COORDINATE PATTERN LAYOUTS WITH ARCHITECT PRIOR TO CUTTING AND STAINLESS STEEL CORNER GUARD, FLUSH 55" AFF. SEE **AE001** CODE PLAN LENGTH OF WALL FROM ONE INTERSECTION TO THE NEXT AND NOT PLACEMENT OF ANY & ALL TILE. SPECIFICATIONS AND FINISH PLANS FOR LOCATIONS. **AE003-5** UL WALL ASSEMBLIES BE TERMINATED BY WINDOWS OR DOORS, U.N.O. FINISH TO CONTINUE WALL TO WALL AND UNDERNEATH **AE006** UL RATED PENETARTIONS PROVIDE A SMOOTH TRANSITION AT ALL CHANGES IN FLOOR MATERIAL -STANDING FURNISHINGS. SEE SHEET AE620 FOR FINISH LEGEND CONTRACTOR TO INSTALL ALL FLOOR FINISHES AT SAME LEVEL, DESPITE CARPET TO BE LAYED OUT WALL TO WALL, INCLUDING UNDER DO NOT SCALE DRAWINGS. DIFFERENCES IN THICKNESS. THE HIGH DENSITY STORAGE(HDS) SYSTEMS. CONTRACTOR TO 'BY' ON FINISH PLAN DENOTES FINISH BY ARCHITECT SELECTION. COORDINATE WITH HDS VENDOR. CONTRACTOR / SUBCONTRACTOR SHALL VERIFY ALL DIMENSIONS AND ALL GYP. BD. CEILINGS SHALL BE PAINTED AS INDICATED IN FINISH LEGEND. NORTH WALL -CONDITIONS BEFORE BEGINNING WORK, AND SHALL REPORT TO THE ARCHITECT OF ANY ERRORS, INCONSISTENCIES OR OMISSIONS BEFORE EXPOSED GYP. BD. CEILINGS SHALL BE PAINTED - REFER TO FINISH PLANS, BEGINNING WORK. SEE GENERAL NOTES AND SPECIFICATIONS. REFLECTED CEILING PLANS, & FINISH SCHEDULE FOR PAINT COLOR. ALL EXISTING GYP. BD. WALL SURFACES TO BE PATCHED AND REPAIRED TO RATED WALL CONDITIONS SHALL REMAIN 5/8" TYPE-X GYP. BOARD. GYP. ATTAIN A LEVEL 5 FINISH. ALL NEW GYP. BD. WALL SURFACES TO BE FINISHED BOARD, BOTH RATED AND NON-RATED, SHALL BE PAINTED WHERE TO A LEVEL 5 FINISH. EXPOSED - REFER TO FINISH LEGEND. SOUTH WALL ALL EXPOSED SURFACES TO RECIEVE FINISH. ANY SURFACE WITHOUT A FINISH RUBBER TRANSITION STRIP → SEE B5/ AE530 PROVIDE SOLID BLOCKING/BACKING FOR ALL WALL MOUNTED DESIGNATION TO RECIEVE GENERAL FINISH FROM FINISH LEGEND. ACCESSORIES. METAL TRANSITION STRIP → SEE D5/ AE530 CONTRACTOR IS REQUIRED TO MAINTAIN ALL EXISITNG FIRE RATED FOR ALL FINISH MATERIALS SEE FINISH LEGEND ON SHEET SHEET AE620 CONSTURCTION AND IS RESPONSIBLE TO PATCH & REPAIR OR REPLACE FOR ALL WALL TILE GREATER THAN 12" IN LENGTH IN ANY EXISTING FIRE RATED ASSEMBLIES AS REQUIRED. COORDINATE ALL FIXTURES AND EQUIPMENT WITH MECHANICAL, DIRECTION, TILE SHALL BE INSTALLED RUNNING BOND WITH PLUMBING, AND ELECTRICAL AS REQUIRED. OFFSET NO GREATER THAN 1/3 THE LENGTH OF THE TILE. PROVIDE BLOCKING FOR ALL CASEWORK, COUNTERTOPS, SHELVING & WALL HUNG ACESSORIES AS REQUIRED. RE: **AE530** - DETAILS ALL EXPOSED PIPES IN ADA UNITS SHOULD BE WRAPPED IN A PVC PROVIDE EPOXY PAINT AT ALL TOILET ROOMS AND JANITOR INSULATION. ROOMS. CENTER FLOOR BOXES IN ROOMS U.N.O ALL WALLS PAINTED PT2 OR PT3, TO BE LEVEL 5 FINISH; EXISTING WALLS TO ALL TILE GROUT JOINTS TO BE NO LARGER THAN 1/8", U.N.O. REFER TO ENLARGED PLANS FOR MORE DETAIL. BE SKIM COATED FOR LEVEL 5 FINISH. FIELD PAINT TO BE PT 1 UNO. FIELD VERIFY ALL DIMENSIONS BEFORE FABRICATION OF REFER TO LOCATIONS OF HORIZONTAL LOUVERS AND ROLLER SHADES ARE MILLWORK. EXTENT OF EXTENT OF SHOWN ON THE RCP. COORDINATE ALL MILLWORK WITH APPLIANCES BEFORE FINISH HATCH: FABRICATION. PRIMARY CARPET FLOOR TILE 1 ACCENT CARPET FLOOR TILE 2 LUXURY VINYL FLOOR TILE 1 STATIC DISSIPATIVE TILE 1 30'-0" 30'-0'' 30'-0" 30'-0" 30'-0" PORCELAIN FLOOR TILE 1 RUBBER FLOOR TILE 1 HATCH & LINETYPE: AREA NOT IN CONTRACT **EXISTING** 925 NEW CONSTRUCTION -R-R-R- RATED CONSTRUCTION - AE001 919 CT2 SYMBOLS: **DESCRIPTION / REFERENCE** SYMBOL (11.4) ADA ADA OPERATOR (11.6)-CARD READER ELECTRICAL DATA ROOM COFFEE BREWER PLUMBING 929 DRINKING FOUNTAIN W/ BOTTLE FILLER (SINGLE FIXTURE ELEC. COOLED) 930 FLOOR BOX DUPLEX ELECTIRCAL 4 (12.4) FLOOR BOX DUPLEX ELECTIRCAL 904 905 (12.6)— 900 FLOOR COPIER 908 FLOOR DRAIN PLUMBING **ICEMAKER** ICE PLUMBING MICROWAVE MW TRAVEL & FLEE COMMUNICATIONS 909 907 REFRIGERATOR REF. PLUMBING SECURITY CAMERA ELECTRICAL (13.6) PLUMBING 30'-0" 30'-0" 30'-0" 30'-0" 30'-0" 30'-0'' TELEVISION (W) (\lor) ELECTRICAL A1 FLOOR PLAN - FINISH

1/8" = 1'-0" SCALE: 1/8" = 1'-0"

ISSUE TYPE: DRAWN BY:

ISSUE DATE:

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ARCHITECT / CONSULTANT

AUTHORITY HAVING JURISDICTION

HEALTHCARE LEVEL 09 TI

PROJECT DESCRIPTION

INTERMOUNTAIN

KEY PRIVATE BANK
CITY CREEK CENTER

SHEET NAME:

REVISIONS

MARK DATE

FINISH FLOOR PLAN

DESCRIPTION

03/26/2020

KL & SR

CD PERMIT SET

36 SOUTH STATE STREET SALT LAKE CITY, UT 84111

salt lake city, ut 84105

CHECKED BY: K. RIGBY PROJECT#: 1953

SHEET NUMBER:

CEILING SYMBOLS LEGEND: CEILING HATCH LEGEND: CEILING NOTES: SURFACE MOUNTED OR LAY-IN CEILING C1 2' X 4' SUSPENDED ACOUSTICAL PANEL CEILING, FLUORESCENT FIXTURE. SEE ELECTRICAL BLACK TILES, BLACK TRACK (EQ. ROCKFON COLOR- SEE AE510 FOR TYPICAL CEILING DETAILS PLAN FOR SIZE AND TYPE. ALL BLACK 08) SURFACE MOUNTED LIGHTING FIXTURE. C2 GYP. CEILING. PAINT.COLOR PT1 SEE ELECTRICAL PLAN FOR SIZE AND TYPE. **KEYED NOTES: CE** EXISTING GYP. CEILING. PAINT.COLOR PT1 DOWN LIGHT FIXTURES. SEE ELECTRICAL C3 2' X 4' SUSPENDED ACOUSTICAL PLAN FOR SIZE AND TYPE. AND SPECIFICATIONS. RECESSED CONTROL JOINT. PANEL CEILING CAN (EQ. ROCKFON KORAL, COLOR- WHITE) AUTOMATED DUAL FIXTURE W/ BLACKOUT ROLLER SHADES, V.I.F. DIMENSIONS LIGHTING SYSTEM SENSORS. SEE Ф PRIOR TO INSTALL. RE: SPECIFCATION 122413 ELECTRICAL PLAN. C4 2' X 4' SUSPENDED 1" ACOUSTICAL ALL EXTERIOR WINDOWS TO RECIVE HORIZONTAL LOUVER BLINDS U.N.O. V.I.F. OCCUPANCY PHOTOCELL PANEL CEILING (EQ. ROCKFON 20100) DIMENSIONS PRIOR TO INSTALL. RE: SPECIFICATION 122113 SENSOR LIFE SAFETY DEVICES. SEE ELECTRICAL C5 WOOD SLAT CEILING (EQ. 9 WOOD EXIT SIGN SUPPLY, RETURN & EXHAUST DIFFUSERS/GRILLES. SEE MECHANICAL. ES EXPOSED TO STRUCTURE ABOVE, PAINT W/ SUPPLY RETURN/ EXH DRYFALL **EXHAUST** AUDIO/VISUAL EQUIPMENT. S COORDINATE LOCATION W/ ELECTRICAL RECESSED & OWNER. SPEAKER EXISTING NEW CONSTRUCTION -R-R-R- RATED CONSTRUCTION - AE001 30'-0" (10.4)-8' - 6" 3 C5 W/ C1 8' - 0" 8' - 6" (11.4) (11.6) 929 928

GENERAL NOTES: SEE SHEET G1002 FOR GENERAL NOTES.

SEE COVER SHEET FOR DRAWING INDEX

DO NOT SCALE DRAWINGS.

CONTRACTORS SHALL VERIFY ALL DIMENSIONS AND CONDITIONS BEFORE BEGINNING WORK AND SHALL REPORT TO THE ARCHITECT ANY ERRORS, INCONSISTENCIES OR OMISSIONS BEFORE BEGINNING WORK. SEE GENERAL NOTES

THIS IS A REFLECTED CEILING PLAN AND IS NOT INTENDED TO BE A LIGHTING PLAN. NO WALL MOUNTED LIGHTING FIXTURES OR OTHER WALL MOUNTED APPURTENANCES ARE SHOWN. SEE THE LIGHTING PLAN FOR ALL LIGHTING AND EGRESS SIGNS, SIZE AND TYPES OF ELECTRICAL FIXTURES ETC. SEE MECHANICAL PLANS FOR ALL CEILING MOUNTED DIFFUSERS / GRILLES ETC.

WHEN THE INTERSTITIAL SPACES SUCH AS A PLENUMS (WHETHER SUPPLY OR RETURN) ARE USED FOR ENVIRONMENTAL AIR THEY SHALL BE NON-COMBUSTIBLE CONSTRUCTION OR HAVE A FLAME SPREAD RATING OF 0-25 AND SMOKE INDEX OF 0-50 WHEN TESTED IN ACCORDANCE TO ASTM E-84.

−(10.4)

HATCH & LINE TYPES:

AREA NOT IN CONTRACT

EXISTING BEAM ABOVE

— - — EXISTING STRUCTURE ABOVE

ARCHITECT / CONSULTANT

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No. 135096

salt lake city, ut 84105

AUTHORITY HAVING JURISDICTION

PROJECT DESCRIPTION

INTERMOUNTAIN HEALTHCARE LEVEL 09 TI

KEY PRIVATE BANK CITY CREEK CENTER 36 SOUTH STATE STREET SALT LAKE CITY, UT 84111

SHEET NAME:

REFLECTED CEILING PLAN

REVISIONS

MARK DATE DESCRIPTION


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ajc architects 703 east 1700 south

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INTERMOUNTAIN HEALTHCARE LEVEL 09 TI

KEY PRIVATE BANK CITY CREEK CENTER 36 SOUTH STATE STREET SALT LAKE CITY, UT 84111

PLAN - REFERENCE

DESCRIPTION

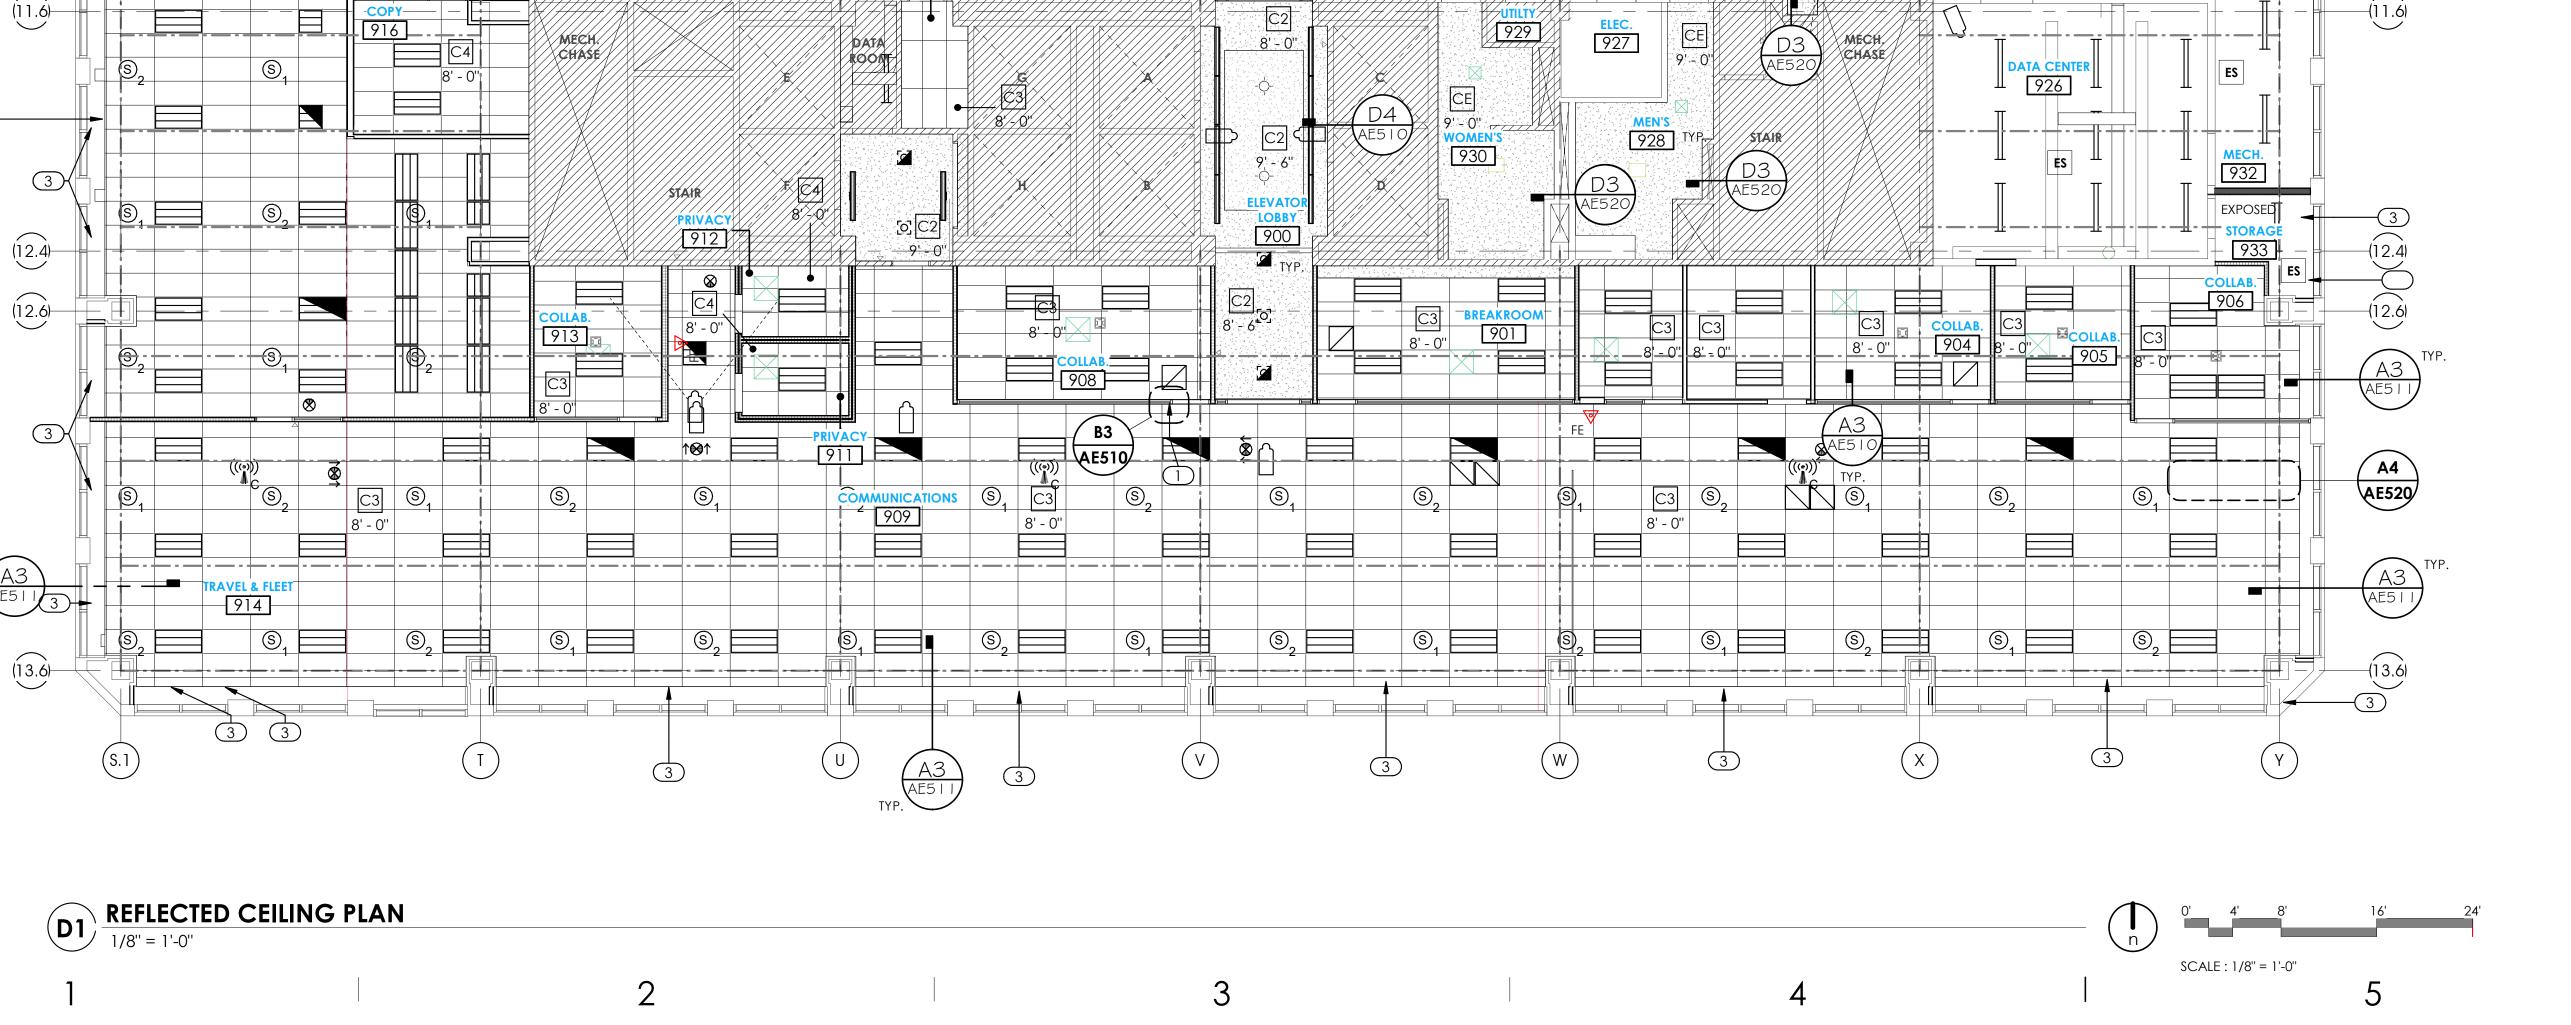
KL & SR

K. RIGBY PROJECT#: **1953**

03/26/2020

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SHEET NUMBER:

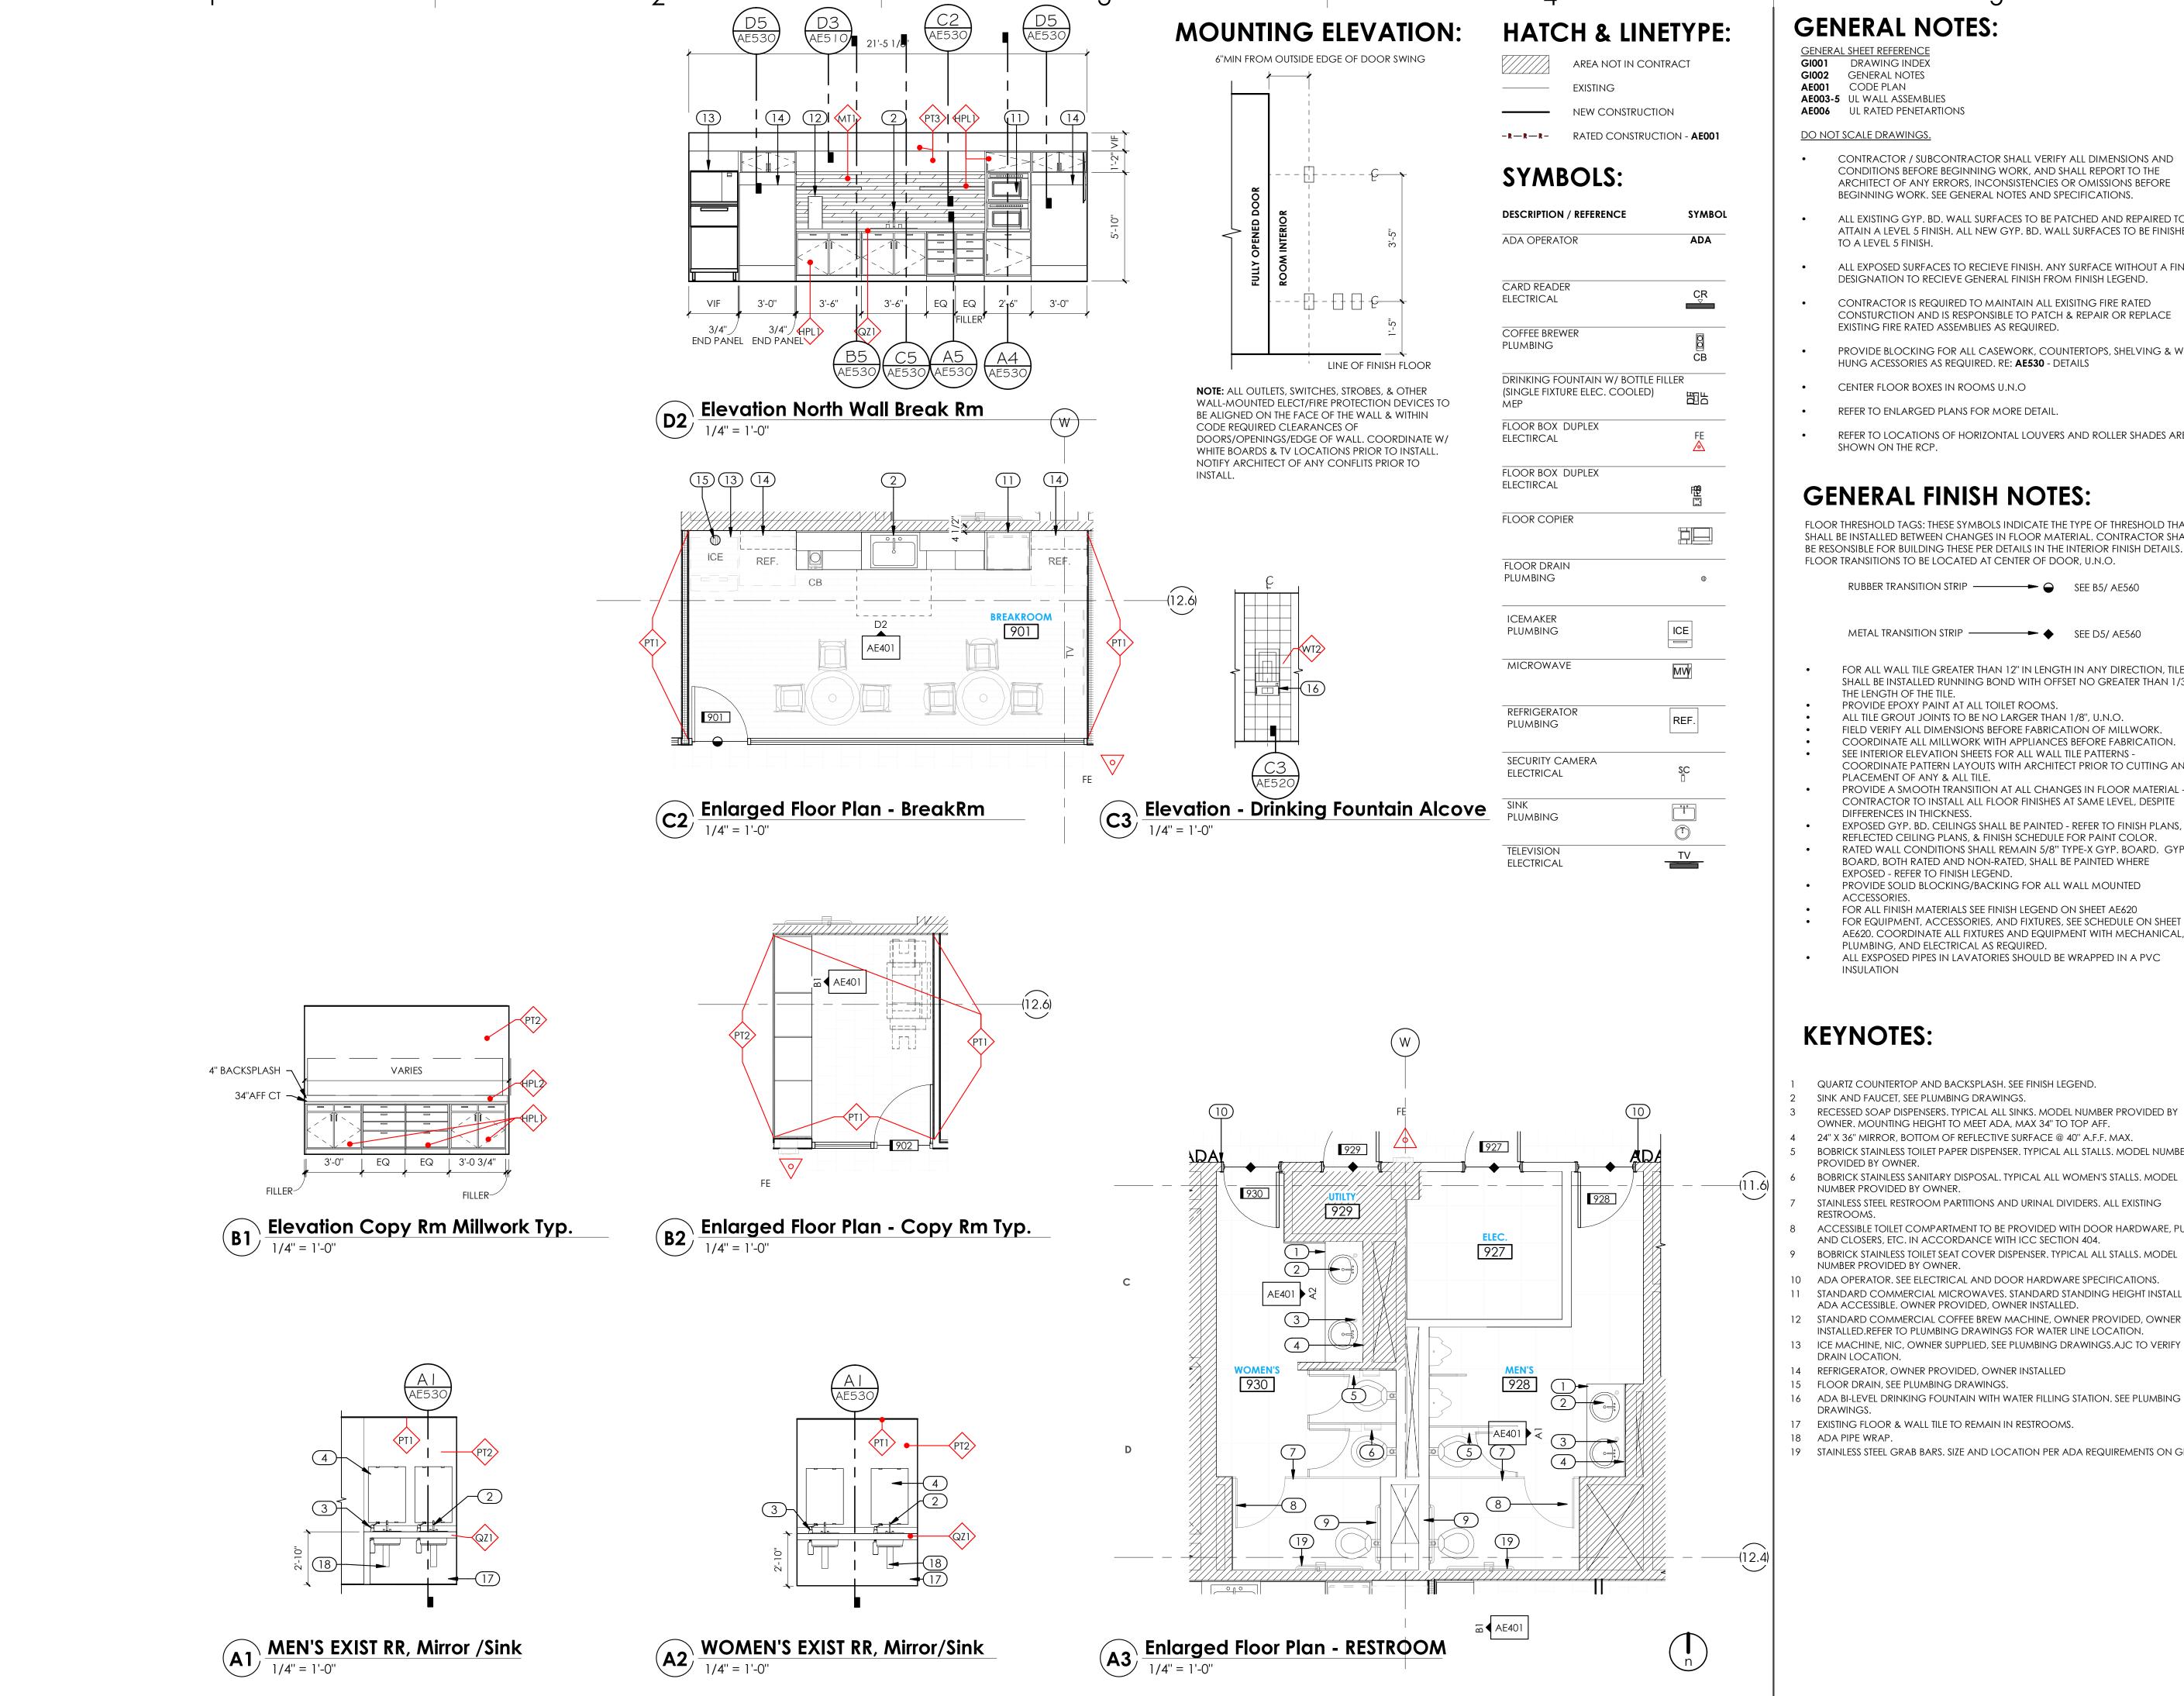

GENERAL NOTES:

GENERAL SHEET REFERENCE GI001 DRAWING INDEX GI002 GENERAL NOTES AE001 CODE PLAN **AE003-5** UL WALL ASSEMBLIES **AE006** UL RATED PENETARTIONS

CONTRACTOR / SUBCONTRACTOR SHALL VERIFY ALL DIMENSIONS AND CONDITIONS BEFORE BEGINNING WORK, AND SHALL REPORT TO THE ARCHITECT OF ANY ERRORS, INCONSISTENCIES OR OMISSIONS BEFORE BEGINNING WORK. SEE GENERAL NOTES AND SPECIFICATIONS.

ALL EXISTING GYP. BD. WALL SURFACES TO BE PATCHED AND REPAIRED TO ATTAIN A LEVEL 5 FINISH. ALL NEW GYP. BD. WALL SURFACES TO BE FINISHED TO A LEVEL 5 FINISH.

ALL EXPOSED SURFACES TO RECIEVE FINISH. ANY SURFACE WITHOUT A FINISH DESIGNATION TO RECIEVE GENERAL FINISH FROM FINISH LEGEND.

CONTRACTOR IS REQUIRED TO MAINTAIN ALL EXISITNG FIRE RATED CONSTURCTION AND IS RESPONSIBLE TO PATCH & REPAIR OR REPLACE EXISTING FIRE RATED ASSEMBLIES AS REQUIRED.

PROVIDE BLOCKING FOR ALL CASEWORK, COUNTERTOPS, SHELVING & WALL HUNG ACESSORIES AS REQUIRED. RE: **AE530** - DETAILS

CENTER FLOOR BOXES IN ROOMS U.N.O

REFER TO ENLARGED PLANS FOR MORE DETAIL.

REFER TO LOCATIONS OF HORIZONTAL LOUVERS AND ROLLER SHADES ARE SHOWN ON THE RCP.

GENERAL FINISH NOTES:

FLOOR THRESHOLD TAGS: THESE SYMBOLS INDICATE THE TYPE OF THRESHOLD THAT SHALL BE INSTALLED BETWEEN CHANGES IN FLOOR MATERIAL. CONTRACTOR SHALL BE RESONSIBLE FOR BUILDING THESE PER DETAILS IN THE INTERIOR FINISH DETAILS. ALL FLOOR TRANSITIONS TO BE LOCATED AT CENTER OF DOOR, U.N.O.

RUBBER TRANSITION STRIP → SEE B5/ AE560

METAL TRANSITION STRIP → SEE D5/ AE560

FOR ALL WALL TILE GREATER THAN 12" IN LENGTH IN ANY DIRECTION, TILE SHALL BE INSTALLED RUNNING BOND WITH OFFSET NO GREATER THAN 1/3

THE LENGTH OF THE TILE. PROVIDE EPOXY PAINT AT ALL TOILET ROOMS.

ALL TILE GROUT JOINTS TO BE NO LARGER THAN 1/8", U.N.O. FIELD VERIFY ALL DIMENSIONS BEFORE FABRICATION OF MILLWORK.

COORDINATE ALL MILLWORK WITH APPLIANCES BEFORE FABRICATION. SEE INTERIOR ELEVATION SHEETS FOR ALL WALL TILE PATTERNS -

COORDINATE PATTERN LAYOUTS WITH ARCHITECT PRIOR TO CUTTING AND PLACEMENT OF ANY & ALL TILE. PROVIDE A SMOOTH TRANSITION AT ALL CHANGES IN FLOOR MATERIAL -

CONTRACTOR TO INSTALL ALL FLOOR FINISHES AT SAME LEVEL, DESPITE DIFFERENCES IN THICKNESS.

EXPOSED GYP. BD. CEILINGS SHALL BE PAINTED - REFER TO FINISH PLANS, REFLECTED CEILING PLANS, & FINISH SCHEDULE FOR PAINT COLOR.

RATED WALL CONDITIONS SHALL REMAIN 5/8" TYPE-X GYP. BOARD. GYP. BOARD, BOTH RATED AND NON-RATED, SHALL BE PAINTED WHERE EXPOSED - REFER TO FINISH LEGEND.

PROVIDE SOLID BLOCKING/BACKING FOR ALL WALL MOUNTED

FOR ALL FINISH MATERIALS SEE FINISH LEGEND ON SHEET AE620 FOR EQUIPMENT, ACCESSORIES, AND FIXTURES, SEE SCHEDULE ON SHEET AE620. COORDINATE ALL FIXTURES AND EQUIPMENT WITH MECHANICAL,

PLUMBING, AND ELECTRICAL AS REQUIRED. ALL EXSPOSED PIPES IN LAVATORIES SHOULD BE WRAPPED IN A PVC INSULATION

KEYNOTES:

QUARTZ COUNTERTOP AND BACKSPLASH. SEE FINISH LEGEND.

SINK AND FAUCET, SEE PLUMBING DRAWINGS. RECESSED SOAP DISPENSERS. TYPICAL ALL SINKS. MODEL NUMBER PROVIDED BY

OWNER. MOUNTING HEIGHT TO MEET ADA, MAX 34" TO TOP AFF.

4 24" X 36" MIRROR, BOTTOM OF REFLECTIVE SURFACE @ 40" A.F.F. MAX.

BOBRICK STAINLESS TOILET PAPER DISPENSER. TYPICAL ALL STALLS. MODEL NUMBER PROVIDED BY OWNER.

BOBRICK STAINLESS SANITARY DISPOSAL. TYPICAL ALL WOMEN'S STALLS. MODEL

NUMBER PROVIDED BY OWNER. STAINLESS STEEL RESTROOM PARTITIONS AND URINAL DIVIDERS. ALL EXISTING

RESTROOMS.

ACCESSIBLE TOILET COMPARTMENT TO BE PROVIDED WITH DOOR HARDWARE, PULLS

AND CLOSERS, ETC. IN ACCORDANCE WITH ICC SECTION 404. 9 BOBRICK STAINLESS TOILET SEAT COVER DISPENSER. TYPICAL ALL STALLS. MODEL

11 STANDARD COMMERCIAL MICROWAVES. STANDARD STANDING HEIGHT INSTALL AND ADA ACCESSIBLE. OWNER PROVIDED, OWNER INSTALLED.

12 STANDARD COMMERCIAL COFFEE BREW MACHINE, OWNER PROVIDED, OWNER

INSTALLED.REFER TO PLUMBING DRAWINGS FOR WATER LINE LOCATION.

DRAIN LOCATION.

14 REFRIGERATOR, OWNER PROVIDED, OWNER INSTALLED 15 FLOOR DRAIN, SEE PLUMBING DRAWINGS.

16 ADA BI-LEVEL DRINKING FOUNTAIN WITH WATER FILLING STATION. SEE PLUMBING

DRAWINGS.

17 EXISTING FLOOR & WALL TILE TO REMAIN IN RESTROOMS.

19 STAINLESS STEEL GRAB BARS. SIZE AND LOCATION PER ADA REQUIREMENTS ON GI003.

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AUTHORITY HAVING JURISDICTION

HEALTHCARE LEVEL 09 TI

PROJECT DESCRIPTION

INTERMOUNTAIN

KEY PRIVATE BANK

CITY CREEK CENTER

SHEET NAME:

ELEVATIONS

REVISIONS

MARK DATE

36 SOUTH STATE STREET

SALT LAKE CITY, UT 84111

ENLARGED FLOOR

PLANS AND INTERIOR

DESCRIPTION

No. 135096

salt lake city, ut 84105

SHEET NUMBER:

GENERAL NOTES:

GI001 DRAWING INDEX GI002 GENERAL NOTES **AE001** CODE PLAN **AE003-5** UL WALL ASSEMBLIES

DO NOT SCALE DRAWINGS.

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REFER TO ENLARGED PLANS FOR MORE DETAIL.

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SEE INTERIOR ELEVATION SHEETS FOR ALL WALL TILE PATTERNS -COORDINATE PATTERN LAYOUTS WITH ARCHITECT PRIOR TO CUTTING AND PLACEMENT OF ANY & ALL TILE.

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FOR ALL FINISH MATERIALS SEE FINISH LEGEND ON SHEET AE620 FOR EQUIPMENT, ACCESSORIES, AND FIXTURES, SEE SCHEDULE ON SHEET AE620. COORDINATE ALL FIXTURES AND EQUIPMENT WITH MECHANICAL, PLUMBING, AND ELECTRICAL AS REQUIRED.

ALL EXSPOSED PIPES IN LAVATORIES SHOULD BE WRAPPED IN A PVC

1 METAL BRACKETS FOR SUPPORT

2 REFER TO MIDWEST DRAWINGS FOR FURNITURE TYPE.

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AUTHORITY HAVING JURISDICTION

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INTERMOUNTAIN HEALTHCARE LEVEL 09 TI

KEY PRIVATE BANK CITY CREEK CENTER **36 SOUTH STATE STREET** SALT LAKE CITY, UT 84111

SHEET NAME:

ENLARGED FLOOR PLANS AND INTERIOR ELEVATIONS

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Mark date DESCRIPTION


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SHEET NUMBER:



- CONTRACTOR / SUBCONTRACTOR SHALL VERIFY ALL DIMENSIONS AND CONDITIONS BEFORE BEGINNING WORK, AND SHALL REPORT TO THE ARCHITECT OF ANY ERRORS, INCONSISTENCIES OR OMISSIONS BEFORE
- ALL EXISTING GYP. BD. WALL SURFACES TO BE PATCHED AND REPAIRED TO ATTAIN A LEVEL 5 FINISH. ALL NEW GYP. BD. WALL SURFACES TO BE FINISHED
- ALL EXPOSED SURFACES TO RECIEVE FINISH. ANY SURFACE WITHOUT A FINISH
- CONTRACTOR IS REQUIRED TO MAINTAIN ALL EXISITNG FIRE RATED CONSTURCTION AND IS RESPONSIBLE TO PATCH & REPAIR OR REPLACE
- REFER TO LOCATIONS OF HORIZONTAL LOUVERS AND ROLLER SHADES ARE

FLOOR THRESHOLD TAGS: THESE SYMBOLS INDICATE THE TYPE OF THRESHOLD THAT SHALL BE INSTALLED BETWEEN CHANGES IN FLOOR MATERIAL. CONTRACTOR SHALL BE RESONSIBLE FOR BUILDING THESE PER DETAILS IN THE INTERIOR FINISH DETAILS. ALL

- FOR ALL WALL TILE GREATER THAN 12" IN LENGTH IN ANY DIRECTION, TILE SHALL BE INSTALLED RUNNING BOND WITH OFFSET NO GREATER THAN 1/3
- FIELD VERIFY ALL DIMENSIONS BEFORE FABRICATION OF MILLWORK.
- COORDINATE ALL MILLWORK WITH APPLIANCES BEFORE FABRICATION. COORDINATE PATTERN LAYOUTS WITH ARCHITECT PRIOR TO CUTTING AND
- PROVIDE A SMOOTH TRANSITION AT ALL CHANGES IN FLOOR MATERIAL -CONTRACTOR TO INSTALL ALL FLOOR FINISHES AT SAME LEVEL, DESPITE
- EXPOSED GYP. BD. CEILINGS SHALL BE PAINTED REFER TO FINISH PLANS, REFLECTED CEILING PLANS, & FINISH SCHEDULE FOR PAINT COLOR.
- BOARD, BOTH RATED AND NON-RATED, SHALL BE PAINTED WHERE
- FOR EQUIPMENT, ACCESSORIES, AND FIXTURES, SEE SCHEDULE ON SHEET

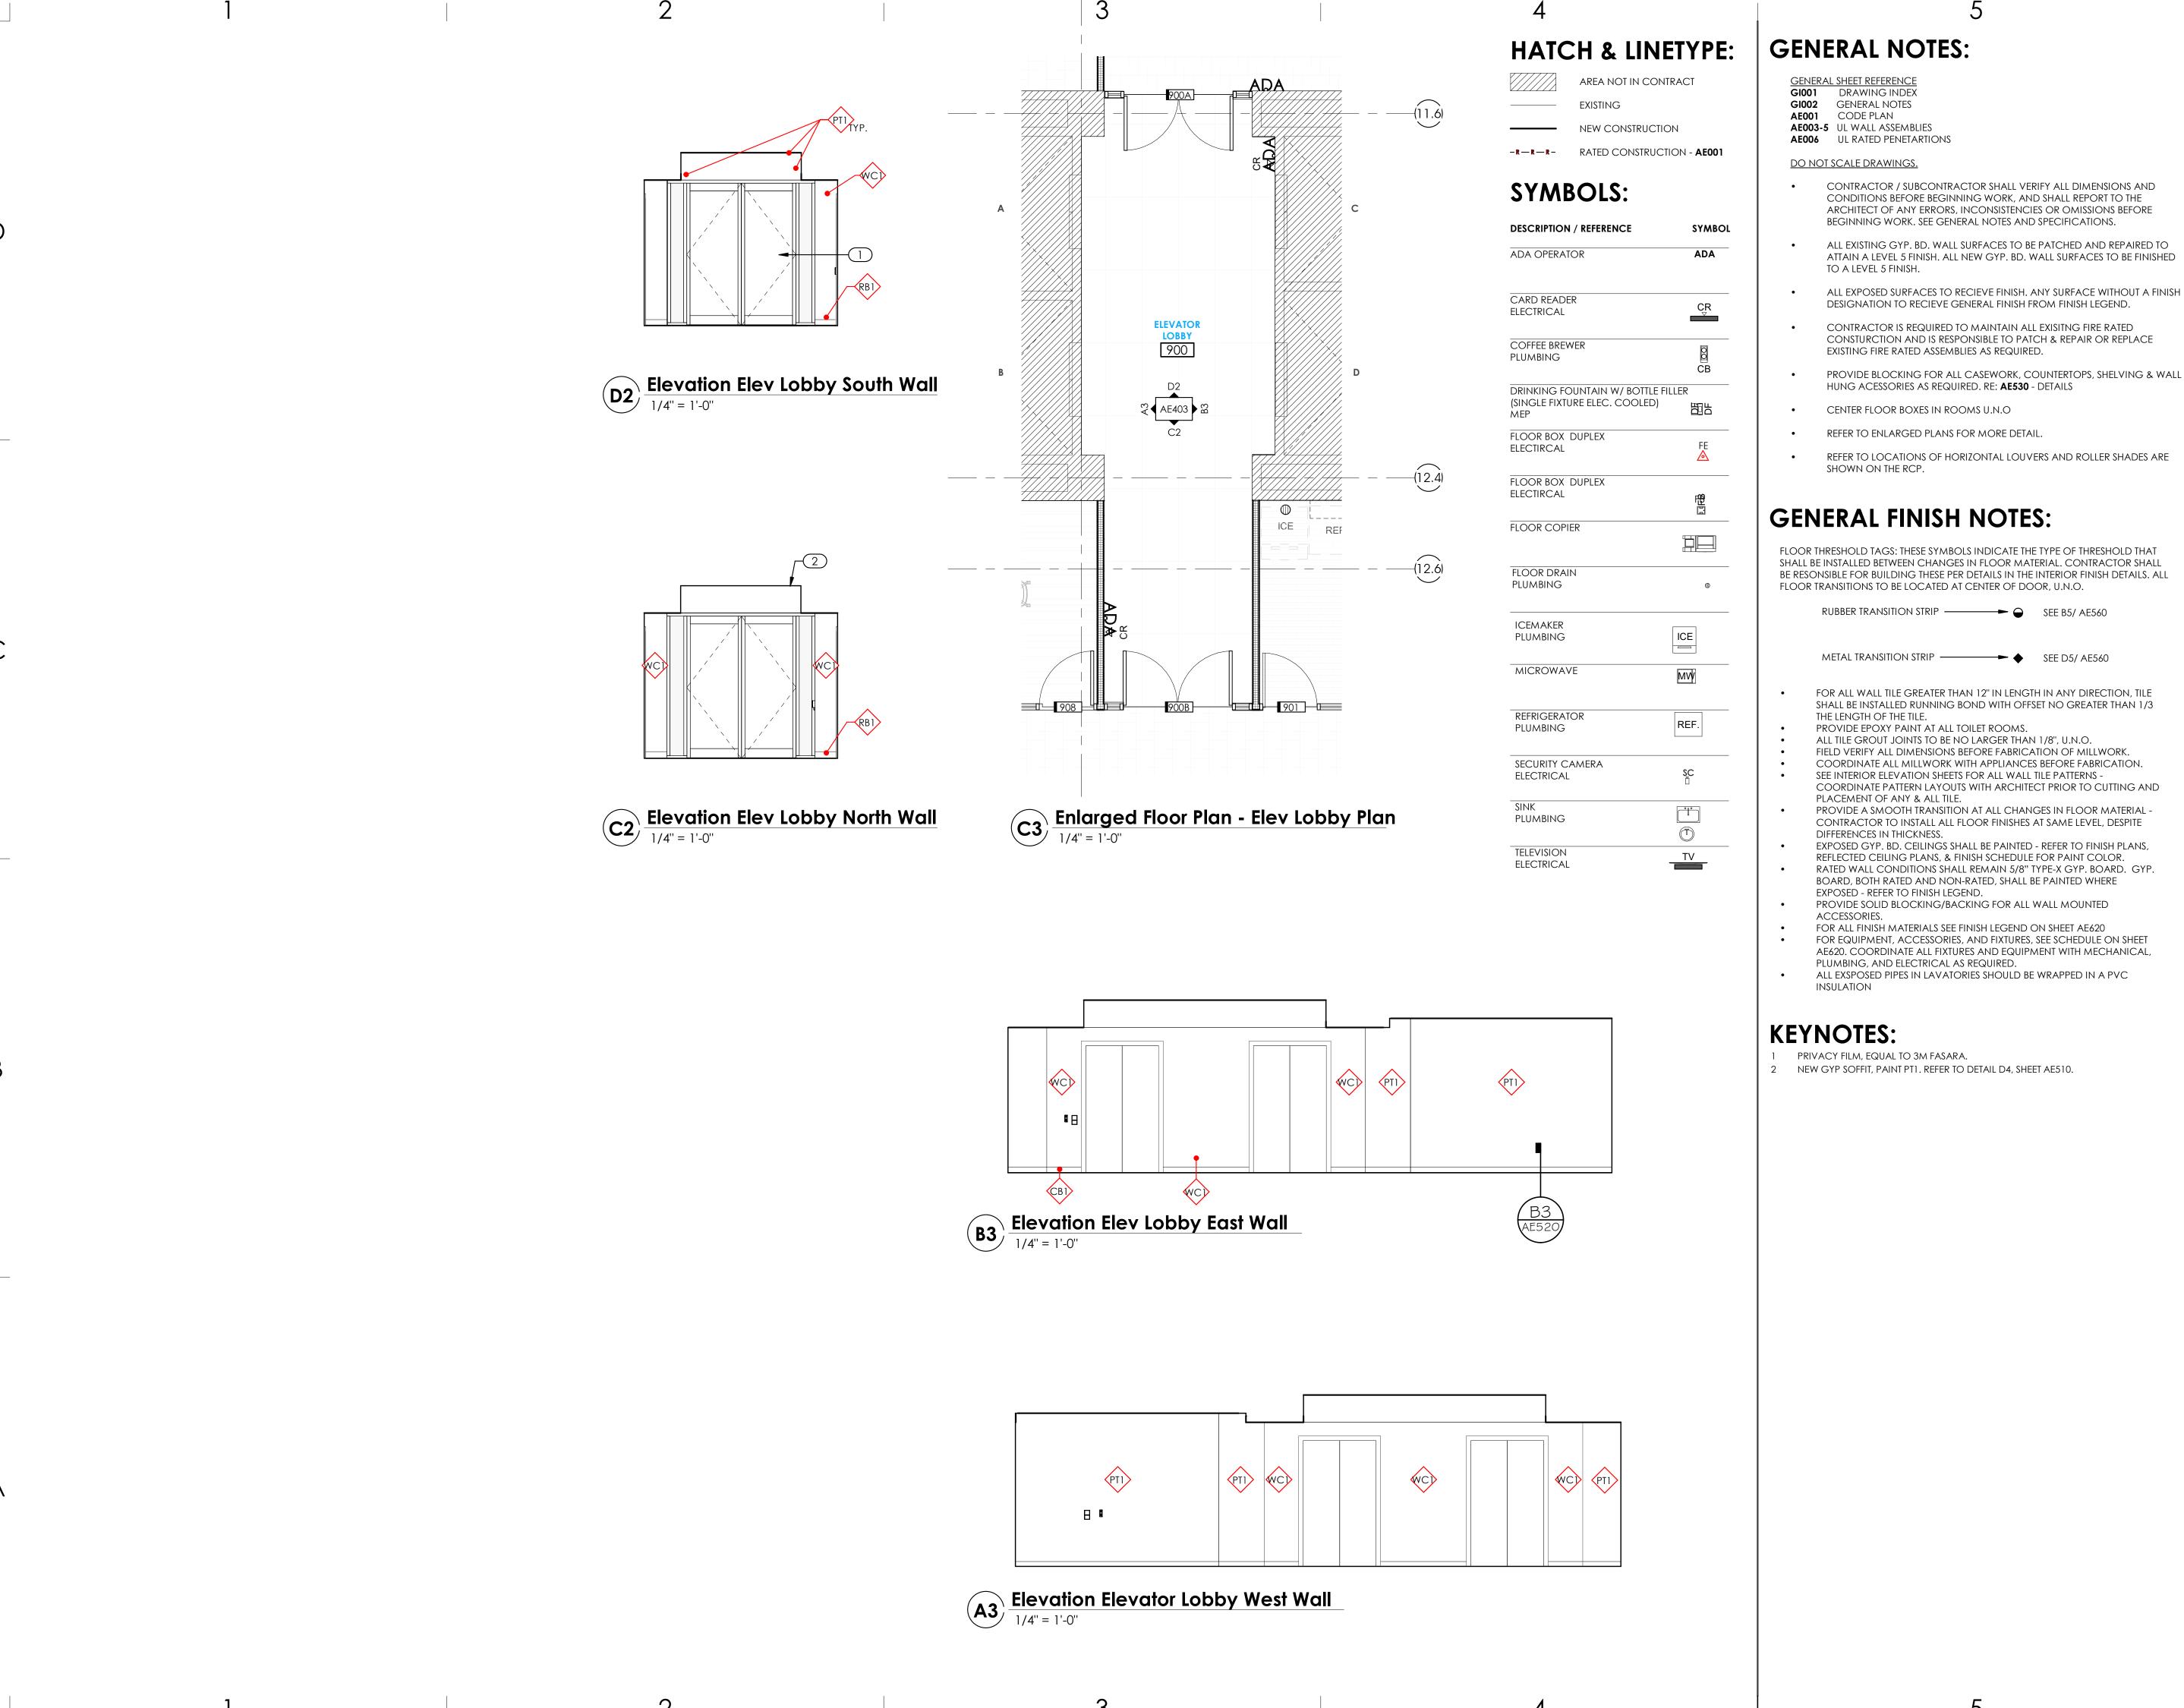ajc architects

703 east 1700 south salt lake city, ut 84105



ARCHITECT / CONSULTANT

ajcarchitects.com

AUTHORITY HAVING JURISDICTION

PROJECT DESCRIPTION

INTERMOUNTAIN HEALTHCARE LEVEL 09 TI

KEY PRIVATE BANK CITY CREEK CENTER 36 SOUTH STATE STREET

SALT LAKE CITY, UT 84111

SHEET NAME:

ENLARGED FLOOR PLANS AND INTERIOR ELEVATIONS

REVISIONS

Mark date DESCRIPTION


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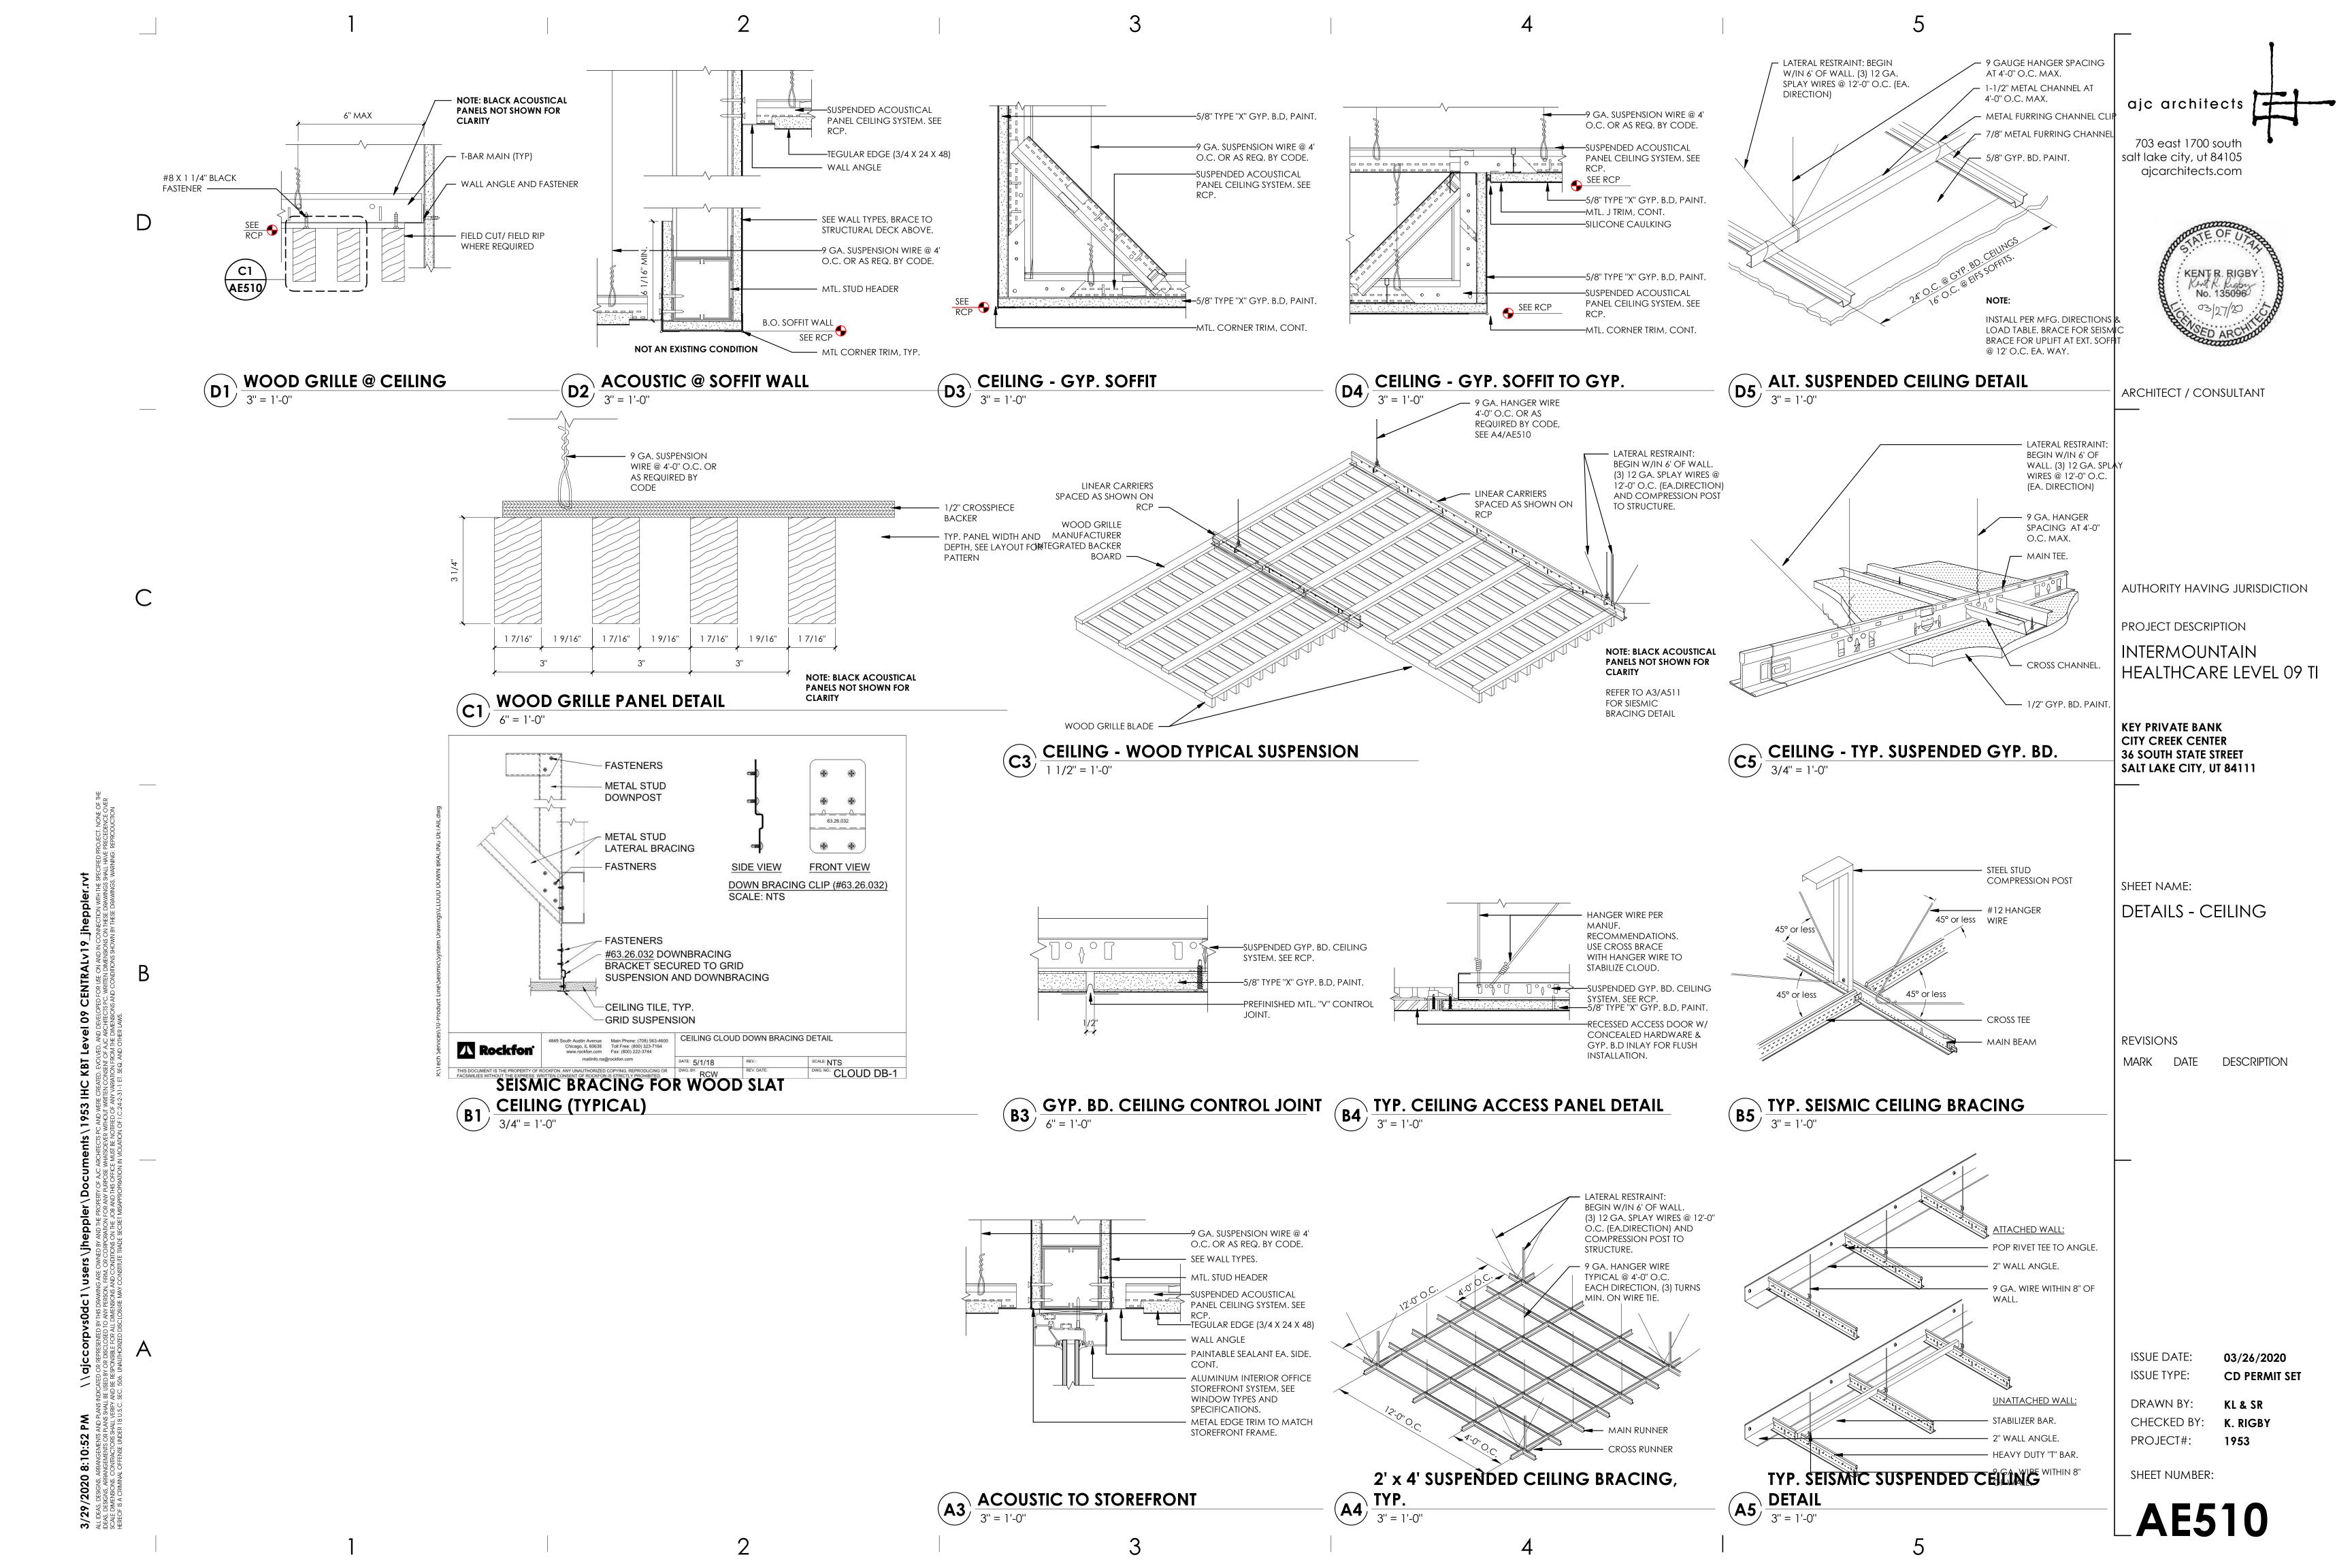
DRAWN BY: KL & SR CHECKED BY: K. RIGBY PROJECT#: 1953


03/26/2020


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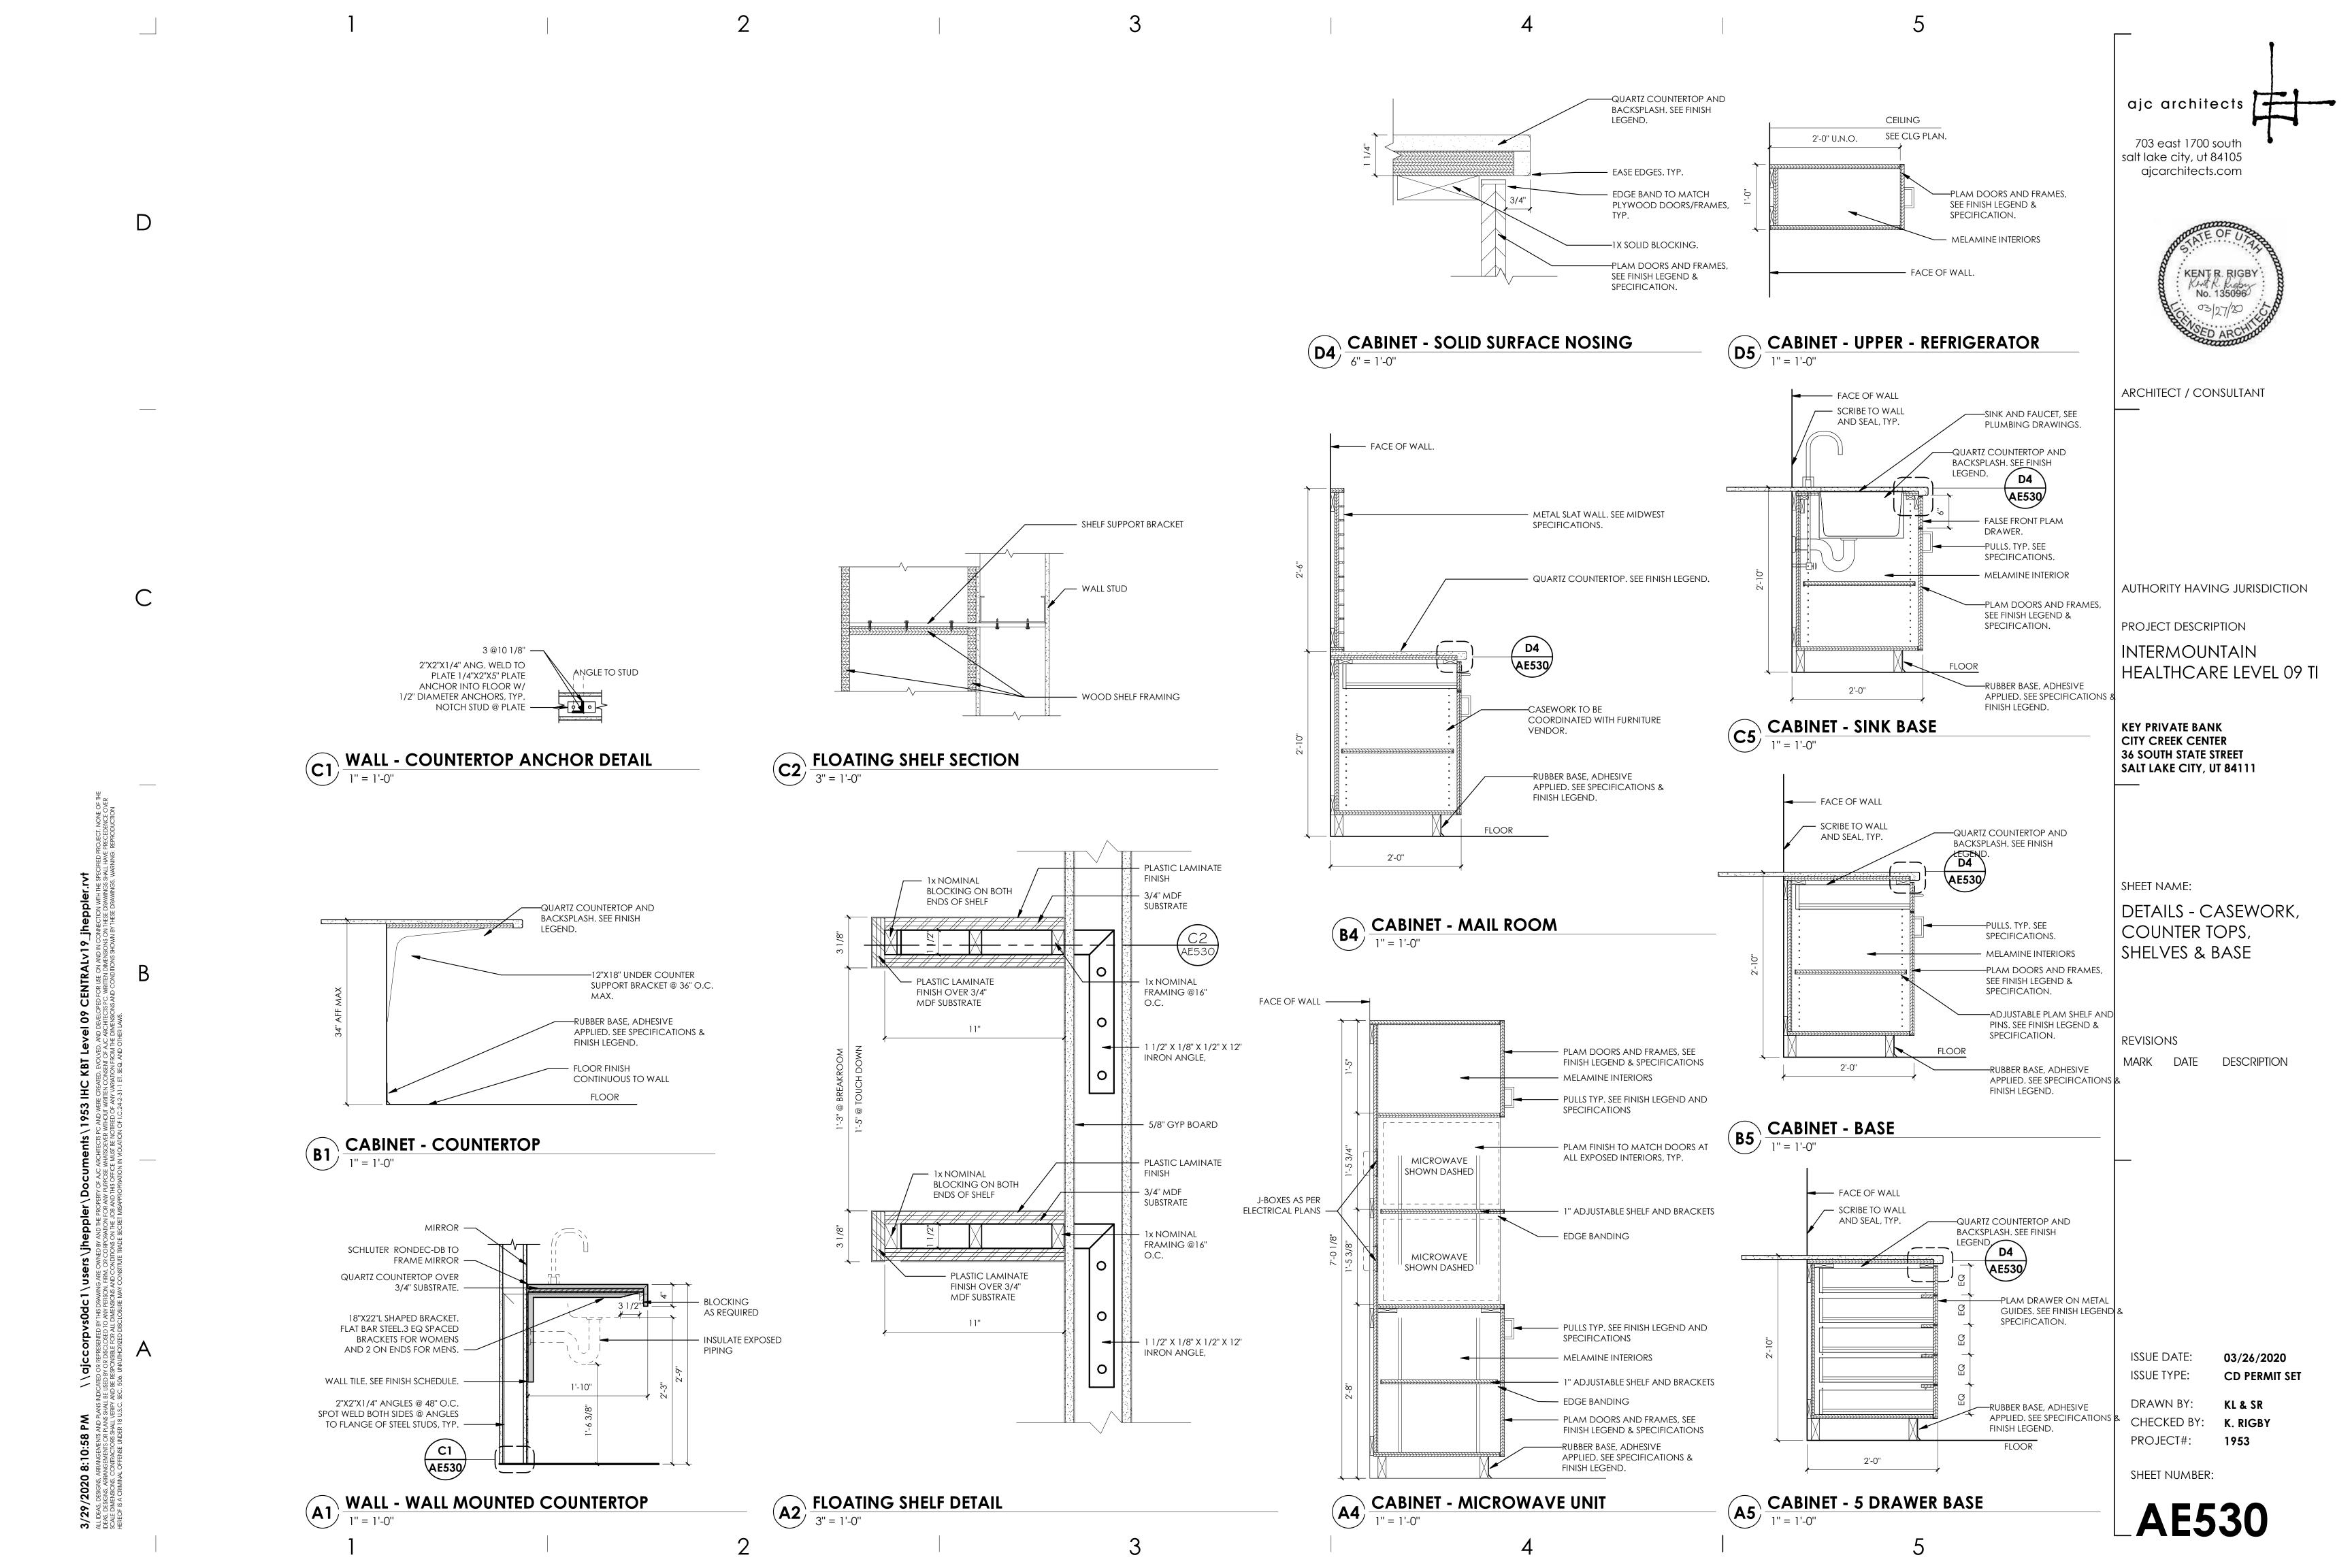
SHEET NUMBER:







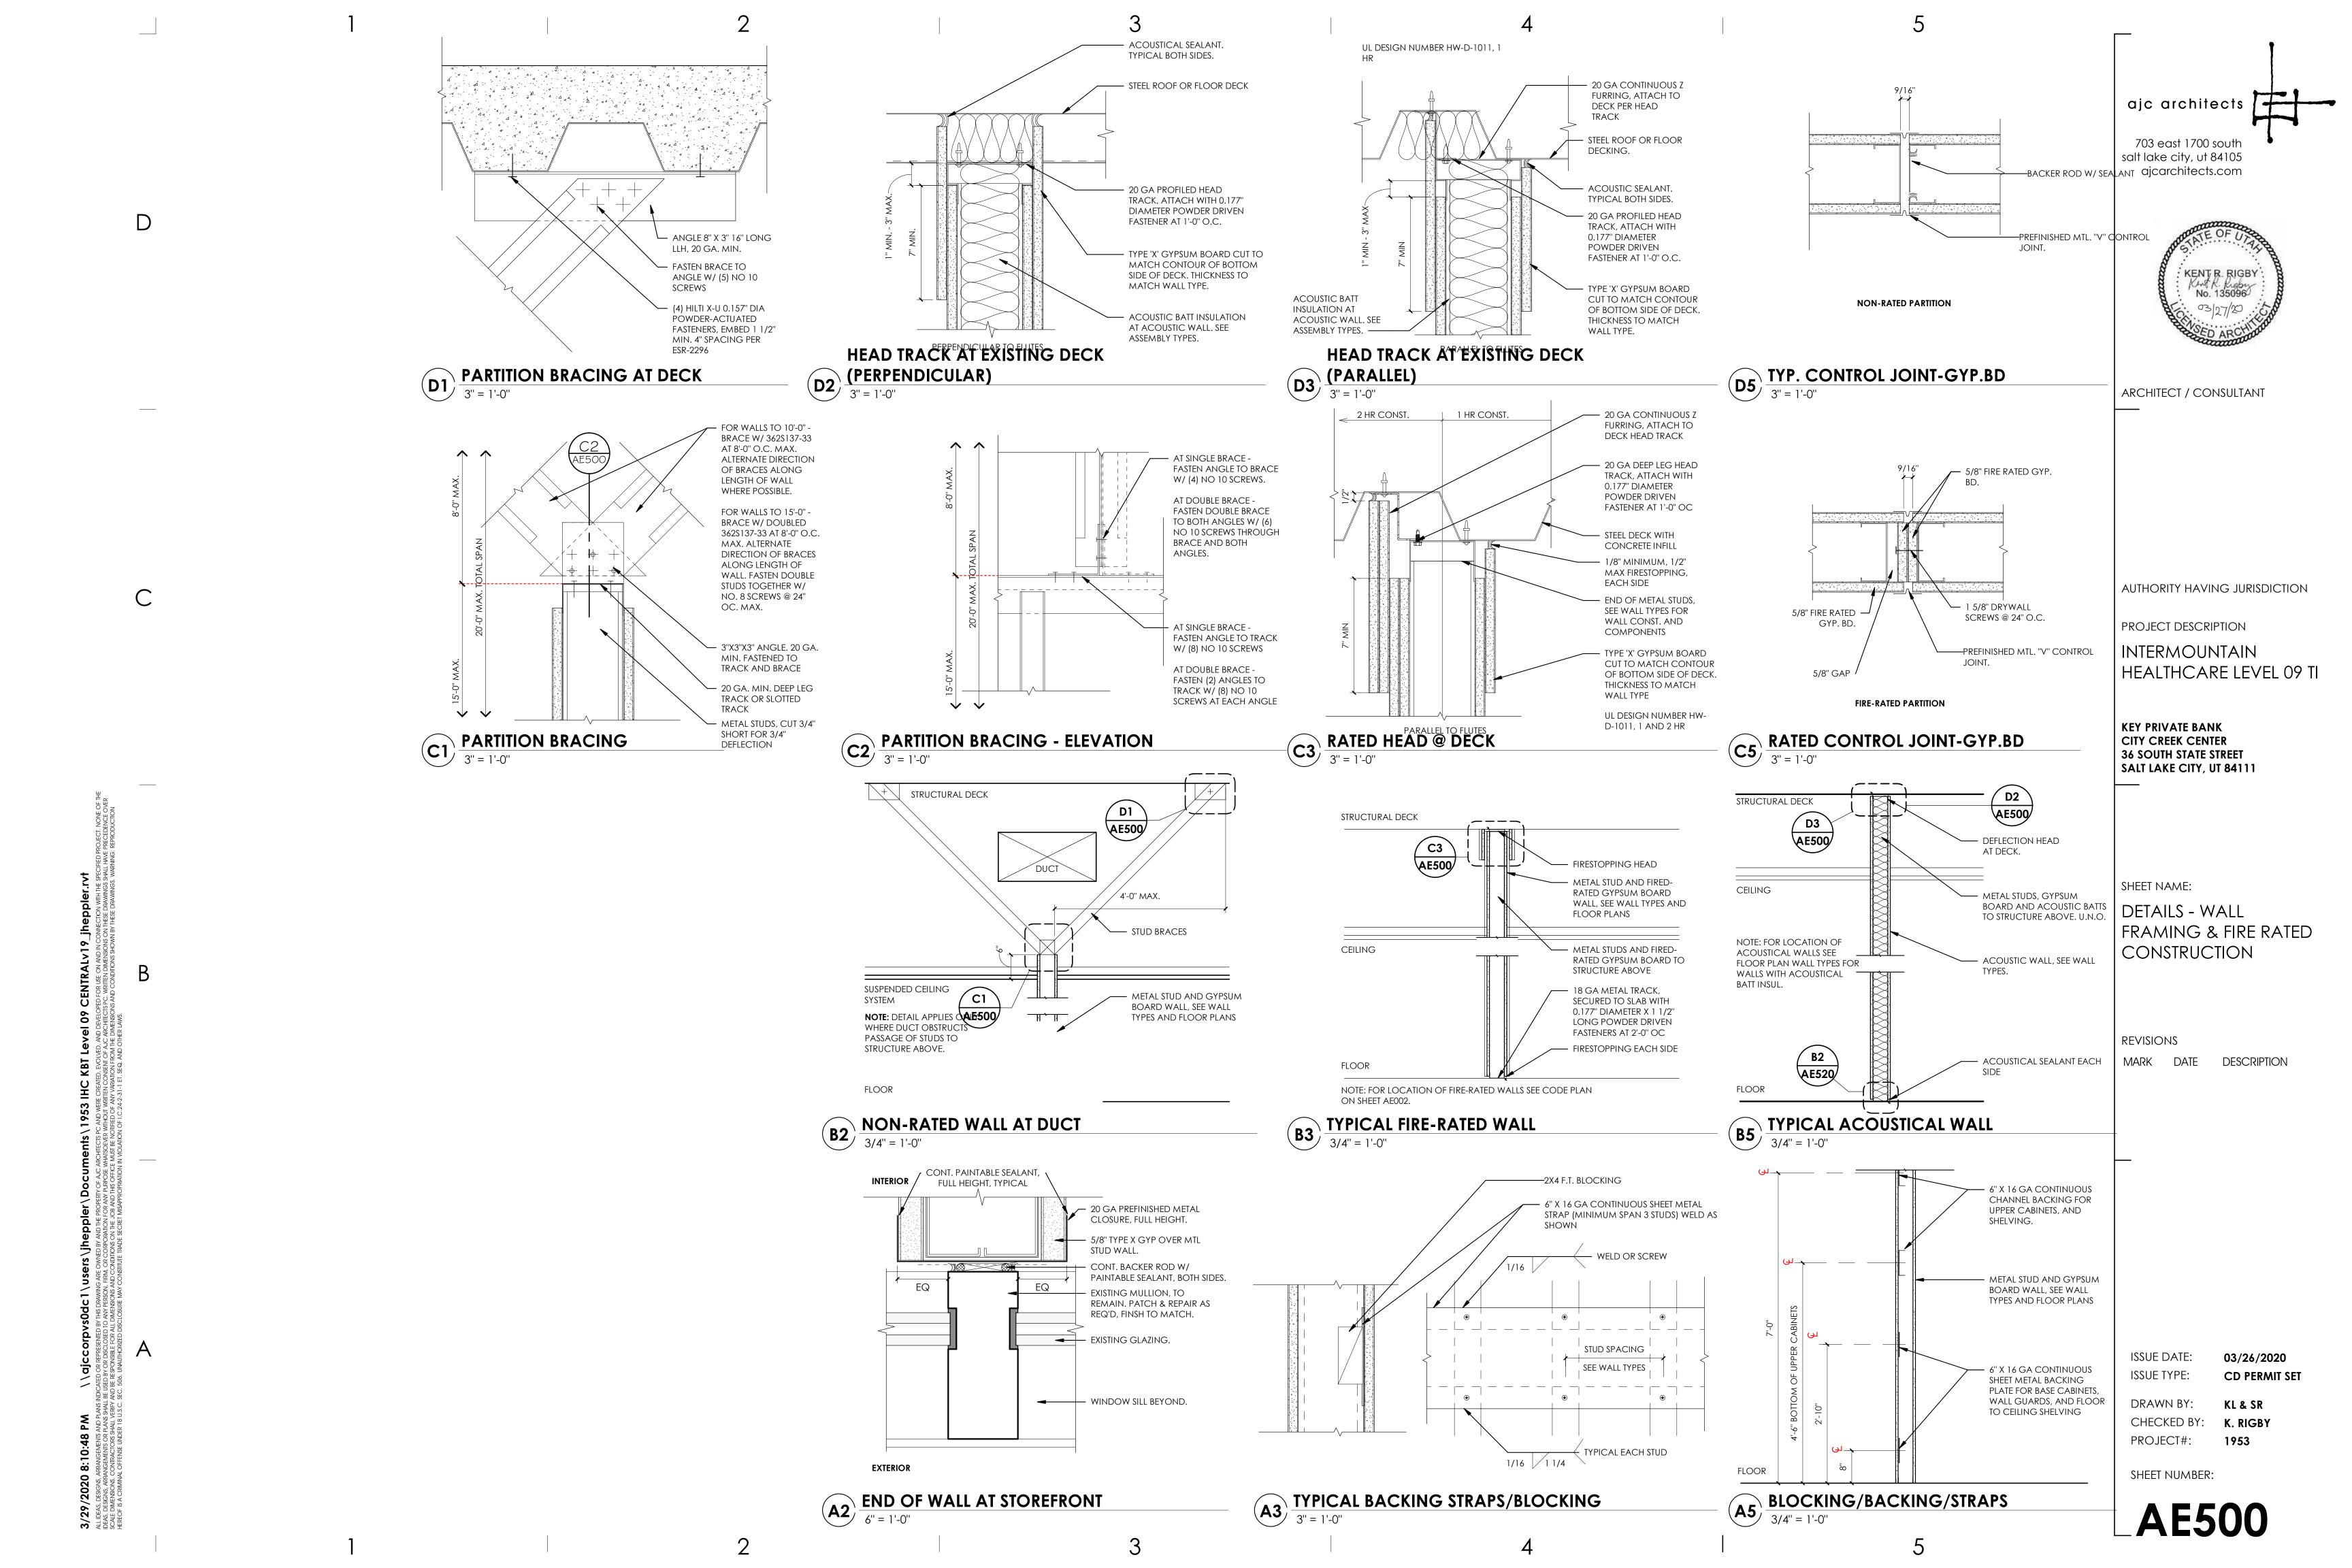

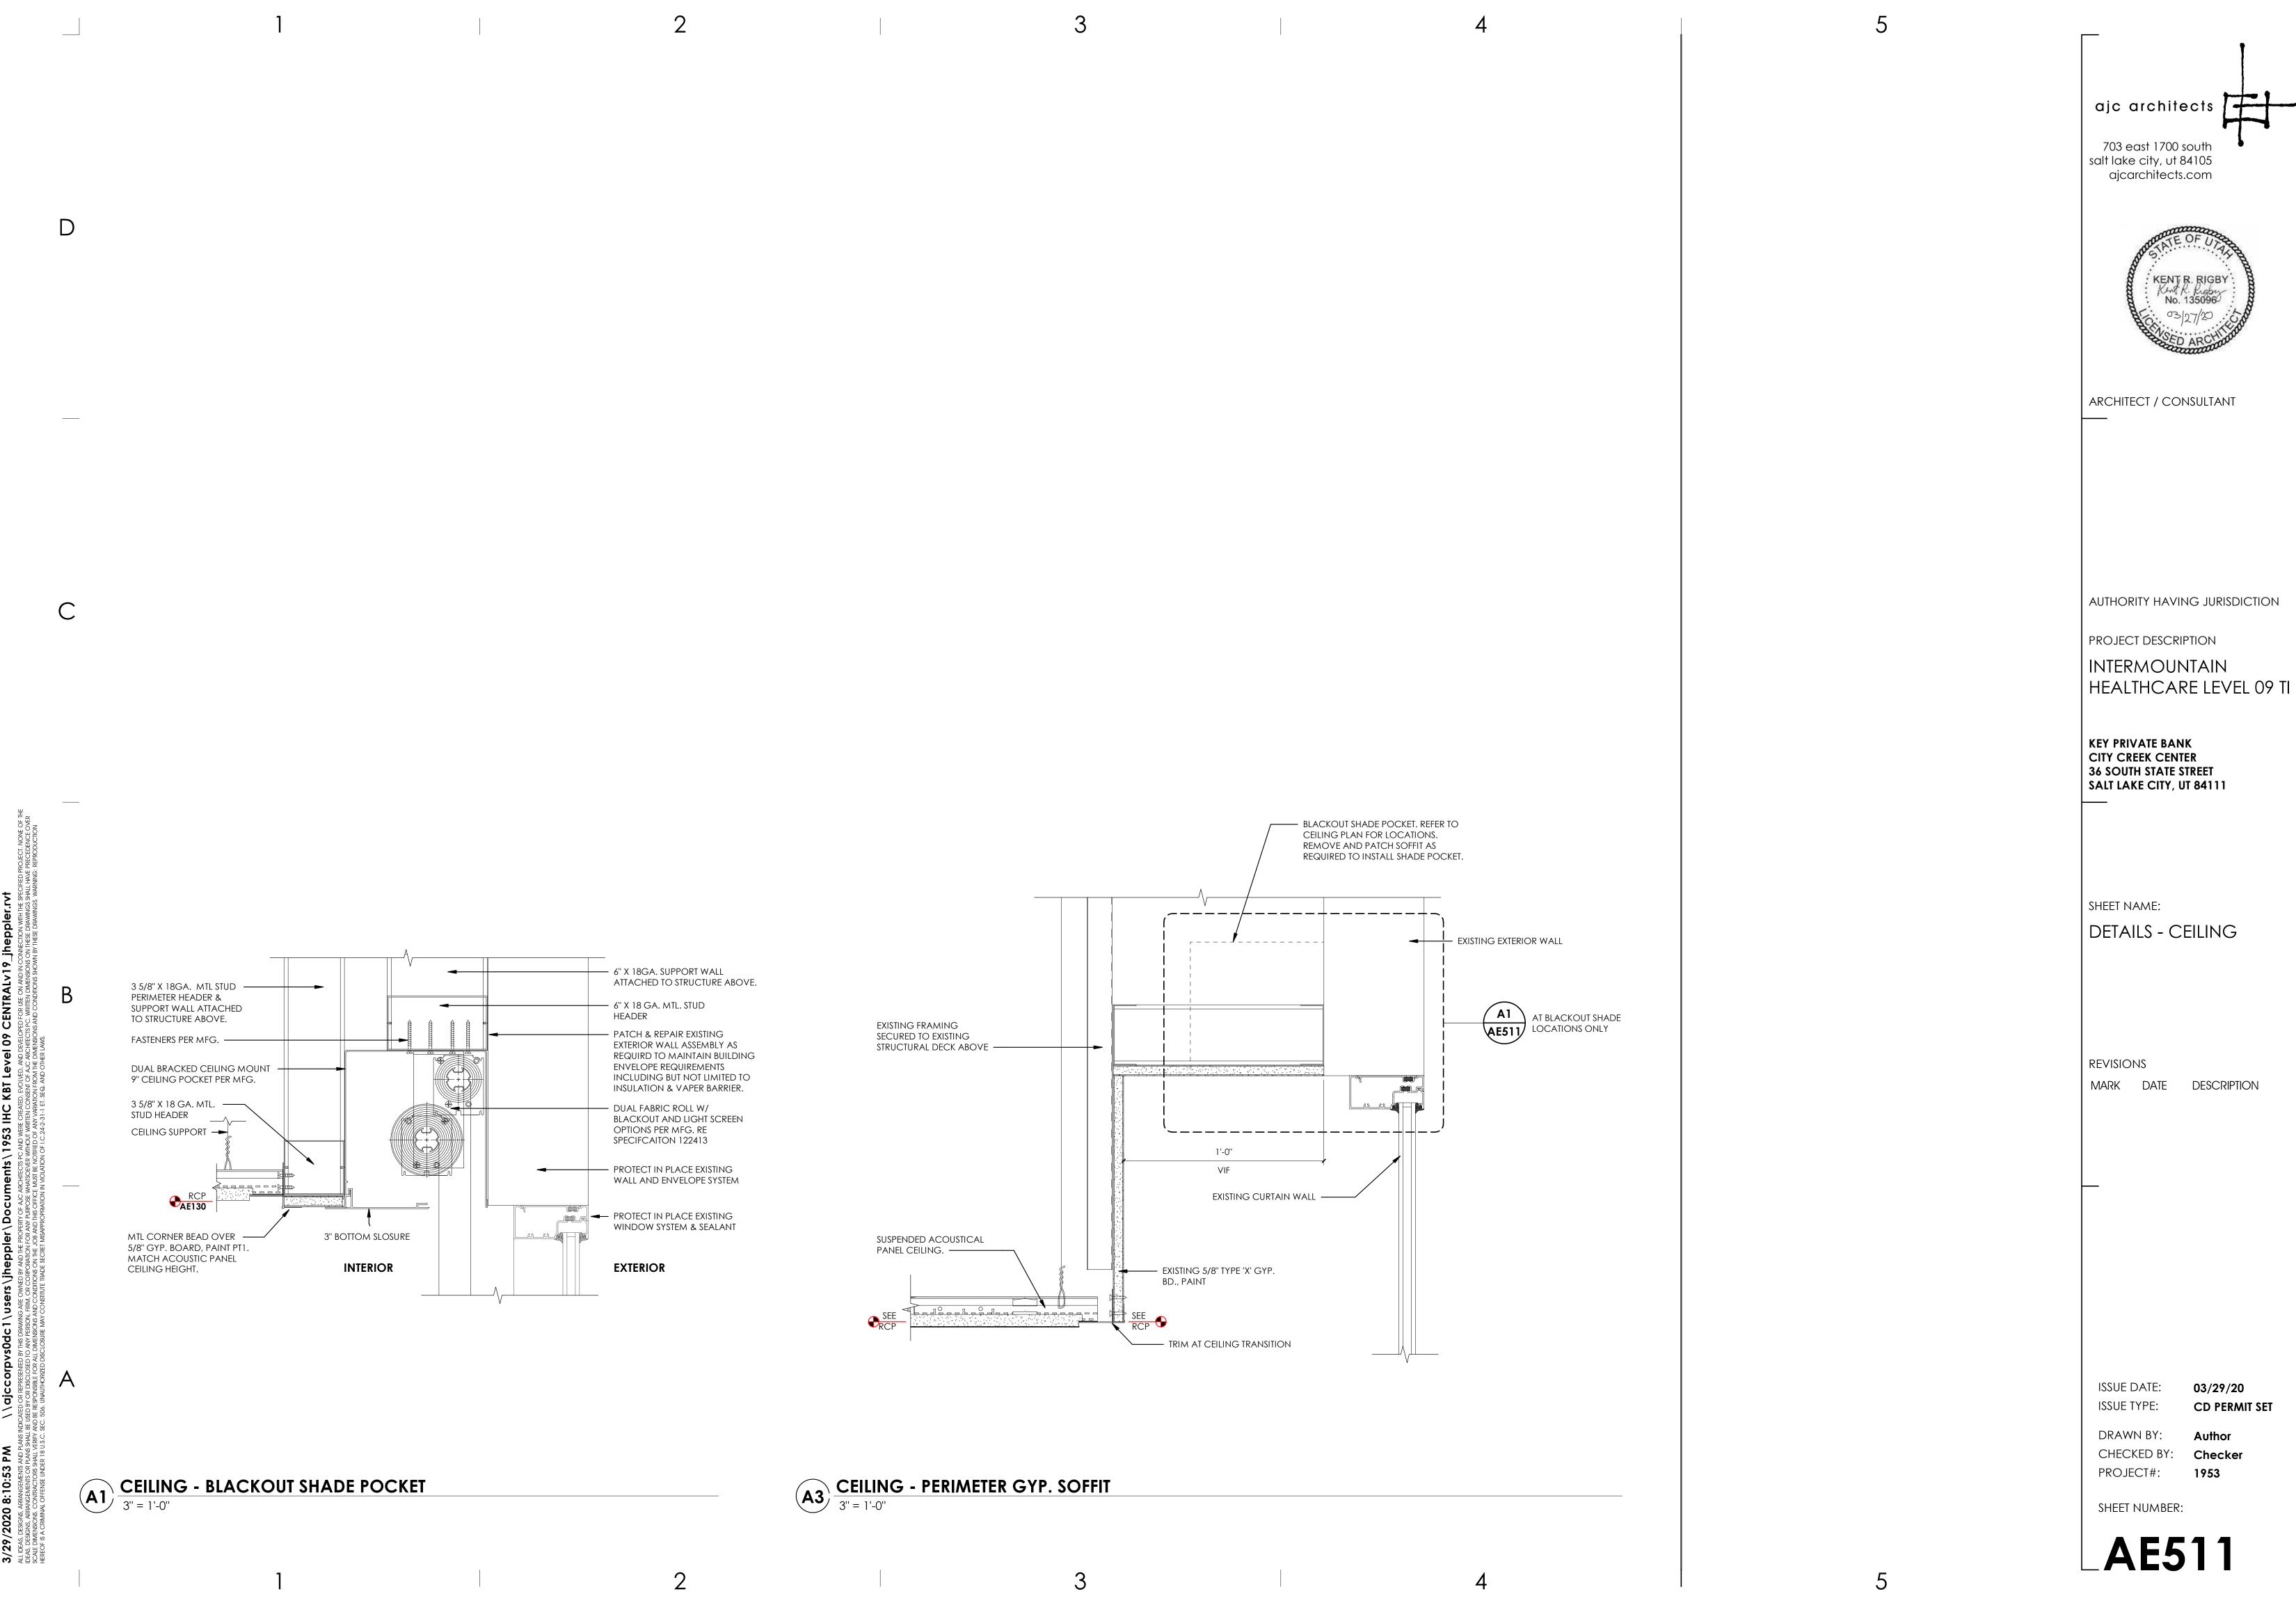

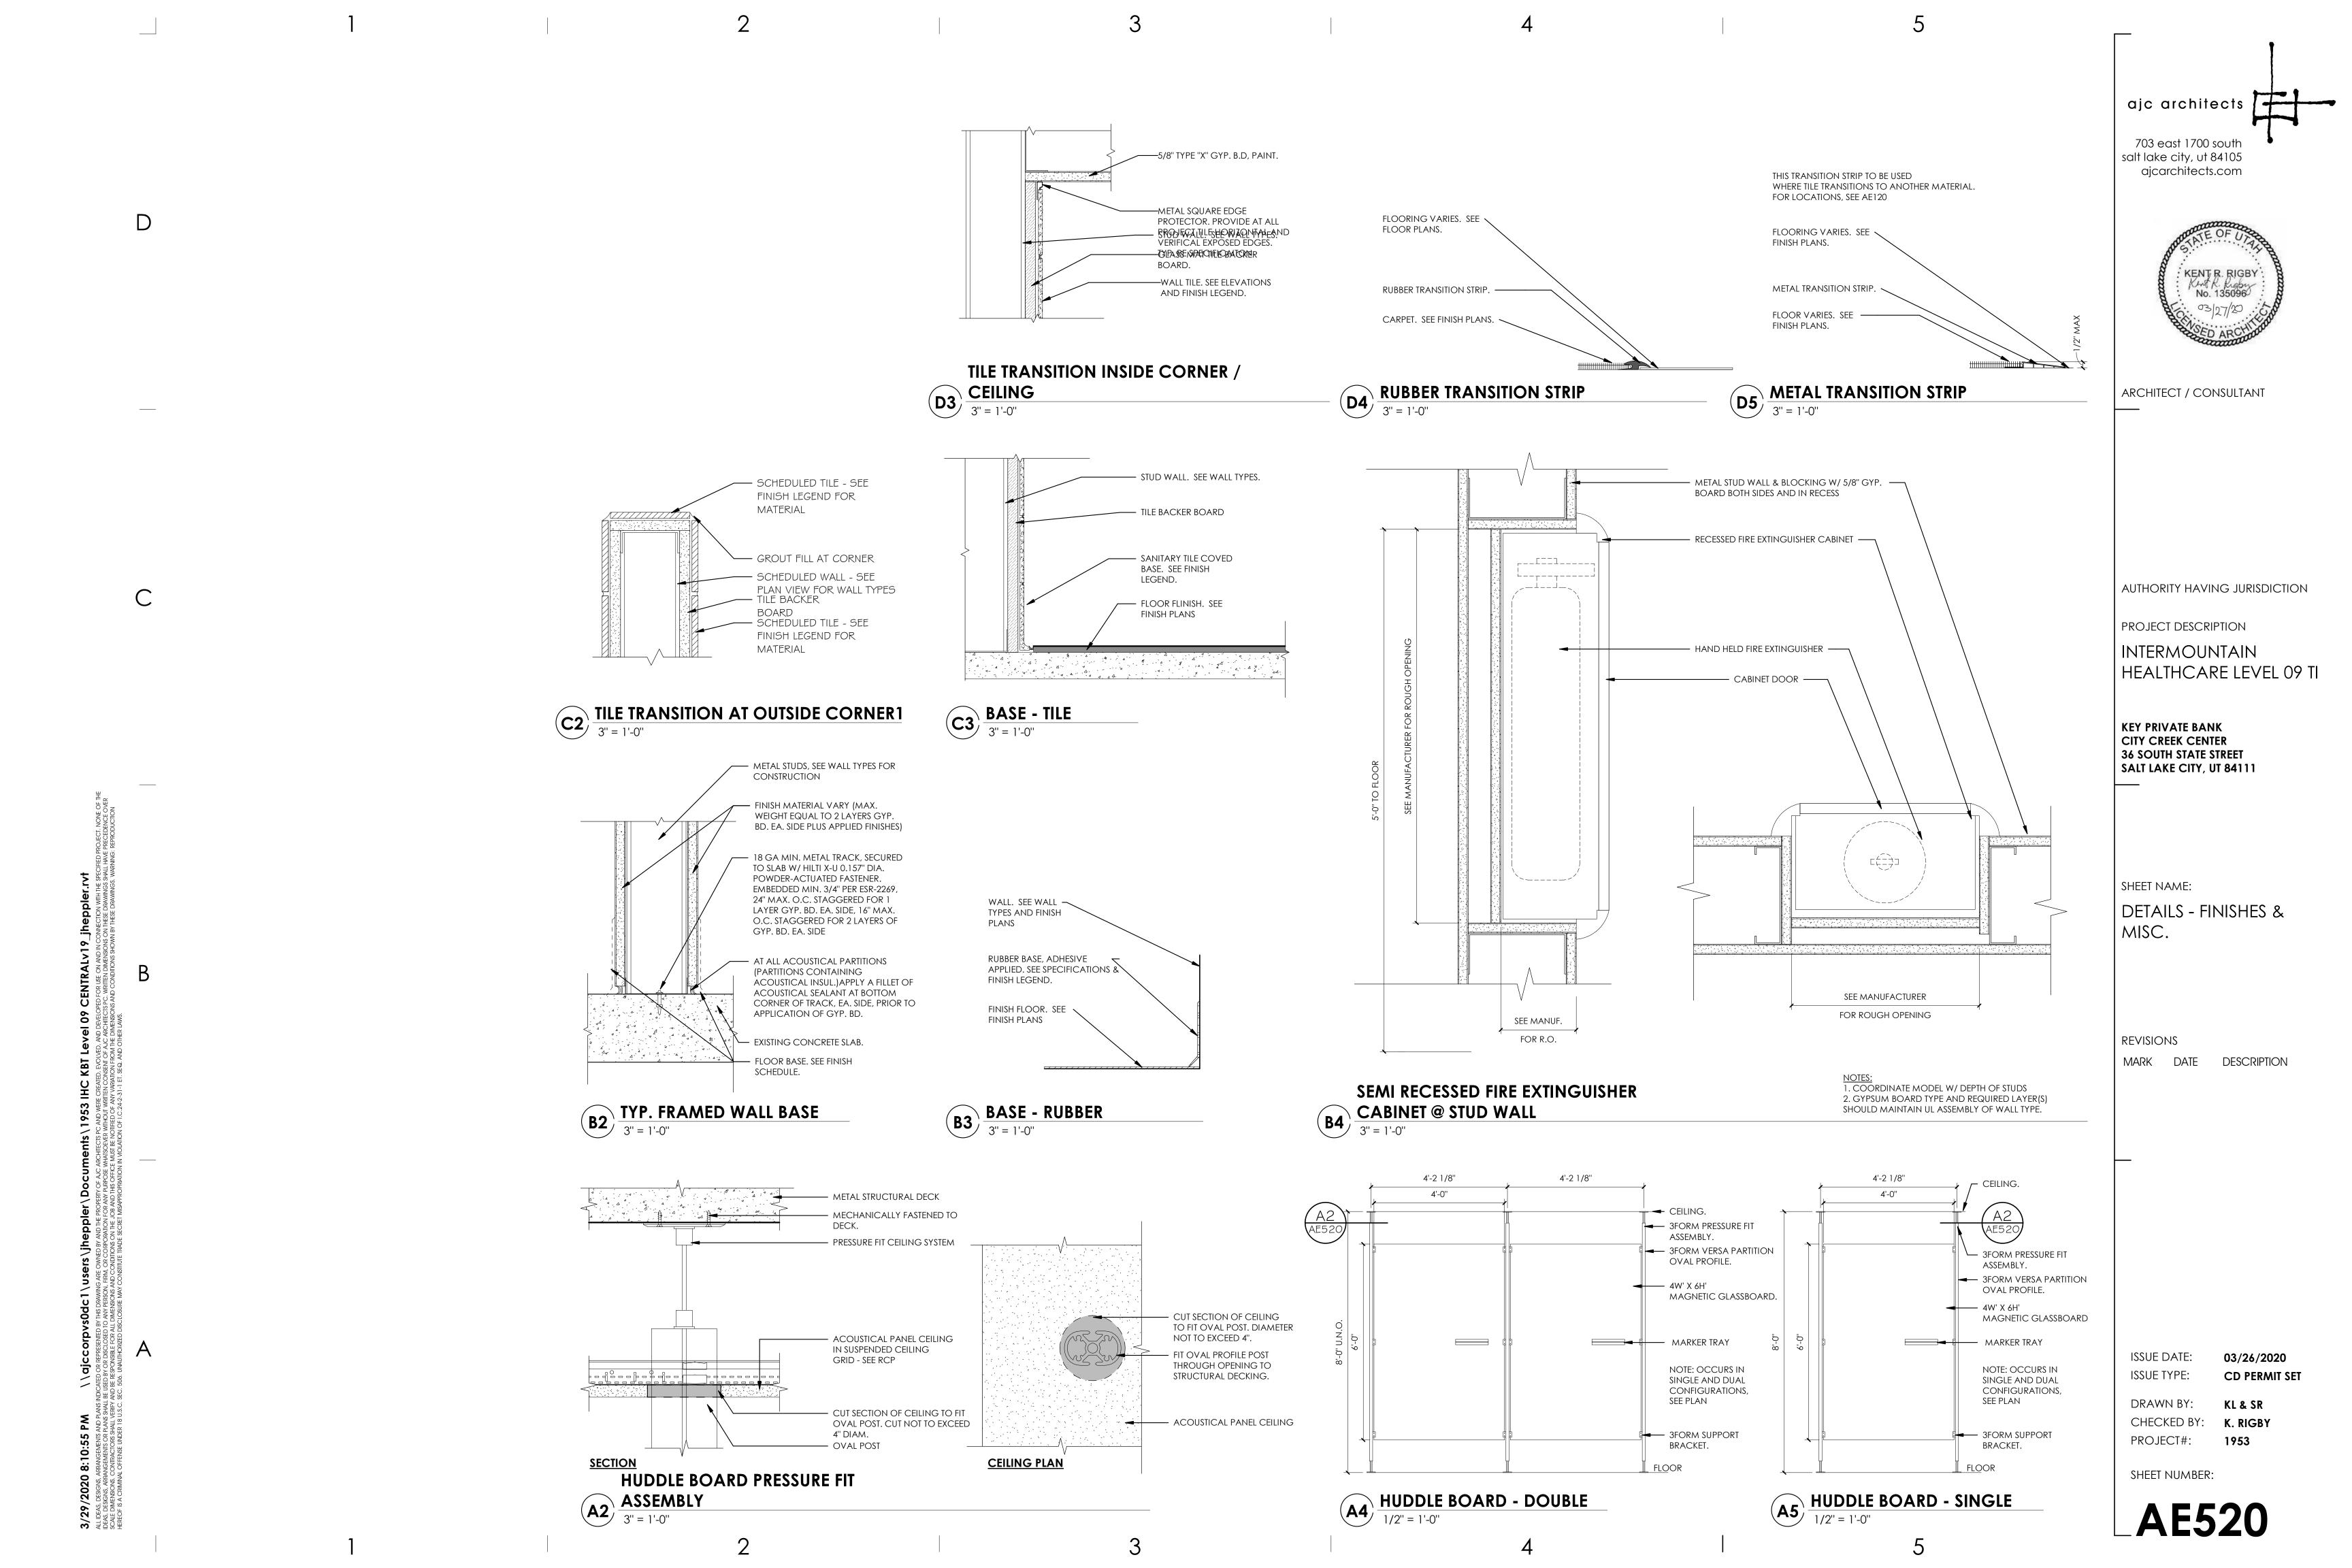

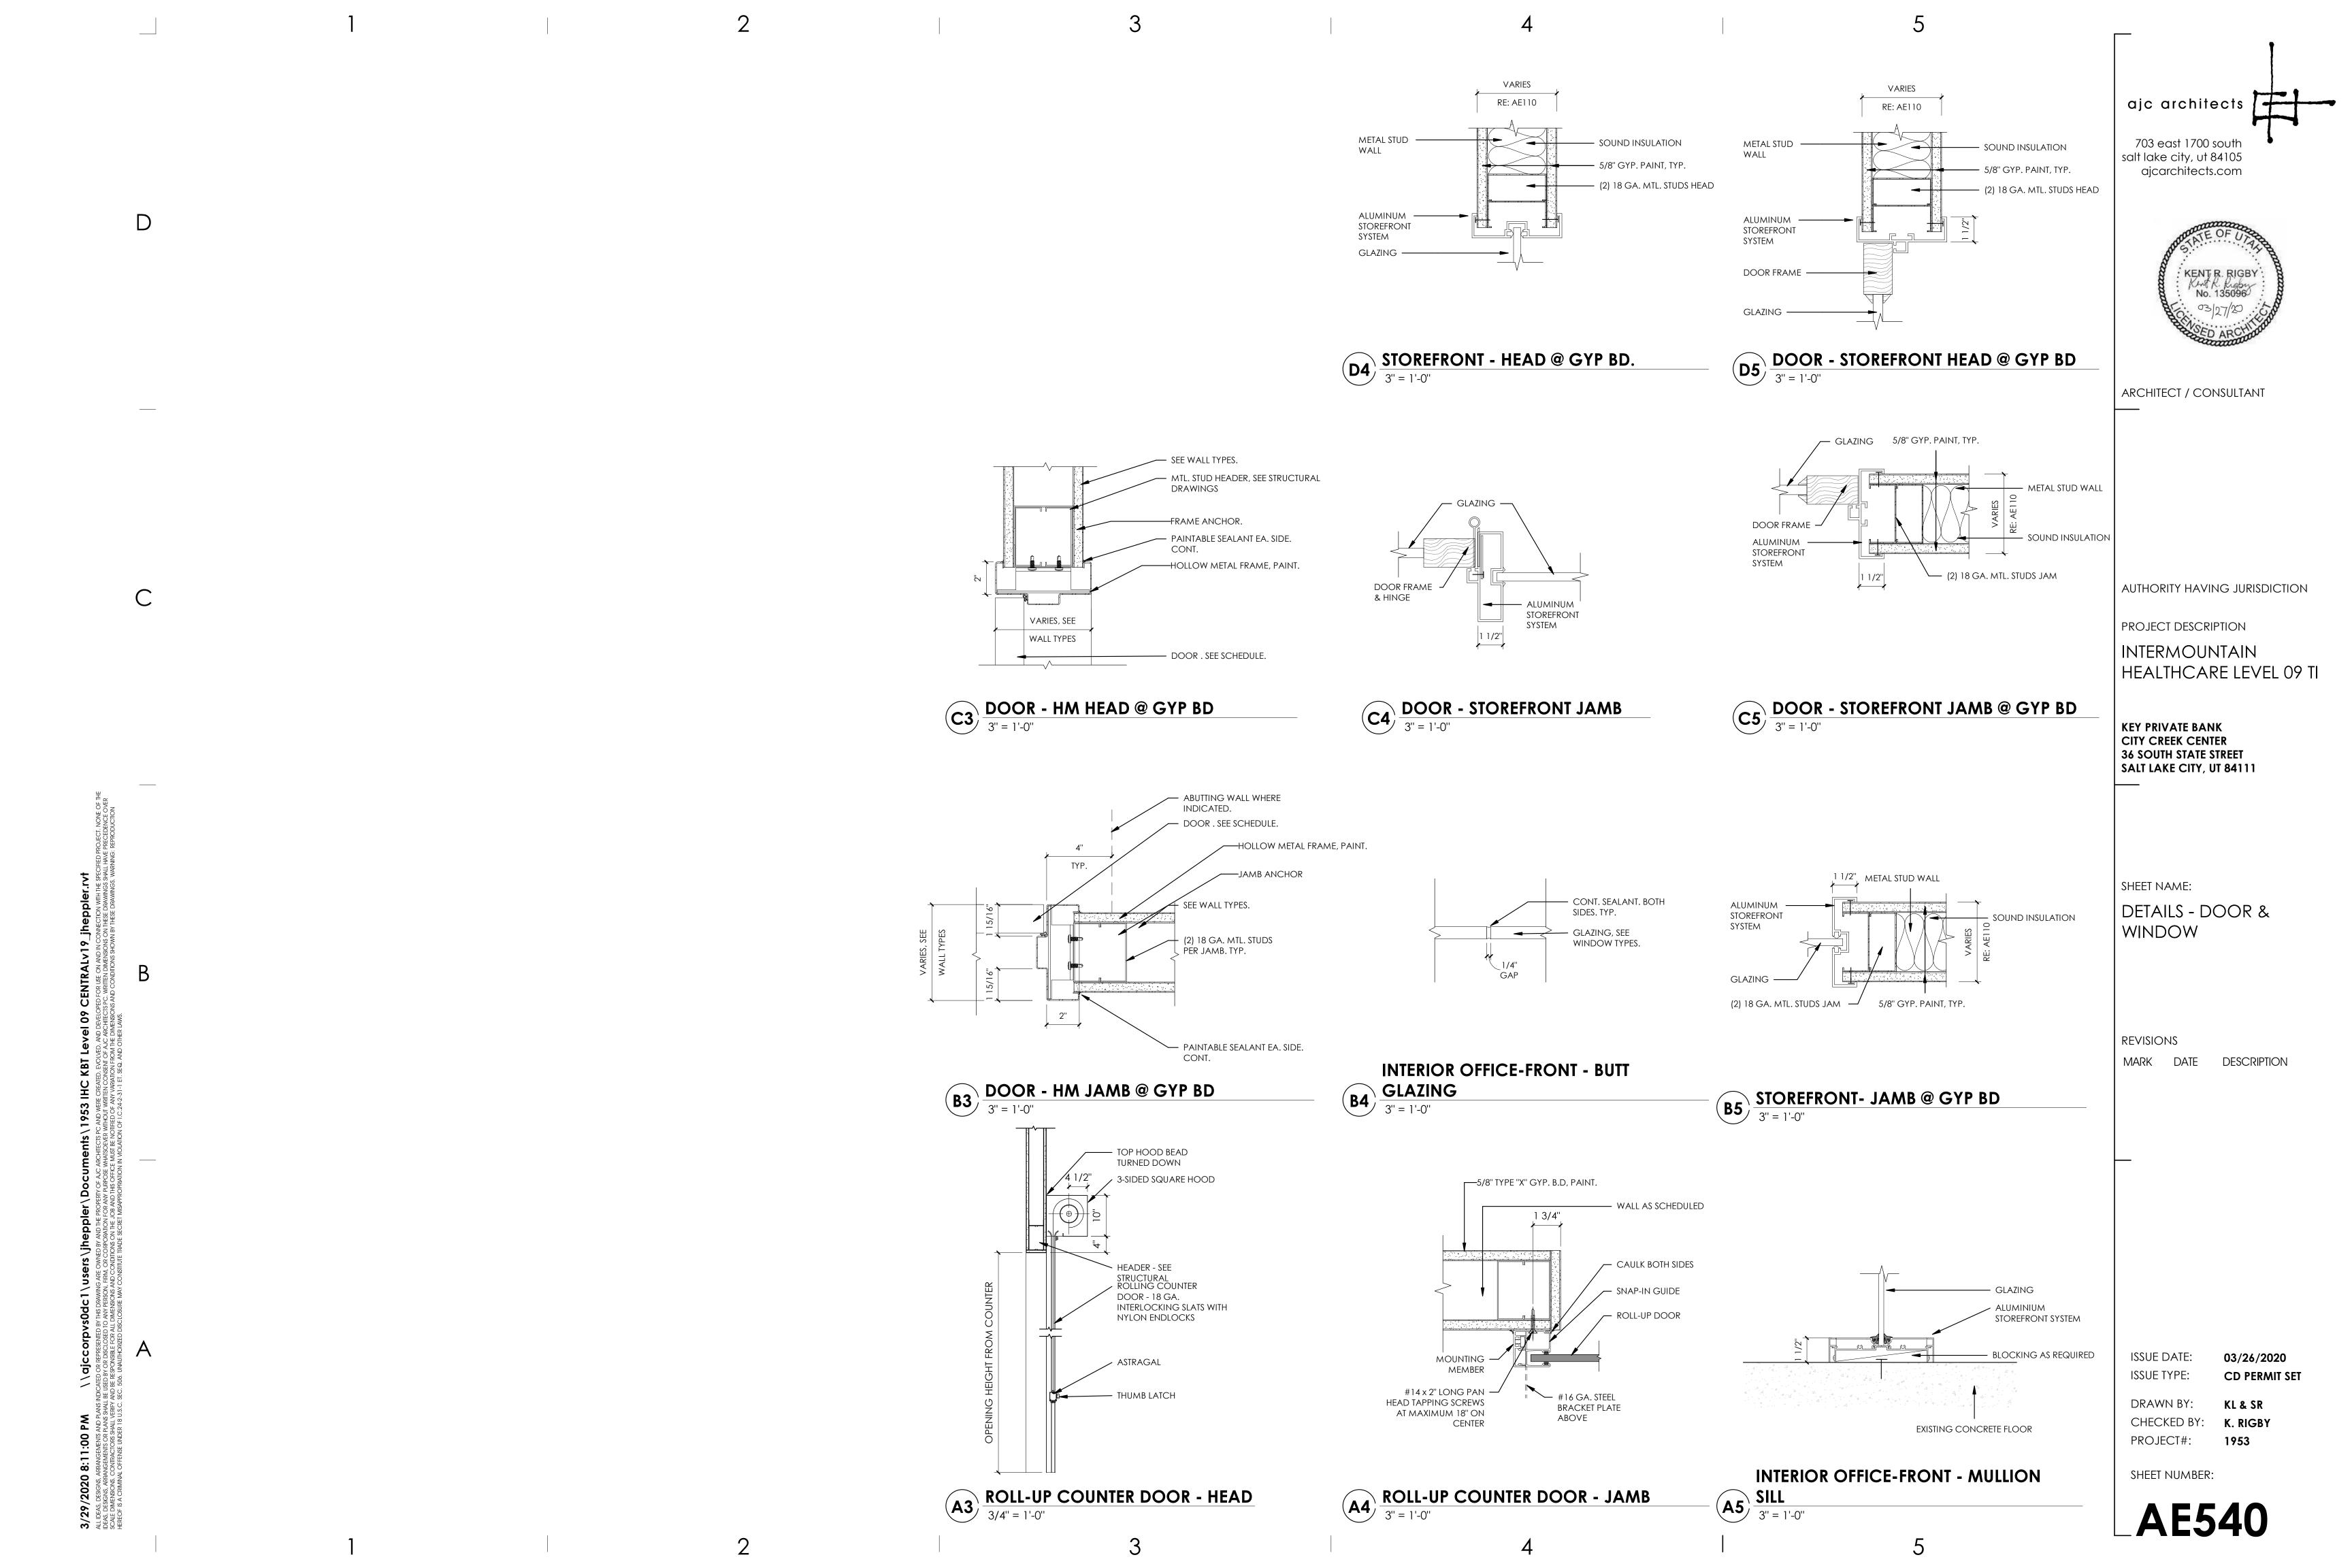

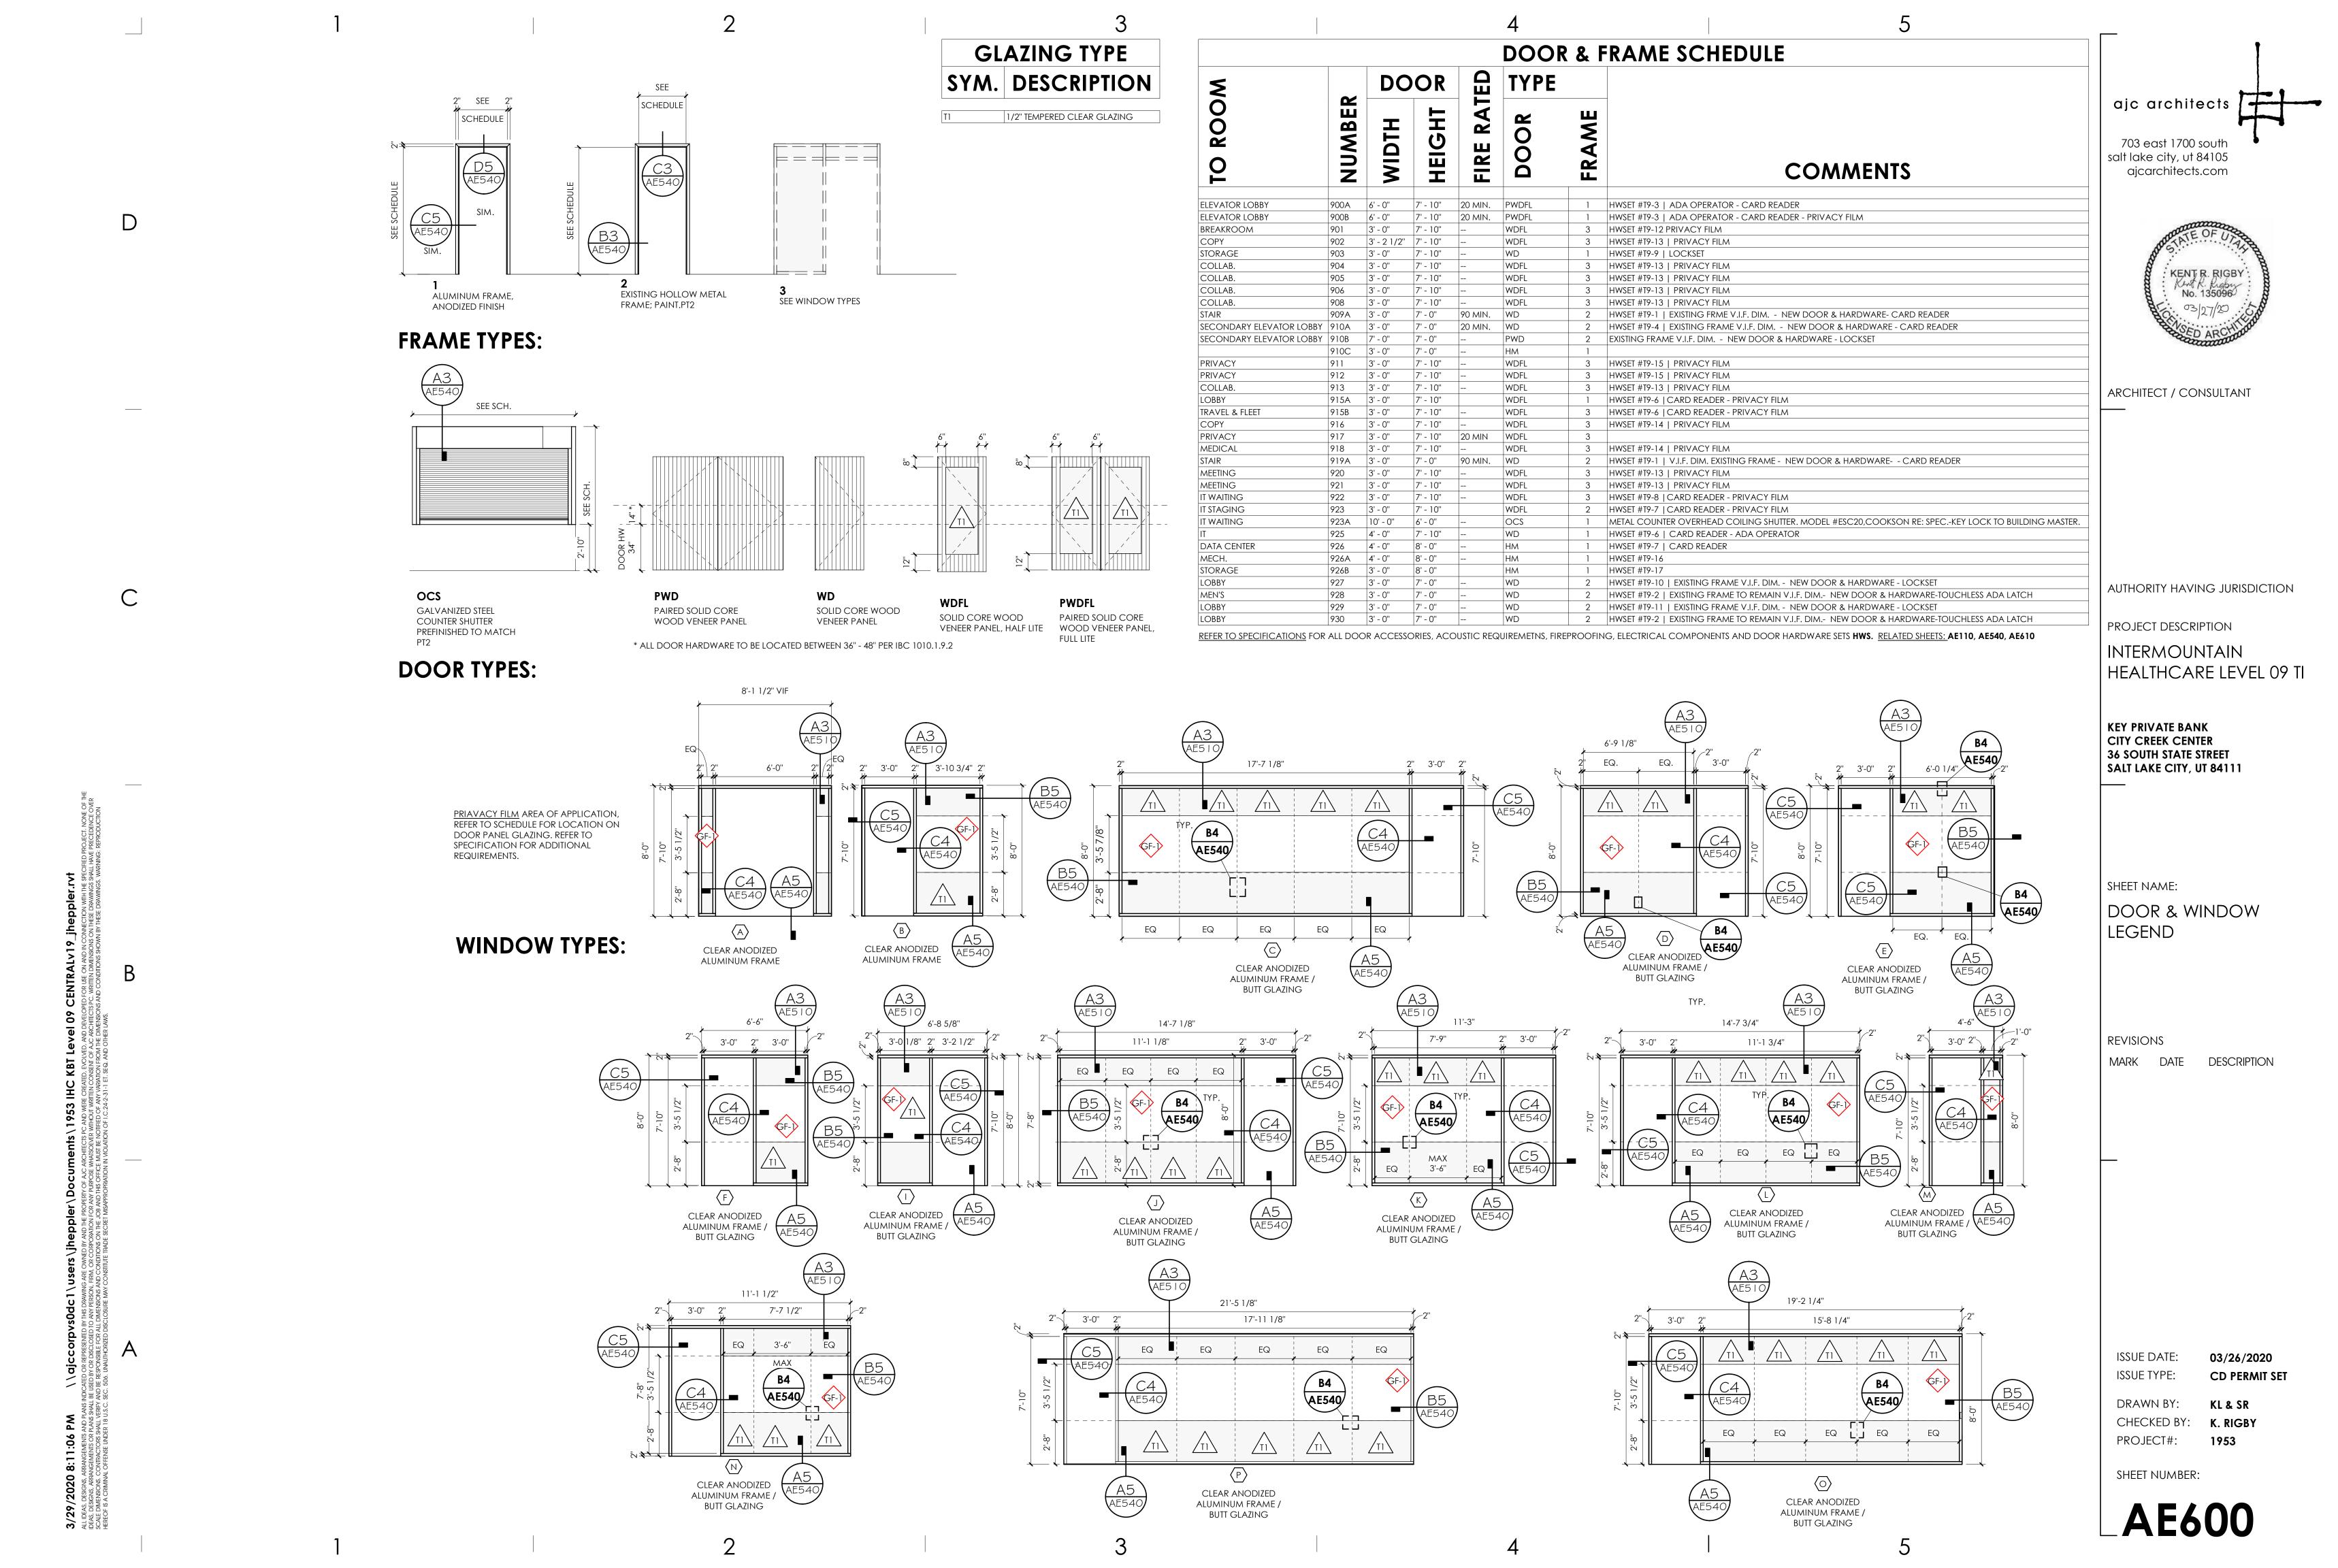

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INTERMOUNTAIN HEALTHCARE - KEY	BANK TOWER - LEVEL 10 & 16 - INTERIOR	FINISH LEGEND	PT-3	Paint Adaptifacturers Shop via Williams	Location/ Notes: Multiple, see finish plan/elevations.	 CEILINGS


Pattern: Stone Attache, Haut Monde, Colorbody Porcelain

Grout Color: Mapei, Pewter 02, Keracolor Sanded Grout

Grout Color: Mapei, Pewter 02, Keracolor Sanded Grout

C-1	ACT,2' X 4'	Suspended Acoustical Ceiling Tile.
- '	Manufacturer: Rockfon	Black Tiles, Black Track.
	Finish: Black 08	Location/Notes:Ceiling type to be installed above wood slat ceiling location in Lobby.
C-2	Gyp. Ceiling	Location: Elevator Lobbies.
	Finish:Painted PT-1	Use Epoxy paint in wet areas.
C-3	ACT, 2' X 4'	Suspended Acoustical Ceiling Tile.
	Manufacturer:Rockfon Koral	·
	Finish:White	
C-4	ACT, 2' X 4'	Location: Privacy Rooms
	Manufacturer: Rockfon	1" Acoustical Ceiling Tile
C-5	Wood Grille Ceiling system	Location/ Notes: Entrance Lobby, See reflected ceiling plan.
	Manufacturer: Mermet,E Screen	Field Verify type and Color.
	Species: Engineered Walnut Veneer (Quarter Sliced)	
	Finish: Stained to match architect's sample	
	Series: 1000 Wood Grilles	
	Style: 1100 Cross Piece Grille, SKU: 1112-8	
WIND	OW COVERING	
	Motorized Blackout Shade	Location / Notes Monting Pres 010/000
	Manufacturer: 9wood	Location/ Notes: Meeting Rms, 918/920
		Field Verify type and Color. Fenestration Properties 10%
	Finish: 2.07 White/Pearl	Shades are installed in contractor built pocket with closure.
	Product Type:Interior/Transparent	Shades are installed in contractor built pocket with closure.
	Manual Blinds	All windows except windows in Rms 918/920
	Manufacturer: SWF Contract	
	Finish: 121P Brushed Aluminum	
	Product Type:1" Customiser Interior Blinds.	

ajc architects 703 east 1700 south salt lake city, ut 84105 ajcarchitects.com

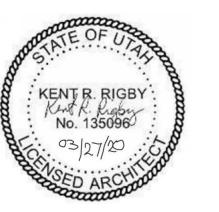

ARCHITECT / CONSULTANT

AUTHORITY HAVING JURISDICTION

PROJECT DESCRIPTION

INTERMOUNTAIN HEALTHCARE LEVEL 09 TI

KEY PRIVATE BANK CITY CREEK CENTER 36 SOUTH STATE STREET SALT LAKE CITY, UT 84111

SHEET NAME: INTERIOR FINISH

REVISIONS

LEGEND

MARK DATE DESCRIPTION

ISSUE DATE: ISSUE TYPE:

DRAWN BY: KL & SR CHECKED BY: K. RIGBY PROJECT#: **1953**

SHEET NUMBER:

AE610

03/26/2020

CD PERMIT SET

CARTE TIAL PROCESSORY Oxford Control Company Oxford	-LOOI	RING PRODUCTS			Manufacturer: Sherwin Williams Color: Mineral Gray SW 2740 Finish: Factor II Satis Finish
And interest the Control Process Process Appear in the Tile Process	CARPET	TILE FLOORING			Finish: Eggshell-Satin Finish Specifications: Latex, unless noted otherwise
Sections of the Control Order Section (1970) Order	`T_1	Carnet Tile	Location/Notes: Multiple see finish plan	PT-4	Paint
Control for Section	,1-1			→	
Security Security Security Security					
State Stat					
Proceedings				_	Specifications: Latex, unless noted otherwise
10 Cognit No. According Portion for Control Porti				PT-5	Paint
Intersections the Content of This Content of T		Installation, Ashlar		+	
Process Proc	T-2	Carpet Tile - Accent	Location/Notes: Multiple, see finish plan.		
Code Contention Company NSSS Proceed of the Code Code Code Code Code Code Code Cod			Coordinates with RB-1		
See A 1 - A				_	Specifications: Latex, unless noted otherwise
Specific Processing					Paint
Section of the control of the cont				\dashv \vdash	
Source Company Compa					Color: Fiery Opal 077
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March State Normagner Commerced Considerate with 81	<u>UXURY</u>	VINYL TILE FLOORING			Specifications: Latex, unless noted otherwise
Monitoritary boarmarghor Conversely Production States 1987 State of Provide States 2 of Provide Institution Average UNITED TRANSPORT Management Region Management	VT-1	Luxury Vinyl Tile	Location/Notes: Break Rooms, see finish plan.	PT-7	Paint
See of the Principal Control (1974) See of the Principal Control (
Specific Process Specific Pr					
Marticoper Amore Marticoper				_	
March Common				_	Specifications: Latex, unless noted otherwise
WC1 Virul Wiskowering WC1		Installation: Ashlar		WALLCO	OVERING
Fill Number Tee Flooring Cocinion/Notes Mail Source Mail Mail Sou	UBBER	TILE FLOORING			
Monadoclarer Soppe Coordinates with 69-1 Poster Notoc 1997 Code Marcon 68 Code Ma				WC-1	
Coor Month Relation (Liberation (Liberation Control (Liberatio) Control (Liberation Control (Liberation Control (Liberation Co	.F-1			\dashv \vdash —	
Code March 1886 See: 24-24-25 Supres Uncoldion: Standard Abraham Manufacture interpret Product SD Robber Standard Abraham Some Code Code Code Code Code Code Code Cod			Coordinates with kb-1	\dashv \vdash	
Size of \$26*Square				\dashv \vdash	
Processing Standard Amendment		Size: 24" x 24" Square		GLASS F	ILM
Sport State Dissipative Tell Monifordure Report Monifordure Report					
Posterior travers Applied Coordinates with R9-1 Coordina	65-	Charles Disabilities with	Location (Alaborett Boson on Patrick	GF-1	
Color words 300 Rebook Star's Control Figer Tile Color words 400 Star's 2 yours Star Act X x 1 yours Star Act X 2 yours St	SDT-1	Static Dissipative Tile			
Coor Marcin 489 Size 2 F2 F3 Garder Bratistolicion Standard Mondiffic Size 2 F2 F3 Garder Subbet 16xF Families Staff Subbet 16xF Families Staff Subbet 16xF Families Staff Marcin 16xF Families Staff Marci			Coordinates with RB-1	+	
Sept 24 x 24 Septions Installation Standard Annothing					
UBBER ASS/TRANSITION STRIP 18-1 Nobber transfromtion Strip 18-1				TILE	
Monutocture: Sterey Williams Waster Assyrtaxistino Stirp (Monutocture: Stepe Cover Store) Monutocture: Stepe Cover Store Cover Store) Monutocture: Stepe Cover Store) Monutocture: Stepe Cover Store) Monutocture: Stepe Cover Store) Monutocture: Steve Williams Monutocture: Steve Willi		Installation: Standard Monolithic			T
Re-1 Rubber Bose/Transition Strip		installation, orangala monolinile		— — — —	
Re-1 Rubber to say framilian Stigs				WT-1	
Marufacturer Roppe Poduct Prince Re Rubber Rose/Rubber Accessories Reducer Strip ing based on flooring applications; provide accordingly. Syle: 4 Standard Cover Technical Residues Strip in an application of provide accordingly. Syle: 4 Standard Cover Technical Residues Strip in a Reducer Strip in Reducer Strip	UBBER			WT-1	Manufacturer: Daltile
Reducer Ship: sing based on fooling applications: provide accordingly. Shipe: 3 Standard Cover Teach Reducer Ship Reducer Ship: See half-filled circle symbol on finish plan. Grout Color. Mppair. Pevaler 02, Kerocolor Scroot See: JR Minimum Recommended Grout Color. Mppair. Pevaler 02, Level 16 Restrooms, see finish plan. Will JR Provided See: JR Minimum Recommended Grout Color. Mppair. Pevaler 02, Kerocolor See: JR Minimum Recommended Se		BASE/TRANSITION STRIP	Location/Notes: Multiple see finish plan/elevations	WT-1	Manufacturer: Daltile Pattern: Stone Attache, Haut Monde, Colorbo
Coor Dolphin 129 Oxcelan Tile (Coorting) For Tile (Coorting) Morulacturer: Datilie (Coorting) For Tile (Coorting) For Tile (Coorting) Morulacturer: Datilie (Coorting) For Tile (Coorting) For		BASE/TRANSITION STRIP Rubber Base/Transition Strip		WT-1	Manufacturer: Daltile Pattern: Stone Attache, Haut Monde, Colorbo Color: Elite Grey HM05, Unpolished Size: 12" x 24"
Pocclain Tile Cocarion Tile Cocarion Tile Cocarion Notes: Bevotor Lobby & Level 16 Restrooms, see finish plan. Manufacturer: Dallile Cocarion Notes: Bevotor Lobby & Level 16 Restrooms, see finish plan. Color: Premier Grey CSSS, Unpolished Cocarion Share Albacine, Consultate, Anlique Color: Premier Grey CSSS, Unpolished Color: Manufacturer: Dallile Color: Color: Color: Manufacturer: Dallile Color: Color: Manufacturer: Dallile Color: Color: Manufacturer: Dallile Color: Color: Manufac		Rubber Base/Transition Strip Manufacturer: Roppe Product: Pinnacle Rubber Base/Rubber Accessories	Coordinates with CT-1, CT-2, LVT-1, RF-1, & SDT-1. Reducer Strip: sizing based on flooring applications; provide accordingly.	WT-1	Manufacturer: Daltile Pattern: Stone Attache, Haut Monde, Colorbo Color: Elite Grey HM05, Unpolished Size: 12" x 24" Installation: Monolithic
Manufacturer: Datilite Location/Notes: Bievator Lobby & Level 1 & Restrooms, see finish plan.		Rubber Base/Transition Strip Manufacturer: Roppe Product: Pinnacle Rubber Base/Rubber Accessories Style: 4" Standard Cove Toe/Reducer Strip	Coordinates with CT-1, CT-2, LVT-1, RF-1, & SDT-1. Reducer Strip: sizing based on flooring applications; provide accordingly.	WT-1	Manufacturer: Daltile Pattern: Stone Attache, Haut Monde, Colorbo Color: Elite Grey HM05, Unpolished Size: 12" x 24" Installation: Monolithic Grout Color: Mapei, Pewter 02, Keracolor San
Manufacturer: Datilie Location/Notes: Bevotor Lobby & Level 16 Restrooms, see finish plan.		Rubber Base/Transition Strip Manufacturer: Roppe Product: Pinnacle Rubber Base/Rubber Accessories Style: 4" Standard Cove Toe/Reducer Strip	Coordinates with CT-1, CT-2, LVT-1, RF-1, & SDT-1. Reducer Strip: sizing based on flooring applications; provide accordingly.	WT-1	Manufacturer: Daltile Pattern: Stone Attache, Haut Monde, Colorbo Color: Elite Grey HM05, Unpolished Size: 12" x 24" Installation: Monolithic Grout Color: Mapei, Pewter 02, Keracolor San
Manufacturer: Datilie Coordinates with CB-1 Potternis Since Attache, Consulate, Antique Good Color: Premier Grey CS0S, Unpolished Grout Color: Mone) Prewter 02, Keracolor Sanded Grout Instabilition: Monolithic BB-1 Paccellan Cave Base Location/Notes: Evador Lobby & Level 16 Restrooms see finish plan/elevations. BB-1 Paccellan Cave Base Location/Notes: Evador Lobby & Level 16 Restrooms see finish plan/elevations. BB-1 Paccellan Cave Base Location/Notes: Evador Lobby & Level 16 Restrooms see finish plan/elevations. BB-1 Paccellan Cave Base Location/Notes: Evador Lobby & Level 16 Restrooms see finish plan/elevations. BB-1 Paccellan Cave Base Location/Notes: Evador Lobby & Level 16 Restrooms see finish plan/elevations. BB-1 Paccellan Cave Base Location/Notes: Evador Lobby & Level 16 Restrooms see finish plan/elevations. BB-1 Paccellan Cave Base Location/Notes: Evador Lobby & Level 16 Restrooms see finish plan/elevations. BB-1 Paccellan Cave Base Location/Notes: Evador Lobby & Level 16 Restrooms see finish plan/elevations. BB-1 Paccellan Cave Base Location/Notes: Evador Lobby & Level 16 Restrooms see finish plan/elevations. BB-1 Paccellan Cave Base Location/Notes: Evador Lobby & Level 16 Restrooms see finish plan/elevations. BB-1 Paccellan Cave Base Location/Notes: Evador Lobby & Level 16 Restrooms see finish plan/elevations. BB-1 Paccellan Cave Base Location/Notes: Evador Lobby & Level 16 Restrooms see finish plan/elevations. BB-1 Paccellan Cave Base Location/Notes: Evador Lobby & Level 16 Restrooms see finish plan/elevations. BB-1 Paccellan Cave Base Location/Notes: Evador Lobby & Level 16 Restrooms see finish plan/elevations. BB-1 Paccellan Cave Base Location/Notes: Evador Lobby & Level 16 Restrooms see finish plan/elevations. BB-1 Paccellan Cave Base Location/Notes: Evador Lobby & Level 16 Restrooms see finish plan/elevations. BB-1 Paccellan Cave Base Location/Notes: Evador Lobby & Level 16 Restrooms see finish plan/elevations. BB-1 Paccellan Cave Base Location/Notes: Evador Base Location/Notes:	B-1	Rubber Base/Transition Strip Manufacturer: Roppe Product: Pinnacle Rubber Base/Rubber Accessories Style: 4" Standard Cove Toe/Reducer Strip Color: Dolphin 129	Coordinates with CT-1, CT-2, LVT-1, RF-1, & SDT-1. Reducer Strip: sizing based on flooring applications; provide accordingly.		Manufacturer: Daltile Pattern: Stone Attache, Haut Monde, Colorbo Color: Elite Grey HM05, Unpolished Size: 12" x 24" Installation: Monolithic Grout Color: Mapei, Pewter 02, Keracolor San Grout Size: 1/8" Minimum Recommended
Pattern: Stone Artache, Consulate, Artique Color: Premier Grey (SSD, Unpolished Grout Color: Mopel, Pewter 02, Kerocolor Sanded Grout Grout Size: 1/8' Minimum Recommended installation: Monolithic B-1 Pacelan Cove Base	RB-1	Rubber Base/Transition Strip Manufacturer: Roppe Product: Pinnacle Rubber Base/Rubber Accessories Style: 4" Standard Cove Toe/Reducer Strip Color: Dolphin 129	Coordinates with CT-1, CT-2, LVT-1, RF-1, & SDT-1. Reducer Strip: sizing based on flooring applications; provide accordingly.		Manufacturer: Daltile Pattern: Stone Attache, Haut Monde, Colorbo Color: Elite Grey HM05, Unpolished Size: 12" x 24" Installation: Monolithic Grout Color: Mapei, Pewter 02, Keracolor San Grout Size: 1/8" Minimum Recommended Porcelain Wall Tile
Color, Premier Grey CS95, Unpolished Grout Color: Mapei, Pewler 02, Keracolor Sanded Grout Grout Size: 1/8* Minimum Recommended Installation: Monotifhic 8a.1 Porcelain Cove Base U.cocation/Notes: Bevator Lobby & Level 1 & Restrooms see finish plan/elevations. Monutacturer: Dailile Coordinates with FT-1 Patier Grout Size: 1/8* Minimum Recommended Installation: Monotifhic Color: Premier Grey CS95, Unpolished Grout Size: 1/8* Minimum Recommended Installation: Monotifhic Color: Premier Grey CS95, Unpolished Grout Size: 1/8* Minimum Recommended Installation: Monotifhic Grout Size: 1/8* Minimum Recommended Installation: Monotifhic WALL PRODUCTS WALL PRODUCTS WALL PRODUCTS Amnufacturer: Shervin Williams Color: Spanje His Size in Finish Specifications: Lates, unless noted otherwise Finish: Eggiphel-Satin Finish Specifications: Lates, unless noted otherwise Finish: Eggiphel-Satin Finish Finish:	RB-1	Rubber Base/Transition Strip Manufacturer: Roppe Product: Pinnacle Rubber Base/Rubber Accessories Style: 4" Standard Cove Toe/Reducer Strip Color: Dolphin 129 AIN TILE FLOORING Porcelain Tile	Coordinates with CT-1, CT-2, LVT-1, RF-1, & SDT-1. Reducer Strip: sizing based on flooring applications; provide accordingly. Reducer Strip: See half-filled circle symbol on finish plan. Location/Notes: Elevator Lobby & Level 16 Restrooms, see finish plan.		Manufacturer: Daltile Pattern: Stone Attache, Haut Monde, Colorbo Color: Elite Grey HM05, Unpolished Size: 12" x 24" Installation: Monolithic Grout Color: Mapei, Pewter 02, Keracolor San Grout Size: 1/8" Minimum Recommended Porcelain Wall Tile Manufacturer: Daltile Pattern: Volume 1.0, Glazed Porcelain
Size: 24" x 48"	B-1	Rubber Base/Transition Strip Manufacturer: Roppe Product: Pinnacle Rubber Base/Rubber Accessories Style: 4" Standard Cove Toe/Reducer Strip Color: Dolphin 129 AIN TILE FLOORING Porcelain Tile Manufacturer: Daltile	Coordinates with CT-1, CT-2, LVT-1, RF-1, & SDT-1. Reducer Strip: sizing based on flooring applications; provide accordingly. Reducer Strip: See half-filled circle symbol on finish plan. Location/Notes: Elevator Lobby & Level 16 Restrooms, see finish plan.		Manufacturer: Daltile Pattern: Stone Attache, Haut Monde, Colorbo Color: Elite Grey HM05, Unpolished Size: 12" x 24" Installation: Monolithic Grout Color: Mapei, Pewter 02, Keracolor San Grout Size: 1/8" Minimum Recommended Porcelain Wall Tile Manufacturer: Daltile Pattern: Volume 1.0, Glazed Porcelain Color: Degrees Silver VL71
Grout Color: Mapei, Pewker 02, Keracotor Sanded Grout Installation: Mornalitic EB-1 Pacetain Cove Base Location/Notes: Elevator Lobby & Level 16 Restrooms see finish plan/elevations. CB-1 Pacetain Cove Base Location/Notes: Elevator Lobby & Level 16 Restrooms see finish plan/elevations. Color: Type State Attache, Consulate, Antique Color: Premier Grey CSUS, Unpolished Grout Color: Premier Grey CSUS, Unpolished Grout Color: Mapei, Pewker 02, Keracotor Sanded Grout Grout Size: 1/8" Minimum Recommended Installation: Monolitic VALL PRODUCTS AINT Finish Specifications: Latex, unless noted otherwise Installation: Monolitic Aunt Color: Pacety Minimum Recommended Installation: Ashlar Installation: Monolitic VALL PRODUCTS AINT Faint Location/ Notes: Mulliple, see finish plan/elevations. Color: Pearly Winte SW 7009 Finish: Segahell-Sortin Finish Specifications: Latex, unless noted otherwise Color: Develai SW 7018 Finish: Siggahell-Sortin Finish Specifications: Latex, unless noted otherwise Installation: Monolitic Minimum Recommended Installation: Monolitic AINT Manufacturer: Shervin Williams Fepoxy Paint in all Restrooms. Color: Pearly Winte SW 7009 Finish: Siggahell-Sortin Finish Specifications: Latex, unless noted otherwise Installation: Monolitic Minimum Recommended Installation: Monolitic Minimum Recommended Installation: Monolitic AINT MillWORK COUNTERTORS Mill Work Counterop Manufacturer: Steatone Manufacturer: Steatone Product: Basiq Series Color: Bearly Winter SW 7009 Finish: Specifications: Latex, unless noted otherwise Installation: Monolitic Mill Manufacturer: Steatone Mill Mill Monolitic AINT MILLWORK COUNTERTORS MILLWORK COUNTERTORS MILLWORK COUNTERTORS MILLWORK COUNTERTORS MILLWORK COUNTERTORS MILLWORK COUNTERTORS MILLWORK COLOR: Report Steatone Mill Work Counterop Manufacturer: Steatone Manufacturer: Steatone Manufacturer: Steatone Manufacturer: Steatone	B-1	Rubber Base/Transition Strip Manufacturer: Roppe Product: Pinnacle Rubber Base/Rubber Accessories Style: 4" Standard Cove Toe/Reducer Strip Color: Dolphin 129 AIN TILE FLOORING Porcelain Tile Manufacturer: Daltile Pattern: Stone Attache, Consulate, Antique	Coordinates with CT-1, CT-2, LVT-1, RF-1, & SDT-1. Reducer Strip: sizing based on flooring applications; provide accordingly. Reducer Strip: See half-filled circle symbol on finish plan. Location/Notes: Elevator Lobby & Level 16 Restrooms, see finish plan.		Manufacturer: Daltile Pattern: Stone Attache, Haut Monde, Colorbo Color: Elite Grey HM05, Unpolished Size: 12" x 24" Installation: Monolithic Grout Color: Mapei, Pewter 02, Keracolor San Grout Size: 1/8" Minimum Recommended Porcelain Wall Tile Manufacturer: Daltile Pattern: Volume 1.0, Glazed Porcelain Color: Degrees Silver VL71 Size: 12" x 12"
Grout Size: 1/8" Minimum Recommended Installation: Manolithic 28-1 Pacelain Cove Base	RB-1	Rubber Base/Transition Strip Manufacturer: Roppe Product: Pinnacle Rubber Base/Rubber Accessories Style: 4" Standard Cove Toe/Reducer Strip Color: Dolphin 129 AIN TILE FLOORING Porcelain Tile Manufacturer: Daltile Pattern: Stone Attache, Consulate, Antique Color: Premier Grey CS05, Unpolished	Coordinates with CT-1, CT-2, LVT-1, RF-1, & SDT-1. Reducer Strip: sizing based on flooring applications; provide accordingly. Reducer Strip: See half-filled circle symbol on finish plan. Location/Notes: Elevator Lobby & Level 16 Restrooms, see finish plan.		Manufacturer: Daltile Pattern: Stone Attache, Haut Monde, Colorbo Color: Elite Grey HM05, Unpolished Size: 12" x 24" Installation: Monolithic Grout Color: Mapei, Pewter 02, Keracolor San Grout Size: 1/8" Minimum Recommended Porcelain Wall Tile Manufacturer: Daltile Pattern: Volume 1.0, Glazed Porcelain Color: Degrees Silver VL71 Size: 12" x 12" Grout Color: Mapei, Pewter 02, Keracolor San
Installation: Monolithic	RB-1	Rubber Base/Transition Strip Manufacturer: Roppe Product: Pinnacle Rubber Base/Rubber Accessories Style: 4" Standard Cove Toe/Reducer Strip Color: Dolphin 129 AIN TILE FLOORING Porcelain Tile Manufacturer: Daltile Pattern: Stone Attache, Consulate, Antique Color: Premier Grey CS05, Unpolished Size: 24" x 48"	Coordinates with CT-1, CT-2, LVT-1, RF-1, & SDT-1. Reducer Strip: sizing based on flooring applications; provide accordingly. Reducer Strip: See half-filled circle symbol on finish plan. Location/Notes: Elevator Lobby & Level 16 Restrooms, see finish plan.		Manufacturer: Daltile Pattern: Stone Attache, Haut Monde, Colorbo Color: Elite Grey HM05, Unpolished Size: 12" x 24" Installation: Monolithic Grout Color: Mapei, Pewter 02, Keracolor San Grout Size: 1/8" Minimum Recommended Porcelain Wall Tile Manufacturer: Daltile Pattern: Volume 1.0, Glazed Porcelain Color: Degrees Silver VL71 Size: 12" x 12" Grout Color: Mapei, Pewter 02, Keracolor San Grout Size: 1/8" Minimum Recommended
Partern: Totalian Cove Base Location/Notes: Elevator Lobby & Level 16 Restrooms see finish plan/elevations.	B-1	Rubber Base/Transition Strip Manufacturer: Roppe Product: Pinnacle Rubber Base/Rubber Accessories Style: 4" Standard Cove Toe/Reducer Strip Color: Dolphin 129 AIN TILE FLOORING Porcelain Tile Manufacturer: Daltile Pattern: Stone Attache, Consulate, Antique Color: Premier Grey CS05, Unpolished Size: 24" x 48" Grout Color: Mapei, Pewter 02, Keracolor Sanded Grout	Coordinates with CT-1, CT-2, LVT-1, RF-1, & SDT-1. Reducer Strip: sizing based on flooring applications; provide accordingly. Reducer Strip: See half-filled circle symbol on finish plan. Location/Notes: Elevator Lobby & Level 16 Restrooms, see finish plan.		Manufacturer: Daltile Pattern: Stone Attache, Haut Monde, Colorbo Color: Elite Grey HM05, Unpolished Size: 12" x 24" Installation: Monolithic Grout Color: Mapei, Pewter 02, Keracolor San Grout Size: 1/8" Minimum Recommended Porcelain Wall Tile Manufacturer: Daltile Pattern: Volume 1.0, Glazed Porcelain Color: Degrees Silver VL71 Size: 12" x 12" Grout Color: Mapei, Pewter 02, Keracolor San Grout Size: 1/8" Minimum Recommended
Manufacturer Datitie Pottern: Stone Attache, Consulate, Antique Color: Premier Grey CS05, Unpolished Color: Premier Grey CS05, Unpolished Size: 6° x 12° Grout Color: Mapei, Pewter 02, Keracolor Sanded Grout Grout Size: 1/8' Minimum Recommended Installation: Monolithic VALL PRODUCTS AINT Finish: Size: Manufacturer: Sherwin Williams Color: Pearly Minish SW 7009 Finish: Eggishel Satin Finish Specifications: Latex, unless noted otherwise Location/ Notes: Multiple, see finish plan/elevations. Manufacturer: Sherwin Williams Color: Devertal SW 718 Finish: Eggishel Satin Finish Specifications: Latex, unless noted otherwise Finish: Eggishel Satin Finish Specifications: Latex, unless noted otherwise Finish: Eggishel Satin Finish Specifications: Latex, unless noted otherwise Finish: Eggishel Satin Finish Specifications: Latex, unless noted otherwise Finish: Eggishel Satin Finish Specifications: Latex, unless noted otherwise Finish: Eggishel Satin Finish Specifications: Latex, unless noted otherwise Finish: Eggishel Satin Finish Specifications: Latex, unless noted otherwise Finish: Eggishel Satin Finish Specifications: Latex, unless noted otherwise Finish: Eggishel Satin Finish Specifications: Latex, unless noted otherwise Finish: Eggishel Satin Finish Specifications: Latex, unless noted otherwise Finish: Eggishel Satin Finish Specifications: Latex, unless noted otherwise Finish: Eggishel Satin Finish Specifications: Latex, unless noted otherwise Finish: Wood Essence WE Finish: Wood Essence	B-1	Rubber Base/Transition Strip Manufacturer: Roppe Product: Pinnacle Rubber Base/Rubber Accessories Style: 4" Standard Cove Toe/Reducer Strip Color: Dolphin 129 AIN TILE FLOORING Porcelain Tile Manufacturer: Daltile Pattern: Stone Attache, Consulate, Antique Color: Premier Grey CS05, Unpolished Size: 24" x 48" Grout Color: Mapei, Pewter 02, Keracolor Sanded Grout Grout Size: 1/8" Minimum Recommended	Coordinates with CT-1, CT-2, LVT-1, RF-1, & SDT-1. Reducer Strip: sizing based on flooring applications; provide accordingly. Reducer Strip: See half-filled circle symbol on finish plan. Location/Notes: Elevator Lobby & Level 16 Restrooms, see finish plan.	WT-2	Manufacturer: Daltile Pattern: Stone Attache, Haut Monde, Colorbo Color: Elite Grey HM05, Unpolished Size: 12" x 24" Installation: Monolithic Grout Color: Mapei, Pewter 02, Keracolor San Grout Size: 1/8" Minimum Recommended Porcelain Wall Tile Manufacturer: Daltile Pattern: Volume 1.0, Glazed Porcelain Color: Degrees Silver VL71 Size: 12" x 12" Grout Color: Mapei, Pewter 02, Keracolor San Grout Size: 1/8" Minimum Recommended Installation: Monolithic Natural Stone Mosaic Tile
Pattern: Stone Attache. Consulate, Antique Color: Premier Grey C305, Unpolished Size: Iregulor Mosaic. Grout Color: Mapei, Pewter 02, Keracolor Size: 1/8" Minimum Recommended Intrin Style: Cove Base, 5-36C97 Grout Color: Mapei, Pewter 02, Keracolor Sanded Grout Grout Size: 1/8" Minimum Recommended Installation: Monolithic VALL PRODUCTS VALL PRODUCTS AINT Color: Patint Color: Mapei, Pewter 02, Keracolor Sanded Grout Installation: Monolithic VALL PRODUCTS T-1 Patint Color: Mapei, Pewter 02, Keracolor Sanded Grout Installation: Monolithic VALL PRODUCTS T-1 Patint Color: Pearly White SW 7009 Finish: Eggshell-Satin Finish Specifications: Latex, unless noted otherwise T-2 Patint Color: Deveral SW 7018 Finish: Eggshell-Satin Finish Specifications: Latex, unless noted otherwise Specifications: Latex, unless noted otherwise Specifications: Latex, unless noted otherwise Manufacturer: Sherwin Williams * Epoxy Paint in all Restrooms. * Epoxy Pa	ORCEI	Rubber Base/Transition Strip Manufacturer: Roppe Product: Pinnacle Rubber Base/Rubber Accessories Style: 4" Standard Cove Toe/Reducer Strip Color: Dolphin 129 AIN TILE FLOORING Porcelain Tile Manufacturer: Daltile Pattern: Stone Attache, Consulate, Antique Color: Premier Grey CS05, Unpolished Size: 24" x 48" Grout Color: Mapei, Pewter 02, Keracolor Sanded Grout Grout Size: 1/8" Minimum Recommended Installation: Monolithic	Coordinates with CT-1, CT-2, LVT-1, RF-1, & SDT-1. Reducer Strip: sizing based on flooring applications; provide accordingly. Reducer Strip: See half-filled circle symbol on finish plan. Location/Notes: Elevator Lobby & Level 16 Restrooms, see finish plan. Coordinates with CB-1	WT-2	Manufacturer: Daltile Pattern: Stone Attache, Haut Monde, Colorbo Color: Elite Grey HM05, Unpolished Size: 12" x 24" Installation: Monolithic Grout Color: Mapei, Pewter 02, Keracolor San Grout Size: 1/8" Minimum Recommended Porcelain Wall Tile Manufacturer: Daltile Pattern: Volume 1.0, Glazed Porcelain Color: Degrees Silver VL71 Size: 12" x 12" Grout Color: Mapei, Pewter 02, Keracolor San Grout Size: 1/8" Minimum Recommended Installation: Monolithic Natural Stone Mosaic Tile Manufacturer: Daltile
Color: Premier Grey CS05, Unpolished Size: 6' X 12" Grout Color: Mappel, Pewter 02, Keracolor Sanded Grout Grout Color, Mappel, Pewter 02, Keracolor Sanded Grout Grout Size: 1/8" Minimum Recommended Installation: Monofithic WALL PRODUCTS AINT T-1 Paint Location/ Notes: Multiple, see finish plan/elevations. Color: Pearly White SW 7009 Finish: Eggshell-Satin Finish Specifications: Latex, unless noted otherwise T-2 Paint Location/ Notes: Multiple, see finish plan/elevations. Color: Dovetal SW 7018 Finish: Eggshell-Satin Finish Specifications: Latex, unless noted otherwise Finish: Eggshell-Satin Finish Specifications: Latex, unless noted otherwise WHI-1 High Pressure Laminate Surfaces Manufacturer: Plante Product Type: Standard HPL WHI-2 High Pressure Laminate Surfaces Manufacturer: Plante Product Type: Standard HPL WHI-1 High Pressure Laminate Surfaces Manufacturer: Plante Product Type: Standard HPL WHI-1 High Pressure Laminate Surfaces Manufacturer: Plante Product Type: Standard HPL WHI-2 High Pressure Laminate Surfaces Manufacturer: Plante Partern/Color: Coastal Cottage WC652-WI Finish: Success Finish: Coastal Cottage WC652-WI	PORCEI	Rubber Base/Transition Strip Manufacturer: Roppe Product: Pinnacle Rubber Base/Rubber Accessories Style: 4" Standard Cove Toe/Reducer Strip Color: Dolphin 129 AIN TILE FLOORING Porcelain Tile Manufacturer: Daltile Pattern: Stone Attache, Consulate, Antique Color: Premier Grey CS05, Unpolished Size: 24" x 48" Grout Color: Mapei, Pewter 02, Keracolor Sanded Grout Grout Size: 1/8" Minimum Recommended Installation: Monolithic Porcelain Cove Base	Coordinates with CT-1, CT-2, LVT-1, RF-1, & SDT-1. Reducer Strip: sizing based on flooring applications; provide accordingly. Reducer Strip: See half-filled circle symbol on finish plan. Location/Notes: Elevator Lobby & Level 16 Restrooms, see finish plan. Coordinates with CB-1 Location/Notes: Elevator Lobby & Level 16 Restrooms see finish plan/elevations.	WT-2	Manufacturer: Daltile Pattern: Stone Attache, Haut Monde, Colorbo Color: Elite Grey HM05, Unpolished Size: 12" x 24" Installation: Monolithic Grout Color: Mapei, Pewter 02, Keracolor San Grout Size: 1/8" Minimum Recommended Porcelain Wall Tile Manufacturer: Daltile Pattern: Volume 1.0, Glazed Porcelain Color: Degrees Silver VL71 Size: 12" x 12" Grout Color: Mapei, Pewter 02, Keracolor San Grout Size: 1/8" Minimum Recommended Installation: Monolithic Natural Stone Mosaic Tile Manufacturer: Daltile Pattern: Limestone Mosaic, Polished Modern
Size: 6" x 12"	PORCEI	Rubber Base/Transition Strip Manufacturer: Roppe Product: Pinnacle Rubber Base/Rubber Accessories Style: 4" Standard Cove Toe/Reducer Strip Color: Dolphin 129 AIN TILE FLOORING Porcelain Tile Manufacturer: Daltile Pattern: Stone Attache, Consulate, Antique Color: Premier Grey CS05, Unpolished Size: 24" x 48" Grout Color: Mapei, Pewter 02, Keracolor Sanded Grout Grout Size: 1/8" Minimum Recommended Installation: Monolithic Porcelain Cove Base Manufacturer: Daltile	Coordinates with CT-1, CT-2, LVT-1, RF-1, & SDT-1. Reducer Strip: sizing based on flooring applications; provide accordingly. Reducer Strip: See half-filled circle symbol on finish plan. Location/Notes: Elevator Lobby & Level 16 Restrooms, see finish plan. Coordinates with CB-1 Location/Notes: Elevator Lobby & Level 16 Restrooms see finish plan/elevations.	WT-2	Manufacturer: Daltile Pattern: Stone Attache, Haut Monde, Colorbo Color: Elite Grey HM05, Unpolished Size: 12" x 24" Installation: Monolithic Grout Color: Mapei, Pewter 02, Keracolor San Grout Size: 1/8" Minimum Recommended Porcelain Wall Tile Manufacturer: Daltile Pattern: Volume 1.0, Glazed Porcelain Color: Degrees Silver VL71 Size: 12" x 12" Grout Color: Mapei, Pewter 02, Keracolor San Grout Size: 1/8" Minimum Recommended Installation: Monolithic Natural Stone Mosaic Tile Manufacturer: Daltile Pattern: Limestone Mosaic, Polished Modern Color: Chenille White L191
Installation: Ashlar Grout Color: Mopel, Pewfer 02, Keracolor Sanded Grout Grout Size: 1/8' Minimum Recommended Installation: Monolithic WALL PRODUCTS **AINT **PINT **PINT **PINT **Color: Pearly White SW 7009 Finish: Eggshell-Sain Finish Specifications: Latex, unless noted otherwise **PI-1 Point	PORCEI	Rubber Base/Transition Strip Manufacturer: Roppe Product: Pinnacle Rubber Base/Rubber Accessories Style: 4" Standard Cove Toe/Reducer Strip Color: Dolphin 129 AIN TILE FLOORING Porcelain Tile Manufacturer: Daltile Pattern: Stone Attache, Consulate, Antique Color: Premier Grey CS05, Unpolished Size: 24" x 48" Grout Color: Mapei, Pewter 02, Keracolor Sanded Grout Grout Size: 1/8" Minimum Recommended Installation: Monolithic Porcelain Cove Base Manufacturer: Daltile Pattern: Stone Attache, Consulate, Antique	Coordinates with CT-1, CT-2, LVT-1, RF-1, & SDT-1. Reducer Strip: sizing based on flooring applications; provide accordingly. Reducer Strip: See half-filled circle symbol on finish plan. Location/Notes: Elevator Lobby & Level 16 Restrooms, see finish plan. Coordinates with CB-1 Location/Notes: Elevator Lobby & Level 16 Restrooms see finish plan/elevations.	WT-2	Manufacturer: Daltile Pattern: Stone Attache, Haut Monde, Colorbo Color: Elite Grey HM05, Unpolished Size: 12" x 24" Installation: Monolithic Grout Color: Mapei, Pewter 02, Keracolor San Grout Size: 1/8" Minimum Recommended Porcelain Wall Tile Manufacturer: Daltile Pattern: Volume 1.0, Glazed Porcelain Color: Degrees Silver VL71 Size: 12" x 12" Grout Color: Mapei, Pewter 02, Keracolor San Grout Size: 1/8" Minimum Recommended Installation: Monolithic Natural Stone Mosaic Tile Manufacturer: Daltile Pattern: Limestone Mosaic, Polished Modern Color: Chenille White L191 Size: Irregular Mosaic
Grout Color: Mapei, Pewter 02, Keracolor Sanded Grout Grout Size: 1/8" Minimum Recommended Installation: Monolithic WALL PRODUCTS WALL PRODUCTS PAINT Paint Location/ Notes: Multiple, see finish plan/elevations. Color: Pearly White SW 7009 Finish: Eggshell-Satin Finish Specifications: Latex, unless noted otherwise PT-2 Paint Location/ Notes: Multiple, see finish plan/elevations. Color: Doverlal SW 7018 Finish: Eggshell-Satin Finish Specifications: Latex, unless noted otherwise Finish: Gagshell-Satin Finish Finish:	PORCEI	Rubber Base/Transition Strip Manufacturer: Roppe Product: Pinnacle Rubber Base/Rubber Accessories Style: 4" Standard Cove Toe/Reducer Strip Color: Dolphin 129 AIN TILE FLOORING Porcelain Tile Manufacturer: Daltile Pattern: Stone Attache, Consulate, Antique Color: Premier Grey CS05, Unpolished Size: 24" x 48" Grout Color: Mapei, Pewter 02, Keracolor Sanded Grout Grout Size: 1/8" Minimum Recommended Installation: Monolithic Porcelain Cove Base Manufacturer: Daltile Pattern: Stone Attache, Consulate, Antique Color: Premier Grey CS05, Unpolished	Coordinates with CT-1, CT-2, LVT-1, RF-1, & SDT-1. Reducer Strip: sizing based on flooring applications; provide accordingly. Reducer Strip: See half-filled circle symbol on finish plan. Location/Notes: Elevator Lobby & Level 16 Restrooms, see finish plan. Coordinates with CB-1 Location/Notes: Elevator Lobby & Level 16 Restrooms see finish plan/elevations.	WT-2	Manufacturer: Daltile Pattern: Stone Attache, Haut Monde, Colorbo Color: Elite Grey HM05, Unpolished Size: 12" x 24" Installation: Monolithic Grout Color: Mapei, Pewter 02, Keracolor San Grout Size: 1/8" Minimum Recommended Porcelain Wall Tile Manufacturer: Daltile Pattern: Volume 1.0, Glazed Porcelain Color: Degrees Silver VL71 Size: 12" x 12" Grout Color: Mapei, Pewter 02, Keracolor San Grout Size: 1/8" Minimum Recommended Installation: Monolithic Natural Stone Mosaic Tile Manufacturer: Daltile Pattern: Limestone Mosaic, Polished Modern Color: Chenille White L191 Size: Irregular Mosaic Grout Color: Mapei, Pewter 02, Keracolor San
Installation: Monolithic WALL PRODUCTS PAINT Paint Location/ Notes: Multiple, see finish plan/elevations. Color: Pearly White SW 7009 Finish: Eggshell-Satin Finish Specifications: Latex, unless noted otherwise Product: Sherwin Williams Location/ Notes: Multiple, see finish plan/elevations. Product: Basiq Series Color: Banco City PLASTIC LAMINATE HPL-1 High Pressure Laminate Surfaces Manufacturer: Pionite Pattern/Color: Absolute Acajou WY160 Finish: Eggshell-Satin Finish Color: Dovetail SW 7018 Finish: Eggshell-Satin Finish Specifications: Latex, unless noted otherwise Specifications: Latex, unless noted otherwise Finish: Eggshell-Satin Finish Specifications: Latex, unless noted otherwise Finish: Wood Specifications: Latex, unless noted otherwise	PORCEI	Rubber Base/Transition Strip Manufacturer: Roppe Product: Pinnacle Rubber Base/Rubber Accessories Style: 4" Standard Cove Toe/Reducer Strip Color: Dolphin 129 AIN TILE FLOORING Porcelain Tile Manufacturer: Daltile Pattern: Stone Attache, Consulate, Antique Color: Premier Grey CS05, Unpolished Size: 24" x 48" Grout Color: Mapei, Pewter 02, Keracolor Sanded Grout Grout Size: 1/8" Minimum Recommended Installation: Monolithic Porcelain Cove Base Manufacturer: Daltile Pattern: Stone Attache, Consulate, Antique Color: Premier Grey CS05, Unpolished Size: 6" x 12"	Coordinates with CT-1, CT-2, LVT-1, RF-1, & SDT-1. Reducer Strip: sizing based on flooring applications; provide accordingly. Reducer Strip: See half-filled circle symbol on finish plan. Location/Notes: Elevator Lobby & Level 16 Restrooms, see finish plan. Coordinates with CB-1 Location/Notes: Elevator Lobby & Level 16 Restrooms see finish plan/elevations.	WT-2	Manufacturer: Daltile Pattern: Stone Attache, Haut Monde, Colorbo Color: Elite Grey HM05, Unpolished Size: 12" x 24" Installation: Monolithic Grout Color: Mapei, Pewter 02, Keracolor San Grout Size: 1/8" Minimum Recommended Porcelain Wall Tile Manufacturer: Daltile Pattern: Volume 1.0, Glazed Porcelain Color: Degrees Silver VL71 Size: 12" x 12" Grout Color: Mapei, Pewter 02, Keracolor San Grout Size: 1/8" Minimum Recommended Installation: Monolithic Natural Stone Mosaic Tile Manufacturer: Daltile Pattern: Limestone Mosaic, Polished Modern Color: Chenille White L191 Size: Irregular Mosaic Grout Color: Mapei, Pewter 02, Keracolor San Grout Size: 1/8" Minimum Recommended
WALL PRODUCTS PAINT PAINT Description Location/ Notes: Multiple, see finish plan/elevations. Manufacturer: Sherwin Williams Color: Pearly White SW 7009 Finish: Eggshell-Satin Finish Specifications: Latex, unless noted otherwise Color: Dovetail SW 7018 Finish: Eggshell-Satin Finish Specifications: Latex, unless noted otherwise Finish: Eggshell-Satin Finish Specifications: Latex, unless noted otherwise Product: Basiq Series Color: Blanco City Manufacturer: Sherwin Williams * Epoxy Paint in all Restrooms. * Epoxy Paint in all Restrooms. Color: Dovetail SW 7018 Finish: Eggshell-Satin Finish Specifications: Latex, unless noted otherwise ##PL-1 High Pressure Laminate Surfaces Manufacturer: Pionite Pattern/Color: Absolute Acajou WY160 Finish: Eggshell-Satin Finish Specifications: Latex, unless noted otherwise ##PL-1 High Pressure Laminate Surfaces Manufacturer: Pionite ##PL-2 High Pressure Laminate Surfaces Manufacturer: Pionite Pattern/Color: Coastal Cottage WC652-WI Finish: Suppose Earling Surfaces Manufacturer: Pionite Pattern/Color: Coastal Cottage WC652-WI Finish: Wood Essence WE	PORCEI	Rubber Base/Transition Strip Manufacturer: Roppe Product: Pinnacle Rubber Base/Rubber Accessories Style: 4" Standard Cove Toe/Reducer Strip Color: Dolphin 129 AIN TILE FLOORING Porcelain Tile Manufacturer: Daltile Pattern: Stone Attache, Consulate, Antique Color: Premier Grey CS05, Unpolished Size: 24" x 48" Grout Color: Mapei, Pewter 02, Keracolor Sanded Grout Grout Size: 1/8" Minimum Recommended Installation: Monolithic Porcelain Cove Base Manufacturer: Daltile Pattern: Stone Attache, Consulate, Antique Color: Premier Grey CS05, Unpolished Size: 6" x 12" Trim Style: Cove Base, S-36C9T Grout Color: Mapei, Pewter 02, Keracolor Sanded Grout	Coordinates with CT-1, CT-2, LVT-1, RF-1, & SDT-1. Reducer Strip: sizing based on flooring applications; provide accordingly. Reducer Strip: See half-filled circle symbol on finish plan. Location/Notes: Elevator Lobby & Level 16 Restrooms, see finish plan. Coordinates with CB-1 Location/Notes: Elevator Lobby & Level 16 Restrooms see finish plan/elevations.	WT-2	Manufacturer: Daltile Pattern: Stone Attache, Haut Monde, Colorbo Color: Elite Grey HM05, Unpolished Size: 12" x 24" Installation: Monolithic Grout Color: Mapei, Pewter 02, Keracolor San Grout Size: 1/8" Minimum Recommended Porcelain Wall Tile Manufacturer: Daltile Pattern: Volume 1.0, Glazed Porcelain Color: Degrees Silver VL71 Size: 12" x 12" Grout Color: Mapei, Pewter 02, Keracolor San Grout Size: 1/8" Minimum Recommended Installation: Monolithic Natural Stone Mosaic Tile Manufacturer: Daltile Pattern: Limestone Mosaic, Polished Modern Color: Chenille White L191 Size: Irregular Mosaic Grout Color: Mapei, Pewter 02, Keracolor San Grout Size: 1/8" Minimum Recommended Installation: Ashlar
## PAINT Paint	PORCEI	Rubber Base/Transition Strip Manufacturer: Roppe Product: Pinnacle Rubber Base/Rubber Accessories Style: 4" Standard Cove Toe/Reducer Strip Color: Dolphin 129 AIN TILE FLOORING Porcelain Tile Manufacturer: Daltile Pattern: Stone Attache, Consulate, Antique Color: Premier Grey CS05, Unpolished Size: 24" x 48" Grout Color: Mapei, Pewter 02, Keracolor Sanded Grout Grout Size: 1/8" Minimum Recommended Installation: Monolithic Porcelain Cove Base Manufacturer: Daltile Pattern: Stone Attache, Consulate, Antique Color: Premier Grey CS05, Unpolished Size: 6" x 12" Trim Style: Cove Base, S-36C9T Grout Color: Mapei, Pewter 02, Keracolor Sanded Grout Grout Size: 1/8" Minimum Recommended	Coordinates with CT-1, CT-2, LVT-1, RF-1, & SDT-1. Reducer Strip: sizing based on flooring applications; provide accordingly. Reducer Strip: See half-filled circle symbol on finish plan. Location/Notes: Elevator Lobby & Level 16 Restrooms, see finish plan. Coordinates with CB-1 Location/Notes: Elevator Lobby & Level 16 Restrooms see finish plan/elevations.	WT-2	Manufacturer: Daltile Pattern: Stone Attache, Haut Monde, Colorbo Color: Elite Grey HM05, Unpolished Size: 12" x 24" Installation: Monolithic Grout Color: Mapei, Pewter 02, Keracolor San Grout Size: 1/8" Minimum Recommended Porcelain Wall Tile Manufacturer: Daltile Pattern: Volume 1.0, Glazed Porcelain Color: Degrees Silver VL71 Size: 12" x 12" Grout Color: Mapei, Pewter 02, Keracolor San Grout Size: 1/8" Minimum Recommended Installation: Monolithic Natural Stone Mosaic Tile Manufacturer: Daltile Pattern: Limestone Mosaic, Polished Modern Color: Chenille White L191 Size: Irregular Mosaic Grout Color: Mapei, Pewter 02, Keracolor San Grout Size: 1/8" Minimum Recommended Installation: Ashlar
PRINT Product: Selection Selection Selection Finish: Eggshell-Satin Finish: Eggshell-Satin Finish: Segshell-Satin Finish: Sepoxy Point in all Restrooms. Product: Basiq Series Product: Basiq Series	PORCEI	Rubber Base/Transition Strip Manufacturer: Roppe Product: Pinnacle Rubber Base/Rubber Accessories Style: 4" Standard Cove Toe/Reducer Strip Color: Dolphin 129 AIN TILE FLOORING Porcelain Tile Manufacturer: Daltile Pattern: Stone Attache, Consulate, Antique Color: Premier Grey CS05, Unpolished Size: 24" x 48" Grout Color: Mapei, Pewter 02, Keracolor Sanded Grout Grout Size: 1/8" Minimum Recommended Installation: Monolithic Porcelain Cove Base Manufacturer: Daltile Pattern: Stone Attache, Consulate, Antique Color: Premier Grey CS05, Unpolished Size: 6" x 12" Trim Style: Cove Base, S-36C9T Grout Color: Mapei, Pewter 02, Keracolor Sanded Grout Grout Size: 1/8" Minimum Recommended	Coordinates with CT-1, CT-2, LVT-1, RF-1, & SDT-1. Reducer Strip: sizing based on flooring applications; provide accordingly. Reducer Strip: See half-filled circle symbol on finish plan. Location/Notes: Elevator Lobby & Level 16 Restrooms, see finish plan. Coordinates with CB-1 Location/Notes: Elevator Lobby & Level 16 Restrooms see finish plan/elevations.	MT-1	Manufacturer: Daltile Pattern: Stone Attache, Haut Monde, Colorbo Color: Elite Grey HM05, Unpolished Size: 12" x 24" Installation: Monolithic Grout Color: Mapei, Pewter 02, Keracolor San Grout Size: 1/8" Minimum Recommended Porcelain Wall Tile Manufacturer: Daltile Pattern: Volume 1.0, Glazed Porcelain Color: Degrees Silver VL71 Size: 12" x 12" Grout Color: Mapei, Pewter 02, Keracolor San Grout Size: 1/8" Minimum Recommended Installation: Monolithic Natural Stone Mosaic Tile Manufacturer: Daltile Pattern: Limestone Mosaic, Polished Modern Color: Chenille White L191 Size: Irregular Mosaic Grout Color: Mapei, Pewter 02, Keracolor San Grout Size: 1/8" Minimum Recommended Installation: Ashlar
Manufacturer: Silestone Product: Basiq Series Color: Pearly White SW 7009 Finish: Eggshell-Satin Finish Specifications: Latex, unless noted otherwise Product: Sherwin Williams * Epoxy Paint in all Restrooms. Plastic Laminate Surfaces Manufacturer: Sherwin Williams * Epoxy Paint in all Restrooms. Plastic Laminate Surfaces Manufacturer: Pionite #Pl-1 High Pressure Laminate Surfaces Manufacturer: Pionite Pattern/Color: Absolute Acajou WY160 Finish: Eggshell-Satin Finish Specifications: Latex, unless noted otherwise ##Pl-2 High Pressure Laminate Surfaces ##Pl-3 High Pressure Laminate Surfaces ##Pl-3 High Pressure Laminate Surfaces ##Pl-4 High Pressure Laminate Surfaces ##Pl-2 High Pressure Laminate Surfaces ##Pl-3 High Pressure Laminate Surfaces ##Pl-3 High Pressure Laminate Surfaces ##Pl-4 High Pressure Laminate Surfaces ##Pl-5 High Pressure Laminate Surfaces ##Pl-6 High Pressure Laminate Surfaces ##Pl-7 High Pressure Laminate Surfaces ##Pl-1 High Pressure Laminate Surfaces #	PORCEI	Rubber Base/Transition Strip Manufacturer: Roppe Product: Pinnacle Rubber Base/Rubber Accessories Style: 4" Standard Cove Toe/Reducer Strip Color: Dolphin 129 AIN TILE FLOORING Porcelain Tile Manufacturer: Daltile Pattern: Stone Attache, Consulate, Antique Color: Premier Grey CS05, Unpolished Size: 24" x 48" Grout Color: Mapei, Pewter 02, Keracolor Sanded Grout Grout Size: 1/8" Minimum Recommended Installation: Monolithic Porcelain Cove Base Manufacturer: Daltile Pattern: Stone Attache, Consulate, Antique Color: Premier Grey CS05, Unpolished Size: 6" x 12" Trim Style: Cove Base, S-36C9T Grout Color: Mapei, Pewter 02, Keracolor Sanded Grout Grout Size: 1/8" Minimum Recommended Installation: Monolithic	Coordinates with CT-1, CT-2, LVT-1, RF-1, & SDT-1. Reducer Strip: sizing based on flooring applications; provide accordingly. Reducer Strip: See half-filled circle symbol on finish plan. Location/Notes: Elevator Lobby & Level 16 Restrooms, see finish plan. Coordinates with CB-1 Location/Notes: Elevator Lobby & Level 16 Restrooms see finish plan/elevations.	MT-1	Manufacturer: Daltile Pattern: Stone Attache, Haut Monde, Colorbo Color: Elite Grey HM05, Unpolished Size: 12" x 24" Installation: Monolithic Grout Color: Mapei, Pewter 02, Keracolor San Grout Size: 1/8" Minimum Recommended Porcelain Wall Tile Manufacturer: Daltile Pattern: Volume 1.0, Glazed Porcelain Color: Degrees Silver VL71 Size: 12" x 12" Grout Color: Mapei, Pewter 02, Keracolor San Grout Size: 1/8" Minimum Recommended Installation: Monolithic Natural Stone Mosaic Tile Manufacturer: Daltile Pattern: Limestone Mosaic, Polished Modern Color: Chenille White L191 Size: Irregular Mosaic Grout Color: Mapei, Pewter 02, Keracolor San Grout Size: 1/8" Minimum Recommended Installation: Ashlar
PT-1 Paint Location/ Notes: Multiple, see finish plan/elevations. Manufacturer: Sherwin Williams Epoxy Paint in all Restrooms. Color: Pearly White SW 7009 Finish: Eggshell-Satin Finish Specifications: Latex, unless noted otherwise PT-2 Paint Location/ Notes: Multiple, see finish plan/elevations. Manufacturer: Sherwin Williams Epoxy Paint in all Restrooms. Manufacturer: Sherwin Williams Epoxy Paint in all Restrooms. Color: Dovetail SW 7018 Finish: Eggshell-Satin Finish Specifications: Latex, unless noted otherwise Specifications: Latex, unless noted otherwise Manufacturer: Pionite Pattern/Color: Absolute Acajou WY160 Finish: Suede SD Product Type: Standard HPL High Pressure Laminate Surfaces Manufacturer: Pionite Pattern/Color: Coastal Cottage WC652-Williams Manufacturer: Pionite Pattern/Color: Coastal Cottage WC652-Williams Finish: Wood Essence WE	PORCEI	Rubber Base/Transition Strip Manufacturer: Roppe Product: Pinnacle Rubber Base/Rubber Accessories Style: 4" Standard Cove Toe/Reducer Strip Color: Dolphin 129 AIN TILE FLOORING Porcelain Tile Manufacturer: Daltile Pattern: Stone Attache, Consulate, Antique Color: Premier Grey CS05, Unpolished Size: 24" x 48" Grout Color: Mapei, Pewter 02, Keracolor Sanded Grout Grout Size: 1/8" Minimum Recommended Installation: Monolithic Porcelain Cove Base Manufacturer: Daltile Pattern: Stone Attache, Consulate, Antique Color: Premier Grey CS05, Unpolished Size: 6" x 12" Trim Style: Cove Base, S-36C9T Grout Color: Mapei, Pewter 02, Keracolor Sanded Grout Grout Size: 1/8" Minimum Recommended Installation: Monolithic	Coordinates with CT-1, CT-2, LVT-1, RF-1, & SDT-1. Reducer Strip: sizing based on flooring applications; provide accordingly. Reducer Strip: See half-filled circle symbol on finish plan. Location/Notes: Elevator Lobby & Level 16 Restrooms, see finish plan. Coordinates with CB-1 Location/Notes: Elevator Lobby & Level 16 Restrooms see finish plan/elevations.	MT-1 MILLWO COUNTE	Manufacturer: Daltile Pattern: Stone Attache, Haut Monde, Colorbo Color: Elite Grey HM05, Unpolished Size: 12" x 24" Installation: Monolithic Grout Color: Mapei, Pewter 02, Keracolor San Grout Size: 1/8" Minimum Recommended Porcelain Wall Tile Manufacturer: Daltile Pattern: Volume 1.0, Glazed Porcelain Color: Degrees Silver VL71 Size: 12" x 12" Grout Color: Mapei, Pewter 02, Keracolor San Grout Size: 1/8" Minimum Recommended Installation: Monolithic Natural Stone Mosaic Tile Manufacturer: Daltile Pattern: Limestone Mosaic, Polished Modern Color: Chenille White L191 Size: Irregular Mosaic Grout Color: Mapei, Pewter 02, Keracolor San Grout Size: 1/8" Minimum Recommended Installation: Ashlar ORK
Manufacturer: Sherwin Williams * Epoxy Paint in all Restrooms. Color: Pearly White SW 7009 Finish: Eggshell-Satin Finish Specifications: Latex, unless noted otherwise PT-2 Paint Location/ Notes: Multiple, see finish plan/elevations. Manufacturer: Sherwin Williams * Epoxy Paint in all Restrooms. Color: Dovetail SW 7018 Finish: Eggshell-Satin Finish Specifications: Latex, unless noted otherwise Product Type: Standard HPL High Pressure Laminate Surfaces Manufacturer: Pionite Pattern/Color: Absolute Acajou WY160 Finish: Suede SD Product Type: Standard HPL HPL-2 High Pressure Laminate Surfaces Manufacturer: Pionite Pattern/Color: Coastal Cottage WC652-WI Finish: Wood Essence WE	PORCEI	Rubber Base/Transition Strip Manufacturer: Roppe Product: Pinnacle Rubber Base/Rubber Accessories Style: 4" Standard Cove Toe/Reducer Strip Color: Dolphin 129 AIN TILE FLOORING Porcelain Tile Manufacturer: Daltile Pattern: Stone Attache, Consulate, Antique Color: Premier Grey CS05, Unpolished Size: 24" x 48" Grout Color: Mapei, Pewter 02, Keracolor Sanded Grout Grout Size: 1/8" Minimum Recommended Installation: Monolithic Porcelain Cove Base Manufacturer: Daltile Pattern: Stone Attache, Consulate, Antique Color: Premier Grey CS05, Unpolished Size: 6" x 12" Trim Style: Cove Base, S-36C9T Grout Color: Mapei, Pewter 02, Keracolor Sanded Grout Grout Size: 1/8" Minimum Recommended Installation: Monolithic	Coordinates with CT-1, CT-2, LVT-1, RF-1, & SDT-1. Reducer Strip: sizing based on flooring applications; provide accordingly. Reducer Strip: See half-filled circle symbol on finish plan. Location/Notes: Elevator Lobby & Level 16 Restrooms, see finish plan. Coordinates with CB-1 Location/Notes: Elevator Lobby & Level 16 Restrooms see finish plan/elevations.	MT-1 MILLWO COUNTE	Manufacturer: Daltile Pattern: Stone Attache, Haut Monde, Colorbo Color: Elite Grey HM05, Unpolished Size: 12" x 24" Installation: Monolithic Grout Color: Mapei, Pewter 02, Keracolor San Grout Size: 1/8" Minimum Recommended Porcelain Wall Tile Manufacturer: Daltile Pattern: Volume 1.0, Glazed Porcelain Color: Degrees Silver VL71 Size: 12" x 12" Grout Color: Mapei, Pewter 02, Keracolor San Grout Size: 1/8" Minimum Recommended Installation: Monolithic Natural Stone Mosaic Tile Manufacturer: Daltile Pattern: Limestone Mosaic, Polished Modern Color: Chenille White L191 Size: Irregular Mosaic Grout Color: Mapei, Pewter 02, Keracolor San Grout Size: 1/8" Minimum Recommended Installation: Ashlar ORK RTOPS Quartz Countertop Manufacturer: Silestone
Color: Pearly White SW 7009 Finish: Eggshell-Satin Finish Specifications: Latex, unless noted otherwise PT-2 Paint Location/ Notes: Multiple, see finish plan/elevations. Manufacturer: Sherwin Williams Epoxy Paint in all Restrooms. Color: Dovetail SW 7018 Finish: Eggshell-Satin Finish Specifications: Latex, unless noted otherwise HPL-1 High Pressure Laminate Surfaces Manufacturer: Pionite Pattern/Color: Absolute Acajou WY160 Finish: Suede SD Product Type: Standard HPL HPL-2 High Pressure Laminate Surfaces Manufacturer: Pionite Pattern/Color: Coastal Cottage WC652-WI Finish: Wood Essence WE	PORCEI T-1 WALL PAINT	Rubber Base/Transition Strip Manufacturer: Roppe Product: Pinnacle Rubber Base/Rubber Accessories Style: 4" Standard Cove Toe/Reducer Strip Color: Dolphin 129 AIN TILE FLOORING Porcelain Tile Manufacturer: Daltile Pattern: Stone Attache, Consulate, Antique Color: Premier Grey CS05, Unpolished Size: 24" x 48" Grout Color: Mapei, Pewter 02, Keracolor Sanded Grout Grout Size: 1/8" Minimum Recommended Installation: Monolithic Porcelain Cove Base Manufacturer: Daltile Pattern: Stone Attache, Consulate, Antique Color: Premier Grey CS05, Unpolished Size: 6" x 12" Trim Style: Cove Base, S-36C9T Grout Color: Mapei, Pewter 02, Keracolor Sanded Grout Grout Size: 1/8" Minimum Recommended Installation: Monolithic	Coordinates with CT-1, CT-2, LVT-1, RF-1, & SDT-1. Reducer Strip: sizing based on flooring applications; provide accordingly. Reducer Strip: See half-filled circle symbol on finish plan. Location/Notes: Elevator Lobby & Level 16 Restrooms, see finish plan. Coordinates with CB-1 Location/Notes: Elevator Lobby & Level 16 Restrooms see finish plan/elevations. Coordinates with FT-1	MT-1 MILLWO COUNTE	Manufacturer: Daltile Pattern: Stone Attache, Haut Monde, Colorbo Color: Elite Grey HM05, Unpolished Size: 12" x 24" Installation: Monolithic Grout Color: Mapei, Pewter 02, Keracolor San Grout Size: 1/8" Minimum Recommended Porcelain Wall Tile Manufacturer: Daltile Pattern: Volume 1.0, Glazed Porcelain Color: Degrees Silver VL71 Size: 12" x 12" Grout Color: Mapei, Pewter 02, Keracolor San Grout Size: 1/8" Minimum Recommended Installation: Monolithic Natural Stone Mosaic Tile Manufacturer: Daltile Pattern: Limestone Mosaic, Polished Modern Color: Chenille White L191 Size: Irregular Mosaic Grout Color: Mapei, Pewter 02, Keracolor San Grout Size: 1/8" Minimum Recommended Installation: Ashlar ORK RTOPS Quartz Countertop Manufacturer: Silestone Product: Basiq Series
Finish: Eggshel-Satin Finish Specifications: Latex, unless noted otherwise PT-2 Paint Location/ Notes: Multiple, see finish plan/elevations. Manufacturer: Sherwin Williams * Epoxy Paint in all Restrooms. Color: Dovetail SW 7018 Finish: Eggshell-Satin Finish Specifications: Latex, unless noted otherwise HPL-1 High Pressure Laminate Surfaces Manufacturer: Pionite Pattern/Color: Absolute Acajou WY160 Finish: Suede SD Product Type: Standard HPL HIGH Pressure Laminate Surfaces Manufacturer: Pionite HPL-2 High Pressure Laminate Surfaces Manufacturer: Pionite Pattern/Color: Coastal Cottage WC652-Will Finish: Wood Essence WE	PORCEI T-1 WALL PAINT	Rubber Base/Transition Strip Manufacturer: Roppe Product: Pinnacle Rubber Base/Rubber Accessories Style: 4" Standard Cove Toe/Reducer Strip Color: Dolphin 129 AIN TILE FLOORING Porcelain Tile Manufacturer: Daltile Pattern: Stone Attache, Consulate, Antique Color: Premier Grey CS05, Unpolished Size: 24" x 48" Grout Color: Mapei, Pewter 02, Keracolor Sanded Grout Grout Size: 1/8" Minimum Recommended Installation: Monolithic Porcelain Cove Base Manufacturer: Daltile Pattern: Stone Attache, Consulate, Antique Color: Premier Grey CS05, Unpolished Size: 6" x 12" Trim Style: Cove Base, S-36C9T Grout Color: Mapei, Pewter 02, Keracolor Sanded Grout Grout Size: 1/8" Minimum Recommended Installation: Monolithic	Coordinates with CT-1, CT-2, LVT-1, RF-1, & SDT-1. Reducer Strip: sizing based on flooring applications; provide accordingly. Reducer Strip: See half-filled circle symbol on finish plan. Location/Notes: Elevator Lobby & Level 16 Restrooms, see finish plan. Coordinates with CB-1 Location/Notes: Elevator Lobby & Level 16 Restrooms see finish plan/elevations. Coordinates with FT-1 Location/Notes: With FT-1 Location/Notes: Multiple, see finish plan/elevations.	MT-1 MILLWO COUNTE	Manufacturer: Daltile Pattern: Stone Attache, Haut Monde, Colorbo Color: Elite Grey HM05, Unpolished Size: 12" x 24" Installation: Monolithic Grout Color: Mapei, Pewter 02, Keracolor San Grout Size: 1/8" Minimum Recommended Porcelain Wall Tile Manufacturer: Daltile Pattern: Volume 1.0, Glazed Porcelain Color: Degrees Silver VL71 Size: 12" x 12" Grout Color: Mapei, Pewter 02, Keracolor San Grout Size: 1/8" Minimum Recommended Installation: Monolithic Natural Stone Mosaic Tile Manufacturer: Daltile Pattern: Limestone Mosaic, Polished Modern Color: Chenille White L191 Size: Irregular Mosaic Grout Color: Mapei, Pewter 02, Keracolor San Grout Size: 1/8" Minimum Recommended Installation: Ashlar ORK RTOPS Quartz Countertop Manufacturer: Silestone Product: Basiq Series
Specifications: Latex, unless noted otherwise PT-2 Paint Location/ Notes: Multiple, see finish plan/elevations. Manufacturer: Sherwin Williams * Epoxy Paint in all Restrooms. Color: Dovetail SW 7018 Finish: Eggshell-Satin Finish Specifications: Latex, unless noted otherwise Finish: Specifications: Latex, unless noted otherwise #PL-1 High Pressure Laminate Surfaces Manufacturer: Pionite Pattern/Color: Absolute Acajou WY160 Finish: Suede SD Product Type: Standard HPL #PL-2 High Pressure Laminate Surfaces Manufacturer: Pionite Pattern/Color: Coastal Cottage WC652-Will Finish: Wood Essence WE	PORCEI T-1 WALL PAINT	Rubber Base/Transition Strip Manufacturer: Roppe Product: Pinnacle Rubber Base/Rubber Accessories Style: 4" Standard Cove Toe/Reducer Strip Color: Dolphin 129 AIN TILE FLOORING Porcelain Tile Manufacturer: Daltile Pattern: Stone Attache, Consulate, Antique Color: Premier Grey CS05, Unpolished Size: 24" x 48" Grout Color: Mapei, Pewter 02, Keracolor Sanded Grout Grout Size: 1/8" Minimum Recommended Installation: Monolithic Porcelain Cove Base Manufacturer: Daltile Pattern: Stone Attache, Consulate, Antique Color: Premier Grey CS05, Unpolished Size: 6" x 12" Trim Style: Cove Base, S-36C9T Grout Color: Mapei, Pewter 02, Keracolor Sanded Grout Grout Size: 1/8" Minimum Recommended Installation: Monolithic PRODUCTS Paint Manufacturer: Sherwin Williams	Coordinates with CT-1, CT-2, LVT-1, RF-1, & SDT-1. Reducer Strip: sizing based on flooring applications; provide accordingly. Reducer Strip: See half-filled circle symbol on finish plan. Location/Notes: Elevator Lobby & Level 16 Restrooms, see finish plan. Coordinates with CB-1 Location/Notes: Elevator Lobby & Level 16 Restrooms see finish plan/elevations. Coordinates with FT-1 Location/Notes: With FT-1 Location/Notes: Multiple, see finish plan/elevations.	MILLWO COUNTE	Manufacturer: Daltile Pattern: Stone Attache, Haut Monde, Colorbo Color: Elite Grey HM05, Unpolished Size: 12" x 24" Installation: Monolithic Grout Color: Mapei, Pewter 02, Keracolor San Grout Size: 1/8" Minimum Recommended Porcelain Wall Tile Manufacturer: Daltile Pattern: Volume 1.0, Glazed Porcelain Color: Degrees Silver VL71 Size: 12" x 12" Grout Color: Mapei, Pewter 02, Keracolor San Grout Size: 1/8" Minimum Recommended Installation: Monolithic Natural Stone Mosaic Tile Manufacturer: Daltile Pattern: Limestone Mosaic, Polished Modern Color: Chenille White L191 Size: Irregular Mosaic Grout Color: Mapei, Pewter 02, Keracolor San Grout Size: 1/8" Minimum Recommended Installation: Ashlar ORK RTOPS Quartz Countertop Manufacturer: Silestone Product: Basiq Series Color: Blanco City
Paint Location/ Notes: Multiple, see finish plan/elevations. Pattern/Color: Absolute Acajou WY160	ORCEI T-1 WALL	Rubber Base/Transition Strip Manufacturer: Roppe Product: Pinnacle Rubber Base/Rubber Accessories Style: 4" Standard Cove Toe/Reducer Strip Color: Dolphin 129 AIN TILE FLOORING Porcelain Tile Manufacturer: Daltile Pattern: Stone Attache, Consulate, Antique Color: Premier Grey CS05, Unpolished Size: 24" x 48" Grout Color: Mapei, Pewter 02, Keracolor Sanded Grout Grout Size: 1/8" Minimum Recommended Installation: Monolithic Porcelain Cove Base Manufacturer: Daltile Pattern: Stone Attache, Consulate, Antique Color: Premier Grey CS05, Unpolished Size: 6" x 12" Trim Style: Cove Base, S-36C9T Grout Color: Mapei, Pewter 02, Keracolor Sanded Grout Grout Size: 1/8" Minimum Recommended Installation: Monolithic PRODUCTS Paint Manufacturer: Sherwin Williams Color: Pearly White SW 7009	Coordinates with CT-1, CT-2, LVT-1, RF-1, & SDT-1. Reducer Strip: sizing based on flooring applications; provide accordingly. Reducer Strip: See half-filled circle symbol on finish plan. Location/Notes: Elevator Lobby & Level 16 Restrooms, see finish plan. Coordinates with CB-1 Location/Notes: Elevator Lobby & Level 16 Restrooms see finish plan/elevations. Coordinates with FT-1 Location/Notes: With FT-1 Location/Notes: Multiple, see finish plan/elevations.	MILLWO COUNTE	Manufacturer: Daltile Pattern: Stone Attache, Haut Monde, Colorbo Color: Elite Grey HM05, Unpolished Size: 12" x 24" Installation: Monolithic Grout Color: Mapei, Pewter 02, Keracolor San Grout Size: 1/8" Minimum Recommended Porcelain Wall Tile Manufacturer: Daltile Pattern: Volume 1.0, Glazed Porcelain Color: Degrees Silver VL71 Size: 12" x 12" Grout Color: Mapei, Pewter 02, Keracolor San Grout Size: 1/8" Minimum Recommended Installation: Monolithic Natural Stone Mosaic Tile Manufacturer: Daltile Pattern: Limestone Mosaic, Polished Modern Color: Chenille White L191 Size: Irregular Mosaic Grout Color: Mapei, Pewter 02, Keracolor San Grout Size: 1/8" Minimum Recommended Installation: Ashlar ORK RTOPS Quartz Countertop Manufacturer: Silestone Product: Basiq Series Color: Blanco City
Manufacturer: Sherwin Williams * Epoxy Paint in all Restrooms. Color: Dovetail SW 7018 Finish: Eggshell-Satin Finish Specifications: Latex, unless noted otherwise Finish: Suede SD Product Type: Standard HPL High Pressure Laminate Surfaces Manufacturer: Pionite Pattern/Color: Coastal Cottage WC652-WI Finish: Wood Essence WE	PORCEI T-1 WALL	Rubber Base/Transition Strip Manufacturer: Roppe Product: Pinnacle Rubber Base/Rubber Accessories Style: 4" Standard Cove Toe/Reducer Strip Color: Dolphin 129 AIN TILE FLOORING Porcelain Tile Manufacturer: Daltile Pattern: Stone Attache, Consulate, Antique Color: Premier Grey CS05, Unpolished Size: 24" x 48" Grout Color: Mapei, Pewter 02, Keracolor Sanded Grout Grouf Size: 1/8" Minimum Recommended Installation: Monolithic Porcelain Cove Base Manufacturer: Daltile Pattern: Stone Attache, Consulate, Antique Color: Premier Grey CS05, Unpolished Size: 6" x 12" Trim Style: Cove Base, S-36C9T Grout Color: Mapei, Pewter 02, Keracolor Sanded Grout Grout Size: 1/8" Minimum Recommended Installation: Monolithic PRODUCTS Paint Manufacturer: Sherwin Williams Color: Pearly White SW 7009 Finish: Eggshell-Satin Finish	Coordinates with CT-1, CT-2, LVT-1, RF-1, & SDT-1. Reducer Strip: sizing based on flooring applications; provide accordingly. Reducer Strip: See half-filled circle symbol on finish plan. Location/Notes: Elevator Lobby & Level 16 Restrooms, see finish plan. Coordinates with CB-1 Location/Notes: Elevator Lobby & Level 16 Restrooms see finish plan/elevations. Coordinates with FT-1 Location/Notes: With FT-1 Location/Notes: Multiple, see finish plan/elevations.	MILLWO COUNTE	Manufacturer: Daltile Pattern: Stone Attache, Haut Monde, Colorbot Color: Elite Grey HM05, Unpolished Size: 12" x 24" Installation: Monolithic Grout Color: Mapei, Pewter 02, Keracolor San Grout Size: 1/8" Minimum Recommended Porcelain Wall Tile Manufacturer: Daltile Pattern: Volume 1.0, Glazed Porcelain Color: Degrees Silver VL71 Size: 12" x 12" Grout Color: Mapei, Pewter 02, Keracolor San Grout Size: 1/8" Minimum Recommended Installation: Monolithic Natural Stone Mosaic Tile Manufacturer: Daltile Pattern: Limestone Mosaic, Polished Modern Color: Chenille White L191 Size: Irregular Mosaic Grout Color: Mapei, Pewter 02, Keracolor San Grout Size: 1/8" Minimum Recommended Installation: Ashlar ORK RTOPS Quartz Countertop Manufacturer: Silestone Product: Basiq Series Color: Blanco City LAMINATE High Pressure Laminate Surfaces
Color: Dovetail SW 7018 Finish: Eggshell-Satin Finish Specifications: Latex, unless noted otherwise HPL-2 High Pressure Laminate Surfaces Manufacturer: Pionite Pattern/Color: Coastal Cottage WC652-WI Finish: Wood Essence WE	PORCEI T-1 CB-1 WALL PAINT	Rubber Base/Transition Strip Manufacturer: Roppe Product: Pinnacle Rubber Base/Rubber Accessories Style: 4" Standard Cove Toe/Reducer Strip Color: Dolphin 129 AIN TILE FLOORING Porcelain Tile Manufacturer: Daltile Pattern: Stone Attache, Consulate, Antique Color: Premier Grey CS05, Unpolished Size: 24" x 48" Grout Color: Mapei, Pewter 02, Keracolor Sanded Grout Grout Size: 1/8" Minimum Recommended Installation: Monolithic Porcelain Cove Base Manufacturer: Daltile Pattern: Stone Attache, Consulate, Antique Color: Premier Grey CS05, Unpolished Size: 6" x 12" Trim Style: Cove Base, S-36C9T Grout Color: Mapei, Pewter 02, Keracolor Sanded Grout Grout Size: 1/8" Minimum Recommended Installation: Monolithic PRODUCTS Paint Manufacturer: Sherwin Williams Color: Pearly White SW 7009 Finish: Eggshell-Satin Finish Specifications: Latex, unless noted otherwise	Coordinates with CT-1, CT-2, LVT-1, RF-1, & SDT-1. Reducer Strip: sizing based on flooring applications; provide accordingly. Reducer Strip: See half-filled circle symbol on finish plan. Location/Notes: Elevator Lobby & Level 16 Restrooms, see finish plan. Coordinates with CB-1 Location/Notes: Elevator Lobby & Level 16 Restrooms see finish plan/elevations. Coordinates with FT-1 Location/Notes: With FT-1 Location/Notes: Elevator Lobby & Level 16 Restrooms see finish plan/elevations. Coordinates with FT-1 Location/Notes: Multiple, see finish plan/elevations. * Epoxy Paint in all Restrooms.	MILLWO COUNTE	Manufacturer: Daltile Pattern: Stone Attache, Haut Monde, Colorbot Color: Elite Grey HM05, Unpolished Size: 12" x 24" Installation: Monolithic Grout Color: Mapei, Pewter 02, Keracolor San Grout Size: 1/8" Minimum Recommended Porcelain Wall Tile Manufacturer: Daltile Pattern: Volume 1.0, Glazed Porcelain Color: Degrees Silver VL71 Size: 12" x 12" Grout Color: Mapei, Pewter 02, Keracolor San Grout Size: 1/8" Minimum Recommended Installation: Monolithic Natural Stone Mosaic Tile Manufacturer: Daltile Pattern: Limestone Mosaic, Polished Modern Color: Chenille White L191 Size: Irregular Mosaic Grout Color: Mapei, Pewter 02, Keracolor San Grout Size: 1/8" Minimum Recommended Installation: Ashlar ORK RTOPS Quartz Countertop Manufacturer: Silestone Product: Basiq Series Color: Blanco City LAMINATE High Pressure Laminate Surfaces Manufacturer: Pionite
Finish: Eggshell-Satin Finish Specifications: Latex, unless noted otherwise HPL-2 High Pressure Laminate Surfaces Manufacturer: Pionite Pattern/Color: Coastal Cottage WC652-WI Finish: Wood Essence WE	PORCEI T-1 CB-1 WALL PAINT	Rubber Base/Transition Strip Manufacturer: Roppe Product: Pinnacle Rubber Base/Rubber Accessories Style: 4" Standard Cove Toe/Reducer Strip Color: Dolphin 129 AIN TILE FLOORING Porcelain Tile Manufacturer: Daltile Pattern: Stone Attache, Consulate, Antique Color: Premier Grey CS05, Unpolished Size: 24" x 48" Grout Color: Mapei, Pewter 02, Keracolor Sanded Grout Grout Size: 1/8" Minimum Recommended Installation: Monolithic Porcelain Cove Base Manufacturer: Daltile Pattern: Stone Attache, Consulate, Antique Color: Premier Grey CS05, Unpolished Size: 6" x 12" Trim Style: Cove Base, S-36C9T Grout Color: Mapei, Pewter 02, Keracolor Sanded Grout Grout Size: 1/8" Minimum Recommended Installation: Monolithic PRODUCTS Paint Manufacturer: Sherwin Williams Color: Pearly White SW 7009 Finish: Eggshell-Satin Finish Specifications: Latex, unless noted otherwise	Coordinates with CT-1, CT-2, LVT-1, RF-1, & SDT-1. Reducer Strip: sizing based on flooring applications; provide accordingly. Reducer Strip: See half-filled circle symbol on finish plan. Location/Notes: Elevator Lobby & Level 16 Restrooms, see finish plan. Coordinates with CB-1 Location/Notes: Elevator Lobby & Level 16 Restrooms see finish plan/elevations. Coordinates with FT-1 Location/Notes: Elevator Lobby & Level 16 Restrooms see finish plan/elevations. Coordinates with FT-1 Location/Notes: Multiple, see finish plan/elevations. * Epoxy Paint in all Restrooms. Location/ Notes: Multiple, see finish plan/elevations.	MILLWO COUNTE	Manufacturer: Daltile Pattern: Stone Attache, Haut Monde, Colorbot Color: Elite Grey HM05, Unpolished Size: 12" x 24" Installation: Monolithic Grout Color: Mapei, Pewter 02, Keracolor San Grout Size: 1/8" Minimum Recommended Porcelain Wall Tile Manufacturer: Daltile Pattern: Volume 1.0, Glazed Porcelain Color: Degrees Silver VL71 Size: 12" x 12" Grout Color: Mapei, Pewter 02, Keracolor San Grout Size: 1/8" Minimum Recommended Installation: Monolithic Natural Stone Mosaic Tile Manufacturer: Daltile Pattern: Limestone Mosaic, Polished Modern Color: Chenille White L191 Size: Irregular Mosaic Grout Color: Mapei, Pewter 02, Keracolor San Grout Size: 1/8" Minimum Recommended Installation: Ashlar ORK RTOPS Quartz Countertop Manufacturer: Silestone Product: Basiq Series Color: Blanco City LAMINATE High Pressure Laminate Surfaces Manufacturer: Pionite Pattern/Color: Absolute Acajou WY160
Specifications: Latex, unless noted otherwise HPL-2 High Pressure Laminate Surfaces Manufacturer: Pionite Pattern/Color: Coastal Cottage WC652-WI Finish: Wood Essence WE	PORCEI T-1 CB-1 WALL PAINT	Rubber Base/Transition Strip Manufacturer: Roppe Product: Pinnacle Rubber Base/Rubber Accessories Style: 4" Standard Cove Toe/Reducer Strip Color: Dolphin 129 AIN TILE FLOORING Porcelain Tile Manufacturer: Daltile Pattern: Stone Attache, Consulate, Antique Color: Premier Grey CS05, Unpolished Size: 24" x 48" Grout Color: Mapei, Pewter 02, Keracolor Sanded Grout Grout Size: 1/8" Minimum Recommended Installation: Monolithic Porcelain Cove Base Manufacturer: Daltile Pattern: Stone Attache, Consulate, Antique Color: Premier Grey CS05, Unpolished Size: 6" x 12" Trim Style: Cove Base, S-36C9T Grout Color: Mapei, Pewter 02, Keracolor Sanded Grout Grout Size: 1/8" Minimum Recommended Installation: Monolithic PRODUCTS Paint Manufacturer: Sherwin Williams Color: Pearly White SW 7009 Finish: Eggshell-Satin Finish Specifications: Latex, unless noted otherwise Paint Manufacturer: Sherwin Williams	Coordinates with CT-1, CT-2, LVT-1, RF-1, & SDT-1. Reducer Strip: sizing based on flooring applications; provide accordingly. Reducer Strip: See half-filled circle symbol on finish plan. Location/Notes: Elevator Lobby & Level 16 Restrooms, see finish plan. Coordinates with CB-1 Location/Notes: Elevator Lobby & Level 16 Restrooms see finish plan/elevations. Coordinates with FT-1 Location/Notes: Elevator Lobby & Level 16 Restrooms see finish plan/elevations. Coordinates with FT-1 Location/Notes: Multiple, see finish plan/elevations. * Epoxy Paint in all Restrooms. Location/ Notes: Multiple, see finish plan/elevations.	MILLWO COUNTE	Manufacturer: Daltile Pattern: Stone Attache, Haut Monde, Colorbot Color: Elite Grey HM05, Unpolished Size: 12" x 24" Installation: Monolithic Grout Color: Mapei, Pewter 02, Keracolor Sar Grout Size: 1/8" Minimum Recommended Porcelain Wall Tile Manufacturer: Daltile Pattern: Volume 1.0, Glazed Porcelain Color: Degrees Silver VL71 Size: 12" x 12" Grout Color: Mapei, Pewter 02, Keracolor Sar Grout Size: 1/8" Minimum Recommended Installation: Monolithic Natural Stone Mosaic Tile Manufacturer: Daltile Pattern: Limestone Mosaic, Polished Modern Color: Chenille White L191 Size: Irregular Mosaic Grout Color: Mapei, Pewter 02, Keracolor Sar Grout Size: 1/8" Minimum Recommended Installation: Ashlar ORK RTOPS Quartz Countertop Manufacturer: Silestone Product: Basiq Series Color: Blanco City LAMINATE High Pressure Laminate Surfaces Manufacturer: Pionite Pattern/Color: Absolute Acajou WY160 Finish: Suede SD
Manufacturer: Pionite Pattern/Color: Coastal Cottage WC652-WI Finish: Wood Essence WE	ORCEI T-1 CB-1 VALL AINT T-1	Rubber Base/Transition Strip Manufacturer: Roppe Product: Pinnacle Rubber Base/Rubber Accessories Style: 4" Standard Cove Toe/Reducer Strip Color: Dolphin 129 AIN TILE FLOORING Porcelain Tile Manufacturer: Daltile Pattern: Stone Attache, Consulate, Antique Color: Premier Grey CS05, Unpolished Size: 24" x 48" Grout Color: Mapei, Pewter 02, Keracolor Sanded Grout Grout Size: 1/8" Minimum Recommended Installation: Monolithic Porcelain Cove Base Manufacturer: Daltile Pattern: Stone Attache, Consulate, Antique Color: Premier Grey CS05, Unpolished Size: 6" x 12" Trim Style: Cove Base, S-36C9T Grout Color: Mapei, Pewter 02, Keracolor Sanded Grout Grout Size: 1/8" Minimum Recommended Installation: Monolithic PRODUCTS Paint Manufacturer: Sherwin Williams Color: Pearly White SW 7009 Finish: Eggshell-Satin Finish Specifications: Latex, unless noted otherwise Paint Manufacturer: Sherwin Williams Color: Dovetail SW 7018	Coordinates with CT-1, CT-2, LVT-1, RF-1, & SDT-1. Reducer Strip: sizing based on flooring applications; provide accordingly. Reducer Strip: See half-filled circle symbol on finish plan. Location/Notes: Elevator Lobby & Level 16 Restrooms, see finish plan. Coordinates with CB-1 Location/Notes: Elevator Lobby & Level 16 Restrooms see finish plan/elevations. Coordinates with FT-1 Location/Notes: Elevator Lobby & Level 16 Restrooms see finish plan/elevations. Coordinates with FT-1 Location/Notes: Multiple, see finish plan/elevations. * Epoxy Paint in all Restrooms. Location/ Notes: Multiple, see finish plan/elevations.	MILLWO COUNTE	Manufacturer: Daltile Pattern: Stone Attache, Haut Monde, Colorbotolor: Elite Grey HM05, Unpolished Size: 12" x 24" Installation: Monolithic Grout Color: Mapei, Pewter 02, Keracolor Sar Grout Size: 1/8" Minimum Recommended Porcelain Wall Tile Manufacturer: Daltile Pattern: Volume 1.0, Glazed Porcelain Color: Degrees Silver VL71 Size: 12" x 12" Grout Color: Mapei, Pewter 02, Keracolor Sar Grout Size: 1/8" Minimum Recommended Installation: Monolithic Natural Stone Mosaic Tile Manufacturer: Daltile Pattern: Limestone Mosaic, Polished Modern Color: Chenille White L191 Size: Irregular Mosaic Grout Color: Mapei, Pewter 02, Keracolor Sar Grout Size: 1/8" Minimum Recommended Installation: Ashlar ORK RTOPS Quartz Countertop Manufacturer: Silestone Product: Basiq Series Color: Blanco City LAMINATE High Pressure Laminate Surfaces Manufacturer: Pionite Pattern/Color: Absolute Acajou WY160 Finish: Suede SD
Finish: Wood Essence WE	DORCEI T-1 CB-1 VALL AINT T-1	Rubber Base/Transition Strip Manufacturer: Roppe Product: Pinnacle Rubber Base/Rubber Accessories Style: 4" Standard Cove Toe/Reducer Strip Color: Dolphin 129 AIN TILE FLOORING Porcelain Tile Manufacturer: Daltile Pattern: Stone Attache, Consulate, Antique Color: Premier Grey CS05, Unpolished Size: 24" x 48" Grout Color: Mapei, Pewter 02, Keracolor Sanded Grout Grout Size: 1/8" Minimum Recommended Installation: Monolithic Porcelain Cove Base Manufacturer: Daltile Pattern: Stone Attache, Consulate, Antique Color: Premier Grey CS05, Unpolished Size: 6" x 12" Trim Style: Cove Base, S-36C9T Grout Color: Mapei, Pewter 02, Keracolor Sanded Grout Grout Size: 1/8" Minimum Recommended Installation: Monolithic PRODUCTS Paint Manufacturer: Sherwin Williams Color: Pearly White SW 7009 Finish: Eggshell-Satin Finish Specifications: Latex, unless noted otherwise Paint Manufacturer: Sherwin Williams Color: Dovetail SW 7018 Finish: Eggshell-Satin Finish	Coordinates with CT-1, CT-2, LVT-1, RF-1, & SDT-1. Reducer Strip: sizing based on flooring applications; provide accordingly. Reducer Strip: See half-filled circle symbol on finish plan. Location/Notes: Elevator Lobby & Level 16 Restrooms, see finish plan. Coordinates with CB-1 Location/Notes: Elevator Lobby & Level 16 Restrooms see finish plan/elevations. Coordinates with FT-1 Location/Notes: Elevator Lobby & Level 16 Restrooms see finish plan/elevations. Coordinates with FT-1 Location/Notes: Multiple, see finish plan/elevations. * Epoxy Paint in all Restrooms. Location/ Notes: Multiple, see finish plan/elevations.	MILLWO COUNTE	Manufacturer: Daltile Pattern: Stone Attache, Haut Monde, Colorbot Color: Elite Grey HM05, Unpolished Size: 12" x 24" Installation: Monolithic Grout Color: Mapei, Pewter 02, Keracolor Sar Grout Size: 1/8" Minimum Recommended Porcelain Wall Tile Manufacturer: Daltile Pattern: Volume 1.0, Glazed Porcelain Color: Degrees Silver VL71 Size: 12" x 12" Grout Color: Mapei, Pewter 02, Keracolor Sar Grout Size: 1/8" Minimum Recommended Installation: Monolithic Natural Stone Mosaic Tile Manufacturer: Daltile Pattern: Limestone Mosaic, Polished Modern Color: Chenille White L191 Size: Irregular Mosaic Grout Color: Mapei, Pewter 02, Keracolor Sar Grout Size: 1/8" Minimum Recommended Installation: Ashlar ORK RTOPS Quartz Countertop Manufacturer: Silestone Product: Basiq Series Color: Blanco City LAMINATE High Pressure Laminate Surfaces Manufacturer: Pionite Pattern/Color: Absolute Acajou WY160 Finish: Suede SD Product Type: Standard HPL High Pressure Laminate Surfaces
	ORCEI T-1 CB-1 VALL AINT T-1	Rubber Base/Transition Strip Manufacturer: Roppe Product: Pinnacle Rubber Base/Rubber Accessories Style: 4" Standard Cove Toe/Reducer Strip Color: Dolphin 129 AIN TILE FLOORING Porcelain Tile Manufacturer: Daltile Pattern: Stone Attache, Consulate, Antique Color: Premier Grey CS05, Unpolished Size: 24" x 48" Grout Color: Mapei, Pewter 02, Keracolor Sanded Grout Grout Size: 1/8" Minimum Recommended Installation: Monolithic Porcelain Cove Base Manufacturer: Daltile Pattern: Stone Attache, Consulate, Antique Color: Premier Grey CS05, Unpolished Size: 6" x 12" Trim Style: Cove Base, S-36C9T Grout Color: Mapei, Pewter 02, Keracolor Sanded Grout Grout Size: 1/8" Minimum Recommended Installation: Monolithic PRODUCTS Paint Manufacturer: Sherwin Williams Color: Pearly White SW 7009 Finish: Eggshell-Satin Finish Specifications: Latex, unless noted otherwise Paint Manufacturer: Sherwin Williams Color: Dovetail SW 7018 Finish: Eggshell-Satin Finish	Coordinates with CT-1, CT-2, LVT-1, RF-1, & SDT-1. Reducer Strip: sizing based on flooring applications; provide accordingly. Reducer Strip: See half-filled circle symbol on finish plan. Location/Notes: Elevator Lobby & Level 16 Restrooms, see finish plan. Coordinates with CB-1 Location/Notes: Elevator Lobby & Level 16 Restrooms see finish plan/elevations. Coordinates with FT-1 Location/Notes: Elevator Lobby & Level 16 Restrooms see finish plan/elevations. Coordinates with FT-1 Location/Notes: Multiple, see finish plan/elevations. * Epoxy Paint in all Restrooms. Location/ Notes: Multiple, see finish plan/elevations.	MILLWO COUNTE	Manufacturer: Daltile Pattern: Stone Attache, Haut Monde, Colorbot Color: Elite Grey HM05, Unpolished Size: 12" x 24" Installation: Monolithic Grout Color: Mapei, Pewter 02, Keracolor San Grout Size: 1/8" Minimum Recommended Porcelain Wall Tile Manufacturer: Daltile Pattern: Volume 1.0, Glazed Porcelain Color: Degrees Silver VL71 Size: 12" x 12" Grout Color: Mapei, Pewter 02, Keracolor San Grout Size: 1/8" Minimum Recommended Installation: Monolithic Natural Stone Mosaic Tile Manufacturer: Daltile Pattern: Limestone Mosaic, Polished Modern Color: Chenille White L191 Size: Irregular Mosaic Grout Color: Mapei, Pewter 02, Keracolor San Grout Size: 1/8" Minimum Recommended Installation: Ashlar ORK RTOPS Quartz Countertop Manufacturer: Silestone Product: Basiq Series Color: Blanco City LAMINATE High Pressure Laminate Surfaces Manufacturer: Pionite Pattern/Color: Absolute Acajou WY160 Finish: Suede SD Product Type: Standard HPL High Pressure Laminate Surfaces Manufacturer: Pionite
	PORCEI T-1 CB-1 WALL PAINT	Rubber Base/Transition Strip Manufacturer: Roppe Product: Pinnacle Rubber Base/Rubber Accessories Style: 4" Standard Cove Toe/Reducer Strip Color: Dolphin 129 AIN TILE FLOORING Porcelain Tile Manufacturer: Daltile Pattern: Stone Attache, Consulate, Antique Color: Premier Grey CS05, Unpolished Size: 24" x 48" Grout Color: Mapei, Pewter 02, Keracolor Sanded Grout Grout Size: 1/8" Minimum Recommended Installation: Monolithic Porcelain Cove Base Manufacturer: Daltile Pattern: Stone Attache, Consulate, Antique Color: Premier Grey CS05, Unpolished Size: 6" x 12" Trim Style: Cove Base, S-36C9T Grout Color: Mapei, Pewter 02, Keracolor Sanded Grout Grout Size: 1/8" Minimum Recommended Installation: Monolithic PRODUCTS Paint Manufacturer: Sherwin Williams Color: Pearly White SW 7009 Finish: Eggshell-Satin Finish Specifications: Latex, unless noted otherwise Paint Manufacturer: Sherwin Williams Color: Dovetail SW 7018 Finish: Eggshell-Satin Finish	Coordinates with CT-1, CT-2, LVT-1, RF-1, & SDT-1. Reducer Strip: sizing based on flooring applications; provide accordingly. Reducer Strip: See half-filled circle symbol on finish plan. Location/Notes: Elevator Lobby & Level 16 Restrooms, see finish plan. Coordinates with CB-1 Location/Notes: Elevator Lobby & Level 16 Restrooms see finish plan/elevations. Coordinates with FT-1 Location/Notes: Elevator Lobby & Level 16 Restrooms see finish plan/elevations. Coordinates with FT-1 Location/Notes: Multiple, see finish plan/elevations. * Epoxy Paint in all Restrooms. Location/ Notes: Multiple, see finish plan/elevations.	MILLWO COUNTE	Manufacturer: Daltile Pattern: Stone Attache, Haut Monde, Colorbot Color: Elite Grey HM05, Unpolished Size: 12" x 24" Installation: Monolithic Grout Color: Mapei, Pewter 02, Keracolor San Grout Size: 1/8" Minimum Recommended Porcelain Wall Tile Manufacturer: Daltile Pattern: Volume 1.0, Glazed Porcelain Color: Degrees Silver VL71 Size: 12" x 12" Grout Color: Mapei, Pewter 02, Keracolor San Grout Size: 1/8" Minimum Recommended Installation: Monolithic Natural Stone Mosaic Tile Manufacturer: Daltile Pattern: Limestone Mosaic, Polished Modern Color: Chenille White L191 Size: Irregular Mosaic Grout Color: Mapei, Pewter 02, Keracolor San Grout Size: 1/8" Minimum Recommended Installation: Ashlar ORK RTOPS Quartz Countertop Manufacturer: Silestone Product: Basiq Series Color: Blanco City LAMINATE High Pressure Laminate Surfaces Manufacturer: Pionite Pattern/Color: Absolute Acajou WY160 Finish: Suede SD Product Type: Standard HPL High Pressure Laminate Surfaces Manufacturer: Pionite Pattern/Color: Coastal Cottage WC652-WE

MT-1	Natural Stone Mosaic Tile	Location/Notes: Breakroom/Prep, see finish plan/elevations.
	Manufacturer: Daltile	
	Pattern: Limestone Mosaic, Polished Modern	
	Color: Chenille White L191	
	Size: Irregular Mosaic	
	Grout Color: Mapei, Pewter 02, Keracolor Sanded Grout	
	Grout Size: 1/8" Minimum Recommended	
	Installation: Ashlar	
MILLW	ORK	
001111		
COUNT	ERTOPS	
07.1	Overthe Country to the	La cartiare (Nactors All politicant) and representation and all other materials
QZ-1	Quartz Countertop	Location/Notes: All millwork countertops, unless noted otherwise.
	Manufacturer: Silestone	See elevations/details for exact placement.
	Product: Basiq Series	* Updating restroom vanities as noted *
	Color: Blanco City	
PLASTIC	CLAMINATE	
	lui	The group of the state of the s
HPL-1	High Pressure Laminate Surfaces	Location/Notes: All millwork casing, unless noted otherwise.
	Manufacturer: Pionite	See elevations/details for exact placement.
	Pattern/Color: Absolute Acajou WY160	
	Finish: Suede SD	
	Product Type: Standard HPL	
HPL-2	High Pressure Laminate Surfaces	Location/Notes: Mailroom Millwork Counters.
	Manufacturer: Pionite	See elevations/details for exact placement.
	Pattern/Color: Coastal Cottage WC652-WE	
	Finish: Wood Essence WE	
	Product Type: Standard HPL	

Location/ Notes: Elevator Doors, see finish plan/ key notes.

ocation/ Notes: Multiple, see finish plan/elevations

Location/ Notes: Multiple, see finish plan/elevations

ocation/ Notes: Multiple, see finish plan/elevations

Location/ Notes: Multiple, see finish plan/elevations.

Location/ Notes: Glass Storefront and Door Lite Panels


Location/Notes: Level 16 Restrooms, see finish plan/elevations.


ocation/Notes: Drinking Fountain Alcove, see finish plan/elevations.

ALL SIGNAGE TYPE AND LOCATION TO BE COORDINATED BY OWNER.

BLACK POWDERCOATED PLATE W/ SQUARE BIKE STORAGE EDGES, MECHANICALLY FASTENED TO THE WALL W/ CONCEALED FASTENERS, COORDINATE TYPE OF FASTENER WITH RAISED ACRYLIC LETTERS IN SHERWIN WILLIAMS 6775 BRINY, GRADE 2 BRAILLE

INTERIOR SIGNAGE TYPE A INTERIOR SIGNAGE TYPE B

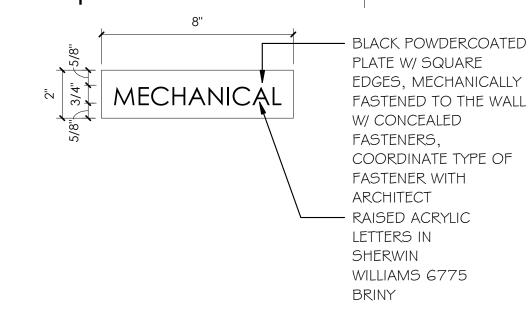

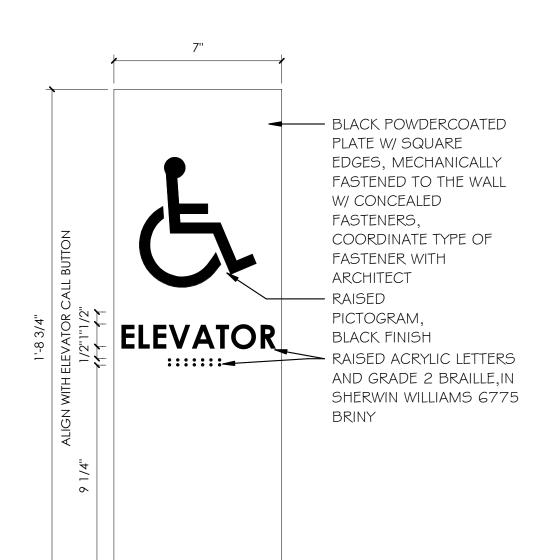


- STAINLESS STEEL PLATE W/ SQUARE EDGES, MECHANICALLY FASTENED TO THE WALL IN CASE OF W/ CONCEALED FIRE FASTENERS, **USE STAIRWAY** COORDINATE TYPE OF DO NOT USE FASTENER WITH ELEVATORS * **ARCHITECT** RAISED LETTERS AND GRADE 2 BRAILLE, BLACK CALL BUTTONS


TYPICAL SIGANGE DETAILS GC TO COORDIANTE ALL SIGNAGE TYPES AND LOCAITONS WITH OWNER PRIOR TO ORDERING.


NOTE: I. PROVIDE FIRE EXTINGUISHER SIGN PER OSHA/IFC REQUIREMENTS 2. ALL TEXT TO BE IN CENTURY GOTHIC FONT 3. PLATE THICKNESS TO BE 0'-0 1/4"

INTERIOR SIGNAGE TYPE C

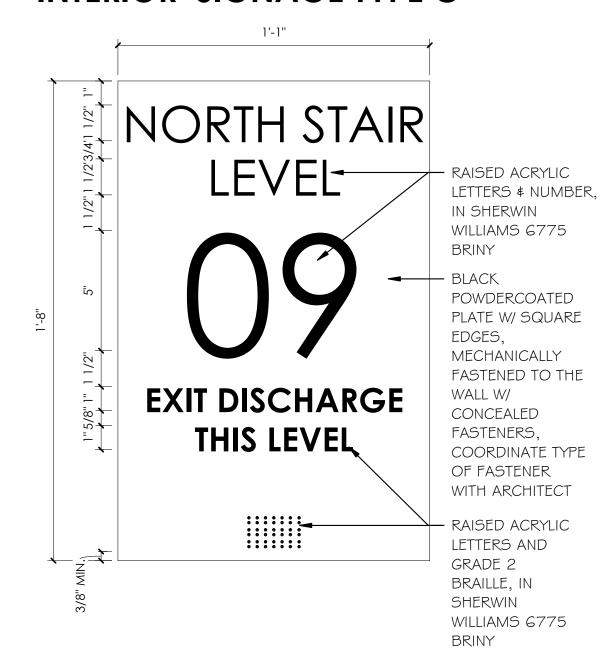


INTERIOR SIGNAGE TYPE D

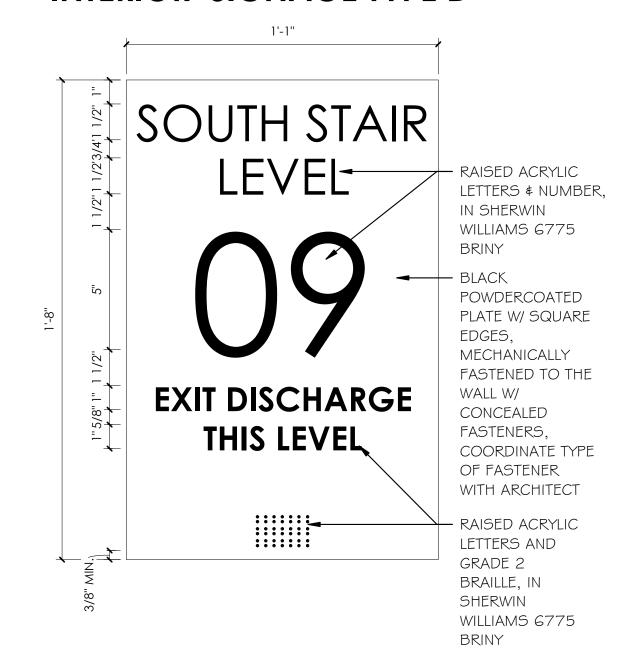


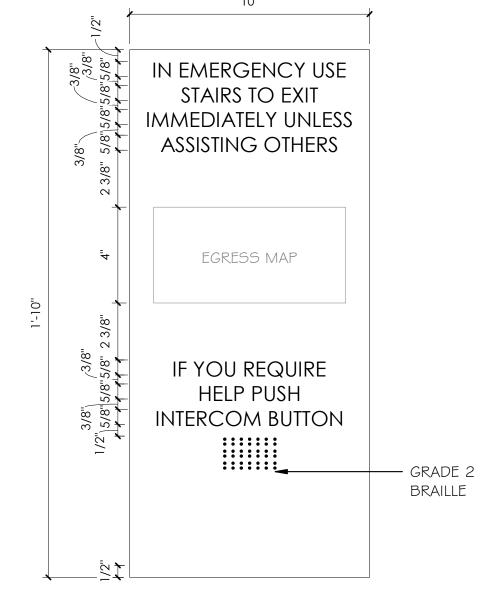


INTERIOR SIGNAGE TYPE E

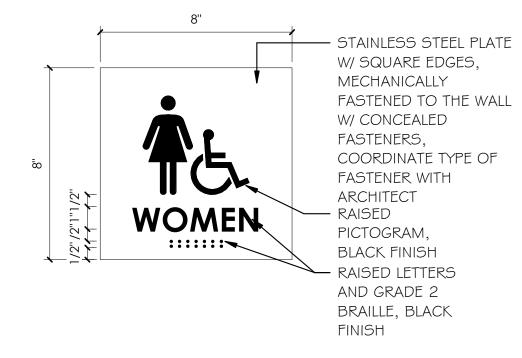

INTERIOR SIGNAGE TYPE L

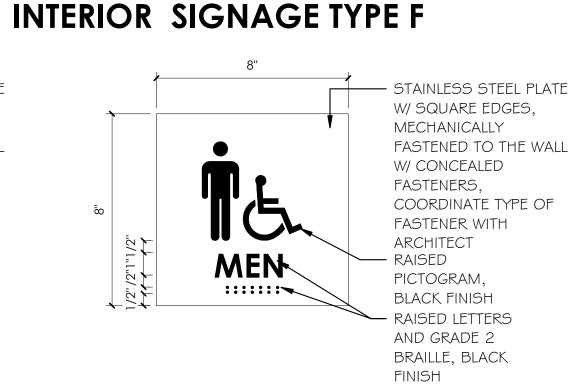


INTERIOR SIGNAGE TYPE M

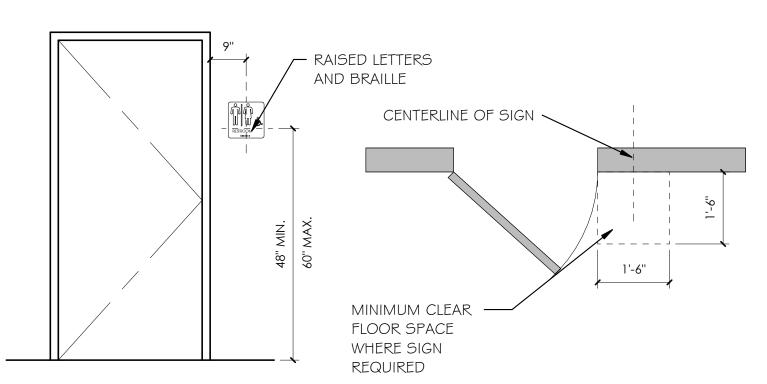

TYPICAL SIGN MOUNTING LOCATION

ajc architects 703 east 1700 south salt lake city, ut 84105 ajcarchitects.com

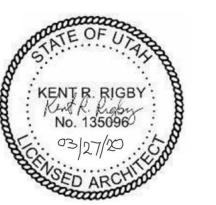

ARCHITECT / CONSULTANT

AUTHORITY HAVING JURISDICTION

PROJECT DESCRIPTION

INTERMOUNTAIN HEALTHCARE LEVEL 09 TI

KEY PRIVATE BANK CITY CREEK CENTER 36 SOUTH STATE STREET SALT LAKE CITY, UT 84111

SHEET NAME:

ROOM SIGNAGE SCHEDULE + SIGNAGE

REVISIONS

MARK DATE DESCRIPTION

ISSUE DATE: 03/26/2020 ISSUE TYPE: **CD PERMIT SET** KL & SR

DRAWN BY: CHECKED BY: K. RIGBY PROJECT#: 1953

SHEET NUMBER:

FC

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PIPING LEGEND							
NOT	E: ALL ABBREVIATIONS MAY NOT BE USED.						
— HPS—— — MPS—— — LPS—— — HPC—— — MPC—— — LPC—— — PC —— — TWS—— — CHWS—— — CHWR—— — HHWS——	HIGH PRESSURE STEAM MEDIUM PRESSURE STEAM LOW PRESSURE STEAM HIGH PRESSURE CONDENSATE RETURN MEDIUM PRESSURE CONDENSATE RETURN LOW PRESSURE CONDENSATE RETURN PUMP DISCHARGE TEMPERED WATER SUPPLY CHILLED WATER RETURN HEATING HOT WATER SUPPLY						

DEFINITIONS

HHWR HEATING HOT WATER RETURN

DRAIN LINE

HOT GAS BYPASS

GLYCOL SUPPLY

GLYCOL RETURN

FUEL OIL SUPPLY

FUEL OIL VENT

CWS

CWR

-gs--

FOV

REFRIGERANT LIQUID

REFRIGERANT SUPPLY

CONDENSER WATER SUPPLY

CONDENSER WATER RETURN

NOTE: ALL DEFINITIONS MAY NOT BE USED

INDICATED: THE TERM "INDICATED" REFERS TO GRAPHIC REPRESENTATIONS, NOTES, OR SCHEDULES ON THE DRAWINGS, OTHER PARAGRAPHS OR SCHEDULES IN THE SPECIFICATIONS, AND SIMILAR REQUIREMENTS IN THE CONTRACT DOCUMENTS. WHERE TERMS SUCH AS "SHOWN". "NOTED". "SCHEDULED". AND "SPECIFIED" ARE USED. IT IS TO HELP THE READER LOCATE THE REFERENCE, NO LIMITATION ON LOCATION IS INTENDED.

DIRECTED: TERMS SUCH AS "DIRECTED", "REQUESTED", AUTHORIZED" "SELECTED", "APPROVED", "REQUIRED", AND "PERMITTED" MEAN "DIRECTED BY THE ENGINEER", "REQUESTED BY THE ENGINEER", AND SIMILAR PHRASES.

APPROVED: THE TERM "APPROVED", WHERE USED IN CONJUNCTION WITH THE ENGINEER'S ACTION ON THE CONTRACTOR'S SUBMITTALS. APPLICATIONS, AND REQUESTS, IS LIMITED TO THE ENGINEER'S DUTIES AND RESPONSIBILITIES AS STATED IN GENERAL AND SUPPLEMENTARY

FURNISH: THE TERM "FURNISH" IS USED TO MEAN "SUPPLY AND DELIVER TO THE PROJECT SITE, READY FOR UNLOADING, UNPACKING, ASSEMBLY, INSTALLATION, AND SIMILAR OPERATIONS."

INSTALL: THE TERM "INSTALL" IS USED TO DESCRIBE OPERATIONS AT PROJECT SITE INCLUDING THE ACTUAL "UNLOADING, UNPACKING, ASSEMBLY, ERECTION, PLACING, ANCHORING, APPLYING, WORKING TO DIMENSION, FINISHING, CURING, PROTECTING, CLEANING, AND SIMILAR OPERATIONS."

PROVIDE: THE TERM "PROVIDE" MEANS "TO FURNISH AND INSTALL, COMPLETE AND READY FOR THE INTENDED USE."

INSTALLER: AN "INSTALLER" IS THE CONTRACTOR OR AN ENTITY ENGAGED BY THE CONTRACTOR, EITHER AS AN EMPLOYEE. SUBCONTRACTOR, OR SUB-SUBCONTRACTOR, FOR PERFORMANCE OF A PARTICULAR CONSTRUCTION ACTIVITY, INCLUDING INSTALLATION, ERECTION, APPLICATION, AND SIMILAR OPERATIONS. INSTALLERS ARE REQUIRED TO BE EXPERIENCED IN THE OPERATIONS THEY ARE ENGAGED TO PERFORM.

SYMBOL LEGEND

ELEVATION OR SECTION INDICATOR, EXTERIOR:

INDICATES ELEVATION OR SECTION NUMBER,

SYMBOL	DESCRIPTION
RFFFR	FNCF LINES AND SYMBOLS

	ENGE LINES / NAD STRIBGES
# SHEET	DETAIL INDICATOR: # INDICATES DETAIL NUMBER, SHEET INDICATES DRAWING SHEET WHERE DETAIL IS SHOWN.

SHEET	SHEET INDICATES DRAWING SHEET WHERE ELEVATION OR SECTION IS SHOWN.
# SHEET	ELEVATION OR SECTION INDICATOR, INTERIOR: # INDICATES ELEVATION OR SECTION NUMBER, SHEET INDICATES DRAWING SHEET WHERE ELEVATION OR SECTION IS SHOWN.
100	SPACE NUMBER
1	KEYNOTE INDICATOR
	REVISION INDICATOR

100	SPACE NUME
1	KEYNOTE INI
	REVISION INI
	EQUIPMENT
	PLUMBING F
TYPE	DIFFUSER/GI

\'_'	RETNOTE INDICATOR
	REVISION INDICATOR
	EQUIPMENT INDICATOR
	PLUMBING FIXTURE INDICATOR
TYPE CFM SIZE	DIFFUSER/GRILLE INDICATOR
TYPE SIZE	DIFFUSER/GRILLE INDICATOR
	BREAK, STRAIGHT
>	BREAK, ROUND
MATCH LINE SEE XX/X-XXX	MATCHLINE INDICATOR
	HIDDEN FEATURES LINE: HIDDEN, THIN LINE

CONTRACT LIMIT LINE: DASHDOT, WIDE LINE

NEW CONNECTION TO EXISTING

POINT OF DEMOLITION

ABBREVIATIONS

NOTE: ALL ABBREVIATIONS MAY NOT BE USED. (E) **EXISTING FUTURE** (F) ACCESS DOOR AD AIR COND AIR CONDITION(-ING,-ED) APD AIR PRESSURE DROP BD BALANCING DAMPER BHP BRAKE HORSE POWER BTU BRITISH THERMAL UNIT BTUH BTU/HOUR CFH CUBIC FEET PER HOUR CFM **CUBIC FEET PER MINUTE** CLG COOLING COMP COMPONENT COND CONDENS(-ER, -ING, -ATION) CV CONTROL VALVE DB DRY BULB TEMPERATURE DCW DOMESTIC COLD WATER DHW DOMESTIC HOT WATER DHWR DOMESTIC HOT WATER RECIRC DIA DIAMETER DISCH DISCHARGE DP DEPTH OR DEEP EΑ EXHAUST AIR EER **ENERGY EFFICIENCY RATIO** EFF **EFFICIENCY** EG ETHYLENE GLYCOL

ELEC **ELECTRIC ELEV ELEVATION** ENT **ENTERING** EVAPORAT(-E, -ING, -ED, -OR) EVAP EWT ENTERING WATER TEMPERATURE EXT EXTERNAL FC FLEXIBLE CONNECT(-OR, -ION) FD FIRE DAMPER FLA FPI FPM

FULL LOAD AMPS FINS PER INCH FEET PER MINUTE FEET PER SECOND FPS FSD FIRE SMOKE DAMPER GAL GALLON(S) GE **GREASE EXHAUST** GPH GALLONS PER HOUR GPM GALLONS PER MINUTE HD HEAD HG **MERCURY** HP **HORSEPOWER**

HOUR HEIGHT HEATING HERTZ (FREQUENCY) **INSIDE DIAMETER** INCH KILOWATT

LEAVING AIR TEMPERATURE POUNDS LENGTH LATENT HEAT

LOCKED ROTOR AMPS LEAVING LEAVING WATER TEMPERATURE THOUSAND BTU PER HOUR MINIMUM CIRCUIT AMPS MANUFACTUR(-ER, -ED)

NOISE CRITERIA NOT IN CONTRACT NORMALLY OPEN NET POSITIVE SUCTION HEAD NOT TO SCALE OUTSIDE AIR

OUTSIDE DIAMETER OUNCE PRESSURE DROP OR DIFFERENCE PROPOLENE GLYCOL PHASE

PARTS PER MILLION **PRESSURE** POUNDS PER SQUARE FOOT POUNDS PER SQUARE INCH PSI ABSOLUTE PSI GAUGE THERMAL RESISTANCE

RECIRCULATE REFRIGERATION REQUIRED RATED LOAD AMPS REVOLUTIONS PER MINUTE SUPPLY AIR SHADING COEFFICIENT

SCFM STANDARD CUBIC FEET PER MINUTE SCW SOFT COLD WATER SF SAFETY FACTOR SH SENSIBLE HEAT SP STATIC PRESSURE SPEC(S) SPECIFICATION(S) SQ SQUARE STD STANDARD SW SOIL, WASTE TA(R) TRANSFER AIR (RETURN)

TRANSFER AIR (SUPPLY) TEMP. DROP OR DIFF. **TEMPERATURE** THERMAL TOTAL **THERMOSTAT** VOLT **VENT**

VAV VARIABLE AIR VOLUME VEL **VELOCITY TEMPERATURE** VEL VELOCITY VENT VENT, VENTILATION **VERT** VERTICAL VFD VARIABLE FREQUENCY DRIVE

WET BULB TEMP WATER COLUMN WATER GAUGE WATER PRESSURE DROP MECHANICAL GENERAL NOTES

THE MECHANICAL DRAWINGS SHOW THE GENERAL DESIGN, ARRANGEMENT & EXTENT OF THE MECHANICAL SYSTEM. BECAUSE OF THE SMALL SCALE OF THE DRAWINGS, THESE DRAWINGS DO NOT SHOW ALL OFFSETS, BENDS OR ELBOWS NECESSARY FOR THE COMPLETE INSTALLATION IN THE SPACE PROVIDED. CONTRACTOR SHALL MAKE SUCH SLIGHT ALTERATIONS AS MAY BE NECESSARY TO MAKE THE SYSTEM COMPLETE & OPERATIONAL IN ACCORDANCE WITH THE

MAJOR DEVIATIONS SUCH AS CHANGES IN COMPONENT SIZES, WEIGHTS, QUANTITIES OR MATERIAL REQUIRE PRIOR APPROVAL BY THE DESIGN ENGINEER.

THE DRAWINGS & SPECIFICATIONS HAVE BEEN PREPARED TO SUPPLEMENT EACH OTHER & SHALL BE INTERPRETED AS AN INTEGRAL UNIT WITH THE ITEMS SHOWN ON ONE & NOT THE OTHER BEING FURNISHED & INSTALLED AS THOUGH SHOWN &

THE ENTIRE MECHANICAL INSTALLATION SHALL CONFORM TO THE REQUIREMENTS OF THE MOST RECENTLY ADOPTED BUILDING CODES, MECHANICAL CODE, PLUMBING CODE, ELECTRICAL CODE, & ALL OTHER APPLICABLE CITY, COUNTY, STATE, & FEDERAL CODES & REGULATIONS IN

THE ENTIRE MECHANICAL INSTALLATION SHALL CONFORM TO ANY CODES, RULES, REGULATIONS & REQUIREMENTS OF THE BUILDING OWNER.

PRIOR TO FABRICATION & INSTALLATION OF ANY MECHANICAL COMPONENT THE CONTRACTOR SHALL COORDINATE THE INSTALLATION OF ALL MECHANICAL WORK WITH ALL OTHER BUILDING TRADES. INCLUDING BUILDING TRADES HIRED DIRECTLY BY THE OWNER. WHERE CONFLICTS MAY OCCUR, THEY SHALL BE RESOLVED PRIOR TO INSTALLATION.

THE SPACE ABOVE ALL CEILINGS IS LIMITED. CAREFUL COORDINATION IS REQUIRED WITH ALL TRADES BEFORE ANY PIPE, DUCT, OR EQUIPMENT IS ORDERED & OR INSTALLED, ANY CONFLICTS &/OR CHANGES FOUND DURING INSTALLATION THAT RESULTS FROM THE LACK OF COORDINATION BY THE CONTRACTORS DURING THE SHOP DRAWING PROCESS ARE THE RESPONSIBILITY OF THE CONTRACTOR.

ALL MECHANICAL INFORMATION IS NOT SHOWN ON THE MECHANICAL DRAWINGS. THE CONTRACTOR SHALL BE RESPONSIBLE FOR COORDINATING ALL INFORMATION ON ALL OTHER CONSTRUCTION DOCUMENT.

THE CONTRACTOR SHALL BE RESPONSIBLE TO REVIEW & USE, WHERE APPROPRIATE, ALL THE MECHANICAL DETAILS SHOWN ON THE DRAWINGS. DETAILS MAY OR MAY NOT BE CALLED OUT ON THE DRAWINGS WITH SYMBOLS OR KEYED NOTES. ANY CHANGES RESULTING FROM FAILURE TO INSTALL THE MECHANICAL SYSTEM WITHOUT USING THE INCLUDED DETAILS SHALL BE THE RESPONSIBILITY OF THE CONTRACTOR.

THE STRUCTURE SHOWN ON ALL DETAILS MAY OR MAY NOT PERTAIN TO A PORTION OR ANY PORTION OF THE BUILDING. COORDINATE ALL MOUNTING REQUIREMENTS WITH ARCHITECTURAL & STRUCTURAL DRAWINGS.

ANY PART OF THE MECHANICAL INSTALLATION THAT FAILS, IS UNFIT, OR BECOMES DAMAGED DURING CONSTRUCTION SHALL BE REPAIRED OR REPLACED BY THE CONTRACTOR AT NO ADDITIONAL COST TO THE OWNER.

SEE ARCHITECTURAL REFLECTED CEILING PLAN FOR EXACT LOCATION OF ALL CEILING DIFFUSERS & GRILLES.

CONTRACTOR SHALL OPERATE THE SYSTEM & DEMONSTRATE ALL ASPECTS OF THE SYSTEM TO THE ENGINEER &/OR OWNER TO PROVE ALL SYSTEMS ARE

DURING CONSTRUCTION, THE CONTRACTOR SHALL MAINTAIN A SET OF AS-BUILT REDLINED RECORD DRAINING AT THE PROJECT SITE. ALL CHANGES IN LAYOUT. ROUTING, EQUIPMENT, COMPONENTS, & ACCESSORIES SHALL BE RECORDED. THESE REDLINED DRAWINGS SHALL BE GIVEN TO THE ARCHITECT/ENGINEER AFTER THE FINAL INSPECTION IN ACCORDANCE WITH SPECIFICATIONS.

GENERAL EQUIPMENT NOTES

ALL CAPACITIES ARE AT JOB SITE CONDITIONS & ARE MINIMUM CAPACITY.

ALL MECHANICAL EQUIPMENT SHALL BE INSTALLED TO CONFORM WITH LOCAL SEISMIC REQUIREMENTS & THE REQUIREMENTS OF THESE CONSTRUCTION

VERIFY ALL REQUIRED SERVICE CONNECTIONS, INCLUDING ELECTRICAL CHARACTERISTICS FOR ALL EQUIPMENT PRIOR TO ORDERING EQUIPMENT.

ALL EQUIPMENT SHALL BE INDEPENDENTLY SUPPORTED FROM STRUCTURAL

ALL EQUIPMENT SHALL BE INSTALLED IN ACCORDANCE WITH MANUFACTURER'S WRITTEN INSTALLATION INSTRUCTIONS.

6 ALL SIMILAR EQUIPMENT SHALL BE OF THE SAME MANUFACTURER.

AIR INLETS & OUTLETS SHALL BE OF THE SAME MANUFACTURER.

THE CONTRACTOR SHALL BE RESPONSIBLE FOR THE HVAC EQUIPMENT CHECK-IN, SAFEKEEPING, & DAMAGE.

MECHANICAL SHEET INDEX

ME001 MECHANICAL COVER SHEET ME501 MECHANICAL DETAILS ME502 MECHANICAL DETAILS ME601 MECHANICAL SCHEDULES LEVEL 9 MECHANICAL DEMO PLAN LEVEL 9 MECHANICAL PLAN LEVEL 9 MECHANICAL PIPING PLAN

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PROJECT DESCRIPTION

INTERMOUNTAIN HEALTHCARE KEY BANK TOWER LEVEL 09

36 S STATE STREET SALT LAKE CITY, UT 84111

AHJ STAMP

SHEET NAME:

MECHANICAL COVER SHEET

REVISIONS

DATE DESCRIPTION

ISSUE DATE: 03/27/20 CD SET ISSUE TYPE:

DRAWN BY: TAC CHECKED BY: RHB

SHEET NUMBER:

FLEXIBLE CONNECTION

DUCT TO BE REMOVED

WC WG WPD WT WTR

HR HT

HTG HΖ ID IN ΚW LAT LBS LG LH LRA

LVG LWT MBH MFR NC NIC NO NPSH NTS OA OD ΟZ PD

PG PH **PRESS** PSF PSI PSIA PSIG RA RECIRC

RETURN AIR REFR REQD RLA RPM SC

TA(S) TEMP THERM TOT TSTAT VAC


VOL WB

WEIGHT WATER

VOLUME

VACUUM

PROJECT#: 1953

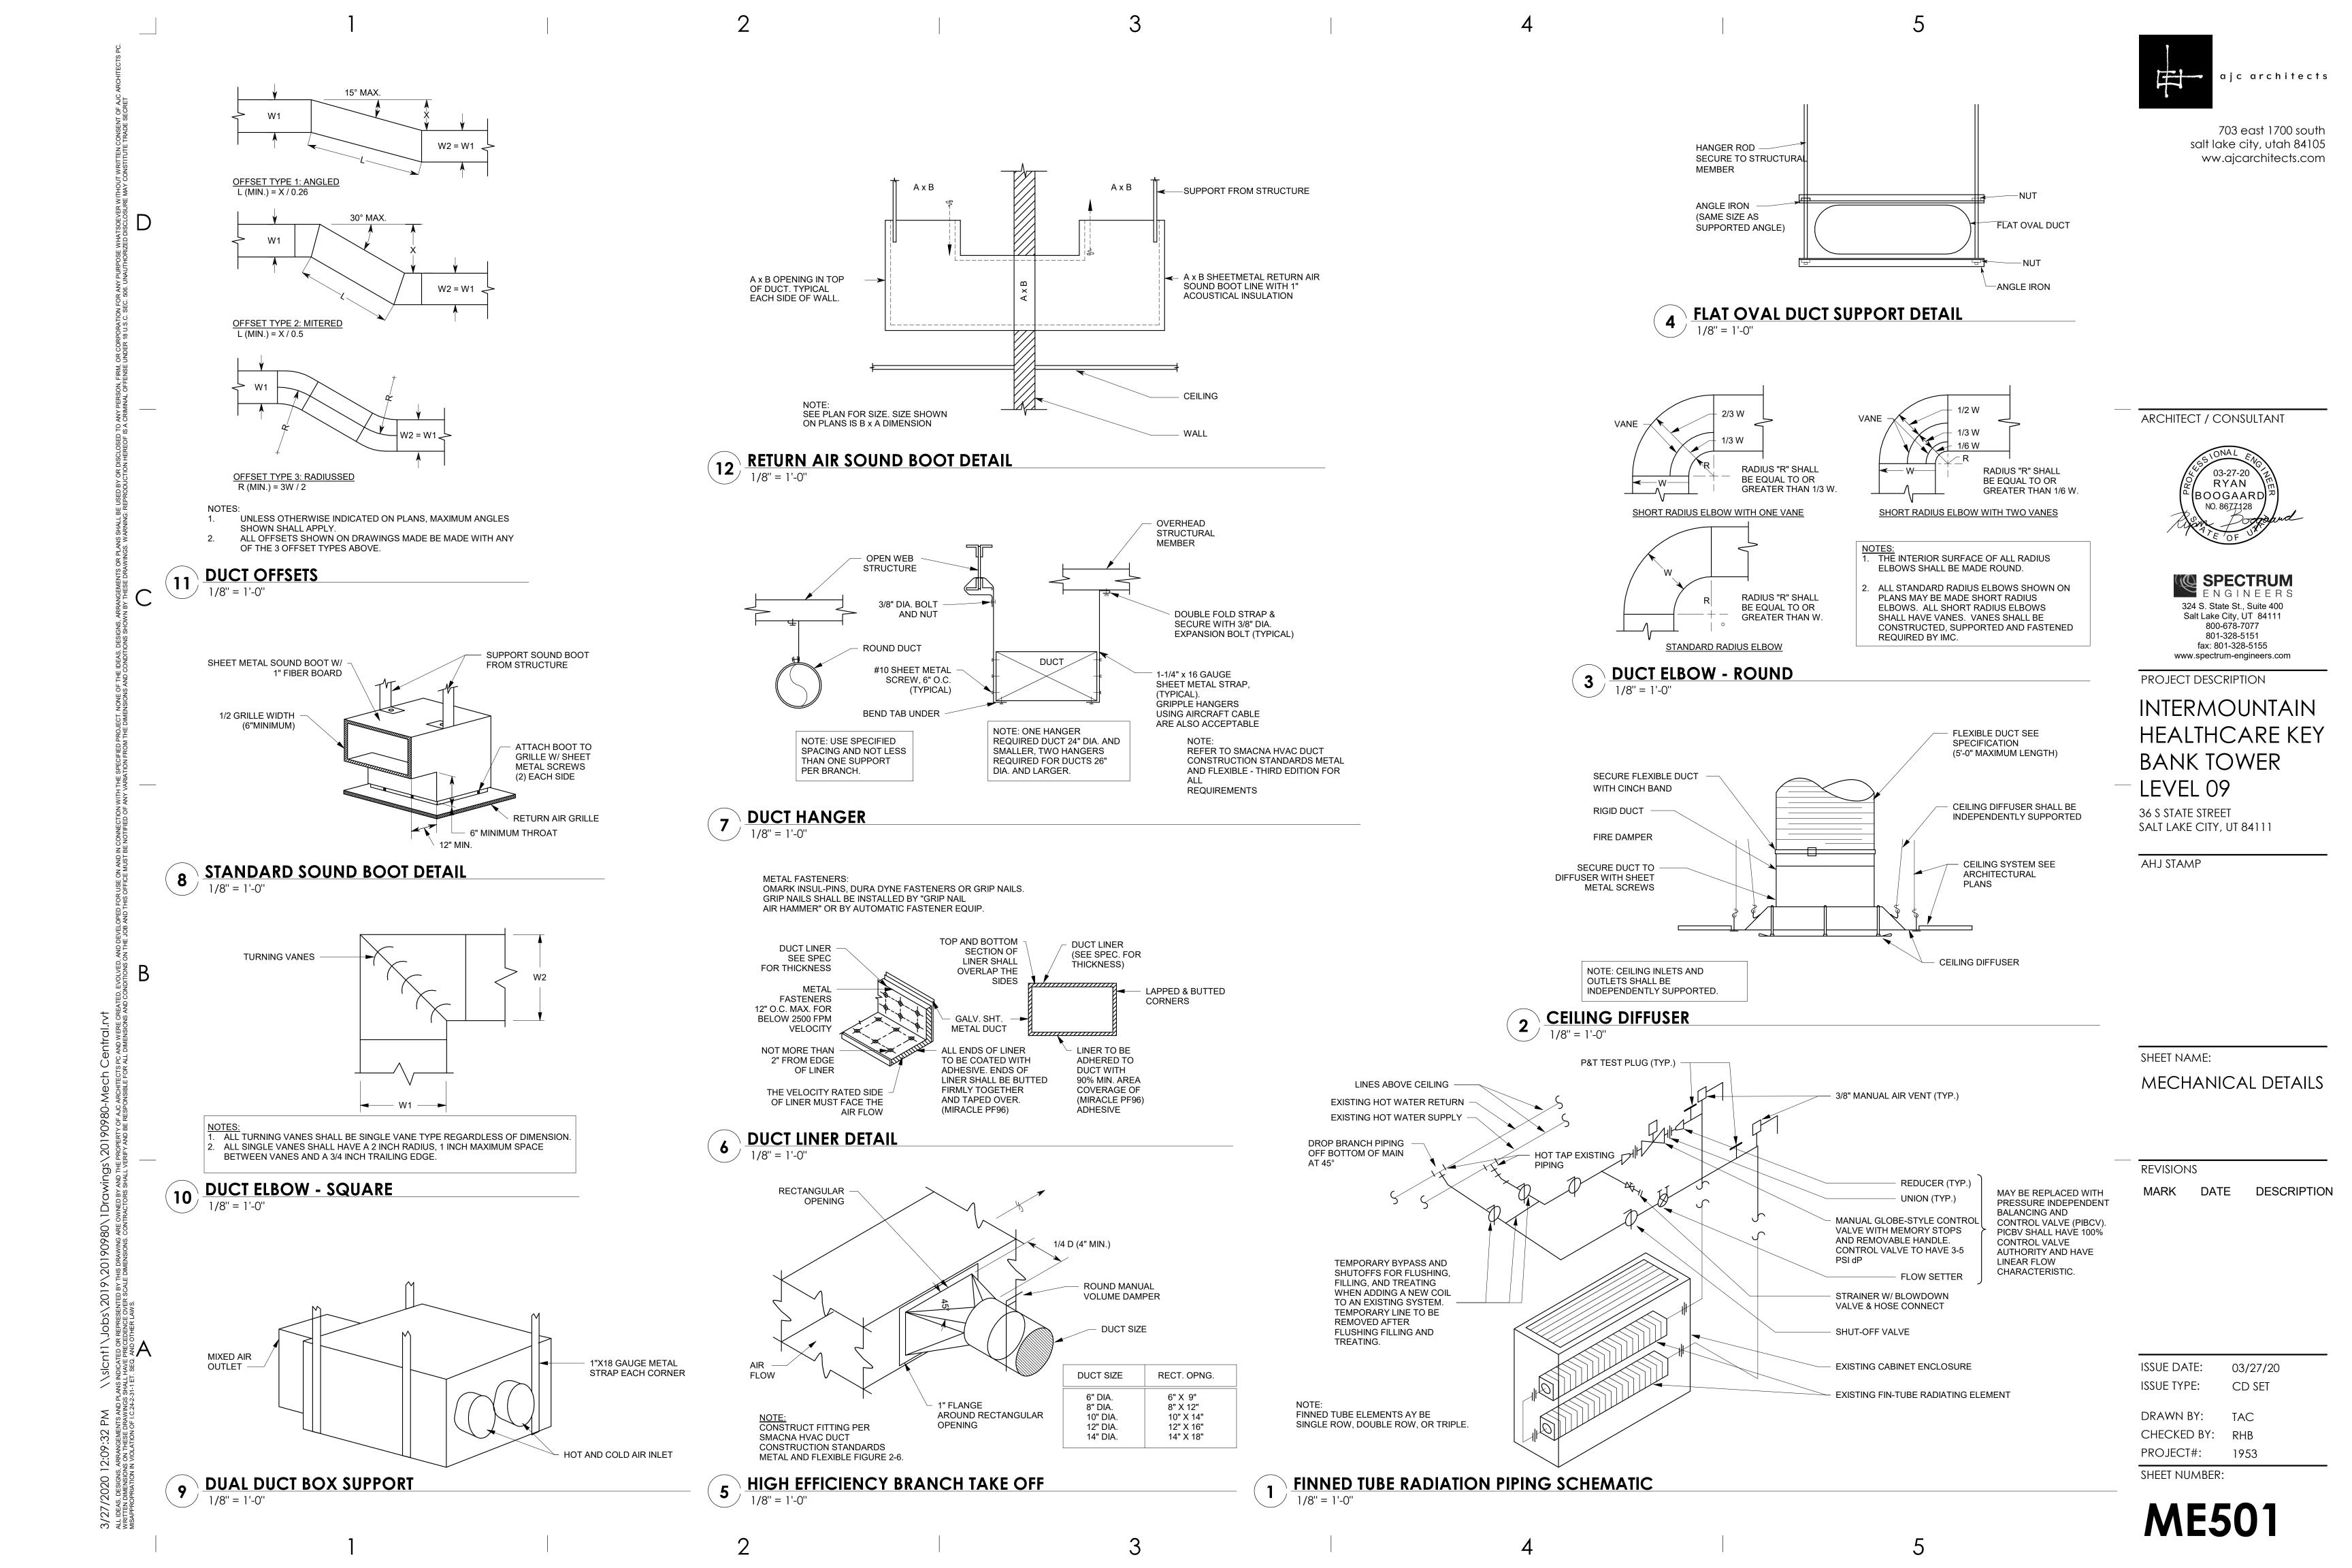


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VERTIV.

LIEBERT CRV

GENERAL ARRANGEMENT DIAGRAM 600mm (24in.) AIR COOLED W/ LIEBERT MC CONDENSER MODELS

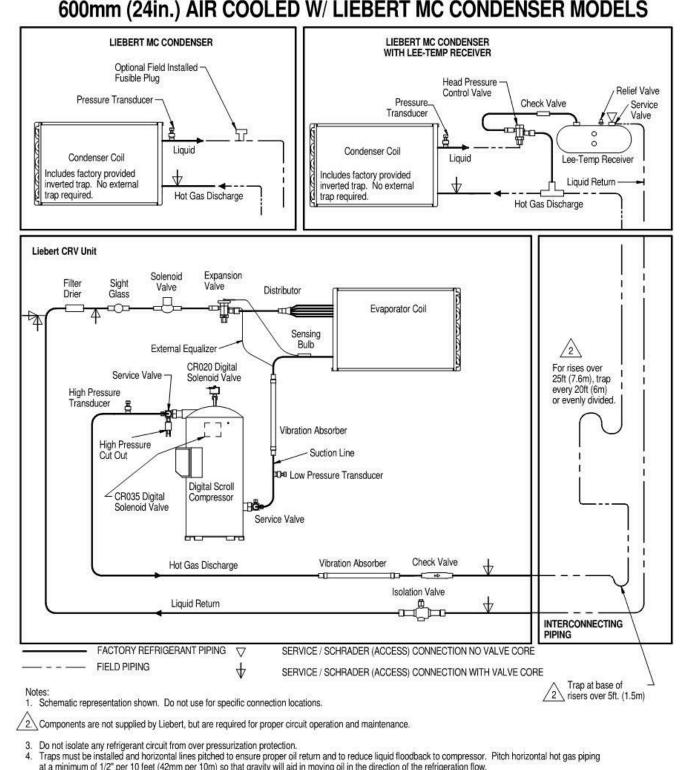

BOOGAARD SPECTRUM FNGINEFDO 324 S. State St., Suite 400 Salt Lake City, UT 84111 800-678-7077

ARCHITECT / CONSULTANT

801-328-5151 fax: 801-328-5155 www.spectrum-engineers.com PROJECT DESCRIPTION

INTERMOUNTAIN HEALTHCARE KEY BANK TOWER LEVEL 09

36 S STATE STREET SALT LAKE CITY, UT 84111

AHJ STAMP

REV: 4 REV DATE: 12/17

METAL DUCT

SHEET NAME:

MECHANICAL DETAILS

REVISIONS

MARK DATE DESCRIPTION

ISSUE DATE: 03/27/20 CD SET ISSUE TYPE:

DRAWN BY: Author CHECKED BY: Checker PROJECT#: 1953

SHEET NUMBER:

 Do not isolate any refrigerant circuit from over pressurization protection.
 Traps must be installed and horizontal lines pitched to ensure proper oil return and to reduce liquid floodback to compressor. Pitch horizontal hot gas piping at a minimum of 1/2" per 10 feet (42mm per 10m) so that gravity will aid in moving oil in the direction of the refrigeration flow. DPN002858 Page :1 /1 HVAC CONROL POWER FROM LINE SIDE OF POWER TO SYSTEM AHU SMOKE PARTITION OR WALL FOR FAN SHUTDOWN SMOKE DAMPER (N.C.) ON SMOKE ALARM. NO INLETS OR OUTLETS BETWEEN DETECTOR AND PNEUMATIC DAMPER. OR TO FIRE ALARM SD (DUCT SMOKE DETECTOR)
AUXILIARY CONTACT ELECTRIC OPERATOR - EP RELAY FOR PNEUMATICS OPERATOR - WIRING FOR ELECTRIC OPERATOR NOTE: REFER TO SMOKE DAMPER DETAIL 2 FIRE/SMOKE DAMPER CONTROL 1/8" = 1'-0" SMOKE PARTITION OR CORRIDOR WALL - 10 GA. STEEL WALL SLEEVE SMOKE DAMPER PROVIDE CLEARANCE FOR ELECTRIC MECHANICAL THERMAL EXPANSION. SEE ACUATOR. REFER MANUFACTURER'S INSTRUCTIONS TO SMOKE DAMPER CONTROL DETAIL. ACCESS DOOR SEE MECHANICAL **GENERAL NOTES** INSULATED SHEET

FOR MORE DETAILS

1" ANGLE COLLARS

FIRE/SMOKE DAMPER

				DU	JAL DUC	CT BOX	SCHE	DULE						
			AIR F	LOW			AIR FL	OW						
LABEL	INLET SIZE	LOCATION	COOLING AIR FLOW (CFM)	HEATING AIR FLOW (CFM)	MAX AIR FLOW (CFM)	MIN AIR FLOW (CFM)	COOLING EAT	HEATING EAT	APD	MAX NC LEVEL	WEIGHT	MANUFACTURER	MODEL	REMARKS
/AV-5-01	5"	PRIVACY - 911/912	150	150	350	100	55 °F	95 °F	0.12 in-wg	30	54.00 lb	TRANE	VDDF	1,2,3,4,5,6,7
AV-5-02	5"	COLLAB - 913	175	175	350	100	55 °F	95 °F	0.17 in-wg	30	54.00 lb	TRANE	VDDF	1,2,3,4,5,6,7
AV-5-03	5"	COPY - 916	175	175	350	100	55 °F	95 °F	0.17 in-wg	30	54.00 lb	TRANE	VDDF	1,2,3,4,5,6,7
AV-5-04	5"	MEETING - 917	130	130	350	100	55 °F	95 °F	0.12 in-wg	30	54.00 lb	TRANE	VDDF	1,2,3,4,5,6,7
AV-6-01	6"	MEETING - 921	250	250	400	350	55 °F	95 °F	0.28 in-wg	30	54.00 lb	TRANE	VDDF	1,2,3,4,5,6,7
/AV-6-02	6"	9TH ELEV LOBBY - SINGLE	250	250	400	350	55 °F	95 °F	0.28 in-wg	30	54.00 lb	TRANE	VDDF	1,2,3,4,5,6,7
/AV-6-03	6"	COLLAB - 908	275	275	400	350	55 °F	95 °F	0.34 in-wg	30	54.00 lb	TRANE	VDDF	1,2,3,4,5,6,7
/AV-6-04	6"	BREAKROOM - 901	275	275	400	350	55 °F	95 °F	0.34 in-wg	30	54.00 lb	TRANE	VDDF	1,2,3,4,5,6,7
/AV-6-05	6"	RESTROOM - 9TH FLOOR	300	300	400	350	55 °F	95 °F	0.40 in-wg	30	54.00 lb	TRANE	VDDF	1,2,3,4,5,6,7
/AV-8-01	8"	COPY - 902 / COLLAB 904 / COLLAB 905	375	375	750	350	55 °F	95 °F	0.18 in-wg	30	54.00 lb	TRANE	VDDF	1,2,3,4,5,6,7
AV-8-02	8"	COLLAB - 906	375	375	750	350	55 °F	95 °F	0.18 in-wg	30	54.00 lb	TRANE	VDDF	1,2,3,4,5,6,7
'AV-8-03	8"	STORAGE - 934	400	400	750	350	55 °F	95 °F	0.20 in-wg	30	54.00 lb	TRANE	VDDF	1,2,3,4,5,6,7
/AV-10-01	10"	LOBBY - 919	800	800	1300	500	55 °F	95 °F	0.30 in-wg	30	56.00 lb	TRANE	VDDF	1,2,3,4,5,6,7
/AV-10-02	10"	MEETING - 918	950	950	1300	500	55 °F	95 °F	0.42 in-wg	30	61.00 lb	TRANE	VDDF	1,2,3,4,5,6,7
/AV-10-03	10"	MEETING - 920	950	950	1300	500	55 °F	95 °F	0.42 in-wg	30	61.00 lb	TRANE	VDDF	1,2,3,4,5,6,7
/AV-10-05	10"	9TH ELEV LOBBY - 900	1000	1000	1300	500	55 °F	95 °F	0.45 in-wg	30	61.00 lb	TRANE	VDDF	1,2,3,4,5,6,7
/AV-10-06	10"	IT STAGING - 931 / IT WAITING - 922	1050	1050	1300	500	55 °F	95 °F	0.47 in-wg	30	83.00 lb	TRANE	VDDF	1,2,3,4,5,6,7
/AV-14-01	14"	IT - 923	1800	1800	2900	1000	55 °F	95 °F	0.32 in-wg	30	83.00 lb	TRANE	VDDF	1,2,3,4,5,6,7
/AV-14-02	14"	IT - 923	1800	1800	2900	1000	55 °F	95 °F	0.32 in-wg	30	83.00 lb	TRANE	VDDF	1,2,3,4,5,6,7
'AV-14-03	14"	TRAVEL & FLEET - 914	2100	2100	2900	1000	55 °F	95 °F	0.41 in-wg	30	81.00 lb	TRANE	VDDF	1,2,3,4,5,6,7
/AV-14-04	14"	MEDICAL - 915	2200	2200	2900	1000	55 °F	95 °F	0.43 in-wg	30	81.00 lb	TRANE	VDDF	1,2,3,4,5,6,7
/AV-14-05	14"	MEDICAL - 915	2200	2200	2900	1000	55 °F	95 °F	0.43 in-wg	30	81.00 lb	TRANE	VDDF	1,2,3,4,5,6,7
/AV-14-06	14"	MEDICAL - 915	2250	2250	2900	1000	55 °F	95 °F	0.44 in-wg	30	81.00 lb	TRANE	VDDF	1,2,3,4,5,6,7
/AV-14-07	14"	MEDICAL - 915	2250	2250	2900	1000	55 °F	95 °F	0.44 in-wg	30	81.00 lb	TRANE	VDDF	1,2,3,4,5,6,7
AV-14-08	14"	MEDICAL - 915	2550	2550	2900	1000	55 °F	95 °F	0.60 in-wg	30	81.00 lb	TRANE	VDDF	1,2,3,4,5,6,7
AV-14-09	14"	OUTREACH - 907	2460	2460	2900	1000	55 °F	95 °F	0.56 in-wg	30	83.00 lb	TRANE	VDDF	1,2,3,4,5,6,7
'AV-14-10	14"	OUTREACH - 907	2460	2460	2900	1000	55 °F	95 °F	0.56 in-wg	30	83.00 lb	TRANE	VDDF	1,2,3,4,5,6,7
AV-14-11	14"	OUTREACH - 907	2460	2460	2900	1000	55 °F	95 °F	0.56 in-wg	30	83.00 lb	TRANE	VDDF	1,2,3,4,5,6,7
AV-14-12	14"	OUTREACH - 907	2200	2200	2900	1000	55 °F	95 °F	0.43 in-wg	30	83.00 lb	TRANE	VDDF	1,2,3,4,5,6,7
AV-14-13	14"	OUTREACH - 907	1755	1755	2900	1000	55 °F	95 °F	0.31 in-wg	30	81.00 lb	TRANE	VDDF	1,2,3,4,5,6,7
AV-14-14	14"	OUTREACH - 907	1755	1755	2900	1000	55 °F	95 °F	0.31 in-wg	30	81.00 lb	TRANE	VDDF	1,2,3,4,5,6,7

1. MAX RADIATED AND DISCHARGE NC OF 30 AT 1.0" PD. NC RATING BASED OFF OF AHRI STANDARD 885-2008 2. 1/2 IN. THICK, MIN. 1.5 LB DENSITY FIBERGLASS INTERNAL INSULATION.

3. PRESSURE INDEPENDENT OPERATION.

4. PROVIDE NEMA 1 ENCLOSURE FOR CONTROLS.

5. PROVIDE INSULATED ACCESS PANEL. 6. ACCEPTABLE MANUFACTURERS: TRANE, PRICE, KRUEGER, TITUS OR PRIOR APPROVED EQUAL.

7. CONTROLS SHALL BE TRANE. SEQUENCE OF UNITS TO BE VARIABLE AIR VOLUME.

	EXHAUST FAN SCHEDULE												
LABEL	CFM	STATIC PRESSURE	FAN RPM	SOUND RATING	WEIGHT	W	FLA	VOLTAGE	PHASE	Hz	MANUFACTURER	MODEL	REMARKS
EF-1	70	0.50 in-wg	950	45	25	35	1 A	115	1	60	Loren Cook Company	GC-168	1,2,3,4,5
EF-2	150	0.50 in-wg	1215	49	30	72	1 A	115	1	60	Loren Cook Company	GC-188	1,2,3,4,5
EF-3	200	0.50 in-wg	1415	47	60	63	1 A	115	1	60	Loren Cook Company	GC-422	1,2,3,4,5

PROVIDE WITH BACKDRAFT DAMPER, DISCONNECT SWITCH, SUPPORT BRACKETS AND ISOLATOR, FLEXIBLE CONNECTION, BELT TENSIONER (BELT DRIVE MODELS ONLY)
 PROVIDE VARIABLE SPEED CONTROLLER FOR ALL DIRECT DRIVE FANS. TEST AND BALANCE CONTRACTOR SHALL MARK BALANCED POSITION ON CONTROLLER.

3. INTERLOCK WITH LIGHTS AND PROVIDE 10 MINUTE RUN DELAY

4. ACCEPTABLE MANUFACTURERS: COOK, GREENHECK, PENN BARRY OR PRIOR APPROVED EQUAL.

5. PROVIDE FACTORY AUTHORIZED STARTUP OF EQUIPMENT INCLUDING STARTUP OF ANY FACTORY CONTROLS TO ENSURE PROPER SEQUENCING AND/OR COMMUNICATION TO BMS.

	REGISTER - GRILLE- DIFFUSER SCHEDULE										
LABEL	TYPE	BLOW PATTERN	MAX AIR FLOW (CFM)	FACE SIZE	NECK SIZE	NC	PRESSURE DROP (in-wg)	THROW	MANUFACTURER	MODEL	REMARKS
R-1	LOUVERED RETURN	N/A	1700	24"x24"	N/A	30	0.100	N/A	PRICE	535	1,2,3,4,5,6,7
R-2	LINEAR RETURN	2-WAY	280	48"	7"	30	0.188	9-12-17(H)/4-6-8(V)	PRICE	SDA/SDS-1"-2 SLOT	1,2,3,4,5,6,7
S-1	SQUARE PLAQUE DIFFUSER	4-WAY	315	12" X 12"	8" Ø	30	0.343	6-9-14	PRICE	SPD	1,2,3,4,5,6,7
S-2	SQUARE PLAQUE DIFFUSER	4-WAY	235	24" X 24"	6" Ø	30	0.093	4-5-8	PRICE	SPD	1,2,3,4,5,6,7
S-3	SQUARE PLAQUE DIFFUSER	4-WAY	350	24" X 24"	8" Ø	30	0.115	4-6-10	PRICE	SPD	1,2,3,4,5,6,7
S-4	SQUARE PLAQUE DIFFUSER	4-WAY	545	24" X 24"	10" Ø	30	0.180	5-8-12	PRICE	SPD	1,2,3,4,5,6,7
S-5	SQUARE PLAQUE DIFFUSER	4-WAY	705	24" X 24"	12" Ø	30	0.210	6-9-14	PRICE	SPD	1,2,3,4,5,6,7
S-6	LINEAR SUPPLY	2-WAY	280	48"	7"	30	0.188	9-12-17(H)/4-6-8(V)	PRICE	SDA/SDS-1"-2 SLOT	1,2,3,4,5,6,7

PROVIDE TRANSITION AS NECESSARY
 PROVIDE LAY-IN MODULE AS NECESSARY

3. COLOR BY ARCHITECT

4. PROVIDE WITH AIR-SCOOP FOR BALANCING

PROVIDE OWNER WITH TWO LINEAR SLOT ADJUSTMENT TOOLS FOR MODIFYING AIRFLOW DIRECTION

LINEAR SLOT DIFFUSER TO HAVE CONTINUOUS LOOK WHEN MULTIPLE ARE ADJACENT TO EACH OTHER.
 ACCEPTABLE MANUFACTURERS: PRICE, KRUEGER, TITUS OR PRIOR APPROVED EQUAL.

	CRAC INDOOR UNIT SCHEDULE												
	AREA		CC	OOLING									
LABEL	SERVED	CFM	TOTAL	SENSIBLE	MCA	VOLTS	PHASE	HZ	MOCP	WEIGHT	MANUFACTURER	MODEL	REMARKS
CRAC-1	IT ROOM	2510	71200.0 Btu/h	68000.0 Btu/h	40.7	208 V	3	60 Hz	60	800 lb	LIEBERT	CR020RA	1,2,3,4,5,6,7,8
CRAC-2	IT ROOM	2510	71200.0 Btu/h	68000.0 Btu/h	40.7	208 V	3	60 Hz	60	800 lb	LIEBERT	CR020RA	1,2,3,4,5,6,7,8

CAPACITIES @ 4500' ELEVATION, CAPACITY BASED ON 90 F DB (61.6 WB) & 27% RH @ 105 F OUTDOOR AMBIENT.
 UNIT IS A LIEBERT CRV COOLED UNIT, INROW COOLING FRONT SUPPLY/REAR RETURN, DIGITAL-SCROLL COMPRESSOR, EC FANS - VSD (ENERGY EFF.).
 UNIT TO COME WITH THE FOLLOWING OPTIONS: FACTORY LOCKING DISCONNECT, ICOM MICROPROCESSOR **, NO HUMIDIFER, NO REHEAT.

4. UNIT TO COME WITH: CONDENSATE PUMP, LEAK DETECTOR-LIQUITECT, COLOR: BLACK GRAY MATTE, LOW SOUND PACKAGE.

5. PROVIDE EQUIPMENT WHICH IS DESIGNED TO WORK WITH R-410A REFRIGERANT (HFC).

6. PROVIDE 1 YEAR OTHER PARTS WARRANTY, 5 YEAR COMPRESSOR WARRANTY.

7. PROVIDE INTELLISLOT IS-UNITY-DP CARD FOR REMOTE COMMUNICATION VIA SNMP, MODBUS, OR BACNET I/P. 8. PROVIDE RIGID FLOOR MOUNT BRACKET.

CRAC CONDENSING UNIT SCHEDULE										
LABEL	EQUIPMENT SERVED	COOLING TOTAL	MCA	VOLT	PHASE	МОСР	WEIGHT	MANUFACTURER	MODEL	REMARKS
CU-1	CRAC-1	71200.0 Btu/h	3.2	208 V	3	15	300 lb	LIEBERT	MCM040E1	1
CU-2	CRAC-2	71200.0 Btu/h	3.2	208 V	3	15	300 lb	LIEBERT	MCM040E1	1

1. UNIT IS A LIEBERT OUTDOOR MICROCHANNEL CONDENSER WITH EC PLUG FAN AND VSD CONTROL

	COOLING ONLY VAV SCHEDULE									
	INLET	OUTLET		COOLING AIR	MIN. AIR	SOUND				
LABEL	DIAMETER	HEIGHT	WIDTH	FLOW MAX. (CFM)	FLOW (CFM)	RATING	WEIGHT	MANUFACTURER	MODEL	REMARKS
VAV-C	6.000	8"	12"	600	180	30	20	PRICE	SDV	1,2,3,4,5,6,7

1. NC BASED OFF OF AHRI STANDARD 885-2008. 1/2" THICK, MIN. 1.5 LB DENSITY FIBERGLASS INTERNAL INSULATION.

PRESSURE INDEPENDENT OPERATION.

PROVIDE NEMA 1 ENCLOSURE FOR CONTROLS.

PROVIDE AN INSULATED ACCESS PANEL.

ACCEPTABLE MANUFACTURERS: TRANE, PRICE, KRUEGER, TITUS, OR PRIOR APPROVED EQUAL.

7. UNIT TO BE FIRST STAGE OF COOLING.

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PROJECT DESCRIPTION

INTERMOUNTAIN HEALTHCARE KEY BANK TOWER LEVEL 09

36 S STATE STREET SALT LAKE CITY, UT 84111

AHJ STAMP

SHEET NAME:

MECHANICAL **SCHEDULES**


REVISIONS

MARK DATE DESCRIPTION

ISSUE DATE: 03/27/20 CD SET ISSUE TYPE:


DRAWN BY: CHECKED BY: RHB PROJECT#:

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PROJECT DESCRIPTION

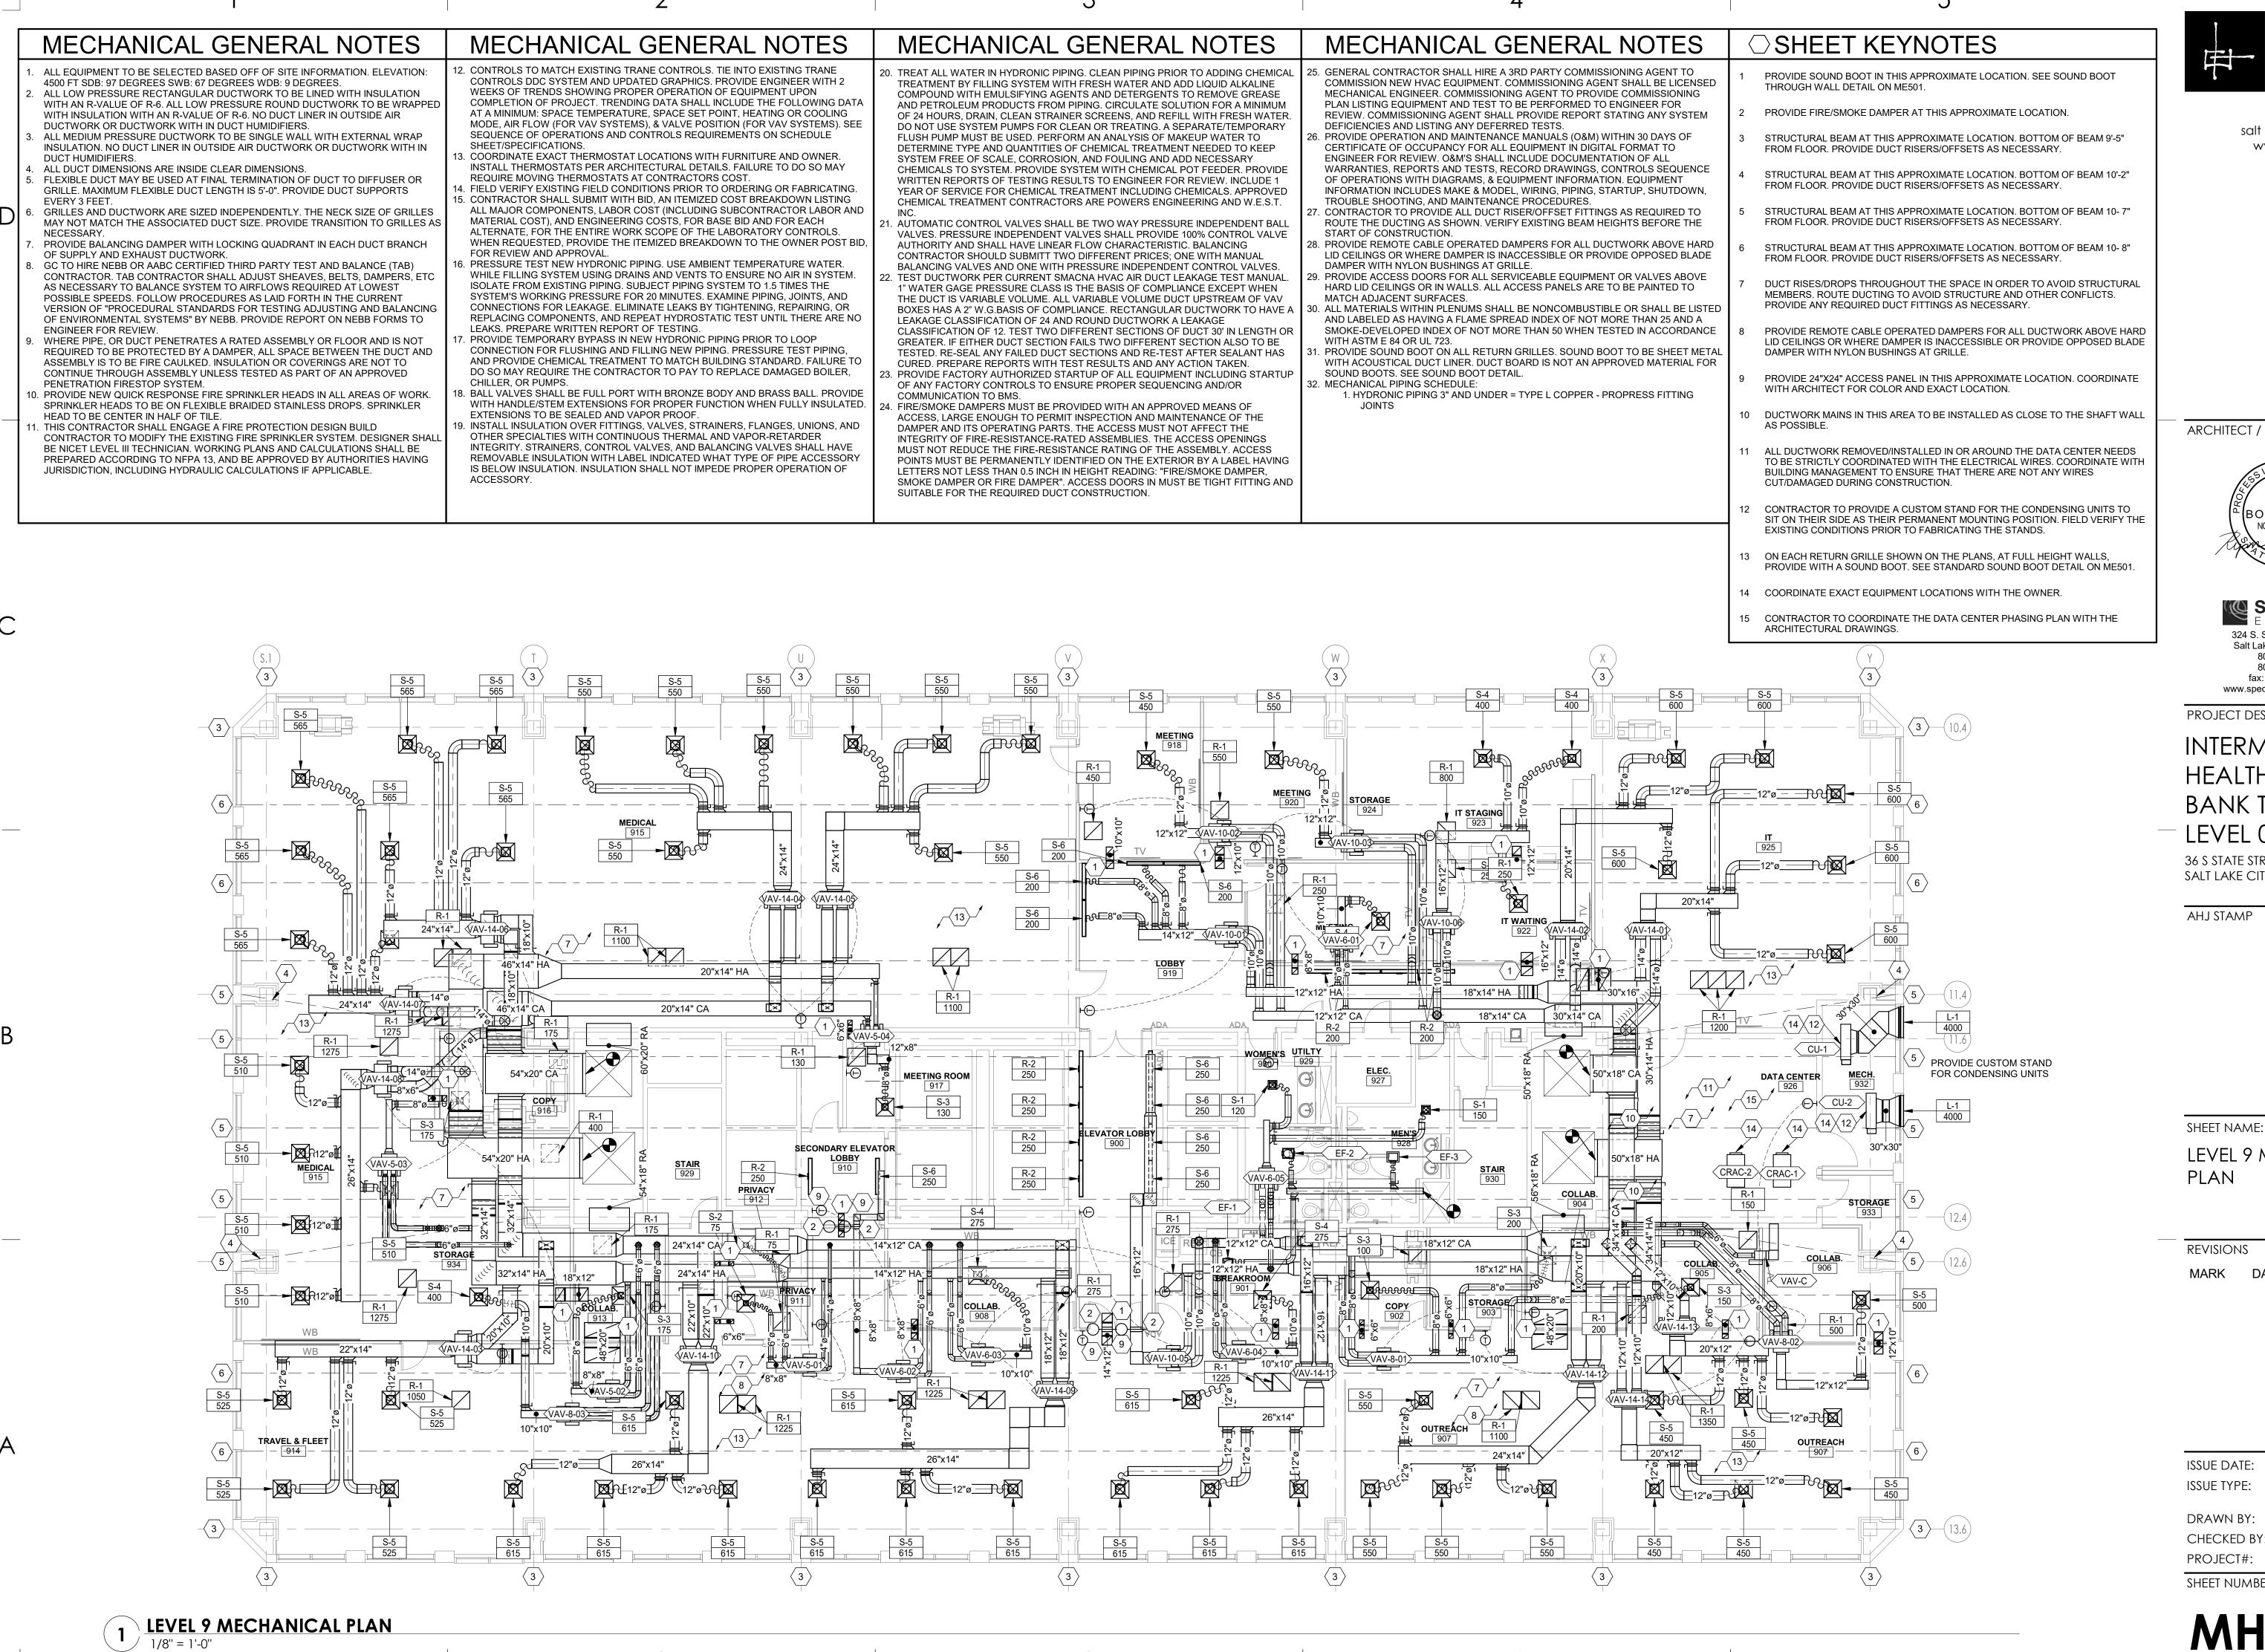INTERMOUNTAIN HEALTHCARE KEY BANK TOWER

36 S STATE STREET SALT LAKE CITY, UT 84111

AHJ STAMP

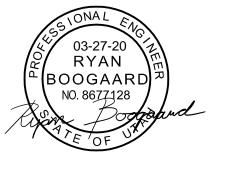LEVEL 9 MECHANICAL PLAN

DATE DESCRIPTION

REVISIONS

ISSUE DATE: 03/27/20 **ISSUE TYPE:** CD SET

PROJECT#:

SHEET NUMBER:


MH101

○ SHEET KEYNOTES MECHANICAL GENERAL NOTES MECHANICAL GENERAL NOTES MECHANICAL GENERAL NOTES MECHANICAL GENERAL NOTES CONTROLS TO MATCH EXISTING TRANE CONTROLS. TIE INTO EXISTING TRANE ALL EQUIPMENT TO BE SELECTED BASED OFF OF SITE INFORMATION. ELEVATION: . TREAT ALL WATER IN HYDRONIC PIPING. CLEAN PIPING PRIOR TO ADDING CHEMICAL HYDRONIC SUPPLY/RETURN PIPING TO BE SUFFICIENTLY LABELED/MARKED FOR 5. GENERAL CONTRACTOR SHALL HIRE A 3RD PARTY COMMISSIONING AGENT TO CONTROLS DDC SYSTEM AND UPDATED GRAPHICS. PROVIDE ENGINEER WITH 2 4500 FT SDB: 97 DEGREES SWB: 67 DEGREES WDB: 9 DEGREES. TREATMENT BY FILLING SYSTEM WITH FRESH WATER AND ADD LIQUID ALKALINE COMMISSION NEW HVAC EQUIPMENT. COMMISSIONING AGENT SHALL BE LICENSED MAINTENANCE PURPOSES. ALL LOW PRESSURE RECTANGULAR DUCTWORK TO BE LINED WITH INSULATION WEEKS OF TRENDS SHOWING PROPER OPERATION OF EQUIPMENT UPON COMPOUND WITH EMULSIFYING AGENTS AND DETERGENTS TO REMOVE GREASE MECHANICAL ENGINEER. COMMISSIONING AGENT TO PROVIDE COMMISSIONING WITH AN R-VALUE OF R-6. ALL LOW PRESSURE ROUND DUCTWORK TO BE WRAPPED COMPLETION OF PROJECT. TRENDING DATA SHALL INCLUDE THE FOLLOWING DATA AND PETROLEUM PRODUCTS FROM PIPING. CIRCULATE SOLUTION FOR A MINIMUM PLAN LISTING EQUIPMENT AND TEST TO BE PERFORMED TO ENGINEER FOR SPLIT EXISTING FIN TUBE AND ENCLOSURE. AT A MINIMUM: SPACE TEMPERATURE, SPACE SET POINT, HEATING OR COOLING WITH INSULATION WITH AN R-VALUE OF R-6. NO DUCT LINER IN OUTSIDE AIR OF 24 HOURS, DRAIN, CLEAN STRAINER SCREENS, AND REFILL WITH FRESH WATER. REVIEW. COMMISSIONING AGENT SHALL PROVIDE REPORT STATING ANY SYSTEM DUCTWORK OR DUCTWORK WITH IN DUCT HUMIDIFIERS. MODE, AIR FLOW (FOR VAV SYSTEMS), & VALVE POSITION (FOR VAV SYSTEMS). SEE DO NOT USE SYSTEM PUMPS FOR CLEAN OR TREATING. A SEPARATE/TEMPORARY DEFICIENCIES AND LISTING ANY DEFERRED TESTS. SEQUENCE OF OPERATIONS AND CONTROLS REQUIREMENTS ON SCHEDULE ALL MEDIUM PRESSURE DUCTWORK TO BE SINGLE WALL WITH EXTERNAL WRAP EXISTING FIN TUBE HEATERS TO REMAIN. FLUSH PUMP MUST BE USED. PERFORM AN ANALYSIS OF MAKEUP WATER TO S. PROVIDE OPERATION AND MAINTENANCE MANUALS (O&M) WITHIN 30 DAYS OF INSULATION. NO DUCT LINER IN OUTSIDE AIR DUCTWORK OR DUCTWORK WITH IN SHEET/SPECIFICATIONS. DETERMINE TYPE AND QUANTITIES OF CHEMICAL TREATMENT NEEDED TO KEEP CERTIFICATE OF OCCUPANCY FOR ALL EQUIPMENT IN DIGITAL FORMAT TO COORDINATE EXACT THERMOSTAT LOCATIONS WITH FURNITURE AND OWNER. DUCT HUMIDIFIERS. SYSTEM FREE OF SCALE, CORROSION, AND FOULING AND ADD NECESSARY ENGINEER FOR REVIEW. O&M'S SHALL INCLUDE DOCUMENTATION OF ALL CONNECT TO EXISTING HHWS IN THIS APPROXIMATE LOCATION. ALL DUCT DIMENSIONS ARE INSIDE CLEAR DIMENSIONS. INSTALL THERMOSTATS PER ARCHITECTURAL DETAILS. FAILURE TO DO SO MAY CHEMICALS TO SYSTEM. PROVIDE SYSTEM WITH CHEMICAL POT FEEDER. PROVIDE WARRANTIES, REPORTS AND TESTS, RECORD DRAWINGS, CONTROLS SEQUENCE FLEXIBLE DUCT MAY BE USED AT FINAL TERMINATION OF DUCT TO DIFFUSER OR REQUIRE MOVING THERMOSTATS AT CONTRACTORS COST. WRITTEN REPORTS OF TESTING RESULTS TO ENGINEER FOR REVIEW. INCLUDE 1 OF OPERATIONS WITH DIAGRAMS, & EQUIPMENT INFORMATION. EQUIPMENT CONNECT TO EXISTING HHWR IN THIS APPROXIMATE LOCATION. GRILLE. MAXIMUM FLEXIBLE DUCT LENGTH IS 5'-0". PROVIDE DUCT SUPPORTS . FIELD VERIFY EXISTING FIELD CONDITIONS PRIOR TO ORDERING OR FABRICATING YEAR OF SERVICE FOR CHEMICAL TREATMENT INCLUDING CHEMICALS. APPROVED INFORMATION INCLUDES MAKE & MODEL, WIRING, PIPING, STARTUP, SHUTDOWN, CONTRACTOR SHALL SUBMIT WITH BID. AN ITEMIZED COST BREAKDOWN LISTING CHEMICAL TREATMENT CONTRACTORS ARE POWERS ENGINEERING AND W.E.S.T. TROUBLE SHOOTING, AND MAINTENANCE PROCEDURES. GRILLES AND DUCTWORK ARE SIZED INDEPENDENTLY. THE NECK SIZE OF GRILLES ALL MAJOR COMPONENTS, LABOR COST (INCLUDING SUBCONTRACTOR LABOR AND PROVIDE WALL ACCESS PANELS FOR ALL HYDRONIC VALVES. . CONTRACTOR TO PROVIDE ALL DUCT RISER/OFFSET FITTINGS AS REQUIRED TO MAY NOT MATCH THE ASSOCIATED DUCT SIZE. PROVIDE TRANSITION TO GRILLES AS MATERIAL COST), AND ENGINEERING COSTS, FOR BASE BID AND FOR EACH AUTOMATIC CONTROL VALVES SHALL BE TWO WAY PRESSURE INDEPENDENT BALL ROUTE THE DUCTING AS SHOWN. VERIFY EXISTING BEAM HEIGHTS BEFORE THE ALTERNATE, FOR THE ENTIRE WORK SCOPE OF THE LABORATORY CONTROLS VALVES. PRESSURE INDEPENDENT VALVES SHALL PROVIDE 100% CONTROL VALVE START OF CONSTRUCTION. PROVIDE BALANCING DAMPER WITH LOCKING QUADRANT IN EACH DUCT BRANCH WHEN REQUESTED, PROVIDE THE ITEMIZED BREAKDOWN TO THE OWNER POST BID AUTHORITY AND SHALL HAVE LINEAR FLOW CHARACTERISTIC. BALANCING 3. PROVIDE REMOTE CABLE OPERATED DAMPERS FOR ALL DUCTWORK ABOVE HARD OF SUPPLY AND EXHAUST DUCTWORK. FOR REVIEW AND APPROVAL CONTRACTOR SHOULD SUBMITT TWO DIFFERENT PRICES; ONE WITH MANUAL LID CEILINGS OR WHERE DAMPER IS INACCESSIBLE OR PROVIDE OPPOSED BLADE GC TO HIRE NEBB OR AABC CERTIFIED THIRD PARTY TEST AND BALANCE (TAB) . PRESSURE TEST NEW HYDRONIC PIPING. USE AMBIENT TEMPERATURE WATER. BALANCING VALVES AND ONE WITH PRESSURE INDEPENDENT CONTROL VALVES. DAMPER WITH NYLON BUSHINGS AT GRILLE. WHILE FILLING SYSTEM USING DRAINS AND VENTS TO ENSURE NO AIR IN SYSTEM. CONTRACTOR. TAB CONTRACTOR SHALL ADJUST SHEAVES, BELTS, DAMPERS, ETC TEST DUCTWORK PER CURRENT SMACNA HVAC AIR DUCT LEAKAGE TEST MANUAL . PROVIDE ACCESS DOORS FOR ALL SERVICEABLE EQUIPMENT OR VALVES ABOVE AS NECESSARY TO BALANCE SYSTEM TO AIRFLOWS REQUIRED AT LOWEST ISOLATE FROM EXISTING PIPING. SUBJECT PIPING SYSTEM TO 1.5 TIMES THE 1" WATER GAGE PRESSURE CLASS IS THE BASIS OF COMPLIANCE EXCEPT WHEN HARD LID CEILINGS OR IN WALLS. ALL ACCESS PANELS ARE TO BE PAINTED TO POSSIBLE SPEEDS. FOLLOW PROCEDURES AS LAID FORTH IN THE CURRENT SYSTEM'S WORKING PRESSURE FOR 20 MINUTES. EXAMINE PIPING, JOINTS, AND THE DUCT IS VARIABLE VOLUME. ALL VARIABLE VOLUME DUCT UPSTREAM OF VAV MATCH ADJACENT SURFACES. VERSION OF "PROCEDURAL STANDARDS FOR TESTING ADJUSTING AND BALANCING CONNECTIONS FOR LEAKAGE. ELIMINATE LEAKS BY TIGHTENING, REPAIRING, OR BOXES HAS A 2" W.G.BASIS OF COMPLIANCE. RECTANGULAR DUCTWORK TO HAVE A . ALL MATERIALS WITHIN PLENUMS SHALL BE NONCOMBUSTIBLE OR SHALL BE LISTED OF ENVIRONMENTAL SYSTEMS" BY NEBB. PROVIDE REPORT ON NEBB FORMS TO REPLACING COMPONENTS, AND REPEAT HYDROSTATIC TEST UNTIL THERE ARE NO LEAKAGE CLASSIFICATION OF 24 AND ROUND DUCTWORK A LEAKAGE AND LABELED AS HAVING A FLAME SPREAD INDEX OF NOT MORE THAN 25 AND A LEAKS. PREPARE WRITTEN REPORT OF TESTING ENGINEER FOR REVIEW. CLASSIFICATION OF 12. TEST TWO DIFFERENT SECTIONS OF DUCT 30' IN LENGTH OR SMOKE-DEVELOPED INDEX OF NOT MORE THAN 50 WHEN TESTED IN ACCORDANCE WHERE PIPE, OR DUCT PENETRATES A RATED ASSEMBLY OR FLOOR AND IS NOT PROVIDE TEMPORARY BYPASS IN NEW HYDRONIC PIPING PRIOR TO LOOP GREATER. IF EITHER DUCT SECTION FAILS TWO DIFFERENT SECTION ALSO TO BE WITH ASTM E 84 OR UL 723. REQUIRED TO BE PROTECTED BY A DAMPER, ALL SPACE BETWEEN THE DUCT AND CONNECTION FOR FLUSHING AND FILLING NEW PIPING. PRESSURE TEST PIPING, TESTED. RE-SEAL ANY FAILED DUCT SECTIONS AND RE-TEST AFTER SEALANT HAS . PROVIDE SOUND BOOT ON ALL RETURN GRILLES. SOUND BOOT TO BE SHEET METAL AND PROVIDE CHEMICAL TREATMENT TO MATCH BUILDING STANDARD. FAILURE TO ASSEMBLY IS TO BE FIRE CAULKED. INSULATION OR COVERINGS ARE NOT TO CURED. PREPARE REPORTS WITH TEST RESULTS AND ANY ACTION TAKEN. WITH ACOUSTICAL DUCT LINER. DUCT BOARD IS NOT AN APPROVED MATERIAL FOR DO SO MAY REQUIRE THE CONTRACTOR TO PAY TO REPLACE DAMAGED BOILER, CONTINUE THROUGH ASSEMBLY UNLESS TESTED AS PART OF AN APPROVED PROVIDE FACTORY AUTHORIZED STARTUP OF ALL EQUIPMENT INCLUDING STARTUP SOUND BOOTS. SEE SOUND BOOT DETAIL. PENETRATION FIRESTOP SYSTEM. CHILLER, OR PUMPS. OF ANY FACTORY CONTROLS TO ENSURE PROPER SEQUENCING AND/OR . MECHANICAL PIPING SCHEDULE: . PROVIDE NEW QUICK RESPONSE FIRE SPRINKLER HEADS IN ALL AREAS OF WORK. . BALL VALVES SHALL BE FULL PORT WITH BRONZE BODY AND BRASS BALL. PROVIDE COMMUNICATION TO BMS. 1. HYDRONIC PIPING 3" AND UNDER = TYPE L COPPER - PROPRESS FITTING SPRINKLER HEADS TO BE ON FLEXIBLE BRAIDED STAINLESS DROPS. SPRINKLER WITH HANDLE/STEM EXTENSIONS FOR PROPER FUNCTION WHEN FULLY INSULATED. FIRE/SMOKE DAMPERS MUST BE PROVIDED WITH AN APPROVED MEANS OF EXTENSIONS TO BE SEALED AND VAPOR PROOF. HEAD TO BE CENTER IN HALF OF TILE. ACCESS, LARGE ENOUGH TO PERMIT INSPECTION AND MAINTENANCE OF THE . INSTALL INSULATION OVER FITTINGS, VALVES, STRAINERS, FLANGES, UNIONS, AND . THIS CONTRACTOR SHALL ENGAGE A FIRE PROTECTION DESIGN BUILD DAMPER AND ITS OPERATING PARTS. THE ACCESS MUST NOT AFFECT THE CONTRACTOR TO MODIFY THE EXISTING FIRE SPRINKLER SYSTEM. DESIGNER SHALL OTHER SPECIALTIES WITH CONTINUOUS THERMAL AND VAPOR-RETARDER INTEGRITY OF FIRE-RESISTANCE-RATED ASSEMBLIES. THE ACCESS OPENINGS BE NICET LEVEL III TECHNICIAN. WORKING PLANS AND CALCULATIONS SHALL BE INTEGRITY. STRAINERS, CONTROL VALVES, AND BALANCING VALVES SHALL HAVE MUST NOT REDUCE THE FIRE-RESISTANCE RATING OF THE ASSEMBLY. ACCESS REMOVABLE INSULATION WITH LABEL INDICATED WHAT TYPE OF PIPE ACCESSOR' PREPARED ACCORDING TO NFPA 13. AND BE APPROVED BY AUTHORITIES HAVING POINTS MUST BE PERMANENTLY IDENTIFIED ON THE EXTERIOR BY A LABEL HAVING IS BELOW INSULATION. INSULATION SHALL NOT IMPEDE PROPER OPERATION OF JURISDICTION, INCLUDING HYDRAULIC CALCULATIONS IF APPLICABLE. LETTERS NOT LESS THAN 0.5 INCH IN HEIGHT READING: "FIRE/SMOKE DAMPER, ACCESSORY. SMOKE DAMPER OR FIRE DAMPER". ACCESS DOORS IN MUST BE TIGHT FITTING AND SUITABLE FOR THE REQUIRED DUCT CONSTRUCTION. 1 1/4"ø HHWS =3/4"ø HHWS₹1"ø HHWS 3/4"ø HHWS --3/4"ø HHWS 3/4"ø HHWS / 1 ≂1/2"ø HHWS___□ ____1/2"ø HHWS[□]____ ˈ3/4"ø HHWS-∯ , --3/4"ø HHWR –3/4"ø HHWR⊸ $\frac{6}{1/2}$ HHWR= <u>〈 6 ∕</u>1/2"ø HHWR⊸



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PROJECT DESCRIPTION

INTERMOUNTAIN HEALTHCARE KEY BANK TOWER LEVEL 09

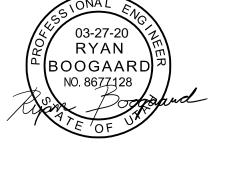36 S STATE STREET SALT LAKE CITY, UT 84111

AHJ STAMP

SHEET NAME:

LEVEL 9 MECHANICAL PIPING PLAN

DESCRIPTION

REVISIONS


MARK DATE

ISSUE DATE: 03/27/20 ISSUE TYPE: CD SET

DRAWN BY: TAC CHECKED BY: RHB PROJECT#: 195

SHEET NUMBER:

MP101

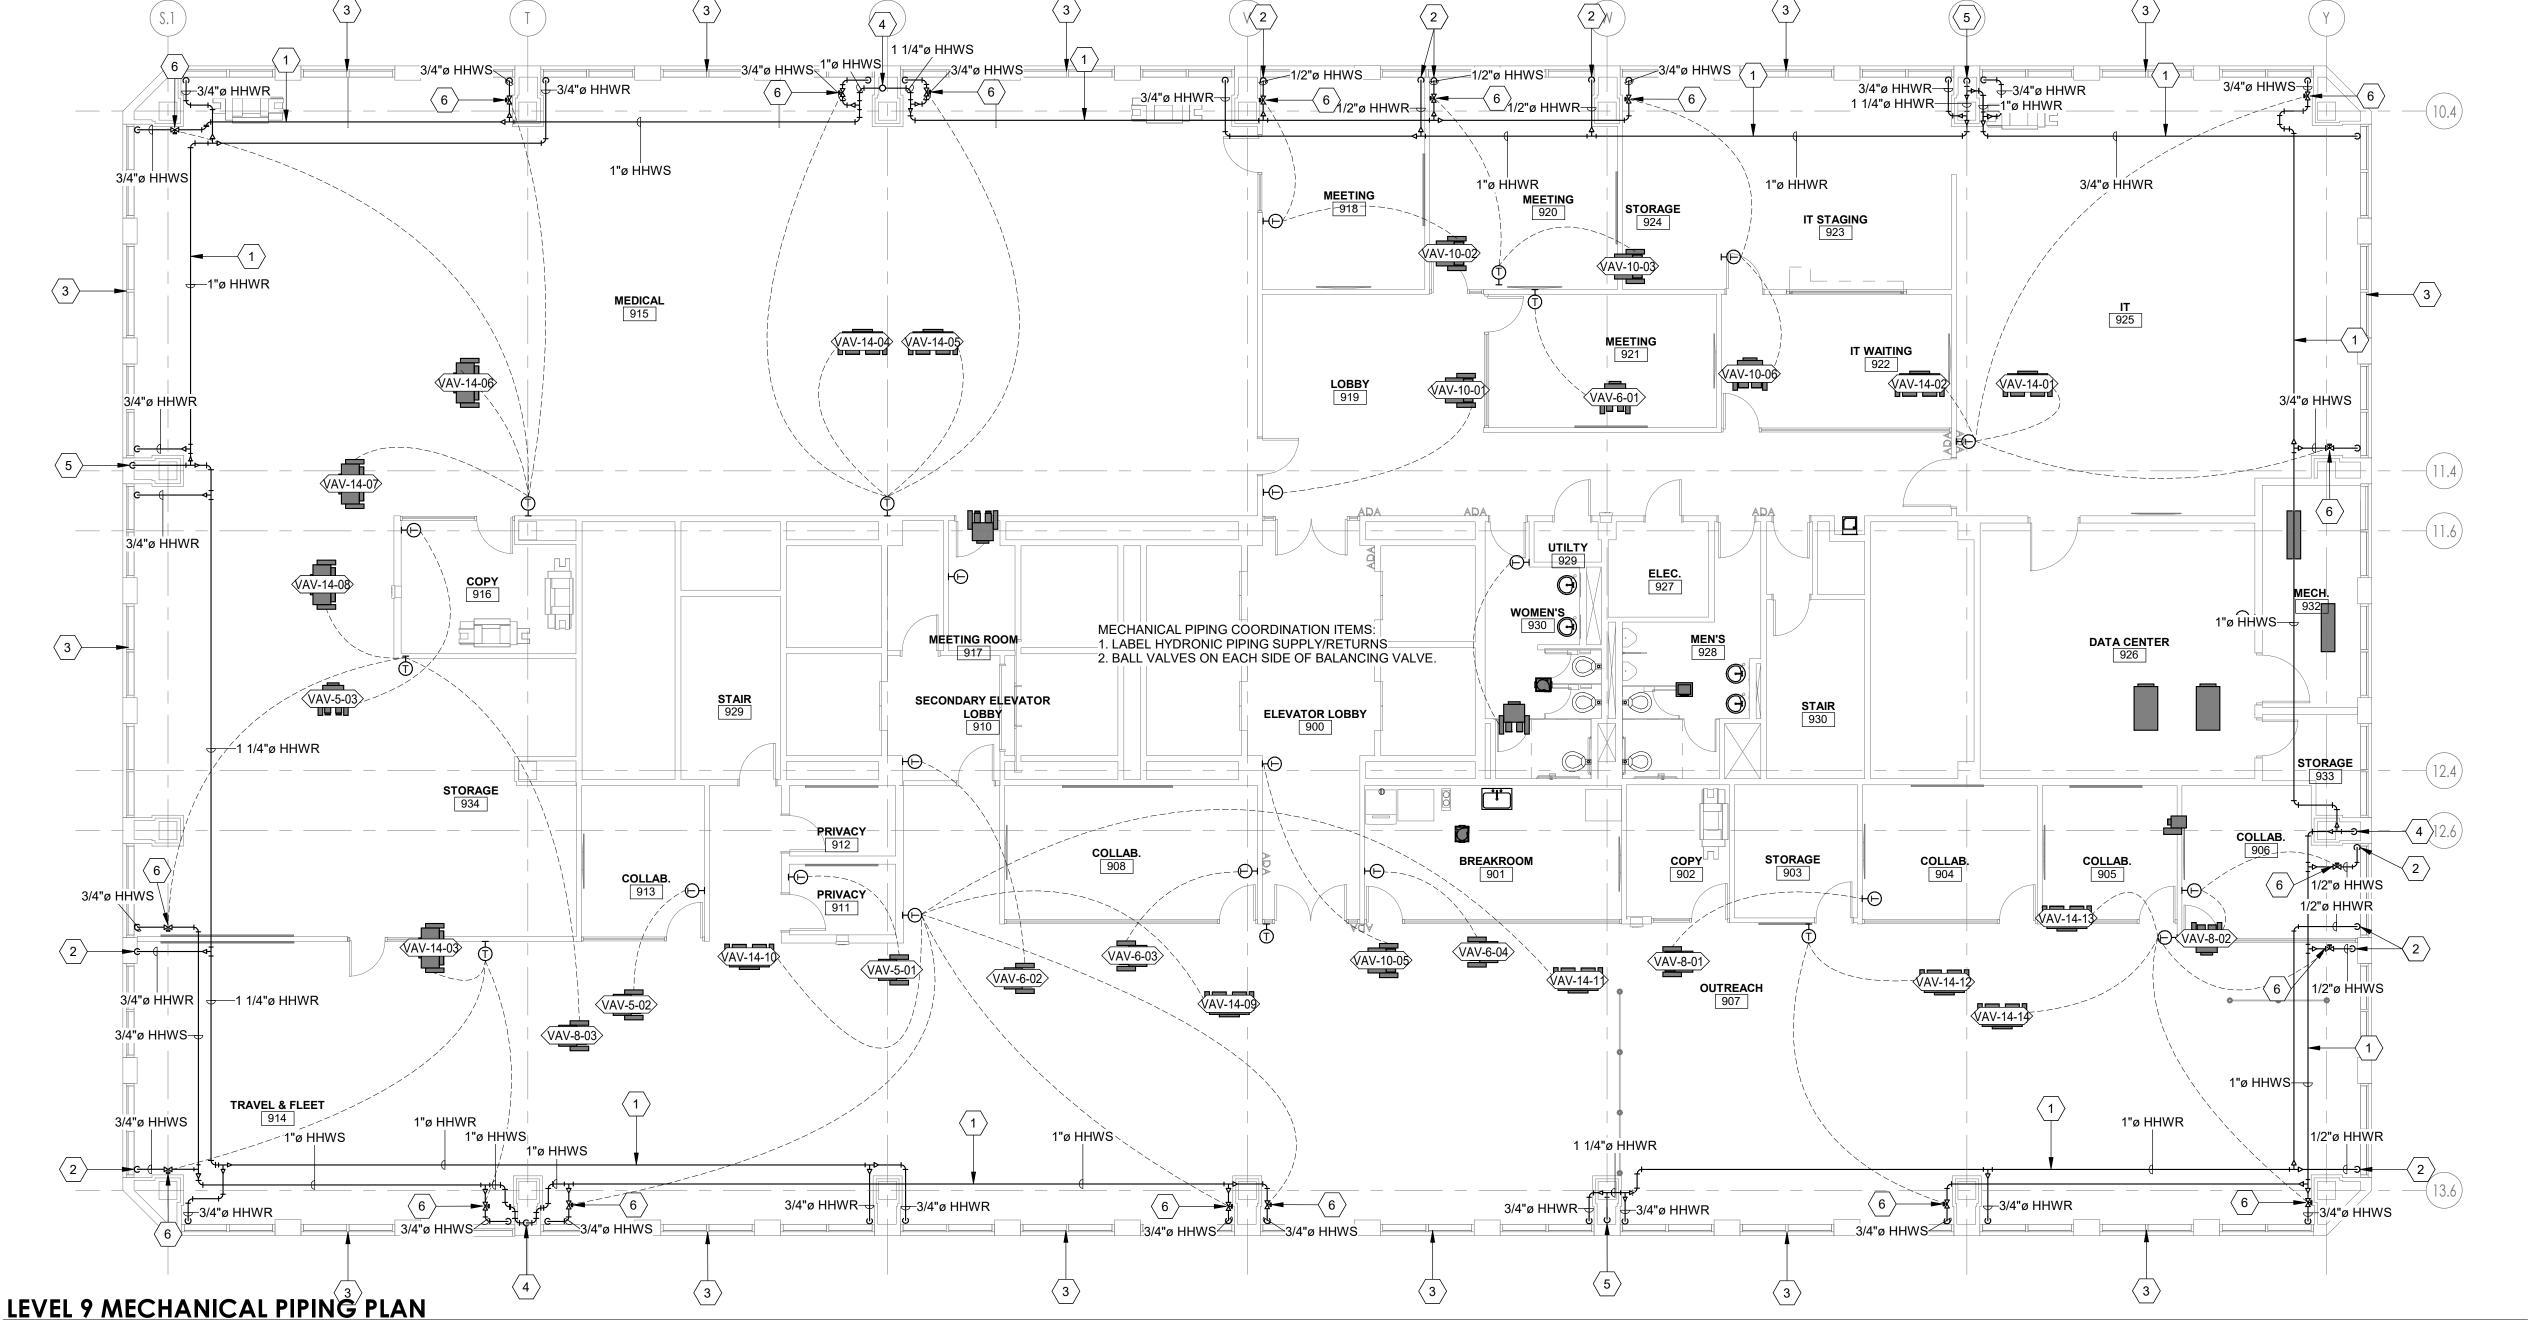

MISC.	SYMBOL LEGEND
SYMBOL	DESCRIPTION
# SHEET	DETAIL INDICATOR: # INDICATES DETAIL NUMBER, SHEET INDICATES DRAWING SHEET WHERE DETAIL IS SHOWN.
# SHEET	ELEVATION OR SECTION INDICATOR, EXTERIOR: # INDICATES ELEVATION OR SECTION NUMBER, SHEET INDICATES DRAWING SHEET WHERE ELEVATION OR SECTION IS SHOWN.
100	ROOM OR SPACE NUMBER.
1	KEYNOTE INDICATOR.
	REVISION INDICATOR.
CU-1	EQUIPMENT INDICATOR.
P-	PLUMBING FIXTURE INDICATOR.
TYPE CFM SIZE	DIFFUSER/GRILLE INDICATOR.
TYPE SIZE	DIFFUSER/GRILLE INDICATOR.
	BREAK, STRAIGHT
5	BREAK, ROUND.
	MATCH LINE INDICATOR
	HIDDEN FEATURES LINE: HIDDEN, THIN LINE.
	CONTRACT LIMIT LINE: DASHDOT, WIDE LINE.
<u> </u>	NEW CONNECTION POINT TO EXISTING

PLUMBING SYMBOL LEGEND SYMBOL DESCRIPTION

C.B.	CATCH BASIN
M.H.	MANHOLE
————— W.H.	WALL HYDRANT
—————————————————————————————————————	HOSE BIBB
—ф	CLEANOUT TO GRADE
—ф	FLOOR CLEANOUT
	WALL CLEANOUT
	1/2 GRATE
	3/4 GRATE
	FULL GRATE

DEFINITIONS

NOTE: ALL DEFINITIONS MAY NOT BE USED.

INDICATED: THE TERM "INDICATED" REFERS TO GRAPHIC REPRESENTATIONS, NOTES, OR SCHEDULES ON THE DRAWINGS, OTHER PARAGRAPHS OR SCHEDULES IN THE SPECIFICATIONS, AND SIMILAR REQUIREMENTS IN THE CONTRACT DOCUMENTS. WHERE TERMS SUCH AS "SHOWN", "NOTED", "SCHEDULED", AND "SPECIFIED" ARE USED, IT IS TO HELP THE READER LOCATE THE REFERENCE, NO LIMITATION ON LOCATION IS INTENDED.

DIRECTED: TERMS SUCH AS "DIRECTED", "REQUESTED", AUTHORIZED", "SELECTED", "APPROVED", "REQUIRED", AND "PERMITTED" MEAN "DIRECTED BY THE ENGINEER", "REQUESTED BY THE ENGINEER", AND SIMILAR PHRASES.

APPROVED: THE TERM "APPROVED", WHERE USED IN CONJUNCTION WITH THE ENGINEER'S ACTION ON THE CONTRACTOR'S SUBMITTALS, APPLICATIONS, AND REQUESTS, IS LIMITED TO THE ENGINEER'S DUTIES AND RESPONSIBILITIES AS STATED IN GENERAL AND SUPPLEMENTARY CONDITIONS.

FURNISH: THE TERM "FURNISH" IS USED TO MEAN "SUPPLY AND DELIVER TO THE PROJECT SITE, READY FOR UNLOADING, UNPACKING, ASSEMBLY, INSTALLATION, AND SIMILAR OPERATIONS."

INSTALL: THE TERM "INSTALL" IS USED TO DESCRIBE OPERATIONS AT PROJECT SITE INCLUDING THE ACTUAL "UNLOADING, UNPACKING, ASSEMBLY, ERECTION, PLACING, ANCHORING, APPLYING, WORKING TO DIMENSION, FINISHING, CURING, PROTECTING, CLEANING, AND SIMILAR OPERATIONS."

PROVIDE: THE TERM "PROVIDE" MEANS "TO FURNISH AND INSTALL, COMPLETE AND READY FOR THE INTENDED USE."

INSTALLER: AN "INSTALLER" IS THE CONTRACTOR OR AN ENTITY ENGAGED BY THE CONTRACTOR, EITHER AS AN EMPLOYEE, SUBCONTRACTOR, OR SUB-SUBCONTRACTOR, FOR PERFORMANCE OF A PARTICULAR CONSTRUCTION ACTIVITY, INCLUDING INSTALLATION, ERECTION, APPLICATION, AND SIMILAR OPERATIONS. INSTALLERS ARE REQUIRED TO BE EXPERIENCED IN THE OPERATIONS THEY ARE ENGAGED TO PERFORM.

SYMBOL	DESCRIPTION
	SANITARY SEWER (SS)
	— GREASE WASTE (GW)
	─ VENT (V)
AV	- ACID VENT
AW	— ACID WASTE
	DOMESTIC COLD WATER (DCW)
	DOMESTIC HOT WATER (DHW)
	DOMESTIC HOT WATER RECIRC (DHWR)
180	— 180°F HOT WATER
180R	— 180° HOT WATER RETURN
160	— 160° HOT WATER
160R	— 160° HOT WATER RETURN
RW-	— RAINWATER
SRW-	— SECONDARY RAINWATER
SD	— STORM DRAIN
VTR	VENT THRU ROOF
	NON POTABLE WATER
(E)	EXISTING PIPE
- — — (E) — — —	EXISTING PIPE TO BE REMOVED
-IW	- IRRIGATION WATER
SS	— SANITARY SEWER
LPS-	LOW PRESSURE STEAM
CHWS	CHILLED WATER SUPPLY
CHWR	— CHILLED WATER RETURN
HHWS-	HEATING HOT WATER SUPPLY
HHWR-	HEATING HOT WATER RETURN
CWS	CONDENSER WATER SUPPLY
CWR	CONDENSER WATER RETURN
GS	GLYCOL SUPPLY
GR	— GLYCOL RETURN
G	— GAS
FP	FIRE PROTECTION
LPG-	— PROPANE
VAC-	- VACUUM
CA	COMPRESSED AIR
MA	MEDICAL AIR
0-	- OXYGEN
NO	- NITROUS OXIDE
N-	- NITROGEN
CO2	CARBON DIOXIDE
EVAC-	— EVACUATION

——EVAC—— | EVACUATION

	SYMBOL LEGEND
SYMBOL	DESCRIPTION
VALVE	S, METERS, AND GAUGES
\bowtie	SHUT OFF VALVE
凶	GATE VALVE
ightharpoonup	CHECK VALVE
內	AUTO 2-WAY VALVE
\mathbb{Z}	AUTO 3-WAY VALVE
\triangleright	GLOBE VALVE
Ф	BALL VALVE
赵	RELIEF VALVE
	CHAIN OPERATED GATE VALVE
 ✓	PRESSURE REDUCING VALVE
Ī	BUTTERFLY VALVE
	SOLENOID VALVE
	ANGLE VALVE
I	VENTURI
8	BALANCING OR PLUG COCK
\boxtimes	FLOW SETTER
\otimes	EXPANSION VALVE (REFRIG.)
ightharpoons	GAS COCK
ZMAV	MANUAL AIR VENT
-	STRAINER
О1	GAUGE COCK
	FLEXIBLE CONNECTION
P	PRESSURE GAUGE
Ą	THERMOMETER
	VICTUALIC COUPLING
→	REDUCER CONCENTRIC
V	REDUCER ECCENTRIC
⊗	REFRIGERANT SITE GLASS
	REFRIGERANT STRAINER
I 🖵	REFRIGERANT FILTER DRIER
—	90 DEG ELBOW UP
— <u> </u>	90 DEG ELBOW DOWN
<u> </u>	90 DEG TEE UP
	90 DEG TEE DOWN
1 1	UNION
	CAPPED PIPE
	ANCHOR

FLOAT AND THERMOSTATIC TRAP

 $\overline{}$

	ABBREVIATIONS OTE: ALL ABBREVIATIONS MAY NOT BE USED.
(E) (F)	EXISTING FUTURE
AD AIR COND	ACCESS DOOR AIR CONDITION(-ING,-ED)
APD BD	AIR PRESSURE DROP BALANCING DAMPER
BHP BTU	BRAKE HORSE POWER BRITISH THERMAL UNIT
BTUH CFH	BTU/HOUR CUBIC FEET PER HOUR
CFM CLG	CUBIC FEET PER MINUTE COOLING
COMP COND	COMPONENT CONDENS(-ER, -ING, -ATION)
CV DB	CONTROL VALVE DRY BULB TEMPERATURE
DCW DHW	DOMESTIC COLD WATER DOMESTIC HOT WATER
DHWR	DOMESTIC HOT WATER RECIRC
DIA DISCH	DIAMETER DISCHARGE
DP EA	DEPTH OR DEEP EXHAUST AIR
EER EFF	ENERGY EFFICIENCY RATIO EFFICIENCY ET IN ENERGY SOLVEN
EG ELEC	ETHYLENE GLYCOL ELECTRIC
ELEV ENT	ELEVATION ENTERING
EVAP EWT	EVAPORAT(-E, -ING, -ED, -OR) ENTERING WATER TEMPERATURE
EXT FC	EXTERNAL FLEXIBLE CONNECT(-OR, -ION)
FD FLA	FIRE DAMPER FULL LOAD AMPS
FPI FPM	FINS PER INCH FEET PER MINUTE
FPS FSD	FEET PER SECOND FIRE SMOKE DAMPER
GAL GE	GALLON(S) GREASE EXHAUST
GPH GPM	GALLONS PER HOUR GALLONS PER MINUTE
HD HG	HEAD MERCURY
HP HR	HORSEPOWER HOUR
HT HTG	HEIGHT HEATING
HZ ID	HERTZ (FREQUENCY) INSIDE DIAMETER
N KW	INCH KILOWATT
LAT LBS	LEAVING AIR TEMPERATURE POUNDS
LG LH	LENGTH LATENT HEAT
LRA LVG	LOCKED ROTOR AMPS LEAVING
LWT MBH	LEAVING WATER TEMPERATURE THOUSAND BTU PER HOUR
MCA MFR	MINIMUM CIRCUIT AMPS MANUFACTUR(-ER, -ED)
NC NIC	NOISE CRITERIA NOT IN CONTRACT
NO NPSH	NORMALLY OPEN NET POSITIVE SUCTION HEAD
NTS OA	NOT TO SCALE OUTSIDE AIR
OD OZ	OUTSIDE DIAMETER OUNCE
PD PG	PRESSURE DROP OR DIFFERENCE PROPOLENE GLYCOL
PH PPM	PHASE PARTS PER MILLION
FFM PRESS PSF	PRESSURE
rsi PSI PSIA	POUNDS PER SQUARE FOOT POUNDS PER SQUARE INCH PSI ABSOLUTE
PSIG	PSI GAUGE THERMAL RESISTANCE
R RA RECIRC	RETURN AIR RECIRCULATE
REFR	REFRIGERATION
REQD RLA	REQUIRED RATED LOAD AMPS REVOLUTIONS DEP MINUTE
RPM SA	REVOLUTIONS PER MINUTE SUPPLY AIR
SC SCFM	SHADING COEFFICIENT STANDARD CUBIC FEET PER MINUTE
SCW SF	SOFT COLD WATER SAFETY FACTOR
SH SP	SENSIBLE HEAT STATIC PRESSURE
SPEC(S) SQ	SPECIFICATION(S) SQUARE
STD SW	STANDARD SOIL, WASTE
TA(R) TA(S)	TRANSFER AIR (RETURN) TRANSFER AIR (SUPPLY)
TD TEMP	TEMP. DROP OR DIFF. TEMPERATURE
THERM TOT	THERMAL TOTAL
TSTAT V	THERMOSTAT VOLT
V VAC	VENT VACUUM
VAV VEL	VARIABLE AIR VOLUME VELOCITY TEMPERATURE
VEL VENT	VELOCITY VENT, VENTILATION
VERT VFD	VERTICAL VARIABLE FREQUENCY DRIVE
VOL WB	VOLUME WET BULB TEMP
WC WG	WATER COLUMN WATER GAUGE

PLUMBING GENERAL NOTES

- THE PLUMBING DRAWINGS SHOW THE GENERAL DESIGN, ARRANGEMENT AND EXTENT OF THE PLUMBING SYSTEM. BECAUSE OF THE SMALL SCALE OF THE DRAWINGS, THESE DRAWINGS DO NOT SHOW ALL OFFSETS, BENDS OR ELBOWS NECESSARY FOR THE COMPLETE INSTALLATION IN THE SPACE PROVIDED. CONTRACTOR SHALL MAKE SUCH SLIGHT ALTERATIONS AS MAY BE NECESSARY TO MAKE THE SYSTEM COMPLETE AND OPERATIONAL IN ACCORDANCE WITH THE DESIGN INTENT. MAJOR DEVIATIONS SUCH AS CHANGES IN COMPONENT SIZES, WEIGHTS, QUANTITIES OR MATERIAL REQUIRE PRIOR APPROVAL BY THE DESIGN
- THE DRAWINGS AND SPECIFICATIONS HAVE BEEN PREPARED TO SUPPLEMENT EACH OTHER AND SHALL BE INTERPRETED AS AN INTEGRAL UNIT WITH THE ITEMS SHOWN ON ONE AND NOT THE OTHER BEING FURNISHED AND INSTALLED AS THOUGH SHOWN AND CALLED OUT IN BOTH.
- THE ENTIRE PLUMBING INSTALLATION SHALL CONFORM TO THE REQUIREMENTS OF THE MOST RECENTLY ADOPTED BUILDING CODES, MECHANICAL CODE, PLUMBING CODE, ELECTRICAL CODE, AND ALL OTHER APPLICABLE CITY, COUNTY, STATE, AND FEDERAL CODES AND REGULATIONS IN EFFECT.
- THE ENTIRE PLUMBING INSTALLATION SHALL CONFORM TO ANY CODES, RULES, REGULATIONS AND REQUIREMENTS OF THE BUILDING OWNER.
- PRIOR TO FABRICATION AND INSTALLATION OF ANY PLUMBING COMPONENT THE CONTRACTOR SHALL COORDINATE THE INSTALLATION OF ALL PLUMBING WORK WITH ALL OTHER BUILDING TRADES, INCLUDING BUILDING TRADES HIRED DIRECTLY BY THE OWNER. WHERE CONFLICTS MAY OCCUR, THEY SHALL BE RESOLVED PRIOR TO INSTALLATION.
- ALL PLUMBING INFORMATION IS NOT SHOWN ON THE PLUMBING DRAWINGS. THE CONTRACTOR SHALL BE RESPONSIBLE FOR COORDINATING ALL INFORMATION ON ALL OTHER CONSTRUCTION DOCUMENTS.
 - . THE CONTRACTOR SHALL BE RESPONSIBLE TO REVIEW AND USE, WHERE APPROPRIATE, ALL THE PLUMBING DETAILS SHOWN ON THE DRAWINGS. DETAILS MAY OR MAY NOT BE CALLED OUT ON THE DRAWINGS WITH SYMBOLS OR KEYED NOTES. ANY CHANGES RESULTING FROM FAILURE TO INSTALL THE PLUMBING SYSTEM WITHOUT USING THE INCLUDED DETAILS SHALL BE THE RESPONSIBILITY OF THE CONTRACTOR.
- ANY PART OF THE PLUMBING INSTALLATION THAT FAILS, IS UNFIT, OR BECOMES DAMAGED DURING CONSTRUCTION SHALL BE REPAIRED OR REPLACED BY THE CONTRACTOR AT NO ADDITIONAL COST TO THE OWNER.
- PROVIDE PROPER PROVISIONS FOR EXPANSION, CONTRACTION, OR MOVEMENT OF ALL PIPING.
- 10 PROVIDE LARGE ENOUGH PIPE SLEEVES THROUGH WALL OR FLOOR TO ALLOW FOR ANTICIPATED DIFFERENTIAL MOVEMENT.
- 11 ALL PIPING SHALL BE SUPPORT WITH CLEVIS HANGERS (MSS TYPE 1). PERFORATED METAL STRAPS OR PLASTIC STRAPPING (PLUMBER TAPE) SHALL NOT BE USED TO SUPPORT OR BRACE ANY PIPE.
- 12 PROVIDE PIPE HANGERS WITHIN 18-INCHES OF ALL CHANGES OF DIRECTION.
- 13 PROVIDE SWAY BRACING FOR ALL PIPING 4" AND LARGER AT ALL CHANGES IN DIRECTION GREATER THAN 45-DEGREES.
- 14 ALL STEEL CLEVIS HANGERS USED TO SUPPORT COPPER PIPING SHALL BE
- COPPER OR PLASTIC COATED. 15 COPPER PIPING SHALL NOT COME IN CONTACT WITH FIRE TREATED LUMBER. PROVIDE 1/3" THICK SLIP-ON CLOSED CELL INSULATION WHERE COPPER PIPING IS ADJACENT TO FIRE TREATED LUMBER. CLOSED CELL INSULATION SHALL EXTEND
- 16 ALL EXPOSED PIPING SHALL BE INSTALLED IN A NEATLY ARRANGED MANNER PARALLEL TO THE BUILDING STRUCTURE.
- 17 ALL EXPOSED DOMESTIC WATER PIPE IN OCCUPIED SPACES SHALL BE POLISHED
- 18 ALL EXPOSED DRAINAGE PIPING IN OCCUPIED SPACES INCLUDING TRAPS UNDER
- SINKS SHALL BE POLISHED CHROME PLATED. 19 DRAWINGS SHOW GENERAL ARRANGEMENT OF THE DRAIN WASTE AND VENT
- SYSTEM WITH THE REQUIRED CLEANOUTS. CONTRACTOR SHALL PROVIDE ALL ADDITIONAL CLEANOUTS AS REQUIRED BY THE PLUMBING CODE.
- 20 ALL SANITARY DRAINAGE SYSTEM PIPING 3" AND LARGER SHALL BE SLOPED IN DIRECTION OF FLOW AT A MINIMUM OF 1/8" PER FOOT.
- 21 ALL SANITARY DRAINAGE SYSTEM PIPING SMALLER THAN 3" SHALL BE SLOPED IN DIRECTION OF FLOW AT A MINIMUM OF 1/4" PER FOOT.
- 22 SLOPE VENT SYSTEM TOWARDS DRAINAGE SYSTEM.

A MINIMUM OF 1-1/2" PAST LUMBER.

- 23 SIMILAR EQUIPMENT SHALL BE OF THE SAME MANUFACTURER.
- 24 ALL EQUIPMENT SHALL PROVIDE THE SCHEDULED PERFORMANCE AT THE JOB SITE ELEVATION.
- 25 FIXTURE AND EQUIPMENT MODEL NUMBERS SHOWN IN PLUMBING FIXTURE SCHEDULE AND PLUMBING EQUIPMENT SCHEDULE ARE SHOWN TO ESTABLISH THE TYPE OF PRODUCT THAT SHALL BE USED. THE SELECTED PRODUCT SHALL MEET THE SCHEDULED PERFORMANCE DATA SHOWN ON THE SCHEDULE EVEN IF A DIFFERENT MODEL IS SUPPLIED THAT IS DIFFERENT THAN THAT SCHEDULED.
- 26 ALL EQUIPMENT SHALL BE INSTALLED IN STRICT ACCORDANCE WITH THE EQUIPMENT MANUFACTURER'S INSTALLATION INSTRUCTIONS. PROVIDE ALL NECESSARY FITTINGS, TRANSITIONS, VALVES AND OTHER DEVICES AND ACCESSORIES REQUIRED FOR A COMPLETE, WORKABLE INSTALLATION.
- 27 SEE "PLUMBING FIXTURE SCHEDULE" FOR INDIVIDUAL TRAPS, WASTE, VENT, AND DOMESTIC WATER PIPING FOR INDIVIDUAL FIXTURES.
- 28 ALL PLUMBING EQUIPMENT SHALL BE LISTED AND LABELED BY AN APPROVED TESTING AGENCY.
- 29 FIXTURES, EQUIPMENT AND PIPING INSTALLATION SHALL MEET NSF STANDARDS.

PLLIMBING SHEET INDEX

PLUMBING SHEET INDEX					
PE001	PLUMBING COVER SHEET				
PE501	PLUMBING DETAILS & SCHEDULES				
PD101	LEVEL 9 PLUMBING DEMOLITION PLAN				
PL101	LEVEL 9 PLUMBING PLAN - WATER				
PL201	LEVEL 9 PLUMBING PLAN - DWV				



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www.spectrum-engineers.com

PROJECT DESCRIPTION

INTERMOUNTAIN HEALTHCARE KEY BANK TOWER LEVEL 09

36 S STATE STREET SALT LAKE CITY, UT 84111

AHJ STAMP

SHEET NAME:

PLUMBING COVER SHEET

REVISIONS

DESCRIPTION

ISSUE DATE: 03/27/20 ISSUE TYPE: CD SET

DRAWN BY: CHECKED BY: RHB PROJECT#:

SHEET NUMBER:

WEIGHT

WATER GAUGE WATER

WATER PRESSURE DROP

WPD WT WTR

PLUMBING FIXTURE SCHEDULE								
LABEL	DESCRIPTION	WASTE	VENT	CW	HW	MANUFACTURER	MODEL	REMARKS
EWC-1	DRINKING FOUNTAIN	1 1/2"	1 1/4"	1/2"	0"	ELKAY	LZS8WSLP	
FD-1	FLOOR DRAIN	3"	0"	0"	0"	ZURN	Z1930	1
L-1	LAVATORY	2"	1 1/4"	1/2"	1/2"	KOHLER / SLOAN	K-2210 / EAF-350-CP	4
S-1	SINK	2"	1 1/4"	1/2"	1/2"	ELKAY / MOEN	EFRU2816TC / 5923EWBL	5
U-1	URINAL	2"	1 1/4"	3/4"	0"	KOHLER / KOHLER	K-4904-ET / K-10958	
WC-1	FLUSH VALVE WATER CLOSET	4"	2"	1 1/4"	0"	KOHLER / KOHLER	K-4325 / K-10956	2
WC-2	FLUSH VALVE ADA WATER CLOSET	Δ"	2"	1 1/4"	0"	KOHI FR / KOHI FR	K-4325 / K-10956	23

703 east 1700 south


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FLOOR DRAIN - PROVIDE WITH TRAP GUARD BY SURESEAL OR EQUAL TO MATCH FLOOR DRAIN SIZE.
 WATER CLOSET - PROVIDE WATER CLOSET WITH A MAP SCORE OF 1000.

ADA WATER CLOSET - MOUNT AT ADA HEIGHT.

LAVATORY - PROVIDE WITH T&S MIXING VALVE SET TO 110°F.
 PROVIDE WITH FAUCET CHECK VALVES.

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PROJECT DESCRIPTION

INTERMOUNTAIN HEALTHCARE KEY BANK TOWER LEVEL 09

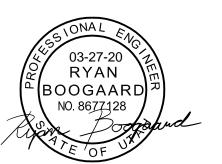36 S STATE STREET SALT LAKE CITY, UT 84111

AHJ STAMP

SHEET NAME: PLUMBING DETAILS & SCHEDULES

REVISIONS

MARK DATE DESCRIPTION TBD

ISSUE DATE: 03/27/20 ISSUE TYPE: CD SET

DRAWN BY: TAC CHECKED BY: RHB PROJECT#: 1953

SHEET NUMBER:

	NEL DRAIN DETAIL
1/8" =	: 1'-0"
	Th Th MAY EXTEND AS
	WALL ———————————————————————————————————
	CHROME WALL
	COVER AND SCREW
	PLUGGED TEE FINISHED FLOOR
	CLEANOUT
	1/8" BEND (TYPICAL)
	45 DEG. WYE (TYPICAL)
	WASTE PIPING —


- CONDENSATE

- MAINTAIN 1" AIR GAP

SINK

1 WALL CLEANOUT
1/8" = 1'-0"


PROVIDE WITH_ TRAP GUARD BY PROSET OR EQUAL

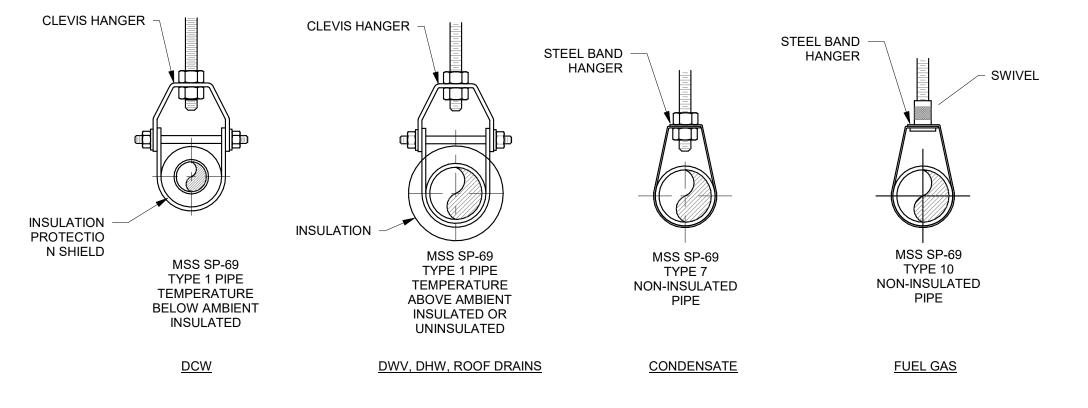

3 PIPE HANGERS
1/8" = 1'-0"

2

PE501

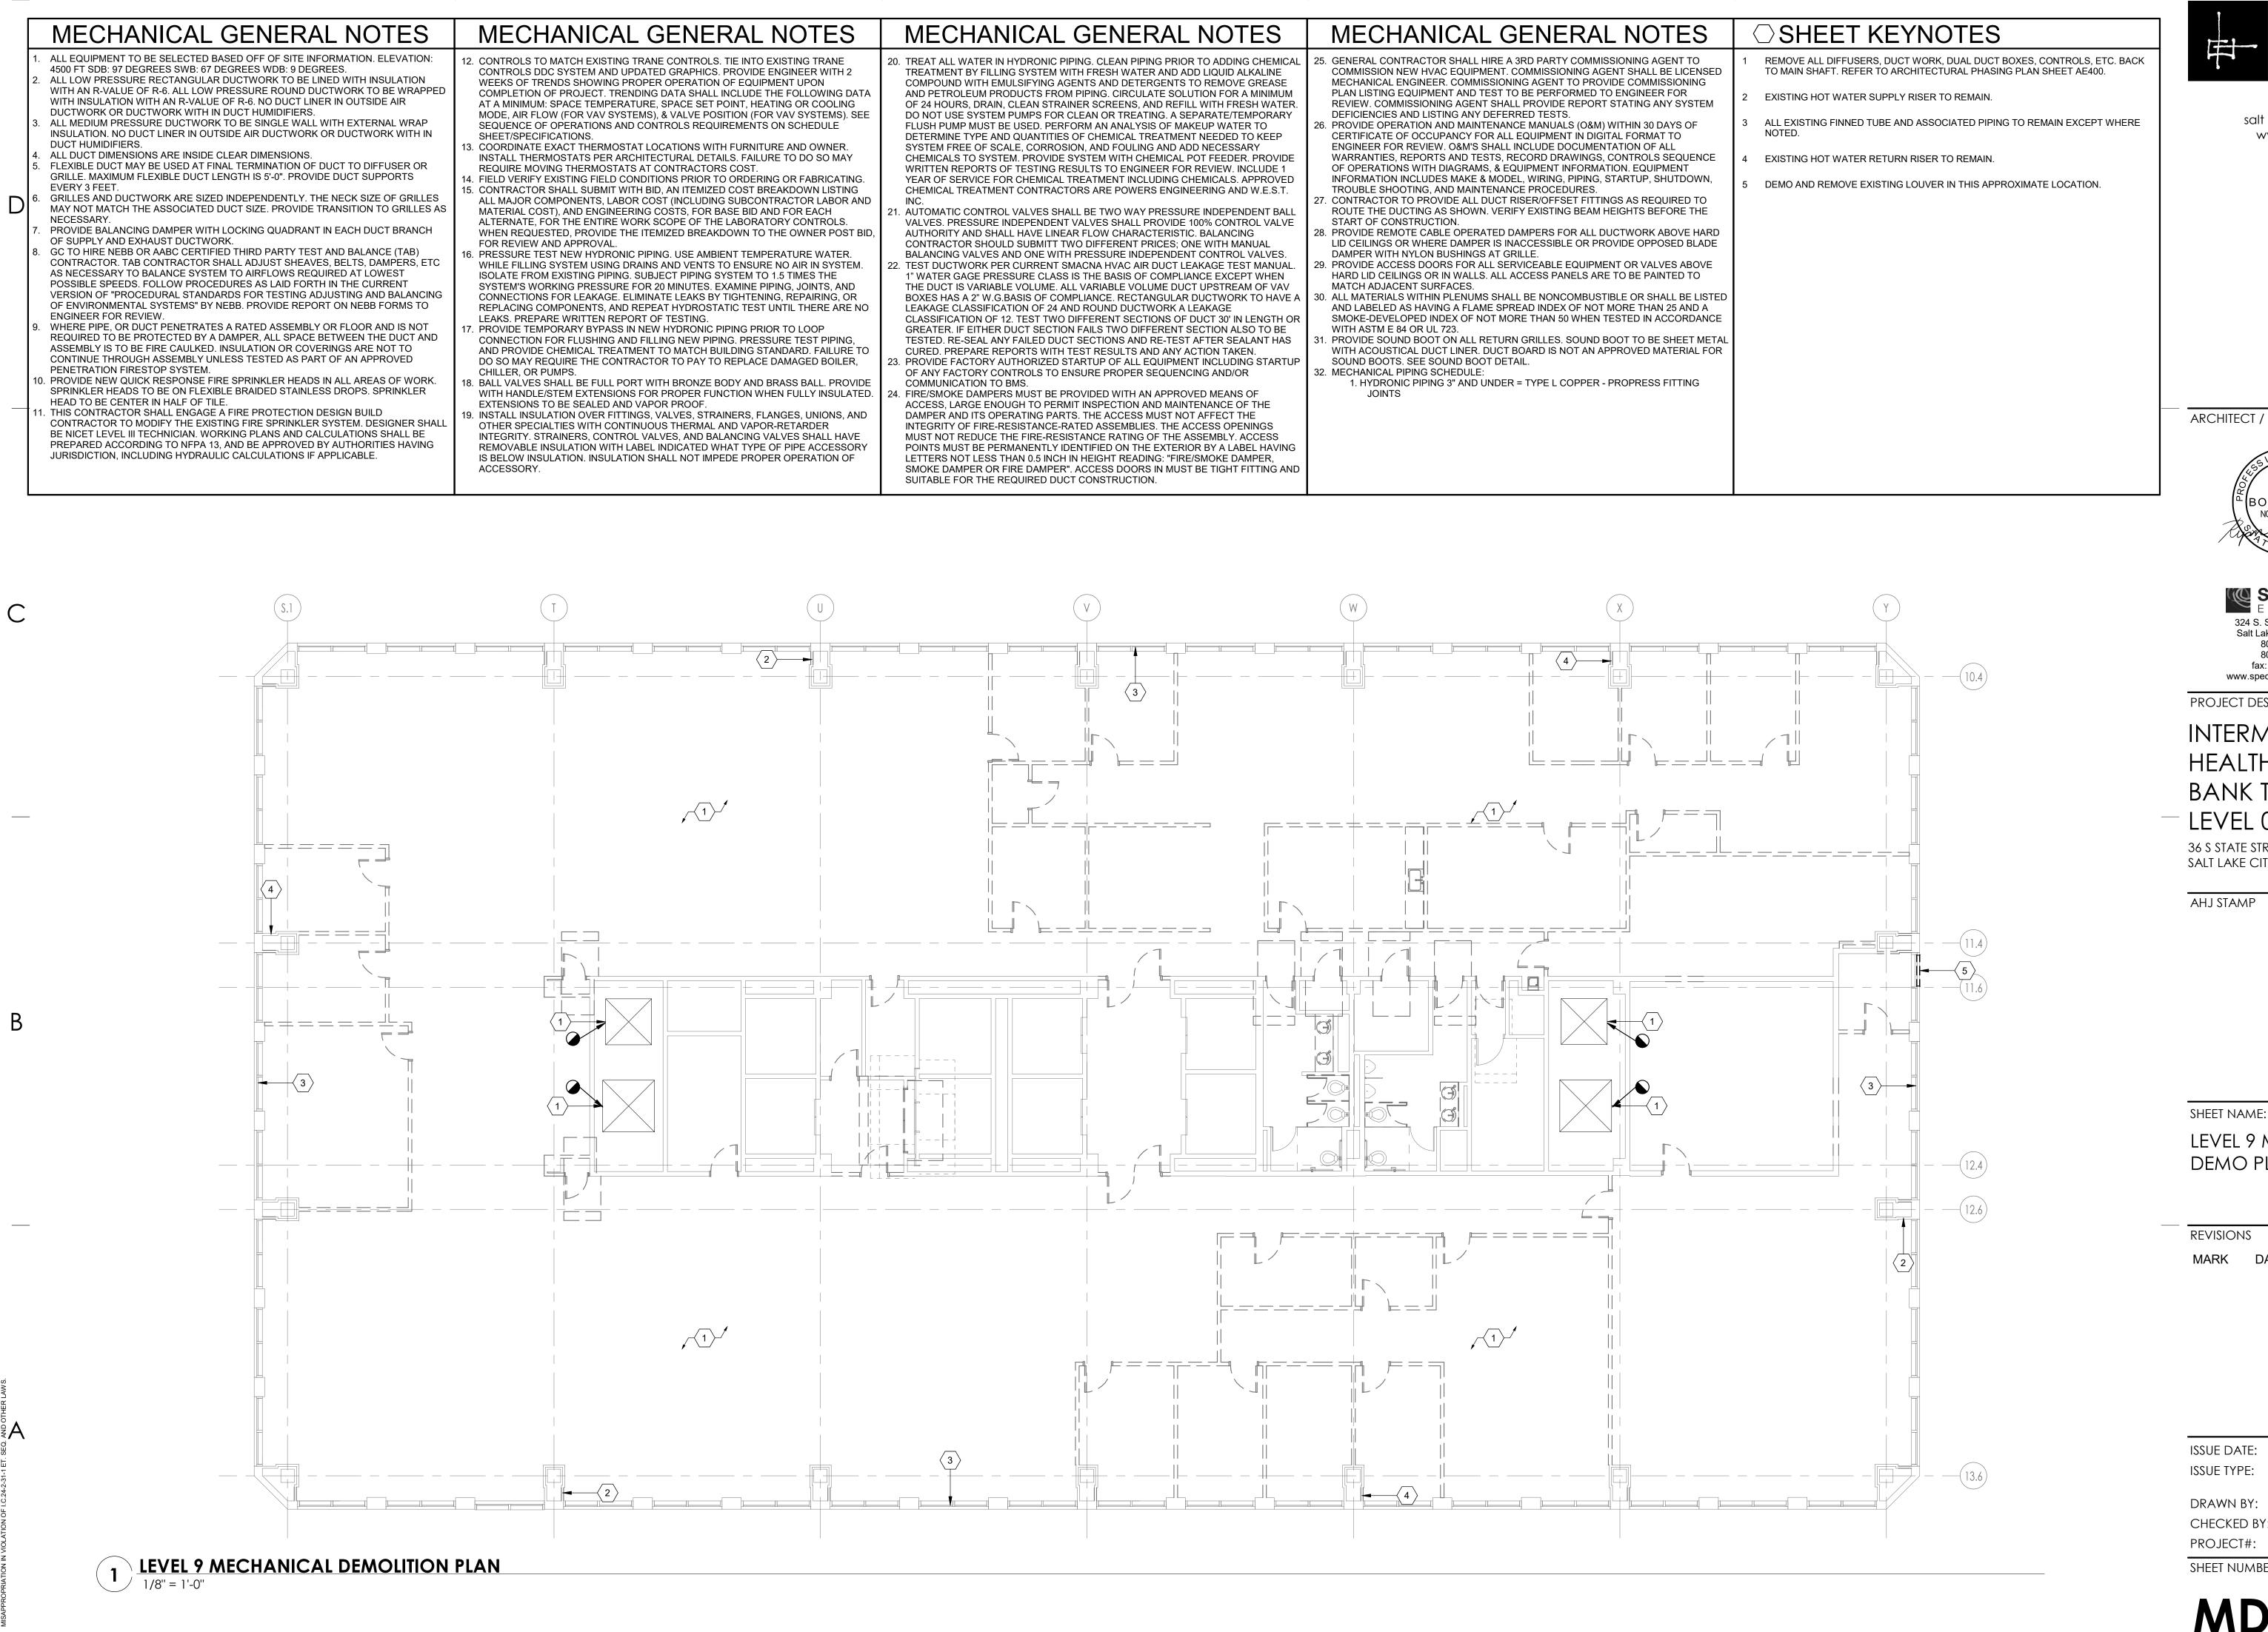

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PROJECT DESCRIPTION

INTERMOUNTAIN HEALTHCARE KEY BANK TOWER

36 S STATE STREET SALT LAKE CITY, UT 84111

AHJ STAMP

LEVEL 9 MECHANICAL DEMO PLAN

REVISIONS

DATE DESCRIPTION

ISSUE DATE: 03/27/20


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PROJECT#:

SHEET NUMBER:

MD101


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HEALTHCARE KEY

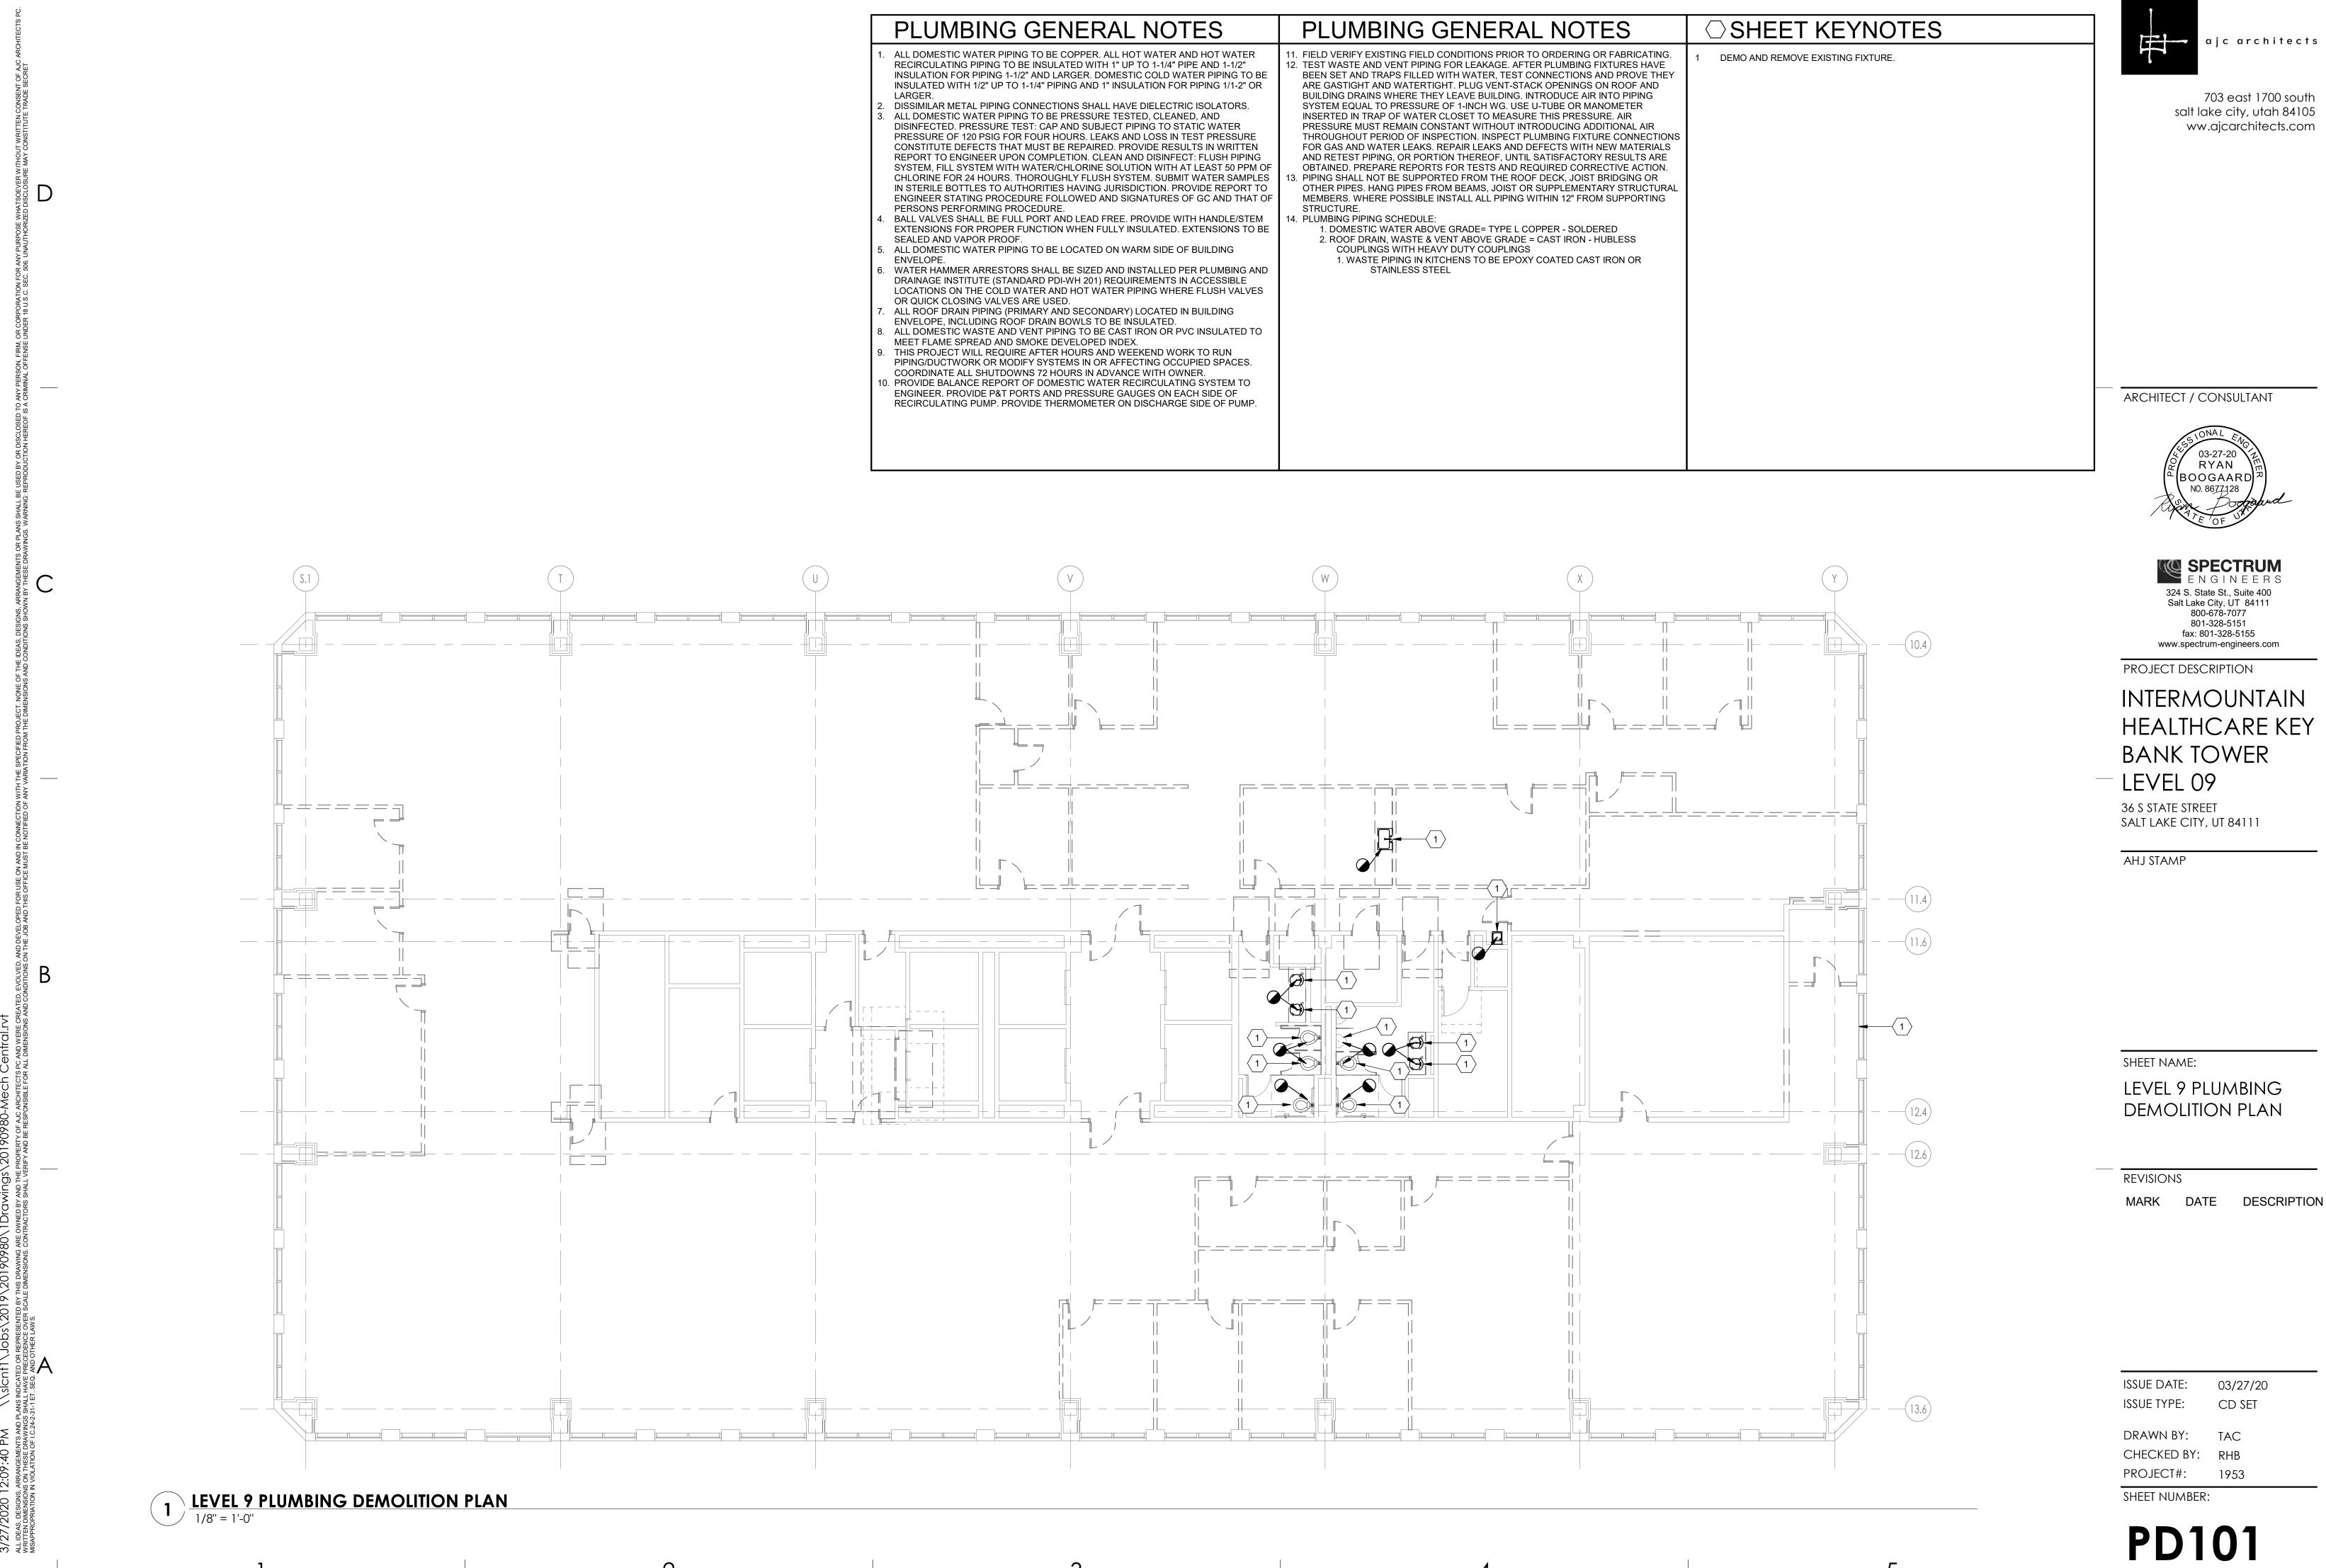

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PROJECT DESCRIPTION


INTERMOUNTAIN HEALTHCARE KEY BANK TOWER

PLAN - WATER

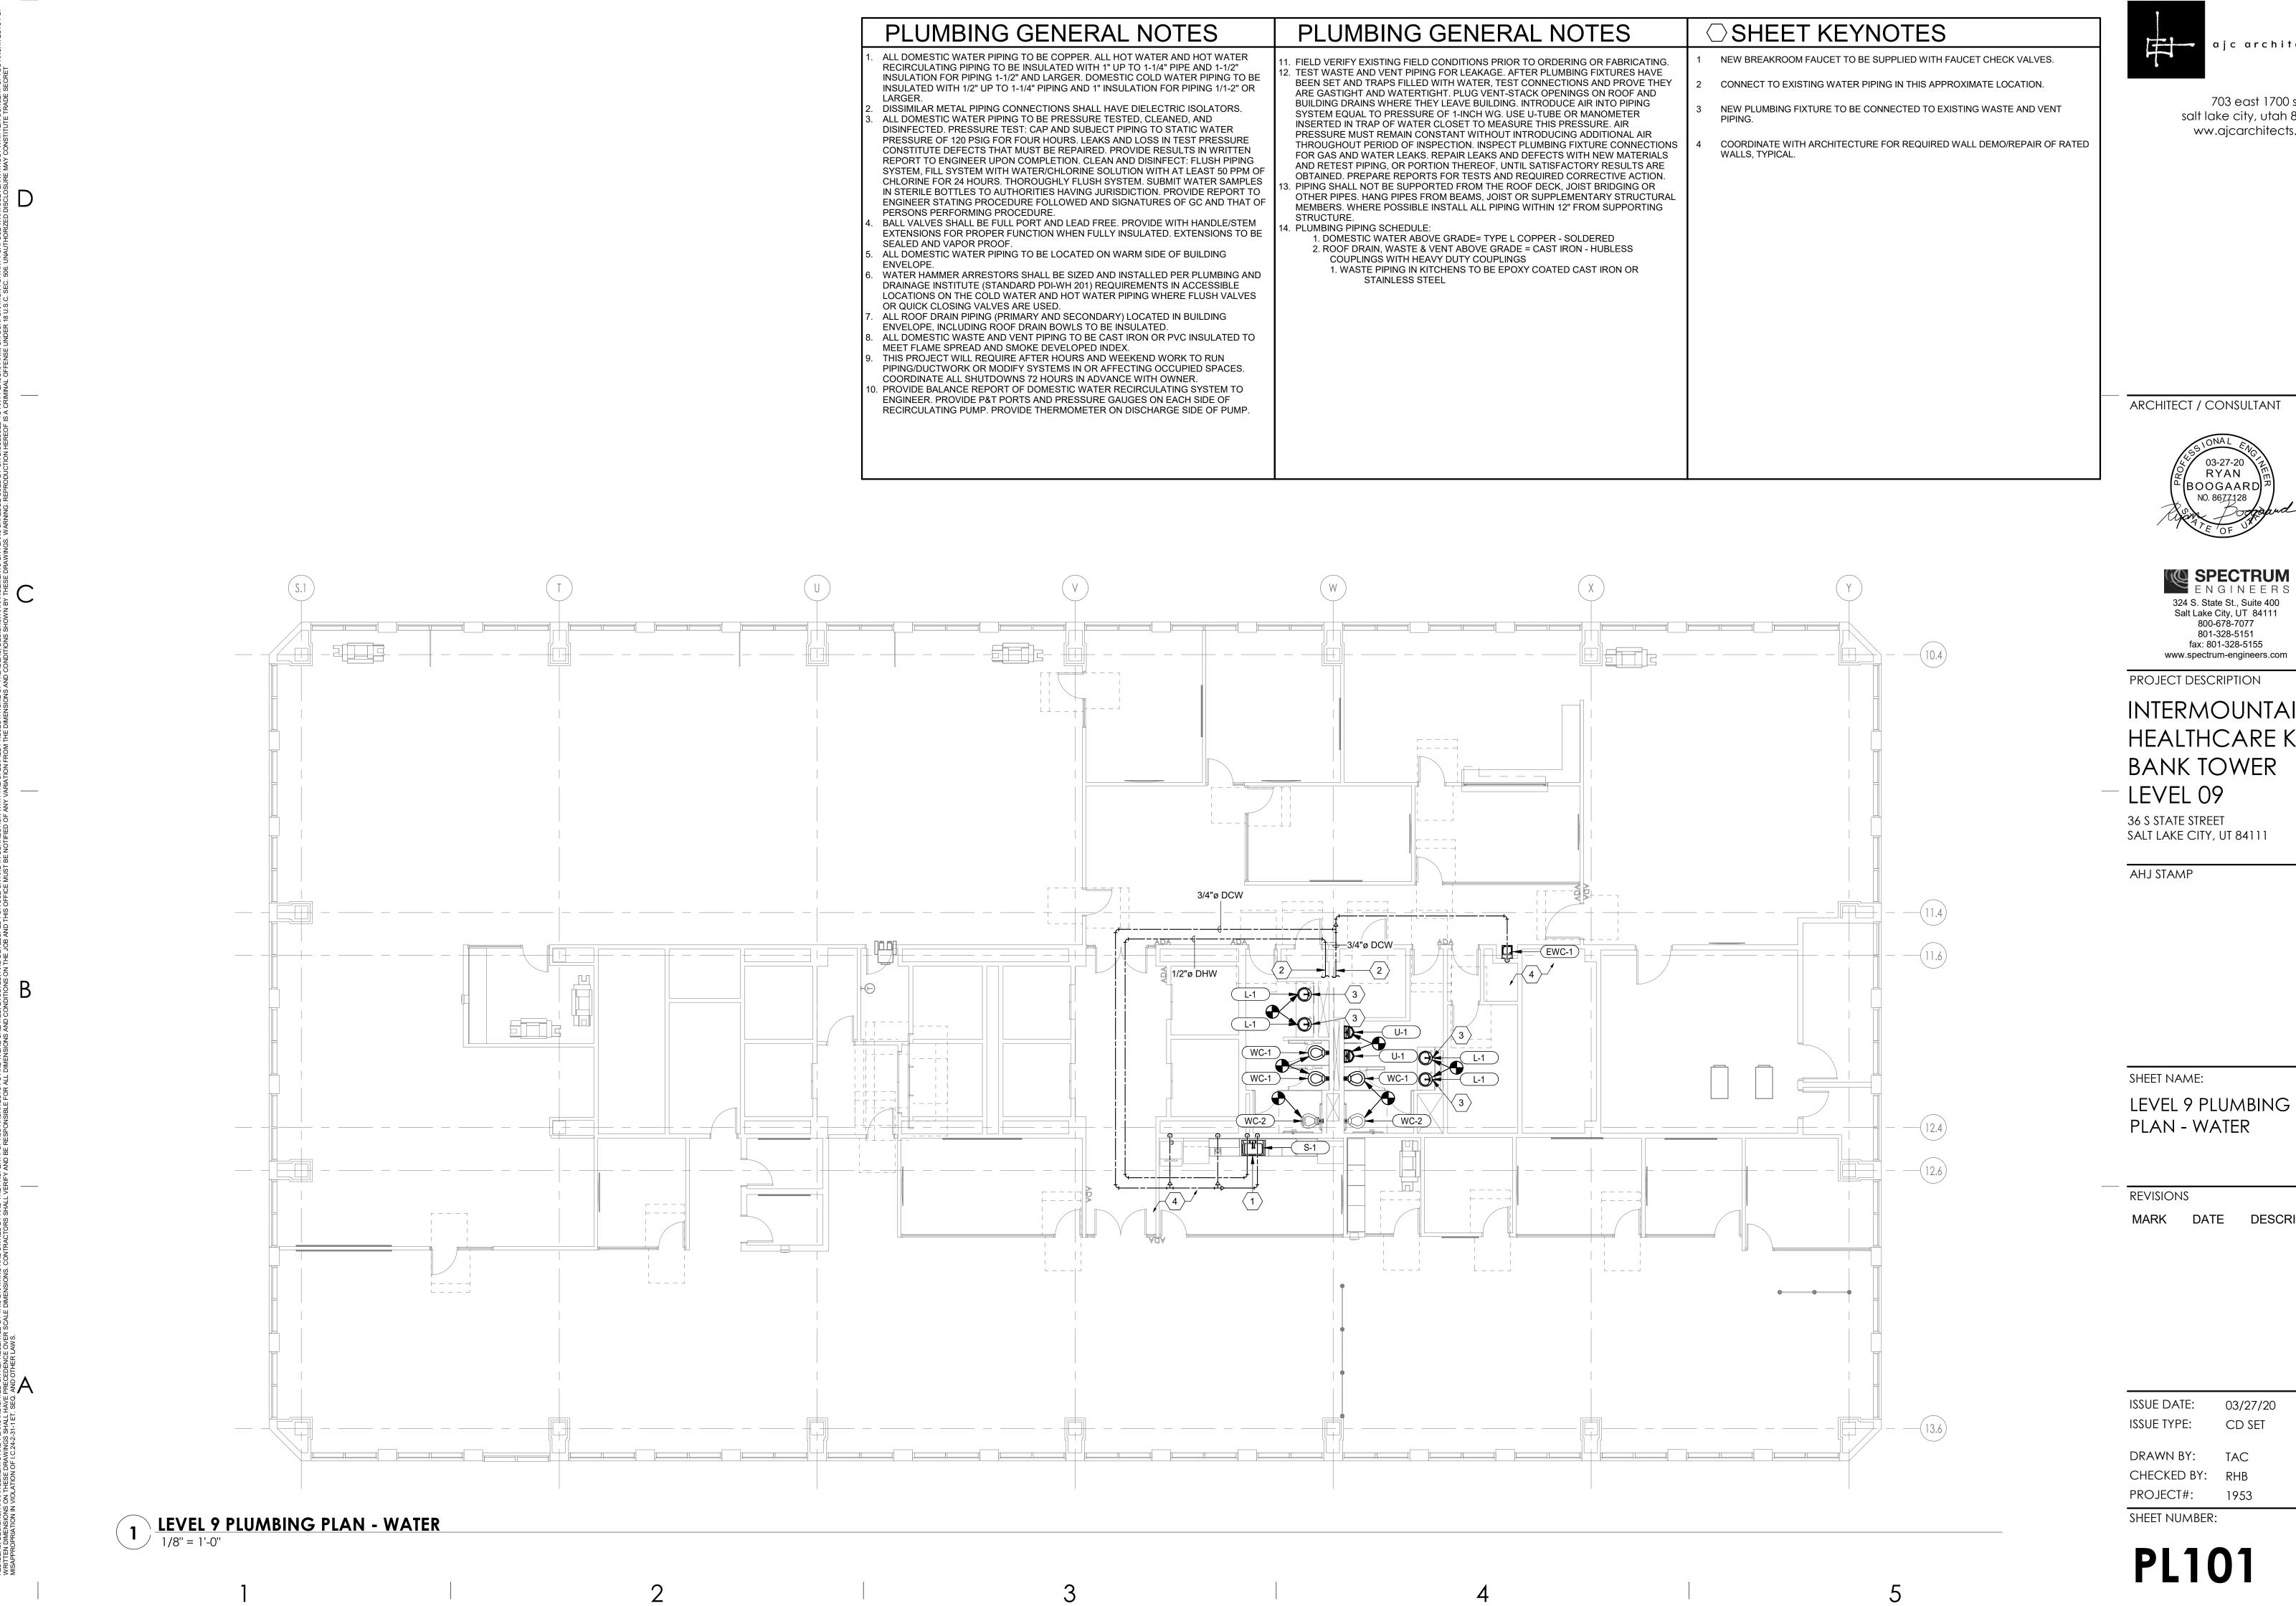MARK DATE DESCRIPTION

CHECKED BY: RHB


PL101

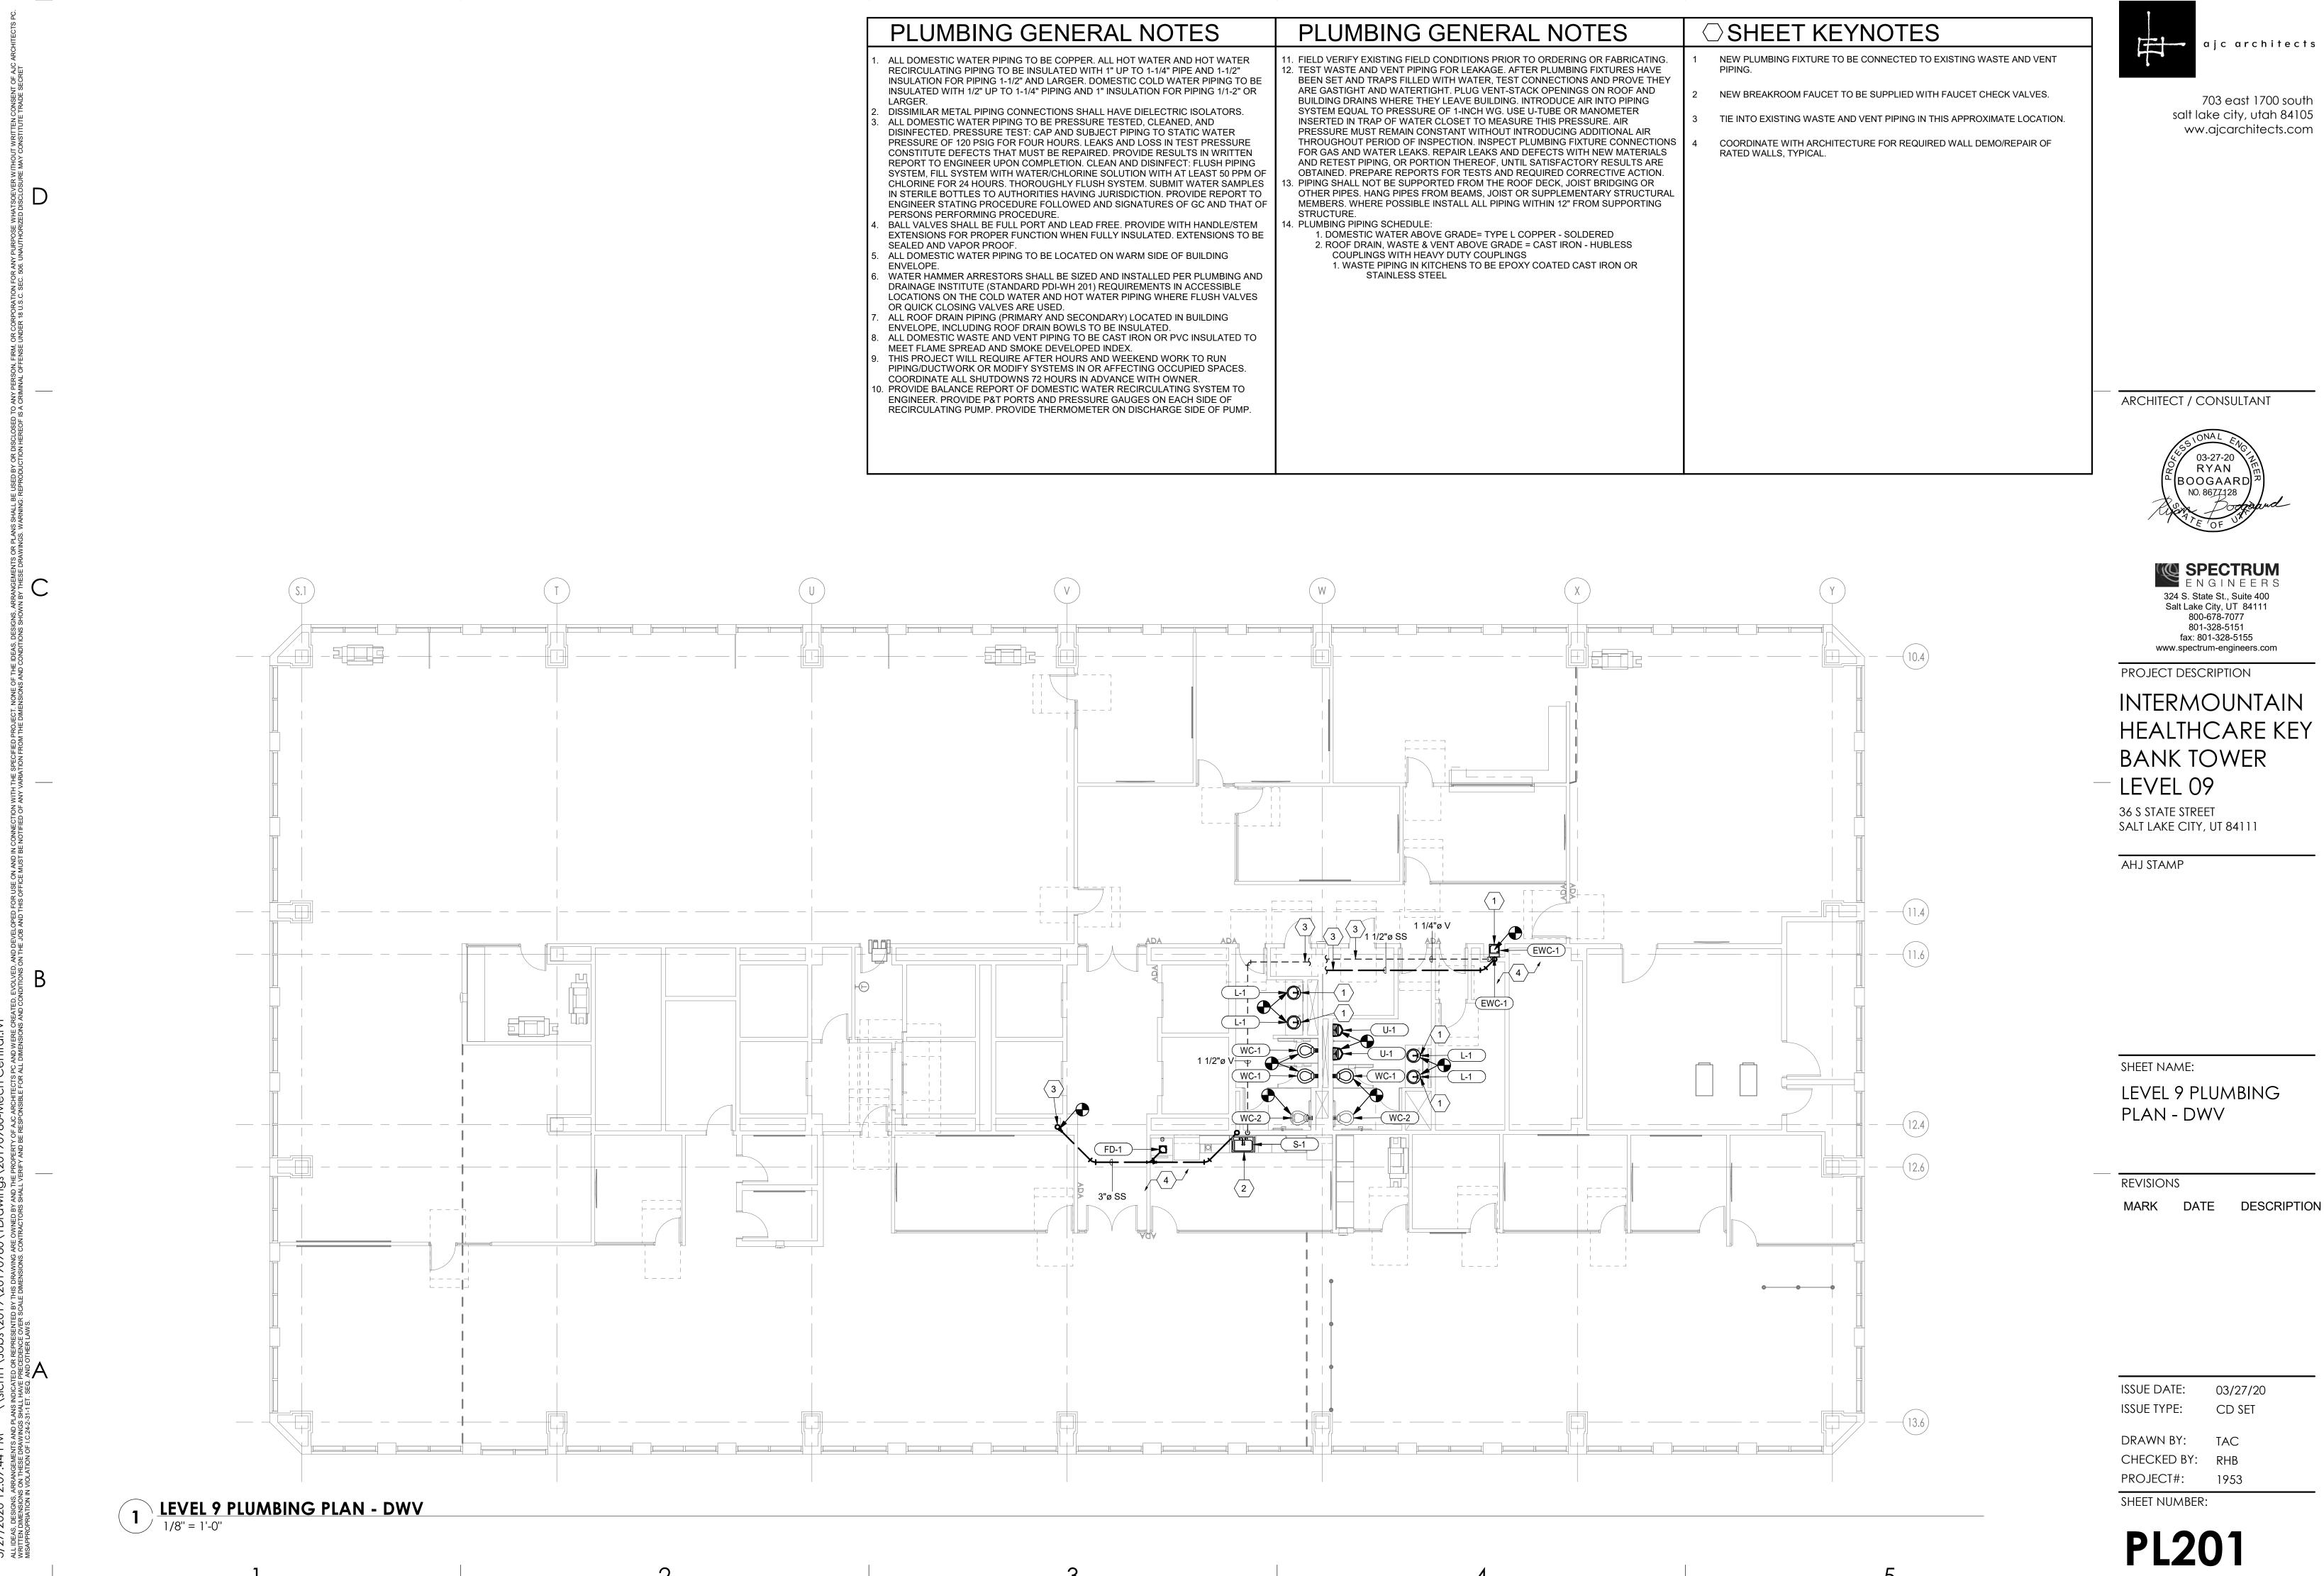

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HEALTHCARE KEY



EXIT SIGN: DOUBLE FACE; CEILING MOUNTED

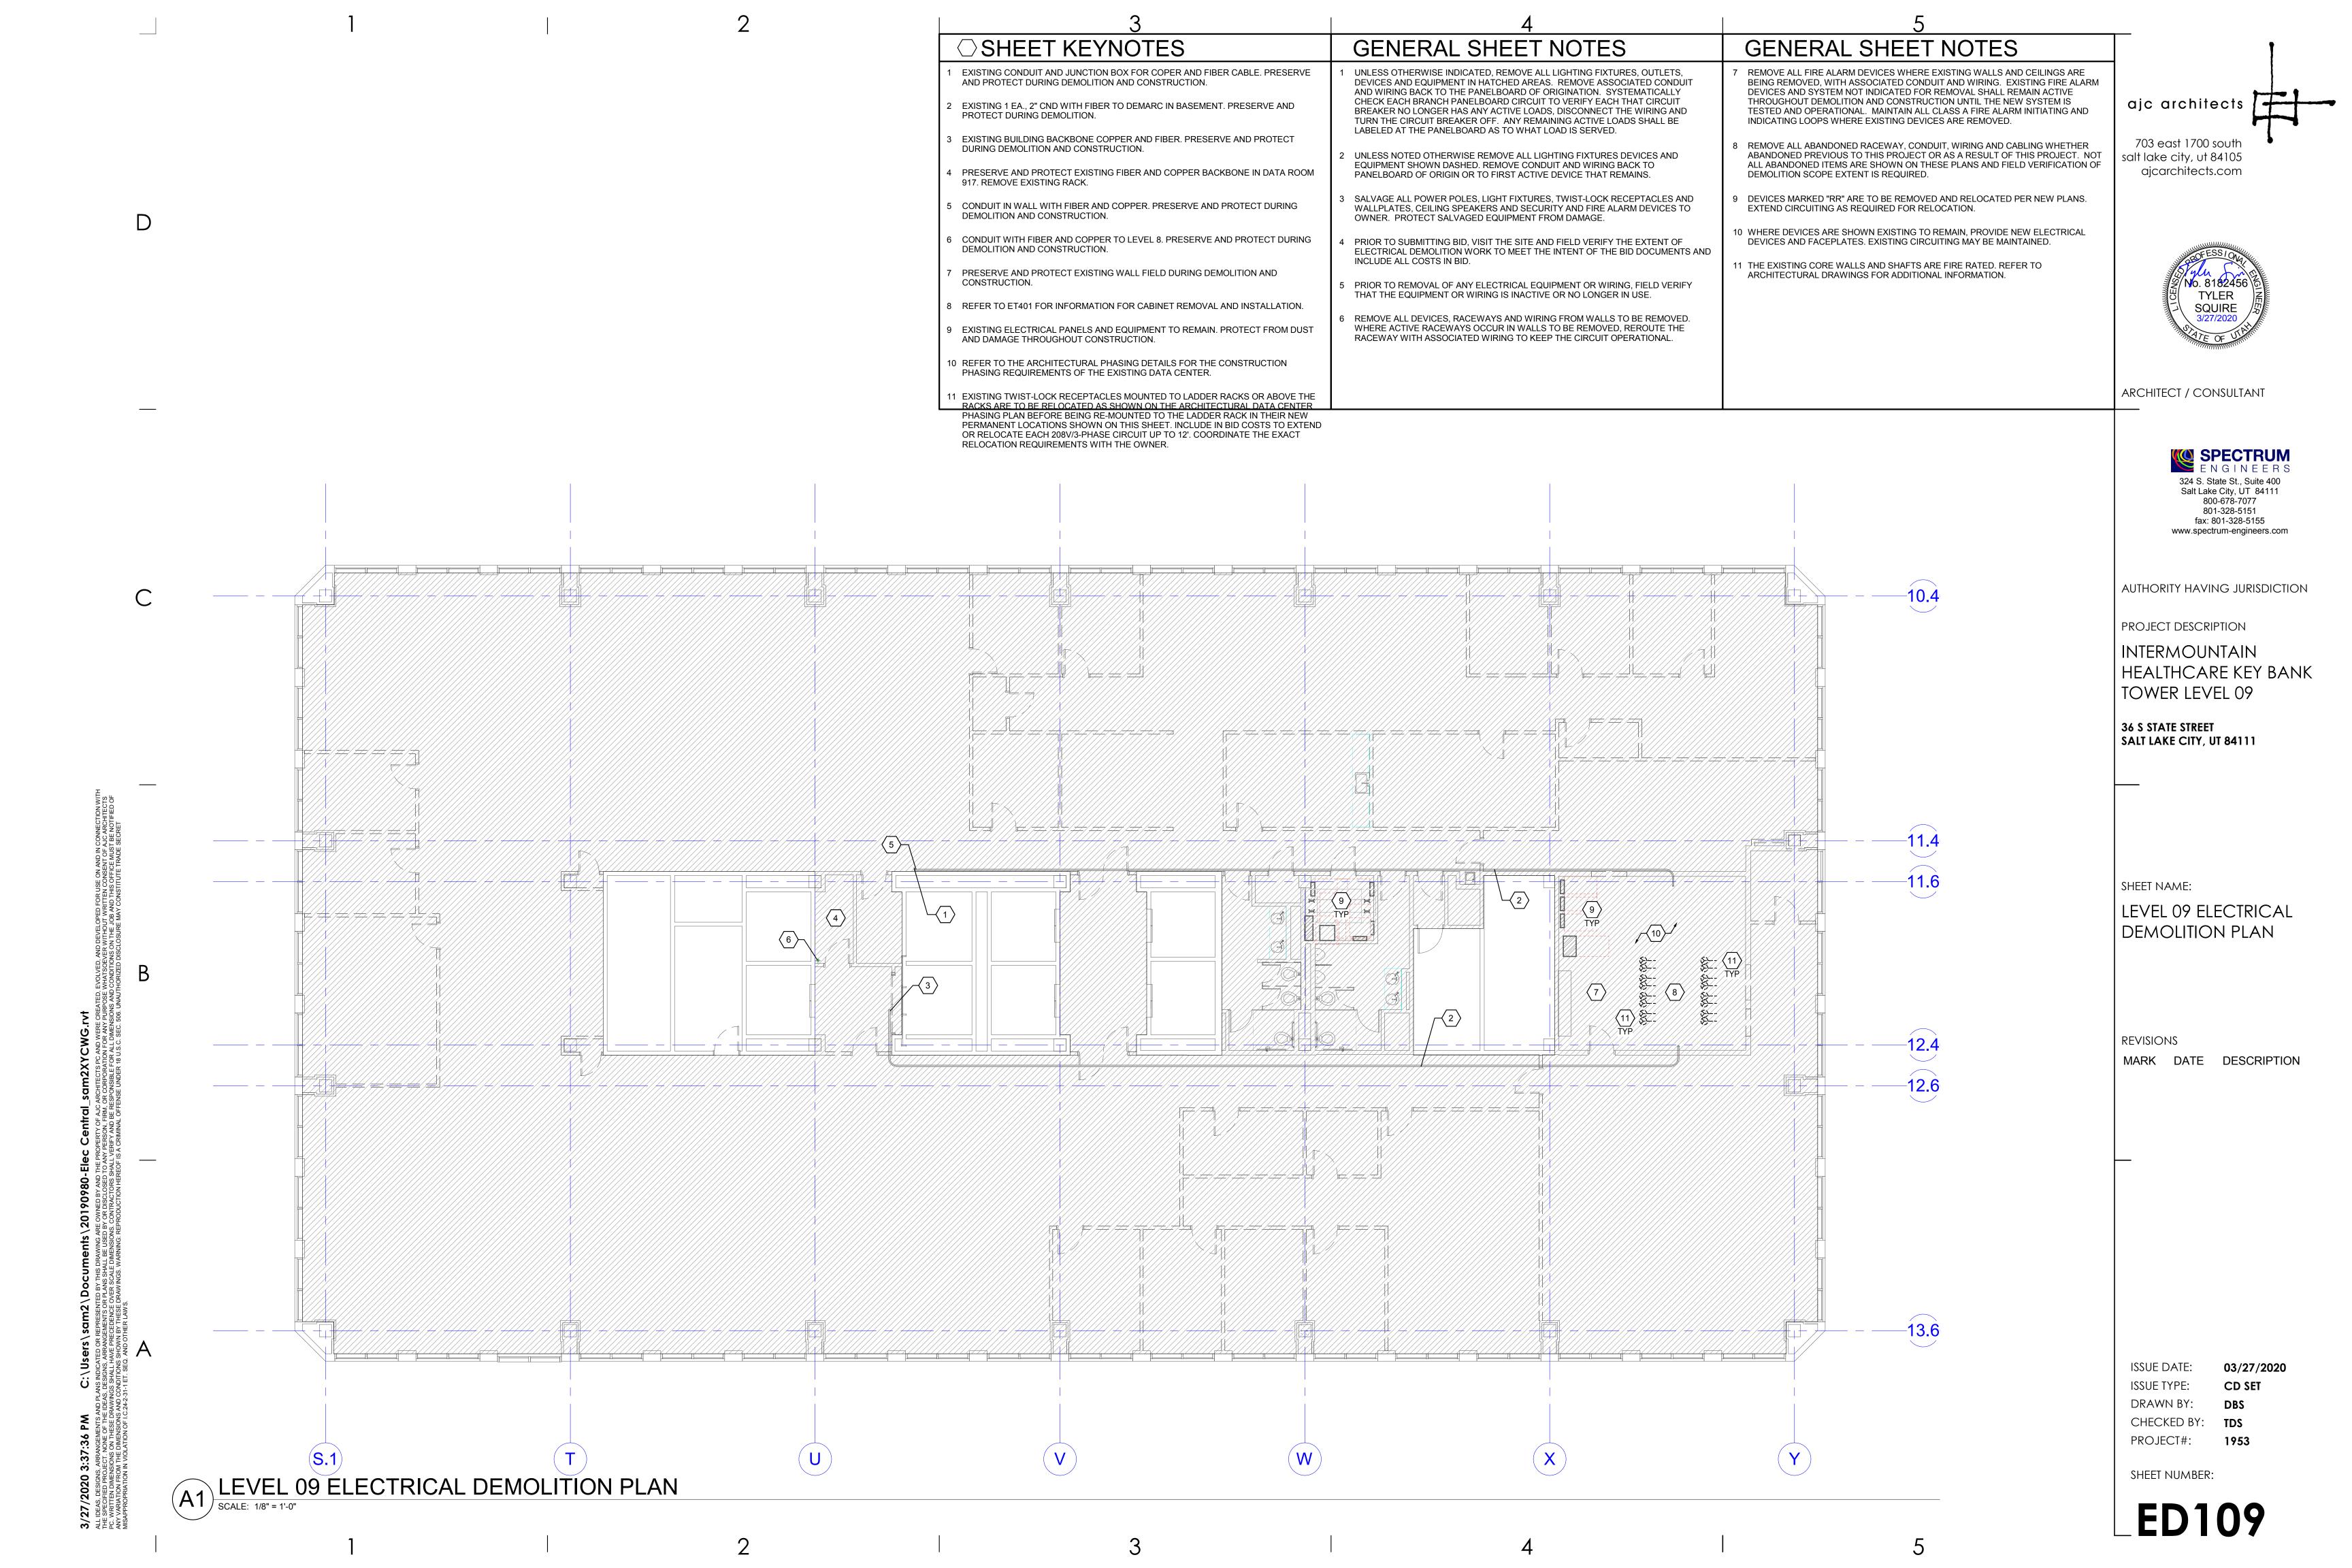EXIT SIGN: DOUBLE FACE; WALL MOUNTED

SYMBOLS LEGEND SYMBOL DESCRIPTION WIRING DEVICES RECEPTACLE, DUPLEX: NEMA 5-20R. RECEPTACLE, DUPLEX, ABOVE COUNTER: NEMA 5-20R. RECEPTACLE, DUPLEX, CEILING: NEMA 5-20R. ECEPTACLE, DUPLEX WITH GROUND FAULT CIRCUIT INTERRUPTER, DRINKING FOUNTAIN: CONCEAL WATER COOLER RECEPTACLE BEHIND WATER COOLER. SEE MECHANICAL/PLUMBING SHOP DRAWINGS FOR INSTALLATION REQUIREMENTS. RECEPTACLE, DUPLEX ON EMERGENCY POWER: NEMA 5-20R. RECEPTACLE, DUPLEX WITH GROUND FAULT CIRCUIT INTERRUPTER: NEMA 5-20R. RECEPTACLE, QUADRAPLEX: NEMA 5-20R. RECEPTACLE, QUADRAPLEX ON EMERGENCY POWER: NEMA 5-20R. RECEPTACLE, SPECIAL PURPOSE. PROVIDE RECEPTACLE TO MATCH EQUIPMENT PLUG. FLUSH FLOOR BOX. "#" SHOWN ON DRAWINGS. REFER TO WIRING DEVICE SCHEDULE IN THE ELECTRICAL SPECIFICATIONS FOR CONFIGURATION AND DEVICES LUSH FIRE RATED POKE THRU. "#" SHOWN ON DRAWINGS REFER TO WIRING DEVICE SCHEDULE IN THE ELECTRICAL SPECIFICATIONS FOR CONFIGURATION AND DEVICES. SWITCH, DIMMER. SWITCH, SINGLE POLE ("x" INDICATES FIXTURES CONTROLLED) SWITCH, THREE-WAY ("x" INDICATES FIXTURES CONTROLLED). SWITCH, PILOT LIGHT SWITCH, TIMER OPERATED. SWITCH, WEATHERPROOF RECEPTACLE, SINGLE PLEX, WITH USB OUTLET STRUCTURED CABLING TELEPHONE, WALL MOUNTED ("X" INDICATES QUANTITY OF CABLES). DATA CONNECTION: WIRELESS ACCESS POINT (WAP). REQUIRES (2) DATA DROPS PER DEVICE TELEPHONE, WALL MOUNTED: WALL PHONE. OUTLET, DATA COMMUNICATION ("X" INDICATES QUANTITY OF \mathbf{A}_{X} OUTLET, BUILDING STANDARD COMBINATION TELEPHONE/ DATA COMMUNICATION. TWO-WAY EMERGENCY COMMUNICATION DEVICE PER IBC, WALL MOUNTED IN RECESSED BOX. TELEPHONE TERMINAL BOARD, FIRE TREATED PLYWOOD LAN RACK, FLOOR STANDING. DATA CABLE, CATEGORY 5 (ONE-LINE DIAGRAM). <u> —</u>D— ——V—— VOICE CABLE, CATEGORY 3 (ONE-LINE DIAGRAM). LIGHTING CONTROL OCCUPANCY SENSOR, DUAL TECHNOLOGY, OMNI-DIRECTIONAL, CEILING. OCCUPANCY SENSOR, DUAL TECHNOLOGY, WALL. OCCUPANCY SENSOR, DUAL TECHNOLOGY, DIRECTIONAL OCCUPANCY SENSOR CONTROL RELAY. VACANCY SENSOR, DUAL TECHNOLOGY, OMNI-DIRECTIONAL, CEILING. VACANCY SENSOR, DUAL TECHNOLOGY, WALL PHOTOCELL. OCCUPANCY SENSOR, SWITCH PACK. SWITCH/OCCUPANCY SENSOR COMBO, DUAL TECHNOLOGY, WALL SWITCH/VACANCY SENSOR COMBO, DUAL TECHNOLOGY, WALL. DIMMER SWITCH/OCCUPANCY SENSOR COMBO. DUAL TECHNOLOGY, WALL. DIMMER SWITCH/VACANCY SENSOR COMBO, DUAL TECHNOLOGY, WALL LOW VOLTAGE DIGITAL LIGHTING CONTROL SWITCH: LETTER "a.b" INDICATES ZONING WHERE SHOWN (REFER TO PLANS. SCHEDULES, AND DETAILS FOR EXACT BUTTON CONFIGURATION AND PROGRAMMING REQUIREMENTS) DIGITAL LIGHTING DIMMING CONTROLLER DIGITAL PLUG LOAD CONTROLLER

DIGITAL LIGHTING ROOM CONTROLLER

SCHEDULE / DIAGRAM.

LIGHTING SPACE CONTROL TYPE. X INDICATES TYPE. SEE

SYMBOLS LEGEND SYMBOL DESCRIPTION **ELECTRICAL POWER AND DISTRIBUTION** VARIABLE FREQUENCY MOTOR CONTROLLER (ONE-LINE \square DISCONNECT SWITCH, FUSED DISCONNECT SWITCH, UNFUSED. lacksquareSTARTER, COMBINATION WITH DISCONNECT SWITCH. STARTER OR MOTOR CONTROLLER • PUSHBUTTON. PUSHBUTTONS, MOTOR CONTROL. PANELBOARD CABINET, FLUSH MOUNTED. PANELBOARD CABINET, SURFACE MOUNTED, 1 SECTION. PANELBOARD CABINET, SURFACE MOUNTED, 2 SECTION. DISTRIBUTION PANEL OR SWITCHBOARD. DP# FIRE ALARM FIRE ALARM CONTROL PANEL, SEMI-RECESSED. FCP FIRE ALARM NOTIFICATION POWER SUPPLY. FTR FIRE ALARM TRANSPONDER OR TRANSMITTER. UTOMATIC DOOR CLOSERS: DOOR CLOSERS SHALL BE FURNISHED WITH DOOR HARDWARE AND CONNECTED TO BY FIRE ALARM INSTALLERS CONTROL MODULE. MM MONITOR MODULE. FIRE ALARM MANUAL PULL STATION SHUT DOWN RELAY: INSTALL RELAY IN CONTROL CIRCUIT OF EQUIPMENT TO BE CONTROLLED IN THE EVENT OF A MAGNETIC DOOR HOLDER DETECTOR, SMOKE ETECTOR, SMOKE WITH AUXILIARY CONTACT DETECTOR, SMOKE, DUCT WITH HOUSING AND SAMPLING TUBE. DETECTOR, HEAT INDICATOR LAMP. STROBE. SUBSCRIPT INDICATES CANDELA RATING.

SPEAKER, EVACUATION.

SMOKE DAMPER.

CANDELA RATING.

FIRE AND SMOKE DAMPER.

INDICATES CANDELA RATING.

∟ SD

SPEAKER, EVACUATION, COMBINATION STROBE.

THE FIRE SPRINKLER SHOP DRAWINGS.

ON THE FIRE SPRINKLER SHOP DRAWINGS

SUBSCRIPT INDICATES CANDELA RATING.

DETECTOR, FLOW SWITCH: FLOW SWITCHES SHALL BE

AND SHALL BE CONNECTED TO LOCATIONS SHOWN ON

PROVIDED AND INSTALLED WITH FIRE SPRINKLER SYSTEM

DETECTOR, TAMPER SWITCH WITH VALVE: TAMPER SWITCHES

SHALL BE PROVIDED AND INSTALLED WITH FIRE SPRINKLER

SYSTEM AND SHALL BE CONNECTED TO LOCATIONS SHOWN

ALARM, HORN/STROBE, ONE ASSEMBLY, CEILING MOUNTED.

ALARM, HORN, CEILING MOUNTED. SUBSCRIPT INDICATES

ALARM, STROBE, CEILING MOUNTED. SUBSCRIPT

ABBREVIATIONS NOTE: ALL ABBREVIATIONS MAY NOT BE USED. SINGLE POLE KILOVOLT 1PH SINGLE-PHASE kVA KILOVOLT AMPERE KILOVOLT AMPERE REACTIVE 1WAY ONE-WAY kVAR 2/C TWO-CONDUCTOR KILOWATT 2WAY TWO-WAY kWh KILOWATT HOUR 3/C THREE-CONDUCTOR LIGHT EMITTING DIODE LED LFMC LIQUID TIGHT FLEXIBLE METAL 3WAY THREE-WAY 4OUT QUADRUPLE RECEPTACLE CONDUIT LFNC LIQUID TIGHT FLEXIBLE FOUR-POLE DOUBLE THROW NONMETALLIC CONDUIT 4PDT LPS LOW PRESSURE SODIUM 4PST FOUR-POLE SINGLE THROW LRA LOCKED ROTOR AMPS FOUR-WIRE LTG LIGHTING 4WAY **FOUR-WAY** LV LOW VOLTAGE ABOVE COUNTER MATV MASTER ANTENNA TELEVISION ARMORED CABLE SYSTEM ADA AMERICANS WITH DISABILITIES MAXIMUM METAL CLAD ADJ ADJACEN^{*} MCA MINIMUM CIRCUIT AMPS AFF ABOVE FINISHED FLOOF MAIN CIRCUIT BREAKER MCB AFG ABOVE FINISHED GRADE MCC MOTOR CONTROL CENTER AIC AMPERE INTERRUPTING MOTOR CIRCUIT PROTECTION CAPACITY MCP ALUM MDP MAIN DISTRIBUTION PANEL AI UMINUM MG MOTOR GENERATOR MH ANNUNCIATOR MANHOLE AP ACCESS POINT (WIRELESS MIN MINIMUM MAIN LUGS ONLY AS REQUIRED MOCP MAXIMUM OVERCURRENT ASC AMPS SHORT CIRCUIT PROTECTION AUTOMATIC TRANSFER NOT APPLICABLE NORMALLY CLOSED AUDIO VISUAL NATIONAL ELECTRICAL CODE AWG AMERICAN WIRE GAGE NEMA NATIOANL ELECTRICAL **BUCK-BOOST TRANSFORMER** MANUFACTURERS **XFMR** ASSOCIATION NATIONAL FIRE CODE CEILING MOUNTED **COMMUNITY ANTENNA** NFPA NATIONAL FIRE PROTECTION CATV TELEVISION ASSOCIATION CIRCUIT BREAKER NOT IN CONTRACT CUSTOM COLOR AS SELECTED CCBA NIGHT LIGHT BY ARCHITECT NORMALLY OPEN CLOSED CIRCUIT TELEVISION NTS NOT TO SCALE CF/CI CONTRACTOR FURNISHED/ OC ON CENTER CONTRACTOR INSTALLED OCP OVER CURRENT PROTECTION CONTRACTOR FURNISHED/ CF/OI OF/CI OWNER FURNISHED/ OWNER INSTALLED CONTRACTOR INSTALLED **CUSTOM FINISH AS SELECTED** OF/OI OWNER FURNISHED/ OWNER BY ARCHITECT **INSTALLED** CKT

OBTAIN FROM PLANS CONSTRUCTION MANAGER OH DR OVERHEAD (COILING) DOOR OVERLOAD PUSHBUTTON **POWER FACTOR** PHASE **PANEL** POTENTIAL TRANSFORMER PTZ PAN/TILT/ZOOM

CO CONVENIENCE OUTLET CONTRACTING OFFICER'S REPRESENTATIVE **CONTROL PANEL** CURRENT TRANSFORMER CTV **CABLE TELEVISION** CU COPPER QTY QUANTITY UNIT OF SOUND LEVEL dBA REMOVE DPDT DOUBLE POLE, DOUBLE RCP REFLECTED CEILING PLAN RIGID METAL CONDUIT DISCONNECT SWITCH RIGID NONMETAL CONDUIT EΑ RPM REVOLUTIONS PER MINUTE l em **EMERGENCY** REMOVE AND RELOCATE l emt ELECTRICAL METALLIC TUBING S/S START/STOP ELECTRIC NONMETALLIC SHORT CIRCUIT AMPS SCBA STANDARD COLOR AS EMERGENCY POWER OFF SELECTED BY ARCHITECT EQUIP EQUIPMENT SQUARE FOOT (FEET) EX **EXISTING** STANDARD FINISH AS SFBA FURNITURE MOUNTED SELECTED BY ARCHITECT FA FIRE ALARM SURGE PROTECTIVE DEVICE

CND

HΖ

I/O

CONDUIT

FCP FIRE ALARM CONTROL PANEL SPDT SINGLE POLE, DOUBLE THROW FULL LOAD AMPS SPEC SPECIFICATION FLEXIBLE METAL CONDUIT SPST SINGLE POLE, SINGLE THROW FREIGHT ON BOARD SINGLE THROW **FVNR** FULL VOLTAGE SWBD SWITCHBOARD NON-REVERSING SWGR SWITCHGEAR FULL VOLTAGE REVERSING TWIST LOCK GROUND TELEPHONE POLE **GENERATOR** GFN GFCI GROUND FAULT INTERRUPTER TTB GROUND FAULT PROTECTION GFP HD **HEAVY DUTY** HIGH INTENSITY DISCHARGE HAND-OFF-AUTOMATIC HORSE POWER

TWISTED PAIR TELEPHONE TERMINAL BOARD TELEVISION TVSS TRANSIENT VOLTAGE SURGE SUPPRESSER HIGH POWER FACTOR HIGH PRESSURE SODIUM UPS HIGH VOLTAGE **HERTZ** INPUT/ OUTPUT ISOLATED GROUND INTERMEDIATE METAL CONDUIT

INSULATED/ ISOLATED

INFRARED

J-BOX JUNCTION BOX

UNDERFLOOR UGND UNDERGROUND UNINTERRUPTIBLE POWER SUPPLY VOLTS VOLT AMPERE VFC/VF VARIABLE FREQUENCY MOTOR CONTROLLER W/O WITHOUT

WEATHERPROOF XFMR TRANSFORMER

CATALOG NUMBER DISCREPANCIES, DISCREPANCIES BETWEEN THE EQUIPMENT SUPPLIED AND THE INTENT OR FUNCTION OF THE EQUIPMENT, ETC. SHALL BE SUBMITTED TO THE ARCHITECT/ENGINEER IN WRITING FOR CLARIFICATION PRIOF TO ISSUANCE OF THE FINAL ADDENDUM AND BIDDING OF THE PROJECT. WHERE DISCREPANCIES OR MULTIPLE INTERPRETATIONS OCCUR, THE MOST STRINGENT (WHICH IS GENERALLY RECOGNIZED AS THE MOST COSTLY) THAT MEETS THE INTENT OF THE DOCUMENTS SHALL BE ENFORCED. OWNER FURNISHED ITEMS: THE OWNER WILL FURNISH MATERIAL AND

CLARIFICATION METHODS: AT THE TIME OF BIDDING, BIDDERS SHALL FAMILIARIZE

THEMSELVES WITH THE DRAWINGS AND SPECIFICATIONS. ANY QUESTIONS,

MISUNDERSTANDINGS, CONFLICTS, DELETIONS, DISCONTINUED PRODUCTS,

EQUIPMENT AS INDICATED IN THE CONTRACT DOCUMENTS TO BE INCORPORATED INTO THE WORK. THESE ITEMS ARE ASSIGNED TO THE INSTALLER AND COSTS FOR RECEIVING, HANDLING, STORAGE, IF REQUIRED, AND INSTALLATION ARE INCLUDED IN THE CONTRACT SUM.

A. THE INSTALLER'S RESPONSIBILITIES ARE THE SAME AS IF THE INSTALLER FURNISHED THE MATERIALS OR EQUIPMENT.

> THE OWNER WILL ARRANGE AND PAY FOR DELIVERY OF OWNER FURNISHED ITEMS FREIGHT ON BOARD JOB SITE AND THE INSTALLER WILL INSPECT DELIVERIES FOR DAMAGE. IF OWNER FURNISHED ITEMS ARE DAMAGED, DEFECTIVE OR MISSING, DOCUMENT DAMAGED ITEMS WITH THE TRANSPORT COMPANY AND THE OWNER WILL ARRANGE FOR REPLACEMENT. THE OWNER WILL ALSO ARRANGE FOR MANUFACTURER'S FIELD SERVICES, AND THE DELIVERY OF MANUFACTURER'S WARRANTIES AND BONDS TO THE INSTALLER.

THE INSTALLER IS RESPONSIBLE FOR DESIGNATING THE DELIVERY DATES OF OWNER FURNISHED ITEMS AND FOR RECEIVING, UNLOADING AND HANDLING OWNER FURNISHED ITEMS AT THE SITE. THE INSTALLER IS RESPONSIBLE FOR PROTECTING OWNER FURNISHED ITEMS FROM DAMAGE, INCLUDING DAMAGE FROM EXPOSURE TO THE ELEMENTS, AND TO REPAIR OR REPLACE ITEMS DAMAGED AS A RESULT OF HIS OPERATIONS.

EXPOSED STRUCTURE AREAS (EXCLUDING MECHANICAL, ELECTRICAL, AND COMMUNICATION SPACES): INSTALL RACEWAYS BETWEEN DECK AND STRUCTURE WHEREVER POSSIBLE IN EXPOSED STRUCTURE CEILING AREAS. ROUTE RACEWAYS IN CONCEALED AREAS WHEREVER POSSIBLE. REFER ALL CONDITIONS WHERE RACEWAYS MUST BE INSTALLED WHICH CANNOT COMPLY WITH THESE REQUIREMENTS TO THE ARCHITECT.

SUBMITTALS: PROVIDE ORIGINAL ELECTRONIC PDF FORMAT, BOUND, BOOKMARKED (EACH SECTION AND PRODUCT), AND HIGHLIGHTED. JOB NAME AND SUBCONTRACTOR SHALL BE ON THE FRONT COVER. PREPARE INDEX OF **EQUIPMENT SUBMITTED IN EACH TAB.**

REFLECTED CEILING PLANS: COORDINATE THE LOCATION OF LIGHT FIXTURES WITH THE ARCHITECTURAL REFLECTED CEILING PLANS. REFER ALL DISCREPANCIES TO THE ARCHITECT AND ENGINEER.

ALL WORK SHALL BE DONE ACCORDING TO THE CURRENT NATIONAL ELECTRIC CODE (NEC), IBC, NFPA, AND IFC. COMPLIANCE AND FINAL APPROVAL IS SUBJECT TO THE ON SITE FIELD INSPECTION OF THE AHJ.

REFER TO ARCHITECTURAL DRAWINGS FOR INFORMATION ON THE FIRE RATINGS OF THE EXISTING BUILDING CORE WALLS AND FLOOR/CEILING ASSEMBLIES.

DEFINITIONS

NOTE: ALL DEFINITIONS MAY NOT BE USED

INDICATED: THE TERM "INDICATED" REFERS TO GRAPHIC REPRESENTATIONS, NOTES, OR SCHEDULES ON THE DRAWINGS, OTHER PARAGRAPHS OR SCHEDULES IN THE SPECIFICATIONS, AND SIMILAR REQUIREMENTS IN THE CONTRACT DOCUMENTS. WHERE TERMS SUCH AS "SHOWN", "NOTED", 'SCHEDULED", AND "SPECIFIED" ARE USED, IT IS TO HELP THE READER LOCATE THE REFERENCE, NO LIMITATION ON LOCATION IS INTENDED.

DIRECTED: TERMS SUCH AS "DIRECTED", "REQUESTED", AUTHORIZED" "SELECTED", "APPROVED", "REQUIRED", AND "PERMITTED" MEAN "DIRECTED BY THE ENGINEER", "REQUESTED BY THE ENGINEER", AND SIMILAR PHRASES.

APPROVED: THE TERM "APPROVED", WHERE USED IN CONJUNCTION WITH THE ENGINEER'S ACTION ON THE CONTRACTOR'S SUBMITTALS, APPLICATIONS, AND REQUESTS, IS LIMITED TO THE ENGINEER'S DUTIES AND RESPONSIBILITIES AS STATED IN GENERAL AND SUPPLEMENTARY CONDITIONS.

FURNISH: THE TERM "FURNISH" IS USED TO MEAN "SUPPLY AND DELIVER TO THE PROJECT SITE, READY FOR UNLOADING, UNPACKING, ASSEMBLY,

PLACING, ANCHORING, APPLYING, WORKING TO DIMENSION, FINISHING,

CURING, PROTECTING, CLEANING, AND SIMILAR OPERATIONS."

INSTALLATION, AND SIMILAR OPERATIONS." INSTALL: THE TERM "INSTALL" IS USED TO DESCRIBE OPERATIONS AT PROJECT \mid SITE INCLUDING THE ACTUAL "UNLOADING, UNPACKING, ASSEMBLY, ERECTION,

PROVIDE: THE TERM "PROVIDE" MEANS "TO FURNISH AND INSTALL, COMPLETE AND READY FOR THE INTENDED USE."

INSTALLER: AN "INSTALLER" IS THE CONTRACTOR OR AN ENTITY ENGAGED BY THE CONTRACTOR, EITHER AS AN EMPLOYEE, SUBCONTRACTOR, OR SUB-SUBCONTRACTOR, FOR PERFORMANCE OF A PARTICULAR CONSTRUCTION ACTIVITY, INCLUDING INSTALLATION, ERECTION, APPLICATION, AND SIMILAR OPERATIONS. INSTALLERS ARE REQUIRED TO BE EXPERIENCED IN THE OPERATIONS THEY ARE ENGAGED TO PERFORM

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GENERAL ELECTRICAL NOTES

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ARCHITECT / CONSULTAN'



Salt Lake City, UT 8411 800-678-7077 801-328-5151 fax: 801-328-5155 www.spectrum-engineers.com

AUTHORITY HAVING JURISDICTION

PROJECT DESCRIPTION

INTERMOUNTAIN HEALTHCARE KEY BANK **TOWER LEVEL 09**

36 S STATE STREET SALT LAKE CITY, UT 8411

SHEET NAME:

SHEET INDEX, ABBREVIATIONS, AND GENERAL NOTES

REVISIONS

MARK DATE DESCRIPTION

ELECTRICAL SHEET INDEX

	ELECTRICAL SHEET INDEX
EE001	SHEET INDEX, ABBREVIATIONS, AND GENERAL NOTES
EE501	ELECTRICAL DETAILS
EE701	TYPICAL MOUNTING HEIGHT DETAILS
EE702	TYPICAL MOUNTING HEIGHT DETAILS
ED109	LEVEL 09 ELECTRICAL DEMOLITION PLAN
EP109	LEVEL 09 POWER PLAN
EP601	EQUIPMENT SCHEDULE
EP602	PANEL SCHEDULES
EL109	LEVEL 09 LIGHTING PLAN
EL209	LEVEL 09 LIGHTING ZONE PLAN
EL601	INTERIOR LIGHTING FIXTURE SCHEDULE
EL602	LIGHTING CONTROL SCHEDULES
ET001	TELECOM SCHEDULES AND NOTES
ET109	LEVEL 09 TELECOM PLAN
ET401	ENLARGED TELECOM PLANS
ET501	TELECOM EQUIPMENT RACK ELEVATIONS
ET502	TELECOM DETAILS
ET503	TELECOM DETAILS
ET504	TELECOM DETAILS
ET505	TELECOM DETAILS
ET506	TELECOM EQUIPMENT RACK GROUNDING DETAIL
ET601	TELECOM CONDUIT RISER DIAGRAMS
ET602	TELECOM CABLE RISER DIAGRAMS
EY001	SECURITY COVER SHEET

ELECTRICAL SHEET INDEX

EY109 LEVEL 09 AUXILIARY PLAN EY601 AUXILIARY RISER DIAGRAMS EJ109 LEVEL 09 AUDIO-VIDEO ROUGH-IN PLAN EJ601 AUDIO-VIDEO ROUGH-IN SCHEDULES, NOTES, DETAILS AND DIAGRAMS TM001 SOUND MASKING DETAILS, DIAGRAMS, NOTES, AND SCHEDULE TA001 AUDIO-VIDEO SYSTEMS EQUIPMENT LIST, SCHEDULES AND NOTES TA601 AUDIO-VIDEO SYSTEMS DETAILS AND DIAGRAMS

> ISSUE DATE: ISSUE TYPE:


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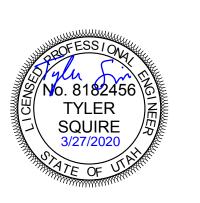
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ajc architects

703 east 1700 south salt lake city, ut 84105 ajcarchitects.com



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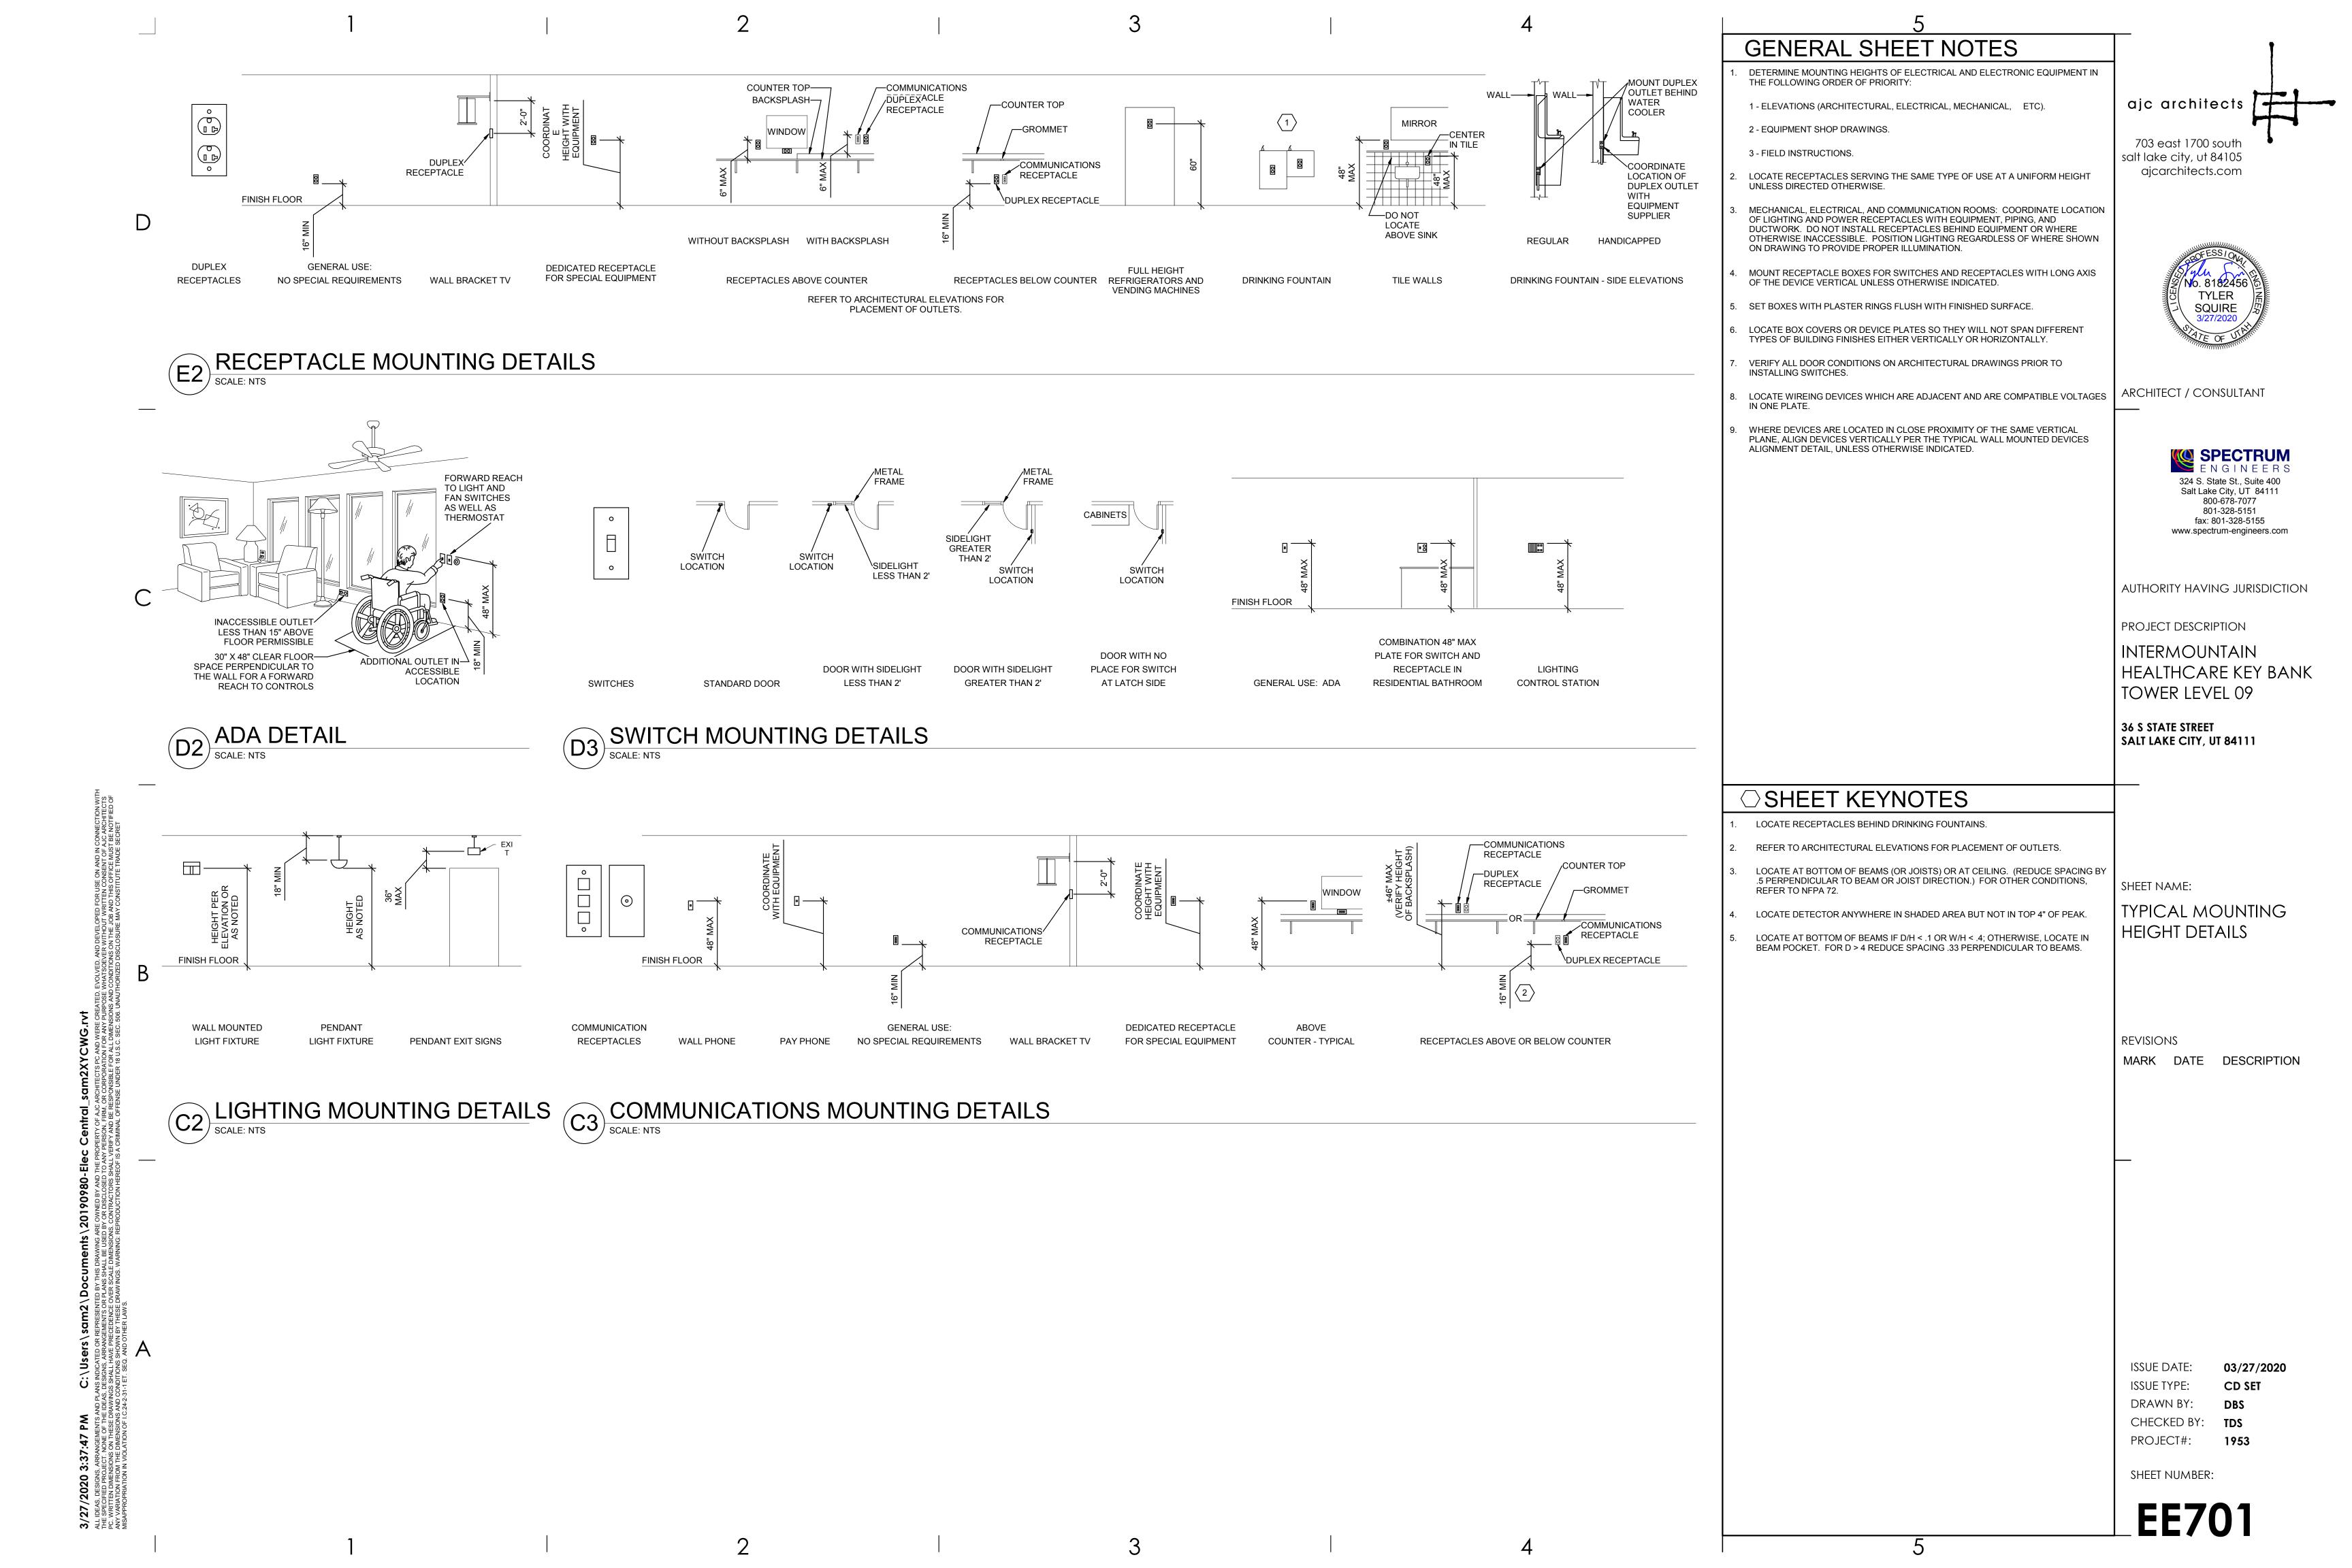
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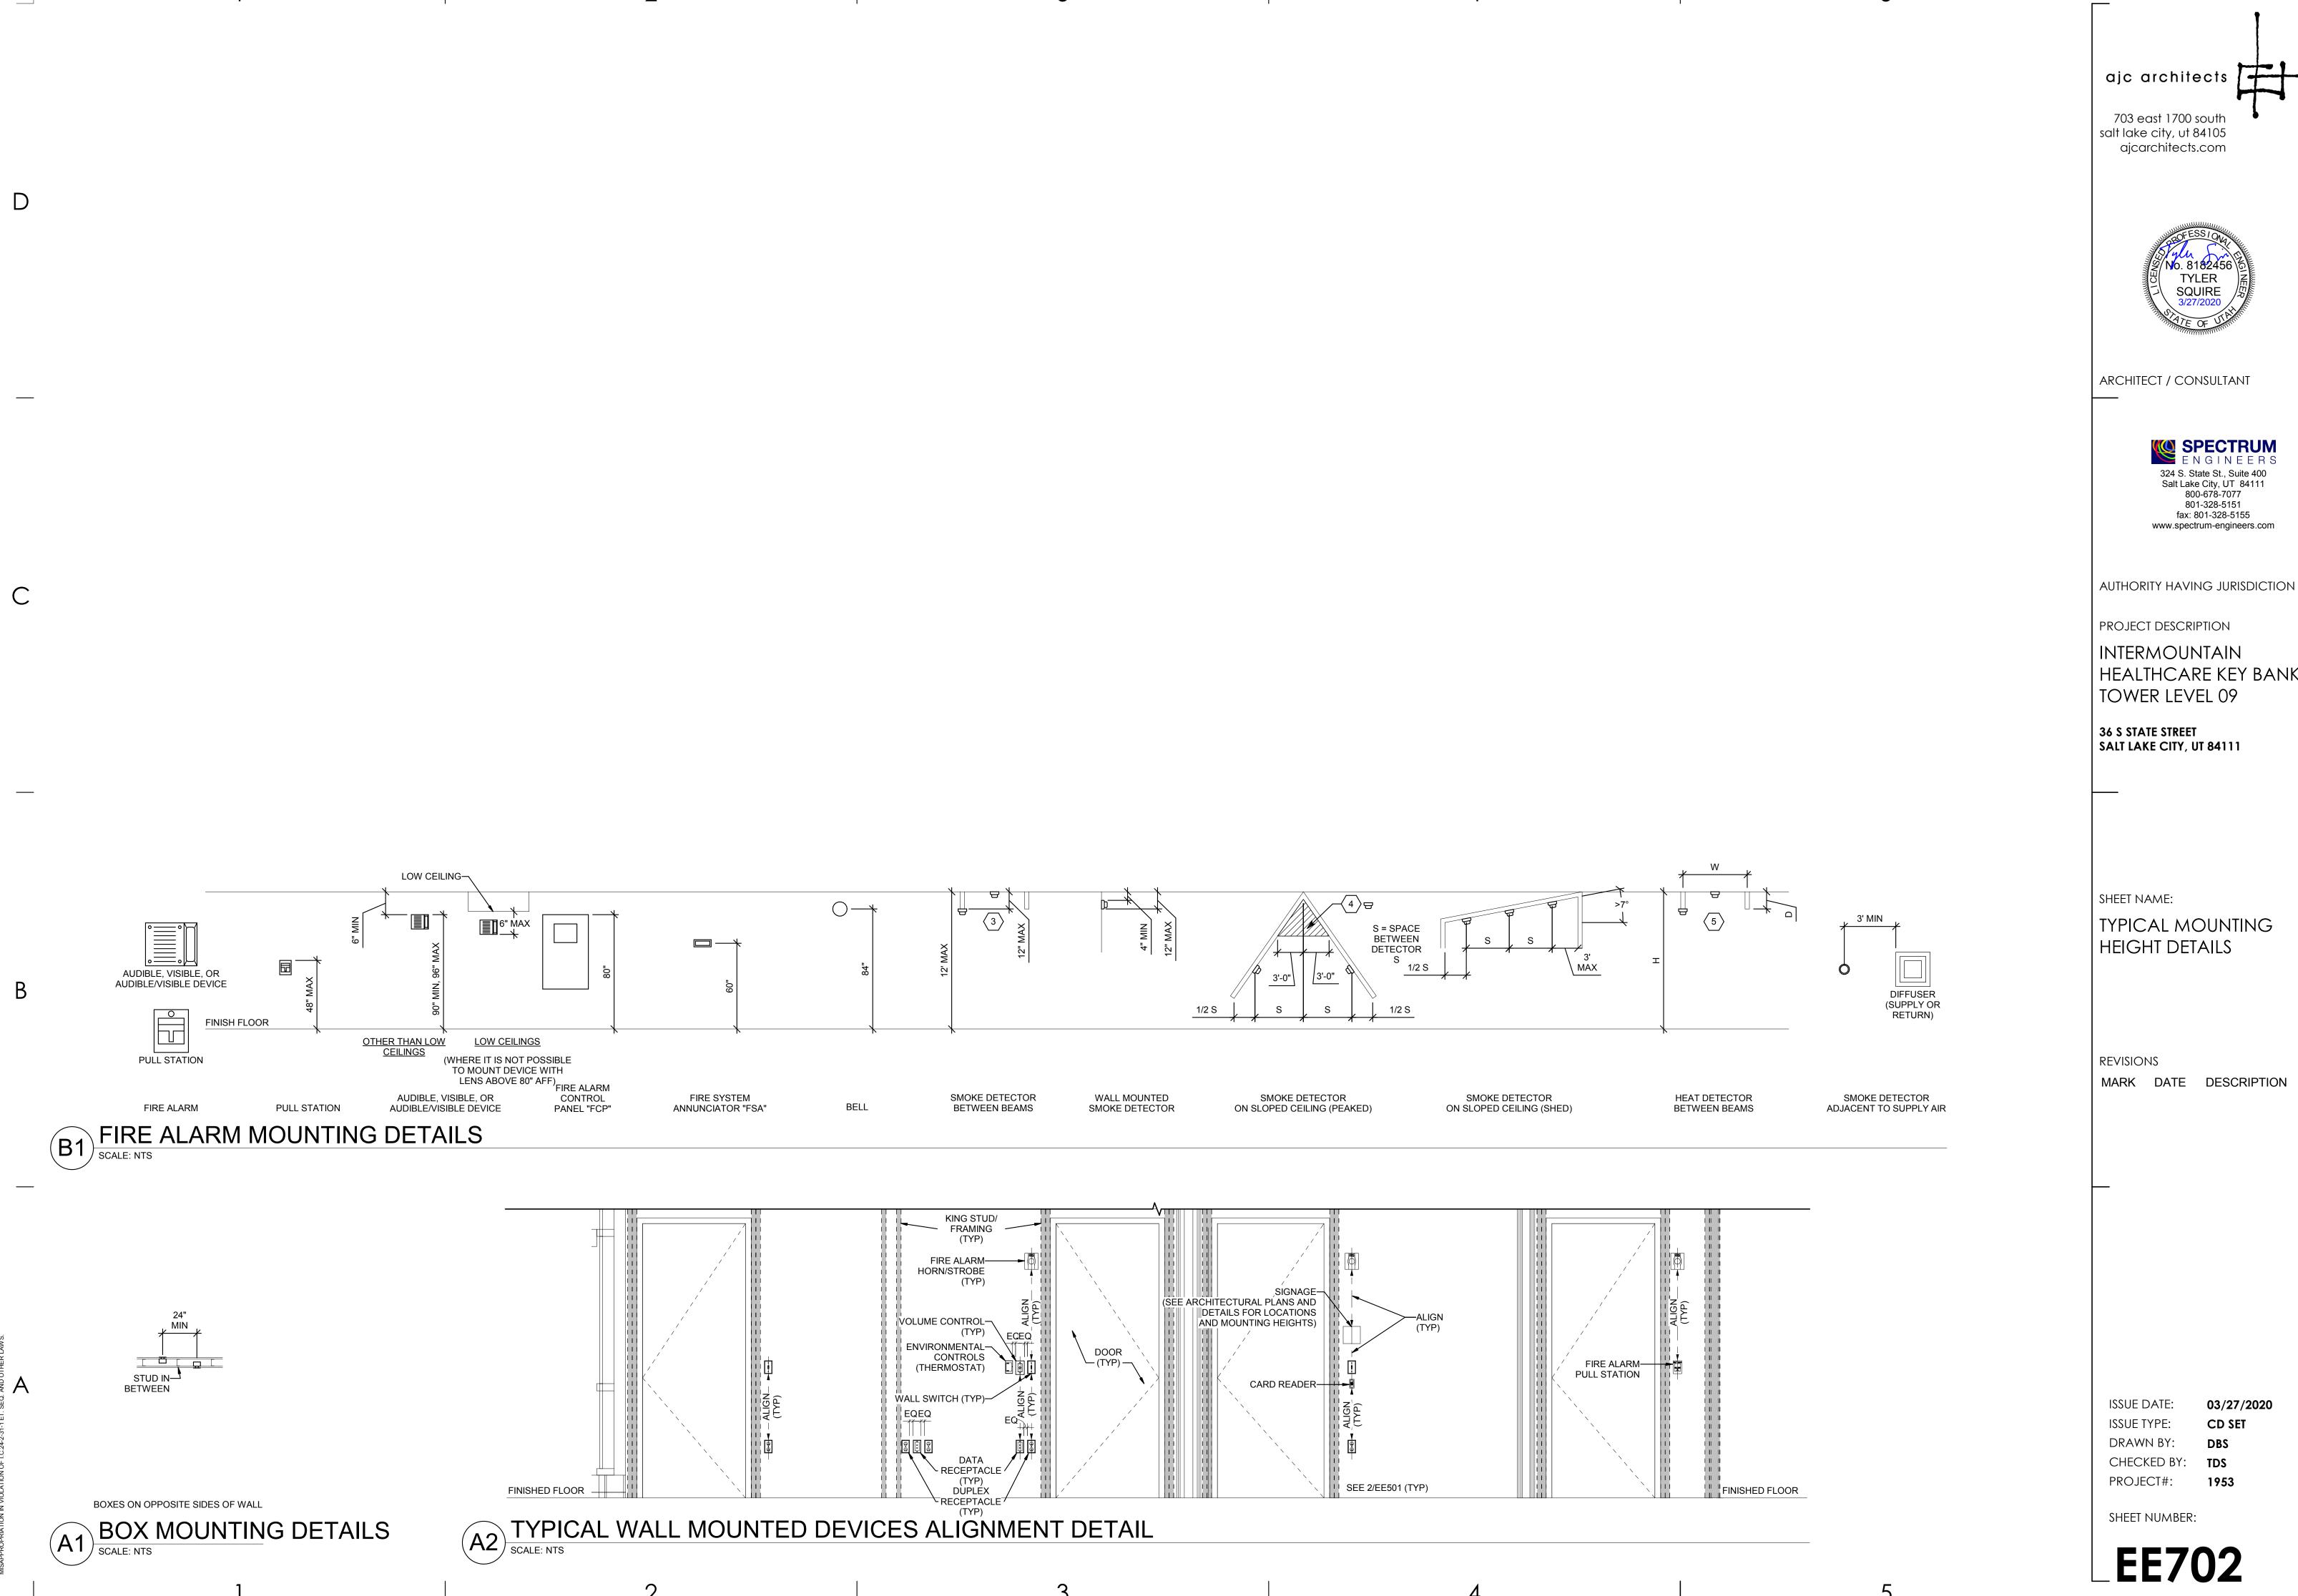
ISSUE DATE: 03/27/2020
ISSUE TYPE: CD SET
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CHECKED BY: TDS
PROJECT#: 1953

SHEET NUMBER:

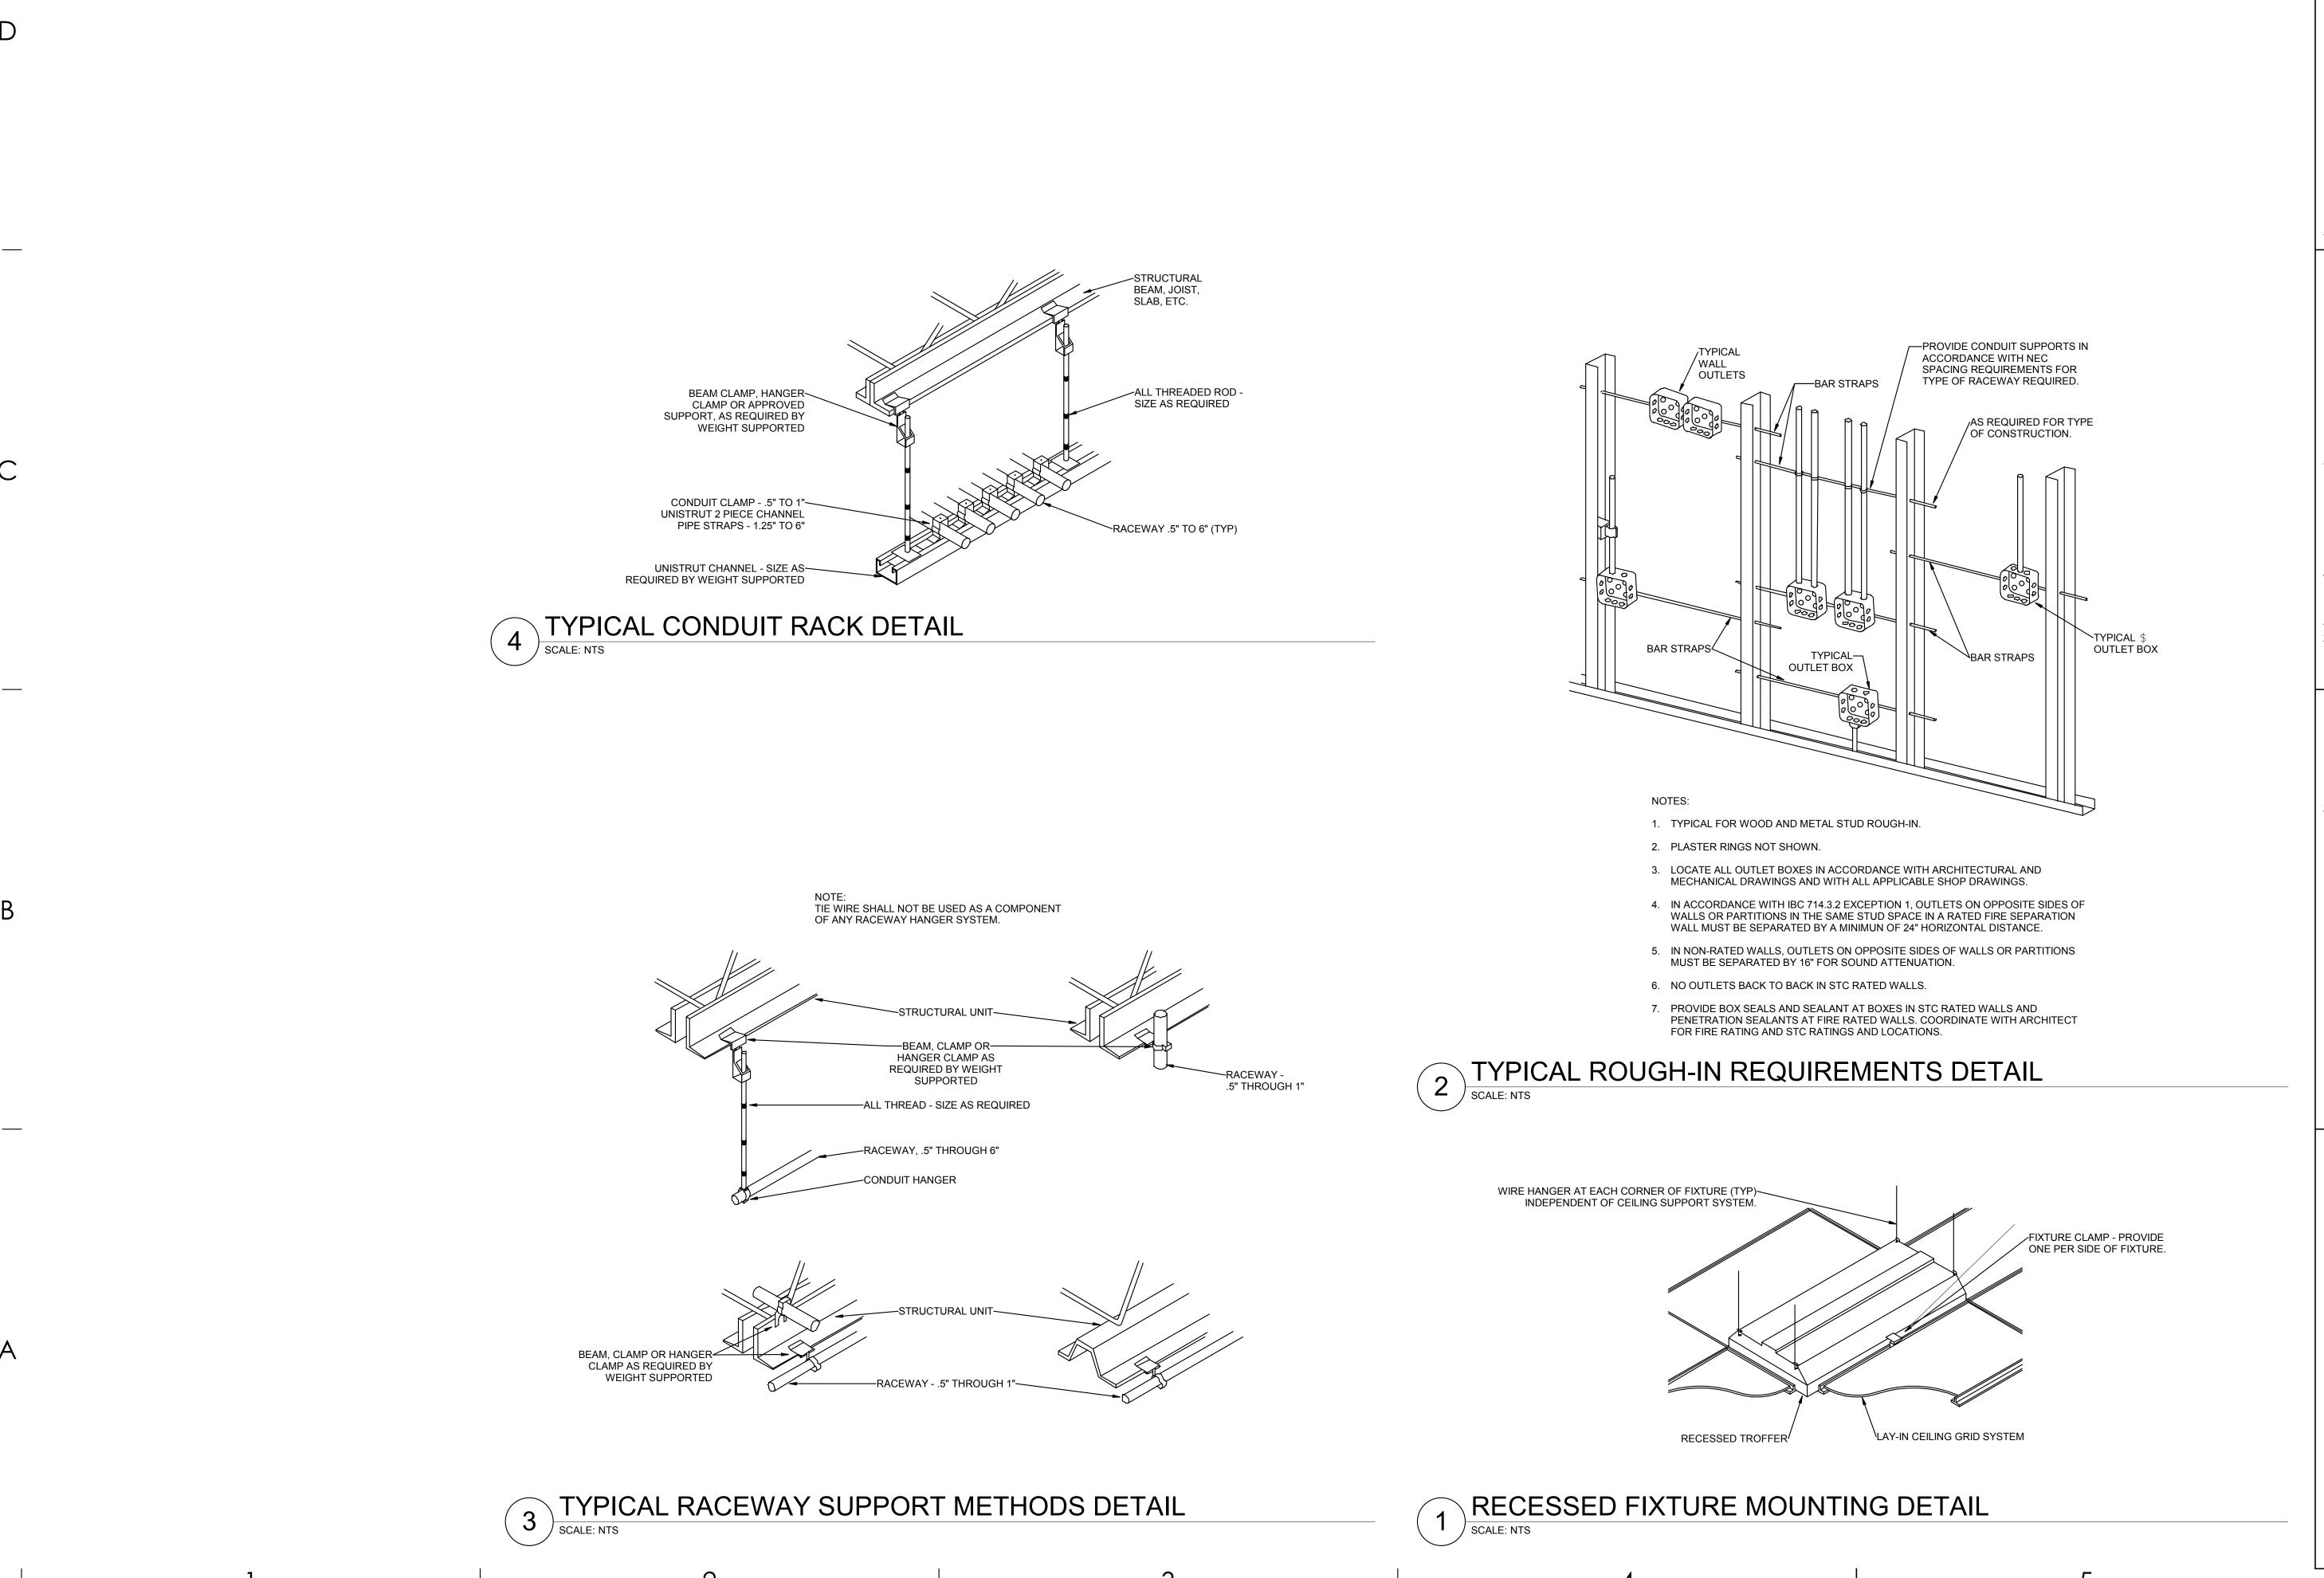EE501









HEALTHCARE KEY BANK

TYPICAL MOUNTING

MARK DATE DESCRIPTION



TO BUILDING

CABLE TRAY

MXX

SYMBOL DESCRIPTION SPECIAL INSTRUCTIONS MOUNTING TABLETOP CONNECTION PANEL IN TABLE INSTALLER FLOOR BOX OR POKE-THRU FLOOR AND LOCATION MASKING SPEAKER ABOVE CEILING INSTALLER CAMERA LOCATION **BELOW MONITOR**

NOTED

FURNISHED AND INSTALLED BY AV INSTALLER FLUSH IN THE WALL AT FLAT PANEL MONITOR JUNCTION BOX, CHIEF PAC 526FCW APPROXIMATELY +60" AFF TO BOTTOM OF BOX, OR AS NOTED ON PLAN SHEETS DETAILS A1/EJ601 AND C1/EJ601 CONDUIT, 3/4" MINIMUM CONCEALED BEHIND FINISHED SURFACES, UNLESS OTHERWISE SIZES & QUANTITIES

AUDIO-VIDEO ROUGH-IN SYSTEMS SCHEDULE

FURNISHED AND INSTALLED BY AV CP2 REFER TO 'EP' SHEETS FOR TYPE FBAV FURNISHED AND INSTALLED BY AV

COORDINATE WITH STRUCTURAL BACKING. AND COORDINATE EXACT ELEVATION WITH ARCHITECTURAL ELEVATIONS, SEE REFER TO RISER DIAGRAMS FOR EXACT

5. IF THE BOXES, ENCLOSURES, & CABINETS SPECIFIED ARE NOT PROVIDED FROM THE MANUFACTURER WITH THE REQUIRED KNOCK OUTS FOR THE SPECIFIED CONDUIT, FIELD CUT ALL REQUIRED KNOCK OUTS TO TERMINATE THE QUANTITY AND SIZES OF THE SPECIFIED CONDUITS.

GENERAL SHEET NOTES

EQUIPMENT.

1. INSTALL ALL CONDUIT IN A CONCEALED FASHION. SURFACE MOUNTED

CONDUIT WILL NOT BE ACCEPTED. CONDUITS AND BOXES ABOVE CEILING

2. MAINTAIN MAXIMUM SEPARATION BETWEEN A/V SYSTEM CONDUIT AND ALL

POWER CONDUIT. MINIMUM SEPARATION REQUIREMENTS IS 24".

4. INSTALL ALL EQUIPMENT IN COMPLIANCE WITH THE MANUFACTURER'S

WRITTEN INSTRUCTIONS, SEISMIC CODES, AND INDUSTRY WIDE ACCEPTED

RIGGING PRACTICES. SUPPORT EQUIPMENT WEIGHT FROM STRUCTURE. DURING THE SUBMITTAL PROCESS, PROVIDE SHOP DRAWINGS WHICH DETAIL


3. INSTALL NYLON PULL STRINGS IN ALL A/V SYSTEM CONDUIT.

PROPOSED MOUNTING FOR ALL SUCH EQUIPMENT.

HEIGHT MAY BE INSTALLED EXPOSED AND PAINTED TO MATCH SURROUNDING

- 6. THE ROUGH-IN LOCATIONS FOR PROJECTORS SHOWN ON THE FLOOR PLAN DRAWINGS ARE APPROXIMATE. COORDINATE WITH AV CONTRACTOR FOR ACTUAL PROJECTION DISTANCES. LOCATE ROUGH-IN FOR PROJECTORS IN COMPLIANCE WITH THE DISPLAY DEVICE SCHEDULE.
- 7. ALL ROUGH-IN SHALL BE IN COMPLIANCE WITH ANSI/TIA/EIA 569-B WHICH INCLUDES, BUT IS NOT LIMITED TO, ALL CONDUITS HAVING NO MORE THAN TWO 90 DEGREE BENDS.
- 8. ALL CONDUIT FOR AV ROUGH-IN SHALL BE EMT.
- 9. ALL CONNECTION PANELS SHALL BE WITHIN 12" OF POWER AND DATA OUTLETS. NOTIFY ENGINEER IF DISCREPANCY IS FOUND.
- 10. ALL AV CONDUITS SHALL BE INSTALLED USING SHORTEST RUNS POSSIBLE. THERE SHOULD BE NO UNNECESSARY BENDS IN CONDUIT RUNS.
- 11. CONDUITS AND JUNCTION BOXES SHOWN NO RISER DIAGRAMS ARE TYPICAL FOR EACH DEVICE IN ROOM.
- 12. COVER ALL JUNCTION BOXES WITH A BLANK NYLON COVER PLATE.



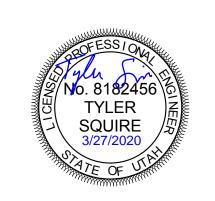

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DEFINITIONS

NOTE: ALL DEFINITIONS MAY NOT BE USED.

INDICATED: THE TERM "INDICATED" REFERS TO GRAPHIC REPRESENTATIONS, NOTES, OR SCHEDULES ON THE DRAWINGS, OTHER PARAGRAPHS OR SCHEDULES IN THE SPECIFICATIONS, AND SIMILAR REQUIREMENTS IN THE CONTRACT DOCUMENTS. WHERE TERMS SUCH AS "SHOWN", "NOTED", "SCHEDULED", AND "SPECIFIED" ARE USED, IT IS TO HELP THE READER LOCATE THE REFERENCE, NO LIMITATION ON LOCATION IS INTENDED.

DIRECTED: TERMS SUCH AS "DIRECTED", "REQUESTED", AUTHORIZED", "SELECTED", "APPROVED", "REQUIRED", AND "PERMITTED" MEAN "DIRECTED BY THE ENGINEER", "REQUESTED BY THE ENGINEER", AND SIMILAR PHRASES.

APPROVE: THE TERM "APPROVED", WHERE USED IN CONJUNCTION WITH THE ENGINEER'S ACTION ON THE CONTRACTOR'S SUBMITTALS, APPLICATIONS, AND REQUESTS, IS LIMITED TO THE ENGINEER'S DUTIES AND RESPONSIBILITIES AS STATED IN GENERAL AND SUPPLEMENTARY CONDITIONS.

FURNISH: THE TERM "FURNISH" IS USED TO MEAN "SUPPLY AND DELIVER TO THE PROJECT SITE, READY FOR UNLOADING, UNPACKING, ASSEMBLY, INSTALLATION, AND SIMILAR OPERATIONS."

INSTALL: THE TERM "INSTALL" IS USED TO DESCRIBE OPERATIONS AT PROJECT SITE INCLUDING THE ACTUAL "UNLOADING, UNPACKING, ASSEMBLY, ERECTION, PLACING, ANCHORING, APPLYING, WORKING TO DIMENSION, FINISHING, CURING, PROTECTING, CLEANING, AND SIMILAR OPERATIONS."

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ABBREVIATIONS

NOTE: ALL ADDDEVIATIONS MAY NOT DE LISEE

		NOTE: ALL ABBREVIATIONS	MAY NO	ΓBE USED.
"A"		AMP OR AMPS	"IG"	INSULATED GROUND
"ADJ"	,	ADJACENT	"IMC"	INTERMEDIATE METAL CND
"AFF"	•	ABOVE FINISHED FLOOR	"IN/IS"	INSULATED/ISOLATED
"AL"		ALUMINUM	"KVA"	KILO VOLT AMPERES
"C"		CONDUIT	"KW"	KILOWATTS
"CB",	"C/B"	CIRCUIT BREAKER	"LFMC"	LIQUID TIGHT FLEXIBLE
"CKT'	"	CIRCUIT		METAL CONDUIT
"CO"		CONVENIENCE OUTLET	"LFNC"	LIQUID TIGHT FLEXIBLE
"C.O.I	R."	CONTRACTING OFFICER'S		NONMETALLIC CONDUIT
		REPRESENTATIVE	"MCA"	MINIMUM CIRCUIT AMPS
"CU"		COPPER	"MLO"	MAIN LUGS ONLY
"EA"		EACH	"N.C."	NORMALLY CLOSED
"ELEC	C"	ELECTRICAL	"N.I.C."	NOT IN CONTRACT
"EM"		EMERGENCY	"N.O."	NORMALLY OPEN
"EMT	"	ELECTRICAL METALLIC TUBING	"O.C."	ON CENTER
"ENT'	"	ELECTRICAL NONMETALLIC TUBING	"OCP"	OVER CURRENT PROTECTION
"EQU	IP"	EQUIPMENT	"QTY"	QUANTITY
"EX"		EXISTING	"R"	REMOVE
"FA"		FIRE ALARM	"RMC"	RIGID METAL CONDUIT
"FACI	Ρ"	FIRE ALARM CONTROL PANEL	"RNC"	RIGID NONMETALLIC CONDU
"FLA"	1	FULL LOAD AMPS	"RR"	REMOVE AND RELOCATE
"FMC	"	FLEXIBLE METAL CONDUIT	"TYP"	TYPICAL
"F.O.E	В."	FREIGHT ON BOARD	"UF"	UNDER FLOOR
"GFI"		GROUND FAULT INTERRUPTER	"UG"	UNDER GROUND
"GR"		GROUND	"\/\/"	WITH

PROJECT DESCRIPTION

INTERMOUNTAIN HEALTHCARE KEY BANK **TOWER LEVEL 09**

AUTHORITY HAVING JURISDICTION

36 S STATE STREET SALT LAKE CITY, UT 84111

SHEET NAME:

AUDIO-VIDEO ROUGH-IN SCHEDULES NOTES, DETAILS AND DIAGRAMS


REVISIONS

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ISSUE DATE: 03/27/2020 ISSUE TYPE: CD SET DRAWN BY: SJT

CHECKED BY: AWA PROJECT#: 1953

SHEET NUMBER:

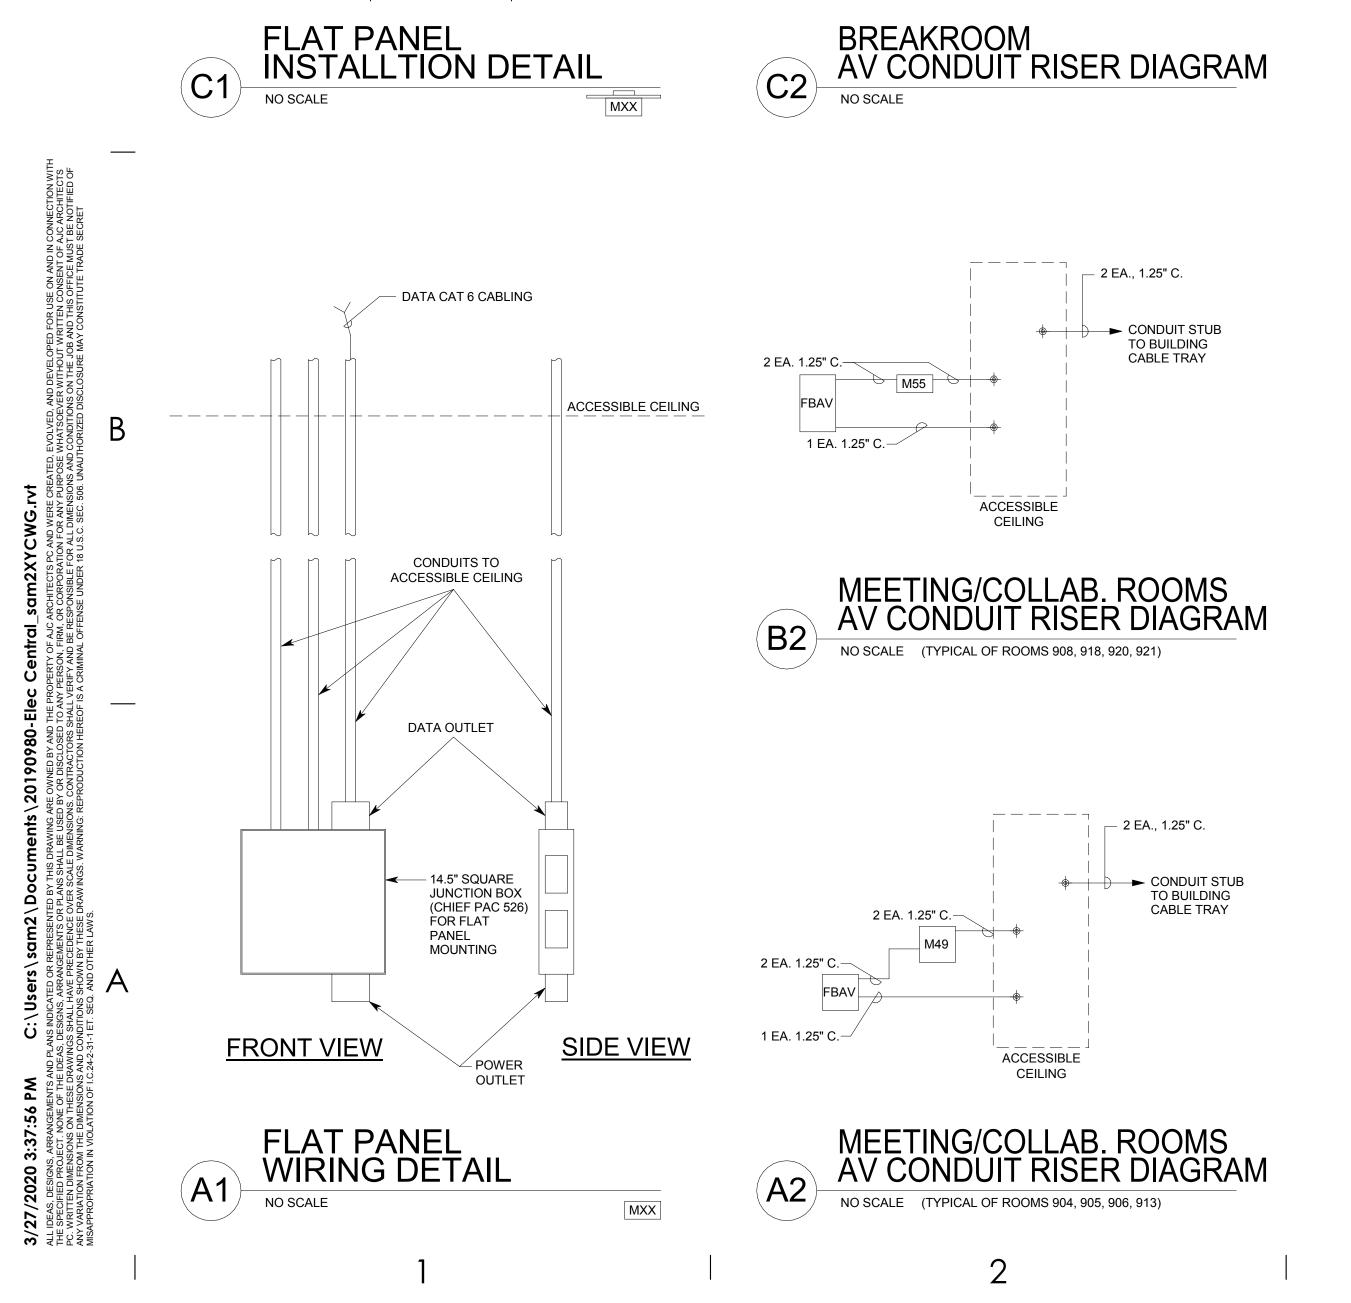

MOUNTING BRACKET, AFFIX TO BUILDING STRUCTURE

JUNCTION BOX (FURNISHED

ELECTRICAL CONTRACTOR)

1 EA. 1.25" C.—

AND INSTALLED BY

TYPICAL

STRUCTURAL BACKING,

MONITOR AND

AV INSTALLER)

CAMERA BAR

INSTALLER)

(FURNISHED AND **INSTALLED BY AV**

MOUNT (FURNISHED

VIDEO CONFERENCING

AND INSTALLED BY


"HOA"

HAND-OFF-AUTO


HORSE POWER

"WP" WEATHER PROOF

"XFMR" TRANSFORMER

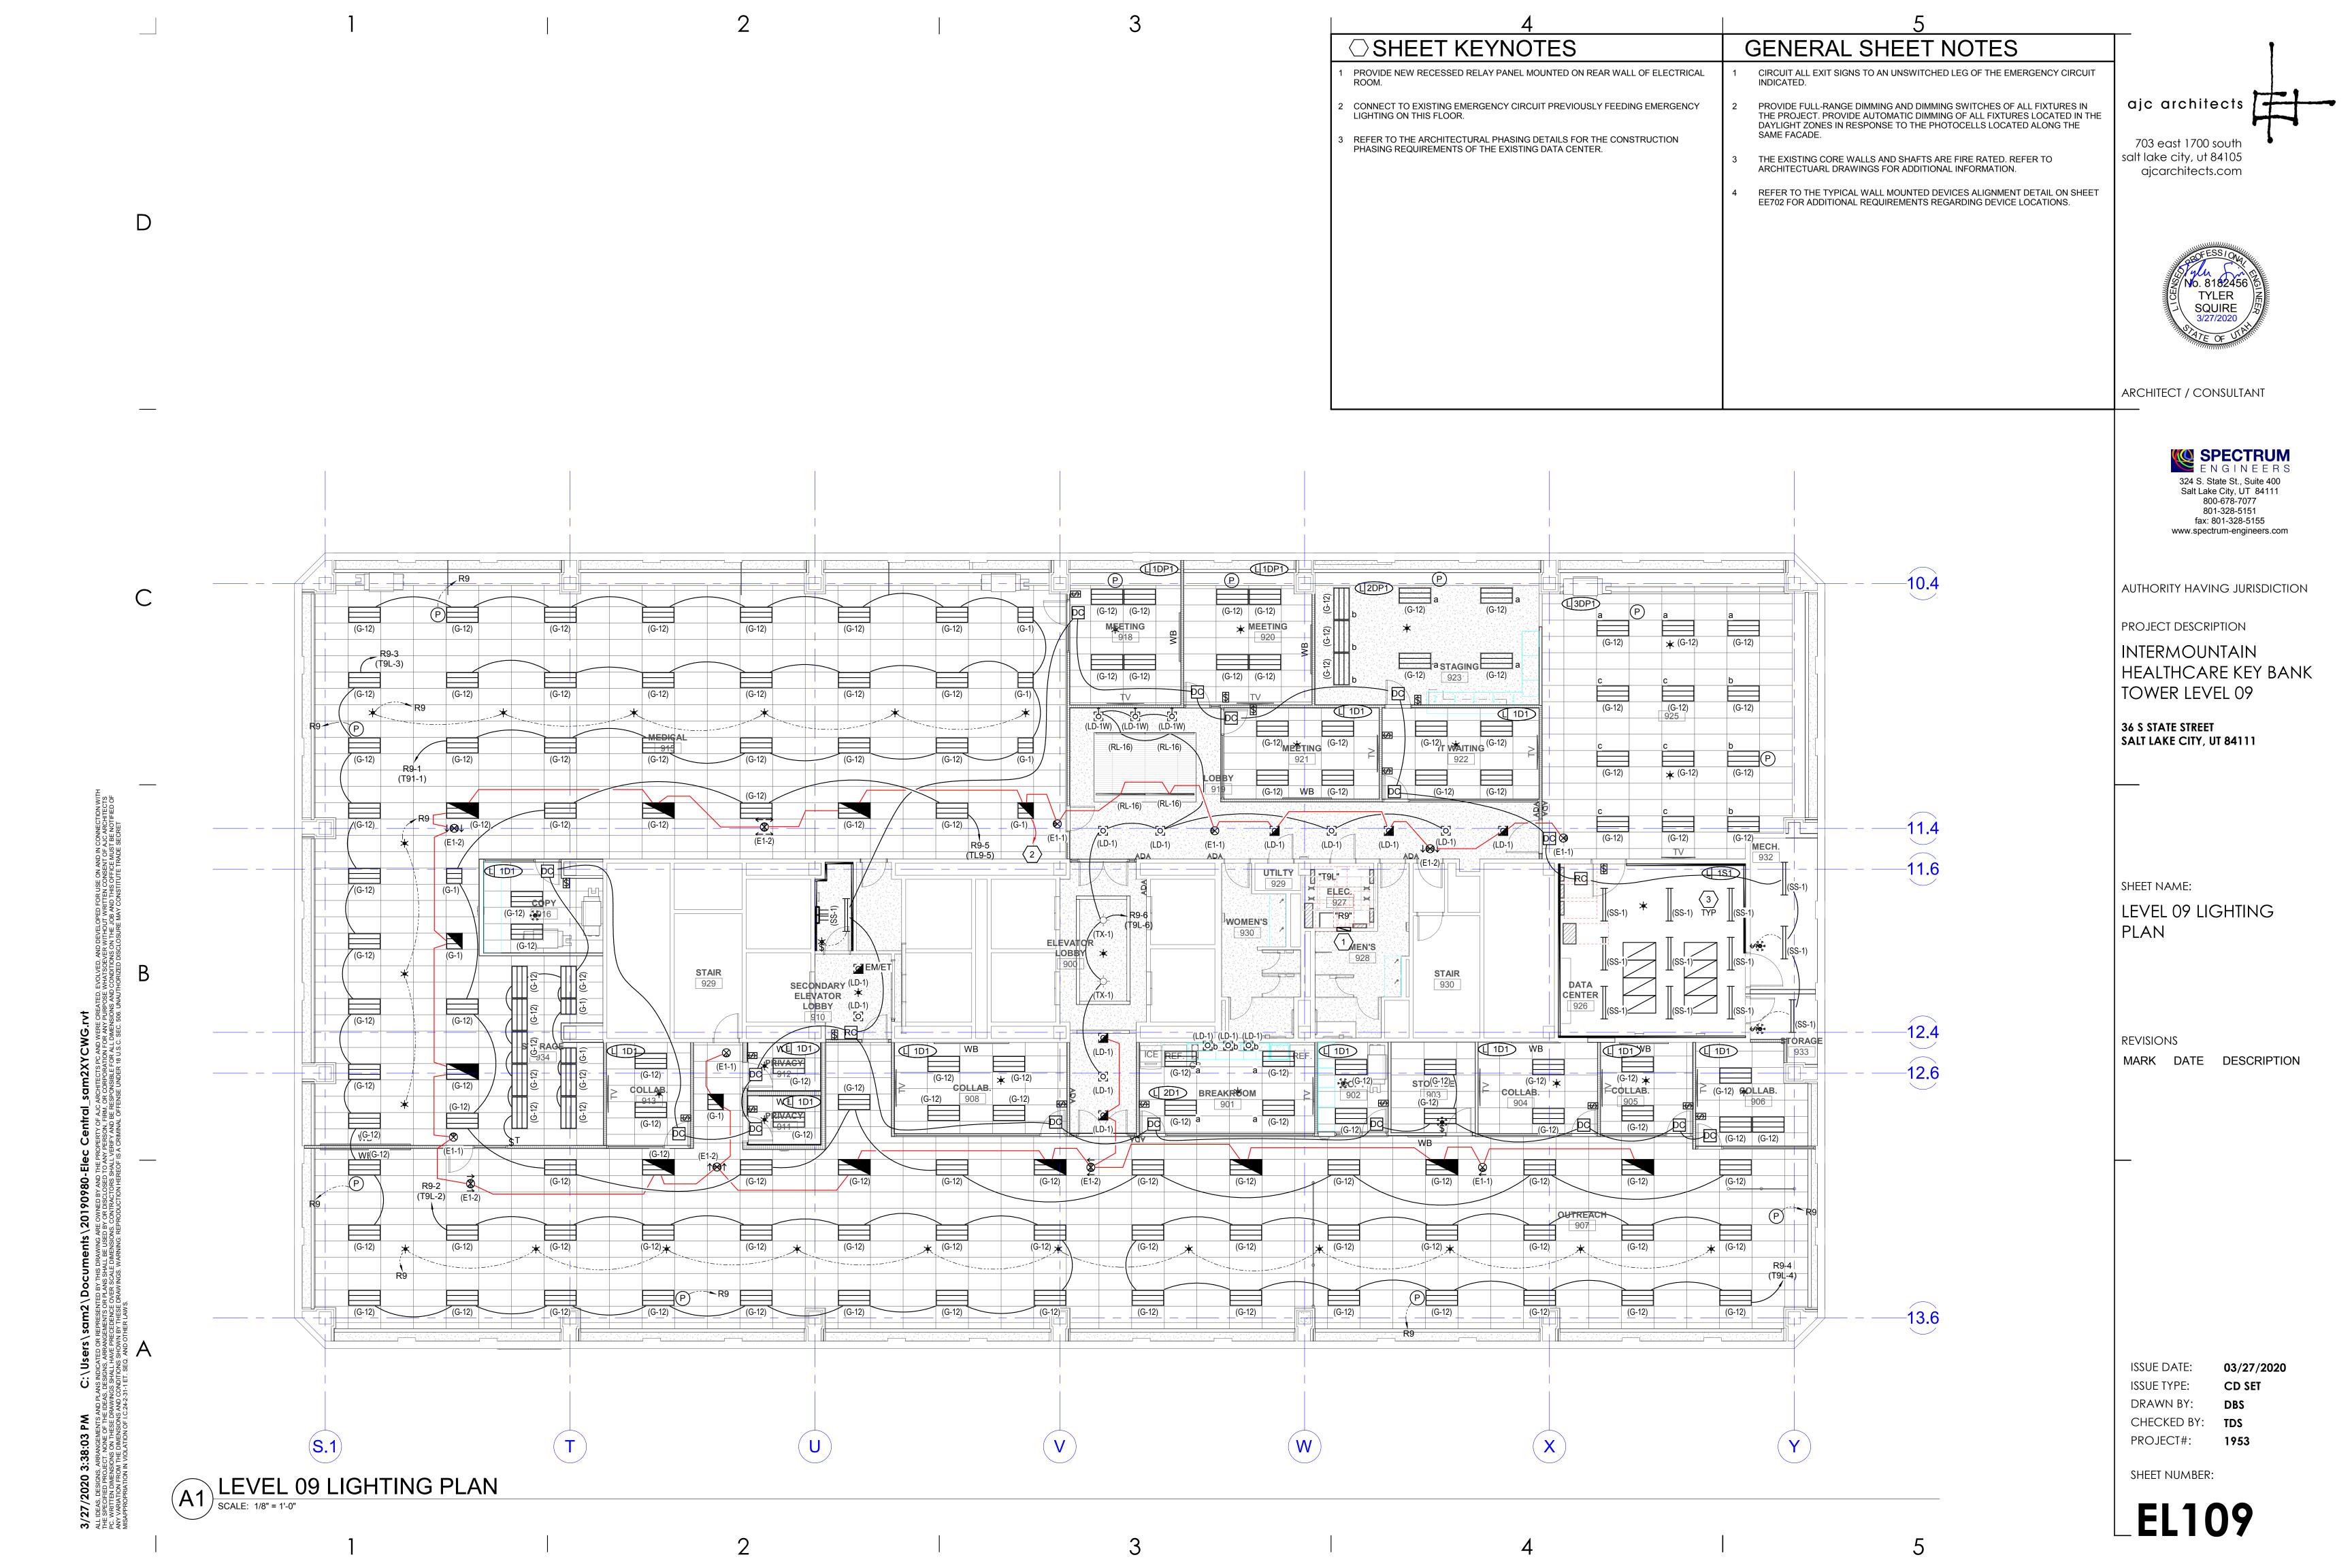



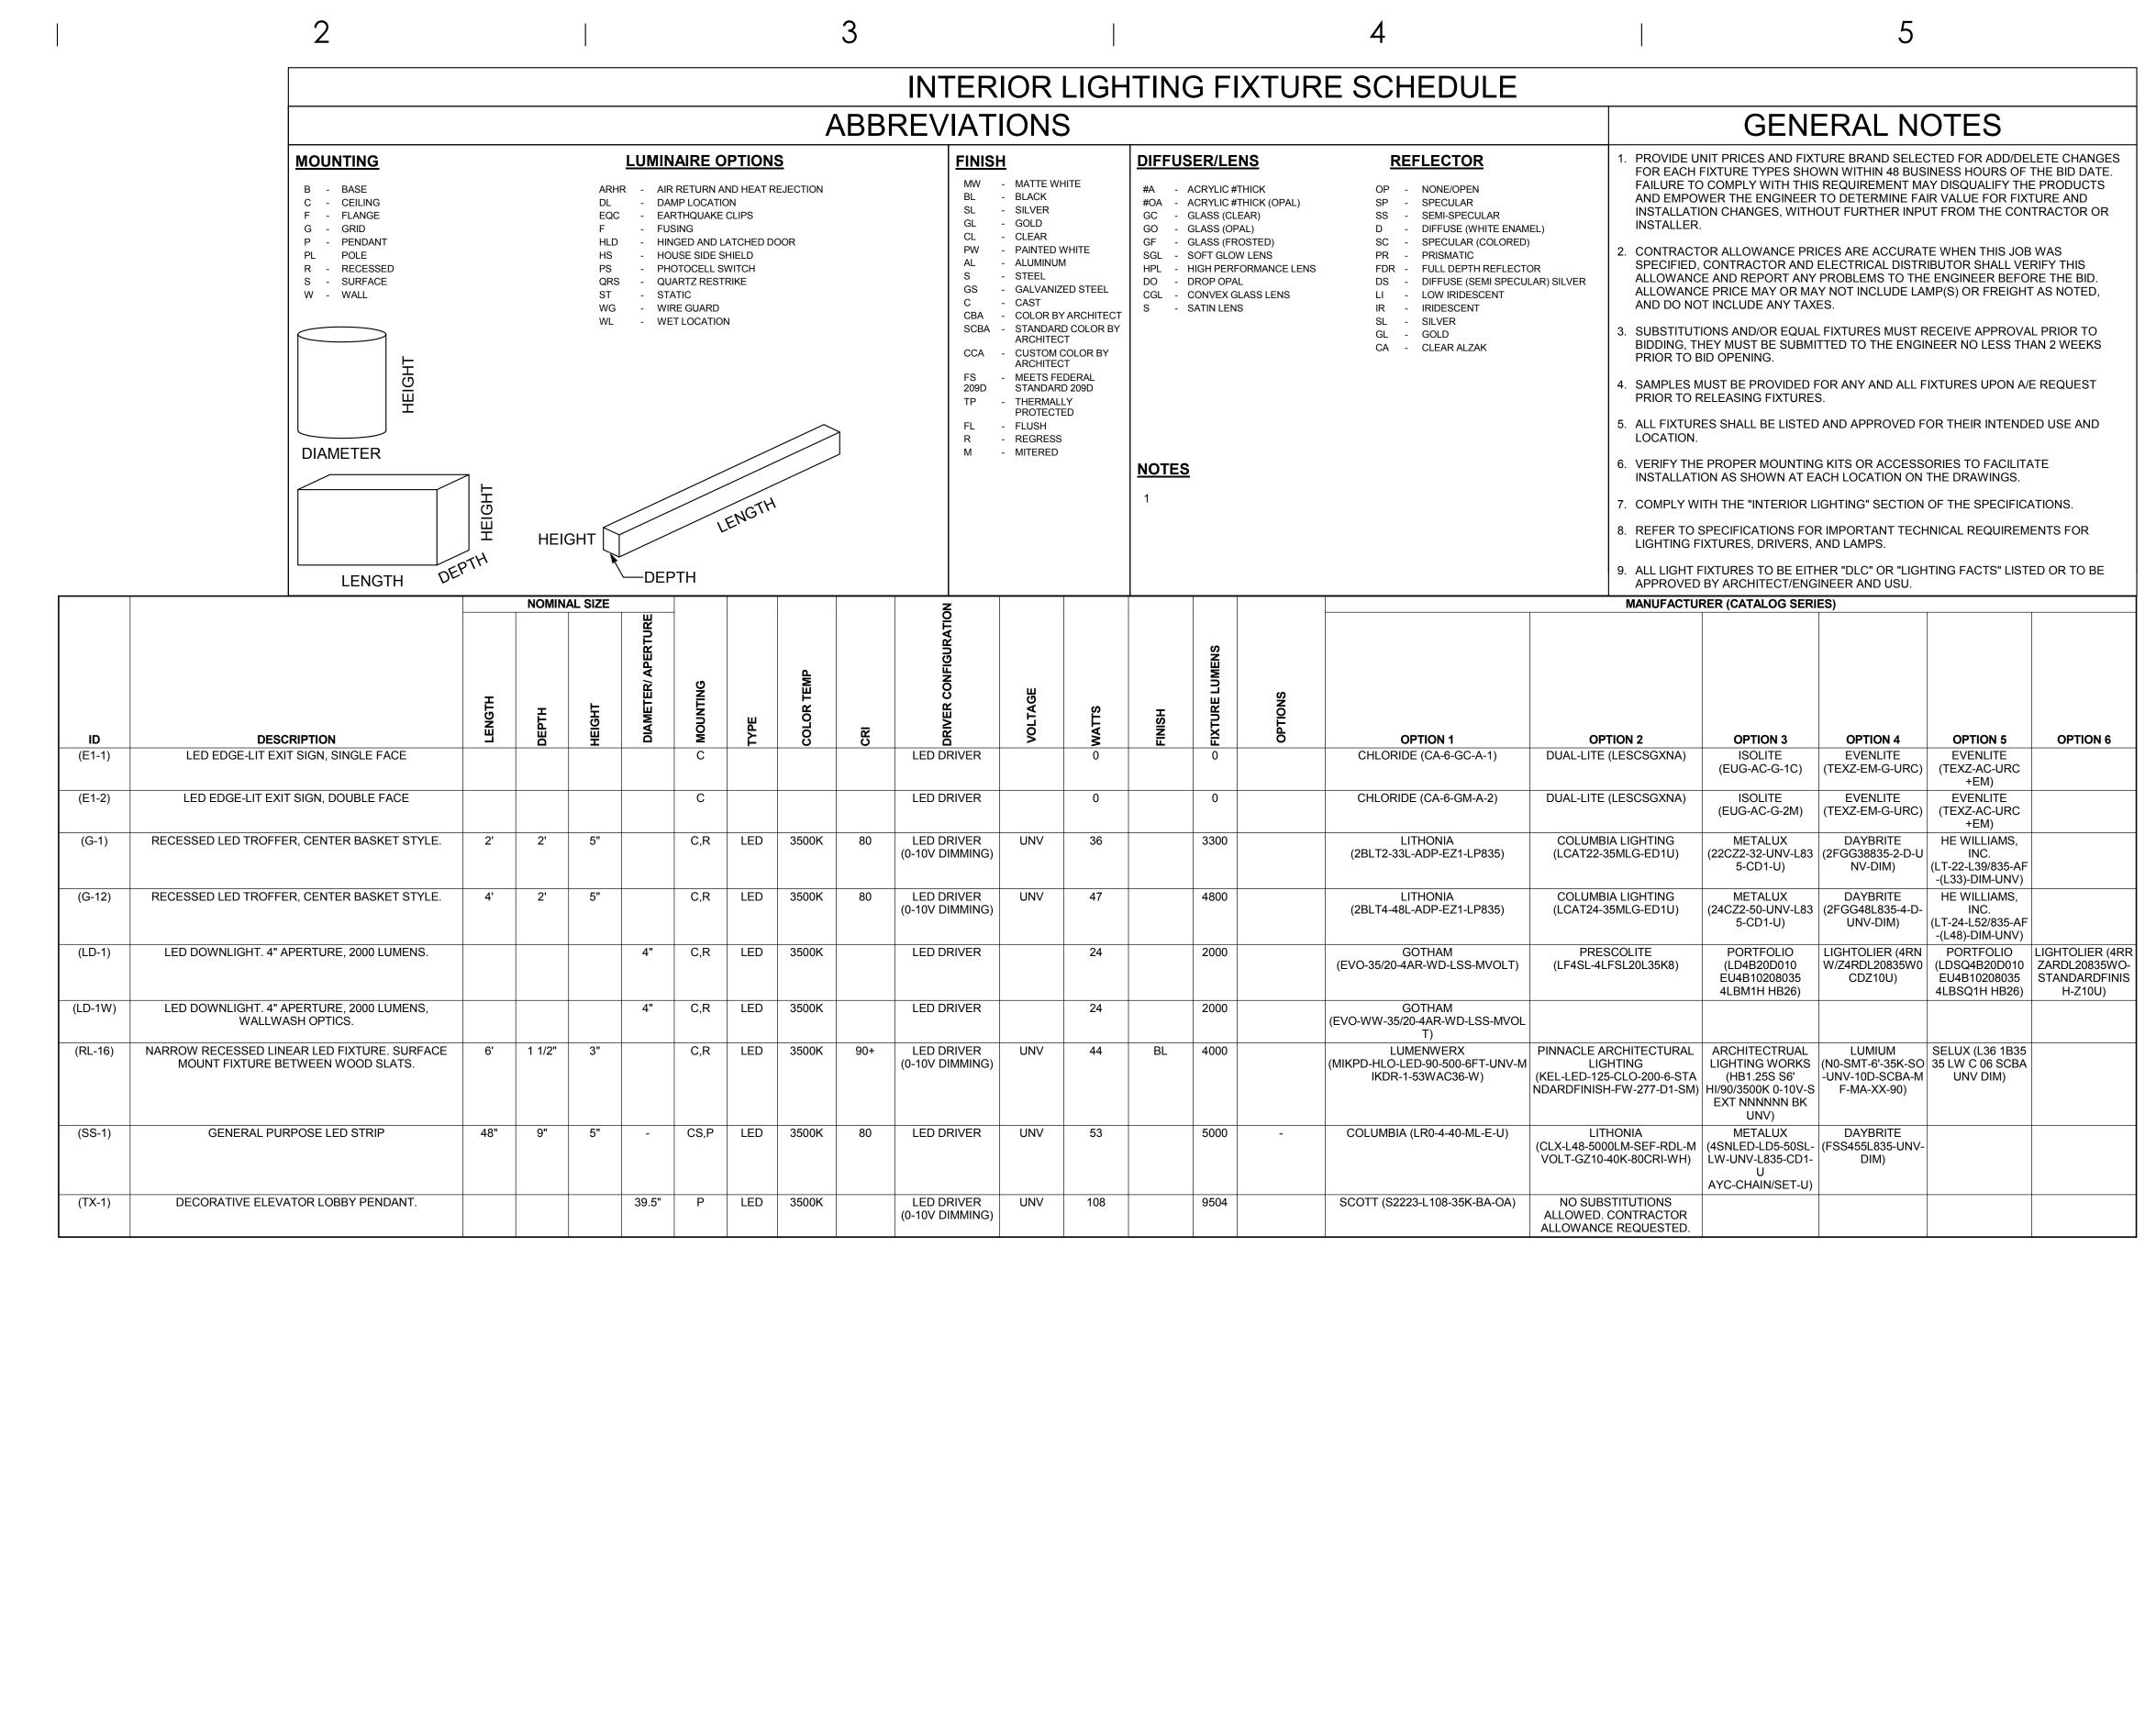



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INTERMOUNTAIN
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TOWER LEVEL 09

36 S STATE STREET
SALT LAKE CITY, UT 84111

SHEET NAME:

INTERIOR LIGHTING FIXTURE SCHEDULE


REVISIONS


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EL601





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PROJECT DESCRIPTION

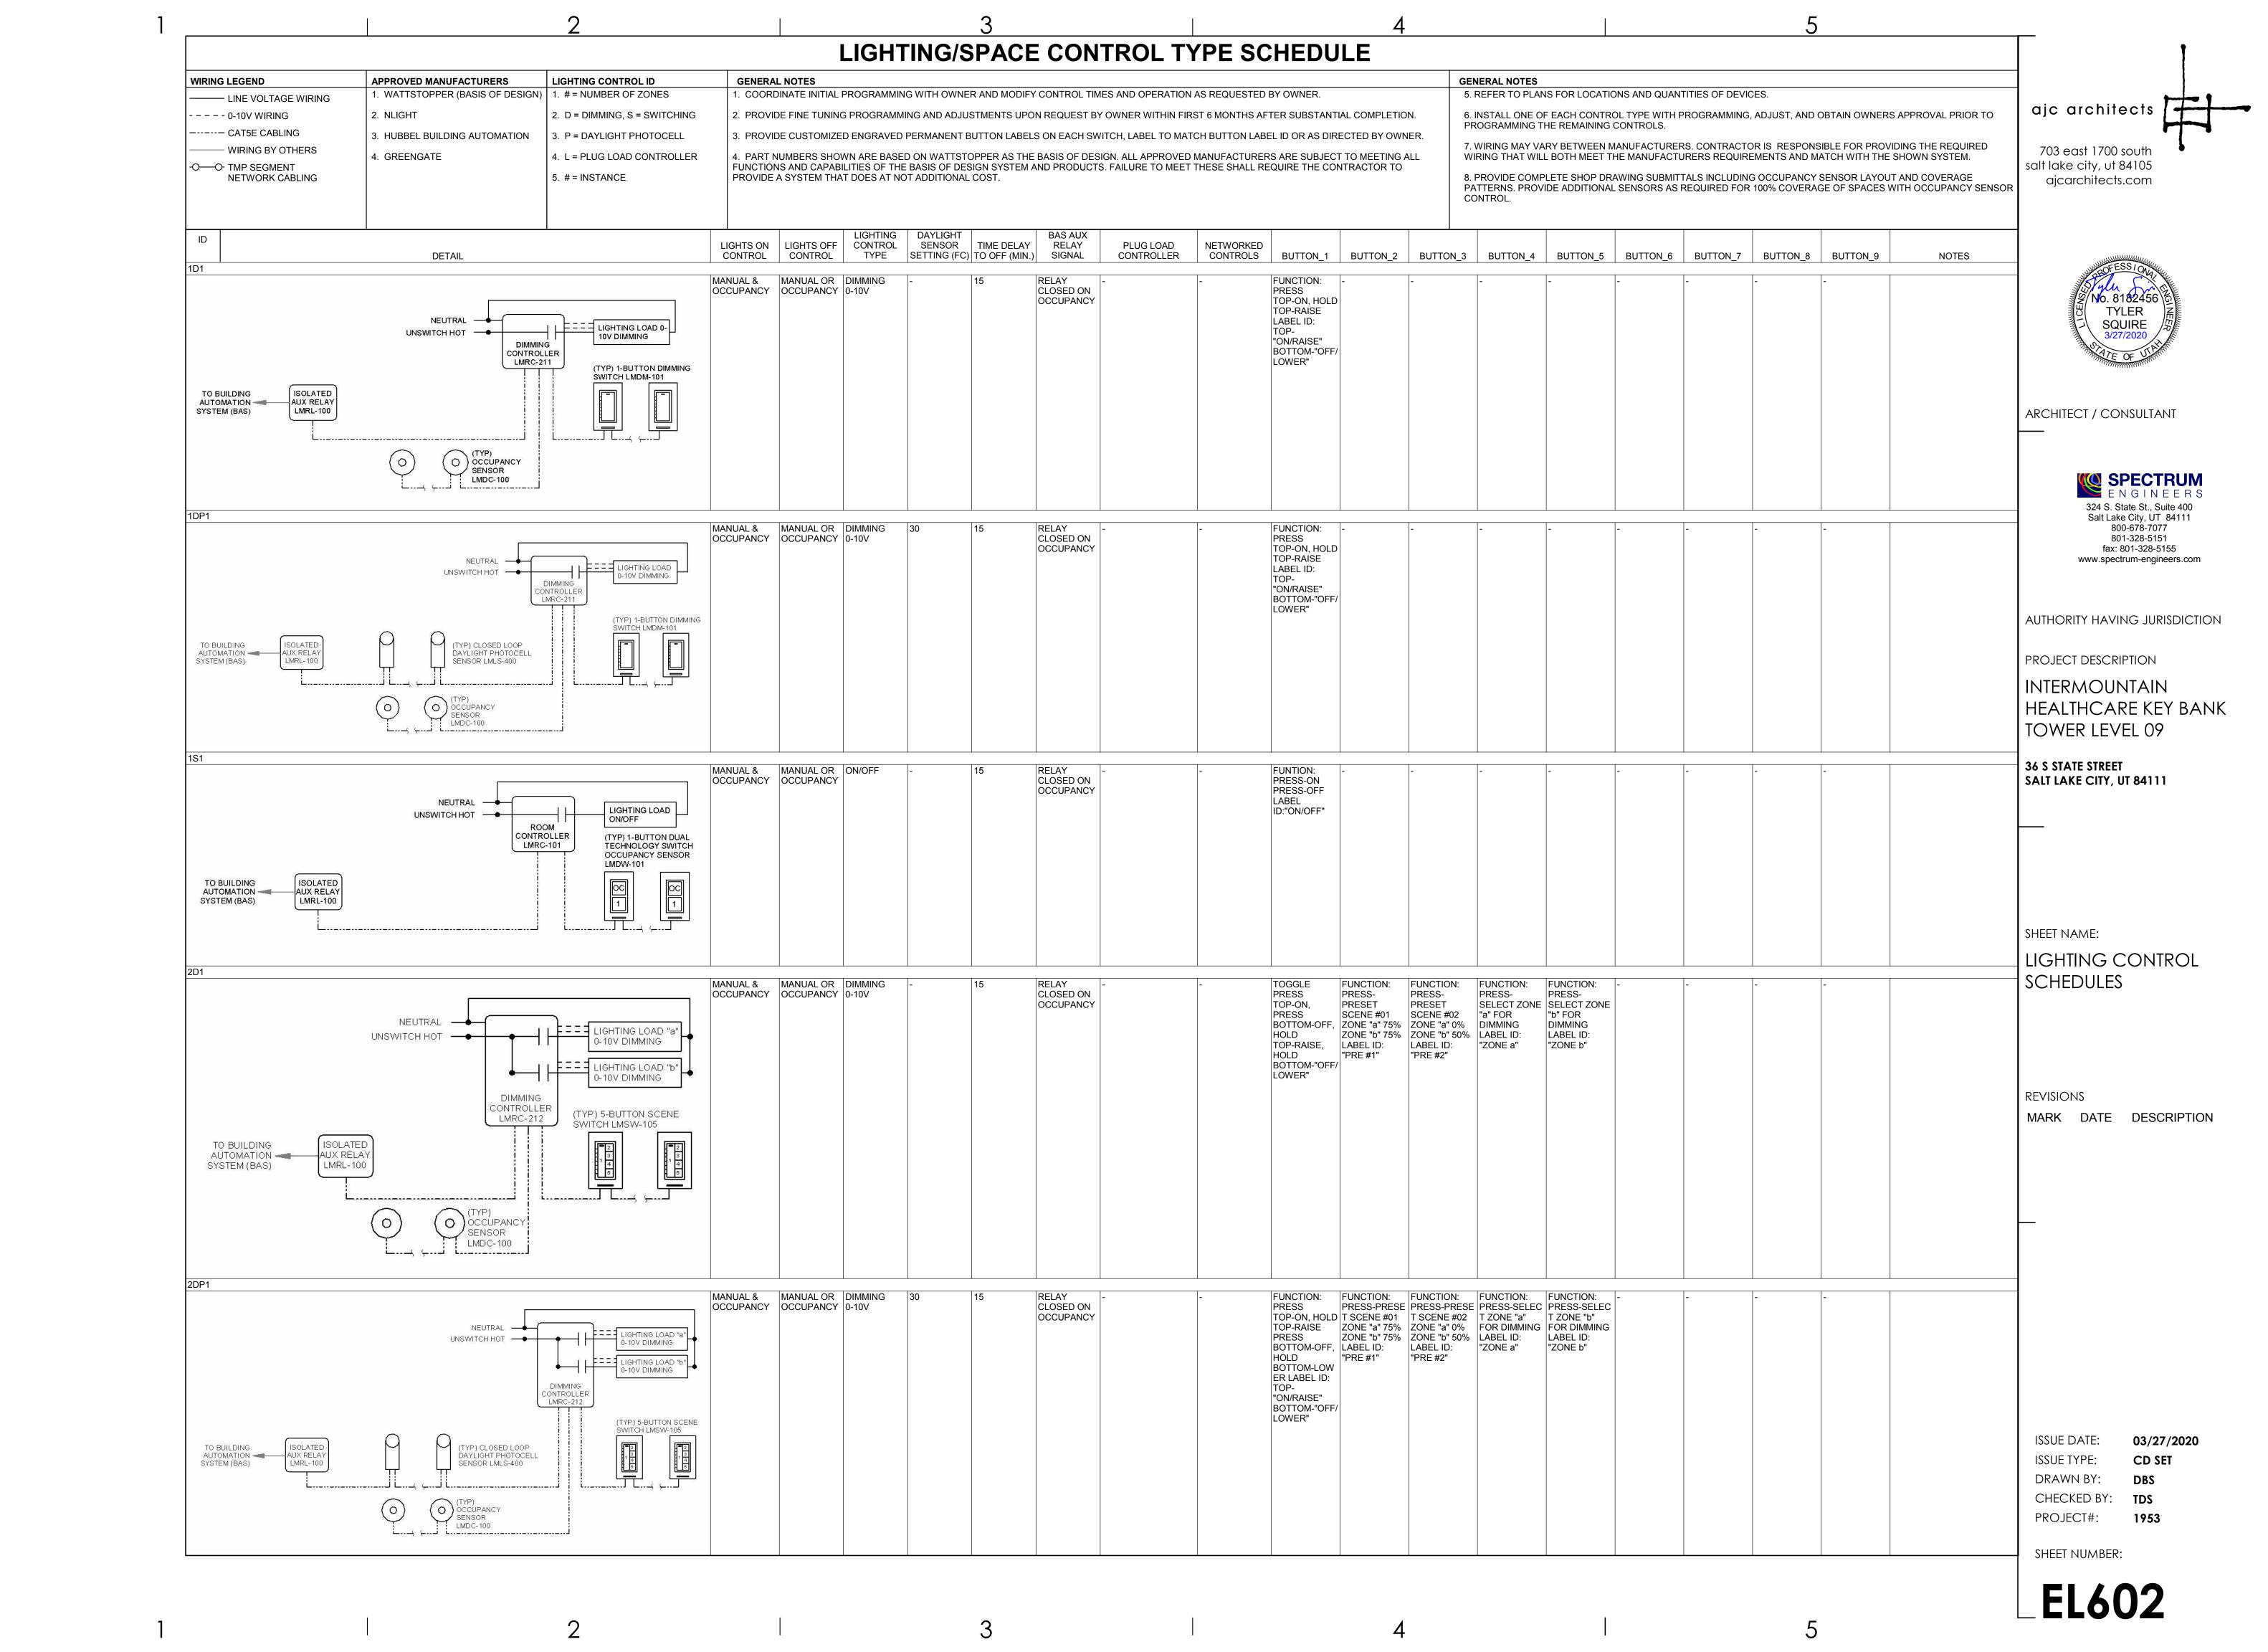INTERMOUNTAIN HEALTHCARE KEY BANK TOWER LEVEL 09
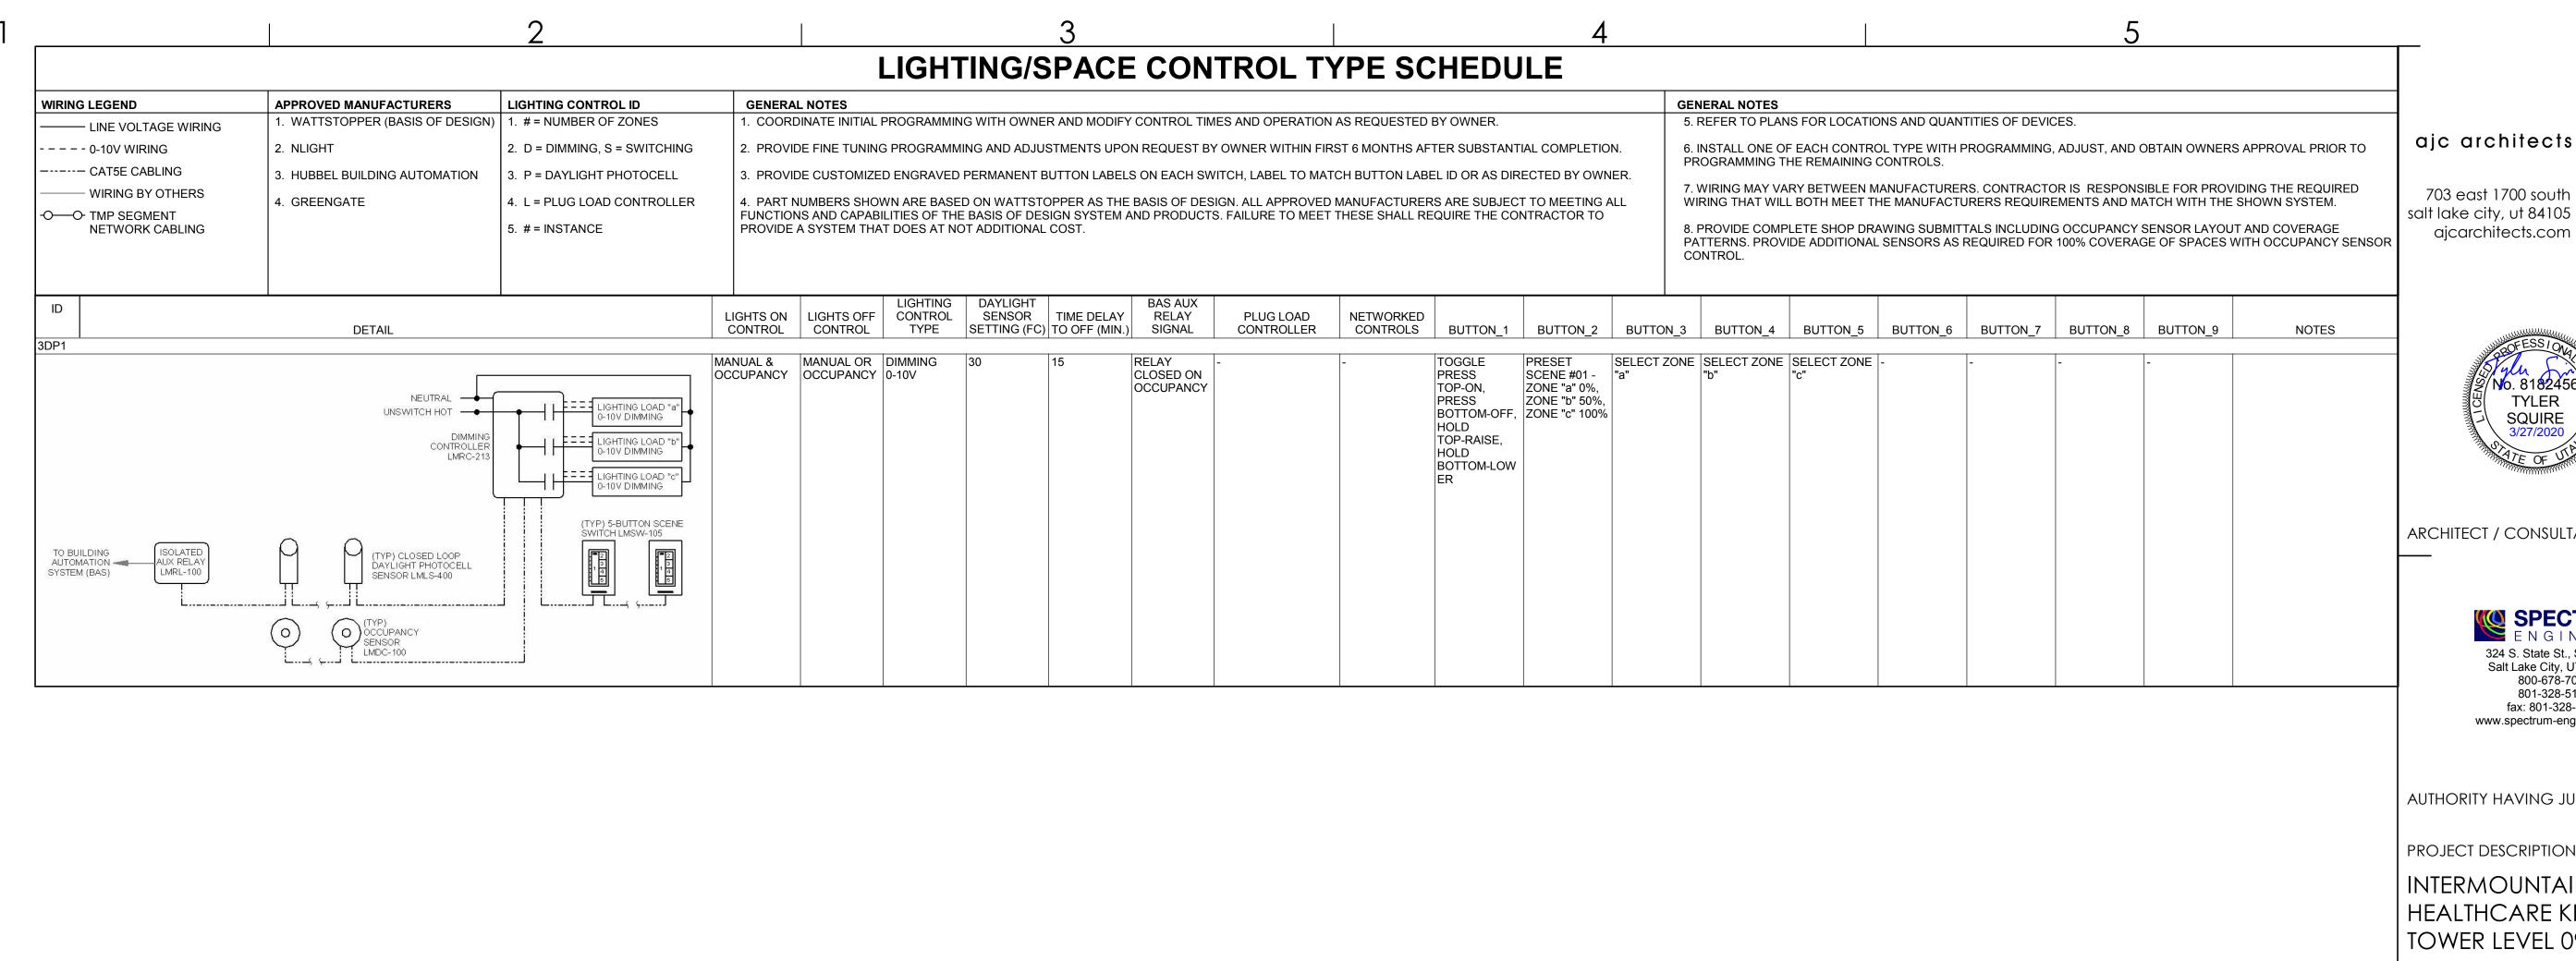
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SHEET NAME:

LIGHTING CONTROL SCHEDULES


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			PER ONE						
**)*		OULE NUMI CRIPT (NOT			(E.0	G.)(5)		
SYM	AMP	HH AMPS	CONDUIT SIZE .75	CONDI QTY 2	JCTOR (I SIZE 12	NOTE 1) G 12	IG/HH 12	SE 8	NOTES
(2) (3)	20	- 24	.75 .75	3	12 12	12 12	12 12	8	2,3 2,3
4	30	-	.75	2	10	10	10	8	2,3
5	30	-	.75	3	10	10	10	8	2
<u>6</u>	30 40	32	.75 1	2	10 8	10	10 8	<u>8</u> 6	2
8	40	-	1	3	8	10	8	6	2
(9) (10)	40 55	44	1	2	8 6	10	8	6 4	2
11	55	-	1	3	6	10	8	4	2
(12) (13)	55 70	60	1.25 1	2	6 4	10 8	8	2	2
14	70	-	1.25	3	4	8	4	2	2
(15) (16)	70 85	76	1.25 1.25	2	3	8	3	2	2
17	85	-	1.25	3	3	8	3	2	2
(18) (19)	85 95	92	1.25 1.25	3	3 2	8	3 2	2	2
20	95	104	1.50	4	2	8	2	2	2
21 22	130	- 116	1.50	3	1	6	2 2	2	2
23	130 150	116	1.50	3	1/0	6	2	1/0	2
24	150	136	2	4	1/0	6	2	1/0	2
25 26	175 175	- 156	2	3 4	2/0 2/0	6	2 2	2/0	2
27	200	-	2	3	3/0	6	2	2/0	2
28 29	200	180	2.50 2.50	4 3	3/0 4/0	6 4	2 2	2/0 2/0	2
30	230	208	2.50	4	4/0	4	2	2/0	2
<u>31</u>	255	-	2.50	3	250	4	1	2/0	2
<u>32</u> 33	255 310	232	2.50	3	250 350	3	1/0	2/0 3/0	2
34	310	280	3	4	350	3	1/0	3/0	2
<u>35</u> 36	380	344	3.50 4	3	500 500	3	3/0 3/0	3/0	2
37	400	-	2 EA 2	3	3/0	3	3/0	3/0	2
38	400	360	2 EA 2.50	4	3/0	3	3/0	3/0	2
(39) (40)	510 510	464	2 EA 2.50 2 EA 3	3	250 250	1 1	4/0 4/0	3/0	2
41	620	-	2 EA 3	3	350	1/0	4/0	3/0	2,4
42	620 760	560	2 EA 3 2 EA 3.50	3	350 500	1/0	4/0 4/0	3/0	2,4
44	760	688	2 EA 4	4	500	1/0	4/0	3/0	2,4
45	855	- 760	3 EA 3	3	300	2/0	4/0	3/0	2,4
46	855 1000	768	3 EA 3 3 EA 3.50	3	300 400	2/0 2/0	4/0 4/0	3/0	2,4
48	1000	912	3 EA 3.50	4	400	2/0	4/0	3/0	4
<u>49</u> <u>50</u>	1140 1140	1032	3 EA 4 3 EA 4	3	500 500	3/0	4/0 4/0	3/0	4
<u>51</u>	1240	-	4 EA 3	3	350	3/0	4/0	3/0	4
<u>52</u> 53	1240 1675	1120 1520	4 EA 3 5 EA 4	4	350 400	3/0 4/0	4/0 4/0	3/0 4/0	4
54	2010	1824	6 EA 4	4	400	250	250	250	4
<u>55</u>	2660	2408	7 EA 4	4	500	350	350	350	4
<u>56</u> <u>57</u>	3040 4180	2752 3784	8 EA 4 11 EA 4	4	500 500	500 500	500 500	500 500	4
58	-	-	5 EA 4	-	-	-	-	-	6
<u>59</u> 60	-	-	5 10 EA 4	-	-	-	-	-	6
2.	AS NC OTHEI PROVI CIRCL TABLE PROVI COMP GROU COND SYMBO	OTED IN RWISE IDE EQUITED IN RWISE IDE EQUITED IN IDE EQUITED IN IDE #10 UTERS IDE #10 UTERS IN IDE #10 UTERS IN IDE #10 UTERS IN IDE #10 UTERS IN IDE #10 UTERS IDE #10 U	S SHOWN NOTE 5. A NOTED. UIPMENT G AKERS ARI NEUTRALS . CONDUCTO	ARE SHALL CON SROUND E SIZED ON MAY ONEU ONEU ON RAT ONE THE SROUND RESEAS. JURRENT ROUND RESEAS. JURRENT RESEAS.	OWN FODUCTOR CONDUCTOR CON	CTORS FER THAN RE BRAN ETED ON NDUCTO ID NEUTI S #1/0 OF DUCTOR LED PHA ONDCUT QUIPMEN EIZE AS T DUE TO RENT CAI CCORDIN MENT GR	PER TABLE AMPERE CH CIRCLE I SERVICE DRS SIZED RAL CONE R	WITH MINIMUM UNLE 250-12: RATING HITS SER ENTRAL LOUCTORS INCLUE THE EUTRAL LOW #1/0 IDING E	LESS 2 WHEN SHOWN II VING NCE S DE HE D
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I۵	RACE	NAY OI	NLY. CONE	DUCTOR	S PROVI	IDED BY	UTILITY.		

EQUIPMENT SCHEDULE

PMENT SCHEDULE


EQUIPMENT SCHEDULE KEY E - DIVISION 26

Q - FURNISHED WITH EQUIPMENT

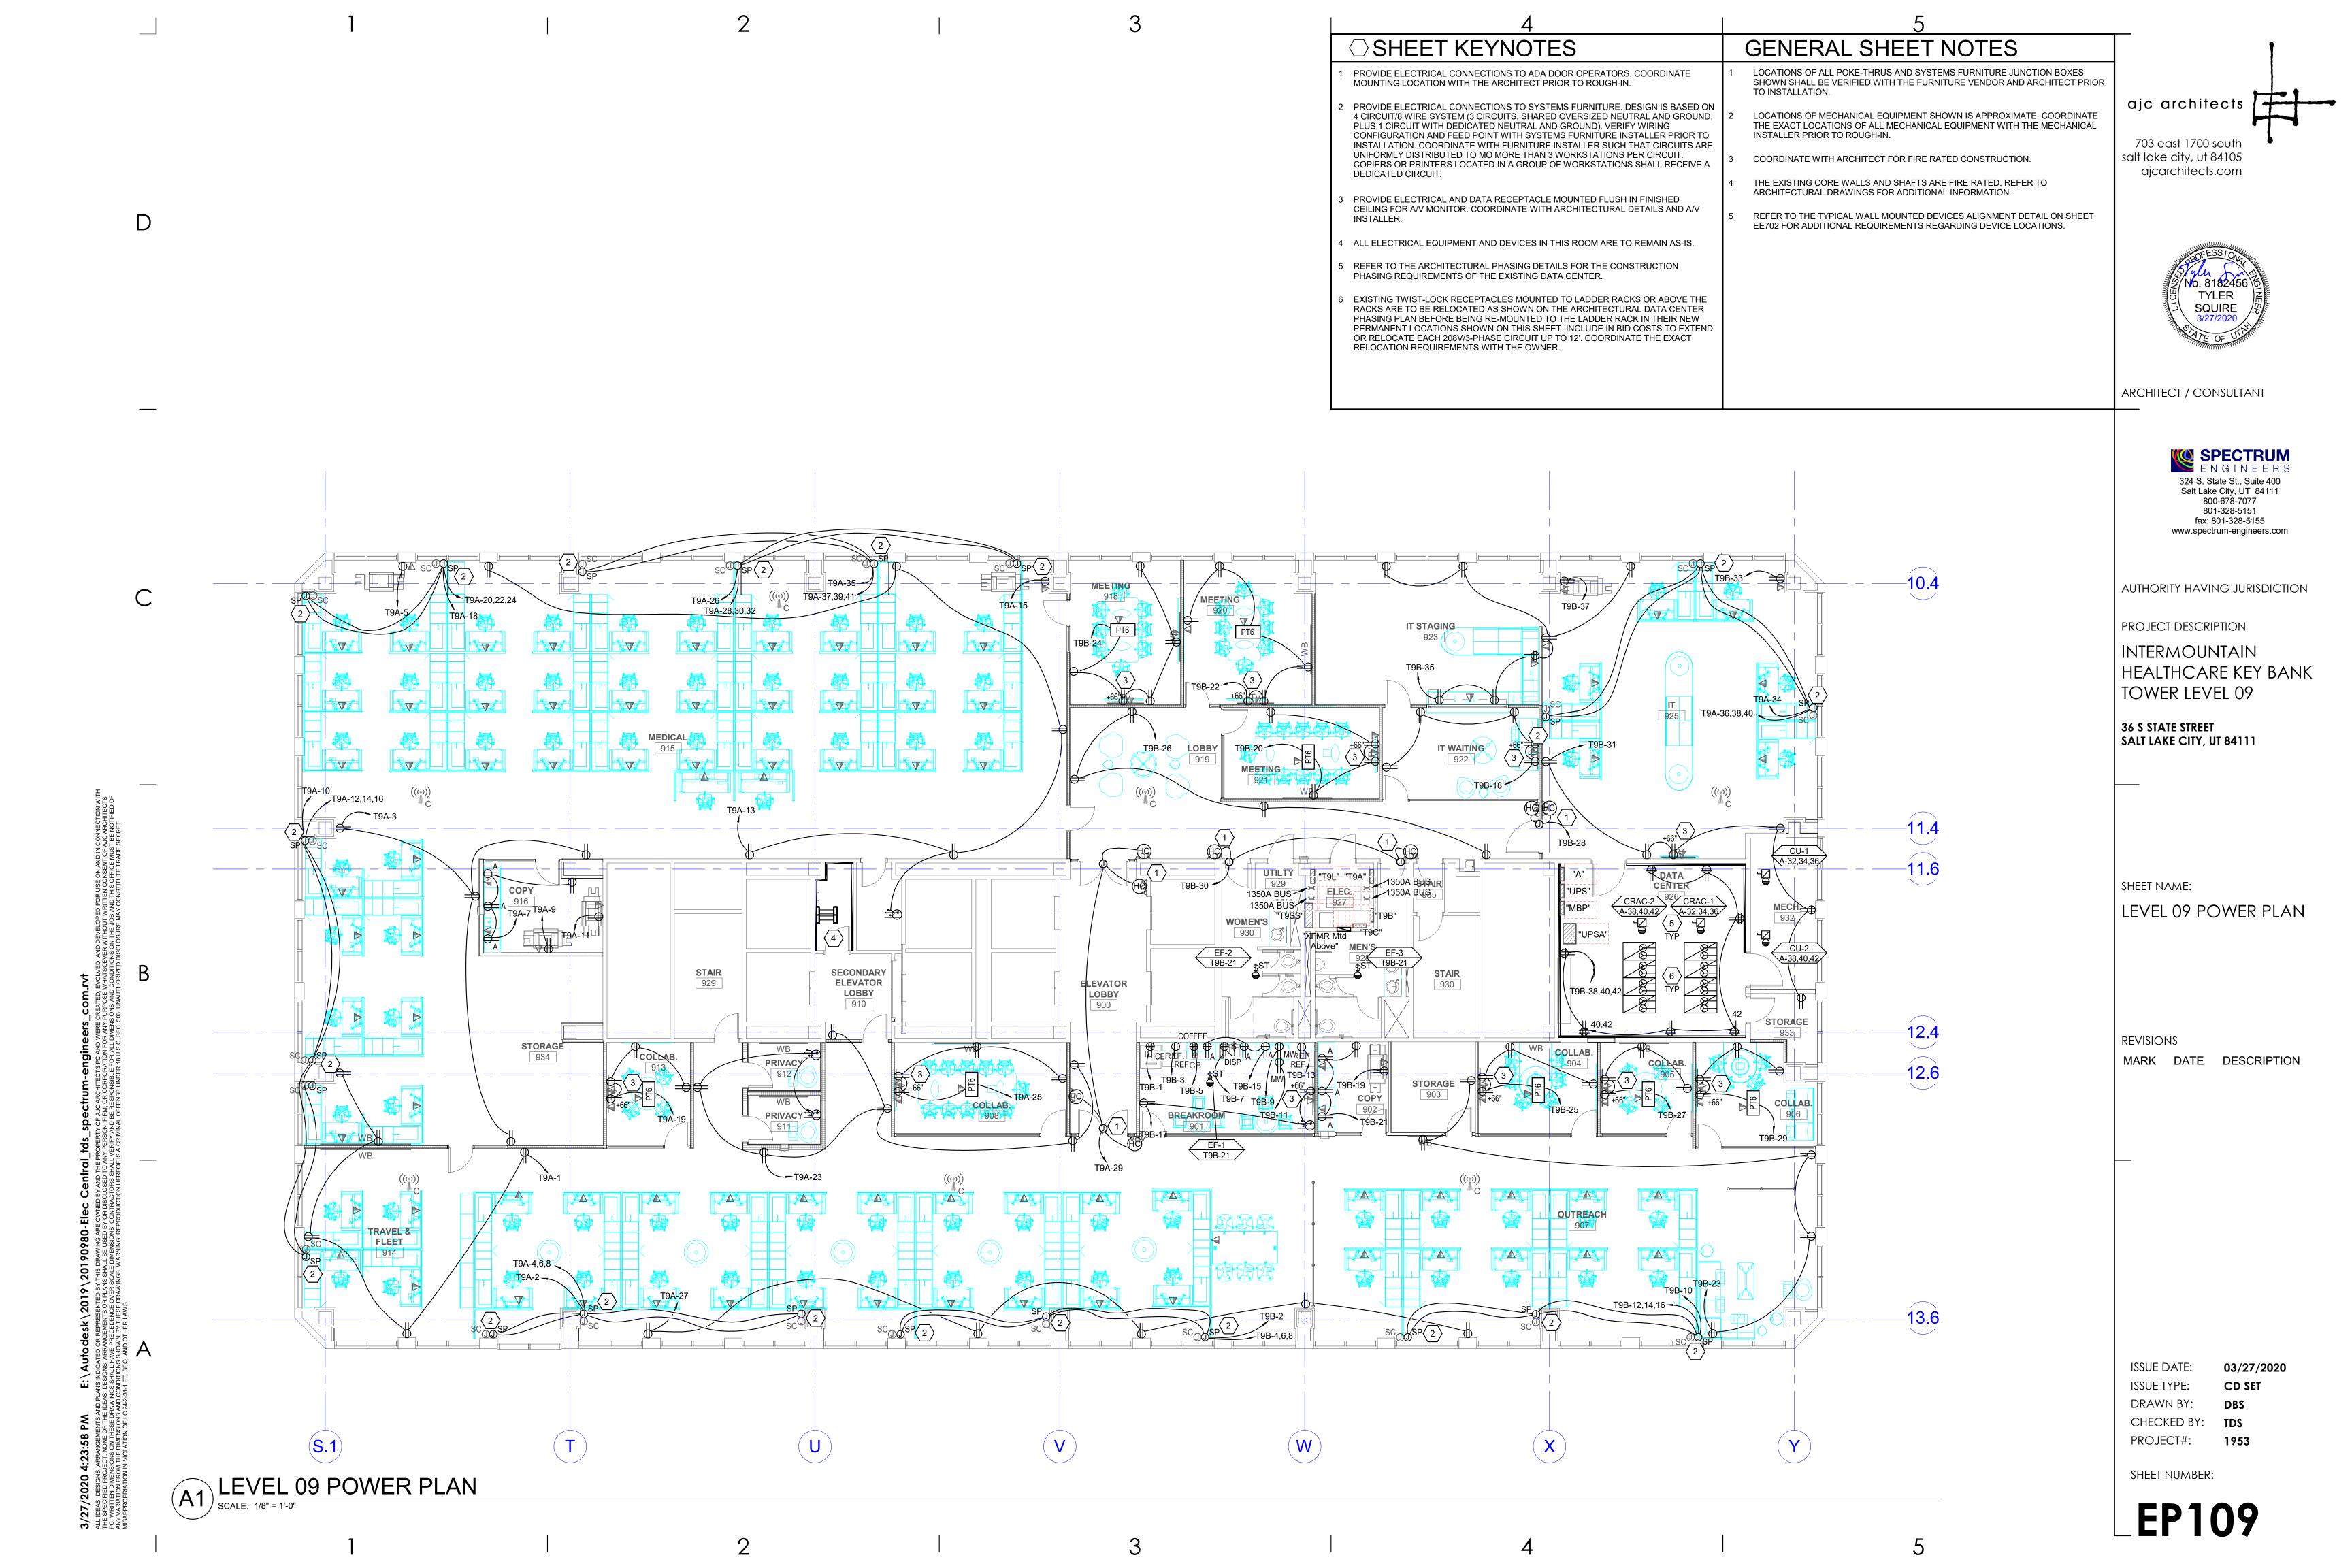- COORDINATE WITH THE DIVISION 23 TEMPERATURE CONTROL INSTALLER

** - AUTOMATIC CONTROL WIRING BY DIVISION 23

												OVERCURF	RENT														
					LO	AD DA	TA					PROTECT	ION		DISCONN	ECT				S	STARTER	R					
																						NORMALLY	NORMALLY	PHASE			
							VOL			WIRE AND	FURN			FURN			FURN			SELECTOR		OPEN		FAILURE			
MARK	QTY	ITEM DESCRIPTION	HP	kW	MCA	FLA	T	PH	Hz	CONDUIT SIZE	BY	DEVICE	LOCATION	BY	DEVICE	LOCATION	BY	DEVICE	SIZES	SWITCH	LAMP	CONTACT	CONTACT	RELAY	NOTES	MARK	
CRAC-1	1	CRAC INDOOR UNIT	-	_	_	40.7	208	3	60	4 #4, #8GR	E	70/3	Α	E	60A/3P	ADJ TO	Q	-	-	-	-	-	-	-		CRAC-1	
										1.25" CND		CB			FRS-60	EQUIP											
CRAC-2	1	CRAC INDOOR UNIT	-	_	_	40.7	208	3	60	4 #4, #8GR	E	70/3	Α	E	60A/3P	ADJ TO	Q	-	-	-	-	-	-	-		CRAC-2	
										1.25" CND		СВ			FRS-60	EQUIP											
CU-1	1	CRAC CONDENSING UNIT	-	_	_	3.2	208	3	60	4 #12, #12GR	E	70/3	Α	E	30A/3P	ADJ TO	Q	-	-	-	-	-	-	-		CU-1	
										0.75" CND		СВ			FRS-15	EQUIP											
CU-2	1	CRAC CONDENSING UNIT	-	-	_	3.2	208	3	60	4 #12, #12GR	E	70/3	Α	E	30A/3P	ADJ TO	Q	-	-	-	-	-	-	-		CU-2	
										0.75" CND		СВ			FRS-15	EQUIP											
EF-1	1	EXHAUST FAN	1/6	_	_	1	120	1	60	2 #12, #12 GR	E	20/1	T9B	E	TOGGLE	ADJ TO	Q	-	-	-	-	-	-	-		EF-1	
										0.75" CND		СВ			SWITCH	EQUIP											
EF-2	1	EXHAUST FAN	1/6	-	_	1	120	1	60	2 #12, #12 GR	E	20/1	T9B	E	TOGGLE	ADJ TO	Q	-	-	-	-	-	-	-		EF-2	
										0.75" CND		СВ			SWITCH	EQUIP											
EF-3	1	EXHAUST FAN	1/6	_	-	1	120	1	60	2 #12, #12 GR	E	20/1	T9B	E	TOGGLE	ADJ TO	Q	-	-	-	-	-	-	-		EF-3	
										0.75" CND		СВ			SWITCH	EQUIP											

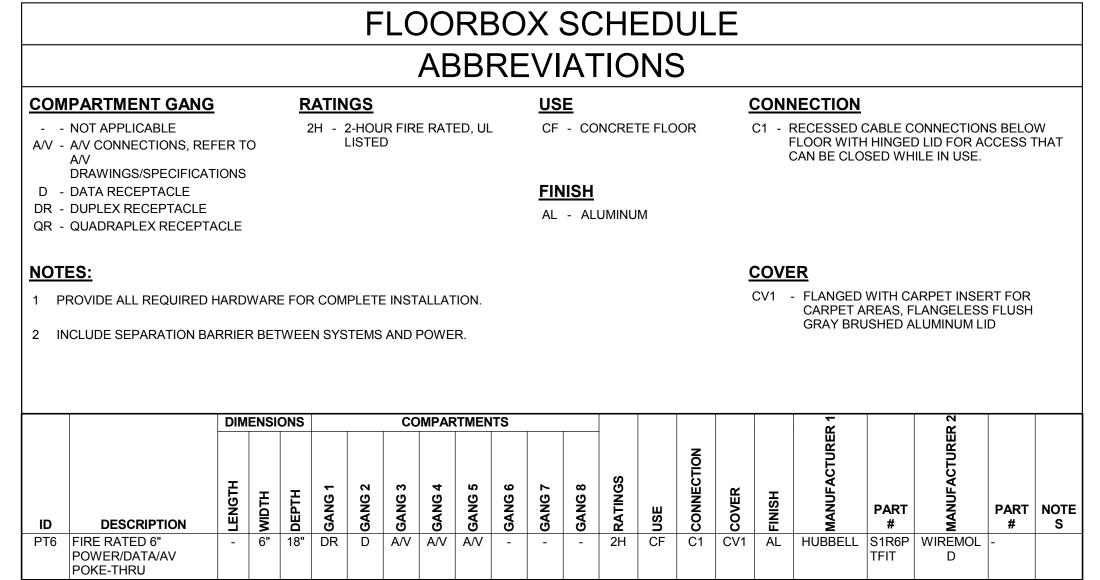

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IHC KEY BANK TOWER - LEVEL 9



ARCHITECT / CONSULTANT



AUTHORITY HAVING JURISDICTION

PROJECT DESCRIPTION

INTERMOUNTAIN
HEALTHCARE KEY BANK
TOWER LEVEL 09

36 S STATE STREET
SALT LAKE CITY, UT 84111

SHEET NAME:

EQUIPMENT SCHEDULE

REVISIONS

MARK DATE DESCRIPTION

ISSUE DATE: 03/27/2020
ISSUE TYPE: CD SET
DRAWN BY: DBS
CHECKED BY: TDS
PROJECT#: 1953

SHEET NUMBER:

EP601


3

/OLT	S/PHA	SE/WIRI	E: F	PANEL	SIZE	& TYPE: MAIN SIZE A	PA AND T				LOC			CABINET:		N	OTES	S :		
20/2	08V, 3 I	PH 4 WI	RE 2	22" W >	6" D,	BOLT-ON 225 AMPERI	E MAIN	l LU	GS		ELEC	C. 927	,	SURFACE						
CCE	SSORI	ES:	F	PANEL	DIRE	CTORY, IDENTIFICATION, GROU	JNDIN	G BA	AR					AIC	RATI	NG: 0				
CKT	0	CP	LO	AD (k	VA)				P	HASE	LOA	D			LO	AD (k)	/A)	OC	P	СКТ
NO				PWR	СО	DESCRIPTION					3			DESCRIPTION	СО			POLE		NO
1	20	1	0.0	0.8	0.0	PWR: BREAKROOM 901 ICE.	(0.8					PWR: ROOM 909 FURNITURE	0.0	0.8	0.0	1	20	2
3	20	1	0.0	0.8	0.0	PWR: BREAKROOM 901				0.8	0.6			PWR: ROOM 909 FURNITURE	0.0	1.9	0.0	3	20	4
5	20	1	0.0	0.8	0.0	PWR: BREAKROOM 901 COFFE	E					0.8	0.6							6
7	20 1 0.0 1.2 0.0 PWR: BREAKROOM 901 DISPOSAL 1.2 0.6 8																			
9	20 1 0.0 1.2 0.0 PWR: BREAKROOM 901 1.2 0.8 PWR: OUTREACH 907 FURNITURE 0.0 0.8 0.0 1 20 10																			
11	20 1 0.0 1.2 0.0 PWR: BREAKROOM 901 1.2 0.5 PWR: OUTREACH 907 FURNITURE 0.0 1.4 0.0 3 20 12																			
13	20 1 0.0 0.8 0.0 PWR: BREAKROOM 901 0.8 0.5 14																			
15	20 1 0.0 0.0 0.5 CO: BREAKROOM 901 0.5 0.5 16																			
17	20 1 0.0 0.3 0.3 CO: BREAKROOM 901 0.6 1.0 CO: IT WAITING 922 0.7 0.3 0.0 1 20 18																			
19	20 1 0.0 1.0 0.0 PWR: COPY 902 COPIER 1.0 1.1 CO: MEETING 921 0.5 0.6 0.0 1 20 20																			
21																				
23	3 20 1 0.0 0.0 0.9 CO: OUTREACH 907 0.9 1.2 CO: MEETING 918 0.9 0.3 0.0 1 20 24																			
25																				
27	20	1	0.0	0.3	0.7	CO: COLLAB. 905				1.0	0.2			PWR: IT 923 ADA DEVICES	0.0	0.2	0.0	1	20	28
29	20	1	0.0	0.3	0.7	CO: COLLAB. 906						1.0	0.4	PWR: RESTROOM ADA DEVICES	0.0	0.4	0.0	1	20	30
31	20	1	0.0	0.6	0.7	CO: IT 923		1.3	0.0					SPARE				1	20	32
33	20	1	0.0	1.0	0.0	PWR: IT 923 COPIER				1.0	0.0			SPARE				1	20	34
35	20	1	0.0	0.0	1.4	CO: IT 923, 931						1.4	0.0	SPARE				1	20	36
37	20	1	0.0	1.0	0.0	PWR: IT 925 COPIER		1.0	0.7					CO: DATA CENTER 926	0.7	0.0	0.0	1	20	38
39	20	1				SPARE				0.0	0.7			CO: DATA CENTER 926	0.7	0.0	0.0	1	20	40
41	20	1				SPARE						0.0		CO: DATA CENTER 926	1.1	0.0	0.0	1	20	42
ATC	LS:					CONNECTED kVA PER PH		1:	2	1	0	1	1	CONNECT						
						CONNECTED AMPS PER PH	ASE	9	8	8	1	9	1	AVERAGE CONNECTED AM	PS PE	R PHA	SE =	89		
EC	DIVERS	IFIED L	.OAD	CALC	ULA	TIONS														
IGH	TING 8	CONT	INUO	US LC	ADS:	0.0 kVA @ Not Computed	100%	CO	NNE	CTED	LOA	D PLU	JS 25°	% DIVERSIF	ED TO	OTAL k	VA =	31		

	3/PHA	SE/WIR	E: F	PANEL	SIZE	& TYPE: MAIN SIZ	E AND	TYPE	:		LOC	ATIO	N:	CABINET:		N	OTES	S :		
120/20	8V, 3	PH 4 WI	IRE 2	22" W >	6" D	, BOLT-ON 225 AMPI	ERE MA	IN LU	IGS		ELEC	C. 927	•	SURFACE						
ACCE	SSOR	IES:	F	PANEL	DIRE	CTORY, IDENTIFICATION, GR	OUNDI	NG BA	4R					Alc	RATI	NG : 0				
СКТ	O	СР	LC	AD (k	VA)				P	HASE	LOA	D			LO	AD (k)	/A)	OC	P	СКТ
NO	AMP	POLE	LTG	PWR	СО	DESCRIPTION		4	4		3	(;	DESCRIPTION	СО	PWR	LTG	POLE	AMP	NO
1	20	1	0.0	0.0	0.9	CO: MEDICAL 915, TRAVEL 8	k FLE	0.9	8.0					PWR: COMMUNICATIONS 909	0.0	0.8	0.0	1	20	2
3	20	1	0.0	0.0	0.7	CO: STORAGE 934, MEDICA	AL 915			0.7	0.6			PWR: COMMUNICATIONS 909	0.0	1.9	0.0	3	20	4
5	20	1	0.0	1.0	0.0	PWR: MEDICAL 915 COP	IER					1.0	0.6							6
7	20	1	0.0	0.0	0.7	CO: COPY 916		0.7	0.6											8
9	20	1	0.0	1.0	0.0	PWR: COPY 916 COPIE	:R			1.0	0.8			PWR: MEDICAL 915 & TRAVEL 914	0.0	0.8	0.0	1	20	10
11	20	1	0.0	1.0	0.0	PWR: COPY 916 COPIE	:R					1.0	0.8	PWR: MEDICAL 915 & TRAVEL 914	0.0	2.4	0.0	3	20	12
13	20	1	0.0	0.0	1.0	CO: MEDICAL 915		1.0	0.8											14
15	20	1	0.0	1.0	0.0	PWR: MEDICAL 915				1.0	0.8									16
17	20	1				SPARE						0.0	8.0	PWR: MEDICAL 915 FURNITURE	0.0	0.8	0.0	1	20	18
19	20	1	0.0	0.3	0.7	CO: COLLAB. 913		1.0	0.5					PWR: MEDICAL 915 FURNITURE	0.0	1.6	0.0	3	20	20
21	20	1				SPARE				0.0	0.5									22
23	20	1	0.0	0.3	1.1	CO: COMMUNICATIONS	909					1.4	0.5							24
25	20	1	0.0	0.3	0.7	CO: COLLAB. 908		1.0	8.0					PWR: MEDICAL 915 FURNITURE	0.0	0.8	0.0	1	20	26
27	20	1	0.0	0.0	0.9	CO: COMMUNICATIONS	909			0.9	0.7			PWR: MEDICAL 915 FURNITURE	0.0	2.2	0.0	3	20	28
29	20	1	0.0	0.5	0.0	PWR: ELEVATOR LOBBY 900	ADA					0.5	0.7							30
31	20	1				SPARE		0.0	0.7											32
33	20	1				SPARE				0.0	0.5			PWR: MEDICAL 915 & IT 923	0.0	0.5	0.0	1	20	34
35	20	1	0.0	8.0	0.0	PWR: MEDICAL 915 FURNI	TURE					0.8	0.4	PWR: MEDICAL 915 & IT 923	0.0	1.1	0.0	3	20	36
37	20	3	0.0	2.4	0.0	PWR: MEDICAL 915 FURNI	TURE	8.0	0.4											38
39										8.0	0.4									40
41												8.0	0.0	SPARE				1	20	42
TOTAL	LS:					CONNECTED kVA PER	PHASE	1	0	9	9	Ş)	CONNEC	TED TO	OTAL k	= AV	28		
						CONNECTED AMPS PER	PHASE	8	5	7	4	7	9	AVERAGE CONNECTED AM	PS PE	R PHA	SE =	79		
NEC D	IVER	SIFIED L	LOAD	CALC	ULA	TIONS														
LIGH	TING	& CONT	INUC	OUS LC	ADS:		- 100	% CO	NNE	CTED	LOA	D PLU	JS 25	% DIVERSIF	IED TO	OTAL k	VA =	28		
			REC	EPTA(CLES:	6.8 kVA @ 100% = 6.8 kVA	- FIR	ST 10	kVA (@ 100)%, R	EMAI	NDEF	R @ 50% AVERAGE AM	PS PE	R PHA	SE =	79		

/OLTS/P	HAS	E/WIR	E: F	ANEL	SIZE	& TYPE: MAIN SIZE AND	TYPE	:		LOC	ATION:	CABINET:		N	IOTES	S :		
180/277 V	, 3 P	PH 4 W	IRE 2	2" W >	6" D,	BOLT-ON 225 AMPERE MA	IN LU	JGS		ELE	C. 927	SURFACE						
ACCESSO	ORIE	S:	F	ANEL	DIRE	CTORY, IDENTIFICATION, GROUNDIN	NG B	AR		•		A	C RAT	ING: 0				
СКТ	ОС	P	LO	AD (k	VA)			P	HASE	LOA	ND .		LC	DAD (k	VA)	00	P	C
	IP I	POLE				DESCRIPTION		A		В	С	DESCRIPTION	СО	· · ·		POLE		-
1 2	-	1	1.1	0.0	0.0	LTG: R9-1	1.1	1				LTG: R9-2	0.0	0.0	0.8	1	20	
3 2	5	1	0.5	0.0	0.0	LTG: R9-3			0.5	0.7		LTG: R9-4	0.0	0.0	0.7	1	20	
5 20	5	1	0.7	0.0	0.0	LTG: R9-5					0.7 0.4	LTG: R9-6	0.0	0.0	0.4	1	20	
7 2)	1	4.0	0.0	0.0	LTG: OFFICES	4.0	0.0				SPARE				1	20	
9 2)	1				SPARE			0.0	0.0		SPARE				1	20	1
11 20	0	1				SPARE					0.0 0.0	SPARE				1	20	1
13 20)	1				SPARE	0.0	0.0				SPARE				1	20	1
15 20)	1				SPARE			0.0	0.0		SPARE				1	20	1
17 20	0	1				SPARE					0.0 0.0	SPARE				1	20	1
19 20	0	1				SPARE	0.0	0.0				SPARE				1	20	2
21 20	0	1				SPARE			0.0	0.0		SPARE				1	20	2
23 20	0	1				SPARE					0.0 0.0	SPARE				1	20	2
25 20)	1				SPARE	0.0	0.0				SPARE				1	20	2
27 20)	1				SPARE			0.0	0.0		SPARE				1	20	2
29 20)	1				SPARE					0.0 0.0	SPARE				1	20	3
31 2	0	1				SPARE	0.0	0.0				SPARE				1	20	3
33 20	0	1				SPARE			0.0	0.0		SPARE				1	20	3
35 20)	1				SPARE					0.0 0.0	SPARE				1	20	3
37 20)	1				SPARE	0.0	0.0				SPARE				1	20	3
00 0	0	1				SPARE			0.0	0.0		SPARE				1	20	4
39 20	า 📗	1				SPARE					0.0 0.0	SPARE				1	20	4
41 20	<i>-</i>					CONNECTED KVA PER PHASE		6		1	1	CONNEC	CTED T	OTAL	(VA =	8		
	<u> </u>					OCHIVEOTED KVYCT EICHTIMOE						AVERAGE CONNECTED AN						



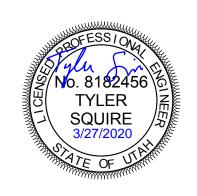

ARCHITECT / CONSULTANT



AUTHORITY HAVING JURISDICTION

PROJECT DESCRIPTION

INTERMOUNTAIN HEALTHCARE KEY BANK TOWER LEVEL 09

36 S STATE STREET SALT LAKE CITY, UT 84111

SHEET NAME:

PANEL SCHEDULES


REVISIONS

MARK DATE DESCRIPTION

ISSUE DATE: 03/27/2020 ISSUE TYPE: CD SET DRAWN BY: CHECKED BY: PROJECT#: **1953**

SHEET NUMBER:

EP602

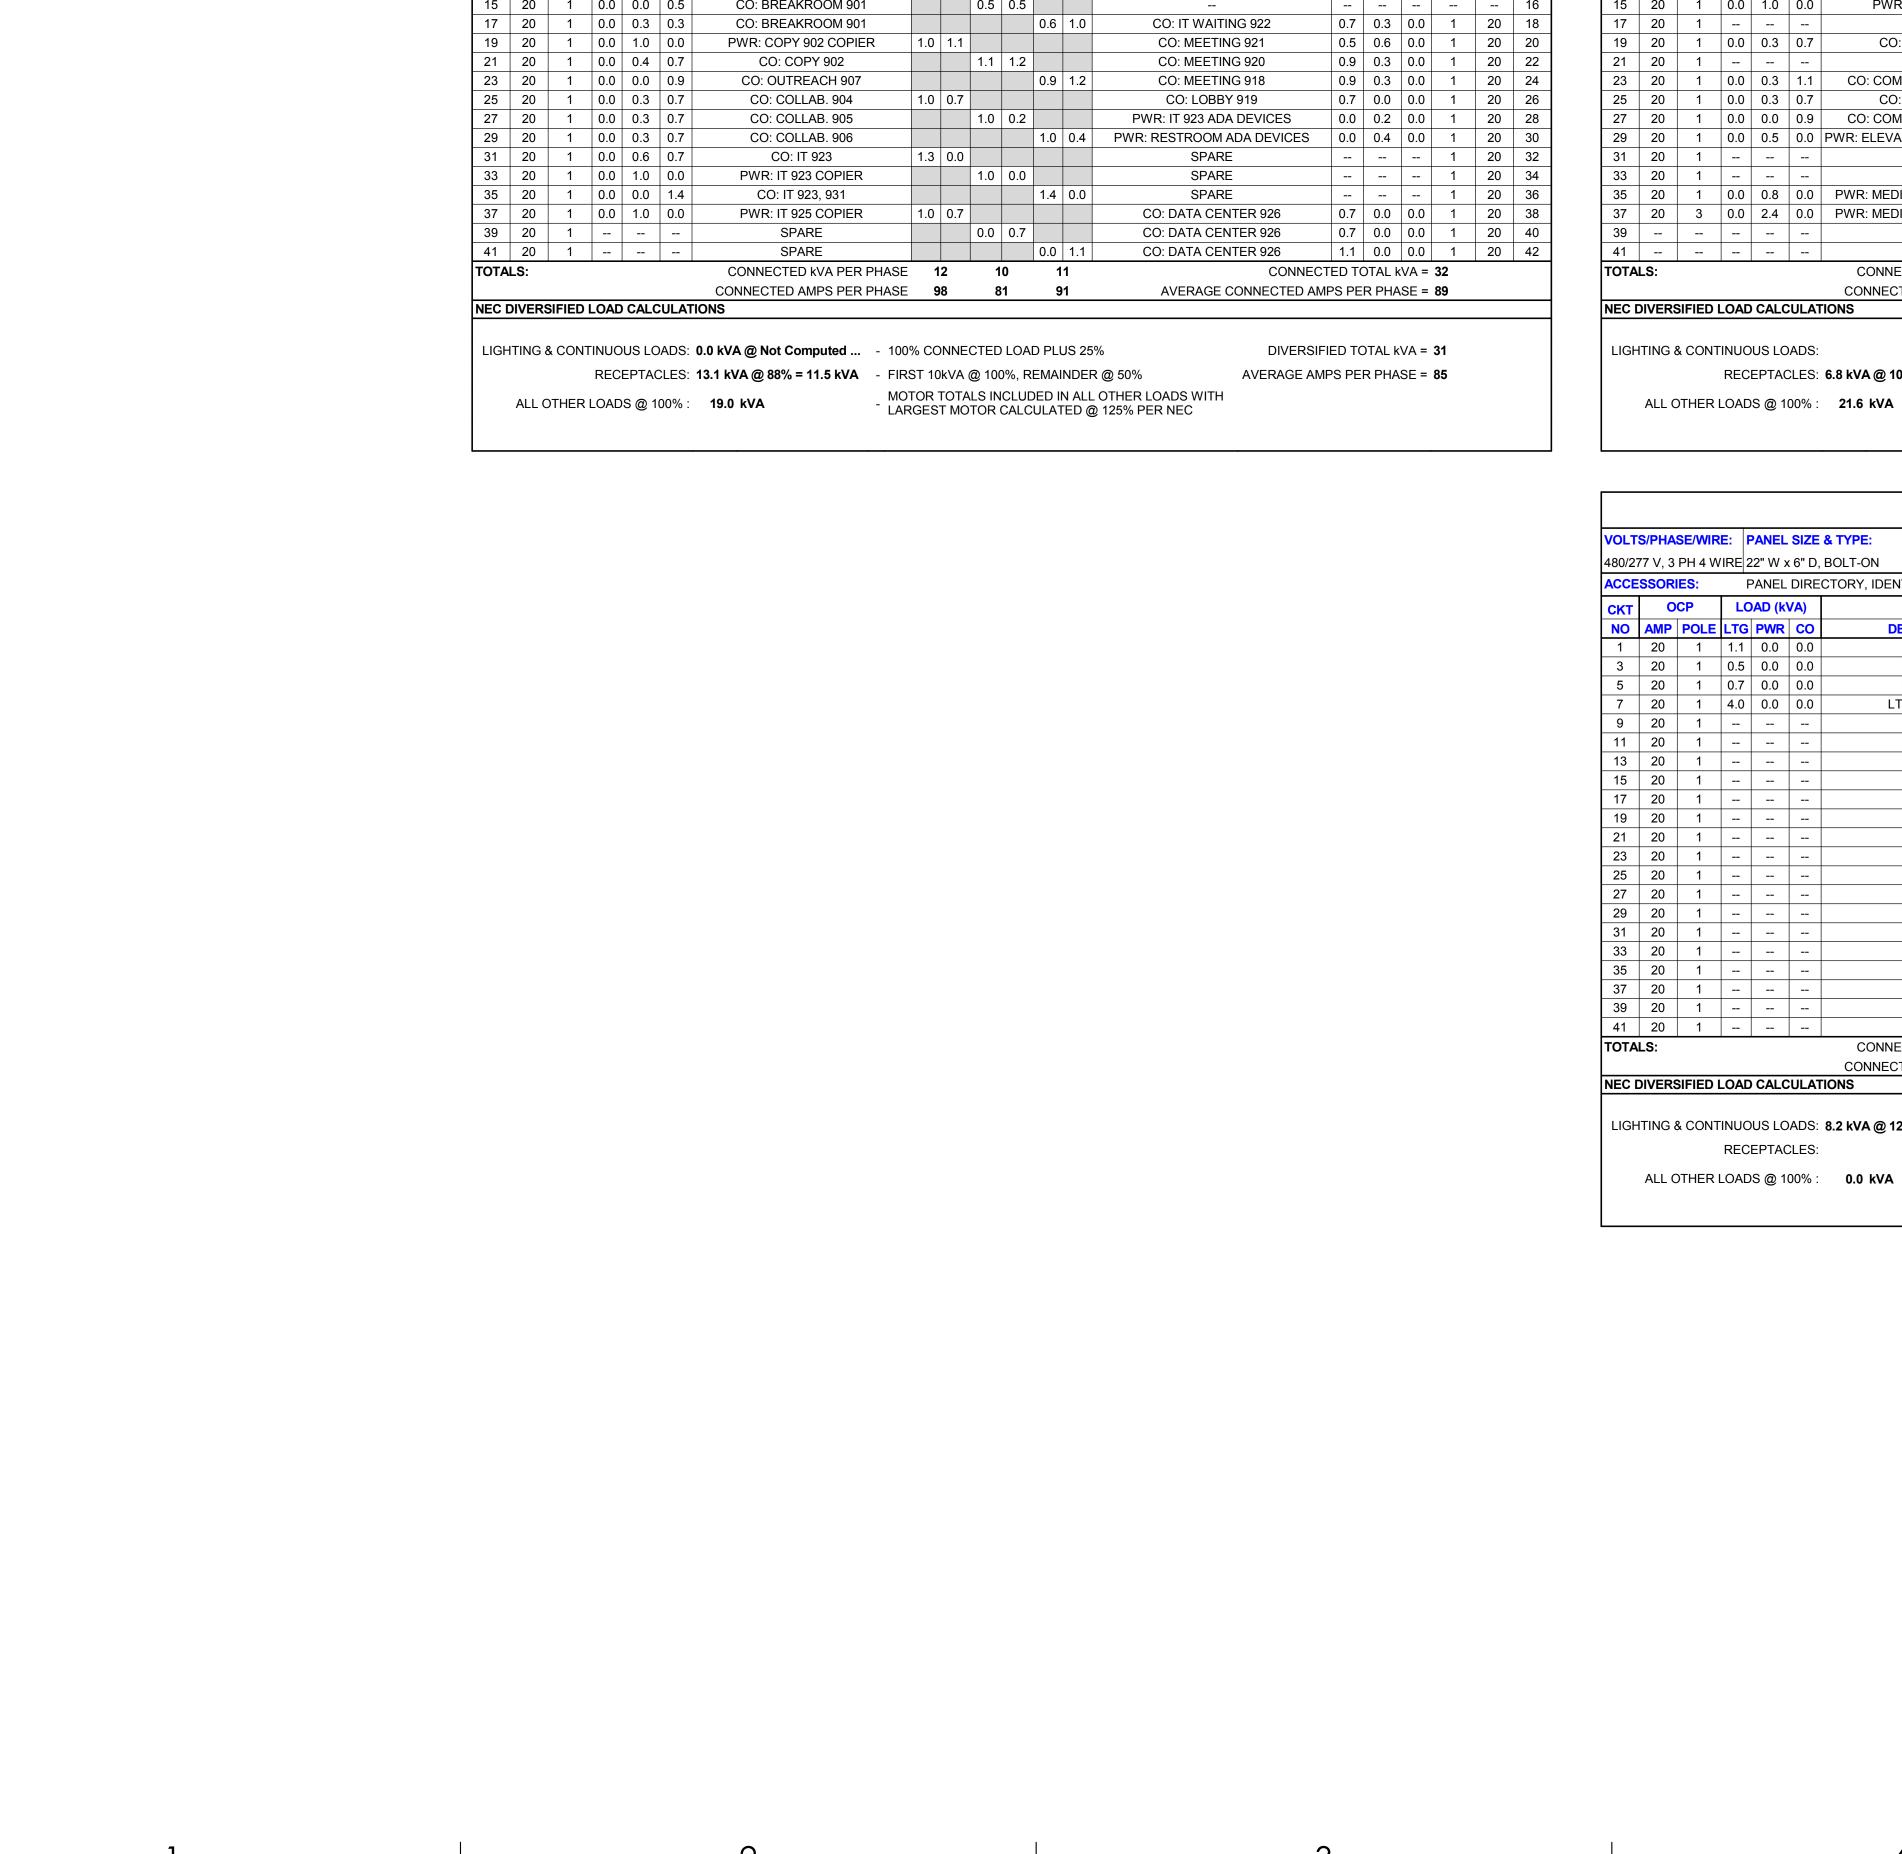

/OLT	S/PHA	SE/WIRI	E: F	PANEL	SIZE	& TYPE:	MAIN SIZE AND 1	ГҮРЕ	:		LOC	ATIO	N:	C	ABINET:		N	OTES	S :		
120/20	8V, 3	PH 4 WI	RE 2	2" W >	د6" D,	BOLT-ON	200 AMPERE MA	IN LU	IGS		DATA	A CEN	NTER 926	s	URFACE						
	SSOR					CTORY, IDENTIFICA	TION, GROUNDIN	NG B	AR							RATI	NG : 0				
KT		CP		AD (k						HASE	LOA	D					AD (k\	/A)	00	CP	СКТ
NO		POLE				DESCRI	PTION		1		3		:	DESCRIPT	ION	.			POLE		NO
1	20	1				SPAF	_	0.0	0.0					SPARE					1	20	2
3	20	1				SPAF	RE			0.0	0.0			SPARE					1	20	4
5	20	1				SPAF	RE					0.0	0.0	SPARE					1	20	6
7	20	1				SPAF	RE	0.0	0.0					SPARE					1	20	8
9	20	1				SPAF	RE			0.0	0.0			SPARE					1	20	10
1	20	1	-			SPAF	RE					0.0	0.0	SPARE					1	20	12
3	20	1				SPAF	RE	0.0	0.0					SPARE					1	20	14
5	20	1				SPAF	RE			0.0	0.0			SPARE					1	20	16
17	20	1				SPAF	RE					0.0	0.0	SPARE					1	20	18
9	20	1				SPAF	RE	0.0	0.0					SPARE					1	20	20
1	20	1				SPAF	RE			0.0	0.0			SPARE					1	20	22
:3	20	1				SPAF	RE					0.0	0.0	SPARE					1	20	24
5	20	1	-			SPAF	RE	0.0	0.0					SPARE					1	20	26
27	20	1	-			SPAF	RE			0.0	0.0			SPARE					1	20	28
29	20	1	-			SPAF	RE					0.0	0.0	SPARE					1	20	30
31	20	1	-			SPAF	RE	0.0	0.0					SPARE					1	20	32
3	20	1	-			SPAF	RE			0.0	0.0			SPARE					1	20	34
35	20	1	-			SPAF	RE					0.0	0.0	SPARE					1	20	36
37	20	1	1			SPAF	RE	0.0	0.0					SPARE					1	20	38
39	20	1				SPAF	RE			0.0	0.0			SPARE					1	20	40
ŀ1	20	1				SPAF	RE					0.0	0.0	SPARE					1	20	42
OTA	LS:					CONNECTED	kVA PER PHASE	())	()		CONNECT	ED TO	OTAL k	VA =	0		
							MPS PER PHASE	()	())	AVERAGE (CONNECTED AME	PS PE	R PHA	SE =	0		
EC [IVER	SIFIED L	OAD	CALC	ULAT	ONS															
₋IG⊦	TING 8	& CONT	INUO	US LC	ADS:		- 1009	% CC	NNE	CTED	LOA) PLU	JS 25%		DIVERSIFII	ED TO	OTAL k	VA =	0		
			REC	EPTAC	CLES:		- FIRS	ST 10	kVA (@ 100)%. R	EMAI	NDER @	50%	AVERAGE AMP	S PE	R PHA	SE =	0		
		THER L				0.0 kVA				_			_	HER LOADS WITH					•		

VOLT	S/PHA	SE/WIF	E: P	ANEL	. SIZE	& TYPE: MAIN SIZE AND T	YPE	:		LOCA	ATIOI	N:	CABINET:		N	OTES	3 :		
120/20	08V, 3 F	PH 4 W	IRE 2	2" W ɔ	x 6" D,	BOLT-ON 200 AMPERE MAIN	N LU	GS		DATA	CEN	NTER	926 SURFACE						
ACCE	SSORI	ES:	P	ANEL	DIREC	CTORY, IDENTIFICATION, GROUNDING	G BA	٩R					AIC	RATI	NG : 0				
СКТ	0	CP	LO	AD (k	VA)			P	HASE	LOAI	D			LO	AD (k\	/A)	OC	P	CK.
NO		POLE	L	•		DESCRIPTION			1	3		;	DESCRIPTION	1			POLE	AMP	NC
1	20	1				SPARE	0.0	0.0					SPARE				1	20	2
3	20	1				SPARE			0.0	0.0			SPARE				1	20	4
5	20	1				SPARE					0.0	0.0	SPARE				1	20	6
7	20	1				SPARE	0.0	0.0					SPARE				1	20	8
9	20	1				SPARE			0.0	0.0			SPARE				1	20	10
11	20	1				SPARE					0.0	0.0	SPARE				1	20	12
13	20	1				SPARE	0.0	0.0					SPARE				1	20	14
15	20	1				SPARE			0.0	0.0			SPARE				1	20	16
17	20	1				SPARE					0.0	0.0	SPARE				1	20	18
19	20	1				SPARE	0.0	0.0					SPARE				1	20	20
21	20	1				SPARE			0.0	0.0			SPARE				1	20	22
23	20	1				SPARE					0.0	0.0	SPARE				1	20	24
25	20	1				SPARE	0.0	0.0					SPARE				1	20	26
27	20	1				SPARE			0.0	0.0			SPARE				1	20	28
29	20	1				SPARE					0.0	0.0	SPARE				1	20	30
31	20	1					0.0	5.3					PWR: CRAC/CU-1	0.0	0.0	0.0	3	70	32
33	20	1				SPARE			0.0										34
35	20	1				SPARE					0.0	5.3							36
37	20	1					0.0	5.3					PWR: CRAC/CU-2	0.0	0.0	0.0	3	70	38
39	20	1				SPARE			0.0										40
41	20	1				SPARE					0.0								42
ΓΟΤΑ	LS:					CONNECTED kVA PER PHASE	1		1		1		CONNECT						
						CONNECTED AMPS PER PHASE	8	8	8	8	8	8	AVERAGE CONNECTED AMP	PS PE	R PHA	SE =	87		
EC I	DIVERS	SIFIED	LOAD	CALC	ULAT		0	<u> </u>	0	0	0	0	AVERAGE CONNECTED AWIF	-3 PE	КРПА	- SE -	07		
LIGH	ITING 8	& CONT	INUO	US LC)ADS:	- 100%	s co	NNE	CTED	LOAD) PLU	JS 25	% DIVERSIFI	ED TO	OTAL k	VA =	16		
			RECI	EPTAC	CLES:	- FIRS	T 10	kVA	@ 100)%, RE	EMAI	NDEF	R @ 50% AVERAGE AMF	S PE	R PHA	SE =	44		
	ALL C	THER				MOTO	OR 1	ГОТА	LS IN	CLUD	ED II	N ALL	OTHER LOADS WITH						

703 east 1700 south salt lake city, ut 84105

ajcarchitects.com



ARCHITECT / CONSULTANT



AUTHORITY HAVING JURISDICTION

PROJECT DESCRIPTION

INTERMOUNTAIN
HEALTHCARE KEY BANK
TOWER LEVEL 09

36 S STATE STREET
SALT LAKE CITY, UT 84111

SHEET NAME:

PANEL SCHEDULES


REVISIONS

MARK DATE DESCRIPTION

ISSUE DATE: 03/27/2020
ISSUE TYPE: CD SET
DRAWN BY: SAM
CHECKED BY: TDS
PROJECT#: 1953

SHEET NUMBER:

EP603

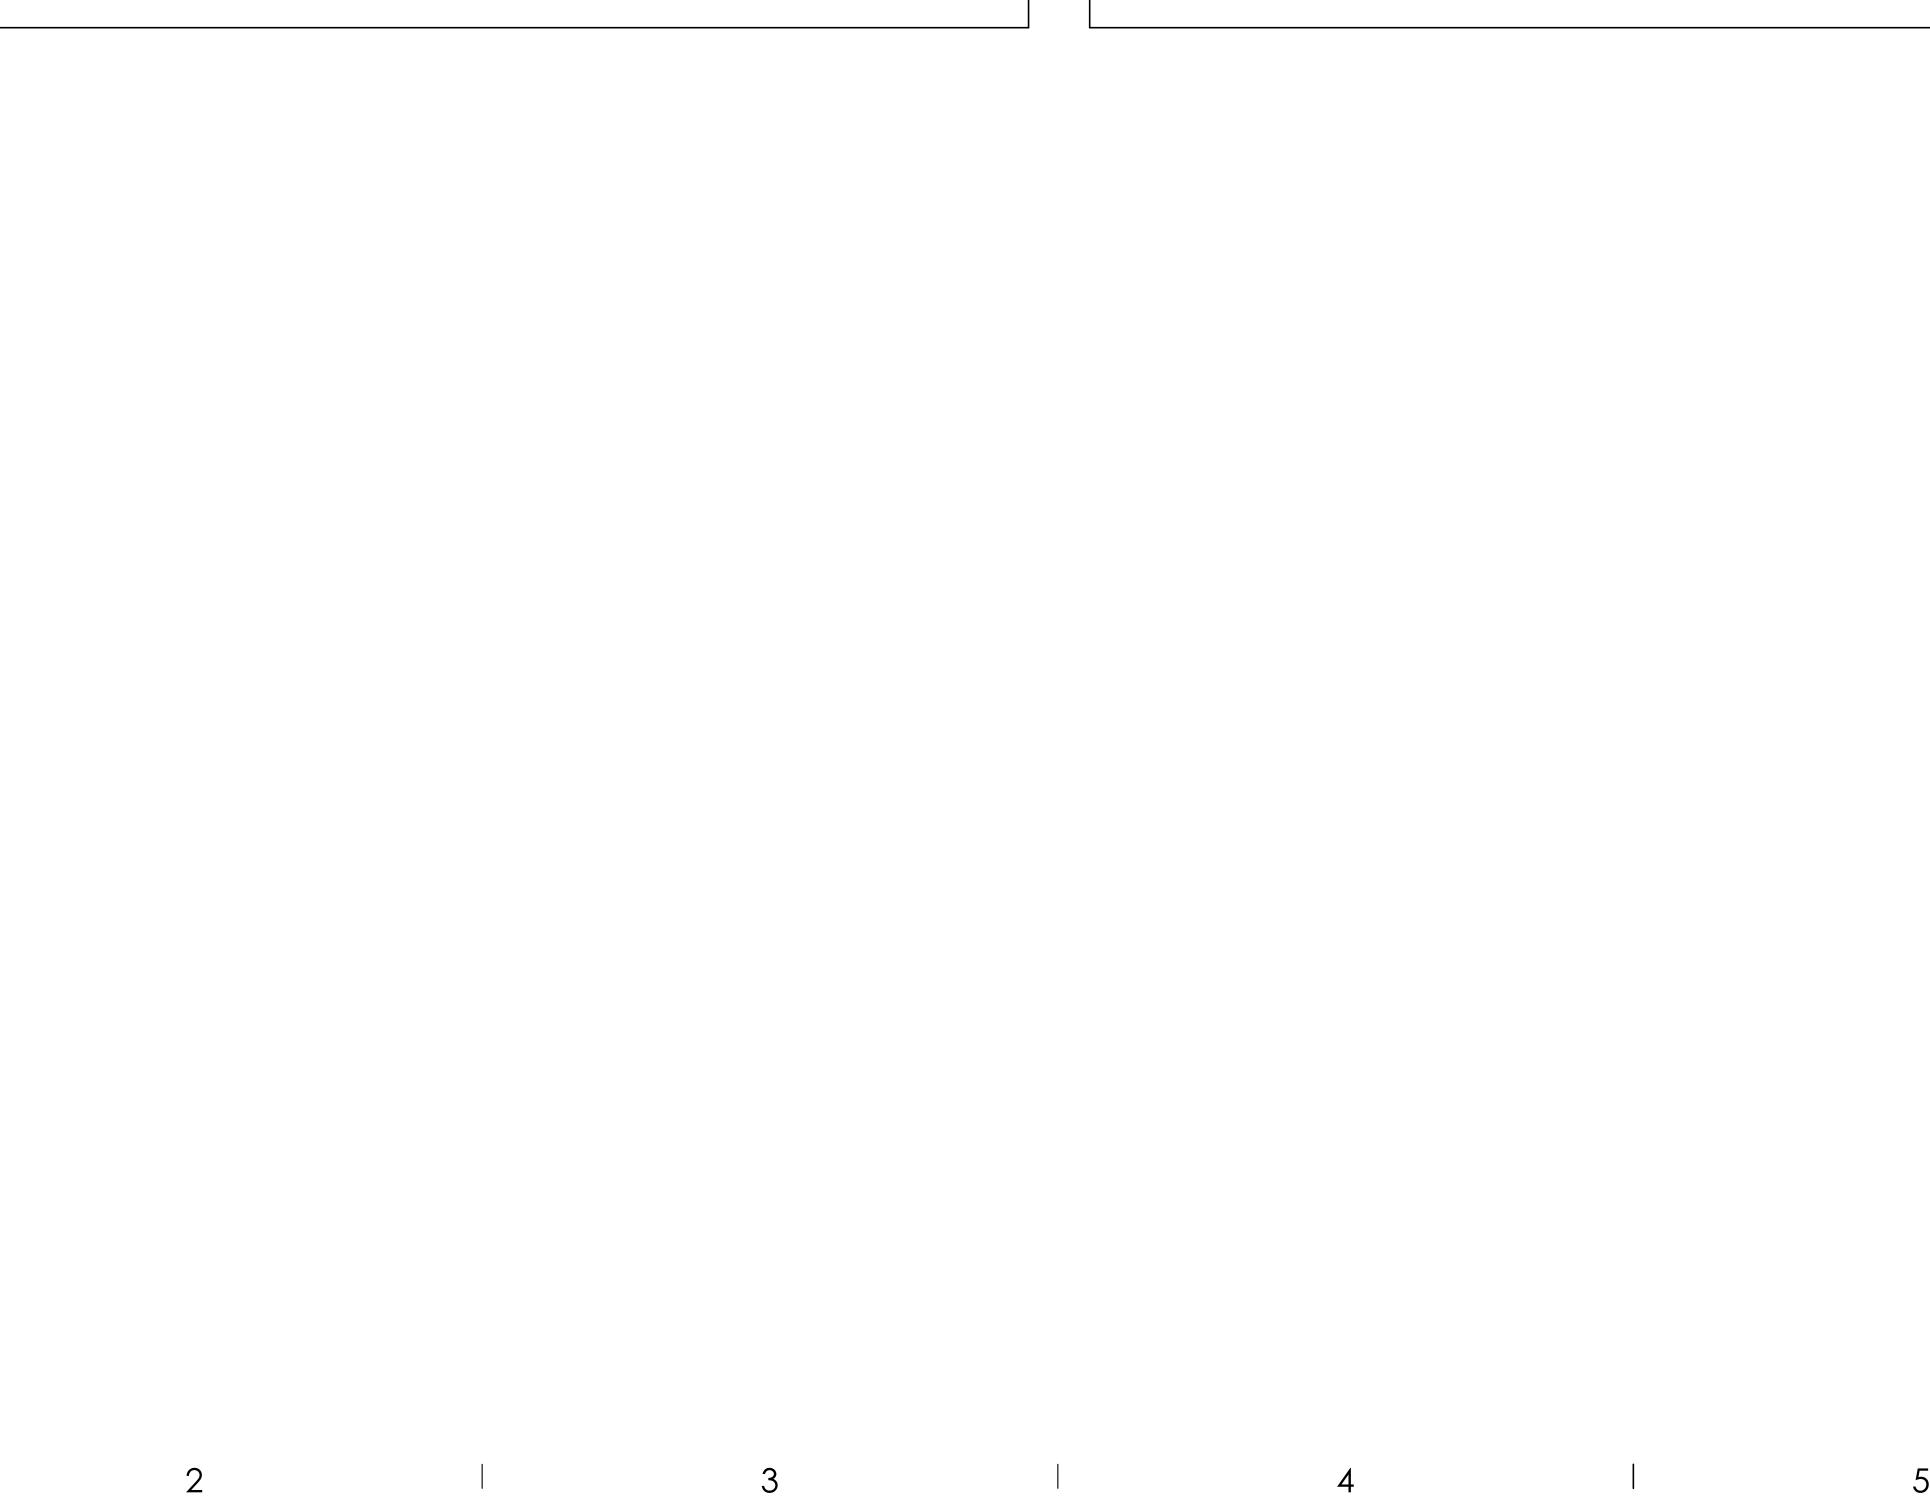

ABBREVIATIONS

NOTE: ALL ABBREVIATIONS MAY NOT BE USED.

AUGMENTED

CATEGORY

ENHANCED

GIGA HERTZ

PLENUM

EQUIPMENT ROOM

NOT IN CONTRACT

POWER SUPPLY RISER PATCH PANEL

OWNER ELECTRONICS

STATION PATCH PANEL

VERTICAL WIRE MANAGEMENT

FIBER PATCH PANEL

HORIZONTAL WIRE MANAGEMENT

TELECOMMUNICATIONS DISTRIBUTION ROOM

DEFINITIONS

NOTE: ALL DEFINITIONS MAY NOT BE USED.

INDICATED: THE TERM "INDICATED" REFERS TO GRAPHIC REPRESENTATIONS,

SCHEDULED", AND "SPECIFIED" ARE USED, IT IS TO HELP THE READER LOCATE

SELECTED", "APPROVED", "REQUIRED", AND "PERMITTED" MEAN "DIRECTED BY

APPROVE: THE TERM "APPROVED", WHERE USED IN CONJUNCTION WITH THE

REQUESTS, IS LIMITED TO THE ENGINEER'S DUTIES AND RESPONSIBILITIES AS

FURNISH: THE TERM "FURNISH" IS USED TO MEAN "SUPPLY AND DELIVER TO THE

PROJECT SITE, READY FOR UNLOADING, UNPACKING, ASSEMBLY, INSTALLATION,

INSTALL: THE TERM "INSTALL" IS USED TO DESCRIBE OPERATIONS AT PROJECT SITE INCLUDING THE ACTUAL "UNLOADING, UNPACKING, ASSEMBLY, ERECTION,

PLACING, ANCHORING, APPLYING, WORKING TO DIMENSION, FINISHING, CURING,

PROVIDE: THE TERM "PROVIDE" MEANS "TO FURNISH AND INSTALL, COMPLETE

INSTALLER: AN "INSTALLER" IS THE CONTRACTOR OR AN ENTITY ENGAGED BY

SUB-SUBCONTRACTOR, FOR PERFORMANCE OF A PARTICULAR CONSTRUCTION

DESCRIBE ALL LOW VOLTAGE SYSTEMS GENERALLY REFERRED TO AS "SPECIAL SYSTEMS". THESE SYSTEMS INCLUDE BUT ARE NOT NECESSARILY LIMITED TO

SOUND SYSTEMS, VIDEO SYSTEMS, TV SYSTEMS, SECURITY SYSTEMS, VOICE AND

ALL SYSTEMS WHICH UTILIZE VOLTAGES OF LESS THAN 71 VOLTS SUCH AS

ACTIVITY, INCLUDING INSTALLATION, ERECTION, APPLICATION, AND SIMILAR OPERATIONS. INSTALLERS ARE REQUIRED TO BE EXPERIENCED IN THE

ELECTRONIC SYSTEMS: THE TERM "ELECTRONIC SYSTEMS" IS USED TO

THE CONTRACTOR, EITHER AS AN EMPLOYEE, SUBCONTRACTOR, OR

ENGINEER'S ACTION ON THE CONTRACTOR'S SUBMITTALS, APPLICATIONS, AND

THE ENGINEER", "REQUESTED BY THE ENGINEER", AND SIMILAR PHRASES.

SCHEDULES IN THE SPECIFICATIONS, AND SIMILAR REQUIREMENTS IN THE

NOTES, OR SCHEDULES ON THE DRAWINGS, OTHER PARAGRAPHS OR

CONTRACT DOCUMENTS. WHERE TERMS SUCH AS "SHOWN", "NOTED",

DIRECTED: TERMS SUCH AS "DIRECTED", "REQUESTED", AUTHORIZED",

THE REFERENCE, NO LIMITATION ON LOCATION IS INTENDED.

STATED IN GENERAL AND SUPPLEMENTARY CONDITIONS.

PROTECTING, CLEANING, AND SIMILAR OPERATIONS."

OPERATIONS THEY ARE ENGAGED TO PERFORM.

AND SIMILAR OPERATIONS."

AND READY FOR THE INTENDED USE."

DATA CABLING SYSTEMS, ETC...

EACH

FR

GIG

NIC

OE

PR

SPP

TDR

TYP

VWM

HWM

2. PROVIDE PLENUM RATED CABLE IN ALL AIR PLENUMS. IF A PLENUM RATED CABLE IS NOT SPECIFIED, PROVIDE THE PLENUM RATED EQUIVALENT TO THE

3. LABEL ALL CABLE INSTALLED UNDER THIS CONTRACT REGARDLESS OF

4. THE EQUIPMENT LABELING IDENTIFIED ON DETAILS IN THESE DRAWINGS ARE EXAMPLES ONLY OF THE ACTUAL LABELING WHICH IS REQUIRED AS PART OF THIS CONTRACT. PRIOR TO FABRICATION, SUBMIT THE NOMENCLATURE FOR ALL LABELS TO THE OWNER FOR REVIEW. THIS REQUIREMENT INCLUDES BUT IS NOT LIMITED TO ALL CABLE LABELING, AND ALL EQUIPMENT LABELING.

5. IF OUTLET IS TERMINATED IN CEILING SPACE, LABEL THE T-BAR GRID WITH THE OUTLET NUMBER FOR EASY LOCATION AND IDENTIFICATION.

COMPLIANCE WITH THE CONTRACT DOCUMENTS.

7. PROVIDE THE QUANTITY OF PATCH PANELS REQUIRED +20% FOR THE TOTAL

8. RACK SPACE ALLOCATION SHOULD BE FOLLOWED PER DRAWINGS. IF YOU HAVE A SYSTEM THAT HAS NO RACK SPACE ALLOCATED PLEASE CALL BOE SAUSEDO AT 801-707-3805

GROUNDED TO THE TEC/TDR, USING A MINIMUM #6 CU.

ORIGINATION.

11. FOR EVERY CABLE PULL SPECIFIED, COIL 15' OF EXCESS CABLE AT THE STATION END FOR FUTURE USE AND 3'-0" OF EXCESS CABLE AT THE TDR END. NEATLY COIL AND SECURE CABLE ABOVE THE CEILING OR BELOW FLOOR WHERE APPLICABLE.

12. COORDINATE WITH ALL SUBS TO ENSURE THAT ALL CABLES ARE PROTECTED FROM ANY DIRECT PAINT OR INCIDENTAL OVERSPRAY.

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324 S. State St., Suite 400 Salt Lake City, UT 84111 800-678-7077 801-328-5151 fax: 801-328-5155

AUTHORITY HAVING JURISDICTION

PROJECT DESCRIPTION

TOWER LEVEL 09

36 S STATE STREET SALT LAKE CITY, UT 84111

TELECOM SCHEDULES AND NOTES

REVISIONS

MARK DATE DESCRIPTION

ISSUE DATE: 03/27/2020 ISSUE TYPE: CD SET

PROJECT#:

SHEET NUMBER:

ETOO1

EQUIPMENT/CABLE LIST THE ITEMS INDICATED BELOW SHALL NOT BE CONSTRUED AS A "BILL OF MATERIALS". THIS LIST IDENTIFIES ITEMS OF SIGNIFICANCE USED DURING THE DESIGN OF THE CABLING INSTALLATION. WHERE THE ITEMS INDICATED ARE ONE PORTION OF AN ASSEMBLY, THE ENTIRE ASSEMBLY SHALL BE PROVIDED UNLESS SPECIFIED OTHERWISE. PROVIDE ALL MISCELLANEOUS HARDWARE AND SUPPORTS WHICH MAY NOT BE LISTED HERE, FOR A COMPLETE INSTALLATION. COMPARE CATALOG NUMBERS WITH DESCRIPTIONS AND NOTIFY ENGINEER OF DISCREPANCIES PRIOR TO BID. IF CATALOG NUMBERS DO NOT MATCH DESCRIPTIONS, THE DESCRIPTIONS TAKE PRECEDENCE. PROVIDE COMPLETE SUBMITTAL FOR APPROVAL PRIOR TO PURCHASING ANY EQUIPMENT OR CABLE. REFER TO SPECIFICATIONS FOR ADDITIONAL REQUIREMENTS. ACCEPTABLE TYPES STATION CABLE, DATA - CATEGORY 6A FUTP PLENUM, BLUE, DATA SIEMON 9A6P4-A5-06-R1A STATION CABLE, DATA - CATEGORY 6A FUTP PLENUM, YELLOW, WIRELESS DATA SIEMON 9A6P4-A5-05-R1A 50 PAIR CATEGORY 3 RISER CABLE, GRAY GENERAL CABLE OR EQUAL FIBER OPTIC CABLE, SINGLE-MODE, 12 STRAND, ARMORED, PLENUM CABLE, YELLOW SIEMON 9BC8P012LE205A LC CONNECTOR. SIMPLEX SINGLEMODE SIEMON FC1-LC-SM-B02 VOICE OUTLET, SINGLE GANG FACEPLATE, WHITE W/WALL HUNG PHONE SIEMON MX-WP-Z6AS-SS MOUNTING STUDS, ONE POSITION W/CATEGORY 6A INSERT DATA OUTLET, SINGLE GANG FACEPLATE, WHITE, 2 POSITION SIEMON 10GMX-FPS02-02 CATEGORY 6A JACK - DATA, BLUE SIEMON Z6A-S06 DATA OUTLET, SURFACE MOUNT BOX, WHITE, 2 POSITION SIEMON MX-SMZ2-02 CATEGORY 6A JACK - DATA, BLUE SIEMON Z6A-S06 DATA OUTLET, FURNITURE FACEPLATE, BLACK SIEMON MX-UMA-01 CATERGPRU 6A JACK - DATA. BLUE SIEMON Z6A-S06 BLANK MODULE, BLACK SIEMON MX-BL-01 DATA OUTLET, SURFACE MOUNT BOX, WHITE, 2 POSITION SIEMON MX-SMZ2-02 CATEGORY 6A JACK - DATA, YELLOW SIEMON Z6A-S05 DATA OUTLET, SURFACE MOUNT BOX, WHITE, 1 POSITION SIEMON MX-SMZ1-02 SIEMON Z6A-S06 CATEGORY 6A JACK - DATA, BLUE 48 PORT, 1RU ANGLE PATCH PANEL WITH OUTLETS SIEMON Z6AS-PA-48 48 PORT, 2RU ANGLE PATCH PANEL, 110 STYLE SIEMON HD5-48A FIBER PATCH PANEL, 3RU SIEMON RIC3-48-01 SIX POSITION FIBER ADAPTOR PANEL, LC SIEMON RIC-F-LCU12-01C WALL MOUNT INTERCONNECT CENTER, BLACK SIEMON SWIC3-M-01 FST FIBER SPLICE TRAY BRACKET SIEMON TRAY-B-01 FIBER SPLICE TRAY SIEMON TRAY-M-3 BLANK ADAPTER PLATE, BLACK SIEMON RIC-F-BLNK-01 HORIZONTAL WIRE MANAGERS, 4RU PANDUIT NCMHAEF4 VERTICAL WIRE MANAGERS, DOUBLE SIDED, BLACK CHATSWORTH 40096-703 EQUIPMENT RACK, 7' x 19", 45RU, BLACK CHATSWORTH 55053-703 CABLE RUNWAY - 24", BLACK WITH ALL REQUIRED MOUNTING ACCESSORIES CHATSWORTH 10250-724 CHATSWORTH 10250-718 CABLE RUNWAY - 18", BLACK WITH ALL REQUIRED MOUNTING ACCESSORIES BUTT SPLICE KIT, BLACK CHATSWORTH 11301-701 JUNCTION SPLICE KIT, BLACK CHATSWORTH 11302-701 FOOT KIT. BLACK CHATSWORTH 11309-701 6" CHANNEL RACK TO RUNWAY, BLACK CHATSWORTH 12409-724 TRIANGLE BRACKETS, BLACK CHATSWORTH 11746-724 END CLOSING KIT, CABLE RUNWAY, BLACK CHATSWORTH 11700-724 WALL ANGLE SUPPORT KIT, CABLE RUNWAY, BLACK CHATSWORTH 11421-724 CABLE RUNWAY ELEVATION KIT, 6" **CHATSWORTH 10506-706** CABLE RUNWAY RADIUS DROP CHATSWORTH 12100-712 STATION PATCH CABLE, CAT 6A SHIELDED, BLUE, 5' SIEMON ZM6A-S0506 STATION PATCH CABLE, CAT 6A SHIELDED, BLUE, 7' SIEMON ZM6A-S0706 STATION PATCH CABLE, CAT 6A SHIELDED, BLUE, 10' SIEMON ZM6A-S1006 STATION PATCH CABLE, CAT 5E, BLUE, 5' SIEMON MC5-8T-05-B06C STATION PATCH CABLE, CAT 5E, BLUE, 7' SIEMON MC5-8T-07-B06C STATION PATCH CABLE, CAT 5E, BLUE, 10' SIEMON MC5-8T-10-B06C PATCH CABLE, FIBER, SINGLEMODE DUPLEX W/ LC CONNECTORS, YELLOW, 3 METER J2-LCLCP-03 PATCH CABLE, FIBER, SINGLEMODE DUPLEX W/ LC CONNECTORS, YELLOW, 5 METER J2-LCLCP-05 PLYWOOD BACKBOARD, 4' X 8', GRADE AC, FIRE TREATED & PAINTED

NOTE: ALL RACKS, LADDER, PATCH PANELS AND ACCESSORIES SHALL BE BLACK IN COLOR.

TELECOMMUNICATIONS MAIN GROUNDING BUS BAR

TELECOMMUNICATIONS GROUNDING BUS BAR

	CABLE/OUTLET COLOR SCHEDULE
COLOR	TYPE
BLACK	TV COAX
BLUE	ANALOG PHONE
BLUE	DATA
BLUE	IP SECURITY CAMERAS
GREY	SECURITY CARD READERS
ORANGE	CLINICAL ENGINEERING / NURSE CALL
RED	FIRE SYSTEMS
RED	FORESEER
WHITE	PUBLIC ADDRESS
YELLOW	WIRELESS
GREEN	VENDOR NETWORK

	Systen	n Responsibi	lity Matrix	
	Designed	Furnished	Installed	
	Ву	Ву	Ву	Notes
Telecomm				
Raceways, Conduit/Cable Tray/J-Hooks	Design Team	Contractor	Contractor	Boxes, Raceways, Cabletray, ect.
Backbone Fiber	Design Team	Contractor	Contractor	Qualified Contractors: IES, CVE, Data Tech Professionals
Fiber Termination Shelves (FPP1, FPP2)	Design Team	Contractor	Contractor	Qualified Contractors: IES, CVE, Data Tech Professionals
Copper Backbone Cabling	Design Team	Contractor	Contractor	Qualified Contractors: IES, CVE, Data Tech Professionals
Riser Patch Panels (RPP1)	Design Team	Contractor	Contractor	Qualified Contractors: IES, CVE, Data Tech Professionals
Fuse Protection for Backbone Cabling	Design Team	Contractor	Contractor	Qualified Contractors: IES, CVE, Data Tech Professionals
Cat 6A Horizontal Cable	Design Team	Contractor	Contractor	Qualified Contractors: IES, CVE, Data Tech Professionals
Patch Panels/Inserts SPP, WPP	Design Team	Contractor	Contractor	Qualified Contractors: IES, CVE, Data Tech Professionals
Horizontal Wire Manager (1RU, 2RU)	Design Team	Contractor	Contractor	Qualified Contractors: IES, CVE, Data Tech Professionals
Vertical Wire Manager	Design Team	Contractor	Contractor	Qualified Contractors: IES, CVE, Data Tech Professionals
RJ45 Inserts, Faceplates, Surface Mount Boxes	Design Team	Contractor	Contractor	Faceplate color to be coordinated with architect and owner.
Fiber optic, Cat 6 and Cat 6A Patch Cords	Owner	Owner	Owner	Patch cord quantities and lengths to be identified by owner.
Building MDF/IDF Racks	Design Team	Contractor	Contractor	Qualified Contractors: IES, CVE, Data Tech Professionals
Building MDF/IDF Ladder Rack	Design Team	Contractor	Contractor	Qualified Contractors: IES, CVE, Data Tech Professionals
Active Network Electronics	Owner	Owner	Contractor	Wireless AP's, L2/L3 network switches, etc.
UPS/PDU	Owner	Owner	Owner	Boe Sausedo

UNLESS OTHERWISE NOTED, INSTALL ALL CABLE INSIDE RACEWAY SYSTEMS.

SPECIFIED CABLE.

6. GROUND ALL EQUIPMENT RACKS INSTALLED UNDER THIS CONTRACT IN

DATA OUTLETS SHOWN ON FLOOR PLANS FOR THE PARTICULAR LEVEL.

9. ENSURE ALL BASKET TRAY AND COMMUNICATIONS CONDUITS HAVE BEEN

10. CONTRACTOR TO LOOSELY BUNDLE ALL CABLES TOGETHER BY FLOOR OR


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INTERMOUNTAIN HEALTHCARE KEY BANK


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DRAWN BY: CHECKED BY:





DATA DEVICE DROP SCHEDULE - DATA ROOM 917 COMM ROOM TOTAL BY LOCATION FLOOR # OF DROPS DATA DEVICE TYPE **DETAIL LOCATION** LEVEL 09 CEILING DATA (2-DROP) SEE DETAIL C4/ET502 CEILING DATA - CAMERA (1-DROP) SEE DETAIL B4/ET502 DATA ROOM 917 SEE DETAIL C5/ET502 DATA ROOM 917 CEILING WIRELESS ACCESS POINT FLOOR DATA (2-DROP) SEE DETAIL A5/ET502 DATA ROOM 917 FURNITURE DATA (2-DROP) DATA ROOM 917 SEE DETAIL A4/ET502 WALL DATA (2-DROP) SEE DETAIL A5/ET502 DATA ROOM 917 WALL DATA - ABOVE COUNTER (2-DROP) SEE DETAIL A5/ET502 DATA ROOM 917

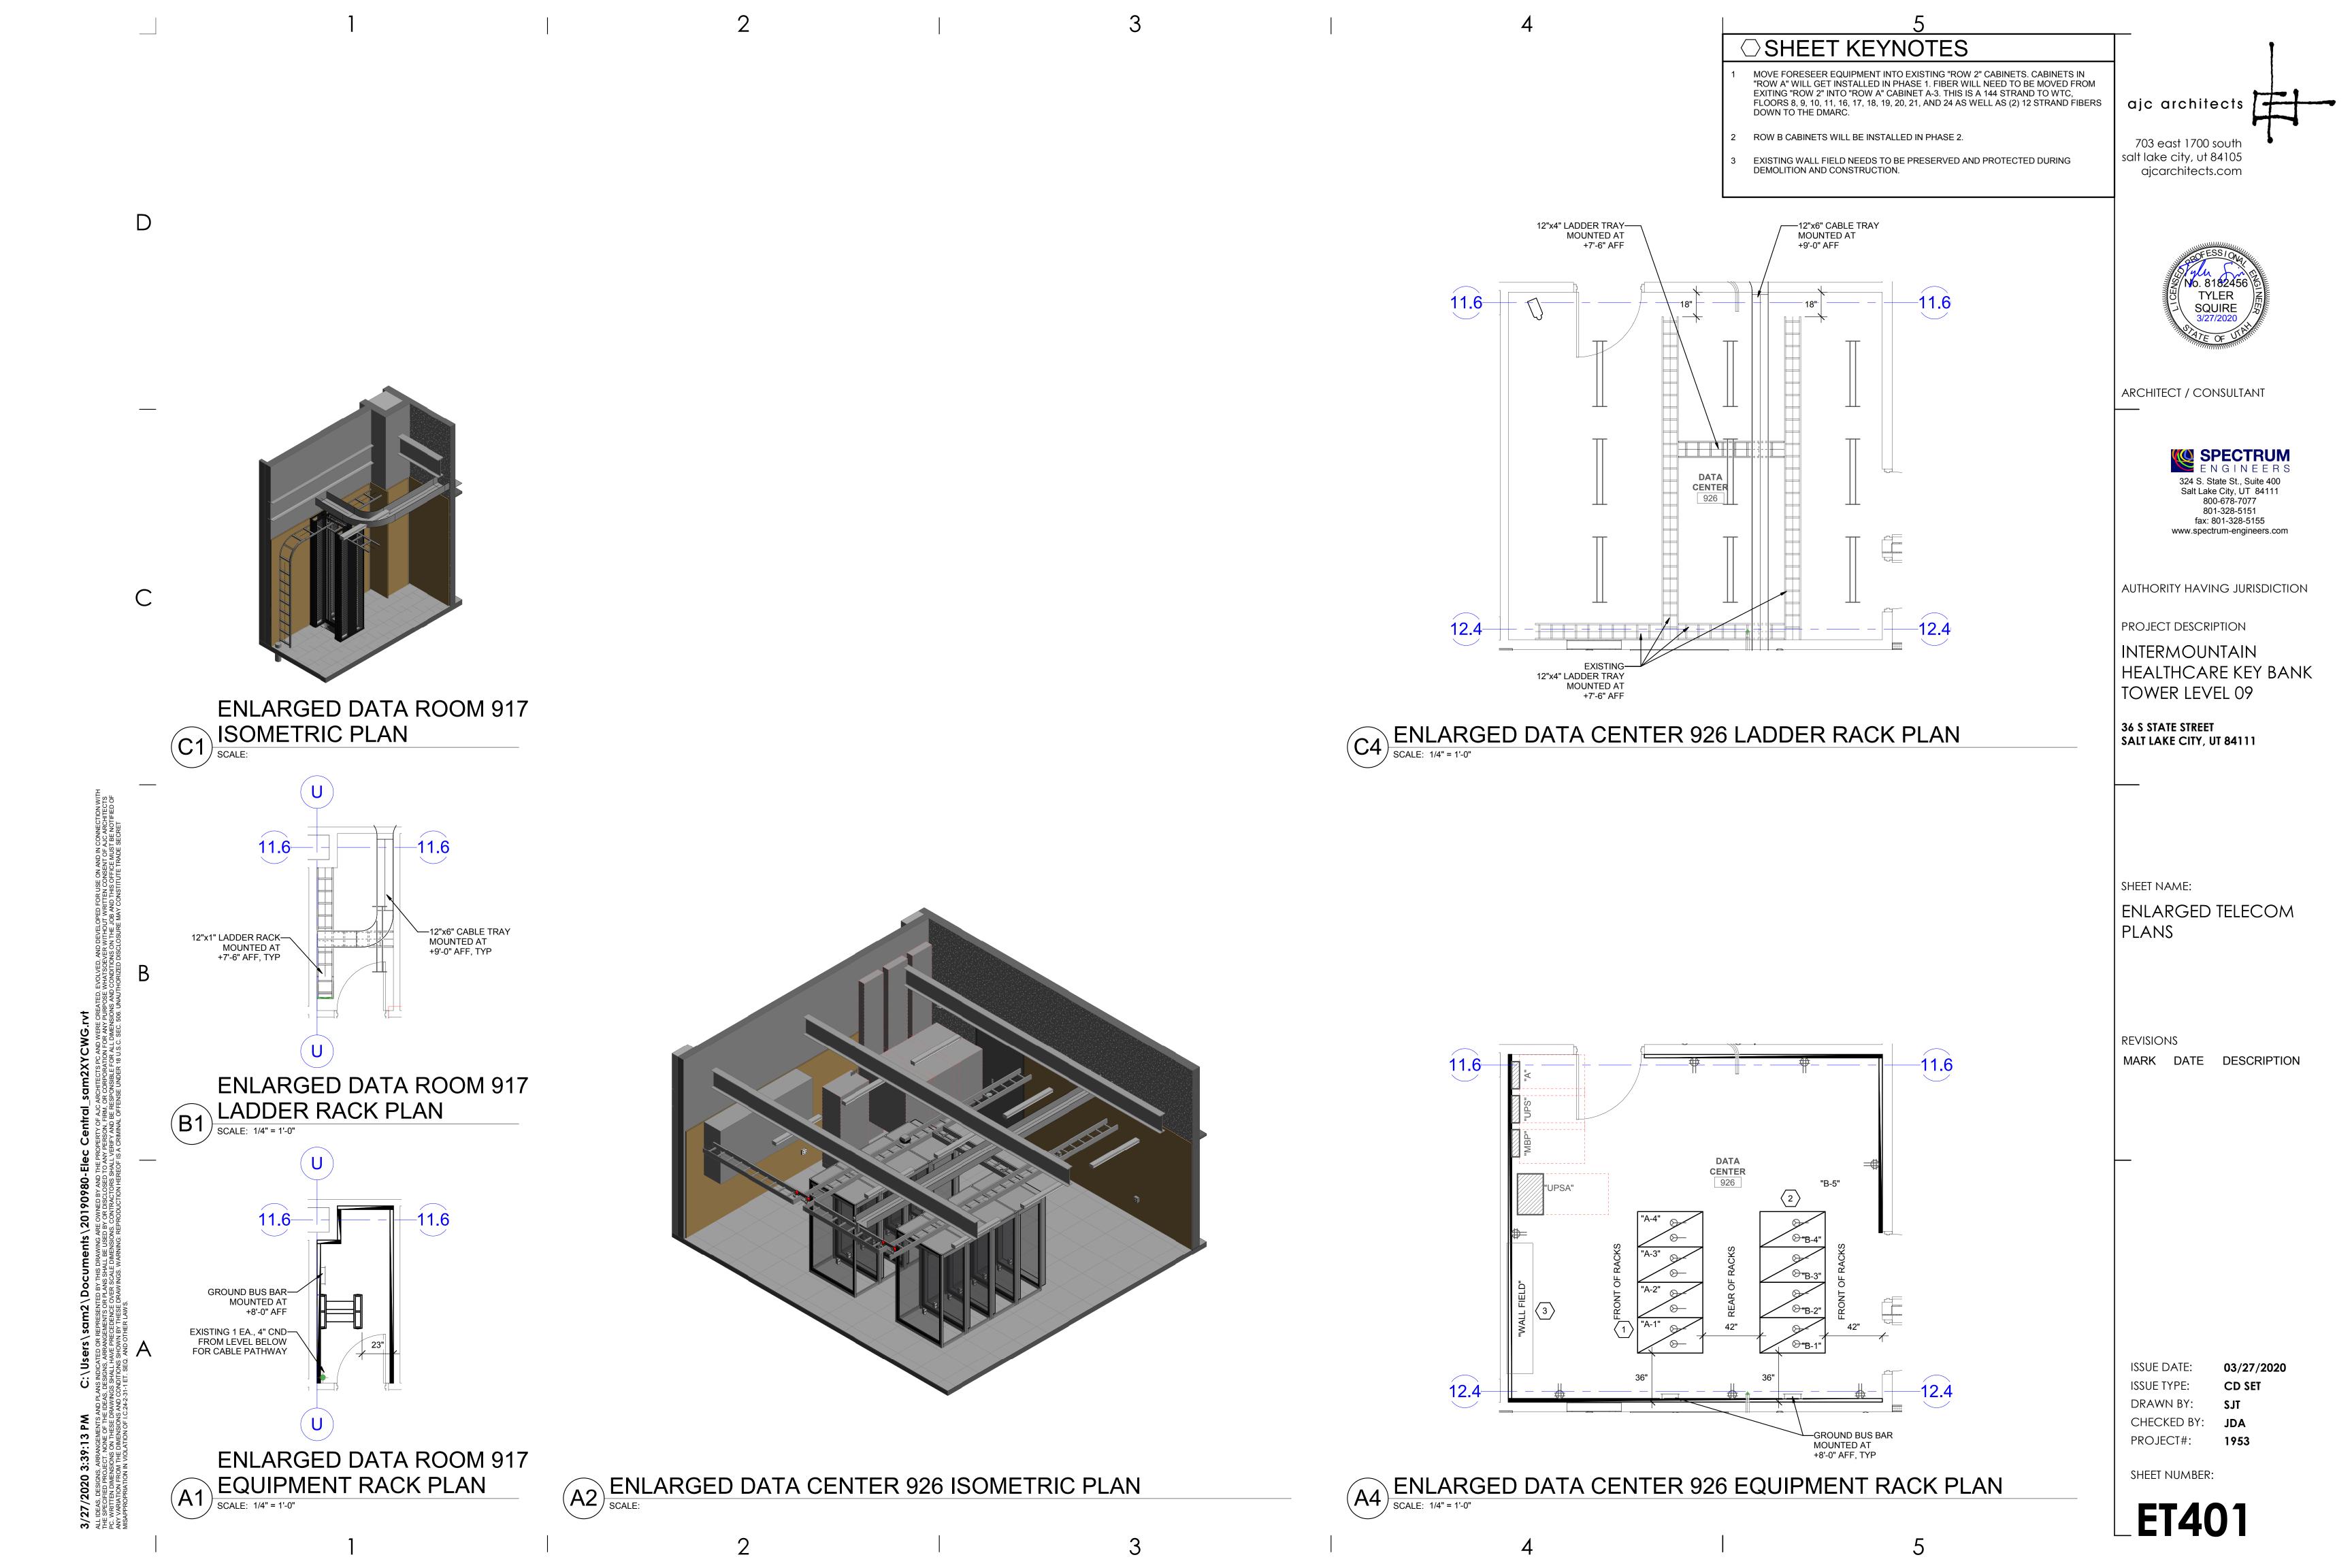

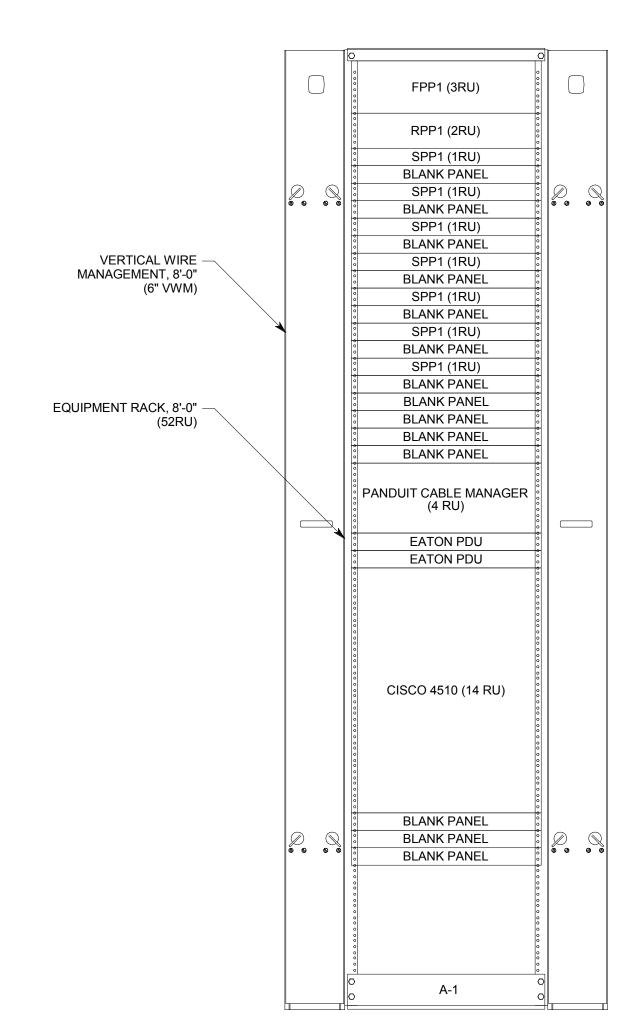TELECOM RACK ELEVEVATION DETAIL, LEVEL 9, DATA ROOM 917

NO SCALE

TELECOM RACK ELEVEVATION DETAIL, LEVEL 9, DATA CENTER 926 NO SCALE

FPP1 (3RU)

FPP1 (3RU)

FPP1 (3RU)

A-1

B-4

B-3

A-2

SHEET NUMBER: **ET501**

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SPECTRUM ENGINEERS

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fax: 801-328-5155 www.spectrum-engineers.com

AUTHORITY HAVING JURISDICTION

HEALTHCARE KEY BANK

TELECOM EQUIPMENT

MARK DATE DESCRIPTION

RACK ELEVATIONS

PROJECT DESCRIPTION

INTERMOUNTAIN

TOWER LEVEL 09

SALT LAKE CITY, UT 84111

36 S STATE STREET

SHEET NAME:

REVISIONS

ISSUE DATE:

ISSUE TYPE: DRAWN BY:


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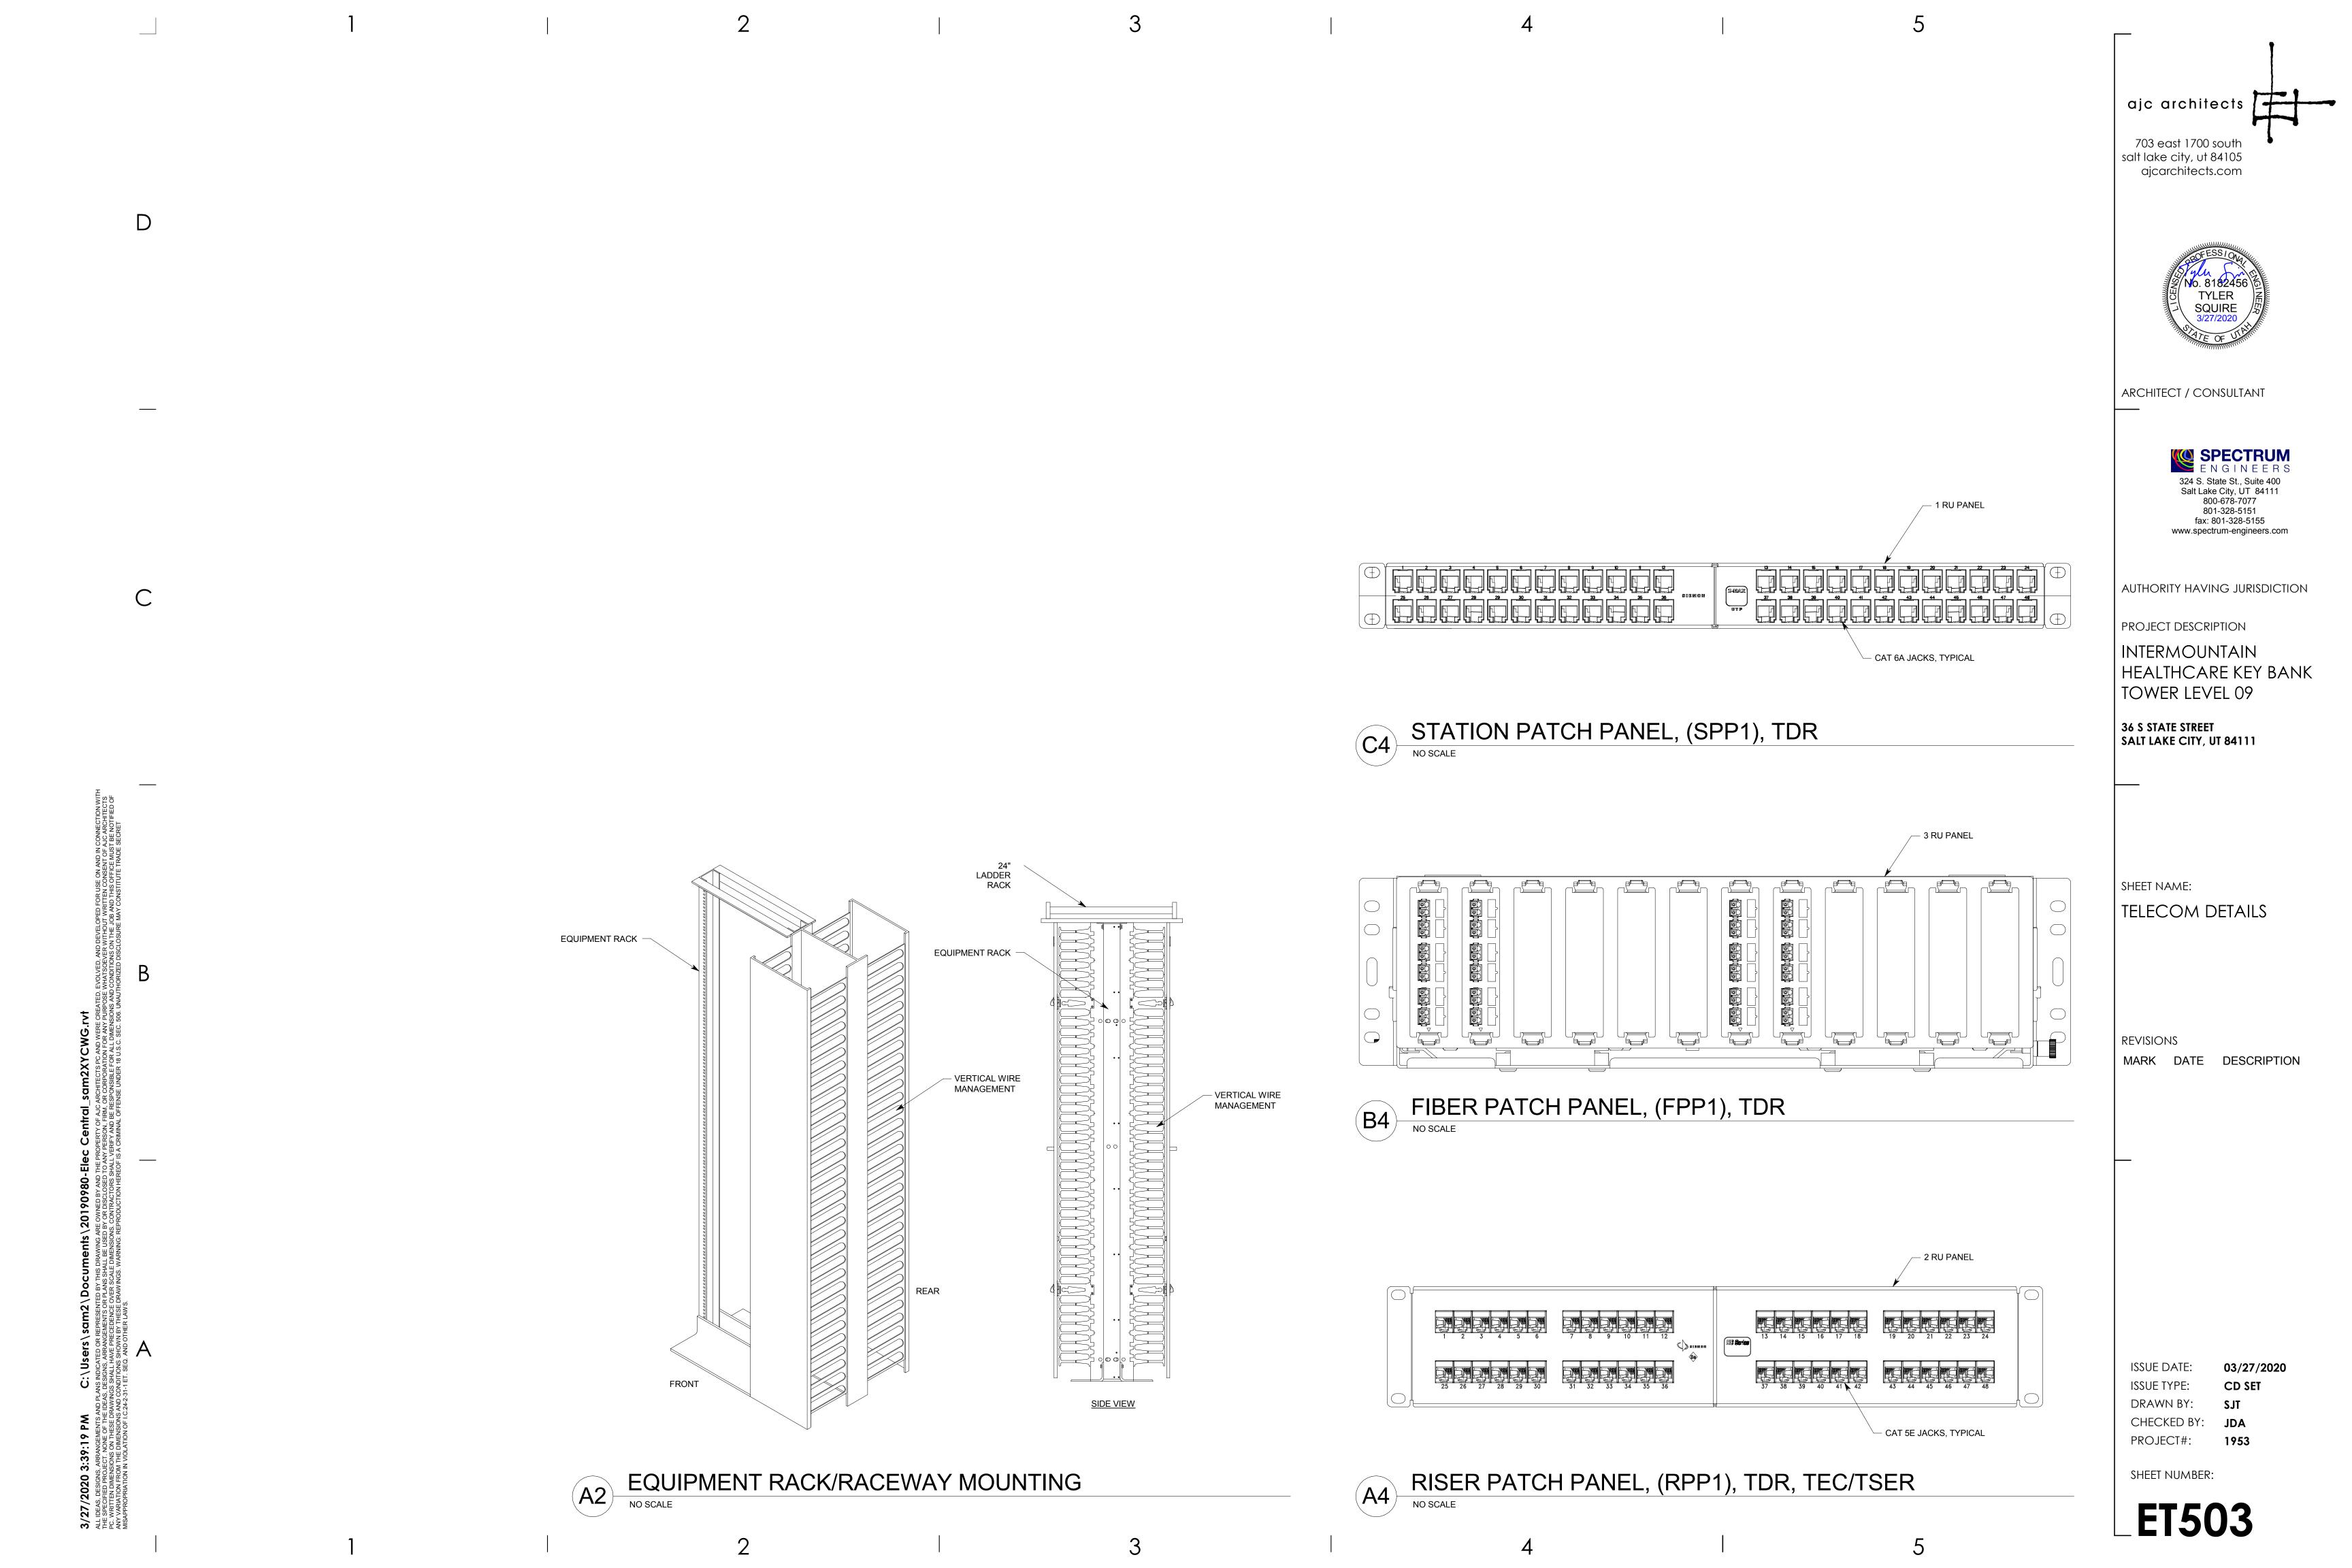
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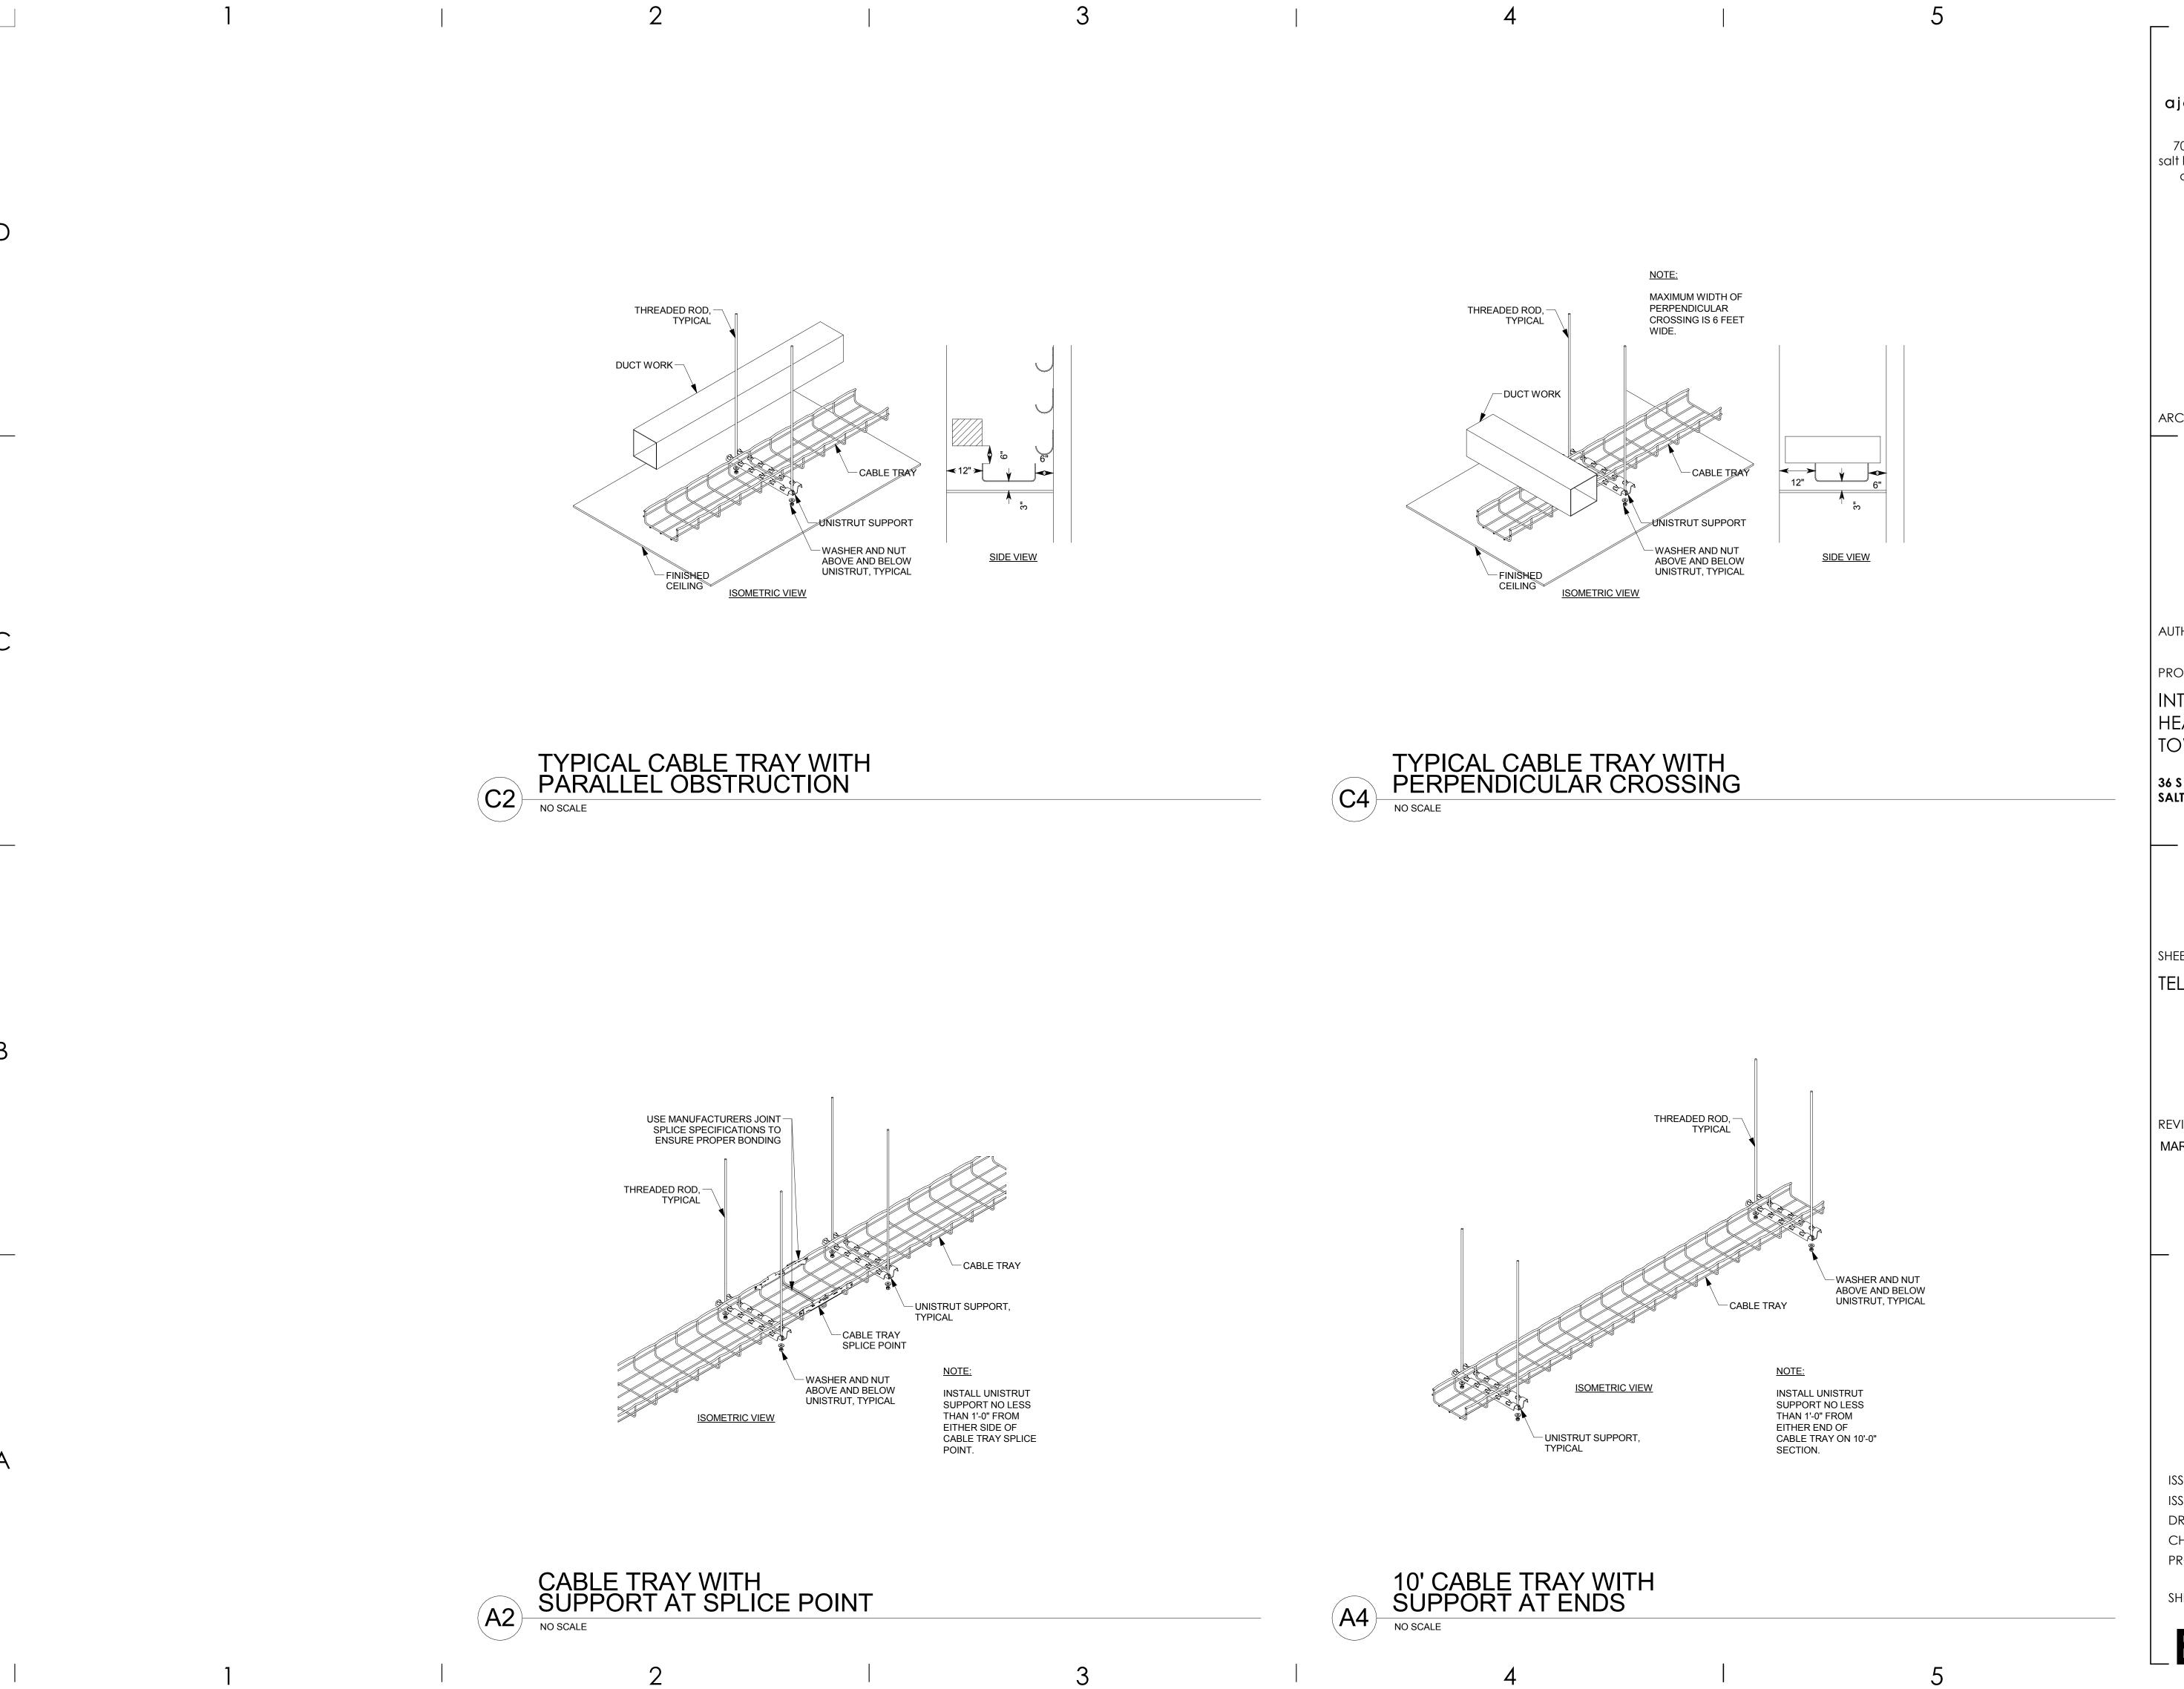
03/27/2020

CD SET

salt lake city, ut 84105





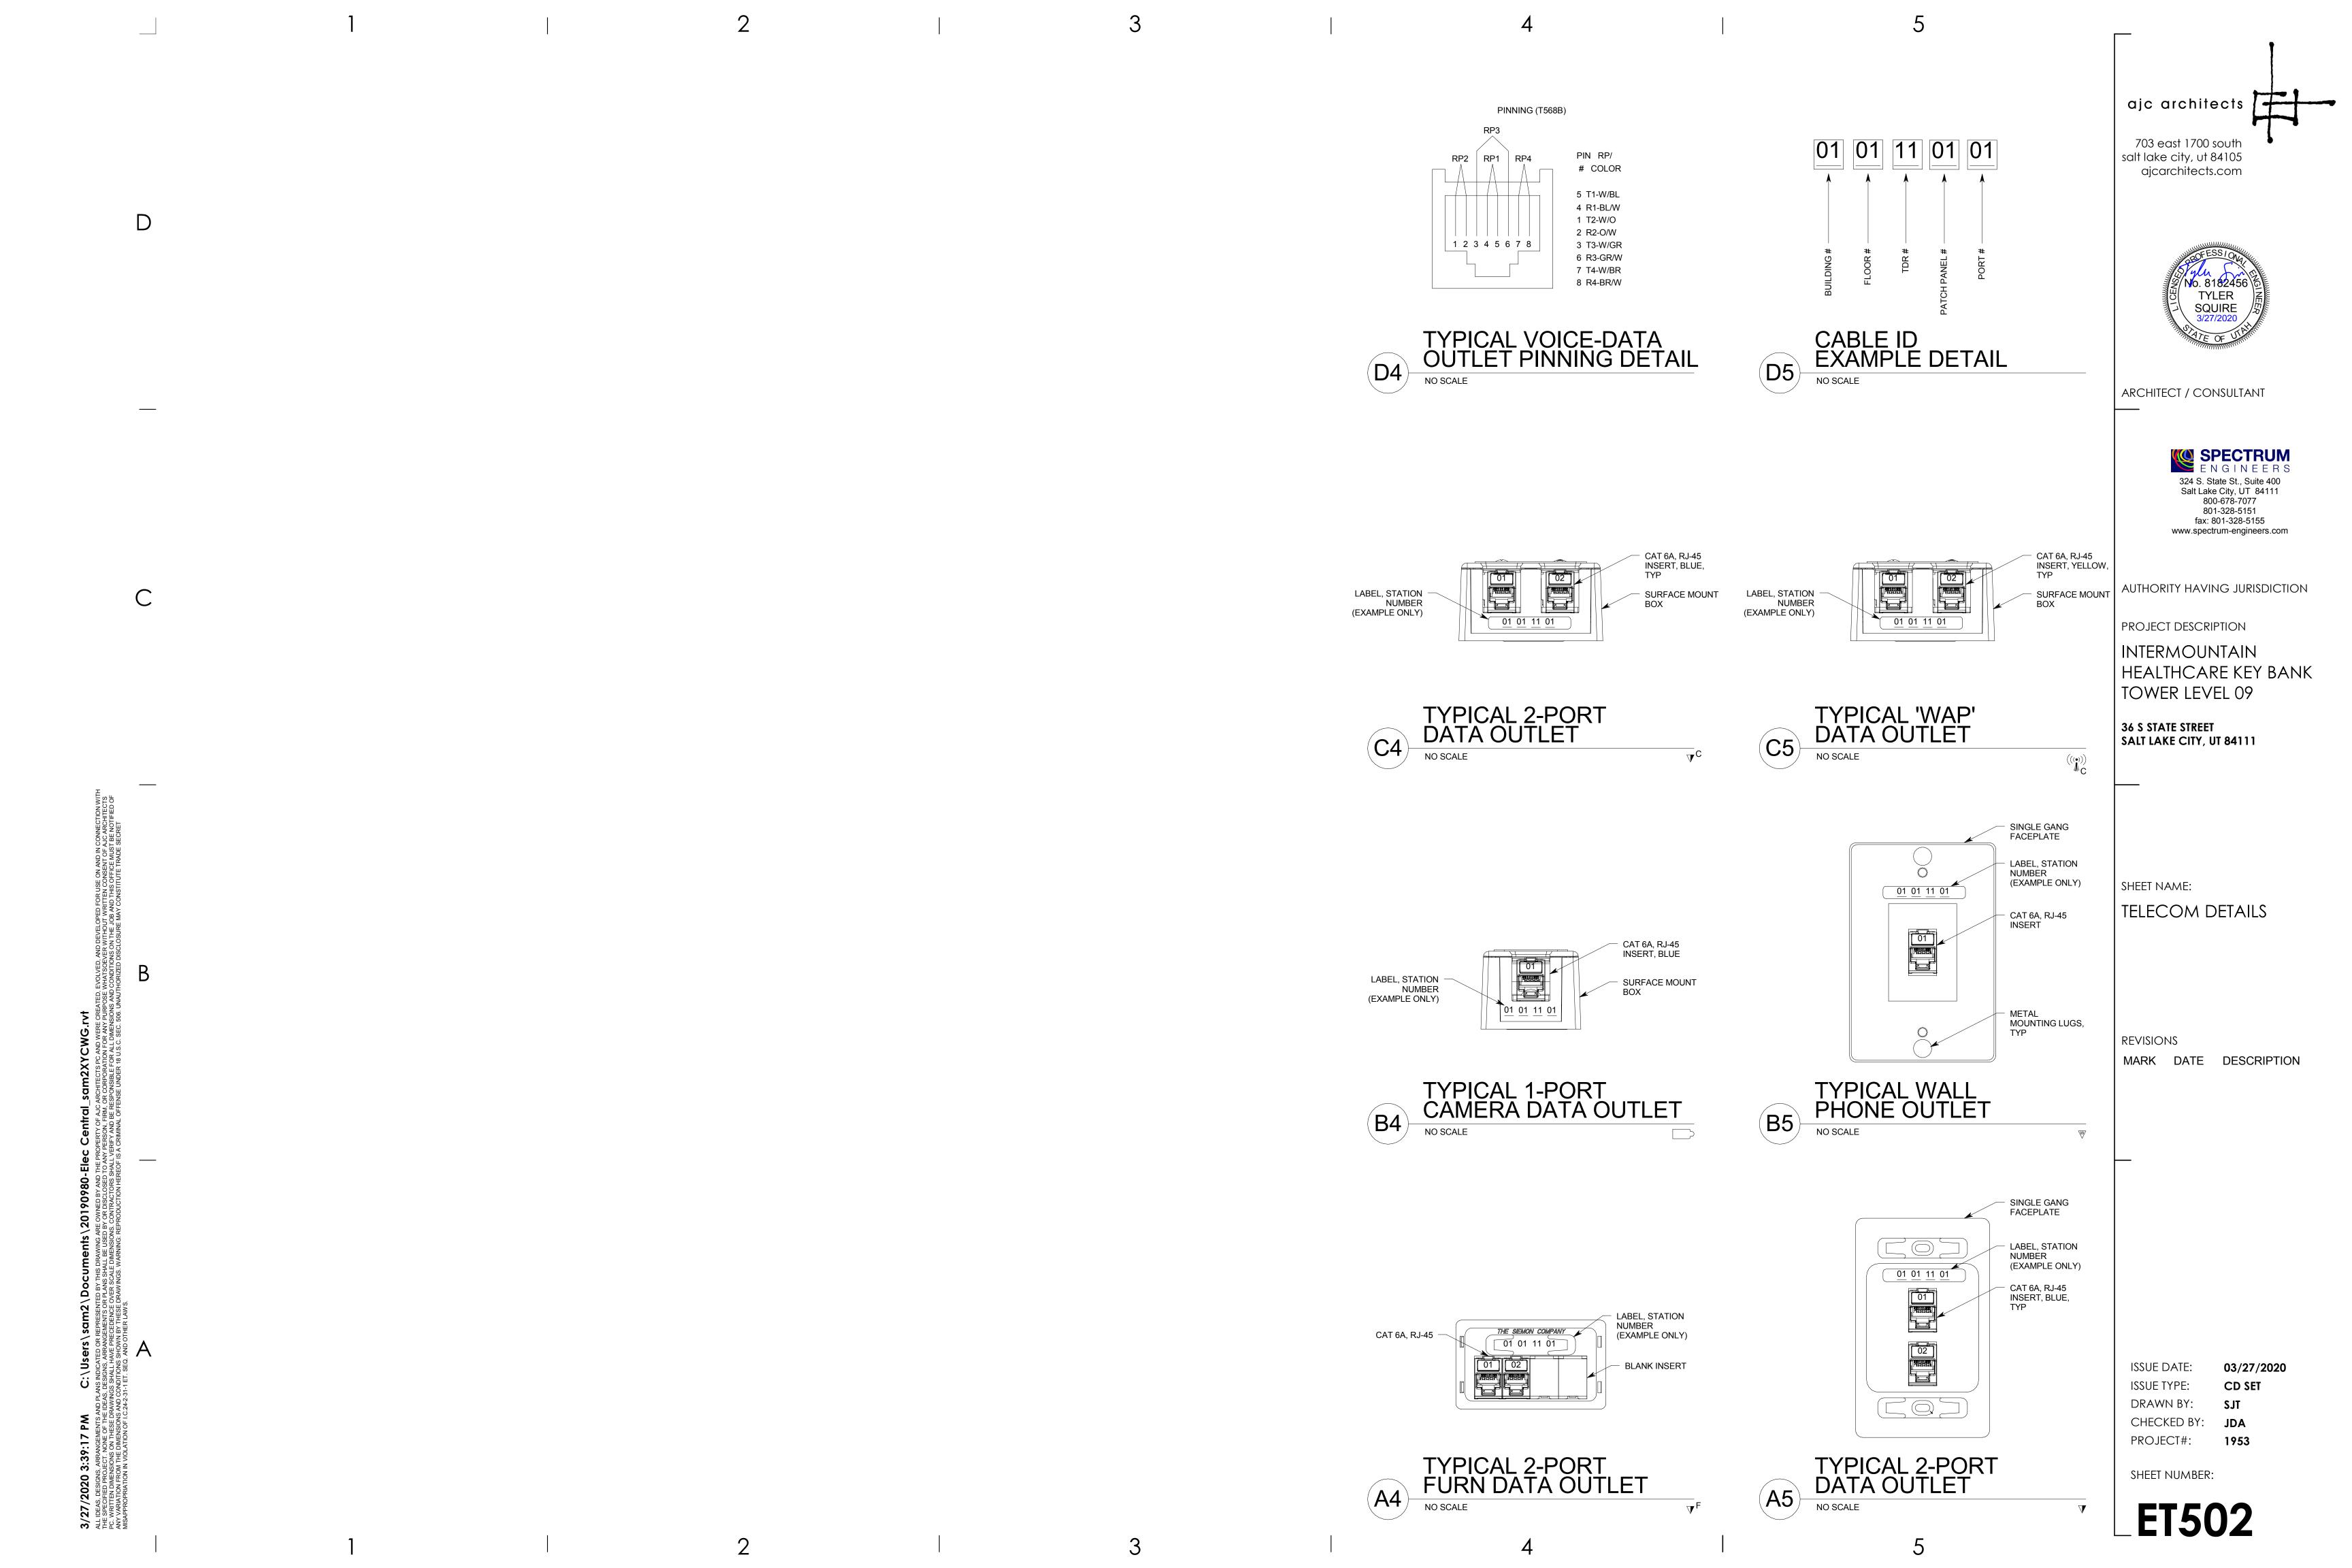

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AUTHORITY HAVING JURISDICTION

PROJECT DESCRIPTION

INTERMOUNTAIN
HEALTHCARE KEY BANK
TOWER LEVEL 09

36 S STATE STREET
SALT LAKE CITY, UT 84111

SHEET NAME:

TELECOM DETAILS

REVISIONS


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ISSUE DATE: 03/27/2020
ISSUE TYPE: CD SET
DRAWN BY: SJT

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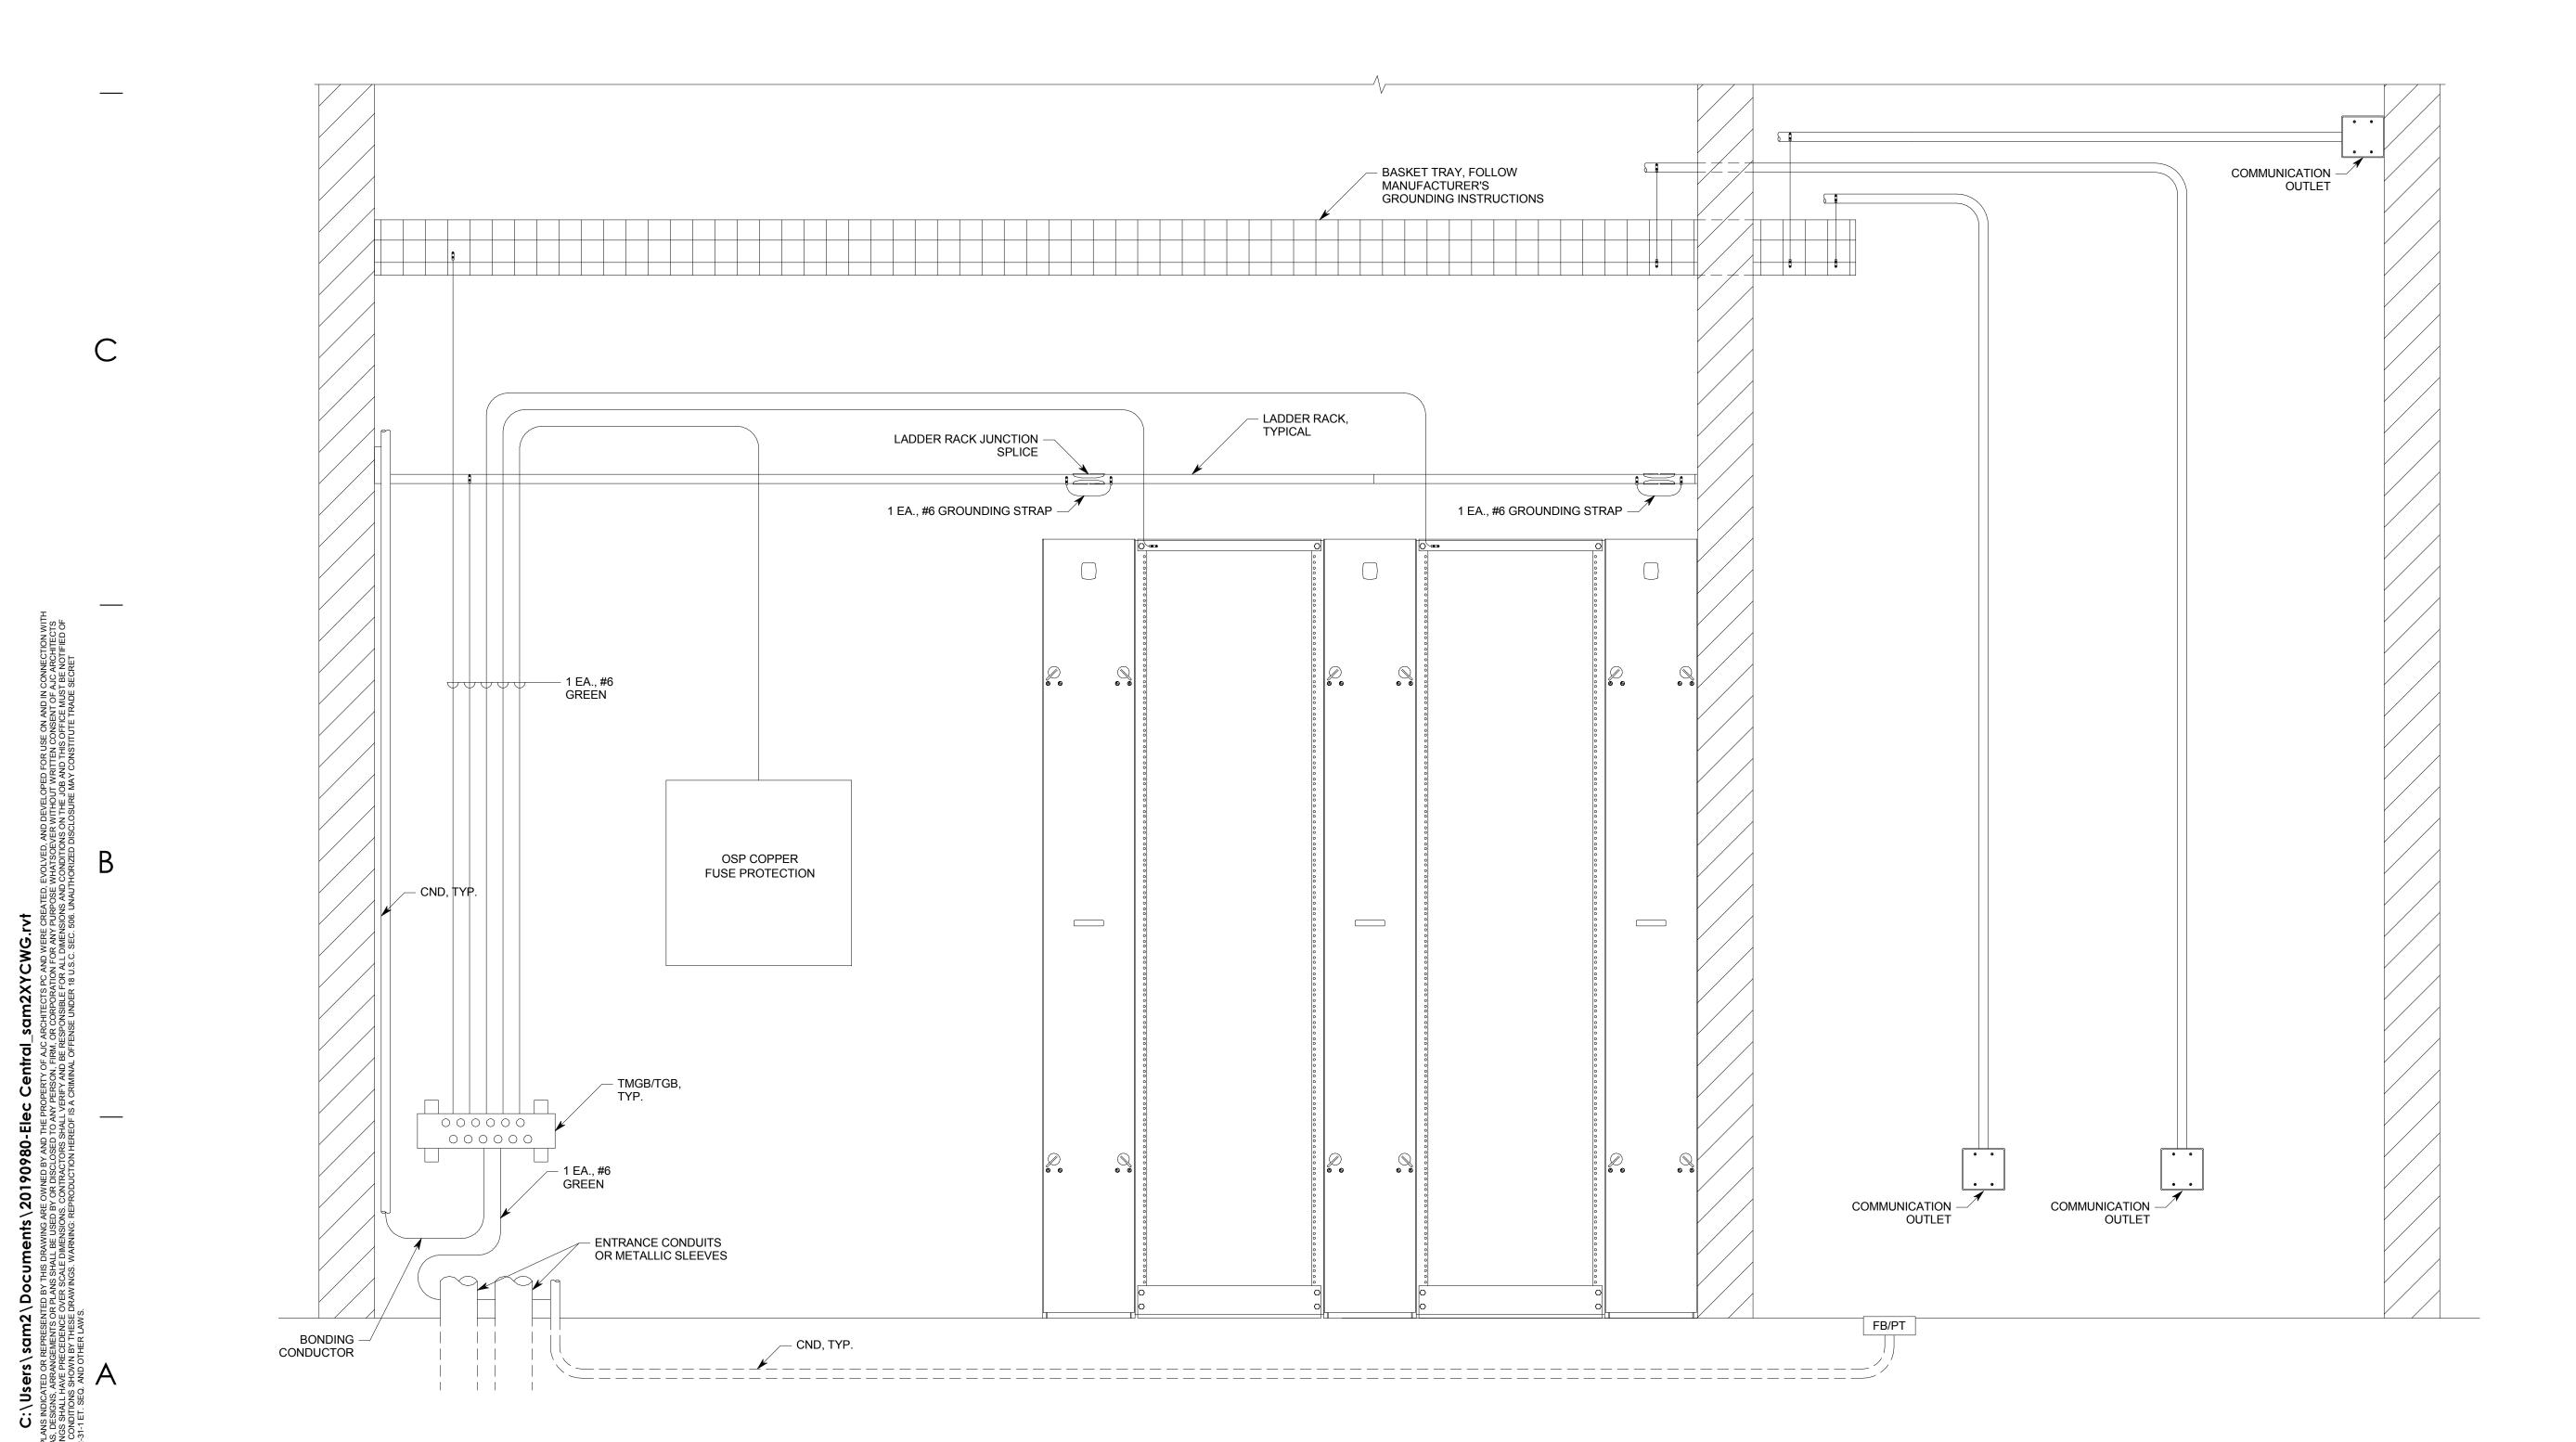
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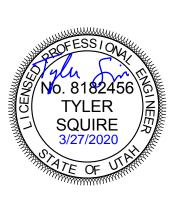


GENERAL NOTES:

- 1. ALL LOW VOLTAGE COMMUNICATIONS CONDUIT SHALL BE GROUNDED TO BASKET TRAY OR TELECOMMUNICATIONS GROUNDING BUS BAR.
- 2. "TMGB" SHOULD BE $\frac{1}{4}$ "x4"x24". PANDUIT PART NUMBER GB4B1028TPI-1, OR EQUAL.
- 3. "TGB" SHOULD BE $\frac{1}{4}$ "x2"x24". PANDUIT PART NUMBER GB2B0514TPI-1, OR EQUAL.
- 4. EMT CONDUIT GROUNDING CLAMP SHOULD BE ELECTROLYTIC CAST BRONZE. PANDUIT PART NUMBER GPL-"X"-"X", OR EQUAL.
- 5. RIGID CONDUIT GROUND CLAMP SHOULD BE O-Z/GEDNEY BLG-XXXX, OR HBLG-XXXX, OR EQUAL.
- GROUNDING LUGS SHOULD BE TWO HOLE LONG BARREL LUGS. PANDUIT PART NUMBER LCC6, OR EQUAL.

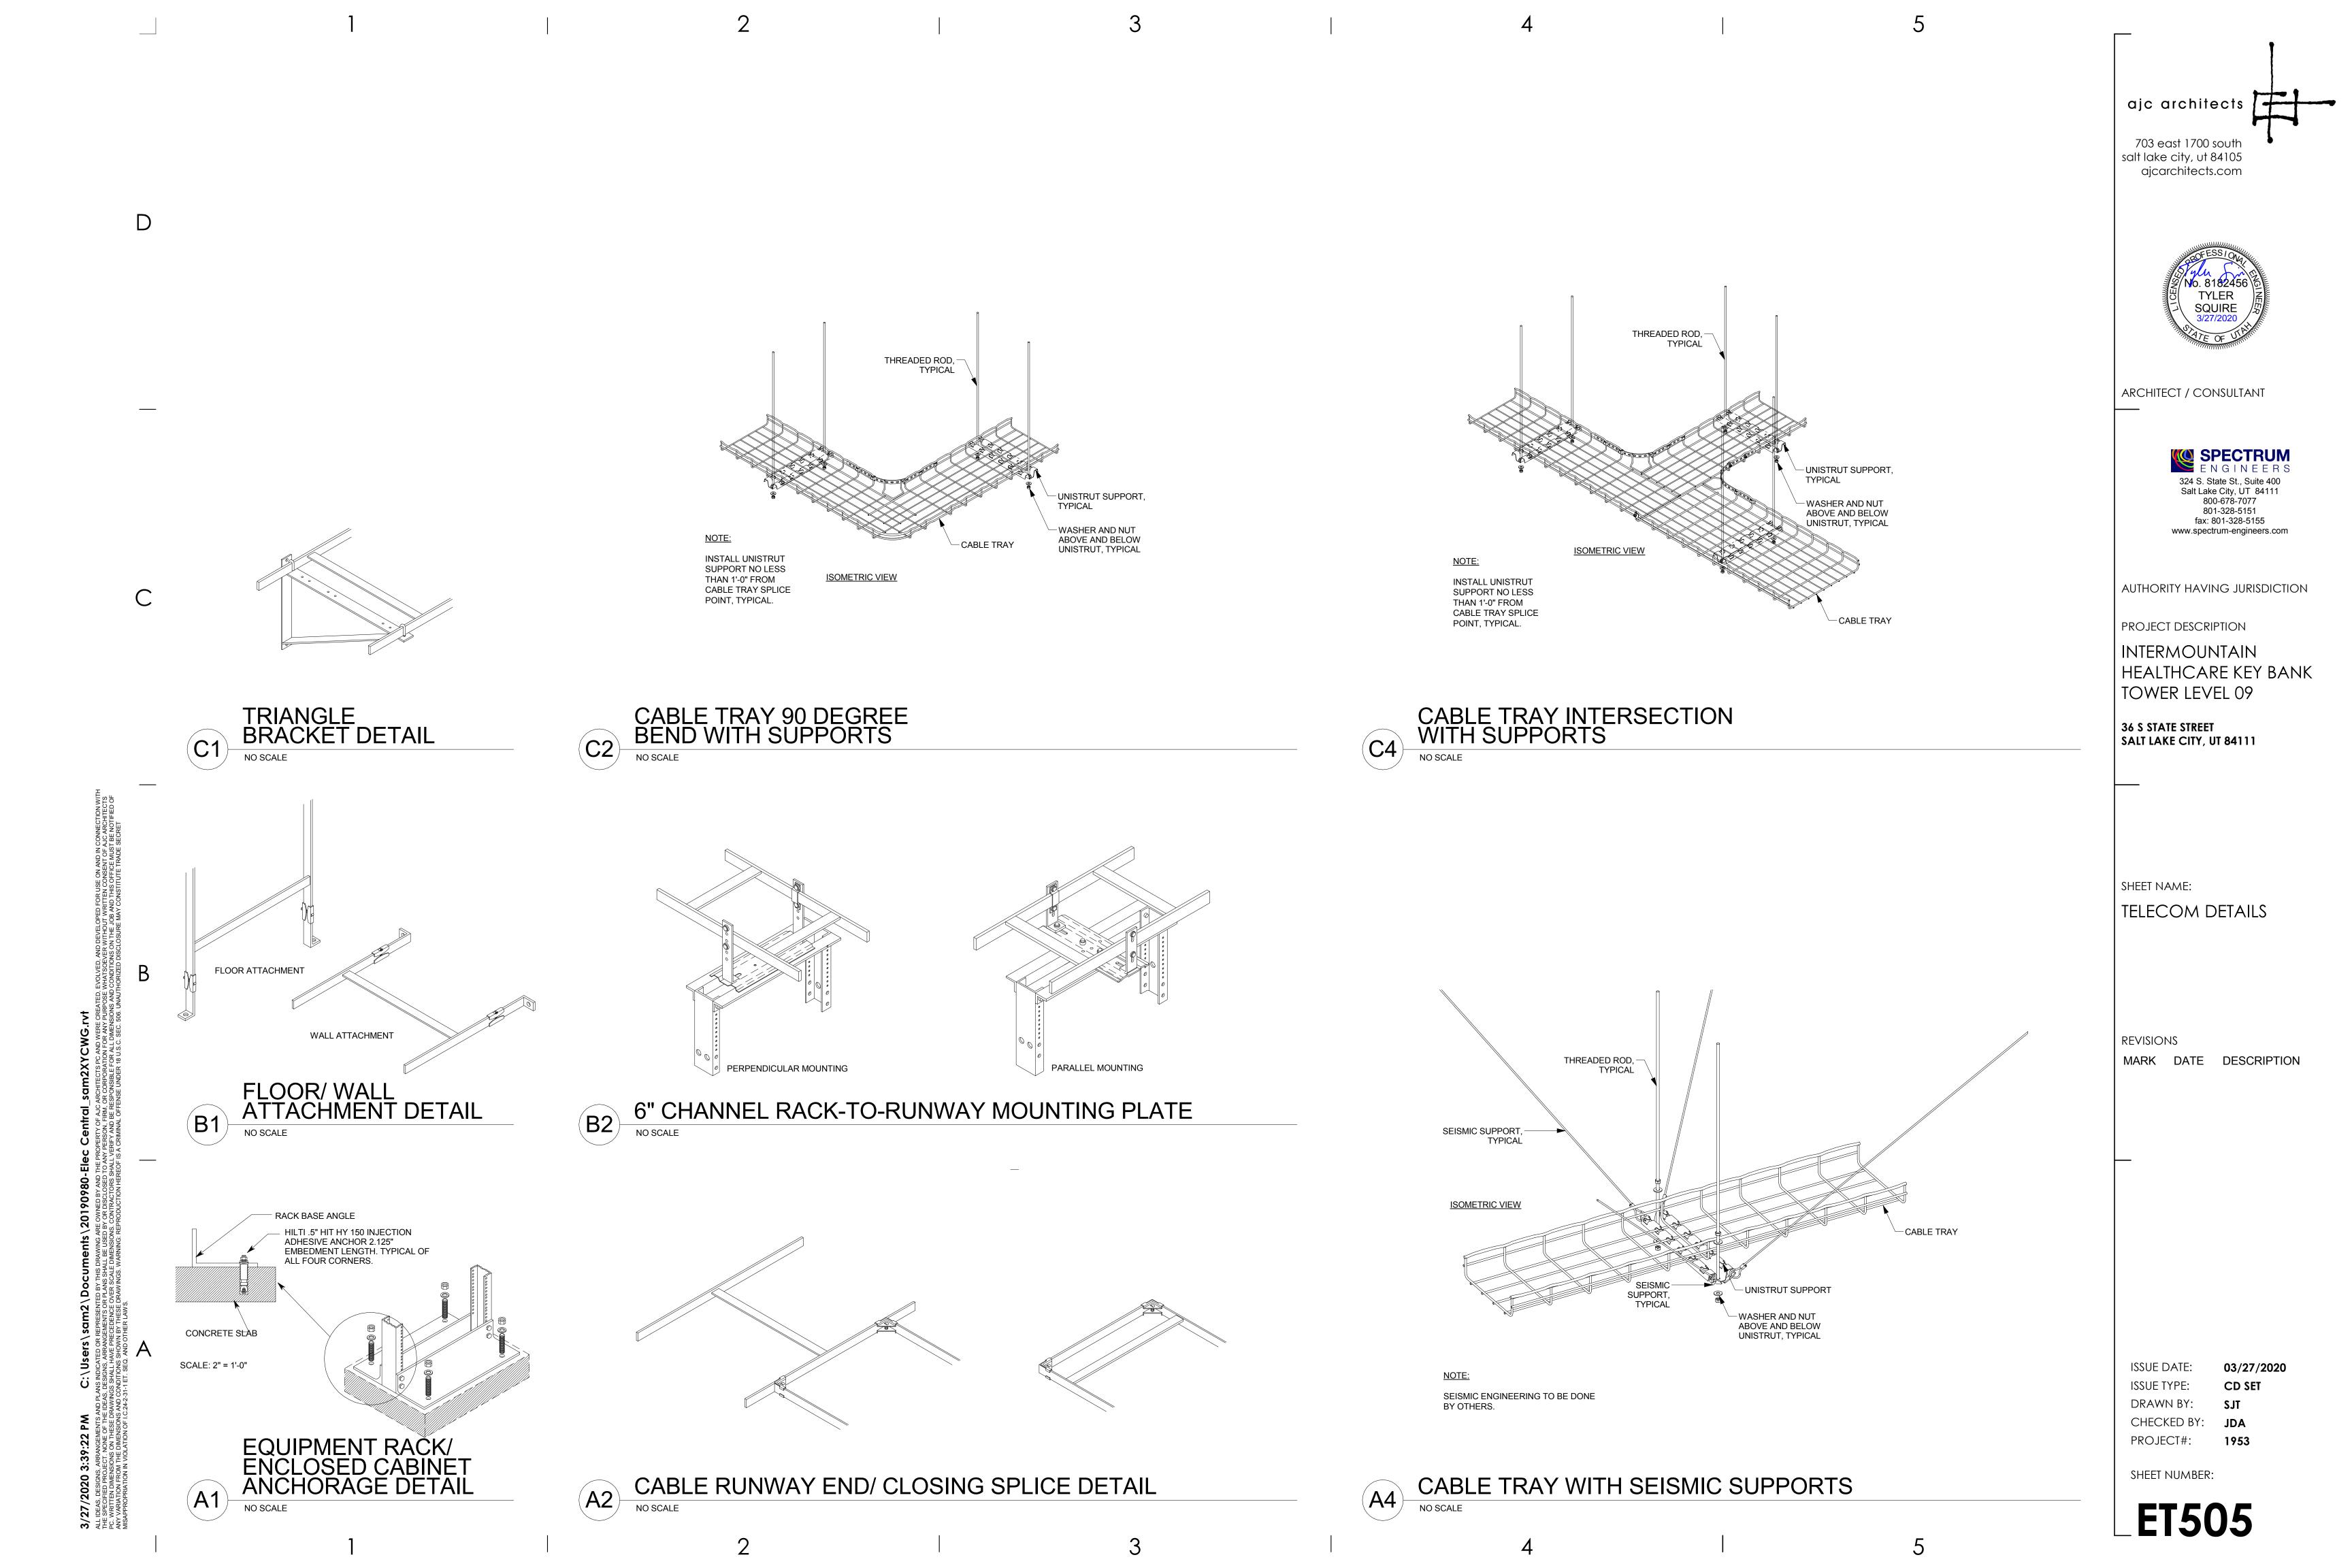

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AUTHORITY HAVING JURISDICTION

PROJECT DESCRIPTION

INTERMOUNTAIN HEALTHCARE KEY BANK TOWER LEVEL 09

36 S STATE STREET SALT LAKE CITY, UT 84111

SHEET NAME:

TELECOM EQUIPMENT RACK GROUNDING DETAIL

REVISIONS

MARK DATE DESCRIPTION

ISSUE DATE: ISSUE TYPE: DRAWN BY:

CHECKED BY: PROJECT#:

03/27/2020

CD SET

SHEET NUMBER:

ET506

TYPICAL GROUNDING RISER DETAIL

GENERAL SHEET NOTES 1. PROVIDE CABLE TRAYS ABOVE CEILINGS IN CORRIDORS LEADING TO THE TDR PER INTERMOUNTAIN HEALTHCARE STRUCTURED CABLING STANDARDS. ajc architects 703 east 1700 south salt lake city, ut 84105 ajcarchitects.com ARCHITECT / CONSULTANT SPECTRUM ENGINEERS 324 S. State St., Suite 400 Salt Lake City, UT 84111 800-678-7077 801-328-5151 fax: 801-328-5155 www.spectrum-engineers.com AUTHORITY HAVING JURISDICTION PROJECT DESCRIPTION INTERMOUNTAIN HEALTHCARE KEY BANK TOWER LEVEL 09 36 S STATE STREET SALT LAKE CITY, UT 84111 SHEET NAME: TELECOM CONDUIT RISER DIAGRAMS COIL OF EXCESS CABLE -COIL OF EXCESS CABLE COIL OF EXCESS CABLE -COIL OF EXCESS CABLE — REVISIONS MARK DATE DESCRIPTION LEVEL 9, DATA ROOM 917 — 12" x 6" BASKET TRAY ACCESSIBLE CEILING LADDER RACK 1" CND, TYP. — 2 EA., 1.25" CND. TYP. 4 11/16" X 3" BOX WITH 5/8" 4 11/16" X 3" BOX WITH 5/8" SINGLE GANG SINGLE GANG MUD RING MUD RING 1 #3 CU TO -GROUNDING ELECTRODE ISSUE DATE: 03/27/2020 2 EA. 1.25" — CND, CD SET ISSUE TYPE: DRAWN BY: CHECKED BY: PROJECT#: SHEET NUMBER: TELECOM CABLING CONDUIT RISER DIAGRAM NO SCALE **ET601**

GENERAL SHEET NOTES 1. PROVIDE CABLE TRAYS ABOVE CEILINGS IN CORRIDORS LEADING TO THE TDR ajc architects PER INTERMOUNTAIN HEALTHCARE STRUCTURED CABLING STANDARDS. 703 east 1700 south salt lake city, ut 84105 ajcarchitects.com SHEET KEYNOTES 1. EXTEND 50 PAIR CAT 3 PLENUM CABLE TO COMM CLOSET. TERMINATE 50 PAIR ON EXISTING 66 BLOCKS ON WALL. USE THE CABLE COUNT 1301-1350. TEST ALL COPPER PAIRS AFTER TERMINATION. CONTRACTOR TO TYLER SQUIRE RE-TERMINATE AND TEST ALL FIBER AND COPPER IN NEW "FPP" AND "RPP". ARCHITECT / CONSULTANT SPECTRUM ENGINEERS 324 S. State St., Suite 400 Salt Lake City, UT 84111 800-678-7077 801-328-5151 fax: 801-328-5155 www.spectrum-engineers.com AUTHORITY HAVING JURISDICTION PROJECT DESCRIPTION INTERMOUNTAIN HEALTHCARE KEY BANK TOWER LEVEL 09 36 S STATE STREET SALT LAKE CITY, UT 84111 SHEET NAME: TELECOM CABLE RISER DIAGRAMS REVISIONS 2 EA. CAT 6A F/UTP CABLE YELLOW -MARK DATE DESCRIPTION 2 EA. CAT 6A F/UTP CABLE BLUE -2 EA. CAT 6A F/UTP CABLE BLUE -1 EA., 12 STRAND SINGLE-MODE FIBER (EXISTING) 1 EA., 50 PAIR CAT 3 UTP (EXISTING) 1 EA. CAT 6A F/UTP CABLE BLUE -TYPICAL OF ALL VIDEO
SURVEILLANCE
CAMERAS (SEE EY
SHEETS) 1 EA. CAT 6A F/UTP CABLE BLUE -RACK
MOUNTED (TYP) STATION PATCH FIBER PATCH FIBER PATCH RISER PATCH PATCH OWNER **PANELS** PANEL (FPP1) PANEL (FPP1) PANEL **PANELS** SWITCH (SPP1) (TYP) (RPP1) (RPP1) STATION OUTLETS (TYPICAL) - CAT 5E PATCH CORDS, TYP SM FIBER PATCH F/UTP CAT 6A PATCH CORDS, TYP CORDS, TYP LEVEL 9, DATA CENTER 926 LEVEL 9, DATA ROOM 917 ISSUE DATE: 03/27/2020 CD SET ISSUE TYPE: DRAWN BY: CHECKED BY: PROJECT#: 1953 SHEET NUMBER: TELECOM CABLING RISER DIAGRAM **ET602**

SECURITY SHEET INDEX

EY001 | SECURITY COVER SHEET

EY109 LEVEL 09 AUXILIARY PLAN

EY601 AUXILIARY RISER DIAGRAMS

EQUIPMENT/CABLE LIST

THE ITEMS INDICATED BELOW SHALL NOT BE CONSTRUED AS A "BILL OF MATERIALS". THIS LIST IDENTIFIES ITEMS OF SIGNIFICANCE USED DURING THE DESIGN OF THE CABLING INSTALLATION. WHERE THE ITEMS INDICATED ARE ONE PORTION OF AN ASSEMBLY, THE ENTIRE ASSEMBLY SHALL BE PROVIDED UNLESS SPECIFIED OTHERWISE. PROVIDE ALL MISCELLANEOUS HARDWARE AND SUPPORTS WHICH MAY NOT BE LISTED HERE, FOR A COMPLETE INSTALLATION. COMPARE CATALOG NUMBERS WITH DESCRIPTIONS AND NOTIFY ENGINEER OF DISCREPANCIES PRIOR TO BID. IF CATALOG NUMBERS DO NOT MATCH DESCRIPTIONS, THE DESCRIPTIONS TAKE PRECEDENCE. PROVIDE COMPLETE SUBMITTAL FOR APPROVAL PRIOR TO PURCHASING ANY EQUIPMENT OR CABLE. REFER TO SPECIFICATIONS FOR ADDITIONAL REQUIREMENTS.

SYMBOL	ITEM DESCRIPTION	ACCEPTABLE TYPES
#X >	DATA OUTLET, FLUSH MOUNT BOX, SEE EY601 FOR ADDITIONAL INFORMATION	COMMSCOPE, PANDUIT, LEVITON, BELDEN
رر ##_	DATA JACK CAT 6	COMMSCOPE, PANDUIT, LEVITON, BELDEN
	CARD READER, SEE EY601 FOR ADDITIONAL INFORMATION	
< CR		
	DOOR ROUGH-IN, SEE EY601 FOR ADDITIONAL INFORMATION	
<#XX		
	ACCESS CONTROL SYSTEM DOOR CONTROLLER PANEL	
ACS		

GENERAL PROJECT NOTES

- UNLESS OTHERWISE NOTED, INSTALL ALL CABLE INSIDE RACEWAY SYSTEMS.
 WHERE RACEWAY SYSTEMS HAVE NOT BEEN PROVIDED OR SPECIFIED, INSTALL
 CABLE THROUGH THE SPECIFIED "CADDY" CLIPS AT THE MINIMUM INTERVALS
 IDENTIFIED IN THE SPECIFICATIONS. SUPPORT "CADDY" CLIPS DIRECTLY FROM
 THE BUILDING STRUCTURE, NOT FROM OTHER BUILDING SYSTEM SUPPORT
 WIRES OR CABLE.
- 2. PROVIDE PLENUM RATED CABLE FOR ALL SPECIFIED CABLE.
- LABEL ALL CABLE INSTALLED UNDER THIS CONTRACT REGARDLESS OF LENGTH. ACCORDING TO WRITTEN SPECIFICATION.
- 4. THE EQUIPMENT LABELING IDENTIFIED ON DETAILS IN THESE DRAWINGS ARE EXAMPLES ONLY OF THE ACTUAL LABELING WHICH IS REQUIRED AS PART OF THIS CONTRACT. PRIOR TO FABRICATION, SUBMIT THE NOMENCLATURE FOR ALL LABELS TO THE OWNER FOR REVIEW. THIS REQUIREMENT INCLUDES BUT IS NOT LIMITED TO ALL CABLE LABELING, AND ALL EQUIPMENT LABELING.
- 5. GROUND ALL EQUIPMENT RACKS LADDER RACK, AND EQUIPMENT INSTALLED UNDER THIS CONTRACT IN COMPLIANCE WITH THE CONTRACT DOCUMENTS AND WRITTEN SPECIFICATION.
- 6. PROVIDE THE QUANTITY OF PATCH PANELS REQUIRED +20% FOR THE TOTAL CABLES SHOWN ON FLOOR PLANS FOR THE PARTICULAR LEVEL.
- 7. COORDINATE WITH OWNER I.T. PERSONNEL ON RACK PATCH PANEL DENSITY PRIOR TO ANY CABLE TERMINATION.
- 8. FOR EVERY CABLE PULL SPECIFIED, COIL 10" OF EXCESS CABLE AT THE STATION END FOR FUTURE USE. NEATLY COIL AND SECURITY CABLE ABOVE CEILING OR BELOW THE FLOOR, WHERE APPLICABLE.
- 9. COORDINATE WITH ALL SUBS TO ENSURE THAT ALL CABLE SHALL BE PROTECTED FROM ANY DIRECT PAINT OR INCIDENTAL OVERSPRAY.
- 10. FACEPLATE COLOR WILL BE DETERMINED BY THE ARCHITECT AND OWNER. FACEPLATE COLOR SHOULD MATCH ELECTRICAL FACEPLATE COLOR, UNLESS OTHERWISE NOTED.

ABBREVIATIONS

NOTE: ALL ABBREVIATIONS MAY NOT BE USED.

A - AUGMENTED CAT - CATEGORY

ER - EQUIPMENT ROOM FPP - FIBER PATCH PANEL

NIC - NOT IN CONTRACT
OE - OWNER ELECTRONICS

PS - POWER SUPPLY
RPP - RISER PATCH PANEL
SPP - TYPE S PATCH PANEL

HWM - HORIZONTAL WIRE MANAGEMENT

TR - TELECOMMUNICATIONS ROOM

VWM - VERTICLE WIRE MANAGEMENT

E - ENHANCED EA - EACH

GIG - GIGA HERTZ

PNM - PLENUM PR - PAIR

TYP - TYPICAL

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AUTHORITY HAVING JURISDICTION

PROJECT DESCRIPTION

INTERMOUNTAIN
HEALTHCARE KEY BANK
TOWER LEVEL 09

36 S STATE STREET
SALT LAKE CITY, UT 84111

SHEET NAME:

SECURITY COVER SHEET

revisions

MARK DATE DESCRIPTION

DEFINITIONS NOTE: ALL DEFINITIONS MAY NOT BE USED.

INDICATED: THE TERM "INDICATED" REFERS TO GRAPHIC REPRESENTATIONS, NOTES, OR SCHEDULES ON THE DRAWINGS, OTHER PARAGRAPHS OR SCHEDULES IN THE SPECIFICATIONS, AND SIMILAR REQUIREMENTS IN THE CONTRACT DOCUMENTS. WHERE TERMS SUCH AS "SHOWN", "NOTED", "SCHEDULED", AND "SPECIFIED" ARE USED, IT IS TO HELP THE READER LOCATE THE REFERENCE, NO LIMITATION ON LOCATION IS INTENDED.

DIRECTED: TERMS SUCH AS "DIRECTED", "REQUESTED", AUTHORIZED", "SELECTED", "APPROVED", "REQUIRED", AND "PERMITTED" MEAN "DIRECTED BY THE ENGINEER", "REQUESTED BY THE ENGINEER", AND SIMILAR PHRASES.

APPROVE: THE TERM "APPROVED", WHERE USED IN CONJUNCTION WITH THE ENGINEER'S ACTION ON THE CONTRACTOR'S SUBMITTALS, APPLICATIONS, AND REQUESTS, IS LIMITED TO THE ENGINEER'S DUTIES AND RESPONSIBILITIES AS STATED IN GENERAL AND SUPPLEMENTARY CONDITIONS.

FURNISH: THE TERM "FURNISH" IS USED TO MEAN "SUPPLY AND DELIVER TO THE PROJECT SITE, READY FOR UNLOADING, UNPACKING, ASSEMBLY, INSTALLATION, AND SIMILAR OPERATIONS."

INSTALL: THE TERM "INSTALL" IS USED TO DESCRIBE OPERATIONS AT PROJECT SITE INCLUDING THE ACTUAL "UNLOADING, UNPACKING, ASSEMBLY, ERECTION, PLACING, ANCHORING, APPLYING, WORKING TO DIMENSION, FINISHING, CURING, PROTECTING, CLEANING, AND SIMILAR OPERATIONS."

PROVIDE: THE TERM "PROVIDE" MEANS "TO FURNISH AND INSTALL, COMPLETE AND READY FOR THE INTENDED USE."

INSTALLER: AN "INSTALLER" IS THE CONTRACTOR OR AN ENTITY ENGAGED BY THE CONTRACTOR, EITHER AS AN EMPLOYEE, SUBCONTRACTOR, OR SUB-SUBCONTRACTOR, FOR PERFORMANCE OF A PARTICULAR CONSTRUCTION ACTIVITY, INCLUDING INSTALLATION, ERECTION, APPLICATION, AND SIMILAR OPERATIONS. INSTALLERS ARE REQUIRED TO BE EXPERIENCED IN THE OPERATIONS THEY ARE ENGAGED TO PERFORM.

ELECTRONIC SYSTEMS: THE TERM "ELECTRONIC SYSTEMS" IS USED TO DESCRIBE ALL LOW VOLTAGE SYSTEMS GENERALLY REFERRED TO AS "SPECIAL SYSTEMS". THESE SYSTEMS INCLUDE BUT ARE NOT NECESSARILY LIMITED TO ALL SYSTEMS WHICH UTILIZE VOLTAGES OF LESS THAN 71 VOLTS SUCH AS SOUND SYSTEMS, VIDEO SYSTEMS, TV SYSTEMS, SECURITY SYSTEMS, VOICE AND DATA CABLING SYSTEMS, ETC...


ISSUE DATE: 03/27/2020
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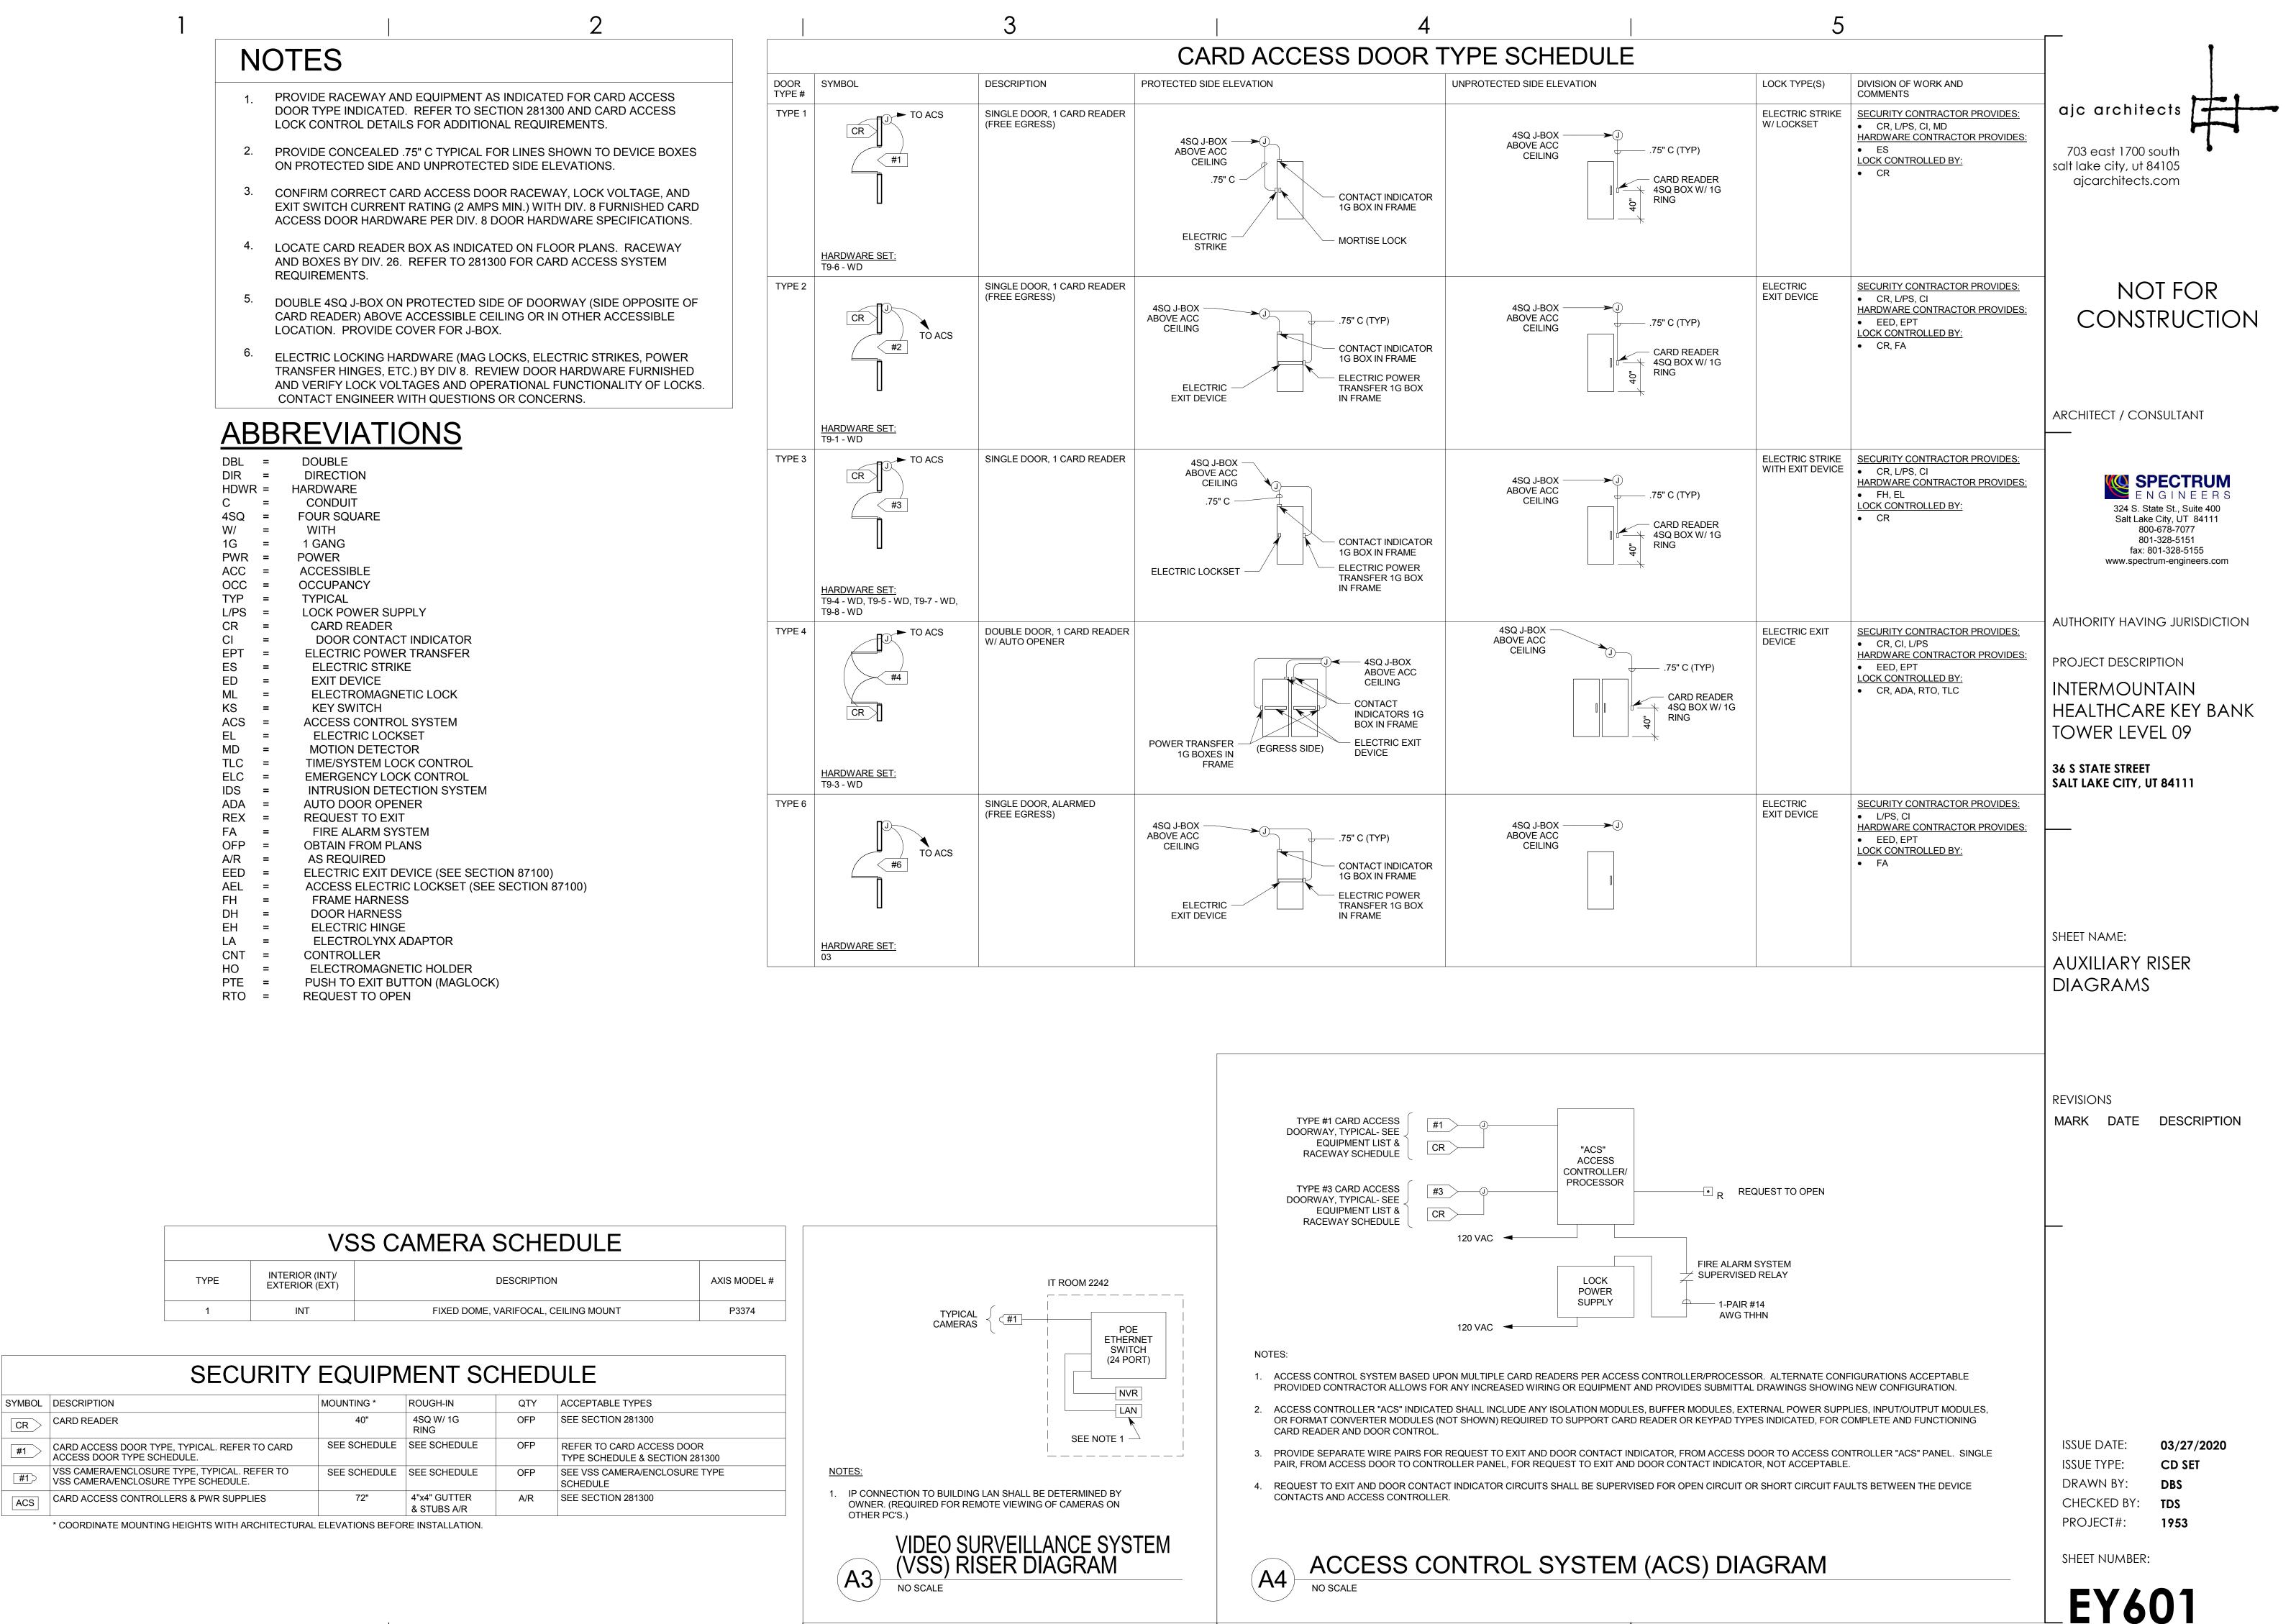
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AUDIO AND VIDEO SYSTEM EQUIPMENT LIST

THE ITEMS INDICATED BELOW SHALL NOT BE CONSTRUED AS A "BILL OF MATERIALS". THIS LIST IDENTIFIES ITEMS OF SIGNIFICANCE USED DURING THE DESIGN OF THE ELECTRONIC SYSTEMS INSTALLATION. WHERE THE ITEMS INDICATED ARE ONE PORTION OF AN ASSEMBLY, THE ENTIRE ASSEMBLY SHALL BE PROVIDED UNLESS SPECIFIED OTHERWISE. PROVIDE ALL MISCELLANEOUS HARDWARE AND SUPPORTS WHICH MAY NOT BE LISTED HERE. FOR A COMPLETE INSTALLATION. COMPARE CATALOG NUMBERS WITH DESCRIPTIONS AND NOTIFY ENGINEER OF DISCREPANCIES PRIOR TO BID. IF CATALOG NUMBERS DO NOT MATCH DESCRIPTIONS, THE DESCRIPTIONS TAKE PRECEDENCE. PROVIDE COMPLETE SUBMITTAL FOR APPROVAL PRIOR TO PURCHASING ANY EQUIPMENT OR CABLE. REFER TO SPECIFICATIONS FOR ADDITIONAL REQUIREMENTS.

SYMBOL	DESCRIPTION	QUANTITY	ACCEPTABLE TYPES
DTX	TWISTED PAIR DIGITAL VIDEO TRANSMITTER/ RECEIVER PAIR IN, W/ MOUNTING HARDWARE	OFP	CRESTRON HD-MD-400-C-E
UTX	TWISTED PAIR USB TRANSMITTER/ RECEIVER PAIR, W/ MOUNTING HARDWARE	OFP	VADDIO ICRON RAVEN 999-1005-032
CP2	CONNECTION PANELS #2, #3	OFP	EXTRON AAP PLATES, SEE DETAILS ON SHEET TA601
M40	FLAT PANEL DISPLAY, 49", LCD, MINIMUM 1080p	OFP	LG 49UT640S, OR AS APPROVED
M49	FIXED WALL MOUNT, LANDSCAPE	OFP	CHIEF MSTU W/ ALL NECESSARY ACCESSORIES, INCLUDING CAMERA SHELF
M55	FLAT PANEL DISPLAY, 55", LCD, MINIMUM 1080p	OFP	LG 55UT640S, OR AS APPROVED
IVIOO	FIXED WALL MOUNT, LANDSCAPE	OFP	CHIEF MSTU W/ ALL NECESSARY ACCESSORIES, INCLUDING CAMERA SHELF
H	WEB CONFERENCING SOUND BAR WITH INTEGRATED CAMERA	OFP	CRESTRON UC-SB1-CAM
CPU	SMALL FORMAT COMPUTER, OWNER FURNISHED AND INSTALLED	0	
	CONNECTORS, SEE NOTE 5	A/R	
	POWER SUPPLIES, MISC. TRANSFORMERS, SIGNAL SENSORS, PROTOCOL CONVERTERS, SEE NOTES 4, 7, 8	A/R	
	PATCH CORDS, SEE NOTE 6	A/R	
	ADAPTER CABLES, SEE NOTE 9	A/R	
	CABLE, SEE AUDIO-VIDEO SYSTEMS CABLE SCHEDULE	A/R	
	HDMI CONNECTOR SUPPORT BRACKETS	A/R	EXTRON LOCKIT
	NYLON BRAIDED EXPANDABLE SLEEVING	A/R	TECH FLEX FLEXO PET
TVSS	TRANSIENT VOLTAGE SURGE SUPPRESSOR AT MONITORS	OFP	SURGEX SA82 OR TRIPP LITE ISOBAR6
TVSS	TRANSIENT VOLTAGE SURGE SUPPRESSOR, 20 AMP, RACK MOUNT	OFP	TRIPP LITE IBAR12-20ULTRA

A/R = AS REQUIRED, OFP = OBTAIN FROM PLANS, OFCI = OWNER FURNISHED CONTRACTOR INSTALLED

AUDIO-VIDEO SYSTEMS CABLE SCHEDULE

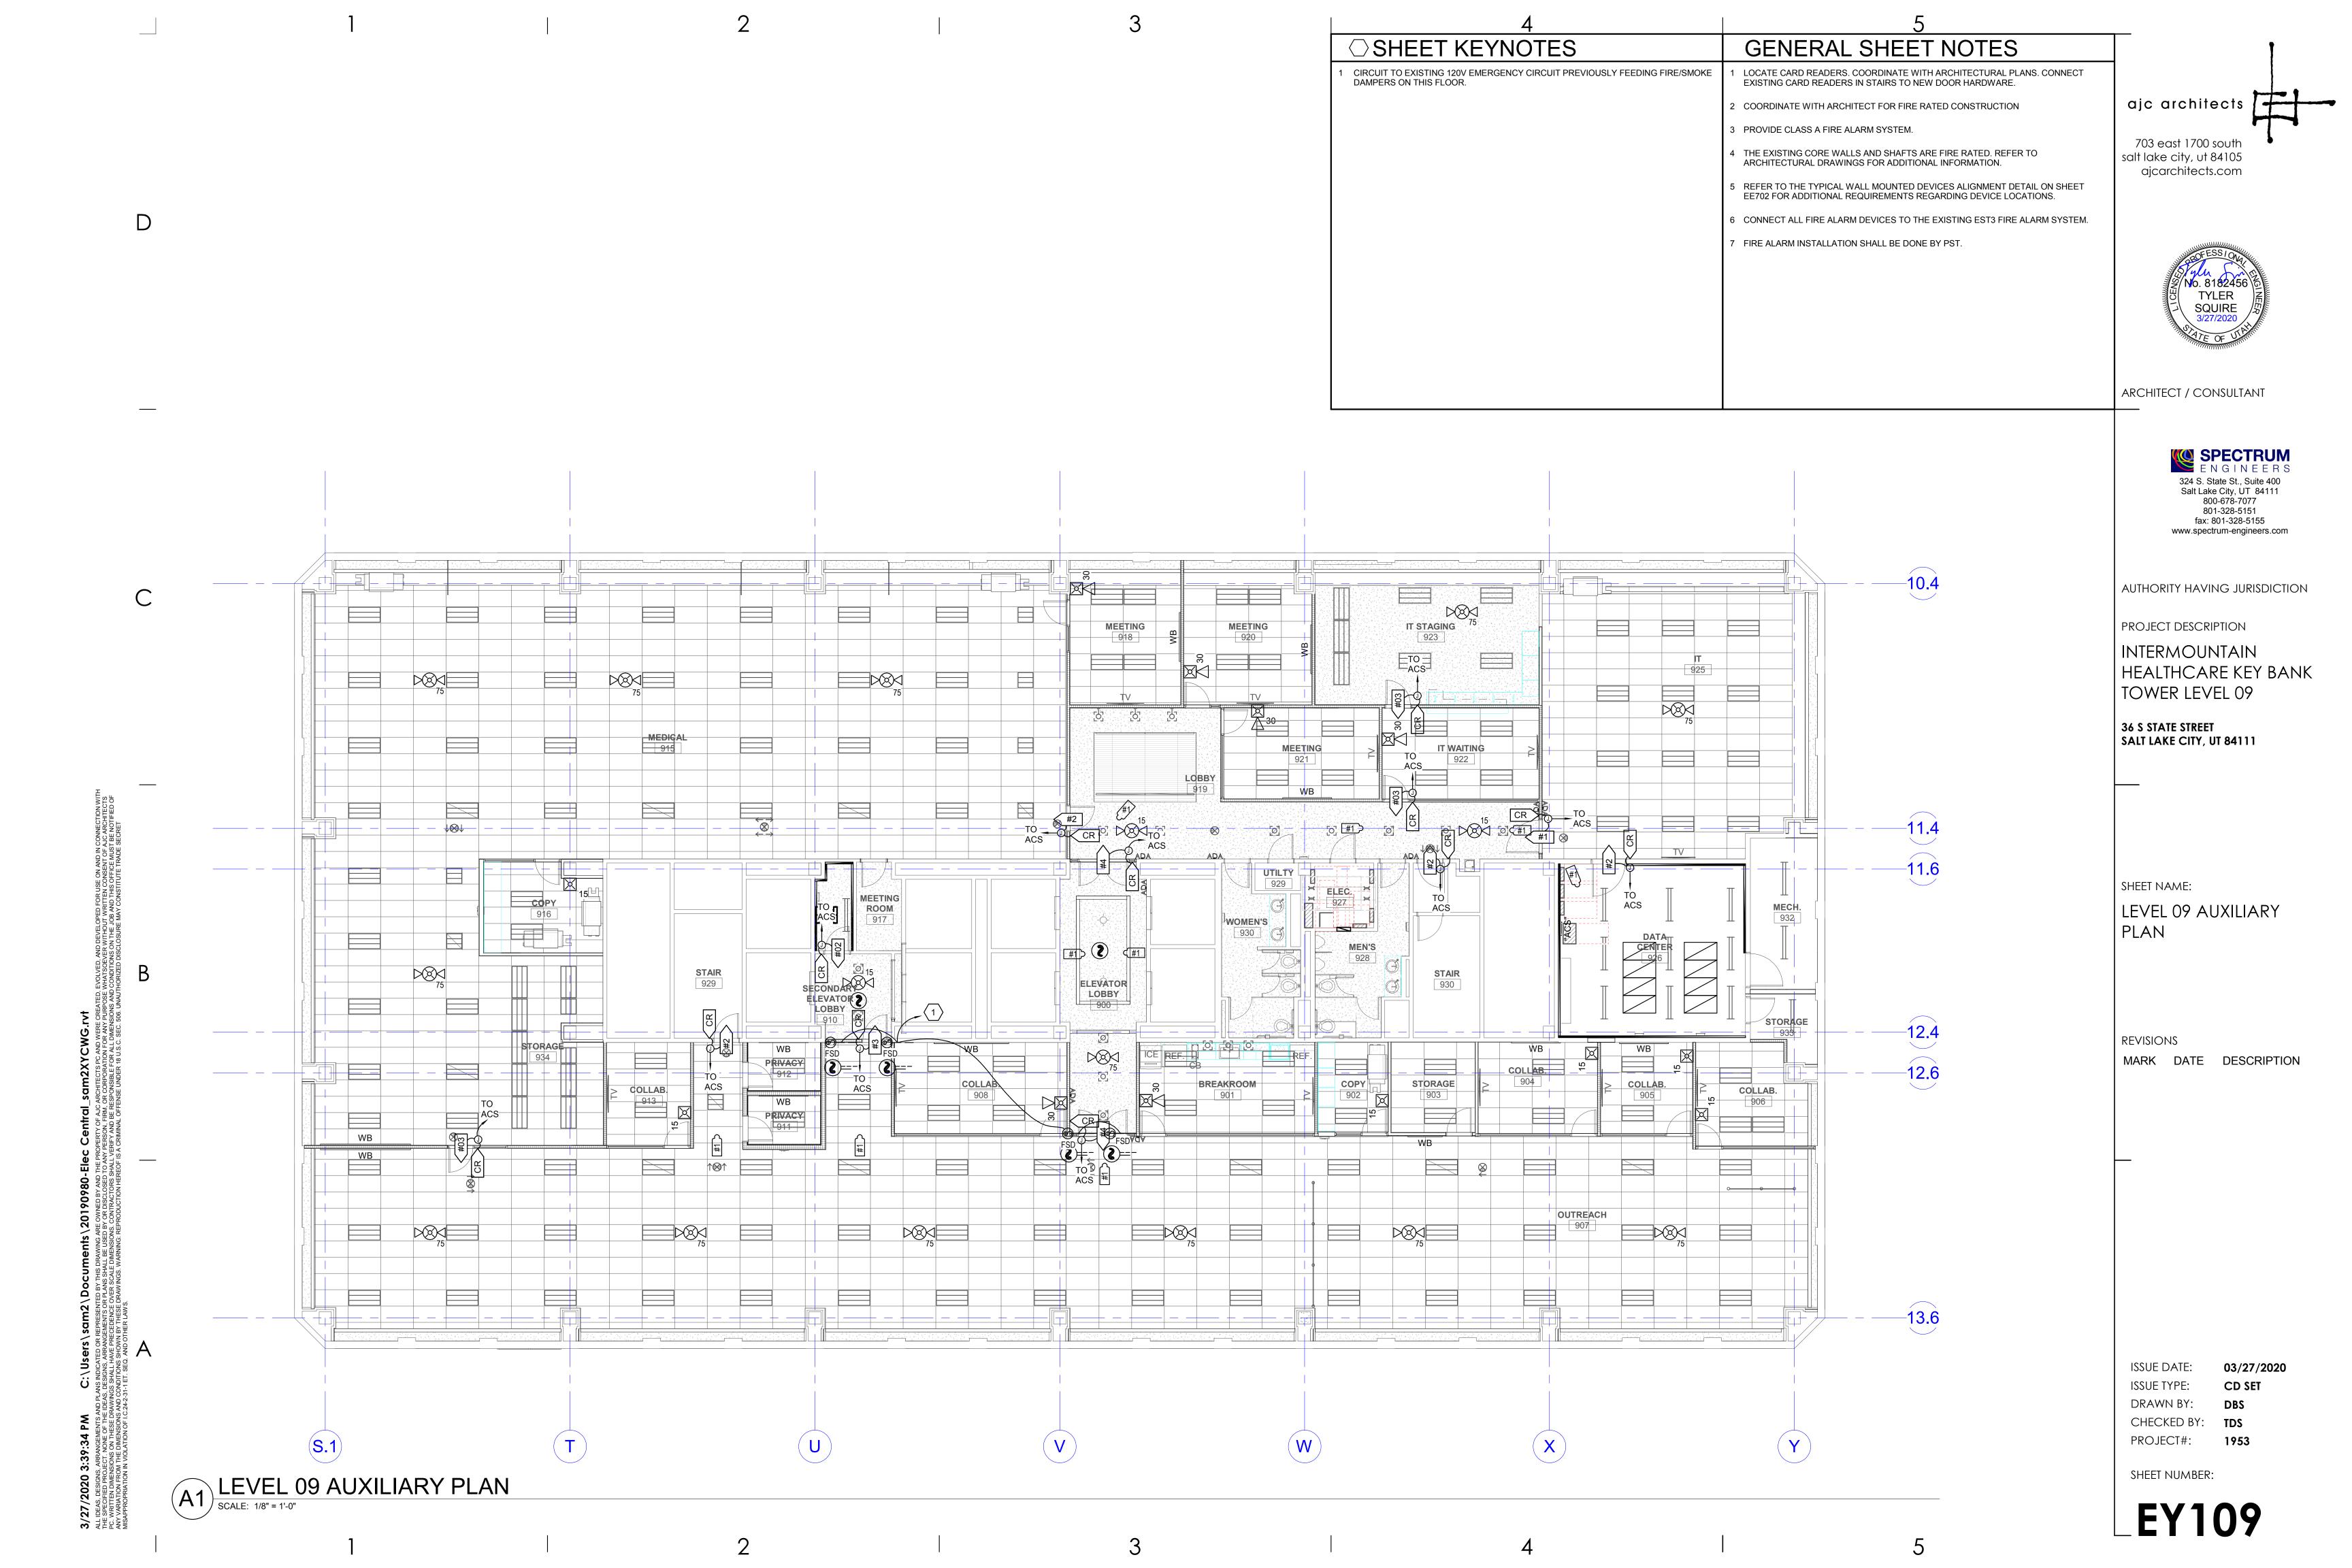CABLE TYPE	DESCRIPTION	ACCEPTABLE TYPES	SPECIAL INSTRUCTIONS
М	MICROPHONE CABLE, 22 AWG, SHIELDED, TWISTED PAIR W/ DRAIN	BELDEN 82761 LIBERTY 22-IP-CMP-EZ-WHY WEST PENN D25454	NOTE 19
L	LINE LEVEL CABLE, 22 AWG, SHIELDED, TWISTED PAIR W/ DRAIN	BELDEN 82761 LIBERTY 22-IP-CMP-EZ-WHY WEST PENN D25454	NOTE 19
S	SPEAKER CABLE, 70 V, 16 AWG, TWISTED PAIR	WEST PENN 25225 LIBERTY 16-2C-TTP	NOTE 19
С	CONTROL CABLE, 24 AWG, 4 PAIR, OVERALL SHIELD	BELDEN 88104 WEST PENN D252404	NOTE 19
D	DATA CABLE, CATEGORY 6	BELDEN 2400 SERIES WEST PENN 254246	NOTE 19
Р	DIGITAL VIDEO CABLE, TWISTED PAIR, SHIELDED	EXTRON XTP DTP 24	NOTE 19
Н	HDMI CABLE	KRAMER CP-AOCH/XL-XX	X=LENGTH NEEDED NOTE 19
U	USB CABLE	WEST PENN BELDEN	

AUDIO-VIDEO SYSTEM CABLE INSTALLATION REQUIREMENTS SCHEDULE

ORIGIN	DESTINATION	CABLE TYPE	QUANTITY	SPECIAL INSTRUCTIONS		
CP2	DISPLAY	Р	1			
CP3	DISPLAY	Р	2			
	ER	U	1			
		L	1			

CABLE INSTALLATION REQUIREMENTS APPLY TO EVERY DEVICE LOCATION SHOWN IN EVERY ROOM.

AV SYSTEMS SHEET INDEX

TM001 SOUND MASKING DETAILS, DIAGRAMS, NOTES, AND SCHEDULE TA001 AUDIO-VIDEO SYSTEMS EQUIPMENT LIST, SCHEDULES AND NOTES TA601 AUDIO-VIDEO SYSTEMS DETAILS AND DIAGRAMS

AUDIO-VIDEO SIGNAL TYPE ABBREVIATIONS SCHEDULE

ABBREVIATION	SIGNAL TYPE
AL	AUDIO, LEFT, (LINE LEVEL)
AR	AUDIO, RIGHT, (LINE LEVEL)
AA	ANALOG AUDIO
F	OPTICAL FIBER
V	VIDEO, COMPOSITE-STANDARD RESOLUTION ANALOG VIDEO
YC	S-VIDEO-STANDARD RESOLUTION ANALOG VIDEO
YUV	COMPONENT VIDEO-STANDARD RESOLUTION ANALOG VIDEO
RGBHV	RED, GREEN, BLUE, HORIZONTAL & VERTICAL SYNC-HIGH RESOLUTION ANALOG VIDEO
XGA/VGA	EXTENDED GRAPHICS ARRAY/VIDEO GRAPHICS ARRAY-HIGH RESOLUTION ANALOG VIDEO
DVI	DIGITAL VIDEO INTERFACE-HIGH RESOLUTION DIGITAL VIDEO
HDMI	HIGH DEFINITION MULTIMEDIA INTERFACE-HIGH RESOLUTION DIGITAL VIDEO
DP	DISPLAY PORT-HIGH RESOLUTION DIGITAL VIDEO
TP	TWISTED PAIR
IP	INTERNET PROTOCOL
SDI	SERIAL DIGITAL INTERFACE

DEFINITIONS

NOTE: ALL DEFINITIONS MAY NOT BE USED.

INDICATED: THE TERM "INDICATED" REFERS TO GRAPHIC REPRESENTATIONS. NOTES, OR SCHEDULES ON THE DRAWINGS, OTHER PARAGRAPHS OR SCHEDULES IN THE SPECIFICATIONS, AND SIMILAR REQUIREMENTS IN THE CONTRACT DOCUMENTS. WHERE TERMS SUCH AS "SHOWN", "NOTED", "SCHEDULED", AND "SPECIFIED" ARE USED, IT IS TO HELP THE READER LOCATE THE REFERENCE, NO LIMITATION ON LOCATION IS INTENDED.

DIRECTED: TERMS SUCH AS "DIRECTED", "REQUESTED", AUTHORIZED", "SELECTED", "APPROVED", "REQUIRED", AND "PERMITTED" MEAN "DIRECTED BY THE ENGINEER", "REQUESTED BY THE ENGINEER", AND SIMILAR PHRASES.

APPROVE: THE TERM "APPROVED", WHERE USED IN CONJUNCTION WITH THE ENGINEER'S ACTION ON THE CONTRACTOR'S SUBMITTALS, APPLICATIONS, AND REQUESTS, IS LIMITED TO THE ENGINEER'S DUTIES AND RESPONSIBILITIES AS STATED IN GENERAL AND SUPPLEMENTARY CONDITIONS.

FURNISH: THE TERM "FURNISH" IS USED TO MEAN "SUPPLY AND DELIVER TO THE PROJECT SITE, READY FOR UNLOADING, UNPACKING, ASSEMBLY, INSTALLATION, AND SIMILAR OPERATIONS."

INSTALL: THE TERM "INSTALL" IS USED TO DESCRIBE OPERATIONS AT PROJECT SITE INCLUDING THE ACTUAL "UNLOADING, UNPACKING, ASSEMBLY, ERECTION, PLACING, ANCHORING, APPLYING, WORKING TO DIMENSION, FINISHING, CURING, PROTECTING, CLEANING, AND SIMILAR OPERATIONS."

PROVIDE: THE TERM "PROVIDE" MEANS "TO FURNISH AND INSTALL, COMPLETE AND READY FOR THE INTENDED USE."

INSTALLER: AN "INSTALLER" IS THE CONTRACTOR OR AN ENTITY ENGAGED BY THE CONTRACTOR, EITHER AS AN EMPLOYEE, SUBCONTRACTOR, OR SUB-SUBCONTRACTOR, FOR PERFORMANCE OF A PARTICULAR CONSTRUCTION ACTIVITY, INCLUDING INSTALLATION, ERECTION, APPLICATION, AND SIMILAR OPERATIONS. INSTALLERS ARE REQUIRED TO BE EXPERIENCED IN THE OPERATIONS THEY ARE ENGAGED TO PERFORM.

TECHNOLOGY SYSTEMS: THE TERM "TECHNOLOGY SYSTEMS" IS USED TO DESCRIBE ALL LOW VOLTAGE SYSTEMS GENERALLY REFERRED TO AS "SPECIAL SYSTEMS". THESE SYSTEMS INCLUDE BUT ARE NOT NECESSARILY LIMITED TO ALL SYSTEMS WHICH UTILIZE VOLTAGES OF LESS THAN 71 VOLTS SUCH AS SOUND SYSTEMS, VIDEO SYSTEMS, TV SYSTEMS, SECURITY SYSTEMS, VOICE AND DATA CABLING SYSTEMS,

ABBREVIATIONS

NOTE: ALL ABBREVIATIONS MAY NOT BE USED.

"A"	AMP OR AMPS	"IG"	INSULATED GROUND
"ADJ"	ADJACENT	"IMC"	INTERMEDIATE METAL CND
"AFF"	ABOVE FINISHED FLOOR	"IN/IS"	INSULATED/ISOLATED
"AL"	ALUMINUM	"KVA"	KILO VOLT AMPERES
"C"	CONDUIT	"KW"	KILOWATTS
"CB","C/B"	CIRCUIT BREAKER	"LFMC"	LIQUID TIGHT FLEXIBLE
"CKT"	CIRCUIT		METAL CONDUIT
"CO"	CONVENIENCE OUTLET	"LFNC"	LIQUID TIGHT FLEXIBLE
"C.O.R."	CONTRACTING OFFICER'S		NONMETALLIC CONDUIT
	REPRESENTATIVE	"MCA"	MINIMUM CIRCUIT AMPS
"CU"	COPPER	"MLO"	MAIN LUGS ONLY
"EA"	EACH	"N.C."	NORMALLY CLOSED
"ELEC"	ELECTRICAL	"N.I.C."	NOT IN CONTRACT
"EM"	EMERGENCY	"N.O."	NORMALLY OPEN
"EMT"	ELECTRICAL METALLIC TUBING	"O.C."	ON CENTER
"ENT"	ELECTRICAL NONMETALLIC TUBING	"OCP"	OVER CURRENT PROTECTION
"EQUIP"	EQUIPMENT	"QTY"	QUANTITY
"EX"	EXISTING	"R"	REMOVE
"FA"	FIRE ALARM	"RMC"	RIGID METAL CONDUIT
"FACP"	FIRE ALARM CONTROL PANEL	"RNC"	RIGID NONMETALLIC CONDU
"FLA"	FULL LOAD AMPS	"RR"	REMOVE AND RELOCATE
"FMC"	FLEXIBLE METAL CONDUIT	"TYP"	TYPICAL
"F.O.B."	FREIGHT ON BOARD	"UF"	UNDER FLOOR
"GFI"	GROUND FAULT INTERRUPTER	"UG"	UNDER GROUND
"GR"	GROUND	"W/"	WITH
"HOA"	HAND-OFF-AUTO	"WP"	WEATHER PROOF
"HP"	HORSE POWER	"XFMR"	TRANSFORMER

GENERAL AUDIO-VIDEO SYSTEMS NOTES

- . CONDUCT AN RF FREQUENCY AUDIT OF THE SITE PRIOR TO SELECTION OF WIRELESS RF OPERATING FREQUENCIES. SELECT FREQUENCIES TO ASSURE INTERFERENCE FREE OPERATION. INSTALL ANTENNAS/TRANCEIVERS OUTSIDE OF THE EQUIPMENT RACK, AT AN ARCHITECT APPROVED LOCATION, WHERE THE BEST SYSTEM PERFORMANCE IS ACHIEVED.
- 2. FILL ALL UNUSED RACK SPACE WITH BLANK/VENT PANELS.
- 3. INSTALL/SUSPEND ALL EQUIPMENT IN COMPLIANCE WITH THE MANUFACTURERS WRITTEN INSTRUCTIONS, SEISMIC SPECIFICATION SECTION, AND INDUSTRY WIDE ACCEPTED RIGGING PRACTICES. SUPPORT EQUIPMENT WEIGHT FROM STRUCTURE ABOVE CEILINGS. DURING THE SUBMITTAL PROCESS, PROVIDE SHOP DRAWINGS WHICH DETAIL PROPOSED MOUNTING FOR ALL SUCH EQUIPMENT.
- 4. PROVIDE MANUFACTURER RECOMMENDED POWER SUPPLIES AND/OR TRANSFORMERS FOR ALL SPECIFIED EQUIPMENT.
- 5. FURNISH AND INSTALL ALL CABLE AND CONNECTORS REQUIRED FOR ALL AUDIO AND VIDEO SYSTEMS TO COMPLETE MANUFACTURER RECOMMENDED CABLE TO EQUIPMENT TERMINATION TO FORM A COMPLETE AND FULLY FUNCTIONAL SYSTEM AS SHOWN. SELECT CONNECTORS WHICH PASS FULL BANDWIDTH CAPABILITY OF SPECIFIED CABLE. PROVIDE CABLE TYPES AS IDENTIFIED IN THE AUDIO/VIDEO CABLE SCHEDULE.
- 6. PROVIDE PATCH CABLES TO FULLY INTERCONNECT ALL SPECIFIED AND/OR OWNER FURNISHED EQUIPMENT WITH THE SPECIFIED CONNECTION PANELS, SYSTEM INTERFACES, AND MISCELLANEOUS EQUIPMENT.
- 7. PROVIDE MANUFACTURER RECOMMENDED, AND INDUSTRY STANDARD, SIGNAL LEVELS AND COMMUNICATION PROTOCOLS THROUGHOUT ENTIRE SYSTEM REGARDLESS OF CABLE LENGTHS. PROVIDE ALL REQUIRED DISTRIBUTION AND PROCESSING EQUIPMENT, INCLUDING BUT NOT LIMITED TO SIGNAL DISTRIBUTION AMPLIFIERS, LINE AMPLIFIERS, LINE DRIVERS, EQUALIZING AMPLIFIERS, GROUND/HUM ISOLATORS, MATCHING/ISOLATION TRANSFORMERS, CONTROL BUS DEVICES, COMMUNICATIONS CONVERTERS. ETC..., WHETHER SHOWN IN THE SINGLE LINE DIAGRAMS OR NOT.
- 8. PROVIDE POWER, CURRENT, AND/OR SIGNAL SENSORS FOR ALL EQUIPMENT WHERE IT IS NECESSARY FOR CORRECT CONTROL SYSTEM OPERATION.
- 9. PROVIDE PRE-MANUFACTURED ADAPTER CABLES WHERE REQUIRED FOR MATING CABLE TO CONNECTORS. THESE WILL INCLUDE, BUT ARE NOT LIMITED TO, ADAPTERS WHICH MATE DVI OR DISPLAY PORT TO HDMI, STEREO AUDIO TO MONO AUDIO, CONNECTORS, AND OTHER SIMILAR TERMINATION AND MATING REQUIREMENTS.
- 10. PROVIDE RACK MOUNT KITS FOR ALL RACK MOUNTED EQUIPMENT. WHERE MANUFACTURERS DO NOT PROVIDE RACK MOUNT KITS, PROVIDE CUSTOM RACK MOUNT KITS AS SPECIFIED.
- 11. WHERE ANY CABLE IS INSTALLED IN A FASHION WHERE EXPOSED TO PUBLIC VIEW, INSTALL CABLE INSIDE THE SPECIFIED BRAIDED EXPANDABLE SLEEVING. EXAMPLES OF SUCH LOCATIONS INCLUDE, BUT ARE NOT LIMITED TO EQUIPMENT ITEMS ON LECTERNS AND CEILING MOUNTED PROJECTORS.
- 12. PROVIDE PERMANENT, MECHANICALLY PRODUCED LABELS ON ALL CABLES AT CONNECTORS AND TERMINATION POINTS.
- 13. CONTROL SPECIFIED DEVICES UTILIZING THE MOST SOPHISTICATED COMMUNICATIONS PROTOCOL AVAILABLE ON THE DEVICE TO BE CONTROLLED. ALWAYS USE RS-232 OR ETHERNET WHEN AVAILABLE.
- 14. COVER JUNCTION BOXES WITH NO SPECIFIED AV DEVICES WITH BLANK NYLON COVER PLATE. COLOR TO MATCH ELECTRICAL DEVICES.
- 15. PROVIDE THE SPECIFIED ETHERNET NETWORK SWITCHES IN ALL CONTROL SYSTEMS WHERE REQUIRED TO COMPLY WITH THE CONTROL SYSTEM SINGLE LINE DIAGRAMS SHOWN IN THE DRAWINGS, AND THE PROGRAMMING OUTLINE. CONNECT EVERY CONTROL SYSTEM PROCESSOR, TO THE OWNER'S ETHERNET NETWORK AND COMPLY WITH ALL PROGRAMING REQUIREMENTS.
- 16. CONNECT ALL SPECIFIED AV EQUIPMENT TO 120 VAC VIA A SPECIFIED TRANSIENT VOLTAGE SURGE SUPPRESSOR INCLUDING ALL MONITORS AND PROJECTORS.
- 17. SET EDID MINDERS FOR ALL EDID CAPABLE DEVICES TO A RESOLUTION DESIGNATED BY THE OWNER/DESIGNER DURING THE SYSTEM COMMISSIONING
- 18. SET ALL PLAYBACK DEVICES (DVD, TUNERS, ETC...) TO RGB COLOR SPACE.
- 19. PROVIDE THE PLENUM RATED EQUIVALENT CABLE IF CABLE IS INSTALLED IN
- 20. VERY CAREFULLY SUPPORT THE WEIGHT OF ALL HDMI CABLES CONNECTED TO RACK MOUNTED EQUIPMENT USING LOCKIT CABLE LACING BRACKETS AND RACK MOUNTED LACING BARS. PROFESSIONALLY DRESS, LACE, AND STRAIN RELIEF CABLES SO THAT NO WEIGHT FROM INDIVIDUAL HDMI CABLES IS TRANSFERRED TO INDIVIDUAL HDMI CONNECTORS.INSTALL THE SPECIFIED HDMI CABLE LACING BRACKETS ON ALL HDMI CONNECTORS IN COMPLIANCE WITH THE MANUFACTURER'S WRITTEN INSTRUCTIONS.
- 21. SEE "EJ" SHEETS FOR AUDIO-VIDEO ROUGH-IN AND DEVICE LOCATIONS.



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PROJECT DESCRIPTION

INTERMOUNTAIN HEALTHCARE KEY BANK TOWER LEVEL 09

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SHEET NAME:

AUDIO-VIDEO SYSTEMS EQUIPMENT LIST, SCHEDULES AND

REVISIONS

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