


**GENERAL SHEET NOTES**

**SHEET KEYNOTES**

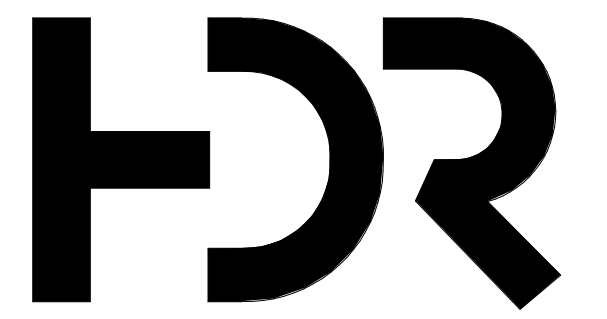

**NJRA Architects, Inc.**  
 5272 S. College Drive, Suite 104  
 Murray, Utah 84123  
 801.364.9259  
 www.njraarchitects.com

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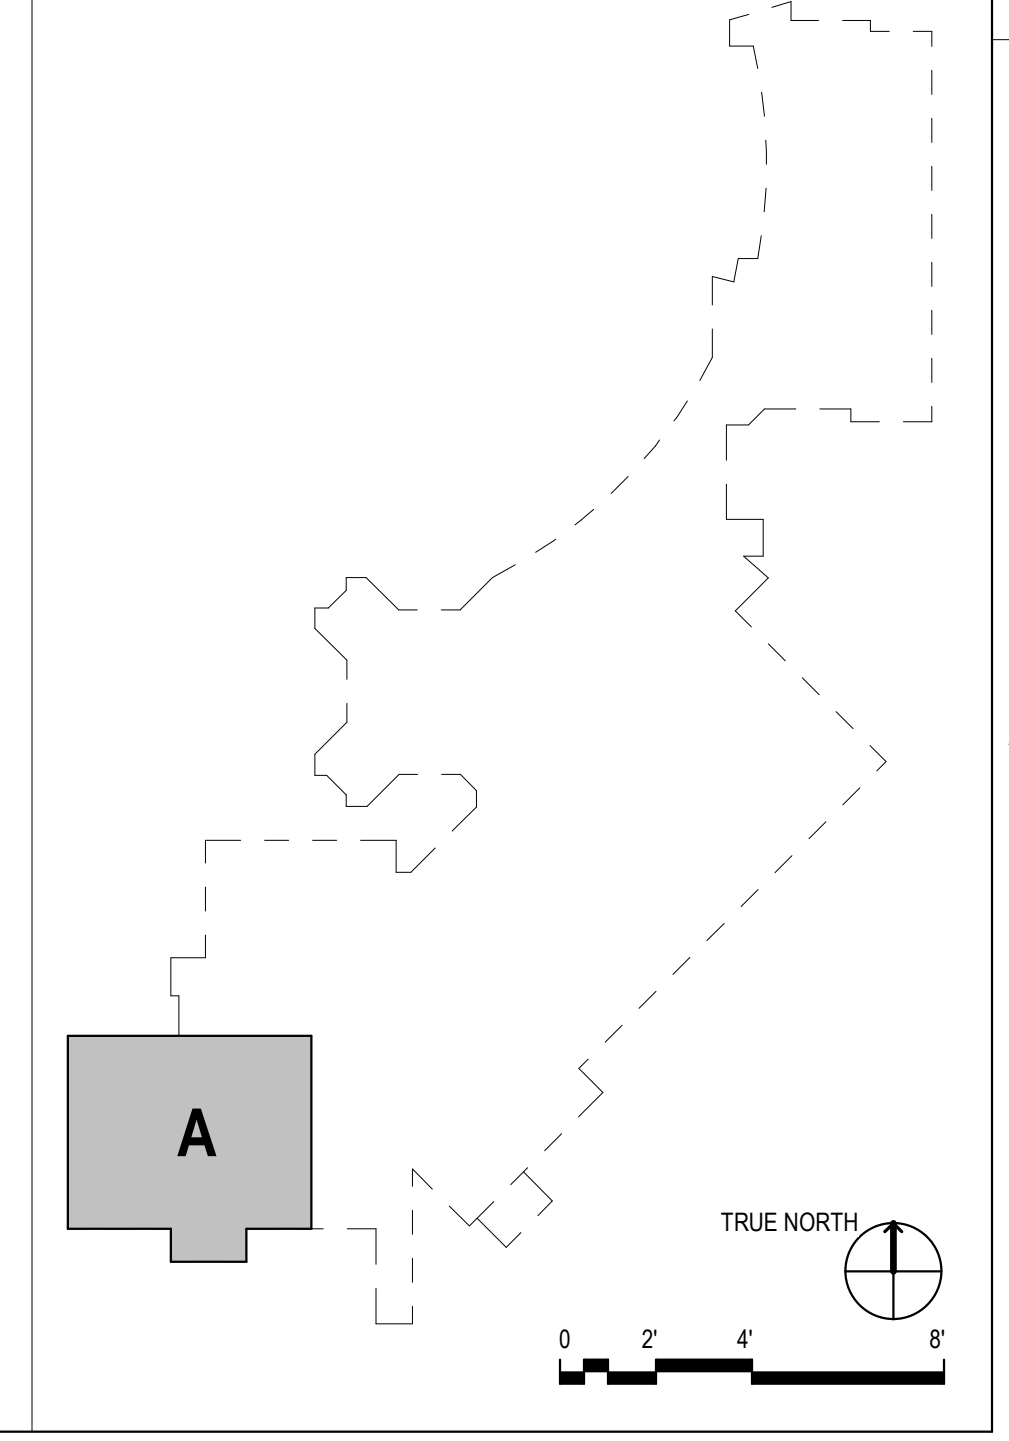
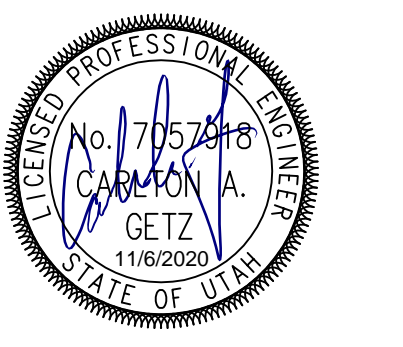
550 E 1400 N, Suite R  
 Logan, UT 84341



Project Manager	TERRI SDOBROOK
Project Designer	ERIC MEUB
Project Architect	FRANK PENROSE
Landscape Architect	ARCOSTO
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Interior Designer	RUBY THORP
Equipment Planner	ROBERT GRIESCHE
Wayfinding	

MARK	DATE	DESCRIPTION

Project Number 10173823  
 Original Issue 11/6/20



Sheet Name  
**LEVEL 4 AUXILIARY PLAN**

Sheet Number  
**EYA101**

Project Status  
 100% Construction Documents

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### HILL-ROM NURSE CALL SYMBOL LIST

SYMBOL	MANUF.	PART #	DESCRIPTION	BACKBOX	BOX MOUNTING HEIGHT
NCM	HILL-ROM	P2500NC1B00	STAFF CONSOLE, DESK MOUNT	STEEL CITY 58371 3/4R, RACO 561, OR ANY OTHER SINGLE GANG BACK BOX.	REFER TO ELEVATION DRAWINGS
NCM	HILL-ROM	P2594NC3A00	STAFF CONSOLE, WALL MOUNT	STEEL CITY 58371 3/4R, RACO 561, OR ANY OTHER SINGLE GANG BACK BOX.	REFER TO ELEVATION DRAWINGS
GA	HILL-ROM	P2594NC3B00	GRAPHICAL ANNUNCIATOR	STEEL CITY 58371 3/4R, RACO 561, OR ANY OTHER SINGLE GANG BACK BOX.	REFER TO ELEVATION DRAWINGS
BC	HILL-ROM	P2505NC1B00	AUDIO STATION BED CONNECTOR (ASBC)	GARVIN 52161-3/4, WITH GARVIN 52C13 RING, OR ANY OTHER 4" SQUARE 3.5" DEEP BACK BOX WITH SINGLE GANG MUD RING.	REFER TO ELEVATION DRAWINGS
EQ	HILL-ROM	P2516A01	EQUIPMENT RECEPTACLE	RACO 231, WITH RACO 778 RING, OR ANY OTHER 4" SQUARE 2.18" DEEP BACK BOX.	REFER TO ELEVATION DRAWINGS
DL	HILL-ROM	P2508NC1B00	ICONS LIGHT, SINGLE LED	RACO 231, WITH RACO 778 RING, OR ANY OTHER 4" SQUARE 2.18" DEEP BACK BOX.	REFER TO ELEVATION DRAWINGS
DL	HILL-ROM	P2508NCC8A00-D	ICONS LIGHT, LED ZONE LIGHT	STEEL CITY CYLE-3/4, RACO 581, OR ANY OTHER 3.5" DEEP SINGLE GANG BACK BOX.	REFER TO ELEVATION DRAWINGS
DL	HILL-ROM	P2508NCC8A00-7	ICONS LIGHT, LED ZONE LIGHT	STEEL CITY CYLE-3/4, RACO 581, OR ANY OTHER 3.5" DEEP SINGLE GANG BACK BOX.	REFER TO ELEVATION DRAWINGS
POE-24	HILL-ROM	P2519NCC1A24	POE SWITCH	RACO 561 BACK BOX, OR ANY OTHER 2.5" DEEP SINGLE GANG BACK BOX.	REFER TO ELEVATION DRAWINGS
SB	HILL-ROM	P2520A07	CODE BLUE PUSH BUTTON SWITCH	RACO 561 BACK BOX, OR ANY OTHER 2.5" DEEP SINGLE GANG BACK BOX.	REFER TO ELEVATION DRAWINGS
SE	HILL-ROM	P2520A08	STAFF EMERGENCY PUSH BUTTON SWITCH	RACO 561 BACK BOX, OR ANY OTHER 2.5" DEEP SINGLE GANG BACK BOX.	REFER TO ELEVATION DRAWINGS
S	HILL-ROM	P2520B01	BATH SWITCH, W/CANCEL, SUPERVISED	RACO 561 BACK BOX, OR ANY OTHER 2.5" DEEP SINGLE GANG BACK BOX.	REFER TO ELEVATION DRAWINGS
S	HILL-ROM	P2520B02	BATH SWITCH, W/O CANCEL, SUPERVISED	RACO 561 BACK BOX, OR ANY OTHER 2.5" DEEP SINGLE GANG BACK BOX.	REFER TO ELEVATION DRAWINGS
UPS, APC Rackmount Non-Seismic	HILL-ROM	P2521B02	UPS, RACK MOUNTABLE, 2U - NON-SEISMIC	STEEL CITY GW-225G, RACO 691 OR ANY OTHER 2.5" DEEP, TWO OR THREE GANG BACK BOX.	REFER TO ELEVATION DRAWINGS
CR	HILL-ROM	P2594NC1B01	STAFF STATION - STANDARD ROOM STATION W/O CODE	STEEL CITY GW-225G, RACO 691 OR ANY OTHER 2.5" DEEP, TWO OR THREE GANG BACK BOX.	REFER TO ELEVATION DRAWINGS
GR	HILL-ROM	P2594NCC2C00	GRAPHICAL ROOM STATION (GRS) - STAFF	STEEL CITY GW-225G, RACO 691 OR ANY OTHER 2.5" DEEP, TWO OR THREE GANG BACK BOX.	REFER TO ELEVATION DRAWINGS
GR	HILL-ROM	P2594NCC2C11	GRAPHICAL ROOM STATION (GRS) - PATIENT	STEEL CITY GW-225G, RACO 691 OR ANY OTHER 2.5" DEEP, TWO OR THREE GANG BACK BOX.	REFER TO ELEVATION DRAWINGS
RA	HILL-ROM	P2594NCC4A10	REMOTE AUDIO DEVICE	STEEL CITY GW-225G, RACO 691 OR ANY OTHER 2.5" DEEP, TWO OR THREE GANG BACK BOX.	REFER TO ELEVATION DRAWINGS
RCB	HILL-ROM	P2599NCC2A00	RCB2 ROOM CONTROL BOARD	STEEL CITY GW-225G, RACO 696 OR ANY OTHER 2.5" DEEP, TWO OR THREE GANG BACK BOX.	REFER TO ELEVATION DRAWINGS
RTLS-CLOSED	HILL-ROM	RTLS-CLOSED	RTLS - STAFF LOCATING LOCATION-CLOSED AREA	STEEL CITY GW-225G, RACO 691 OR ANY OTHER TWO GANG BACK BOX.	REFER TO ELEVATION DRAWINGS
RTLS-OPEN	HILL-ROM	RTLS-OPEN	RTLS - STAFF LOCATING LOCATION-GLASS/OPEN AREA	STEEL CITY GW-225G, RACO 691 OR ANY OTHER TWO GANG BACK BOX.	REFER TO ELEVATION DRAWINGS
RTLS-BAY	HILL-ROM	RTLS-BAY	RTLS - STAFF LOCATING LOCATION-BAY	STEEL CITY GW-225G, RACO 691 OR ANY OTHER TWO GANG BACK BOX.	REFER TO ELEVATION DRAWINGS
R	CURBELL	MAP985A	REMOTE ENTERTAINMENT STATION	STEEL CITY GW-225C, RACO 691 OR ANY OTHER TWO GANG BACK BOX.	REFER TO ELEVATION DRAWINGS

### TV DISTRIBUTION EQUIPMENT LIST

SYMBOL	DESCRIPTION	QTY	ACCEPTABLE TYPES
BP	MULTI-PORT SPLITTER	OFF	2-PORT BLONDER TONGUE SXRS-2 4-PORT BLONDER TONGUE SXRS-4 8-PORT BLONDER TONGUE SXRS-8
DA	BROADBAND AMPLIFIER	OFF	BLONDER TONGUE BIDA 75A-43P
WT	WALL TAP PLATE	OFF	BLONDER TONGUE VERSATAP SERIES MODEL V-1GF-FT W/ COVER PLATE
RF	RF TERMINATOR	A/R	75 OHM TERMINATOR
CO	COAXIAL CABLE, HORIZONTAL DROP	A/R	RG-6 (SEE SPECIFICATIONS)
TR	COAXIAL CABLE, TRUNK	A/R	RG-11 (SEE SPECIFICATIONS)

### NOTES


- PROVIDE RACEWAY AND EQUIPMENT AS INDICATED FOR CARD ACCESS DOOR TYPE INDICATED. REFER TO SECTION 281300 AND CARD ACCESS LOCK CONTROL DETAILS FOR ADDITIONAL REQUIREMENTS.
- PROVIDE CONCEALED .75" C TYPICAL FOR LINES SHOWN TO DEVICE BOXES ON PROTECTED SIDE AND UNPROTECTED SIDE ELEVATIONS.
- CONFIRM CORRECT CARD ACCESS DOOR RACEWAY, LOCK VOLTAGE, AND EXIT SWITCH CURRENT RATING (2 AMPS MIN.) WITH DIV. 8 FURNISHED CARD ACCESS DOOR HARDWARE PER DIV. 8 DOOR HARDWARE SPECIFICATIONS.
- LOCATE CARD READER BOX AS INDICATED ON FLOOR PLANS. RACEWAY AND BOXES BY DIV. 26. REFER TO 281300 FOR CARD ACCESS SYSTEM REQUIREMENTS.
- DOUBLE 4SQ J-BOX ON PROTECTED SIDE OF DOORWAY (SIDE OPPOSITE OF CARD READER) ABOVE ACCESSIBLE CEILING OR IN OTHER ACCESSIBLE LOCATION. PROVIDE COVER FOR J-BOX.
- ELECTRIC LOCKING HARDWARE (MAG LOCKS, ELECTRIC STRIKES, POWER TRANSFER HINGES, ETC.) BY DIV. 8. REVIEW DOOR HARDWARE FURNISHED AND VERIFY LOCK VOLTAGES AND OPERATIONAL FUNCTIONALITY OF LOCKS. CONTACT ENGINEER WITH QUESTIONS OR CONCERNS.

### ABBREVIATIONS

DBL = DOUBLE  
DIR = DIRECTION  
HW = HARDWARE  
C = CONDUIT  
4SQ = FOUR SQUARE  
W/ = WITH  
1G = 1 GANG  
PWR = POWER  
ACC = ACCESSIBLE  
OCC = OCCUPANCY  
TYP = TYPICAL  
LPS = LOCK POWER SUPPLY  
CR = CARD READER  
CI = DOOR CONTACT INDICATOR  
EPT = ELECTRIC POWER TRANSFER  
ES = ELECTRIC STRIKE  
ED = EXIT DEVICE  
ML = ELECTROMAGNETIC LOCK  
KS = KEY SWITCH  
ACS = ACCESS CONTROL SYSTEM  
EL = ELECTRIC LOCKSET  
MD = MOTION DETECTOR  
TLC = TIME SYSTEM LOCK CONTROL  
ELC = EMERGENCY LOCK CONTROL  
EMC = ELECTROMAGNETIC CLOSER  
IDS = INTRUSION DETECTION SYSTEM  
ADA = AUTO DOOR OPENER  
REX = REQUEST TO EXIT  
RL = REMOTE OPEN SWITCH  
FA = FIRE ALARM SYSTEM  
OPF = OBTAIN FROM PLANS  
AIR = AS REQUIRED  
EED = ELECTRIC EXIT DEVICE (SEE SECTION 87100)  
AEL = ACCESS ELECTRIC LOCKSET (SEE SECTION 87100)  
FH = FRAME HARNESS  
DH = DOOR HARNESS  
EH = ELECTRIC HINGE  
LA = ELECTROLINX ADAPTOR  
CNT = CONTROLLER  
HO = ELECTROMAGNETIC HOLDER  
HC = WAVE-TO-OPEN WALL SWITCH

### CARD ACCESS DOOR TYPE SCHEDULE

DOOR TYPE #	SYMBOL	DESCRIPTION	PROTECTED SIDE ELEVATION	UNPROTECTED SIDE ELEVATION	LOCK TYPE(S)	DIVISION OF WORK AND COMMENTS
TYPE 1		DOUBLE DOOR, 1 CARD READER, 1 HAND WAVE, MAGNETIC LOCKS, FREE EGRESS ONE LEAF			MAGNETIC LOCK	SECURITY CONTRACTOR PROVIDES: • CR HARDWARE CONTRACTOR PROVIDES: • FH, DH, LPS, EED, HC LOCK CONTROLLED BY: • CR, HC
TYPE 2		SINGLE DOOR, CARD READER, NORMALLY LOCKED			EXIT DEVICE	SECURITY CONTRACTOR PROVIDES: LPS, ED HARDWARE CONTRACTOR PROVIDES: • FH, DH, CR LOCK CONTROLLED BY: • CR
TYPE 3		SINGLE DOOR, 1 CARD READER, ELECTRIC STRIKE, 1 HAND WAVE, NORMALLY LOCKED			ELECTRIC STRIKE	SECURITY CONTRACTOR PROVIDES: • CR, LPS HARDWARE CONTRACTOR PROVIDES: • EPT, ES, ADA, HC, HC LOCK CONTROLLED BY: • CR, HC
TYPE 4		SINGLE DOOR, 1 CARD READER, ELECTRIC STRIKE, 1 HAND WAVE, 2 RELEASE BUTTONS, NORMALLY LOCKED			ELECTRIC STRIKE	SECURITY CONTRACTOR PROVIDES: • CR, LPS HARDWARE CONTRACTOR PROVIDES: • ES, ADA, HC, RL LOCK CONTROLLED BY: • CR, HC, RL
TYPE 5		SINGLE DOOR, CARD READER, NORMALLY LOCKED, ELECTROMECHANICAL CLOSER, FAIL SAFE DISCONNECT ON FIRE ALARM			ELEC CLOSER	SECURITY CONTRACTOR PROVIDES: • LPS, ED HARDWARE CONTRACTOR PROVIDES: • FH, DH, CR, EMC LOCK CONTROLLED BY: • CR
TYPE 6		SINGLE DOOR, ELECTRIC STRIKE, 2 HAND WAVES			ELECTRIC STRIKE	SECURITY CONTRACTOR PROVIDES: • NONE HARDWARE CONTRACTOR PROVIDES: • ES, ADA, HC LOCK CONTROLLED BY: • HC
TYPE 7		DOUBLE DOOR, ELECTRIC STRIKE, 2 HAND WAVES			ELECTRIC STRIKE	SECURITY CONTRACTOR PROVIDES: • NONE HARDWARE CONTRACTOR PROVIDES: • EPT, ES, ADA, HC, DH, FH LOCK CONTROLLED BY: • HC
TYPE 8		1 CARD READER, ELECTRIC STRIKE			ELECTRIC STRIKE	SECURITY CONTRACTOR PROVIDES: • CR HARDWARE CONTRACTOR PROVIDES: • ES LOCK CONTROLLED BY: • CR

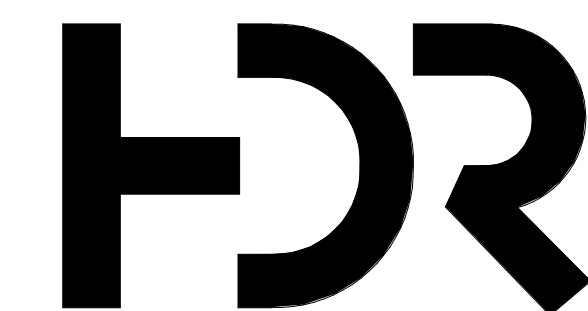

**NJR Architects, Inc.**  
5272 S. College Drive, Suite 104  
Murray, Utah 84123  
801.364.9259  
www.njrarchitects.com

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550 E 1400 N, Suite R  
Logan, UT 84341




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**Project Designer** ERIC MEUB  
**Project Architect** FRANK PENROSE  
**Landscape Architect** ARCSITTO  
**Civil Engineer** GREAT BASIN  
**Structural Engineer** REAVELEY  
**Mechanical Engineer** VAN BOERUM & FRANK  
**Electrical Engineer** SPECTRUM  
**Plumbing Engineer** VAN BOERUM & FRANK  
**Interior Designer** RUBY THORP  
**Equipment Planner** ROBERT GRIESCHE  
**Wayfinding**

**Sheet Reviewer** | Author

**MARK DATE DESCRIPTION**

**Project Number** 10173823  
**Original Issue** 11/6/20

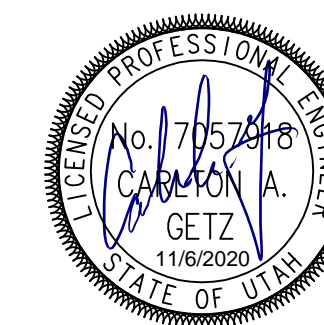

**Sheet Name**


**AUXILIARY SCHEDULES**

**Sheet Number**

**EYA601**

**Project Status**


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**GENERAL SHEET NOTES**

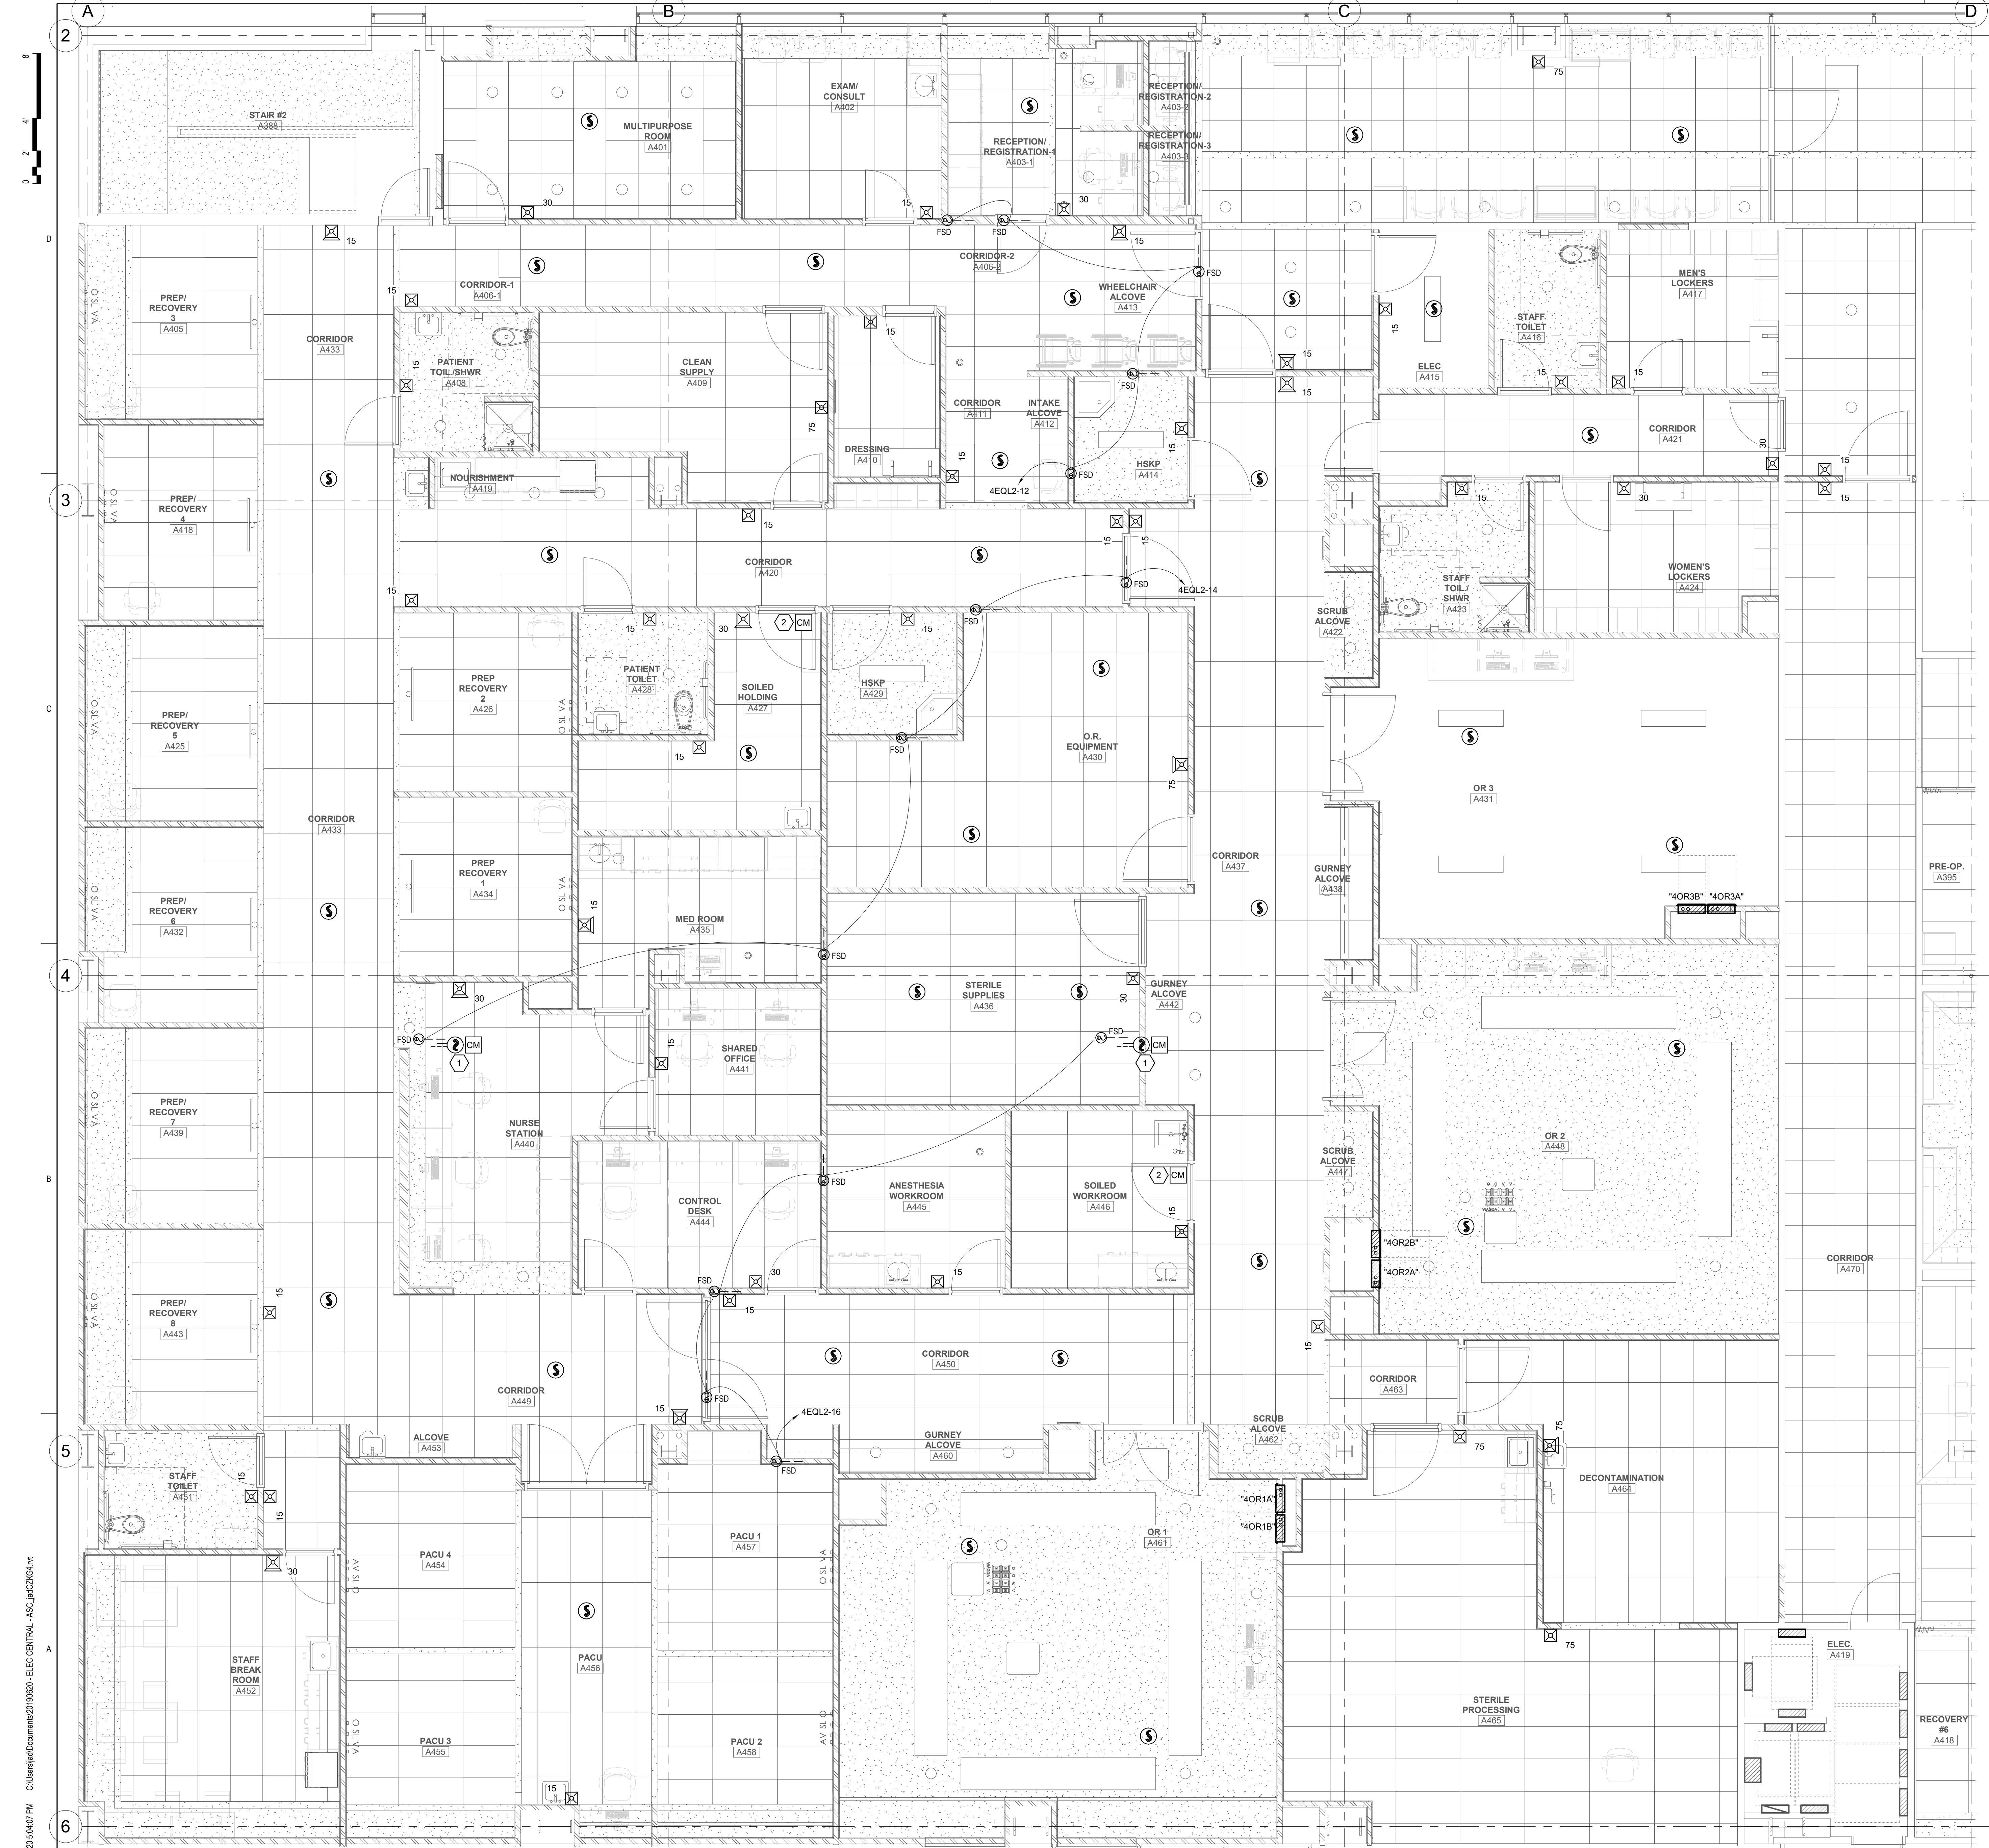**SHEET KEYNOTES**

- 1 PROVIDE DUCT SMOKE DETECTOR FOR ROOFTOP AHU. PROVIDE WITH CONTROL MODULE FOR AHU SHUT OFF.
- 2 PROVIDE CONTROL MODULE AND CONNECTION TO SAFE ZONE DOOR CLOSER. SEE POWER PLAN FOR POWER CONNECTION.



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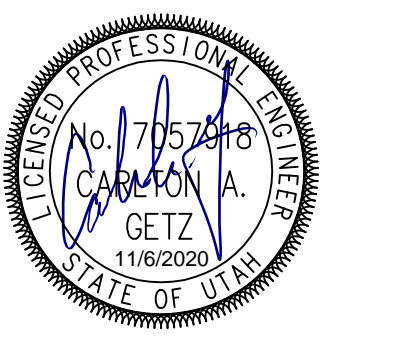
550 E 1400 N, Suite R  
 Logan, UT 84341

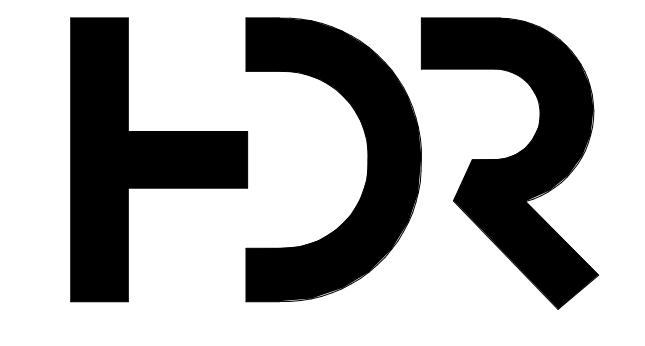

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<b>Interior Designer</b>	RUBY THORP
<b>Equipment Planner</b>	ROBERT GRIESCHE
<b>Wayfinding</b>	

<b>MARK</b>	<b>DATE</b>	<b>DESCRIPTION</b>


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Sheet Name  
**LEVEL 4 FIRE ALARM PLAN**

Sheet Number  
**FAA101**

Project Status  
 100% Construction Documents



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**A5 LEVEL 4 FIRE ALARM PLAN**  
 SCALE: 1/4" = 1'-0"

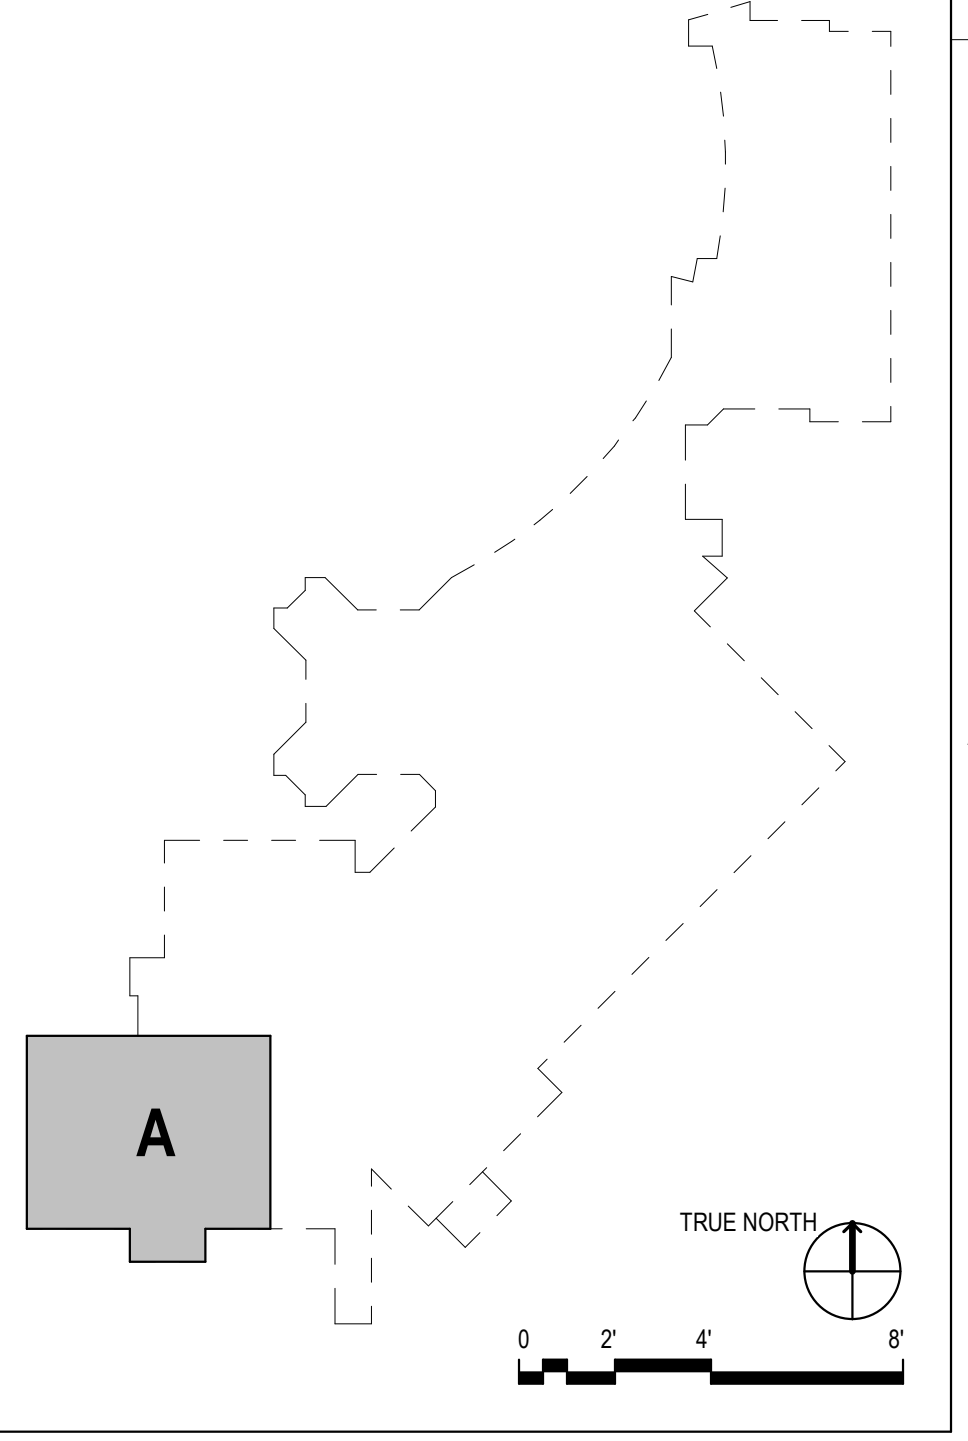
WIRING SCHEDULE				
FUNCTION	< 500'	< 1000'	1000'-3000'	> 3000'
ADDRESSABLE LOOP	#16 TSP	#18 TSP	#16 TSP	#14 TSP
POWER LOOP	#14 THWN	#14 THWN	#12 THWN	#10 THWN
SPARE LOOP	#14 THWN	#14 THWN	#12 THWN	#10 THWN
STROBE HORNS	#14 THWN	#14 THWN	#12 THWN	#10 THWN
MAGNETIC DOOR HOLDER	#12 THWN	#10 THWN		
SPEAKERS	#16 TSP	#16 TSP	#14 TSP	#14 TSP

NOTIFICATION SCHEDULE				
SYMBOL	STROBE SIZE	COVERAGE	AVERAGE CURRENT	MAXIMUM PER CIRCUIT ALONE
	15 CD	20'x20'	.085A	17
	30 CD	30'x30'	.135A	11
	75 CD	40'x40'	.200A	7
	110 CD	50'x50'	.225A	6

FIRE ALARM INPUT/OUTPUT MATRIX		OUTPUT DEVICES														NOTES
		GENERAL ALARM	DOOR HOLDER/CLOSERS	ELEVATOR RECALL MAIN LEVEL	ELEVATOR RECALL ALTERNATE LEVEL	FAN SHUTDOWN	FIRE DAMPER	MAIN LEVEL ELEVATOR DOORS HOLD OPENS	2ND LEVEL ELEVATOR DOORS HOLD OPENS	3RD LEVEL ELEVATOR DOORS HOLD OPENS	4TH LEVEL ELEVATOR DOORS HOLD OPENS	5TH LEVEL ELEVATOR DOORS HOLD OPENS	ELEVATOR SHUNT TRIP			
ZONE																
1	MAIN FLOW	o														
2	MAIN TAMPER															
3	MAIN LEVEL FLOW															
4	MAIN LEVEL TAMPER															
5	2ND LEVEL FLOW															
6	2ND LEVEL TAMPER															
7	3RD LEVEL FLOW															
8	3RD LEVEL TAMPER															
9	4TH LEVEL FLOW															
10	4TH LEVEL TAMPER															
11	5TH LEVEL FLOW															
12	5TH LEVEL TAMPER															
13	PENTHOUSE FLOW															
14	PENTHOUSE TAMPER															
15	MAIN LEVEL INITIATING LOOP															
16	MAIN LEVEL ELEVATOR DETECTOR															
17	MAIN LEVEL DUCT DETECTOR															
18	2ND LEVEL INITIATING LOOP															
19	2ND LEVEL ELEVATOR DETECTOR															
20	2ND LEVEL DUCT DETECTOR															
21	3RD LEVEL INITIATING LOOP															
22	3RD LEVEL ELEVATOR DETECTOR															
23	3RD LEVEL DUCT DETECTOR															
24	4TH LEVEL INITIATING LOOP															
25	4TH LEVEL ELEVATOR DETECTOR															
26	4TH LEVEL DUCT DETECTOR															
27	5TH LEVEL INITIATING LOOP															
28	5TH LEVEL ELEVATOR DETECTOR															
29	5TH LEVEL DUCT DETECTOR															
30	PENTHOUSE LEVEL INITIATING LOOP															
31	PENTHOUSE LEVEL ELEVATOR DETECTOR															
32	PENTHOUSE LEVEL DUCT DETECTOR															
33	FIRE PUMP PUMP RUNNING															
34	FIRE PUMP LOSS OF POWER															
35	FIRE PUMP PHASE REVERSAL															
36	ELEVATOR SPRINKLER HEAT DETECTORS															

GENERAL SHEET NOTES

- PLANS ARE BASED UPON 99 MONITOR AND CONTROL DEVICES PER ADDRESSABLE LOOP. OTHER CONFIGURATIONS ARE ACCEPTABLE SUBJECT TO CONTRACTOR ALLOWING FOR INCREASED WIRING REQUIREMENTS AND SUBMITTAL DRAWINGS SHOWING NEW WIRING CONFIGURATION. MAXIMUM INITIAL DEVICES PER LOOP SHALL NOT EXCEED 75% MAXIMUM ALLOWABLE.
- PLANS ARE BASED UPON THE WIRING SCHEDULE SHOWN. WHERE MANUFACTURERS REQUIREMENTS EXCEED REQUIREMENTS SHOWN, INCLUDE ADDITIONAL ASSOCIATED COSTS AND SUBMITTAL DRAWINGS INDICATING NEW WIRING CONFIGURATION.
- PLANS ARE BASED UPON 2 AMPS AT 24 VDC, NOT TO EXCEED 75% (1.50 AMPS AVAILABLE). POWER SUPPLY CAPACITY PER NOTIFICATION CIRCUIT. NOTIFICATION DEVICE LOADS ARE BASED UPON NOTIFICATION DEVICE SCHEDULE SHOWN. INCLUDE ADDITIONAL ASSOCIATED COSTS FOR INCREASED WIRING AND POWER SUPPLY CAPACITY IF LOADS OF ACTUAL DEVICES PROVIDED EXCEED CIRCUIT CAPACITY, OR IF LOAD OUTPUT OF ACTUAL POWER SUPPLIES PROVIDED IS SIZED DIFFERENTLY. PROVIDE SUBMITTAL DRAWINGS SHOWING NEW WIRING CONFIGURATION.
- FLOW AND TAMPER CONFIGURATION BASED UPON FIRE SPRINKLER DESIGN CONCEPT. FIELD VERIFY ACTUAL REQUIREMENTS. INCLUDE ANY ADDITIONAL MONITOR MODULES REQUIRED BY ACTUAL DESIGN REQUIREMENTS.
- HEAT DETECTORS WHEN INSTALLED IN ELEVATOR SHAFTS OR MECHANICAL ROOMS FOR ELEVATOR SHUT DOWN SHALL HAVE HEAT DETECTOR WITH LOWER RESPONSE TIME INDEX THAN SPRINKLER HEAD.
- PROVIDE POWER SUPPLY CAPACITY AS REQUIRED FOR DOOR HOLD OPENS SHOWN.
- BATTERY CAPACITY TO BE ADEQUATE TO OPERATE 15 MINUTES AFTER 24 HOURS PLUS 25% SPARE CAPACITY.
- VFD REQUIRES TWO RELAYS, ONE FOR SMOKE CONTROL, ONE SPARE.
- RUN SPARE LOOPS IN SAME CONDUIT. DO NOT EXCEED 40% AREA FILL OF CONDUITS.
- PROVIDE DUCT DETECTORS FOR SUPPLY AND RETURN AIR SYSTEMS OVER 2000 CFM. INSTALL DUCT DETECTORS PER NFPA 72 REQUIREMENTS AND PROVIDE ADDITIONAL DUCT DETECTORS DEPENDING UPON FINAL DUCT ARRANGEMENT.
- PROVIDE DUCT DETECTOR AT EACH FLOOR, PRIOR TO CONNECTION TO A COMMON RETURN AND PRIOR TO RECIRCULATING OR FRESH AIR INLET IN AIR RETURN SYSTEMS OVER 15,000 CFM CAPACITY AND SERVING MORE THAN ONE STORY.
- PROVIDE MANUAL PULL STATIONS IN BOILER ROOMS AND KITCHENS.
- PROVIDE ONE YEAR OFF SITE MONITORING INCLUDING ALL INTERFACE DEVICES AND MONITORING CHARGES. COORDINATE WITH BUILDING OWNER'S OFF-SITE MONITORING COMPANY.
- LOCATE SMOKE DETECTORS MINIMUM 3' FROM AIR SUPPLY AND RETURN LOUVERS.
- PROVIDE SYNCHRONIZED STROBES THROUGHOUT FACILITY. PROVIDE SYNCHRONIZATION MODULES PER MANUFACTURER'S REQUIREMENTS. INCLUDE ADDITIONAL WIRING, IF REQUIRED.
- INITIATING AND INDICATING LOOPS SHALL NOT SERVE AN AREA OF GREATER THAN 22,500 SQUARE FEET. PROVIDE ADDITIONAL LOOPS FOR AREAS LARGER THAN THIS.
- ALL OUTPUT DEVICES ARE DESIGNED ON SYSTEMS WITH 2 AMP POWER SUPPLY.
- HORN/STROBE BASED ON 120 MILLIAMPS, DOOR HOLDERS BASED ON 70 MILLIAMPS.
- INSTALL DUCT DETECTORS PER NFPA 72 REQUIREMENTS AND PROVIDE ADDITIONAL DUCT DETECTORS DEPENDING UPON FINAL DUCT ARRANGEMENT.

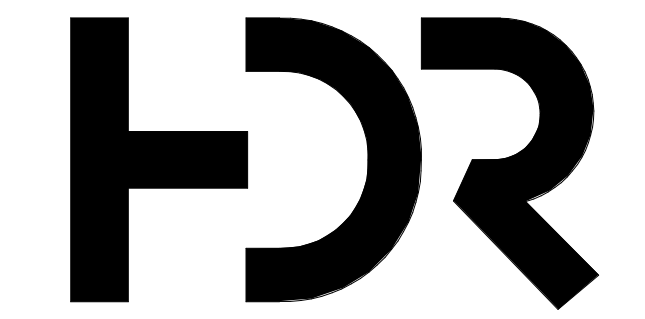

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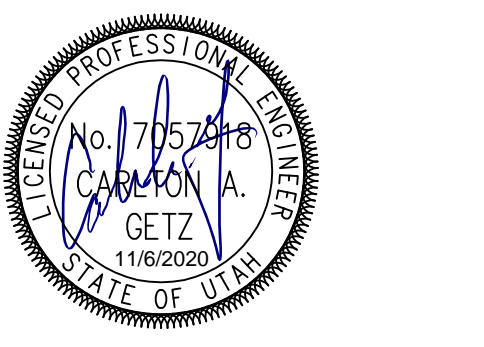


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Sheet Reviewer | Author

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Sheet Name  
FIRE ALARM RISER

Sheet Number  
FAA601

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100% Construction Documents