

REVISION NO.	DESCRIPTION	DATE

HKS PROJECT NUMBER
24805.000

DATE
09/13/2021

ISSUE
CONSTRUCTION DOCUMENTS

SHEET TITLE
FINISH PLAN / ROOF PLAN / INFORMATION


SHEET NO.
A3.51




03 ROOF PIC 1
1/4" = 1'-0"



04 ROOF PIC 2
1/4" = 1'-0"

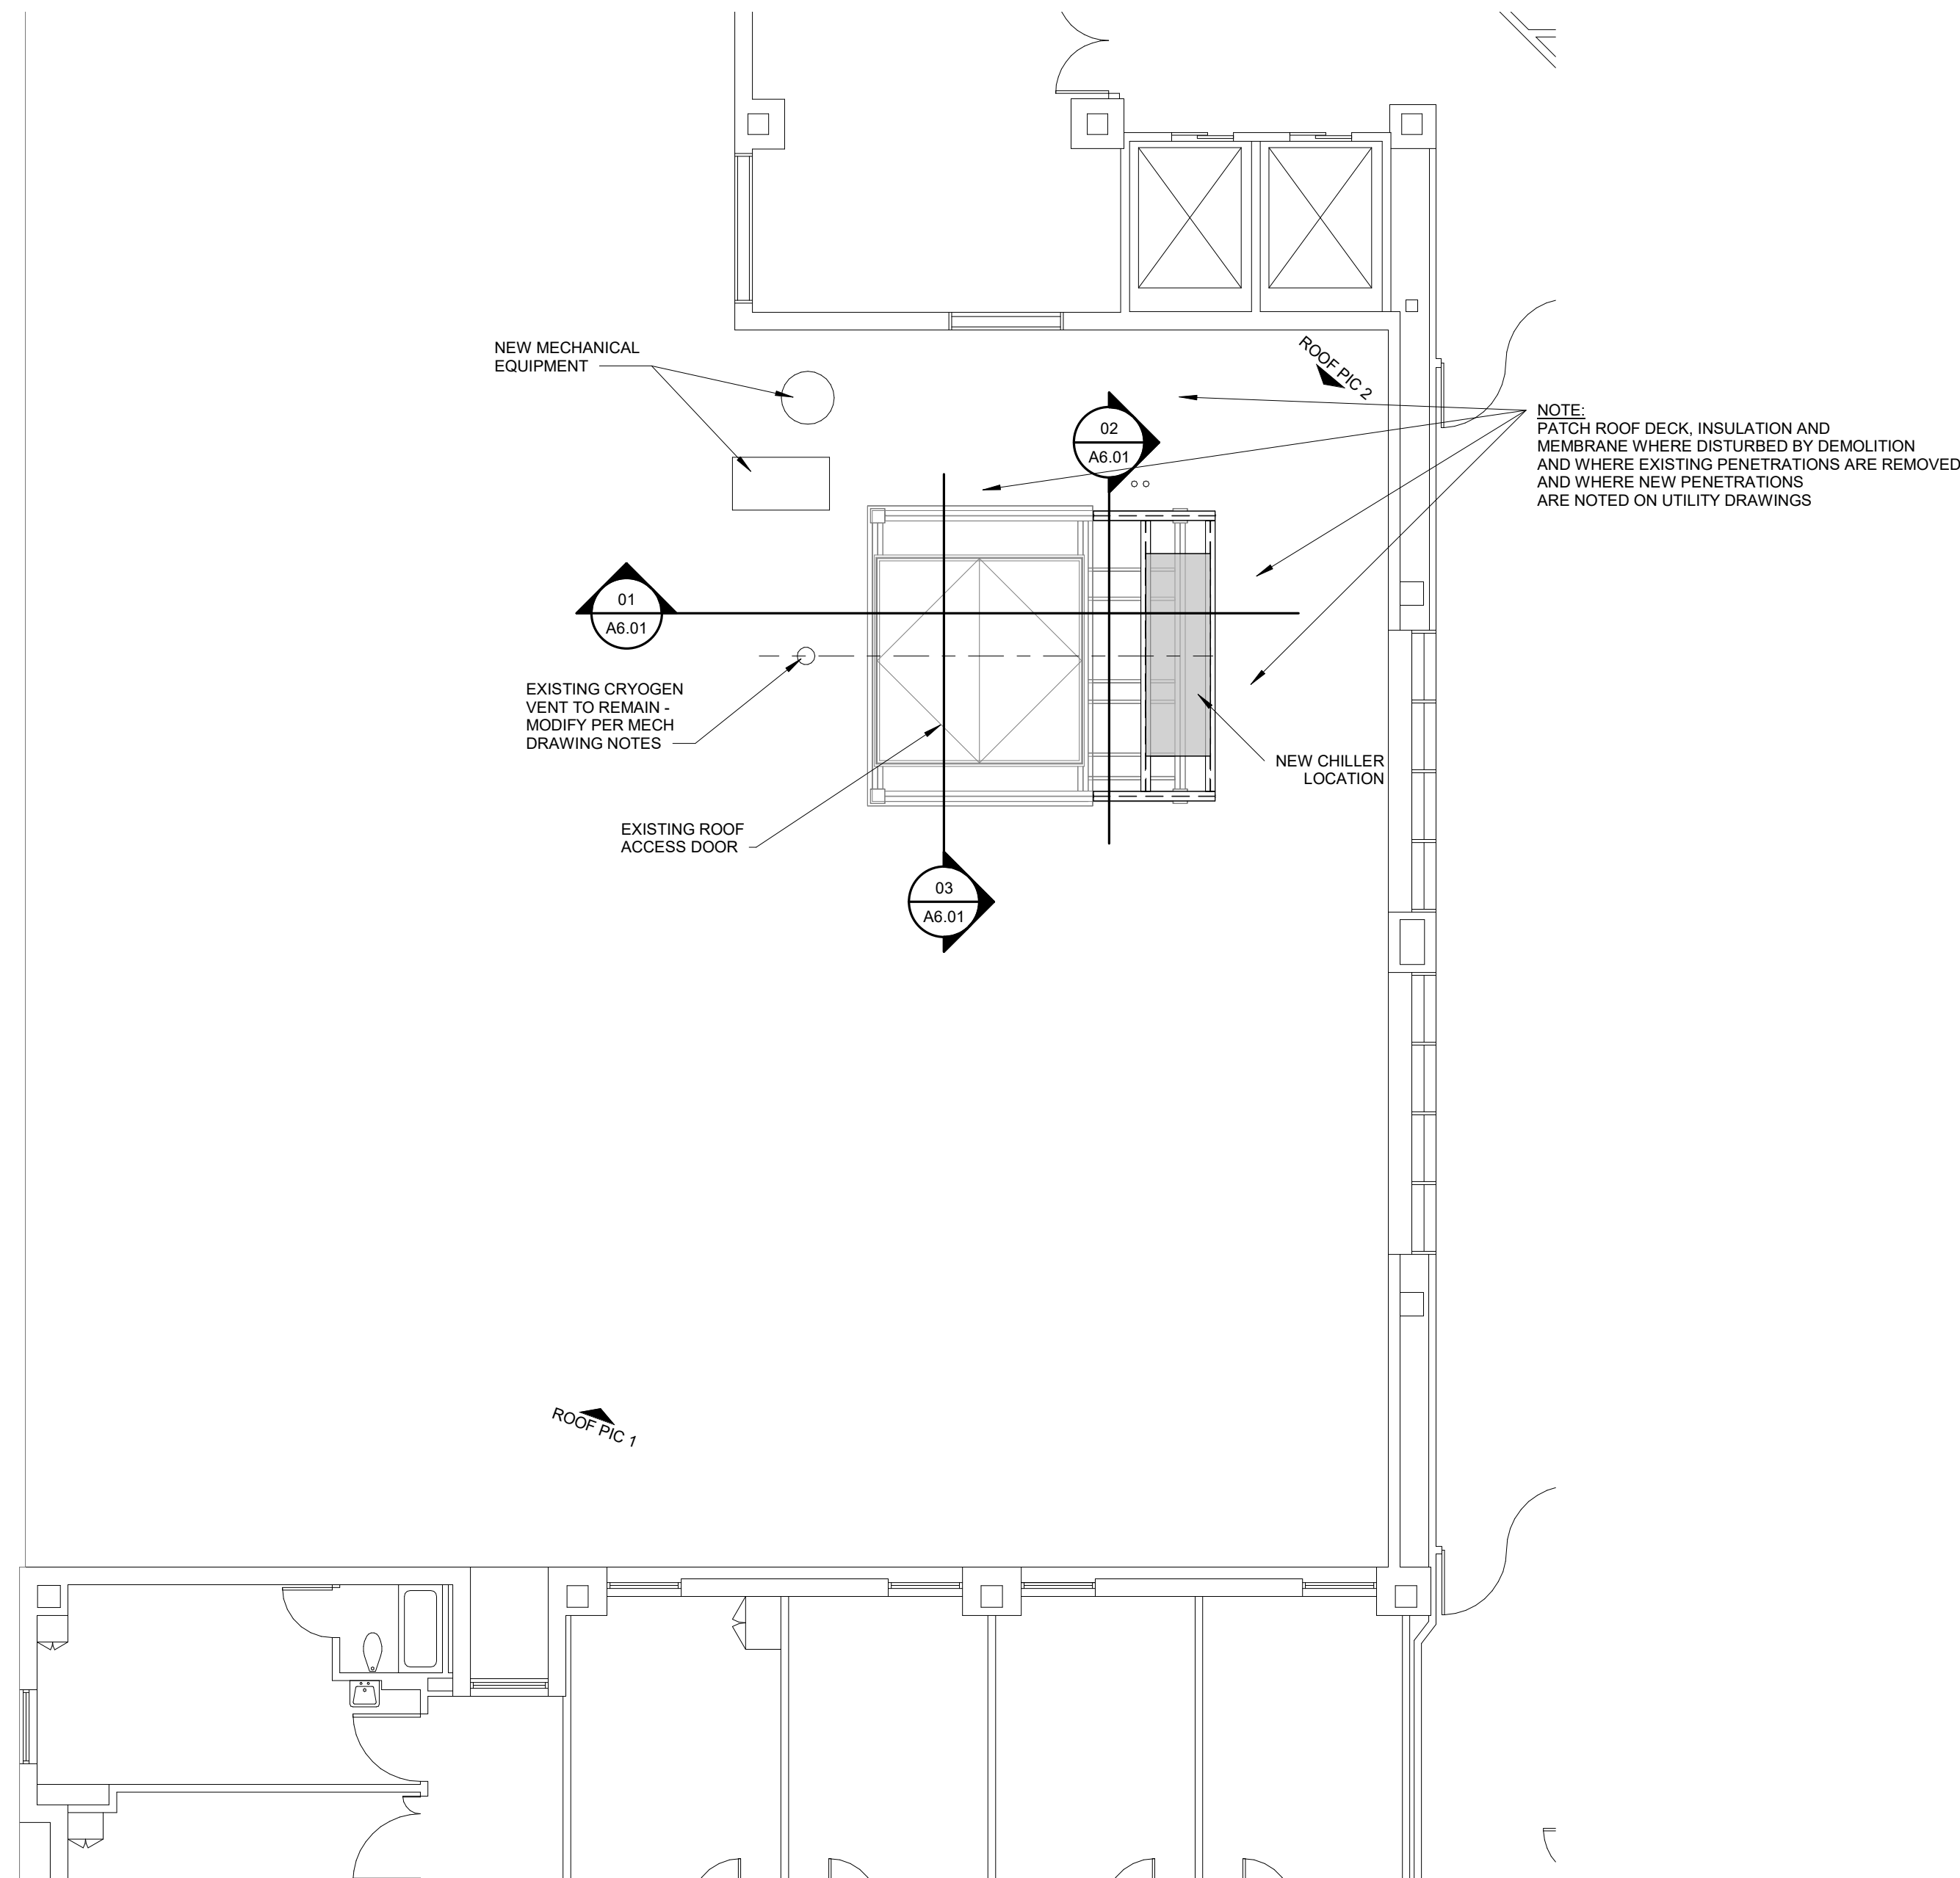

02 LEVEL 1 ROOF PLAN
1/8" = 1'-0"

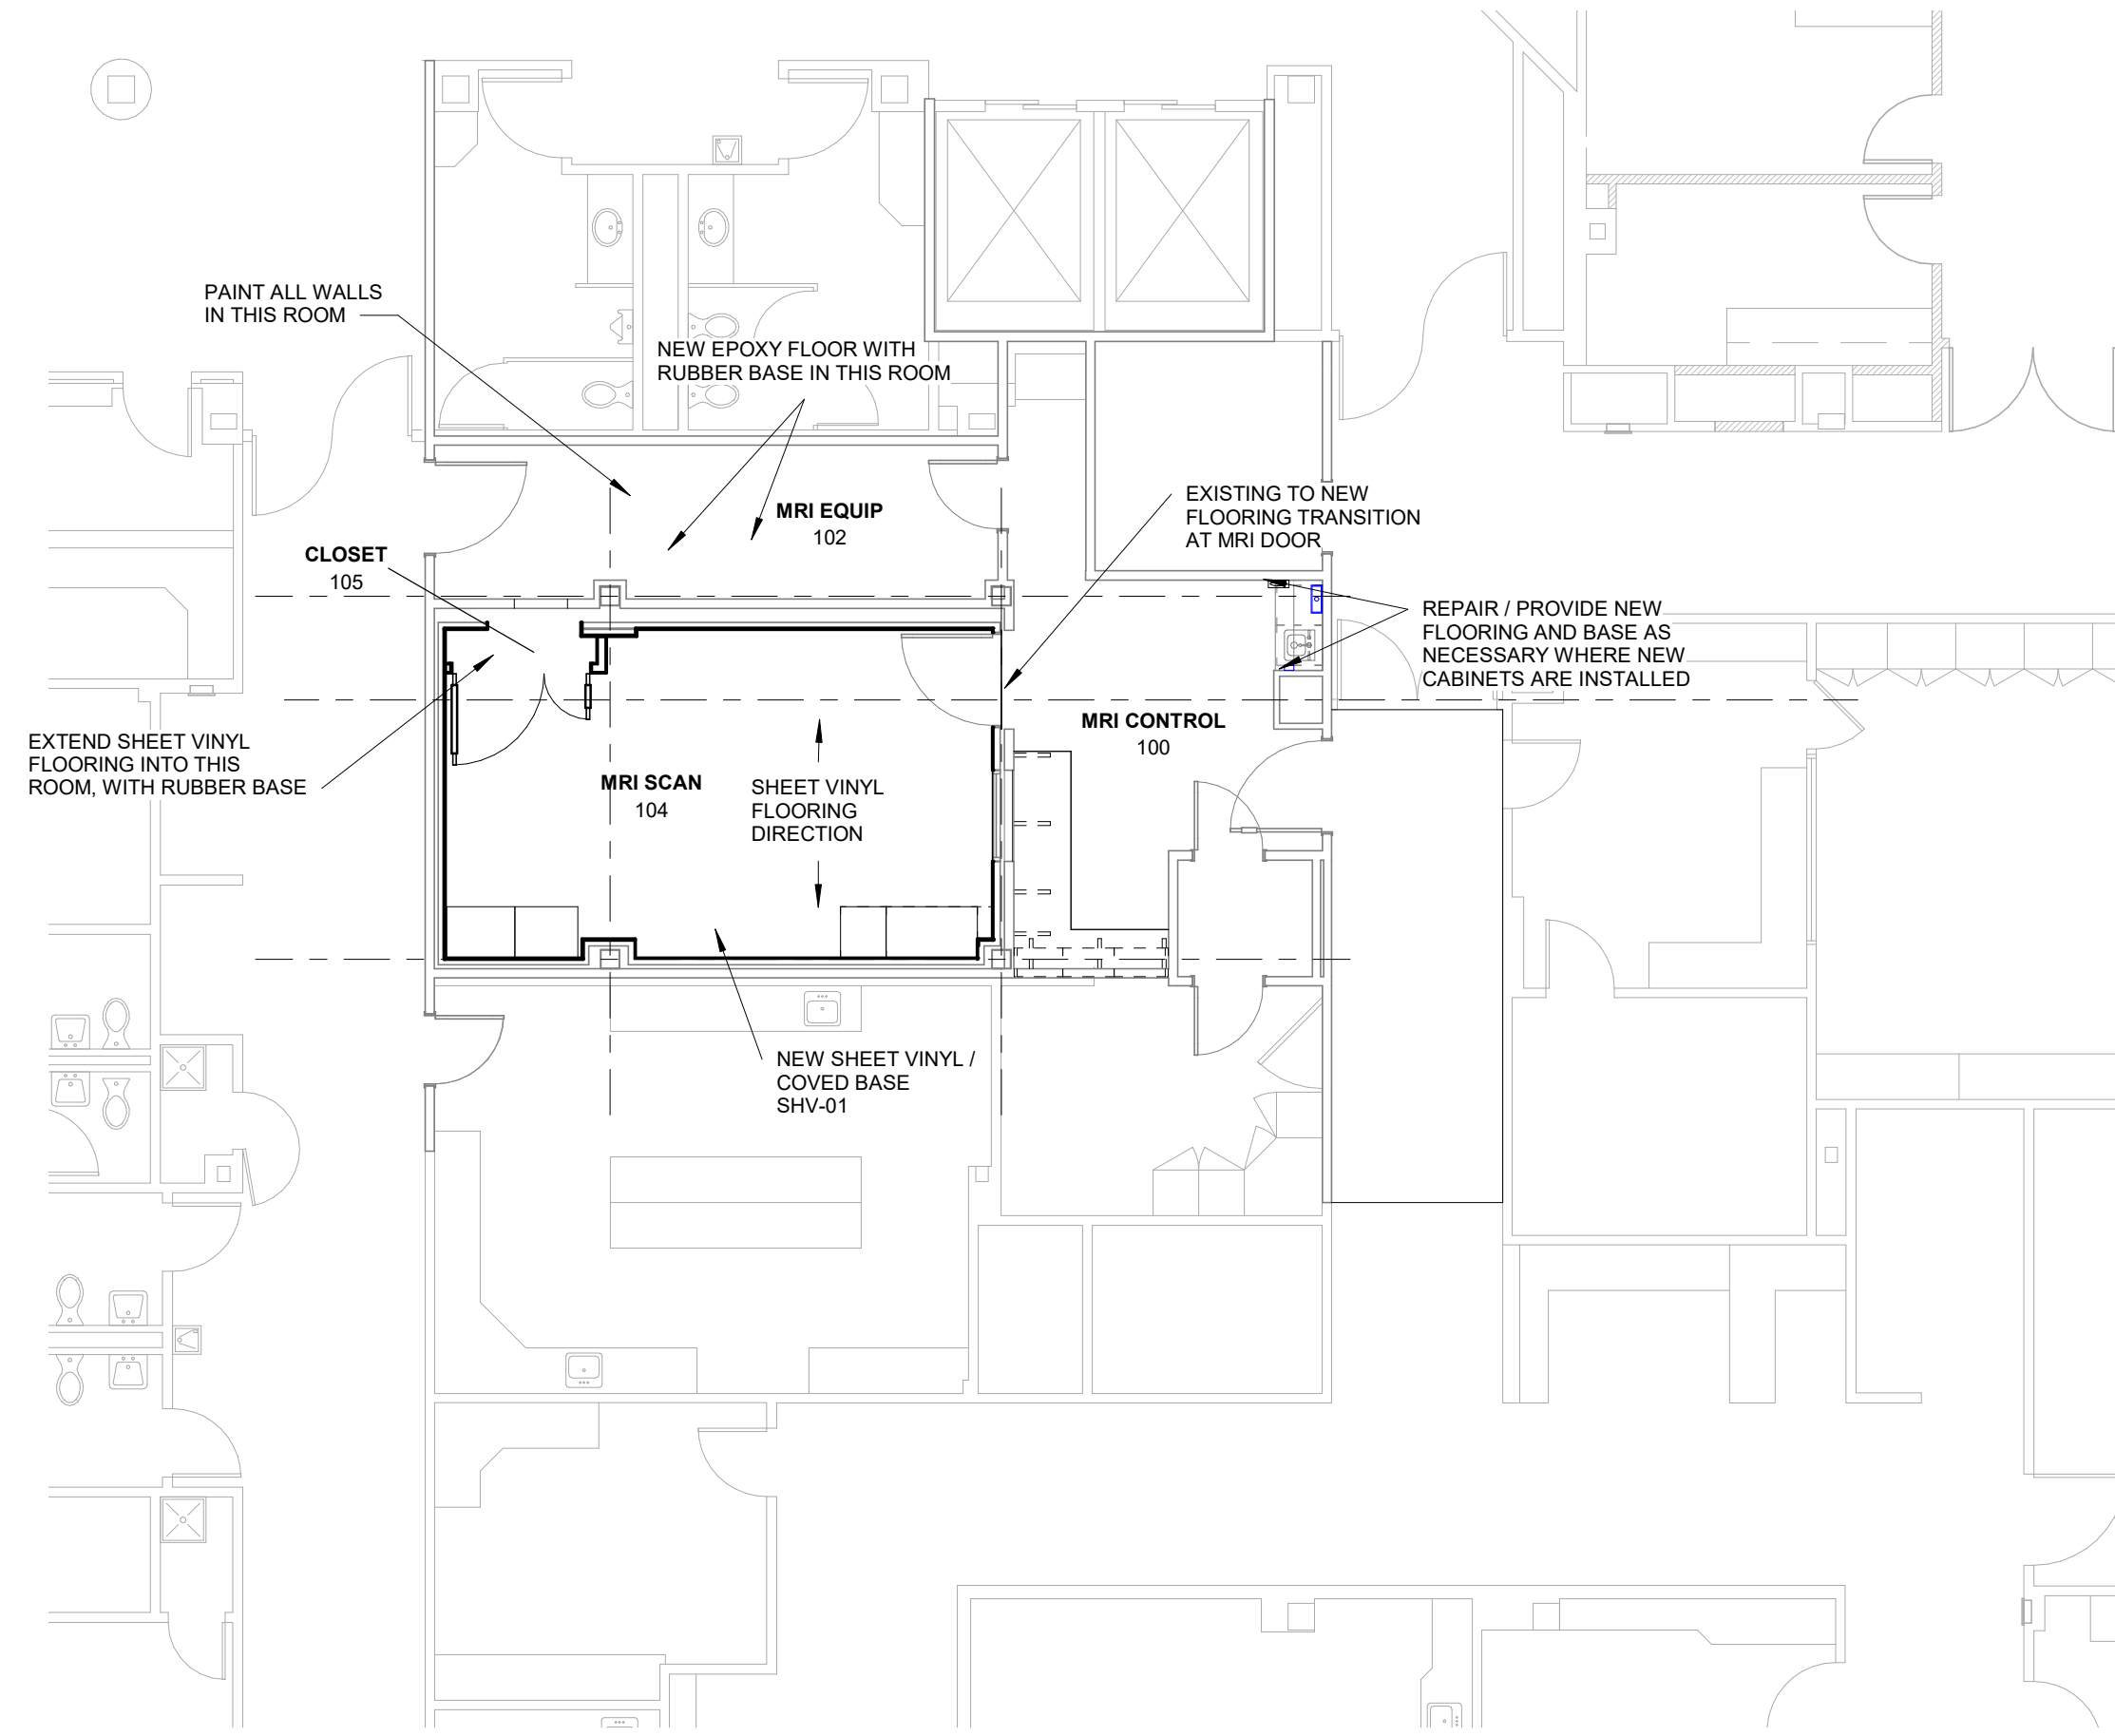

01 LEVEL 1 FINISH PLAN
1/8" = 1'-0"

PLASTIC LAMINATE ON DOOR TO MATCH ON REPLACEMENT DOOR



06 DOOR LAMINATE
1/4" = 1'-0"



05 COUNTERTOP / CABINETS
1/4" = 1'-0"

FINISH NOTES

- FLOORING TRANSITIONS SHALL OCCUR UNDER DOORS.
- FLOORING TRANSITIONS SHALL BE A BUTT JOINT BETWEEN THE 2 MATERIALS. NO TRANSITION STRIP
- SEALANTS SHALL MATCH ADJACENT FINISHES UNLESS PAINTED

FINISH INFORMATION

- IPF-01: WALL PAINT - BEHR, BOTANY BEIGE (SATIN FINISH) 0032909
- SHV-01: SHEET VINYL FLOORING (OLI, MATURE SELECT (WOOD GRAINED LOCK) COVE, 4" UP WALLS)
- EPF-01: EPOXY FLOOR PAINT - SEE SPECIFICATIONS, COLOR: GREY
- RB-01: RUBBER BASE, COVERED TOE - SEE SPECIFICATIONS, COLOR: GREY TO MATCH EXISTING BASE
- ACP-01: ACOUSTICAL CEILING PANEL, FACILITY STANDARD 24"x48", STRAIGHT EDGE, ARMSTRONG 7508, WHITE, 1"-GRID, WHITE
- VL-01: VERTICAL PLASTIC LAMINATE WOOD WORKS, STYLE: EURO (SEE PICTURE 05)
- WD-01: PLASTIC LAMINATE ON ALL NEW WOOD DOORS - MATCH LAMINATE ON CATH LAB DOOR (RIGHT ACROSS THE HALL - SEE PICTURE 06)
- SS-01: SOLID SURFACE COUNTERTOP - MRI CONTROL ROOM - MATCH COUNTERTOPS AT RADIOLOGY RECEPTION DESK (SEE PICTURE 05)



PLUMBING FIXTURE SCHEDULE						
ID	FIXTURE	CW (IN)	HW (IN)	W (IN)	V (IN)	DESCRIPTION
S-1	WORK SINK	1/2	1/2	2	2	COUNTER MOUNTED, STAINLESS STEEL, WITH WRISTBLADES

NOTES
SINK (STAINLESS STEEL, COUNTER MOUNTED, SINGLE COMPARTMENT) JUST SL-2119-A-GR 18 GA. TYPE 304 STAINLESS STEEL SINK, 16" X 16" X 7 1/2" DEEP BASIN, SELF RIMMING, WITH INTEGRAL DRAIN AND 8" CENTERS DRILLING. CHICAGO 788-GNFCXK46CP FAUCET WITH WRISTBLADE HANDLES. 3/8" FC RIGID SWING GOOSENECK SPOUT WITH 1 1/2" LAMINAR FLOW CONTROL IN SPOUT. FLEXIBLE STAINLESS STEEL SUPPLIES WITH LOOSE KEY ANGLE STOPS. CAST BRASS P-TRAP WITH CLEAN OUT PLUG, AND JUST J-35-FS OPEN GRID STRAINER MOUNTED FLUSH WITH SINK BOTTOM.

DEMO KEYED NOTES



- CUT EXISTING CONDENSATE CONNECTIONS TO CEILING HUNG INDOOR COOLING UNITS.
- REMOVE HANDWASH SINK AND FAUCET WHEN CABINET IS DEMOLISHED CAP UTILITIES, WASTE, AND VENT PIPING.
- DEMOLISH DOMESTIC WATER FEED BACK TO RPB IN EQUIPMENT ROOM.
- EXISTING INDIRECT DRAIN WITH FUNNEL ASSEMBLY TO REMAIN.

KEYED NOTES

- EXTEND CONDENSATE AND DOMESTIC COLD WATER TO NEW CEILING HUNG INDOOR COOLING UNITS.
- PROVIDE NEW HAND WASHING SINK IN NEW CABINET AND COUNTERTOP. SEE FIXTURE SCHEDULE FOR DETAILS.
- ALL FIRE SPRINKLER MATERIALS IN MRI ROOM INCLUDING PIPE, FITTINGS, HANGERS, AND SPRINKLER HEADS SHALL BE LISTED AND OF NON-FERROUS MATERIAL.
- CONTRACTOR TO ADD WATER BUG IN EQUIPMENT ROOM. CONNECT TO BMS AND ALARM IF WATER IS DETECTED. CONTROL CONTRACTOR TO EXTEND 24V POWER FROM NEAREST VAV BOX.
- SPRINKLERS SHALL BE STANDARD RESPONSE TO MATCH EXISTING HEADS IF BEING REPLACED OR RELOCATED. IF A SPRINKLER HEAD IS REMOVED, IT MUST BE REPLACED WITH NEW. SPRINKLER HEADS CANNOT BE REUSED, TYPICAL.
- MEW G.E. WATER BYPASS CABINET TO BE PIPED FOR DOMESTIC COLD WATER AND DRAIN. SEE DETAIL.

GENERAL NOTES

- HYDRAULIC RECALCULATION REQUIRED WHEN REPLACING HARD PIPE DROPS WITH FLEXDROPS.
- FOLLOW STANDARDS FOR SPRINKLER HEAD CLEARANCES WITH WALLS AND OBSTRUCTIONS PER NFPA 13.
- MAINTAIN EXISTING FIRE SPRINKLER SYSTEMS, REPLACE ALL PIPE, FITTINGS, HANGERS, DROPS, AND SPRINKLER HEADS TO THE EXTENT SHOWN ON THE DRAWINGS.
- PRESSFIT OR PROGRESS FITTINGS NOT ALLOWED ON FIRE SPRINKLER PIPING.
- INSTALL SPRINKLERS ACCORDING TO NFPA 13.

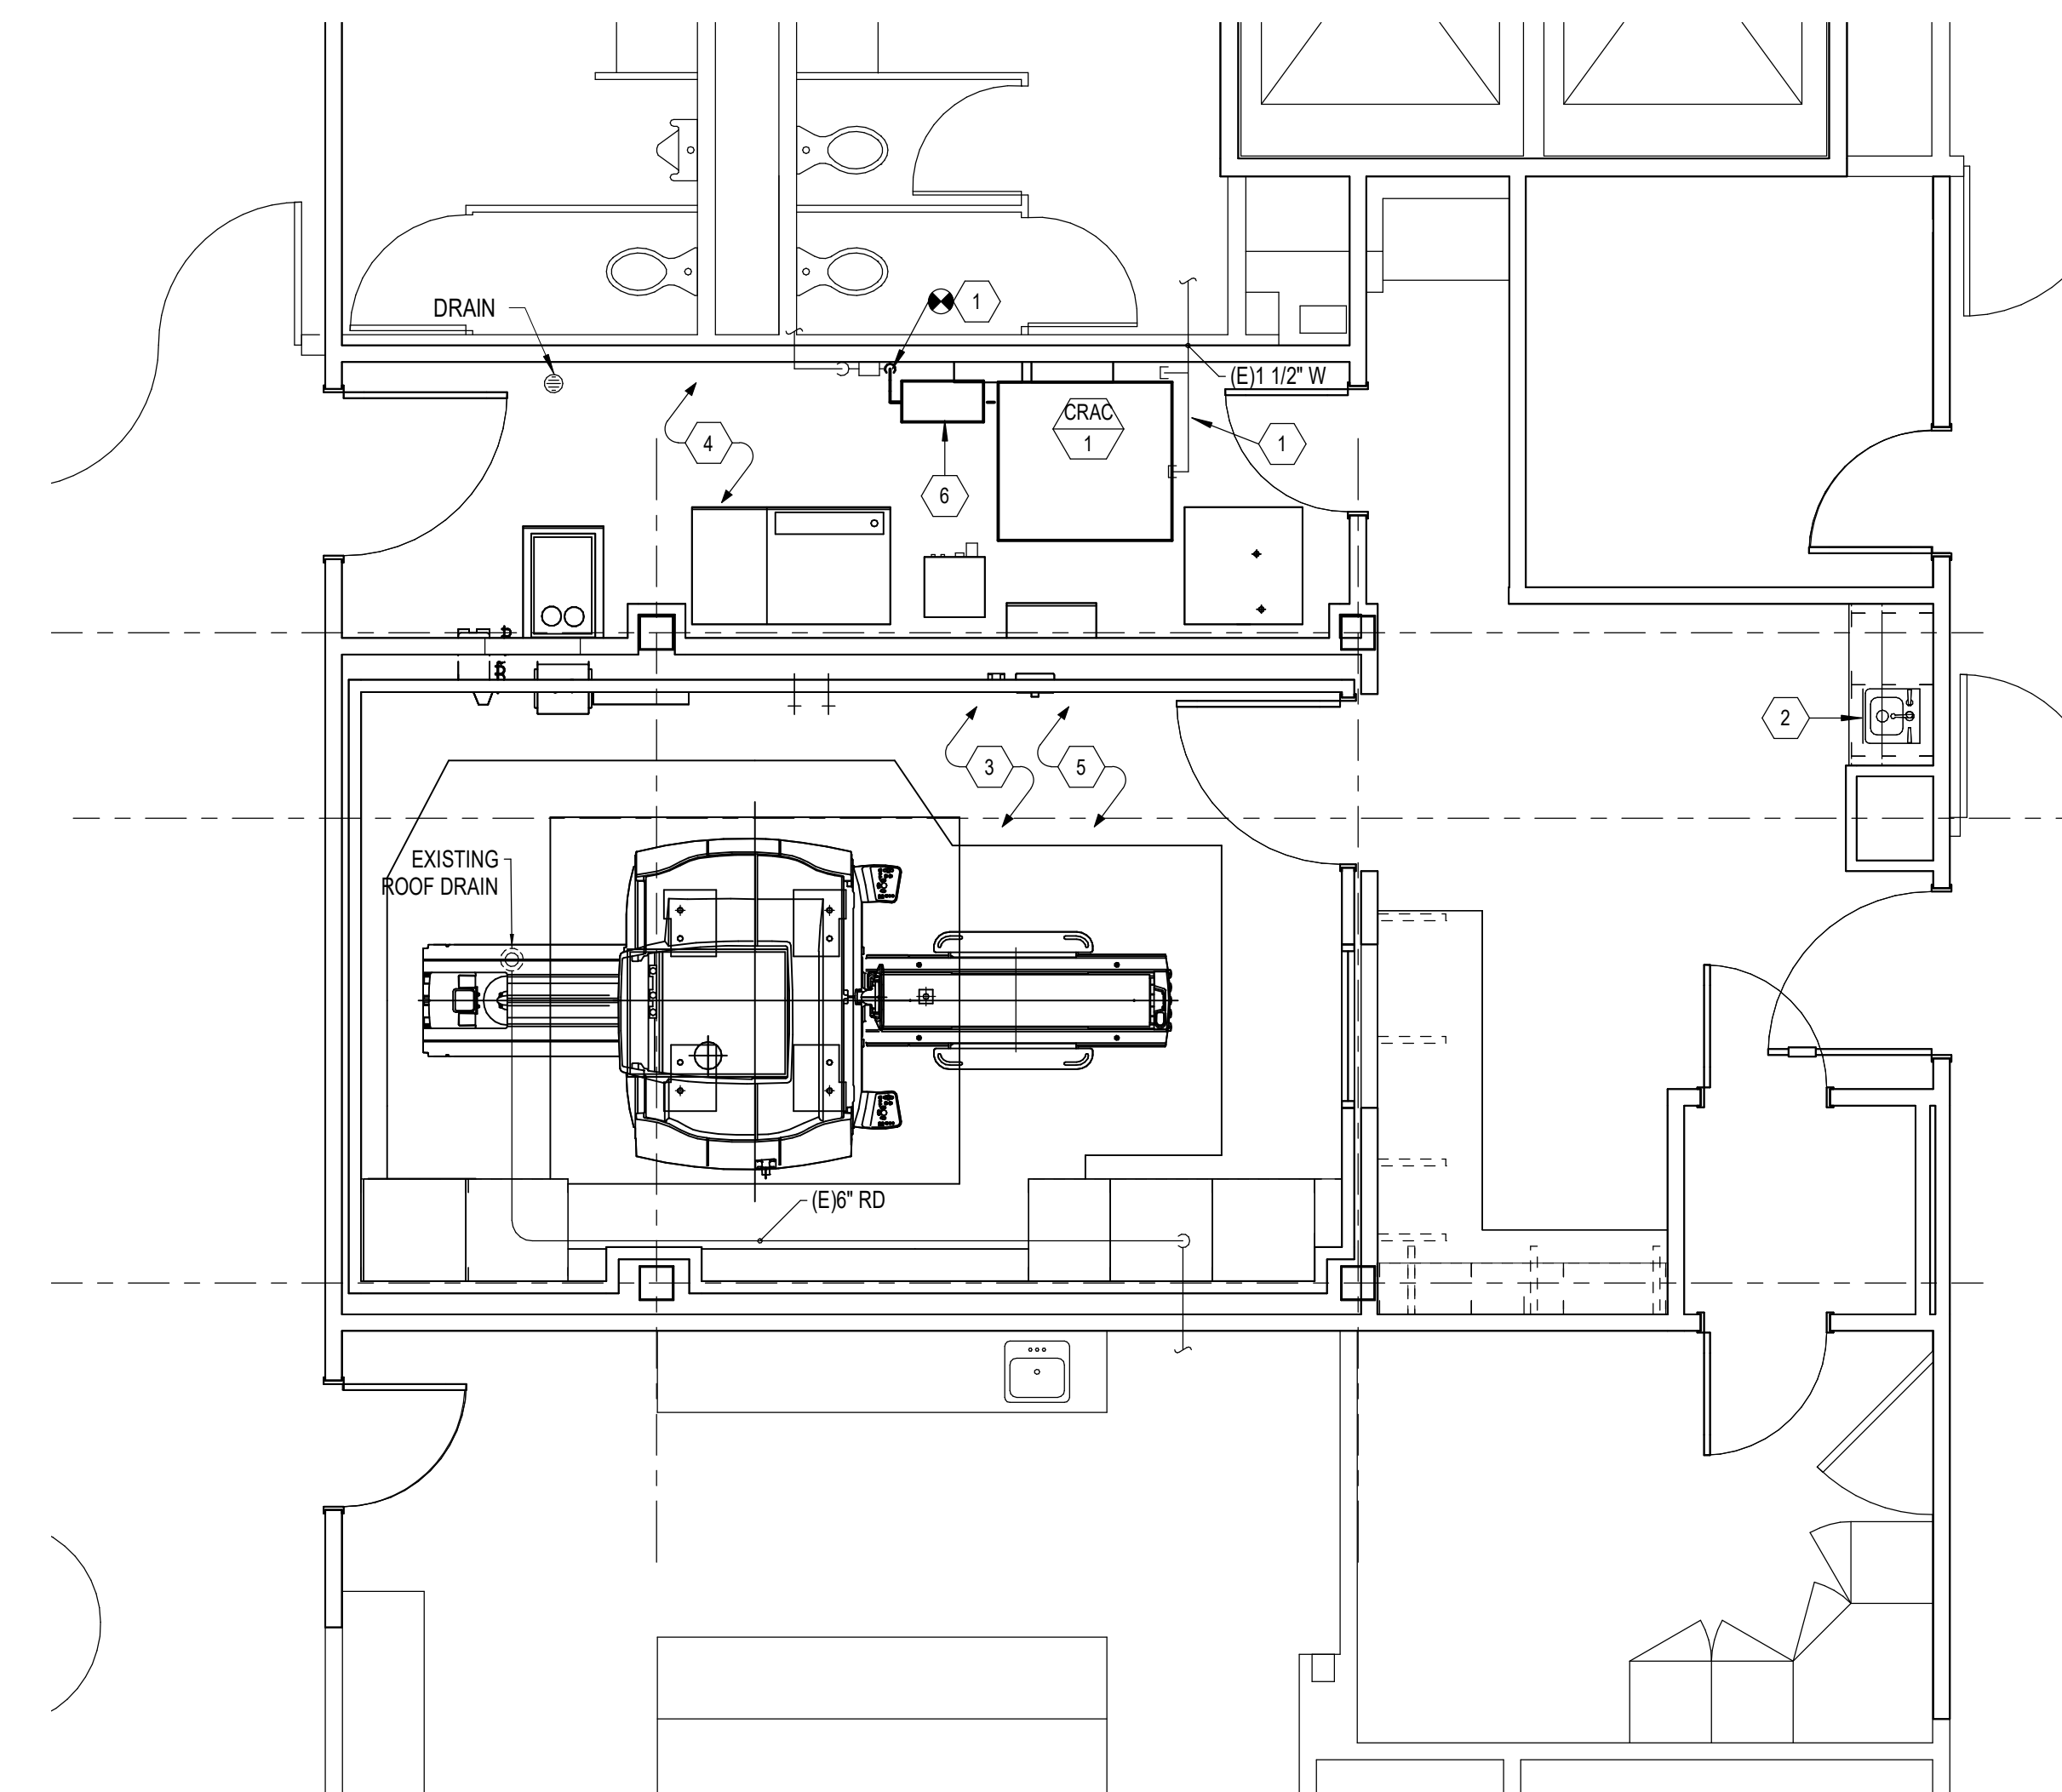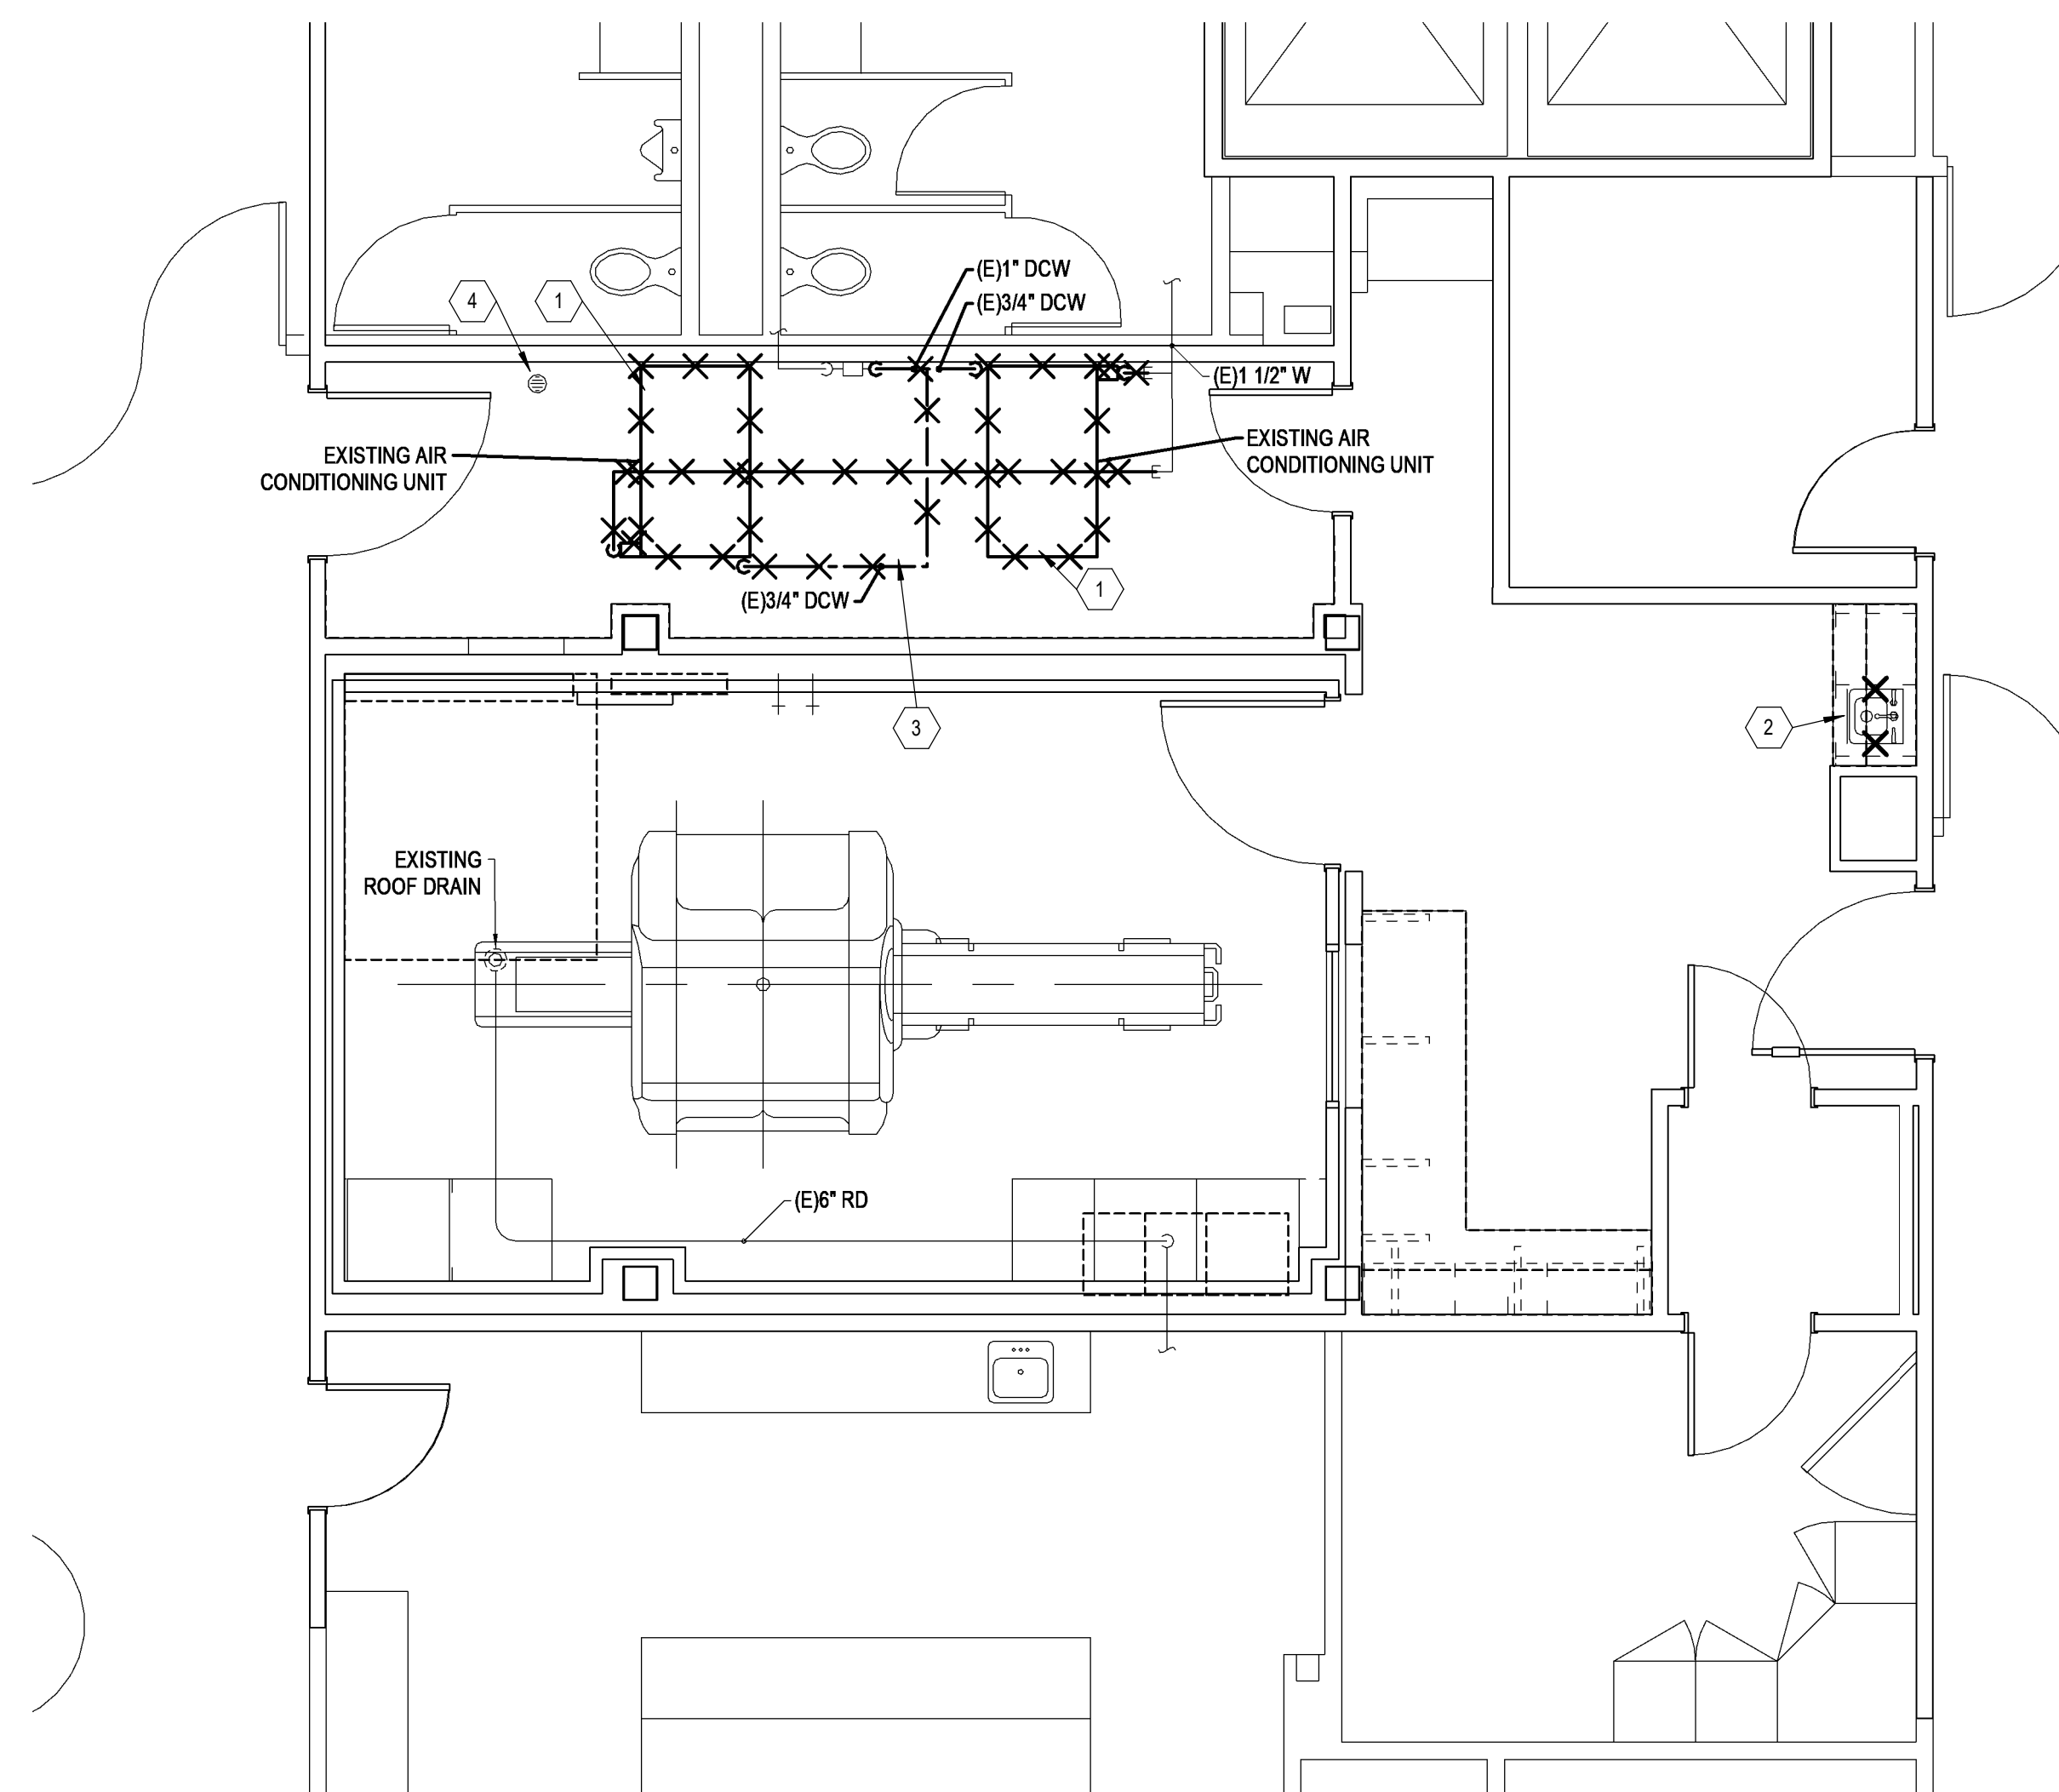

1 LEVEL 1 PLUMBING DEMOLITION PLAN
1/4" = 1'-0"
PLAN NORTH

2 LEVEL 1 PLUMBING REMODEL PLAN
1/4" = 1'-0"
PLAN NORTH

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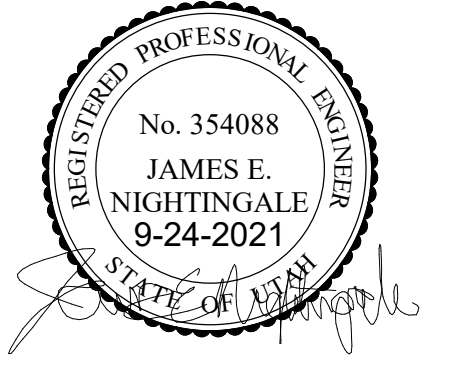
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SHEET TITLE
PLUMBING FLOOR PLANS

SHEET NO.
P1.01





DEMO KEYED NOTES

1. EXISTING MEDICAL VACUUM AND OXYGEN OUTLETS TO REMAIN. REMOVE AND REINSTALL COVERS AS NEEDED FOR REFINISH OF ROOM.
2. PENETRATION PANEL LOCATION.

KEYED NOTES

1. MEDICAL AIR OUTLET TO BE ADDED TO MRI MAGNET ROOM. REFER TO G.E. FOR PENETRATION PANEL CONNECTION FOR EXISTING OR NEW SHIELDING. MATCH EXISTING MANUFACTURER AND TYPE/STYLE OF OUTLET USED IN HOSPITAL.
2. PENETRATION PANEL LOCATION.
3. ROUTE NEW 1/2" MEDICAL GRADE COPPER PIPING TO BLOOD ROOM VALVE BOX. THIS VALVE BOX IS SOURCE FOR OXYGEN AND VACUUM ALREADY. ADD CONNECTION DOWN STREAM OF ISOLATION VALVE AND RECERTIFY AS NEEDED.

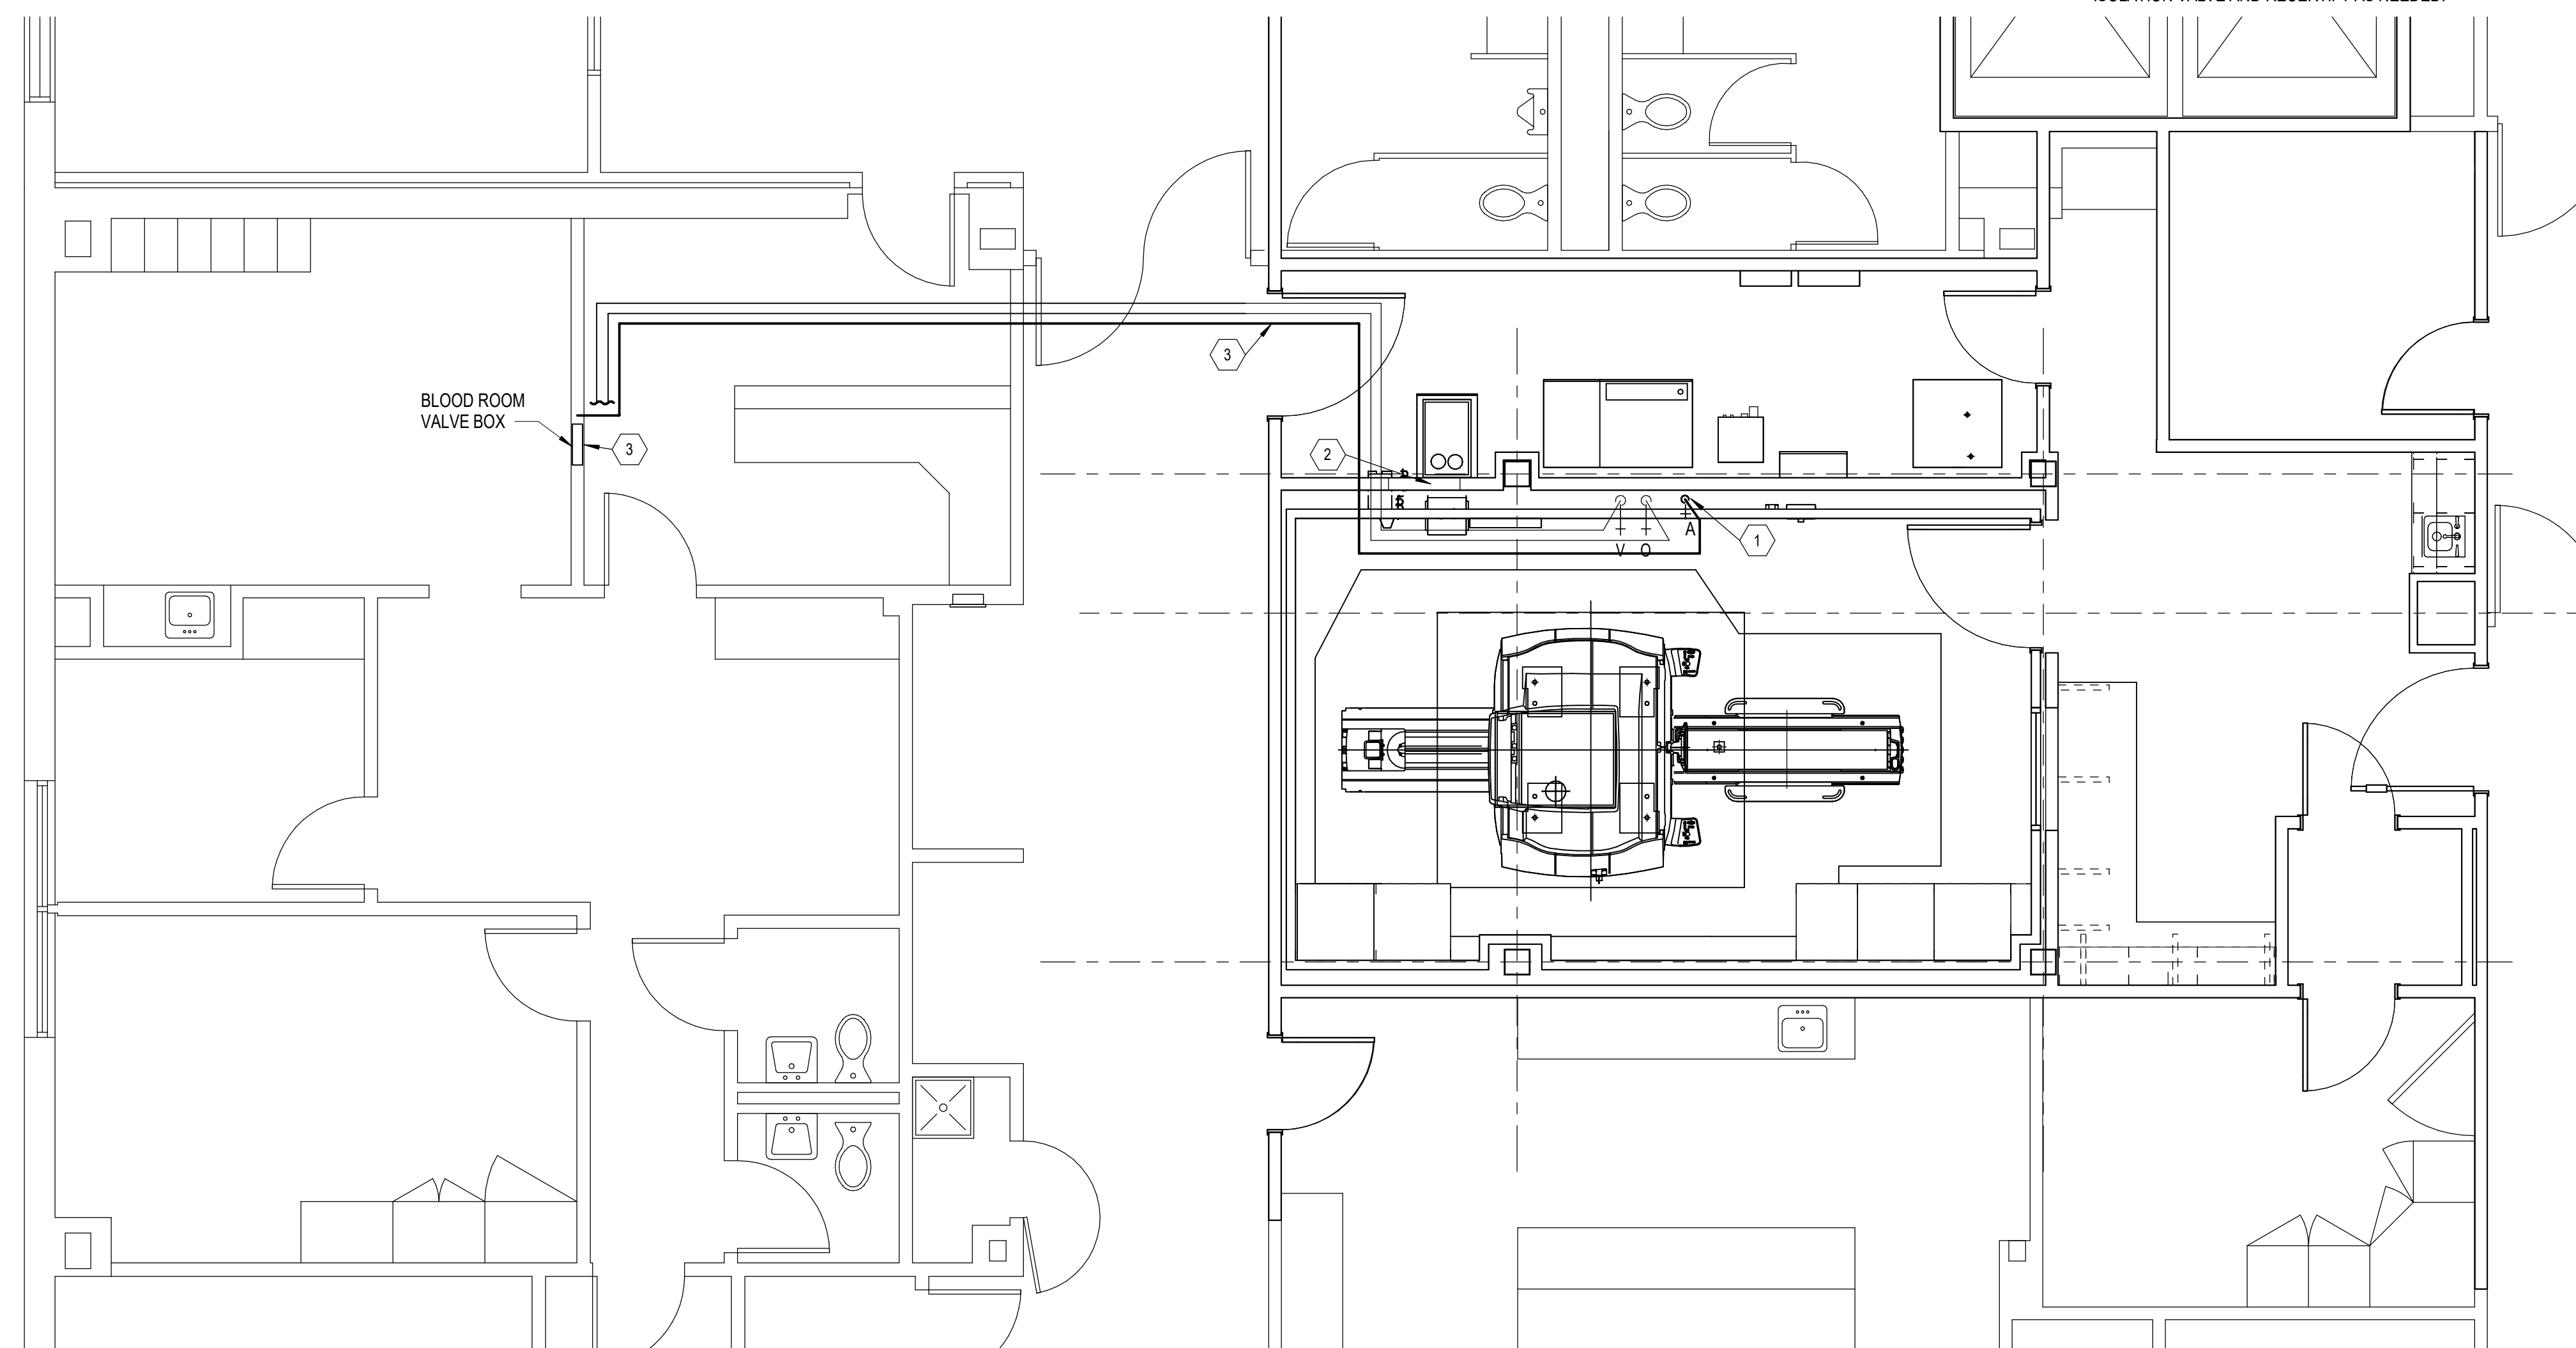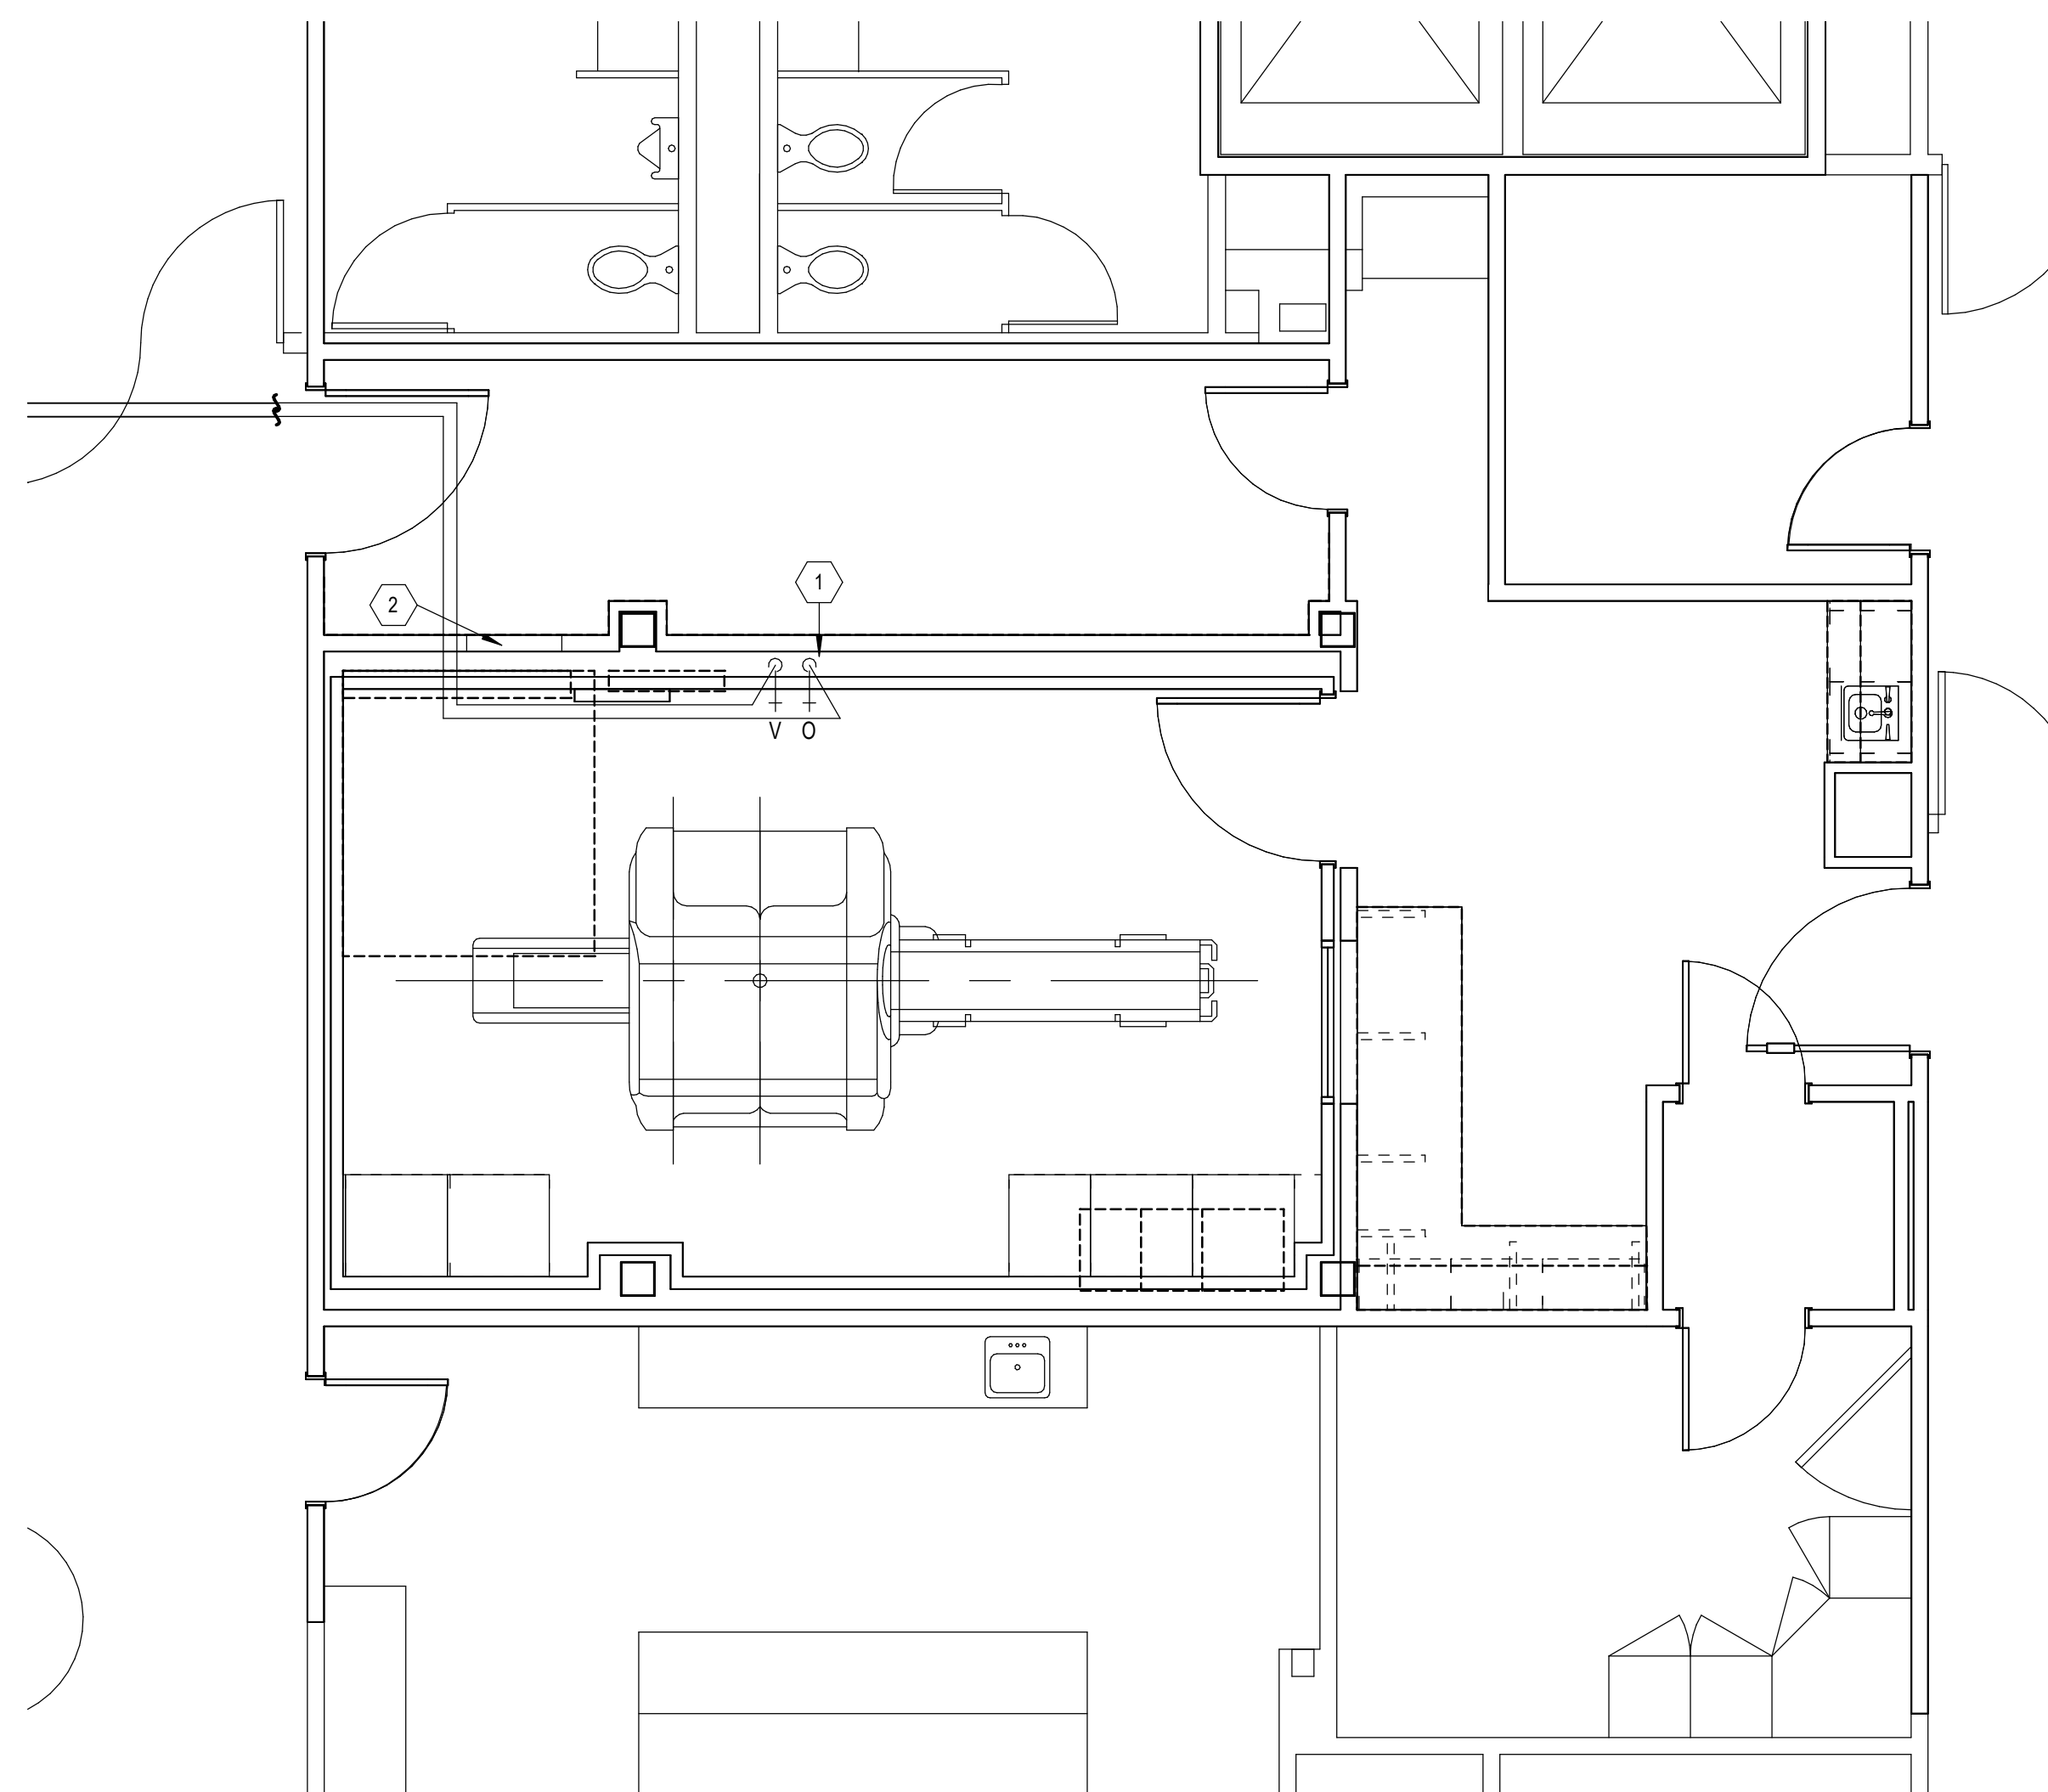

1 LEVEL 1 MEDICAL GAS DEMOLITION PLAN
1/4" = 1'-0"
PLAN NORTH

2 LEVEL 1 MEDICAL GAS REMODEL PLAN
1/4" = 1'-0"
PLAN NORTH

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SHEET TITLE
MEDICAL GAS FLOOR PLANS

SHEET NO.
P2.01

SYMBOLS LEGEND

SYMBOL	DESCRIPTION
REFERENCE AND LINE SYMBOLS	
01	DETAIL INDICATOR. AS INDICATES DETAIL NUMBER. E-501 INDICATES DRAWING SHEET WHERE DETAIL IS SHOWN.
02	ELEVATION OR SECTION INDICATOR, EXTERIOR. AS INDICATES ELEVATION OR SECTION NUMBER. E-201 INDICATES DRAWING SHEET WHERE ELEVATION OR SECTION IS SHOWN.
03	ELEVATION OR SECTION INDICATOR, INTERIOR. AS INDICATES ELEVATION OR SECTION NUMBER. E-201 INDICATES DRAWING SHEET WHERE ELEVATION OR SECTION IS SHOWN.
04	ROOM IDENTIFIER WITH ROOM NAME AND NUMBER.
05	KEYNOTE INDICATOR.
06	REVISION INDICATOR.
07	EQUIPMENT INDICATOR.
09	BREAK, STRAIGHT: TO BREAK PARTS OF DRAWING
10	BREAK, ROUND
12	NEW LINE: MEDIUM LINE.
13	HIDDEN FEATURES LINE: HIDDEN, THIN LINE
14	EXISTING TO REMAIN LINE: THIN LINE.
15	DEMOLITION LINE: DASHED, MEDIUM LINE
16	PROPERTY LINE: DASHED, WIDE LINE.
17	CONTRACT LIMIT LINE: DASHDOT, WIDE LINE.
WIRING METHODS	
01	WIRING.
04	BRANCH CIRCUIT HOME RUN TO PANELBOARD: NUMBER OF ARROWS INDICATES NUMBER OF CIRCUITS. LETTER AND NUMBER NOTATIONS IDENTIFY PANEL AND CIRCUIT NUMBERS. USE #12 CONDUCTORS, EXCEPT #10 CONDUCTORS SHALL BE INSTALLED IF DISTANCES EXCEED THOSE SPECIFIED IN THE ELECTRICAL SPECIFICATIONS.
05	BRANCH CIRCUIT HOME RUN TO PANELBOARD: NUMBER OF ARROWS INDICATES NUMBER OF CIRCUITS. LETTER AND NUMBER NOTATIONS IDENTIFY PANEL AND CIRCUIT NUMBERS. NUMBER IN BOX REFERS TO THE CONDUCTOR AND CONDUIT SCHEDULE. FOR BRANCH WIRING USE #12 CONDUCTORS, EXCEPT #10 CONDUCTORS SHALL BE INSTALLED IF DISTANCES EXCEED THOSE SPECIFIED IN THE ELECTRICAL SPECIFICATIONS.
07	FLEXIBLE WIRING.
08	WIRING AND/OR RACEWAY: THIN LINE. WHERE "X" =: CATV = CABLE TELEVISION NC = NURSE CALL CCTV = CLOSED CIRCUIT P = POWER TV = TELEVISION RC = RIGID CONDUIT FA = FIRE ALARM S = SOUND FO = FIBER OPTICS T = TELEPHONE I = INTERCOM TV = TELEVISION OTHERS AS NOTED IN OTHER SCHEDULES. RACEWAYS AND WIRING SHALL BE SIZED AS SHOWN AND/OR SPECIFIED.
09	LOW VOLTAGE WIRING: DIVIDE, MEDIUM LINE.
10	CONDUIT STUB. DIMENSION RECORD DRAWINGS AND MARK.
11	CONDUCTOR & CONDUIT (CC) SCHEDULE INDICATOR. REFER TO ONE-LINE DIAGRAM.
12	ADA ACCESS PUSH PLATE
13	JUNCTION BOX.
14	JUNCTION BOX, SYSTEMS FURNITURE COMMUNICATION CONNECTION.
15	JUNCTION BOX, SYSTEMS FURNITURE POWER CONNECTION.
16	CABLE TRAY ABOVE ACCESSIBLE CEILING.
17	WIREWAY.
21	EARTH GROUND (ONE-LINE DIAGRAM).
22	JUNCTION BOX, CEILING.
25	MECHANICAL EQUIPMENT CONNECTION. REFER TO EQUIPMENT SCHEDULE FOR REQUIREMENTS.
LIGHTING	
01	FIXTURE IDENTIFICATION: (W-3) INDICATES FIXTURE TYPE AS SCHEDULED.
02	FIXTURE IDENTIFICATION, EMERGENCY WITH BATTERY PACK, CONNECTED TO GENERATOR AS INDICATED: (W-3) INDICATES FIXTURE TYPE AS SCHEDULED.
05	EGRESS DIRECTION ARROW (EXIT SIGNS).
06	EXIT SIGN: SINGLE FACE; CEILING MOUNTED
08	EXIT SIGN: SINGLE FACE; WALL MOUNTED
09	EXIT SIGN: DOUBLE FACE; CEILING MOUNTED
10	EXIT SIGN: DOUBLE FACE; WALL MOUNTED
LIGHTING CONTROL	
01	OCCUPANCY SENSOR, DUAL TECHNOLOGY, OMNI-DIRECTIONAL, CEILING
02	OCCUPANCY SENSOR, DUAL TECHNOLOGY, WALL
03	OCCUPANCY SENSOR, DUAL TECHNOLOGY, DIRECTIONAL
04	OCCUPANCY SENSOR, ULTRASONIC, OMNI-DIRECTIONAL, CEILING
05	OCCUPANCY SENSOR CONTROL RELAY.
06	VACANCY SENSOR, DUAL TECHNOLOGY, OMNI-DIRECTIONAL, CEILING
07	VACANCY SENSOR, DUAL TECHNOLOGY, WALL
08	PHOTOCCELL.
18	LOW VOLTAGE DIGITAL LIGHTING CONTROL SWITCH: LETTER "a,b" INDICATES ZONING WHERE SHOWN (REFER TO PLANS, SCHEDULES, AND DETAILS FOR EXACT BUTTON CONFIGURATION AND PROGRAMMING REQUIREMENTS)
19	DIGITAL LIGHTING DIMMING CONTROLLER
20	DIGITAL PLUG LOAD CONTROLLER
21	LIGHTING NETWORK SWITCH.
22	LIGHTING NETWORK ROUTER.
23	DIGITAL LIGHTING ROOM CONTROLLER
26	LIGHTING SPACE CONTROL TYPE. X INDICATES TYPE. SEE SCHEDULE / DIAGRAM.

SYMBOLS LEGEND

SYMBOL	DESCRIPTION
WIRING DEVICES	
01	RECEPTACLE, SINGLE: NEMA 5-20R.
02	RECEPTACLE, DUPLEX: NEMA 5-20R.
03	RECEPTACLE, DUPLEX, ABOVE COUNTER: NEMA 5-20R.
04	RECEPTACLE, DUPLEX, CEILING: NEMA 5-20R.
05	RECEPTACLE, DUPLEX, DEDICATED CIRCUIT: NEMA 5-20R.
06	RECEPTACLE, DUPLEX WITH GROUND FAULT CIRCUIT INTERRUPTER, DRINKING FOUNTAIN, CONICAL WATER COOLER RECEPTACLE BEHIND WATER COOLER. SEE MECHANICAL/PLUMBING SHOP DRAWINGS FOR INSTALLATION REQUIREMENTS.
07	RECEPTACLE, DUPLEX, ISOLATED GROUND: NEMA 5-20R.
08	RECEPTACLE, DUPLEX, SWITCHED: NEMA 5-20R.
09	RECEPTACLE, DUPLEX, FLOOR, UNDER CARPET: NEMA 5-20R.
10	RECEPTACLE, DUPLEX WITH GROUND FAULT CIRCUIT INTERRUPTER, WET LABEL, "WEATHERPROOF IN USE": NEMA 5-20R.
11	RECEPTACLE, DUPLEX, HOSPITAL GRADE: NEMA 5-20R.
13	RECEPTACLE, DUPLEX ON EMERGENCY POWER: NEMA 5-20R.
14	RECEPTACLE, DUPLEX, HOSPITAL GRADE ON EMERGENCY POWER: NEMA 5-20R.
16	RECEPTACLE, DUPLEX WITH GROUND FAULT CIRCUIT INTERRUPTER: NEMA 5-20R.
17	RECEPTACLE, DUPLEX WITH GROUND FAULT CIRCUIT INTERRUPTER, HOSPITAL GRADE: NEMA 5-20R.
19	RECEPTACLE, DUPLEX WITH GROUND FAULT CIRCUIT INTERRUPTER, WEATHERPROOF: NEMA 5-20R.
22	RECEPTACLE, QUADRAPLEX: NEMA 5-20R.
23	RECEPTACLE, QUADRAPLEX ON EMERGENCY POWER: NEMA 5-20R.
24	RECEPTACLE, QUADRAPLEX, HOSPITAL GRADE: NEMA 5-20R.
25	RECEPTACLE, QUADRAPLEX, HOSPITAL GRADE ON EMERGENCY POWER: NEMA 5-20R.
27	RECEPTACLE, QUADRAPLEX WITH GROUND FAULT CIRCUIT INTERRUPTER: NEMA 5-20R.
28	RECEPTACLE, SPECIAL PURPOSE. PROVIDE RECEPTACLE TO MATCH EQUIPMENT PLUG.
29	RECEPTACLE, SPECIAL PURPOSE ON EMERGENCY POWER. PROVIDE RECEPTACLE TO MATCH EQUIPMENT PLUG.
32	RECEPTACLE, CLOCK HANGER: NEMA 5-15R.
33	MULTI-OUTLET ASSEMBLY: NEMA 5-20R.
36	FLUSH FLOOR BOX. "F" SHOWN ON DRAWINGS. REFER TO WIRING DEVICE SCHEDULE IN THE ELECTRICAL SPECIFICATIONS FOR CONFIGURATION AND DEVICES.
37	POWER POLE. "F" SHOWN ON DRAWINGS. REFER TO WIRING DEVICE SCHEDULE IN THE ELECTRICAL SPECIFICATIONS FOR CONFIGURATION AND DEVICES.
38	FLUSH FIRE RATED POKE THRU. "F" SHOWN ON DRAWINGS. REFER TO WIRING DEVICE SCHEDULE IN THE ELECTRICAL SPECIFICATIONS FOR CONFIGURATION AND DEVICES.
39	SWITCH, DIMMER.
40	SWITCH, SINGLE POLE ("X" INDICATES FIXTURES CONTROLLED).
41	SWITCH, DOUBLE POLE ("X" INDICATES FIXTURES CONTROLLED).
42	SWITCH, THREE-WAY ("X" INDICATES FIXTURES CONTROLLED).
43	SWITCH, FOUR-WAY ("X" INDICATES FIXTURES CONTROLLED).
44	SWITCH, DOOR.
45	SWITCH, KEY OPERATED.
47	SWITCH, MOMENTARY.
52	RECEPTACLE, DUPLEX, TAMPER RESISTANT: NEMA 5-20R.
53	RECEPTACLE, QUADRAPLEX WITH GROUND FAULT CIRCUIT INTERRUPTER, HOSPITAL GRADE: NEMA 5-20R.
54	RECEPTACLE, QUADRAPLEX WITH GROUND FAULT CIRCUIT INTERRUPTER, HOSPITAL GRADE ON EMERGENCY POWER: NEMA 5-20R.
56	RECEPTACLE, SINGLE PLEX, WITH USB OUTLET
57	RECEPTACLE, DUPLEX, RECESSED, NEMA 5-20R, AUTOMATICALLY CONTROLLED THROUGH TIME OR OCCUPANCY BASED CONTROLS (REFER TO PLANS FOR CONTROL METHOD)
58	RECEPTACLE, QUADRAPLEX, RECESSED, NEMA 5-20R, AUTOMATICALLY CONTROLLED THROUGH TIME OR OCCUPANCY BASED CONTROLS (REFER TO PLANS FOR CONTROL METHOD)
59	INDICATES A RECEPTACLE IS AUTOMATICALLY CONTROLLED THROUGH TIME OR OCCUPANCY BASED CONTROLS (REFER TO PLANS FOR CONTROL METHOD)
STRUCTURED CABLING	
01	COMMUNICATIONS DEVICE (1 DATA).
02	COMMUNICATIONS DEVICE (1 DATA / 1 ANALOG).
03	COMMUNICATIONS DEVICE (1 DATA WALL PHONE).
04	COMMUNICATIONS DEVICE (2 DATA).
05	COMMUNICATIONS DEVICE (3 DATA).
06	COMMUNICATIONS DEVICE (4 DATA).
07	COMMUNICATIONS DEVICE (6 DATA).
08	COMMUNICATIONS DEVICE PHYSIOLOGICAL MONITOR (1 DATA).
02	DATA CONNECTION: WIRELESS ACCESS POINT (WAP). REQUIRES (2) DATA DROPS PER DEVICE
08	TELEPHONE TERMINAL BOARD, FIRE TREATED PLYWOOD PAINTED.
08	LAN RACK, FLOOR STANDING.
TECHNOLOGY SYSTEMS	
02	SPEAKER, CEILING MOUNTED.
03	SPEAKER, WALL MOUNTED.
40	CONNECTION PANEL.

SYMBOLS LEGEND

SYMBOL	DESCRIPTION
ELECTRICAL POWER AND DISTRIBUTION	
01	FUSE WITH RATING (ONE-LINE DIAGRAM).
02	DISCONNECT, FUSED (ONE-LINE DIAGRAM).
03	DISCONNECT, NONFUSED (ONE-LINE DIAGRAM).
04	DISCONNECT WITH FUSE AND MOTOR STARTER COMBINATION (ONE-LINE DIAGRAM).
05	OVERLOAD RELAY (ONE-LINE DIAGRAM).
06	STARTER (ONE-LINE DIAGRAM).
06	CIRCUIT BREAKER, MOLDED CASE (ONE-LINE DIAGRAM).
08	CIRCUIT BREAKER, MOLDED CASE WITH SHUNT TRIP (ONE-LINE DIAGRAM).
09	CIRCUIT BREAKER, MOTOR CIRCUIT PROTECTION (ONE-LINE DIAGRAM).
10	CIRCUIT BREAKER, SOLID STATE (ONE-LINE DIAGRAM).
11	CIRCUIT BREAKER, SOLID STATE WITH GROUND FAULT PROTECTION (ONE-LINE DIAGRAM).
12	MOTOR.
15	HEATER, ELECTRIC RESISTANCE.
16	TRANSFORMER (ONE-LINE DIAGRAM).
17	TRANSFORMER, CURRENT (ONE-LINE DIAGRAM).
18	BATTERY (ONE-LINE DIAGRAM).
20	CAPACITOR (ONE-LINE DIAGRAM).
21	DELTA CONNECTION (ONE-LINE DIAGRAM).
22	WYE CONNECTION (ONE-LINE DIAGRAM).
38	PANELBOARD (ONE-LINE DIAGRAM).
39	PANELBOARD WITH MAIN LUGS ONLY. BUS SIZE AND PHASE AS SHOWN (ONE-LINE DIAGRAM).
42	PANELBOARD WITH MAIN CIRCUIT BREAKER. SIZE AND PHASE AS SHOWN (ONE-LINE DIAGRAM).
43	PANELBOARD WITH MAIN AND SUB FEED CIRCUIT BREAKER (ONE-LINE DIAGRAM).
26	PANELBOARD WITH MAIN LUGS ONLY AND SURGE PROTECTION WITH CIRCUIT BREAKER (ONE-LINE DIAGRAM).
NURSE CALL	
01	JUNCTION BOX.
02	CORRIDOR LIGHT.
03	BATHROOM PULL CORD STATION.
04	DUTY STATION.
05	EMERGENCY ASSISTANCE CALL STATION.
06	EMERGENCY ASSISTANCE CODE BLUE CALL STATION.
07	PATIENT STATION.
08	STAFF STATION.
09	TOUCH SCREEN NURSE CALL MASTER STATION.
10	ZONE LIGHT CONTROLLER.
11	NURSE CALL AREA CONTROL UNIT & POWER SUPPLIES.
SECURITY	
01	SECURITY CABLE. SEE EQUIPMENT SCHEDULE FOR CABLE TYPE.
02	ACCESS CONTROL HEADEND EQUIPMENT.
03	SECURITY CONTROL PANEL.
04	INTRUSION DETECTION HEADEND EQUIPMENT.
05	CARD ACCESS DOOR TYPE #1 OR AS NOTED. SEE SCHEDULE.
06	CARD READER.
07	KEYPAD/CARD READER COMBINATION.
08	PANIC DURESS SWITCH.
TV DISTRIBUTION	
01	TV DISTRIBUTION CABLE, INDIVIDUAL DROPS.
02	TV DISTRIBUTION CABLE, TRUNK.
03	COMBINER.
04	DIRECTIONAL COUPLER.
05	DISTRIBUTION AMPLIFIER (ONE-LINE DIAGRAM).
06	SPLITTER (ONE-LINE DIAGRAM).
07	TV OUTLET.
08	SATELLITE ANTENNA.
09	TV ANTENNA (ONE-LINE DIAGRAM).
10	TERMINATOR, 75 OHM (TV DISTRIBUTION).

SYMBOLS LEGEND


SYMBOL	DESCRIPTION		
FIRE ALARM			
01	FIRE SYSTEM ANNUNCIATOR.		
02	FIRE ALARM CONTROL PANEL, SEMI-RECESSED.		
03	FIRE ALARM NOTIFICATION POWER SUPPLY.		
04	FIRE ALARM TRANSPONDER OR TRANSMITTER.		
05	SMOKE CONTROL PANEL.		
06	AUTOMATIC DOOR CLOSERS: DOOR CLOSERS SHALL BE FURNISHED WITH DOOR HARDWARE AND CONNECTED TO BY FIRE ALARM INSTALLERS.		
07	CONTROL MODULE.		
08	MONITOR MODULE.		
09	FIRE ALARM MANUAL PULL STATION.		
10	SHUT DOWN RELAY. INSTALL RELAY IN CONTROL CIRCUIT OF EQUIPMENT TO BE CONTROLLED IN THE EVENT OF A FIRE.		
11	MAGNETIC DOOR HOLDER.		
12	FIRE SERVICE OR EMERGENCY TELEPHONE STATION, ACCESSIBLE.		
13	FIRE SERVICE OR EMERGENCY TELEPHONE STATION, HANDSET.		
14	FIRE SERVICE OR EMERGENCY TELEPHONE STATION, JACK.		
15	DETECTOR, SMOKE.		
16	DETECTOR, SMOKE WITH AUXILIARY CONTACT.		
17	DETECTOR, SMOKE, BEAM RECEIVER.		
18	DETECTOR, SMOKE, BEAM TRANSMITTER.		
19	DETECTOR, SMOKE, ELEVATOR RECALL DESIGNATION.		
20	DETECTOR, SMOKE WITH GUARD.		
21	DETECTOR, SMOKE, RESIDENTIAL.		
22	DETECTOR, SMOKE, DUCT WITH HOUSING AND SAMPLING TUBE.		
23	DETECTOR, HEAT.		
24	INDICATOR LAMP.		
25	STROBE.		
27	ALARM, HORN/SPEAKER, WEATHERPROOF.		
28	ALARM, HORN/STROBE, ONE ASSEMBLY.		
29	ALARM, HORN/STROBE, ONE ASSEMBLY. SUBSCRIPT INDICATES CANDELA RATING.		
30	ALARM, CHIME/STROBE, ONE ASSEMBLY.		
31	ALARM, HORN/STROBE WITH GUARD, ONE ASSEMBLY.		
32	ALARM, MINI HORN/STROBE, ONE ASSEMBLY.		
33	SPEAKER, EVACUATION.		
34	SPEAKER, EVACUATION, COMBINATION STROBE.		
35	DETECTOR, FLOW SWITCH: FLOW SWITCHES SHALL BE PROVIDED AND INSTALLED WITH FIRE SPRINKLER SYSTEM AND SHALL BE CONNECTED TO LOCATIONS SHOWN ON THE FIRE SPRINKLER SHOP DRAWINGS.		
36	DETECTOR, TAMPER SWITCH WITH VALVE: TAMPER SWITCHES SHALL BE PROVIDED AND INSTALLED WITH FIRE SPRINKLER SYSTEM AND SHALL BE CONNECTED TO LOCATIONS SHOWN ON THE FIRE SPRINKLER SHOP DRAWINGS.		
37	SMOKE DAMPER.		
38	FIRE AND SMOKE DAMPER.		
39	BELL (GONG).		
40	DETECTOR, CARBON MONOXIDE.		
42	ALARM, HORN/STROBE, ONE ASSEMBLY, CEILING MOUNTED. SUBSCRIPT INDICATES CANDELA RATING.		
43	ALARM, HORN, CEILING MOUNTED. SUBSCRIPT INDICATES CANDELA RATING.		
44	ALARM, STROBE, CEILING MOUNTED. SUBSCRIPT INDICATES CANDELA RATING.		
ABBREVIATIONS			
NOTE: ALL ABBREVIATIONS MAY NOT BE USED.			
1P	SINGLE POLE	KV	KILOVOLT
1PH	SINGLE-PHASE	KVA	KILOVOLT AMPERE
1WAY	ONE-WAY	KVAR	KILOVOLT AMPERE REACTIVE
2/C	TWO-CONDUCTOR	KW	KILOWATT
2WAY	TWO-WAY	KWH	KILOWATT HOUR
3/C	THREE-CONDUCTOR	LED	LIGHT EMITTING DIODE
3WAY	THREE-WAY	LFCM	LIQUID TIGHT FLEXIBLE METAL CONDUIT
4/OUT	QUADRUPLE RECEPTACLE OUTLET	LFLC	LIQUID TIGHT FLEXIBLE NONMETALLIC CONDUIT
4PDT	FOUR-POLE DOUBLE THROW	LPS	LOW PRESSURE SODIUM
4PST	FOUR-POLE SINGLE THROW	LRA	LOCKED ROTOR AMPS
4W	FOUR-WIRE	LTG	LIGHTING
4WAY	FOUR-WAY	LV	LOW VOLTAGE
A	ABOVE COUNTER	MA	MASTER ANTENNA TELEVISION SYSTEM
AC	ARMORED CABLE	MAX	MAXIMUM
ADA	AMERICANS WITH DISABILITIES ACT	MC	MINIMUM
ADJ	ADJACENT	MCA	MINIMUM CIRCUIT AMPS
AF	ABOVE FINISHED FLOOR	MCB	MAIN CIRCUIT BREAKER
AFG	ABOVE FINISHED GRADE	MCC	MOTOR CONTROL CENTER
AIC	AMPERE INTERRUPTING CAPACITY	MCP	MOTOR CIRCUIT PROTECTION
ALUM	ALUMINUM	MDP	MAIN DISTRIBUTION PANEL
AMP	AMPERE	MG	MOTOR GENERATOR
ANN	ANNUNCIATOR	MH	MANHOLE
AN	ACCESS POINT (WIRELESS DATA)	MIN	MINIMUM
AR	AS REQUIRED	NL	NIGHT LIGHT
ASC	AMPS SHORT CIRCUIT	MOC	MAXIMUM OVERCURRENT PROTECTION
ATS	AUTOMATIC TRANSFER SWITCH	MNTS	MANUAL TRANSFER SWITCH
AV	AUDIO VISUAL	NA	NOT APPLICABLE
AWG	AMERICAN WIRE GAGE	NC	NORMALLY CLOSED
BB	BUCK-BOOST TRANSFORMER	NEC	NATIONAL ELECTRICAL CODE
CFMR	CUSTOM FINISH AS SELECTED BY ARCHITECT	NEMA	NATIONAL ELECTRICAL MANUFACTURERS ASSOCIATION
CATV	COMMUNITY ANTENNA TELEVISION	NFC	NATIONAL FIRE CODE
CB	CIRCUIT BREAKER	NFPA	NATIONAL FIRE PROTECTION ASSOCIATION
CCBA	CUSTOM COLOR AS SELECTED BY ARCHITECT	NIC	NOT IN CONTRACT
CCTV	CLOSED CIRCUIT TELEVISION	NO	NORMALLY OPEN
CF/CI	CONTRACTOR FURNISHED/ CONTRACTOR INSTALLED	NTS	NOT TO SCALE
CF/CI	CONTRACTOR FURNISHED/ OWNER INSTALLED	OC	ON CENTER
CFBA	CUSTOM FINISH AS SELECTED BY ARCHITECT	OCIP	OVER CURRENT PROTECTION
CKT	CIRCUIT	OF/CI	OWNER FURNISHED/ CONTRACTOR INSTALLED
CM	CONSTRUCTION MANAGER	OF/CI	OWNER FURNISHED/ OWNER INSTALLED
CON	CONVENIENCE OUTLET	OPF	OBTAIN FROM PLANS
COR	CONTRACTING OFFICER'S REPRESENTATIVE	OH DR	OVERHEAD (COILING) DOOR
CP	CURRENT TRANSFORMER	OL	OVERLOAD
CT	CABLE TELEVISION	PL	PULL BOX (SIGNAL)
CU	COPPER	PF	POWER FACTOR
DBA	UNIT OF SOUND LEVEL	PH	PHASE
DPDT	DOUBLE POLE, DOUBLE THROW	PNL	PANEL
DS	DISCONNECT SWITCH	RCP	REFLECTED CEILING PLAN
EA	EACH	RMC	RIGID METAL CONDUIT
EM	EMERGENCY	RNC	RIGID NONMETAL CONDUIT
EMT	ELECTRICAL METALLIC TUBING	RPM	REVOLUTIONS PER MINUTE
ENT	ELECTRIC NONMETALLIC TUBING	RR	REMOVE AND RELOCATE
EPO	EMERGENCY POWER OFF EQUIPMENT	SIS	START/STOP
EX	EXISTING	SCA	SHORT CIRCUIT AMPS
FA	FIRE ALARM	SCBA	STANDARD COLOR AS SELECTED BY ARCHITECT
FCP			

GENERAL SHEET NOTES

- DETERMINE MOUNTING HEIGHTS OF ELECTRICAL AND ELECTRONIC EQUIPMENT IN THE FOLLOWING ORDER OF PRIORITY:
 - ELEVATIONS (ARCHITECTURAL, ELECTRICAL, MECHANICAL, ETC.)
 - EQUIPMENT SHOP DRAWINGS.
 - FIELD INSTRUCTIONS.
- LOCATE RECEPTACLES SERVING THE SAME TYPE OF USE AT A UNIFORM HEIGHT UNLESS DIRECTED OTHERWISE.
- MECHANICAL, ELECTRICAL, AND COMMUNICATION ROOMS: COORDINATE LOCATION OF LIGHTING AND POWER RECEPTACLES WITH EQUIPMENT, PIPING, AND DUCTWORK. DO NOT INSTALL RECEPTACLES BEHIND EQUIPMENT OR WHERE OTHERWISE INACCESSIBLE. POSITION LIGHTING REGARDLESS OF WHERE SHOWN ON DRAWING TO PROVIDE PROPER ILLUMINATION.
- MOUNT RECEPTACLE BOXES FOR SWITCHES AND RECEPTACLES WITH LONG AXIS OF THE DEVICE VERTICAL UNLESS OTHERWISE INDICATED.
- SET BOXES WITH PLASTER RINGS FLUSH WITH FINISHED SURFACE.
- LOCATE BOX COVERS OR DEVICE PLATES SO THEY WILL NOT SPAN DIFFERENT TYPES OF BUILDING FINISHES EITHER VERTICALLY OR HORIZONTALLY.
- VERIFY ALL DOOR CONDITIONS ON ARCHITECTURAL DRAWINGS PRIOR TO INSTALLING SWITCHES.
- LOCATE WIRING DEVICES WHICH ARE ADJACENT AND ARE COMPATIBLE VOLTAGES IN ONE PLATE.
- WHERE DEVICES ARE LOCATED IN CLOSE PROXIMITY OF THE SAME VERTICAL PLANE, ALIGN DEVICES VERTICALLY PER THE TYPICAL WALL MOUNTED DEVICES ALIGNMENT DETAIL, UNLESS OTHERWISE INDICATED.


SHEET KEYNOTES

- LOCATE RECEPTACLES BEHIND DRINKING FOUNTAINS.
- REFER TO ARCHITECTURAL ELEVATIONS FOR PLACEMENT OF OUTLETS.
- LOCATE AT BOTTOM OF BEAMS (OR JOISTS) OR AT CEILING. (REDUCE SPACING BY 5 PERPENDICULAR TO BEAM OR JOIST DIRECTION.) FOR OTHER CONDITIONS, REFER TO NFPA 72.
- LOCATE DETECTOR ANYWHERE IN SHADED AREA BUT NOT IN TOP 4" OF PEAK.
- LOCATE AT BOTTOM OF BEAMS IF D/H < .1 OR W/H < .4; OTHERWISE, LOCATE IN BEAM POCKET. FOR D > 4 REDUCE SPACING .33 PERPENDICULAR TO BEAMS.

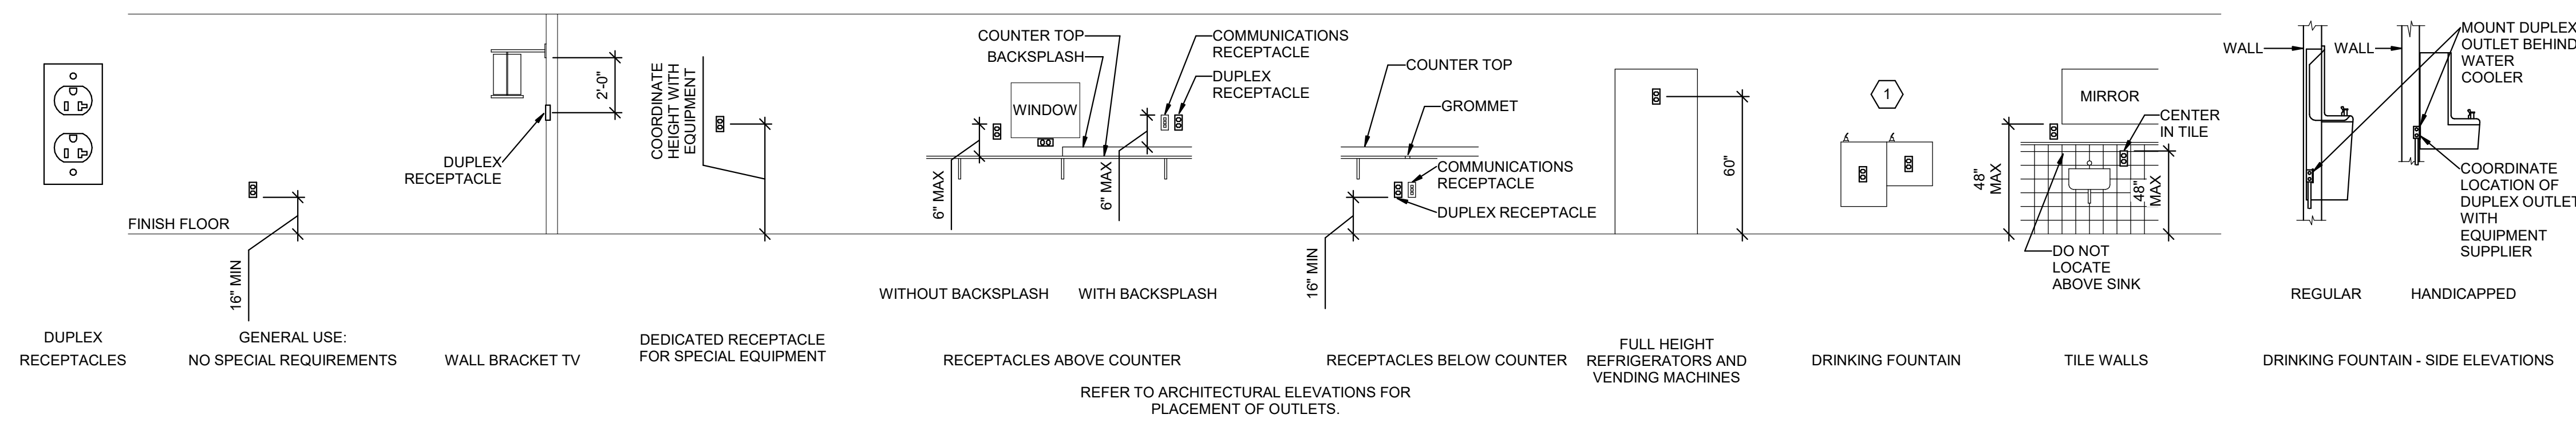


9 RECEPTACLE MOUNTING DETAILS

SCALE: NTS

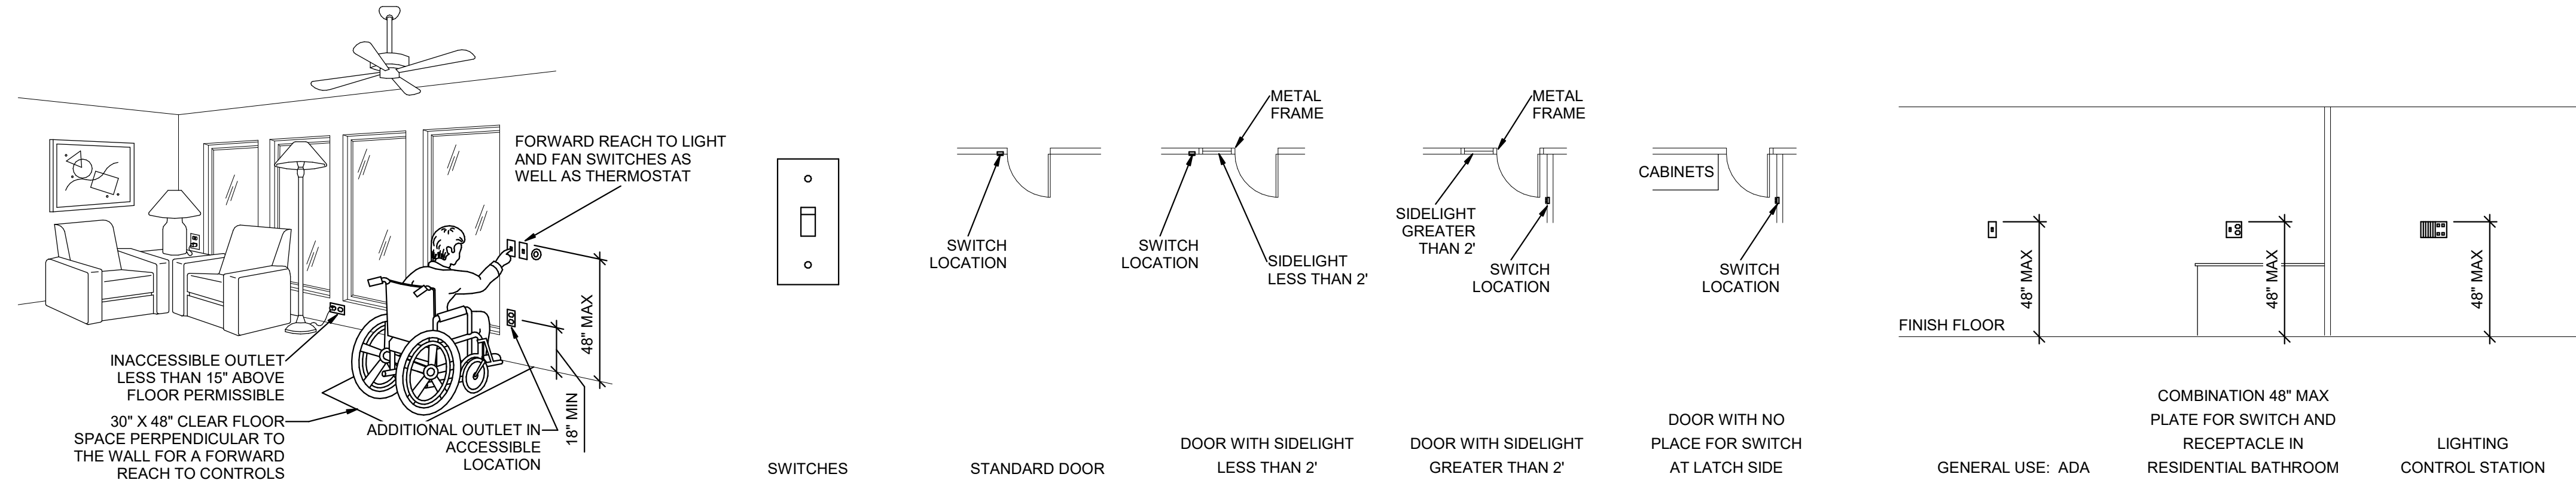


8 SWITCH MOUNTING DETAILS

SCALE: NTS

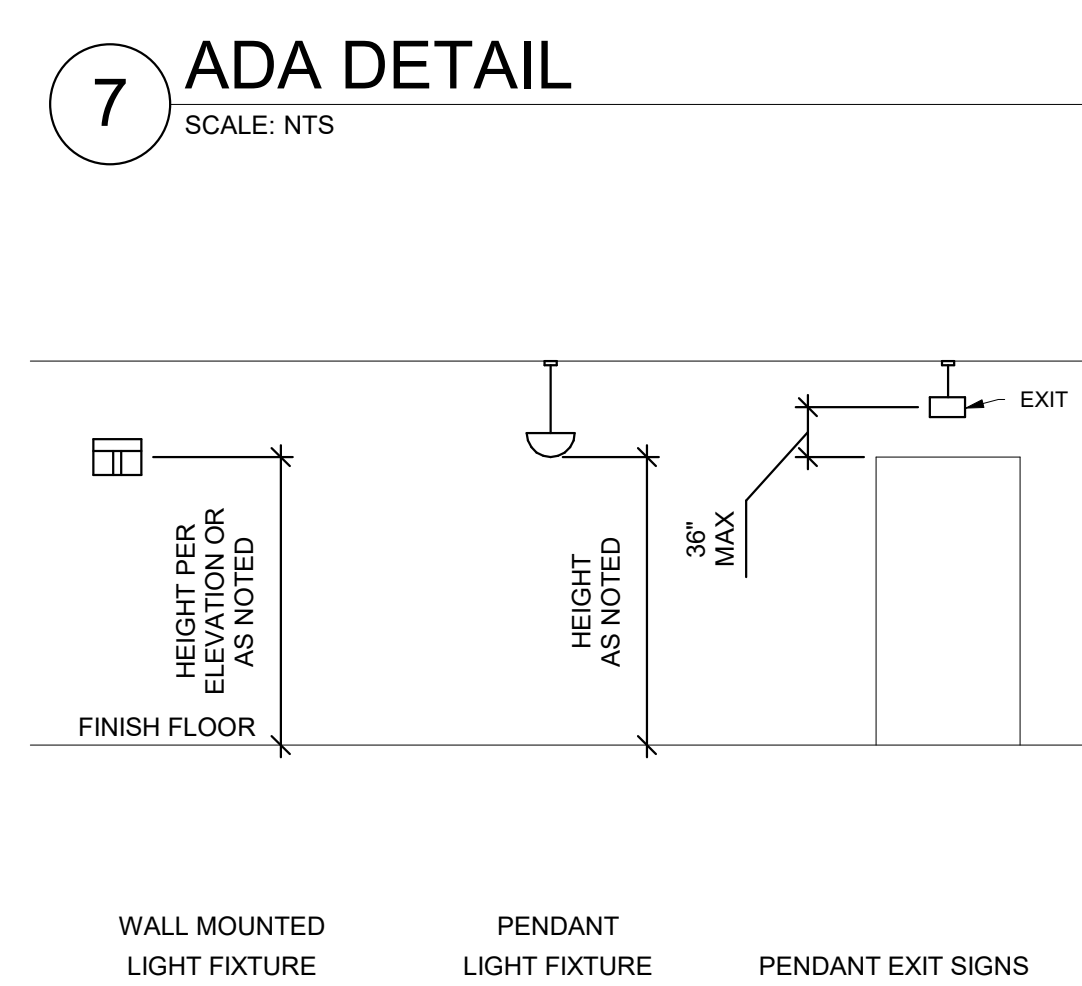

7 ADA DETAIL

SCALE: NTS

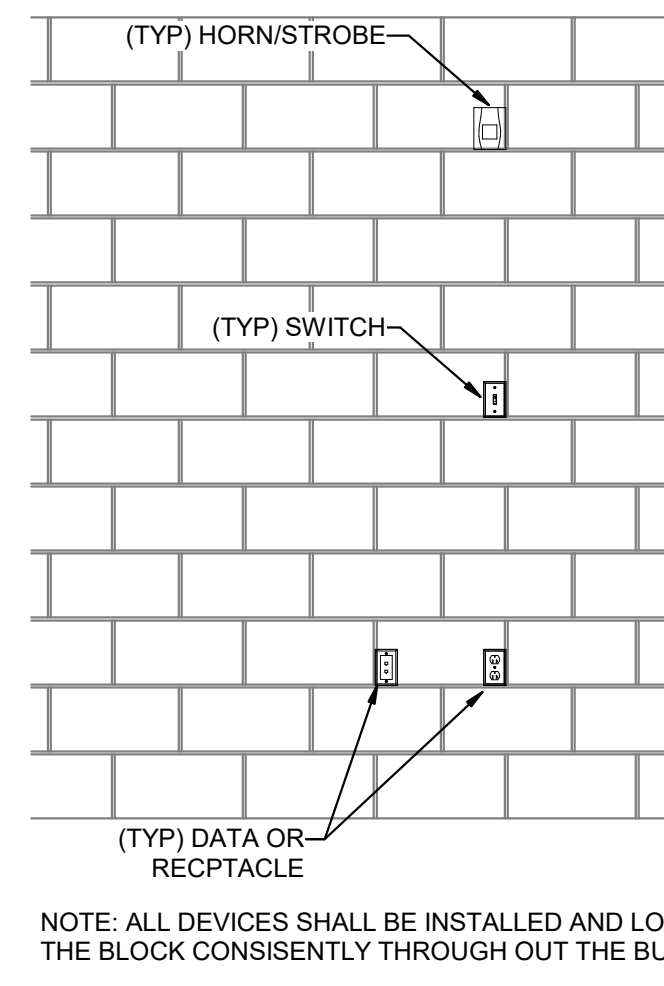

4 CMU DEVICE MOUNTING ALIGNMENT DETAIL


SCALE: NTS

5 LIGHTING MOUNTING DETAILS

SCALE: NTS


6 COMMUNICATIONS MOUNTING DETAILS

SCALE: NTS

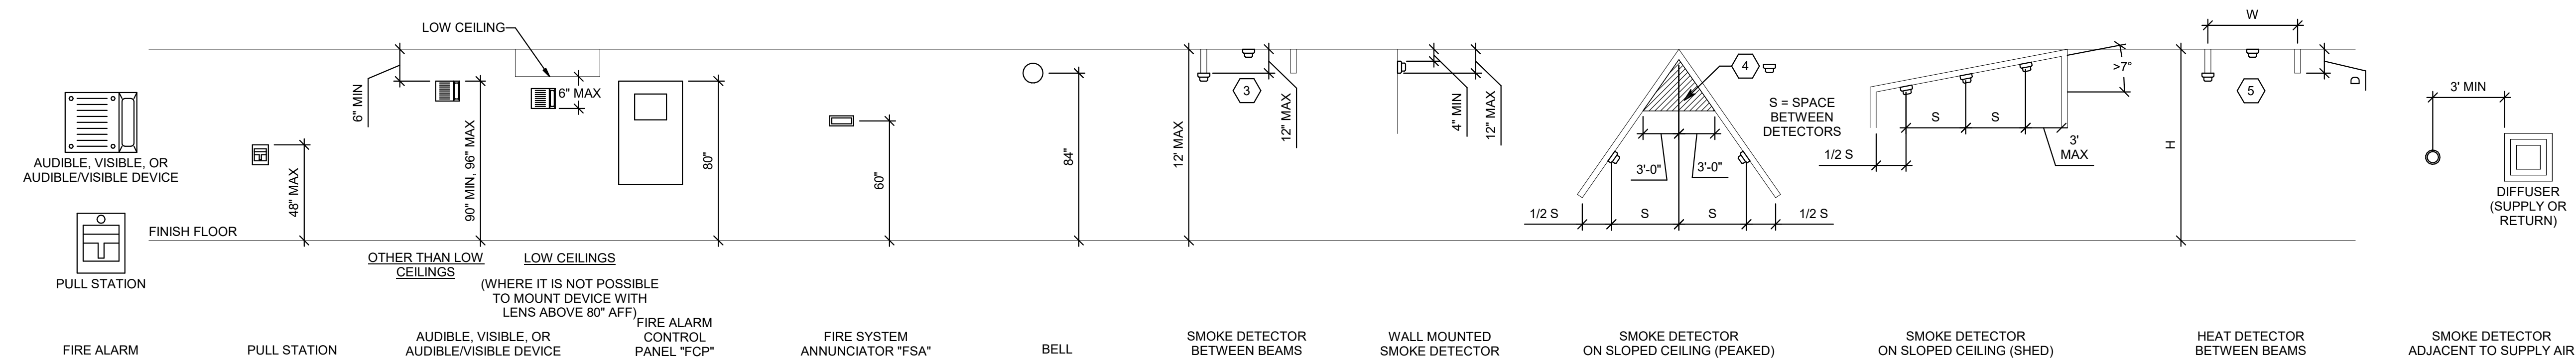

3 FIRE ALARM MOUNTING DETAILS

SCALE: NTS

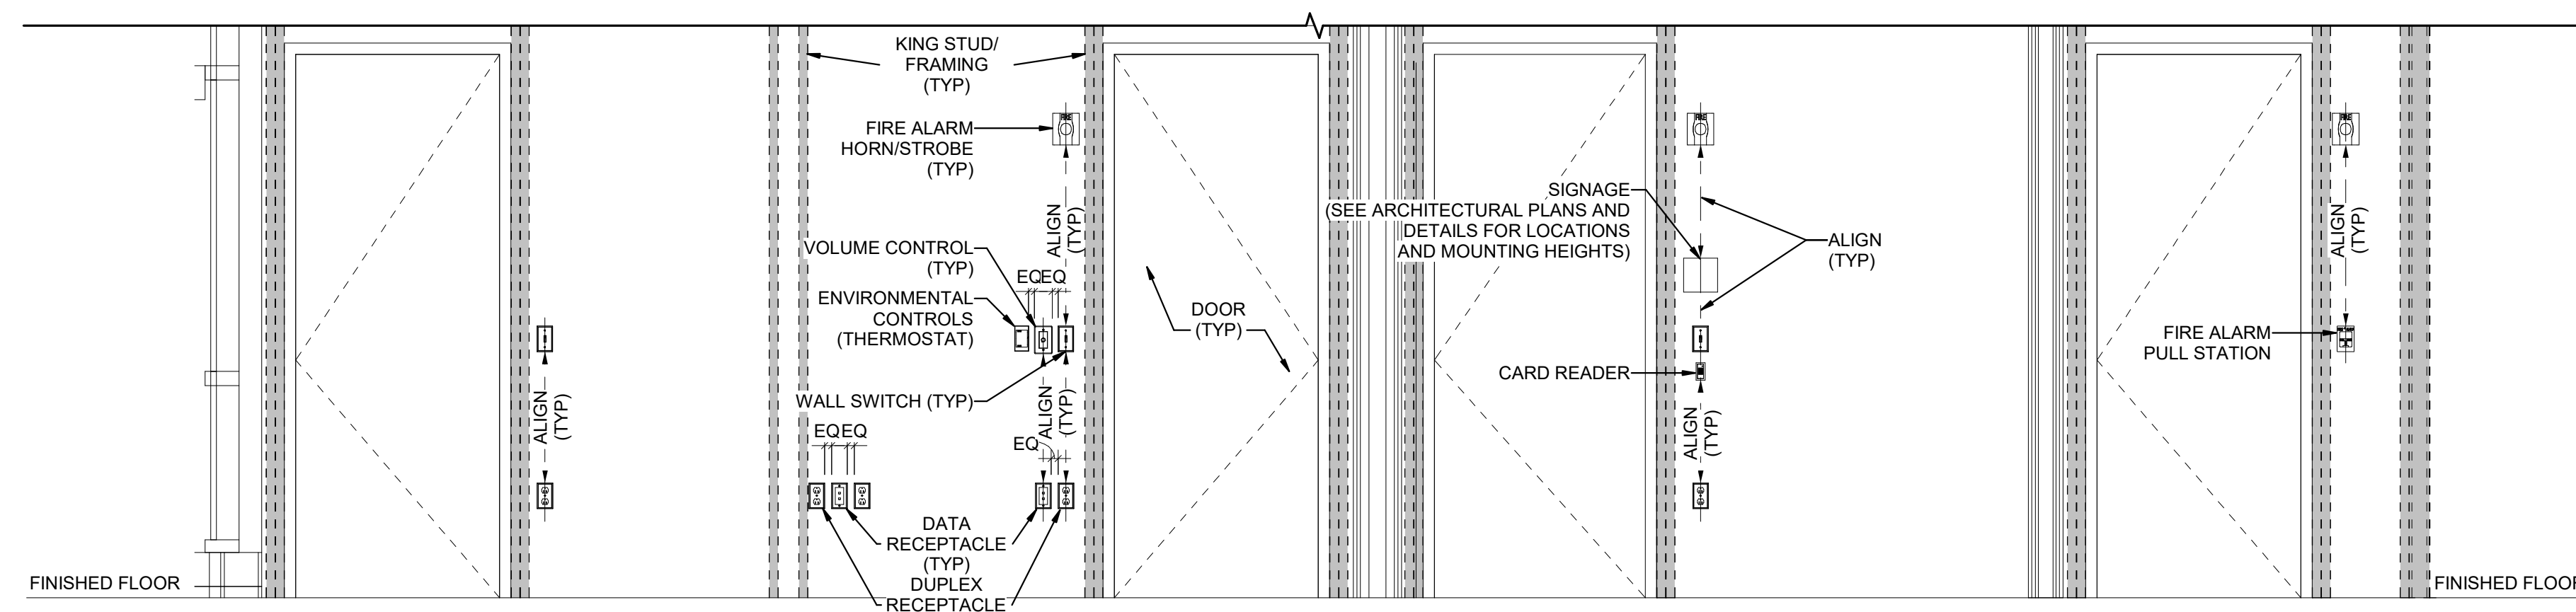


2 TYPICAL WALL MOUNTED DEVICES ALIGNMENT DETAIL

SCALE: NTS

1 BOX MOUNTING DETAILS

SCALE: NTS

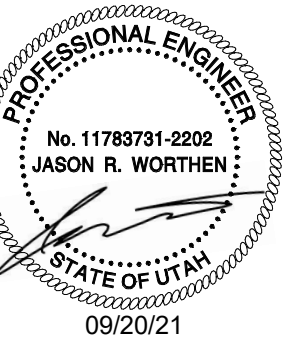

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24805.000

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02/20/15

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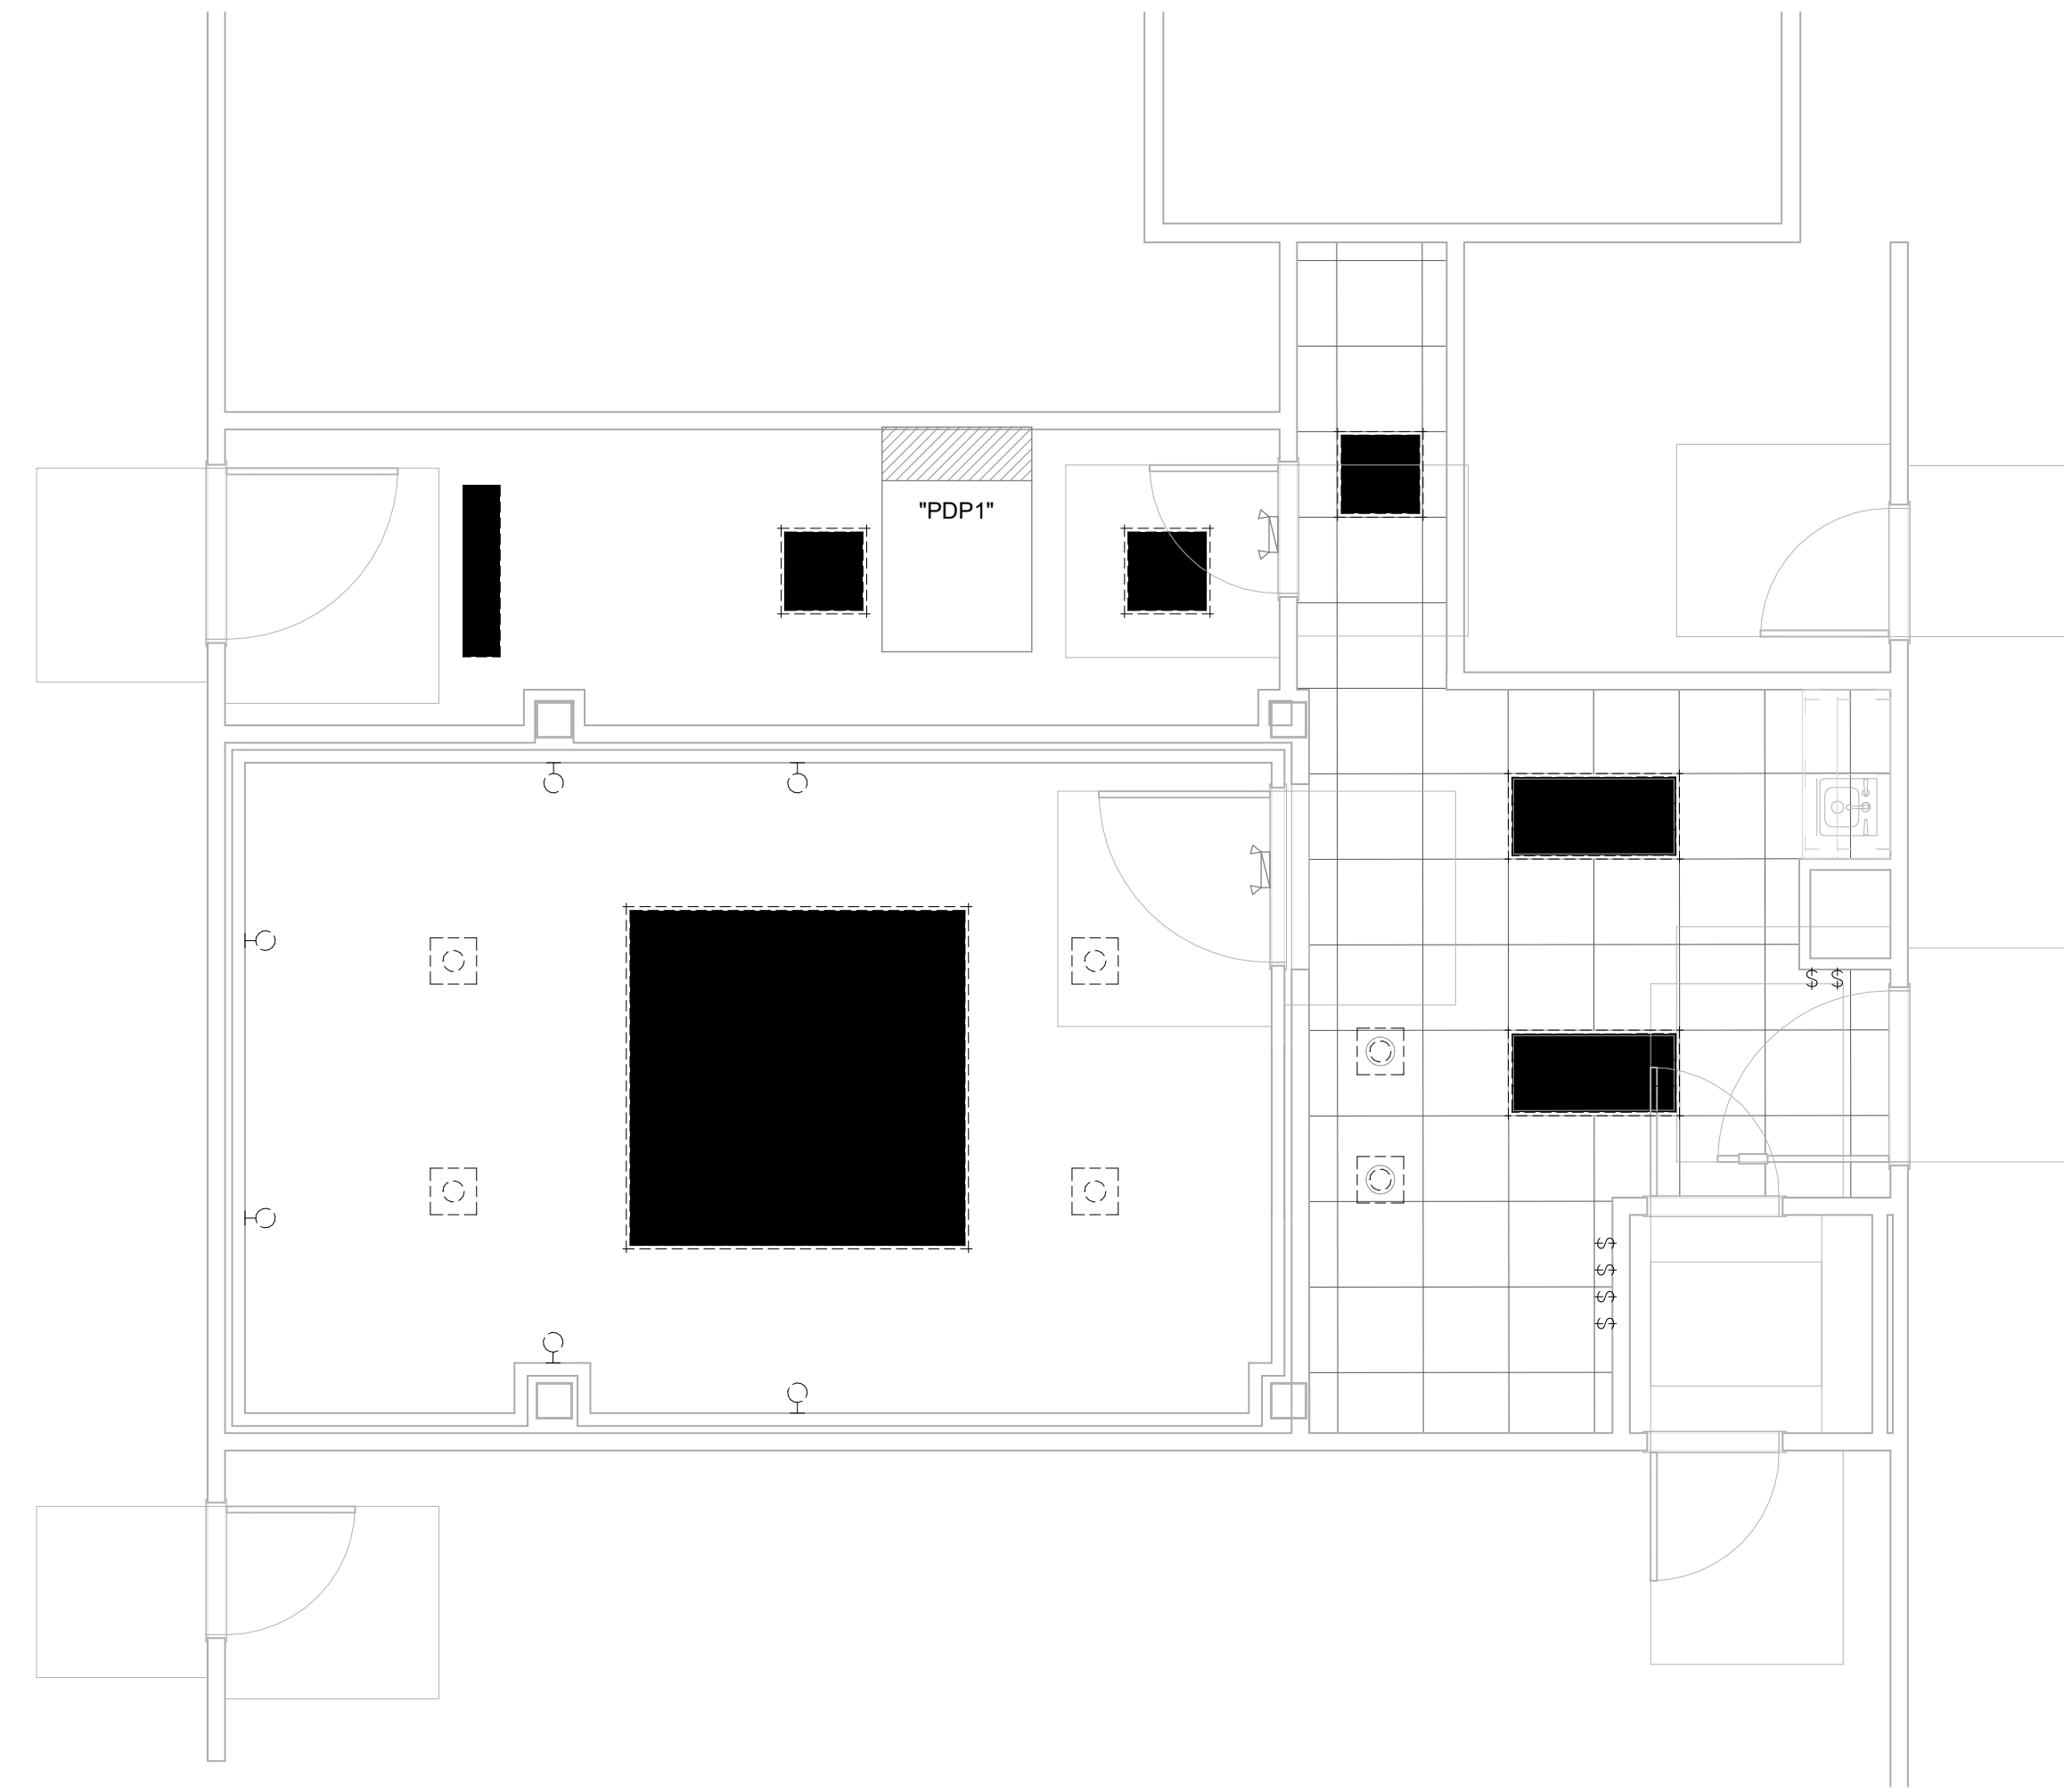
SHEET TITLE
**LEVEL 1
ELECTRICAL
DEMOLITION PLAN**

SHEET NO.


ED101

- ### GENERAL SHEET NOTES
- UNLESS NOTED OTHERWISE REMOVE ALL LIGHTING FIXTURES DEVICES AND EQUIPMENT SHOWN DASHED. REMOVE CONDUIT AND WIRING BACK TO PANELBOARD OF ORIGIN OR TO FIRST ACTIVE DEVICE THAT REMAINS.
 - SALVAGE ALL LIGHT FIXTURES, TWIST-LOCK RECEPTACLES AND WALLPLATES, CEILING SPEAKERS AND SECURITY AND FIRE ALARM DEVICES TO OWNER. PROTECT SALVAGED EQUIPMENT FROM DAMAGE.
 - PRIOR TO SUBMITTING BID, VISIT THE SITE AND FIELD VERIFY THE EXTENT OF ELECTRICAL DEMOLITION WORK TO MEET THE INTENT OF THE BID DOCUMENTS AND INCLUDE ALL COSTS IN BID.
 - PRIOR TO REMOVAL OF ANY ELECTRICAL EQUIPMENT OR WIRING, FIELD VERIFY THAT THE EQUIPMENT OR WIRING IS INACTIVE OR NO LONGER IN USE.
 - REMOVE ALL DEVICES, RACEWAYS AND WIRING FROM WALLS TO BE REMOVED. WHERE ACTIVE RACEWAYS OCCUR IN WALLS TO BE REMOVED, RE-ROUTE THE RACEWAY WITH ASSOCIATED WIRING TO KEEP THE CIRCUIT OPERATIONAL.
 - REMOVE ALL FIRE ALARM DEVICES WHERE EXISTING WALLS AND CEILINGS ARE BEING REMOVED, WITH ASSOCIATED CONDUIT AND WIRING. EXISTING FIRE ALARM DEVICES AND SYSTEM NOT INDICATED FOR REMOVAL SHALL REMAIN ACTIVE THROUGHOUT DEMOLITION AND CONSTRUCTION UNTIL THE NEW SYSTEM IS TESTED AND OPERATIONAL. MAINTAIN ALL CLASS A FIRE ALARM INITIATING AND INDICATING LOOPS WHERE EXISTING DEVICES ARE REMOVED.
 - REMOVE ALL ABANDONED RACEWAY, CONDUIT, WIRING AND CABLING WHETHER ABANDONED PREVIOUS TO THIS PROJECT OR AS A RESULT OF THIS PROJECT. NOT ALL ABANDONED ITEMS ARE SHOWN ON THESE PLANS AND FIELD VERIFICATION OF DEMOLITION SCOPE EXTENT IS REQUIRED.
 - DEVICES MARKED "RR" ARE TO BE REMOVED AND RELOCATED PER NEW PLANS. EXTEND CIRCUITING AS REQUIRED FOR RELOCATION.
 - REMOVE FEEDERS FOR ALL DEMOLISHED PANELS, DISCONNECTS, ETC. BACK TO SOURCE
 - ALL ITEMS INDICATED TO REMAIN SHALL BE PROTECTED DURING ALL PHASES OF CONSTRUCTION.

○ SHEET KEYNOTES



2 LEVEL 1 CEILING DEMOLITION PLAN
SCALE: 1/4" = 1'-0"

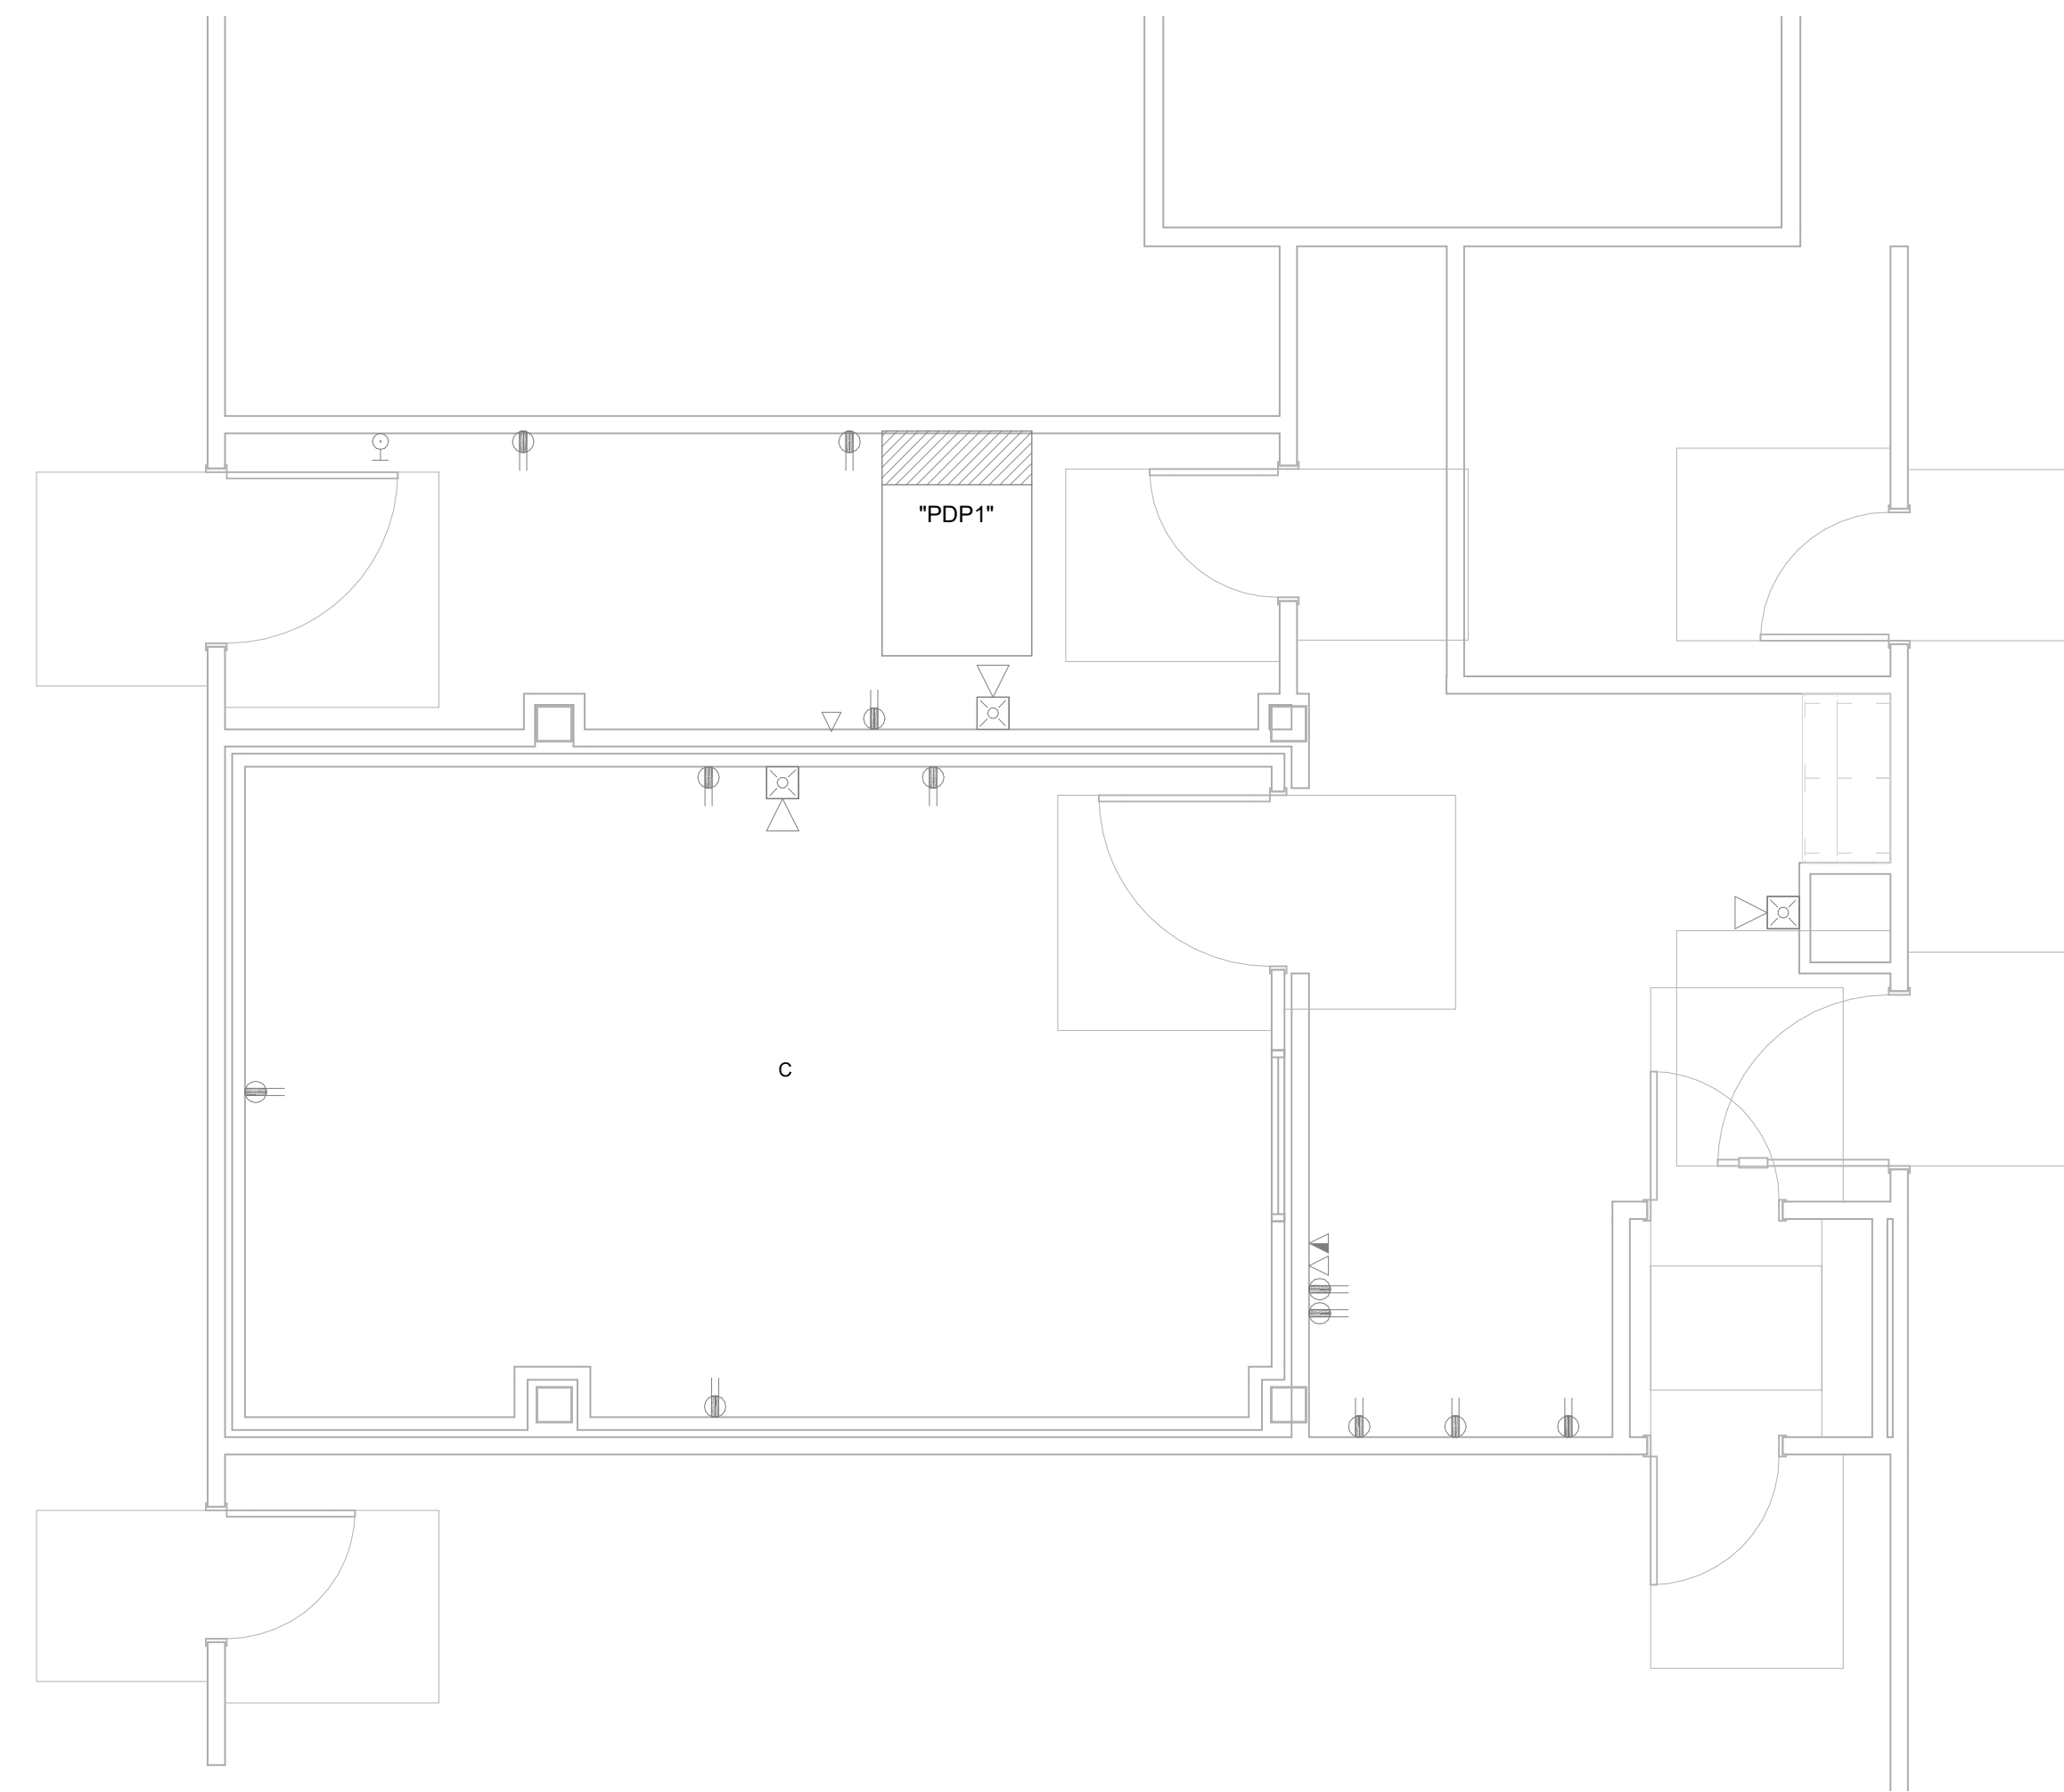

1 LEVEL 1 ELECTRICAL DEMOLITION PLAN
SCALE: 1/4" = 1'-0"

GENERAL SHEET NOTES

- 1 AS PART ADD ALTERNATE #1, REMOVE ALL EXISTING ELECTRICAL DEVICES IN THE MRI ROOM AND REINSTALL IN THE NEW SHIELDED WALL. REUSE ALL EXISTING CIRCUITING.
- 2 PROVIDED DEDICATED NEUTRALS FOR ALL BRANCH CIRCUITS.
- 3 PROVIDE NEW TYPED PANEL SCHEDULES FOR ALL PANELS AFFECTED BY THE PROJECT.
- 4 AUXILIARY PLAN SHOWN FOR REFERENCE ONLY. NO EXPECTED SCOPE FOR NURSE CALL, FIRE ALARM OR SECURITY SYSTEMS. CONTRACTOR TO PROTECT ALL EXISTING DEVICES DURING CONSTRUCTION.
- 5 CONTRACTOR TO REFER TO GE DRAWINGS FOR ADDITIONAL CONTRACTOR RESPONSIBILITIES.

SHEET KEYNOTES

- 1 PROVIDE NEW 20A BREAKER IN EXISTING SQUARE D PANELBOARD.
- 2 PROVIDE NEW 20A BREAKER IN EXISTING GE PANELBOARD.

HKS
ARCHITECT
 HKS ARCHITECTS, INC.
 90 SOUTH 400 WEST, SUITE 110
 SALT LAKE CITY, UT 84101
STRUCTURAL ENGINEER
 DUNN ASSOCIATES, INC.
 380 WEST 800 SOUTH
 SALT LAKE CITY, UT 84101
MECHANICAL ENGINEER
 VIBA, INC.
 181 EAST 5600 SOUTH, SUITE 200
 MURRAY, UTAH 84107
ELECTRICAL ENGINEER
 SPECTRUM ENGINEERS
 324 SOUTH STATE STREET
 SALT LAKE CITY, UT 84111

**Mountain View Hospital
 MRI Replacement**

1000 EAST 100 NORTH, PAVENHOL, UTAH 84051



REVISION NO.	DESCRIPTION	DATE

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24805.000
 DATE
09/16/21
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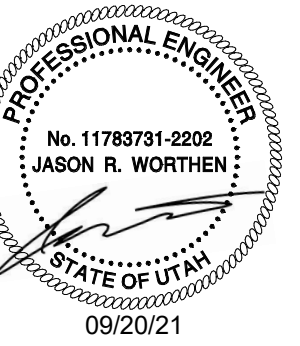
SHEET TITLE
**LEVEL 1 OVERALL
 POWER PLAN**

SHEET NO.
EP100



1 LEVEL 1 OVERALL POWER PLAN
 SCALE: 3/32" = 1'-0"

PLOT DATE: 09/20/21 7:29:54 PM TEMPLATE VERSION: 3.0.0.20170923



REVISION NO. DESCRIPTION DATE

NO.	DESCRIPTION	DATE

HKS PROJECT NUMBER
24805.000

DATE
12/23/09

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SHEET TITLE
**LEVEL 1
ELECTRICAL
PLANS**


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GENERAL SHEET NOTES


- AS PART ADD ALTERNATE #1, REMOVE ALL EXISTING ELECTRICAL DEVICES IN THE MRI ROOM AND REINSTALL IN THE NEW SHIELDED WALL. REUSE ALL EXISTING CIRCUITING.
- PROVIDE DEDICATED NEUTRALS FOR ALL BRANCH CIRCUITS.
- PROVIDE NEW TYPED PANEL SCHEDULES FOR ALL PANELS AFFECTED BY THE PROJECT.
- AUXILIARY PLAN SHOWN FOR REFERENCE ONLY. NO EXPECTED SCOPE FOR NURSE CALL, FIRE ALARM OR SECURITY SYSTEMS. CONTRACTOR TO PROTECT ALL EXISTING DEVICES DURING CONSTRUCTION.
- CONTRACTOR TO REFER TO GE DRAWINGS FOR ADDITIONAL CONTRACTOR RESPONSIBILITIES.

SHEET KEYNOTES


-
- CIRCUIT LIGHTING TO THE EXISTING LIGHTING CIRCUIT THAT PREVIOUSLY FED LIGHTING IN THIS AREA.
- PROVIDE A SINGLE POLE SWITCH FOR CRYOGEN FANS.
- PROVIDE 120V CIRCUIT FOR FERROGUARD DOOR SYSTEM REFER TO FERROGUARD INSTALLATION REQUIREMENTS FOR ADDITIONAL CONTRACTOR RESPONSIBILITIES.
- REFER TO FERROGUARD DRAWINGS FOR SWITCH MOUNTING HEIGHT.

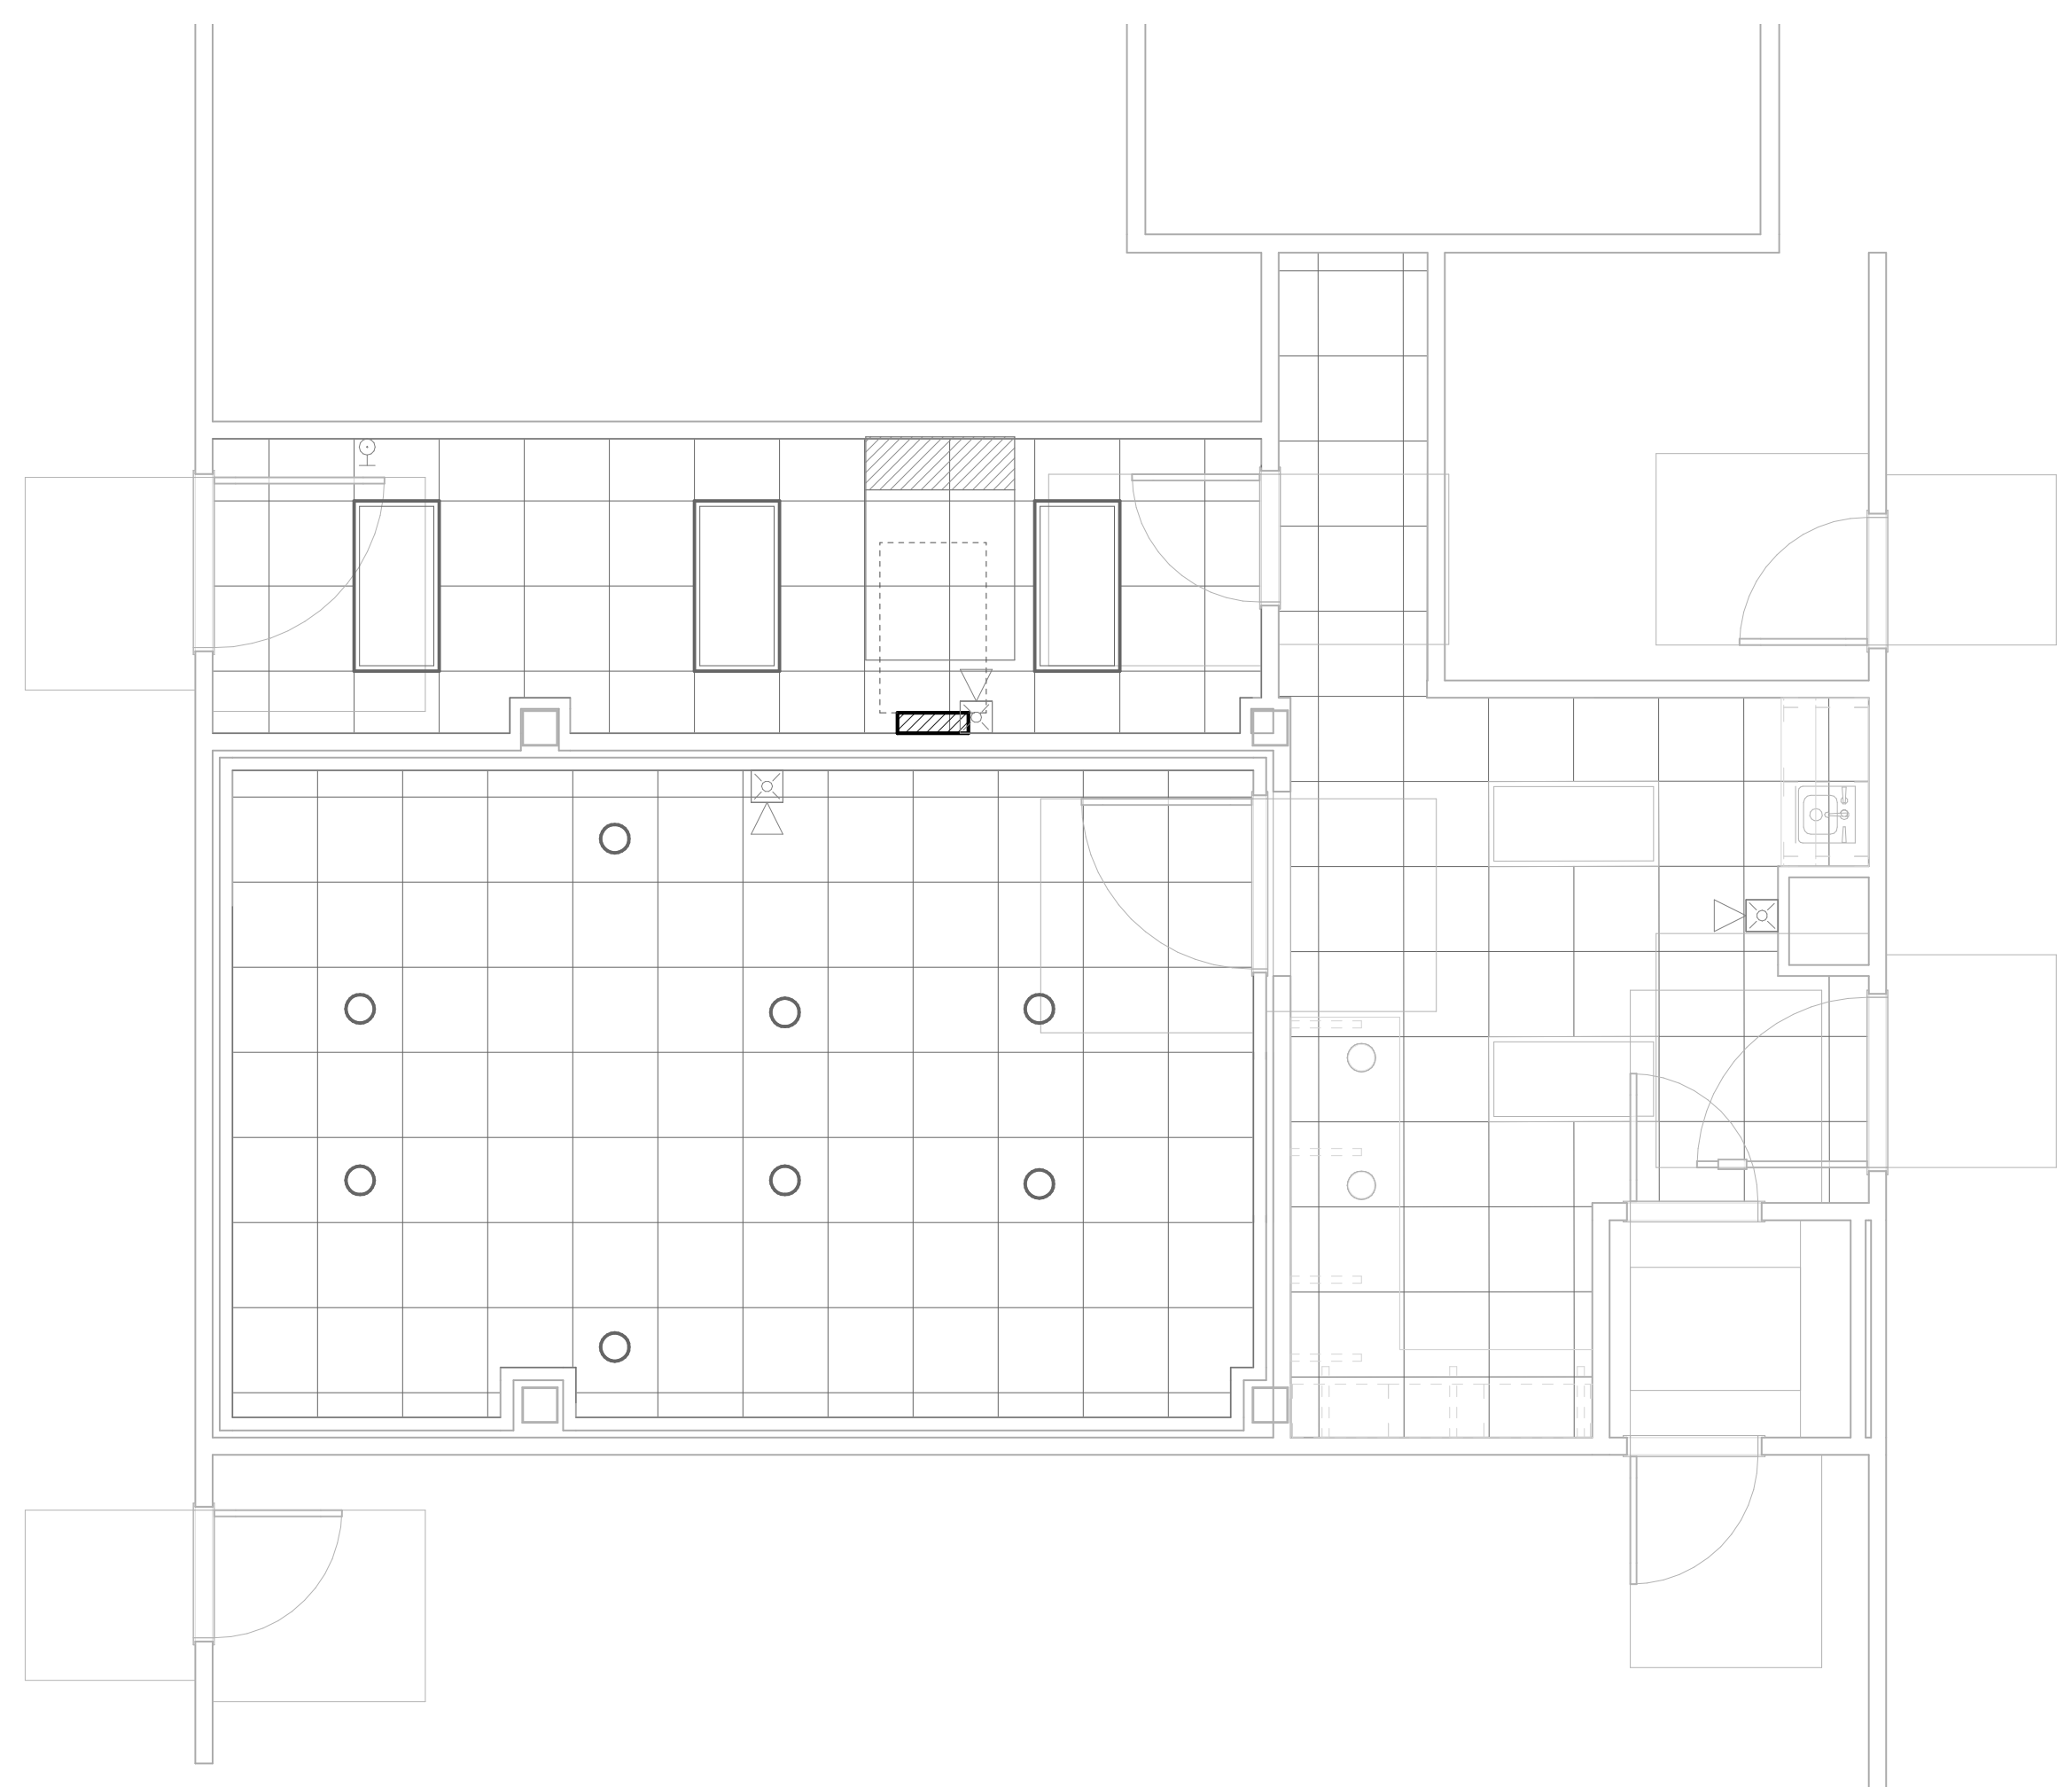

3 LEVEL 1 AUXILIARY PLAN
SCALE: 1/4" = 1'-0"

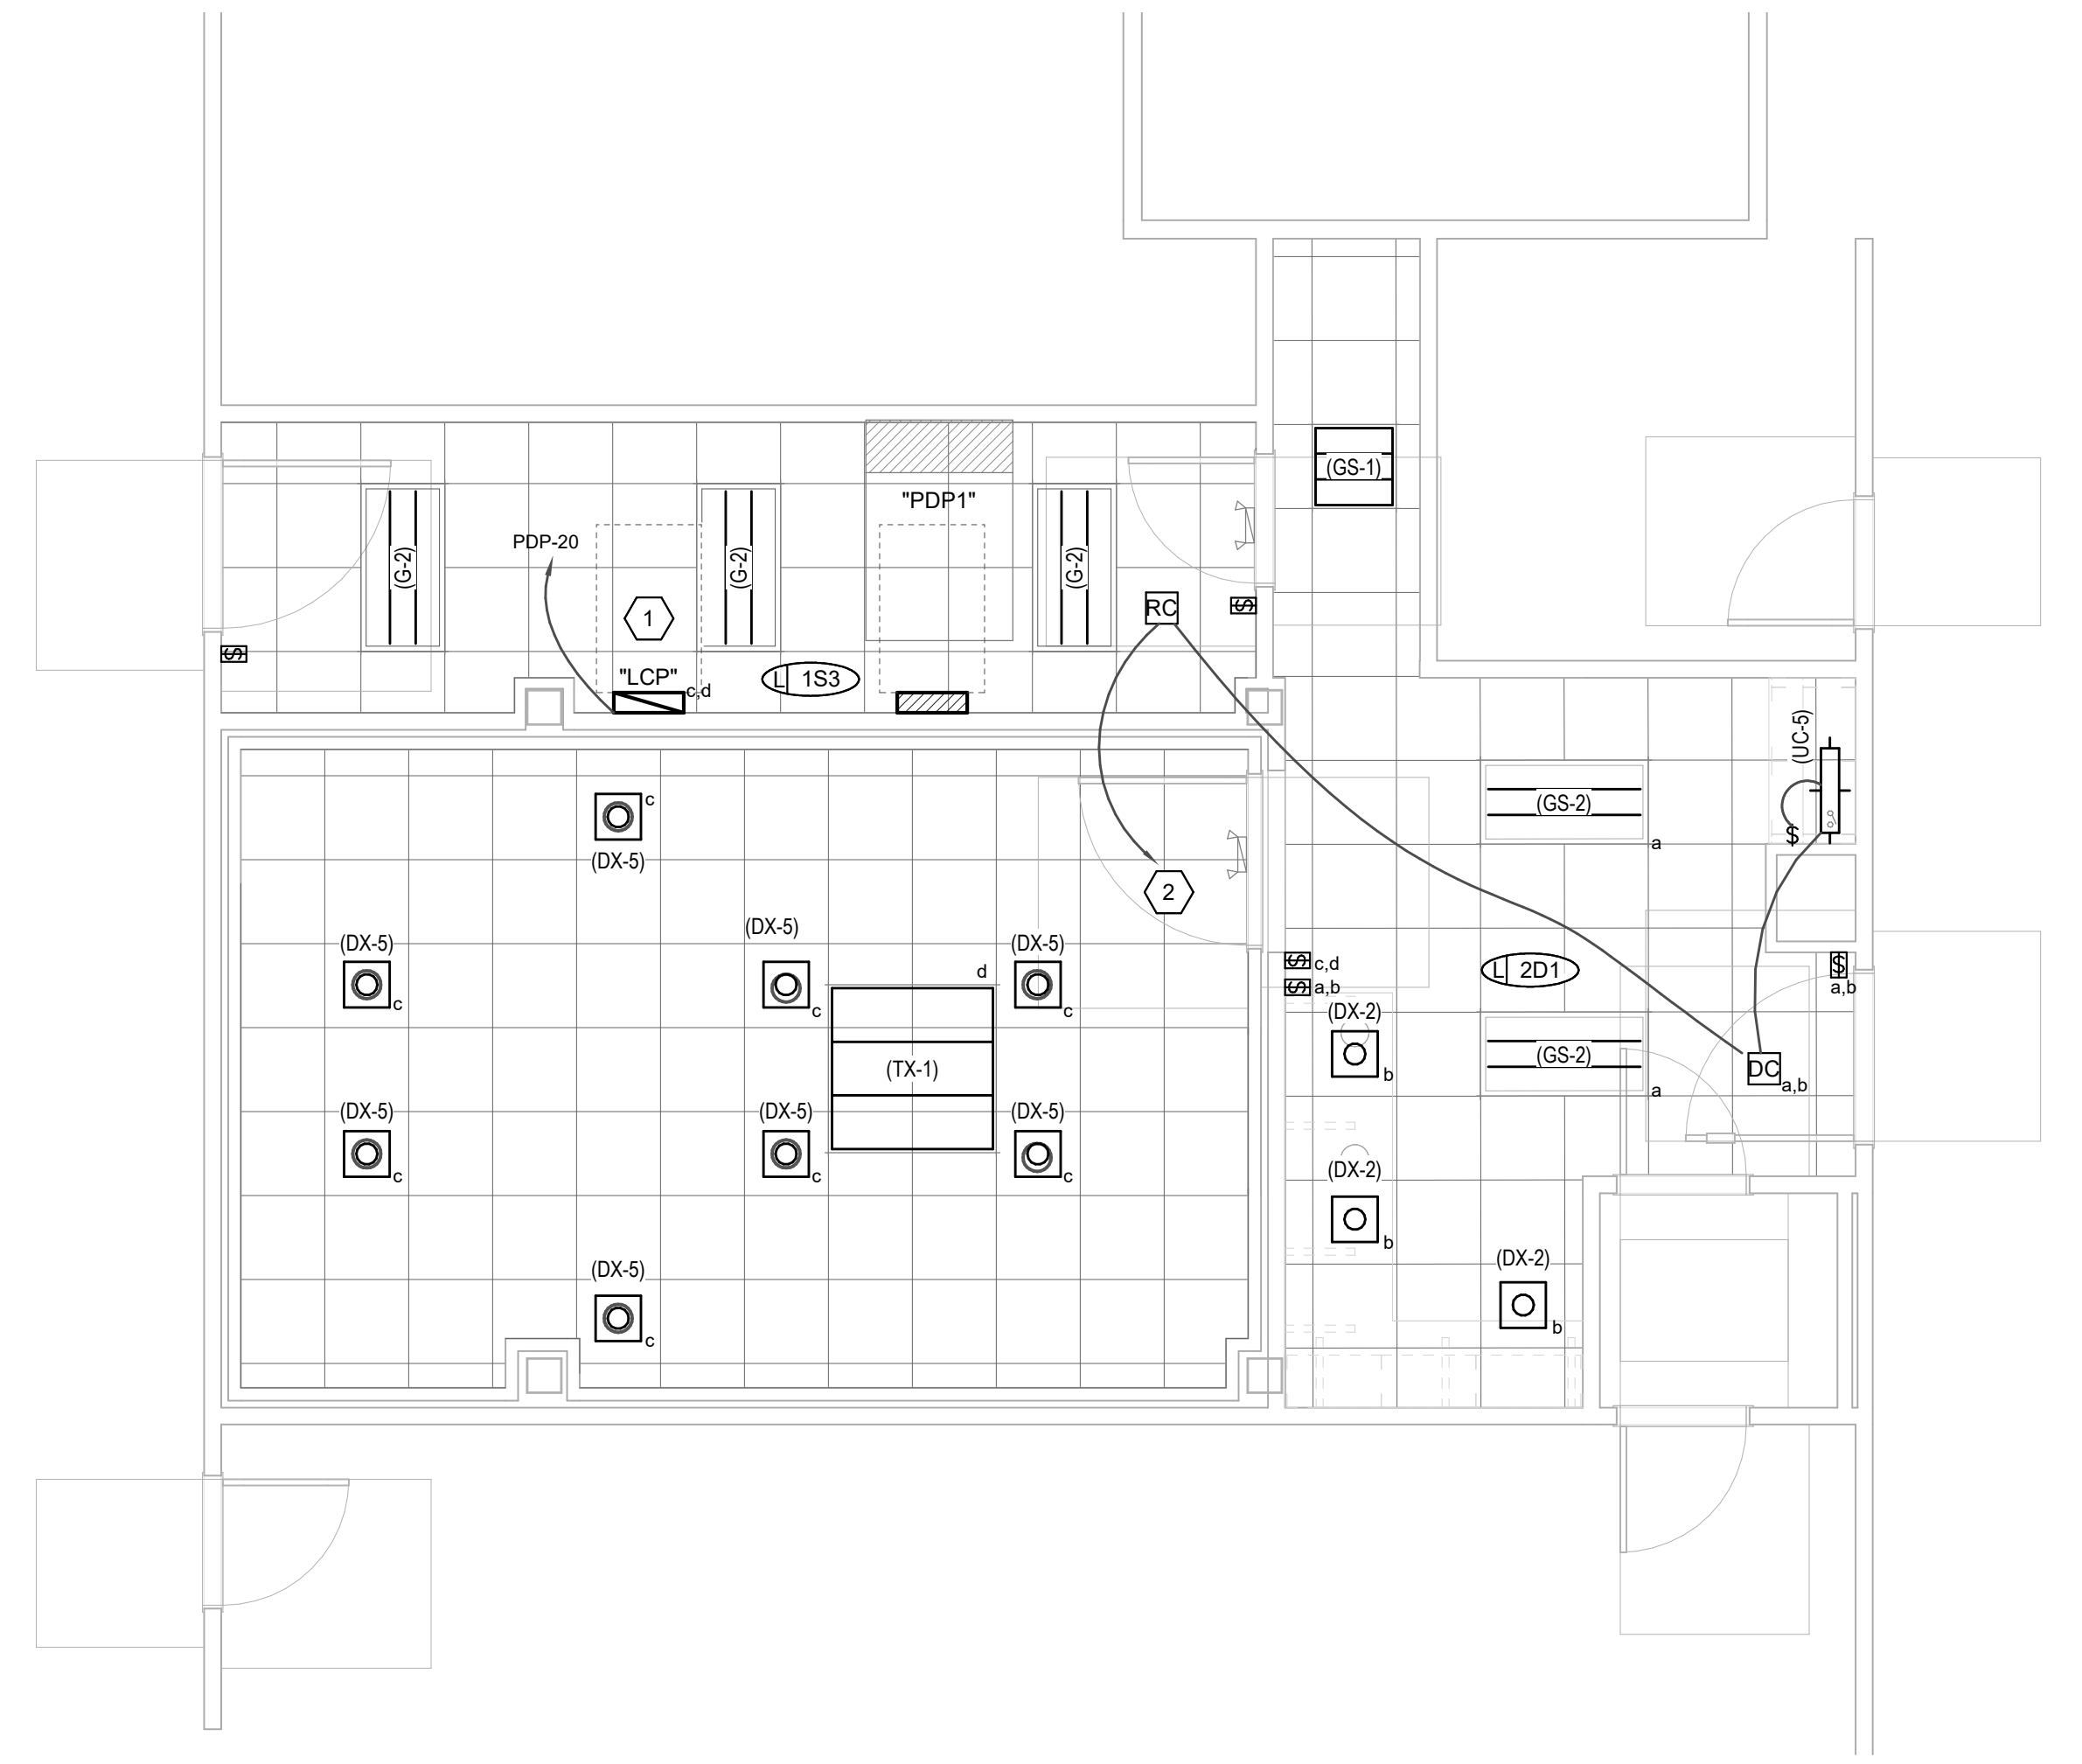


2 LEVEL 1 LIGHTING PLAN
SCALE: 1/4" = 1'-0"

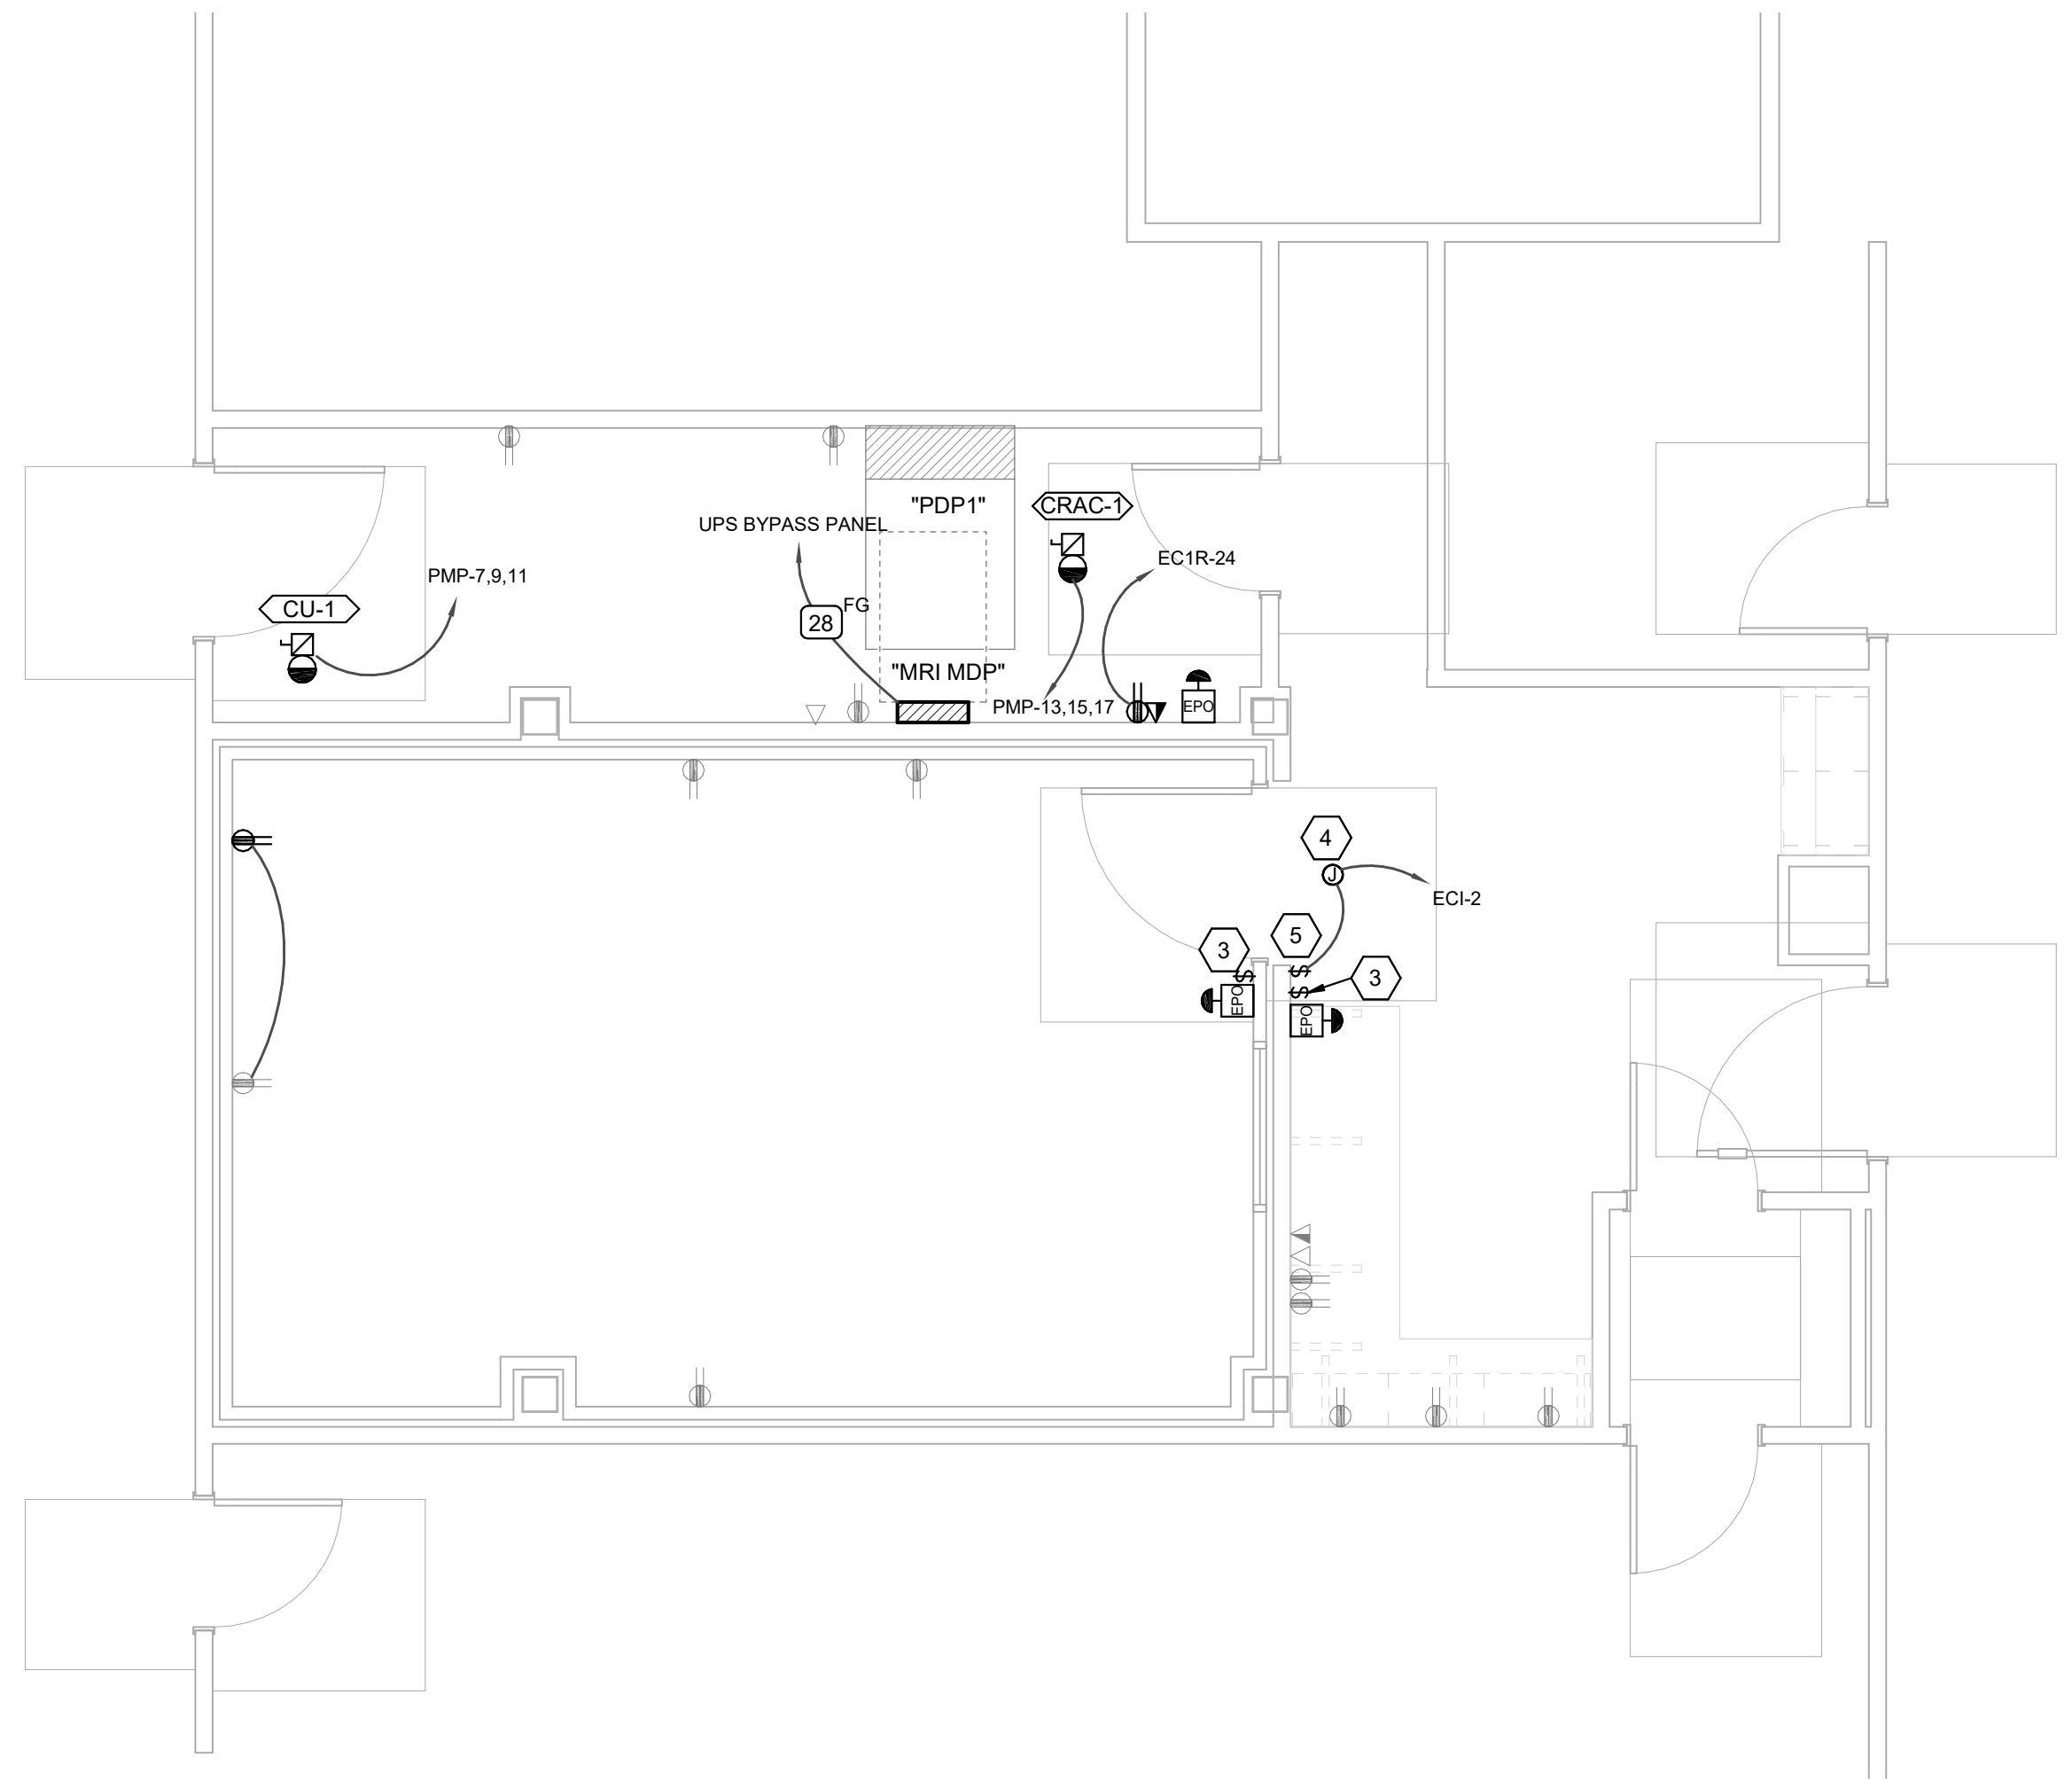

1 LEVEL 1 POWER PLAN
SCALE: 1/4" = 1'-0"

LIGHTING/SPACE CONTROL TYPE SCHEDULE

WIRING LEGEND	APPROVED MANUFACTURERS	LIGHTING CONTROL ID	GENERAL NOTES																		
_____ LINE VOLTAGE WIRING - - - - - 0-10V WIRING ----- CATSE CABLING _____ WIRING BY OTHERS ○-○ TWP SEGMENT NETWORK CABLING	1. WATTSTOPPER (BASIS OF DESIGN) 2. NLIGHT 3. HUBBELL BUILDING AUTOMATION 4. GREENGATE	1. # = NUMBER OF ZONES 2. D = DIMMING, S = SWITCHING 3. P = DAYLIGHT PHOTOCCELL 4. L = PLUG LOAD CONTROLLER 5. # = INSTANCE	1. COORDINATE INITIAL PROGRAMMING WITH OWNER AND MODIFY CONTROL TIMES AND OPERATION AS REQUESTED BY OWNER. 2. PROVIDE FINE TUNING PROGRAMMING AND ADJUSTMENTS UPON REQUEST BY OWNER WITHIN FIRST 6 MONTHS AFTER SUBSTANTIAL COMPLETION. 3. PROVIDE CUSTOMIZED ENGRAVED PERMANENT BUTTON LABELS ON EACH SWITCH, LABEL TO MATCH BUTTON LABEL ID OR AS DIRECTED BY OWNER. 4. PART NUMBERS SHOWN ARE BASED ON WATTSTOPPER AS THE BASIS OF DESIGN. ALL APPROVED MANUFACTURERS ARE SUBJECT TO MEETING ALL FUNCTIONS AND CAPABILITIES OF THE BASIS OF DESIGN SYSTEM AND PRODUCTS. FAILURE TO MEET THESE SHALL REQUIRE THE CONTRACTOR TO PROVIDE A SYSTEM THAT DOES AT NOT ADDITIONAL COST.																		
			5. REFER TO PLANS FOR LOCATIONS AND QUANTITIES OF DEVICES. 6. INSTALL ONE OF EACH CONTROL TYPE WITH PROGRAMMING, ADJUST, AND OBTAIN OWNERS APPROVAL PRIOR TO PROGRAMMING THE REMAINING CONTROLS. 7. WIRING MAY VARY BETWEEN MANUFACTURERS. CONTRACTOR IS RESPONSIBLE FOR PROVIDING THE REQUIRED WIRING THAT WILL BOTH MEET THE MANUFACTURERS REQUIREMENTS AND MATCH WITH THE SHOWN SYSTEM. 8. PROVIDE COMPLETE SHOP DRAWING SUBMITTALS INCLUDING OCCUPANCY SENSOR LAYOUT AND COVERAGE PATTERNS. PROVIDE ADDITIONAL SENSORS AS REQUIRED FOR 100% COVERAGE OF SPACES WITH OCCUPANCY SENSOR CONTROL.																		
ID	DETAIL	LIGHTS ON CONTROL	LIGHTS OFF CONTROL	LIGHTING CONTROL TYPE	DAYLIGHT SENSOR SETTING (FC)	TIME DELAY TO OFF (MIN.)	BAS AUX RELAY SIGNAL	PLUG LOAD CONTROLLER	NETWORKED CONTROLS	BUTTON 1	BUTTON 2	BUTTON 3	BUTTON 4	BUTTON 5	BUTTON 6	BUTTON 7	BUTTON 8	BUTTON 9	NOTES		
1S3		MANUAL & OCCUPANCY	MANUAL OR OCCUPANCY	ON/OFF	-	15	RELAY CLOSED ON OCCUPANCY	-	-	FUNCTION: PRESS-ON LABEL ID: "ON"	FUNCTION: PRESS-OFF LABEL ID: "OFF"	-	-	-	-	-	-	-	-	-	
ZD1		MANUAL & OCCUPANCY	MANUAL OR OCCUPANCY	DIMMING 0-10V	-	15	RELAY CLOSED ON OCCUPANCY	-	-	TOGGLE: PRESS: TOP-ON, PRESS: BOTTOM-OFF, HOLD: TOP-RAISE, HOLD: BOTTOM-OFF/LOWER	FUNCTION: PRESS-PRESET SCENE #01 ZONE "a" 75% DIMMING LABEL ID: "PRE #1"	FUNCTION: PRESS-PRESET SCENE #02 ZONE "b" 0% DIMMING LABEL ID: "PRE #2"	FUNCTION: PRESS-SELECT ZONE "a" FOR DIMMING LABEL ID: "ZONE a"	FUNCTION: PRESS-SELECT ZONE "b" FOR DIMMING LABEL ID: "ZONE b"	-	-	-	-	-	-	-

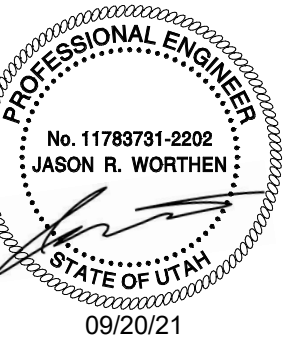

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12/22/16
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SHEET TITLE
LIGHTING CONTROL SCHEDULES
 SHEET NO.

